


TOTAL SHEET SHEETS NO. SECTION COUNTY 94 COOK 860 112 STA. 2200+00.00 TO STA. 2362+00.00 FED. ROAD DIST. NO. ILLINOIS FED. AID PROJECT • (1516.1, 1717 & 1818) R-8

→�→z

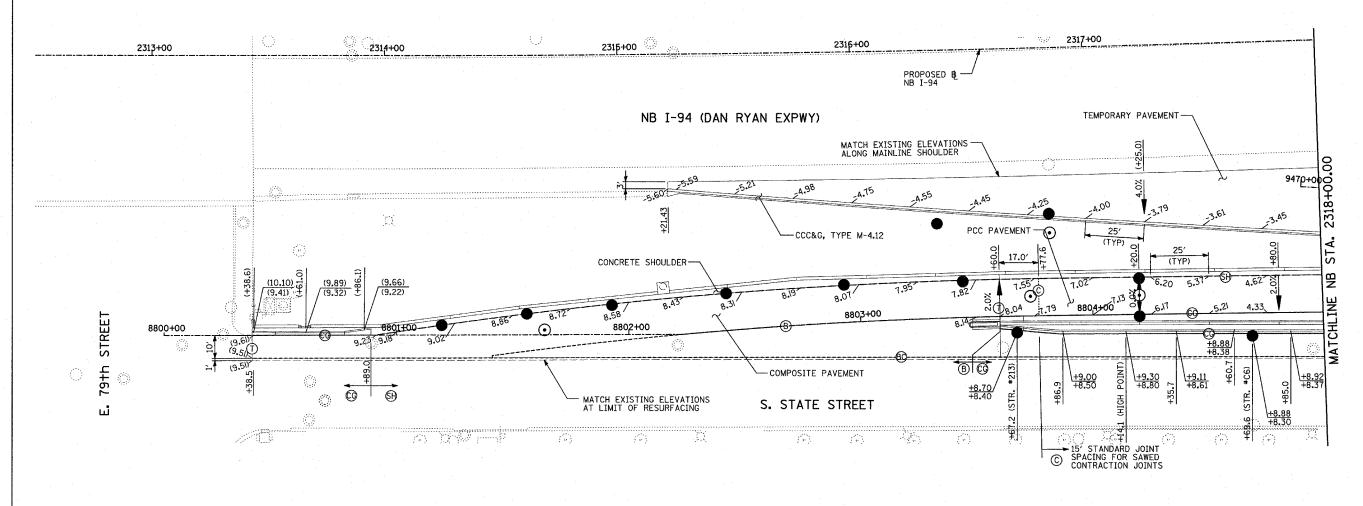



- 1. SEE MISCELLANEOUS PAVEMENT ELEVATION AND JOINTING DETAILS FOR SLEEPER SLAB DETAIL.
- 2. THE DIMENSIONS FOR THE PAVEMENT JOINTS ARE BASED ON THE CENTERLINE DISTANCE BETWEEN THE JOINTS.
- 3. ALL DEFORMED TIE BARS SHALL BE EPOXY COATED.
- 4. CONTRACTION JOINTS (UNDOWELED-SAWED OR GROOVED)
 SHALL BE PROVIDED ACROSS ALL PCC SHOULDERS. JOINT
 SPACING SHALL BE 15' C-C UNLESS OTHERWISE NOTED.
- 5. ELEVATIONS ARE SPACED AT 25' INTERVALS UNLESS OTHERWISE NOTED.
- 6. ELEVATIONS FOR CURB & GUTTER ALONG TEMPORARY PAVEMENT ARE APPROXIMATE AND MAY VARY, DEPENDING ON EXISTING PAVEMENT ELEVATIONS AND CONDITION. CONTRACTOR SHALL ENSURE POSITIVE DRAINAGE.

LEGEND:

- TRANSVERSE CONSTRUCTION JOINT WITH NO. 8 DEFORMED TIE BAR (EPOXY COATED), 24" LONG @ 12" C-C, DRILL AND GROUT INTO PCC BASE COURSE (INCLUDED IN THE COST OF PCC PAVEMENT OR SHOULDERS)
- CONSTRUCTION JOINT WITH NO. 6 DEFORMED TIE BAR (EPOXY COATED), 24" LONG & 24" C-C, DRILL & GROUT IN PLACE (INCLUDED IN THE COST OF CURB & GUTTER)
- SAWED LONGITUDINAL JOINT WITH NO. 8 DEFORMED TIEBAR (EPOXY COATED), 30" LONG & 24" C-C (INCLUDED IN THE COST OF PCC PAVEMENT)
- SAWED LONGITUDINAL JOINT WITH NO. 6 DEFORMED TIE BAR (EPOXY COATED), 30" LONG & 30" C-C (INCLUDED IN THE COST OF PCC BASE COURSE)
- LONGITUDINAL SHOULDER CONSTRUCTION JOINT WITH NO. 8 DEFORMED TIE BAR (EPOXY COATED), 30" LONG @ 24" C-C, DRILL & GROUT IN PLACE (INCLUDED IN THE COST OF PCC PAVEMENT)

- LONGITUDINAL CONSTRUCTION JOINT WITH NO. 8 DEFORMED TIE BAR (EPOXY COATED), 30" LONG @ 24" C-C, DRILL & GROUT IN PLACE (INCLUDED IN THE COST OF PCC PAVEMENT)
- LONGITUDINAL CONSTRUCTION JOINT WITH NO. 8 DEFORMED TIE BAR (EPOXY COATED), 24" LONG @ 24" C-C, DRILL & GROUT INTO EXISTING PCC BASE COURSE (INCLUDED IN THE COST OF PCC BASE COURSE)
- LONGITUDINAL CONSTRUCTION JOINT WITH NO. 8 DEFORMED TIE BAR (EPOXY COATED), 24" LONG @ 24" (INCLUDED IN THE COST OF PCC PAVEMENT OR SHOULDERS)
- SAWED CONTRACTION JOINT WITH SMOOTH DOWEL BARS (EPOXY COATED), 11/2" DIA., 18" LONG € 12" C-C (INCLUDED IN THE COST OF PCC PAVEMENT)
- 2" EXPANSION JOINT WITH 11/2" DIA. CAPPED DOWELS, 18" LONG & 12" C-C (BARS TO BE DRILLED AND GROUTED)
- LONGITUDINAL KEYED JOINT WITHOUT TIE BARS (INCLUDED IN THE COST OF PCC PAVEMENT).
 (IF TEMPORARY PCC PAVEMENT OPTION USED, POLYETHELENE BOND BREAKER MUST BE INCLUDED IN THE COST OF PCC PAVEMENT.)

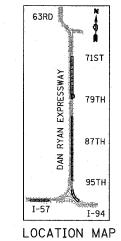

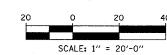

REVISIONS NAME	DATE	ILLINOIS DEPARTMENT OF TRANSPORTATION	
	<u> </u>	F.A.I. 94 (DAN RYAN EXPRESSWAY)	
		PAVEMENT JOINTING AND ELEVATION PLAN	
		NB 79th to 76th STREET C-D RAMP	
		NB I-94 STA. 2312+50.00 TO 2318+00.00	

ELEVATION PLAN EET C-D RAMP TO 2318+00.00

SCALE: 1"=20' DATE: MARCH 18, 2005

CHECKED BY: JPA


TYLININTERNATIONAL


MAINLINE & STATION RAMP & STATION


LEGEND:

+XX.X

DRAWN BY: PAW

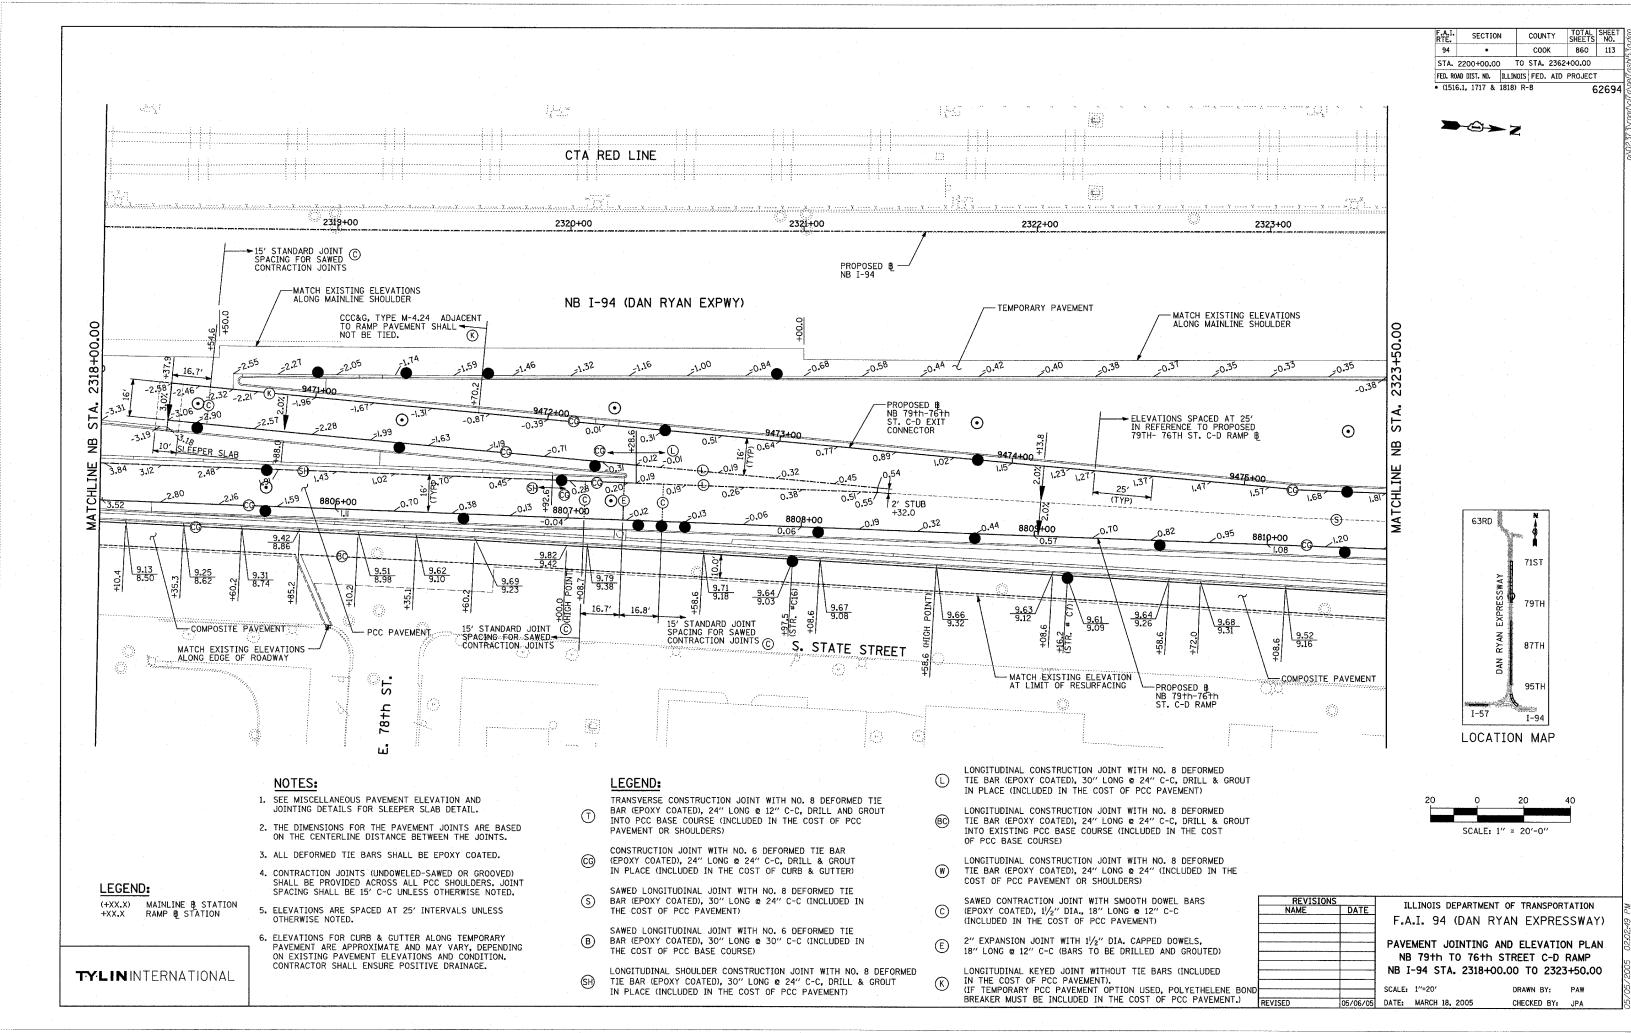

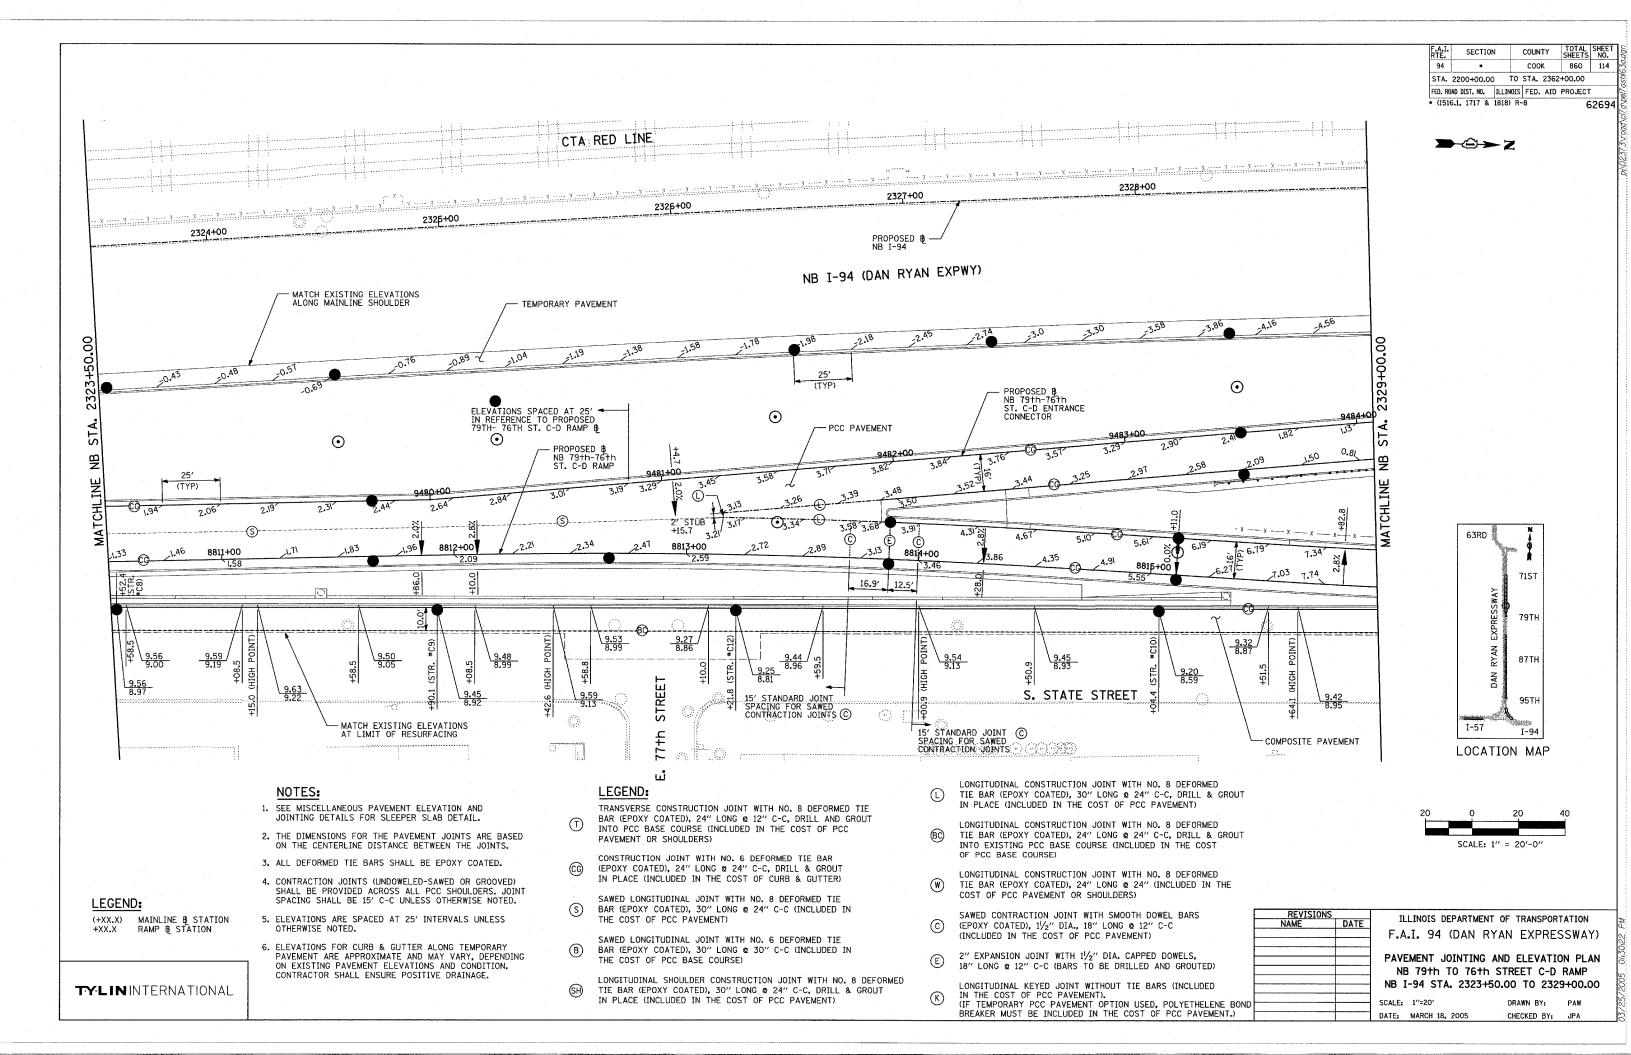


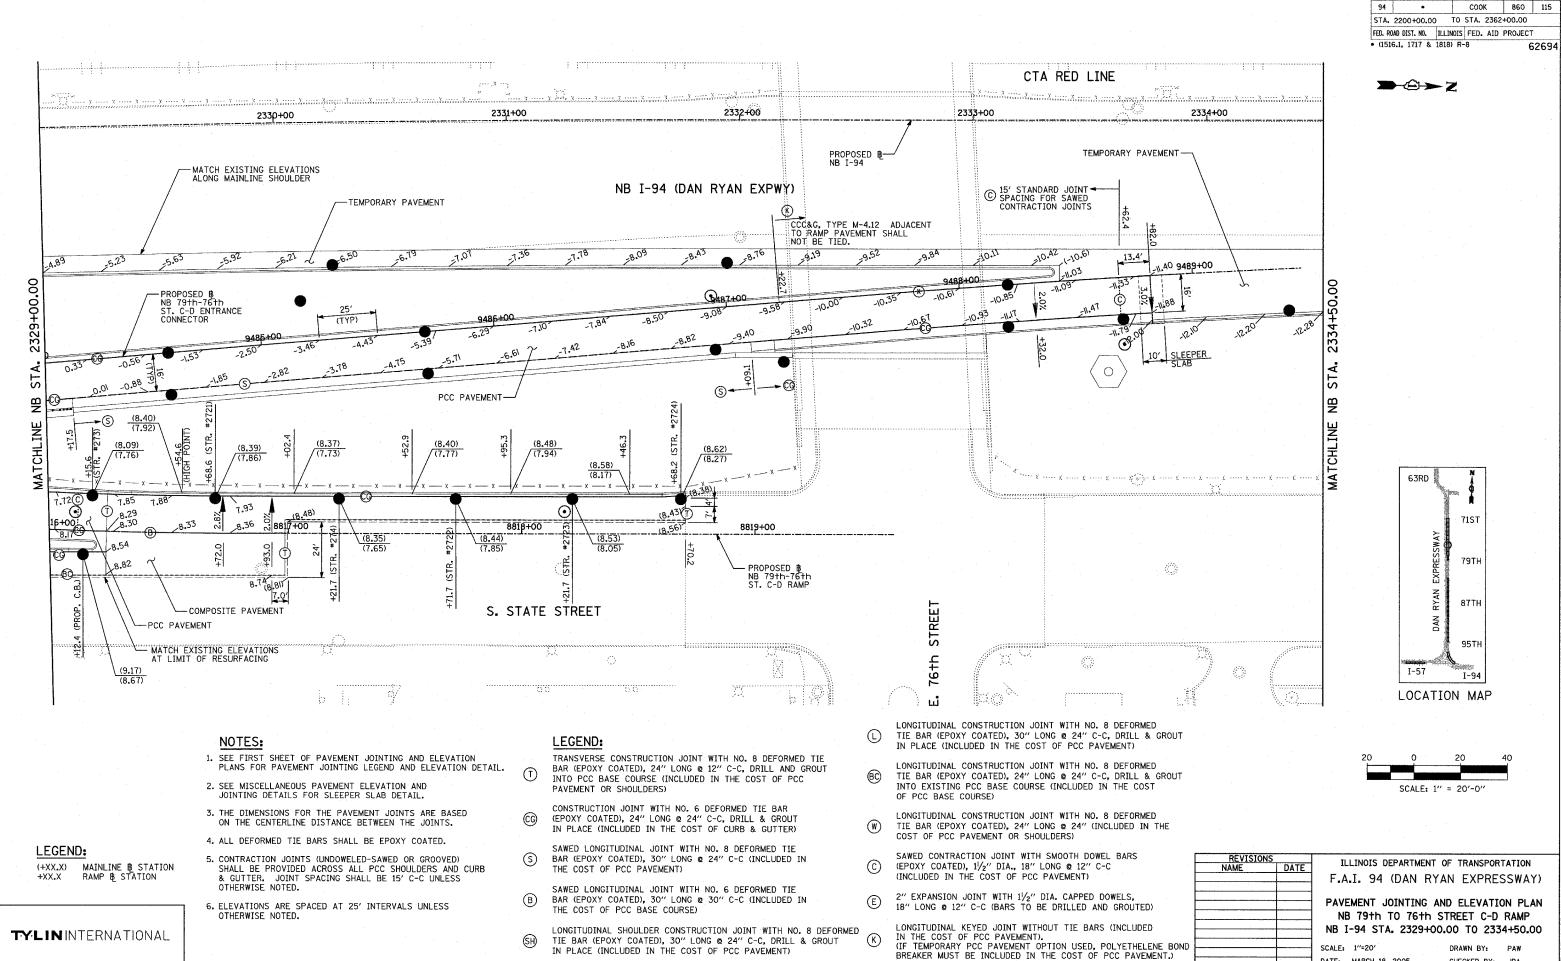

TOTAL SHEE SHEETS NO. SECTION COUNTY 860 115

DATE: MARCH 18, 2005

CHECKED BY: JPA

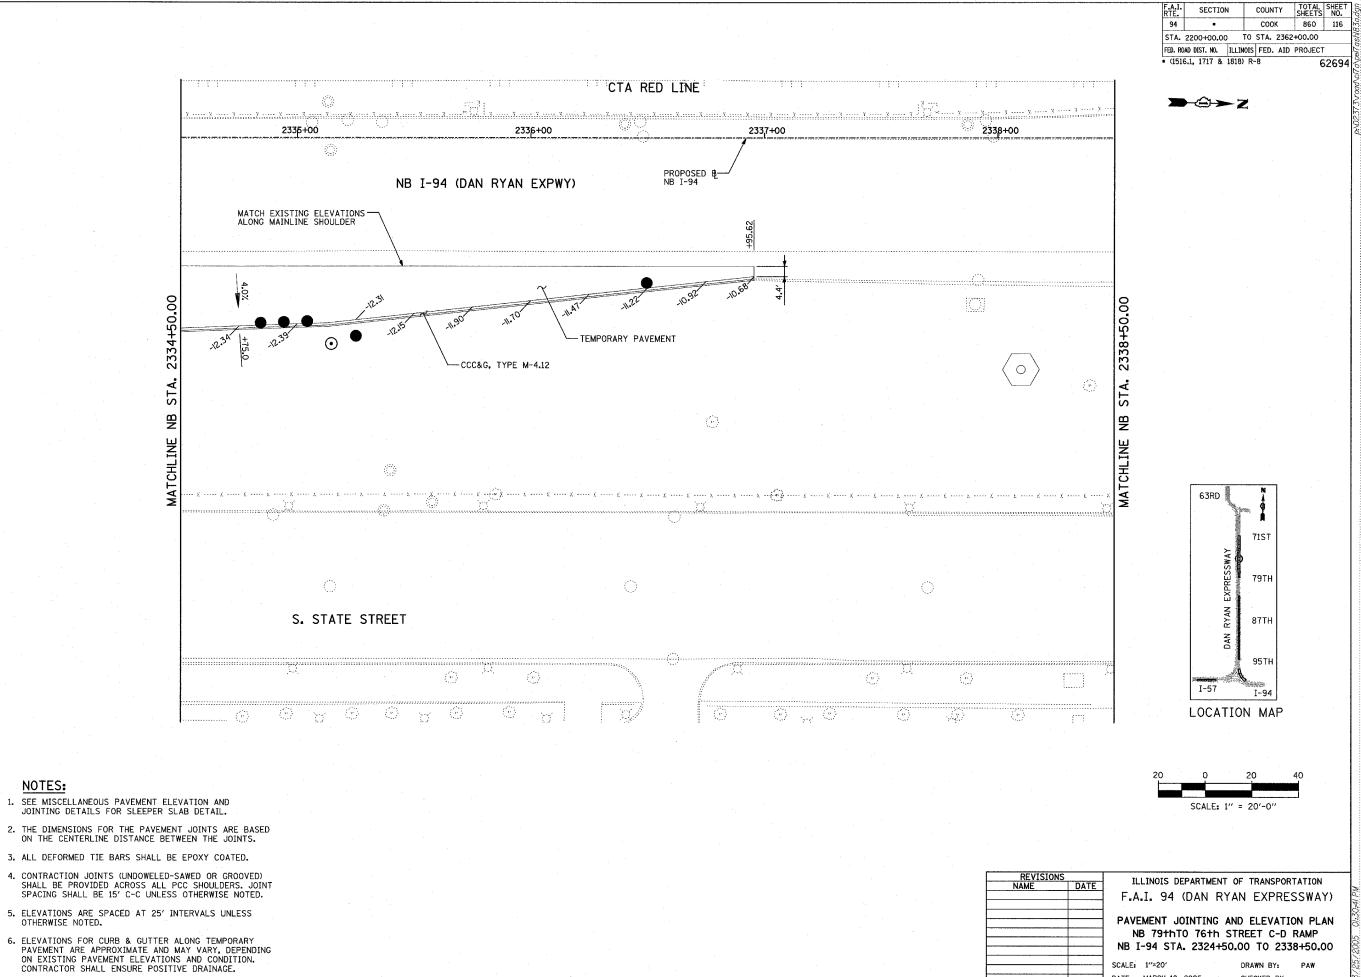

DRAWN BY: PAW

CHECKED BY:


DATE: MARCH 18, 2005

LEGEND:


(+XX.X) MAINLINE & STATION +XX.X RAMP & STATION


NOTES:


TYLIN INTERNATIONAL

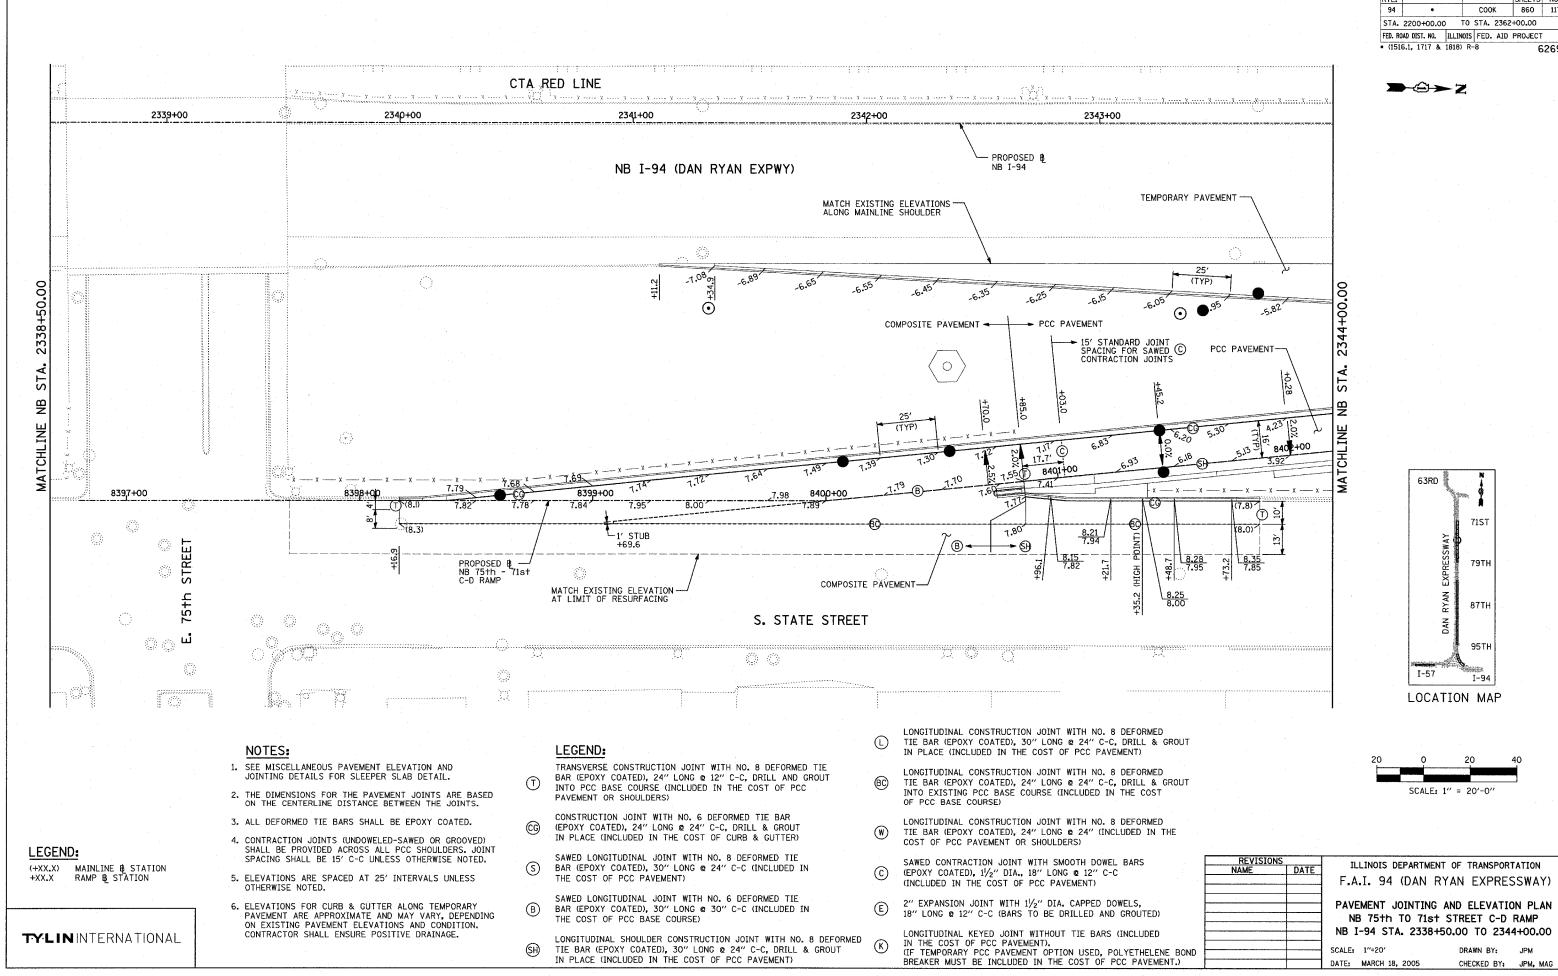



TOTAL SHEET SHEETS NO. COUNTY 860 117

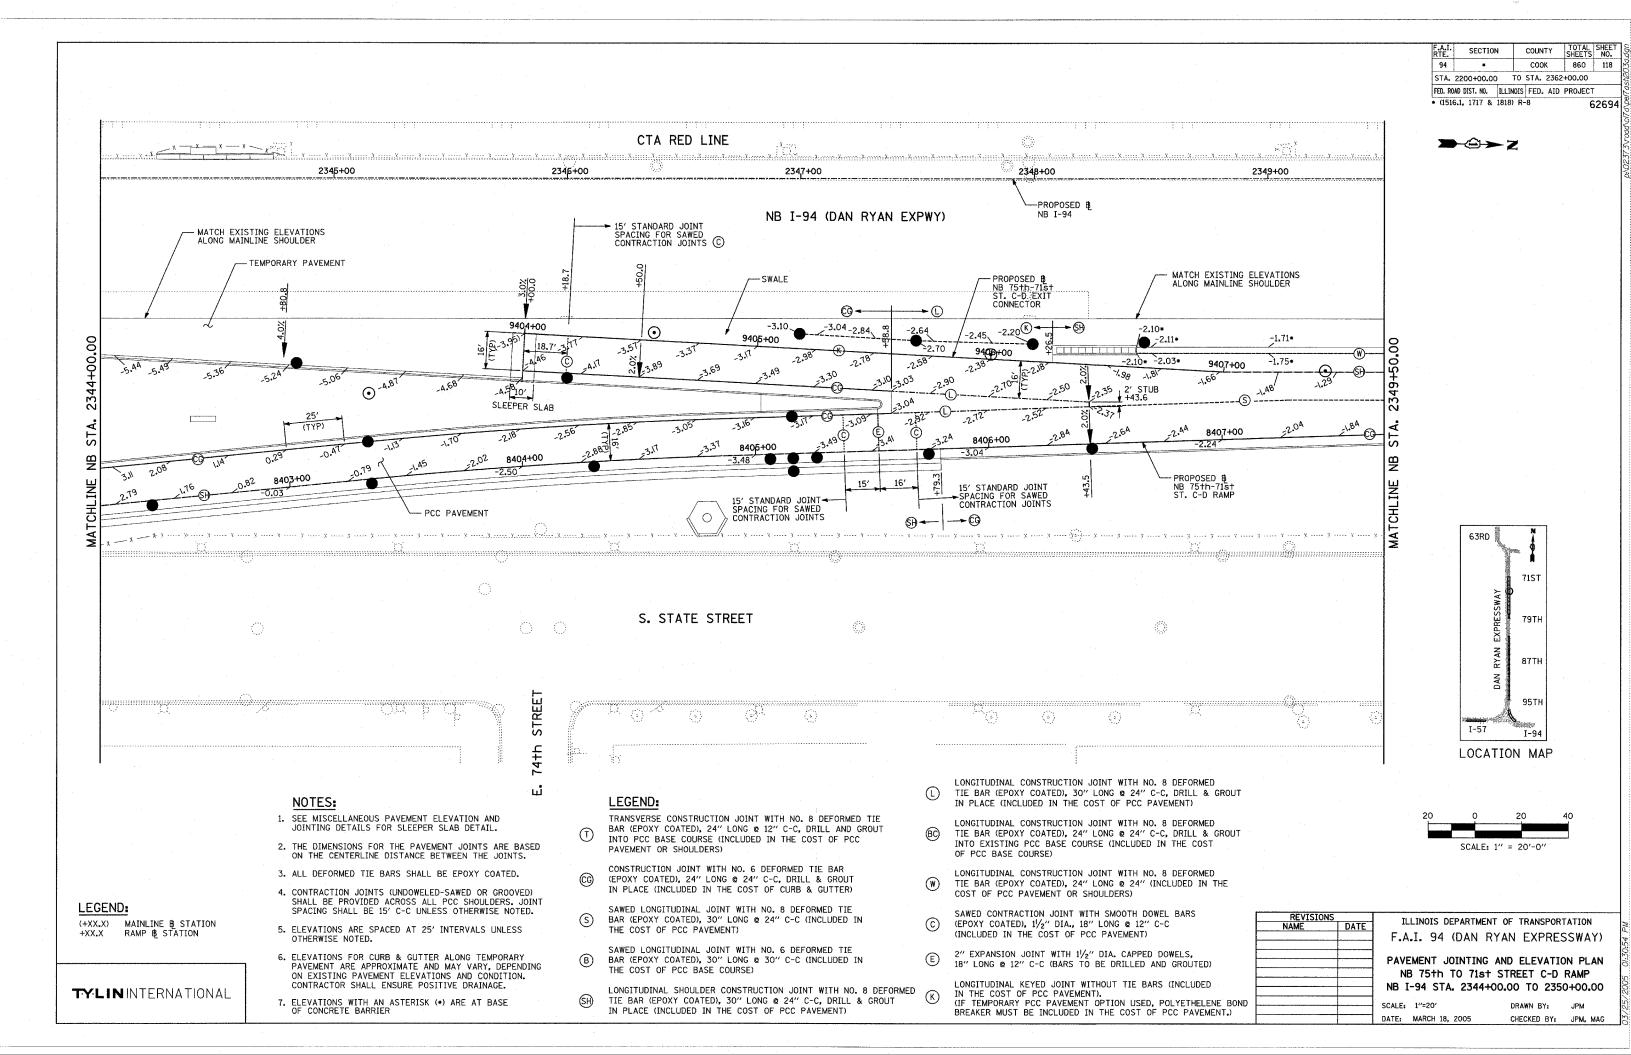

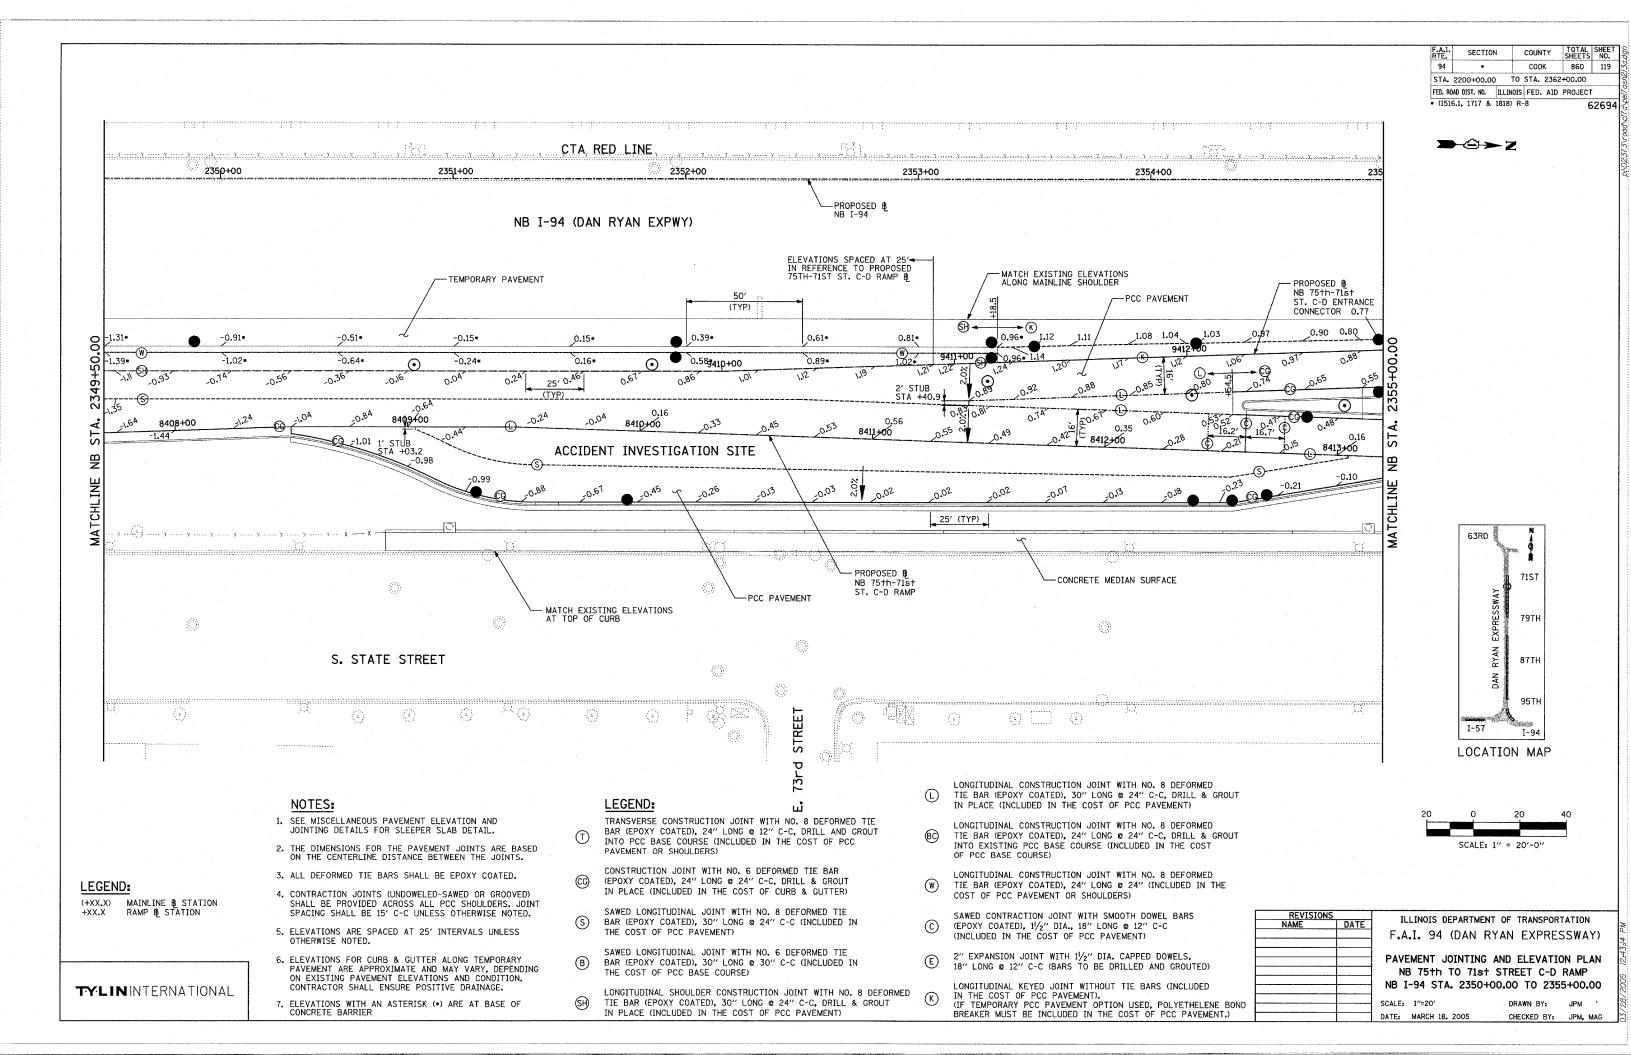


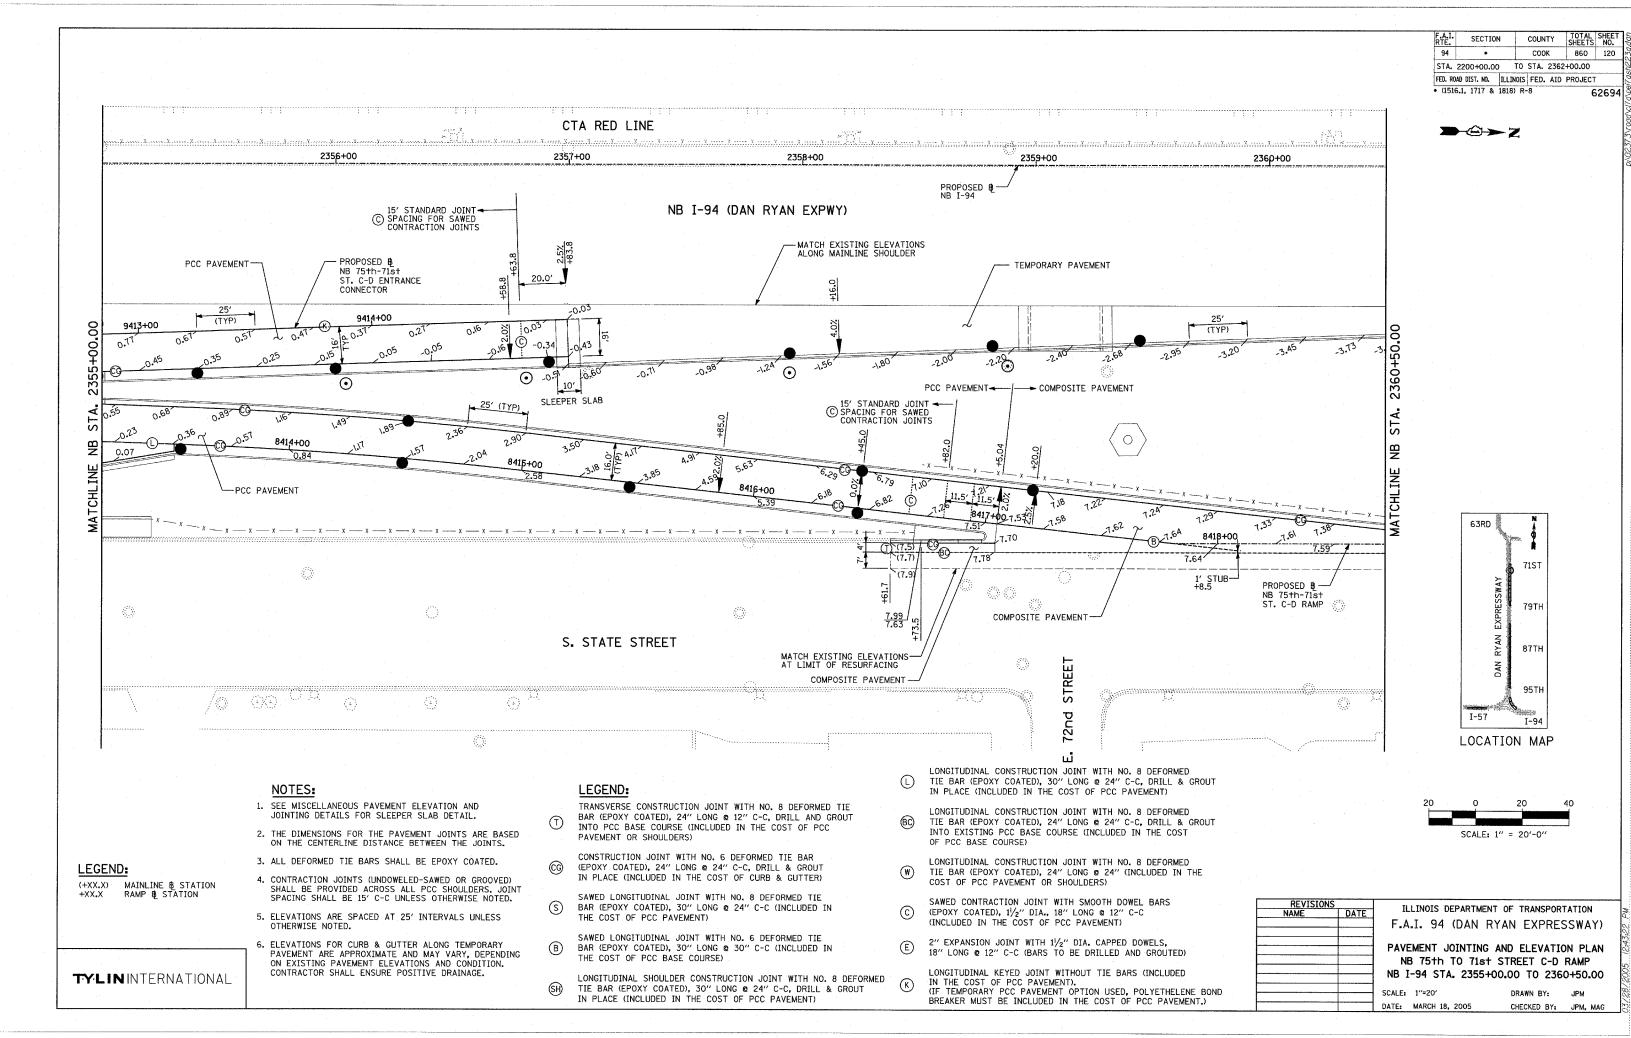

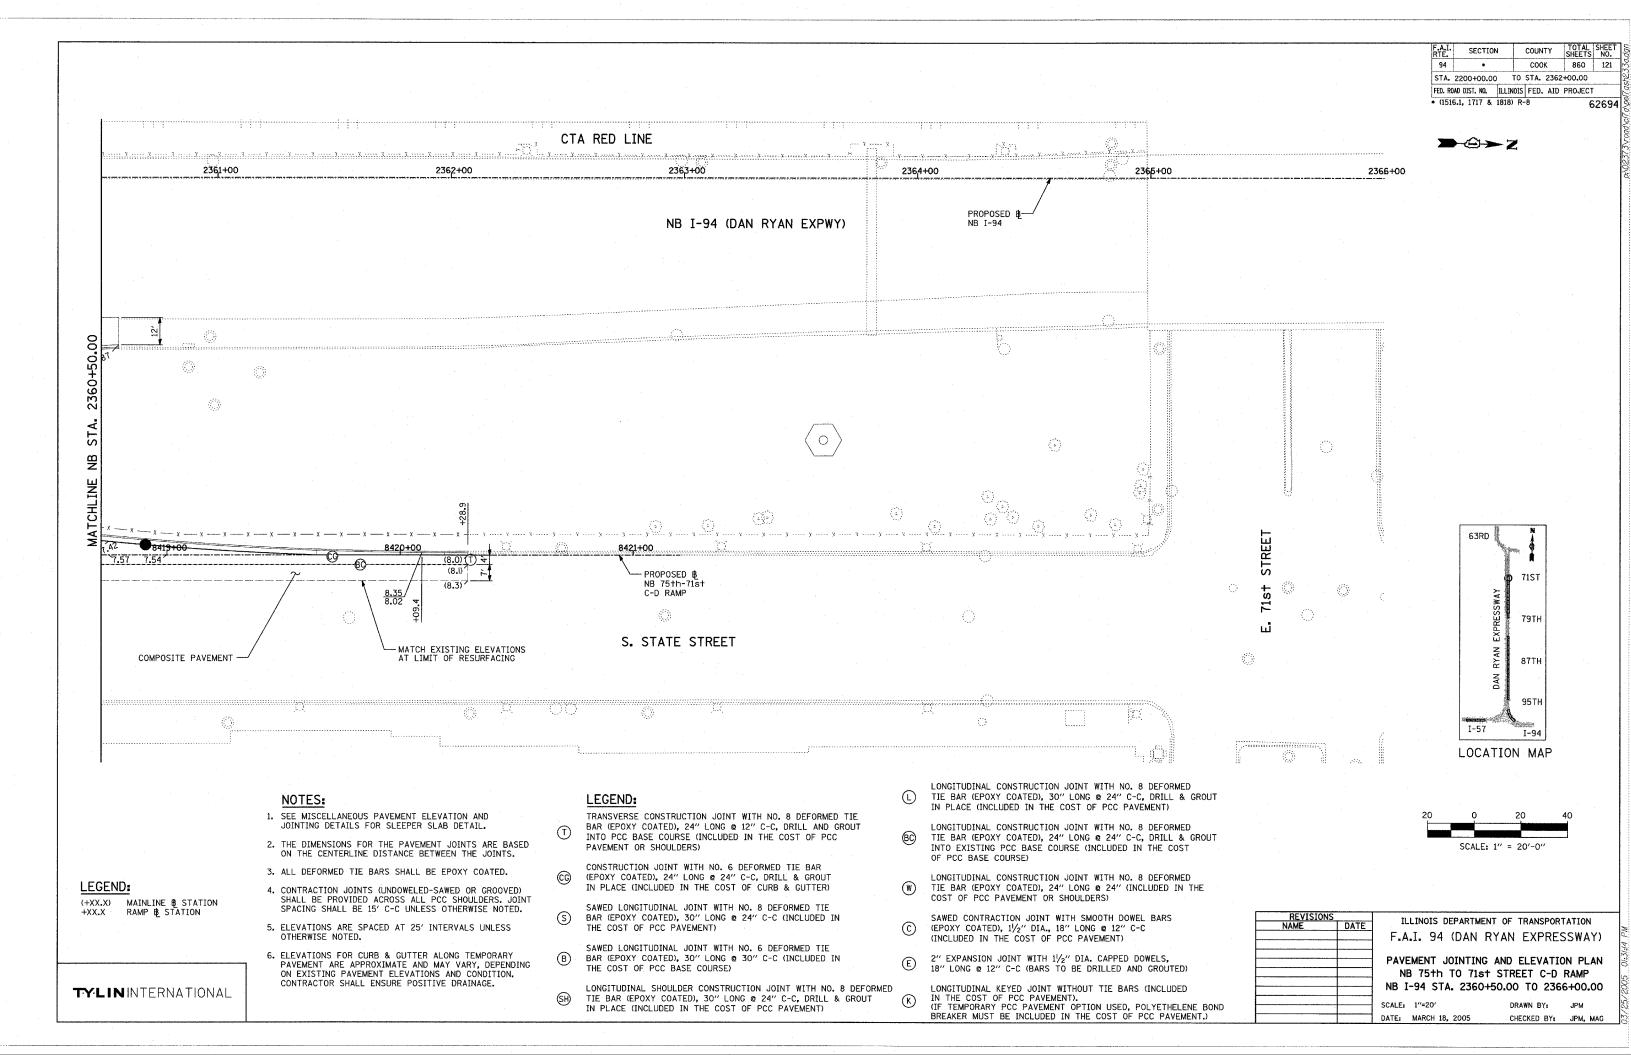

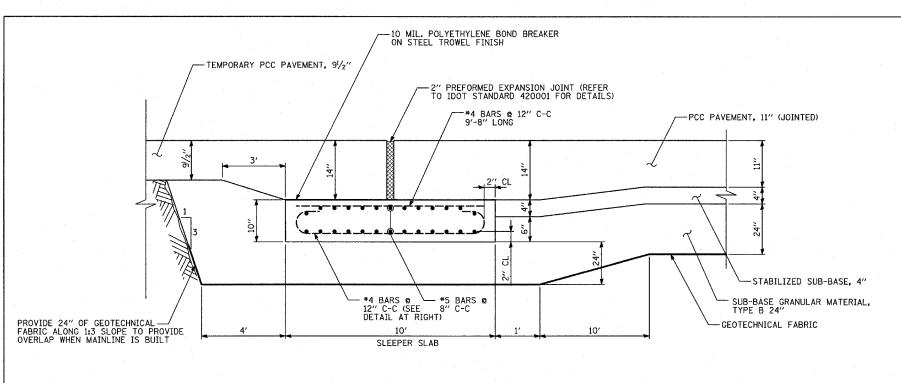

SLEEPER SLAB DETAIL AT RAMP TERMINALS (WITH PCC TEMPORARY PAVEMENT)

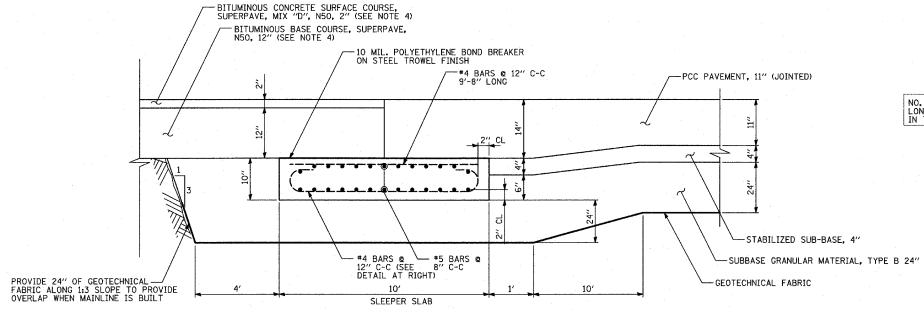

SLEEPER SLAB DETAIL AT RAMP TERMINALS (WITH BITUMINOUS TEMPORARY PAVEMENT)


SLEEPER SLAB NOTES:

TY:LININTERNATIONAL

- THE SLEEPER SLAB SHALL BE PAID FOR AT THE CONTRACT UNIT PRICE PER SUARE YARD FOR "SLEEPER SLAB" WHICH PRICE SHALL INCLUDE FURNISHING AND PLACING PC CONCRETE, REINFORCEMENT, BOND BREAKER, AND EXPANSION MATERIAL AS SHOWN.
- THE THICKENED EDGE OF PCC PAVEMENT AND TEMPORARY PCC PAVEMENT SHALL BE INCLUDED IN THE COST OF THE PCC PAVEMENT OF THE THICKNESS SPECIFIED.
- 3. THE PAY LIMITS FOR THE SLEEPER SLAB ARE FROM 2" BEYOND THE LEFT EDGE OF RAMP PAVEMENT TO 2" BEYOND BACK OF CURB (20'-11" TYP.), AND 10' WIDE. THE CURB AND GUTTER SHALL BE THICKENED TO MATCH THE ADJACENT PAVEMENT. THE THICKENING SHALL BE INCLUDED IN THE COST OF THE CURB AND GUTTER.
- REFER TO THE TEMPORARY PAVEMENT DETAIL ON THE TYPICAL SECTION PAVEMENT DETAILS SHEET.


GENERAL PAVEMENT JOINTING & ELEVATION NOTES:

- ALL REINFORCEMENT AND DOWEL BARS SHALL BE EPOXY COATED AND SHALL BE IN ACCORDANCE WITH APPLICABLE PORTIONS OF THE STANDARD SPECIFICATIONS. ALL BARS SHALL BE INCLUDED IN THE COST OF THE APPLICABLE PAVEMENT ITEMS.
- 6. SLOPE SHOULDER AREA BETWEEN CATCH BASIN GRATE AND BARRIER WALL TOWARDS GRATE, IF DICTATED BY FIELD CONDITIONS.
- ALL CATCH BASINS ARE LAID OUT TO AVOID SOLDIER PILES AND ENCASEMENT. WOOD LAGGING IS REQUIRED TO BE REMOVED FOR THE CONTRACT AREA BETWEEN THE CATCH BASIN AND WALL TO ALLOW FOR CATCH BASIN CONSTRUCTION

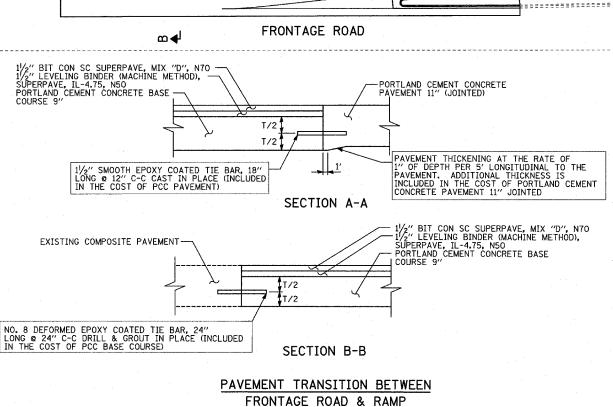

FULL DEPTH 9" COMPOSITE -PAVEMENT (SEE TYPICAL SECTIONS)

ω ◀.

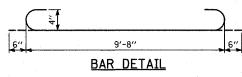

REVISIONS	5	ILLINOIS DEPARTMENT OF TRANSPORTATION
IAME	DATE	TELINOIS DEI MINIMENT OF THANSPORTATION
		F.A.I. 94 (DAN RYAN EXPRESSWAY)

MISCELLANEOUS PAVEMENT ELEVATION AND JOINTING DETAILS

SCALE: NONE DATE: MARCH 18, 2005

DRAWN BY: CHECKED BY:

COUNTY TOTAL SHEET NO.

860 122

62694

COOK


STA. 2200+00.00 TO STA. 2362+00.00 FED. ROAD DIST. NO. ILLINOIS FED. AID PROJECT

PORTLAND CEMENT CONCRETE PAVEMENT 11" (JOINTED)

SECTION

* (1516.1, 1717 & 1818) R-8

RAMP

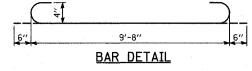

GENERAL NOTES:

SEE SPECIAL PROVISION TITLED TRAFFIC CONTROL AND PROTECTION (SPECIAL)

SEE SPECIAL PROVISION TITLED TRAFFIC CONTROL AND PROTECTION (EXPRESSWAYS)

SEE SPECIAL PROVISION TITLED TRAFFIC STAGING.

THE CONTRACTOR SHALL COORDINATE WITH THE CITY OF CHICAGO TO IMPLEMENT A NO PARKING RESTRICTION ALONG W. 99TH STREET, SOUTH WABASH AVENUE, AND STATE STREET WHILE TEMPORARY LANE OR ROADWAY CLOSURES ARE IN EFFECT. THE CONTRACTOR SHALL SCHEDULE THE WORK TO MINIMIZE THE LENGTH OF TIME PARKING IS RESTRICTED.

TEMPORARY CHAIN LINK FENCE (PORTABLE) SHALL BE PROVIDED ALONG FRONTAGE ROAD WORK ZONE LOCATIONS TO PROTECT THE PUBLIC AND DIRECT PEDESTRIAN TRAFFIC AROUND AND AWAY FROM THE WORK ZONES.

QUANTITY FOR TEMPORARY PAYEMENT MARKING - LINE 6" WAS ASSUMED EQUAL TO THE LENGTH OF TEMPORARY CONCRETE BARRIER LOCATED ONE FOOT OR LESS FROM THE EDGE OF TRAVELED WAY.

THE CONTRACTOR MUST COMPLETE BOTH JUNCTION CHAMBER #61 AND RELATED PIPE JACKING PRIOR TO IMPLEMENTING THE MULTI-LANE WEAVE SHOWN IN STAGE 1 OF THE MAINTENANCE OF TRAFFIC PLANS - SHEET 1B OF 10.

ALL FRONTAGE ROAD SIGNING AND TRAFFIC CONTROL DEVICES SHALL BE PAID FOR UNDER THE LUMP SUM FOR TRAFFIC CONTROL AND PROTECTION (SPECIAL).

W1-6 ARROW SIGNS SHALL BE MOUNTED ON EITHER TYPE III BARRICADES OR TEMPORARY CONCRETE BARRIER AS DEPICTED IN THE MAINTENANCE OF TRAFFIC PLANS.

ALL TEMPORARY PAVEMENT MARKINGS SHALL BE PAID FOR AS EPOXY PAVEMENT MARKING OF THE LINE TYPE AND WIDTH SPECIFIED UNLESS OTHERWISE NOTED IN THE MAINTENANCE OF TRAFFIC PLANS.

A TOTAL OF 10 CHANGEABLE MESSAGE SIGNS SHALL BE LOCATED ALONG THE MAINLINE AND NEAR RAMP CLOSURES FOR THE DURATION OF THIS CONTRACT. EXACT PLACEMENT OF THE SIGNS SHALL BE DETERMINED BY THE RESIDENT ENGINEER.

TRAFFIC CONTROL SURVEILLANCE WILL BE USED AT NIGHT AFTER THE CONTRACTOR HAS STOPPED WORK FOR THE DAY TO MONITOR ALL NON-EXPRESSWAY ROADS.

ANY RAISED REFLECTIVE PAVEMENT MARKERS THAT CONFLICT WITH THE TEMPORARY TRAFFIC LANES MUST HAVE THE REFLECTIVE LENSES REMOVED AS DIRECTED BY THE RESIDENT ENGINEER. MEASURE OF PAYMENT FOR REMOVAL OF REFLECTORS IS INCLUDED IN THE CONTRACT UNIT PRICE FOR TRAFFIC CONTROL AND PROTECTION (EXPRESSWAYS). REPLACEMENT REFLECTORS SHALL BE PAID FOR SEPARATELY.

CONSTRUCTION STAGING NOTES FOR EXPRESSWAY

PRESTAGE 1 - INSTALL TEMPORARY TRAFFIC CONTROL DEVICES - NIGHT TIME OPERATIONS

INSTALL RAMP CLOSURE ADVANCE INFORMATION SIGNS ON STAGE 1 RAMP CLOSURES A MINIMUM OF 2 WEEKS IN ADVANCE OF THE CLOSURE.

INSTALL TEMPORARY CONSTRUCTION SIGNS AHEAD OF WORK ZONE PER DISTRICT 1 DETAILS, ACCORDING TO THE PLANS.

COVER PERMANENT SIGNS AS NEEDED FOR STAGE 1 EXIT RAMP CLOSURES.

REMOVE EXISTING PAVEMENT MARKINGS STA. 192+70 TO 208+00 AND STA. 2028+95 TO 2041+88, AND REPLACE WITH EPOXY PAVEMENT MARKING

DEMONE LENGES FROM DATES DEFLECTIVE DAVISOR MARKET MARKET

REMOVE LENSES FROM RAISED REFLECTIVE PAVEMENT MARKERS WITHIN THE PREVIOUSLY SPECIFIED LIMITS.

INSTALL TEMPORARY TRAFFIC CONTROL DEVICES FOR STAGE 1 MULTI-LANE WEAVE AND SHIFT TRAFFIC.

INSTALL TEMPORARY TRAFFIC CONTROL DEVICES FOR REMAINING STAGE 1 CONSTRUCTION.

EXCAVATE EXISTING CURB AND GUTTER, BARRIER WALL, AND INSTALL TEMPORARY PAVEMENT PRIOR TO INSTALLING TEMPORARY CONCRETE BARRIER WALL.

INSTALL TEMPORARY CONCRETE BARRIER

STAGE 1 - I-94 CONSTRUCTION

INSTALL EROSION CONTROL MEASURES.

BEGIN PAVEMENT, SHOULDER AND CURB & GUTTER REMOVAL ITEMS.

CONSTRUCT PROPOSED MEDIAN FOUNDATIONS FOR OVERHEAD STRUCTURES UTILIZING NIGHT TIME LANE CLOSURE OPERATIONS AND CONCRETE BARRIER REMOVAL

CONSTRUCT REMAINING OVERHEAD AND CANTILEVER SIGN FOUNDATIONS.

INSTALL OVERHEAD SIGN STRUCTURES.

REMOVE EXISTING RETAINING WALLS.

CONSTRUCT PROPOSED RETAINING WALLS.

SUGGESTED SEQUENCE OF CONSTRUCTION FOR "STAGE 1" 16' RAMPS

CONSTRUCT CURB & GUTTER AND 2' SHOULDER AT EDGES OF RAMPS.

PLACE RAMP PAVEMENT.

INSTALL PAVEMENT MARKINGS.

PLACE TOPSOIL AND SEED.

COMPLETE CLEAN-UP AND PUNCH LIST.

COMPLETE REMAINING CONSTRUCTION WORK.

END CONSTRUCTION

RESTORE CONCRETE CURB AND GUTTER AND FURNISH TEMPORARY CONCRETE BARRIER.

RE-ESTABLISH PERMANENT PAVEMENT MARKING IN ACCORDANCE WITH DISTRICT I DETAILS UTILIZING NIGHT LANE CLOSURES. REPLACE LENSES ON RAISED REFLECTIVE PAVEMENT MARKERS WHERE REMOVED. SHIFT TRAFFIC.

PRESTAGE 2 - ADJUST TEMPORARY TRAFFIC CONTROL DEVICES - NIGHT TIME OPERATIONS

INSTALL RAMP CLOSURE ADVANCE INFORMATION SIGNS ON STAGE 2 RAMP CLOSURES A MINIMUM OF 1 WEEK IN ADVANCE OF THE CLOSURE.

REMOVE ALL CONSTRUCTION SIGNING AND TRAFFIC CONTROL MEASURES FROM STAGE 1 CLOSURES, INCLUDING THOSE ON THE FRONTAGE ROADS.

UNCOVER PERMANENT SIGNS AS NEEDED FOR OPEN RAMPS.

COVER PERMANENT SIGNS AS NEEDED FOR STAGE 2 EXIT RAMP CLOSURES.

INSTALL TEMPORARY TRAFFIC CONTROL DEVICES FOR STAGE 2 RAMP CLOSURES WHERE SHOWN.

EXCAVATE EXISTING CURB AND GUTTER, BARRIER WALL, AND INSTALL TEMPORARY PAVEMENT PRIOR TO INSTALLING TEMPORARY CONCRETE BARRIER WALL.

INSTALL TEMPORARY CONCRETE BARRIER.

STAGE 2 - I-94 CONSTRUCTION

INSTALL EROSION CONTROL MEASURES.

BEGIN PAVEMENT, SHOULDER AND CURB & GUTTER REMOVAL ITEMS.

CONSTRUCT PROPOSED OVERHEAD STRUCTURE FOUNDATIONS UTILIZING NIGHT TIME LANE CLOSURES AND CONCRETE BARRIER REMOVAL FOR MEDIAN FOUNDATIONS.

INSTALL OVERHEAD SIGN STRUCTURES.

REMOVE EXISTING RETAINING WALLS.

CONSTRUCT PROPOSED RETAINING WALLS.

SUGGESTED SEQUENCE OF CONSTRUCTION FOR "STAGE 2" 16' RAMPS

CONSTRUCT CURB & GUTTER AND 2' SHOULDER AT EDGES OF RAMPS.

PLACE RAMP PAVEMENT.

INSTALL PAVEMENT MARKINGS.

PLACE TOPSOIL AND SEED.

COMPLETE CLEAN-UP AND PUNCH LIST.

COMPLETE REMAINING CONSTRUCTION WORK.


END CONSTRUCTION


RESTORE CONCRETE CURB AND GUTTER AND FURNISH TEMPORARY CONCRETE BARRIER.


ESTABLISH PERMANENT PAVEMENT MARKING IN ACCORDANCE WITH THE PLANS AND DISTRICT 1 DETAILS UTILIZING NIGHT TIME LANE CLOSURES.


REMOVE ALL CONSTRUCTION SIGNING AND TRAFFIC CONTROL MEASURES INCLUDING THOSE ON THE FRONTAGE ROADS

UNCOVER ALL PERMANENT SIGNS.

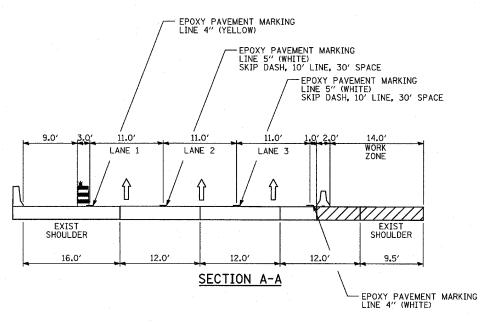


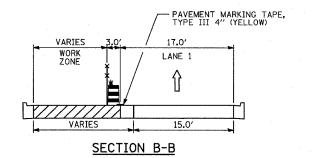

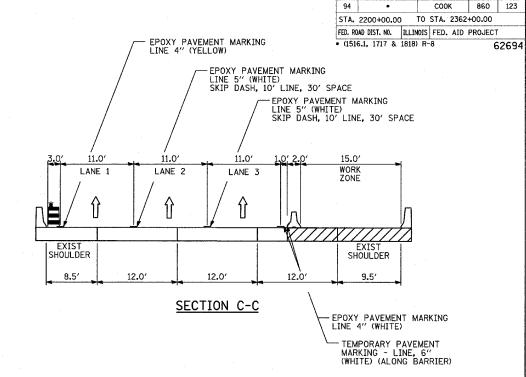

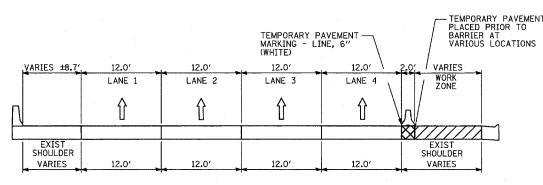

SECTION D-D

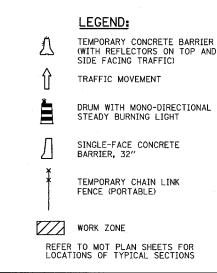

REVISIONS
NAME DATE

F.A.I. 94 (DAN RYAN EXPRESSWAY)
GENERAL NOTES
CONSTRUCTION STAGING NOTES
MAINTENANCE OF TRAFFIC DETAILS
(1 OF 3)

SCALE: NO SCALE
DATE: MARCH 18, 2005


DRAWN BY: RTM
CHECKED BY: JPA

TOTAL SHEET NO.


COUNTY

SECTION


TY:LIN INTERNATIONAL

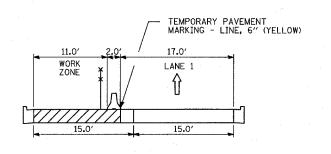


SECTION E-E

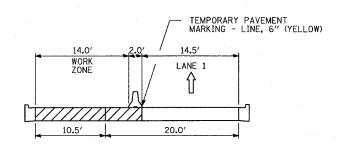


SECTION F-F

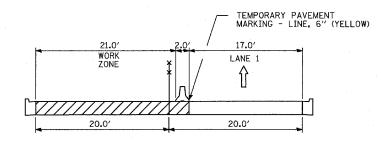


SECTION G-G

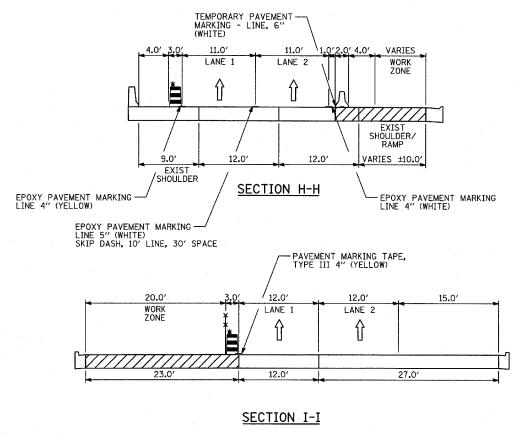


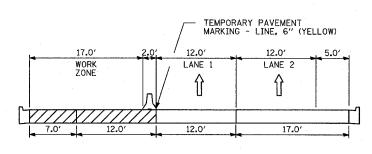

SECTION J-J

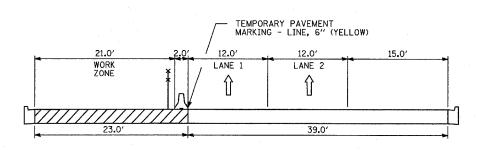

SECTION K-K

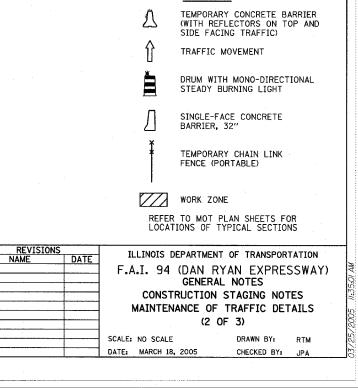

F.A.I. RTE. 94

EPOXY PAVEMENT MARKING -LINE 4" (WHITE)

LANE 2

12.0'

EPOXY PAVEMENT MARKING — LINE 5" (WHITE) SKIP DASH, 10' LINE, 30' SPACE

12.0

LANE 3

EPOXY PAVEMENT MARKING — LINE 5" (WHITE) SKIP DASH, 10' LINE, 30' SPACE

21.0'

WORK ZONE

SHOULDER

EPOXY PAVEMENT MARKING LINE 4" (YELLOW)

SECTION

• (1516.1, 1717 & 1818) R-8

STA. 2200+00.00

LANE 1

EXIST RAMP

TOTAL SHEET NO.

860 124

62694

COUNTY COOK


FED. ROAD DIST. NO. ILLINOIS FED. AID PROJECT

TO STA. 2362+00.00


11.0'

EXIST SHOULDER


10.0'

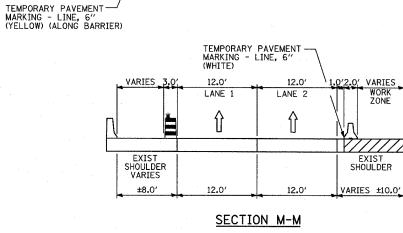



SECTION L-L

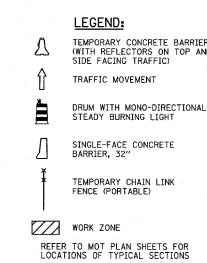



TYLININTERNATIONAL

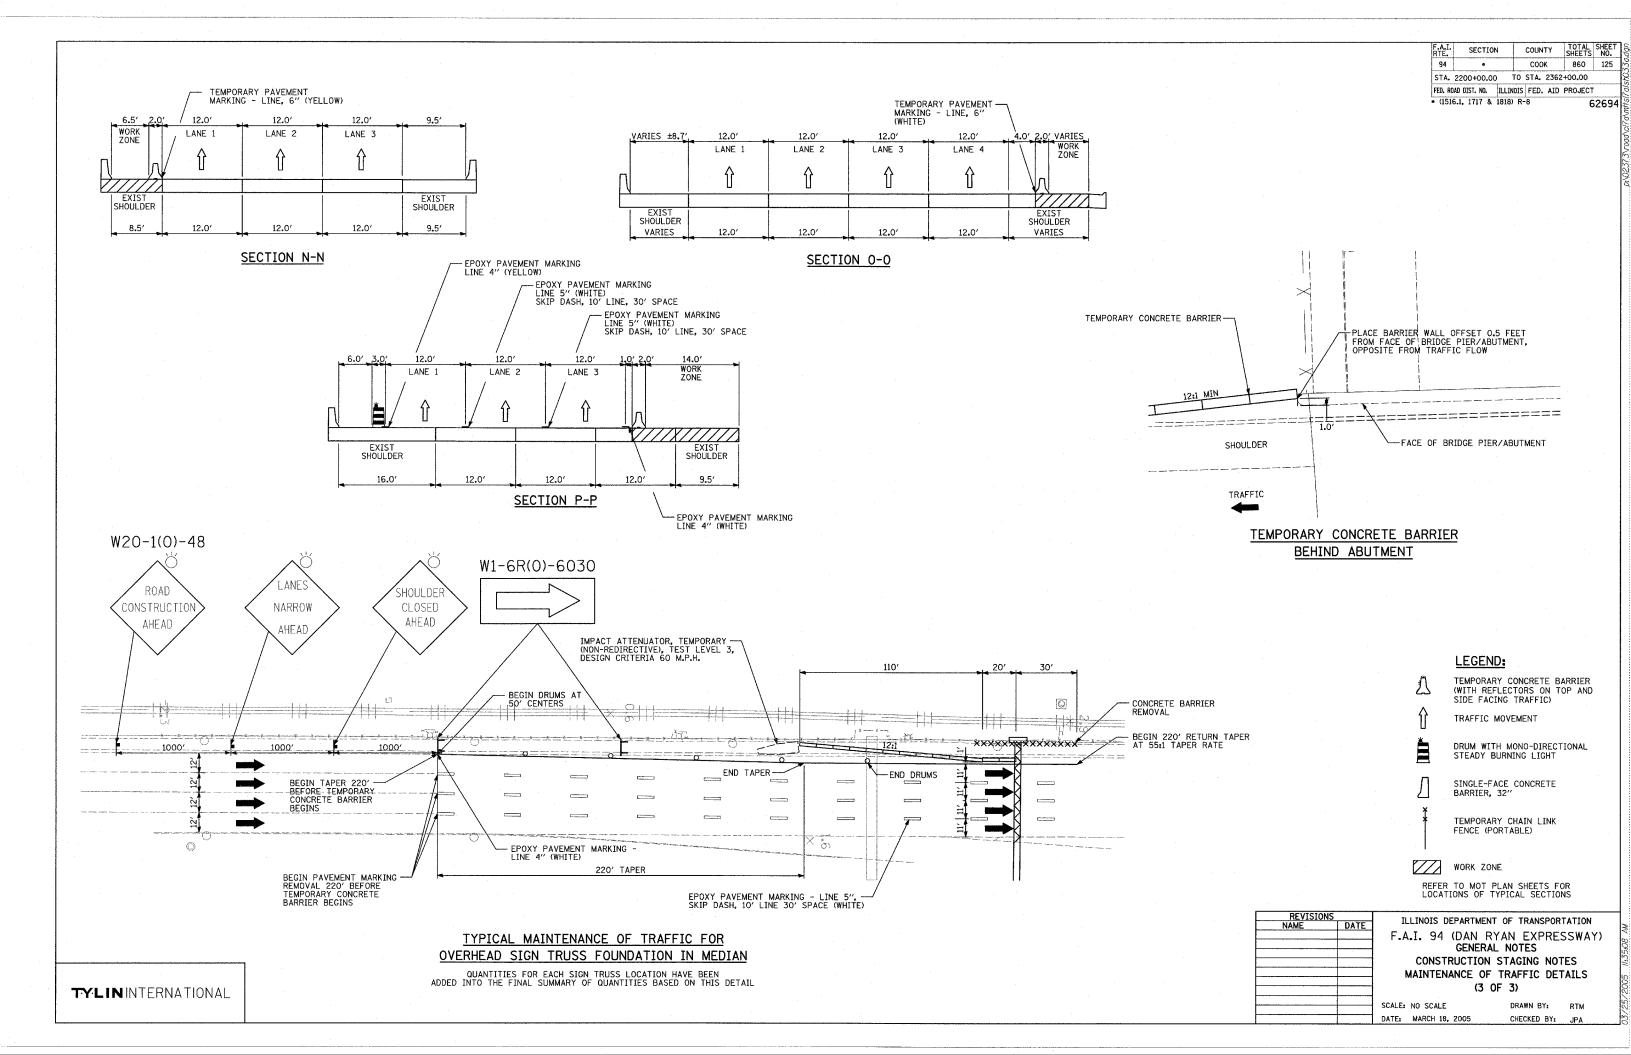


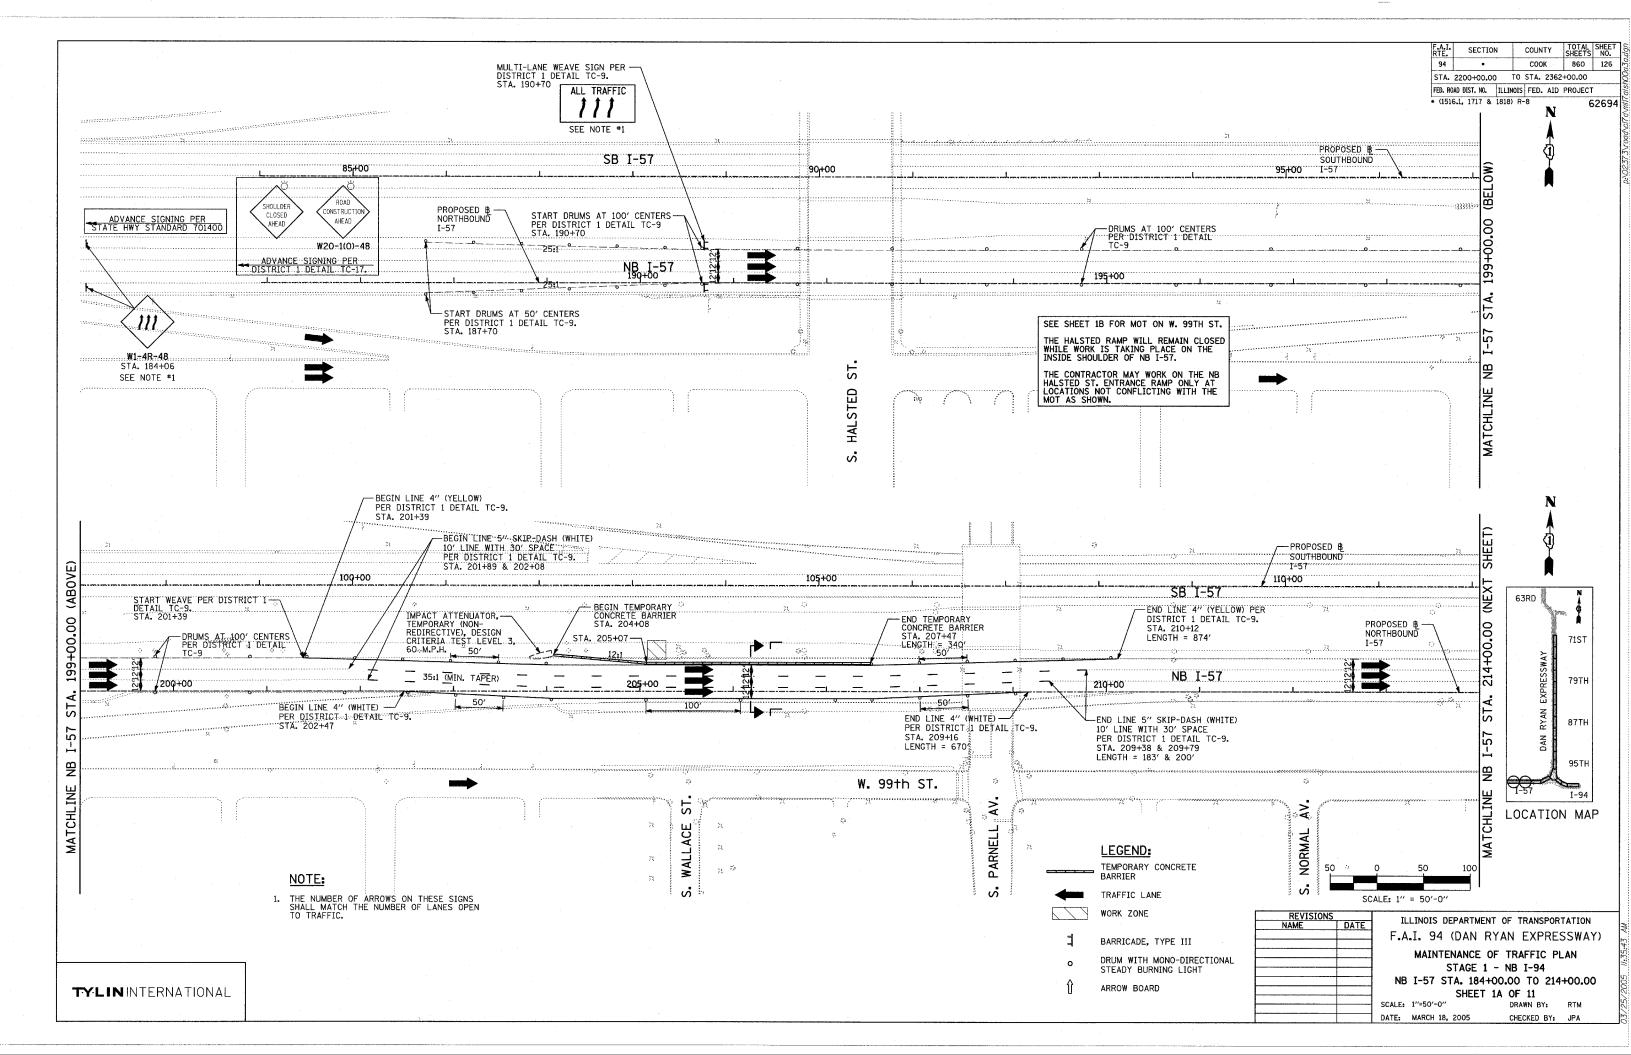


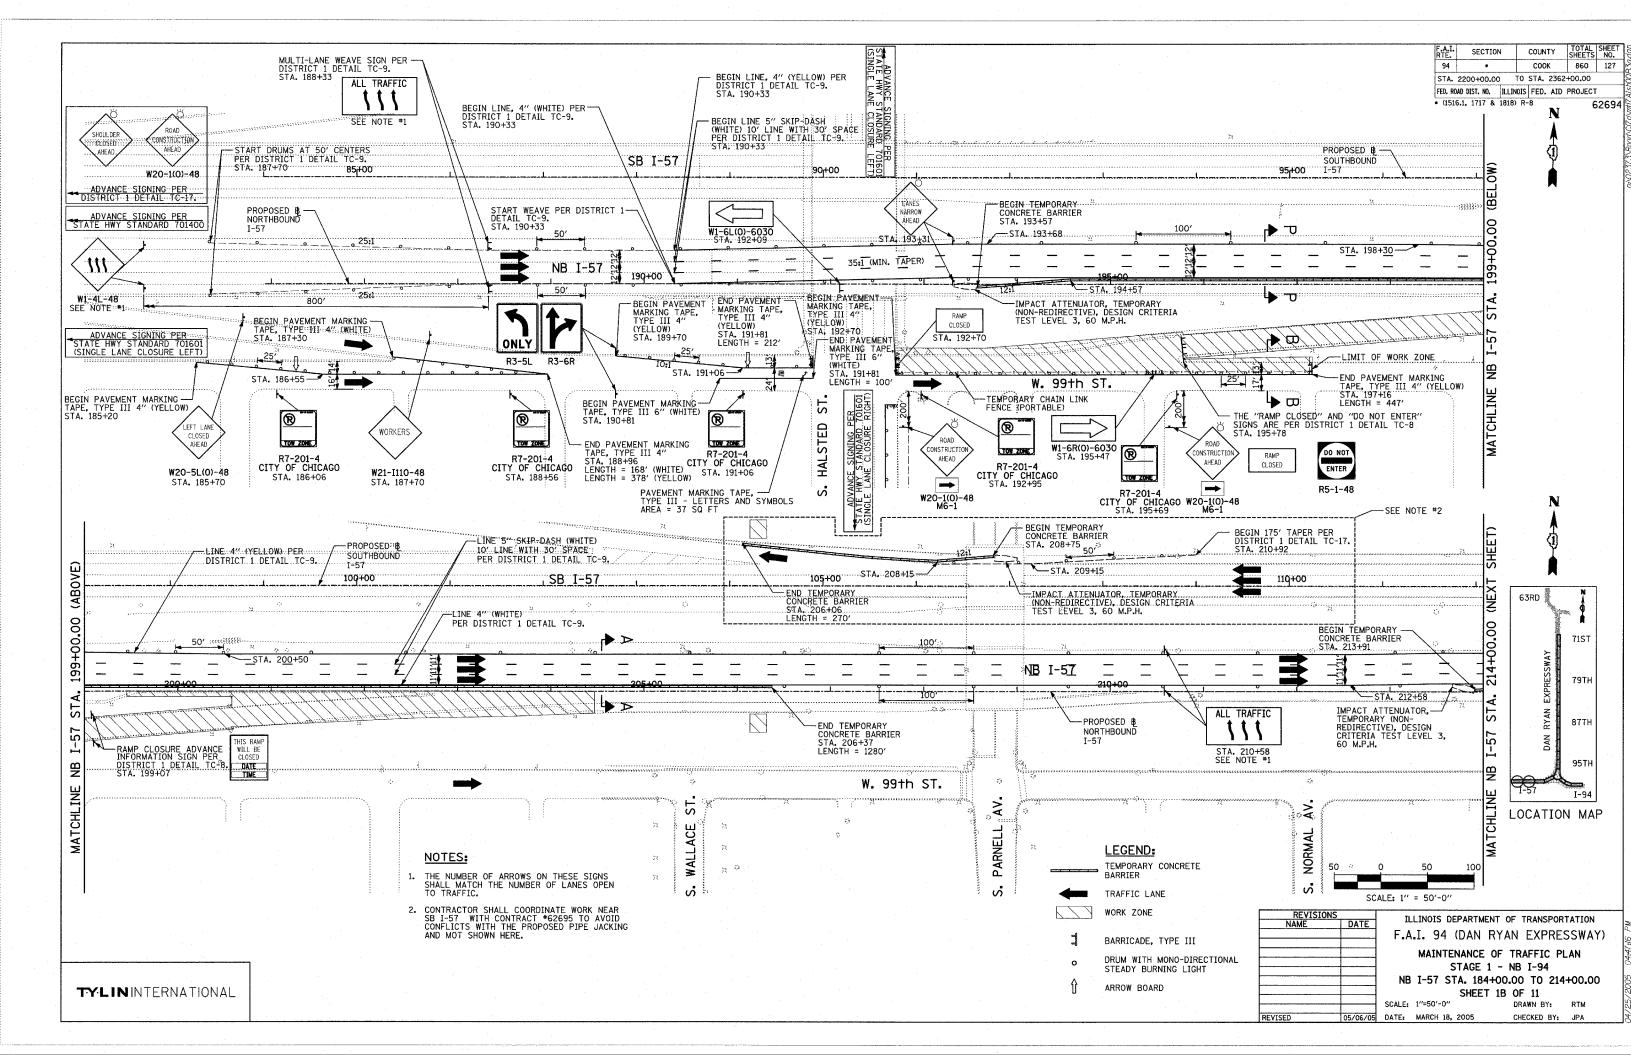


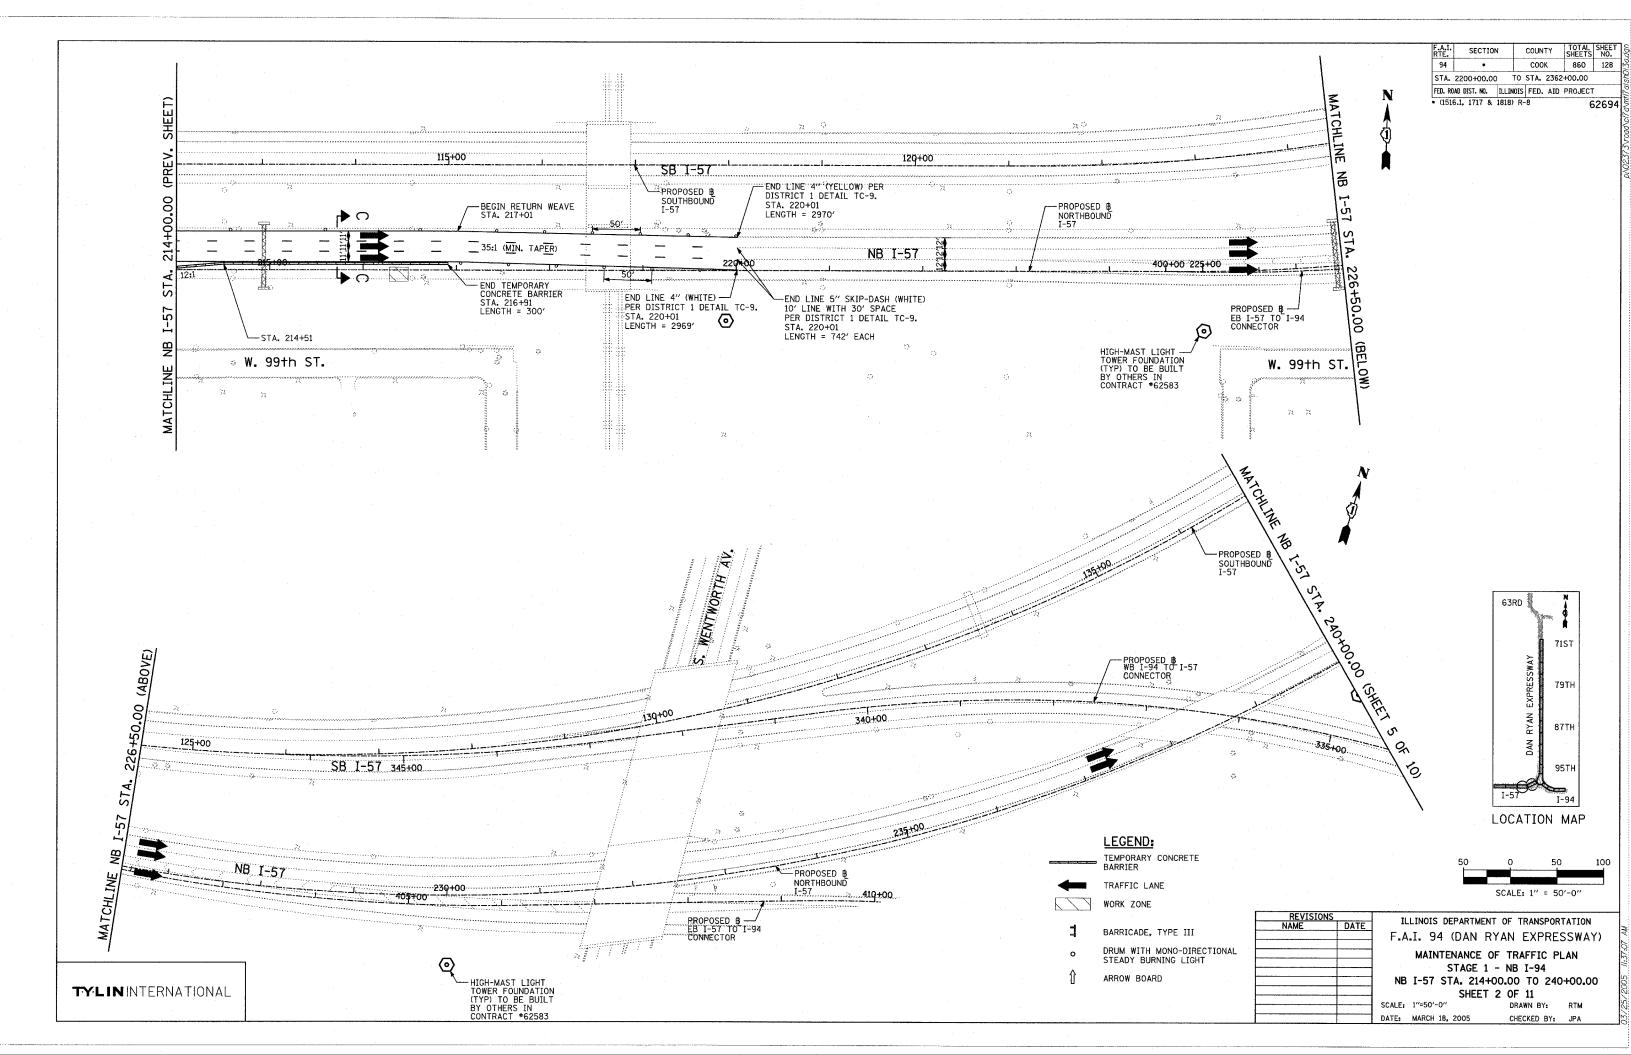


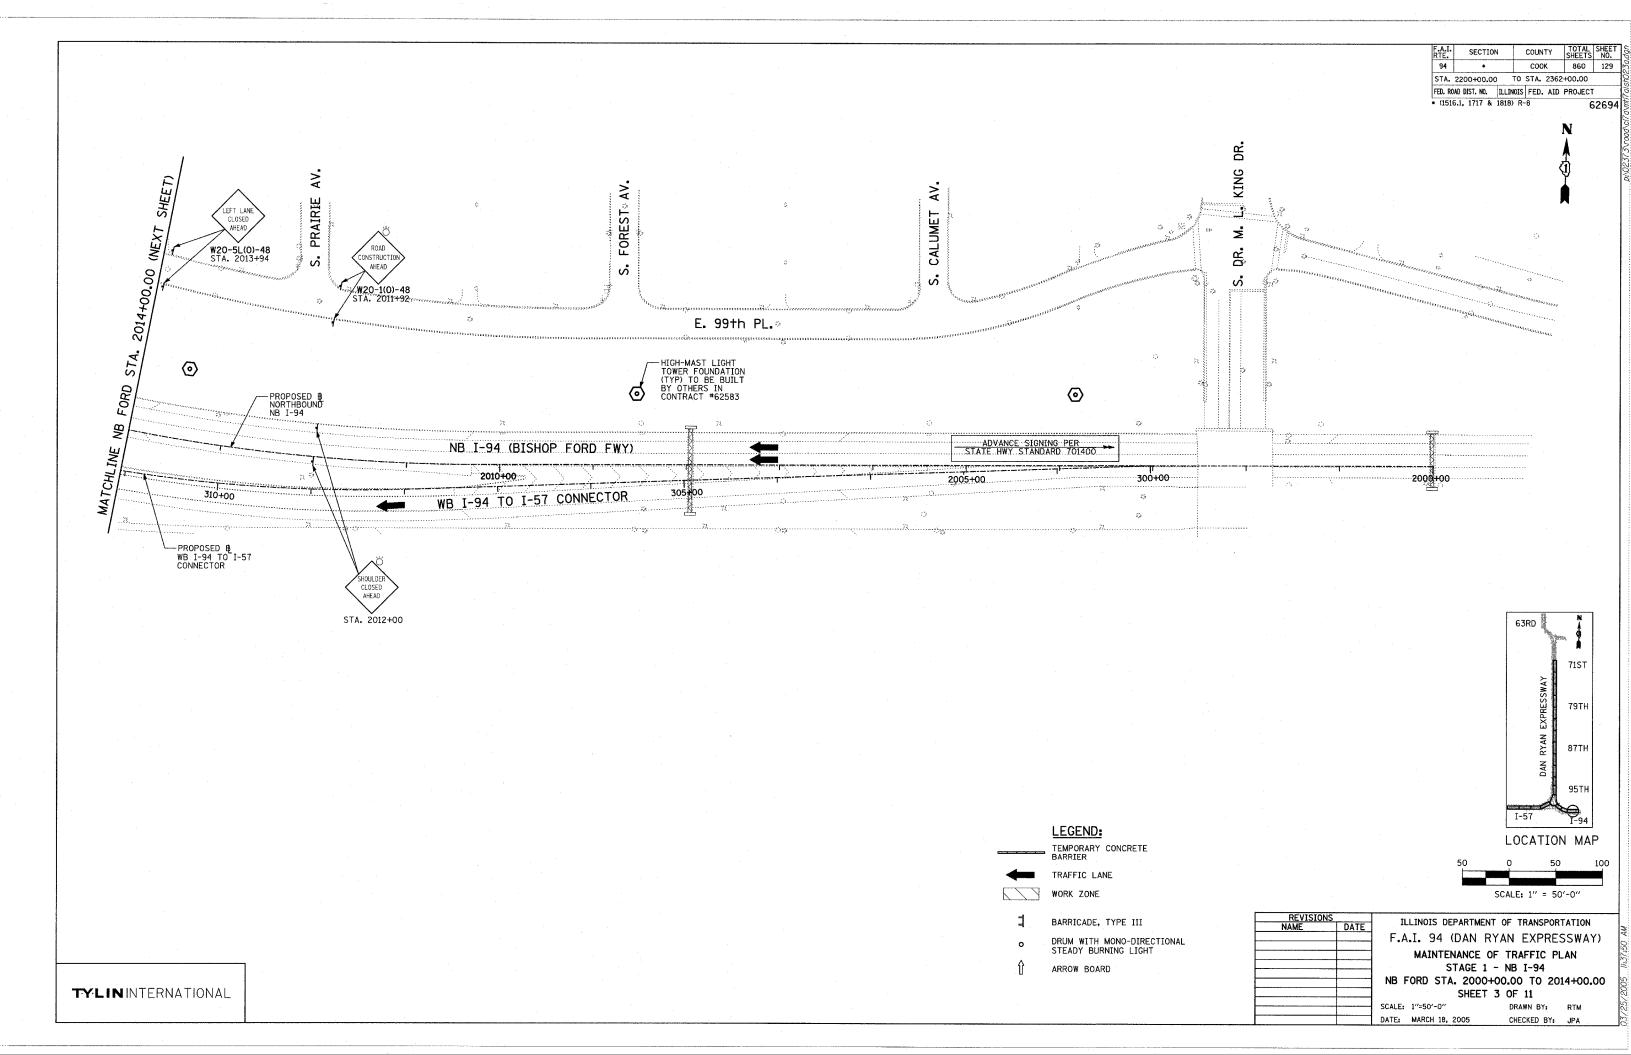


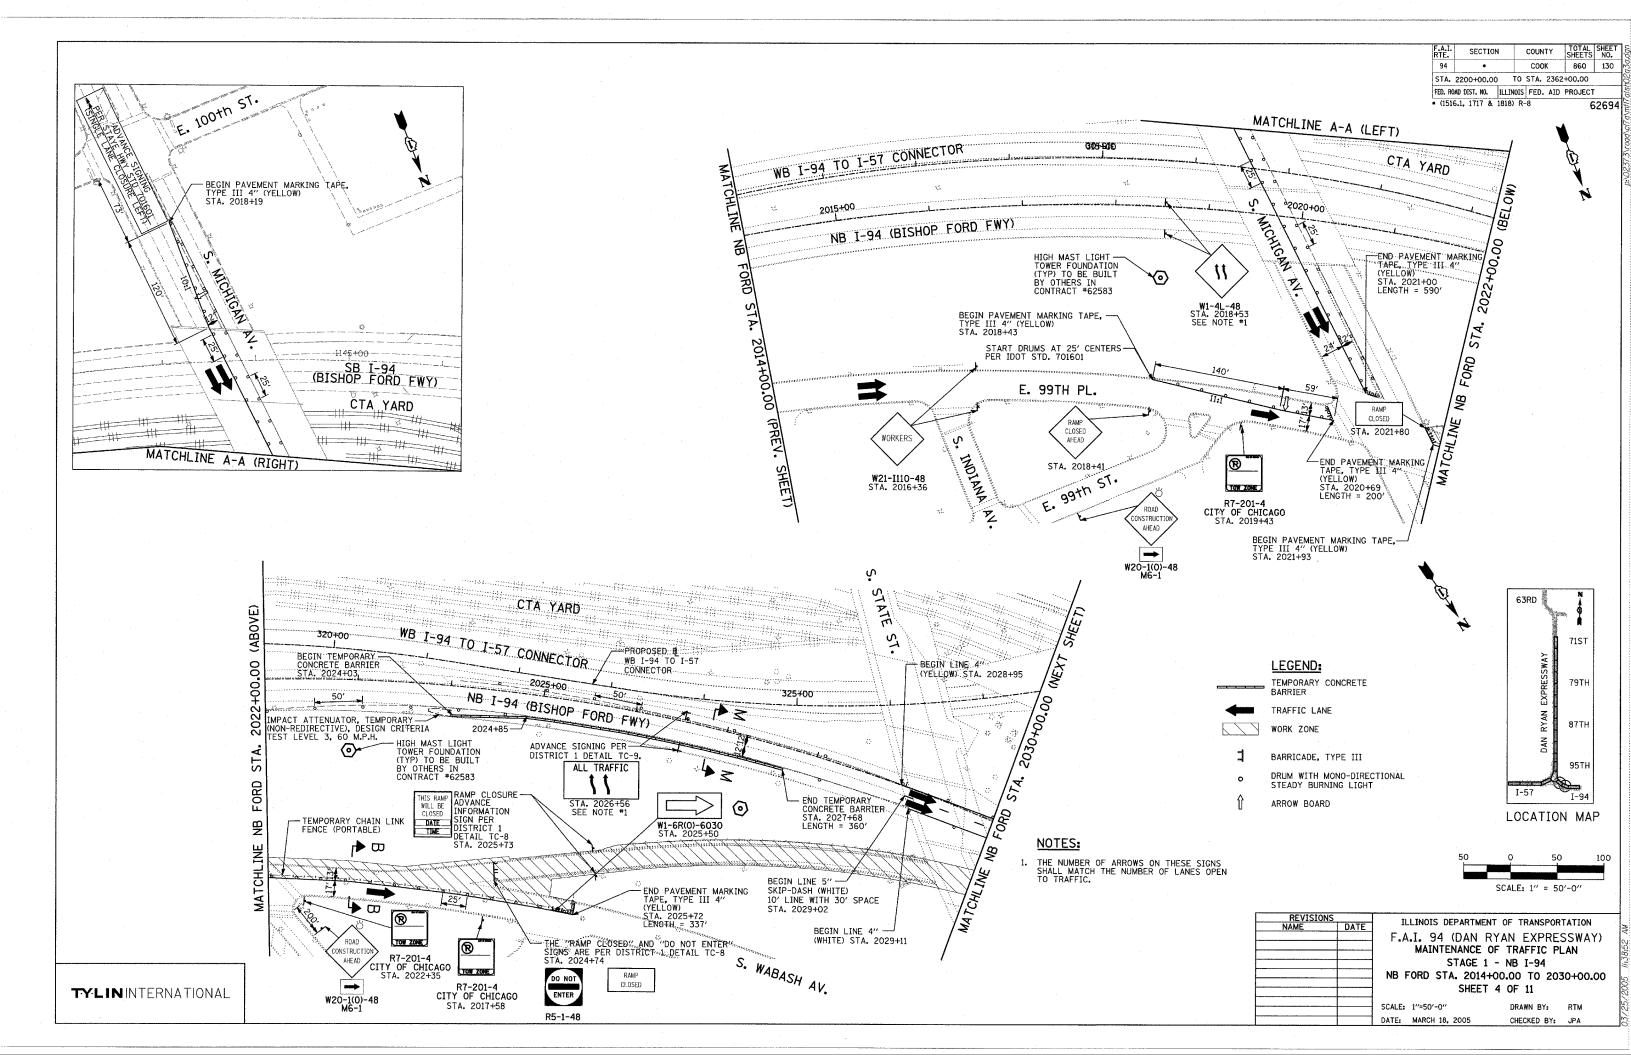


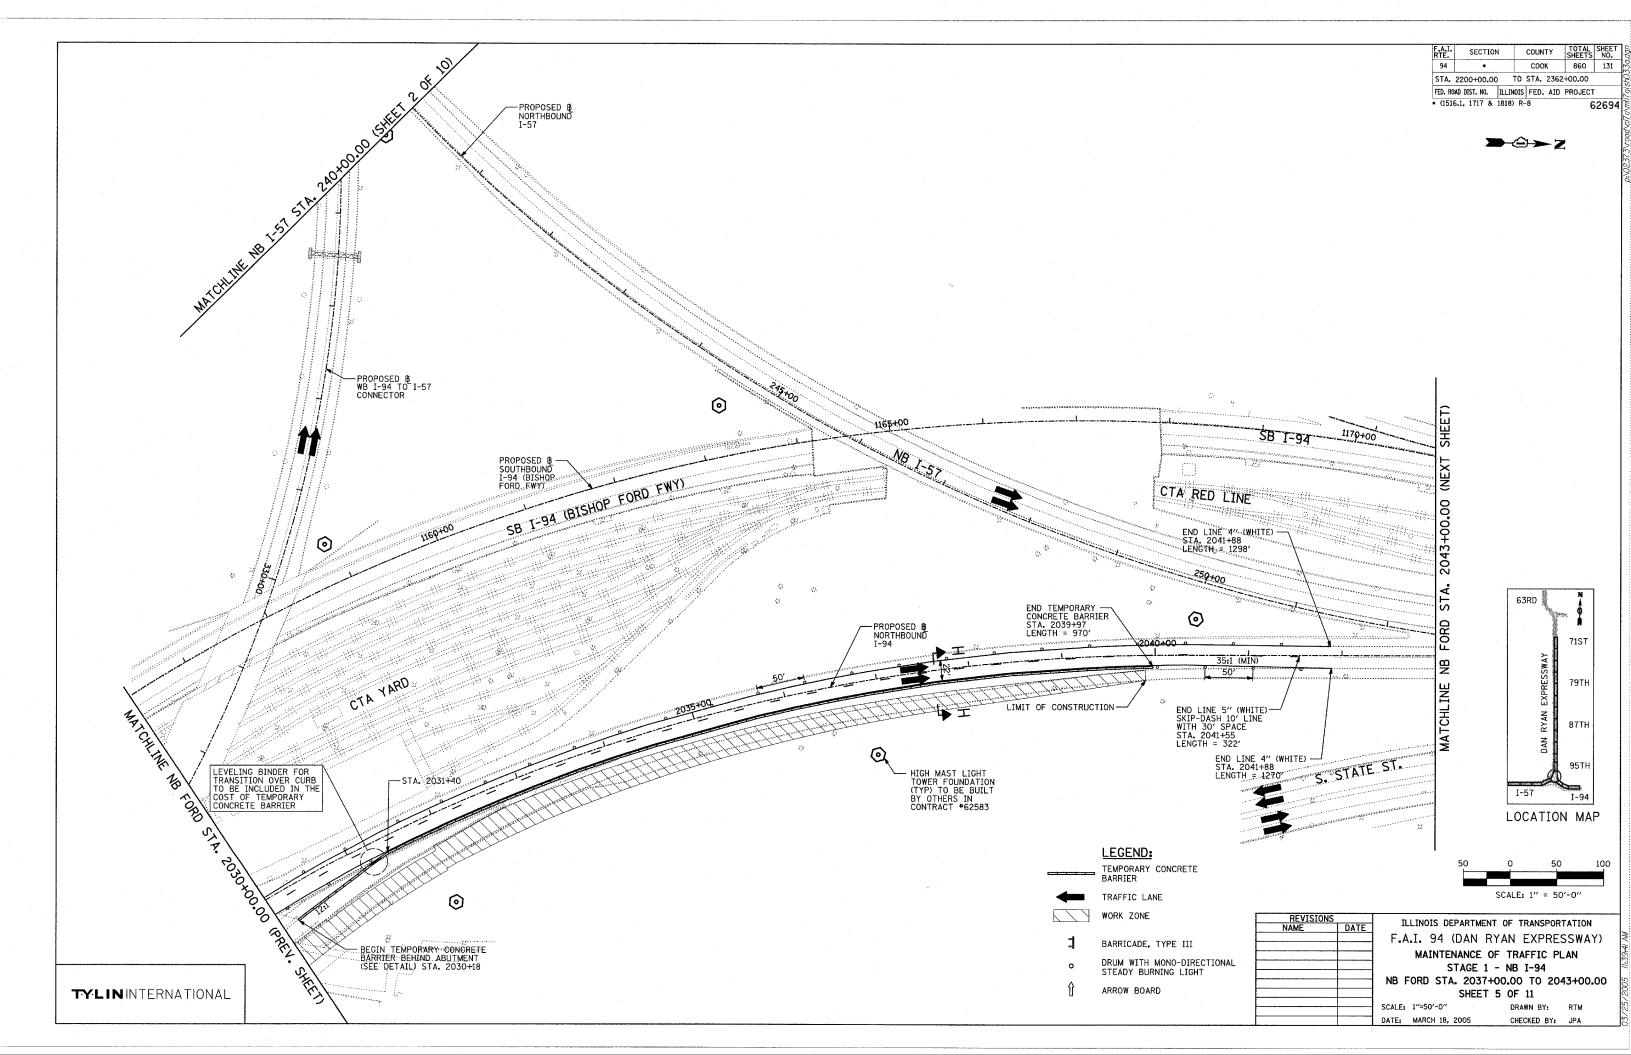


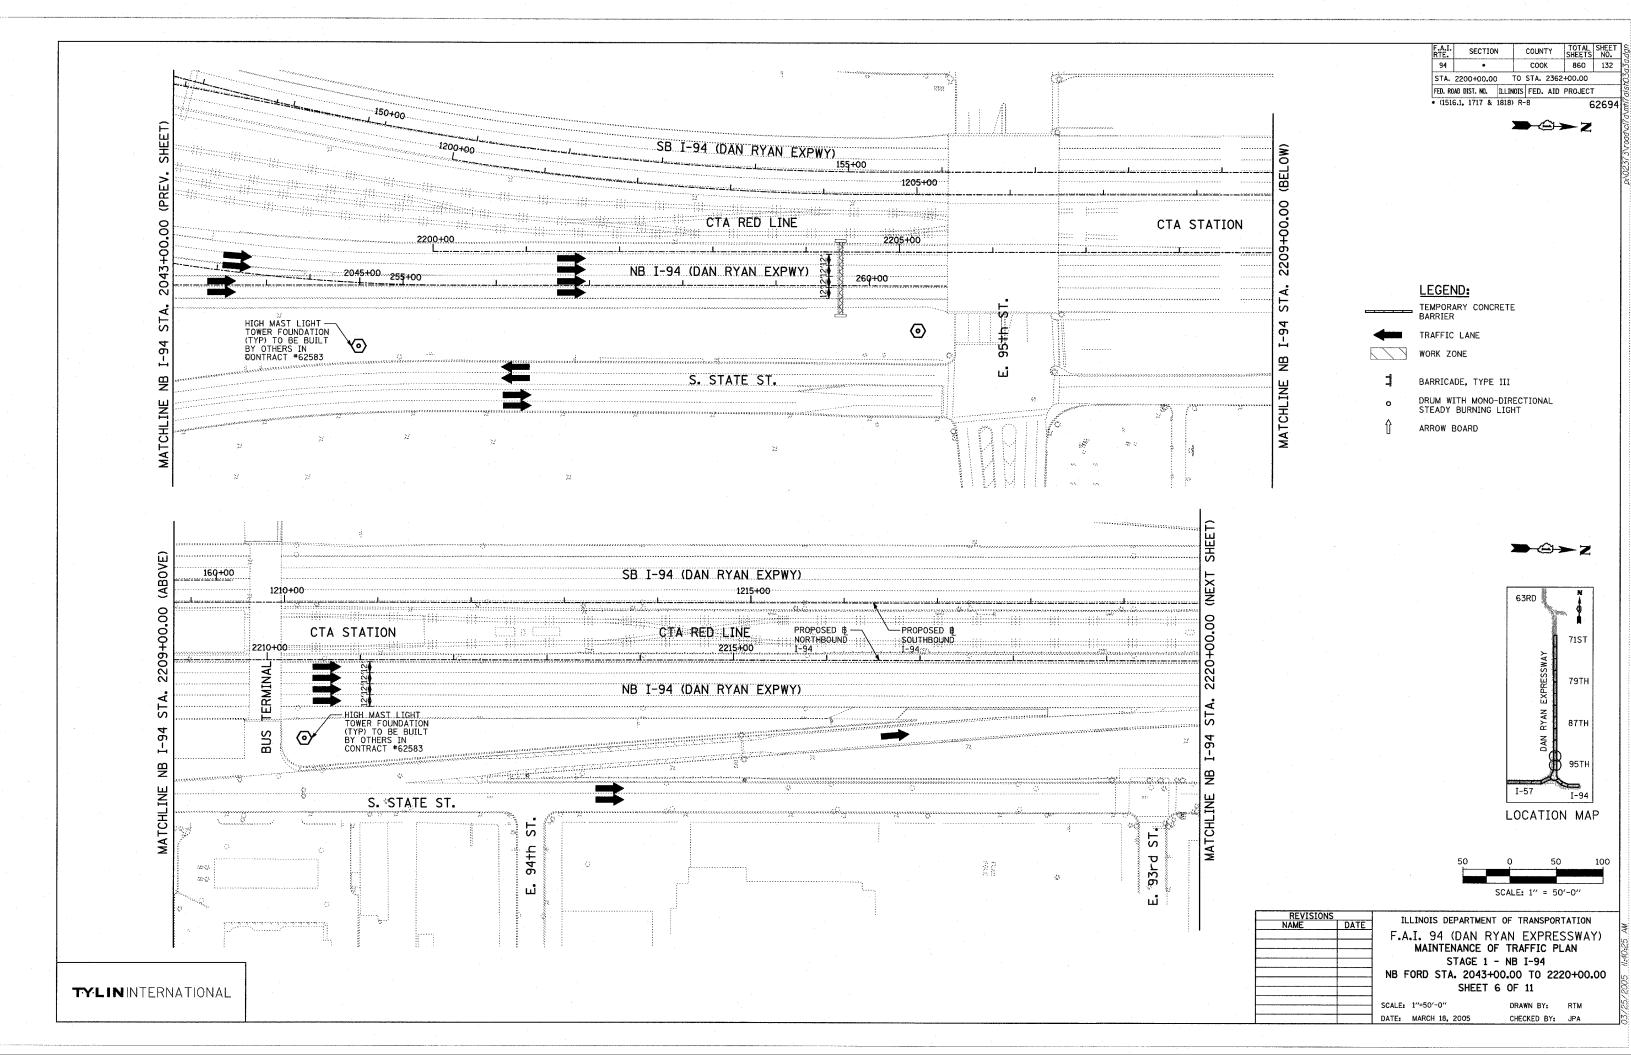


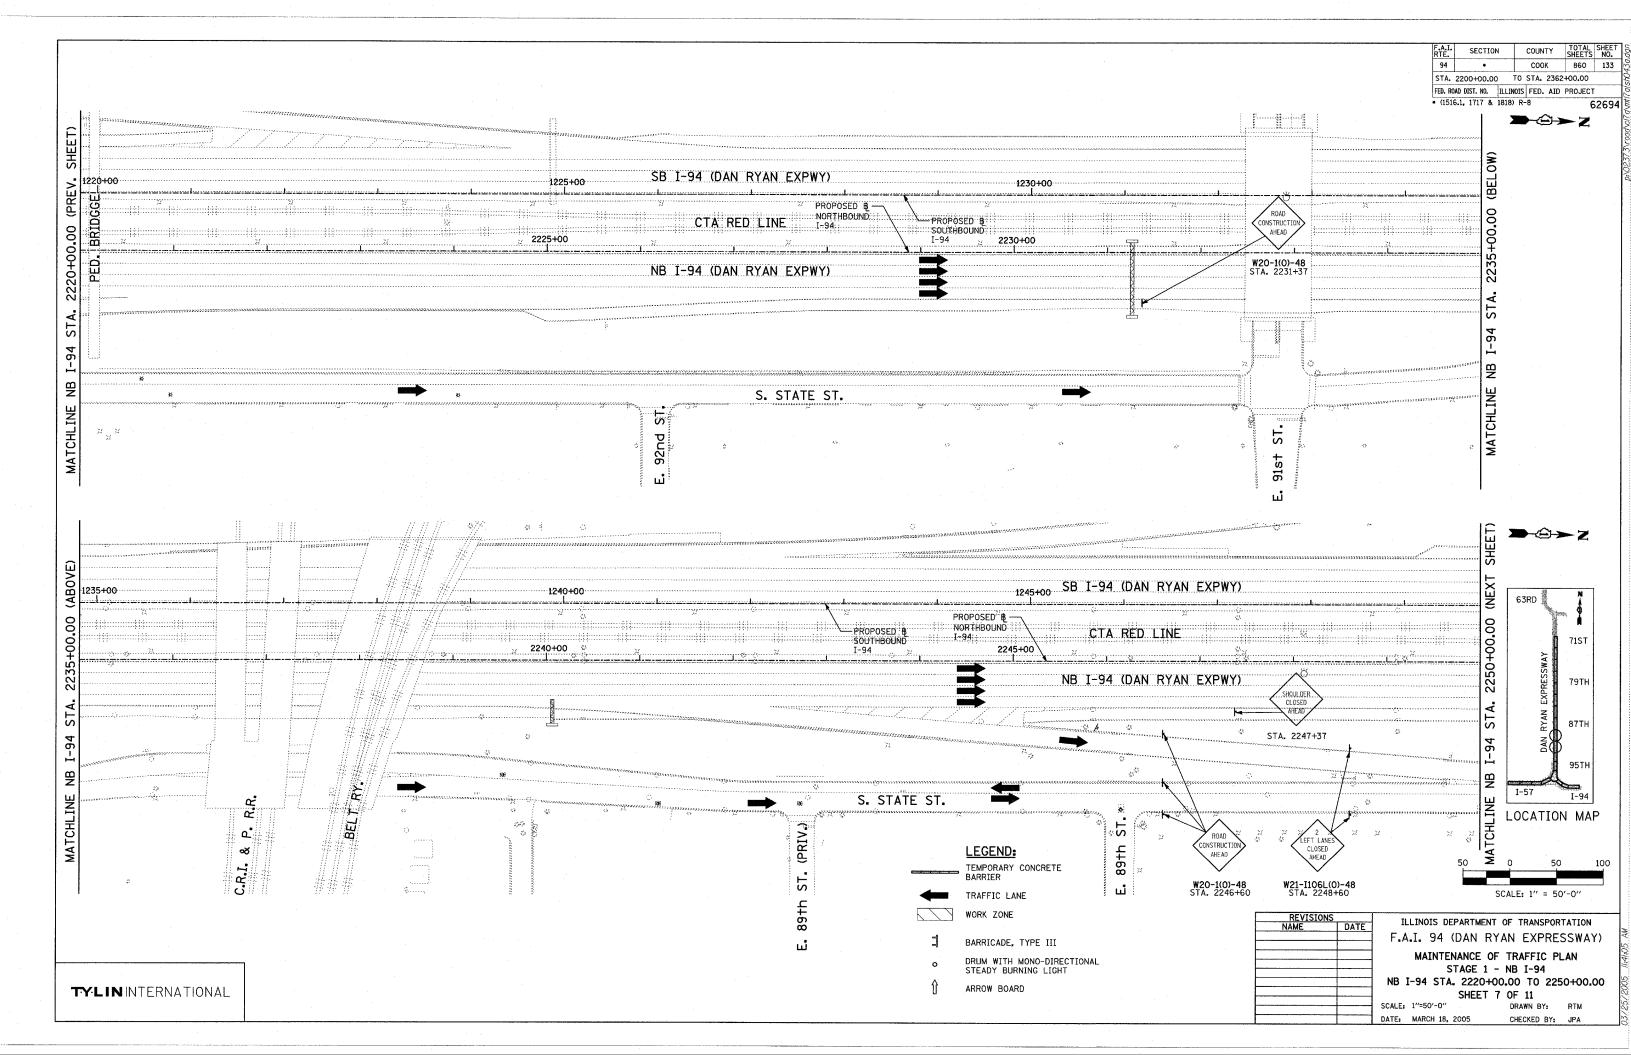


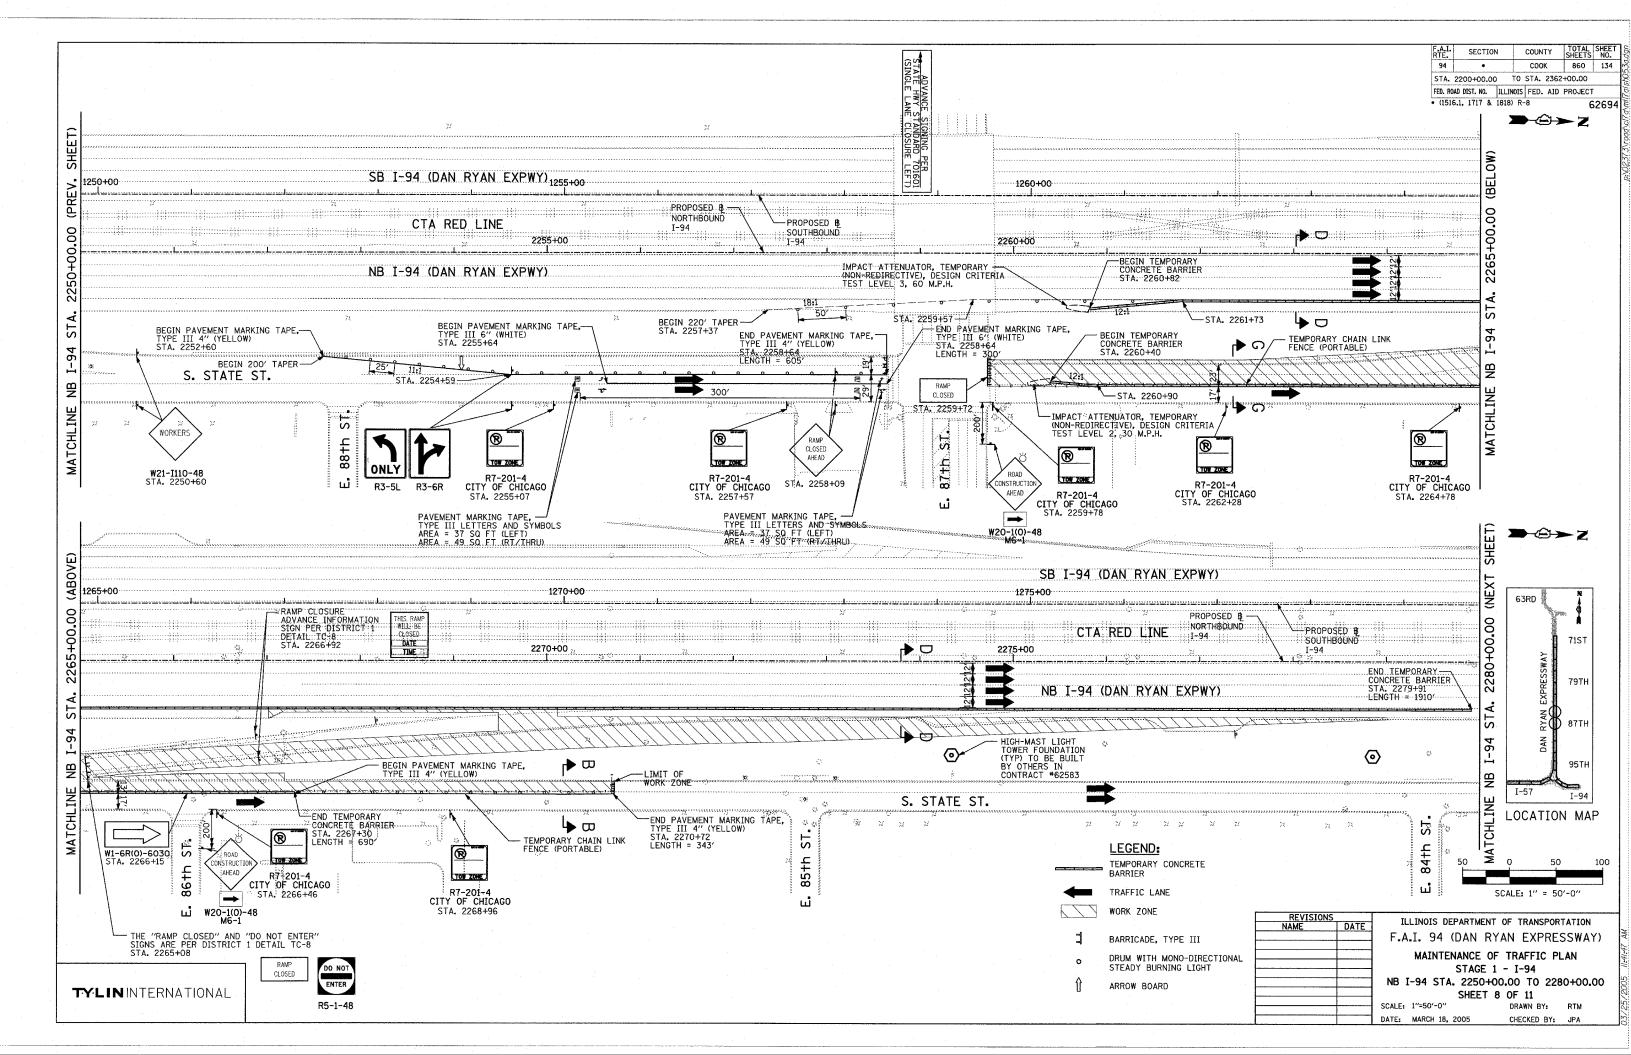


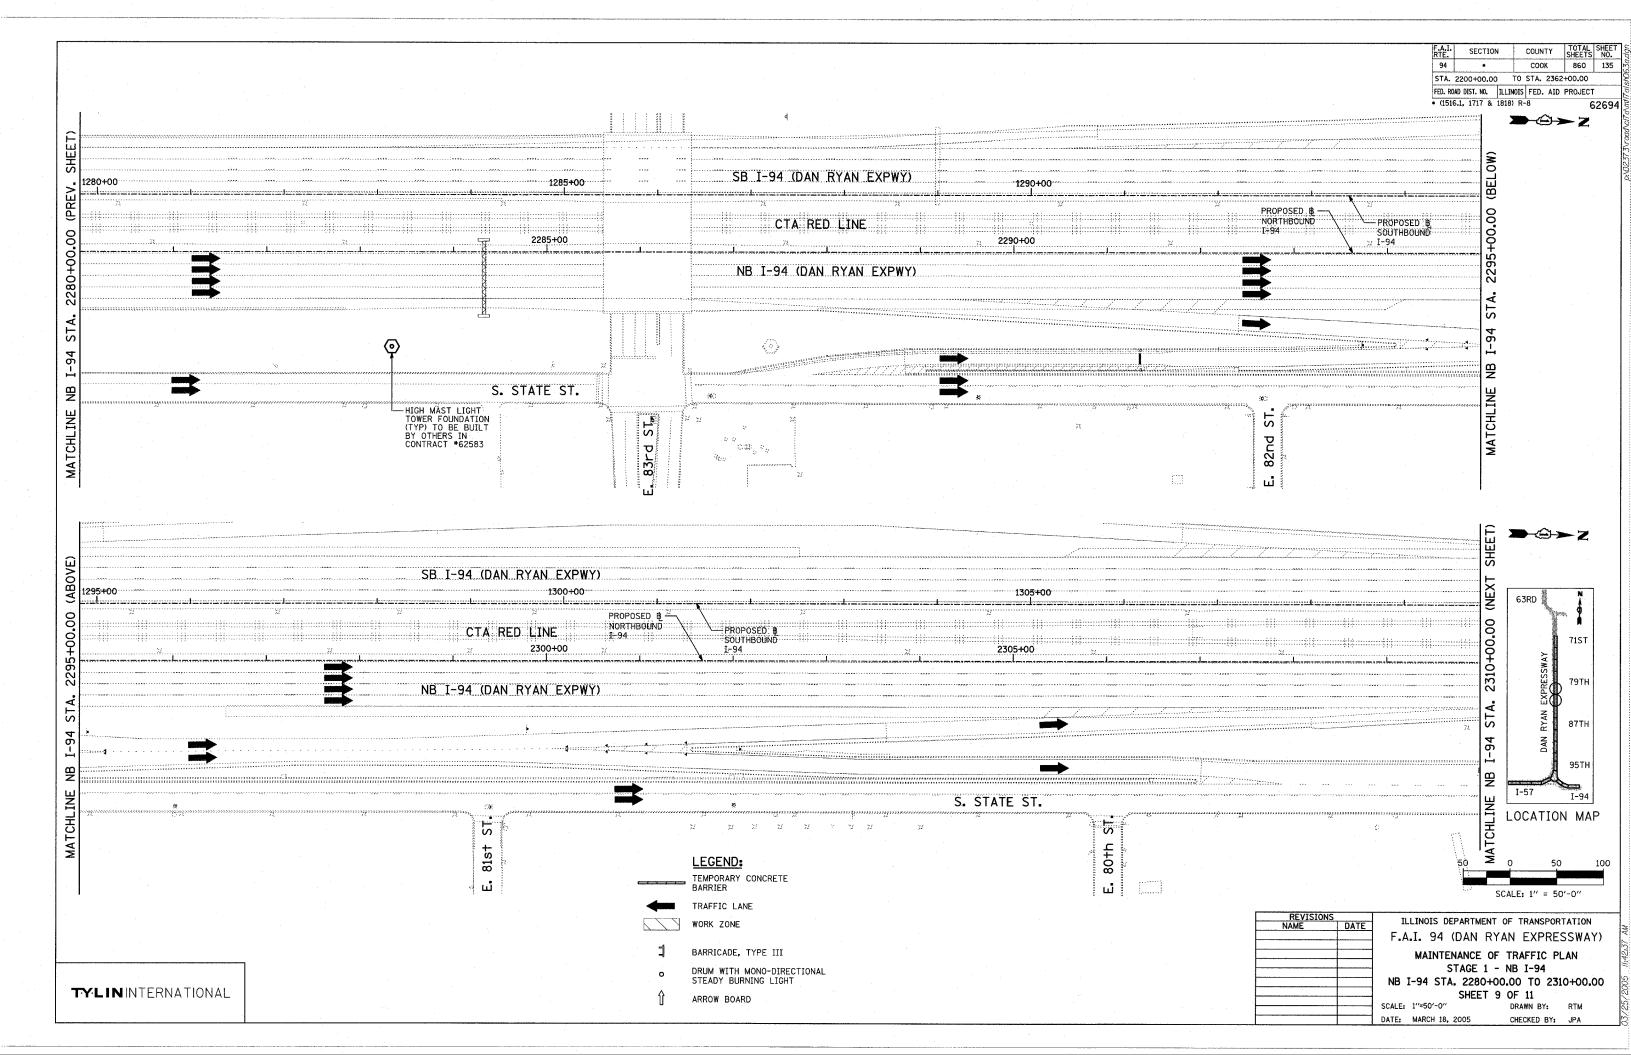


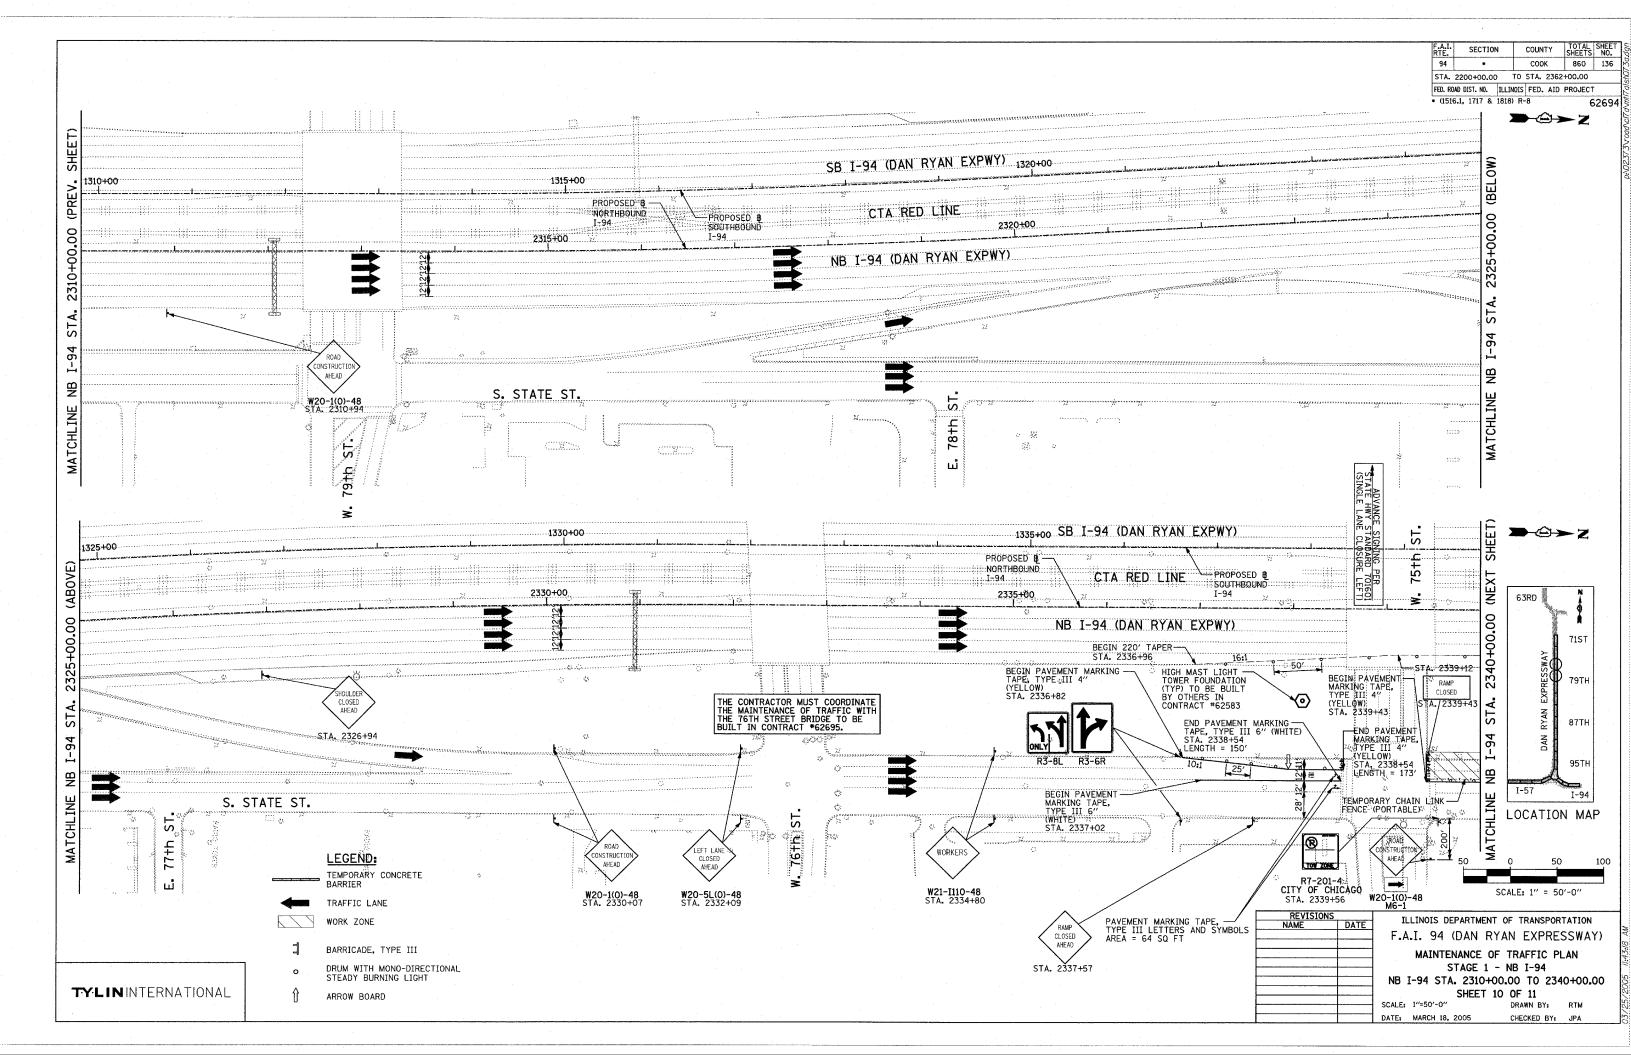


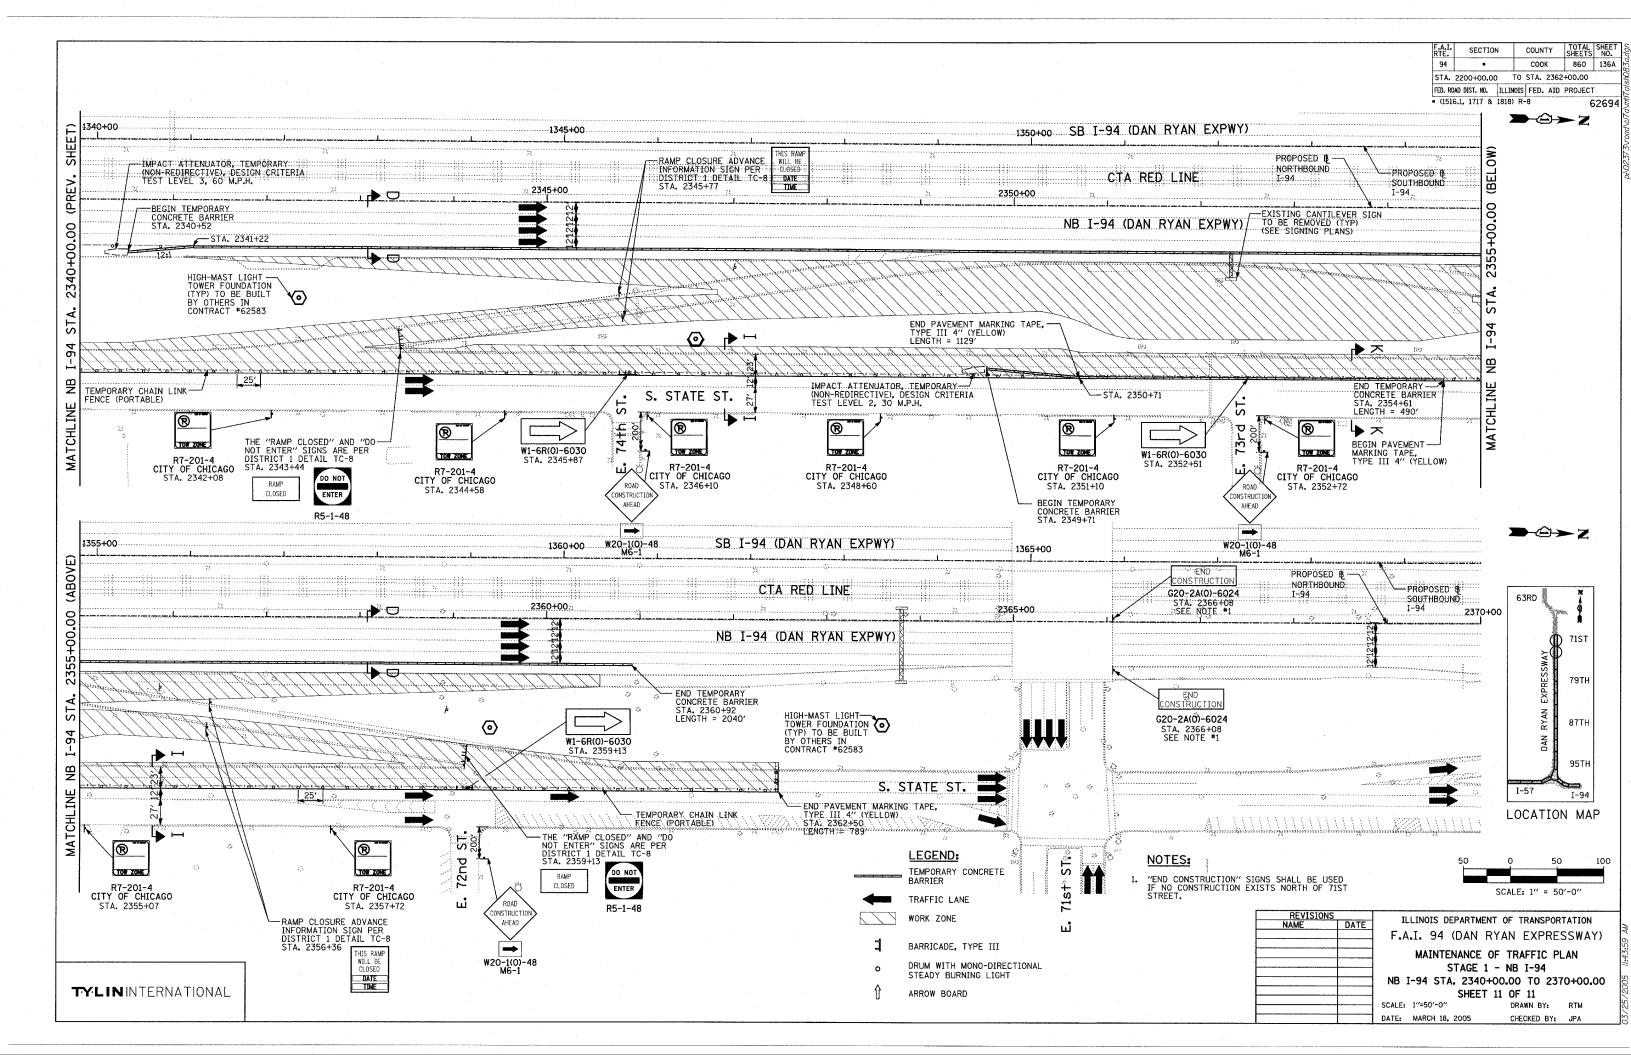


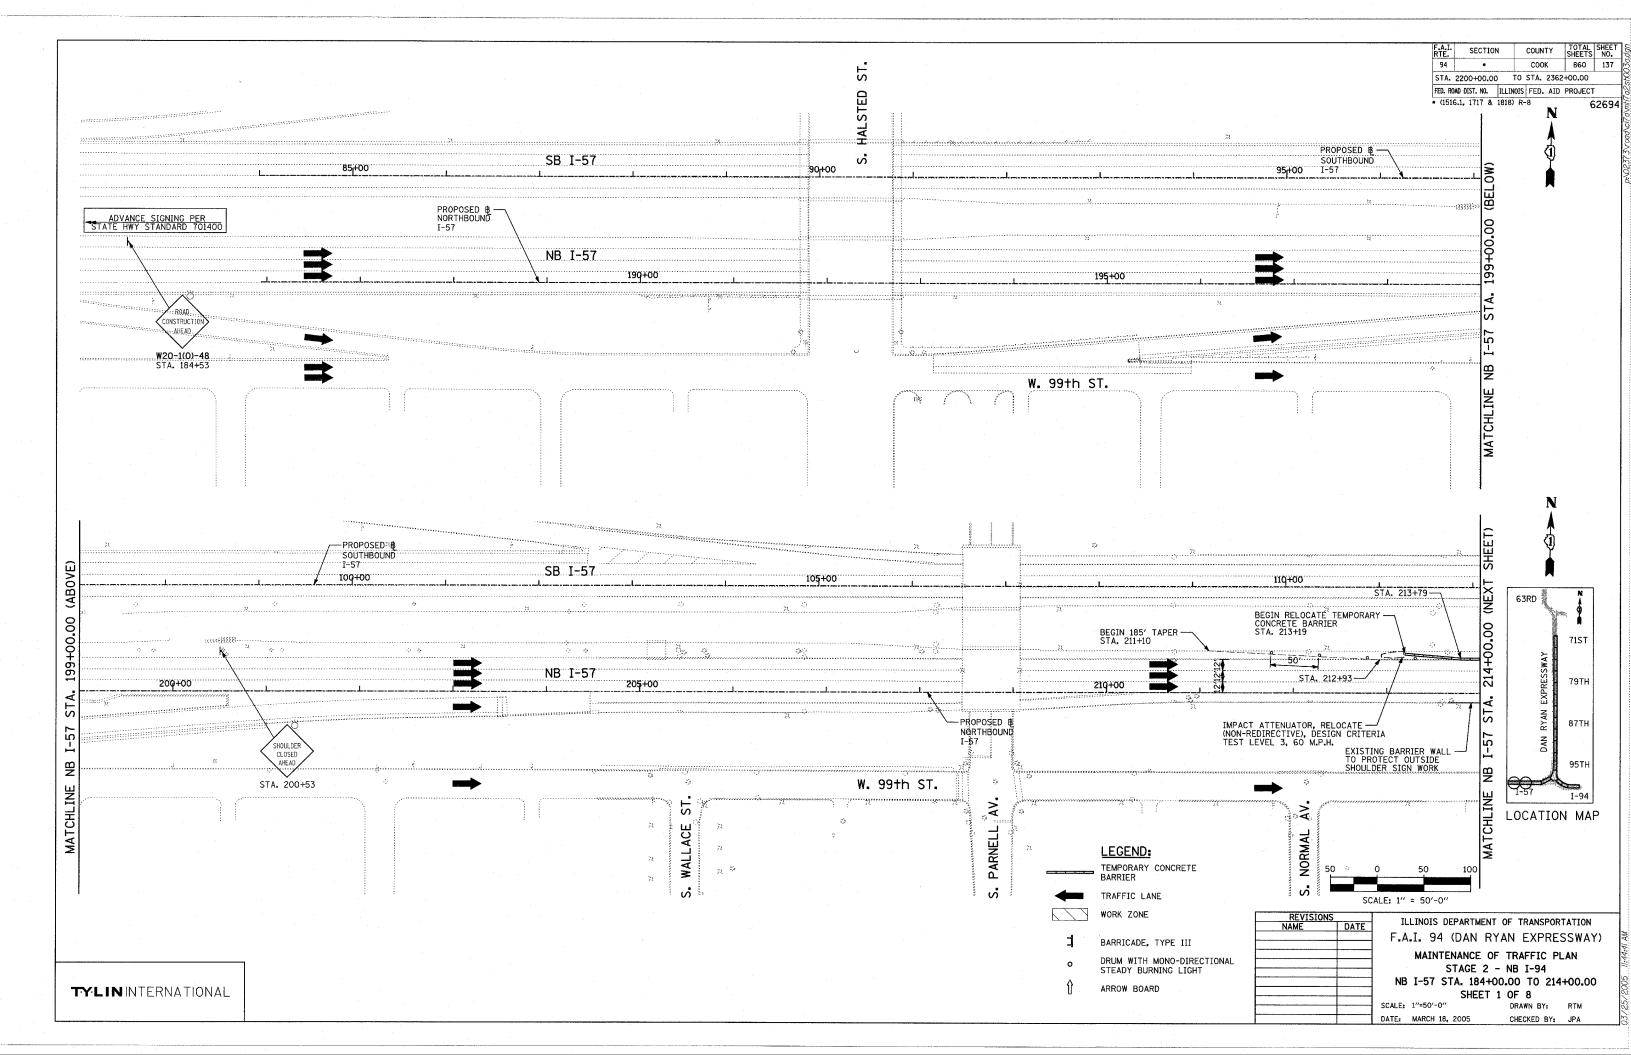


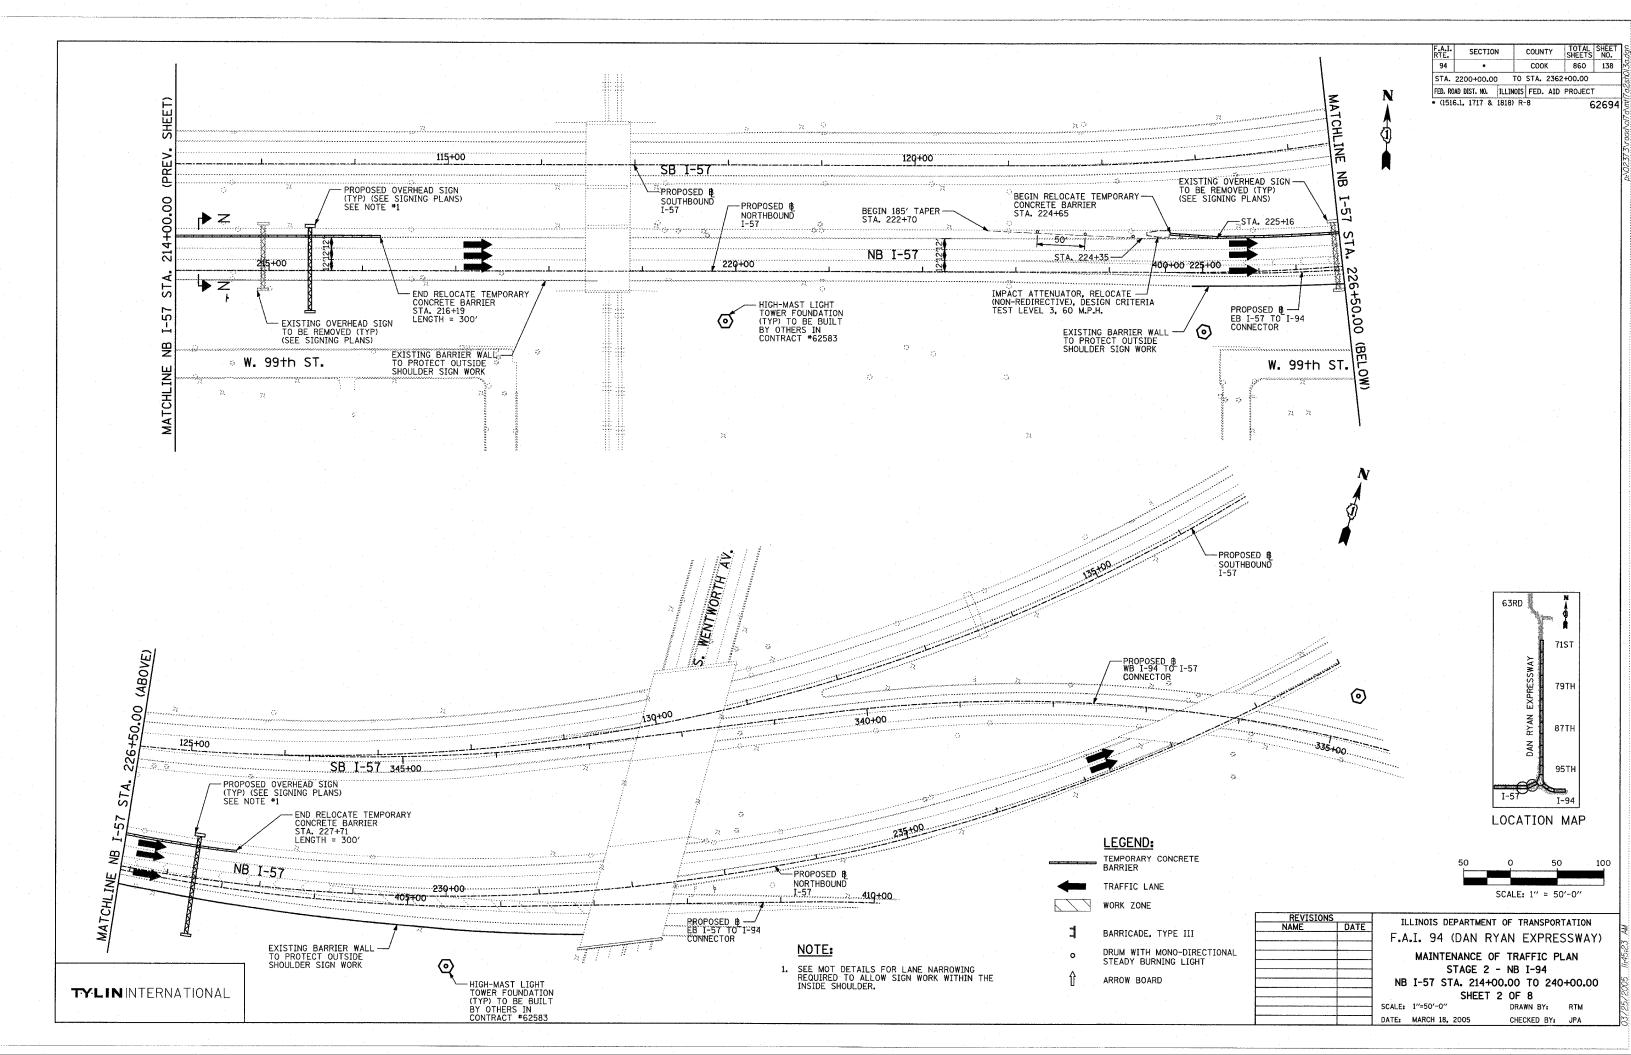


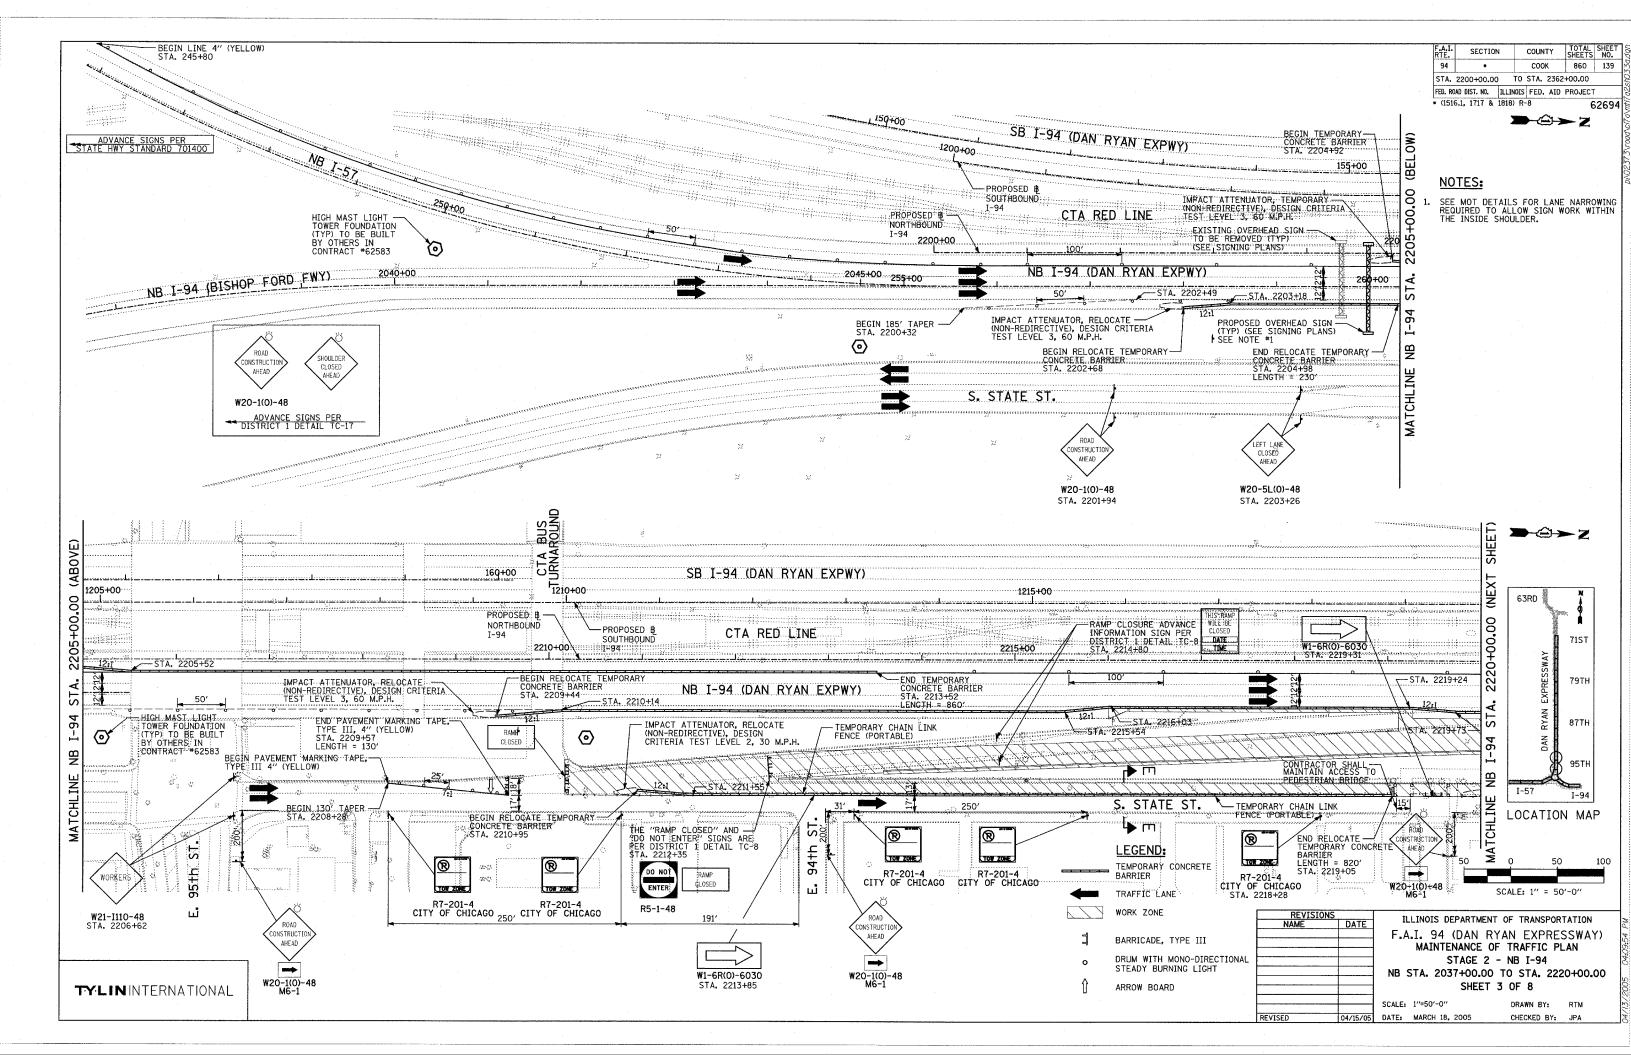


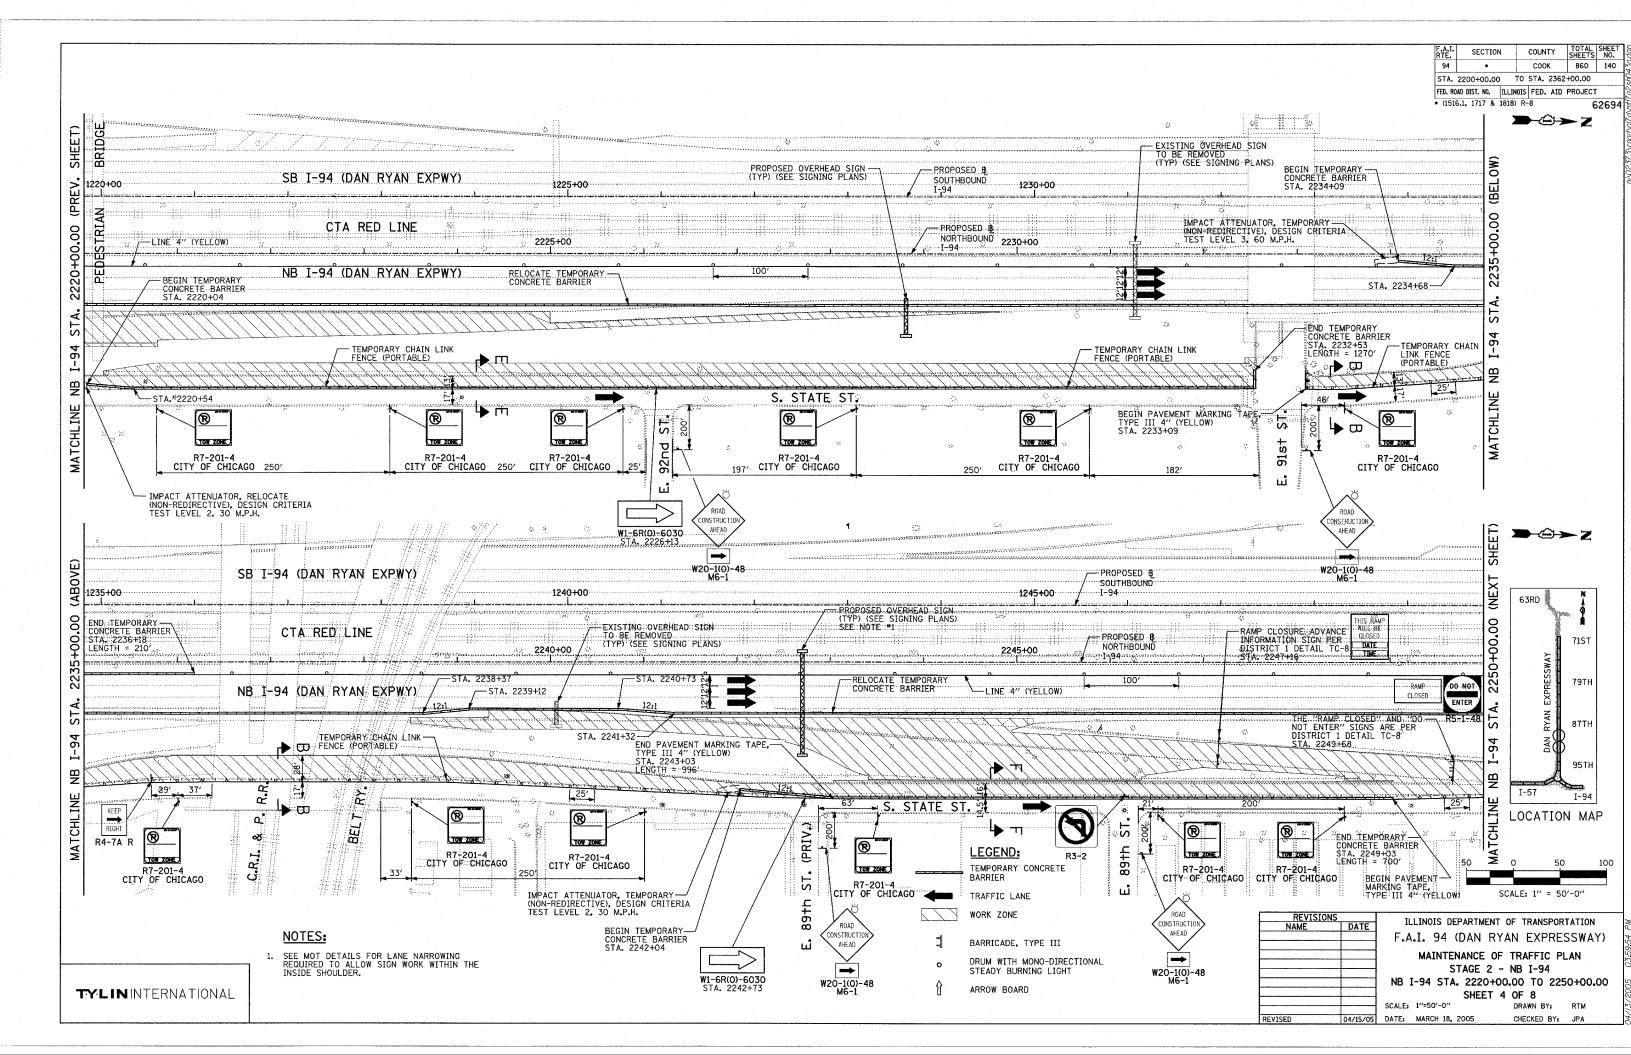


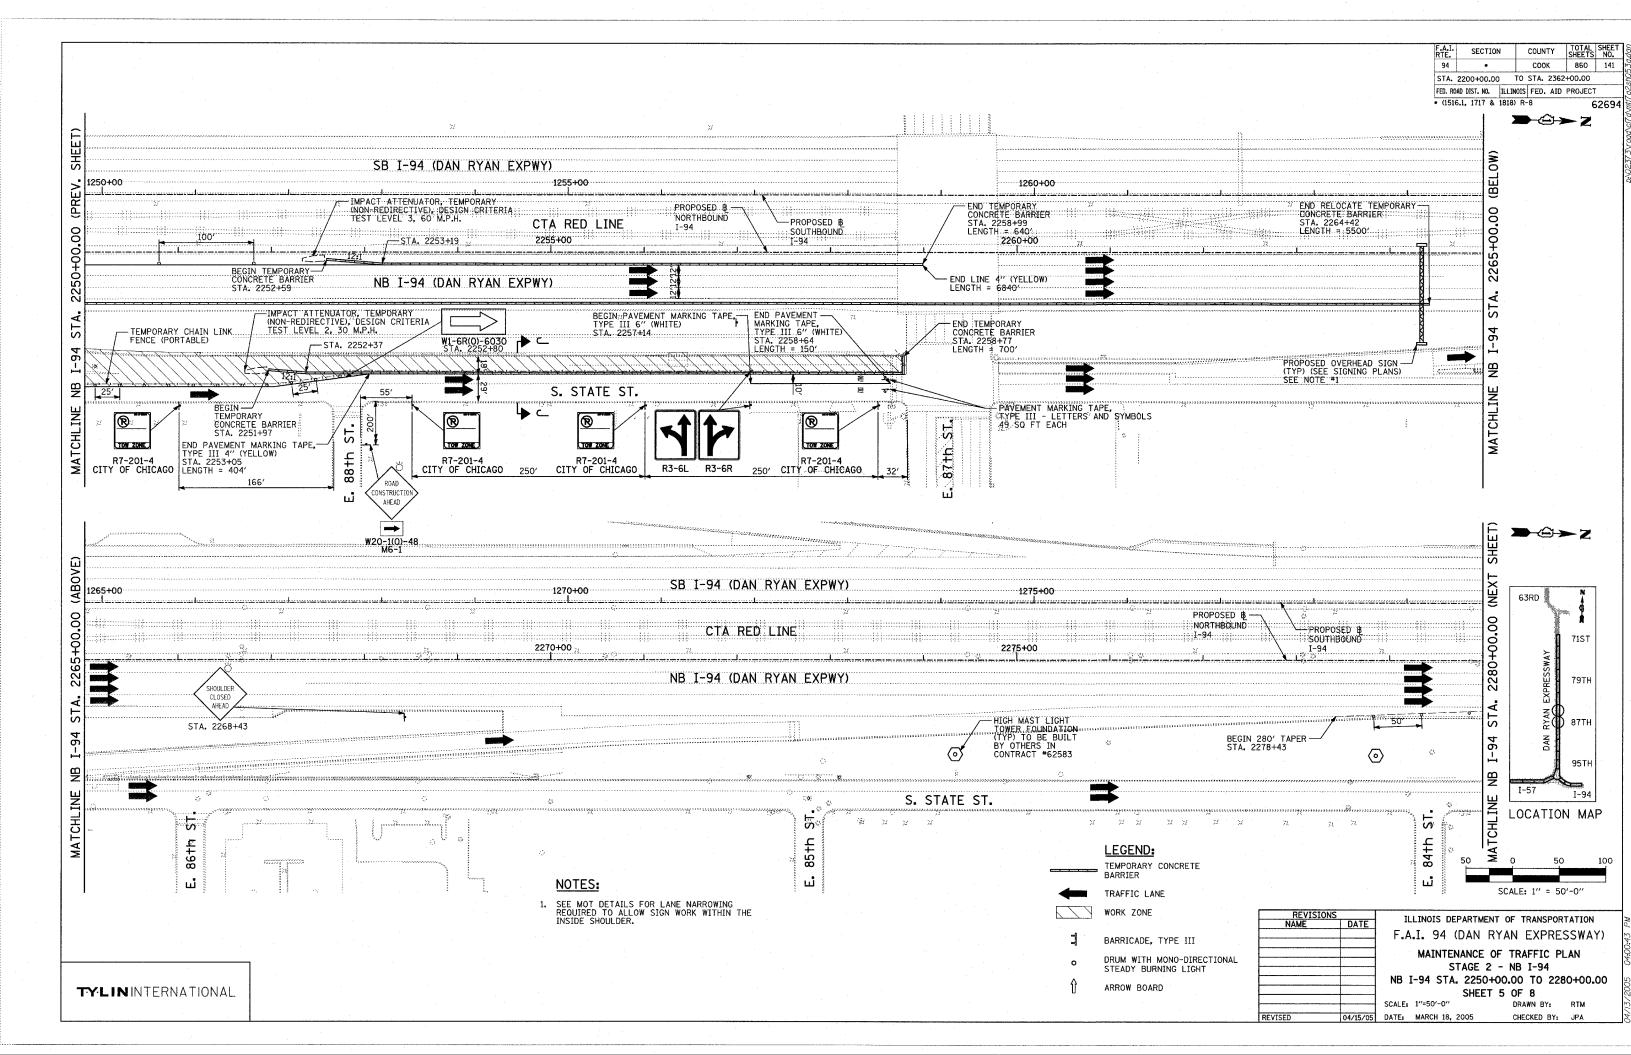


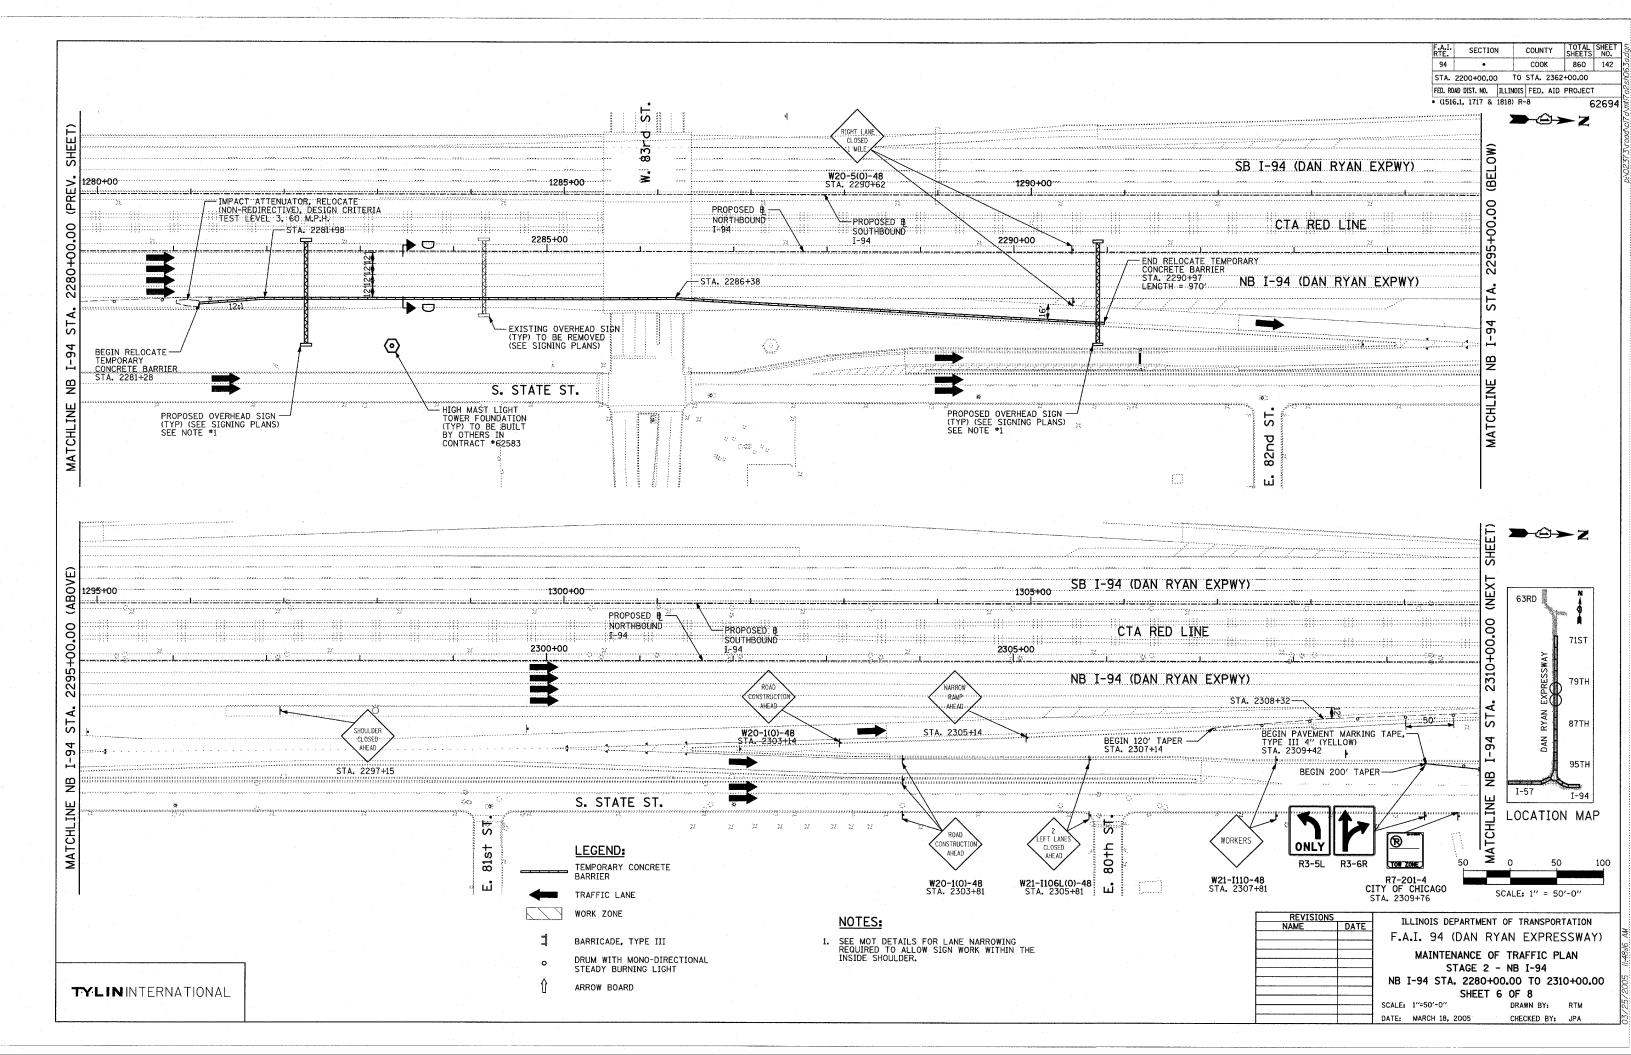


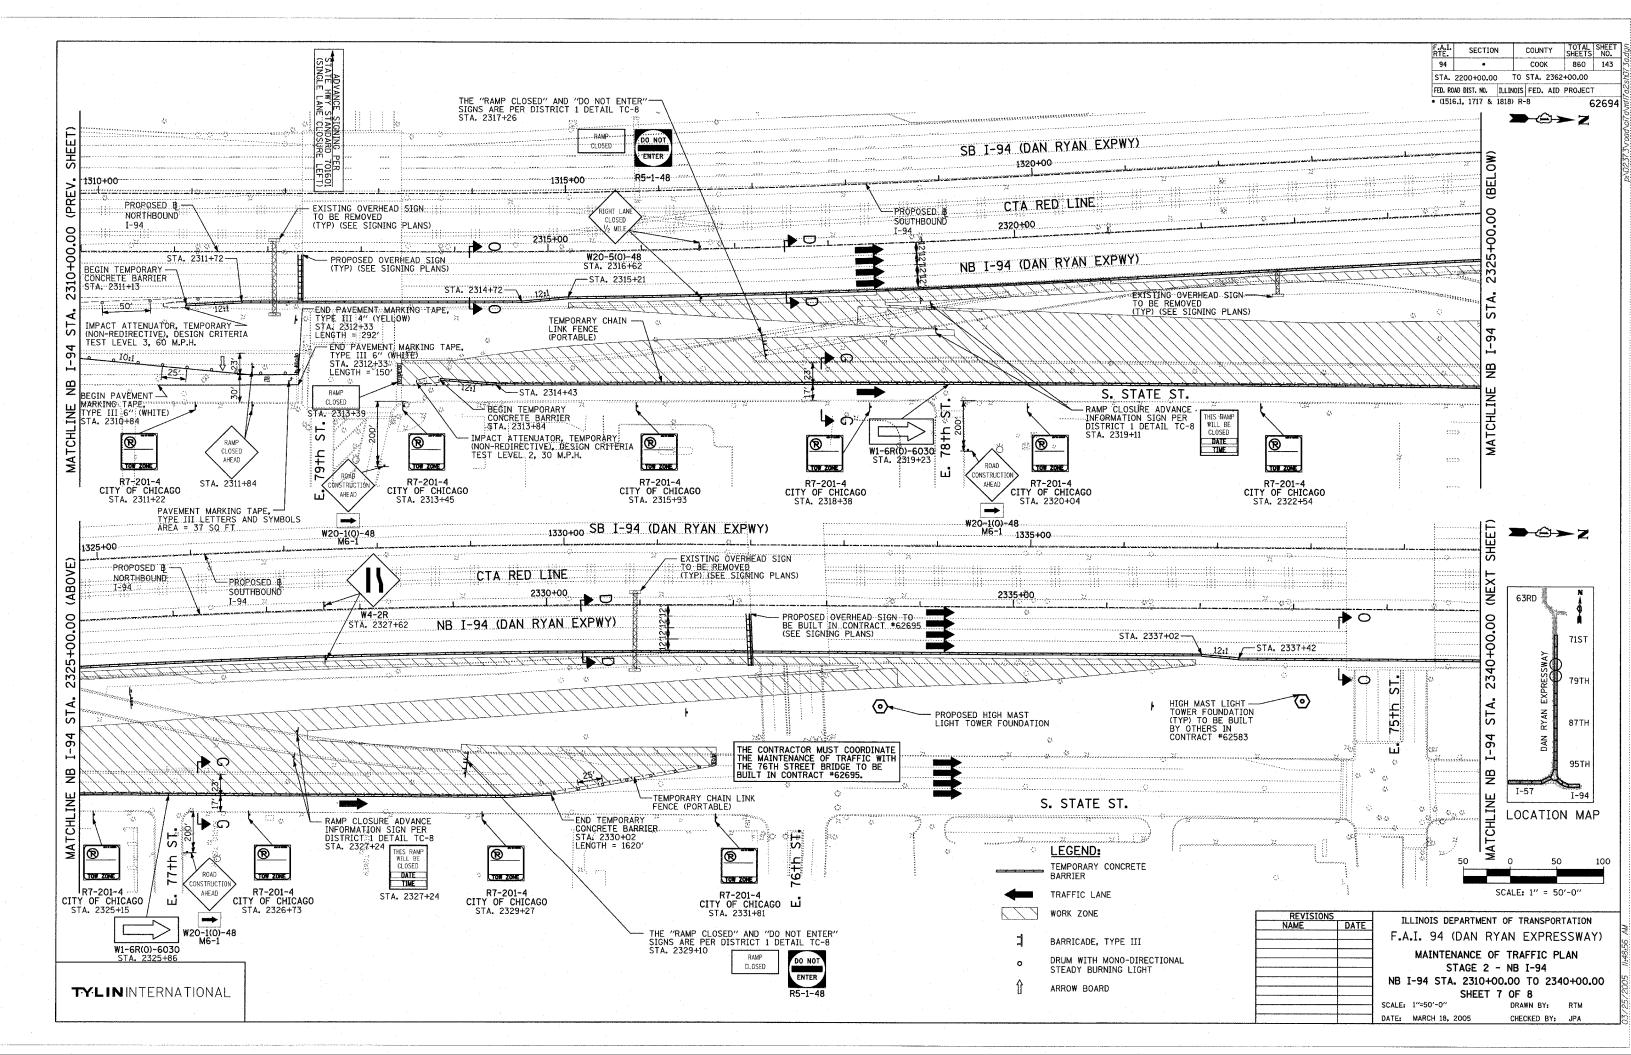


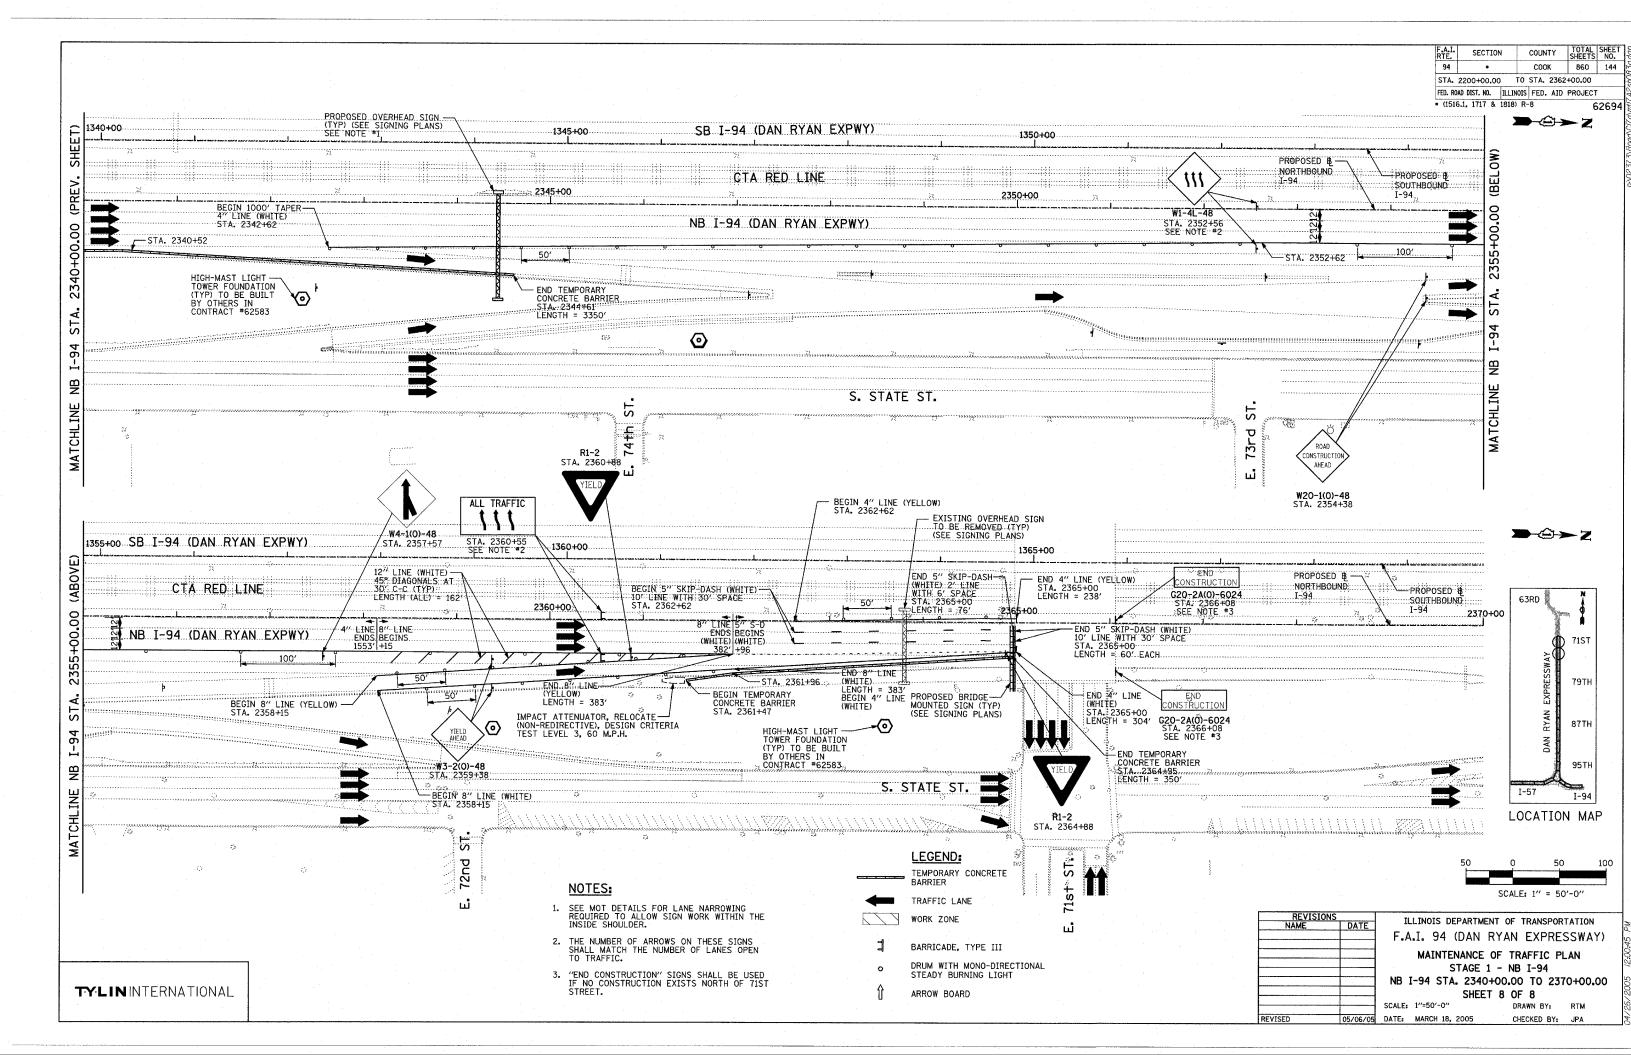


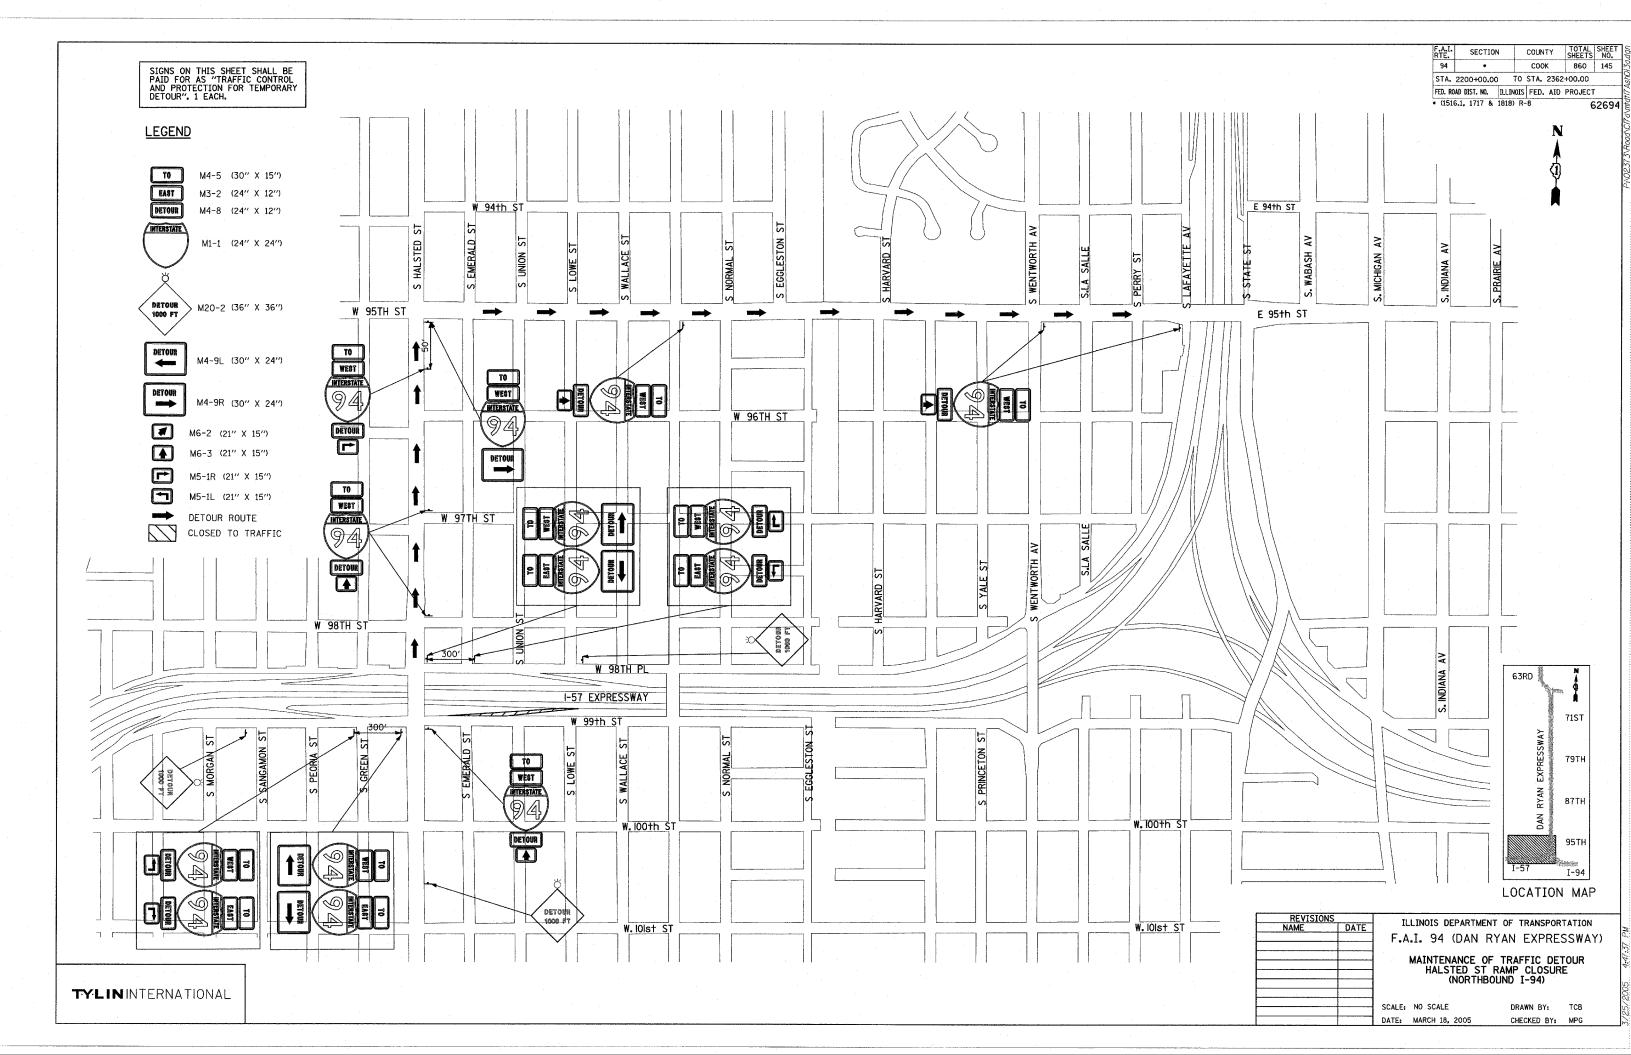


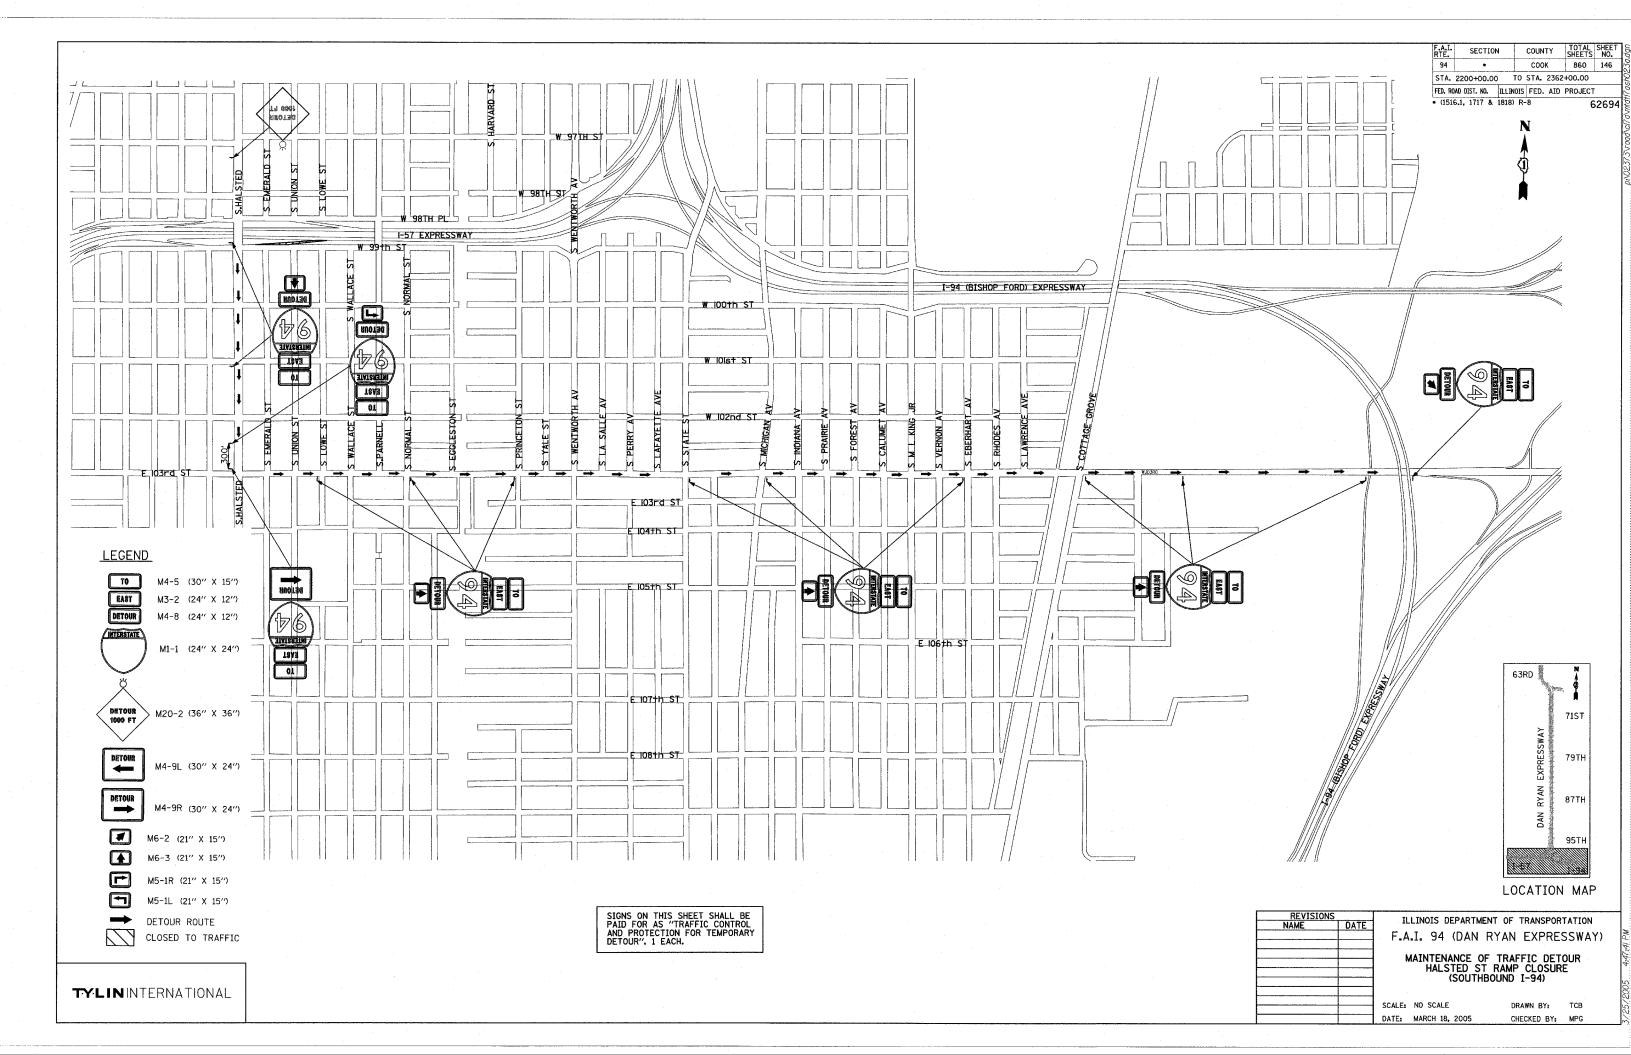


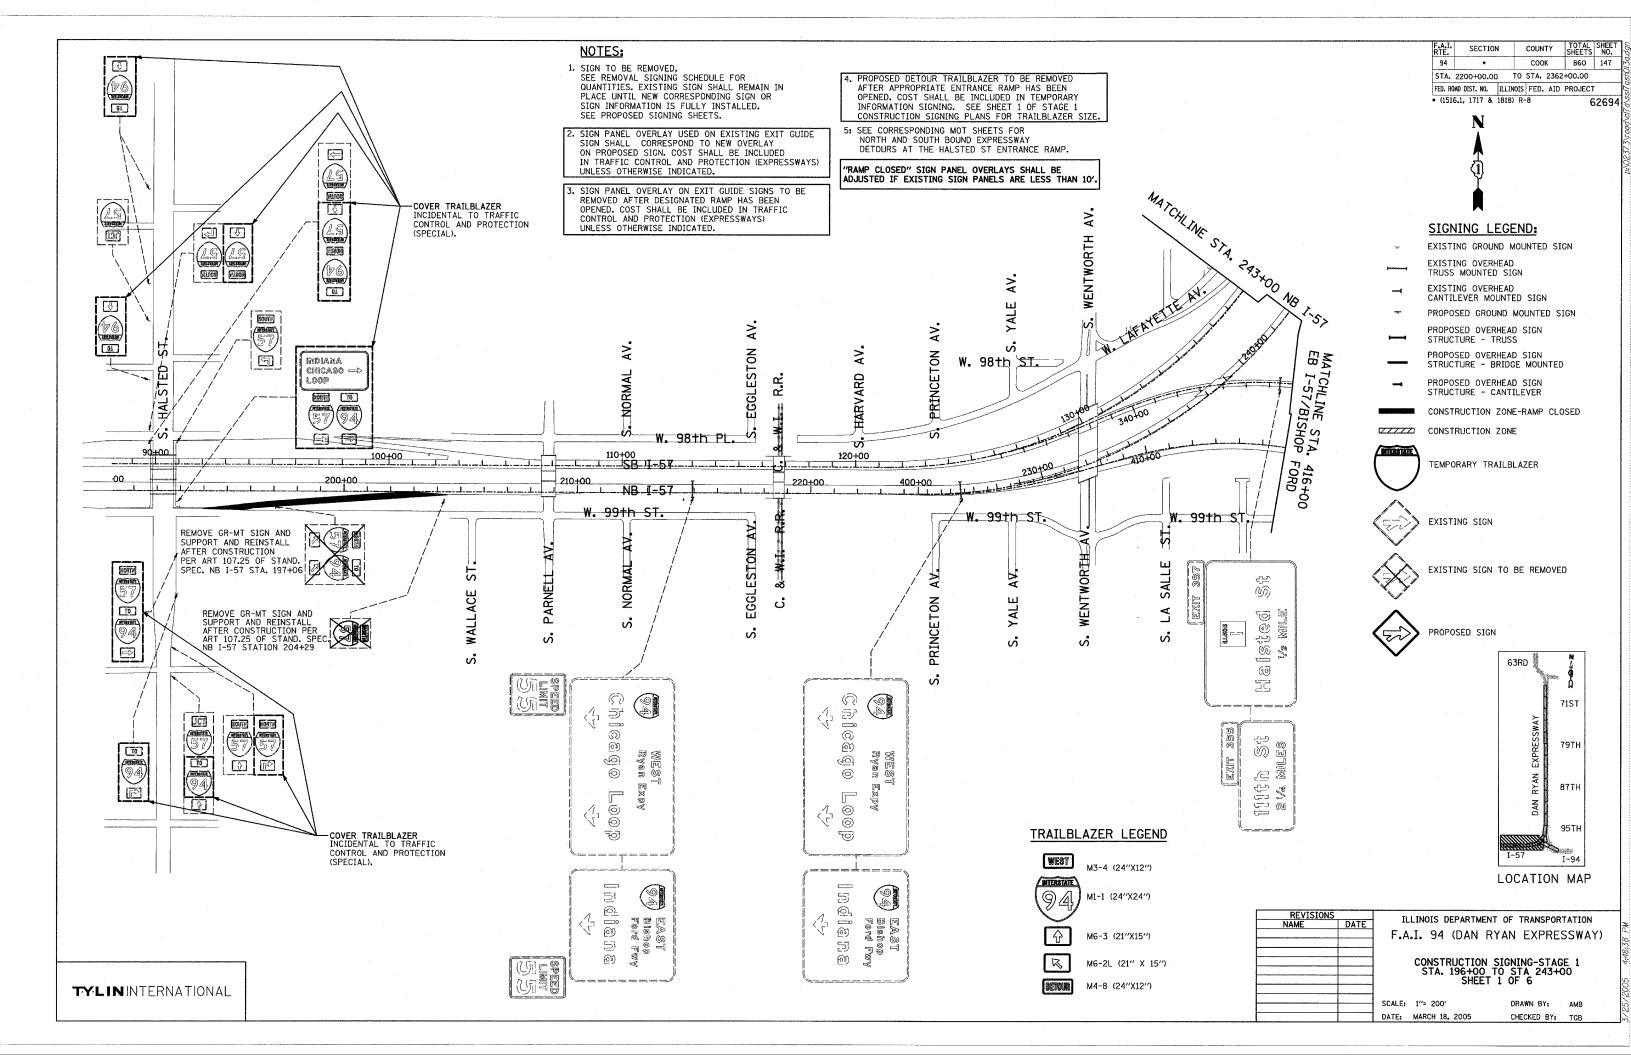


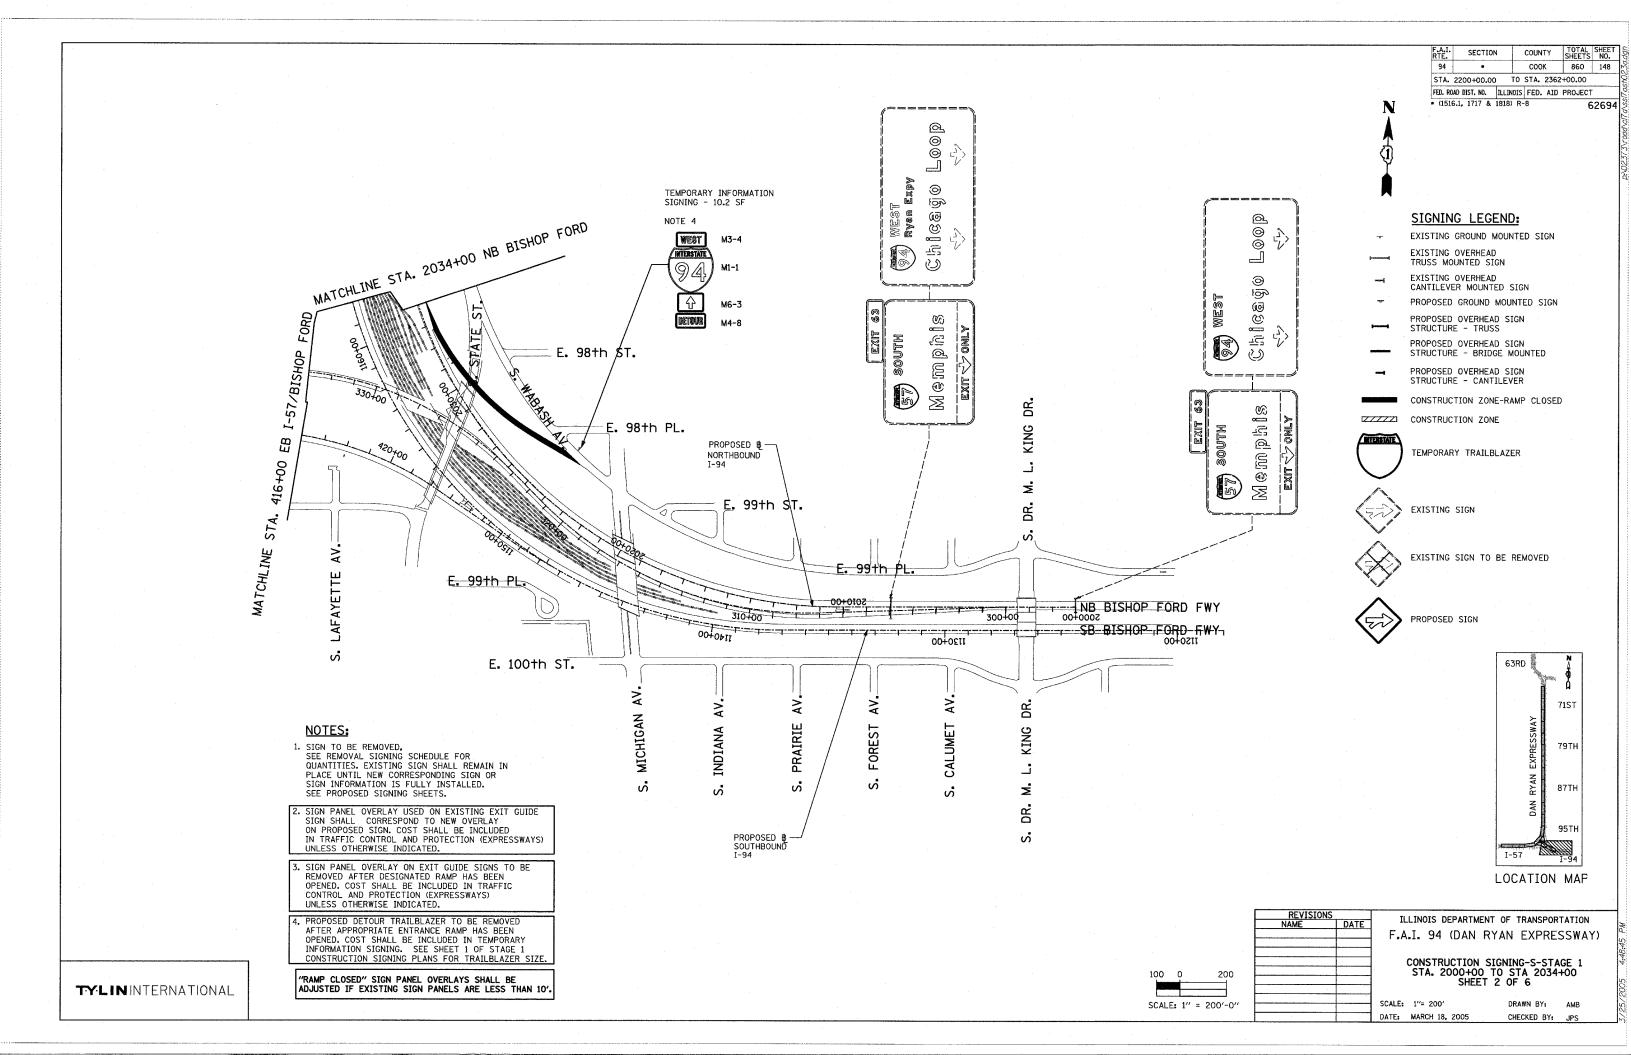


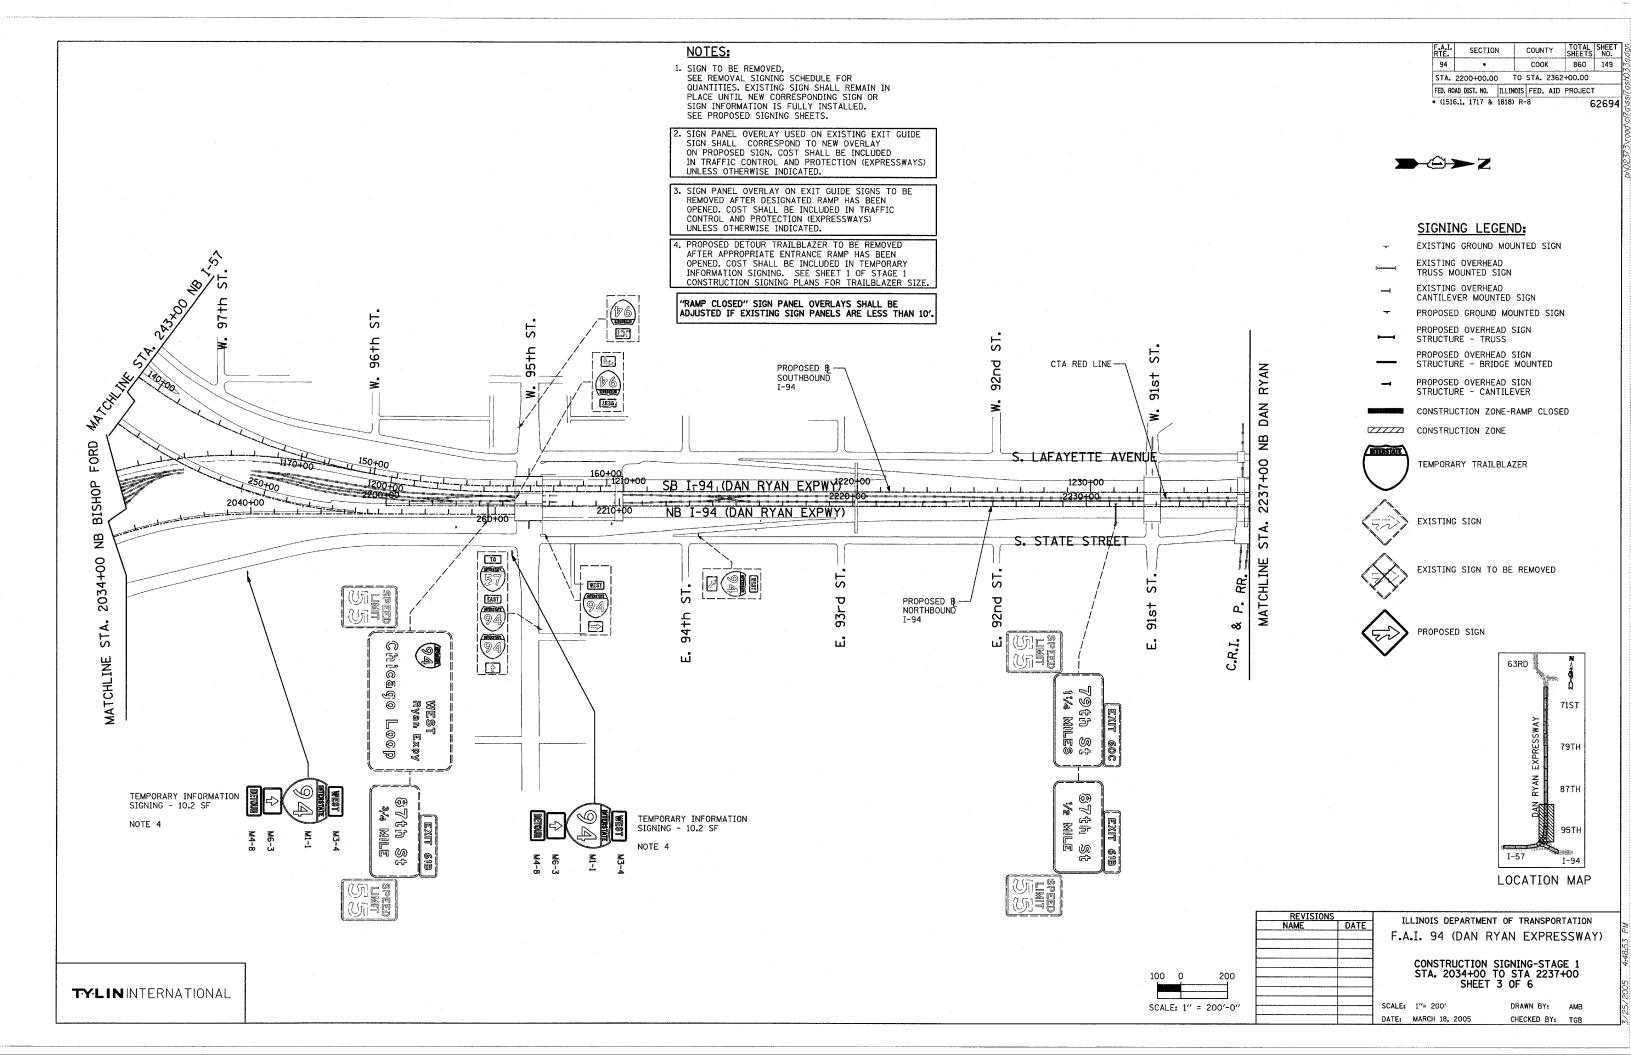


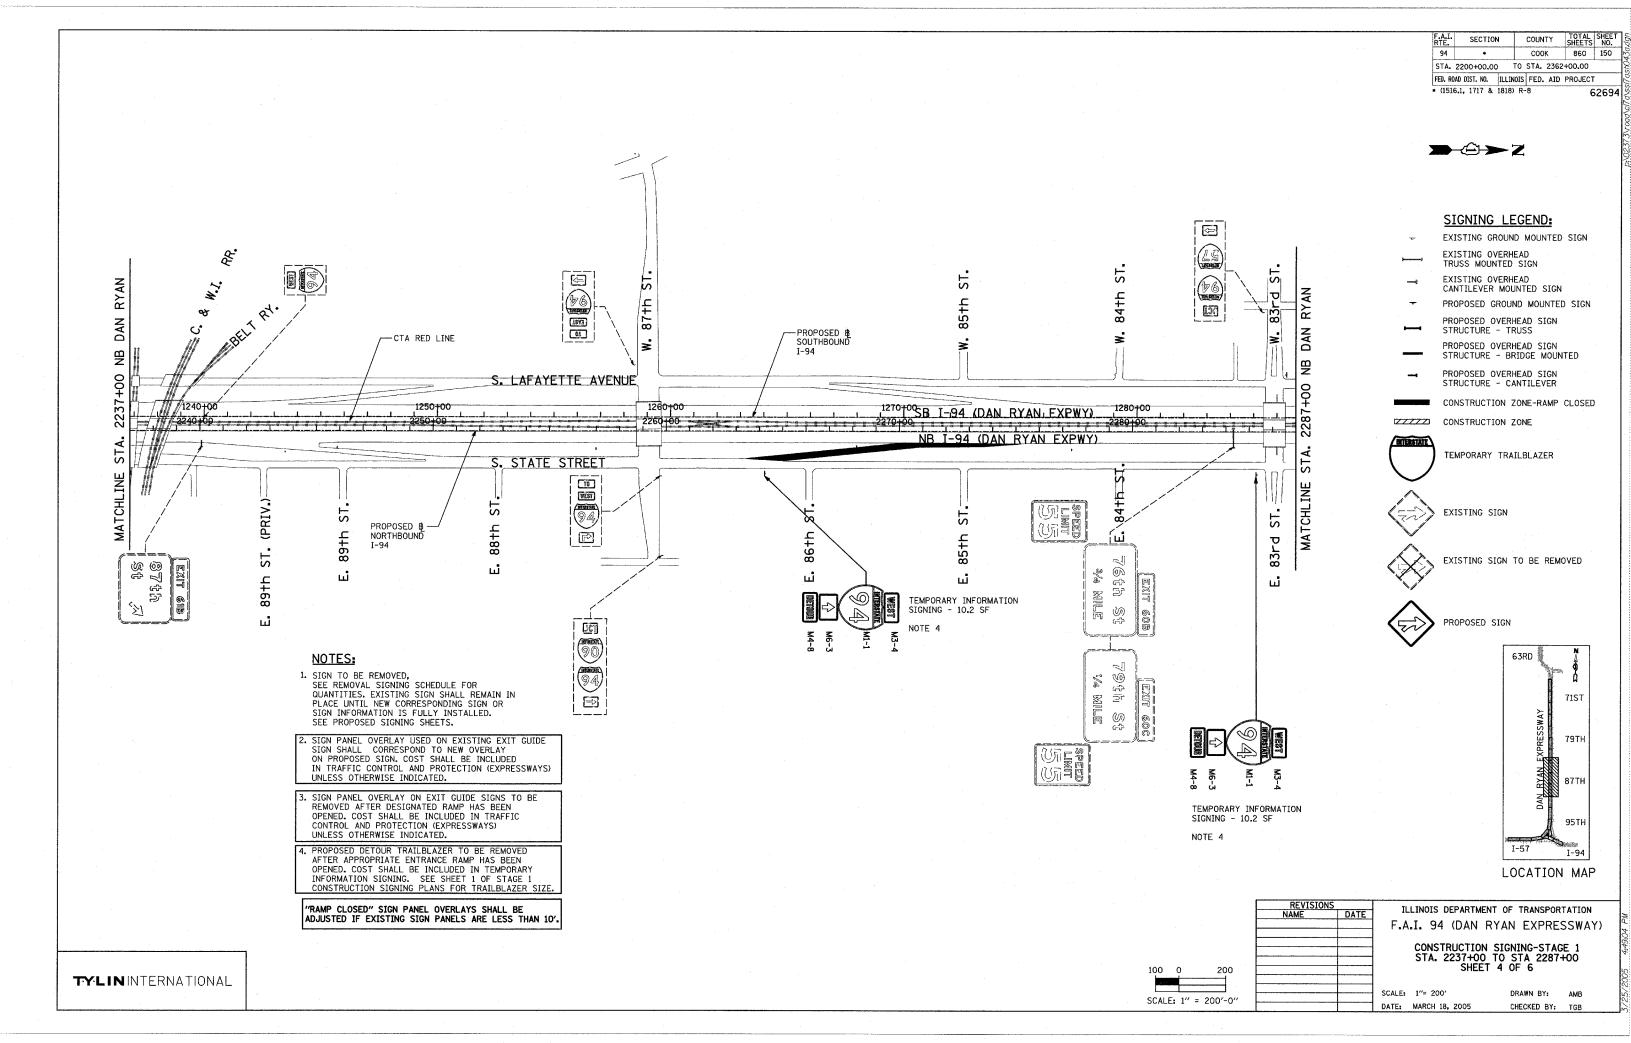

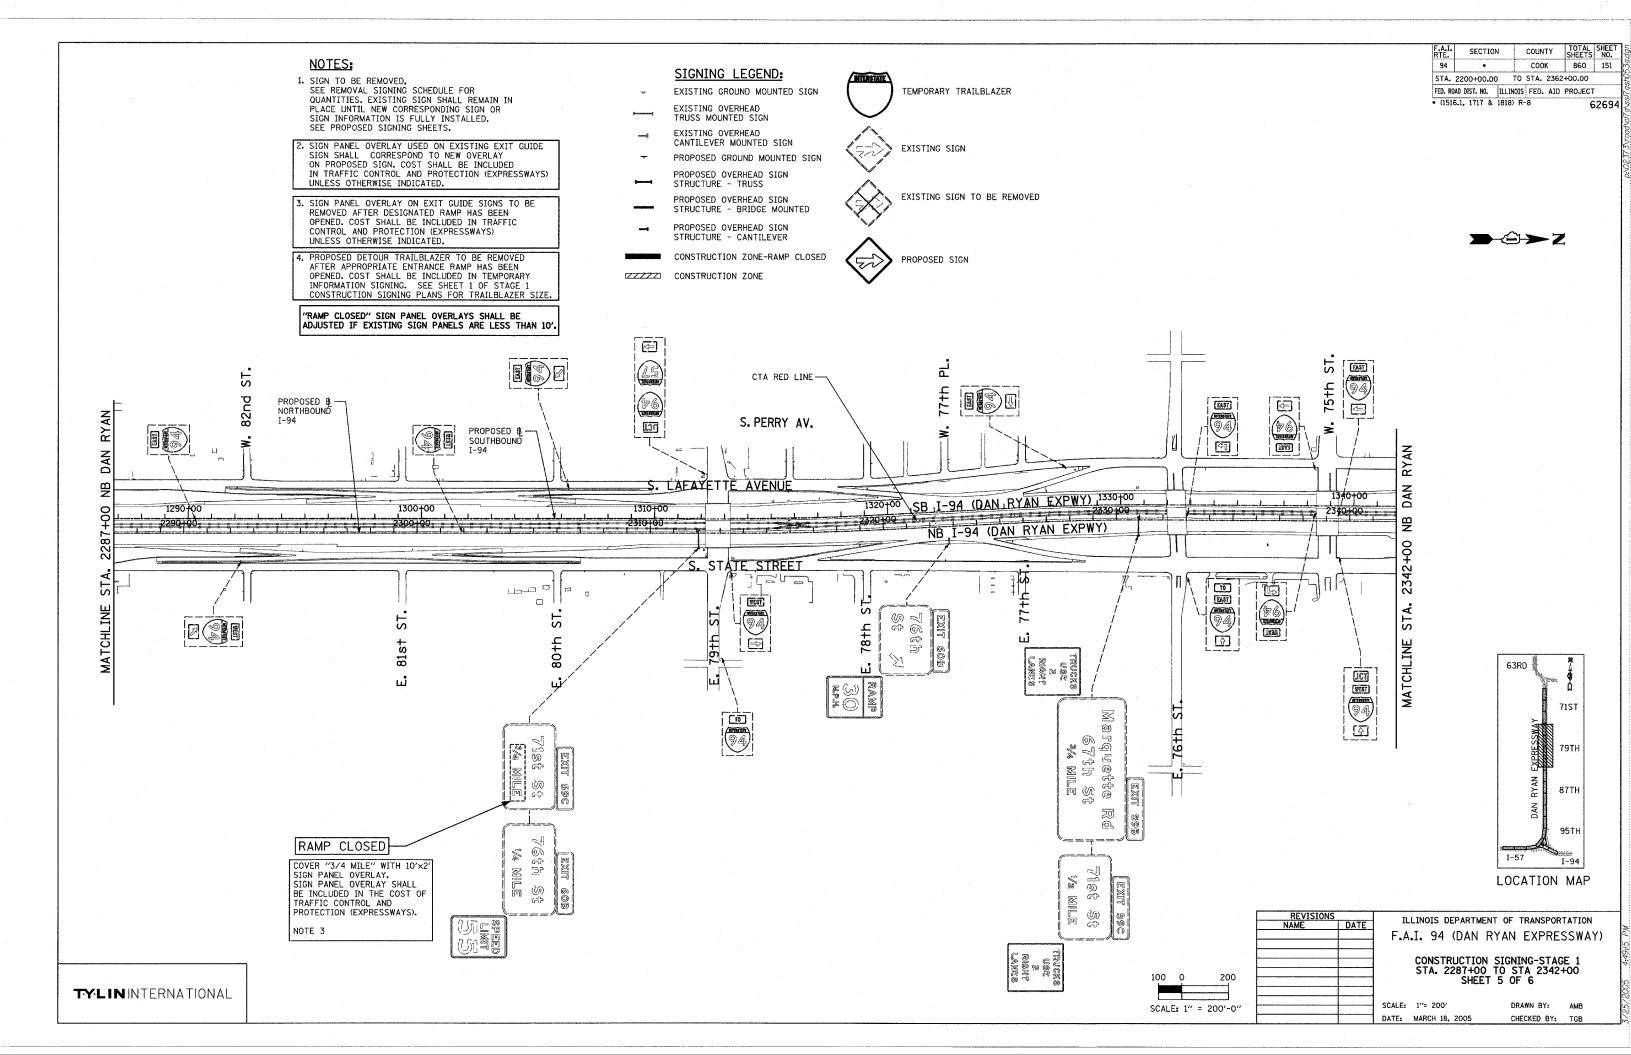

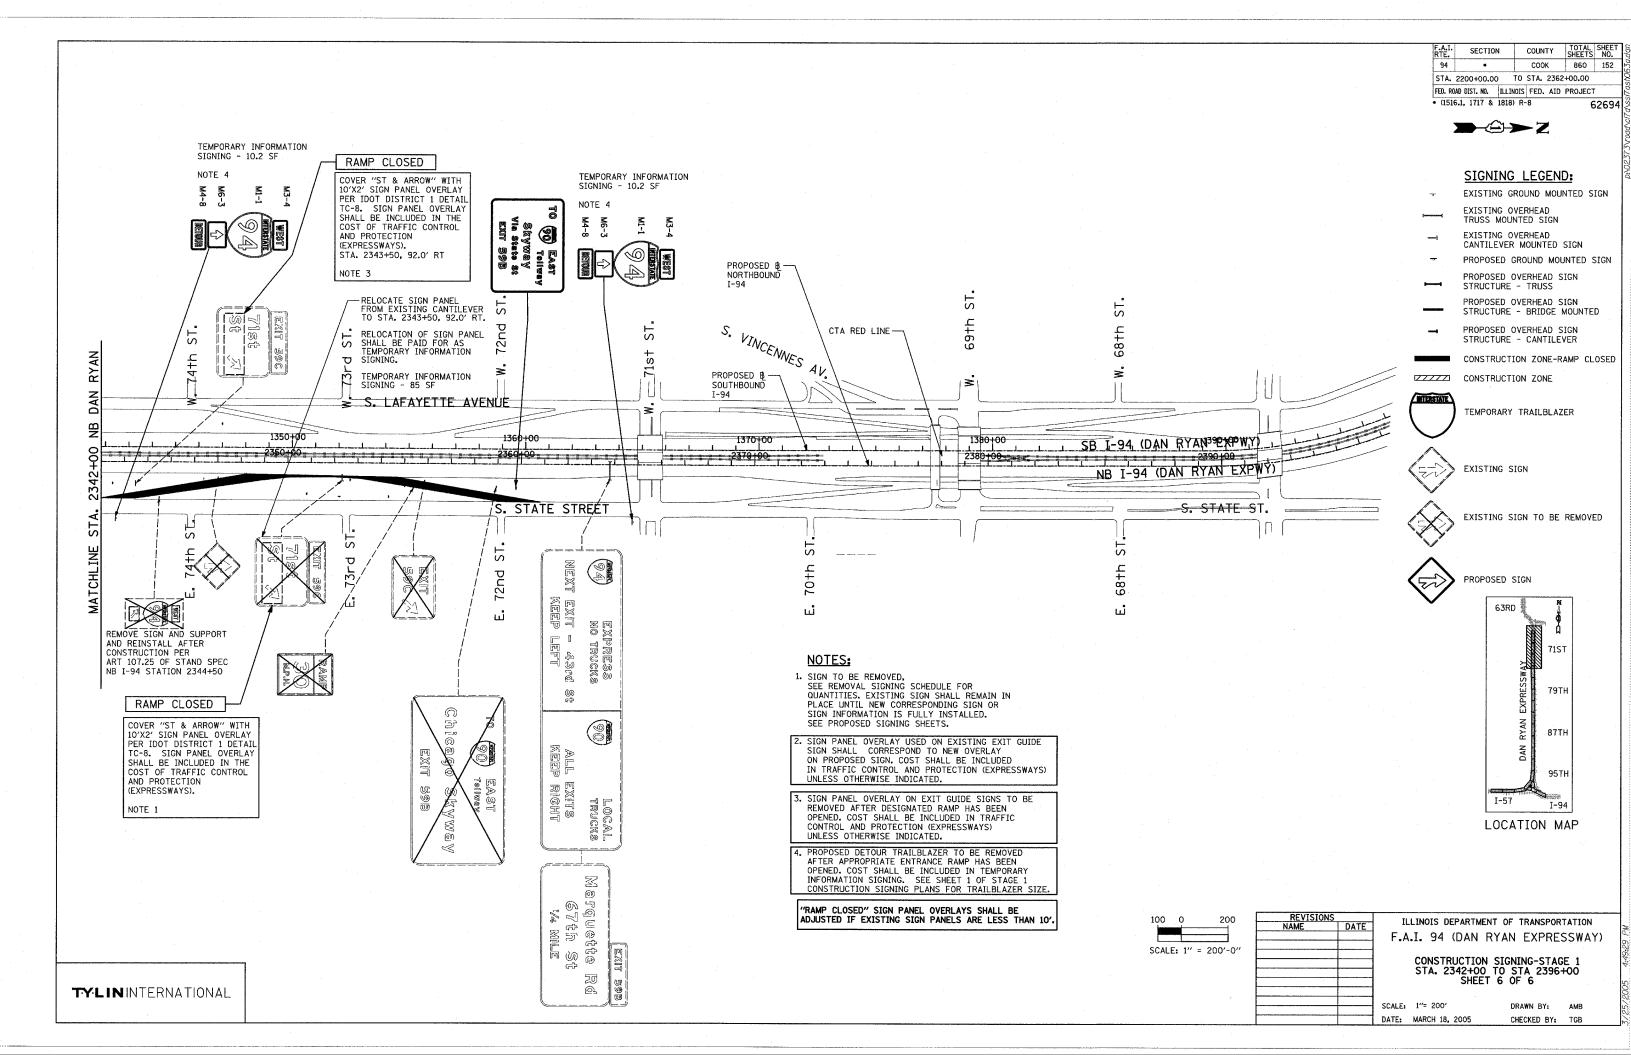

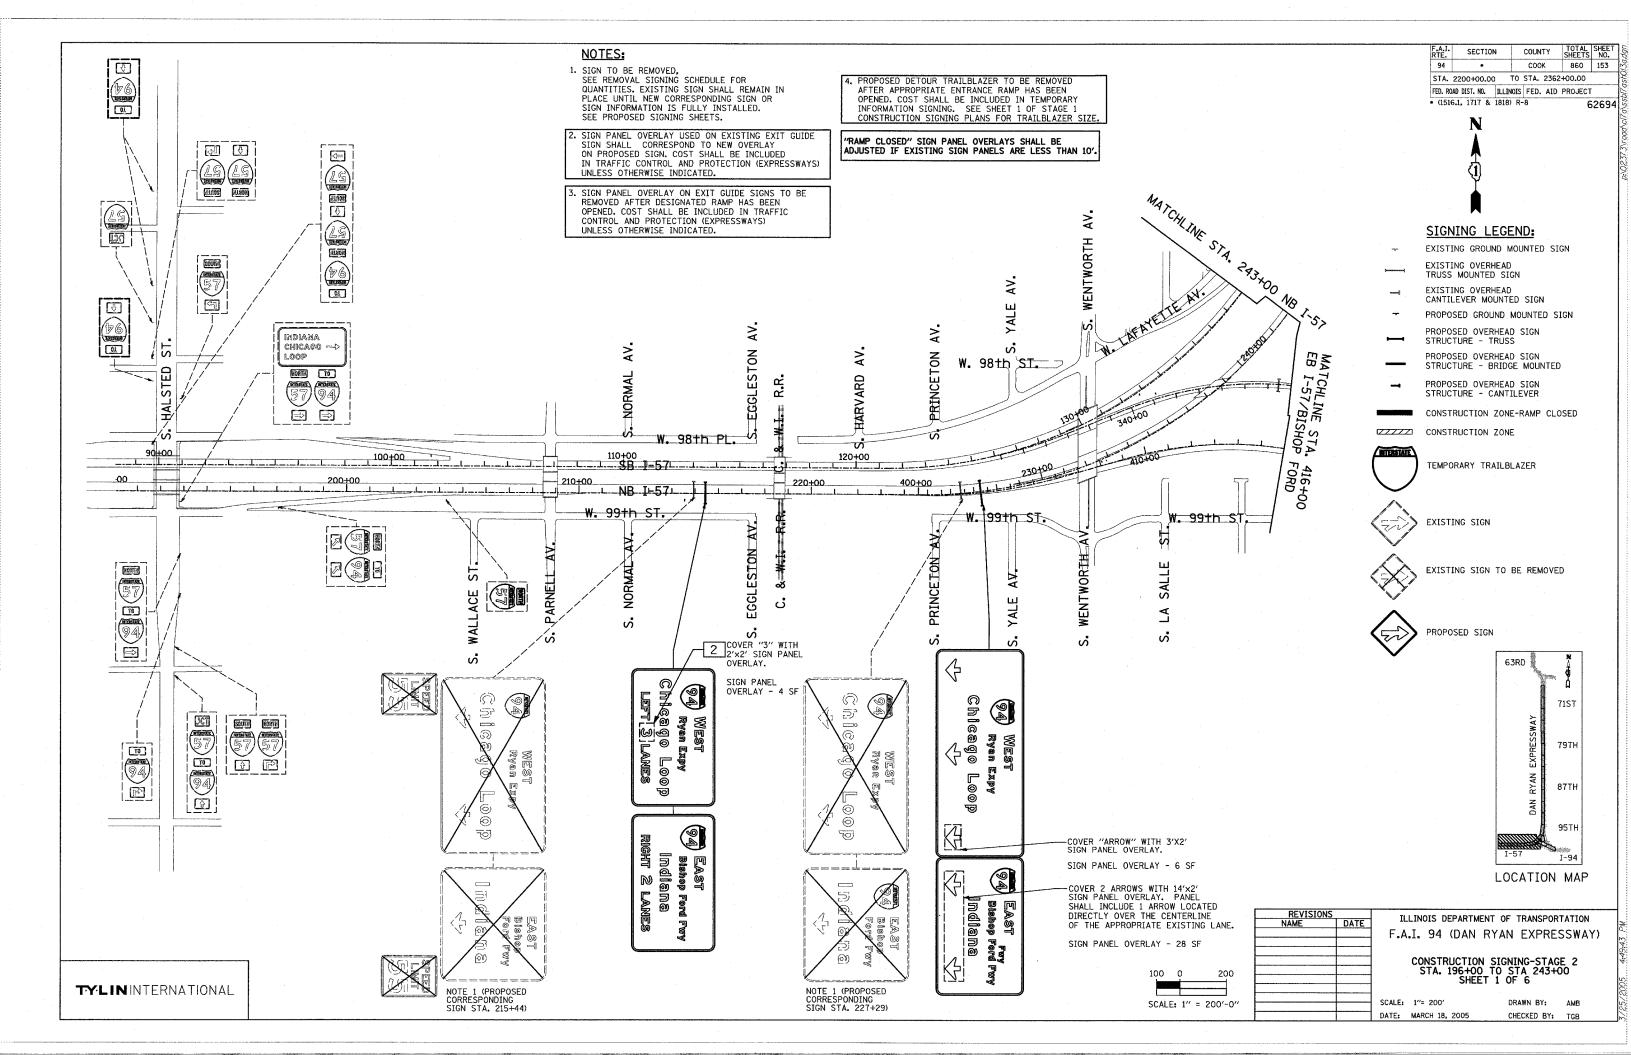


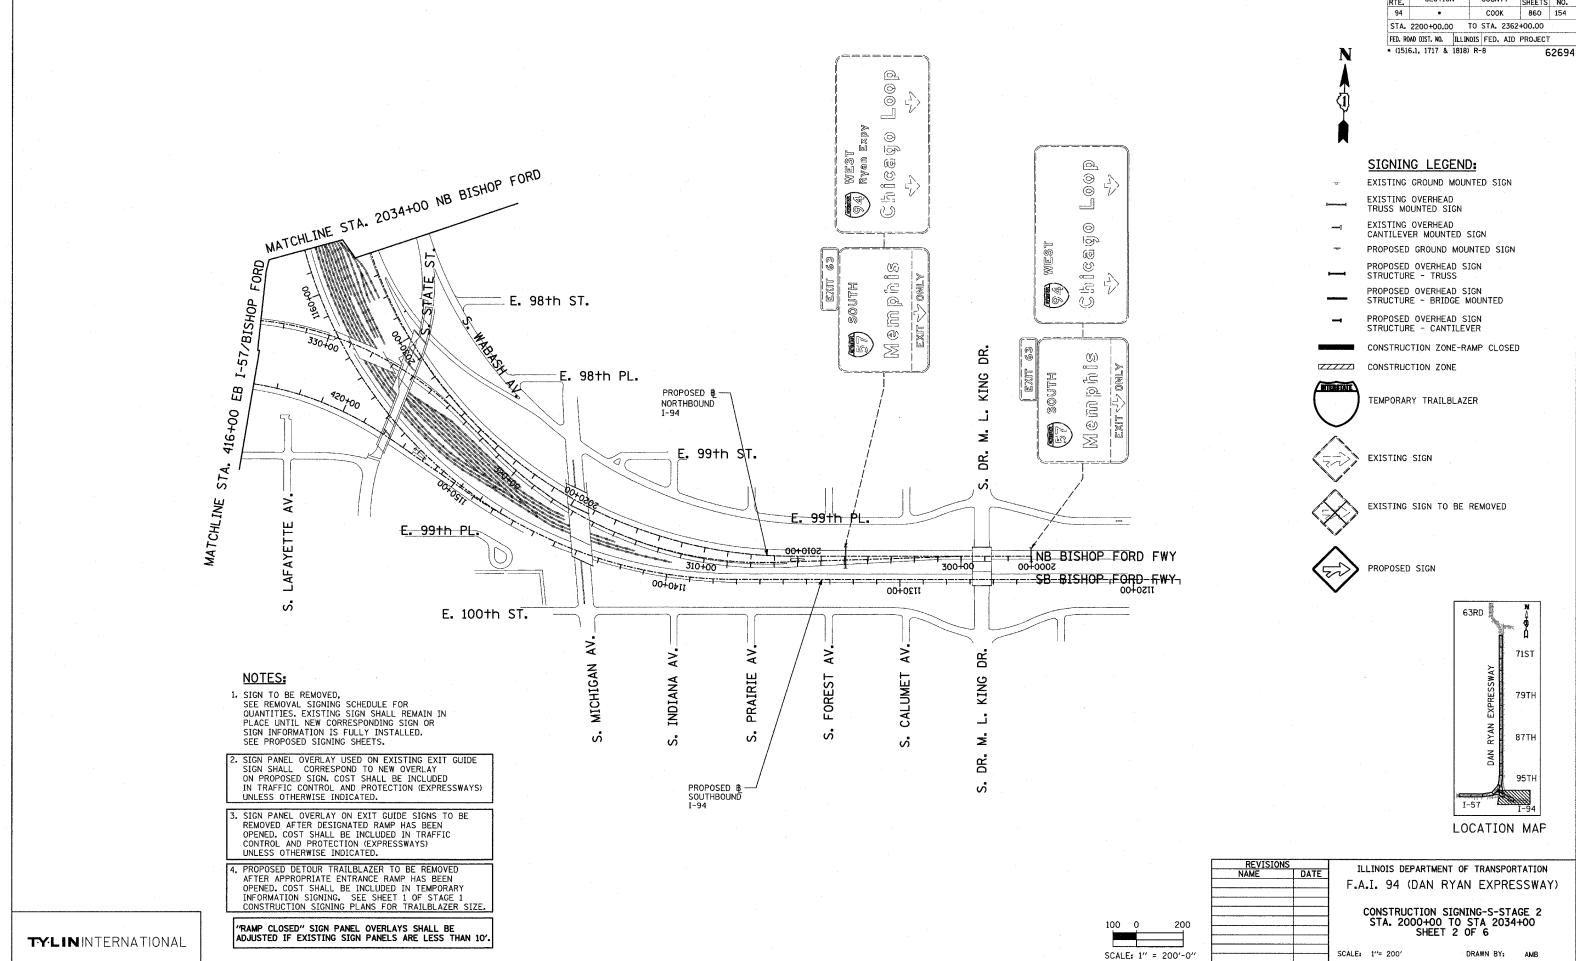



TOTAL SHEET SHEETS NO. SECTION COUNTY 860 154


DATE: MARCH 18, 2005


CHECKED BY:

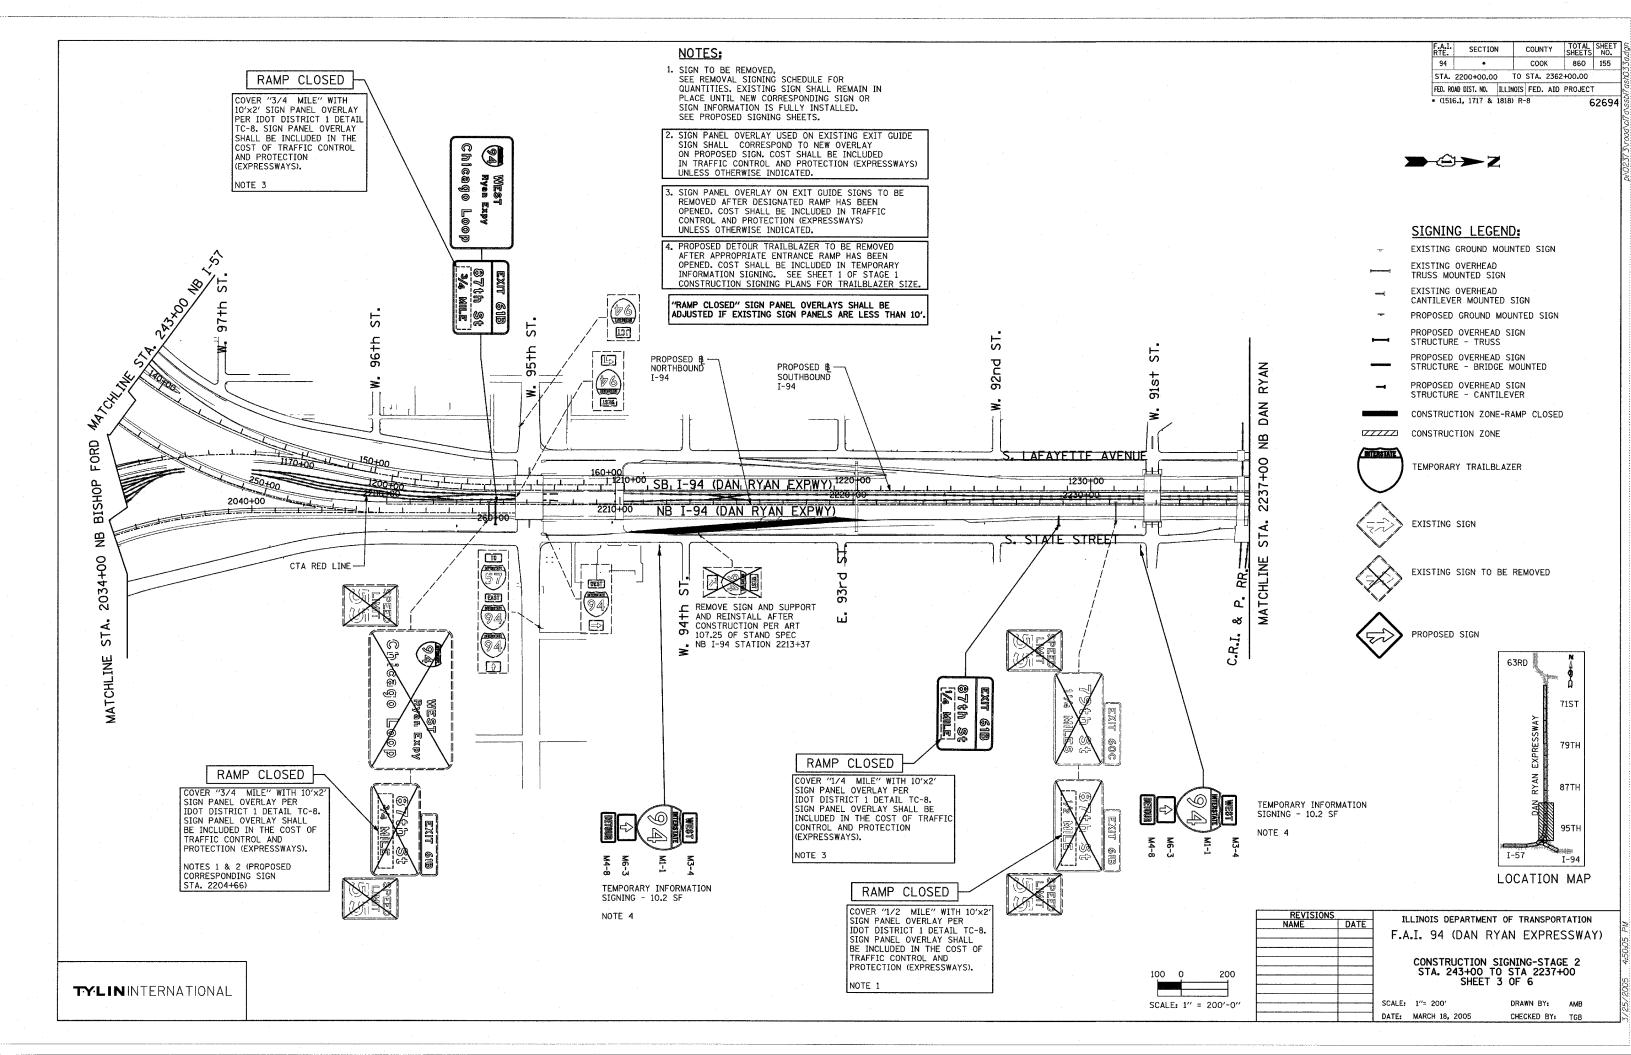


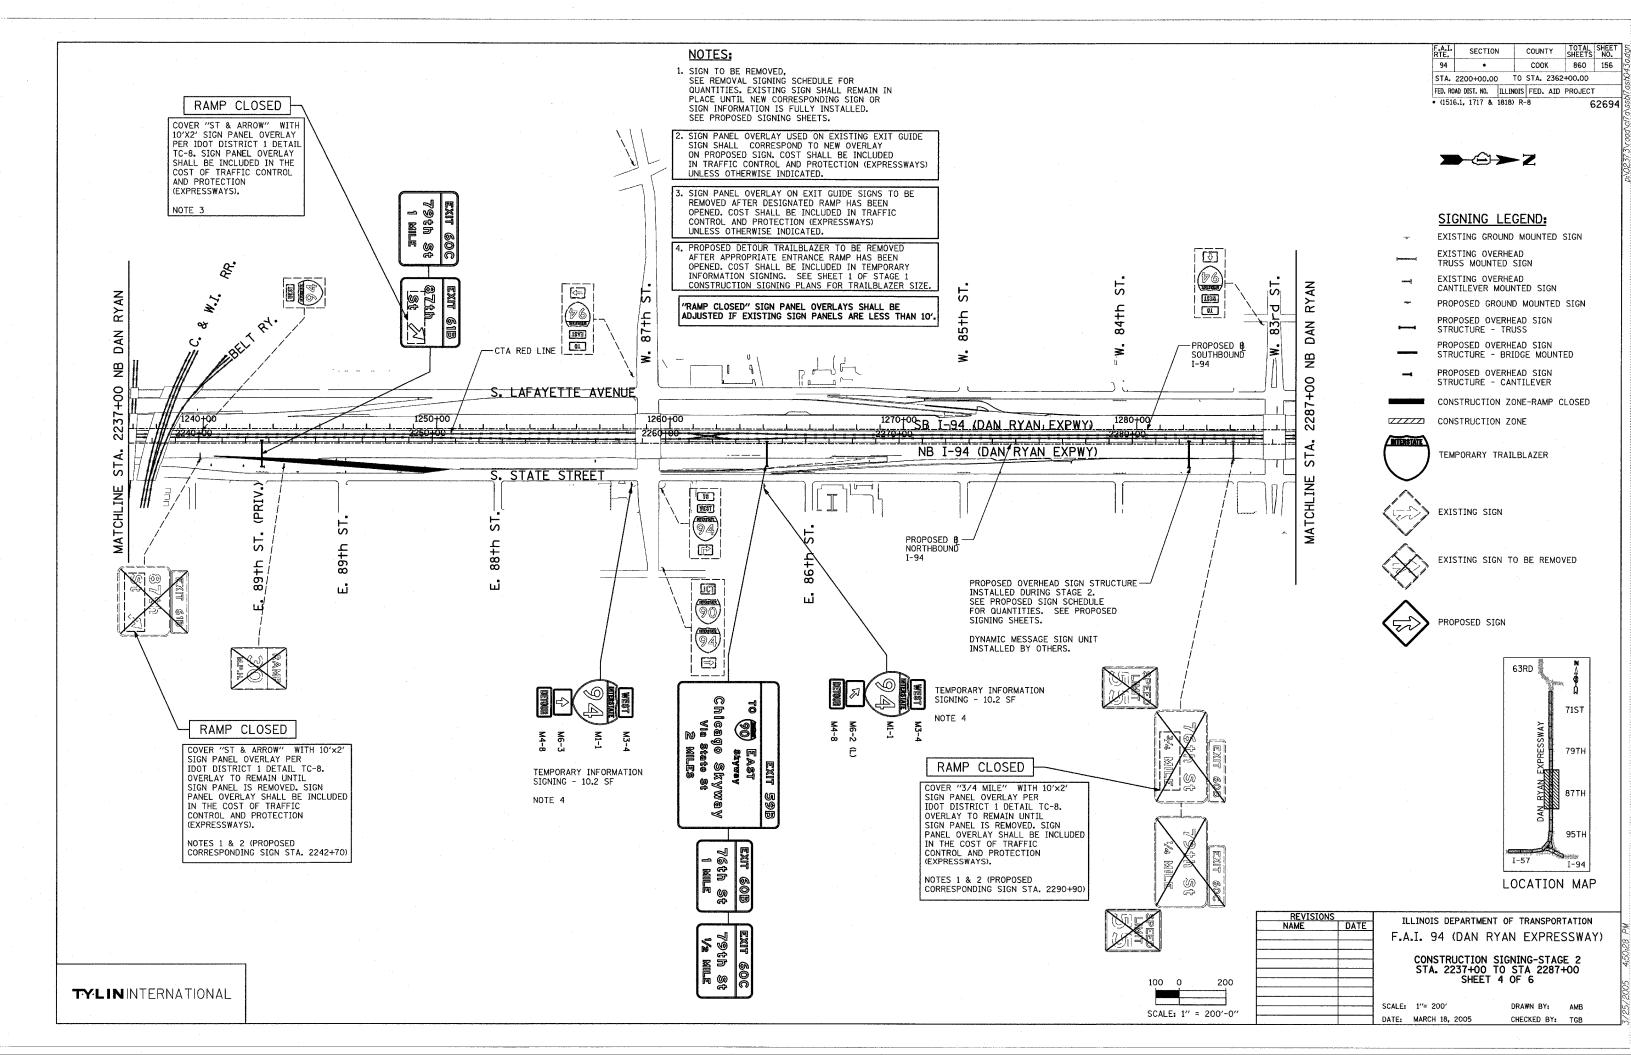


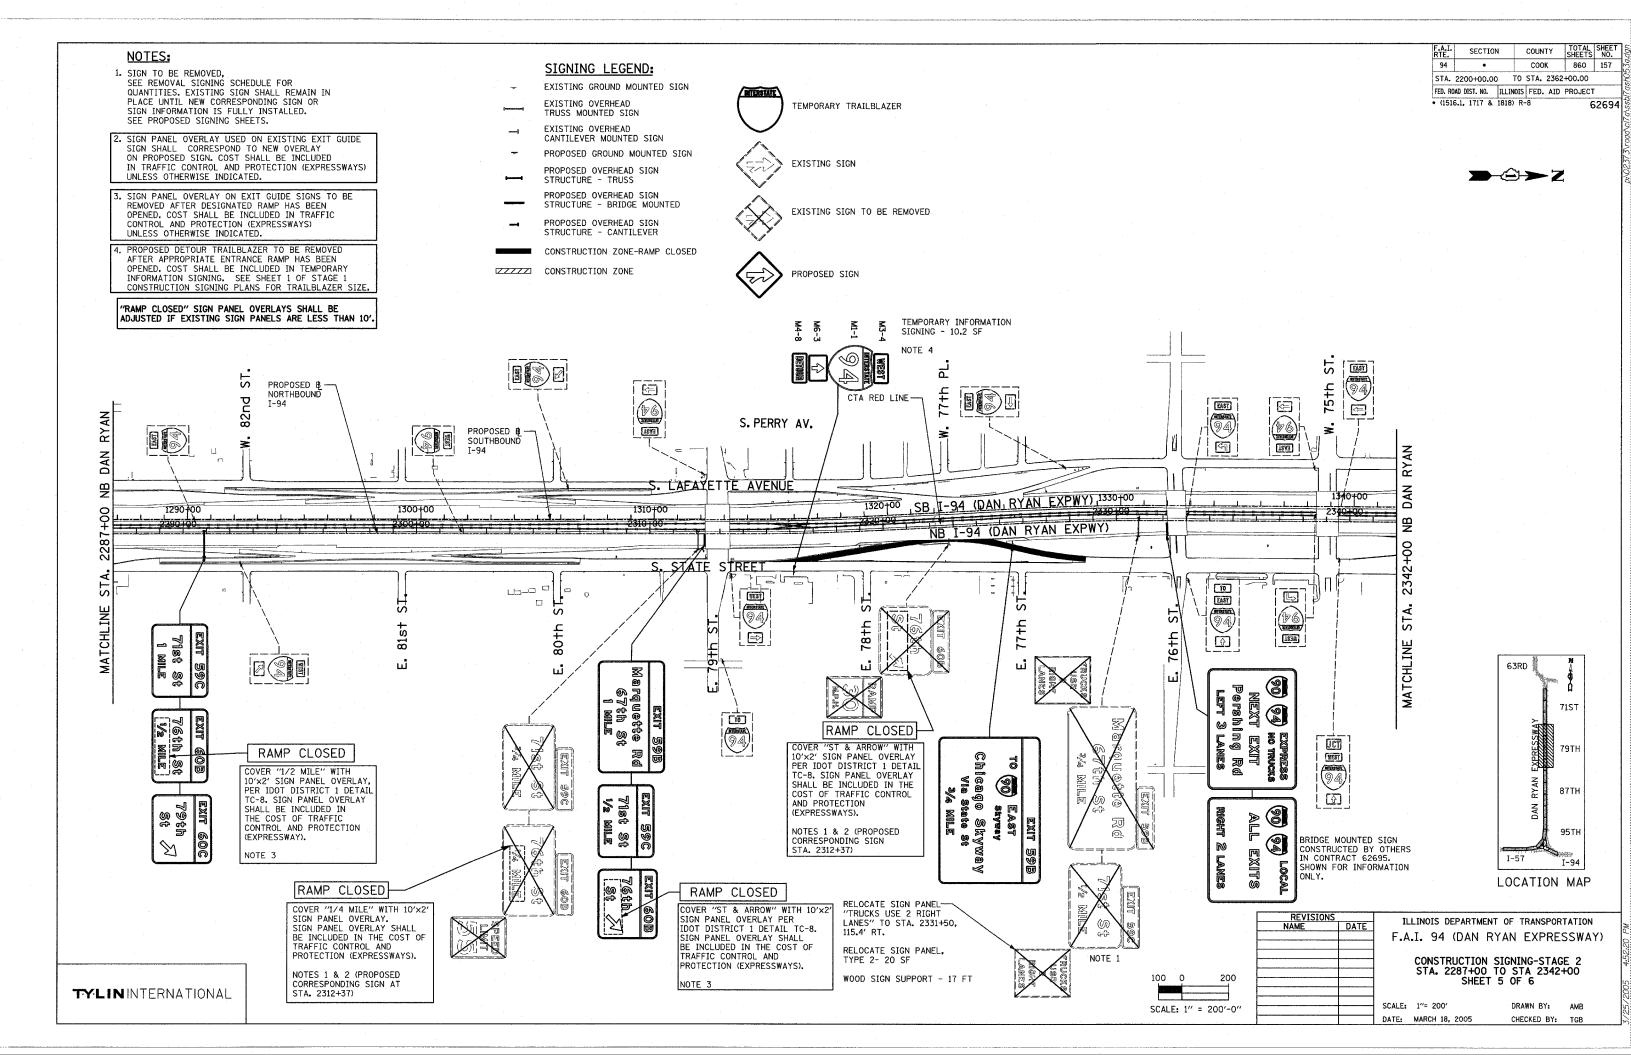


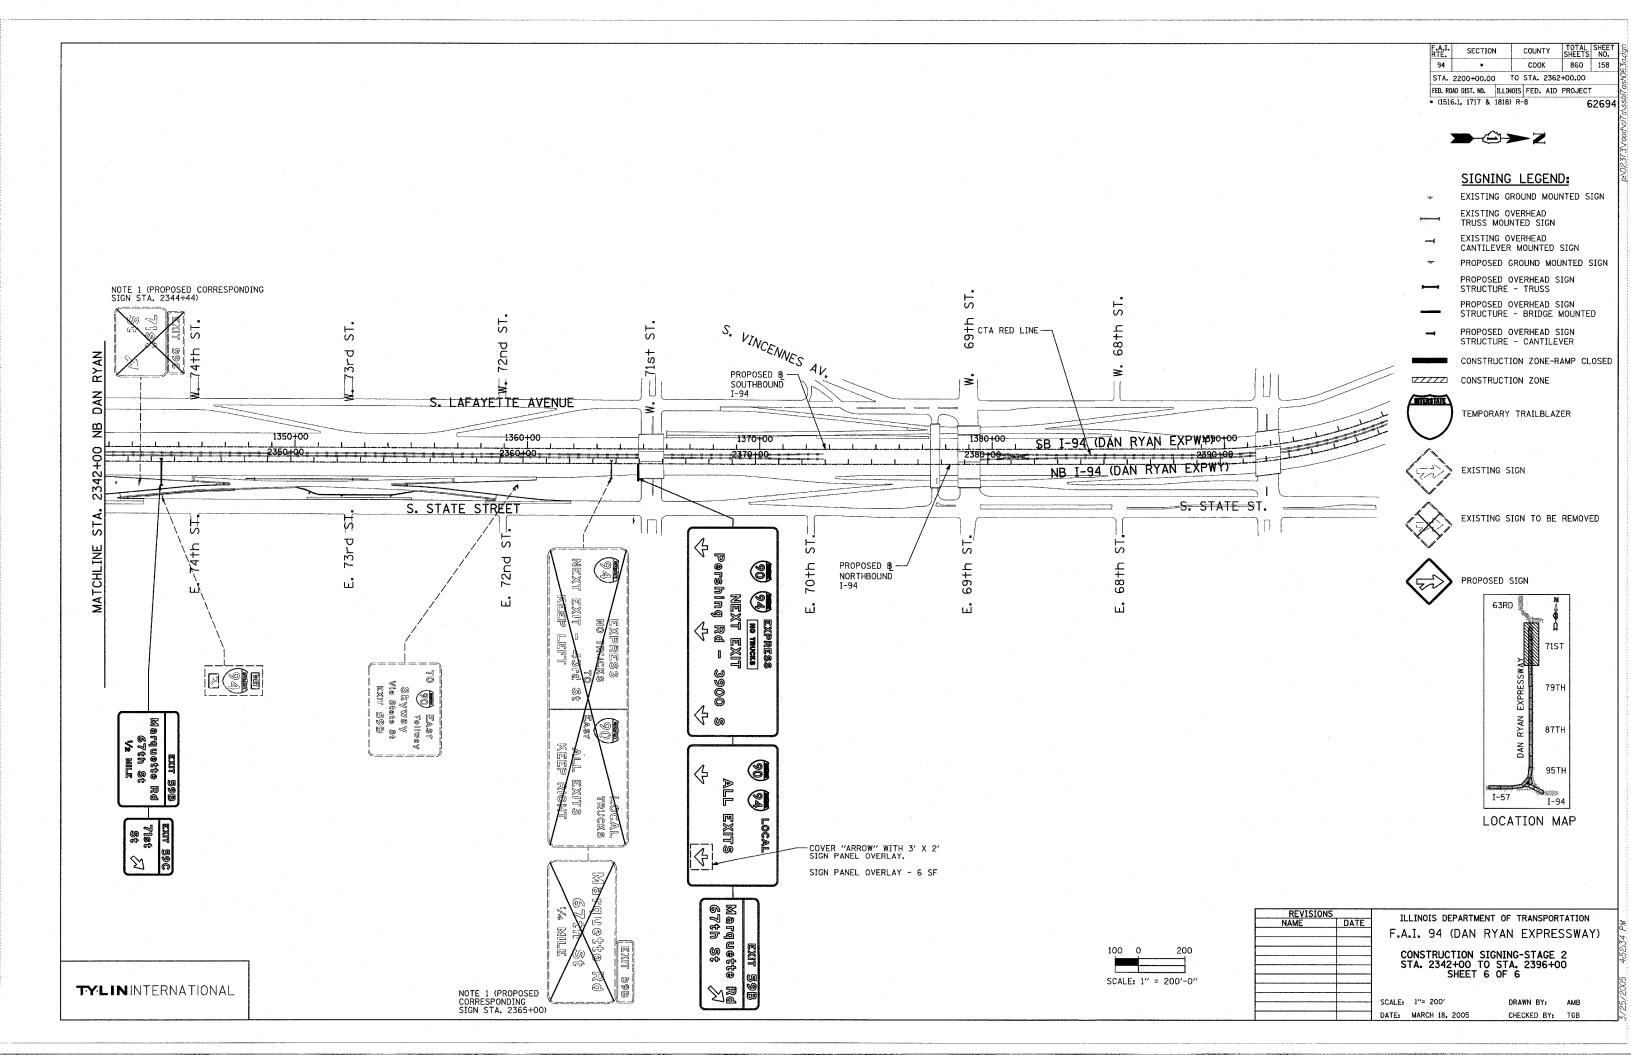


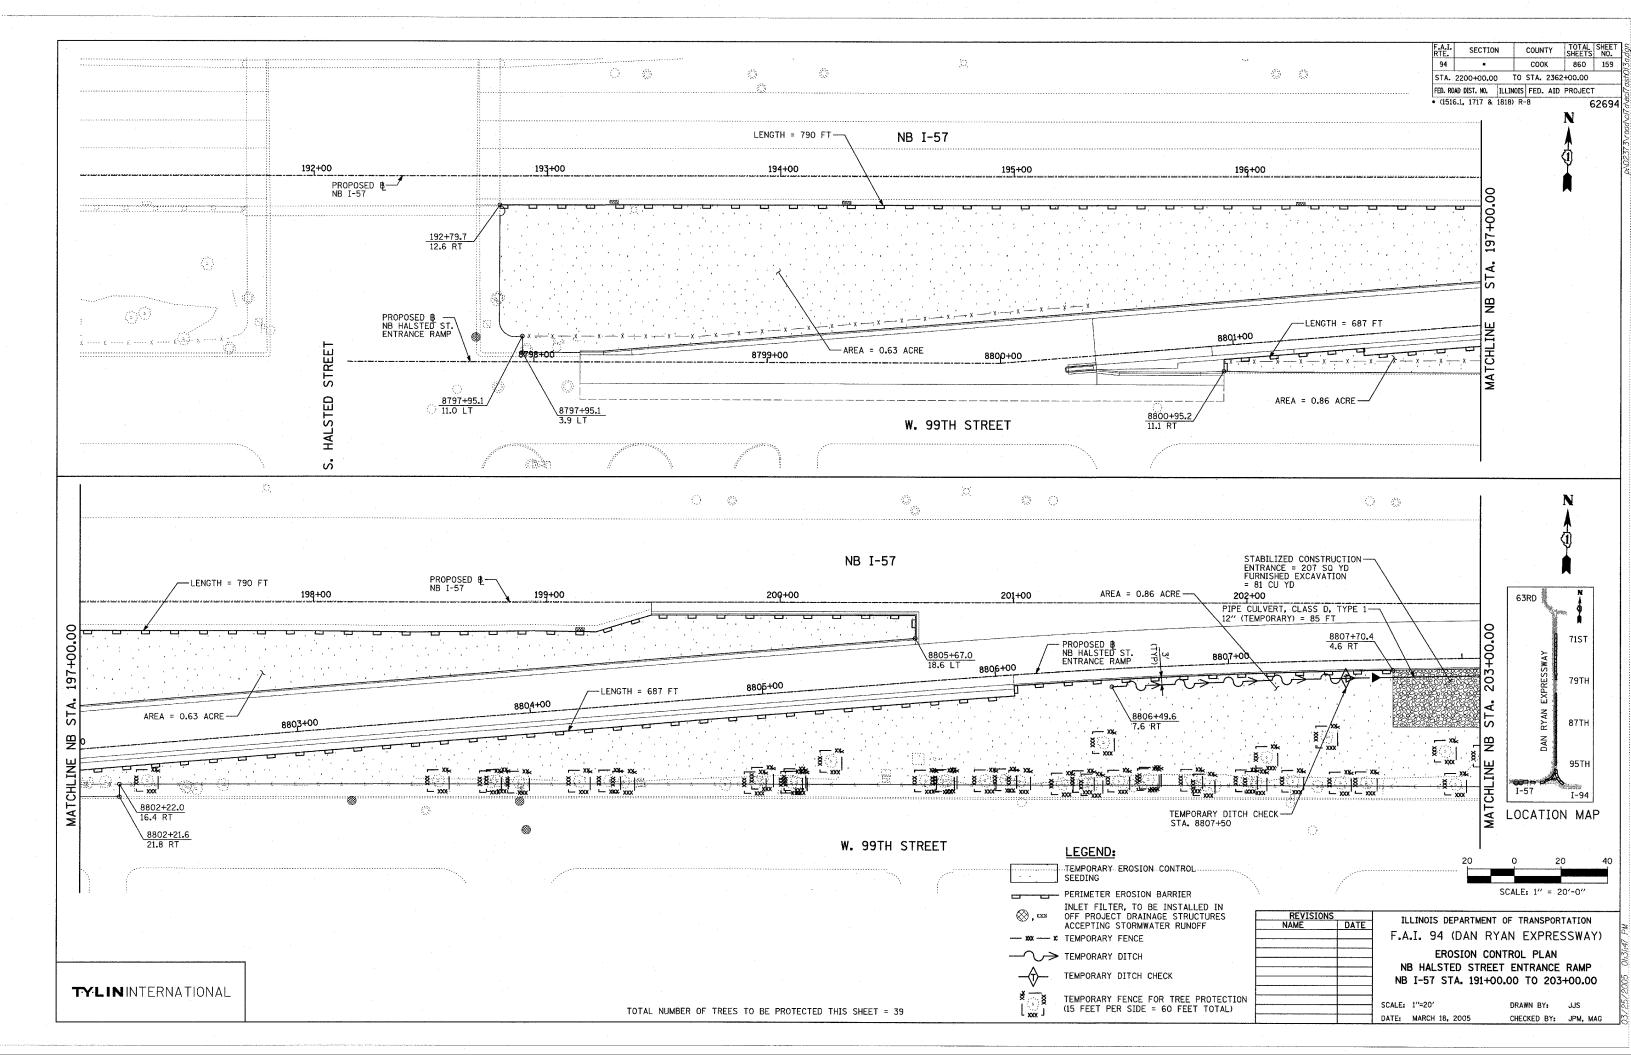


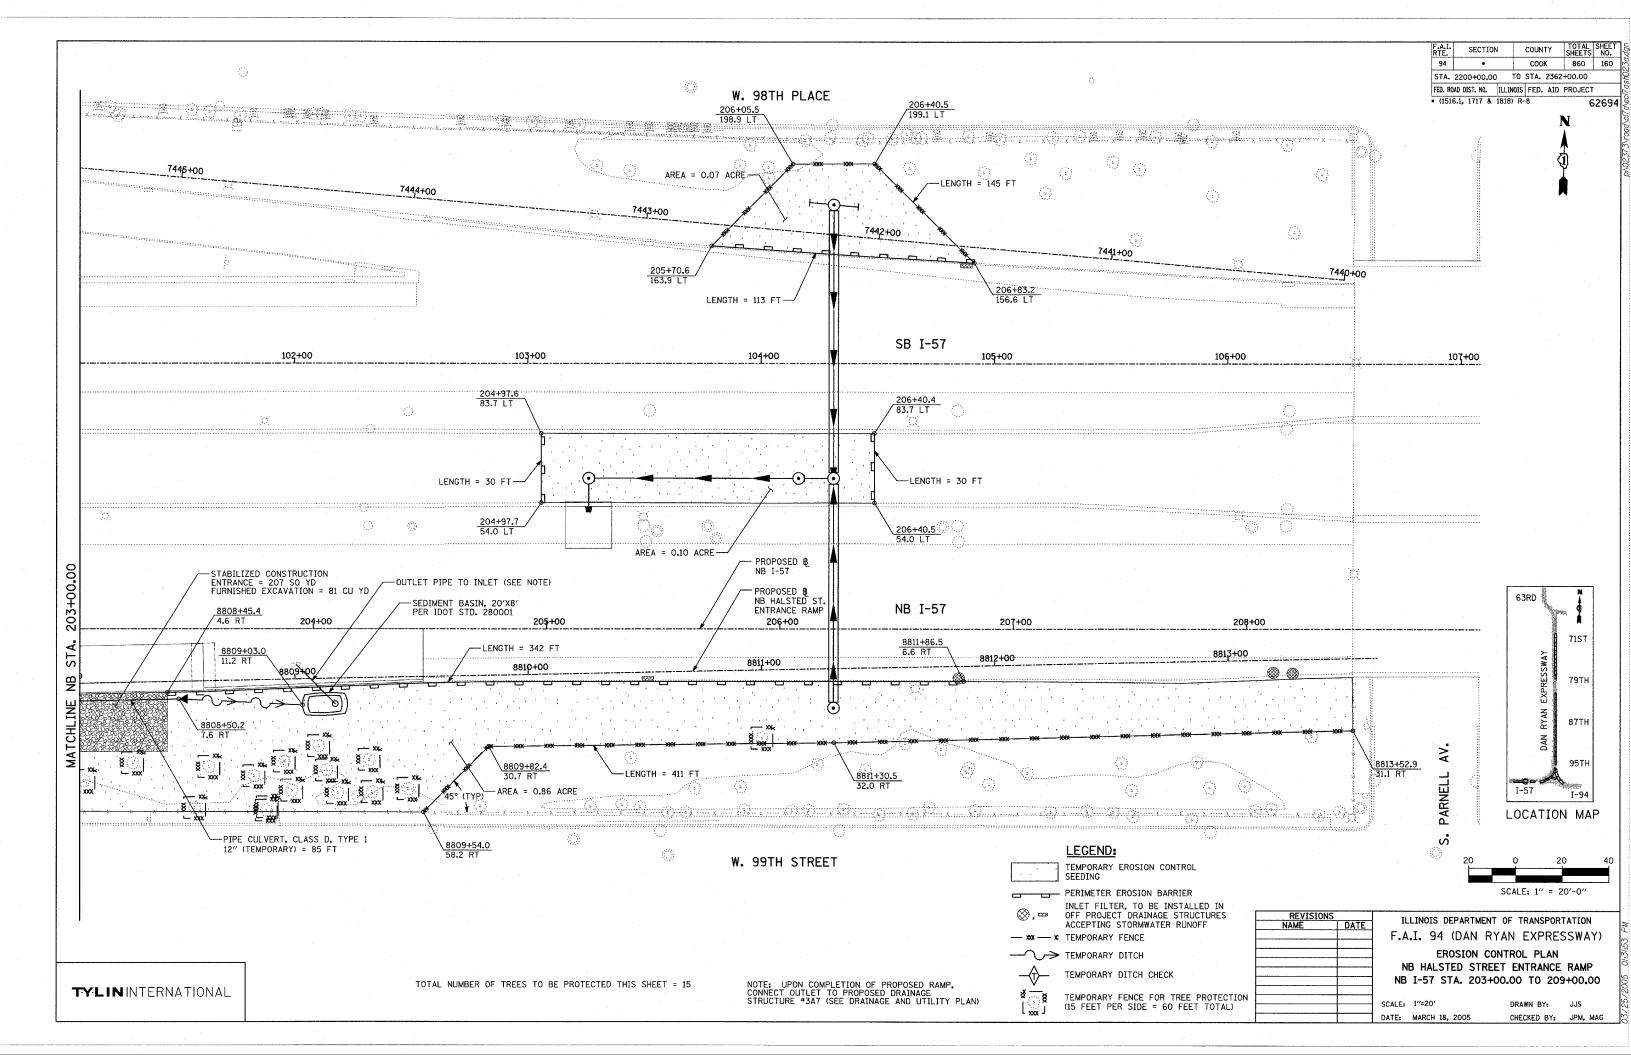


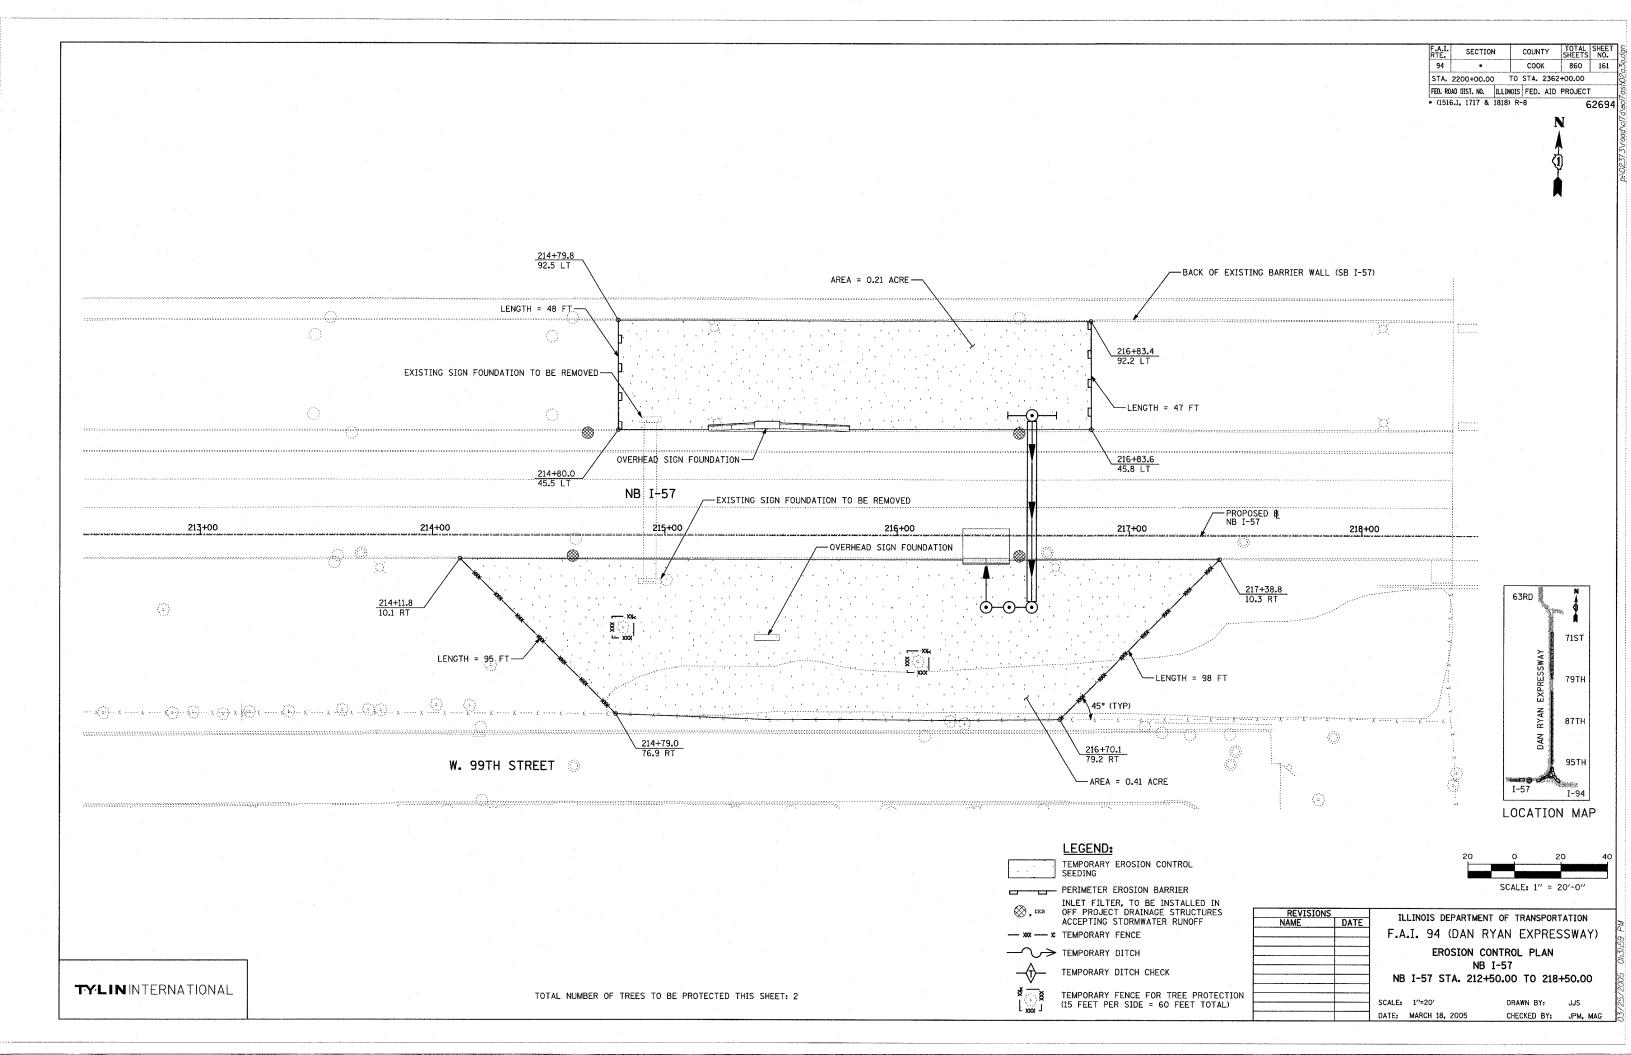


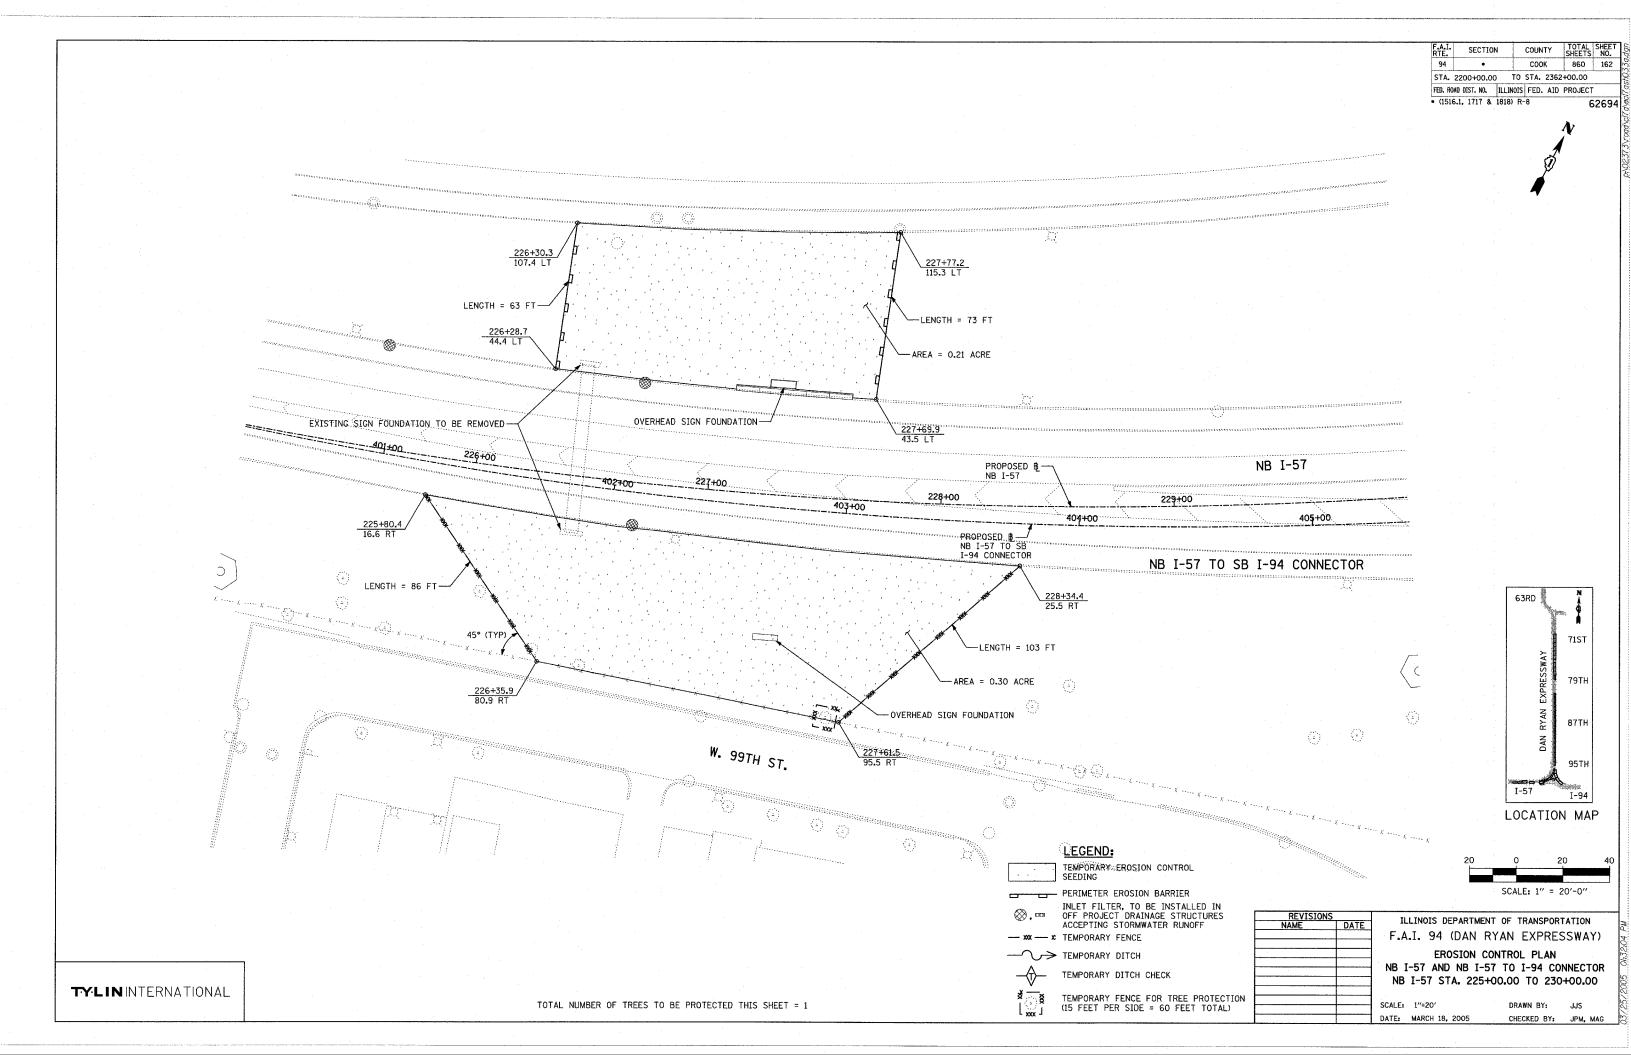

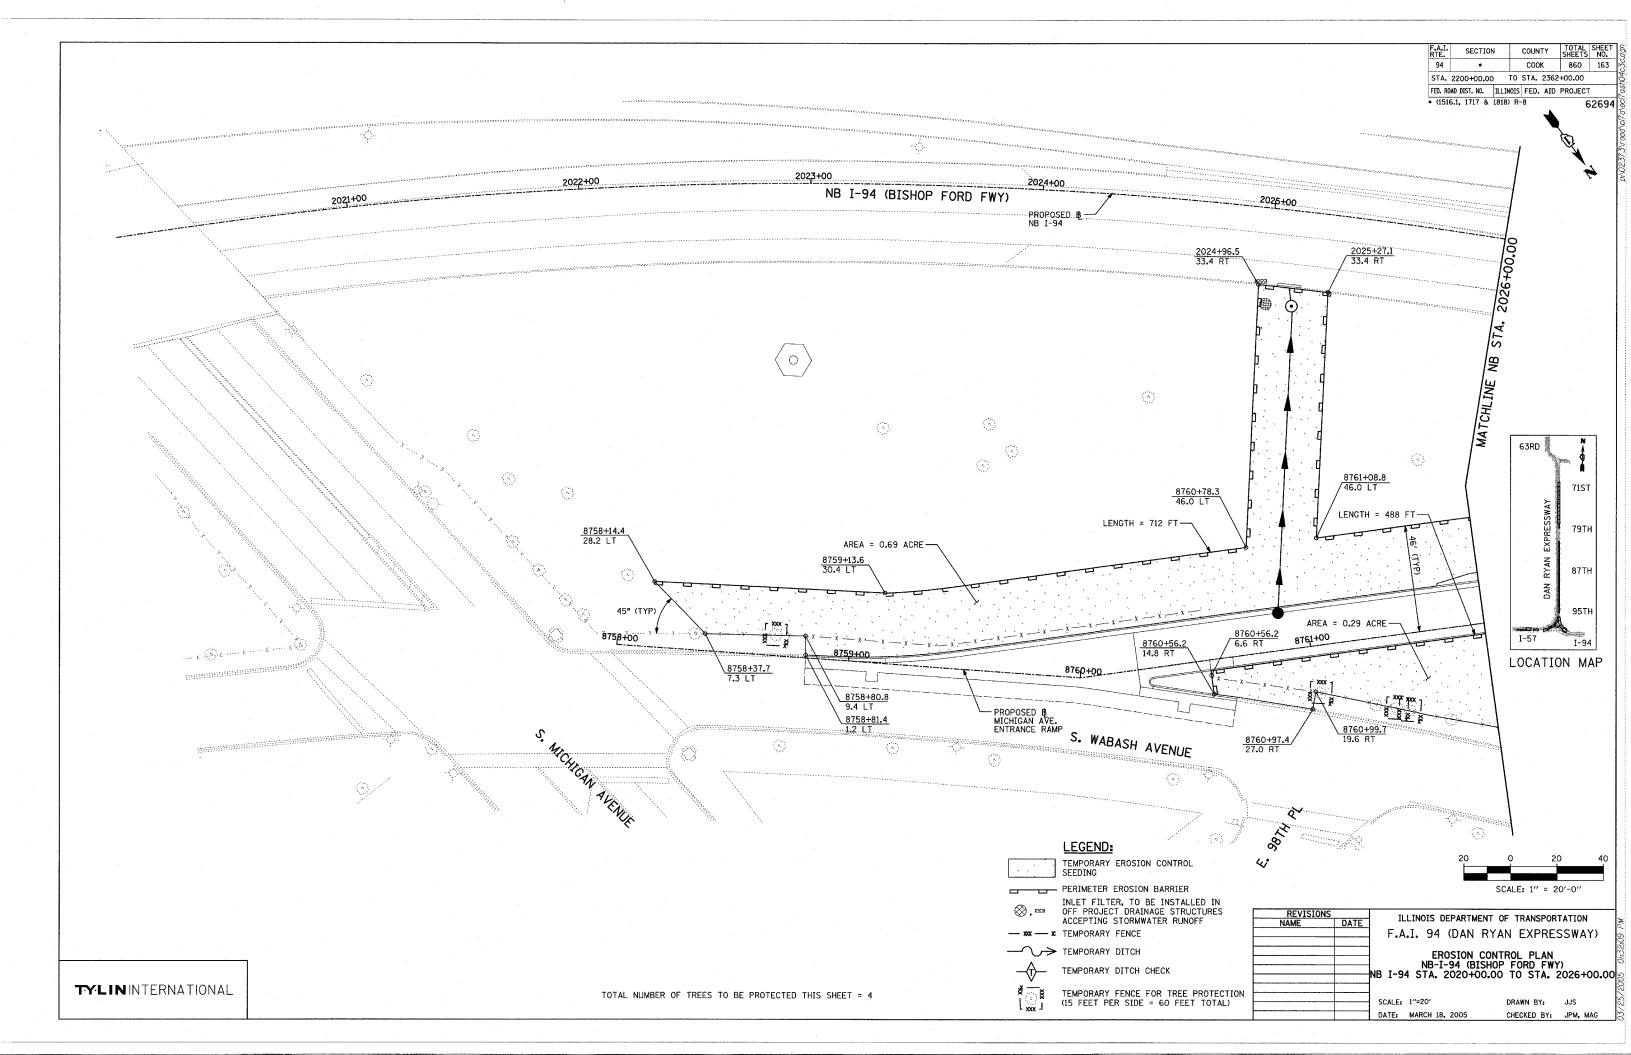


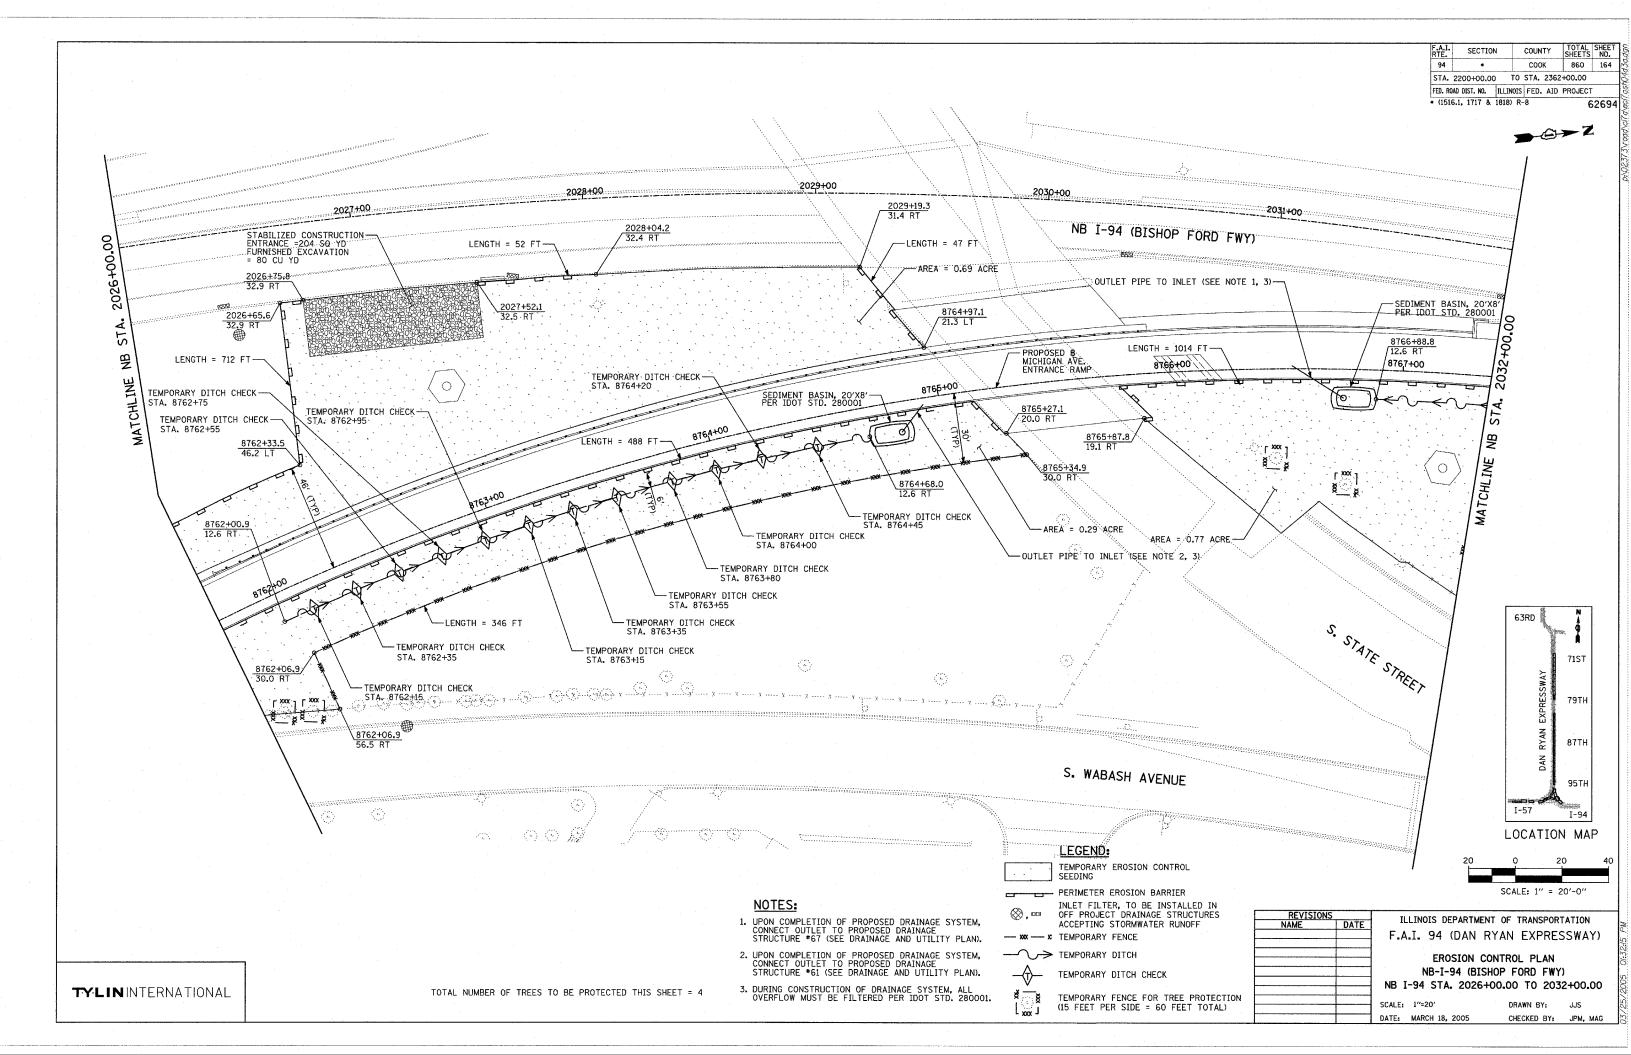

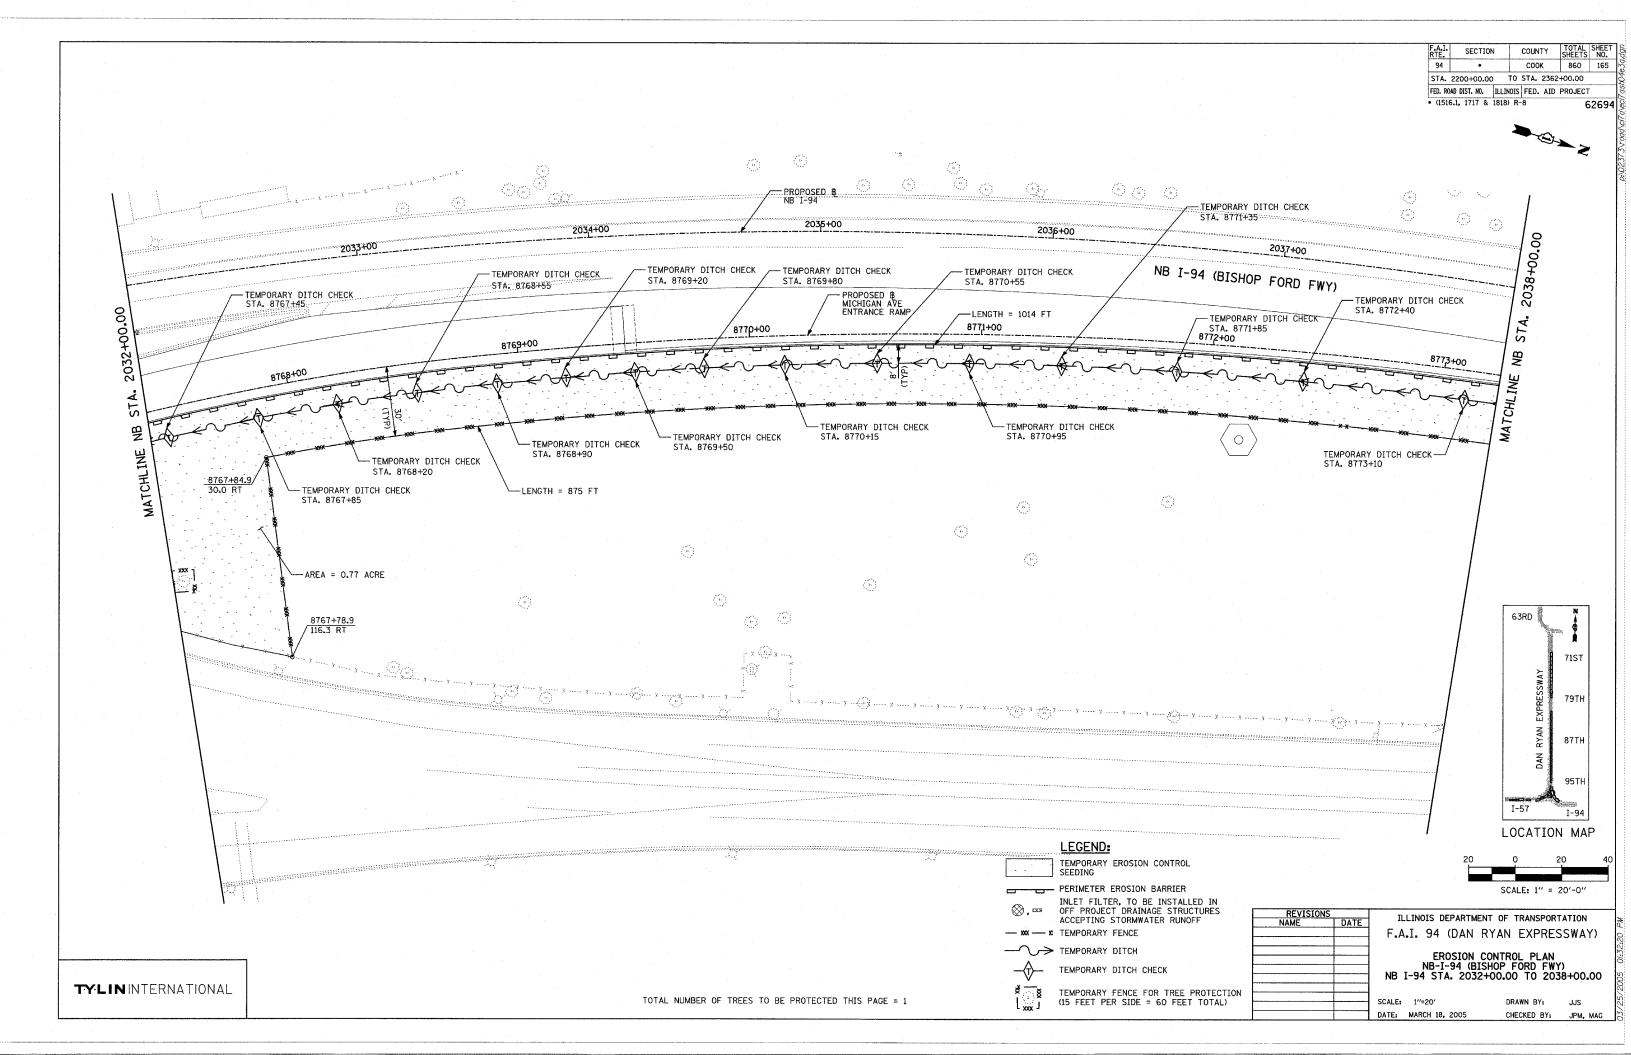

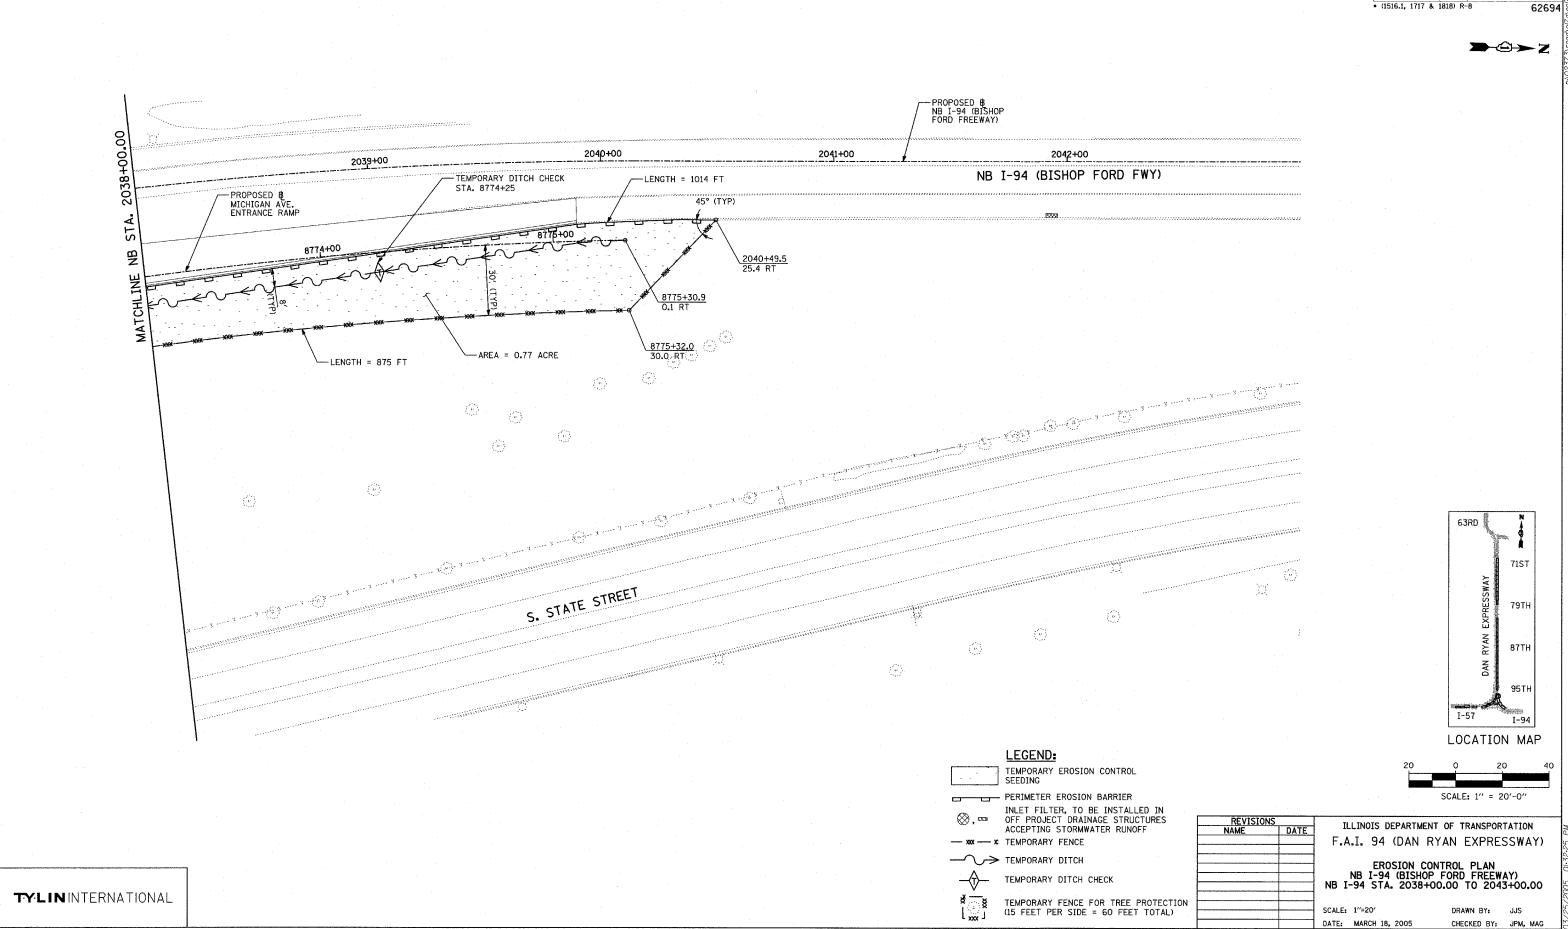

F.A.I.	SECTION	COUNTY	SHEETS	NO.
94	•	COOK	860	166
STA. 2200+00.00	TO STA. 2362+00.00			
FED. ROAD DIST. NO.	ILLINOIS	FED. AID	PROJECT	
• (1516.1, 1717 & 1818) R-8	62694			

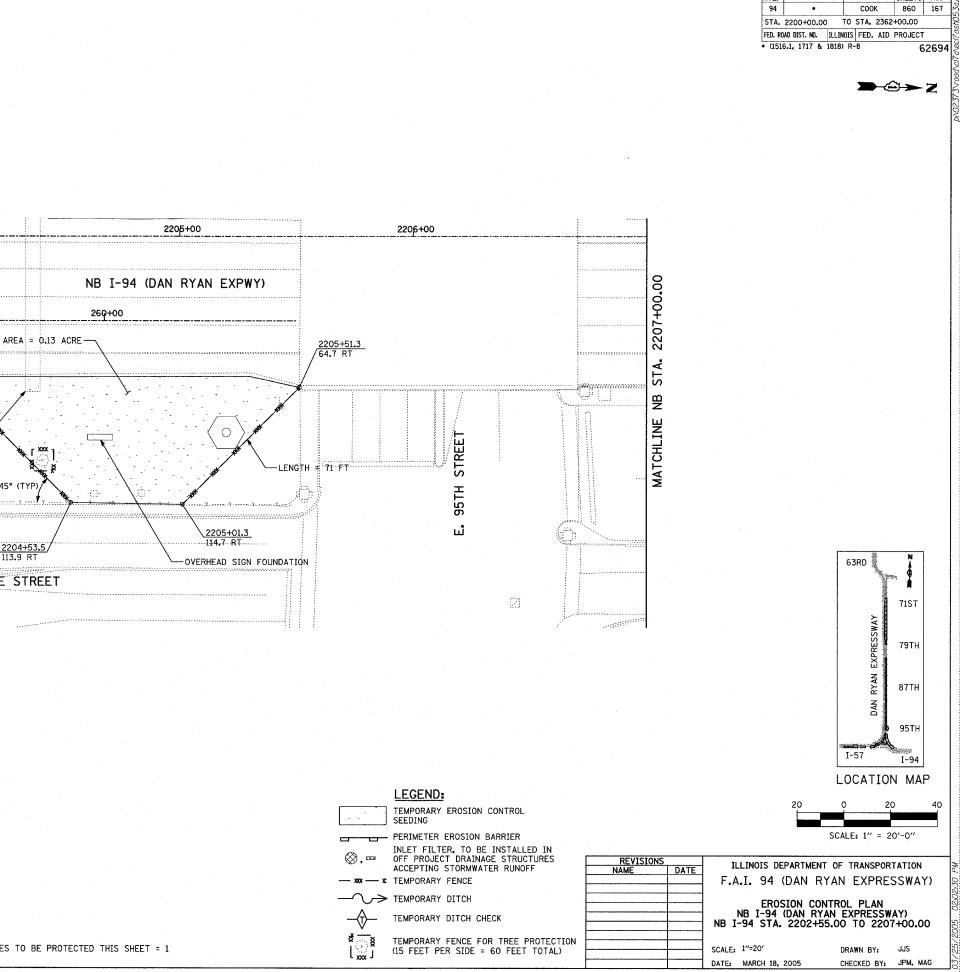

COUNTY TOTAL SHEET NO. SECTION

2203+00

—PROPOSED BL NB I-57

258+00

TYLININTERNATIONAL

220,4+00

-PROPOSED B NB I-94 (DAN RYAN EXPRESSWAY)


EXISTING SIGN FOUNDATION TO BE REMOVED-


259+00


2204+00.1 60.3 RT


LENGTH = 76 FT-


S. STATE STREET

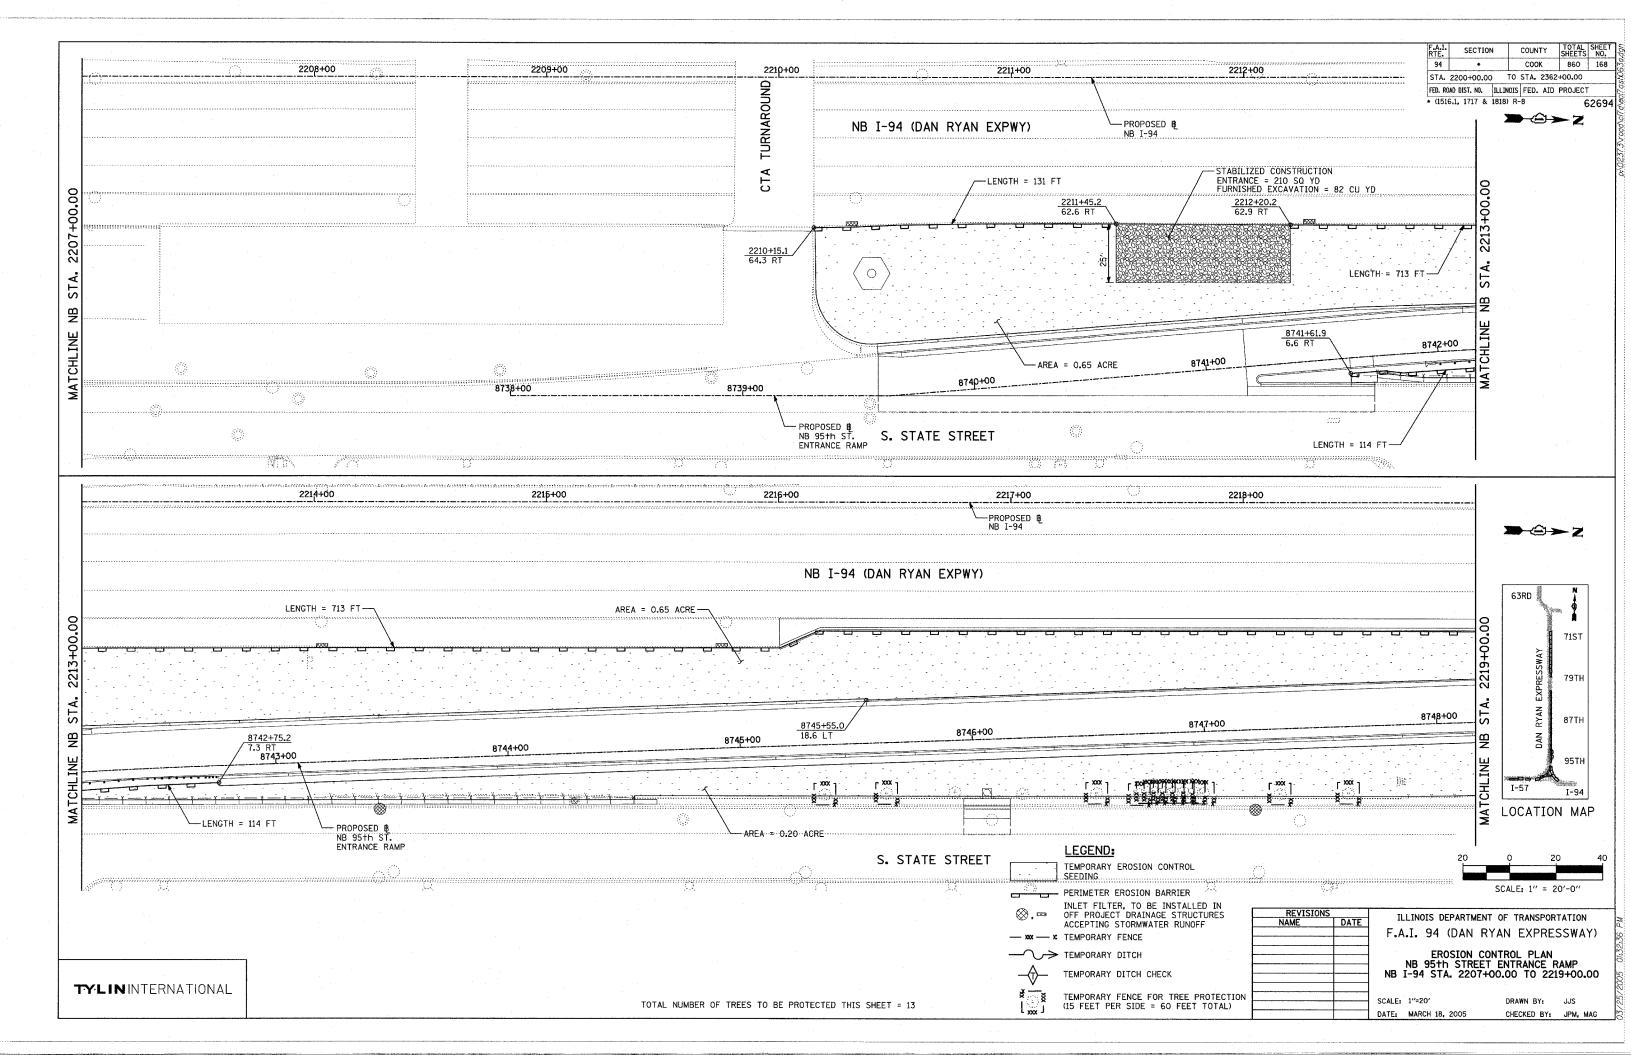


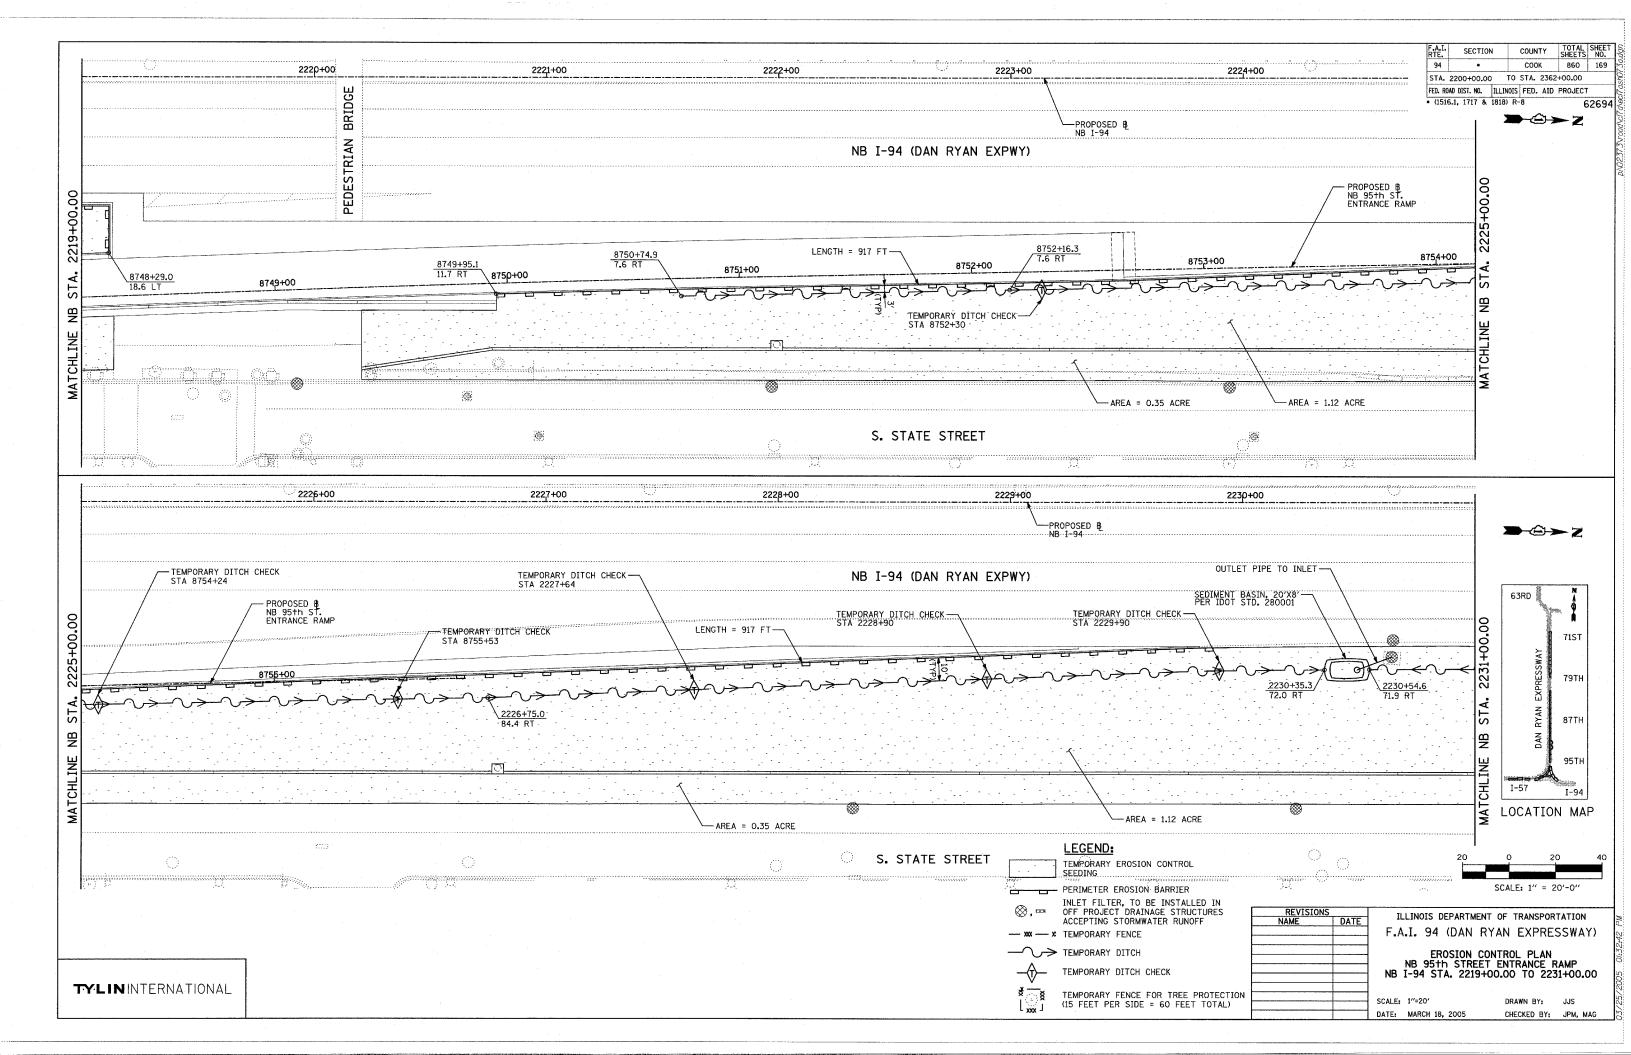


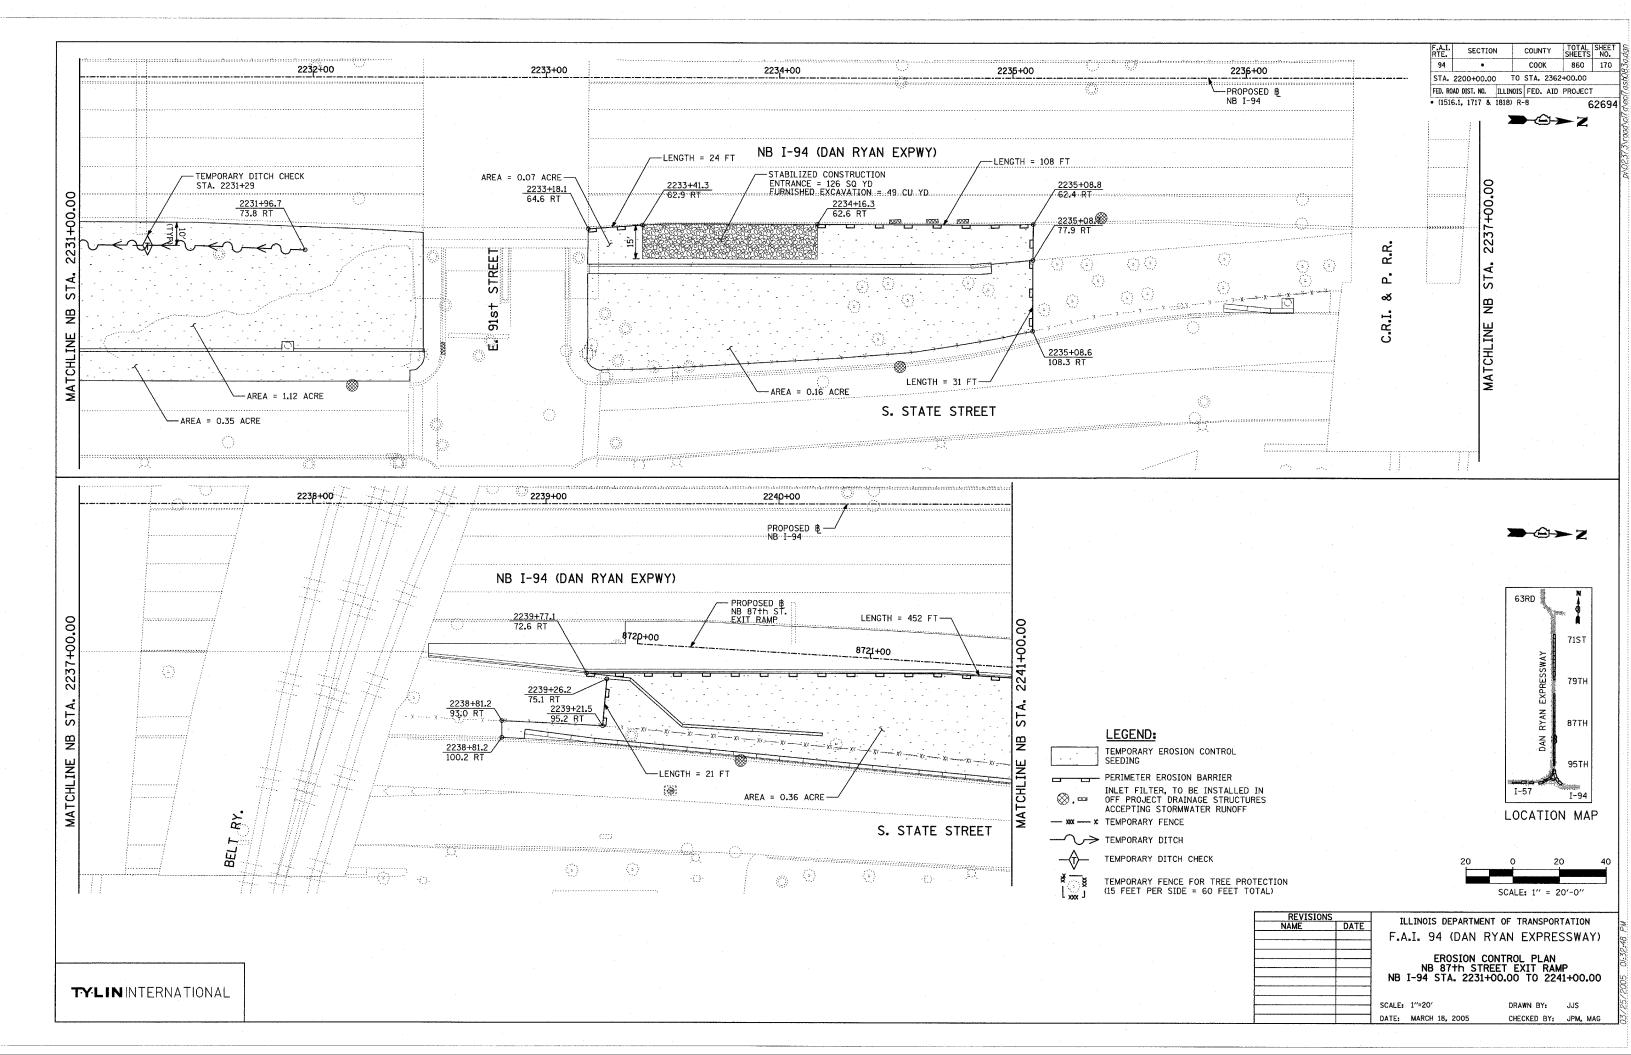


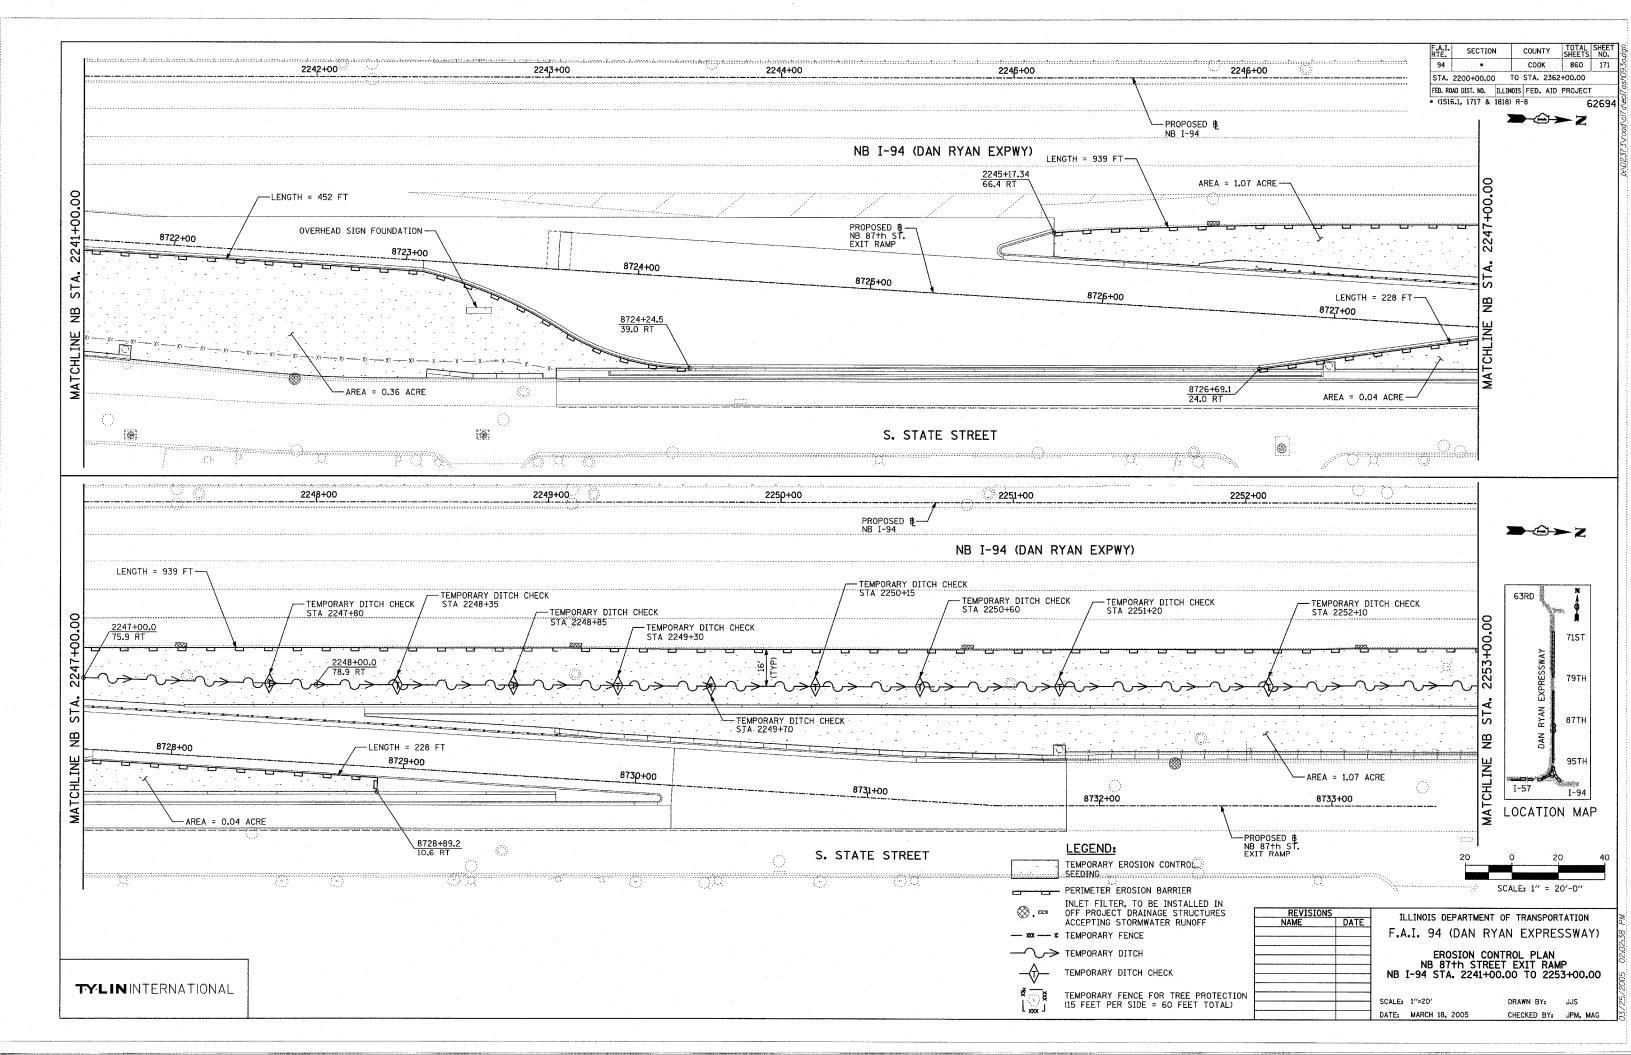

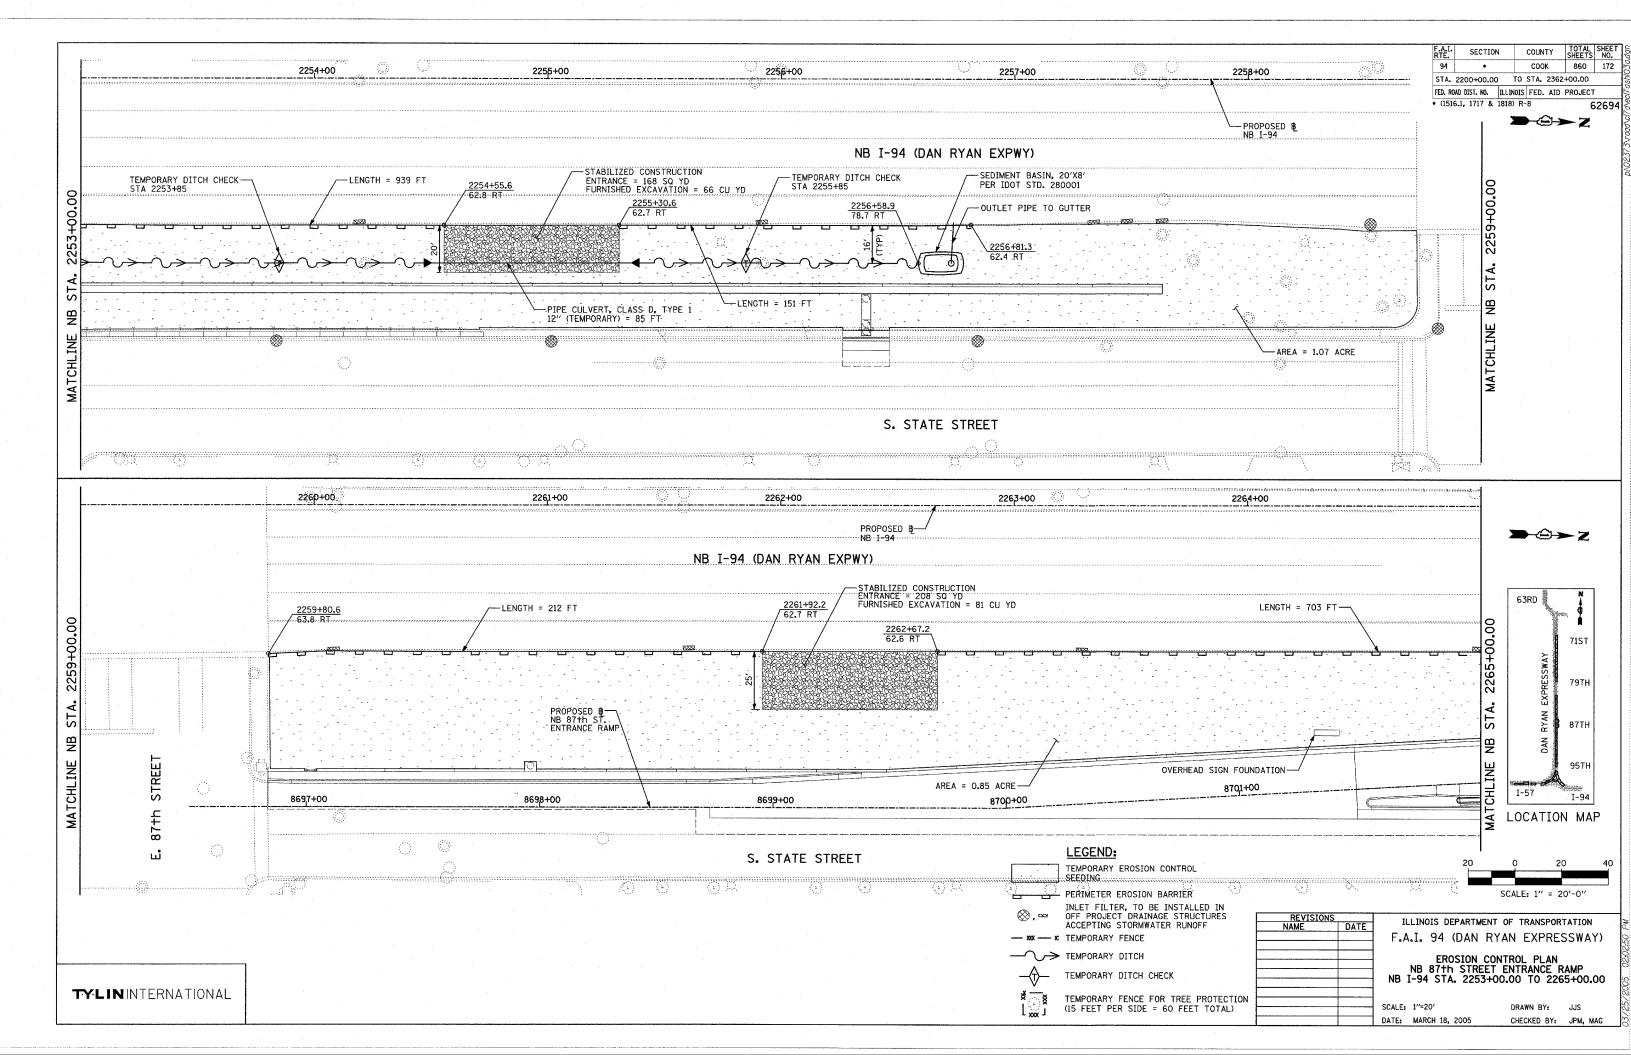

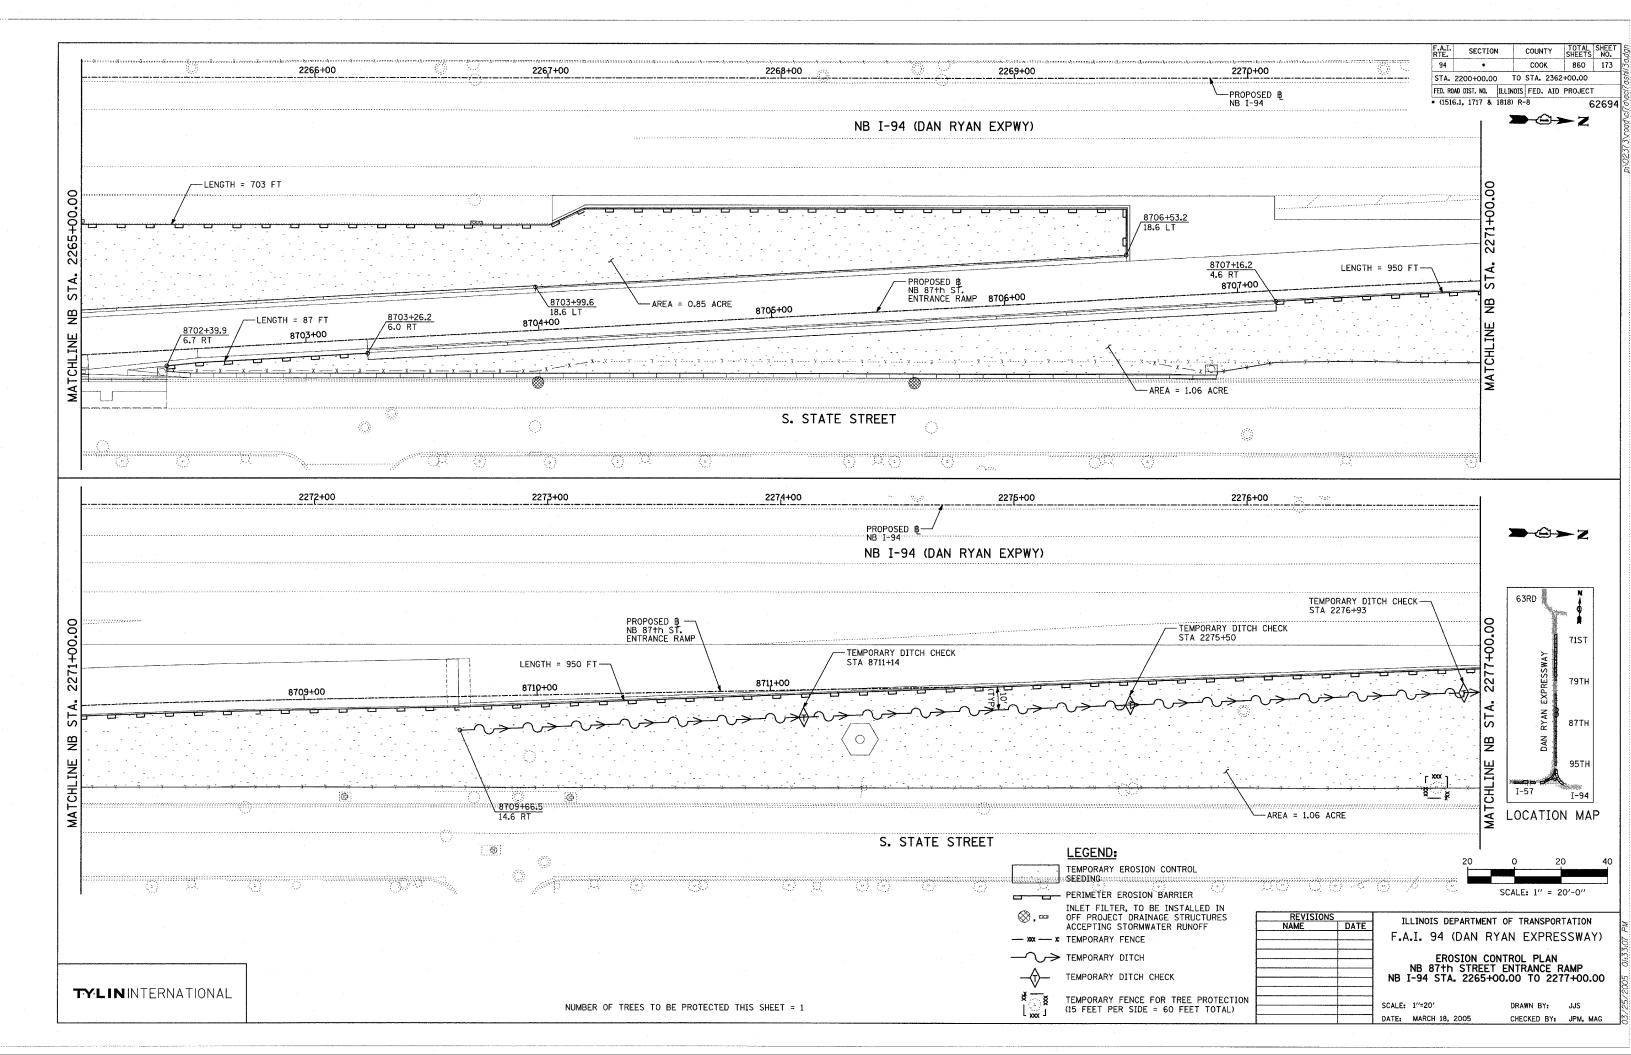


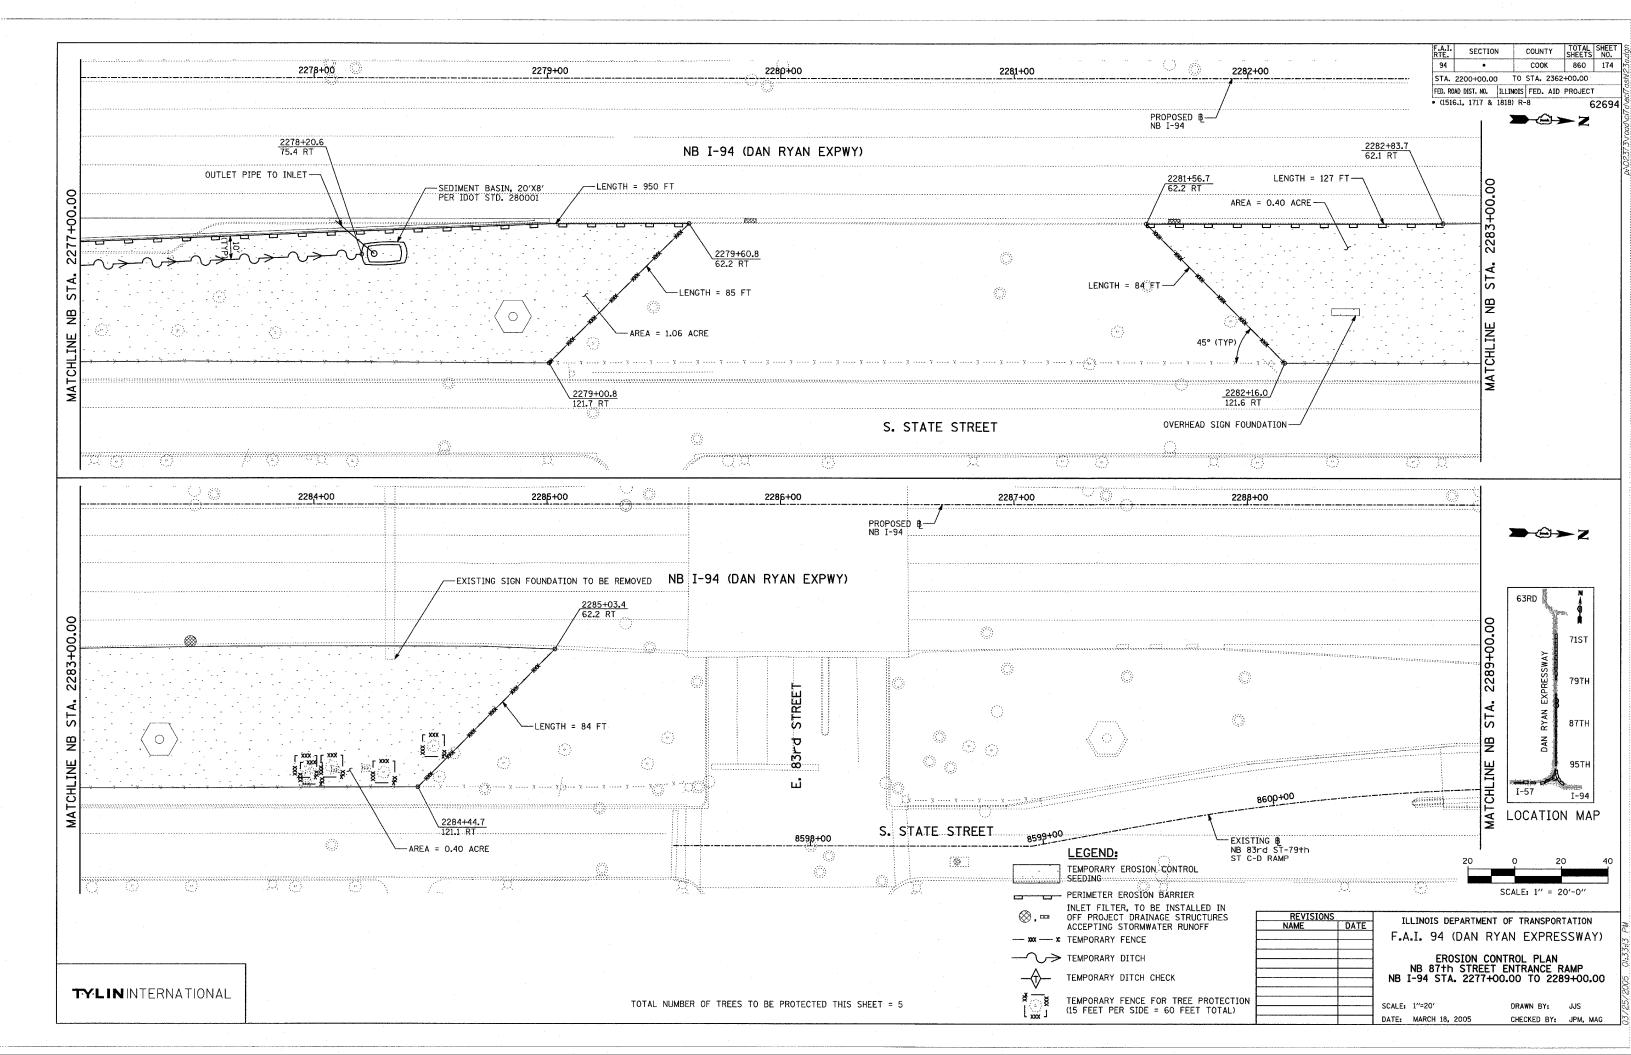


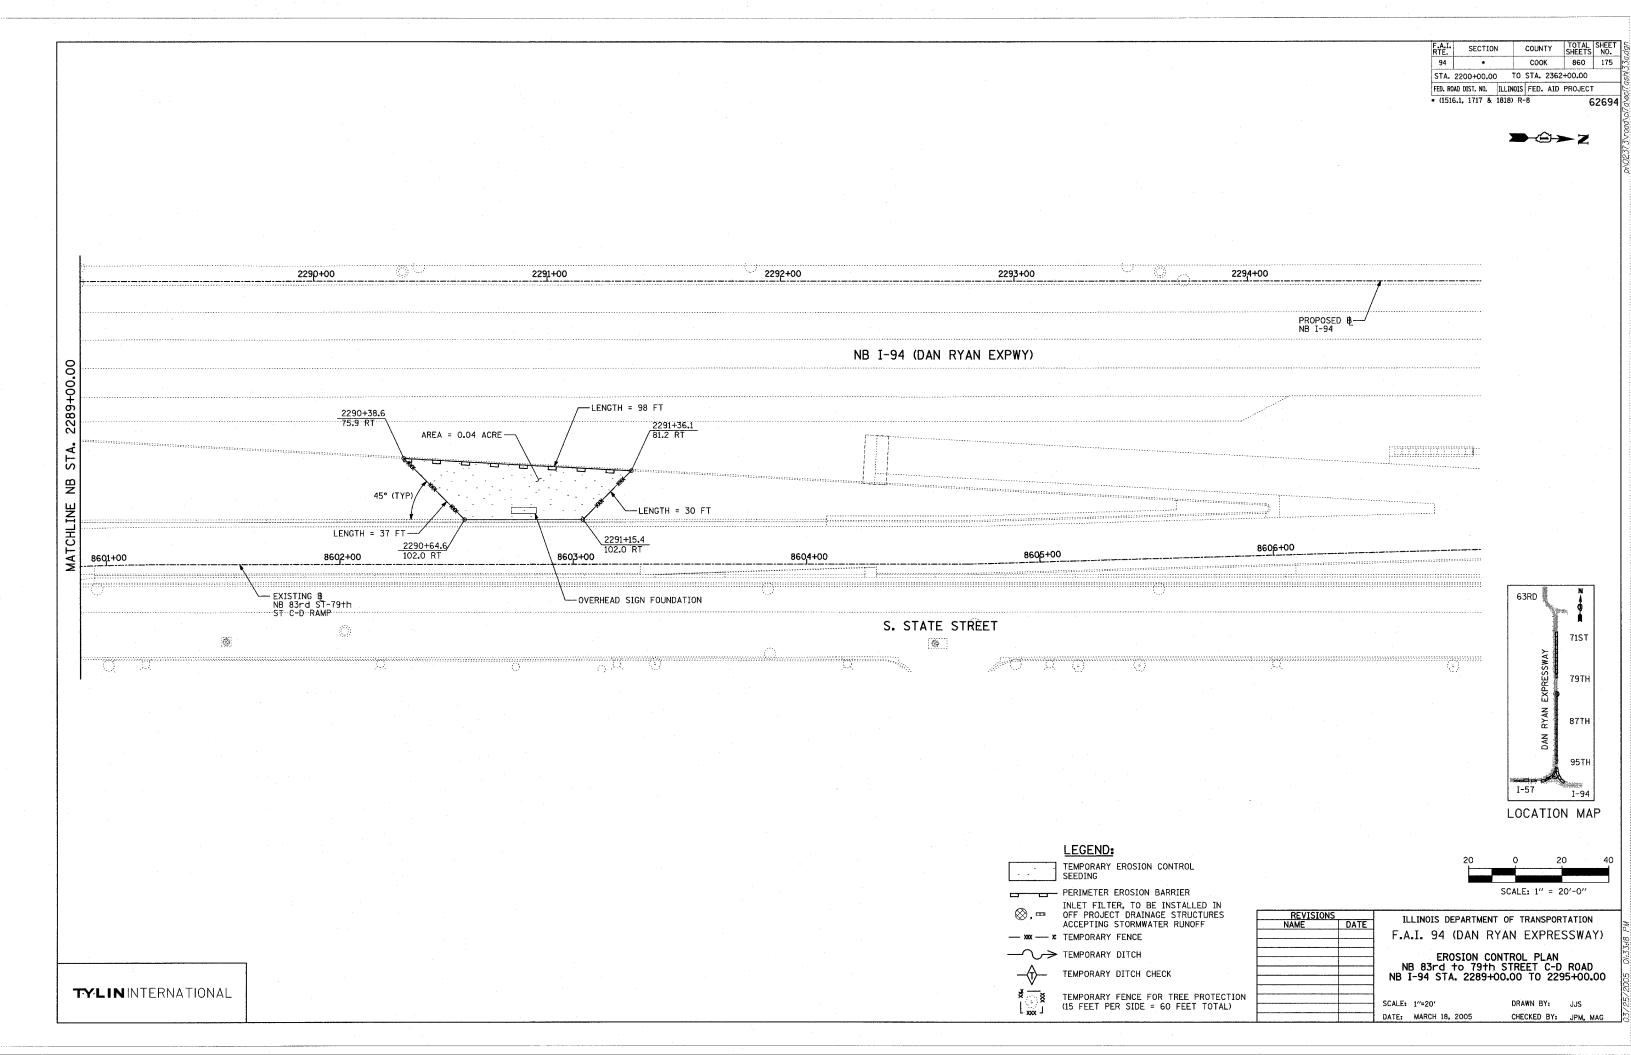

| F.A.I. | SECTION | COUNTY | TOTAL | SHEET |

→ © → Z

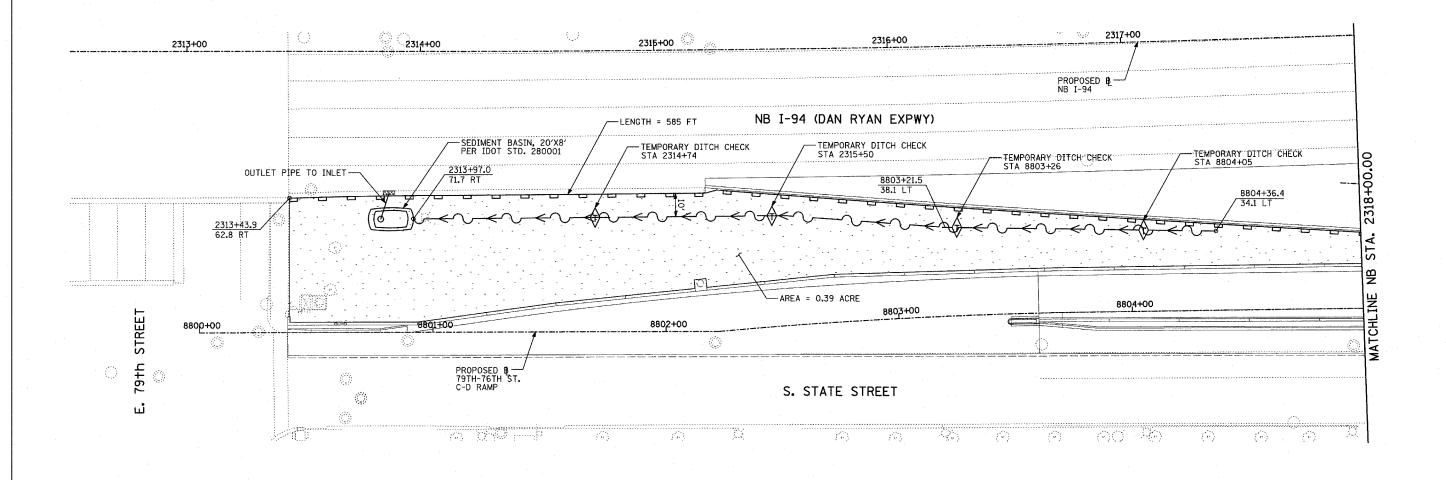

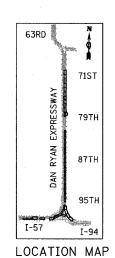

20 0 20 SCALE: 1" = 20'-0"

ILLINOIS DEPARTMENT OF TRANSPORTATION
F.A.I. 94 (DAN RYAN EXPRESSWAY)

EROSION CONTROL PLAN
NB 79+h TO 76+h STREET C-D ROAD

EROSION CONTROL PLAN
NB 79th TO 76th STREET C-D ROAD
NB I-94 STA. 2312+50.00 TO 2318+00.00


SCALE: 1"=20"


DATE: MARCH 18, 2005


REVISIONS NAME


DRAWN BY: JJS
CHECKED BY: JPM, MAG


TYLIN INTERNATIONAL

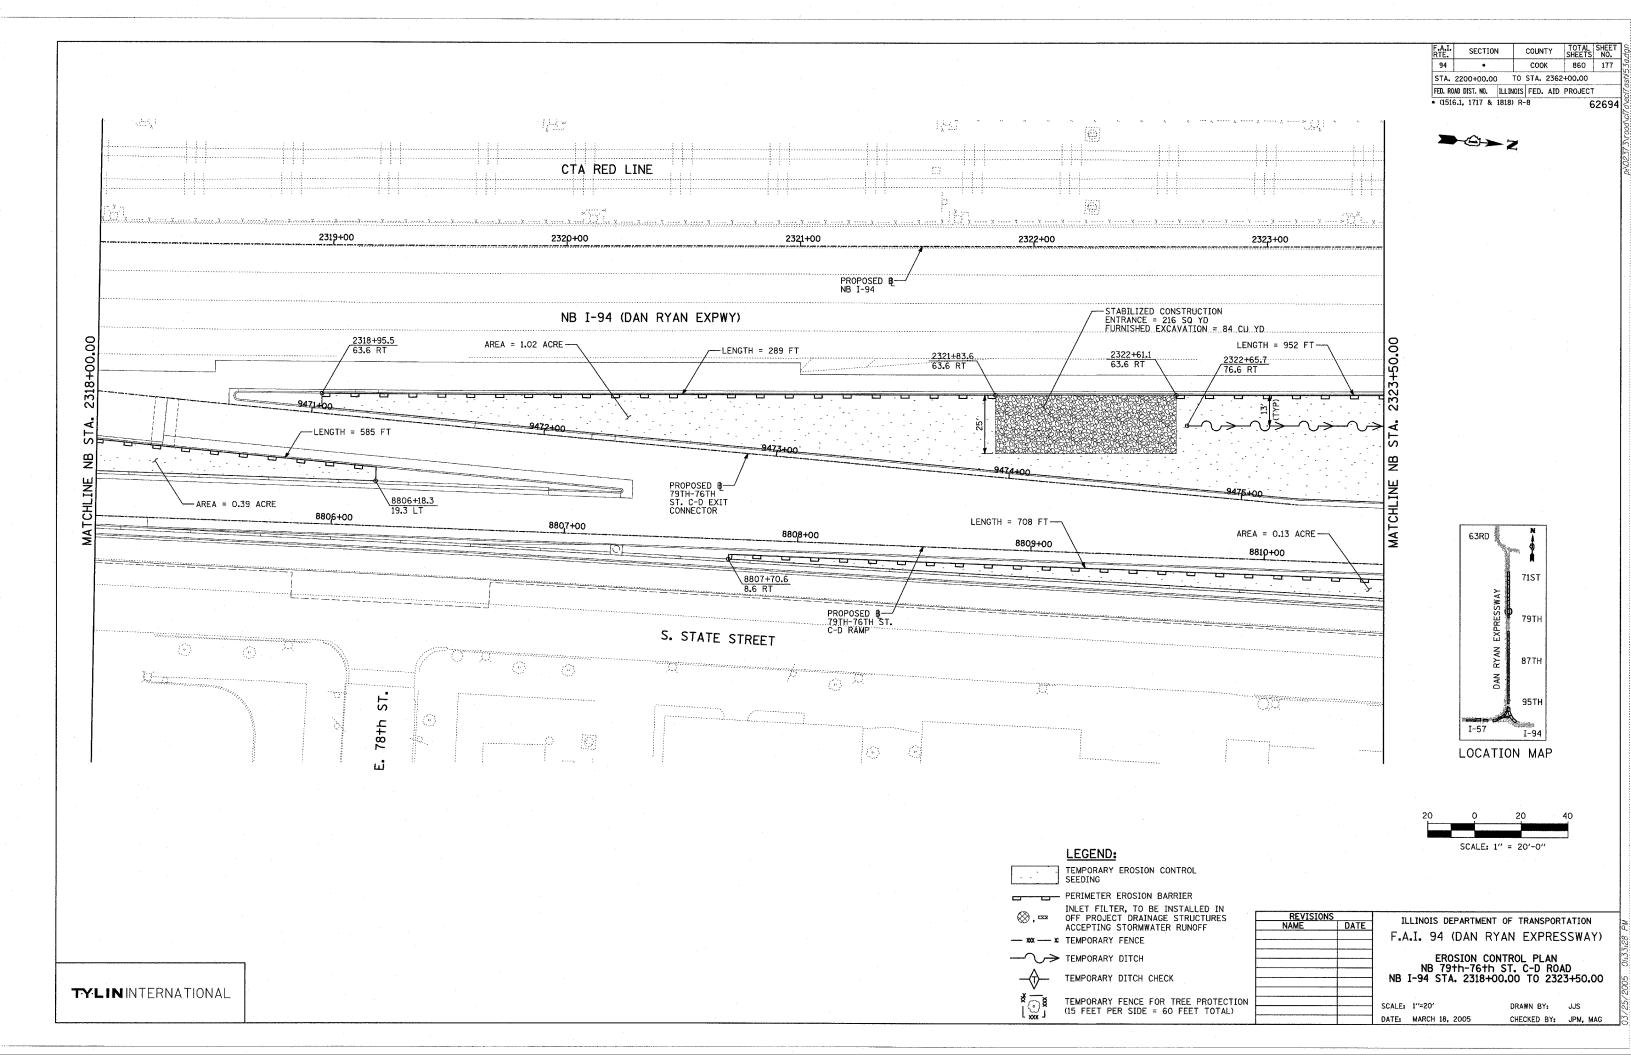


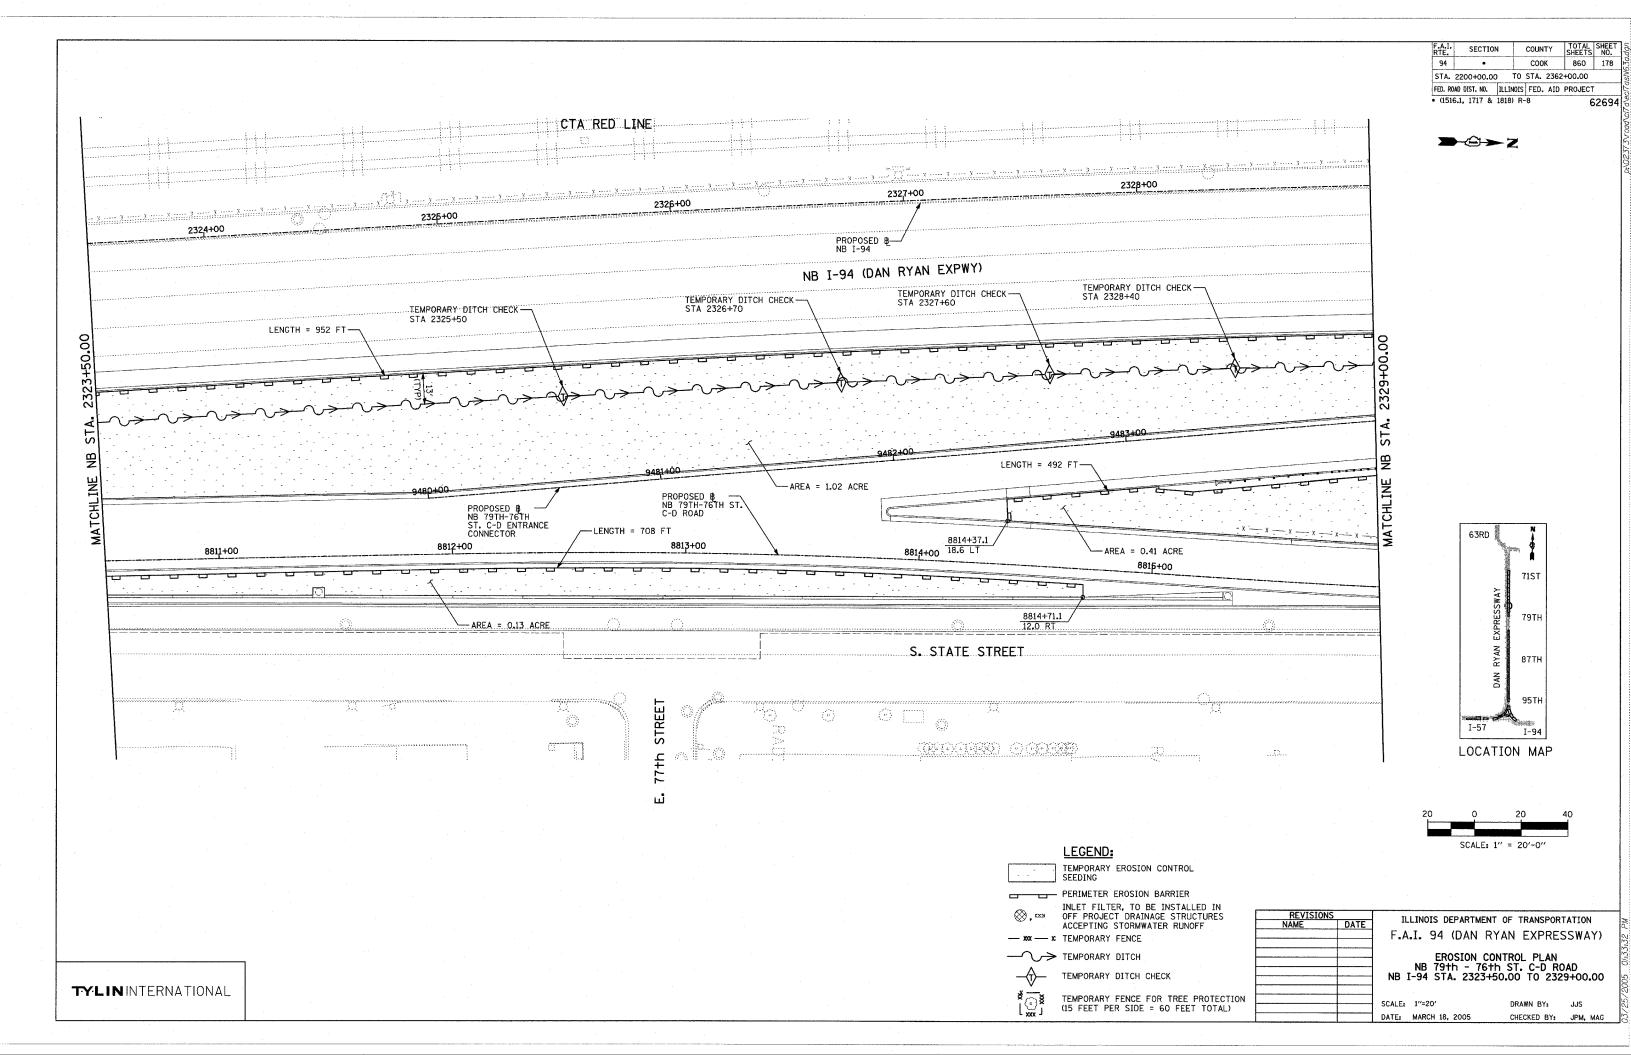


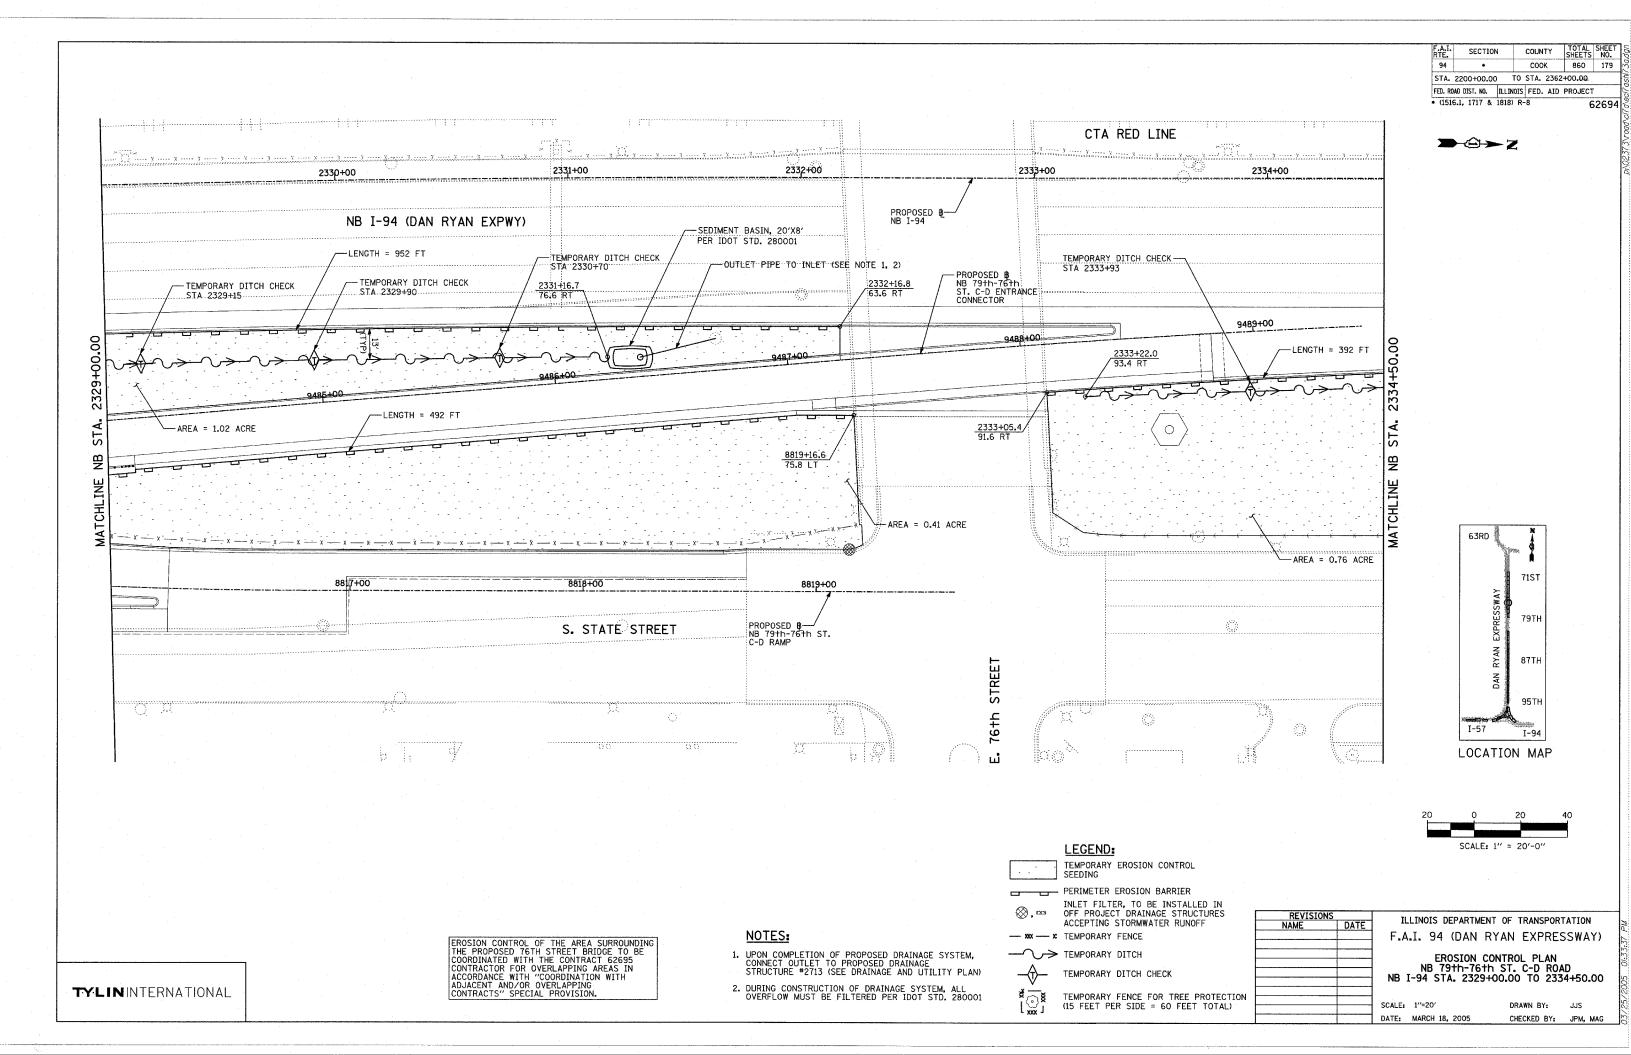


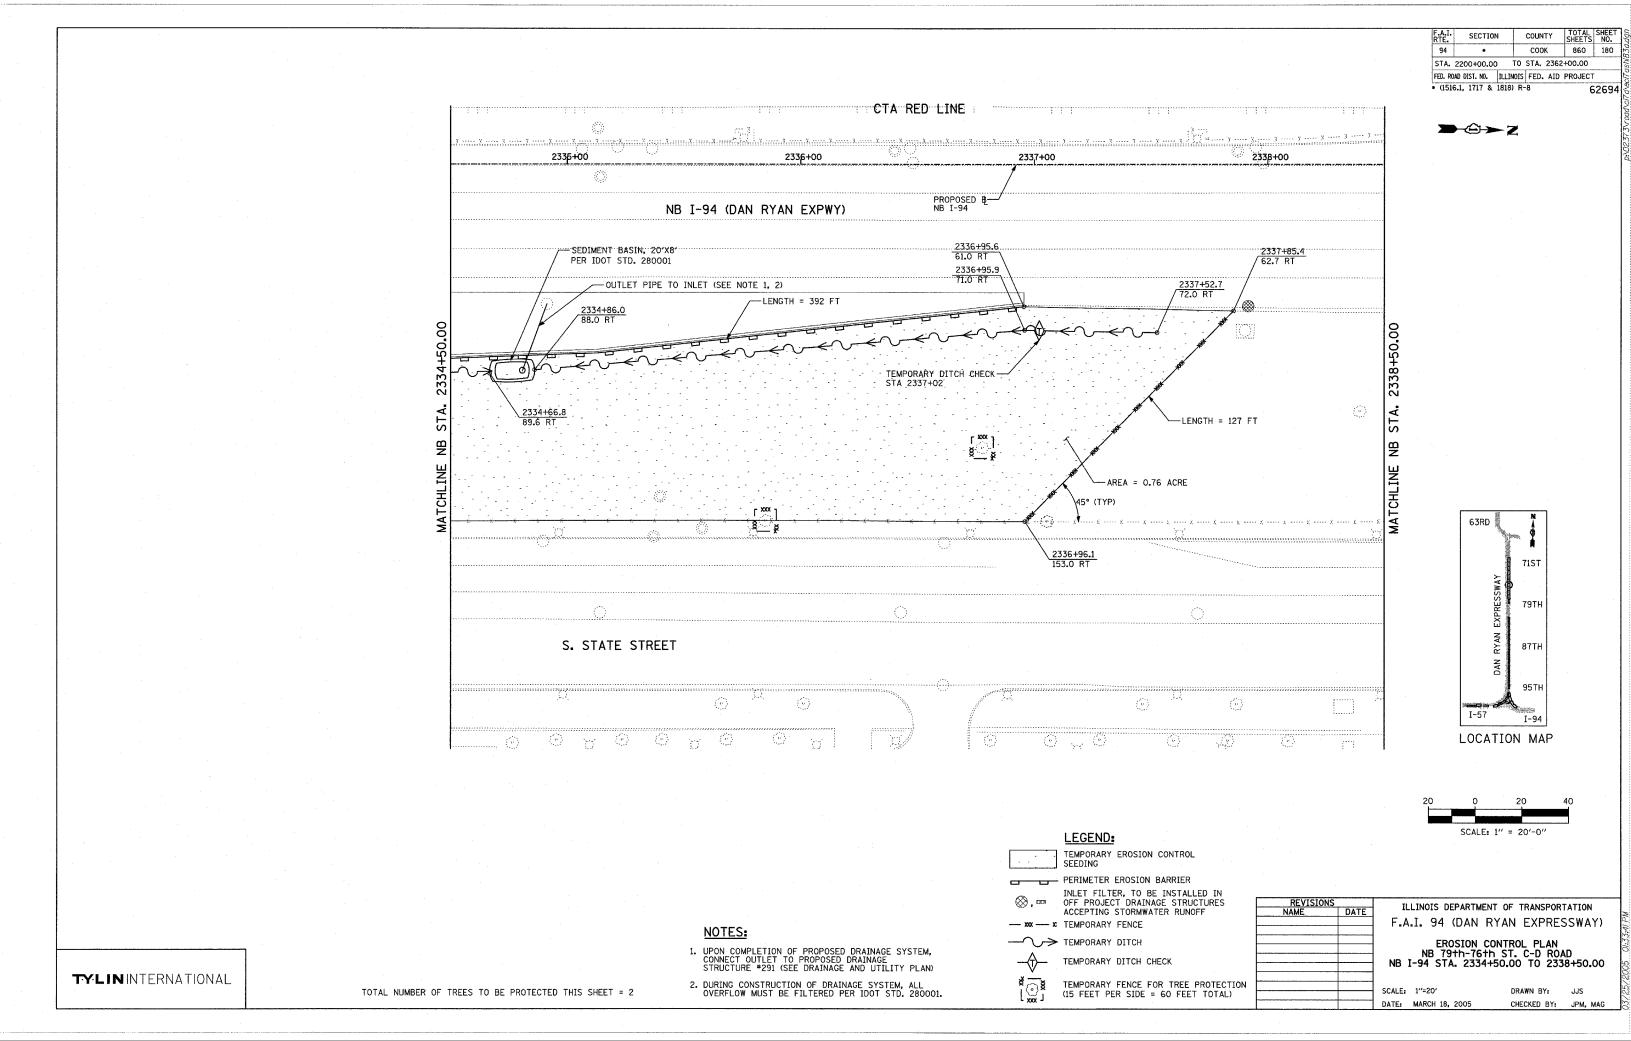


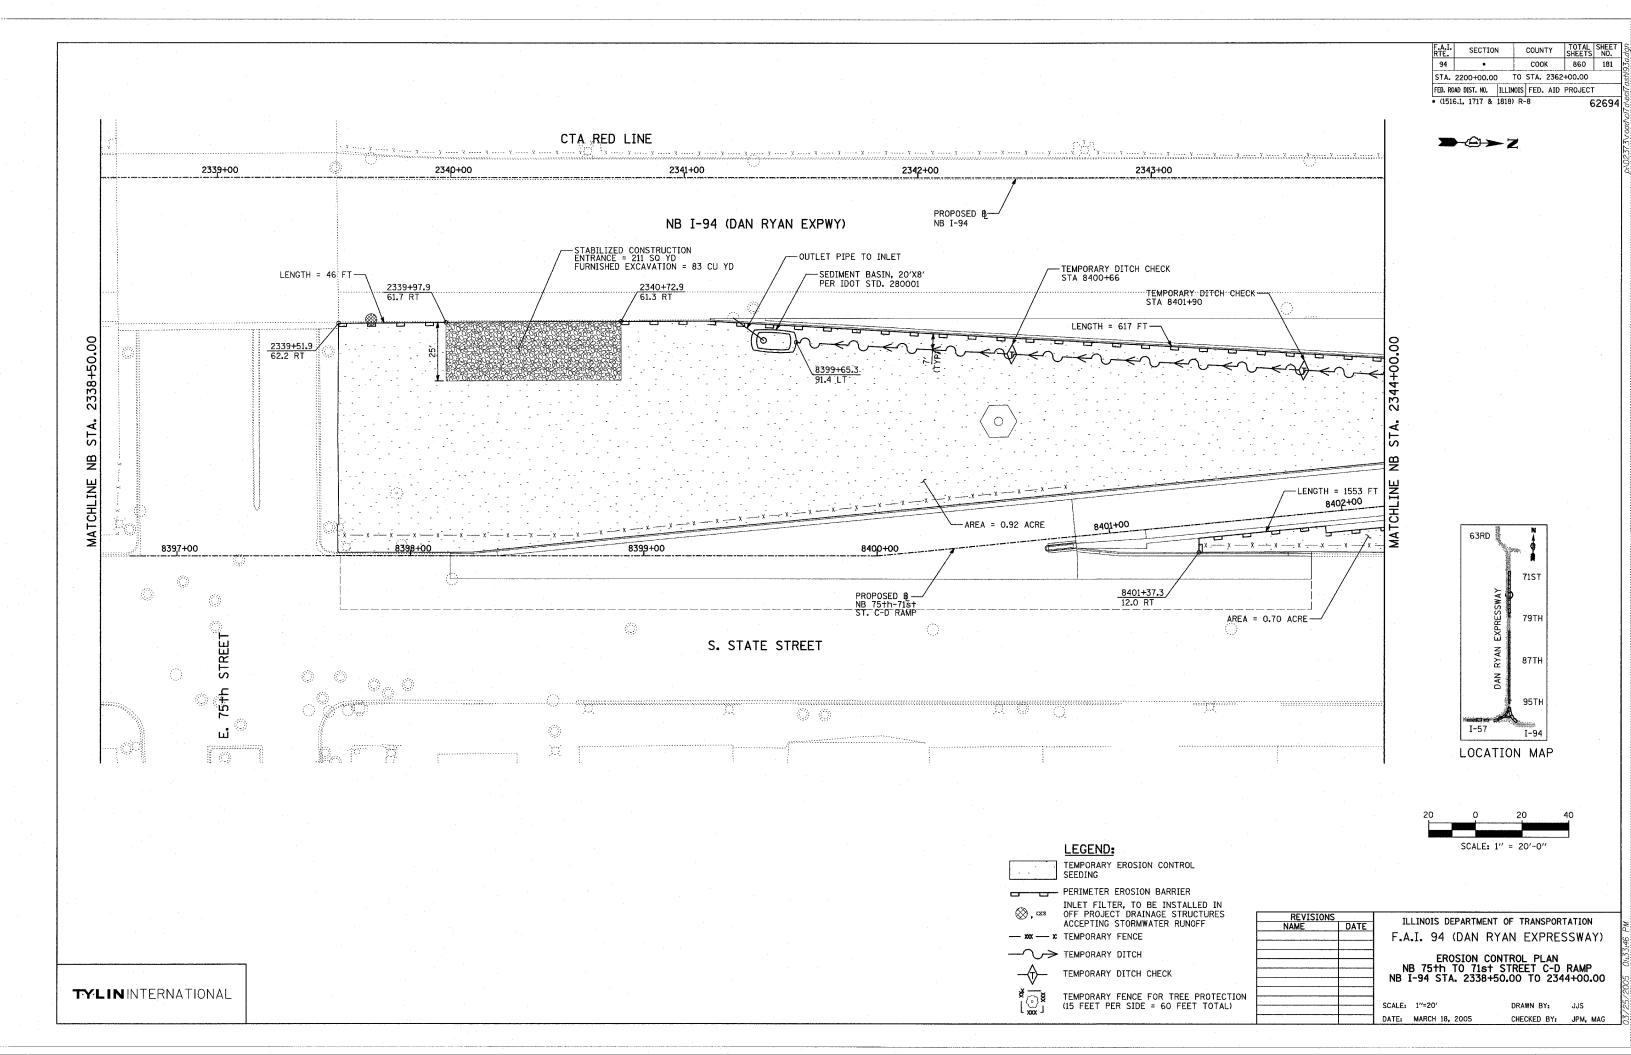


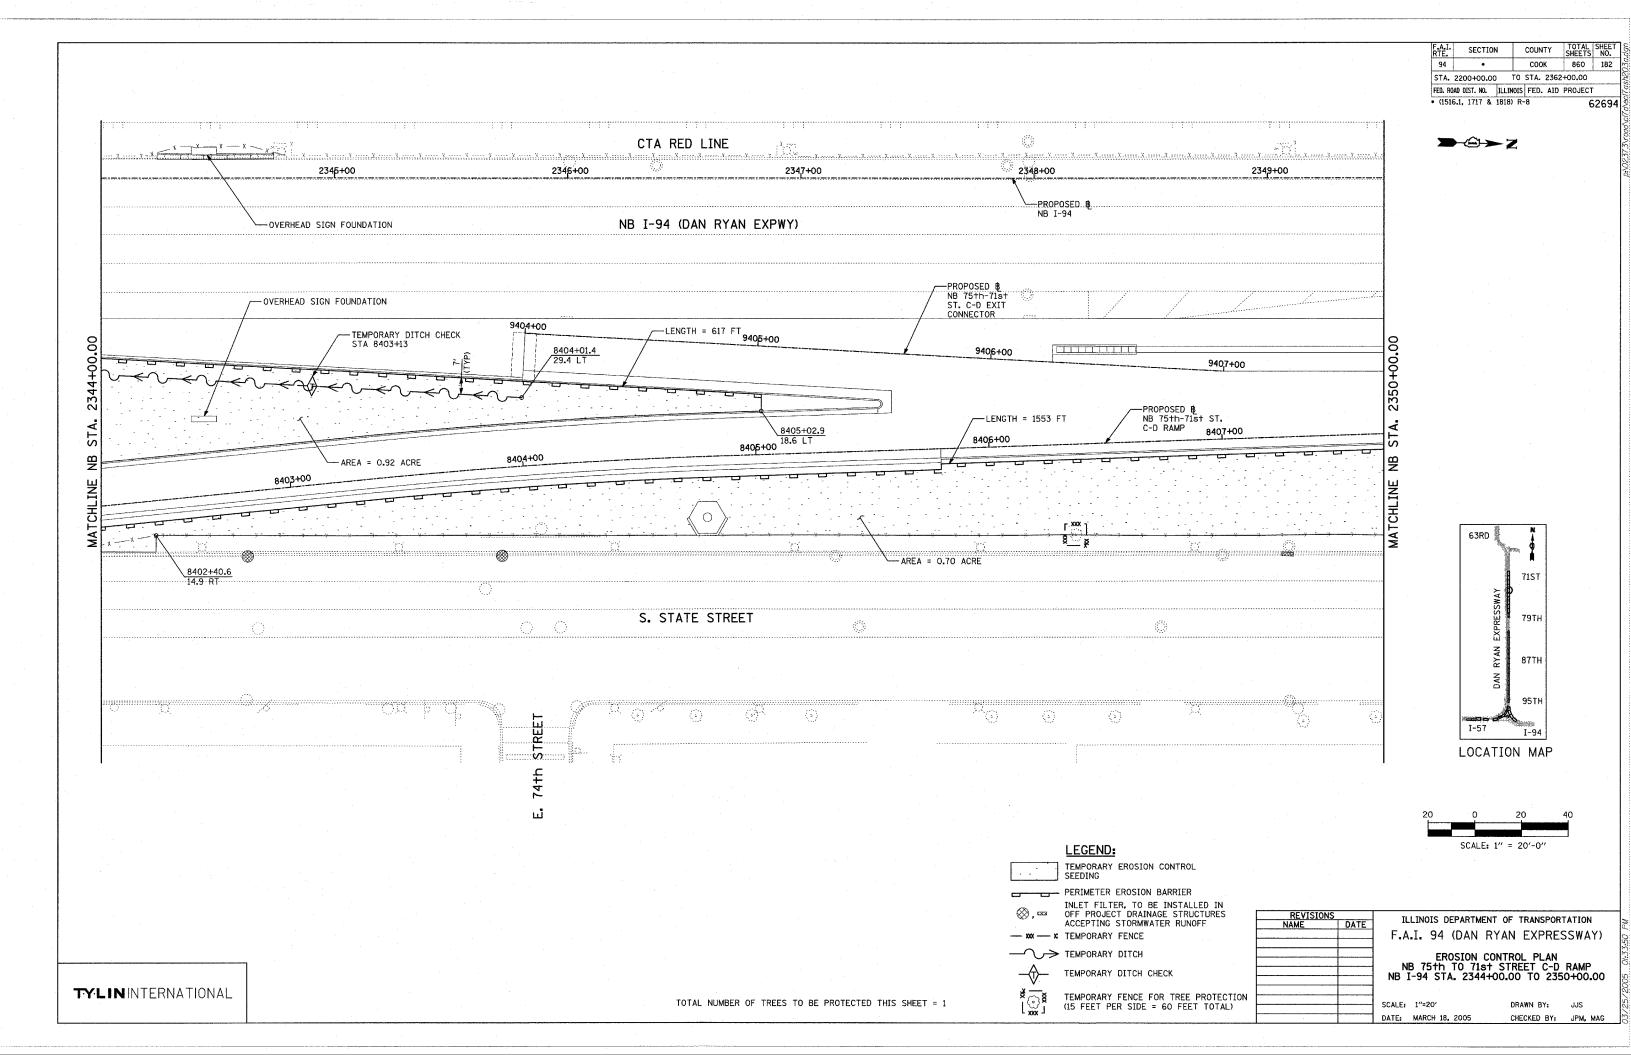


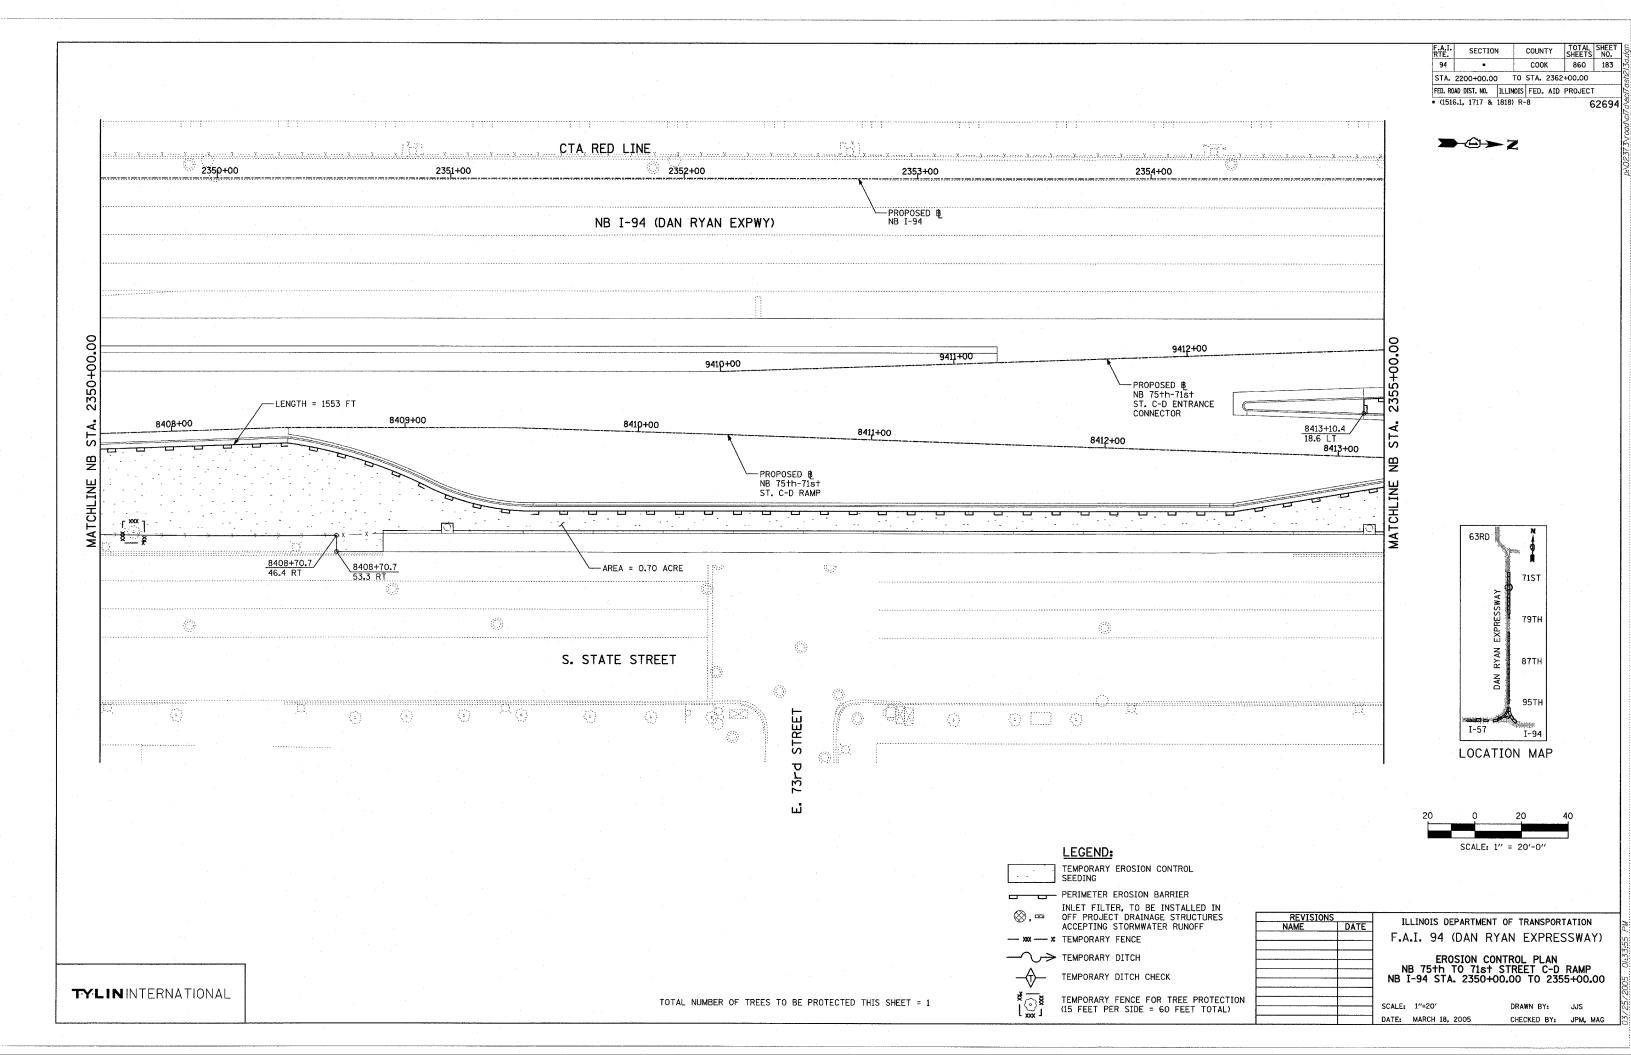

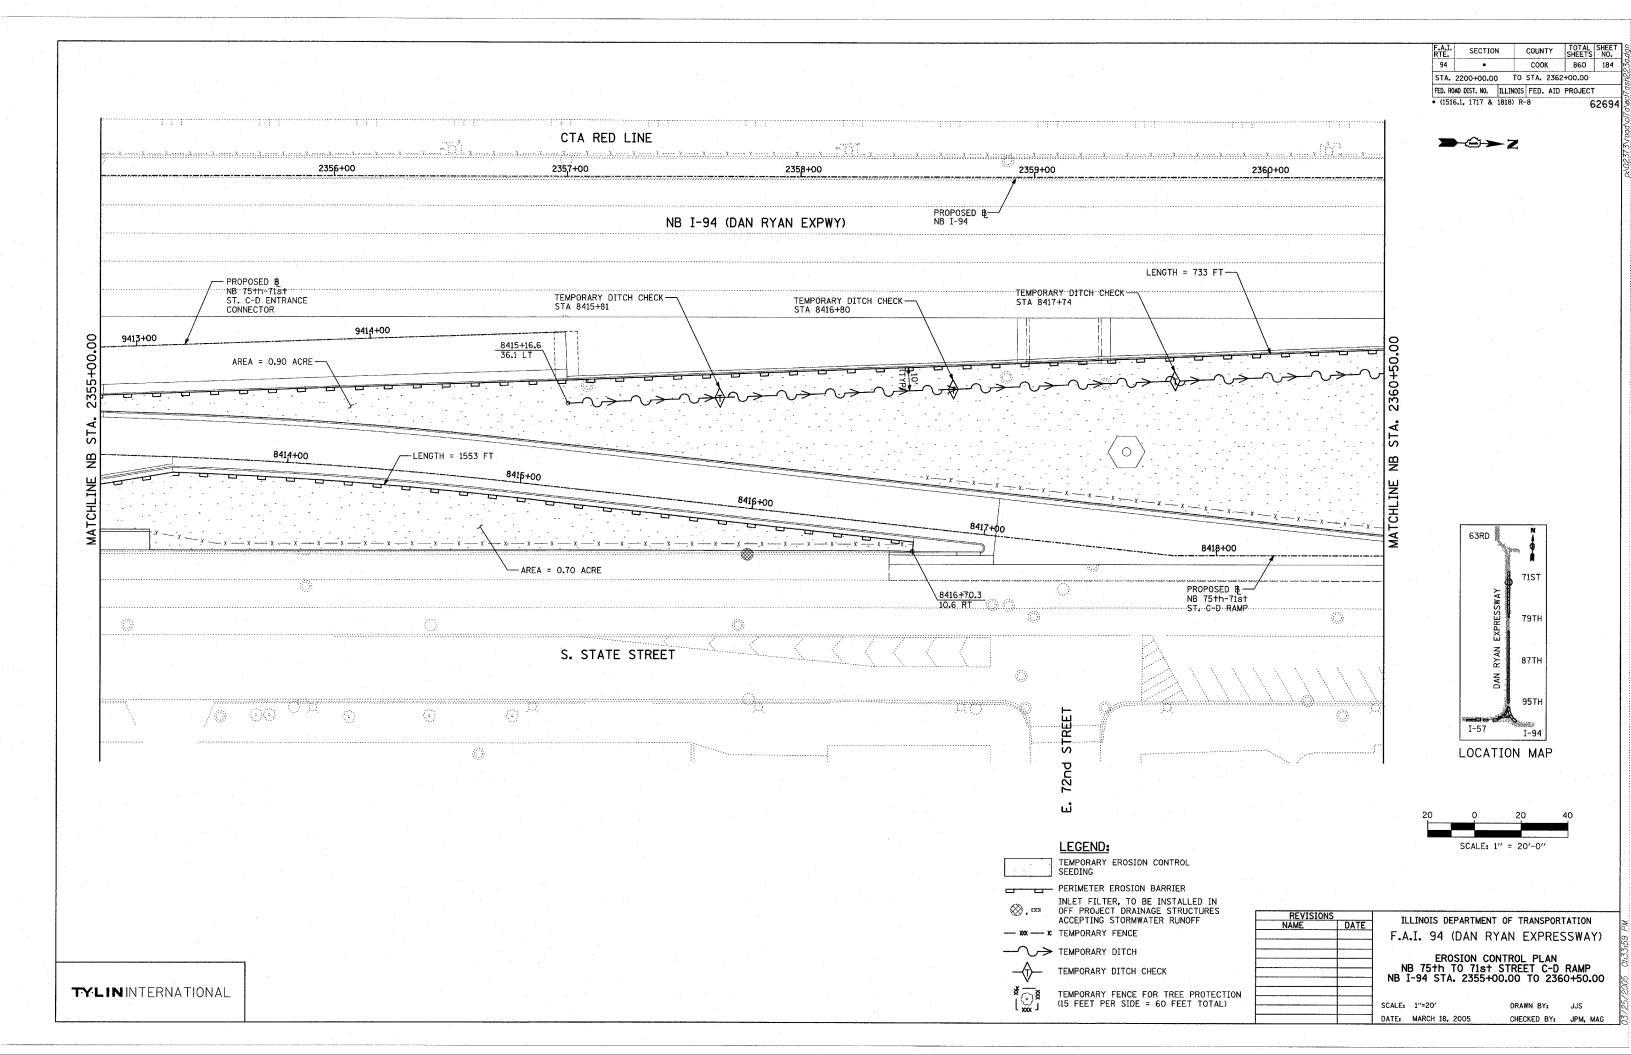

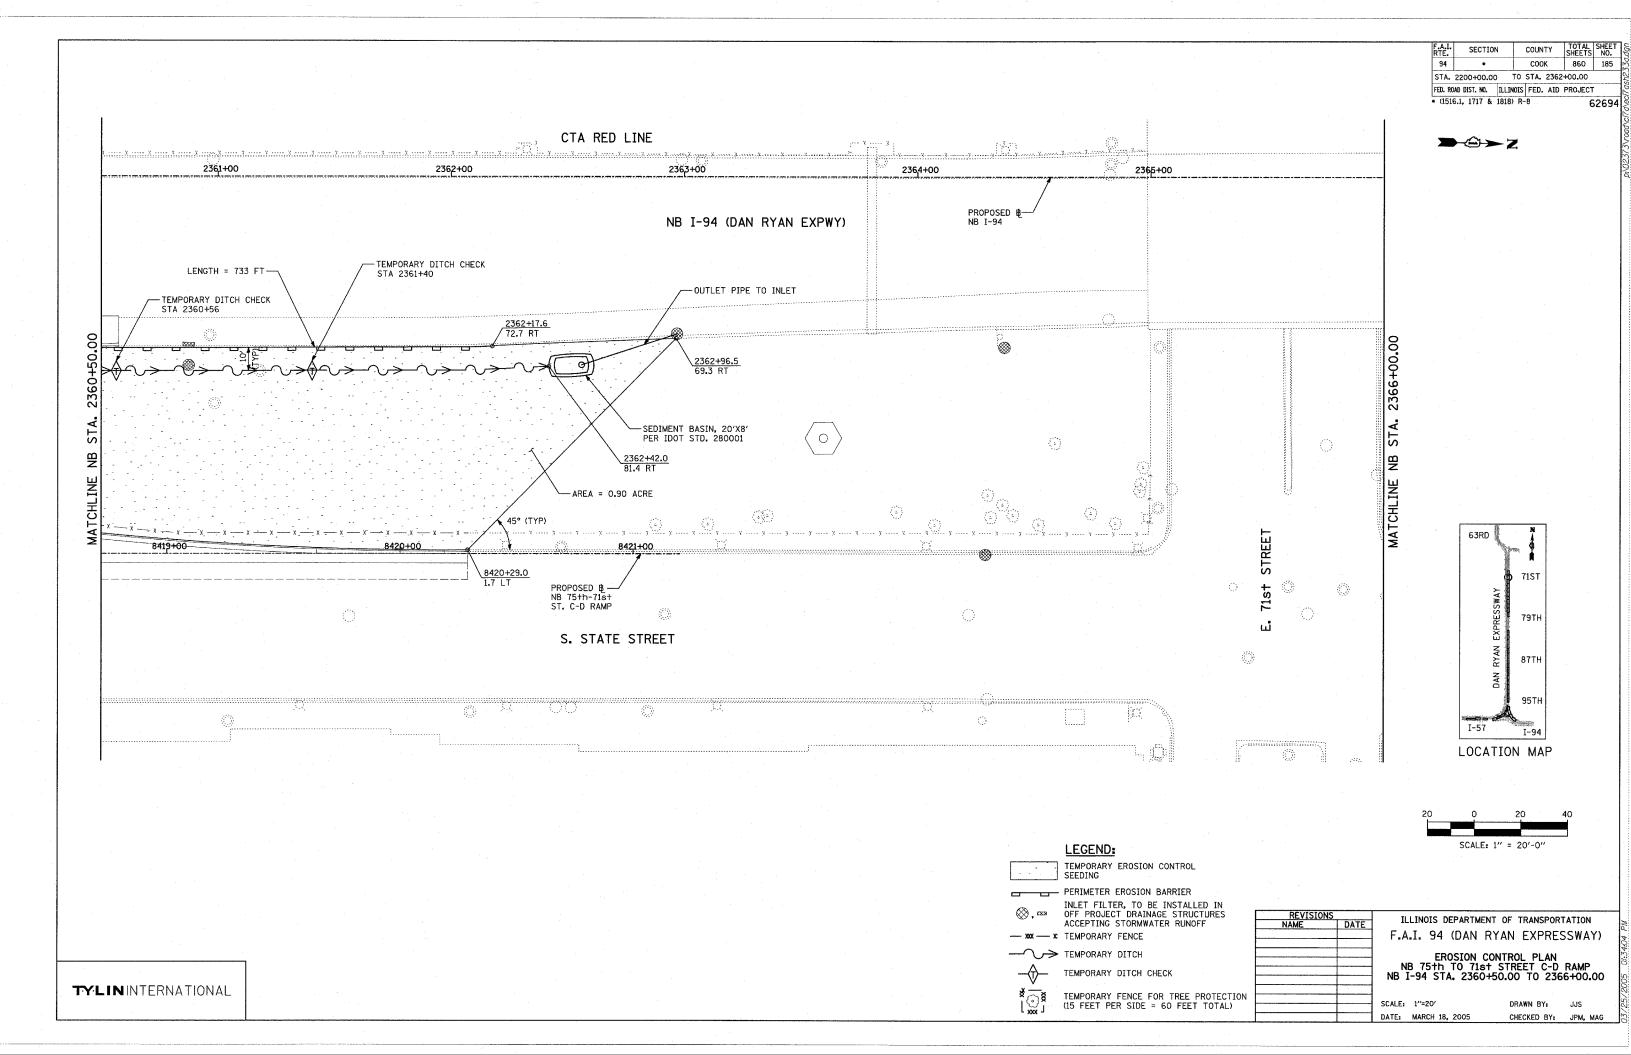

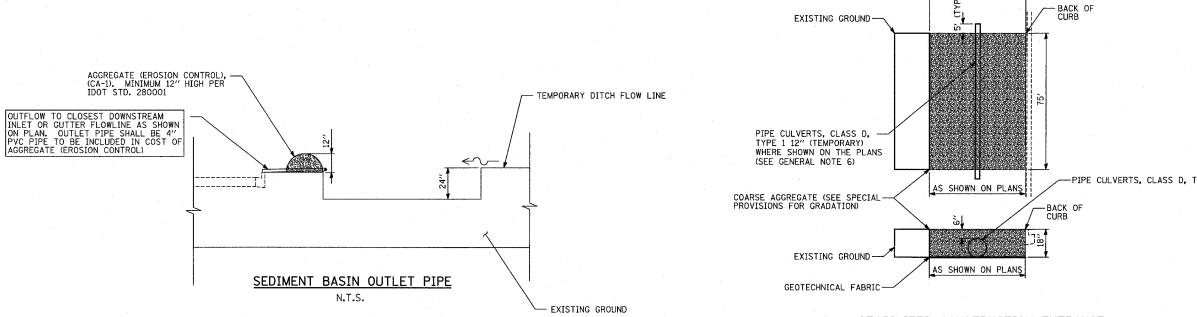


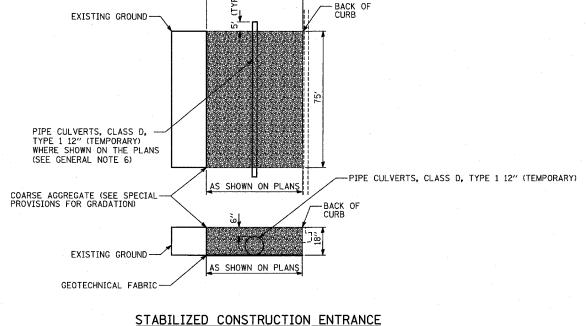

AS SHOWN ON PLANS

TOPSOIL, FURNISH AND PLACE, 4" EXISTING GROUND BACK OF FURNISHED EXCAVATION AS SHOWN ON PLANS NOTE: FURNISHED EXCAVATION PAID FOR SEPARATELY. TOPSOIL FURNISH AND PLACE, 4" PAID FOR AS PART OF THE RESTORATION FOR LANDSCAPING AREAS.

STABILIZED CONSTRUCTION ENTRANCE RESTORATION N.T.S.

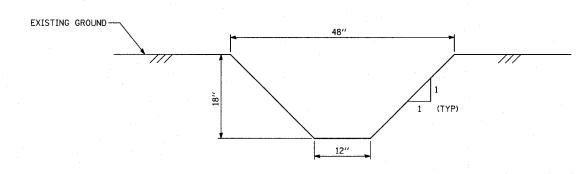

TEMPORARY DITCH DETAIL N.T.S.

(SHOWN WITH TEMPORARY PIPE CULVERT) N.T.S.

GENERAL NOTES:

- EROSION CONTROL ITEMS ARE CONSIDERED TO BE HIGH PRIORITY ITEMS ON THIS CONTRACT. THE ENGINEER WILL IMPLEMENT ALL PROVISIONS OF THE SPECIFICATION NECESSARY TO ASSURE THAT EROSION CONTROL ITEMS ARE CONSTRUCTED AND MAINTAINED IN A TIMELY WAY. ALL EROSION CONTROL MEASURES SHALL BE INSTALLED PRIOR TO BEGINNING ANY CONSTRUCTION ACTIVITIES, WHICH WILL POTENTIALLY CREATE ERODIBLE CONDITIONS CONDITIONS.
- THE EROSION CONTROL MEASURES SHOWN ARE BUT A GRAPHICAL REPRESENTATION OF SUGGESTED MEASURES. DEVIATIONS FROM THIS PLAN ARE TO BE EXPECTED PENDING A JOB SITE INSPECTION BETWEEN THE CONTRACTOR AND THE DEPARTMENT.
- THE CONTRACTOR WILL BE REQUIRED TO IMPLEMENT AND MAINTAIN SEDIMENT CONTROL MEASURES PRIOR TO STRIPPING EXISTING VEGETATION.
- TEMPORARY FENCE USED FOR DRIP LINE PROTECTION IS 60 LINEAR FEET FOR EACH TREE PROTECTED. ACTUAL LENGTH TO BE ADJUSTED BY THE ENGINEER TO FIT FIELD CONDITIONS.
- 5. TREE REMOVAL QUANTITIES APPEAR ON THE REMOVAL PLANS.
 - CONTRACTOR MAY USE SALVAGED 12" WATER MAIN PIPE FOR TEMPORARY CULVERTS WHEN APPROVED BY THE ENGINEER.

REVISIONS	ILLINOIS DEPARTMENT OF TRANSPORTATION
NAME DATE	ILLINOIS DEI ANTIMENT OF TRANSPORTATION
	F.A.I. 94 (DAN RYAN EXPRESSWAY)
	DETAILS AND GENERAL NOTES
	EROSION CONTROL PLAN DETAILS AND GENERAL NOTES

SCALE: NOT TO SCALE DATE: MARCH 18, 2005

CHECKED BY:

JPA, JJS

MPG

DRAWN BY:

SECTION

* (1516.1, 1717 & 1818) R-8

STA. 2200+00.00

COUNTY

COOK

FED. ROAD DIST. NO. ILLINOIS FED. AID PROJECT

TO STA. 2362+00.00

TOTAL SHEET NO.

860 186

62694

TYLININTERNATIONAL

