STATE OF ILLINOIS

DEPARTMENT OF TRANSPORTATION

DIVISION OF HIGHWAYS

PLANS FOR FEDERAL AID HIGHWAY

SECTION: 08-00061-00-RS

PROJECT: HPP-4071(001)

JOB NO.: C-91-102-08

ENTRYWAY TO CHILDREN'S LEARNING CENTER CAMPUS PARKING LOT

THE PROJECT IS LOCATED IN THE VILLAGE OF GLENCOE

DESIGN DESIGNATION: <1000(2010) LOCAL N/A (N/A)

7 NORTH-END EXISTING CONDITIONS AND DEMOLITION PLAN 8 SOUTH-END EXISTING CONDITIONS AND GRADING PLAN

10 NORTH-END EROSION AND SEDIMENTATION CONTROL PLAN 11 SOUTH-END EROSION AND SEDIMENTATION CONTROL PLAN

ADT = <1000 (2010)

INDEX OF SHEETS

1 COVER

2 GENERAL NOTES AND STANDARDS

3 SUMMARY OF QUANTITIES 4 TYPICAL SECTIONS

5 ALIGNMENT AND CONTROL

9 NORTH-END PLAN AND PROFILE

13 NORTH-END SUBGRADE PLAN

14 NORTH-END LANDSCAPE PLAN 15 - 16 NORTH-END IRRIGATION PLAN

17 - 27 NORTH-END CROSS-SECTIONS

28 DETAILS

12 NORTH-END GRADING AND DRAINAGE PLAN

6 TRAFFIC CONTROL PLAN

 \circ

 \bigcirc


DESIGN SPEED = 20 MPH

POSTED SPEED = 15 MPH

ENGINEERING SCALES. REDUCED SIZED PLANS WILL NOT CONFORM TO STANDARD SCALES. IN MAKING MEASUREMENTS ON REDUCED PLANS, THE ABOVE SCALES MAY BE USED.

JOINT UTILITY LOCATION INFORMATION FOR EXCAVATION 1-800-892-0123 OR 811

VILLAGE OF GLENCOE CHICAGO BOTANIC GARDEN **COOK COUNTY**

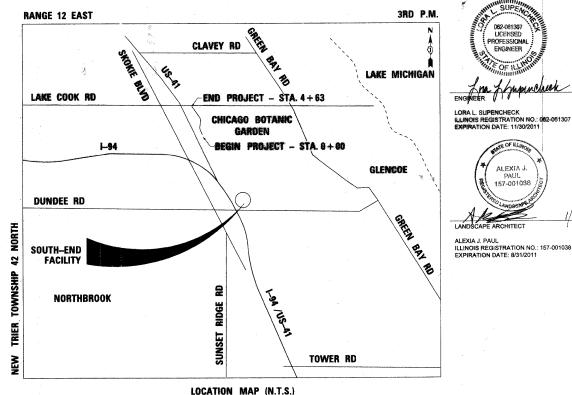

GROSS PROJECT LENGTH = 470 FEET NET PROJECT LENGTH = 470 FEET

08-00061-00-RS COOK 28 1 ILLINOIS CONTRACT NO. 63449 FED. ROAD DIST. NO. _

D-91-495-09



HNTB

DEPARTMENT OF TRANSPORTATION AGENCY RESPONSIBLE FOR LETTING 1/28/10 Lavil C. Man VILLAGE OF GLENCOE, DIRECTOR OF PUBLIC WORKS PASSED FEBRUARY ! 2010

RELEASING FOR BID

1/27/2010

REVIEW FEBRUARY 11, 2010 DEPUTY DIRECTOR OF HIGHWAYS, REGION 1 ENGINEER

PRINTED BY THE AUTHORITY OF THE STATE OF ILLINOIS

STALLWORTH (847) 705-1469 ASSOCIATE FIELD

CONTRACT NO. 63449

KEVIN

0

 \bigcirc

BEFORE STARTING EXCAVATION, THE CONTRACTOR SHALL CALL "J.U.L.I.E." AT 1-800-892-0123 OR 811 FOR FIELD LOCATIONS OF WATER MAIN, BURIED ELECTRIC, TELEPHONE AND GAS FACILITIES.

PRIOR TO INITIATION OF CONSTRUCTION, THE CONTRACTOR SHALL COORDINATE WITH THE LOCAL EMERGENCY SERVICES TO ALLOW CONTINUOUS SERVICE DURING THE CONSTRUCTION - PHASE OF THE PROJECT.

THE CONTRACTOR SHALL COORDINATE CONSTRUCTION ACTIVITIES WITH UTILITY COMPANIES, THE VILLAGE OF GLENCOE, THE CHICAGO BOTANIC GARDEN, AND THE ILLINOIS DEPARTMENT OF TRANSPORTATION

THE INFORMATION SHOWN ON THESE DRAWINGS CONCERNING THE TYPE AND LOCATION OF UNDERGROUND UTILITIES IS NOT GUARANTEED TO BE ACCURATE OR ALL INCLUSIVE. THE CONTRACTOR IS RESPONSIBLE FOR MAKING HIS OR HER OWN DETERMINATION AS TO

* THE TYPE AND LOCATION OF UNDERGROUND UTILITIES AS MAY BE NECESSARY TO AVOID & DAMAGE HERETO.

10 FEET TRANSITIONS SHALL BE USED TO MATCH PROPOSED CURB AND GUTTER TO EXISTING CURBS & GUTTERS IN THE FIELD, UNLESS OTHERWISE SHOWN. THE TRANSITIONS SHALL BE PAID FOR AS "COMBINATION CONCRETE CURB AND GUTTER, TYPE M-2.06"

THE CONTRACTOR WILL NOT BE ALLOWED TO SET UP A YARD OR FIELD OFFICE ON STATE, VILLAGE, OR CHICAGO BOTANIC GARDEN PROPERTY WITHOUT WRITTEN PERMISSION FROM THE ILLINOIS DEPARTMENT OF TRANSPORTATION.

ALL EXCESS MATERIAL (BROKEN CONCRETE, CULVERT PIPE, WASTE ROADWAY EXCAVATION, SURPLUS MATERIAL FROM SEWER TRENCHES, ETC.) SHALL BE LEGALLY DISPOSED OF OUTSIDE THE LIMITS OF THE RIGHT-OF-WAY. IT SHALL BE THE CONTRACTORS RESPONSIBILITY TO SELECT DUMP SITES AND OBTAIN PERMISSION AND ALL NECESSARY PERMITS TO USE SUCH DUMP SITES. PAYMENT FOR THIS WORK SHALL BE INCLUDED IN THE CONTRACT UNIT PRICE FOR EARTH EXCAVATION.

WHERE SECTION OR SUBSECTION MONUMENTS ARE ENCOUNTERED, THE ENGINEER SHALL BE NOTIFIED BEFORE THE MONUMENTS ARE REMOVED. THE CONTRACTOR SHALL PROTECT AND CAREFULLY PRESERVE ALL PROPERTY MARKS AND MONUMENTS UNTIL THE OWNER, AUTHORIZED SURVEYOR OR AGENT HAS WITNESSED OR OTHERWISE REFERENCED THEIR LOCATION.

THE CONTRACTOR WILL BE REQUIRED TO RELOCATE OR REMOVE AND REPLACE SIGNS WHICH INTERFERE WITH HIS CONSTRUCTION OPERATIONS AND ARE NOT OTHERWISE CALLED FOR REMOVAL/RELOCATION AND TO TEMPORARILY RESET ALL SUCH SIGNS DURING CONSTRUCTION OPERATIONS AS STATED IN ARTICLE 107.25 OF THE STANDARD SPECIFICATIONS. THIS WORK SHALL NOT BE PAID FOR SEPARATELY BUT SHALL BE INCLUDED IN THE CONTRACT EXCEPT WHERE NOTED ON THE PLANS.

ALL RADII FOR THE PROPOSED CURB AND GUTTER ARE TO THE EDGE OF PAVEMENT AND SHALL BE CONSTRUCTED AS SPECIFIED IN THE PLANS.

THE ELEVATIONS SHOWN ON THE PLANS ARE FINISHED GRADES OF THE PROPOSED PAVEMENT, UNLESS OTHERWISE INDICATED. BEFORE SETTING THE TOP OF CURB ELEVATION, THE ENGINEER SHALL CHECK THE EXISTING ELEVATIONS AT THE ADJACENT PROPERTY LINE AND, IF NECESSARY, REQUIRE THE CONTRACTOR TO VARY THE CURB EXPOSURE AND/OR GUTTER ELEVATIONS TO MORE CLOSELY MEET THE PROPERTY LINE GRADES.

ALL ELEVATIONS REFER TO U.S.G.S. MEAN SEA LEVEL DATUM.

ALL SAW CUTS NECESSARY FOR STAGING AND THE REMOVAL OF ITEMS WILL NOT BE PAID FOR SEPARATELY, BUT SHALL BE INCLUDED IN THE COST OF THE ITEMS BEING REMOVED.

DRIVEWAY PAVEMENT COMPOSED OF PORTLAND CEMENT CONCRETE OR BITUMINOUS PAVEMENT SHALL BE MEASURED AND PAID FOR AS "DRIVEWAY PAVEMENT REMOVAL" IN ACCORDANCE WITH SECTION 440 OF THE STANDARD SPECIFICATIONS.

ALL EXISTING GRANULAR AND BITUMINOUS MATERIALS TO BE REMOVED AND NOT PAID AS A SPECIFIC ITEM SHALL BE CONSIDERED EARTH EXCAVATION AND WILL BE PAID FOR AT THE CONTRACT UNIT PRICE FOR EARTH EXCAVATION.

THE COST OF MAKING SEWER CONNECTIONS TO EXISTING DRAINAGE STRUCTURES/PIPES SHALL BE INCLUDED IN THE VARIOUS CONTRACT UNIT PRICES FOR STORM SEWER WORK.

WHEN EXISTING DRAINAGE OR SEWER FACILITIES ARE DISTURBED, THE CONTRACTOR SHALL PROVIDE AND MAINTAIN TEMPORARY OUTLETS AND CONNECTIONS FOR ALL PRIVATE OR PUBLIC DRAINS, SEWERS, INLETS OR CATCH BASINS. THE CONTRACTOR SHALL BE PREPARED AT ALL TIMES TO DISPOSE OF THE WATER RECEIVED FROM THESE TEMPORARY CONNECTIONS UNTIL SUCH TIME AS THE PERMANENT CONNECTIONS WITH SEWERS ARE BUILT AND IN SERVICE. THIS WORK SHALL NOT BE PAID FOR SEPARATELY, BUT SHALL BE INCLUDED IN THE PAYMENT FOR THE STORM SEWER CONSTRUCTION AND THE RESPECTIVE STORM SEWER ITEMS. TEMPORARY CONNECTIONS SHALL BE MADE WITH PIPE OR FLUMES OF EQUAL SIZE PIPE OR LARGER.

THE CONTRACTOR SHALL NOT START WORK BEFORE AUGUST 15, 2010 WITHIN THE NORTH-END, CHILDREN'S LEARNING CENTER CAMPUS AS DIRECTED BY THE CHICAGO BOTANIC GARDEN. WORK CAN BEGIN AT AN EARLY DATE, BUT NOT BEFORE JULY 1, 2010 FOR SITE PREPARATION ACTIVITIES AND STORM SEWER INSTALLATION AT THE SOUTH-END FACILITY AT THE SOUTHERN LIMITS OF THE CHICAGO BOTANIC GARDEN.

280001-05	TEMPORARY EROSION CONTROL SYSTEMS
420001-07	PAVEMENT JOINTS
424001-05	CURB RAMPS FOR SIDEWALKS
542301-02	PRECAST REINFORCED FLARED END SECTION
602001-01	CATCH BASIN TYPE A
602301-02	INLET - TYPE A
602401-02	MANHOLE TYPE A
602701-02	MANHOLE STEPS
604001-03	FRAME AND LIDS TYPE 1
604036-02	GRATE TYPE 8
604066-02	FRAME AND LID TYPE 15
606001-04	CONCRETE CURB TYPE B AND COMBINATION CONCRETE CURB AND GUTTER
701001-02	OFF-RD OPERATIONS, 2L, 2W, MORE THAN 15' AWAY
701006-03	OFF-RD OPERATIONS, 2L, 2W, 15' TO 24" FROM PAVEMENT EDGE
701901-01	TRAFFIC CONTROL DEVICES

DISTRICT 1 DETAIL SHEET

TC-13

DISTRICT ONE TYPICAL PAVEMENT MARKINGS

STATE OF ILLINOIS
DEPARTMENT OF TRANSPORTATION

· · · · · · · · · · · · · · · · · · ·						
CHICAGO BOTANIC GARDEN - CLC ENTRYWAY	F.A. RTE	SEC.	TION	COUNTY	TOTAL SHEETS	SHEET NO.
GENERAL NOTES AND STANDARDS	N/	A 08-0006	1-00-RS	соок	28	2
GENERAL MOTES AND STANDARDS				CONTRAC	T NO. 6	53449
SCALE: N.T.S. SHEET NO. 1 OF 1 SHEETS STA. N/A TO STA. N/	'A FED.	. ROAD DIST. NO	ILLINOIS FED. AI	D PROJECT		

SUMMARY OF QUANTITIES

	CODE NO.	PAY ITEM DESCRIPTION	UNIT	TOTAL QUANTITY	ROADWAY 80% FEDERAL 20% LOCAL IOOO-2A		CODE NO.	PAY ITEM DESCRIPTION
	20101100	TREE TRUNK PROTECTION	E.ACH	11	11	* #	70,000 1550	PVC WATER MAIN 6"
	20101200	TREE ROOT PRUNING	EACH	5	5	* #	7,7,000,70	WATER SERVICE LINE, SPECIAL
	20101400	NITROGEN FERTILIZER NUTRIENT	POUND	70	70	* #		GATE VALVE AND BOX 6"
	20101500	PHOSPHORUS FERTILIZER NUTRIENT	POUND	70	70	* #		STOP VALVE 3/4" AND VALVE BOX
	20101600	POTASSIUM FERTILIZER NUTRIENT	POUND	70 .	70	* #	7171001100	QUICK COUPLE
	20200100	EARTH EXCAVATION	CU YD	2,600	2,600	* #	XX007263	GATE VALVE WITH BOX 4"
	20200410	EARTH EXCAVATION (SPECIAL)	CU YD	4,830	4,830	*	XX008001	AGGREGATE PATH, 8"
	20700420	POROUS GRANULAR EMBANKMENT, SUBGRADE	CU YD	1,310	1,310	* #	XX008185	PVC WATER MAIN 4"
	20800150	TRENCH BACKFILL	CU YD	151	151	* #	XX011700	WATER MAIN FITTINGS
	21101665	TOPSOIL FURNISH AND PLACE, 18"	SQ YD	6,038	6,038	* #	CZC014G5	SHRUB, CORNUS MAS 'DRIPPING CHERRIES' (DRIPPING CHERRIES CORNELIAN CHERRY DOC
	25000200	SEEDING, CLASS 2	ACRE	0.53	0.53			WOOD), 5-GALLON CONTAINER
	25200100	SODDING	SQ YD	5,618	5,618	* #	CZCOZYGZ	SHRUB, DIERVILLA 'COOL SPLASH' (COOL SPLASH DIERVILLA), 2 Gallon Cont.
	25400100	PERENNIAL PLANTS	UNIT	16.80	16.80	* #	AZ005055	TREE, GYMNOCLADUS DIOICUS 'PRAIRIE TITAN' (PRAIRIE TITAN KENTUCKY COFFEETREE)
	25400105	PERENNIAL PLANTS	EACH	240.00	240.00			5" CALIPER, BALLED AND BURLAPPED
	28000400	PERIMETER EROSION BARRIER	FOOT	814	814	* #	AZOO7ZIZ	TREE, QUERCUS X SCHUETTI (SCHUETTES OAK), 7" CALIPER, BALLED AND BURLAPPED
	28000510	INLET FILTERS	EACH	11	11			
	28100105	STONE RIPRAP, CLASS A3	SQ YD	5	5			
	28200200	FILTER FABRIC	SQ YD	5.	5			
		AGGREGATE BASE COURSE, TYPE B 12"	SQ YD	2,150	2,150			
	35102400	BITUMINOUS MATERIALS (PRIME COAT)	GALLON	1	1,072			
	40300100		TON	270	270			
	40603080	HOT-MIX ASPHALT BINDER COURSE, IL-19.0, N50	TON	180	180			
	40603310	HOT-MIX ASPHALT SURFACE COURSE, MIX "C", N50			3,585			
	42400200	PORTLAND CEMENT CONCRETE SIDEWALK 5 INCH	SQ FT	3,585	•			
	42400800	DETECTABLE WARNINGS	SQ FT	76	76			
	44000200	DRIVEWAY PAVEMENT REMOVAL	SQ YD	82	82	1		
	44000500	COMBINATION CURB AND GUTTER REMOVAL	FOOT	1,972	1,972			
	48301000	PROTECTIVE COAT	SQ YD	590	590			
	54213657	PRECAST REINFORCED CONCRETE FLARED END SECTIONS 12"	EACH	1	1			
	550A0050	STORM SEWERS, CLASS A, TYPE 1 12"	FOOT	213	213			
	550A0340	STORM SEWERS, CLASS A, TYPE 2 12"	FOOT	183	183	11		
	550A0360	STORM SEWERS, CLASS A, TYPE 2 15"	FOOT	50	50			
	55100300	STORM SEWER REMOVAL 8"	FOOT	122	122		1.5	
	55100700	STORM SEWER REMOVAL 15"	FOOT	50	50			
	60107600	PIPE UNDERDRAINS 4"	FOOT	812	812			
	60108000	PIPE UNDERDRAINS 12"	F00T	186	186			
	60200805	CATCH BASINS, TYPE A, 4'-DIAMETER, TYPE 8 GRATE	EACH	2	2			
	60201305	CATCH BASINS, TYPE A, 4'-DIAMETER, TYPE 15 FRAME AND LID	EACH	2	2			
	60218400	MANHOLES, TYPE A, 4'-DIAMETER, TYPE 1 FRAME, CLOSED LID	EACH	4	4			
	60219000	MANHOLES, TYPE A, 4'-DIAMETER, TYPE 8 GRATE	EACH	. 2	2	-		
	60237000	INLETS, TYPE A, TYPE 15 FRAME AND LID	EACH	2	2			
	60250200	CATCH BASINS TO BE ADJUSTED	EACH	1	1			
	60255500	MANHOLES TO BE ADJUSTED	EACH	1	1			
	60500060	REMOVING INLETS	EACH	3	3			
	60600605	CONCRETE CURB, TYPE B	FOOT	532	532			
	60608250	COMBINATION CONCRETE CURB AND GUTTER, TYPE M-2.06	FOOT	949	949			
	60608600	COMBINATION CONCRETE CURB AND GUTTER, TYPE M-6.06	FOOT	202	202			
	66411900	TEMPORARY FENCE	FOOT	750	750			, 4
	67000400	ENGINEER'S FIELD OFFICE, TYPE A	CAL MO	i .	6			
	67100100	MOBILIZATION	L SUM	1	1			
		TRAFFIC CONTROL AND PROTECTION (SPECIAL)	L SUM	1	1	11		
	70101800	THERMOPLASTIC PAVEMENT MARKING - LETTERS AND SYMBOLS	SQ FT	25	25			
	78000100		FOOT	328	328			
	78000200	THERMOPLASTIC PAVEMENT MARKING - LINE 4"	FOOT	48	48			
	78000400	THERMOPLASTIC PAVEMENT MARKING - LINE 6"		ı	1			
1	78000650	THERMOPLASTIC PAVEMENT MARKING - LINE 24"	FOOT	27	27			
	Z0013798	CONSTRUCTION LAYOUT	L SUM	1 70	1 70			
	C2008318	SHRUB, ROSA PURPLE PAVEMENT (PURPLE PAVEMENT ROSE), 18" HEIGHT, CONTAINER	EACH	70	70			
	K0030421	PERENNIAL PLANTS, NARCISSUS	UNIT	30.00	30.00			
	K1004465	PERENNIAL PLANTS, BULBS	UNIT	12.00	12.00			
	K1005875	TREE TRANSPLANT	EACH	5	5			
	X0656300	PAVEMENT REMOVAL AND REPLACEMENT	SQ YD	6	6			
	XX000052	REMOVE EXISTING WATERMAIN	FOOT	879	879			
	XX003885	IRRIGATION SYSTEM	L SUM	1	1	1 1	1	1

- * DENOTES SPECIAL PROVISIONS
- # DENOTES SPECIALITY ITEM

- * DENOTES SPECIAL PROVISIONS
- * DENOTES SPECIALITY ITEM

FILE NAME =	USER NAME = Isupencheck	DE
49105_sht_sum-quant.dgn		ĎΕ
TUL		CH
DESIGNED BY	PLOT DATE =	D٨

_	USER NAME = Isupencheck	DESIGNED	-	LLS	REVISED	-	W 44 100
		DRAWN	-	LLS	REVISED	-	
	-	CHECKED	-	KJK	REVISED	-	
	PLOT DATE =	DATE		02/16/2010	REVISED	-	

STATE	E OF	ILLINOIS	
DEPARTMENT	OF	TRANSPORTATION	

CHICAGO BOTANIC GARDEN - CLC ENTR	YWAY	RTE. SECTION	COUNTY TOTAL SHEET NO.
OUNTERDY OF OUR STITE	1,	/N/A 08-00061-00-RS	COOK 28 3
SUMMARY OF QUANTITIES	2 × 1 ×		CONTRACT NO. 63449
SCALE: N.T.S SHEET NO.1 OF 1 SHEETS STA. N/A	TO STA, N/A	FED. ROAD DIST. NO ILLINOIS FED. A	ID PROJECT

SUMMARY OF QUANTITIES

ROADWAY 80% FEDERAL

20% LOCAL I000-2A

670

2,192

2

13

22

291

389

960

254

148

9

1

TOTAL

QUANTITY

670

2,192

2

13

22

291

389

960

254

148

9

UNIT

FOOT

FOOT

EACH

EACH

EACH

EACH SQ YD

FOOT


POUND


EACH


EACH


EACH


EACH

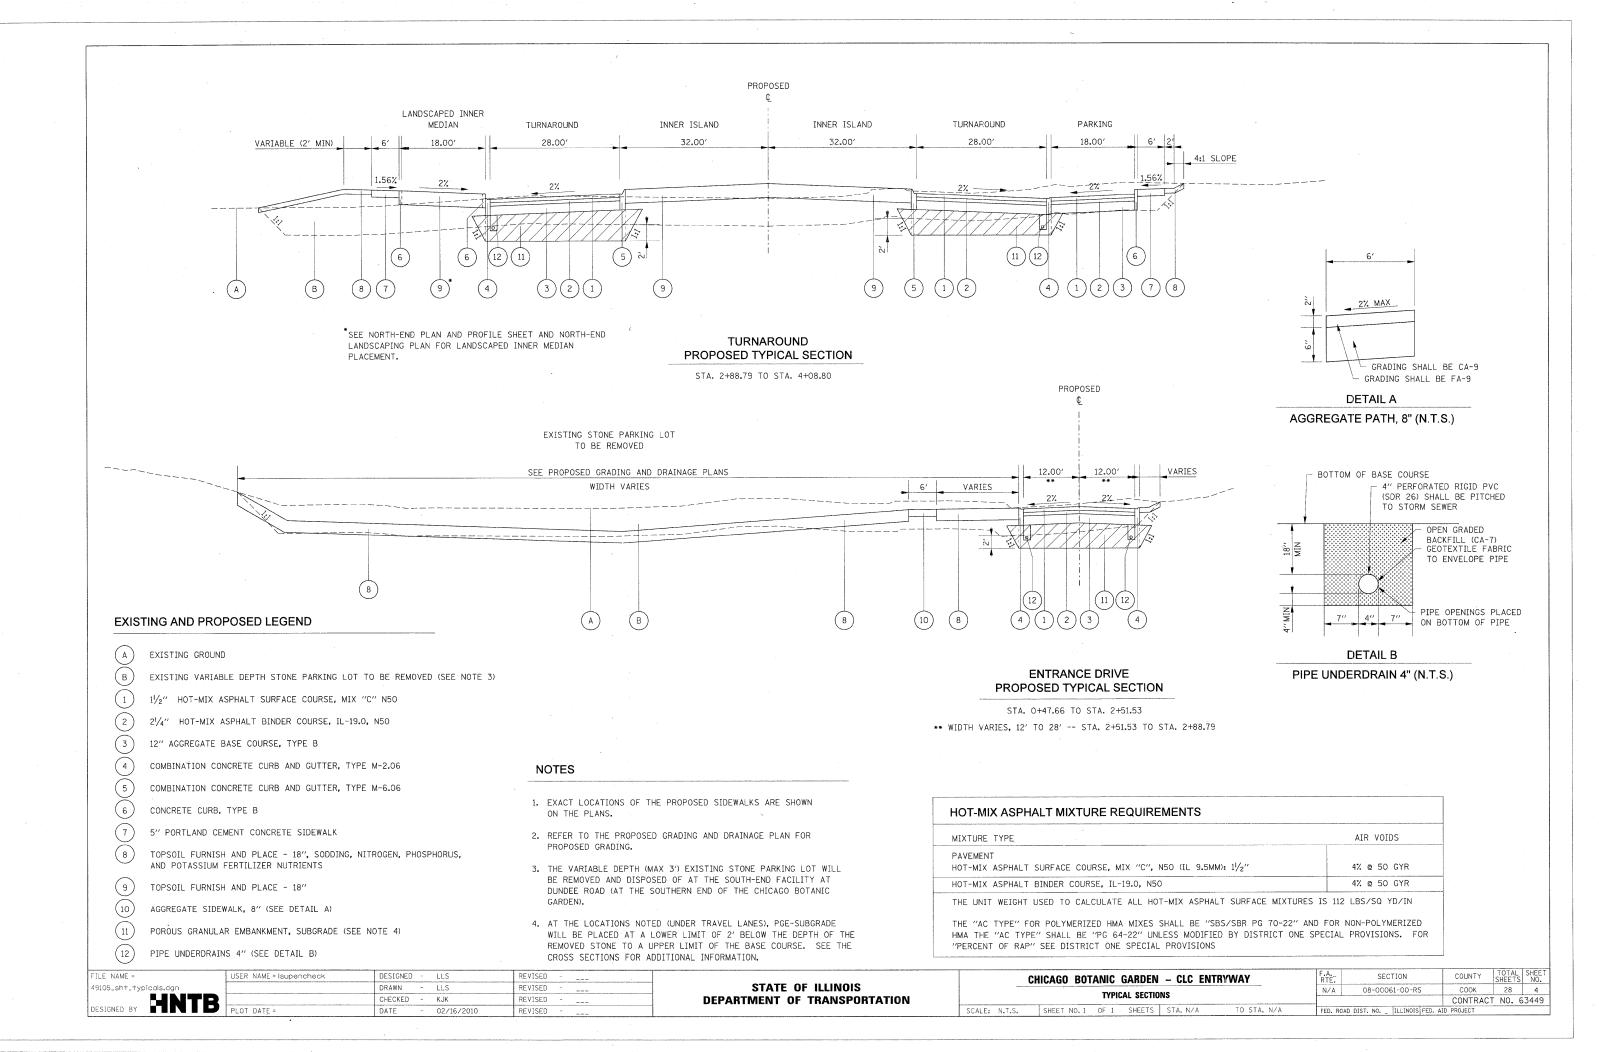


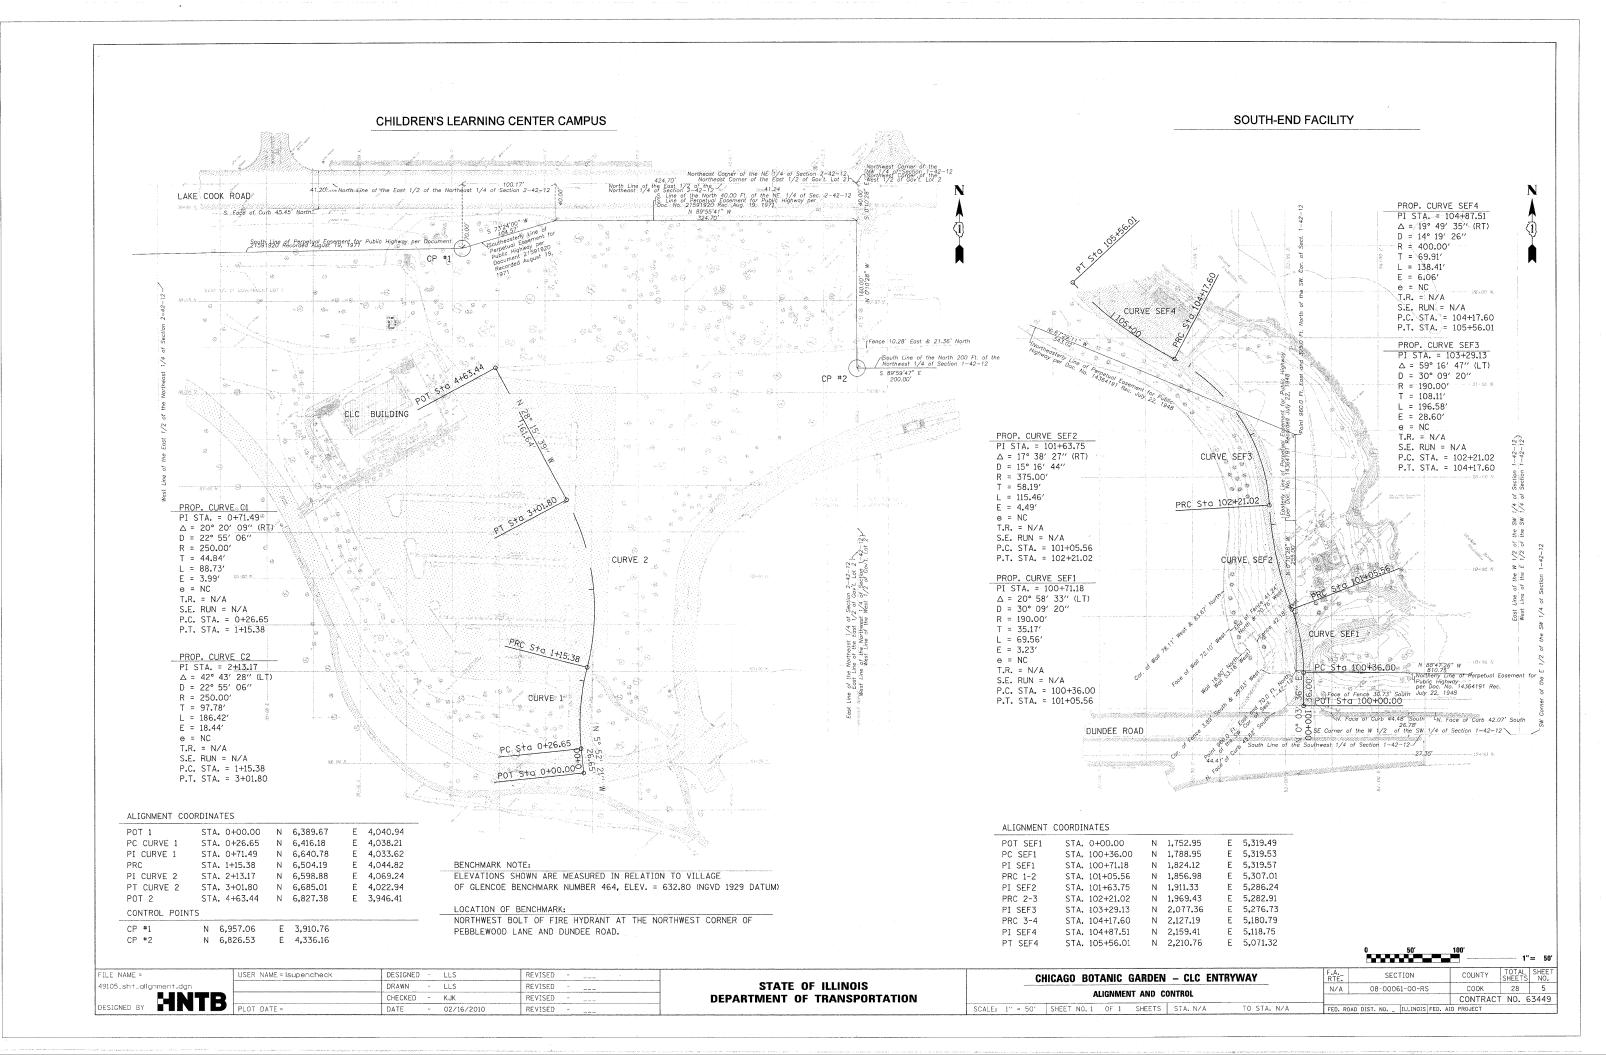

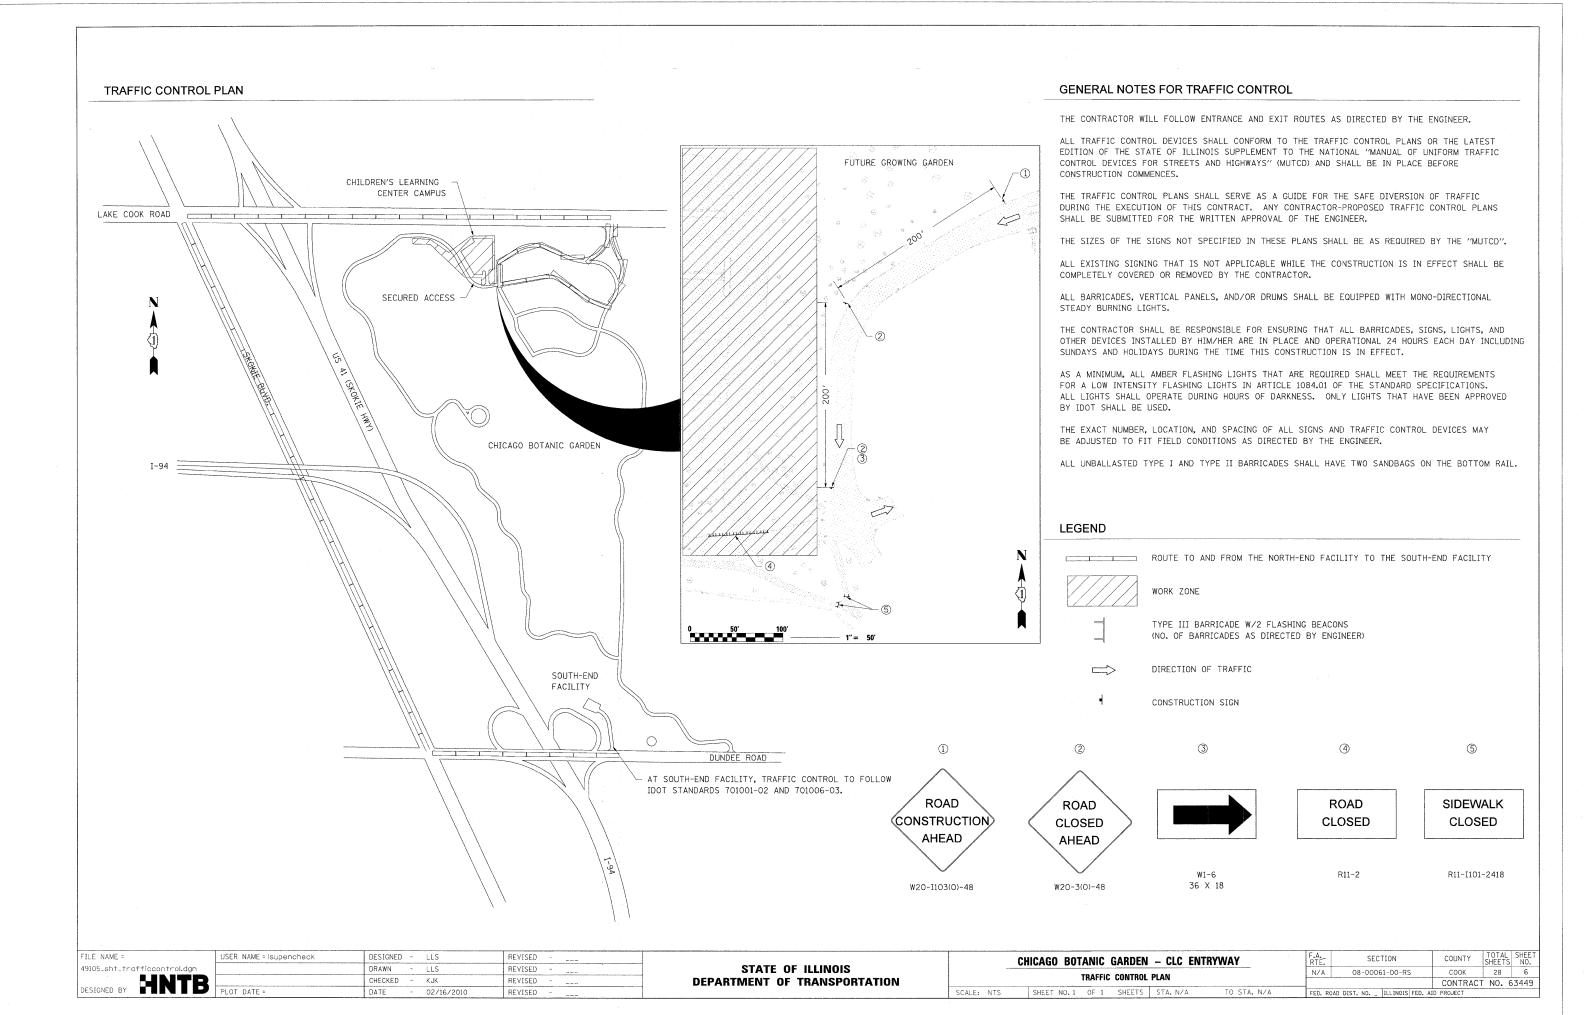


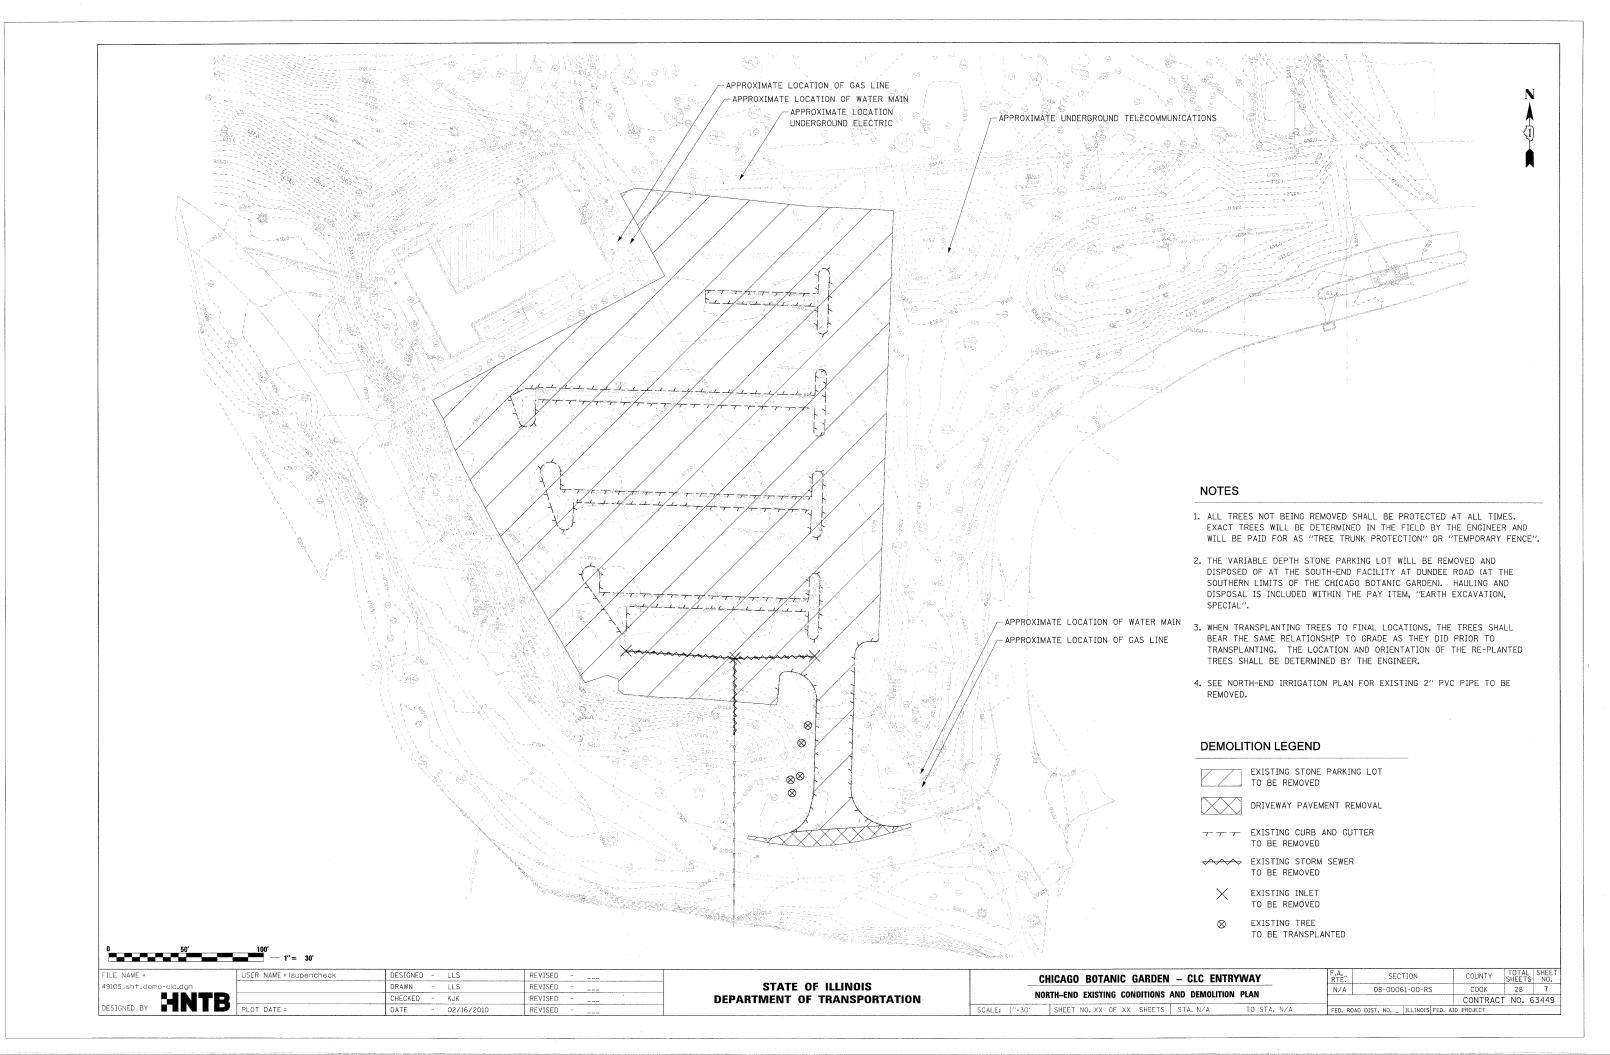

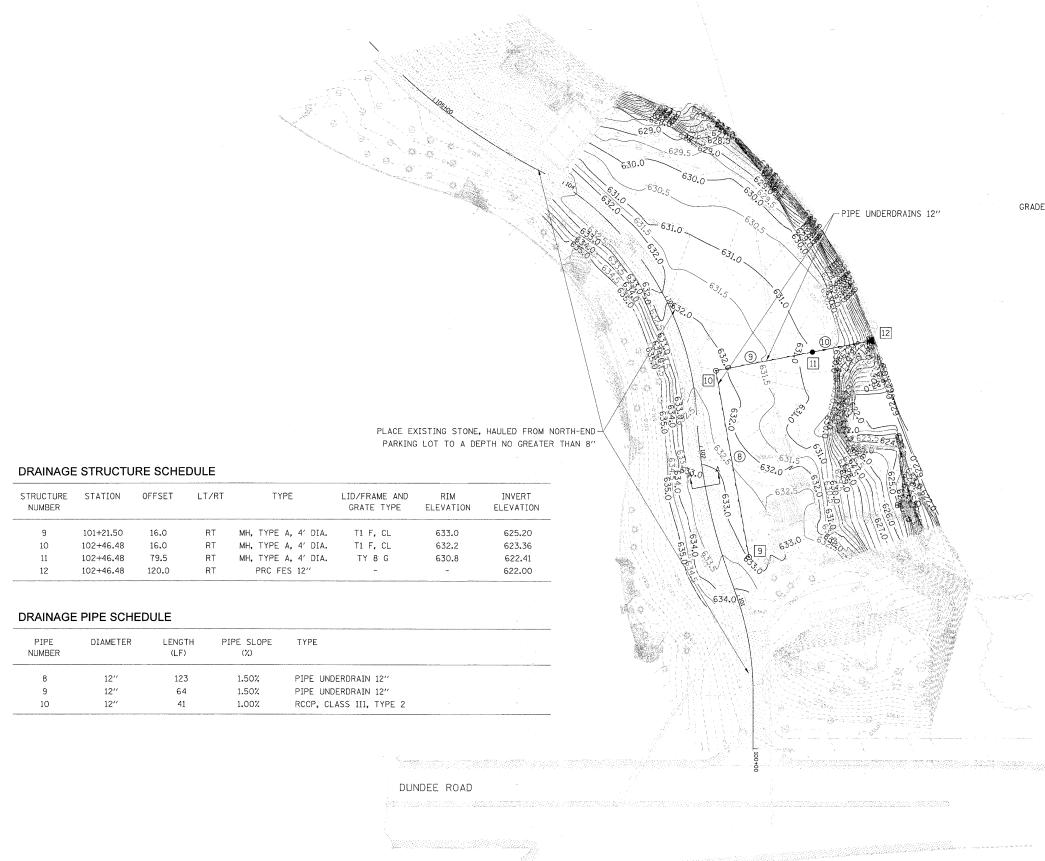

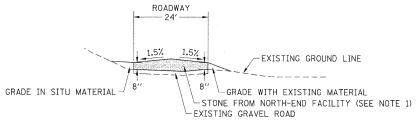

SECTION A-A (N.T.S.)

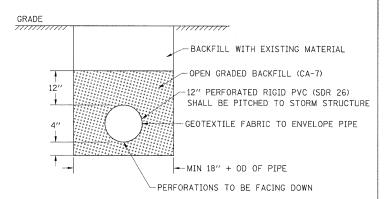

DETAIL FOR PIPE UNDERDRAINS 12" (N.T.S.)


SOUTH-END GRADING AND DRAINAGE PLAN NOTES


- STONE REMOVED FROM THE EXISTING NORTH-END PARKING LOT WILL BE DISPOSED AT THIS LOCATION. STONE WILL BE PLACED ON EXISTING GRAVEL ROAD TO A MAXIMUM THICKNESS OF 8 INCHES. SEE SECTION A-A.
- 2. FINAL GRADING FOR THE SOUTH-END FACILITY WILL FOLLOW SECTION 212 IN THE STANDARD SPECIFICATIONS.


LEGEND

- X DRAINAGE STRUCTURE

	1 – 30							
FILE NAME =	USER NAME = Isupencheck	DESIGNED -	LLS	REVISED		CHICAGO BOTANIC GARDEN – CLC ENTRYWAY	F.A. SECTION	COUNTY TOTAL SHEET
49105_sht_grading-mulch.dgn		DRAWN -	LLS	REVISED	STATE OF ILLINOIS		N/A 08-00061-00-RS	COOK 28 8
DESIGNED BY HNTB F		CHECKED -	KJK	REVISED	DEPARTMENT OF TRANSPORTATION	SOUTH-END EXISTING CONDITIONS AND GRADING PLAN		CONTRACT NO. 63449
	PLOT DATE =	DATE -	02/16/2010	REVISED		SCALE: 1"=30' SHEET NO. 1 OF 1 SHEETS STA. N/A TO STA. N/A	FED. ROAD DIST. NO ILLINOIS F	FED. AID PROJECT

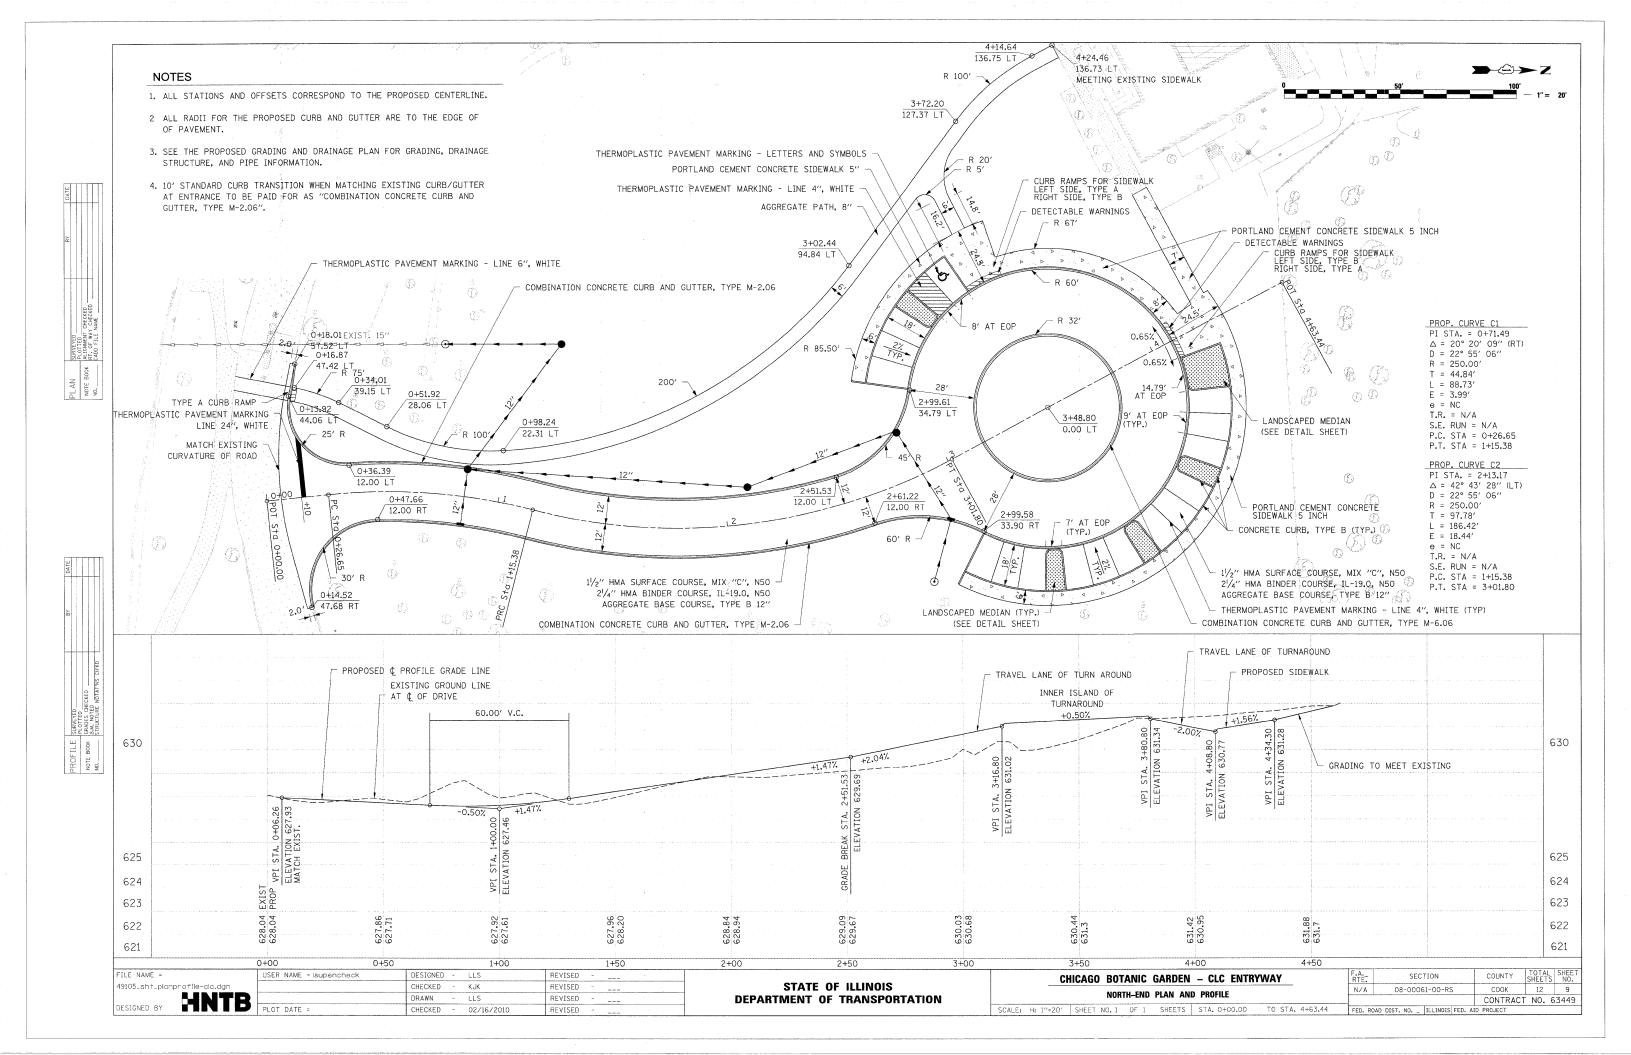

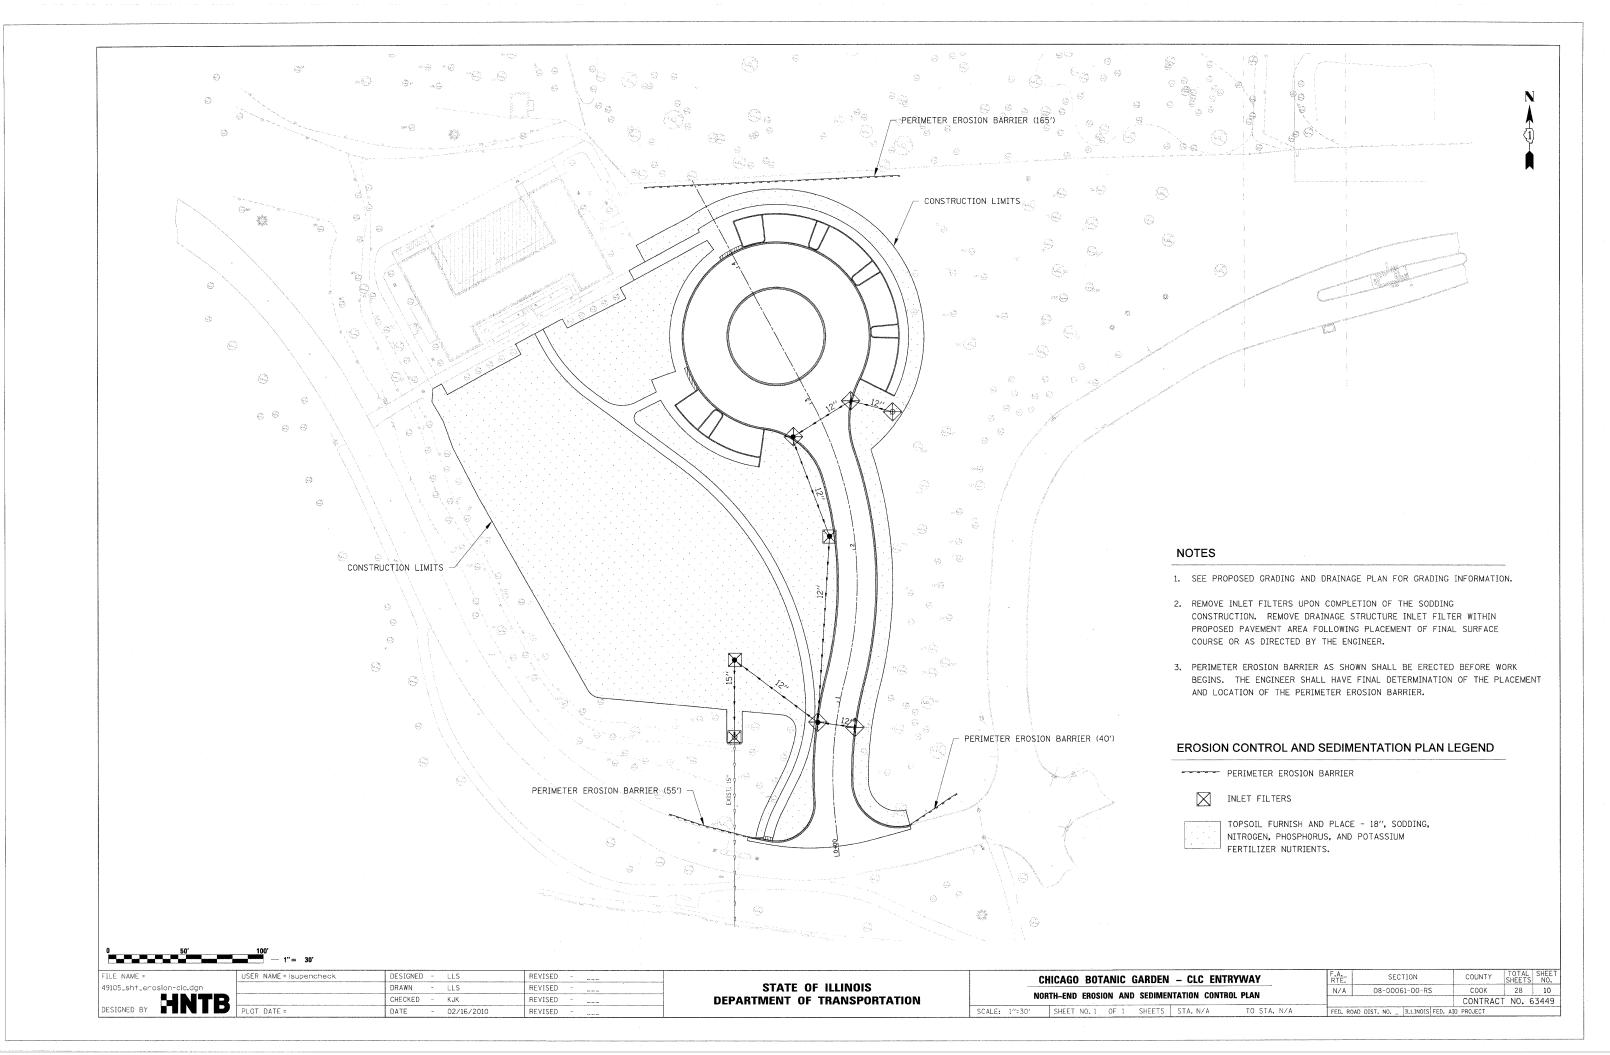

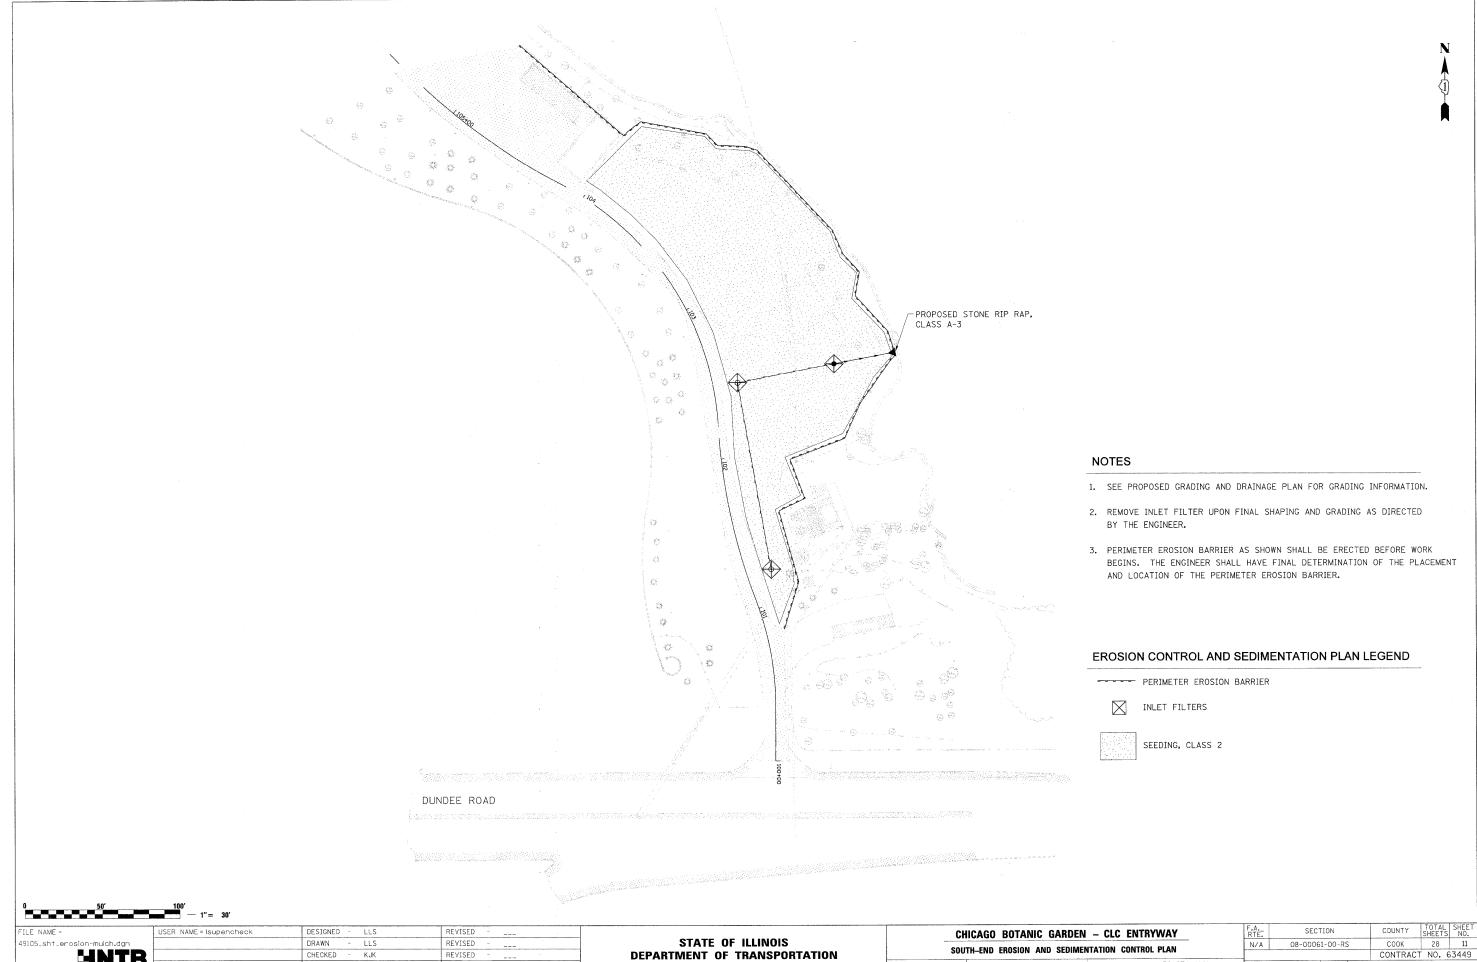

49105_sht_erosion-mulch.dgn
DESIGNED BY HNTB PLOT DATE =

CHECKED - KJK REVISED REVISED

DEPARTMENT OF TRANSPORTATION

CHICAGO BOTANIC GARDEN – CLC ENTRYWAY	F.A RTE.	SECTION	COL
SOUTH-END EROSION AND SEDIMENTATION CONTROL PLAN	N/A	08-00061-00-RS	CC
20014-END EKOSION WAD SEDIMENTATION CONTROL FLAN			CON
SCALE: 1"=30" SHEET NO. 1 OF 1 SHEETS STA. N/A TO STA. N/A	FED. R	OAD DIST. NO ILLINOIS FED. A	.ID PROJE



Ś	TRUCTU NUMBEF	–	STATION	OFFSET	LT/RT	TYPE	LID/FRAME AND GRATE TYPE	RIM ELEVATION	INVERT ELEVATION
	1		0+72.08	64.6	LT	MH, TYPE A, 4' DI	A. T1 F, CL	632.3	623.33
	2		1+10.88	72.5	LT	CB, TYPE A, 4' DI	A. TY 8 G	626.0	623.50
	3		0+85.22	12.0	: LT	CB, TYPE A, 4' DI	A. T15 F & L	627.34	623.84
	4		0+85.22	12.0	RT	IN, TYPE A	T15 F & L	627.34	623.96
	5	:	2+10.75	15.8	LT	CB, TYPE A, 4' DI	A. TY 8 G	628.8	624.45
	6		2+84.80	21.7	LT	CB, TYPE A, 4' DI	A. T15 F & L	629.66	624.79
	7		2+90.27	22.9	RT	IN, TYPE A	T15 F & L	629.68	625.02
	8		2+74.79	44.7	RT	MH, TYPE A, 4' DI	A. T1 F, CL	630.7	625.16

STATIONS, OFFSETS, AND RIM ELEVATIONS FOR ALL INLETS AND CATCH BASINS LOCATED IN CURB AND GUTTER ARE GIVEN AT THE EDGE OF PAVEMENT.

DRAINAGE PIPE SCHEDULE

	PIPE NUMBER	DIAMETER	LENGTH (LF)	PIPE SLOPE (%)	TYPE	
	1	15′′	50	0.34%	RCCP, CLASS III, TYPE 2	
	2	12"	68	0.50%	RCCP, CLASS IV, TYPE 1	,
	3	12"	24	0.50%	RCCP, CLASS IV, TYPE 1	
	4	12"	121	0.50%	RCCP, CLASS IV, TYPE 1	
	5	12''	69	0.50%	RCCP, CLASS III, TYPE 2	
	6	12''	45	0.50%	RCCP, CLASS III, TYPE 2	
1 897	7	12''	28	0.50%	RCCP, CLASS III, TYPE 2	

LEGEND

X DRAINAGE STRUCTURE

X PIPE

GRADING AND DRAINAGE PLAN NOTES

- SEE THE NORTH-END PLAN AND PROFILE SHEET FOR TURNAROUND AND DRIVE GEOMETRICS.
- 2. SEE THE NORTH-END EROSION AND SEDIMENTATION CONTROL PLAN SHEET FOR ALL EROSION CONTROL ACTIVITIES.
- 3. SEE TRAFFIC CONTROL PLAN FOR TRAFFIC CONTROL NOTES.


FILE NAME =
49105_sht_grading-clc.dgn


DESIGNED BY HNTB

USER NAME = Isupencheck	DESIGNED	-	LLS	REVISED	-	 ŕ	
	DRAWN	-	LLS	REVISED	-		
	CHECKED	-	KJK	REVISED	-		
PLOT DATE =	DATE	-	02/16/2010	REVISED	-		

STATE OF ILLINOIS
DEPARTMENT OF TRANSPORTATION

CHICAGO BOTANIC GARDEN – CLC ENTRYWAY	F.A RTE.	SECTION	COUNTY	TOTAL	SHEET NO.
MODELL CAID CRADING AND DRAINAGE DIAM	N/A	08-00061-00-RS	COOK	28	12
NORTH-END GRADING AND DRAINAGE PLAN			CONTRACT	NO. 6	53449
CALE: 1"=30' SHEET NO. 1 OF 1 SHEETS STA. N/A TO STA. N/A	FED. RO	AD DIST. NO ILLINOIS FED. AI	D PROJECT		

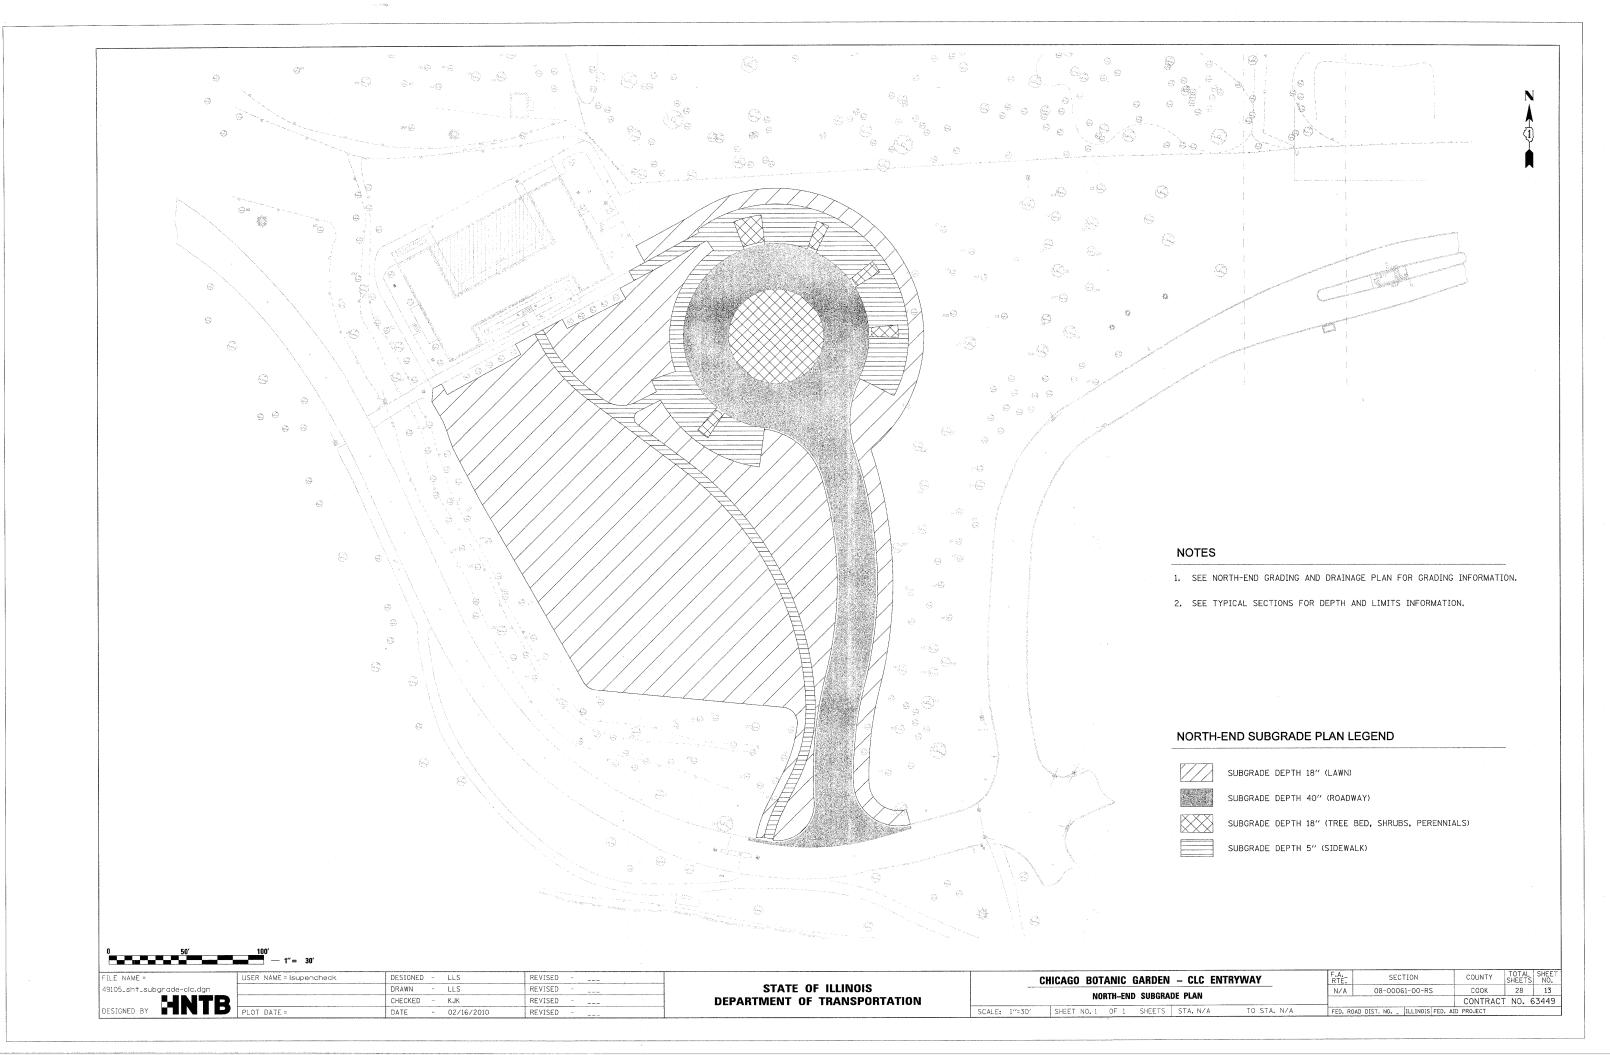

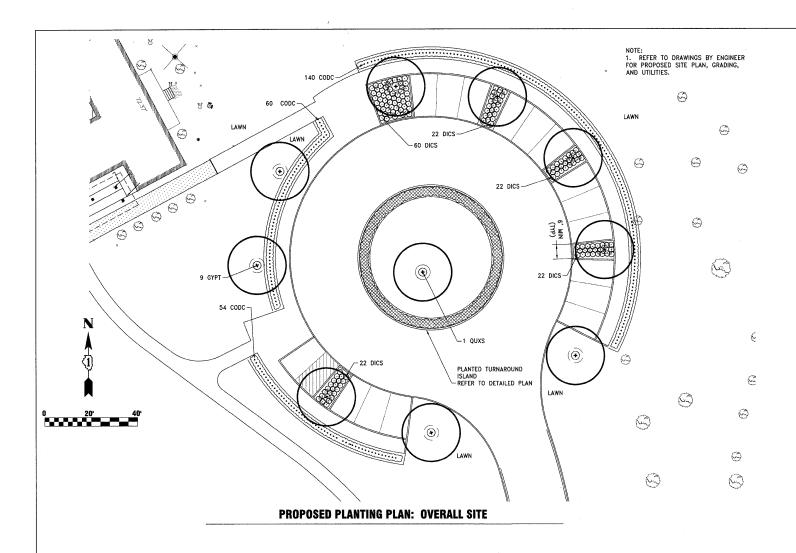

DRAWING KEY	ITEM	BOTANIC NAME	COMMON NAME	SPACING	PLANT NOTES	UNIT	QTY
	TREES						
		GYMNOCLADUS DIOICA 'PRAIRIE TITAN'	KENTUCKYCOFFEETREE	SEE PLAN	·	EACH	9
	TREE, QUERCUS X SCHUETTI (SCHUETTES OAK), 7" CALIPER, BALLED AND BURLAPPED	QUERCUS X SCHUETTI	SCHUETTES OAK	SEE PLAN		EACH	1
	SHRUBS						
		CORNUS MAS 'DRIPPING CHERRIES'	CORNELIAN DRIPPING CHERRY DOGWOOD	18" OC	DECIDUOUS HEDGE - MAINTAIN AT 36"	EACH	254
DICS	SHRUB, DIERVILLA 'COOL SPLASH' (COOL SPLASH DIERVILLA), 24" PLANT, 2 GALLON CONTAINER	DIERVILLA 'COOL SPLASH'	DIERVILLA	SEE PLAN	RECOMMEND INTERPLANTING OF BULBS FOR APRIL AND MAY INTEREST, PLANT LEAFS OUT LATE MAY	EACH	148


NOTE: REFER TO SPECIAL PROVISIONS FOR UNITS OF MEASURE

PROPOSED PLANTING SCHEDULE: OVERALL SITE

FILE NAME =	USER NAME = \$USER\$	DESIGNED	-	AJP	REVISED	-	 Γ
\$FILEL\$		DRAWN	-	AJP	REVISED	-	
		CHECKED	-		REVISED	-	
	PLOT DATE = \$DATE\$	DATE	-	2/16/2010	REVISED	-	

STATE OF ILLINOIS DEPARTMENT OF TRANSPORTATION



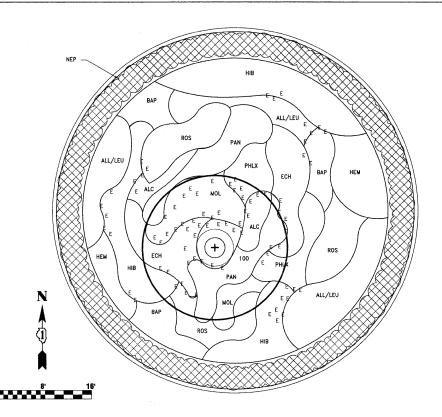



PROPOSED PLAN: TURNAROUND PLANTING BED

		I	1					
DRAWING KEY	ITEM	BOTANIC NAME	COMMON NAME	PLANTING STYLE	SPACING	PLANT NOTES	UNIT	QTY
	PERENNIAL PLANTS					TOTAL UNITS		16.80
ALC	ALCEA RUGOSA (RUSSIAN YELLOW HOLLYHOCK), 1 GALLON POT	ALCEA RUGOSA	RUSSIAN YELLOW HOLLYHOCK	IN MASSES	12" OC	6-8' TALL HOLLYHOCK, YELLOW FLOWER	UNIT	0.92
ALC	ALCEA RUGOSA (RUSSIAN YELLOW HOLLYHOCK), 1 GALLON POT	ALCEA RUGOSA	RUSSIAN YELLOW HOLLYHOCK	INTERMIXED	ONSITE LAYOUT	6-8' TALL HOLLYHOCK, YELLOW FLOWER	UNIT	1.08
BAP	BAPTISIA 'SCREAMING YELLOW' (SCREAMING YELLOW BAPTISIA), 1 GALLON POT	BAPTISIA 'SCREAMING YELLOW'	SCREAMING YELLOW BAPTISIA	IN MASSES	18" OC	2.5', GOLDEN YELLOW FLOWERS, COMPACT FORM	UNIT	0.60
ECH	ECHINACEA PURPUREA 'MERLOT' (MERLOT ECHINACEA), 1 GALLON POT	ECHINACEA PURPUREA 'MERLOT'	MERLOT ECHINACEA	IN MASSES	15" OC	5" WINE-RED FLOWERS, 30" HT	UNIT	1.60
HEM	HEMEROCALLIS 'DOUBLE RIVER WYE', 1 GALLON POT	HEMEROCALLIS 'DOUBLE RIVER WYE'	DOUBLE RIVER WYE DAYLILLIES	IN MASSES	15" OC	FRAGRANT, DOUBLE YELLOW FLOWERS ON STRONG STEMS, 30" HT	UNIT	1.60
LEU	LEUCANTHEMUM BANANA CREAM (BANANA CREAM SHASTA DAISIES), 1 GALLON POT	LEUCANTHEMUM BANANA CREAM	BANANA CREAM SHASTA DAISIES	IN MASSES	18"	15"-18" HT, PALE YELLOW FLOWERS	UNIT	2.00
NEP	NEPETA SUBSESSILLIS 'COOL CAT' (JAPANESE COOL CAT CATMINT), 1 GALLON POT	NEPETA SUBSESSILLIS 'COOL CAT'	COOL CAT JAPANESE CATMINT	IN MASSES	12" OC	LARGE LAVENDER-BLUE FLOWERS ON 24" HT X 12" W PLANTS	UNIT	8.00
PHLX	PHLOX 'NICKI' (NICKI'S PHLOX), 1 GALLON POT	PHLOX'NICKI'	NICKI FLOX	IN MASSES	15" OC	FRAGRANT MAGENTA PURPLE FLOWERS, DISEASE RESISTANT, 3' HT X 18-20" WIDTH	UNIT	1.00
	PERENNIAL PLANTS							
нв	HIBISCUS 'CRANBERRY CRUSH' (CRANBERRY CRUSH HIBISCUS), 2 GALLON CONTAINER	HIBISCUS 'CRANBERRY CRUSH'	CRANBERRY CRUSH ROSE MALLOW	IN MASSES	24" OC	SEMI-DOUBLE DARK SCARLET FLOWERS, 3'HT	EACH	130.00
MOL	MOLINIA LITORALIS 'FONTANE' (FONTAINE MOORE GRASS), 3 GALLON CONTAINER	MOLINIA LITORALIS 'FONTANE'	FONTANE MOOR GRASS	IN MASSES	30" OC	3' HT FOLIAGE, FLOWERS TO 6' HT, GRACEFUL ARCHING CULMS, GOLDEN FALL COLOR	EACH	50.00
PAN	PANICUM VIRGATUM 'HEILIGER HAIN' (HEILIGER HAIN PANIC GRASS), 3 GALLON CONTAINER	PANICUM VIRGATUM 'HEILIGER HAIN'	BLUE SWITCH GRASS	IN MASSES	24" OC	4' BLUISH FOLIAGE, STRONG BURGUNDY FALL COLOR	EACH	60.00
	SHRUBS							
ROS	SHRUB, ROSA PURPLE PAVEMENT (PURPLE PAVEMENT ROSE), 18" HEIGHT, CONTAINER	ROSA (PAVEMENT)	(PAVEMENT CV)	IN MASSES	30" OC		EACH	70.00
	PERENNIAL PLANTS, NARCISSUS					TOTAL UNITS		30.00
NAR	NARCISSUS 'CURLY LACE' (CURLY LACE NARCISSUS), BULB	NARCISSUS 'CURLY LACE'	CURLY LACE NARCISSUS	INTERMIX	ONSITE LAYOUT	YELLOW FLOWERS AT 18" HT MID-SPRING	UNIT	30.00
	PERENNIAL PLANTS, BULBS					TOTAL UNITS		12.00
ALL	ALLIUM GLADIATOR (GLADIATOR ORNAMENTAL ONION), BULB	ALLIUM GLADIATOR	GLADIATOR ALLIUM	MIXW/ LEUCANTHEMUM	18" OC	6" PURPLE FLOWERS ON 42" STEMS	UNIT	1.80
ALL	ALLIUM GLADIATOR (GLADIATOR ORNAMENTAL ONION), BULB	ALLIUM GLADIATOR	GLADIATOR ALLIUM	MIX W/ BAPTISIA	18" OC	6" PURPLE FLOWERS ON 42" STEMS	UNIT	0.80
ALL	ALLIUM GLADIATOR (GLADIATOR ORNAMENTAL ONION), BULB	ALLIUM GLADIATOR	GLADIATOR ALLIUM	INTERMIXED	ONSITE LAYOUT	6" PURPLE FLOWERS ON 42" STEMS	UNIT	7.40
E	EREMURUS X RUBUSTUS (DESERT CANDLE), BULB	EREMURUS X RUBUSTUS	DESERT CANDLE	INTERMIXED	ONSITE LAYOUT	PINK FLOWERS ON 8-10' STALKS	UNIT	2.00


NOTE: REFER TO SPECIAL PROVISIONS FOR UNITS OF MEASURE

PLANTING SCHEDULE: TURNAROUND PLANTING BED

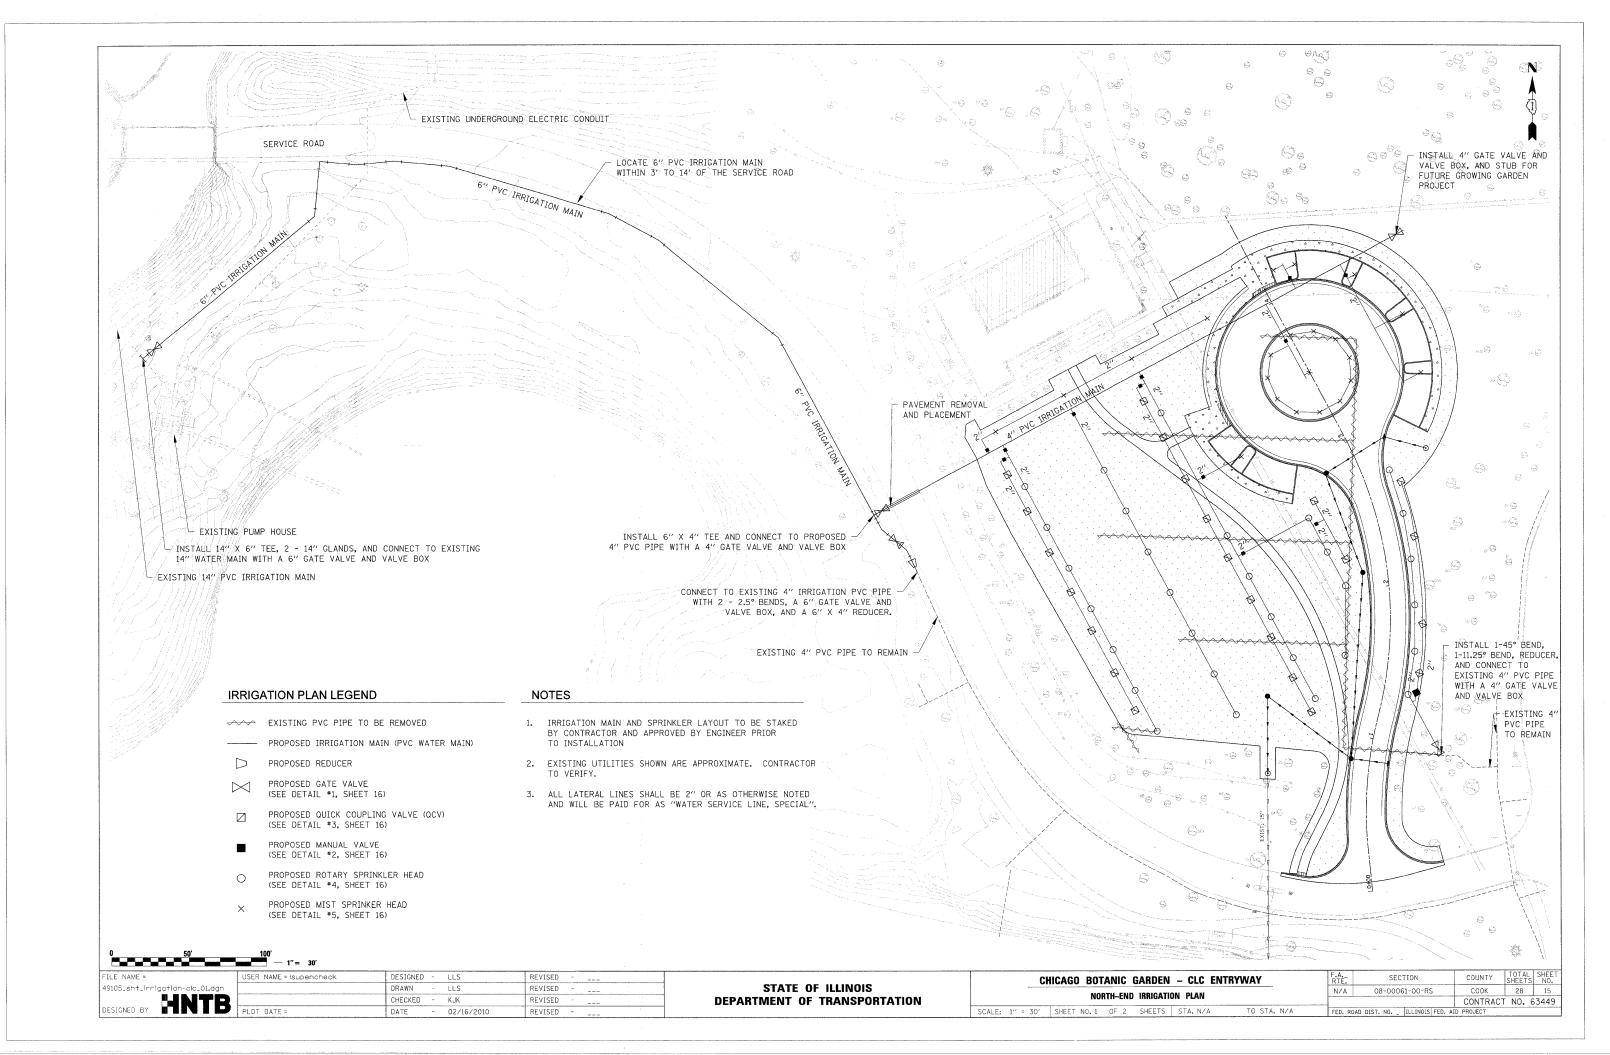


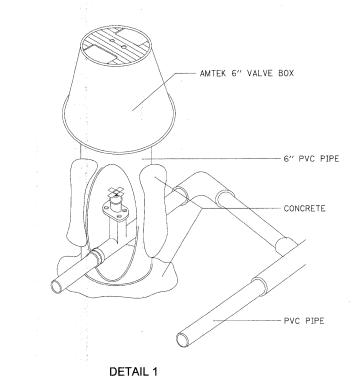

GATE VALVE INSTALLATION (N.T.S.)

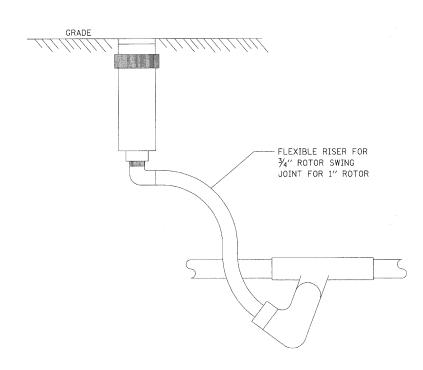


DETAIL 4
ROTARY SPRINKLER INSTALLATION (N.T.S.)

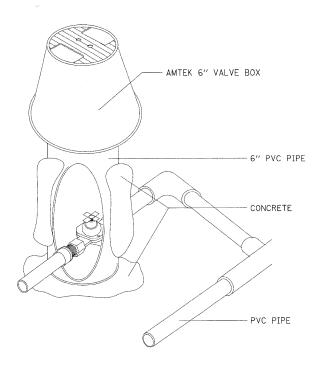


DETAIL 2

MANUAL VALVE INSTALLATION (N.T.S.)

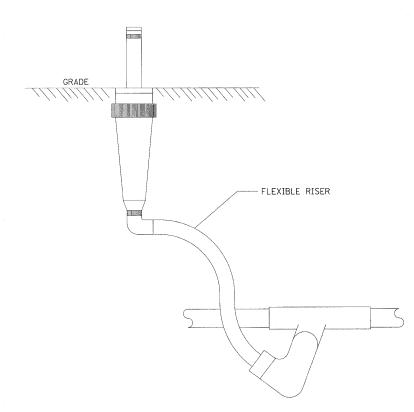


DETAIL 5
MIST SPRAY SPRINKLER INSTALLATION (N.T.S.)

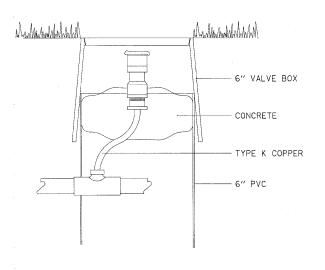

DETAIL 3

QUICK COUPLE VALVE INSTALLATION (N.T.S.)

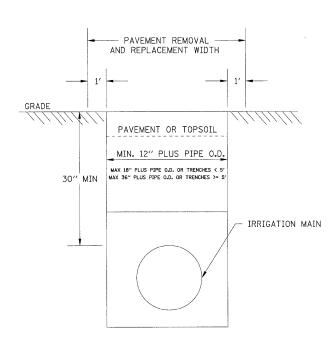

DETAIL 6
IRRIGATION PIPE TRENCH DETAIL (N.T.S.)

FILE NAME =
49105_sht_irrigation-clc_02.dgn
"JNTD
DESIGNED BY

USER NAME = Isupencheck	DESIGNED	-	LLS	REVISED	-	
	DRAWN	-	LLS	REVISED	-	
	CHECKED	-	KJK .	REVISED	-	
PLOT DATE =	DATE	-	02/16/2010	REVISED	-	

STATE OF ILLINOIS
DEPARTMENT OF TRANSPORTATION

CHICAGO BOTANIC GARDEN – CLC ENTRYWAY NORTH-END IRRIGATION PLAN						SECTION	COUNTY	TOTAL SHEETS	SHEET NO.
						08-00061-00-RS	COOK	28	16
							CONTRACT	NO. 6	3449
CALE: N.T.S.	SHEET NO. 2 OF 2	SHEETS	STA. N/A	TO STA. N/A	FED. RO	AD DIST. NO ILLINOIS FED. AI	D PROJECT		

