SUMMARY OF QUANTITIES ROADWAY

UNTT

FACH

EACH

POUND

POLIND

POUND

CU YD

CU YD

CU YD

CU YE

CU YD

SQ YD

ACRE

SQ YD

UNIT

EACH

POUND

FOOT

EACH

SQ YD

SQ YD

SQ YD

GALLON

TON

TON

SQ FT

SQ FT

SQ YD

FOOT

SQ YD

EACH

FOOT

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CAL MC

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SQ FT

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FOOT

EACH

FOOT

EACH

FOOT

FOOT

L SUM

TOTAL

QUANTITY

70

70

70

2,600

4,830

1,310

151_

1.474

6,038

0.53

5,618

16.80

240.00

900

1,328

12

5

2,150

1,072

270

180

3,585

76

82

1.972

590

92

183

50

122

50

812

187

3

532

949

202

(2,090)

1

25

328

48

644

713

80% FEDERAL

20% LOCAL I000-2A

70

70

70

2,600

4,830

1,310

151 1.474 / 1

6,038

0.53

5,618

16.80

240.00

12

2,150

1,072

270

180

3,585 76

82

1,972

590

183

50

122

50

812

187

2

3

532

949

202

1

25

328

48

27

1

644

713 '

STATE OF ILLINOIS **DEPARTMENT OF TRANSPORTATION**

2,090/1

4)/1\

92)/1\

900,}/1 1,328

CODE NO.	PAY ITEM DESCRIPTION	UNIT	TOTAL QUANTITY	80% FEDERAL 20% LOCAL 1000-2A
* Z0022800	FENCE REMOVAL	FOOT	310	310
# C2008318	SHRUB, ROSA PURPLE PAVEMENT (PURPLE PAVEMENT ROSE), 18" HEIGHT, CONTAINER	EACH	70	70
# K0030421	PERENNIAL PLANTS, NARCISSUS	UNIT	30.00	30.00
# K1004465	PERENNIAL PLANTS, BULBS	UNIT	12.00	12.00
# K1005875	TREE TRANSPLANT	EACH	18	18 4
# X0320903	CIRCUIT BREAKER AND ENCLOSURE	EACH	1	L (1) (1
X0656300	PAVEMENT REMOVAL AND REPLACEMENT	SQ YD	6	6
# XX000052	REMOVE EXISTING WATERMAIN	FOOT	879	879
# XX003855	IRRIGATION SYSTEM	L SUM	1	1
# XX004998	PVC WATER MAIN 6"	FOOT	670	670
* XX005434	WATER SERVICE LINE, SPECIAL	FOOT	2,192	2,192
# XX006077		EACH	i	i .
	GATE VALVE AND BOX 6"	~ / ~~~	2	2
XX006282	STORM SEWERS, DUCTILE IRON, TYPE 1 12"	FOOT.	121	
* XX006755	STOP VALVE 34" AND VALVE BOX	EACH	13	13
# XX007186	QUICK COUPLE	EACH	22	22
# XX007263	GATE VALVE WITH BOX 4"	EACH	3	3 ^
* \ XX007469	UPLIGHTS	ĚAČH	10	10 /1
XX008001	ACCREGATE PATH. 8"	SQ YD	291	291
# XX008185	PVC WATER MAIN 4"	FOOT	_ 389_	389
* XX008207	LIGHTS PEDESTRIAN	EACH	7	7) 1
* XX011700	WATER MAIN FITTINGS	POUND	960	960
		1	1	1
# <2C014G5	SHRUB, CORNUS MAS 'DRIPPING CHERRIES' (DRIPPING CHERRIES CORNELIAN CHERRY DOG	EACH	254	254
	WOOD), 5-GALLON CONTAINER			
# c2co24G2	SHRUB, DIERVILLA 'COOL SPLASH' (COOL SPLASH DIERVILLA), 24" PLANT, 2 GALLON CONT.	EACH	148	148
# A2005055		EACH	9	9
	5" CALIPER, BALLED AND BURLAPPED			
# A2007212	TREE, QUERCUS X SCHUETTI (SCHUETTES OAK), 7" CALIPER, BALLED AND BURLAPPED	EACH	1	1
			,	
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			·	

SUMMARY OF QUANTITIES

*	DENOTES	SPECIAL	PROVISIONS

PAY ITEM DESCRIPTION

TREE REMOVAL, ACRES

TREE ROOT PRUNING

EARTH EXCAVATION

TRENCH BACKFILL

SEEDING, CLASS 2

PERENNIAL PLANTS

PERENNIAL PLANTS

INLET FILTERS

FILTER FABRIC

SODDING

TREE TRUNK PROTECTION

NITROGEN FERTILIZER NUTRIENT

PHOSPHORUS FERTILIZER NUTRIENT

POTASSIUM FERTILIZER NUTRIENT

POROUS GRANULAR EMBANKMENT, SUBGRADE

TOPSOIL EXCAVATION AND PLACEMENT

TEMPORARY EROSION CONTROL SEEDING

AGGREGATE BASE COURSE, TYPE B 12"

BITUMINOUS MATERIALS (PRIME COAT)

HOT-MIX ASPHALT BINDER COURSE, IL-19.0, N50

PORTLAND CEMENT CONCRETE SIDEWALK 5 INCH

COMBINATION CURB AND GUTTER REMOVAL

STORM SEWERS, CLASS A, TYPE 1 12"

STORM SEWERS, CLASS A, TYPE 2 12"

STORM SEWERS, CLASS A, TYPE 2 15"

HOT-MIX ASPHALT SURFACE COURSE, MIX "C", N50

PRECAST REINFORCED CONCRETE FLARED END SECTIONS 12"

CATCH BASINS, TYPE A, 4'-DIAMETER, TYPE 8 GRATE

MANHOLES, TYPE A, 4'-DIAMETER, TYPE 8 GRATE

INLETS. TYPE A. TYPE 15 FRAME AND LID

CATCH BASINS TO BE ADJUSTED

ENGINEER'S FIELD OFFICE, TYPE A

CONDUIT IN TRENCH, 1" DIA., PVC

TRAFFIC CONTROL AND PROTECTION (SPECIAL)

THERMOPLASTIC PAVEMENT MARKING - LINE 4"

THERMOPLASTIC PAVEMENT MARKING - LINE 6"

THERMOPLASTIC PAVEMENT MARKING - LINE 24"

ELECTRIC SERVICE INSTALLATION, SPECIAL

CONCRETE FOUNDATION TYPE A (SPECIAL)

MANHOLES TO BE ADJUSTED

CONCRETE CURB, TYPE B

REMOVING INLETS

TEMPORARY FENCE

HANDHOLE (SPECIAL)

CONSTRUCTION LAYOUT

MOBILIZATION

CATCH BASINS, TYPE A, 4'-DIAMETER, TYPE 15 FRAME AND LID

MANHOLES, TYPE A, 4'-DIAMETER, TYPE 1 FRAME, CLOSED LID

COMBINATION CONCRETE CURB AND GUTTER, TYPE M-2.06

COMBINATION CONCRETE CURB AND GUTTER, TYPE M-6.06

THERMOPLASTIC PAVEMENT MARKING - LETTERS AND SYMBOLS

ELECTRIC CABLE IN CONDUIT, 600V (EPR-TYPE RHW) 3-1/C NO. 8

TOPSOIL FURNISH AND PLACE, 18"

PERIMETER EROSION BARRIER

STONE RIPRAP, CLASS A3

DETECTABLE WARNINGS

PROTECTIVE COAT

DRIVEWAY PAVEMENT REMOVAL

STORM SEWER REMOVAL 8"

PIPE UNDERDRAINS 4"

PIPE UNDERDRAINS 12"

STORM SEWER REMOVAL 15"

EARTH EXCAVATION (SPECIAL)

CODE NO.

20100500

20101100

20101200

20101400

20101500 20101600

20200100

20200410

20700420

20800150

21101665

25000200 25200100

25400100

25400105

28000250

28000400

28000510

28100105

28200200

35102400

40300100

40603080

40603310

42400200

42400800

44000200

44000500

48301000

54213657

550A0050

550A0340

550A0360

55100300

55100700

60107600

60108000

60200805

60201305

60218400

60219000

60237000

60250200

60255500

60500060

60600605

60608250

60608600

66411900

67000400

67100100

70101800

78000100

78000200

78000400

78000650

80400105

81012300

81400105

81700325

87800110

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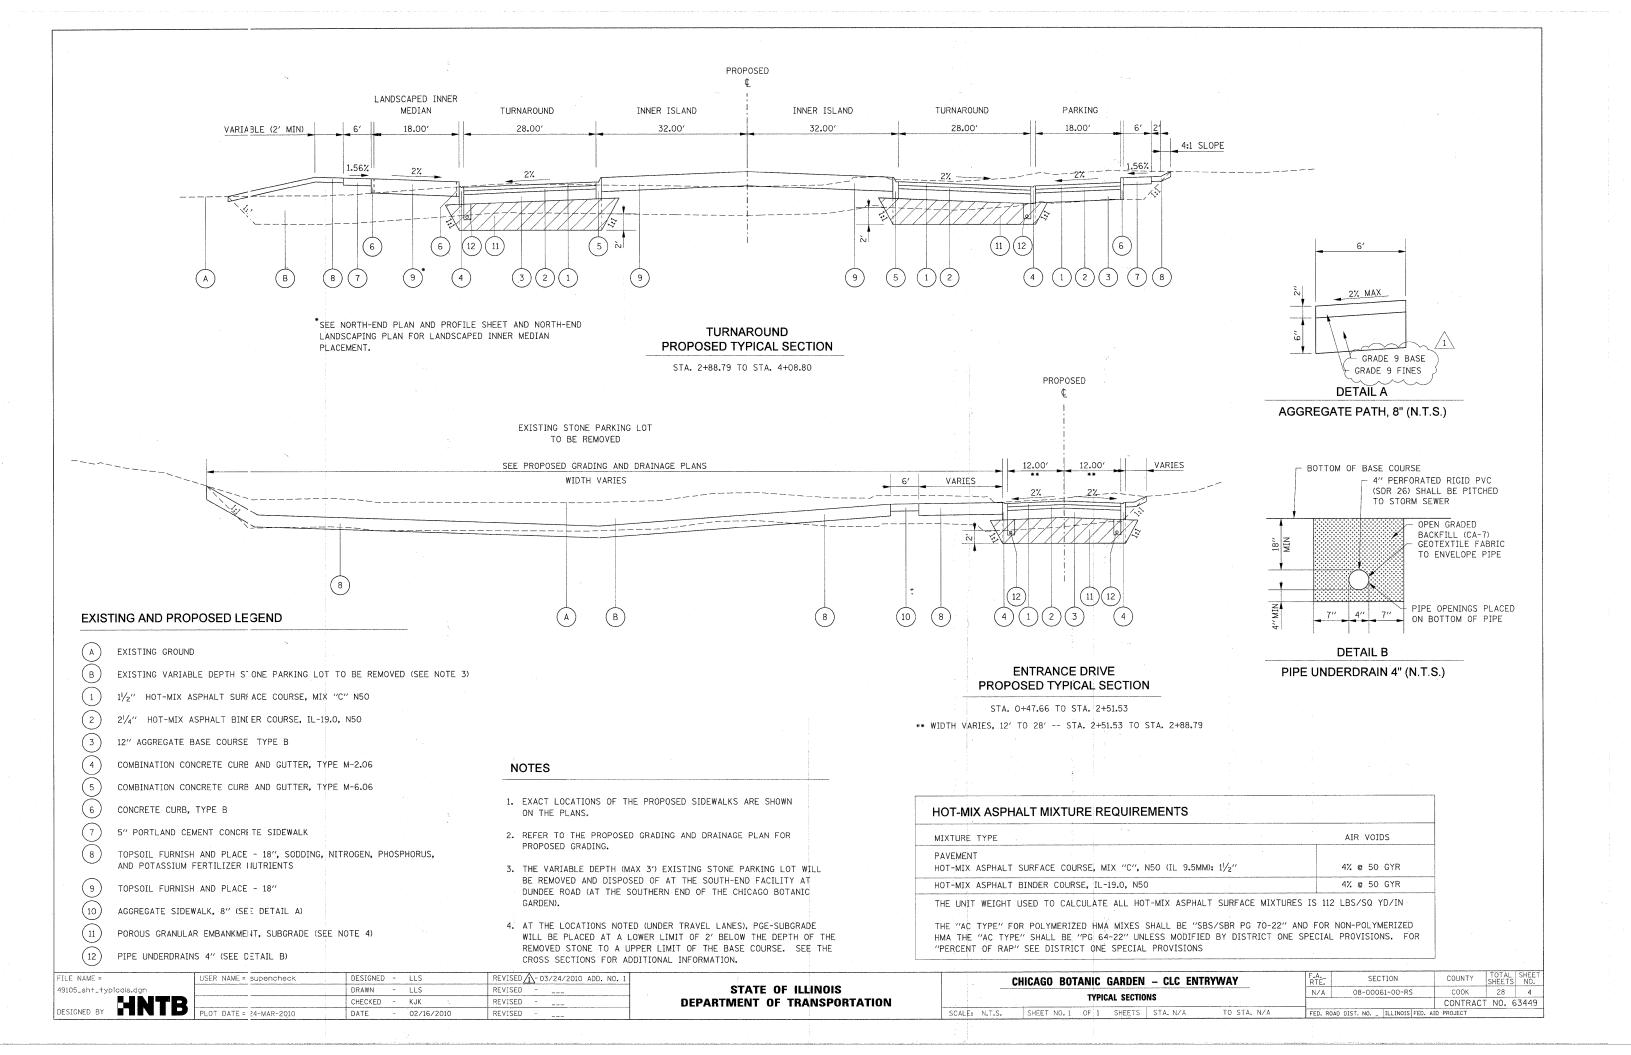
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CHICAGO BOTANIC GARDEN – CLC ENTRYWAY	RTE.	SECT
SUMMARY OF QUANTITIES	N/A	08-00061
SUMMANT OF COMMITTIES		
SHEET NO 1 OF 1 SHEETS STA N/A TO STA N/A	ECO DOAL	DIET NO

F.A. RTE.	SECTION	COUNTY	TOTAL SHEETS	SHEET NO.					
N/A	08-00061-00-RS	COOK	28	3					
52.5		CONTRACT	NO. 6	3449					
FEO. R	DAD DIST, NO ILLINOIS FED. A	ID PROJECT							

ROADWAY

[#] DENOTES SPECIALITY ITEM



GENERAL NOTES FOR TRAFFIC CONTROL TRAFFIC CONTROL PLAN THE CONTRACTOR WILL FOLLOW ENTRANCE AND EXIT ROUTES AS DIRECTED BY THE ENGINEER. ALL TRAFFIC CONTROL DEVICES SHALL CONFORM TO THE TRAFFIC CONTROL PLANS OR THE LATEST EDITION OF THE STATE OF ILLINOIS SUPPLEMENT TO THE NATIONAL "MANUAL OF UNIFORM TRAFFIC FUTURE GROWING GARDEN CONTROL DEVICES FOR STREETS AND HIGHWAYS" (MUTCD) AND SHALL BE IN PLACE BEFORE CONSTRUCTION COMMENCES. CHILDREN'S LEARNING CENTER CAMPUS THE TRAFFIC CONTROL PLANS SHALL SERVE AS A GUIDE FOR THE SAFE DIVERSION OF TRAFFIC DURING THE EXECUTION OF THIS CONTRACT. ANY CONTRACTOR-PROPOSED TRAFFIC CONTROL PLANS LAKE COOK ROAD SHALL BE SUBMITTED FOR THE WRITTEN APPROVAL OF THE ENGINEER. THE SIZES OF THE SIGNS NOT SPECIFIED IN THESE PLANS SHALL BE AS REQUIRED BY THE "MUTCD". ALL EXISTING SIGNING THAT IS NOT APPLICABLE WHILE THE CONSTRUCTION IS IN EFFECT SHALL BE COMPLETELY COVERED OR REMOVED BY THE CONTRACTOR. SECURED ACCESS ALL BARRICADES, VERTICAL PANELS, AND/OR DRUMS SHALL BE EQUIPPED WITH MONO-DIRECTIONAL STEADY BURNING LIGHTS. THE CONTRACTOR SHALL BE RESPONSIBLE FOR ENSURING THAT ALL BARRICADES, SIGNS, LIGHTS, AND OTHER DEVICES INSTALLED BY HIM/HER ARE IN PLACE AND OPERATIONAL 24 HOURS EACH DAY INCLUDING SUNDAYS AND HOLIDAYS DURING THE TIME THIS CONSTRUCTION IS IN EFFECT. AS A MINIMUM, ALL AMBER FLASHING LIGHTS THAT ARE REQUIRED SHALL MEET THE REQUIREMENTS FOR A LOW INTENSITY FLASHING LIGHTS IN ARTICLE 1084.01 OF THE STANDARD SPECIFICATIONS. ALL LIGHTS SHALL OPERATE DURING HOURS OF DARKNESS. ONLY LIGHTS THAT HAVE BEEN APPROVED THE EXACT NUMBER, LOCATION, AND SPACING OF ALL SIGNS AND TRAFFIC CONTROL DEVICES MAY BE ADJUSTED TO FIT FIELD CONDITIONS AS DIRECTED BY THE ENGINEER. CHICAGO BOTANIC GARDEN ALL UNBALLASTED TYPE I AND TYPE II BARRICADES SHALL HAVE TWO SANDBAGS ON THE BOTTOM RAIL. LEGEND ROUTE TO AND FROM THE NORTH-END FACILITY TO THE SOUTH-END FACILITY WORK ZONE (S NEAR VISTOR'S CENTER, TYPE III BARRICADE W/2 FLASHING BEACONS (NO. OF BARRICADES AS DIRECTED BY ENGINEER) 1" = 50" AS DIRECTED BY ENGINEER DIRECTION OF TRAFFIC SOUTH-END FACILITY CONSTRUCTION SIGN \circ 4 (3) (5) DUNDEE ROAD AT SOUTH-END FACILITY, TRAFFIC CONTROL TO FOLLOW IDOT STANDARDS 701001-02 AND 701006-03. ROAD ROAD SIDEWALK ROAD (CONSTRUCTION) **CLOSED** CLOSED CLOSED AHEAD AHEAD R11-I101-2418 W1-6 R11-2 36 X 18 W20-I103(0)-48 W20-3(0)-48 FILE NAME = USER NAME = supencheck DESIGNED - LLS REVISED 1-03/24/2010 ADD, NO. SECTION COUNTY SHEETS NO. CHICAGO BOTANIC GARDEN - CLC ENTRYWAY DRAWN REVISED STATE OF ILLINOIS

DEPARTMENT OF TRANSPORTATION

COOK

CONTRACT NO. 63449

08-00061-00-RS

FED. ROAD DIST. NO. _ ILLINOIS FED. AID PROJECT

TRAFFIC CONTROL PLAN

TO STA, N/A

SHEET NO. 1 OF 1 SHEETS STA. N/A


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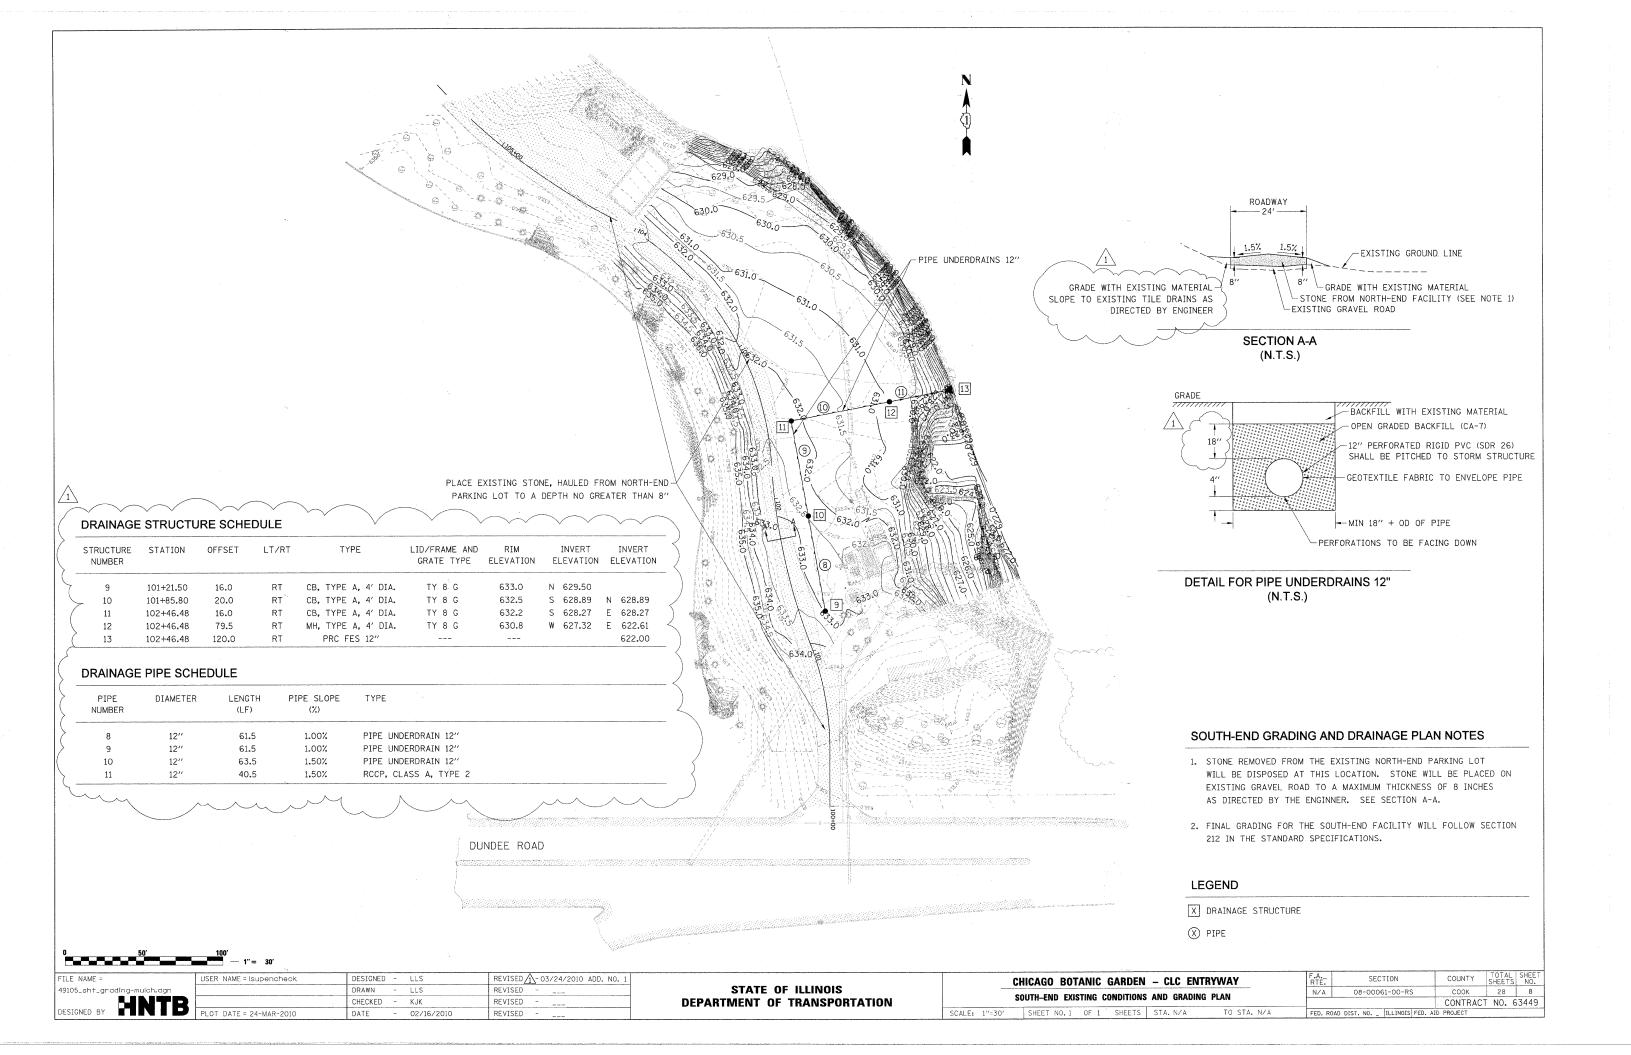
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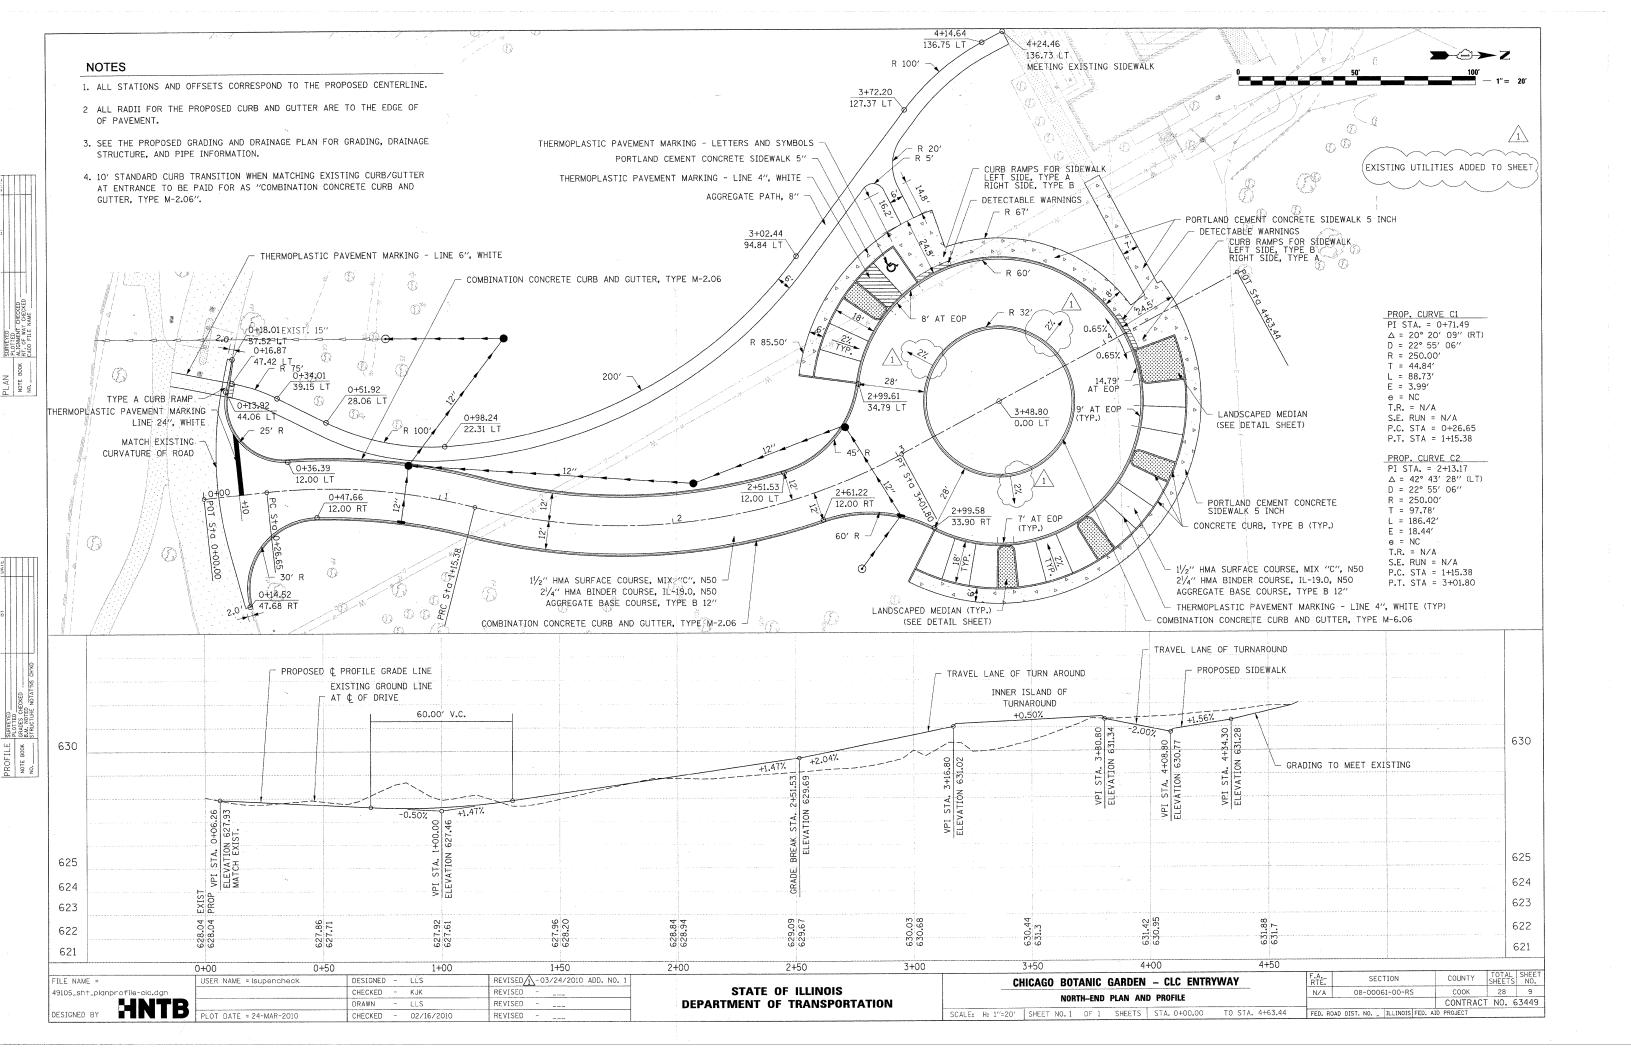
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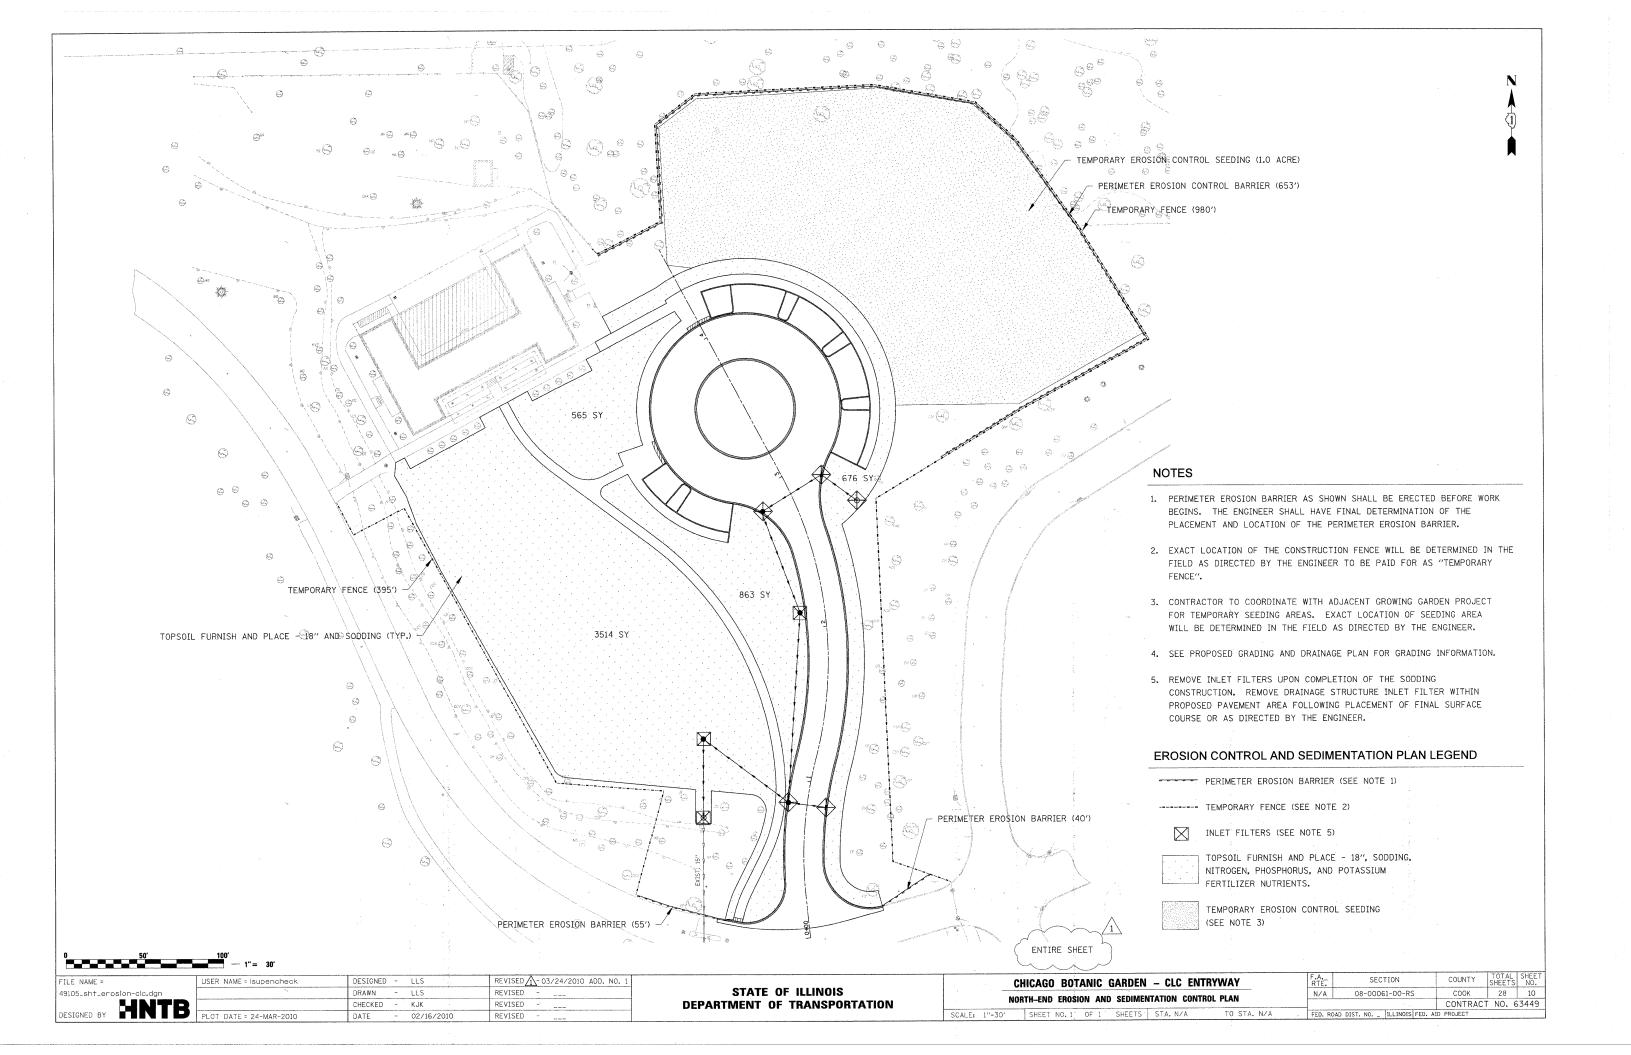
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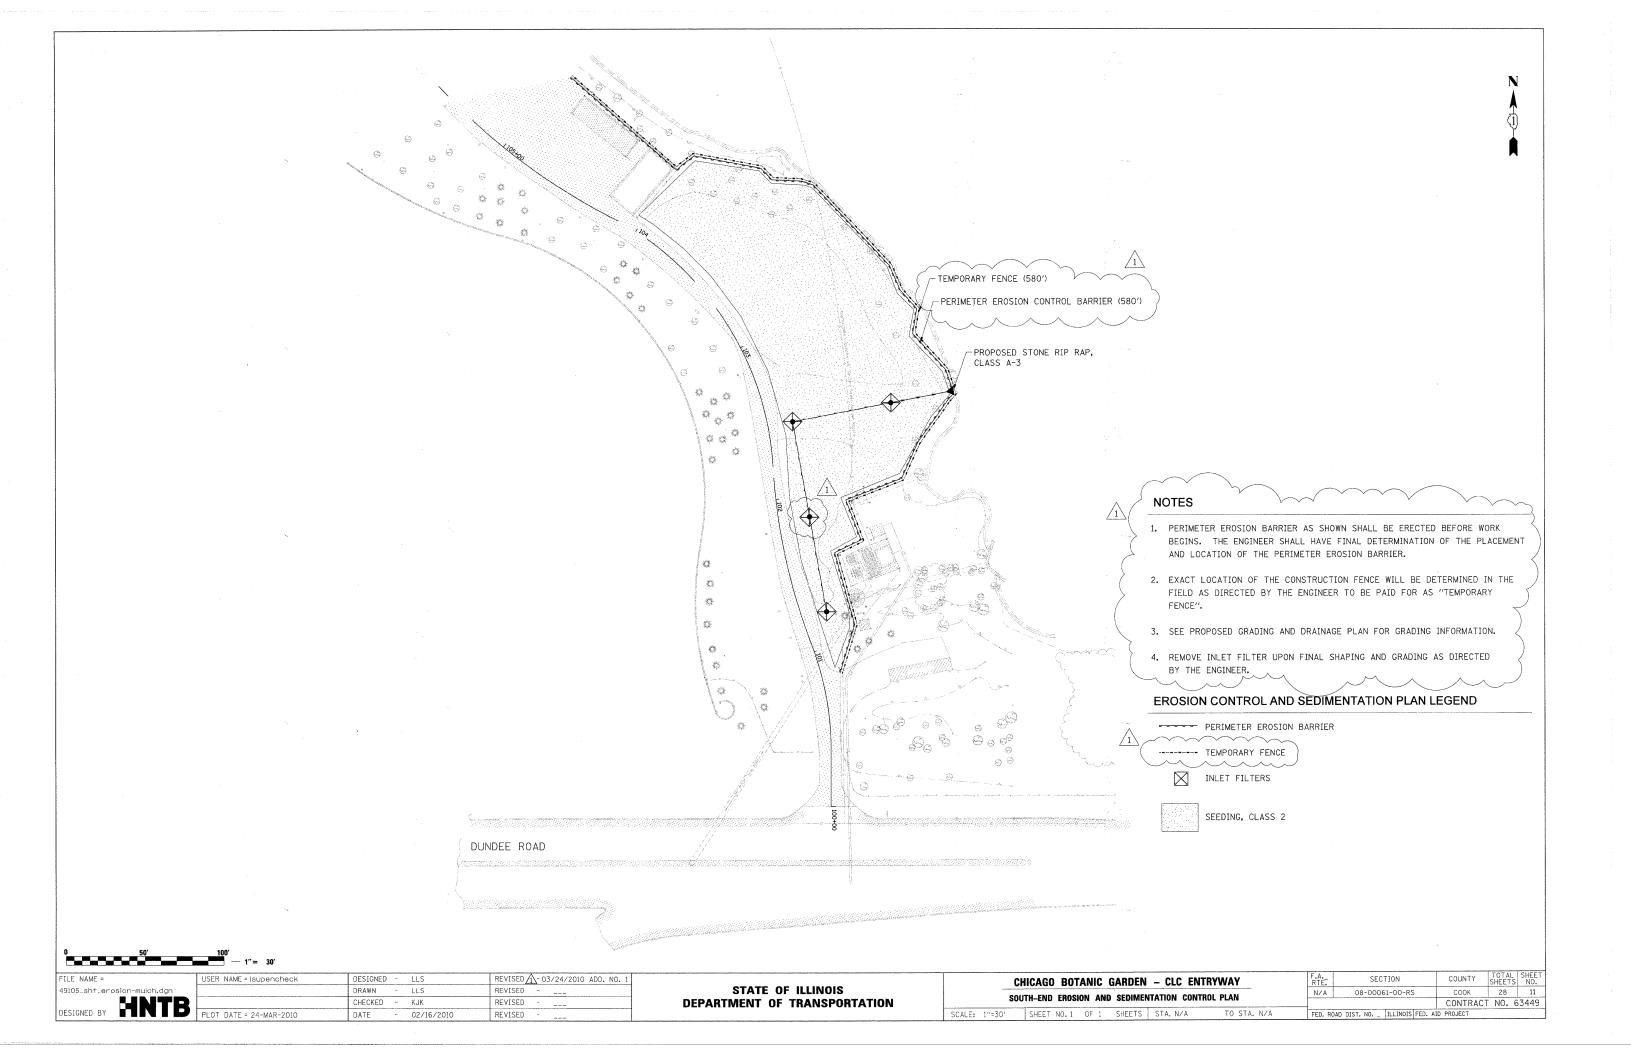
PLOT DATE = 24-MAR-2010









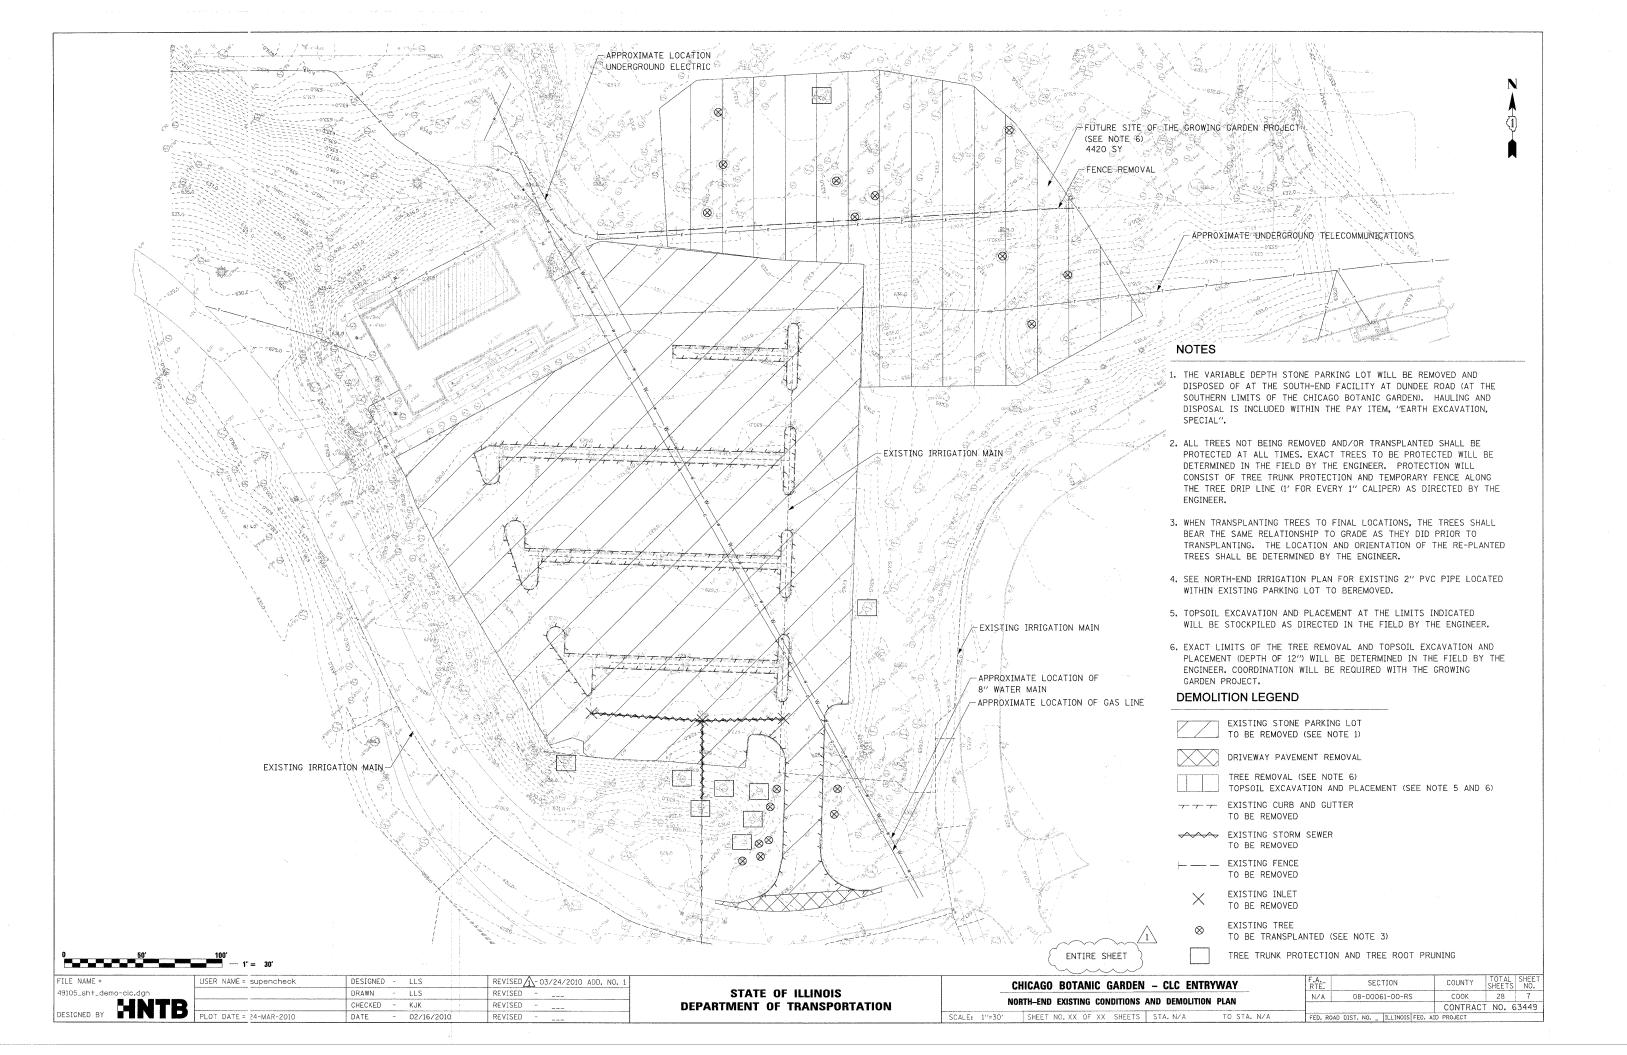



DRAINAGE STRUCTURE SCHEDULE

/	STRUCTURE NUMBER	STATION	OFFSET	LT/RT	TYPE	LID/FRAME AND GRATE TYPE	RIM ELEVATION	INVERT ELEVATION
	1	0+72.08	64.6	LT	MH, TYPE A, 4' DIA.	T1 F, CL	632.3	623.33
	2	1+10.88	72.5	LT	CB, TYPE A, 4' DIA.	TY 8 G	626.0	623.50
-\z	3	0+85.22	12.0	LT	CB, TYPE A, 4' DIA.	T15 F & L	627.34	623.84
, ,	4	0+85.22	12.0	RT	IN, TYPE A	T15 F & L	627.34	623.96
	5	2+10.75	15.8	LT	CB, TYPE A, 4' DIA.	TY 8 G	628.8	624.45
, .	6	2+84.80	21.7	LT	CB, TYPE A, 4' DIA.	T15 F & L	629.66	624.79
	. 7	2+90.27	22.9	RT	IN, TYPE A	T15 F & L	629.68	625.02
2/2	1 8	2+68.74	37.1	RT	MH, TYPE A, 4' DIA.	T1 F, CL	630.2	625.16

STATIONS, OFFSETS, AND RIM ELEVATIONS FOR ALL INLETS AND CATCH BASINS LOCATED IN CURB AND GUTTER ARE GIVEN AT THE EDGE OF PAVEMENT.

DRAINAGE PIPE SCHEDULE

PIPE NUMBER	DIAMETER	LENGTH (LF)	PIPE SLOPE (%)	TYPE
1	15"	50	0.34%	RCCP, CLASS A, TYPE 2
2	12"	68	0.50%	RCCP, CLASS A, TYPE 2
3	12"	24	0.50%	RCCP, CLASS A, TYPE 2
4	12''	121	0.50%	STORM SEWER, DUCTILE IRON, TYPE 1
5	12"	69	0.50%	RCCP, CLASS A, TYPE 2
6	12"	45	0.50%	RCCP, CLASS A, TYPE 2
7	12"	28	0.50%	RCCP, CLASS A, TYPE 2

LEGEND

X DRAINAGE STRUCTURE

X PIPE

GRADING AND DRAINAGE PLAN NOTES

- 1. SEE THE NORTH-END PLAN AND PROFILE SHEET FOR TURNAROUND AND DRIVE GEOMETRICS.
- 2. SEE THE NORTH-END EROSION AND SEDIMENTATION CONTROL PLAN SHEET FOR ALL EROSION CONTROL ACTIVITIES.
- 3. FINAL GRADING FOR THE ADJACENT GROWING GARDEN PROJECT WILL BE DONE BY OTHERS.
- 4. SEE TRAFFIC CONTROL PLAN FOR TRAFFIC CONTROL NOTES.


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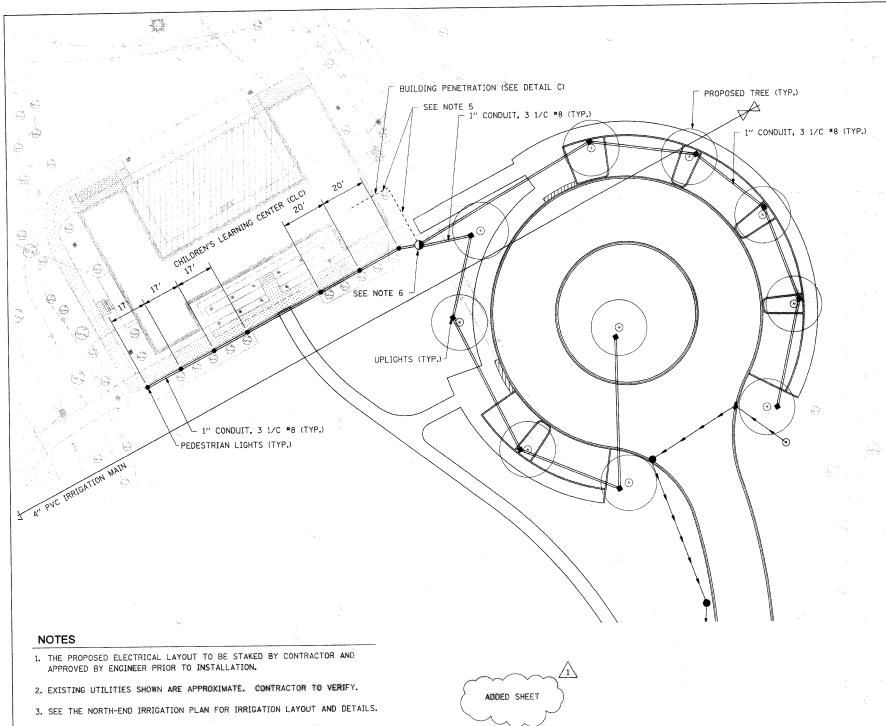
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1	PLOT DATE = 24-MAR-2010	DATE	- ,	02/16/2010	REVISED	

STATE OF ILLINOIS
DEPARTMENT OF TRANSPORTATION

PROPOSED FINAL GRADING BY OTHERS
(SEE NOTE 3)

1	CHICAGO BOTANIC GARDEN – CLC ENTRYWAY					SECTION	COUNTY	TOTAL SHEETS	SHEET NO.
1		MODELL CHID ODADING AND	DRAINACE DI AN		N/A	08-00061-00-RS	соок	28	12
	NORTH-END GRADING AND DRAINAGE PLAN						CONTRACT	NO. 1	63449
Ì	SCALE: 1"=30"	SHEET NO. 1 OF 1 SHEETS	STA. N/A TO S	STA. N/A	FED. RO	AD DIST. NO ILLINOIS FED. A	ID PROJECT		



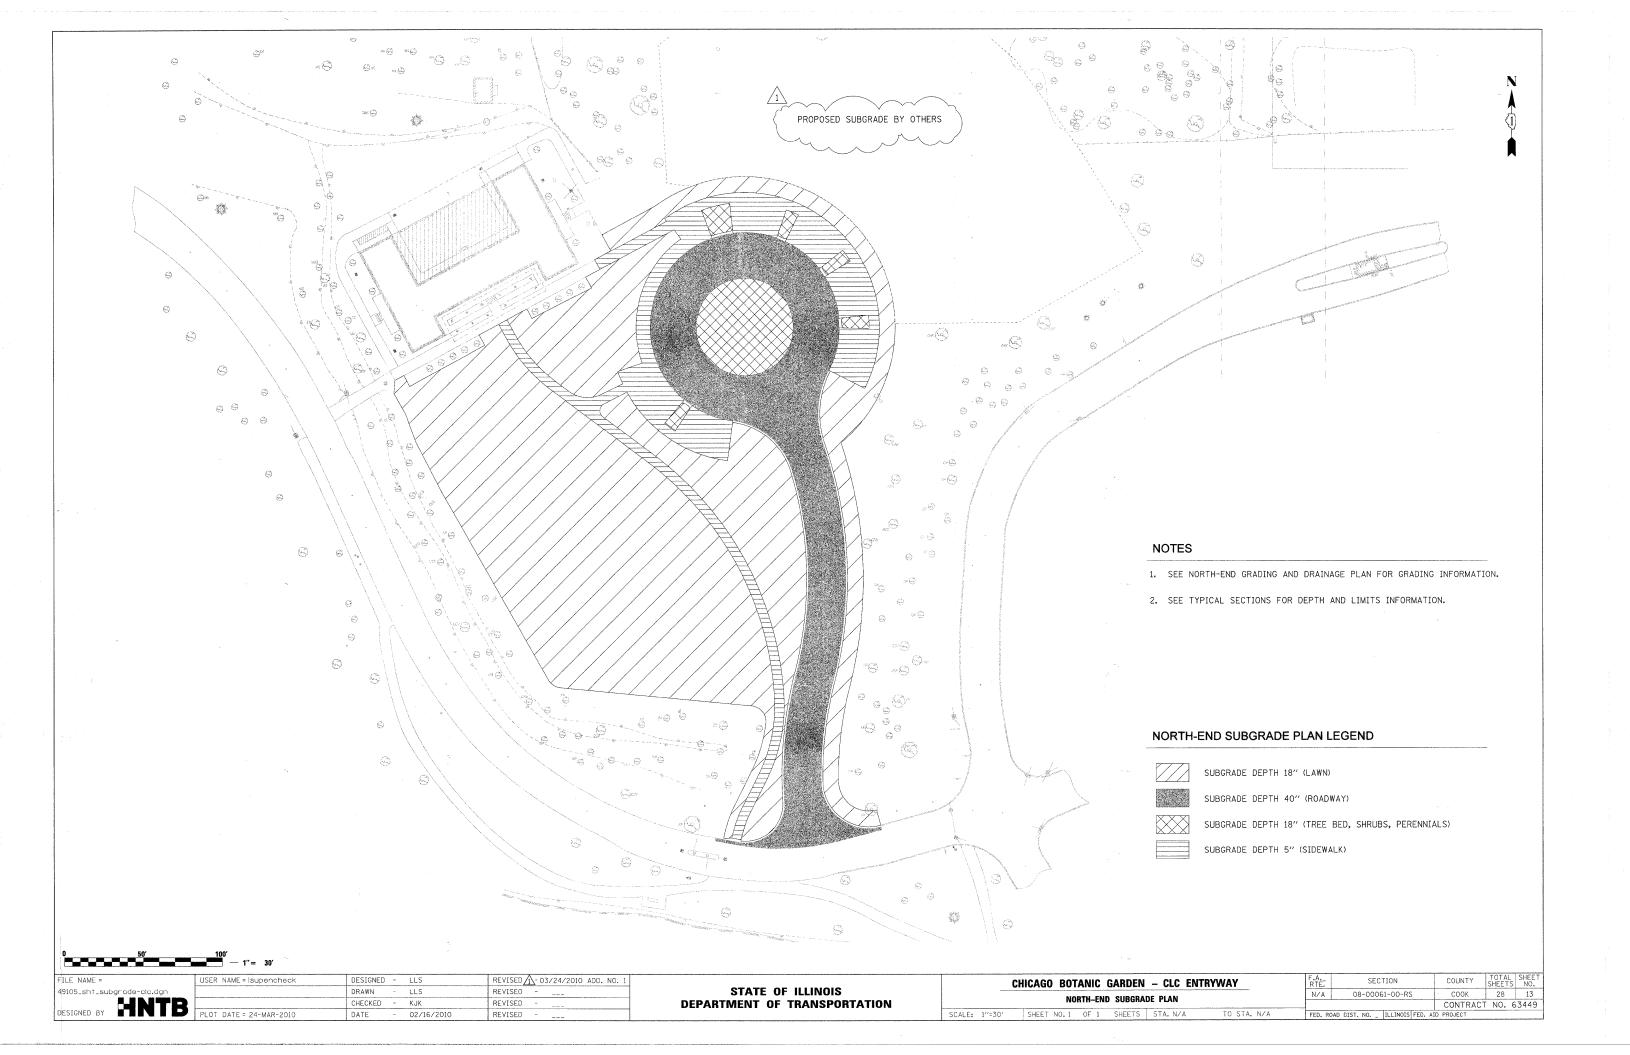


- 4. SEE THE NORTH-END LANDSCAPE PLAN FOR PROPOSED LANDSCAPE DESIGN.
- 5. CONTRACTOR TO FURNISH/INSTALL ONE (1) 120V, 20A SINGLE POLE BREAKER IN EXISTING DISTRIBUTION PANEL, ROUTE OF CABLE AND CONDUIT INSIDE BUILDING AND OUT TO HANDHOLE TO BE DETERMINED IN THE FIELD AND APPROVED BY THE ENGINEER.
- 6. CONTRACTOR TO FURNISH/INSTALL HANDHOLE AND SPLICE CONDUCTORS FOR UPLIGHTS AND PEDESTRIAN LIGHTS INSIDE THE HANDHOLE.
- 7. ENGINEER TO DETERMINE LOCATION OF HONEYWELL CONTROLLER WITHIN THE CLC BUILDING. CONTROLLER WILL NEED LOCAL POWER. CONNECTION TO EXISTING HONEYWELL EQUIPMENT WILL BE BY OTHERS.

ELECTRICAL PLAN LEGEND


- PEDESTRIAN LIGHTS (SEE DETAIL A FOR BASE)
- UPLIGHTS (SEE DETAIL B FOR MOUNTING)
- HANDHOLE (SEE DETAIL D)
- CONDUIT IN TRENCH, 1" DIAMETER, SCHD 40 PVC 3 1/C *8

---- SEE NOTE 5

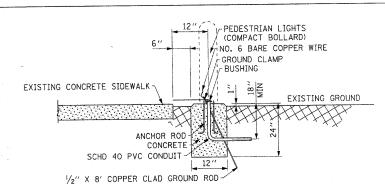


DETAIL A


CONCRETE FOUNDATION DETAIL PEDESTRIAN LIGHTS (COMPACT BOLLARD)

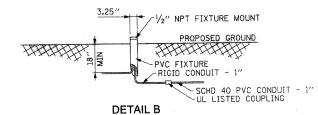

MOUNTING DETAIL UPLIGHTS (TREE ACCENT LIGHT)

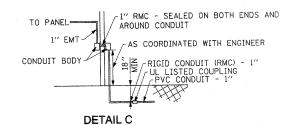

BUILDING PENETRATION DETAIL

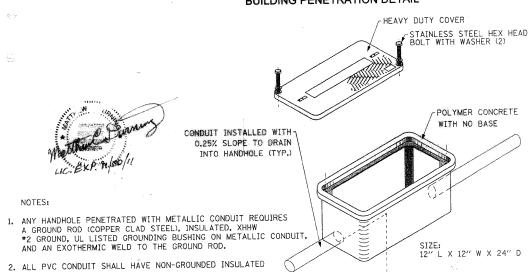

DETAIL D

HANDHOLE DETAIL

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LINTO		CHECKED	-	MCD	REVISED -		
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STATE OF ILLINOIS DEPARTMENT OF TRANSPORTATION

-	CHICAGO BOTANIC GARDEN - CLC ENTRYWAY	F.A RTE.	SECTION	COUNTY	SHEETS	SHEET NO.
	OHIONGO DOTANIO GRAIDE	NZA	08-00061-00-RS	COOK	28	164
	NORTH-END ELECTRICAL PLAN			CONTRACT	Γ NO. €	3449
	SCALE: 1" = 20' SHEET NO. 1 OF 1 SHEETS STA. N/A TO STA. N/A	FED. RC	OAD DIST. NO ILLINOIS FED. AI	D PROJECT		