FOR INDEX OF SHEETS, SEE SHEET NO. 2

FOR INDEX OF HIGHWAY STANDARDS, SEE SHEET NO. 2

PROJECT LOCATED IN THE VILLAGE OF PLAINFIELD

STATE OF ILLINOIS
DEPARTMENT OF TRANSPORTATION
DIVISION OF HIGHWAYS

PLANS FOR PROPOSED FEDERAL-AID HIGHWAY

DuPAGE RIVER TRAIL IMPROVEMENTS

PROJECT No.: -TE-HPP-3033(001)

SECTION No.: 01-P4015-00-BT

JOB No.: C-91-219-06

PLAINFIELD PARK DISTRICT
WILL COUNTY

PROPOSED TRAIL

PROPOSED RIVERVIEW BRIDGE

Walker

130 (59)

PROJECT BEGINS
STA. 151+62


PROJECT BEGINS
STA. 113+83

PLAINFIELD TOWNSHIP

GROSS LENGTH OF IMPROVEMENT = 4,079.00 LF (0.77 MILES)

NET LENGTH OF IMPROVEMENT = 4,079.00 LF (0.77 MILES)



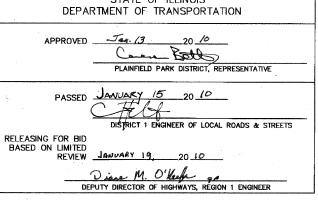




ENGINEERING
RESOURCE
ASSOCIATES, INC.
CONSULTING ENGINEERS, SCIENTISTS
& SURVEYORS

3S701 WEST AVENUE, SUITE 150 WARRENVILLE, ILLINOIS 60555 PHONE (630) 393-3060 FAX (630) 393-2152



John F. Mayer, P.E. IL. P.E. NO. 062-047345 Expires November 30, 2011

PRINTED BY THE AUTHORITY OF THE STATE OF ILLINOIS

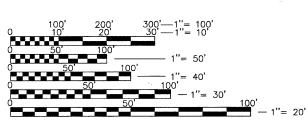

FULL SIZE PLANS HAVE BEEN PREPARED USING STANDARD ENGINEERING SCALES. REDUCED SIZED PLANS WILL NOT CONFORM TO STANDARD SCALES. IN MAKING MEASUREMENTS ON REDUCED PLANS, THE ABOVE SCALES MAY BE USED.

J.U.L.I.E.
JOINT UTILITY LOCATION INFORMATION FOR EXCAVATION
1-800-892-0123
OR 811

CONTRACT NO. 63325

.

 \circ

0

 \circ

0

GENERAL NOTES

- 1. BEFORE STARTING ANY EXCAVATION, THE CONTRACTOR SHALL CALL "JULIE" AT 800-892-0123 FOR FIELD LOCATIONS OF BURIED ELECTRIC, TELEPHONE AND GAS FACILITIES. (48 HOURS NOTIFICATION IS REQUIRED).
- 2. BARRICADES: THE CONTRACTOR SHALL PROVIDE AND INSTALL TWO (2) WEIGHTED SAND BAGS ON EACH TYPE I OR TYPE II BARRICADE USED. (ONE (1) WEIGHTED SAND BAG ACROSS EACH BOTTOM RAIL.)
- 3. ALL WORK SHALL BE IN ACCORDANCE WITH THE IDOT "STANDARD SPECIFICATIONS FOR ROAD AND BRIDGE CONSTRUCTION" (LATEST EDITION), THE WILL COUNTY "COUNTYWIDE STORMWATER AND FLOOD PLAIN ORDINANCE" AND THE EROSION & SEDIMENT CONTROL PRACTICES SHALL BE ACCORDING TO THE ILLINOIS URBAN MANUAL (REVISED FEBRUARY 2002)
- 4. NO WORK SHALL COMMENCE UNTIL TRAFFIC CONTROL REQUIREMENTS ARE MET.
- 5. ALL UTILITIES, SCHOOL DISTRICTS, LOCAL POLICE, AND FIRE DEPARTMENTS SHALL BE NOTIFIED BY THE CONTRACTOR PRIOR TO THE START OF CONSTRUCTION.
- 6. UNLESS AUTHORIZED BY THE ENGINEER, ALL EXISTING ACCESS POINTS SHALL BE MAINTAINED AT ALL TIMES BY THE CONTRACTOR.
- 7. DURING THE CONSTRUCTION, THE CONTRACTOR WILL BE REQUIRED, AT HIS EXPENSE, TO HAVE AVAILABLE A WATER TRUCK OR SIMILAR EQUIPMENT TO CONTROL DUST. IF NECESSARY, THE CONTRACTOR SHALL BE REQUIRED TO CONTROL DUST DURING NON-WORKING HOURS. PAYMENT FOR THIS WORK SHALL BE INCIDENTAL TO THE COST OF EARTH EXCAVATION.
- 8. ALL EXCESS MATERIAL (BROKEN CONCRETE, CULVERT PIPE, WASTE ROADWAY EXCAVATION AND SURPLUS MATERIAL FROM SEWER TRENCHES) SHALL BE LEGALLY DISPOSED OF OUTSIDE THE LIMITS OF THE RIGHT-OF-WAY. IT SHALL BE THE CONTRACTOR'S RESPONSIBILITY TO SELECT DUMP SITES AND OBTAIN PERMISSION AND ALL NECESSARY PERMITS TO USE SUCH DUMP SITES. PAYMENT FOR THIS WORK SHALL BE INCIDENTAL TO THE COST OF EARTH EXCAVATION.
- ALL SOIL EROSION AND SEDIMENT CONTROL DEVICES SHALL BE INSTALLED PRIOR TO UPLAND DISTURBANCE.
- 10. THE CONTRACTOR WILL PERFORM ALL CONSTRUCTION LAYOUT.

TREE REMOVAL

CLEARING

HEDGE REMOVAL

TREES NOT MARKED FOR REMOVAL SHALL BE CONSIDERED AS DESIGNATED TO BE SAVED AND SHALL BE PROTECTED AND PAID FOR UNDER THE PROVISIONS OF ARTICLE 201.05, TEMPORARY FENCE.

ALL LIMBS, BRANCHES, AND OTHER DEBRIS RESULTING FROM THIS WORK SHALL BE DISPOSED OF BY THE CONTRACTOR AT HIS OWN EXPENSE OUTSIDE THE LIMITS OF THE RIGHT-OF-WAY.

OVERHANGING LIMBS

LIMB PRUNING SHALL BE PERFORMED UNDER THE SUPERVISION OF AN APPROVED TREE EXPERT AS STATED IN THESE SPECIAL PROVISIONS AND SHALL BE UNDERTAKEN IN A TIMELY FASHION SO AS NOT TO INTERFERE WITH CONSTRUCTION.

ALL CUTS OVER 1 INCH IN DIAMETER SHALL BE MADE FLUSH WITH THE NEXT LARGE BRANCH.

ALL LIMBS, BRANCHES AND OTHER DEBRIS RESULTING FROM THIS WORK SHALL BE DISPOSED OF BY THE CONTRACTOR AT HIS EXPENSE OUTSIDE THE LIMITS OF THE RIGHT-OF-WAY.

THE COST OF THIS WORK WILL NOT BE PAID FOR SEPARATELY, BUT SHALL BE CONSIDERED INCIDENTAL TO TREE REMOVAL OR TREE PRUNING.

TOPSOIL

TOPSOIL SHALL BE PLACED TO A DEPTH OF 6 INCHES UNLESS OTHERWISE SPECIFIED ON THE PLANS. THIS COST SHALL BE CONSIDERED INCIDENTAL TO THE COST OF EARTH EXCAVATION.

THE CROSS SECTIONS INDICATE THE FINISHED GRADE OF TOPSOIL

TOPSOIL SHALL NOT BE STOCKPILED WITHIN THE LIMITS OF CONSTRUCTION; THE LOCATIONS OF TOPSOIL STOCKPILES WITHIN THE RIGHT-OF-WAY MUST BE APPROVED BY THE ENGINEER.

PATH EXCAVATION

ALL EXISTING GRANULAR AND BITUMINOUS MATERIALS TO BE REMOVED AND NOT PAID AS A SPECIFIC ITEM SHALL BE CONSIDERED EARTH EXCAVATION AND WILL BE PAID FOR AT THE UNIT PRICE FOR EARTH EXCAVATION. THE CONTRACTOR WILL HAVE THE OPTION OF REMOVING THE EXISTING BITUMINOUS MATERIAL BY GRINDING OR EXCAVATING THE MATERIAL. IF THE BITUMINOUS MATERIAL IS REMOVED BY EXCAVATION, IT MAY NOT BE USED IN EMBANKMENT AREAS UNLESS SPECIFICALLY AUTHORIZED BY THE ENGINEER. BITUMINOUS MATERIAL REMOVED BY GRINDING MAY BE USED AS EMBANKMENT MATERIAL. NO BITUMINOUS MATERIAL SHALL BE REMOVED IN AREAS TO BE USED FOR TEMPORARY ACCESS.

THE CONTRACTOR SHALL NOT CROSS COMPLETED BASE COURSE OR EXISTING PAVEMENT, NOT SCHEDULED TO BE REMOVED, WITH ANY TRACKED EQUIPMENT.

ALL EMBANKMENTS AND SUB-GRADE SHALL BE COMPACTED TO THE SATISFACTION OF THE ENGINEER PRIOR TO PLACING AGGREGATE SUBGRADE OR SUBBASE GRANULAR MATERIAL. ALL EMBANKMENT AND SUBGRADE SHOULD BE CONSTRUCTED IN ACCORDANCE WITH SECTION 205 (EMBANKMENT) AND SECTION 300 (SUBGRADES, SUBBASES AND BASE COURSES) OF THE STANDARD SPECIFICATIONS FOR ROAD AND BRIDGE CONSTRUCTION, ADOPTED JANUARY 1, 2007, AS WELL AS TO THE SPECIFICATION OF THE ENGINEER.

THERE MAY BE AREAS INVOLVING DRAINAGE DITCHES, CULVERT ENTRANCES AND EXITS, AND DEPRESSIONAL PONDED AREAS THAT MAY HAVE DEPOSITS OF UNSUITABLE OR UNSTABLE MATERIAL. THESE AREAS MUST BE PUMPED DRY OF ANY WATER AND ALL UNSUITABLE/UNSTABLE MATERIAL REMOVED BEFORE ANY EMBANKMENT MATERIAL IS PLACED.

STORM SEWERS

STRUCTURES

UTILITIES

SCALE:

THE CONTRACTOR SHALL BE RESPONSIBLE FOR CONTACTING LOCAL AGENCIES MAINTAINING SANITARY SEWERS, WATERMAINS, AND STREET LIGHTS TO VERIFY THE MATERIALS AND METHODS ALLOWED FOR THE ADJUSTMENT OR PROTECTION OF THE UTILITY INVOLVED.

THE LOCATION AND ELEVATION OF EXISTING UTILITIES ARE APPROXIMATE. THE EXACT LOCATIONS AND ELEVATIONS ARE TO BE VERIFIED BY THE CONTRACTOR THROUGH THE OWNER OF THE UTILITY.

EMBANKMENTS SHALL BE COMPLETED TO THE SATISFACTION OF THE ENGINEER PRIOR TO EXCAVATION FOR STORM SEWERS.

ALL FIELD TILES ENCOUNTERED SHALL BE CAREFULLY PRESERVED AND CONNECTED TO PROPOSED DRAINAGE STRUCTURES, SEWERS OR DITCHES AS DIRECTED BY THE ENGINEER; THIS WORK WILL BE PAID AT THE APPLICABLE CONTRACT UNIT PRICE OR IN ACCORDANCE WITH ARTICLE 109.04.

HOT-MIX ASPHALT AND HOT-MIX ASPHALT BASE COURSE

HOT-MIX ASPHALT SURFACE COURSE SHALL NOT BE PLACED UNTIL ALL EARTH EXCAVATION, TOPSOIL PLACEMENT, AGGREGATE BASE COURSE AND HOT-MIX ASPHALT BINDER COURSE HAVE BEEN COMPLETED TO THE SATISFACTION OF THE FINGINFER

SAWCUT CONSTRUCTION JOINTS SHALL BE PROVIDED AT ALL EXISTING PAVED SURFACES. SAWCUT CONSTRUCTION JOINTS SHALL ALSO BE PROVIDED AT THE BEGINNING AND END OF THE PROJECT. THE COST SHALL BE INCLUDED IN THE COST OF HOT-MIX ASPHALT SURFACE COURSE.

THE MAXIMUM COMPACTED THICKNESS OF A LIFT OF BASE COURSE WILL BE 6 INCHES UNLESS OTHERWISE AUTHORIZED BY THE ENGINEER.

BASE COURSE SHALL NOT BE PLACED ADJACENT TO ALL CONCRETE WORK UNTIL THE CONCRETE WORK HAS BEEN BACKFILLED TO THE SATISFACTION OF THE ENGINEER.

THE UNIT PRICES FOR ITEMS USED TO CONSTRUCT TEMPORARY ACCESS ROADS SHALL INCLUDE ALL LABOR AND MATERIAL REQUIRED TO PLACE, REMOVE AND DISPOSE OF THE TEMPORARY PAVEMENT OR ACCESS ROAD.

TRENCH BACKFILL

WHERE TRENCH BACKFILL IS REQUIRED, THE MATERIAL USED SHALL BE COMPACTED AS SPECIFIED IN ARTICLE 550.07 OF THE STANDARD SPECIFICATIONS USING METHOD ONE.

- DENOTES INCIDENTAL WORK ITEMS

INDEX OF SHEETS

SHEET NO.	SHEET DESCRIPTION
1 2 3 4 5 7 8 9 - 11 12 13 14 - 15 16 - 18 19 20 21 22 23 24 25 26 27 28 - 30 31 32 33 - 39	COVER SHEET GENERAL NOTES, INDEX OF SHEETS AND HIGHWAY STANDARDS SUMMARY OF QUANTITIES AND EARTHWORK TABLE TYPICAL CROSS SECTIONS AND LEGEND ALIGNMENT, TIES AND BENCHMARKS PLAN AND PROFILE SHEET KEY PLAN AND PROFILE SHEET KEY PLAN AND PROFILE SHEETS DUPAGE RIVER BRIDGE APPROACH DETAILS WEST NORMAN CROSSING GRADING DETAIL EROSION AND SEDIMENT CONTROL PLAN WETLAND IMPACT AND PLANTING EXHIBIT WETLAND IMPACT AND PLANTING EXHIBIT WETLAND IMPACT AND PLANTING GENERAL NOTES AND SPECIFICATIONS DUPAGE RIVER BRIDGE SOUTH ABUTMENT AND RETAINING WALL LAYOU' DUPAGE RIVER BRIDGE SOUTH ABUTMENT AND RETAINING WALL LAYOU' DUPAGE RIVER BRIDGE SOUTH ABUTMENT PLAN DUPAGE RIVER BRIDGE SOUTH ABUTMENT PLAN DUPAGE RIVER BRIDGE NORTH ABUTMENT PLAN DUPAGE RIVER BRIDGE NORTH ABUTMENT PLAN DUPAGE RIVER BRIDGE NORTH ABUTMENT ELEVATION DUPAGE RIVER BRIDGE NORTH ABUTMENT TELEVATION DUPAGE RIVER BRIDGE ABUTMENT SECTIONS DUPAGE RIVER BRIDGE ABUTMENT SECTIONS DUPAGE RIVER BRIDGE ABUTMENT DETAILS WEST NORMAN BOX CULVERT WEST NORMAN BOX CULVERT WEST NORMAN BOX CULVERT BND SECTION DETAIL PROPOSED PATH CROSS SECTIONS
40 41	PATH APPROACH SOUTH OF BRIDGE PATH APPROACH NORTH OF BRIDGE

IDOT HIGHWAY STANDARDS

STANDARD 000001-05	STANDARD SYMBOLS, ABBREVIATIONS AND PATTERNS
STANDARD 280001-05	TEMPORARY EROSION CONTROL SYSTEMS
STANDARD 542301-02	PRECAST REINFORCED CONCRETE FLARED END SECTION
STANDARD 701701-06	URBAN LANE CLOSURE, MULTILANE INTERSECTION
STANDARD 701901-01	TRAFFIC CONTROL DEVICES

ENGINEERING RESOURCE ASSOCIATES, INC. CONSULTING ENGINEERS, SCIENTISTS & SURVEYORS

	5.1					
JSER NAME ==	DESIGNED		BD	REVISED		
	DRAWN	_	DB	REVISED	_	
PLOT SCALE =	CHECKED	_	JFM	REVISED	-	
PLOT DATE =	DATE	_	JANUARY, 2010	REVISED	_	

STATE OF ILLINOIS DEPARTMENT OF TRANSPORTATION GENERAL NOTES, INDEX OF SHEETS AND HIGHWAY STANDARDS

SHEET NO. 1 OF 1 SHEETS

F.A RTE.	SEC-	TION		COUNTY	TOTAL SHEETS	SHEET NO.
01-P4015-01-BT			WILL	41	2	
				CONTRACT	NO. 6	3325
FED. R	OAD DIST. NO. 1	ILLINOIS	FED. A	D PROJECT		

	ITEM	DESCRIPTION	LINIT	OLIANTITY
	I I E IVI	DESCRIPTION	UNIT	QUANTITY
	20400440	TREE REMOVAL (C. 45 LINITO DIAMETER)	LINITE	00
1		TREE REMOVAL (6-15 UNITS DIAMETER)	UNIT	60
2		TEMPORARY FENCE	FOOT	3,897
3		TREE ROOT PRUNING	EACH	11
4		TREE PRUNING (1 TO 10 INCH DIAMETER)	EACH	6
5		TREE PRUNING (OVER 10 INCH DIAMETER)	EACH	5
6		SUPPLEMENTAL WATERING	UNIT	108
7		EARTH EXCAVATION	CUYD	10,093
8		REMOVAL AND DISPOSAL OF UNSUITABLE MATERIAL	CUYD	1,258
9		FURNISHED EXCAVATION	CUYD	4,000
10		POROUS GRANULAR EMBANKMENT - SUBGRADE	CUYD	1,258
11		TRENCH BACKFILL	CUYD	28
12		GEOTECHNICAL FABRIC FOR GROUND STABILIZATION	SQ YD	4,770
13		EROSION CONTROL BLANKET	SQ YD	14,559
14		TEMPORARY EROSION CONTROL SEEDING	POUND	300
15		PERIMETER EROSION BARRIER	FOOT	9,648
16		STONE RIPRAP, CLASS A3	SQ YD	446
17	28200200	FILTER FABRIC	SQ YD	446
18	31102000	SUB-BASE GRANULAR MATERIAL, TYPE C, CA-11	CUYD	211
19	35102000	AGGREGATE BASE COURSE, TYPE B, 8"	SQ YD	4,773
20	40600100	BITUMINOUS MATERIALS (PRIME COAT)	GALLON	435
21	40603310	HOT-MIX ASPHALT, SURFACE COURSE, MIX "C" N50	TON	493
22	50200100	STRUCTURE EXCAVATION	CU YD	1,013
23	50300225	CONCRETE STRUCTURES	CU YD	990
24	50800205	REINFORCEMENT BARS, EPOXY COATED	POUND	107,620
25	51201400	FURNISHING STEEL PILES, HP10x42	FOOT	6,600
26	51202305	DRIVING PILES	FOOT	6,600
27	51203400	TEST PILE STEEL HP10X42	EACH	2
28	51204650	PILE SHOES	EACH	134
29	54010604	PRECAST CONCRETE BOX CULVERT 6' X 4'	FOOT	40
30	54010605	PRECAST CONCRETE BOX CULVERT 6' X 5'	FOOT	20
31	54213657	PRECAST REINFORCED CONCRETE FLARED END SECTIONS 12"	EACH	4
32		GRATING FOR CONCRETE FLARED END SECTION 12"	EACH	4
33		STORM SEWERS, CLASS A, TYPE 2 12"	FOOT	62
34		MOBILIZATION	LSUM	1
35		TRAFFIC CONTROL AND PROTECTION 701701	LSUM	1
36		SIGN PANEL - TYPE 1	SQFT	24
37		METAL POST - TYPE A	FOOT	30
38		PAINT PAVEMENT MARKING - LINE 4"	FOOT	600
39		PRAIRIE SEEDING (SPECIAL)	ACRE	2.71
40		PEDESTRIAN TRUSS SUPERSTRUCTURE	SQFT	2,128
41		STABILIZED CONSTRUCTION ENTRANCE	SQ YD	500
42		SEEDING, SEDGE MEADOW MIX	ACRE	0.99
43		CONSTRUCTION LAYOUT	L SUM	1
44		-		
45	70077900	WOOD POST AND RAIL FENCE	FOOT	500
46		NATIVE PLANT PLUGS (INCLUDING GOOSE GRID BARRIER)	EACH	4,854
	17700 3337	* Indicates specialty items	LAOIT	7,007

Indicates specialty items

EARTHWORK TABLE

STATION	EARTH EXCAVATION*	EMBANKMENT**	TOPSOIL PLACEMENT	REMOVAL AND DISPOSA OF UNSUITABLE MATERIAL
	(CY)	(CY)	(CY)	(CY)
113+83	4.3	0.0	0.0	5.3
113+96	1.3	0.0	0.0	1.6
114+00	33.4	0.0	0.0	40.7
115+00	64.4	0.0	0.0	40.7
116+00	127.5	0.0	0.0	40.7
710-00	121.0	0.0	0.0	10.7
125+00	811.6	0.0	0.0	20.4
125+50	859.8	0.0	0.0	20.4
126+00	921.6	0.0	0.0	20.4
126+50	998.4	0.0	0.0	20.4
127+00	1179.5	0.0	0.0	20.4
127+50	1437.9	0.0	0.0	20.4
128+00	1955.8	0.1	0.0	40.7
129+00	446.7	0.1	0.0	40.7
130+00	73.8	0.0	0.0	40.7
131+00	30.0	0.0	0.0	16.7
131+41	42.7	0.0	0.0	24.0
132+00	81.8	0.0	0.0	40.7
133+00	69.8	0.0	0.0	40.7
134+00	33.3	2.2	0.0	40.7
135+00	22.8	2.2	0.0	40.7
136+00	38.8	0.0	0.0	40.7
137+00	29.6	7.0	0.0	40.7
138+00	39.4	7.0	0.0	40.7
139+00	61.2	0.0	0.0	40.7
140+00	47.7	0.0	0.0	40.7
141+00	13.1	0.0	0.0	15.1
141+37	36.1	0.0	0.0	25.7
142+00	66.1	0.0	0.0	40.7
143+00	23.4	26.4	0.0	35.4
143+87	0.0	32.1	0.0	21.6
144+70	0.0	31.2	0.0	16.3
145+10	10.1	36.4	0.0	36.7
146+00	37.8	1.4	0.0	40.7
147+00	4.4	0.0	0.0	4.1
147+10	28.3	0.0	0.0	36.7
148+00	72.9	0.0	0.0	40.7
149+00	71.4	0.1	0.0	40.7
150+00	25.3	0.3	0.0	40.7
151+00	37.9	4.7	0.0	40.7
152+00	61.2	4.6	0.0	40.7
			:	
200+00	81.9	0.0	0.0	0.0
200+50	74.6	0.0	0.0	0.0
201+00	9.1	0.0	0.0	0.0
201+08	9.1	0.0	0.0	0.0
300+41	3.0	175.6	0.0	0.0
300+64	0.0	251.1	0.0	0.0
300+78	0.0	543.9	0.0	0.0
301+06	0.0	483.4	0.0	0.0
301+36	0.0	262.1	0.0	0.0
301+57	0.0	121.6	0.0	0.0
301+70	0.0	77.1	0.0	0.0
400+35	0.0	445.3	0.0	0.0
400+51	0.0	615.9	0.0	0.0
400+75	4.3	675.9	0.0	0.0
401+11	4.5	185.0	0.0	0.0
401+25	5.0	154.7	0.0	0.0
			:	
TOTAL	10092.6	4147.4	3100.0	1257.7


^{*} APPROXIMATELY 3,100 CY OF EARTH EXCAVATION SHALL BE USED FOR TOPSOIL



USER NAME =	DESIGNED	_	BD	REVISED	_	 Γ
	DRAWN		DB	REVISED		
PLOT SCALE =	CHECKED	_	JFM	REVISED		
PLOT DATE =	DATE	_	JANUARY, 2010	REVISED		


	SEC	TION	COUNTY	TOTAL SHEETS	SHEET NO.	
01-P4015-00-BT			WILL	41	3	
CONTRACT NO. 63325						
. R	DAD DIST. NO. 1	ILLINOIS FED.	AID PROJECT			

^{**} APPROXIMATELY 4,000 CY OF EMBANKMENT QUANTITY SHALL BE PAID AS FURNISHED EXCAVATION IF SUITABLE MATERIAL IS NOT FOUND ON SITE AND ONLY AS DIRECTED BY THE ENGINEER

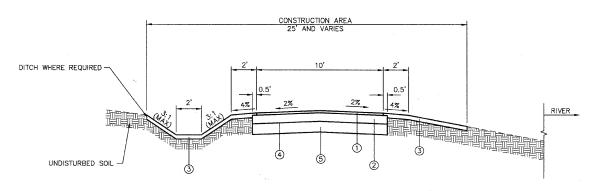


PROPOSED PATH TYPICAL SECTION (10') N.T.S

(STA. 127+50 TO STA. 130+00) (STA. 143+00 TO STA. 147+10)

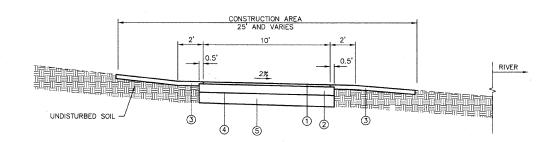

PROPOSED PATH

TYPICAL SECTION (10')
N.T.S
(STA. 120+00 TO STA. 123+00)
(STA. 124+00 TO STA. 125+50) (STA. 132+00 TO STA. 143+00) (STA. 149+00 TO STA. 150+00) (STA. 150+75 TO STA. 151+25)

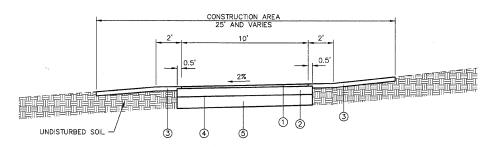

PROPOSED PATH
TYPICAL SECTION (10')
(STA. 113+83NTOSSTA. 120+00)
(STA. 123+00 TO STA. 124+00) (STA. 125+50 TO STA. 127+50) (STA. 130+00 TO STA. 132+00) (STA. 147+10 TO STA. 149+00) (STA. 150+00 TO STA. 150+75) (STA. 151+25 TO STA. 152+00)

NOTE: CONTRACTOR TO ENSURE THAT A CLEAR ZONE OF 2 FEET EXISTS ADJACENT TO BOTH SIDES OF THE PATH IN ACCORDANCE WITH AASHTO GUIDELINES.

- 1) HOT-MIX ASPHALT SURFACE COURSE, MIX C, N50, 2"
- 2 AGGREGATE BASE COURSE, TYPE B, 8"
- 3 TOPSOIL, 6" (FURNISH AND PLACE)
- 4 GEOTECHNICAL FABRIC FOR GROUND STABILIZATION.
- (5) REMOVAL OF UNSUITABLE MATERIAL. REPLACE WITH PGE AS DIRECTED BY ENGINEER.

	LEGEND	
CURB & GUTTER	EXISTING	PROPOSED
WATER GAS SANITARY SEWER STORM SEWER		
MANHOLE CATCH BASIN	© O	⊙ •
VALVE VAULT	□ ⊚ ⊗	■ ⑥ ⊗
VALVE & BOX BUFFALO BOX GAS VALVE HYDRANT HANDICAPPED RAMP FILL STRUCTURE	⊗ e g ∀ 	8 8 8 4 1
ADJUST STRUCTURE	⊗ A	
TREE		
TREE REMOVAL		
ELEVATION	+ xxx.x	+ xxx.x
CONTOUR	XXX	——————————————————————————————————————
EDGE OF WATER		
LIMITS OF CONSTRUCTION		
R.O.W.		
FENCE	X	
DOUBLE ROW SILT FENCE		
FLOW	==	
WETLAND FLAG	5	
RIP RAP PROPOSED PATH		

HOT-MIX	ASPHALT	MIXTURE	REQUIREM	(ENTS
MIX	AIR VOIDS • Ndes			
HOT-MIX-ASPHALT SURFACE	COURSE, MIX	"C", N50 ; 2	" (IL 9.5 MM)	4% © 50 Gyr.

THE UNIT WEIGHT USED TO CALCULATE ALL HMA SURFACE MIXTURE QUANTITIES IS 112 LBS/SQ. YD/IN.

THE "AC TYPE" FOR POLYMERIZED HMA MIXES SHALL BE "SBS/SBR PG 70-22" AND FOR NON-POLYMERIZED HMA THE "AC TYPE" SHALL BE "PG 64-22" UNLESS MODIFIED BY DISTRICT ONE SPECIAL PROVISIONS. FOR "PERCENT OF RAP" SEE DISTRICT ONE SPECIAL PROVISIONS.

RESOURCE ASSOCIATES, INC. CONSULTING ENGINEERS, SCIENTISTS & SURVEYORS	E	ASSOCIATES, INC. CONSULTING ENGINEERS, SCIENTISTS	
--	---	---	--


USER NAME =	DESIGNED		BD	REVISED		
	DRAWN	_	DB	REVISED		
PLOT SCALE =	CHECKED		JFM	REVISED	_	
PLOT DATE =	DATE		JANUARY, 2010	REVISED	_	


STATE OF ILLINOIS DEPARTMENT OF TRANSPORTATION


SCALE:

ΥP	ICAL	CF	₹0	SS	SEC	TIC	NS	AND	LEGEND	
	SHEET	NO.	1 (OF 1	SHEETS					

<u>:-</u>	SECTION							COUNTY	TOTAL	SHEET NO.
	01-P4015-01-BT							WILL	41	4
								CONTRACT	NO.	3325
). R	OAD	DIST.	NO.	1	ILLINOIS	FED.	AID	PROJECT		

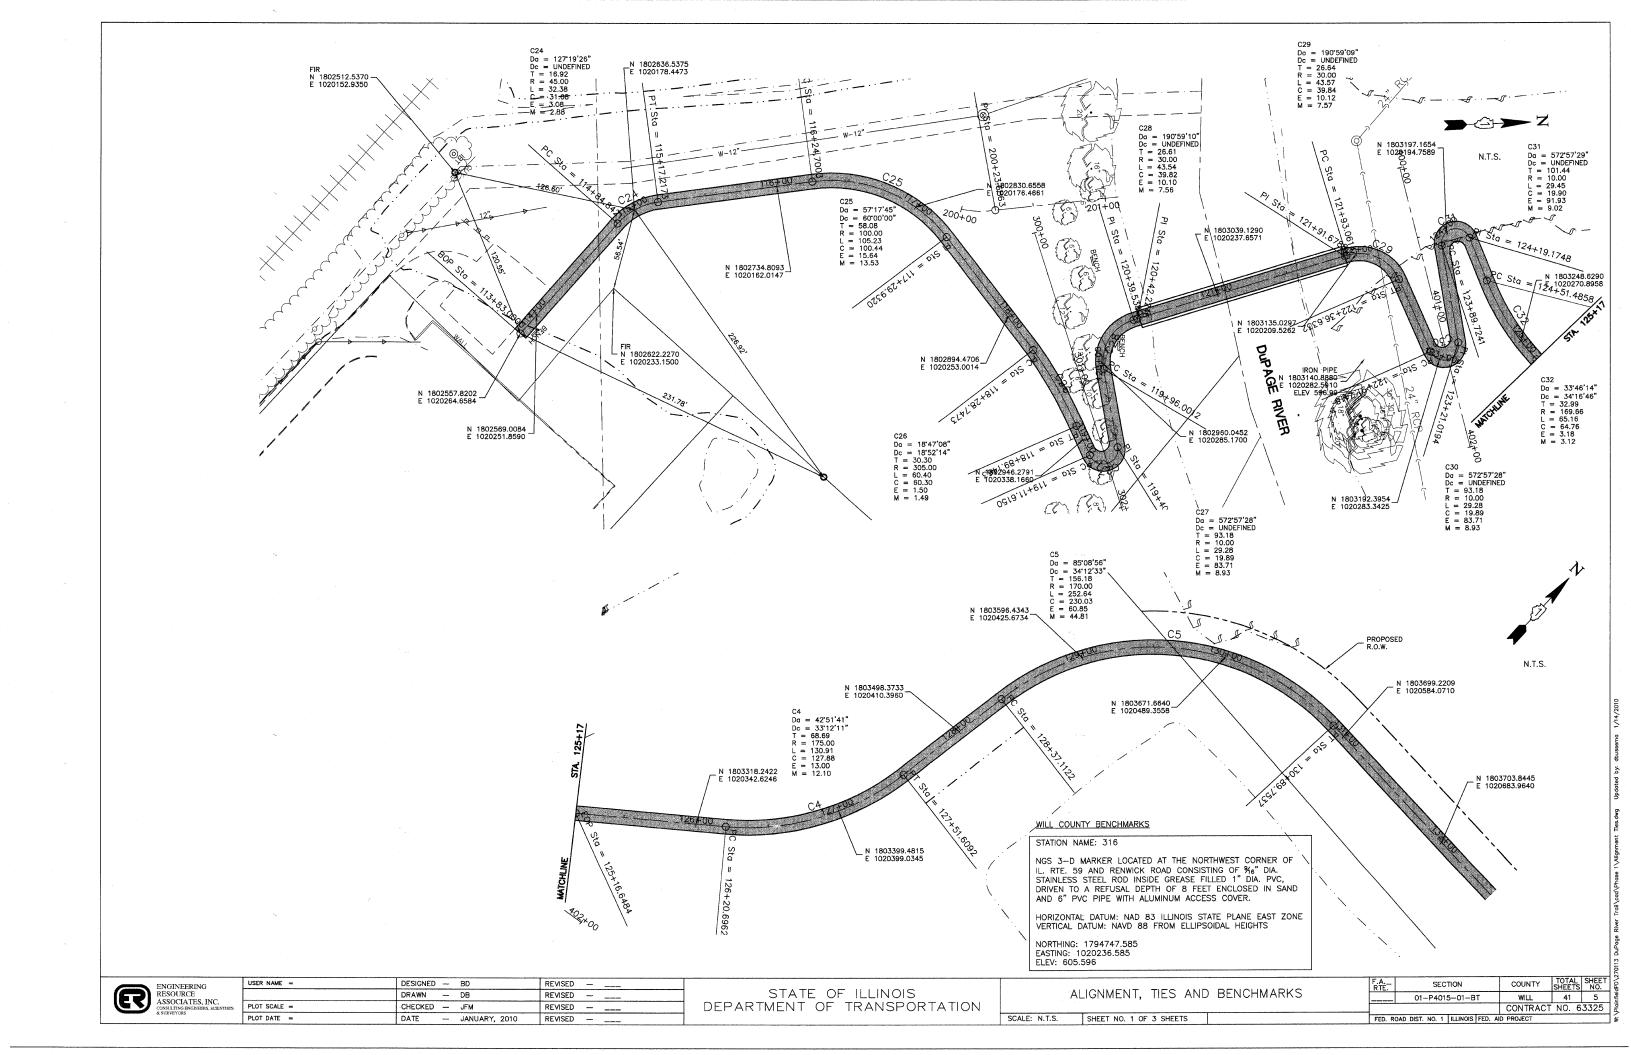

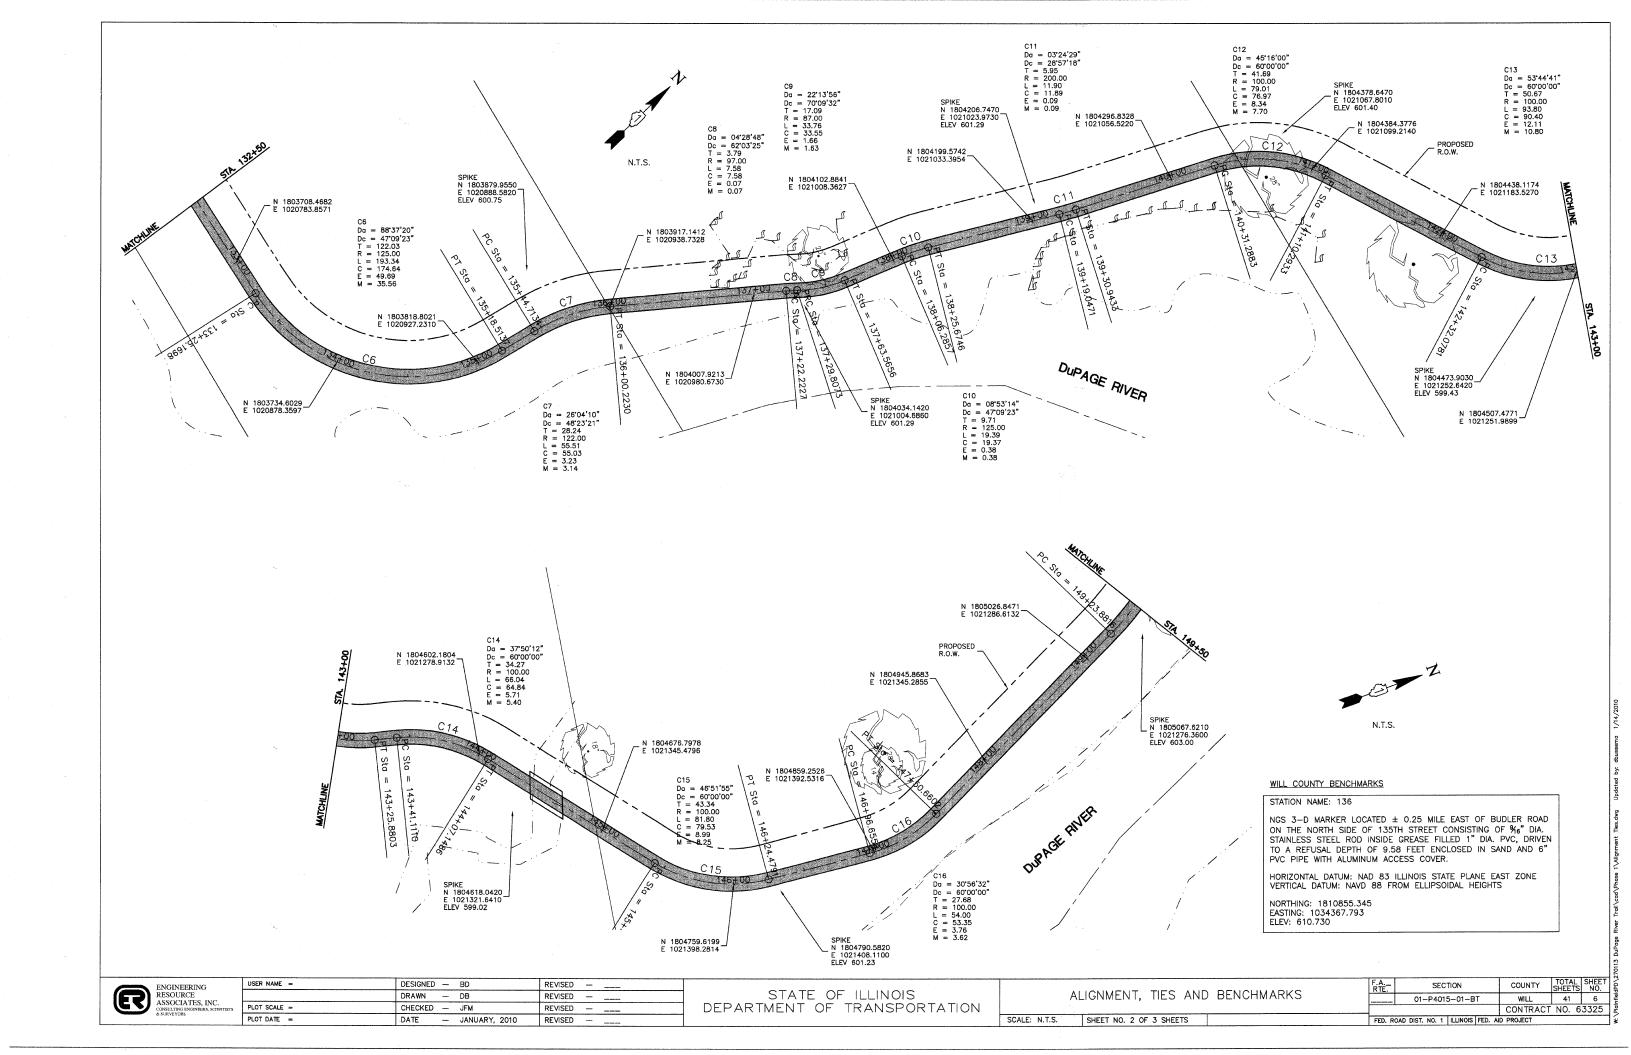

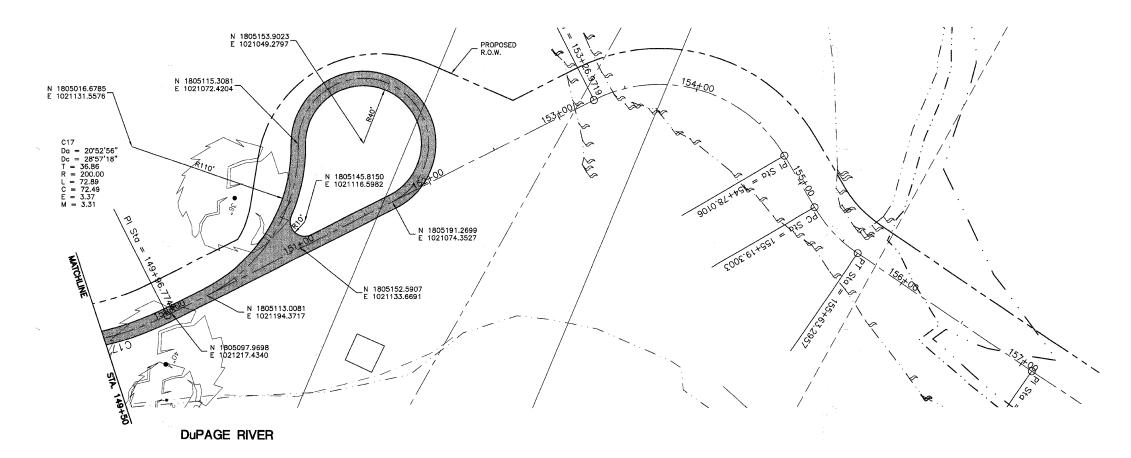

WILL COUNTY BENCHMARKS

STATION NAME: 306

NGS 3-D MARKER LOCATED \pm 0.40 MILE EAST OF HEGGS ROAD ON THE SOUTH SIDE OF 135TH STREET CONSISTING OF $\%_6$ " DIA. STAINLESS STEEL ROD INSIDE GREASE FILLED 1" DIA. PVC, DRIVEN TO A REFUSAL DEPTH OF 12 FEET ENCLOSED IN SAND AND 6" PVC PIPE WITH ALUMINUM ACCESS COVER.

HORIZONTAL DATUM: NAD 83 ILLINOIS STATE PLANE EAST ZONE VERTICAL DATUM: NAVD 88 FROM ELLIPSOIDAL HEIGHTS

NORTHING: 1810010.773 EASTING: 1004539.356 ELEV: 672.594


R	ENGINEERING RESOURCE ASSOCIATES, INC. CONSULTING ENGINEERS, SCIENTISTS & SURVEYORS
---	--

DRAWN DB	USER NAME =	DESIGNED	_	BD	REVISED		
		DRAWN		DB	REVISED	_	
PLOT DATE = DATE - JANUARY 2010 REVISED -	PLOT SCALE =	CHECKED	_	JFM	REVISED	_	
Ditte Districtly Lots	PLOT DATE =	DATE	_	JANUARY, 2010	REVISED	_	

STATE	E OF	ILLINOIS
DEPARTMENT	OF	TRANSPORTATION


A	LIGNMENT,	TIES	AND	BENCHMARKS
SCALE: N.T.S.	SHEET NO. 3 OF	3 SHEET	'S	


Ė.		S	EC	TION		COUNTY	TOTAL SHEETS	SHEET NO.
	01-P4015-01-BT					WILL	41	7
					CONTRACT	NO. 6	3325	
). R	OAD DIS	T. NO.	1	ILLINOIS	FED. A	D PROJECT		

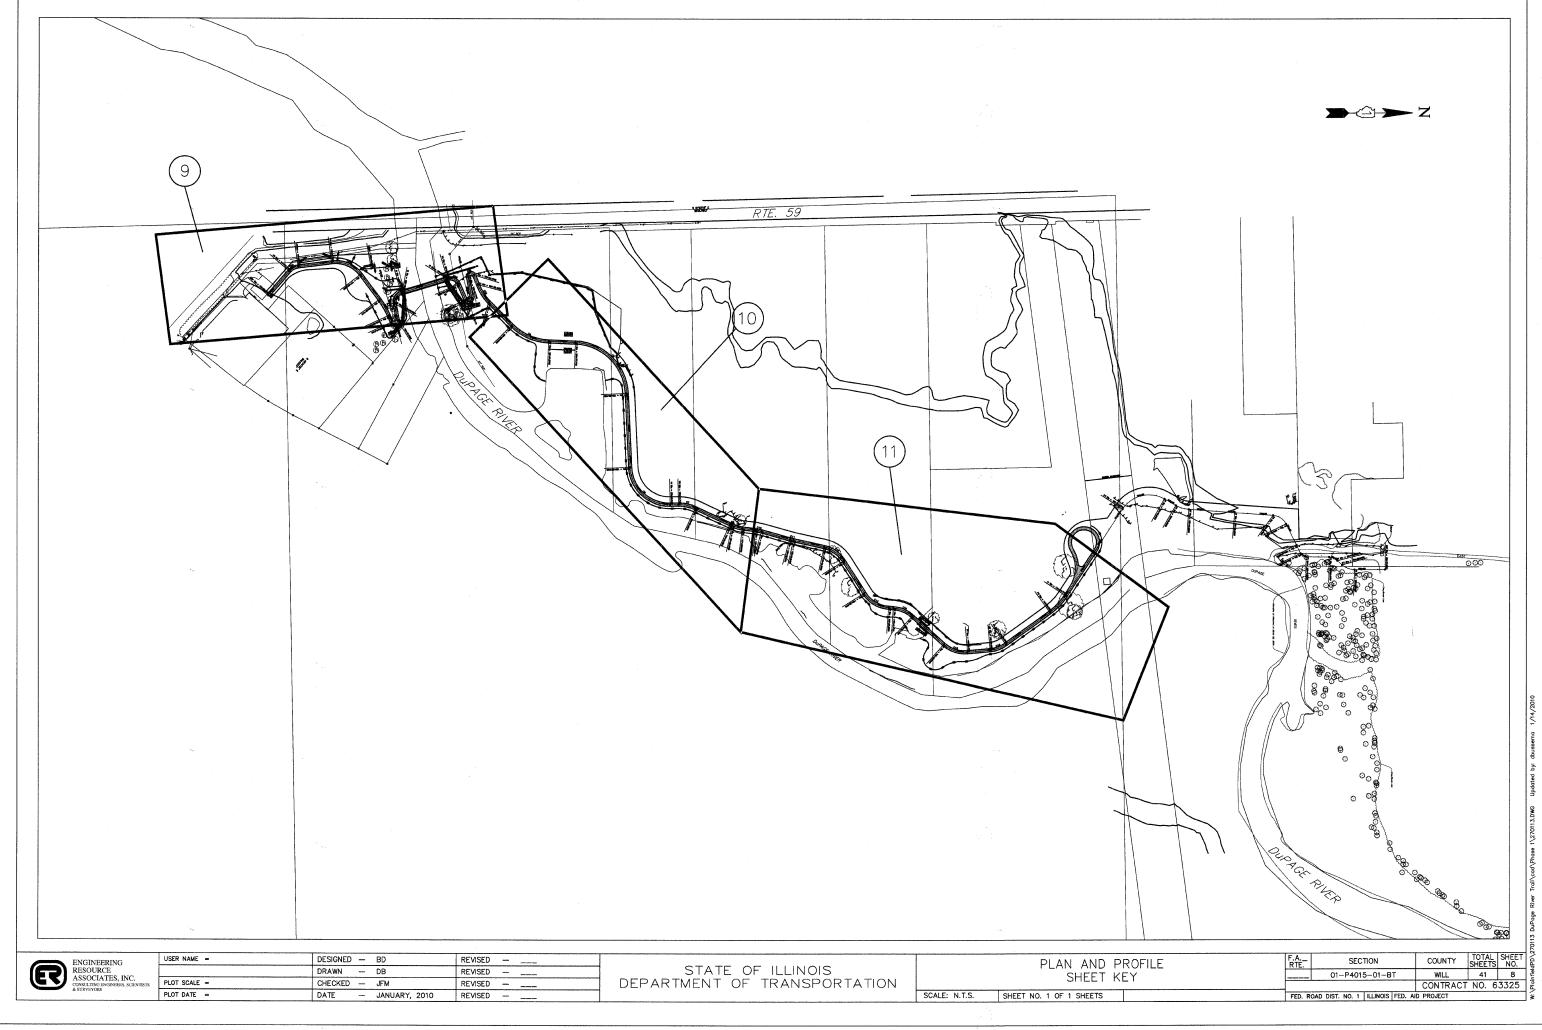



CHECKED — JFM
DATE — JANUARY, 2010 REVISED - ___ PLOT DATE = REVISED -___

SCALE: N.T.S. SHEET NO. 1 OF 1 SHEETS

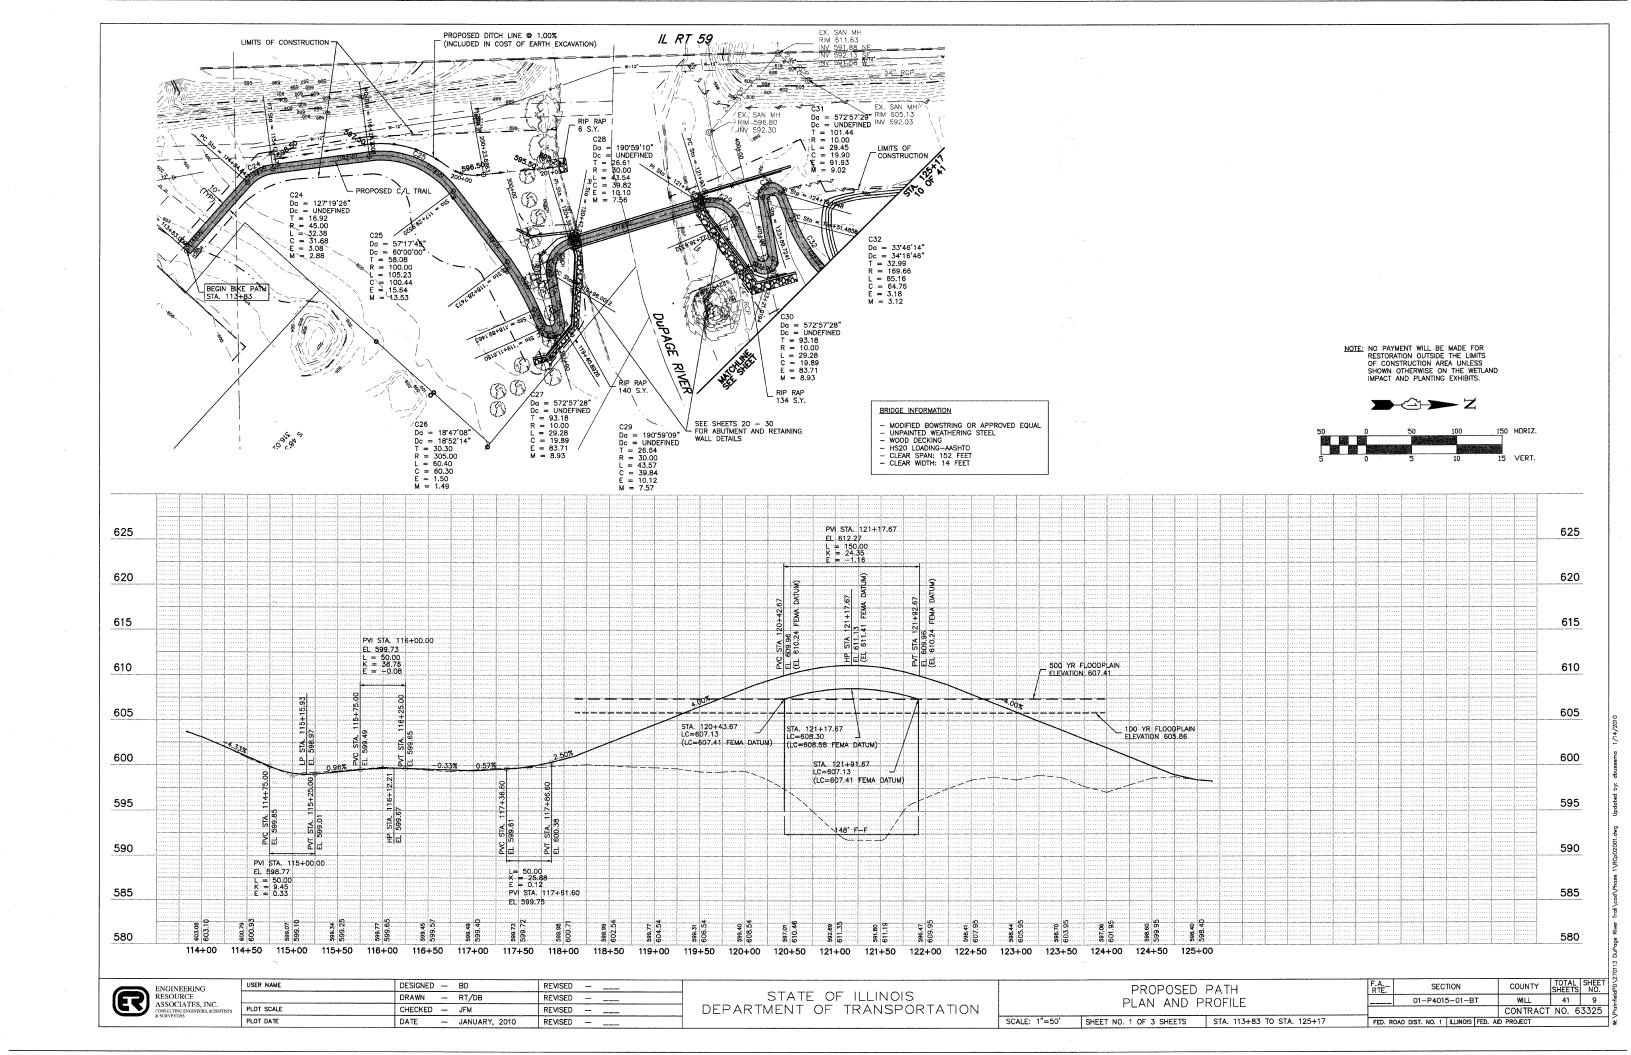

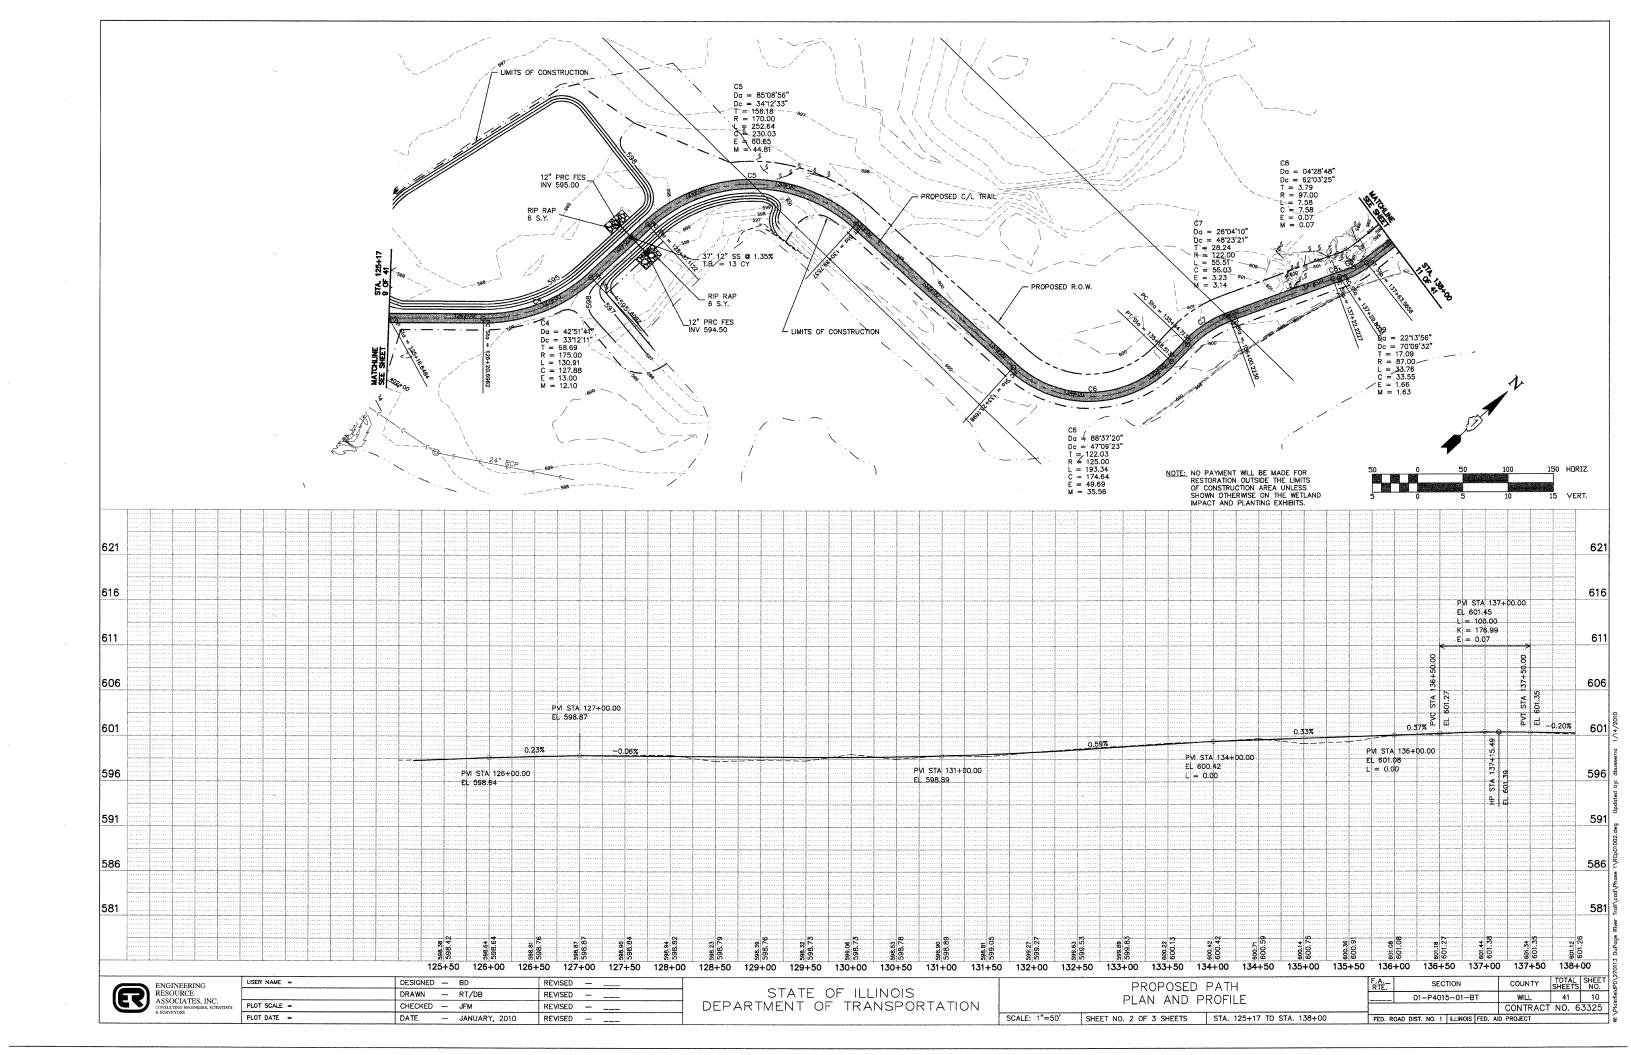

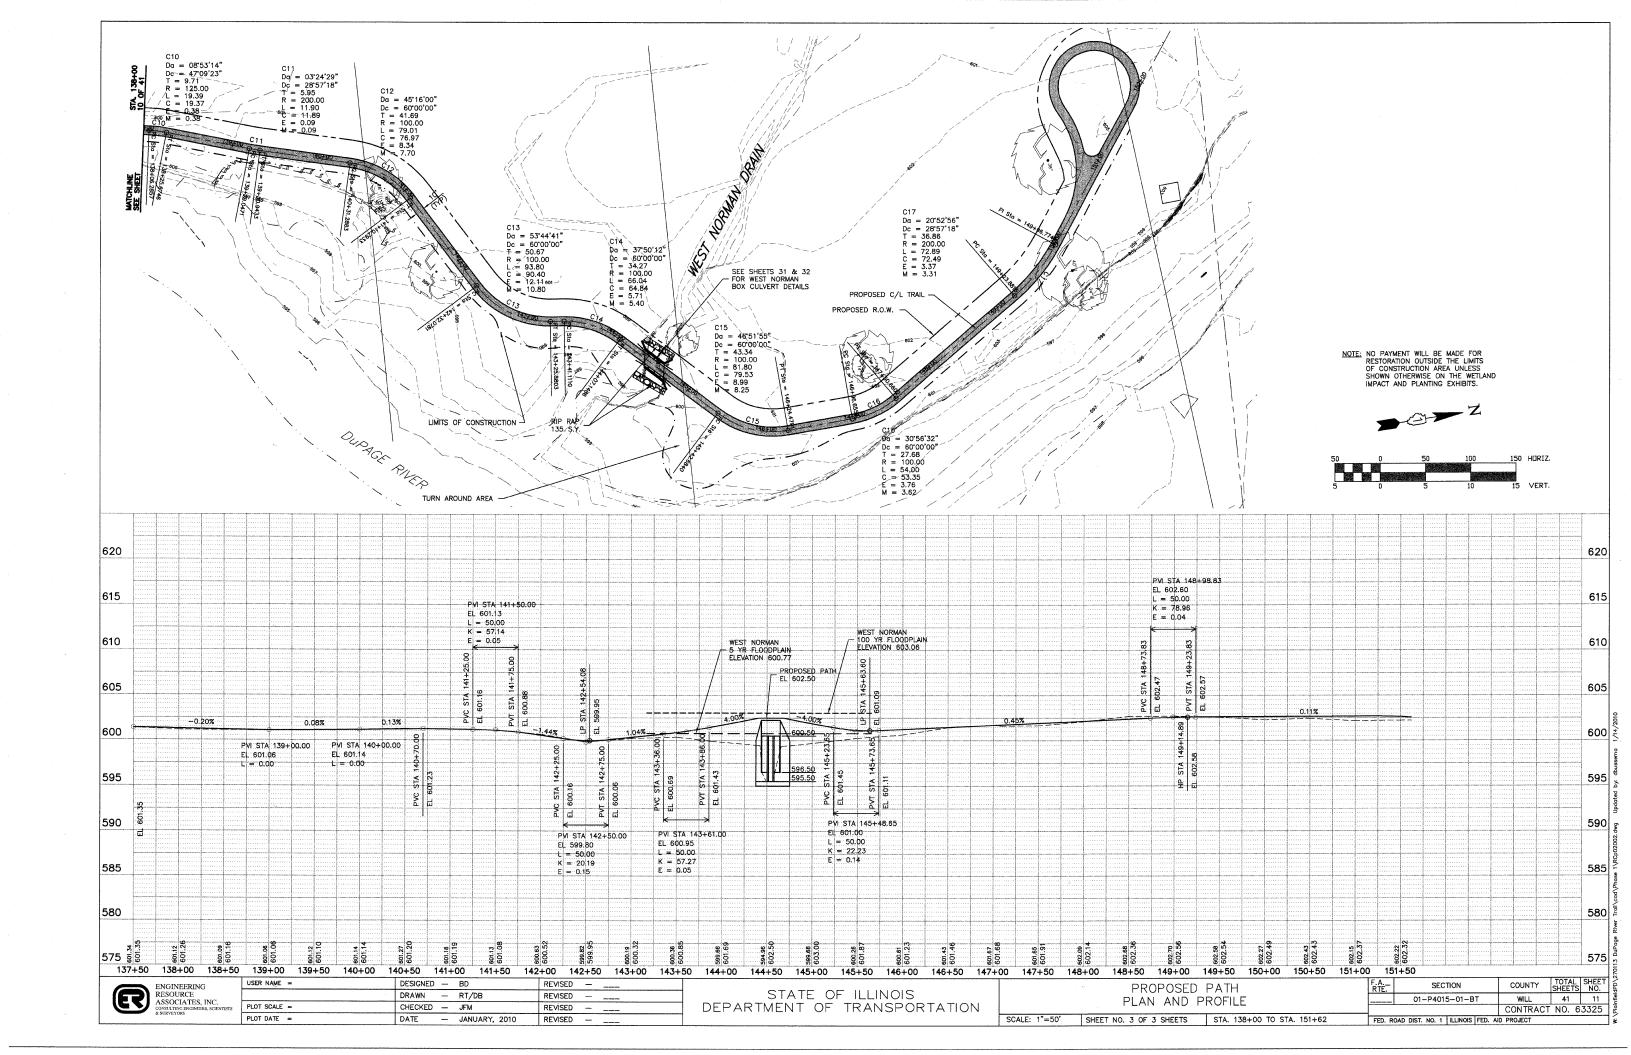

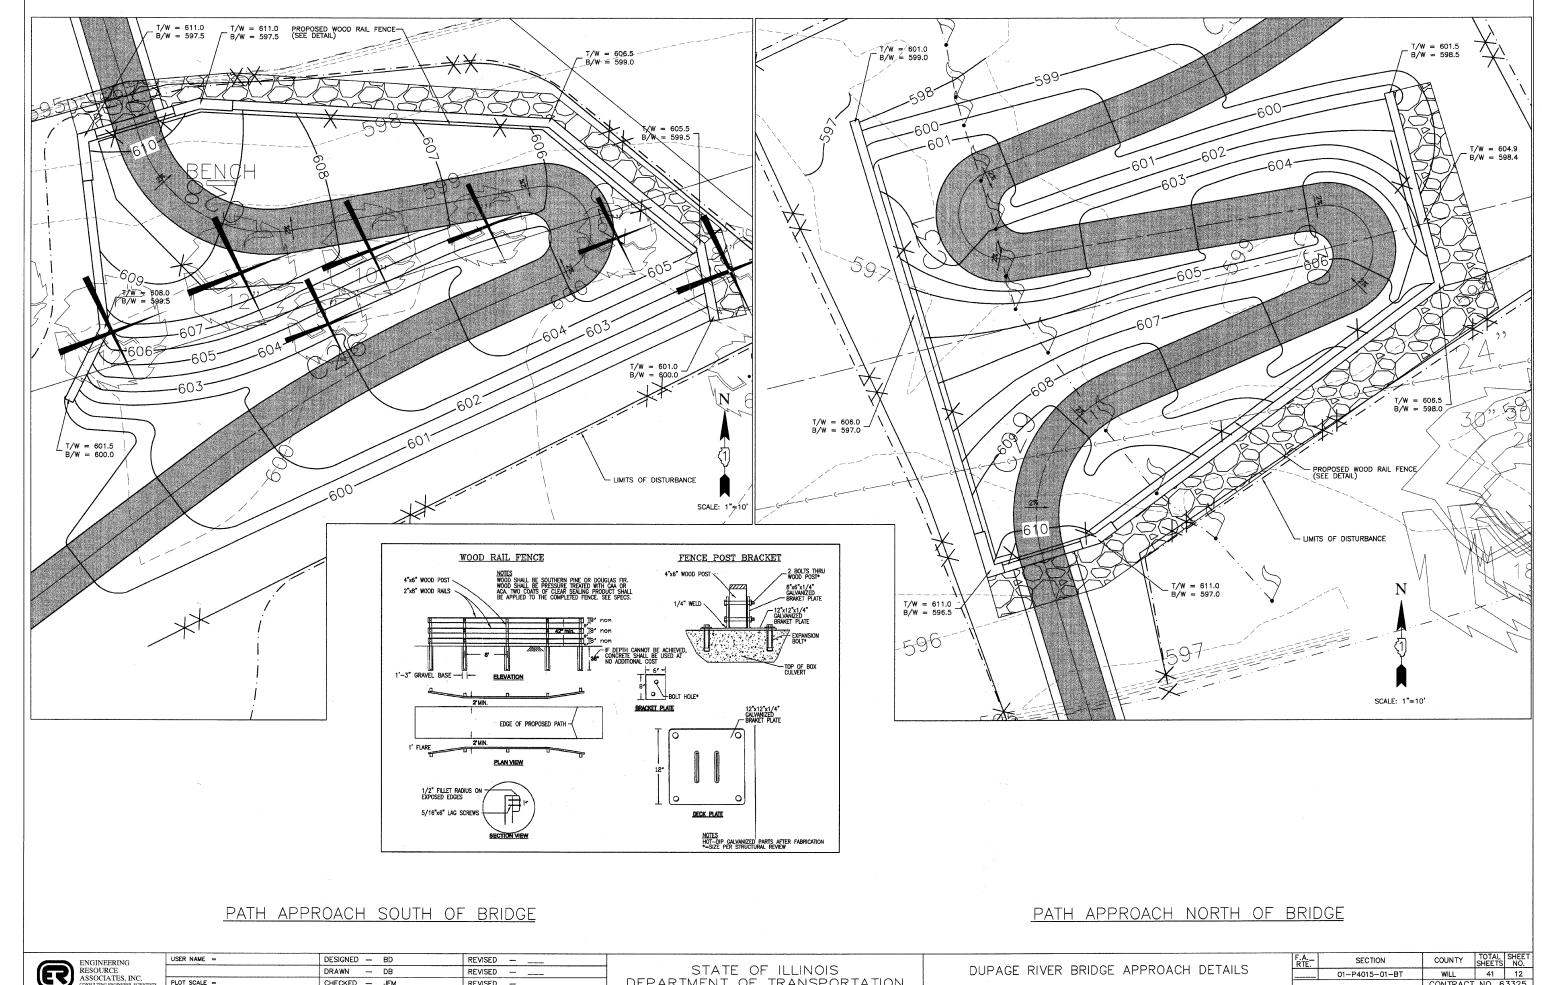


ENGINEERING
RESOURCE
ASSOCIATES, INC.
CONSULTING ENGINEERS. SCIPN

PLOT SCALE == CHECKED - JFM REVISED — ____ PLOT DATE = DATE — JANUARY, 2010 REVISED ---

DEPARTMENT OF TRANSPORTATION

SCALE: 1"=10' SHEET NO. 1 OF 1 SHEETS STA. TO STA.

WILL 41 12 CONTRACT NO. 63325 FED. ROAD DIST. NO. 1 | ILLINOIS | FED. AID PROJECT

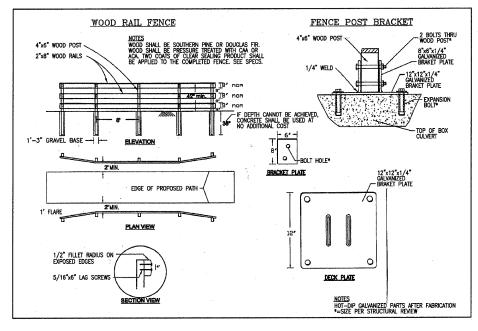

WEST NORMAN CROSSING

ENGINEERING
RESOURCE
ASSOCIATES, INC.
CONSULTING ENGINEERS, SCIENTISTS
& SURVEYOR

USER NAME =	DESIGNED		BD	REVISED	_	
	DRAWN	_	DB	REVISED	_	
PLOT SCALE =	CHECKED	_	JFM	REVISED	_	
PLOT DATE =	DATE	_	JANUARY, 2010	REVISED	_	


STATE OF ILLINOIS DEPARTMENT OF TRANSPORTATION

	WEST NORMAN C GRADING DE	
T	SHEET NO. 1 OF 1 SHEETS	STA. TO STA.

SCALE: 1"=10'

- ALL DISTURBED AREAS SHALL BE SEEDED DE SODDED AS SOON AS PRACTICAL AFTER CONSTRUCTION ACTIVITIES IN THAT AREA HAVE CONCILUIDED. ALL ERODABLEPARE AREAS SHALL BE SEEDED EVERY 7 DAYS WITH TEMPORARY EROSION CONTROL SEEDING. ERODABLE AREAS OUTSIDE AND DOWN SLOPE FROM THE CONSTRUCTION LIMITS MAY BE SIMILARLY SEEDED. IF A TOPSOIL STOKEN ACTIVITY ACFORMED THAT THREE DAYS, EROSION CONTROL DEMANS HE AGE FOR MEET HAN THREE DAYS.
- 5. THE CONTRACTOR SHALL TAKE ALL PRECAUTIONS TO PROTECT WEILANDS TO REMAIN FROM DAMAGE BY SEDIMENT. CONSTRUCTION EQUIPMENT OR BY HIS WORK CREWS. THE CONTRACTOR SHALL ASSURE THAT DEBRIS OR ANY CONSTRUCTION MATERIAL IS NOT DISPOSED OF IN WEILANDS.
- 6. WATER PUMPED OR OTHERWISE DISCHARGED FROM THE SITE DURING CONSTRUCTION DEWATERING SHALL BE FILTERED.
- 7. WHEN TEMPORARY DRAINAGE IS ESTABLISHED EROSION CONTROL MEASURES MAY BE REQUIRED BY THE ENGINEER.

- 14. ALL EROSION CONTROL MEASURES SHALL BE KEPT OPERATIONAL AND MAINTAINED CONTINUOUSLY THROUGHOUT THE PERIOD OF LAND DISTURBANCE UNTIL PERMANENT SEDIMENT AND EROSION CONTROL MEASURES ARE OPERATIONAL.

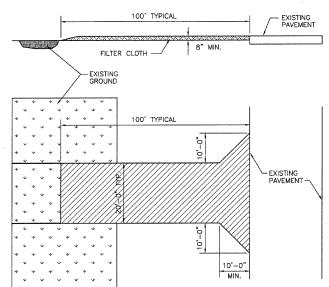

STABILIZED TEMPORARY CONSTRUCTION ENTRANCE

NOT TO SCALE

CONSTRUCTION **ENTRANCE SPECIFICATIONS**

- 1. THE ENTRANCE SHALL BE IN PLACE PRIOR TO ANY SITE GRADING ACTIVITIES.
 2. STONE SIZE USE 2" STONE, OR RECYCLE CONCRETE EQUIVALENT.
 3. THICKNESS NOT LESS THAN 8".
 4. FILTER FABRIC SHALL BE PLACED OVER THE ENTIRE AREA PRIOR TO PLACING OF STONE.
 5. MAINTENANCE THE ENTRANCE SHALL BE MAINTAINED IN A CONDITION WHICH WILL PREVENT TRACKING OR FLOWING OF SEDIMENT INTO PUBLIC RIGHTS—OF—WAY. THIS MAY REQUIRE PERIODIC TOP DRESSING WITH ADDITIONAL STONE AS CONDITIONS DEMAND AND REPAIR AND/OR CLEANOUT OF ANY MEASURES USED TO TRAP SEDIMENT. ALL SEDIMENT SPILLED, DROPPED, WASHED OR TRACKED INTO PUBLIC RIGHTS—OF—WAY MUST BE REMOVED IMMEDIATELY.
 6. WASHING WHEELS SHALL BE CLEANED TO REMOVE SEDIMENT PRIOR TO ENTRANCE INTO PUBLIC RIGHT—OF—WAY. WHEN WASHING IS REQUIRED, IT SHALL BE DONE ON AN AREA STABILIZED WITH STONE AND WHICH DRAINS INTO AN APPROVED SEDIMENT TRAPPING DEVICE.
 7. PERIODIC INSPECTION AND NEEDED MAINTENANCE SHALL BE UTILIZED BY ALL CONSTRUCTION TRAFFIC UNTIL PERMANENT PAVEMENTS ARE IN PLACE.

LEGEND EXISTING PROPOSED TREE + XXX.X T XXXX FLEVATION -XXX CONTOUR ---xxx----EDGE OF WATER FENCE DOUBLE ROW SILT FENCE \Longrightarrow \Longrightarrow FLOW WETLAND FLAG 25050 RIP RAP PROPOSED PATH



SCALE: 1"=50'

 USER NAME =	DESIGNED	_	BD	REVISED		 _
	DRAWN	_	DB	REVISED		
PLOT SCALE ==	CHECKED	_	JFM	REVISED	_	
PLOT DATE =	DATE	_	JANUARY, 2010	REVISED	_	

STATE OF ILLINOIS DEPARTMENT OF TRANSPORTATION


LOUBLE ROW SILT FENCE

DOUBLE ROW SILT FENCE

SCALE: 1"=50'

											ı
RTE. SECTION								COUNTY	TOTAL SHEETS	SHEET NO.	
01-P4015-01-BT						Т	WILL	41	14		
								CONTRACT	NO. 6	3325	
FED. R	OAD	DIST.	NO.	1	ILLINOIS	FED.	AID	PROJECT			

EROSION AND SEDIMENT CONTROL PLAN SCALE: 1"=50' SHEET NO. 1 OF 2 SHEETS

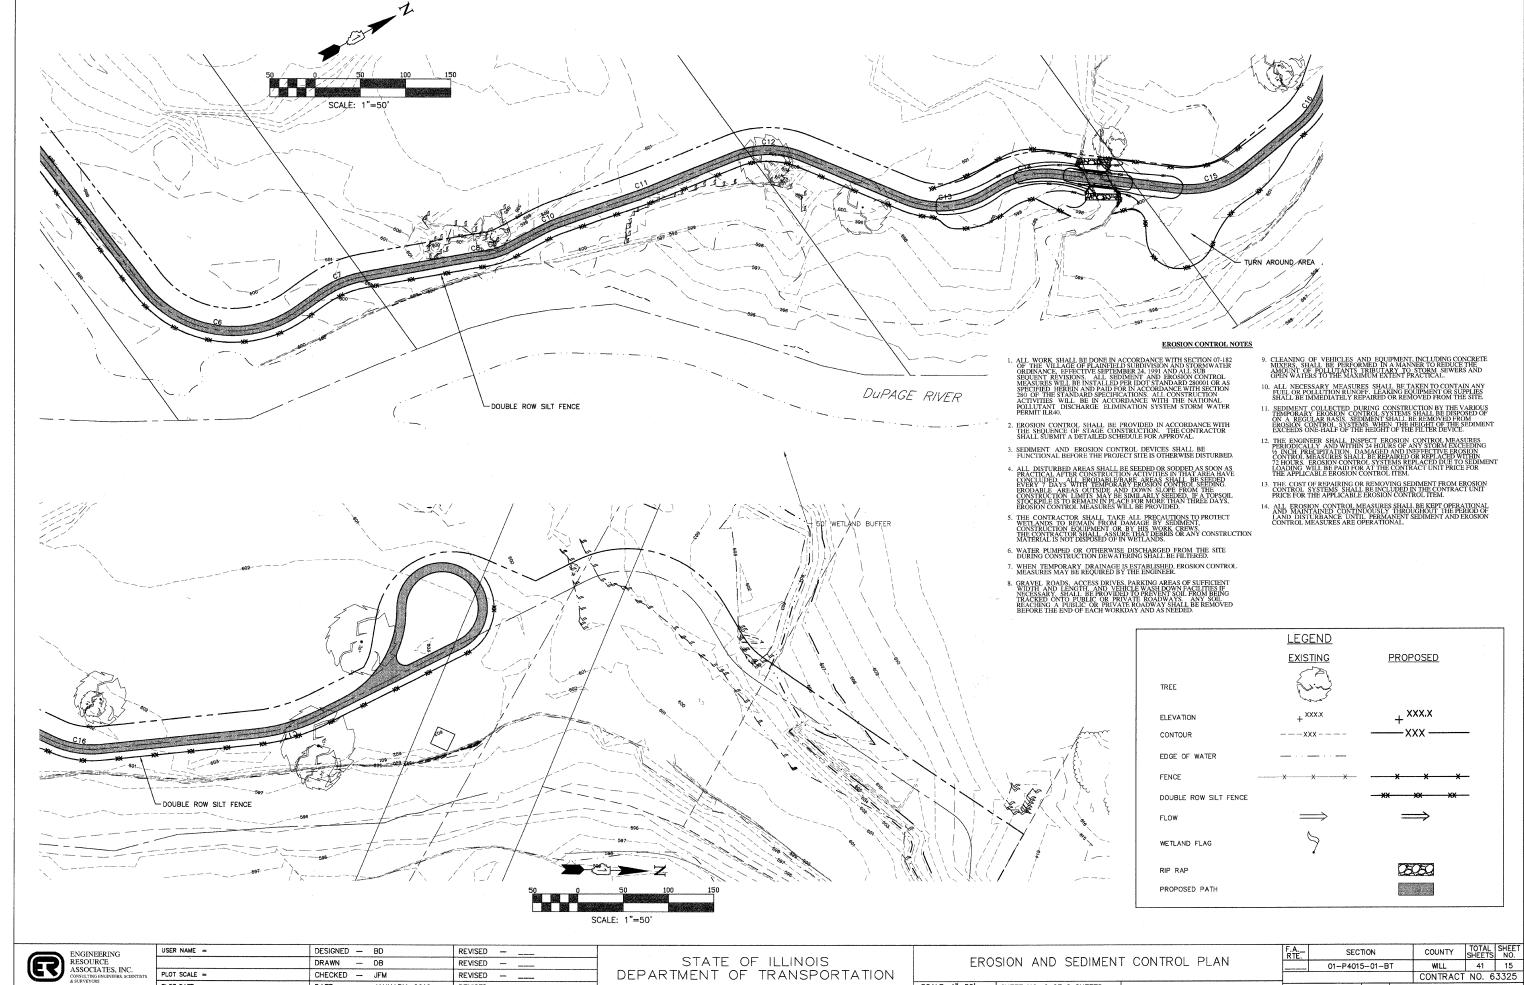


SCALE: 1"=50' SHEET NO. 2 OF 2 SHEETS


PLOT DATE =

DATE - JANUARY, 2010

REVISED

FED. ROAD DIST. NO. 1 ILLINOIS FED. AID PROJECT

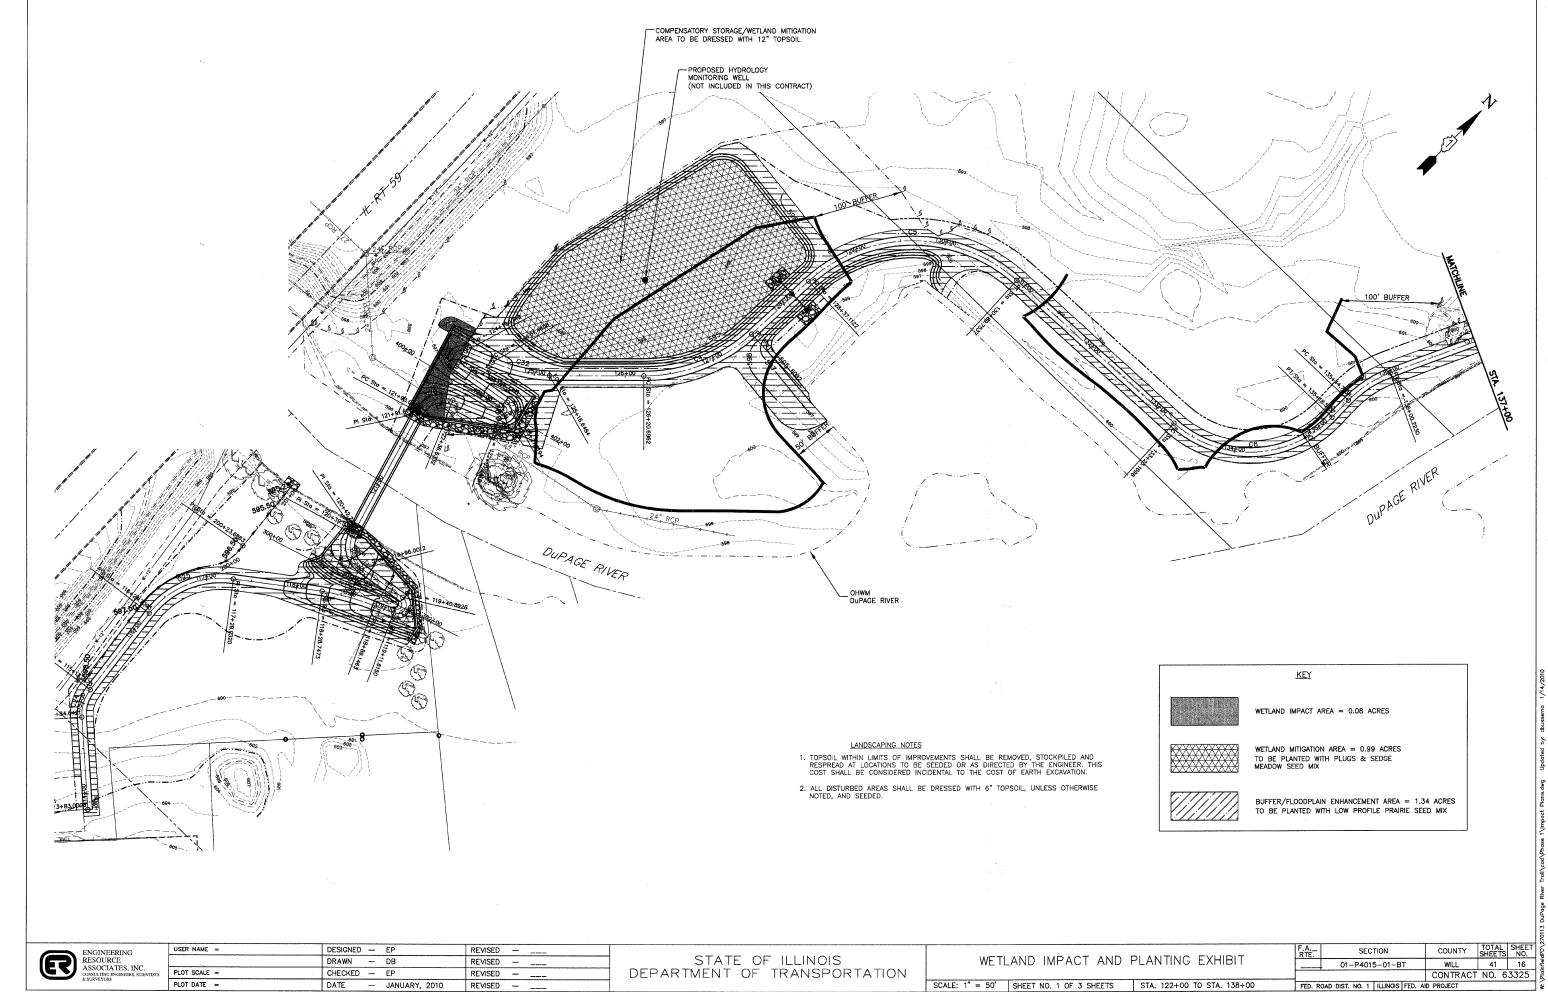

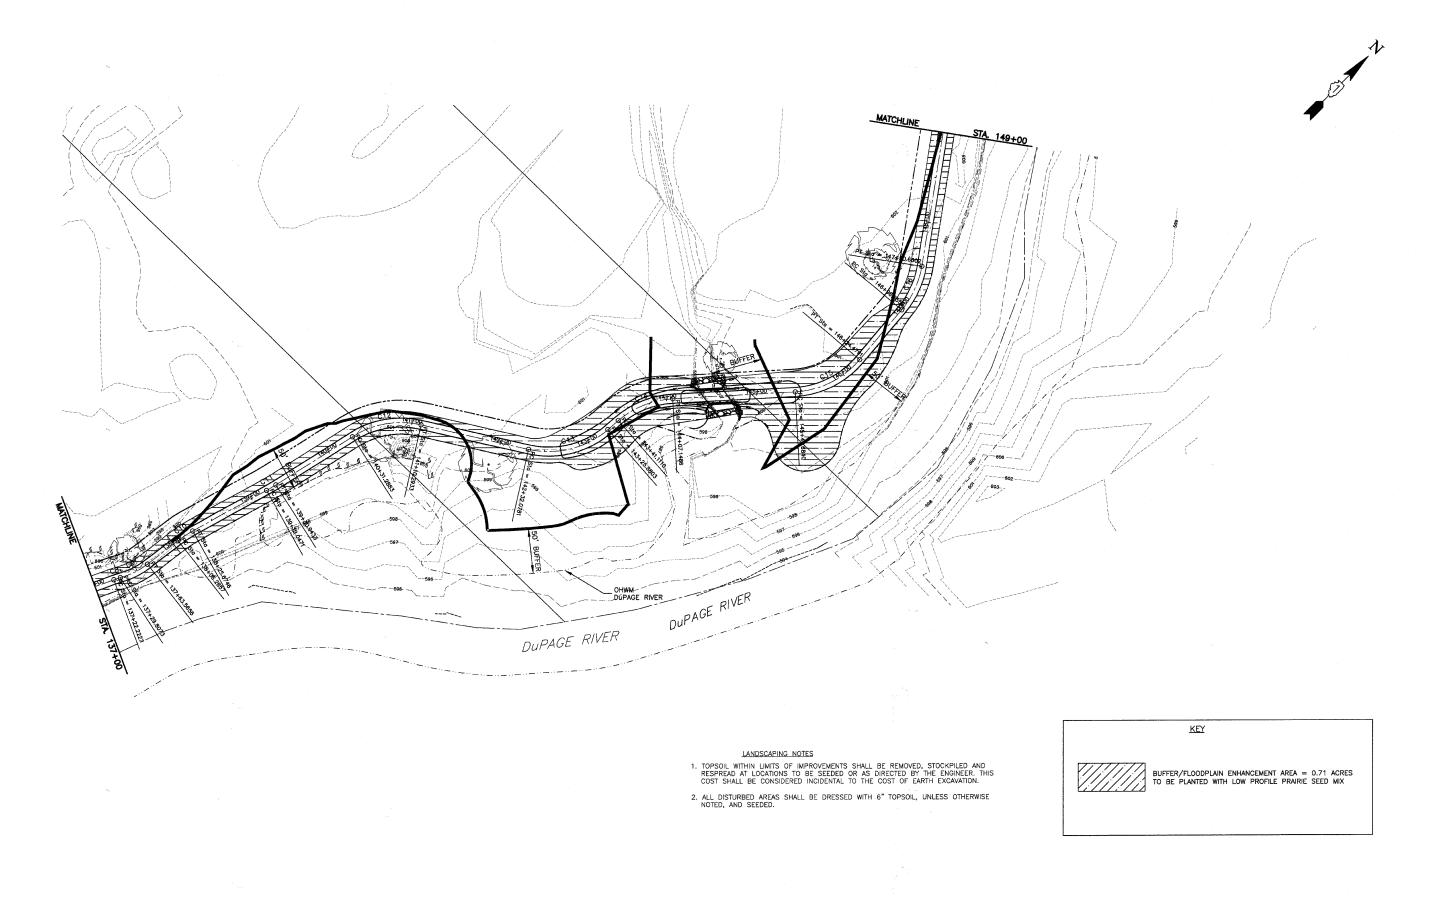

(ER)	ENGINEERING RESOURCE ASSOCIATES, INC. CONSULTING ENGINEERS, SCIENTISTS	F
	& SURVEYORS	H

USER NAME = DESIGNED -) — EP	REVISED —
DRAWN -	— DB	REVISED —
PLOT SCALE = CHECKED -	— EP	REVISED —
PLOT DATE = DATE -	 JANUARY, 2010 	REVISED

STATE OF ILLINOIS DEPARTMENT OF TRANSPORTATION

WETLAND	IMPACT AND	PLANTING EXHIBIT
SCALE: 1" = 50' SHEET	NO. 2 OF 3 SHEETS	STA. 138+00 TO STA. 149+00

F.A RTE.	SEC.	COUNTY	TOTAL SHEETS	SHEET NO.		
01-P4015-01-BT				WILL	41	17
				CONTRACT	NO. 6	3325
FED. F	ROAD DIST. NO. 1	ILLINOIS F	ED. AID	PROJECT		

13 DuPage River Trail\cad\Phase i\impact Plans.dwg Updated by: dbuss

RESOURCE ASSOCIA	CE TES, INC.

USER NAME =	DESIGNED	_	EP	REVISED	_	
	DRAWN	_	DB	REVISED		
PLOT SCALE =	CHECKED	_	EP	REVISED		
PLOT DATE =	DATE	_	JANUARY, 2010	REVISED	_	

STATE OF ILLINOIS DEPARTMENT OF TRANSPORTATION WETLAND IMPACT AND PLANTING EXHIBIT

SCALE: 1" = 50' SHEET NO. 3 OF 3 SHEETS | STA. 149+00 TO STA. 151+62

F.A RTE.	(SEC	TION	COUNTY	TOTAL SHEETS	SHEET NO.	
	. 01-P	401	5-01-BT	WILL	41	18	
					CONTRACT	NO. 6	3325
FED. R	OAD DIST. NO	. 1	ILLINOIS FEI). Al	D PROJECT		

113 DuPage River Trail\cad\Phase 1\inpact Plans.dwg Updated by. dbussema

AS THE SOILS ARE HYDRIC WITHIN THE PROPOSED WETLAND MITIGATION AREA NO OUTSIDE SOILS ARE NEEDED. ALL EXCAVATION WORK SHALL BE EXECUTED DURING DRY WEATHER. THE CONTRACTOR SHALL TAKE MEASUREMENTS TO MINIMIZE OVER WORKING AND COMPACTION OF PLACED SOIL. EQUIPMENT USED FOR EXCAVATION SHALL BE WITH LOW PSI EQUIPMENT (E.G. CATERPILLAR 2878 OR EQUIVALENT).

FINAL GRADE IS EXPECTED TO CONFORM, AFTER NATURAL COMPACTION, TO ELEVATIONS AND CONTOURS DELINEATED ON THE GRADING PLAN. PRIOR TO SEEDING, THE SOIL SURFACE SHALL BE ROUGH RAKED TO ENHANCE RETENTION OF SURFACE WATER.

HYDROLOGY PLAN

THE DUPAGE RIVER AND ASSOCIATED WETLANDS ARE LOCATED ADJACENT TO THE MITIGATION AREA. AS THE RIVER HAS DOWN CUT THE WETLANDS LOCATED ON THE RIVER BANKS HAVE LOST MUCH OF THEIR HYDROLOGY, AS SUCH, EXCAVATING THE TOPSOIL TO MATCH THE GRADE OF THE EXISTING WETLANDS WILL RETURN THE HYDROLOGY TO THIS AREA. THE MITIGATION AREA WILL BE SURFACE WATER AND GROUNDWATER DRIVEN. MUCH OF THE TRIBUTARY AREAS WILL CONSIST OF MODERATE TO GOOD URBAN WATER QUALITY DUE TO DRAINAGE. THE DESIGN INCLUDES ONE GROUNDWATER MONITORING WELL.

PLANTING PLAN

THE COVER CROP MATRIX WILL BE PLANTED THROUGHOUT THE WETLAND MITIGATION AREAS IMMEDIATELY AFTER GRADING TO PREVENT EROSION IF CONDITIONS ARE NOT CONDUCINE FOR NATIVE SPECIES SEEDING. PERMANENT NATIVE SPECIES SHALL BE DORMANT SEEDED DURING THE FALLWINTER MONTHS OR DURING THE FIRST AVAILABLE GROWING SEASON AT THE APPROPRIATE TIME AND CONDITIONS FOR SUCH PLANTINGS. ALL SEEDING SHALL BE COMPLETED ACCORDING TO INDUSTRY STANDARDS FOR NATIVE SEED INSTALLATION. THE PREFERRED METHOD OF SEED INSTALLATION SHALL BE THE RANGELAND-TYPE NATIVE GRASS AND WILDFLOWER SEED DRILLATION SHALL BE THE RANGELAND-TYPE NATIVE GRASS AND WILDFLOWER SEED DRILL/BROADCAST METHOD, EXCEPT WHERE SLOPES ARE STEEPER THAN 3:1, SOIL IS SATURATED, OR SIZE CONSTRAINTS PROHIBIT THE USE OF A RANGELAND PRILL.

WHERE SLOPES, SATURATED SOILS, OR SIZE CONSTRAINTS PROHIBIT THE USE OF A DRILL SEEDER, THE BROADCAST OR HYDROSEED METHODS MAY BE USED WITH APPROVAL FROM THE WETLAND CONSULTANT. IF, A BROADCAST METHOD OF SEEDING IS USED (INCLUDING HYDROSEEDING), THE FOLLOWING REQUIREMENTS SHALL BE FOLLOWED. THE AMOUNT OF SEED PER ACRE WILL BE DOUBLE THE INDICATED DRILL SEED RATE. FURTHER, BROADCAST-APPLIED SEED WILL BE EITHER ROLLED OR HAND RAKED INTO THE SOIL TO ENSURE GOOD SOIL-SEED CONTACT. WITHIN 12 HOURS, IF CONDITIONS PERMIT OR AS SOON THEREAFTER AS PRACTICAL, ALL SEEDED AREAS SHALL BE ROLLED AT RIGHT ANGLES TO THE RUNOFF WITH AN APPROVED TYPE ROLLER OR CULTIPACKER TO FIRM THE SEEDBED AND PLACE THE SEED IN CONTACT WITH THE SOIL.

PLUGS SHALL BE PLANTED ON 24° CENTERS AFTER MAY 1ST WHEN FROST IS NO LONGER LIKELY AT THE APPROPRIATE TIME AND CONDITIONS FOR SUCH PLANTINGS. HOLES FOR PLUGS SHALL BE AS DEEP OR SLIGHTLY DEEPER THEN THE PLUG ROOTS AND SOIL SHALL BE LIGHTLY PACKED AROUND THE ROOTS OF THE PLUG. GOOSE GRID SHALL BE INSTALLED IMMEDIATELY FOLLOWING PLANTING TO PROTECT THEM FROM PREDATION. THE SOIL SURFACE SHOULD BE DAMP FOR THE FIRST TWO WEEKS FOLLOWING PLANTING; AS SUCH, WATERING MAY BE NECESSARY.

THE CONTRACTOR SHALL SUPPLY WATER AS NECESSARY TO ESTABLISH THE PLANTED AREAS. NO FERTILIZER SHALL BE APPLIED IN CONJUNCTION WITH SEEDING OR THEREAFTER UNLESS RECOMMENDED BY THE WETLAND CONSULTA

THE PROPOSED SPECIES, SPECIFICATIONS, AND DRILL SEEDING RATES FOR THE PLANTING AREAS ARE PROVIDED IN THE FOLLOWING TABLES:

NATIVE PLANT PLUGS 0.99 ACRES

PLANT ON 24" CENTERS

PERMANENT GRASSES, SEDGE	-,	
SCIENTIFIC NAME	COMMON NAME	QUANTITY
CAREX COMOSA	BRISTLY SEDGE	304
CAREX STRICTA	COMMON TUSSOCK SEDGE	304
CAREX VULPINOIDEA	BROWN FOX SEDGE	304
JUNCUS EFFUSUS	COMMON RUSH	304
SCIRPUS PUNGENS	CHAIRMAKER'S RUSH	304
SPARTINA PECTINATA	PRAIRIE CORD GRASS	304
	SUBTOTAL	1824
FORBS:		
SCIENTIFIC NAME	COMMON NAME	QUANTITY
ASCLEPIAS INCARNATA	SWAMP MILKWEED	303
EUTHAMIA GRAMINIFOLIA	GRASS-LEAVED GOLDENROD	303
FILIPENDULA RUBRA	QUEEN OF THE PRAIRIE	303
GENTIANA ANDREWSII	BOTTLE GENTIAN	303
HELENIUM AUTUMNALE	SNEEZEWEED	303
HIBISCUS LAEVIS	SMOOTH ROSE MALLOW	303
IRIS VIRGINICA	BLUE FLAG IRIS	303
MIMULUS RINGENS	MONKEY FLOWER	303
SPARGANIUM EURYCARPUM	COMMON BUR REED	303
VERNONIA FASICULATA	COMMON IRONWEED	303
	SUBTOTAL	3030
	TOTAL	4854


SEDGE MEADOW SEED MIX	J.F. NEW, WALKERTON, INDIA	VA.
BOTANICAL NAME	COMMON NAME	PLS OUNCES/ACRE
PERMANENT GRASSES/SEDGES:		
CALAMAGROSTIS CANADENSIS	BLUEJOINT GRASS	0.50
CAREX COMOSA	BRISTLY SEDGE	1.50
CAREX CRISTATELLA	CRESTED OVAL SEDGE	1.50
CAREX FRANKII	BRISTLY CATTAIL SEDGE	3.00
CAREX LUPULINA	COMMON HOP SEDGE	2.50
CAREX LURIDA	BOTTLEBRUSH SEDGE	4.00
CAREX STIPATA	COMMON FOX SEDGE	1.00
CAREX VULPINOIDEA	BROWN FOX SEDGE	4.00
ELYMUS VIRGINICUS	VIRGINIA WILD RYE	30.00
GLYCERIA STRIATA	FOWL MANNA GRASS	0.50
JUNCUS EFFUSUS	COMMON RUSH	0.25
LEERSIA ORYZOIDES	RICE CUT GRASS	1.25
PANICUM VIRGATUM	SWITCH GRASS	1.50
SCIRPUS ATROVIRENS	DARK GREEN RUSH	0.75
SCIRPUS PENDULUS	RED BULRUSH	0.25
SCIRPUS PUNGENS	CHAIRMAKER'S RUSH	1.00
SCIRPUS VALIDUS	GREAT BULRUSH	4.00
SPARTINA PECTINATA	PRAIRIE CORD GRASS	2.00
	тот	AL 59.50

ALISMA SPP.	WATER PLANTAIN (VARIOUS MIX)	2.00
	` /	
ANGELICA ATROPURPUREA	GREAT ANGELICA	4.00
ASCLEPIAS INCARNATA	SWAMP MILKWEED	1.00
ASTER LANCEOLATUS	PANICLED ASTER	0.25
ASTER NOVAE-ANGLIAE	NEW ENGLAND ASTER	0.50
ASTER PUNICEUS	SWAMP ASTER	1.00
ASTER UMBELLATUS	FLAT-TOP ASTER	0.25
BIDENS CERNUA	NODDING SWAMP MARIGOLD	2.00
SENNA HEBECARPA	WILD SENNA	0.75
COREOPSIS TRIPTERIS	TALL COREOPSIS	2.50
EUPATORIUM MACULATUM	SPOTTED JOE-PYE WEED	1.00
EUPATORIUM PERFOLIATUM	COMMON BONESET	0.50
FILIPENDULA RUBRA	QUEEN OF THE PRAIRIE	0.25
GENTIANA ANDREWSII	BOTTLE GENTIAN	0.25
HELENIUM AUTUMNALE	SNEEZEWEED	2.00
HIBISCUS LAEVIS	SMOOTH ROSE MALLOW	2.00
IRIS VIRGINICA	BLUE FLAG IRIS	3.00
LIATRIS SPICATA	MARSH BLAZING STAR	2.50
LOBELIA CARDINALIS	CARDINAL FLOWER	0.25
LOBELIA SIPHILITICA	GREAT BLUE LOBELIA	2.00
LUDWIGIA ALTERNIFOLIA	SEED BOX	0.25
PHYSOSTEGIA VIRGINIANA	FALSE DRAGONHEAD	0.25
PYCNANTHEMUM VIRGINIANUM	VIRGINIA MOUNTAIN MINT	0.50
SAGITTARIA LATIFOLIA	BROAD-LEAF ARROWHEAD	2.00
SILPHIUM PERFOLIATUM	CUP PLANT	3.00
SPARGANIUM EURYCARPUM	COMMON BUR REED	4.00
SPIRAEA ALBA / SPIRAEA TOMENTOSA	MEADOWSWEET / STEEPLEBUSH	0.25
THALICTRUM DASYCARPUM	PURPLE MEADOW RUE	2.50
VERBENA HASTATA	BLUE VERVAIN	2.00
VERNONIA SPP.	IRONWEED (VARIOUS MIX)	1.00
ZIZIA AUREA	GOLDEN ALEXANDERS	1.00
	TOTAL	44.75

BOTANICAL NAME	COMMON NAME	OUNCES/ACRE
PERMANENT GRASSES:		
BOUTELOUA CURTIPENDULA	SIDE OATS GRAMA	10.00
CAREX SPP.	PRAIRIE SEDGE MIX	1.00
ELYMUS CANADENSIS	CANADA WILD RYE	16.00
KOELERIA PYRAMIDATA	JUNE GRASS	2.00
PANICUM VIRGATUM	SWITCH GRASS	1.00
SCHIZACHYRIUM SCOPARIUM	LITTLE BLUESTEM	28.00
SPOROBOLUS HETEROLEPIS	PRAIRIE DROPSEED	3.00
	TOTAL	61.00
FORBS:		
AMORPHA CANESCENS	LEAD PLANT	1.00
ANEMONE CYLINDRICA	THIMBLEWEED	0.50
AQUILEGIA CANADENSIS	WILD COLUMBINE	0.50
ASCLEPIAS TUBEROSA	BUTTERFLY MILKWEED	2.00
ASTER ERICOIDES	HEATH ASTER	0.25
ASTER LAEVIS	SMOOTH BLUE ASTER	0.75
ASTER NOVAE-ANGLIAE	NEW ENGLAND ASTER	0.25
BAPTISIA LACTEA	WHITE WILD INDIGO	1.00
CHAMAECRISTA FASCICULATA	PARTRIDGE PEA	9.00
COREOPSIS LANCEOLATA	SAND COREOPSIS	1.50
COREOPSIS PALMATA	PRAIRIE COREOPSIS	1.00
DALEA CANDIDUM	WHITE PRAIRIE CLOVER	1.50
DALEA PURPUREA	PURPLE PRAIRIE CLOVER	1.50
ECHINACEA PURPUREA	BROAD-LEAVED PURPLE CONEFLOWER	3.50
ERYNGIUM YUCCIFOLIUM	RATTLESNAKE MASTER	2.50
KUHUNIA EUPATOIDES	FALSE BONE-SET	0.50
LESPEDEZA CAPITATA	ROUND-HEAD BUSH CLOVER	2.00
LIATRIS ASPERA	ROUGH BLAZING STAR	0.50
LUPINUS PERENNIS	WILD LUPINE	2.00
MONARDA FISTULOSA	WILD BERGAMOT	0.50
PARTHENIUM INTEGRIFOLIUM	WILD QUININE	1.00
PENSTEMON DIGITALIS	FOXGLOVE BEARD TONGUE	0.50
PHYSOSTEGIA VIRGINIANA	FALSE DRAGONHEAD	0.25
PYCNANTHEMUM VIRGINIANUM	COMMON MOUNTAIN MINT	1.00
RATIBIDA PINNATA	YELLOW CONEFLOWER	3.00
RUDBECKIA HIRTA	BLACK-EYED SUSAN	2.00
RUDBECKIA SUBTOMENTOSA	SWEET BLACK-EYED SUSAN	1.00
SILPHIUM INTEGRIFOLIUM	ROSIN WEED	0.50
SILPHIUM TEREBINTHINACEUM	PRAIRIE DOCK	2.00
SOLIDAGO NEMORALIS	OLD-FIELD GOLDENROD	0.25
SOLIDAGO RIGIDA	STIFF GOLDENROD	1.00
TRADESCANTIA OHIENSIS	COMMON SPIDERWORT	0.75
VERNONIA SPP.	IRONWEED (VARIOUS MIX)	1.75
VERONICASTRUM VIRGINIANUM	CULVER'S ROOT	0.25
	TOTAL	49.75
ANNUAL/PERENNIAL FORBS MIX		32.00

SCALE:

LOW-PROFILE PRAIRIE SEED MIX J.F. NEW, WALKERTON, INDIANA

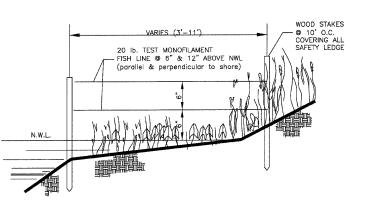

GOOSE GRID BARRIER DETAIL

NOTE: THIS ITEM SHALL BE INCLUDED IN THE COST OF FURNISHING AND INSTALLING THE WETLAND PLUGS.


USER NAME =	DESIGNED	_	EP	REVISED	_	
	DRAWN	_	DB	REVISED		
PLOT SCALE =	CHECKED	_	EP	REVISED	_	
PLOT DATE -	DATE	_	JANUARY, 2010	REVISED	_	

STATE OF ILLINOIS DEPARTMENT OF TRANSPORTATION

WETLAND IMPACT AND PLANTING GENERAL NOTES & SPECIFICATIONS	
 SHEET NO. 1 OF 1 SHEETS	

F.A RTE. SECTION								COUNTY	TOTAL SHEETS	SHEET NO.		
01-P4015-01-BT							Т	WILL	41	19		
							CONTRACT NO. 63325					
FED. RO	OAD	DIST.	NO.	_	ILLINOIS	FED.	AID	PROJECT				

. DuPace River Trail\cad\Phase 1\Wetland Im

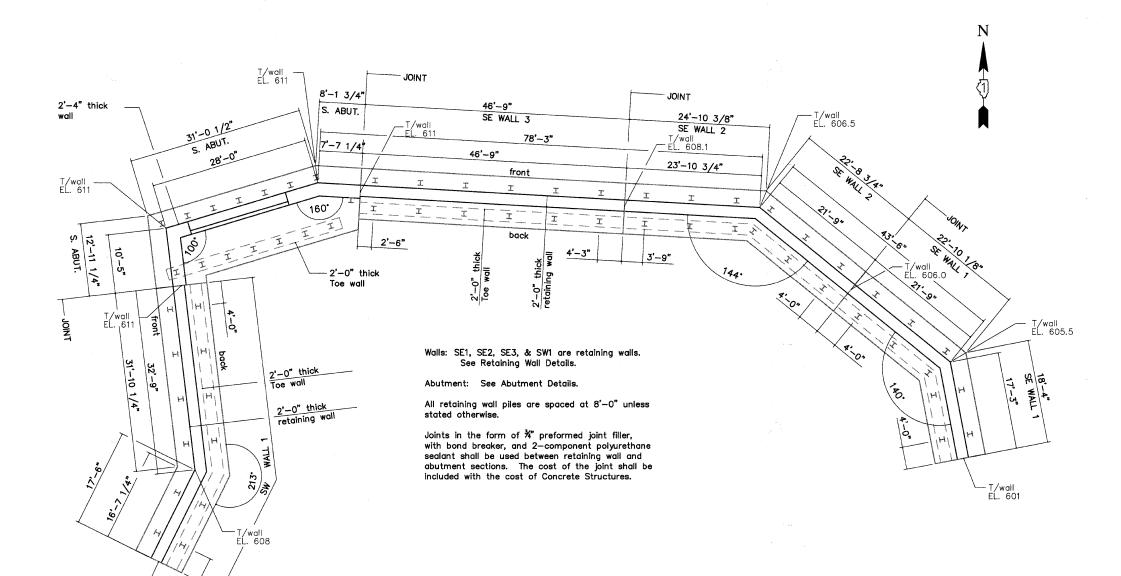



certify that to the best of my knowledge, information and belief, this bridge design is structurally adequate for the design loading shown on the plans. The design is an economical one for the style of structure and compiles with the requirements of the current "AASHTO Standard Specifications for Highway Bridges."

T/wall — EL. 601.5

Kelly Jo Hoffmann KELLY JO HOFFMANN Illinois Licensed Structural Engineer Number 4192 License Expres 11/30/10 Engineer Number 4192

FRAUENHOFFER

Frauenhoffer and Associates, P.C. Consulting Engineers 3002 Crossing Court Champaign, IL 61822 217-351-6268

SOUTH PLAN	SHEET	Х
	DWG NO.	abut.DWG
	DATE	NOV 2009
	PROJ NO.	8137

ASSOCIATES, INC.	(EZ)	CONSULTING ENGINEERS, SCIENTISTS
------------------	------	----------------------------------


	USER NAME ==	DESIGNED	_	KJH	REVISED	_	
		DRAWN	_	KJH	REVISED		
İ	PLOT SCALE =	CHECKED	_	JF	REVISED		
	PLOT DATE =	DATE	-	JANUARY, 2010	REVISED	_	

STATE OF ILLINOIS DEPARTMENT OF TRANSPORTATION

DUPAGE RIVER BRIDGE SOUTH ABUTMENT
AND RETAINING WALL LAYOUT
SCALE: 1/8"=1'-0" SHEET NO. 1 OF 1 SHEETS

۸ E.		SE	CTION		COUNTY	TOTAL SHEETS	SHEET NO.
	01-	-P40	15-01-B	Т	WILL	41	20
				CONTRACT	NO. 6	3325	
D. R	OAD DIST.	NO. 1	ILLINOIS	FED. A	D PROJECT		

DuPage River Trail\cad\Phase 1\Frauenhoffer Details.dwg Updated by: dbussema 1/14/201

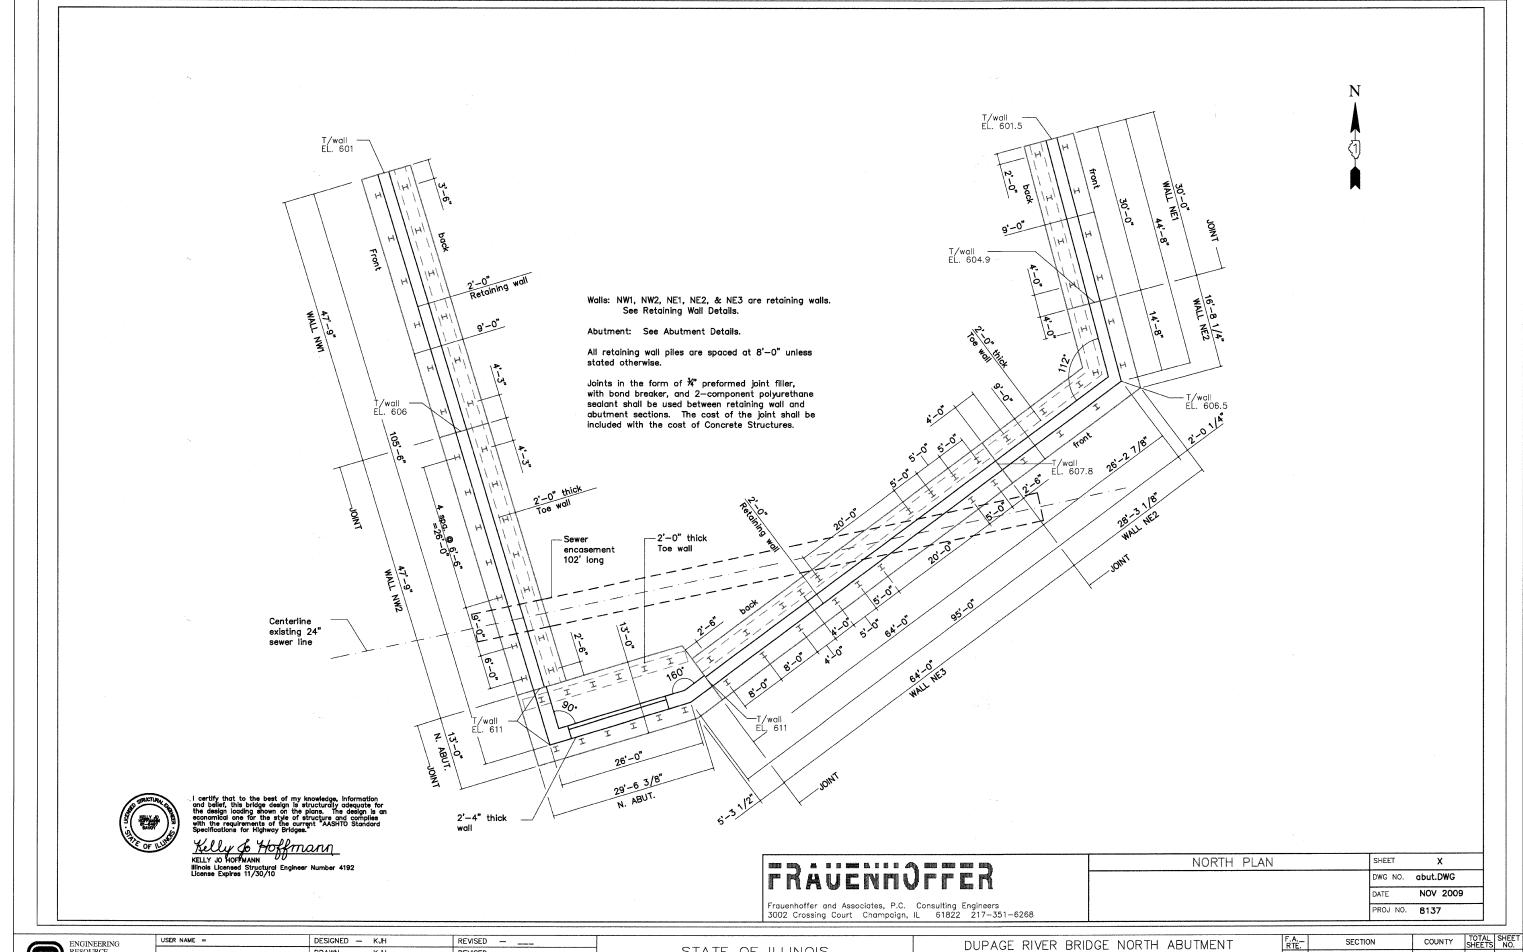


ENGINEERING
RESOURCE
ASSOCIATES, INC.
CONSULTING INFIGUREERS, SCIENTISTS
& SURVEYORS

| DESIGNED - KJH REVISED - ______
| DRAWN - KJH REVISED - _____
| PLOT SCALE = CHECKED - JF REVISED - _____
| PLOT DATE = DATE - JANUARY, 2010 REVISED - ____

STATE OF ILLINOIS DEPARTMENT OF TRANSPORTATION DUPAGE RIVER BRIDGE NORTH ABUTMENT
AND RETAINING WALL LAYOUT

SCALE: 1/8"=1'-0" | SHEET NO. 1 OF 1 SHEETS



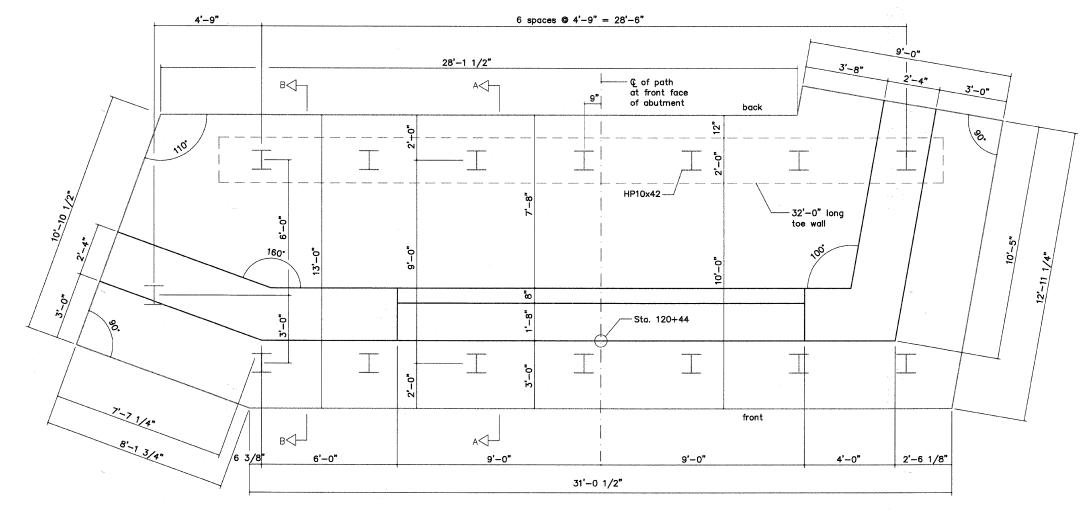

SOUTH ABUTMENT PLAN

Place 2" dia. PVC weep holes @ 10' max c/c. Cost shall be included in Concrete Structures. The height of the holes shall be the higher of 1'-6" above the top of the cap or 6" above the finish grade at the front of the wall.

Clear covers shall be: 3" bottom, 2" sides of walls 3" sides of footing, 2" top $\,$

All edges shall receive a 3/4" chamfer.

Spacing of bars shown shall be the maximum allowed. Bars may be adjusted to miss piles.

The following reinforcing laps shall be used when

#4 = 2'-0" #5 = 2'-6" #6 = 3'-0" #7 = 4'-6" #8 = 5'-6"

Joints in the form of $\frac{\mathcal{H}^n}{2}$ preformed joint filler, with bond breaker, and 2—component polyurethane seciant shall be used between retaining wall and abutment sections. The cost of the joint shall be included with the cost of Concrete Structures.

r RA

Frauenhoffer 3002 Crossing


	SOUTH ABUTMENT PLAN	SHEET X
NUENNUPPEK T		DWG NO. abut.DWG
		DATE NOV 2009
r and Associates, P.C. Consulting Engineers ing Court Champaign, IL 61822 217-351-6268		PROJ NO. 8137



USER NAME =	DESIGNED	_	KJH	REVISED	_	
	DRAWN	-	KJH	REVISED		
PLOT SCALE =	CHECKED	_	JF	REVISED	_	
PLOT DATE =	DATE	_	JANUARY, 2010	REVISED	_	

	DUPAGE RIVER BRIDGE									
SOUTH ABUTMENT PLAN										
SCALE: 1/2"=1'-0"	SHEET NO. 1 OF 1 SHEETS									

F.A RTE. SECTION								COUNTY	TOTAL SHEETS	SHEET NO.
01-P4015-01-BT								WILL	41	22
							Т	CONTRACT	NO. 6	3325
FED. F	ROAD	DIST.	NO.	1	ILLINOIS	FED.	AłD	PROJECT		

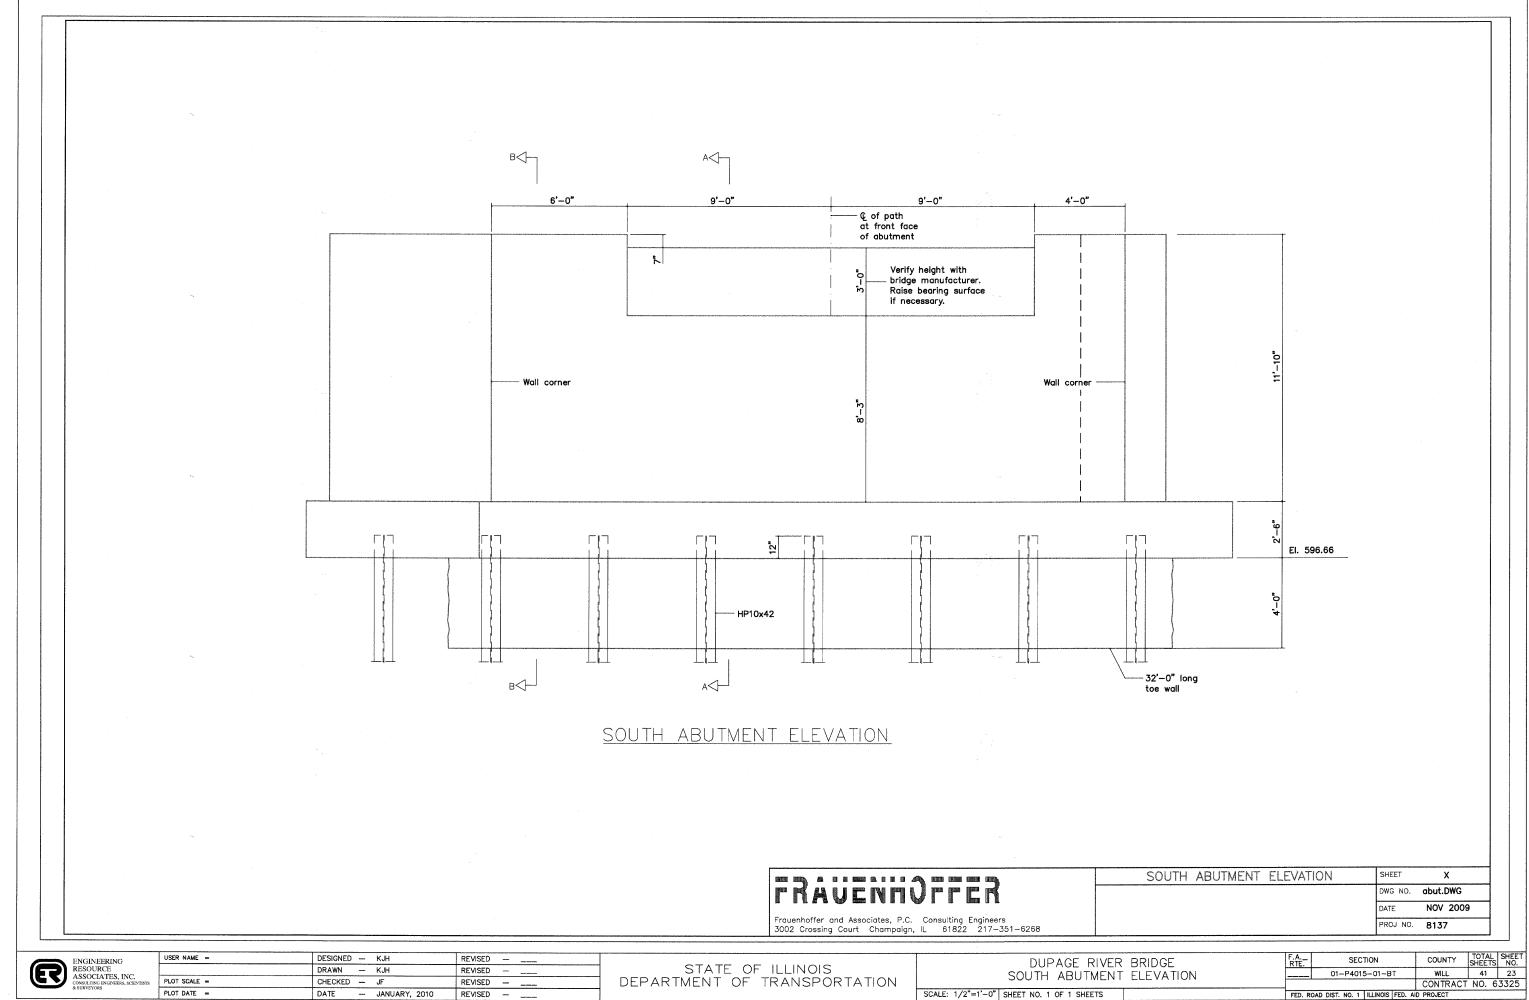


ENGINEERING
RESOURCE
ASSOCIATES, INC.
COMBILTING ENGINEERS, SCIENTISTS
& SURVEYORS

USER NAME =	DESIGNED		KJH	REVISED	_	 _
	DRAWN	_	KJH	REVISED		
PLOT SCALE =	CHECKED	_	JF	REVISED		
PLOT DATE =	DATE	_	JANUARY, 2010	REVISED		

DUPAGE RIVER SOUTH ABUTMENT	000
'-0" SHEET NO. 1 OF 1 SHEETS	

A TE.	SECTION	COUNTY	TOTAL SHEETS	SHEET NO.
	01-P4015-01-BT	WILL	41	23
		CONTRACT	NO. 6	3325
D. R	OAD DIST. NO. 1 ILLINOIS FED. A	D PROJECT		



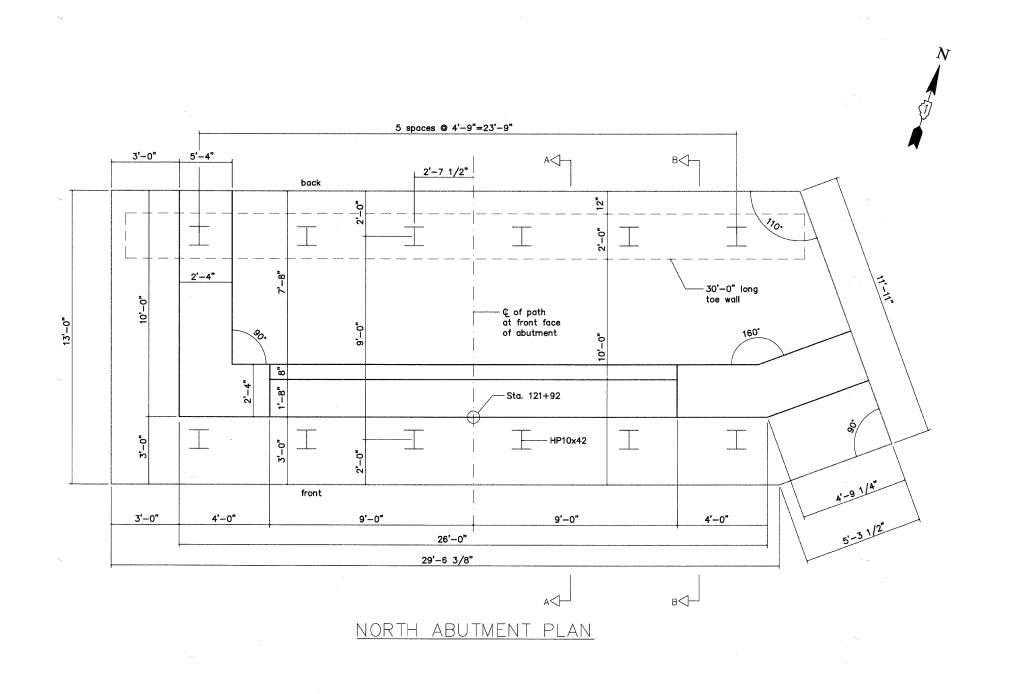

Place 2" dia. PVC weep holes @ 10' max c/c. Cost shall be included in Concrete Structures. The height of the holes shall be the higher of 1'-6" above the top of the cap or 6" above the finish grade at the front of the wall.

Clear covers shall be: 3" bottom, 2" sides of walls 3" sides of footing, 2" top

All edges shall receive a ¾" chamfer.

Spacing of bars shown shall be the maximum allowed. Bars may be adjusted to miss piles.

The following reinforcing laps shall be used when necessary:

#4 = 2'-0" #5 = 2'-6" #6 = 3'-0" #7 = 4'-6" #8 = 5'-6"

Joints in the form of X preformed joint filler, with bond breaker, and 2—component polyurethane sealant shall be used between retaining wall and abutment sections. The cost of the joint shall be included with the cost of Concrete Structures.

-		NORTH
_	TKAUENNUTTEK	
	Frauenhoffer and Associates, P.C. Consulting Engineers 3002 Crossing Court Champaign, IL 61822 217—351—6268	


H ABUTMENT PLAN	SHEET	X
	DWG NO.	abut.DWG
	DATE	NOV 2009
	PROJ NO.	8137

ER)	ENGINEERING RESOURCE ASSOCIATES, INC. CONSULTING ENGINEERS, SCIENTISTS & SURVEYORS
-----	--

USER NAME =	DESIGNED	_	KJH	REVISED	_	
	DRAWN	-	KJH	REVISED		
PLOT SCALE	CHECKED	_	JF .	REVISED	_	
PLOT DATE =	DATE	_	JANUARY, 2010	REVISED	_	

DUPAGE RIVER BRIDGE NORTH ABUTMENT PLAN
SCALE: 1/2"=1'-0" SHEET NO. 1 OF 1 SHEETS

F.A RTE. SECTION						COUNTY	TOTAL SHEETS	SHEET NO.		
01-P4015-01-BT						T	WILL	41	24	
							T	CONTRACT	NO. 6	3325
FED. R	OAD	DIST.	NO.	1	ILLINOIS	FED.	AID	PROJECT		

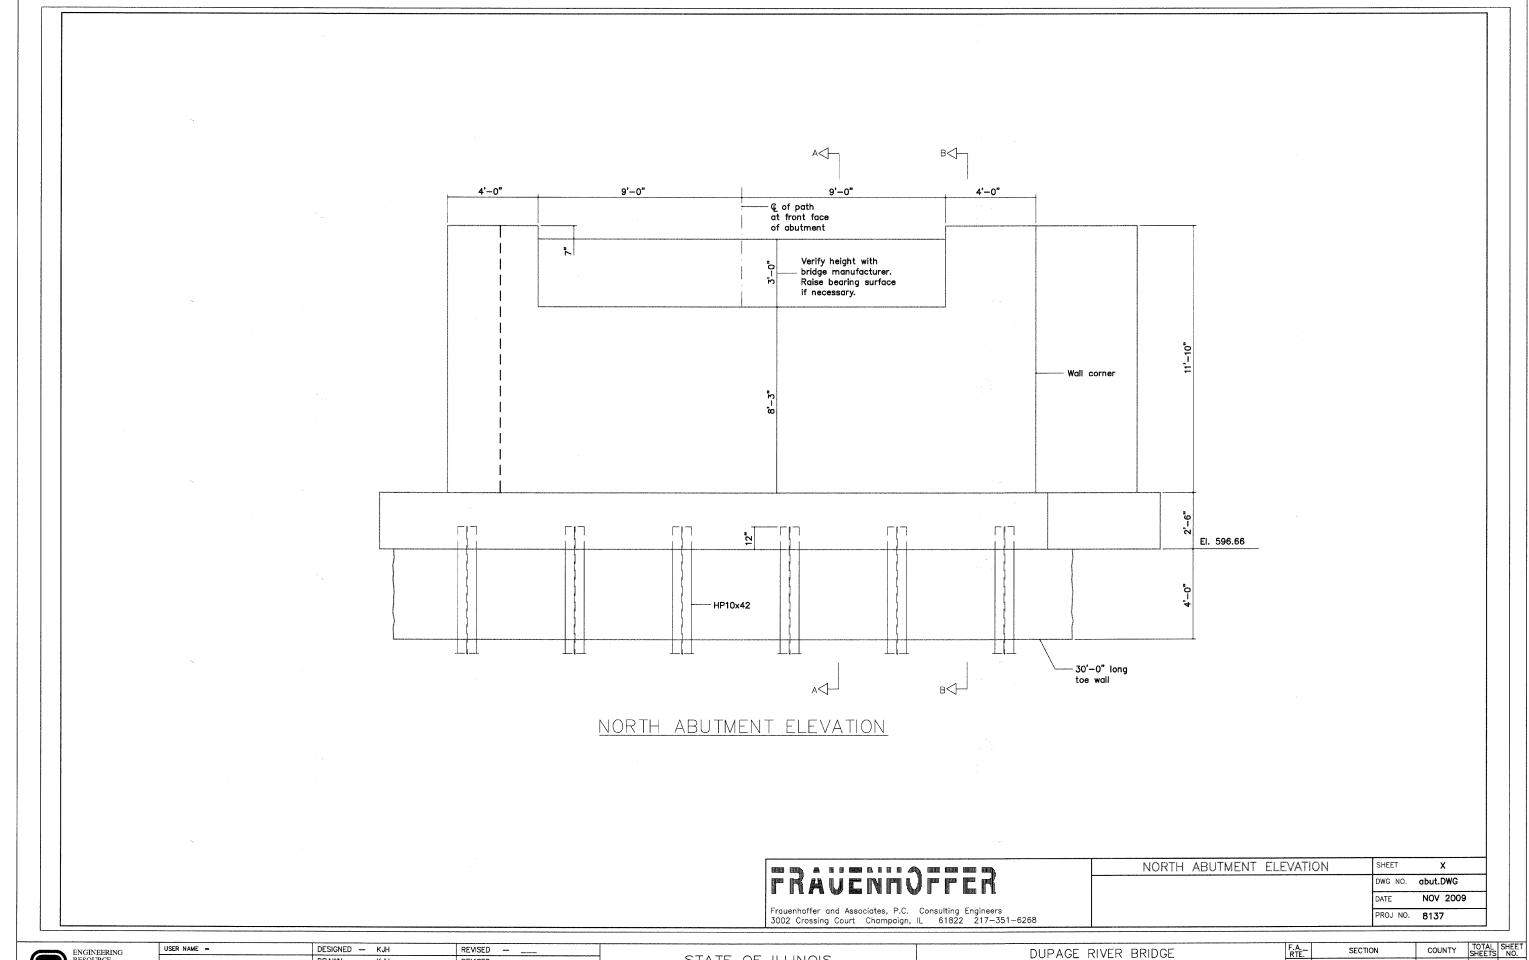

ENGINEERING RESOURCE ASSOCIATES, INC. CONSULTING ENGINEERS, SCIENT & SURVEYORS


USER NAME =	DESIGNED	_	KJH	REVISED	_	
	DRAWN	_	KJH	REVISED	_	
PLOT SCALE =	CHECKED		JF .	REVISED	_	
PLOT DATE ==	DATE	_	JANUARY, 2010	REVISED		


STATE OF ILLINOIS DEPARTMENT OF TRANSPORTATION

DUPAGE RIVER BRIDGE NORTH ABUTMENT ELEVATION
SCALE: 1/2"=1'-0" SHEET NO. 1 OF 1 SHEETS

E.	SECTION	COUNTY	TOTAL SHEETS	SHEET NO.	
	01-P4015-01-BT	WILL	41	25	
		CONTRACT	NO. 6	3325	
D R	OAD DIST NO 1 HILINOIS FED AL	D PROJECT			ľ

FED. ROAD DIST

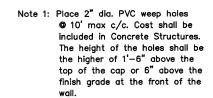

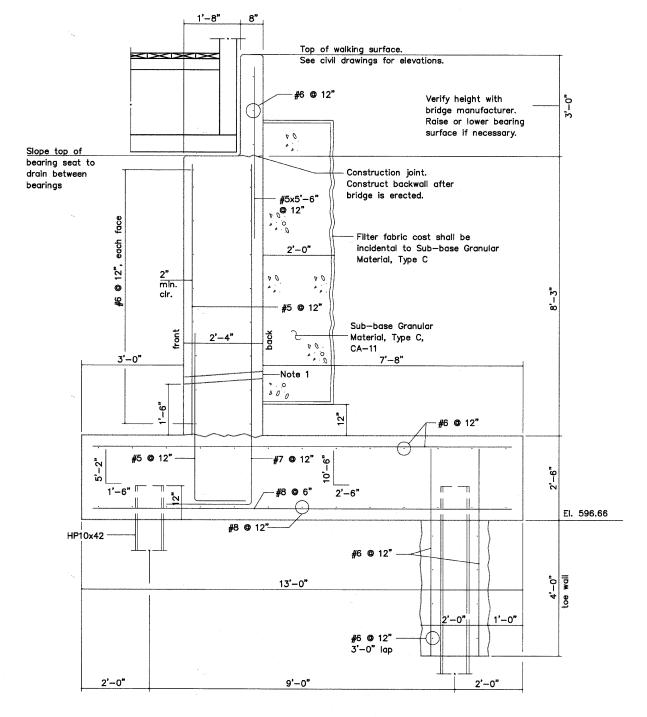

-- #5 **©** 12" Filter fabric cost shall be incidental to Sub-base Granular 2'-0" Material, Type C min. clr. Sub-base Granular 2'-4" Material, Type C, CA-11 3'-0" -Note 1 #5 @ 12" -#7 **⊕** 12" -#8 **©** 6" 2'-6" El. 596.66 #8 @ 12"---HP10x42 #6 @ 12" -13'-0" 1'-0" 2'-0" #6 @ 12" _ 2'-0" 9'-0"

三川三川

000

SECTION A-A

Clear covers 3" bottom

be: 3" sides of footing 2" sides of walls

All edges shall receive a ¾ chamfer.

Frauenhoffer and Associates, P.C. Consulting Engineers 3002 Crossing Court Champaign, IL 61822 217-351-6268

ABUTMENT SECTIONS

ENGINEERING RESOURCE ASSOCIATES, INC. CONSULTING ENGINEERS, SCIENTI & SURVEYORS

USER NAME =	DESIGNED	_	KJH	REVISED	_	
	DRAWN	_	KJH	REVISED		
PLOT SCALE =	CHECKED	_	JF .	REVISED	_	
PLOT DATE =	DATE	_	JANUARY, 2010	REVISED	_	


STATE OF ILLINOIS DEPARTMENT OF TRANSPORTATION

DUPAGE RIVER BRIDGE	
ABUTMENT SECTIONS	
SCALE: 3/4"=1'-0" SHEET NO. 1 OF 1 SHEETS	_


SECTION B-B

SHEET


WALL CORNER DETAIL ANGLES LESS THAN 120 DEGREES

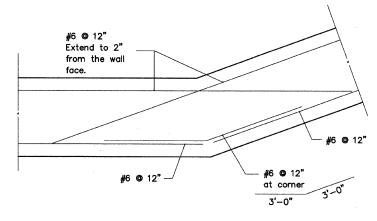

WALL CORNER DETAIL ANGLES GREATER THAN 120 DEGREES

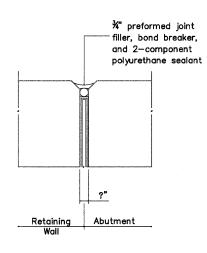

JOINT DETAIL

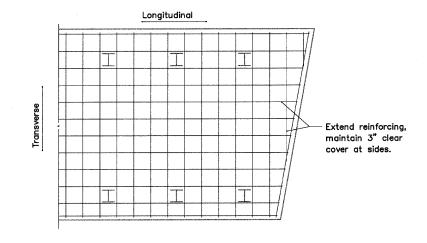

PILE CAP REINFORCING DETAIL

PILE DATA

NUMBER REQ'D

11 NORTH ABUTMENT 14 SOUTH ABUTMENT

NOM. REQ'D BEARING

335 KIPS/PILE

ALLOWABLE AVAILABLE RESISTANCE 110 KIPS/PILE

EST. LENGTH

50 FT., NORTH ABUTMENT AND 50 FT., SOUTH ABUTMENT

ALL PILES DRIVEN TO REFUSAL

TEST PILES

1 NORTH ABUTMENT 1 SOUTH ABUTMENT

BILL OF MATERIAL 2 ABUTMENTS

		N. Abut.	S. Abut.	<u>Total</u>
ITEM	UNIT	QTY	QTY	QTY
Concrete Structures	Cu. Yd.	82.2	95.6	177.8
Reinforcement Bars	Pounds	12,700	14,400	27,100
Test Pile, Steel HP10x42	Each	1	11	2
Furnishing Steel Piles, HP10x42	Feet	700	550	1250
Driving Piles	Feet	700	550	1250
Pile Shoes	Each	30	15	27
Structure Excavation	Cu. Yd.	23	30	30
Sub-base Granular Material, Type C, CA-11	Cu. Yd.		28	51

Frauenhoffe 3002 Cross


	ABUTMENT DETAILS	SHEET	x	ı
AVENDUTTER		DWG NO.	abut.DWG	
		DATE	NOV 2009	
offer and Associates, P.C. Consulting Engineers cossing Court Champaign, IL 61822 217—351—6268		PROJ NO.	8137	




USER NAME =	DESIGNED	_	KJH	REVISED	_	
	DRAWN		KJH	REVISED	_	
PLOT SCALE ==	CHECKED	_	JF	REVISED		
PLOT DATE =	DATE	_	JANUARY, 2010	REVISED		

1	DUPAGE RIVER BRIDGE
	ABUTMENT DETAILS
SCALE: 3/4"=1'-0" SHEET	NO. 1 OF 1 SHEETS

È.	SECTION				COUNTY	TOTAL SHEETS	SHEET NO.				
		01~	P40	215	5-01-B	Т	Т	WILL	41	27	
								CONTRACT	NO. 6	3325	
D. R	OAD D	IST.	NO.	1	ILLINOIS	FED.	AID	PROJECT			ı

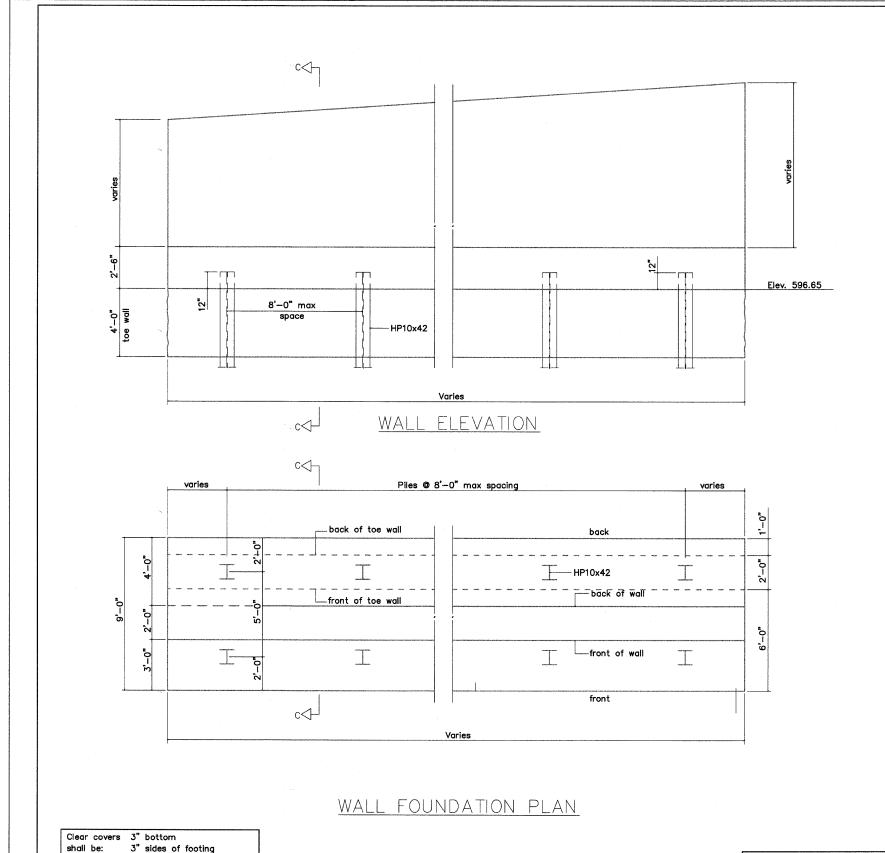

* Filter fabric cost shall be incidental to Sub-base Granular Material, Type C

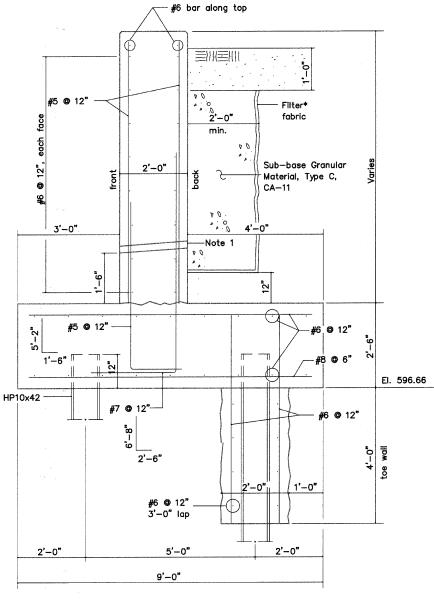

SECTION C-C

Note 1: Place 2" dia. PVC weep holes @ 10' max c/c. Cost shall be included in Concrete Structures. The height of the holes shall be the higher of 1'-6" above the top of the cap or 6" above the finish grade at the front of the wall.

RETAINING WALL DETAILS

2" sides of walls

2" top

All edges shall receive a ¾" chamfer.

FRAUENHOFFER Frauenhoffer and Associates, P.C. Consulting Engineers 3002 Crossing Court Champaign, IL 61822 217—351—6268

 DWG NO.	abut.DWG
DATE	NOV 2009
PROJ NO.	8137

SHEET


ENGINEERING
RESOURCE
ASSOCIATES, INC.
CONSULTING ENGINEERS, SCIEN
& SERVEYORS

USER NAME ==	DESIGNED	_	KJH	REVISED	_	
	DRAWN		KJH	REVISED	_	
PLOT SCALE =	CHECKED		JF	REVISED		
PLOT DATE =	DATE	_	JANUARY, 2010	REVISED		


DUPAGE RIVER BRIDGE RETAINING WALL DETAILS
SCALE: 3/8"=1'-0" SHEET NO. 1 OF 3 SHEETS

Ë.	SEC.	TION	COUNTY	TOTAL SHEETS	SHEET NO.
	01-P401	5-01-BT	WILL	41	28
			CONTRACT	NO. 6	3325
). R	OAD DIST. NO. 1	ILLINOIS FED. A	ID PROJECT		




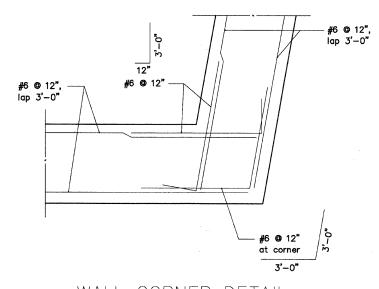


WALL CORNER DETAIL
ANGLES LESS
THAN 120 DEGREES

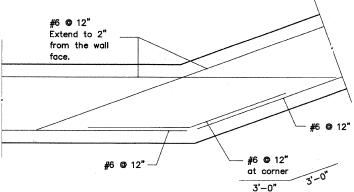

WALL CORNER DETAIL
ANGLES GREATER
THAN 120 DEGREES

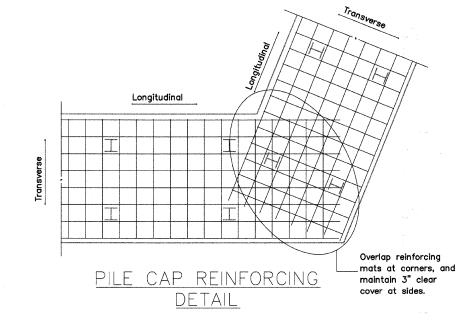

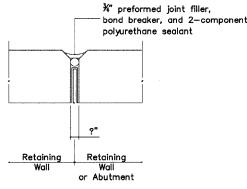

JOINT DETAIL

Place 2" dia. PVC weep holes @ 10' max c/c. Cost shall be included in Concrete Structures. The height of the holes shall be the higher of 1'−6" above the top of the cap or 6" above the finish grade at the front of the wall.

Clear covers shall be: 3" bottom, 2" sides of walls 3" sides of footing, 2" top

All edges shall receive a ¾" chamfer.

Spacing of bars shown shall be the maximum allowed. Bars may be adjusted to miss piles.

The following reinforcing laps shall be used when

#4 = 2'-0" #5 = 2'-6" #6 = 3'-0" #7 = 4'-6" #8 = 5'-6"

The #5 and #7 vertical dowels may be trimmed to maintain clear cover at walls with shorter heights.

Joints in the form of X^* preformed joint filler, with bond breaker, and 2-component polyurethane sealant shall be used between retaining wall and abutment sections. The cost of the joint shall be included with the cost of Concrete Structures.

PILE DATA

NUMBER REQ'D

SEE BILL OF MATERIAL

NOM. REQ'D BEARING

335 KIPS/PILE

ALLOWABLE AVAILABLE RESISTANCE 110 KIPS/PILE

EST. LENGTH

50 FT. FOR NE1, NE2, NE3, NW1, NW2,

50 FT. FOR NET, NEZ, NES, NWT,

ALL PILES DRIVEN TO REFUSAL

CEWED

TEST PILES

TEST PILES FROM THE ADJACENT

ABUTMENT CAN BE USED TO ESTIMATE
PILE LENGTHS FOR THE RETAINING WALLS

BILL OF MATERIAL 9 RETAINING WALLS, PROTECT SEWER

		054	CEO	CE 7	CVIII	NIE1	NEO	NEZ	NIW/I	NW2	PROTECTION	TOTAL
		SE1	SE2	<u>SE3</u>	<u>SW1</u>	NE1	NE2	NE3	<u>NW1</u>	INVVZ	FROIECTION	TOTAL
ITEM	UNIT	QTY	QTY	QTY	QTY	QTY	QTY	QTY	QTY	QTY	QTY	QTY
Concrete Structures	Cu. Yd.	54.6	75.7	88.8	91.3	42.9	65.6	120.8	69.3	87	56	752
Reinforcement Bars	Pounds	6050	7950	9200	9100	4860	7750	12810	7690	9590	1840	76840
Test Pile, Steel HP10x42	Each	0	0	0	0	0	0	0	0	0	0	0
Furnishing Steel Piles,	Feet	600	600	500	600	400	500	850	600	700	0	5350
HP10x42												
Driving Piles	Feet	600	600	500	600	400	500	850	600	700	0	5350
Pile Shoes & # Piles	Each	12	12	10	12	8	10	17	12	14	0	107
Structure Excavation	Cu. Yd.	103	110	59	138	59	58	65	72	49	240	953
Sub-base Granular Material,	Cu. Yd.	5	18	27	23	3	16	37	7	24	0	160
Type C, CA-11												

SCALE: 3/4"=1'-0" SHEET NO. 2 OF 3 SHEETS

FRAUENHOFFER

Frauenhoffer and Associates, P.C. Consulting Engineers 3002 Crossing Court Champaign, IL 61822 217-351-6268


RETAINING WALL DETAILS	SHEET X
	DWG NO. abut.DWG
	DATE NOV 2009
	PROJ NO. 8137

ENGINEERING RESOURCE ASSOCIATES, II CONSULTING ENGINEERS. & SURVEYORS	
---	--

USER NAME ==	DESIGNED -	KJH	REVISED —
	DRAWN -	KJH	REVISED —
PLOT SCALE =	CHECKED -	JF	REVISED
PLOT DATE ==	DATE	JANUARY, 2010	REVISED

DUPAGE	RIVER	BRIDGE	
RETAINING	WALL	DETAILS	

Ė-	SECTION							COUNTY	TOTAL SHEETS	SHEET NO.
	01-P4015-01-BT							WILL	41	29
						T	CONTRACT	NO. 6	3325	
). R	OAD	DIST.	NO.	1	ILLINOIS	FED.	AID	PROJECT		

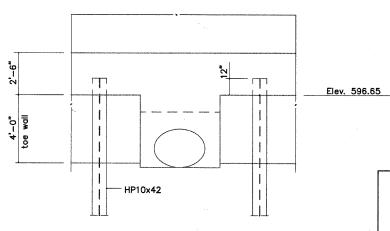


WALL FOUNDATION ELEVATION AT SEWER PROTECTION

SEWER PROTECTION GUIDELINES.

- 1) Expose sewer line.
- 2) Excavate around sewer for placement of concrete protection.
- 3) Place concrete and rebar for sewer protection.
- 4) Drive piling for retaining walls and abutments.

SEWER PROTECTION MUST BE IN PLACE BEFORE ANY PILES ARE DRIVEN.

WALL FOUNDATION PLAN AT SEWER PROTECTION

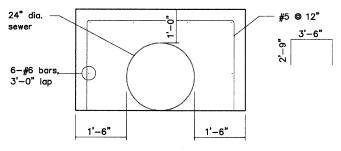

SEWER PROTECTION


102' OF PROTECTION

* Filter fabric cost shall be incidental to Sub-base Granular Material, Type C

#6 bar along top

Note 1: Place 2" dia. PVC weep holes

© 10' max c/c. Cost shall be
included in Concrete Structures.
The height of the holes shall be
the higher of 1'-6" above the
top of the cap or 6" above the
finish grade at the front of the
wall.

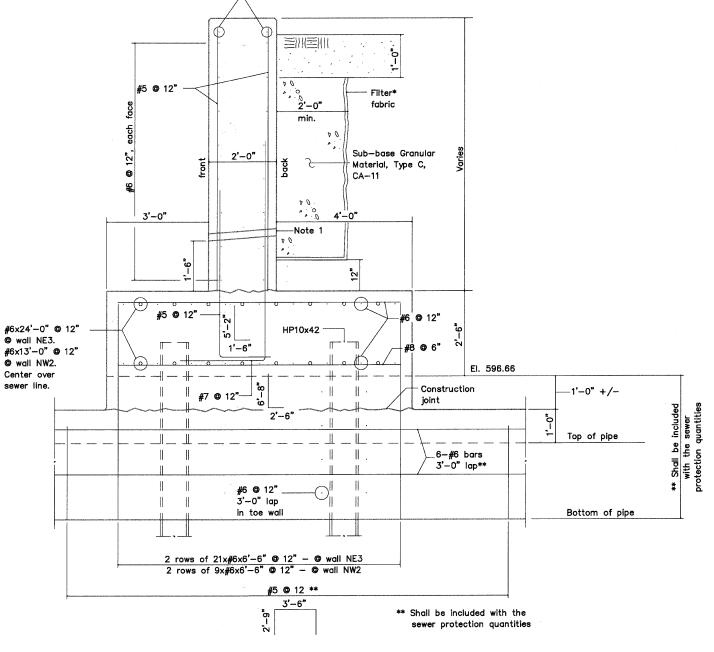

WALL SECTION THROUGH
SEWER PROTECTION

FRAUENHOFFER

Frauenhoffer and Associates, P.C. Consulting Engineers 3002 Crossing Court Champaign, IL 61822 217—351—6268

RETAINING	WALL	DETAILS	19000	AT	SEWER	SHEET	X
						DWG NO.	abut.DWG
						DATE NOV 2009	
						PROJ NO.	8137

ENGINEERING RESOURCE	ľ
ASSOCIATES, INC. CONSULTING ENGINEERS, SCIENTISTS	*
& SURVEYORS	F

Clear covers 3" bottom

All edges shall receive

a ¾" chamfer.

3" sides of footing 2" sides of walls

2"top

USER NAME =	DESIGNED	_	KJH	REVISED	_	
	DRAWN	_	KJH	REVISED	_	
PLOT SCALE =	CHECKED	_	JF	REVISED	_	
PLOT DATE =	DATE		JANUARY, 2010	REVISED	_	


STATE OF ILLINOIS DEPARTMENT OF TRANSPORTATION


_	DUPAGE RIVER BRIDGE RETAINING WALL DETAILS
	SCALE: 3/8"=1'-0" SHEET NO. 3 OF 3 SHEETS


F.A RTE.	SECTION	COUNTY	TOTAL SHEETS	SHEET NO.	ag PD/
	01-P4015-01-BT	WILL	41	30	uffel
		CONTRACT	NO. 6	3325	E.
FED. F	ROAD DIST. NO. 1 ILLINOIS FED. A	AID PROJECT			¥

Trail\cad\Phase 1\Frauenhoffer Details.dwg Updated by: dbussema 1/14/2010



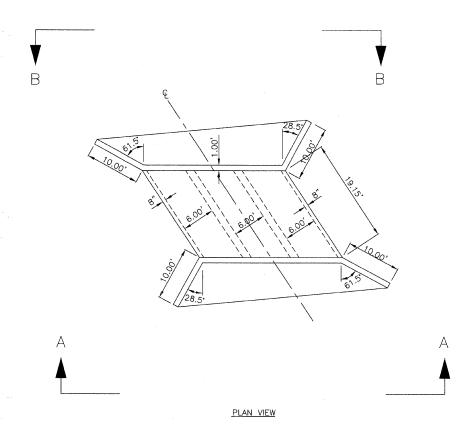

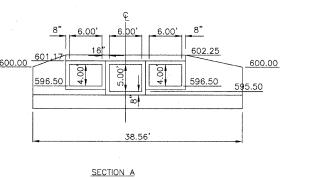

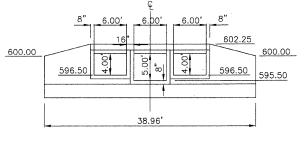

SECTION B

SCALE: N.T.S.


WEST NORMAN
BOX CULVERT
NOT TO SCALE

E	ENGINEERING RESOURCE ASSOCIATES, INC. CONSULTING ENGINEERS, SCIENTISTS & SURVEYORS
---	--

USER NAME ==	DESIGNED	_	BD	REVISED	_	
	DRAWN	_	DB	REVISED		
PLOT SCALE =	CHECKED	_	JFM	REVISED	_	Allega halah hanay
PLOT DATE =	DATE	_	JANUARY, 2010	REVISED	_	

STATE OF ILLINOIS DEPARTMENT OF TRANSPORTATION

WEST	NORMAN	BOX	CULVERT	
 SHEET NO	1 OF 1 SHEETS		The state of the s	

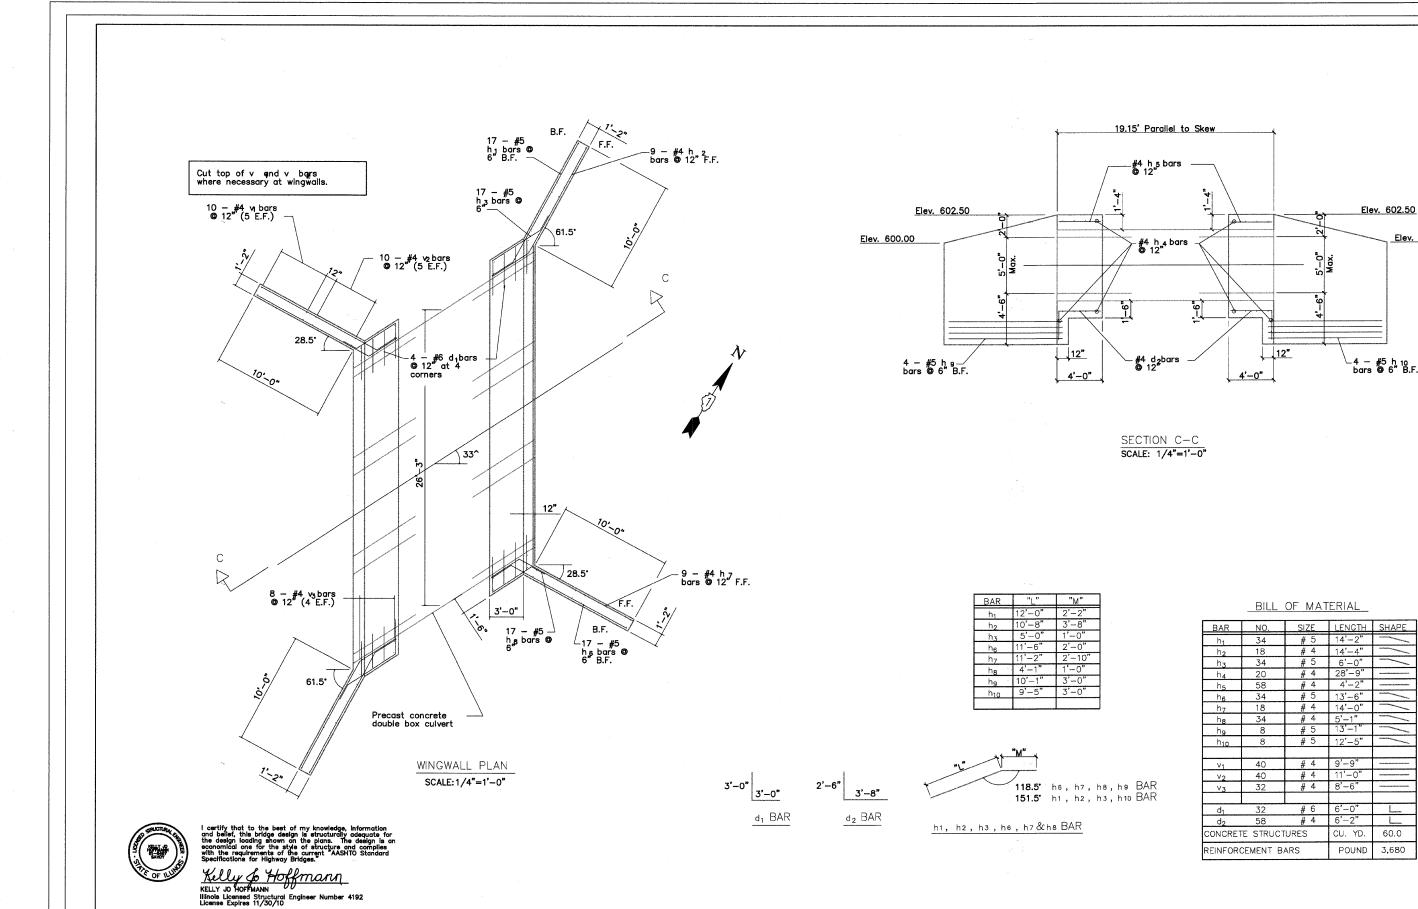

R	ENGINEERING RESOURCE ASSOCIATES, INC. CONSULTING ENGINEERS, SCIENTISTS & SURVEYORS	


USER NAME =	DESIGNED	_	KJH	REVISED		
	DRAWN	_	KJH	REVISED	_	
PLOT SCALE =	CHECKED	_	JF	REVISED	_	
PLOT DATE =	DATE		JANUARY, 2010	REVISED		

STATE OF ILLINOIS DEPARTMENT OF TRANSPORTATION

	WEST NORMAN BOX CULVERT END SECTION DETAIL
SCALE: 1/4"=1'-0"	SHEET NO. 1 OF 1 SHEETS

-				_								
	F.A. SECTION							COUNTY	SHEETS	NO.	1	
	01-P4015-01-BT						T	WILL	41	32	lie	
								T	CONTRACT	NO. 6	3325	Pigin
	FED. F	ROAD	DIST.	NO.	1	ILLINOIS	FED.	AIC	PROJECT] ≨

Elev. 600.00

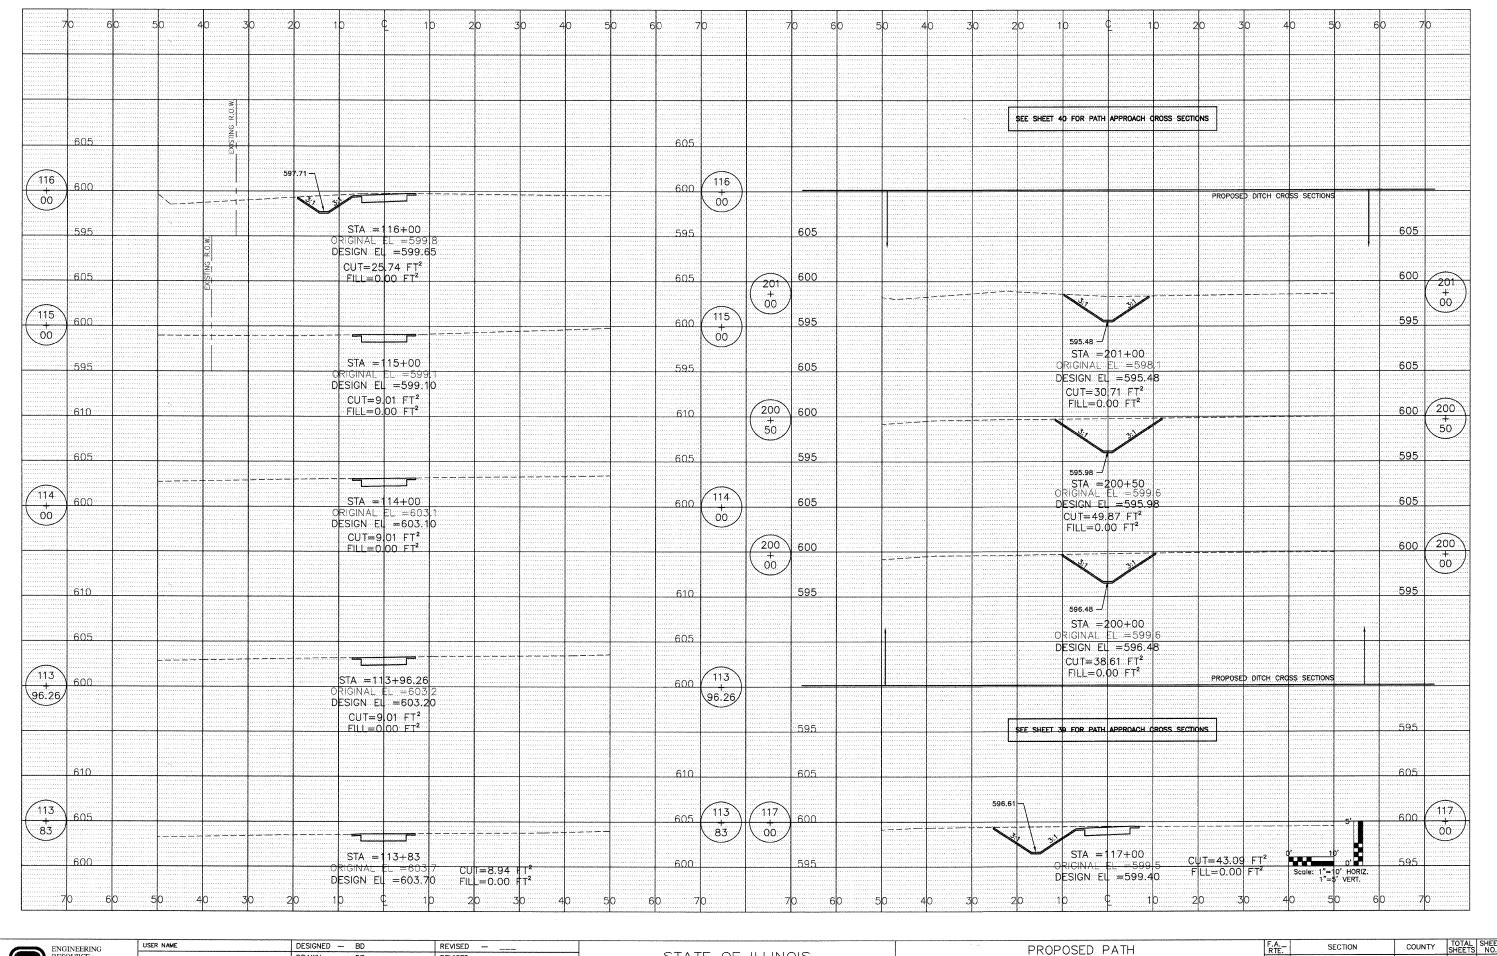


ENGINEERING
RESOURCE
ASSOCIATES, INC.
CONSULTING ENGINEERS, SCIENTI
& SURVEYORS

USER NAME	DESIGNED		BD	REVISED	_	
	DRAWN	_	DB	REVISED		
PLOT SCALE	CHECKED	_	JFM	REVISED	_	****
PLOT DATE	DATE		JANUARY, 2010	REVISED	_	

STATE OF ILLINOIS DEPARTMENT OF TRANSPORTATION

	CROSS SECTIONS									
SCALE: NONE	SHEET NO. 1 OF 9 SHEETS	STA. 113+83 TO STA. 117+00	_							

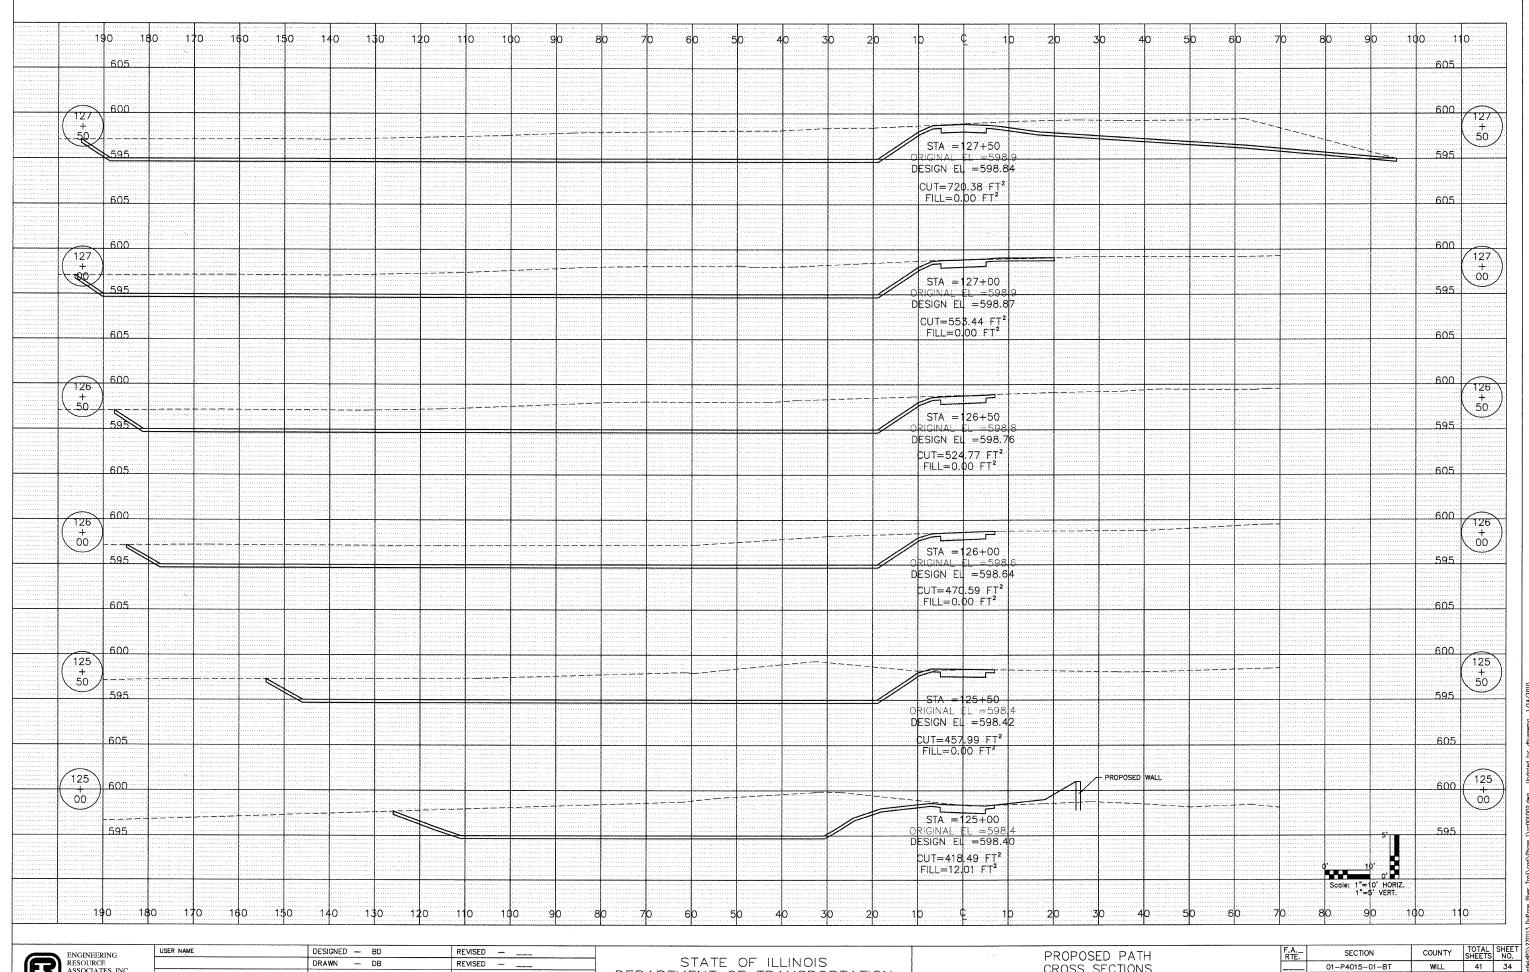


ENGINEERING
RESOURCE
ASSOCIATES, INC.
CONSULTING PROINTERS, SCRENTISTS
& SURVEYORS

REVISED -REVISED — ___ PLOT SCALE CHECKED - JFM PLOT DATE DATE - JANUARY, 2010 REVISED -

STATE OF ILLINOIS DEPARTMENT OF TRANSPORTATION

	S. sa	PROPOSED PATH CROSS SECTIONS	
CALE:	NONE	SHEET NO. 2 OF 9 SHEETS STA. 125+00 TO STA. 127+50	

| COUNTY | TOTAL | SHEET | NO. | NO. | NO. | SHEET | SHEET | NO. | SHEET | S FED. ROAD DIST. NO. 1 | ILLINOIS | FED. AID PROJECT

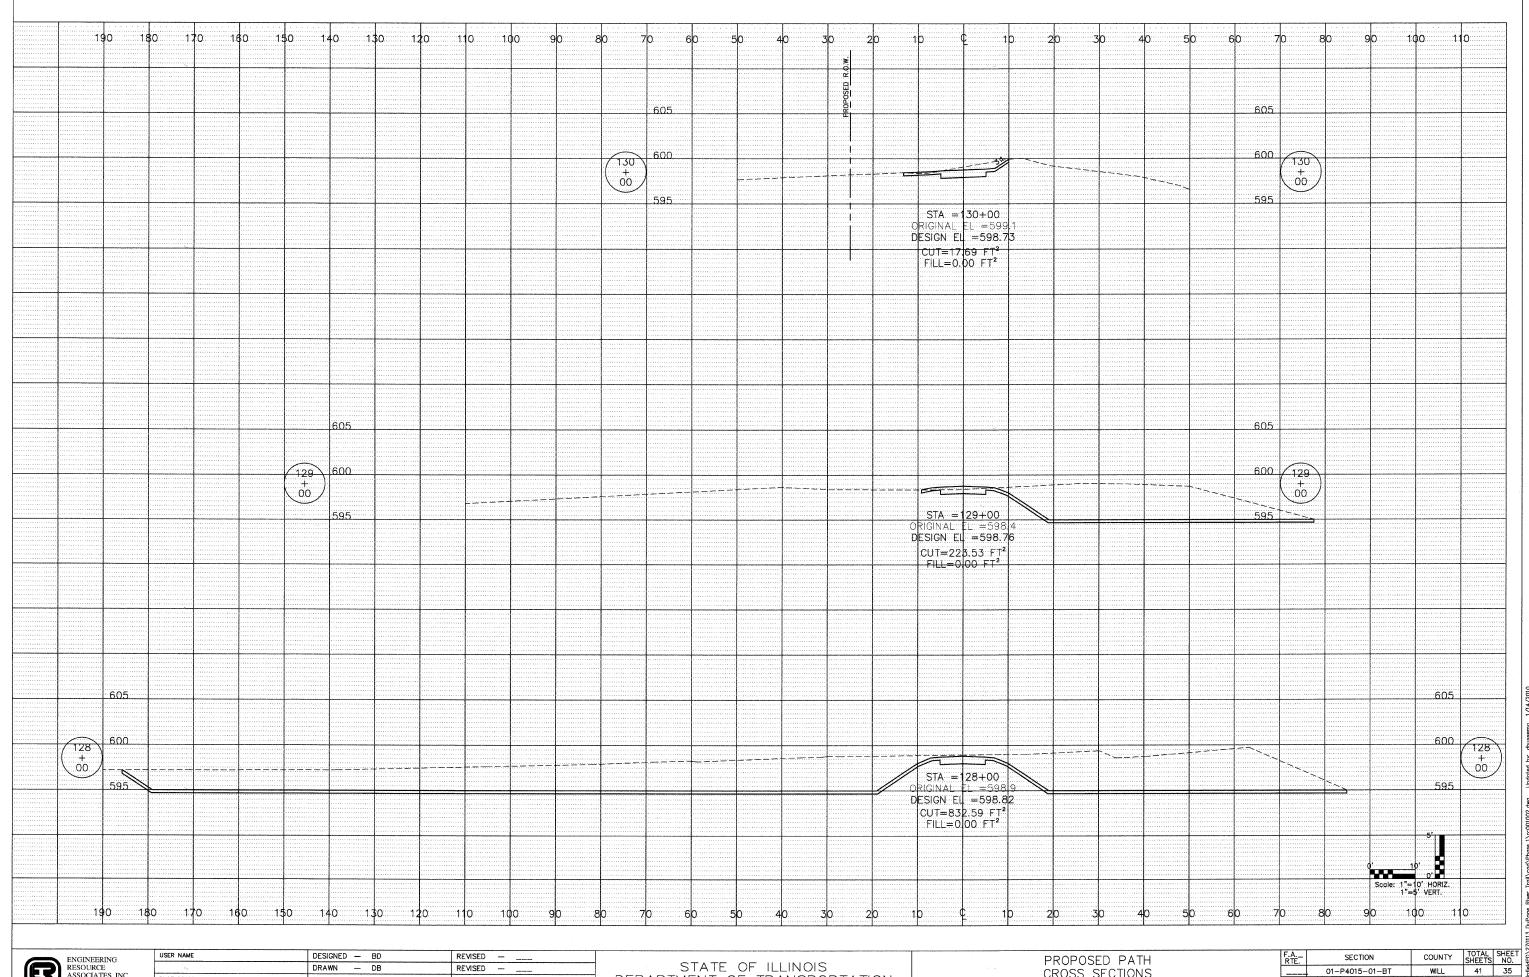


ENGINEERING RESOURCE ASSOCIATES, INC. CONSULTING ENGINEERS, SCIENTISTS & SURVINETS

REVISED — PLOT SCALE CHECKED — JFM PLOT DATE DATE - JANUARY, 2010 REVISED —

STATE OF ILLINOIS DEPARTMENT OF TRANSPORTATION

	PROPOSED PATH CROSS SECTIONS	
ALE: NONE	SHEET NO. 3 OF 9 SHEETS STA. 128+00	TO STA. 130+00

FED. ROAD DIST. NO. 1 | ILLINOIS | FED. AID PROJECT

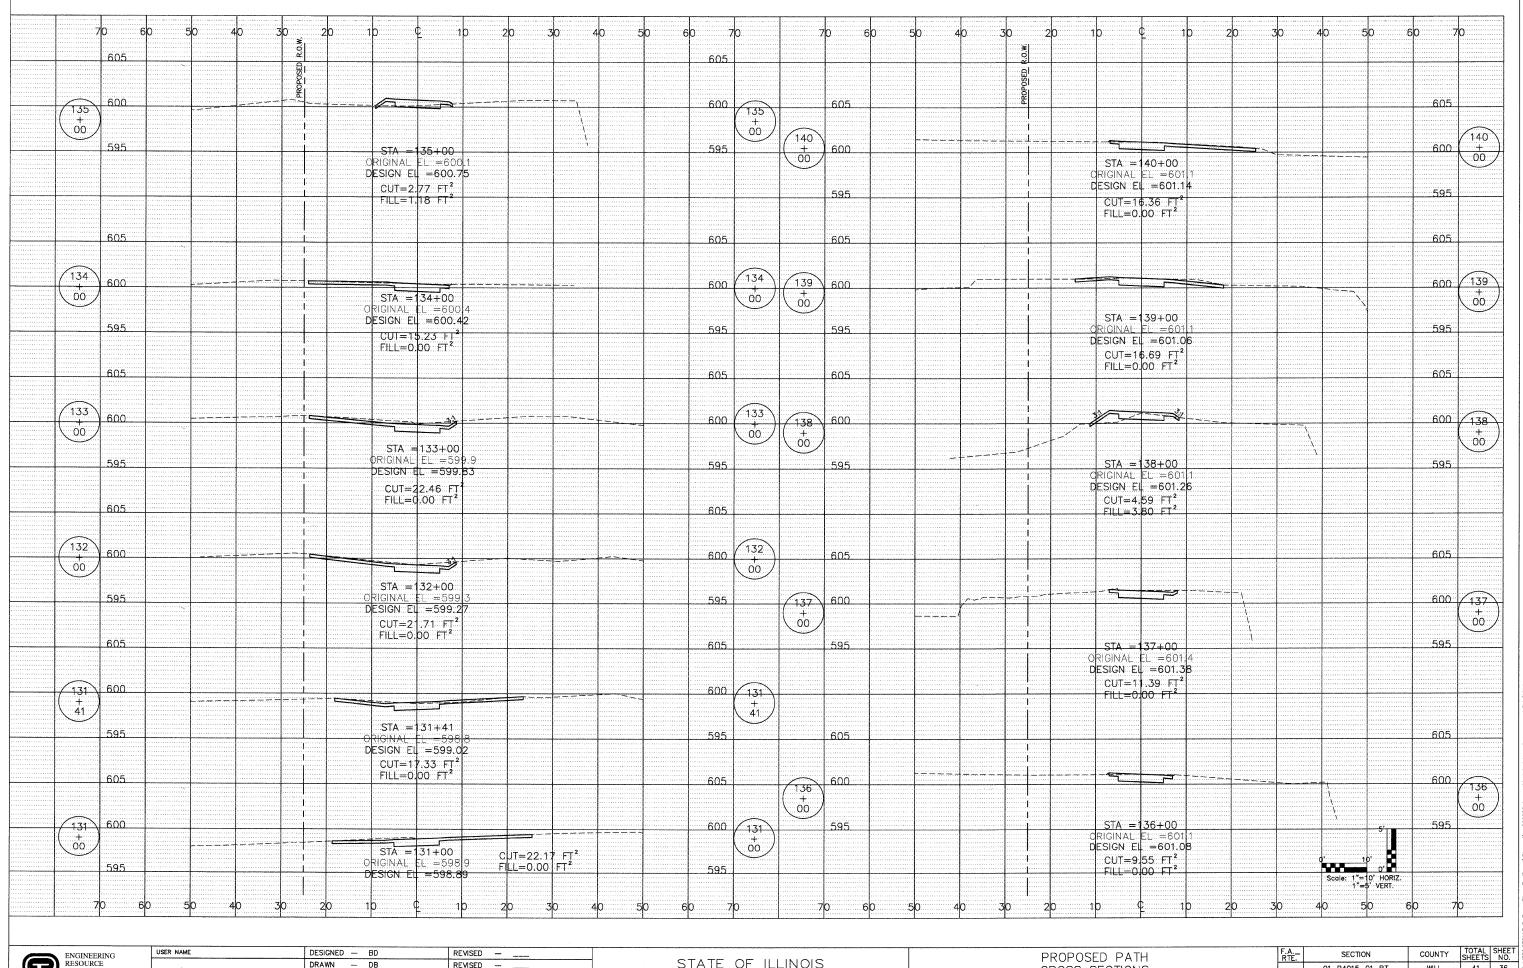


ENGINEERING RESOURCE ASSOCIATES, INC. CONSULTING ENGINEERS OFFER

DRAWN - DB REVISED -PLOT SCALE CHECKED - JFM REVISED ---PLOT DATE DATE - JANUARY, 2010 REVISED -

STATE OF ILLINOIS DEPARTMENT OF TRANSPORTATION

CROSS SECTIONS SCALE: NONE SHEET NO. 4 OF 9 SHEETS STA. 131+00 TO STA. 140+00


01-P4015-01-BT FED. ROAD DIST. NO. 1 ILLINOIS FED. AID PROJECT

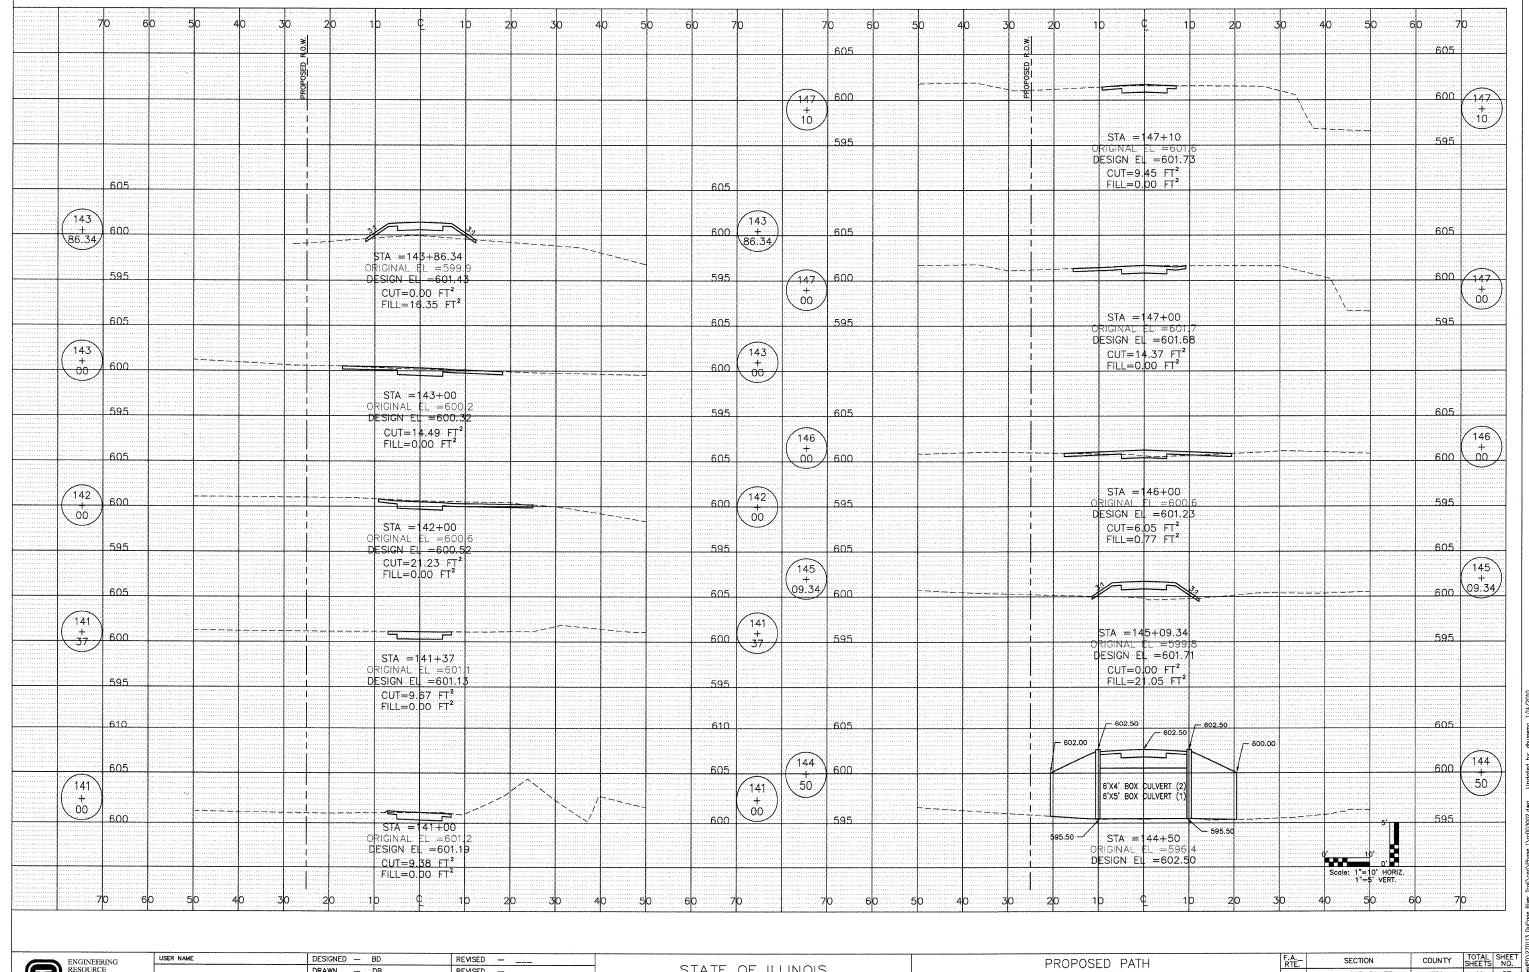

ENGINEERING
RESOURCE
ASSOCIATES, INC.
CONSULTING BROWNERS, SCIENTISTS
& SURVEYORS

STATE OF ILLINOIS DEPARTMENT OF TRANSPORTATION

	,		SED PAT SECTION			
LE: NONE	SHEET NO.	5 OF 9 SHE	ETS STA	. 141+00	TO STA.	147+

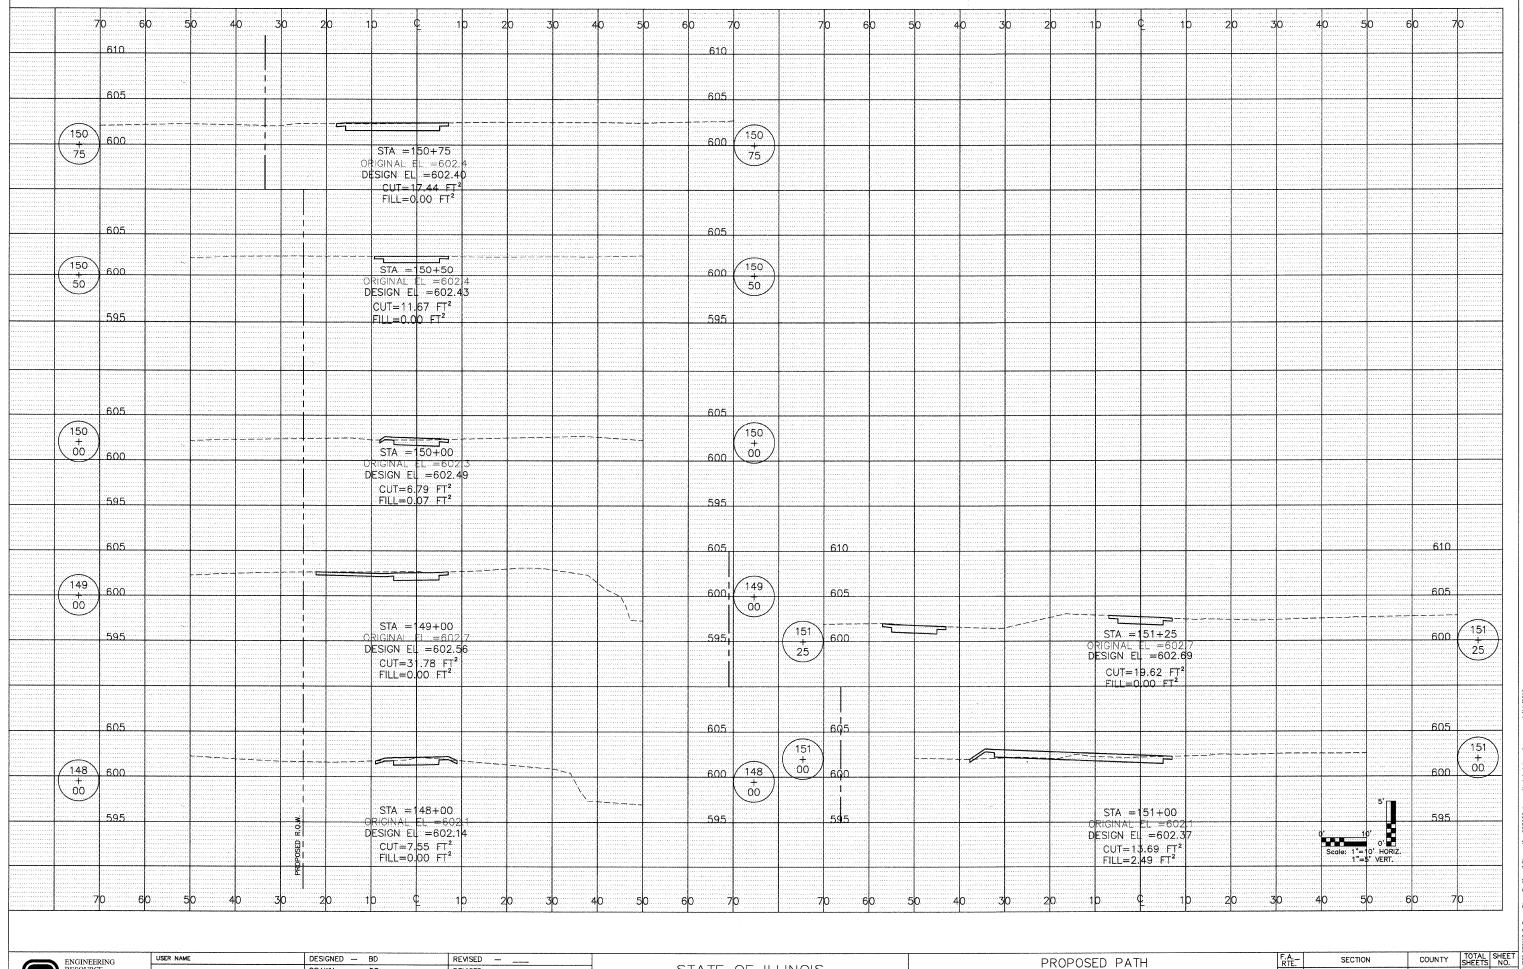


ENGINEERING RESOURCE ASSOCIATES, INC. CONSULTING ENGINEERS. SCIENTISTS & SCIENTISTS

USER NAME	DESIGNED	_	BD	REVISED		
	DRAWN		DB	REVISED		
PLOT SCALE	CHECKED	_	JFM	REVISED		
PLOT DATE	DATE	_	JANUARY, 2010	REVISED	_	

STATE OF ILLINOIS DEPARTMENT OF TRANSPORTATION

PROPOSED PATH									
	CROSS SECTIONS	ŀ	=						
SCALE: NONE	SHEET NO. 6 OF 9 SHEETS STA. 148+00 TO STA. 151+25		-						

| COUNTY | TOTAL SHEET | NO. |
| WILL | 41 | 38 |
| CONTRACT | NO. | 63325 | 01-P4015-01-BT FED. ROAD DIST. NO. 1 ILLINOIS FED. AID PROJECT

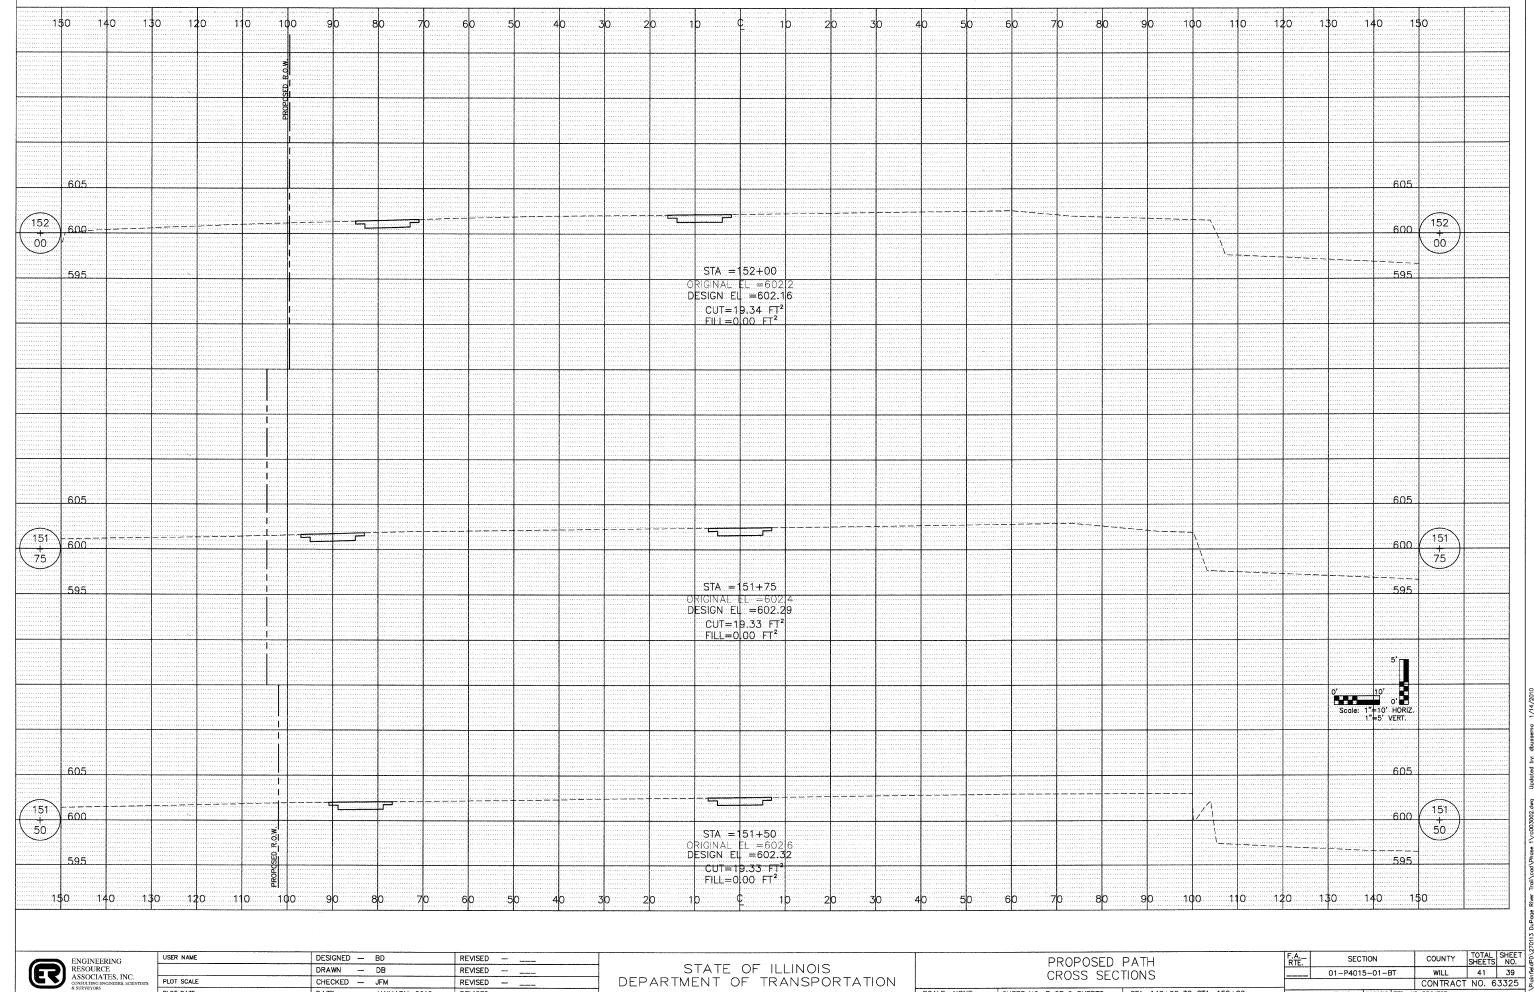


ENGINEERING
RESOURCE
ASSOCIATES, INC.
CONSULTING BIOLINEERS, SCIEN
& SURVEYORS


REVISED -- ____ PLOT SCALE CHECKED - JFM PLOT DATE DATE - JANUARY, 2010 REVISED - ____

DEPARTMENT OF TRANSPORTATION

SCALE: NONE SHEET NO. 7 OF 9 SHEETS STA. 148+00 TO STA. 152+00

FED. ROAD DIST. NO. 1 | ILLINOIS | FED. AID PROJECT

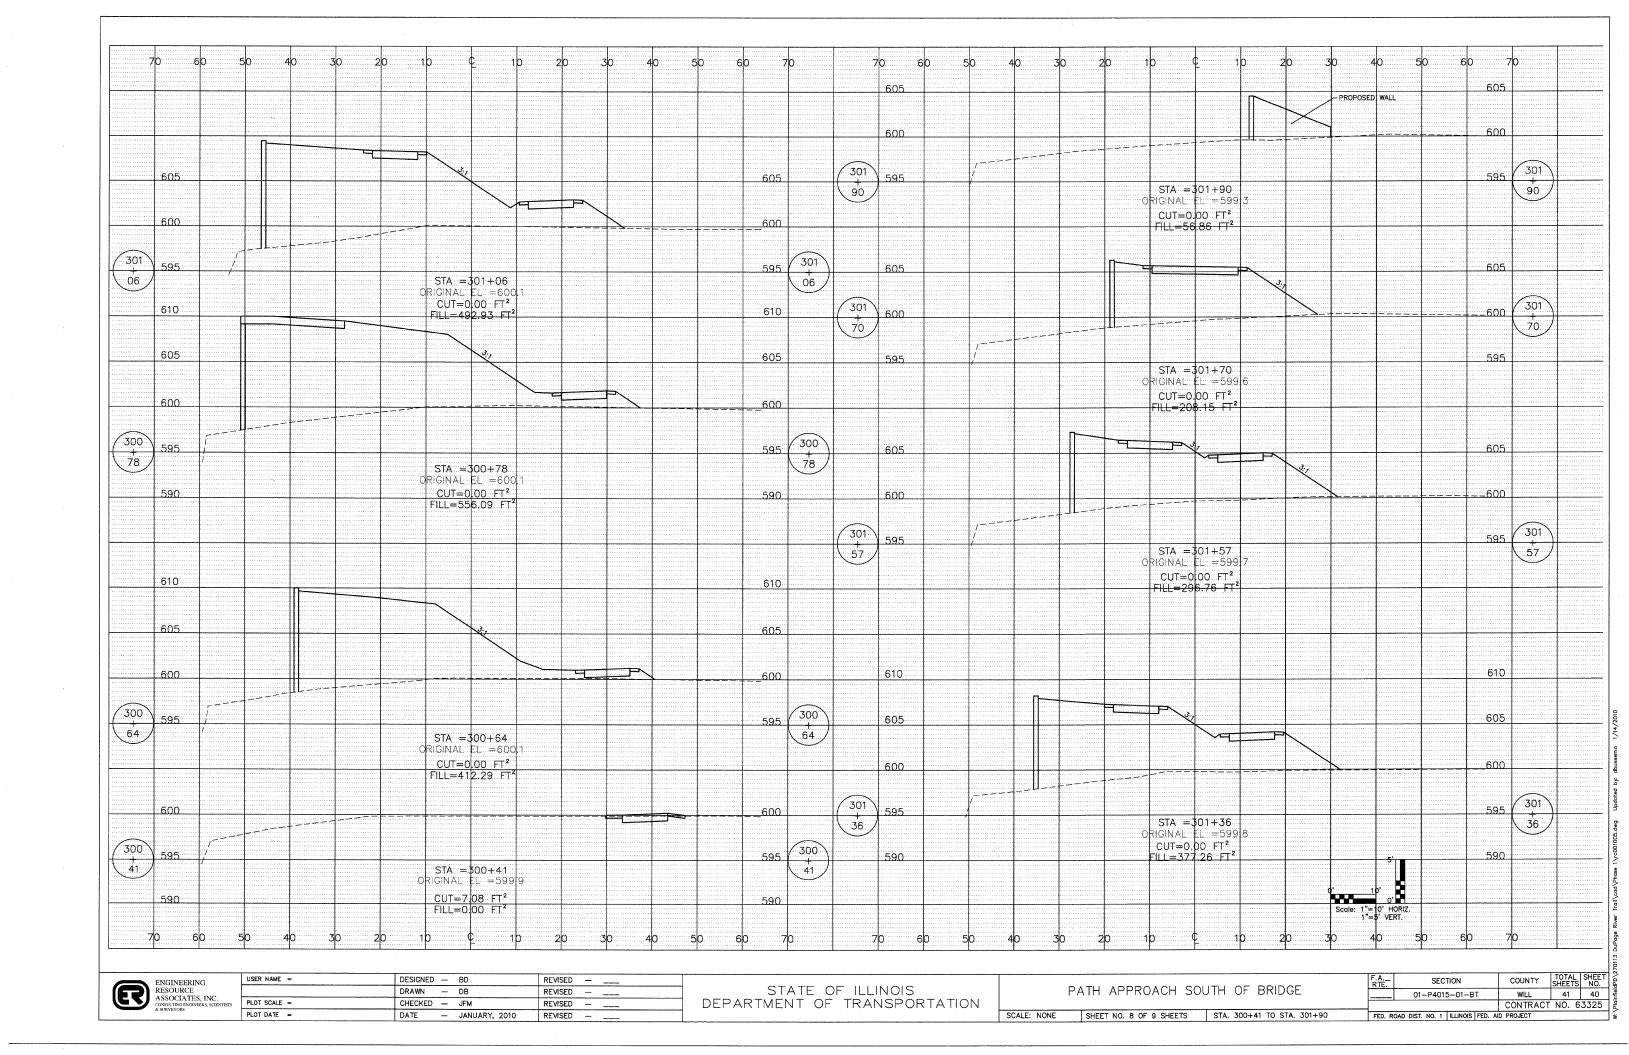

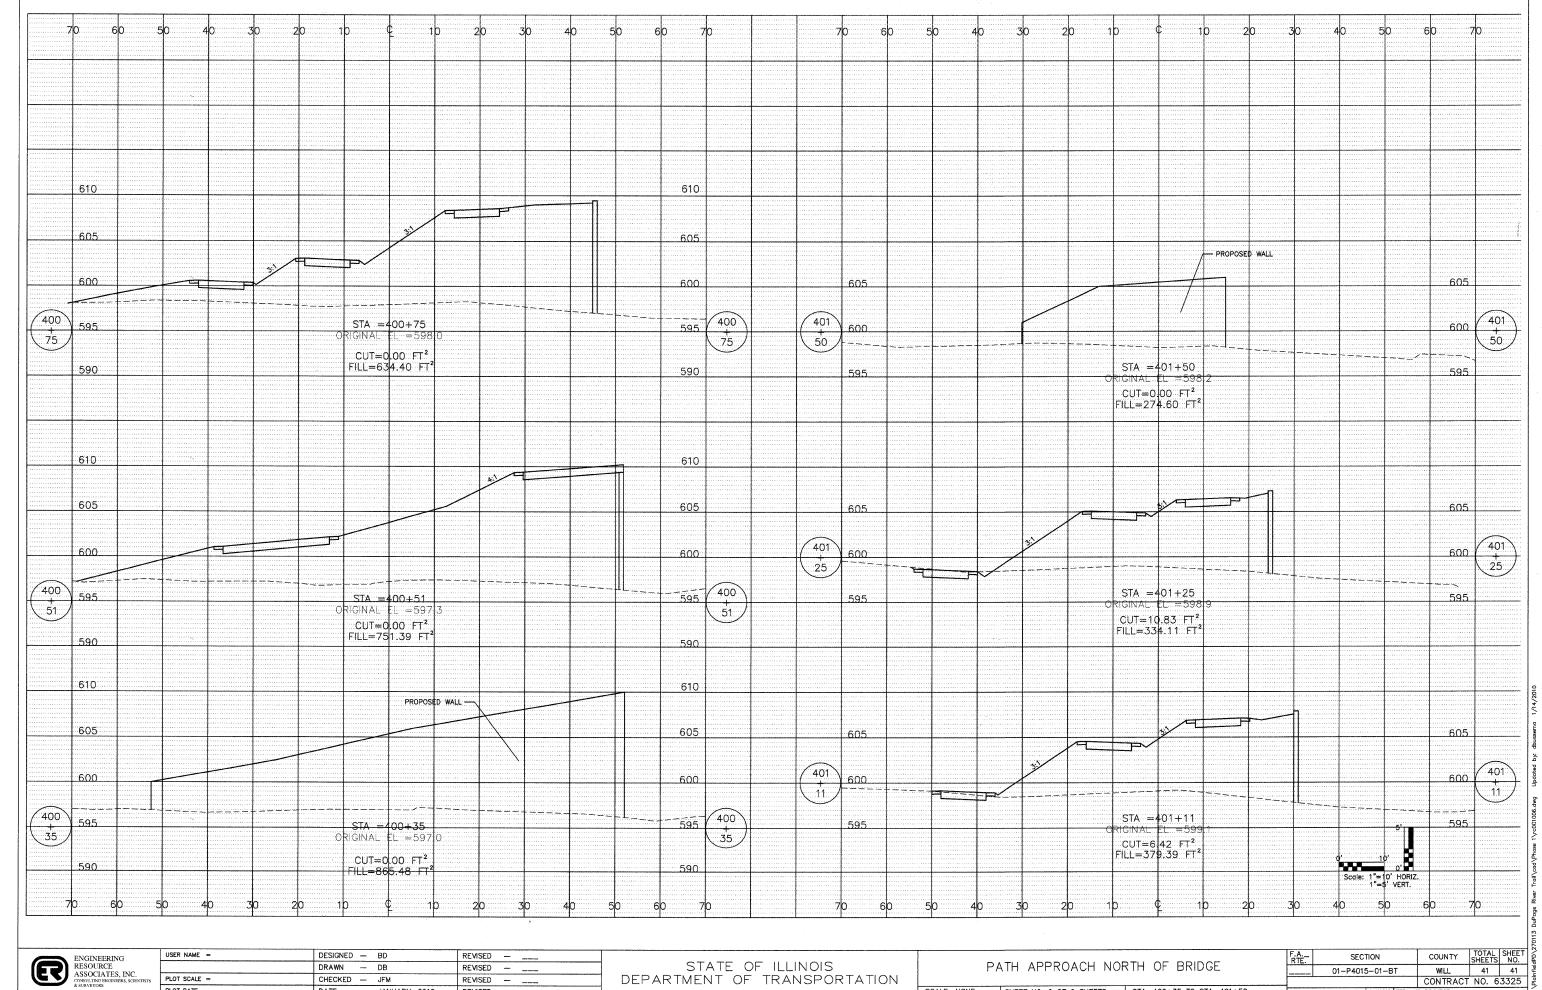

ENGINEERING RESOURCE ASSOCIATES, INC. CONSULTING ENGINEERS, SCIEN & SURVEYORS

PLOT SCALE = REVISED - ____ CHECKED - JFM PLOT DATE = DATE - JANUARY, 2010 REVISED - ___

STATE OF ILLINOIS DEPARTMENT OF TRANSPORTATION

SCALE: NONE SHEET NO. 9 OF 9 SHEETS STA. 400+35 TO STA. 401+50

FED. ROAD DIST. NO. 1 ILLINOIS FED. AID PROJECT