


RTE	SECTION	COUNTY	TOTAL SHEETS	SHEET NO.
1551	*	DuPAGE	53	31
STA. 2+35	TO STA.	32+00		
FED. ROAD DIST. NO.	ILLINOIS	FED. AID PROJECT		

* 88-00024-00PV

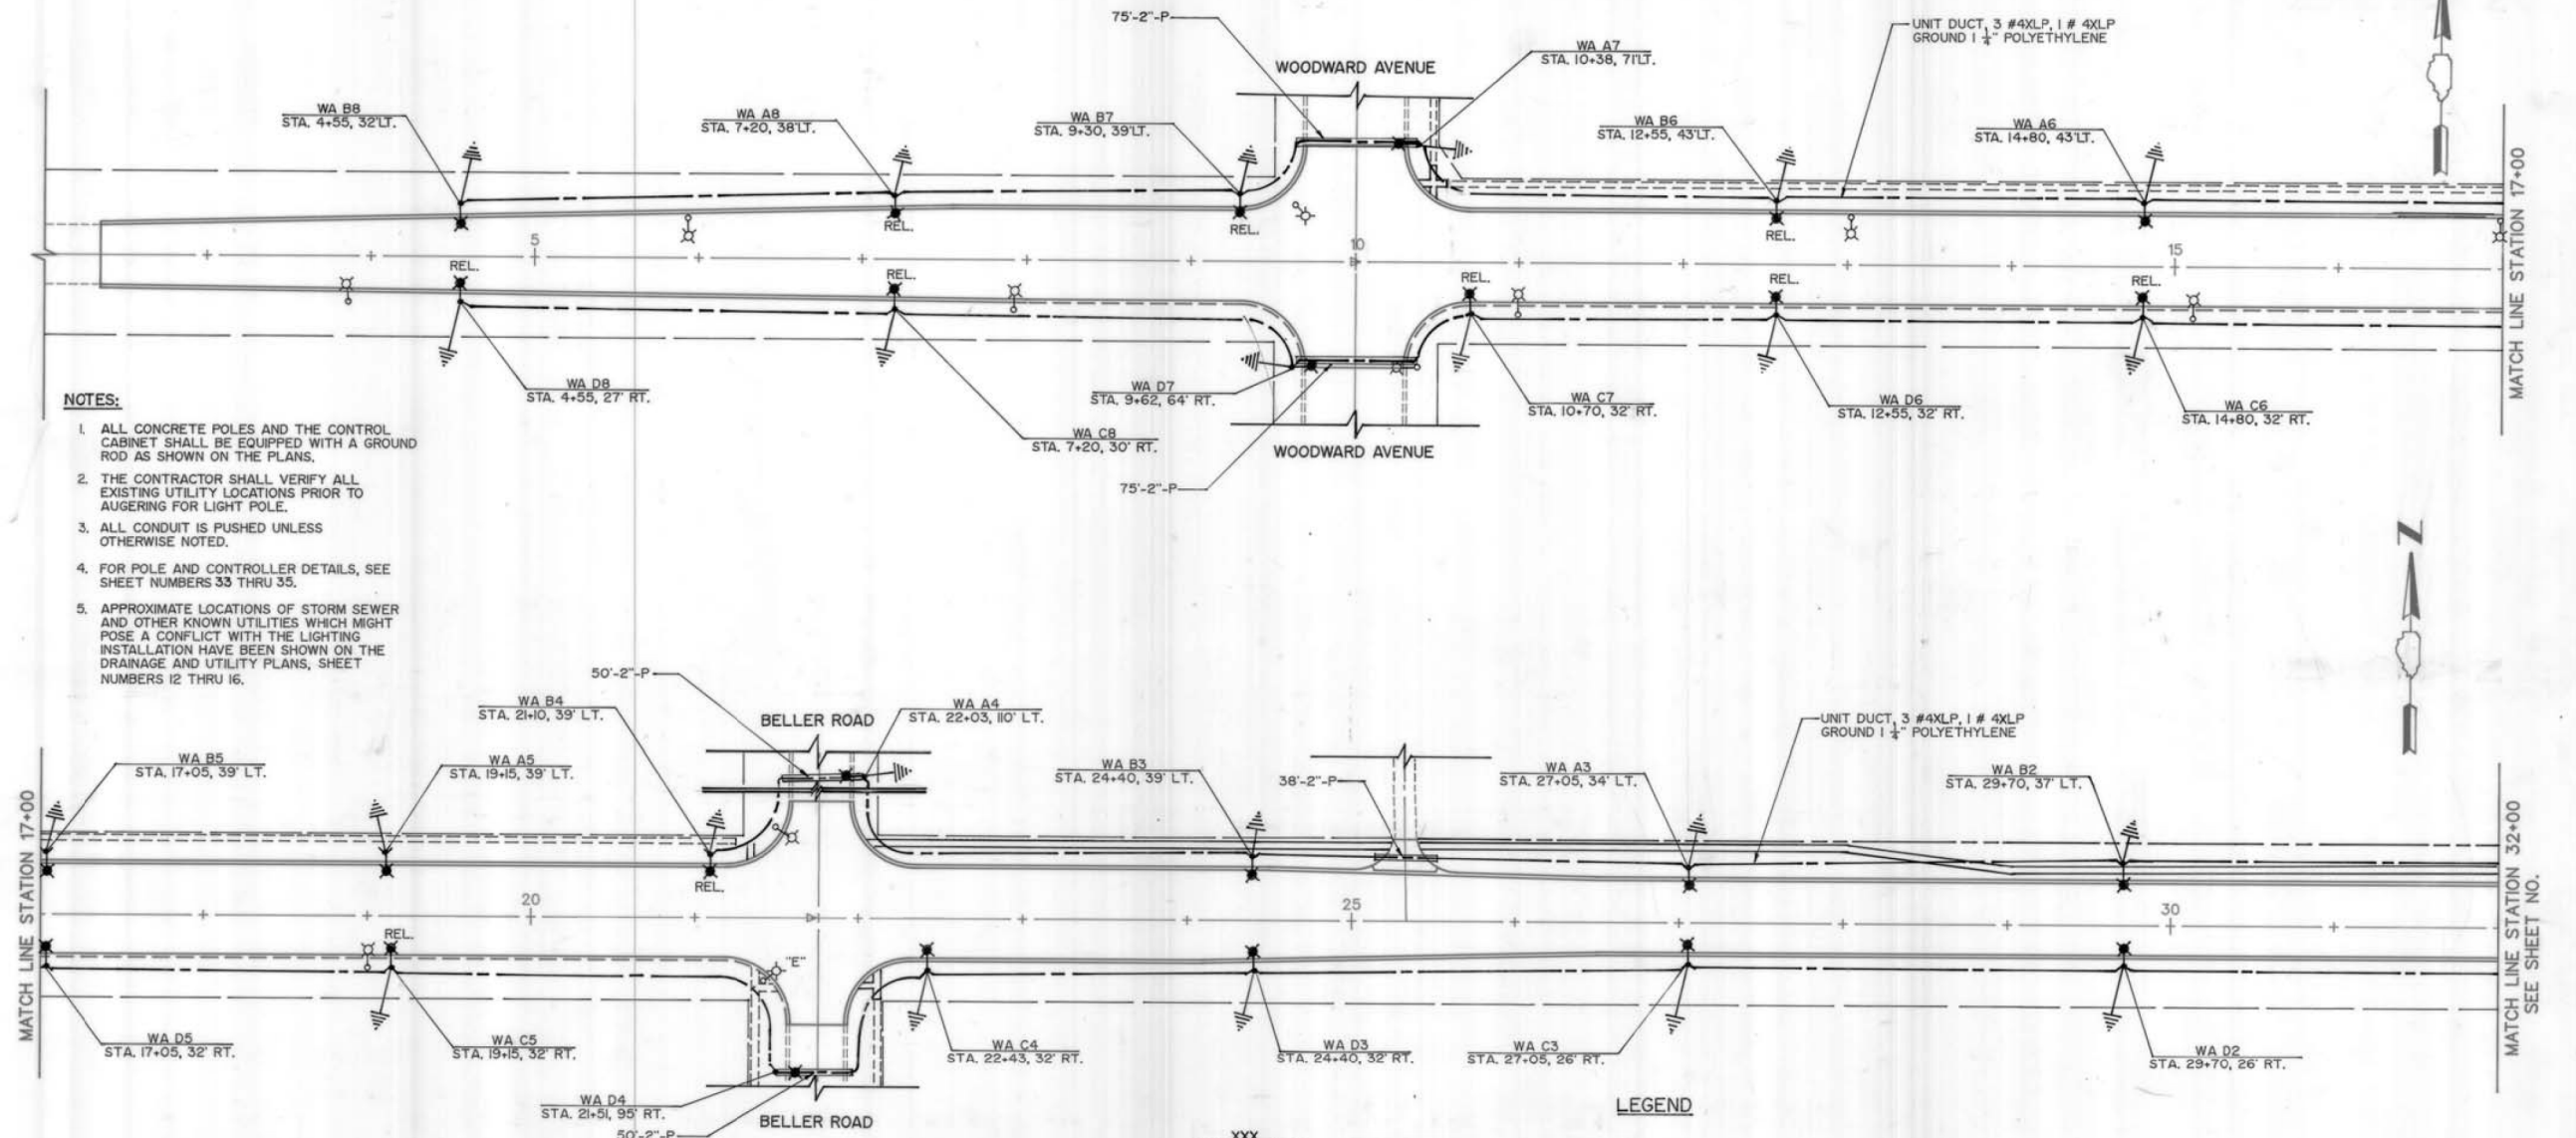

NOTES:

1. ALL CONCRETE POLES AND THE CONTROL CABINET SHALL BE EQUIPPED WITH A GROUND ROD AS SHOWN ON THE PLANS.
2. THE CONTRACTOR SHALL VERIFY ALL EXISTING UTILITY LOCATIONS PRIOR TO AUGERING FOR LIGHT POLE.
3. ALL CONDUIT IS PUSHED UNLESS OTHERWISE NOTED.
4. FOR POLE AND CONTROLLER DETAILS, SEE SHEET NUMBERS 33 THRU 35.
5. APPROXIMATE LOCATIONS OF STORM SEWER AND OTHER KNOWN UTILITIES WHICH MIGHT POSE A CONFLICT WITH THE LIGHTING INSTALLATION HAVE BEEN SHOWN ON THE DRAINAGE AND UTILITY PLANS, SHEET NUMBERS 12 THRU 16.

LEGEND

XXX
STA. X+XX

LIGHT POLE CIRCUIT / STATION

UNIT DUCT, 3 #4XLP, 1 #4XLP
GROUND 1-1/4" POLYETHYLENE

CONDUIT PUSHED (P), 2" DIAMETER,
GALVANIZED STEEL (UNLESS OTHERWISE
NOTED).

CONTROL CABINET, DUPLEX, CONSOLE TYPE

SERVICE INSTALLATION, 240/480 V, 1Ø,
3 CONDUCTORS

GROUND ROD, 5/8" DIAMETER x 10 FT.

COMMON TRENCH

PUSHED


TRENCH

PROPOSED LIGHTING UNIT
LIGHTPOLE: CONCRETE LOCATED 8 FEET BEHIND PROPOSED
EDGE OF PAVEMENT, 36-1/2 FT. M.H., 1 FT. MAST ARM
LUMINAIRE: HIGH PRESSURE SODIUM VAPOR, HORIZONTAL MOUNT,
250 WATT (TYPE II, MEDIUM, CUTOFF)

REL. RELOCATED EXISTING LIGHTING UNIT
LIGHTPOLE: CONCRETE, LOCATED 8 FEET BEHIND PROPOSED
EDGE OF PAVEMENT, 36-1/2 FT. M.H., 1 FT. MAST ARM
EXISTING LUMINAIRE: SODIUM VAPOR, HORIZONTAL MOUNT,
250 WATT.

EXISTING LIGHTING UNIT LOCATION:
EXISTING LIGHTING UNIT IS TO BE RELOCATED

EXISTING LIGHTING UNIT LOCATION:
REMOVE LIGHTING UNIT, OWNER SALVAGE
(AS DIRECTED BY THE ENGINEER).

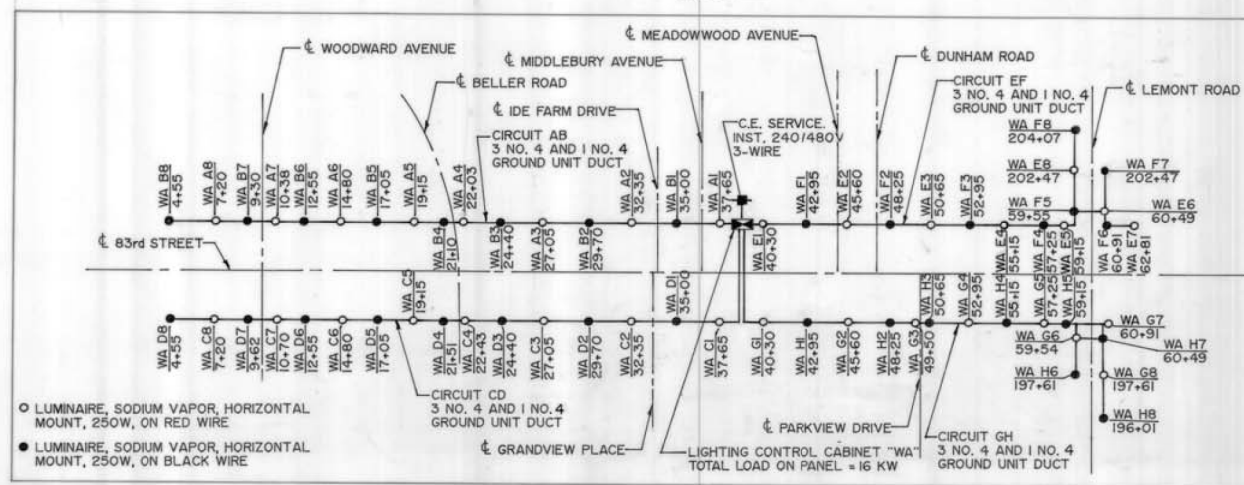

- LUMINAIRE, SODIUM VAPOR, HORIZONTAL MOUNT, 250W, ON RED WIRE
- LUMINAIRE, SODIUM VAPOR, HORIZONTAL MOUNT, 250W, ON BLACK WIRE

CIRCUIT CD
3 NO. 4 AND 1 NO. 4
GROUND UNIT DUCT

LIGHTING CONTROL CABINET "WA"
TOTAL LOAD ON PANEL = 16 KW

CIRCUIT GH
3 NO. 4 AND 1 NO. 4
GROUND UNIT DUCT

FOR INFORMATION ONLY

ILLINOIS DEPARTMENT OF TRANSPORTATION

ROADWAY LIGHTING PLAN
83rd STREET
STA. 2+35 TO STA. 32+00

HORIZ. 50 0 50 DATE
DRAWN BY YDZ
CHECKED BY SRF

REVISIONS	NAME	DATE

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Light-06.dgn

AMES Engineering, Inc.
CONSULTING ENGINEERS
6330 Belmont Road, Unit 4B
Downers Grove, IL 60516

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PLOT SCALE = 0.0889' / in.	DRAWN - MD	REVISED -
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	DATE - 06-01-23	REVISED -

DUPAGE COUNTY
DIVISION OF TRANSPORTATION


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				CONTRACT NO. 61J01
		ILLINOIS	FED. AID PROJECT	

LT-06

RTE	SECTION	COUNTY	TOTAL SHEETS	SHEET NO
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STA.		TO STA.		
FED. ROAD DIST. NO.		ILLINOIS	FED. AID PROJECT	
* 88-00024-00PV				



REVISIONS	
NAME	DATE

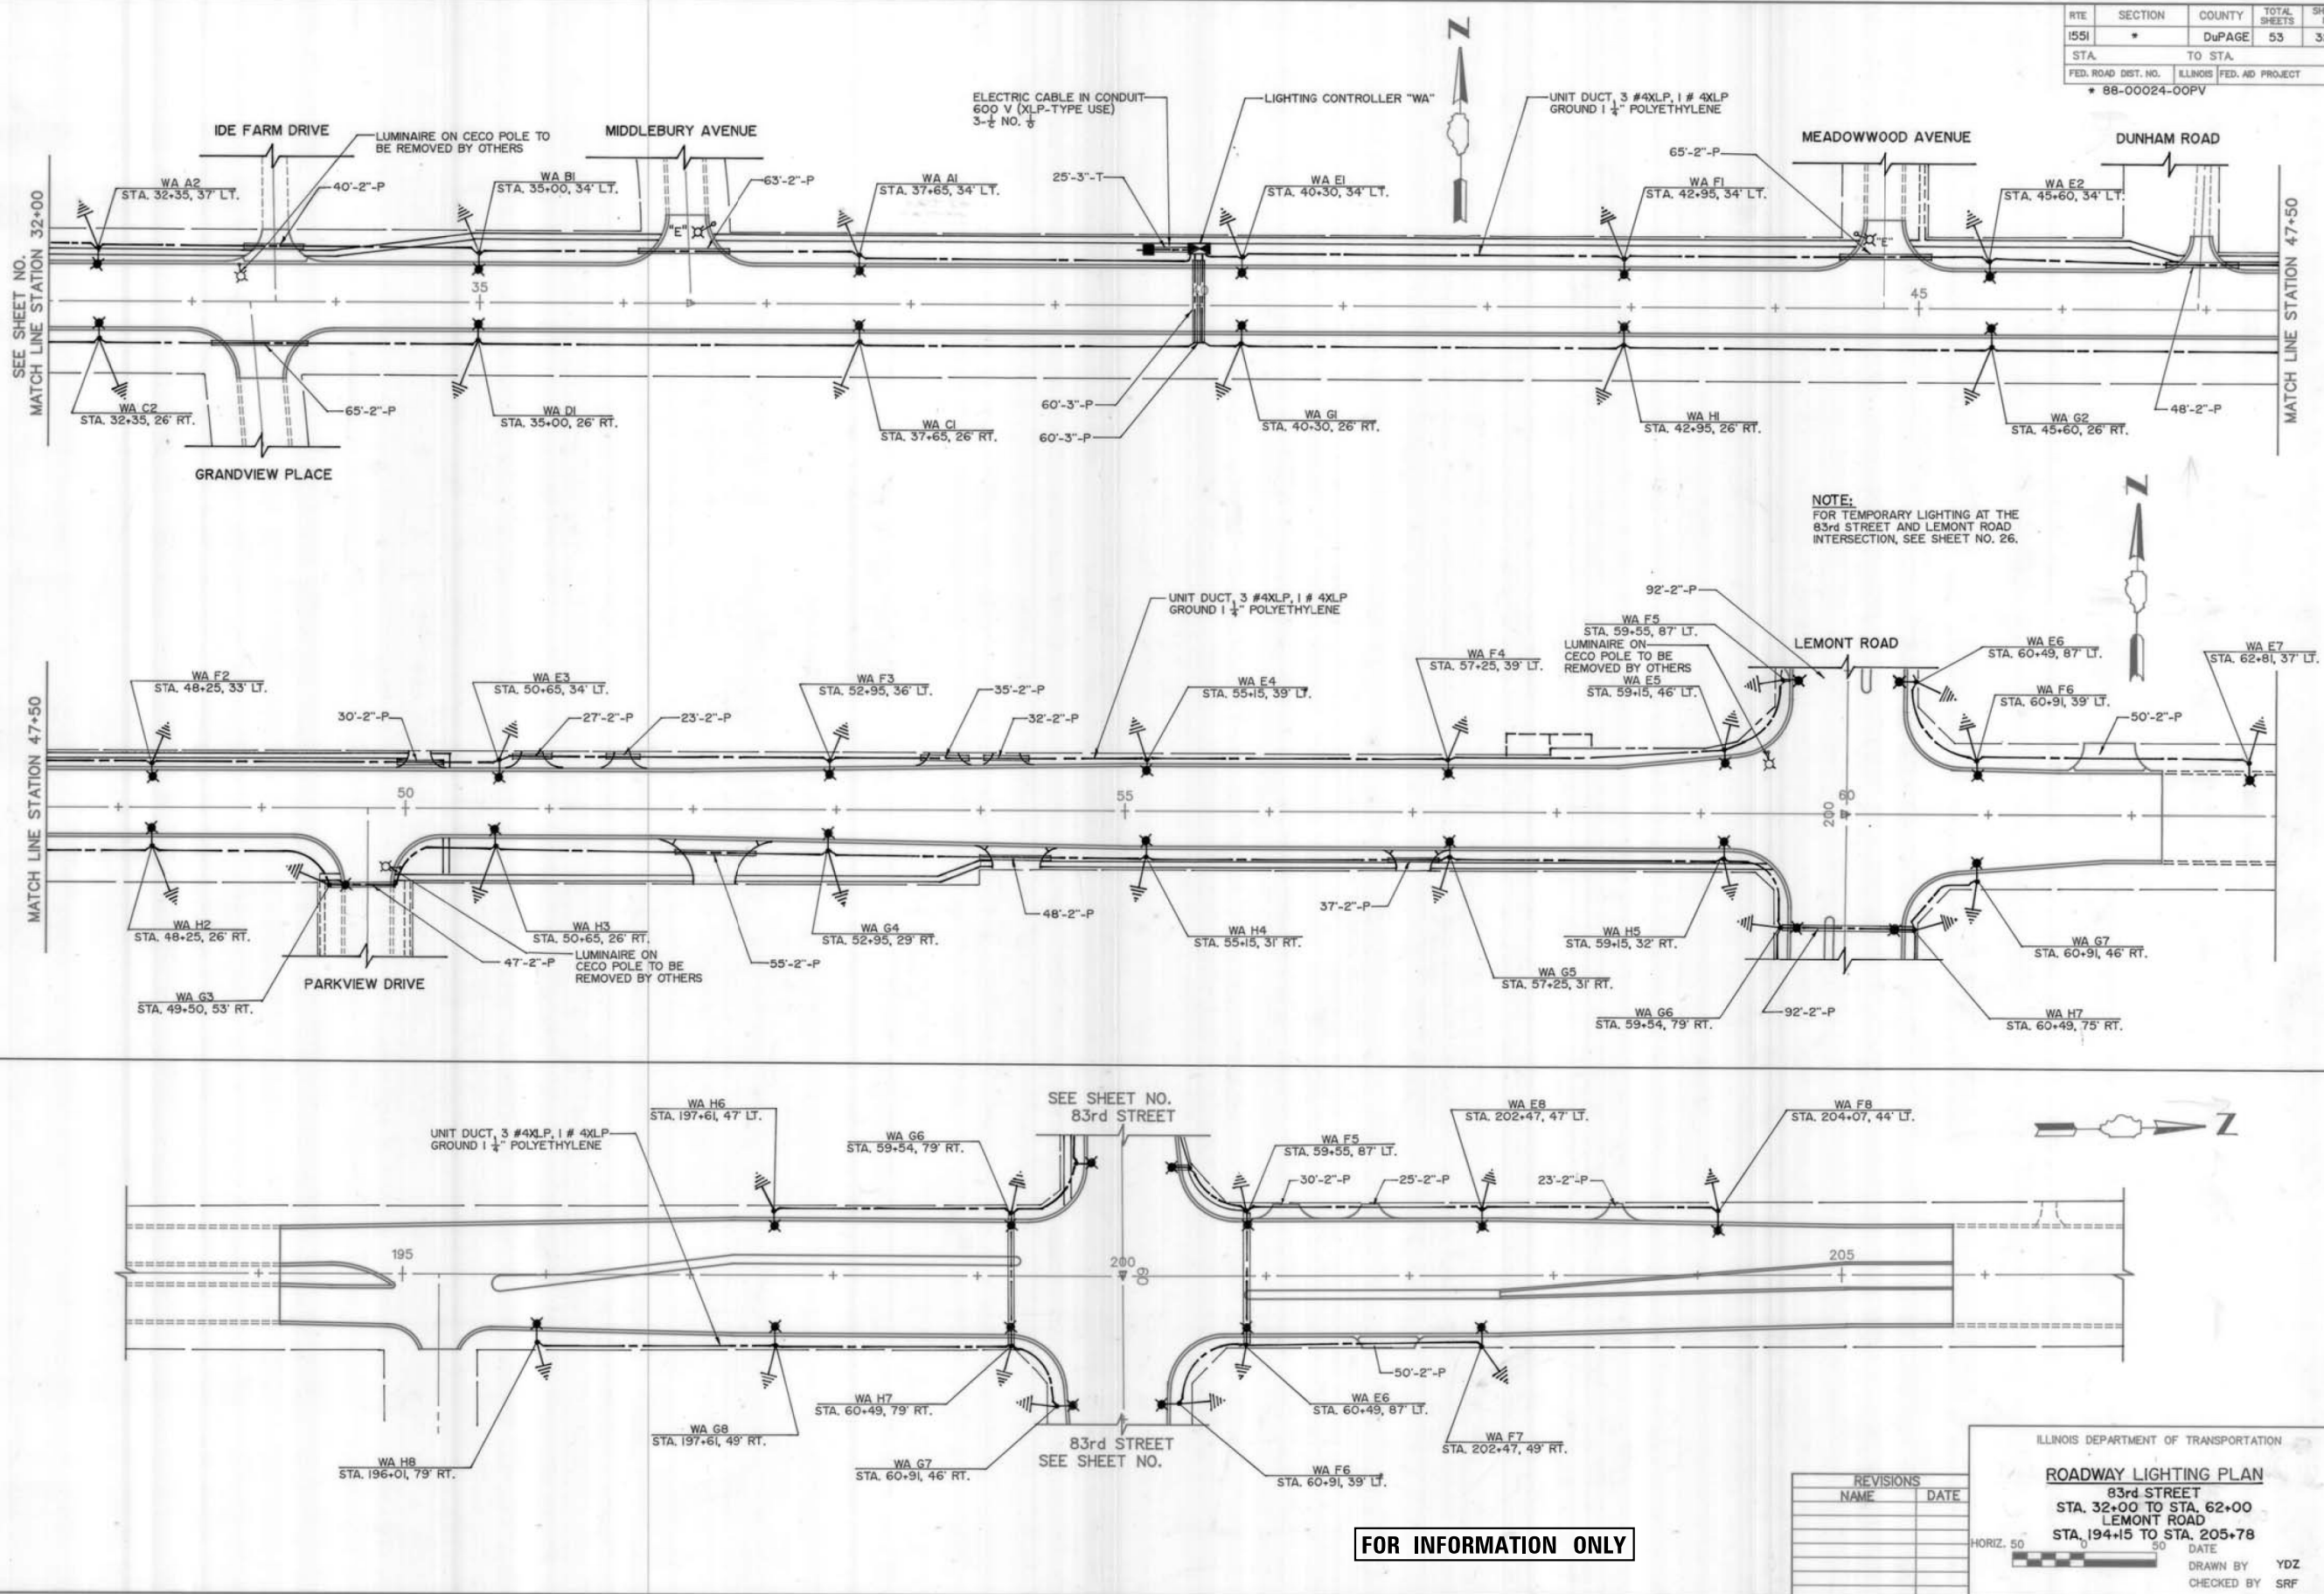ILLINOIS DEPARTMENT OF TRANSPORTATION	
ROADWAY LIGHTING PLAN	
83rd STREET	
STA. 32+00 TO STA. 62+00	
LEMONT ROAD	
STA. 194+15 TO STA. 205+78	
HORIZ. 50	DATE
DRAWN BY YDZ	CHECKED BY SRP

FOR INFORMATION ONLY

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AMES Engineering, Inc.
CONSULTING ENGINEERS
6330 Belmont Road, Unit 4B
Downers Grove, IL 60516

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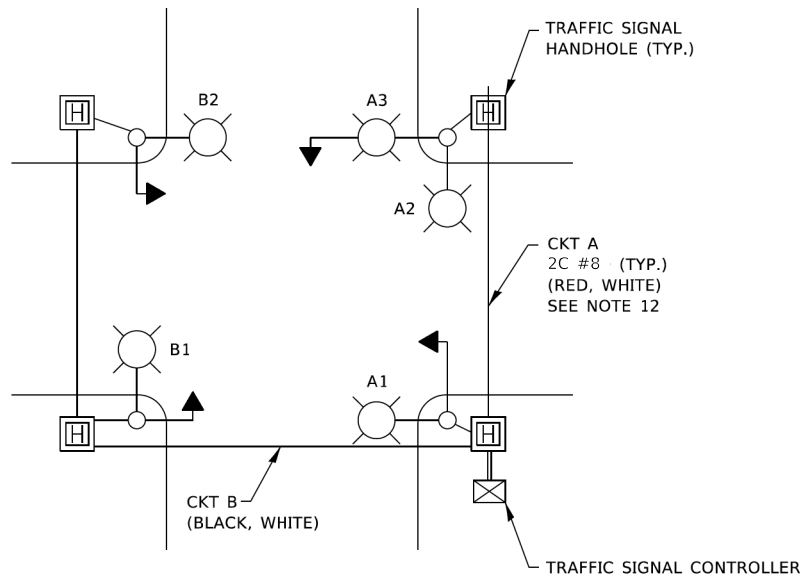
DUPAGE COUNTY
DIVISION OF TRANSPORTATION

LEMONT ROAD AT 83RD STREET


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ILLINOIS FED. AID PROJECT				

LT-07




TYPICAL LIGHTING CIRCUIT
(NOT TO SCALE)

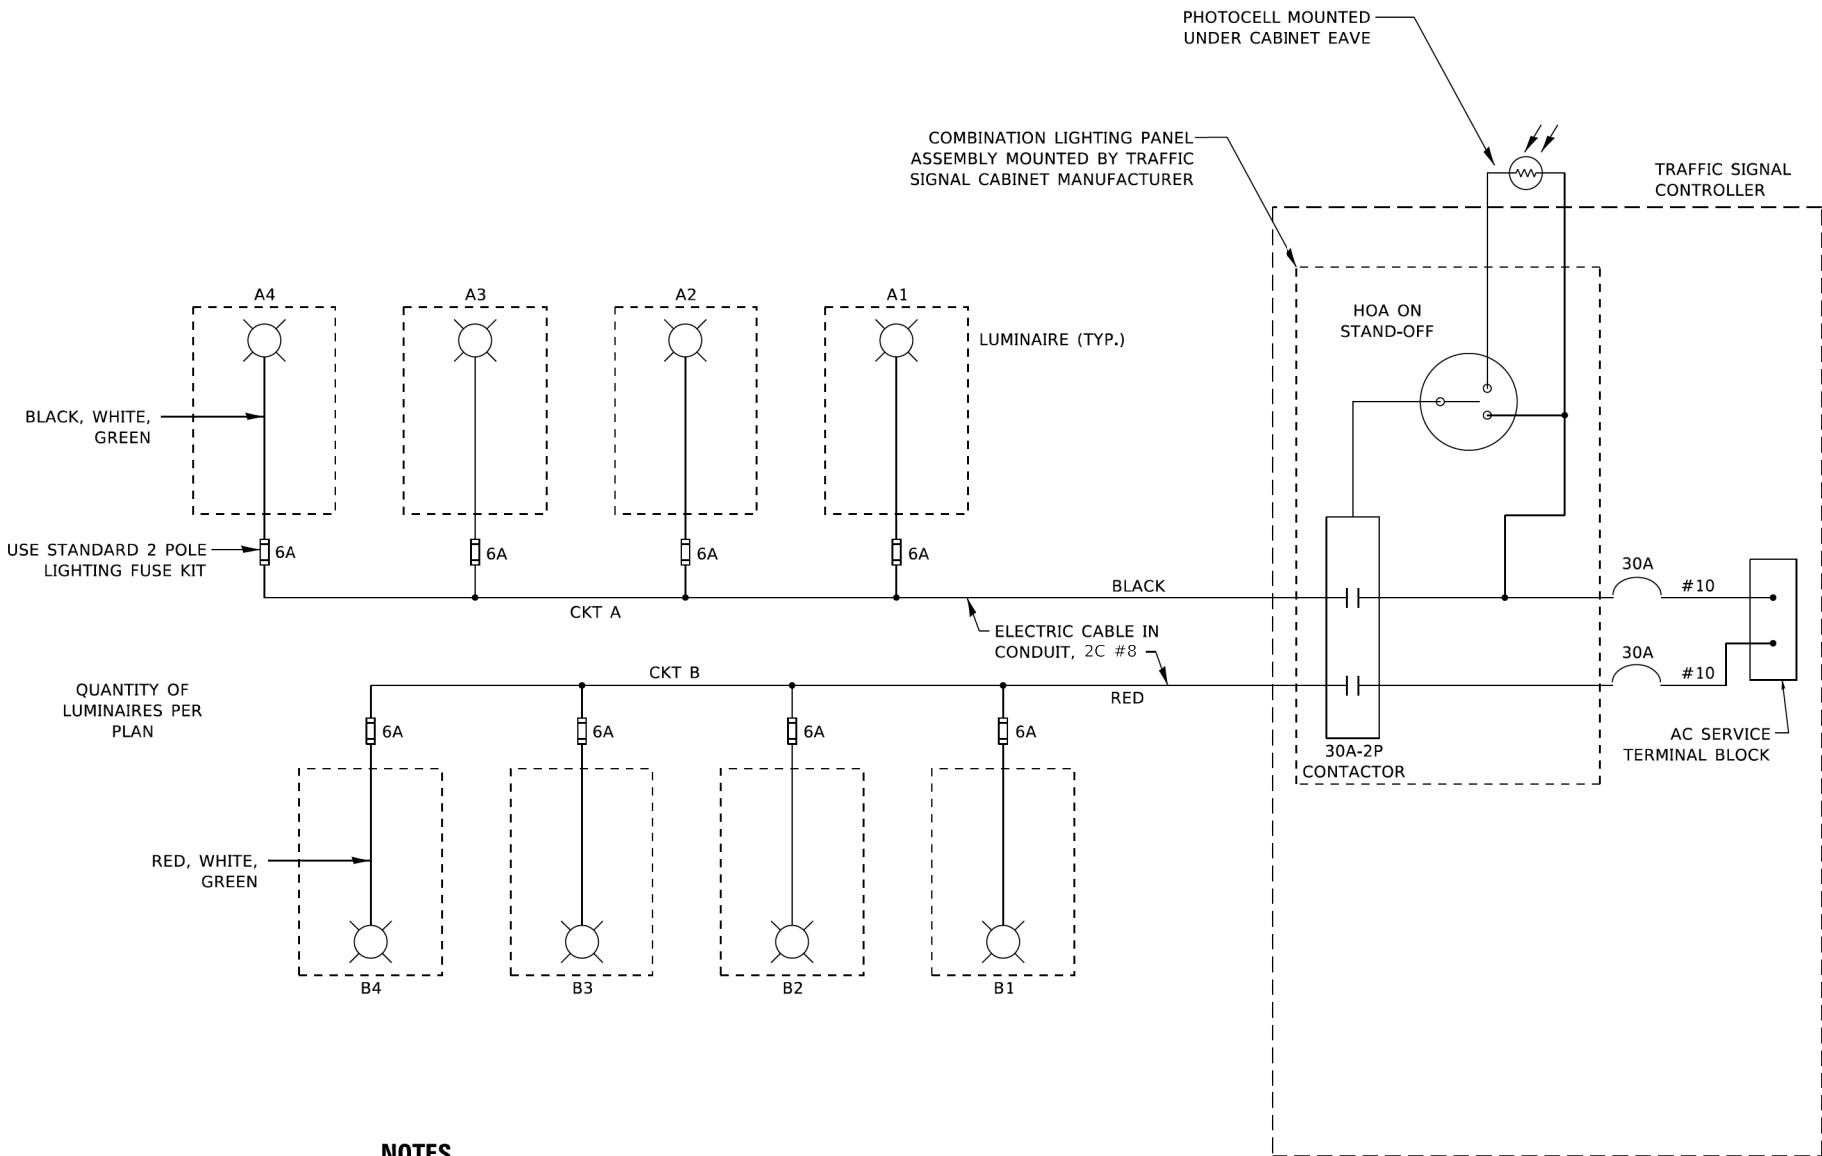

NOTES

- 4 LUMINAIRES PER CIRCUIT, MAXIMUM.
- TWO #10 (XLP-TYPE USE) CABLES TO BE USED FOR LIGHTING CIRCUITS.
- ROUTE LIGHTING CIRCUITS IN TRAFFIC SIGNAL CONDUIT SYSTEM.
- ALL SPLICES AND CONNECTIONS FOR ROADWAY LIGHTING SHALL BE AT POLE BASE ONLY.
- FOR LIGHTING CIRCUITS, CONNECT TWO CIRCUIT BREAKERS TO AC SERVICE TERMINAL BLOCK.
- ALL WIRING SHALL BE NEATLY DRESSED, IDENTIFIED BY TAGS, AND SUPPORTED. (UNDERGROUND SPLICING OF LIGHTING CONDUCTORS IS NOT PERMITTED).
- THE H.O.A. SWITCH SHALL BE LABELED AS "LIGHTING CONTROL" WITH THE POSITIONS "AUTO", "OFF" AND "TEST" WITH ENGRAVED NAME PLATES.
- LIGHTING CONNECTED TO UPS BYPASS CIRCUIT.
- COMBINATION LIGHTING MUST BE INSTALLED PRIOR TO SIGNAL TURN ON.
- LUMINAIRE VOLTAGE SHALL BE 120V
- POLE WIRING & FUSE KITS ARE INCLUDED IN THE LUMINAIRE PAY ITEM.
- THE UNDERGROUND EQUIPMENT GROUND WIRE IS SHOWN IN THE TRAFFIC SIGNAL PLANS AND IS INCLUDED IN THE SIGNAL PLANS. IT IS SHARED GROUND BETWEEN SIGNALS AND LIGHTING.

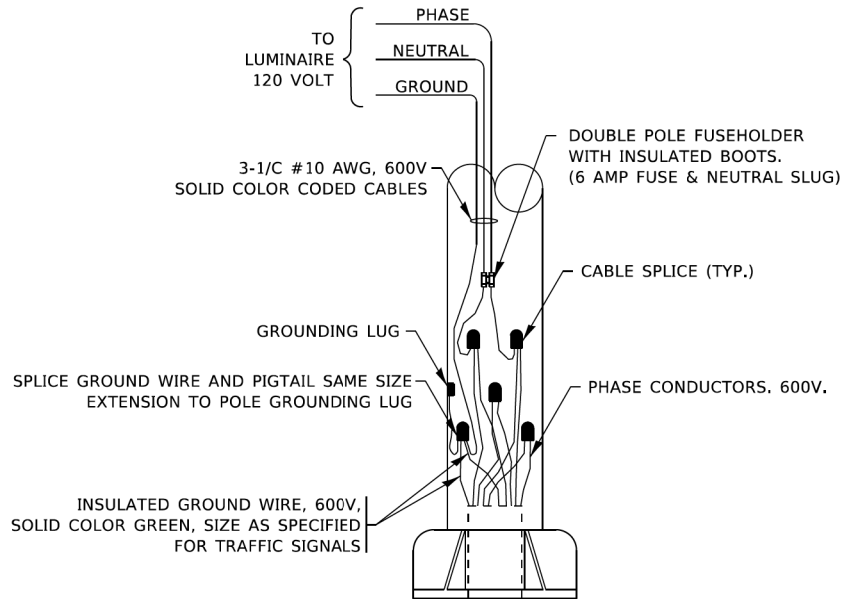



COMBINATION POLE WIRING DETAIL
(NOT TO SCALE)

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2612	16-00232-00-CH	DuPage	248	203
BE-240		CONTRACT NO. 61J01		
		ILLINOIS FED. AID PROJECT		

LIGHT POLE FOUNDATION DEPTH TABLE
 40 FT. (12.192 m) TO 47.5 FT. (14.478 m) MOUNTING HEIGHT

SOIL CONDITIONS	DESIGN DEPTH "D" OF FOUNDATION	
	SINGLE ARM POLE	TWIN ARM POLE
SOFT CLAY Ou = 0.375 TON/SQ. FT.	13'-0" (3.96 m)	15'-0" (4.57 m)
MEDIUM CLAY Ou = 0.75 TON/SQ.FT	9'-6" (2.99 m)	10'-9" (3.23 m)
STIFF CLAY Ou = 1.50 TON/SQ. FT.	7'-0" (2.13 m)	8'-0" (2.44 m)
LOOSE SAND φ = 34°	9'-0" (2.74 m)	10'-0" (3.05 m)
MEDIUM SAND φ = 37.5°	8'-3" (2.52 m)	9'-0" (2.74 m)
DENSE SAND φ = 40°	7'-9" (2.36 m)	9'-0" (2.74 m)

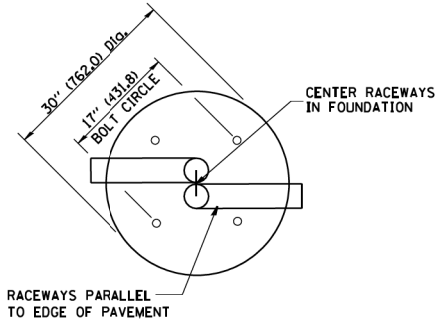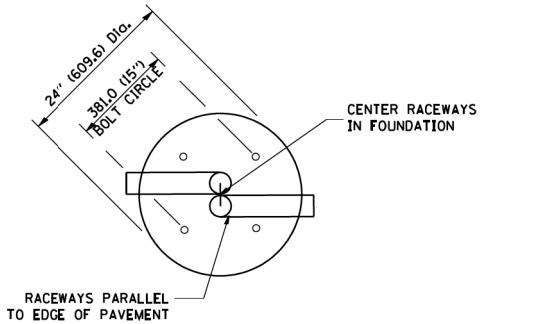


TOP VIEW


TOP VIEW

NOTES


- ALL DIMENSIONS ARE IN INCHES (MILLIMETERS) UNLESS OTHERWISE SHOWN.
- THE ANCHOR RODS AND RACEWAYS SHALL BE PROPERLY SECURED IN PLACE BEFORE THE CONCRETE IS PLACED.
- THE FOUNDATION SHALL NOT PROTRUDE MORE THAN 100MM (4 IN.) ABOVE THE FINISHED GRADE WITHIN A 60 IN. (1.5 m) CHORD ACROSS THE FOUNDATION, WITH ANCHOR RODS INCLUDED. IN ACCORDANCE WITH AASHTO GUIDELINES, IF THE FOUNDATION HEIGHT, INCLUDING ANCHOR RODS, EXTENDS BEYOND THESE SPECIFIED LIMITS, THE FOUNDATION SHALL BE REPLACED AT THE CONTRACTOR'S EXPENSE. SEE FOUNDATION EXTENSION DETAIL.
- THE HOLE FOR THE FOUNDATION SHALL BE MADE BY DRILLING WITH AN AUGER, OF THE SAME DIAMETER AS THE FOUNDATION. IF SOIL CONDITIONS REQUIRE THE USE OF A LINER TO FORM THE HOLE, THE LINER SHALL BE WITHDRAWN AS THE CONCRETE IS DEPOSITED.
- THE TOP OF THE FOUNDATION SHALL BE CONSTRUCTED LEVEL. A LINER OR FORM SHALL BE USED TO PRODUCE A UNIFORM SMOOTH SIDE TO THE TOP OF THE FOUNDATION. FOUNDATION TOP SHALL BE CHAMFERED 3/4-IN. (20 mm).
- THE CONCRETE SHALL BE CLASS SI. CONCRETE SHALL CURE ACCORDING TO ARTICLE 1020.13 BEFORE LIGHT POLES ARE INSTALLED.
- THE ANCHOR ROD SHALL BE A HOOK ROD TYPE, COLD BENDING OF THE ANCHOR ROD WILL NOT BE ALLOWED. THE RADIUS OF THE HOOK BEND SHALL NOT BE LESS THAN 4 TIMES THE NOMINAL DIAMETER OF THE ANCHOR ROD. A TACK WELDED ANCHOR ROD MAY BE SUBSTITUTED WITH THE APPROVAL OF THE ENGINEER.
- THE ANCHOR RODS SHALL BE ACCORDING TO ASTM F1554 GRADE 725 (GRADE 105). NUTS SHALL BE HEXAGON NUTS ACCORDING TO ASTM A 194 2H OR ASTM A 563 DH, AND WASHERS SHALL BE ACCORDING TO ASTM F 436.
- ANCHOR RODS, NUTS AND WASHERS SHALL BE COMPLETELY GALVANIZED BY EITHER THE HOT-DIPPED PROCESS CONFORMING WITH AASHTO M 232, THE MECHANICAL PLATING METHOD CONFORMING TO AASHTO M 298, CLASS 50 WITH A MAXIMUM COATING THICKNESS OF 150 UMG MILS) OR THE ELECTROLYTIC PROCESS ACCORDING TO ASTM F 1136.
- THE ANCHOR RODS SHALL BE THREADED A MINIMUM OF 6 INCHES (150 mm) WITH A MINIMUM OF 3 INCHES (75 mm) OF THREADED ANCHOR ROD EMBEDDED IN THE FOUNDATION.
- ANCHOR RODS SHALL PROJECT 2 3/4" (69.9 mm) ABOVE THE TOP OF THE FOUNDATION. IF BREAKAWAY COUPLINGS ARE SPECIFIED, THE CONTRACTOR SHALL CAREFULLY COORDINATE THE ANCHOR ROD PROJECTION WITH THE INSTALLATION REQUIREMENTS OF THE BREAKAWAY COUPLINGS.
- THE CONTRACTOR SHALL USE A #3 SPIRAL AT 6" (152.4 mm) PITCH OR MAY SUBSTITUTE #3 TIES AT 12" (304.8 mm) O.C. WITH THE APPROVAL OF THE ENGINEER.
- THE CABLE TRENCHES AND FOUNDATION SHALL BE BACK FILLED AND COMPACTED AS SPECIFIED BEFORE THE LIGHT POLE IS ERECTED.
- THE RACEWAYS SHALL PROJECT 1" (25.4 mm) ABOVE THE TOP OF THE FOUNDATION.

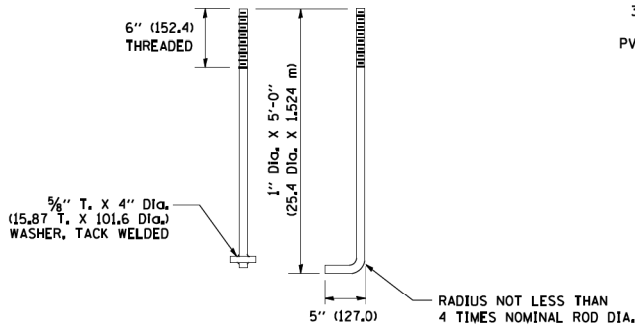


ANCHOR ROD DETAIL

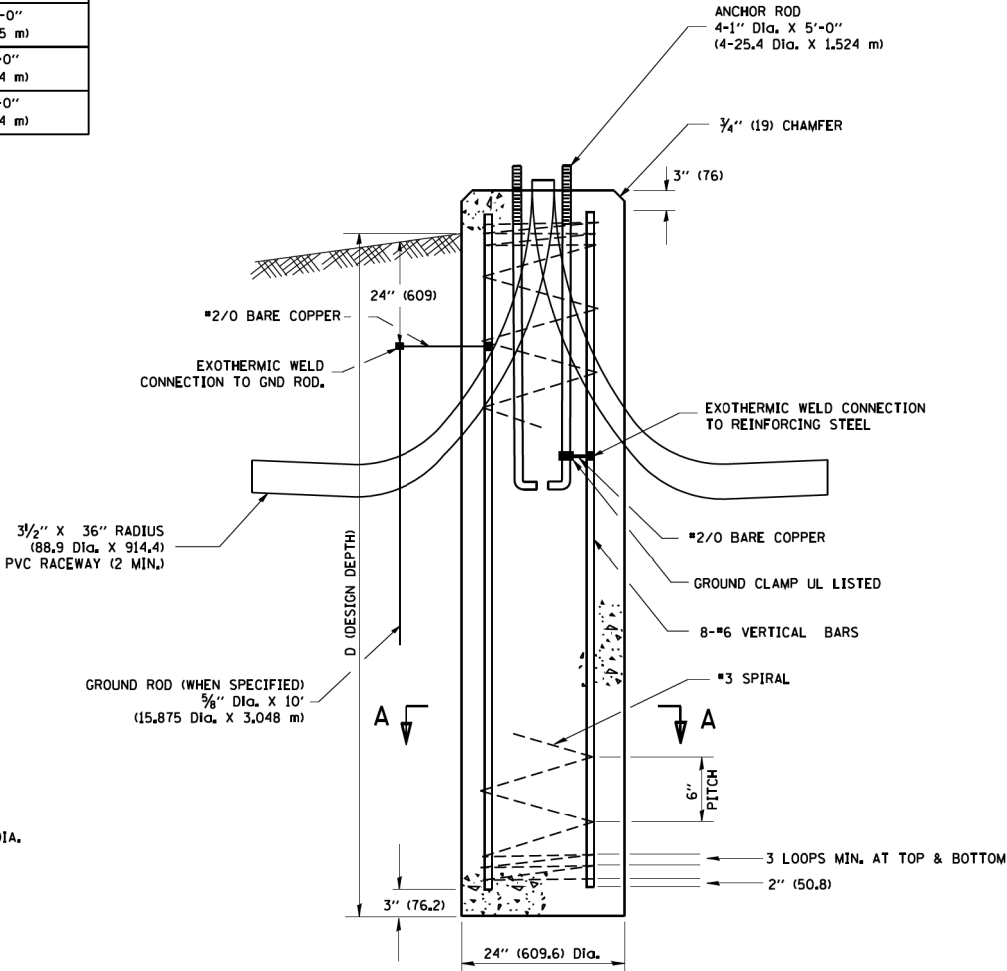


FOUNDATION DETAIL

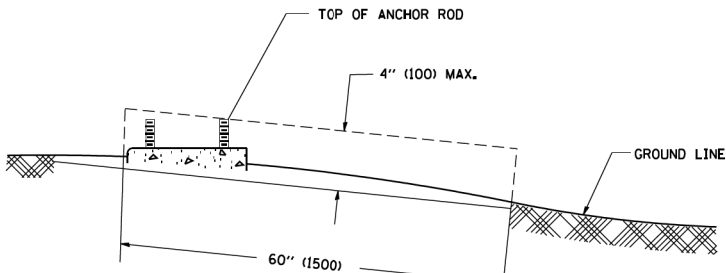

FOUNDATION EXTENSION DETAIL

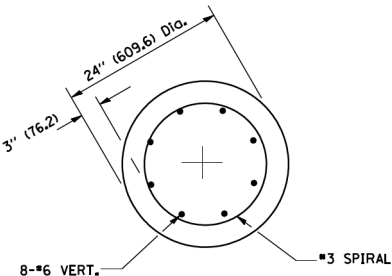


SECTION A-A

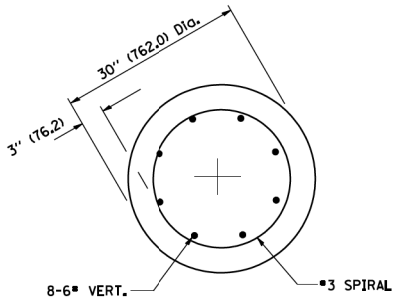


SECTION A-A


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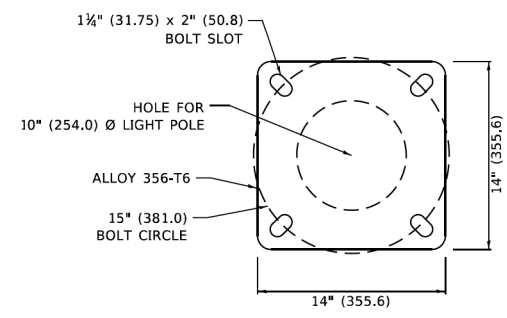
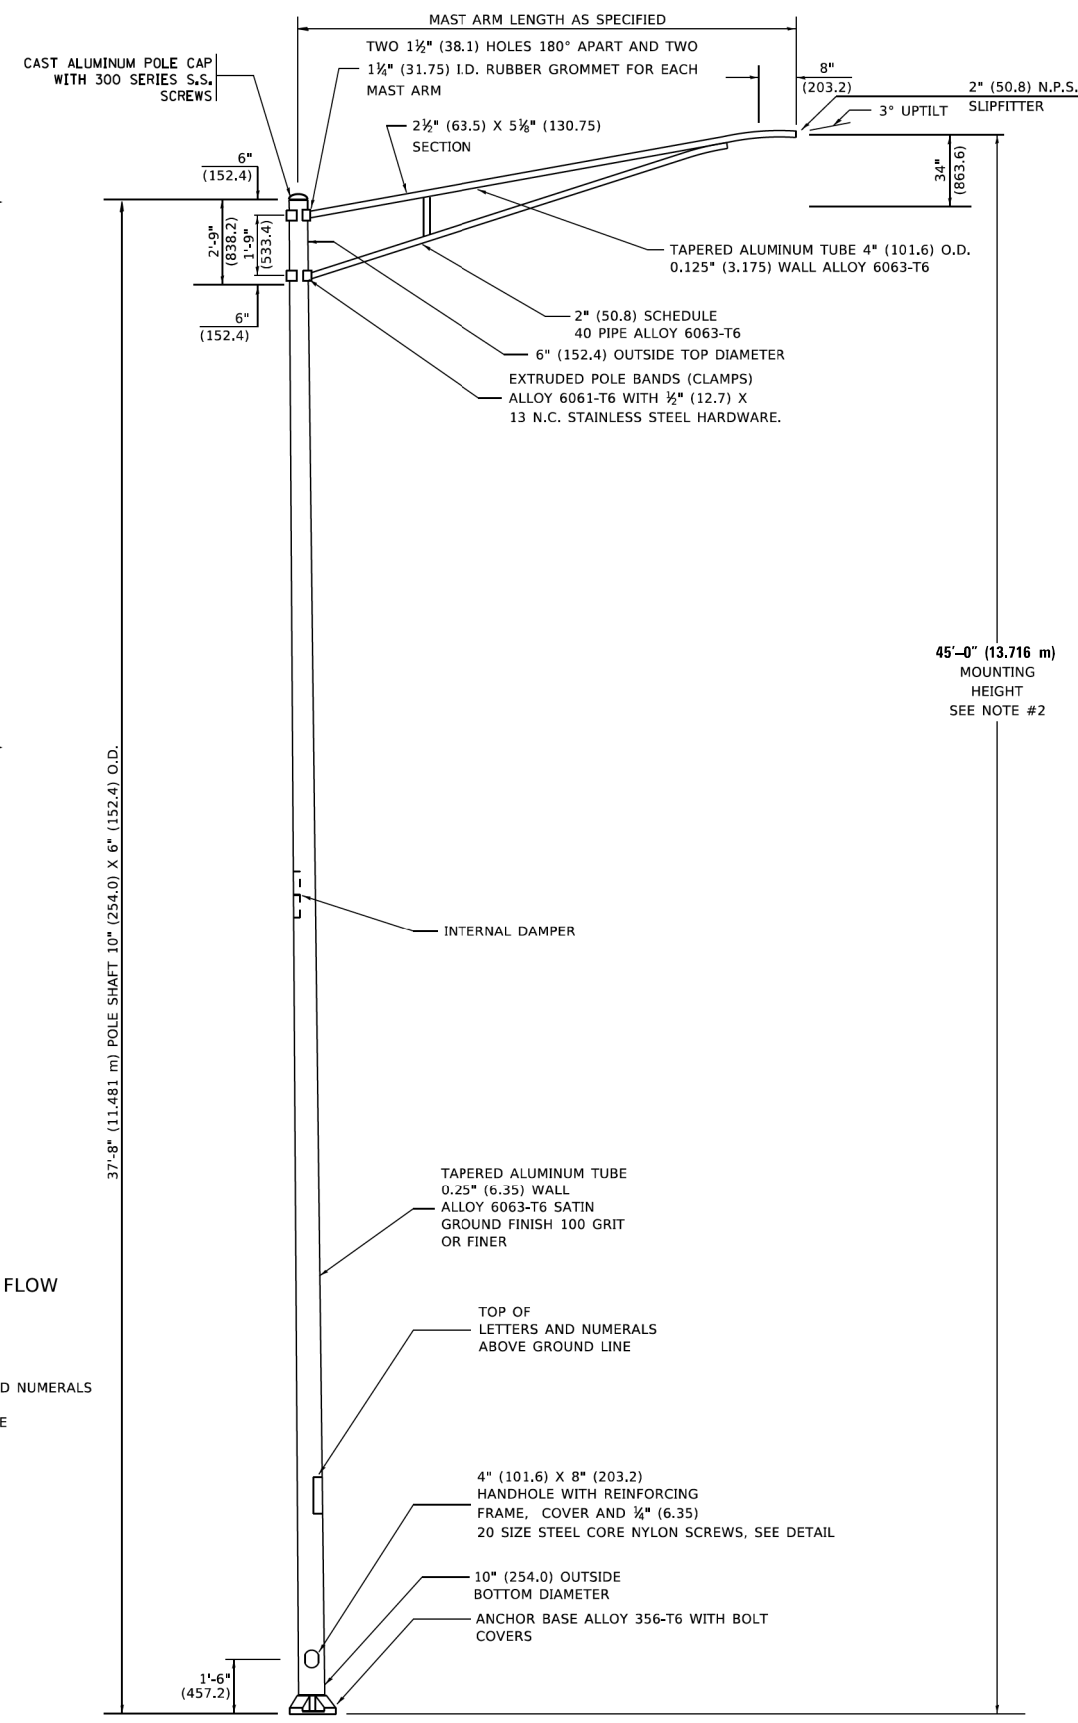
**POSITION OF HANDHOLE AND
POLE NUMBER FOR SINGLE
MAST ARM POLES MOUNTED
ON BRIDGE PARAPET OR
BARRIER WALL**

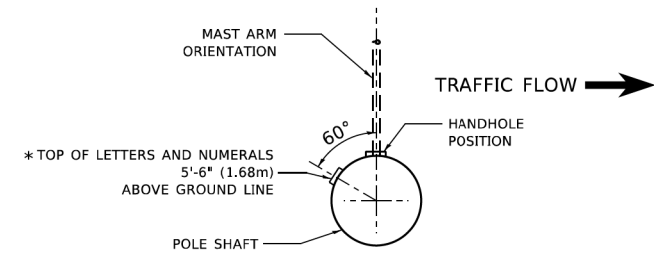


**POSITION OF HANDHOLE AND
POLE NUMBER FOR SINGLE
MAST ARM POLES**

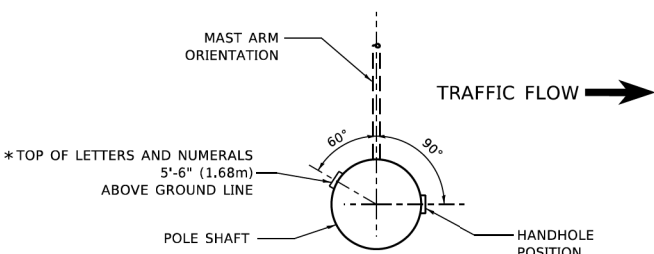

**POSITION OF HANDHOLE AND
POLE NUMBER FOR TWIN
MAST ARM POLES**

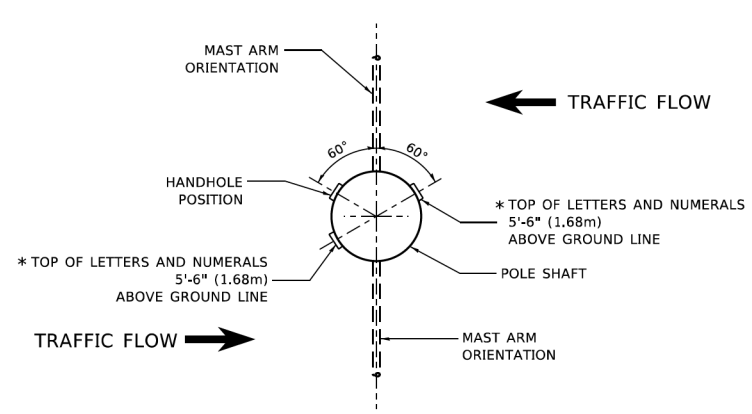

LIGHT POLE BASE PLATE DETAIL
15 INCH (381.0) BOLT CIRCLE

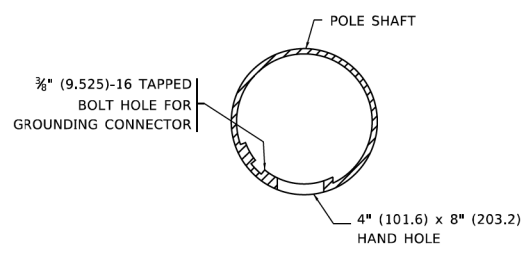


HANDHOLE DETAIL
(N.T.S.)


NOTES

1. ALL DIMENSIONS ARE IN INCHES (MILLIMETERS) UNLESS OTHERWISE SHOWN.
2. MOUNTING HEIGHT IS DEFINED AS THE DISTANCE FROM THE CENTERLINE OF THE TENON TO THE BOTTOM OF THE ANCHOR BASE.
3. THE LIGHT POLE WILL MEET AASHTO DESIGN CRITERIA AS SPECIFIED.
4. THE INSTALLING CONTRACTOR WILL PROVIDE A UL LISTED GROUNDING CONNECTOR. BURNDY K2C23, T&B SP4DL OR APPROVED EQUAL.
5. LIGHT POLES WILL NOT BE INSTALLED WITHOUT MAST ARMS AND LUMINAIRES.
6. LIGHT POLES WILL BE SET PLUMB ON THE FOUNDATION WITHOUT THE USE OF LEVELING NUTS, WASHERS OR SHIMS.
7. LIGHTING UNIT IDENTIFICATION NUMBERS SHALL BE INSTALLED BEFORE THE LIGHTING UNIT IS ENERGIZED.



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SIDE VIEW (TRUSS ARM)
N.T.S.

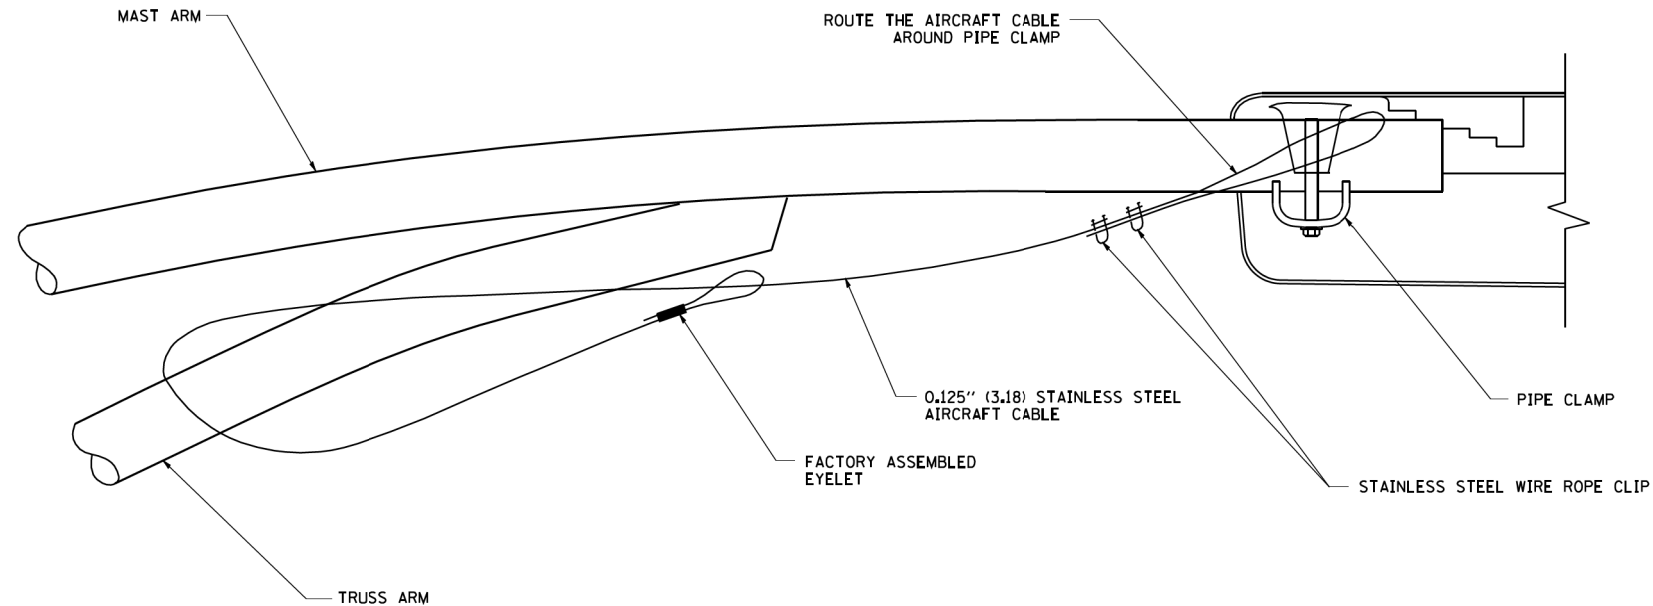

SIDE VIEW (SINGLE MEMBER OR DAVIT ARM)
N.T.S.

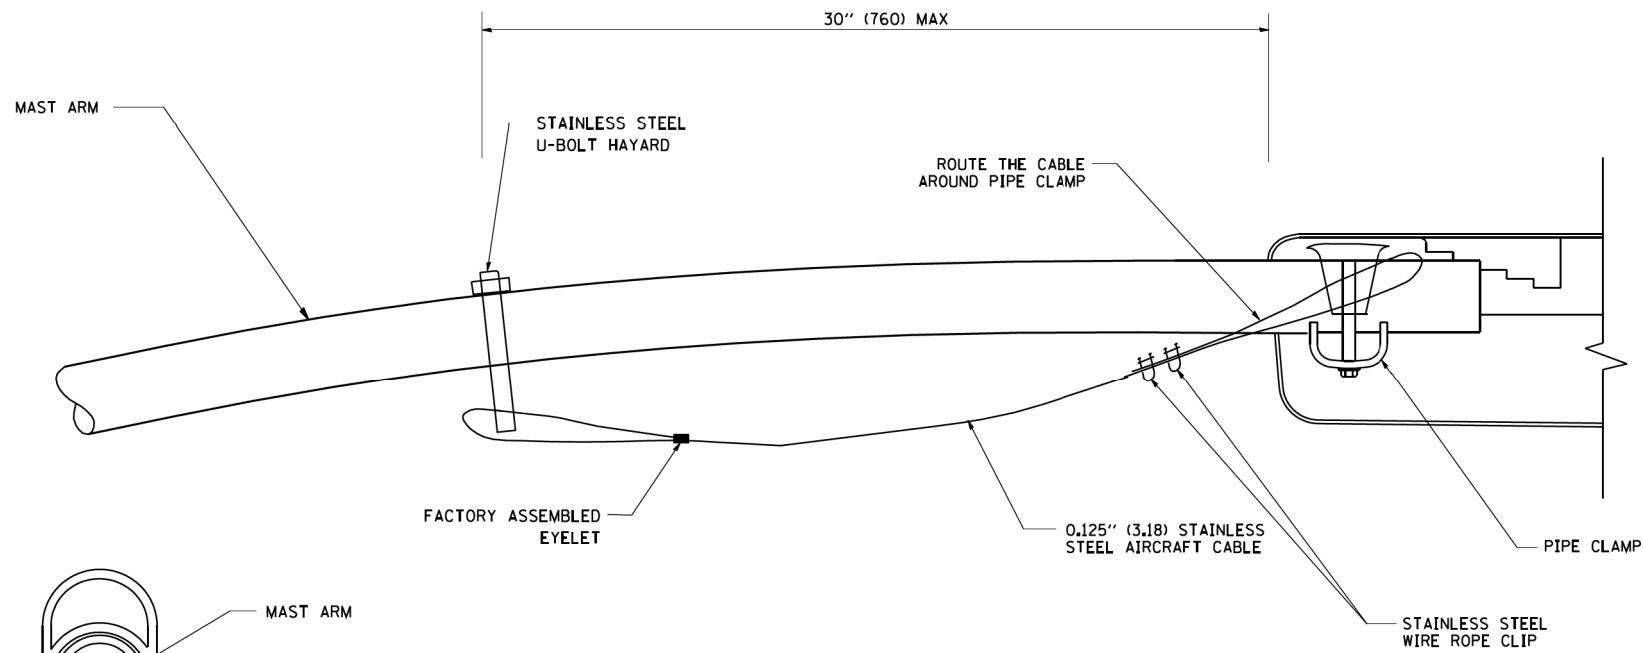

BOTTOM VIEW
N.T.S.

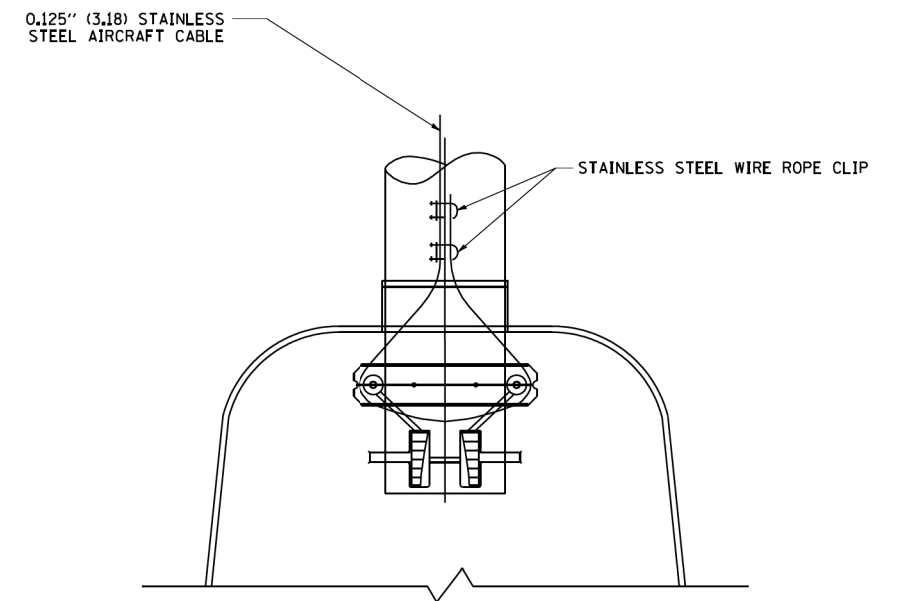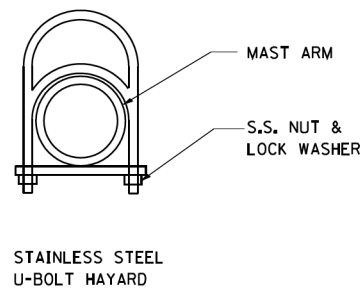NOTES:

1. ALL DIMENSIONS ARE IN MILLIMETERS (INCHES) UNLESS OTHERWISE SHOWN.
2. CONTRACTOR SHALL ADJUST THE WIRE CLIP TO ELIMINATE ANY SLACK FROM THE WIRE ROPE.
3. THE 0.125" (3.18) STAINLESS STEEL AIRCRAFT CABLE SHALL REMAIN VISIBLE FROM THE GROUND LEVEL.
4. THE BREAKING STRENGTH OF THE CABLE SHALL BE 1700 LBS. MIN.

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AMES Engineering, Inc.
CONSULTING ENGINEERS
6330 Belmont Road, Unit 4B
Downers Grove, IL 60516

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DESIGNED -
DRAWN -
CHECKED -
DATE -

REVISED - 08-08-03
REVISED -
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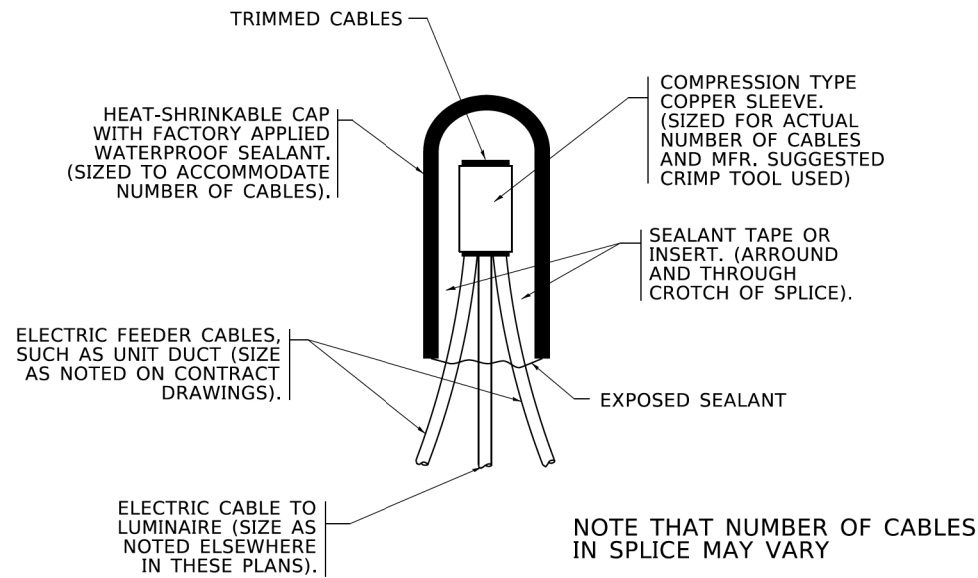
STATE OF ILLINOIS
DEPARTMENT OF TRANSPORTATION

LUMINAIRE SAFETY CABLE ASSEMBLY


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BE-701		CONTRACT NO. 61J01		
FED. ROAD DIST. NO. 1	ILLINOIS	FED. AID PROJECT		


LT-11



TYPICAL SPLICE DETAIL
N.T.S.

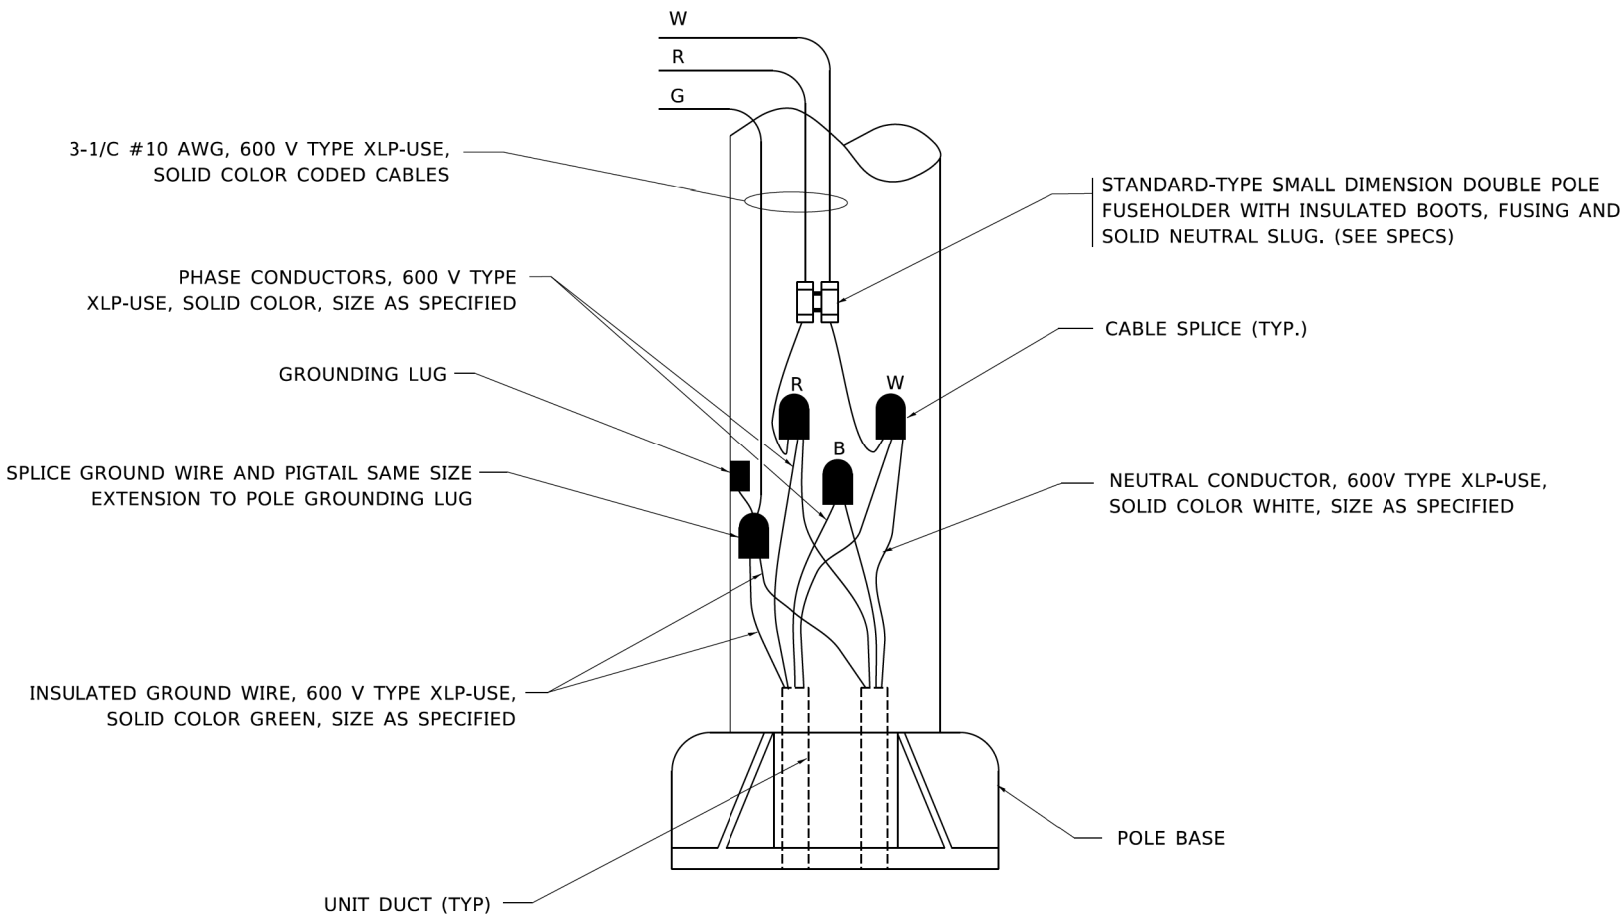

POLE WIRING DETAIL
N.T.S.

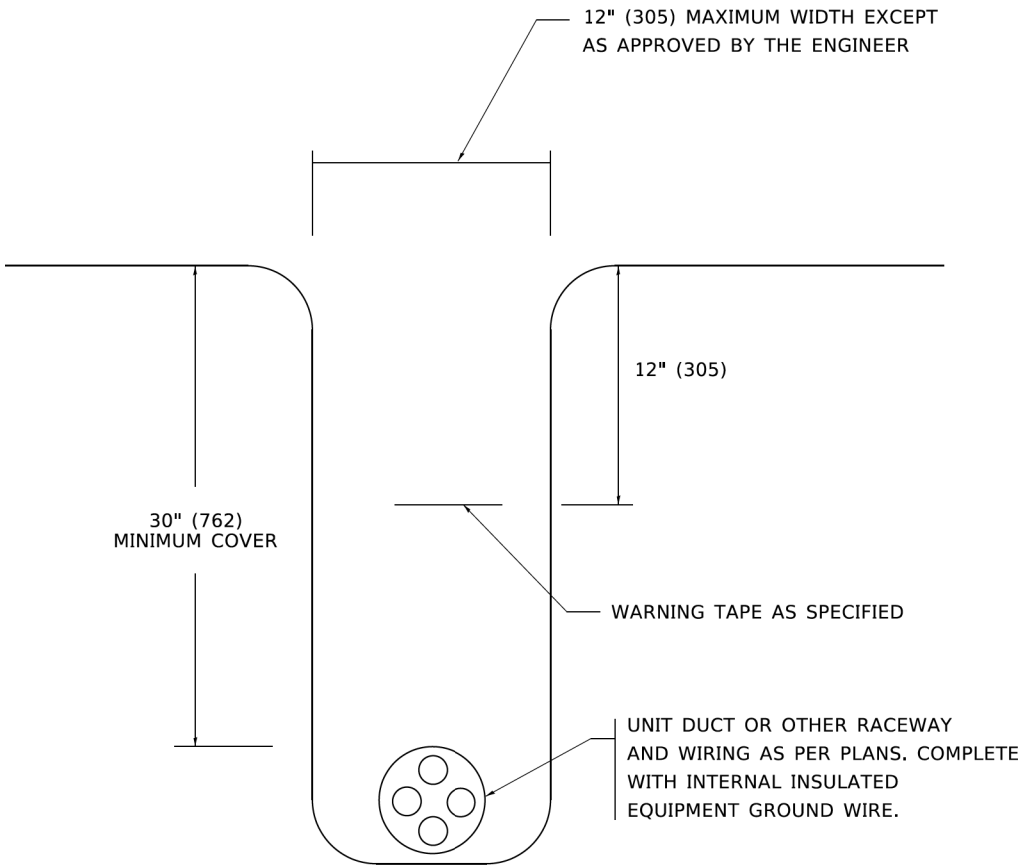

TYPICAL WIRING IN TRENCH DETAIL
N.T.S.

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AMES Engineering, Inc.
CONSULTING ENGINEERS
6330 Belmont Road, Unit 4B
Downers Grove, IL 60516

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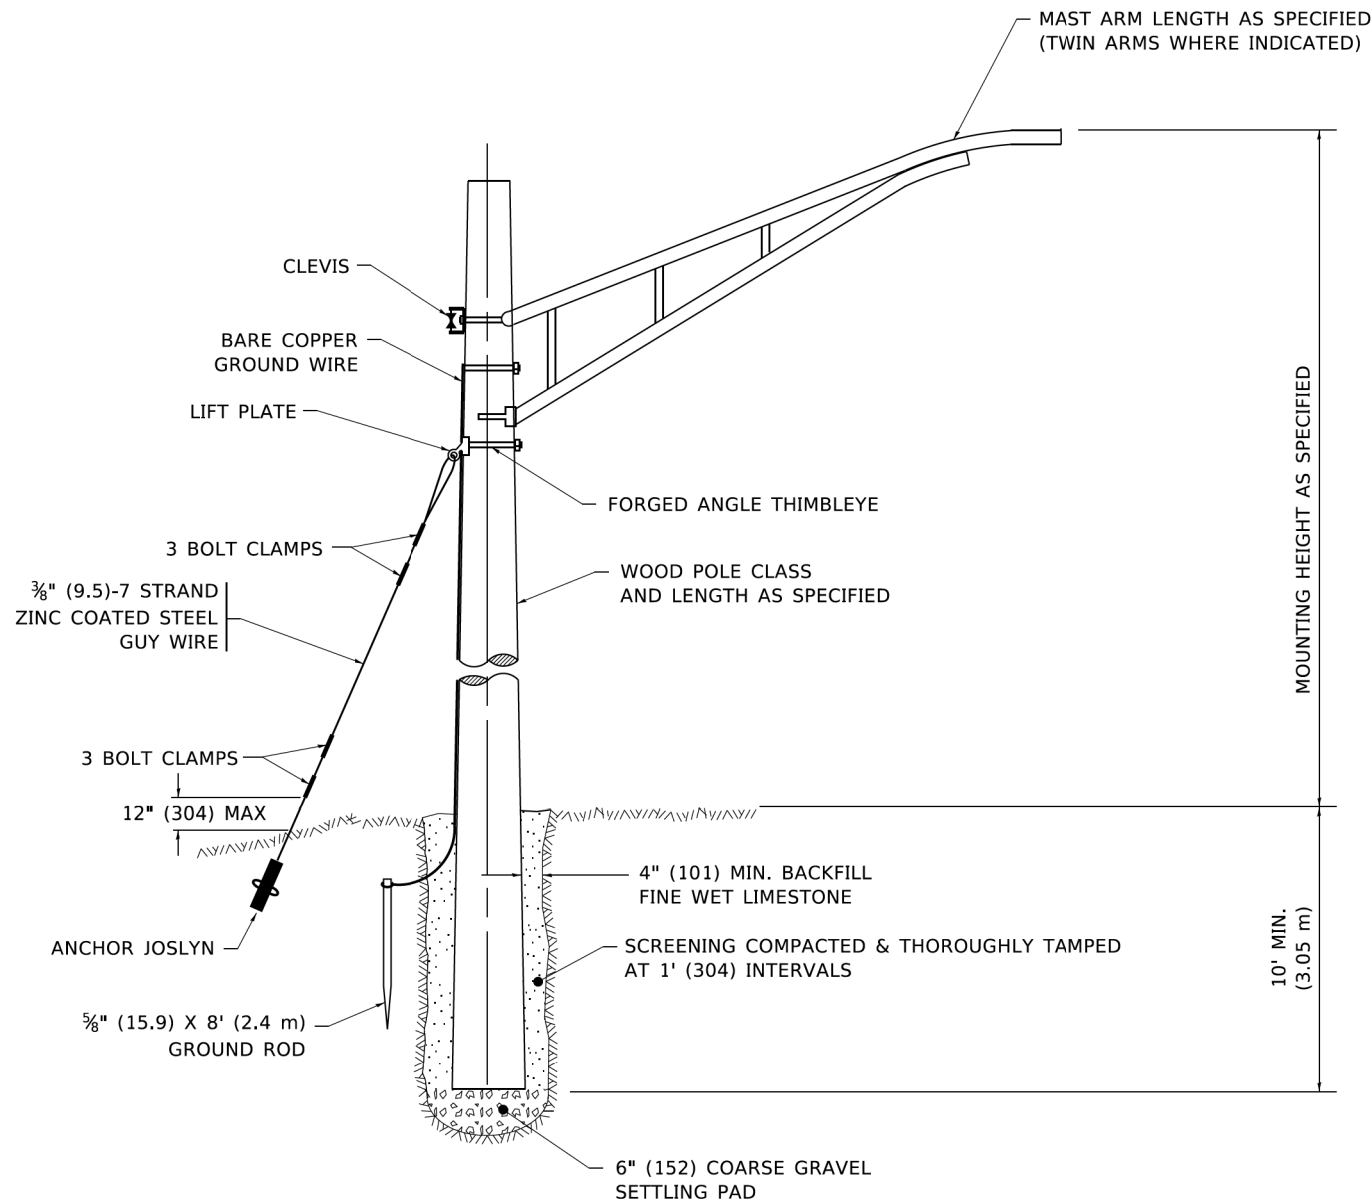
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STATE OF ILLINOIS
DEPARTMENT OF TRANSPORTATION

MISC. ELECTRICAL DETAILS
SHEET A

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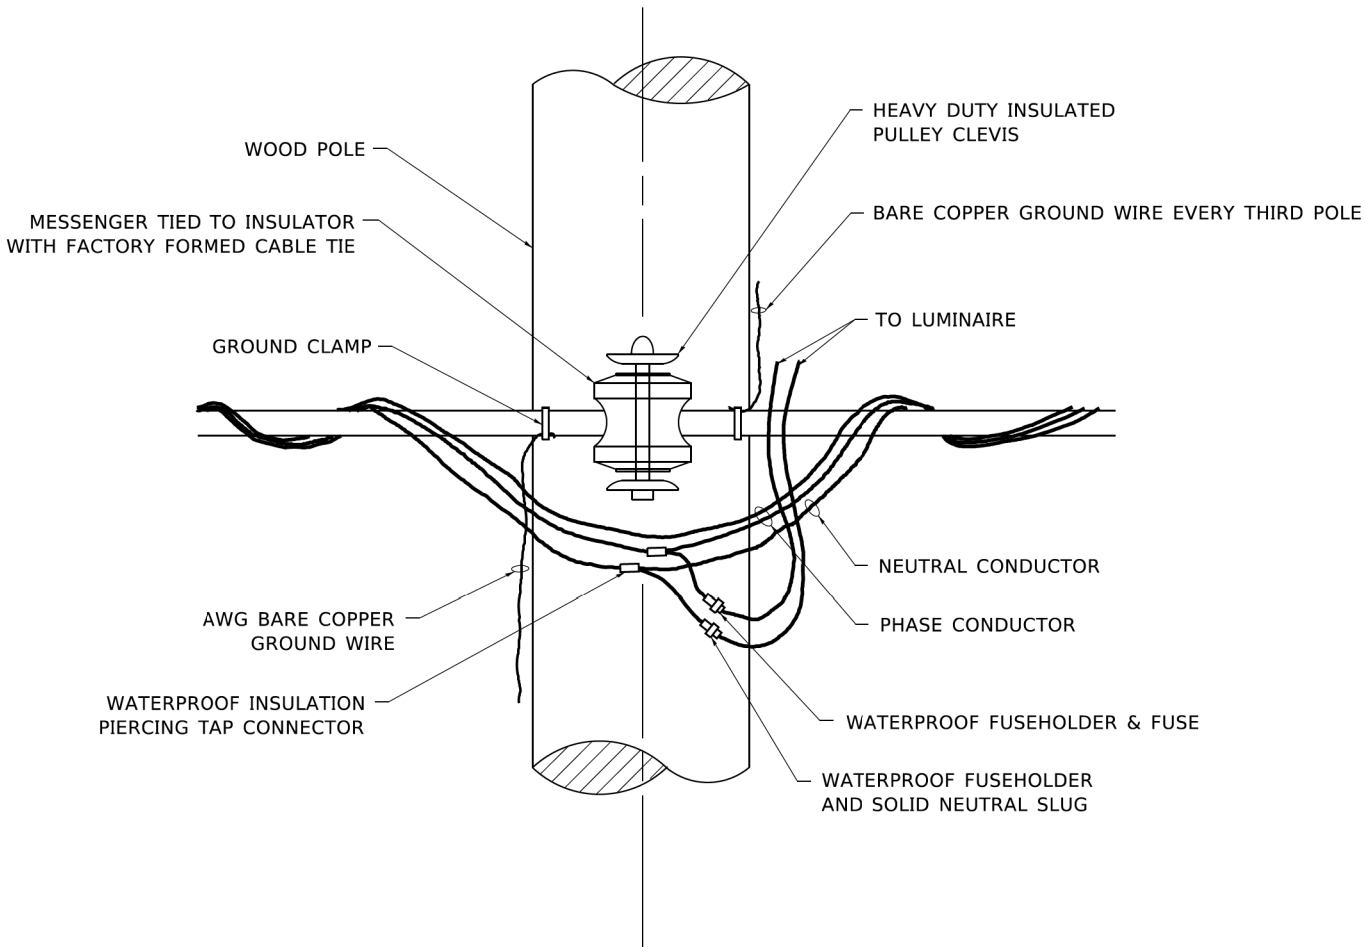
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2612	16-00232-00-CH	DuPage	248	207
BE-702		CONTRACT NO. 61J01		



TEMPORARY LIGHT POLE DETAIL

NOTE:

- 1. ALL DIMENSIONS IN INCHES (MILLIMETERS) UNLESS OTHERWISE INDICATED.
- 2. MAST ARM SHALL BE RATED FOR THE SPECIFIED MOUNTING HEIGHT.



TEMPORARY LIGHT POLE ATTACHMENT DETAIL

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AMES Engineering, Inc.
CONSULTING ENGINEERS
6330 Belmont Road, Unit 4B
Downers Grove, IL 60516

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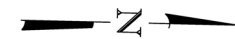
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STATE OF ILLINOIS
DEPARTMENT OF TRANSPORTATION

TEMPORARY LIGHT POLE DETAILS			
SCALE: NONE	SHEET 1	OF 1 SHEETS	STA. TO STA.


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2612	16-00232-00-CH	DuPage	248	208
BE-800		CONTRACT NO. 61J01		

Existing Structure: None



ITEM	UNIT	QUANTITY
Segmental Concrete Block Wall	Sq. Ft.	525
Concrete Sealer	Sq. Ft.	247
Pipe Underdrains for Structures 4"	Foot	185


2020 AASHTO LRFD Bridge Design Specifications, 9th Edition

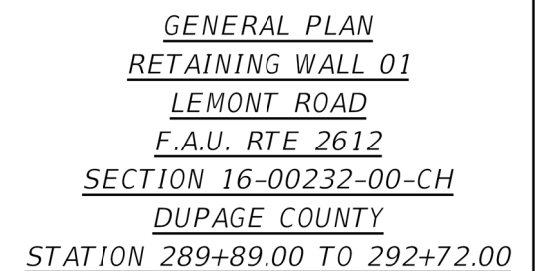

<div><div>B</div><div>BLA, Inc.</div></div>	USER NAME =	DESIGNED - HB	REVISED -	<div>DUPAGE COUNTY</div> <div>DIVISION OF TRANSPORTATION</div>	<div>RETAINING WALL 01</div> <div>LEMONT ROAD</div>	F.A.U	SECTION	COUNTY	TOTAL	SHEET
		CHECKED - JJI	REVISED -			RTE.			SHEETS	NO.
	PLOT SCALE =	DRAWN - HB	REVISED -			2612	16-00232-00-CH	DUPAGE	248	209
	PLOT DATE = 12/1/2025	CHECKED - JJI	REVISED -			CONTRACT NO. 61J01				
					SHEET 1 OF 5 SHEETS	ILLINOIS FED. AID PROJECT				

Bench Mark: Cut "X" on westerly bolt (arrow bolt) of second fire hydrant west of Lemont Road on the south side of 87th street near house #2853. (BM #3) Elevation = 760.035

Existing Structure: The existing structure is a concrete cantilever retaining wall running along the outer edge of the existing sidewalk. The structure is to be removed a minimum of 2'-0" below the finished grade at the front face of the wall. Wall foundation is unknown. Backfill with suitable excavated material as required.

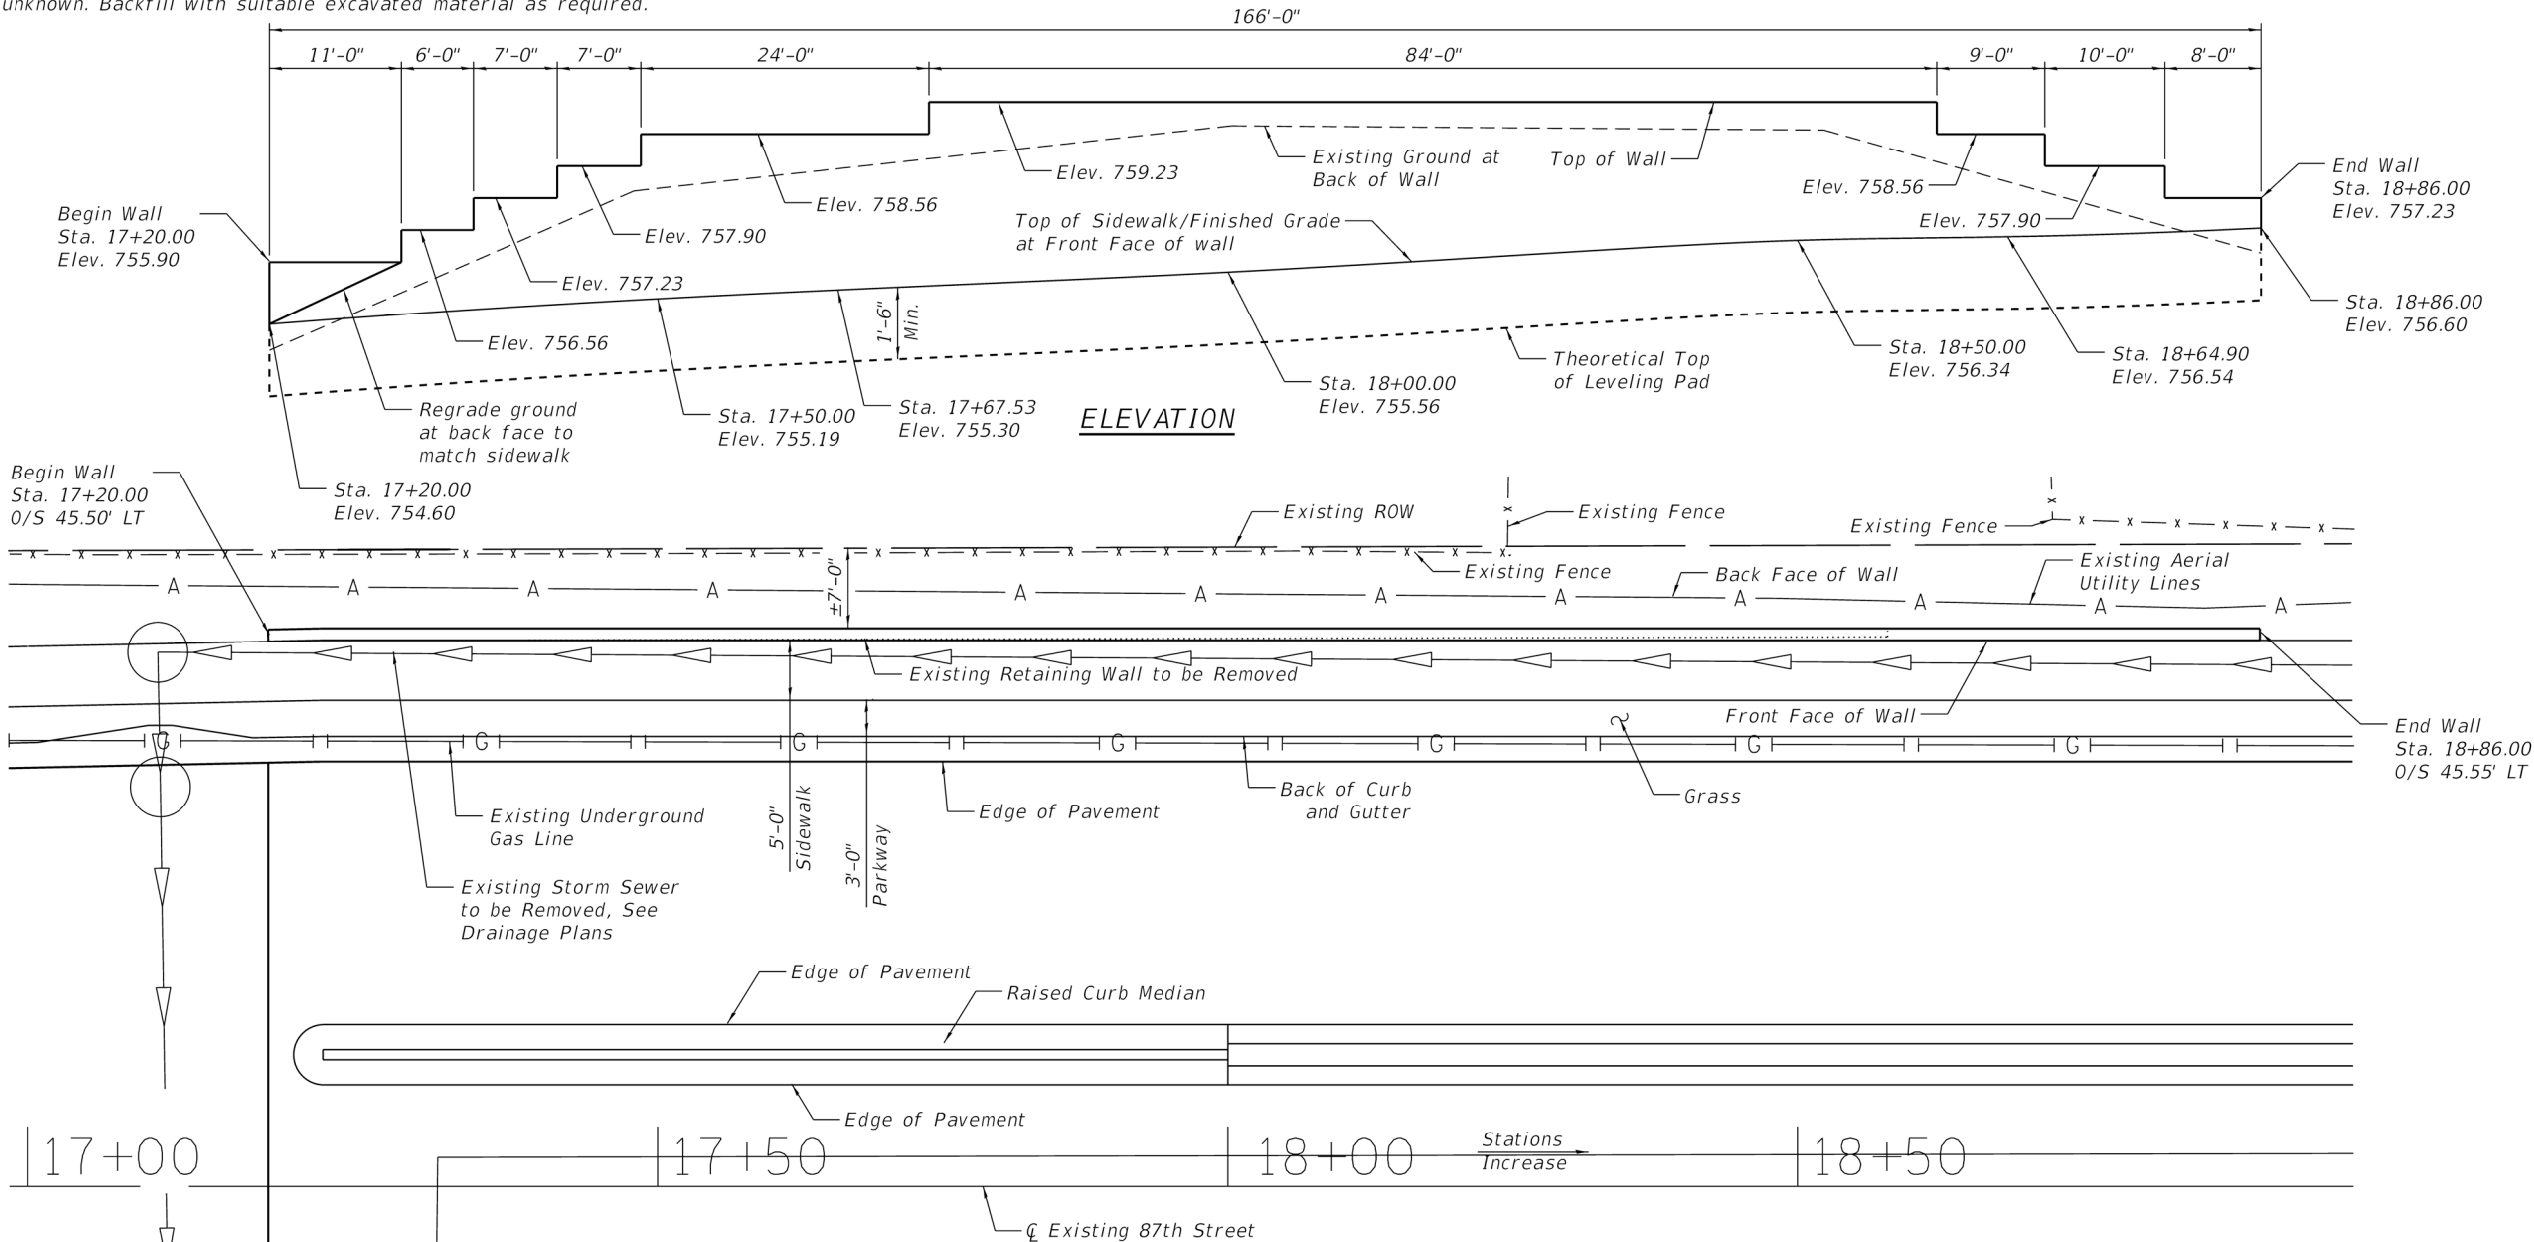


TOTAL BILL OF MATERIAL


ITEM	UNIT	QUANTITY
Removal of Existing Structures	Each	1
Segmental Concrete Block Wall	Sq. Ft.	738
Concrete Sealer	Sq. Ft.	489
Pipe Underdrains for Structures 4"	Foot	166

GENERAL PLAN
RETAINING WALL 02
87TH STREET
F.A.U. RTE 3580
SECTION 16-00232-00-CH
DUPAGE COUNTY
STATION 17+25.00 TO 18+86.00

DESIGN SPECIFICATIONS
2020 AASHTO LRFD Bridge Design
Specifications, 9th Edition

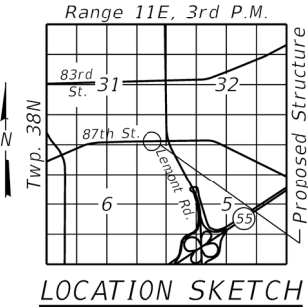

PROFILE GRADE
(along Existing 87th Street)

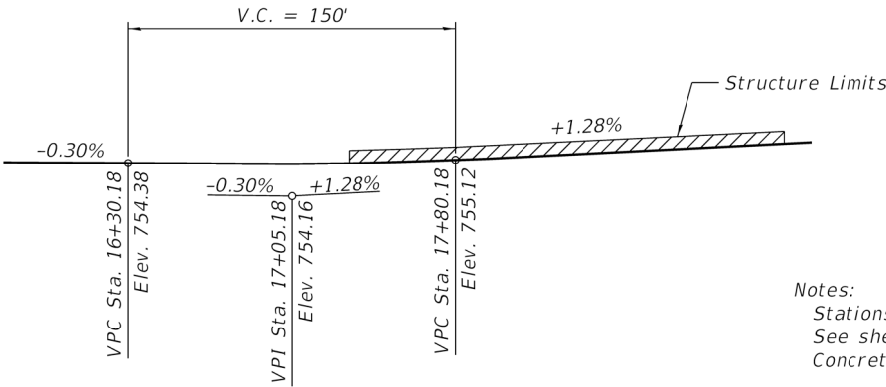

Notes:
Stations and offsets are measured to the front face of the wall.
See sheet 5 of 5 for General Notes and typical section.
Concrete Sealer is to be applied to the exposed areas of the wall.

FILE NAME = W:\451-046 DuDOT Lemont Rd\AAD\Drawings\Struct\16-00232-00-CH.sht, 02, 87th North.dgn

BLA, Inc.

USER NAME =	DESIGNED - HB	REVISED -
	CHECKED - JJI	REVISED -
PLOT SCALE =	DRAWN - HB	REVISED -
PLOT DATE = 12/11/2025	CHECKED - JJI	REVISED -

DUPAGE COUNTY
DIVISION OF TRANSPORTATION


RETAINING WALL 02
87TH STREET

SHEET 2 OF 5 SHEETS


F.A.U. RTE.	SECTION	COUNTY	TOTAL SHEETS	SHEET NO.
3580	16-00232-00-CH	DUPAGE	248	210
CONTRACT NO. 61J01				

ILLINOIS FED. AID PROJECT


Existing Structure: None

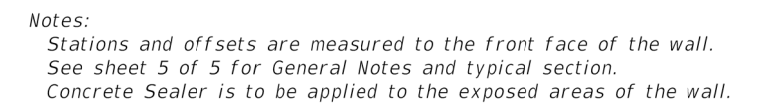

ITEM	UNIT	QUANTITY
Precast Modular Retaining Wall	Sq. Ft.	242
Concrete Sealer	Sq. Ft.	152
Pipe Underdrains for Structures 4"	Foot	60

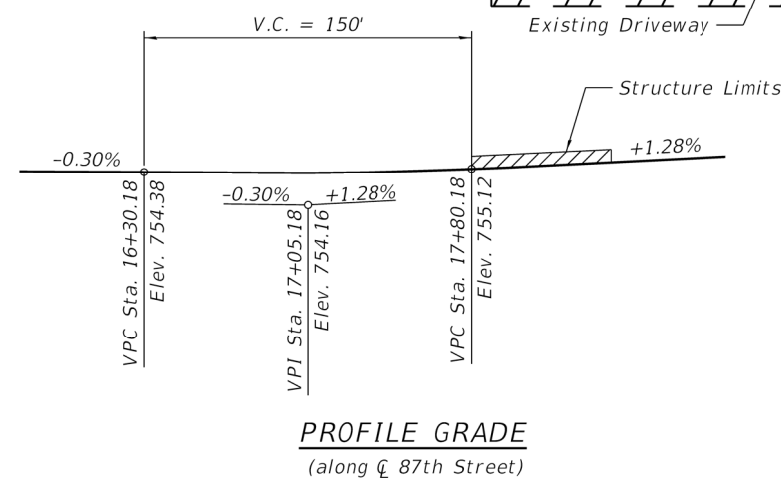



DESIGN SPECIFICATIONS
2020 AASHTO LRFD Bridge Design
Specifications, 9th Edition

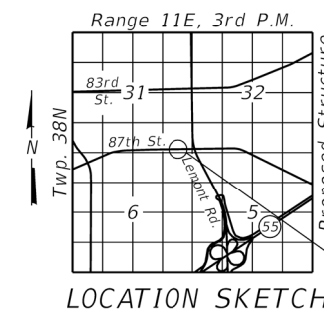


GENERAL PLAN
RETAINING WALL 03
87TH STREET
F.A.U. RTE 3580
SECTION 16-00232-00-CH
DUPAGE COUNTY
STATION 17+79.00 TO 18+44.00

Bench Mark: Cut square in southwesterly part of concrete foundation for traffic signal cantilever.
Signal is located at the northeast corner of 83rd Street and Lemont Road. (BM #7) Elevation = 774.403

Existing Structure: None

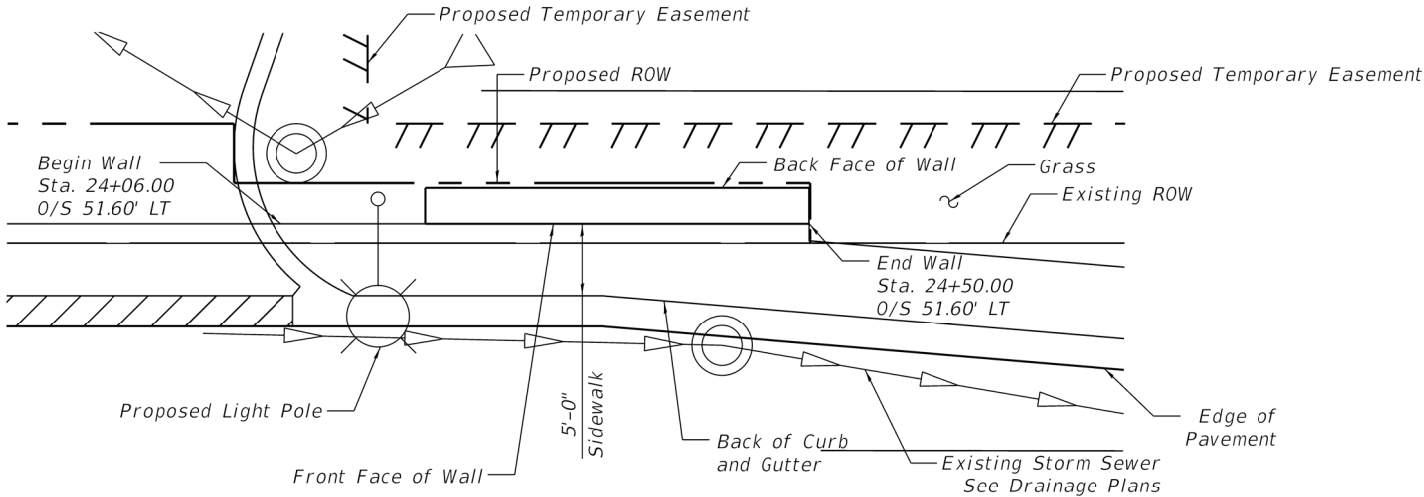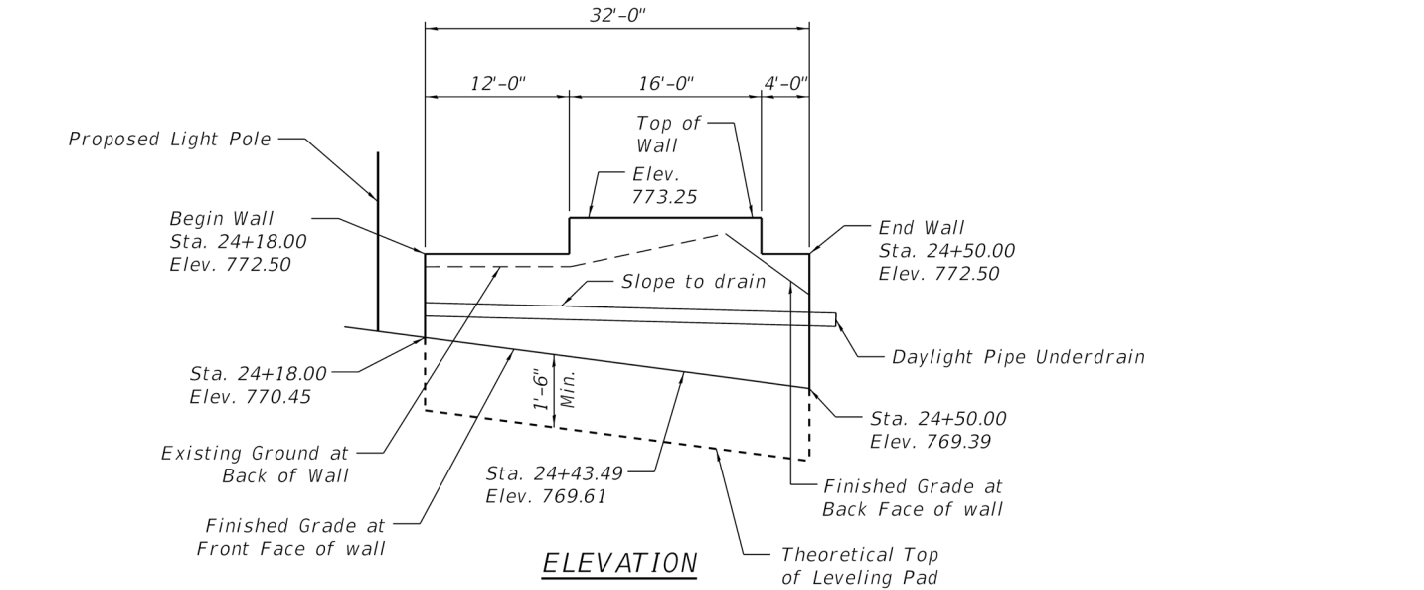

Notes:
Stations and offsets are measured to the front face of the wall.
See sheet 5 of 5 for General Notes and typical section.
Concrete Sealer is to be applied to the exposed areas of the wall.

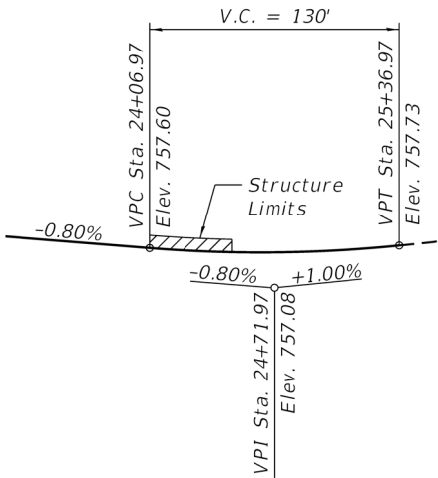

PROFILE GRADE
(along CL 83rd Street)


TOTAL BILL OF MATERIAL

ITEM	UNIT	QUANTITY
Precast Modular Retaining Wall	Sq. Ft.	143
Concrete Sealer	Sq. Ft.	95
Pipe Underdrains for Structures 4"	Foot	32

PLAN

DESIGN SPECIFICATIONS


2020 AASHTO LRFD Bridge Design
Specifications, 9th Edition

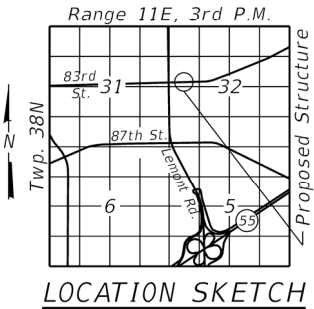


GENERAL PLAN
RETAINING WALL 04
83RD STREET
F.A.U. RTE 1551
SECTION 16-00232-00-CH
DUPAGE COUNTY
STATION 24+06.00 TO 24+50.00

FILE NAME = W:\451-046 DuDOT Lemont Rd\CA002.Sheets\Structural\16-00232-00-CH.sht.Struct.04.83rd-d.dgn

	USER NAME =		DESIGNED - HB	REVISED -	DUPAGE COUNTY DIVISION OF TRANSPORTATION	RETAINING WALL 04 83RD STREET		F.A.U. RTE.	SECTION	COUNTY	TOTAL SHEETS	SHEET NO.
			CHECKED - JJI	REVISED -				1551	16-00232-00-CH	DUPAGE	248	212
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	PLOT DATE = 12/1/2025		CHECKED - JJI	REVISED -		SHEET 4 OF 5 SHEETS		ILLINOIS FED. AID PROJECT				


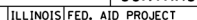


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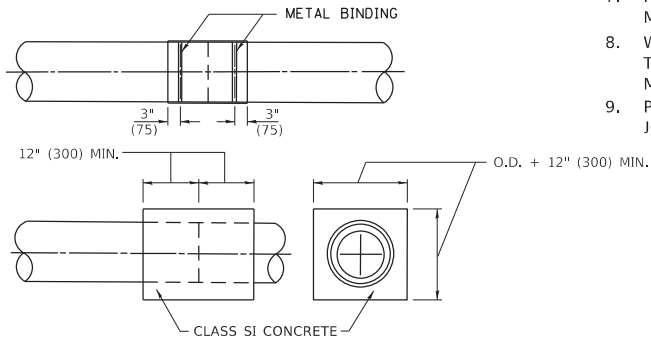
DETAIL "A"

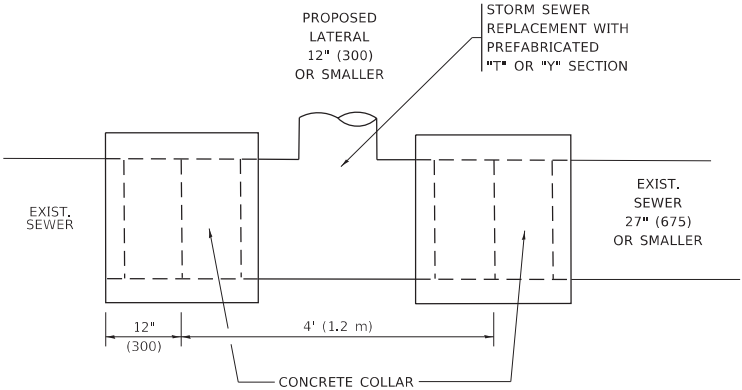LATERAL CONNECTION TO EXISTING SEWER
OF 27" (675) OR SMALLER




DETAIL "B"

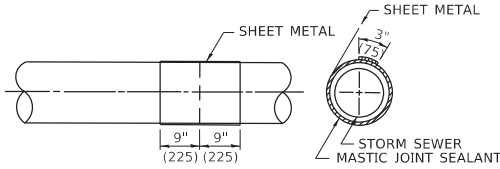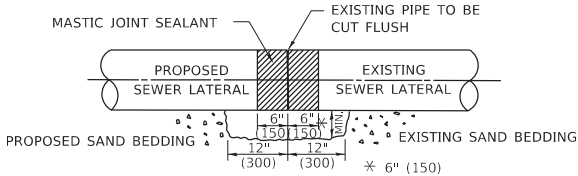CLASS SI CONCRETE COLLAR



CONSTRUCTION SEQUENCE

1. CUT THE EXISTING END OF THE PIPE SO AS TO PRESENT A FLUSH BUTT JOINT. BRUSH AND CLEAN ALL PIPES.
2. APPLY THE MASTIC JOINT SEALANT TO THE FIRST 6" (150) OF EACH PIPE.
3. BUTT THE PIPES TOGETHER LEAVING A MINIMUM OF 12' x 6' (300 x 150) DEEP EXCAVATION UNDER AND AROUND EACH PIPE END.
4. CUT A PIECE OF SHEET METAL GAGE NO. 19 1.1 (0.0418) 18" (450) WIDE BY THE OUTSIDE CIRCUMFERANCE OF THE PIPE PLUS 3" (75) LONG.
5. WRAP THE SHEET METAL AROUND THE PIPES, 9" (225) ON EACH SIDE OF THE JOINT, STARTING AT THE TOP OF THE PIPE.
6. LAP THE SHEET METAL AT LEAST 3" (75) AT THE TOP OF THE PIPE AND PLACE THE MASTIC JOINT SEALANT BETWEEN THE LAP.
7. PLACE TWO METAL BANDS AROUND THE SHEET METAL AND TIGHTEN.
8. WIPE OFF ANY EXCESS MASTIC JOINT SEALANT THAT OOOZES OUT FROM BETWEEN THE SHEET METAL AND THE PIPES.
9. PLACE CLASS SI CONCRETE AROUND THE JOINT.

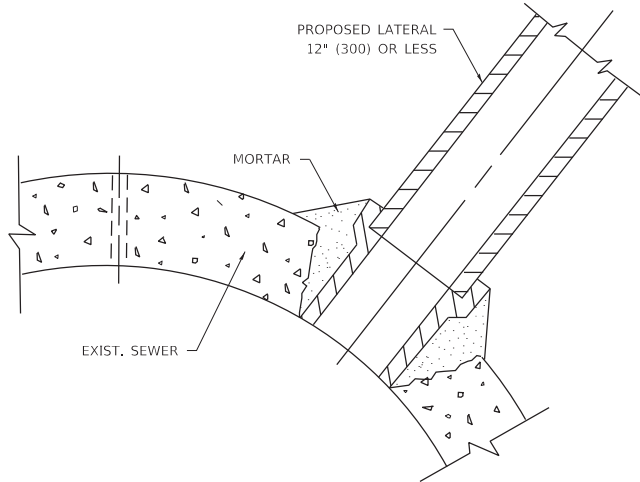

DETAIL "C"

PROPOSED LATERAL
CONNECTION TO EXISTING SEWER
OF 30" (750) OR LARGER

NOTES:

MATERIAL

MATERIAL USED FOR THE TEE OR WYE SECTION SHALL BE COMPATIBLE WITH THE EXISTING STORM SEWER OR THE PROPOSED STORM SEWER.

CONSTRUCTION METHODS

1. THIS WORK SHALL BE CONSTRUCTED IN CONFORMANCE WITH THE APPLICABLE PORTIONS OF SECTION 550 OF THE STANDARD SPECIFICATIONS.
2. CONNECTION TO AN EXISTING STORM SEWER SHALL BE BY EITHER OF THE FOLLOWING METHODS:
 - A) PROPOSED STORM SEWER CONNECTION TO EXISTING SEWER OF 27" (675) OR SMALLER SEE DETAIL "A" AND "B".
 - B) PROPOSED STORM SEWER CONNECTION TO EXISTING SEWER OF 30" (750) OR LARGER SEE DETAIL "C".

IF THE EXISTING SEWER PIPE IS CRACKED, BROKEN OR OTHERWISE DAMAGED BY THE CONTRACTOR IN MAKING THE CIRCULAR OPENING, THE CONTRACTOR SHALL REPLACE THAT SECTION OF PIPE WITH PIPE EQUAL AND SIMILAR IN ALL RESPECTS TO THE PIPE IN THE EXISTING SEWER, IN A CAREFUL WORKMANLIKE MANNER, WITHOUT EXTRA COMPENSATION.

GENERAL


1. CARE MUST BE TAKEN TO PREVENT DEBRIS FROM ENTERING THE SEWER. ALL DEBRIS WHICH ENTERS THE SEWER MUST BE REMOVED. THE SEWER MUST BE LEFT CLEAN AND UNOBSTRUCTED UPON COMPLETION OF THE CONTRACT.
2. CARE MUST BE TAKEN TO PREVENT ANY PART OF THE NEW PIPE CONNECTION FROM PROJECTING INTO THE EXISTING SEWER.

BASIS OF PAYMENT

1. TEE OR WYE CONNECTIONS SHALL BE PAID FOR AT THE CONTRACT UNIT PRICE EACH FOR STORM SEWER TEE OR WYE OF THE TYPE AND SIZE SPECIFIED IN THE PLANS, THIS PRICE SHALL INCLUDE ALL EXCAVATION OF THE TRENCH, REMOVAL OF THE EXISTING STORM SEWER, FURNISHING AND INSTALLING THE SPECIFIED TEE OR WYE SECTION, FURNISHING AND INSTALLING THE REQUIRED CONCRETE COLLAR, AND ALL OTHER MATERIAL NECESSARY TO COMPLETE THIS WORK AS SHOWN AND SPECIFIED.
2. REMOVAL AND REINSTALLATION OF EXISTING STORM SEWER ADJACENT TO THE PROPOSED TEE OR WYE SECTION, FOR THE PURPOSE OF FACILITATING THE INSTALLATION OF THE TEE OR WYE SECTION, WILL NOT BE PAID FOR SEPARATELY BUT SHALL BE INCLUDED IN THE UNIT PRICE BID FOR THE WORK.
3. TRENCH BACKFILL, EXCAVATION IN ROCK AND REMOVAL AND REPLACEMENT OF UNSUITABLE MATERIAL BELOW PLAN BEDDING GRADE WILL BE PAID FOR SEPARATELY.
4. CONCRETE COLLAR FOR CONNECTING A PROPOSED STORM SEWER TO AN EXISTING STORM SEWER WILL NOT BE PAID FOR SEPARATELY BUT SHALL BE INCLUDED IN THE COST OF THE PROPOSED STORM SEWER.

* ALL DIMENSIONS ARE IN INCHES (MILLIMETERS)
UNLESS OTHERWISE SHOWN.

	USER NAME = Lawrence,DeManche		DESIGNED - M. DE YONG	REVISED - R. SHAH 09-09-94	STATE OF ILLINOIS DEPARTMENT OF TRANSPORTATION	DETAIL OF STORM SEWER CONNECTION TO EXISTING SEWER		F.A.U RTE.	SECTION	COUNTY	TOTAL SHEETS	SHEET NO.
	DRAWN -		DRAWN -	REVISED - R. SHAH 10-25-94				2612	16-00232-00-CH	DUPAGE	248	214
	PLOT SCALE = 100.0000 ' / in.		CHECKED -	REVISED - R. SHAH 06-12-96		BD500-01 (BD-07)		CONTRACT NO. 61J01				
	PLOT DATE = 11/18/2022		DATE - 07-25-90	REVISED - K. SMITH 11-18-22		SCALE: NONE	SHEET 1 OF 1 SHEETS	STA.	TO STA.	ILLINOIS FED. AID PROJECT		

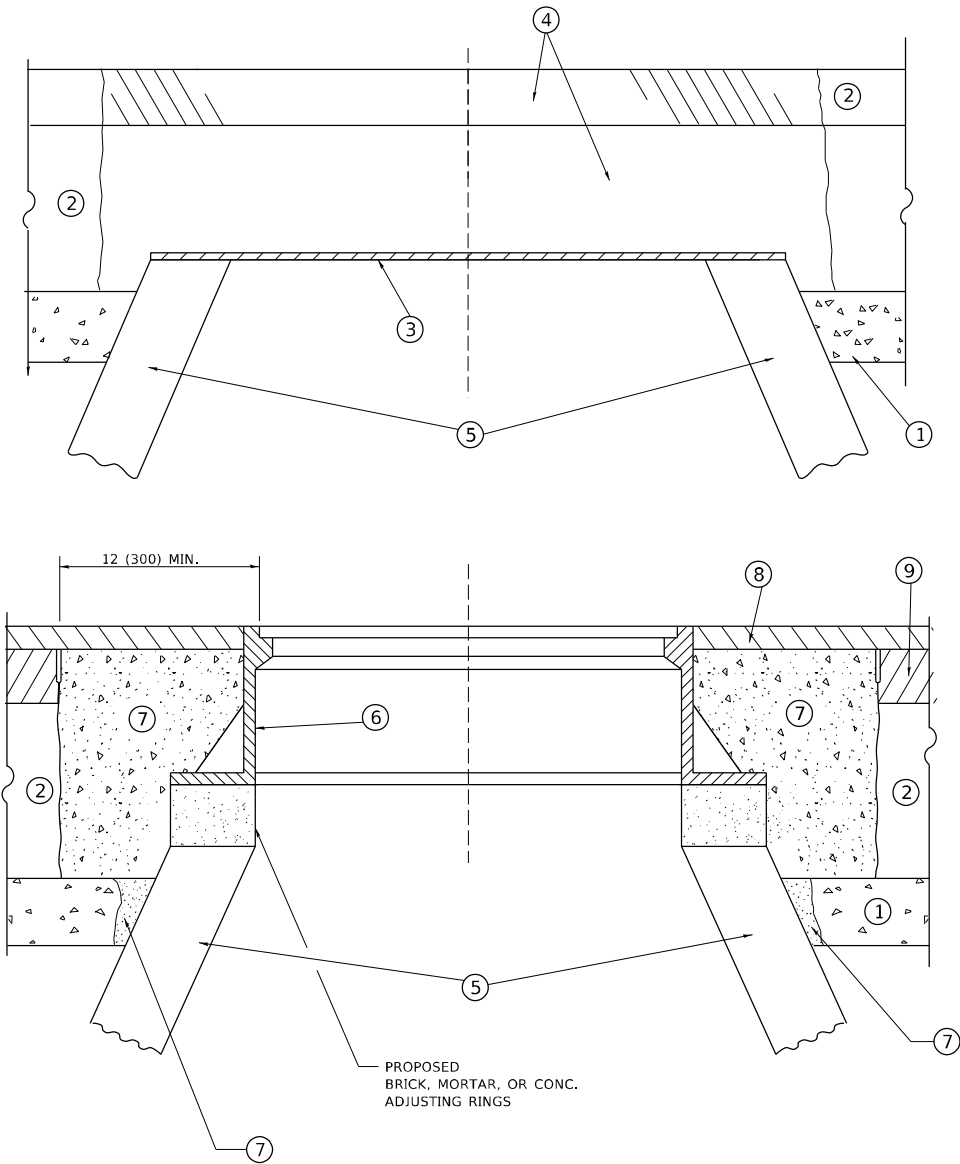

**DETAILS FOR FRAMES AND LIDS ADJUSTMENT
WITH MILLING**

NOTES

- EXISTING BROKEN FRAMES AND LIDS SHALL BE REMOVED AND DISPOSED OF BY THE CONTRACTOR AND SHALL BE REPLACED AS DIRECTED BY THE ENGINEER. REPLACEMENT FRAMES AND LIDS WILL BE PAID FOR IN ACCORDANCE WITH ARTICLE 109.04 OF THE STANDARD SPECIFICATIONS UNLESS A SEPARATE PAY ITEM HAS BEEN PROVIDED.
- IF THE EXISTING LIDS ARE OPEN, THE FRAME WILL BE ADJUSTED TO THE ELEVATION OF THE MILLED PAVEMENT SURFACE PRIOR TO THE MILLING OPERATION. THE FRAME WILL NOT BE REMOVED AND COVERED BY THE METAL PLATE.
- CITY OF CHICAGO CASTINGS ARE THE PROPERTY OF THE CITY AND THE CONTRACTOR SHALL NOTIFY THE CITY FOR REMOVAL AND DISPOSITION OF THE CASTINGS.
- THE METAL PLATE USED TO COVER THE STRUCTURE SHALL REMAIN THE PROPERTY OF THE CONTRACTOR.

CONSTRUCTION PROCEDURES

- STAGE 1 (BEFORE PAVEMENT MILLING)**
- REMOVE A MINIMUM OF 12 (300) OF THE PAVEMENT FROM AROUND THE STRUCTURE.
 - REMOVE THE EXISTING FRAME AND LID FROM THE STRUCTURE.
 - COVER THE STRUCTURE OPENING WITH A 36 (900) DIAMETER METAL PLATE.
 - BACKFILL WITH CRUSHED STONE AND HMA SURFACE MIX APPROVED BY THE ENGINEER. (MIN. 1 1/2 (40) HMA TO REMAIN AFTER MILLING).
- STAGE 2 (AFTER PAVEMENT MILLING)**
- REMOVE THE HMA SURFACE MIX AND CRUSHED STONE.
 - INSTALL THE FRAME AND LID; ADJUST THE FRAME TO ITS FINAL SURFACE ELEVATION.
 - THE SURROUNDING SPACE SHALL BE FILLED WITH CLASS*PP-1 CONCRETE TO THE ELEVATION OF THE SURFACE OF THE EXISTING BASE COURSE OR THE BINDER COURSE.
- * UNLESS OTHERWISE SPECIFIED IN THE PLANS.

THE PROCEDURE EXPLAINED ABOVE SHALL CONFORM TO THE APPLICABLE PORTIONS OF SECTIONS 353, 406, 602, AND 603 OF THE STANDARD SPECIFICATIONS EXCEPT THAT "THE CONTRACTOR SHALL ADJUST THE STRUCTURES TO THE FINISHED PAVEMENT ELEVATION NO MORE THAN 5 CALENDAR DAYS PRIOR TO PLACEMENT OF THE FINAL LIFT OF SURFACE UNLESS APPROVED BY THE ENGINEER."

LEGEND

- | | |
|--|-------------------------------|
| ① SUB-BASE GRANULAR MATERIAL | ⑥ FRAME AND LID (SEE NOTES) |
| ② EXISTING PAVEMENT | ⑦ CLASS*PP-1 CONCRETE |
| ③ 36 (900) DIAMETER METAL PLATE | ⑧ PROPOSED HMA SURFACE COURSE |
| ④ PROPOSED CRUSHED STONE AND HMA SURFACE MIX | ⑨ PROPOSED HMA BINDER COURSE |
| ⑤ EXISTING STRUCTURE | |

LOCATION OF STRUCTURES

THE CONTRACTOR WILL BE REQUIRED TO KEEP A RECORD OF THE LOCATIONS OF THE BURIED STRUCTURES ACCORDING TO THE STATION AND DISTANCE LEFT OR RIGHT OF THE CENTERLINE OF PAVEMENT. UPON COMPLETION OF THE WORK, THE CONTRACTOR WILL DELIVER THE RECORD TO THE ENGINEER.

BASIS OF PAYMENT

- REMOVING FRAMES AND LIDS ON DRAINAGE AND UTILITY STRUCTURES IN THE PAVEMENT PRIOR TO MILLING, AND ADJUSTING TO FINAL GRADE PRIOR TO PLACING THE SURFACE COURSE, WILL BE PAID FOR AT THE CONTRACT UNIT PRICE EACH FOR "FRAMES AND LIDS TO BE ADJUSTED (SPECIAL)."
- THIS WORK WILL NOT BE PAID FOR WHEN DRAINAGE AND UTILITY STRUCTURES ARE SPECIFIED FOR PAYMENT AS STRUCTURE RECONSTRUCTION.
- NEW FRAMES AND LIDS, WHEN SPECIFIED, WILL BE PAID FOR SEPARATELY.
- WHEN STRUCTURES ARE TO BE ADJUSTED OR RECONSTRUCTED, THE LOWERING AND RAISING OF THE FRAMES AND LIDS WILL NOT BE PAID FOR SEPARATELY BUT WILL BE INCLUDED IN THE COST OF THE CORRESPONDING PAY ITEM.

ALL DIMENSIONS ARE IN INCHES (MILLIMETERS) UNLESS OTHERWISE SHOWN

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		DRAWN -	REVISED - R. BORO 03-09-11					2612	16-00232-00-CH	DUPAGE	248	215
	PLOT SCALE = 100,0000 ' / In.	CHECKED -	REVISED - R. BORO 12-06-11		BD600-03 (BD-08)			CONTRACT NO. 61J01				
	PLOT DATE = 11/18/2022	DATE - 10-25-94	REVISED - K. SMITH 11-18-22		SCALE: NONE	SHEET 1	OF 1 SHEETS	STA.	TO STA.	ILLINOIS FED. AID PROJECT		

REFER TO SECTION 442 OF THE STANDARD SPECIFICATIONS FOR ROAD AND BRIDGE CONSTRUCTION AND THE RECURRING SPECIAL PROVISION "PATCHING WITH HOT-MIX ASPHALT OVERLAY REMOVAL."

1. REFER TO SECTION 442 OF THE STANDARD SPECIFICATIONS FOR ROAD AND BRIDGE CONSTRUCTION AND THE RECURRING SPECIAL PROVISION "PATCHING WITH HOT-MIX ASPHALT OVERLAY REMOVAL."
2. SAW CUT/SCORING OF EXISTING HMA OVERLAY IS INCLUDED IN THE COST OF PAVEMENT PATCHING.
3. SAW CUT/SCORING OF EXISTING PAVEMENT IS INCLUDED IN THE COST OF PAVEMENT PATCHING.



1. REMOVE THE EXISTING HMA MATERIAL OVER THE AREA TO BE PATCHED.
2. REMOVE AND REPLACE WITH CLASS C OR D PATCH.
3. REPLACE HMA MATERIAL OVER THE AREA TO BE PATCHED.


1. MILL HMA FIRST IF THERE IS AT LEAST 4½ INCHES OR MORE OF HMA MATERIAL ON TOP OF THE EXISTING PAVEMENT OR IF THE PAVEMENT IS FULL DEPTH HMA. A MINIMUM OF 2 INCHES OF HMA MATERIAL SHALL BE IN PLACE AFTER MILLING.
2. REMOVE AND REPLACE WITH FULL DEPTH CLASS D PATCHES TO TOP OF MILLED SURFACE.

ALL DIMENSIONS ARE IN INCHES (MILLIMETERS) UNLESS OTHERWISE SHOWN.

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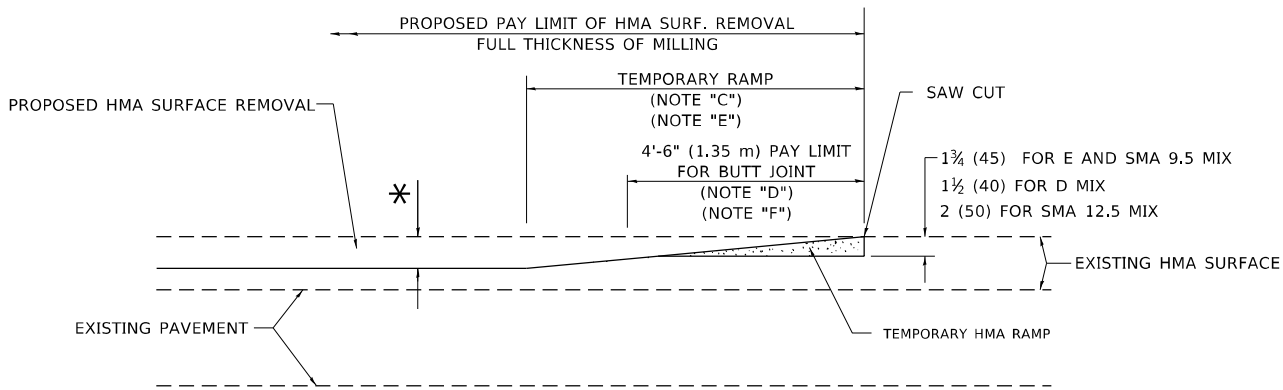
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		DRAWN	-	REVISED	- R. BORO 09-04-07		2612	16-00232-00-CH		DUPAGE	248	216					
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PLOT DATE	= 11/18/2022	DATE	- 10-25-94	REVISED	- K. SMITH 11-18-22		SCALE: NONE	SHEET 1	OF 1	SHEETS	STA.			ILLINOIS	FED. AID PROJECT		

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MILLED TEMPORARY RAMP
(FOR BUTT JOINT AND HMA TAPER SEE DETAIL BELOW)


OPTION 1

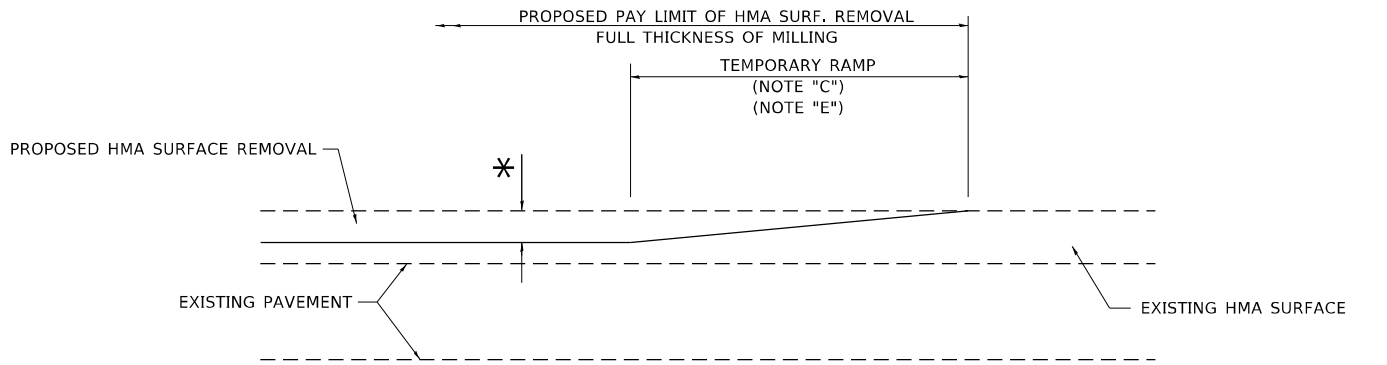

HMA CONSTRUCTED TEMPORARY RAMP
(FOR BUTT JOINT AND HMA TAPER SEE DETAIL BELOW)


OPTION 2

TYPICAL TEMPORARY RAMP

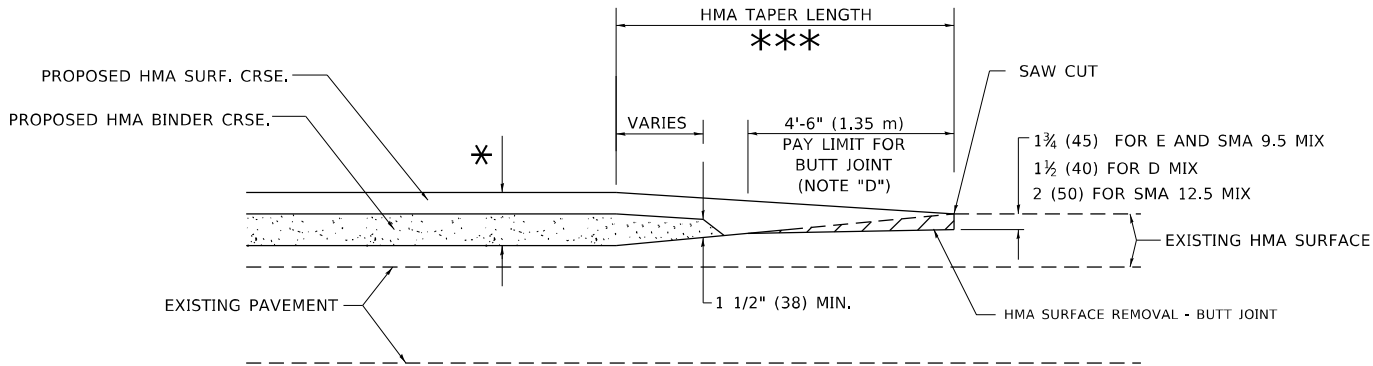


BUTT JOINT AND
HMA TAPER

TYPICAL BUTT JOINT AND HMA TAPER
FOR MILLING AND RESURFACING

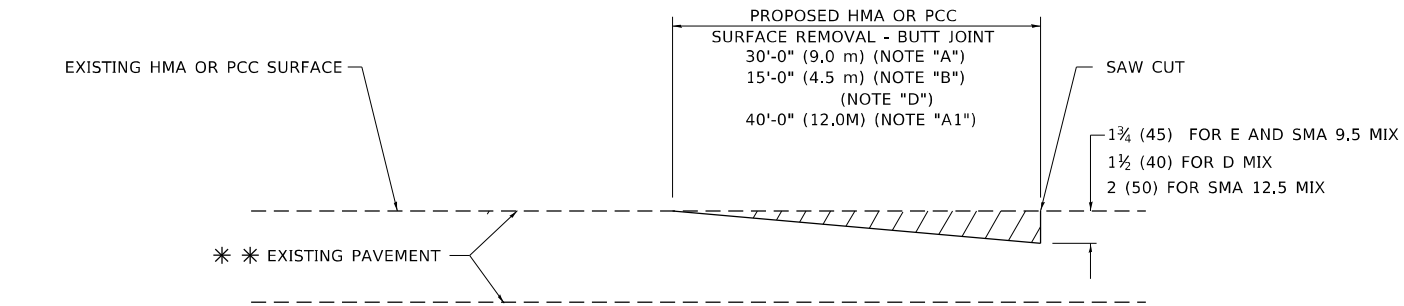

BUTT JOINT DETAIL

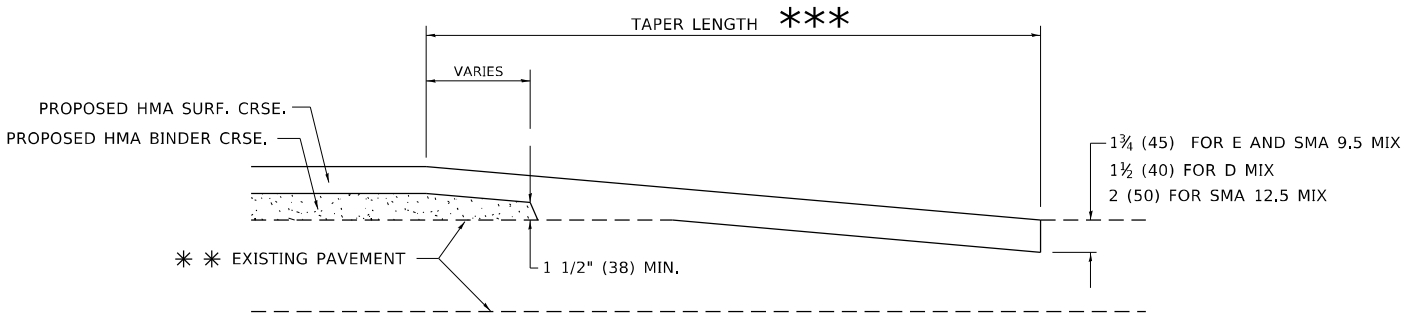

HMA TAPER DETAIL

TYPICAL BUTT JOINT AND HMA TAPER
FOR RESURFACING ONLY

** PC CONCRETE, HMA OR HMA RESURFACED PAVEMENT.

GENERAL NOTES

- A. MAINLINE ARTERIAL ROADWAYS AND MAJOR SIDE ROADS.
- A1. INTERSTATES
- B. MINOR SIDE ROADS.
- C. THE TEMP. RAMP SHALL BE CONSTRUCTED IMMEDIATELY UPON REMOVAL OF THE EXISTING HMA SURFACE.
- D. THE BUTT JOINT SHALL BE CONSTRUCTED IMMEDIATELY PRIOR TO PLACING THE PROPOSED HMA COURSES.
- E. TAPER THE TEMP. RAMP AT A RATE OF 3' - 4" (1.02m) PER 1 INCH (25 mm) OF MILLING THICKNESS.
* SEE TYPICAL SECTIONS FOR MILLING THICKNESS.
- F. SEE ARTICLE 406.08 AND 406.14 OF THE STANDARD SPECIFICATIONS FOR "HMA AND/OR PCC SURFACE REMOVAL, BUTT JOINT".
*** 20'-0" (6.1 m) PER 1 (25) RESURFACING (NOTE "A")
10'-0" (3.0 m) PER 1 (25) RESURFACING (NOTE "B")

BASIS OF PAYMENT

- 1. THE BUTT JOINT WILL BE PAID FOR AT THE CONTRACT UNIT PRICE PER SQUARE YARD (SQUARE METER) FOR "HOT-MIX ASPHALT SURFACE REMOVAL - BUTT JOINT" OR FOR "PORTLAND CEMENT CONCRETE SURFACE REMOVAL- BUTT JOINT".
- 2. THE TEMPORARY RAMP AND SAW CUT SHALL BE INCLUDED IN THE UNIT COST FOR HMA OR PCC SURFACE REMOVAL-BUTT JOINT.

ALL DIMENSIONS ARE IN INCHES (MILLIMETERS) UNLESS OTHERWISE SHOWN.

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USER NAME = Lawrence,DeManche	DESIGNED - M. DE YONG	REVISED - A. ABBAS 03-21-97
	DRAWN -	REVISED - M. GOMEZ 04-06-01
PLOT SCALE = 100,0000 ' / in.	CHECKED -	REVISED - R. BORO 01-01-07
PLOT DATE = 11/18/2022	DATE - 06-13-90	REVISED - K. SMITH 11-18-22

STATE OF ILLINOIS
DEPARTMENT OF TRANSPORTATION

BUTT JOINT AND
HMA TAPER DETAILS


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F.A. RTE.	SECTION	COUNTY	TOTAL SHEETS	SHEET NO.
2612	16-00232-00-CH	DUPAGE	248	217
BD400-05 BD-32		CONTRACT NO.61J01		
		ILLINOIS	FED. AID PROJECT	

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MODEL: TC-10 [Sheet]
FILE NAME: c:\pw_work\pwtcd\lawrence.demanche@illinois.gov\d0951415\TC-10.dgn




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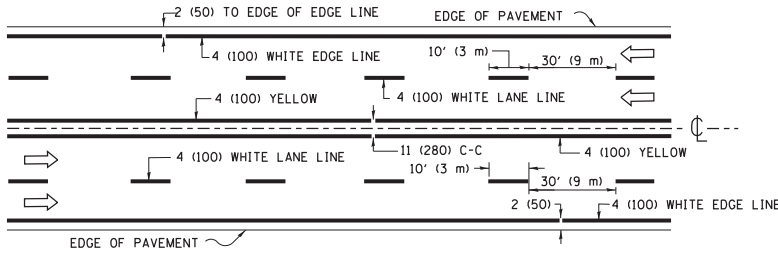
- SIDE ROAD WITH A SPEED LIMIT OF 40 MPH (60 km/h) OR LESS AS SHOWN ON THE DRAWING AND AS DIRECTED BY THE ENGINEER:
 - ONE "ROAD CONSTRUCTION AHEAD" SIGN 36 x 36 (900x900) WITH A FLASHER MOUNTED ON IT APPROXIMATELY 200' (60 m) IN ADVANCE OF THE MAIN ROUTE.
 - THE CLOSED PORTION OF THE MAIN ROUTE SHALL BE PROTECTED BY BLOCKING WITH TYPE I, TYPE II OR TYPE III BARRICADES, 1/3 OF THE CROSS SECTION OF THE CLOSED PORTION.
- SIDE ROAD WITH A SPEED LIMIT GREATER THAN 40 MPH (60 km/h) AS SHOWN ON THE DRAWING AND AS DIRECTED BY THE ENGINEER:
 - ONE "ROAD CONSTRUCTION AHEAD" SIGN 48 x 48 (1.2 m x 1.2 m) WITH A FLASHER MOUNTED ON IT APPROXIMATELY 500' (150 m) IN ADVANCE OF THE MAIN ROUTE.
 - THE CLOSED PORTION OF THE MAIN ROUTE SHALL BE PROTECTED BY BLOCKING WITH TYPE III BARRICADES, 1/2 OF THE CROSS SECTION OF THE CLOSED PORTION.
- CONES MAY BE SUBSTITUTED FOR BARRICADES OR DRUMS AT HALF THE SPACING DURING DAY OPERATIONS. CONES SHALL BE A MINIMUM OF 28 (710) IN HEIGHT.
- WHEN THE SIDE ROAD LIES BETWEEN THE BEGINNING OF THE MAINLINE SIGNING AND THE WORK ZONE, A SINGLE HEADED ARROW (M6-1) SHALL BE USED IN LIEU OF THE DOUBLE HEADED ARROW (M6-4).
- WHEN WORK IS BEING PERFORMED ON A SIDE ROAD OR DRIVEWAY, FOLLOW THE APPLICABLE STANDARD(S). THE DIRECTIONAL ARROW (M6-1 OR M6-4) SHALL BE COVERED OR REMOVED WHEN NO LONGER CONSISTENT WITH THE TRAFFIC CONTROL SET-UP.
- ADVANCE WARNING SIGNS ARE TO BE OMITTED ON DRIVEWAYS UNLESS OTHERWISE SPECIFIED IN THE PLANS OR BY THE ENGINEER.
- THE TRAFFIC CONTROL AND PROTECTION FOR SIDE ROADS, INTERSECTIONS, AND DRIVEWAYS SHALL BE INCLUDED IN THE COST OF SPECIFIED TRAFFIC CONTROL STANDARDS OR ITEMS.

All dimensions are in inches (millimeters)
unless otherwise shown.

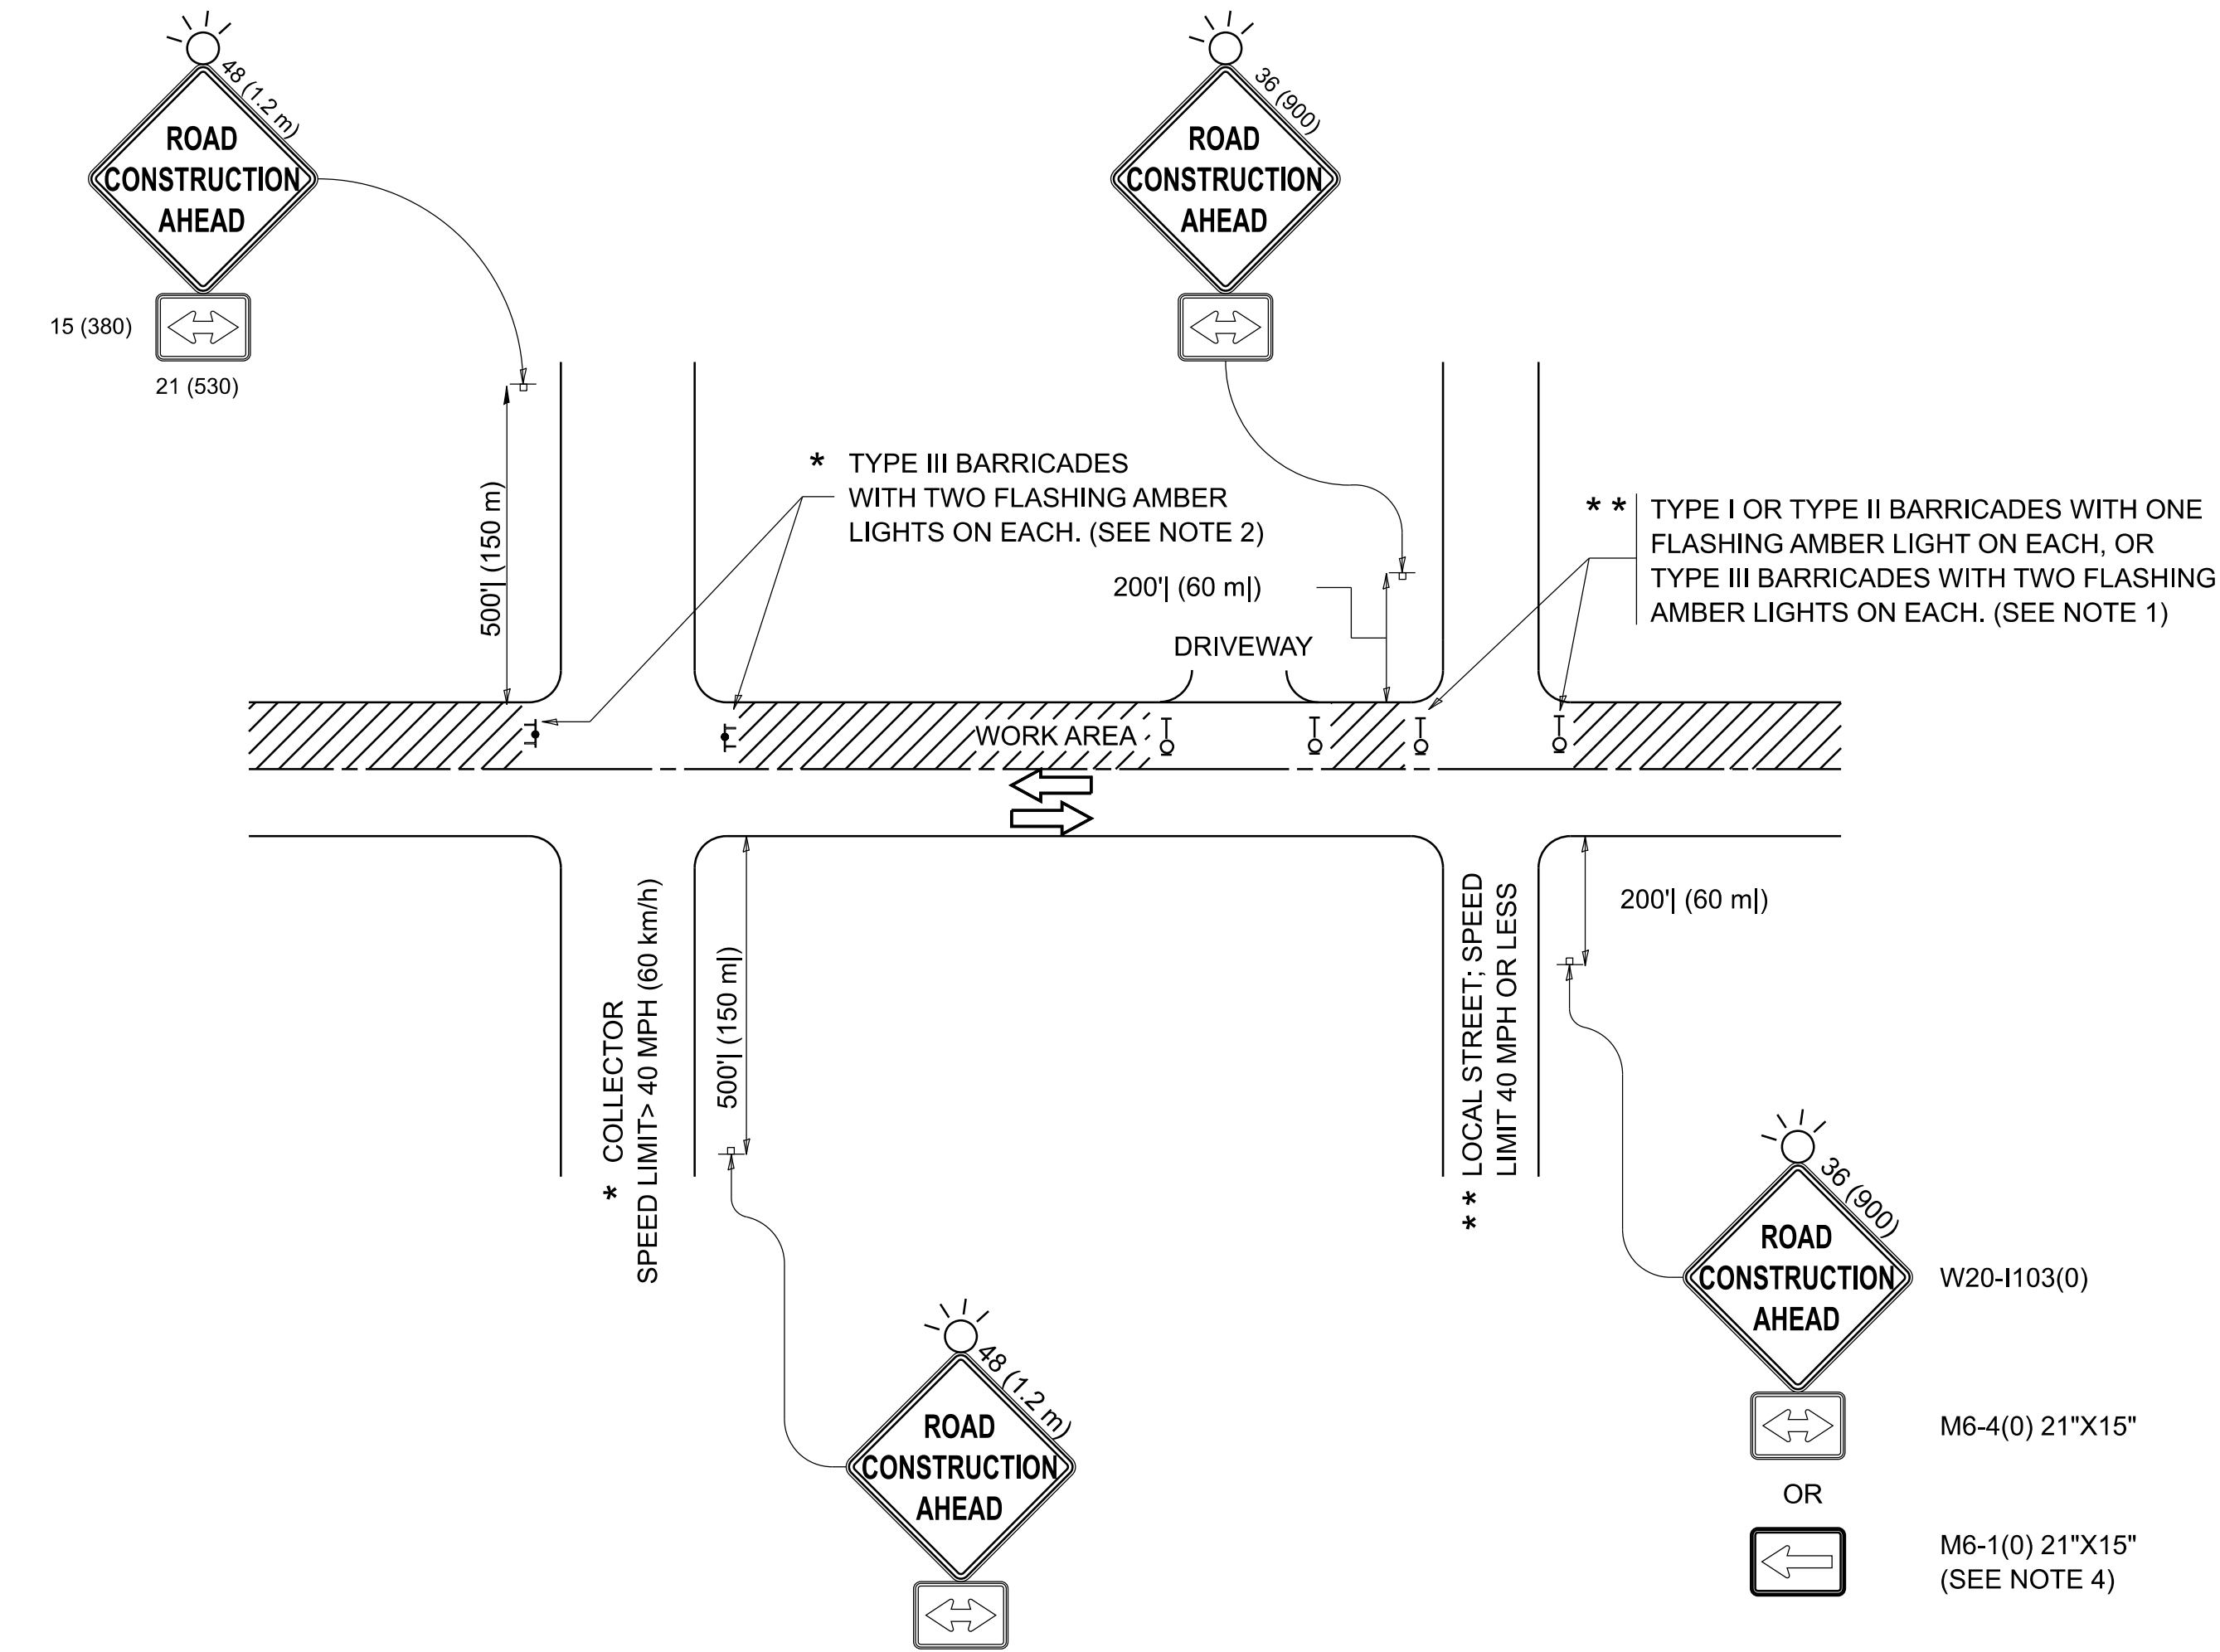
	USER NAME	* lawrence,demanche	DESIGNED	-	L.H.A.	REVISED	-	T. RAMMACHER 01-06-00	STATE OF ILLINOIS DEPARTMENT OF TRANSPORTATION	TRAFFIC CONTROL AND PROTECTION FOR SIDE ROADS, INTERSECTIONS, AND DRIVEWAYS	SCALE:	SHEET	OF	SHEETS	STA.	TO STA.	F.A.P RTE.	SECTION	COUNTY	TOTAL SHEETS	SHEET NO.
	DRAWN	-				REVISED	-	A. SCHUETZE 07-01-13									2612	16-00232-00-CH	DUPAGE	248	219
	PLOT SCALE	=	0.08333317	' / in.		CHECKED	-	A. SCHUETZE 09-15-06									TC-10		CONTRACT NO. 61J01		
	PLOT DATE	=	10/2/2025			DATE	-	06-89											ILLINOIS	FED. AID PROJECT	

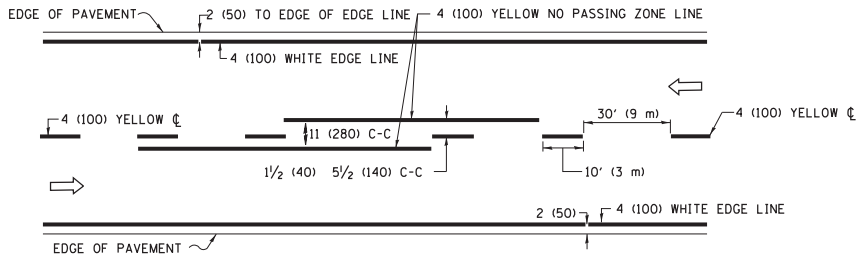

2-LANE ROADWAY




MULTI-LANE UNDIVIDED

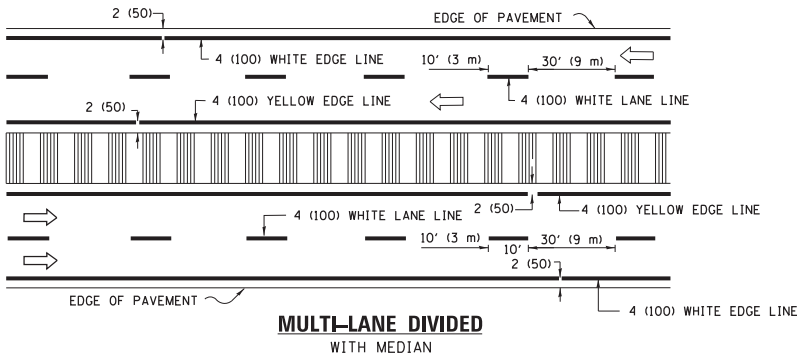

MULTI-LANE DIVIDED
WITH MEDIAN

TYPICAL LANE AND EDGE LINE MARKING

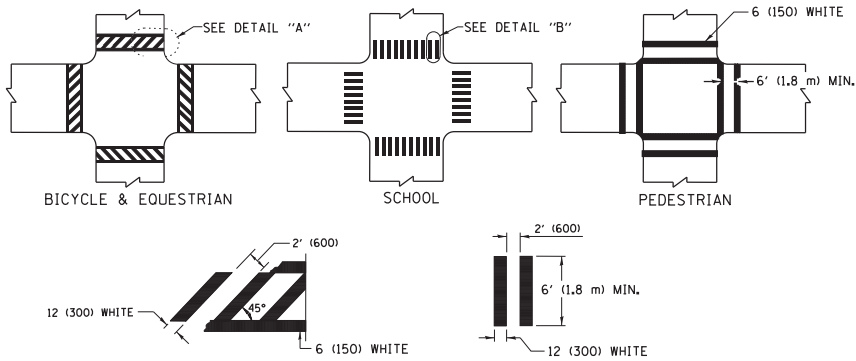


DETAIL "A"


DETAIL "B"

TYPICAL CROSSWALK MARKING

* MARKINGS SHALL BE INSTALLED PARALLEL TO THE CENTERLINE OF THE ROAD WHICH IT CROSSES

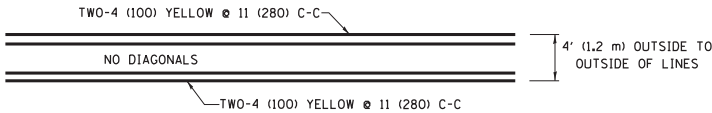


4' (1.2 m) WIDE MEDIANS ONLY

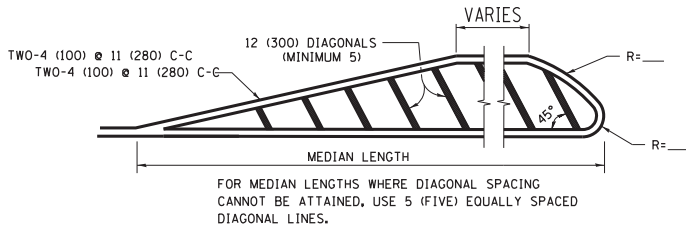


DIAGONAL LINE SPACING: 50' (15 m) C-C (LESS THAN 30MPH (50 km/h))
75' (25 m) C-C 30MPH (50 km/h) TO 45MPH (70 km/h)
150' (45 m) C-C (MORE THAN 45MPH (70 km/h))

MEDIANS OVER 4' (1.2 m) WIDE

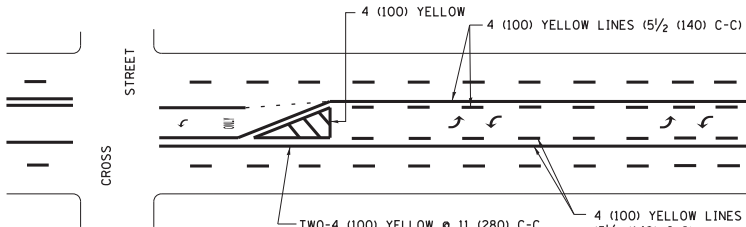


A MINIMUM OF TWO PAIRS OF TURN ARROWS SHALL BE USED, WHITE IN COLOR. ADDITIONAL PAIRS SHALL BE PLACED AT 200' (60 m) TO 300' (90 m) INTERVALS.

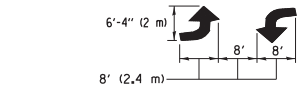

MEDIAN WITH TWO-WAY LEFT TURN LANE

TYPICAL PAINTED MEDIAN MARKING

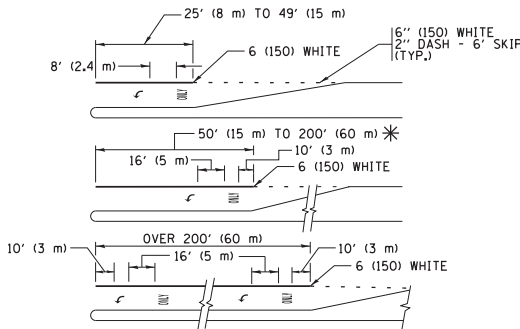


FULL SIZE LETTERS 8' (2.4 m) AND ARROWS SHALL BE USED.
AREA = 15.6 SQ. FT. (1.5 m²) ONLY AREA = 20.8 SQ. FT. (1.9 m²)


* TURN LANES IN EXCESS OF 400' (120 m) IN LENGTH MAY HAVE AN ADDITIONAL SET OF ARROW - "ONLY" INSTALLED MIDWAY BETWEEN THE OTHER TWO SETS OF ARROW - "ONLY".

TYPICAL LEFT (OR RIGHT) TURN LANE

TYPICAL TURN LANE MARKING

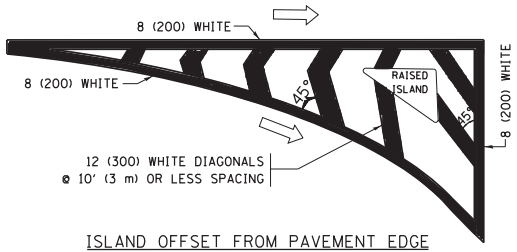


ISLAND OFFSET FROM PAVEMENT EDGE

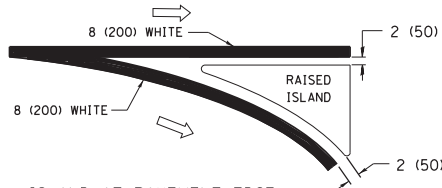


ISLAND AT PAVEMENT EDGE

TYPICAL ISLAND MARKING

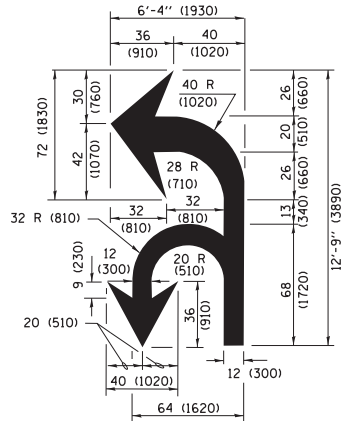

COMBINATION
LEFT AND U-TURN

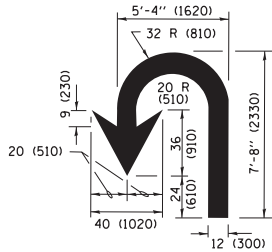

U-TURN

LANE REDUCTION TRANSITION

* LANE REDUCTION ARROWS REQUIRED AT SPEEDS OF 45 MPH OR GREATER OR WHEN SPECIFIED IN PLANS.

D(FT)	SPEED LIMIT
345	30
425	35
500	40
580	45
665	50
750	55

TYPE OF MARKING	WIDTH OF LINE	PATTERN	COLOR	SPACING /REMARKS
CENTERLINE ON 2 LANE PAVEMENT	4 (100)	SKIP-DASH	YELLOW	10' (3 m) LINE WITH 30' (9 m) SPACE
CENTERLINE ON MULTI-LANE UNDIVIDED PAVEMENT	2 @ 4 (100)	SOLID	YELLOW	11 (280) C-C
NO PASSING ZONE LINES: FOR ONE DIRECTION FOR BOTH DIRECTIONS	4 (100) 2 @ 4 (100)	SOLID SOLID	YELLOW YELLOW	5 1/2 (140) C-C FROM SKIP-DASH CENTERLINE 11 (280) C-C OMIT SKIP-DASH CENTERLINE BETWEEN
LANE LINES	4 (100) 5 (125) ON FREEWAYS	SKIP-DASH SKIP-DASH	WHITE WHITE	10' (3 m) LINE WITH 30' (9 m) SPACE
DOTTED LINES (EXTENSIONS OF CENTER, LANE OR TURN LANE MARKINGS)	SAME AS LINE BEING EXTENDED	SKIP-DASH	SAME AS LINE BEING EXTENDED	2' (600) LINE WITH 6' (1.8 m) SPACE
EDGE LINES	4 (100)	SOLID	YELLOW-LEFT WHITE-RIGHT	OUTLINE MEDIANS IN YELLOW
TURN LANE MARKINGS	6 (150) LINE: FULL SIZE LETTERS & SYMBOLS (8' (2.4m))	SOLID	WHITE	SEE TYPICAL TURN LANE MARKING DETAIL
TWO WAY LEFT TURN MARKING	2 @ 4 (100) EACH DIRECTION 8' (2.4m) LEFT ARROW	SKIP-DASH AND SOLID IN PAIRS	YELLOW WHITE	10' (3 m) LINE WITH 30' (9 m) SPACE FOR SKIP-DASH 5 1/2 (140) C-C BETWEEN SOLID LINE AND SKIP-DASH LINE SEE TYPICAL TWO-WAY LEFT TURN MARKING DETAIL
CROSSWALK LINES (PEDESTRIAN) A. DIAGONALS (BIKE & EQUESTRIAN) B. LONGITUDINAL BARS (SCHOOL)	2 @ 6 (150) 12 (300) @ 45° 12 (300) @ 90°	SOLID SOLID SOLID	WHITE WHITE WHITE	NOT LESS THAN 6' (1.8 m) APART 2' (600) APART SEE TYPICAL CROSSWALK MARKING DETAILS.
STOP LINES	24 (600)	SOLID	WHITE	PLACE 4' (1.2 m) IN ADVANCE OF AND PARALLEL TO CROSSWALK, IF PRESENT, OTHERWISE, PLACE AT DESIRED STOPPING POINT, PARALLEL TO CROSSROAD CENTERLINE, WHERE POSSIBLE
PAINTED MEDIANS	2 @ 4 (100) WITH 12 (300) DIAGONALS @ 45° NO DIAGONALS USED FOR 4' (1.2 m) WIDE MEDIANS	SOLID	YELLOW: TWO WAY TRAFFIC WHITE: ONE WAY TRAFFIC	11 (280) C-C FOR THE DOUBLE LINE SEE TYPICAL PAINTED MEDIAN MARKING.
GORE MARKING AND CHANNELIZING LINES	8 (200) WITH 12 (300) DIAGONALS @ 45°	SOLID	WHITE	DIAGONALS: 15' (4.5 m) C-C (LESS THAN 30MPH (50 km/h)) 20' (6 m) C-C 30MPH (50 km/h) TO 45MPH (70 km/h) 30' (9 m) C-C (OVER 45MPH (70 km/h))
RAILROAD CROSSING	24 (600) TRANSVERSE LINES: "RR" IS 6' (1.8 m) LETTERS: 16 (400) LINE FOR "X"	SOLID	WHITE	SEE STATE STANDARD 780001 AREA OF: "R"=3.6 SQ. FT. (0.33 m ²) EACH "X"=54.0 SQ. FT. (5.0 m ²)
SHOULDER DIAGONALS (REQUIRED FOR SHOULDERS ≥ 8')	12 (300) @ 45°	SOLID	WHITE - RIGHT YELLOW - LEFT	50' (15 m) C-C (LESS THAN 30MPH (50 km/h)) 75' (25 m) C-C (30 MPH (50 km/h) TO 45MPH (70 km/h)) 150' (45 m) C-C (OVER 45MPH (70 km/h))
U TURN ARROW	SEE DETAIL	SOLID	WHITE	16.3 SF
2 ARROW COMBINATION LEFT AND U TURN	SEE DETAIL	SOLID	WHITE	30.4 SF

FOR FURTHER DETAILS ON PAVEMENT MARKING REFER TO STANDARD SPECIFICATIONS FOR ROAD AND BRIDGE CONSTRUCTION AND STATE STANDARD 780001.

All dimensions are in inches (millimeters) unless otherwise shown.

FILE NAME =	USER NAME = footemj	DESIGNED - EVERS	REVISED - C. JUCIUS 09-09-09
p:\1\1084EBID\INTEG\illinois.gov\PWIDOT\Documents\DOT Offices\District 1\Projects\District 1\CAD\Drawings\CAD\Drawings\1084EBID\1084EBID.dgn		CHECKED -	REVISED - C. JUCIUS 07-01-13
Default	PLOT SCALE = 50.000' / in.	DATE - 03-19-90	REVISED - C. JUCIUS 12-21-15
	PLOT DATE = 4/13/2016		REVISED - C. JUCIUS 04-12-16

STATE OF ILLINOIS
DEPARTMENT OF TRANSPORTATION

DISTRICT ONE
TYPICAL PAVEMENT MARKINGS

SCALE: NONE	SHEET 1	OF 1	SHEETS	STA.	TO STA.
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F.A.P. RTE.	SECTION	COUNTY	TOTAL SHEETS	SHEET NO.
2612	16-00232-00-CH	DUPAGE	248	220
	TC-13	CONTRACT NO.	61101	
	ILLINOIS	FED. AID PROJECT		

**TURN BAY ENTRANCE AT START
OF LANE CLOSURE TAPER**


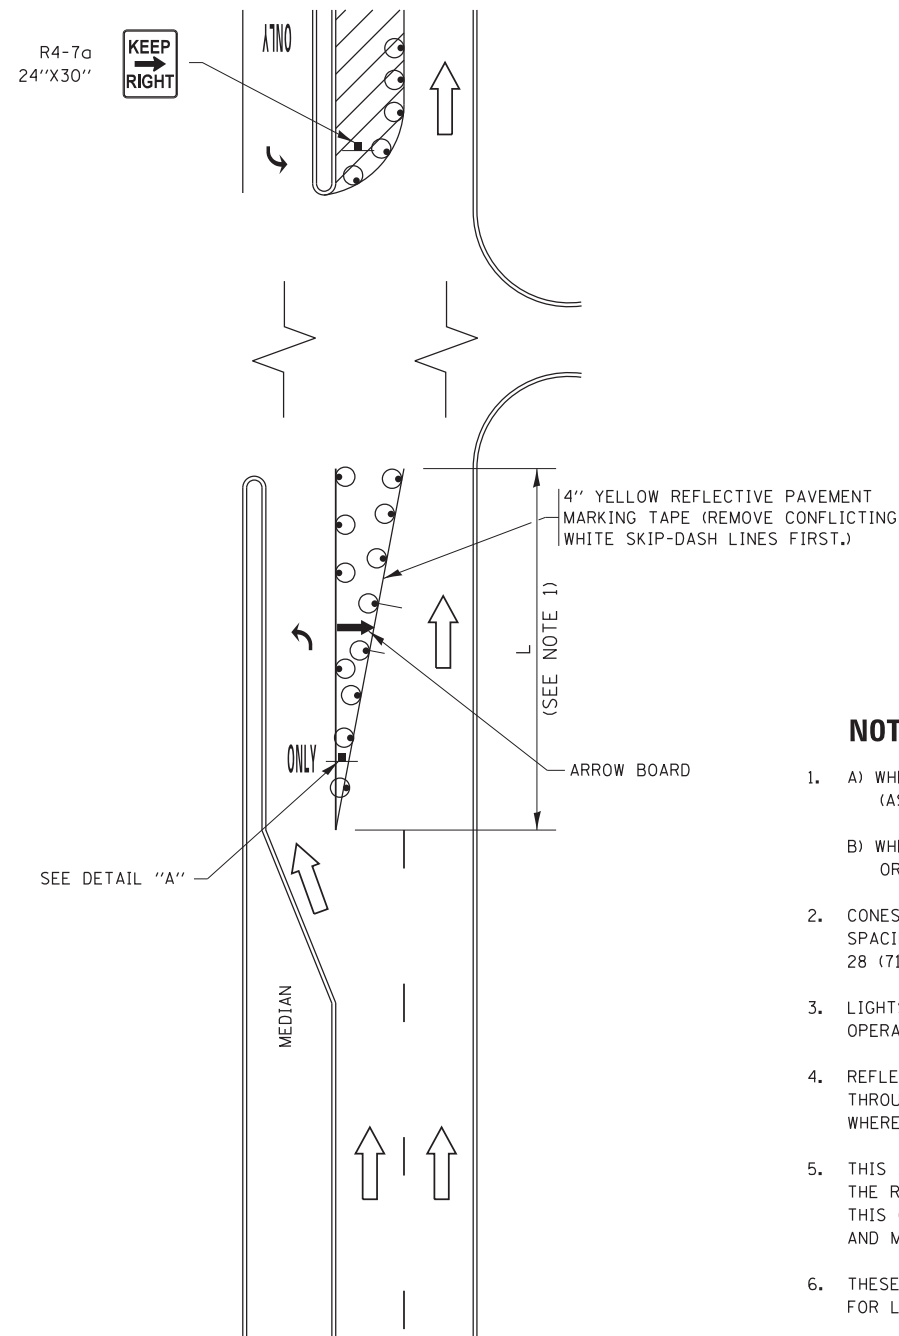


FIGURE 1

LEGEND

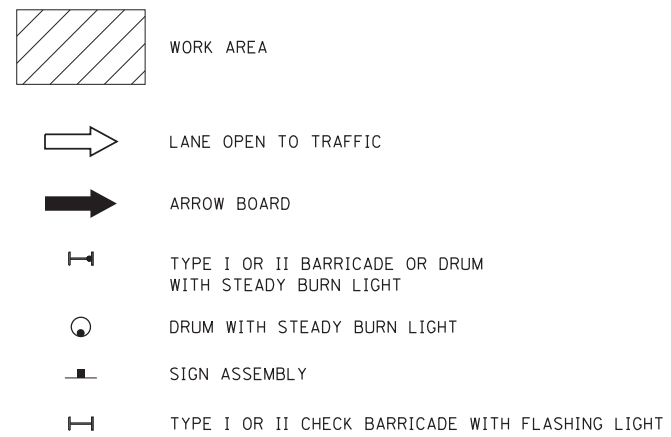

NOTES:

1. A) WHEN "L" IS \leq THE STORAGE LENGTH OF THE TURN LANE
(AS SHOWN IN FIG. 1), USE FIGURE 1.

B) WHEN "L" IS $>$ THE STORAGE LENGTH OF THE TURN LANE
OR THE TURN LANE IS WITHIN THE LANE CLOSURE, USE FIGURE 2.
2. CONES MAY BE SUBSTITUTED FOR BARRICADES OR DRUMS AT HALF THE
SPACING DURING DAY OPERATIONS. CONES SHALL BE A MINIMUM OF
28 (710) IN HEIGHT.
3. LIGHTS SHALL NOT BE REQUIRED ON BARRICADES OR DRUMS FOR DAY
OPERATIONS. ALL LIGHTS SHALL BE MONODIRECTIONAL.
4. REFLECTIVE TEMPORARY PAVEMENT MARKINGS SHALL BE PLACED
THROUGHOUT THE BARRICADED AREAS OF EACH TURN BAY AS SHOWN
WHERE THE CLOSURE TIME IS GREATER THAN FOURTEEN (14) DAYS.
5. THIS APPLICATION ALSO APPLIES WHEN WORK IS BEING PERFORMED IN
THE RIGHT LANE(S) AND THE RIGHT TURN BAY IS TO REMAIN OPEN. UNDER
THIS CONDITION, "RIGHT TURN LANE" R3-110OR 24 x 24 (600 x 600)
AND M6-2R 21 x 15 (530 x 380) SHALL BE USED.
6. THESE CONTROLS SHALL SUPPLEMENT MAINLINE TRAFFIC CONTROL
FOR LANE CLOSURES.
7. THE SIGNS SHALL BE MOUNTED ABOVE THE BARRICADES/DRUMS
ON SEPARATE SIGN SUPPORTS THAT MEET NCHRP 350 OR MASH
PREQUIREMENTS.
8. TRAFFIC CONTROL AND PROTECTION AT TURN BAYS (TO REMAIN OPEN
TO TRAFFIC) SHALL BE INCLUDED IN THE COST OF SPECIFIED TRAFFIC
CONTROL STANDARDS OR ITEMS.

TURN BAY ENTRANCE WITHIN A LANE CLOSURE



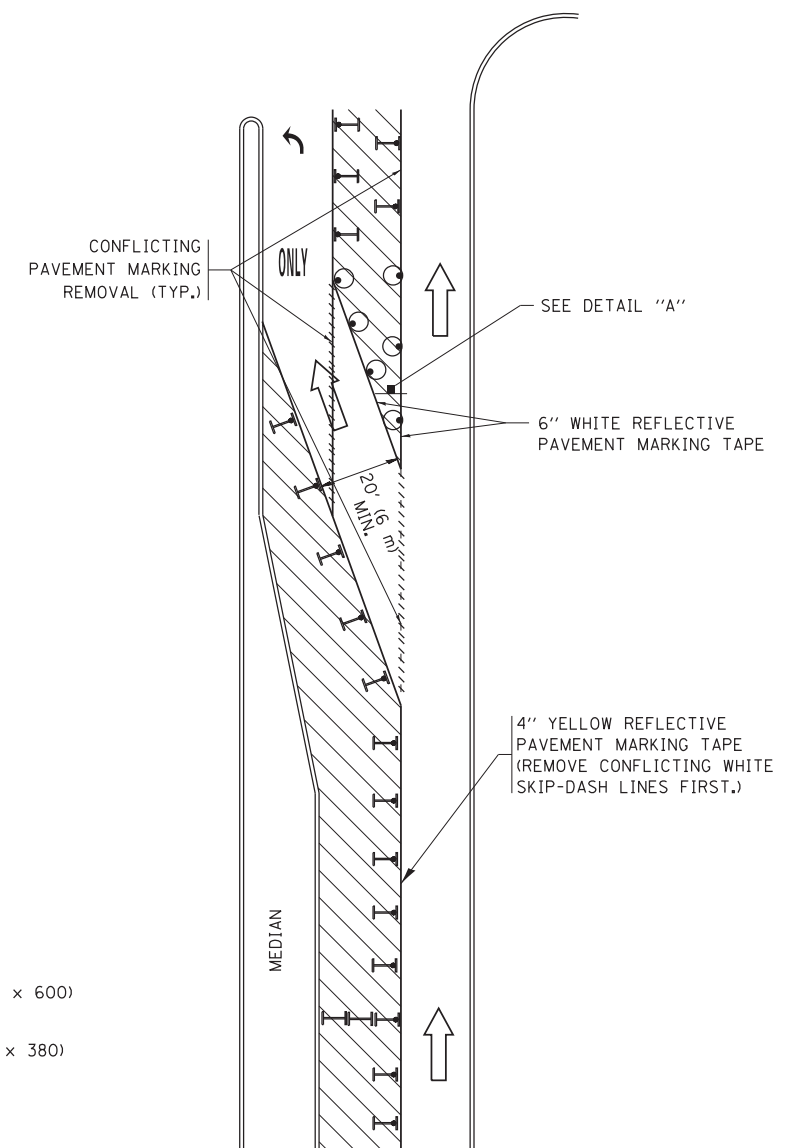


FIGURE 2

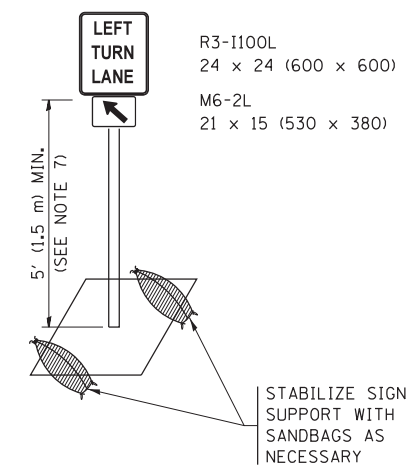



DETAIL A

All dimensions are in inches (millimeters)
unless otherwise shown.

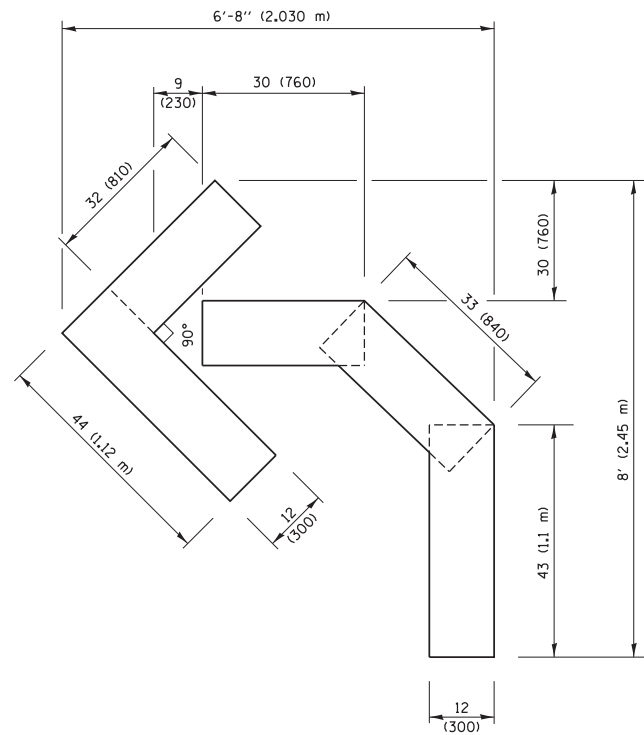


QUANTITY

4 (100) LINE = 45.5 ft. (13.9 m)
15.2 sq. ft. (1.41 sq. m)

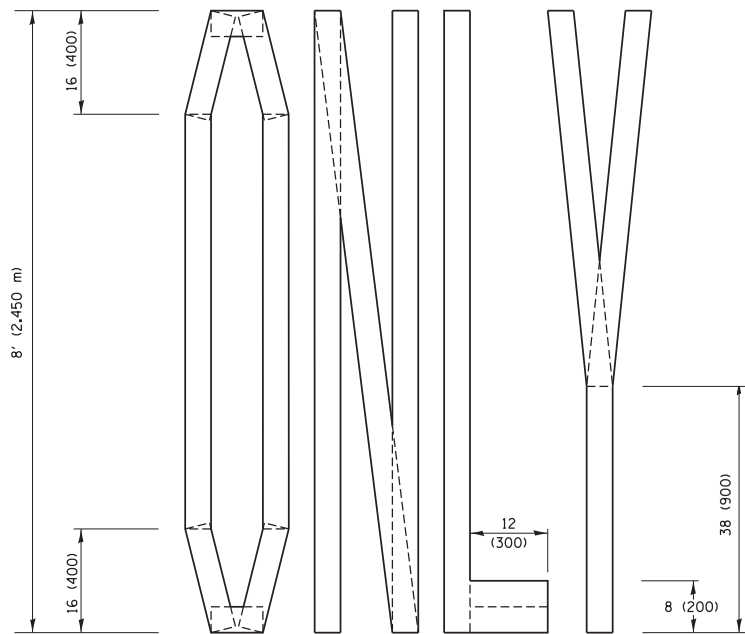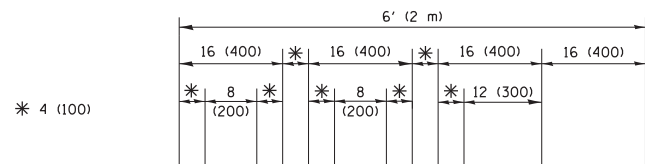

QUANTITY

4 (100) LINE = 64.1 ft. (19.5 m)
21.4 sq. ft. (1.99 sq. m)

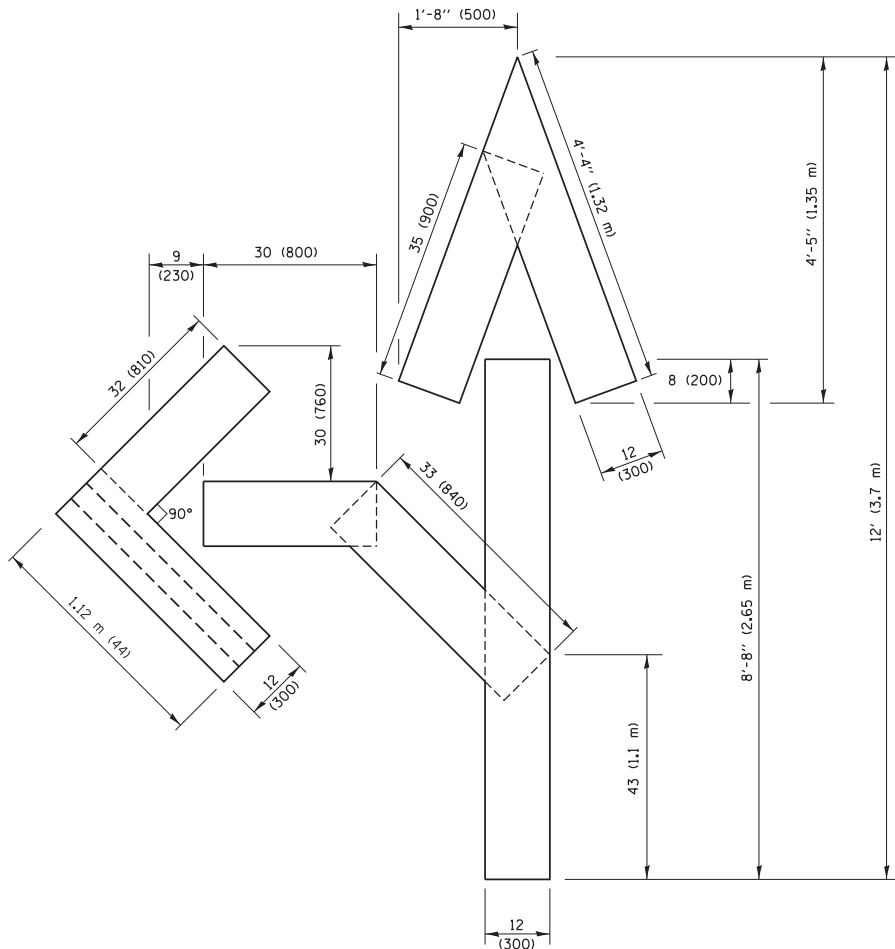


QUANTITY

4 (100) LINE = 82.5 ft. (25.1 m)
27.5 sq. ft. (2.53 sq. m)

NOTE:

ALL QUANTITIES OF PLACEMENT ARE REPRESENTED IN LINEAR FEET OF 4" LINES TO MATCH THE 4" TEMPORARY TAPE PAY ITEM AND REPRESENTS THE TOTAL QUANTITY OF 4" TAPE REQUIRED.

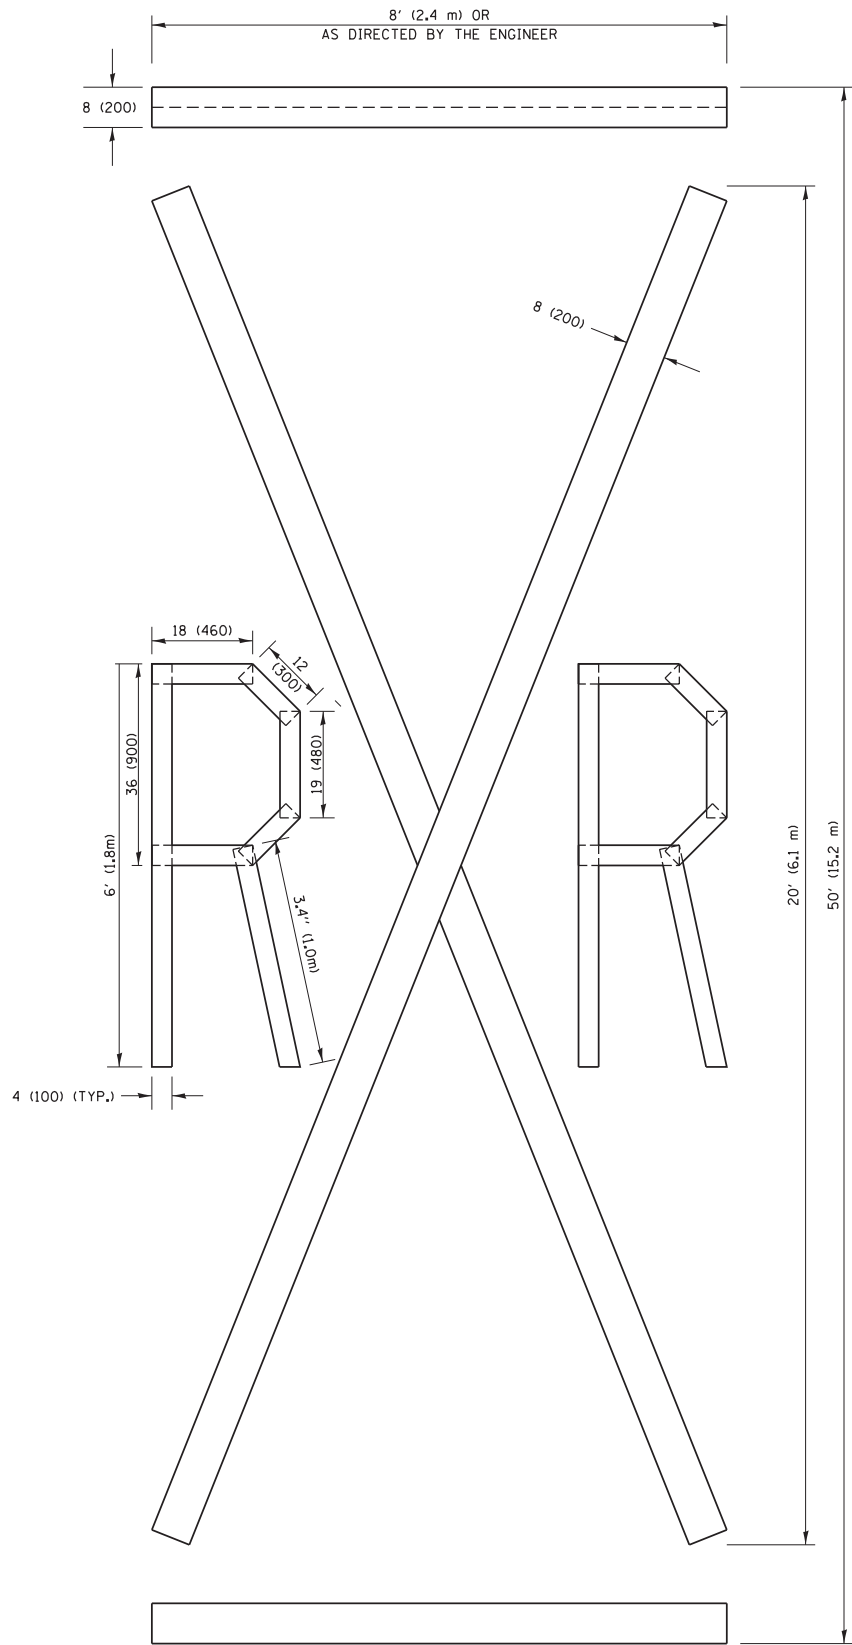


QUANTITY

4 (100) LINE = 225.9 ft. (68.9 m)
75.3 sq. ft. (6.99 sq. m)

All dimensions are in inches (millimeters) unless otherwise shown.

FILE NAME = p:\w\11084EBID\INTEG\Illinois.gov\PWIDOT\Documents\IDOT Offices\District 1\Projects\Dist 1\CD\DATA\CAD\Sheets\tc16.dgn	USER NAME = footemj	DESIGNED -	REVISED -T. RAMMACHER 03-02-98	STATE OF ILLINOIS DEPARTMENT OF TRANSPORTATION	SHORT TERM PAVEMENT MARKING LETTERS AND SYMBOLS			F.A.P. RTE.	SECTION	COUNTY	TOTAL SHEETS	SHEET NO.
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	PLOT DATE = 9/15/2016	DATE - 09-18-94	REVISED -A. SCHUETZE 09-15-16		SCALE: NONE SHEET NO. 1 OF 1 SHEETS STA. TO STA.			TC-16		CONTRACT NO.	61J01	
								FED. ROAD DIST. NO. 1 ILLINOIS FED. AID PROJECT				

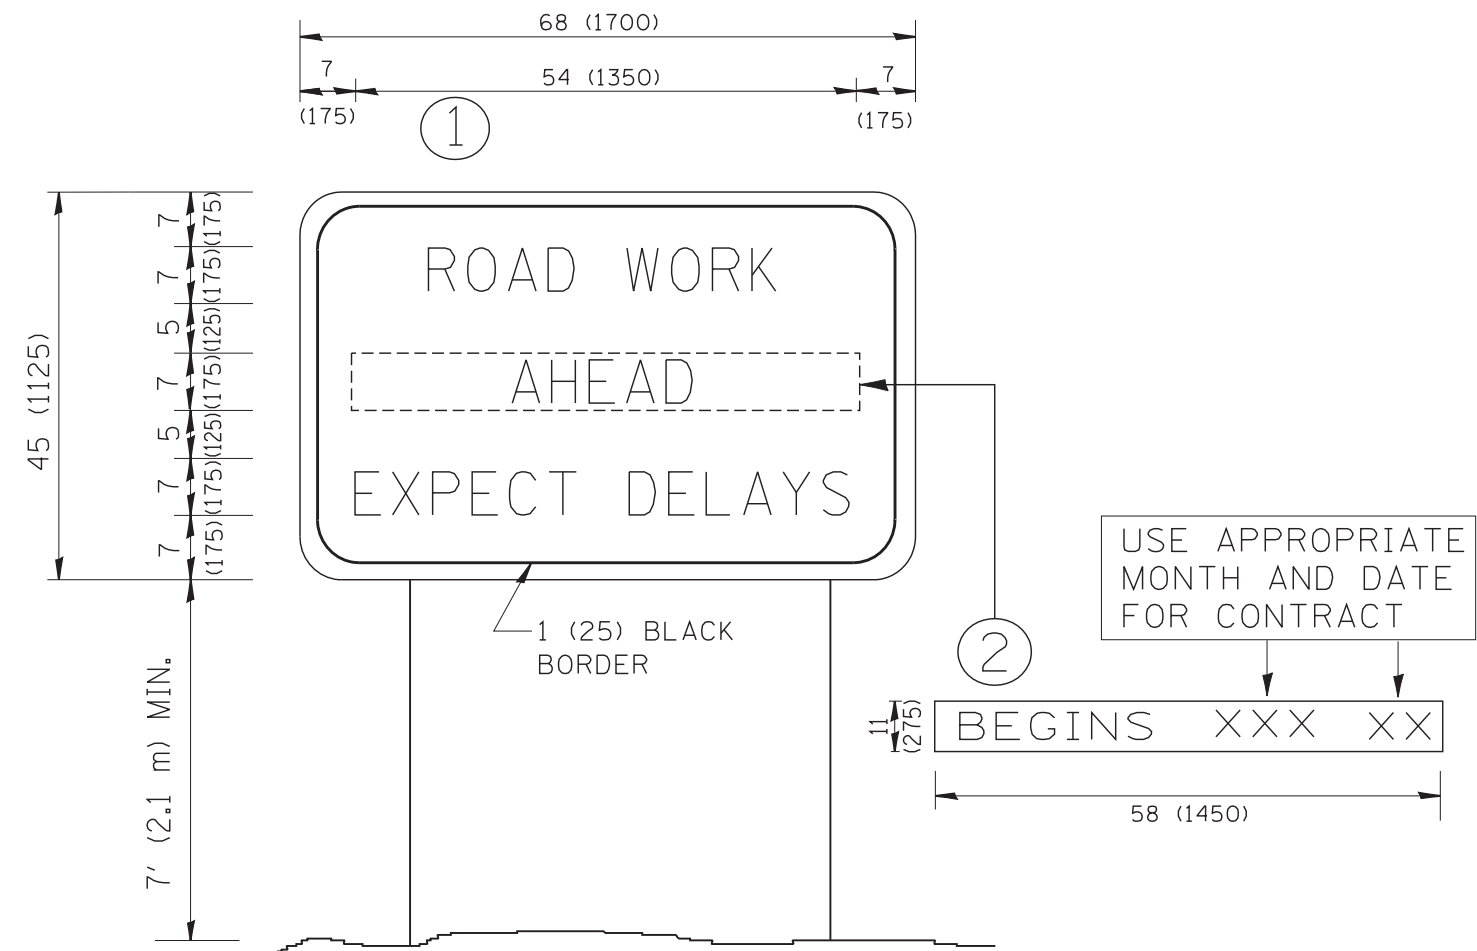

NOTES:

1. USE BLACK LETTERING ON ORANGE BACKGROUND.
2. ERECT SIGNS IN ADVANCE OF THE LOCATION FOR THE "ROAD CONSTRUCTION AHEAD" SIGN AT LOCATIONS AS DIRECTED BY THE ENGINEER.
3. ERECT SIGN ① WITH INSTALLED PANEL ② ONE WEEK PRIOR TO THE START OF CONSTRUCTION.
4. REMOVE PANEL ② SOON AFTER THE START OF CONSTRUCTION.
5. SEE SPECIAL PROVISION FOR "TEMPORARY INFORMATION SIGNING" FOR ADDITIONAL INFORMATION.
6. ONE SIGN ASSEMBLY EQUALS 25.70 SQ. FT. (2.3 SQ. M.)
7. SHALL BE PAID FOR AS TEMPORARY INFORMATION SIGNING.

ALL DIMENSIONS ARE IN INCHES (MILLIMETERS)
UNLESS OTHERWISE SHOWN.

FILE NAME = W:\diststd\22x34\tc22.dgn	USER NAME = gaglianob1	DESIGNED -	REVISED - R. MIRS 09-15-97	STATE OF ILLINOIS DEPARTMENT OF TRANSPORTATION	ARTERIAL ROAD INFORMATION SIGN			F.A.P. RTE.	SECTION	COUNTY	TOTAL SHEETS	SHEET NO.		
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	PLOT DATE = 1/4/2008	DATE -	REVISED - C. JUCIUS 01-31-07					SCALE: NONE	SHEET NO. 1 OF 1 SHEETS	STA.	TO STA.	FED. ROAD DIST. NO. 1 ILLINOIS FED. AID PROJECT		




3.0" RADIUS, 0.5" BORDER, WHITE ON GREEN; REFLECTORIZED
"DRIVEWAY" D; "ENTRANCE" D; STANDARD ARROW CUSTOM 12.0" x 5.0"

NOTES:

1. HALF OF THE SIGNS WILL REQUIRE A LEFT HAND FACING ARROW.
2. TWO SIGNS SHALL BE USED AT EACH COMMERCIAL ENTRANCE
PLACED BACK-TO-BACK; ONE WITH A RIGHT HAND ARROW (SHOWN)
SHALL BE PLACED ON THE NEAR RIGHT SIDE THE DRIVEWAY
AND ONE WITH A LEFT HAND ARROW SHALL BE PLACED ON THE
FAR LEFT SIDE OF THE DRIVEWAY.
3. SIGNS TO BE PAID FOR AS ITEM "TEMPORARY INFORMATION SIGNING".

FILE NAME = c:\pw\work\p\idot\gaglianob\0108315\tc26.dgn	USER NAME = gaglianob	DESIGNED -	REVISED -	C. JUCIUS 02-15-07	STATE OF ILLINOIS DEPARTMENT OF TRANSPORTATION	DRIVEWAY ENTRANCE SIGNING			F.A.P. RTE.	SECTION	COUNTY	TOTAL SHEETS	SHEET NO.
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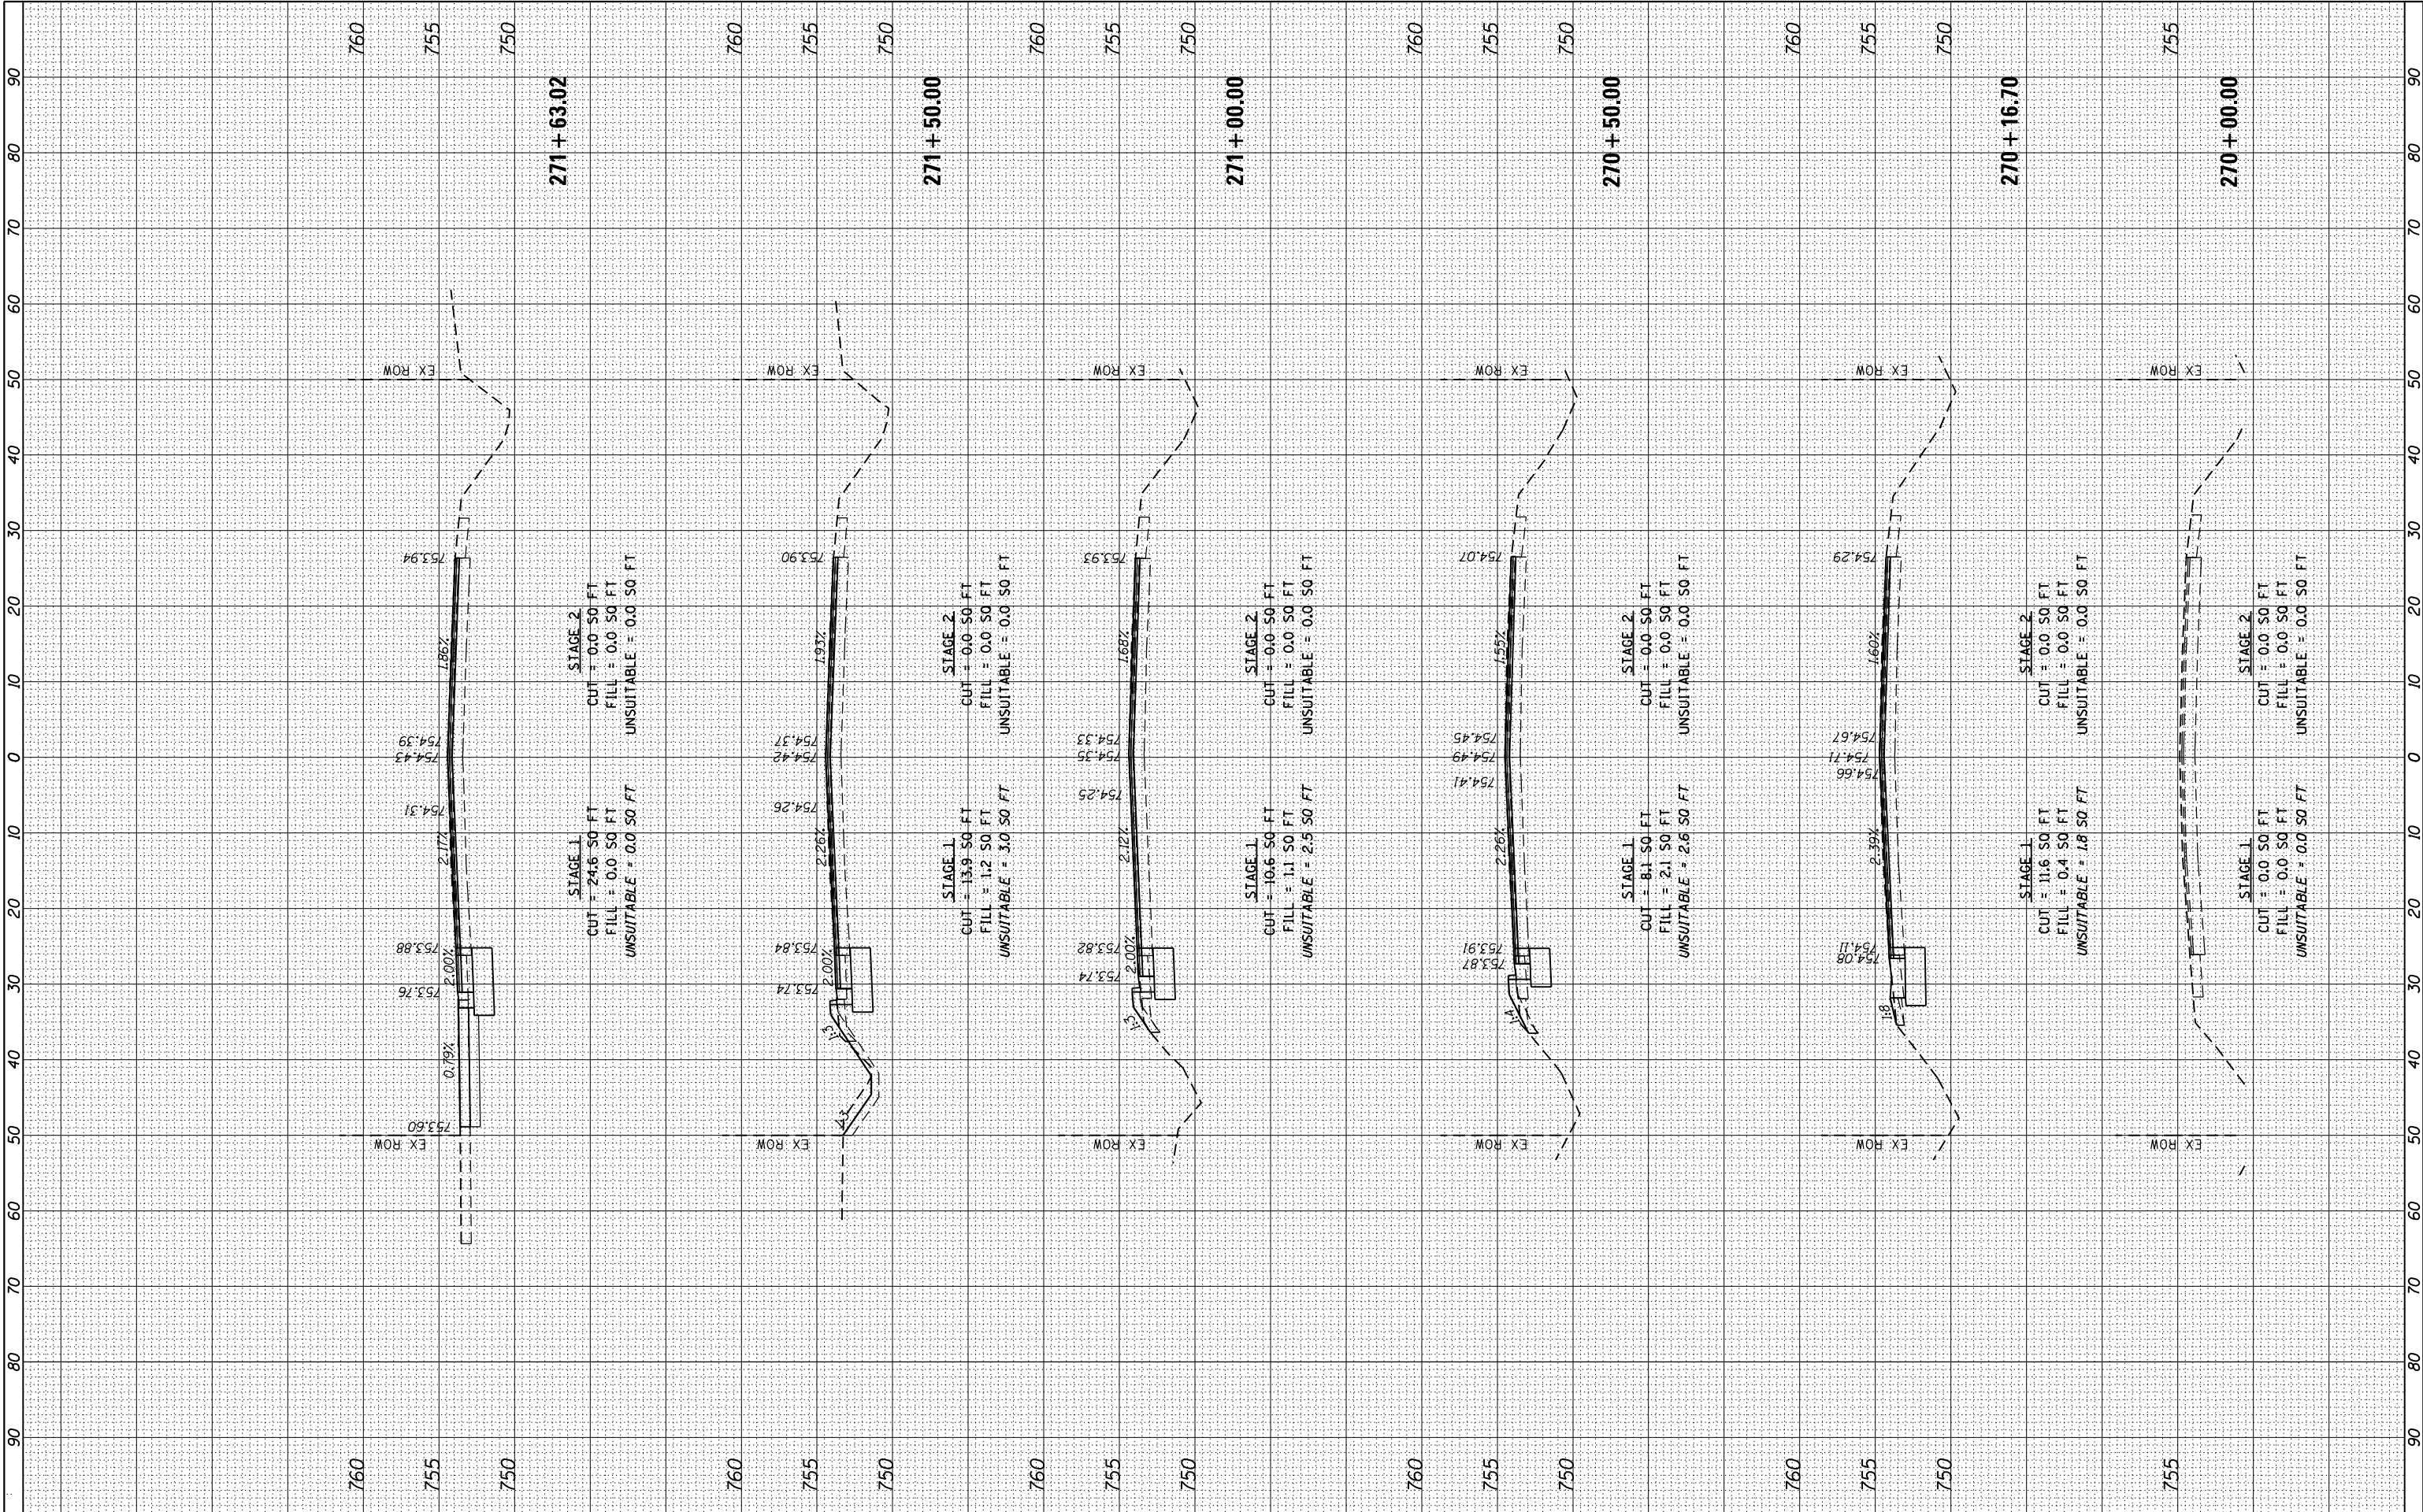
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FINAL SURVEY NOTE BOOK NO.	SURVEYED PLOTTED TEMPLATE AREAS CHECKED	BY	DATE

ORIGINAL SURVEY NOTE BOOK NO.	SURVEYED PLOTTED TEMPLATE AREAS CHECKED	BY	DATE

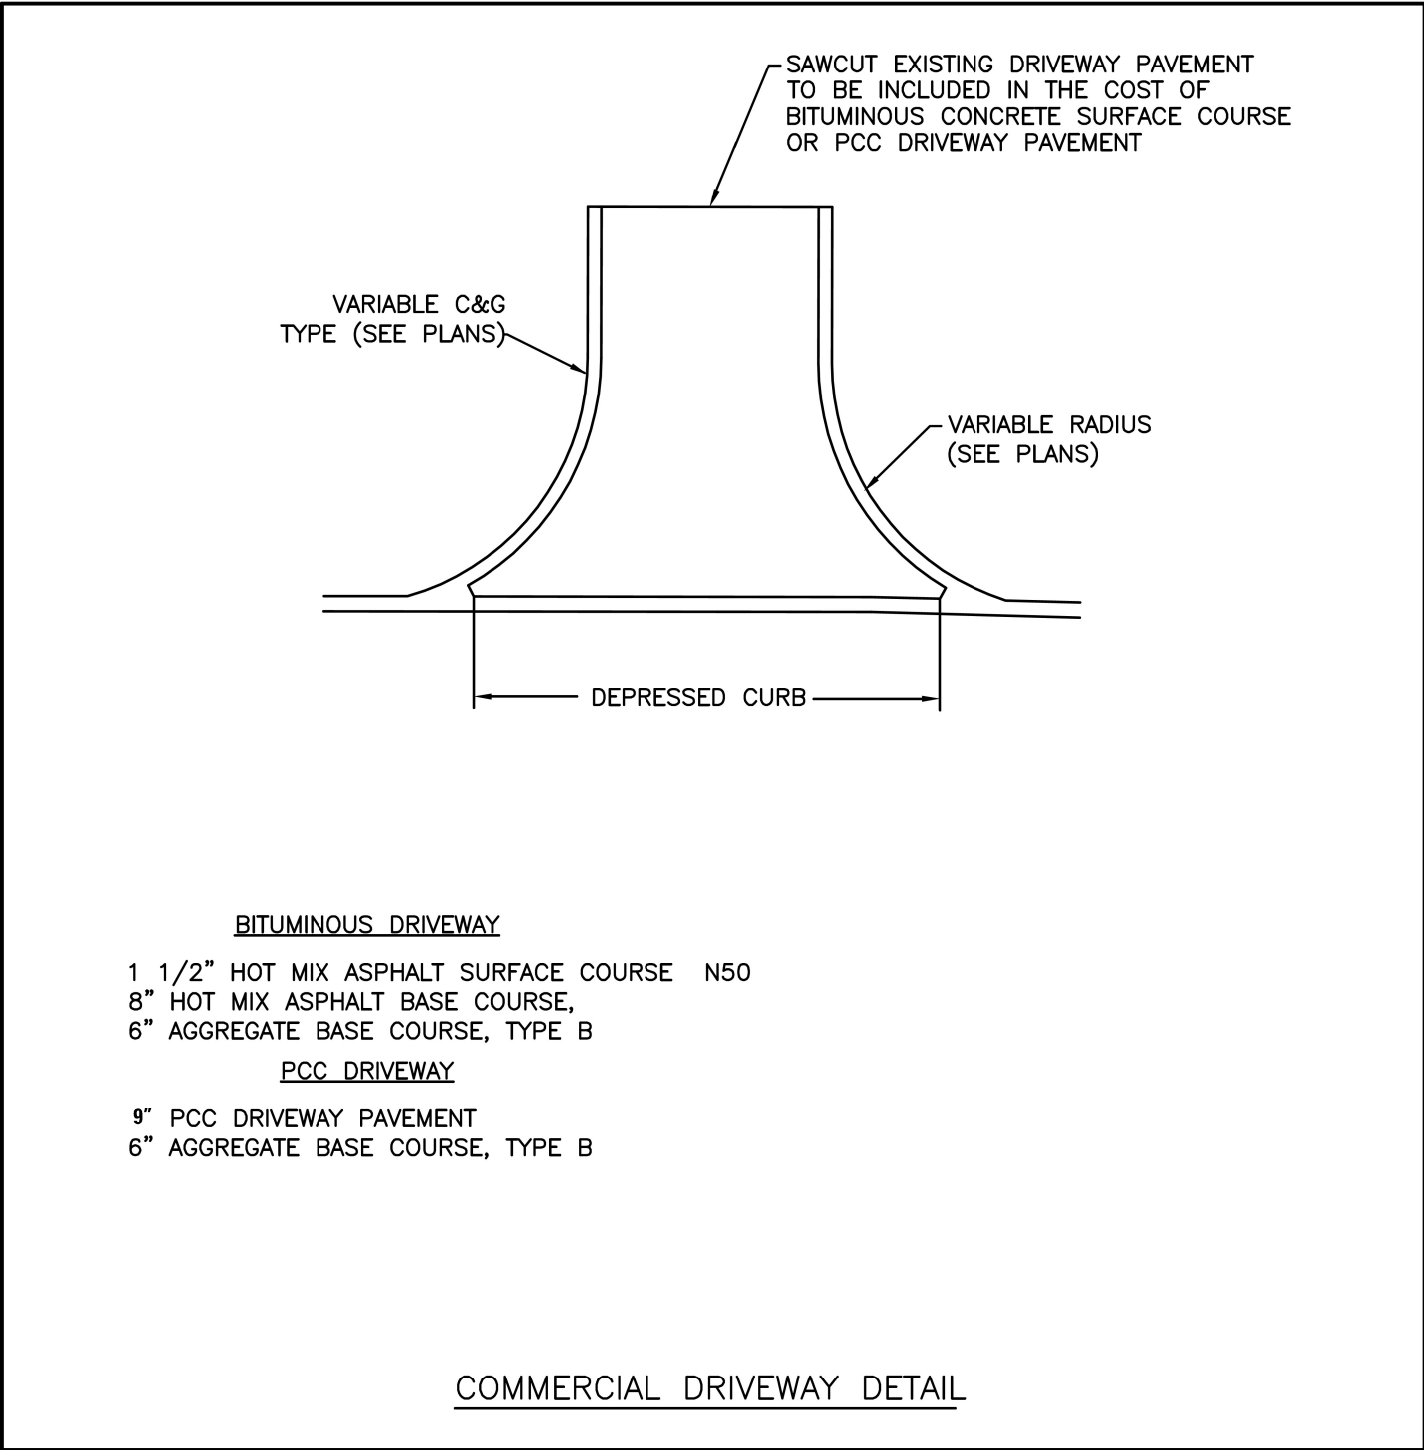FILE NAME = M:\451-945 DUDOT Lemont Rd\CA00 Streets\16-00232-00 CH1.crs cross sections 2.dgn



FINAL	SURVEYED	BY	DATE
SURVEY	PLOTTED		
NOTE BOOK	TEMPLATE		
NO.	AREAS CHECKED		

ORIGINAL	SURVEYED	BY	DATE
SURVEY	PLOTTED		
NOTE BOOK	TEMPLATE		
NO.	AREAS CHECKED		

FILE NAME = M:\451-94E DUDOT Lemont Rd\CA00 Streets\16-00232-00 CH Light cross sections 2.dgn




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PLOT SCALE = 20.0000 ' / in.	DRAWN - GJE	REVISED -
PLOT DATE = 8/31/2023	CHECKED - MTC	REVISED -
	DATE - 09/08/2023	REVISED -

STATE OF ILLINOIS
DEPARTMENT OF TRANSPORTATION

1"=5' VERT.
SCALE: 1"=10' HORZ. SHEET 2 OF 22 SHEETS STA. 272+00.00 TO STA. 274+00.00

CROSS SECTIONS
LEMONT ROAD


F.A.U RTE.	SECTION	COUNTY	TOTAL SHEETS	SHEET NO.
2612	16-00232-00-CH	DUPAGE	248	226
CONTRACT NO. 61J01				
ILLINOIS FED. AID PROJECT				

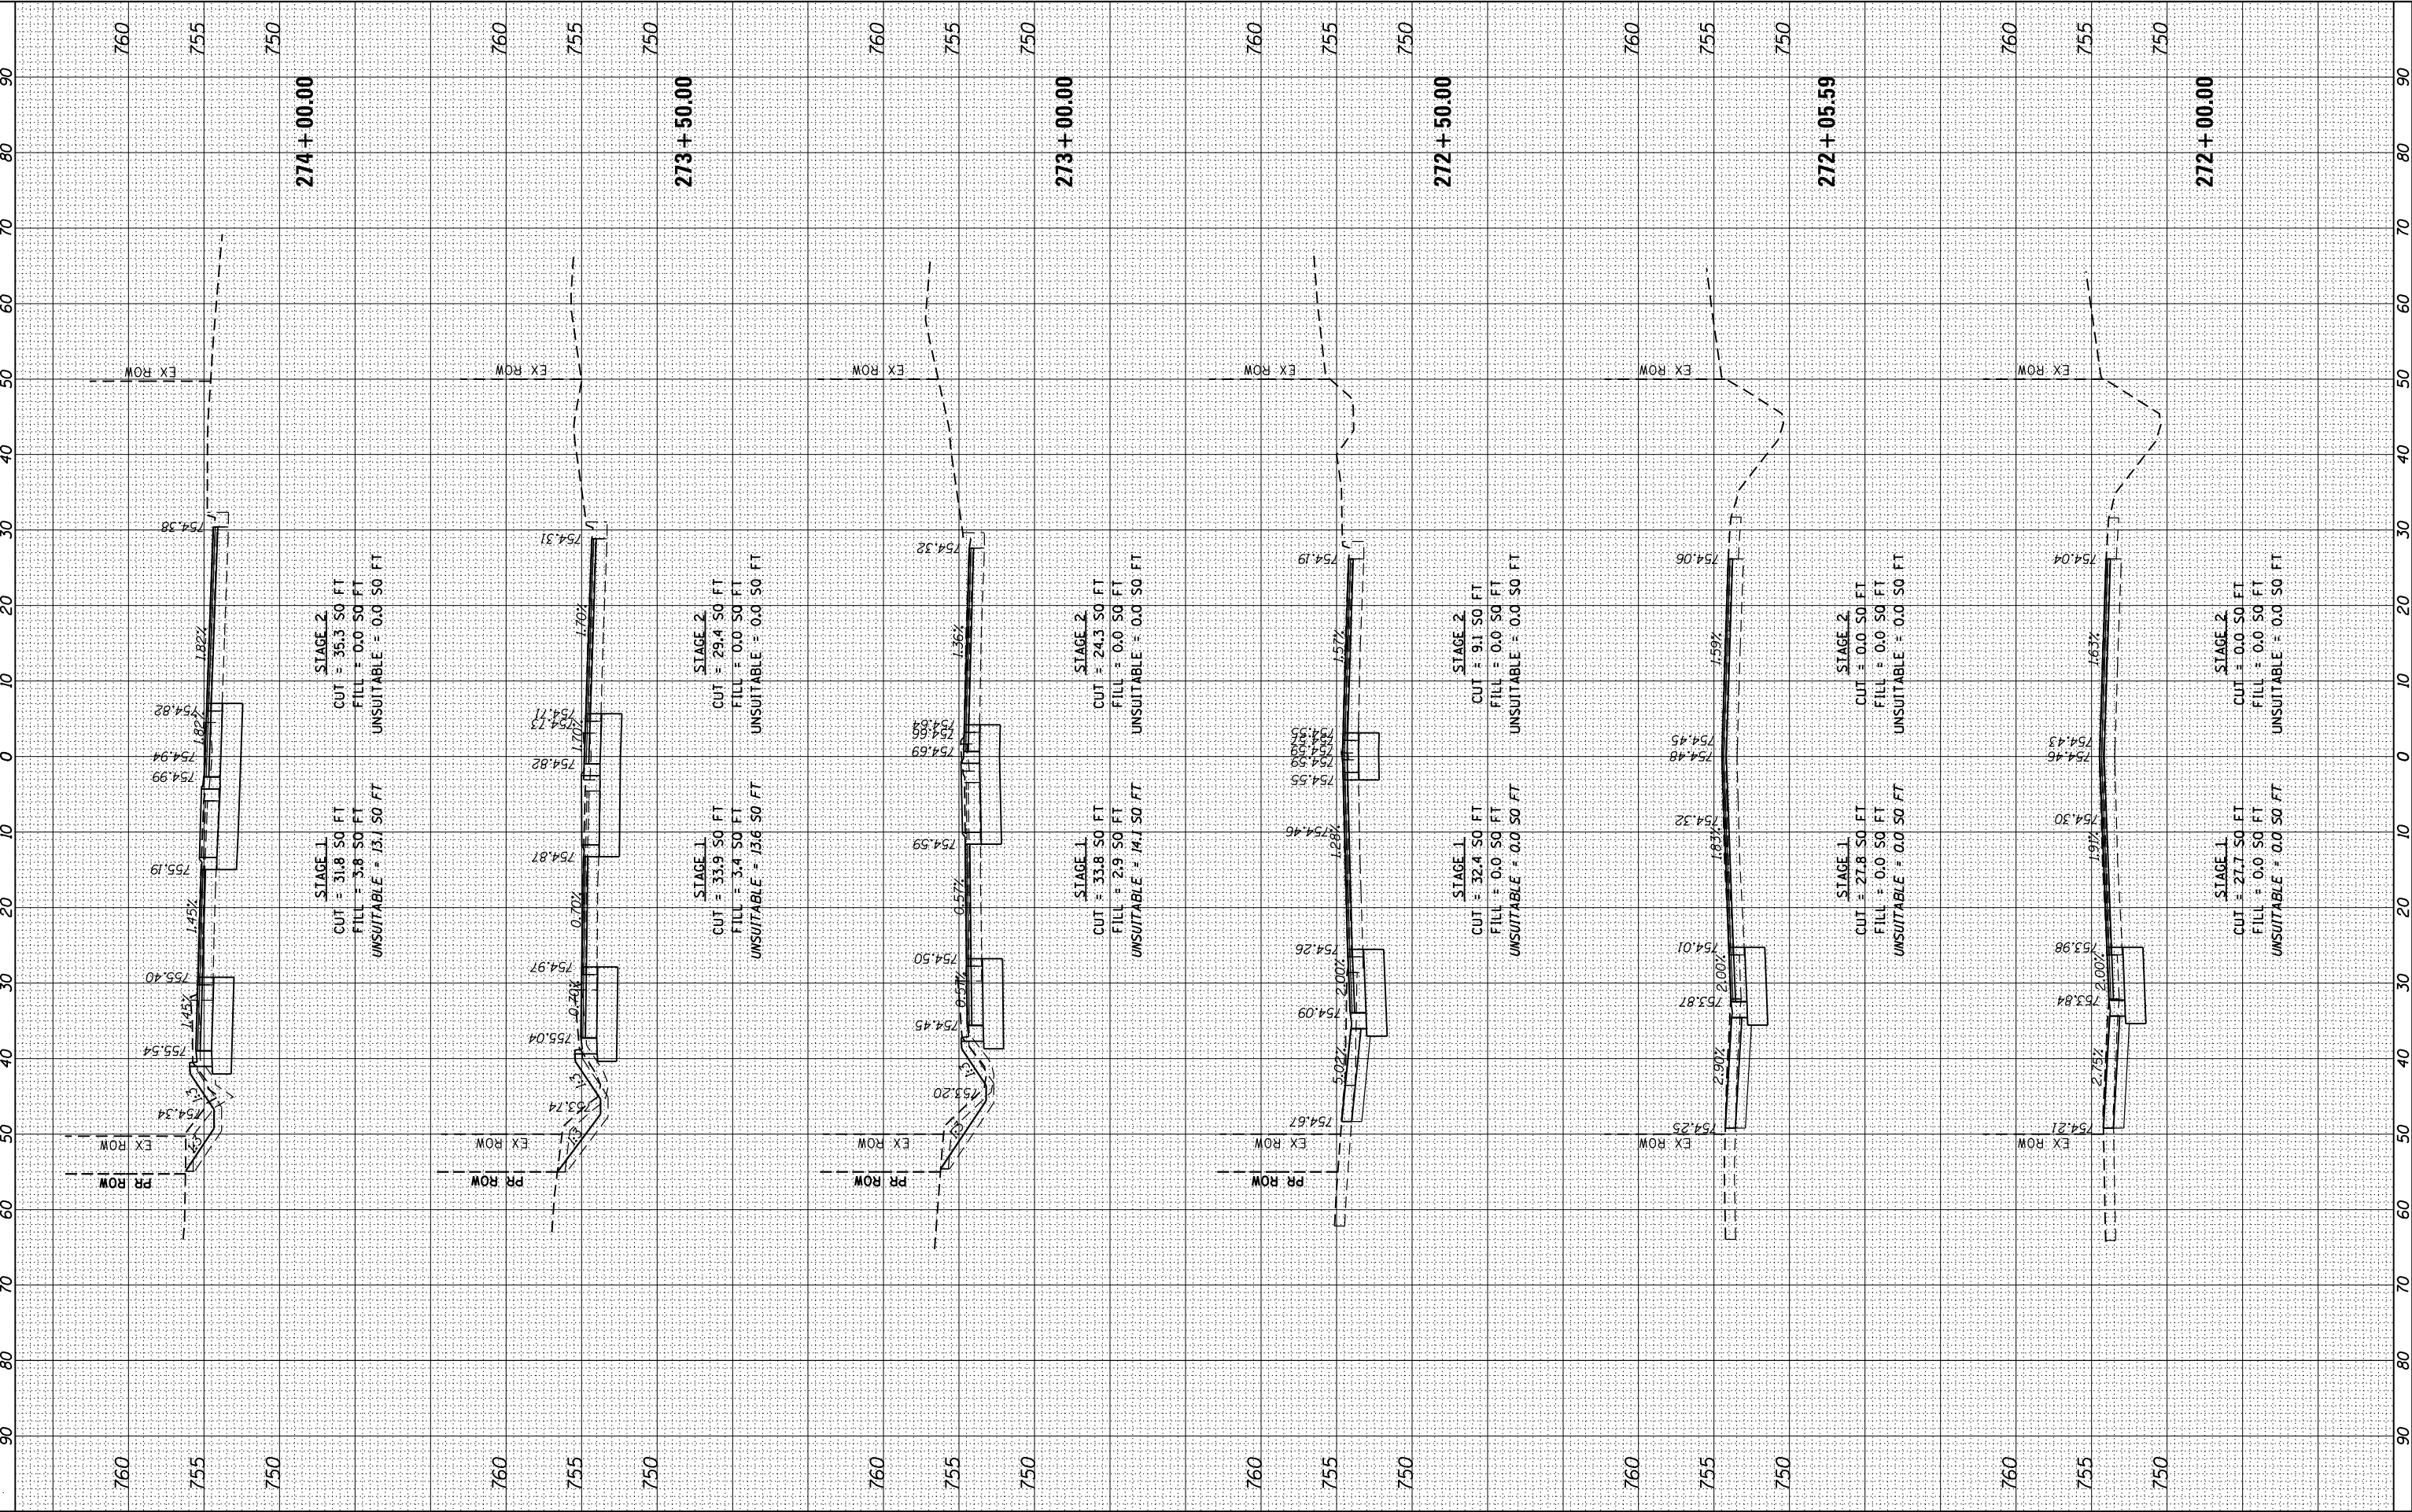

FINAL	SURVEYED	BY	DATE
SURVEY	PLOTTED		
NOTE BOOK	TEMPLATE		
NO.	AREAS CHECKED		

ORIGINAL	SURVEYED	BY	DATE
SURVEY	PLOTTED		
NOTE BOOK	TEMPLATE		
NO.	AREAS CHECKED		

FILE NAME = M:\151-045 DUDOT Lemont Rd\CA00 Streets\16-00232-00 CH12 cross sections 2.dgn

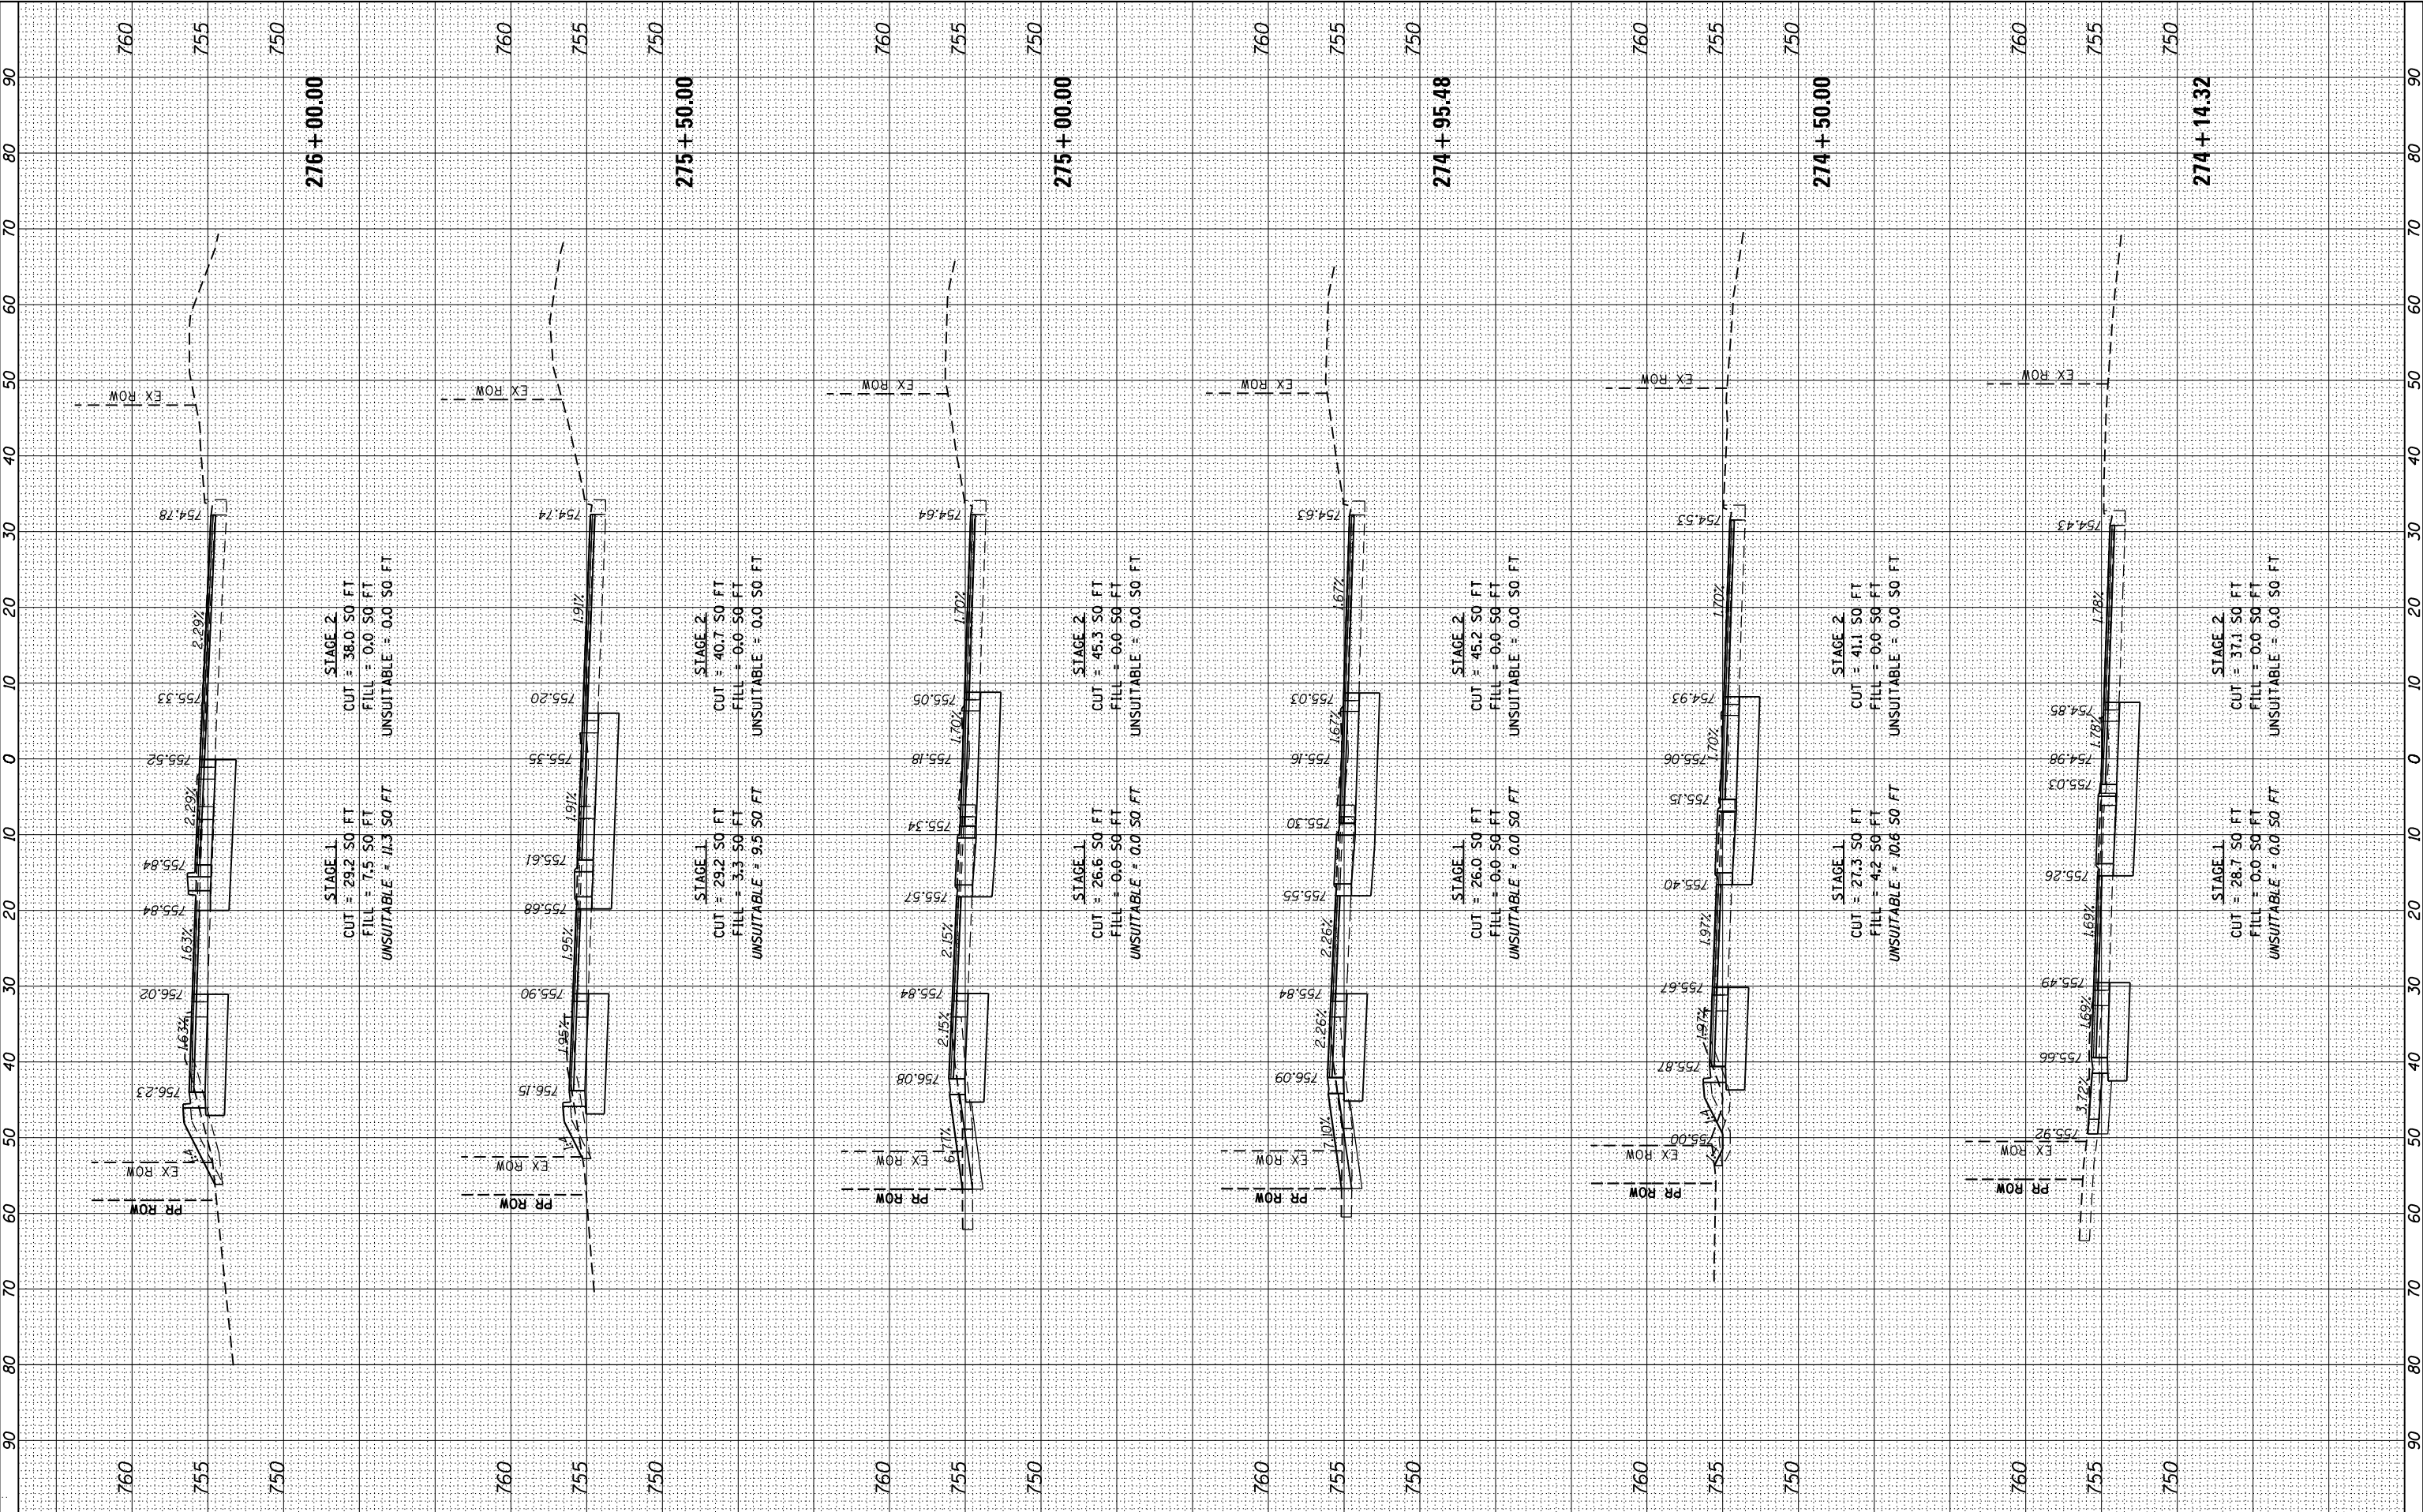

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PLOT SCALE = 20.0000' / in.	DRAWN - GJE	REVISED -
PLOT DATE = 8/31/2023	CHECKED - MTC	REVISED -
	DATE - 09/08/2023	REVISED -

STATE OF ILLINOIS
DEPARTMENT OF TRANSPORTATION

CROSS SECTIONS			
LEMONT ROAD			
1"=5' VERT.			
SCALE: 1"=10' HORIZ.	SHEET 3	OF 22 SHEETS	STA. 274+14.32 TO STA. 276+00.00

F.A.U. RTE.	SECTION	COUNTY	TOTAL SHEETS	SHEET NO.
2612	16-00232-00-CH	DUPAGE	248	227
CONTRACT NO. 61J01				

ILLINOIS FED. AID PROJECT

FINAL SURVEY	SURVEYED PLOTTED NOTE BOOK	BY	DATE
NO.	AREAS CHECKED		

ORIGINAL SURVEY	SURVEYED PLOTTED NOTE BOOK	BY	DATE
NO.	AREAS CHECKED		

FILE NAME = M:\451-945 DUDOT Lemont Rd\CA00 Streets\16-00232-00 CH\ht cross sections 2.dgn




USER NAME = cesario	DESIGNED - GJE	REVISED -
PLOT SCALE = 20.0000' / in.	DRAWN - GJE	REVISED -
PLOT DATE = 8/31/2023	CHECKED - MTC	REVISED -
	DATE - 09/08/2023	REVISED -

STATE OF ILLINOIS
DEPARTMENT OF TRANSPORTATION

CROSS SECTIONS
LEMONT ROAD

1"=5' VERT.
SCALE: 1"=10' HORZ. SHEET 4 OF 22 SHEETS STA. 276+50.00 TO STA. 279+00.00

F.A.U RTE.	SECTION	COUNTY	TOTAL SHEETS	SHEET NO.
2612	16-00232-00-CH	DUPAGE	248	228
CONTRACT NO. 61J01				
ILLINOIS FED. AID PROJECT				

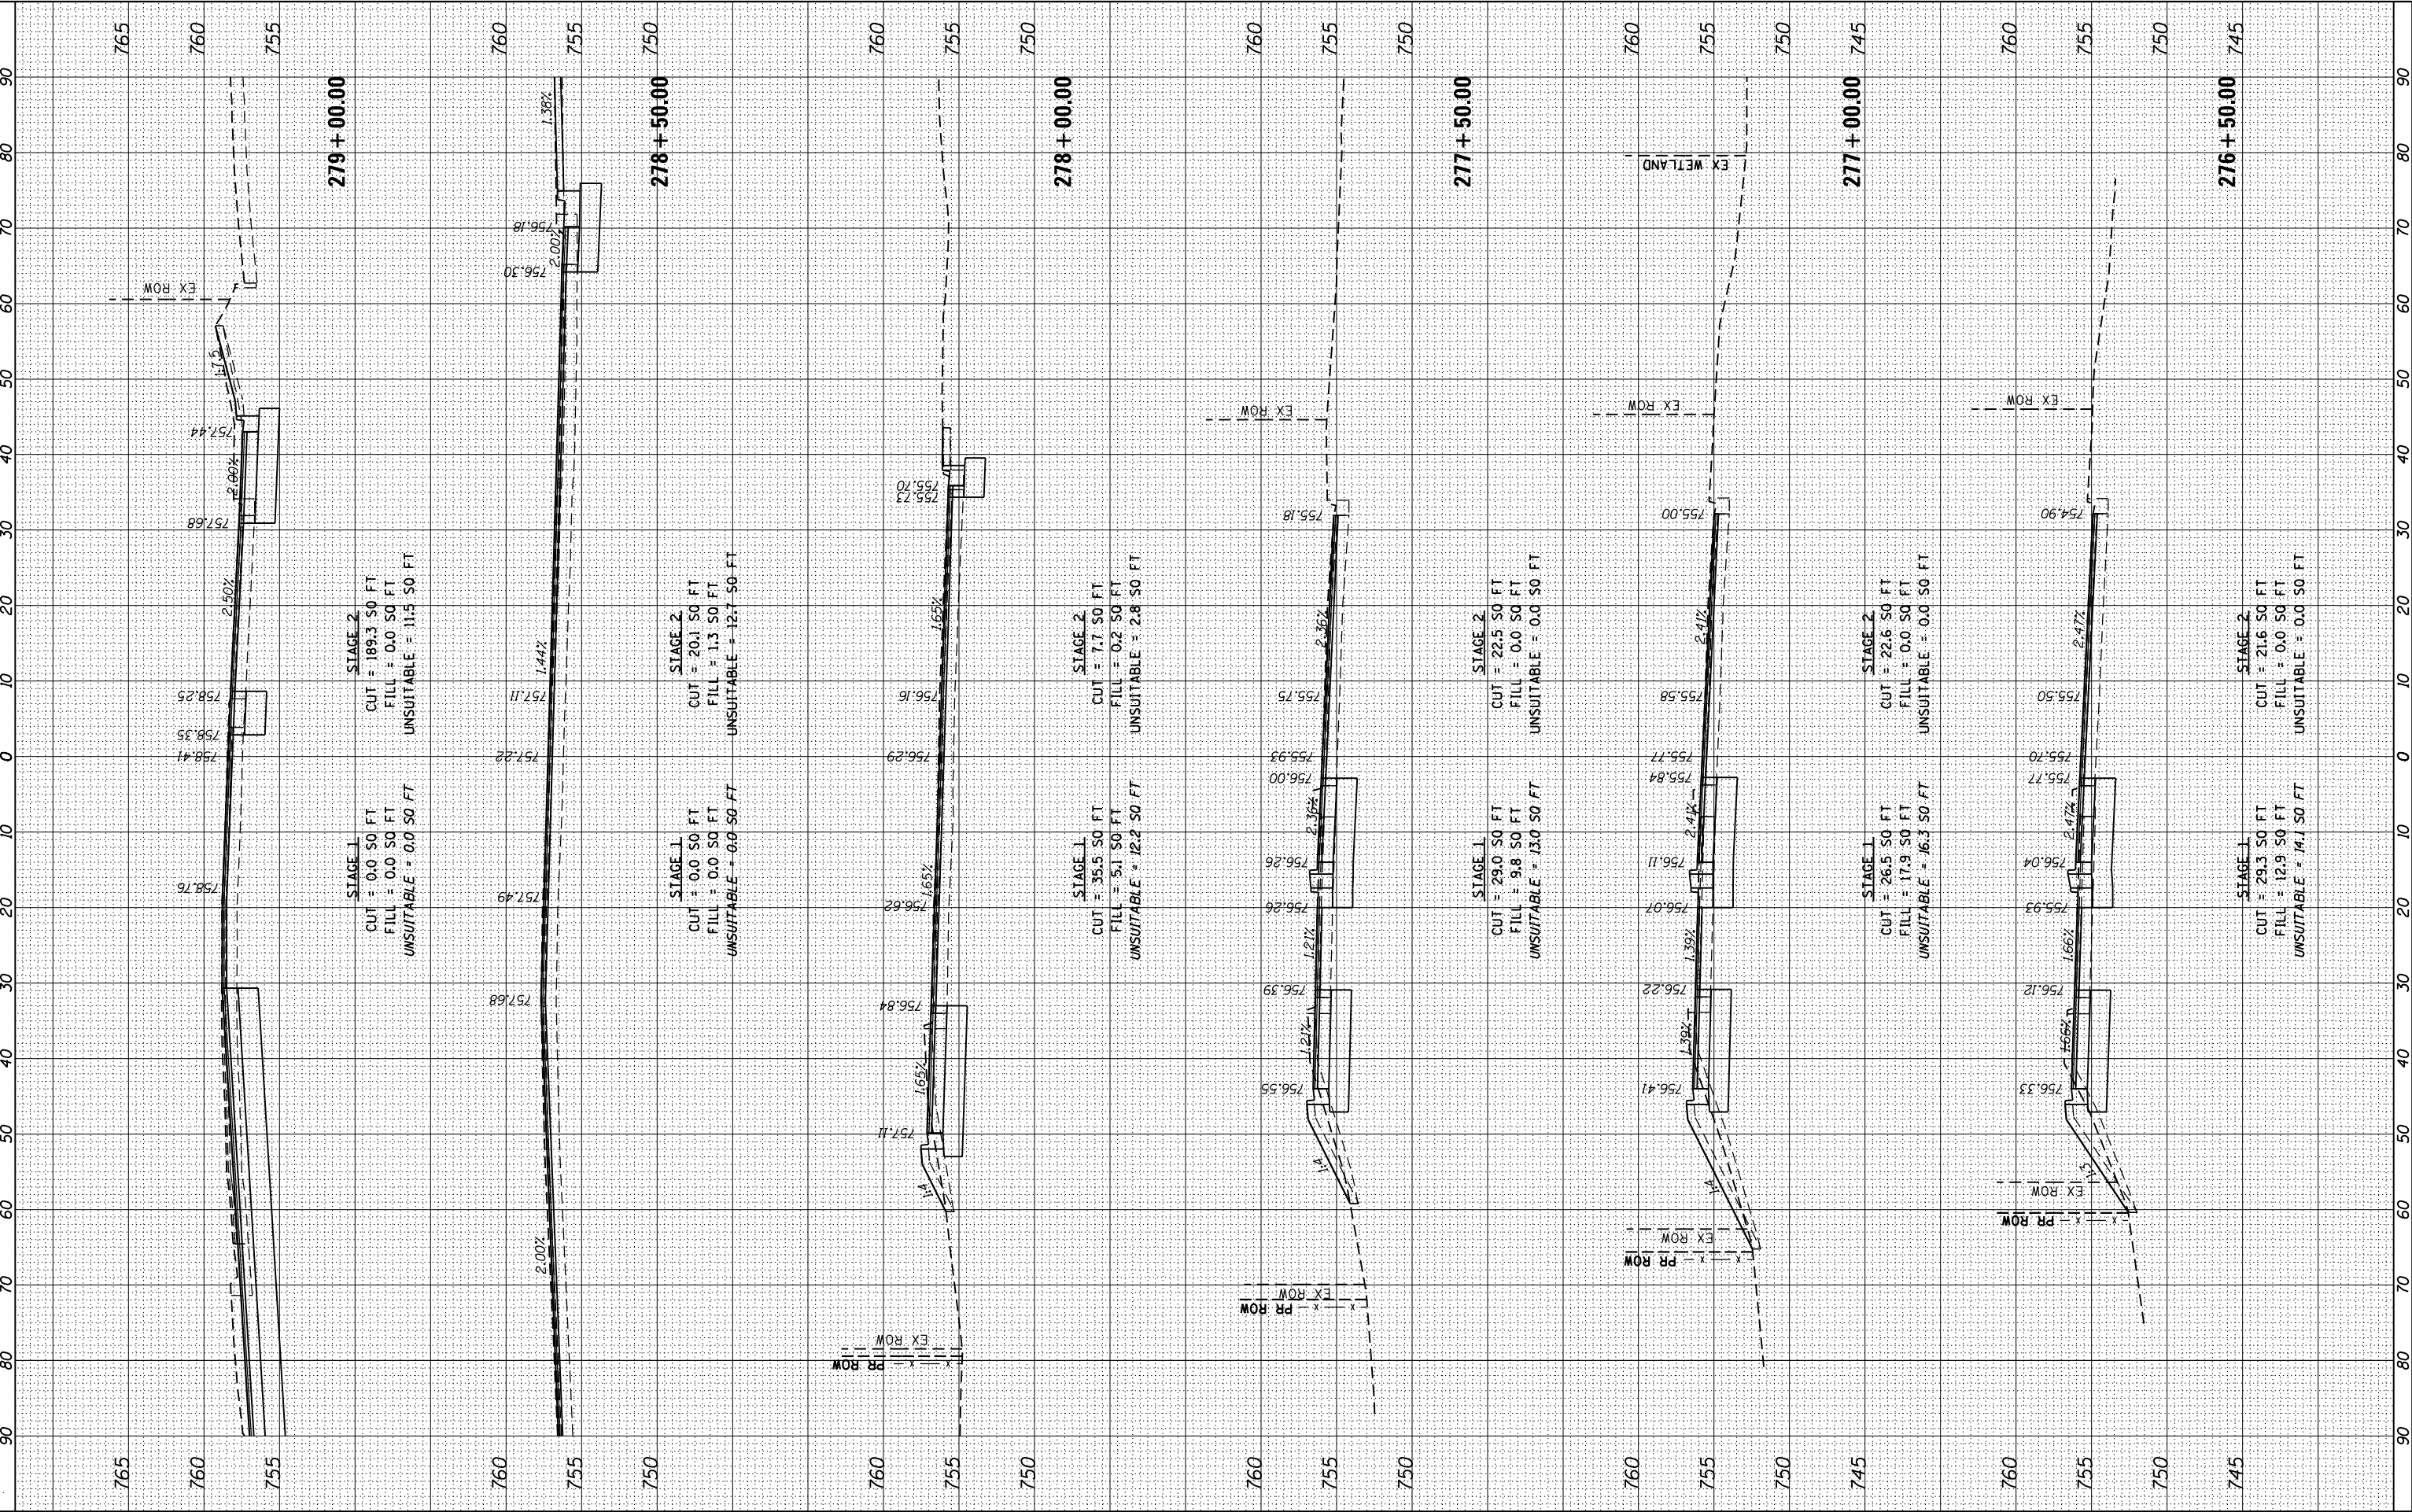

FINL SURVEY NOTE BOOK NO.	SURVEYED PLOTTED TEMPLATE AREAS CHECKED	BY	DATE

ORIGINAL SURVEY NOTE BOOK NO.	SURVEYED PLOTTED TEMPLATE AREAS CHECKED	BY	DATE

FILE NAME = M:\451-046 DUDOT Lemont Rd\CA001 Streets\16-00232-00-CH.dwg sections 2.dgn



USER NAME = cesario	DESIGNED - GJE	REVISED -
PLOT SCALE = 20.0000 ' / in.	DRAWN - GJE	REVISED -
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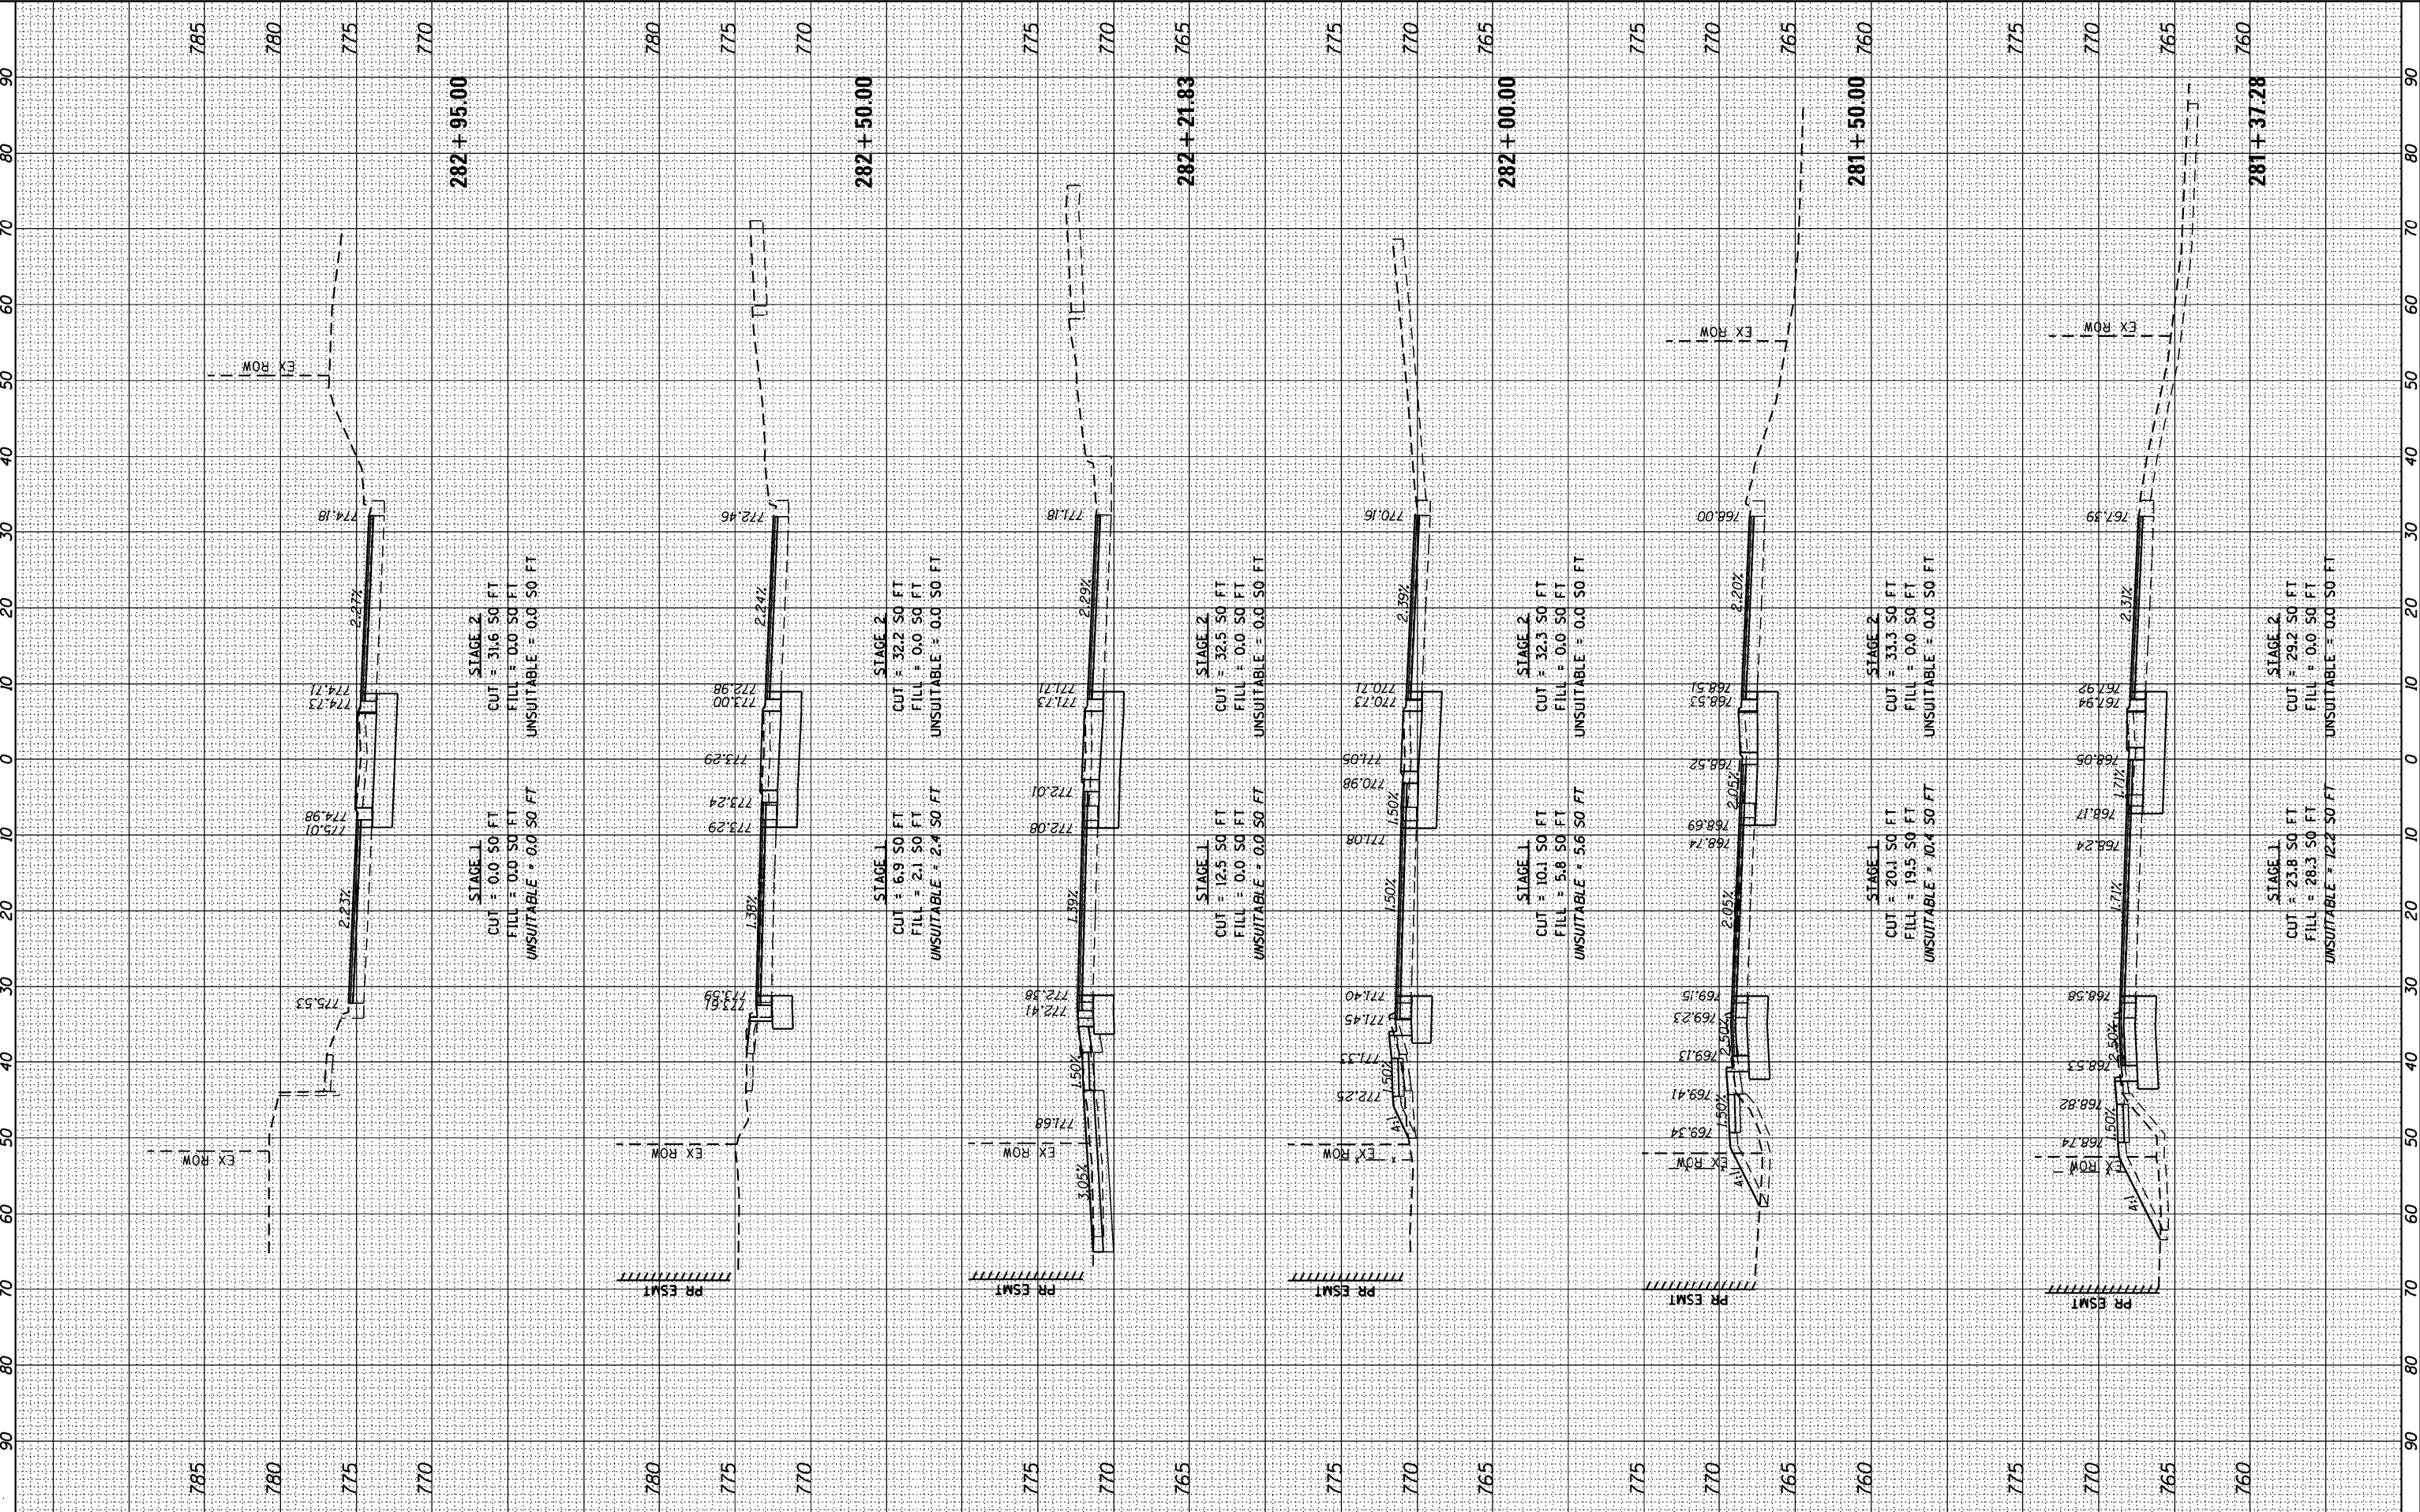
STATE OF ILLINOIS
DEPARTMENT OF TRANSPORTATION

1"=5' VERT.
SCALE: 1"=10' HORZ.

CROSS SECTIONS
LEMONT ROAD

SHEET 6 OF 22 SHEETS STA. 281+37.28 TO STA. 282+95.00

F.A.U RTE.	SECTION	COUNTY	TOTAL SHEETS	SHEET NO.
2612	16-00232-00-CH	DUPAGE	248	230
CONTRACT NO. 61J01				
ILLINOIS FED. AID PROJECT				



FINAL SURVEY	SURVEYED PLOTTED NOTE BOOK	BY	DATE

ORIGINAL SURVEY	SURVEYED PLOTTED NOTE BOOK	BY	DATE

FILE NAME = M:\451-945 D\DOT Lemont Rd\CA00 Streets\16-00232-00 CH\ht cross sections 2.dgn




USER NAME = cesario	DESIGNED - GJE	REVISED -
PLOT SCALE = 20.0000 ' / in.	DRAWN - GJE	REVISED -
PLOT DATE = 8/31/2023	CHECKED - MTC	REVISED -
	DATE - 09/08/2023	REVISED -

STATE OF ILLINOIS
DEPARTMENT OF TRANSPORTATION

CROSS SECTIONS LEMONT ROAD			
1'=5' VERT.	OF 22 SHEETS	STA. 292+50.00	TO STA. 301+77.22
SCALE: 1'=10' HORZ.	SHEET		


F.A.U RTE.	SECTION	COUNTY	TOTAL SHEETS	SHEET NO.
2612	16-00232-00-CH	DUPAGE	248	232
CONTRACT NO. 61J01				
ILLINOIS FED. AID PROJECT				

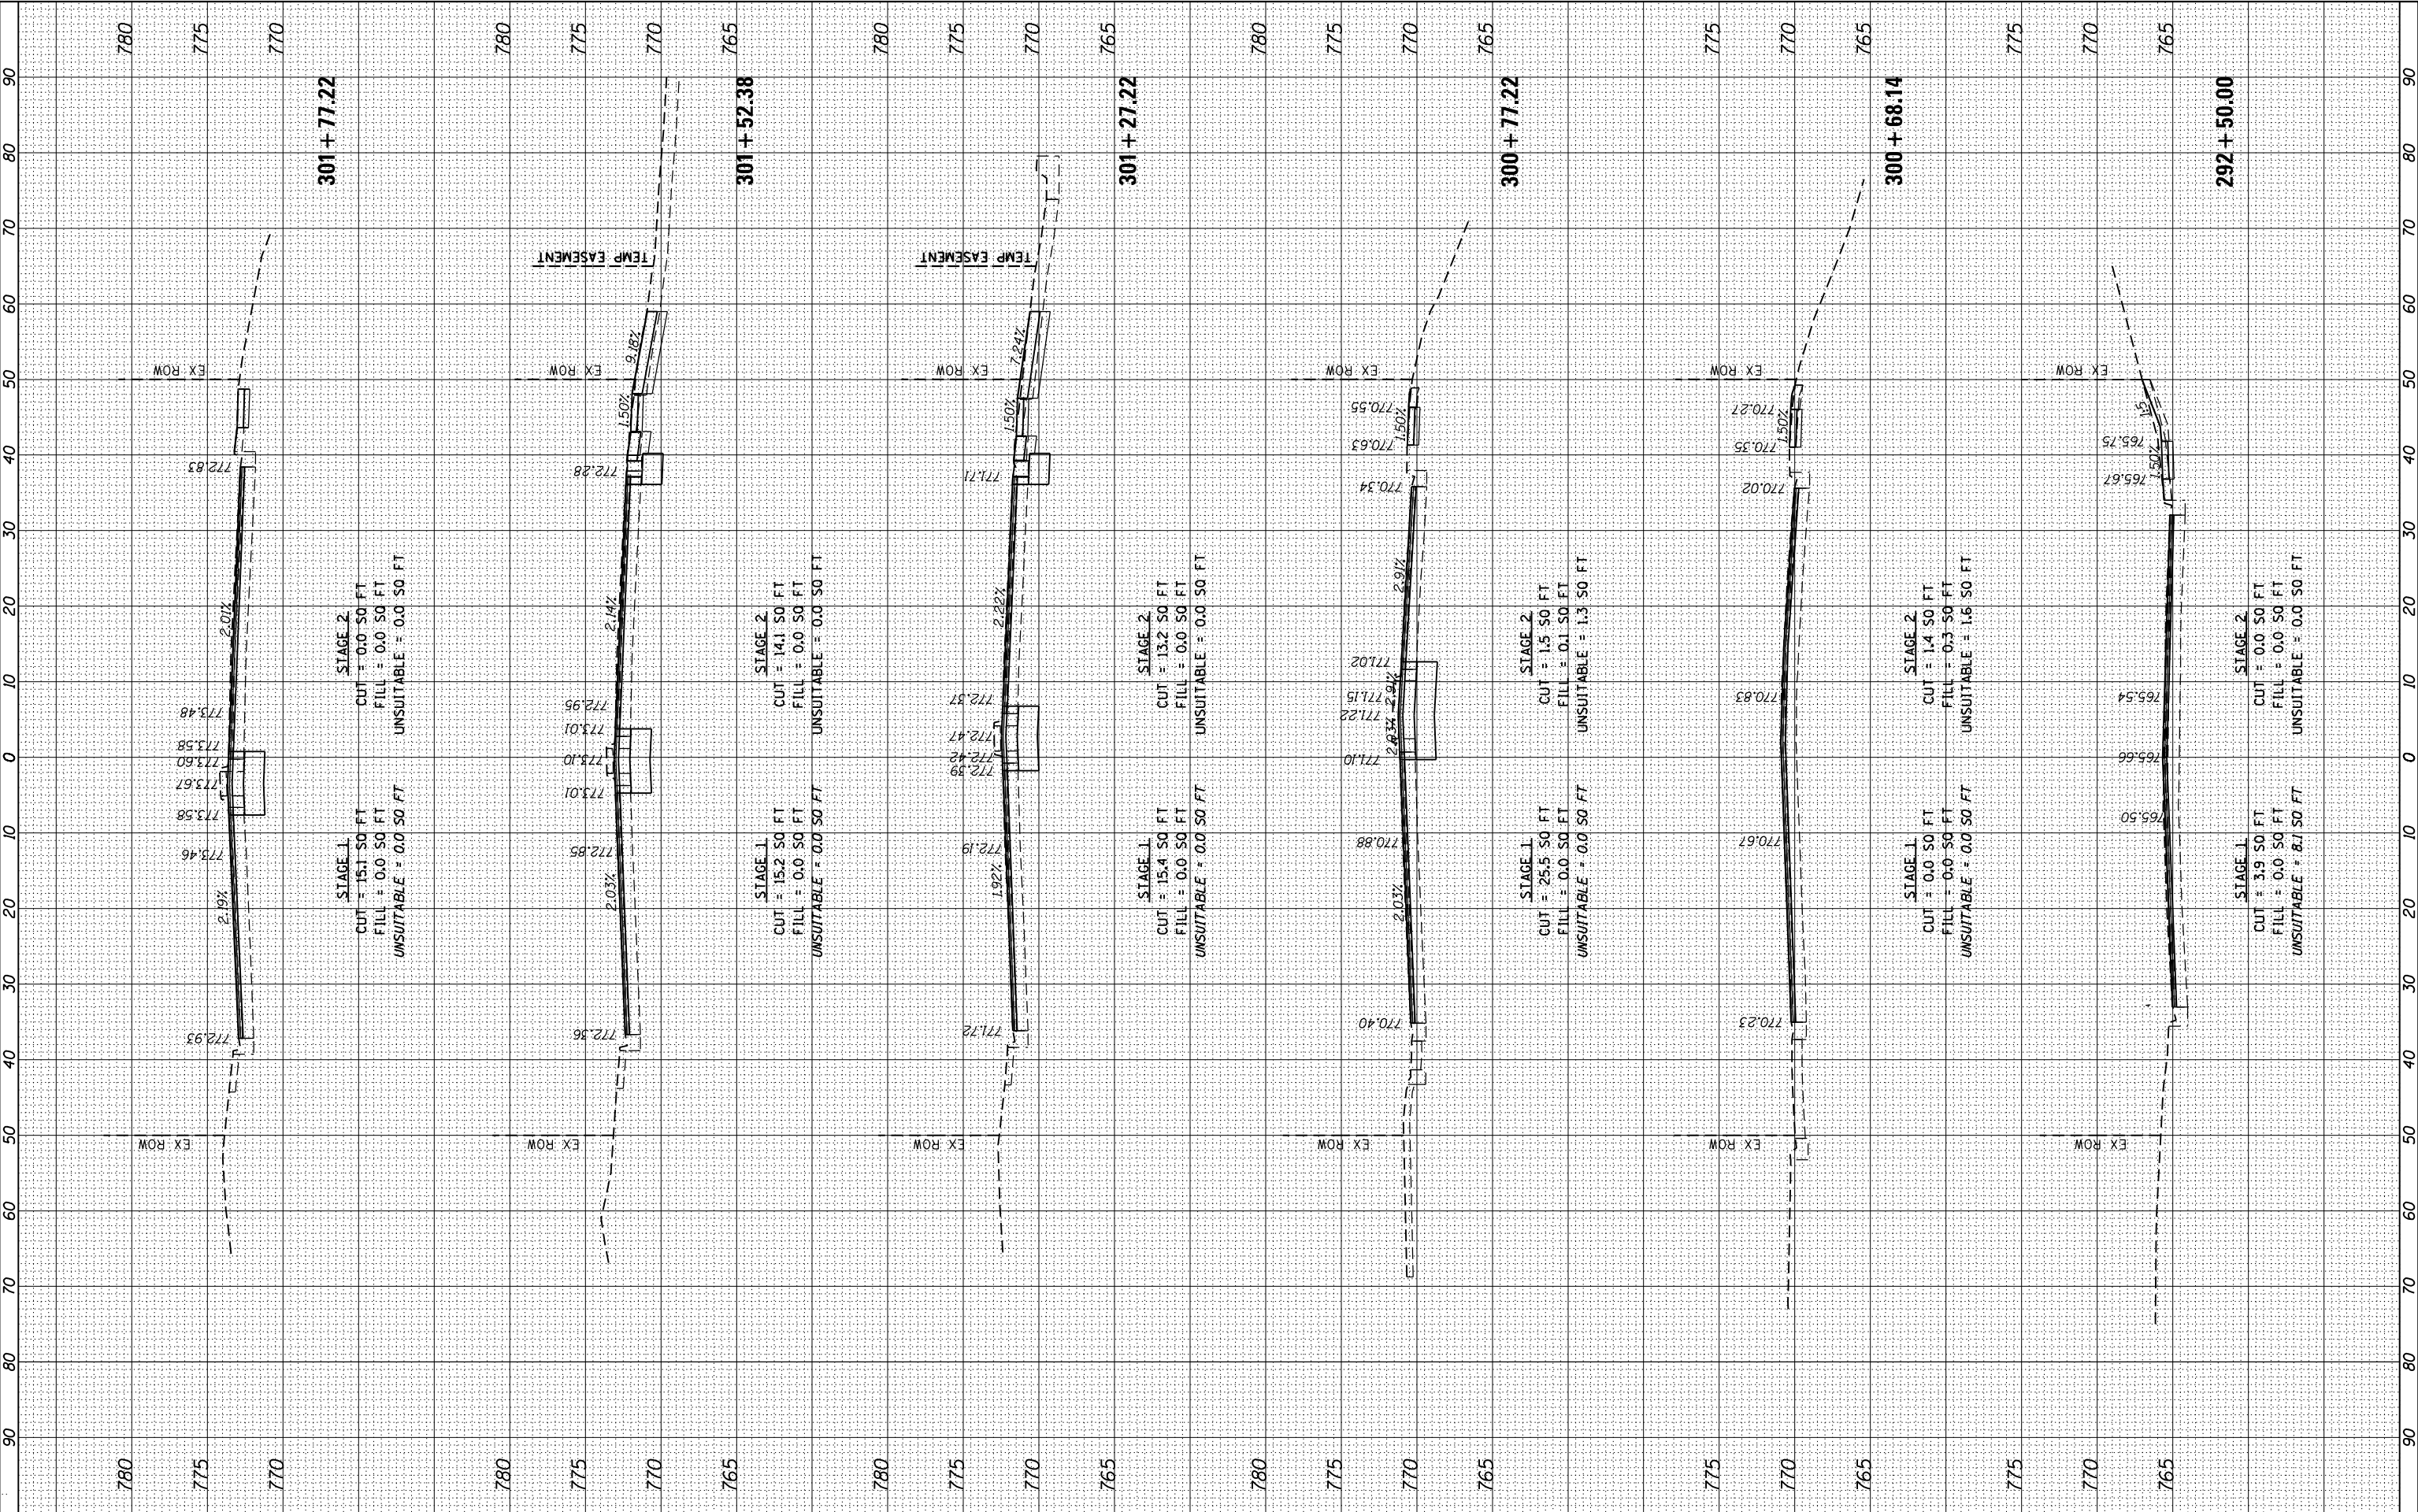

FINAL SURVEY NOTE BOOK NO.	SURVEYED PLOTTED TEMPLATE AREAS CHECKED	BY	DATE

ORIGINAL SURVEY NOTE BOOK NO.	SURVEYED PLOTTED TEMPLATE AREAS CHECKED	BY	DATE

FILE NAME = M:\451-946 DUDOT Lemont Rd\CA00 Streets\16-00232-00 CH\ht cross sections 2.dgn

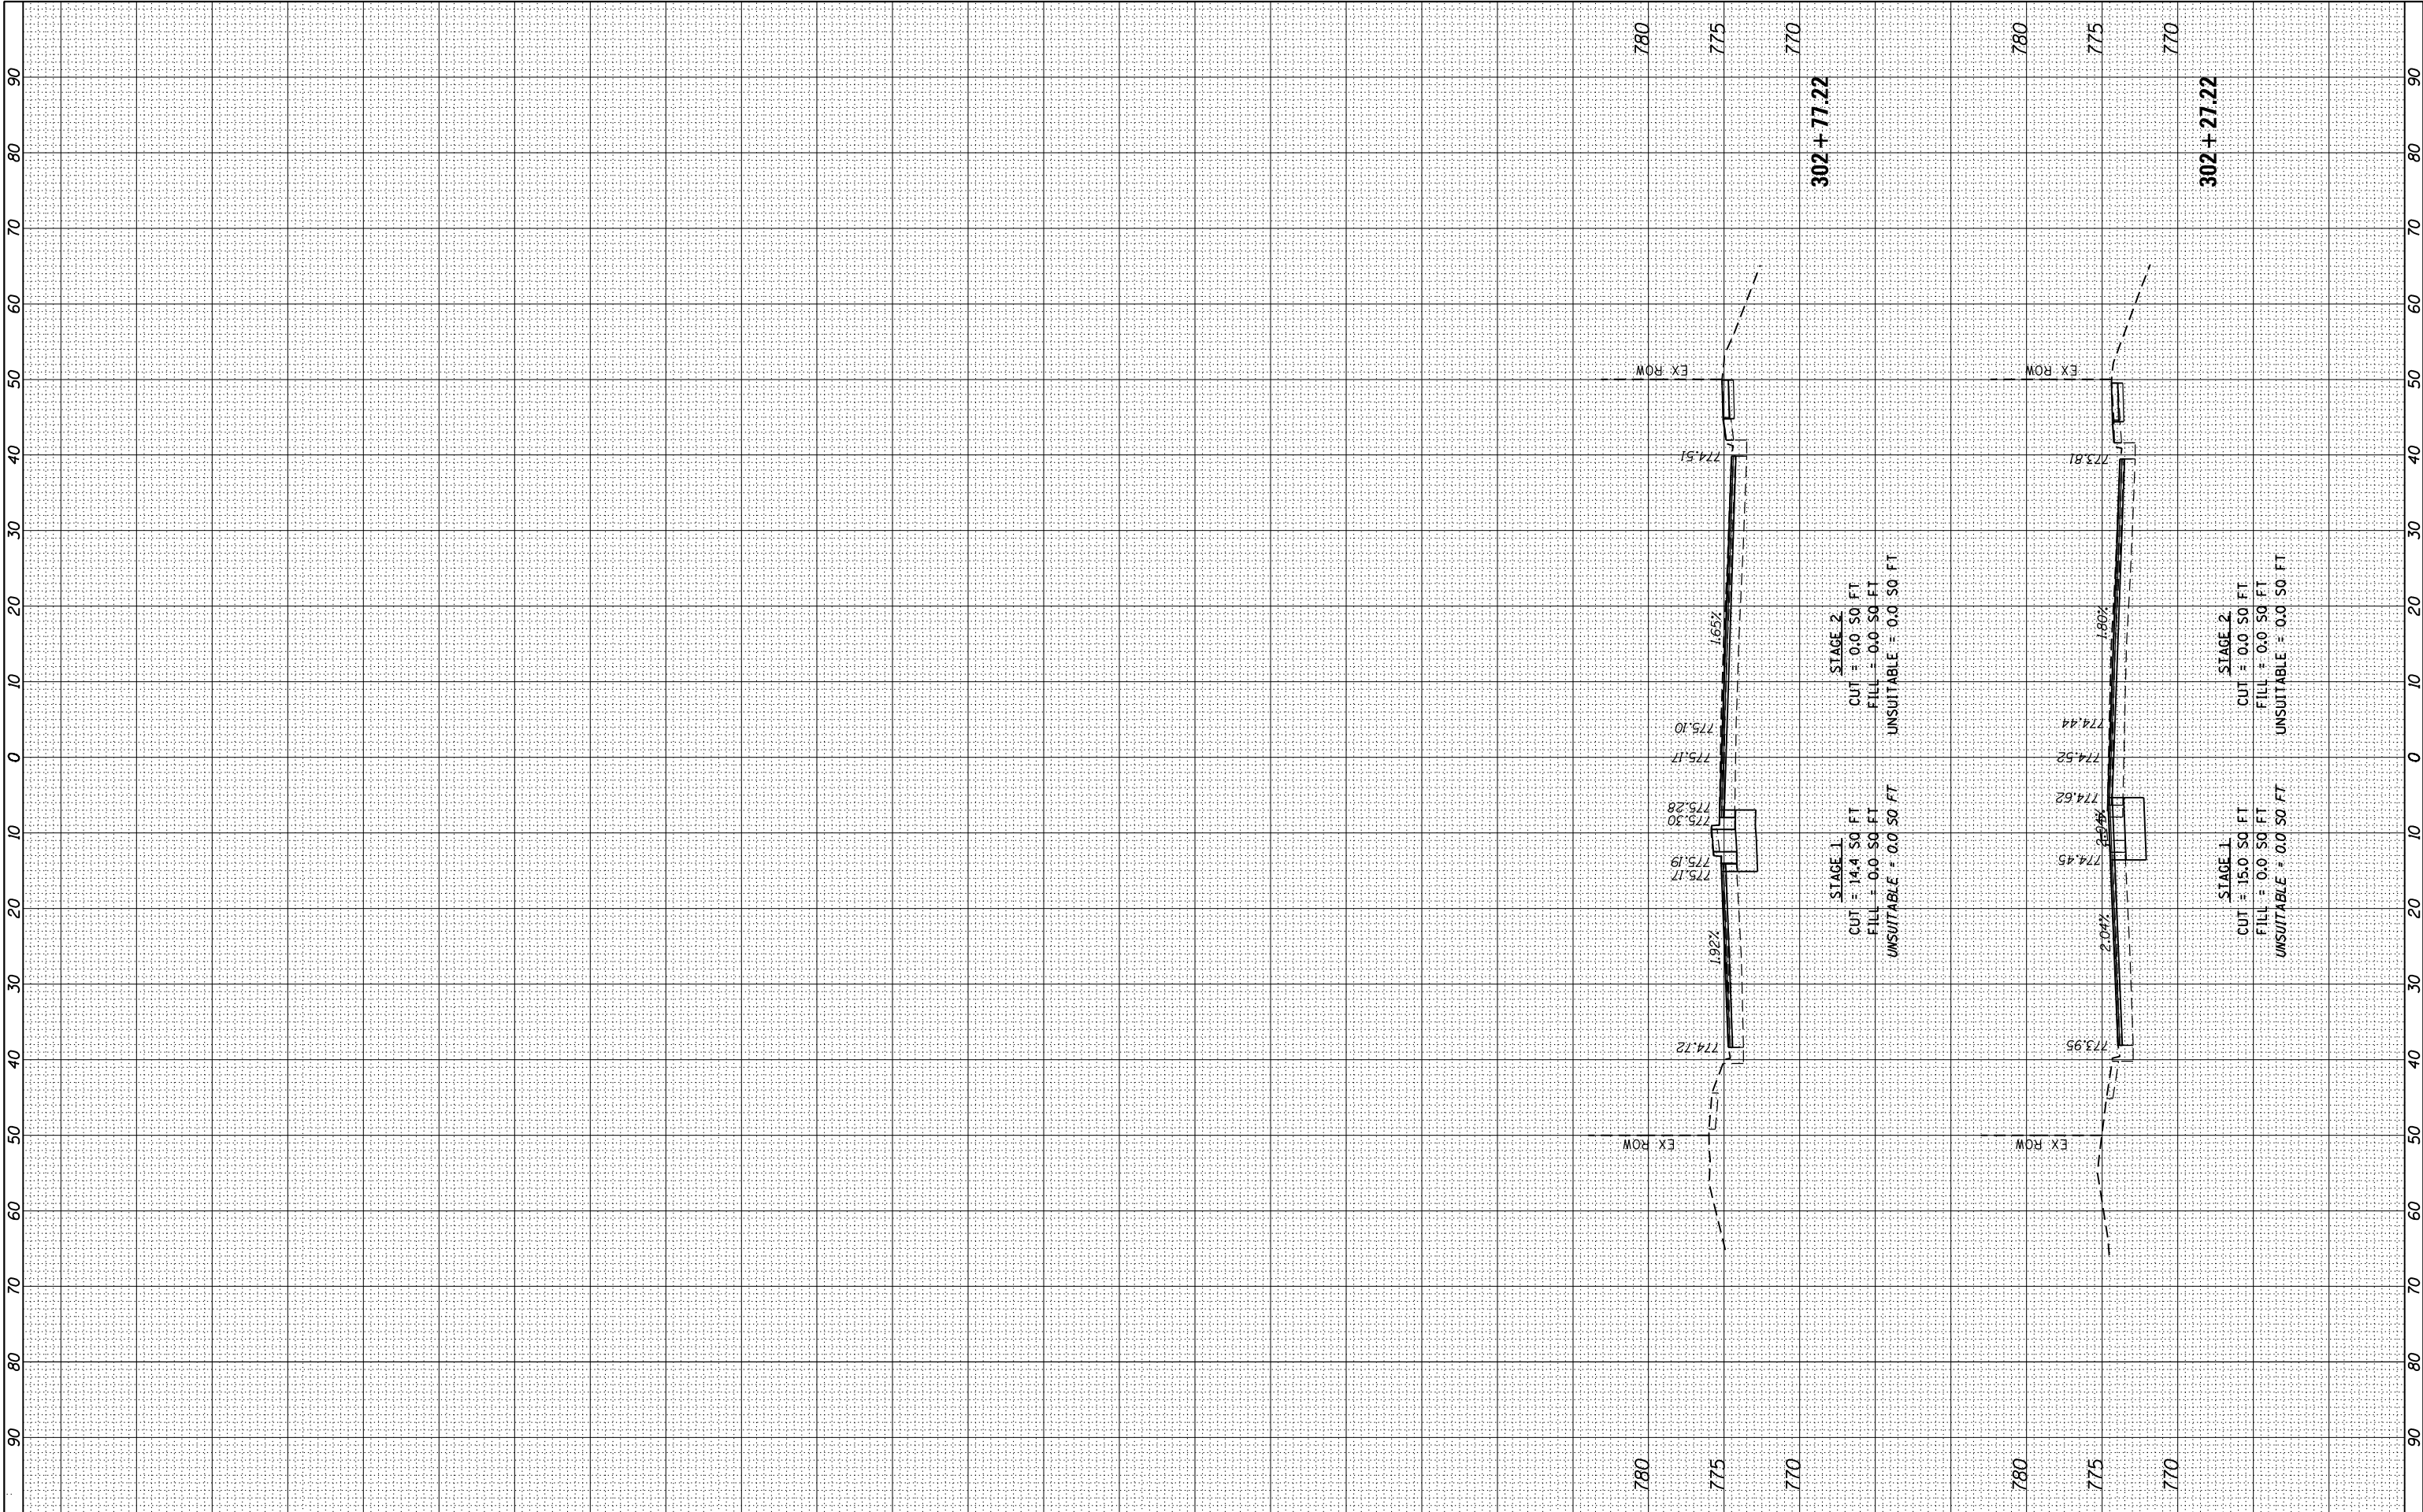

USER NAME = cesario

DESIGNED - GJE

DRAWN - GJE

CHECKED - MTC

DATE - 09/08/2023

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STATE OF ILLINOIS

DEPARTMENT OF TRANSPORTATION

1"=5' VERT.

SCALE: 1"=10' HORZ.

CROSS SECTIONS

LEMONT ROAD

1"=10' HORZ.

SHEET

OF 22 SHEETS

STA. 302+27.22 TO STA. 302+77.22

F.A.U. RTE.

2612

SECTION

16-00232-00-CH

COUNTY

DUPAGE

TOTAL SHEETS

248

SHEET NO.

233

CONTRACT NO. 61J01

ILLINOIS FED. AID PROJECT

FINAL SURVEY NOTE BOOK NO.	SURVEYED PLOTTED TEMPLATE AREAS CHECKED	BY	DATE

ORIGINAL SURVEY NOTE BOOK NO.	SURVEYED PLOTTED TEMPLATE AREAS CHECKED	BY	DATE

FILE NAME = W:\451-946 DUDOT Lemont Rd\CA00 Sheets\16-00232-00 CH.dwg




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PLOT DATE = 8/31/2023	CHECKED - MTC	REVISED -
	DATE - 09/08/2023	REVISED -

STATE OF ILLINOIS
DEPARTMENT OF TRANSPORTATION

CROSS SECTIONS LEMONT ROAD			
1"=5' VERT.			
SCALE: 1"=10' HORIZ.	SHEET 8	OF 22 SHEETS	STA. 303+00.00 TO STA. 304+50.00

F.A.U. RTE.	SECTION	COUNTY	TOTAL SHEETS	SHEET NO.
2612	16-00232-00-CH	DUPAGE	248	234
CONTRACT NO. 61J01				
ILLINOIS FED. AID PROJECT				

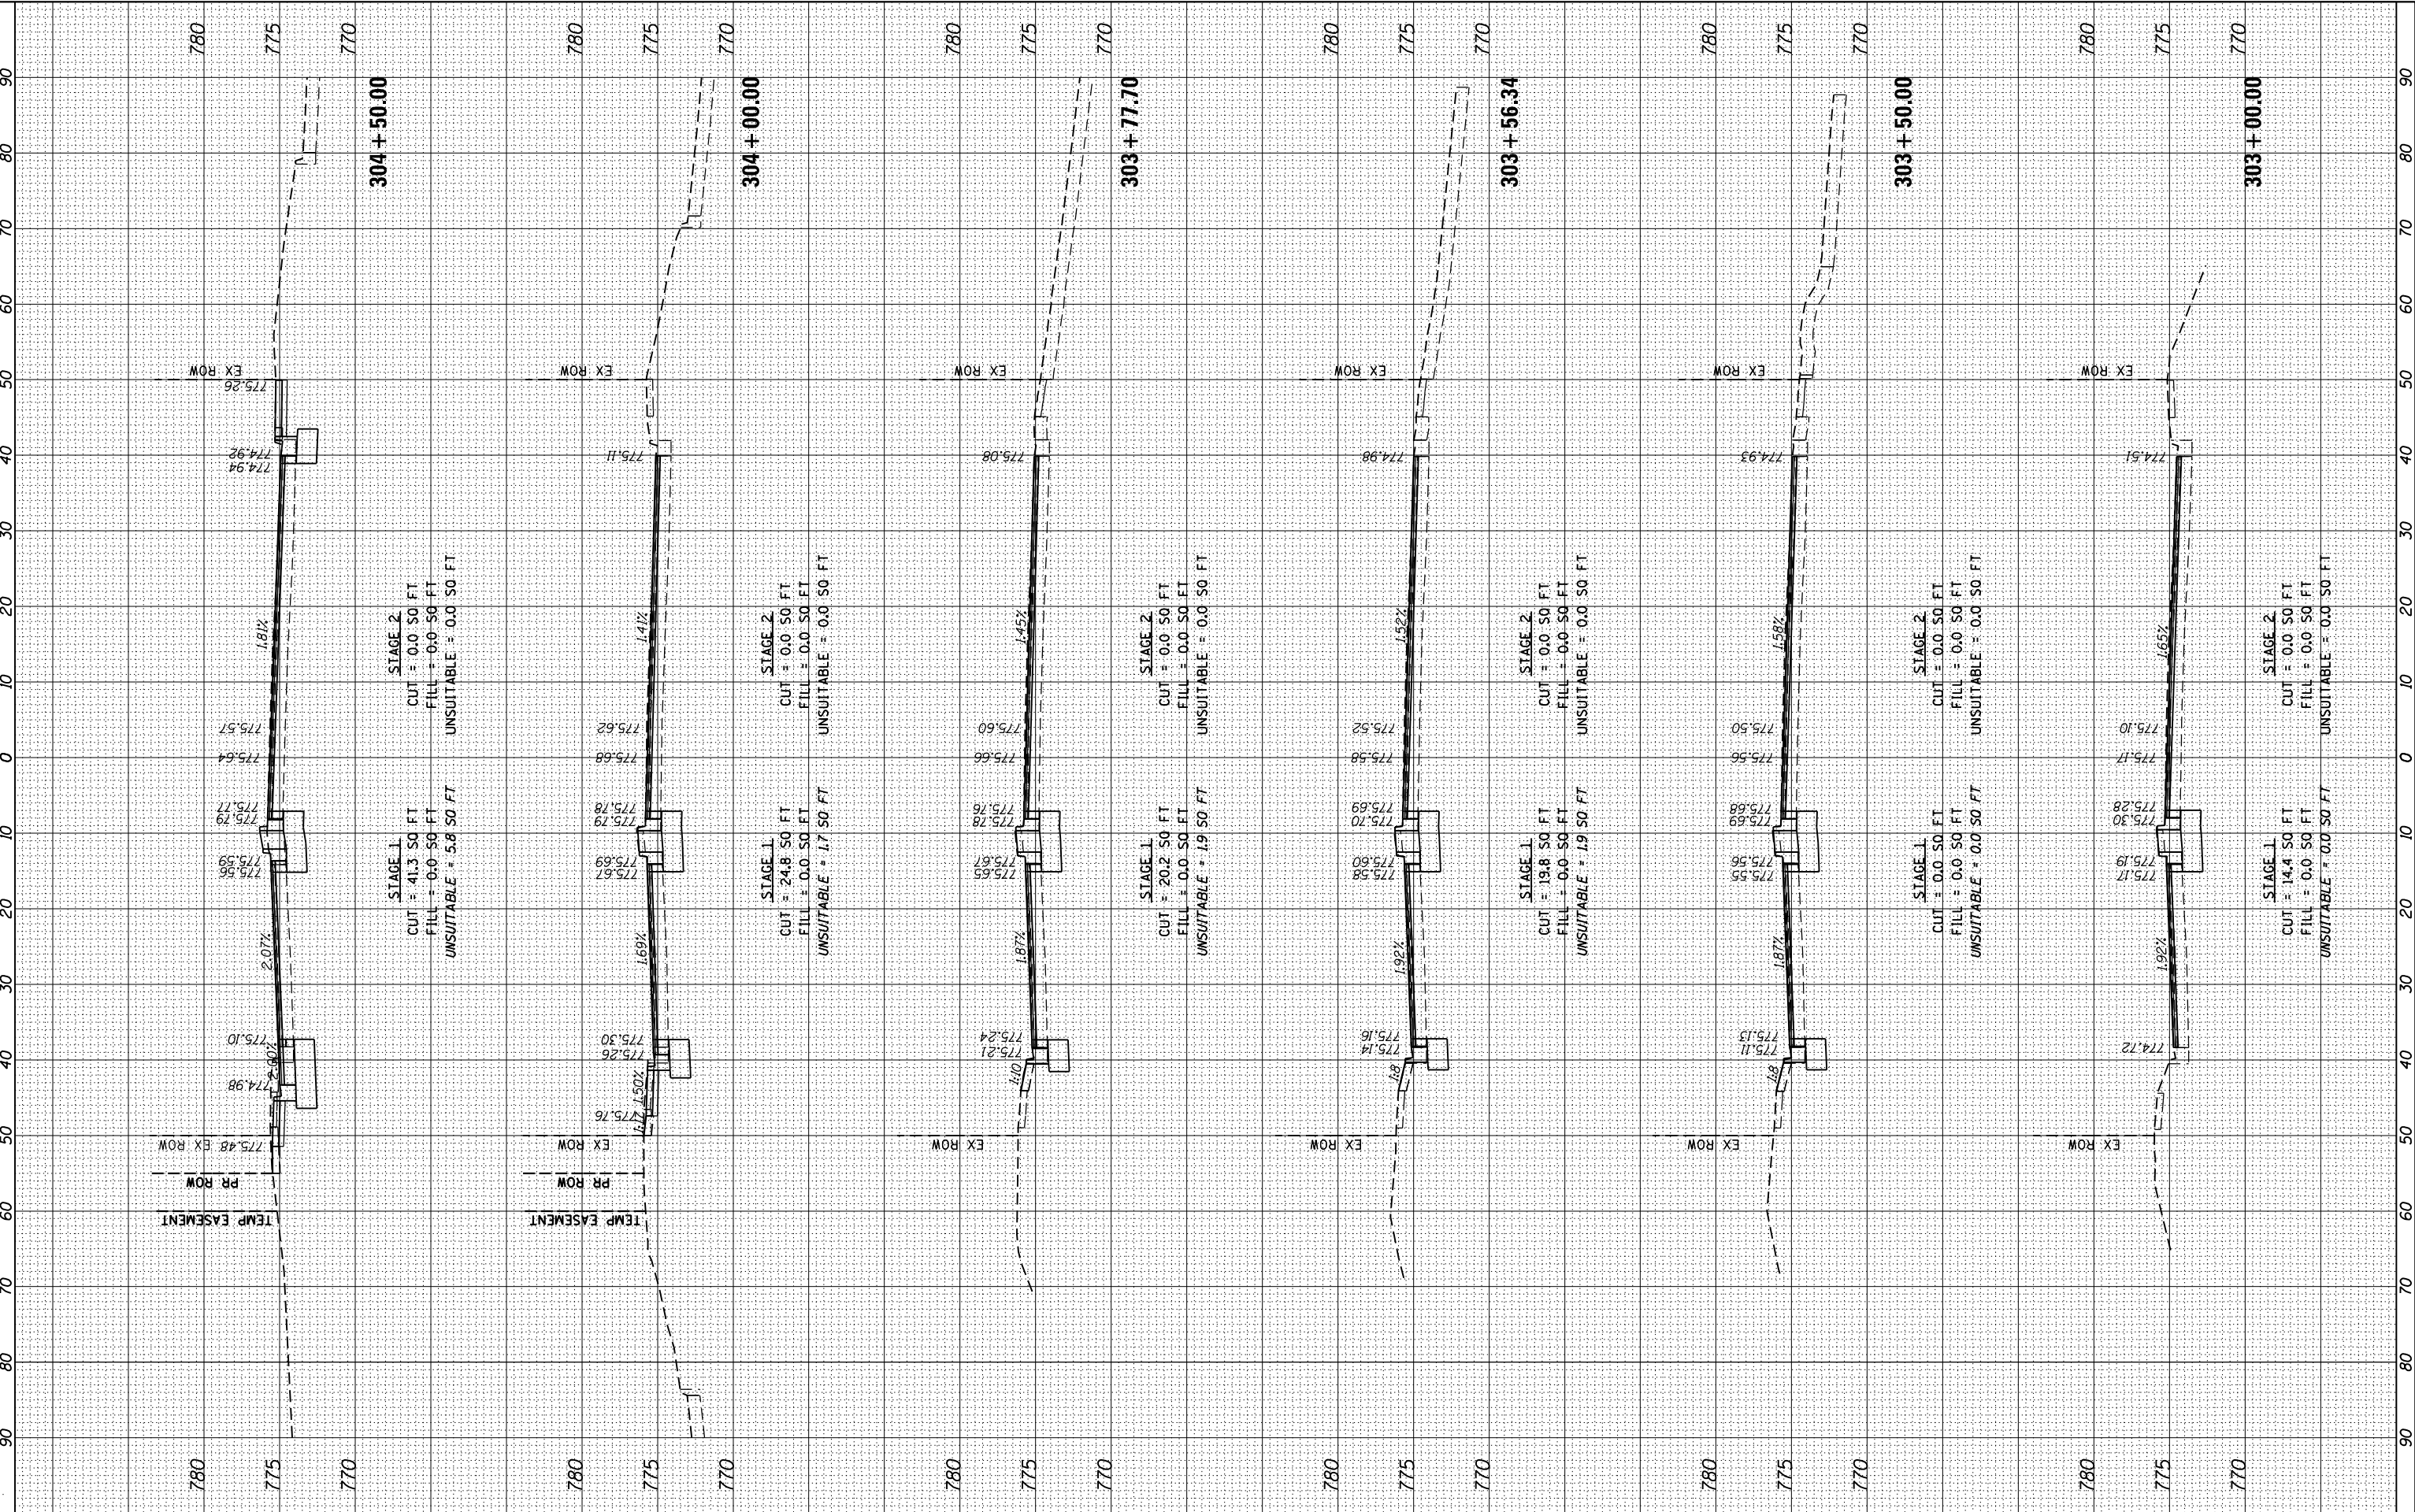

FINAL SURVEY	SURVEYED PLOTTED NOTE BOOK	BY	DATE
NO.	AREAS CHECKED		

ORIGINAL SURVEY	SURVEYED PLOTTED NOTE BOOK	BY	DATE
NO.	AREAS CHECKED		

FILE NAME = W:\451-946 DUDOT Lemont Rd\CA000 Sheets\16-00232-00 CH Light cross sections 2.dgn



USER NAME = cesario
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PLOT DATE = 8/31/2023

DESIGNED - GJE
DRAWN - GJE
CHECKED - MTC
DATE - 09/08/2023


REVISED -
REVISED -
REVISED -
REVISED -

STATE OF ILLINOIS
DEPARTMENT OF TRANSPORTATION

1"=5' VERT.
SCALE: 1"=10' HORZ. SHEET 9 OF 22 SHEETS STA. 305+00.00 TO STA. 308+80.00

CROSS SECTIONS
LEMONT ROAD

F.A.U. RTE.	SECTION	COUNTY	TOTAL SHEETS	SHEET NO.
2612	16-00232-00-CH	DUPAGE	248	235
CONTRACT NO. 61J01				
ILLINOIS FED. AID PROJECT				

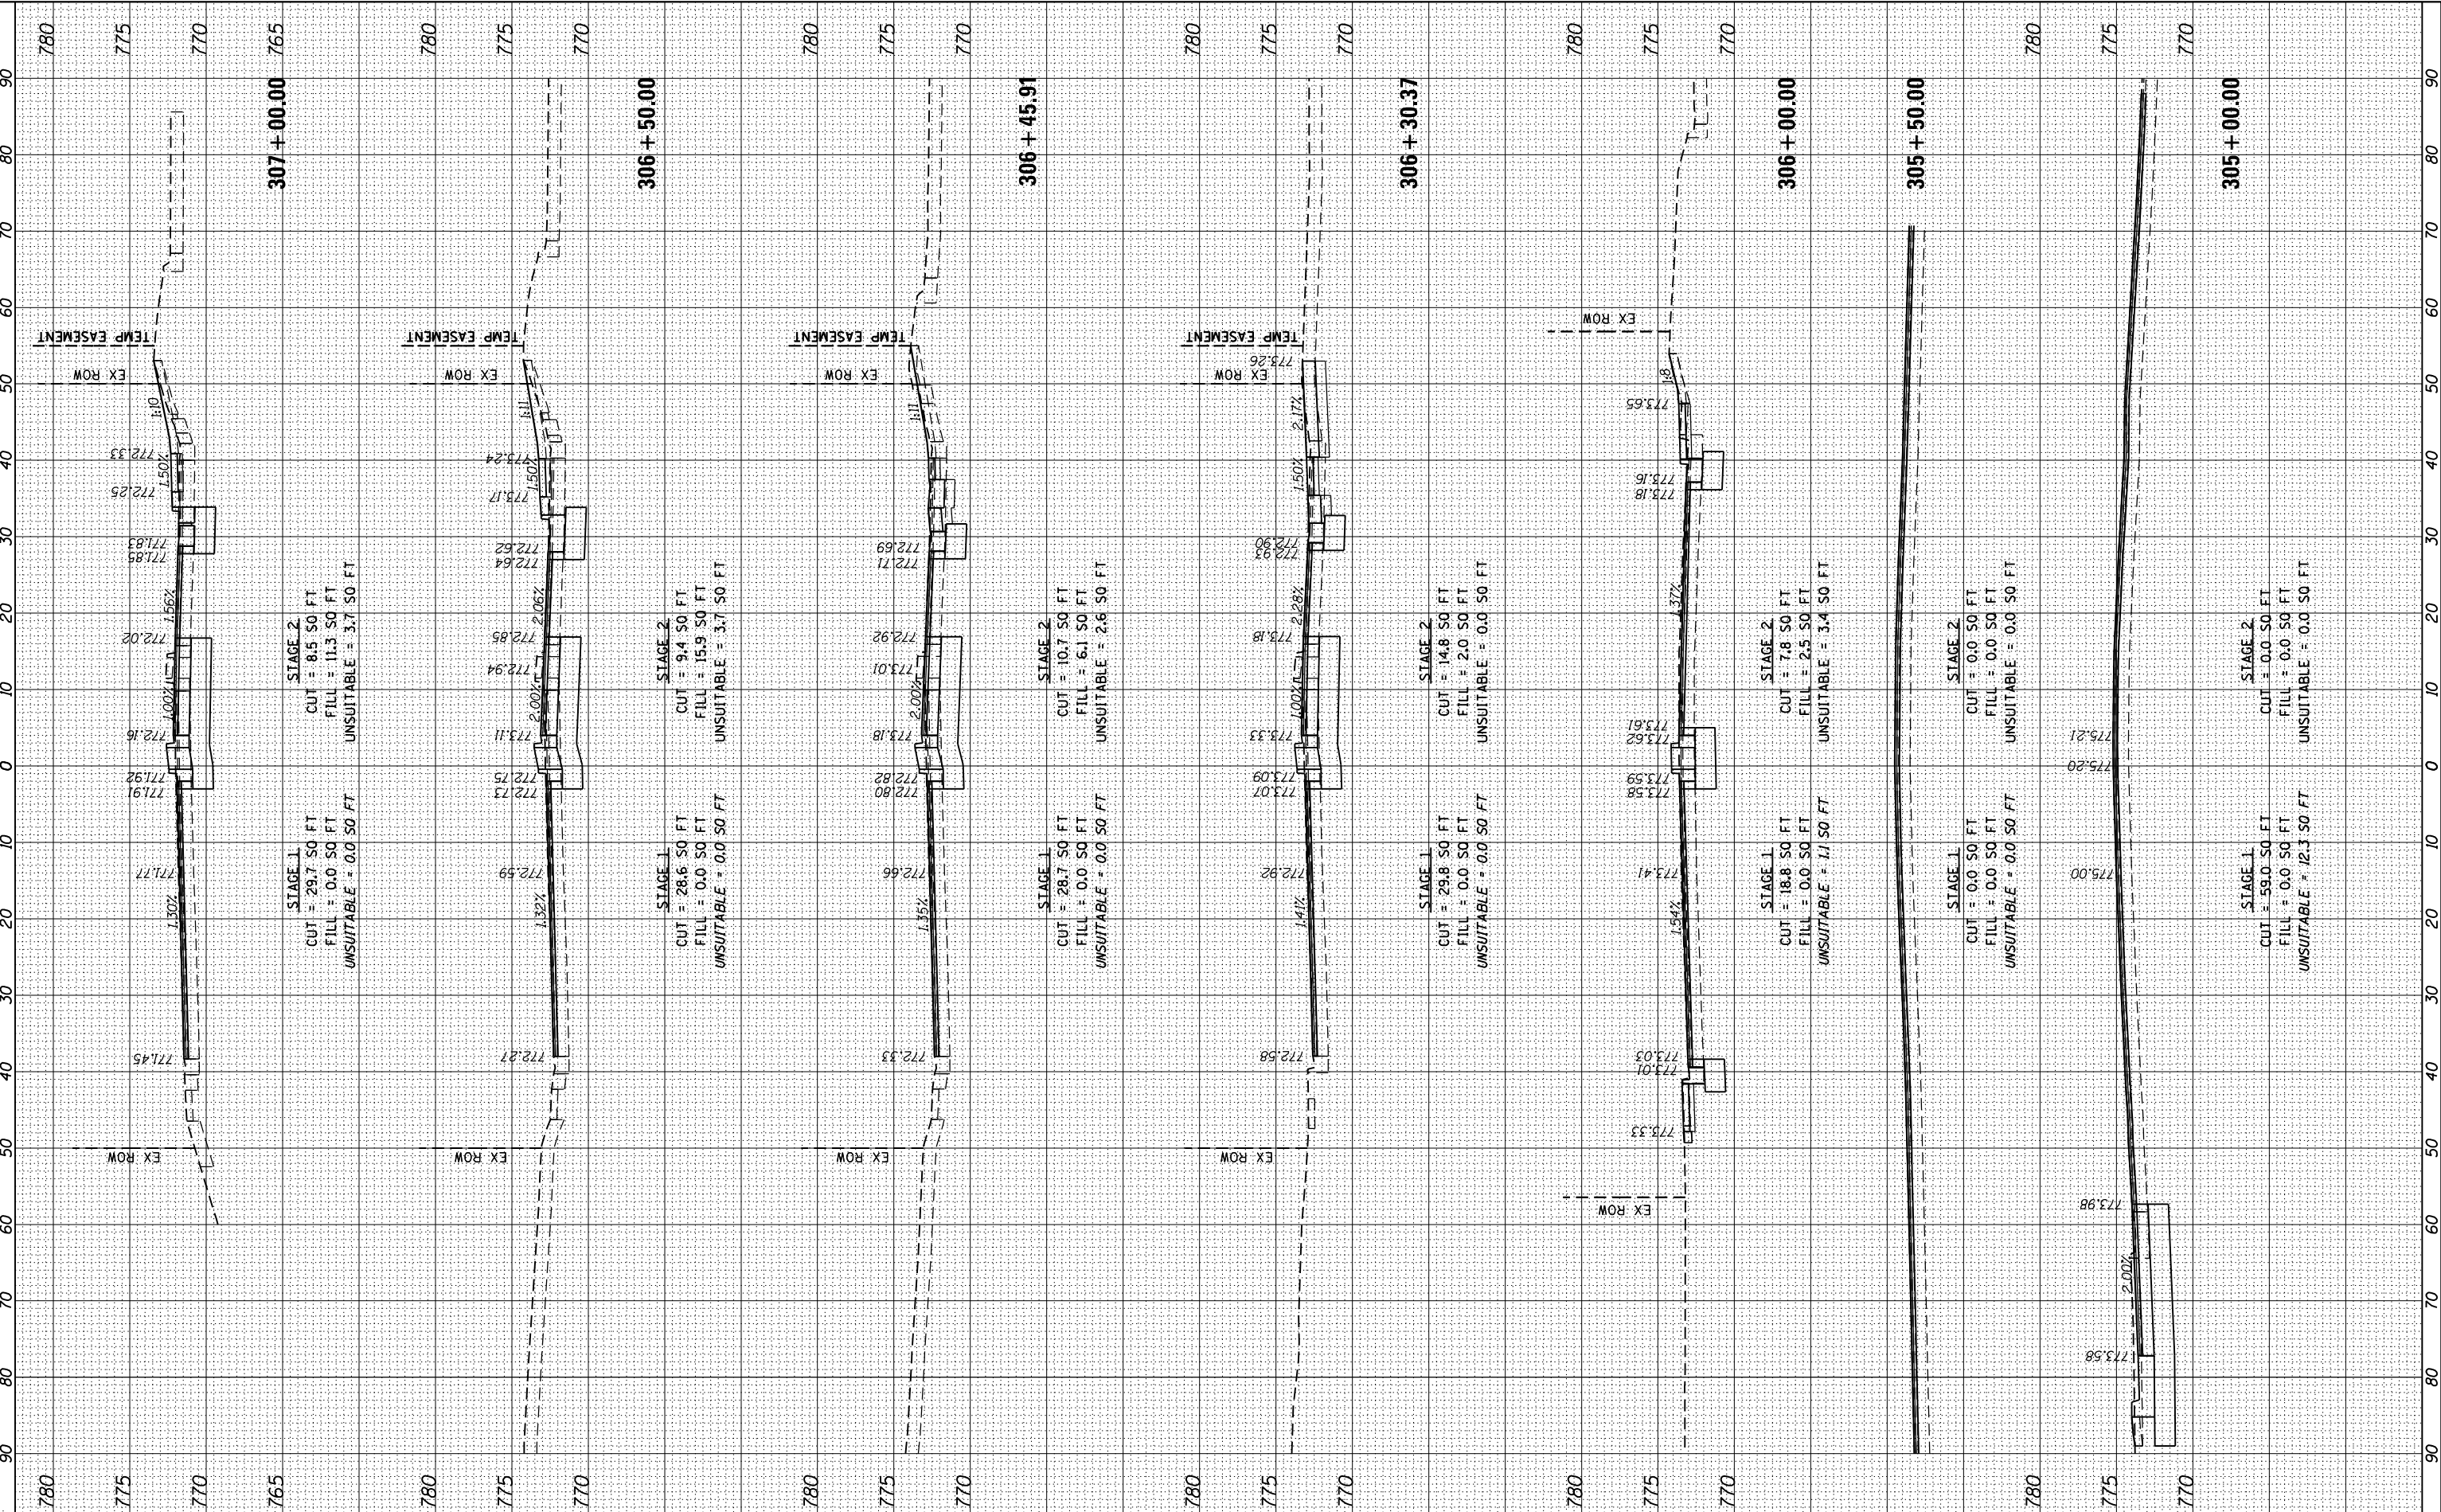

FINAL SURVEY	SURVEYED PLOTTED NOTE BOOK	BY	DATE

ORIGINAL SURVEY	SURVEYED PLOTTED NOTE BOOK	BY	DATE

FILE NAME = W:\451-946 DUDOT Lemont Rd\CA000 Sheets\16-00232-00 CH Light cross sections.dgn




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PLOT SCALE = 20.0000' / in.	DRAWN - GJE	REVISED -
PLOT DATE = 8/31/2023	CHECKED - MTC	REVISED -
	DATE - 09/08/2023	REVISED -

STATE OF ILLINOIS
DEPARTMENT OF TRANSPORTATION

CROSS SECTIONS LEMONT ROAD			
1"=5' VERT.			
SCALE: 1"=10' HORIZ.	SHEET 10	OF 22 SHEETS	STA. 307+06.86 TO STA. 308+36.00

F.A.U. RTE.	SECTION	COUNTY	TOTAL SHEETS	SHEET NO.
2612	16-00232-00-CH	DUPAGE	248	236
CONTRACT NO. 61J01				
ILLINOIS FED. AID PROJECT				

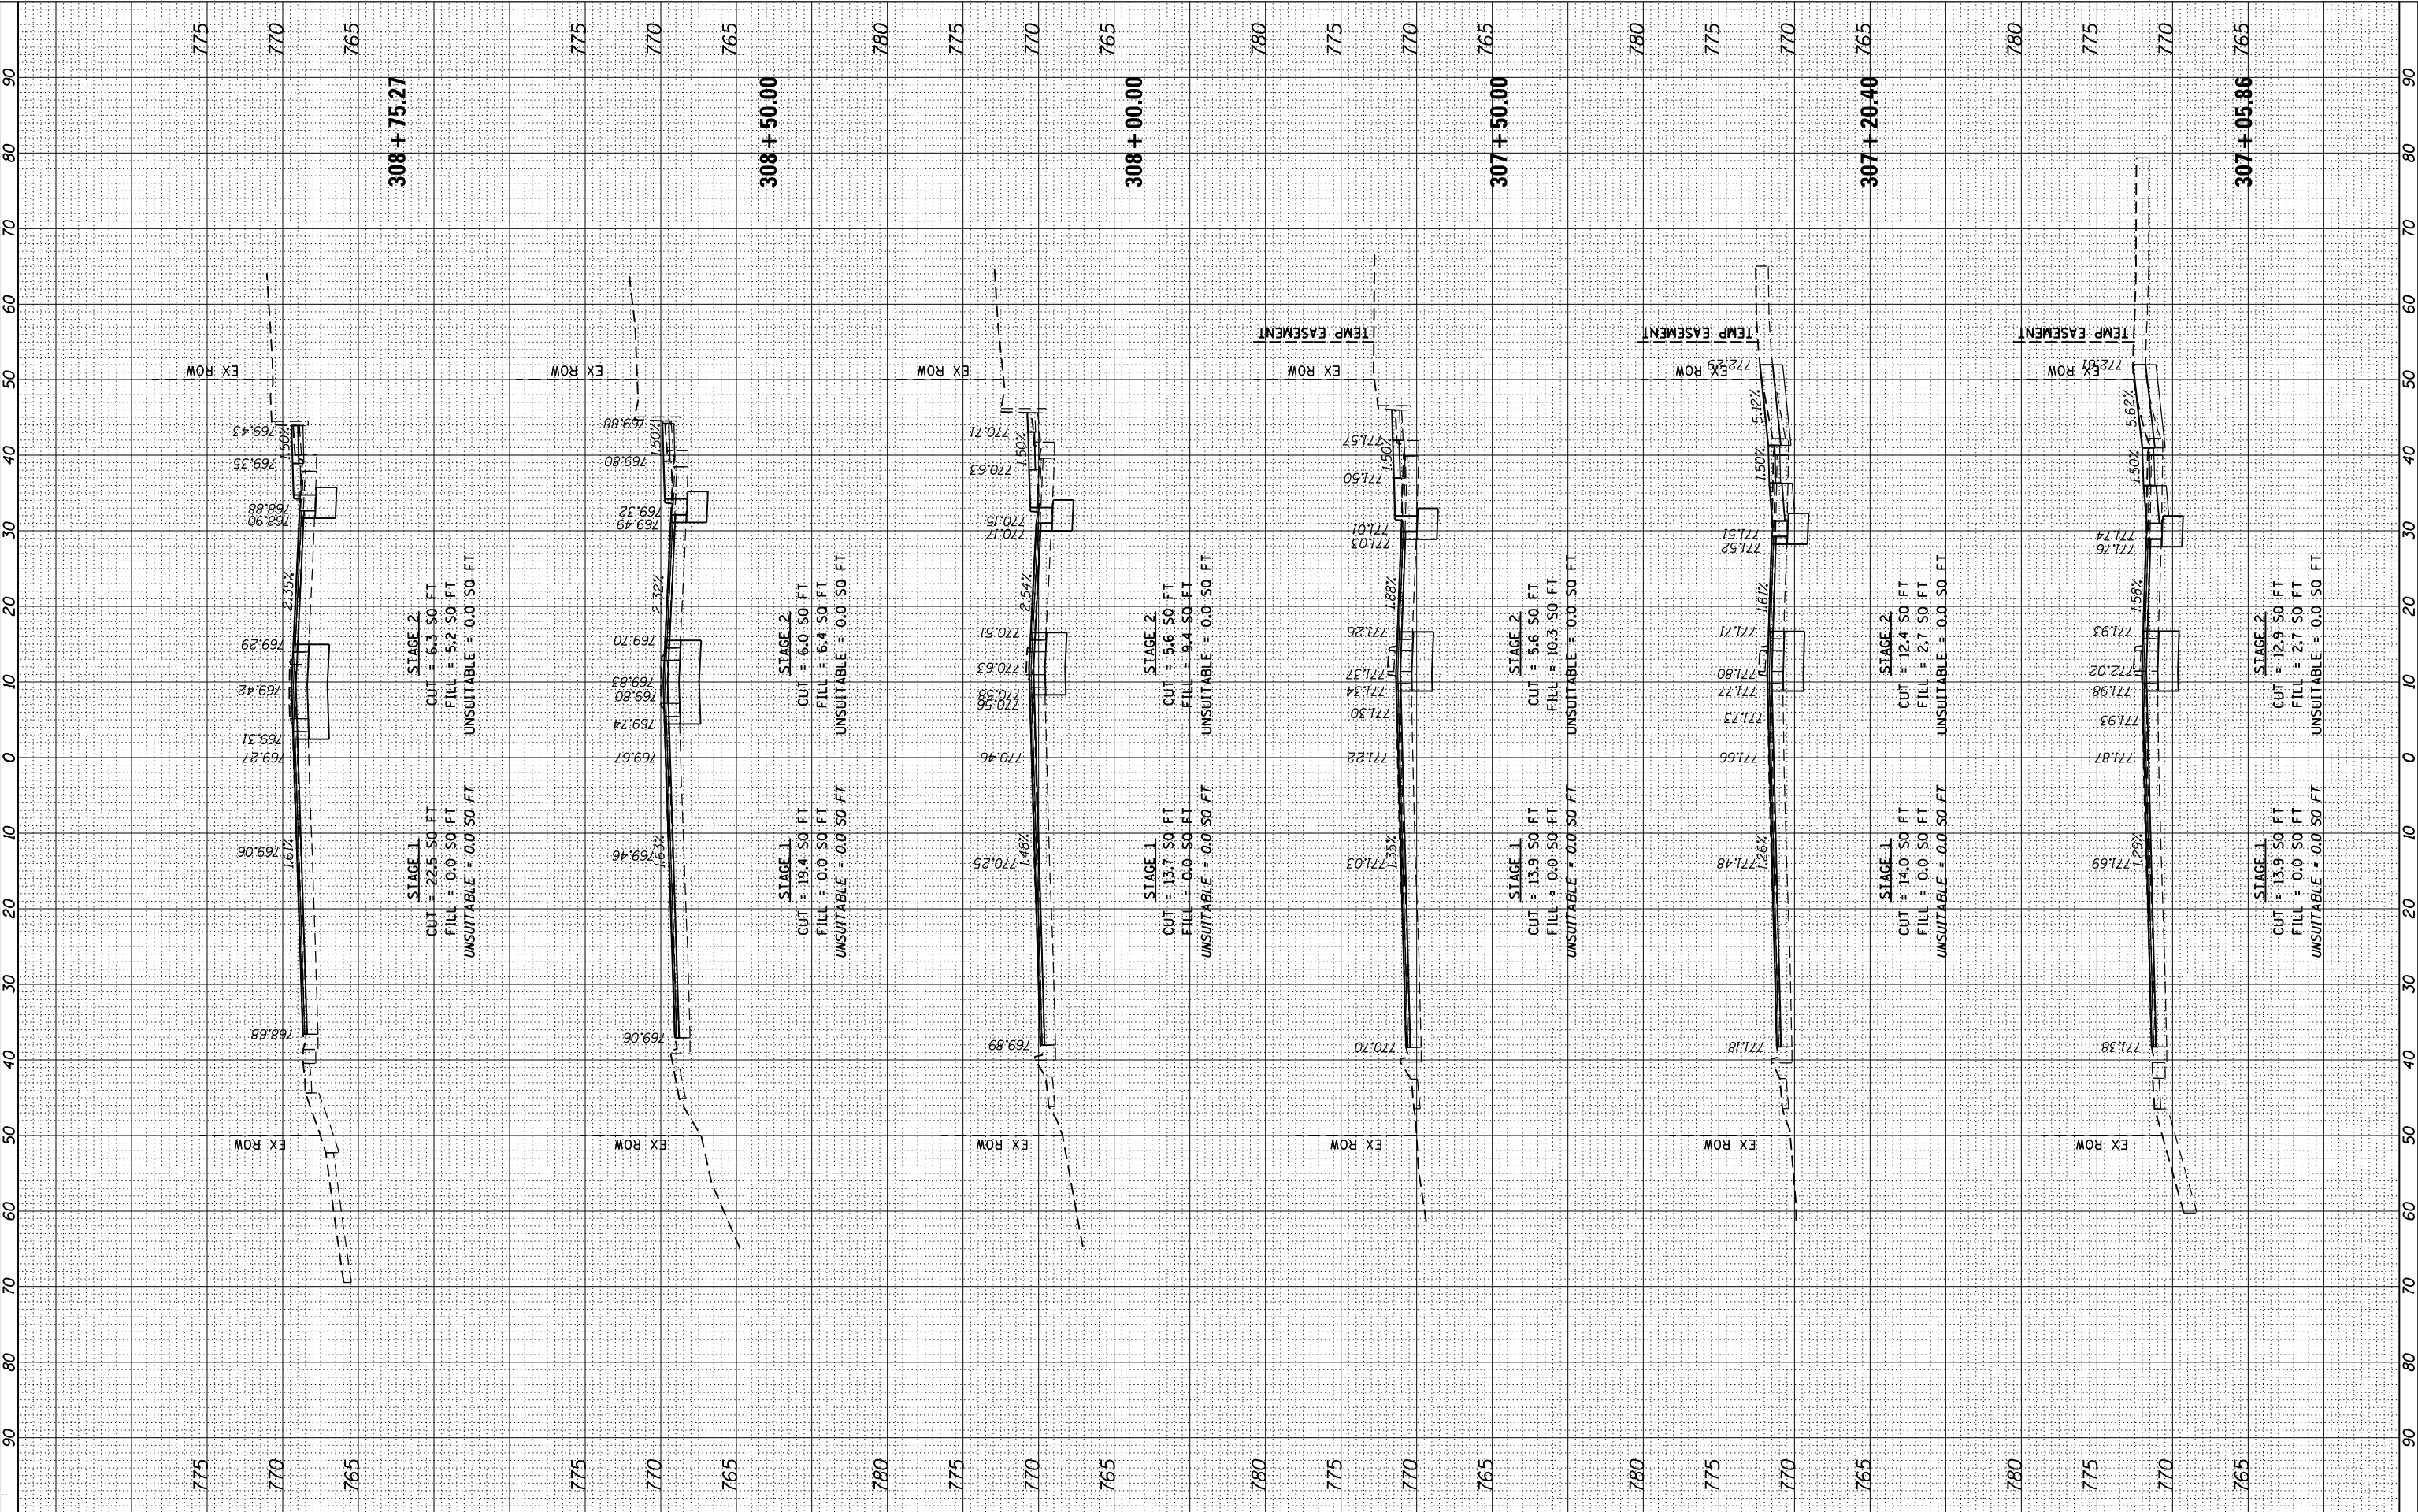

FINAL	SURVEYED	BY	DATE
SURVEY	PLOTTED		
NOTE BOOK	TEMPLATE		
NO.	AREAS	CHECKED	

ORIGINAL	SURVEYED	BY	DATE
SURVEY	PLOTTED		
NOTE BOOK	TEMPLATE		
NO.	AREAS	CHECKED	

FILE NAME = W:\451-946 DUDOT Lemont Rd\CA00 Sheets\16-00232-00 CH Light cross sections 2.dgn




USER NAME = cesario	DESIGNED - GJE	REVISED -
	DRAWN - GJE	REVISED -
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PLOT DATE = 8/31/2023	DATE - 09/08/2023	REVISED -

STATE OF ILLINOIS
DEPARTMENT OF TRANSPORTATION

CROSS SECTIONS			
LEMONT ROAD			
1"=5' VERT.			
SCALE: 1"=10' HORZ.			
SHEET 11	OF 22 SHEETS	STA. 308+06.00	TO STA. 311+00.00

F.A.U. RTE.	SECTION	COUNTY	TOTAL SHEETS	SHEET NO.
2612	16-00232-00-CH	DUPAGE	248	237
CONTRACT NO. 61J01				
ILLINOIS FED. AID PROJECT				

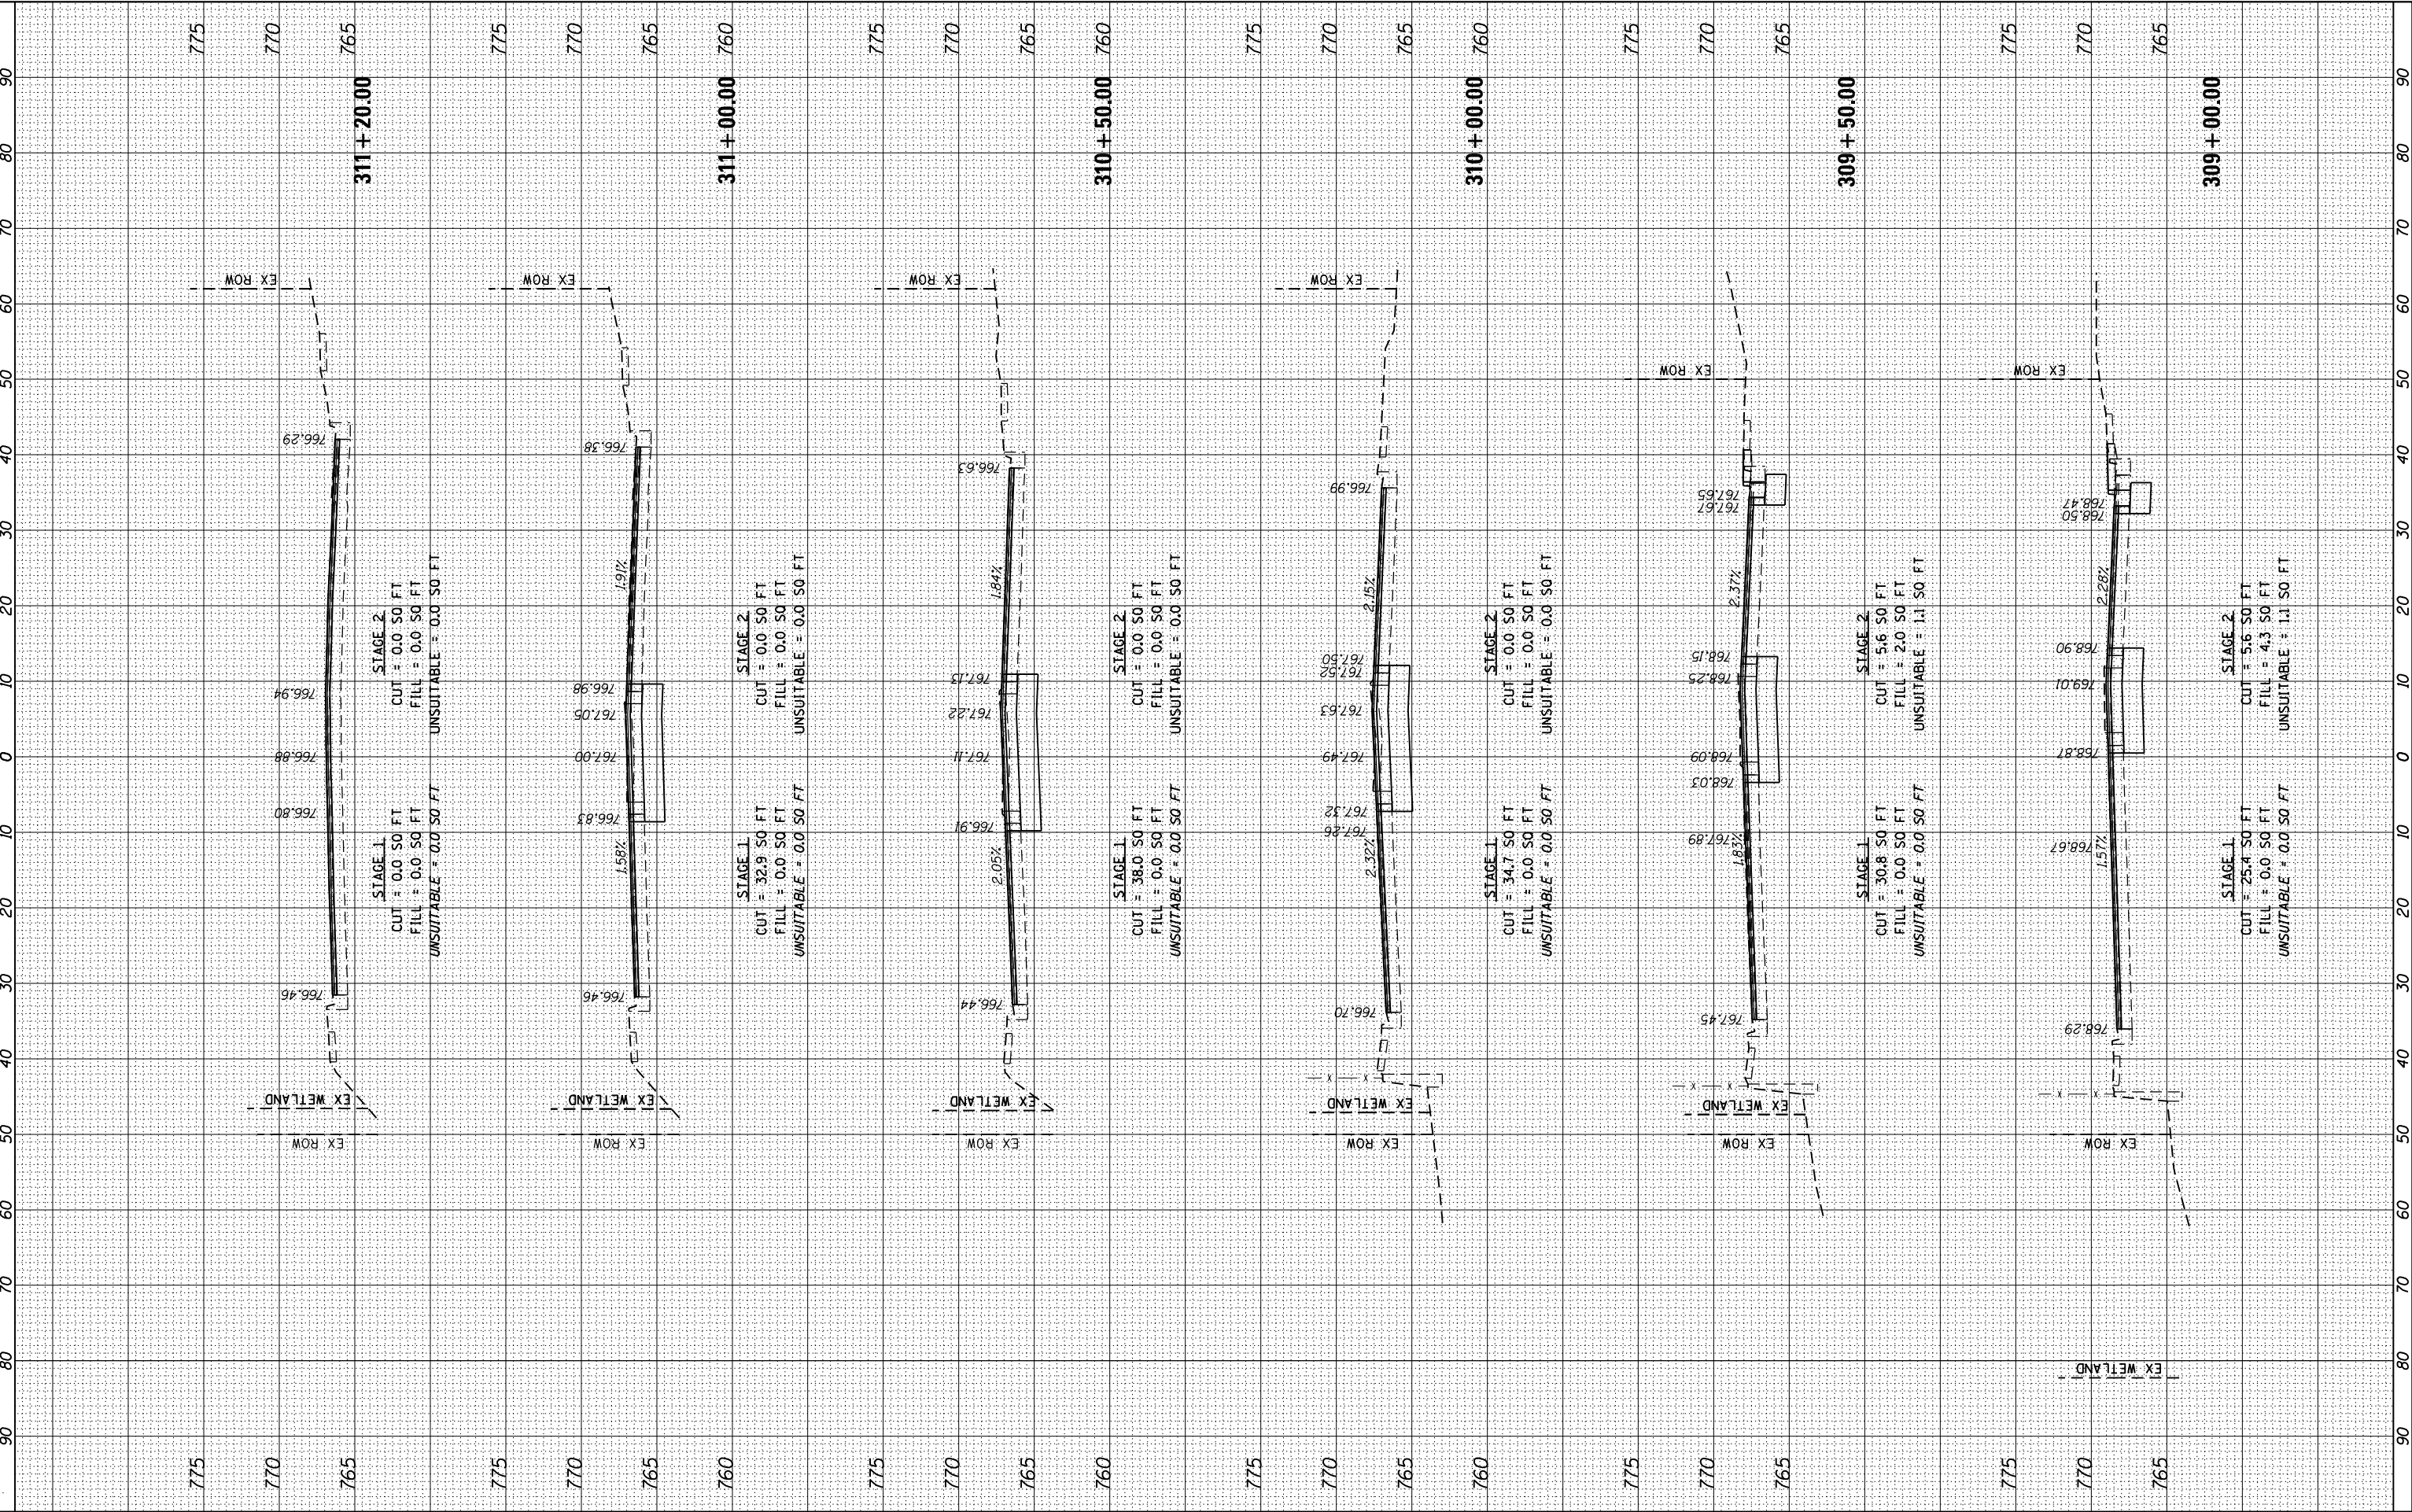

FINAL SURVEY NOTE BOOK NO.	SURVEYED PLOTTED TEMPLATE AREAS CHECKED	BY	DATE

ORIGINAL SURVEY NOTE BOOK NO.	SURVEYED PLOTTED TEMPLATE AREAS CHECKED	BY	DATE

FILE NAME = M:\451-945 DUDOT Lemont Re\CA00 Streets\16-00232-00 CH\ht cross sections 2.dgn




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PLOT DATE = 8/31/2023	DATE - 09/08/2023	REVISED -

STATE OF ILLINOIS
DEPARTMENT OF TRANSPORTATION

1"=5' VERT.
SCALE: 1"=10' HORZ. SHEET 13 OF 22 SHEETS STA. 13+50.00 TO STA.15+50.00

CROSS SECTIONS
87TH STREET

F.A.U RTE.	SECTION	COUNTY	TOTAL SHEETS	SHEET NO.
2612	16-00232-00-CH	DUPAGE	248	239
CONTRACT NO. 61J01				
ILLINOIS FED. AID PROJECT				

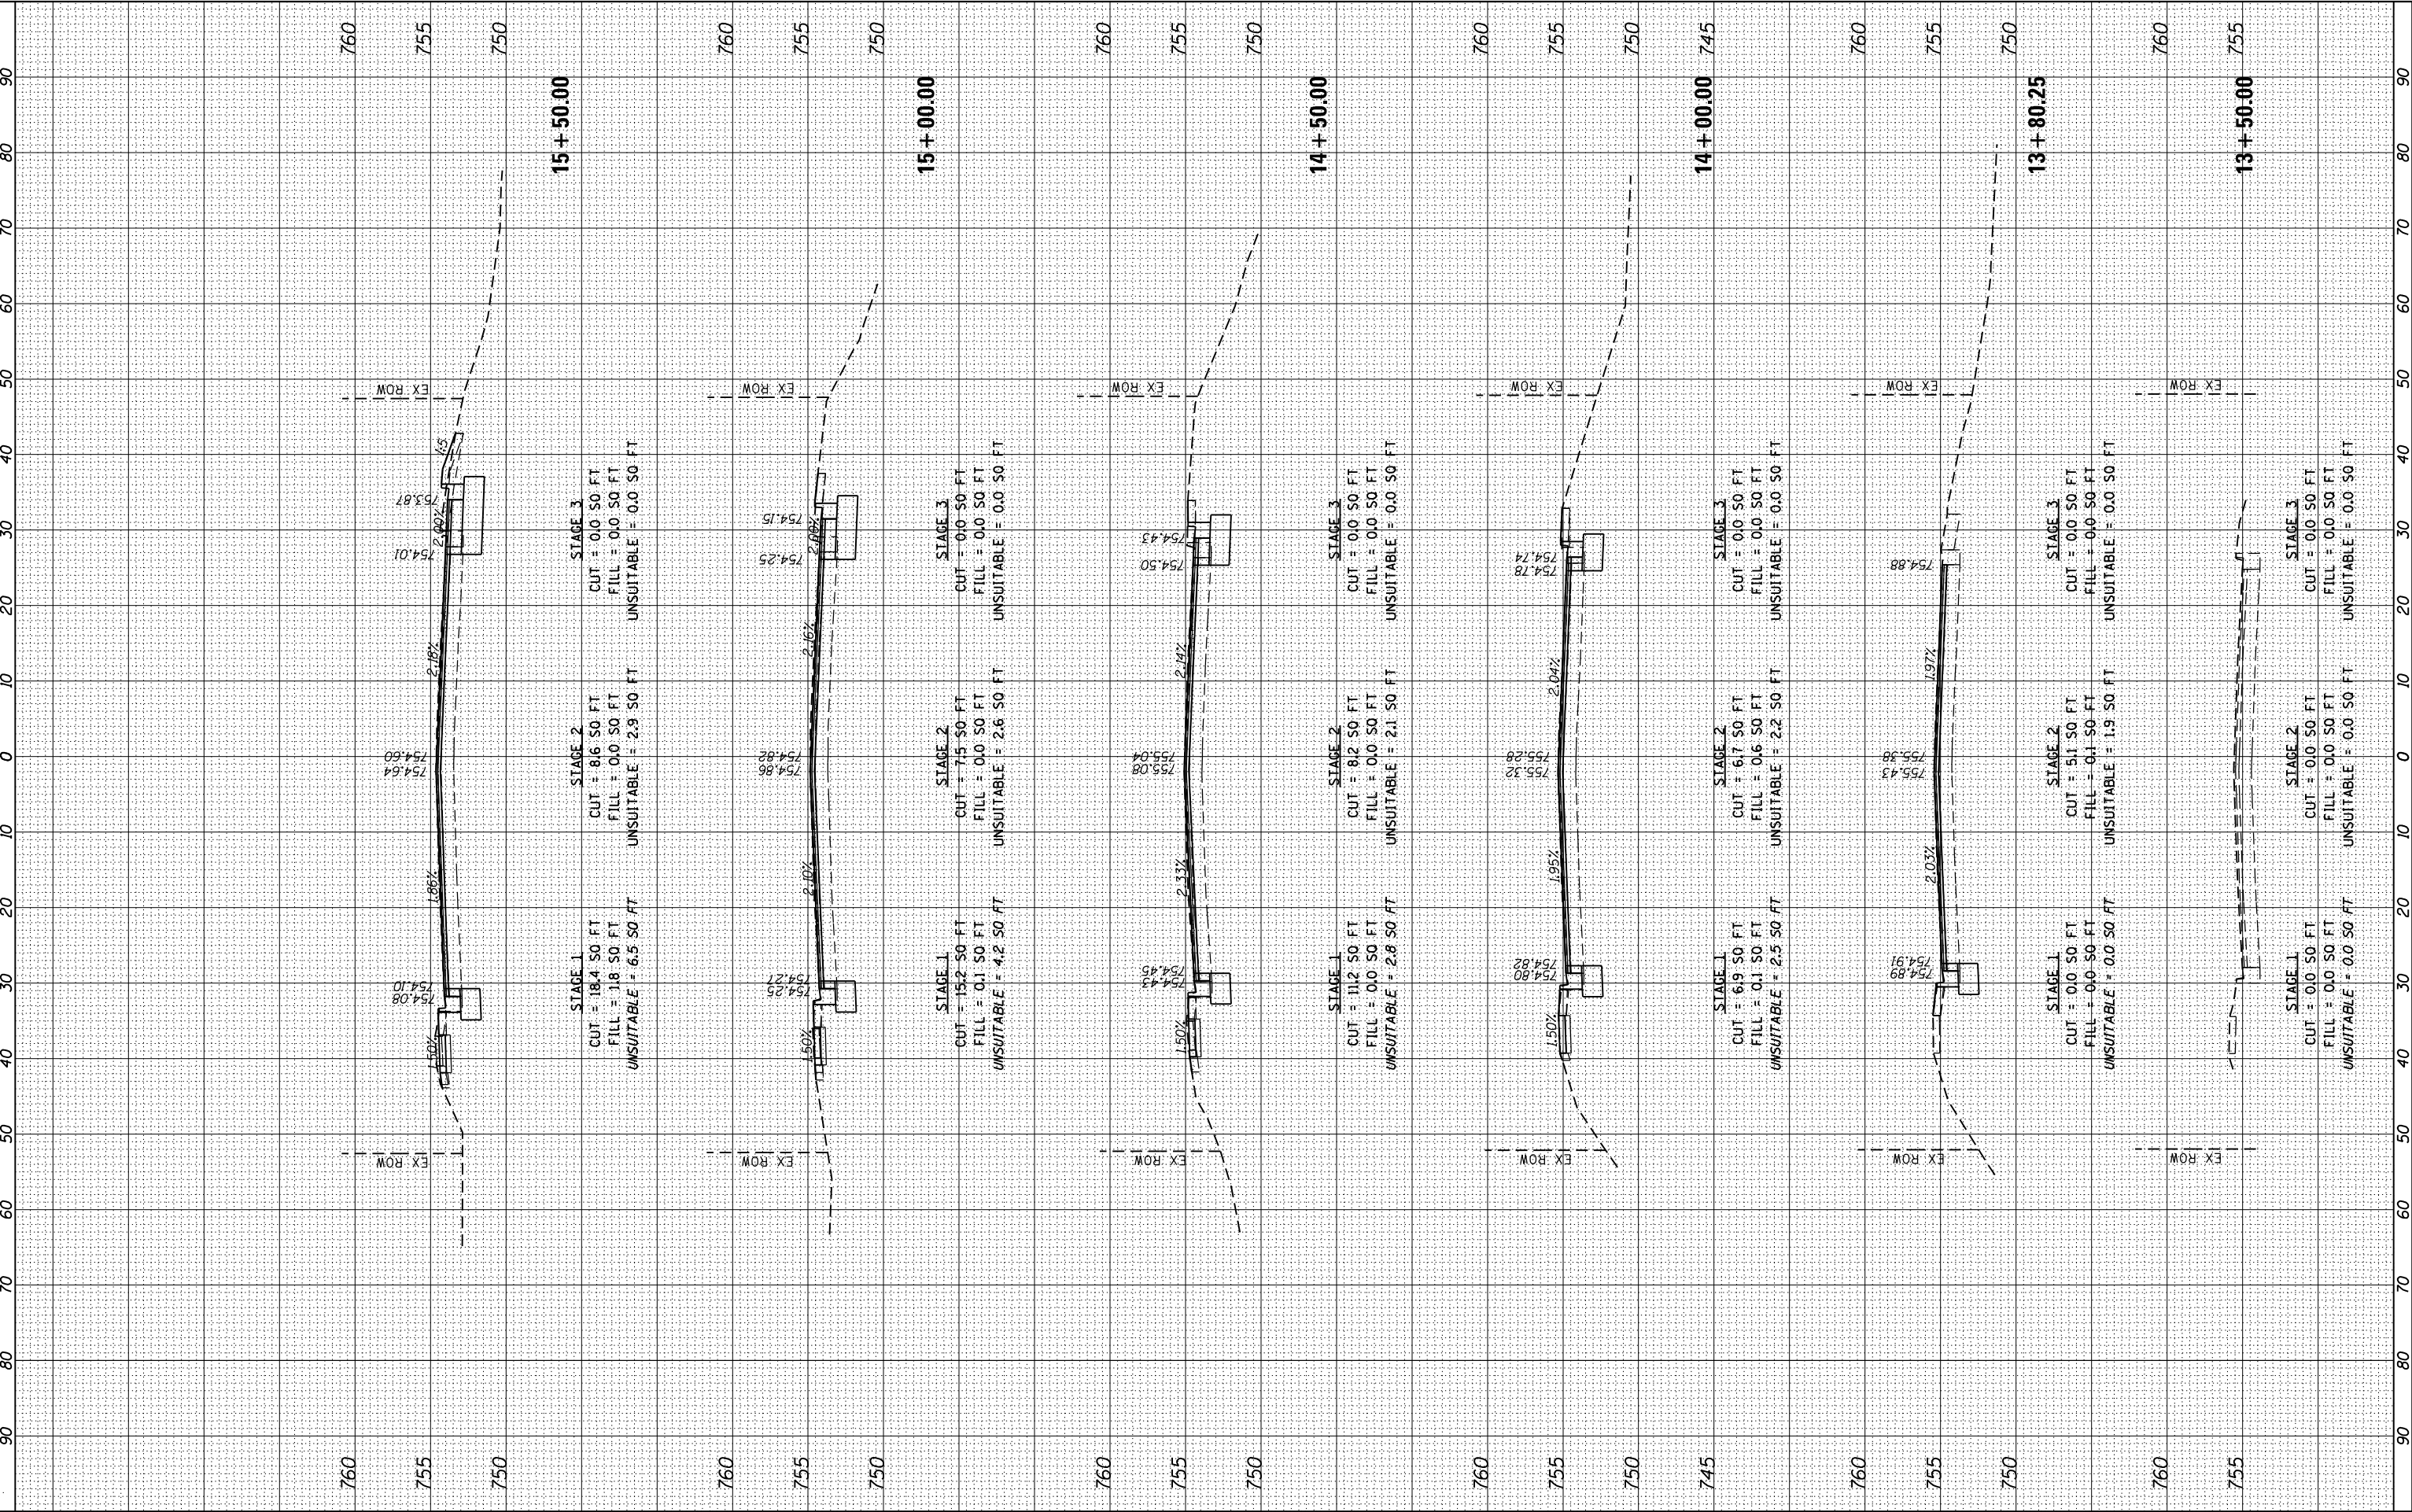

FINAL SURVEY NO.	SURVEYED PLOTTED NOTE BOOK AREAS CHECKED	BY	DATE

ORIGINAL SURVEY NO.	SURVEYED PLOTTED NOTE BOOK AREAS CHECKED	BY	DATE

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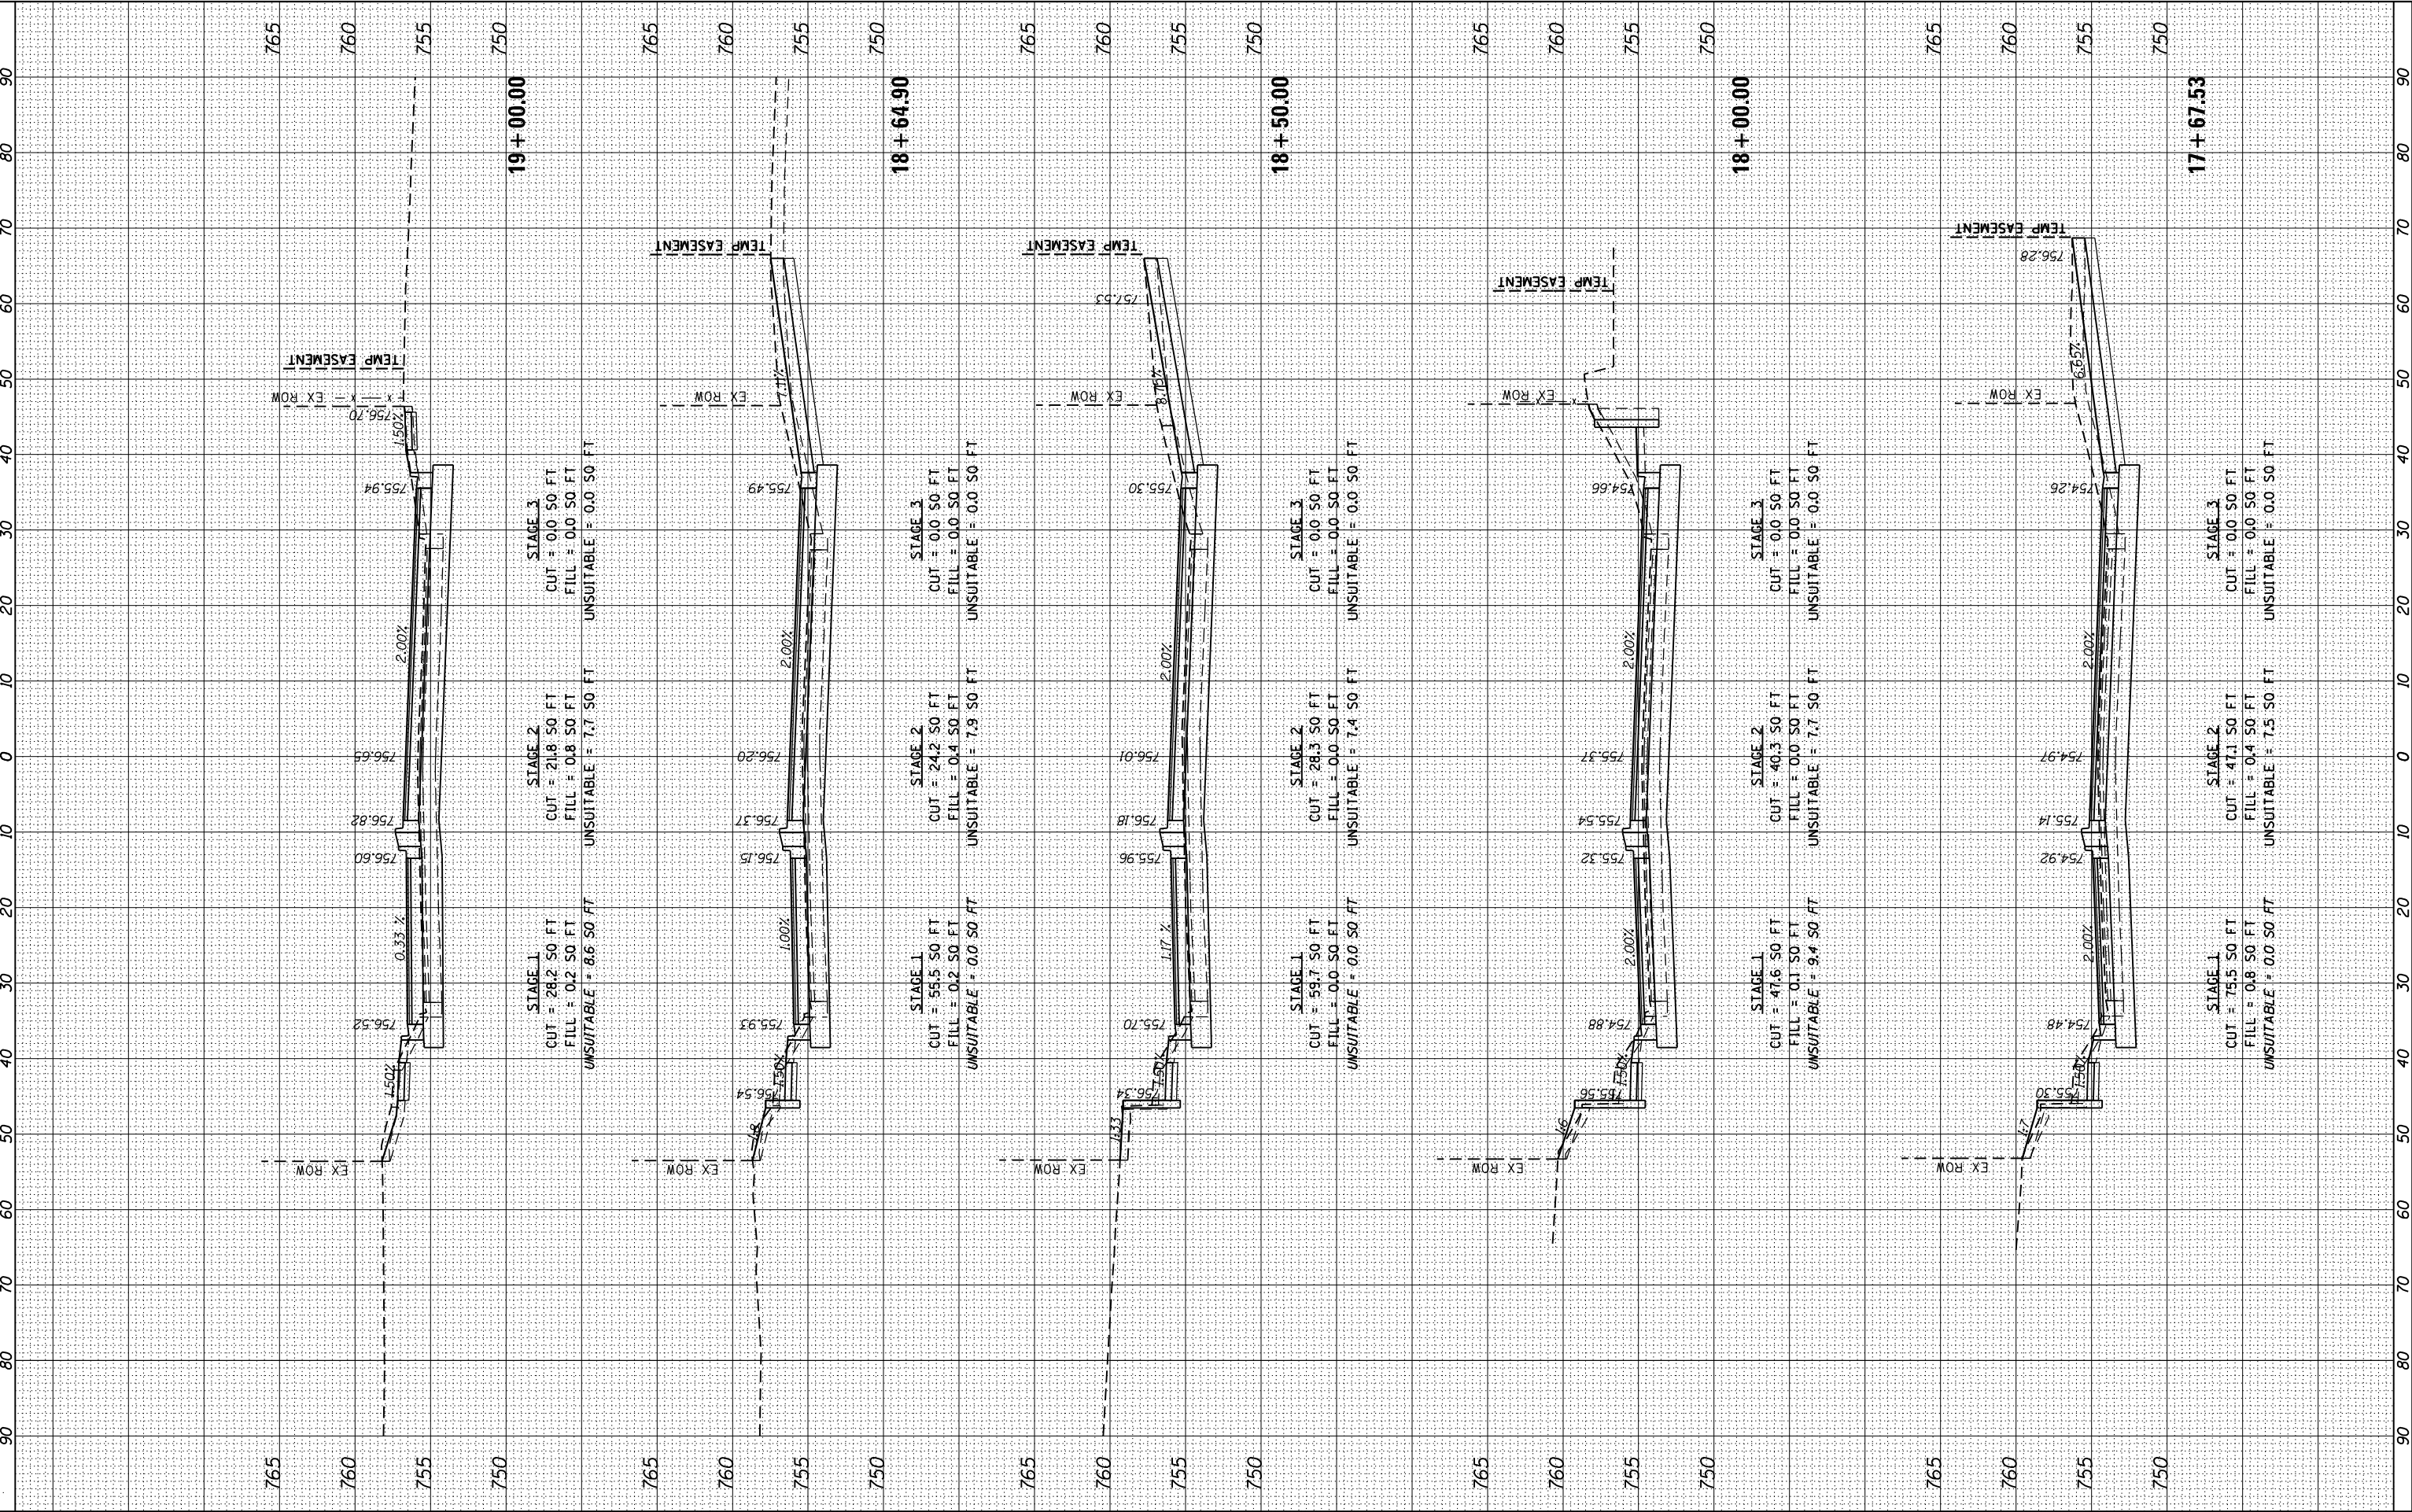


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PLOT DATE = 8/31/2023	CHECKED - MTC	REVISED -
	DATE - 09/08/2023	REVISED -

STATE OF ILLINOIS
DEPARTMENT OF TRANSPORTATION

CROSS SECTIONS 87TH STREET			
1"=5' VERT.			
SCALE: 1"=10' HORZ.	SHEET 15	OF 22 SHEETS	STA. 17+67.53 TO STA.19+00.00

F.A.U RTE.	SECTION	COUNTY	TOTAL SHEETS	SHEET NO.
2612	16-00232-00-CH	DUPAGE	248	241
CONTRACT NO. 61J01				
ILLINOIS FED. AID PROJECT				



FINAL SURVEY NOTE BOOK NO.	SURVEYED PLOTTED TEMPLATE AREAS CHECKED	BY	DATE

ORIGINAL SURVEY NOTE BOOK NO.	SURVEYED PLOTTED TEMPLATE AREAS CHECKED	BY	DATE

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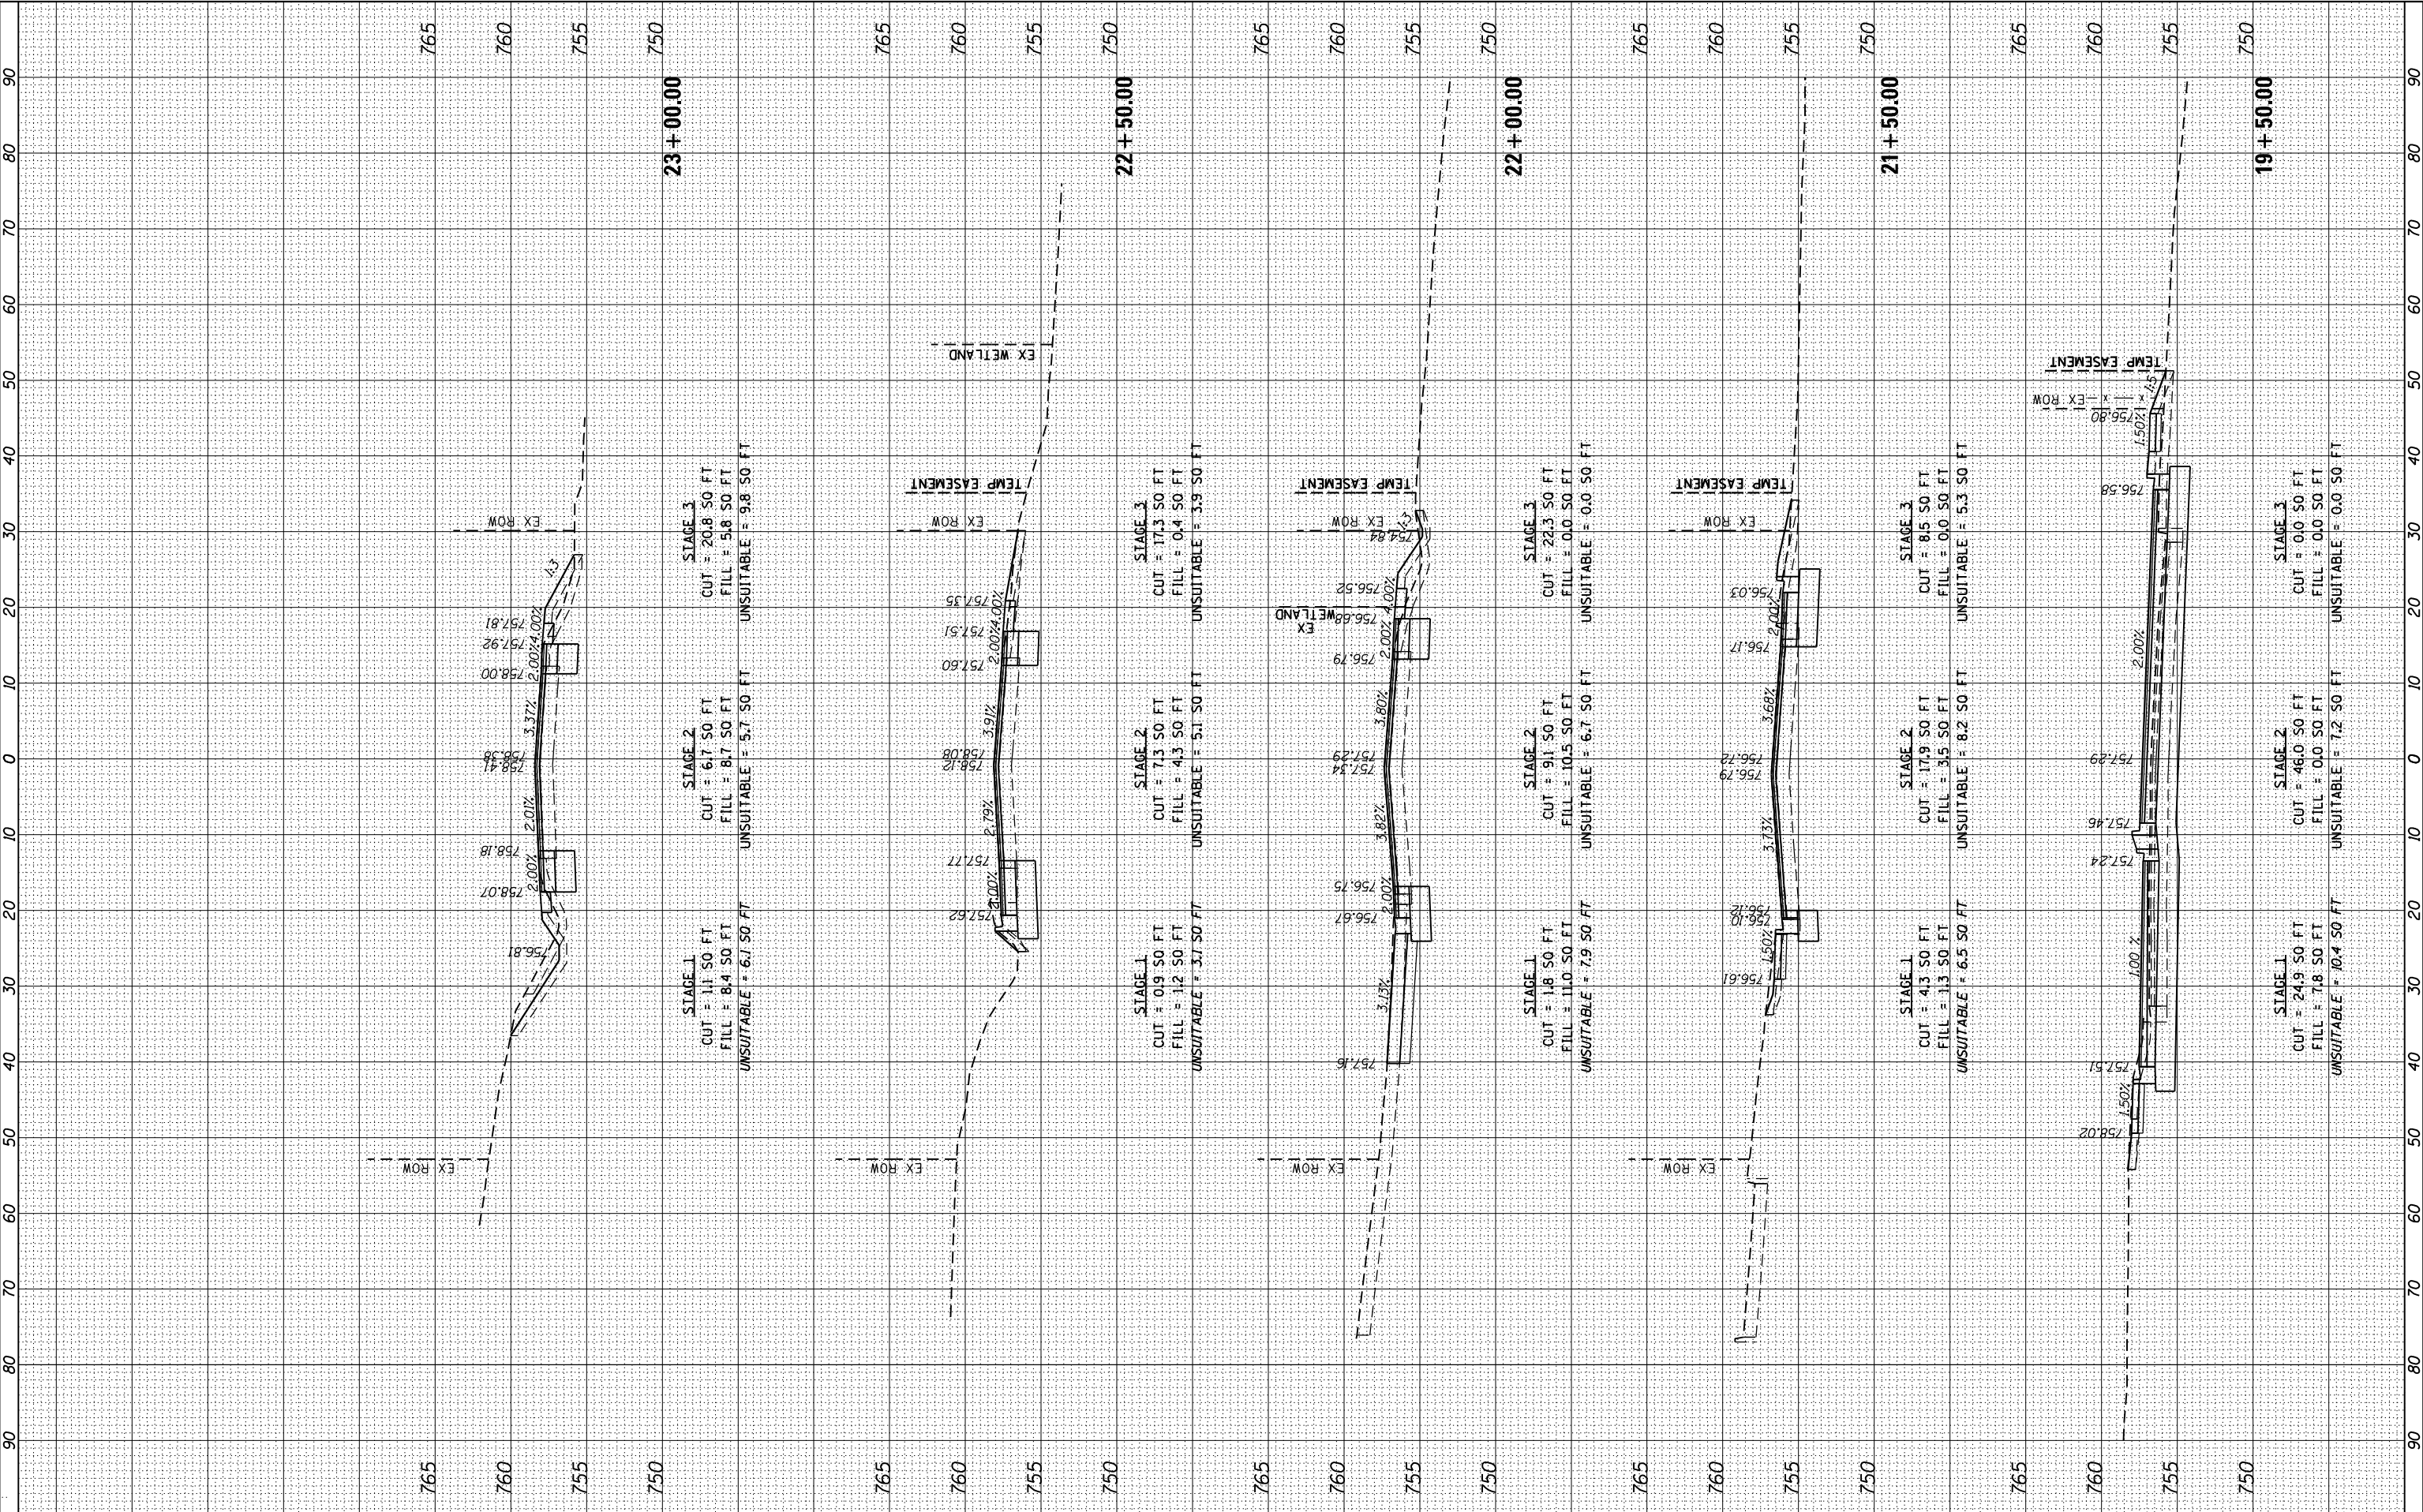


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	DRAWN - GJE	REVISED -
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PLOT DATE = 8/31/2023	DATE - 09/08/2023	REVISED -

STATE OF ILLINOIS
DEPARTMENT OF TRANSPORTATION

CROSS SECTIONS 87TH STREET			
1"=5' VERT.			
SCALE: 1"=10' HORZ.	SHEET 16	OF 22 SHEETS	STA. 19+50.00 TO STA. 23+00.00

F.A.U RTE.	SECTION	COUNTY	TOTAL SHEETS	SHEET NO.
2612	16-00232-00-CH	DUPAGE	248	242
CONTRACT NO. 61J01				
ILLINOIS FED. AID PROJECT				



FINAL	SURVEYED	BY	DATE
SURVEY	PLOTTED		
NOTE BOOK	TEMPLATE		
NO.	AREAS CHECKED		

ORIGINAL	SURVEYED	BY	DATE
SURVEY	PLOTTED		
NOTE BOOK	TEMPLATE		
NO.	AREAS CHECKED		

FILE NAME = M:\451-946 DUDOT Lemont Re\CA00 Streets\16-00232-00 CH\16-cross sections 2.dgn




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PLOT DATE = 8/31/2023	DATE - 09/08/2023	REVISED -

STATE OF ILLINOIS
DEPARTMENT OF TRANSPORTATION

1"=5' VERT.
SCALE: 1"=10' HORZ. SHEET 17 OF 22 SHEETS STA. 23+17.73 TO STA. 24+50.00

CROSS SECTIONS
87TH STREET


F.A.U RTE.	SECTION	COUNTY	TOTAL SHEETS	SHEET NO.
2612	16-00232-00-CH	DUPAGE	248	243
CONTRACT NO. 61J01				
ILLINOIS FED. AID PROJECT				

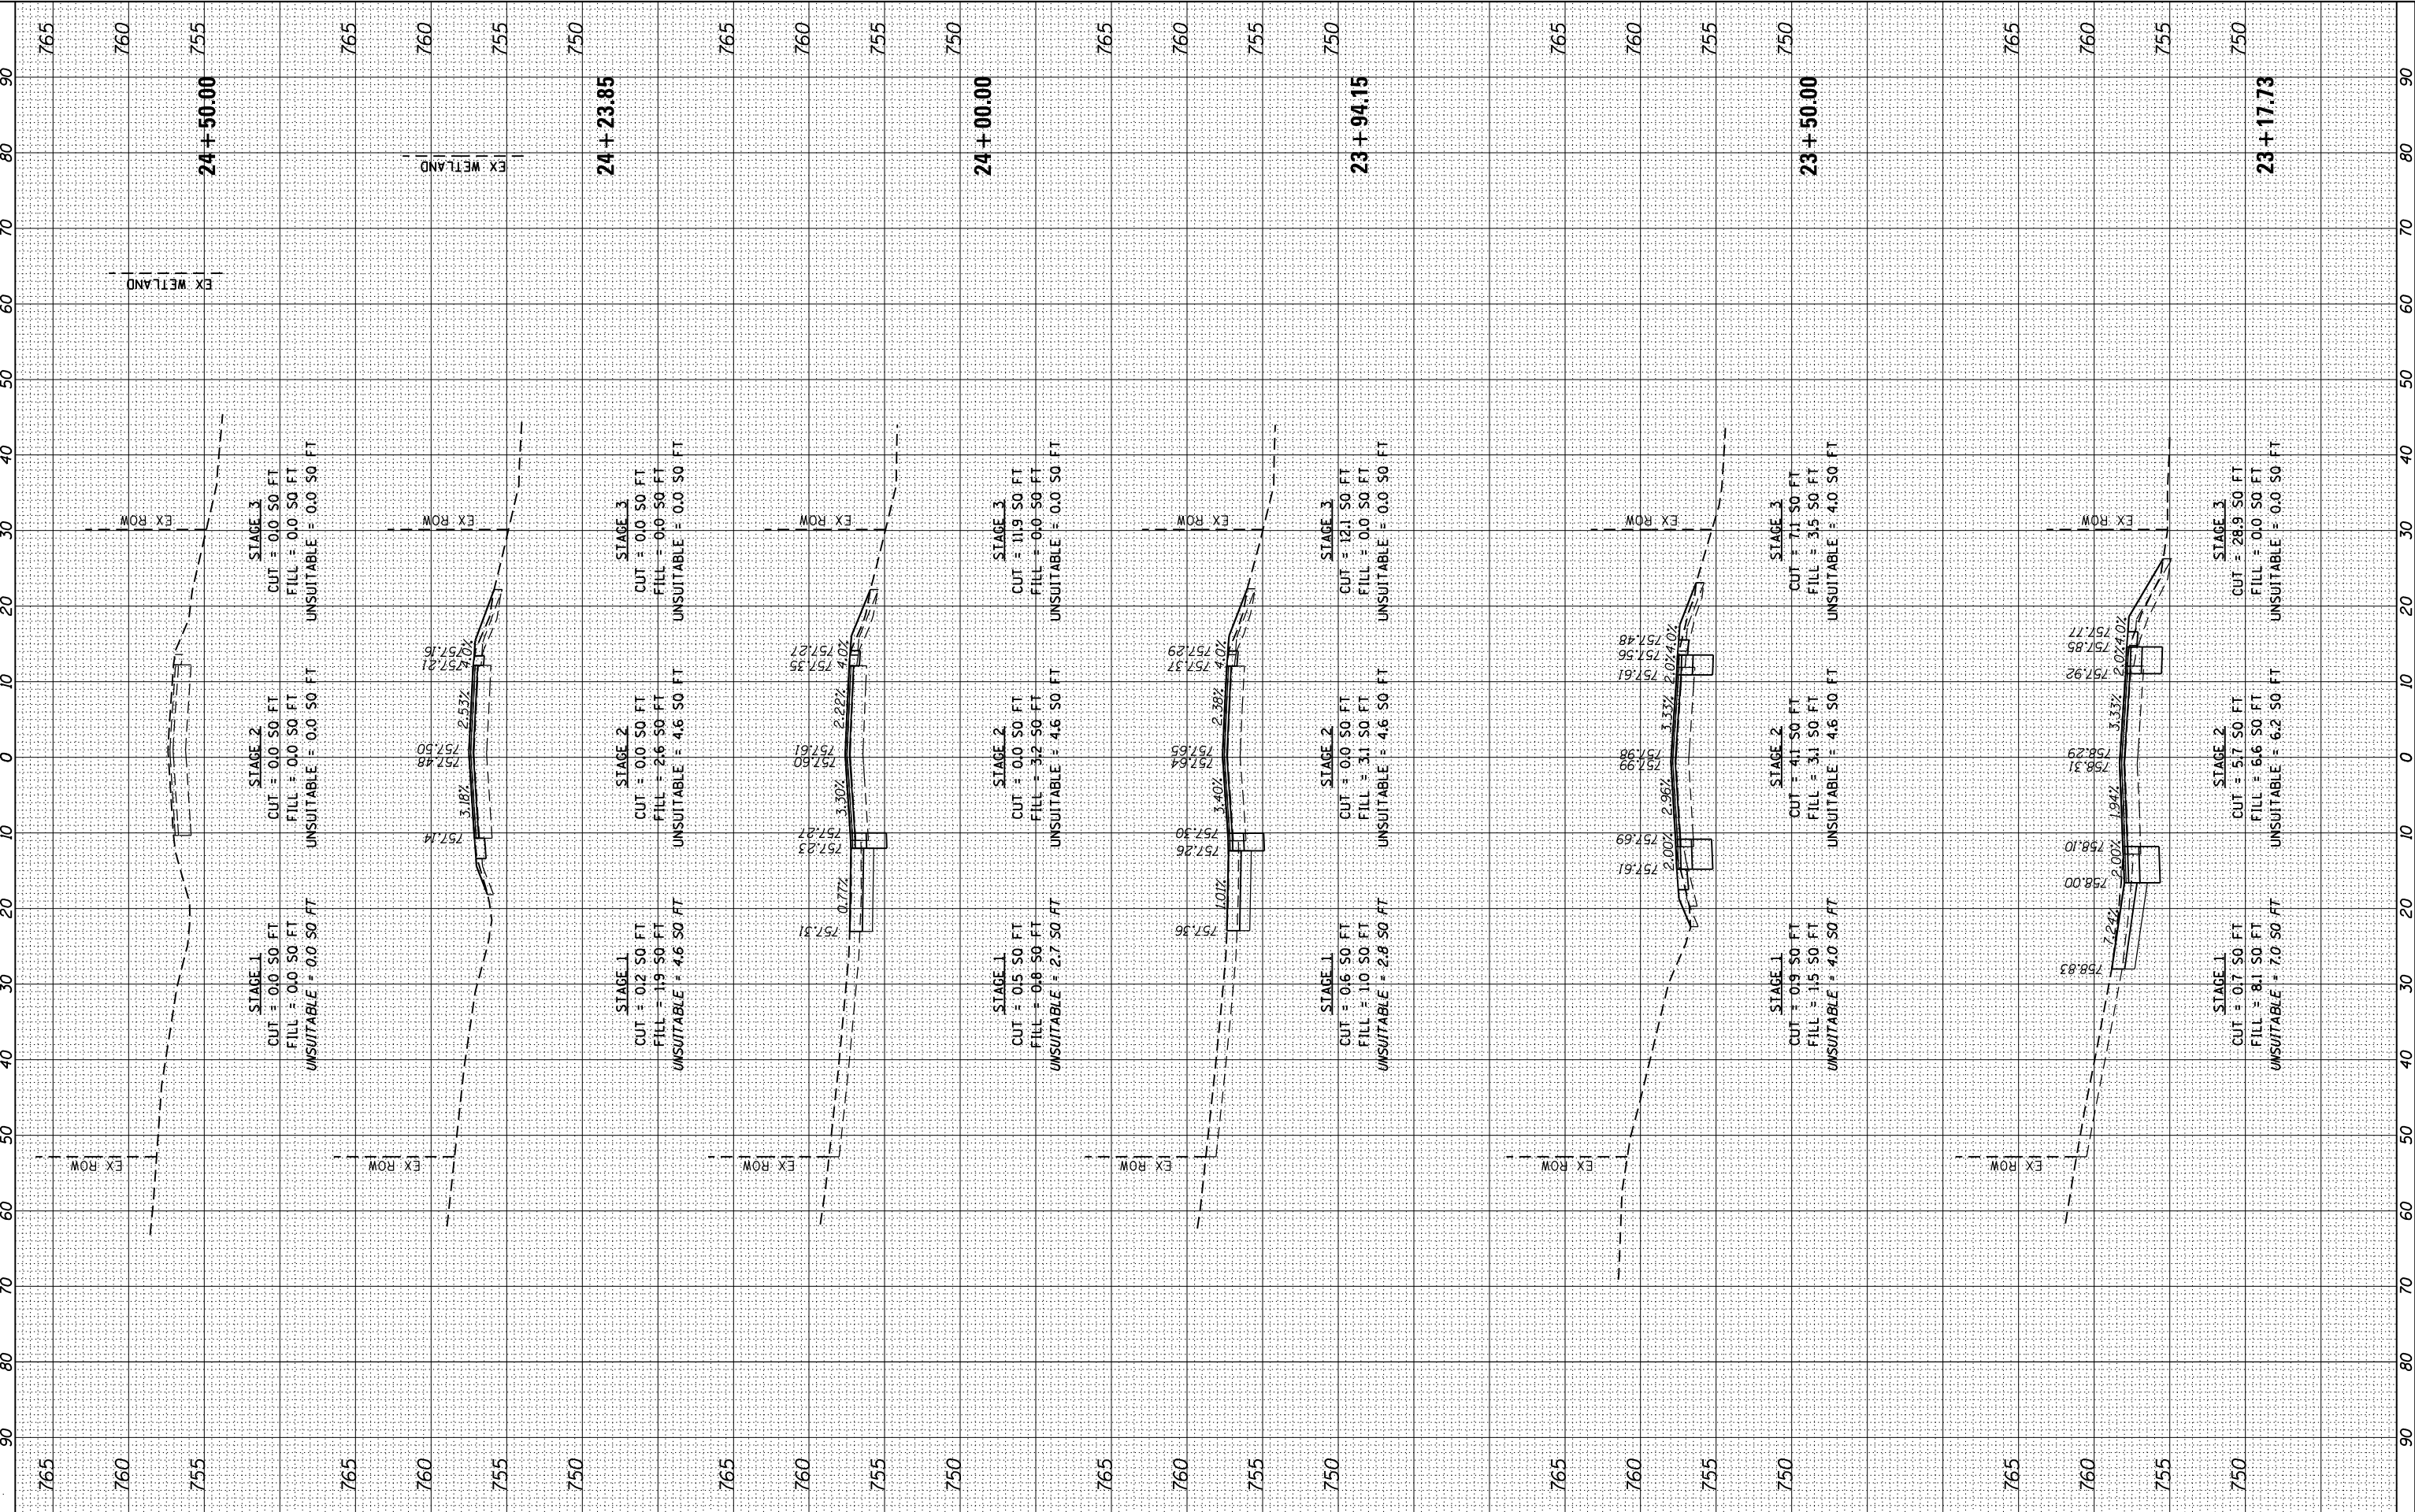

FINAL SURVEY	SURVEYED _____	BY _____	DATE _____
	PLOTTED _____		
NOTE BOOK	TEMPLATE _____		
	AREAS _____		
NO. _____	AREAS CHECKED _____		

ORIGINAL SURVEY	SURVEYED _____	BY _____	DATE _____
	PLOTTED _____		
NOTE BOOK	TEMPLATE _____		
	AREAS _____		
NO. _____	AREAS CHECKED _____		

FILE NAME = M:\451-945 DUDOT Lemont Re\CA00 Streets\16-00232-00 CH\ht cross sections 2.dgn

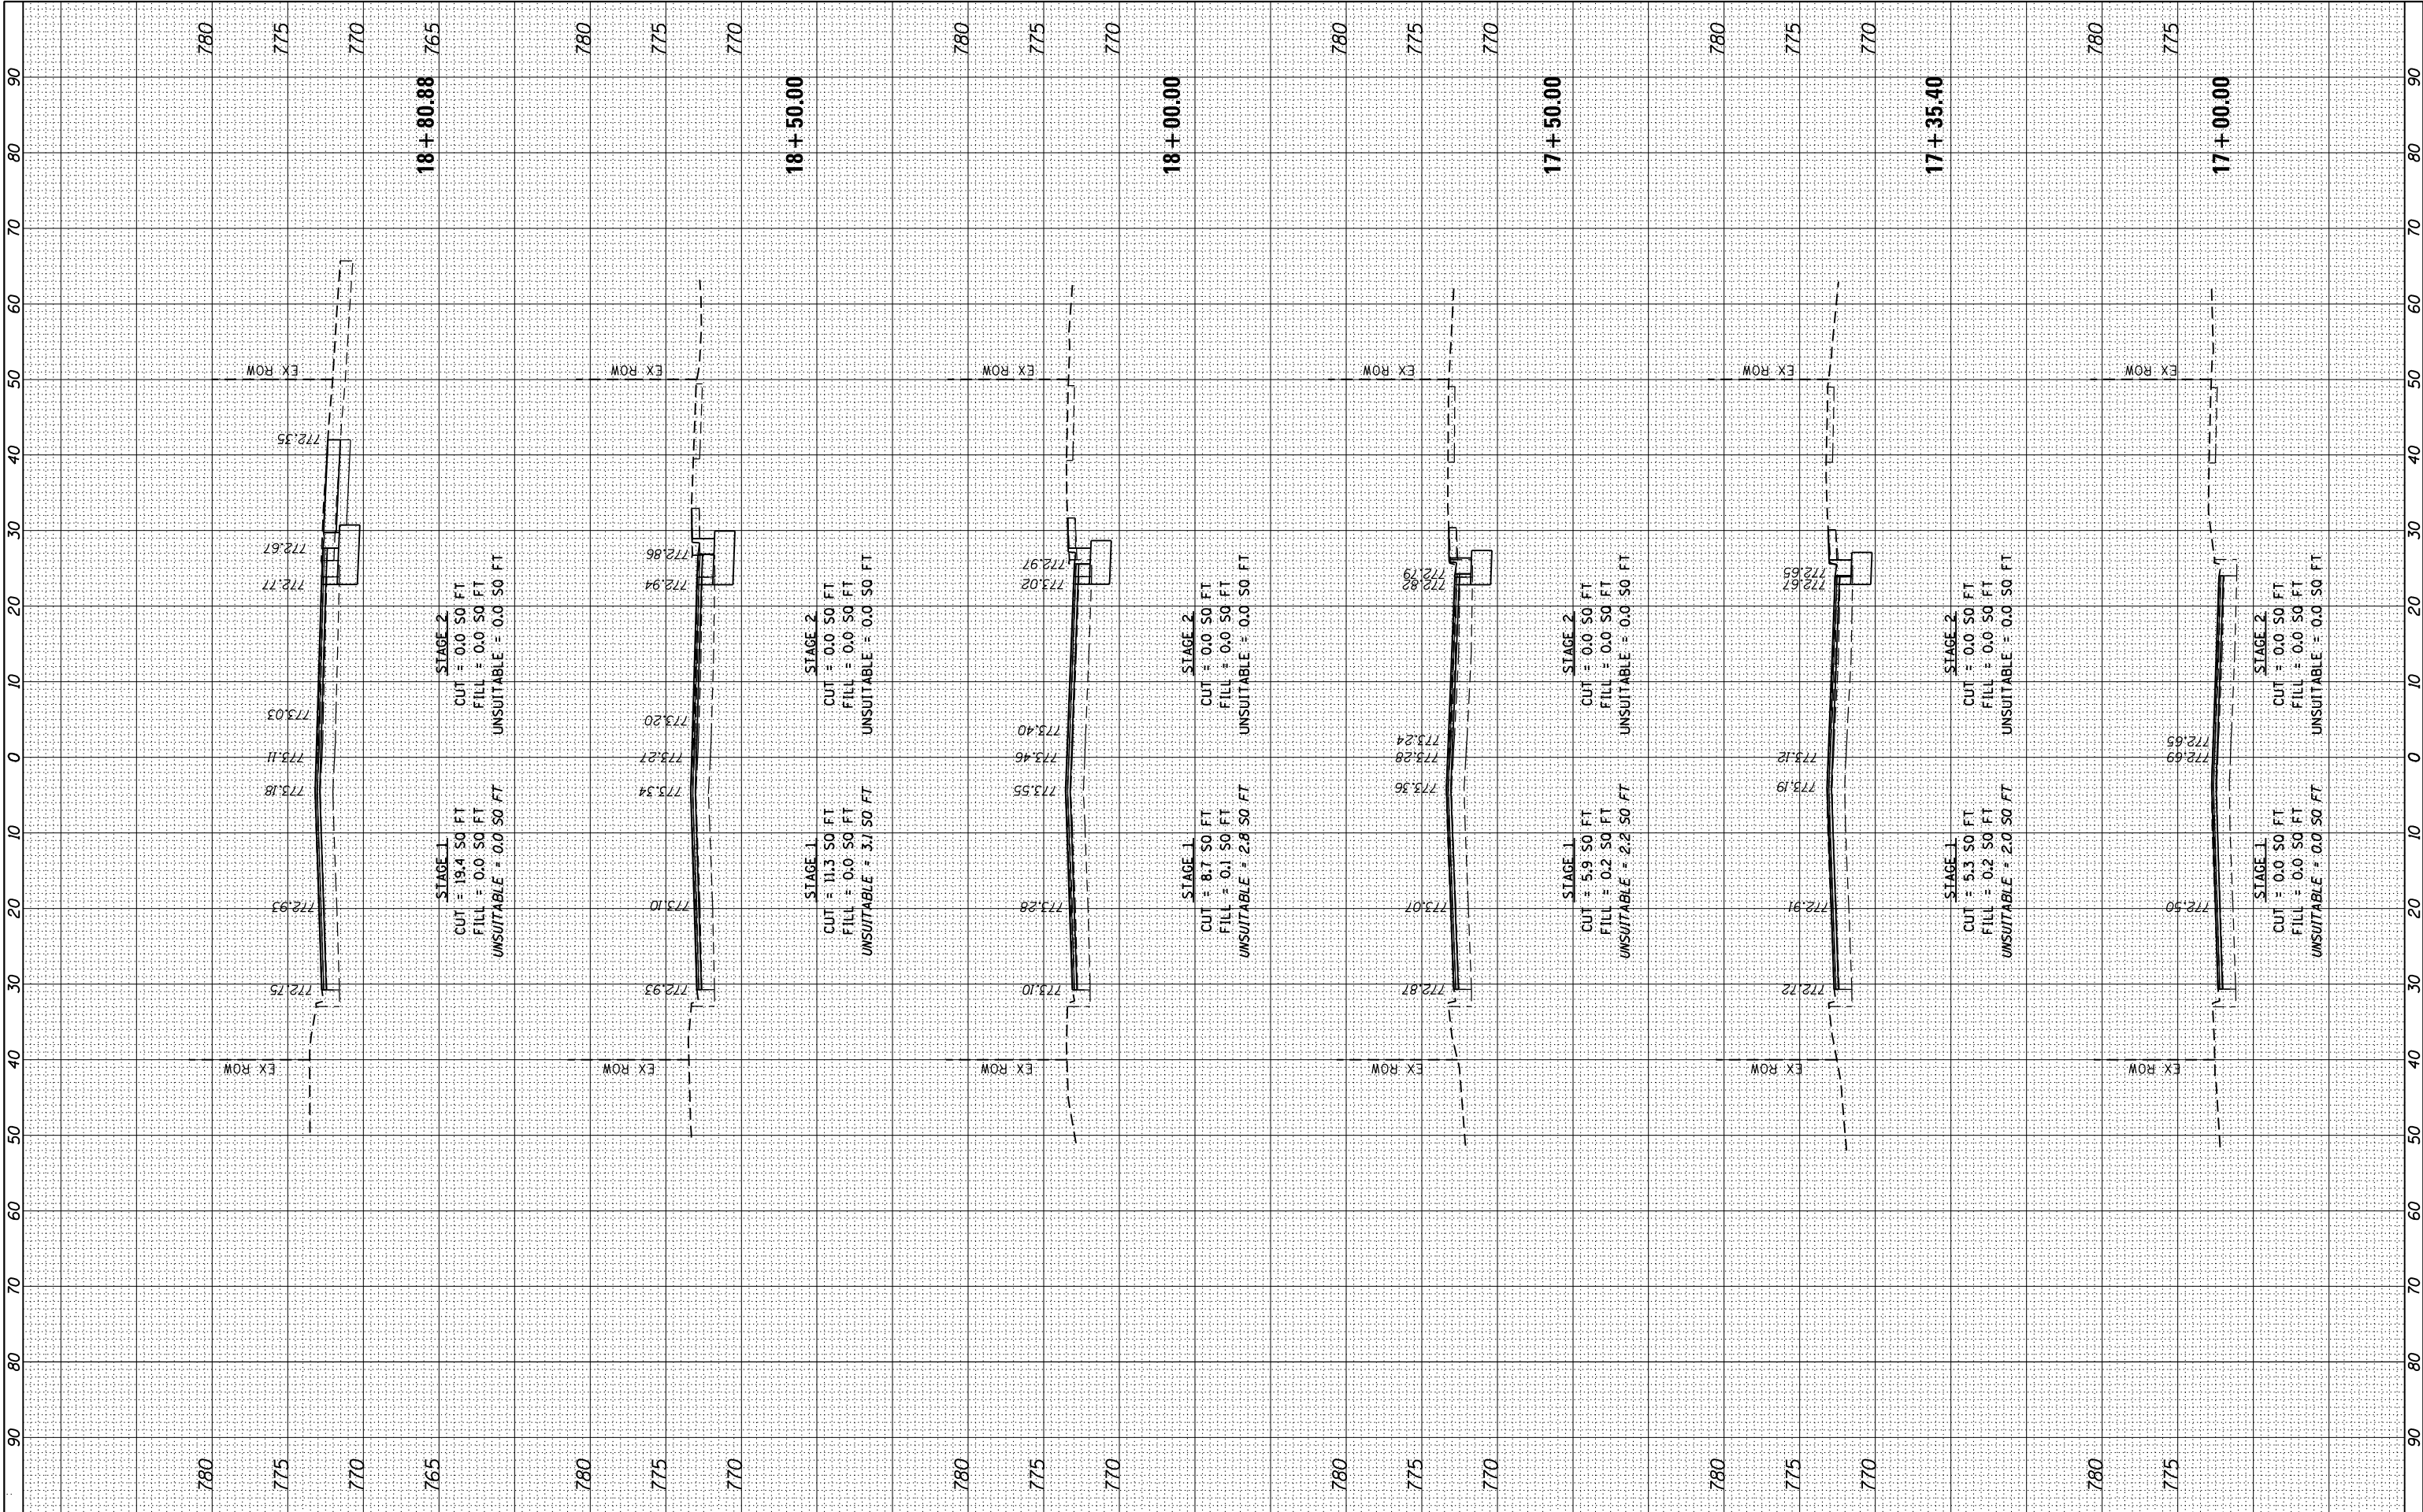

FINAL SURVEY	SURVEYED _____	BY _____	DATE _____
NOTE BOOK	PLOTTED _____		
	TEMPLATE _____		
	AREAS _____		
NO. _____	AREAS CHECKED _____		

ORIGINAL SURVEY		BY _____	DATE _____
NOTE BOOK			
	SURVEYED _____		
	PLOTTED _____		
	TEMPLATE _____		
	AREAS _____		
NO. _____	AREAS CHECKED _____		

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PLOT DATE = 8/31/2023	DATE - 09/08/2023

DESIGNED	-	GJE
DRAWN	-	GJE
CHECKED	-	MTC
DATE	-	09/08/2023

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REVISED	-
REVISED	-
REVISED	-


**STATE OF ILLINOIS
DEPARTMENT OF TRANSPORTATION**

1'=5' VERT.

SCALE: 1'=10' HORZ.	SHEET 19 OF 22 SHEETS	STA. 19+00.00 TO STA. 20+27.82
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**CROSS SECTIONS
83RD STREET**

F.A.U RTE.	SECTION	COUNTY	TOTAL SHEETS	SHEET NO.
2612	16-00232-00-CH	DUPAGE	248	245
		CONTRACT NO. 61J01		
ILLINOIS		FED. AID PROJECT		

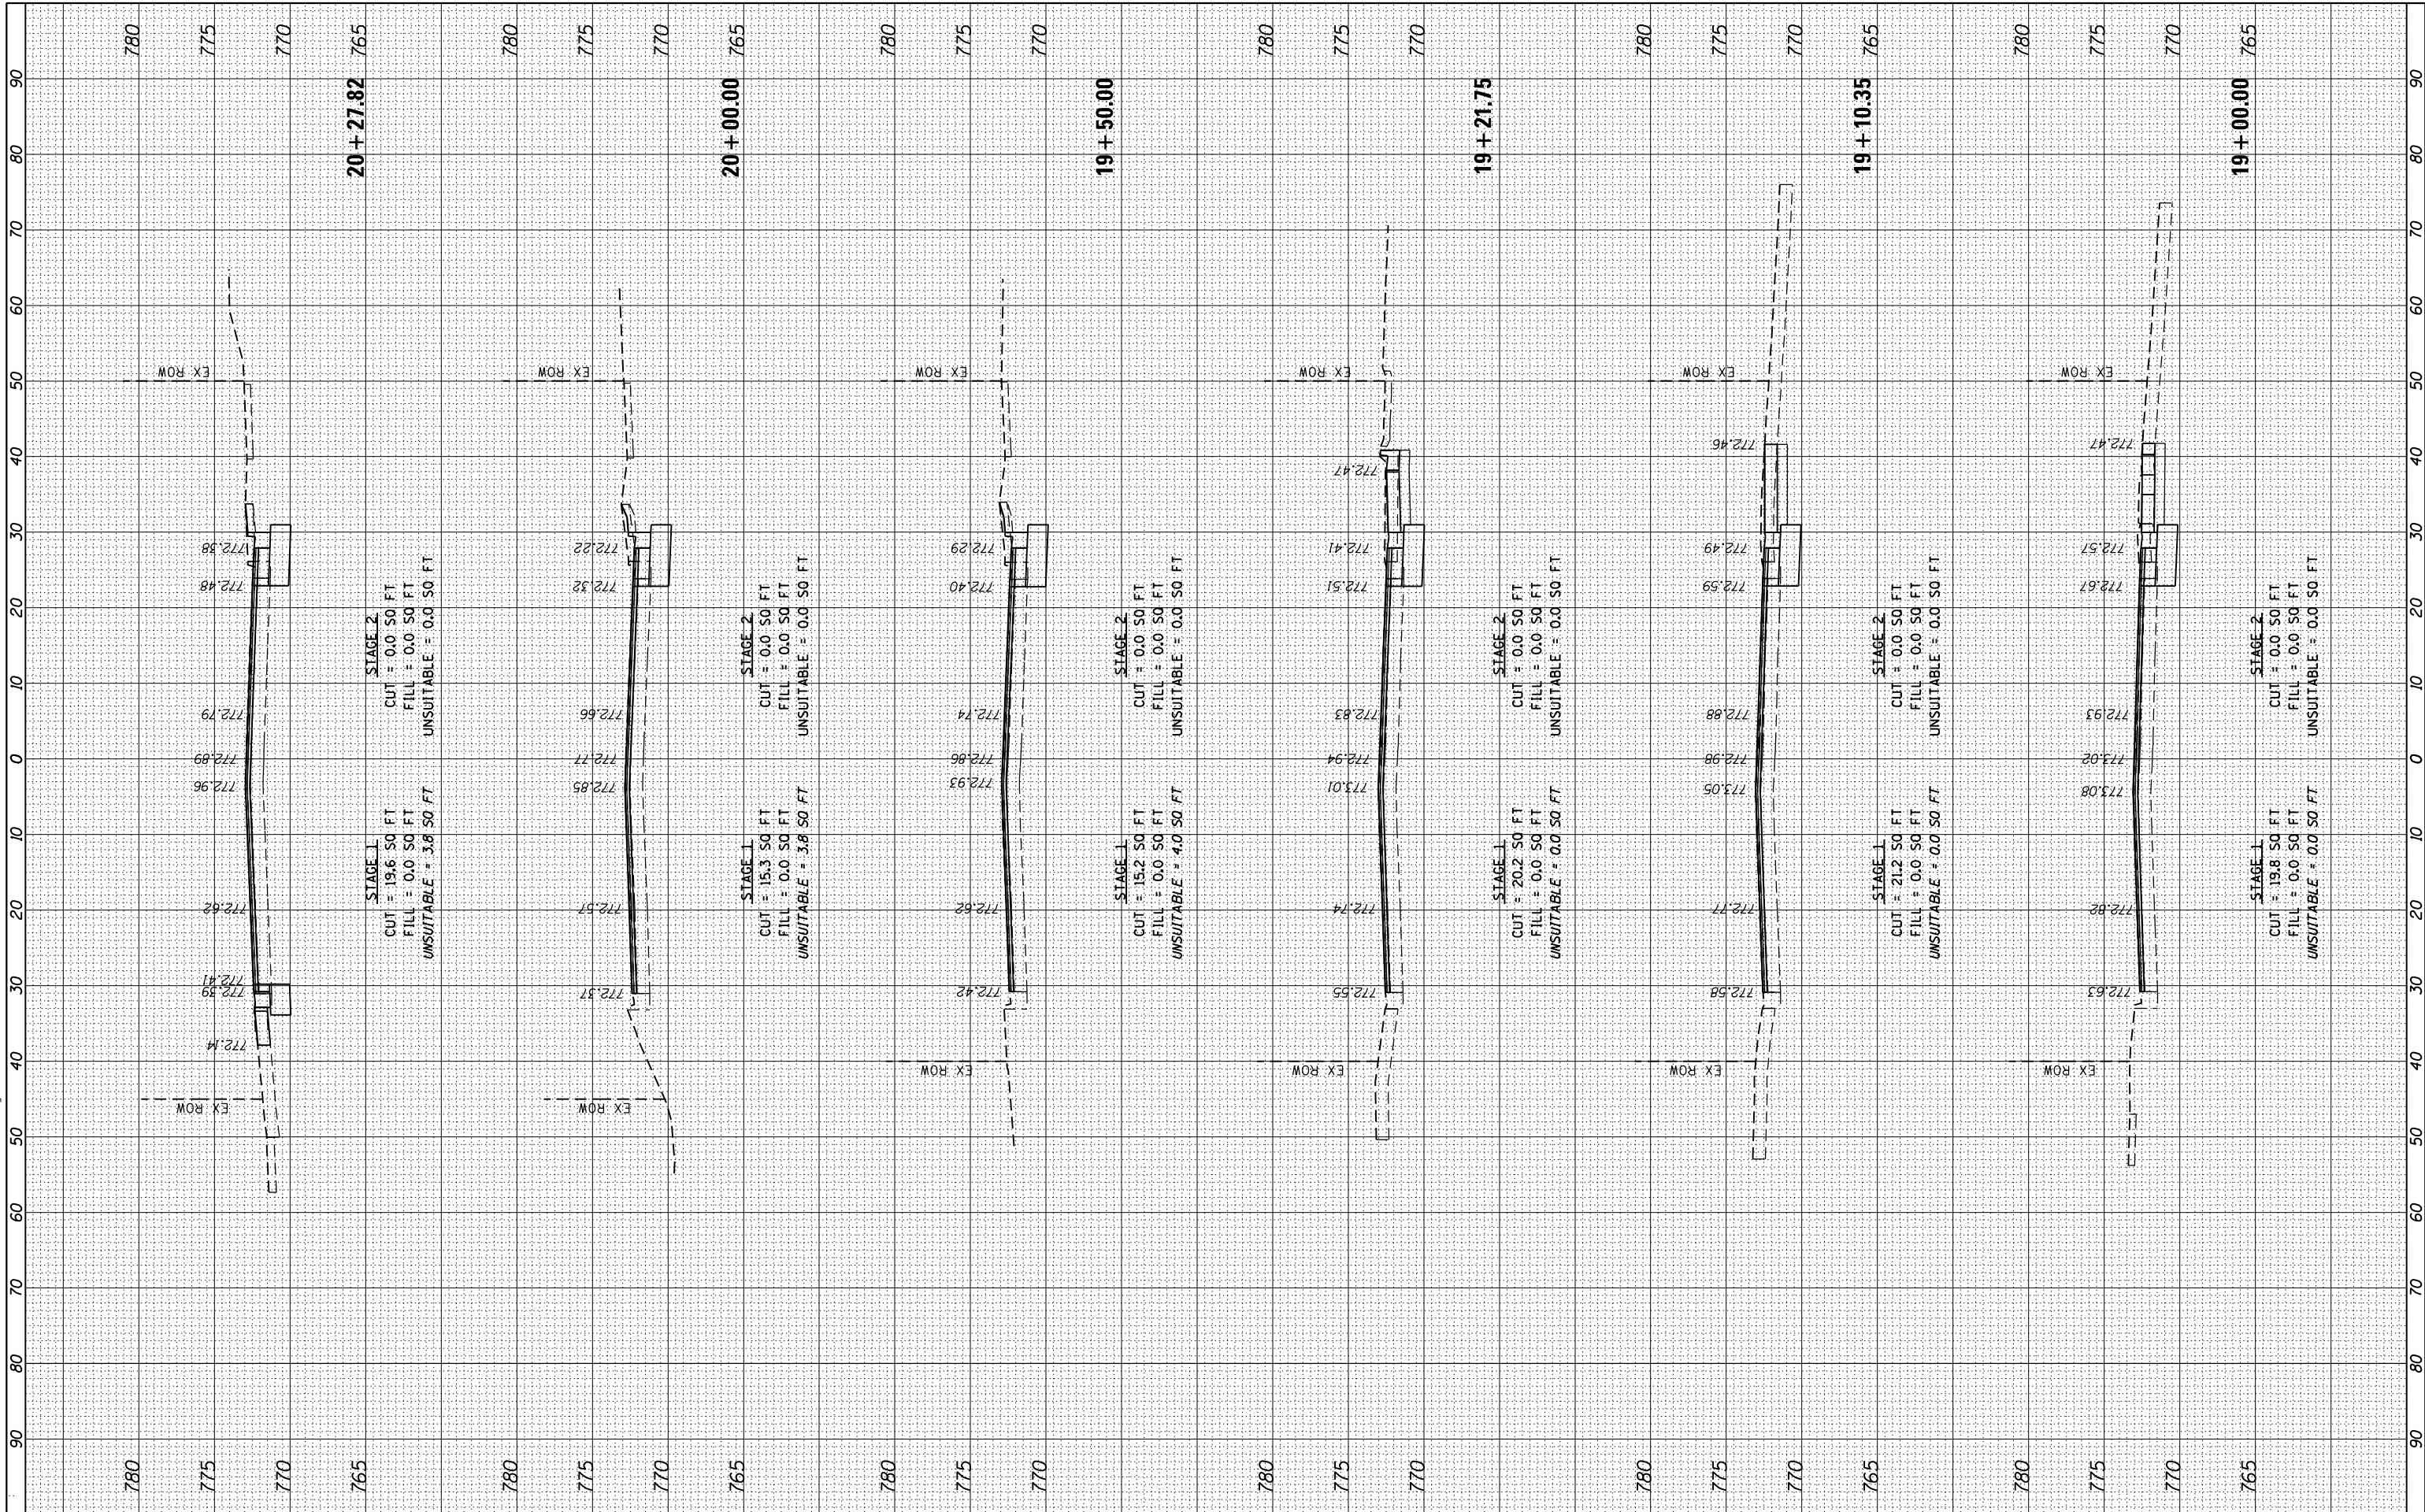

FINAL SURVEY	SURVEYED PLOTTED	BY	DATE
NOTE BOOK	TEMPLATE		
NO.	AREAS CHECKED		

ORIGINAL SURVEY	SURVEYED PLOTTED	BY	DATE
NOTE BOOK	TEMPLATE		
NO.	AREAS CHECKED		

FILE NAME = M:\151-945 DUDOT Lemont Re\CA00 Streets\16-00232-00 CH\11 cross sections 2.dgn



USER NAME = cesario	DESIGNED - GJE
	DRAWN - GJE
PLOT SCALE = 20.0000' / in.	CHECKED - MTC
PLOT DATE = 8/31/2023	DATE - 09/08/2023

REVISED -
REVISED -
REVISED -
REVISED -

STATE OF ILLINOIS
DEPARTMENT OF TRANSPORTATION

1"=5' VERT.
SCALE: 1"=10' HORZ. SHEET 21 OF 22 SHEETS STA. 24+43.49 TO STA. 26+50.00

CROSS SECTIONS
83RD STREET

F.A.U RTE.	SECTION	COUNTY	TOTAL SHEETS	SHEET NO.
2612	16-00232-00-CH	DUPAGE	248	247
CONTRACT NO. 61J01				
ILLINOIS FED. AID PROJECT				

