PROJECT IS LOCATED IN THE

01-16-2026 LETTING ITEM 194

EXISTING STRUCTURE LOCATION SN 099-0210 4-SPAN MULTI-BEAM

OVER I-55 WITH SPILL THROUGH

ABUTS AND CONCRETE PIERS. BACK TO BACK LENGTH = 189'-0"

OUT TO OUT WIDTH = 51'-0"

STATE OF ILLINOIS


DEPARTMENT OF TRANSPORTATION

PROPOSED HIGHWAY PLANS

FAI 55 (I-55) AT CATON FARM ROAD (3 MILES N. OF US 52) **SECTION FAI 55 22 BRIDGE REHAB** PROJECT NO: NHPP-JM31(164) BRIDGE DECK OVERLAY AND JOINT REPAIR

WILL COUNTY

C-91-232-22

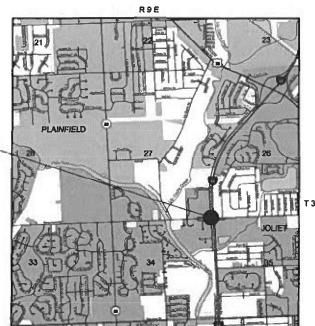

D-91-186-22


SECTION

55 FAI 55 22 BRIDGE REHAB WILL

COUNTY

ILLINOIS CONTRACT NO. 62R76

31 1

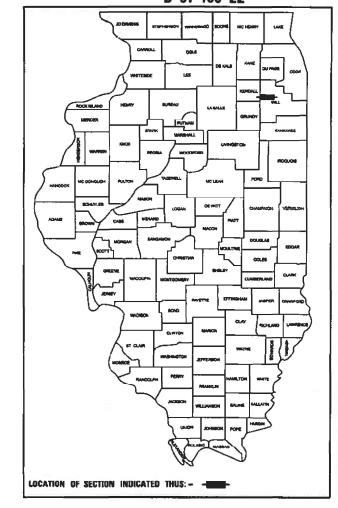

STATE OF ILLINOIS DEPARTMENT OF TRANSPORTATION

PRINTED BY THE AUTHORITY OF THE STATE OF ILLINOIS

TRAFFIC DATA

CITY OF JOLIET

0

0

CATON FARM ROAD: FUNCTION CLASS = MINOR ARTERIAL ADT (2023) = 18,100POSTED SPEED LIMIT = 35 MPH

FUNCTION CLASS = INTERSTATE ADT (2023) = 78,800POSTED SPEED LIMIT = 55 MPH

HOWARD J. HAMILTON, PE, CFM, CPESC SHEETS 1-13

ILUNOIS LICENSE NO. 062-047406 EXPIRES 11/30/2025

MAJLINDA AGOJCI P.E., S.E. SHEETS 14-22

ILLINOIS LICENSE NO. 081-006911 **EXPIRES 11/30/2026**

FULL SIZE PLANS HAVE BEEN PREPARED USING STANDARD ENGINEERING SCALES. REDUCED SIZED PLANS WILL NOT CONFORM TO STANDARD SCALES. IN MAKING MEASUREMENTS ON REDUCED PLANS, THE ABOVE SCALES MAY BE USED.

J.U.L.I.E. JOINT UTILITY LOCATION INFORMATION FOR EXCAVATORS 1-800-892-0123 OR 811

PROJECT MANAGER, PRAVEEN KAINI, PE (847) 705-4237

GROSS LENGTH = 290.00 FT. = 0.055 MILE NET LENGTH = 290.00 FT, = 0.055 MILE

CONTRACT NO. 62R76

TRUCTURAL MAJLINDA AGOJCI 081-006911

NOT TO SCALE

SHEET INDEX

COVER

GENERAL NOTES/SHEET INDEX 2.

SUMMARY OF QUANTITIES 3-5.

MOT GENERAL NOTES/CONSTRUCTION SEQUENCING

MAINTENANCE OF TRAFFIC TYPICAL SECTION 7. 8-9 MAINTENANCE OF TRAFFIC PLAN STAGE 1

DISTRICT 1 STANDARD DETAIL TC-22

MAINTENANCE OF TRAFFIC PLAN STAGE 2 10-11.

ROADWAY PLAN 12.

PAVEMENT MARKING PLAN 13.

STRUCTURE PLANS 14-22.

31.

23. **DISTRICT 1 STANDARD DETAIL BD-24** DISTRICT 1 STANDARD DETAIL BD-32 24. DISTRICT 1 STANDARD DETAIL TC-8 25. 26. DISTRICT 1 STANDARD DETAIL TC-9 27. DISTRICT 1 STANDARD DETAIL TC-10 DISTRICT 1 STANDARD DETAIL TC-11 28. 29. DISTRICT 1 STANDARD DETAIL TC-13 DISTRICT 1 STANDARD DETAIL TC-17 30.

HIGHWAY STANDARDS

000001-09 STANDARD SYMBOLS, ABBREVIATIONS AND PATTERNS

606001-09 CONCRETE CURB TYPE BAND COMBINATION CONCRETE CURB AND GUTTER

630001-13 STEEL PLATE BEAM GUARDRAIL

OFF-RD OPERATIONS, 2L, 2W, 15' TO 24" FROM PAVEMENT EDGE 701006-05

701101-05 OFF-RD OPERATIONS, 15' (4.5 m) TO 24" (600 mm) FROM PAVEMENT EDGE

701106-02 OFF ROAD OPERATIONS, MULTILANE, MORE THAN 15' AWAY

701301-04 LANE CLOSURE, 2L, 2W, SHORT TIME OPERATIONS

LANE CLOSURE, 2L, 2W, MOVING OPERATIONS-DAY ONLY 701311-03

701331-05 LANE CLOSURE, 2L, 2W, WITH RUNAROUND FOR SPEEDS ≥ 45

701400-12 APPROACH TO LANE CLOSURE FREEWAY/EXPRESSWAY LANE CLOSURE, FREEWAY/EXPRESSWAY 701401-13

701411-09 LANE CLOSURE, MULTILANE, AT ENTRANCE OR EXIT RAMP. FOR SPEEDS ≥ 45

701427-05 LANE CLOSURE, MULTILANE, INTERMITTENT OR MOVING OPER., FOR SPEEDS ≤ 40

701428-01 TRAFFIC CONTROL SETUP AND REMOVAL FREEWAY/EXPRESSWAY

TWO LANE CLOSURE, FREEWAY/EXPRESSWAY 701446-11

701606-10 URBAN SINGLE LANE CLOSURE, MULTILANE, 2W WITH MOUNTABLE MEDIAN

701611-01 URBAN HALF ROAD CLOSURE, MULTILANE, 2W WITH MOUNTABLE MEDIAN

701901-11 TRAFFIC CONTROL DEVICES

704001-08 TEMPORARY CONCRETE BARRIER

780001-05 TYPICAL PAVEMENT MARKINGS

GUARDRAIL AND BARRIER WALL REFLECTOR MOUNTING DETAILS

HMA MIXTURE REQUIREMENTS

MIXTURE TYPE	AIR VOIDS @ NDES	QUALITY MANAGEMENT PROGRAM (QMP)				
HMA OVERLAY AND BUTT JOINT						
HOT MIX ASPHALT SURFACE COURSE, IL-9.5, MIX "D", N70, 1 ½" 4% AT 70 GYR. QC/QA						
QMP DESIGNATION: QUALITY CONTROL/ QUALITY ASSURANCE (QC/QA), QUALITY CONTROL FOR PERFORMANCE (QCP), PAY FOR PERFORMANCE (PFP)						

- 1. THE UNIT WEIGHT USED TO CALCULATE ALL HOT-MIX ASPHALT SURFACE MIXTURE QUANTITIES IS 112 LBS/SQ.YD/IN.
- 2. THE "AC TYPE" FOR POLYMERIZED HMA MIXES SHALL BE "SBS/SBR PG 76-22" AND FOR NON-POLTMERIZED HMA THE "AC TYPE" SHALL BE "PG 64-22" UNLESS MODIFIED BY RECLAIMED MATERIALS SPECIFICATIONS.

GENERAL NOTES

- THE CONTRACTOR WILL NOT BE ALLOWED TO SET UP A YARD OR FIELD OFFICE ON STATE OR CITY PROPERTY WITHOUT WRITTEN PERMISSION FROM THE DEPARTMENT.
- IT SHALL BE THE CONTRACTOR'S RESPONSIBILITY TO VERIFY ALL DIMENSIONS AND CONDITIONS EXISTING IN THE FIELD PRIOR TO CONSTRUCTION AND ORDERING OF MATERIALS.
- THE CONTRACTOR SHALL TAKE EXTREME CARE WHEN PERFORMING DEMOLITION AND REMOVAL AROUND THE EXISTING FACILITIES TO REMAIN IN PLACE. IF EXISTING ELEMENTS ARE DAMAGED, THE CONTRACTOR SHALL REPAIR/RESTORE TO MATCH THE EXISTING CONDITIONS OR BETTER.
- BEFORE BEGINNING ANY WORK, THE CONTRACTOR SHALL RETAIN AND RECORD FOR FUTURE REFERENCES, ALL EXISTING PAVEMENT MARKING LINES (AND RAISED REFLECTIVE PAVEMENT MARKERS) IN ORDER THAT THESE LOCATIONS CAN BE RE-
- THE CONTRACTOR SHALL CONTACT KALPANAKANNAN-HOSADURGA, THE DISTRICT ONE TRAFFIC CONTROL SUPERVISOR, AT KALPANA.KANNAN-HOSADURGA@ILLINOIS.GOV A MINIMUM OF 72 HOURS IN ADVANCE OF BEGINNING
- THE CONTRACTOR SHALL CONTACT CARLOS MUNOZ. THE DISTRICT ONE EXPRESSWAY TRAFFIC CONTROL SUPERVISOR, AT CARLOS MUNOZ@ILLINOIS GOV A MINIMUM OF 72 HOURS IN ADVANCE OF BEGINNING WORK.
- TWO WEEKS PRIOR TO THE PLACEMENT OF PERMANENT PAVEMENT MARKINGS, THE ENGINEER SHALL CONTACT MR. ERIC CAMPOS, AREA TRAFFIC FIELD ENGINEER, AT ERIC CAMPOS@ILLINOIS GOV.
- THE CONTRACTOR SHALL REQUEST AND GAIN APPROVAL FROM THE ILLINOIS DEPARTMENT OF TRANSPORTATION'S EXPRESSWAY TRAFFIC OPERATIONS ENGINEER AT WWW.IDOTLCS.COM TWENTY FOUR (24) HOURS IN ADVANCE OF ALL DAILY LANE, RAMP, AND SHOULDER CLOSURES AND SEVEN DAYS IN ADVANCE OF ALL PERMANENT AND WEEKEND CLOSURES ON ALL FREEWAYS AND/OR EXPRESSWAYS IN DISTRICT ONE. THIS ADVANCE NOTIFICATION IS CALCULATED BASED ON THE WORKWEEK OF MONDAY THROUGH FRIDAY AND SHALL NOT INCLUDE WEEKENDS OR HOLIDAYS.
- NO WORK SHALL COMMENCE UNTIL TRAFFIC CONTROL REQUIREMENTS ARE MET.
- DURING CONSTRUCTION OPERATIONS, WHENEVER LOOSE MATERIAL IS DEPOSIT IN THE FLOW LINE OF GUTTER, DRAINAGE STRUCTURES, DITCHES, ETC. SUCH THAT THE NATURAL FLOW LINE OF WATER IS OBSTRUCTED, THE LOOSE MATERIAL SHALL BE REMOVED AT THE CLOSE OF EACH WORKING DAY. AT THE CONCLUSION OF THE CONSTRUCTION OPERATIONS, ALL DRAINAGE STRUCTURES AND FLOW LINES SHALL BE FREE FROM DIRT AND DEBRIS.
- WHEN ARTIFICIAL LIGHTS ARE USED THE CONTRACTOR SHALL EXERCISE THE UTMOST PRECAUTIONS IN PREVENTING ADVERSE VISIBILITY TO THE MOTORING PUBLIC AND ADJOINING RESIDENTIAL AREAS.
- SAW CUTS (FULL DEPTH) SHALL BE REQUIRED WITHIN THE PAVEMENT, SIDEWALK, AND CURB & GUTTER AND THAT TO BE LEFT IN PLACE OR DIRECTED BY THE ENGINEER. THE WORK WILL NOT BE PAID FOR SEPARATELY BUT SHALL BE INCLUDED IN THE COST OF REMOVAL ITEMS.
- TEN (10) FOOT TRANSITIONS SHALL BE USED TO MATCH PROPOSED CURB AND GUTTER AND MEDIAN ITEMS OF WORK TO EXISTING CURB AND GUTTER AND MEDIAN IN THE FIELD, UNLESS OTHERWISE SHOWN.
- THE CONTRACTOR SHALL BE RESPONSIBLE FOR THE PROTECTION OF ALL UNDERGROUND OR SURFACE UTILITIES EVEN THOUGH THEY MAY NOT BE SHOWN ON THE PLANS. ANY UTILITY THAT IS DAMAGED DURING CONSTRUCTION SHALL BE REPAIRED OR REPLACED TO THE SATISFACTION OF THE ENGINEER. THIS WORK SHALL BE AT THE CONTRACTOR'S EXPENSE.
- THE CONTRACTOR SHALL TAKE WHATEVER PRECAUTIONS WHICH MAY BE NECESSARY TO PROTECT THE PROPERTY OF THE VARIOUS PUBLIC UTILITIES WHICH MAY BE LOCATED UNDERGROUND OR ABOVE GROUND, AT OR ADJACENT TO THE SITE OF THIS IMPROVEMENT, HE WILL BE REQUIRED TO REPAIR OR REPLACE AT HIS OWN EXPENSE, OR BEAR THE COST, TO REPAIR OR REPLACE, ANY PUBLIC UTILITY PROPERTY WHICH HAS BEEN DAMAGED BY HIS EFFORTS.

i					
i	EXCellence, Dedication, Innovation	USER NAME = mbuiting	DESIGNED - MGB	REVISED -	Γ
-			DRAWN - MGB	REVISED -	ı
4	Environmental Design International inc. Civil, Survey, Environmental and Construction Inspection Services		CHECKED - HJH	REVISED -	ı
	33 W. MONROE STREET, SUITE 1825, CHICAGO, IL 60603	P OT DATE = 8/7/2025	DATE -	REVISED -	i

DEPARTMENT OF TRANSPORTATION SCALE:

STATE OF ILLINOIS

SECTION I-55 AT CATON FARM ROAD 55 FAI 55 22 BRIDGE REHAB **GENERAL NOTES/SHEET INDEX** OF 1 SHEETS STA. SHEET 1 TO STA. ILLINOIS FED. AID PROJECT

COUNTY

WILL | 31 | 2

CONTRACT NO. 62R76

SI	JMMARY OF QUANTITIES			CONSTR. CODE	
	JUNIARI OF GOARTITIES			90% FEDERAL 10% STATE	
CODE NO.	ITEM	UNIT	TOTAL QUANTITY	BRIDGE 0059 SN 099-0210	
40600290	BITUMINOUS MATERIALS (TACK COAT)	POUND	212	212	
40600982	HOT-MIX ASPHALT REMOVAL-BUTT JOINT	SQ YD	306	306	
40604062	HOT-MIX ASPHALT SURFACE COURSE, IL-9.5, MIX "D", N70	TON	54	54	
50102400	CONCRETE REMOVAL	CU YD	15	15	
50157300	PROTECTIVE SHIELD	SQ YD	162	162	
50300255	CONCRETE SUPERSTRUCTURE	CU YD	17	17	
50300300	PROTECTIVE COAT	SQ YD	1115	1115	
50800205	REINFORCEMENT BARS, EPOXY COATED	POUND	2580	2580	
50800515	BAR SPLICERS	EACH	24	24	
52000110	PREFORMED JOINT STRIP SEAL	FOOT	102	102	
60260100	INLETS TO BE ADJUSTED	EACH	4	4	
63100085	TRAFFIC BARRIER TERMINAL, TYPE 6	EACH	1	1	
63200310	GUARDRAIL REMOVAL	FOOT	37.5	37.5	
67100100	MOBILIZATION	L SUM	1	1	
70107025	CHANGEABLE MESSAGE SIGN	CAL DA	120	120	

USER NAME = mbuiting

Environmental Design International inc.

Chick Survey, Environmental and Construction Impaction Services
SS M. MONGE STREET, SIZE 1826. CHICAGO, 0.6803
Ph. (312) 346-1400 Fax (312)346-0529 www.envirolesigni.com PLOT DATE = 6/25/2024

STATE OF ILLINOIS
DEPARTMENT OF TRANSPORTATION

I-55 AT CATON FARM ROAD SUMMARY OF QUANTITIES

SCALE: N.A. SHEET 1 OF 3 SHEETS STA.

TO STA.

					CONSTR. CODE
			T		90% FEDERAL
					10% STATE
	CODE	ITEM	UNIT	TOTAL	BRIDGE 0059
	NO.	11 2.17	ONT	QUANTITY	SN 099-0210
	70300150	SHORT TERM PAVEMENT MARKING REMOVAL	SQ FT	3263	3263
	70307120	TEMPORARY PAVEMENT MARKING - LINE 4" - TYPE IV TAPE	FOOT	9790	9790
	70400100	TEMPORARY CONCRETE BARRIER	FOOT	614	614
	70400200	RELOCATE TEMPORARY CONCRETE BARRIER	FOOT	614	614
	70600241	IMPACT ATTENUATORS, TEMPORARY (NON- REDIRECTIVE, NARROW), TEST LEVEL 2	EACH	2	2
	70600341	IMPACT ATTENUATORS, RELOCATE (NON- REDIRECTIVE, NARROW), TEST LEVEL 2	EACH	2	2
*	78000200	THERMOPLASTIC PAVEMENT MARKING - LINE 4"	FOOT	3163	3163
*	78000600	THERMOPLASTIC PAVEMENT MARKING - LINE 12"	FOOT	35	35
-					
4	79004625	PREFORMED PLASTIC PAVEMENT MARKING, TYPE D - STANDARD LINE 7"	FOOT	48	48
	76004635	PREFORMED PLASTIC PAVEMENT MARKING, TYPE D - STANDARD LINE /	1001	40	40
J.	78009004	MODIFIED URETHANE PAVEMENT MARKING, TYPE D - LINE 4"	FOOT	380	380
*	78009004	WOODITIED ORETTANE PAVEIVIENT WARRING, TIPE D - LINE 4	F001	360	360
	70000040	MODIFIED LIBETHANIE DAVEMENT MADIZINO, TYPE D. LINE 401	5007	0.5	0.5
*	78009012	MODIFIED URETHANE PAVEMENT MARKING, TYPE D - LINE 12"	FOOT	35	35
*	78011040	GROOVING FOR RECESSED PAVEMENT MARKING 8"	FOOT	48	48
*	78200005	GUARDRAIL REFLECTORS, TYPE A	EACH	84	84
*	78200011	BARRIER WALL REFLECTORS, TYPE C	EACH	32	32
			l		

* SPECIALTY ITEM

Environmental Design International inc.

Environmental Design International inc.

Civil, Survey, Environmental and Construction Inspection Services

30 W. MONROE STREET, SUTE 1925 CHICAGO, IL 60603

Ph. 012) 304-4040 Fex 3(213246-5928 www.awn-designal.com

STATE OF ILLINOIS
DEPARTMENT OF TRANSPORTATION

I-55 AT CATON FARM ROAD SUMMARY OF QUANTITIES

SCALE: N.A. SHEET 2 OF 3 SHEETS STA.

TO STA.

 F.A.I. RTE.
 SECTION
 COUNTY SHEETS
 TOTAL SHEETS
 SHEET NO.

 55
 FAI 55 22 BRIDGE REHAB
 WILL
 31
 4

 CONTRACT NO. 62R76

 ILLINOIS
 FED. AID PROJECT

				CONSTR. COD
				90% FEDERAL
				10% STATE
				BRIDGE
CODE	ITEM	UNIT	TOTAL	0059
NO.	112	Ortin	QUANTITY	SN 099-0210
78300200	RAISED REFLECTIVE PAVEMENT MARKER REMOVAL	EACH	12	12
78300202	PAVEMENT MARKING REMOVAL-WATER BLASTING	SQ FT	558	558
(4400503	COMBINATION CURB AND GUTTER REMOVAL AND REPLACEMENT GREATER THAN 10 FEET	FOOT	160	160
X5030250	BRIDGE DECK GROOVING (LONGITUDINAL)	SQ YD	914	914
X6700407	ENGINEER'S FIELD OFFICE TYPE A (D1)	CAL MO	12	12
X0700407	ENGINEERS FIELD OF FIGE FIT E A (DT)	CAL IVIO	12	12
X7010216	TRAFFIC CONTROL AND PROTECTION (SPECIAL)	LSUM	1	1
X7011015	TRAFFIC CONTROL AND PROTECTION (EXPRESSWAYS)	L SUM	1	1
Z0001800	APPROACH SLAB REPAIR (PARTIAL DEPTH)	SQ YD	14	14
Z0006014	BRIDGE DECK LATEX CONCRETE OVERLAY, 2½ INCHES	SQ YD	997	997
Z0012130	BRIDGE DECK SCARIFICATION 3/4"	SQ YD	997	997
Z0012754	STRUCTURAL REPAIR OF CONCRETE (DEPTH EQUAL TO OR LESS THAN 5 INCHES)	SQ FT	166	166
Z0012755	STRUCTURAL REPAIR OF CONCRETE (DEPTH GREATER THAN 5 INCHES)	SQ FT	8	8
Z0029090	DIAMOND CRINDING (PRIDGE SECTION)	SOVD	914	014
	DIAMOND GRINDING (BRIDGE SECTION)	SQ YD	914	914
X72 00061	TEMPORARY INFORMATION SIGNING	SQ FT	102.8	102.8

Excellence, Dedication, Innovation

Environmental Design International inc.

District Survey, Environmental and Construction Inspection Services is aw Monitor Street; Survey 1250, CHICAGO, 160003

Ph. (312) 346-1400 Fax (312)345-0529 www.ndesigni.com

PLOT DATE = 5/20/2024

STATE OF ILLINOIS
DEPARTMENT OF TRANSPORTATION

I-55 AT CATON FARM ROAD
SUMMARY OF QUANTITIES

SCALE: N.A. | SHEET 3 OF 3 SHEETS| STATE TO STATE

MAINTENANCE OF TRAFFIC GENERAL NOTES

- THE MAINTENANCE OF TRAFFIC CONTROL (MOT) PLANS SHALL SERVE AS A GUIDE FOR SAFE DIVERSION OF TRAFFIC DURING EXECUTION OF THIS CONTRACT. HOWEVER, THE CONTRACTOR MAY MODIFY THE MOT PLANS TO MEET CONSTRUCTION NEEDS, BUT NOT AT THE EXPENSE OF PUBLIC SAFETY OR CONVENIENCE. ANY CHANGES TO THE MOT PLANS SHALL BE SUBMITTED TO THE ENGINEER FOR APPROVAL.
- 2. THE ENGINEER SHALL BE INFORMED 48 HOURS IN ADVANCE OF ANY PROPOSED CHANGE TO THE MOT PLANS.
- 3. CHANGEABLE MESSAGE SIGNS SHALL BE INSTALLED TWO WEEKS PRIOR TO ALL TRAFFIC STAGE CHANGES ON EACH APPROACH OF THE EFFECTED ROADWAY TO WARN MOTORISTS OF THE UPCOMING EVENT. THE SIGNS SHALL BE REMOVED TWO WEEKS THEREAFTER UNLESS THEY ARE NEEDED IN A SUBSEQUENT FUTURE EVENT THAT WILL OCCUR WITHIN TWO WEEKS ON THE SAME APPROACH OF THE AFFECTED ROADWAY. CHANGEABLE MESSAGE SIGN LOCATION SHALL BE AS DIRECTED BY THE ENGINEER.
- 4. TYPE C BI-DIRECTIONAL CRYSTAL REFLECTORS INSTALLED ON EXISTING BRIDGE PARAPET SHALL BE REMOVED AT THE CONCLUSION OF MOT OPERATIONS AT NO ADDITIONAL COST TO THE DEPARTMENT.
- 5. ALL EXISTING LANE LINE PAVEMENT MARKINGS AND RAISED REFLECTIVE PAVEMENT MARKER REFLECTORS LOCATED WITHIN THE TEMPORARY PAVEMENT MARKING TAPE USED FOR STAGING SHALL BE REMOVED VIA WATER BLASTING WITH VACUUM RECOVERY IF THE STAGING WILL REMAIN IN PLACE FOR MORE THAN 14 DAYS. THE EXISTING PAVEMENT MARKINGS AND RAISED REFLECTORS THAT WERE REMOVED SHALL BE RESTORED IN KIND AFTER THE COMPLETION OF STAGING.
- 6. TEMPORARY CONCRETE BARRIER SHALL BE INSTALLED IN ACCORDANCE WITH SECTION 704 OF THE IDOT STANDARD SPECIFICATIONS. ALL TEMPORARY CONCRETE BARRIER APPROACH AND DEPARTING END UNITS SHALL BE ANCHORED TO THE PAVEMENT USING SIX ANCHOR PINS AS SHOWN IN IDOT STANDARD 704001. PINNING OF ADDITIONAL BARRIER UNITS WITH THREE ANCHOR PINS ON THE TRAFFIC SIDE HOLES WITHIN THE INSTALLATION SHALL BE REQUIRED WHEN EQUIPMENT, VEHICLES, FIXED OBJECTS, OR DROP-OFFS ARE LOCATED WITHIN 24" BEHIND THE BARRIER. THE 24" OF CLEAR PAVEMENT MEASUREMENT SHALL BE FROM THE BASE OF THE NON-TRAFFIC SIDE OF THE BARRIER. TRAFFIC SIDE PINNED BARRIER SHALL HAVE A MINIMUM OF 6" OF CLEAR PAVEMENT BEHIND THE BARRIER. WHERE BOTH PINNED AND UNPINNED BARRIER UNITS ARE USED IN A CONTINUOUS INSTALLATION, A TRANSITION SHALL BE PROVIDED BETWEEN THEM, THE TRANSITION FROM PINNED TO UNPINNED SHALL CONSIST OF TWO ANCHOR PINS INSTALLED IN THE END HOLES ON THE TRAFFIC SIDE OF THE FIRST BARRIER REYOND THE PINNED SECTION AND ONE ANCHOR PIN INSTALLED IN THE MIDDLE HOLE OF THE TRAFFIC SIDE OF THE SECOND BARRIER BEYOND THE PINNED SECTION. THE THIRD BARRIER BEYOND THE PINNED SECTION SHALL BE UNPINNED.

STATE OF ILLINOIS DEPARTMENT OF TRANSPORTATION

SUGGESTED MAINTENANCE OF TRAFFIC SEQUENCING - CATON FARM RD

STAGE

- REMOVE PERMANENT PAVEMENT MARKINGS TO THE LIMITS SHOWN IN THE PLANS AND THE SCHEDULE OF PAVEMENT MARKING REMOVAL.
- INSTALL ALL STAGE 1 CONSTRUCTION TRAFFIC CONTROL SIGNS, DRUMS, BARRICADES, TEMPORARY
 CONCRETE BARRIER, TEMPORARY IMPACT ATTENUATORS, AND TEMPORARY PAVEMENT MARKINGS AS
 DETAILED IN STAGE 1 PLANS AND APPROPRIATE STANDARD DRAWINGS.
- SHIFT ALL TRAFFIC TO THE NORTH OF THE CENTERLINE OF SN 099-0210.
- COORDINATE WORK TO BE COMPLETED IN THIS STAGE WITH DETAILS IN THE BRIDGE PLANS.

STAGE 2


- REMOVE STAGE 1 TEMPORARY PAVEMENT MARKINGS THAT WOULD CONFLICT WITH STAGE 2 TRAFFIC MOVEMENT.
- INSTALL ALL STAGE 2 CONSTRUCTION TRAFFIC CONTROL SIGNS, DRUMS, BARRICADES, TEMPORARY CONCRETE BARRIER, TEMPORARY IMPACT ATTENUATORS, AND TEMPORARY PAVEMENT MARKINGS AS DETAILED IN STAGE 1 PLANS AND APPROPRIATE STANDARD DRAWINGS.
- SHIFT ALL TRAFFIC TO THE SOUTH OF THE CENTERLINE OF SN 099-0210.
- COORDINATE WORK TO BE COMPLETED IN THIS STAGE WITH DETAILS IN THE BRIDGE PLANS.

POST STAGE


- REMOVE ALL CONSTRUCTION TRAFFIC CONTROL AND TEMPORARY CONSTRUCTION ITEMS.
- REMOVE ANY REMAINING EXISTING TEMPORARY PAVEMENT MARKINGS WITHIN THE PERMANENT PAVEMENT MARKING LIMITS.
- INSTALL PERMANENT PAVEMENT MARKINGS.

SUGGESTED MAINTENANCE OF TRAFFIC SEQUENCING - I-55

TEMPORARY SHOULDER/ LANE CLOSURES ARE REQUIRED TO PERFORM SUBSTRUCTURE REPAIRS. LANE CLOSURES ALONG I-55 SHALL BE IN ACCORDANCE WITH SPECIAL PROVISION "TRAFFIC CONTROL AND PROTECTION (EXPRESSWAYS)". LANE CLOSURES SHALL OCCUR ONLY DURING NIGHTTIME HOURS IN ACCORDANCE WITH SPECIAL PROVISION "KEEPING THE EXPRESSWAYS OPEN TO TRAFFIC".

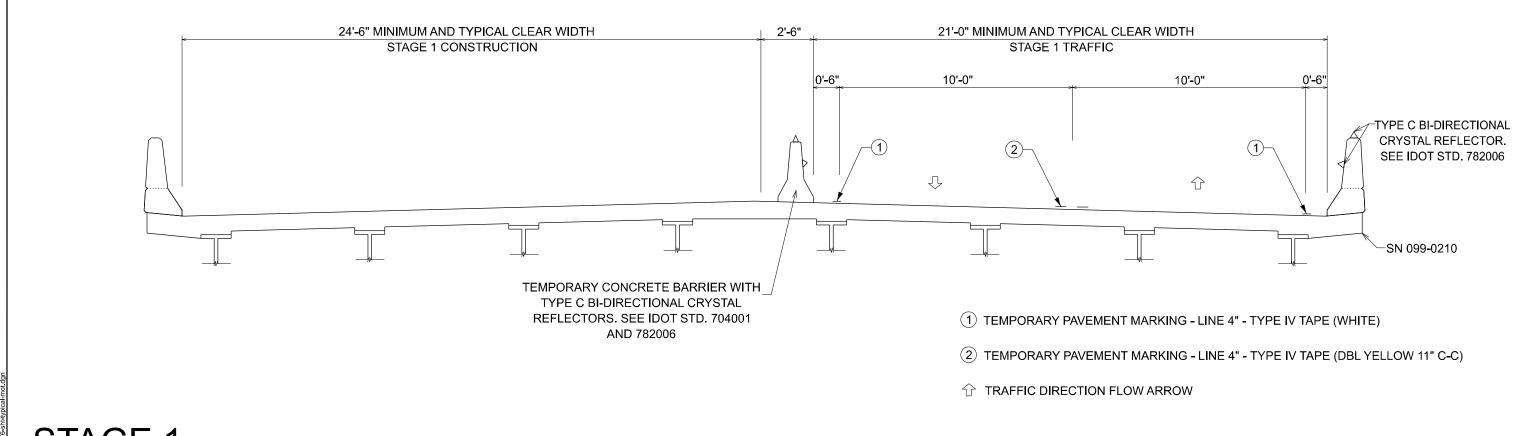

STAGE 1

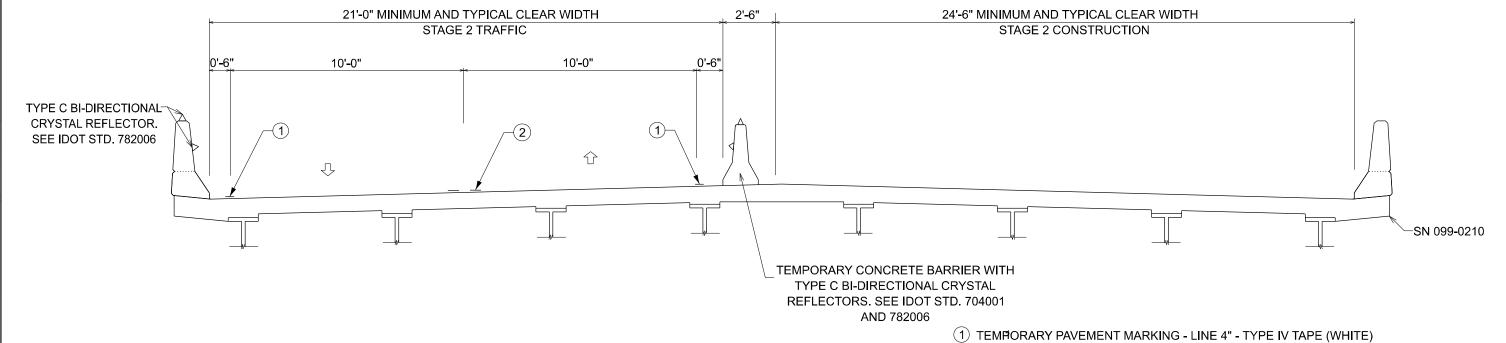

STAGE 2


2 TEMPORARY PAVEMENT MARKING - LINE 4" - TYPE IV TAPE (DBL YELLOW 11" C-C)

E 3		Ţ
- ¥	Excellence, Dedication, Innovation	Г
ᇳ	Environmental Design International inc.	г
\circ	Civil, Survey, Environmental and Construction Inspection Services	ᆫ
ŽΕ	33 W. MONROE STREET, SUITE 1825, CHICAGO, IL 60603	٦,
	Ph. (312) 345-1400 Fax (312)345-0529 www.envdesigni.com	

USER NAME = aseiber	DESIGNED - MGB	REVISED -
	DRAWN - MGB	REVISED -
	CHECKED -	REVISED -
PLOT DATE = 12/17/2024	DATE -	REVISED -

STATE OF ILLINOIS	
EPARTMENT OF TRANSPORTATION	

I-55 AT CATON FARM ROAD WAINTENANCE OF TRAFFIC TYPICAL SECTION						F.A.I. SECTION				COUNTY	
						55	FAI 55 22 BRI	DGE REI	HAB	WILL	
MAINTENANCE OF TRAFFIC TIFICAL SECTION									CONTRA		
	SHEET 1	OF	1	SHEETS	STA.	TO STA.			ILLINOIS	FED. AII	D PROJECT

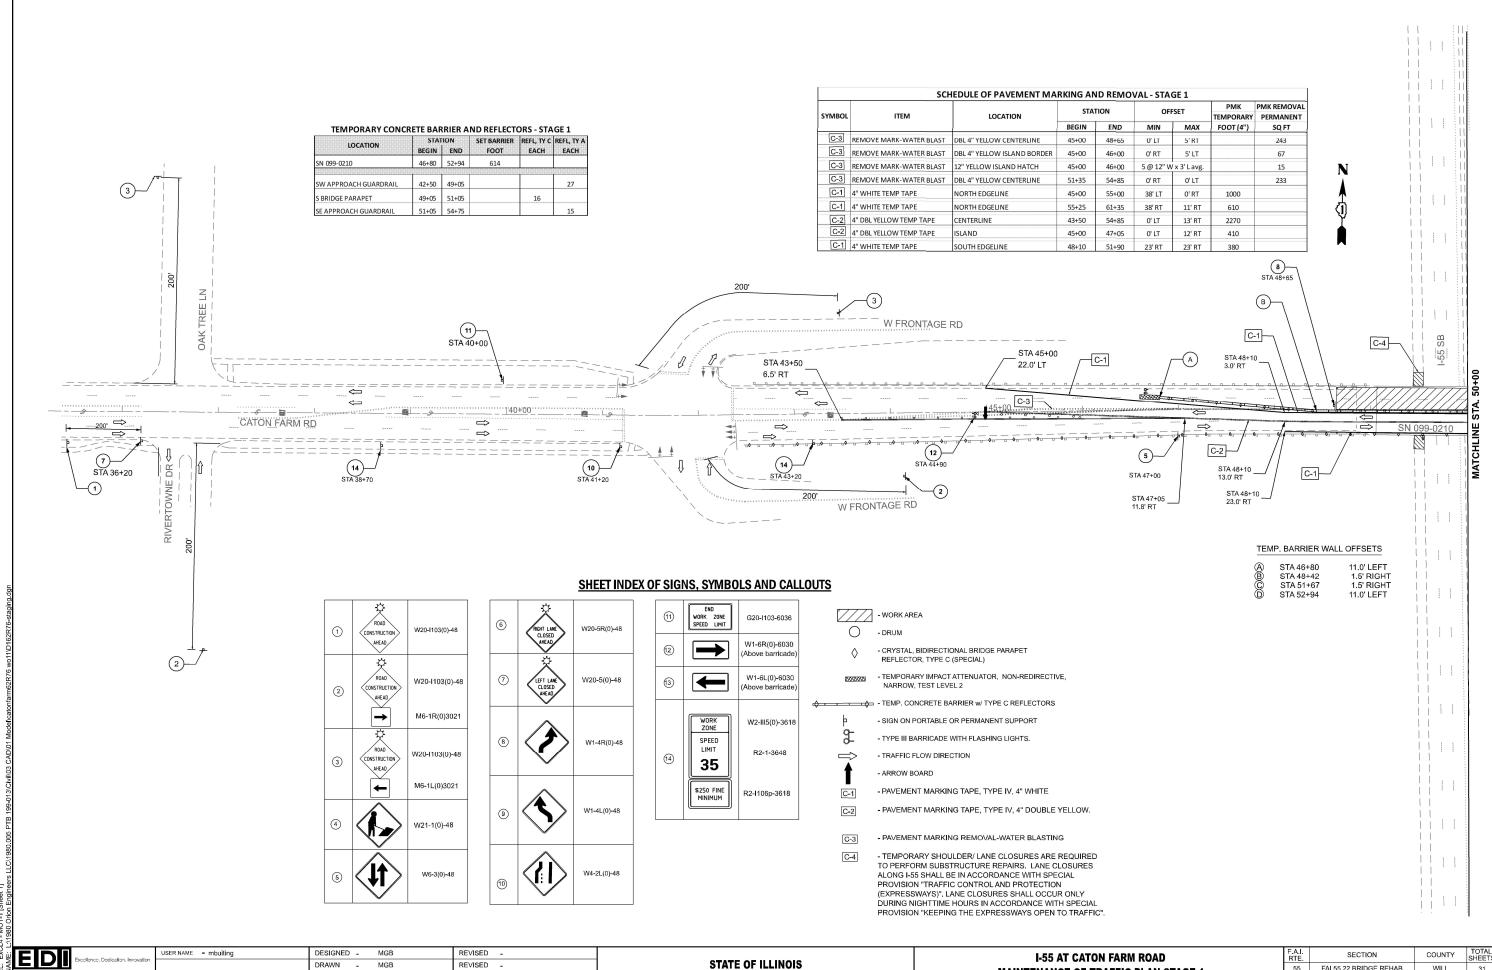


CHECKED REVISED Mronmental and Construction Inspection Ser STREET, SUITE 1825, CHICAGO, IL 60603 PLOT DATE = 12/16/2024 REVISED DATE

DEPARTMENT OF TRANSPORTATION

SCALE: 1"=50'

FAI 55 22 BRIDGE REHAB WILL 31 8 MAINTENANCE OF TRAFFIC PLAN STAGE 1 CONTRACT NO. 62R76 SHEET 1 OF 2 SHEETS STA. 31+20.00 TO STA. 50+00.00

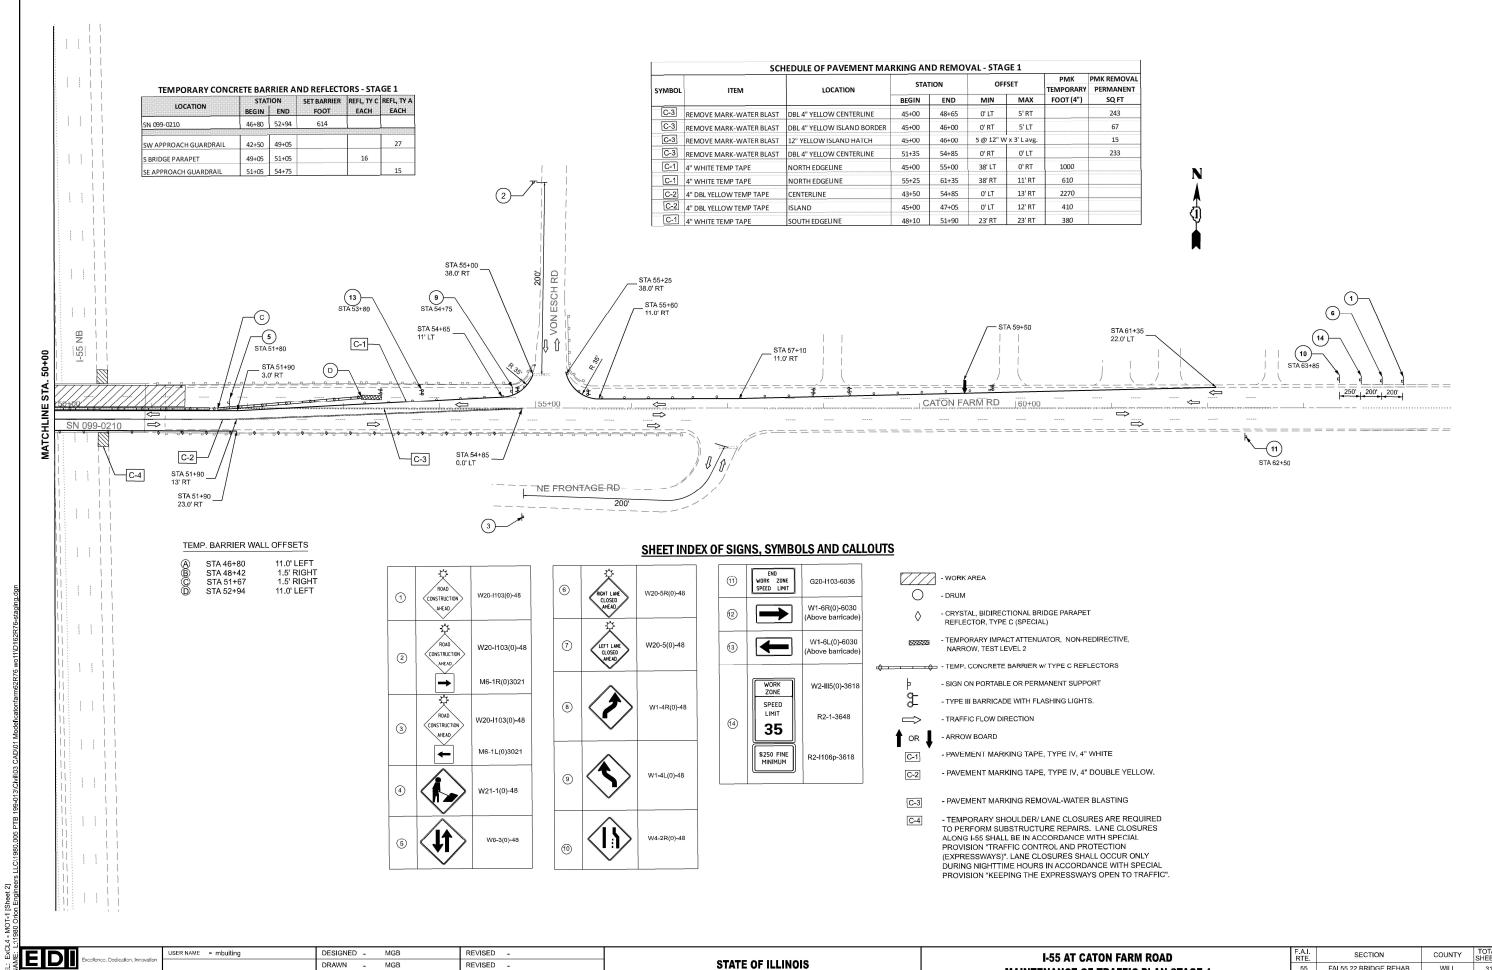

E STREET, SUITE 1825, CHICAGO, IL 60603 400 Fax (312)345-0529 www.envdesigni.

PLOT DATE = 12/16/2024

CHECKED

DATE


REVISED

REVISED

MAINTENANCE OF TRAFFIC PLAN STAGE 1 SHEET 2 OF 2 SHEETS STA. 50+00.00 TO STA. 67+35.00

SCALE: 1"=50'


55 FAI 55 22 BRIDGE REHAB WILL 31 CONTRACT NO. 62R76

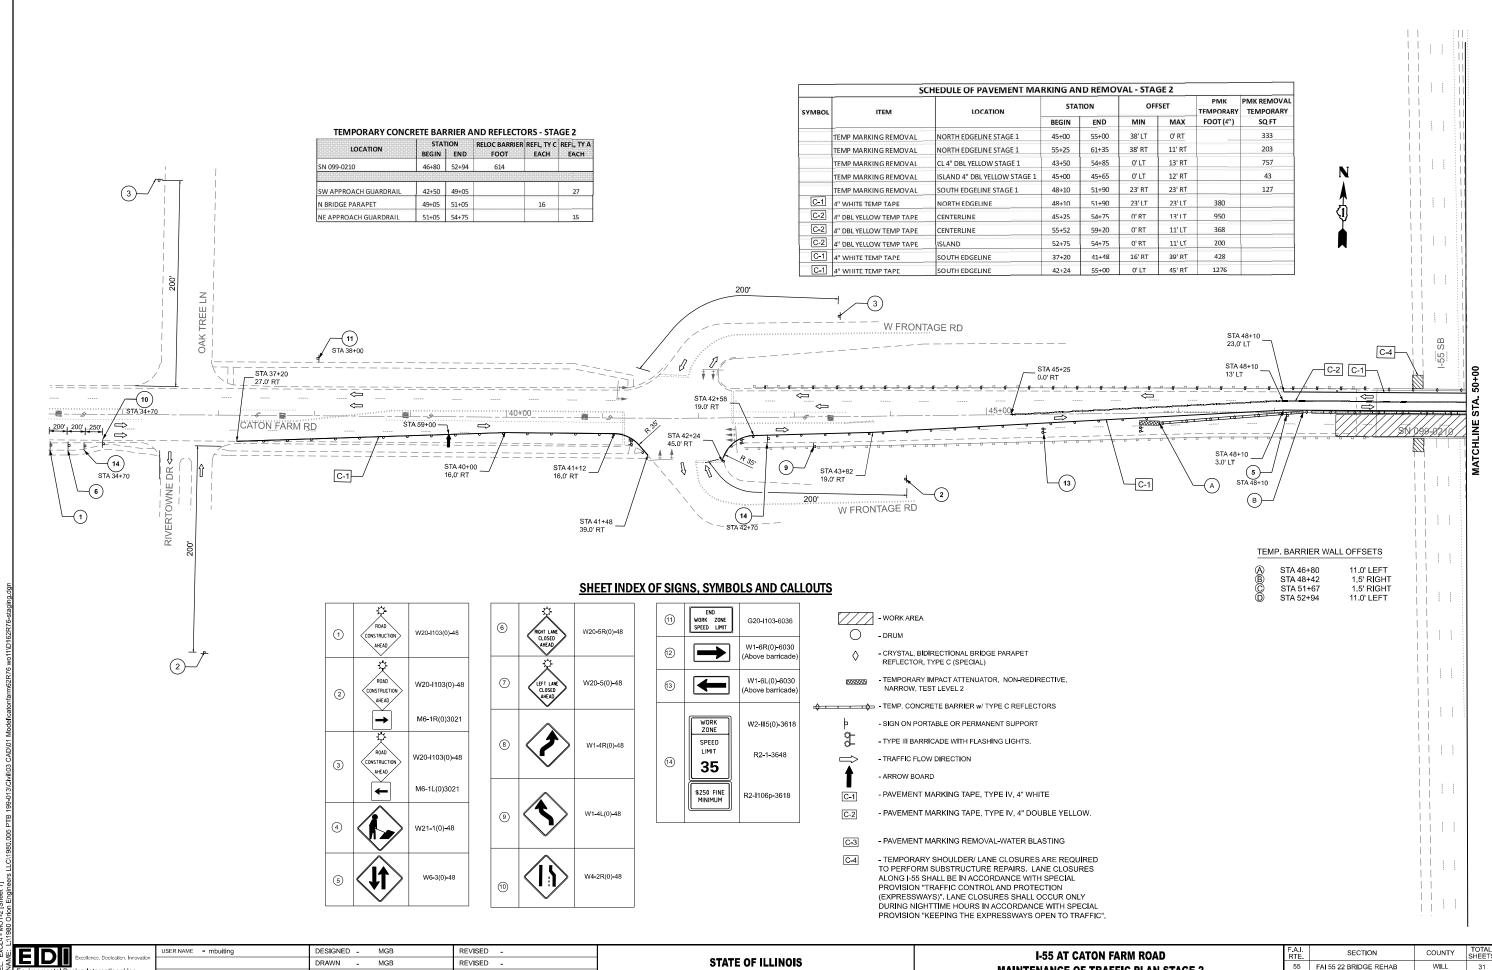

CHECKED REVISED Environmental and Construction Inspection Servi OE STREET, SUITE 1825, CHICAGO, IL 80603 i-1400 Fax (312)345-0529 www.envdesigni.co PLOT DATE = 12/16/2024 DATE REVISED

DEPARTMENT OF TRANSPORTATION

55 FAI 55 22 BRIDGE REHAB 31 MAINTENANCE OF TRAFFIC PLAN STAGE 2 CONTRACT NO. 62R76 SHEET 1 OF 2 SHEETS STA. 31+20.00 TO STA. 50+00.00

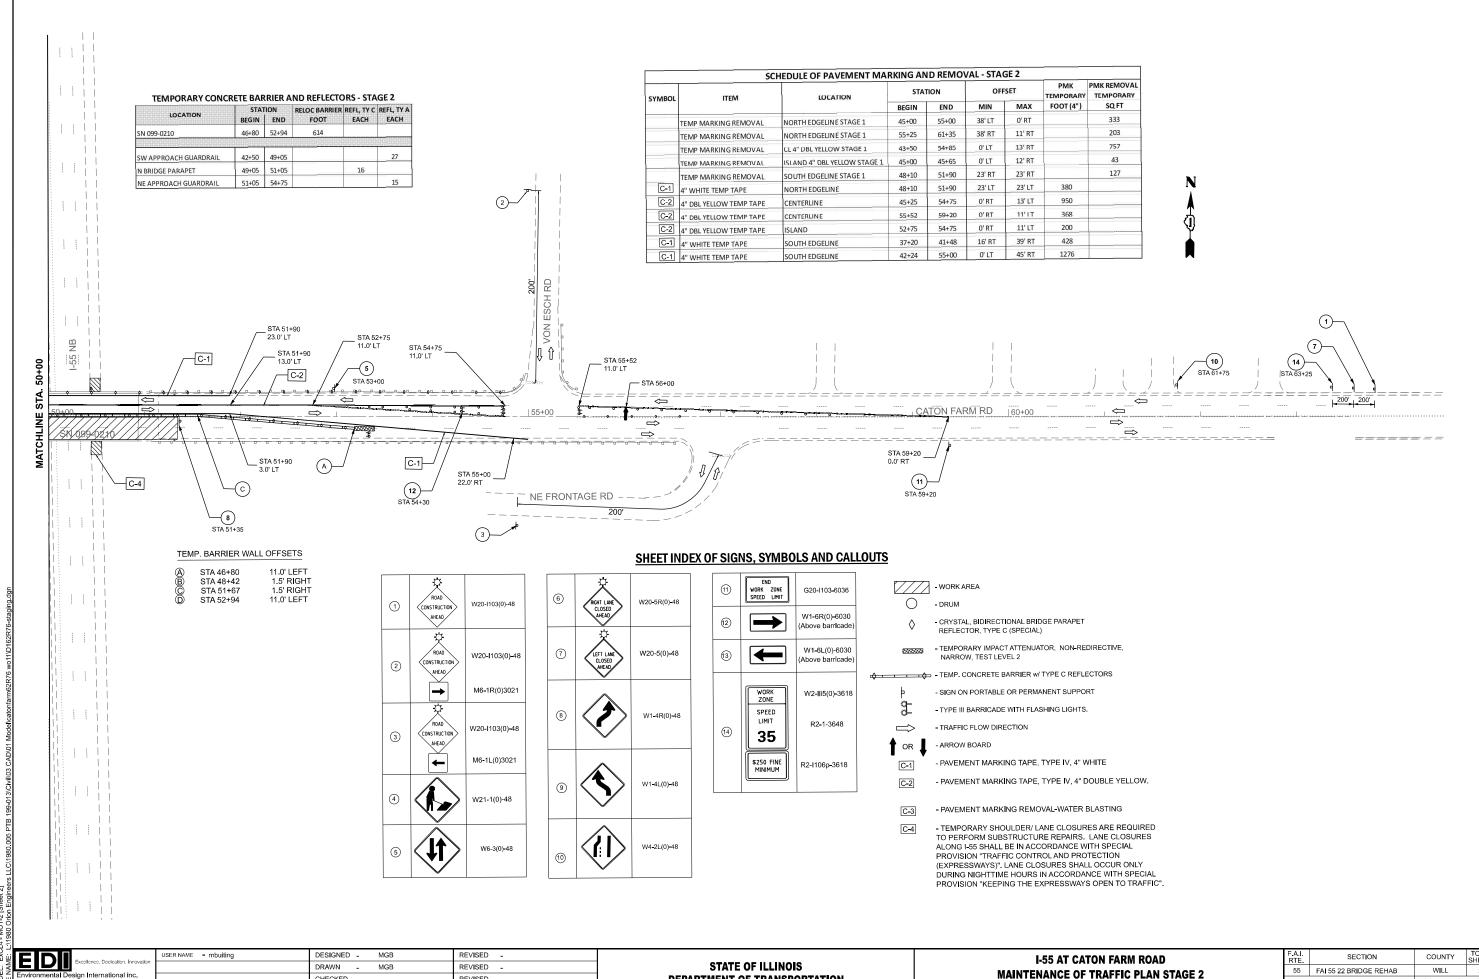


CHECKED -REVISED , Environmental and Construction Inspection Servi ROE STREET, SUITE 1825, CHICAGO, IL 60603 5-1400 Fax (312)345-0529 www.envdesigni.co PLOT DATE = 12/16/2024 DATE REVISED


DEPARTMENT OF TRANSPORTATION

SCALE: 1"=50'

I-55 AT CATON FARM ROAD				F.A.I. RTE	SECTION		COUNTY	TOTAL SHEETS	SHEET NO.		
MAINTENANCE OF TRAFFIC PLAN STAGE 2						55	FAI 55 22 BRIDGE REHA	ιB	WILL	31	11
MAINTENANCE OF TRAFFIC FEAR STAGE 2								CONTRACT	NO. 62	R76	
	SHEET	OF	SHEETS	STA, 50+00.00	TO STA, 67+35.00		ILLINOIS	FED AIR	PROJECT		

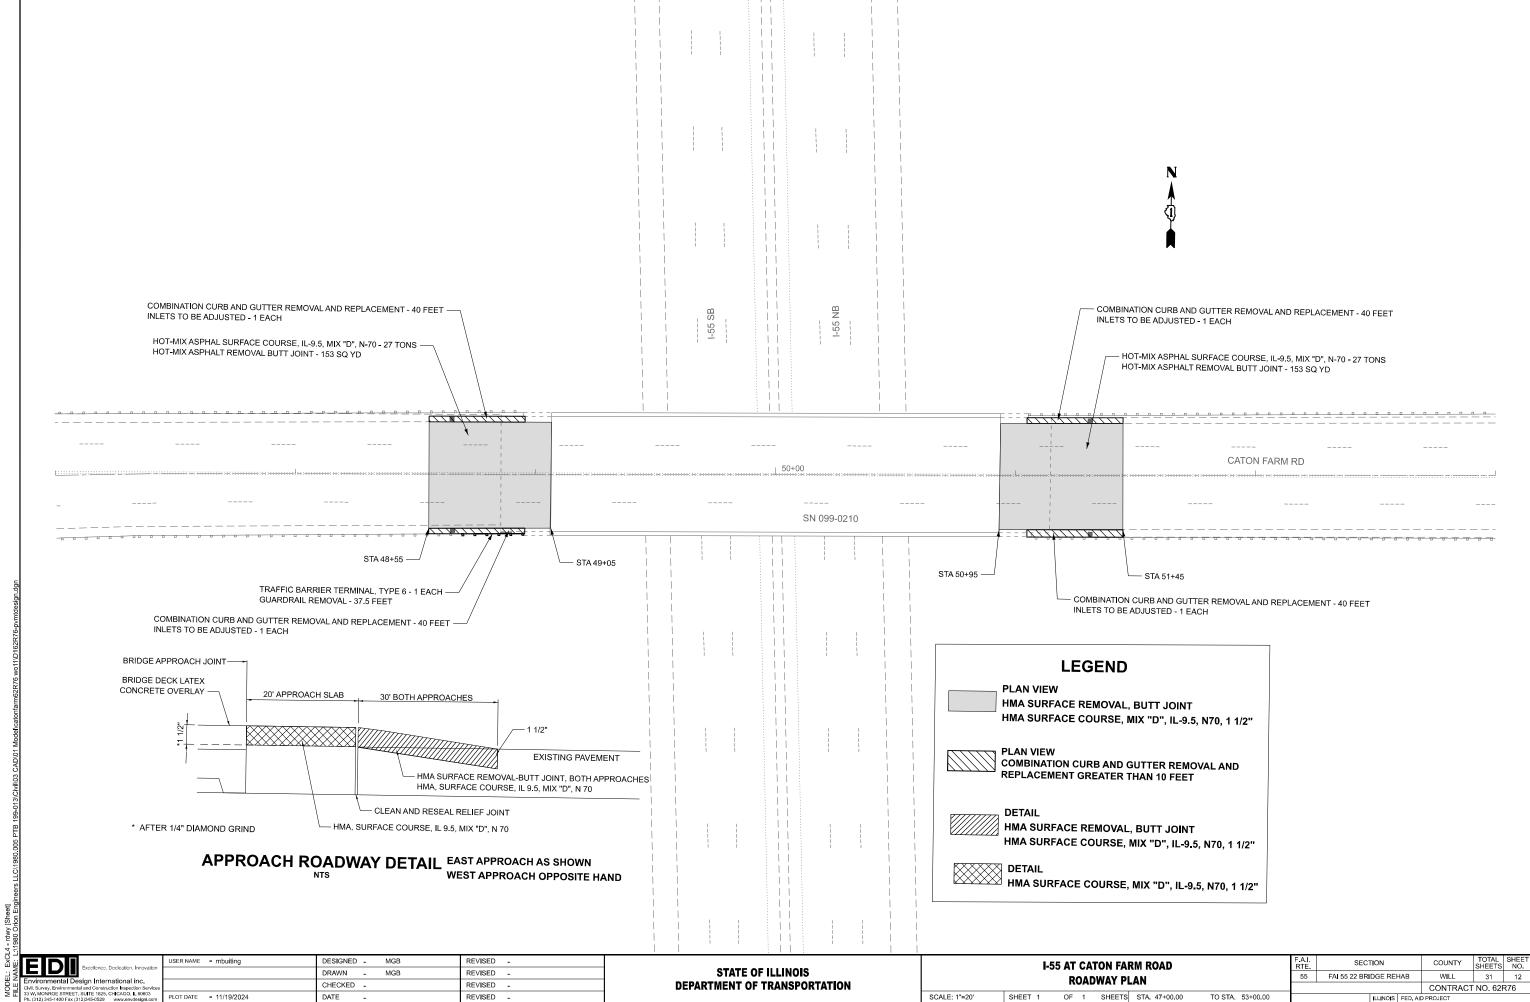

SCALE: 1"=20'

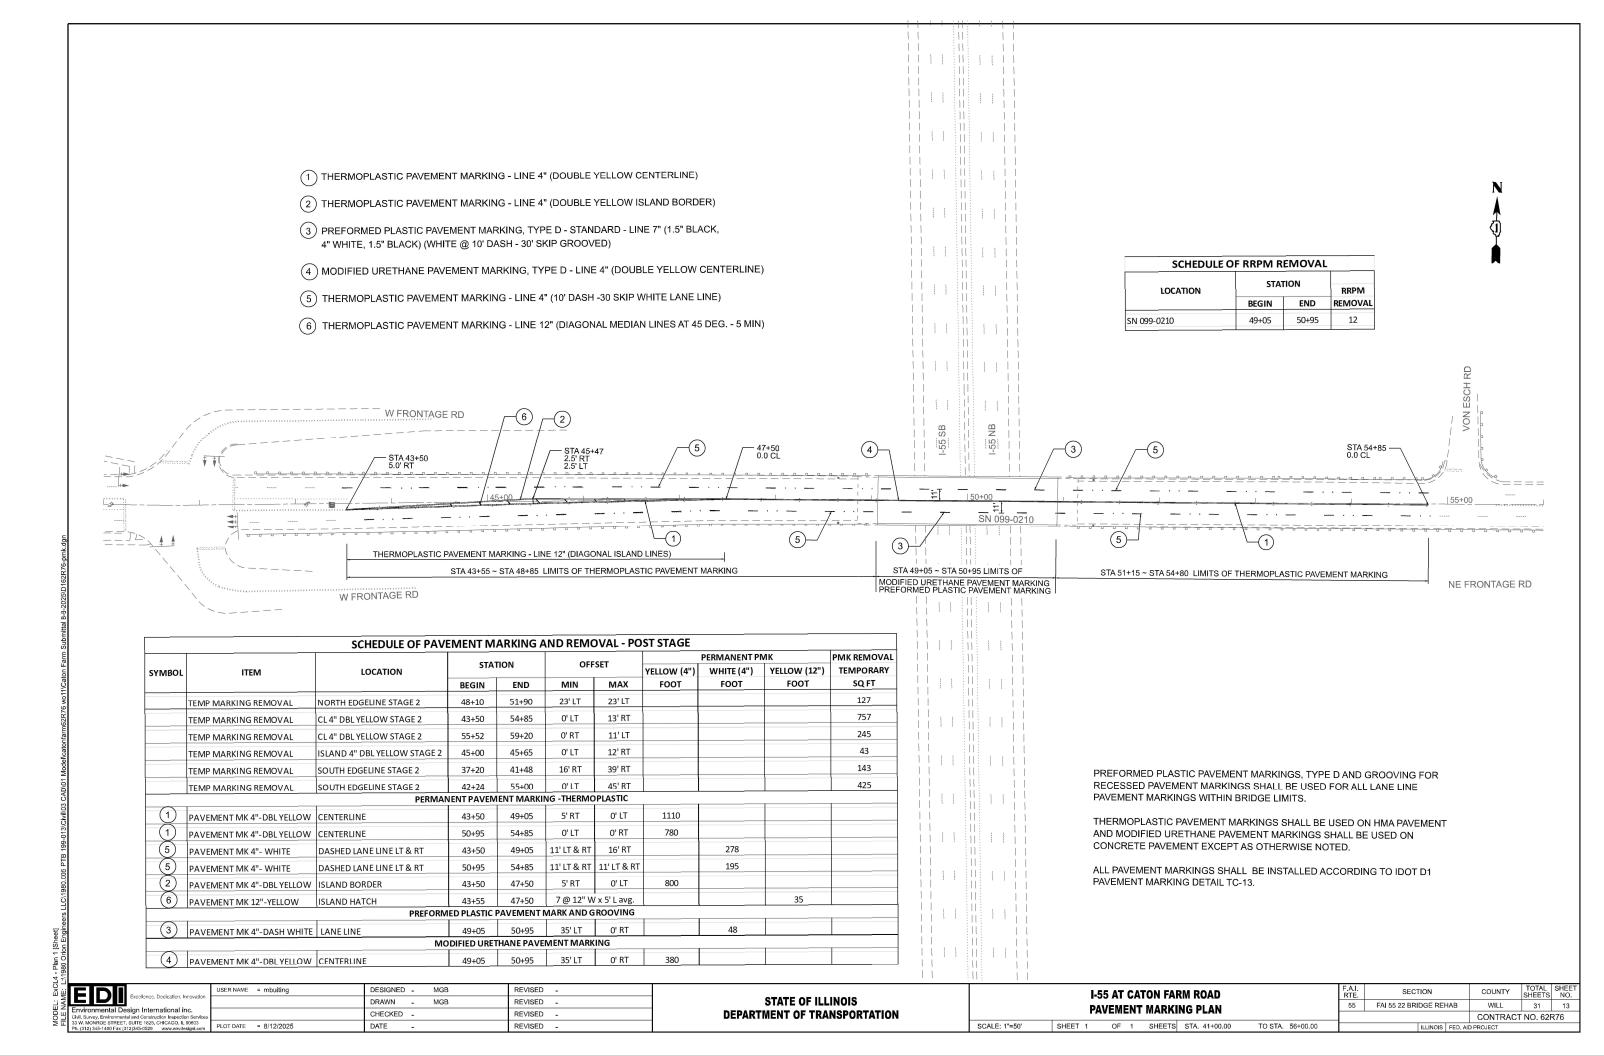

Existing Structure:

SN 099-0210 was originally constructed in 1988. The bridge consists of 4-span reinforced concrete deck on steel rolled sections. The substructure consists of reinforced concrete piers and abutments.

Traffic Control:

Stage Construction will be utilized. Two lanes of traffic shall be maintained on the north side of Canton Farm Road for Stage I construction. Two lanes of traffic shall be maintained on the south side of Caton Farm Road for Stage II construction.

No Salvage.



f'c = 3,500 PSI (Concrete) fy = 50,000 PSI (Reinforcement)

PROPOSED CAST IN PLACE CONCRETE

f'c=4,000 psi (Superstructure) f'c=3,500 psi (Substructure) fy=60,000 psi (Reinforcement)


DESIGN SPECIFICATIONS


AASHTO LRFD Bridge Design Specifications, 17th Edition.

Illinois Department Of Transportation Bridge Manual Dated January 2025.

LOADING HS20-44

No future wearing surface allowed

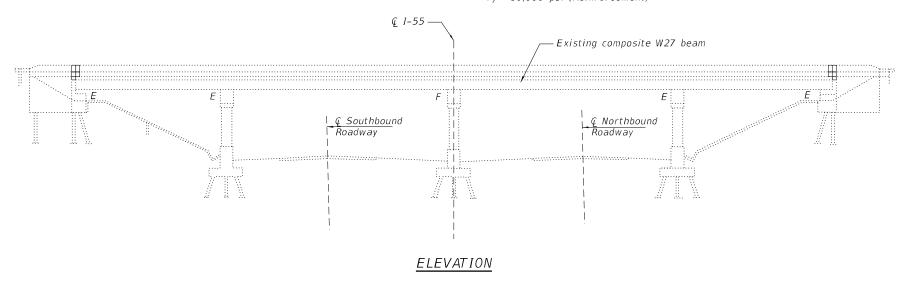

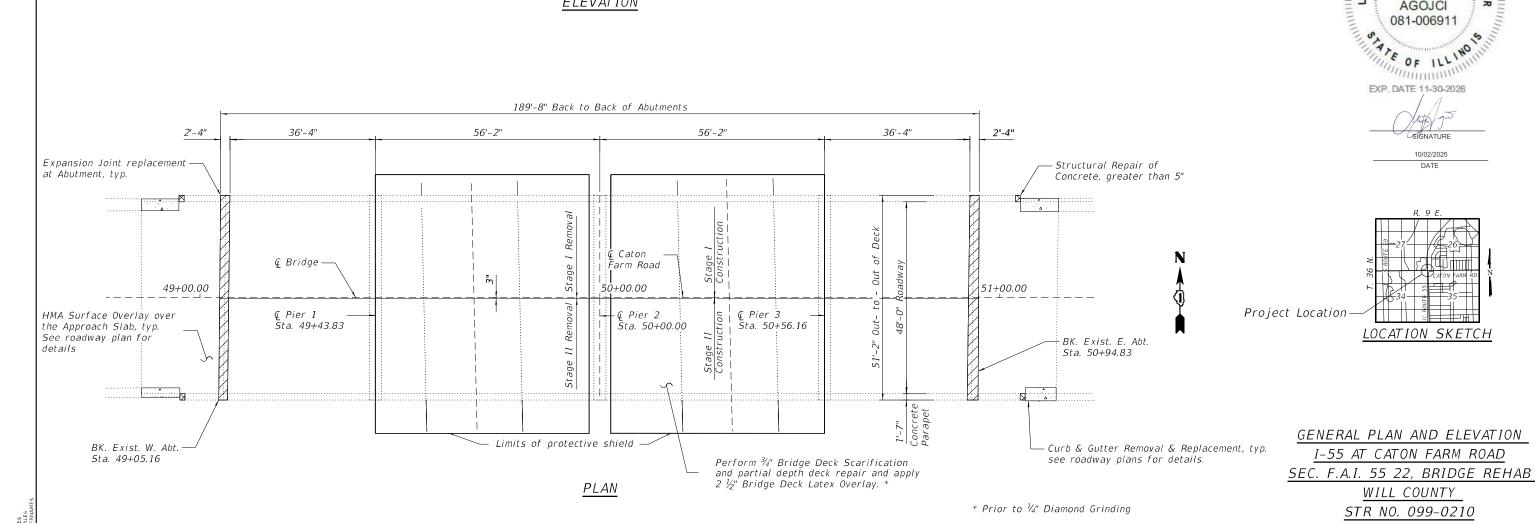

USER NAME =	DESIGNED - AAA	REVISED -
	DRAWN - AAA	REVISED -
PLOT SCALE =	CHECKED - KZ	REVISED -
PLOT DATE =	DATE - ·11/22/2024	REVISED -

STATE OF ILLINOIS
DEPARTMENT OF TRANSPORTATION

		GENERAL PLAN AND I STRUCTURE NO. 09		l
SCALE:	·1"=24	SHEET NO. S1 OF S9 SHEETS	STA. ·	TO STA.

F.A.I. RTE.	SECT	ПОИ	COUNTY	TOTAL SHEETS	SHEET NO.	
55	F.A.I. 55 22 B	RIDGE R	EHAB	WILL	31	1.4
				CONTRACT	NO. 6	2R76
FED. R	OAD DIST, NO. 1	ILLINOIS	D PROJECT			

TICENS TRUCTURAL MANAGEMENT OF THE PROPERTY OF

INDEX OF SHEETS

SHEET NO.	<u>DESCRIPTION</u>
<i>S1</i>	GENERAL PLAN AND ELEVATION
52	GENERAL NOTES, INDEX OF SHEETS, BILL OF MATERIALS
<i>S3</i>	STAGE CONSTRUCTION DETAILS
<i>S4</i>	DECK OVERLAY AND SLAB REPAIR PLANS
<i>S5</i>	EXPANSION JOINT DETAILS
56	PREFORMED JOINT STRIP SEAL (BASE SHEET)
<i>S</i> 7	ABUTMENT REPAIR DETAILS
<i>S8</i>	PIER REPAIR DETAILS
59	BAR SPLICER ASSEMBLY AND MECHANICAL SPLICER

TOTAL BILL OF MATERIAL

ITEM	UNIT	TOTAL
Concrete Removal	Cu Yd	15.0
Protective Shield	Sq Yd	162
Concrete Superstructure	Cu Yd	17.0
Protective Coat	Sq Yd	1115
Reinforcement Bars, Epoxy Coated	Pound	2580
Bar Splicers	Each	24
Preformed Joint Seal	Foot	102
Bridge Deck Grooving (Longitudinal)	Sq Yd	914
Approach Slab Repair (Partial Depth)	Sq Yd	14
Bridge Deck Latex Concrete Overlay, 2 ½ Inches	Sq Yd	997
Bridge Deck Scarification 3/4"	Sq Yd	997
Structural Repair Of Concrete (Depth Equal to or Less Than 5 Inches)	Sq Ft	166
Structural Repair Of Concrete (Depth Greater than 5")	Sq Ft	8
Diamond Grinding (Bridge Section)	Sq Yd	914

GENERAL NOTES

- 1. Plan dimensions and details relative to existing plans are subject to routine variations. The Contractor shall field verify existing dimensions and details affecting new construction and make necessary approved adjustments prior to construction or ordering of materials. Such variations shall not be cause for additional compensation for a change in scope of the work, however, the Contractor will be paid for the quantity actually furnished based upon the unit price bid for the work.
- 2. Existing reinforcement bars extending into the removal area shall be cleaned, straightened and incorporated into the new construction. Any reinforcement bars that are damaged during concrete removal shall be replaced with an approved bar splicer or anchorage system. Cost included with Concrete Removal.
- 3. Reinforcement bars designated "(E)" shall be epoxy coated.
- 4. Reinforcement bar bending details shall be in accordance with the latest "Manual of Standard Practice for Detailing Reinforced Concrete Structures, ACI 315".
- 5. Reinforcement bar bending dimensions are out to out.
- 6. Contractor shall not scale dimensions from the Contract Plans for construction purposes. Scales shown are for information only.
- 7. No construction joints except those shown on the plans shall be allowed unless approved by the Engineer.
- 8. No concrete cutting shall be permitted until the cutting limits have been outlined by the Contractor and approved by the Engineer.
- 9. Joint openings shall be adjusted according with Article 520.04 of the Standard Specs, when the deck is poured at an ambient temperature other than 50°F.

SCOPE OF WORK


- To be completed under stage construction:
- 1. Install Protective Shield over lane and shoulders of I-55.
- 2. Perform 3/4" Bridge Deck Scarification.
- 3. Reconstruct bridge deck expansion joints at the Abutments with preformed joint strip seal.
- 4. Perform Structural Repair on approach concrete barriers.
- 5. Perform partial depth deck patching as required and, apply $2\frac{1}{2}$ Bridge Deck Latex Overlay and perform Bridge Deck Grooving, and diamond grinding.
- 6. Apply Protective Coat to the existing parapet concrete and to new concrete overlay.
- 7. Perform Structural Repair on Abutments and Piers 1 & 3.




USER NAME =	DESIGNED - ·	REVISED -
	DRAWN - AAA	REVISED -
PLOT SCALE =	CHECKED - KZ	REVISED -
PLOT DATE =	DATE - ·11/22/2024	REVISED -

SCALE: •


GENERA	L NOTES, INDEX OF SHEETS	AND BILL C	OF MATERIA	\LS	F.A.I. RTE	SECTION	COUNTY	TOTAL SHEETS	SHEET NO.
	STRUCTURE NO. 09	30_0210			55	F.A.I. 55 22 BRIDGE REHAB	WILL	31	1.5
	SINUCIUNE NO. US	J9-02 IU					CONTRAC	T NO. 6	2R76
	SHEET NO S2 OF S9 SHEETS	STA ·	TO STA		EED 0	OAD DICT NO 1 THEMOSE FED.	ID DDOJECT		

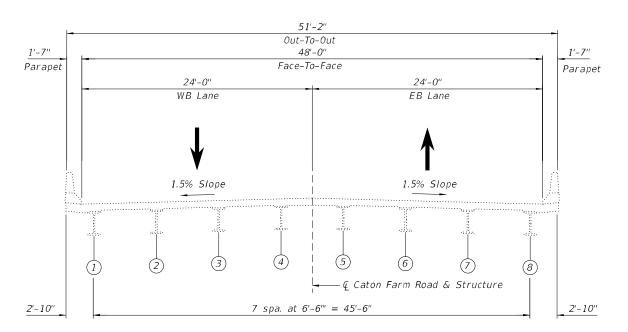




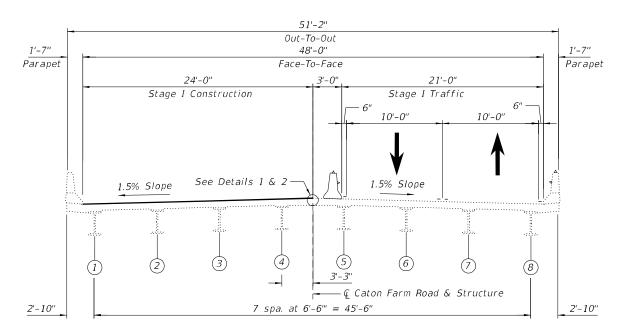


STAGE I
(Looking East)

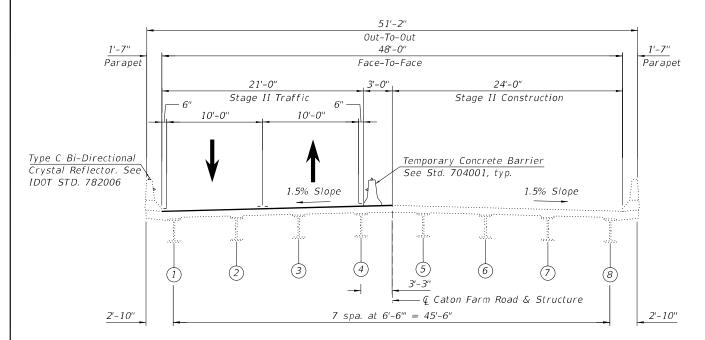

STAGE II (Looking East)

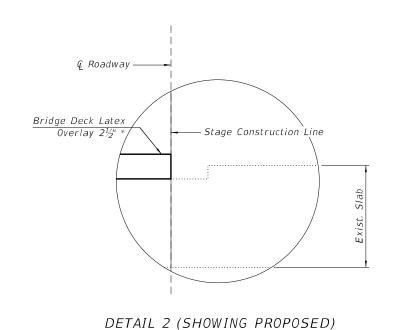

BETTHE E (STIGWING THOTOSE

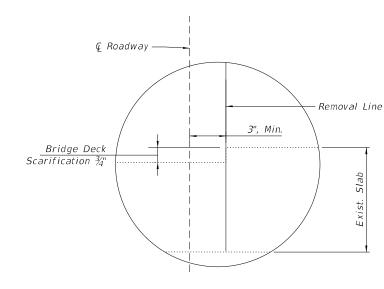

DETAIL 1 (SHOWING REMOVAL)


* Prior to 1/4" Diamond Grinding

GSG CONSULTANTS, INC.
755 E. REMNOTON RD, SCHAUMBURG, IL 60173
TEL: 1630.994.2600 | WWW.GSG-CONSULTANTS.COI

USER NAME ■	DESIGNED	-	AAA	REVISED	-
	DRAWN	-	AAA	REVISED	-
PLOT SCALE	CHECKED	-	KZ	REVISED	-
PLOT DATE	DATE	-	11/22/2024	REVISED	-

STATE OF ILLINOIS
DEPARTMENT OF TRANSPORTATION

STAGE CONSTR	JCTION DETAILS		F.A.I. RTE	SEC	TION		
CTDIICTIIDE	IN NOO_0210		55	F.A.I. 55 22 B	RIDG		
SINUCIONE	STRUCTURE NO. 099-0210						
SCALE: 1 = 10 SHEET NO. S3 OF S9 SHEE	TS STA.	TO STA.	FED. R	OAD DIST, NO. 1	ILLIN		

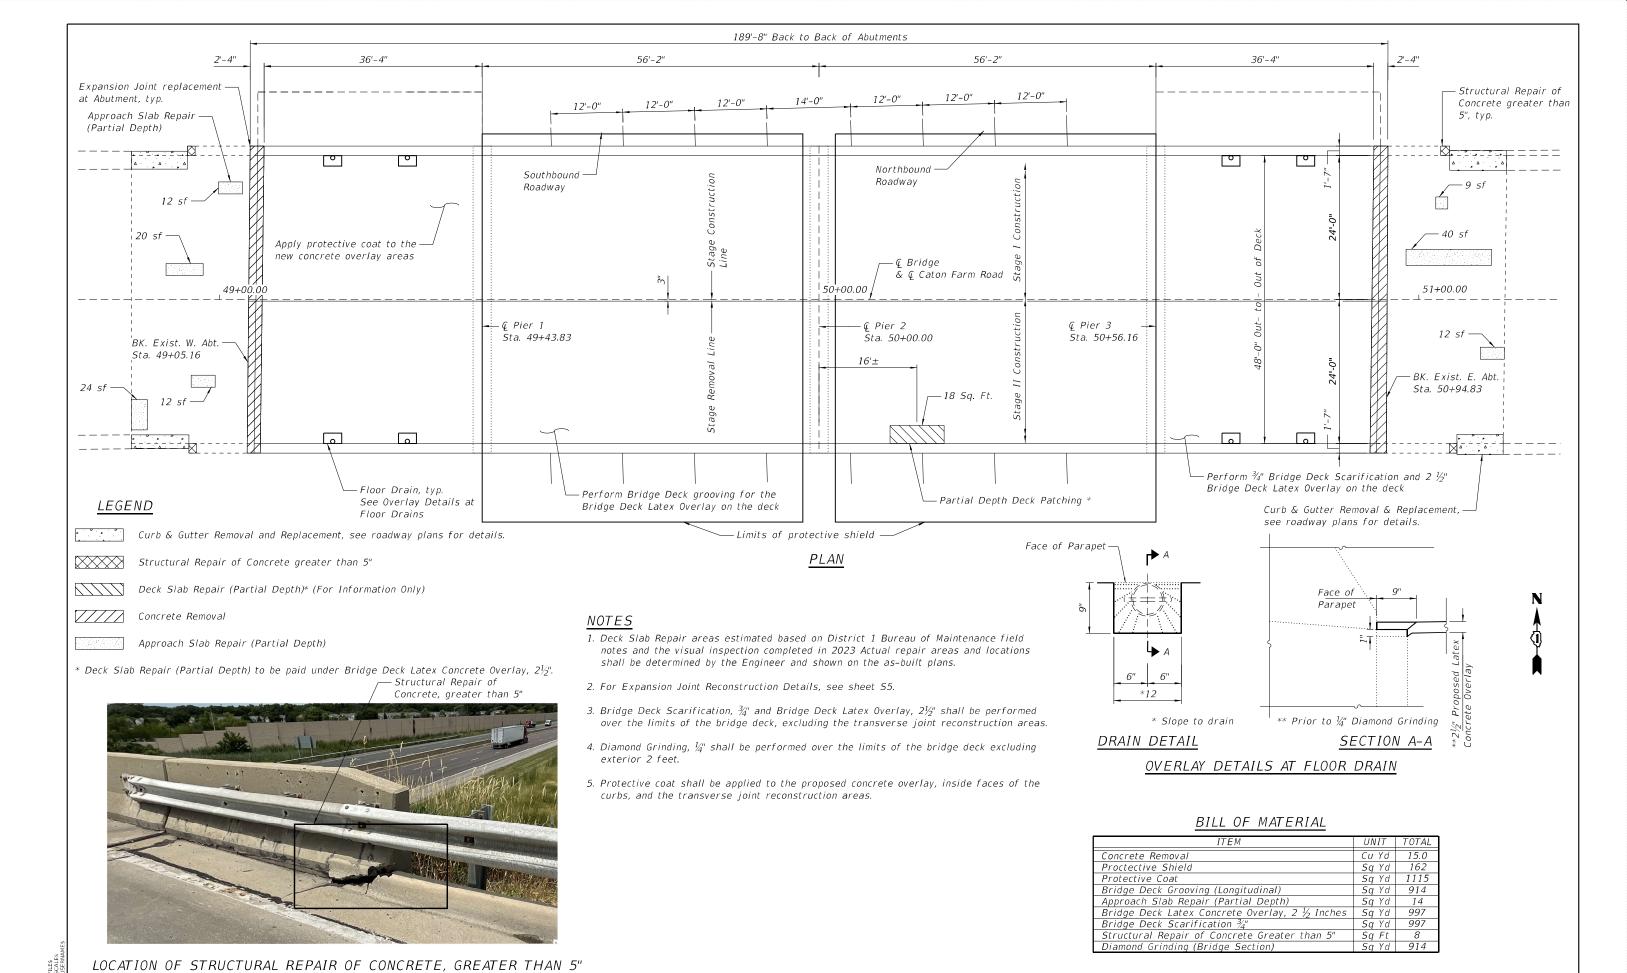

GSG CONSULTANTS, INC.
75 E REMINISTOR RD, SCHAUMBURG, IL 60173
TEL: 14809/94/2600 | WWW.655C-CONSULTANTS.COM

 USER NAME
 =
 DESIGNED
 AAA
 REVISED

 DRAWN


 PLOT SCALE
 =
 CHECKED
 KZ
 REVISED


 PLOT DATE
 =
 DATE

STATE OF ILLINOIS DEPARTMENT OF TRANSPORTATION

SCALE: ·1"=16'

	DECK OVERLAY AND SLABS REPAIR PLANS			F.A.I. SECTION		COUNTY	TOTAL SHEETS	SHEET NO.			
				55	F.A.I. 55 22 BRIDGE REHAB		EHAB	WILL	3-1	1.7	
	STRUCTURE NO. 099-0210								CONTRACT	NO. 6	2R76
	SHEET NO. S4 OF S9 SHEETS	STA. ·	TO STA.		FED. R	OAD DIST, NO. 1	ILLINOIS	FED. AI	D PROJECT		

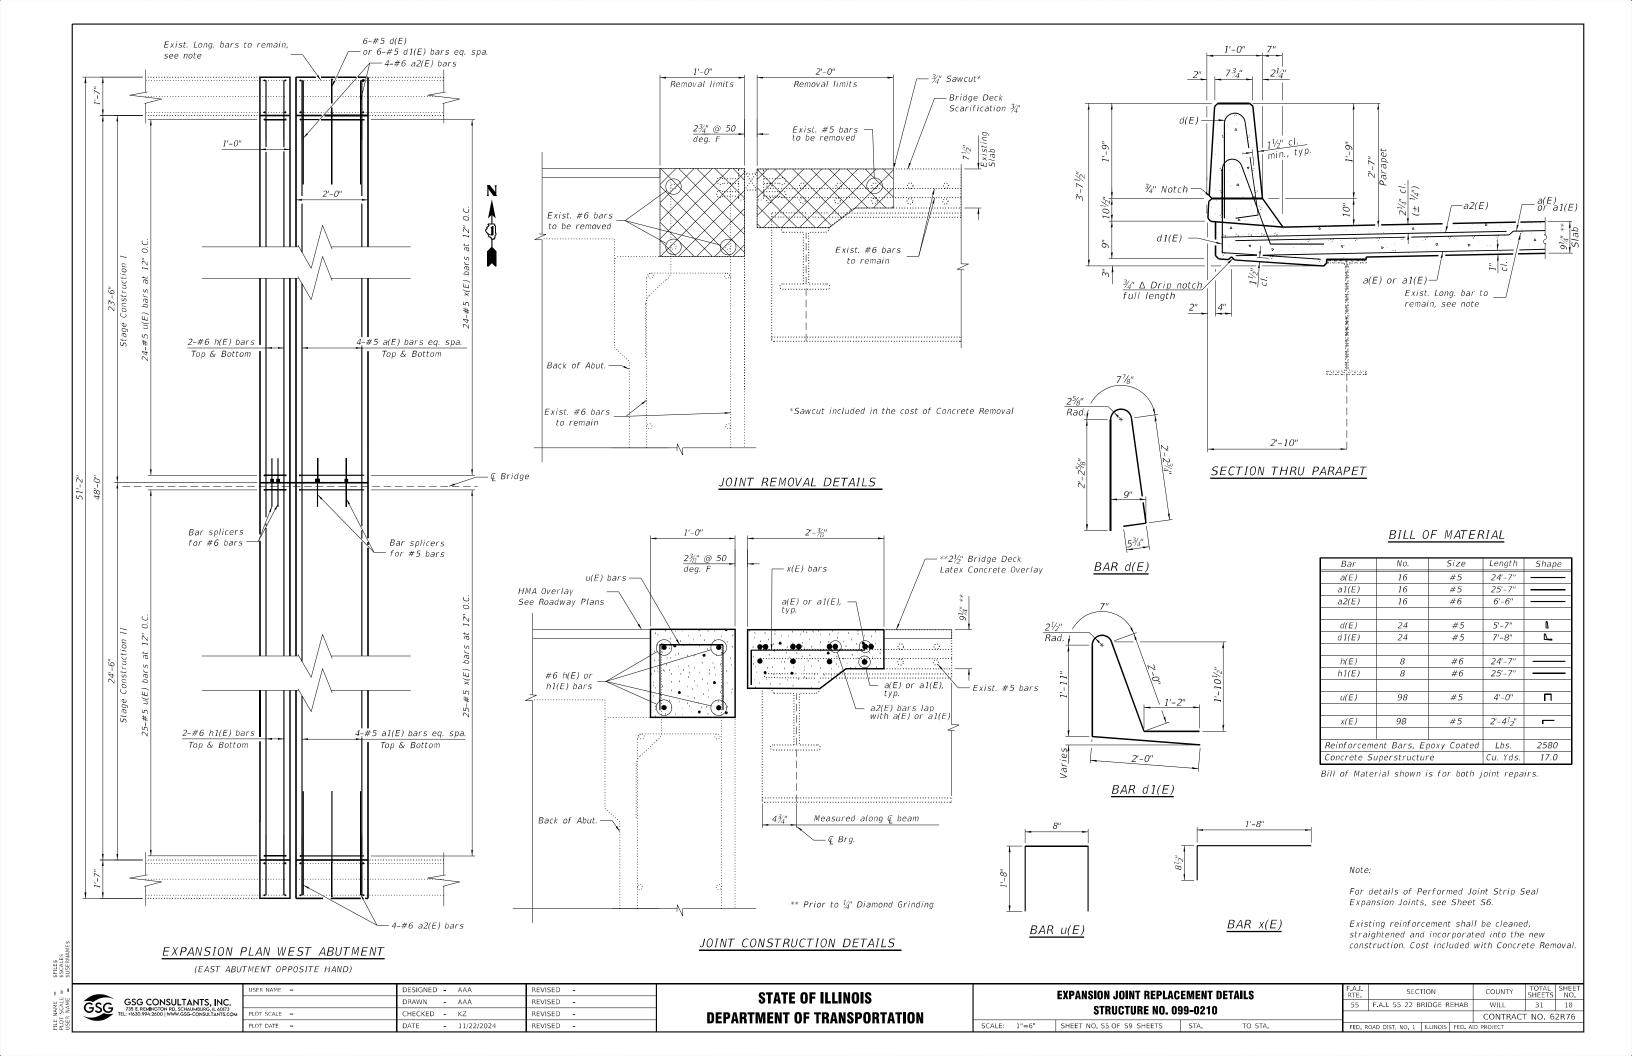


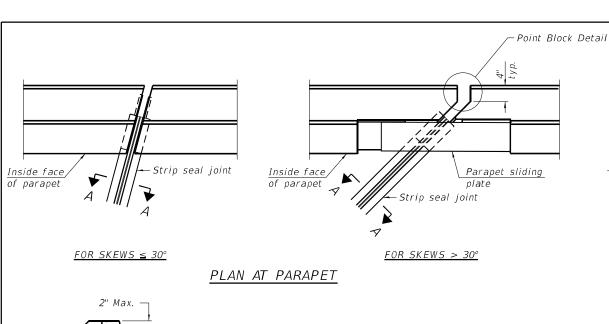



Top of locking

Top of deck

edge rail

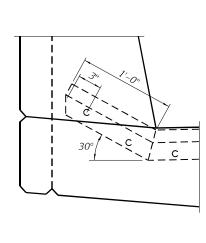

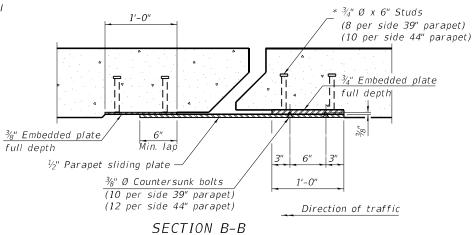

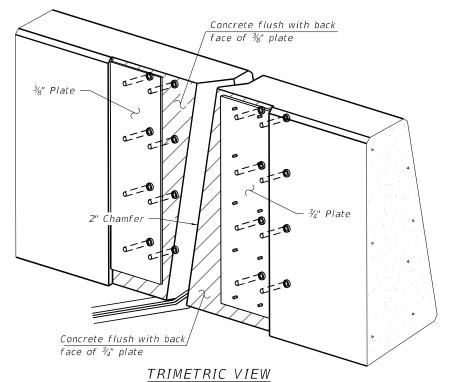

Notes:

The strip seal shall be made continuous and shall have a minimum thickness of $\frac{1}{4}$ ". The configuration of the strip seal shall match the configuration of the locking edge rails. Open or "webbed" strip seal gland configurations are not permitted. The gland shall be sized for a maximum rated movement of 4 inches.

The locking edge rails depicted are configured for typical applications and are conceptual only. The actual configuration of the locking edge rails and matching strip seal may vary from manufacturer to manufacturer provided they fit the application and meet the minimum anchorage shown. Flanged edge rails, however, will not be allowed. Locking edge rails may exceed the $4\frac{1}{2}$ " maximum depth provided the anchorage system is revised according to the manufacturer's recommendation.

The manufacturer's recommended installation methods shall be followed.

All steel components shall be galvanized after fabrication according to Article 520.03 of the Standard Specifications.

The Maximum space between locking edge rail segments shall be $\frac{3}{16}$ and sealed with a suitable sealant; however, any rail joint within 10' measured perpendicular to the face of the curb or parapet shall be welded as shown in the locking edge rail splice detail.

Cost of parapet sliding plates, embedded plates, and anchorage studs included with Preformed Joint Strip Seal. 39" constant slope barrier shown, 44" constant slope barrier similar as noted.

The concrete opening below the strip seal will vary based on the locking edge rail chosen by the Contractor. Deck and parapet lengths shown elsewhere in the plans are dimensioned to the concrete opening, not the joint opening, and are based on the rolled locking edge rail. If the Contractor elects to use a different locking edge rail, dimensional adjustments may be required. One exception to this would be the strip seal joint at the end of the precast bridge approach slab. For these cases the pavement connector length shall be adjusted, not the length of the bridge approach slab.


SECTION AT PARAPET

Parapet sliding

Inside Face

of Parapet


(Skews > 30° shown. Skews ≤ 30° similar except as shown in plan view.)

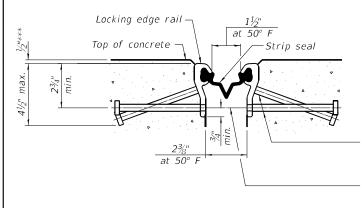


1-1-2020

SHOWING ROLLED RAIL JOINT

DETAIL A

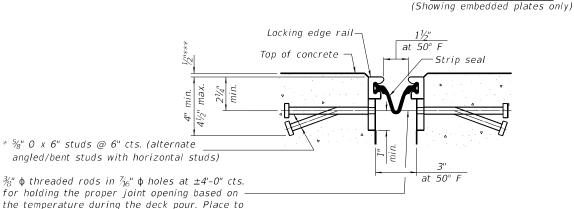


SHOWING WELDED RAIL JOINT

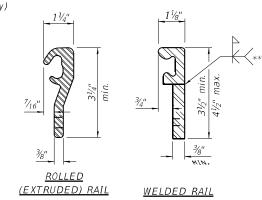

LOCKING EDGE RAILS

** Back gouge not required if complete joint penetration is verified by mock-up.

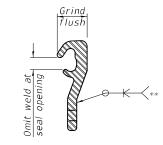

LOCKING EDGE RAIL SPLICE

The inside of the locking edge rail groove shall be free of weld residue. Rolled rail shown, welded rail similar.

BILL OF MATERIAL

Item	Unit	Tot al
Preformed Joint Strip Seal	Foot	102

SECTION A-A

* Granular or solid flux filled headed studs conforming to Article 1006.32 of the Std. Specs., automatically end welded.

miss studs. All rods shall be burned, or sawed

off flush with the plates after concrete is set.

*** Prior to 1/4" Diamond Grinding

GSG CONSULTANTS, INC. GSG

USER NAME ■	DESIGNED	-	AAA	REVISED	-
	DRAWN	-	AAA	REVISED	-
PLOT SCALE	CHECKED	-	SK	REVISED	-
PLOT DATE ■	DATE	-	11/22/2024	REVISED	-

STATE OF ILLINOIS DEPARTMENT OF TRANSPORTATION


PREFORMED JOINT STRIP SEAL (BASE SHEET) Structure No. 099-0210								
	SHEET NO. S6 OF S9 SHEETS	STA.	TO STA.					

F.A.I. RTE	SEC	ΠΟN		COUNTY	TOTAL SHEETS	SHEET NO.
55	F.A.I. 55 22 B	RIDGE R	EHAB	WILL	30	19
				CONTRACT	NO. 6	2R76
FED, R	OAD DIST, NO. 1	ILLINOIS	D PROJECT			


EJ-SS

Detail A

5/8" Ø x 6" Studs

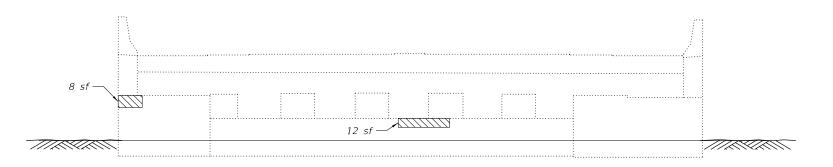

WEST ABUTMENT Looking East

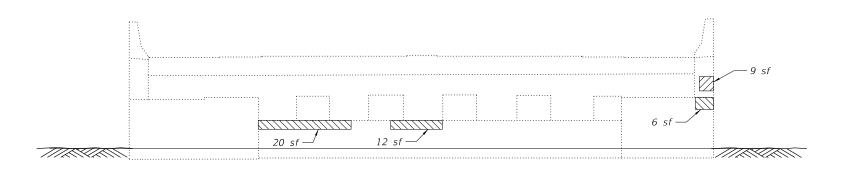

EAST ABUTMENT Looking West

LEGEND


Structural Repair of Concrete less than 5 Inches


TOTAL BILL OF MATERIAL

ITEM	UNIT	TOTAL	l
Structural Repair of Concrete (Depth Equal to or Less than 5 Inches)	Sq Ft	67	l

USER NAME ■	DESIGNED -	AAA	REVISED -
	DRAWN -	AAA	REVISED -
PLOT SCALE	CHECKED -	KZ	REVISED -
PLOT DATE	DATE -	11/22/2024	REVISED -

	ABUTMENT REPAIR	DETAIL	S	F.A.I. RTE	SEC	TION
	STRUCTURE NO. 09	99_0210	1	55	F.A.I. 55 22 E	RIDGE RI
	OTHEOTORE NO. C.	JJ UL 10	<u></u>			
SCALE: 1 = 16	SHEET NO. S7 OF S9 SHEETS	STA.	TO STA.	FED.	ROAD DIST, NO. 1	ILLINOIS

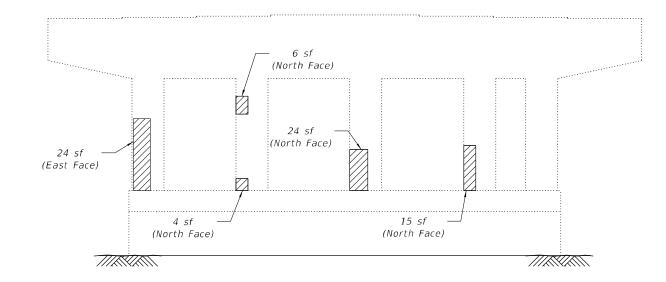

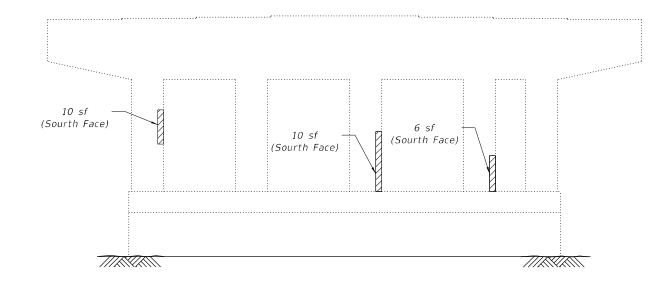

<u>PIER 1</u> West Elevation <u>PIER 3</u> West Elevation

<u>LEGEND</u>

Structural Repair of Concrete less than 5 Inches


TOTAL BILL OF MATERIAL

ITEM	UNIT	TOTAL
Structural Repair of Concrete (Depth Equal to or Less than 5 Inc	ches Sq Ft	99



USER NAME ■	DESIGNED - AAA	REVISED -
	DRAWN - AAA	REVISED -
PLOT SCALE	CHECKED - KZ	REVISED -
PLOT DATE	DATE - 11/22/2024	REVISED -

	PIER REPAIR DE	TAILS		F.A.I. RTE	SECTION	COUNTY	TOTAL SHEETS	SHEET NO.
	STRUCTURE NO. 09	00_0210		55	F.A.I. 55 22 BRIDGE REHAB	WILL	28	21
	SINUCIUNE NO. U	33-0210				CONTRAC	T NO. 6	2R76
SCALE: N/A	SHEET NO. S8 OF S9 SHEETS	STA.	TO STA.	FED. F	ROAD DIST, NO. 1 ILLINOIS FED. A	ID PROJECT		

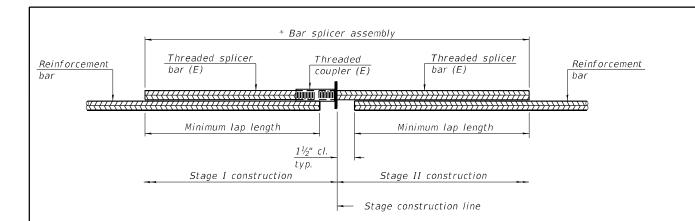


STANDARD BAR SPLICER ASSEMBLY PLAN (All components shall be provided from one supplier)

Threaded splicer bar length = min. lap length + $1\frac{1}{2}$ " + thread length


* Epoxy not required on Bar Splicer Assembly components used in conjunction with black bars.

Location	Bar size	No. assemblies required	Minimum lap length
Deck	#5	16	3'-4"
Abutment	#6	8	4'-0"

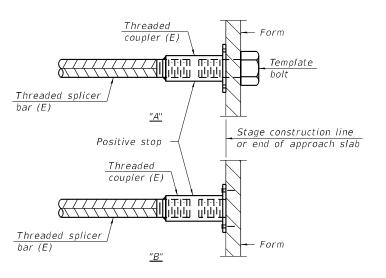

INSTALLATION AND SETTING METHODS

"A": Set bar splicer assembly by means of a template bolt. "B" : Set bar splicer assembly by nailing to wood forms or cementing to steel forms. (E): Indicates epoxy coating.

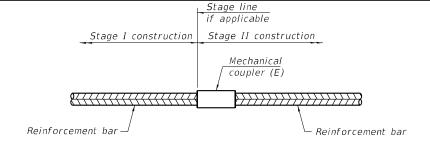

STANDARD MECHANICAL SPLICER

Location	Bar size	No. assemblies required

Notes:

Splicer bars shall be deformed with threaded ends and have a minimum 60 ksi yield strength.

All reinforcement shall be lapped and tied to the splicer bars.

Bar splicer assemblies shall be epoxy coated according to the requirements for reinforcement bars. See Section 508 of the Standard Specifications.

See approved list of bar splicer assemblies and mechanical splicers for alternatives.


BSD-1

2-1-2023



USER NAME = AAA	DESIGNED	•		REVISED	-
	DRAWN	-	AAA	REVISED	-
PLOT SCALE • 1"=2"	CHECKED	-	KZ	REVISED	-
PLOT DATE	DATE	-	11/22/2024	REVISED	-

BAR SPLI	CER ASSEMBLY AND MECH	ANICAL SPLICER DETAILS	F.A.I. RTE	SECTION	COUNTY	TOTAL SHEETS	SHEET NO.
	STRUCTURE NO. 0	00_0210	55	F.A.I. 55 22 BRIDGE REHAB	WILL	30	22
	SINUCIUNE NO. U	33-U2 IU			CONTRAC	T NO. 6	2R76
SCALE: 1"=2"	SHEET NO. S9 OF S9 SHEETS	STA. TO STA.	FED. F	OAD DIST, NO. 1 ILLINOIS FED, A	ID PROJECT		

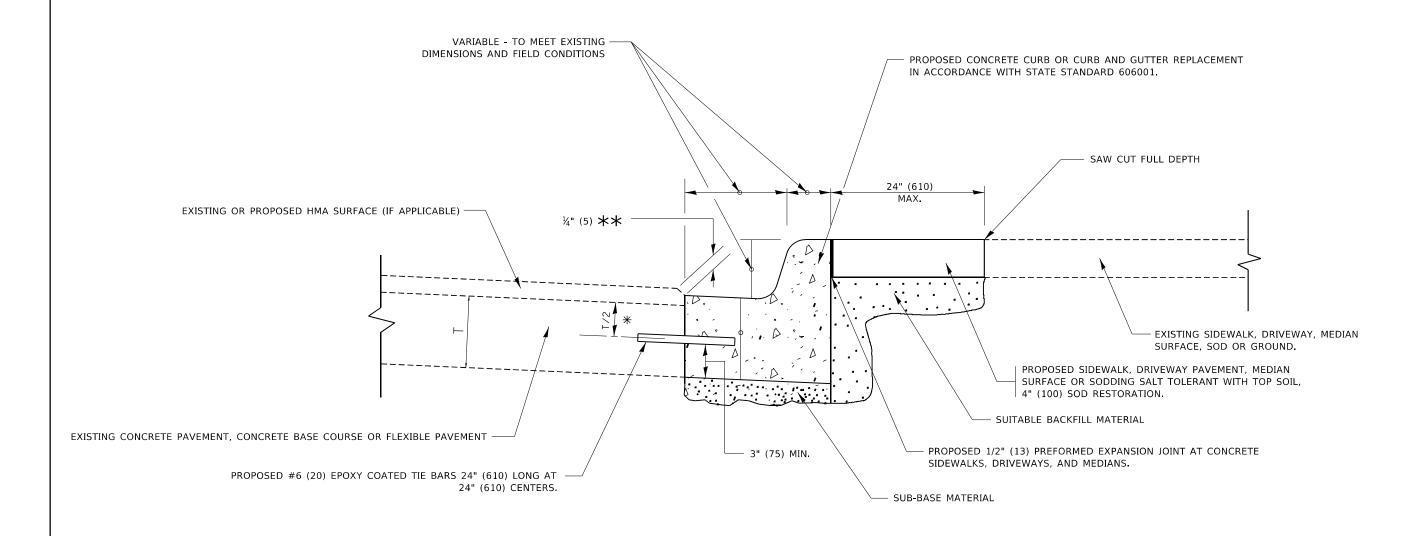


- 💥 3" (75) MINIMUM FROM TOP AND BOTTOM OF THE CONCRETE PAVEMENT OR BASE COURSE.
- $\star\star$ IF THE FINAL SURFACE OF THE PAVEMENT IS CONCRETE, THE GUTTER IS TO BE FLUSH WITH THE PAVEMENT.

CURB OR CURB AND GUTTER REMOVAL AND REPLACEMENT

ALL DIMENSIONS ARE IN INCHES (MILLIMETERS) UNLESS OTHERWISE SHOWN.


USER NAME = footemj	DESIGNED - A. HOUSEH	REVISED - A. ABBAS 03-21-97		CURB OR CURB AND GUTTER	F.A.I. RTE	SECTION	COUNTY	TOTAL	SHEET NO.
	DRAWN -	REVISED - M. GOMEZ 01-22-01	STATE OF ILLINOIS	REMOVAL AND REPLACEMENT	55	FAI 55 22 BRIDGE REHAB	WILL	31	23
PLOT SCALE = 50.0000 / in	CHECKED -	REVISED - R. BORO 12-15-09	DEPARTMENT OF TRANSPORTATION	NEIVIOVAE AIND NEFEAGEIVIENT		BD600-06 (BD-24)	CONTRACT	T NO.	62R76
PLOT DATE = 7/11/2019	DATE - 03-11-94	REVISED - K. SMITH 07-11-19		SCALE: NONE SHEET 1 OF 1 SHEETS STA. TO STA.		ILLINOIS FED. A	AID PROJECT		

10 1:53:2

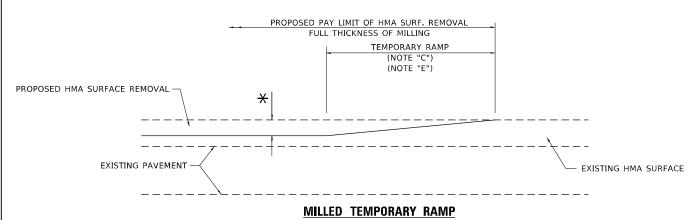

(FOR BUTT JOINT AND HMA TAPER SEE DETAIL BELOW)

OPTION 1

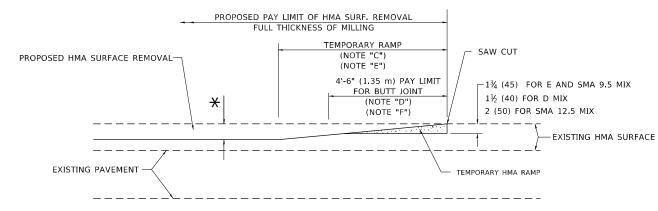


HMA CONSTRUCTED TEMPORARY RAMP

(FOR BUTT JOINT AND HMA TAPER SEE DETAIL BELOW)


OPTION 2


TYPICAL TEMPORARY RAMP

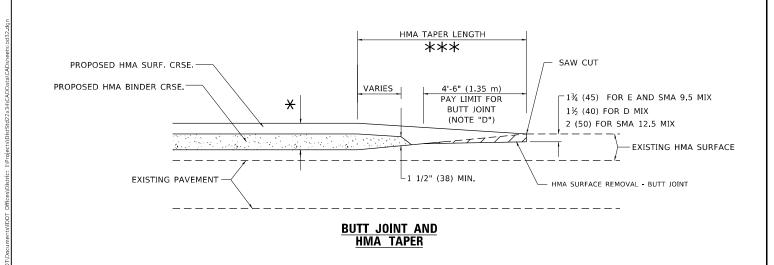

TYPICAL BUTT JOINT AND HMA TAPER FOR MILLING AND RESURFACING

STATE OF ILLINOIS
DEPARTMENT OF TRANSPORTATION

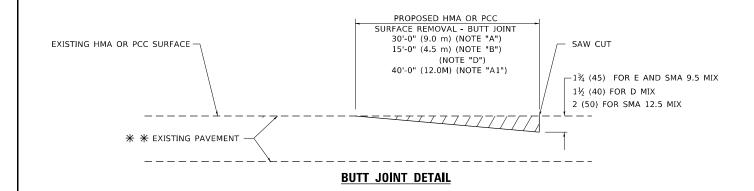

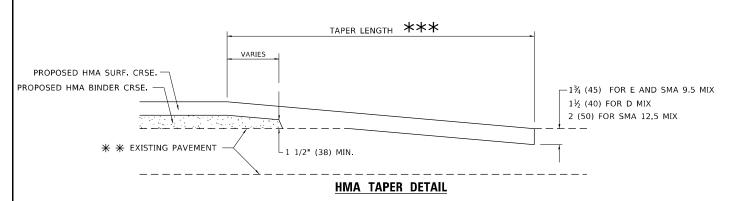

TYPICAL BUTT JOINT AND HMA TAPER FOR RESURFACING ONLY

** PC CONCRETE, HMA OR HMA RESURFACED PAVEMENT.

GENERAL NOTES

- A. MAINLINE ARTERIAL ROADWAYS AND MAJOR SIDE ROADS.
- A1. INTERSTATES
- B. MINOR SIDE ROADS.
- C. THE TEMP. RAMP SHALL BE CONSTRUCTED IMMEDIATELY UPON REMOVAL OF THE EXISTING HMA SURFACE.
- D. THE BUTT JOINT SHALL BE CONSTRUCTED IMMEDIATELY PRIOR TO PLACING THE PROPOSED HMA COURSES.
- E. TAPER THE TEMP. RAMP AT A RATE OF 3' 4" (1.02m) PER 1 INCH (25 mm) OF MILLING THICKNESS.
 - igstar SEE TYPICAL SECTIONS FOR MILLING THICKNESS.
- F. SEE ARTICLE 406.08 AND 406.14 OF THE STANDARD SPECIFICATIONS FOR "HMA AND/OR PCC SURFACE REMOVAL, BUTT JOINT".
- ***

 20'-0" (6.1 m) PER 1 (25) RESURFACING (NOTE "A")

 10'-0" (3.0 m) PER 1 (25) RESURFACING (NOTE "B")

BASIS OF PAYMENT

- THE BUTT JOINT WILL BE PAID FOR AT THE CONTRACT UNIT PRICE PER SQUARE YARD (SQUARE METER) FOR "HOT-MIX ASPHALT SURFACE REMOVAL - BUTT JOINT" OR FOR "PORTLAND CEMENT CONCRETE SURFACE REMOVAL- BUTT JOINT"
- 2. THE TEMPORARY RAMP AND SAW CUT SHALL BE INCLUDED IN THE UNIT COST FOR HMA OR PCC SURFACE REMOVAL-BUTT JOINT


SCALE: NONE


ALL DIMENSIONS ARE IN INCHES (MILLIMETERS) UNLESS OTHERWISE SHOWN.

WILL

31 24

CONTRACT NO. 62R76

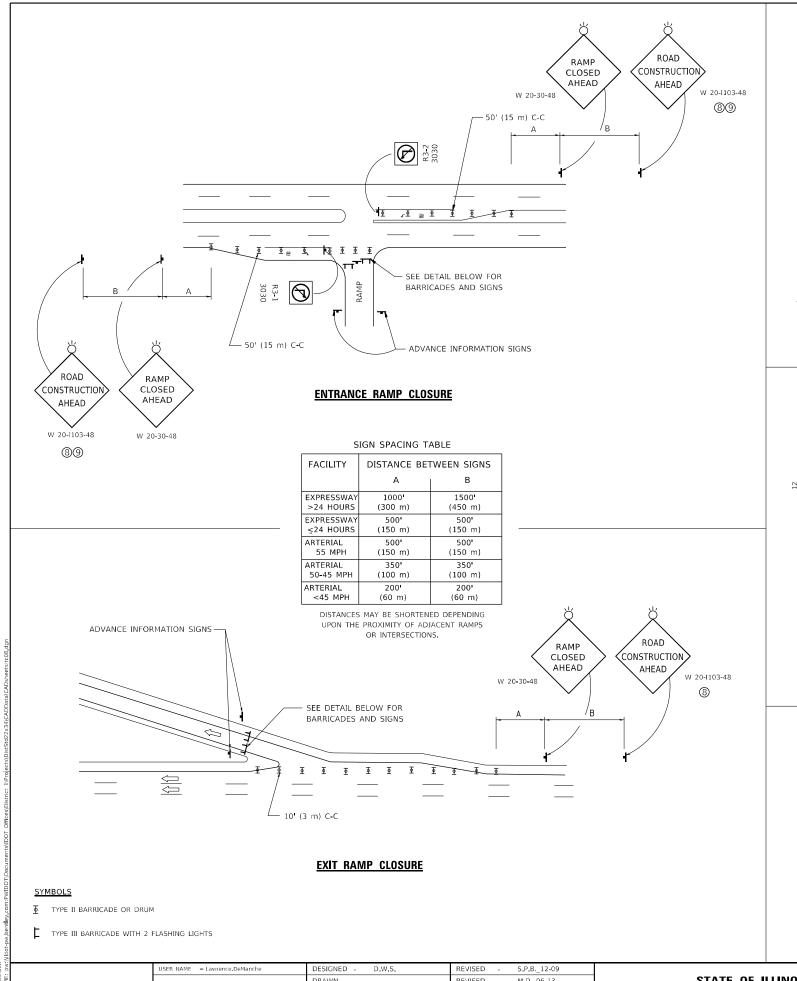

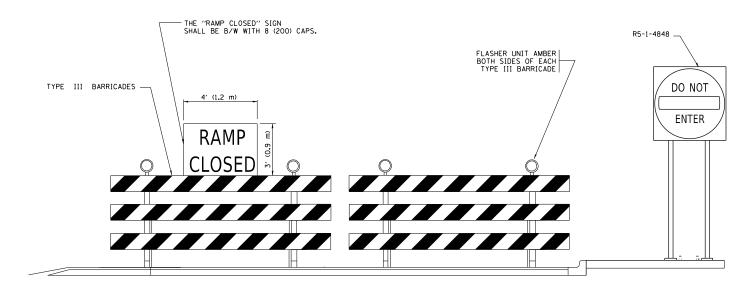

DETAIL FOR REQUIRED BARRICADES & SIGNS

RAMP CLOSURE ADVANCE INFORMATION SIGN




RAMP CLOSURE ADVANCE WARNING SIGN

10' (3 m)

BLACK LEGEND ON ORANGE BACKGROUND MOUNTED DIAGONALLY E MOD FONT

1 (25) BORDER THESE SIGNS ARE REQUIRED ON ALL THE EXIT GUIDE SIGNS FOR EXIT RAMPS THAT WILL BE CLOSED FOR MORE THAN FOUR (4) CONSECUTIVE DAYS.

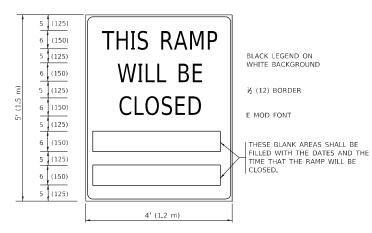

THESE SIGNS ARE REQUIRED ON BOTH SIDES OF THE RAMP, MINIMUM OF 1 WEEK IN ADVANCE OF THE CLOSURE.

THESE SIGNS SHALL BE FABRICATED AND PAID FOR ACCORDING TO THE TEMPORARY INFORMATION SIGNING SPECIAL PROVISION

GENERAL NOTES:

- CONES MAY BE SUBSTITUTED FOR DRUMS OR TYPE II BARRICADES DURING DAY OPERATIONS. CONES SHALL BE A MINIMUM OF 28 (700) HIGH.
- (2) VERTICAL BARRICADES SHALL NOT BE USED FOR RAMP CLOSURES.
- 3 A FLAGGER SHALL BE POSITIONED AT EACH CLOSED RAMP THAT IS OPEN TO CONSTRUCTION VEHICLES, PRECEEDED BY A W20-7 FLAGGER WARNING SIGN.
- 4 ALL ROUTE MARKERS AND TRAILBLAZER ASSEMBLIES WHICH DIRECT MOTORISTS TO A CLOSED ENTRANCE RAMP SHALL BE COVERED WHEN THE RAMP IS CLOSED FOR MORE THAN FOUR (4) DAYS.
- 5 THE SIGNING AND BARRICADING WHICH IS REQUIRED BY THIS DETAIL SHALL BE INCLUDED IN THE COST OF TRAFFIC CONTROL AND PROTECTION (EXPRESSWAYS).

SCALE: NONE

(6) AUTHORIZATION FROM THE DISTRICT'S BUREAU OF TRAFFIC IS REQUIRED FOR ALL RAMP CLOSURES.

55

- THE RAMP CLOSURE ADVANCE INFORMATION SIGNS SHALL BE ERECTED IF THE CLOSURE TIME EXCEEDS TWENTY-FOUR (24) HOURS. ADDITIONAL ADVANCE WARNING SIGNS ON EXIT GUIDE SIGNING WILL BE REQUIRED FOR EXIT RAMP CLOSURES THAT EXCEED FOUR (4) DAYS IN LENGTH
- (8) ROAD CONSTRUCTION AHEAD SIGNS MAY BE OMITTED WHEN THIS DETAIL IS USED IN CONJUNCTION WITH OTHER TRAFFIC CONTROL THAT ALREADY INCLUDES A ROAD CONSTRUCTION AHEAD SIGN.
- ARTERIAL ROAD CONSTRUCTION AHEAD SIGNS SHALL BE INSTALLED ON THE LEFT SIDE OF TRAFFIC IF THE MEDIAN IS MORE THAN 10 FT WIDE.


ALL DIMENSIONS ARE IN INCHES (MILLIMETERS) UNLESS OTHERWISE SHOWN.


	USER NAME = Lawrence.DeManche	DESIGNED - D.W.S.	REVISED -	S.P.B12-09
		DRAWN -	REVISED -	M.D06-13
İ	PLOT SCALE = 100.0000 / in.	CHECKED -	REVISED -	M.D01-18
	DIOT DATE - E/2/2024	DATE 02.02	DEMICED	D.C. 0E 34

STATE OF ILLINOIS **DEPARTMENT OF TRANSPORTATION**

ENTRANCE_AND_EXIT_RAMP Closure_details									
	SHEET	1	OF	1	SHEETS	STA.	TO STA.		

SECTION	COUNTY	TOTAL SHEETS	SHI
FAI 55 22 BRIDGE REHAB	WILL	31	2
TC-08	CONTRACT	NO. 62	2R76

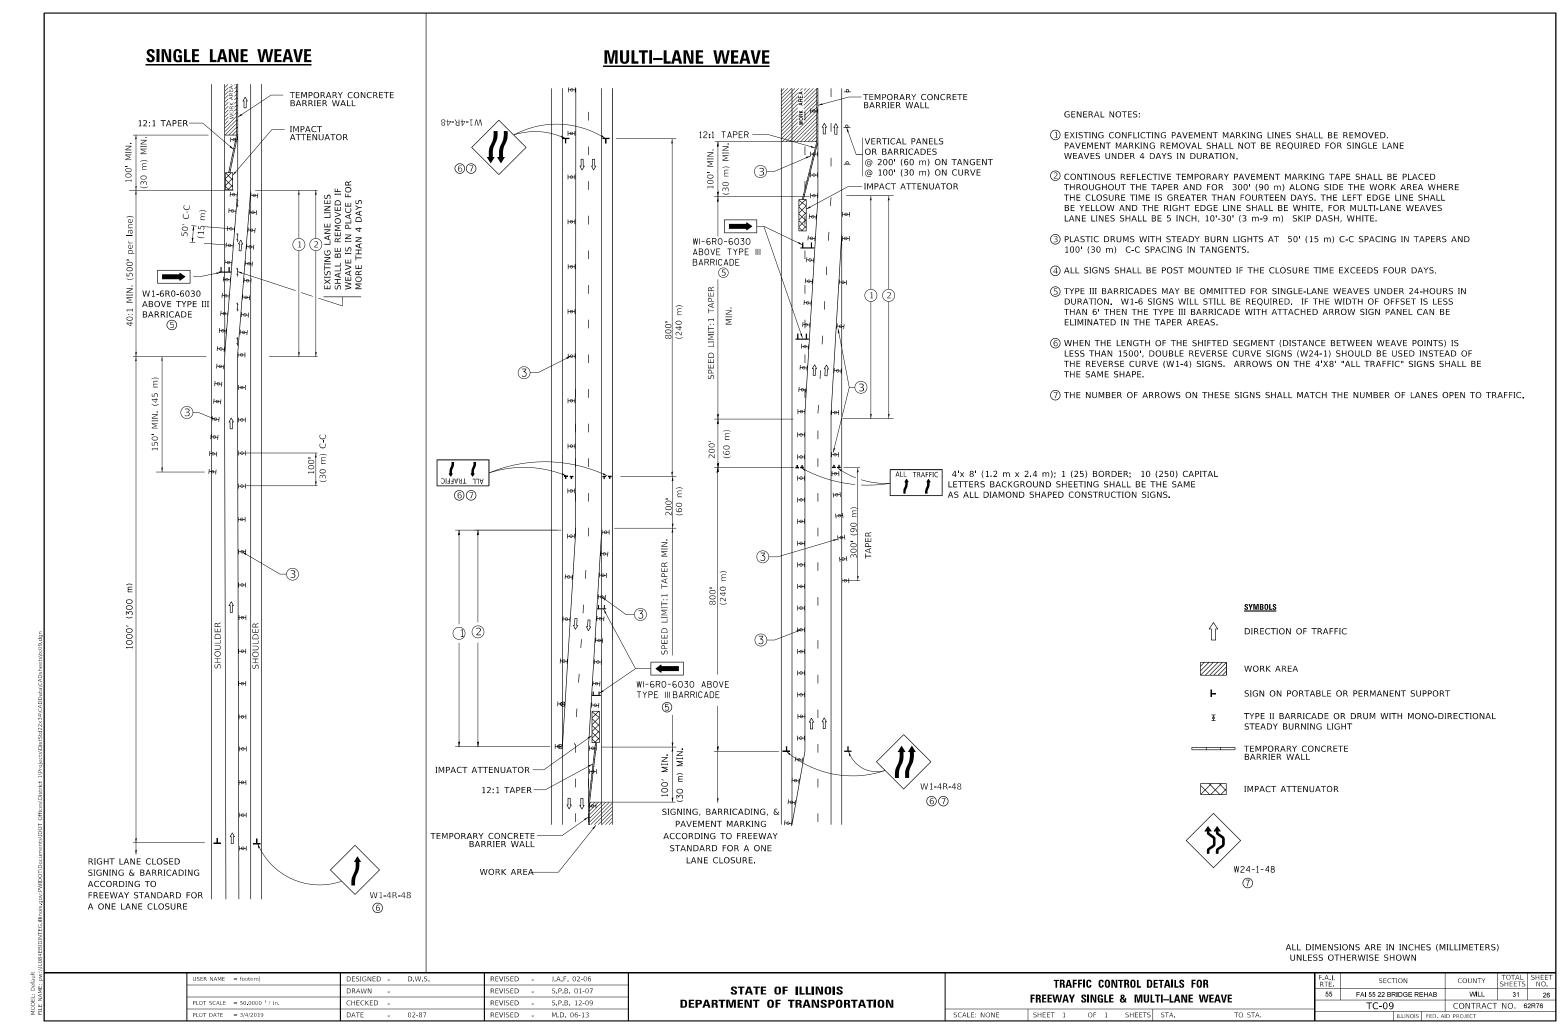

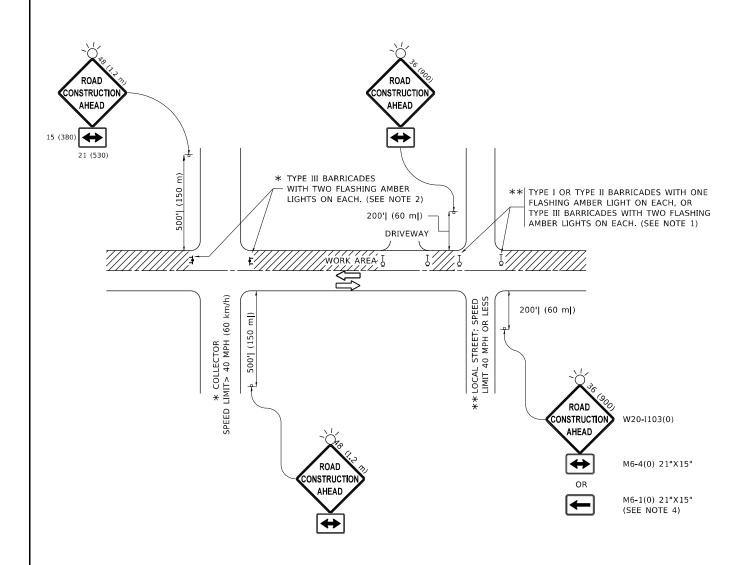

NOTES:

- 1. SIDE ROAD WITH A SPEED LIMIT OF 40 MPH (60 km/h) OR LESS AS SHOWN ON THE DRAWING AND AS DIRECTED BY THE ENGINEER:
- a) ONE "ROAD CONSTRUCTION AHEAD" SIGN 36 x 36 (900x900) WITH A FLASHER MOUNTED ON IT APPROXIMATELY 200' (60 m) IN ADVANCE OF THE MAIN ROUTE.
- b) THE CLOSED PORTION OF THE MAIN ROUTE SHALL BE PROTECTED BY BLOCKING WITH TYPE I, TYPE II OR TYPE III BARRICADES, 1/3 OF THE CROSS SECTION OF THE CLOSED PORTION.
- SIDE ROAD WITH A SPEED LIMIT GREATER THAN 40 MPH (60 km/h) AS SHOWN ON THE DRAWING AND AS DIRECTED BY THE ENGINEER:
- a) ONE "ROAD CONSTRUCTION AHEAD" SIGN 48 x 48 (1.2 m x 1.2 m) WITH A FLASHER MOUNTED ON IT APPROXIMATELY 500' (150 m) IN ADVANCE OF THE MAIN ROUTE.
- THE CLOSED PORTION OF THE MAIN ROUTE SHALL BE PROTECTED BY
 b) BLOCKING WITH TYPE III BARRICADES, 1/2 OF THE CROSS SECTION
 OF THE CLOSED PORTION.
- CONES MAY BE SUBSTITUTED FOR BARRICADES OR DRUMS AT HALF THE SPACING DURING DAY OPERATIONS. CONES SHALL BE A MINIMUM OF 28 (710) IN HEIGHT
- WHEN THE SIDE ROAD LIES BETWEEN THE BEGINNING OF THE MAINLINE
 4. SIGNING AND THE WORK ZONE, A SINGLE HEADED ARROW (M6-1) SHALL
 BE USED IN LIEU OF THE DOUBLE HEADED ARROW (M6-4).

- WHEN WORK IS BEING PERFORMED ON A SIDE ROAD OR DRIVEWAY, FOLLOW THE APPLICABLE STANDARD(S). THE DIRECTIONAL ARROW (M6-1 OR M6-4) SHALL BE COVERED OR REMOVED WHEN NO LONGER CONSISTENT WITH THE TRAFFIC CONTROL SET-UP.
- 6. ADVANCE WARNING SIGNS ARE TO BE OMITTED ON DRIVEWAYS UNLESS OTHERWISE SPECIFIED IN THE PLANS OR BY THE ENGINEER
- 7. THE TRAFFIC CONTROL AND PROTECTION FOR SIDE ROADS, INTERSECTIONS, AND DRIVEWAYS SHALL BE INCLUDED IN THE COST OF SPECIFIED TRAFFIC CONTROL STANDARDS OR ITEMS.

All dimensions are in inches (millimeters) unless otherwise shown.

 USER NAME
 = Lawrence.DeManche
 DESIGNED
 - L.H.A.
 REVISED
 - T. RAMMACHER 01-06-00

 DRAWN
 REVISED
 - A. SCHUETZE 07-01-13

 PLOT SCALE
 = 100,0000 '/ in.
 CHECKED
 REVISED
 - A. SCHUETZE 09-15-16

 PLOT DATE
 = 5/3/2024
 DATE
 - 06-89
 REVISED
 - D. SENDERAK 05-03-24

STATE OF ILLINOIS
DEPARTMENT OF TRANSPORTATION


TRAFFIC CONTROL AND PROTECTION FOR SIDE ROADS, INTERSECTIONS, AND DRIVEWAYS


SHEET 1 OF 1 SHEETS STA. TO ST

F.A.J. SECTION COUNTY TOTAL SHEET NO.


55 FAI 55 22 BRIDGE REHAB MLL 31 27

TC-10 CONTRACT NO. 62R76

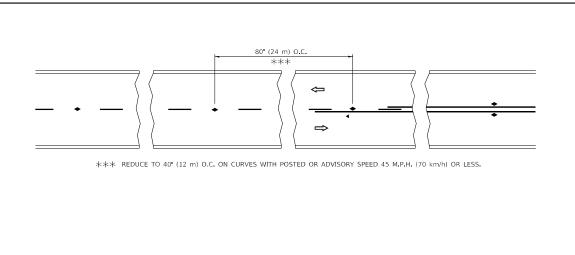


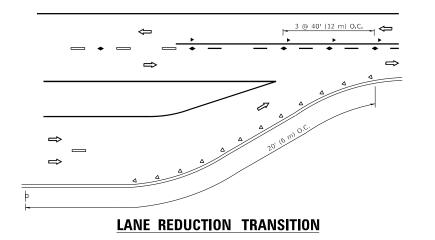


SEE FIGURE 3B-14 MUTCD

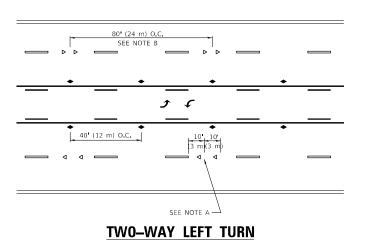


TWO-LANE/TWO-WAY

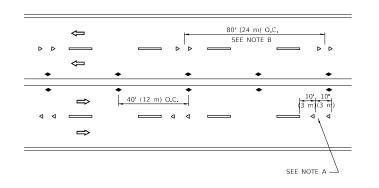


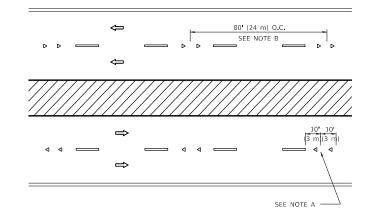

MULTI-LANE/UNDIVIDED



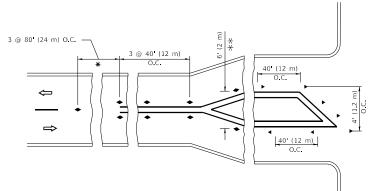

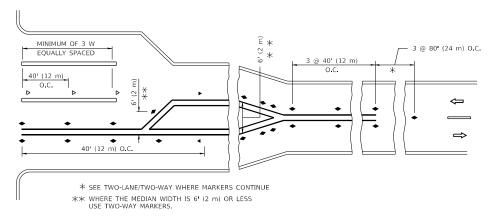

TURN LANES

GENERAL NOTES

- MARKERS USED WITH DASHED LINES SHALL BE CENTERED IN THE GAP BETWEEN SEGMENTS.
- MARKERS USED ADJACENT TO SOLID LINES SHALL BE OFFSET 2 TO 3 (50 TO 75) TOWARD TRAFFIC AS SHOWN.
- MARKERS THROUGH TANGENTS LESS THAN 500' (150 m) IN LENGTH BETWEEN CURVES SHALL BE INSTALLED AT THE LESSER OF THE TWO CURVE SPACINGS.
- 4. MARKERS ARE TO BE USED ADJACENT TO BOTH SOLID WHITE LINES IN DUAL LEFT TURN LANES

LANE MARKER NOTES

- A. USE DOUBLE LANE LINE MARKERS SPACED AS SHOWN.
- B. REDUCE TO 40' (12 m) O.C. ON CURVES WHERE ADVISORY SPEEDS ARE 10 M.P.H (20 km/h) LOWER THAN POSTED SPEEDS.

DESIGN NOTES

- 1. DOUBLE LANE LINE MARKERS SHALL BE USED UNLESS SPECIFIED OTHERWISE.
- EXCEPT AS SHOWN ON THE LANE REDUCTION TRANSITION AND FREEWAY EXIT RAMP DETAIL, MARKERS ARE NOT TO BE SPECIFIED ON RIGHT EDGE LINES.
- 3. THE EXACT MARKER LIMITS, SPACING, AND COLOR SHALL BE INCLUDED IN THE PLANS WHEN STANDARD SPECIFICATIONS ARE NOT BEING USED.
- MARKERS SHOULD NOT BE USED ALONGSIDE CURBS EXCEPT FOR EXTREMELY SHORT SECTIONS OF CURBS WHERE NOT MORE THAN TWO MARKERS WOULD BE INVOLVED.

All dimensions are in inches (millimeters) unless otherwise shown.

STATE OF ILLINOIS
DEPARTMENT OF TRANSPORTATION

TYPICAL APPLICATIONS

RAISED REFLECTIVE PAVEMENT MARKERS (SNOW–PLOW RESISTANT)

SCALE: NONE SHEET 1 OF 1 SHEETS STA. TO STA.

PEEDS ARE

SYMBOLS

ONE-WAY AMBER MARKER


TWO-WAY AMBER MARKER

ONE-WAY CRYSTAL MARKER (W/O)

YELLOW STRIPE

WHITE STRIPE

WDOT OTHERSTONES AND SECURISED TO A
MODEL: Default

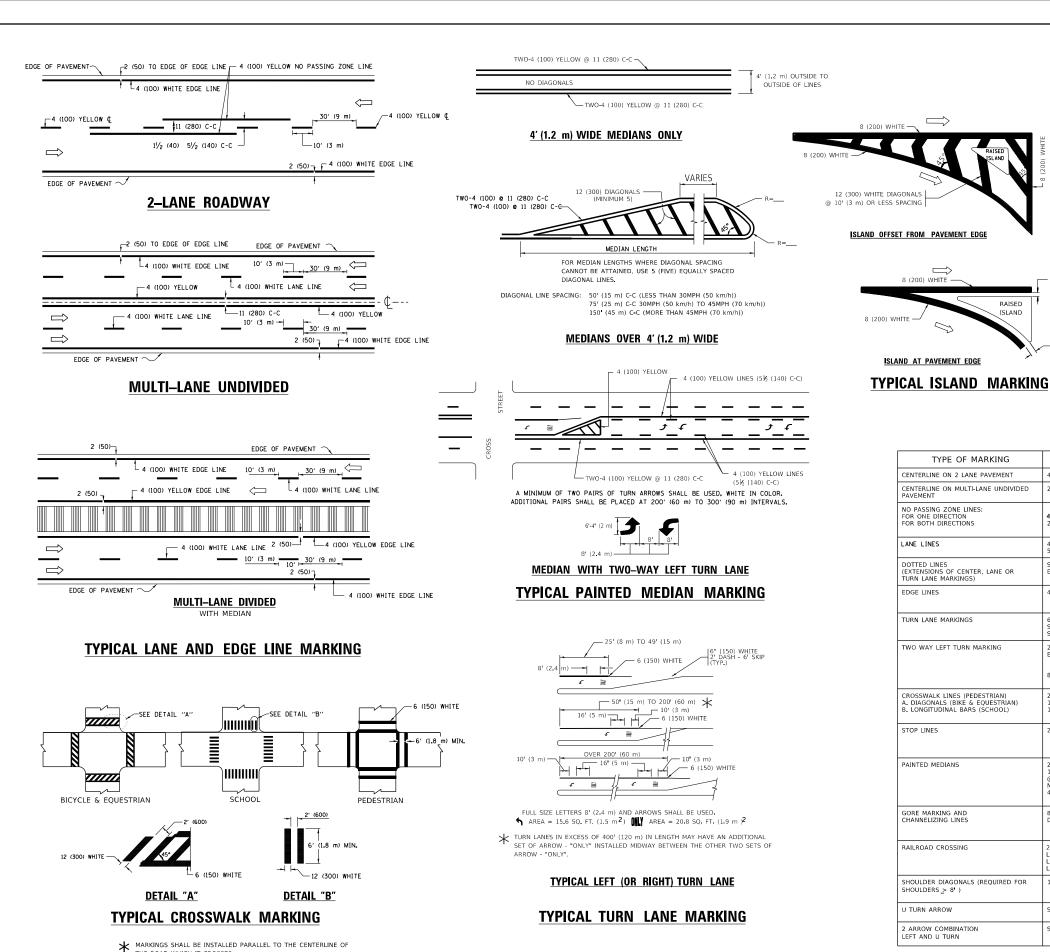

D(FT) SPEED LIMIT 580 45 665 50 750 55 COMBINATION LEFT AND U-TURN 32 R (810) LANE REDUCTION TRANSITION * LANE REDUCTION ARROWS REQUIRED AT SPEEDS OF 45 MPH OR GREATER OR WHEN SPECIFIED IN PLANS. **U-TURN**

TYPE OF MARKING WIDTH OF LINE PATTERN SPACING / REMARKS COLOR CENTERLINE ON 2 LANE PAVEMENT SKIP-DASH YELLOW 10' (3 m) LINE WITH 30' (9 m) SPACE SOLID YELLOW 11 (280) C-C NO PASSING ZONE LINES: FOR ONE DIRECTION FOR BOTH DIRECTIONS **4 (100)** 2 @ 4 (100) YELLOW YELLOW OMIT SKIP-DASH CENTERLINE BETWEEN LANE LINES SKIP-DASH SKIP-DASH 10' (3 m) LINE WITH 30' (9 m) SPACE 4 (100) 5 (125) ON FREEWAYS DOTTED LINES (EXTENSIONS OF CENTER, LANE OR TURN LANE MARKINGS) SAME AS LINE BEING EXTENDED SKIP-DASH SAME AS LINE BEING EXTENDED 2 (600) LINE WITH 6 (1.8 m) SPACE EDGE LINES SOLID OUTLINE MEDIANS IN YELLOW 4 (100) YELLOW-LEFT WHITE-RIGHT 6 (150) LINE, FULL SIZE LETTERS & SYMBOLS (8' (2.4m) TURN LANE MARKINGS SOLID SEE TYPICAL TURN LANE MARKING DETAIL 10' (3 m) LINE WITH 30' (9 m) SPACE FOR SKIP-DASH; 5½ (140) C-C BETWEEN SOLID LINE AND SKIP-DASH LINE SEE TYPICAL TWO-WAY LEFT TURN MARKING DETAIL TWO WAY LEFT TURN MARKING 2 @ 4 (100) EACH DIRECTION 8 (2.4m) LEFT ARROW 2 @ 6 (150) 12 (300) @ 45° 12 (300) @ 90° CROSSWALK LINES (PEDESTRIAN) A. DIAGONALS (BIKE & EOUESTRIAN) NOT LESS THAN 6' (1.8 m) APART . LONGITUDINAL BARS (SCHOOL) SOLID WHITE ' (600) APART SEE TYPICAL CROSSWALK MARKING DETAILS. PLACE 4' (1.2 m) IN ADVANCE OF AND PARALLEL TO CROSSWALK, IF PRESENT. OTHERWISE, PLACE AT DESIRED STOPPING POINT. PARALLEL TO CROSSROAD CENTERLINE, WHERE POSSIBLE STOP LINES 24 (600) SOLID WHITE PAINTED MEDIANS SOLID 11 (280) C-C FOR THE DOUBLE LINE SEE TYPICAL PAINTED MEDIAN MARKING. 2 @ 4 (100) WITH 12 (300) DIAGONALS YELLOW: TWO WAY TRAFFIC WHITE: ONE WAY TRAFFIC @ 45° NO DIAGONALS USED FOR 4' (1.2 m) WIDE MEDIANS DIAGONALS: 15' (4.5 m) C-C (LESS THAN 30MPH (50 km/h)) 20' (6 m) C-C 30MPH (50 km/h) TO 45MPH (70 km/h)) 30' (9 m) C-C (OVER 45MPH (70 km/h)) 24 (600) TRANSVERSE LINES; "RR" IS 6' (1.8 m) LETTERS; 16 (400) LINE FOR "X" RAILROAD CROSSING SOLID WHITE SEE STATE STANDARD 780001 AREA OF: "R"=3.6 SQ. FT. (0.33 m PEACH "X"=54.0 SQ. FT. (5.0 m)2 50' (15 m) C-C (LESS THAN 30MPH (50 km/h)) 75' (25 m) C-C (30 MPH (50 km/h) TO 45MPH (70 km/h)) 150' (45 m) C-C (OVER 45MPH (70 km/h)) SHOULDER DIAGONALS (REQUIRED FOR 12 (300) @ 45° SOLID WHITE - RIGHT YELLOW - LEFT SHOULDERS > 8') U TURN ARROW SEE DETAIL SOLID WHITE 2 ARROW COMBINATION SOLID 30.4 SF

FOR FURTHER DETAILS ON PAVEMENT MARKING REFER TO STANDARD SPECIFICATIONS FOR ROAD AND BRIDGE CONSTRUCTION AND STATE STANDARD 780001.

SCALE: NONE

8 (200) WHITE -

— 2 (50)

2 (50)


RAISED

SER NAME = footem EVERS DESIGNED -C. JUCIUS 09-09-09 DRAWN REVISED C. JUCIUS 07-01-13 HECKED REVISED DATE

THE ROAD WHICH IT CROSSES

STATE OF ILLINOIS **DEPARTMENT OF TRANSPORTATION**

SECTION DISTRICT ONE FAI 55 22 BRIDGE REHAB 55 WILL 31 29 TYPICAL PAVEMENT MARKINGS CONTRACT NO.62R76 OF 2 SHEETS STA TO STA.

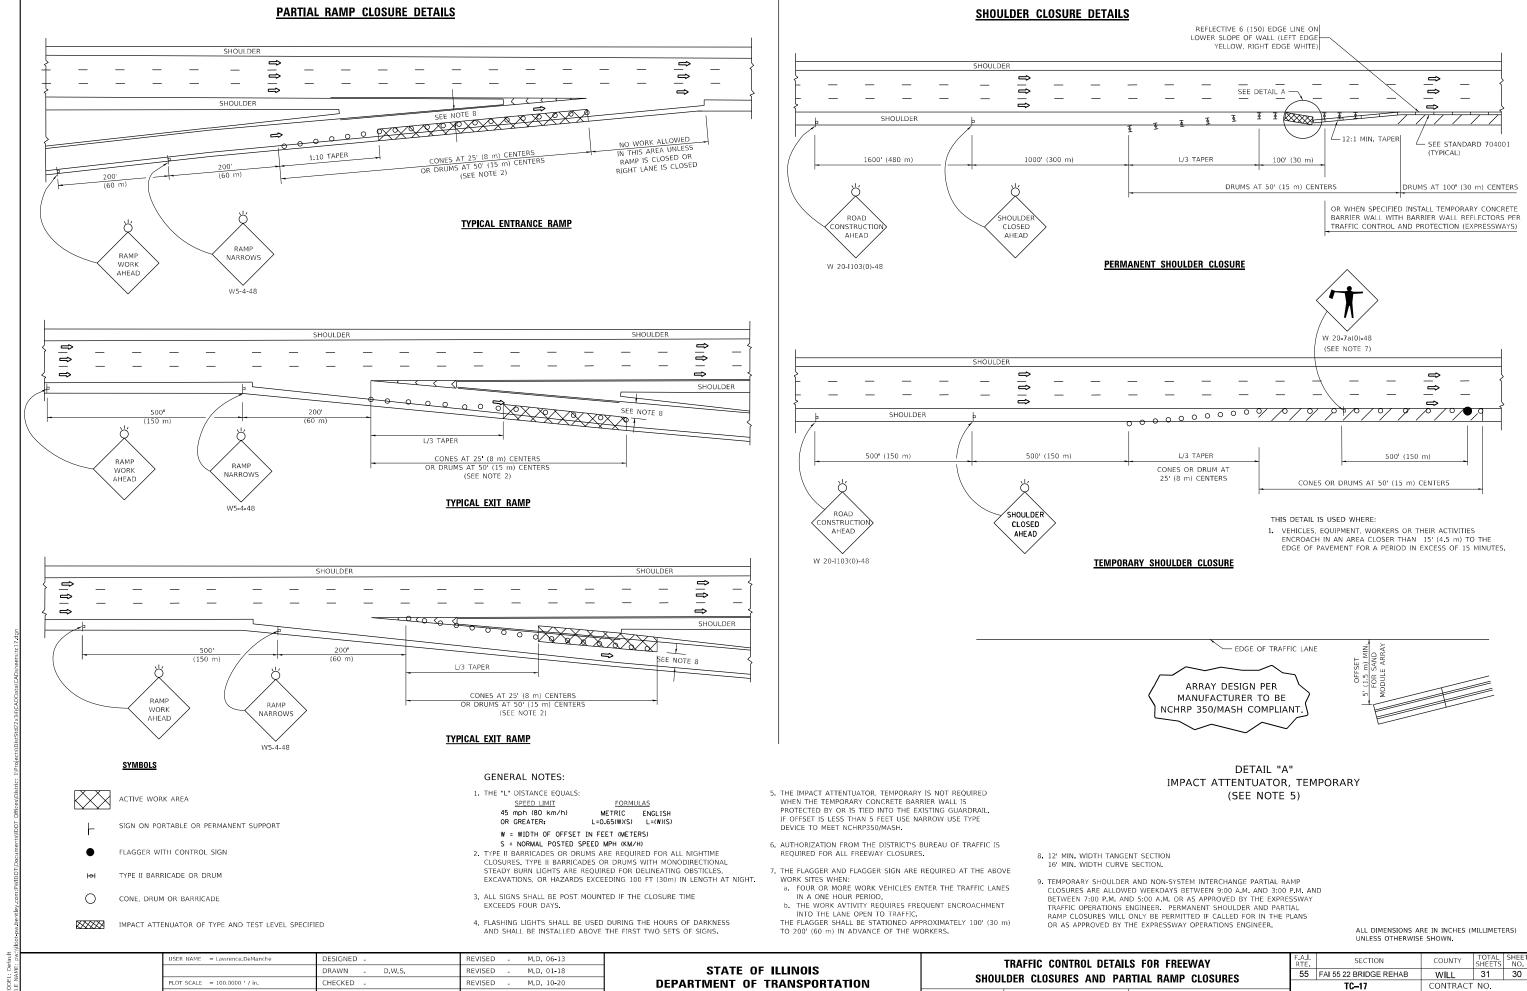


D.S. 05-24

REVISED

DATE

SHEET 1 OF 1 SHEETS STA.

1

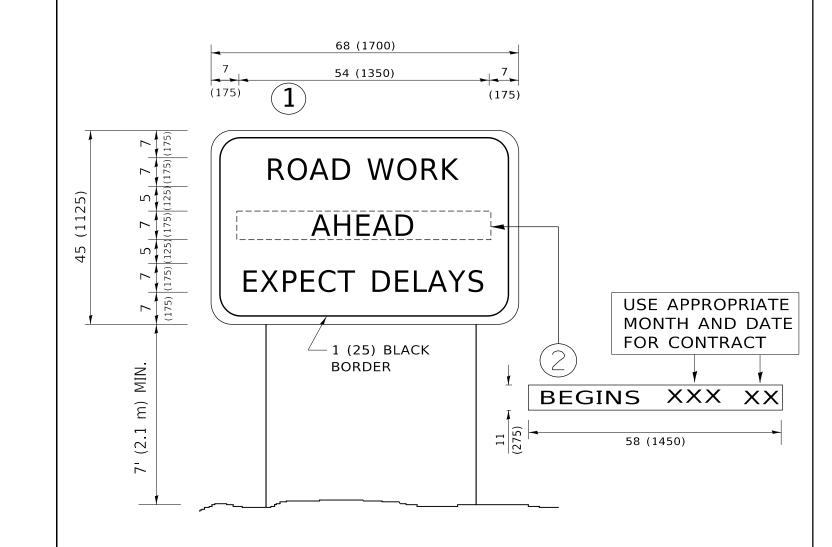

NOTES:

- 1. USE BLACK LETTERING ON ORANGE BACKGROUND.
- 2. ERECT SIGNS IN ADVANCE OF THE LOCATION FOR THE "ROAD CONSTRUCTION AHEAD" SIGN AT LOCATIONS AS DIRECTED BY THE ENGINEER.
- 3. ERECT SIGN 1 WITH INSTALLED PANEL 2 ONE WEEK PRIOR TO THE START OF CONSTRUCTION.
- 4. REMOVE PANEL(2)SOON AFTER THE START OF CONSTRUCTION.
- 5. SEE SPECIAL PROVISION FOR "TEMPORARY INFORMATION SIGNING" FOR ADDITIONAL INFORMATION.
- 6. ONE SIGN ASSEMBLY EQUALS 25.70 SQ. FT. (2.3 SQ. M.)

SCALE: NONE

7. SHALL BE PAID FOR AS TEMPORARY INFORMATION SIGNING.

ALL DIMENSIONS ARE IN INCHES (MILLIMETERS) UNLESS OTHERWISE SHOWN.

USER NAME = footemj	DESIGNED -	REVISED	-	R. MIRS 09-15-97
	DRAWN -	REVISED	-	R. MIRS 12-11-97
PLOT SCALE = 50.0000 ' / in.	CHECKED -	REVISED	- T.	RAMMACHER 02-02-9
PLOT DATE = 3/4/2019	DATE -	REVISED		C IUCIUS 01-31-07

STATE OF ILLINOIS								
DEPARTMENT OF	TRANSPORTATION							

ARTERIAL ROAD INFORMATION SIGN							F.A.I. RTE		
							55	FAI 55 22 BRIDGE	
			liai	Un	IVIATION	SIGN			TC-22
	SHEET	1	OF	1	SHEETS	STA.	TO STA.		ILLIN