# STATE OF ILLINOIS **DEPARTMENT OF TRANSPORTATION**

# ST. CLAIR 6 1 CONTRACT NO. 76U72

D-98-067-25

# FOR INDEX OF SHEETS, SEE SHEET NO. 2

0

0

	TRAFFIC DATA WATER ST
LOCATION	IL 3 TO ST. LAMBERT DR
2025 ADT	3000 (ACTUAL)
2045 ADT	3600 (ESTIMATED)
MU%	1.7%
SU%	6.1%

	TRAFFIC DATA WATER ST.
LOCATION	ST. LAMBERT DR. TO OLD IL 3
2025 ADT	1600 (ACTUAL)
2045 ADT	2000 (ESTIMTED)
MU%	2.5%
SU%	8.8%

# **PROPOSED HIGHWAY PLANS**

FAU ROUTE 9206 (WATER ST.) SECTION 64Q **CM - CHIP SEAL** ST. CLAIR COUNTY

C-98-136-25



BEGIN PROJECT: STA. 15+36.00 LAT: 38.566766 LONG: -90.191050

BRIDGE OMISSION STA. 76+31 TO STA. 79+82

LOCATION OF SECTION INDICATED THUS: -

**FUNCTIONAL CLASSIFICATION: MAJOR COLLECTOR** 

PCC PAVEMENT OMISSION STA. 74+16 TO STA. 74+28

PCC PAVEMENT OMISSION STA. 80+50 TO STA. 80+62

**FULL SIZE PLANS HAVE BEEN PREPARED USING STANDARD ENGINEERING SCALES. REDUCED SIZED PLANS WILL NOT** CONFORM TO STANDARD SCALES. IN MAKING MEASUREMENTS ON REDUCED PLANS, THE ABOVE SCALES MAY BE USED.

J.U.L.I.E. JOINT UTILITY LOCATION INFORMATION FOR EXCAVATION 1-800-892-0123 OR 811

PROJECT ENGINEER: BILLIE OWEN **PROJECT MANAGER: MIKE BERG** 

END PROJECT: STA. 104+68 LAT: 38.543795 LONG: -90.197439

STATE OF ILLINOIS **DEPARTMENT OF TRANSPORTATION** 

PRINTED BY THE AUTHORITY OF THE STATE OF ILLINOIS

NOT TO SCALE

GROSS LENGTH = 9.609.6 FT. = 1.82 MILE NET LENGTH = 9,234.6 FT. = 1.74 MILE

CONTRACT NO. 76U72

#### **INDEX OF SHEETS**

- COVER SHEET
- . INDEX OF SHEETS, HIGHWAY STANDARDS, GENERAL NOTES AND COMMITMENTS
- 3. SUMMARY OF QUANTITIES
- 4. TYPICAL SECTION
- SCHEDULE OF QUANTITIES
- 6. LOCATION MAP, DETAILS

#### **HIGHWAY STANDARDS**

000001-09 STANDARDS SYMBOLS ABBREVIATIONS & PATTERNS

001006 DECIMAL OF INCH & FOOT

701011-04 OFF ROAD MOVING OPERATIONS, 2L, 2W, DAY ONLY
701201-05 LANE CLOSURE, 2L 2W, DAY ONLY, FOR SPEEDS ≥ 45 MPH

701201-05 LANE CLOSURE, 2L 2W, DAY ONLY, FOR SPEEDS ≥ 45 MP 701301-04 LANE CLOSURE, 2L 2W, SHORT TIME OPERATIONS

701306-04 LANE CLOSURE, 2L 2W, SLOW MOVING OPERATIONS, DAY ONLYFOR SPEEDS ≥ 45 MPH

701311-03 LANE CLOSURE, 2L 2W, MOVING OPERATIONS, DAY ONLY

701901-11 TRAFFIC CONTROL DEVICES

780001-05 TYPICAL PAVEMENT MARKINGS

781001-04 TYPICAL APPLICATIONS RAISED REFLECTIVE PAVEMENT MARKERS

782001-01 CURB REFLECTORS

#### **GENERAL NOTES**

1. UTILITIES KNOWN TO HAVE FACILITIES WITHIN THE PROJECT ARES

OTILITIES KNOWN TO HAVE FACILITIES WITHIN THE	PROJECTARES		
		AERIAL	BURIED
AMEREN ILLINOIS	(GAS & ELECTRIC)	X	X
AT&T ILLINOIS	(COMMUNICATIONS)	X	X
BUCKEYE PARTNERS L.P. WOODRIVER PIPELINE	(PIPELINE)		X
VILLAGE OF CAHOKIA	(WATER, SANITARY SEWER)		X
CHARTER COMMUNICATIONS, INC	(COMMUNICATIONS)	X	X
CITY OF COLUMBIA.	(WATER, SANITARY SEWER)		X
VILLAGE OF DUPO	(WATER, SANITARY SEWER)		X
VILLAGE OF DUPO	(GAS)		Χ
HARRISONVILLE TELEPHONE COMPANY	(COMMUNICATION)	X	X
VERIZON BUSINESS	(COMMUNICATIONS)	X	X
METRO EAST SANITARY DISTRICT	(SANITARY SEWER)		X
PARIRIE DU PONT PUBLIC WATER DISTRICT	(WATER)		Χ
SEGRA	(COMMUNICATION)	X	X
SUGAR LOAF TOWNSHIP SEWER SYSTEM	(SANITARY SEWER)		×

- NO SURVEY WAS PERFORMED FOR THIS PROJECT AND THE PLANS WERE CREATED USING MICROFLIM AND FIELD MEASUREMENTS.
- 3. THE RESIDENT ENGINEER SHALL VERIFY THE EXISTENCE OF HIGHWAY LIGHTING, INTELLIGENT TRANSPORTATION SYSTEMS (I.T.S.) UTILITIES, AND/OR ELECTRICAL CABLES ASSOCIATED WITH TRAFFIC SIGNALS WITHIN THE PROJECT LIMITS. IF ANY OF THESE EXIST WITHIN THE PROJECT LIMITS, AND IF THESE ITEMS REQUIRE LOCATING, THE CONTRACTOR SHALL BE DIRECTED TO DO SO ACCORDING TO SECTION 803 OF THE STANDARD SPECIFICATIONS. THIS WORK SHALL BE PAID FOR ACCORDING TO ARTICLE 109.04 OF THE STANDARD SPECIFICATIONS.
- 4. THE DEPARTMENT STRONGLY ENCOURAGES THE PRIME CONTRACTOR AND THEIR APPROVED SUB-CONTRACTORS TO HIRE MINORITY, WOMEN AND DISADVANTAGED INDIVIDUALS FROM ITS FEDERALLY FUNDED HIGHWAY CONSTRUCTION CAREERS TRAINING PROGRAM (HCCTP) TO HELP MEET WORKFORCE AND TRAINEE GOALS. THIS PROGRAM IS TRAINING MINORITIES, WOMEN AND DISADVANTAGED INDIVIDUALS IN HIGHWAY CONSTRUCTION-RELATED SKILLS, E.G., MATH FOR THE TRADES, JOB READINESS, TECHNICAL SKILLS COURSEWORK (CARPENTRY, CONCRETE FLATWORK, BLUEPRINT READING, SITE PLANS, SITE WORK, TOOLS USE, ETC.) AND OSHA 10 HOUR CERTIFICATION, TO PREPARE THEM FOR A CAREER IN THE HIGHWAY CONSTRUCTION TRADES. GRADUATES ARE WELL-TRAINED AND READY TO BECOME PRODUCTIVE ENTRY-LEVEL CONSTRUCTION WORKERS. CONTACT THE DISTRICT 8 EEO OFFICE AT 618-346-3360 AND/OR THE HCCTP COORDINATOR AT 618-874-6528 TO LEARN MORE ABOUT THE PROGRAM AND FOR ASSISTANCE IN MEETING WORKFORCE AND TRAINEE GOALS.
- 5. THE VOID IN THE PAVEMENT WHICH RESULTS FROM THE RAISED REFLECTIVE PAVEMENT MARKER REMOVAL SHALL BE REPAIRED WITH MATERIAL AS DIRECTED BY THE ENGINEER. THE MATERIAL AND WORK SHALL BE PAID FOR IN ACCORDANCE WITH ARTICLE 783 OF THE STANDARD SPECIFICATIONS.
- 6. ALL TURF AREAS DISTURBED BY THE CONTRACTOR SHALL BE SEEDED WITH THE APPROPRAITE EROSION CONTROL, AS DIRECTED BY THE ENGINEER, AT THE CONTRACTOR'S EXPENSE.
- 7. THE CONTRACTOR SHALL USE CA-16 FOR THE SEAL AND COVER AGGREGATE.
- 8. TWO CHANGEABLE MESSAGE SIGNS SHALL BE PROVIDED ALONG IL 3 AND OLD IL 3 (STOLLE RD.) TO ALERT DRIVERS OF THE UPCOMING ROAD CONSTRUCTION. CHANGEABLE MESSAGE SIGNS SHALL BE PLACED 14 DAYS PRIOR TO BEGINNING WORK, EXACT LOCATIONS OF THE CHANGEABLE MESSAGE SIGNS SHALL BE DETERMINED BY THE ENGINEER.
- 9. THE DESIGNATED APPLICATION RATE FOR THE FOG SEAL IS 0.04LB/SQ FT.
- 10. THE PROPOSED PAVEMENT MARKING SHALL MATCH THE LOCATIONS OF THE EXISTING PAVEMENT MARKING, AS DIRECTED BY THE ENGINEER.

COMMITMENTS

SCALE: NTS

NONE

USER NAME = rahshun.miller	DESIGNED -	REVISED -
	DRAWN -	REVISED -
	CHECKED -	REVISED -
PLOT DATE = 8/25/2025	DATE -	REVISED -

STATE OF ILLINOIS
DEPARTMENT OF TRANSPORTATION

	INDEX OF	SHEETS	S. HIGHV	IAY ST	ANDARDS,	F.A.U RTE.	SECTION	COUNTY	TOTAL SHEETS	SHEET NO.
	GENERAL NOTES, COMMITMENTS						64Q	ST. CLAIR	5	2
								CONTRAC	NO. 76	U72
	SHEET 1	OF 1	SHEETS	STA.	TO STA.		ILLINOIS FE	D. AID PROJECT		

\* SPECIALTY ITEM

USER NAME = rahshun.miller DESIGNED -REVISED -DRAWN -REVISED -CHECKED -REVISED -PLOT DATE = 10/7/2025 DATE REVISED -

**DEPARTMENT OF TRANSPORTATION** 

SCALE: NTS

F.AU RTE. 9206 **SUMMARY OF QUANTITIES** SHEET 1 OF 1 SHEETS STA. TO STA.

SECTION

				100% STAT
			T	ROADWAY
CODE			TOTAL	0005
NO.	ITEM	UNIT	QUANTITY	URBAN
67100100	MOBILIZATION	L SUM	1	1
70100450	TRAFFIC CONTROL AND PROTECTION, STANDARD 701201	L SUM	1	1
70100460	TRAFFIC CONTROL AND PROTECTION, STANDARD 701306	L SUM	1	1
70300100	SHORT TERM PAVEMENT MARKING	FOOT	778	778
70300150	SHORT TERM PAVEMENT MARKING REMOVAL	SQ FT	259	259
70300211	TEMPORARY PAVEMENT MARKING LETTERS AND SYMBOLS - PAINT	SQ FT	63	63
70300221	TEMPORARY PAVEMENT MARKING - LINE 4"- PAINT	FOOT	22549	22549
70300261	TEMPORARY PAVEMENT MARKING - LINE 12"- PAINT	FOOT	52	52
70300281	TEMPORARY PAVEMENT MARKING - LINE 24"- PAINT	FOOT	69	69
78001100	PAINT PAVEMENT MARKING - LETTERS AND SYMBOLS	SQ FT	63	63
78001130	PAINT PAVEMENT MARKING - LINE 6"	FOOT	24005	24005
78001150	PAINT PAVEMENT MARKING - LINE 12"	FOOT	52	52
78001180	PAINT PAVEMENT MARKING - LINE 24"	FOOT	69	69
78300200	RAISED REFLECTIVE PAVEMENT MARKER REMOVAL	EACH	107	107

NO.	ITEM	UNIT	QUANTITY	URBAN	
9					
78300201	PAVEMENT MARKING REMOVAL - GRINDING	SQ FT	8040	8040	
X1500005	BITUMINOUS SURFACE TREATMENT, A2	SQ YD	21834	21834	
X <b>4</b> 060107	BITUMINOUS MATERIALS (FOG SEAL)	POUND	8734	8734	
X7810400	TEMPORARY RAISED PAVEMENT MARKER	EACH	1089	1089	
Z0048665	RAILROAD PROTECTIVE LIABILITY INSURANCE	L SUM	1	1	

CONSTR. CODE


CODE

CONSTR. CODE

100% STATE

ROADWAY 0005


TOTAL

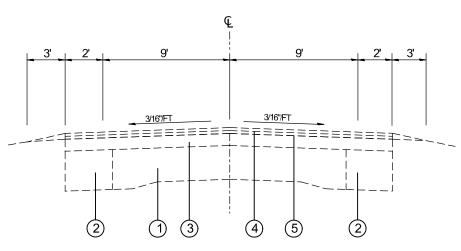

### **EXISTING TYPICAL SECTION**

FAU 9206 (WATER ST.)

STA. 15+56 TO STA. 44+51 STA. 54+55 TO STA. 62+80 STA. 74+16 TO STA. 74+28 (PCC PAVEMENT OMISSION) STA. 75+19 TO STA. 76+05 STA. 76+05 TO STA. 79+82 (BRIDGE OMISSION) STA. 79+82 TO STA. 80+08 STA. 80+50 TO STA. 80+62 (PCC PAVEMENT OMISSION) STA. 82+21 TO STA. 104+68

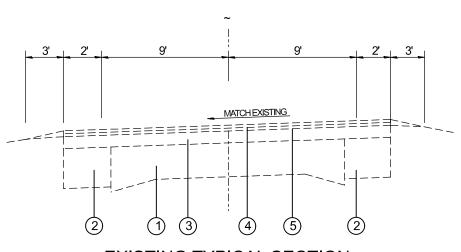


# EXISTING TYPICAL SECTION

FAU 9206 (WATER ST.) STA. 44+51 TO STA. 54+55 STA. 62+80 TO STA. 74+16 STA. 74+28 TO STA. 75+19 STA. 80+08 TO STA. 80+50 STA. 80+62 TO STA. 82+21

#### LEGEND


- 1) EXISTING PCC PAVEMENT (9"-7"-9")
- 2 EXISTING 8" P.C.C. BASE COURSE WIDENING
- (3) EXISTING RESURFACING 3"
- (4) EXISTING LEVELING BINDER (MM), MIX C, TYPE 2, 3/4"
- (5) EXISTING BIT CONC SURF CRSE, MIX D, CL I, TYP 2, 1 1/2"
- (6) PROPOSED CHIP SEAL

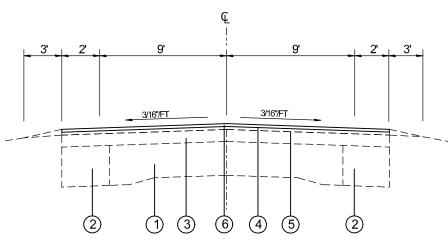

## PROPOSED TYPICAL SECTION

FAU 9206 (WATER ST.)

STA. 15+56 TO STA. 44+51 STA. 54+55 TO STA. 62+80 STA. 74+16 TO STA. 74+28 (PCC PAVEMENT OMISSION) STA. 75+19 TO STA. 76+05 STA. 76+05 TO STA. 79+82 (BRIDGE OMISSION) STA. 79+82 TO STA. 80+08 STA. 80+50 TO STA. 80+62 (PCC PAVEMENT OMISSION) STA. 82+21 TO STA. 104+68

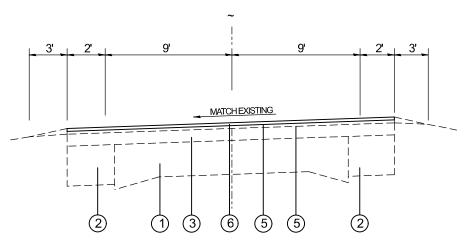

# PROPOSED TYPICAL SECTION

FAU 9206 (WATER ST.)

STA. 44+51 TO STA. 54+55 STA. 62+80 TO STA. 74+16 STA. 74+28 TO STA. 75+19 STA. 80+08 TO STA. 80+50 STA. 80+62 TO STA. 82+21

SCALE: NTS

USER NAME = rahshun.miller	DESIGNED -	REVISED -
	DRAWN -	REVISED -
	CHECKED -	REVISED -
PLOT DATE = 10/7/2025	DATE -	REVISED -

	TYPICAL SECTION						SEC.	TION		COUNTY	TOTAL SHEETS	SHEET NO.
I TPICAL SECTION						9206	64	Q		ST. CLAIR	6	2
							•			CONTRAC	T NO. 76	J72
	SHEET 1	OF 1	SHEETS	STA.	TO STA.			ILLINOIS	FED. AII	D PROJECT		

	PAVEMENT MARKING SCHEDULE																		
				NO	PAINT L				LINE			RMOPLASTIC	The second secon	RAISED R	EFLECTIVE	WORK ZONE	SHORT	PAVEMENT	
STA	то	STA	LENGTH		YELLOW LANE	EDGE	EDGE	ISLAND	YELLOW LANE	YELLOW 10'-30'	YELLOW LINE 12"	WHITE LINE 24"	WHITE LETTERS AND	PAVEMENT	MARKERS	PAVEMENT MARKINGS	TERM PAVEMENT	MARKING	TEMPORARY RPM
318		JIA		DIRECTION NB/SB	LINE	LINE		@ IL 3	LINE	SKIP-DASH	DIAGONAL LINE	STOP BAR	SYMBOLS	AMBER	REMOVAL	REMOVAL	MARKINGS	REMOVAL	
	Ш		FOOT	ND/3D	FOOT	FOOT	FOOT	FOOT	FOOT	FOOT	FOOT	FOOT	SQ FT	EACH	EACH	SQ FT	FOOT	SQ FT	EACH
15.26	TO	104.60	0557				17114	F 2					-	107	107	5077	770	5077	1000
15+36	10	104+68	8557				17114	52				-	<del>                                     </del>	107	107	5977	778	5977	1089
15+26	ТО	16+13	87	NB/SB					348		5 2		<del>                                     </del>			168	<del>                                     </del>	168	
16+13	ТО	20+20	407	SB					407	103						170		170	
		67+72	4752							1188						396		396	
67+72			859	SB					859	215						358		358	
		ISSION																	
76+31	ТО	79+82	351	NB/SB	702	702													
70192	TO	91+48	1166	NB					1166	292						486		486	
	TO		792	IND					1100	198			-			66		66	
		104+68	528	SB					528	132				<del>                                     </del>		220	<del>                                     </del>	220	
33110	10	101100	320	35					320	132						220		220	
1	03+6	58										22	61.2			105		105	
1	04+6	58										11	İ			22		22	
1	6+0	0										14				28		28	
	6+0	1000										22				4.4		44	
1	5+5	0																	
		CHD T	OTAL		700	700			2206	2127	F 2								
		SUB T	OTAL:		702	702	17114	52	3308	2127	5 2	6.0	61.2	107	107	8.040	770	8040	1000
		ТОТ	AL:		1 4	0 4		2	2601		5 2	69	01.2	107	107	8,040	778	8040	1089

	RESURFACING SCHEDULE							
STATION	ATION TO STATION		LENGTH WIDTH		TH WIDTH BITUMINOUS SURFACE TREATMENT A2			
			(FOOT)	(FOOT)	(SQ YD)	(LBS)		
15+36	ТО	74+16	5880	22	14373	5749.3		
PCC C	I MC	SSION						
74+16	ТО	74+28	12	22	29	11.7		
74+28	TO	76+31	203	22	496	198.5		
BRIDGE	OM	IISSION						
76+31	ТО	79+82	351	22	858	343.2		
79+82	TO	80+50	68	22	166	66.5		
PCC C	MI:	SSION						
80+50	ТО	80+62	12	22	29	11.7		
80+62	TO	104+68	2406	22	5881	2352.5		
		TOTAL			21834	8734		


USER NAME = rahshun.miller	DESIGNED -	REVISED -	
	DRAWN -	REVISED -	
	CHECKED -	REVISED -	
PLOT DATE = 9/15/2025	DATE -	REVISED -	
			Т

STATE OF ILLINOIS								
DEPARTMENT OF TRANSPORTATION								

SCALE: NTS

									TOTAL	SHEET
SCHEDULE OF QUANTITIES					F.A.U RTE.		COUNTY	SHEETS	NO.	
					9206	64Q	ST. CLAIR	6	4	
						CONTRACT NO. 76U72				
	SHEET 1	OF 1	SHEETS	STA.	TO STA.		ILLINOIS FED. AID PROJECT			

L: Schedule [Sheet] |AME: c:\pw work\pwidot\millerra\d1140456\D876U72-sht-schedu

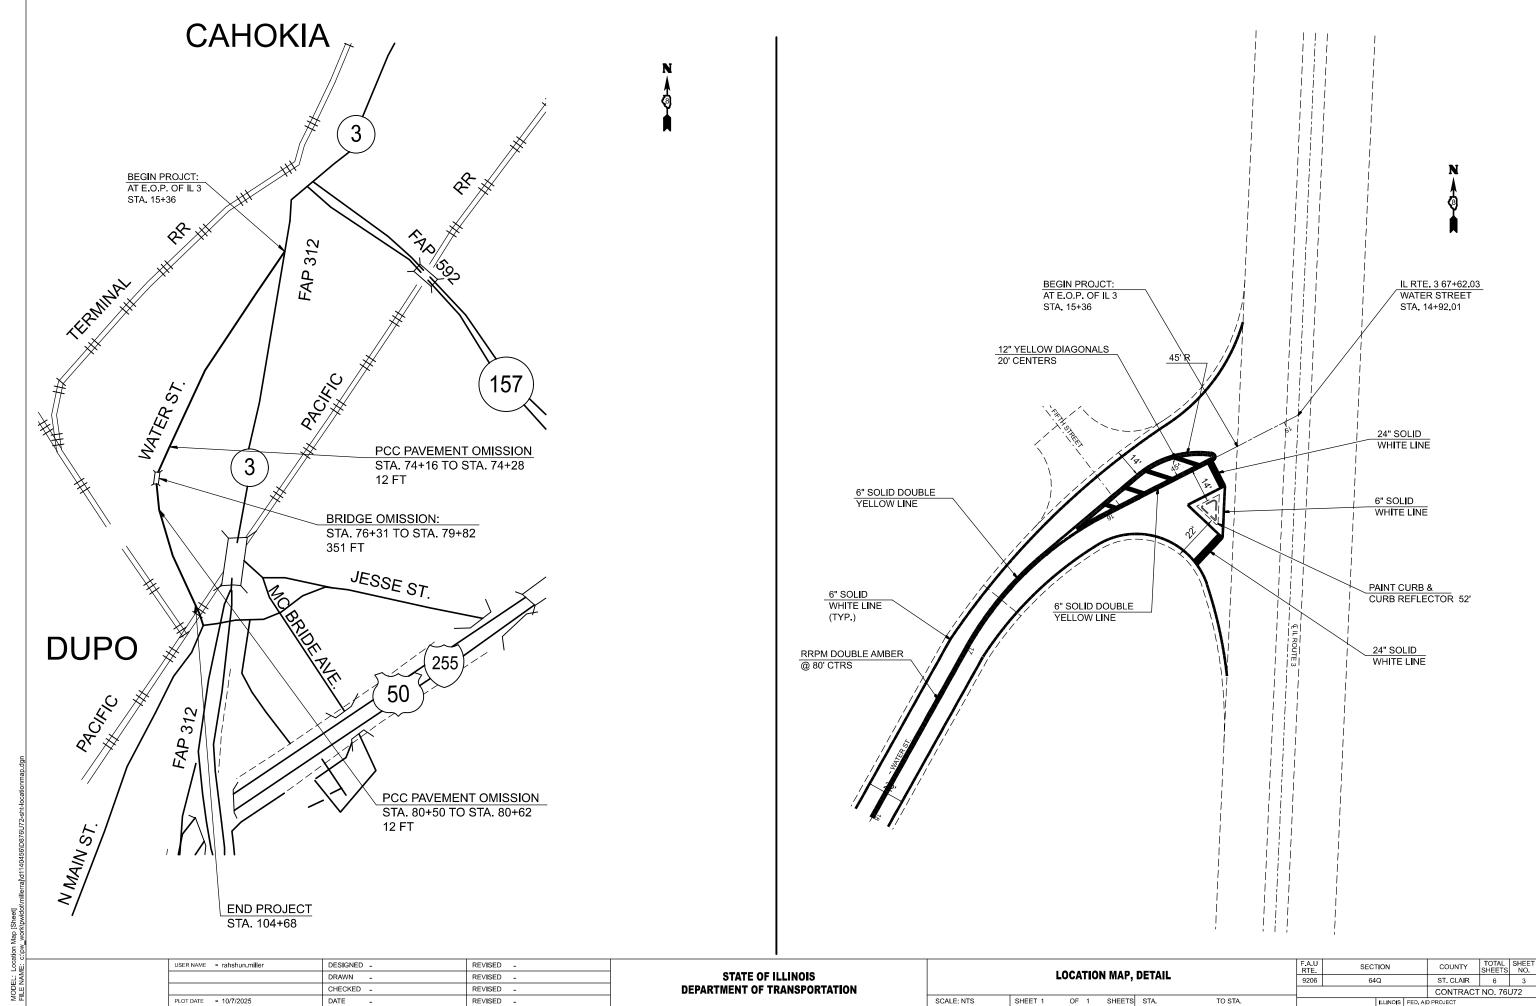

ILLINOIS FED. AID PROJECT

REVISED -

DATE