FOR INDEX OF SHEETS, SEE SHEET NO. 2 FOR LIST OF HIGHWAY STANDARDS SEE SHEET NO. 2 01-16-2026 LETTING ITEM 017

HIGHWAY CLASSIFICATION WINN ROAD - MAJOR COLLECTOR EAST SOLON ROAD - MAJOR COLLECTOR

TRAFFIC DATA 2024 ADT WINN ROAD - 3,800 EAST SOLON ROAD - 1,600

POSTED & DESIGN SPEED LIMIT WINN ROAD - 35 MPH EAST SOLON ROAD - 45 MPH

ENGINEERING SCALES. REDUCED SIZED PLANS WILL NOT CONFORM TO STANDARD SCALES. IN MAKING MEASUREMENTS ON REDUCED PLANS, THE ABOVE SCALES MAY BE USED.


1-800-892-0123 OR 811

STATE OF ILLINOIS **DEPARTMENT OF TRANSPORTATION**

PLANS FOR PROPOSED FEDERAL-AID HIGHWAY

WINN ROAD (FAU 0157) & EAST SOLON ROAD (FAU 0165) US-12 TO EAST SOLON ROAD WEST VILLAGE LIMIT TO WINN ROAD RESURFACING SECTION: 23-00021-00-RS PROJECT NO.: D6XJ(947) **VILLAGE OF SPRING GROVE** MCHENRY COUNTY C-91-015-26

> PROJECT LOCATION MAP N.T.S.

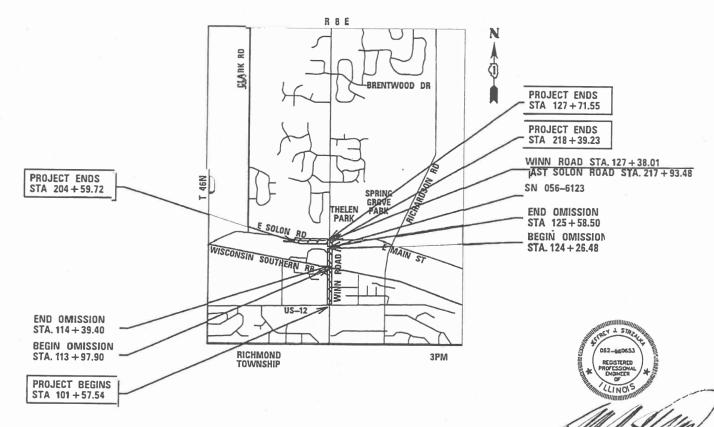


PROJECT LENGTH

GROSS LENGTH OF PROJECT = 3,994 FT. = 0.756 MILES NET LENGTH OF PROJECT = 3,853 FT. = 0.730 MILES

COUNTY 23-00021-00-RS MCHENRY ILLINOIS CONTRACT NO. 61MO7 FED. ROAD DIST. NO 1

~0165/0157



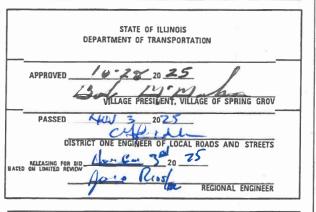



1391 CORPORATE DRIVE, SUITE 203 | McHENRY, ILLINOIS 60050
Phono: 815.385.1778 | Toll Frod: 800.728.7805 | Fox: 815.385.1781 | HRGraen.com
ILLINOIS PROFESSIONAL DESIGN FIRM #184-001322

PRINTED BY THE AUTHORITY OF THE STATE OF ILLINOIS

FULL SIZE PLANS HAVE BEEN PREPARED USING STANDARD

JOINT UTILITY LOCATION INFORMATION FOR EXCAVATION

CONTRACT NO. 61M07

ENGINEER: CARMEN

PROGRAM

AID

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INDEX OF SHEETS

COVER SHEET

11 - 12

INDEX OF SHEETS, STATE STANDARDS, DISTRICT ONE DETAILS AND GENERAL NOTES 2 - 3

SUMMARY OF QUANTITIES

PAVEMENT MARKING AND DRIVEWAY SCHEDULE

10 PAVEMENT SCHEDULE

TYPICAL SECTIONS 13 ALIGNMENT, TIES & BENCHMARKS

RESURFACING PLAN 14 - 15

DETECTOR LOOP REPLACEMENT PLAN 16

STORM SEWER PLAN 17

18 EROSION CONTROL PLAN AT THE CULVERT

19 CULVERT CROSS SECTIONS CONSTRUCTION DETAILS 20 - 34

DISTRICT ONE DETAILS

TC-10 TRAFFIC CONTROL AND PROTECTION FOR SIDE ROADS INTERSECTIONS AND DRIVEWAYS TC-13 DISTRICT ONE TYPICAL PAVEMENT MARKINGS TC-16 SHORT TERM PAVEMENT MARKING LETTERS AND SYMBOLS TC-22 ARTERIAL ROAD INFORMATION SIGN BD-32 BUTT JOINT AND HMA TAPER DETAILS BD-34 DETAILS FOR DEPRESSED CURB AND GUTTER AND SHOULDER TREATMENT AT TBT TY.1 SPL

STATE STANDARDS

000001-09	STANDARD SYMBOLS, ABBREVIATIONS AND PATTERNS
280001-07	TEMPORARY EROSION CONTROL ITEMS
424001-12	PERPENDICULAR CURB RAMPS FOR SIDEWALKS
442201-04	CLASS C AND D PATCHES
630001-13	STEEL PLATE BEAM GUARDRAIL
630101-11	STRONG POST GUARDRAIL ATTACHED TO CULVERT
701001-02	OFF-RD OPERATIONS, 2L, 2W, MORE THAN 15' AWAY
701006-05	OFF-RD OPERATIONS, 2L, 2W, 15' TO 24" FROM PAVEMENT EDGE
701306-04	LANE CLOSURE, 2L, 2W, SLOW MOVING OPERATIONS DAY ONLY,
	FOR SPEEDS GREATER THAN OR EQUAL TO 45 MPH
701311-03	LANE CLOSURE, 2L, 2W, MOVING OPERATIONS DAY ONLY,
701501-06	URBAN LANE CLOSURE, 2L 2W, UNDIVIDED
701701-10	URBAN LANE CLOSURE, MULTILANE INTERSECTION
701801-06	SIDEWALK, CORNER OF CROSSWALK CLOSURE
701901-11	TRAFFIC CONTROL DEVICES
704001-08	TEMPORARY CONCRETE BARRIER
725001-01	OBJECT AND TERMINAL MARKERS
782006-01	GUARDRAIL AND BARRIER WALL MOUNTING DETAILS
886001-01	DETECTOR LOOP INSTALLATIONS

GENERAL_NOTES

- 1. ALL REFERENCES TO "STANDARD SPECIFICATIONS" IN THESE GENERAL NOTES SHALL BE INTERPRETED TO MEAN "STANDARD SPECIFICATIONS FOR ROAD AND BRIDGE CONSTRUCTION" ADOPTED BY THE ILLINOIS DEPARTMENT OF TRANSPORTATION, JANUARY 1, 2022. ALL WORK TO BE COMPLETED IN ACCORDANCE WITH THE STANDARD SPECIFICATIONS
- 2. IT IS THE CONTRACTOR'S RESPONSIBILITY TO ASCERTAIN EXISTING FIELD CONDITIONS PRIOR TO BIDDING ON THE PROJECT.
- 3. BEFORE STARTING ANY EXCAVATION, THE CONTRACTOR SHALL CALL "JULIE" (JOINT UTILITY LOCATION INFORMATION FOR EXCAVATION) AT (800) 892-0123 FOR FIELD LOCATIONS OF BURIED UTILITIES (48 HOURS NOTIFICATION IS REQUIRED).
- 4. THE CONTRACTOR WILL NOT BE ALLOWED TO SET UP A YARD OR FIELD OFFICE ON MUNICIPAL PROPERTY WITHOUT WRITTEN PERMISSION FROM THE ENGINEER.
- 5. THE CONTRACTOR SHALL BE RESPONSIBLE FOR SWEEPING AND CLEANING STREETS OF ANY DEBRIS AND MATERIAL THAT HAS ACCUMULATED AS A RESULT OF THE CONSTRUCTION ACTIVITY. A MECHANICAL SWEEPER, MECHANICALLY DRIVEN AIR AND HANDWORK WITH SHOVEL AND BROOM SHALL BE UTILIZED TO PROVIDE A CLEAN STREET FOR THE MOTORING PUBLIC. WITHIN 24 HOURS OF PLACING TACK COAT AND THE LAYING OF HMA, THE CONTRACTOR SHALL SWEEP THE PAVEMENT AND REMOVE STANDING WATER, EARTH, WEEDS, LEAVES, DIRT, CONSTRUCTION DEBRIS, AND ALL LOOSE MATERIAL.
- 6. THE CONTRACTOR SHALL PROVIDE POSITIVE DRAINAGE AND TEMPORARY DRAINAGE OUTLETS WITHIN THE WORK ZONE AT ALL TIMES. SHOULD ANY EXCAVATED AREA BECOME INUDATED WITH WATER DURING CONSTRUCTION, THE CONTRACTOR WILL BE REQUIRED TO REMOVE AND REPLACE AND LAYERS OF THE WORK ZONE IMPACTED. IMPACTED AREAS REQUIRING REMEDIATION WILL BE DETERMINED AT THE SOLE DISCRETION OF THE ENGINEER.
- 7. ABANDONED UNDERGROUND UTILITIES THAT CONFLICT WITH CONSTRUCTION SHALL BE DISPOSED OF OUTSIDE VILLAGE PROPERTY ACCORDING TO ARTICLE 202.03 OF THE STANDARD SPECIFICATIONS AND AS DIRECTED BY THE ENGINEER.
- 8. PER VILLAGE ORDINANCE NO. 2636.2, CONSTRUCTION WORK MAY BE PERFORMED MONDAY THRU SATURDAY DURING THE HOURS OF 7:00 A.M. TO 8:00 P.M. AND ON SUNDAYS FROM 8:00 A.M. TO 6:00 P.M. NO WORK MAY BE PERFORMED PRIOR OR BEYOND THIS PERIOD WITHOUT PRIOR WRITTEN APPROVAL FROM THE VILLAGE.

UTILITIES

- 1. THE CONTRACTOR SHALL BE RESPONSIBLE FOR THE PROTECTION OF ALL UNDERGROUND AND SURFACE UTILITIES EVEN THOUGH THEY MIGHT NOT BE SHOWN ON THE PLANS. ANY UTILITY PROPERTY DAMAGED DURING CONSTRUCTION SHALL BE REPAIRED OR REPLACED TO THE SATISFACTION OF THE OWNER.
- 2. THE CONTRACTOR SHALL USE ALL NECESSARY PRECAUTIONS AND PROTECTION MEASURES REQUIRED TO MAINTAIN EXISTING UTILITIES, SEWERS, AND APPURTENANCES THAT MUST BE KEPT IN OPERATION.
- 3. ANY LOOSE MATERIAL DEPOSITED IN THE FLOWLINE OF CULVERTS OR DITCHES, WHICH OBSTRUCTS THE NATURAL FLOW OF WATER SHALL BE REMOVED AT THE CLOSE OF EACH WORKING DAY, PRIOR TO ACCEPTANCE OF THE IMPROVEMENT, ALL DRAINAGE APPURTENANCES SHALL BE FREE OF DIRT AND DEBRIS.

SCALE

4. THE INDISCRIMINATE USE OF FIRE HYDRANTS OR EXISTING STREAMS, CREEKS, WETLANDS OR PONDS IS STRICTLY PROHIBITED. THE CONTRACTOR SHALL PROVIDE A WATER TRUCK AND DRIVER AS REQUIRED TO OBTAIN AND TRANSPORT THIS WATER. THE CONTRACTOR SHALL BE RESPONSIBLE FOR OBTAINING THIS WATER FROM AN APPROVED SOURCE. IF THIS WATER IS FROM A SOURCE OTHER THAN HIS YARD, WRITTEN APPROVAL FROM THE AGENCY HAVING JURISDICTION FOR THE SOURCE OF THE WATER MUST BE RECEIVED BY THE ENGIEER PRIOR TO USE OF THE WATER

BACKFILL

- 1. STORM SEWERS SHALL BE BACKFILLED IN ACCORDANCE WITH ARTICLE 550.07, METHOD 1 ONLY.
- 2. PROVIDE TRENCH BACKFILL FOR ALL UTILITY LINES WITHIN 2' OF PAVED AREAS. ALL TRENCH BACKFILL QUANTITIES FOR BOX CULVERT HAVE BEEN COMPUTED AND SHALL BE PAID FOR IN ACCORDANCE WITH THE STATE OF ILLINOIS DEPARTMENT OF TRANSPORTATION DIVISION OF HIGHWAYS BUREAU OF CONSTRUCTION TRENCH BACKFILL TABLE, BASED ON PIPE SIZE AND INVERT DEPTH FROM SUBGRADE.
- 3. AT STORM SEWER CROSSING LOCATIONS, TRENCH BACKFILL SHALL BE PLACED TO THE TOP OF TRENCH AS A TEMPORARY CONDITION UNTIL THE CLASS D PATCH IS CONSTRUCTED. MAINTENANCE OF THE TRENCH BACKFILL SURFACE IN THE TEMPORARY CONDITION WILL BE THE RESPONSIBILITY OF THE CONTRACTOR.

SEDIMENTATION AND EROSION CONTROL

- 1. SOIL DISTURBANCE SHALL BE CONDUCTED IN SUCH A MANNER AS TO MINIMIZE EROSION. AREAS OF THE DEVELOPMENT SITE THAT ARE NOT TO BE GRADED SHALL BE PROTECTED FROM CONSTRUCTION TRAFFIC OR OTHER DISTURBANCE UNTIL FINAL SEEDING IS PERFORMED.
- 2. SOIL STABILIZATION MEASUR ES SHALL CONSIDER THE TIME OF YEAR. DEVELOPMENT SITE CONDITIONS AND THE USE OF TEMPORARY OR PERMANENT MEASURES
- 3. STABILIZATION BY SEEDING SHALL INCLUDE TOPSOIL PLACEMENT AND FERTILIZATION, AS NECESSARY.
- 4. NATIVE SEED MIXTURES SHALL INCLUDE RAPID-GROWING ANNUAL GRASSES OR SMALL GRAINS TO PROVIDE INITIAL, TEMPORARY SOIL STABILIZATION.
- 5. OFFSITE PROPERTY SHALL BE PROTECTED FROM EROSION AND SEDIMENTATION. VELOCITY DISSIPATION DEVICES SHALL BE PLACED AT CONCENTRATED DISCHARGE LOCATIONS ALONG THE LENGTH OF ANY OUTFALL CHANNEL, AS NECESSARY TO PREVENT EROSION.
- 6. SEDIMENT CONTROL MEASURES SHALL BE INSTALLED PRIOR TO THE DISTURBANCE OF TRIBUTARY AREAS.

		G	ENE	RAL NO	TES			F.A. RTE.	SECTION	COUNTY	SHEETS	SHEE NO.
WINN	Rſ	AD	ΔΙ	ND FΔS	T SOLON	ROAD		*	23-00021-00-RS	McHENRY	34	2
******		,,,,	A.			IIIOAD		*0165, 0	0157	CONTRACT	NO. 6	1M07
SHEET	1	OF	2	SHEETS	STA.	TO	STA.		LILLINOIS LEED. A	ID PROJECT		

GENERAL NOTES CONTINUED

- 7. STABILIZATION OF DISTURBED AREAS SHALL BE INITIATED IMMEDIATELY WHENEVER ANY CLEARING, GRADING, EXCAVATING OR OTHER EARTH DISTURBING ACTIVITIES HAVE PERMANENTLY CEASED ON ANY PORTION OF THE DEVELOPMENT SITE, OR TEMPORARY CEASED ON ANY PORTION OF THE DEVELOPMENT SITE AND WILL NOT RESUME FOR A PERIOD EXCEEDING 14 CALENDAR DAYS. STABILIZATION OF DISTURBED AREAS SHALL BE I NITIATED WITHIN 1 WORKING DAY OF PERMANENT OR TEMPORARY CESSATION OF EARTH DISTURBING ACTIVITIES AND SHALL BE COMPLETED AS SOON AS POSSIBLE, BUT NO LATER THAN 14 CALENDAR DAYS FROM THE INITIATION OF STABILIZATION WORK IN THE AREA. EXCEPTIONS TO THESE TIME FRAMES ARE SPECIFIED AS INSTANCES WHEN THE INITIATION OF STABILIZATION MEASURES IS PRECLUDED BY SNOW COVER. STABILIZATION MEASURES SHALL BE INITIATED AS SOON AS PRACTICABLE AND IN AREAS WHERE CONSTRUCTION ACTIVITY HAS TEMPORARILY CEASED AND WILL RESUME AFTER 14 DAYS, A TEMPORARY STABILIZATION METHOD MAY BE USED.
- 8. DISTURBANCE OF STEEP SLOPES SHALL BE MINIMIZED. AREAS OR EMBANKMENTS HAVING SLOPES STEEPER THAN 3:1 SHALL BE STABILIZED WITH STAKING IN PLACE SOD, EROSION CONTROL BLANKET IN COMBINATION WITH SEEDING, OR EQUIVALENT CONTROL MEASURE.
- 9. PERIMETER CONTROL MEASURES SHALL BE PROVIDED DOWNSLOPE AND PERPENDICULAR TO THE FLOW OF RUNOFF FROM DISTURBED AREAS, WHERE THE TRIBUTARY AREA IS GREATER THAN 5,000 SQUARE FEET, AND WHERE RUNOFF WILL FLOW IN A SHEET FLOW MANNER. PERIMETER EROSION CONTROL SHALL ALSO BE PROVIDED AT THE BASE OF SOIL STOCKPILES.
- 10. THE DRAINAGE SYSTEM SHALL BE PROTECTED FROM EROSION AND SEDIMENTATION DOWNSLOPE FROM DISTURBED AREAS. INLET PROTECTION THAT REDUCES SEDIMENT LOADING, WHILE ALLOWING RUNOFF TO ENTER THE INLET SHALL BE REQUIRED FOR ALL STORM SEWER. CHECK DAMS, OR AN EQUIVALENT CONTROL MEASURE, SHALL BE REQUIRED FOR ALL CHANNELS. FILTER FABRIC INLET PROTECTION AND STRAW BALE DITCH CHECKS ARE NOT ACCEPTABLE CONTROL MEASURES.
- 11. IF DEWATERING SERVICES ARE USED, ADJOINING PROPERTIES AND DISCHARGE
 LOCATIONS SHALL BE PROTECTED FROM EROSION. DISCHARGES SHALL BE ROUTED
 THROUGH AN EFFECTIVE SEDIMENT CONTROL MEASURE (E.G., SEDIMENT TRAP,
 SEDIMENT BASIN, OR OTHER APPROPRIATE MEASURES). THE ENGINEER AND THE
 WILL COUNTY SOIL AND WATER CONSERVATION DISTRICT SHALL BE NOTIFIED PRIOR
 TO THE COMMENCEMENT OF DEWATERING ACTIVITIES.
- 12. ALL TEMPORARY SOIL EROSION AND SEDIMENT CONTROL MEASURES SHALL BE
 REMOVED WITHIN THIRTY (30) DAYS AFTER FINAL SITE STABILIZATION IS ACHIEVED
 OR AFTER THE TEMPORARY MEASURES ARE NO LONGER NEEDED. TRAPPED
 SEDIMENT AND OTHER DISTURBED SOIL AREAS SHALL BE PERMANENTLY
 STABILIZED
- 13. STOCKPILED SOIL AND MATERIALS SHALL BE REMOVED FROM FLOOD HAZARD AREAS
 AT THE END OF EACH WORK DAY. SOIL AND MATERIALS STOCKPILED IN IWMC OR
 BUFFER AREAS SHALL BE PLACED ON TIMBER MATS, OR AN EQUIVALENT CONTROL
 MFASURF

- 14. EFFECTIVE CONTROL MEASURES SHALL BE UTILIZED TO MINIMIZE THE DISCHARGE
 OF POLLUTANTS FROM THE DEVELOPMENT SITE. AT A MINIMUM, CONTROL
 MEASURES SHALL BE IMPLEMENTED IN ORDER TO MINIMIZE THE DISCHARGE OF
 POLLUTANTS FROM EQUIPMENT AND VEHICLE WASHING, WHEEL WASH WATER, AND
 OTHER WASH WATER. MINIMIZE THE EXPOSURE OF BUILDING MATERIALS, BUILDING
 PRODUCTS, CONSTRUCTION WASTES, TRASH, LANDSCAPE MATERIALS, FERTILIZERS,
 PESTICIDES, HERBICIDES, DETERGENTS, VEHICLE FLUIDS, SANITARY WASTE, AND
 OTHER MATERIALS PRESENT ON THE DEVELOPMENT SITE TO PRECIPITATION AND TO
 STORMWATER
- 15. ADEQUATE RECEPTACLES SHALL BE PROVIDED FOR THE DEPOSITION OF ALL CONSTRUCTION MATERIAL DEBRIS GENERATED DURING THE DEVELOPMENT PROCESS. THE CONTRACTOR SHALL NOT CAUSE OR PERMIT THE DUMPING, DEPOSITING, DROPPING, THROWING, DISCARDING OR LEAVING OR CONSTRUCTION MATERIAL DEBRIS UPON OR INTO ANY DEVELOPMENT SITE, CHANNEL OR IWMC. THE DEVELOPMENT SITE SHALL BE MAINTAINED FREE OF CONSTRUCTION MATERIAL DEBRIS.
- 16. A STABILIZED MAT OF AGGREGATE UNDERLAIN WITH FILTER CLOTH (OR OTHER APPROPRIATE MEASURES) SHALL BE LOCATED AT ANY POINT WHERE TRAFFIC WILL BE ENTERING OR LEAVING A CONSTRUCTION-SITE OF A MAJOR DEVELOPMENT TO OR FROM A PUBLIC RIGHT-OF-WAY, STREET ALLEY, OR PARKING AREA. ANY SEDIMENT OR SOIL REACHING AN IMPROVED PUBLIC RIGHT-OF-WAY, STREET, ALLEY OR PARKING AREA SHALL BE SCRAPED OR STREET CLEANED AS ACCUMULATIONS WARRANT AND TRANSPORTED TO A CONTROLLED SEDIMENT DISPOSAL AREA.
- 17. ALL TEMPORARY AND PERMANENT EROSION AND SEDIMENT CONTROL MEASURES SHALL BE MAINTAINED IN AN EFFECTIVE WORKING CONDITION. ANY PUBLIC ROW, STREET, ALLEY OR PARKING LOT NOT CLEANED TO THE SATISFACTION OF THE ENGINEER AT THE END OF EACH WORK DAY WILL BE SUBJECT TO AN EROSION CONTROL DEFICIENCY.
- 18. DRAIN TILE SYSTEMS DISTURBED DURING DEVELOPMENT MUST BE RECONNECTED BY THOSE RESPONSIBLE FOR THEIR DISTURBANCE UNLESS THE APPROVED ENGINEERING PLANS INDICATE HOW THE DRAIN TILE SYSTEM IS TO BE CONNECTED TO THE PROPOSED STORMWATER MANAGEMENT SYSTEM.
- 19. ALL ABANDONED DRAIN TILES SHALL BE REMOVED IN THEIR ENTIRETY WITHIN THE
 EXISTING ROW AND/OR FASEMENT
- 20. DRAIN TILES WITHIN THE DISTURBED AREA OF THE DEVELOPMENT SHALL BE REPLACED, BYPASSED AROUND THE DEVELOPMENT OR INTERCEPTED AND CONNECTED TO THE DRAINAGE SYSTEM FOR THE DEVELOPMENT. THE SIZE OF THE REPLACED OR BYPASSED DRAIN TILE SHALL BE EQUIVALENT TO THE EXISTING DRAIN TILE.

PAVING

- TRANSVERSE CONSTRUCTION JOINTS WILL BE ALLOWED DURING PAVING PROVIDED
 THE CONTRACTOR COMPLETE A SAWCUT AT LEAST SIX INCHES INTO THE ADJACENT
 MAT AT THE START OF PAVING THE FOLLOWING DAY.
- ALL TRANSVERSE MILLING AND PAVING CONSTRUCTION JOINTS MUST BE RAMPED AND SIGNED WITH 'BUMP' SIGNAGE AT THE END OF EACH DAY.

SIGNING AND STRIPING

- SIGNS SHALL NOT BE MOVED OR COVERED UNTIL PROGRESS OF WORK NECESSITATES IT.
- 2. THE CONTRACTOR WILL BE REQUIRED TO TEMPORARILY RESET ALL SUCH SIGNS
 THAT INTERFERE WITH HIS CONSTRUCTION OPERATIONS. ALL SUCH SIGNS MUST BE
 MAINTAINED STRAIGHT AND CLEAN FOR THE DURATION OF THE TEMPORARY
 SETTING AND MUST BE RE-ERECTED AT A TEMPORARY LOCATION IN A
 WORKMANLIKE MANNER AND BE VISIBLE TO THE TRAFFIC FOR WHICH IT IS
 INTENDED.
- 3. SEE IDOT DISTRICT ONE DETAILS AND PLAN SHEETS FOR PAVEMENT MARKING DETAILS.

RAILROAD

1. IT IS THE CONTRACTOR'S SOLE RESPONSIBILITY TO COORDINATE WITH THE
WISCONSIN SOUTHERN RAILROAD WHENEVER CONSTRUCTION ACTIVITY IS WITHIN
25 FEET OF THE RAILROAD ROW. THE CONTRACTOR SHALL RETAIN FLAGMEN
EMPLOYED AND DESIGNATED BY THE WISCONSIN SOUTHERN RAILROAD TO
MONITOR ON-COMING TRAIN TRAFFIC, AND ADVISE CONTRACTOR PERSONNEL WHEN
ACTIVITY ON OR NEAR THE RAILROAD RIGHT-OF-WAY MAY PROCEED. THIS ITEM
WILL BE PAID FOR ACCORDING TO ARTICLE 107.12 AND WILL BE REIMBURSED
ACCORDING TO ARTICLE 109.05.

_COMMITMENTS

1. TREES THREE (3) INCHES OR GREATER IN DIAMETER AT BREAST HEIGHT SHALL NOT BE CLEARED FROM APRIL 1ST THROUGH SEPTEMBER 30TH OF ANY GIVEN YEAR.

USER NAME = txu	DESIGNED	-	xx	REVISED	-	XX/XX/XXXX
	DRAWN	-	XX	REVISED	-	XX/XX/XXXX
PLOT SCALE = 2,0000 ' / in,	CHECKED	-	JJS	REVISED	-	XX/XX/XXXX
PLOT DATE = 10/28/2025	DATE	-	7/23/2025	REVISED	-	XX/XX/XXXX

				STU
CODE NO.	ITEM	UNIT	TOTAL QUANTITY	80% FEDERAL 20% LOCAL 0005
20200600 E	EXCAVATING AND GRADING EXISTING SHOULDER	UNIT	4	4
20700220	DODOUG CDANULAD EMPANIZMENT	CH VD	2.4	24
20700220 P	POROUS GRANULAR EMBANKMENT	CU YD	34	34
20800150 T	RENCH BACKFILL	CU YD	18	18
21101615 7	OPSOIL FURNISH AND PLACE, 4"	SQ YD	1,279	1,279
25000210	EEEDING, CLASS 2A	ACRE	1	1
25000400 N	ITROGEN FERTILIZER NUTRIENT	POUND	28	28
25000600 P	POTASSIUM FERTILIZER NUTRIENT	POUND	28	28
25100125 N	MULCH, METHOD 3	ACRE	1	1
28000250 T	EMPORARY EROSION CONTROL SEEDING	POUND	31	31
28000305 T	TEMPORARY DITCH CHECKS	FOOT	120	120
30000400	AND WESTER PROCESS AND PROPERTY.	FOOT	402	403
28000400 P	PERIMETER EROSION BARRIER	FOOT	402	402
28000510 II	NLET FILTERS	EACH	2	2
28100707 S	STONE DUMPED RIPRAP, CLASS A4	SQ YD	52	52
35101600 A	AGGREGATE BASE COURSE, TYPE B 4"	SQ YD	36	36
22101000 P	NOTICONIE DAGE COUNTE, TITE B 4	30 10	30	36
40600275 E	BITUMINOUS MATERIALS (PRIME COAT)	POUND	768	768
40600290 E	BITUMINOUS MATERIALS (TACK COAT)	POUND	8,543	8,543
40600370	ONGITUDINAL IQINT SEALANT	FOOT	5.025	5.025
40600370 L	ONGITUDINAL JOINT SEALANT	1001	5,035	5,035

CONSTRUCTION CODE

SUMMARY OF QUANTITIES	F.A. U RTE.	SECTION	COUNTY	TOTAL SHEETS	SHEET NO.
WINN ROAD AND EAST SOLON ROAD	*	23-00021-00-RS	McHENRY	34	4
WHITE HOAD AND EAST SOLON HOAD	* 0165,	0157	CONTRACT	NO. 6	1M07
SHEET 1 OF 5 SHEETS STA. TO STA.		(ILLINOIS (FED. A	ID PROJECT		i i

^{*} SPECIALTY ITEM

				CONSTRUCTION CODE
CODE NO.	ITEM	UNIT	TOTAL QUANTITY	STU 80% FEDERAL 20% LOCAL 0005
40600400	MIXTURE FOR CRACKS, JOINTS, AND FLANGEWAYS	TON	10	10
40600982	HOT-MIX ASPHALT SURFACE REMOVAL - BUTT JOINT	SQ YD	209	209
40603200	POLYMERIZED HOT-MIX ASPHALT BINDER COURSE, IL-4.75, N50	TON	699	699
40604060	HOT-MIX ASPHALT SURFACE COURSE, IL-9.5, MIX "D", N50	TON	60	60
40604062	HOT-MIX ASPHALT SURFACE COURSE, IL-9.5, MIX "D", N70	TON	1,423	1,423
42400200	PORTLAND CEMENT CONCRETE SIDEWALK 5 INCH	SQ FT	323	323
42400800	DETECTABLE WARNINGS	SQ FT	20	20
44000159	HOT-MIX ASPHALT SURFACE REMOVAL, 2 1/2"	SQ YD	12,603	12,603
44000200	DRIVEWAY PAVEMENT REMOVAL	SQ YD	343	343
44000600	SIDEWALK REMOVAL	SQ FT	323	323
44201711	CLASS D PATCHES, TYPE IV, 5 INCH	SQ YD	420	420
48101200	AGGREGATE SHOULDERS, TYPE B	TON	153	153
48203021	HOT-MIX ASPHALT SHOULDERS, 6"	SQ YD	155	155
50105220	PIPE CULVERT REMOVAL	FOOT	102	102
50200450	REMOVAL AND DISPOSAL OF UNSUITABLE MATERIAL FOR STRUCTURES	CU YD	34	34
52200020	TEMPORARY SOIL RETENTION SYSTEM	SQ FT	620	620
54001001	BOX CULVERT END SECTIONS, CULVERT NO. 1	EACH	2	2

* SPECIALTY ITEM

									F.A.U RTE				COUNTY	TOTAL SHEETS	
	WINN ROAD AND EAST SOLON ROAD						*	23-0002	1-00-RS		McHENRY	34	5		
_	WINN HUAD AND LAST SULUN HUAD							* 0165,	0157			CONTRACT	NO.	51M07	
	SHEET	2	OF	5	SHEETS	STA.	TO	STA.			ILLINOIS	FED. A	D PROJECT		

CODE NO.	ITEM	UNIT	TOTAL QUANTITY	CONSTRUCTION COD STU 80% FEDERAL 20% LOCAL 0005
54011206	PRECAST CONCRETE BOX CULVERTS 12' X 6'	FOOT	39	39
550B0120	STORM SEWERS, CLASS B, TYPE 1 24"	FOOT	123	123
55101200	STORM SEWER REMOVAL 24"	FOOT	123	123
59300100	CONTROLLED LOW-STRENGTH MATERIAL	CU YD	47	47
60300305	FRAMES AND LIDS TO BE ADJUSTED	EACH	1	1
63000030	STRONG POST GUARDRAIL ATTACHED TO CULVERT	FOOT	28	28
63100167	TRAFFIC BARRIER TERMINAL, TYPE 1 (SPECIAL) TANGENT	EACH	4	4
63200310	GUARDRAIL REMOVAL	FOOT	84	84
67100100	MOBILIZATION	L SUM	1	1
70100450	TRAFFIC CONTROL AND PROTECTION, STANDARD 701201	L SUM	1	1
70100460	TRAFFIC CONTROL AND PROTECTION, STANDARD 701306	L SUM	1	1
70102620	TRAFFIC CONTROL AND PROTECTION, STANDARD 701501	L SUM	1	1
70102635	TRAFFIC CONTROL AND PROTECTION, STANDARD 701701	L SUM	1	1
70102640	TRAFFIC CONTROL AND PROTECTION, STANDARD 701801	L SUM	1	1
70300100	SHORT TERM PAVEMENT MARKING	FOOT	4,064	4,064
70300150	SHORT TERM PAVEMENT MARKING REMOVAL	SQ FT	1,055	1,055
70400100	TEMPORARY CONCRETE BARRIER	FOOT	115	115

* SPECIALTY ITEM

		SU	MMA	ARY	OF QU	ANTITIES	S		F.A.U RTE	SECT	ΠΟN		COUNTY	TOTAL SHEETS	SHEET NO.
	WINN	RΛ	AD	Λ.	ID FAC	T SOLO	N ROAD		*	23-0002	1-00-RS		McHENRY	34	6
WINN ROAD AND EAST SOLON ROAD								* 0165,	0157			CONTRACT	NO. 6	1M07	
	SHEET	3	OF	5	SHEETS	STA.	TO	STA.			ILLINOIS	FED. AI	ID PROJECT		

	CODE NO.	ITEM	UNIT	TOTAL QUANTITY	STU 80% FEDERAL 20% LOCAL 0005
	70400125	PINNING TEMPORARY CONCRETE BARRIER	EACH	30	30
	70400200	RELOCATE TEMPORARY CONCRETE BARRIER	FOOT	250	250
	70600305	IMPACT ATTENUATORS, TEMPORARY (FULLY REDIRECTIVE, RESETTABLE), TEST LEVEL 3	EACH	2	2
	70600330	IMPACT ATTENUATORS, RELOCATE (FULLY REDIRECTIVE), TEST LEVEL 3	EACH	2	2
k	72501000	TERMINAL MARKER - DIRECT APPLIED	EACH	4	4
	78009000	MODIFIED URETHANE PAVEMENT MARKING - LETTERS AND SYMBOLS	SQ FT	1,215	1,215
k	78009004	MODIFIED URETHANE PAVEMENT MARKING - LINE 4"	FOOT	10,113	10,113
k	78009006	MODIFIED URETHANE PAVEMENT MARKING - LINE 6"	FOOT	384	384
k	78009012	MODIFIED URETHANE PAVEMENT MARKING - LINE 12"	FOOT	200	200
k	78009024	MODIFIED URETHANE PAVEMENT MARKING - LINE 24"	FOOT	119	119
Ī					
k	78011000	GROOVING FOR RECESSED PAVEMENT MARKING, LETTERS AND SYMBOLS	SQ FT	1,215	1,215
Ī					
	78011025	GROOVING FOR RECESSED PAVEMENT MARKING 5"	FOOT	10,113	10,113
	78011035	GROOVING FOR RECESSED PAVEMENT MARKING 7"	FOOT	321	321
ľ					
k	78011065	GROOVING FOR RECESSED PAVEMENT MARKING 13"	FOOT	200	200
ŀ					
k	78011125	GROOVING FOR RECESSED PAVEMENT MARKING 25"	FOOT	119	119
ŀ					
	78200005	GUARDRAIL REFLECTORS, TYPE A	EACH	8	8
ŀ					
ŀ	X0326806	WASHOUT BASIN	L SUM	1	1
Į.		1	+		

CONSTRUCTION CODE

* SPECIALTY ITEM

USER NAME = jstrzal	DESIGNED -	XX	REVISED -	XX/XX/XXXX
	DRAWN -	XX	REVISED -	XX/XX/XXXX
PLOT SCALE = 2 0000 ' / in	CHECKED -	JJS	REVISED -	XX/XX/XXXX
PLOT DATE = 10/28/2025	DATE -	7/23/2025	REVISED -	XX/XX/XXXX

STATE OF ILLINOIS						
DEPARTMENT	0F	TRANSPORTATION				

	SUMMARY OF QUANTITIES						F.A. U RTE	SE	CTION		COUNTY	TOTAL SHEETS			
WINN ROAD AND EAST SOLON ROAD					*	* 23-00021-00-RS			McHENRY	34	7				
_	VVIIVIV	110	ערי		ND LAS	I JULUI	1 IIOAD		* 0165	0157			CONTRACT	NO. 6	51M07
l	SHEET	4	OF	5	SHEETS	STA.	TO	STA.			ILLINOIS	FED. A	ID PROJECT		

			I	CONSTRUCTION CODE
CODE NO.	ІТЕМ	UNIT	TOTAL QUANTITY	STU 80% FEDERAL 20% LOCAL 0005
X0327487	TRIAXIAL GEOGRID REINFORCEMENT, TYPE I	SQ YD	102	102
X1200274	TEMPORARY BYPASS PUMPING SYSTEM	L SUM	1	1
X2130010	EXPLORATION TRENCH (SPECIAL)	FOOT	100	100
X2510900	TURF REINFORCEMENT MAT (SPECIAL)	SQ YD	397	397
X4830030	PORTLAND CEMENT CONCRETE SHOULDERS 8" (SPECIAL)	SQ YD	11	11
X5427600	REMOVE AND RELOCATE END SECTIONS	EACH	1	1
X6330801	GUARDRAIL POST REPAIR	EACH	7	7
X7200061	TEMPORARY INFORMATION SIGNING	SQ FT	103	103
X8860105	DETECTOR LOOP REPLACEMENT	FOOT	158	158
Z0013798	CONSTRUCTION LAYOUT	L SUM	1	1
Z0048665	RAILROAD PROTECTIVE LIABILITY INSURANCE	L SUM	1	1

* SPECIALTY ITEM

HRG PROJECT NO. 220908
HRG PROJ. CON'ACT:
FILE NAME: 220908.s91. quontities.dgn
PLOT DRIVER: IL.pdf. bw.pitcfg
PEN TABLE: piortobei.tbi

H33	HRGreen.com Illinois Professional Design Fi # 184-001322
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	DRAWN _	XX	REVISED	-	XX/XX/XXXX
PLOT SCALE = 2,0000 ' / in.	CHECKED _	JJS	REVISED	-	XX/XX/XXXX
PLOT DATE = 10/28/2025	DATE _	7/23/2025	REVISED	-	XX/XX/XXXX

STATE	OF IL	LINOIS
DEPARTMENT	OF TRA	ANSPORTATION

SUMMARY OF QUANTITIES	F.A. U SECTION COUNTY TOTAL SHEETS NO.
WINN ROAD AND EAST SOLON ROAD	* 23-00021-00-RS McHENRY 34 8
WHITE HOAD AND EAST SOLON HOAD	* 0165, 0157 CONTRACT NO. 61M07
SHEET 5 OF 5 SHEETS STA. TO STA.	(ILLINOIS (FED. AID PROJECT

		70300100	70300150	78009000		7800	9004		780	09006	78009012	78009024	78011000	78011025	78011035	78011065	78011125
LC	OCATION	SHORT TERM PAVEMENT MARKING	SHORT TERM PAVEMENT MARKING REMOVAL	MODIFIED URETHANE PAVEMENT MARKING - LETTERS AND SYMBOLS	MODIF	FIED URETI MARKING			PAVEMEN') URETHANE T MARKING - NE 6"	MODIFIED URETHANE PAVEMENT MARKING - LINE 12"	MODIFIED URETHANE PAVEMENT MARKING - LINE 24"	GROOVING FOR RECESSED PAVEMENT MARKING, LETTERS AND SYMBOLS	GROOVING FOR RECESSED PAVEMENT MARKING 5"	GROOVING FOR RECESSED PAVEMENT MARKING 7"	GROOVING FOR RECESSED PAVEMENT MARKING 13"	GROOVING FOR RECESSED PAVEMENT MARKING 25"
STATION FROM	STATION TO	FOOT	SQ FT	SQ FT		FO	ОТ		F	ООТ	FOOT	FOOT	SQ FT	FOOT	FOOT	FOOT	FOOT
WINN ROAD					SOLID W	DBL Y CL	SKIP Y	SKIP/SOLID	SOLID W	DOTTED W							
101+81.72		137.0	16.0	15.60									15.60				
102+18.61		193.0	22.0	20.80									20.80				
111+69.16		678.0	75.0	589.20									589.20				
116+64.53		678.0	75.0	589.20									589.20				
101+59.54	104+25.74	144.0	48.0	303.20		532.40							303120	532.40			
104+90.90	107+60.55	146.0	49.0			332.10	67.41							67.41			
108+48.17	109+37.45	297.0	98.0				22.00							22.32			
		83.0	83.0	+			22.00	E7E E6	1	-	-					1	
109+37.45	113+97.90						1	575.56	1	-	-			575.56		1	
114+39.40	118+26.78	324.0	107.0	1			F0.71	484.00	-	-	-			484.23		1	
118+26.78	120+37.61	114.0	38.0				52.71							52.71			
120+45.63	124+26.48	206.0	68.0				95.00							95.21			
125+58.50	126+89.11	71.0	24.0				32.65							32.65			
101+57.54	113+97.90	31.0	11.0		1,241.18									1,241.18			
114+39.40	120+37.56				598.16									598.16			
120+45.58	124+26.48				380.93									380.93			
125+58.50	127+14.63				157.99									157.99			
101+57.54	104+25.74				268.20									268.20			
104+90.90	107+60.55				269.65									269.65			
108+48.17	113+97.90				549.73									549.73			
114+39.40	120+37.66				598.26									598.26			
120+45.68	124+26.45				380.77									380.77			
125+58.41	127+24.24				185.17									185.17			
					33.99									33.99			
127+55.43	127+71.61				33.99				112.00	-				33.99	112.00		
101+59.54	102+72.54								113.00						113.00		
102+72.54	103+61.36								ļ.,	22.20					22.20		
120+37.51	120+37.67								37.03						37.03		
120+45.53	120+45.70								36.93						36.93		
127+05.90	127+71.49								65.82						65.82		
127+15.18	127+60.14								45.12						45.12		
120+41.54	12+41.67								63.00		64.20					64.20	
127+07.72	127+70.20										135.80					135.80	
101+59.54	101+59.54	68.0	23.0									22.38					22.38
113+95.90	113+95.90	33.0	11.0									11.00					11.00
114+41.40	114+41.40	33.0	11.0									11.00					11.00
120+17.63	120+17.63	33.0	11.0									11.00				1	11.00
120+65.61	120+65.61	33.0	11.0									11.00				1	11.00
126+89.31	126+89.11	34.0	11.0									11.00					11.00
127+83.34	127+83.34	31.0	-1.0				1					14.00					14.00
127103.34	127 1 03.34											11.00					17.00
EAST SOLON ROA									1							1	
204+59.72	210+98.92	728.0	263.0					799.00						799.00			
210+98.92	217+43.59	, 20.0	200.0				161.20							161.20			
204+60.00	217+72.11				1,314.78									1,314.78			
204+59.72	217+68.17				1,310.61									1,310.61			
217+43.64	217+43.59											11.01					11.01
218+38.23	218+38.23											16.00					16.00
TOTALS		4,064	1,055	1,215	7,290	533	431	1,859	361	23	200	119	1,215	10,113	321	200	119

		LIOT MIX	
LOCATION	BITUMINOUS MATERIALS (PRIME COAT)	HOT-MIX ASPHALT SURFACE COURSE, IL-9.5, MIX "D", N50	DRIVEWAY PAVEMENT REMOVAL
STA FROM STA TO	POUND	TON	SQ YD
WINN ROAD			
106+18.17 106+74	5 62.00	5.00	28.00
110+67.03 111+52	9 130.00	10.00	58.00
110+78.60 111+30	62.00	5.00	28.00
112+63.59 113+46	00 204.00	16.00	91.00
114+75.00 114+91	0 168.00	13.00	75.00
118+81.37 119+41	0 142.00	11.00	63.00
TOTALS	768.00	60.00	343.00

HRG PROJECT NO.: 220908	HRG PROJ. CONTACT:	FILE NAME: 220908_sht_schedules.dgn	PLOT DRIVER: IL_pdf_bw.pitcfg	PEN TABLE: plotiabel.tbl	
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USER NAME = jstrzal	DESIGNED	-	XX	REVISED	-	XX/XX/XXXX
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PLOT SCALE = 2.0000 / in.	CHECKED	-	JJS	REVISED	-	XX/XX/XXXX
PLOT DATE = 10/28/2025	DATE	-	7/23/2025	REVISED	-	XX/XX/XXXX

STATE OF ILLINOIS					
DEPARTMENT	0F	TRANSPORTATION			

PAVEMENT MARKING AND DRIVEWAY SCHEDULE	F.A.U RTE	SECTION	COUNTY	TOTAL SHEETS	SHEET NO.
WINN ROAD AND EAST SOLON ROAD	*	23-00021-00-RS	34	9	
WINN HOAD AND LAST SOLON HOAD	* 0165,	0157	CONTRACT	NO. 6	1M07
SHEET 1 OF 2 SHEETS STA. TO STA.		TILLINOIS EED A	ID DROIECT		

		35101600	40600370	40600982	40603200	40604062	42400200	42400800	44000159	44000600	48101200
LOCAT	ION	AGGREGATE BASE COURSE, TYPE B 4"	LONGITUDINAL JOINT SEALANT	HOT-MIX ASPHALT SURFACE REMOVAL - BUTT JOINT	POLYMERIZED HOT-MIX ASPHALT BINDER COURSE, IL- 4.75, N50	HOT-MIX ASPHALT SURFACE COURSE, IL-9.5, MIX "D", N70	PORTLAND CEMENT CONCRETE SIDEWALK 5 INCH	DETECTABLE WARNINGS	HOT-MIX ASPHALT SURFACE REMOVAL, 2 1/2"	SIDEWALK REMOVAL	AGGREGATE SHOULDERS, TYPE B
STA FROM	STA TO	SQ YD	FOOT	SQ YD	TON	TON	SQ FT	SQ FT	SQ YD	SQ FT	TON
WINN ROAD	31A 10	30 15	1001	30 10	TON	1011	3011	3011	30 10	3011	1011
101+57.54	113+97.90		1,245.0		230	469			4,178		
101+57.54	104+25.00		270.0		230	403			4,170		
114+39.40	123+97.00		960.0		237	483			4,304		
115+00.00	123+97.00		900.0		2	4			4,504		
125+88.00	127+75.00		190.0		2	4					
125+88.00	127+71.55		185.0		59	119			1.052		
126+84.55	127+18.39	36	105.0		33	119	323	20	1,052	323	
101+57.54	101+57.54	30		21			323	20		323	
104+30.60	105+17.80			44							
107+65.13	108+40.82			38							
113+97.90	113+97.90			15							
114+39.40	114+39.40			15							
124+26.49	124+26.44			15							
125+58.50	125+58.61			16							
127+23.25	127+56.43			17							
127+71.49	127+71.62			17							
127+11.19	127+70.31			17							
101+68.79	104+92.05										
105+58.19	107+79.51										8.2
108+27.24	108+85.86										2.0
109+31.46	110+79.79										5.4
111+42.10	112+74.47										4.8
113+40.18	113+97.90										2.2
101+80.37 105+16.99	103+47.09										6.4 3.9
	106+23.57										
106+64.98 108+38.32	107+66.95										3.6 9.1
111+25.06	110+84.83 113+97.91										10.3
123+97.21	125+88.71										10.5
EAST SOLON ROAD	123+00./1										
204+59.72	217+43.59		1.285.0	11	169	344			3.069		
204+59.72	207+22.92		1,265.0	11	109	344			2,009		10.0
207+43.80	211+58.27										15.6
211+79.39	211+58.27										20.3
211+79.39 217+33.69	217+17.17										
204+59.72											1.6 49.4
204+39.72	217+63.77						-				49.4
TOTALS		36	5,035	209	699	1,423	323	20	12,603	323	153


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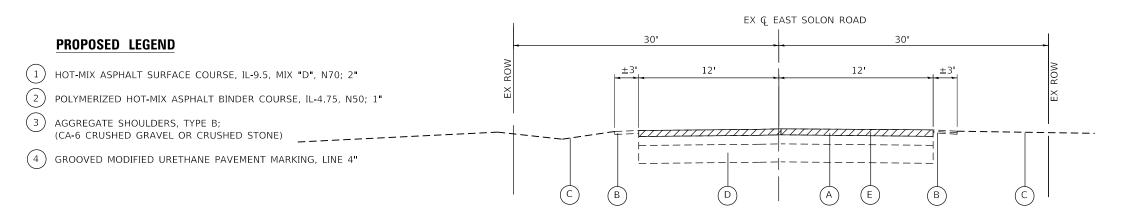
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PLOT DATE = 10/28/2025	DATE -	7/23/2025	REVISED -	XX/XX/XXXX
PLOT DATE = 10/28/2025	DATE -	7/23/2025	REVISED -	XX/XX/XXXX

STATE	OF ILLINOIS
DEPARTMENT (OF TRANSPORTATION

PAVEMENT SCHEDULE							F.A. U RTE	SECTION	COUNTY	TOTAL SHEETS	SHEET NO.	
WINN ROAD AND EAST SOLON ROAD					*	23-00021-00-RS McHENRY 34						
WINN HUAD AND EAST SULUN HUAD						* 0165,	0157	CONTRACT	Г NO. 6	1M07		
SHEET	2	OF	2	SHEETS	STA.	TO	STA.		ILLINOIS FED. A	ID PROJECT		



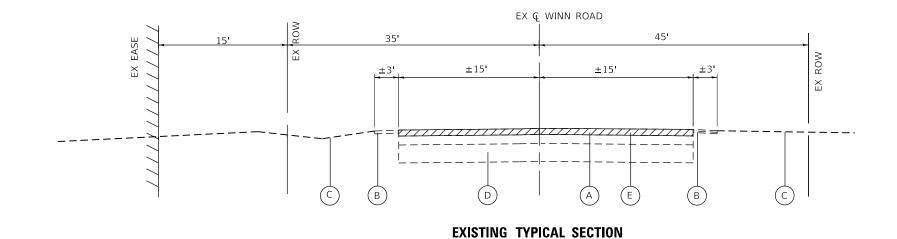

HMA SURFACE REM, $2\frac{1}{2}$ "

EXISTING LEGEND

EXISTING GROUND

(D)

HOT-MIX ASPHALT PAVEMENT; 7"

AGGREGATE/HMA SHOULDERS

AGGREGATE BASE COURSE; 12"

HMA SURFACE REMOVAL, $2\frac{1}{2}$ "

EXISTING TYPICAL SECTION
EAST SOLON ROAD: 204+59.72 TO 217+93.48

WINN ROAD: 101+57.54 TO 127+38.01

HOT-MIX ASPHALT MIXTURE REQUIREMENTS							
MIXTURE TYPE	AIR VOIDS	QMP					
PAVEMENT RESURFACING							
HMA SURFACE COURSE, MIX "D", N70 (IL-9.5); 2"	4.0% @ 70 GYR.	LR 1030-2					
POLYMERIZED HOT-MIX ASPHALT BINDER COURSE, IL-4.75, N50; 1"	3.5% @ 50 GYR.	LR 1030-2					
PAVEMENT PATCHING	•	•					
CLASS D PATCHES. (HMA BINDER, IL-19); 5"	4.0% @ 70 GYR.	LR 1030-2					
DRIVEWAY PAVEMENT							
HMA SURFACE COURSE, MIX "D", N50 (IL-9.5); 3"	4.0% @ 50 GYR.	LR 1030-2					
HMA SHOULDERS, 6"							
HMA BINDER COURSE IL 19.0, N70; 6"	4.0% @ 70 GYR.	LR 1030-2					
QMP DESIGNATION: QUALITY CONTROL/QUALITY ASSURANCE (QC/QA) PE	R LR 1030-2	•					

SCALE: N.T.S

THE UNIT WEIGHT TO CALCULATE ALL HMA SURFACE MIXTURE QUATITIES IS 112 LBS/SQ YD/IN.

THE "AC TYPE" FOR POLYMERIZED HMA MIXES SHALL BE "SBS/SBR PG 76-22" AND FOR NON-POLYMERIZED HMA THE "AC TYPE" SHALL BE "PG 64-22" UNLESS MODIFIED BY RECLAIMED MATERIAL SPECIFICATIONS.

PATCHING LOCATIONS TO BE DETERMINED BY THE ENGINEER AFTER MILLING OPERATIONS.

LONGITUDINAL JOINT SEALANT SHALL BE PLACED OVER THE POLY HMA BC, IL-4.75, N50.


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	DRAWN	-	XX	REVISED	-	XX/XX/XXXX
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PLOT DATE = 10/28/2025	DATE	-	7/23/2025	REVISED	-	XX/XX/XXXX

STATE (OF ILLINOIS						
DEPARTMENT OF TRANSPORTATION							

TYPICAL SECTIONS						F.A.U RTE	SECT	ION		COUNTY	TOTAL SHEETS	SHEET NO.		
WINN ROAD AND EAST SOLON ROAD					*	23-0002	1-00-RS		McHENRY	34	11			
MININ HOAD AND EAST SOLON HOAD						* 0165,	0157			CONTRACT	NO. 6	1M07		
SHEET	2	OF	2	SHEETS	STA.	TO	STA.			ILLINOIS	FED. AI	D PROJECT		



PROPOSED TYPICAL SECTION

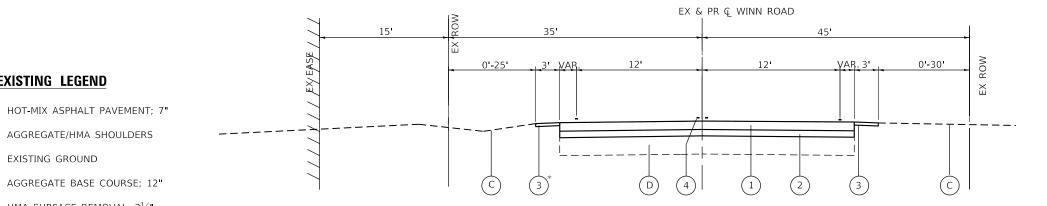WINN ROAD 101+57.54 TO 113+97.90 114+39.40 TO 120+45.46

120+45.46 TO 124+26.48 AGGREGATE SHOULDER OMIT AT THIS STATION RANGE 125+58.50 TO 127+38.01 *AGGREGATE SHOULDER OMIT AT THIS STATION RANGE

PROPOSED LEGEND


EXISTING LEGEND

EXISTING GROUND

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AGGREGATE/HMA SHOULDERS

HMA SURFACE REMOVAL, $2\frac{1}{2}$ "

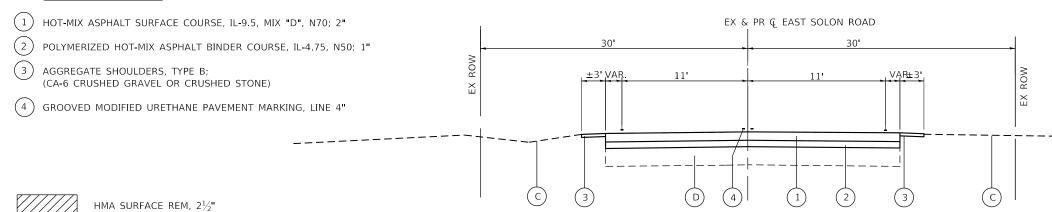


PROPOSED TYPICAL SECTION


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EAST SOLON ROAD 204+59.72 TO 217+93.48


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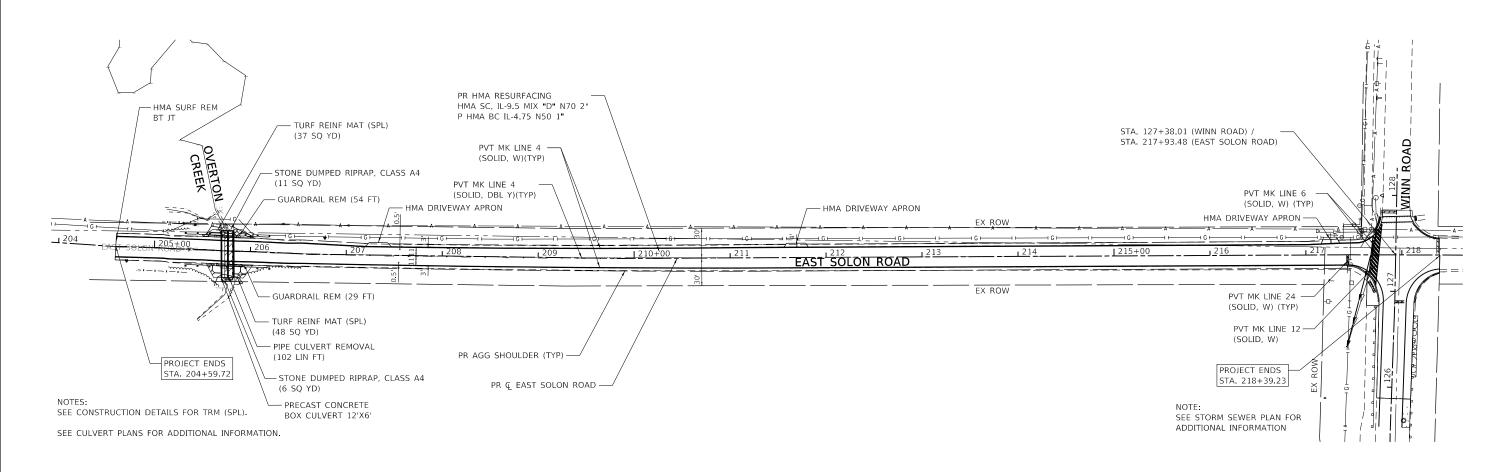
		TYF	PICA	L SECT	IONS			F.A.U RTE	SECTION	COUNTY	TOTAL SHEETS	SHEET NO.
WINN	RO	۸n	۸۱	ID FAC	T SOLON	RUVD		*	23-00021-00-RS	McHENRY	34	12
AAHAHA	nu	ΑU	ΑI	ID LAS	I SOLUN	NUAD		* 0165,	0157	CONTRACT	NO. 6	1M07
SHEET	1	OF	2	SHEETS	STA.	TO	STA.		ILLINOIS FED. A	ID PROJECT		



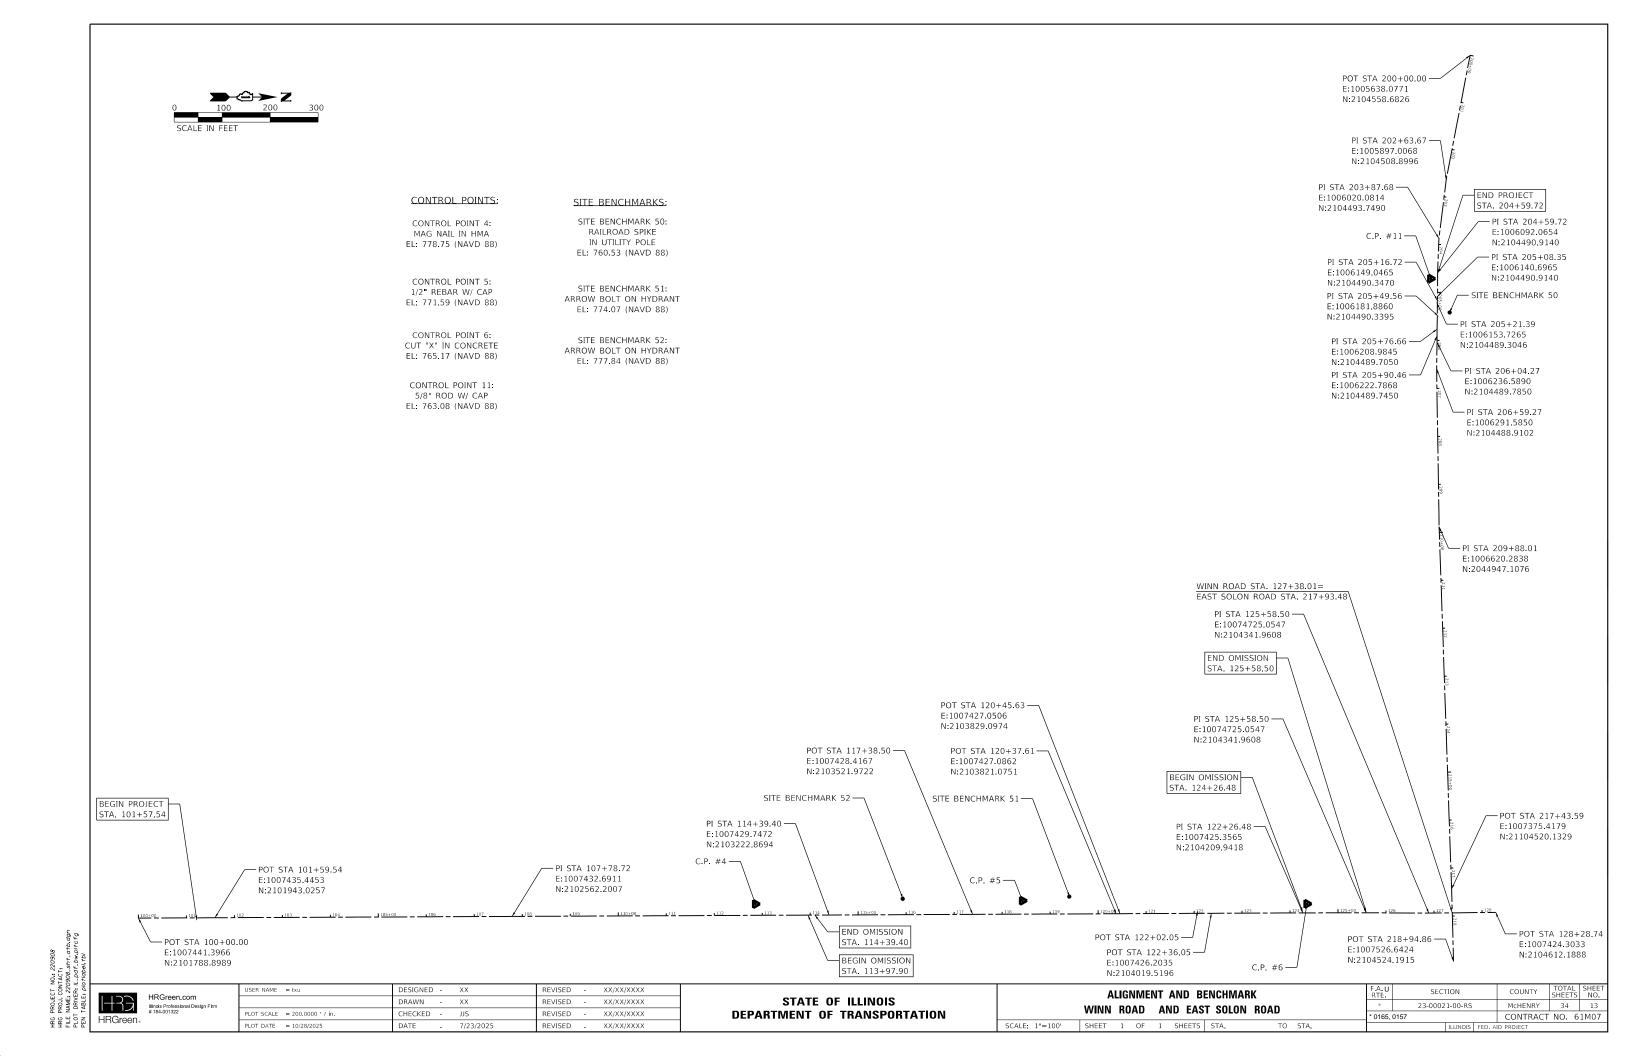

HRG PROJECT NO. 220908
HRG PROJ. CONTACT:
FILE NAME: 220908.shr_plant.ag
PLOT DRIVER: IL_Daf_Dw_pltcfg
PEN TABLE: plotobel.tb/

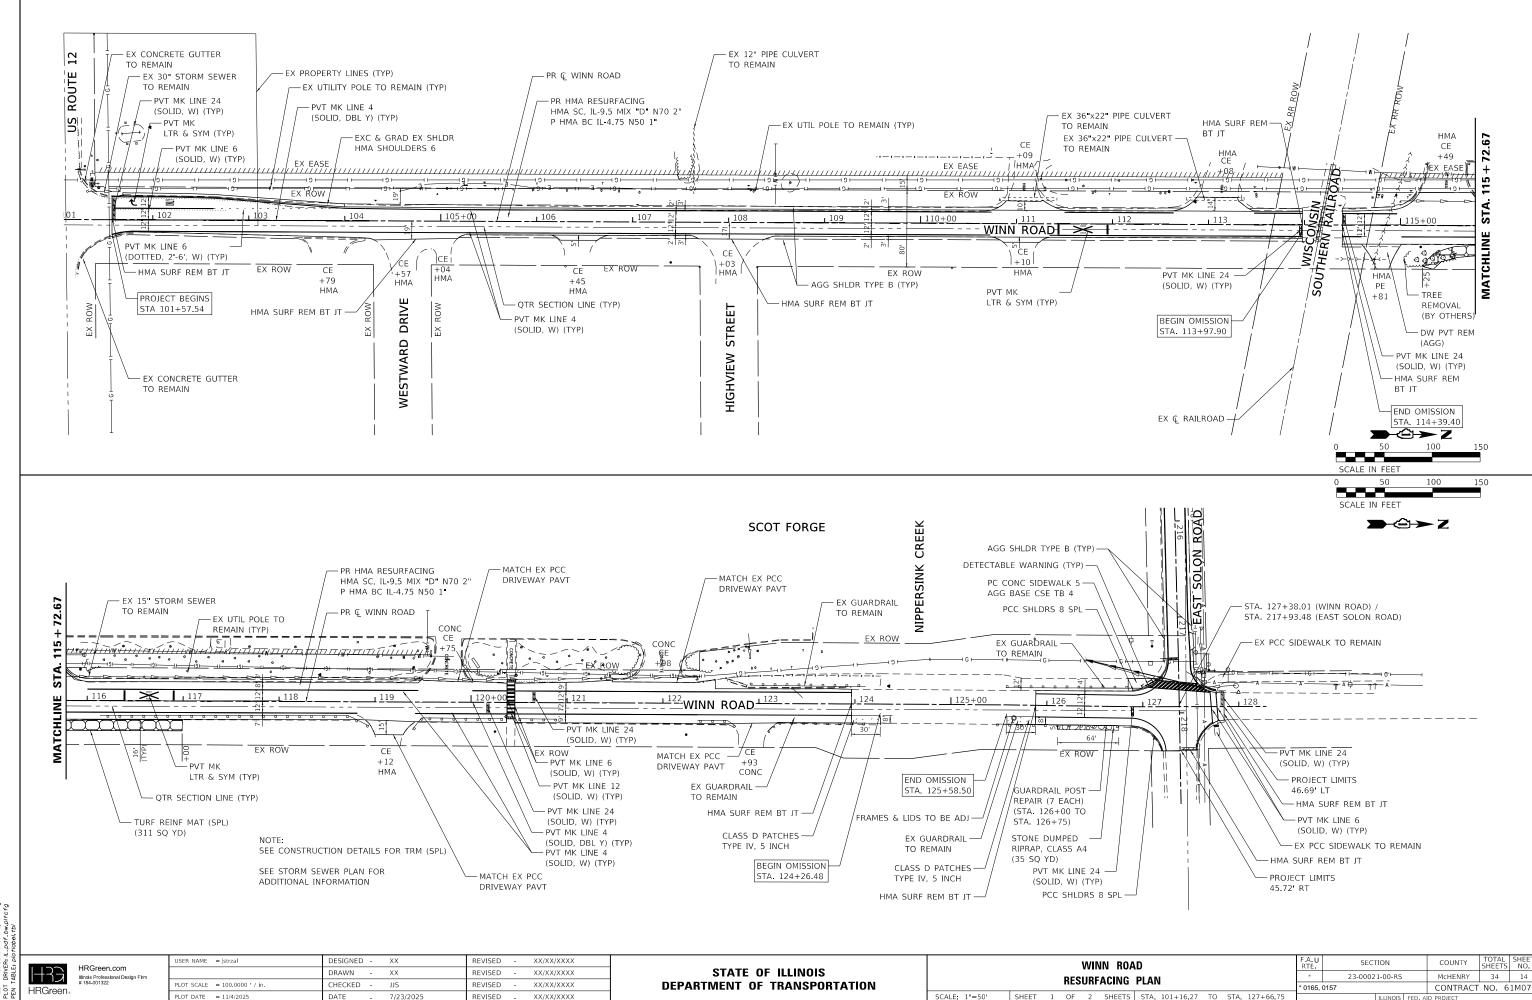

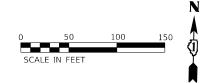

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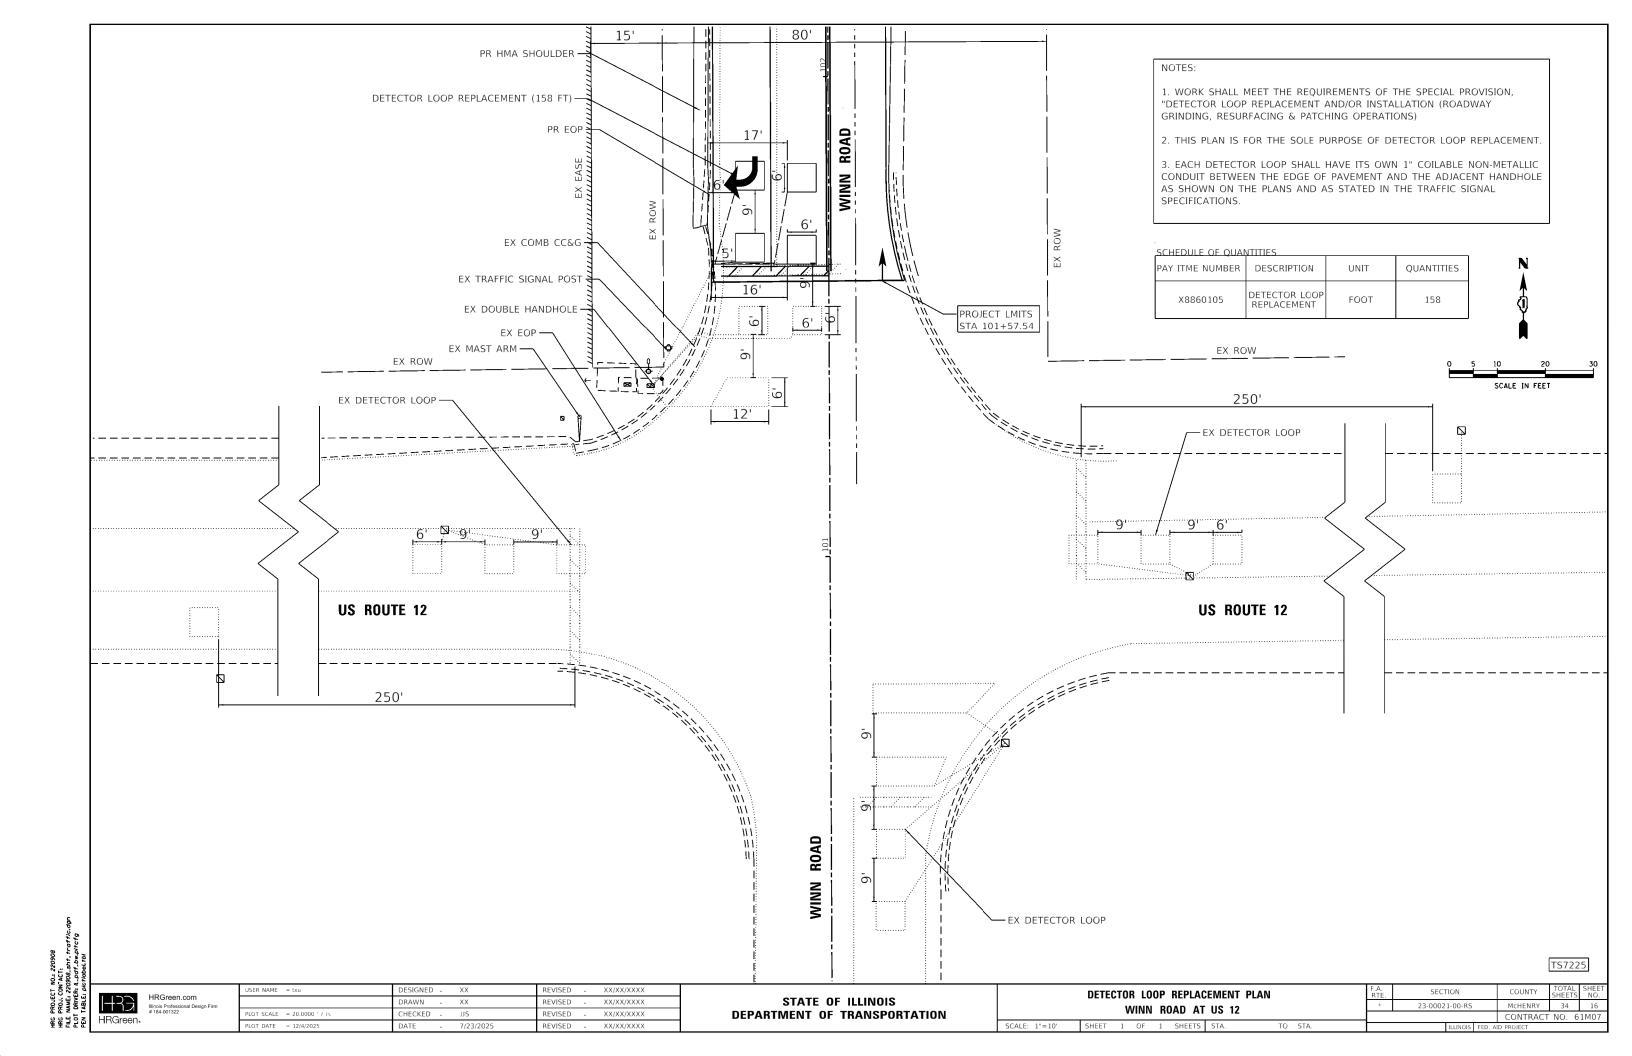
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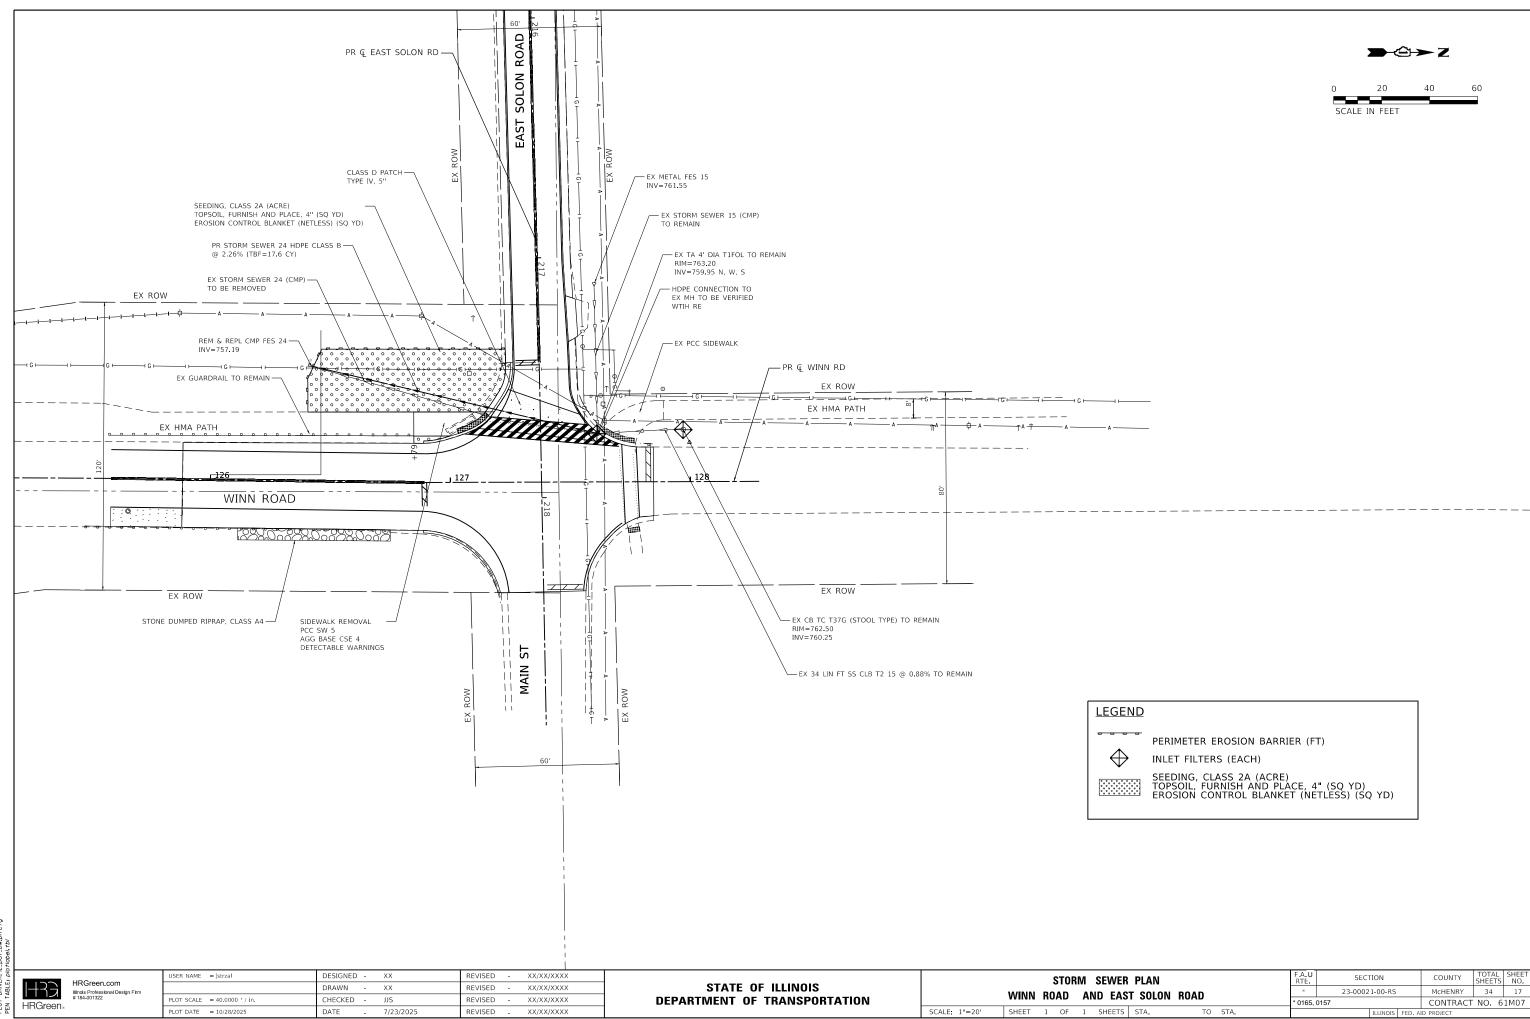
STAT	E OI	F ILLINOIS
DEPARTMENT	0F	TRANSPORTATION

SCALE: 1"=50' SHEET


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	RESURFACING PLAN							2	3-0002	1-00-RS		McHENR'
	IILO	UIII	AUINU	ILAN			* 0165,	0157				CONTRA
2	OF	2	SHEETS	STA. 204+59.71	TO	STA. 218+34.70				ILLINOIS	FED. A	ID PROJECT

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HRG PROJECT NO., 220908
HRG PROJ. CONTACT:
FILE NAME: 220908.snt.storm sewer plan.
PLOT DRIVER IL. poft.bw.pitcfg
PEN TABLE: plottobel.tb!





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DEPARTMENT OF TRANSPORTATION

SHEET 1 OF 1 SHEETS STA. 204+72.63 TO STA. 207+43.73

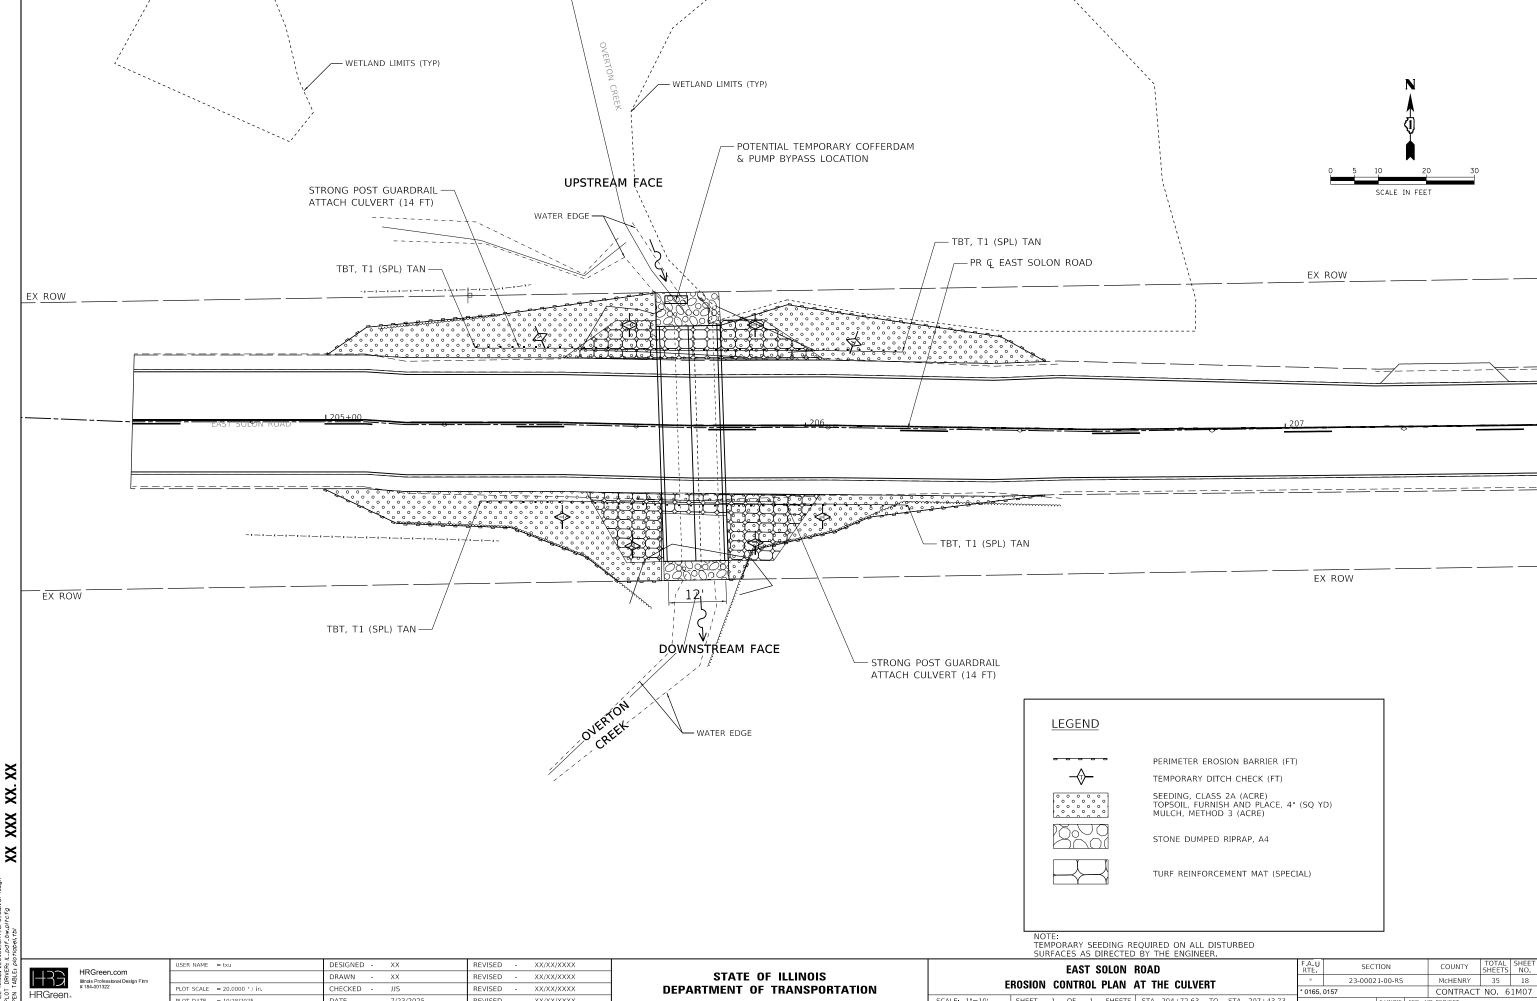* 0165, 0157 CONTRACT NO. 61M07



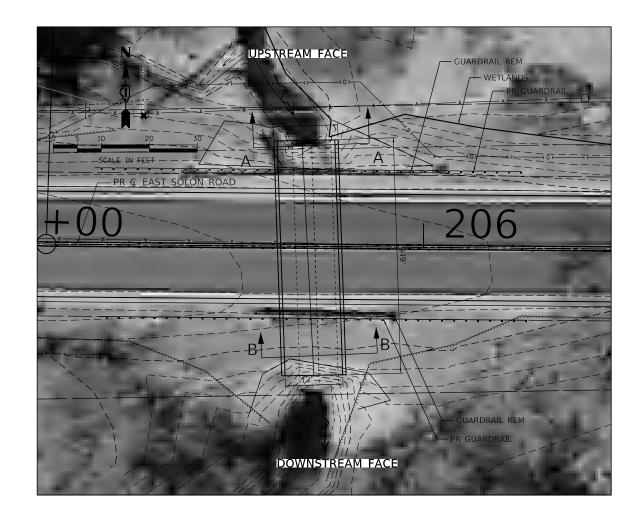

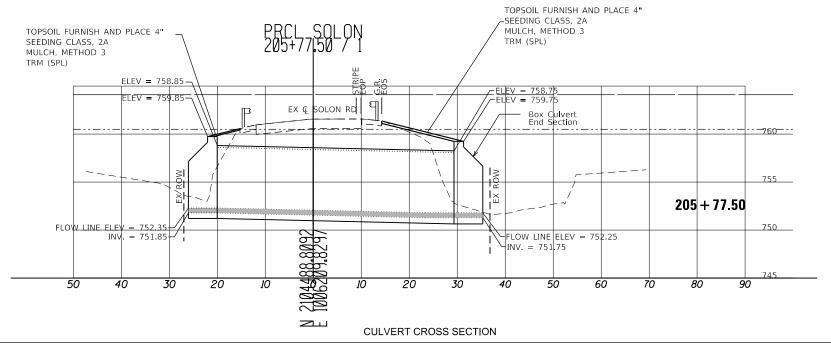
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PLOT DRIVER A. Lod's. be.pate's
FILE NAME: 220908-por-culvert-sections.dgn
PLOT DRIVER A. LOG's. be.pateen.dgn
PLOT DRIVER A. LOG's. be.pat


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STATE OF ILLINOIS
DEPARTMENT OF TRANSPORTATION

		EAS	T 5	SOLON	ROAD			F.A. U RTE	SECTION	COUNTY	TOTAL SHEETS	SHEET NO.
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R.O.W. 60'-0" R.O.W. 60'-0' CLSM (PER CY)--EXISTING PAVEMENT SECTION - CLSM (PER CY) PRECAST CONC. BOX CULVERT-ALTERNATING TWO WAY TRAFFIC ALTERNATING TWO WAY TRAFFIC -PRECAST CONC BOX CULVERT STAGE 2 HMA SHOULDERS, 6" (STAGE 1A, SHOULDER WIDENING TO SHIFT TRAFFIC) -EXISTING SLOPE PRECAST END SECTIONS SEE DETAIL SEE DETAIL -TEMPORARY SOIL TEMPORARY SOIL RETENTION SYSTEM RETENTION SYSTEM COFFERDAM - COFFERDAM COFFERDAM COFFERDAM

SEQUENCE OF CONSTRUCTION

- 1. FOLLOWING IS A SUGGESTED SEQUENCE OF CONSTRUCTION. THE CONTRACTOR WILL BE ALLOWED TO MODIFY THE PROPOSED SEQUENCE PROVIDED THE ROADWAY IS 'DRIVE-ABLE' IN BOTH DIRECTIONS AT THE END OF EACH DAY. THE CONTRACTOR SHALL PERFORM HIS WORK IN A MANNER CAUSING MINIMAL INCONVENIENCE TO THE RESIDENTS AND THE MOTORING PUBLIC.
- 2. UPON THE START OF CULVERT REPLACEMENT WORK ALL TRAFFIC WILL BE SHIFTED TO ONE SIDE OF THE ROAD. THE CONTRACTOR SHALL PLACE TYPE III BARRICADES AND TEMPORARY CONCRETE BARRIERS TO CLOSE ONE SIDE OF THE ROAD TO TRAFFIC. THE CONTRACTOR WILL HAVE ACCESS TO COMPLETE WORK ON THE CLOSED SIDE OF THE ROADWAY. SEE PLANS FOR CULVERT STAGING DETAILS.
- 3. EXCAVATION(S) WITHIN THE ROADWAY MUST BE STEEL PLATED WITH RAMPS DURING NON-WORKING
- 4. ALL STREETS MUST BE OPEN TO 2 LANES 2 WAY DURING NON-WORKING HOURS AND OVER THE WEEKEND WHEN WORK IS NOT OCCURING.

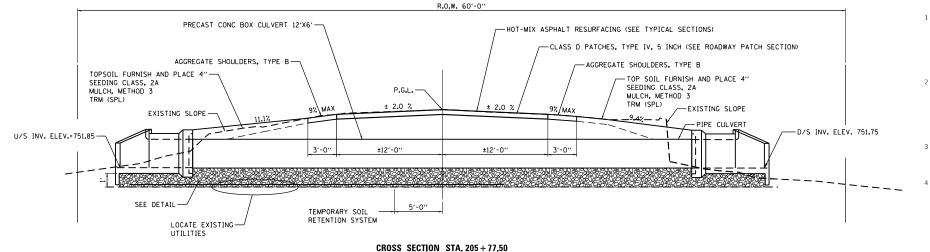STAGE 1

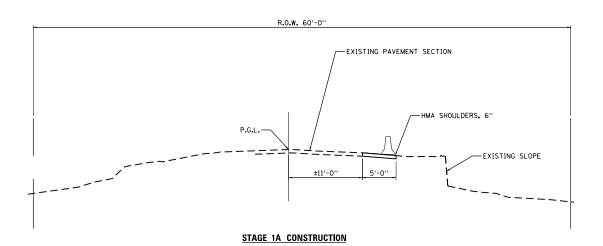- 1. THE CONTRACTOR WILL REMOVE BOTH CULVERTS WITHIN THE WORK AREA. THE CONTRACTOR WILL THEN CONSTRUCT GRANULAR EMBANKMENT CULVERT PAD. THE NEW BOX CULVERT WILL THEN BE LAID AND HAUNCHED INTO PLACE WITHIN THE WORK AREA. THE ENDS OF THE PROPOSED CULVERTS SHALL BE CAPPED WITH MINIMUM 3/4" PLYWOOD. THE BOX CULVERT WILL THEN BE BACKFILLED WITH CLSM TO MATCH THE EXISTING ROADWAY SURFACE ELEVATION.
- 2. THE CONTRACTOR WILL APPROPRIATELY ADJUST MAINTENANCE OF TRAFFIC SIGNAGE AND RELOCATE TEMPORARY CONCRETE BARRIERS, OPENING THE ROAD TO TWO-WAY TRAFFIC PRIOR TO LEAVING THE JOB SITE AT THE END OF THE DAY.

STAGE 2

- 1. THE CONTRACTOR WILL REMOVE BOTH CULVERTS WITHIN THE WORK AREA. THE CONTRACTOR WILL THEN CONSTRUCT THE GRANULAR EMBANKMENT CULVERT PAD. THE CONTRACTOR SHALL EXPOSE AND REMOVE THE PLYWOOD CAP PLACED DURING STAGE 1. THE NEW BOX CULVERT WILL THEN BE LAID, CONNECTED TO THE STAGE 1 CULVERTS AND SUBSEQUENTLY HAUNCHED IN PLACE WITHIN THE WORK AREA. THE BOX CULVERT WILL THEN BE BACKFILLED WITH CLSM TO MATCH THE EXISTING ROADWAY SURFACE ELEVATION.
- 2. THE CONTRACTOR WILL APPROPRIATELY ADJUST MAINTENANCE OF TRAFFIC SIGNAGE AND RELOCATE TEMPORARY CONCRETE BARRIERS, OPENING THE ROAD TO TWO-WAY TRAFFIC PRIOR TO LEAVING THE JOB SITE AT THE END OF THE DAY
- 3. UPON COMPLETION OF STAGE 2 THE CONTRACTOR WILL MAINTAIN TRAFFIC CONTROL AND PROTECTION IN ACCORDANCE WITH HIGHWAY STANDARD 701501 DURING CONSTRUCTION OPERATIONS.
- 4. TEMPORARY CONCRETE BARRIERS MAY BE REMOVED UPON INSTALLATION OF THE STEEL PLATE
- 5. CLASS D PATCH 5" MUST BE INSTALLED WITHIN 5 CALENDAR DAYS OF THE COMPLETION OF WORK ON ALL THE SEGMENTS AS SPECIFIED ABOVE.
- 6. THE CONTRACTOR SHALL INSTALL AND MAINTAIN TEMPORARY MAINTENANCE OF TRAFFIC SIGNAGE IN THE PARKWAY TWENTY-FOUR (24) HOURS PRIOR TO STARTING WORK ON EACH SIDE OF THE STREET. THE CONTRACTOR SHALL REMOVE THE SIGNS AND REINSTALL THEM AS NEEDED.
- . WHERE THE CULVERTS ARE TO BE REMOVED AND REPLACED, THE CONTRACTOR SHALL LIMIT HIS OPERATIONS TO ONE SIDE OF THE STREET ONLY, ONCE CULVERT REPLACEMENT OPERATIONS ARE COMPLETE ON ONE SIDE OF THE ROAD, THE CONTRACTOR MAY MOVE TO THE OTHER SIDE OF THE STREET TO START CULVERT REPLACEMENT OPERATIONS.

CONTRACTOR TO PROVIDE A MINIMUM OF 6" BETWEEN THE EDGE OF THE TEMPORARY CONCRETE BARRIER AND THE DROP OFF / SOIL RETENTION SYSTEM.

SECTIONS OF BARRIERS WITH LESS THAN 24" BEHIND THE BARRIER WILL REQUIRE PINNING OR AN ALTERNATE

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LOCATE EXISTING

DESIGNED - XX REVISED - XX/XX/XXXX JSER NAME = txu DRAWN -XX REVISED -XX/XX/XXXX HECKED -REVISED XX/XX/XXXX XX/XX/XXXX PLOT DATE = 10/28/2025 DATE 7/23/2025 REVISED -


STAGE 1 CONSTRUCTION


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STAGE 2 CONSTRUCTION

SHEET NO. 61M07

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GENERAL NOTES

- PRECAST CONCRETE BOX CULVERT 12'x6' SECTIONS SHALL CONFORM TO THE REQUIREMENTS OF ARTICLE 540.06 OF THE STANDARD SPECIFICATIONS FILL = 2.0 FT.
- 2. THE MINIMUM CONCRETE STRENGTH SHALL BE 5,000 PSI.
- LIFTING HOLES SHALL BE FILLED WITH CONCRETE PLUGS AND MASTIC AFTER BOX SECTIONS ARE IN PLACE.

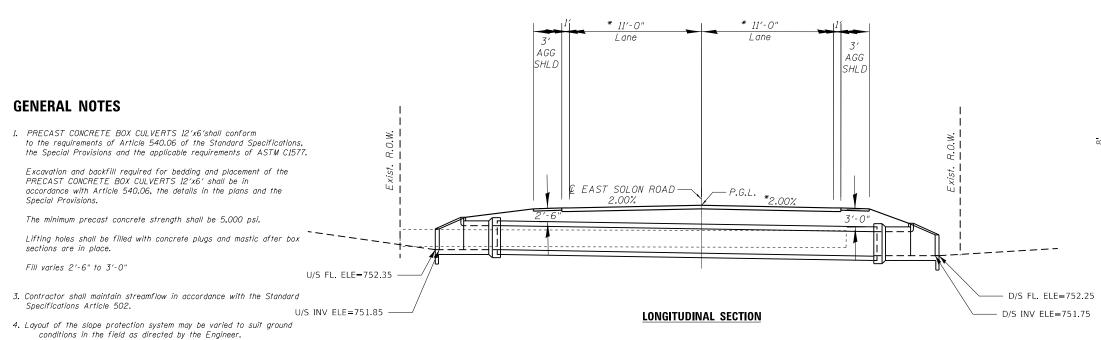BENCHMARK 1:

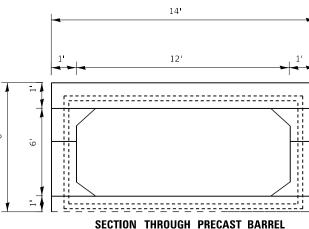SITE BENCHMARK 50: RAILROAD SPIKE IN UTILITY POLE EL: 760.53 (NAVD 88)

EXISTING PIPE CULVERT:

THE EXISTING PIPE CULVERT CONSISTS OF TWO (2) 48" CMP CULVERTS APPROXIMATELY 51' LONG. STAGED CONSTRUCTION WILL BE UTILIZED.

5. Reinforcement bars designated (E) shall be epoxy coated


WATERWAY INFORMATION

Drainage Are	ea = 0.25	5 Sq. m	i.						
Flood	Freq.	0	Opening	Sq. Ft.	Nat.	Head	- Ft.	Headwo	iter El.
1-1000	Yr.	C.F.S.	Exist.	Prop.	H.W.E.	Exist.	Prop.	Exist.	Prop.
	10	321	16	53	757.0	3.3	0.3	760.3	757.3
Design	30	459	16	64	757.4	3.2	0.8	760.6	758.2
	50	515	16	66	757.5	3.2	1.0	760.7	758.5
Base	100	602	16	66	757.7	3.1	2.1	760.8	759.8
Max. Calc.	500	813	16	66	758.1	3.0	2.3	761.1	760.4

10-YEAR VELOCITY THROUGH EXISTING STRUCTURE=7.7 FT/S

10-YEAR VELOCITY THROUGH PROPOSED STRUCTURE=3.4 FT/S

2-YEAR FLOW RATE=137 CU FT/S

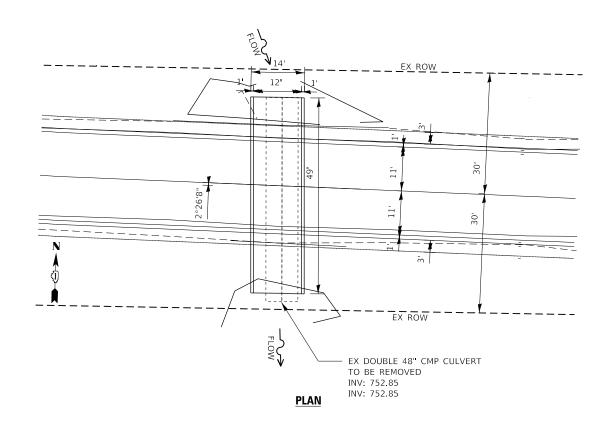

SECTION THRU PRECAST BARREL

Furnished and installed under the pay item "Precast Concrete Box Culverts" (Section 540 of the Standard Specifications)

DESIGN SPECIFICATIONS

2014 AASHTO LRFD Bridge Design Specifications, 7th Edition

DESIGN STRESSES

f'c = 3.500 psi fy = 60.000 psi (Reinforcement) $\frac{PRECAST \text{ UNITS}}{f'c = 5.000 \text{ psi}}$ fy = 65.000 psi (Welded Wire Fabric)

LOADING HL-93

Allow 50#/sq. ft. for future wearing surface.

BILL OF MATERIAL

ITEM		UNIT	TOTAL
PRECAST CO	NCRETE BOX	EOOT	30
CULVERT 12'	×6′	F 001	75

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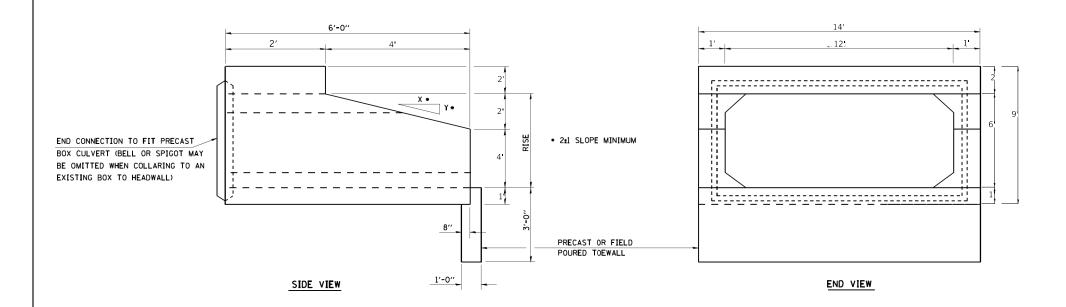
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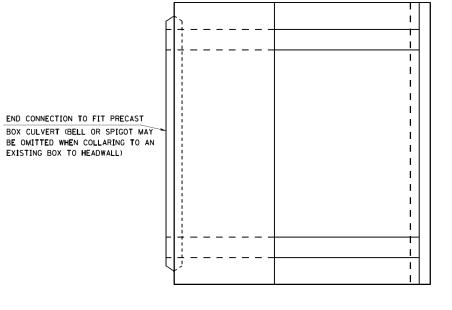
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CONSTRUCTION DETAILS - BOX CULVERT								F.A. U RTE			
WINN ROAD AND EAST SOLON ROAD							•	23-			
							* 0165,	0157			
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_	* 0165,	0157		CONTRACT	NO. 6	1M07	
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<u>PLAN</u>

ISOMETRIC VIEW

GENERAL NOTES

- 1. PRECAST CONCRETE BOX CULVERT 12'x6' SECTIONS SHALL CONFORM TO THE REQUIREMENTS OF ARTICLE 540.06 OF THE STANDARD SPECIFICATIONS FILL = 2.0 FT.
- 2. THE MINIMUM CONCRETE STRENGTH SHALL BE 5,000 PSI.
- 3. LIFTING HOLES SHALL BE FILLED WITH CONCRETE PLUGS AND MASTIC AFTER BOX SECTIONS ARE IN PLACE.

BILL OF MATERIAL

ITEM	UNIT	TOTAL
BOX CULVERT END SECTIONS CULVERT NO. 1	EACH	2

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EXISTING BOX TO HEADWALL)

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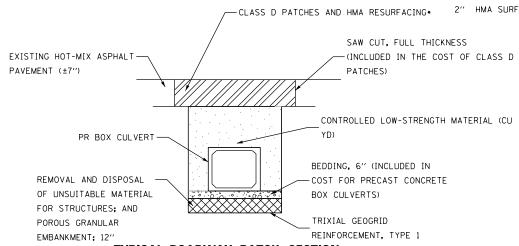
STATE OF ILLINOIS **DEPARTMENT OF TRANSPORTATION**

CONSTRUCTION DETAILS - BOX CULVERT McHENRY 34 22 23-00021-00-RS WINN ROAD AND EAST SOLON ROAD CONTRACT NO. 61M07 SHEET 3 OF 9 SHEETS STA.

•HMA RESURFACING:

1" POLYMERIZED HMA BINDER COURSE, IL-4.75

2" HMA SURFACE COURSE, MIX "D", N70




TYPICAL ROADWAY PATCH SECTION

BEDDING MATERIALS AND EXCAVATION.


REQUIRED FOR INSTALLATION OF PRECAST CONCRETE BOX

CULVERTS OF THE SIZE SPECIFIED AND THE BOX CULVERT END


SECTIONS SHALL BE INCLUDED IN THE COST OF EACH.

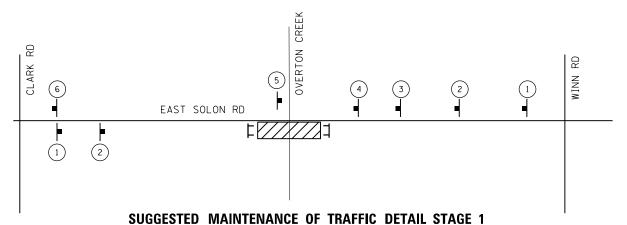

FURNISH AND PLACE IN ACCORDANCE
WITH MUTCD FIGURE 6H-11 - TYPICAL APPLICATION 11

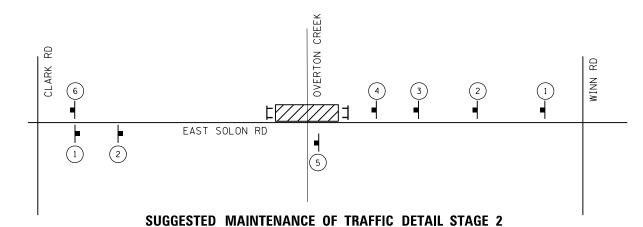

FURNISH AND PLACE IN ACCORDANCE
WITH MUTCD FIGURE 6H-11 - TYPICAL APPLICATION 11

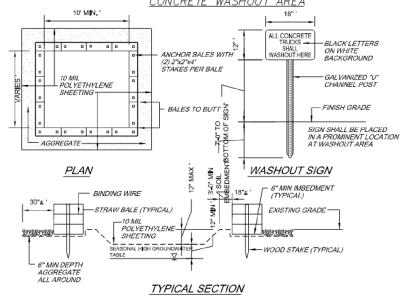

NOTES:

- CONTAINMENT MUST BE STRUCTURALLY SOUND
 AND LEAK FREE AND CONTAIN ALL LIQUID WASTES.
 CONTAINMENT DEVICES MUST BE OF SUFFICIENT
 QUANTITY OR VOLUME TO COMPLETELY CONTAIN
- THE LIQUID WASTES GENERATED.
 3. WASHOUT MUST BE CLEANED OR NEW FACILITIES CONSTRUCTED AND READY TO USE ONCE WASHOUT IS 75% FULL.
- WASHOUT AREA(S) SHALL BE INSTALLED IN A LOCATION EASILY ACCESSIBLE BY CONCRETE
- 5. ONE OR MORE AREAS MAY BE INSTALLED ON THE CONSTRUCTION SITE AND MAY BE RELOCATED AS CONSTRUCTION PROGRESSES.
- AT LEAST WEEKLY REMOVE ACCUMULATION OF SAND AND AGGREGATE AND DISPOSE OF PROPERLY.




W20-I103(0) (48"×48") WITH DISTANCE SIGN AND FLASHING AMBER LIGHT



W2O-4(0) (48"×48") WITH FLASHING AMBER LIGHT



W3-2(0) (48''×48'')

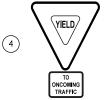

R1-2 (48"×48"×48") WITH R1-2a (36"×30")



W1-4(0) (48"×48")

6 E

G20-I105(0) (60''×24'')



WORK AREA

NOTE:
THE MAINTENANCE OF TWO-WAY TRAFFIC UNDER FLAGGERS WITH SIGNAGE AS SUGGESTED IN
THIS DETAIL SHALL NOT BE PAID FOR SEPARATELY, BUT INCLUDED IN THE COST OF
TRAFFIC CONTROL AND PROTECTION, STANDARD 701501.

SEE BOX CULVERT CONSTRUCTION DETAILS FOR PLACEMENT OF TEMPORARY CONCRETE BARRIERS AND TEMPORARY ATTENUATORS.

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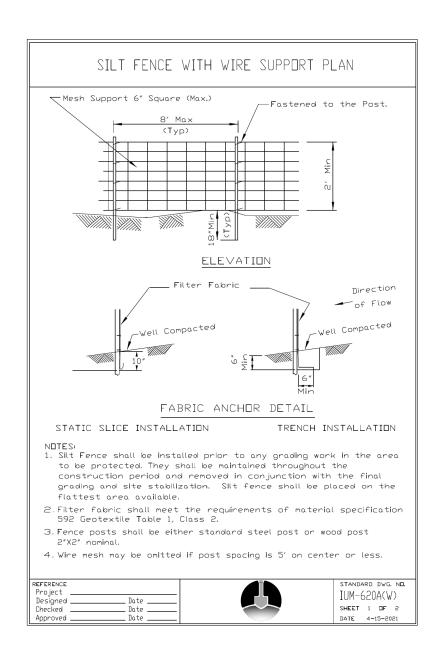
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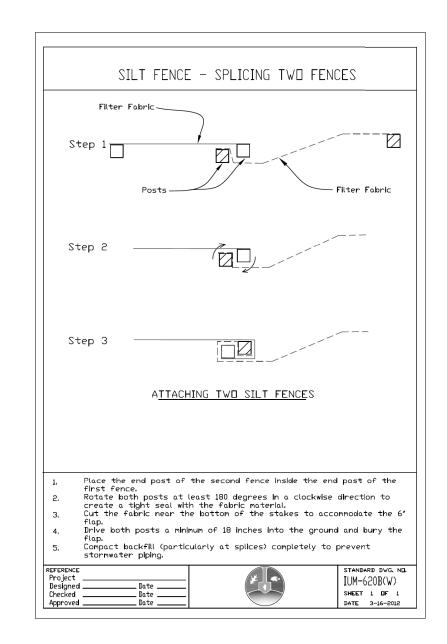
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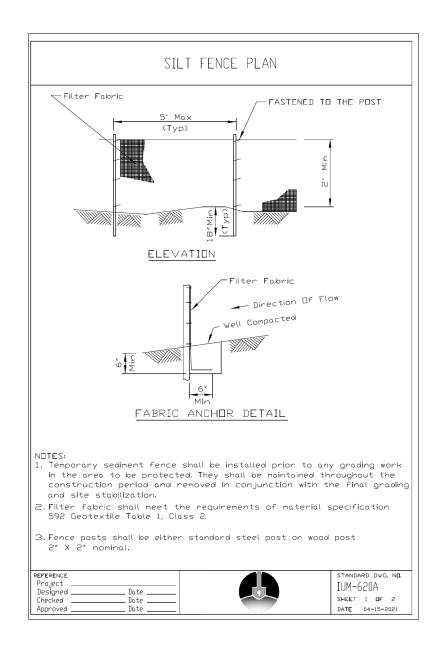
STATE OF ILLINOIS
DEPARTMENT OF TRANSPORTATION

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	* 0165,	0157				CONTRACT	NO. 6	1M07
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SCALE: N.T.S.



COFFERDAM PROFILE

PLAN VIEW COFFERDAM PUMP WORK AREA SUMP PIT

DISSIPATING

NOTES:

- 1. ALL DISCHARGES SHOULD BE ON ENERGY DISSIPATING SURFACES.
- 2. LOCATIONS FOR THE SUMP PIT, FILTRATION AREA, AND ENERGY DISSIPATING SURFACES MAY VARY DEPENDING ON SITE CONDITIONS.

UNITED STATES ARMY CORPS OF ENGINEERS NOTES:

- 1. EARTHEN COFFERDAMS OR OTHER PRACTICES THAT WOULD RESULT IN A RELEASE OF SEDIMENT INTO WATERS OF THE U.S. ARE NOT AUTHORIZED FOR USE. COFFERDAMS SHALL BE CONSTRUCTED OF NON-ERODIBLE MATERIALS ONLY. ACCEPTABLE PRACTICES INCLUDE, BUT ARE NOT LIMITED TO: PRE-FABRICATED RIGID COFFERDAMS, SHEET PILING, INFLATABLE BLADDERS, SANDBAGS AND FABRIC-LINED BASINS. WORK IN THE WATERWAY SHOULD BE TIMED TO TAKE PLACE DURING LOW ORNO-FLOW CONDITIONS. LOW FLOW CONDITIONS ARE FLOW AT OR BELOW THE NORMALWATER ELEVATION.
- 2. WATER SHALL BE ISOLATED FROM THE IN-STREAM WORK AREA USING ACOFFERDAM CONSTRUCTED OF NON-ERODIBLE MATERIALS (STEEL SHEETS, AQUABARRIERS, RIP RAP AND GEOTEXTILE FABRIC, ETC.). EARTHEN COFFERDAMS ARE NOTPERMISSIBLE.
- 3. WORK MAY NOT BE PERFORMED IN THE WATER, EXCEPT FOR THE PLACEMENT OFTHE MATERIALS NECESSARY FOR THE CONSTRUCTION OF THE COFFERDAM. THECOFFERDAM MUST BE CONSTRUCTED FROM THE UPLAND AREA AND NO EQUIPMENT MAYENTER THE WATER AT ANY TIME. IF THE INSTALLATION OF THE COFFERDAM CANNOTBE COMPLETED FROM SHORE AND ACCESS IS NEEDED TO REACH THE AREA TO BECOFFERED, OTHER MEASURES, SUCH AS THE CONSTRUCTION OF A CAUSEWAY, WILL BENECESSARY TO ENSURE THAT EQUIPMENT DOES NOT ENTER THE WATER. ONCE THECOFFERDAM IS IN PLACE AND THE ISOLATED AREA IS DEWATERED, EQUIPMENT MAYENTER THE COFFERED AREA TO PERFORM THE REQUIRED WORK.
- 4. IF BYPASS PUMPING IS NECESSARY, THE INTAKE HOSE SHALL BE PLACED ON ASTABLE SURFACE OR FLOATED TO PREVENT SEDIMENT FROM ENTERING THE HOSE. THE BYPASS DISCHARGE SHALL BE PLACED ON A NON-ERODIBLE, ENERGYDISSIPATING SURFACE PRIOR TO REJOINING THE STREAM FLOW AND SHALL NOTCAUSE EROSION. FILTERING OF BYPASS WATER IS NOT NECESSARY UNLESS THEBYPASS WATER HAS BECOME SEDIMENT-LADEN AS A RESULT OF THE CURRENTCONSTRUCTION ACTIVITIES.
- 5. DURING DEWATERING OF THE COFFERED AREA, ALL WATER MUST BE FILTERED TOREMOVE SEDIMENT. POSSIBLE OPTIONS FOR SEDIMENT REMOVAL INCLUDE BAFFLESYSTEMS, ANIONIC POLYMERS, DEWATERING BAGS, OR OTHER APPROPRIATE METHODS.WATER SHALL HAVE SEDIMENT REMOVED PRIOR TO BEING RE-INTRODUCED TO THEDOWNSTREAM WATERWAY. A STABILIZED CONVEYANCE FROM THE DEWATERINGDEVICE TO THE WATERWAY MUST BE IDENTIFIED. DISCHARGE WATER IS CONSIDEREDCLEAN IF IT DOES NOT RESULT IN A VISUALLY IDENTIFIABLE DEGRADATION OFWATER CLARITY.
- 6. THE PORTION OF THE SIDE SLOPE THAT IS ABOVE THE OBSERVED WATERELEVATION SHALL BE STABILISED AS SPECIFIED IN THE PLANS PRIOR TOACCEPTING FLOWS. THE SUBSTRATE AND TOE OF SLOPE THAT HAS BEEN DISTURBEDDUE TO CONSTRUCTION ACTIVITIES SHALL BE RESTORED TO PRE-CONSTRUCTIONCONDITIONS AND FULLY STABILIZED PRIOR TO ACCEPTING FLOWS.

MCHENRY COUNTY STORMWATER PERMIT REQUIREMENTS

SOIL DISTURBANCE SHALL BE CONDUCTED IN SUCH A MANNER AS TO MINIMIZE EROSION. AREAS OF THE DEVELOPMENT SITE THAT ARE NOT TO BE GRADED SHALL BE PROTECTED FROM CONSTRUCTION TRAFFIC OR OTHER DISTURBANCE UNTIL FINAL SEEDING IS PREFORMED.

SOIL STABILIZATION MEASURES SHALL CONSIDER THE TIME OF YEAR, DEVELOPMENT SITE CONDITIONS AND THE USE OF TEMPORARY OR PERMANENT MEASURES.

STABILIZATION BY SEEDING SHALL INCLUDE TOPSOIL PLACEMENT AND FERTILIZATION, AS NECESSARY.

NATIVE SEED MIXTURES SHALL INCLUDE RAPID-GROWING ANNUAL GRASSES OR SMALL GRAINS TO PROVIDE INITIAL, TEMPORARY SOIL STABILIZATION.

OFFSITE PROPERTY SHALL BE PROTECTED FROM EROSION AND SEDIMENTATION. VELOCITY DISSIPATION DEVICES SHALL BE PLACED AT CONCENTRATED DISCHARGE LOCATIONS ALONG THE LENGTH OF ANY OUTFALL CHANNEL, AS NECESSARY TO PREVENT EROSION.

SEDIMENT CONTROL MEASURES SHALL BE INSTALLED PRIOR TO THE DISTURBANCE

STABILIZATION OF DISTURBED AREAS SHALL BE INITIATED IMMEDIATELY WHENEVER ANY CLEARING, GRADING, EXCAVATING OR OTHER EARTH DISTURBING ACTIVITIES HAVE PERMANENTLY CEASED ON ANY PORTION OF THE DEVELOPMENT SITE, OR TEMPORARY CEASED ON ANY PORTION OF THE DEVELOPMENT SITE AND WILL NOT RESUME FOR A PERIOD EXCEEDING 14 CALENDAR DAYS. STABILIZATION OF DISTURBED AREAS SHALL BE INITIATED WITHIN 1 WORKING DAY OF PERMANENT OR TEMPORARY CESSATION OF EARTH DISTURBING ACTIVITIES AND SHALL BE COMPLETED AS SOON AS POSSIBLE, BUT NO LATER THAN 14 CALENDAR DAYS FROM THE INITIATION OF STABILIZATION WORK IN THE AREA. EXCEPTIONS TO THESE TIME FRAMES ARE SPECIFIED AS INSTANCES WHEN THE INITIATION OF STABILIZATION MEASURES IS PRECLUBED BY SNOW COVER, STABILIZATION MEASURES IS PRECLUBED BY SNOW COVER, STABILIZATION MEASURES SHALL BE INITIATED AS SOON AS PRACTICABLE AND IN AREAS WHERE CONSTRUCTION ACTIVITY HAS TEMPORARLY CEASED AND WILL RESUME AFTER 14 DAYS, A TEMPORARY STABILIZATION METHOD MAY BE USED.

DISTURBANCE OF STEEPS SLOPES SHALL BE MINIMIZED. AREAS OR EMBANKMENTS HAVING SLOPES STEEPER THAN 3:1 SHALL BE STABILIZED WITH STAKING IN PLACE SOD, EROSION CONTROL BLANKET IN COMBINATION WITH SEEDING, OR FOULVALENT CONTROL MEASURE.

PERIMETER CONTROL MEASURES SHALL BE PROVIDED DOWNSLOPE AND PERPENDICULAR TO THE FLOW OF RUNOFF FROM DISTURBED AREAS, WHERE THE TRIBUTARY AREA IS GREATER THAN 5,000 SQUARE FEET, AND WHERE RUNOFF WILL FLOW IN A SHEET FLOW MANNER. PERIMETER EROSION CONTROL SHALL ALSO BE PROVIDED AT THE BASE OF SOIL STOCKPILES.

THE DRAINAGE SYSTEM SHALL BE PROTECTED FROM EROSION AND SEDIMENTATION DOWNSLOPE FROM DISTURBED AREAS. INLET PROTECTION THAT REDUCES SEDIMENT LOADING, WHILE ALLOWING RUNOFF TO ENTER THE INLET SHALL BE REQUIRED FOR ALL STORM SEWERS. CHECK DAMS, OR AN EQUIVALENT CONTROL MEASURE, SHALL BE REQUIRED FOR ALL CHANNELS. FILTER FABRIC INLET PROTECTION AND STRAW BALE DITCH CHECKS ARE NOT ACCEPTABLE CONTROL MEASURES.

IF DEWATERING SERVICES ARE USED, ADJOINING PROPERTIES AND DISCHARGE LOCATIONS SHALL BE PROTECTED FROM EROSION. DISCHARGES SHALL BE ROUTED THROUGH AN EFFECTIVE SEDIMENT CONTROL MEASURE (E.G., SEDIMENT TRAP, SEDIMENT BASIN, OR OTHER APPROPRIATE MEASURES). THE ENGINEER AND THE MCHENRY COUNTY SOIL AND WATER CONSERVATION DISTRICT SHALL BE NOTIFIED PRIOR TO THE COMMENCEMENT OF DEWATERING ACTIVITIES.

ALL TEMPORARY SOIL EROSION AND SEDIMENT CONTROL MEASURES SHALL BE REMOVED WITHIN THIRTY (30) DAYS AFTER FINAL SITE STABILIZATION IS ACHIEVED OR AFTER THE TEMPORARY MEASURES ARE NO LONGER NEEDED. TRAPPED SEDIMENT AND OTHER DISTURBED SOIL AREAS SHALL BE PERMANENTLY STABILIZED

STOCKPILED SOIL AND MATERIALS SHALL BE REMOVED FROM FLOOD HAZARD AREAS AT THE END OF EACH WORK DAY. SOIL AND MATERIALS STOCKPILED IN IWMC OR BUFFER AREAS SHALL BE PLACED ON TIMBER MATS, OR AN EQUIVALENT CONTROL MEASURE

EFFECTIVE CONTROL MEASURES SHALL BE UTILIZED TO MINIMIZE THE DISCHARGE OF POLLUTANTS FROM THE DEVELOPMENT SITE. AT A MINIMUM, CONTROL MEASURES SHALL BE IMPLEMENTED IN ORDER TO:

MINIMIZE THE DISCHARGE OF POLLUTANTS FROM EQUIPMENT AND VEHICLE WASHING, WHEEL WASH WATER, AND OTHER WASH WATER.

MINIMIZE THE EXPOSURE OF BUILDING MATERIALS, BUILDING PRODUCTS, CONSTRUCTION WASTES, TRASH, LANDSCAPE MATERIALS, FERTILIZERS, PESTICIDES, HERBICIDES, DETERGENTS, VEHICLE FLUIDS, SANITARY WASTE, AND OTHER MATERIALS PRESENT ON THE DEVELOPMENT SITE TO PRECIPITATION AND TO STOPMWATER

ADEQUATE RECEPTACLES SHALL BE PROVIDED FOR THE DEPOSITION OF ALL CONSTRUCTION MATERIAL DEBRIS GENERATED DURING THE DEVELOPMENT PROCESS. THE CONTRACTOR SHALL NOT CAUSE OR PERMIT THE DUMPING, DEPOSITING, DROPPING, THROWING, DISCARDING OR LEAVING OF CONSTRUCTION MATERIAL DEBRIS UPON OR INTO ANY DEVELOPMENT SITE, CHANNEL OR IWMC. THE DEVELPMENT SITE SHALL BE MAINTAINED FREE OF CONSTRUCTION MATERIAL DEFRIS OF CONSTR

A STABILIZED MAT OF AGGREGATE UNDERLAIN WITH FILTER CLOTH (OR OTHER APPROPRIATE MEASURES) SHALL BE LOCATED AT ANY POINT WHERE TRAFFIC WILL BE ENTERING OR LEAVING A CONSTRUCTION-SITE OF A MAJOR DEVELOPMENT TO OR FROM A PUBLIC RIGHT-OF-WAY, STREET ALLEY, OR PARKING AREA. ANY SEDIMENT OR SOIL REACHING AN IMPROVED PUBLIC RIGHT OF WAY, STREET, ALLEY OR PARKING AREA SHALL BE SCRAPED OR STREET CLEANED AS ACCUMULATIONS WARRANT AND TRANSPORTED TO A CONTROLLED SEDIMENT DISPOSAL AREA.

ALL TEMPORARY AND PERMANENT EROSION AND SEDIMENT CONTROL MEASURES SHALL BE MAINTAINED IN AN EFFECTIVE WORKING CONDITION.

DRAIN TILE SYSTEMS DISTURBED DURING DEVELOPMENT MUST BE RECONNECTED BY THOSE RESPONSIBLE FOR THEIR DISTURBANCE UNLESS THE APPROVED ENGINEERING PLANS INDICATE HOW THE DRAIN TILE SYSTEM IS TO BE CONNECTED TO THE PROPOSED STORMWATER MANAGEMENT SYSTEM.

ALL ABANDONED DRAIN TILES SHALL BE REMOVED IN THEIR ENTIRETY WITHIN THE EXISTING ROW AND/OR EASEMENT.

DRAIN TILES WITHIN THE DISTURBED AREA OF THE DEVELOPMENT SHALL BE REPLACED. BYPASSED AROUND THE DEVELOPMENT OR INTERCEPTED AND CONNECTED TO THE DRAINAGE SYSTEM FOR THE DEVELOPMENT. THE SIZE OF THE REPLACED OR BYPASSED DRAIN TILE SHALL BE EQUIVALENT TO THE EXISTING

SCALE: N.T.S.


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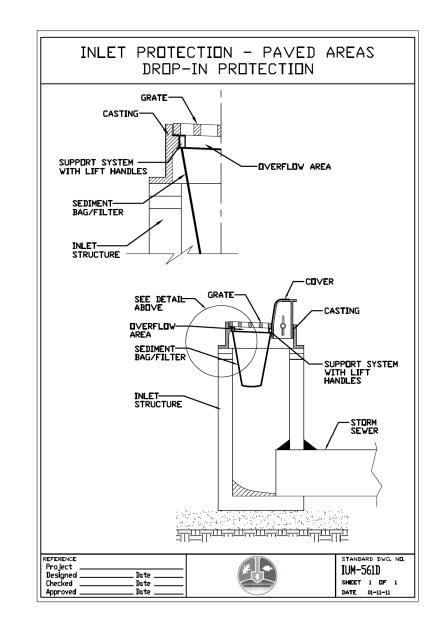
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	DRAWN -	XX	REVISED -
PLOT SCALE = 8.0000 ' / in	CHECKED -	JJS	REVISED -
PLOT DATE = 10/28/2025	DATE -	7/23/2025	REVISED -

STATE OF ILLINOIS
DEPARTMENT OF TRANSPORTATION

CONST	CONSTRUCTION DETAILS - BOX CULVERT WINN ROAD AND EAST SOLON ROAD						F.A. U RTE	SECT	SECTION COUNTY		COUNTY	TOTAL SHEETS	SHEET NO.	
WINI							•	23-0002	23-00021-00-RS McF		McHENRY	34	25	
VVIIVI	WINN HUAD AND EAST SOLUN HUAD						* 0165, 0157 CONTRACT NO. 61N			1M07				
SHEET	6	OF	9	SHEETS	STA.	TO	STA.			ILLINOIS	EED ΔI	D PROJECT		



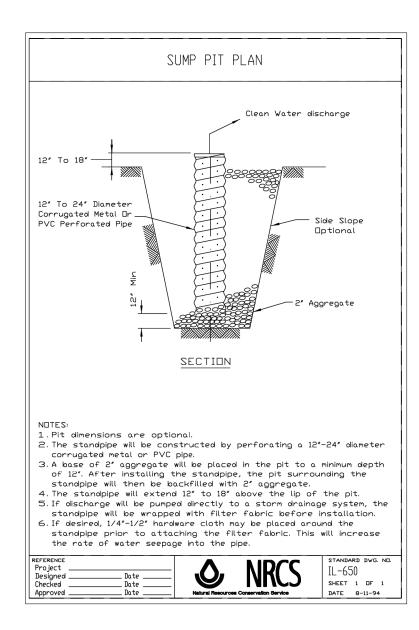



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	DRAWN -	XX	REVISED -	
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PLOT DATE = 10/28/2025	DATE -	7/23/2025	REVISED -	


STAT	E 01	F ILLINOIS
DEPARTMENT	0F	TRANSPORTATION

SCALE: N.T.S.

CONSTRUCTION DETAI	.S	F.A.U RTE	SECTION	COUNTY	TOTAL SHEETS	SHEET NO.
WINN ROAD AND EAST SOL	IN ROAD	•	23-00021-00-RS	McHENRY	34	26
WINN HOAD AND LAST SOL	N HOAD	* 0165,	0157	CONTRAC	T NO. (1M07
SHEET 7 OF 9 SHEETS STA.	TO STA.		ILLINOIS FED.	AID PROJECT		

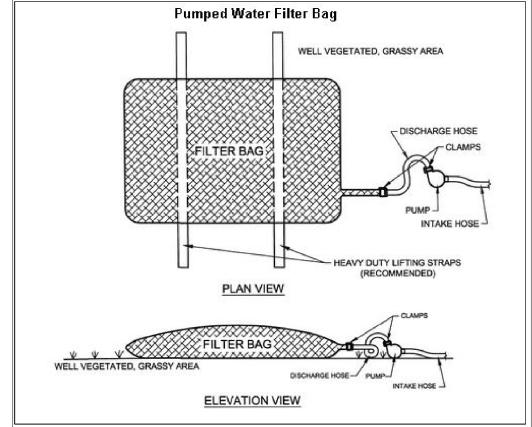

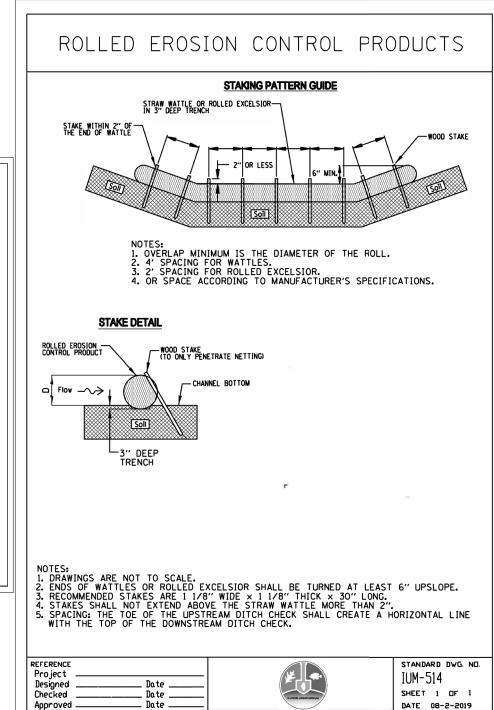


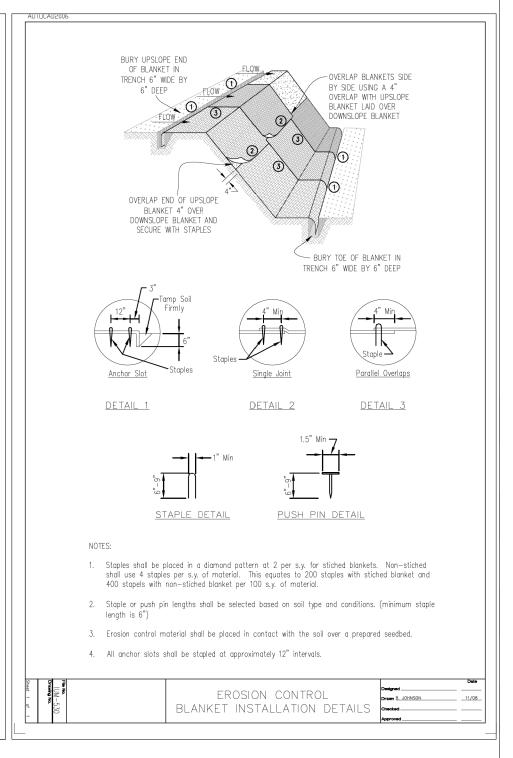

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USER NAME = txu	DESIGNED - XX	REVISED -
	DRAWN - XX	REVISED -
PLOT SCALE = 8.0000 / in.	CHECKED - JJS	REVISED -
PLOT DATE = 10/28/2025	DATE - 7/23/2025	REVISED -


SCALE: N.T.S.

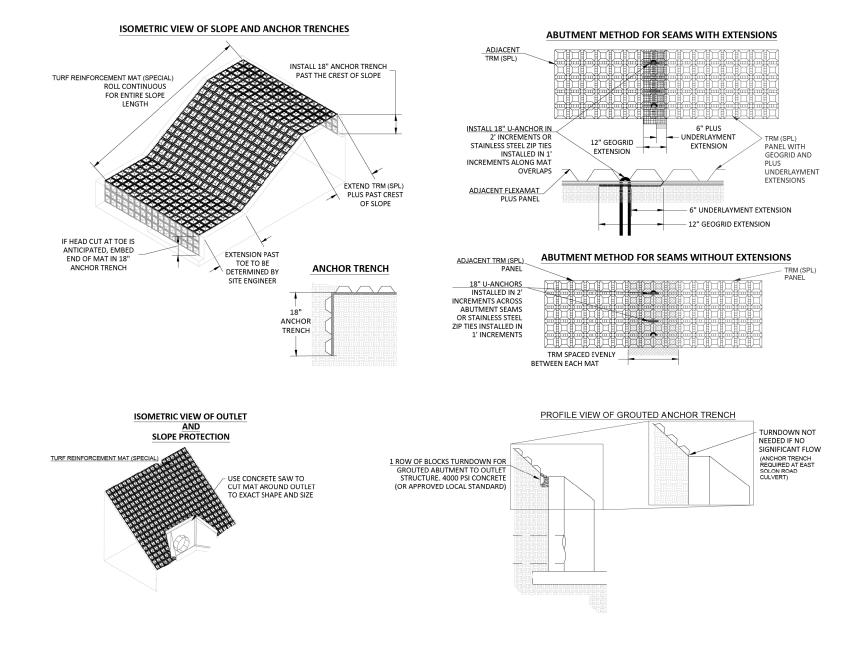

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	DRAWN -	XX	REVISED -
PLOT SCALE = 8.0000 ' / in.	CHECKED -	JJS	REVISED -
PLOT DATE = 10/28/2025	DATE -	7/23/2025	REVISED -

STATE OF ILLINOIS									
DEPARTMENT	0F	TRANSPORTATION							

CONSTRUCTI	ON DETA	ILS -	- TL	JRF REIN	IFORCEN	MENT MAT	(SPECIAL)	F.A. U RTE	SECTION	COUNTY	TOTAL SHEETS	
WINN ROAD AND EAST SOLON ROAD						•	23-00021-00-RS	McHENRY	34	28		
WINN HOAD AND LAST SOLON HOAD						* 0165,	0157	CONTRACT	NO. 6	51M07		
SCALE: N.T.S.	SHEET 9	OF	9	SHEETS	STA.	TO	STA.	ILLINOIS FED. AID PROJECT				

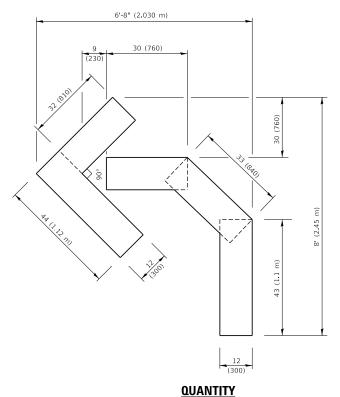

4 (100) LINE = 45.5 ft. (13.9 m) 15.2 sq. ft. (1.41 sq. m)

6' (2 m)

16 (400) | | 16 (400) | | 16 (400) | 16 (400) * 12 (300) ***** 4 (100)

> 4 (100) LINE = 64.1 ft. (19.5 m) 21.4 sq. ft. (1.99 sq. m)

> > DESIGNED -

CHECKED

09-18-94

DRAWN

DATE


QUANTITY

USER NAME = footemj

PLOT DATE = 3/4/2019

PLOT SCALE = 50.0068 ' / in.

4 (100)

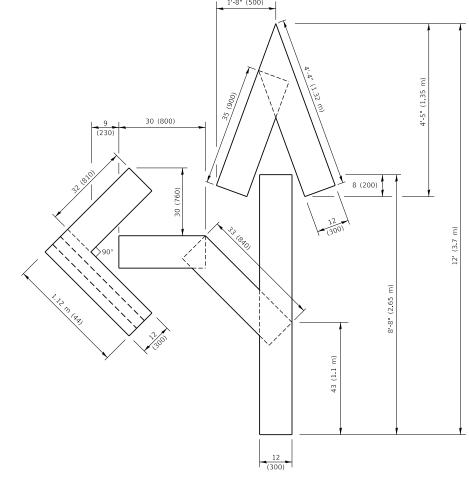


QUANTITY

4 (100) LINE = 82.5 ft. (25.1 m) 27.5 sq. ft. (2.53 sq. m)

NOTE:

ALL QUANTITIES OF PLACEMENT ARE REPRESENTED IN LINEAR FEET OF 4" LINES TO MATCH THE 4" TEMPORARY TAPE PAY ITEM AND REPRESENTS THE TOTAL QUANTITY OF 4" TAPE REQUIRED.

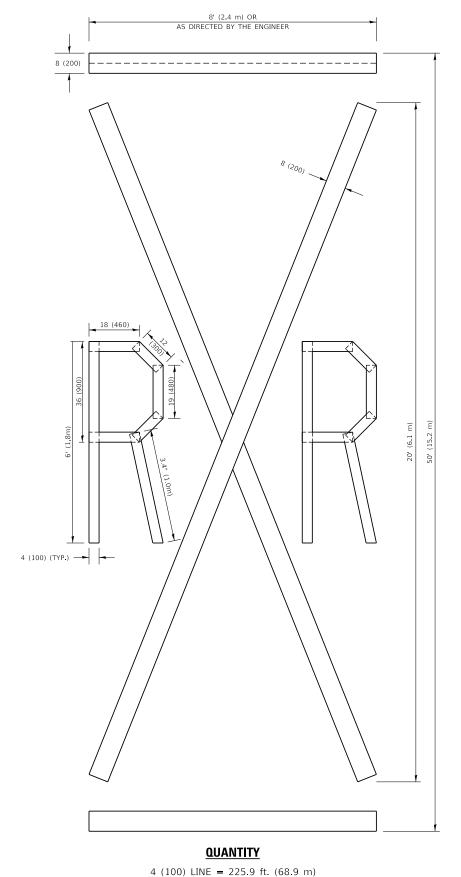

75.3 sq. ft. (6.99 sq. m)

All dimensions are in inches (millimeters) unless otherwise shown.


* 0165, 0157

SECTION McHENRY 34 29 23-00021-00-RS TC-16 CONTRACT NO. 61M07

REVISED	- T. RAMMACHER 03-02-98
REVISED	- E. GOMEZ 08-28-00
REVISED	- E. GOMEZ 08-28-00
REVISED	- A. SCHUETZE 09-15-16


STATE OF ILLINOIS **DEPARTMENT OF TRANSPORTATION**

SHORT TERM PAVEMENT MARKING LETTERS AND SYMBOLS SCALE: NONE SHEET 1 OF 1 SHEETS STA.

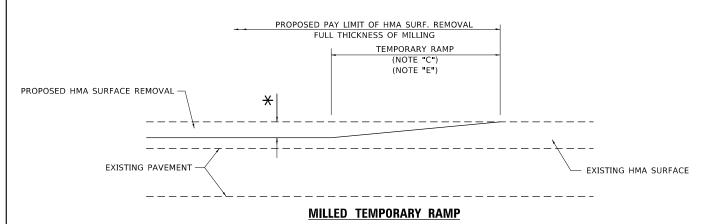

(FOR BUTT JOINT AND HMA TAPER SEE DETAIL BELOW)

OPTION 1

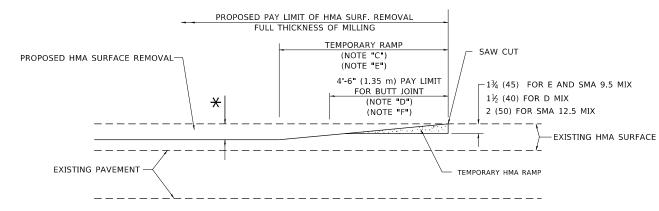


HMA CONSTRUCTED TEMPORARY RAMP

(FOR BUTT JOINT AND HMA TAPER SEE DETAIL BELOW)

OPTION 2

TYPICAL TEMPORARY RAMP

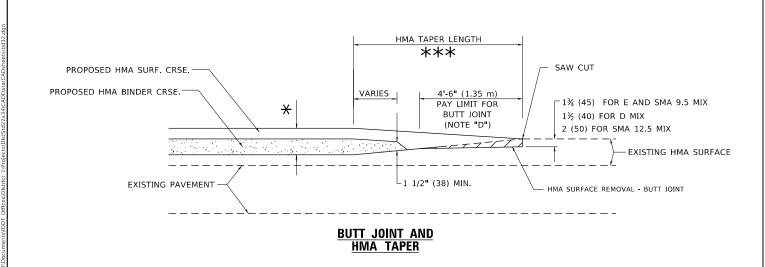

TYPICAL BUTT JOINT AND HMA TAPER FOR MILLING AND RESURFACING

DESIGNED -

DRAWN CHECKED

DATE

JSER NAME = Lawrence.DeManche

LOT DATE = 11/18/2022


PROPOSED HMA OR PCC
SURFACE REMOVAL - BUTT JOINT
30'-0" (9.0 m) (NOTE "B")
15'-0" (4.5 m) (NOTE "B")
(NOTE "D")
40'-0" (12.0M) (NOTE "A1")

** * EXISTING PAVEMENT

** * EXISTING PAVEMENT

** * EXISTING PAVEMENT

** * BUTT JOINT DETAIL

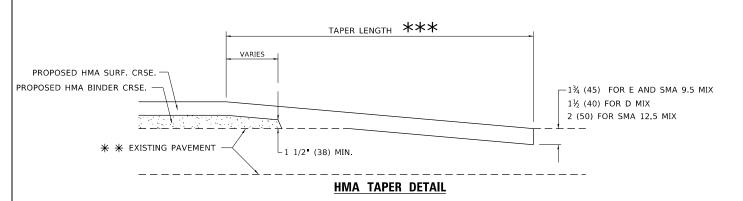

TYPICAL BUTT JOINT AND HMA TAPER FOR RESURFACING ONLY

** PC CONCRETE, HMA OR HMA RESURFACED PAVEMENT.

GENERAL NOTES

- A. MAINLINE ARTERIAL ROADWAYS AND MAJOR SIDE ROADS.
- A1. INTERSTATES
- B. MINOR SIDE ROADS.
- C. THE TEMP. RAMP SHALL BE CONSTRUCTED IMMEDIATELY UPON REMOVAL OF THE EXISTING HMA SURFACE.
- D. THE BUTT JOINT SHALL BE CONSTRUCTED IMMEDIATELY PRIOR TO PLACING THE PROPOSED HMA COURSES.
- E. TAPER THE TEMP. RAMP AT A RATE OF 3' 4" (1.02m) PER 1 INCH (25 mm) OF MILLING THICKNESS.
 - igstar SEE TYPICAL SECTIONS FOR MILLING THICKNESS.
- F. SEE ARTICLE 406.08 AND 406.14 OF THE STANDARD SPECIFICATIONS FOR "HMA AND/OR PCC SURFACE REMOVAL, BUTT JOINT".
- *** 20'-0" (6.1 m) PER 1 (25) RESURFACING (NOTE "A")
 10'-0" (3.0 m) PER 1 (25) RESURFACING (NOTE "B")

BASIS OF PAYMENT

- THE BUTT JOINT WILL BE PAID FOR AT THE CONTRACT UNIT PRICE PER SQUARE YARD (SQUARE METER) FOR "HOT-MIX ASPHALT SURFACE REMOVAL - BUTT JOINT" OR FOR "PORTLAND CEMENT CONCRETE SURFACE REMOVAL- BUTT JOINT".
- THE TEMPORARY RAMP AND SAW CUT SHALL BE INCLUDED IN THE UNIT COST FOR HMA OR PCC SURFACE REMOVAL-BUTT JOINT.

ALL DIMENSIONS ARE IN INCHES (MILLIMETERS) UNLESS OTHERWISE SHOWN.


* 0165, 0157

M. DE YONG	REVISED	-	A. ABBAS 03-21-97
	REVISED	-	M. GOMEZ 04-06-01
	REVISED	-	R. BORO 01-01-07
06-13-90	REVISED	_	K. SMITH 11-18-22

STATE OF ILLINOIS
DEPARTMENT OF TRANSPORTATION

			В	JTT	JOINT .	AND		F.A. U RTE	SECTI	ON	COUNTY	TOTAL SHEETS	SHEE NO.
HMA TAPER DETAILS					*	23-00021-	-00-RS	McHENRY	34	30			
					BD400-05 B	D-32	CONTRACT	NO.	61M07				
	SHEET	1	OF	1	SHEETS	STA.	TO STA.		I	LLINOIS FED. AI	ID PROJECT		

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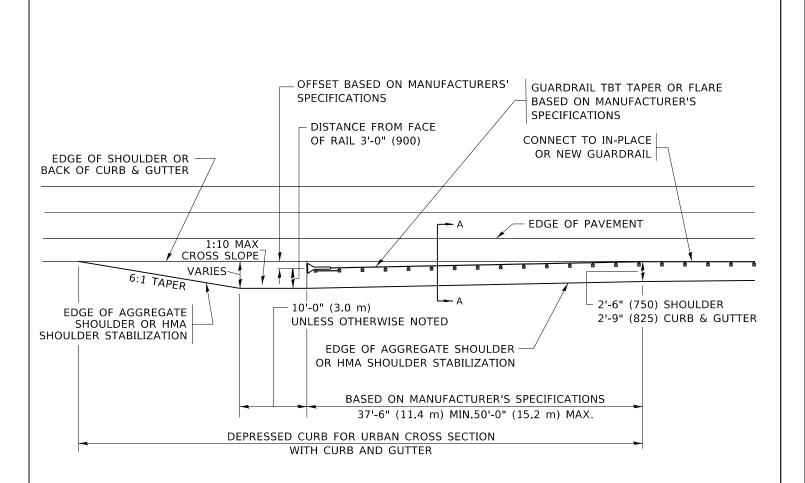


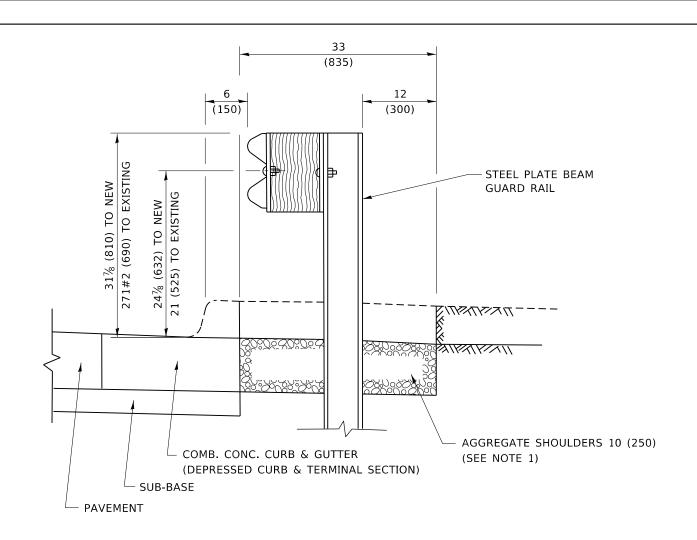SECTION A-A

NOTES:

- 1. THE AGGREGATE SHOULDER, 10 (250) OR HMA SHOULDER, 6 (150) (IF REQUIRED) SHALL EXTEND UNDER THE TRAFFIC BARRIER TERMINAL.
- 2. "EXISTING" GUARDRAIL REFERS TO CONNECTING TERMINAL SECTION TO GUARD RAILING PRIOR TO THE MIDWEST GUARDRAIL SYSTEM.
- 3. THE CONTRACTOR SHALL VERIFY THE TYPE/HEIGHT OF GUARDRAIL IN-PLACE BEFORE ORDERING THE NEW TERMINAL SECTION. COST INCLUDED WITH THE COST OF THE TERMINAL. THE EXISTING GUARDRAIL HEIGHT SHALL TRANSISTION TO MATCH THE NEW TERMINAL END SECTION AND SHALL BE PAID FOR AS VERTICAL ADJUSTMENT OF EXISTING GUADRAIL.

DETAILS FOR STEEL PLATE BEAM GUARD RAIL ADJACENT TO CURB AND GUTTER [FOR ROADWAY SPEED 35 MPH (60 kmh) TO 45 MPH (70 kmh)]



DEPRESSED CURB AND GUTTER AND SHOULDER TREATMENT AT TBT TY. 1 SPL.

AGGREGATE SHOULDER, 10 (250) WILL BE PAID ACCORDING TO SECTION 481.

HMA SHOULDERS 6 (150) (IF REQUIRED) WILL BE PAID ACCORDING TO SECTION 482.

COMB. CONC. C&G, STEEL PLATE BEAM GUARD RAIL AND TRAFFIC BARRIER TERMINAL, OF THE TYPE SPECIFIED WILL BE PAID FOR SEPARATELY.

TBT = TRAFFIC BARRIER TERMINAL


ALL DIMENSIONS ARE IN INCHES (MILLIMETERS) UNLESS OTHERWISE SHOWN.

DETAILS FOR DEPRESSED CURB & GUTTER AND SHOULDER TREATMENT AT TBT TY. 1 SPL. SHEET 1 OF 1 SHEETS STA.

23-00021-00-RS McHENRY 34 31 BD600-10 (BD-34) CONTRACT NO. 61M07

DESIGNED - M. DE YONG REVISED R. BORO 09-14-2009 SER NAME = Lawrence, DeManche DRAWN REVISED -R. BORO 08-06-2012 HECKED LOT DATE = 11/18/2022 K. SMITH 11-18-22 DATE

STATE OF ILLINOIS **DEPARTMENT OF TRANSPORTATION**

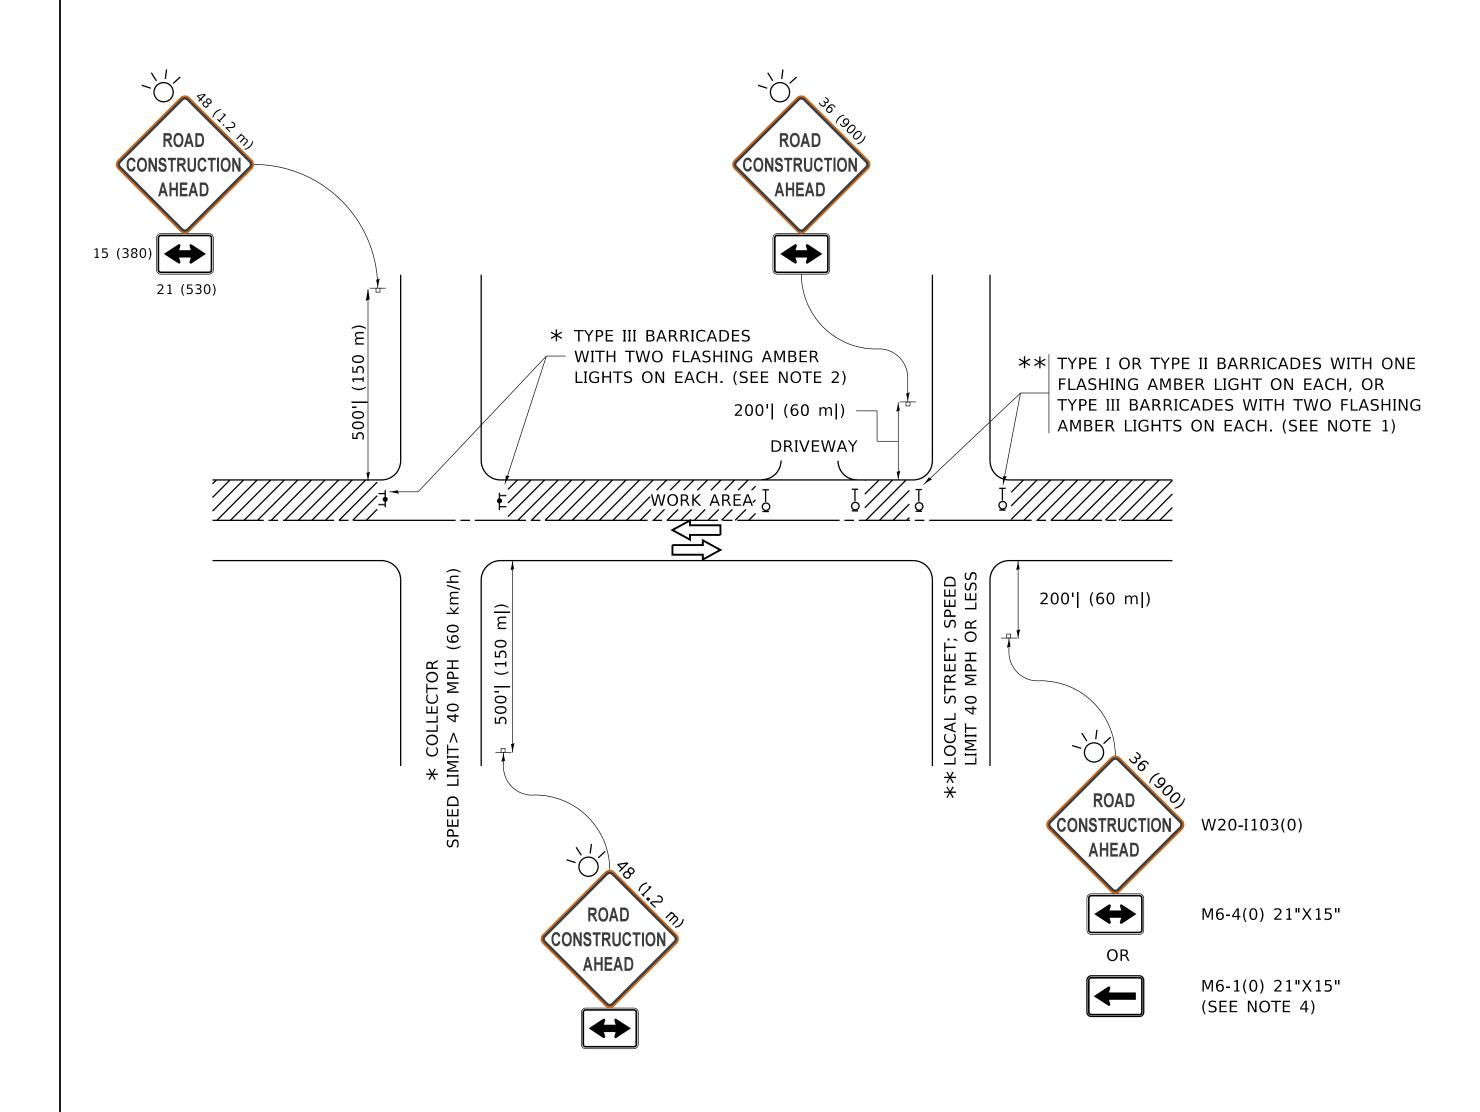

NOTES:

- 1. SIDE ROAD WITH A SPEED LIMIT OF 40 MPH (60 km/h) OR LESS AS SHOWN ON THE DRAWING AND AS DIRECTED BY THE ENGINEER:
- a) ONE "ROAD CONSTRUCTION AHEAD" SIGN 36 x 36 (900x900) WITH A FLASHER MOUNTED ON IT APPROXIMATELY 200' (60 m) IN ADVANCE OF THE MAIN ROUTE.
- b) THE CLOSED PORTION OF THE MAIN ROUTE SHALL BE PROTECTED BY BLOCKING WITH TYPE I, TYPE II OR TYPE III BARRICADES, 1/3 OF THE CROSS SECTION OF THE CLOSED PORTION.
- 2. SIDE ROAD WITH A SPEED LIMIT GREATER THAN 40 MPH (60 km/h) AS SHOWN ON THE DRAWING AND AS DIRECTED BY THE ENGINEER:
- a) ONE "ROAD CONSTRUCTION AHEAD" SIGN 48 x 48 (1.2 m x 1.2 m) WITH A FLASHER MOUNTED ON IT APPROXIMATELY 500' (150 m) IN ADVANCE OF THE MAIN ROUTE.
- THE CLOSED PORTION OF THE MAIN ROUTE SHALL BE PROTECTED BY
 b) BLOCKING WITH TYPE III BARRICADES, 1/2 OF THE CROSS SECTION
 OF THE CLOSED PORTION.
- 3. CONES MAY BE SUBSTITUTED FOR BARRICADES OR DRUMS AT HALF THE SPACING DURING DAY OPERATIONS. CONES SHALL BE A MINIMUM OF 28 (710) IN HEIGHT.
- WHEN THE SIDE ROAD LIES BETWEEN THE BEGINNING OF THE MAINLINE
 4. SIGNING AND THE WORK ZONE, A SINGLE HEADED ARROW (M6-1) SHALL
 BE USED IN LIEU OF THE DOUBLE HEADED ARROW (M6-4).

- 5. WHEN WORK IS BEING PERFORMED ON A SIDE ROAD OR DRIVEWAY, FOLLOW THE APPLICABLE STANDARD(S). THE DIRECTIONAL ARROW (M6-1 OR M6-4) SHALL BE COVERED OR REMOVED WHEN NO LONGER CONSISTENT WITH THE TRAFFIC CONTROL SET-UP.
- 6. ADVANCE WARNING SIGNS ARE TO BE OMITTED ON DRIVEWAYS UNLESS OTHERWISE SPECIFIED IN THE PLANS OR BY THE ENGINEER.
- 7. THE TRAFFIC CONTROL AND PROTECTION FOR SIDE ROADS, INTERSECTIONS, AND DRIVEWAYS SHALL BE INCLUDED IN THE COST OF SPECIFIED TRAFFIC CONTROL STANDARDS OR ITEMS.

All dimensions are in inches (millimeters) unless otherwise shown.

* 0165, 0157

TRAFFIC CONTROL AND PROTECTION FOR

SIDE ROADS, INTERSECTIONS, AND DRIVEWAYS

SHEET 1 OF 1 SHEETS STA. TO STA.

F.A. U RTE. SECTION


* 23-00021-00-RS McHENRY 34 32

TC-10 CONTRACT NO. 61M07

USER NAME = footemj	DESIGNED - L.H.A.	REVISED - A. HOUSEH 10-15-96
	DRAWN -	REVISED - T. RAMMACHER 01-06-00
PLOT SCALE = 50.0000 ' / in.	CHECKED -	REVISED - A. SCHUETZE 07-01-13
PLOT DATE = 3/4/2019	DATE - 06-89	REVISED - A. SCHUETZE 09-15-16

STATE OF ILLINOIS
DEPARTMENT OF TRANSPORTATION

SCALE: NONE SHEET 1 OF 1 SHEETS STA. TO STA.

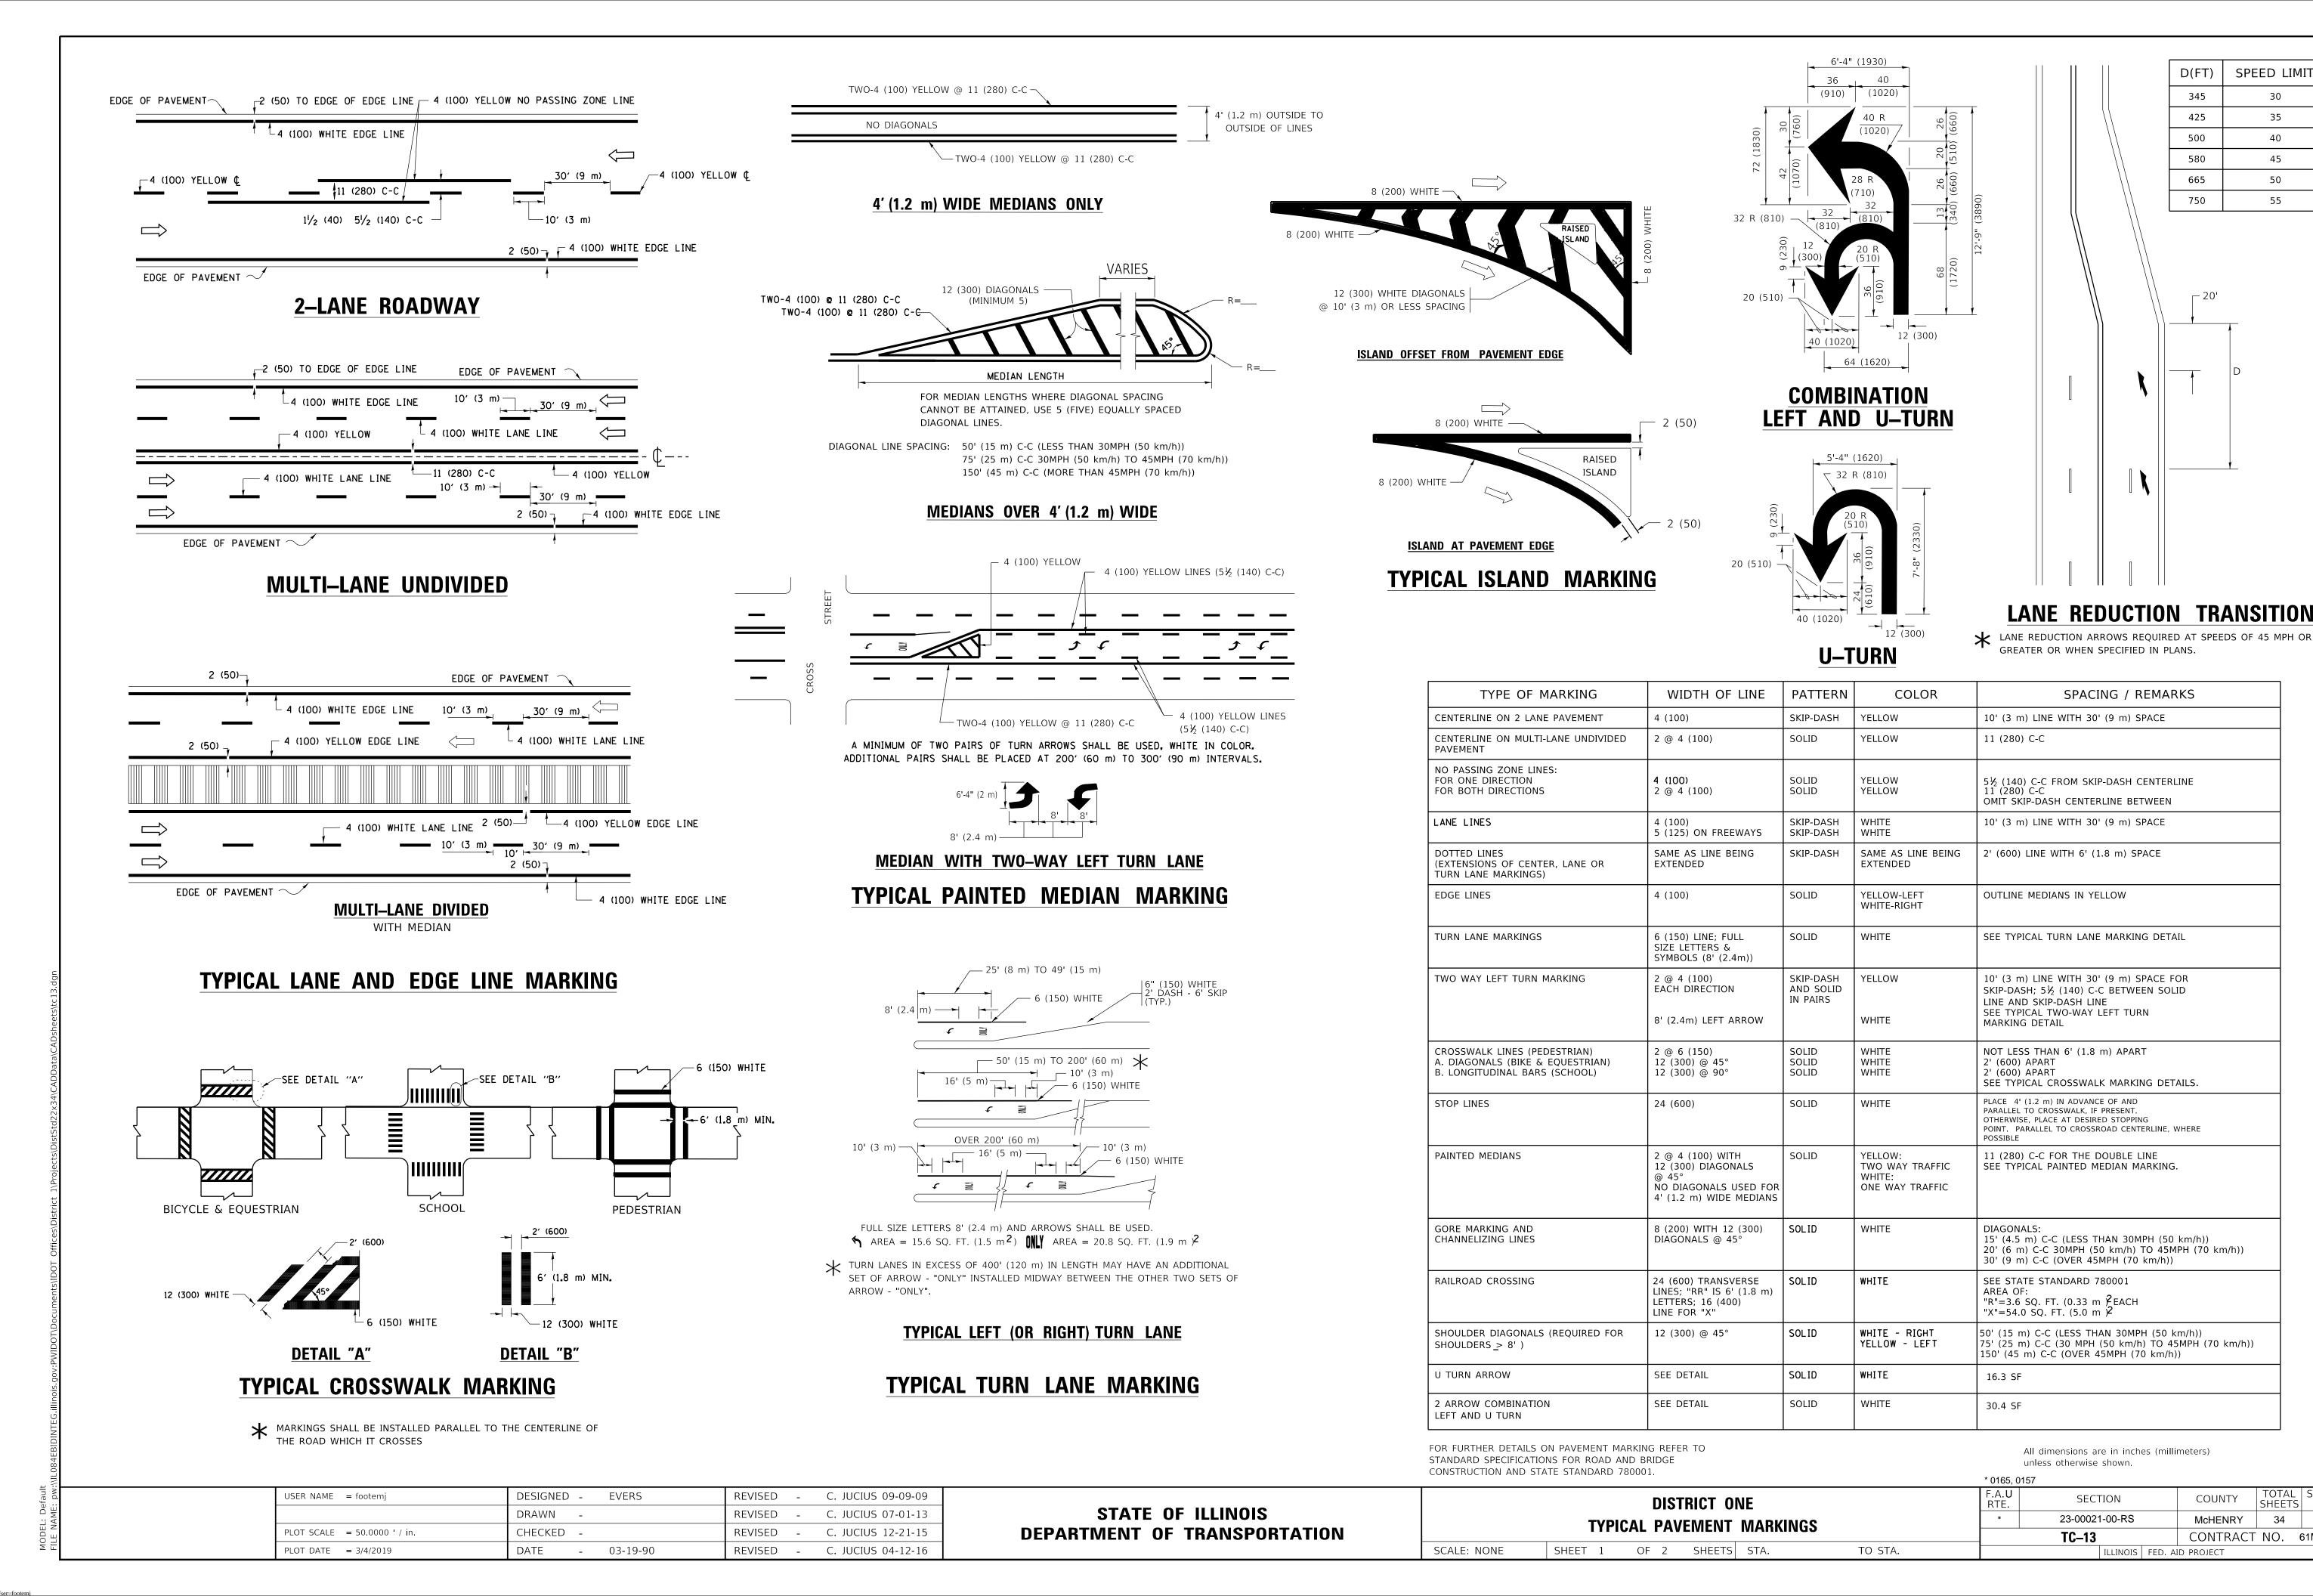

D(FT)

425

500

580

665

750

LANE REDUCTION TRANSITION

GREATER OR WHEN SPECIFIED IN PLANS

SPACING / REMARKS

All dimensions are in inches (millimeters)

TOTAL SHEET NO.

34 33

COUNTY

ILLINOIS | FED. AID PROJECT

McHENRY

CONTRACT NO. 61M07

unless otherwise shown.

TC-13

SECTION

23-00021-00-RS

SPEED LIMIT


35

40

45

50

55

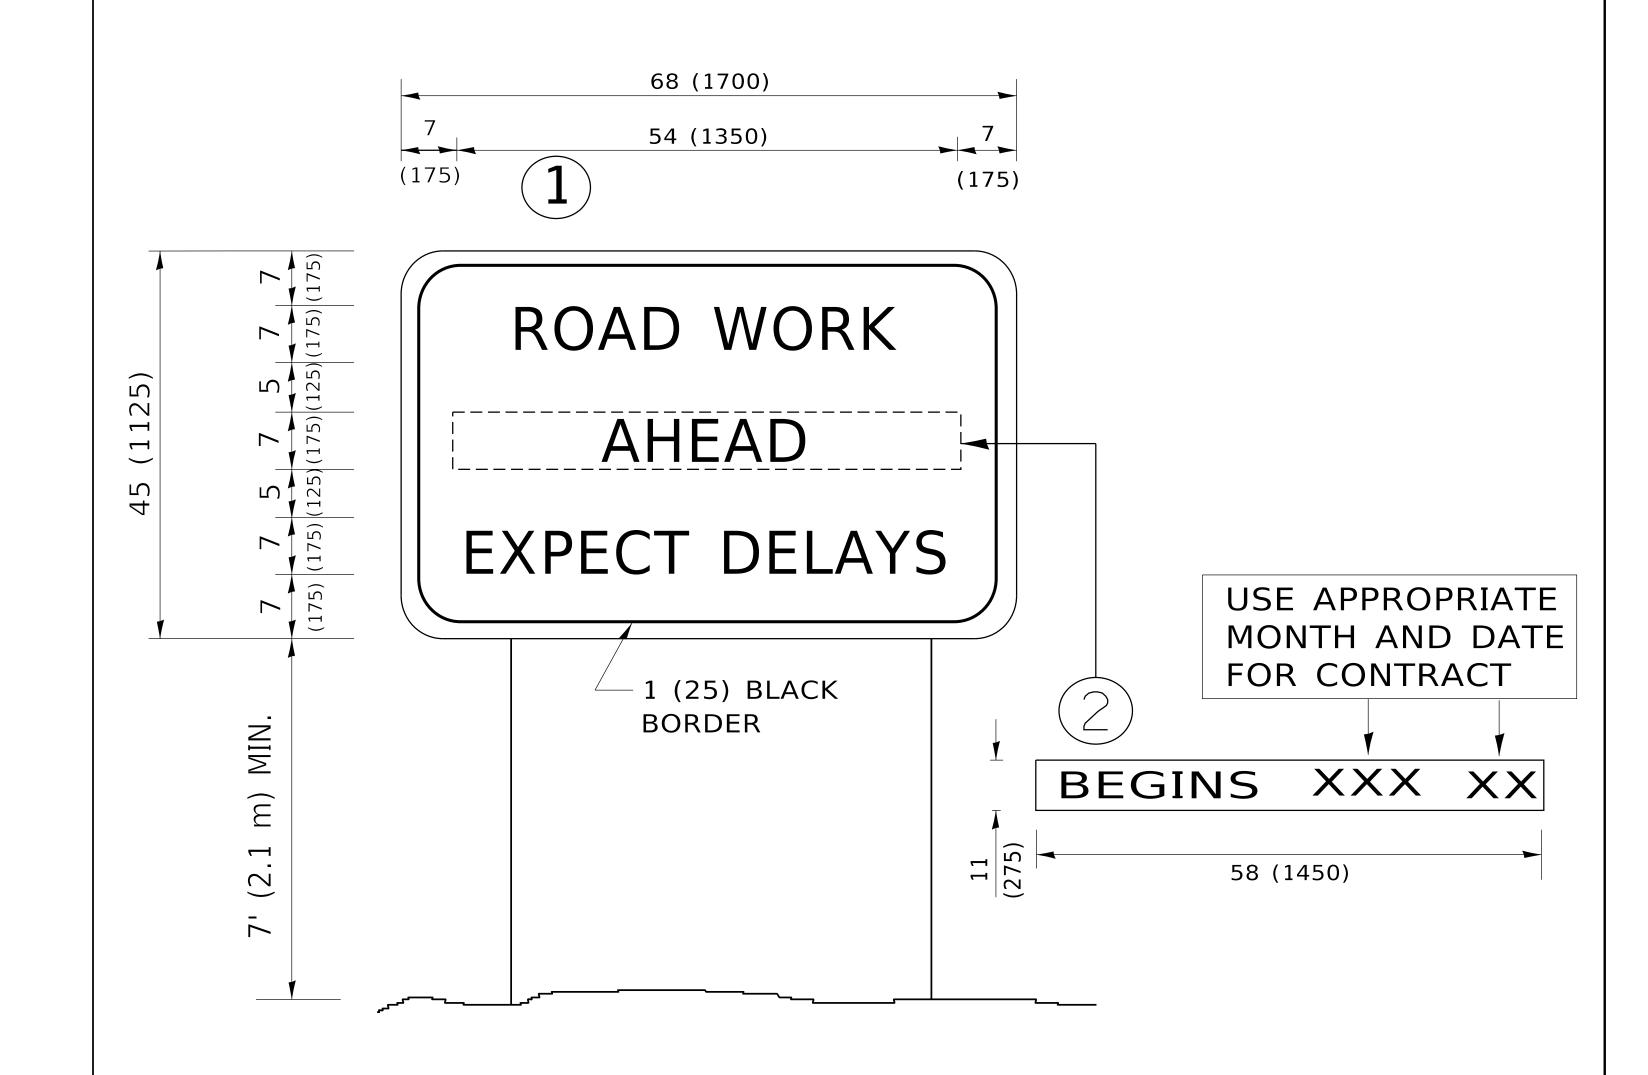

NOTES:

- 1. USE BLACK LETTERING ON ORANGE BACKGROUND.
- 2. ERECT SIGNS IN ADVANCE OF THE LOCATION FOR THE "ROAD CONSTRUCTION AHEAD" SIGN AT LOCATIONS AS DIRECTED BY THE ENGINEER.
- 3. ERECT SIGN 1 WITH INSTALLED PANEL 2 ONE WEEK PRIOR TO THE START OF CONSTRUCTION.
- 4. REMOVE PANEL 2 SOON AFTER THE START OF CONSTRUCTION.
- 5. SEE SPECIAL PROVISION FOR "TEMPORARY INFORMATION SIGNING" FOR ADDITIONAL INFORMATION.
- 6. ONE SIGN ASSEMBLY EQUALS 25.70 SQ. FT. (2.3 SQ. M.)
- 7. SHALL BE PAID FOR AS TEMPORARY INFORMATION SIGNING.

ALL DIMENSIONS ARE IN INCHES (MILLIMETERS)
UNLESS OTHERWISE SHOWN.

							0100, 0101		
USER NAME = footemj	DESIGNED -	REVISED - R. MIRS 09-15-97		ARTERIAL ROAD			F.A.U RTF	SECTION	COUNTY TOTAL SHEET NO
	DRAWN -	REVISED - R. MIRS 12-11-97	STATE OF ILLINOIS			*	23-00021-00-RS	McHENRY 34 34	
PLOT SCALE = 50.0000 ' / in.	CHECKED -	REVISED -T. RAMMACHER 02-02-99	DEPARTMENT OF TRANSPORTATION	INFORMATION SIGN				TC-22	CONTRACT NO. 61M07
PLOT DATE = 3/4/2019	DATE -	REVISED - C. JUCIUS 01-31-07		SCALE: NONE	SHEET 1 OF 1 SHEETS STA.	TO STA.		ILLINOIS FED	. AID PROJECT