MASSIE MASSIE & ASSOCIATES, INC. **NEIL F. BRUMLEVE, PLA** #157-001366

Mul F. Bow

DATE: 7/29/2025 SIGNATURE AND SEAL APPLIES TO **DRAWING NO. 59-71**



CRAWFORD, MURPHY & TILLY, INC. LOUIS D. WELLER, P.E. #062-054095

DATE: 7/29/2025 SIGNATURE AND SEAL APPLIES TO DRWG NO. 72-84

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expires: 11-30-25

HUTCHISON ENGINEERING, INC. ANTHONY W. MILLER, P.E.

SIGNATURE AND SEAL APPLIES TO DRWG NO. 1-58 & 85-144




UTILITIES

WATER /GAS CITY OF PITTSFIELD 742 NORTH MONROE STREET PITTSFIELD, IL. 62363 (217) 285-6850

FRONTIER COMMUNICATIONS 1919 MCKINNEY AVENUE DALLAS, TX. 75201

TELEPHONE CASS CO. TELEPHONE & CABLE 100 REDBUD ROAD P.O. BOX 200 VIRGINIA, IL. 62691 (217) 452-7725

ELECTRIC AMEREN ILLINOIS (NORTH MT. STERLING, IL 62353

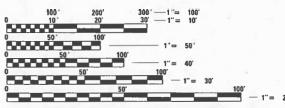

FULL SIZE PLANS HAVE BEEN PREPARED USING STANDARD ENGINEERING SCALES. REDUCED SIZED PLANS WILL NOT CONFORM TO STANDARD SCALES. IN MAKING MEASUREMENTS ON REDUCED PLANS, THE ABOVE SCALES MAY BE USED.

JOINT UTILITY LOCATION INFORMATION FOR EXCAVATION 1-800-892-0123

OR 811

STATE OF ILLINOIS

11/07/2025 LETTING ITEM 135
DEPARTMENT OF TRANSPORTATION PLANS FOR PROPOSED

ILLINOIS TRANSPORTATION ENHANCEMENT PROGRAM AND ILLINOIS DEPARTMENT OF COMMERCE AND ECONOMIC OPPORTUNITY

CITY OF PITTSFIELD

PIKE COUNTY

SECTION 24-00037-00-RS

HISTORIC DOWNTOWN SQUARE RECONSTRUCTION WEST ADAMS STREET, NORTH MADISON STREET, AND NORTH MONROE STREET FEDERAL PROJECT NO. PI5B(056)

JOB NO. C-96-027-25



DESIGN DESIGNATION FUNCTIONAL CLASSIFICATION: LOCAL ROAD (2024) ADAMS ST-ADT = 900

LOCAL ROAD MADISON ST-ADT = 850

LOCAL ROAD MONROE ST-ADT = 650 WEST ADAMS STREET:

TOTAL LENGTH OF PROJECT = 887.62 FEET = 0.168 MILES NET LENGTH OF PROJECT = 887.62 FEET = 0.168 MILES **NORTH MADISON STREET:** TOTAL LENGTH OF PROJECT = 769.45 FEET = 0.146 MILES **NET LENGTH OF PROJECT** 769.45 FEET = 0.146 MILES NORTH MONROE STREET: =


GRAPHIC SCALE IN MILES

TOTAL LENGTH OF PROJECT = 465.28 FEET = 0.088 MILES NET LENGTH OF PROJECT = 465.28 FEET = 0.088 MILES

SECTION COUNTY PIKE 144 1 24-00037-00-RS FLERNOTS CONTRACT NO. 93847

CONTRACT NO. 93847



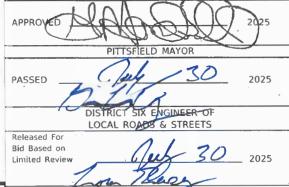

Hutchison

REGION FOUR ENGINEER STATE OF ILLINOIS DEPARTMENT OF TRANSPORTATION

GENERAL NOTES

- 1. THE LOCATION OF UNDERGROUND UTILITIES SHOWN ON THE PLANS REPRESENTS THE BEST KNOWLEDGE OF THE CITY AND THE INDICATED ADJUSTMENTS OR RECONSTRUCTION ARE CONSIDERED TO BE REASONABLY ACCURATE. IT SHALL BE THE CONTRACTORS RESPONSIBILITY TO VERIFY LOCATIONS OF UNDERGROUND INSTALLATIONS BEFORE STARTING CONSTRUCTION OPERATIONS. THE CONTRACTOR SHALL INDEMNIFY THE CITY, ITS OFFICERS, AND EMPLOYEES AGAINST ALL CLAIMS DUE TO DAMAGE TO CORPORATE OR PRIVATE PROPERTY RESULTING FROM HIS CONSTRUCTION OPERATIONS AS DESCRIBED IN ARTICLE 107.20 AND 107.26 OF THE STANDARD SPECIFICATIONS FOR ROAD AND BRIDGE CONSTRUCTION.
- THE CONTRACTOR MAY BE REQUIRED TO CONDUCT SOME OF HIS GRADING AND TRENCHING OPERATIONS AROUND TRANSMISSION POLES AND UNDER TRANSMISSION LINES. THE ADDED COST OF DOING SO SHALL BE INCLUDED WITH THE COST OF THE STORM SEWER.
- 3. EXISTING CONCRETE SIGN BASES, SIGN POSTS, WOOD PLANTERS AND MISCELLANEOUS CONCRETE NOT SPECIFICALLY SHOWN ON THE PLANS, BUT INTERFERING WITH PROPOSED CONSTRUCTION, SHALL BE REMOVED. COST OF THIS WORK SHALL BE INCLUDED IN THE COST OF THE SIDEWALK REMOVAL.
- 4. WHERE SECTION OR SUB-SECTION MONUMENTS ARE ENCOUNTERED, THE ENGINEER SHALL BE NOTIFIED BEFORE SUCH MONUMENTS ARE REMOVED. THE CONTRACTOR SHALL PROTECT AND PRESERVE PROPERTY MARKERS AND MONUMENTS UNTIL THE OWNER, AN AUTHORIZED SURVEYOR OR AGENT HAS WITNESSED OR OTHERWISE REFERENCED THEIR LOCATION.
- WHEREVER IN THESE PLANS REFERENCE IS MADE TO THE "STANDARD SPECIFICATIONS", IT IS UNDERSTOOD TO INCLUDE THE "SUPPLEMENTAL SPECIFICATIONS" INCLUDED IN THE PROPOSAL.
- 6. ALL ELEVATIONS SHOWN REFER TO THE U.S.G.S. DATUM NAVD 88.
- 7. THE CONTRACTOR WILL BE REQUIRED TO COMPLY WITH ALL STATE REGULATIONS REGARDING AIR, WATER AND NOISE POLLUTION. THE CONTRACTOR WILL NOT BE ALLOWED TO BUILD FIRES ON THE SITE
- 8. IT IS THE CONTRACTOR'S RESPONSIBILITY TO ASCERTAIN EXISTING FIELD CONDITIONS BEFORE BIDDING ON THIS PROJECT, SPECIFICALLY AS THEY RELATE TO THE LUMP SUM PAY ITEMS.
- 9. THE CONTRACTOR SHALL NOTIFY THE AGENCIES AND UTILITIES AT LEAST 10 (TEN) DAYS PRIOR TO ANY CONSTRUCTION IN THE AREA AND SHALL COMPLY WITH ALL RESTRICTIONS FOR EQUIPMENT MOVEMENTS AND CLEARANCES AS REGARDS TO THEIR FACILITIES.
- BEFORE STARTING ANY EXCAVATION, THE CONTRACTOR MUST CALL J.U.L.I.E. AT 1-800-892-0123 or 811
 FOR FIELD LOCATIONS OF BURIED ELECTRICAL, TELEPHONE, GAS FACILITIES, AND ALL PUBLIC
 UTILITIES. A 48 HOUR NOTIFICATION IS REQUIRED.
- 11. THE CONTRACTOR SHALL USE ALL NECESSARY PRECAUTIONS AND PROTECTIVE MEASURES REQUIRED TO MAINTAIN EXISTING UTILITIES, SEWER AND APPURTENANCES THAT MUST BE KEPT IN OPERATION. IN PARTICULAR, THE CONTRACTOR WILL TAKE ADEQUATE MEASURES TO PREVENT THE UNDERMINING OF UTILITIES AND SEWERS WHICH ARE STILL IN SERVICE. ANY DAMAGE TO THE EXISTING UTILITIES CAUSED BY THE CONTRACTOR'S WORK SHALL BE REPAIRED BY THE CONTRACTOR AT HIS/HER EXPENSE.
- 12. VERIFICATION OF DIMENSIONS: IT IS THE CONTRACTOR'S RESPONSIBILITY TO VERIFY ALL DIMENSIONS AND CONDITIONS EXISTING IN THE FIELD PRIOR TO CONSTRUCTION AND ORDERING MATERIALS.
- 13. THE CONTRACTOR SHALL BE REQUIRED TO PROVIDE ACCESS TO ABUTTING PROPERTY OWNERS AT ALL TIMES DURING CONSTRUCTION OF THE PROJECT.
- 14. DURING CONSTRUCTION OPERATIONS, IF ANY LOOSE MATERIAL IS DEPOSITED IN THE FLOW LINE OF DITCHES, GUTTERS OR DRAINAGE STRUCTURES SO THAT THE NATURAL FLOW OF WATER IS OBSTRUCTED, IT SHALL BE REMOVED AT THE CLOSE OF EACH WORKING DAY. AT THE CONCLUSION OF CONSTRUCTION OPERATIONS, ALL DRAINAGE STRUCTURES SO AFFECTED SHALL BE FREE FROM ALL DEBRIS. THIS WORK SHALL BE INCLUDED WITH THE COST OF THE DRAINAGE STRUCTURES INVOLVED.
- 15. ALL FRAMES, GRATES, SIGNS, FENCES AND DELINEATORS, DRIVEWAY PAVEMENT, CURB AND GUTTER, SIDEWALK, NEW OR EXISTING, DAMAGED THROUGH CONTRACTOR'S NEGLIGENCE DURING CONSTRUCTION SHALL BE REPLACED BY THE CONTRACTOR AT NO ADDITIONAL COST TO THE DEPARTMENT.
- 16. THE COST OF ADDITIONAL LABOR AND MATERIALS NOT ACCOUNTED FOR ON THE PLANS, WHICH MIGHT BE INVOLVED IN CONNECTING EXISTING DRAIN TILE OR STORM SEWERS TO PROPOSED DRAINAGE STRUCTURES, SHALL BE INCLUDED WITH THE COST OF THE STORM SEWER.
- 17. THE ENDS OF EXISTING DRAINAGE LINES WHICH ARE NOT TO BE INCORPORATED INTO THE PROPOSED IMPROVEMENT ARE TO BE SEALED (PLUGGED) TO THE SATISFACTION OF THE ENGINEER. COST OF SUCH WORK SHALL BE INCLUDED WITH THE COST OF THE STORM SEWER.
- 18. THE CONTRACTOR SHALL COMPLY WITH THE ENVIRONMENTAL PROTECTION AGENCY (E.P.A.) REGULATIONS WHICH APPLY TO STORM SEWER CONSTRUCTION REGARDING THE HORIZONTAL AND VERTICAL SEPARATION OF A STORM SEWER LINE FROM ANY EXISTING OR PROPOSED WATER MAIN, AT LOCATIONS WHERE THE SEPARATION IS INADEQUATE, THE CONTRACTOR SHALL ADJUST THE WATER MAIN TO PROVIDE THE REQUIRED SEPARATION OR CONSTRUCT THE STORM SEWER OF THE MATERIAL SPECIFIED IN THE E.P.A. REGULATIONS.
- 19. THE ELEVATIONS AND EXACT SIZE OF ALL EXISTING WATER MAINS AND SANITARY SEWERS SHALL BE DETERMINED BY THE CONTRACTOR PRIOR TO BEGINNING CONSTRUCTION OF EACH RUN OF STORM SEWER TRUNK LINE OR LATERAL LINE WITHIN WHICH A CROSSING OF EITHER OR BOTH TYPES OF THESE EXISTING UTILITIES IS TO BE ENCOUNTERED. THE CONTRACTOR SHALL THEN DETERMINE WHICH OF THE ABOVE OPTIONS HE WILL USE TO RESOLVE THE CONFLICT BETWEEN THE PROPOSED STORM SEWER AND THE EXISTING UTILITY. THE APPROVAL OF THE RESIDENT ENGINEER AND THE SUPERINTENDENT OF THE UTILITY SHALL BE OBTAINED BY THE CONTRACTOR PRIOR TO STARTING CONSTRUCTION OF THIS SEGMENT OF STORM SEWER.
- 20. FOR INLETS AND MANHOLES CONSTRUCTED IN CONJUNCTION WITH THE CURB/GUTTER, THE OFFSET DISTANCE SHOWN ON THE PLANS IS FROM THE CENTERLINE OF CONSTRUCTION TO THE FACE OF CURB/GUTTER. IT SHALL BE THE RESPONSIBILITY OF THE CONTRACTOR TO CONSTRUCT EACH INLET OR MANHOLE AT THE PROPOSED LOCATION SO THAT THE FRAME MATCHES THE CURB LINE.
- 21. THE CONTRACTOR SHALL COOPERATE WITH THE CITY OF PITTSFIELD ON ANY UNDERGROUND CONSTRUCTION WHICH THE CITY MAY WISH TO PLACE BEFORE THE PROJECT IS COMPLETED.
- 22. THE REMOVAL OF HOT-MIX ASPHALT SURFACING ON A RIGID TYPE BASE SHALL BE REMOVED WITH THE BASE AS PAVEMENT REMOVAL.
- 23. WHENEVER IT IS NECESSARY TO REMOVE BITUMINOUS AGGREGATE MIXTURE, OIL AND CHIP SURFACE, EXISTING GRAVEL OR CRUSHED STONE BASE COURSE, IT SHALL BE REMOVED AND INCLUDED IN THE COST OF PREPARATION OF BASE.
- 24. FRAMES AND GRATES ON EXISTING STRUCTURES, PIPE CULVERTS AND WATER MAIN WHICH ARE TO BE REMOVED, ABANDONED, OR WHICH OTHERWISE ARE NOT INCORPORATED INTO THE IMPROVEMENT SHALL BECOME THE PROPERTY OF THE CITY OF PITTSFIELD. THE CONTRACTOR SHALL STORE THE FRAMES AND GRATES WITHIN THE RIGHT OF WAY AT LOCATIONS DESIGNATED BY THE ENGINEER.

DESIGNED - AWM

DRAWN - JCW

CHECKED - AWM

- 11/22/2024

DATE

REVISED -

REVISED -

REVISED -

REVISED -

JSER NAME = JWhite

PLOT DATE = 11/22/2024

Hutchison

- 25. ALL SIDEWALKS ADJACENT TO DEPRESSED CURBS AT ADA SIDEWALK RAMP LOCATIONS SHALL BE THICKEDD TO 6 INCHES FOR A DISTANCE NO LESS THAN 3 FOOT BEYOND THE BACK OF CURB THIS WORK SHALL BE INCLUDED IN THE COST OF THE SIDEWALK.
- 26. THE FOLLOWING MIXTURE REQUIREMENTS ARE APPLICABLE FOR THIS PROJECT:

MIXTURE USES	HMA	HMA
MIXTORE USES	SURF CRSE	BINDER CRSE
AC/PG	PG 64-22	PG 64-22
DESIGN AIR VOIDS	4% @ N50	4% @ N50
MIX COMPOSITION:	IL-9.5	IL-9.5FG
(GRADATION MIXTURE)		
FRICTION AGGREGATE	MIX C"	N/A
QUALITY MANAGEMENT	QC/QA	QC/QA

HMA QUANTITIES CALCULATED USING 112 LB/SY/IN

LEGEND

0	PROPOSED MANHOLE
-	PROPOSED INLET
$^{\mathbb{B}}$	TRENCH BACKFILL - CU YD
(II 11.5)	PAVEMENT PATCHING, TYPE & SQ YD

SSWMR	STORM SEWER (WATER MAIN REQUIREMEN
L = XXX	LID ELEVATION
G = XXX	GRATE ELEVATION
TC = XXX	TOP OF CURB ELEVATION

1V = XXX	INVERT ELEVATION
L = XXX	FLOWLINE ELEVATION
	PAVEMENT PATCHING 8" OF TYP



STANDARDS

000001-08	STANDARD SYMBOLS, ABBREVIATIONS AND PATTERNS
280001-07	TEMPORARY EROSION CONTROL SYSTEMS
420001-10	PAVEMENT JOINTS
424001-12	PERPENDICULAR CURB RAMPS FOR SIDEWALKS
424006-06	DIAGONAL CURB RAMPS FOR SIDEWALKS
424026-04	ENTRANCE/ALLEY PEDESTRIAN CROSSING
442201-03	CLASS C AND D PATCHES
602301-04	INLET - TYPE A
602306-03	INLET - TYPE B
602401-07	PRECAST MANHOLE TYPE A 4' (1.22m) DIAMETER
602601-06	PRECAST REINFORCED CONCRETE FLAT SLAB TOP
602701-02	MANHOLE STEPS
604001-05	FRAME AND LIDS TYPE 1
604006-05	FRAME AND GRATE TYPE 3
606001-08	CONCRETE CURB TYPE B AND COMBINATION CONCRETE CURB AND GUTTER
701501-06	URBAN LANE CLOSURE, 2L, 2W, UNDIVIDED
701601-09	URBAN LANE CLOSURE, MULTILANE, 1W OR 2W WITH NONTRAVERSABLE MEDIAN
701701-10	URBAN LANE CLOSURE, MULTILANE INTERSECTION
701801-06	SIDEWALK, CORNER OR CROSSWALK CLOSURE
701901-10	TRAFFIC CONTROL DEVICES
720001-01	SIGN PANEL MOUNTING DETAILS
720006-04	SIGN PANEL ERECTION DETAILS
728001-01	TELESCOPING STEEL SIGN SUPPORT
780001-05	TYPICAL PAVEMENT MARKINGS
836001-05	LIGHT POLE FOUNDATION
BLR 21-9	TYPICAL APPLICATION OF TRAFFIC CONTROL DEVICES FOR CONSTRUCTION ON RURAL LOCAL HIGHWAYS

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STATE OF ILLINOIS
DEPARTMENT OF TRANSPORTATION

PITTSFIELD HISTORIC DOWNTOWN SQUARE RECONSTRUCTION

GENERAL NOTES, LEGEND, STANDARDS, AND INDEX OF SHEETS

ENONE SHEET OF SHEETS STA. TO STA.

SECTION COUNTY SHEETS N

24-00037-00-RS PIKE 144

CONTRACT NO. 93847

HE)	Hutchiso Engineering, Ir

	USER NAME = JWhite	DESIGNED	-	AWM	REVISED	-
		DRAWN	-	JCW	REVISED	-
		CHECKED	-	AWM	REVISED	-
5	PLOT DATE = 11/22/2024	DATE	-	11/22/2024	REVISED	-
	,					

STATE OF ILLINOIS **DEPARTMENT OF TRANSPORTATION**

80% ITEP

20% LOCAL

0028

410

0.25

23

23

23

25

1200

24

2966

4101

1389

TOTAL

QUANTITY

625

0.25

23

23

23

25

1200

24

2966

4101

1389

7975

216

UNIT

CU YD

ACRE

POUND

POUND

POUND

POUND

FOOT

EACH

SQ YD

SQ YD

TON

POUND

SQ YD

50% ITEP

50% LOCAL

0028

URBAN

SAFETY HIGHWAY LIGHTING ROADWAY

100% LOCAL

0028

215

PITTSFIELD HISTORIC DOWNTOWN SQUARE RECONSTRUCTION								
SUMMARY OF QUANTITIES								
SCALE: NONE	SHEET 1	OF	9	SHEETS	STA.	TO STA		

7975

216

COUNTY TOTAL SHEET NO.

PIKE 144 3 SECTION 24-00037-00-RS CONTRACT NO. 93847

*	SPI	ECIALTY	ITEM	

*	SPF	$\Delta I \supset \overline{A}$	I TY	ITEN

40600990 TEMPORARY RAMP

CODE

20800150 TRENCH BACKFILL

25000115 SEEDING, CLASS 1B

25000400 NITROGEN FERTILIZER NUTRIENT

25000500 PHOSPHORUS FERTILIZER NUTRIENT

25000600 POTASSIUM FERTILIZER NUTRIENT

28000250 TEMPORARY EROSION CONTROL SEEDING

35300300 PORTLAND CEMENT CONCRETE BASE COURSE 8"

25100630 EROSION CONTROL BLANKET

28000400 PERIMETER EROSION BARRIER

28000500 INLET AND PIPE PROTECTION

35800100 PREPARATION OF BASE

35800200 AGGREGATE BASE REPAIR

40600290 BITUMINOUS MATERIALS (TACK COAT)

ITEM

(HE)	Hutchison Engineering, Inc

	USER NAME = JWhite	DESIGNED	-	AWM	REVISED	-
		DRAWN	-	JCW	REVISED	-
		CHECKED	-	AWM	REVISED	-
5	PLOT DATE = 11/22/2024	DATE	-	11/22/2024	REVISED	-

STATE OF ILLINOIS DEPARTMENT OF TRANSPORTATION

PITTSFIELD HISTORIC DOWNTOWN SQUARE RECONSTRUCTION									
SUMMARY OF QUANTITIES									
SCALE: NONE	SHEET 2	OF	9	SHEETS	STA.	TO STA			

 COUNTY
 TOTAL SHEETS NO.

 PIKE
 144
 4

 CONTRACT NO. 93847
 SECTION 24-00037-00-RS

			80% IIEP	50% IIEP		
				20% LOCAL	50% LOCAL	100% LOCAL
				SAFETY	HIGHWAY LIGHTING	ROADWAY
CODE			TOTAL	0028	0028	0028
NO.	ITEM	UNIT	QUANTITY		URBAN	
40602965	HOT-MIX ASPHALT BINDER COURSE, IL-9.5FG, N50	TON	1290			1290
40604050	HOT-MIX ASPHALT SURFACE COURSE, IL-9.5, MIX "C", N50	TON	993			993
42001300	PROTECTIVE COAT	SQ YD	4856	4856		
42300400	PORTLAND CEMENT CONCRETE DRIVEWAY PAVEMENT, 8 INCH	SQ YD	291	291		
42400100	PORTLAND CEMENT CONCRETE SIDEWALK 4 INCH	SQ FT	30530	30530		
42400800	DETECTABLE WARNINGS	SQ FT	393	393		
44000100	PAVEMENT REMOVAL	SQ YD	5644	5644		
44000156	HOT-MIX ASPHALT SURFACE REMOVAL, 1 3/4"	SQ YD	8555			8555
	,					
44000200	DRIVEWAY PAVEMENT REMOVAL	SQ YD	125	125		
44000500	COMBINATION CURB AND GUTTER REMOVAL	FOOT	1974	1974		
44000600	SIDEWALK REMOVAL	SQ FT	29229	29229		
44200089	PAVEMENT PATCHING, TYPE I, 8 INCH	SQ YD	5	5		
44200094	PAVEMENT PATCHING, TYPE II, 8 INCH	SQ YD	153	144		9
44200099	PAVEMENT PATCHING, TYPE III, 8 INCH	SQ YD	41	25		16
		54.15	1 ''			
	1				1	

80% ITEP

50% ITEP

* SPECIALTY ITEM

(HE)	Hutchison Engineering, Inc

STATE OF ILLINOIS DEPARTMENT OF TRANSPORTATION

PITTSFIELD HISTORIC DOWNTOWN SQUARE RECONSTRUCTION
SUMMARY OF QUANTITIES

SCALE: NONE SHEET 3 OF 9 SHEETS STA. TO STA

*	SPE	CIALTY	ITEM

	T	1	T	80% ITEP 20% LOCAL	50% ITEP 50% LOCAL HIGHWAY LIGHTING	100% LOCAL ROADWAY
CODE			TOTAL	SAFETY 0028	0028	0028
NO.	ITEM	UNIT	QUANTITY		URBAN	3323
44200101	PAVEMENT PATCHING, TYPE IV, 8 INCH	SQ YD	188	117		71
50901760	PIPE HANDRAIL	FOOT	261	261		
55100300	STORM SEWER REMOVAL 8"	FOOT	26	26		
55100400	STORM SEWER REMOVAL 10"	FOOT	383	383		
55100500	STORM SEWER REMOVAL 12"	FOOT	448	448		
56100700	WATER MAIN 8"	FOOT	2070			2070
56105000	WATER VALVES 8"	EACH	11			11
56108800	TAPPING VALVES AND SLEEVES 6"	EACH	1			1
56109000	TAPPING VALVES AND SLEEVES 10"	EACH	1			1
56200300	WATER SERVICE LINE 1"	FOOT	654			654
56200500	WATER SERVICE LINE 1 1/2"	FOOT	254			254
56200700	WATER SERVICE LINE 2"	FOOT	86			86
56300100	ADJUSTING SANITARY SEWERS, 8-INCH DIAMETER OR LESS	FOOT	100			100
56300200	ADJUSTING SANITARY SEWERS, OVER 8-INCH DIAMETER	FOOT	100			100

(HE)	Hutchiso Engineering, Ir

	USER NAME = JWhite	DESIGNED	-	AWM	REVISED	
n		DRAWN	-	JCW	REVISED	-
C.		CHECKED	-	AWM	REVISED	-
075	PLOT DATE = 11/22/2024	DATE	-	11/22/2024	REVISED	

STATE OF ILLINOIS DEPARTMENT OF TRANSPORTATION

PITTSFIELD HISTORIC DOWNTOWN SQUARE RECONSTRUCTION										
SUMMARY OF QUANTITIES										
SCALE: NONE	SHEET 4	OF	9	SHEETS	STA.	TO STA				

*	SPECIALTY	ITEM

				80% ITEP 20% LOCAL SAFETY	50% ITEP 50% LOCAL HIGHWAY LIGHTING	100% LOCAL
CODE			TOTAL	0028	0028	0028
NO.	ITEM	UNIT	QUANTITY		URBAN	
56400500	FIRE HYDRANTS TO BE REMOVED	EACH	5			5
56500500	DOMESTIC METER VAULTS	EACH	15			15
			1			
60218400	MANHOLES, TYPE A, 4'-DIAMETER, TYPE 1 FRAME, CLOSED LID	EACH	4	4		
60218500	MANHOLES, TYPE A, 4'-DIAMETER, TYPE 3 FRAME AND GRATE	EACH	2	2		
60234200	INLETS, TYPE A, TYPE 1 FRAME, OPEN LID	EACH	1	1		
60235700	INLETS, TYPE A, TYPE 3 FRAME AND GRATE	EACH	16	16		
60240220	INLETS, TYPE B, TYPE 3 FRAME AND GRATE	EACH	5	5		
60255500	MANHOLES TO BE ADJUSTED	EACH	3			3
60500040	REMOVING MANHOLES	EACH	2	2		
30300040	TEMOTING IN UTILIZE	2.011				
60500060	REMOVING INLETS	EACH	6	6		
60604400	COMBINATION CONCRETE CURB AND GUTTER, TYPE B-6.18	FOOT	4084	4084		
61139800	STORM SEWERS (SPECIAL), 4"	FOOT	100	100		
61139900	STORM SEWERS (SPECIAL), 6"	FOOT	100	100		
66900200	NON-SPECIAL WASTE DISPOSAL	CU YD	7	7		

(HE)	Hutchiso Engineering, In

	USER NAME = JWhite	DESIGNED	-	AWM	REVISED	-
1		DRAWN	-	JCW	REVISED	-
		CHECKED	-	AWM	REVISED	
75	PLOT DATE = 11/22/2024	DATE	-	11/22/2024	REVISED	

STATE OF ILLINOIS **DEPARTMENT OF TRANSPORTATION**

PITTSFIELD HISTORIC DOWNTOWN SQUARE RECONSTRUCTION									
	SI	JMMA	RY	OF QUA	NTITIE	S			
SCALE: NONE	SHEET 5	OF	9	SHEETS	STA.	TO STA			

COUNTY TOTAL SHEET NO.

PIKE 144 7 SECTION 24-00037-00-RS CONTRACT NO. 93847

*	SPECIALTY	ITEM

72000100 SIGN PANEL - TYPE 1

70300261 TEMPORARY PAVEMENT MARKING - LINE 12"- PAINT

70300281 TEMPORARY PAVEMENT MARKING - LINE 24"- PAINT

CODE

NO.

66900530	SOIL DISPOSAL ANALYSIS	EACH	1	1	
66901001	REGULATED SUBSTANCES PRE-CONSTRUCTION PLAN	L SUM	1	1	
66901003	REGULATED SUBSTANCES FINAL CONSTRUCTION REPORT	L SUM	1	1	
66901006	REGULATED SUBSTANCES MONITORING	CAL DA	2	2	
67100100	MOBILIZATION	L SUM	1	1	
70300100	SHORT TERM PAVEMENT MARKING	FOOT	1428	1428	
70000100	or our religion where	1 001	1420	1420	
70300150	SHORT TERM PAVEMENT MARKING REMOVAL	SQ FT	476	476	
70300211	TEMPORARY PAVEMENT MARKING LETTERS AND SYMBOLS - PAINT	SQ FT	296		296
70300231	TEMPORARY PAVEMENT MARKING - LINE 5"- PAINT	FOOT	7457		7457
70300241	TEMPORARY PAVEMENT MARKING - LINE 6"- PAINT	FOOT	459		459
70200254	TEMPODADY DAVIENTAL MADVING. LINE OF DANK	5007	4000		4000
70300251	TEMPORARY PAVEMENT MARKING - LINE 8"- PAINT	FOOT	4000		4000

FOOT

FOOT

SQ FT

3078

308

308

ITEM

80% ITEP

20% LOCAL

0028

TOTAL

UNIT QUANTITY

50% ITEP 20% LOCAL 50% LOCAL 100% LOCAL SAFETY HIGHWAY LIGHTING ROADWAY

0028

URBAN

0028

3078

HE)	Hutchison Engineering, Ind

	USER NAME = JWhite	DESIGNED	-	AWM	REVISED	-
n		DRAWN	-	JCW	REVISED	-
c.		CHECKED	-	AWM	REVISED	-
75	PLOT DATE = 11/22/2024	DATE	-	11/22/2024	REVISED	-

* SPECIALTY ITEM

CODE

NO.

STATE OF ILLINOIS DEPARTMENT OF TRANSPORTATION

PITTSFIELD HISTORIC DOWNTOWN SQUARE RECONSTRUCTION									
SUMMARY OF QUANTITIES									
SCALE: NONE	SHEET 6	OF 9	SHEETS	STA.	TO STA				

COUNTY TOTAL SHEET NO.

PIKE 144 8 SECTION 24-00037-00-RS CONTRACT NO. 93847

*	78009000	MODIFIED URETHANE PAVEMENT MARKING - LETTERS AND SYMBOLS	SQ FT	296		296
*	78009005	MODIFIED URETHANE PAVEMENT MARKING - LINE 5"	FOOT	7457		7457
*	78009006	MODIFIED URETHANE PAVEMENT MARKING - LINE 6"	FOOT	459		459
*	78009008	MODIFIED URETHANE PAVEMENT MARKING - LINE 8"	FOOT	4000		4000
*	78009012	MODIFIED URETHANE PAVEMENT MARKING - LINE 12"	FOOT	3078		3078
*	78009024	MODIFIED URETHANE PAVEMENT MARKING - LINE 24"	FOOT	89		89
	78300202	PAVEMENT MARKING REMOVAL - WATER BLASTING	SQ FT	11777		11777
*						
^	80400100	ELECTRIC SERVICE INSTALLATION	EACH	1	1	
*	81028330	UNDERGROUND CONDUIT, PVC, 1 1/4" DIA.	FOOT	627	627	
·	61020330	UNDERGROUND CONDUIT, PVC, 1 1/4 DIA.	FOOI	021	627	
*	81028340	UNDERGROUND CONDUIT, PVC, 1 1/2" DIA.	FOOT	5346	5346	
	01020340	UNDERCROOME CONDUIT, I VC, I 1/2 DIA.	1 001	3340	3340	
*	81028350	UNDERGROUND CONDUIT, PVC, 2" DIA.	FOOT	100	100	
*	81028390	UNDERGROUND CONDUIT, PVC, 4" DIA.	FOOT	100	100	
*	81400730	HANDHOLE, COMPOSITE CONCRETE	EACH	8	8	
*	81702130	ELECTRIC CABLE IN CONDUIT, 600V (XLP-TYPE USE) 1/C NO. 6	FOOT	14378	14378	

ITEM

80% ITEP

TOTAL UNIT QUANTITY

50% ITEP
 20% LOCAL
 50% LOCAL
 100% LOCAL

 SAFETY
 HIGHWAY LIGHTING
 ROADWAY

 0028
 0028
 0028

URBAN

(HE)	Hutchison Engineering, Inc

	USER NAME = JWhite	DESIGNED	-	AWM	REVISED	-
١.		DRAWN	-	JCW	REVISED	-
		CHECKED	-	AWM	REVISED	-
5	PLOT DATE = 11/22/2024	DATE	-	11/22/2024	REVISED	-

* SPECIALTY ITEM

STATE OF ILLINOIS DEPARTMENT OF TRANSPORTATION

PITTSFIELD HISTORIC DOWNTOWN SQUARE RECONSTRUCTION										
	SUMMARY OF QUANTITIES									
SCALE: NONE	SHEET 7	OF	9	SHEETS	STA.	TO STA				

			1	1	20% LOCAL SAFETY	50% ITEP 50% LOCAL HIGHWAY LIGHTING	100% LOCAL
	CODE			TOTAL	0028	0028	0028
	NO.	ITEM	UNIT	QUANTITY	0020	URBAN	0020
*	81702140	ELECTRIC CABLE IN CONDUIT, 600V (XLP-TYPE USE) 1/C NO. 4	FOOT	4056	4056		
*	81702150	ELECTRIC CABLE IN CONDUIT, 600V (XLP-TYPE USE) 1/C NO. 2	FOOT	116	116		
*	84200500	REMOVAL OF LIGHTING UNIT, SALVAGE	EACH	3	3		
*	84200600	REMOVAL OF LIGHTING UNIT, NO SALVAGE	EACH	18	18		
*	A2001820	TREE, ACER SACCHARUM GREEN MOUNTAIN (GREEN MOUNTAIN SUGAR MAPLE). 2-1/2" CALIPER. BALLED AND BURLAPPED	EACH	1	1		
*	A2002520	TREE, CARPINUS CAROLINIANA (AMERICAN HORNBEAM), 2-1/2" CALIPER, BALLED AND BURLAPPED	EACH	2	2		
*	A2007724	TREE, TAXODIUM DISTICHUM SHAWNEE BRAVE (SHAWNEE BRAVE BALD CYPRESS). 3" CALIPER. BALLED AND BURLAPPED	EACH	2	2		
*	K0012990	PERENNIAL PLANTS, ORNAMENTAL TYPE, GALLON POT	UNIT	0.78	0.78		
*	K0013020	PERENNIAL PLANTS, PRAIRIE TYPE, GALLON POT	UNIT	0.84	0.84		
	10013020	I EIGHNIAET DAVIO, I VAINE III E, GALLOVI OI	ONT	0.04	0.04		
*	X0325495	LANDSCAPE PLANTER	EACH	15	15		
*	X0326654	ORNAMENTAL LIGHT UNIT, COMPLETE	EACH	25	25		
*	X0327547	ABANDON EXISTING UTILITIES	L SUM	1			1
	AU321341	ADAIDON EVIOLINO OLIFILES	L SUIVI	'			1
	X0327997	TRASH RECEPTACLES	EACH	5			5
*	X1400403	LUMINAIRE REPLACEMENT SPECIAL	EACH	13	13		

80% ITEP

50% ITEP

(HE)	Hutchison Engineering, Ind
24	JOB# 507

STATE OF ILLINOIS DEPARTMENT OF TRANSPORTATION

PITTSFIELD HISTORIC DOWNTOWN SQUARE RECONSTRUCTION
SUMMARY OF QUANTITIES

SCALE: NONE SHEET 8 OF 9 SHEETS STA. TO STA

*	X1400431	LIGHTING ASSEMBLY (SPECIAL)	EACH	11		11	
	X1700067	STAMPED COLORED PORTLAND CEMENT CONCRETE SIDEWALK, 5 INCH	SQ FT	7556	7556		
*	X2110100	TOPSOIL FURNISH AND PLACE (SPECIAL)	CU YD	276	276		
	X4021000	TEMPORARY ACCESS (PRIVATE ENTRANCE)	EACH	60	60		
	X4022000	TEMPORARY ACCESS (COMMERCIAL ENTRANCE)	EACH	13	13		
	X5220090	RETAINING WALL (SPECIAL)	SQ FT	88			88
*	X5610020	WATER MAIN ENCASEMENT	FOOT	162			162
*	X5610675	WATER MAIN ABANDONMENT	EACH	1			1
*	X5610746	WATER MAIN LINE STOP 6"	EACH	6			6
*	X5610748	WATER MAIN LINE STOP 8"	EACH	4			4
*	X5640175	FIRE HYDRANT COMPLETE	EACH	5			5
	X6061005	CONCRETE CURB, TYPE B (SPECIAL)	FOOT	36	36		
*	X6640618	ORNAMENTAL FENCE	FOOT	192	192		
	X7010216	TRAFFIC CONTROL AND PROTECTION, (SPECIAL)	L SUM	1	1		

ITEM

80% ITEP

20% LOCAL

0028

TOTAL

UNIT QUANTITY

SAFETY

50% ITEP

50% LOCAL

0028

URBAN

HIGHWAY LIGHTING

100% LOCAL ROADWAY0028

* SPECIALTY ITEM

CODE

NO.

(HE)	Hutchison Engineering, Inc.

	USER NAME = JWhite	DESIGNED	-	AWM	REVISED	-
1		DRAWN	-	JCW	REVISED	-
. l		CHECKED	-	AWM	REVISED	
75	PLOT DATE = 11/22/2024	DATE	-	11/22/2024	REVISED	

STATE OF ILLINOIS DEPARTMENT OF TRANSPORTATION

PITTSFIEL	PITTSFIELD HISTORIC DOWNTOWN SQUARE RECONSTRUCTION SUMMARY OF QUANTITIES						
SCALE: NONE	SHEET 9	OF 9	SHEETS	STA.	TO STA		

					SAFETY	HIGHWAY LIGHTING	ROADWAY
	CODE			TOTAL	0028	0028	0028
	NO.	ITEM	UNIT	QUANTITY		URBAN	
*	X7280105	TELESCOPING STEEL SIGN SUPPORT (SPECIAL)	FOOT	441	441		
*	X7290004	DECORATIVE SIGN POST	EACH	7	7		
*	X8250505	LIGHTING CONTROLLER (SPECIAL)	EACH	1	1		
*				<u> </u>			
	X8780105	CONCRETE FOUNDATIONS (SPECIAL)	EACH	1	1		
	XX008870	STREET CLOCK	EACH	1	1		
	Z0003850	BENCHES	EACH	6	6		
	Z0003855	BICYCLE RACKS	EACH	2	2		
	Z0012450	CONCRETE STEPS	CU YD	8.5	8.5		
#	Z0076600	TRAINEES	HOUR	2000			
	Z0013798	CONSTRUCTION LAYOUT	L SUM	1	1		
#	Z0076604	TRAINEES TRAINING PROGRAM GRADUATE	HOUR	2000			
	Z0056608	STORM SEWER (WATER MAIN REQUIREMENTS) 12 INCH	FOOT	1585	1585		

80% ITEP

20% LOCAL

50% ITEP

50% LOCAL

100% LOCAL

* SPECIALTY ITEM


Hutchison

USER NAME - JVVIIILE	DESIGNED -	KEVISED -
	DRAWN -	REVISED -
	CHECKED -	REVISED -
PLOT DATE = 7/28/2025	DATE -	REVISED -

STATE OF ILLINOIS						
DEPARTMENT OF TRANSPORTATION						

SCALE: NONE

PITTSFIELD HISTORIC DOWNTOWN SQUARE RECONSTRUCTION						SECTION COUNTY			COUNTY	TOTAL SHEETS	SHEET NO.	
EXISTING TYPICAL SECTIONS					24-00037-00-RS			PIKE	144	12	ı	
		311110 1	IIIOAL	old i loi					CONTRACT	NO. 938	347	ı
LE: NONE	SHEET 1	OF 2	SHEETS	STA.	TO STA.		ILLINOIS	FED. AID	PROJECT			Ĺ

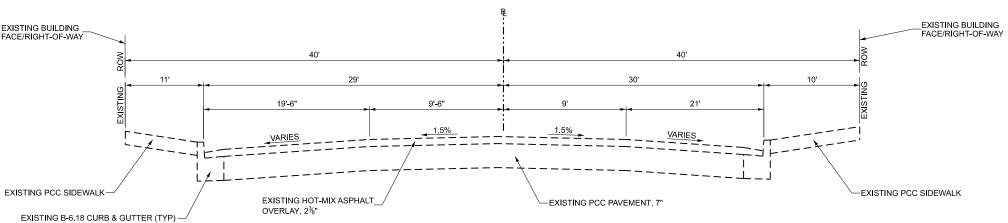


EXISTING TYPICAL SECTION ADAMS STREET ALLEY TO MADISON ST STA 32+10.25 TO STA 34+20.66

Hutchison Engineering, Inc.
Since 1945

EVISED -
EVISED _
EVISED -
١

STATE OF ILLINOIS
DEPARTMENT OF TRANSPORTATION

	PITTSFIELD HISTORIC DOWNTOWN SQUARE RECONSTRUCTION EXISTING TYPICAL SECTIONS							SECTION	COUNTY	TOTAL SHEETS	SHEET NO.
l								24-00037-00-RS	PIKE	144	13
ļ									CONTRACT	NO. 938	347
l	SCALE: NONE	SHEET 2	OF 2	SHEETS	STA.	TO STA.	ILLINOIS FED. AID PROJECT				

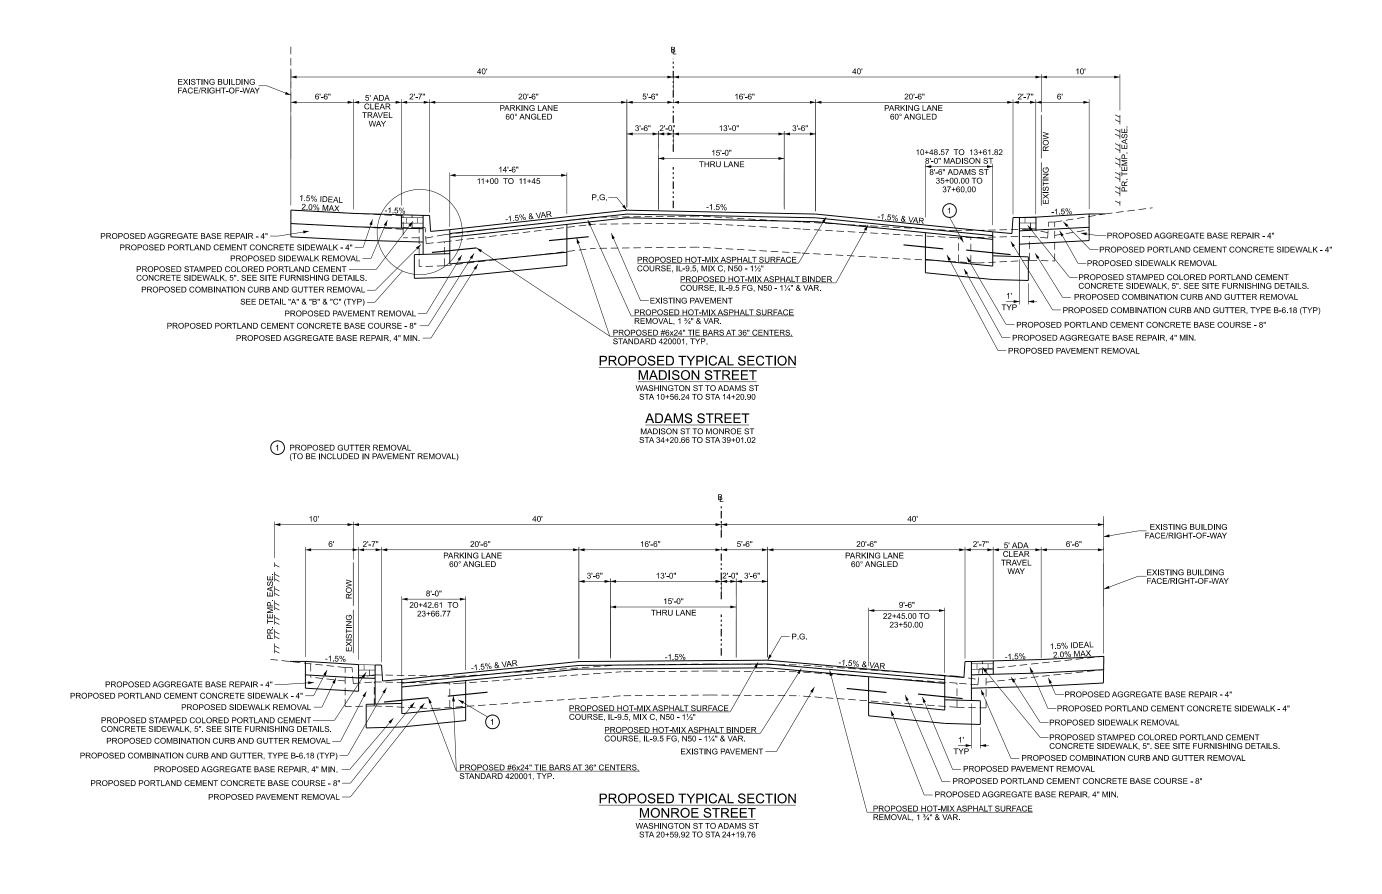



(HE)	Hutchison Engineering, Inc.
	Cinco 104E

USER NAME = JWhite	DESIGNED -	REVISED -
	DRAWN -	REVISED -
	CHECKED -	REVISED -
PLOT DATE = 7/28/2025	DATE -	REVISED -

STATE OF ILLINOIS
DEPARTMENT OF TRANSPORTATION

PITTSFIELD HISTORIC DOWNTOWN SQUARE RECONSTRUCTION						SECTION	COUNTY	TOTAL SHEETS	SHEET NO.
PROPOSED TYPICAL SECTIONS						24-00037-00-RS	PIKE	144	14
		UJL	J I II IOAL	. SECTIO	,110		CONTRACT	NO. 938	347
SCALE: NONE	SHEET 1	OF	2 SHEETS	STA.	TO STA.	ILLINOIS FED.	AID PROJECT		

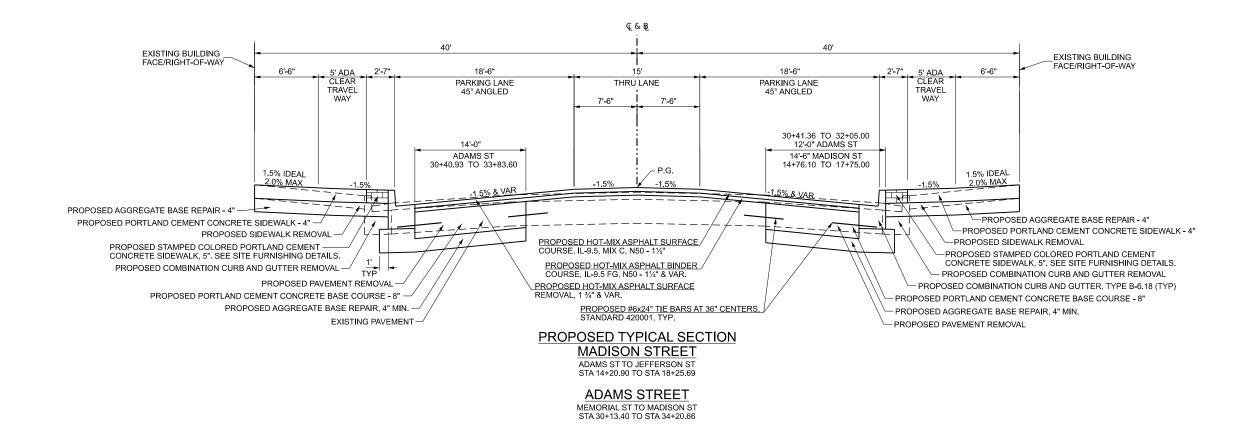


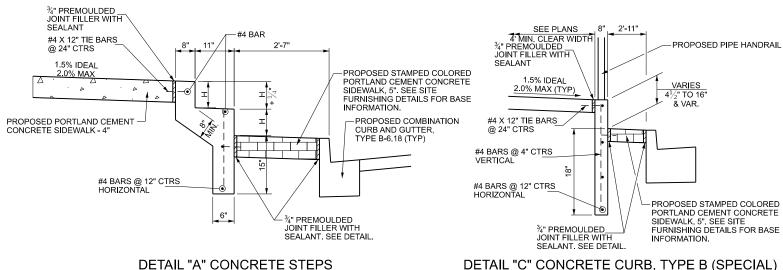



MADISON STREET MADISON STREET STA 10+48.57 LT TO STA 10+59.26 LT (H = 7" STEPS) STA 10+68.82 LT TO STA 10+83.32 LT (H = 8" STEPS)

STA 10+59.26 LT TO STA 10+68.82 LT STA 10+83.32 LT TO STA 10+93.82 LT STA 11+33.32 LT TO STA 11+48.82 LT

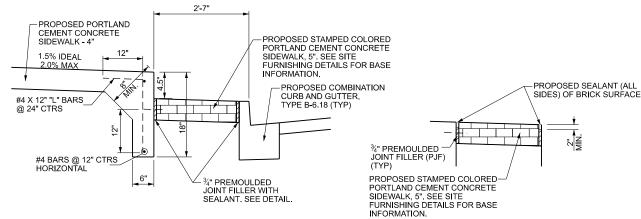

DETAIL "B" CONCRETE STEPS

MADISON STREET STA 11+48.82 LT TO STA 12+00.68 LT

PREMOUI DEI	I ED DETAIL

1	
(HFI)	Hutchison
(IIII)	Engineering, Inc.
	Since 10/15

USER NAME = JWhite	DESIGNED -	REVISED -
	DRAWN -	REVISED -
	CHECKED -	REVISED -
PLOT DATE = 7/28/2025	DATE -	REVISED -

STA 10+93.82 LT TO STA 11+33.32 LT (H = 7.5" STEPS)

STATE OF ILLINOIS **DEPARTMENT OF TRANSPORTATION**

PITTSFIELD HISTORIC DOWNTOWN SQUARE RECONSTRUCTION						SEC	TION		COUNTY	TOTAL SHEETS	SHEET NO.	
PROPOSED TYPICAL SECTIONS						24-0003	7-00-RS		PIKE	144	15	
	TROI GOLD TITIONE GLOTIONS									CONTRAC	T NO. 93	847
SCALE: NONE	SHEET 2	OF :	2 SHEETS	STA.	TO STA.			ILLINOIS	FED. AII	D PROJECT		

			60604400	X6061005	Z0012450	35800200	35800100	42001300
STATION TO STATION SIDE		COMBINATION CONCRETE CURB AND GUTTER, TYPE B-6.18	CONCRETE CURB, TYPE B (SPECIAL)	STEPS	BASE REPAIR	PREPARATION OF BASE	COAT	
			F00	Т	CU YD	TON	sq	/D
MADISON	STREET							
10+48.57	10+59.26	LT			1.1			3.2
10+48.57	13+80.56	LT	342.0			21.6	95.0	95.0
10+48.57	13+72.79	RT	329.0			20.8	91.4	91.4
10+59.29	10+68.82	LT		9.6				2.1
10+68.82	10+83.32	LT			1.2			4.7
10+83.32	10+93.32	LT		10.0				2.2
10+93.32	11+33.32	LT			3.2			12.6
11+33.32	11+48.82	LT		15.5				3.4
11+48.82	12+02.77	LT			2.8			9.2
14+61.29	18+24.40	LT	387.0			24.5	107.5	107.5
14+63.49	18+23.99	RT	388.5			24.6	107.9	107.9
MONROE S	TREET							
20+48.71	23+78.10	RT	336.6			21.3	93.5	93.5
20+50.43	23+72.38	LT	329.2			20.8	91.4	91.4
24+61.95	24+77.63	RT	22.2			1.4	6.2	6.2
24+69.96	24+85.19	LT	21.5			1.4	6.0	6.0
24+94.96	25+10.64	RT	15.7			1.0	4.4	4.4
ADAMS STI	REET							
30+14.74	34+12.02	RT	441.7			27.9	122.7	122.7
30+15.04	34+06.50	LT	436.2			27.6	121.2	121.2
34+34.41	38+27.25	LT	468.2			29.6	130.1	130.1
34+40.28	38+21.70	RT	429.7			27.2	119.4	119.4
38+49.45	38+97.46	RT	70.0			4.4	19.4	19.4
38+55.51	38+98.92	LT	65.8			4.2	18.3	18.3
TOTAL			4083.3	35.1	8.3	258.4	1134.3	1171.8
USE			4084	36	8.5	259	1135	1172

ENTRANCE SCHEDULE

			42300400	42001300	35800200	X4022000	
STATION TO STATION		SIDE	PORTLAND CEMENT CONCRETE DRIVEWAY PAVEMENT, 8 INCH	PROTECTIVE COAT	AGGREGATE BASE REPAIR	TEMPORARY ACCESS (COMMERCIAL ENTRANCE)	
			SQ YD		TON	EACH	
MADISON S	TREET						
12+00.68	12+20.85	LT	30.1	30.1	6.9	1	
16+15.94	16+42.10	RT	39.1	39.1	8.9	1	
16+22.48	16+42.65	LT	30.7	30.7	7.0	1	
16+67.01	16+90.53	LT	19.8	19.8	4.5	1	
16+77.29	17+05.81	RT	18.7	18.7	4.2	1	
MONROE ST	TREET						
22+00.28	22+20.45	RT	30.1	30.1	6.9	1	
22+32.26	22+47.77	RT	3.2	3.2	0.7	1	
22+70.75	22+86.27	RT	3.2	3.2	0.7	1	
ADAMS STR	EET						
31+35.35	31+60.87	LT	19.9	19.9	4.5	1	
32+00.17	32+20.34	RT	30.2	30.2	6.9	1	
32+00.19	32+20.36	LT	30.0	30.0	6.8	1	
34+60.82	34+80.76	LT	4.3	4.3	1.0	1	
36+19.85	36+40.02	LT	30.9	30.9	7.0	1	
TOTAL		·	290.1	290.1	66.1	13	
USE			291	291	67	13	

PLANTING BED SCHEDULE

			K0012990	K0013020				
			PERENNIAL PLANTS, GALLON POT					
STATION TO STATION		SIDE	ORNAMENTAL TYPE	PRAIRIE TYPE				
			UNI	I				
MADISON STREET								
17+04	18+04	RT		0.38				
MONROE S	STREET							
20+45	20+70	LT	0.78					
ADAMS ST	REET							
31+15	32+00	RT		0.31				
TOTAL			0.78	0.69				
USE			0.78	0.69				

STRUCTURE ADJUSTMENT AND REMOVAL SCHEDULE

		56400500	60255500	60500040	60500060						
STATION	OFFSET	FIRE HYDRANTS TO BE REMOVED		REMOVING MANHOLES	REMOVING INLETS						
			EACH								
MADISON	MADISON STREET										
11+97.80	30.65' LT	1									
13+68.53	31.54' LT			1							
13-79.13	30.27' LT	1									
13+81.80	15.34' LT			1							
14+92.46	00.34' RT		1								
18+20.66	29.20' LT				1						
MONROE	STREET										
22+23.64	30.81' RT	1									
ADAMS \$1	TREET										
30+19.22	29.28' RT				1						
30+20.68	29.73' LT				1						
31+11.83	31.86' RT		1								
33+55.32	1.01' LT		1								
33+77.56	29.73' RT				1						
33+77.66	28.60' LT				1						
36+18.12	31.20' LT	1									
38+02.56	30.66' LT	1									
38+11.53	29.47' RT				1						
TOTAL		5	3	2	6						
USE		5	3	2	6						

PAVEMENT SCHEDULE

40602965 BITUMINOUS HOT-MIX ASPHALT HOT-MIX ASPHALT

MATERIALS BINDER COURSE, IL SURFACE COURSE,

40600290

40604050

73.4 84.3 992.4 993

	PORTLAND	CEMENT	CONCRETE BASE COURSE SCHEDULE				
			35300300	35800100	35800200		
STATION TO STATION		SIDE	PORTLAND CEMENT CONCRETE BASE COURSE 8"	PREPARATION OF BASE	AGGREGATE BASE REPAIR		
			SQ YI)	TON		
MADISON ST	TREET						
10+48.57	13+61.82	RT	276.9	276.9	63.1		
11+00.00	11+45.00	LT	72.5	72.5	16.5		
13+61.82	14+76.11	LT/RT	791.7	791.7	180.3		
14+76.11	17+75.00	RT	497.1 497.1		113.2		
MONROE ST	REET						
20+42.61	23+61.77	LT	260.2	260.2	59.3		
22+45.00	23+50.00	RT	110.8	110.8 110.8			
ADAMS STRE	ET	, and the second		·			
30+40.93	33+83.60	LT	498.2	498.2	113.5		
30+41.11	32+05.00	RT	212.4	212.4	48.4		
35+00.00	37+60.00	RT	245.6	245.6	55.9		
TOTAL		, and the second	2965.4	2965.4	675.5		
USE			2966	2966	676		

		(TACK COAT) 9.5FG, N50		IL-9.5, MIX "C", N50
		POUND	T	ON
MADISON	STREET			
10+48.57	12+00.00	680.4	57.4	84.7
12+00.00	13+61.82	747.6	101.1	93.0
14+90.00	16+50.00	633.8	128.8	78.9
16+50.00	18+25.69	601.8	109.3	74.9
MONROE S	TREET			
20+42.51	22+00.00	702.8	81.9	87.5
22+00.00	23+54.27	713.6	141.3	88.8
ADAMS STI	REET			
30+13.56	32+05.00	670.7	83.0	83.5
32+05.00	33+52.72	574.5	96.7	71.5
33+52.72	34+86.28	625.8	64.9	77.9
34+86.28	36+50.00	756.1	106.9	94.1

	USE		7975	1290
	TOTAL		7974.4	1289.9
	37+81.05	39+01.02	677.6	168.7
	36+50.00	37+81.05	589.7	149.9
	34100.20	30+30.00	/50.1	100.5

STATION TO STATION

SIDEWALK SCHEDILLE

				SIDEWALK SC	HEDULE		
			42400100	42400800	X1700067	42001300	35800200
STATION TO STATION SIDE		SIDE	PORTLAND CEMENT CONCRETE SIDEWALK 4 INCH	DETECTABLE WARNINGS	STAMPED COLORED PORTLAND CEMENT CONCRETE SIDEWALK, 5 INCH	PROTECTIVE COAT	AGGREGATE BASE REPAIR
	SQ FT					SQ YD	TON
MADISON S	STREET						
10+48.07	12+00.68	LT	1627.1	10.0	302.5	180.8	20.6
10+48.57	13+75.20	RT	2040.5		607.6	226.7	25.8
12+20.85	13+81.01	LT	1855.9	10.0	519.3	206.2	23.5
14+60.68	16+15.94	RT	1457.0	10.0	493.2	161.9	18.4
14+61.13	16+22.48	LT	1791.1	10.0	474.9	199.0	22.7
16+42.10	18+23.39	RT	1495.9	30.0	259.4	166.2	18.9
16+42.65	18+23.82	LT	1010.0	30.0		112.2	12.8
MONROE S	TREET						
20+48.20	22+00.28	RT	1740.8	10.0	299.4	193.4	22.0
20+50.21	23+74.18	LT	1989.5		614.5	221.1	25.2
22+20.45	23+80.10	RT	1825.5	10.0	543.7	202.8	23.1
25+00.95	25+11.89`	RT	52.4			5.8	0.7
ADAMS STE	REET						
30+15.34	32+00.17	LT	1055.5	30.0	157.8	117.3	13.4
30+15.63	32+00.19	RT	1073.3	30.0		119.3	13.6
32+20.34	34+10.22	RT	2088.1	30.0	706.5	232.0	26.4
32+20.36	34+04.70	LT	2084.8	30.0	708.4	231.6	26.4
34+35.18	36+19.85	LT	1921.4	30.0	432.9	213.5	24.3
34+44.35	38+17.77	RT	2336.2	53.0	647.6	259.6	29.6
36+40.01	38+26.50	LT	2277.0	30.0	665.7	253.0	28.8
38+51.32	38+84.92	RT	339.4	20.0	121.8	37.7	4.3
38+57.39	39+01.02	LT	468.4	20.0		52.0	5.9
TOTAL			30529.8	393.0	7555.2	3392.2	386.3
USE			30530	393	7556	3393	387

VAULT AND TUNNEL SCHEDULE

	VACET AND TOWNER SCHEDOLE								
			20800150	X5220090	X0327547	44200094	44200099	44200101	
STATION TO STATION		SIDE	TRENCH BACKFILL	RETAINING WALL (SPECIAL)	ABANDON EXISTING	PAVEN	PAVEMENT PATCHING, 8"		
			DACKFILL	WALL (SPECIAL)	UTILITIES	TYPE II	TYPE III	TYPE IV	
			CU YD	SQ FT	LSUM		SQ YD		
MADISON STRE	ET								
10+56.05 10+	59.62	LT	0.6	10.0					
MONROE STREE	Т								
22+77.33		RT	4.8	9.0					
23+55.12		RT	2.2	6.0					
ADAMS STREET									
33+40.72		LT	1.2	12.5					
33+73.00		RT	1.8	6.0					
37+67.19 38+	82.07	LT/RT	204.4	44.0	1	9.0	15.9	70.3	
TOTAL			215.0	87.5	1.0	9.0	15.9	70.3	
USE		•	215	88	1	9	16	71	

PIPE HANDRAIL SCHEDULE

PIPE HANDRAIL SCHEDULE								
			50901760					
STATION T	O STATION	SIDE	PIPE HANDRAIL					
			FOOT					
MADISON S	STREET							
10+48.07	10+59.76	LT	15.1					
10+58.69	10+91.34	L	32.7					
10+68.32	10+83.82	L	20.3					
10+93.32	11+48.57	LT	59.3					
12+27.58	12+40.58	LT	13.0					
15+19.60	15+43.50	LT	23.9					
MONROE S	TREET							
23+60.65	12+73.65	RT	13.0					
ADAMS ST	REET							
32+26.88	32+52.03	RT	25.2					
37+00.18	37+12.18	LT	12.0					
37+18.09	39+40.32	LT	22.2					
37+76.98	38+00.89	LT	23.9					
TOTAL			260.5					
USE			261					

TEMPORARY RAMP SCHEDULE

		40600990		
STATION TO	CTATION	TEMPORARY		
STATION I	RAMP			
	SQ YD			
MADISON S	TREET			
10+48.57	10+54.57	38.4		
18+19.58	35.2			
MONROE ST	TREET			
20+42.46	20+48.46	31.9		
25+01.00	25+07.00	38.3		
ADAMS STR	EET			
30+13.24	30+19.24	35.2		
38+95.02	39+01.02	36.3		
TOTAL		215.2		
USE	216			

Hutchison Engineering, Inc.

	USER NAME = JWhite	DESIGNED -	AWM	REVISED	-
		DRAWN -	JCW	REVISED	-
		CHECKED -	AWM	REVISED	-
5	PLOT DATE = 11/22/2024	DATE -	11/22/2024	REVISED	-

PITTSFIEL					QUARE ANTITIE	RECONSTRUCTION ES
SCALE: NONE	SHEET 1	OF	10	SHEETS	STA.	TO STA.

A.P. TE.	SEC ⁻	Γ Ι ΟΝ	COUNTY	COUNTY TOTAL SHEETS			
	24-0003	7-00-RS	PIKE	144	16		
·				CONTRACT	NO. 938	347	
		ILLINOIS) PROJECT				

		P	AVEMENT	MARKING	SCHEDULE				
		78009000	78009005	78009006	78009008	78009012	78009024	78300202	
		M	DAN/EN AFAIT						
ATION	SIDE	LETTERS &	LINE 5"	LINE 6"	LINE 8"	LINE 12"	LINE 24"	PAVEMENT MARKING REMOVAL	
ATION	SIDE	SYMBOLS	LINES	LINEO	LINE 6 LINE 8		LIINE 24	WATER BLASTING	
			SOLID WHITE						
		SOFT			FOOT			SOFT	

		78009000	78009005	78009006	78009008	78009012	78009024	78300202
TATION TO STATION	SIDE	M	ODIFIED U	DAVENSENT				
		LETTERS &	LINE 5"	LINE 6"	LINE 8"	LINE 12"	LINE 24"	PAVEMENT MARKING REMOVAL
		SYMBOLS	LINE 3					WATER BLASTING
			WATER BLASTING					
		SQ FT	SQ FT FOOT					SQ FT
MADISON STREET								

	1		MODIFIED CHARLES THE CONTRACTOR						DAYERAENT
STATION TO STATION		SIDE	LETTERS & SYMBOLS	LINE 5"	LINE 6"	LINE 8"	LINE 12"	LINE 24"	PAVEMENT MARKING REMOVAL
				•	SOLID V	VHITE			WATER BLASTING
			SQ FT			FOOT			SQ FT
MADISON	STREET								
10+3	38.88	LT/RT				57.1			38.1
10+4	14.88	LT/RT				54.4			36.3
10+48.88	10+50.88	LT/RT						22.0	44.0
10+50.88	11+10.88	RT				60.0			40.0
10+50.88	11+92.77	LT				142.0			94.7
10+50.88	13+86.84	RT				336.5			224.3
10+53.05	12+24.99	RT		328.6		49.7	27.9		198.0
10+55.65	12+02.77	LT		264.0		50.9	66.6		210.5
10+59.32	10+68.88	RT	15.4						15.4
10+62.88	10+68.88	RT	9.1						9.1
11+01.32	11+10.88	RT	15.4						15.4
11+04.88	11+10.88	RT	9.1						9.1
11+8	31.57	LT/RT	8.9						8.9
12+18.77	13+79.73	LT		264.0		86.4	85.0		252.6
12+24.99	13+62.40	RT		286.0					119.2
12+2	25.76	LT/RT	8.9						8.9
12+37.43	13+86.82	LT				149.6			99.7
13+6	52.52	LT/RT	8.9						8.9
13+86.82	14+54.96	LT				105.3			70.2
13+86.82	14+54.97	RT				140.2			93.5
14+54.95	16+18.02	RT		192.3		109.8	133.8		287.1
14+54.96	16+24.57	LT		216.4		100.9	122.2		279.6
14+58.96	14+60.96	LT/RT						15.3	30.6
14+69.40	14+78.96	RT	15.3						15.3
14+9	91.69	RT	8.8						8.8
15+9	99.59	LT	8.8						8.8
									1

144.3

168.3

346.1

141.5

263.3

241.3

263.3

109.7

157.4

53.7

P	AVEMENT	MARKING	SCHEDULE	

			78009000			78009008		78009024	78300202
						PAVEMENT			70300202
			LETTERS &				IVIANNIV	<u> </u>	PAVEMENT
STATION T	O STATION	SIDE	SYMBOLS	LINE 5"	LINE 6"	LINE 8"	LINE 12"	LINE 24"	MARKING REMOVAL
			311110013		SOLID V	L VHITE	<u> </u>		WATER BLASTING
			SQ FT		30212	FOOT			SQFT
24+53.87	26+22.69	LT		255.7		101.8	62.3		236.7
-	26+22.86	RT		187.2		149.7	157.0		334.8
	33.64	RT	8.8	107.2		113.7	137.0		8.8
	01.49	LT	8.8						8.8
	27+97.64	LT	0.0	228.3		104.5	127.4		292.2
	27+97.57	RT		176		207.0	179.8		391.1
	L7.70	RT	8.8	170		207.0	175.0		8.8
	35.86	RT	8.8						8.8
	75.55	LT	8.8						8.8
27+95.62 27+97.62		LT/RT	0.0					18.0	36.0
28+01.57	28+07.57	RT			56.6			10.0	28.3
28+01.57	28+07.64	LT			53.6				26.8
ADAMS STREET		l ri			33.0	I.			20.0
30+34.26		LT			25.4				12.7
30+34.36	30+40.36	RT			25.3				12.7
30+44.25	32+02.27	LT		96.2	25.5	155.6	229.9		373.7
30+44.28	30+46.28	LT/RT		30.2		133.0	223.3	15.0	30.0
30+44.37	32+12.25	RT		216.4		100.6	110.0	15.0	267.2
32+18.25	33+86.55	RT		216.4		71.3	74.6		212.3
32+18.27		LT		192.3		108.1	104.1		256.4
	15.35	RT	8.8	152.5		100.1	101.1		8.8
	16.49	LT	8.8						8.8
34+54.72		LT	0.0	157.3					65.5
34+54.83	38+07.10	RT		353.1					147.1
34+63.20	34+72.76	RT	15.3	333.1					15.3
34+68.78	36+44.22	RT	15.5	285.2		90.0	59.9		238.8
34+78.89	36+21.93	LT		219.4		104.7	117.8		279.0
	00.76	LT	8.8	213.4		104.7	117.0		8.8
	37+98.74	LT	0.0	263.3		86.3	82.9		250.1
	14.99	RT	8.8	203.3		55.5	02.3		8.8
36+45.95		RT	0.0	285.2					118.8
36+56.59	38+07.12	LT		150.6					62.8
	31.84	LT	8.8	150.0					8.8
38+78.94		RT	0.0	145.7		218.0	279.8		485.8
38+79.36	38+81.36	LT/RT		2.5.7				18.0	36.0
38+80.51	40+42.51	LT		254.1		96.1	121.4	10.0	291.3
38+89.73	38+99.29	RT	15.3	20.12		55.2			15.3
40+59.26	41+90.16	RT	15.5	270.6		54.9	46.2		195.6
40+61.51	41+92.71	LT		117.6		181.6	101.3		271.3
	37.05	LT	8.8	117.0		101.0	101.5		8.8
	05.52	LT	8.8						8.8
	24.00	LT	8.8						8.8
TOTAL			295.3	7456.7	458.1	3999.1	3077.5	88.3	9551.5
USE			296	7457	459	4000	3078	89	9552
UJL			L 230	7437	707	+000	J0/0	ون ا	9332

TREE SCHEDULE

138.2

105.3

155.2 147.9

117.4 161.2

95.4 114.2

98.8 121.9

39.7 31.2

219.6 211.3

311.5

309.6

26.9

144.2 59.0

287.5

288.2

8.8

8.8

167.3

403.5

65.6

8.8

15.3

69.1

52.7

		INCL	CHEDOLE			
		A2001820	A2002520	A2007724		
STATION OFFSET		TREE, ACER SACCHARUM GREEN MOUNTAIN (GREEN MOUNTAIN SUGAR MAPLE), 2-1/2" CALIPER, BALLED AND BURLAPPED	TREE, CARPINUS CAROLINIANA (AMERICAN HORNBEAM), 2-1/2" CALIPER, BALLED AND BURLAPPED	TREE, TAXODIUM DISTICHUM SHAWNEE BRAVE (SHAWNEE BRAVE BALD CYPRESS), 3" CALIPER, BALLED AND BURLAPPED		
			EACH			
MADISON	STREET					
17+00	30' LT		1			
17+30	30' LT		1			
ADAMS ST	REET					
30+70	31' LT			1		
31+00	31' LT	1				
31+75	31' LT			1		
TOTAL		1	2	2		
USE		1	2	2		

CHORT TERM DAVEMENT MARKING COHEDINE

	SHORT TERM PAVEMENT MARKING SCHEDULE											
			70300100	70300150								
			SHORT TERM	SHORT TERM								
TATION T	O STATION	NOTE	PAVEMENT	PAVEMENT MARKING								
			MARKING	REMOVAL								
			FOOT	SQ FT								
/ADISON S	STREET											
10+48.57	13+86.81	EDGE LINES	202.9	67.6								
14+54.93	18+03.58	EDGE LINES	209.2	69.7								
/ONROE S	TREET											
20+39.90	23+85.72	EDGE LINES	207.5	69.2								
24+53.93	27+95.59	EDGE LINES	205.0	68.3								
DAMS STI	REET											
30+46.28	33+86.54	EDGE LINES	204.2	68.1								
34+54.72	38+07.12	EDGE LINES	211.4	70.5								
38+81.36	41+92.71	EDGE LINES	186.8	62.3								
OTAL			1427.0	475.7								
JSE			1428	476								

SEEDING SCHEDULE

					ING SCHEDULE			
			25000115	25000400	25000500	25000600	28000250	25100630
			SEEDING	F	ERTILIZER NUTRI	NT	TEMPORARY	EROSION
STATION T	O STATION	SIDE	, CLASS	NITDOCEN	PHOSPHOROUS	DOTACCILINA	EROSION	CONTROL
			1B	NIIKOGEN	PHOSPHOROUS	POTASSICIVI	CONTROL	BLANKET
			ACRE		P	OUND		SQ YD
MADISON	STREET							
10+48.57	13+75.20	RT	0.020	1.8	1.8	1.8	2.0	96.8
13+63.36	13+86.36	RT	0.006	0.6	0.6	0.6	0.6	29.8
16+42.65	16+68.77	LT	0.005	0.4	0.4	0.4	0.5	23.9
16+88.77	18+04.36	LT	0.020	1.8	1.8	1.8	2.0	96.2
17+86.79	18+04.01	RT	0.003	0.3	0.3	0.3	0.3	15.2
18+09.01	18+23.15	RT	0.004	0.4	0.4	0.4	0.4	19.4
18+09.44	18+23.17	LT	0.003	0.3	0.3	0.3	0.3	16.3
MONROE S	TREET							
20+50.21	23+74.18	LT	0.022	2.0	2.0	2.0	2.2	108.0
23+55.71	23+84.99	LT	0.007	0.7	0.7	0.7	0.7	35.2
24+53.31	24+84.36	LT	0.008	0.7	0.7	0.7	0.8	36.4
24+53.96	24+76.80	RT	0.008	0.7	0.7	0.7	0.8	38.2
ADAMS ST	REET							
30+15.61	30+34.95	RT	0.006	0.6	0.6	0.6	0.6	30.3
30+15.89	30+34.73	LT	0.006	0.5	0.5	0.5	0.6	29.1
30+39.68	31+37.11	LT	0.019	1.7	1.7	1.7	1.9	93.6
30+39.89	31+20.69	RT	0.016	1.4	1.4	1.4	1.6	76.4
31+59.11	32+00.19	LT	0.007	0.7	0.7	0.7	0.7	35.7
34+55.37	34+84.84	RT	0.007	0.7	0.7	0.7	0.7	35.3
37+82.59	38+06.60	LT	0.007	0.6	0.6	0.6	0.7	31.9
38+74.61	38+97.05	RT	0.005	0.4	0.4	0.4	0.5	22.1
38+75.00	39+01.02	LT	0.007	0.6	0.6	0.6	0.7	33.4
TOTAL			0.187	16.8	16.8	16.8	18.7	903.2
USE			0.25	23	23	23	25	1210

PAVEMENT MARKING REMOVAL SCHEDULE

				78300202
674710417		SID.	DESCRIPTION	PAVEMENT MARKING
SIATION I	O STATION	SIDE DESCRIPTION		REMOVAL - WATER BLASTING
				SQ FT
MONROE STR	EET			
25+07.00	28+07.61	RT	PARKING LANE LINES - 4"	126.0
25+07.00	28+07.61	RT	ADA PARKING - BLUE PAINT	810.0
25+07.00	28+07.61	RT	PARKING LANE LINES - 4" (YELLOW)	59.7
25+07.00	28+07.61	LT	ADA PARKING - BLUE PAINT	432.0
25+07.00	25+07.00 28+07.61		PARKING LANE LINES - 4"	145.3
ADAMS STREE	Т			
39+01.03	41+92.71	RT	PARKING LANE LINES - 4"	126.0
39+01.03	41+92.71	RT	ADA PARKING - BLUE PAINT	234.0
39+01.03	41+92.71	RT	PARKING LANE LINES - 4" (YELLOW)	17.0
39+01.03	41+92.71	LT	PARKING LANE LINES - 4" (YELLOW)	184.7
39+01.03	41+92.71	LT	PARKING LANE LINES - 4"	90.0
TOTAL		,		2224.7
USE				2225

Hutchison Engineering, Inc.

16+40.02 18+02.43 RT

16+40.57 17+99.86 LT

20+39.90 23+85.58 LT 20+39.90 21+81.40 RT

20+39.93 22+13.48 LT

20+43.51 22+02.37 RT

22+12.90 23+71.67 LT

22+18.37 23+77.49 RT

22+28.37 23+85.70 RT

23+67.66 23+77.22 LT 23+85.55 24+53.86 LT

23+85.73 24+53.94 RT

23+52.21 RT

RT

8.8

8.8

15.3

20+66.16

21+95.97

MONROE STREET

18+03.58 18+09.80 LT/RT

	USER NAME = JWhite	DESIGNED -	AWM	REVISED -
ı		DRAWN -	JCW	REVISED -
		CHECKED -	AWM	REVISED -
75	PLOT DATE = 11/22/2024	DATE -	11/22/2024	REVISED -

STATE OF ILLINOIS **DEPARTMENT OF TRANSPORTATION**

PITTSFIELD HISTORIC DOWNTOWN SQUARE RECONSTRUCTION								A.P. SECTION		COUNTY	TOTAL SHEETS	SHEET NO.	
	SCHEDULE OF QUANTITIES							24-00037-00-RS PIKE		144	17		
SOURCE OF GOARTHES											CONTRAC	T NO. 938	847
SCALE: NONE	SHEET 2	OF	10	SHEETS	STA.	TO STA.			ILLINOIS	FED. AID	PROJECT		

			44000100	MOVAL SCHEDULE 44000156	44000200	44000500	44000600
STATION T	O STATION	SIDE	PAVEMENT REMOVAL	HOT-MIX ASPHALT SURFACE REMOVAL, 1¾"	DRIVEWAY PAVEMENT REMOVAL	CURB AND GUTTER REMOVAL	SIDEWALK REMOVAL
MADISON S	STREET			SQ YD		FOOT	SQ FT
10+48.07	12+02.77	LT			1		2029.2
10+48.57	13+61.82	LT	209.4				2025.2
10+48.57	12+06.01	RT	203.4			159.6	
10+48.57	13+61.82	LT/RT		1740.9		155.0	
10+48.57	13+61.82	RT	397.9	27 1015			
10+48.57	13+75.22	RT	337.13				1976.1
12+16.33	13+75.22	RT				158.9	207012
12+18.77	13+81.50	LT				100.0	1975.8
14+59.79	16+19.11	LT				160.3	207010
14+60.71	15+90.23	RT				134.3	
14+61.13	16+22.60	LT					1672.0
14+66.24	16+21.92	RT					1224.7
14+90.00	18+25.46	RT	723.5				
14+90.00	18+25.49	LT/RT		1275.4			
14+90.00	18+25.90	ĹT	167.5				
16+40.03	16+68.88	LT					102.0
16+41.57	16+79.01	RT				51.7	
16+41.69	16+79.01	RT					380.5
16+41.79	16+68.78	LT				35.8	
16+63.15	16+93.41	LT			31.8		
16+74.46	17+08.72	RT			35.3		
16+88.76	18+23.84	LT					576.5
17+04.05	18+24.52	RT				122.2	
17+04.08	18+23.60	RT	138.5				
18+17.23	18+24.24	LT				13.1	
MONROE S	TREET						•
20+42.46	23+81.69	LT/RT		1783.1			
20+42.61	23+61.77	LT	405.7				
20+48.20	22+02.17	RT					1963.5
20+48.47	20+57.30	RT				15.0	
20+50.00	23+69.48	RT	256.0				
20+50.21	23+74.77	LT					1986.5
22+19.74	23+78.61	RT					1925.3
22+21.21	23+65.65	LT				144.5	
24+58.92	24+87.31	RT					153.7
24+59.72	25+25.00	LT					692.1
24+62.33	25+25.01	RT				62.8	
25+00.99	25+11.93	RT					52.4

			RE	MOVAL SCHEDULE			
			44000100	44000156	44000200	44000500	44000600
STATION T	O STATION	SIDE	PAVEMENT REMOVAL	HOT-MIX ASPHALT SURFACE REMOVAL, 1 ³ ⁄ ₄ "	DRIVEWAY PAVEMENT REMOVAL	CURB AND GUTTER REMOVAL	SIDEWALK REMOVAL
				SQ YD		FOOT	SQ FT
ADAMS STI	REET						
30+13.24	33+83.60	RT	454.3				
30+13.27	33+83.60	LT/RT		1194.5			
30+13.54	33+83.60	LT	731.9				
30+15.05	31+91.58	RT				177.7	
30+15.32	31+33.57	LT				135.2	
30+15.37	31+97.09	RT					1156.1
30+15.39	31+37.11	RT					1486.4
31+34.89	31+59.87	LT			32.5		
32+19.86	33+90.77	LT					1751.2
32+20.34	34+02.92	RT					1869.4
32+24.80	34+03.23	RT				211.4	
32+56.43	33+91.06	LT				139.4	
33+83.60	34+86.28	LT/RT	1151.3				
34+49.74	34+60.94	LT					124.6
34+59.49	38+01.60	RT					2071.2
34+60.72	34+79.06	LT			25.0		
34+66.05	36+12.27	RT				146.2	
34+78.89	36+20.80	LT					1509.1
34+86.28	38+28.74	LT	263.3				
34+86.28	38+23.12	RT	543.7				
34+86.28	39+01.02	LT/RT		2560.5			
36+39.83	38+12.03	LT					2018.7
37+22.51	37+88.99	RT				66.5	
38+47.94	38+99.60	RT	106.3				
38+54.01	39+01.02	LT	94.5				
38+68.05	39+01.02	LT					333.0
38+71.03	39+01.02	LT					198.8
38+81.10	39+01.02	RT				19.9	
38+81.78	39.01.02	LT				19.2	
TOTAL			EC 40.0	0554.4	424.6	4070.7	20220.0

STREETSCAPE	SCHEDULE	- 1	OF	2

8555

5643.8

5644

TOTAL

USE

1973.7

1974 29229

29228.8

124.6

125

			X6640618	X2110100
STATION T	O STATION	SIDE	ORNAMENTAL	TOPSOIL FURNISH AND
STATION	USTATION	SIDE	FENCE	PLACE (SPECIAL)
			FOOT	CU YD
MADISON STR	EET			
16+42.65	16+68.19	LT		5.3
13+63.36	13+86.35	RT		10.0
16+89.35	18+4.44	LT		35.3
17+4.05	18+3.96	RT		17.3
17+9.05	17+97.05	RT	88	
17+86.79	18+4.06	RT		4.7
18+9.01	18+23.15	RT		6.5
MONROE STRI	EET			
23+55.71	23+85.03	LT		11.8
24+53.31	24+84.36	LT		12.0
24+53.52 24+86.84		RT		12.9
ADAMS STREE	т			
31+22.05	31.94.05	RT	72	
31+62.19	31+94.19	LT	32	
30+15.61	30+34.90	RT		10.1
30+15.61	30+34.90	LT		9.8
30+39.90	31+20.70	RT		25.5
30+39.90	31+37.11	LT		34.6
31+20.75	32+00	RT		25.4
31+59.11	32+00	LT		11.6
34+55.37	34+84.84	RT		11.8
37+82.59	38+6.66	RT		10.7
38+60.11	38+69.92	LT		2.0
38+74.70	39+00	RT		7.1
38+74.70	39+00	LT		11.1
TOTAL			192	275.6
USE			192	276

USE		2,070	11	1	1	6	4	5	162
TOTAL		2,070	11	1	1	6	4	5	161.3
38+82	LT								
		5	2				1		
38+77	LT					·			
		71	1					1	
38+06	LT							_	
20.00		420	1					2	
33+86	LT	3/3			1				42.3
30+11	LT	375			1	2			42.9
									1
24+72 ADAMS S1									
24+72	LT	17	2				1		
24+55	LT								
24+55	RT								
		399	2			2		1	
20+56	RT								
MONROE	STREET								
18+52	LT								55.5
14+30	LI	396	1	1			2		55.9
14+56	LT	387	2			2		1	62.5
10+69	LT	207	2			2		1	62.5
MADISON				1					
		FOOT			E	ACH			FOOT
		8"	8"	6"	10"	6"	8"	COMPLETE	12"
STATION	SIDE	MAIN	VALVES	SLEE	EVES	STO	OPS	HYDRANT	ENCASEM
		WATER	WATER	TAPPING V	ALVES AND	WATERN	AAIN LINE	FIRE	WATER M
		56100700	56105000	56108800	56109000	X5610746	X5610748	X5640175	X561002

STREETSCAPE SCHEDULE - 2 OF 2

		X0325495	Z0003850	Z0003855	X0327997	K0013020
		LANDSCAPE		BICYCLE	TRASH	PERENNIAL
STATION	OFFSET	PLANTER	BENCHES	RACK	RECEPTACLES	PLANTS, PRAIRIE
		PLANTER		KACK	RECEPTACLES	TYPE, GALLON PO
			EA	CH		UNIT
MADISON ST	REET					
13+78	24' LT			1		
13+82	24' LT			1		
14+57	25' RT				1	
14+60	25' RT	1				0.01
14+64	25' RT	1				0.01
14+66	26' LT		1			
14+68	25' RT	1				0.01
MONROE STE	REET					
23+70	26' RT		1			
23+75	20' RT	1				0.01
23+79	20' RT	1				0.01
23+83	20' RT	1				0.01
23+83	26' RT				1	
24+39	26' LT	1				0.01
24+43	26' LT	1				0.01
24+46	26' LT	1				0.01
ADAMS STRE	ET	•	•		•	•
33+69	26' RT		1			
33+69	26' LT		1			
33+73	19' RT	1				0.01
33+73	19' LT	1				0.01
33+77	19' RT	1				0.01
33+77	19' LT	1				0.01
33+81	19' RT	1				0.01
33+81	19' LT	1				0.01
33+84	26' RT				1	
33+84	26' LT				1	
36+90	38' LT		1			
37+98	26' LT		1			
38+06	26' LT				1	
22+81	31' LT					
22+81	31' LT					
22+89	31' LT					
TOTAL		15	6	2	5	0.15
USE		15	6	2	5	0.15

	USER NAME = JWhite	DESIGNED	-	AWM	REVISED	-
		DRAWN	-	JCW	REVISED	-
		CHECKED	-	AWM	REVISED	-
75	PLOT DATE = 11/22/2024	DATE	-	11/22/2024	REVISED	-

STATE OF ILLINOIS DEPARTMENT OF TRANSPORTATION

					<u> </u>	•	•			_		
PITTSFIELD H	HISTORIC	DOW	NTOWN S	QUARE REC	CONSTRUCTION	F.A.P. RTE.	SEC	TION		COUNTY	TOTAL SHEETS	SHEET NO.
	SCI	HEDIII	E OF OU	ANTITIES			24-0003	37-00-RS		PIKE	144	18
		ILDUL	L OI QU	ANTITIES						CONTRAC	T NO. 93	847
SCALE: NONE SH	HEET 3	OF 1	0 SHEETS	STA.	TO STA.			ILLINOIS	FED. AID	PROJECT		

STORM SEWER REMOVAL SCHEDULE										
			55100300	55100400	55100500	20800150				
STATION T	O STATION	SIDE	STORM	SEWER RE	MOVAL	TRENCH				
SIATION	USTATION	SIDE	8"	8" 10" 12"						
				FOOT		CU YD				
MADISON	STREET									
10+29.39	13+81.80	LT			352.4					
13+68.53	13+91.12	LT	25.4			7.5				
18+21.08	18+21.69	LT			18.9					
MONROE S	TREET									
20+29.68	23+90.29	LT		360.6						
ADAMS ST	REET									
30+16.43	30+19.22	RT			3.2					
30+17.08	30+20.68	LT		4.5						
33+77.56	33+90.30	RT		17.6		5.5				
33+77.66	34+05.27	LT/RT			73.1	24.4				
TOTAL	·	, and the second	25.4	382.7	447.6	37.4				
USE	•	, and the second	26	383	448	38				

STORM SEWER SCHEDULE

													1
		Z0056608	60234200	60235700	60240220	60218400	60218500	28000250	20800150	44200089	44200094	44200099	44200101
STATION TO	STATION	STORM SEWER (WATER MAIN REQUIREMENTS)		INLETS		MANI	HOLES	INLET AND PIPE PROTECTION	TRENCH BACKFILL		PAVEMENT I	PATCHING, 8"	
		12"	A-1-0	A-3	B-3	4' A-1-C	4' A-3		271311112	TYPEI	TYPE II	TYPE III	TYPE IV
		FOOT	AIG		EA		7 7 7	l.	CU YD			YD	
MADISON STREET		1001			LA	L11			6015	<u>l</u>		(10	
	10.54.02.45.551.5	22							7		42.7		
10+29.39, 15.57' LT	10+54.92, 15.55' LT	22				1			7		13.7		
10+54.92, 15.55' LT 10+61.08, 26.00' LT				1		1		1					
	10,54.03. 15.55! 17.	10		1				1	2	4.5			
10+61.08, 26.00' LT	10+54.92, 15.55' LT	10		1				1		4.5			
10+54.92, 37.00' RT	40.54.02.45.551.7	50		1				1	7		22.4		
10+54.92, 37.00' RT	10+54.92, 15.55' LT	50									22.1	24.2	116.6
10+54.92, 15.55' LT	13+69.51, 15.34' LT	311				1			120			24.3	116.6
13+69.51, 15.34' LT				4		1		4					
13+69.51, 26.00' LT	42.50.54.45.241.5			1				1					
13+69.51, 26.00' LT	13+69.51, 15.34' LT	8		4				4	1				
14+46.69, 37.17 ^t RT	40.00.05.07.701.07	45		1				1					
14+46.69, 37.17' RT	13+99.36, 37.73' RT	45							6				
13+99.36, 37.73' RT					1			1	_				
13+99.36, 37.73' RT	13+61.69, 37.00' RT	36							7				
13+61.69, 37.00' RT					1			1					
13+61.69, 37.00' RT	13+69.51, 15.34' LT	50							12				
13+69.51, 15.34' LT	13+97.83, 16.19' LT	25							7				
13+97.83, 16.19' LT							1	1					<u> </u>
13+97.83, 16.19' LT	14+42.82, 22.86' LT	42							8				<u> </u>
14+42.82, 22.86' LT					1			1					
17+85.05, 26.00' RT				1				1					
17+85.05, 26.00' RT	17+82.48, 26.00' LT	50							7		21.9		
17+82.48, 26.00' LT					1			1					
17+82.48, 26.00' LT	18+21.40, 26.06' LT	36							6				
18+21.40, 26.06' LT							1	1					1
18+21.08, 44.61' LT	18+21.40, 26.06' LT	15							5				1
MONROE STREET													
20+29.68, 30.68' LT	20+51.41, 30.62' LT	18							4		6.5		
20+51.41, 30.62' LT						1							
20+51.43, 37.00' LT				1				1					
20+51.43, 37.00' LT	20+51.41, 30.62' LT	4							1				
20+69.55, 26.00' RT	•			1				1					
20+69.55, 26.00' LT	20+51.41, 30.62' LT	57							8		29.9		
20+51.41, 30.62' LT	23+83.10, 29.70' LT	328							95				
23+83.10, 29.70' LT	•					1							
23+59.61, 26.00' RT				1		_		1					
23+59.61, 26.00' RT	23+82.31, 21.52' LT	50						_	7		25.6		
23+82.31, 21.52' LT					1			1	-				
23+82.31, 21.52' LT	23+83.10, 29.70' LT	6			_			_	1				
23+82.77, 60.29' LT		-		1				1					
23+82.77, 60.29' LT	23+83.10, 29.70' LT	28		<u> </u>				_	4				
24+45.77, 52.73' LT				1				1	•				
24+45.77, 52.73 LT	23+83.10, 29.70' LT	64						_	9		23.7		
ADAMS STREET				l .	1			ı		ı	25.7	1	-
30+16.44, 28.79' RT				1				1					
30+16.44, 28.79 RT	31+58.00, 26.00' RT	141		1				1	19				
31+58.00, 26.00' RT	31+30.00, 20.00 KI	141		1				1	13				
30+17.38, 27.22' LT				1				1					
30+17.38, 27.22 LT 30+17.38, 27.22 LT	21 (20 00 26 00) IT	101		1				1	16				
	31+20.00, 26.00' LT	101		1				1	16				
31+20.00, 26.00' LT				1				1					
33+52.35, 26.00' LT	22.00 00 25 00 17	13		1				1	2				
33+52.35, 26.00' LT	33+65.59, 25.00' LT	12							2				
33+65.59, 25.00' LT	22.07.75.24.001.5	22	1					1					
33+65.59, 25.00' LT	33+97.75, 21.88' LT	32						_	5				
33+57.98, 26.00' RT	24.04.44.22.55	**		1				1					<u> </u>
33+57.98, 26.00' RT	34+04.44, 23.06' RT	44			_				6				
		1585	1	16	5	4	2	24	372	4.5 5	143.4	24.3	116.6 117
TOTAL USE		1585	1	16	5	4	2	24	372		144	25	

(HE)	Hutchison Engineering, Inc.

USER NAME = JWhite	DESIGNED - AWM	REVISED -
	DRAWN - JCW	REVISED -
	CHECKED - AWM	REVISED -
PLOT DATE = 11/22/2024	DATE - 11/22/2024	REVISED -

PITTSFIEL				TOWN S OF QUA		RECONSTRUCTION S
SCALE: NONE	SHEET 4	OF	10	SHEETS	STA.	TO STA.

F.A.P. RTE.	SEC ⁻	Γ Ι ΟΝ		COUNTY	TOTAL SHEETS	SHEE NO.
	24-0003	7-00-RS		PIKE	144	19
				CONTRACT	NO. 938	347
		ILLINOIS	FED. AI	D PROJECT		

	WATER SERVICE SCHEDULE											
				56200300	56200500	56200700			56500500	NUMBER OF		
STATION	WATER SERVICE ADDRESS	SIDE	ID NUMBER	WATER SERVICE LINE 1"	WATER SERVICE LINE 1 1/2"	WATER SERVICE LINE 2"	NUMBER OF METERS SERVED	METER/S ON ROW Y/N	DOMESTIC METER VAULTS	METERS IN VAULT	CUSTOMER TYPE	
					FOOT				EAC	CH		
MONROE STREE			100			I	*		I	1	le	
20+71.00 20+94.00	104 N. Monroe St. 106 N. Monroe St.	RT RT	100	8			*				Empty Lot Empty Lot	
21+10.00	108 1/2 N. Monroe St.	RT	2	8			1	Υ	1	1	Apt. Upstairs	
21+25.00	108 N. Monroe St.	RT	1	8			1	N	1		Business	
21+56.00	110 & 110 1/2 N. Monroe St.	RT	3&4		8		1	N			Business and Apt. Upstairs	
21+75.00	114 & 114 1/2 N. Monroe St.	RT	102		8		*					
21+95.00	114 & 114 1/2 N. Monroe St.	RT	5&6									
21+95.00	116 & 116 1/2 N. Monroe St.	RT	7&8			8	6				Businesse & Apartment Upstairs	
21+95.00 22+53.00	116 & 116 1/2 N. Monroe St. Rear 118 & 126 1/2 N. Monroe St.	RT RT	9 & 10 11 & 12		8		2	N N			Business & Apt. Upstairs	
22+96.00	118 & 120 1/2 N. Wolff de 3t.	RT	103	8			*	IN .			business & Apt. Opstairs	
23+09.00		RT	104	8			*					
23+30.00	128 & 128 1/2 N. Monroe St.	RT	13 & 14		8		2	N			Business & Apt. Upstairs	
23+54.50	130 N. Monroe St.	RT	15	8			1	Υ	1	2	Business	
23+55.00	130 1/2 N. Monroe St.	RT	16	8			1	Υ	1		Apt. Upstairs	
23+74.50	132 1/2A N Monroe St.	RT	17A	8			1	Y			Apt. Upstairs	
23+75.00	132 1/2B N. Monroe St. 132 N. Monroe St.	RT RT	17B 18	8			1	Y	1	3	Apt. Upstairs	
23+75.50 ADAMS STREET		KI	12	δ		I	1 1	ľ	<u> </u>	<u> </u>	Business	
37+74.50	128 E. Adams St.	LT	19	8			1	Υ			Business	
37+75.00	128 1/2A E. Adams St.	LT	20	8			1	Y	1	3	Apt. Upstairs	
37+73.50	128 1/2B E. Adams St.	LT	21	8			1	Y			Apt. Upstairs	
37+65.50	Courthouse	RT	119	78			1	Υ	1	1	Pike County Courthouse	
37+65.00	Courthouse	RT	120			78	1	Υ	1	1	Pike County Courthouse	
37+52.00	126 E. Adams St.	LT	105		8		*				Business & Apt. Upstairs	
37+25.00	124 .E Adams St.	LT	25		8		*	N			Business & Apt. Upstairs	
37+00.50	122 E. Adams St.	LT LT	106	8			*	N			Business	
37+00.00 36+82.00	122 1/2 E. Adams St.	LI	107 108	8			*	N			Apt. Upstairs Empty Lot	
36+63.00			109	8			*				Empty Lot	
35+66.00	108 East Adams St.	LT	26	8			1	N			Business	
35+06.00	108 East Adams St. New building	LT	27	8			1	N			Business	
33+41.50	201 1/2 N. Madison St.	LT	32	8			1	Υ	1	2	Apt. Upstairs	
33+41.00	201 N. Madison St.	LT	33	8			1	Υ			Business	
33+04.00	108 1/2 W. Adams St. Upstairs	LT	34	8			1	Y	1	1	Apt. Upstairs	
34+90.00 32+72.00	110 W. Adams St. 112 W. Adams St.	LT LT	35 36		<u>8</u> 8		1 1	N Y	1	1	Business & Apt. Upstairs	
32+28.00	112 W. Adams St.	LT	37		8		1	Y	1	1 1	Business & Apt. Upstairs Business & Apt. Upstairs	
32+30.00	115 W/ Adams St	RT	39		78		1	N	1		Business & Apt. Upstairs	
33+35.00	131 1/2 N. Madison St.	RT	43	78	,,,		1	Y	1	1	Apt. Upstairs	
32+70.00	111 W. Adams St.	RT	42	78			1	N			Business	
32+47.00	113 W. Adams St.	RT	41	78			1	N			Business	
32+45.00	113 1/2 W. Adams St.	RT	40	78			1	N			Apt. Upstairs	
MADISON STRE				1		T	ı		T	1	T	
10+53.00	101 N. Madison St.	LT	55		8		*	Υ	1	1	Business & Apt. upstairs	
10+73.00 10+89.00	105 N. Madison St.	LT LT	110 54		8 8		1	N			Business & Apt. upstairs Business & Apt. upstairs	
11+09.00	109 N. Madison St.	LT	53		8		1	N			Business & Apt. upstairs	
11+31.00	203 IV. IVIdai Sori St.	LT	111		8		*				Business & Apt. Upstairs	
11+52.00		LT	112		8		*				Business & Apt. upstairs	
11+67.00		LT	113		8		*				Business & Apt. upstairs	
11+90.00	115 N. Madison St.	LT	52		8		1	Υ	1	1	Business & Apt. upstairs	
12+26.00	117 1/2 N. Madison St.	LT	51	8			1	N			Apt Upstairs	
12+30.00	117 N. Madison St.	LT	50	8			1	N			Business	
12+51.00 12+91.00	119 N. Madison St. 123 N. Madison St.	LT LT	49 48		8		1 1	N N			Business & Apt. upstairs Business & Apt. upstairs	
13+14.00	125 N. Madison St.	LT	47		8		1	N			Business & Apt. upstairs	
13+37.00	127 & 127 1/2 N. Madison St.	LT	45 & 46		8		2	N			Businees & Apt. upstairs	
13+56.00	129 N. Madison St.	LT	44	8			1	N			Business	
15+05.00	203 N. Madison St.	LT	31	8			1	N			Apartment Upstairs	
15+23.00	205 N. Madison St.	LT	114		8		1	Υ	1	1	Business & Apt. upstairs	
15+48.00		LT	115	8			*				Apt Upstairs	
15+49.00		LT	116	8			*				Business	
15+80.00 16+44.00	220 N. Madison St.	LT RT	117 118	8			1	N			Business Business	
16+76.00	113 E. Jefferson St	RT	28	8	*		1	Y	1	1	Business	
17+08.00		RT	29	8			*				Empty Lot	
TOTAL			•	654	254	86			15			
							•			•		

- 1	USER NAME = JWhite	DESIGNED -	-	AWM	REVISED	-
		DRAWN -	-	JCW	REVISED	-
		CHECKED -	-	AWM	REVISED	-
5	PLOT DATE = 11/22/2024	DATE -	-	11/22/2024	REVISED	-

STATE OF ILLINOIS	
DEPARTMENT OF TRANSPORTATION	

	PITTSFIEL	D HISTORI	C DO	MN.	TOWN S	F.A.P. RTE	SECTION		COUNTY	TOTAL SHEETS	SHEET NO.
ı		OF QU		24-00037-00-RS		PIKE	144	20			
ı			,,,,,	OLL	01 40				CONTRACT	NO. 938	347
	SCALE: NONE	CALE: NONE SHEET 5 OF 10 SHEETS STA. TO STA.					ILLINOIS	FED. AIC	PROJECT		

 ICH.	TING	CCL	

											SCHEDULE									
STREET	STATION	SIDE	DESCRIPTION	XX008870 STREET CLOCK	80400100 ELECTRIC SERVICE INSTALLATION	HANDHOLE, COMPOSITE CONCRETE	84200500 REMOVAL OF LIGHTING UNIT, SALVAGE	84200600 REMOVAL OF LIGHTING UNIT, NO SALVAGE	X8250505 LIGHTING CONTROLLER (SPECIAL)		X0326654 ORNAMENTAL LIGHT UNIT, COMPLETE	X1400403 LUMINAIRE REPLACEMENT SPECIAL	X8780105 CONCRETE FOUNDATIONS (SPECIAL)	81028330 UNDERGROUND CONDUIT, PVC, 1 1/4" DIA.		81028350 UNDERGROUND CONDUIT, PVC, 2" DIA.	CONDUIT, PVC, 4" DIA.	600V (XLP-TYPE	81702140 ELECTRIC CABLE IN CONDUIT, 600V (XLP-TYPE USE) 1/C NO. 4	IN CONDUIT, 600V (XLP-TYPE
								EACH									FOOT			
CIRCUIT 1					,								_	_	1	•				
ADAMS	36+44	43FT LT	CONTROLLER		1				1											
	25.02	205717				-									41			188		
ADAMS	36+02	28FT LT	B-19								1				100			440		
ADAME	24106	2057.17	D 10								1				106			448		
ADAMS	34+96	28FT LT	B-18			+					1				51			228		
ADAMS	34+45	26FT LT	HH4			1									31			220		
/ (B/ (IVIS	541.45	2011121	1111-7			 									107			452		
MADISON	15+53	28FT RT	B-13								1									
															108			456		
MADISON	16+61	28FT RT	A-6							1										
															63			276		
MADISON	17+23	28FT RT	B-15								1									
															51			228		
MADISON	17+74	28FT RT	B-17								1									
CIRCUIT 2													_			_				
ADAMS	36+44	43FT LT	CONTROLLER																	
															195			804		
ADAMS	34+45	26FT LT	HH4																	
															50			224		
ADAMS	33+95	26FT LT	HH5			1														
	44.60	405717													14			80		
MADISON	14+60	19FT LT	A-5							1					(2)			272		
NAA DICON	15.20	2057.17	B-12								1				62			2/2		
MADISON	15+20	28FTLT	B-12			+					1		+		64			280		
MADISON	15+83	28FT LT	B-14								1				04			200		
WADISON	13+63	ZOFILI	D-14								1				163			676		
MADISON	17+46	30FT LT	B-16								1				105			070		
111111111111111	27110	561 1 21	5 20								_				56			248		
MADISON	18+2	30FT LT	A-7							1										
CIRCUIT 3								I.			ı					I.				
ADAMS	36+44	43FT LT	CONTROLLER																	
															195			804		
ADAMS	34+45	26FT LT	HH4																	
															50			224		
ADAMS	33+95	26FT LT	HH5																	
															64			280		
ADAMS	33+31	28FT LT	B-7								1									
															64			280		
ADAMS	32+68	28FT LT	B-5								1									
						-									75			324		
ADAMS	31+93	31FT LT	A-2			-				1										
454446	20:42	2057.17													153			636		
ADAMS	30+42	20FT LT	A-1	1	1	1	<u> </u>	L	1	1	<u> </u>	<u> </u>	<u> </u>	L	1		1	<u> </u>		
CIRCUIT 4	20.44	42CT : T	CONTROLLER	T	I	1	1		1	1		I	T		T		I	I	1	
ADAMS	36+44	43FT LT	CONTROLLER				+						-		105			201	502	┼──┤
ADARAC	34+45	265717	11114	1			+						-		195		1	201	603	
ADAMS	34+45	26FT LT	HH4	1			+						+		50			56	168	\vdash
ADAMS	33+95	26FT LT	HH5				 						 		30		<u> </u>	30	100	\vdash
UNIND	25125	ZULLI	נווו ו			+	1								50			56	168	
ADAMS	33+95	24FT RT	HH6			1									30			30	100	
,	23.33	101				 	1								34			40	120	
ADAMS	33+62	28FT RT	B-8	1		1					1				1			1		
															54			60	180	
ADAMS	33+08	28FT RT	B-6								1									
															64	<u> </u>		70	210	
ADAMS	32+45	28FT RT	B-4								1									
															64			70	210	
ADAMS	31+81	35FT RT	B-3								1									
															60			66	198	
ADAMS	31+21	35FT RT	B-2								1									
				1		1	ļ						ļ		61		1	67	201	<u> </u>
ADAMS	30+62	34FT RT	B-1								1									
CIRCUIT 5				1	T	1	1	1	1		ı	1			T		1			
ADAMS	36+44	43FT LT	CONTROLLER	<u> </u>	<u> </u>		<u></u>	<u></u>			<u></u>	<u> </u>	<u> </u>	<u> </u>	<u> </u>	<u> </u>	<u> </u>	<u> </u>	<u> </u>	
USER NAM	IE = JWhite		DESIG	GNED - AWM	RE	VISED -								DITTELL	HISTORIC DOM	NTOWN SQUA	DE DECONSTE	HICTION	F.A.P. SE	ECTION

Hutchison Engineering, Inc.

	USER NAME = JVVIIITO	DESIGNED	-	AVVIVI	KEVISED	-
n		DRAWN	-	JCW	REVISED	-
ο.		CHECKED	-	AWM	REVISED	-
075	PLOT DATE = 11/22/2024	DATE	-	11/22/2024	REVISED	-

STATE OF ILLINOIS
DEPARTMENT OF TRANSPORTATION

ı	PITTSFIELD HISTORIC DOWNTOWN SQUARE RECONSTRUCTION											
	SCHEDULE OF QUANTITIES											
	SCALE: NONE	SHEET 6	OF	10	SHEETS	STA.	TO STA.					

F.A.P. RTE	SECTION		COUNTY	TOTAL SHEETS	SHE	
	24-00037-00-RS	PIKE 144				
		CONTRACT	NO 938	347		
	ILLINOIS	FED, AID	PROJECT			

										LIGHTING	SCHEDULE									
		Т	I	XX008870	80400100	81400730	84200500	84200600	X8250505	X1400431		X1400403	X8780105	81028330	81028340	81028350	81028390	81702130	81702140	81702150
				XX000870	80400100		REMOVAL OF	REMOVAL OF										ELECTRIC CABLE		
CTDEET	CTATION	CIDE	DESCRIPTION	STREET CLOCK	ELECTRIC SERVICE	HANDHOLE,	LIGHTING	LIGHTING	LIGHTING		ORNAMENTAL	LUMINAIRE	CONCRETE	UNDERGROUND				IN CONDUIT,	IN CONDUIT,	IN CONDUIT,
STREET	STATION	SIDE	DESCRIPTION	STREET CLOCK	INSTALLATION	COMPOSITE CONCRETE	UNIT,	UNIT, NO	CONTROLLER (SPECIAL)	(SPECIAL)	LIGHT UNIT, COMPLETE	REPLACEMENT SPECIAL	FOUNDATIONS (SPECIAL)	CONDUIT, PVC, 1 1/4" DIA.	CONDUIT, PVC, 1 1/2" DIA.	CONDUIT, PVC, 2" DIA.	CONDUIT, PVC, 4" DIA.		600V (XLP-TYPE	600V (XLP-TYPE
						CONCRETE	SALVAGE	SALVAGE	(SFECIAL)	(SFECIAL)	CONFEETE	SFECIAL	(SFECIAL)	11/4 DIA.	1/2 DIA.	Z DIA.		USE) 1/C NO. 6	USE) 1/C NO. 4	USE) 1/C NO. 2
			<u> </u>		T		1	EACH		1	Г	1	T		T	Г	FOOT	T	1	
151116	24.45	205717													195			804		
ADAMS	34+45	26FT LT	HH4												50			224		
ADAMS	33+95	26FT LT	HH5												50			224		
															50			224		
ADAMS	33+95	24FT RT	HH6																	
															21			108		
MADISON	13+83	11FT LT	A-4							1										
NAA DICON	12.21	205717	D 11								1				70			304		
MADISON	13+21	28FT LT	B-11						-		1				62			272		
MADISON	12+59	28FT LT	B-10								1				02			2/2		
											_				65			284		
MADISON	11+94	28FT LT	A-3							1										
															54			240		
MADISON	11+40	28FT LT	B-9								1									
CIRCUIT 6		T	T	1	I	_			_			1			T		1	1		
ADAMS	36+44	43FT LT	CONTROLLER						-						22			112		
ADAMS	36+58	28FT LT	A-8							1					22			112		-
ADAIVIS	30+38	ZOFFET	A-6							1					62			272		
ADAMS	37+20	28FT LT	B-20								1									
															64			280		
ADAMS	37+84	28FT LT	B-21								1									
															33			156		
ADAMS	38+16	25FT LT	HH1			1			-						45			0.4		
MONROE	24+59	18FT LT	A-9						-	1					15			84		
IVIOINNOE	24+33	TOFILI	A-3							1					27					
			CAP ON SPARE												27					
MONROE	24+83	29FT LT	CONDUIT																	
CIRCUIT 7																		_		
ADAMS	36+44	43FT LT	CONTROLLER																	
															178					
ADAMS	38+16	25FT LT	HH1						-											
ADAMS	38+67	25FT LT	HH2			1									52					
ADAIVIS	30107	251111	1112			<u> </u>									30					
			CAP ON SPARE																	
MONROE	24+75	29FT RT	CONDUIT																	
CIRCUIT 8																1				
ADAMS	36+44	43FT LT	CONTROLLER																	
	20.46	055515													178					
ADAMS	38+16	25FT LT	HH1												52	-	+		-	
ADAMS	38+67	25FT LT	HH2												J2.					
	30.07														30					
			CAP ON SPARE																	
ADAMS	38+97	29FT LT	CONDUIT																	
CIRCUIT 9			1	1	1							1			_			T	1	
ADAMS	36+44	43FT LT	CONTROLLER	1		-							-			-	-		-	
A D A B 40	20.10	255717	11114	-		+							-		178	-	 		1	
ADAMS	38+16	25FT LT	HH1	1									1		52		+		1	
ADAMS	38+67	25FT LT	HH2												32					
, , , , , , , , , , , , , , , , , , , ,	55.57														52					
ADAMS	38+65	25FT RT	HH3			1														
															30					
]		CAP ON SPARE																	
ADAMS	38+94	29FT RT	CONDUIT																<u> </u>	
CIRCUIT 10	20.44	425717	CONTROLLER	1								I			T			I	T .	Τ
ADAMS	36+44	43FT LT	CONTROLLER										-		178	-	+	184	552	-
ADAMS	38+16	25FT LT	HH1			+									1/6		+	104	552	
	30.10														52			58	174	
ADAMS	38+67	25FT LT	HH2																	
															52			58	174	
V D V V VC	20.05	1 SECTION	כווו	1	1	Ī _			1	I	I		1	1			1	1	1	1

5		ADA	MS	38+65	25FT RT	
:						
i			USER I	NAME = JWI	nite	
	(HFI) Hutch	ison				
	Engineeri					
-	2024	IOR# 5075	PLOT E	ATE = 11/2	22/2024	

	USER NAME = JWhite	DESIGNED	-	AWM	REVISED -
ı		DRAWN	-	JCW	REVISED -
		CHECKED	-	AWM	REVISED -
75	PLOT DATE = 11/22/2024	DATE	_	11/22/2024	REVISED -

HH3

STATE OF ILLINOIS DEPARTMENT OF TRANSPORTATION

PITTSFIELD HISTORIC DOWNTOWN SQUARE RECONSTRUCTION SCHEDULE OF QUANTITIES SCALE: NONE SHEET 7 OF 10 SHEETS STA. TO STA.										
SCALE	NONE	SHEET 7	OF	10	SHEETS	STA.	TO STA.			

F.A.P. RTE	SEC ⁻	ΓΙΟΝ		COUNTY	TOTAL SHEETS	SHE
	24-0003	7-00-RS	PIKE	144	22	
				CONTRACT	NO. 938	347
		ILLINOIS	D PROJECT			

LIGHTING SCHEDULE XX008870 80400100 81400730 84200500 84200600 X8250505 X1400431 X0326654 REMOVAL OF **REMOVAL OF** HANDHOLE LIGHTING LIGHTING ORNAMENTAL ELECTRIC SERVICE LIGHTING LIGHTING STREET STATION DESCRIPTION STREET CLOCK SIDE COMPOSITE CONTROLLER ASSEMBLY LIGHT UNIT, INSTALLATION UNIT, NO UNIT, CONCRETE (SPECIAL) (SPECIAL) COMPLETE SALVAGE SALVAGE

MONROE 23+81 13FTRT

MONROE 23+21 28FT RT

MONROE 22+61 28FT RT

MONROE 21+93 28FT RT

MONROE 21+30 28FT RT

MONROE 20+77 28FTRT

ADAMS 38+16 25FTLT

ADAMS 38+67 25FT LT ADAMS 38+65 25FT RT

MONROE 20+70 31FR RT

ADAMS 30+41 42FTLT ADAMS 31+17 42FT LT

CIRCUIT 12, CIRCUIT 14

ON EXISTING CIRCUIT

ADAMS 36+44 43FTLT CONTROLLER

MONROE 20+63 47FT LT TIMECLOCK (TC)

ADAMS 36+44 43FTLT CONTROLLER ADAMS 36+54 28FT LT EV STATION

CIRCUIT 11

A-10

B-22

B-23

B-24

B-25

HH1

HH3

HH7

C-2

EACH

ION	SCALE: NONE	SCHED SHEET 8 OF	F.A.P. SECTION CO. RTE. 24-00037-00-RS CO. ILLINOIS FED. AID PROJ					
•	PITTSFIE	LD HISTORIC DO	OWNTOWN SOU	IARE RECONS	STRUCTION	F.A.P. RTE	SECTION	一
								\dashv
			100	100				
			100	100				=
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1		46			58		116	_
								-
		80			258			
		340			1038			
		52			174			-
		52			174			_
		178			552			

X1400403

LUMINAIRE

REPLACEMENT

SPECIAL

X8780105

CONCRETE

FOUNDATIONS

(SPECIAL)

81028330

1 1/4" DIA.

81028340

1/2" DIA.

65

61

69

63

53

UNDERGROUND UNDERGROUND UNDERGROUND

CONDUIT, PVC, CONDUIT, PVC, CONDUIT, PVC, CONDUIT, PVC,

81028350

2" DIA.

81028390

4" DIA.

FOOT

81702130

ELECTRIC CABLE

IN CONDUIT,

71

67

75

69

59

81702140

ELECTRIC CABLE

IN CONDUIT,

600V (XLP-TYPE | 600V (XLP-TYPE | 600V (XLP-TYPE

USE) 1/C NO. 6 USE) 1/C NO. 4 USE) 1/C NO. 2

213

201

225

207

177

81702150

ELECTRIC CABLE

IN CONDUIT,

Hutchison Engineering, Inc.

F.A.P. RTE.	SECTION		COUNTY	TOTAL SHEETS	SHEET NO.
	24-00037-00-RS		PIKE	144	23
			CONTRACT	NO 938	347
	ILLINOIS	FED. All	PROJECT		

LIGHTING SCHEDULE

				XX008870	80400100	81400730	84200500	84200600	X8250505	X1400431	X0326654	X1400403	X8780105	81028330	81028340	81028350	81028390	81702130	81702140	81702150
STREET	STATION	SIDE	DESCRIPTION	STREET CLOCK	ELECTRIC SERVICE INSTALLATION	HANDHOLE, COMPOSITE CONCRETE	REMOVAL OF LIGHTING UNIT, SALVAGE	REMOVAL OF LIGHTING UNIT, NO SALVAGE	LIGHTING CONTROLLER (SPECIAL)		ORNAMENTAL LIGHT UNIT, COMPLETE	LUMINAIRE REPLACEMENT SPECIAL	CONCRETE FOUNDATIONS (SPECIAL)	UNDERGROUND CONDUIT, PVC, 1 1/4" DIA.					IN CONDUIT,	
								EACH									FOOT			
														169						
ADAMS	38+16	25FT LT	HH1																	
														48						
ADAMS	38+67	25FT LT	HH2																	
														48						
ADAMS	38+65	25FT RT	HH3																	
														17						
MONROE			A-10																	
FUTURE SOU					1					Г		I								
ADAMS	38+16	25FT LT	HH1																	
														13						
MONROE	24+59	18FT LT	A-9																	
FUTURE SOU																				
ADAMS	33+95	26FT LT	HH5																	
														13						
MADISON			A-5																	
FUTURE SOL																				
ADAMS	36+49	45FT LT																		
														207						
ADAMS	34+45	26FT LT	HH4																	
														48						
ADAMS	33+95	26FT LT	HH5																	
														47						
ADAMS	33+95	24FT RT	HH6																	
														17						
MADISON	13+83	11FT LT	A-4			<u> </u>	_													
TOTAL				1	1	8	3	18	1	11	25	13	1	627	5346	100	100	14378	4056	116
USE				1	1	8	3	18	1	11	25	13	1	627	5346	100	100	14378	4056	116

SIG	NING	S SCH	EDU	LE

					72000100	X7280105	X0327018			
STATION	OFFSET	FACING	DESIGNATION	SIZE (W x H)	SIGN PANEL TYPE 1	TELESCOPING STEEL SIGNING SUPPORT (SPECIAL)	DECORATIVE SIGN POST	DESCRIPTION		
				INCH	SQ FT	FOOT	EACH	1		
//ADISON STREET										
10+46	32.0' LT	S	R5-1	30 x 30	6.3			DO NOT ENTER		
10+50	36.0' RT	S	R5-1	30 x 30	6.3		1	DO NOT ENTER		
11+76	28.0' LT	E	R7-8, R7-I101 (250)	12 x 24	2.0	12.0		RESERVED PARKING (HANDICAP) - \$250 FINE		
12+00	28.0' LT	W	R6-2(R)	24 x 30	5.0	12.0		ONE WAY (RIGHT)		
12+04	39.0' RT	W	R6-1(R)	36 x 12	3.0	11.0		ONE WAY (RIGHT)		
12+20	39.0' RT	W	R7-8, R7-I101 (250)	12 x 24	2.0	12.0		RESERVED PARKING (HANDICAP) - \$250 FINE		
13+58	28.0' LT	E	R7-8, R7-I101 (250)	12 x 24	2.0	12.0		RESERVED PARKING (HANDICAP) - \$250 FINE		
13+82	10.7' LT	N	R2-1 (15)	24 x 30	5.0			SPEED LIMIT 15 MPH		
		S	R5-1	30 x 30	6.3			DO NOT ENTER		
14+60	19.0' LT	N	R1-1	30 x 30	6.3			STOP		
14+60		N	W4-4P	24 x 12	2.0			CROSS TRAFFIC DOES NOT STOP		
								STREET NAME SIGNS TO BE PROVIDED BY THE CI		
		S	R5-1	30 x 30	6.3			DO NOT ENTER		
14+61	16.0' RT	N	R1-1	30 x 30	6.3		1	STOP		
		N	W4-4P	24 x 12	2.0			CROSS TRAFFIC DOES NOT STOP		
14+82	28.0' RT	W	R7-8, R7-I101 (250)	12 x 24	2.0	12.0		RESERVED PARKING (HANDICAP) - \$250 FINE		
15+90	28.0' LT	E	R7-8, R7-I101 (250)	12 x 24	2.0	12.0		RESERVED PARKING (HANDICAP) - \$250 FINE		
16.22	20.0117	w	R6-2(R)	24 x 30	5.0	12.0		ONE WAY (RIGHT)		
16+22	28.0' LT	Е	R6-2(L)	24 x 30	5.0	12.0		ONE WAY (LEFT)		
16.42	20 OLDT	W	R6-2(R)	24 x 30	5.0	12.0		ONE WAY (RIGHT)		
16+43	28.0' RT	E	R6-2(L)	24 x 30	5.0	12.0		ONE WAY (LEFT)		
18+10	32.0' LT					12.0		STREET NAME SIGNS TO BE PROVIDED BY THE CI		
18+20	41.0' LT	w	R1-1	30 x 30	6.3	12.0		STOP		

(HE)	Hutchison Engineering, Inc.
2024	JOB# 5075

	USER NAME = JWhite	DESIGNED -	AWM	REVISED -
n		DRAWN -	JCW	REVISED -
o.		CHECKED -	AWM	REVISED -
075	PLOT DATE = 11/22/2024	DATE -	11/22/2024	REVISED -

Т	DITTECICI	WN	TOWN 9	F.A.P. RTE	SEC ⁻	ΓΙΟΝ		COUNTY	TOTAL	SHEET NO.				
	PITTSFIELD HISTORIC DOWNTOWN SQUARE RECONSTRUCTION SCHEDULE OF QUANTITIES											PIKE	144	24
	SCHEDOLL OF QUANTITIES											CONTRAC	T NO. 938	347
SCALE	: NONE	SHEET 9	OF	10	SHEETS	STA.	TO STA.	ILLINOIS FED, AID PROJECT						

SIGNING SCHEDULE

					SIGNING SCHED			T	
					72000100	X7280105	X0327018		
]		SIGN	TELESCOPING STEEL		1	
STATION	OFFSET	FACING	DESIGNATION	SIZE (W x H)	PANEL	SIGNING	DECORATIVE	DESCRIPTION	
SIAMON	011021	174645	DESIGNATION		TYPE 1	SUPPORT (SPECIAL)	SIGN POST	DESCRIPTION	
			ŀ		_				
I				INCH	SQ FT	FOOT	EACH		
MONROE STREET									
20+77	27.6' RT	S	R2-1 (15)	24 x 30	5.0			SPEED LIMIT 15 MPH	
20+71	28.0' RT	w	R7-8, R7-I101 (250)	12 x 24	2.0	12.0		RESERVED PARKING (HANDICAP) - \$250 FINE	
22+01	39.0' LT	E	R7-8, R7-I101 (250)	12 x 24	2.0	12.0		RESERVED PARKING (HANDICAP) - \$250 FINE	
22+20	39.0' LT	E	R6-1(R)	36 x 12	3.0	11.0		ONE WAY (RIGHT)	
22+24	27.6' RT	E	R6-2(R)	24 x 30	5.0	12.0		ONE WAY (RIGHT)	
23+58	28.0' RT	w	R7-8, R7-I101 (250)	12 x 24	2.0	12.0		RESERVED PARKING (HANDICAP) - \$250 FINE	
		N				12.0	1	·	
23+73	22.1' LT		R5-1	30 x 30	6.3		1	DO NOT ENTER	
23+81	13.5' RT	N	R5-1	30 x 30	6.3			DO NOT ENTER	
24+58								STREET NAME SIGNS TO BE PROVIDED BY THE CI	
24+93	31.8' RT	W	R7-8, R7-I101 (250)	12 x 24	2.0	12.0		RESERVED PARKING (HANDICAP) - \$250 FINE	
26+08	30.5' LT	E	R7-8, R7-I101 (250)	12 x 24	2.0	12.0		RESERVED PARKING (HANDICAP) - \$250 FINE	
26+19	30.3' LT	w	R6-2(L)	24 x 30	5.0	12.0		ONE WAY (LEFT)	
20+19	30.3 LI	E	R6-2(R)	24 x 30	5.0	12.0		ONE WAY (RIGHT)	
		w	R6-2(L)	24 x 30	5.0			ONE WAY (LEFT)	
26+41	30.3' RT	E	R6-2(R)	24 x 30	5.0	12.0		ONE WAY (RIGHT)	
27+25	30.3' RT	w	R7-8, R7-I101 (250)	12 x 24	2.0	12.0		RESERVED PARKING (HANDICAP) - \$250 FINE	
27+43	30.3' RT	W	R7-8, R7-I101 (250)	12 x 24	2.0	12.0		RESERVED PARKING (HANDICAP) - \$250 FINE	
27+96	11.0' LT	S	R1-1	30 x 30	6.3	12.0		STOP	
		N	R5-1	30 x 30	6.3			DO NOT ENTER	
27+96	11.0' RT	S	R1-1	30 x 30	6.3	12.0		STOP	
27.50	11.0 1(1	N	R5-1	30 x 30	6.3	12.0		DO NOT ENTER	
ADAMS STREET									
		Е	R1-1	30 x 30	6.3			STOP	
30+42	19.9' LT	w	R5-1	30 x 30	6.3			DO NOT ENTER	
	15.5 L1	- "	113 1	30 N 30	0.5			STREET NAME SIGNS TO BE PROVIDED BY THE CI	
		E	D1 1	20 × 20	6.2			STOP	
30+42	18.0' RT		R1-1	30 x 30	6.3	12.0			
		W	R5-1	30 x 30	6.3			DO NOT ENTER	
32+00	27.5' LT	N	R6-2(R)	24 x 30	5.0	12.0		ONE WAY (RIGHT)	
		S	R6-2(L)	24 x 30	5.0			ONE WAY (LEFT)	
32+21	28.0' RT	N	R6-2(R)	24 x 30	5.0	12.0		ONE WAY (RIGHT)	
32.21	20.0 111	S	R6-2(L)	24 x 30	5.0	12.0		ONE WAY (LEFT)	
32+36	28.0' RT	N	R7-8, R7-I101 (250)	12 x 24	2.0	12.0		RESERVED PARKING (HANDICAP) - \$250 FINE	
33+38	28.0' LT	S	R7-8, R7-I101 (250)	12 x 24	2.0	12.0		RESERVED PARKING (HANDICAP) - \$250 FINE	
34+47	15.7' LT	w	R5-1	30 x 30	6.3		1	DO NOT ENTER	
34+67	22.1' RT	w	R5-1	30 x 30	6.3		1	DO NOT ENTER	
35+95	28.0' LT	S	R7-8, R7-I101 (250)	12 x 24	2.0	12.0	<u> </u>	RESERVED PARKING (HANDICAP) - \$250 FINE	
36+19	28.0' LT	N	_ ` ` '	24 x 30	5.0	12.0		ONE WAY (RIGHT)	
			R6-2(R)					1	
36+23	28.0' RT	N	R6-1(R)	36 x 12	3.0	11.0		ONE WAY (RIGHT)	
36+40	39.0' RT	N	R7-8, R7-I101 (250)	12 x 24	2.0	12.0		RESERVED PARKING (HANDICAP) - \$250 FINE	
37+77	28.0' LT	S	R7-8, R7-I101 (250)	12 x 24	2.0	12.0		RESERVED PARKING (HANDICAP) - \$250 FINE	
37+83	27.6' LT	E	R2-1 (15)	24 x 30	5.0			SPEED LIMIT 15 MPH	
		E	R1-1	30 x 30	6.3			STOP	
38+81	16.0' LT	w	R5-1	30 x 30	6.3		1	DO NOT ENTER	
		Е	W4-4P	24x12	2.0			CROSS TRAFFIC DOES NOT STOP	
		E	R1-1	30 x 30	6.3			STOP	
38+81	16.0' RT	w	R5-1	30 x 30	6.3		1	DO NOT ENTER	
30.01	20.0 111	E	W4-4P	24x12	2.0			CROSS TRAFFIC DOES NOT STOP	
-					_				
40+41	31.0 ' LT	N	R6-2(R)	24 x 30	5.0	12.0		ONE WAY (RIGHT)	
		S	R6-2(L)	24 x 30	5.0			ONE WAY (LEFT)	
40+62	30.0' RT	N	R6-2(R)	24 x 30	5.0	12.0		ONE WAY (RIGHT)	
.5.02	55.5 111	S	R6-2(L)	24 x 30	5.0	22.0		ONE WAY (LEFT)	
41+20	27.4' LT	S	R7-8, R7-I101 (250)	12 x 24	2.0	12.0		RESERVED PARKING (HANDICAP) - \$250 FINE	
					1				
TOTAL					307.9	441.0	7		


(HE)	Hutchison Engineering, Inc.

	USER NAME = JWhite	DESIGNED -	AWM	REVISED -
		DRAWN -	JCW	REVISED -
		CHECKED -	AWM	REVISED -
5	PLOT DATE = 11/22/2024	DATE -	11/22/2024	REVISED -

						F.A.P. RTE				COUNTY	TOTAL SHEETS		
SCHEDULE OF QUANTITIES								24-00037-00-RS			PIKE	144	25
CONLEDGE OF WORKTITIES											CONTRAC	Γ NO. 93	847
SCALE: NONE	SHEET 10	OF	10	SHEETS	STA.	TO STA.		ILLINOIS FED. AID PROJECT					

BENCHMARKS:


- BM#1 DISK IN TOP WEST HAND RAIL BLOCK AT NORTH ENTRANCE TO COURTHOUSE. $\frac{5}{8}$ " IROD, EAST SIDE OF COURTHOUSE. NORTH OF SIDEWALK, WEST SIDE OF MONROE STREET. ELEV. 739.87
- BM#2 CHISELED 'X' ON EAST FLANGE BOLT, SOUTH OF ALLEY, WEST SIDE OF MADISON STREET ELEV. 740.13
- BM#3 CHISELED 'X' ON WEST FLANGE BOLT ON FIRE HYDRANT ON EAST SIDE OF MONROE STREET, NORTH SIDE OF ALLEY.
- BM#4 CHISELED 'I' ON SOUTHWEST CORNER OF CLOCK BASE AT THE NORTHEAST QUADRANT OF MADISON AND ADAMS INTERSECTION.
- BM#5 CHISELED '' ON SOUTHEAST CORNER OF CONCRETE BASE AT THE WEST SIDE OF MADISON AND SOUTH OF ALLEY. ELEV. 735.25
- BM#6 CHISELED '□' ON SOUTHEAST CORNER OF CONCRETE BASE AT THE SOUTHWEST QUADRANT OF MADISON AND JEFFERSON INTERSECTION. ELEV. 734.50
- BM#7 CHISELED 'X' ON EAST FLANGE BOLT ON FIRE HYDRANT AT NORTHWEST QUADRANT OF ADAMS AND MEMORIAL INTERSECTION. ELEV. 739.20
- BM#8 CHISELED '□' ON NORTHEAST CORNER OF CONCRETE BASE, ±40' EAST OF MONROE ON SOUTH SIDE OF ADAMS.
- BM#9 CHISELED 'I' ON SOUTHWEST CORNER OF CONCRETE, SOUTH SIDE OF ALLEY AND EAST SIDE OF MONROE. ELEV. 732.02

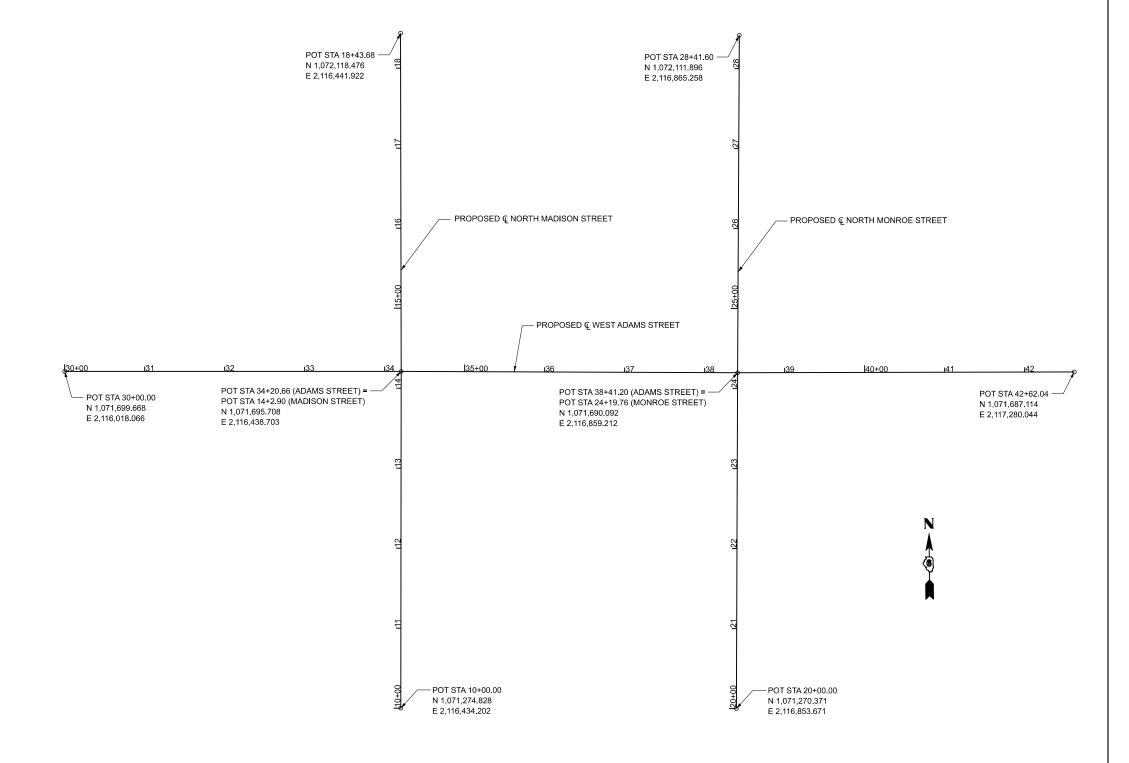


SCALE: 1"=60'

(HE)	Hutchison Engineering, Inc.

USER NAME = JWhite	DESIGNED -	REVISED -	
	DRAWN -	REVISED -	
	CHECKED -	REVISED -	
PLOT DATE = 7/25/2025	DATE -	REVISED -	

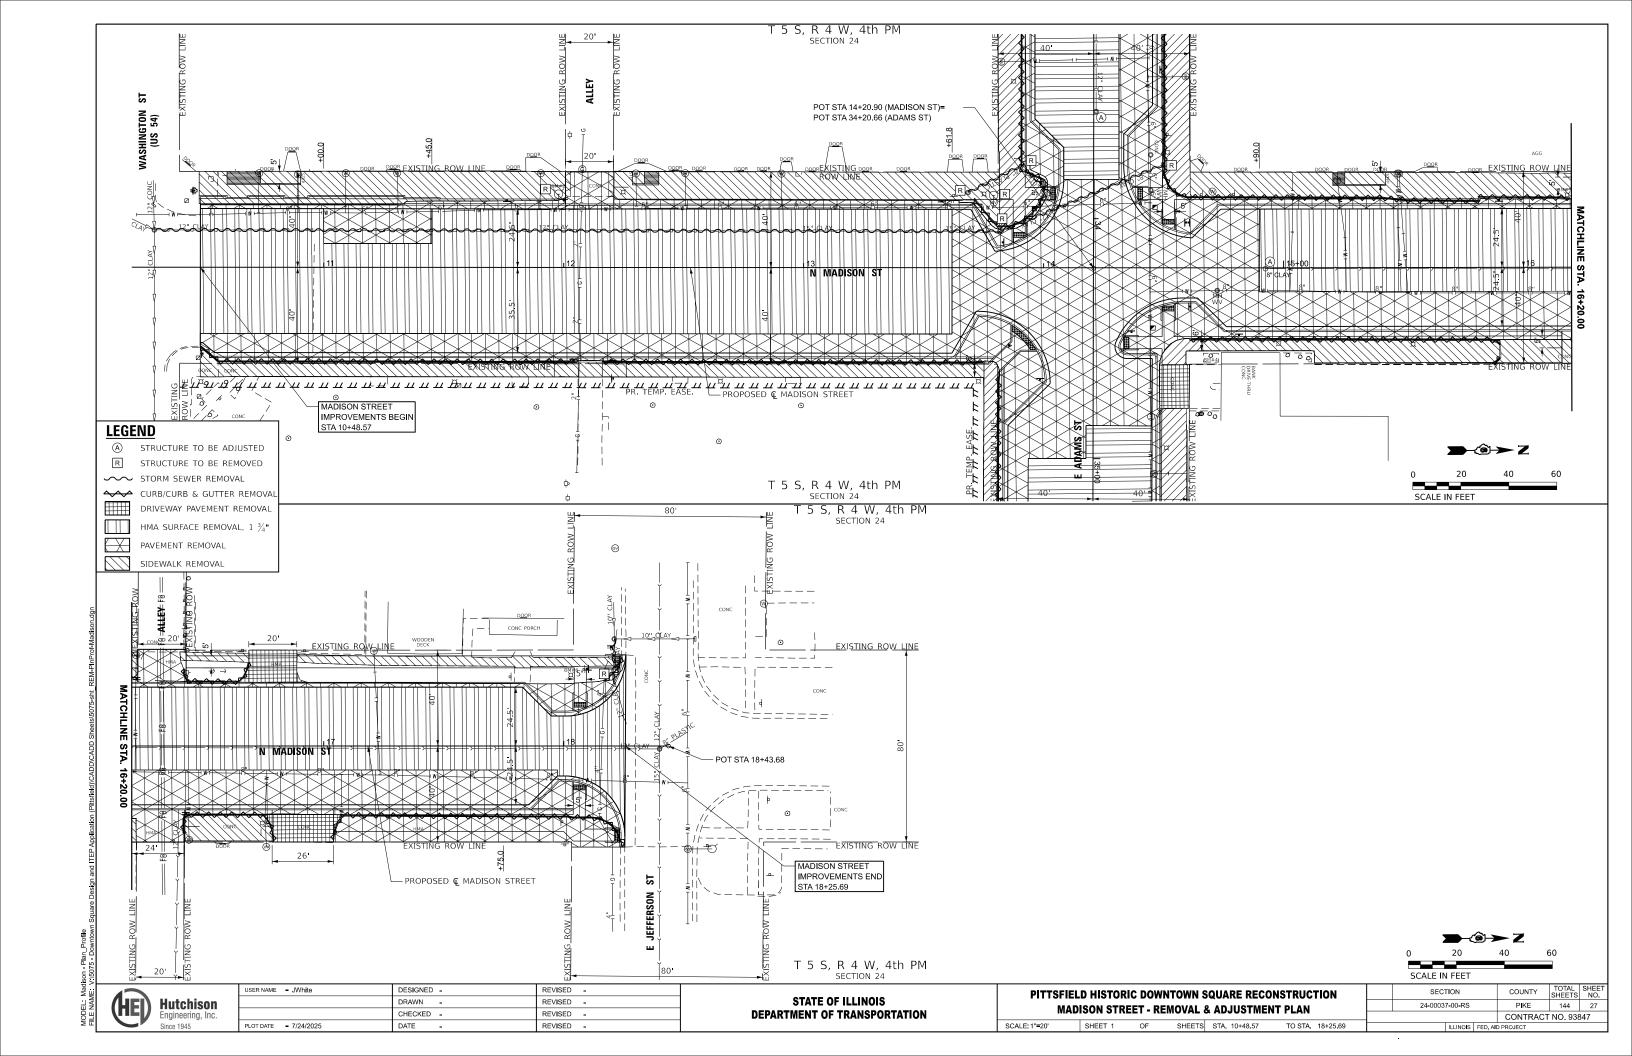

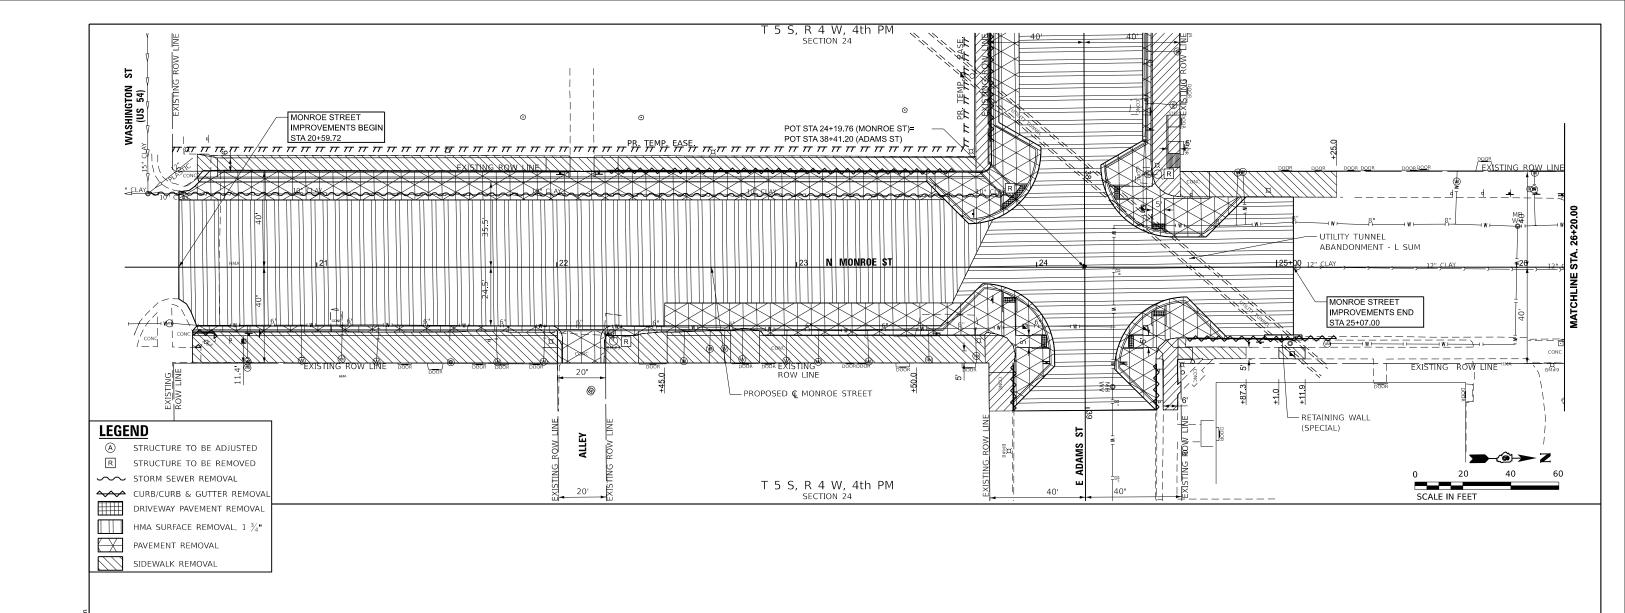

Hutchison Engineering, Inc.

 USER NAME
 = JWhite
 DESIGNED
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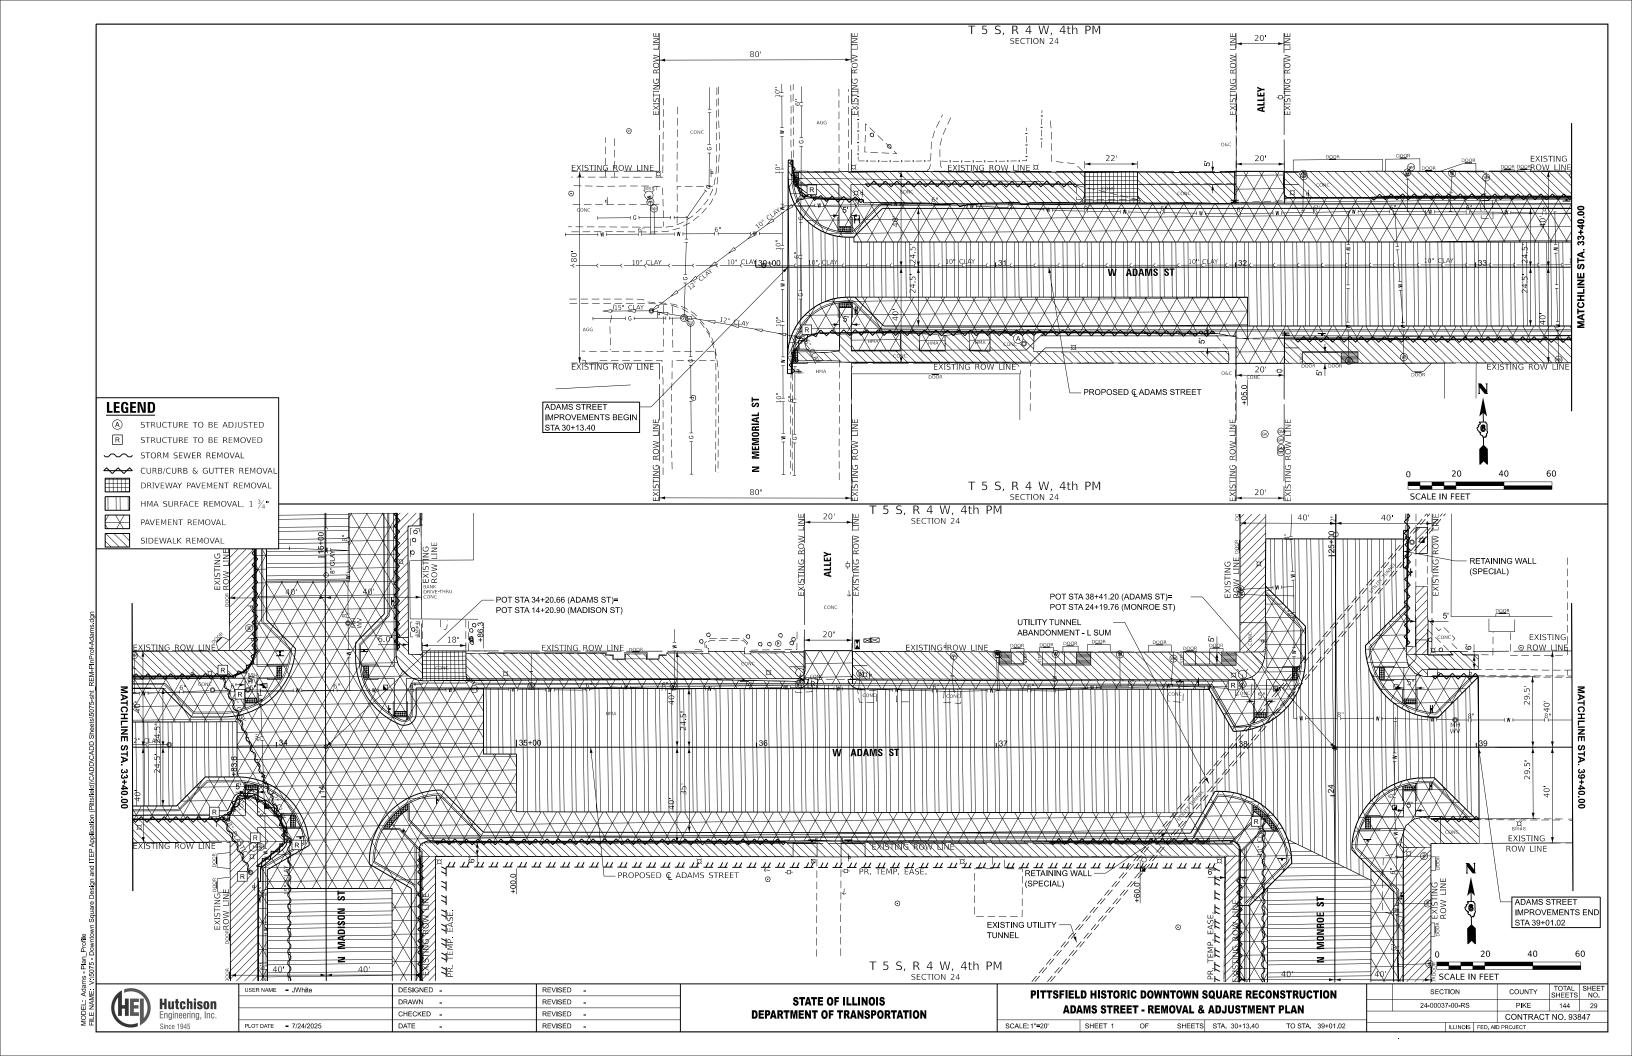
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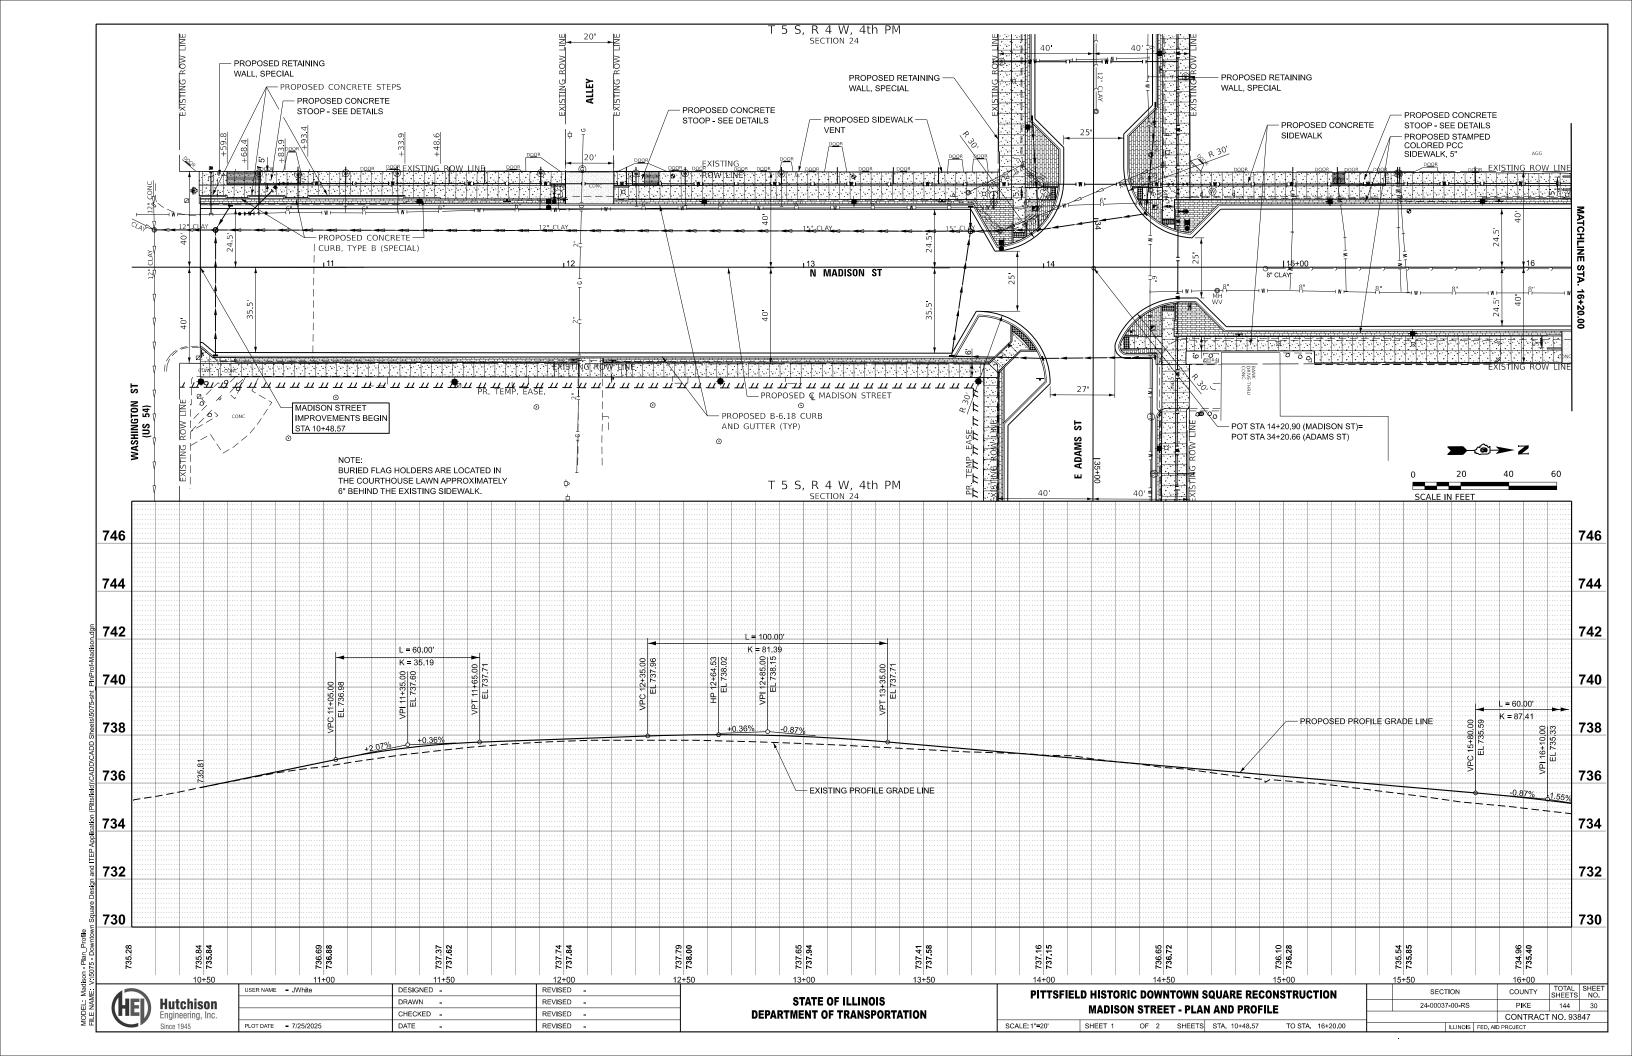
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 = 7/24/2025
 DATE
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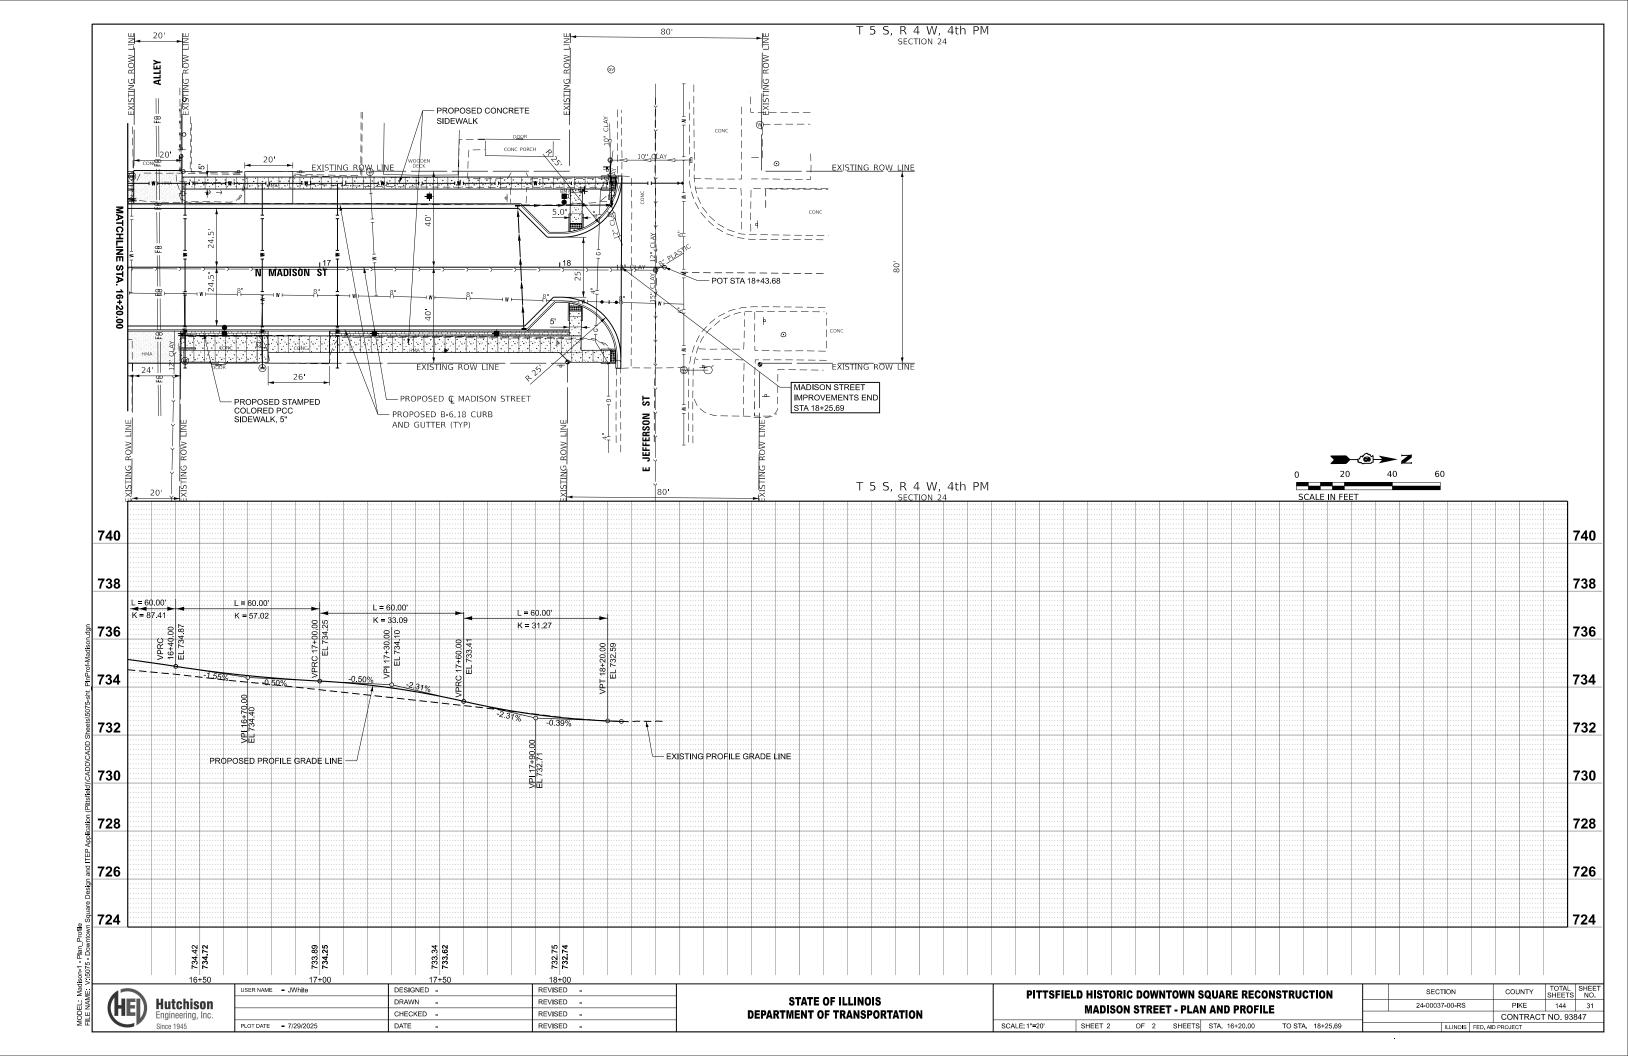
STATE OF ILLINOIS
DEPARTMENT OF TRANSPORTATION


PITTSFIELD HISTORIC DOWNTOWN SQUARE RECONSTRUCTION
MONROE STREET - REMOVAL & ADJUSTMENT PLAN


SCALE: 1°=20' SHEET 1 OF SHEETS STA. 20+59.72 TO STA. 25+07.00










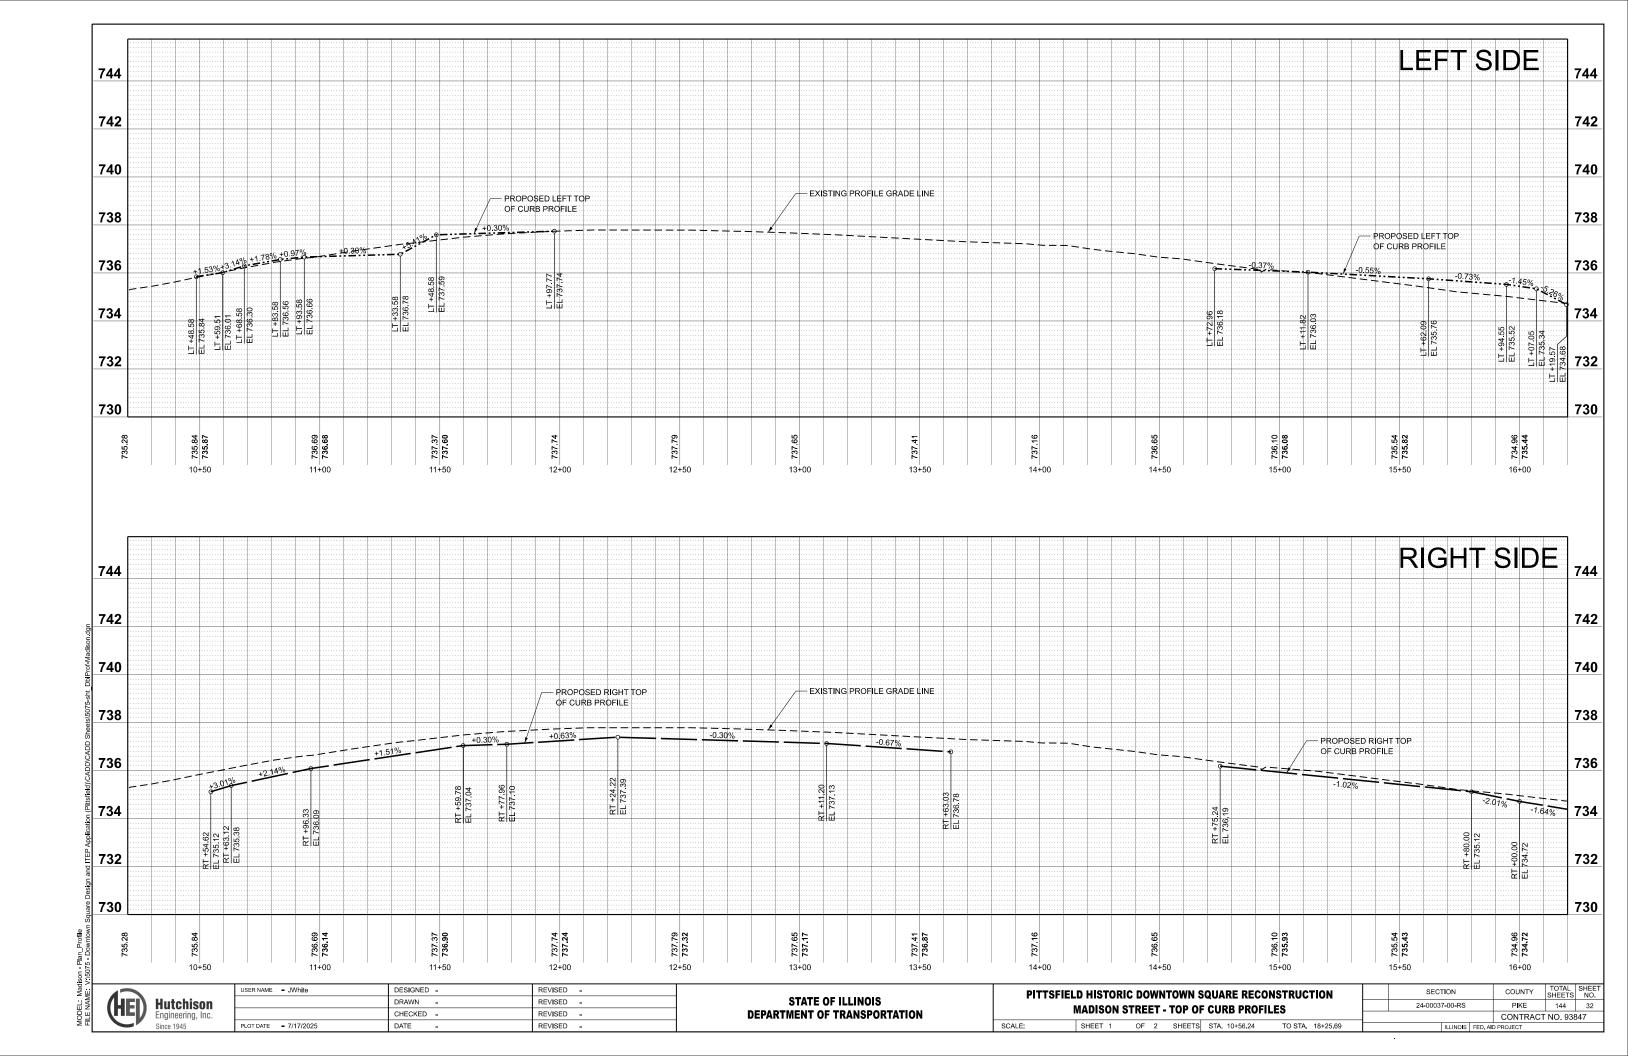


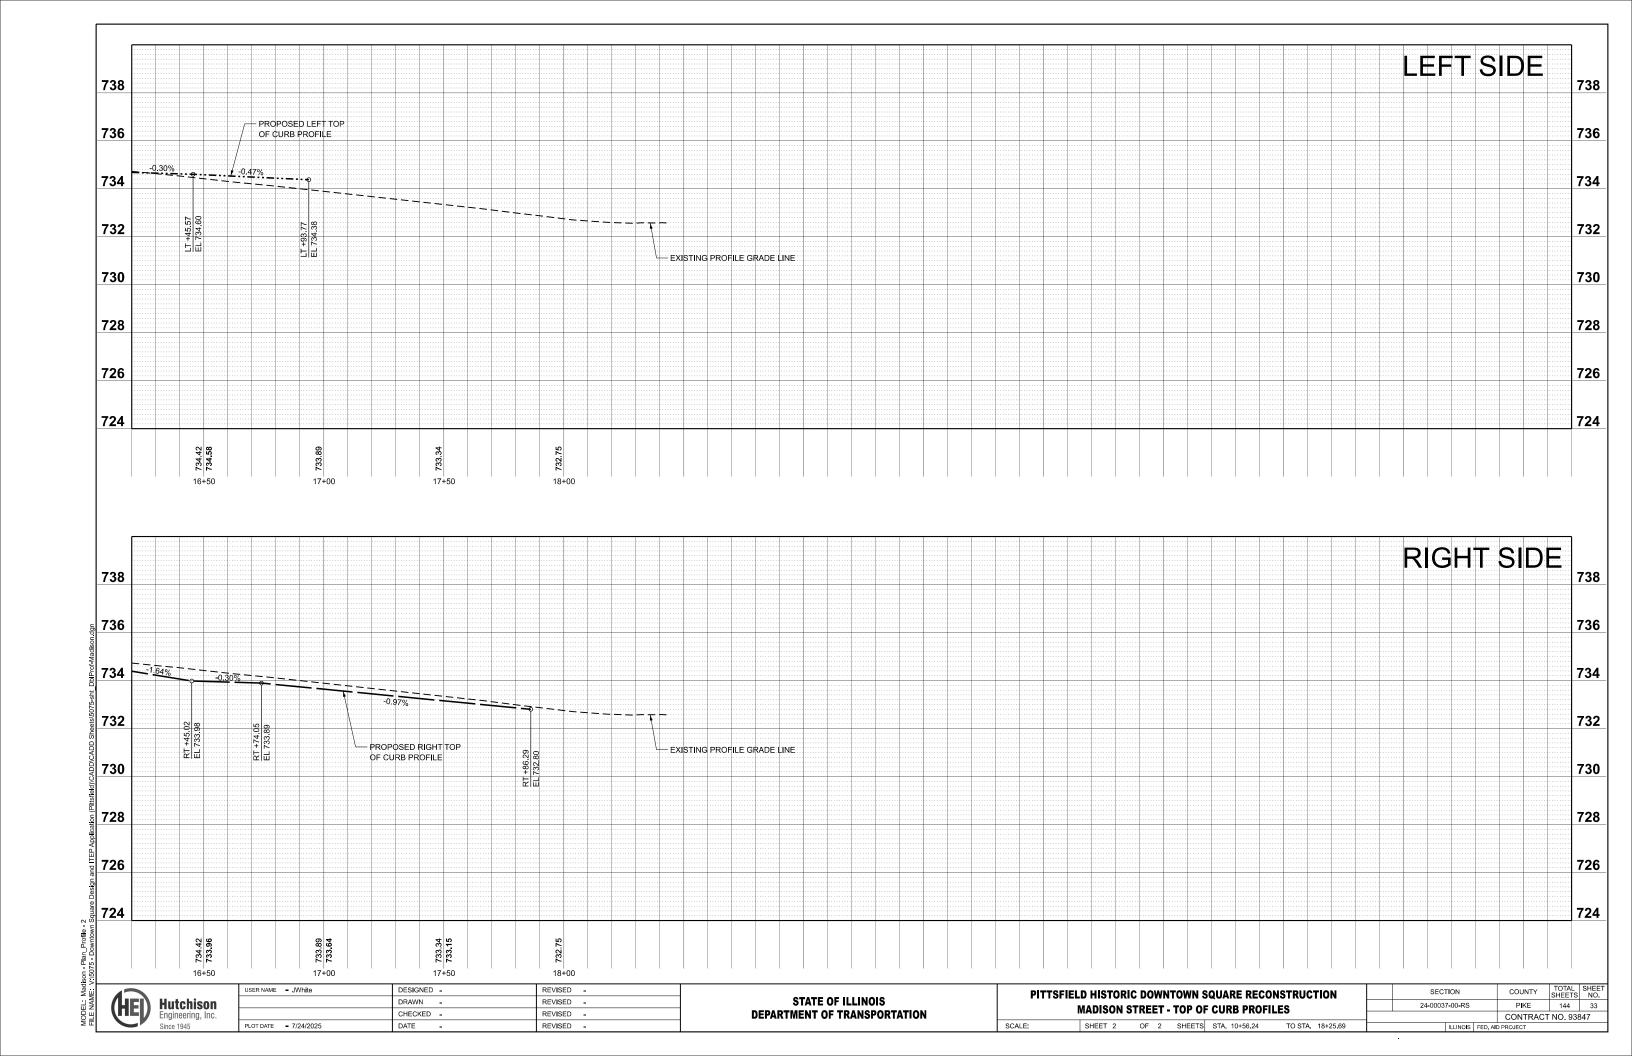


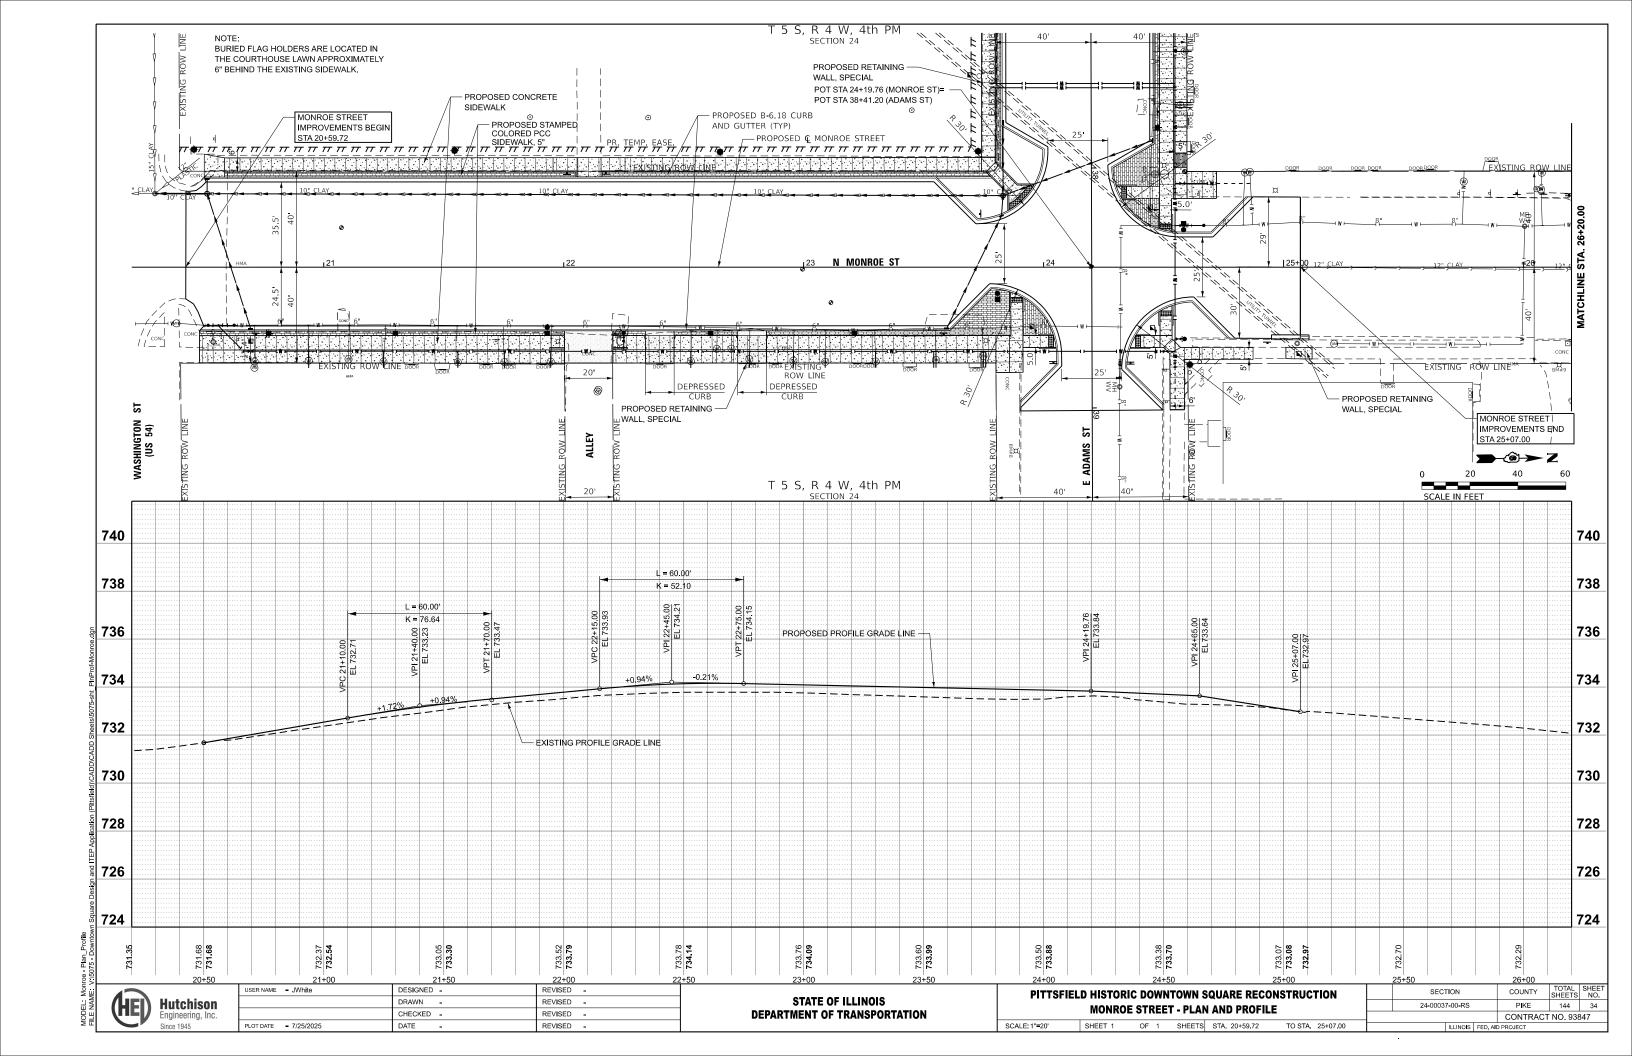


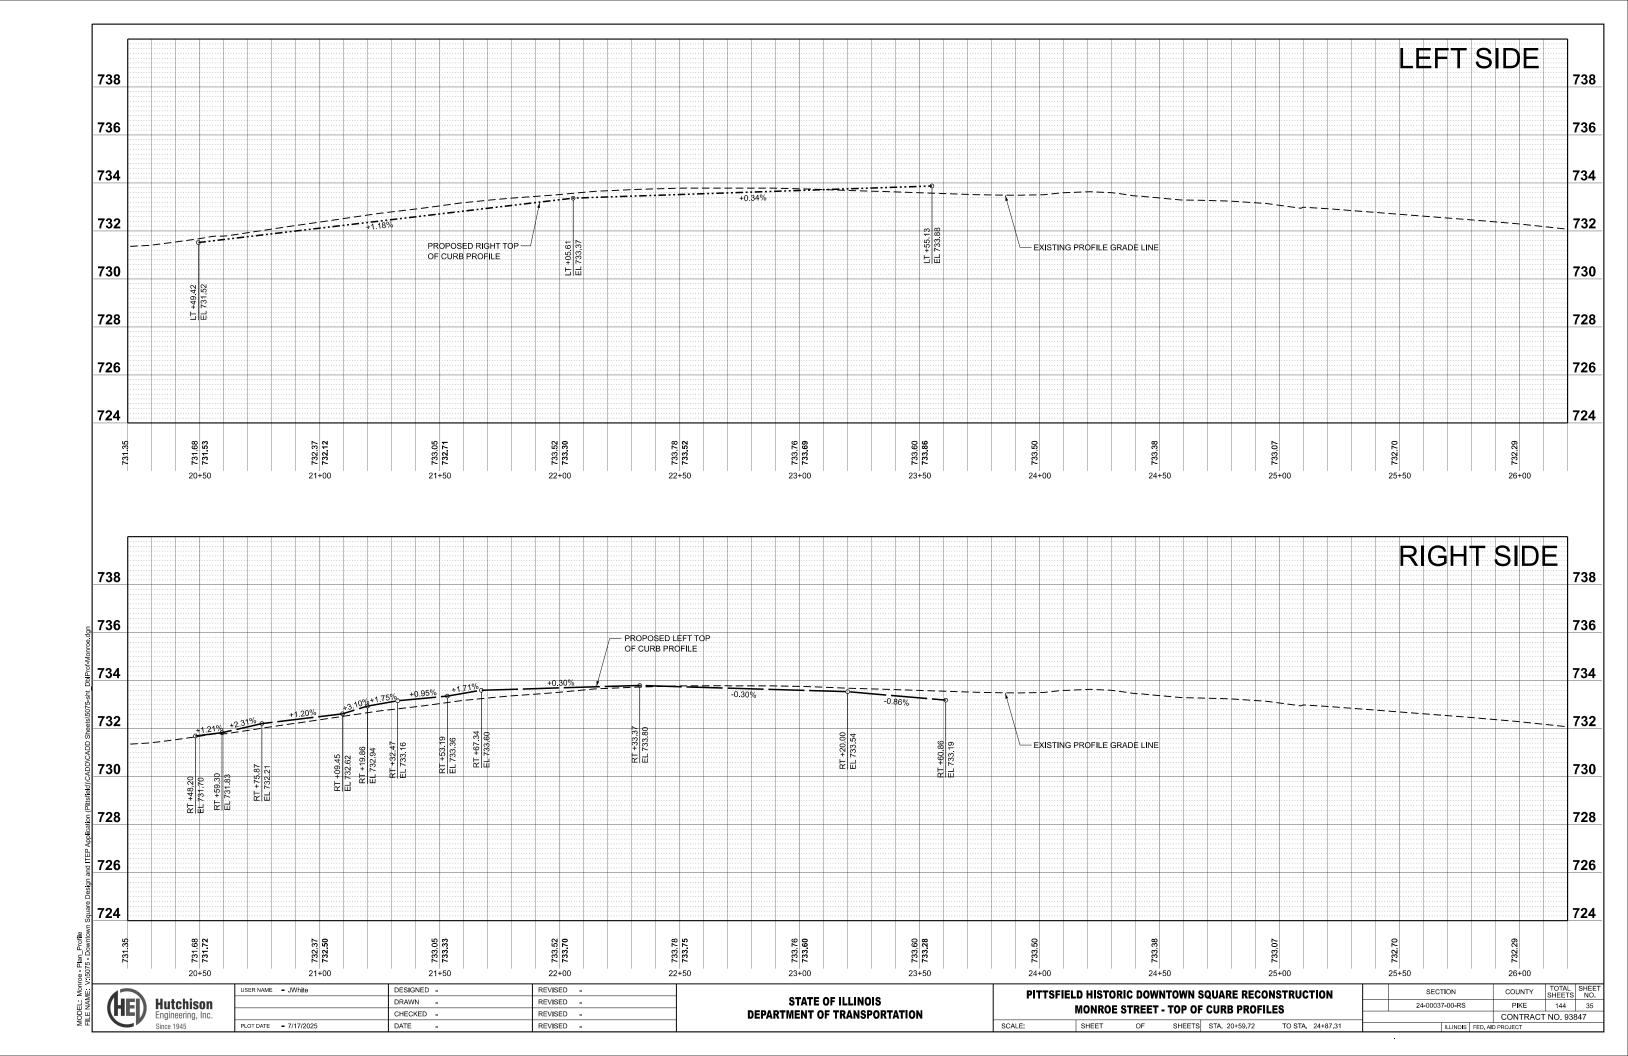


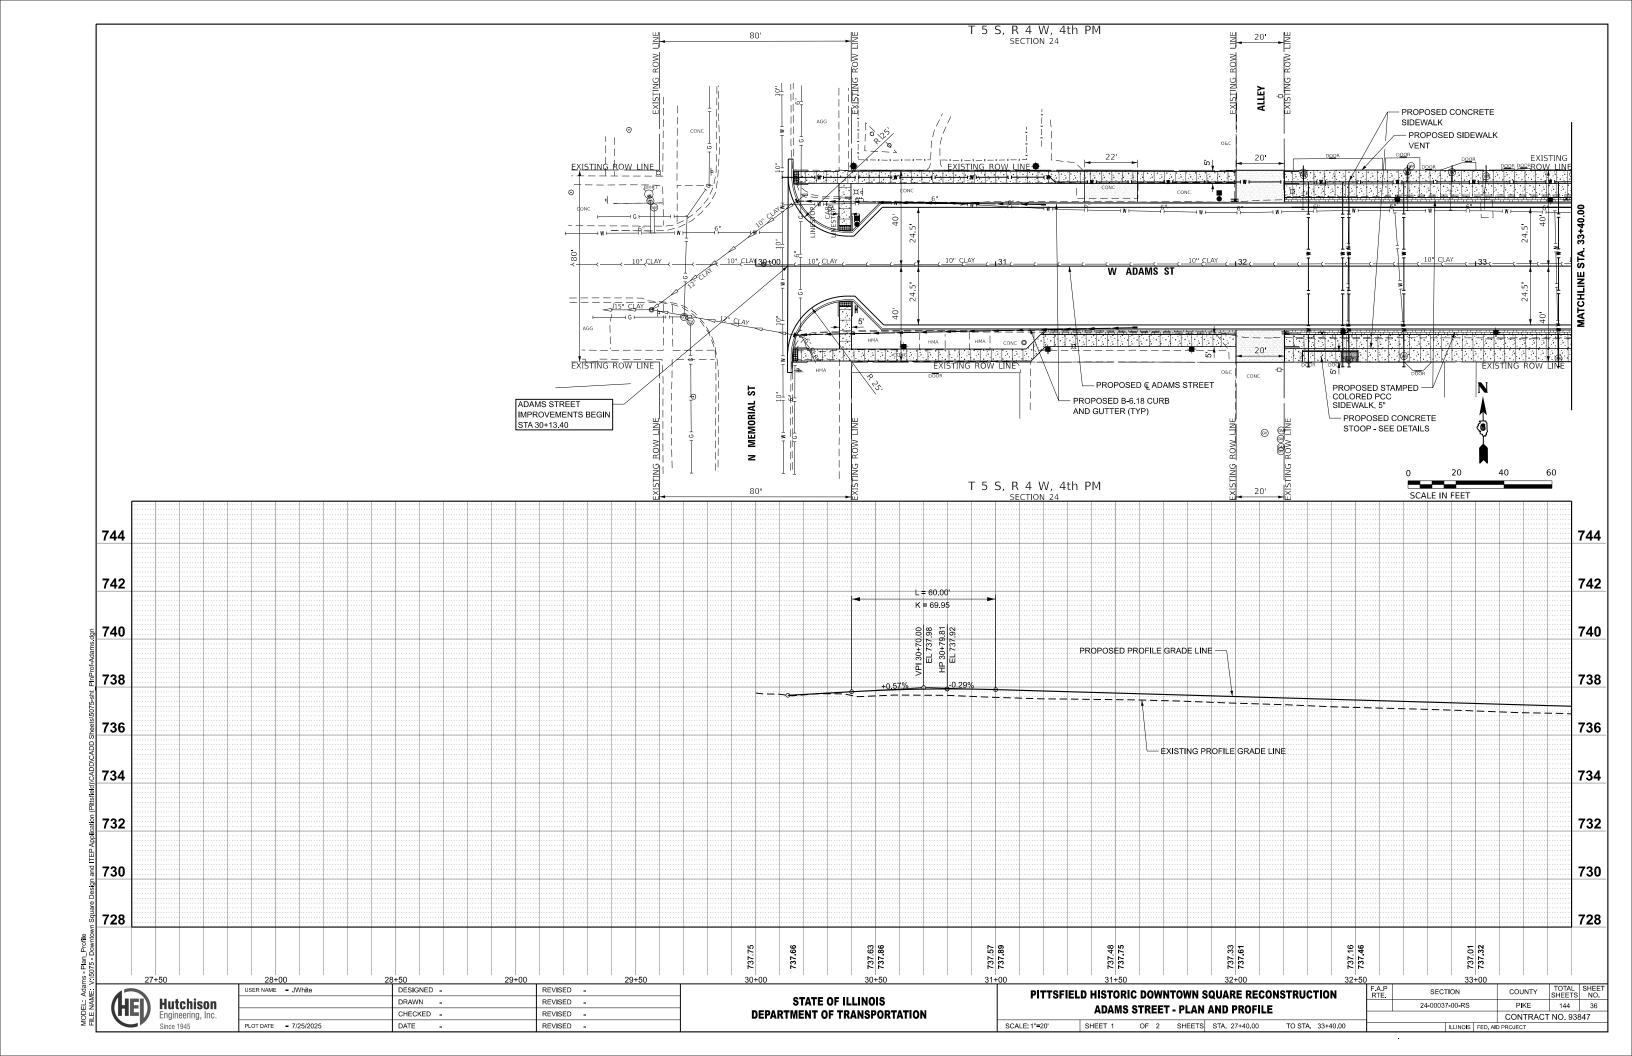


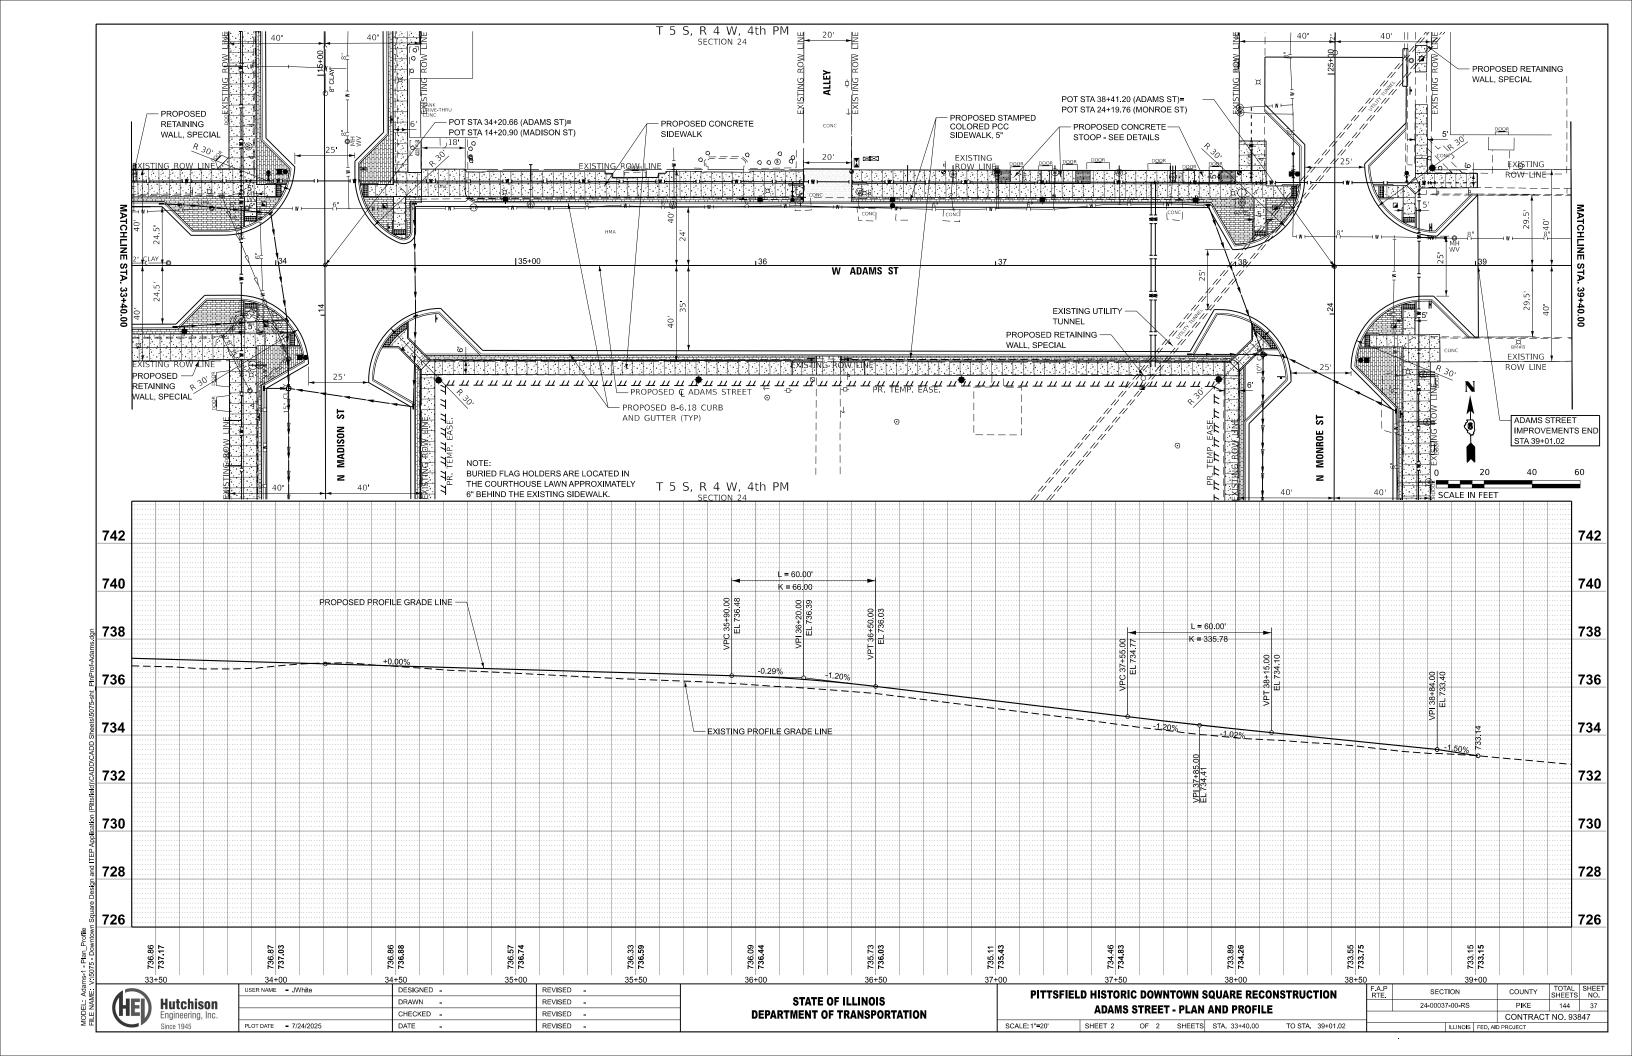


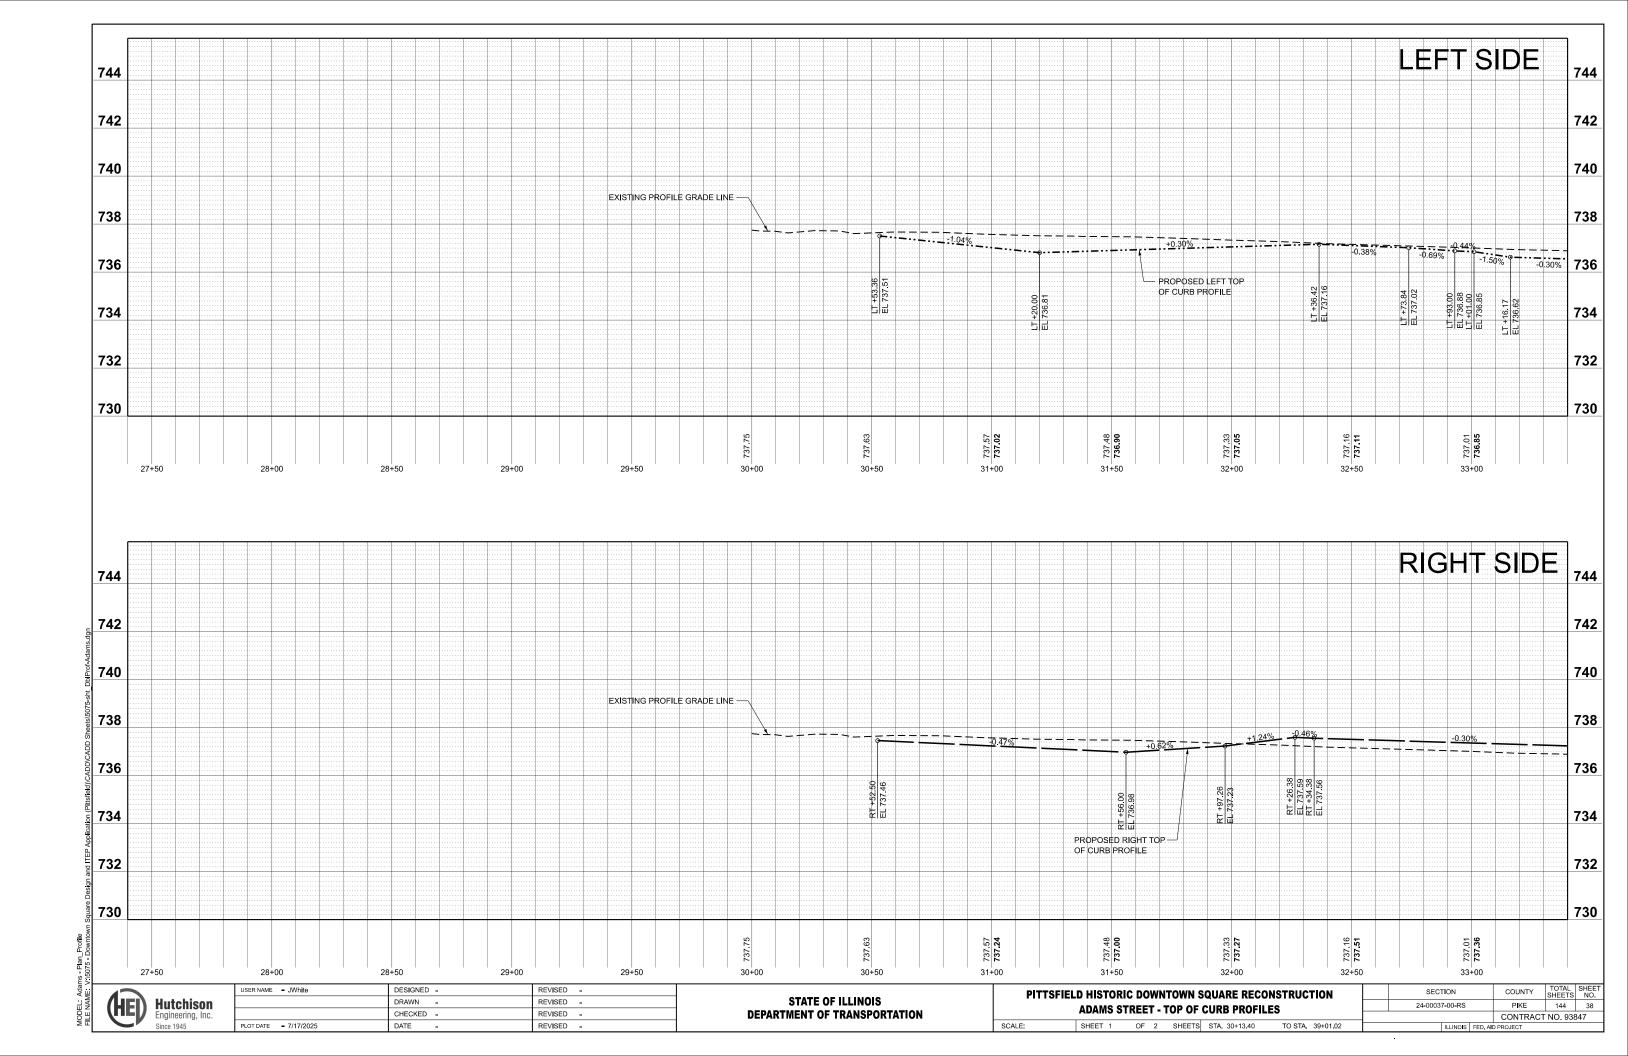


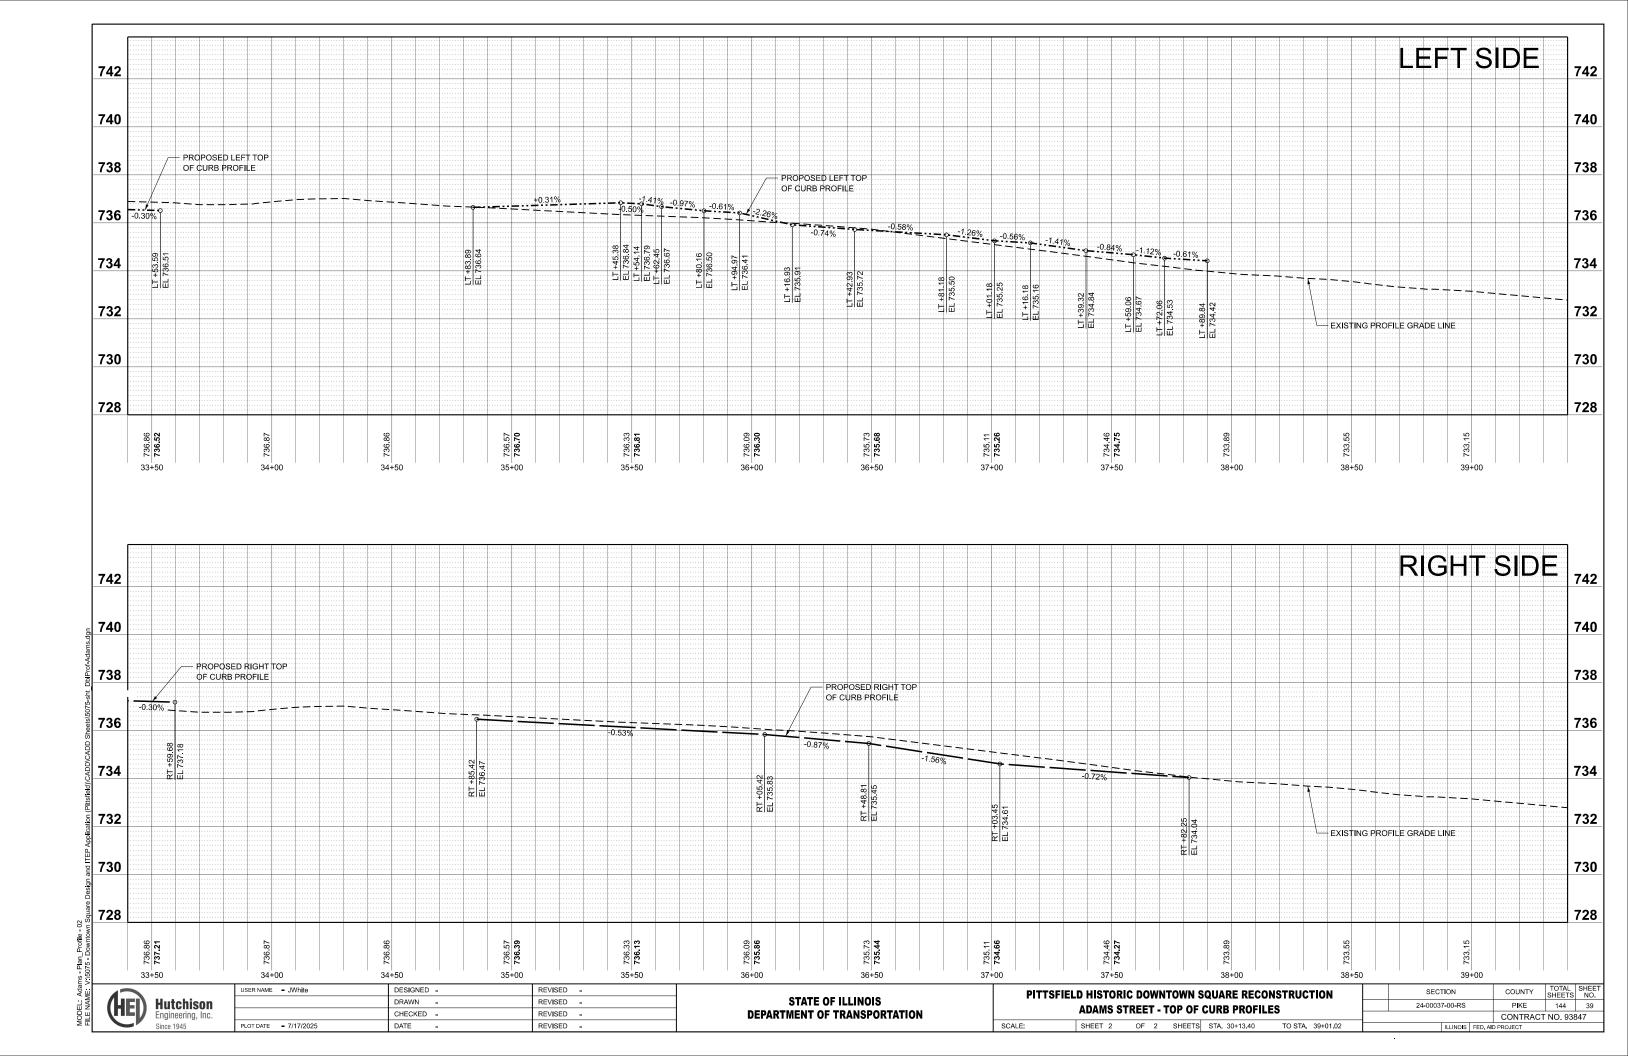


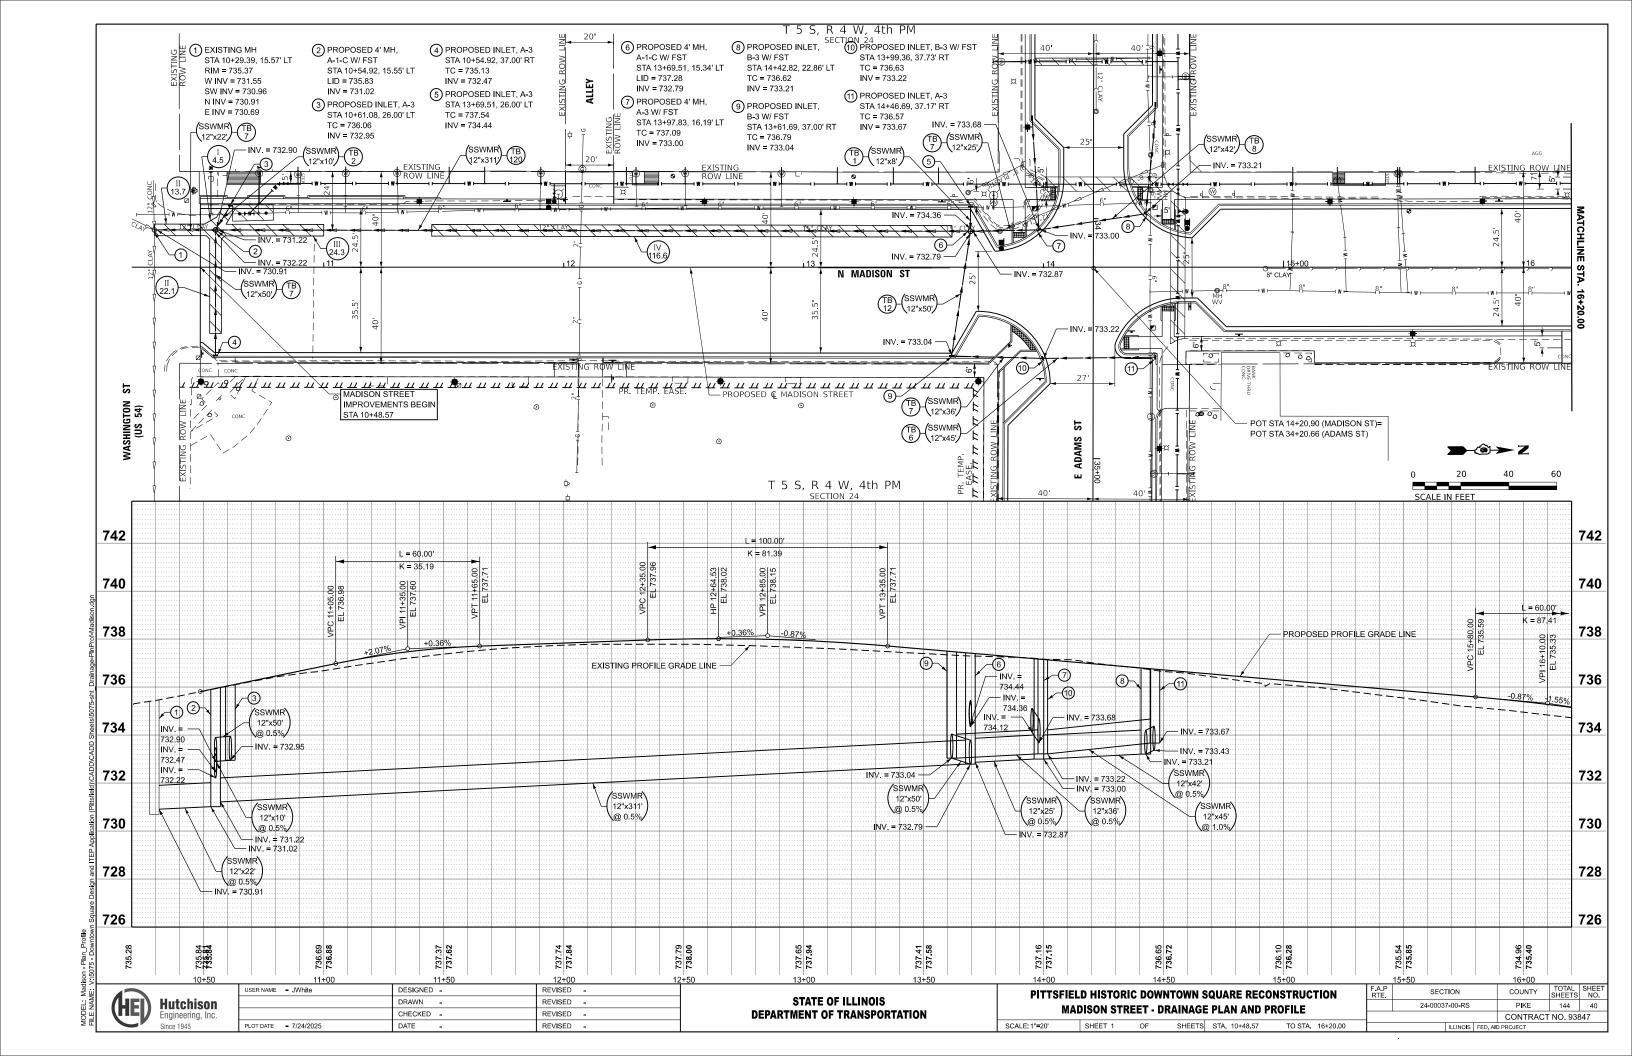


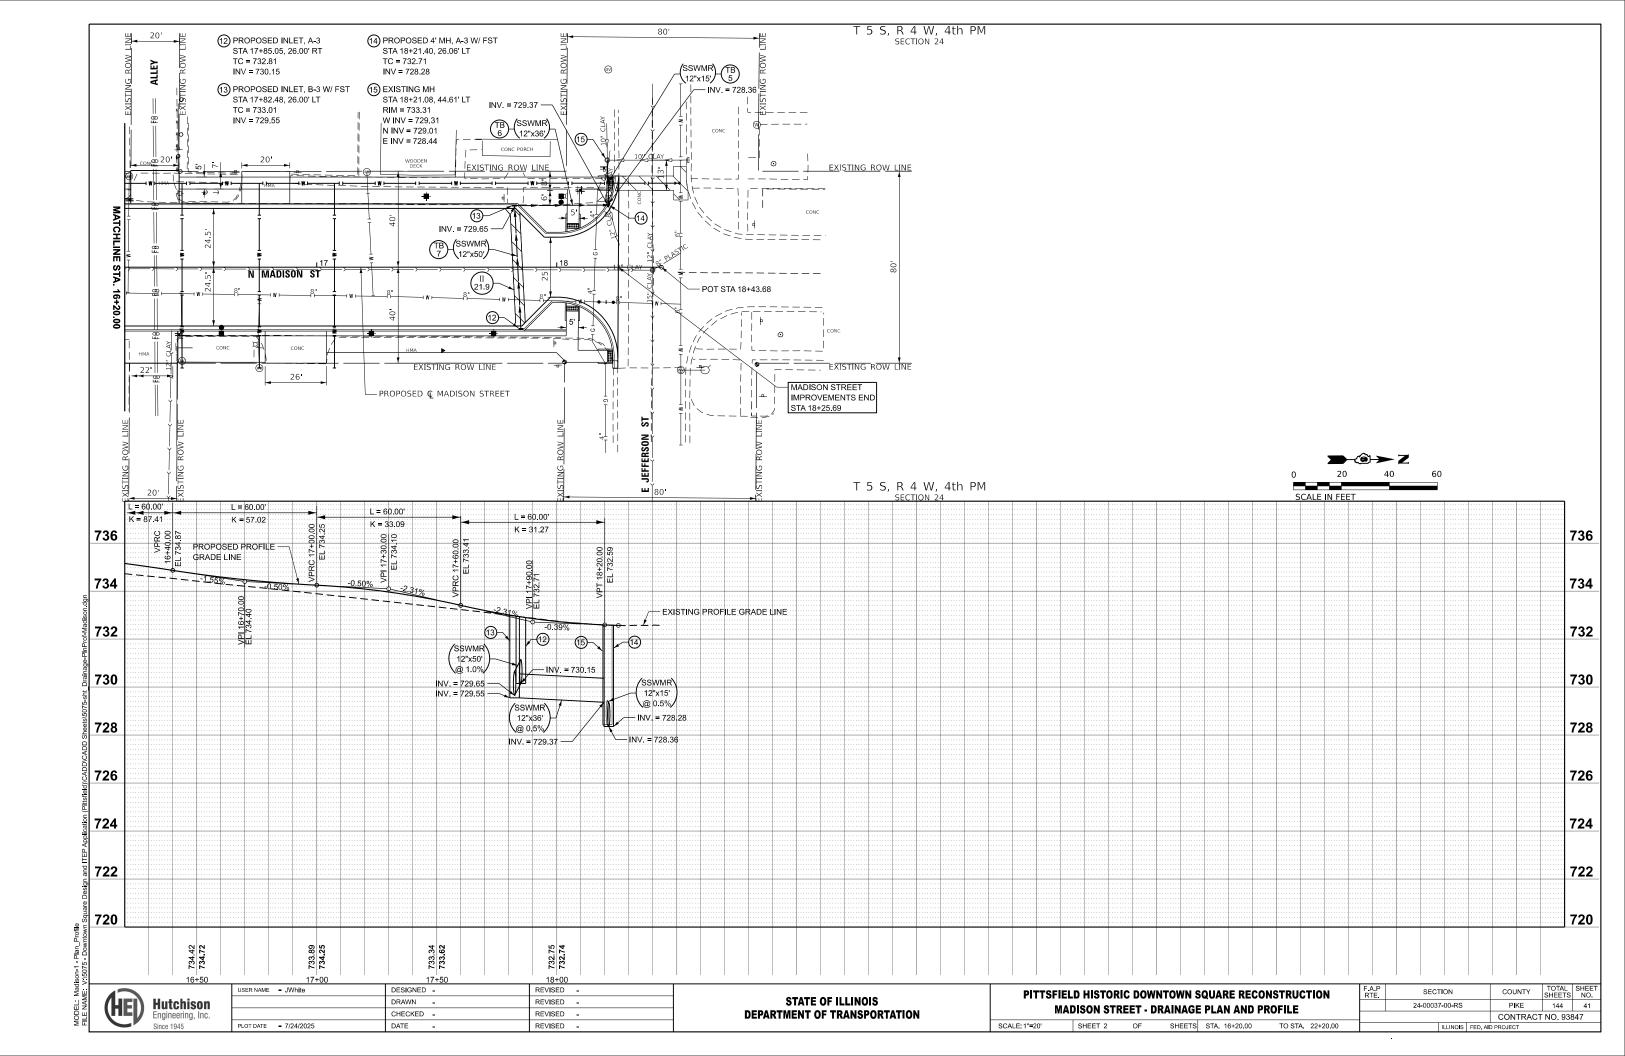


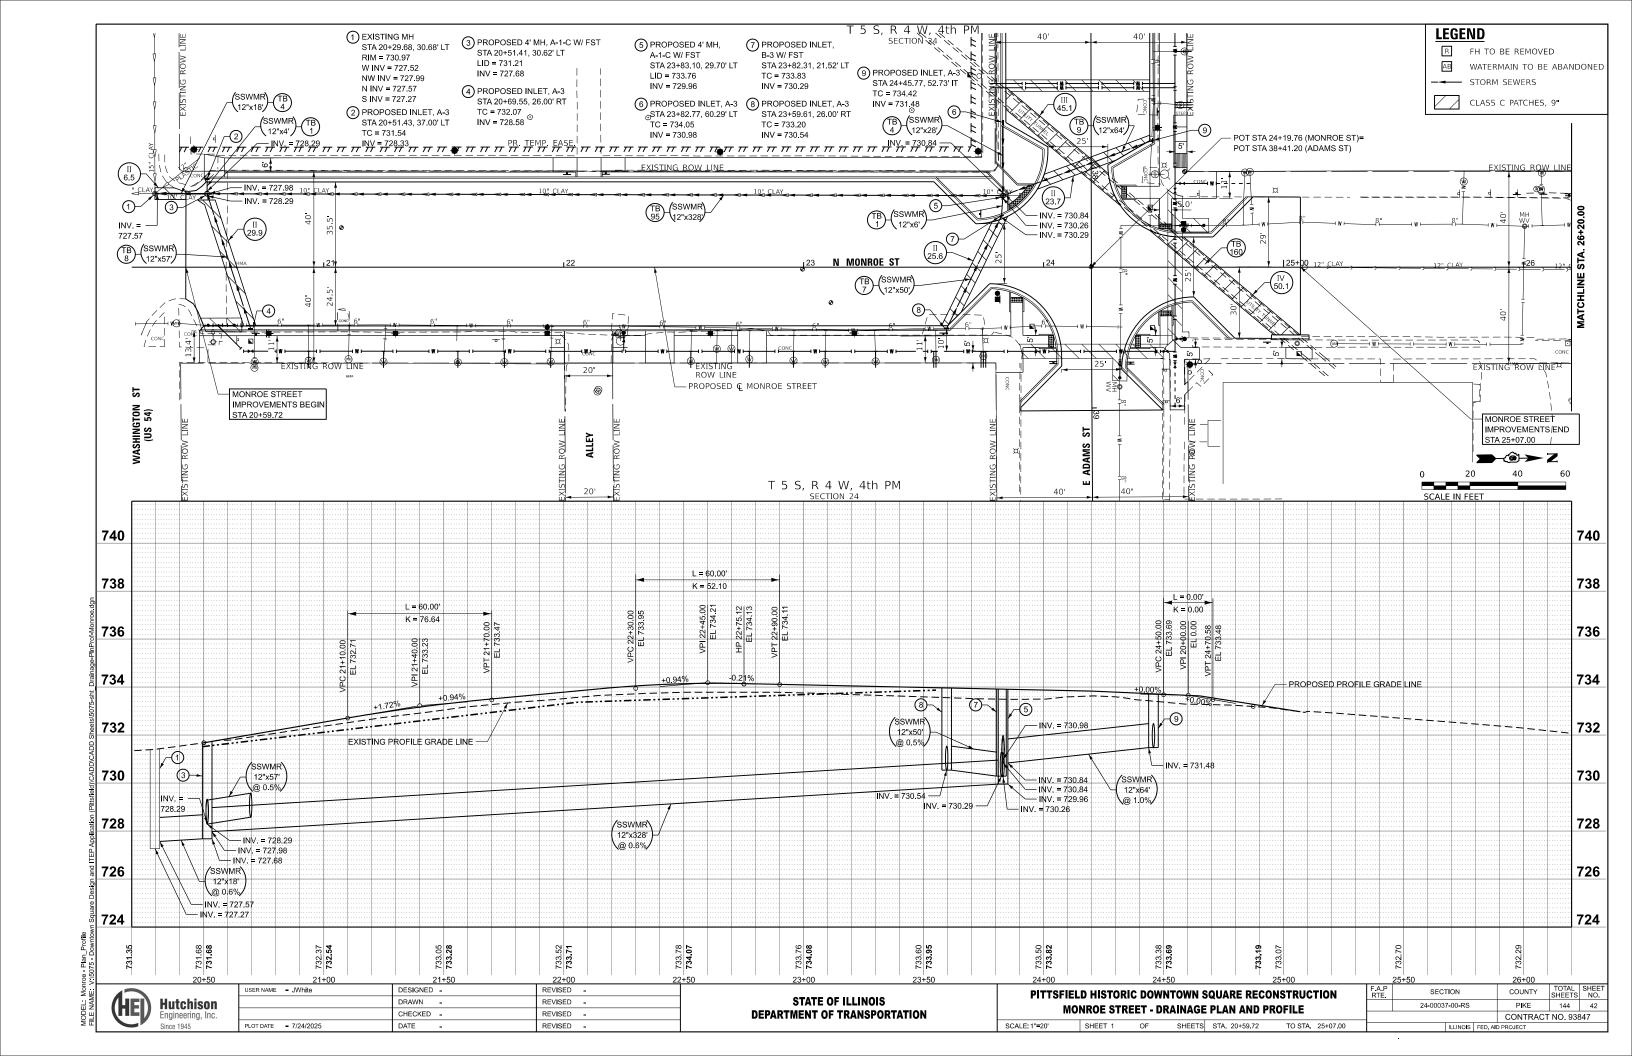


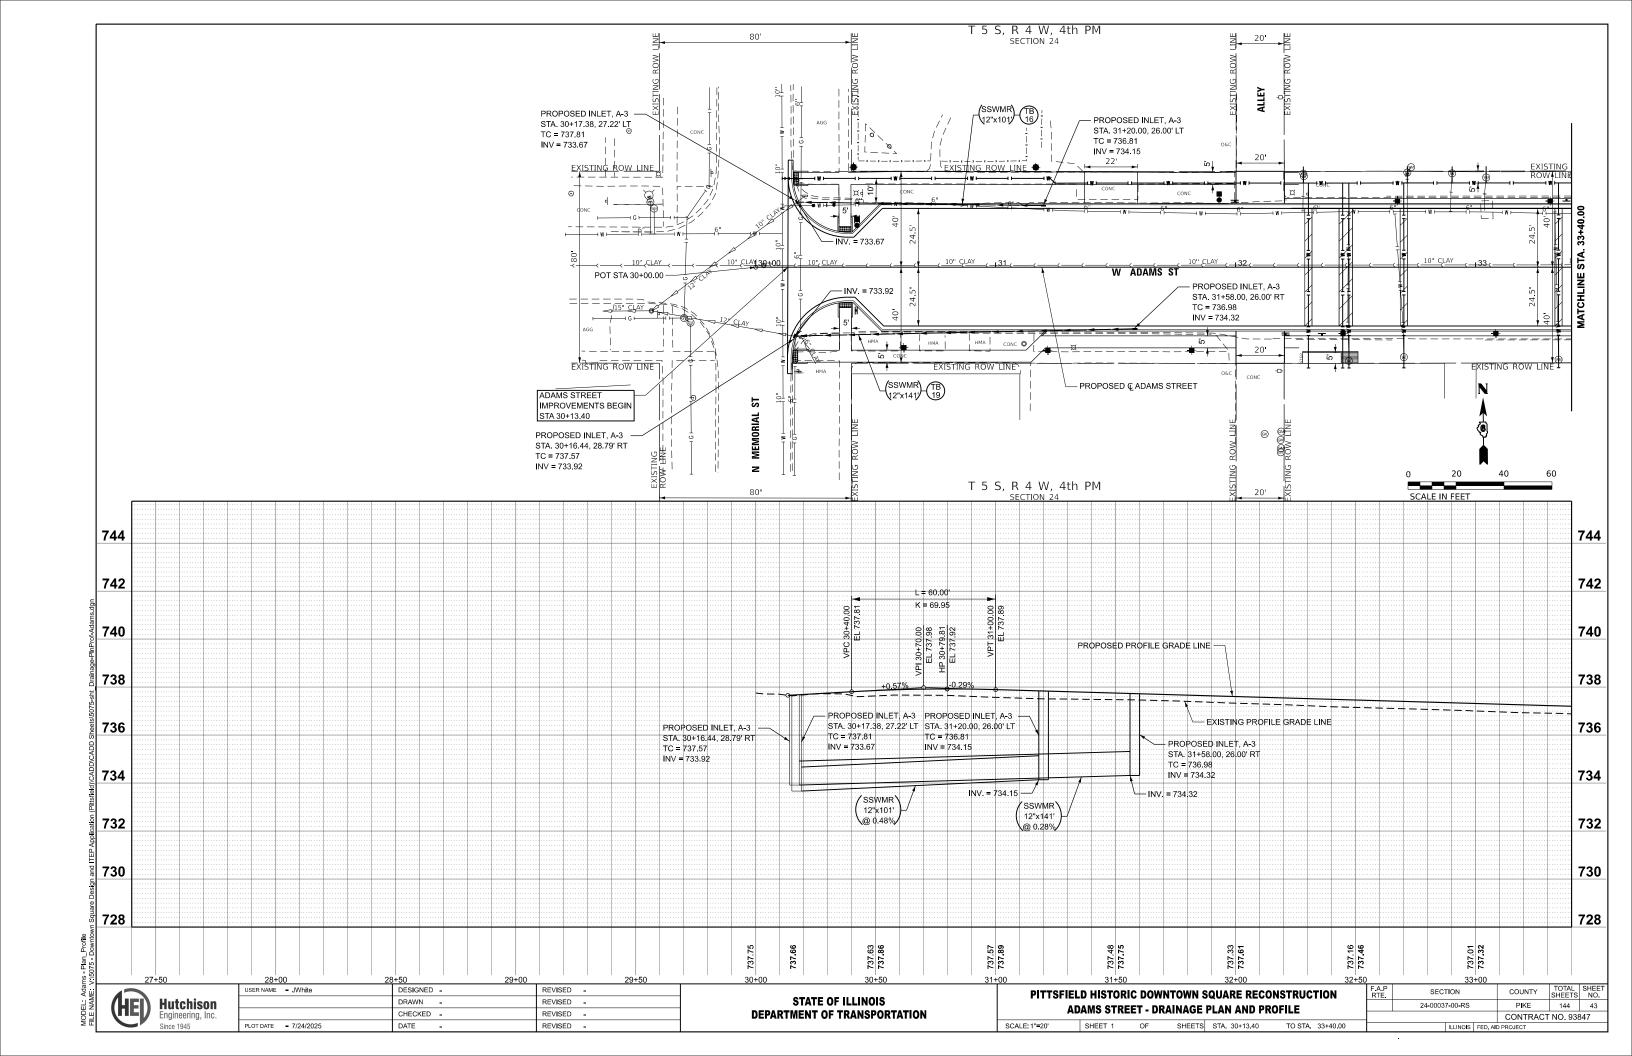


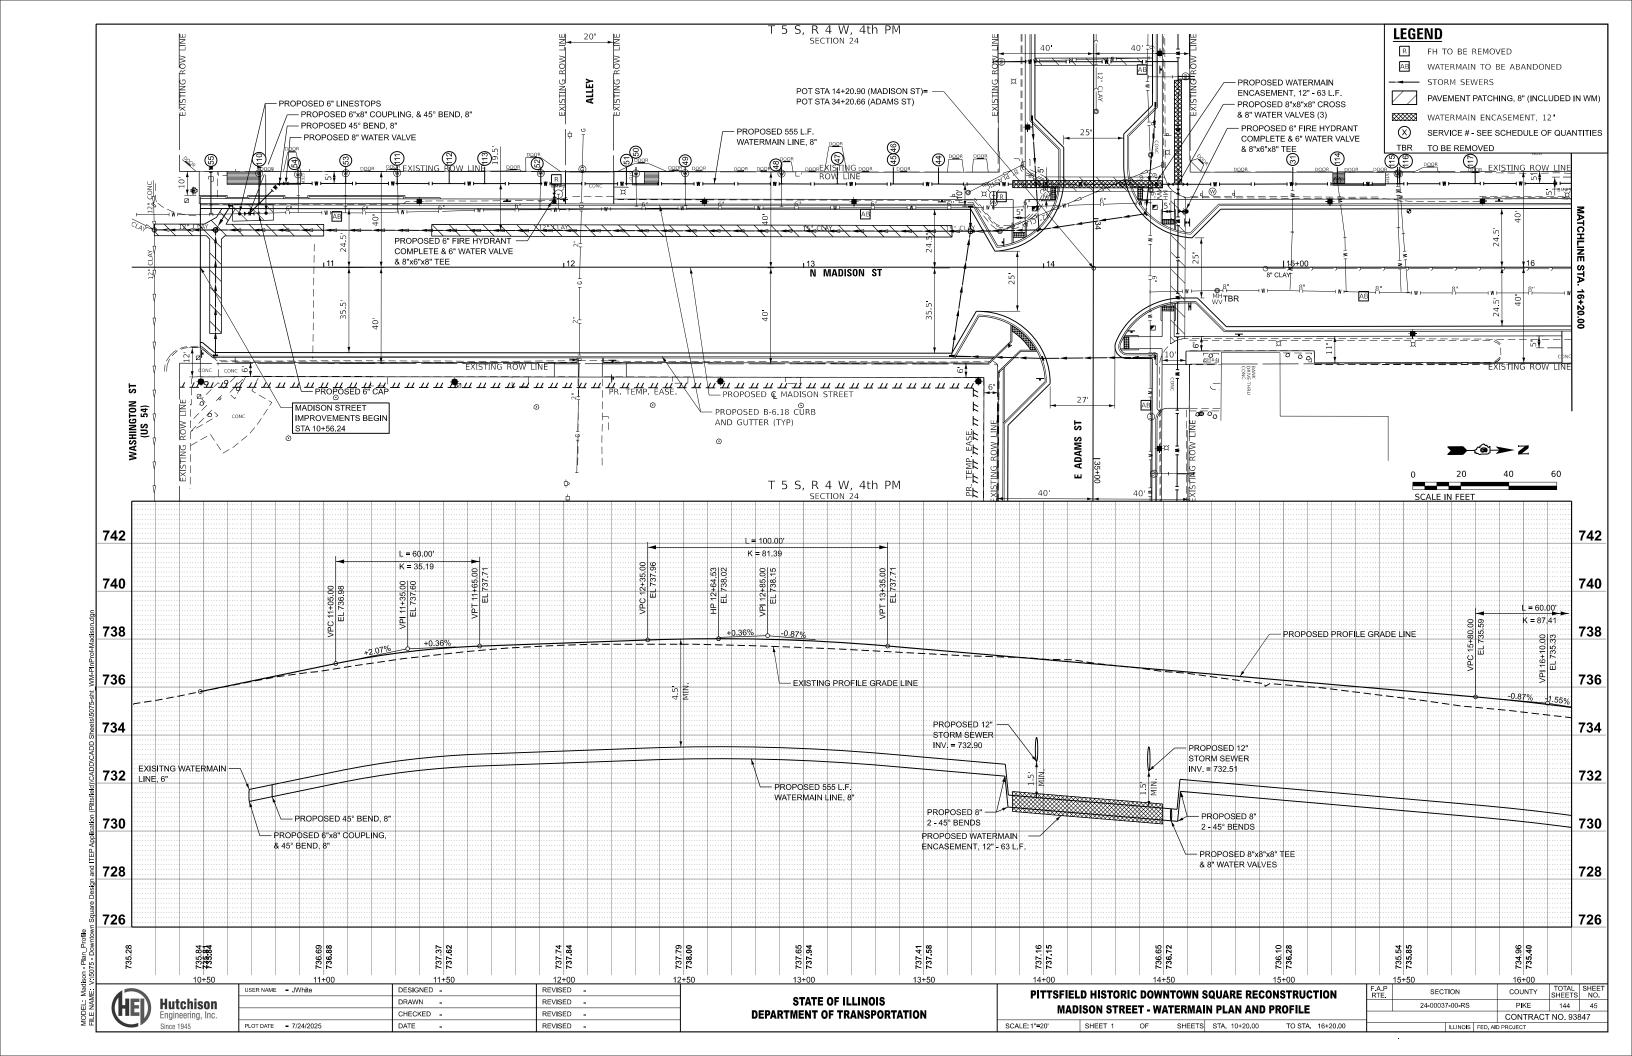


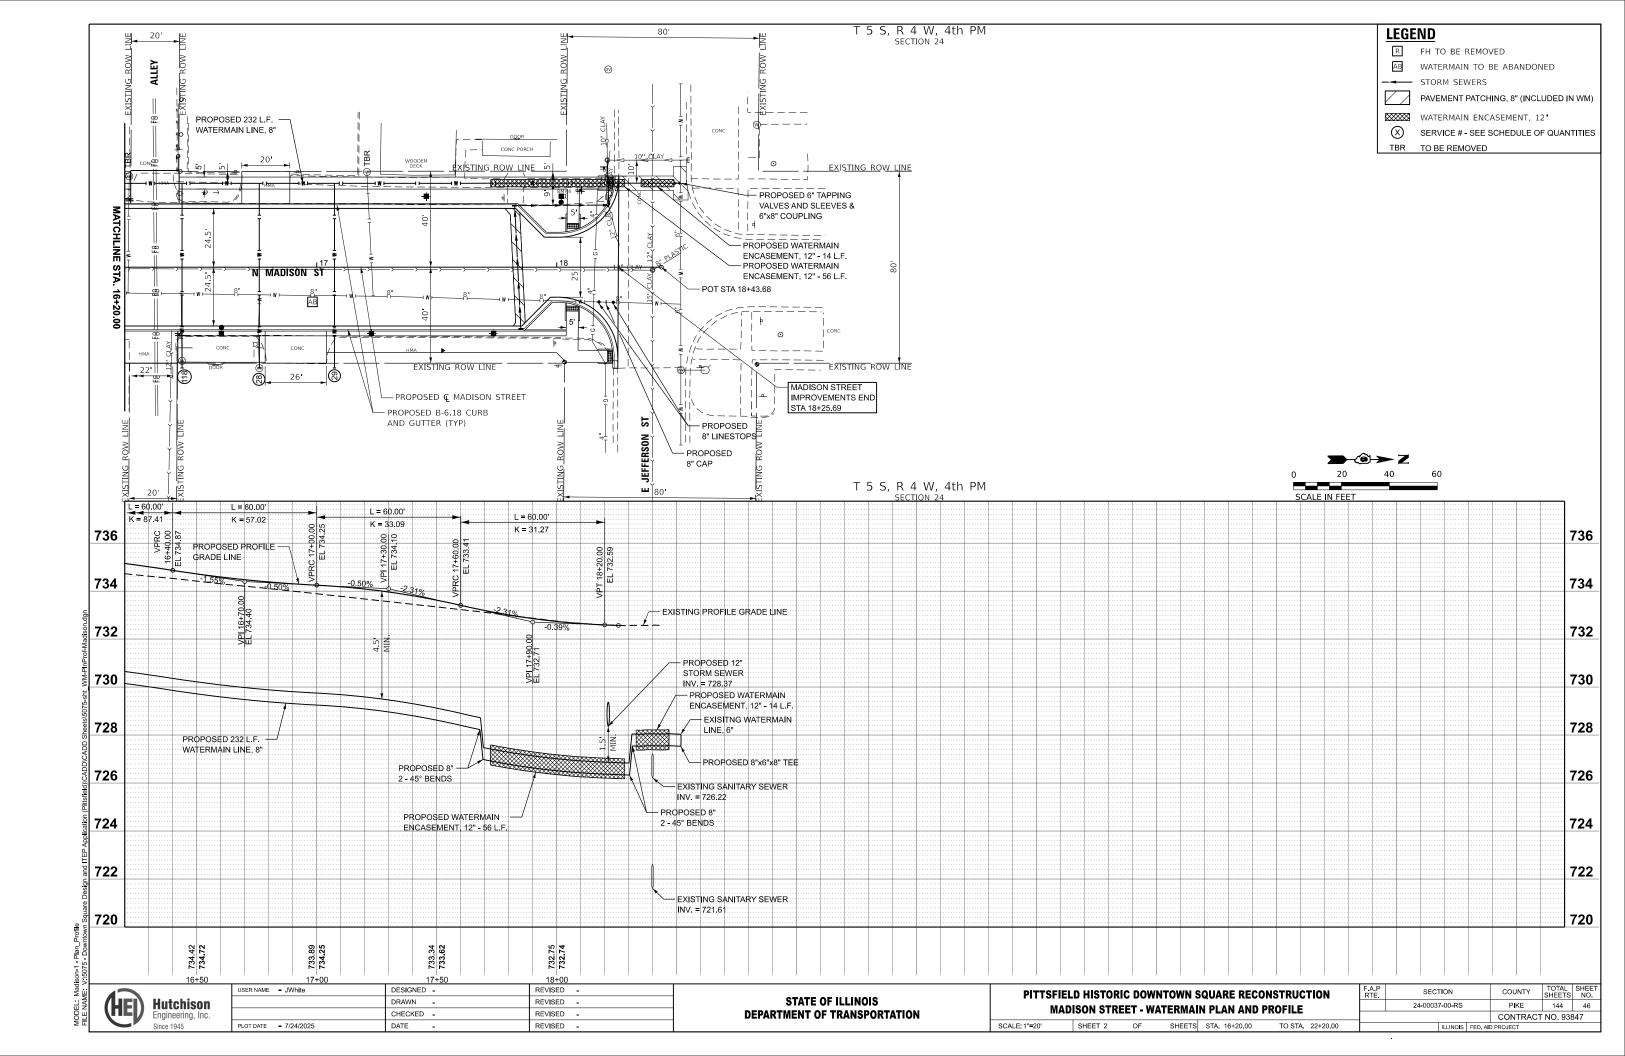


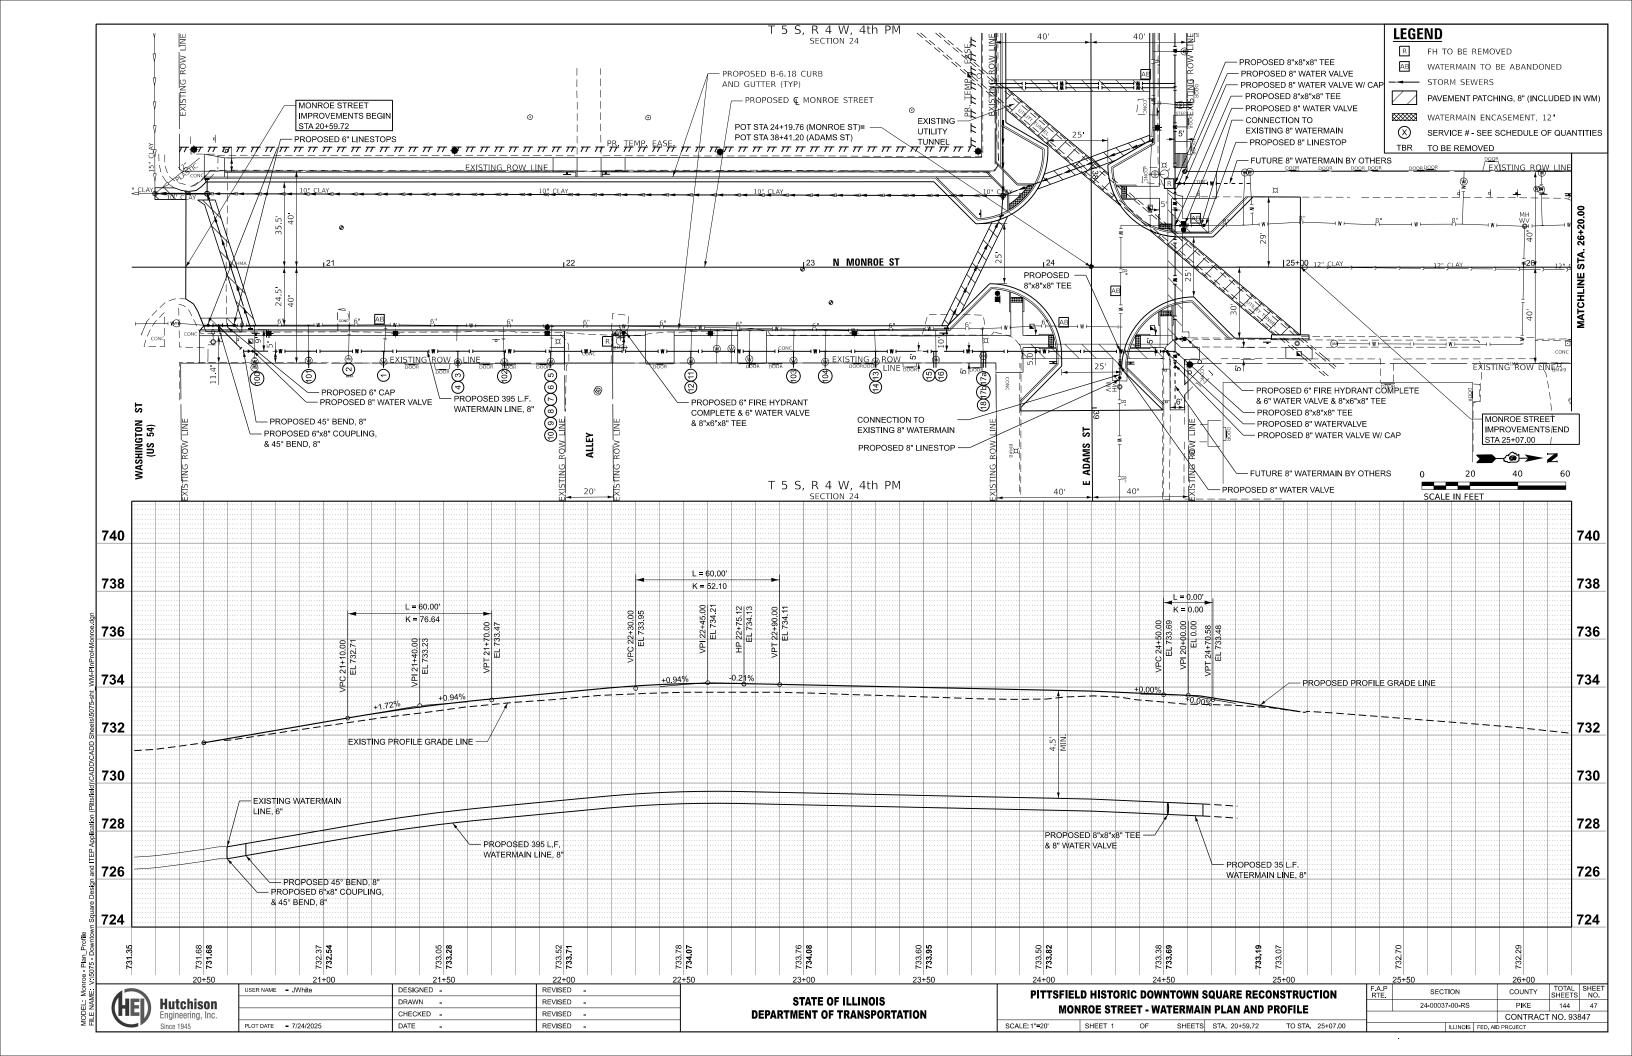

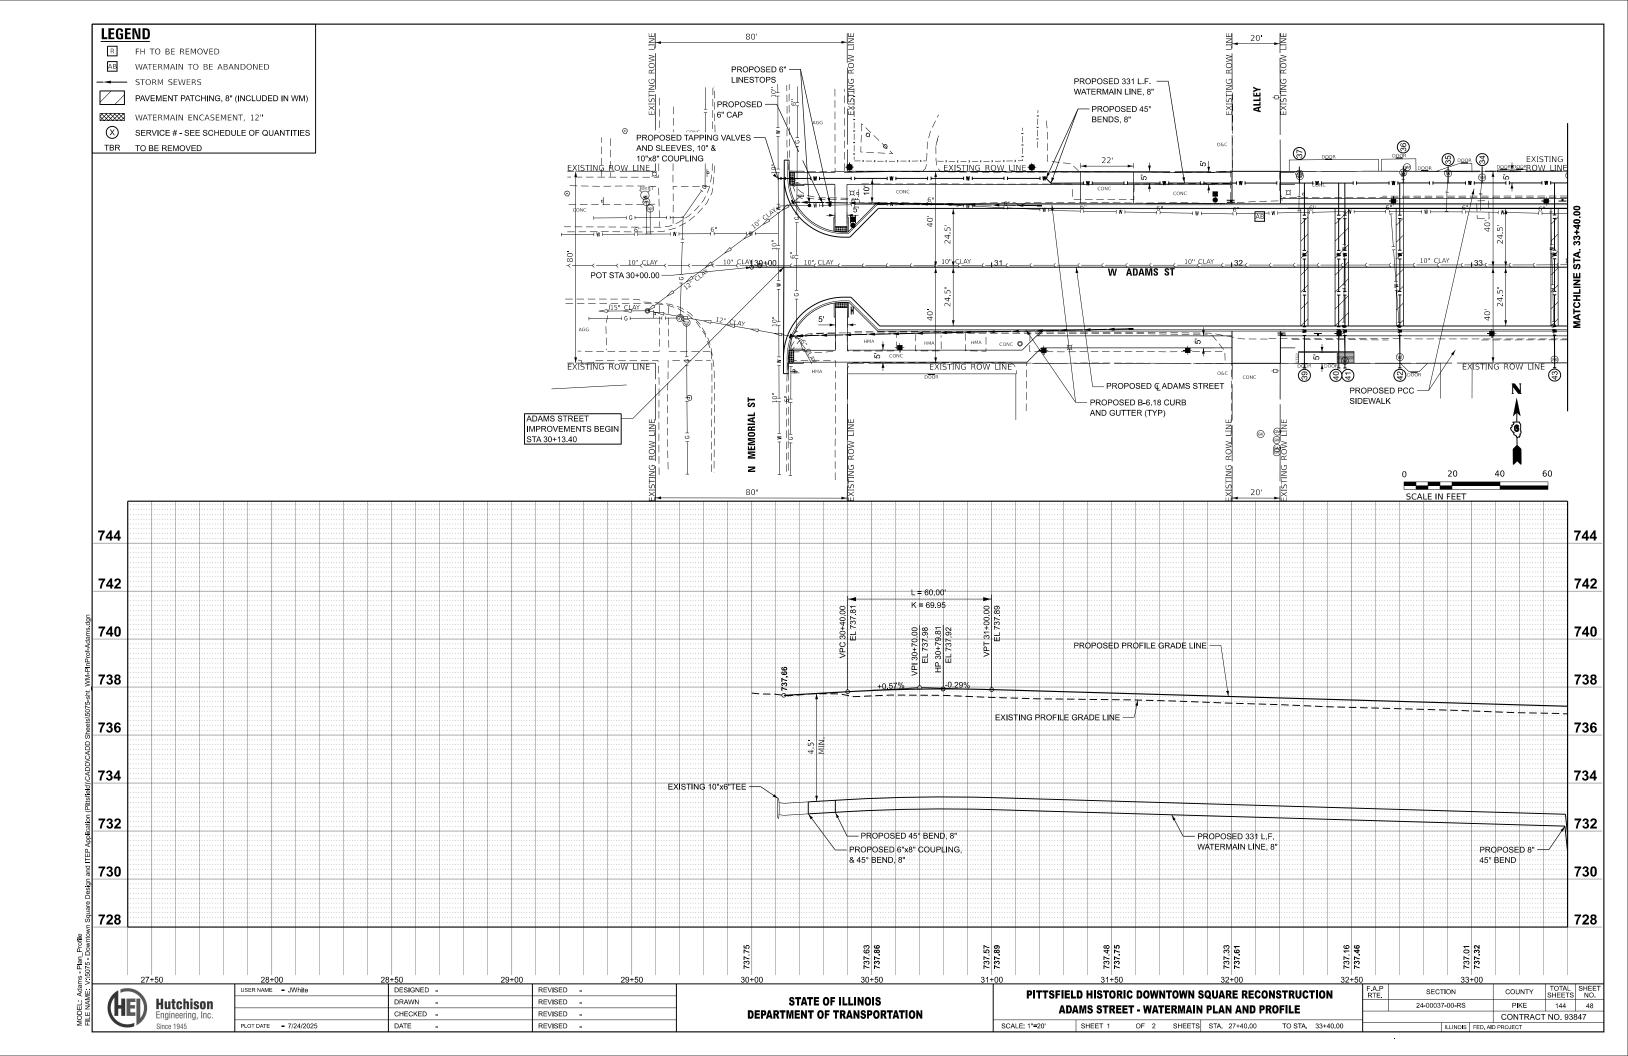


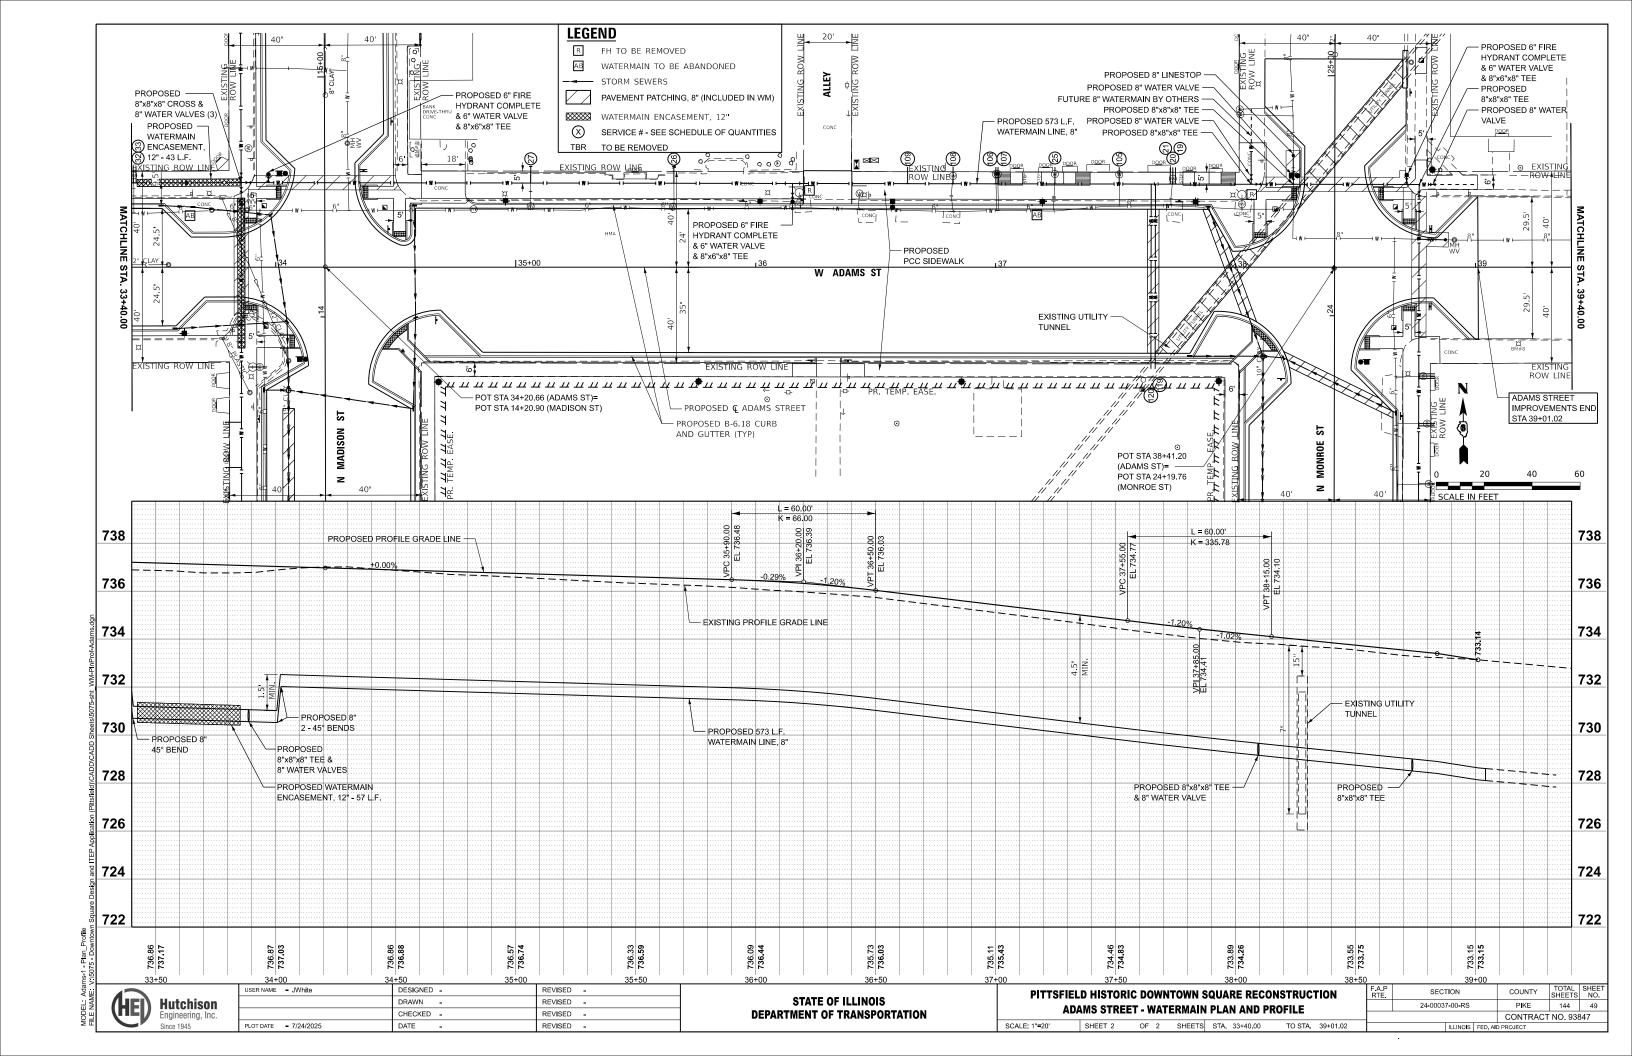

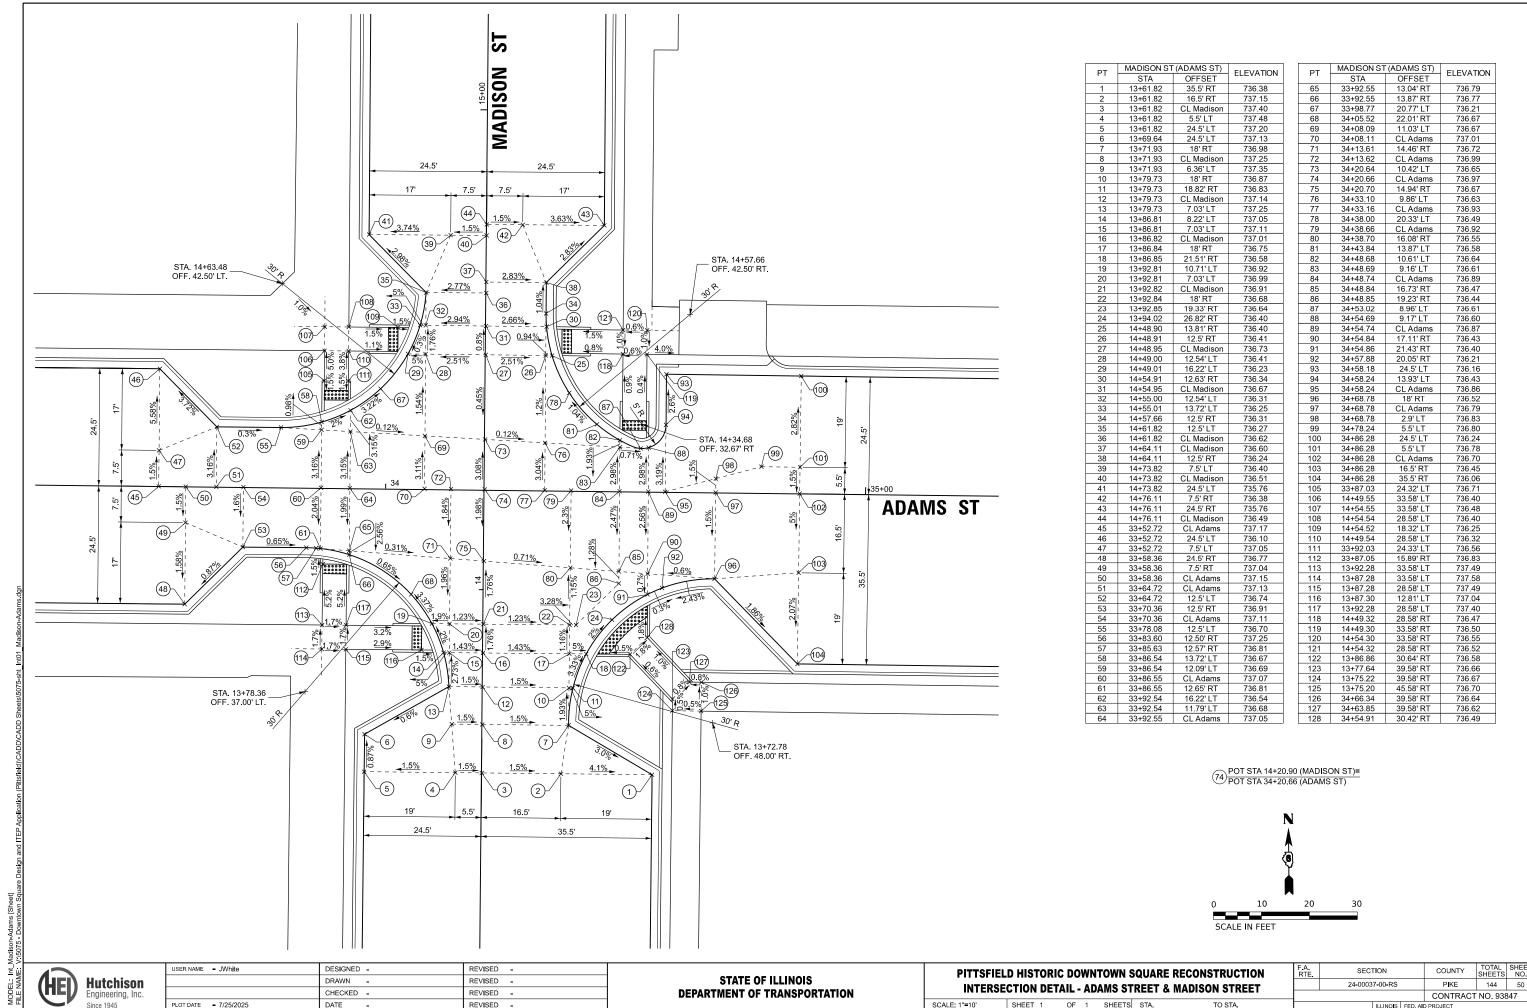


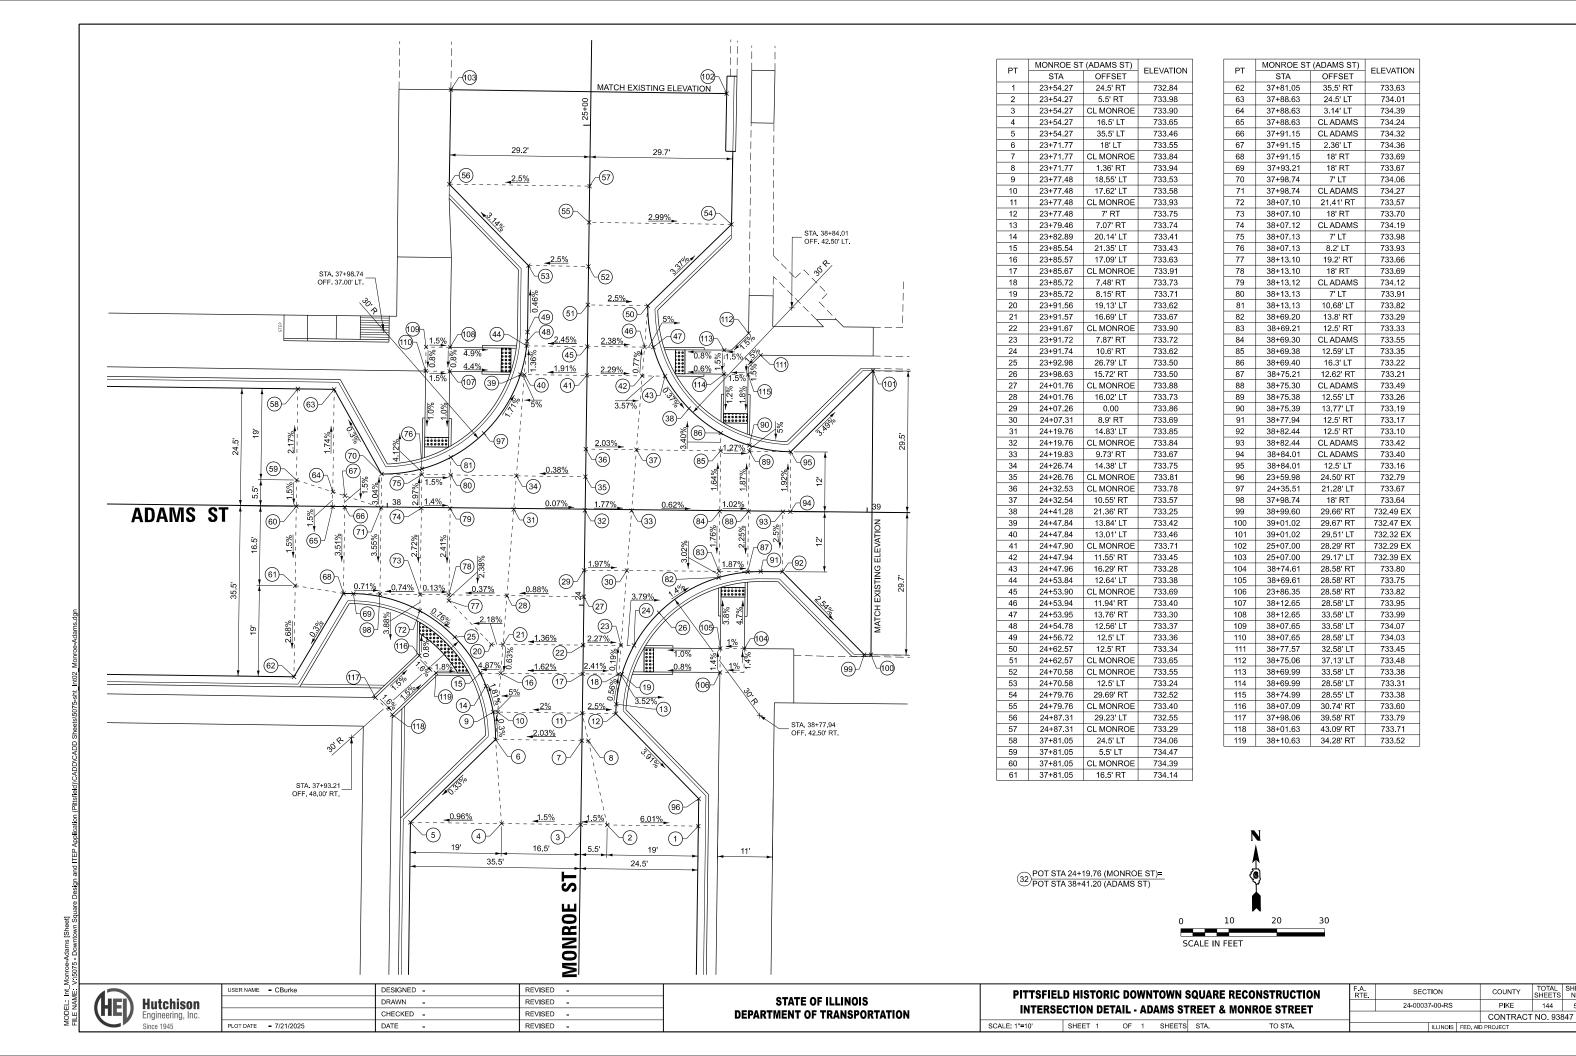

144 51

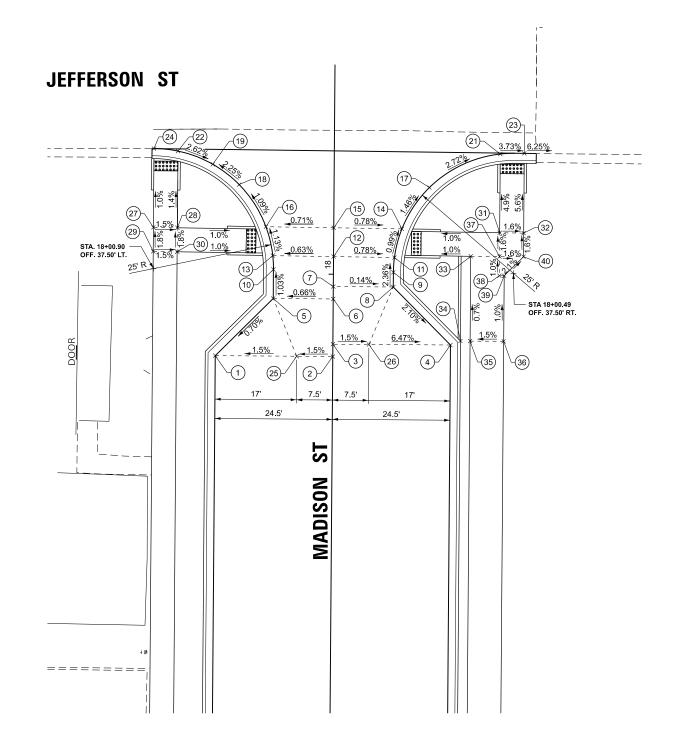

PT		EFFERSON ST) OFFSET	ELEVATION	
STA 1 17+82.85		24.5' LT	732.59	
2				
	17+82.85	CL MADISON	732.96	
3	17+85.43	CL MADISON	732.92	
5	17+85.43	24.5' RT	732.39	
	17+94.85	12.5' LT	732.71	
6	17+94.85	CL MADISON	732.79	
7	17+97.43	CL MADISON	732.76	
8	17+97.43	12.5' RT	732.75	
9	18+00.49	12.50' RT	732.68	
10	18+00.90	12.5' LT	732.65	
11	18+03.58	12.69' RT	732.60	
12	18+03.68	CL MADISON	732.70	
13	18+03.78	12.67' LT	732.62	
14	18+09.57	14.21' RT	732.54	
15	18+09.68	CL MADISON	732.65	
16	18+09.80	14.14' LT	732.55	
17	18+18.21	19.87' RT	732.39	
18	18+18.53	19.77' LT	732.44	
19	18+22.74	25.34' LT	732.30	
20	18+23.62	28.03' RT	732.19	
21	18+25.32	34.58' RT	732.01	
22	18+25.41	32.58' LT	732.50	
23	18+25.48	39.58' RT	731.82	
24	18+25.90	37.58' LT	732.64	
25	17+82.85	7.50' LT	732.85	
26	17+85.43	7.50' RT	732.81	
27	18+09.48	37.58' LT	732.76	
28	18+09.44	32.58' LT	732.68	
29	18+04.48	37.58' LT	732.85	
30	18+04.44	32.58' LT	732.77	
31	18+08.91	34.58' RT	732.64	
32	18+08.87	39.58' RT	732.61	
33	18+03.96	28.58' RT	732.71	
34	17+86.29	26.58' RT	732.80	
35	17+86.28	28.58' RT	732.84	
36	17+86.22	35.58' RT	732.95	
37	18+03.91	34.58' RT	732.77	
38	17+99.96	34.58' RT	732.81	
39	17+99.96	35.58' RT	732.81	
40	18+03.96	39.58' RT	732.69	

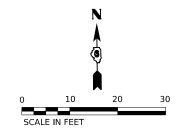


(HE)	Hutchison Engineering, Inc.
	Since 1945


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	DRAWN -	REVISED -
	CHECKED -	REVISED -
PLOT DATE = 7/21/2025	DATE -	REVISED -

STATE OF ILLINOIS
DEPARTMENT OF TRANSPORTATION

PITTSFIELD HISTORIC DOWNTOWN SQUARE RECONSTRUCTION							F.A. RTE.	SECT	FION		
NTERSECTION DETAIL - MADISON STREET & JEFFERSON STREET							24-0003	7-00-RS			
MILITOLOI	ION DE IAIL	IVI	יועה	3011 311		a oli i lkoon o i klli					С
: 1"=10'	SHEET 1	OF	1	SHEETS	STA.	TO STA.			ILLINOIS	FED, AII	PRO

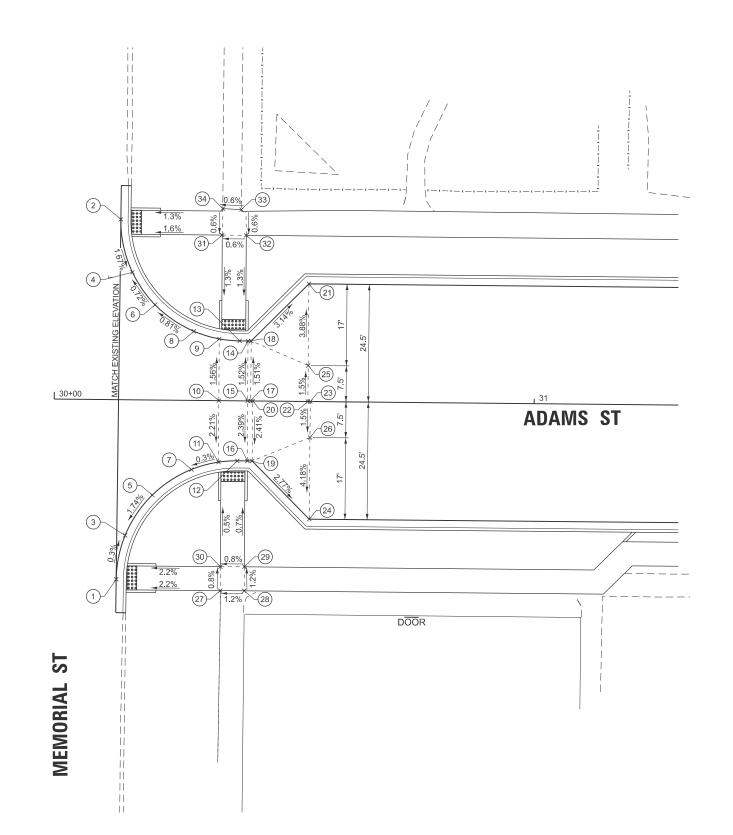

PT	ADAMS ST (N	MEMORIAL ST)	ELEVATION
F 1	STA	OFFSET	LLLVATION
1	30+13.27	37.41' RT	737.19
2	30+13.54	37.59' LT	737.59
3	30+15.04	28.26' RT	737.16
4	30+16.04	26.59' LT	737.40
5	30+20.62	19.79' RT	737.34
6	30+20.83	19.85' LT	737.46
7	30+28.72	14.39' RT	737.48
8	30+28.95	14.41' LT	737.54
9	30+34.26	12.87' LT	737.58
10	30+34.31	CL ADAMS	737.78
11	30+34.36	12.81' RT	737.50
12	30+38.27	12.5' RT	737.51
13	30+38.53	12.5' LT	737.61
14	30+40.26	12.5' LT	737.62
15	30+40.31	CL ADAMS	737.81
16	30+40.36	12.5' RT	737.51
17	30+40.93	CL ADAMS	737.82
18	30+40.93	12.5' LT	737.63
19	30+41.36	12.5' RT	737.52
20	30+41.36	CL ADAMS	737.82
21	30+52.84	24.5' LT	737.10
22	30+52.84	CL ADAMS	737.87
23	30+53.36	CL ADAMS	737.87
24	30+53.36	24.5' RT	737.05
25	30+52.84	7.50' LT	737.76
26	30+53.36	7.50' RT	737.76
27	30+34.97	39.57' RT	737.60
28	30+39.97	39.57' RT	737.66
29	30+39.95	34.55' RT	737.60
30	30+34.95	34.58' RT	737.56
31	30+34.68	34.50' LT	737.80
32	30+39.68	34.50' LT	737.83
33	30+39.66	39.52' LT	737.86
34	30+34.76	40.01' LT	737.83

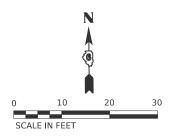

(HE)	Hutchison Engineering, Inc.
	Since 1945


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	DRAWN -	REVISED -
	CHECKED -	REVISED -
PLOT DATE = 7/28/2025	DATE -	REVISED -
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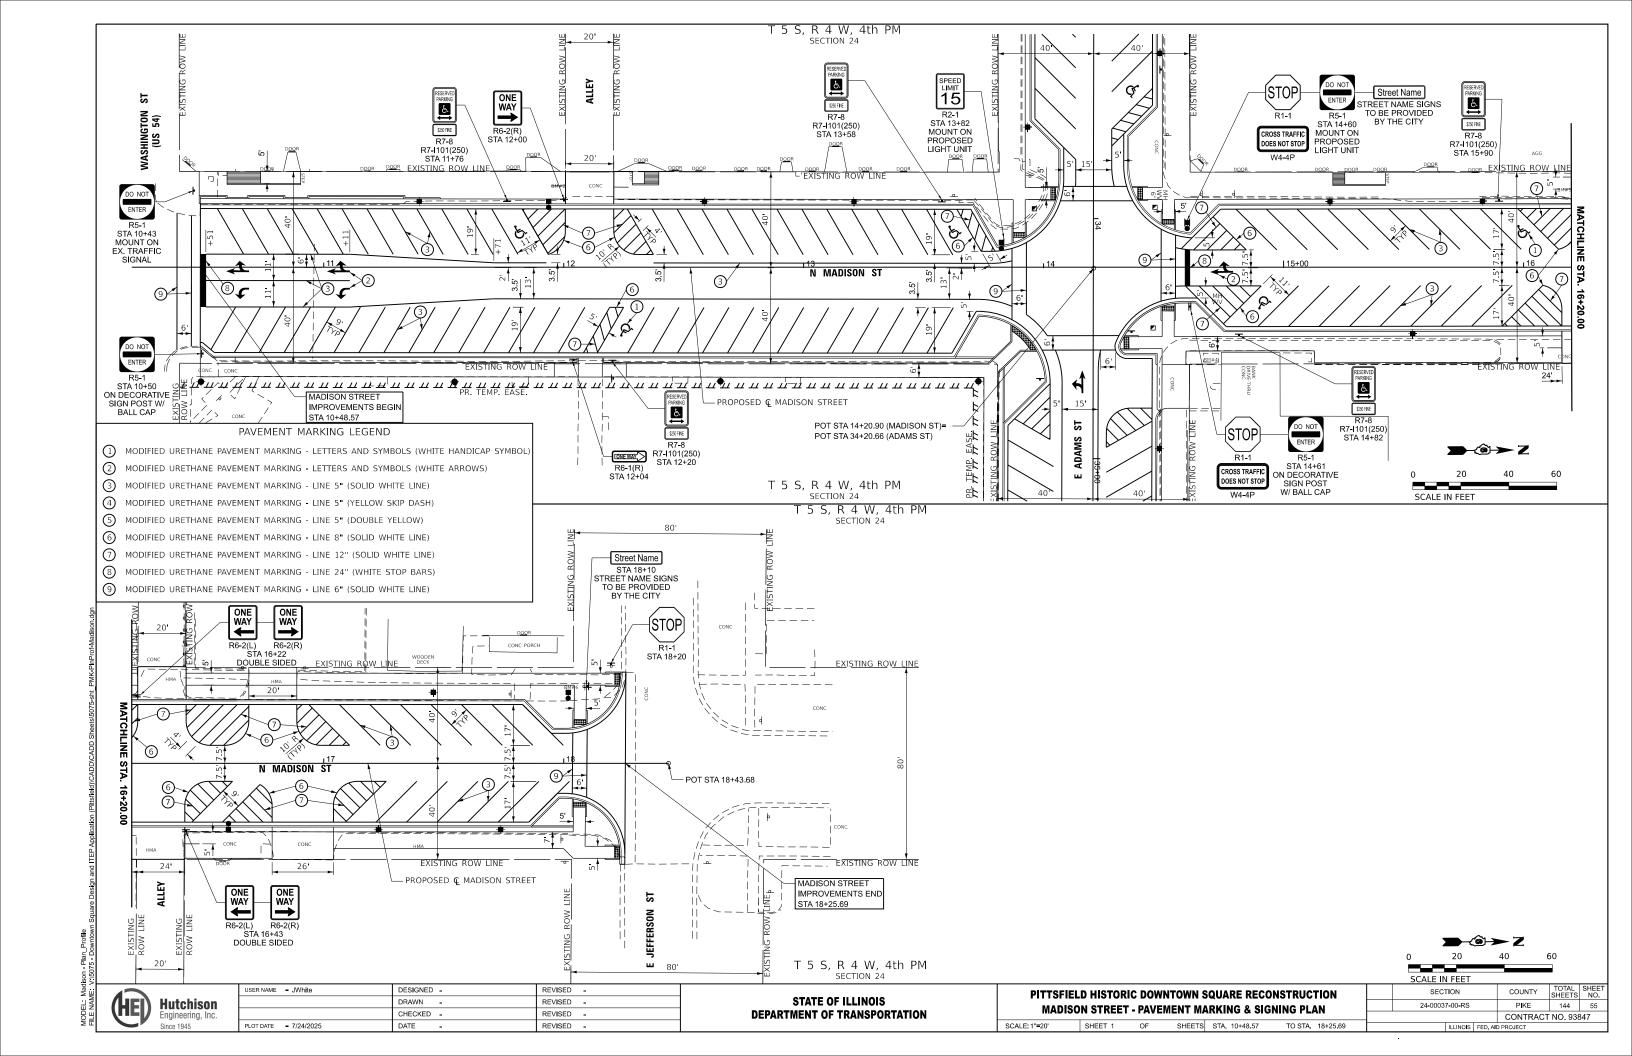
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ENT C	OF TRAN	ISPORTATION	


I	PITTSFIELD HISTORIC DOWNTOWN SQUARE RECONSTRUCTION							F.A. RTE.	SEC.	TION	
ı	INTERSECTION DETAIL - ADAMS STREET & MEMORIAL STREET							24-0003	7-00-RS		
I	INTEROLO	TION DET	AIL - /		1110 011		a memoriae officer				
	SCALE: 1"=10'	SHEET 1	OF	1	SHEETS	STA.	TO STA.			ILLINOIS	FED. AID


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	24-00037-00-RS	PIKE	144	53	
			CONTRACT	NO. 938	347
	ILLINOIS	FED. AII	D PROJECT		


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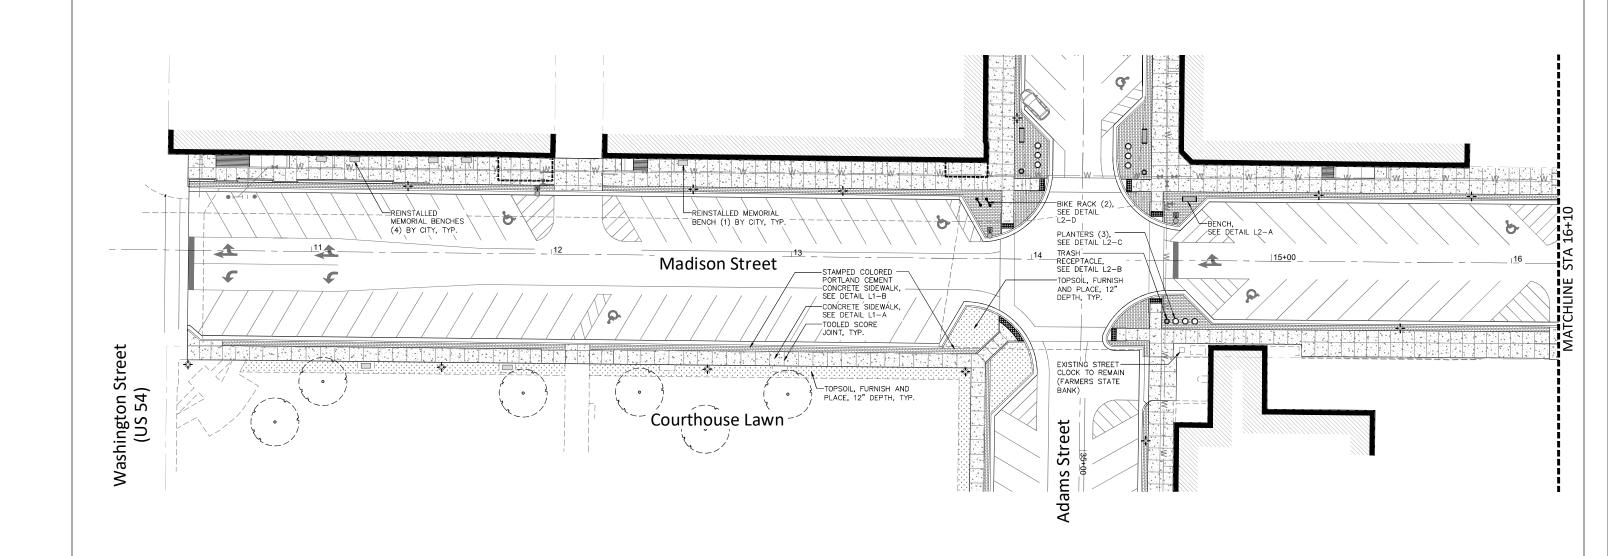


(HE)	Hutchison Engineering, Inc.

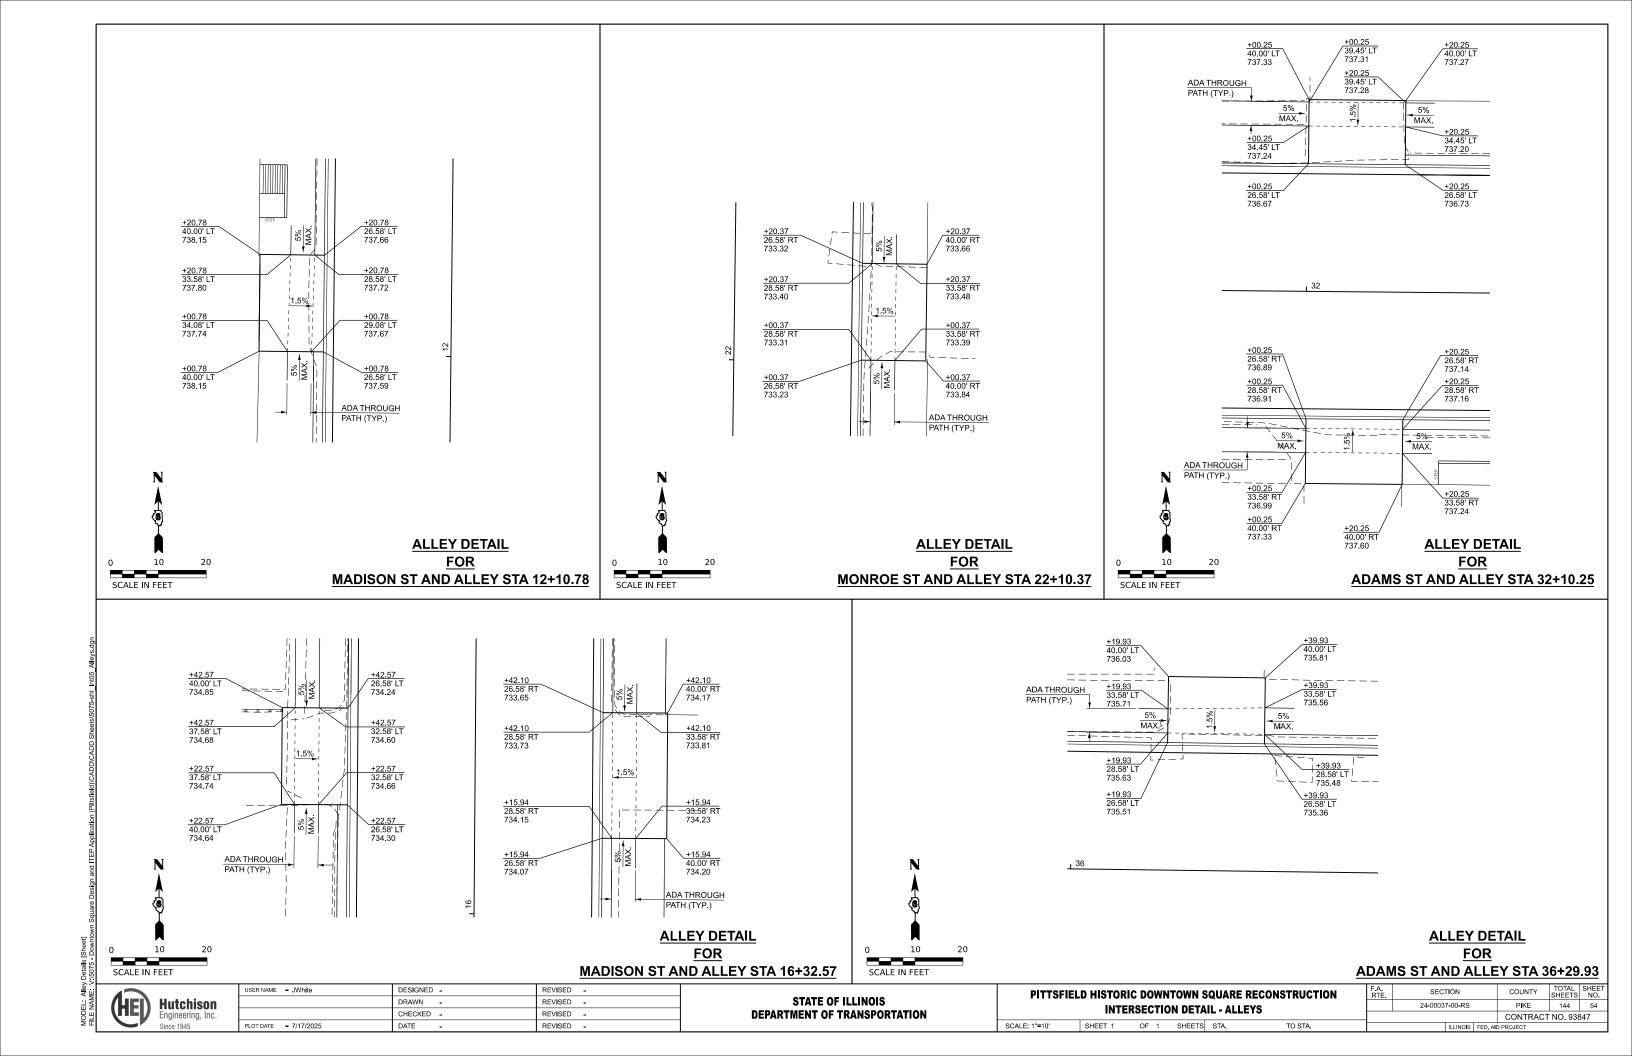USER NAME = JWhite	DESIGNED -	REVISED -
	DRAWN -	REVISED -
	CHECKED -	REVISED -
PLOT DATE = 7/24/2025	DATE -	REVISED -

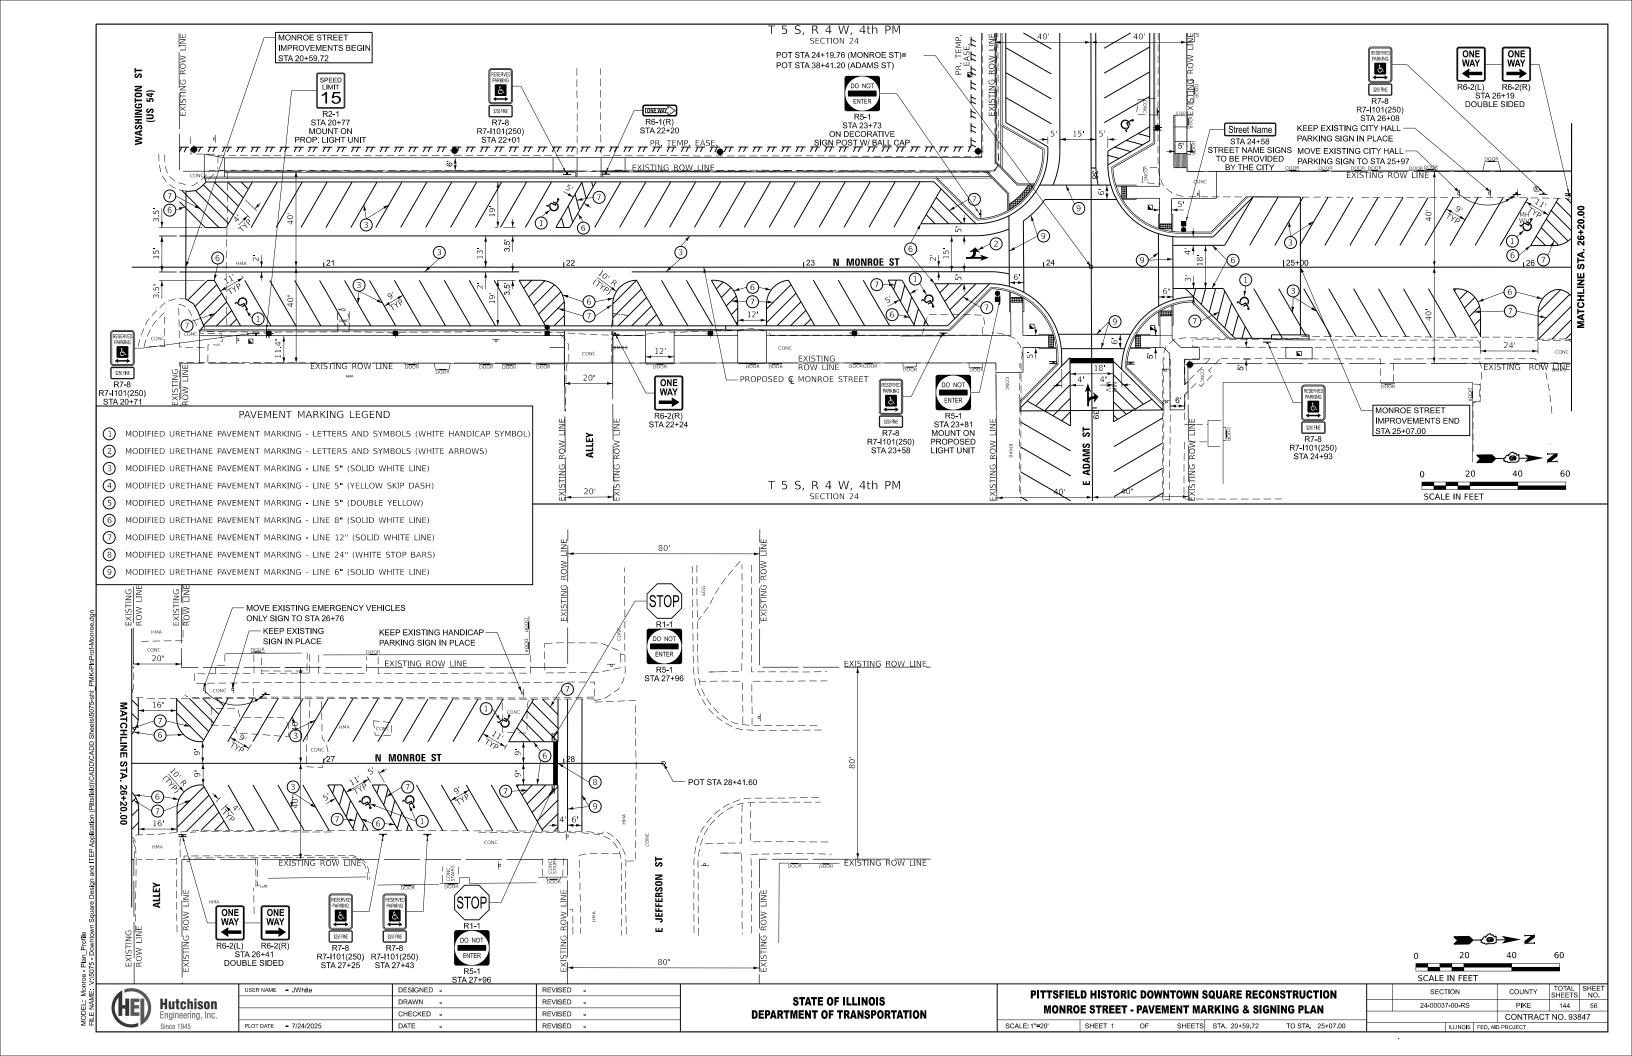PITTSFIELD HISTORIC DOWNTOWN SQUARE RECONSTRUCTION									
ADAM:	ADAMS STREET - PAVEMENT MARKING & SIGNING PLAN								
APAIII	JUNEEL	TAVEINE		KKINO & SIOI	11110 I EAIT				
SCALE: 1"=20'	SHEET 2	OF 2	SHEETS	STA. 39+40.00	TO STA. 42+62.04				

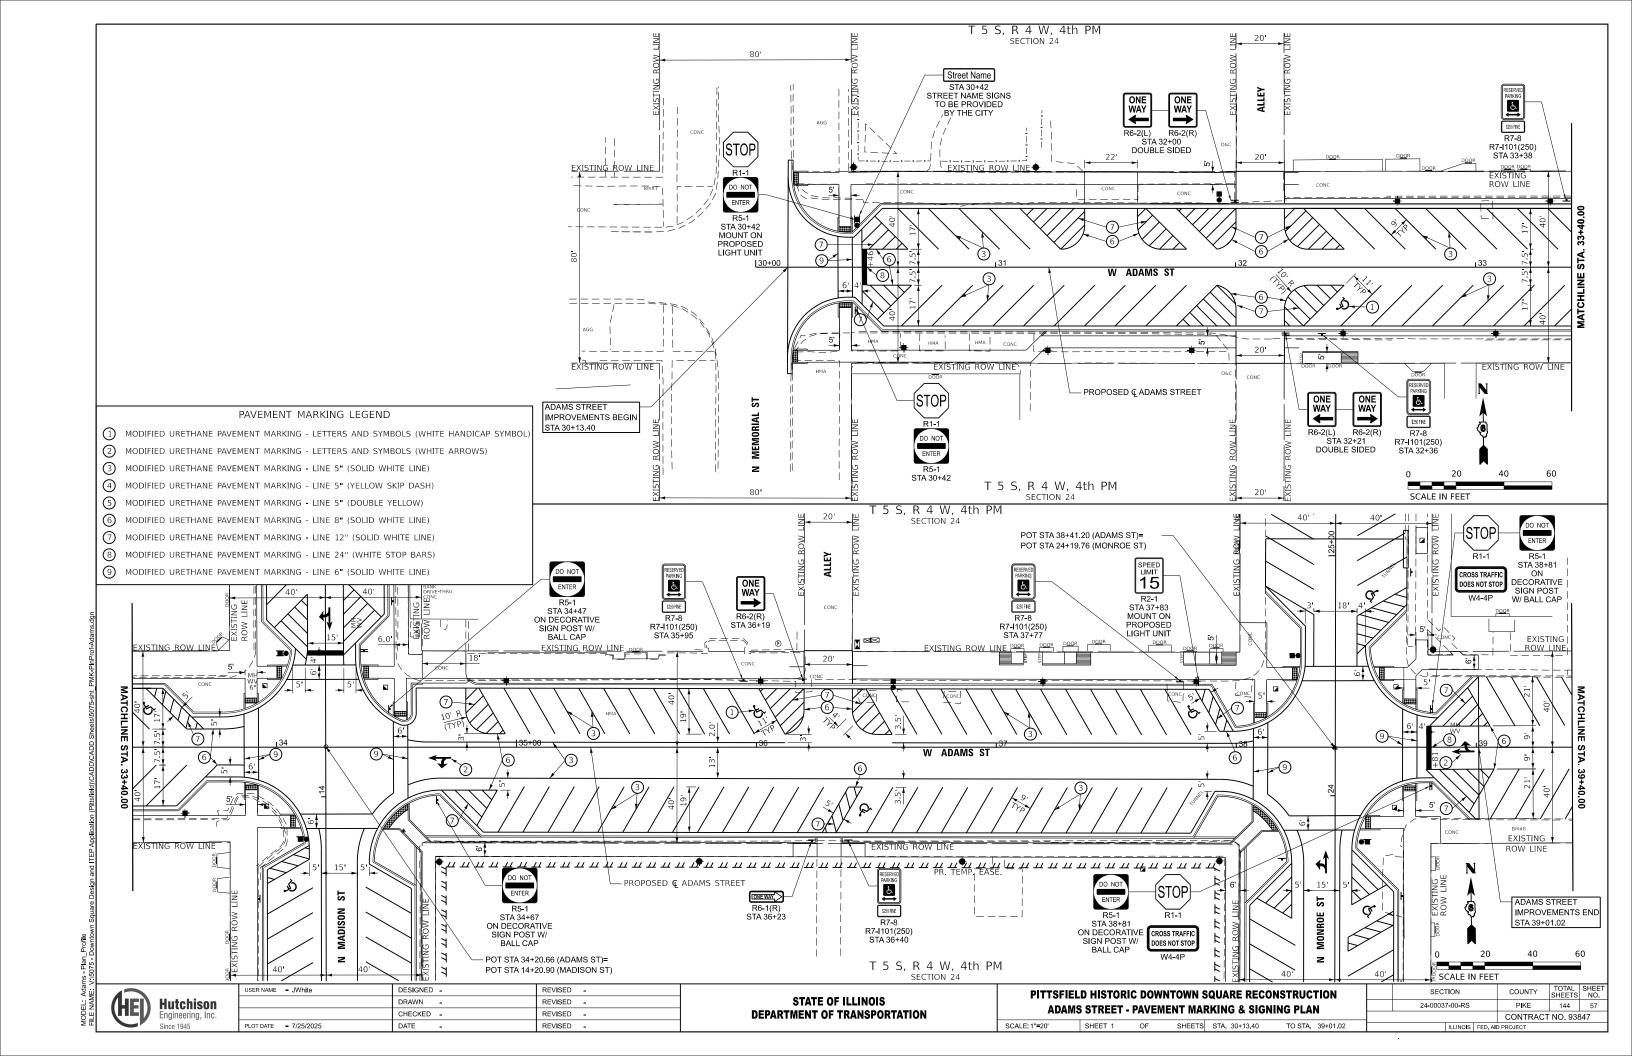	SECTION			COUNTY	TOTAL SHEETS	SHEET NO.
	24-00037-00-RS			PIKE	144	58
			CONTRACT	NO. 938	347	
ILLINOIS FED. AII			PROJECT			

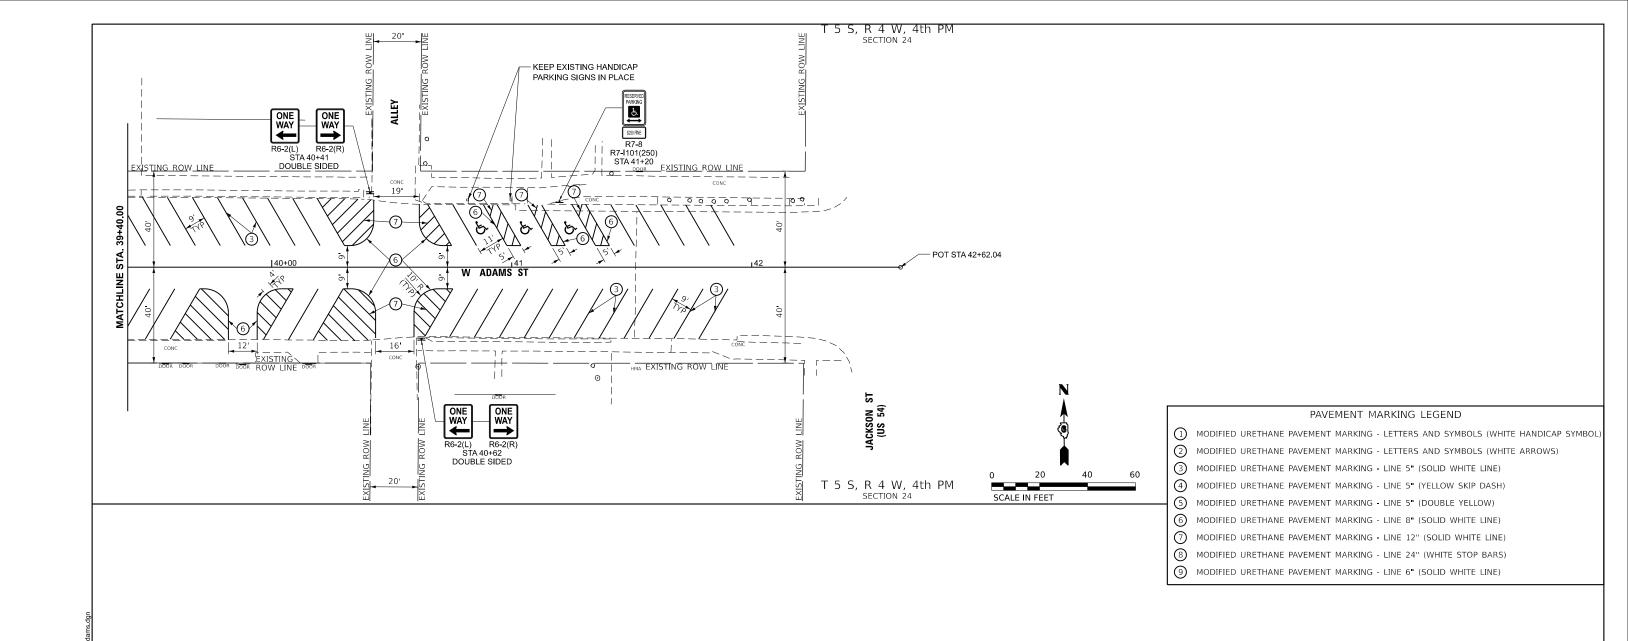

Concrete Sidewalk

Stamped Colored Portland Cement Concrete Sidewalk

Ornamental Fence

Furnish and Place Topsoil, 12" depth at seeded areas 24" depth at plant beds 48" depth at tree locations

- Area Light Assemblies
 See Elec. Sheets
- Pedestrian Light Assemblies See Elec. Sheets
- Luminaire Replacement See Elec. Sheets
- Street Clock See Elec. Sheets

- Bicycle Rack
- Bench, (new-6' backless)
- Bench (existing memorial bench to be reinstalled by Others)
- Trash Receptacle (new)
- Landscape Planter (30" dia. x 24" ht.)

CONCRETE PAVEMENT FINISH

- SEE CIVIL ENGINEER'S SHEETS FOR REINFORCEMENT, MIX DESIGN, PAVEMENT THICKNESS, ELEVATIONS AND DIMENSIONS.
- JOINTS TO BE AS SHOWN ON PLANS. JOINTS NOT INDICATED ON THE PLANS TO BE LOCATED TO FIT THE PATTERN AND DESIGN OF THE SURFACE AS DETERMINED BY THE OWNER'S REPRESENTATIVE.
- EXPANSION JOINTS REQUIRED ALONG ALL ADJACENT FOUNDATIONS, FOOTINGS, EXISTING PAVEMENTS, AND EVERY 30' ALONG THE LENGTH OF THE SIDEWALKS.
- SCORE JOINTS FOR STANDARD CONCRETE SIDEWALK TO BE TOOLED
 WITH 2" SMOOTH EDGES BOTH SIDES (SAW CUTS ARE NOT ALLOWED).
 OUTSIDE EDGES OF SIDEWALK TO HAVE 2" SMOOTH, TOOLED BORDER.
- ALL SCORE JOINTS WITHIN THE DRIVEWAY ENTRANCES AND PARKING AREAS (ALL VEHICULAR AREAS) ARE TO BE TOOLED WITH 2" SMOOTH EDGES BOTH SIDES. AFTER THE CONCRETE HAS HARDENED, CUT ALONG THIS TOOLED JOINT TO 1/4 THE THICKNESS OF THE PAVEMENT EOR JOINT CONTROL
- STANDARD CONCRETE SIDEWALKS TO HAVE MEDIUM-BROOM FINISH PERPENDICULAR TO PEDESTRIAN TRAFFIC FLOW.
- SCORE JOINTS FOR STAMPED COLORED SIDEWALK TO BE SAW CUT ALONG BRICK PATTERN JOINTS TO MINIMIZE THE VISUAL IMPACT, APPROX. 5' ON-CENTER.
- ALL EXPOSED CONCRETE SURFACES TO HAVE TWO COATS OF SEALER.






USER NAME =	DESIGNED - NFB	REVISED -
	DRAWN - JV	REVISED -
	CHECKED - KLM	REVISED -
PLOT DATE = 7/23/2025	DATE - 7/23/2025	REVISED -

STATE OF ILLINOIS
DEPARTMENT OF TRANSPORTATION

Ī	_		-		-		RECONSTRUCTION NGS PLAN 1
SCALE:	SHEET	59	OF	144	SHEETS	STA.	TO STA.

SECTION		COUNTY	TOTAL SHEETS	SHEE NO.
24-00037-00-RS		PIKE	144	59
		CONTRACT	NO. 938	347
	EED 415	DD0 IEOT		

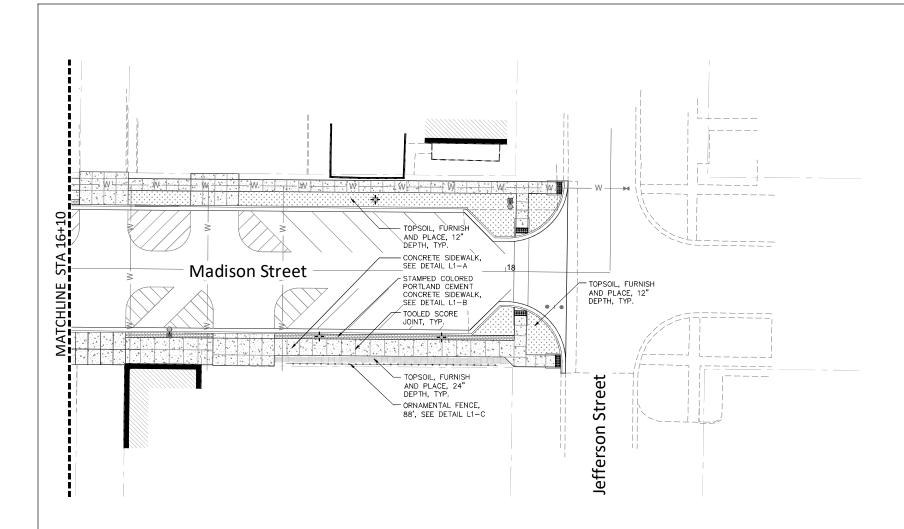

Concrete Sidewalk

Stamped Colored Portland Cement Concrete Sidewalk

Ornamental Fence

Furnish and Place Topsoil, 12" depth at seeded areas 24" depth at plant beds 48" depth at tree locations

- Area Light Assemblies See Elec. Sheets
- Pedestrian Light Assemblies See Elec. Sheets
- Luminaire Replacement See Elec. Sheets
- Street Clock See Elec. Sheets

- Bicycle Rack
- Bench, (new-6' backless)
- Bench (existing memorial bench to be reinstalled by Others)
- Trash Receptacle (new)
- Landscape Planter (30" dia. x 24" ht.)

CONCRETE PAVEMENT FINISH

- SEE CIVIL ENGINEER'S SHEETS FOR REINFORCEMENT, MIX DESIGN, PAVEMENT THICKNESS, ELEVATIONS AND DIMENSIONS.
- JOINTS TO BE AS SHOWN ON PLANS. JOINTS NOT INDICATED ON THE PLANS TO BE LOCATED TO FIT THE PATTERN AND DESIGN OF THE SURFACE AS DETERMINED BY THE OWNER'S REPRESENTATIVE.
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- STANDARD CONCRETE SIDEWALKS TO HAVE MEDIUM-BROOM FINISH PERPENDICULAR TO PEDESTRIAN TRAFFIC FLOW.
- SCORE JOINTS FOR STAMPED COLORED SIDEWALK TO BE SAW CUT ALONG BRICK PATTERN JOINTS TO MINIMIZE THE VISUAL IMPACT, APPROX. 5' ON-CENTER.
- ALL EXPOSED CONCRETE SURFACES TO HAVE TWO COATS OF SEALER.






USER NAME =	DESIGNED - NFB	REVISED -
	DRAWN - JV	REVISED -
	CHECKED - KLM	REVISED -
PLOT DATE = 7/23/2025	DATE - 7/23/2025	REVISED -

STATE OF ILLINOIS	
DEPARTMENT OF TRANSPORTATION	

SCALE:

PITTSFIELD HISTORIC DOWNTOWN SQUARE RECONSTRUCTION		SECT	TION		COUNTY	TOTAL SHEETS	SHEE NO.
MADISON STREET - SITE FURNISHING PLAN 2		24-0003	7-00-RS		PIKE	144	60
MADIOUR STREET - SITE I ORRIGINATO FEAR Z					CONTRACT	NO. 938	347
SHEET 60 OF 144 SHEETS STA. TO STA.			ILLINOIS	FFD AID	PROJECT		

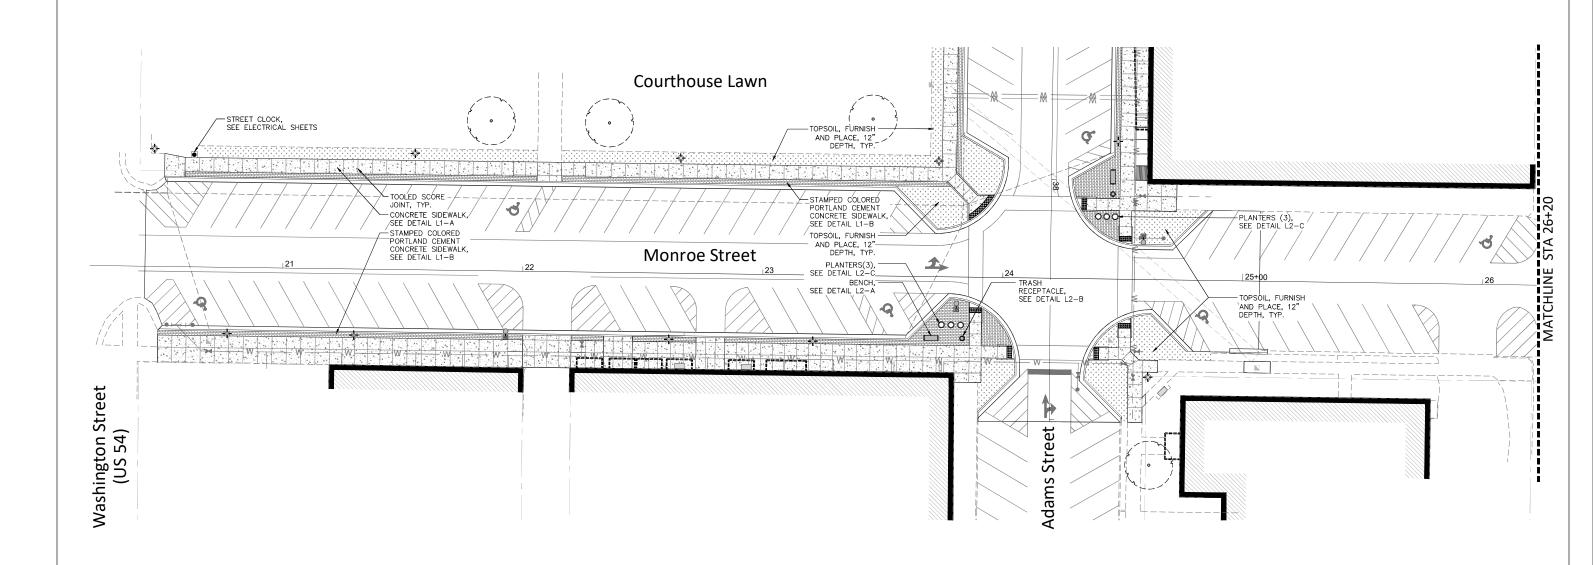

Concrete Sidewalk

Stamped Colored Portland Cement Concrete Sidewalk

Ornamental Fence

Furnish and Place Topsoil, 12" depth at seeded areas 24" depth at plant beds 48" depth at tree locations

- Area Light Assemblies See Elec. Sheets
- Pedestrian Light Assemblies See Elec. Sheets
- Luminaire Replacement See Elec. Sheets
- Street Clock See Elec. Sheets

- Bicycle Rack
- Bench, (new-6' backless)
- Bench (existing memorial bench to be reinstalled by Others)
- Trash Receptacle (new)
- Landscape Planter (30" dia. x 24" ht.)

0

CONCRETE PAVEMENT FINISH

- SEE CIVIL ENGINEER'S SHEETS FOR REINFORCEMENT, MIX DESIGN, PAVEMENT THICKNESS, ELEVATIONS AND DIMENSIONS.
- JOINTS TO BE AS SHOWN ON PLANS. JOINTS NOT INDICATED ON THE PLANS TO BE LOCATED TO FIT THE PATTERN AND DESIGN OF THE SURFACE AS DETERMINED BY THE OWNER'S REPRESENTATIVE.
- EXPANSION JOINTS REQUIRED ALONG ALL ADJACENT FOUNDATIONS, FOOTINGS, EXISTING PAVEMENTS, AND EVERY 30' ALONG THE LENGTH OF THE SIDEWALKS.
- SCORE JOINTS FOR STANDARD CONCRETE SIDEWALK TO BE TOOLED WITH 2" SMOOTH EDGES BOTH SIDES (SAW CUTS ARE NOT ALLOWED).
 OUTSIDE EDGES OF SIDEWALK TO HAVE 2" SMOOTH, TOOLED BORDER.
- ALL SCORE JOINTS WITHIN THE DRIVEWAY ENTRANCES AND PARKING. AREAS (ALL VEHICULAR AREAS) ARE TO BE TOOLED WITH 2" SMOOTH EDGES BOTH SIDES. AFTER THE CONCRETE HAS HARDENED, CUT ALONG THIS TOOLED JOINT TO 1/4 THE THICKNESS OF THE PAVEMENT
- STANDARD CONCRETE SIDEWALKS TO HAVE MEDIUM-BROOM FINISH PERPENDICULAR TO PEDESTRIAN TRAFFIC FLOW.
- SCORE JOINTS FOR STAMPED COLORED SIDEWALK TO BE SAW CUT ALONG BRICK PATTERN JOINTS TO MINIMIZE THE VISUAL IMPACT. APPROX. 5' ON-CENTER.
- ALL EXPOSED CONCRETE SURFACES TO HAVE TWO COATS OF SEALER.






USER NAME =	DESIGNED - NFB	REVISED -
	DRAWN - JV	REVISED -
	CHECKED - KLM	REVISED -
PLOT DATE = 7/23/2025	DATE - 7/23/2025	REVISED -

STATE OF ILLINOIS DEPARTMENT OF TRANSPORTATION

PITTSF	_		-			-•-	RECONSTRUCTION NG PLAN
SCALE:	SHEET	61	OF	144	SHEETS	STA.	TO STA.

_					
ΓΙΟΝ	COUNTY	TOTAL SHEETS	SHEE NO.		
7-00-RS	PIKE	144	61		
	CONTRACT NO. 93847				

IEL	D HIST	ORIC	DO:	WN.	TOWN S	QUAR	E RECONS	TRUCTION	F.A.P RTE.	SEC	TION		COUNTY	TOTAL SHEETS	SHEET NO.
	MONDO	E G.	TDE	ET .	CITE EI	IDNICL	TING DI AN	1		24-0003	7-00-RS		PIKE	144	61
	MONROE STREET - SITE FURNISHING PLAN											CONTRAC	T NO. 938	347	
	SHEET	61	OF	144	SHEETS	STA		TO STA			BLUMOIS	EED AIR	DPO IECT		

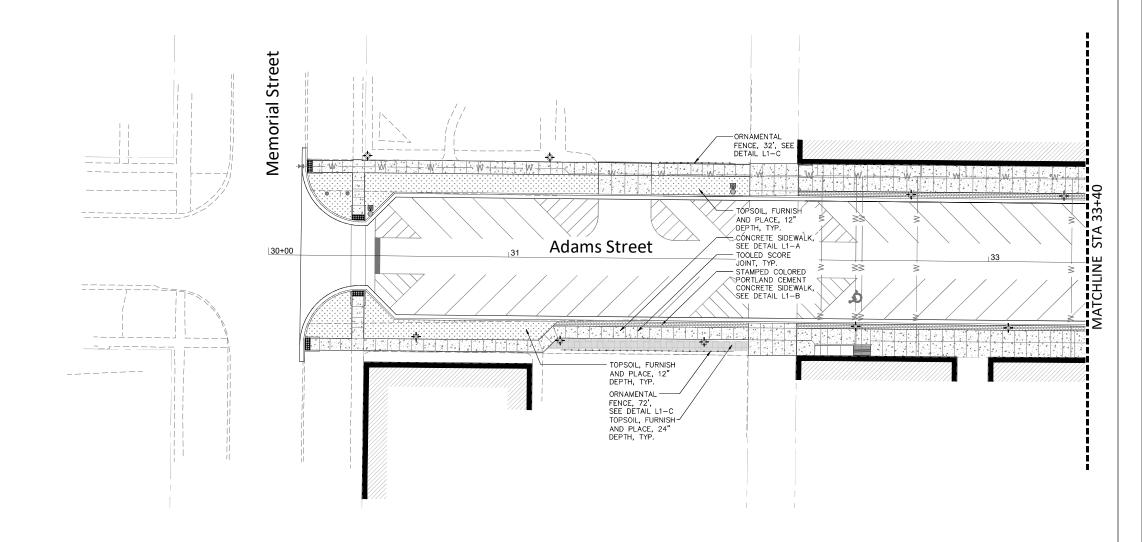

Concrete Sidewalk

Stamped Colored Portland Cement Concrete Sidewalk

Ornamental Fence


Furnish and Place Topsoil, 12" depth at seeded areas 24" depth at plant beds 48" depth at tree locations

- Area Light Assemblies See Elec. Sheets
- Pedestrian Light Assemblies See Elec. Sheets
- Luminaire Replacement See Elec. Sheets
- Street Clock See Elec. Sheets

- Bicycle Rack
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- Bench (existing memorial bench to be reinstalled by Others)
- Trash Receptacle (new)
- Landscape Planter (30" dia. x 24" ht.)

CONCRETE PAVEMENT FINISH

- SEE CIVIL ENGINEER'S SHEETS FOR REINFORCEMENT, MIX DESIGN, PAVEMENT THICKNESS, ELEVATIONS AND DIMENSIONS.
- JOINTS TO BE AS SHOWN ON PLANS. JOINTS NOT INDICATED ON THE PLANS TO BE LOCATED TO FIT THE PATTERN AND DESIGN OF THE SURFACE AS DETERMINED BY THE OWNER'S REPRESENTATIVE.
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 OUTSIDE EDGES OF SIDEWALK TO HAVE 2" SMOOTH, TOOLED BORDER.
- ALL SCORE JOINTS WITHIN THE DRIVEWAY ENTRANCES AND PARKING. AREAS (ALL VEHICULAR AREAS) ARE TO BE TOOLED WITH 2" SMOOTH EDGES BOTH SIDES. AFTER THE CONCRETE HAS HARDENED, CUT ALONG THIS TOOLED JOINT TO 1/4 THE THICKNESS OF THE PAVEMENT
- STANDARD CONCRETE SIDEWALKS TO HAVE MEDIUM-BROOM FINISH PERPENDICULAR TO PEDESTRIAN TRAFFIC FLOW.
- SCORE JOINTS FOR STAMPED COLORED SIDEWALK TO BE SAW CUT ALONG BRICK PATTERN JOINTS TO MINIMIZE THE VISUAL IMPACT, APPROX. 5' ON-CENTER.
- ALL EXPOSED CONCRETE SURFACES TO HAVE TWO COATS OF SEALER.

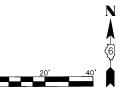


TOTAL SHEET NO.




Since 1945

Engineering, Inc.

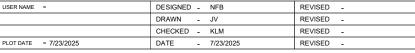

STATE OF ILLINOIS DEPARTMENT OF TRANSPORTATION

PITTSFIEL							F.A.P RTE.	SEC	TION		COUNTY	TOTAL SHEETS	SHEE NO.		
ADAMS STREET - SITE FURNISHING PLAN 1							24-0003	7-00-RS		PIKE	144	62			
ADAMS STREET - SITE FORMSHING FLANT											CONTRACT	NO. 938	847		
LE:	SHEET	62	OF	144	SHEETS	STA.	TO STA.				ILLINOIS	FED. AID	PROJECT		

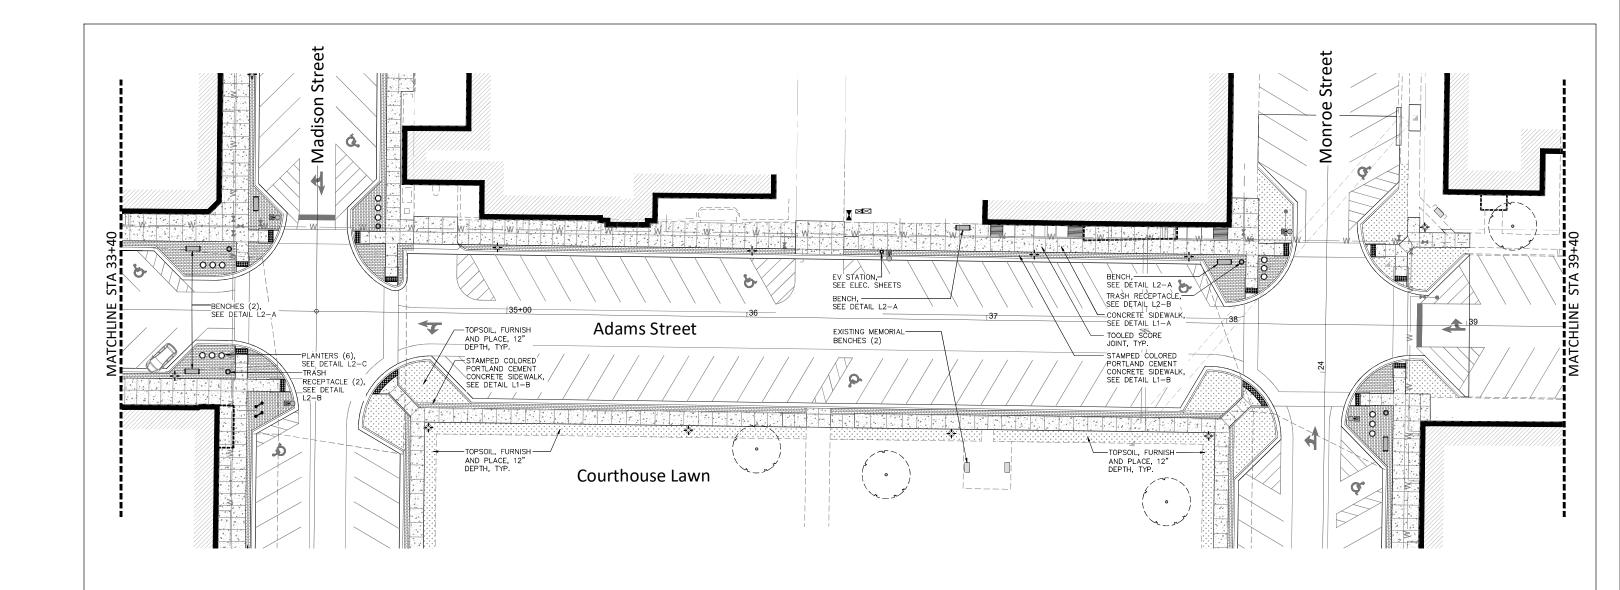

Concrete Sidewalk

Stamped Colored Portland Cement Concrete Sidewalk

Ornamental Fence

Furnish and Place Topsoil, 12" depth at seeded areas 24" depth at plant beds 48" depth at tree locations

- Area Light Assemblies
 See Elec. Sheets
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- Bicycle Rack
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- STANDARD CONCRETE SIDEWALKS TO HAVE MEDIUM-BROOM FINISH PERPENDICULAR TO PEDESTRIAN TRAFFIC FLOW.
- SCORE JOINTS FOR STAMPED COLORED SIDEWALK TO BE SAW CUT ALONG BRICK PATTERN JOINTS TO MINIMIZE THE VISUAL IMPACT, APPROX. 5' ON-CENTER.
- ALL EXPOSED CONCRETE SURFACES TO HAVE TWO COATS OF SEALER.








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PLOT DATE = 7/23/2025		CHECKED - KLM	REVISED -
	PLOT DATE = 7/23/2025	DATE - 7/23/2025	REVISED -

STATE OF ILLINOIS
DEPARTMENT OF TRANSPORTATION

PITTSFIEL	PITTSFIELD HISTORIC DOWNTOWN SQUARE RECONSTRUCTION						F.A.P RTE.	
	апаме	STE	FET	GI	TE EIID	иісній	IG PLAN 2	
	APAIIIO	011	<u> </u>	- 01	I L I ON		O FLAN 2	
.E:	SHEET	63	OF	144	SHEETS	STA.	TO STA.	

F.A.P RTE.	SECT	ΓΙΟΝ	COUNTY	TOTAL SHEETS	SHEE NO.	
	24-0003	7-00-RS		PIKE	144	63
				CONTRACT	NO. 938	347
		SIONLLII	D PPO IECT			

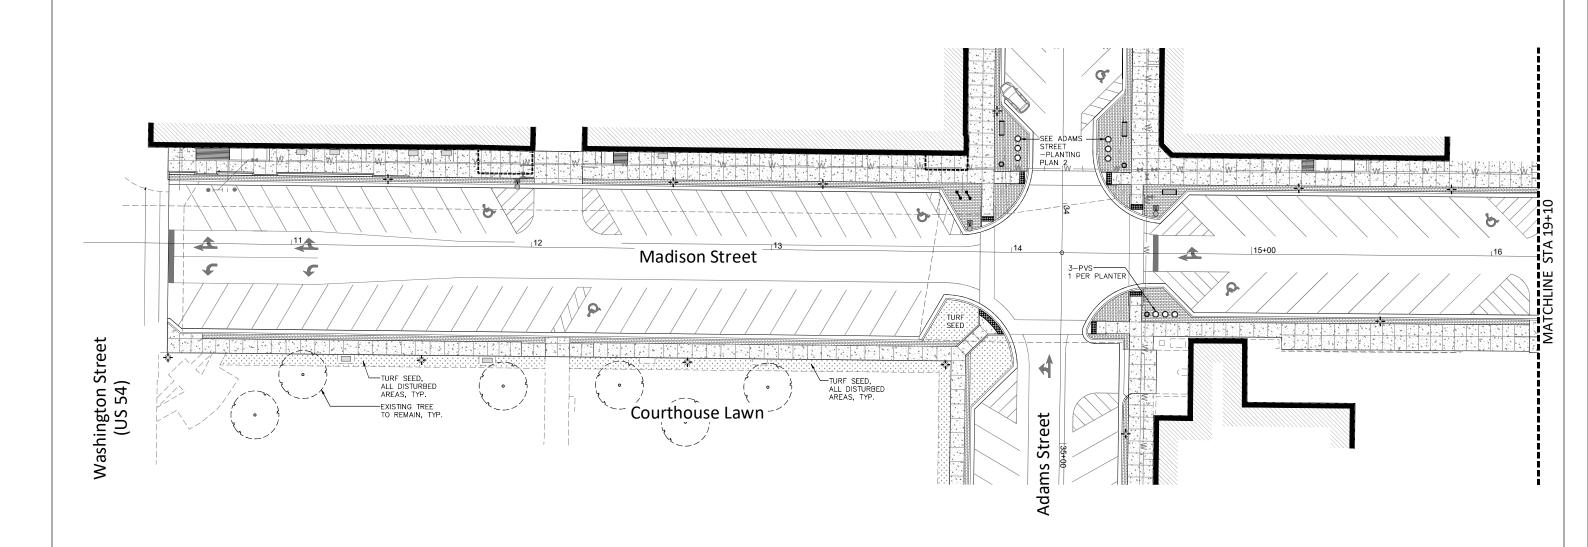





Deciduous Tree



Ornamental Grass Groundcover



Turf Seed

PLANT SCHEDULE 1 - MADISON STREET (STA. 10+56.24 to 16+20)
--

DESIGNATION	BOTANICAL NAME	COMMON NAME	SIZE	QUANTITY
ORNAMEN	NTAL GRASS			
PVS	PANICUM VIRGATUM SHENANDOAH	'SHENANDOAH' SWITCH GRASS	1 GAL. WELL DEVELOPED	3

PLANTING NOTES

- QUANTITIES PROVIDED FOR CONVENIENCE. IT IS THE CONTRACTOR'S RESPONSIBILITY
 TO VERIFY QUANTITIES PRIOR TO BIDDING AND ORDERING PLANT MATERIAL.
- \bullet contractor to verify utility locations prior to excavating for plants.
- ENTIRE PLANTING BED AREAS TO BE MULCHED.

TURF SEED MIX								
IDOT CLASS 1B-LOW MAINTENANCE LAWN MIXTURE								
COMMON NAME								

IDOT CLASS 1B-LOW MAINTENANCE LAWN MIXTURE	
COMMON NAME	LBS/ACRE
FINE LEAF TURF-TYPE FESCUE (3 VARIETIES)	150
PERENNIAL RYEGRASS	20
RED TOP	10
CREEPING RED FESCUE	20

SEEDING NOTES

SCALE:

- SEED ALL AREAS DISTURBED BY CONSTRUCTION OPERATIONS.
 APPROXIMATE LOCATION OF SEEDED AREAS SHOWN ON PROJECT PLANS.
- INSTALL STRAW BLANKET OVER ALL SEEDED AREAS.





USER NAME =	DESIGNED - NFB	REVISED -
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STATE OF ILLINOIS	
DEPARTMENT OF TRANSPORTATION	


PITTSFIELD HISTORIC DOWNTOWN SQUARE RECONSTRUCTION									
MADISON STREET - PLANTING PLAN 1									
MADISON STREET - PLANTING PLANT									
E-	SHEET	64	OF	144	SHEETS	STA	TO STA		




CONTRACT NO. 93847

SECTION

ILLINOIS FED. AID PROJECT

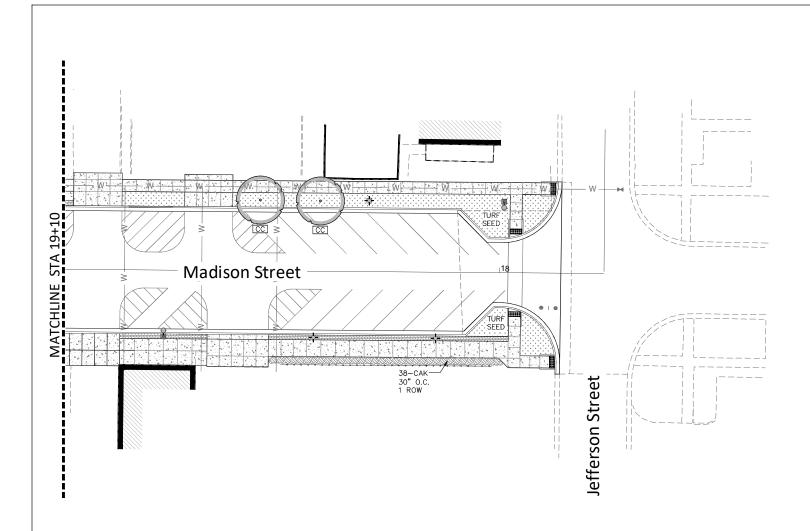

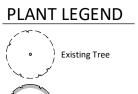





Turf Seed

PLANT SCHEDULE 2 - MADISON STREET (STA. 16+20 TO 18+25.69)											
DESIGNATION	BOTANICAL NAME	COMMON NAME	SIZE	QUANTITY							
DECIDUOUS TREES											
СС	CARPINUS CAROLINIANA	AMERICAN HOPHORNBEAM	2.5" CALIPER, B.B.	2							
ORNAMENTAL GRASS											
CAK	CALAMAGROSTIS ACUTIFLORA 'KARL FOERSTER'	KARL FOERSTER FEATHER REED GRASS	1 GAL. WELL DEVELOPED	38							

PLANTING NOTES

- QUANTITIES PROVIDED FOR CONVENIENCE. IT IS THE CONTRACTOR'S RESPONSIBILITY
 TO VERIFY QUANTITIES PRIOR TO BIDDING AND ORDERING PLANT MATERIAL.
- CONTRACTOR TO VERIFY UTILITY LOCATIONS PRIOR TO EXCAVATING FOR PLANTS.
- ENTIRE PLANTING BED AREAS TO BE MULCHED.

TURF SEED MIX	
IDOT CLASS 1B-LOW MAINTENANCE LAWN MIXTURE	
COMMON NAME	LBS/ACRE
FINE LEAF TURF-TYPE FESCUE (3 VARIETIES)	150
PERENNIAL RYEGRASS	20
RED TOP	10
CREEPING RED FESCUE	20


SEEDING NOTES

- SEED ALL AREAS DISTURBED BY CONSTRUCTION OPERATIONS.
 APPROXIMATE LOCATION OF SEEDED AREAS SHOWN ON PROJECT PLANS.
- INSTALL STRAW BLANKET OVER ALL SEEDED AREAS.






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		DRAWN - JV	REVISED -
PLOT DATE = 7/23/2025 DATE 7/23/2025 REVISED		CHECKED - KLM	REVISED -
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							A.P RTE.	SEC	CTION		COUNTY	TOTAL SHEETS	SHEET NO.				
									24-000	37-00-RS		PIKE	144	65			
		IVIAD	100	1 01	1/22	1		F LAIT 2							CONTRACT	NO. 93	847
	SCALE:	SHEET	65	OF	144	SHEETS	STA.		TO STA.				ILLINOIS	FED. A	ID PROJECT		

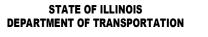

PLANT LEGEND

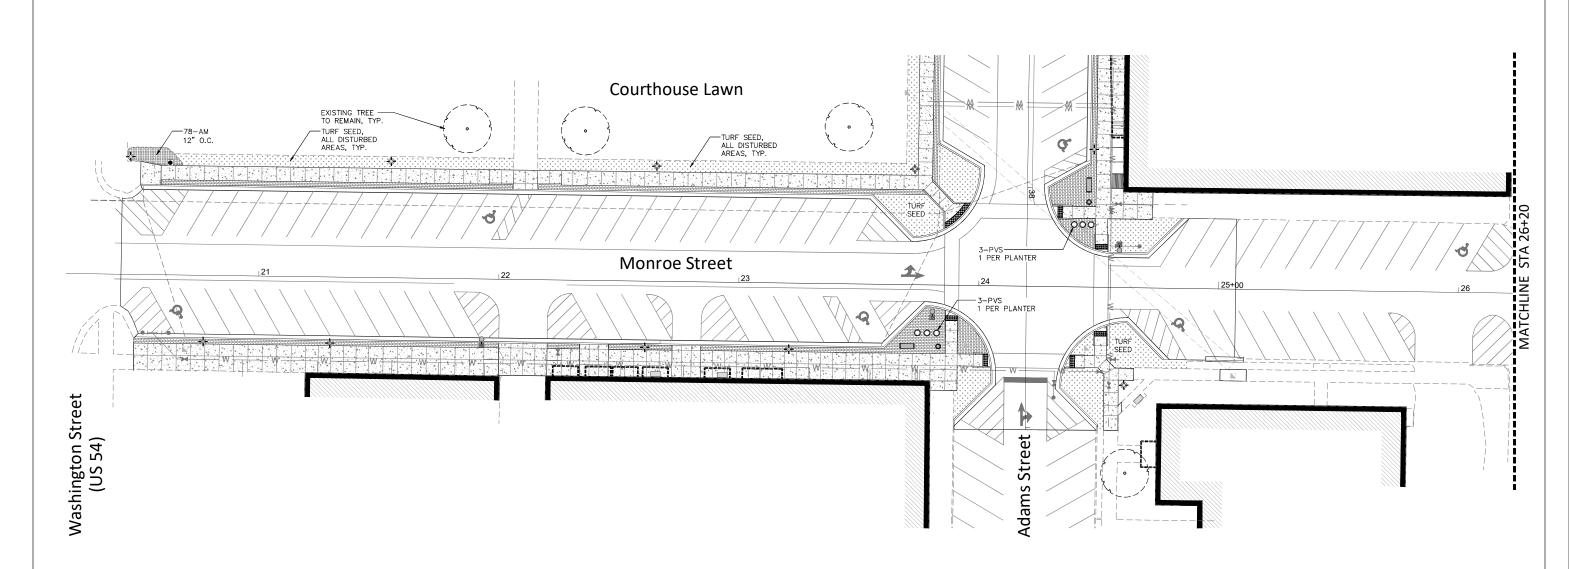





Groundcover Turf Seed

PLANT SCHEDULE 3 - MONROE STREET (STA. 20+59.72 to 26+20)										
DESIGNATION	BOTANICAL NAME	COMMON NAME	SIZE	QUANTITY						
ORNAMENTAL GRASS										
PVS	PANICUM VIRGATUM 'SHENANDOAH'	'SHENANDOAH' SWITCH GRASS	1 GAL. WELL DEVELOPED	6						
PERENNIAL FLOWERS AND GROUNDCOVER										
AM	ALLIUM 'MILLENIUM'	MILLENIUM ORNAMENTAL ONION	1 GAL. WELL DEVELOPED	78						

PLANTING NOTES

- QUANTITIES PROVIDED FOR CONVENIENCE. IT IS THE CONTRACTOR'S RESPONSIBILITY
 TO VERIFY QUANTITIES PRIOR TO BIDDING AND ORDERING PLANT MATERIAL.
- CONTRACTOR TO VERIFY UTILITY LOCATIONS PRIOR TO EXCAVATING FOR PLANTS.
- ENTIRE PLANTING BED AREAS TO BE MULCHED.

TURF SEED MIX								
IDOT CLASS 1B-LOW MAINTENANCE LAWN MIXTURE	_							
COMMON NAME	l							
CINIC LEVE THEE TABLE LEGGLIC (2 AMDIETICS)								

LBS/ACRE
150
20
10
20

SEEDING NOTES

- SEED ALL AREAS DISTURBED BY CONSTRUCTION OPERATIONS.
 APPROXIMATE LOCATION OF SEEDED AREAS SHOWN ON PROJECT PLANS.
- INSTALL STRAW BLANKET OVER ALL SEEDED AREAS.




(HEI)	Hutchison Engineering, Inc.
	Since 1945

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	CHECKED - KLM	REVISED -
PLOT DATE = 7/23/2025	DATE - 7/23/2025	REVISED -

STATE OF ILLINOIS
DEPARTMENT OF TRANSPORTATION

PITTSFIELD HISTORIC DOWNTOWN SQUARE RECONSTRUCTION								F.A.P RTE.	SECTION
MONROE STREET - PLANTING PLAN									24-00037-00-RS
LE:	SHEET	66	OF	144	SHEETS	STA.	TO STA.		ILLINOIS

C DOWNTOWN SQUARE RECONSTRUCTION					F.A.P RTE.	SECT	TION		COUNTY	TOTAL SHEETS	SHEET NO.	
OE STREET - PLANTING PLAN					24-0003	7-00-RS		PIKE	144	66		
UE SIREEI - PLANTING PLAN									CONTRACT	NO. 938	347	
OF	144	SHEETS	STA.	TO STA.			ILLINOIS	FED. AID	PROJECT			

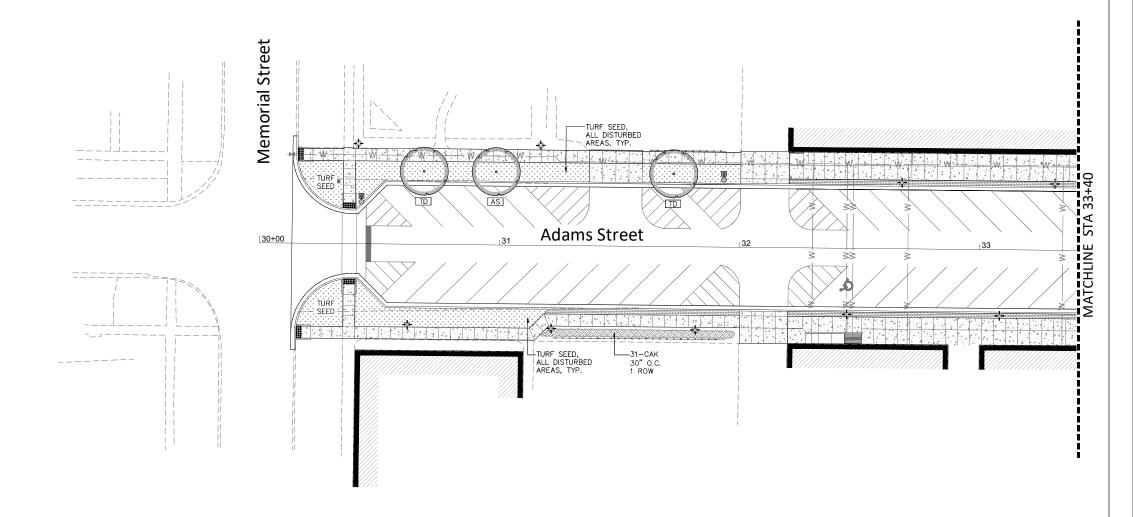

PLANT LEGEND



Existing Tree



Deciduous Tree



Ornamental Grass



Groundcover Turf Seed

PLANT SCHEDULE 4 - ADAMS STREET (STA. 30+13.40 to 33+40)									
DESIGNATION	BOTANICAL NAME	COMMON NAME	SIZE	QUANTITY					
DECIDUOL	IS TREES								
AS	ACER SACCHARUM 'GREEN MOUNTAIN'	GREEN MOUNTAIN SUGAR MAPLE	2.5" CALIPER, B.B.	1					
TD	TAXODIUM DISTICHUM 'SHAWNEE BRAVE'	SHAWNEE BRAVE BALD CYPRESS	3" CALIPER, B.B.	2					
ORNAMEN	ITAL GRASS								
CAK	CALAMAGROSTIS ACUTIFLORA 'KARL FOERSTER'	KARL FOERSTER FEATHER REED GRASS	1 GAL. WELL DEVELOPED	31					

PLANTING NOTES

- QUANTITIES PROVIDED FOR CONVENIENCE. IT IS THE CONTRACTOR'S RESPONSIBILITY
 TO VERIFY QUANTITIES PRIOR TO BIDDING AND ORDERING PLANT MATERIAL.
- CONTRACTOR TO VERIFY UTILITY LOCATIONS PRIOR TO EXCAVATING FOR PLANTS.
- ENTIRE PLANTING BED AREAS TO BE MULCHED.

TURF SEED MIX							
IDOT CLASS 1B-LOW MAINTENANCE LAWN MIXTURE							
COMMON NAME	LBS/ACRE						
FINE LEAF TURF-TYPE FESCUE (3 VARIETIES)	150						
PERENNIAL RYEGRASS	20						
RED TOP	10						
CREEPING RED FESCUE	20						

SEEDING NOTES

SCALE:

- SEED ALL AREAS DISTURBED BY CONSTRUCTION OPERATIONS.
 APPROXIMATE LOCATION OF SEEDED AREAS SHOWN ON PROJECT PLANS.
- INSTALL STRAW BLANKET OVER ALL SEEDED AREAS.





USER NAME =	DESIGNED - NFB	REVISED -	
	DRAWN - JV	REVISED -	
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PLOT DATE = 7/23/2025	DATE - 7/23/2025	REVISED -	




PITTSFIELD HISTORIC DOWNTOWN SQUARE RECONSTRUCTION								F.A.P RTE.	SEC ⁻	TION	
	ΔD	ΔМС	STE	FET	- PLAN	TING	DI AN 1		24-0003	7-00-RS	
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LE:	SHEET	67	OF	144	SHEETS	STA.	TO STA.			ILLINOIS	FED

COUNTY TOTAL SHEET NO.

PIKE 144 67

CONTRACT NO. 93847

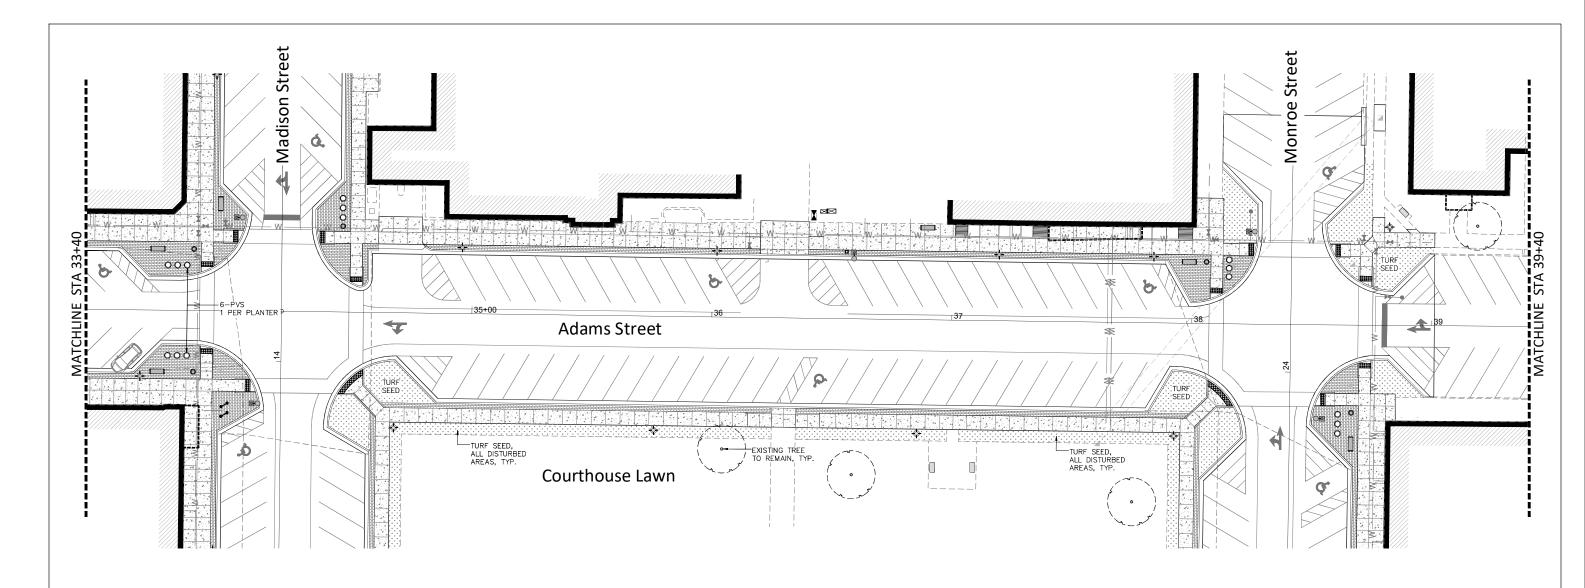

PLANT LEGEND







Ornamental Grass Groundcover



Turf Seed

PLANT SCHEDULE 5 - ADAMS STREET (STA. 33+40 to 39+40)

, .		LE O MOMINIO STREET	3171. 33 . 10 10 1	
DESIGNATION	BOTANICAL NAME	COMMON NAME	SIZE	QUANTITY
ORNAMENT	AL GRASS			
PVS	PANICUM VIRGATUM SHENANDOAH	'SHENANDOAH' SWITCH GRASS	1 GAL. WELL DEVELOPED	6

PLANTING NOTES

- QUANTITIES PROVIDED FOR CONVENIENCE. IT IS THE CONTRACTOR'S RESPONSIBILITY
 TO VERIFY QUANTITIES PRIOR TO BIDDING AND ORDERING PLANT MATERIAL.
- \bullet contractor to verify utility locations prior to excavating for plants.
- ENTIRE PLANTING BED AREAS TO BE MULCHED.

TURF SEED MIX

IDOT CLASS 1B-LOW MAINTENANCE LAWN MIXTU	JRE
COMMON NAME	LBS/ACRE
FINE LEAF TURF-TYPE FESCUE (3 VARIETIES)	150
PERENNIAL RYEGRASS	20
RED TOP	10
CREEPING RED FESCUE	20

SEEDING NOTES

- SEED ALL AREAS DISTURBED BY CONSTRUCTION OPERATIONS. APPROXIMATE LOCATION OF SEEDED AREAS SHOWN ON PROJECT PLANS.
- INSTALL STRAW BLANKET OVER ALL SEEDED AREAS.

	PLANT SCHEDULE - OVERALL PROJECT AREA											
PAY ITEM	DESIGNATION	BOTANICAL NAME	COMMON NAME	SIZE	AREA QTY.	1 AREA 2 QTY.	AREA 3 QTY.	AREA 4 QTY.	AREA 5 QTY.	TOTAL QTY.		
DECIDUO	DECIDUOUS TREES											
A2001820	AS	ACER SACCHARUM 'GREEN MOUNTAIN'	GREEN MOUNTAIN SUGAR MAPLE	2.5" CALIPER, B.B.	-	_	_	1	-	1		
A2002520	СС	CARPINUS CAROLINIANA	AMERICAN HOPHORNBEAM	2.5" CALIPER, B.B.	-	2	-	-	-	2		
A2007724	TD	TAXODIUM DISTICHUM 'SHAWNEE BRAVE'	SHAWNEE BRAVE BALD CYPRESS	ESS 3" CALIPER, B.B.		_	-	2	-	2		
ORNAME	NTAL GRASS											
K0013020	CAK	CALAMAGROSTIS ACUTIFLORA 'KARL FOERSTER'	KARL FOERSTER FEATHER REED GRASS	1 GAL. WELL DEVELOPED	-	38	-	31	-	69		
K0013020	PVS	PANICUM VIRGATUM 'SHENANDOAH'	'SHENANDOAH' SWITCH GRASS	1 GAL. WELL DEVELOPED	3	_	6	-	6	15		
PERENN	IIAL FLOWERS	AND GROUNDCOVER										
K0012990	AM	ALLIUM 'MILLENIUM'	MILLENIUM ORNAMENTAL ONION	1 GAL. WELL DEVELOPED	-	_	78	-	-	78		






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	DRAWN - JV	REVISED -
	CHECKED - KLM	REVISED -
PLOT DATE = 7/23/2025	DATE - 7/23/2025	REVISED -


STATE OF ILLINOIS
DEPARTMENT OF TRANSPORTATION

PITTSFIELD HISTORIC DOWNTOWN SQUARE RECONSTRUCTION										
										ADAMS STREET - PLANTING PLAN 2
			-							
	SHEET	68	OF	144	SHEETS	STA	TO STA			


F.A.P RTE.	SECT	ΓΙΟΝ		COUNTY	TOTAL SHEETS	SHE
	24-0003	24-00037-00-RS			144	68
				CONTRACT	NO. 938	347
		ILLINOIS	FED. AID	PROJECT		

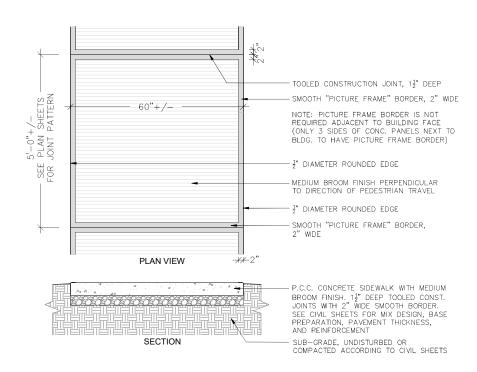



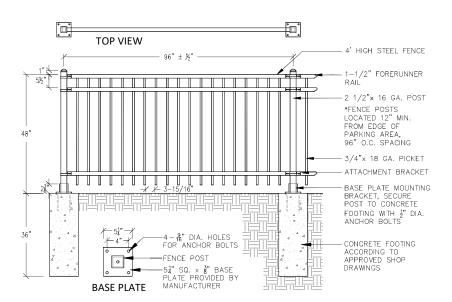



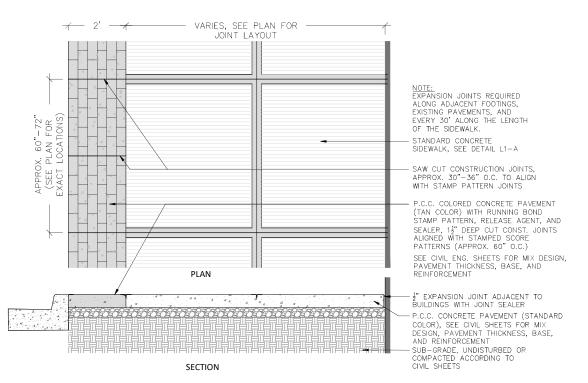

B STAMPED COLORED CONCRETE SIDEWALK

NOT TO SCALE








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STATE OF ILLINOIS
DEPARTMENT OF TRANSPORTATION


PITTSFIEL	D HISTOR	IC DO	WN1	TOWN S	QUARE	RECONSTRUCTION	F.A.P RTE.	SECT		COUNTY	TOTAL SHEETS	SHEET NO.	
			ITE	DETAI	9		24-00037-00-RS				PIKE 144		69
	SITE DETAILS										CONTRAC	T NO. 938	347
LE:	SHEET 69	OF	144	SHEETS	STA.	TO STA.			ILLINOIS	FED AIR	PROJECT		-



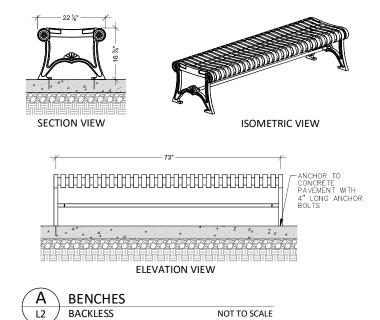

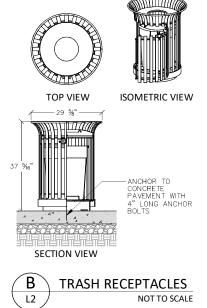

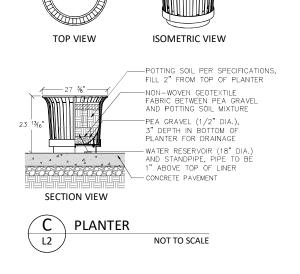SCALE:

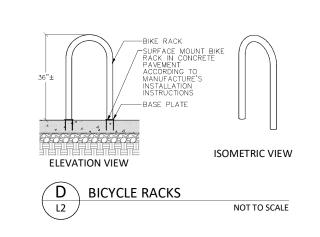





- MEMEORIAL BENCH TO BE REMOVED AND REINSTALLED BY THE CITY

E MEMORIAL BENCH REMOVAL AND RELOCATION NOT TO SCALE





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(PEI)	Hutchison	
(UE)	Engineering, Inc.	L
	Since 1945	

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STATE OF ILLINOIS	
DEPARTMENT OF TRANSPORTATION	

PITTSFIEL	D HIST	ORIC	DO:	WN	TOWN S	F.A.P RTE. SECTION				COUNTY	SHEET NO.			
SITE FURNISHING DETAILS									24-00037-	-00-RS		PIKE	144	70
				FUN	MISHIN	G DE I	NIES					CONTRACT	NO. 938	347
LE: SHEET 70 OF 144 SHEETS STA. TO STA.									l l	LLINOIS	FED. AID	PROJECT		



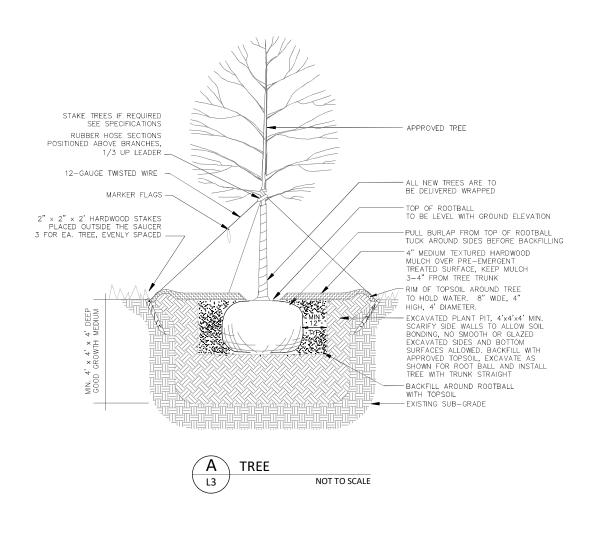

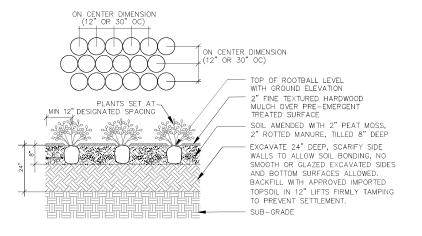PERENNIAL PLANTS L3

PRAIRIE AND ORNAMENTAL TYPE


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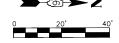
PITTSFIEL	D HIST	ORIG	C DO	WN.	TOWN S	QUARE	RECONSTRUCTION	F.A.P RTE. SECTION				COUNTY	TOTAL SHEETS	SHEET NO.
	PLANTING DETAILS								24-0003		PIKE 144		71	
				-AI1	11110 0	LIAILU						CONTRAC	T NO. 938	347
LE:	SHEET	71	OF	144	SHEETS	STA.	TO STA.			ILLINOIS	FED. AID	PROJECT		



GENERAL NOTES:

SEE SPECIAL PROVISIONS FOR FURTHER INFORMATION.
 REMOVAL OF LIGHTING UNIT SHALL ALSO INCLUDE REMOVAL OF THE ASSOCIATED OVERHEAD WIRING ALL THE WAY BACK TO THE SOURCE.



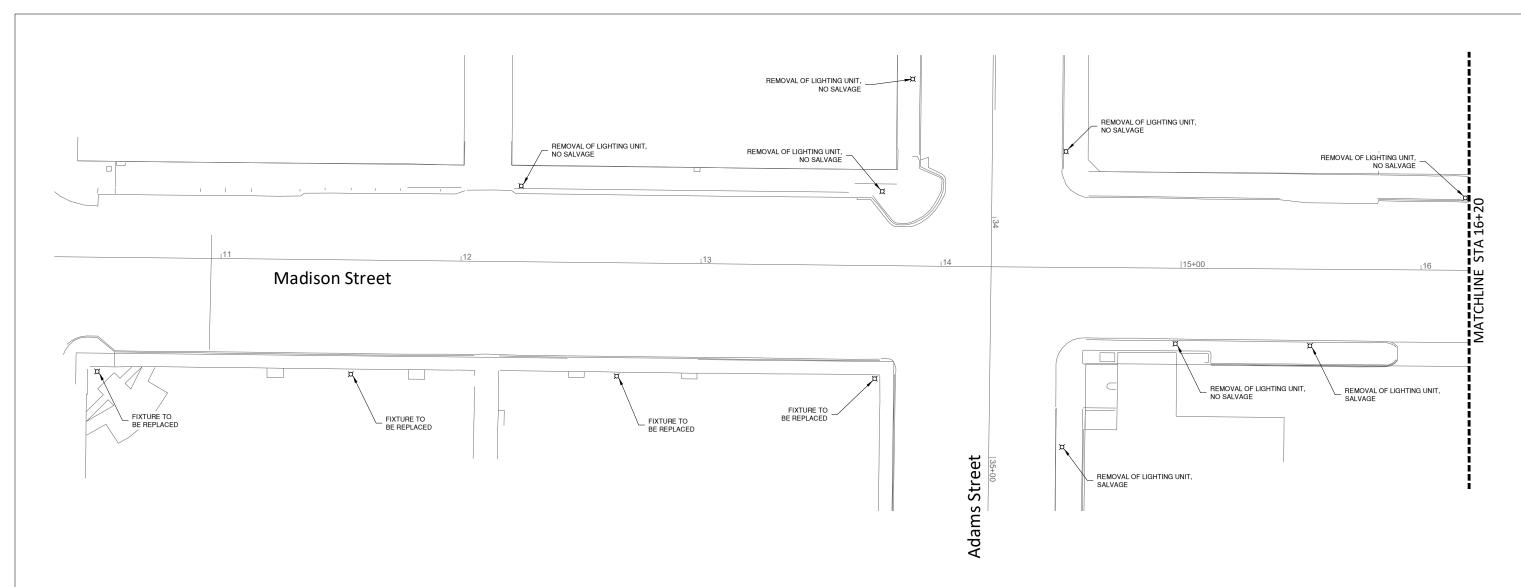




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DEPARTMENT OF TRANSPORTATION	


PITTSFIEL	D HIST	ORI	C DO	WN	TOWN S	QUAR	E RECONSTRUCTION	F.A.P RTE.	
MADI		24							
MADI	3014 3	IKL			CINICA	- DLIN	OLITION PLAN 1		
E:	SHEET	X	OF	XX	SHEETS	STA.	TO STA.		

A.P TE.	SECTION		COUNTY	TOTAL SHEETS	SHEET NO.
	24-00037-00-RS	PIKE	144	72	
			CONTRACT	NO. 9	3847
	ILLINOIS	FED. AII	PROJECT		

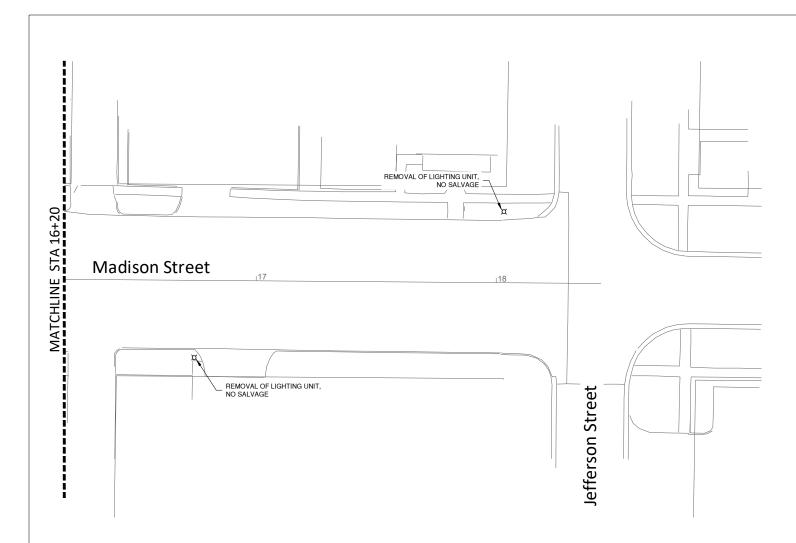

SEE SPECIAL PROVISIONS FOR FURTHER INFORMATION.
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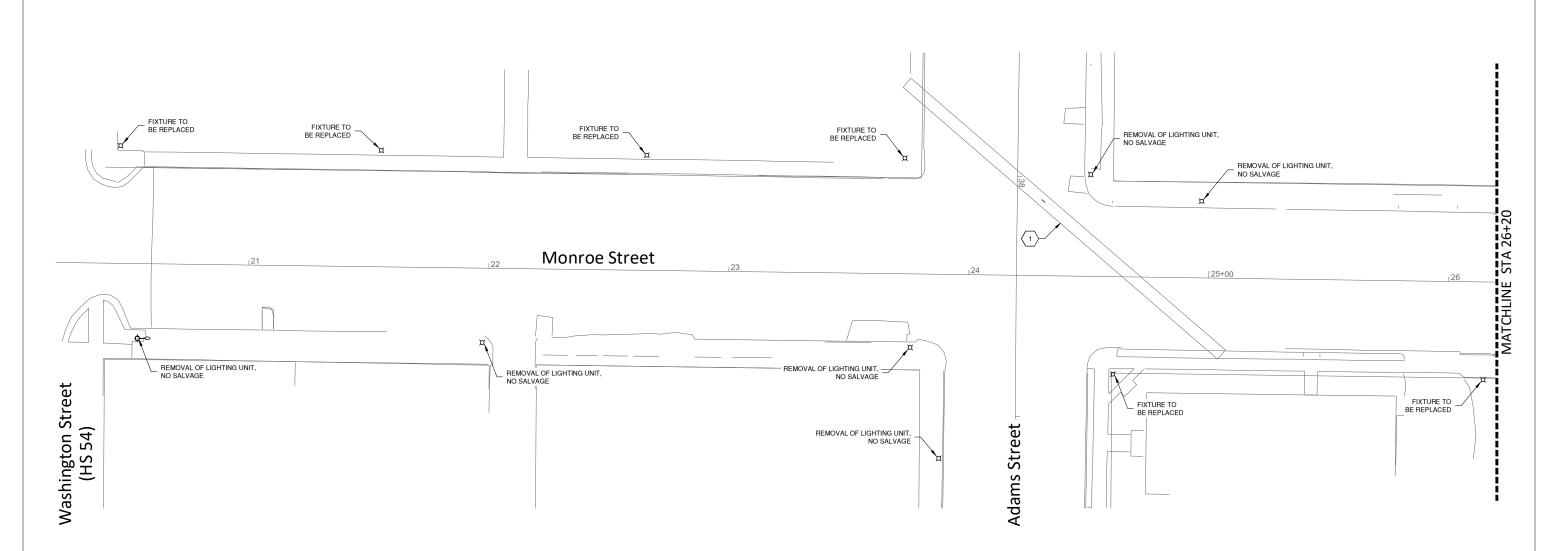


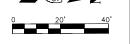

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STATE OF ILLINOIS	
DEPARTMENT OF TRANSPORTATION	

PITTSFIELD HISTORIC DOWNTOWN SQUARE RECONSTRUCTION				F.A.P RTE.	SEC ⁻	TION		COUNTY	TOTAL SHEETS	SHEET NO.			
еом ет	DEE	т., к	:I E <i>(</i>	TDICA	DEMO	I ITION DI AN 2		24-0003	7-00-RS		PIKE	144	73
30N 31				TINION	L DLING	LITION FLAN Z					CONTRACT	NO. 9	3847
SHEET	Χ	OF	XX	SHEETS	STA.	TO STA.			ILLINOIS	FED. AID	PROJECT		
	SON ST	SON STREE	SON STREET - I	SON STREET - ELEC	SON STREET - ELECTRICA	SON STREET - ELECTRICAL DEMO	SON STREET - ELECTRICAL DEMOLITION PLAN 2	D HISTORIC DOWNTOWN SQUARE RECONSTRUCTION RTE. SON STREET - ELECTRICAL DEMOLITION PLAN 2	D HISTORIC DOWNTOWN SQUARE RECONSTRUCTION SON STREET - ELECTRICAL DEMOLITION PLAN 2 24-0003	D HISTORIC DOWNTOWN SQUARE RECONSTRUCTION SON STREET - ELECTRICAL DEMOLITION PLAN 2 24-00037-00-RS	D HISTORIC DOWNTOWN SQUARE RECONSTRUCTION SON STREET - ELECTRICAL DEMOLITION PLAN 2 24-00037-00-RS	D HISTORIC DOWNTOWN SQUARE RECONSTRUCTION SON STREET - ELECTRICAL DEMOLITION PLAN 2 CONTRACT CONTRACT	D HISTORIC DOWNTOWN SQUARE RECONSTRUCTION SON STREET - ELECTRICAL DEMOLITION PLAN 2 CONTRACT NO. 9



- SEE SPECIAL PROVISIONS FOR FURTHER INFORMATION.
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KEYED NOTES:

TUNNEL LOCATED BELOW GRADE WITH EXISTING CONDUIT AND WIRING FOR A 120VAC CIRCUIT. THE CONTRACTOR SHALL FIND THE SOURCE, REMOVE POWER AND ABANDON IN ORDER TO FILL TUNNEL WITHIN THE CITY'S RIGHT OF WAY.






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(PEI)	Hutchison		
(IIII)	Engineering, Inc.		
	Since 1945	PLOT DATE	-

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STATE OF ILLINOIS	
DEPARTMENT OF TRANSPORTATION	

PITTSFIEL	D HISTOR	C DOWN	TOWN S	QUARE	RECONSTRUCTION	F.A.P RTE.	SECTION	COUNTY	TOTAL SHEETS	SHEET NO.
MOR	NDOE STOR	ET_ELE	CTDICA	I DEMO	LITION PLAN		24-00037-00-RS	PIKE	144	74
IIIOI	INOL STAL		.OINIOA	L DLINO	LITION FLAN			CONTRACT	NO. 9	3847
I E:	SHEET Y	OF XX	SHEETS	STA	TO STA		ILLINOIS EED AIT	DROJECT		-

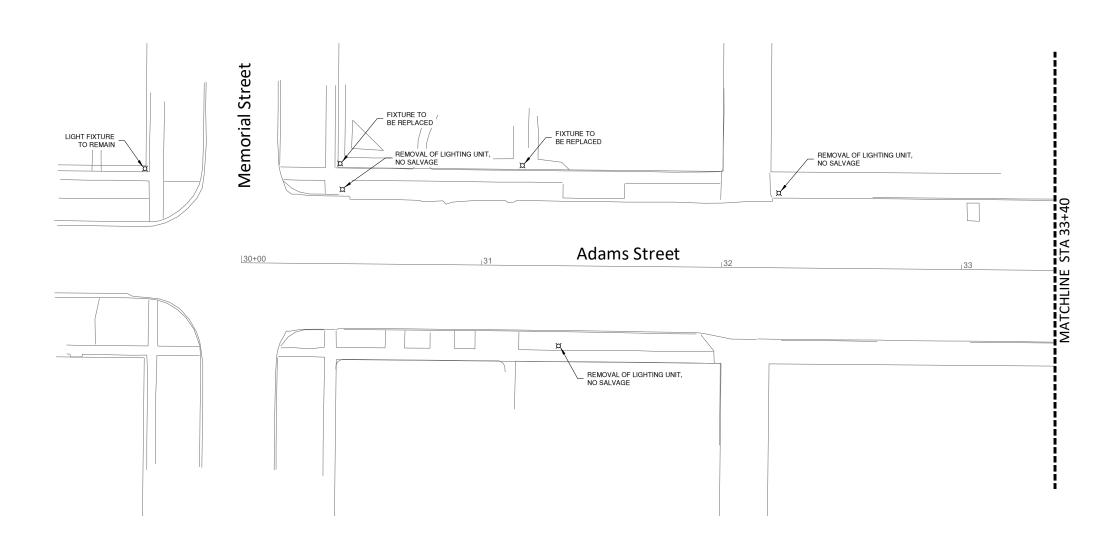

- SEE SPECIAL PROVISIONS FOR FURTHER INFORMATION.
 REMOVAL OF LIGHTING UNIT SHALL ALSO INCLUDE REMOVAL OF THE ASSOCIATED OVERHEAD WIRING ALL THE WAY BACK TO THE SOURCE.







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STATE OF ILLINOIS DEPARTMENT OF TRANSPORTATION

PITTSFIELD HISTORIC DOWNTOWN SQUARE RECONSTRUCTION ADAMS STREET - ELECTRICAL DEMOLITION PLAN 1 SHEET X OF XX SHEETS STA. TO STA. F.A.P RTE. SECTION COUNTY SHEETS NO. 24-00037-00-RS PIKE 144 75 CONTRACT NO. 93847						
ADAMS STREET - ELECTRICAL DEMOLITION PLAN 1 CONTRACT NO. 93847	PITTSFIELD HISTORIC DOWNTOWN SQUARE RECONSTRUCTION		SECTION	COUNTY		
CONTRACT NO. 93847	ADAMS STREET - ELECTRICAL DEMOLITION DI AN 4		24-00037-00-RS	PIKE	144	75
SHEET X OF XX SHEETS STA. TO STA. ILLINOIS FED. AID PROJECT	ADAMS STREET - ELECTRICAL DEMOLITION FLANT			CONTRAC	T NO. 9	3847
	SHEET X OF XX SHEETS STA. TO STA.	ILLINOIS FED. AID PROJECT				



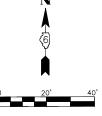
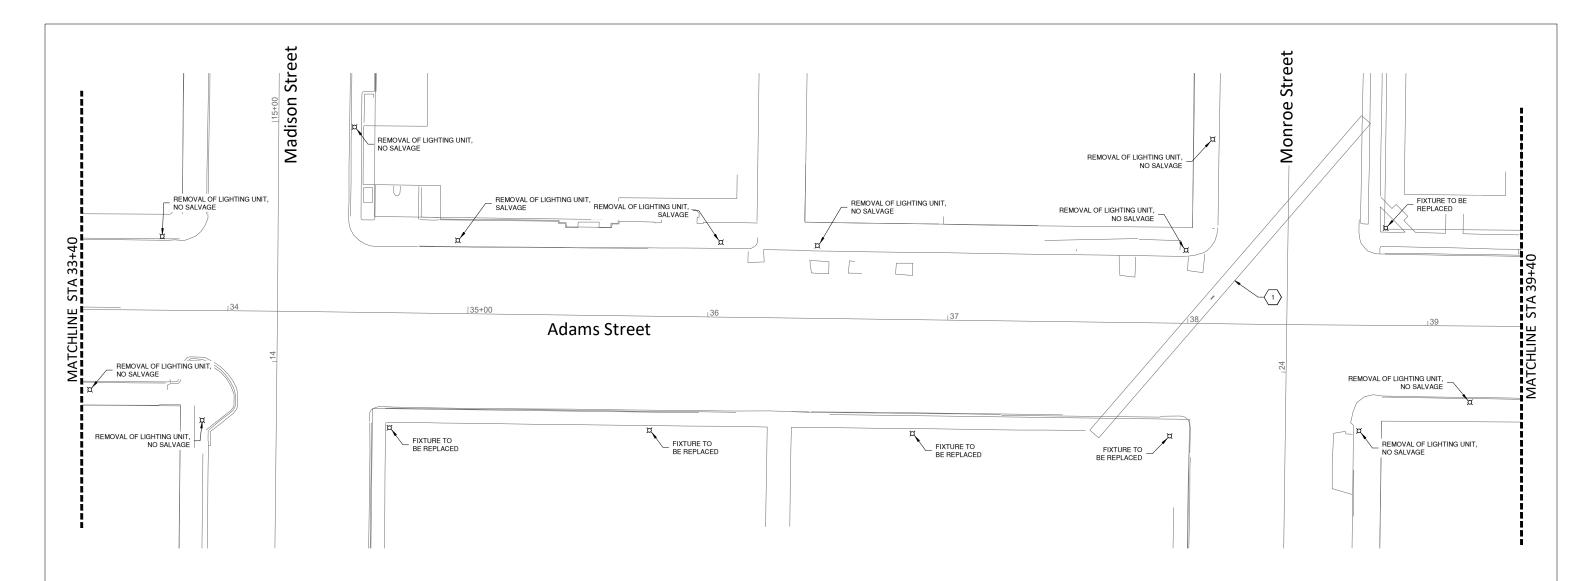
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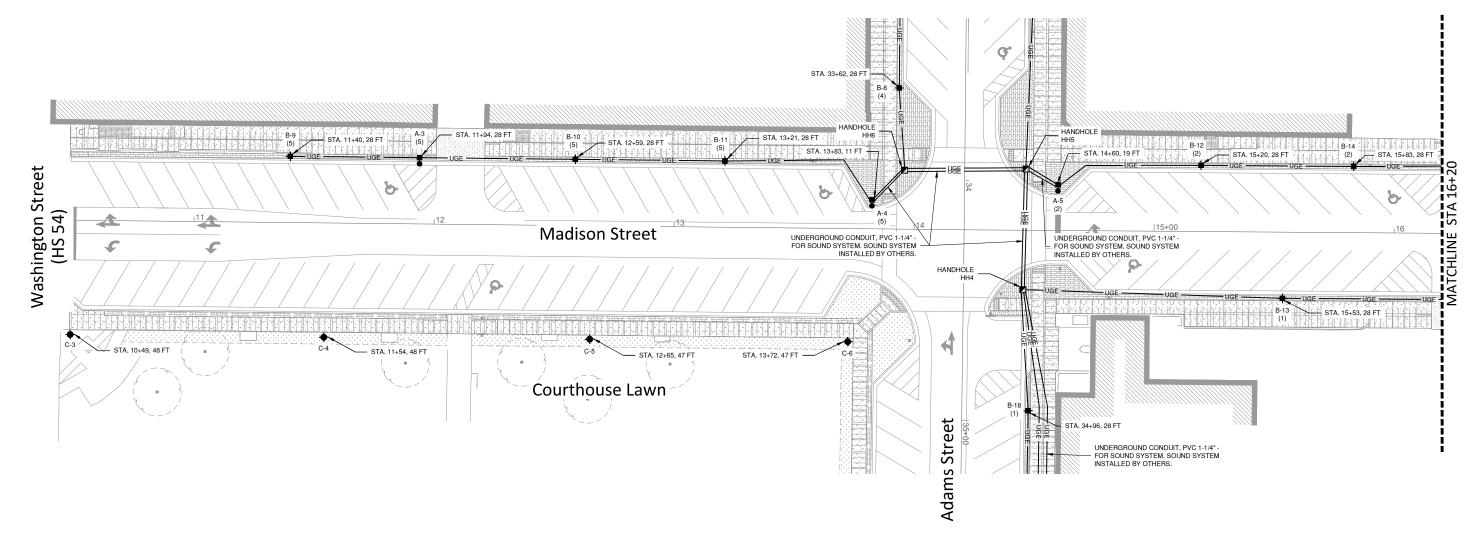
(HEI)	Hutchison Engineering, Inc.	
	Since 1945	

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STATE OF ILLINOIS	
DEPARTMENT OF TRANSPORTATION	

PITTSFIEL	D HIST	ORI	C DO	WN	TOWN S	QUARE	RECONSTRUCTION	F.A.P RTE.	SE	
ADAMS STREET - ELECTRICAL DEMOLITION PLAN 2									24-00	
ADA	ADAMS STREET - ELECTRICAL DEMOLITION PLAN 2									
_E:	SHEET	Х	OF	XX	SHEETS	STA.	TO STA.			

SECTION		COUNTY	TOTAL SHEETS	SHEE NO.
24-00037-00-RS		PIKE	144	76
		CONTRACT	NO. 9	3847
ILLINOIS	FFD All	D PROJECT		



- ALL ELECTRICAL EQUIPMENT SHALL BE INSTALLED IN CONFORMANCE WITH NFPA 70 (CURRENT LOCAL VERSION IN FORCE), THE RESPECTIVE EQUIPMENT MANUFACTURERS DIRECTIONS AND ALL OTHER APPLICABLE LOCAL CODES, LAWS, ORDINANCES AND REQUIREMENTS IN FORCE. ANY INSTALLATION WHICH VOID THE U.L. LISTINGS (OR THIRD PARTY LISTING) AND/OR THE MANUFACTURER'S WARRANTY OF A DEVICE SHALL NOT BE PERMITTED
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- 3. ALL WORK IN THE ELECTRICAL SYSTEM REQUIRED BY THE CONTRACT DOCUMENTS SHALL BE COORDINATED WITH THE WORK OF ALL OTHER DIVISIONS/TRADES PRIOR TO THE COMMENCEMENT OF WORK. AVOID INTERFERENCES WITH THE PROGRESS OF OTHER DIVISIONS/TRADES.
- 4. CONDUIT AND WIRE BURIED A MINIMUM OF 24" BELOW GRADE.
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LEGEND

- PROPOSED LIGHTING ASSEMBLY (SPECIAL) (A)
- PROPOSED ORNAMENTAL LIGHT UNIT, COMPLETE (B)
- PROPOSED FIXTURE REPLACEMENT (C)
- PROPOSED ORNAMENTAL STREET CLOCK (TC)
- -UGE UNDERGROUND ELECTRIC
- HANDHOLE






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PLOT DATE =	DATE -	REVISED -	

STATE OF ILLINOIS DEPARTMENT OF TRANSPORTATION

SCALE:

PITTSFIEL	PITTSFIELD HISTORIC DOWNTOWN SQUARE RECONSTRUCTION MADISON STREET - LIGHTING PLAN 1							P SECTION (SHEET NO.
								24-00037-00-RS PIKE		144	77
									CONTRAC	T NO. 9	3847
LE:	SHEET X	OF X	SHEETS	STA.	TO STA.			ILLINOIS FED A	ID PROJECT		$\overline{}$



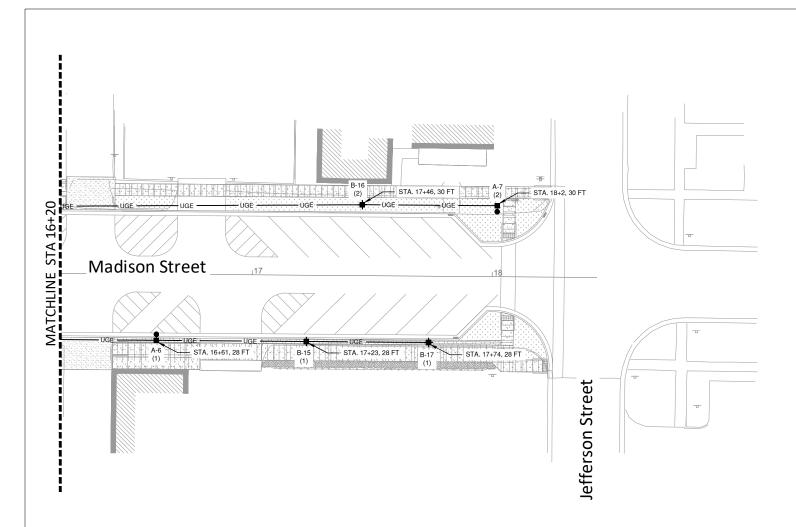

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LEGEND

- PROPOSED LIGHTING ASSEMBLY (SPECIAL) (A)
- PROPOSED ORNAMENTAL LIGHT UNIT, COMPLETE (B)
- PROPOSED FIXTURE REPLACEMENT (C)
- PROPOSED ORNAMENTAL STREET CLOCK (TC)
- -UGE UNDERGROUND ELECTRIC
- ✓ HANDHOLE






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STATE OF ILLINOIS DEPARTMENT OF TRANSPORTATION

PITTSFIEL	PITTSFIELD HISTORIC DOWNTOWN SQUARE RECONSTRUCTION								SECTION COUNTY		TOTAL SHEETS	SHEET NO.			
MADISON STREET - LIGHTING PLAN 2									24-00037-00-RS		PIKE	144	78		
	MADISON STREET - LIGHTING PLAN 2								CONTRACT NO. 9			3847			
LE:	SHEET	Х	OF	XX	SHEETS	STA.	TO STA.			ILLINOIS	FED. AII	D PROJECT			

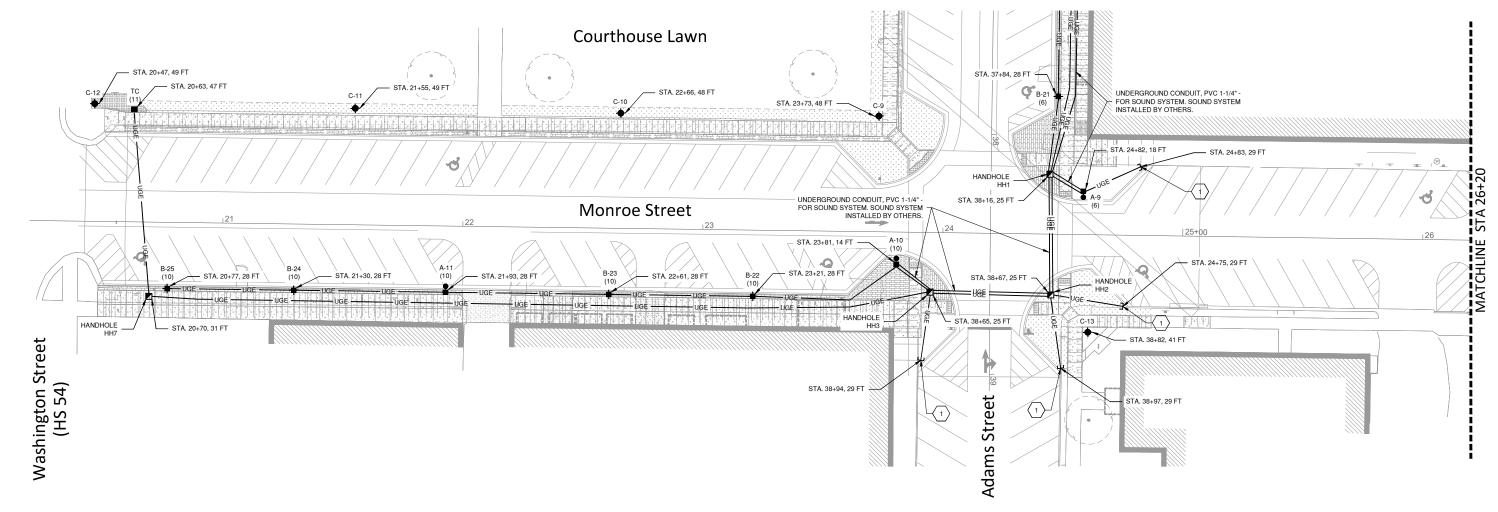

KEYED NOTES:

1. SPARE 1 - 1-1/2" CONDUIT STUBBED OUT AND TO BE CAPPED AT EDGE OF PROJECT LIMITS FOR FUTURE EXTENSION.

GENERAL NOTES:

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- PROPOSED ORNAMENTAL STREET CLOCK (TC)
- -UGE UNDERGROUND ELECTRIC
- HANDHOLE







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STATE OF ILLINOIS DEPARTMENT OF TRANSPORTATION

SCALE:

PITTSFIEL	PITTSFIELD HISTORIC DOWNTOWN SQUARE RECONSTRUCTION							SECTION			COUNTY	TOTAL SHEETS	SHEET NO.
MONROE STREET - LIGHTING PLAN								24-00037-00-RS		PIKE	144	79	
	MONROE STREET - LIGHTING PLAN										CONTRACT	ΓNO. 9	3847
LE:	SHEET X	0	F XX	SHEETS	STA.	TO STA.			ILLINOIS	FED. AID	PROJECT		



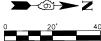
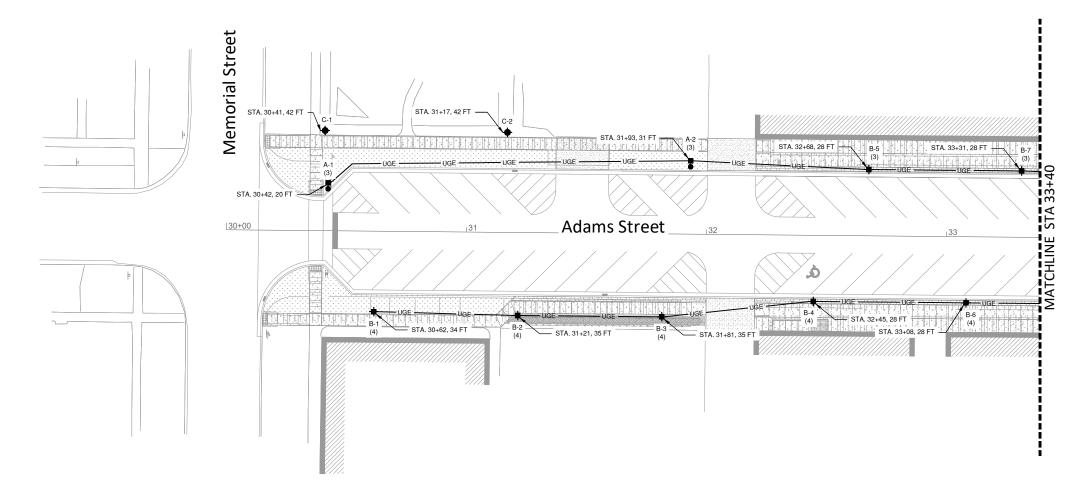
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- ✓ HANDHOLE







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PITTSFIEL	PITTSFIELD HISTORIC DOWNTOWN SQUARE RECONSTRUCTION								SECTION	COUNTY	TOTAL SHEETS	SHEET NO.	
	ADAMS STREET - LIGHTING PLAN 1								24-00037-00-RS	PIKE	144	80	
	ADAMS STREET - LIGHTING FLANT									CONTRACT	NO. 9	3847	
Ē:	SHEET	Х	OF	XX	SHEETS	STA.	TO STA.		ILLINOIS FED AIR	PROJECT			



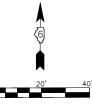

KEYED NOTES:

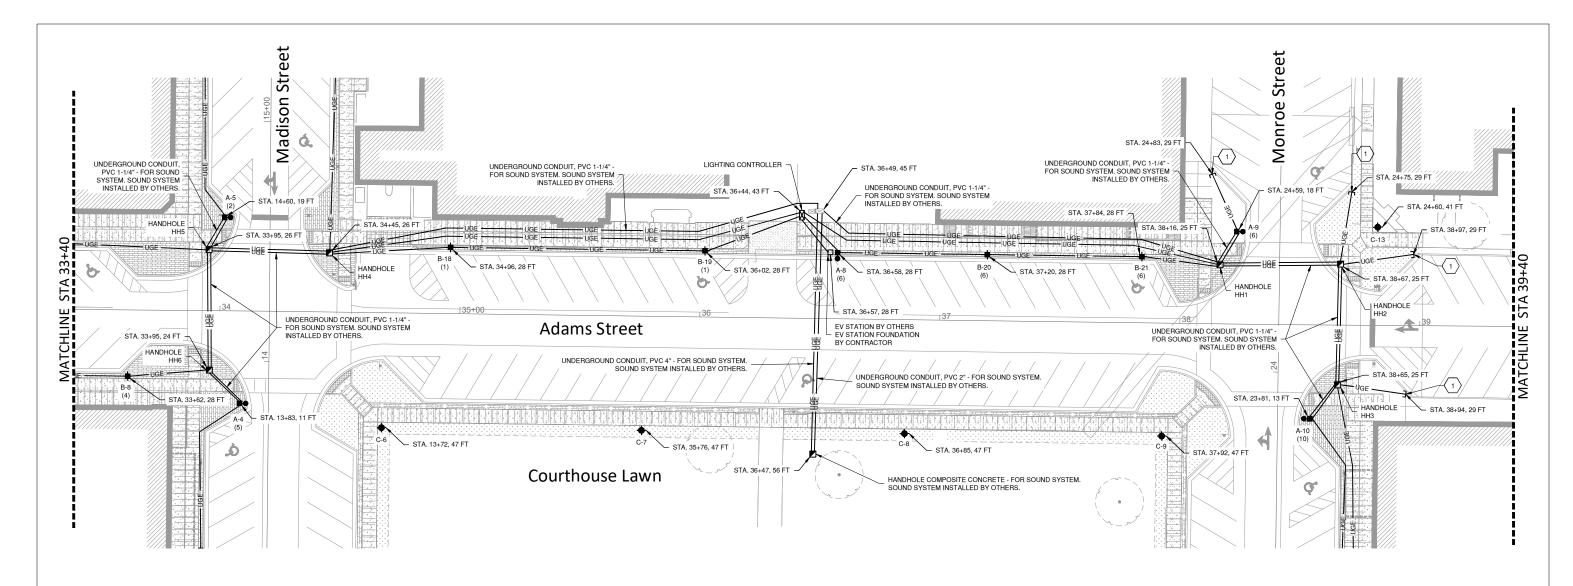
1. SPARE 1 - 1-1/2" CONDUIT STUBBED OUT AND TO BE CAPPED AT EDGE OF PROJECT LIMITS FOR FUTURE EXTENSION.

GENERAL NOTES:

- ALL ELECTRICAL EQUIPMENT SHALL BE INSTALLED IN CONFORMANCE WITH NFPA 70 (CURRENT LOCAL VERSION IN FORCE), THE RESPECTIVE EQUIPMENT MANUFACTURER'S DIRECTIONS AND ALL OTHER APPLICABLE LOCAL CODES, LAWS, ORDINANCES AND REQUIREMENTS IN FORCE. ANY INSTALLATION WHICH VOID THE U.L. LISTINGS (OR THIRD PARTY LISTING) AND/OR THE MANUFACTURER'S WARRANTY OF A DEVICE SHALL NOT BE PERMITTED.
- 2. THE LOCATION, SIZE, AND TYPE OF MATERIAL OF EXISTING UNDERGROUND UTILITIES INDICATED ON THE PLANS IS NOT REPRESENTED AS BEING ACCURATE, SUFFICIENT OR COMPLETE. IT SHALL BE THE CONTRACTOR'S RESPONSIBILITY TO DETERMINE THE ACTUAL LOCATION OF ALL SUCH FACILITIES, INCLUDING SERVICE CONNECTIONS TO UNDERGROUND UTILITIES PRIOR TO COMPANIES OF HIS OPERATIONAL PLANS AND SHALL OBTAIN FROM THE RESPECTIVE UTILITY COMPANIES DETAILED INFORMATION AND ASSISTANCE RELATIVE TO THE LOCATION OF THE FACILITIES AND THE WORKING SCHULE OF THE COMPANIES FOR REMOVAL OR ADJUSTMENT WHERE REQUIRED. IN THE EVENT AN UNEXPECTED UTILITY COMPANY OF JURISDICTION. THE ENGINEER SHALL BE MISSISTANCE REMINING CONSTRUCTION, THE CONTRACTOR SHALL IMMEDIATELY NOTIFE? ANY SUCH MAINS AND SERVICES SHALL BE RESTORED TO SERVICE AT ONCE AND PAID FOR BY THE CONTRACTOR AT NO ADDITIONAL COST TO THE CONTRACT.
- ALL WORK IN THE ELECTRICAL SYSTEM REQUIRED BY THE CONTRACT DOCUMENTS SHALL BE COORDINATED WITH THE WORK OF ALL OTHER DIVISIONS/TRADES PRIOR TO THE COMMENCEMENT OF WORK. AVOID INTERFERENCES WITH THE PROGRESS OF OTHER DIVISIONS/TRADES.
- 4. CONDUIT AND WIRE BURIED A MINIMUM OF 24" BELOW GRADE.
- 5. ONE UGE LINE TYPE (INDICATING UNDERGROUND ELECTRIC) IS DIAGRAMMATIC TO INDICATE LENGTH AND USED FOR CLARITY BETWEEN FIXTURES AND HANDHOLES. ALL CIRCUITS SHOULD NOT BE ROUTED THROUGH EACH LIGHTING UNIT, BUT RATHER IN THE SAME APPROXIMATE LOCATION UNLESS NEEDED FOR THAT PARTICULAR LIGHTING UNIT. SEE LIGHTING CONTROLLER CIRCUIT DIAGRAM FOR THE NUMBER OF CONDUITS AND CIRCUITS BETWEEN HANDHOLES AND LIGHTING UNIT.

LEGEND

- PROPOSED LIGHTING ASSEMBLY (SPECIAL) (A)
- PROPOSED ORNAMENTAL LIGHT UNIT, COMPLETE (B)
- PROPOSED FIXTURE REPLACEMENT (C)
- PROPOSED ORNAMENTAL STREET CLOCK (TC)
- -UGE UNDERGROUND ELECTRIC
- HANDHOLE

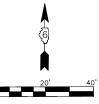








ISER NAME =	DESIGNED - JRV	REVISED -	
	DRAWN - JRV	REVISED -	
	CHECKED - LDW	REVISED -	
LOT DATE =	DATE -	REVISED -	


STATE OF ILLINOIS	
DEPARTMENT OF TRANSPORTATION	

PITTSFIELD HISTORIC DOWNTOWN SQUARE RECONSTRUCTION ADAMS STREET - LIGHTING PLAN 2								F.A.P RTE.	SECTION			COUNTY	TOTAL SHEETS	SHEE NO.		
									24-00037-00-RS			PIKE	144	81		
	ADAMS SIREET - LIGHTING PLAN 2													CONTRACT	NO. 9	3847
LE:	SHEET	Χ	OF	XX	SHEETS	STA.		TO STA.				ILLINOIS	FED. AII	D PROJECT		

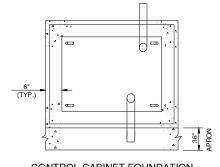


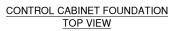

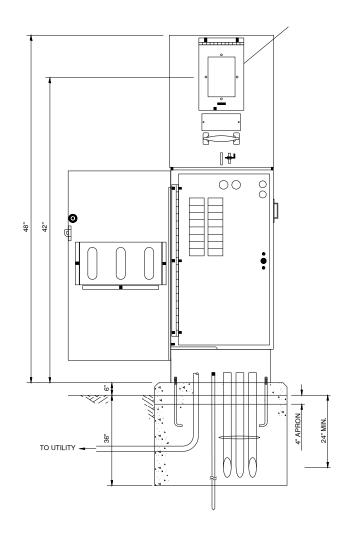

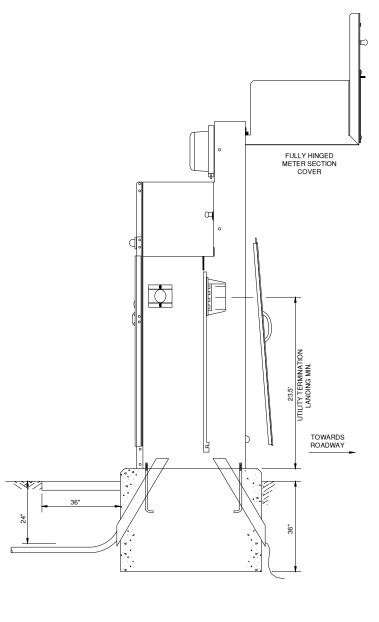




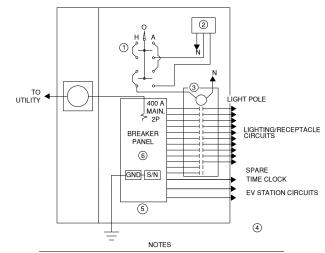

- H-O-A SWITCH WITH ENGRAVED NAMEPLATE AS DETAILED, MOUNTED BEHIND DOOR.

- PHOTOCELL WITH INTEGRAL SURGE SUPPRESSOR.
 CONTACTOR, 30A, 2 8P, 120V COIL, ELECTRICALLY HELD.
 GND AND NEUTRAL CONDUCTORS NOT SHOW FOR CLARITY.
- PROVIDE MAIN BONDING JUMPER AND CONNECT TO GROUND ROD.
- 400A, 120/240V, SINGLE PHASE, 3 WIRE, 24 POLE BREAKER PANEL WITH 400A MAIN CB OR EQUIVALENT PROVIDE 2 100A, 2P CB AND 20 20A, 1P CB.

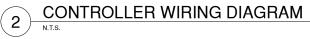







DESIGNED - VLR	REVISED -
DRAWN - VLR	REVISED -
CHECKED - LDW	REVISED -
DATE -	REVISED -
	DRAWN - VLR CHECKED - LDW

STATE OF ILLINOIS
DEPARTMENT OF TRANSPORTATION

PITTSFIELD HISTORIC DOWNTOWN SQUARE RECONSTRUCTION									SECTION	COUNTY	TOTAL SHEETS	SHEET NO.
ELECTRICAL DETAILS I									24-00037-00-RS	PIKE	144	82
			LLL	, 1 1/1	CAL DL			CONTRACT	NO. 9	3847		
LE: SHEET X OF XX SHEETS STA. TO STA.												

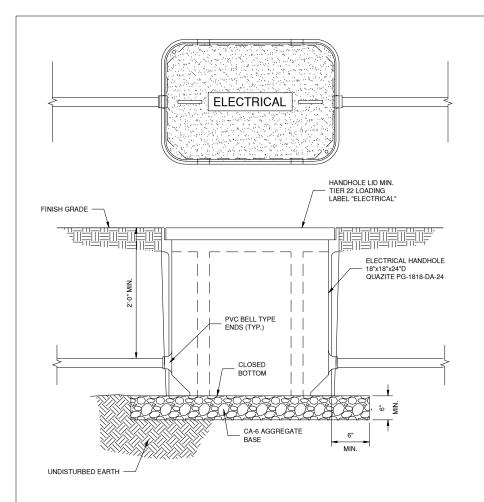



ELECTRICAL HANDHOLE DETAIL

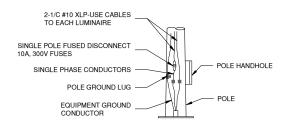

POLE BASE WIRING



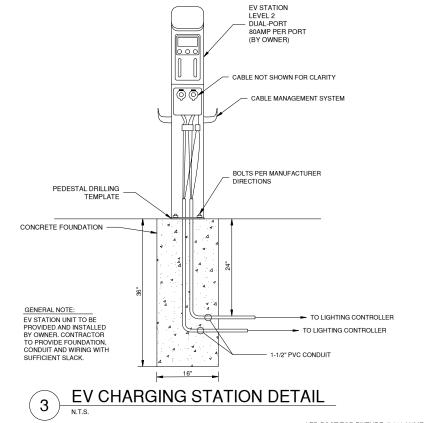

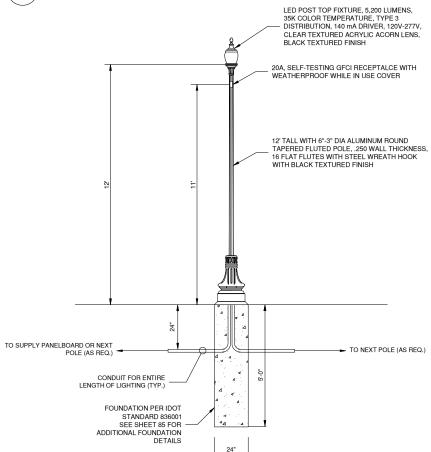

LED ACORN, MEDIUM FIXTURE, SHORT SHADE, 6000 LUMENS, 35K COLOR TEMPERATURE, TYPE 3 DISTRIBUTION, 900 mA DRIVER, 120V-277V, ACRYLIC CLEAR TEARDROP LENS, BLACK TEXTURED FINISH BREAKAWAY BANNER ARM SET WITH REMOVABLE BALL END CAPS SET FOR 18" X 36" BANNER ROUND TAPERED FLUTED POLE, ASTM 6063T6 ALUMINUM, 16 FLAT FLUTES, INTEGRAL VIBRATION DAMPER, BLACK TEXTURED FINISH STUB CONDUITS UP 3" ABOVE BASE WITH PLASTIC BUSHING PLATE. ACCESS DOOR 24" DIA. 2 PIECE CLAMP ON BASE WITH ONE ACCESS DOOR - PVC CONDUIT FOUNDATION PER IDOT STANDARD 836001 SEE SHEET 85 FOR ADDITIONAL FOUNDATION



ORNAMENTAL LIGHT UNIT, COMPLETE


LIGHTING ASSEMBLY (SPECIAL) 5



ison g, Inc.	USER NAME =	DESIGNED - VLR	REVISED -
		DRAWN - VLR	REVISED -
		CHECKED - LDW	REVISED -
	PLOT DATE =	DATE -	REVISED -

STATE OF ILLINOIS DEPARTMENT OF TRANSPORTATION

PITTSFIELD HISTORIC DOWNTOWN SQUARE RECONSTRUCTION									F.A.P RTE. SECTION		TOTAL SHEETS	SHEET NO.
	ELECTRICAL DETAILS II								24-00037-00-RS		144	83
			LLU	11/1/	OAL DL	AILS II		CONTRACT NO. 9			3847	
LE: SHEET X OF XX SHEETS STA. TO STA. JILLINGIS FED AID PROJECT												

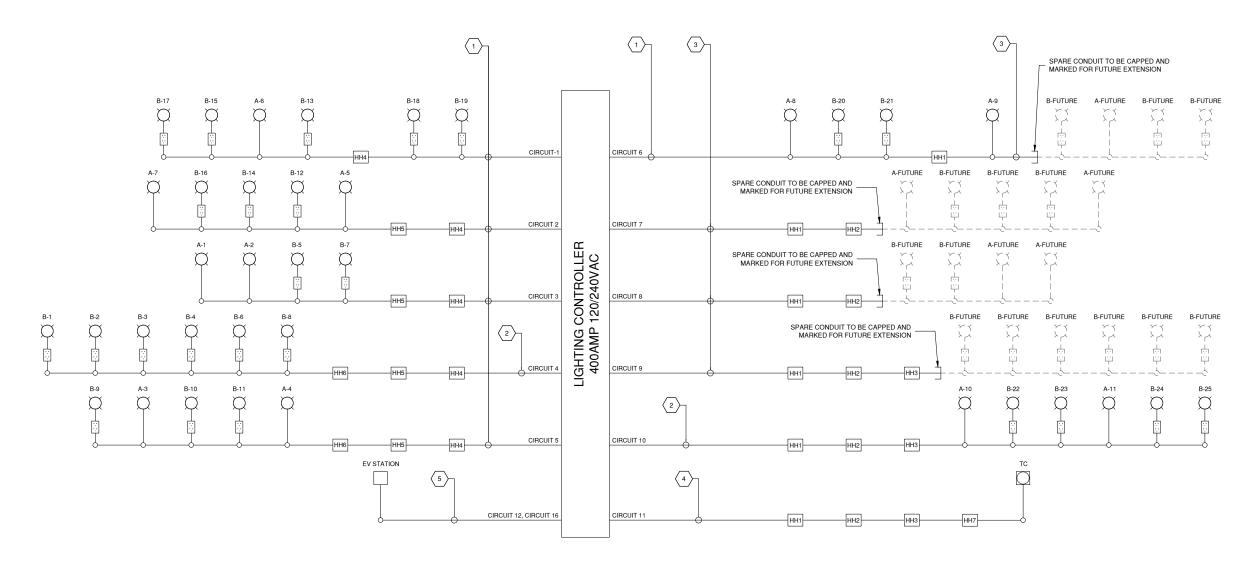

LIGHTING CONTROLLER CIRCUIT DIAGRAM

- KEYED NOTES:

 1. 2-#6 AWG (120VAC), 1-#6 AWG (SPARE LINE CONDUCTOR), 1-#6 GND IN 1-1/2* CONDUIT

 2. 2-#4 AWG (120VAC), 1-#6 AWG (SPARE LINE CONDUCTOR), 1-#4 GND IN 1-1/2* CONDUIT

 3. SPARE 1-1/2* CONDUIT
- 4. 2 #6 AWG (120VAC), 1 #6 GND IN 1-1/2" CONDUIT
- 5. TWO 1-1/2" CONDUITS EACH WITH 2 #2 AWG (240VAC), 1 #6 GND

GENERAL NOTES:

1. THE SAME MAKEUP OF THE KEYED NOTE
CONDUIT AND WIRING SHALL BE EXTENDED FOR
EACH CIRCUIT TO EACH OF THE FIXTURES AND/OR HANDHOLES UNLESS INDICATED.

2. SPARE CONDUCTOR TO BE MARKED WITH A NUMBER AT BOTH ENDS THEN TAPED AND LABELED AS SPARE. INCLUDE SLACK FOR FUTURE USE.

D







USER NAME =	DESIGNED - VLR	REVISED -
	DRAWN - VLR	REVISED -
	CHECKED - LDW	REVISED -
PLOT DATE =	DATE -	REVISED -

STATE OF ILLINOIS	
EPARTMENT OF TRANSPORTATION	

PITTSFIELD HISTORIC DOWNTOWN SQUARE RECONSTRUCTION ELECTRICAL DETAILS III								F.A.P RTE.	SECTION		COUNTY	TOTAL SHEETS	SHEET NO.		
									24-00037-00-RS		PIKE	144	84		
	ELECTRICAL DETAILS III											CONTRAC	TNO. 9	3847	
LE: SHEET X OF XX SHEETS STA. TO STA.															

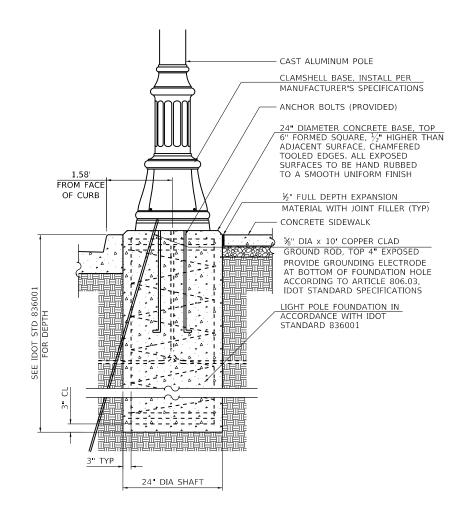

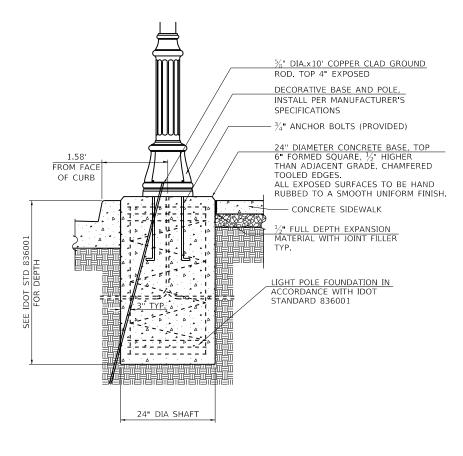

ORNAMENTAL LIGHT UNIT, COMPLETE (NOT TO SCALE)

LIGHTING ASSEMBLY (SPECIAL)

(NOT TO SCALE)

NOTE: BASE PLATE DETAILS ON STANDARD 636001 SHALL NOT APPLY.

PCC DRIVEWAY
PAVEMENT, 8" OR
PCC SIDEWALK, 4"


PORTLAND CEMENT
CONCRETE SIDEWALK

PLAN

 $A \blacktriangleleft$

STAMPED COLORED PCC SIDEWALK, 5"

WHERE APPLICABLE

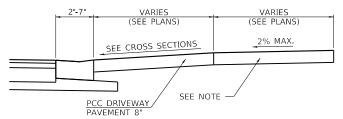

SECTION A-A

PROPOSED ENTRANCE DETAIL

NOTES FOR ENTRANCES

1. SIDEWALK THROUGH ENTRANCES TO MATCH DRIVEWAY PAVEMENT THICKNESS, BUT SHALL BE FORMED SEPARATELY, FINISHED AND PAID FOR PER SQUARE FOOT AS PORTLAND CEMENT CONCRETE SIDEWALK, 4" AS SPECIFIED IN SECTION 424 OF THE STANDARD SPECIFICATIONS.

Hutchison Engineering, Inc.


| DESIGNED - AWM | REVISED - | DRAWN - JCW | REVISED - | | DATE - 7/25/2025 | DATE - 2/5/2024 | REVISED - | | DATE - 2/5/2024 | REVISED - | | DATE - 2/5/2024 | DATE - 2/5

STATE OF ILLINOIS
DEPARTMENT OF TRANSPORTATION


PITTSFIELD HISTORIC DOWNTOWN SQUARE RECONSTRUCTION
SPECIAL DETAILS

N/A SHEET 1 OF 6 SHEETS

NOWNTOWN SQUARE RECONSTRUCTION
SQUARE RECONSTRUCTION
SQUARE RECONSTRUCTION
FA.P SECTION COUNTY TOTAL SHEET NO.
24-00037-00-RS PIKE 144 85
CONTRACT NO. 93847

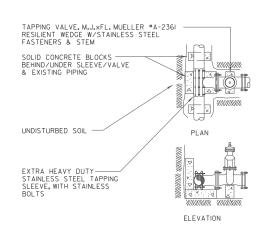


TAPPING SLEEVE & VALVE BLOCKING

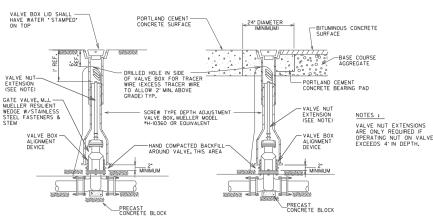


VALVE BOX INSTALLATION

VALVE BOX INSTALLATION IN PERMANENT SURFACE ROADWAYS


SCALE: NONE

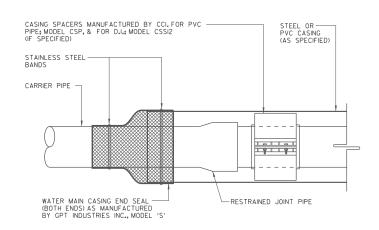

CASING END SEAL & SPACER DETAIL SCALE: NONE

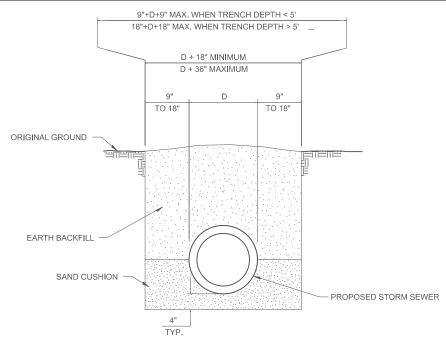


DETAIL OF TRENCH EXCAVATION AND BACKFILL UNDER TURF

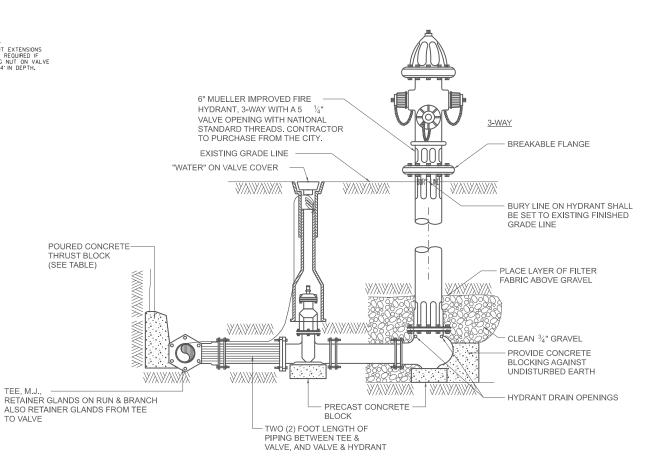


HYDRANT INSTALLATION

(NOT TO SCALE)

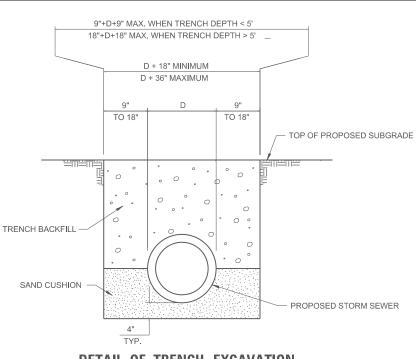

DETAIL OF TRENCH EXCAVATION AND BACKFILL UNDER PROPOSED **ROADWAY PAVEMENT AND ENTRANCES**

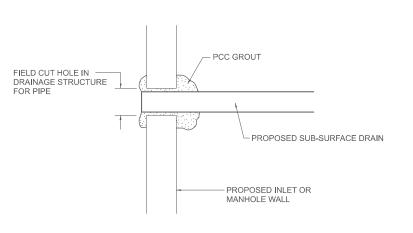

NOTE: ALL ITEMS REQUIRED FOR CONNECTING SUB-SURFACE DRAINS TO PROPOSED DRAINAGE STRUCTURES SHALL BE CONSIDERED INCLUDED IN THE COST OF CONSTRUCTION THE PROPOSED DRAINAGE STRUCTURE.


DETAIL OF CONNECTING SUB-SURFACE DRAINS TO PROPOSED DRAINAGE STRUCTURES

(HE)	Hutchison Engineering, Inc.

	USER NAME = CBurke	DESIGNED -	REVISED -
		DRAWN -	REVISED -
	PLOT SCALE = \$SCALE\$	CHECKED -	REVISED -
5	PLOT DATE = 8/12/2025	DATE -	REVISED -

SCALE: N/A

PITTSFIELI	PITTSFIELD HISTORIC DOWNTOWN SQUARE RECONSTRUCTION		F.A.P RTE.	SECTION	COUNTY	TOTAL SHEETS	SHEE NO.		
SPECIAL DETAILS						24-00037-00-RS	PIKE	144	86
		01 201				CONTRACT	NO. 938	347	
E. NI/A	CUEET 2	OF 6	CHEETC			ILLINOID FED AL	D DDO IFOT		

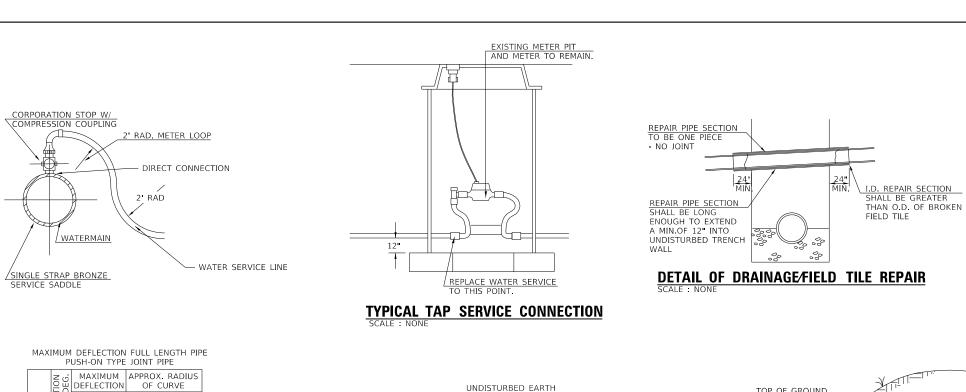

	TION DEG.		IMUM CTION	APPROX. RADIUS OF CURVE			
SIZE OF PIPE "	DEFLECT ANGLE I	18-ft. LENGTH	20-ft. LENGTH	18-ft. LENGTH	20-ft. LENGTH		
6"	5°	19"	21"	205'	230'		


D	40	50	60	70	80	90
6"	1.2	1.5	1.7	2.0*	2.3	2.6
4"	1.2	1.5	1.7	2.0*	2.3	2.6

*ESTIMATED BEARING SURFACES FOR THIS PROJECT


SCHEDULE FOR REACTION BLOCKING

. BEARING SURFACE IN SQ. FT LINE PRESSURE (psi)

NOTE: PLACE PLASTIC SHEETING OVER FITTING AND NUTS AND BOLTS PRIOR TO PLACING CONCRETE THRUST BLOCKING.

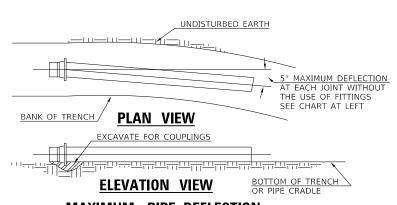


MAXIMUM PIPE DEFLECTION

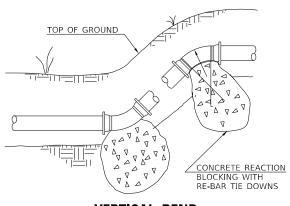


VERTICAL BEND


SCALE: N/A

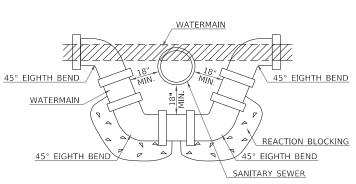

DETAIL OF LOWERING WATERMAIN

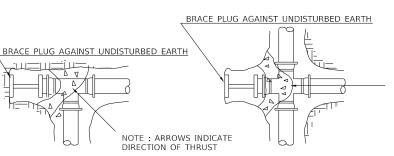




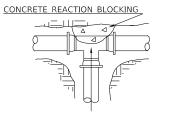


<u>TEE</u>




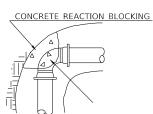


90° & 45° BEND

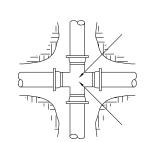

CROSS

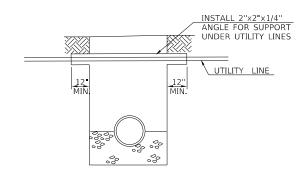

DETAIL OF UTILITY CROSSING SUPPORT

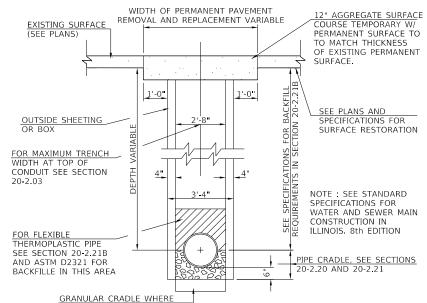

GRANULAR CRADLE WHERE
REQUESTED BY THE ENGINEER
SEE SECTION 20-2.20


TRENCH DETAIL

	SCALE : NONE
(HE)	Hutchison Engineering, Inc.


	USER NAME = JWhite	DESIGNED -	-	AWM	REVISED	-
		DRAWN -	-	JCW	REVISED	-
	PLOT SCALE = 100.000 ' / in.	CHECKED -	-	AWM	REVISED	-
5	PLOT DATE = 7/25/2025	DATE -	-	2/5/2024	REVISED	-

STATE OF ILLINOIS
DEPARTMENT OF TRANSPORTATION


PITTSFIELD HISTORIC DOWNTOWN SQUARE RECONSTRUCTION				F.A.P RTE	SECTION			COUNTY	TOTAL SHEETS	SHEET NO.
WATERMAIN STANDARDS					24-000	037 - 00-RS		PIKE	144	87
								CONTRAC	T NO. 9	3847
F: N/A	SHEET 3 OF 6	SHEETS	F			ILLINOIS	FED /	AID PROJECT		

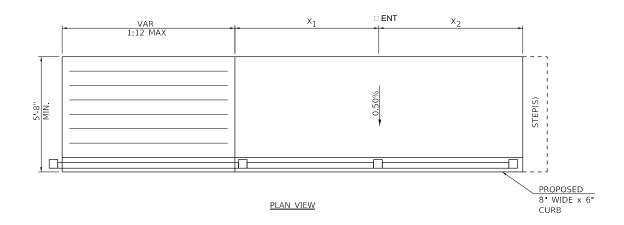


NOTE: $\rm X_1$ AND X $_2$ SHALL BE ADJUSTED AS NECESSARY BASED ON DOORWAY SWING TO MAKE BUILDING ENTRANCE ADA COMPLIANT.

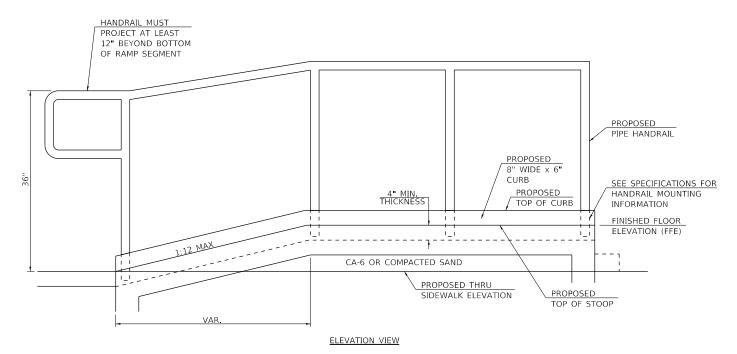

CONCRETE STOOP DETAIL

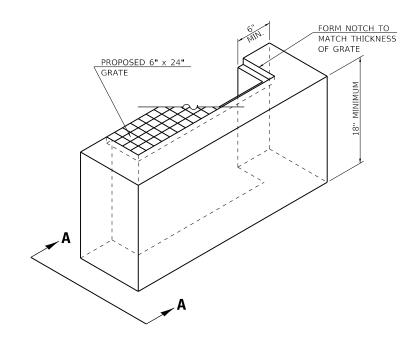

NOTE: PROPOSED GRATE SHALL BE PERMANENTLY FASTENED TO PROPOSED SIDEWALK WITH TAPCONS TO THE SATISFACTION OF THE ENGINEER.

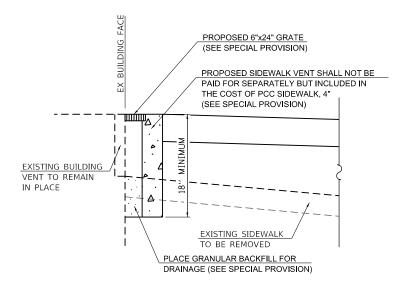

SECTION A-A


SIDEWALK VENT DETAIL

SCALE: N/A


Hutchison Engineering, Inc.

USER NAME = JWhite	DESIGNED - AWM	REVISED -
	DRAWN - JCW	REVISED -
PLOT SCALE = 100.000 / in.	CHECKED - AWM	REVISED -
PLOT DATE = 7/25/2025	DATE - 2/5/2024	REVISED -


PITTSFIELD HISTORIC DOWNTOWN SQUARE RECONSTRUCTION		F.A.P RTE			COUNTY	TOTAL SHEETS	SHEET NO.						
SPECIAL DETAILS						24-000	037 - 00-RS		PIKE	144	88		
									CONTRAC	CT NO. 9	3847		
LE: N/A	SHEET 4	OF	6	SHEETS	l	ILLINOIS FED. AID PROJECT							

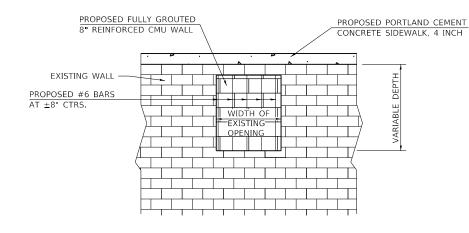

FRONT VIEW

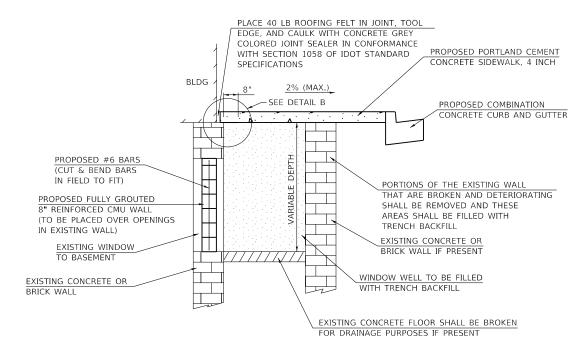

SIDE VIEW

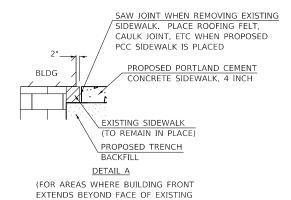


THE CONTRACTOR SHALL FIELD VERIFY EXISTING DIMENSIONS AND DETAILS AFFECTING NEW CONSTRUCTION AND MAKE NECESSARY APPROVED ADJUSTMENTS PRIOR TO CONSTRUCTION OR ORDERING MATERIALS. ALL ADJUSTMENTS SHALL BE APPROVED BY THE ENGINEER.


THE MORTAR USED FOR THE CMU PLACEMENT SHALL BE PORTLAND CEMENT TYPE M MORTAR.

ALL MASONRY BLOCK SHALL BE PLACED USING RUNNING BOND CONSTRUCTION.


REINFORCED CMU OPTION

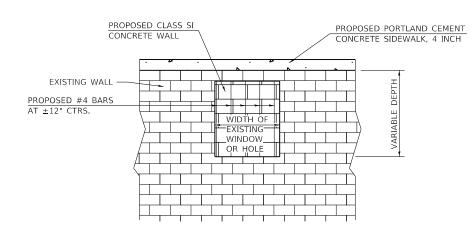

FRONT VIEW

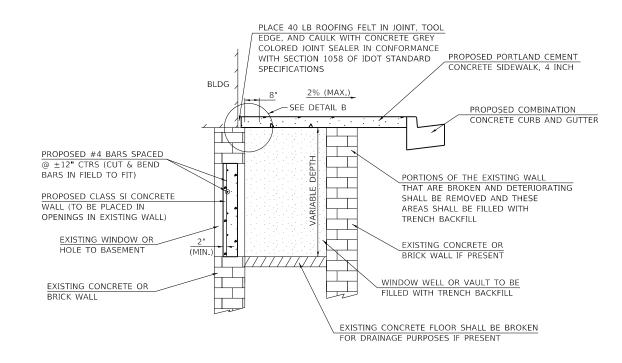

SIDE VIEW

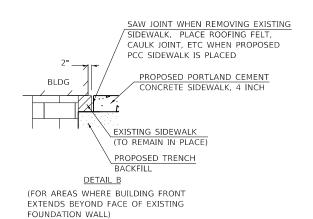

METAL FORMS SHALL BE BRACED SUFFICIENTLY TO PREVENT DISTORTION AND METAL SNAP TIES SHALL REMAIN UNDISTURBED AFTER THE FORMS ARE REMOVED.

REINFORCED CONCRETE OPTION


FILLING EXISTING WINDOW WELLS AND VAULTS WITHIN RIGHT-OF-WAY AND/OR SEALING EXISTING BASEMENT WALL OPENINGS




DESIGNED - AWM JSER NAME = JWhite REVISED -DRAWN - JCW REVISED -REVISED -

STATE OF ILLINOIS **DEPARTMENT OF TRANSPORTATION**

SECTION COUNTY PITTSFIELD HISTORIC DOWNTOWN SQUARE RECONSTRUCTION 24-00037-00-RS PIKE 144 89 **SPECIAL DETAILS** CONTRACT NO. 93847 OF 6 SHEETS SHEET 5

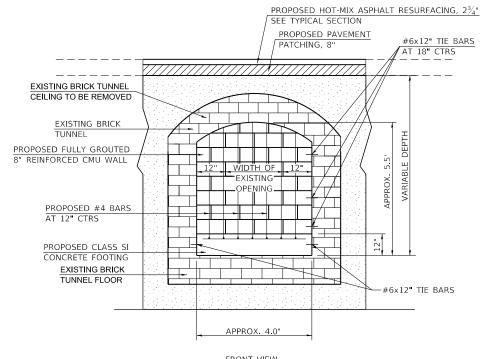

FRONT VIEW

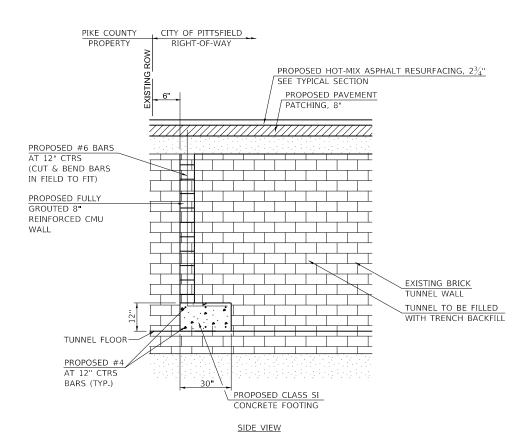

NOTES:

THE CONTRACTOR SHALL FIELD VERIFY EXISTING TUNNEL DIMENSIONS AND DETAILS AFFECTING NEW CONSTRUCTION AND MAKE NECESSARY APPROVED ADJUSTMENTS PRIOR TO CONSTRUCTION OR ORDERING MATERIALS. ALL ADJUSTMENTS SHALL BE APPROVED BY THE ENGINEER.

THE MORTAR USED FOR THE CMU PLACEMENT SHALL BE PORTLAND CEMENT TYPE M MORTAR.

ALL MASONRY BLOCK SHALL BE PLACED USING RUNNING BOND CONSTRUCTION.


EXISTING TUNNEL FLOOR SHALL BE BROKEN TO PROVIDE FOR POSITIVE GROUNDWATER PERCOLATION THROUGH FLOOR.

FILLING EXISTING UTILITY TUNNEL



USER NAME = JWhite DESIGNED - AWM REVISED -	
	ı
DRAWN - JCW REVISED -	1
PLOT SCALE = 100.000 / in CHECKED AWM REVISED	1
PLOT DATE = 7/25/2025 DATE - 2/5/2024 REVISED	l

PITTSFIELD H	HISTORIC DOWNTOW	F.A.P RTE			TOTAL SHEETS	SHE	
SPECIAL DETAILS				24-00037-00-RS	PIKE	144	9
					CONTRACT	NO. 9384	7
SCALE: N/A SHI	HEET 6 OF 6 SHEE	5		ILLINOIS FED	. AID PROJECT		

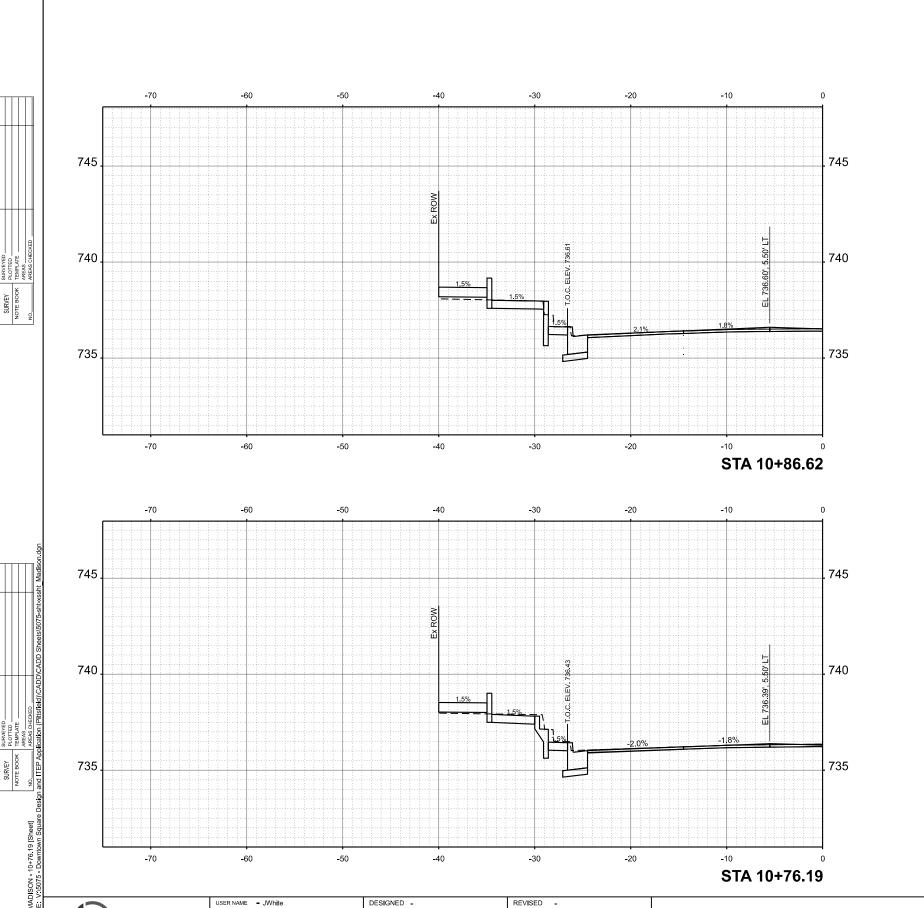



Hutchison Engineering, Inc. Since 1945


STATE OF ILLINOIS DEPARTMENT OF TRANSPORTATION

PITTSFIELD HISTORIC DOWNTOWN SQUARE RECONSTRUCTION
MADISON STREET - CROSS SECTIONS

SCALE: 1"=5" SHEET 1 OF 22 SHEETS STA. 10+76.19 TO STA. 10+86.62

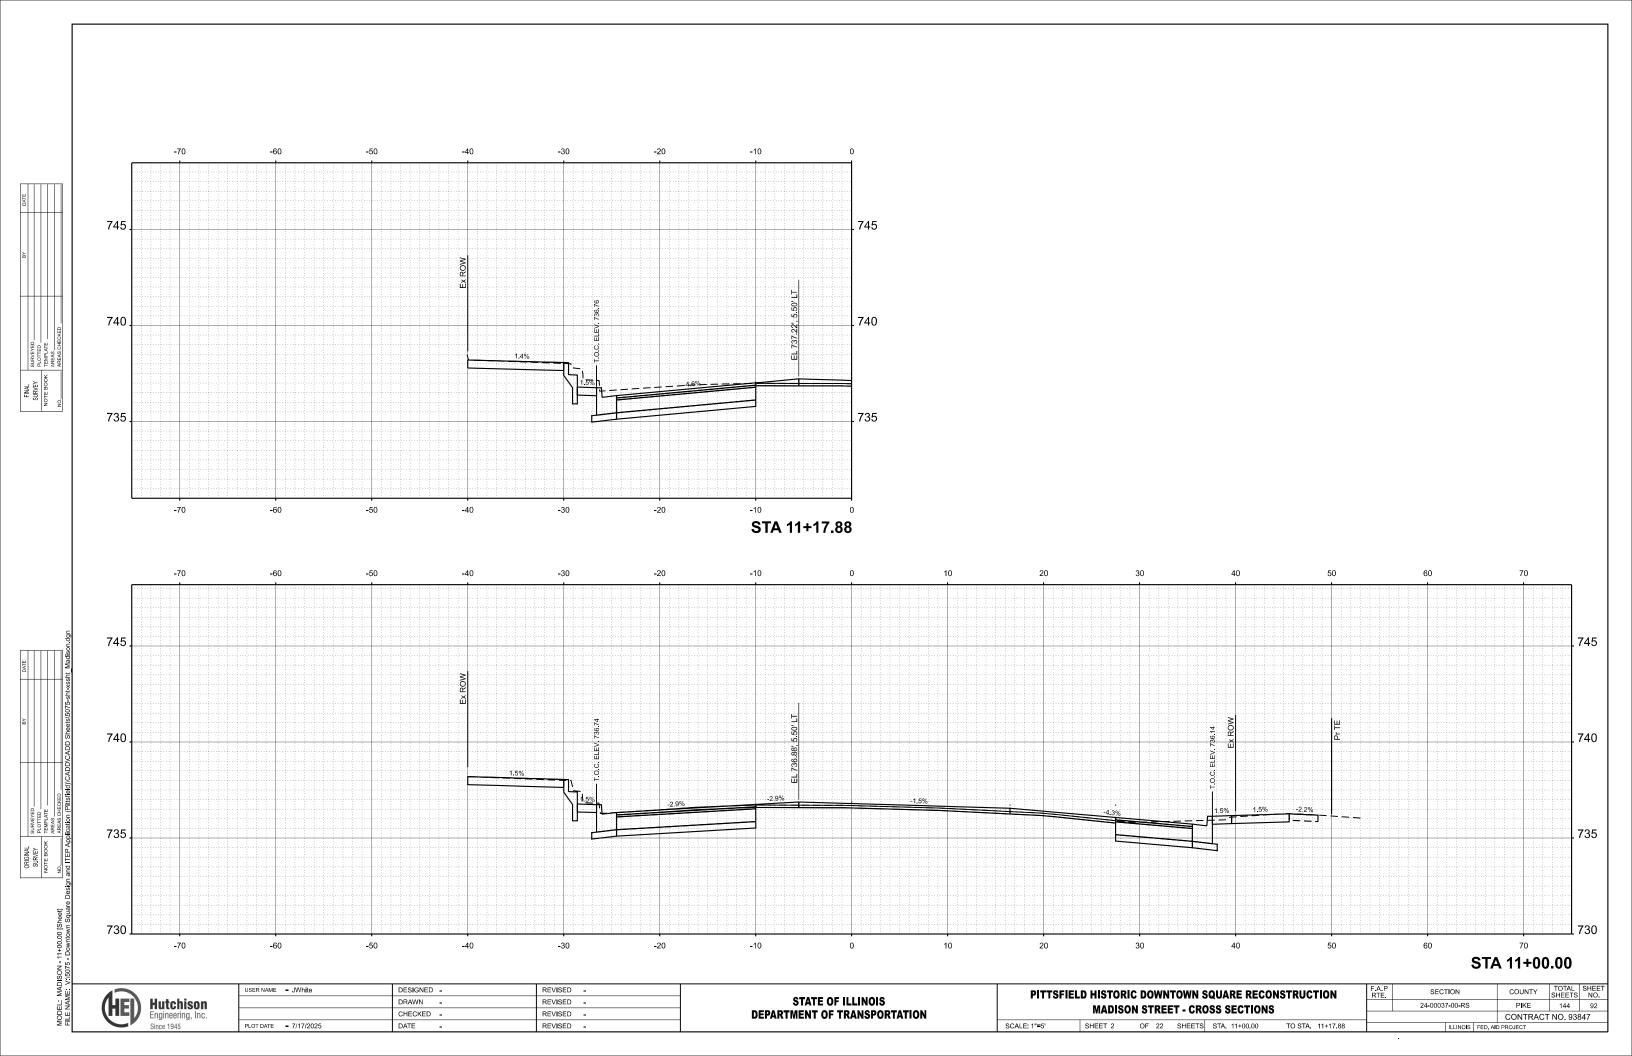

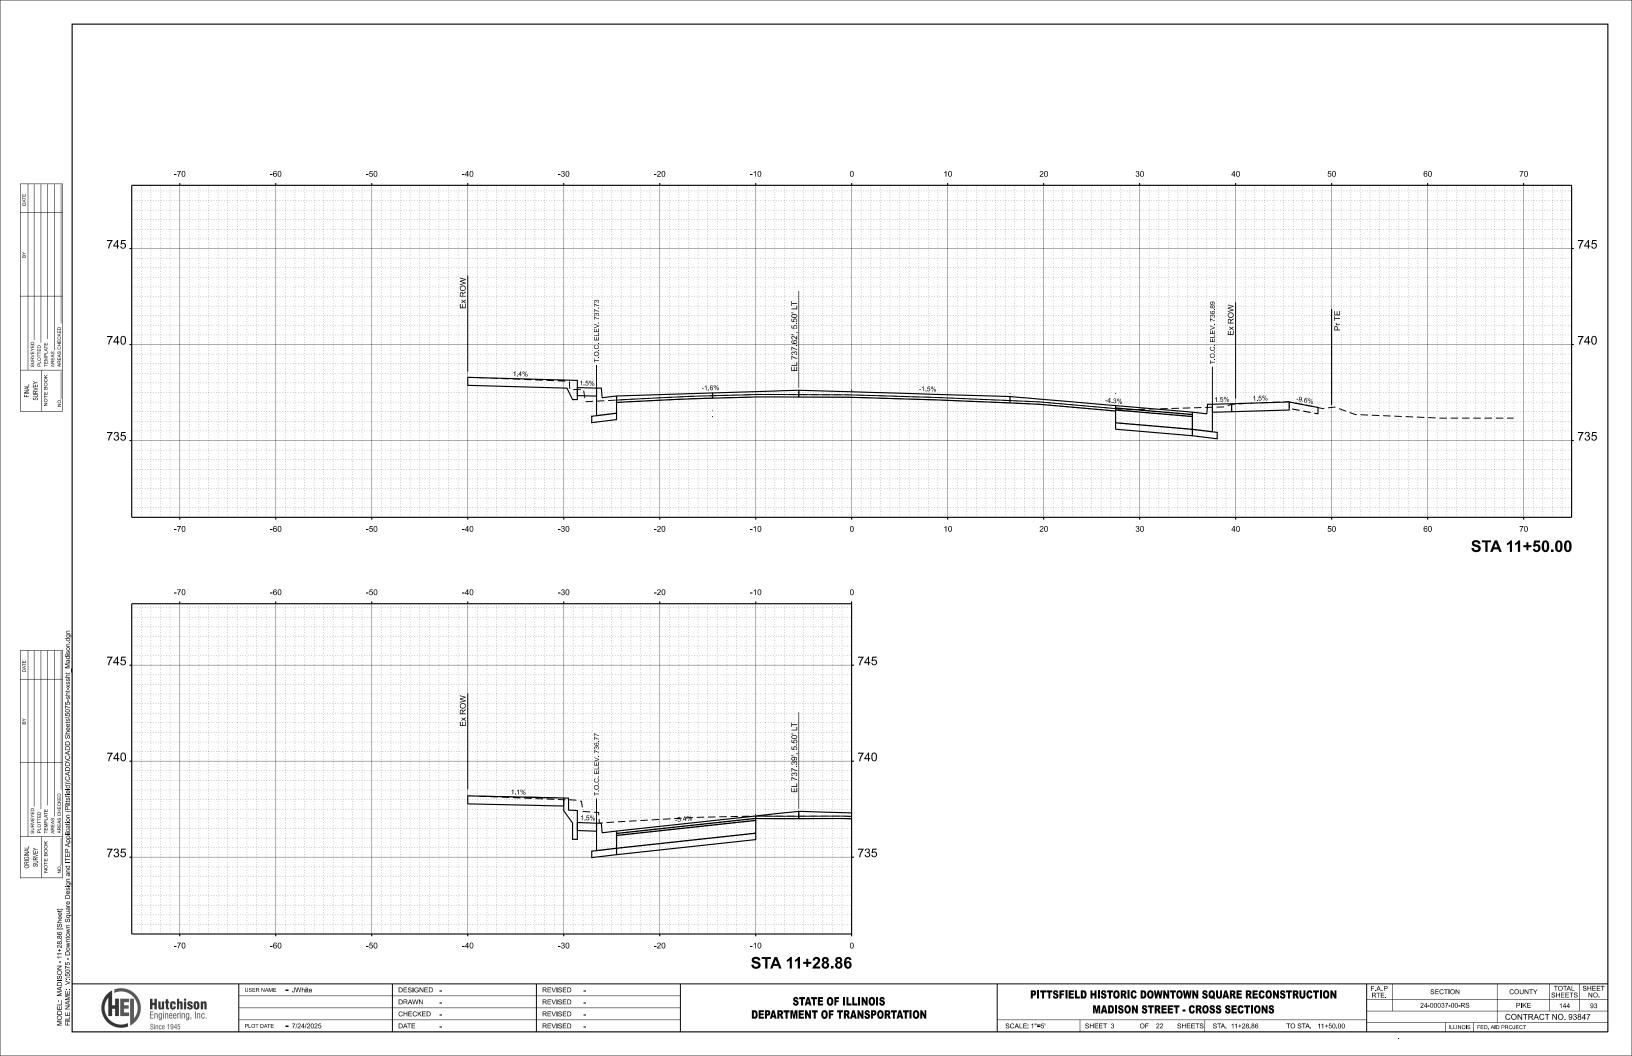


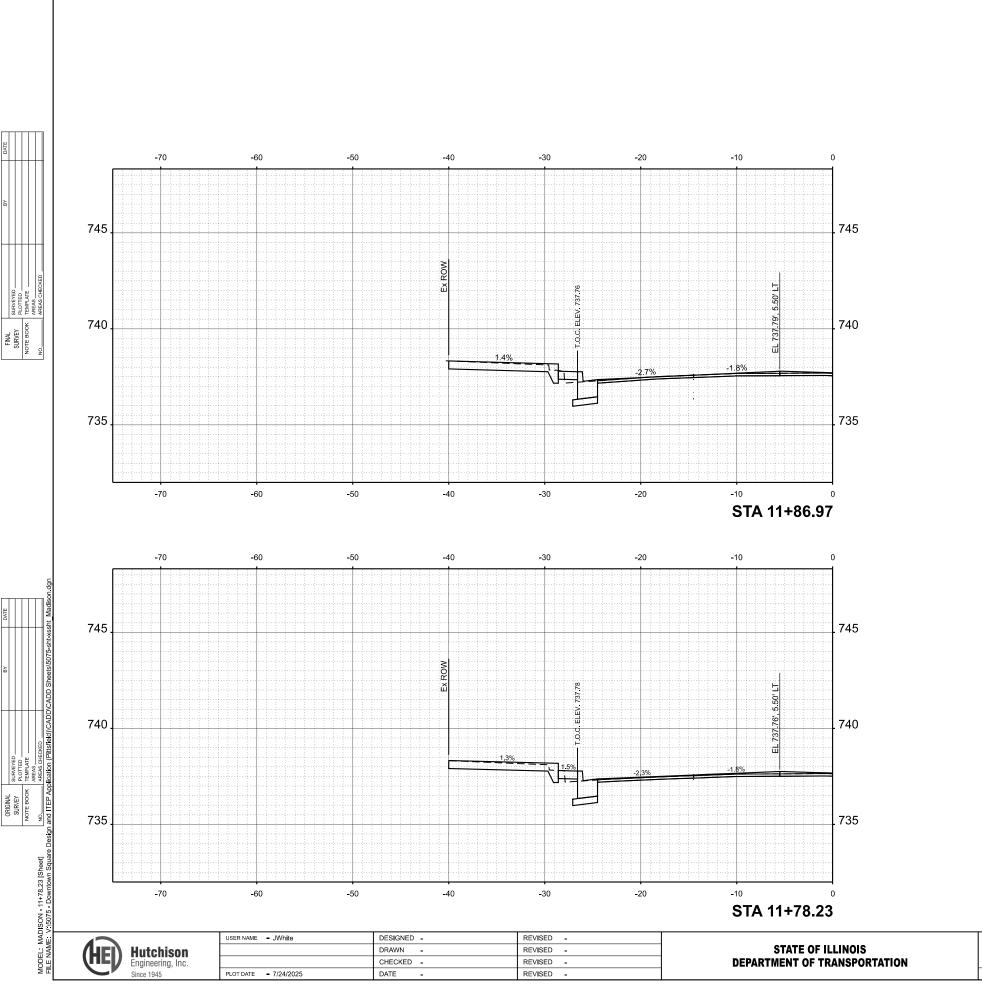



 PITTSFIELD HISTORIC DOWNTOWN SQUARE RECONSTRUCTION
 F.A.P. RTE.
 SECTION
 COUNTY
 TOTAL SHEETS NO.


 MADISON STREET - CROSS SECTIONS
 24-00037-00-RS
 PIKE
 144
 94

 SCALE: 1"=5"
 SHEET 4
 OF 22
 SHEETS
 STA. 11+78.23
 TO STA. 11+86.97
 IILLINOS
 FED. AID PROJECT

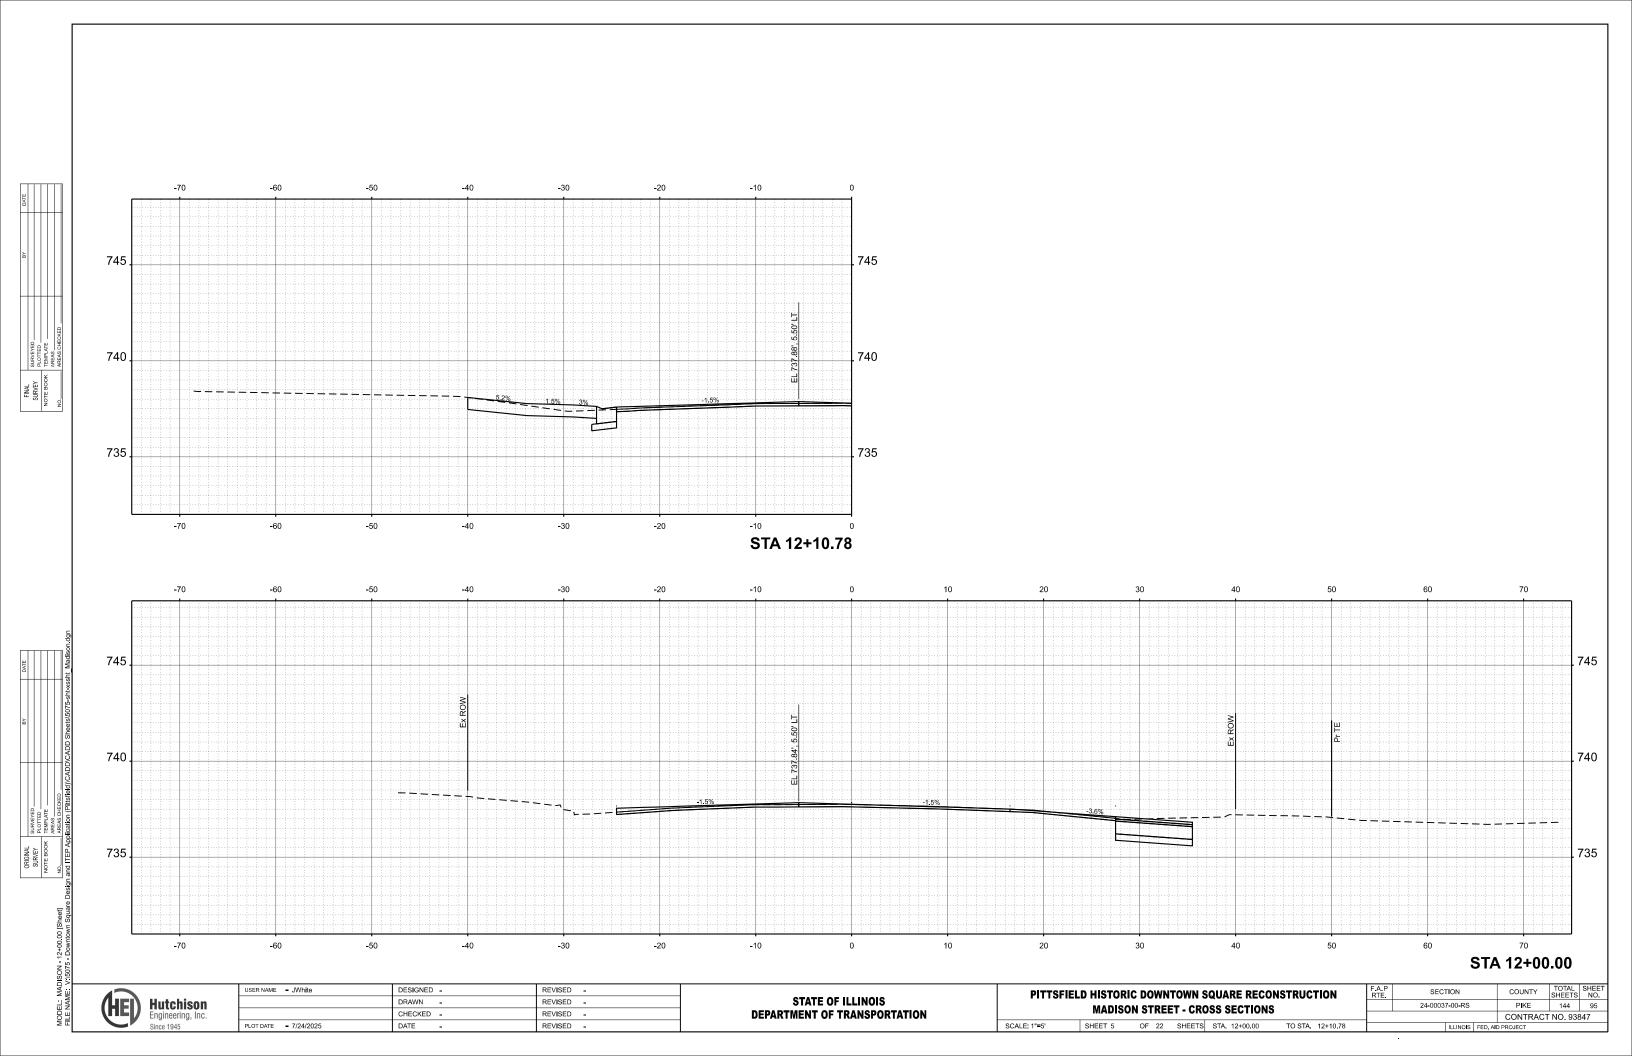

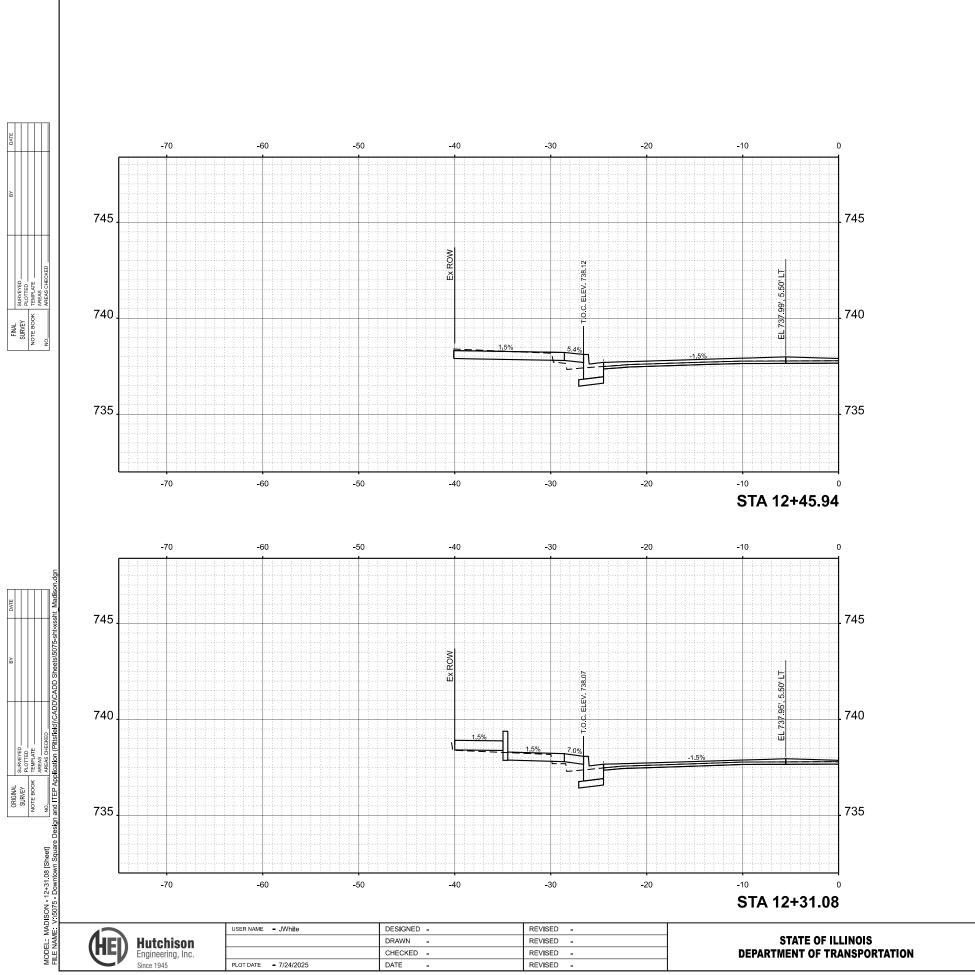


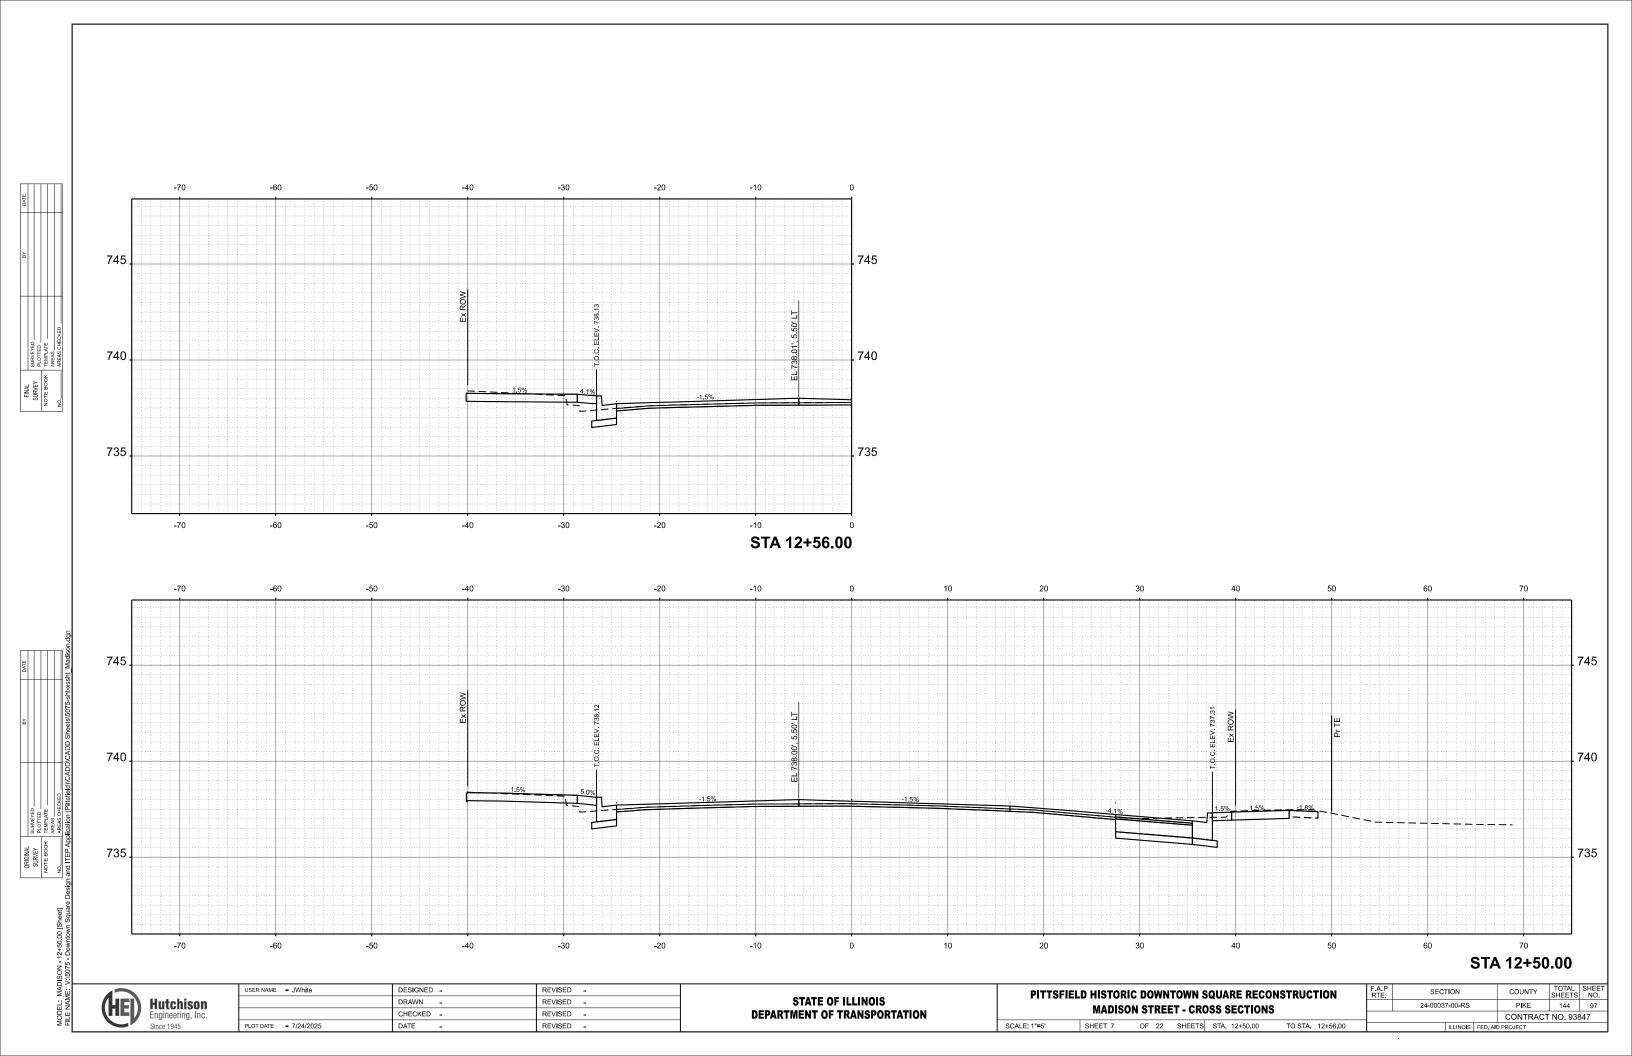


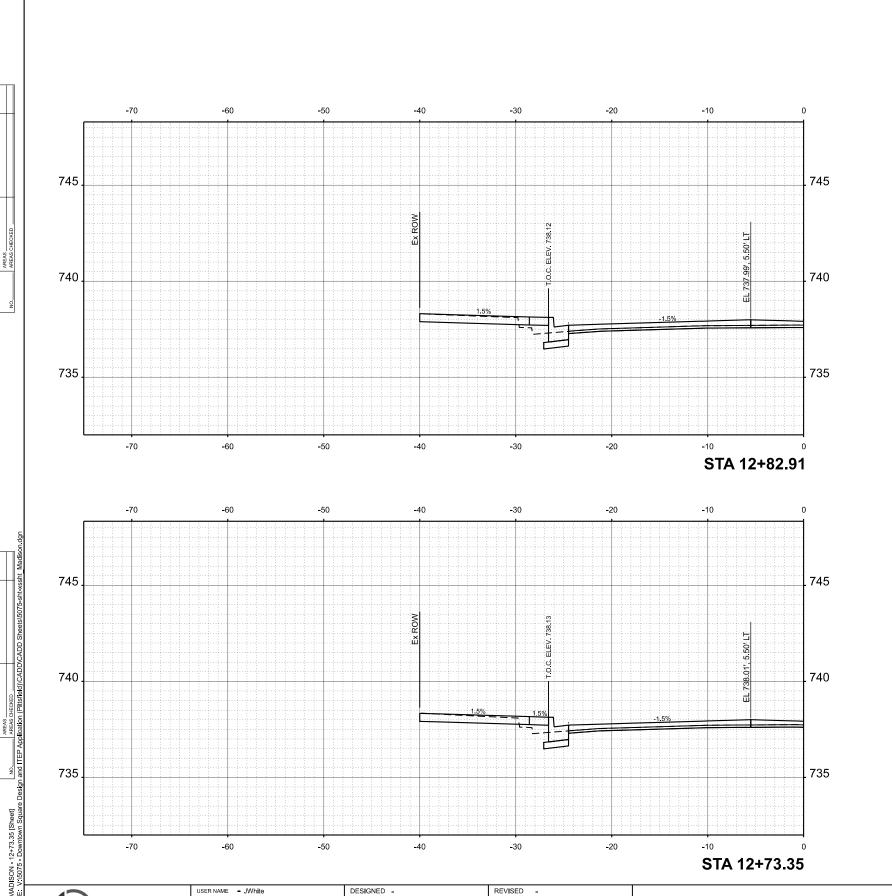

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STATE OF ILLINOIS DEPARTMENT OF TRANSPORTATION



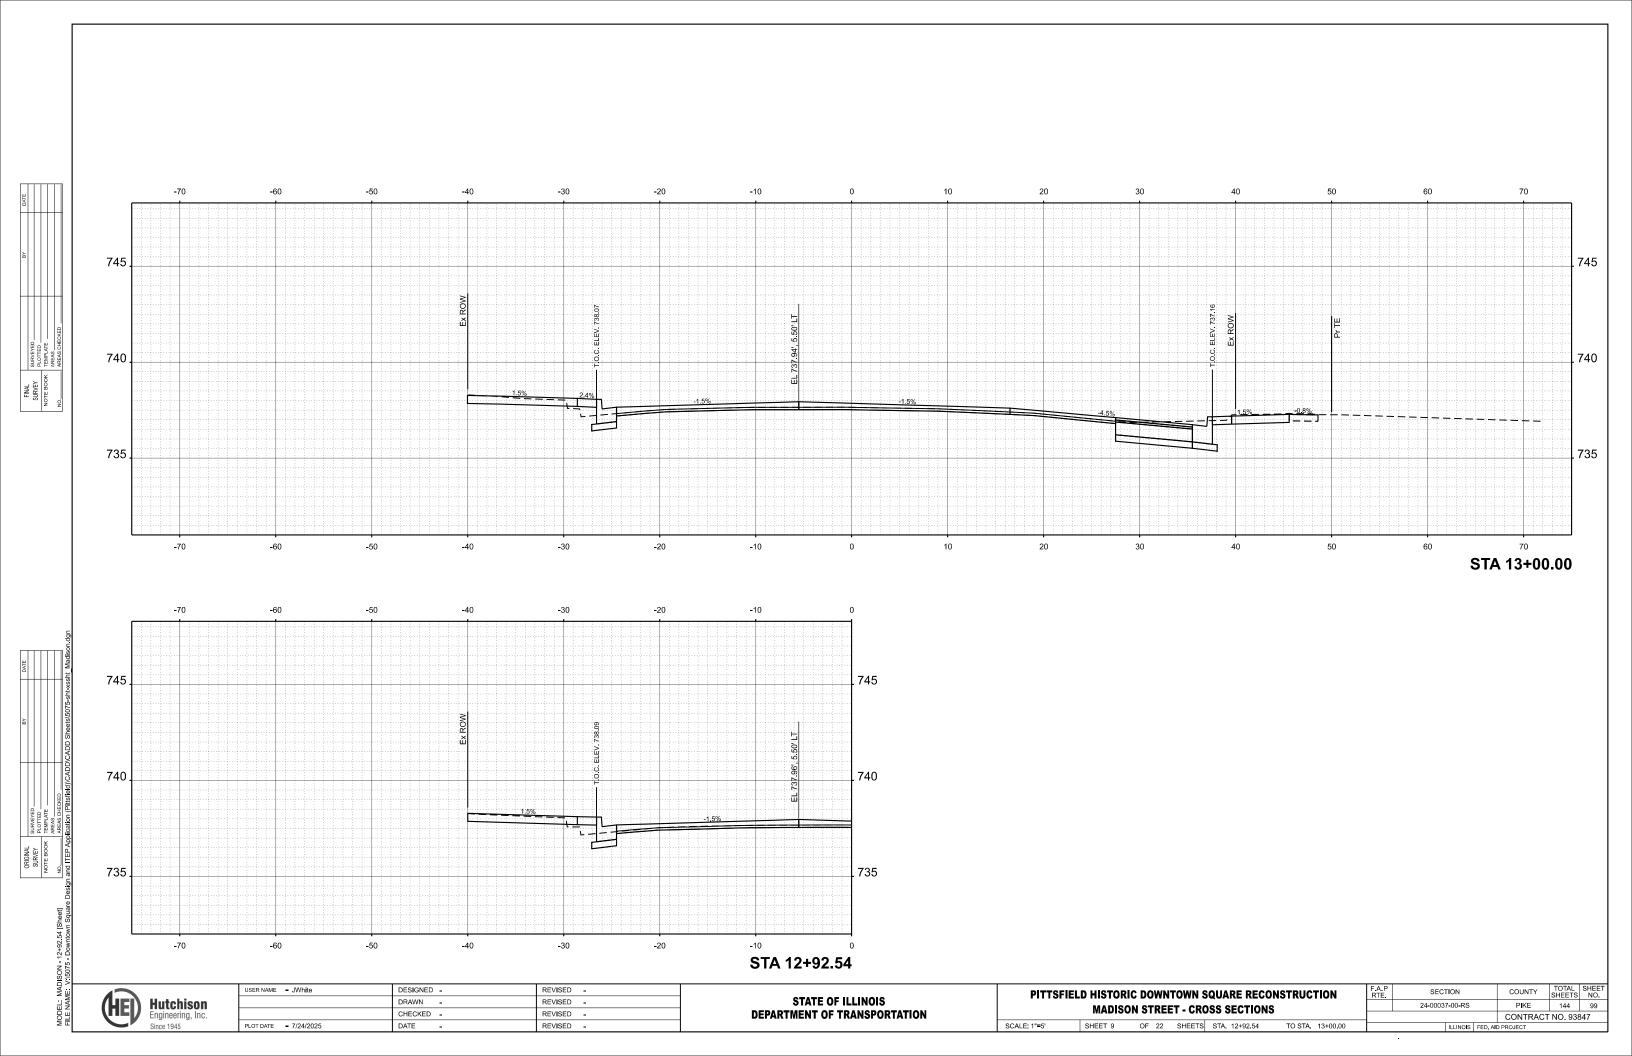
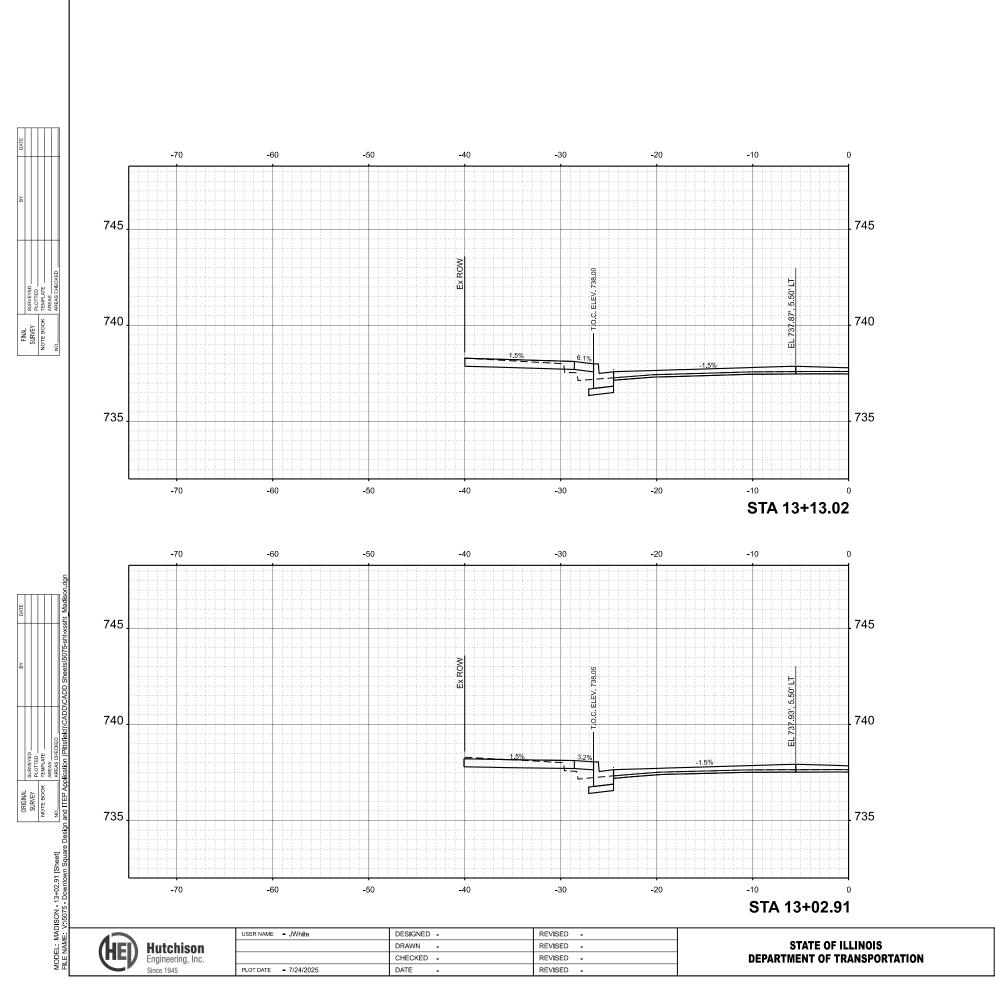
| PITTSFIELD HISTORIC DOWNTOWN SQUARE RECONSTRUCTION | F.A.P | RTE. | SECTION | SHEETS | NO. | 100 | 100 | 1