11/07/2025 LETTING ITEM 111

STATE OF ILLINOIS **DEPARTMENT OF TRANSPORTATION**

23-00127-00-RS LAKE 1234 LUNDIS CONTRACT NO. 611.83

FOR INDEX OF SHEETS, SEE SHEET NO. 2 FOR INDEX OF HIGHWAY STANDARDS, SEE SHEET NO. 2

PLANS FOR PROPOSED FEDERAL AID HIGHWAY

F.A.U. ROUTE 1234 (OAK SPRING ROAD) APPLEY AVENUE/SECOND STREET TO ST. MARY'S ROAD

> PAVEMENT RESURFACING SECTION: 23-00127-00-RS

PROJECT: JXAM(339)

VILLAGE OF LIBERTYVILLE

TRAFFIC DATA

OAK SPRING ROAD

SCHAUMBURG,

P in

RAMOS,

CARMEN

ENGINEER:

AID

0

0

DESIGN SPREED -25 MPH (WEST OF DES PLAINES RIVER)


35 MPH (EAST OF DES PLAINES RIVER)

POSTED SPREED - 25 MPH (WEST OF DES PLAINES RIVER)

35 MPH (EAST OF DES PLAINES RIVER)

HIGHWAY CLASSIFICATION

MAJOR COLLECTOR (2023 ADT = 5,100)

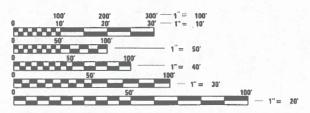


ENGINEERING SCALES, REDUCED SIZED PLANS WILL NOT CONFORM TO STANDARD SCALES. IN MAKING MEASUREMENTS ON REDUCED PLANS, THE ABOVE SCALES MAY BE USED.

JOINT UTILITY LOCATION INFORMATION FOR EXCAVATION 1-800-892-0123

OR 811

CONTRACT NO. 61L83

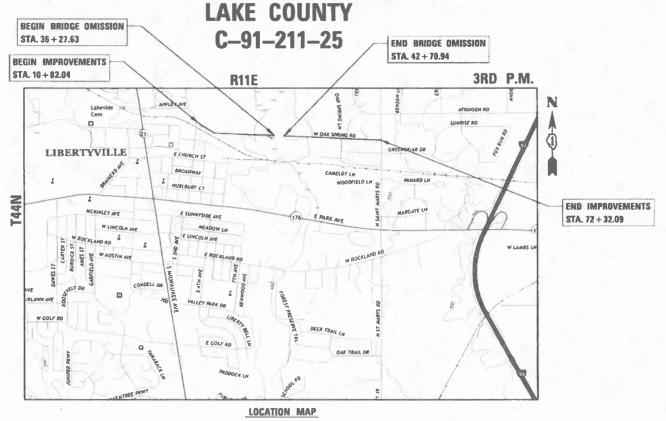

(NOT TO SCALE)

LIBERTYVILLE TOWNSHIP


GROSS LENGTH = 6,150.1 FT. (1.165 MILES) NET LENGTH = 5506.8 FT. (1.043 MILES)



PLANS PREPARED BY

Two Pierce Place, Suite 1400 - Itasca, Illinois 60143 Tel: 630.773.3900 - Fax: 630.773.3975 www.civiltechinc.com



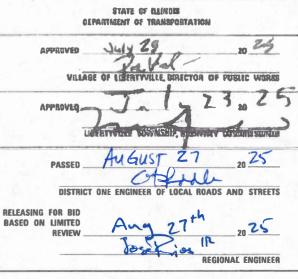

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HIGHWAY STANDARDS

| 000001-08 | STANDARD SYMBOLS, ABBREVIATIONS AND PATTERNS |
|-----------|---|
| 424016-06 | MID-BLOCK CURB RAMPS FOR SIDEWALKS |
| 424026-04 | ENTRANCE / ALLEY PEDESTRIAN CROSSINGS |
| 442201-03 | CLASS C & D PATCHES |
| 606001-08 | CONCRETE CURB TYPE B AND COMBINATION CONCRETE CURB AND GUTTER |
| 701006-05 | OFF-RD OPERATIONS, 2L, 2W, 15 TO 24" FROM PAVEMENT EDGE |
| 701011-04 | OFF-RD MOVING OPERATIONS, 2L, 2W, DAY ONLY |
| 701301-04 | LANE CLOSURE, 2L, 2W, SHORT TIME OPERATIONS |
| 701311-03 | LANE CLOSURE, 2L, 2W, MOVING OPERATIONS-DAY ONLY |
| 701501-06 | URBAN LANE CLOSURE, 2L, 2W, UNDIVIDED |
| 701701-10 | URBAN LANE CLOSURE MULTILANE INTERSECTION |
| 701801-06 | SIDEWALK, CORNER OR CROSSWALK CLOSURE |
| 701901-10 | TRAFFIC CONTROL DEVICES |
| 720001-01 | SIGN PANEL MOUNTING DETAILS |
| 720006-04 | SIGN PANEL ERECTION DETAILS |
| 780001-05 | TYPICAL PAVEMENT MARKINGS |
| | |

IDOT DISTRICT ONE STANDARDS

| BD-08 | DETAILS FOR FRAMES AND LIDS ADJUSTMENT WITH MILLING |
|-------|---|
| | |
| BD-32 | BUTT JOINT AND HMA TAPER DETAILS |
| TC-10 | TRAFFIC CONTROL AND PROTECTION FOR SIDE ROADS, INTERSECTIONS, AND DRIVEWAYS |
| TC-13 | DISTRICT ONE TYPICAL PAVEMENT MARKINGS |
| TC-16 | PAVEMENT MARKING LETTERS AND SYMBOLS FOR TRAFFIC STAGING |
| TC-22 | ARTERIAL ROAD INFORMATION SIGN |

SPECIFICATIONS, STANDARDS AND SPECIAL PROVISIONS

- ALL CONSTRUCTION SHALL BE IN ACCORDANCE WITH THE "STANDARD SPECIFICATIONS FOR ROAD AND BRIDGE CONSTRUCTION" ("STANDARD SPECIFICATIONS"), ADOPTED JANUARY 1, 2022; THE "SUPPLEMENTAL SPECIFICATIONS AND RECURRING SPECIAL PROVISIONS", ADOPTED JANUARY 1, 2025; THE LATEST EDITION OF THE "ILLINOIS MANUAL ON UNIFORM TRAFFIC CONTROL DEVICES FOR STREETS AND HIGHWAYS", (IMUTCD); "THE STANDARD SPECIFICATIONS FOR WATER AND SEWER MAIN CONSTRUCTION IN ILLINOIS" EIGHTH EDITION, THE DETAILS IN THE PLANS, AND THE SPECIAL PROVISIONS AND IDOT STANDARD DRAWINGS INCLUDED IN THE CONTRACT DOCUMENTS.
- 2. NO WORK SHALL COMMENCE UNTIL TRAFFIC CONTROL REQUIREMENTS ARE MET AND APPROPRIATE PERMITS HAVE BEEN OBTAINED.
- 3. IT SHALL BE THE CONTRACTOR'S RESPONSIBILITY TO VERIFY ALL DIMENSIONS AND CONDITIONS EXISTING IN THE FIELD PRIOR TO ORDERING MATERIALS AND BEGINNING CONSTRUCTION.
- 4. WHEN REMOVING CURB AND GUTTER, PAVEMENT OR ANY OTHER STRUCTURE, THE CONTRACTOR SHALL TAKE EVERY PRECAUTION NECESSARY TO ENSURE THAT THERE WILL BE NO DAMAGE TO UNDERGROUND PUBLIC OR PRIVATE UTILITIES. UNDER NO CIRCUMSTANCES WILL THE USE OF A FROST BALL CONCRETE BREAKER BE ALLOWED.
- 5. THE CONTRACTOR IS PROHIBITED FROM BURNING ANY MATERIAL WITHIN OR ADJACENT TO THE PROJECT LIMITS. ALL EXCESS OR WASTE MATERIAL SHALL BE EITHER HAULED AWAY FROM THE PROJECT SITE BY THE CONTRACTOR AND DEPOSITED AT LOCATIONS PROVIDED BY HIM/HER, OR DISPOSED OF WITHIN THE RIGHT-OF-WAY IN A MANNER OTHER THAN BURNING, SUBJECT TO THE APPROVAL OF THE ENGINEER.
- 6. THE ENGINEER AND ALL UTILITY COMPANIES, LOCAL POLICE, AND FIRE DEPARTMENTS SHALL BE NOTIFIED BY THE CONTRACTOR AT LEAST 72 HOURS PRIOR TO THE START OF CONSTRUCTION.
- 7. THE CONTRACTOR SHALL CONTACT THE IDOT TRAFFIC CONTROL SUPERVISOR AT KALPANA.KANNAN-HOSADURGA@ILLINOIS.GOV A MINIMUM OF 72 HOURS IN ADVANCE OF BEGINNING WORK.

PAVING, SHOULDERS, CURB & GUTTER AND SIDEWALK

- HOT-MIX ASPHALT SURFACE COURSE SHALL NOT BE PLACED UNTIL ALL EARTH EXCAVATION, AND TOPSOIL PLACEMENT HAVE BEEN COMPLETED TO THE SATISFACTION OF THE ENGINEER.
- 2. THE THICKNESSES OF HOT-MIX ASPHALT MIXTURES SHOWN ON THE PLANS ARE NOMINAL. DEVIATIONS MAY OCCUR DUE TO IRREGULARITIES IN THE SURFACE, BINDER, OR BASE UPON WHICH THE HOT-MIX ASPHALT MATERIALS ARE PLACED.
- 3. THE EXISTING CURB AND GUTTER SHALL BE SAW CUT AT EACH LIMIT OF REMOVAL AND THE NEW CURB AND GUTTER SHALL BE TIED IN TO THE EXISTING WITH TWO 3/4 INCH STEEL DOWEL BARS (18" LONG), DRILLED INTO THE EXISTING CURB AND GUTTER END. THE ENGINEER MUST INSPECT AND APPROVE THE BASE AND FORMWORK BEFORE ANY CONCRETE IS POURED. A MINIMUM 24 HOUR NOTICE SHALL BE PROVIDED FOR FORM WORK INSPECTION.
- 4. FOR WORK OUTSIDE THE LIMITS OF BRIDGE APPROACH PAVEMENT, ALL REFERENCES IN THE HIGHWAY STANDARDS AND STANDARD SPECIFICATIONS FOR REINFORCEMENT, DOWEL BARS, AND TIE BARS IN PAVEMENT, SHOULDERS, CURB, GUTTER, COMBINATION CURB AND GUTTER, MEDIAN, AND CHAIR SUPPORTS FOR CRC PAVEMENT, SHALL BE EPOXY COATED, UNLESS NOTED ON THE PLAN.

UTILITIES

- THE CONTRACTOR SHALL COORDINATE CONSTRUCTION ACTIVITIES WITH UTILITY COMPANIES.
 THE LOCATION OF PUBLIC OR PRIVATE UTILITIES SHOWN ON THE PLANS ARE APPROXIMATE
 AND THE ENGINEER DOES NOT GUARANTEE THEIR ACCURACY.
- COORDINATION OF ANY UTILITY WORK INVOLVED IN THE CONSTRUCTION AREA WILL BE DISCUSSED AT THE PRECONSTRUCTION CONFERANCE.
- BEFORE STARTING ANY EXCAVATION, THE CONTRACTOR SHALL CALL "JULIE" AT 1-800-892-0123 FOR FIELD LOCATIONS OF BURIED ELECTRIC, TELEPHONE, GAS, WATER, SEWER AND CABLE TELEVISION FACILITIES. (48 HOURS NOTIFICATION IS REQUIRED.)
- 4. THE CONTRACTOR SHALL BE RESPONSIBLE FOR THE PROTECTION OF ALL ABOVE AND BELOW GROUND UTILITIES EVEN THOUGH THEY MAY NOT BE SHOWN ON THE PLANS. ANY UTILITY THAT IS DAMAGED DURING CONSTRUCTION BY THE CONTRACTOR SHALL BE REPAIRED OR REPLACED TO THE SATISFACTION OF THE ENGINEER AS COORDINATED WITH THE UTILITY OWNER. THIS WORK SHALL BE AT THE CONTRACTOR'S EXPENSE. THE CONTRACTOR SHALL NOTIFY ALL UTILITY OWNERS OF HIS/HER CONSTRUCTION SCHEDULE AND SHALL COORDINATE CONSTRUCTION OPERATIONS WITH THE UTILITY OWNERS SO THAT THE RELOCATION OF UTILITY LINES AND STRUCTURES MAY PROCEED IN AN ORDERLY MANNER. NOTIFICATION SHALL BE IN WRITING, WITH COPIES TRANSMITTED TO THE ENGINEER

COMMITMENTS

EXTENDED RESTRICTIONS WILL APPLY FOR TREE CLEARING AND PRUNING, TREES THREE (3) INCHES IN DIAMETER OR GREATER AT BREAST HEIGHT SHALL NOT BE CLEARED OR PRUNED FROM APRIL 1ST THROUGH OCTOBER 31ST OF ANY GIVEN YEAR.

SHOULD THE PROJECT REQUIRE NEW/ADDITIONAL TEMPORARY OR PERMANENT LIGHTING, OR REPLACING EXISTING PERMANENT LIGHTS, ALL LIGHTS SHALL BE INSTALLED IN ACCORDANCE WITH IDOT BDE MANUAL - CHAPTER 56 AND WITH THE USFWS PBO FOR IBAT, NLEB AND TRICOLORED BAT. THIS INCLUDES THE FOLLOWING:

- DIRECT TEMPORARY LIGHTING AWAY FROM SUITABLE HABITAT DURING THE ACTIVE SEASON
- UTILIZING THE BUG SYSTEM, THE PROJECT SHOULD BE AS CLOSE TO 0 FOR ALL THREE RATINGS WITH PRIORITY OF "UPLIGHT" OF 0 AND "BACKLIGHT" AS LOW AS PRACTICABLE.

| USER NAME = nen | n | DESIGNED | - | NEM | REVISED | - |
|-------------------|-------------|----------|---|-----------|---------|---|
| | | DRAWN | - | JRS | REVISED | = |
| PLOT SCALE = 2.00 | 000 ' / in. | CHECKED | - | NEM | REVISED | = |
| PLOT DATE = 8/1 | 7/2025 | DATE | | 5/16/2025 | REVISED | |

| STATE OF ILLINOIS | |
|-------------------------------------|--|
| DEPARTMENT OF TRANSPORTATION | |

| OAK SPRING ROAD GENERAL NOTES | | F.A.U. SECTION | | COUNTY | TOTAL SHEETS | SHEE NO. | |
|----------------------------------|---------------------|----------------|----------------|---------|-----------------|----------|------|
| | | 1234 | 23-00127-00-RS | | LAKE | 36 | 2 |
| | | | | | CONTRACT | NO. 63 | 1L83 |
| | SHEET 1 OF 2 SHEETS | | ILLINOIS | EED ΔΙΓ | PROJECT | | |

STORM & SANITARY AND WATER MAIN

UNLESS OTHERWISE NOTED ON THE PLANS, THE EXISTING DRAINAGE FACILITIES SHALL REMAIN IN
USE DURING THE PERIOD OF CONSTRUCTION. LOCATIONS OF EXISTING DRAINAGE STRUCTURES AND
SEWERS AS SHOWN ON THE PLANS ARE APPROXIMATE. PRIOR TO COMMENCING WORK THE CONTRACTOR,
AT HIS OWN EXPENSE, SHALL DETERMINE THE EXACT LOCATIONS OF EXISTING STRUCTURES WHICH ARE
WITHIN THE PROPOSED CONSTRUCTION LIMITS

DURING CONSTRUCTION, IF THE CONTRACTOR ENCOUNTERS OR OTHERWISE BECOMES AWARE OF ANY SEWERS, UNDERDRAINS OR FIELD DRAINS WITHIN THE RIGHT-OF-WAY OTHER THAN THOSE SHOWN ON THE PLANS, HE/SHE SHALL SO INFORM THE ENGINEER, WHO SHALL DIRECT THE WORK NECESSARY TO MAINTAIN OR REPLACE THE FACILITIES IN SERVICE AND TO PROTECT THEM FROM DAMAGE DURING CONSTRUCTION IF MAINTAINED. EXISTING FACILITIES TO BE MAINTAINED THAT ARE DAMAGED BECAUSE OF THE NON-COMPLIANCE WITH THIS PROVISION SHALL BE REPLACED. SHOULD THE ENGINEER HAVE DIRECTED THE REPLACEMENT OF A FACILITY, THE NECESSARY WORK AND PAYMENT SHALL BE IN ACCORDANCE WITH SECTIONS 550 AND 601, AND ARTICLE 104.02 OF THE STANDARD SPECIFICATIONS.

CONSTRUCTION SEQUENCE

THIS CONSTRUCTION SEQUENCE WAS DEVELOPED TO MINIMIZE IMPACTS TO PROPERTY OWNERS AND TO PROVIDE AN ADEQUATE METHOD OF INSPECTING THE CONDITION OF THE PAVEMENT BASE AND CURB AND GUTTER. THIS CONSTRUCTION SEQUENCE SHALL BE FOLLOWED UNLESS AN ALTERNATE SEQUENCE IS APPROVED BY THE ENGINEER.

- SET UP APPLICABLE TRAFFIC CONTROL MEASURES USING IDOT HIGHWAY STANDARDS AND DISTRICT ONE DETAILS PROVIDED IN THE PLANS. DAILY LANE CLOSURES SHALL BE USED FOR ALL WORK DEPICTED IN THESE PLANS. PERMANENT LANE CLOSURES SHALL NOT BE ALLOWED UNLESS SHOWN ON THE PLANS OR OTHERWISE APPROVED BY THE ENGINEER.
- 2. REMOVE AND REPLACE CURB AND GUTTER AND ADJUST UTILITY STRUCTURES AS DETERMINED BY THE ENGINEER.
- 3. REMOVE AND INSTALL SIDEWALK AND DETECTABLE WARNINGS.
- LANDSCAPE RESTORATION.
- 5. REMOVE HMA PAVEMENT SURFACE.
- 6. THE ENGINEER SHALL INSPECT THE CONDITION OF THE PAVEMENT AND MARK THE AREAS REQUIRING PAVEMENT PATCHING. UNDER NO CONDITION SHALL THE CONTRACTOR PROCEED WITH THIS WORK WITHOUT PRIOR CONSENT FROM THE ENGINEER. PERFORM PAVEMENT PATCHING.
- 7. INSTALL BINDER AND HMA SURFACE.
- 8. INSTALL AGGREGATE SHOULDER.
- 9. INSTALL PERMANENT PAVEMENT MARKINGS AND SIGNING.
- 10. REMOVE TRAFFIC CONTROL.

MAINTENANCE OF TRAFFIC GENERAL NOTES

- I. TRAFFIC CONTROL DEPICTED IN THESE PLANS AND THE APPLICABLE IDOT DETAILS AND STANDARDS ARE THE MINIMUM REQUIREMENTS. OTHER WORK OR SIGNING MAY BE REQUIRED BY THE ENGINEER. TRAFFIC CONTROL AND PROTECTION SHALL BE PERFORMED IN ACCORDANCE WITH THE STANDARD SPECIFICATIONS, DIVISION 700; APPLICABLE GUIDELINES IN THE ILLINOIS MANUAL ON UNIFORM TRAFFIC CONTROL DEVICES FOR STREETS AND HIGHWAYS; AND APPLICABLE HIGHWAY STANDARDS FOR TRAFFIC CONTROL, UNLESS HEREIN REVISED.
- . THE EXACT NUMBER, LOCATION AND SPACING OF ALL SIGNS AND TRAFFIC CONTROL DEVICES SHALL FIT FIELD CONDITIONS AS DIRECTED BY THE ENGINEER.
- . ALL CONSTRUCTION WARNING SIGNS SHALL HAVE FLUORESCENT ORANGE BACKGROUNDS.
- . ALL SIGNS SHALL BE MOUNTED ON METAL POSTS, 7 FEET ABOVE THE EXISTING GROUND AND DRIVEN A MINIMUM OF 3 FEET INTO THE GROUND, UNLESS OTHERWISE NOTED. A J.U.L.I.E. LOCATE SHALL BE PERFORMED PRIOR TO THE INSTALLATION OF THE POSTS.
- 5. DRUMS WILL BE REQUIRED ADJACENT TO PAVEMENT EDGES WHERE WIDENING, CURB AND GUTTER OR OVERLAYING WORK IS BEING DONE, AS SPECIFIED IN SECTION 701 OF THE STANDARD SPECIFICATIONS, EXCEPT THAT THE BARRICADES SHALL BE NON-METALLIC DRUMS. SPACING SHALL BE AS SHOWN ON THE HIGHWAY STANDARDS UNLESS OTHERWISE DIRECTED BY THE ENGINEER. BARRICADES THAT MUST BE PLACED IN EXCAVATED AREAS SHALL HAVE LEG EXTENSIONS INSTALLED SUCH THAT THE TOPS OF THE BARRICADES ARE IN COMPLIANCE WITH THE HEIGHT REQUIREMENTS OF STANDARD 701901
- 6. DRUMS WILL BE REQUIRED AT ALL OPEN TRENCHES, EXCAVATIONS, OPEN OR EXPOSED SEWER STRUCTURES, AND AT ANY OTHER LOCATIONS DESIGNATED BY THE ENGINEER OR LAW ENFORCEMENT AGENCIES. BARRICADES SHALL BE PLACED AT 50' CENTERS ALONG TANGENTS, 20' CENTERS ALONG TAPERS, AND 10' CENTERS IN CURVES AND RADII.
- TYPE III BARRICADES ARE TO BE PLACED IN ACCORDANCE WITH STANDARD 701901 UNLESS AUTHORIZED BY THE ENGINEER TO USE AN ALTERNATE ARRANGEMENT.
- . EXISTING TRAFFIC CONTROL SIGNS AND DEVICES SHALL BE REMOVED OR RELOCATED BY THE CONTRACTOR AFTER THE TRAFFIC CONTROL REQUIREMENTS ARE MET OR AS AUTHORIZED BY THE ENGINEER; ANY SIGNS OR DEVICES LEFT IN PLACE ARE TO BE PROTECTED FROM DAMAGE AND MAINTAINED. ANY DAMAGE CAUSED BY THIS WORK SHALL BE REPAIRED TO THE SATISFACTION OF THE ENGINEER.
- THE FIRST TWO WARNING SIGNS IN EACH DIRECTION OF TRAVEL SHALL BE EQUIPPED WITH MONO-DIRECTIONAL AMBER FLASHING LIGHTS DURING HOURS OF DARKNESS. FLAGS ARE OPTIONAL.
- 10. EXISTING TRAFFIC CONTROL DEVICES ARE TO BE PROTECTED FROM DAMAGE BY THE CONTRACTOR. ANY DAMAGE CAUSED BY HIS/HER WORK SHALL BE REPAIRED TO THE SATISFACTION OF THE ENGINEER
- 11. W21-1(O) "WORKERS" SIGNS SHALL ONLY BE ERECTED WHEN WORKERS ARE PRESENT. SIGN MUST BE COVERED OR REMOVED WHEN NO WORKERS ARE PRESENT.

CONSTRUCTION REQUIREMENTS

- 1. WHEN WORKING ADJACENT TO THE ROAD AND UTILIZING DAILY LANE CLOSURES, DROP-OFFS ADJACENT TO THE TRAVEL LANES SHALL BE KEPT TO A MINIMUM. PROTECTION OF THE DROP-OFF SHALL BE ACCORDING TO THE IDOT BUREAU OF SAFETY PROGRAMS AND ENGINEERING, SAFETY ENGINEERING POLICTY MEMORANDUM 4-21. DROP-OFFS GREATER THAN THE SPECIFIED MAXIMUM DROP-OFF DEPTH SHOWN IN TABLE 2, CONDITION II OF THE SAFETY 4-21 POLICY WILL NOT BE ALLOWED AT LOCATIONS WHERE THE DROP-OFF IS LOCATED WITHIN 8 FEET OF THE EDGE OF THE NEAREST OPEN TRAFFIC LANE. THE CONTRACTOR WILL BE REQUIRED TO PERFORM THE EXCAVATION REQUIRED FOR THE CONSTRUCTION DURING THE TIME THAT THE ADJACENT LANE IS CLOSED. AS NOTED ABOVE, PRIOR TO REOPENING THE LANE TO TRAFFIC, THE CONTRACTOR SHALL PLACE SUFFICIENT MATERIAL TO REDUCE THE DROP-OFF TO LESS THAN THE SPECIFIED MAXIMUM DROP-OFF DEPTH SHOWN IN TABLE 2, CONDITION II OF THE SAFETY 4-21 POLICY AND ENSURE THAT THE DROP-OFF AREAS MEET THE OFFSET, HEIGHT, AND DURATION REQUIREMENTS TO USE BARRICADES/DRUMS AT THE END OF EACH WORKDAY. THE CONTRACTOR SHALL BE RESPONSIBLE TO DETERMINE THE AMOUNT OF WORK THAT CAN BE COMPLETED WITHIN THE TIME OF THE DAILY LANE CLOSURE.
- ALL WORK SHALL BE IN ACCORDANCE WITH IDOT'S SAFETY ENGINEERING POLICY MEMORANDUM, SAFETY 4-21, INCLUDING THE REQUIREMENT FOR USE OF TEMPORARY OR MILLED SLOPE EDGES (MIN OF 1:3). THIS MAY REQUIRE ADDITIONAL PASSES OF THE MILLING MACHINE OR THE USE OF A SECONDARY, SMALLER MILLING MACHINE TO CREATE THE REQUIRED EDGE.
- 3. "UNEVEN LANES" SIGNS (W8-1(O)-4848) SHALL BE PLACED AT THE INTERVALS REQUIRED BY THE ENGINEER WHEN TRAFFIC IS ADJACENT TO THE MILLED SURFACE.

CONSTRUCTION SIGNS

W21-2(O)
48" X 48"

FRESH
OIL

9" X 36"

DATE XX-XX-XX

BLACK 6" LETTERS ON ORANGE RETROREFLECTIVE BACKGROUND

THESE SIGNS SHALL BE PLACED AS DIRECTED BY THE ENGINEER. W21-2(O) SHALL BE PLACED 48 HOURS PRIOR TO TACKING.

| | | | | | CONSTRUCT STP URBAN | |
|--------|------|--|-------|-------------------|------------------------|------------|
| | | | | | 80% FEDERAL | / 20% LOCA |
| CODE | NO. | ITEM | UNIT | TOTAL QUANTITY | 0005 | 0021 |
| | | | | | ROADWAY RESURFACE | SAFETY |
| 20200 | 0100 | EARTH EXCAVATION | CU YD | 50 | 50 | |
| 20201 | 1200 | REMOVAL AND DISPOSAL OF UNSUITABLE MATERIAL | CU YD | 24 | 24 | |
| 21101 | 1615 | TOPSOIL FURNISH AND PLACE, 4" | SQ YD | 11 | 11 | |
| 25200 | 0110 | SODDING, SALT TOLERANT | SQ YD | 11 | 11 | |
| 25200 |)200 | SUPPLEMENTAL WATERING | UNIT | 1 | 1 | |
| 28000 |)510 | INLET FILTERS | EACH | 9 | 9 | |
| 35101 | 1598 | AGGREGATE BASE COURSE, TYPE B 3" | SQ YD | 60 | 60 | |
| 35101 | 1500 | AGGREGATE BASE COURSE, TYPE B | CU YD | 76 | 76 | |
| 406003 |)290 | BITUMINOUS MATERIALS (TACK COAT) | POUND | 10961 | 10961 | |
| 406003 |)370 | LONGITUDINAL JOINT SEALANT | FOOT | 5507 | 5507 | |
| 40600 | 0400 | MIXTURE FOR CRACKS, JOINTS, AND FLANGEWAYS | TON | 80 | 80 | |
| 40600 |)982 | HOT-MIX ASPHALT SURFACE REMOVAL - BUTT JOINT | SQ YD | 119 | 119 | |
| 40603 | 3080 | HOT-MIX ASPHALT BINDER COURSE, IL-19.0, N50 | TON | 2270 | 2270 | |
| 40604 | 1060 | HOT-MIX ASPHALT SURFACE COURSE, IL-9.5, MIX "D", N50 | TON | 1362 | 1362 | |
| 42001 | 1300 | PROTECTIVE COAT | SQ YD | 67 | 67 | |
| 42400 |)200 | PORTLAND CEMENT CONCRETE SIDEWALK 5 INCH | SQ FT | 546 | 546 | |

| ODELNAME\$ | \3994-sht-S0Q.dgr |
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| MOD | FILE |

SHEET

| OAK SPRING ROAD SUMMARY OF QUANTITIES | | SECTION | | | COUNTY | TOTAL SHEETS | SHEET NO. |
|--|--|--------------------|----------|--------|-----------|-----------------|--------------|
| | | 234 23-00127-00-RS | | | LAKE | 36 | 4 |
| JOHNMANT OF GOARTITIES | | | | | CONTRACT | NO. 6 | 1L83 |
| 1 OF 4 SHEETS | | | TLLINOIS | EED AI | D DDOJECT | | |

| | | | | | CONSTRUCT STP URBAN | |
|-----------------|----------|--|--------|-------------------|------------------------|-------------|
| | | | | | 80% FEDERAL | / 20% LOCAL |
| 1 1 | CODE NO. | ITEM | UNIT | TOTAL QUANTITY | 0005 | 0021 |
| SPECIALIY II EM | | | | , | ROADWAY RESURFACE | SAFETY |
| | 42400800 | DETECTABLE WARNINGS | SQ FT | 101 | 101 | |
| | 44000165 | HOT-MIX ASPHALT SURFACE REMOVAL, 4" | SQ YD | 16237 | 16237 | |
| | 44201737 | CLASS D PATCHES, TYPE I, 8 INCH | SQ YD | 844 | 844 | |
| | 44201741 | CLASS D PATCHES, TYPE II, 8 INCH | SQ YD | 1106 | 1106 | |
| | 44201745 | CLASS D PATCHES, TYPE III, 8 INCH | SQ YD | 1120 | 1120 | |
| | 44201747 | CLASS D PATCHES, TYPE IV, 8 INCH | SQ YD | 1553 | 1553 | |
| | 48101498 | AGGREGATE SHOULDERS, TYPE B 4" | SQ YD | 1033 | 1033 | |
| | 67000400 | ENGINEER'S FIELD OFFICE, TYPE A | CAL MO | 6 | 6 | |
| | 67100100 | MOBILIZATION | L SUM | 1 | 1 | |
| | 70102620 | TRAFFIC CONTROL AND PROTECTION, STANDARD 701501 | L SUM | 1 | 1 | |
| | 70102635 | TRAFFIC CONTROL AND PROTECTION, STANDARD 701701 | L SUM | 1 | 1 | |
| | 70102640 | TRAFFIC CONTROL AND PROTECTION, STANDARD 701801 | L SUM | 1 | 1 | |
| | 70107025 | CHANGEABLE MESSAGE SIGN | CAL DA | 150 | | 1 |
| | 70300100 | SHORT TERM PAVEMENT MARKING | FOOT | 1502 | | 15 |
| | 70300150 | SHORT TERM PAVEMENT MARKING REMOVAL | SQ FT | 500 | | 5(|
| | 70300211 | TEMPORARY PAVEMENT MARKING LETTERS AND SYMBOLS - PAINT | SQ FT | 73 | | - |

IODEL: \$MODELNAME\$ ILE NAME: ...\3994-sht-SOO.do

| USER NAME = nem | DESIGNED | - | NEM | REVISED | - |
|------------------------------|----------|---|-----------|---------|---|
| | DRAWN | - | JRS | REVISED | - |
| PLOT SCALE = 40.0000 ' / in. | CHECKED | - | NEM | REVISED | - |
| PLOT DATE = 8/17/2025 | DATE | _ | 5/16/2025 | REVISED | _ |

| OAK SPRING ROAD | | SECTION | COUNTY | TOTAL SHEETS | SHEET NO. |
|-----------------------|------|------------------|-----------|-----------------|--------------|
| SUMMARY OF QUANTITIES | 1234 | 23-00127-00-RS | LAKE | 36 | 5 |
| SOMMANT OF GOARTITIES | | | CONTRACT | NO. 61 | IL83 |
| SHEET 2 OF 4 SHEETS | | ILLINOIS FED. AI | D PROJECT | | |

| | | | | | CONSTRUCT STP URBAN | |
|----------------|----------|--|-------|-------------------|------------------------|--------|
| Σ | | | | | 80% FEDERAL | |
| SPECIALTY ITEM | CODE NO. | ITEM | UNIT | TOTAL QUANTITY | 0005 002 | |
| SPECI/ | | | | QOANTIT | ROADWAY RESURFACE | SAFETY |
| | 70300221 | TEMPORARY PAVEMENT MARKING - LINE 4"- PAINT | FOOT | 21518 | | 21518 |
| | 70300241 | TEMPORARY PAVEMENT MARKING - LINE 6"- PAINT | FOOT | 134 | | 134 |
| | 70300261 | TEMPORARY PAVEMENT MARKING - LINE 12"- PAINT | FOOT | 92 | | 92 |
| | 70300281 | TEMPORARY PAVEMENT MARKING - LINE 24"- PAINT | FOOT | 66 | | 66 |
| Х | 72000100 | SIGN PANEL - TYPE 1 | SQ FT | 154 | | 154 |
| | 72400100 | REMOVE SIGN PANEL ASSEMBLY - TYPE A | EACH | 32 | | 32 |
| Х | 72800100 | TELESCOPING STEEL SIGN SUPPORT | FOOT | 273 | | 273 |
| Х | 78000100 | THERMOPLASTIC PAVEMENT MARKING - LETTERS AND SYMBOLS | SQ FT | 146 | | 146 |
| Х | 78000200 | THERMOPLASTIC PAVEMENT MARKING - LINE 4" | FOOT | 21753 | | 21753 |
| Х | 78000400 | THERMOPLASTIC PAVEMENT MARKING - LINE 6" | FOOT | 199 | | 199 |
| Х | 78000600 | THERMOPLASTIC PAVEMENT MARKING - LINE 12" | FOOT | 92 | | 92 |
| X | 78000650 | THERMOPLASTIC PAVEMENT MARKING - LINE 24" | FOOT | 103 | | 103 |
| | 78300202 | PAVEMENT MARKING REMOVAL - WATER BLASTING | SQ FT | 256 | | 250 |
| | X0327036 | BIKE PATH REMOVAL | SQ YD | 61 | 61 | |
| | X4060280 | HOT-MIX ASPHALT DRIVEWAY PAVEMENT, 3" | SQ YD | 19 | 19 | |
| | X4060995 | TEMPORARY RAMP (SPECIAL) | SQ YD | 220 | 220 | |

DDEL: \$MODELNAME\$

E NAME: ...\3994-sht-SOO.dan

| USER NAME = nem | DESIGNED | - | NEM | REVISED - |
|------------------------------|----------|---|-----------|-----------|
| | DRAWN | - | JRS | REVISED - |
| PLOT SCALE = 40.0000 ' / in. | CHECKED | - | NEM | REVISED - |
| PLOT DATE = 8/17/2025 | DATE | - | 5/16/2025 | REVISED - |

STATE OF ILLINOIS DEPARTMENT OF TRANSPORTATION


| OAK SPRING ROAD | F.A.U. RTE. | SECTION | | COUNTY | TOTAL SHEETS | SHEET NO. |
|-----------------------|----------------|---------------------|----------|----------|-----------------|--------------|
| SUMMARY OF QUANTITIES | 1234 | 1234 23-00127-00-RS | | LAKE | 36 | 6 |
| SUMMANT OF QUANTITIES | | | | CONTRACT | NO. 61 | 1L83 |
| SHEET 3 OF 4 SHEETS | | ILLINOIS | FED. AID | PROJECT | | |


| | | | | | CONSTRUCT | TION CODES |
|----------------|----------|--|----------|-------------------|----------------------|---|
| | | | | | STP URBAN | N FUNDING |
| ITEM | | | | | 80% FEDERAL | STP URBAN FUNDING 0% FEDERAL / 20% LOCAL 0005 0021 OADWAY SAFETY 40 70 50 85 |
| SPECIALTY ITEM | CODE NO. | ITEM | UNIT | TOTAL QUANTITY | 0005 | 0021 |
| SPEC | | | | | ROADWAY RESURFACE | SAFETY |
| | X4400221 | CURR REMOVAL AND REPLACEMENT LEGG THAN OR FOLIAL TO 10 FEET | FOOT | 40 | 40 | |
| | X4400221 | CURB REMOVAL AND REPLACEMENT LESS THAN OR EQUAL TO 10 FEET | F001 | 40 | 40 | |
| | X4400223 | CURB REMOVAL AND REPLACEMENT GREATER THAN 10 FEET | FOOT | 70 | 70 | |
| | | | | | | |
| | X4400501 | COMBINATION CURB AND GUTTER REMOVAL AND REPLACEMENT LESS THAN OR EQUAL TO 10 FEET | FOOT | 50 | 50 | |
| | | | | | | |
| | X4400503 | COMBINATION CURB AND GUTTER REMOVAL AND REPLACEMENT GREATER THAN 10 FEET | FOOT | 85 | 85 | |
| | | | | | | |
| | X6030310 | FRAMES AND LIDS TO BE ADJUSTED (SPECIAL) | EACH | 5 | 5 | |
| | X7200061 | TEMPORARY INFORMATION SIGNING | SQ FT | 52 | | 52 |
| | | | | | | |
| | Z0013798 | CONSTRUCTION LAYOUT | L SUM | 1 | 1 | |
| | Z0017400 | DRAINAGE & UTILITY STRUCTURES TO BE ADJUSTED | EACH | 5 | 5 | |
| | | | 2, (6) 1 | | | |

| USER NAME = nem | DESIGNED - | NEM | REVISED - |
|------------------------------|------------|-----------|-----------|
| | DRAWN - | JRS | REVISED - |
| PLOT SCALE = 40.0000 ' / in. | CHECKED - | NEM | REVISED - |
| PLOT DATE = 9/2/2025 | DATE - | 5/16/2025 | REVISED - |


| | | OAK | SI | PRING | ROAD |
|------|-----|-----|-----|--------|----------|
| | SU | MMA | \RY | OF QU | ANTITIES |
| JEET | - 1 | OF | - 4 | CHEETC | |

| F.A.U. RTE | SECT | ΓΙΟΝ | | COUNTY | TOTAL SHEETS | SHEE NO. |
|---------------|---------|----------|--------|------------|-----------------|-------------|
| 1234 | 23-0012 | 7-00-RS | | LAKE | 36 | 7 |
| | | | | CONTRACT | NO. 6 | 1L83 |
| | | ILLINOIS | FED. A | ID PROJECT | | |

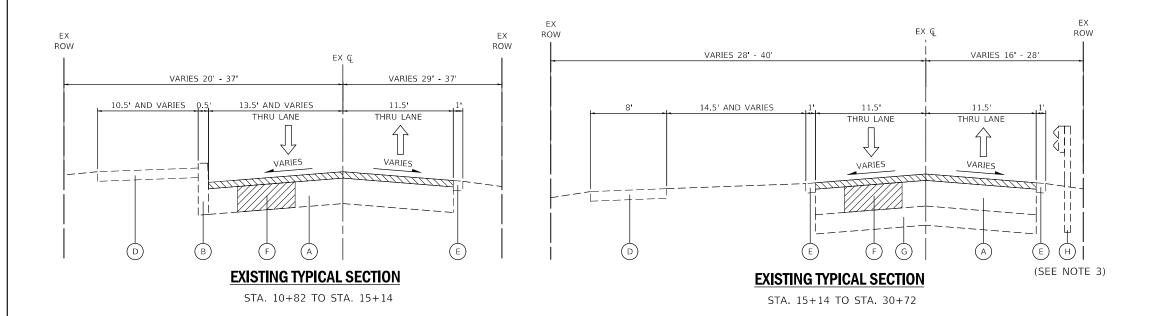

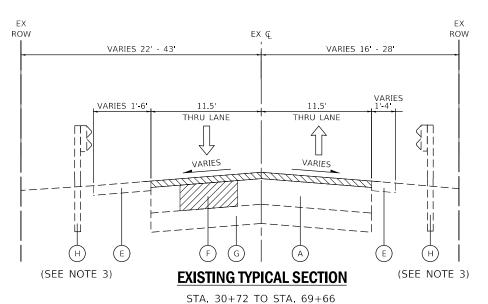

(BRIDGE OMISSION STA. 36+28 TO STA. 42+71)

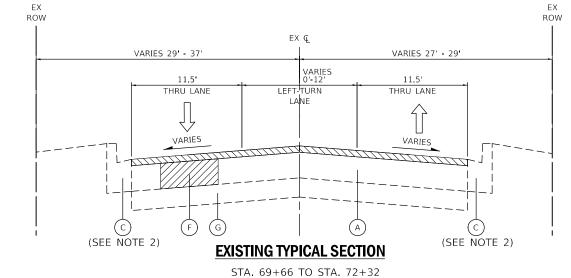

LEGEND

- (A) EXISTING HOT-MIX ASPHALT PAVEMENT:
 -OAK SPRING ROAD = 7" TO 15"
- B) EXISTING CONCRETE CURB, TYPE B
- EXISTING COMBINATION CONCRETE CURB AND GUTTER TYPE B-6.18
- (D) EXISTING HOT-MIX ASPHALT PATH
- E EXISTING AGGREGATE SHOULDER (REMOVAL PAID FOR AS EARTH EXCAVATION)
- PROPOSED CLASS D PATCH, 8 INCH (SEE NOTE 1)
- G EXISTING BASE COURSE VARIES 0"-11.5"
- (H) EXISTING STEEL PLATE BEAM GUARDRAIL



HOT-MIX ASPHALT SURFACE REMOVAL, 4"



CLASS D PATCH (8")

NOTES

- THE ENGINEER SHALL MAKE THE FINAL DETERMINATION OF THE LOCATION, WIDTH, AND LENGTH OF CLASS D PATCHES IN THE FIELD.
- THE ENGINEER SHALL MAKE THE FINAL DETERMINATION OF THE LOCATION AND LENGTH OF THE REMOVAL AND REPLACEMENT OF COMBINATION CONCRETE CURB AND GUTTER IN THE FIELD. SEE DETAIL "CURB OR CURB AND GUTTER REMOVAL AND REPLACEMENT" FOR ADDITIONAL DETAILS.
- 3. EXISTING STEEL PLATE BEAM GUARDRAIL IS LOCATED AT STATION RANGES 30+94.59 TO 32+09.80, 42+71 TO 43+58.64 LT, AND 30+07.20 TO 30+70.96, 30+93.65 TO 32+10.11 RT.


| USER NAME = nem | DESIGNED - | NEM | REVISED - | |
|---------------------------|------------|-----------|-----------|--|
| | DRAWN - | JRS | REVISED - | |
| PLOT SCALE = 2.0000 / in. | CHECKED - | NEM | REVISED - | |
| PLOT DATE = 8/17/2025 | DATE - | 5/16/2025 | REVISED - | |


STATE OF ILLINOIS
DEPARTMENT OF TRANSPORTATION

OAK SPRING ROAD
EXISTING TYPICAL SECTIONS

SCALE: N.T.S. SHEET 1 OF 2 SHEETS


MODEL: \$MODELNAME\$ FILE NAME: ...\3994-sht-typical01.dc

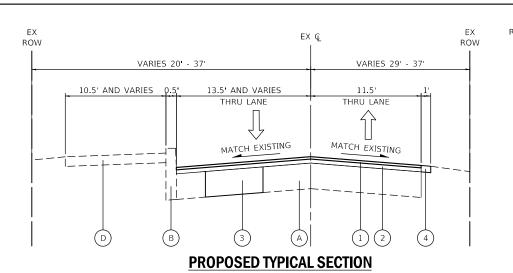

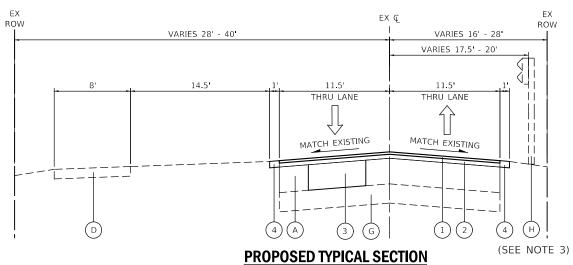

STA. 15+14 TO STA. 30+72

STA. 10+82 TO STA. 15+14

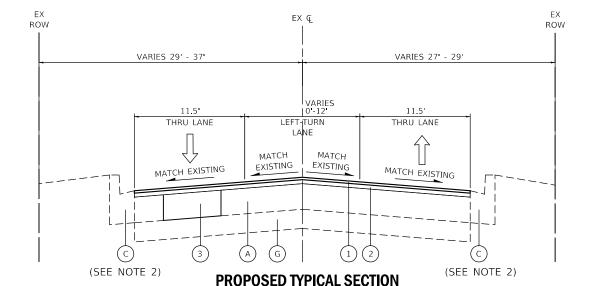

PROPOSED TYPICAL SECTION

STA. 30+72 TO STA. 69+66

(SEE NOTE 3)

(BRIDGE OMISSION STA. 36+28 TO STA. 42+71)

STA. 69+66 TO STA. 72+32

SCALE:

NOTES

(SEE NOTE 3)

- THE ENGINEER SHALL MAKE THE FINAL DETERMINATION OF THE LOCATION, WIDTH, AND LENGTH OF CLASS D PATCHES IN THE FIELD.
- 2. THE ENGINEER SHALL MAKE THE FINAL DETERMINATION OF THE LOCATION AND LENGTH OF THE REMOVAL AND REPLACEMENT OF COMBINATION CONCRETE CURB AND GUTTER IN THE FIELD. SEE DETAIL "CURB OR CURB AND GUTTER REMOVAL AND REPLACEMENT" FOR ADDITIONAL DETAILS.
- 3. EXISTING STEEL PLATE BEAM GUARDRAIL IS LOCATED AT STATION RANGES 30+94.59 TO 32+09.80, 42+71 TO 43+58.64 LT, AND 30+07.20 TO 30+70.96, 30+93.65 TO 32+10.11 RT.

LEGEND

- A EXISTING HOT-MIX ASPHALT PAVEMENT:
 -OAK SPRING ROAD = 7" TO 15"
- (B) EXISTING CONCRETE CURB, TYPE B
- C EXISTING COMBINATION CONCRETE CURB AND GUTTER
- (D) EXISTING HOT-MIX ASPHALT PATH
- E EXISTING AGGREGATE SHOULDER (REMOVAL PAID FOR AS EARTH EXCAVATION)
- G EXISTING BASE COURSE VARIES 0"-11.5"
- H) EXISTING STEEL PLATE BEAM GUARDRAIL, TYPE A, 6 FOOT POSTS
- 1) HOT-MIX ASPHALT SURFACE COURSE, IL-9.5, MIX "D", N50, 1.5"
- 2) HOT-MIX ASPHALT BINDER COURSE, IL-19.0, N50, 2.5"
- CLASS D PATCHES, TYPE AS NOTED ON PLANS, 8 INCH (SEE NOTE 1)
- (4) AGGREGATE SHOULDERS, TYPE B, 4"

| HOT-MIX ASPHALT MIXTURE REQUIREMENTS T | ABLE | |
|--|------------------|-----------|
| MIXTURE TYPE | AIR VOIDS @ Ndes | QMP |
| PROPOSED RESURFACING | | |
| HOT-MIX ASPHALT SURFACE COURSE, IL-9.5, MIX "D", N50, 1½" | 4% @ 50 GYR. | LR 1030-2 |
| HOT-MIX ASPHALT BINDER COURSE, IL-19.0, N50, 2½" | 4% @ 50 GYR. | LR 1030-2 |
| HMA DRIVEWAY PAVEMENT, 3" | | |
| HOT-MIX ASPHALT SURFACE COURSE, IL-9.5, MIX "D", N50, 3" (IN 2 LIFTS) | 4% @ 50 GYR. | LR 1030-2 |
| TEMPORARY RAMP (SPECIAL) | | |
| HOT-MIX ASPHALT SURFACE COURSE, IL-9.5, MIX "D", N50; VARIABLE DEPTH | 4% @ 50 GYR. | LR 1030-2 |
| CLASS D PATCHES | | |
| CLASS D PATCH (HMA BINDER IL-19 mm) | 4% @ 70 GYR. | LR 1030-2 |
| QMP DESIGNATION: QUALITY CONTROL/QUALITY ASSURANCE (QC/QA) PER LR 1030-2 | • | |


- 1. THE UNIT WEIGHT USED TO CALCULATE ALL HOT-MIX ASPHALT SURFACE MIXTURE QUANTITIES IS 112 LB/SY-IN.
- . THE "AC TYPE" FOR POLYMERIZED HMA MIXES SHALL BE "SBS/SBR PG 76-22" AND FOR NON-POLYMERIZED HMA THE "AC TYPE" SHALL BE "PG 64-22" UNLESS MODIFIED BY RECLAIMED MATERIALS SPECIFICATIONS.
- 3. THE CONTRACTOR SHALL MILL THE PAVEMENT BEFORE PATCHING.
- 4. THE LONGITUDINAL JOINT SEALANT SHALL BE PLACED ON THE HMA BINDER COURSE, IL-19.0, N50.

| USER NAME = nem | DESIGNED - | NEM | REVISED - | |
|-----------------------------|------------|-----------|-----------|--|
| | DRAWN - | JRS | REVISED - | |
| PLOT SCALE = 2.0000 ' / in. | CHECKED - | NEM | REVISED - | |
| PLOT DATE = 8/17/2025 | DATE - | 5/16/2025 | REVISED - | |
| | | | | |

STATE OF ILLINOIS
DEPARTMENT OF TRANSPORTATION

| | OAK SPRING ROAD PROPOSED TYPICAL SECTIONS | | | | | | F.A.U. RTE | SECT | ION | | COUNTY | TOTAL SHEETS | SHEET NO. | |
|--------|---|------|-----|-----|-------|----------|---------------|-------------|----------|---------|-----------|-----------------|--------------|------|
| | | | | | | 1234 | 23-0012 | 00127-00-RS | | LAKE | 36 | 9 | | |
| | | 1101 | UJL | י י | HIGAL | SECTIONS | | | | | | CONTRACT | NO. 6 | 1L83 |
| N.T.S. | N.T.S. SHEET 2 OF 2 SHEETS | | | | | | | | ILLINOIS | FED. AI | D PROJECT | | | |

FILE NAME: ...\3994-sht-typical01.dgn

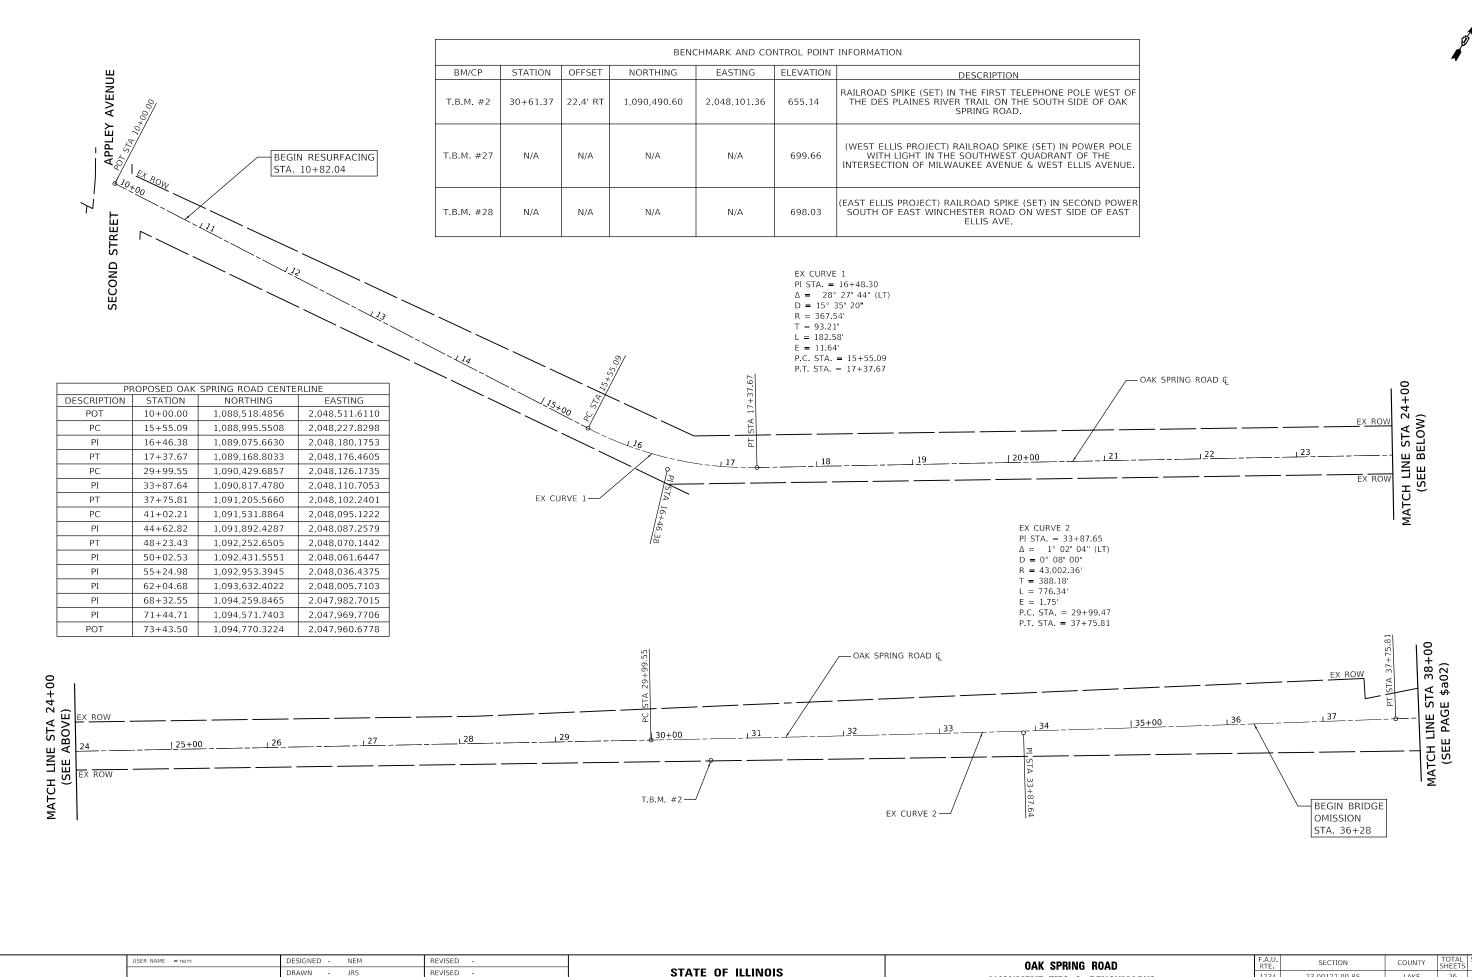

MODEL: \$MODELNAME\$ FILE NAME: ...\3994-sht-ATE

LOT SCALE = 100.0000 ' / in.

PLOT DATE = 8/17/2025

HECKED -

DATE

NEM

5/16/2025

REVISED

REVISED


STATE OF ILLINOIS
DEPARTMENT OF TRANSPORTATION


OAK SPRING ROAD


ALIGNMENT TIES & BENCHMARKS


SHEET 1 OF 2 SHEETS STA, 10+00 TO STA, 38+00

SCALE: 1"=50'

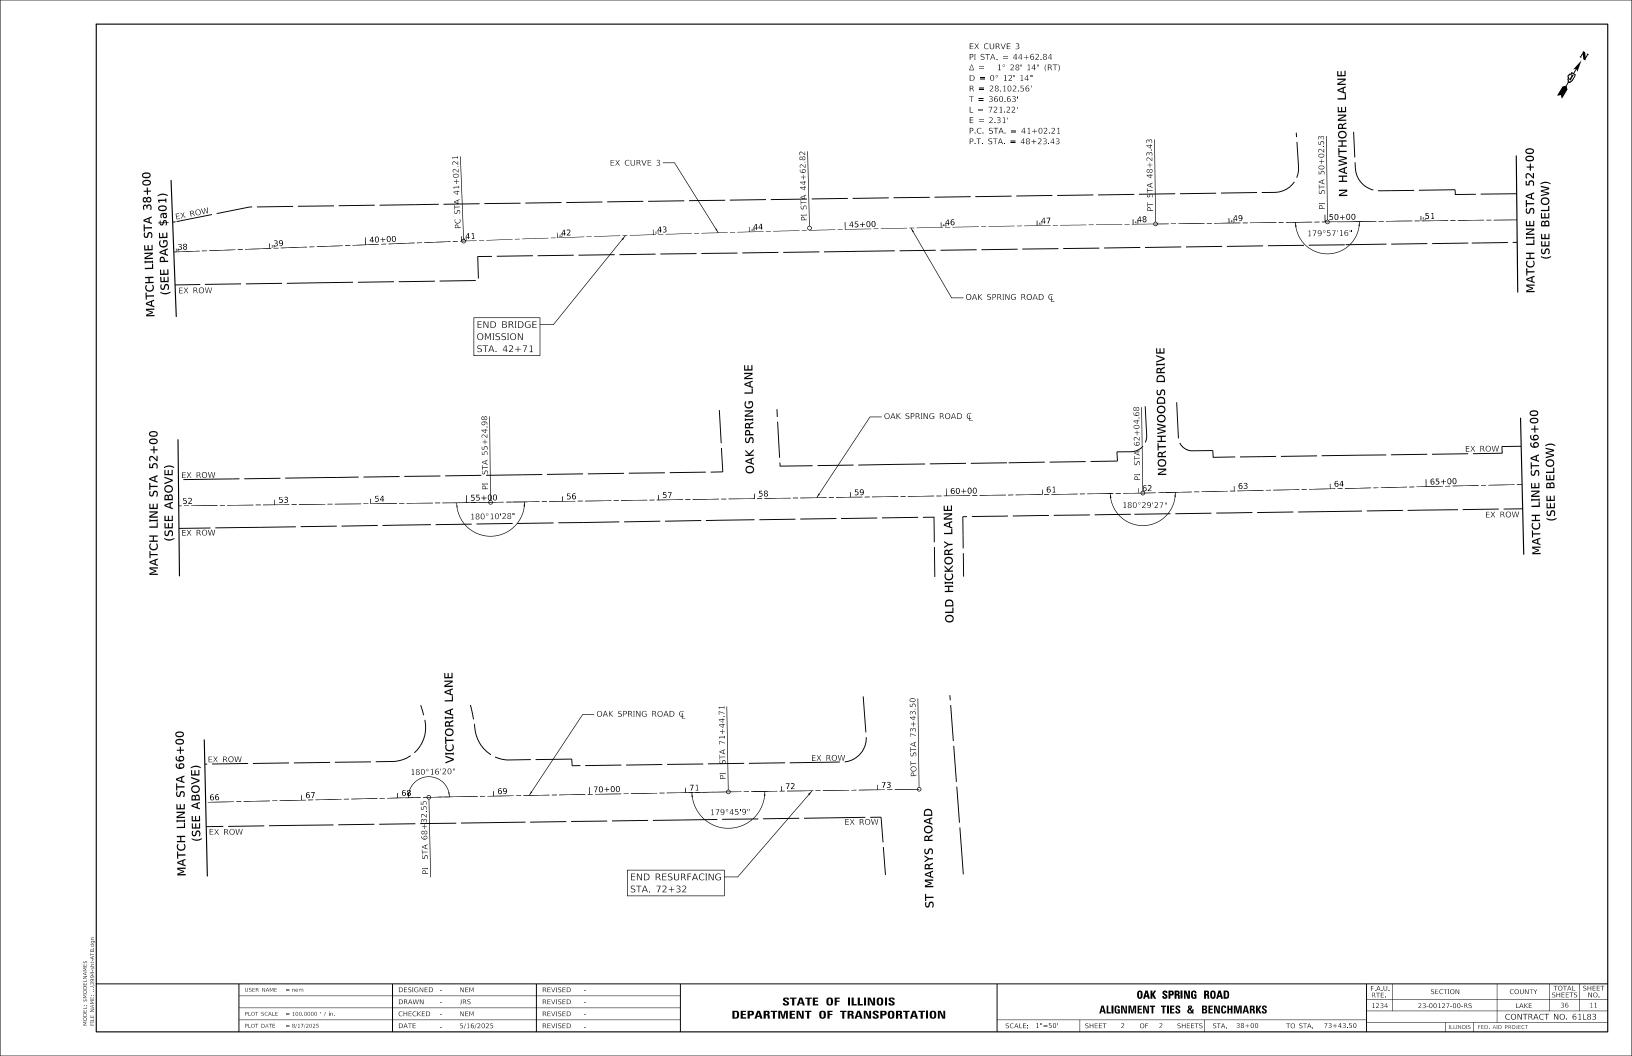

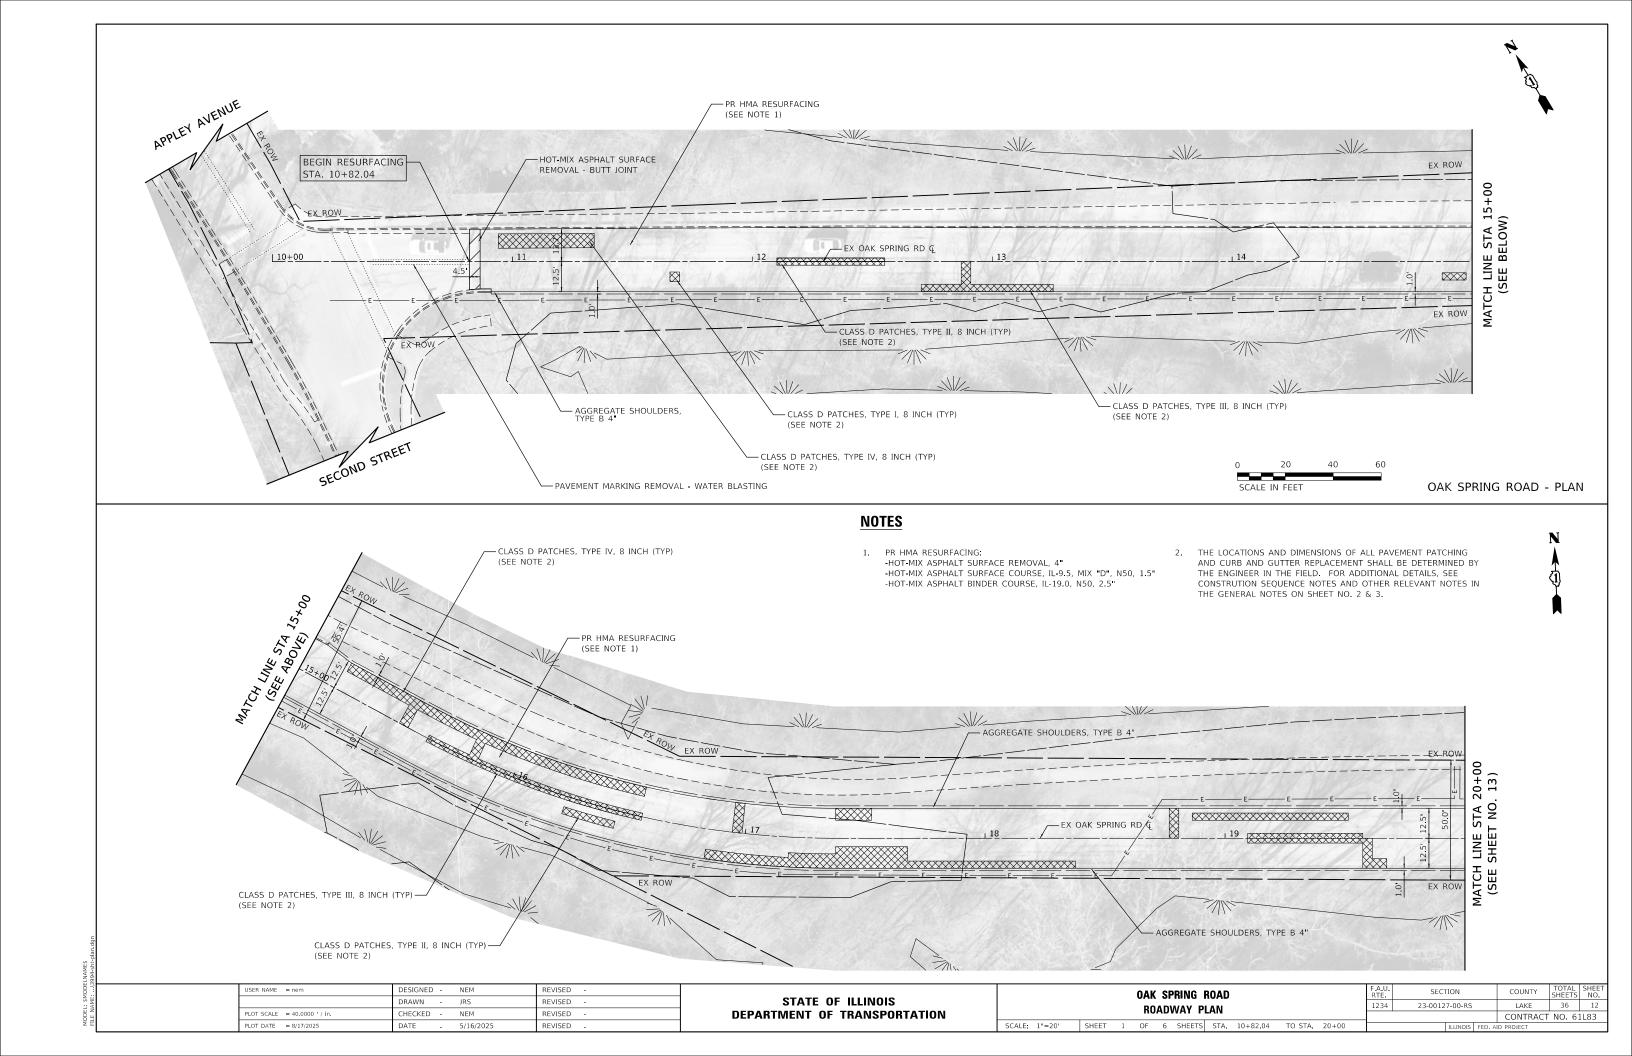

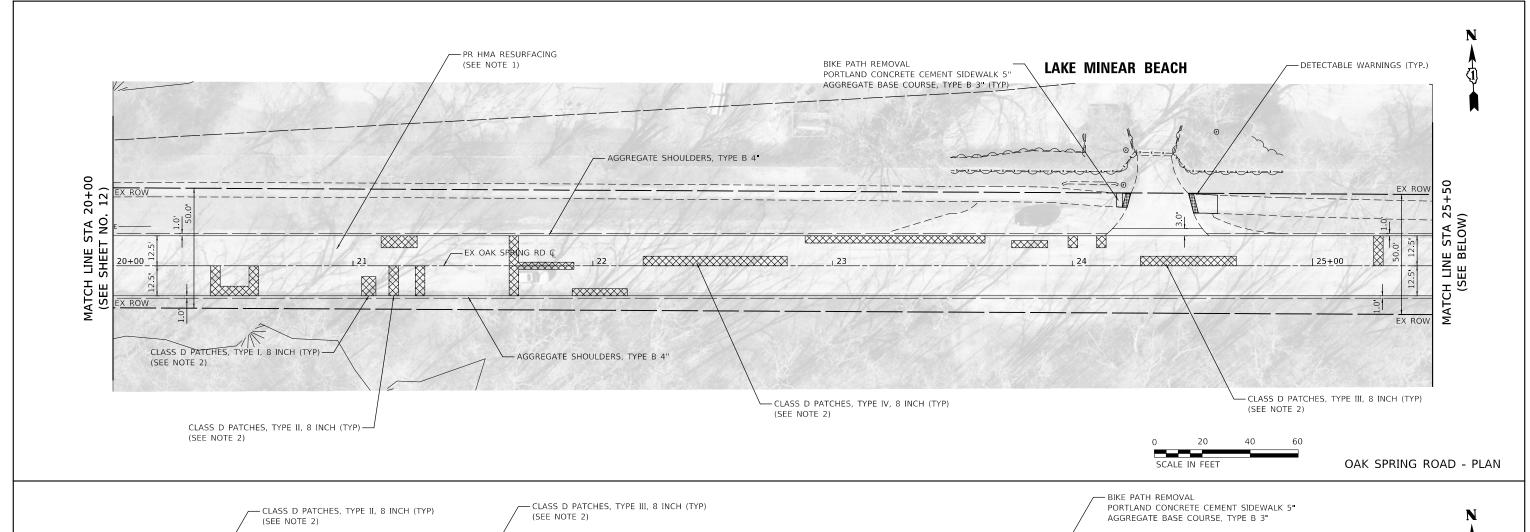


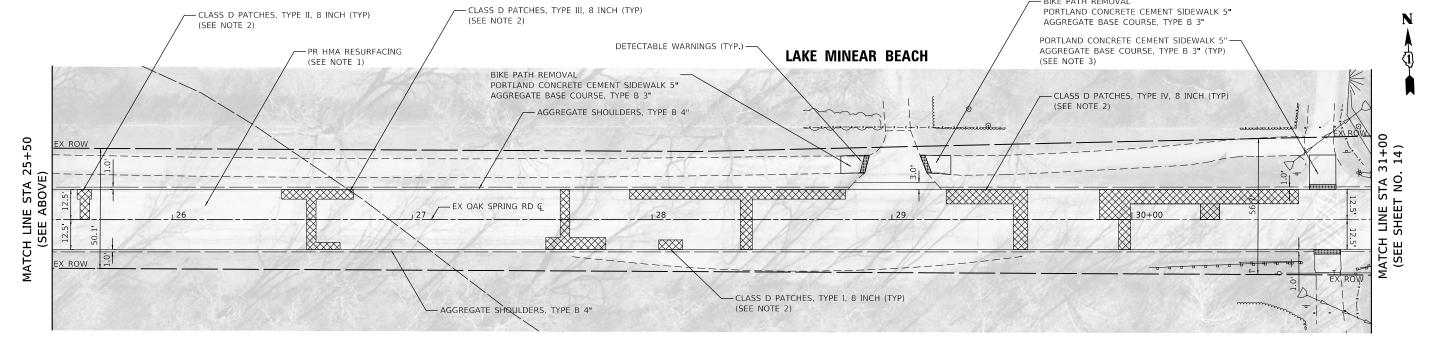


NOTES

- 1. PR HMA RESURFACING:
 -HOT-MIX ASPHALT SURFACE REMOVAL, 4"
 -HOT-MIX ASPHALT SURFACE COURSE, IL-9.5, MIX "D", N50, 1.5"
 -HOT-MIX ASPHALT BINDER COURSE, IL-19.0, N50, 2.5"
- 2. THE LOCATIONS AND DIMENSIONS OF ALL PAVEMENT PATCHING AND CURB AND GUTTER REPLACEMENT SHALL BE DETERMINED BY THE ENGINEER IN THE FIELD. FOR ADDITIONAL DETAILS, SEE CONSTRUTION SEQUENCE NOTES AND OTHER RELEVANT NOTES IN THE GENERAL NOTES ON SHEET NO. 2 & 3.
- 3. ADA RAMP SHALL BE CONSTRUCTED IN TWO STAGES TO MAINTAIN ACCESS FOR THE BIKE PATH.

| USER NAME = nem | DESIGNED - NEM | REVISED - | | OAK SPRING ROAD | F.A.U. RTF | SECTION | COUNTY | TOTAL SHEET SHEETS NO. |
|------------------------------|------------------|-----------|------------------------------|--|---------------|-----------------|-------------|------------------------|
| | DRAWN - JRS | REVISED - | STATE OF ILLINOIS | | | 23-00127-00-RS | LAKE | 36 13 |
| PLOT SCALE = 40.0000 ' / in. | CHECKED - NEM | REVISED - | DEPARTMENT OF TRANSPORTATION | ROADWAY PLAN | 1234 | | CONTRACT | NO. 61L83 |
| PLOT DATE = 8/17/2025 | DATE - 5/16/2025 | REVISED - | | SCALE: 1"=20' SHEET 2 OF 6 SHEETS STA. 20+00 TO STA. 31+00 | | ILLINOIS FED. A | AID PROJECT | |

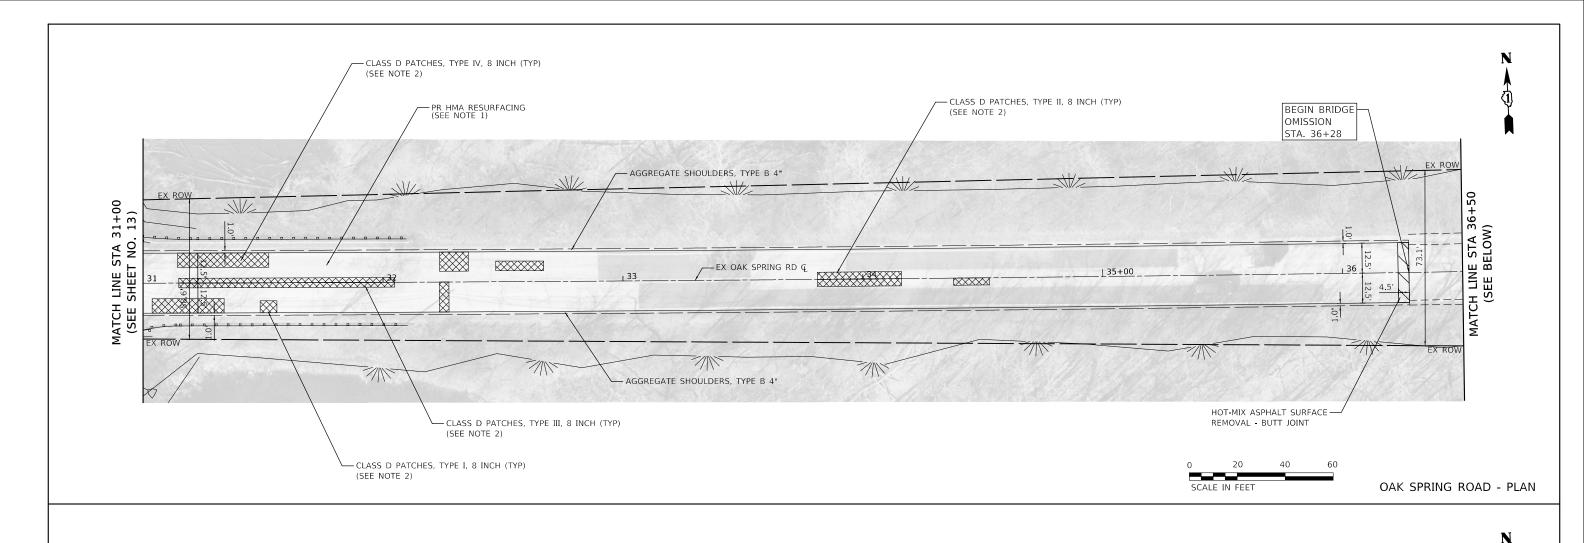

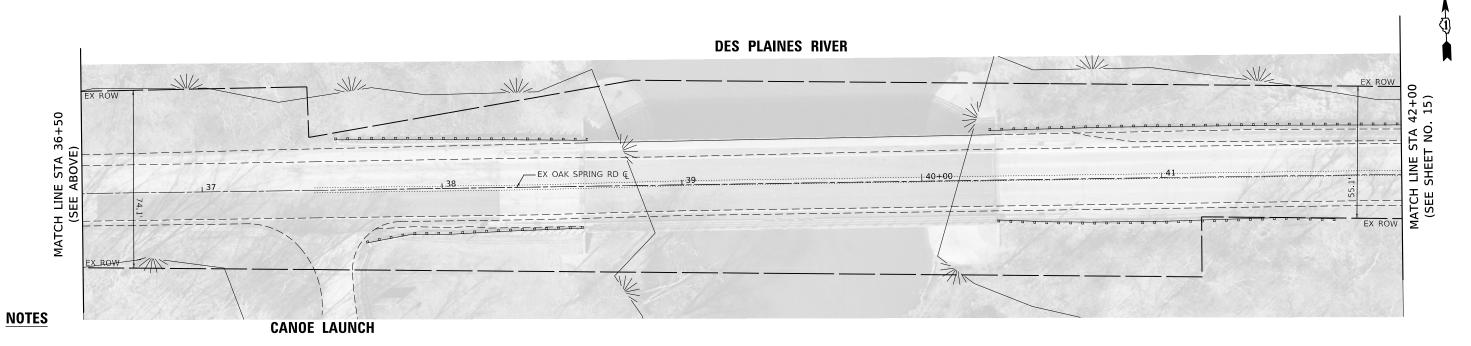


1. PR HMA RESURFACING:
-HOT-MIX ASPHALT SURFACE REMOVAL, 4"
-HOT-MIX ASPHALT SURFACE COURSE, IL-9.5, MIX "D", N50, 1.5"
-HOT-MIX ASPHALT BINDER COURSE, IL-19.0, N50, 2.5"


2. THE LOCATIONS AND DIMENSIONS OF ALL PAVEMENT PATCHING AND CURB AND GUTTER REPLACEMENT SHALL BE DETERMINED BY THE ENGINEER IN THE FIELD. FOR ADDITIONAL DETAILS, SEE CONSTRUTION SEQUENCE NOTES AND OTHER RELEVANT NOTES IN THE GENERAL NOTES ON SHEET NO. 2 & 3.

| USER NAME = nem | DESIGNED - | NEM | REVISED - |
|----------------------------|------------|-----------|-----------|
| | DRAWN - | JRS | REVISED - |
| PLOT SCALE = 40.0000 / in. | CHECKED - | NEM | REVISED - |
| PLOT DATE = 8/17/2025 | DATE - | 5/16/2025 | REVISED - |

STATE OF ILLINOIS
DEPARTMENT OF TRANSPORTATION

| | OAK SPRING ROAD | | | | | | | | | | F.A.U. SECTION | | | COUNTY TOTAL SHEETS | | SHEET NO. |
|-------------|-----------------|---|----|-----|--------|------|-------|---------|-------|------|----------------|----------|----------|---------------------|--------|--------------|
| | ROADWAY PLAN | | | | | | | | | 1234 | 23-00127 | '-00-RS | | LAKE | 36 | 14 |
| | | | nu | ADI | WALFI | -AIN | | | | | | | | CONTRACT | NO. 63 | 1L83 |
| ALE: 1"=20" | SHEET | 3 | OF | 6 | SHEETS | STA. | 31+00 | TO STA. | 42+00 | | | ILLINOIS | FED. AII | D PROJECT | | |

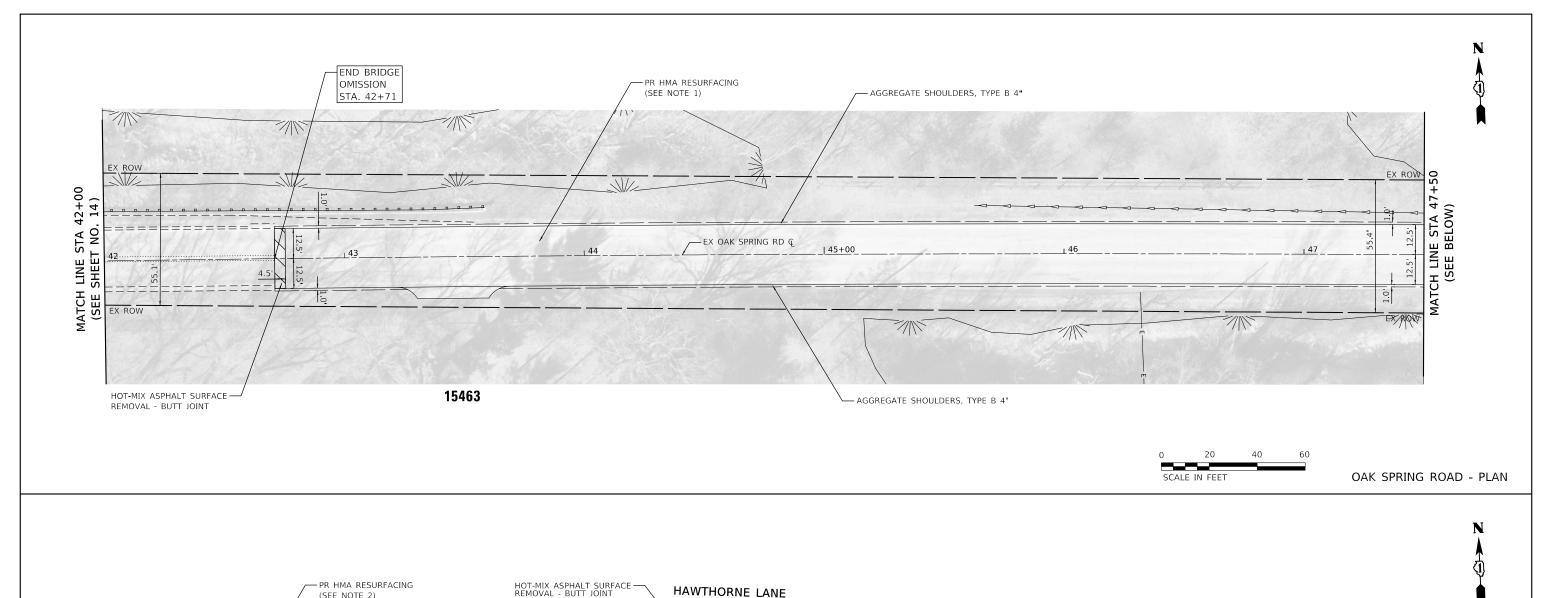

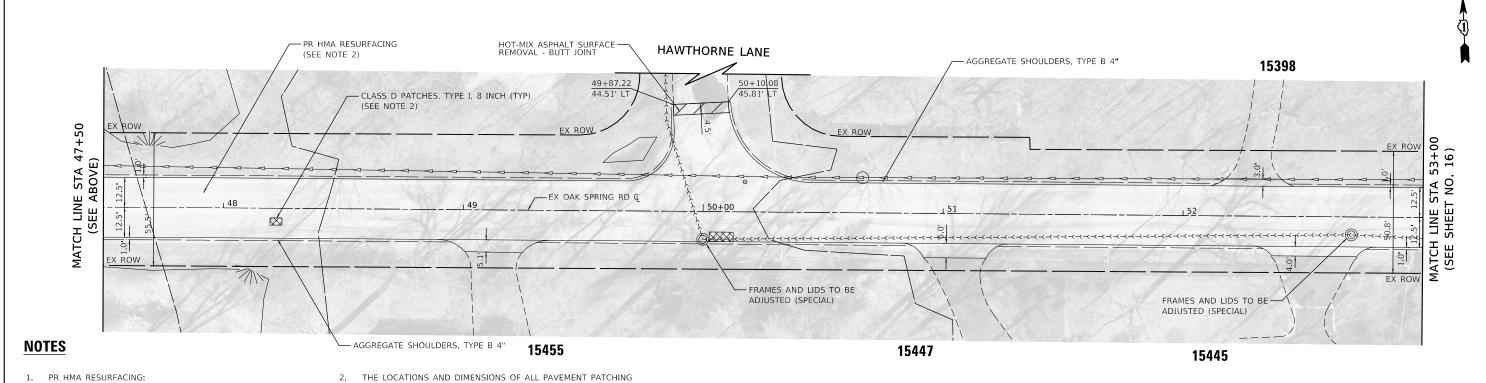



PR HMA RESURFACING:

 HOT-MIX ASPHALT SURFACE REMOVAL, 4"
 HOT-MIX ASPHALT SURFACE COURSE, IL-9.5, MIX "D", N50, 1.5"
 HOT-MIX ASPHALT BINDER COURSE, IL-19.0, N50, 2.5"


THE LOCATIONS AND DIMENSIONS OF ALL PAVEMENT PATCHING AND CURB AND GUTTER REPLACEMENT SHALL BE DETERMINED BY THE ENGINEER IN THE FIELD. FOR ADDITIONAL DETAILS, SEE CONSTRUTION SEQUENCE NOTES AND OTHER RELEVANT NOTES IN THE GENERAL NOTES ON SHEET NO. 2 & 3.

| USER NAME = nem | DESIGNED - NEM | REVISED - | | | OAK SPRING ROAD | | F.A.U. RTF | SECTION | COUNTY | TOTAL SHEET SHEETS NO. |
|------------------------------|------------------|-----------|------------------------------|---------------|--------------------------------|---------------|---------------|----------------|-------------|---------------------------|
| | DRAWN - JRS | REVISED - | STATE OF ILLINOIS | | ROADWAY PLAN | | 1234 | 23-00127-00-RS | LAKE | 36 15 |
| PLOT SCALE = 40,0000 ' / in. | CHECKED - NEM | REVISED - | DEPARTMENT OF TRANSPORTATION | | RUADWAT PLAN | | | | CONTRAC | T NO. 61L83 |
| PLOT DATE = 8/17/2025 | DATE - 5/16/2025 | REVISED - | | SCALE: 1"=20' | SHEET 4 OF 6 SHEETS STA. 42+00 | TO STA. 53+00 | | ILLINOIS FED. | AID PROJECT | |

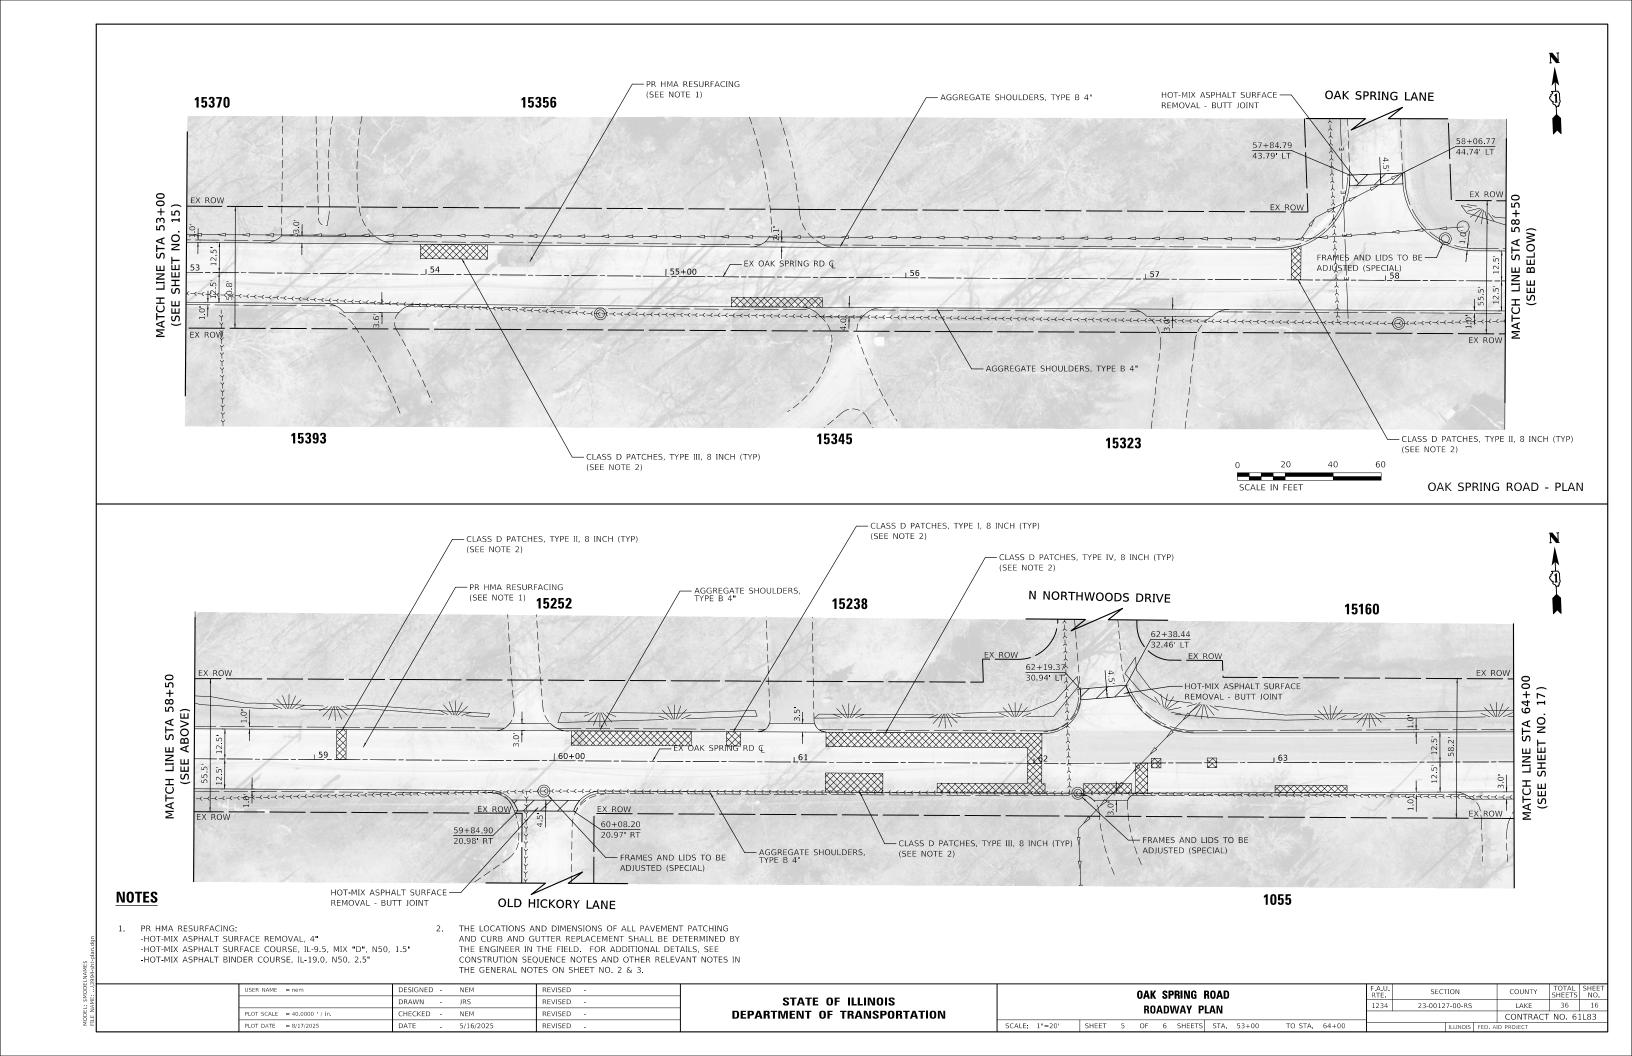

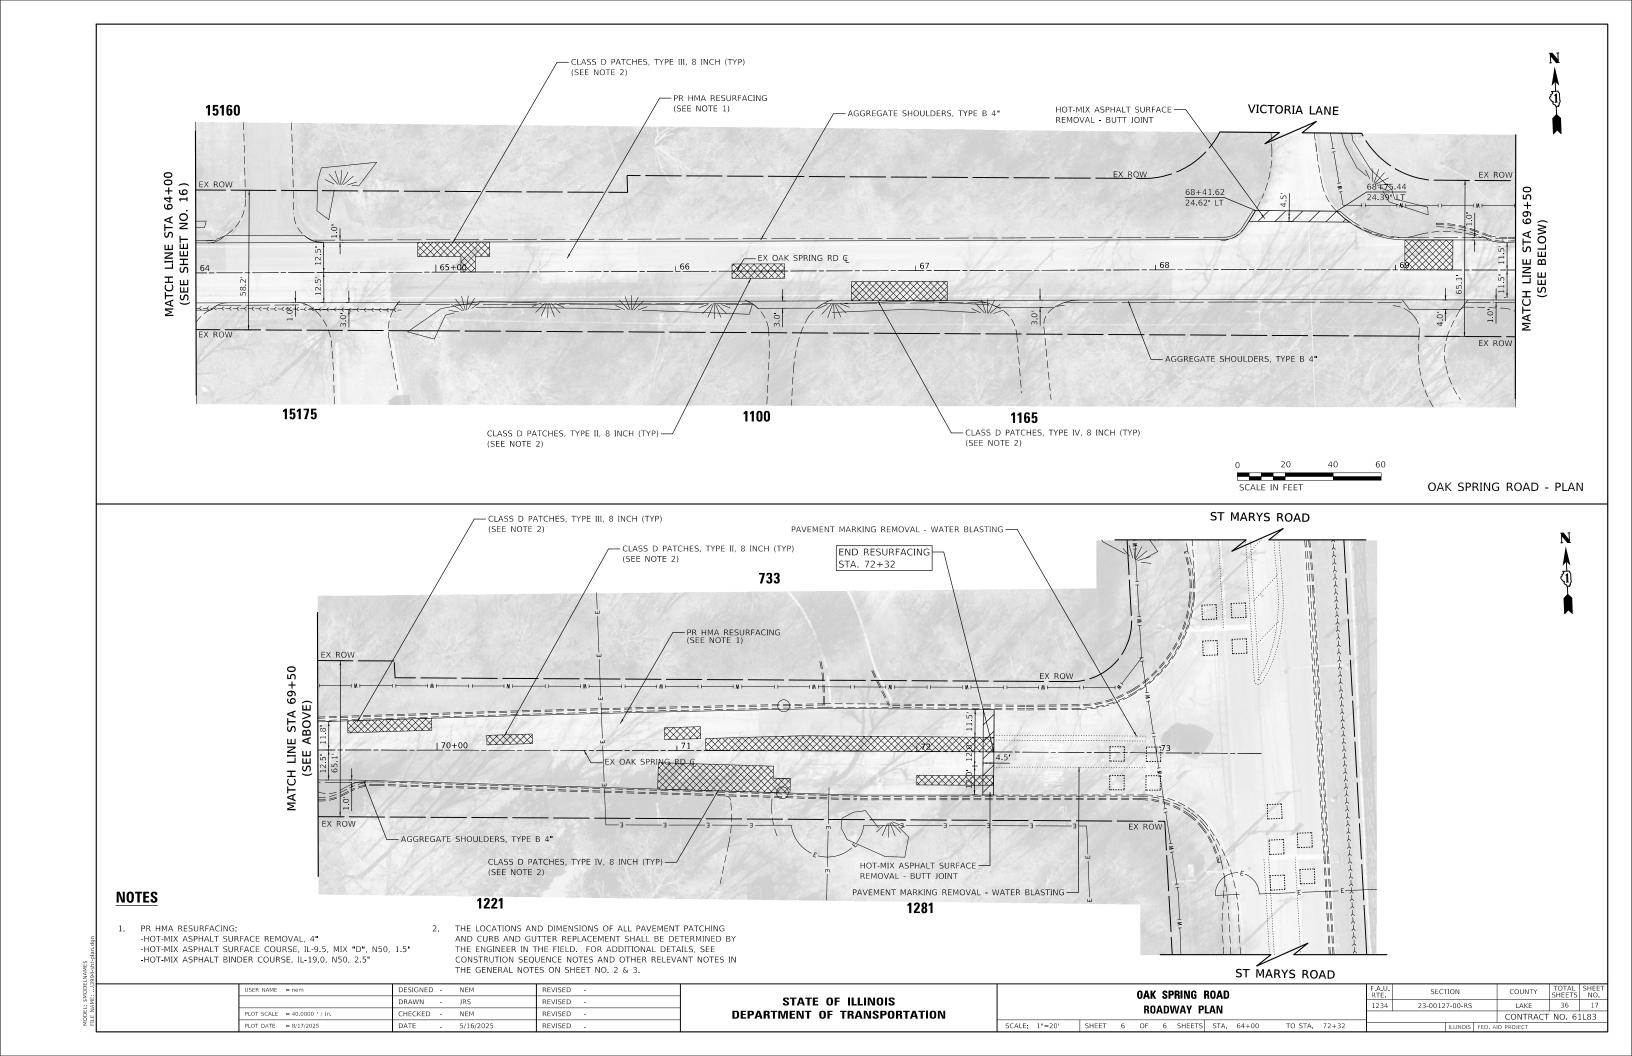


| BIKE PATH CROSSING | | | | | | | | | | | | |
|--------------------|----------|--------|----|-----------|--|--|--|--|--|--|--|--|
| | STATION | OFFSE | Т | ELEVATION | | | | | | | | |
| Α | 30+85.04 | 26.82 | LT | 653.22 | | | | | | | | |
| В | 30+74.04 | 26.82 | LT | 653.25 | | | | | | | | |
| С | 30+85.04 | 19.66 | LT | 653.78 | | | | | | | | |
| D | 30+74.04 | 19.66 | LT | 653.81 | | | | | | | | |
| Е | 30+85.04 | 12.50 | LT | 653.88 | | | | | | | | |
| F | 30+74.04 | 12.50 | LT | 653.91 | | | | | | | | |
| G | 30+75.85 | 12.50' | RT | 654.14 | | | | | | | | |
| Н | 30+76.01 | 16.67 | RT | 654.04 | | | | | | | | |
| I | 30+76.49 | 22.11 | RT | 653.89 | | | | | | | | |
| J | 30+86.86 | 12.50 | RT | 654.10 | | | | | | | | |
| K | 30+87.01 | 16.54 | RT | 654.00 | | | | | | | | |
| L | 30+86.82 | 22.18 | RT | 653.76 | | | | | | | | |

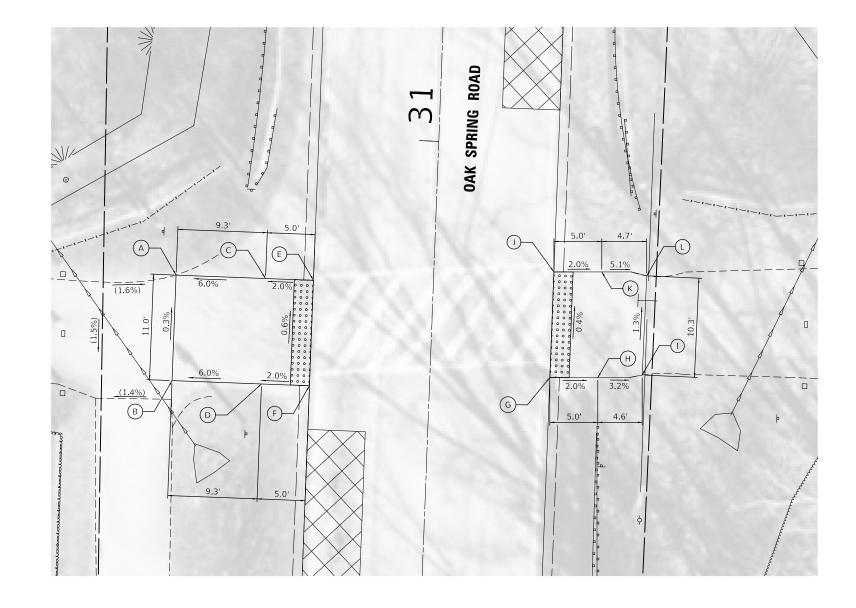




| USER NAME = nem | DESIGNED - | NEM | REVISED - | | | OAK SPRING ROAD | F.A.I RTE | U. SEC | ΓΙΟΝ | COUNTY | TOTAL S | SHEET |
|----------------------------|------------|-----------|-----------|------------------------------|--------------|---------------------|--------------|-----------|-----------------|-------------|---------|-------|
| | DRAWN - | JRS | REVISED - | STATE OF ILLINOIS | | | 123 | 4 23-0012 | 7-00-RS | LAKE | 36 | 18 |
| PLOT SCALE = 10.0000 / in. | CHECKED - | NEM | REVISED - | DEPARTMENT OF TRANSPORTATION | | GRADING PLAN | | | | CONTRACT | NO. 611 | L83 |
| PLOT DATE = 8/17/2025 | DATE - | 5/16/2025 | REVISED - | | SCALE: 1"=5" | SHEET 1 OF 3 SHEETS | | | ILLINOIS FED. A | AID PROJECT | | |

| EAST BEACH ENTRANCE | | | | | | | | | | | |
|---------------------|----------|-----------|-----------|--|--|--|--|--|--|--|--|
| | STATION | OFFSET | ELEVATION | | | | | | | | |
| Α | 29+24.52 | 26.07'LT | 653.65 | | | | | | | | |
| В | 29+19.56 | 26.81'LT | 653.66 | | | | | | | | |
| С | 29+11.70 | 26.81'LT | 653.69 | | | | | | | | |
| D | 29+24.52 | 18.74'LT | 653.80 | | | | | | | | |
| Е | 29+19.56 | 19.38'LT | 653.79 | | | | | | | | |
| F | 29+14.56 | 19.38'LT | 653.79 | | | | | | | | |
| G | 28+90.60 | 26.81'LT | 653.49 | | | | | | | | |
| Н | 28+83.66 | 26.81'LT | 653.47 | | | | | | | | |
| I | 28+78.67 | 26.43' LT | 653.46 | | | | | | | | |
| J | 28+88.66 | 19.38 LT | 653.62 | | | | | | | | |
| К | 28+83.66 | 19.38 LT | 653.61 | | | | | | | | |
| L | 28+78.67 | 19.25'LT | 653.61 | | | | | | | | |

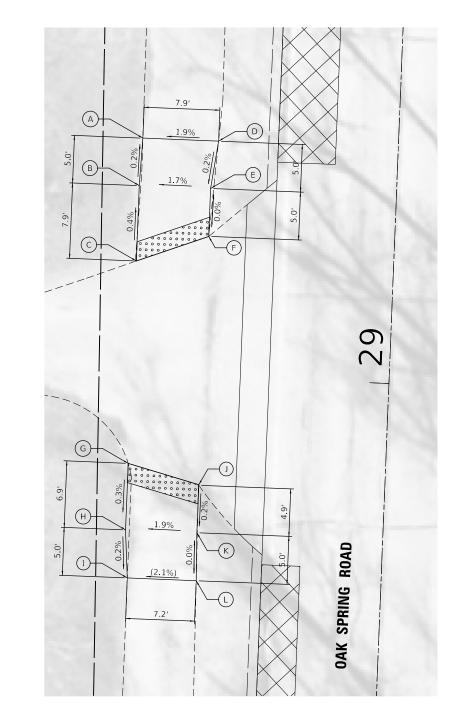

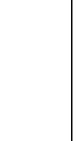

COUNTY TOTAL SHEET NO.

LAKE 36 19


CONTRACT NO. 61L83 F.A.U. RTE. 1234 SECTION 23-00127-00-RS

| USER NAME = nem | DESIGNED - | NEM | REVISED - |
|----------------------------|------------|-----------|-----------|
| | DRAWN - | JRS | REVISED - |
| PLOT SCALE = 10.0000 / in. | CHECKED - | NEM | REVISED - |
| PLOT DATE = 8/17/2025 | DATE - | 5/16/2025 | REVISED - |
| | | | |

STATE OF ILLINOIS
DEPARTMENT OF TRANSPORTATION


OAK SPRING ROAD **GRADING PLAN** SCALE: 1"=5' SHEET 2 OF 3 SHEETS


| | WEST BEACH ENTRANCE | | | | | | | | | | | |
|---|---------------------|----------|-----------|--|--|--|--|--|--|--|--|--|
| | STATION | OFFSET | ELEVATION | | | | | | | | | |
| А | 24+60.39 | 29.46'LT | 654.40 | | | | | | | | | |
| В | 24+52.39 | 29.90'LT | 654.41 | | | | | | | | | |
| С | 24+48.30 | 30.12'LT | 654.41 | | | | | | | | | |
| D | 24+60.39 | 21.78'LT | 654.49 | | | | | | | | | |
| Е | 24+55.39 | 22.00'LT | 654.48 | | | | | | | | | |
| F | 24+50.39 | 22.00'LT | 654.48 | | | | | | | | | |
| G | 24+24.23 | 30.23'LT | 654.52 | | | | | | | | | |
| Н | 24+20.67 | 30.23'LT | 654.52 | | | | | | | | | |
| I | 24+18.30 | 30.40'LT | 654.53 | | | | | | | | | |
| J | 24+22.67 | 24.39'LT | 654.56 | | | | | | | | | |
| К | 24+20.67 | 24.39'LT | 654.58 | | | | | | | | | |
| L | 24+18.30 | 24.57'LT | 654.59 | | | | | | | | | |

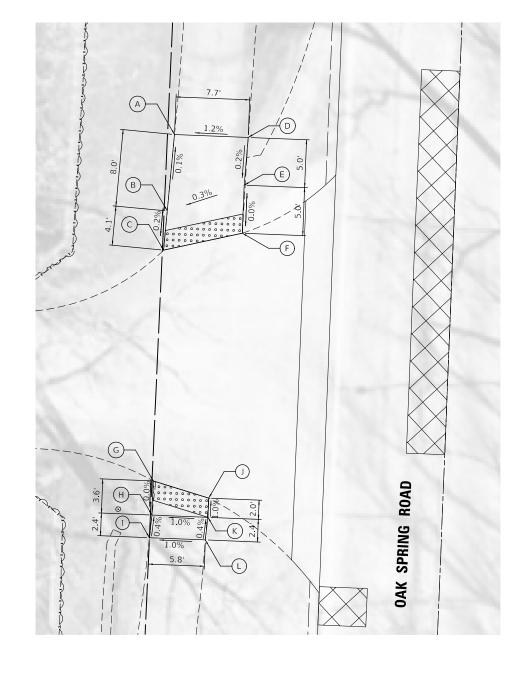






| USER NAME = nem | DESIGNED - NEM | REVISED - | | | OAK SPRING ROAD | F.A.U. RTF | SECTION | COUNTY | TOTAL SHEET |
|------------------------------|------------------|-----------|------------------------------|--------------|---------------------|---------------|-----------------|-------------|-------------|
| | DRAWN - JRS | REVISED - | STATE OF ILLINOIS | | GRADING PLAN | 1234 | 23-00127-00-RS | LAKE | 36 20 |
| PLOT SCALE = 10.0000 ' / in. | CHECKED - NEM | REVISED - | DEPARTMENT OF TRANSPORTATION | | UNADING FLAN | | | CONTRAC | T NO. 61L83 |
| PLOT DATE = 8/17/2025 | DATE - 5/16/2025 | REVISED - | | SCALE: 1"=5" | SHEET 3 OF 3 SHEETS | | ILLINOIS FED. A | AID PROJECT | |

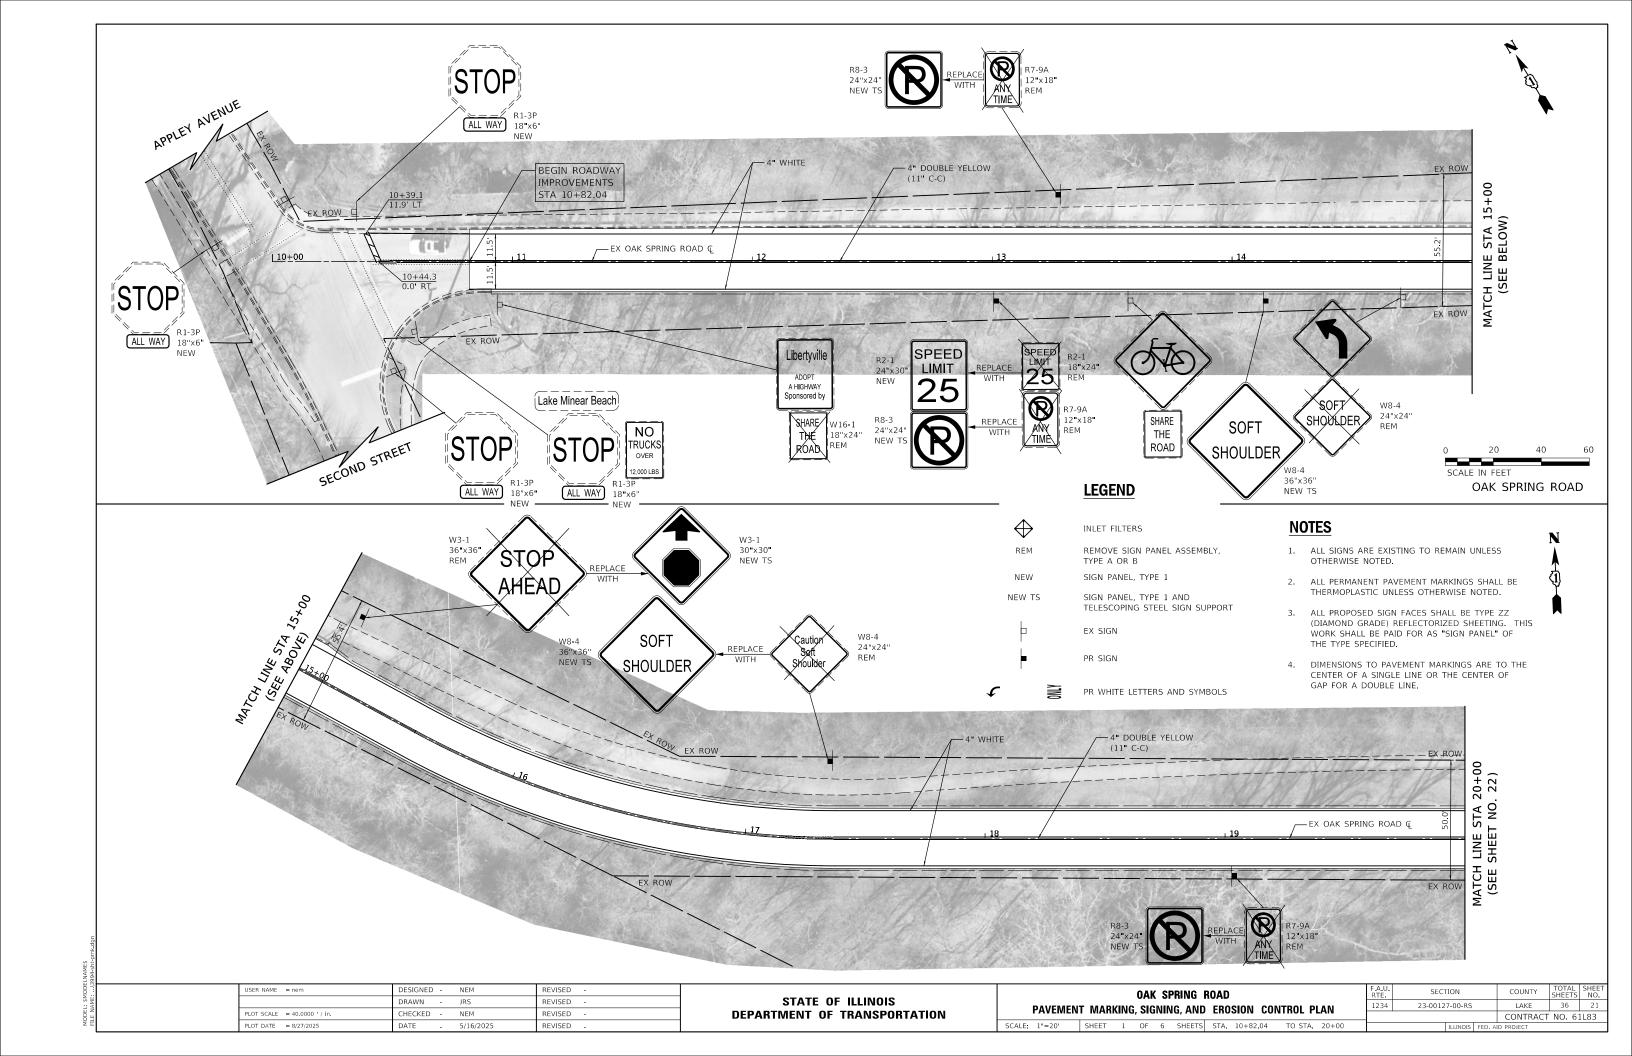


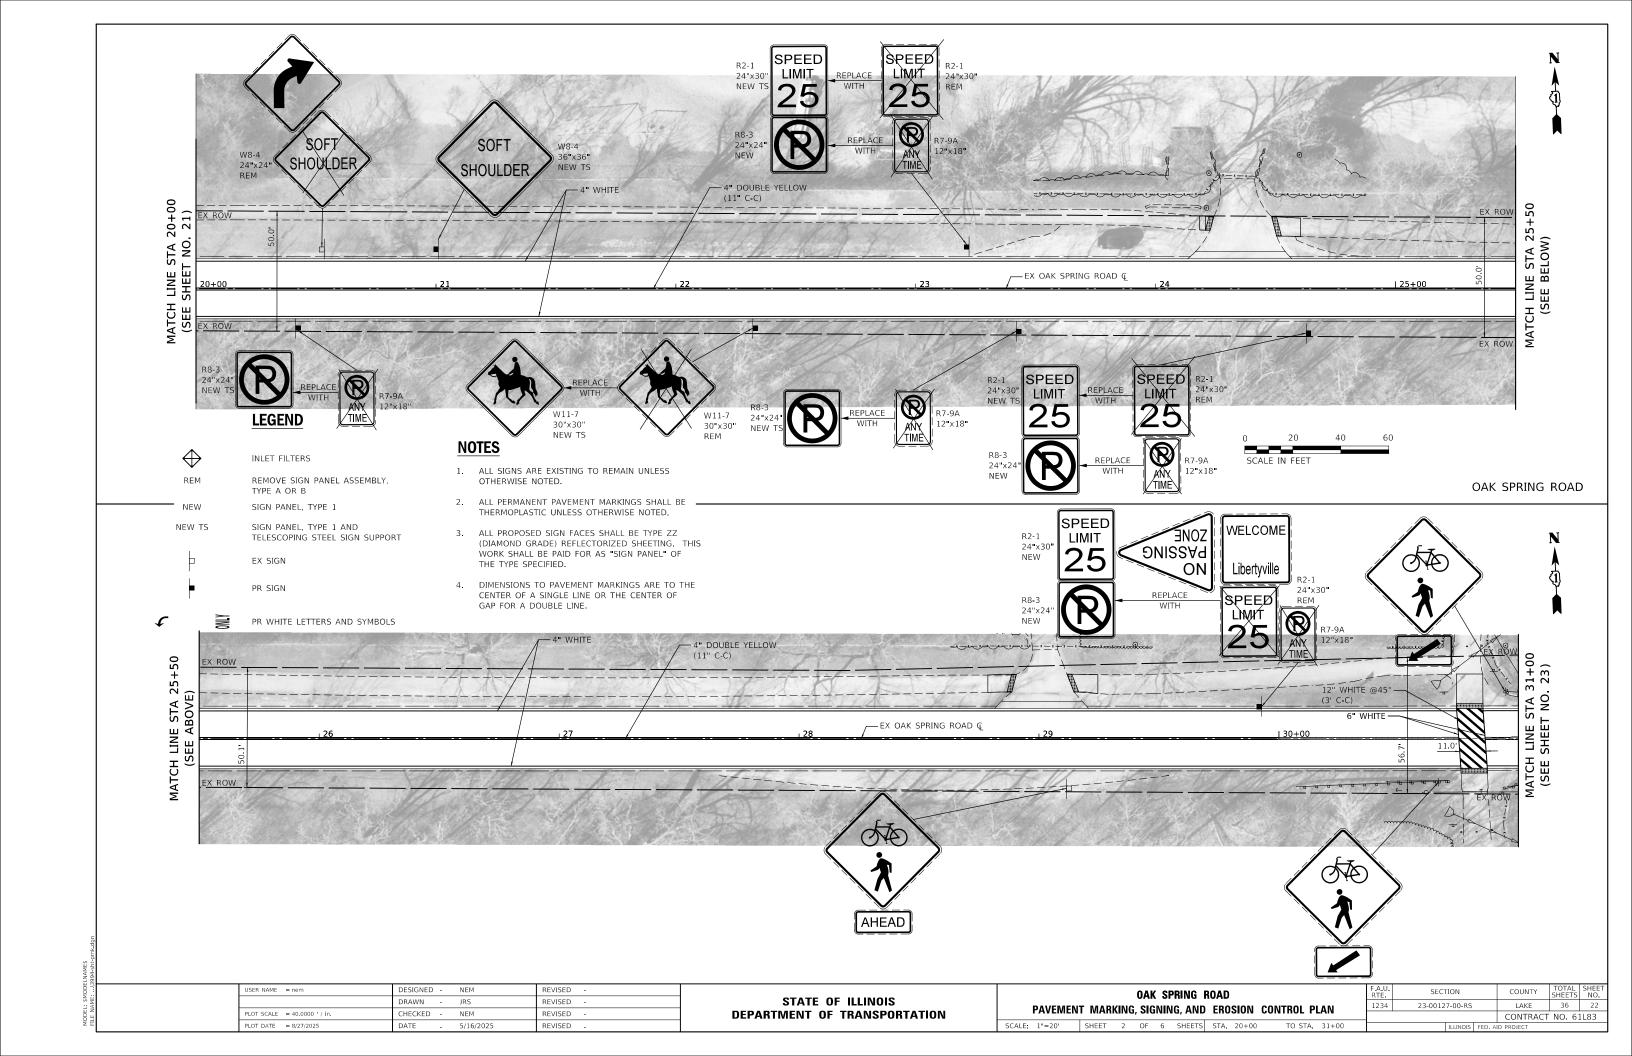


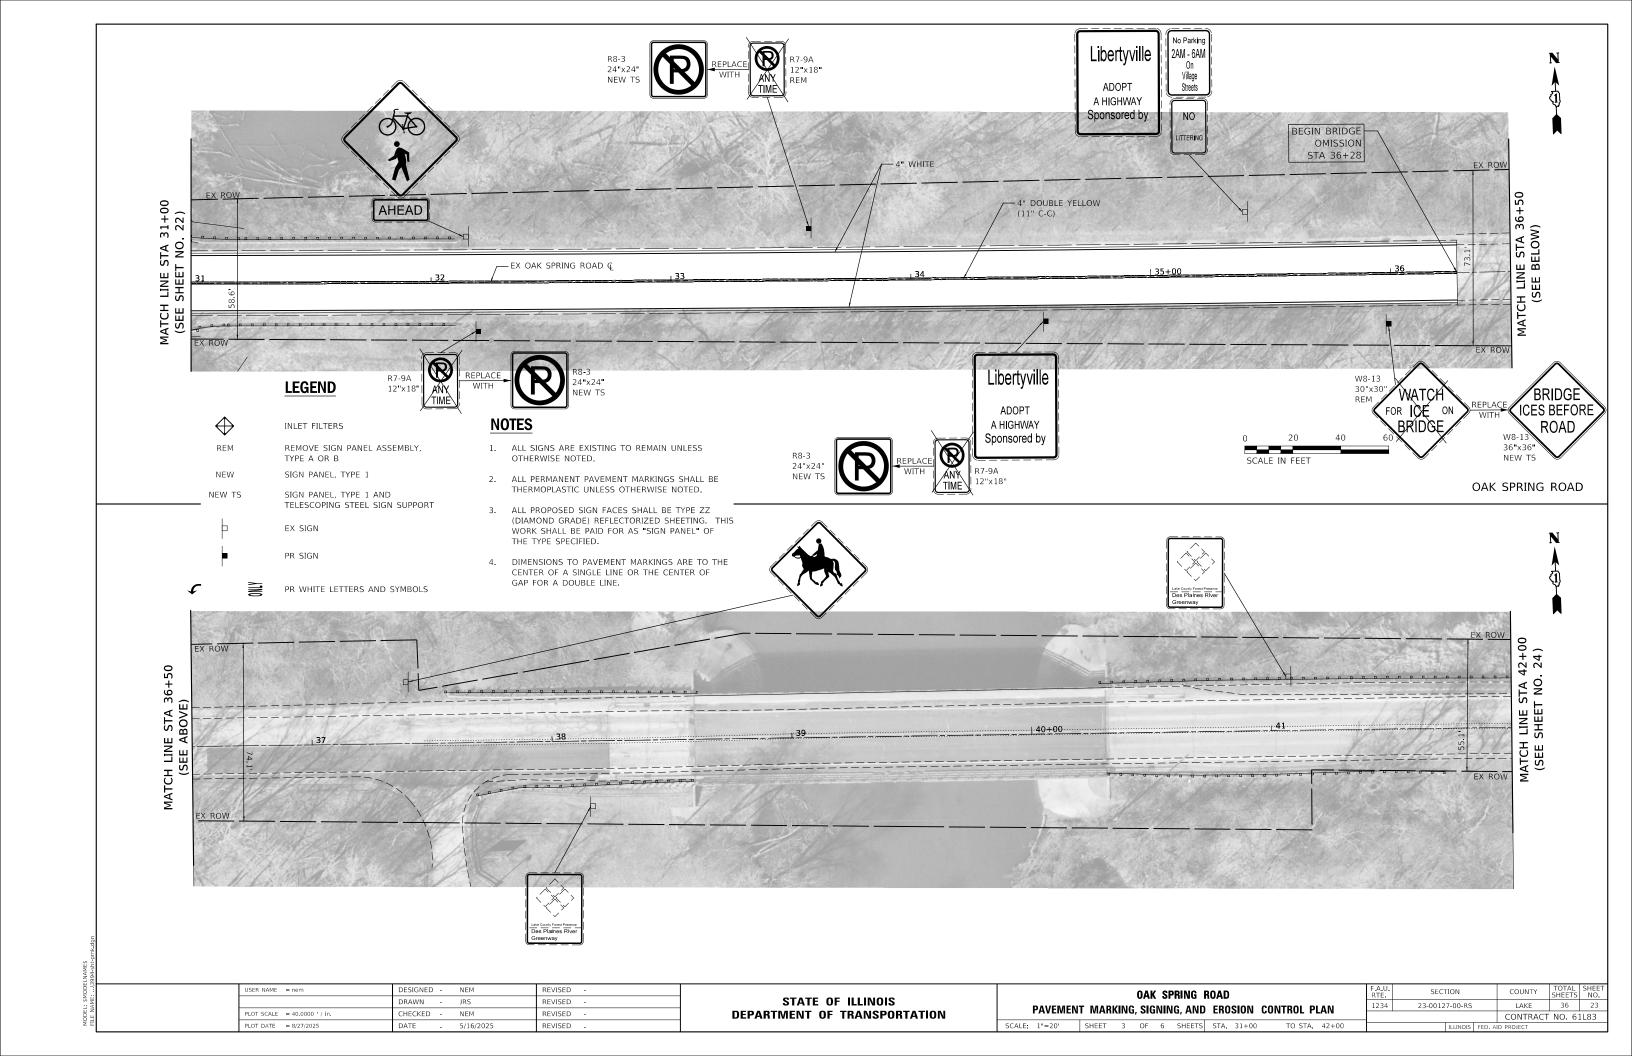

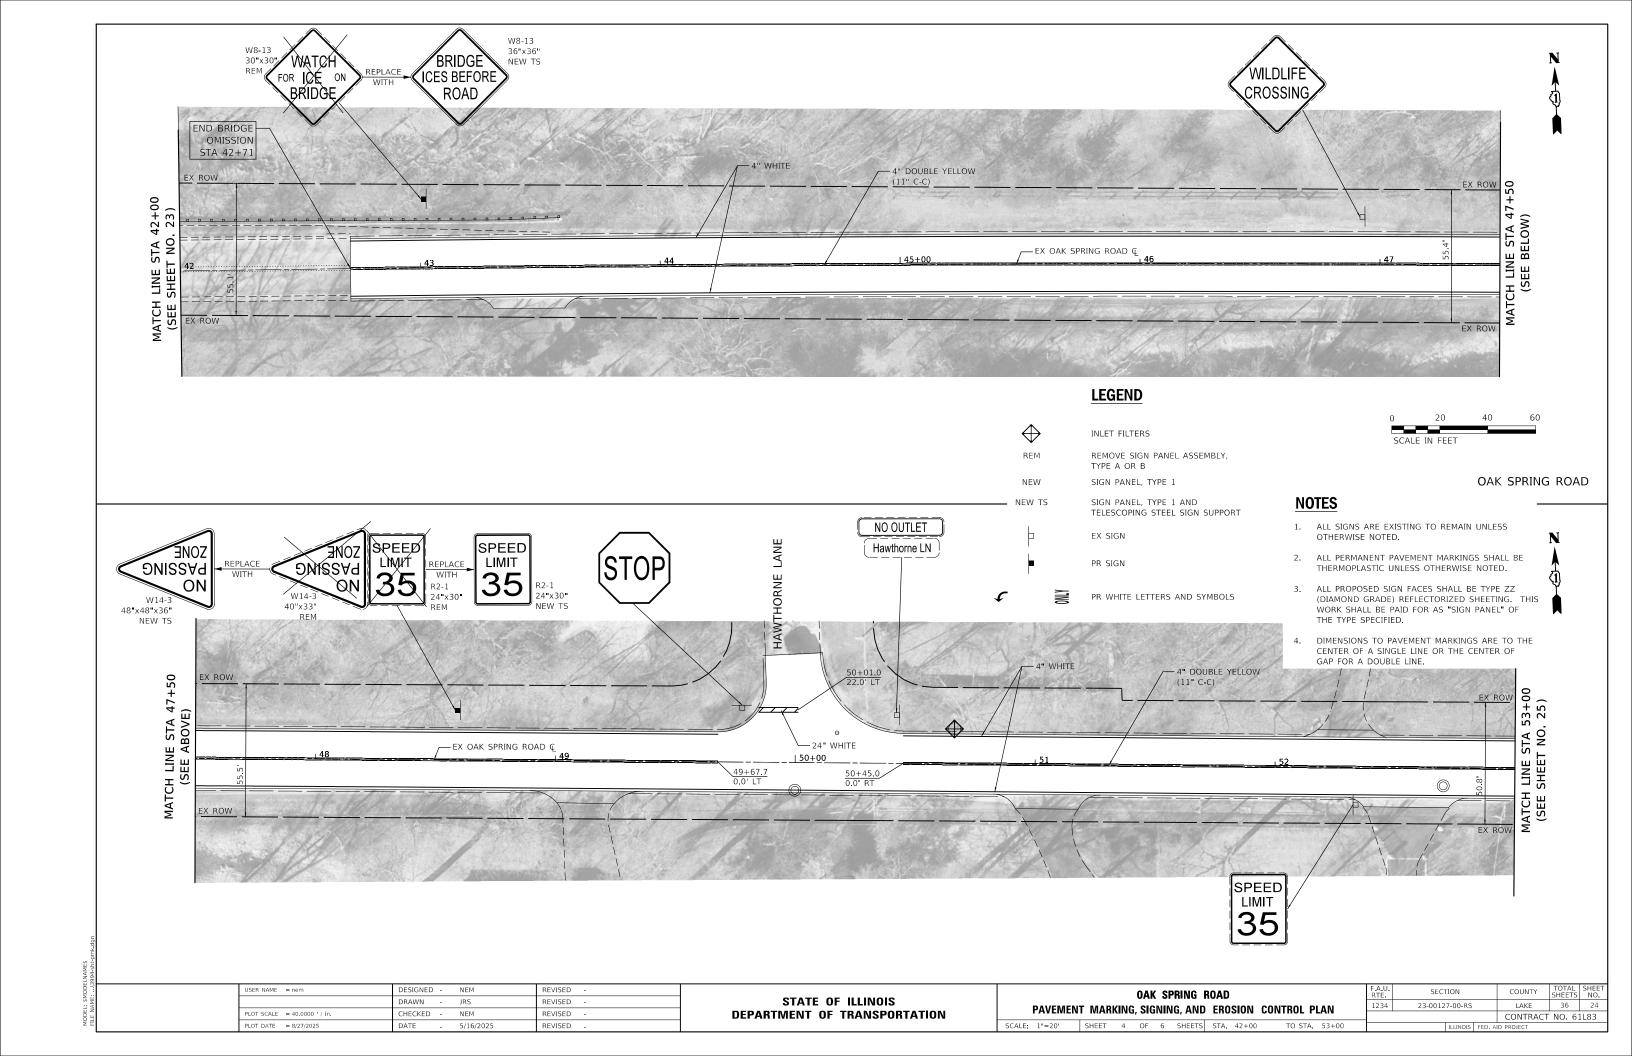

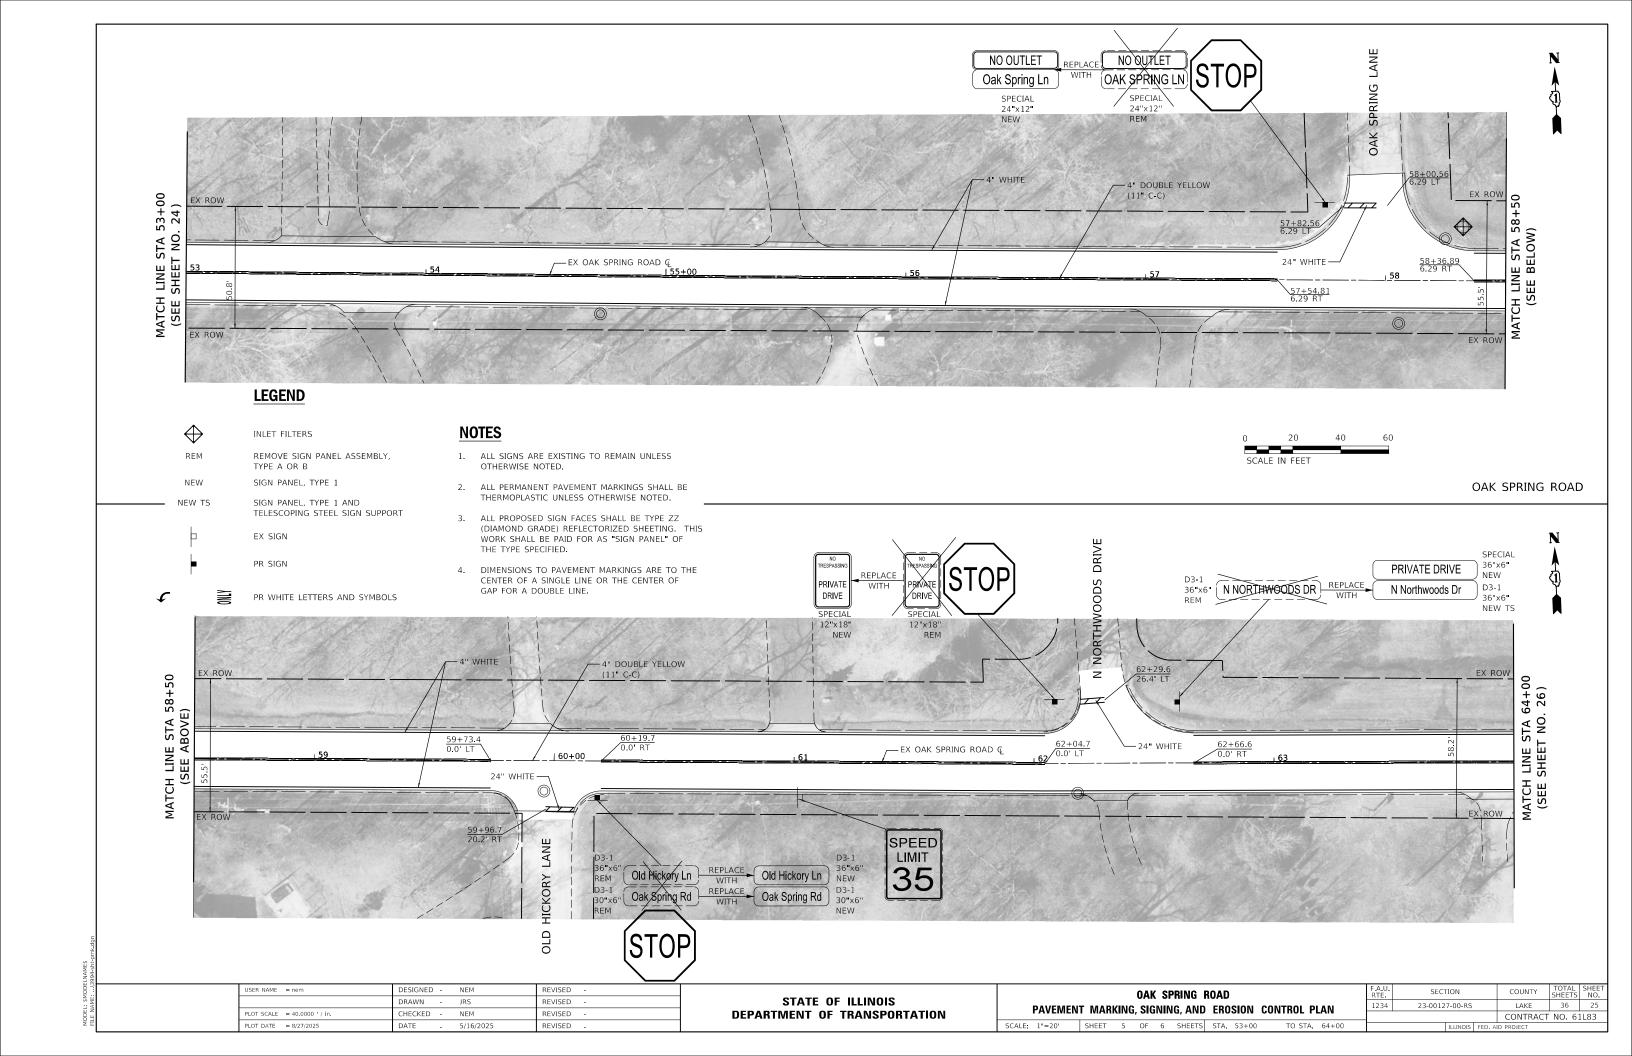

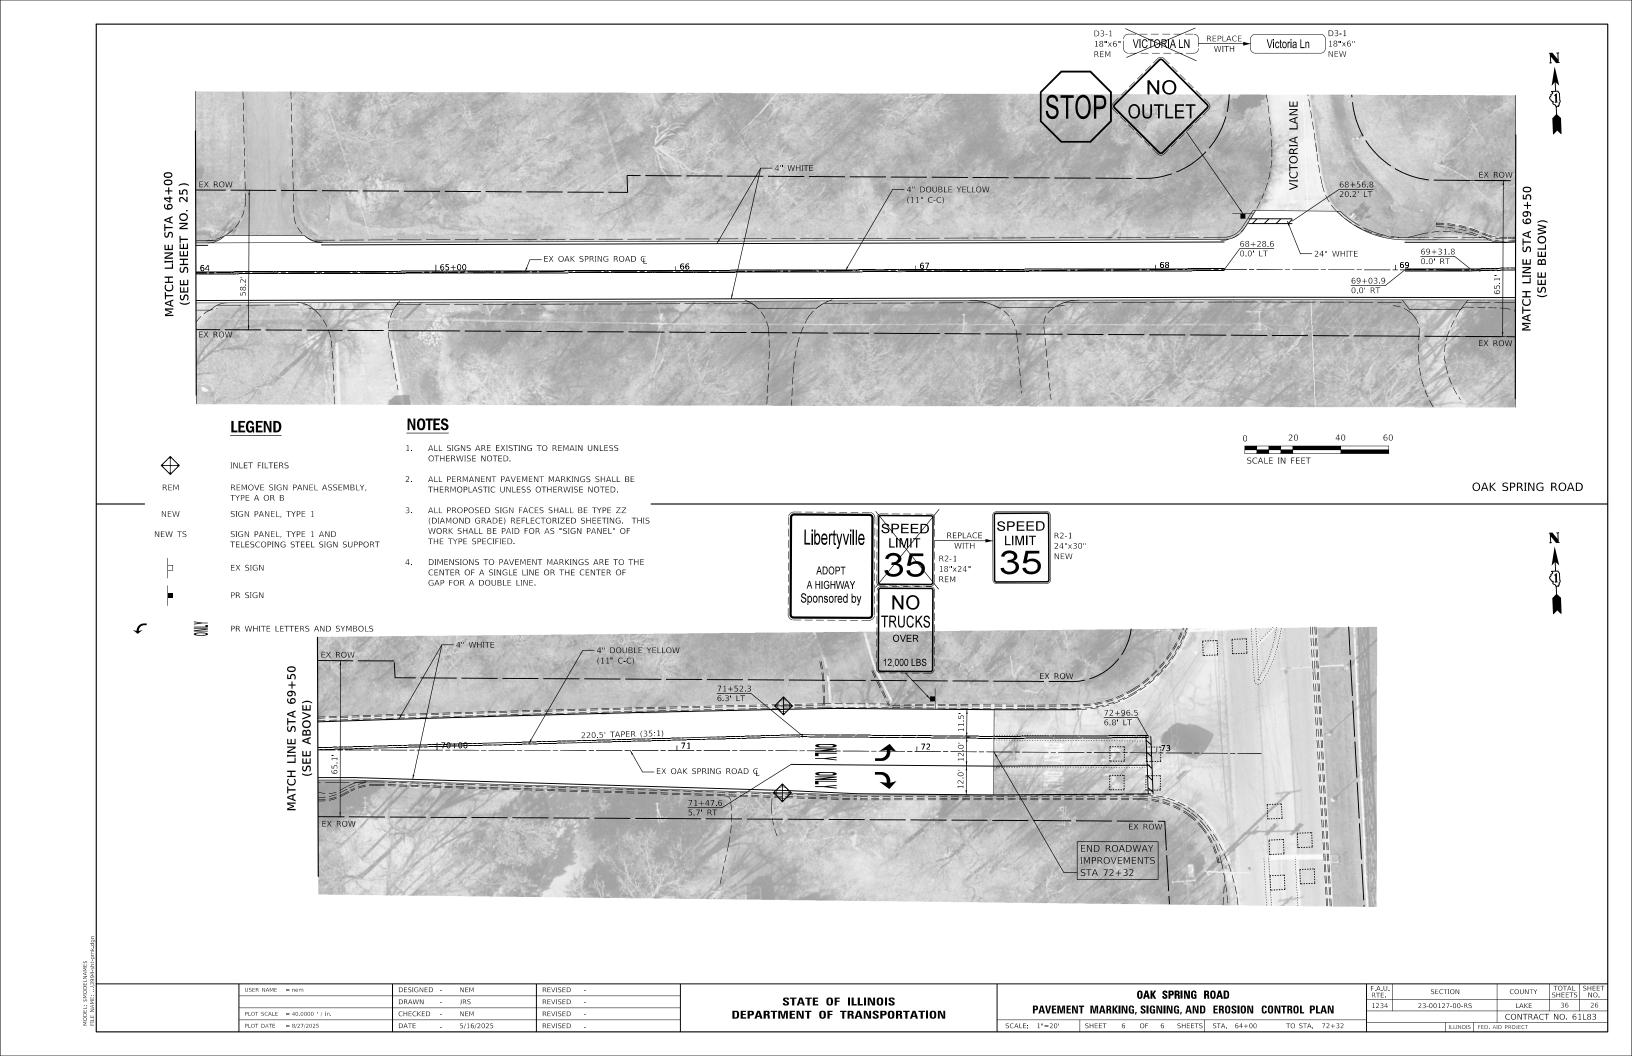


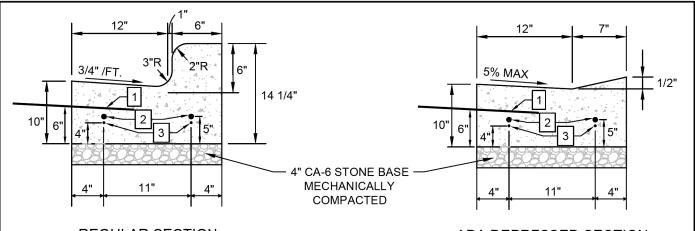

REGULAR SECTION

ADA DEPRESSED SECTION

- 24" LONG #6 (3") EPOXY-COATED, DEFORMED TIE BARS, GRADE 60 INSTALLED 24" ON-CENTER, EMBEDDED 8" AND EPOXIED IN PLACE (FOR P.C.C. PAVEMENT ONLY).
- TWO (2) #8 EPOXY COATED SMOOTH DOWEL BARS WITH GREASED CAPS TO BE INSTALLED AT ALL EXPANSION JOINTS
- TWO (2) #4 ($\frac{1}{2}$ ") EPOXY COATED DEFORMED CONTINUOUS STEEL REINFORCEMENT BARS ARE TO BE INSTALLED ALONG THE ENTIRE LENGTH OF THE CURB ONLY TO BE INTERRUPTED AT EXPANSION JOINTS. SUPPORT BARS WITH CHAIRS EVERY FIVE (5) FEET, MINIMUM OF TWO (2) CHAIRS.

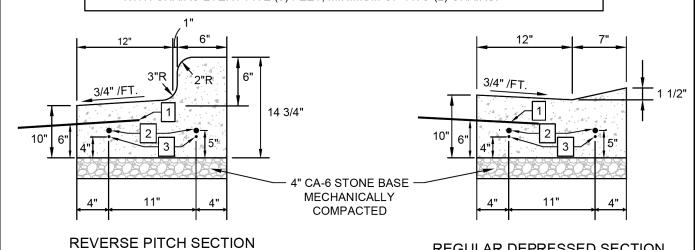


NOTES:

- 1. EXPANSION JOINTS TO BE SET AT ALL PC'S, PT'S, FIVE (5) FEET ON EITHER SIDE OF ANY FRAMES, AND AT 45' MAX. INTERVALS. ADDITIONAL LOCATIONS MAY BE SPECIFIED BY THE ENGINEER.
- 2. CONTRACTION JOINTS ARE TO BE CONSTRUCTED AT 15' MAX. INTERVALS AND AT ADDITIONAL LOCATIONS AS MAY BE SPECIFIED BY ENGINEER.
- 3. ANY CONTINUOUS CURB REMOVALS OF TEN (10) FEET OR GREATER IN LENGTH SHALL HAVE CONTINUOUS STEEL REINFORCEMENT BARS PER 3 ABOVE. REMOVALS LESS THAN TEN (10) FEET IN LENGTH SHALL ONLY HAVE DOWEL BARS INSTALLED AT ENDS PER 2 ABOVE.

B6.12 CURB & GUTTER



REGULAR DEPRESSED SECTION

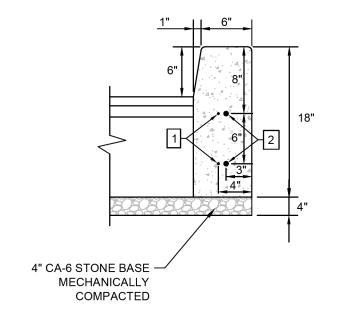

- TWO (2) #4 (2") EPOXY COATED DEFORMED CONTINUOUS STEEL REINFORCEMENT BARS ARE TO BE INSTALLED ALONG THE ENTIRE LENGTH OF THE CURB ONLY TO BE INTERRUPTED AT EXPANSION JOINTS. SUPPORT BARS WITH CHAIRS EVERY FIVE (5) FEET, MINIMUM OF TWO (2) CHAIRS.
- TWO (2) #8 EPOXY COATED SMOOTH DOWEL BARS WITH GREASED CAPS TO BE **INSTALLED AT ALL EXPANSION JOINTS**

NOTES:

- 1. EXPANSION JOINTS TO BE SET AT ALL PC'S, PT'S, FIVE (5) FEET ON EITHER SIDE OF ANY FRAMES, AND AT 45' MAX. INTERVALS. ADDITIONAL LOCATIONS MAY BE SPECIFIED BY THE ENGINEER.
- 2. CONTRACTION JOINTS ARE TO BE CONSTRUCTED AT 15' MAX. INTERVALS AND AT ADDITIONAL LOCATIONS AS MAY BE SPECIFIED BY ENGINEER.
- 3. ANY CONTINUOUS CURB REMOVALS OF TEN (10) FEET OR GREATER IN LENGTH SHALL HAVE CONTINUOUS STEEL REINFORCEMENT BARS PER 1 ABOVE. REMOVALS LESS THAN TEN (10) FEET IN LENGTH SHALL ONLY HAVE DOWEL BARS INSTALLED AT ENDS PER 2 ABOVE.


TYPE B BARRIER CURB

| <u></u> | Libertyville |
|--------------------------------|--------------------------|
| LAST REVISED: 02/15/2023 | STANDARD DETAIL PAV - 04 |

| USER NAME = nem | DESIGNED - | NEM | REVISED - |
|---------------------------|------------|-----------|-----------|
| | DRAWN - | JRS | REVISED - |
| PLOT SCALE = 2.0000 / in. | CHECKED - | NEM | REVISED - |
| PLOT DATE = 8/17/2025 | DATE - | 5/16/2025 | REVISED - |
| | | | |

| STATE C | F ILLINOIS |
|---------------|----------------|
| DEPARTMENT OF | TRANSPORTATION |


| OAK SPRING ROAD | | SECT | ION | | COUNTY | TOTAL SHEETS | SHEET NO. |
|----------------------|------|---------|----------|-------|-----------|-----------------|--------------|
| CONSTRUCTION DETAILS | 1234 | 23-0012 | LAKE | 36 | 27 | | |
| | | | | | CONTRACT | NO. 6 | 1L83 |
| 1 OF 4 SHEETS | | | ILLINOIS | FED A | D PROJECT | | |

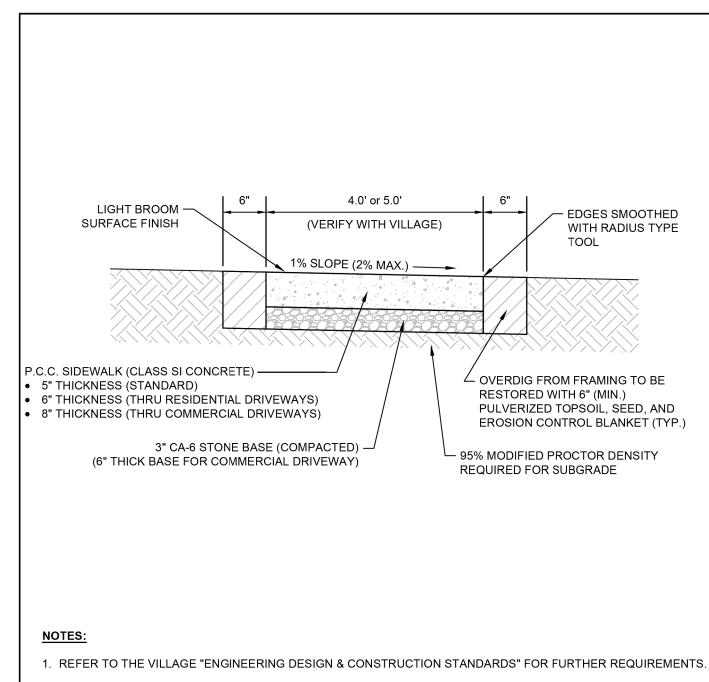

- 2. PROVIDE $\frac{1}{2}$ " THICK FIBER EXPANSION JOINTS AT POINTS ABUTTING CURB OR PAVEMENT AND AT 50-FOOT MAXIMUM INTERVALS.
- 3. CONTROL JOINTS SHALL BE $\frac{1}{8}$ " TO $\frac{1}{4}$ " WIDE AND 1/4 OF THE SIDEWALK THICKNESS DEEP. THE EDGE OF THE CONTROL JOINTS SHALL BE GIVEN A $\frac{1}{4}$ " RADIUS.
- 4. CONTROL JOINTS TO BE PROVIDED AT 5' ON-CENTER SPACING. SPACING CAN BE INCREASED FOR SIDEWALKS IN EXCESS OF 5-FOOT IN WIDTH AS DIRECTED BY THE ENGINEER.
- 5. PLACING, FINISHING, AND CURING OF P.C.C. SIDEWALK SHALL MEET THE REQUIREMENTS OF SECTION 424 OF THE STANDARD SPECIFICATIONS FOR ROAD AND BRIDGE CONSTRUCTION.

P.C.C. SIDEWALK



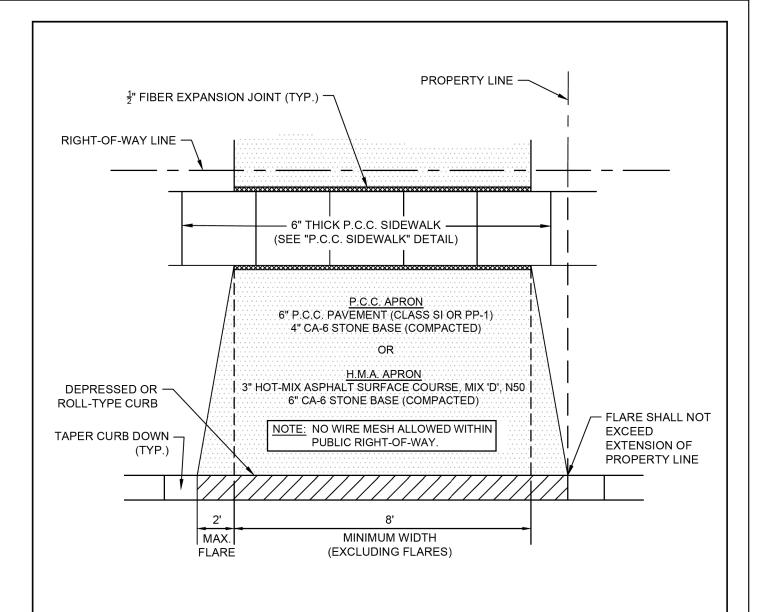

NOTES:

- 1. ALL EXISTING ABUTTING EXPANSION JOINT MATERIAL SHALL BE REMOVED AND REPLACED.
- 2. WHITE CURING COMPOUND, PER IDOT SECTION 1022.01(C), SHALL BE APPLIED TO THE CONCRETE IMMEDIATELY AFTER IT HAS BEEN FINISHED OR PER MANUFACTURER'S RECOMMENDATION.
- 3. DRIVEWAY FLARE SHALL BE A MAXIMUM OF 2-FEET WIDE AS MEASURED FROM THE SIDEWALK TO THE BACK-OF-CURB. IF NO SIDEWALK EXISTS, THE WIDTH OF THE FLARE SHALL BE MEASURED FROM A POINT 6-FEET BEHIND THE BACK-OF-CURB TO THE BACK-OF-CURB.
- PRE-POUR INSPECTION REQUIRED BY THE ENGINEERING DIVISION PRIOR TO PLACEMENT OF PAVEMENT AFTER FORMING IS IN PLACE. PLEASE CALL (847) 918-2020 TO SCHEDULE INSPECTIONS.

RESIDENTIAL DRIVEWAY APRON

SHEET 2 OF

| <u></u> <u> </u> | Libertyville |
|------------------|-------------------|
| LAST REVISED: | STANDARD DETAIL # |
| 02/15/2023 | PAV - 07 |

| USER NAME = nem | DESIGNED - | NEM | REVISED - |
|---------------------------|------------|-----------|-----------|
| | DRAWN - | JRS | REVISED - |
| PLOT SCALE = 2.0000 / in. | CHECKED - | NEM | REVISED - |
| PLOT DATE = 8/17/2025 | DATE - | 5/16/2025 | REVISED - |
| | | | |


STATE OF ILLINOIS
DEPARTMENT OF TRANSPORTATION

| OAK SPRING ROAD | | SECTIO | N | | COUNTY | TOTAL SHEETS | SHEET NO. |
|----------------------|------|------------|-------|---------|-----------|-----------------|--------------|
| CONSTRUCTION DETAILS | 1234 | 23-00127-0 | 00-RS | | LAKE | 36 | 28 |
| | | | | | CONTRACT | NO. 63 | L83 |
| 2 OF 4 SHEETS | | ILL | INOIS | FED. AI | D PROJECT | | |

MODEL: SMODELNAMES






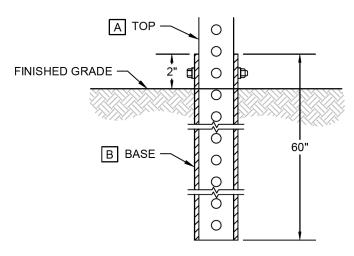

- A TOP 2" x 2" x VARIABLE LENGTH
- B BASE FOR GROUND MOUNT 2" x 2" x 60"
- C SLEEVE FOR PAVEMENT MOUNT 2-1/2" x 2-1/2" x 18"
- D BASE FOR PAVEMENT MOUNT 2-1/4" x 2-1/4" x 36"



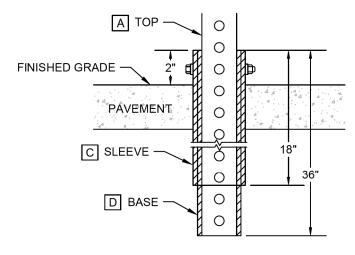

NOTES:

- 1. INSTALLATION HEIGHTS OF ALL SIGNAGE SHALL BE IN ACCORDANCE STATE OR OTHER APPLICABLE REGULATIONS.
- 2. ALL BOLTS AND OTHER ASSEMBLY MATERIAL SHALL BE IN ACCORDANCE WITH MANUFACTURER'S SPECIFICATIONS.
- 3. IF A SURFACE ANCHOR BOLT MOUNT IS REQUIRED, INSTALLATION SHALL BE PERFORMED IN ACCORDANCE WITH MANUFACTURER'S SPECIFICATIONS.

SIGN POST

& Libertyville

REVISED: 02/15/2023


STANDARD DETAIL # PAV - 10

| USER NAME = nem | DESIGNED | - | NEM | REVISED - |
|-----------------------------|----------|---|-----------|-----------|
| | DRAWN | - | JRS | REVISED - |
| PLOT SCALE = 2.0000 ' / in. | CHECKED | - | NEM | REVISED - |
| PLOT DATE = 8/17/2025 | DATE | - | 5/16/2025 | REVISED - |

| STATE OF ILLINOIS |
|------------------------------|
| DEPARTMENT OF TRANSPORTATION |

| OAK SPRING ROAD | | F.A.U. SECTION | | | COUNTY | TOTAL SHEETS | SHEET NO. |
|----------------------|------|----------------|---------|-------|-----------|-----------------|--------------|
| CONSTRUCTION DETAILS | 1234 | 23-00127-00-RS | | | LAKE | 36 | 29 |
| | | | | | CONTRACT | NO. 6 | 1L83 |
| 3 OF 4 SHEETS | | | TLUMOTO | CCD A | D DDOLECT | | - |

SHEET 3

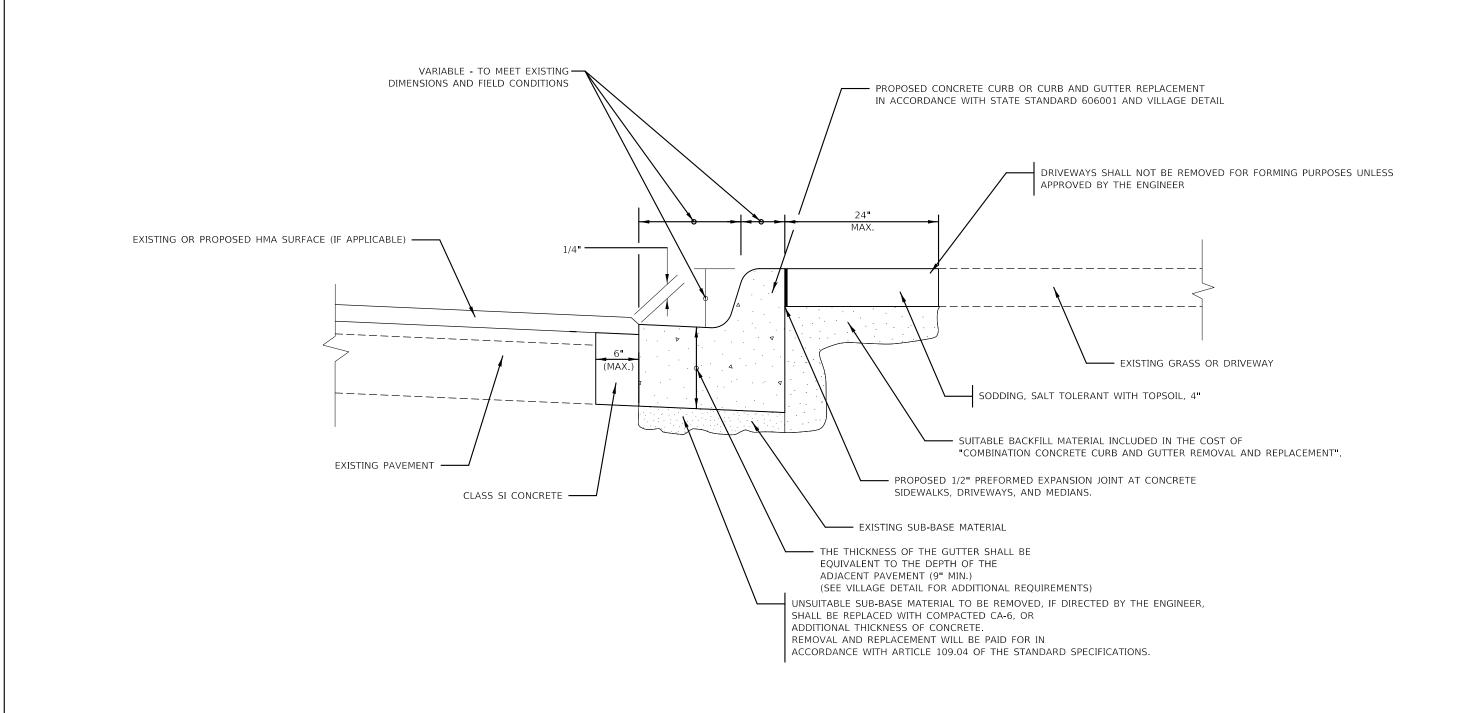


CURB AND GUTTER REMOVAL AND REPLACEMENT DETAIL

| USER NAME = nem | DESIGNED - | NEM | REVISED - |
|------------------------------|------------|-----------|-----------|
| | DRAWN - | JRS | REVISED - |
| PLOT SCALE = 20.0000 ' / in. | CHECKED - | NEM | REVISED - |
| PLOT DATE = 8/17/2025 | DATE - | 5/16/2025 | REVISED - |

STATE OF ILLINOIS DEPARTMENT OF TRANSPORTATION

| | F.A.U. RTE | SECT | ION | | COUNTY | TOTAL SHEETS | SHEET NO. |
|--|---------------------------|---------|---------|--|----------|-----------------|--------------|
| CONSTRUCTION DETAILS | 1234 | 23-0012 | 7-00-RS | | LAKE | 36 | 30 |
| CONTOURING DETAILS | | | | | CONTRACT | NO. 6 | 1L83 |
| SCALE: N.T.S. SHEET 4 OF 4 SHEETS STA. TO STA. | ILLINOIS FED. AID PROJECT | | | | | | |

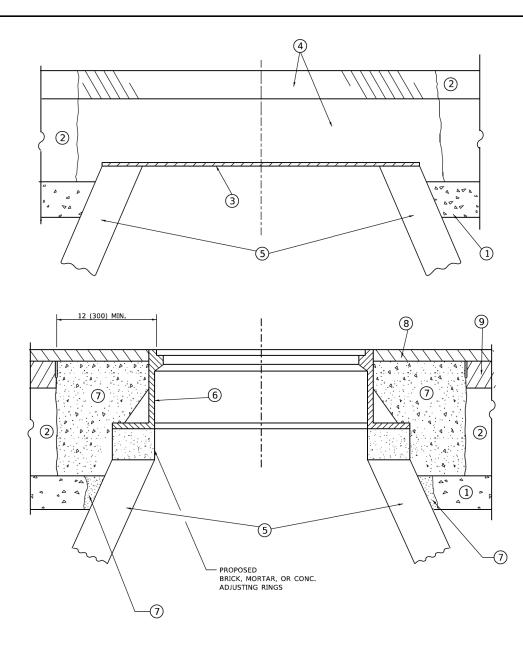

DETAILS FOR FRAMES AND LIDS ADJUSTMENT WITH MILLING

NOTES

- 1. EXISTING BROKEN FRAMES AND LIDS SHALL BE REMOVED AND DISPOSED OF BY THE CONTRACTOR AND SHALL BE REPLACED AS DIRECTED BY THE ENGINEER. REPLACEMENT FRAMES AND LIDS WILL BE PAID FOR IN ACCORDANCE WITH ARTICLE 109.04 OF THE STANDARD SPECIFICATIONS UNLESS A SEPARATE PAY ITEM HAS BEEN PROVIDED.
- IF THE EXISTING LIDS ARE OPEN, THE FRAME WILL BE ADJUSTED TO THE ELEVATION OF THE MILLED PAVEMENT SURFACE PRIOR TO THE MILLING OPERATION. THE FRAME WILL NOT BE REMOVED AND COVERED BY THE METAL PLATE.
- 3. CITY OF CHICAGO CASTINGS ARE THE PROPERTY OF THE CITY AND THE CONTRACTOR SHALL NOTIFY THE CITY FOR REMOVAL AND DISPOSITION OF THE CASTINGS.
- 4. THE METAL PLATE USED TO COVER THE STRUCTURE SHALL REMAIN THE PROPERTY OF THE CONTRACTOR.
- THE CONTRACTOR SHALL REMOVE ALL TRAFFIC CONTROL DEVICES BY THE END OF EACH WORK SHIFT.

CONSTRUCTION PROCEDURES

STAGE 1 (BEFORE PAVEMENT MILLING)

- A) REMOVE A MINIMUM OF 12 (300) OF THE PAVEMENT FROM AROUND THE STRUCTURE.
- B) REMOVE THE EXISTING FRAME AND LID FROM THE STRUCTURE.
- C) COVER THE STRUCTURE OPENING WITH A 36 (900) DIAMETER METAL PLATE.
- D) BACKFILL WITH CRUSHED STONE AND HMA SURFACE MIX APPROVED BY THE ENGINEER. (MIN. 3 (80) HMA TO REMAIN AFTER MILLING).

STAGE 2 (AFTER PAVEMENT MILLING)

- A) REMOVE THE HMA SURFACE MIX AND CRUSHED STONE.
- B) INSTALL THE FRAME AND LID; ADJUST THE FRAME TO ITS FINAL SURFACE ELEVATION.
- C) THE SURROUNDING SPACE SHALL BE FILLED WITH CLASS PP-2* CONCRETE TO THE ELEVATION OF THE SURFACE OF THE EXISTING BASE COURSE OR THE BINDER COURSE.
- *UNLESS OTHERWISE SPECIFIED IN THE PLANS.

THE PROCEDURE EXPLAINED ABOVE SHALL CONFORM TO THE APPLICABLE PORTIONS OF SECTIONS 353, 406, 602, AND 603 OF THE STANDARD SPECIFICATIONS EXCEPT THAT "THE CONTRACTOR SHALL ADJUST THE STRUCTURES TO THE FINISHED PAVEMENT ELEVATION NO MORE THAN 5 CALENDAR DAYS PRIOR TO PLACEMENT OF THE FINAL LIFT OF SURFACE UNLESS APPROVED BY THE ENGINEER."

LEGEND

1 SUB-BASE GRANULAR MATERIAL

(5) EXISTING STRUCTURE

- (6) FRAME AND LID (SEE NOTES)
- 2 EXISTING PAVEMENT
- (7) CLASS PP-2* CONCRETE
- 3 36 (900) DIAMETER METAL PLATE
- 8 PROPOSED HMA SURFACE COURSE
- 4 PROPOSED CRUSHED STONE AND HMA SURFACE MIX
- (9) PROPOSED HMA BINDER COURSE

LOCATION OF STRUCTURES

THE CONTRACTOR WILL BE REQUIRED TO KEEP A RECORD OF THE LOCATIONS OF THE BURIED STRUCTURES ACCORDING TO THE STATION AND DISTANCE LEFT OR RIGHT OF THE CENTERLINE OF PAVEMENT. UPON COMPLETION OF THE WORK, THE CONTRACTOR WILL DELIVER THE RECORD TO THE ENGINEER.

BASIS OF PAYMENT

- 1. REMOVING FRAMES AND LIDS ON DRAINAGE AND UTILITY STRUCTURES IN THE PAVEMENT PRIOR TO MILLING, AND ADJUSTING TO FINAL GRADE PRIOR TO PLACING THE SURFACE COURSE, WILL BE PAID FOR AT THE CONTRACT UNIT PRICE EACH FOR "FRAMES AND LIDS TO BE ADJUSTED (SPECIAL)."
- 2. THIS WORK WILL NOT BE PAID FOR WHEN DRAINAGE AND UTILITY STRUCTURES ARE SPECIFIED FOR PAYMENT AS STRUCTURE RECONSTRUCTION.
- NEW FRAMES AND LIDS, WHEN SPECIFIED, WILL BE PAID FOR SEPARATELY.
- 4. WHEN STRUCTURES ARE TO BE ADJUSTED OR RECONSTRUCTED, THE LOWERING AND RAISING OF THE FRAMES AND LIDS WILL NOT BE PAID FOR SEPARATELY BUT WILL BE INCLUDED IN THE COST OF THE CORRESPONDING PAY ITEM.

ALL DIMENSIONS ARE IN INCHES (MILLIMETERS) UNLESS OTHERWISE SHOWN


STATE OF ILLINOIS
DEPARTMENT OF TRANSPORTATION

DETAILS FOR
FRAMES AND LIDS ADJUSTMENT WITH MILLING

IE SHEET 1 OF 1 SHEETS STA. TO STA.


F.A. RTE. SECTION COUNTY TOTAL SHEE SHEETS NO. 1234 23-00127-00-RS LAKE 36 31

BD600-03 (BD-08) CONTRACT NO. 61L83

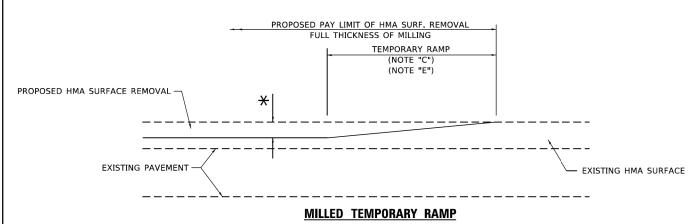

(FOR BUTT JOINT AND HMA TAPER SEE DETAIL BELOW)


OPTION 1

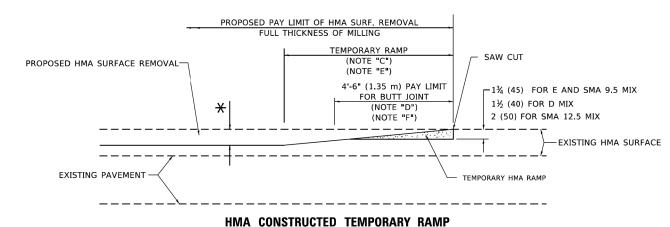

(FOR BUTT JOINT AND HMA TAPER SEE DETAIL BELOW)


OPTION 2


TYPICAL TEMPORARY RAMP

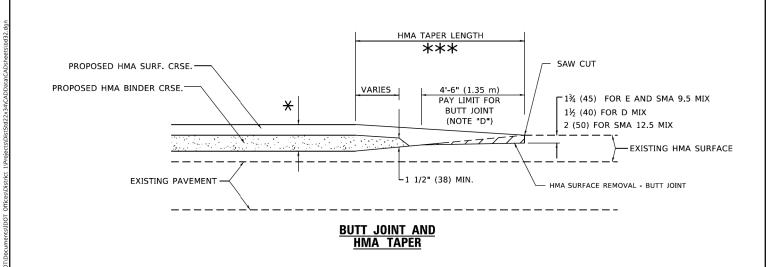

TYPICAL BUTT JOINT AND HMA TAPER FOR MILLING AND RESURFACING

STATE OF ILLINOIS DEPARTMENT OF TRANSPORTATION

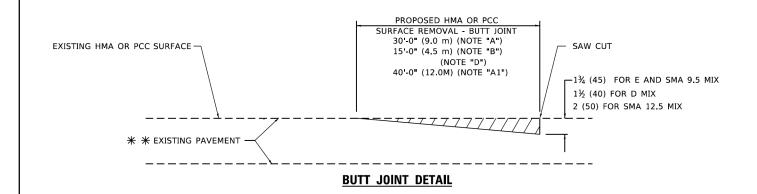

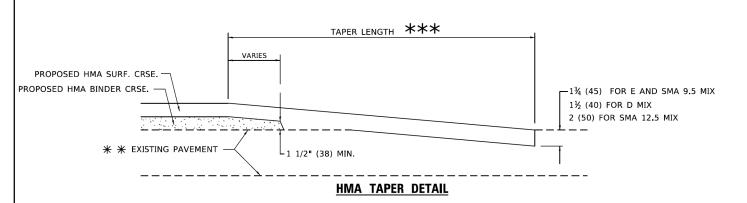

TYPICAL BUTT JOINT AND HMA TAPER FOR RESURFACING ONLY

** PC CONCRETE, HMA OR HMA RESURFACED PAVEMENT.

GENERAL NOTES

- A. MAINLINE ARTERIAL ROADWAYS AND MAJOR SIDE ROADS.
- A1. INTERSTATES
- B. MINOR SIDE ROADS.
- C. THE TEMP. RAMP SHALL BE CONSTRUCTED IMMEDIATELY UPON REMOVAL OF THE EXISTING HMA SURFACE.
- D. THE BUTT JOINT SHALL BE CONSTRUCTED IMMEDIATELY PRIOR TO PLACING THE PROPOSED HMA COURSES.
- E. TAPER THE TEMP. RAMP AT A RATE OF 3' 4" (1.02m) PER 1 INCH (25 mm) OF MILLING THICKNESS.
 - ★ SEE TYPICAL SECTIONS FOR MILLING THICKNESS
- F. SEE ARTICLE 406.08 AND 406.14 OF THE STANDARD SPECIFICATIONS FOR "HMA AND/OR PCC SURFACE REMOVAL, BUTT JOINT".
- ***

 20'-0" (6.1 m) PER 1 (25) RESURFACING (NOTE "A")


 10'-0" (3.0 m) PER 1 (25) RESURFACING (NOTE "B")

BASIS OF PAYMENT

- THE BUTT JOINT WILL BE PAID FOR AT THE CONTRACT UNIT PRICE PER SQUARE YARD (SQUARE METER) FOR "HOT-MIX ASPHALT SURFACE REMOVAL - BUTT JOINT" OR FOR "PORTLAND CEMENT CONCRETE SURFACE REMOVAL- BUTT JOINT".
- 2. THE TEMPORARY RAMP AND SAW CUT SHALL BE INCLUDED IN THE UNIT COST FOR HMA OR PCC SURFACE REMOVAL-BUTT JOINT.

SCALE: NONE

ALL DIMENSIONS ARE IN INCHES (MILLIMETERS) UNLESS OTHERWISE SHOWN.

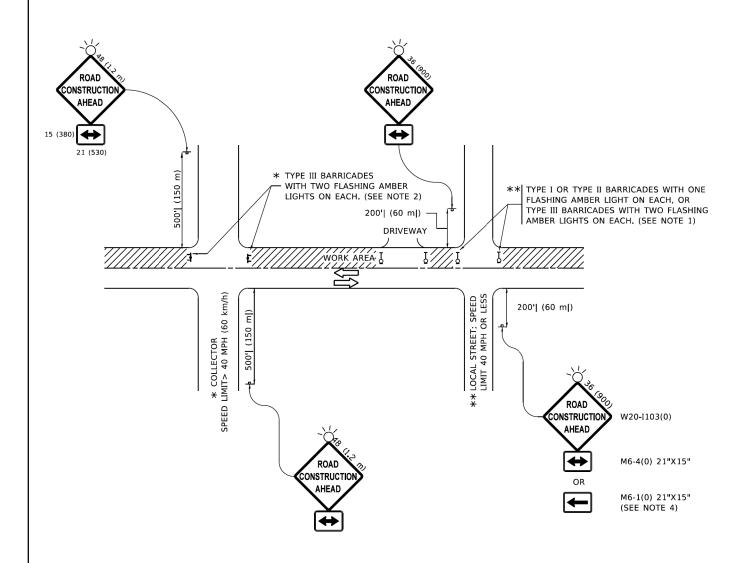

NOTES:

- 1. SIDE ROAD WITH A SPEED LIMIT OF 40 MPH (60 km/h) OR LESS AS SHOWN ON THE DRAWING AND AS DIRECTED BY THE ENGINEER:
- a) ONE "ROAD CONSTRUCTION AHEAD" SIGN 36 x 36 (900x900) WITH A FLASHER MOUNTED ON IT APPROXIMATELY 200' (60 m) IN ADVANCE OF THE MAIN ROUTE.
- b) THE CLOSED PORTION OF THE MAIN ROUTE SHALL BE PROTECTED BY BLOCKING WITH TYPE I, TYPE II OR TYPE III BARRICADES, 1/3 OF THE CROSS SECTION OF THE CLOSED PORTION.
- SIDE ROAD WITH A SPEED LIMIT GREATER THAN 40 MPH (60 km/h) AS SHOWN ON THE DRAWING AND AS DIRECTED BY THE ENGINEER:
- a) ONE "ROAD CONSTRUCTION AHEAD" SIGN 48 x 48 (1.2 m x 1.2 m) WITH A FLASHER MOUNTED ON IT APPROXIMATELY 500' (150 m) IN ADVANCE OF THE MAIN POLITE
- THE CLOSED PORTION OF THE MAIN ROUTE SHALL BE PROTECTED BY
 b) BLOCKING WITH TYPE III BARRICADES, 1/2 OF THE CROSS SECTION
 OF THE CLOSED PORTION.
- 3. CONES MAY BE SUBSTITUTED FOR BARRICADES OR DRUMS AT HALF THE SPACING DURING DAY OPERATIONS. CONES SHALL BE A MINIMUM OF 28 (710) IN HEIGHT
- WHEN THE SIDE ROAD LIES BETWEEN THE BEGINNING OF THE MAINLINE
 4. SIGNING AND THE WORK ZONE, A SINGLE HEADED ARROW (M6-1) SHALL
 BE USED IN LIEU OF THE DOUBLE HEADED ARROW (M6-4).

- WHEN WORK IS BEING PERFORMED ON A SIDE ROAD OR DRIVEWAY, FOLLOW THE APPLICABLE STANDARD(S), THE DIRECTIONAL ARROW (M6-1 OR M6-4) SHALL BE COVERED OR REMOVED WHEN NO LONGER CONSISTENT WITH THE TRAFFIC CONTROL SET-UP.
- 6. ADVANCE WARNING SIGNS ARE TO BE OMITTED ON DRIVEWAYS UNLESS OTHERWISE SPECIFIED IN THE PLANS OR BY THE ENGINEER
- THE TRAFFIC CONTROL AND PROTECTION FOR SIDE ROADS, INTERSECTIONS, AND DRIVEWAYS SHALL BE INCLUDED IN THE COST OF SPECIFIED TRAFFIC CONTROL STANDARDS OR ITEMS.


All dimensions are in inches (millimeters) unless otherwise shown.

| USER NAME = Lawrence.DeManche | DESIGNED - L.H.A. | REVISED - T. RAMMACHER 01-06-00 |
|-------------------------------|-------------------|---------------------------------|
| | DRAWN - | REVISED - A. SCHUETZE 07-01-13 |
| PLOT SCALE = 100,0000 ' / in. | CHECKED - | REVISED - A. SCHUETZE 09-15-16 |
| PLOT DATE = 5/3/2024 | DATE - 06-89 | REVISED - D. SENDERAK 05-03-24 |

STATE OF ILLINOIS
DEPARTMENT OF TRANSPORTATION

TRAFFIC CONTROL AND PROTECTION FOR SIDE ROADS, INTERSECTIONS, AND DRIVEWAYS

SHEET 1 OF 1 SHEETS STA. TO STA

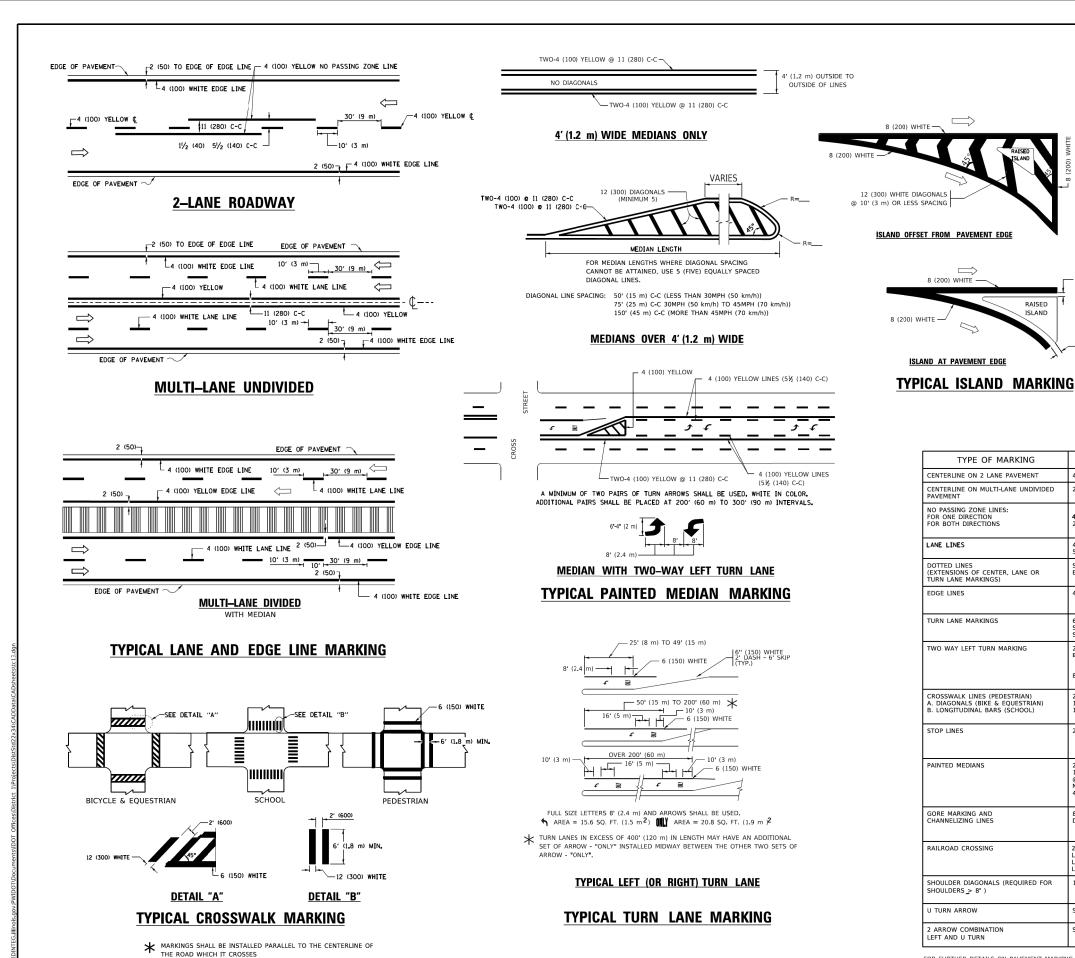

COMBINATION LEFT AND U-TURN 5'-4" (1620) LANE REDUCTION TRANSITION 40 (1020) * LANE REDUCTION ARROWS REQUIRED AT SPEEDS OF 45 MPH OF GREATER OR WHEN SPECIFIED IN PLANS. **U_TURN** WIDTH OF LINE PATTERN COLOR SPACING / REMARKS 5½ (140) C-C FROM SKIP-DASH CENTERLINE 11 (280) C-C OMIT SKIP-DASH CENTERLINE BETWEEN 4 (100) 2 @ 4 (100) SKIP-DASH SKIP-DASH 10' (3 m) LINE WITH 30' (9 m) SPACE (125) ON FREEWAYS SAME AS LINE BEING EXTENDED SKIP-DASH SAME AS LINE BEING EXTENDED 2' (600) LINE WITH 6' (1.8 m) SPACE SOLID YELLOW-LEFT WHITE-RIGHT OUTLINE MEDIANS IN YELLOW 6 (150) LINE; FULL SIZE LETTERS & SYMBOLS (8' (2.4m)) SOLID SEE TYPICAL TURN LANE MARKING DETAIL WHITE 2 @ 4 (100) EACH DIRECTION YELLOW 10' (3 m) LINE WITH 30' (9 m) SPACE FOR SKIP-DASH; 5½ (140) C-C BETWEEN SOLID LINE AND SKIP-DASH LINE SEE TYPICAL TWO-WAY LEFT TURN MARKING DETAIL NOT LESS THAN 6' (1.8 m) APART 2' (600) APART 2' (600) APART SEE TYPICAL CROSSWALK MARKING DETAILS. PLACE 4' (1.2 m) IN ADVANCE OF AND PARALLEL TO CROSSWALK, IF PRESENT. OTHERWISE, PLACE AT DESIRED STOPPING POINT. PARALLEL TO CROSSROAD CENTERLINE, WHERE SOLID WHITE 11 (280) C-C FOR THE DOUBLE LINE SEE TYPICAL PAINTED MEDIAN MARKING. 2 @ 4 (100) WITH 12 (300) DIAGONALS SOLID YELLOW: TWO WAY TRAFFIC WHITE: ONE WAY TRAFFIC NO DIAGONALS USED FOR 4' (1.2 m) WIDE MEDIANS

D(FT)

665

750

SPEED LIMIT

50

STATE OF ILLINOIS **DEPARTMENT OF TRANSPORTATION**

DISTRICT ONE TYPICAL PAVEMENT MARKINGS OF 2 SHEETS STA. SHEET 1

SOLID

SOLID

SOL TO

WHITE

WHITE

WHITE - RIGHT YELLOW - LEFT

2 (50)

(50)

4 (100)

24 (600)

8 (200) WITH 12 (300) DIAGONALS @ 45°

24 (600) TRANSVERSE LINES; "RR" IS 6' (1.8 m) LETTERS; 16 (400) LINE FOR "X"

12 (300) @ 45°

SEE DETAIL

FOR FURTHER DETAILS ON PAVEMENT MARKING REFER TO STANDARD SPECIFICATIONS FOR ROAD AND BRIDGE CONSTRUCTION AND STATE STANDARD 780001.

SCALE: NONE

RAISED

TYPE OF MARKING

23-00127-00-RS LAKE CONTRACT NO. 61L83

DIAGONALS: 15' (4.5 m) C-C (LESS THAN 30MPH (50 km/h)) 20' (6 m) C-C 30MPH (50 km/h) TO 45MPH (70 km/h)) 30' (9 m) C-C (OVER 45MPH (70 km/h))

50' (15 m) C-C (LESS THAN 30MPH (50 km/h)) 75' (25 m) C-C (30 MPH (50 km/h) TO 45MPH (70 km/h)) 150' (45 m) C-C (OVER 45MPH (70 km/h))

SEE STATE STANDARD 780001

unless otherwise shown.

30.4 SF

USER NAME = footemj

PLOT SCALE = 50.0000 ' / in

DESIGNED -

DRAWN

DATE

CHECKED


EVERS

REVISED - C. JUCIUS 09-09-09

REVISED - C. JUCIUS 07-01-13


C. JUCIUS 12-21-15

REVISED -

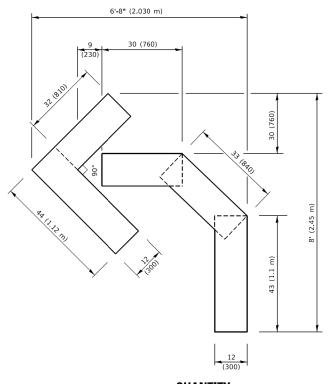


QUANTITY

4 (100) LINE = 45.5 ft. (13.9 m) 15.2 sq. ft. (1.41 sq. m)

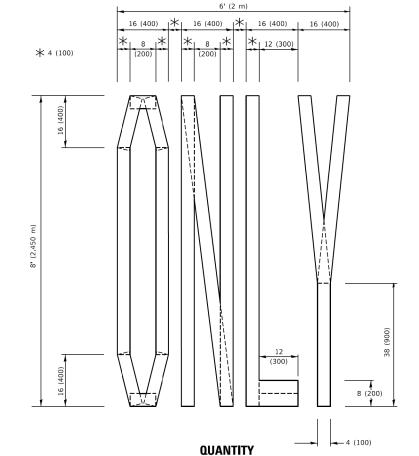

4 (100) LINE = 64.1 ft. (19.5 m)

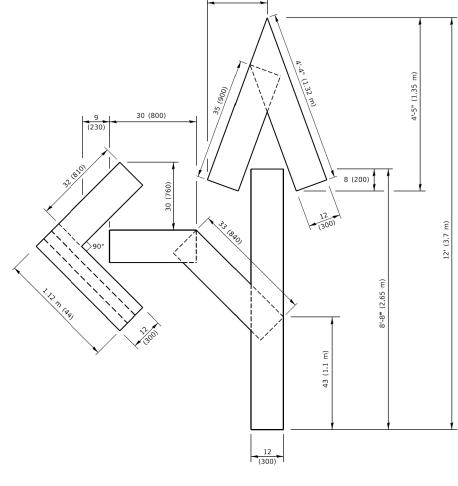


QUANTITY

4 (100) LINE = 82.5 ft. (25.1 m) 27.5 sq. ft. (2.53 sq. m)

NOTE:

ALL QUANTITIES OF PLACEMENT ARE REPRESENTED IN LINEAR FEET OF 4" LINES TO MATCH THE 4" TEMPORARY TAPE PAY ITEM AND REPRESENTS THE TOTAL QUANTITY OF 4" TAPE REQUIRED.

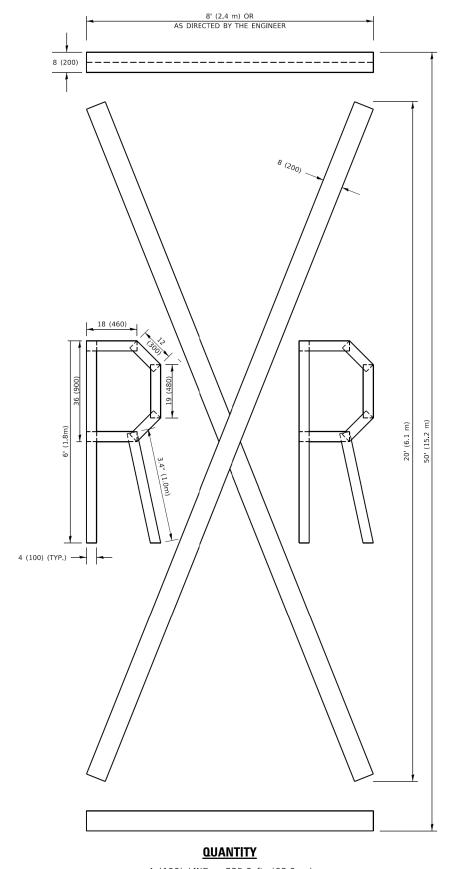

4 (100) LINE = 225.9 ft. (68.9 m) 75.3 sq. ft. (6.99 sq. m)

All dimensions are in inches (millimeters) unless otherwise shown.

21.4 sq. ft. (1.99 sq. m)

STATE OF ILLINOIS
DEPARTMENT OF TRANSPORTATION


SHORT TERM PAVEMENT MARKING LETTERS AND SYMBOLS

SCALE: NONE SHEET 1 OF 1 SHEETS STA. TO STA.

 F.A. RTE.
 SECTION
 COUNTY
 TOTAL SHEETS NO.

 1234
 23-00127-00-RS
 LAKE
 36
 35

 TC-16
 CONTRACT NO. 61L83

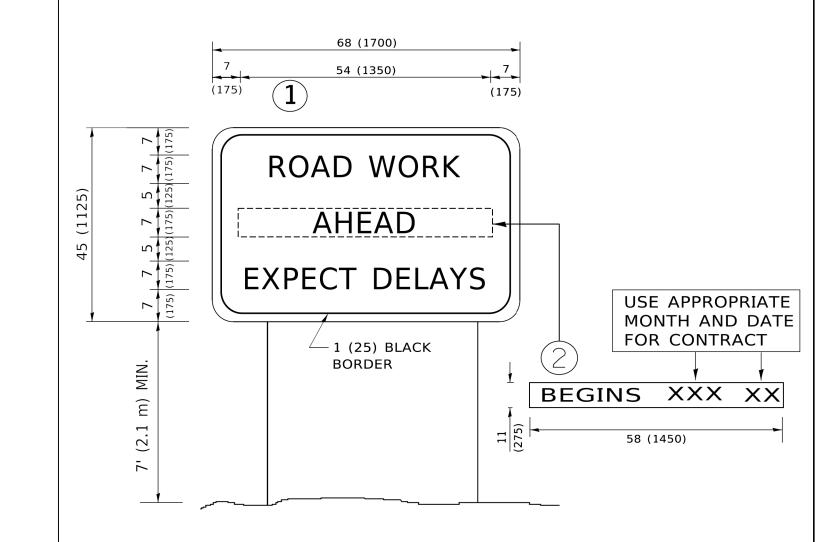

NOTES:

- 1. USE BLACK LETTERING ON ORANGE BACKGROUND.
- 2. ERECT SIGNS IN ADVANCE OF THE LOCATION FOR THE "ROAD CONSTRUCTION AHEAD" SIGN AT LOCATIONS AS DIRECTED BY THE ENGINEER.
- 3. ERECT SIGN 1 WITH INSTALLED PANEL 2 ONE WEEK PRIOR TO THE START OF CONSTRUCTION.
- 4. REMOVE PANEL 2 SOON AFTER THE START OF CONSTRUCTION.
- 5. SEE SPECIAL PROVISION FOR "TEMPORARY INFORMATION SIGNING" FOR ADDITIONAL INFORMATION.
- 6. ONE SIGN ASSEMBLY EQUALS 25.70 SQ. FT. (2.3 SQ. M.)
- 7. SHALL BE PAID FOR AS TEMPORARY INFORMATION SIGNING.

ALL DIMENSIONS ARE IN INCHES (MILLIMETERS) UNLESS OTHERWISE SHOWN.

| _ | USER NAME = footemj | DESIGNED - | REVISED - R. MIRS 09-15-97 | | | | | ERIAL R | | | F.A. | SECTION | COUNTY | TOTAL | SHEET NO. |
|---|------------------------------|------------|--------------------------------|------------------------------|-------------|---------|--------|---------|------|---------|------|-----------------|------------|--------|--------------|
| _ | | DRAWN - | REVISED - R. MIRS 12-11-97 | STATE OF ILLINOIS | | | | | | | 1234 | 23-00127-00-RS | LAKE | 36 | 36 |
| _ | PLOT SCALE = 50.0000 ' / in. | CHECKED - | REVISED -T. RAMMACHER 02-02-99 | DEPARTMENT OF TRANSPORTATION | | | INFURI | MATION | SIGN | | | TC-22 | CONTRACT | NO. 61 | .L83 |
| | PLOT DATE = 3/4/2019 | DATE - | REVISED - C. JUCIUS 01-31-07 | | SCALE: NONE | SHEET 1 | OF 1 | SHEETS | STA. | TO STA. | | ILLINOIS FED. A | ID PROJECT | | |