

11/07/2025 LETTING ITEM 104

FOR INDEX OF SHEETS, SEE SHEET NO. 2
FOR INDEX OF HIGHWAY STANDARDS, SEE SHEET NO. 2

FUNCTIONAL CLASSIFICATION
MAJOR COLLECTOR

TRAFFIC DATA
9TH AVENUE
ADT (2022) = 9,300

POSTED SPEED LIMIT
9TH AVENUE = 25 MPH

DESIGN SPEED LIMIT
9TH AVENUE = 25 MPH

STATE OF ILLINOIS

DEPARTMENT OF TRANSPORTATION

PLANS FOR PROPOSED FEDERAL AID HIGHWAY

FAU 2743 (9TH AVENUE)
VAN BUREN STREET TO QUINCY STREET
PEDESTRIAN SAFETY IMPROVEMENTS
SECTION NO.: 24-00144-00-MS
PROJECT NO.: DS43 (688)
VILLAGE OF MAYWOOD
COOK COUNTY

C-91-176-25

FAU ROUTE NO.	SECTION	COUNTY	TOTAL SHEETS	SHEET NO.
2743	24-00144-00-MS	COOK	22	1
ILLINOIS PROJECT	C-91-176-25			
CONTRACT NO.	61L76			



LOCATION OF SECTION
INDICATED THUS:



◆ Civil Engineers 9933 Roosevelt Road
Westchester, IL, 60154-2780
◆ Municipal Consultants Phone: 708-865-0300
◆ Established 1911 www.ehancock.com

Contact the Metropolitan
Water Reclamation District
of Greater Chicago 2 days
before starting work.

P (708) 588-4055
E WMOJobStart@mwrdd.org

0 10' 20' 30' SCALE: 1" = 10'

0 50' 100' SCALE: 1" = 50'

0 50' 100' SCALE: 1" = 40'


0 50' 100' SCALE: 1" = 30'

0 50' 100' SCALE: 1" = 20'

FULL SIZE PLANS HAVE BEEN PREPARED USING STANDARD
ENGINEERING SCALES. REDUCED SIZED PLANS WILL NOT
CONFORM TO STANDARD SCALES. IN MAKING MEASUREMENTS
ON REDUCED PLANS, THE ABOVE SCALES MAY BE USED.


J.U.L.I.E.
JOINT UTILITY LOCATION INFORMATION FOR EXCAVATION
1-800-892-0123
OR 811

CONTRACT NO. 61L76

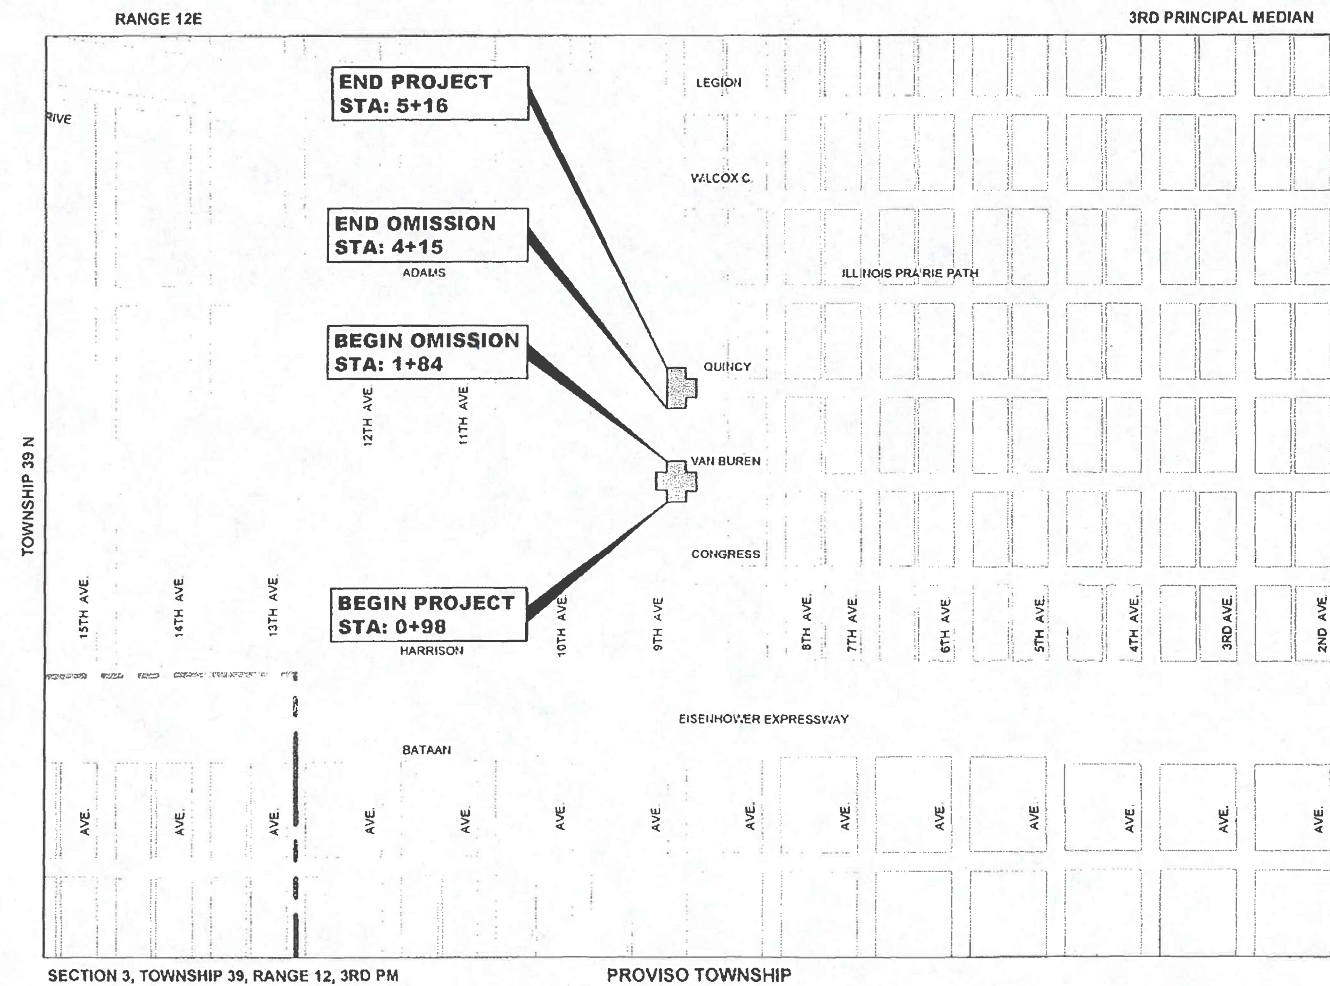

LOCATION MAP
NOT TO SCALE

GROSS LENGTH OF IMPROVEMENT = 370 FT = 0.07 MI
NET LENGTH OF IMPROVEMENT = 183 FT = 0.03 MI

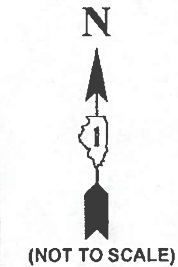

STATE OF ILLINOIS	
ILLINOIS DEPARTMENT OF TRANSPORTATION	
DIVISION OF HIGHWAYS	
APPROVED August 21, 2025	20 25
VILLAGE OF MAYWOOD, PRESIDENT	
PASSED Sept 3, 2025	20 25
DISTRICT 1 ENGINEER OF LOCAL ROADS & STREETS	
RELEASING FOR BID BASED ON LIMITED REVIEW	20 25
REGIONAL ENGINEER	



SIGNED:
DATE: 08/25/2025 LICENSE EXPIRES: 11-30-26

PRINTED BY THE AUTHORITY
OF THE STATE OF ILLINOIS

Drawing file: W:\projects_by_village\Maywood\66024168 - pedestrian safety inputs\LEGEND OF SYMBOLS.dwg | Sep 11, 2025 - 8:43am

INDEX OF SHEETS

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14	ROADWAY DETAILS
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I.D.O.T. STANDARD DRAWINGS

STANDARD NO.	TITLE OR DESCRIPTION
000001-08	STANDARD SYMBOLS, ABBREVIATIONS AND PATTERNS
280001-07	TEMPORARY EROSION CONTROL SYSTEMS
424001-12	PERPENDICULAR CURB RAMPS FOR SIDEWALKS
424021-07	DEPRESSED CORNER FOR SIDEWALKS
442101-09	CLASS B PATCHES
604001-05	FRAME AND LIDS, TYPE 1
701006-05	OFF ROAD OPERATIONS MARKERS, 2L, 2W 15' (4.5 M) TO 24" (600 MM) FROM PAVEMENT EDGE
701301-04	LANE CLOSURE, 2-LANE, 2-WAY SHORT TIME OPERATIONS
701311-03	LANE CLOSURE, 2-LANE, 2-WAY MOVING OPERATIONS, DAY ONLY
701501-06	URBAN LANE CLOSURE, 2L, 2W UNDIVIDED
701801-06	SIDEWALK, CORNER, OR CROSSWALK CLOSURE
701901-10	TRAFFIC CONTROL DEVICES
720001-01	SIGN PANEL MOUNTING DETAILS
720006-04	SIGN ERECTION DETAILS
729001-01	APPLICATIONS OF TYPE A AND B METAL POSTS
780001-05	TYPICAL PAVEMENT MARKINGS



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DESIGNED -	-	REVISED -	
DRAWN -	LW, SPA, DMM, AJ	REVISED -	
CHECKED -	-	REVISED -	
DATE -	4-30-25	REVISED -	9-10-25

STATE OF ILLINOIS
DEPARTMENT OF TRANSPORTATION

INDEX OF SHEETS & IDOT STANDARDS

SCALE: -	SHEET NO. - OF - SHEETS	STA. - TO STA. -
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MUN RTE.	SECTION	COUNTY	TOTAL SHEETS	SHEET NO.
XX	24-00144-00-MS	COOK	22	2
FIELD BOOK NO. : -		CONTRACT NO. 61L76		
FED. ROAD DIST. NO. 1		ILLINOIS	FED. AID PROJECT	

E.H.E. PROJECT NO. 665-24-16880

Drawing file: W:\projects_by_village\Maywood\66624168 - pedestrian safety imports\General Notes.dwg Sep 11, 2025 - 9:40am

GENERAL NOTES

1. SSRBC - ALL CONSTRUCTION SHALL BE DONE IN ACCORDANCE WITH THE “STANDARD SPECIFICATION FOR ROAD AND BRIDGE CONSTRUCTION”, ADOPTED JANUARY 1, 2022; THE “SUPPLEMENTAL SPECIFICATIONS AND RECURRING SPECIAL PROVISIONS”, ADOPTED JANUARY 1, 2025; THE LATEST EDITION OF THE “ILLINOIS MANUAL ON UNIFORM TRAFFIC CONTROL DEVICES FOR STREETS AND HIGHWAYS”, (ILMUTCD); “THE STANDARD SPECIFICATIONS FOR WATER AND SEWER MAIN CONSTRUCTON IN ILLINOIS”, JULY 2014, SEVENTH EDITION.

2. UTLITITES - BEFORE STARTING ANY EXCAVATION, THE CONTRACTOR SHALL CALL "JULIE" AT 811 FOR FIELD LOCATIONS OF BURIED ELECTRICAL, TELEPHONE AND GAS FACILITIES. (48 HOURS NOTIFICATION IS REQUIRED).

THE LOCATIONS OF THE UNDERGROUND UTILITIES IF SHOWN ON THE PLANS HAVE BEEN OBTAINED BY FIELD SURVEYS AND SEARCHES OF AVAILABLE RECORDS. IT IS BELIEVED THAT DATA IS ESSENTIALLY CORRECT, BUT THE VILLAGE OF MAYWOOD, THE ILLINOIS DEPARTMENT OF TRANSPORTATION AND/OR OTHER OFFICES AND AGENCIES ASSOCIATED WITH THE DEVELOPMENT OF THESE PLANS DO NOT GUARANTEE THEIR ACCURACY OR COMPLETENESS. THE CONTRACTOR WILL BE REQUIRED TO VERIFY THE EXACT LOCATION OF EACH FACILITY WITH THE UTILITY COMPANY, AND SHALL TAKE DUE CARE IN ALL PHASES OF THE CONSTRUCTION TO PROTECT ANY SUCH FACILITIES WHICH MAY BE AFFECTED BY THE WORK. ANY DAMAGE TO EXISTING UTILITIES SHALL BE REPAIRED.

THE CONTRACTOR SHALL COORDINATE CONSTRUCTION ACTIVITIES WITH UTILITY COMPANIES AND THE VILLAGE OF MAYWOOD.

3. INCIDENTAL EXCAVATION - DURING THE REMOVAL OF CONCRETE SIDEWALK, DRIVEWAY, CURB AND GUTTER, OR PAVEMENT, THE CONTRACTOR SHALL EXCAVATE AS NECESSARY SO THAT THE REQUIRED THICKNESS OF PROPOSED CONCRETE, INCLUDING BEDDING CAN BE CONSTRUCTED. THE EXCAVATED MATERIAL, AS WELL AS THE BROKEN CONCRETE, SHALL BE DISPOSED OF OFF THE JOB SITE AT A DUMP TO BE FOUND BY THE CONTRACTOR. A LOW SUB-GRADE MAY BE BROUGHT TO THE PROPER ELEVATION WITH CRUSHED STONE MEETING A CA-6 GRADATION AS APPROVED BY THE ENGINEER.

4. GARBAGE AND EMERGENY VEHICLES - THE CONTRACTOR WILL BE REQUIRED TO MAINTAIN ACCESS FOR EMERGENCY VEHICLES AND GARBAGE TRUCKS AT ALL TIMES. IF THE GARBAGE TRUCKS ARE NOT ABLE TO HAVE ACCESS TO ALL OF THE PROPERTIES WITHIN THE PROJECT LIMITS, THEN THE CONTRACTOR SHALL BE RESPONSIBLE FOR PLACING ANY GARBAGE THAT IS AFFECTED IN A LOCATION WHERE THE GARBAGE TRUCKS CAN PICK IT UP. THE CONTRACTOR SHALL ALSO BE REQUIRED TO RETURN THE GARBAGE CANS TO THE PARKWAY OF THE RESPECTIVE PROPERTY BY THE END OF THE DAY.

5. SAW-CUTTING - THIS WORK SHALL BE DONE WHERE ANY NEW PAVEMENT, CURB AND GUTTER, FRAMES AND GRATES, STRUCTURES, SIDEWALKS, OR DRIVEWAYS ABUT EXISTING PAVEMENT, CURB AND GUTTER, SIDEWALKS, OR DRIVEWAYS OR AS DIRECTED BY THE ENGINEER.

FRAMES AND LIDS TO BE ADJUSTED AS PART OF THE CONTRACT SHALL BE SAW CUT PRIOR TO BREAKING PAVEMENT AROUND THEM TO COMPLETE THE ADJUSTMENT.

6. ITEMS TO BE SALVAGED - ALL FRAMES AND LIDS, WATER VALVES, VALVE BOXES, AND FIRE HYDRANTS WHICH ARE TO BE ABANDONED DUE TO THE CONSTRUCTION OF THIS IMPROVEMENT ARE TO REMAIN THE PROPERTY OF THE VILLAGE OF MAYWOOD. THE CONTRACTOR IS TO DELIVER THE ITEMS TO BE SALVAGED TO THE VILLAGE OF MAYWOOD PUBLIC WORKS YARD.

7. LINES AND GRADES - ALL WORK UNDER THIS CONTRACT SHALL BE BUILT IN ACCORDANCE WITH THE LINES AND GRADES SHOWN ON THE PLANS AND AS GIVEN BY THE ENGINEER. THE CONTRACTOR SHALL PROVIDE MATERIALS, SUCH AS STAKES, PAINT, AND GIVE SUCH ASSISTANCE AS MAY BE REQUIRED FOR SETTING LINE AND GRADE BOARDS, AND STAKES OR MARKS SO GIVEN SHALL BE CAREFULLY PRESERVED. THE CONTRACTOR SHALL KEEP THE ENGINEER INFORMED A REASONABLE TIME IN ADVANCE, AT LEAST FORTY-EIGHT (48) HOURS, AS TO HIS NEED FOR ADDITIONAL GRADES AND LINES IN ORDER THAT THE SAME MAY BE FURNISHED AND ALL NECESSARY MEASUREMENTS MADE FOR RECORD AND PAYMENT WITH THE MINIMUM OF INCONVENIENCE TO THE ENGINEER OR OF DELAY TO THE CONTRACTOR.

8. STRUCTURES ENCOUNTERED - THE CONTRACTOR SHALL BE ENTIRELY RESPONSIBLE FOR DAMAGE TO WATER LINES, ELECTRIC CONDUITS AND LINES, EXISTING STRUCTURES, DRAINS, SIDEWALKS, CURBS, FENCES, TREES, CULVERTS, AND OTHER STRUCTURES OF ANY KIND AND SHALL BE LIABLE FOR DAMAGES TO PUBLIC AND PRIVATE PROPERTY, EXCEPT WHERE THESE ITEMS ARE TO BE REMOVED AND REPLACED AS CALLED FOR ON THE SPECIFICATIONS OR AS DIRECTED BY THE ENGINEER.

9. MAINTENANCE OF WORK SITE - THE CONTRACTOR SHALL KEEP THE SITE OF THE WORK AND ADJACENT PREMISES AS FREE FROM MATERIAL, DEBRIS AND RUBBISH AS IS PRACTICABLE, AND SHALL REMOVE SAME FROM ANY PORTION OF THE SITE, IF, IN THE OPINION OF THE ENGINEER, SUCH MATERIAL, DEBRIS, OR RUBBISH CONSTITUTES A NUISANCE OR IS OBJECTIONABLE IN ANY WAY TO THE PUBLIC. THE CONTRACTOR SHALL REMOVE ALL MACHINERY, MATERIALS, BARRICADES, STAGING, FALSE-WORK, DEBRIS AND RUBBISH CONNECTED WITH, OR CAUSED BY SAID WORK, IMMEDIATELY UPON THE COMPLETION OF THE SAME AND SHALL CLEAN ALL STRUCTURES AND WORK CONSTRUCTED UNDER THE CONTRACT TO THE SATISFACTION OF THE ENGINEER AND LEAVE THE PREMISES IN AN APPROVED CONDITION INSOFAR AS AFFECTED BY THE WORK UNDER THIS CONTRACT.

WHEN DURING THE CONSTRUCTION OPERATIONS, ANY LOOSE MATERIAL IS DEPOSITED IN THE FLOW LINE OF ANY GUTTERS AND DRAINAGE STRUCTURE SO THAT THE NATURAL FLOW OF WATER IS OBSTRUCTED, IT SHALL BE REMOVED AT THE CLOSE OF EACH WORKING DAY. AT THE CONCLUSION OF THE CONSTRUCTION OPERATIONS, ALL DRAINAGE FACILITIES SHALL BE CLEAN AND FREE OF ALL OBSTRUCTIONS DUE TO CONSTRUCTION OPERATIONS.

10.PROTECTION OF PAVEMENT - WHENEVER THE PROPOSED CONSTRUCTION IS LOCATED ADJACENT TO OR ACROSS AN EXISTING PAVEMENT STRUCTURE SUCH AS CURB AND GUTTER, SIDEWALK AND DRIVEWAY PAVEMENT, THE CONTRACTOR SHALL TAKE ALL NECESSARY PRECAUTIONS TO MAINTAIN AND PROTECT ALL PAVEMENTS NOT DESIGNATED FOR REMOVAL. TRENCH WIDTH SHALL BE CONTROLLED TO LIMIT THE EXTENT OF REMOVAL WITHIN THE BOUNDS ESTABLISHED BY THE ENGINEER. DAMAGE TO ADJACENT PAVEMENT STRUCTURES TO REMAIN SHALL BE REPAIRED TO THE SATISFACTION OF THE ENGINEER.

11.RESTORATION OF PROPERTY - THE CONTRACTOR SHALL RESTORE OR REPLACE ALL PAVEMENTS, STRUCTURES, OR OTHER PROPERTY DAMAGED BY CONSTRUCTION ACTIVITIES TO THE CONDITION THAT EXISTED IMMEDIATELY PRIOR TO THE START OF THE WORK. ALL FENCES AND OTHER STRUCTURES IN THE VICINITY OF THE WORK SHALL BE PROTECTED AND IF DAMAGED SHALL BE REPAIRED OR REPLACED TO THE SATISFACTION OF THE ENGINEER. ALL TREES SHALL BE SATISFACTORILY PROTECTED BY BOXES OR BOARDS.

TREE BRANCHES AND ROOTS SHALL NOT BE CUT EXCEPT BY PERMISSION OF THE ENGINEER. ALL CUTTING SHALL BE DONE TO THE SATISFACTION OF THE ENGINEER. SHRUBS AND BUSHES, WHICH LIE WITHIN THE CONSTRUCTION ACTIVITY, MAY BE DUG UP, TEMPORARILY MOVED, AND REPLANTED IN THEIR ORIGINAL LOCATIONS IF PERMITTED BY THE ENGINEER. IF THE PLANTS ARE DAMAGED OR DO NOT SATISFACTORILY GROW AFTER REPLANTING, THEY SHALL BE REPLACED BY THE CONTRACTOR, WITH PLANTS OF SAME KIND AND SIZE.

12.UNSUITABLE MATERIAL - IF MATERIAL IS FOUND WHICH IN THE OPINION OF THE ENGINEER IS UNSUITABLE AS A SUB BASE, IT SHALL BE REMOVED AND A MATERIAL SELECTED BY THE ENGINEER SHALL BE INSTALLED AND COMPACTED.

13.MISCELLANEOUS ADJUSTMENTS - THE ADJUSTMENT OF ANY PUBLIC UTILITY VALVE BOXES OR STRUCTURES WITHIN THE PROJECT LIMITS SHALL BE DONE BY PERSONNEL OF THE RESPECTIVE PUBLIC UTILITY. THE CONTRACTOR SHALL BE RESPONSIBLE FOR NOTIFYING THE UTILITY OF THE REQUIRED WORK AND COORDINATING THESE ACTIVITIES WITH HIS OWN SCHEDULE OF CONSTRUCTION. THIS SHALL NOT APPLY TO VILLAGE BUFFALO BOXES, VALVE BOXES OF VILLAGE OWNED FRAMES

14.VILLAGE WATER USAGE - THE VILLAGE REQUIRES THE USE OF A WATER METER FOR ALL CONTRACTORS THAT NEED ACCESS TO A VILLAGE FIRE HYDRANT. THE WATER METERS ARE AVAILABLE AT THE VILLAGE OF MAYWOOD PUBLIC WORKS BUILDING. THE CONTRACTOR WILL BE REQUIRED TO PLACE A DEPOSIT PRIOR TO BEING ISSUED A WATER METER. THE DEPOSIT IS REFUNDABLE, UPON THE RETURN OF THE WATER METER, IN ITS ORIGINAL CONDITION.

IT IS THE RESPONSIBILITY OF THE CONTRACTOR TO USE AN APPROVED HYDRANT OPERATING WRENCH WHEN OPENING AND CLOSING ANY FIRE HYDRANTS. THE USE OF A PIPE WRENCH IS NOT ALLOWED IF THE CONTRACTOR IS OBSERVED TAKING WATER FROM THE VILLAGE'S WATER SYSTEM WITHOUT A WATER METER OR WRITTEN PERMISSION FROM THE PUBLIC WORKS DIRECTOR TO DO SO, THE CONTRACTOR WILL BE REQUIRED TO OBTAIN WATER FROM A DIFFERENT SOURCE.

15.VILLAGE STREET SIGNS ON POSTS - IT SHALL BE THE CONTRACTOR'S RESPONSIBILITY TO REMOVE, STORE IN A PROTECTED LOCATION, AND THEN RESET ALL STREET SIGNS ON POSTS ENCOUNTERED WITHIN THE BOUNDARIES OF THIS PROJECT. THE CONTRACTOR SHALL ALSO BAG ANY REGULATORY SIGNS THAT WILL NOT BE IN EFFECT DURING CONSTRUCTION AND PROVIDE TEMPORARY SIGNAGE FOR ANY ADJUSTMENT TO EXISTING TRAFFIC PATTERNS.

16. SOIL BORING - SOIL BORINGS HAVE NOT BEEN TAKEN ALONG THE ROUTE OF THE PROPOSED IMPROVEMENTS. THE CONTRACTOR SHALL VERIFY SUBSURFACE SOIL CONDITIONS TO HIS SATISFACTION PRIOR TO THE COMMENCEMENT OF CONSTRUCTION AND SHALL ASSUME FULL RESPONSIBILITY FOR MEETING AND OVERCOMING ALL SOIL CONDITIONS, INCLUDING ROCK, HARDPAN, ISOLATED BOULDERS, SATURATED SOIL, RUNNING SAND, OR OTHER MATERIAL THAT IS ENCOUNTERED.

17.EXTENDED ENGINEERING SERVICES - EXTENDED ENGINEERING SERVICES ARE DEFINED AS ALL ADDITIONAL ENGINEERING SERVICES REQUIRED AS A RESULT OF THE CONTRACTOR'S FAILURE TO COMPLETE THE WORK WITHIN THE CONTRACT COMPLETION TIME AND ANY DEPARTMENT'S EXTENSIONS OF THAT COMPLETION TIME. THE COST OF SUCH EXTRA ENGINEERING SERVICES SHALL INCLUDE THE ENTIRE COST OF ENGINEERING SERVICES, INCLUDING TRAVEL EXPENSES AND OVERTIME CHARGES, AND ALL COSTS INCLUDING TRAVEL EXPENSES AND OVERTIME CHARGES FOR EMPLOYEES OF THE ENGINEER, BOTH IN THE OFFICE AND AT THE JOB SITE NECESSARY FOR PROPER ADMINISTRATION OF THE PROJECT, WHICH WOULD NOT HAVE BEEN INCURRED IF THE WORK HAD BEEN COMPLETED WITHIN THE TIME ALLOWED IN THE CONTRACT (INCLUDING DEPARTMENT'S EXTENSIONS OF THE COMPLETION TIME).

THE DEPARTMENT WILL CONTINUE TO PAY ENGINEERING COSTS, BUT THE COST OF ALL EXTRA ENGINEERING SERVICES AS DEFINED ABOVE SHALL BE DEDUCTED FROM PAYMENTS DUE TO THE CONTRACTOR. IF THE AMOUNTS DUE THE CONTRACTOR ARE INSUFFICIENT TO COVER THE COSTS OF SUCH EXTRA ENGINEERING SERVICES, THE CONTRACTOR SHALL REIMBURSE THE DEPARTMENT IN THE AMOUNT NECESSARY TO COVER THESE COSTS.

18.NIGHT, SUNDAY, AND HOLIDAY WORK - IF IT IS FOUND NECESSARY TO CONTINUE THE WORK AT NIGHT, ON SUNDAY OLEGAL HOLIDAYS, THE CONTRACTOR WILL BE CHARGED FOR THE ENGINEERING AND INSPECTION AT SUCH TIMES AT RATES DESCRIBED IN THE SPECIFICATIONS UNDER THE HEADING OF OVERTIME ENGINEERING.

19.NOTIFICATION OF RESIDENTS - THE CONTRACTOR WILL BE RESPONSIBLE FOR PROVIDING WRITTEN NOTICE TO ALL RESIDENCES AND/OR PLACES OF BUSINESS TWENTY-FOUR (24) HOURS IN ADVANCE OF PERFORMING ANY CONSTRUCTION ACTIVITY THAT WILL AFFECT ACCESS TO THEIR PROPERTY AND AN ADDITIONAL NOTICE TWENTY-FOUR (24) HOURS IN ADVANCE OF PERFORMING ANY CONSTRUCTION ACTIVITY ON THEIR RESPECTIVE SECTION OF ROADWAY. ALL NOTICES SHALL BE SUBMITTED TO THE ENGINEER FOR REVIEW AND APPROVAL PRIOR TO ISSUANCE.

CONCRETE GENERAL NOTES

1. FORMS FOR CONCRETE SIDEWALKS, DRIVEWAYS, AND GUTTER FLAGS - A 2" X 6" BOARD WILL BE USED AS A FORM FOR ALL SIDEWALKS TO BE INSTALLED FIVE INCHES (5") IN THICKNESS. A 2" X 8" BOARD WILL BE USED AS A FORM FOR ALL DRIVEWAYS TO BE INSTALLED SEVEN INCHES (7") IN THICKNESS. A 2" X 12" BOARD WILL BE USED AS THE FORM FOR THE FACE OF THE GUTTER FLAGS. NO METAL FORMS WILL BE ALLOWED EXCEPT. ALL FORMS MUST BE OF A MINIMUM HEIGHT OF THE PROPOSED THICKNESS OF THE RESPECTIVE CONCRETE ITEMS TO BE INSTALLED.

2. PROTECTION OF NEWLY POURED CONCRETE - ALL CONCRETE CONSTRUCTION SHALL BE PROTECTED BY THE CONTRACTOR TO PREVENT ACCIDENTAL OR PRE-MEDITATED DAMAGE. SUPERVISION OF FRESHLY POURED AREAS SHALL BE PROVIDED UNTIL THE MATERIAL HAS ADEQUATELY CURED. THE CONTRACTOR SHALL KEEP EMPLOYEES AT THE JOB SITE AFTER THE CONCRETE HAS BEEN POURED UNTIL IT HAS CURED SUFFICIENTLY SO THAT GRAFFITI CAN NOT BE INSCRIBED IN THE NEWLY POURED CONCRETE SURFACES. ANY CONCRETE ITEMS THAT ARE DEFACED SHALL BE REPLACED BY THE CONTRACTOR.

3. BITUMINOUS EXPANSION JOINTS - THREE-QUARTER INCH (3/4") NOMAFLEX EXPANSION JOINTS SHALL BE INSTALLED WHERE NEW SIDEWALK OR CURB AND GUTTER OR DRIVEWAY PAVEMENT ABUTS AN EXISTING CONCRETE WALK, DRIVE, OR CURB WHICH IS TO REMAIN IN PLACE, AND AT NOT LESS THAN SEVENTY-FIVE FEET (75') INTERVALS AT LOCATIONS WHERE SIDEWALK REPLACEMENT IS IN EXCESS OF SEVENTY-FIVE FEET (75'), AND AT LOCATIONS AS DIRECTED BY THE ENGINEER.

EXPANSION JOINTS WILL BE PLACED IN CURB AND GUTTER AT ALL RADIUS POINTS, ALL BEND POINTS, ON BOTH SIDES OF FRAMES AND GRATES THAT ARE IN THE CURB AND GUTTER, AND AT NOT LESS THAN NINETY FOOT (90') INTERVALS AT LOCATIONS WHERE CURB REPLACEMENT IS IN EXCESS OF NINETY FEET (90'), AND AT LOCATIONS AS DIRECTED BY THE ENGINEER.

ALL EXPANSION JOINTS LOCATED IN THE CURB AND GUTTER SHALL HAVE TWO (2) THREE QUARTER INCH (3/4") DIAMETER, SMOOTH, ROUND, EPOXY COATED DOWEL BARS, EIGHTEEN INCHES (18") IN LENGTH, WITH PLASTIC END CAPS INSERTED TO ALLOW THE CURB AND GUTTER TO EXPAND AND CONTRACT LATERALLY.

4. SIDEWALK AND CURB AND GUTTER REPLACEMENT - LOCATIONS OF SIDEWALK AND CURB AND GUTTER REPLACEMENT ARE APPROXIMATE. EXACT LOCATIONS WILL BE DETERMINED DURING CONSTRUCTION.

5. DEPRESSED CURBS - THE TOP OF CURBS SHALL BE DEPRESSED WHERE THE CURB AND GUTTER IS CONSTRUCTED AT HANDICAP ACCESSIBLE SIDEWALK RAMPS AT ALLEY RETURNS AND STREET INTERSECTIONS, AND FOR PRIVATE AND COMMERCIAL DRIVES AND AS DIRECTED BY THE ENGINEER

6. DRAINAGE OPENINGS - AT ALL LOCATIONS WHERE CASTINGS ARE TO BE INCORPORATED IN THE CURB AND GUTTER, A 3/4" EXPANSION JOINT SHALL BE INSTALLED IN THE CURB AND GUTTER A DISTANCE OF 5 FT. FROM EACH SIDE OF THE CASTING. 2-NO. 4 RE-BARS, 9' IN LENGTH, SHALL BE INCORPORATED IN THE CONTINUOUS PORTION OF CONCRETE CURB BEHIND THE CASTING.

7. DETECTABLE WARNINGS - DETECTABLE WARNINGS SHALL BE INSTALLED AT HANDICAP ACCESSIBLE SIDEWALK RAMPS, AT ALLEY RETURNS, AND STREET INTERSECTIONS. THESE SHALL BE CONSTRUCTED IN ACCORDANCE WITH THE APPLICABLE IDOT STANDARDS AND CURRENT PROWAG REQUIREMENTS.

8. SLIPFORM CONSTRUCTION - VERTICAL FACES MAY BE BATTERED AT THE RATE OF 3/4" PER FOOT OF HEIGHT TO AID IN SLIPFORM OPERATIONS. THE PROPOSED CURB HEIGHT IS VARIABLE.

9. DEPRESSED CURB HEIGHT - THE HEIGHT OF THE DEPRESSED CURB SHALL BE 1-1/2" AT DRIVEWAYS. SEE IDOT STANDARD 424001-05 FOR HEIGHT AT SIDEWALK RAMP.

THE EDWIN HANCOCK ENGINEERING COMPANY AND THE VILLAGE PUBLIC WORKS DEPARTMENT SHALL BE NOTIFIED AT LEAST TWO (2) WORKING DAYS PRIOR TO ANY CONSTRUCTION ACTIVITY.



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DATE -	4-30-25

REVISED -	
REVISED -	
REVISED -	
REVISED -	9-10-25

STATE OF ILLINOIS
DEPARTMENT OF TRANSPORTATION

GENERAL NOTES

SCALE: - SHEET NO. - OF - SHEETS STA. - TO STA. -

MUN RTE.	SECTION	COUNTY	TOTAL SHEETS	SHEET NO.
XX	24-00144-00-MS	COOK	22	3
FIELD BOOK NO. : -		CONTRACT NO. 61L76		
FED. ROAD DIST. NO. 1		ILLINOIS	FED. AID PROJECT	

E.H.E. PROJECT NO. 565-24-16880

SEWER AND WATER GENERAL NOTES

1. INSPECTION OF PIPE AND ACCESSORIES - ANY DEFECTIVE, DAMAGED OR UNSOUND MATERIAL SHALL BE REPAIRED OR REPLACED AS DIRECTED BY THE ENGINEER. ALL FOREIGN MATTER OR DIRT SHALL BE INSPECTED FOR DEFECTS PRIOR TO LOWERING INTO POSITION IN THE TRENCH. PIPE SHALL BE KEPT CLEAN BY MEANS APPROVED BY THE ENGINEER DURING AND AFTER LAYING.

2. TRENCH EXCAVATION - THE TRENCH SHALL BE DUG TO THE REQUIRED ALIGNMENT AND DEPTH SHOWN ON THE DRAWINGS OR AS SUBSEQUENTLY APPROVED IN WRITING BY THE ENGINEER, AND ONLY SO FAR IN ADVANCE OF PIPE LAYING AS PERMITTED BY THE ENGINEER. THE CONTRACTOR WILL BE REQUIRED TO HANDLE EXCAVATED MATERIAL CAREFULLY TO MINIMIZE THE ACCUMULATION ON EXISTING PAVED SURFACES. WHEREVER POSSIBLE THE EXCAVATED MATERIAL SHOULD BE DIRECTLY LOADED INTO A WAITING TRUCK FOR DIRECT DISPOSAL. THE CONTRACTOR WILL CLEAN ALL PAVEMENT AREAS TO THE SATISFACTION OF THE ENGINEER.

3. EXCAVATION NEAR EXISTING STRUCTURES - ALL EXISTING PIPES, CONDUITS, CABLES, POLES, PAVEMENTS, AND OTHER STRUCTURES NOT DESIGNATED TO BE REMOVED BY THE CONTRACT DOCUMENTS ARE TO BE PROTECTED FROM DAMAGE BY THE CONTRACTOR. THE TEMPORARY SUPPORT, PROTECTION, AND MAINTENANCE OF THE STRUCTURES, SHALL BE FURNISHED BY THE CONTRACTOR. WHERE THE GRADE OR ALIGNMENT OF THE PIPE IS OBSTRUCTED BY EXISTING UTILITY STRUCTURES SUCH AS CONDUITS, DUCTS, PIPES, BRANCH CONNECTIONS TO MAIN SEWERS, OR MAIN DRAINS, THE OBSTRUCTION SHALL BE PERMANENTLY SUPPORTED, RELOCATED, REMOVED, OR RECONSTRUCTED BY THE CONTRACTOR IN COOPERATION WITH THE OWNERS OF SUCH UTILITY STRUCTURES. WHENEVER NECESSARY TO DETERMINE THE LOCATION OF EXISTING UNDERGROUND UTILITY STRUCTURES, THE CONTRACTOR, AFTER AN EXAMINATION OF AVAILABLE RECORDS, SHALL MAKE ALL EXPLORATIONS AND EXCAVATIONS FOR SUCH PURPOSE AS MAY BE DIRECTED BY THE ENGINEER.

4. CUTTING PIPE - ALL PIPES SHALL BE CUT TO ITS REQUIRED LENGTH IN THE FIELD BY A POWERED MECHANICAL ROTARY SAW AND THE EXPOSED END GROUND BY A MECHANICAL GRINDING TOOL TO A SMOOTH BEVELED FINISH.

5. THE CONTRACTOR SHALL CONDUCT HIS OPERATIONS AS TO MAINTAIN AT ALL TIMES FLOW THROUGH EXISTING STORM AND SANITARY SEWER SYSTEMS. THEY SHALL ALSO PROVIDE AND MAINTAIN AN EFFICIENT PUMPING PLANT IF NECESSARY AND A TEMPORARY OUTLET AND BE PREPARED AT ALL TIMES TO DISPOSE OF THE WATER COLLECTED IN A SAFE MANNER WITHOUT DAMAGE OF ANY KIND TO ADJACENT PROPERTIES. THE ENDS OF EXISTING DRAINAGE LINES WHICH ARE NOT TO BE INCORPORATED INTO THE PROJECT ARE TO BE SEALED AS SPECIFIED IN THE SPECIAL PROVISIONS.

6. EXPLORATORY EXCAVATION - IT SHALL BE THE CONTRACTOR'S RESPONSIBILITY TO DETERMIANE THE ELEVATION OF EXISTING WATER MAINS, GAS MAINS, TELEPHONE DUCTS, AND OTHER PUBLIC UTILITIES WHICH ARE TO BE CROSSED WITH THE PROPOSED SEWER A SUFFICIENT LENGTH AHEAD OF PIPE LAYING OPERATIONS SO THAT THE PROPOSED SEWER MAIN CAN BE INSTALLED AT AN ELEVATION WHICH WILL AVOID CONFLICTS WITH THE EXISTING UTILITIES WITHOUT REQUIRING THE USE OF BENDS AND/OR FITTINGS ON THE PROPOSED SEWER. THE ENGINEER SHALL ASSIST THE CONTRACTOR BY DETERMINING THE ELEVATION OF THE EXISTING UTILITY ONCE IT HAS BEEN EXPOSED BY THE CONTRACTOR.

7. MATERIALS - THE CONTRACTOR SHALL VERIFY THE TYPE OF ALL SEWER PIPE MATERIALS AND WATER MAIN HARDWARE INCLUDING VALVES, FIRE HYDRANTS, VALVE BOXES, CORPORATION STOPS, CURB STOPS, AND WATER SERVICES BOXES WITH THE ENGINEER PRIOR TO ORDERING SUCH MATERIAL.

8. FRAMES AND LIDS - THE TYPE OF FRAMES AND GRATES REQUIRED FOR ALL CATCH BASINS AND MANHOLES LISTED IN THE SUMMARY OF QUANTITIES MAY BE FOUND ON THE PLANS AT THEIR RESPECTIVE LOCATIONS. WHERE LIDS ARE CALLED FOR ON THE PLANS, THEY SHALL BE IN ACCORDANCE WITH ARTICLE 604.01 OF THE STANDARD SPECIFICATIONS AND THE TERM LID IS USED IN LIEU OF GRATE.

THE WORD "WATER", "SANITARY", OR "STORM" SHALL BE CAST INTO THE LID OF EACH RESPECTIVE MANHOLE OR VALVE VAULT.

9. POINT REPAIRS - FIGURES SHOWN SEWER REPAIRS INDICATED DISTANCES FROM MANHOLES.

10. WHEN EXISTING DRAINAGE FACILITIES ARE DISTURBED, THE CONTRACTOR SHALL PROVIDE AND MAINTAIN TEMPORARY OUTLETS AND CONNECTIONS FOR ALL PRIVATE OR PUBLIC DRAINAGE STRUCTURES OR SEWERS UNTIL PERMANENT CONNECTIONS TO SEWERS ARE BUILT AND IN SERVICE.

11. IF, DURING CONSTRUCTION OPERATIONS, ANY LOOSE MATERIALS ARE DEPOSITED IN THE FLOW LINES OF GUTTERS OR DRAINAGE STRUCTURES SO THAT THE NATURAL FLOW OF WATER IS OBSTRUCTED, THE OBSTRUCTING MATERIALS SHALL BE REMOVED AT THE CLOSE OF EACH WORK DAY. AT THE CONCLUSION OF THE CONSTRUCTION OPERATIONS, ALL DRAINAGE STRUCTURES ARE TO BE FREE OF ALL DIRT, DEBRIS, AND OBSTRUCTING MATERIALS.

12. ALL PROPOSED WATER MAINS SHALL BE INSTALLED IN ACCORDANCE WITH IN THE "STANDARD SPECIFICATIONS FOR WATER AND SEWER MAIN CONSTRUCTION IN ILLINOIS", SEVENTH EDITION, DATED 2014, AND ALL REVISIONS THERETO.
13. UNLESS OTHERWISE SPECIFIED, ABANDONED SEWERS AND DRAINS, AS DESIGNATED BY THE ENGINEER, SHALL BE PLUGGED WITH CLASS "SI" CONCRETE OR BRICK AND SUITABLE MORTAR TO THE SATISFACTION OF THE ENGINEER.
14. THE CONTRACTOR SHALL BE RESPONSIBLE FOR FIELD CHECKING ALL DIMENSIONS AND LOCATIONS OF PROPOSED STRUCTURES TO VERIFY ALL EXISTING AND PROPOSED PIPES ARE CORED AT THE CORRECT SIZE, LOCATION AND ELEVATION OF THE STRUCTURE. THE CONTRACTOR WILL ALSO BE REQUIRED TO VERIFY THAT ALL PIPES IN EXISTING STRUCTURES TO BE REPLACED ARE ACCOUNTED FOR.

ASPHALT GENERAL NOTES

1. THE ASPHALT PAVING MACHINE SHALL HAVE A SCREED WITH A CLOSED PAVING WIDTH OF NOT LESS THAN TEN FEET (10').
2. THE INTERSECTION RETURNS SHALL BE PAVED AT THE SAME TIME AS THE MAINLINE PAVEMENT.
3. THE CONTRACTOR WILL BE REQUIRED TO CLOSE UP ALL STREETS IN THE SAME DAY. NO OPEN LONGITUDINAL JOINTS WILL BE LEFT OPEN OVERNIGHT.
4. THE LOCATION OF ALL TRANSVERSE COLD JOINTS LEFT BETWEEN DAYS OF PAVING SHALL BE APPROVED BY THE ENGINEER.
5. TACK COAT - PRIME COAT MUST BE INSTALLED NO EARLIER THAN TWENTY-FOUR (24) HOURS PRIOR TO PLACEMENT OF HOT-MIX ASPHALT. NOTICES SHALL BE PROVIDED TO ALL ADJACENT PROPERTIES IMPACTING VEHICLE ACCESS A MINIMUM OF 24 HOURS PRIOR TO PLACEMENT OF TACK COAT.
6. MILLED BUTT JOINTS - WHEN MILLED PAVEMENT IS OPEN TO TRAFFIC THE MAXIMUM GRADE DIFFERENTIAL BETWEEN PASSES OF THE MILLING MACHINE SHALL NOT EXCEED 1½ INCHES (40 MM) WHERE THE SPEED LIMIT IS 45 MPH (80 KM/H) OR LESS AND 1 INCH (25 MM) WHERE THE SPEED LIMIT IS GREATER THAN 45 MPH (80 KM/H). WITH WRITTEN APPROVAL FROM THE ENGINEER, A MAXIMUM GRADE DIFFERENTIAL OF 3 INCHES (75 MM) MAY BE ALLOWED IF THE EDGE OF THE MILLING IS SLOPED A MINIMUM 1:3 (V:H)
7. BUTT JOINT REMOVAL - BUTT JOINTS SHALL BE CUT NO MORE THAN 24 HOURS PRIOR TO FINAL SURFACE PAVING. SUITABLE GUIDELINES OR DEVICES SHALL BE USED TO ASSURE CUTTING A NEAT, STRAIGHT LINE AS SHOWN ON THE PLANS.

LANDSCAPING GENERAL NOTES

1. ONCE CONCRETE IMPROVEMENTS ARE COMPLETED AND PRIOR TO FINAL SURFACE COURSE BEING PLACED, ALL LANDSCAPE AREAS ARE TO BE BACKFILLED AND HAVE TOPSOIL PLACED, UNLESS OTHERWISE DIRECTED BY THE ENGINEER. ANY EXCAVATION AND GRADING OF THE PARKWAY WHICH IS REQUIRED TO GIVE A UNIFORM SLOPE FROM THE LIMIT OF SOD RESTORATION TO THE TOP OF THE CURB SHALL BE INCLUDED IN THIS CONTRACT.
2. THE CONTRACTOR SHALL BE RESPONSIBLE FOR WEED PREVENTION AND REMOVING ANY WEEDS PRIOR TO THE PLACEMENT OF THE SOD. THE CONTRACTOR WILL ALSO BE RESPONSIBLE FOR MAINTENANCE OF WEEDS WITHIN NEWLY TOPSOILED AREAS. ONCE ANY WEEDS, AS DETERMINED BY THE ENGINEER, HAVE EXCEEDED SIX INCHES (6") IN HEIGHT, THEY SHALL BE REMOVED BY THE CONTRACTOR AS DIRECTED BY THE ENGINEER. THE METHOD OF WEED CONTROL AND WEED REMOVAL MUST BE APPROVED BY THE ENGINEER.

ELECTRIC GENERAL NOTES

1. WHEN INSTALLATION OF STEEL CONDUIT IS REQUIRED WITHIN THE AREA OF ANY PROPOSED IMPROVEMENT, THE STEEL CONDUIT SHALL BE INSTALLED DURING THE EXCAVATION FOR THE PROPOSED IMPROVEMENT. NO DIRECTIONAL BORING BENEATH NEWLY COMPLETED PROPOSED IMPROVEMENT WILL BE ALLOWED.

COMMITMENTS

1. ALL APPLICABLE SPECIAL WASTE RELATED PAY ITEMS ARE INCLUDED IN THIS PROJECT.
2. MWRD PERMIT IS INCLUDED IN THIS PROJECT.
3. UTILITY COORDINATION CAN BE FOUND IN THE PROJECT SPECIFICATIONS.
4. COORDINATION WITH GARFIELD ELEMENTARY SCHOOL AND OTHER ENTITIES INCLUDING MAYWOOD POLICE AND FIRE DEPARTMENT HAS BEEN PERFORMED.

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STATE OF ILLINOIS

DEPARTMENT OF TRANSPORTATION

GENERAL NOTES	
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M.W.R.D.G.C. GENERAL NOTES

A. REFERENCED SPECIFICATIONS

1. ALL CONSTRUCTION SHALL BE IN ACCORDANCE WITH THE APPLICABLE SECTIONS OF THE FOLLOWING, EXCEPT AS MODIFIED HEREIN OR ON THE PLANS:
- * STANDARD SPECIFICATIONS FOR ROAD AND BRIDGE CONSTRUCTION (LATEST EDITION), BY THE ILLINOIS DEPARTMENT OF TRANSPORTATION (IDOT SS) FOR ALL IMPROVEMENTS EXCEPT SANITARY SEWER AND WATER MAIN CONSTRUCTION;
 - * STANDARD SPECIFICATIONS FOR WATER AND SEWER MAIN CONSTRUCTION IN ILLINOIS, LATEST EDITION (SSWS) FOR SANITARY SEWER AND WATER MAIN CONSTRUCTION;
 - * VILLAGE OF MAYWOOD MUNICIPAL CODE;
 - * THE METROPOLITAN WATER RECLAMATION DISTRICT OF GREATER CHICAGO (MWRD) WATERSHED MANAGEMENT ORDINANCE AND TECHNICAL GUIDANCE MANUAL;
 - * IN CASE OF CONFLICT BETWEEN THE APPLICABLE ORDINANCES NOTED, THE MORE STRINGENT SHALL TAKE PRECEDENCE AND SHALL CONTROL ALL CONSTRUCTION.

B. NOTIFICATIONS

1. THE MWRD LOCAL SEWER SYSTEMS SECTION FIELD OFFICE MUST BE NOTIFIED AT LEAST TWO (2) WORKING DAYS PRIOR TO THE COMMENCEMENT OF ANY WORK (CALL 708-588-4055 OR SEND EMAIL NOTIFICATION WITH PROJECT NAME, LOCATION AND PERMIT NUMBER TO WMOJOBSTART@MWRD.ORG).
2. THE VILLAGE OF MAYWOOD ENGINEERING DEPARTMENT AND PUBLIC MUST BE NOTIFIED AT LEAST 24 HOURS PRIOR TO THE START OF CONSTRUCTION AND PRIOR TO EACH PHASE OF WORK. CONTRACTOR SHALL DETERMINE ITEMS REQUIRING INSPECTION PRIOR TO START OF CONSTRUCTION OR EACH WORK PHASE.
3. THE CONTRACTOR SHALL NOTIFY ALL UTILITY COMPANIES PRIOR TO BEGINNING CONSTRUCTION FOR THE EXACT LOCATIONS OF UTILITIES AND FOR THEIR PROTECTION DURING CONSTRUCTION. IF EXISTING UTILITIES ARE ENCOUNTERED THAT CONFLICT IN LOCATION WITH NEW CONSTRUCTION, IMMEDIATELY NOTIFY THE ENGINEER SO THAT THE CONFLICT CAN BE RESOLVED. CALL J.U.L.I.E. AT 1-800-892-0123.

C. GENERAL NOTES

1. ALL ELEVATIONS SHOWN ON PLANS REFERENCE THE NORTH AMERICAN VERTICAL DATUM OF 1988 (NAVD88). CONVERSION FACTOR IS 0 FT.
2. MWRD, THE MUNICIPALITY AND THE OWNER OR OWNER'S REPRESENTATIVE SHALL HAVE THE AUTHORITY TO INSPECT, APPROVE, AND REJECT THE CONSTRUCTION IMPROVEMENTS.
3. THE CONTRACTOR(S) SHALL INDEMNIFY THE OWNER, ENGINEER, MUNICIPALITY, MWRD, AND THEIR AGENTS, ETC., FROM ALL LIABILITY INVOLVED WITH THE CONSTRUCTION, INSTALLATION, OR TESTING OF THIS WORK ON THE PROJECT.
4. THE PROPOSED IMPROVEMENTS MUST BE CONSTRUCTED IN ACCORDANCE WITH THE ENGINEERING PLANS AS APPROVED BY MWRD AND THE MUNICIPALITY UNLESS CHANGES ARE APPROVED BY MWRD, THE MUNICIPALITY, OR AUTHORIZED AGENT. THE CONSTRUCTION DETAILS, AS PRESENTED ON THE PLANS, MUST BE FOLLOWED. PROPER CONSTRUCTION TECHNIQUES MUST BE FOLLOWED ON THE IMPROVEMENTS INDICATED ON THE PLANS.
5. THE LOCATION OF VARIOUS UNDERGROUND UTILITIES WHICH ARE SHOWN ON THE PLANS ARE FOR INFORMATION ONLY AND REPRESENT THE BEST KNOWLEDGE OF THE ENGINEER. VERIFY LOCATIONS AND ELEVATIONS PRIOR TO BEGINNING THE CONSTRUCTION OPERATIONS.
6. ANY EXISTING PAVEMENT, SIDEWALK, DRIVEWAY, ETC., DAMAGED DURING CONSTRUCTION OPERATIONS AND NOT CALLED FOR TO BE REMOVED SHALL BE REPLACED AT THE EXPENSE OF THE CONTRACTOR.
7. MATERIAL AND COMPACTION TESTING SHALL BE PERFORMED IN ACCORDANCE WITH THE REQUIREMENTS OF THE MUNICIPALITY, MWRD, AND OWNER.
8. THE UNDERGROUND CONTRACTOR SHALL MAKE ALL NECESSARY ARRANGEMENTS TO NOTIFY ALL INSPECTION AGENCIES.
9. ALL NEW AND EXISTING UTILITY STRUCTURES ON SITE AND IN AREAS DISTURBED DURING CONSTRUCTION SHALL BE ADJUSTED TO FINISH GRADE PRIOR TO FINAL INSPECTION.
10. RECORD DRAWINGS SHALL BE KEPT BY THE CONTRACTOR AND SUBMITTED TO THE ENGINEER AS SOON AS UNDERGROUND IMPROVEMENTS ARE COMPLETED. FINAL PAYMENTS TO THE CONTRACTOR SHALL BE HELD UNTIL THEY ARE RECEIVED. ANY CHANGES IN LENGTH, LOCATION OR ALIGNMENT SHALL BE SHOWN IN RED. ALL WYES OR BENDS SHALL BE LOCATED FROM THE DOWNSTREAM MANHOLE. ALL VALVES, B-BOXES, TEES OR BENDS SHALL BE TIED TO A FIRE HYDRANT.

D. SANITARY SEWER

1. THE CONTRACTOR SHALL TAKE MEASURES TO PREVENT ANY POLLUTED WATER, SUCH AS GROUND AND SURFACE WATER, FROM ENTERING THE EXISTING SANITARY SEWERS.
2. A WATER-TIGHT PLUG SHALL BE INSTALLED IN THE DOWNSTREAM SEWER PIPE AT THE POINT OF SEWER CONNECTION PRIOR TO COMMENCING ANY SEWER CONSTRUCTION. THE PLUG SHALL REMAIN IN PLACE UNTIL REMOVAL IS AUTHORIZED BY THE MUNICIPALITY AND/OR MWRD AFTER THE SEWERS HAVE BEEN TESTED AND ACCEPTED.
3. DISCHARGING ANY UNPOLLUTED WATER INTO THE SANITARY SEWER SYSTEM FOR THE PURPOSE OF SEWER FLUSHING OF LINES FOR THE DEFLECTION TEST SHALL BE PROHIBITED WITHOUT PRIOR APPROVAL FROM THE MUNICIPALITY OR MWRD.
4. ALL SANITARY SEWER CONSTRUCTION SHALL BE IN ACCORDANCE WITH THE STANDARD SPECIFICATIONS FOR WATER AND SEWER MAIN CONSTRUCTION IN ILLINOIS (LATEST EDITION).
5. ALL FLOOR DRAINS SHALL DISCHARGE TO THE SANITARY SEWER SYSTEM.
6. ALL DOWNSPOUTS AND FOOTING DRAINS SHALL DISCHARGE TO THE STORM SEWER SYSTEM.
7. ALL SANITARY SEWER PIPE MATERIALS AND JOINTS (AND STORM SEWER PIPE MATERIALS AND JOINTS IN A COMBINED SEWER AREA) SHALL CONFORM TO THE FOLLOWING:

PIPE MATERIAL	PIPE SPECIFICATIONS	JOINT SPECIFICATIONS
VITRIFIED CLAY PIPE	ASTM C-700	ASTM C-425
REINFORCED CONCRETE SEWER PIPE	ASTM C-76	ASTM C-443
CAST IRON SOIL PIPE	ASTM A-74	ASTM C-564
DUCTILE IRON PIPE	ANSI A21.51	ANSI A21.11
POLYVINYL CHLORIDE (PVC) PIPE 6-INCH TO 15-INCH DIAMETER SDR 26 18-INCH TO 27-INCH DIAMETER F/DY=46	ASTM D-3034 ASTM F-679	ASTM D-3212 ASTM D-3212
HIGH DENSITY POLYETHYLENE (HDPE)	ASTM D-3350 ASTM D-3035	ASTM D-3261,F-2620 (HEAT FUSION) ASTM D-3212,F-477 (GASKETED)
WATER MAIN QUALITY PVC 4-INCH TO 36-INCH 4-INCH TO 12-INCH 14-INCH TO 48-INCH	ASTM D-2241 AWWA C900 AWWA C905	ASTM D-3139 ASTM D-3139 ASTM D-3139

THE FOLLOWING MATERIALS ARE ALLOWED ON A QUALIFIED BASIS SUBJECT TO DISTRICT REVIEW AND APPROVAL PRIOR TO PERMIT ISSUANCE. A SPECIAL CONDITION WILL BE ADDED TO THE PERMIT WHEN THE PIPE MATERIAL BELOW IS USED FOR SEWER CONSTRUCTION OR A CONNECTION IS MADE.

PIPE MATERIAL	PIPE SPECIFICATIONS	JOINT SPECIFICATIONS
POLYPROPYLENE (PP) PIPE		
12-INCH TO 24-INCH DOUBLE WALL	ASTM F-2736	D-3212, F-477
30-INCH TO 60-INCH TRIPLE WALL	ASTM F-2764	D3212, F-477

8. ALL SANITARY SEWER CONSTRUCTION (AND STORM SEWER CONSTRUCTION IN COMBINED SEWER AREAS), REQUIRES STONE BEDDING WITH STONE ¼ " TO 1" IN SIZE, WITH MINIMUM BEDDING THICKNESS EQUAL TO ¼ THE OUTSIDE DIAMETER OF THE SEWER PIPE, BUT NOT LESS THAN FOUR (4) INCHES NOR MORE THAN EIGHT (8) INCHES. MATERIAL SHALL BE CA-7, CA-11 OR CA-13 AND SHALL BE EXTENDED AT LEAST 12" ABOVE THE TOP OF THE PIPE WHEN USING PVC.
9. NON-SHEAR FLEXIBLE-TYPE COUPLINGS SHALL BE USED IN THE CONNECTION OF SEWER PIPES OF DISSIMILAR PIPE MATERIALS.
10. ALL MANHOLES SHALL BE PROVIDED WITH BOLTED, WATERTIGHT COVERS. SANITARY LIDS SHALL BE CONSTRUCTED WITH A CONCEALED PICKHOLE AND WATERTIGHT GASKET WITH THE WORD "SANITARY" CAST INTO THE LID.
11. WHEN CONNECTING TO AN EXISTING SEWER MAIN BY MEANS OTHER THAN AN EXISTING WYE, TEE, OR AN EXISTING MANHOLE, ONE OF THE FOLLOWING METHODS SHALL BE USED:
- a) A CIRCULAR SAW-CUT OF SEWER MAIN BY PROPER TOOLS ("SEWER-TAP" MACHINE) AND PROPER INSTALLATION OF HUBWYE SADDLE OR HUB-TEE SADDLE.
 - b) REMOVE AN ENTIRE SECTION OF PIPE (BREAKING ONLY THE TOP OF ONE BELL) AND REPLACE WITH A WYE OR TEE BRANCH SECTION.
 - c) WITH PIPE CUTTER, NEATLY AND ACCURATELY CUT OUT DESIRED LENGTH OF PIPE FOR INSERTION OF PROPER FITTING, USING "BAND SEAL" COUPLINGS TO HOLD IT FIRMLY IN PLACE.
12. WHENEVER A SANITARY/COMBINED SEWER CROSSES UNDER A WATERMAIN, THE MINIMUM VERTICAL DISTANCE FROM THE TOP OF THE SEWER TO THE BOTTOM OF THE WATERMAIN SHALL BE 18 INCHES. FURTHERMORE, A MINIMUM HORIZONTAL DISTANCE OF 10 FEET BETWEEN SANITARY/COMBINED SEWERS AND WATERMAINS SHALL BE MAINTAINED UNLESS: THE SEWER IS LAID IN A SEPARATE TRENCH, KEEPING A MINIMUM 18" VERTICAL SEPARATION; OR THE SEWER IS LAID IN THE SAME TRENCH WITH THE WATERMAIN LOCATED AT THE OPPOSITE SIDE ON A BENCH OF UNDISTURBED EARTH, KEEPING A MINIMUM 18" VERTICAL SEPARATION. IF EITHER THE VERTICAL OR HORIZONTAL DISTANCES DESCRIBED CANNOT BE MAINTAINED, OR THE SEWER CROSSES ABOVE THE WATER MAIN, THE SEWER SHALL BE CONSTRUCTED TO WATER MAIN STANDARDS OR IT SHALL BE ENCASED WITH A WATER MAIN QUALITY CARRIER PIPE WITH THE ENDS SEALED.
13. ALL EXISTING SEPTIC SYSTEMS SHALL BE ABANDONED. ABANDONED TANKS SHALL BE FILLED WITH GRANULAR MATERIAL OR REMOVED.
14. ALL SANITARY MANHOLES, (AND STORM MANHOLES IN COMBINED SEWER AREAS), SHALL HAVE A MINIMUM INSIDE DIAMETER OF 48 INCHES, AND SHALL BE CAST IN PLACE OR PRE-CAST REINFORCED CONCRETE.
15. ALL SANITARY MANHOLES, (AND STORM MANHOLES IN COMBINED SEWER AREAS), SHALL HAVE PRECAST "RUBBER BOOTS" THAT CONFORM TO ASTM C-923 FOR ALL PIPE CONNECTIONS. PRECAST SECTIONS SHALL CONSIST OF MODIFIED GROOVE TONGUE AND RUBBER GASKET TYPE JOINTS.
16. ALL ABANDONED SANITARY SEWERS SHALL BE PLUGGED AT BOTH ENDS WITH AT LEAST 2 FEET LONG NON-SHRINK CONCRETE OR MORTAR PLUG.
17. EXCEPT FOR FOUNDATION/FOOTING DRAINS PROVIDED TO PROTECT BUILDINGS, OR PERFORATED PIPES ASSOCIATED WITH VOLUME CONTROL FACILITIES, DRAIN TILES/FIELD TILES/UNDERDRAINS/PERFORATED PIPES ARE NOT ALLOWED TO BE CONNECTED TO OR TRIBUTARY TO COMBINED SEWERS, SANITARY SEWERS, OR STORM SEWERS TRIBUTARY TO COMBINED SEWERS IN COMBINED SEWER AREAS. CONSTRUCTION OF NEW FACILITIES OF THIS TYPE IS PROHIBITED; AND ALL EXISTING DRAIN TILES AND PERFORATED PIPES ENCOUNTERED WITHIN THE PROJECT AREA SHALL BE PLUGGED OR REMOVED, AND SHALL NOT BE CONNECTED TO COMBINED SEWERS, SANITARY SEWERS, OR STORM SEWERS TRIBUTARY TO COMBINED SEWERS.
18. A BACKFLOW PREVENTER IS REQUIRED FOR ALL DETENTION BASINS TRIBUTARY TO COMBINED SEWERS. REQUIRED BACKFLOW PREVENTERS SHALL BE INSPECTED AND EXERCISED ANNUALLY BY THE PROPERTY OWNER TO ENSURE PROPER OPERATION, AND ANY NECESSARY MAINTENANCES SHALL BE PERFORMED TO ENSURE FUNCTIONALITY. IN THE EVENT OF A SEWER SURCHARGE INTO AN OPEN DETENTION BASIN TRIBUTARY TO COMBINED SEWERS, THE PERMITTEE SHALL ENSURE THAT CLEAN UP AND WASH OUT OF SEWAGE TAKES PLACE WITHIN 48 HOURS OF THE STORM EVENT.

E. EROSION AND SEDIMENT CONTROL

1. THE CONTRACTOR SHALL INSTALL THE EROSION AND SEDIMENT CONTROL DEVICES AS SHOWN ON THE APPROVED EROSION AND SEDIMENT CONTROL PLAN.
2. EROSION AND SEDIMENT CONTROL PRACTICES SHALL BE FUNCTIONAL PRIOR TO HYDROLOGIC DISTURBANCE OF THE SITE.
3. ALL DESIGN CRITERIA, SPECIFICATIONS, AND INSTALLATION OF EROSION AND SEDIMENT CONTROL PRACTICES SHALL BE IN ACCORDANCE WITH THE ILLINOIS URBAN MANUAL.
4. A COPY OF THE APPROVED EROSION AND SEDIMENT CONTROL PLAN SHALL BE MAINTAINED ON THE SITE AT ALL TIMES.
5. INSPECTIONS AND DOCUMENTATION SHALL BE PERFORMED, AT A MINIMUM:
- a) UPON COMPLETION OF INITIAL EROSION AND SEDIMENT CONTROL MEASURES, PRIOR TO ANY SOIL DISTURBANCE.
 - b) ONCE EVERY SEVEN (7) CALENDAR DAYS AND WITHIN 24 HOURS OF THE END OF A STORM EVENT WITH GREATER THAN 0.5 INCH OF RAINFALL OR LIQUID EQUIVALENT PRECIPITATION.
6. SOIL DISTURBANCE SHALL BE CONDUCTED IN SUCH A MANNER AS TO MINIMIZE EROSION. IF STRIPPING, CLEARING, GRADING, OR LANDSCAPING ARE TO BE DONE IN PHASES, THE CO-PERMITTEE SHALL PLAN FOR APPROPRIATE SOIL EROSION AND SEDIMENT CONTROL MEASURES.
7. A STABILIZED MAT OF CRUSHED STONE MEETING THE STANDARDS OF THE ILLINOIS URBAN MANUAL SHALL BE INSTALLED AT ANY POINT WHERE TRAFFIC WILL BE ENTERING OR LEAVING A CONSTRUCTION SITE. SEDIMENT OR SOIL REACHING AN IMPROVED PUBLIC RIGHT-OF-WAY, STREET, ALLEY OR PARKING AREA SHALL BE REMOVED BY SCRAPING OR STREET CLEANING AS ACCUMULATIONS WARRANT AND TRANSPORTED TO A CONTROLLED SEDIMENT DISPOSAL AREA.
8. CONCRETE WASHOUT FACILITIES SHALL BE CONSTRUCTED IN ACCORDANCE WITH THE ILLINOIS URBAN MANUAL AND SHALL BE INSTALLED PRIOR TO ANY ON SITE CONSTRUCTION ACTIVITIES INVOLVING CONCRETE.
9. MORTAR WASHOUT FACILITIES SHALL BE CONSTRUCTED IN ADDITION TO CONCRETE WASHOUT FACILITIES FOR ANY BRICK AND MORTAR BUILDING ENVELOPE CONSTRUCTION ACTIVITIES.
10. TEMPORARY DIVERSIONS SHALL BE CONSTRUCTED AS NECESSARY TO DIRECT ALL RUNOFF FROM HYDROLOGICALLY DISTURBED AREAS TO AN APPROPRIATE SEDIMENT TRAP OR BASIN. VOLUME CONTROL FACILITIES SHALL NOT BE USED AS TEMPORARY SEDIMENT BASINS.
11. DISTURBED AREAS OF THE SITE WHERE CONSTRUCTION ACTIVITIES HAVE TEMPORARILY OR PERMANENTLY CEASED SHALL BE STABILIZED WITH TEMPORARY OR PERMANENT MEASURES WITHIN SEVEN (7) DAYS.
12. ALL FLOOD PROTECTION AREAS AND VOLUME CONTROL FACILITIES SHALL, AT A MINIMUM, BE PROTECTED WITH A DOUBLE-ROW OF SILT FENCE (OR EQUIVALENT).
13. VOLUME CONTROL FACILITIES SHALL NOT BE CONSTRUCTED UNTIL ALL OF THE CONTRIBUTING DRAINAGE AREA HAS BEEN STABILIZED.
14. SOIL STOCKPILES SHALL, AT A MINIMUM, BE PROTECTED WITH PERIMETER SEDIMENT CONTROLS. SOIL STOCKPILES SHALL NOT BE PLACED IN FLOOD PROTECTION AREAS OR THEIR BUFFERS.
15. EARTHEN EMBANKMENT SIDE SLOPES SHALL BE STABILIZED WITH APPROPRIATE EROSION CONTROL BLANKET.
16. STORM SEWERS THAT ARE OR WILL BE FUNCTIONING DURING CONSTRUCTION SHALL BE PROTECTED BY APPROPRIATE SEDIMENT CONTROL MEASURES.
17. THE CONTRACTOR SHALL EITHER REMOVE OR REPLACE ANY EXISTING DRAIN TILES AND INCORPORATE THEM INTO THE DRAINAGE PLAN FOR THE DEVELOPMENT. DRAIN TILES CANNOT BE TRIBUTARY TO A SANITARY OR COMBINED SEWER. DRAIN TILES ALLOWED IN COMBINED SEWER AREA FOR GREEN INFRASTRUCTURE PRACTICES.
18. IF DEWATERING SERVICES ARE USED, ADJOINING PROPERTIES AND DISCHARGE LOCATIONS SHALL BE PROTECTED FROM EROSION AND SEDIMENTATION. DEWATERING SYSTEMS SHOULD BE INSPECTED DAILY DURING OPERATIONAL PERIODS. THE SITE INSPECTOR MUST BE PRESENT AT THE COMMENCEMENT OF DEWATERING ACTIVITIES.
19. THE CONTRCTOR SHALL BE RESPONSIBLE FOR TRENCH DEWATERING AND EXCAVATION FOR THE INSTALLATION OF SANITARY SEWERS, STORM SEWERS, WATERMAINS AS WELL AS THEIR SERVICES AND OTHER APPURTENANCES. ANY TRENCH DEWATERING, WHICH CONTAINS SEDIMENT SHALL PASS THROUGH A SEDIMENT SETTLING POND OR EQUALLY EFFECTIVE SEDIMENT CONTROL DEVICE. ALTERNATIVES MAY INCLUDE DEWATERING INTO A SUMP PIT, FILTER BAG OR EXISTING VEGETATED UPSLOPE AREA. SEDIMENT LADEN WATERS SHALL NOT BE DISCHARGE TO WATERWAYS, FLOOD PROTECTION AREAS OR THE COMBINED SEWER SYSTEM.
20. ALL PERMANENT EROSION CONTROL PRACTICES SHALL BE INITIATED WITHIN SEVEN (7) DAYS FOLLOWING THE COMPLETION OF SOIL DISTURBING ACTIVITIES.
21. ALL EROSION AND SEDIMENT CONTROL MEASURES SHALL BE MAINTAINED AND REPAIRED AS NEEDED ON A YEAR-ROUND BASIS DURING CONSTRUCTION AND ANY PERIODS OF CONSTRUCTION SHUTDOWN UNTIL PERMANENT STABILIZATION IS ACHIEVED.
22. ALL TEMPORARY EROSION AND SEDIMENT CONTROL MEASURES SHALL BE REMOVED WITHIN THIRTY (30) DAYS AFTER PERMANENT SITE STABILIZATION.
23. THE EROSION AND SEDIMENT CONTROL MEASURES SHOWN ON THE PLANS ARE THE MINIMUM REQUIREMENTS. ADDITIONAL MEASURES MAY BE REQUIRED, AS DIRECTED BY THE ENGINEER, SITE INSPECTOR, OR MWRD.



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STATE OF ILLINOIS
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MWRD GENERAL NOTES

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XX	24-00144-00-MS	COOK	22	5
FIELD BOOK NO. : -		CONTRACT NO. 61L76		
FED. ROAD DIST. NO. 1		ILLINOIS	FED. AID PROJECT	

E.H.E. PROJECT NO. 565-24-16880

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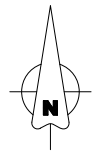
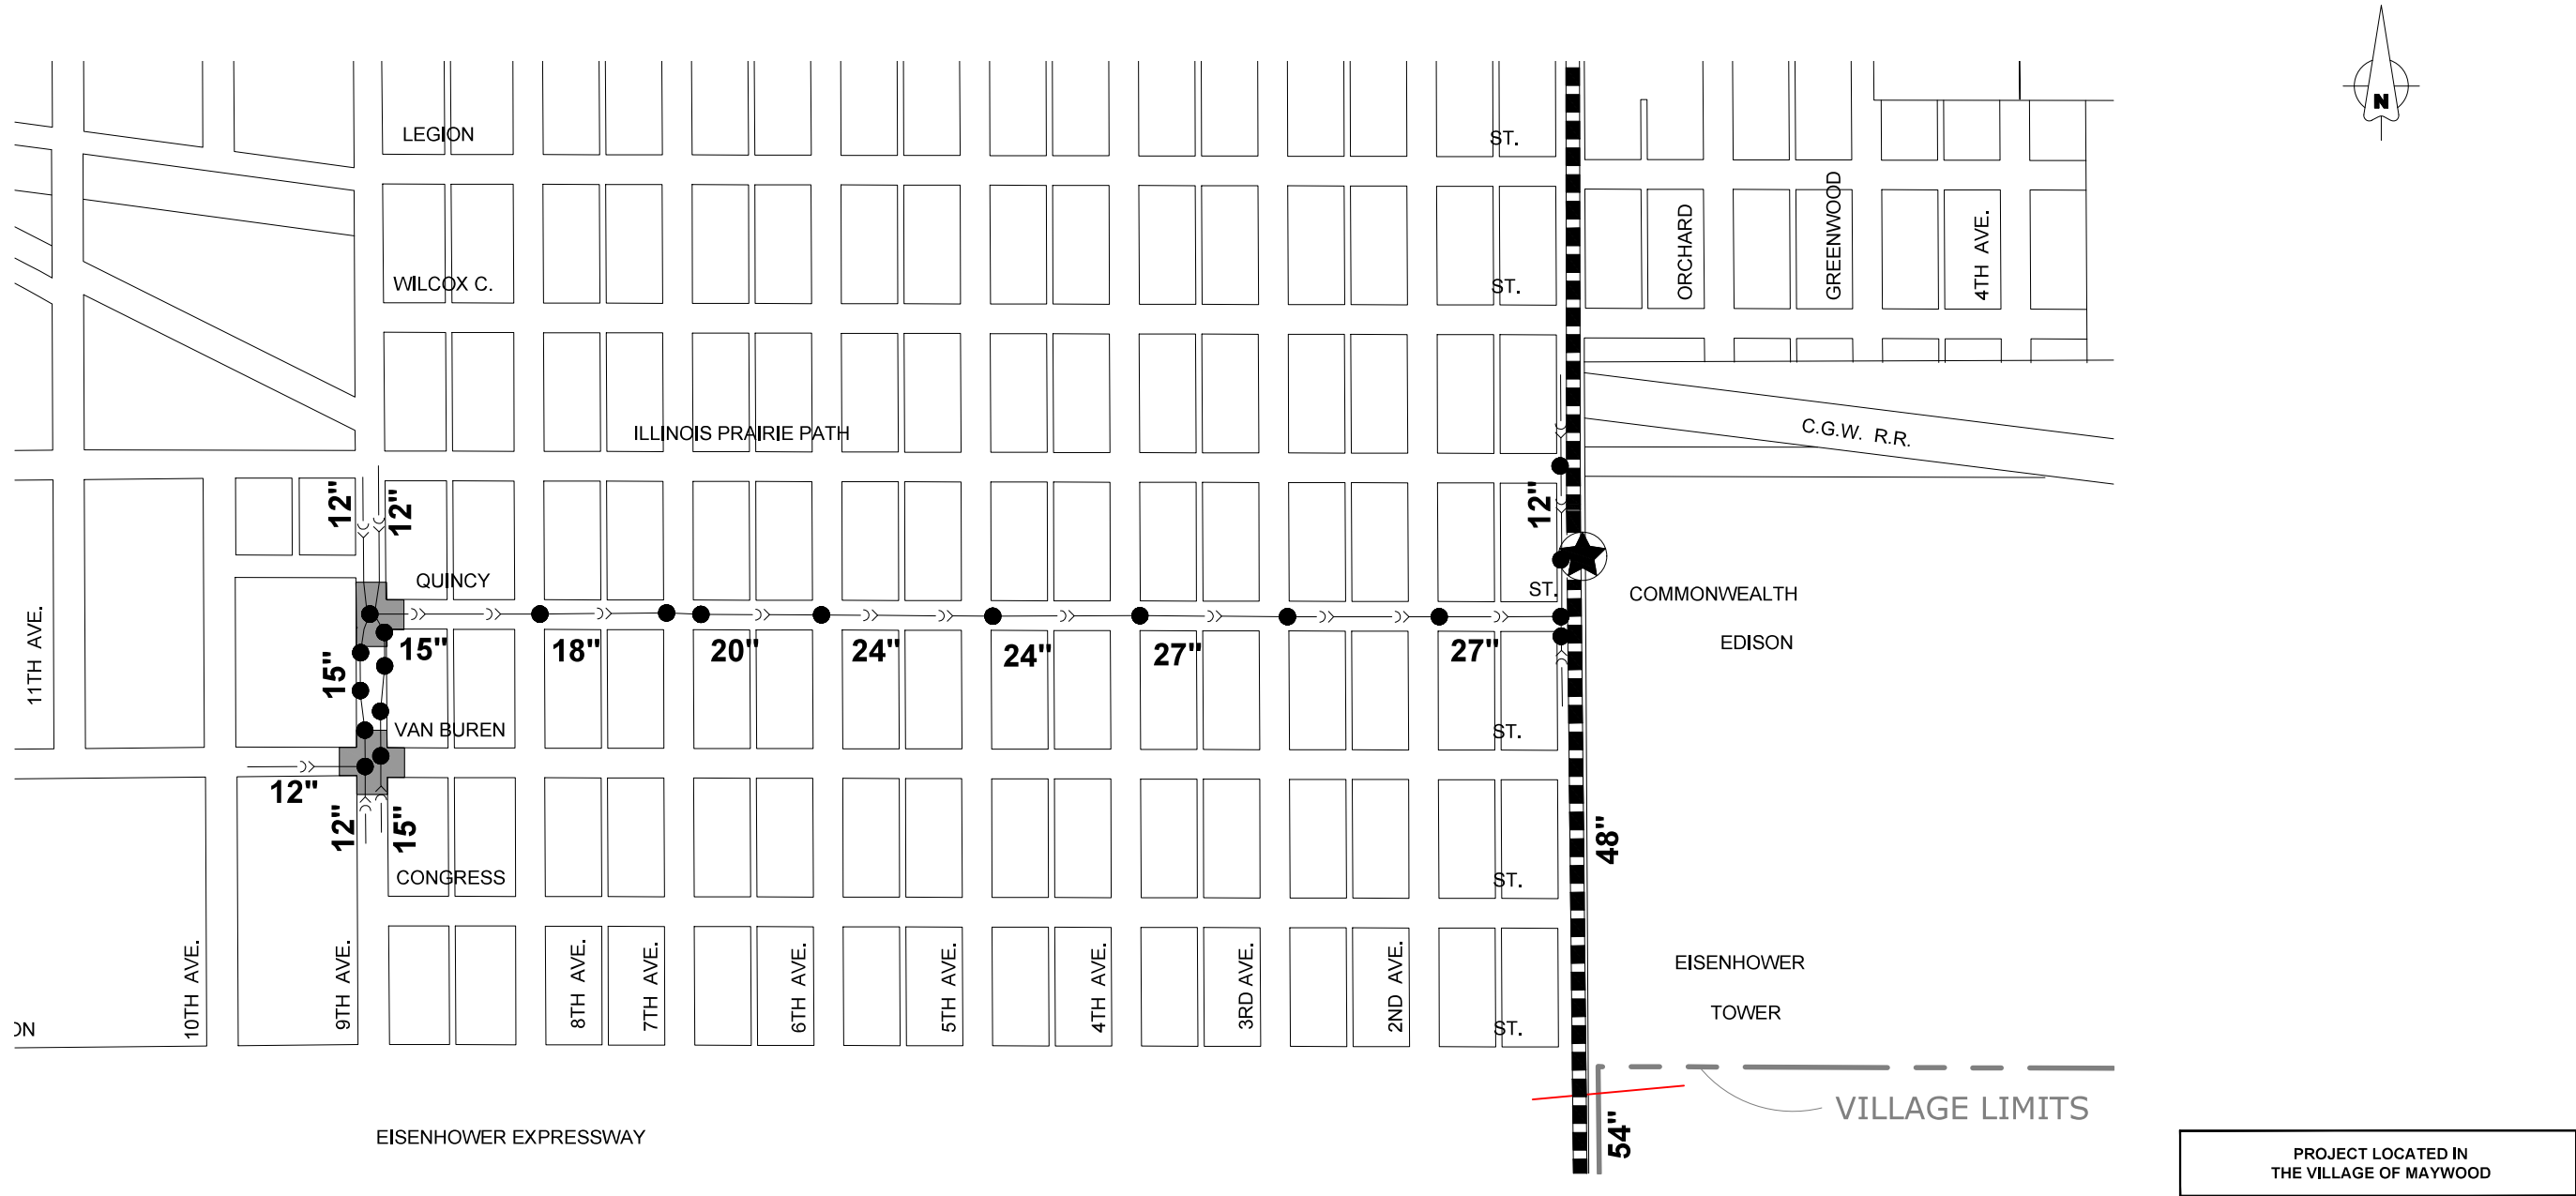
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STATE OF ILLINOIS
DEPARTMENT OF TRANSPORTATION

MWRD ROUTE OUTLET MAP			
SCALE:	SHEET NO. - OF - SHEETS	STA. -	TO STA. -

MUN RTE.	SECTION	COUNTY	TOTAL SHEETS	SHEET NO.
XX	24-00144-00-MS	COOK	22	6
FIELD BOOK NO. : -		CONTRACT NO. 61L76		
FED. ROAD DIST. NO. 1 ILLINOIS		FED. AID PROJECT		

E.H.E. PROJECT NO. 565-24-16880



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SUMMARY OF QUANTITIES					Const. Type Code
					100% Federal
SPLTY ITEM	Code No.	Description	Unit	Total Quantity	Resurfacing 005 Urban
	20800150	TRENCH BACKFILL	CU YD	50	50
	21101615	TOPSOIL FURNISH AND PLACE, 4"	SQ YD	200	200
	25200110	SODDING, SALT TOLERANT	SQ YD	200	200
	25200200	SUPPLEMENTAL WATERING	UNIT	10	10
	28000510	INLET FILTERS	EACH	14	14
	40600290	BITUMINOUS MATERIALS (TACK COAT)	POUND	700	700
	40600400	MIXTURE FOR CRACKS, JOINTS, AND FLANGEWAYS	TON	5	5
	40600982	HOT-MIX ASPHALT SURFACE REMOVAL - BUTT JOINT	SQ YD	70	70
	40602978	HOT-MIX ASPHALT BINDER COURSE, IL-9.5,N50	TON	100	100
	40604060	HOT-MIX ASPHALT SURFACE COURSE, IL-9.5, MIX "D", N50	TON	125	125
	40800050	INCIDENTAL HOT-MIX ASPHALT SURFACING	TON	5	5
	42101300	PROTECTIVE COAT	SQ YD	250	250
	42400200	PORTLAND CEMENT CONCRETE SIDEWALK 5 INCH	SQ FT	1500	1500
	42400800	DETECTABLE WARNINGS	SQ FT	100	100
	44000100	PAVEMENT REMOVAL	SQ YD	70	70
	44000500	COMBINATION CURB AND GUTTER REMOVAL	FOOT	380	380



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SUMMARY OF QUANTITIES

SCALE: - SHEET NO. 1 OF 3 SHEETS STA. - TO STA. -

MUN RTE.	SECTION	COUNTY	TOTAL SHEETS	SHEET NO.
XX	24-00144-00-MS	COOK	22	7
FIELD BOOK NO. : -		CONTRACT NO. 61L76		
FED. ROAD DIST. NO. 1 ILLINOIS		FED. AID PROJECT		

E.H.E. PROJECT NO. 565-24-16880

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SUMMARY OF QUANTITIES					Const. Type Code
					100% Federal
SPLTY ITEM	Code No.	Description	Unit	Total Quantity	Resurfacing 005 Urban
	44000600	SIDEWALK REMOVAL	SQ FT	1500	1500
	44200934	CLASS B PATCHES, TYPE II, 8 INCH	SQ YD	60	60
	44200942	CLASS B PATCHES, TYPE III, 8 INCH	SQ YD	90	90
	60200105	CATCH BASINS, TYPE A, 4'-DIAMETER, TYPE 1 FRAME, OPEN LID	EACH	1	1
	60234200	INLETS, TYPE A, TYPE 1 FRAME, OPEN LID	EACH	4	4
	60257900	MANHOLES TO BE RECONSTRUCTED	EACH	4	4
	60300305	FRAMES AND LIDS TO BE ADJUSTED	EACH	14	14
	60406000	FRAMES AND LIDS, TYPE 1, OPEN LID	EACH	1	1
	60406100	FRAMES AND LIDS, TYPE 1, CLOSED LID	EACH	11	11
	60500060	REMOVING INLETS	EACH	2	2
	60604100	COMBINATION CONCRETE CURB AND GUTTER, TYPE B-6.12 (MODIFIED)	FOOT	420	420
	67100100	MOBILIZATION	LSUM	1	1
	70102620	TRAFFIC CONTROL AND PROTECTION, STANDARD 701501	LSUM	1	1
	70102635	TRAFFIC CONTROL AND PROTECTION, STANDARD 701701	LSUM	1	1
	70102640	TRAFFIC CONTROL AND PROTECTION, STANDARD 701801	LSUM	1	1
	70300100	SHORT TERM PAVEMENT MARKING	FOOT	75	75



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STATE OF ILLINOIS
DEPARTMENT OF TRANSPORTATION

SUMMARY OF QUANTITIES

SCALE: - SHEET NO. 2 OF 3 SHEETS STA. - TO STA. -

MUN RTE.	SECTION	COUNTY	TOTAL SHEETS	SHEET NO.
XX	24-00144-00-MS	COOK	22	8
FIELD BOOK NO. : -		CONTRACT NO. 61L76		
FED. ROAD DIST. NO. 1 ILLINOIS FED. AID PROJECT				

E.N.E. PROJECT NO. 565-24-1688D

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SUMMARY OF QUANTITIES					Const. Type Code
					100% Federal
SPLTY	Code No.	Description	Unit	Total Quantity	Resurfacing 005 Urban
	70300150	SHORT TERM PAVEMENT MARKING REMOVAL	SQ FT	30	30
*	72000100	SIGN PANEL - TYPE 1	SQ FT	100	100
*	72900100	METAL POST - TYPE A	FOOT	100	100
*	72900200	METAL POST - TYPE B	FOOT	110	110
*	78000200	THERMOPLASTIC PAVEMENT MARKING - LINE 4"	FOOT	90	90
*	78000600	THERMOPLASTIC PAVEMENT MARKING - LINE 12"	FOOT	300	300
*	78000650	THERMOPLASTIC PAVEMENT MARKING - LINE 24"	FOOT	75	75
	X0326806	WASHOUT BASIN	LSUM	1	1
*	X0326899	SOLAR-POWERED FLASHING BEACON ASSEMBLY (COMPLETE)	EACH	2	2
	X4401198	HOT-MIX ASPHALT SURFACE REMOVAL, VARIABLE DEPTH	SQ YD	1075	1075
	X6020399	CONNECTION TO EXISTING MANHOLE	EACH	4	4
	X6030310	FRAMES AND LIDS TO BE ADJUSTED (SPECIAL)	EACH	2	2
	XX009453	STORM SEWERS, PVC, TYPE1, 8"	FOOT	75	75
	X7200061	TEMPORARY INFORMATION SIGNING	SQ FT	128.5	128.5
	Z0062456	TEMPORARY PAVEMENT	SQ YD	150	150



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STATE OF ILLINOIS
DEPARTMENT OF TRANSPORTATION

SUMMARY OF QUANTITIES

SCALE: - SHEET NO. 3 OF 3 SHEETS STA. - TO STA. -

MUN RTE.	SECTION	COUNTY	TOTAL SHEETS	SHEET NO.
XX	24-00144-00-MS	COOK	22	9
FIELD BOOK NO. : -		CONTRACT NO. 61L76		
FED. ROAD DIST. NO. 1		ILLINOIS FED. AID PROJECT		

E:\H.E. PROJECT NO. 265-24-1680


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HOT-MIX ASPHALT MIXTURE REQUIREMENTS

MIXTURE TYPE	AIR VOIDS @ Ndes	QMP
INCIDENTAL HOT-MIX ASPHALT SURFACING		
HOT-MIX ASPHALT SURFACE COURSE, IL-9.5, MIX "D", N50, 3" (2 LIFTS)	4% @ 50 Gyr.	LR 1030-2
TEMPORARY PAVEMENT		
HOT-MIX ASPHALT SURFACE COURSE, IL-9.5, MIX "D", N50, 1.5"	4% @ 50 Gyr.	LR 1030-2
9TH AVENUE		
HOT-MIX ASPHALT SURFACE COURSE, IL-9.5, MIX "D", N50, 2"	4% @ 50 Gyr.	LR 1030-2
HOT-MIX ASPHALT BINDER COURSE, IL 9.5, N50, 1.5"	4% @ 50 Gyr.	LR 1030-2
QMP DESIGNATION: QUALITY CONTROL/QUALITY ASSURANCE (QC/QA) PER LR 1030-2		

THE UNIT WEIGHT USED TO CALCULATE ALL HMA SURFACE MIXTURE QUANTITIES IS 112 LBS/SQ YD/IN.

THE "AC TYPE" FOR POLYMERIZED HMA MIXES SHALL BE "SBS/SBR PG 76-22" AND FOR NON-POLYMERIZED HMA THE "AC TYPE" SHALL BE "PG 64-22" UNLESS MODIFIED BY RECLAIMED MATERIALS SPECIFICATIONS.

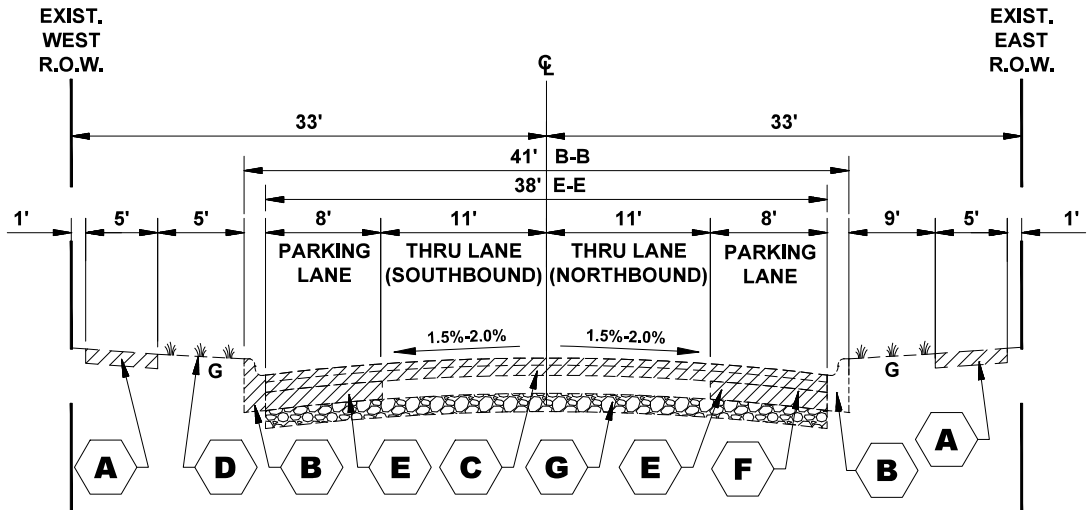

EXISTING TYPICAL SECTION

9TH AVENUE
STATION 0+98 TO STATION 1+81 (VAN BUREN STREET)
STATION 4+16 TO STATION 5+16 (QUINCY STREET)

TYPICAL SECTION LEGEND

EXISTING

- A** EXISTING PORTLAND CEMENT CONCRETE SIDEWALK, 5" REMOVAL
- B** EXISTING COMBINATION CONCRETE CURB AND GUTTER, TYPE B-6.12 REMOVAL
- C** HOT-MIX ASPHALT SURFACE REMOVAL, VARIABLE DEPTH
- D** GRASS PARKWAY
- E** PAVEMENT REMOVAL
- F** 8" PCC BASE COURSE
- G** AGGREGATE SUB BASE


LEGEND

- REMOVAL ITEMS
- PROPOSED CONCRETE
- AGGREGATE SUB BASE
- PROPOSED HMA

TYPICAL SECTION LEGEND

PROPOSED

- 1** PROPOSED PORTLAND CEMENT CONCRETE SIDEWALK, 5"
- 2** PROPOSED COMBINATION CONCRETE CURB AND GUTTER, TYPE B-6.12 (MODIFIED)
- 3** PROPOSED DETECTABLE WARNING
- 4** HOT-MIX ASPHALT BINDER COURSE, IL-9.5, N50, 1½"
- 5** HOT-MIX ASPHALT SURFACE COURSE, IL-9.5, MIX "D", N50, 2"

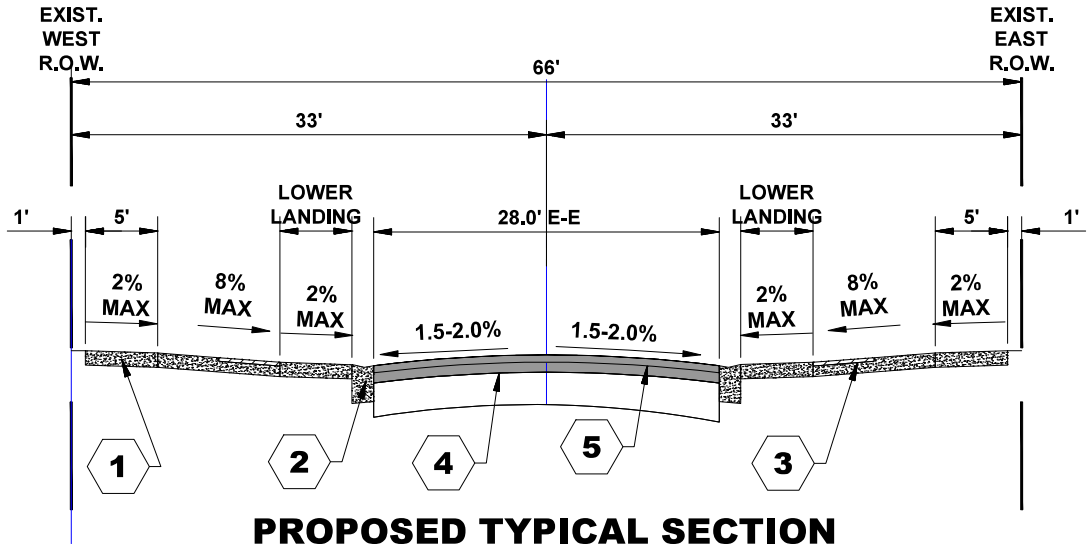

PROPOSED TYPICAL SECTION

9TH AVENUE
STATION 0+98 TO STATION 1+81 (VAN BUREN STREET)
STATION 4+16 TO STATION 5+16 (QUINCY STREET)



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EXISTING AND PROPOSED TYPICAL SECTIONS

SCALE: SHEET NO. OF SHEETS STA. TO STA.

MUN RTE.	SECTION	COUNTY	TOTAL SHEETS	SHEET NO.
XX	24-00144-00-MS	COOK	22	10
FIELD BOOK NO. : -		CONTRACT NO. 61L76		
FED. ROAD DIST. NO. 1		ILLINOIS	FED. AID PROJECT	


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LEGEND OF SYMBOLS

(TO BE USED IN CONJUNCTION WITH I.D.O.T. STANDARD 000001-07)

SYMBOL	DESCRIPTION
	EXISTING FIRE HYDRANT
	EXISTING WATER VALVE BOX
	EXISTING WATER MAIN VALVE VAULT
	EXISTING STORM SEWER INLET
	EXISTING STORM SEWER CATCH BASIN

	EXISTING SEWER MANHOLE		EXISTING CURB AND GUTTER
	EXISTING STREET LIGHT POLE		EXISTING SHARED USE PATH
	EXISTING POWER POLE		EXISTING STORM SEWER
	EXISTING HANDHOLE		EXISTING COMBINED SEWER
	EXISTING ELECTRICAL TOWER		EXISTING WATER MAIN
	EXISTING SIGN POST		EXISTING RIGHT OF WAY LINE
	EXISTING FENCE		EXISTING TREE
	EXISTING GAS UTILITY		

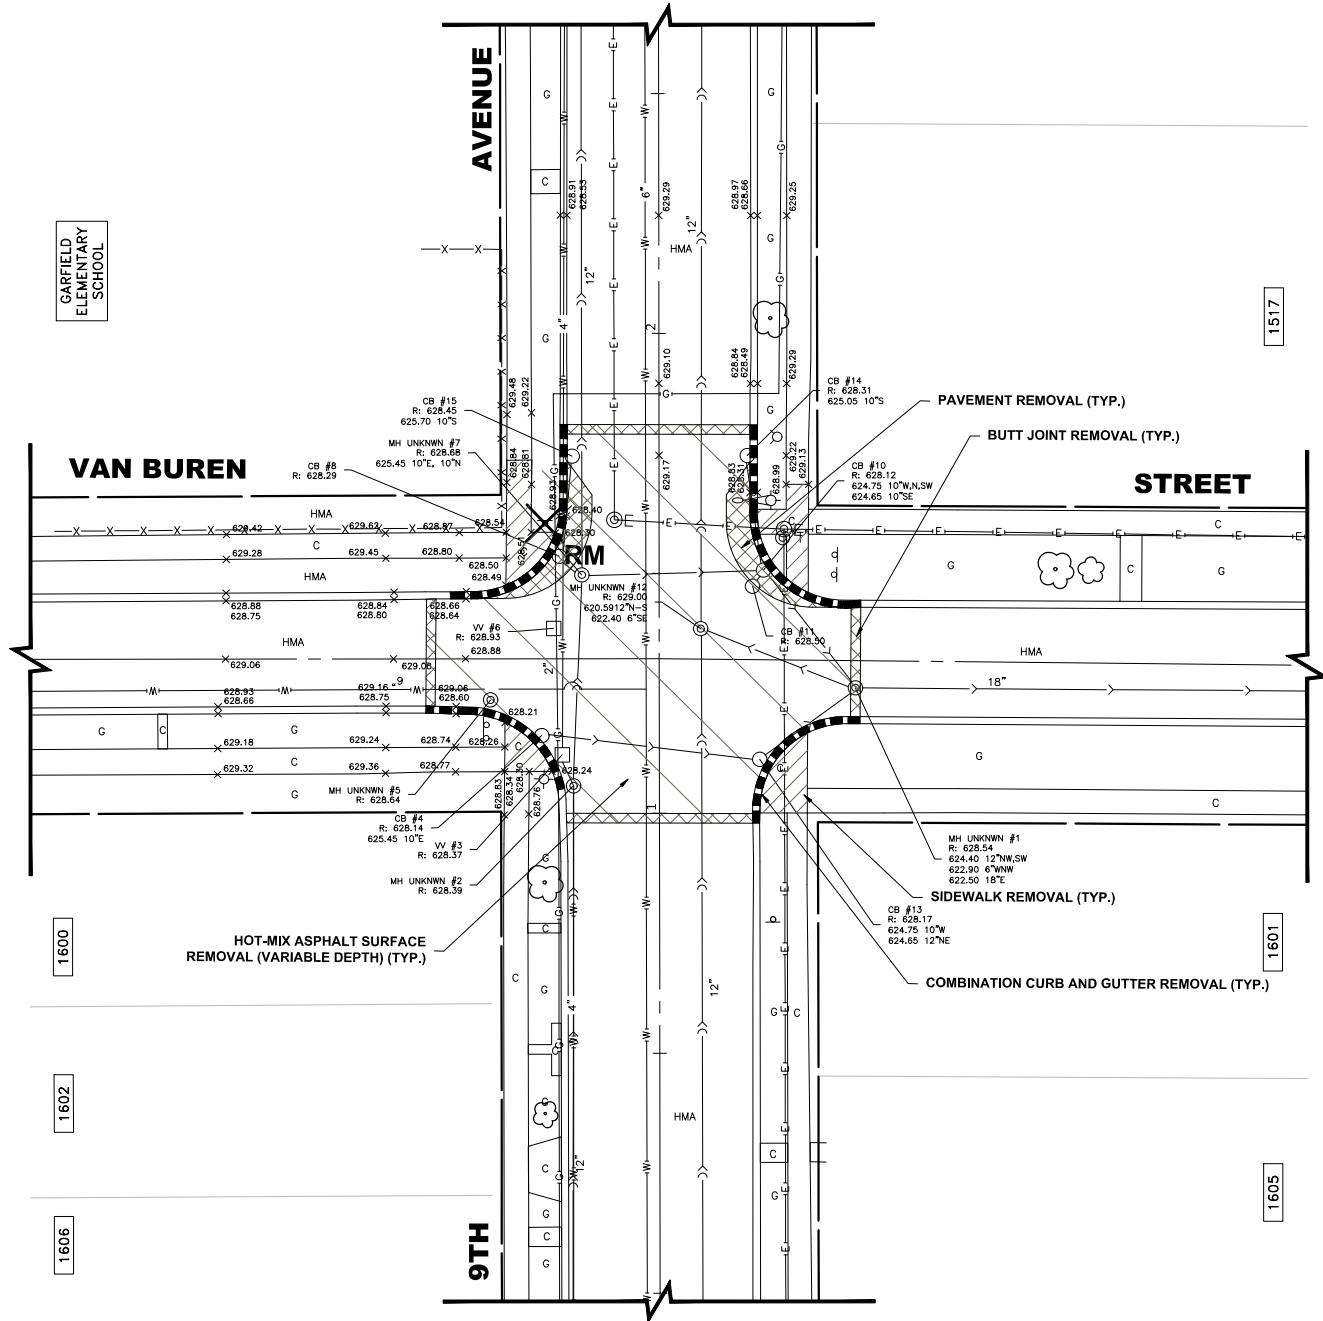


REMOVAL ITEMS

	CONCRETE REMOVAL
	CURB AND GUTTER REMOVAL
	HMA REMOVAL
	ITEM TO BE REMOVED
	PAVEMENT REMOVAL

EXISTING TOPOGRAPHY

	PROPOSED COMBINATION CONCRETE CURB AND GUTTER - TYPE B - 6.12	RC	RECONSTRUCT EXISTING STRUCTURE
	PROPOSED CONCRETE AREA, 5" SIDEWALK	A	FRAMES AND LIDS TO BE ADJUSTED
	PROPOSED HOT-MIX ASPHALT RESURFACING AREA	1C	TYPE 1 FRAME W/ CLOSED LID
	PROPOSED ELECTRICAL JUNCTION BOX	1P	TYPE 1 FRAME W/ OPEN LID
	PROPOSED ELECTRICAL CONNECTION	\$	EDGE OF PAVEMENT SUMMIT
	PROPOSED SIGN AND POST		

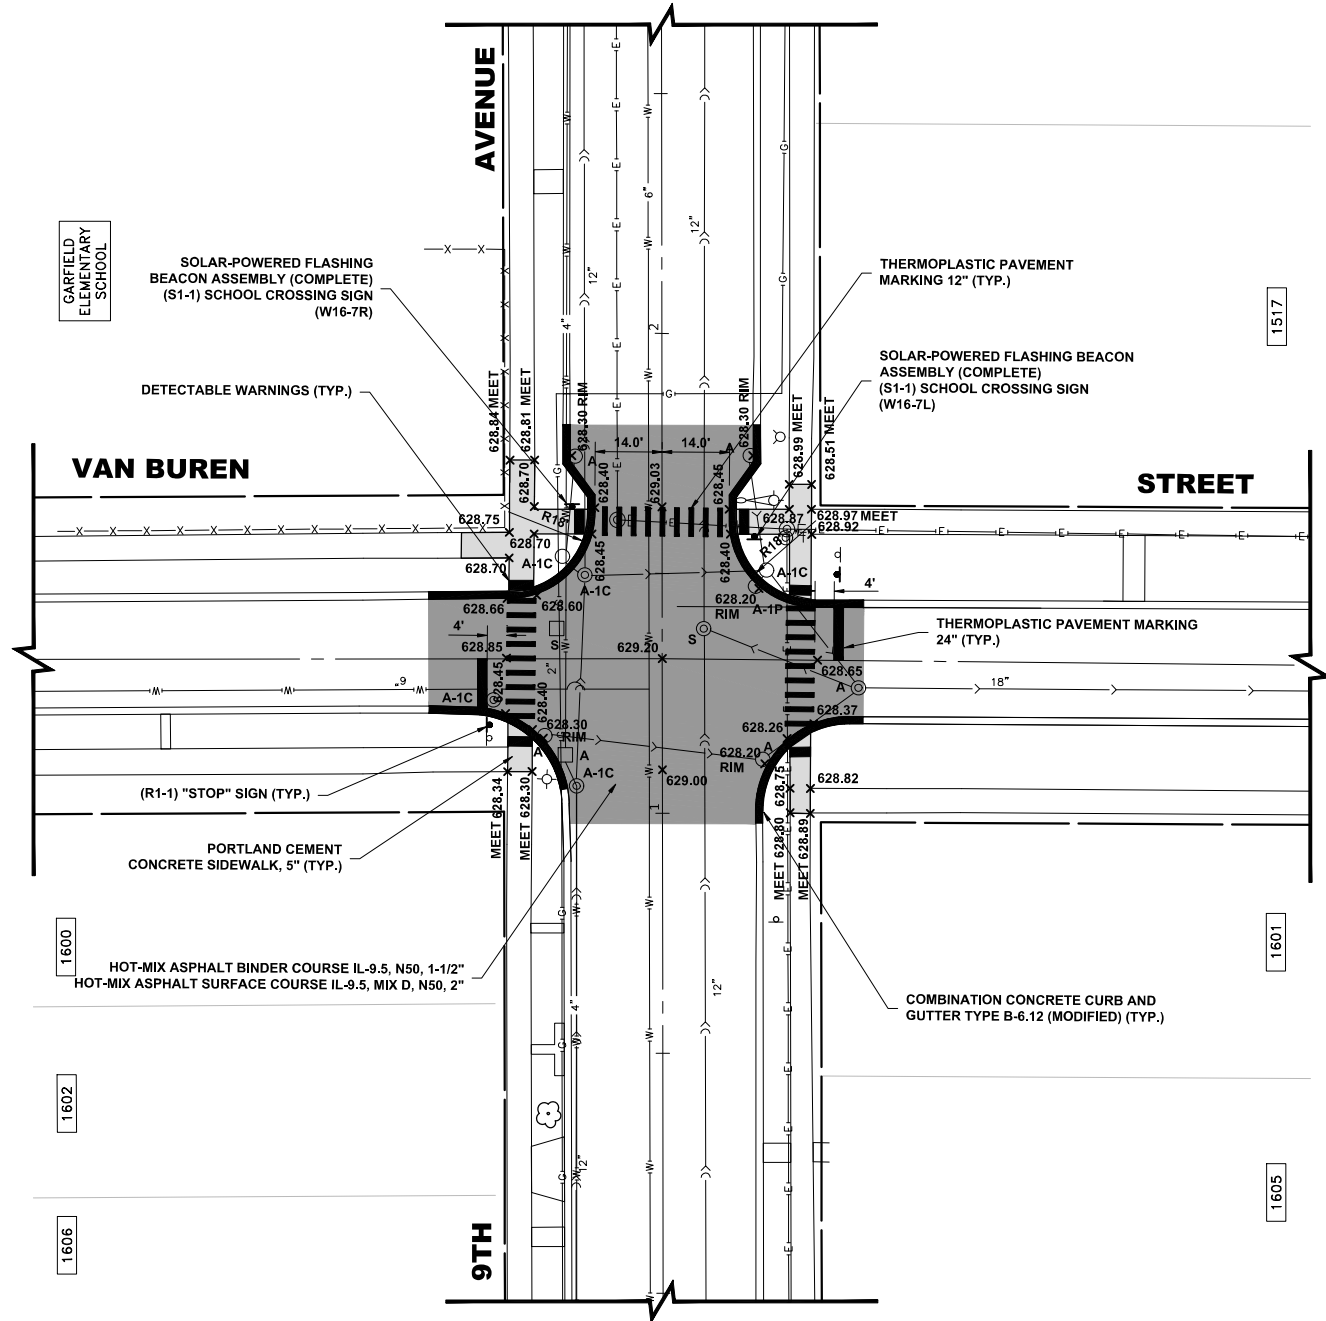

NOTE: ALL ABANDONED SANITARY SEWERS SHALL BE PLUGGED AT BOTH ENDS WITH AT LEAST 2 FEET LONG NON-SHRINK CONCRETE OR MORTAR PLUG.

PROPOSED TOPOGRAPHY



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9TH AVENUE AND VAN BUREN STREET
EXISTING AND PROPOSED

SCALE: 1"=20'H SHEET NO. OF SHEETS STA. TO STA.


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XX	24-00144-00-MS	COOK	22	11
FIELD BOOK NO. : -		CONTRACT NO. 61L76		
FED. ROAD DIST. NO. 1		ILLINOIS	FED. AID PROJECT	

LEGEND OF SYMBOLS

(TO BE USED IN CONJUNCTION WITH I.D.O.T. STANDARD 000001-07)

SYMBOL	DESCRIPTION
	EXISTING FIRE HYDRANT
	EXISTING WATER VALVE BOX
	EXISTING WATER MAIN VALVE VAULT
	EXISTING STORM SEWER INLET
	EXISTING STORM SEWER CATCH BASIN

	EXISTING SEWER MANHOLE		EXISTING CURB AND GUTTER
	EXISTING STREET LIGHT POLE		EXISTING SHARED USE PATH
	EXISTING POWER POLE		EXISTING STORM SEWER
	EXISTING HANDHOLE		EXISTING COMBINED SEWER
	EXISTING ELECTRICAL TOWER		EXISTING WATER MAIN
	EXISTING SIGN POST		EXISTING RIGHT OF WAY LINE
	EXISTING FENCE		EXISTING TREE
	EXISTING GAS UTILITY		

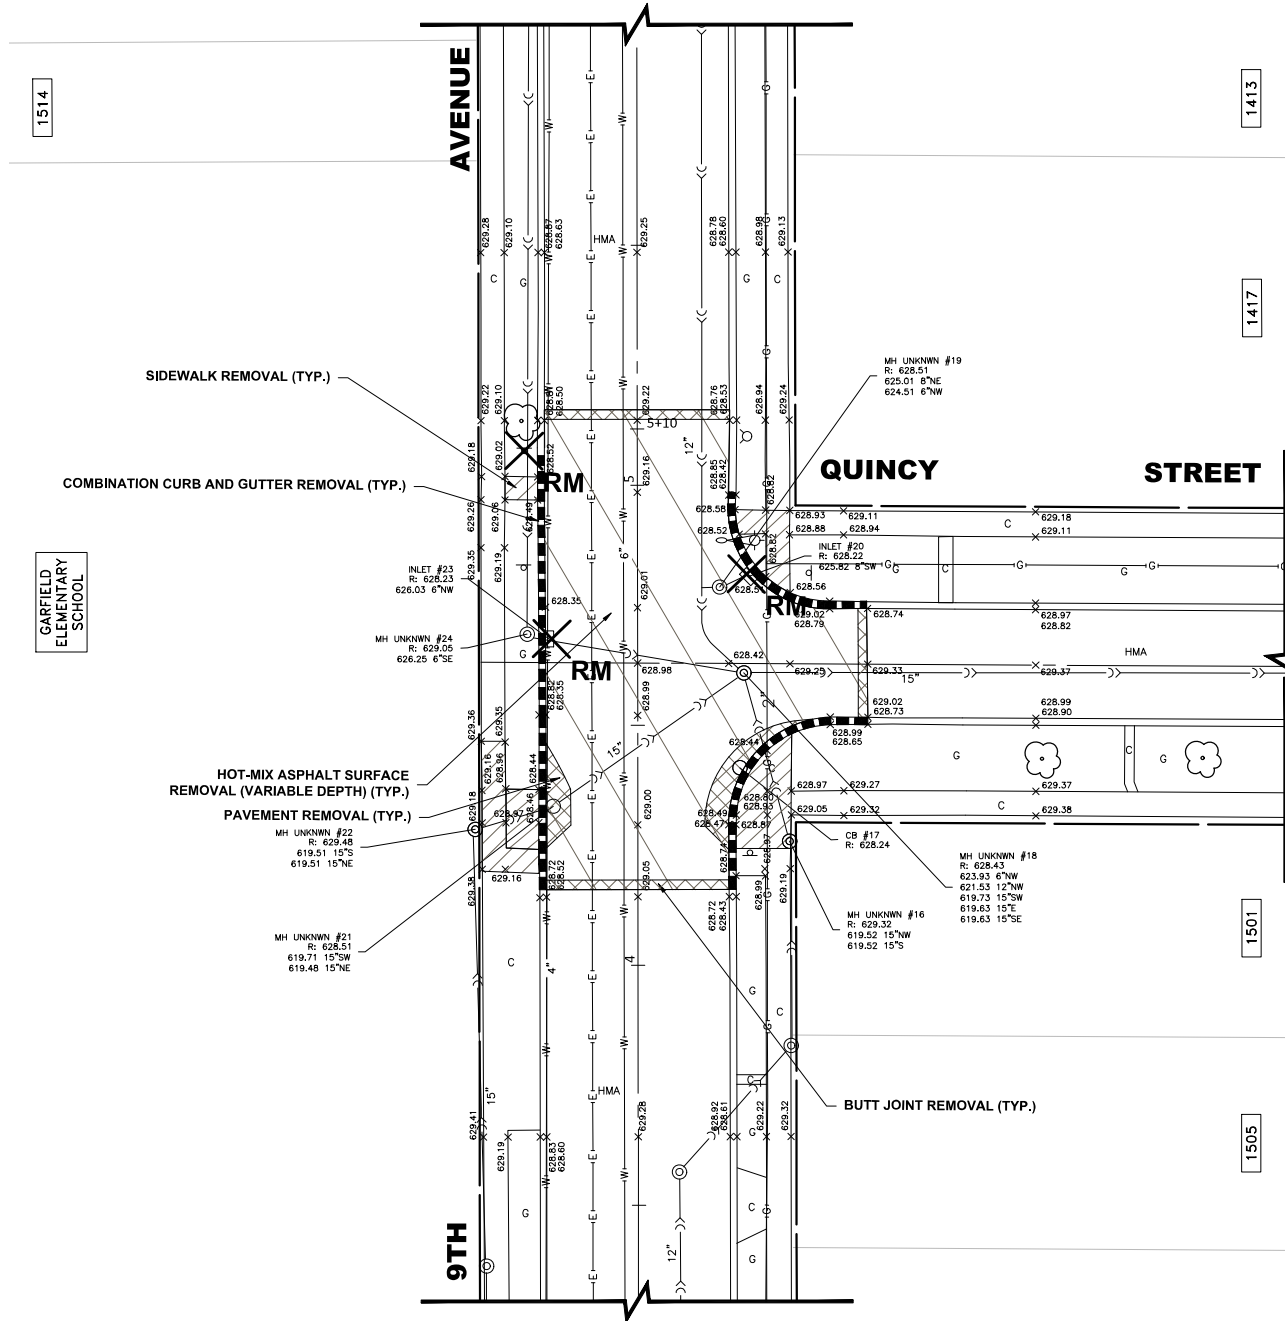


REMOVAL ITEMS

	CONCRETE REMOVAL
	CURB AND GUTTER REMOVAL
	HMA REMOVAL
	ITEM TO BE REMOVED
	PAVEMENT REMOVAL

EXISTING TOPOGRAPHY

	PROPOSED STORM SEWER		PROPOSED STORM SEWER CATCH BASIN
	PROPOSED COMBINATION CONCRETE CURB AND GUTTER - TYPE B - 6.12		PROPOSED STORM SEWER INLET
	PROPOSED CONCRETE AREA, 5' SIDEWALK		RECONSTRUCT EXISTING STRUCTURE
	PROPOSED HOT-MIX ASPHALT RESURFACING AREA		FRAMES AND LIDS TO BE ADJUSTED
	PROPOSED ELECTRICAL JUNCTION BOX		TYPE 1 FRAME W/ CLOSED LID
	PROPOSED ELECTRICAL CONNECTION		TYPE 1 FRAME W/ OPEN LID
	PROPOSED SIGN AND POST		EDGE OF PAVEMENT SUMMIT

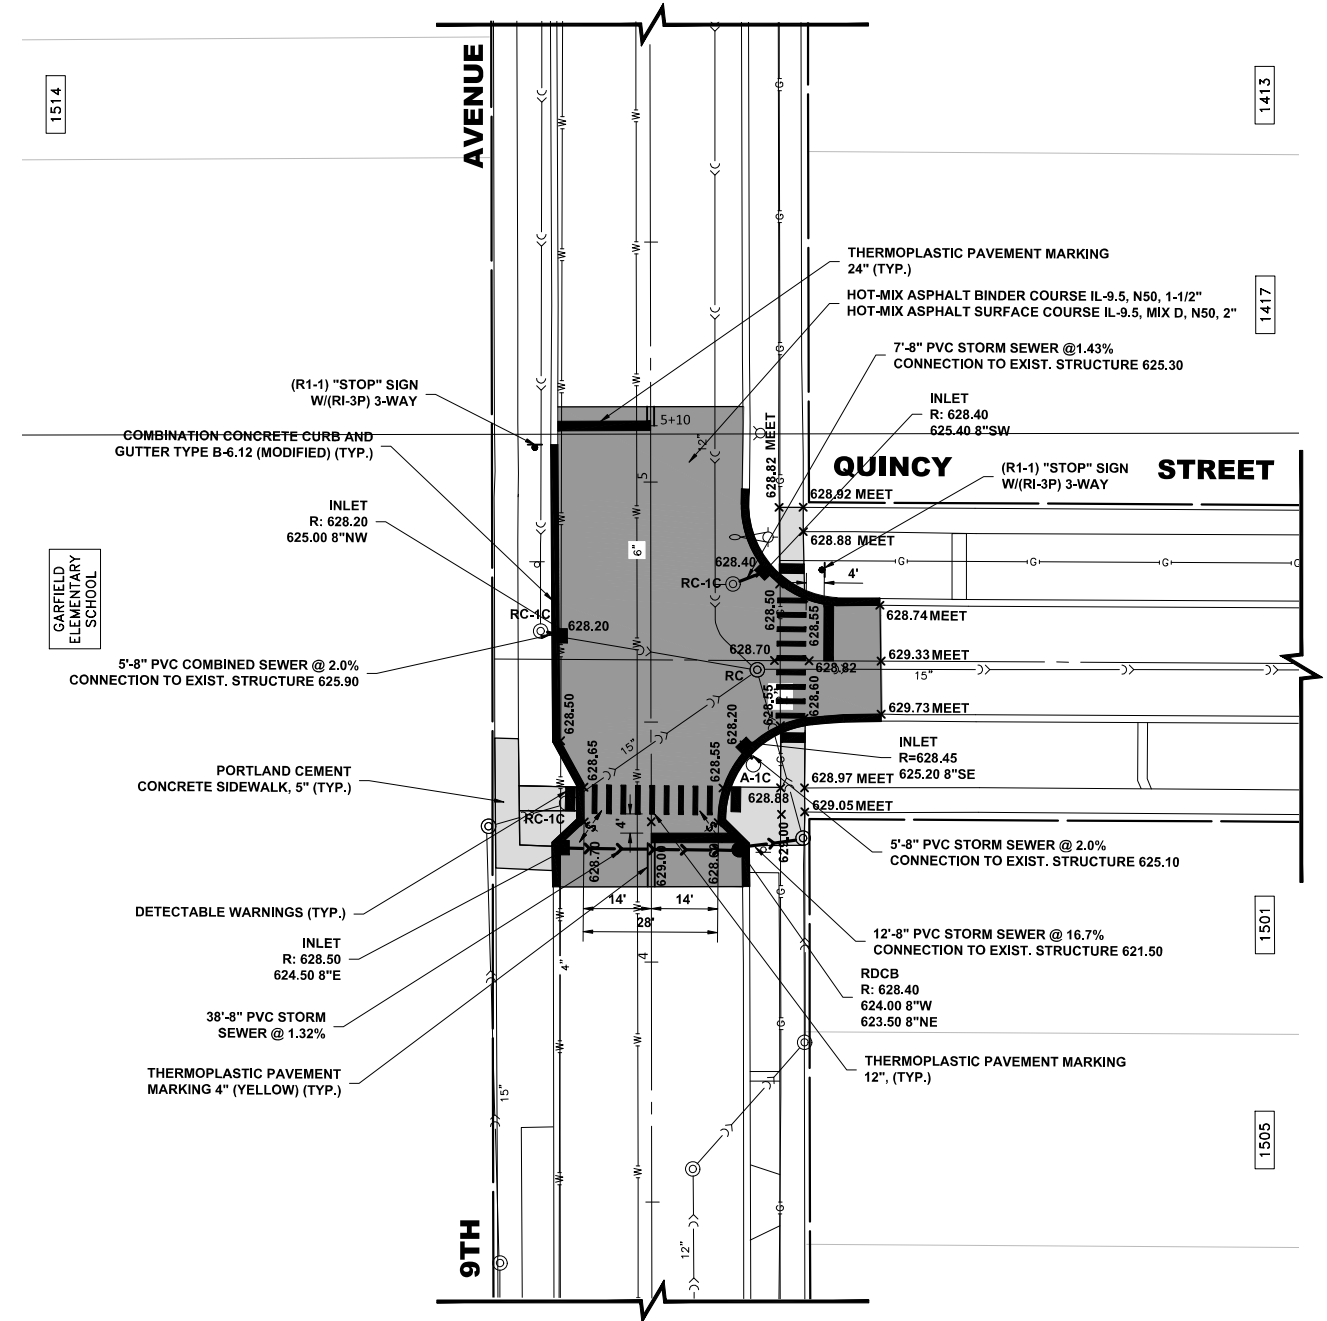

NOTE: ALL ABANDONED SANITARY SEWERS SHALL BE PLUGGED AT BOTH ENDS WITH AT LEAST 2 FEET LONG NON-SHRINK CONCRETE OR MORTAR PLUG.

PROPOSED TOPOGRAPHY



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9TH AVENUE AND QUINCY STREET PLAN AND PROFILE

SCALE: 1"=20'H SHEET NO. OF SHEETS STA. TO STA.

MUN RTE.	SECTION	COUNTY	TOTAL SHEETS	SHEET NO.
XX	24-00144-00-MS	COOK	22	12
FIELD BOOK NO. : -		CONTRACT NO. 61L76		
FED. ROAD DIST. NO. 1		ILLINOIS	FED. AID PROJECT	

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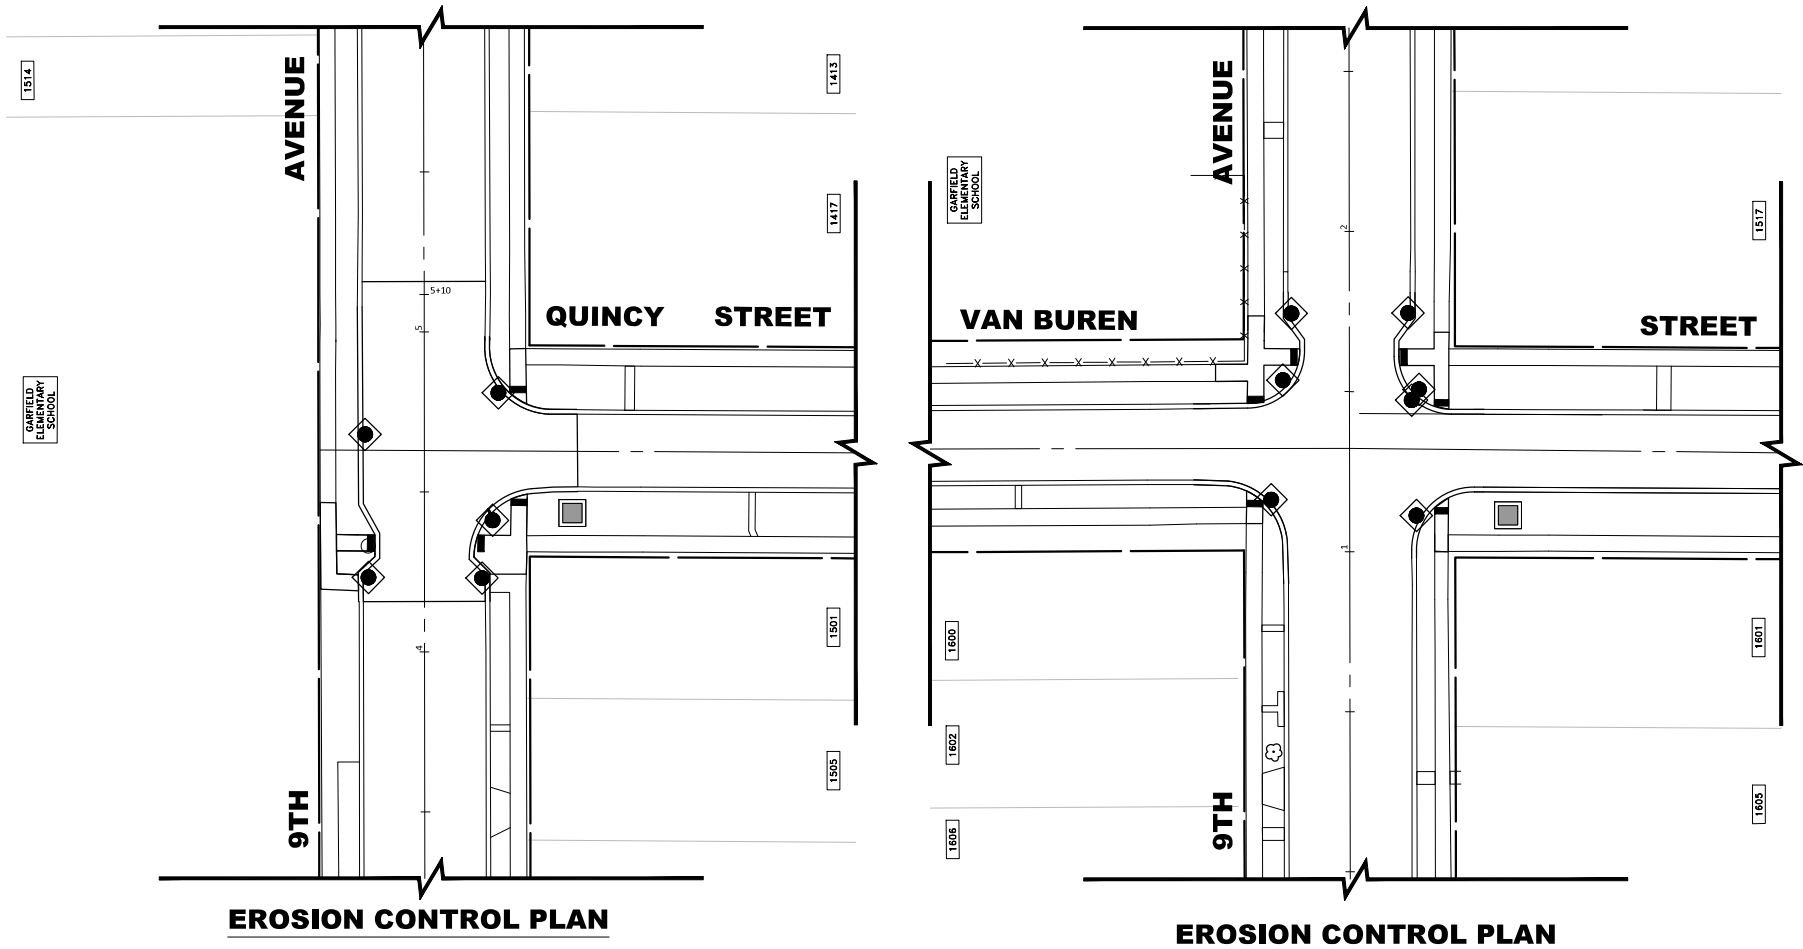
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EROSION CONTROL DETAILS

SCALE: - SHEET NO. - OF - SHEETS STA. - TO STA. -

MUN RTE.	SECTION	COUNTY	TOTAL SHEETS	SHEET NO.
XX	24-00144-00-MS	COOK	22	13
FIELD BOOK NO. : -		CONTRACT NO. 61L76		
FED. ROAD DIST. NO. 1		ILLINOIS	FED. AID PROJECT	



EROSION AND SEDIMENT CONTROL PLAN

THE EXISTING LAND COVER CONSISTS OF PAVED STREETS WITH MINOR GRASS PARKWAYS LOCATED IN A RESIDENTIAL AREA. THE AREAS ADJACENT TO THE PROJECT SITE ARE COMPRISED OF DENSE RESIDENTIAL PROPERTIES, FLOOD PROTECTION AREAS AND POINTS OF DISCHARGE TO JURISDICTIONAL WATERS OF THE U.S. DO NOT EXIST ON THIS PROJECT. WE DO NOT BELIEVE THERE ARE ANY AREAS SUSCEPTIBLE TO EROSION OR SEDIMENTATION DUE TO THESE IMPROVEMENTS. SOIL DATA IS NOT AVAILABLE BUT, PAST PROJECTS IN THE SUBJECT VILLAGE CONCLUDE THAT THE EXISTING SOIL CONSISTS OF CLAY WITH SOME MINOR SILT AND TRACES OF SAND.

PRIOR TO ANY SOIL/PAVEMENT DISTURBANCE, INLET FILTER ASSEMBLIES SHALL BE INSTALLED AS SHOWN ON PLANS.

THE INLET FILTER, PRIMARY PURPOSE IS TO TRAP SEDIMENT, REQUIRED FOR THIS PROJECT WILL BE A DROP IN INLET PROTECTION DEVICE SIMILAR TO FLEXSTORM INLET FILTERS. INLET FILTERS OF THIS TYPE HAVE BEEN USED ON PAST PROJECTS OF SIMILAR SIZE AND SCOPE AND HAVE HAD SATISFACTORY RESULTS.

THE INLET FILTER ASSEMBLY SHALL BE APPROVED BY THE ENGINEER OR VILLAGE PRIOR TO ORDERING AND INSTALLATION. THE INLET FILTER SHALL BE INSPECTED WEEKLY AND AFTER A 0.5 INCH RAIN EVENT BY THE ENGINEER. THE ENGINEER WILL REPORT ANY ISSUES, VIA VERBAL OR WRITTEN COMMUNICATION, THAT NEED TO BE ADDRESSED BY THE CONTRACTOR.

MAINTENANCE OF THE PROPOSED INLET FILTER WILL BE PER MANUFACTURE RECOMMENDATIONS AND WILL BE DONE BY THE CONTRACTOR. TYPICAL MAINTENANCE PRACTICES INCLUDE INSPECTION AFTER A RUNOFF EVENT, SEDIMENT REMOVAL AT 50% CAPACITY, AND REPAIRS/REPLACEMENT AS NEEDED.

PRIOR TO ANY PORTLAND CEMENT CONCRETE (PCC) POUR, CONCRETE WASHOUT BOXES SHALL BE INSTALLED AS SHOWN ON PLANS OR AS DIRECTED BY THE ENGINEER.

CONCRETE WASHOUT BOXES, PRIMARY PURPOSE IS TO CONTAIN CONCRETE LIQUIDS AND PREVENT CONCRETE LIQUID RUNOFF FROM ENTERING SEWERS OR WATERWAYS, REQUIRED FOR THIS PROJECT WILL CONSIST OF A BARRIER WALL LINED WITH 30-MIL POLYETHYLENE OR AN ENGINEER APPROVED EQUAL WASHOUT. CONCRETE WASHOUT BOXES OF THIS TYPE HAVE BEEN USED ON PAST PROJECTS OF SIMILAR SIZE AND SCOPE AND HAVE HAD SATISFACTORY RESULTS.

THE PLAN FOR THE CONCRETE WASHOUT BOX SHALL BE SUBMITTED AND APPROVED BY THE ENGINEER OR VILLAGE PRIOR TO INSTALLATION AND WILL BE INSPECTED AFTER INSTALLATION. THE WASHOUT BOX SHALL BE INSPECTED PRIOR TO A CONCRETE POUR AND AFTER A CONCRETE POUR BY THE ENGINEER. THE ENGINEER WILL REPORT ANY ISSUES, VIA VERBAL OR WRITTEN COMMUNICATION, THAT NEED TO BE ADDRESSED BY THE CONTRACTOR.

MAINTENANCE OF THE PROPOSED CONCRETE WASHOUT BOXES WILL BE DONE BY THE CONTRACTOR. TYPICAL MAINTENANCE PRACTICES INCLUDE REPLACING DAMAGED LINER, DISPOSING OF SOLIDIFIED CONCRETE WASHOUT, AND REMOVAL OF ANY DISCHARGES WITHIN 24 HOURS.


ALL DISPOSAL OF CONSTRUCTION MATERIAL, SEDIMENT, AND SOLIDIFIED CONCRETE SHALL BE AT A CCDD FACILITY

CONSTRUCTION SEQUENCE :

1. INSTALL EROSION CONTROL MEASURES
2. COMPLETE ALL UNDERGROUND WORK
3. PAVEMENT PATCHING
4. RESURFACE PAVEMENTS
5. RESTORE DAMAGED AREAS ADJACENT TO IMPROVEMENTS
6. REMOVE EROSION CONTROL MEASURES


LEGEND

SYMBOL	DESCRIPTION
	INLET FILTER/SEDIMENT CONTROL, DRAINAGE STRUCTURE, INLET FILTER CLEANING
	CONCRETE WASHOUT

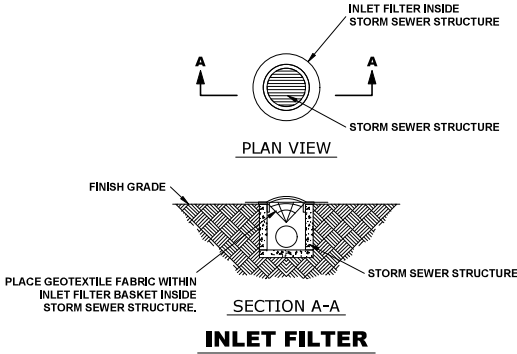

NOTES

1. SEE IDOT STANDARD 280001-07 FOR TEMPORARY EROSION CONTROL SYSTEMS.
2. THE CONTRACTOR SHALL ENSURE THAT ADJACENT PROPERTIES REMAIN PROTECTED FROM SEDIMENT DEPOSITION.
3. SOIL STOCKPILES SHALL BE PROTECTED WITH PERIMETER EROSION BARRIER OR OTHER EROSION PROTECTION SPECIFIED BY THE RESIDENT ENGINEER. THE COST SHALL BE INCLUDED IN THE UNIT PRICE FOR THE INDIVIDUAL SOIL MATERIALS.
4. WHEREVER CONSTRUCTION VEHICLE ACCESS ROUTES INTERSECT PAVED PUBLIC ROADS, PROVISIONS SHALL BE MADE TO MINIMIZE THE TRANSPORT OF SEDIMENT BY RUNOFF OR VEHICLE TRACKING ONTO THE PAVED SURFACE. THE PROVISIONS MAY INCLUDE SPRAYING VEHICLE WHEELS TO CLEAR SEDIMENT BEFORE EXITING THE CONSTRUCTION SITE OR OTHER MEASURES APPROVED BY THE ENGINEER.
5. INLET FILTERS SHALL BE PAID FOR UNDER THE PAY ITEM FOR INLET FILTERS. THE COST OF THE CONCRETE WASHOUTS SHALL BE INCLUDED IN THE COST OF WASHOUT BASIN.
6. INLET FILTER SHALL BE INSTALLED PRIOR TO CONSTRUCTION AND SHALL BE REMOVED AFTER CONSTRUCTION IS COMPLETED. FILTERS WILL BE INSPECTED WEEKLY AND THE CONTRACTOR WILL BE NOTIFIED OF ANY CORRECTIVE MEASURES THAT WILL BE REQUIRED TO BE MADE BY THE CONTRACTOR.
7. NO RUNOFF FROM CONCRETE WASHOUT BOXES SHALL BE PERMITTED TO ENTER LOCAL SEWERS OR STORMWATER MANAGEMENT FACILITIES.

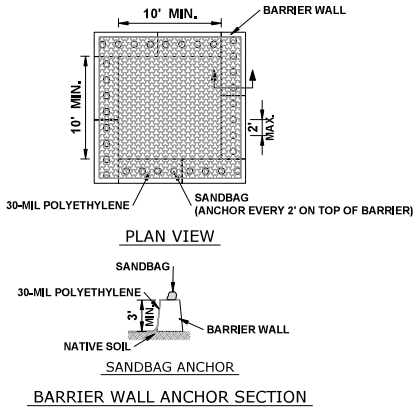


NOTES


1. MAINTAINING TEMPORARY CONCRETE FACILITIES SHALL INCLUDE REMOVING AND DISPOSING OF HARDEN CONCRETE AND/OR SLURRY AND RETURNING THE FACILITIES TO A FUNCTIONAL CONDITION.
2. FACILITY SHALL BE CLEANED OR RECONSTRUCTED IN A NEW AREA ONCE WASHOUT BECOMES TWO-THIRDS FULL.

CONCRETE WASHOUT


E.H.E. PROJECT NO. 565-24-16880

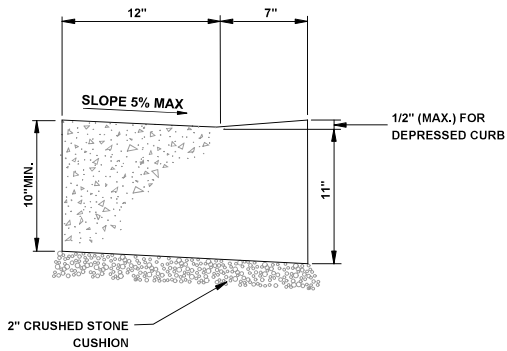


CURB AND GUTTER AT A.D.A. RAMPS

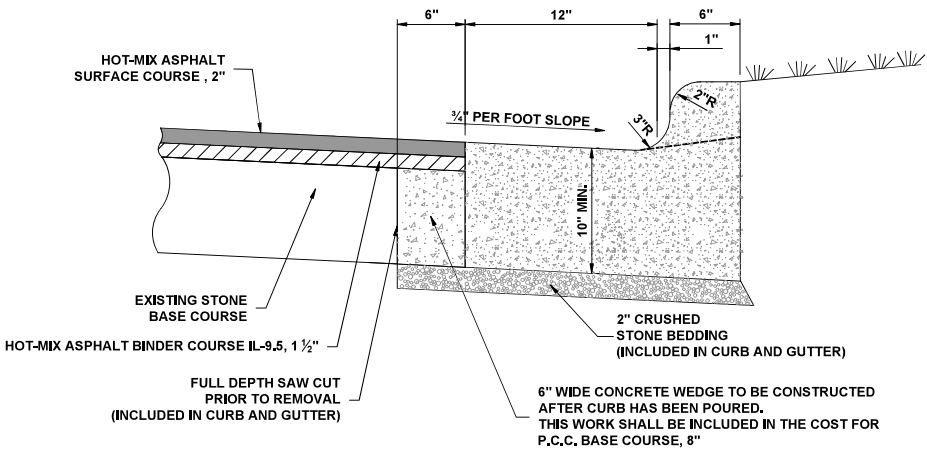


COMBINATION CONCRETE CURB & GUTTER, TYPE B-6.12 (MODIFIED)

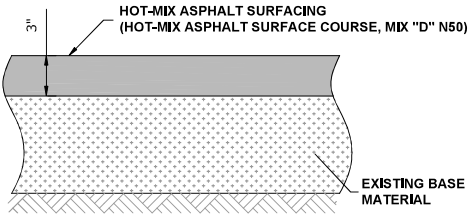


INCIDENTAL HOT-MIX ASPHALT SURFACING, 3"

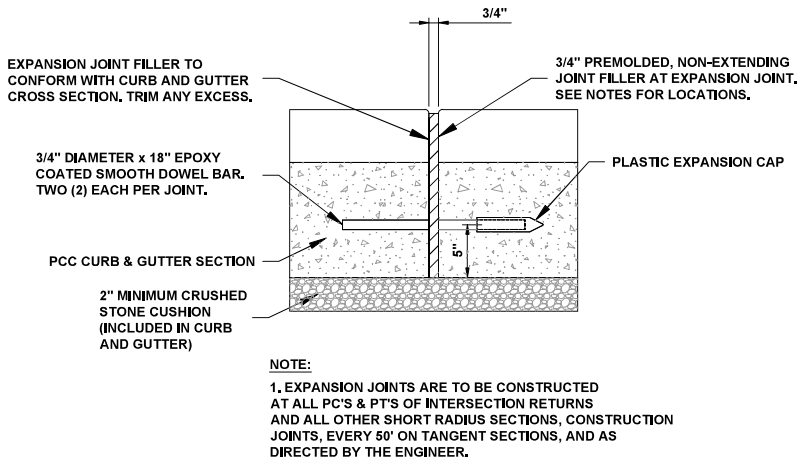


TYPICAL CURB AND GUTTER EXPANSION JOINT

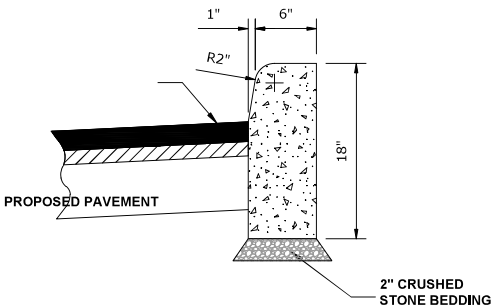

BARRIER CURB

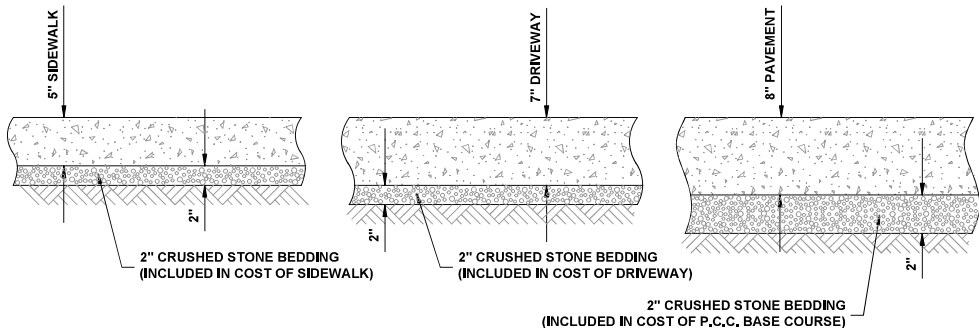

TYPICAL P.C.C. SIDEWALK, 5", 7" DRIVEWAY, AND 8" ALLEY PAVEMENT

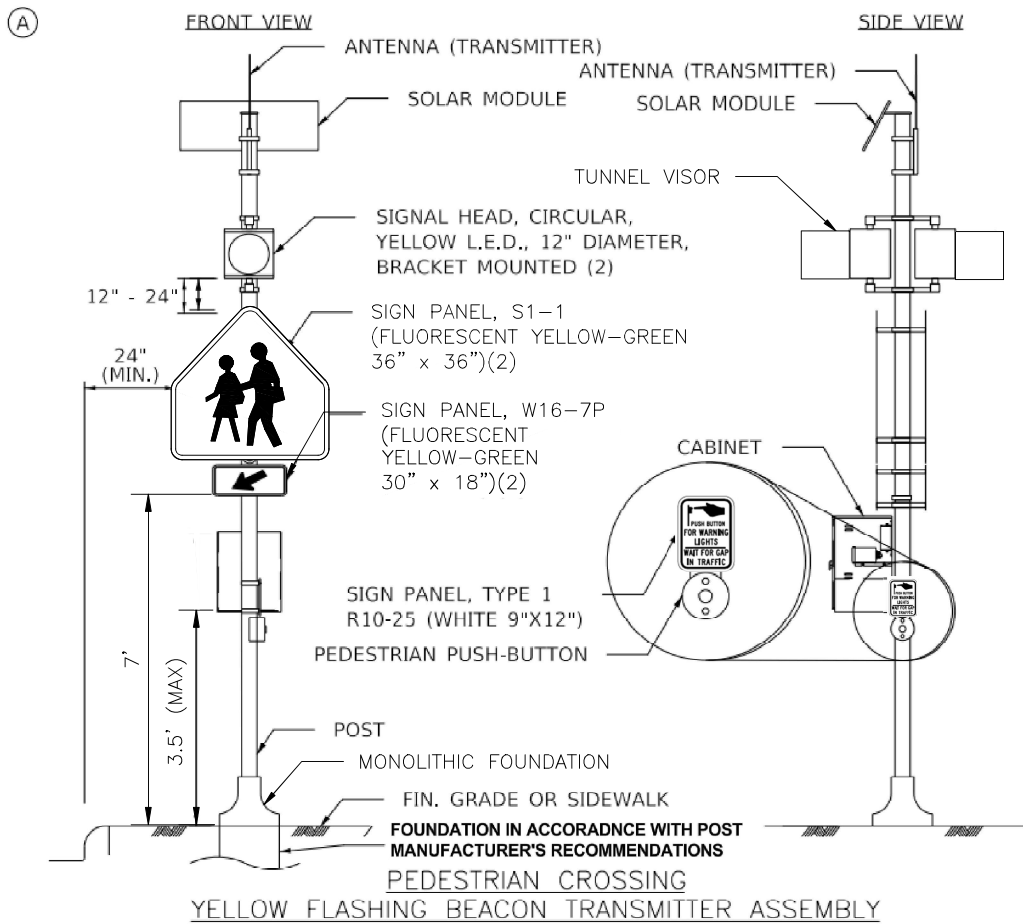

NOTES:
MATERIALS SUBMITTALS FOR THE BEACON ASSEMBLY SHALL BE REVIEWED BY THE VILLAGE OF MAYWOOD OR AN AUTHORIZED REPRESENTATIVE PRIOR TO SUBMITTAL FOR LOCAL ROADS REVIEW.

Drawing file: W:\projects_by_village\Maywood\66624168 - pedestrian safety imports\DETAILS.dwg Sep 11, 2025 - 9:41am



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DESIGNED -	-	REVISED -	
DRAWN -	LW, SPA, DMM, AJ	REVISED -	
CHECKED -	-	REVISED -	
DATE -	4-30-25	REVISED -	9-10-25


STATE OF ILLINOIS
DEPARTMENT OF TRANSPORTATION

ROADWAY DETAILS

SCALE: - SHEET NO. - OF - SHEETS STA. - TO STA. -

MUN RTE.	SECTION	COUNTY	TOTAL SHEETS	SHEET NO.
XX	24-00144-00-MS	COOK	22	14
FIELD BOOK NO. : -		CONTRACT NO. 61L76		
FED. ROAD DIST. NO. 1		ILLINOIS	FED. AID PROJECT	

E.H.E. PROJECT NO. 666-24-16880

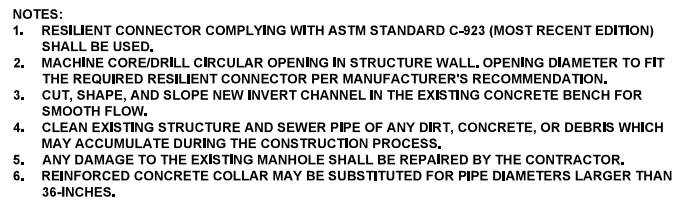

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PROPOSED SEWER LINE WITH 18" MINIMUM VERTICAL SEPARATION ABOVE EXISTING WATER MAIN

GUIDELINES

1. IF SELECT GRANULAR BACKFILL EXISTS: REMOVE WITHIN WIDTH OF PROPOSED SEWER TRENCH AND REPLACE WITH SELECT EXCAVATED MATERIAL (CLASS IV) AND COMPACT
2. OMIT SELECT GRANULAR EMBEDMENT AND GRANULAR BACKFILL TO ONE (1) FOOT OVER TOP OF SEWER AND USE SELECT EXCAVATED MATERIAL (CLASS IV) AND COMPACT THE LENGTH OF "L" FEET.
3. A) CONSTRUCT "L" FEET OF PROPOSED SEWER OF WATER MAIN MATERIAL AND PRESSURE TEST, OR;
B) USE "L" FEET OF WATER MAIN MATERIAL FOR CASING OF PROPOSED SEWER AND SEAL ENDS OF CASING.

NOTE: "S" THE LENGTH NECESSARY TO PROVIDE 10 FEET OF SEPARATION AS MEASURED PERPENDICULAR TO THE EXISTING WATER MAIN

*BASED ON STANDARD SPECIFICATIONS FOR WATER AND SEWER MAIN CONSTRUCTION IN ILLINOIS.

PROPOSED SEWER LINE BELOW EXISTING WATER MAIN WITH LESS THAN 18" MINIMUM VERTICAL SEPARATION

GUIDELINES

1. OMIT SELECT GRANULAR EMBEDMENT AND GRANULAR BACKFILL TO ONE (1) FOOT OVER TOP OF SEWER AND USE SELECT EXCAVATED MATERIAL (CLASS IV) AND COMPACT FOR "S" FEET ON EACH SIDE OF WATER MAIN.
2. A) CONSTRUCT "L" FEET OF PROPOSED SEWER OF WATER MAIN MATERIAL AND PRESSURE TEST, OR;
B) USE "L" FEET OF WATER MAIN MATERIAL FOR CASING OF PROPOSED SEWER AND SEAL ENDS OF CASING.
3. PROVIDE ADEQUATE SUPPORT FOR EXISTING WATER MAIN TO PREVENT DAMAGE DUE TO SETTLEMENT OF SEWER TRENCH

NOTE: "S" THE LENGTH NECESSARY TO PROVIDE 10 FEET OF SEPARATION AS MEASURED PERPENDICULAR TO THE EXISTING WATER MAIN

*BASED ON STANDARD SPECIFICATIONS FOR WATER AND SEWER MAIN CONSTRUCTION IN ILLINOIS.

PROPOSED WATER MAIN ABOVE EXISTING SEWER LINE WITH LESS THAN 18" VERTICAL SEPARATION

GUIDELINES

1. OMIT SELECT GRANULAR EMBEDMENT AND GRANULAR BACKFILL TO ONE (1) FOOT OVER TOP OF WATER MAIN AND USE SELECT EXCAVATED MATERIAL (CLASS IV) AND COMPACT THE LENGTH OF "L".
2. IF SELECT GRANULAR BACKFILL EXISTS, REMOVE WITHIN WIDTH OF EXISTING SEWER LINE TRENCH AND REPLACE WITH SELECT EXCAVATED MATERIAL (CLASS IV) AND COMPACT.
3. USE "L" FEET OF WATER MAIN MATERIAL FOR CASING OF PROPOSED WATER MAIN AND SEAL ENDS OF CASING.
4. POINT LOADS SHALL NOT BE ALLOWED BETWEEN WATER MAIN CASING AND SEWER

NOTE: "S" THE LENGTH NECESSARY TO PROVIDE 10 FEET OF SEPARATION AS MEASURED PERPENDICULAR TO THE EXISTING SEWER LINE.

*BASED ON STANDARD SPECIFICATIONS FOR WATER AND SEWER MAIN CONSTRUCTION IN ILLINOIS.

PROPOSED SEWER LINE BELOW EXISTING WATER MAIN WITH 18" MINIMUM VERTICAL SEPARATION

GUIDELINES

1. PROVIDE ADEQUATE SUPPORT FOR EXISTING WATER MAIN TO PREVENT DAMAGE DUE TO SETTLEMENT OF SEWER TRENCH.

*BASED ON STANDARD SPECIFICATIONS FOR WATER AND SEWER MAIN CONSTRUCTION IN ILLINOIS.

PLACEMENT OF WATER MAIN BELOW EXISTING OR PROPOSED SEWER LINE WITH LESS THAN 18" MINIMUM VERTICAL SEPARATION. **NOT ALLOWED.**

NOT ALLOWED*
MUST MAINTAIN 18" VERTICAL SEPARATION

*BASED ON STANDARD SPECIFICATIONS FOR WATER AND SEWER MAIN CONSTRUCTION IN ILLINOIS.

PROPOSED WATER MAIN BELOW EXISTING SEWER LINE WITH 18" MINIMUM VERTICAL SEPARATION

GUIDELINES

1. OMIT SELECT GRANULAR EMBEDMENT AND GRANULAR BACKFILL TO ONE (1) FOOT OVER TOP OF WATER MAIN AND USE SELECT EXCAVATED MATERIAL (CLASS IV) AND COMPACT THE LENGTH OF "L".
2. IF SELECT GRANULAR BACKFILL EXISTS, REMOVE WITHIN WIDTH OF EXISTING SEWER LINE TRENCH AND REPLACE WITH SELECT EXCAVATED MATERIAL (CLASS IV) AND COMPACT.
3. PROVIDE ADEQUATE SUPPORT FOR EXISTING SEWER LINE TO PREVENT DAMAGE DUE TO SETTLEMENT.
4. USE "L" FEET OF WATER MAIN MATERIAL FOR CASING OF PROPOSED WATER MAIN AND SEAL ENDS OF CASING.

*BASED ON STANDARD SPECIFICATIONS FOR WATER AND SEWER MAIN CONSTRUCTION IN ILLINOIS.

PROPOSED OR EXISTING SEWER LINE

PROPOSED OR EXISTING WATER MAIN

10' HORIZONTAL

PLAN VIEW

PER IEPA, WHEN **PROPOSED** SEWER (OR WATER) IS LOCATED 10 FEET OR MORE FROM EXISTING WATER (OR SEWER), NO SPECIAL CONSTRUCTION REQUIRED

*BASED ON STANDARD SPECIFICATIONS FOR WATER AND SEWER MAIN CONSTRUCTION IN ILLINOIS.



TECHNICAL GUIDANCE MANUAL

WATER AND SEWER SEPARATION REQUIREMENTS (PER IEPA)

7/1/15

STD. DWG. NO. 41

PAGE NO. 42



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DESIGNED -	-
DRAWN -	LW, SPA, DMM, AJ
CHECKED -	-
DATE -	4-30-25

REVISED -	-
REVISED -	-
REVISED -	-
REVISED -	9-10-25

STATE OF ILLINOIS
DEPARTMENT OF TRANSPORTATION


IEPA WATER AND SEWER SEPARATION REQUIREMENTS

SCALE: - SHEET NO. - OF - SHEETS STA. - TO STA. -

MUN. RTE.	SECTION	COUNTY	TOTAL SHEETS	SHEET NO.
XX	24-00144-00-MS	COOK	22	16
FIELD BOOK NO. -		CONTRACT NO. 61L76		
FED. ROAD DIST. NO. 1		ILLINOIS FED. AID PROJECT		

E:\H\PROJECT NO. 565-24-16880

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DETAILS FOR FRAMES AND LIDS ADJUSTMENT
WITH MILLING

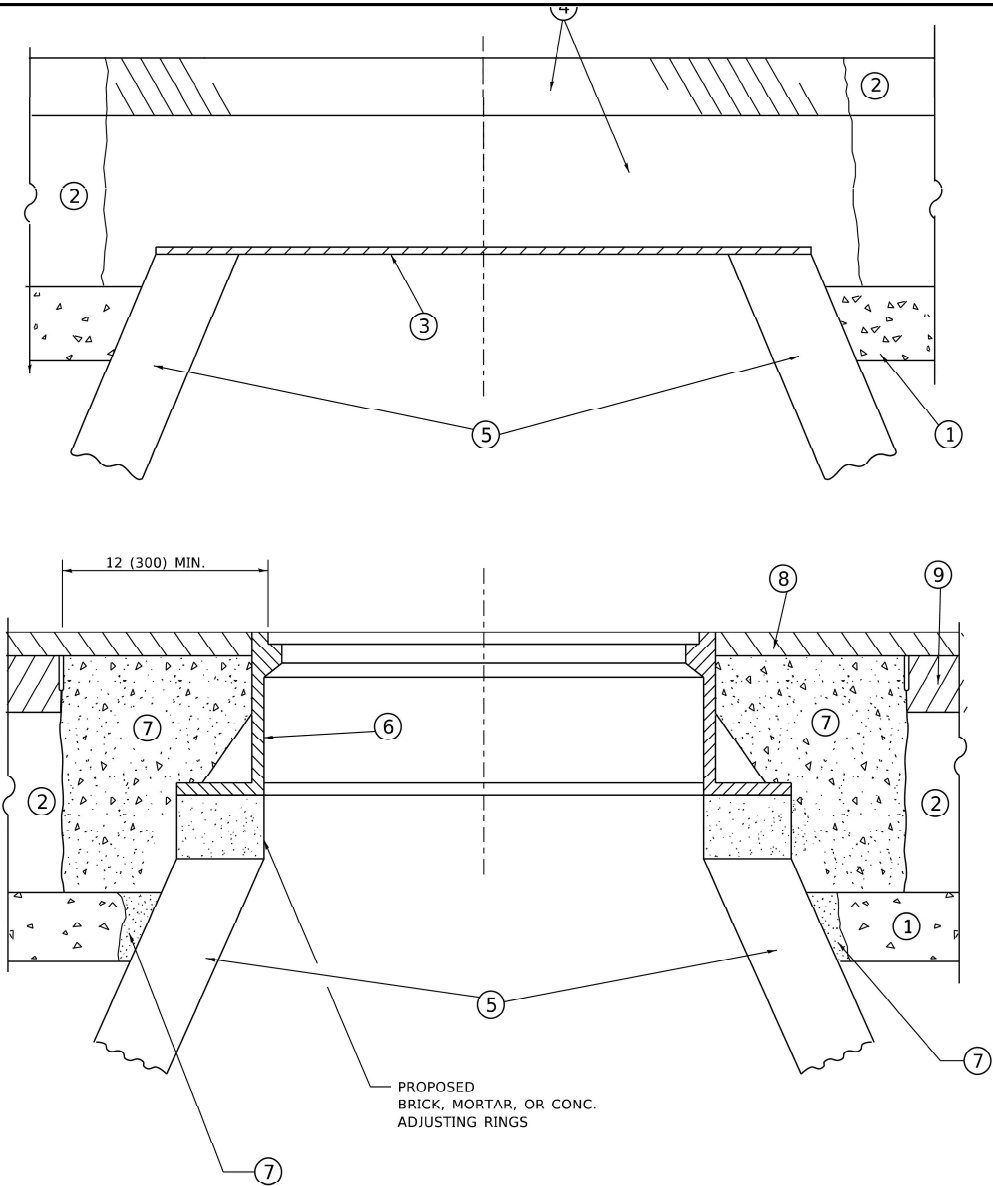NOTES

- EXISTING BROKEN FRAMES AND LIDS SHALL BE REMOVED AND DISPOSED OF BY THE CONTRACTOR AND SHALL BE REPLACED AS DIRECTED BY THE ENGINEER. REPLACEMENT FRAMES AND LIDS WILL BE PAID FOR IN ACCORDANCE WITH ARTICLE 109.04 OF THE STANDARD SPECIFICATIONS UNLESS A SEPARATE PAY ITEM HAS BEEN PROVIDED.
- IF THE EXISTING LIDS ARE OPEN, THE FRAME WILL BE ADJUSTED TO THE ELEVATION OF THE MILLED PAVEMENT SURFACE PRIOR TO THE MILLING OPERATION. THE FRAME WILL NOT BE REMOVED AND COVERED BY THE METAL PLATE.
- CITY OF CHICAGO CASTINGS ARE THE PROPERTY OF THE CITY AND THE CONTRACTOR SHALL NOTIFY THE CITY FOR REMOVAL AND DISPOSITION OF THE CASTINGS.
- THE METAL PLATE USED TO COVER THE STRUCTURE SHALL REMAIN THE PROPERTY OF THE CONTRACTOR.
- THE CONTRACTOR SHALL REMOVE ALL TRAFFIC CONTROL DEVICES BY THE END OF EACH WORK SHIFT.

CONSTRUCTION PROCEDURES

STAGE 1 (BEFORE PAVEMENT MILLING)

- REMOVE A MINIMUM OF 12 (300) OF THE PAVEMENT FROM AROUND THE STRUCTURE.
- REMOVE THE EXISTING FRAME AND LID FROM THE STRUCTURE.
- COVER THE STRUCTURE OPENING WITH A 36 (900) DIAMETER METAL PLATE.
- BACKFILL WITH CRUSHED STONE AND HMA SURFACE MIX APPROVED BY THE ENGINEER. (MIN. 3 (80) HMA TO REMAIN AFTER MILLING).

STAGE 2 (AFTER PAVEMENT MILLING)

- REMOVE THE HMA SURFACE MIX AND CRUSHED STONE.
 - INSTALL THE FRAME AND LID; ADJUST THE FRAME TO ITS FINAL SURFACE ELEVATION.
 - THE SURROUNDING SPACE SHALL BE FILLED WITH CLASS PP-2* CONCRETE TO THE ELEVATION OF THE SURFACE OF THE EXISTING BASE COURSE OR THE BINDER COURSE.
- * UNLESS OTHERWISE SPECIFIED IN THE PLANS.

THE PROCEDURE EXPLAINED ABOVE SHALL CONFORM TO THE APPLICABLE PORTIONS OF SECTIONS 353, 406, 602, AND 603 OF THE STANDARD SPECIFICATIONS EXCEPT THAT "THE CONTRACTOR SHALL ADJUST THE STRUCTURES TO THE FINISHED PAVEMENT ELEVATION NO MORE THAN 5 CALENDAR DAYS PRIOR TO PLACEMENT OF THE FINAL LIFT OF SURFACE UNLESS APPROVED BY THE ENGINEER."

LEGEND

- | | |
|--|-------------------------------|
| ① SUB-BASE GRANULAR MATERIAL | ⑥ FRAME AND LID (SEE NOTES) |
| ② EXISTING PAVEMENT | ⑦ CLASS PP-2* CONCRETE |
| ③ 36 (900) DIAMETER METAL PLATE | ⑧ PROPOSED HMA SURFACE COURSE |
| ④ PROPOSED CRUSHED STONE AND HMA SURFACE MIX | ⑨ PROPOSED HMA BINDER COURSE |
| ⑤ EXISTING STRUCTURE | |

LOCATION OF STRUCTURES

THE CONTRACTOR WILL BE REQUIRED TO KEEP A RECORD OF THE LOCATIONS OF THE BURIED STRUCTURES ACCORDING TO THE STATION AND DISTANCE LEFT OR RIGHT OF THE CENTERLINE OF PAVEMENT. UPON COMPLETION OF THE WORK, THE CONTRACTOR WILL DELIVER THE RECORD TO THE ENGINEER.

BASIS OF PAYMENT

- REMOVING FRAMES AND LIDS ON DRAINAGE AND UTILITY STRUCTURES IN THE PAVEMENT PRIOR TO MILLING, AND ADJUSTING TO FINAL GRADE PRIOR TO PLACING THE SURFACE COURSE, WILL BE PAID FOR AT THE CONTRACT UNIT PRICE EACH FOR "FRAMES AND LIDS TO BE ADJUSTED (SPECIAL)."
- THIS WORK WILL NOT BE PAID FOR WHEN DRAINAGE AND UTILITY STRUCTURES ARE SPECIFIED FOR PAYMENT AS STRUCTURE RECONSTRUCTION.
- NEW FRAMES AND LIDS, WHEN SPECIFIED, WILL BE PAID FOR SEPARATELY.
- WHEN STRUCTURES ARE TO BE ADJUSTED OR RECONSTRUCTED, THE LOWERING AND RAISING OF THE FRAMES AND LIDS WILL NOT BE PAID FOR SEPARATELY BUT WILL BE INCLUDED IN THE COST OF THE CORRESPONDING PAY ITEM.

ALL DIMENSIONS ARE IN INCHES (MILLIMETERS) UNLESS OTHERWISE SHOWN


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		DRAWN	-	REVISED	- R. BORO 12-06-11
PLOT SCALE	= 100.0000 ' / in.	CHECKED	-	REVISED	- K. SMITH 11-18-22
PLOT DATE	= 9/13/2023	DATE	- 10-25-94	REVISED	- K. SMITH 09-15-23

STATE OF ILLINOIS
DEPARTMENT OF TRANSPORTATION

DETAILS FOR
FRAMES AND LIDS ADJUSTMENT WITH MILLING

SCALE: NONE SHEET 1 OF 1 SHEETS STA. TO STA.


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XX	24-00144-00-MS	COOK	22	17
FIELD BOOK NO. : -BD600-03 (BD-8)		CONTRACT NO. 61L76		
FED. ROAD DIST. NO. 1		ILLINOIS		
FED. AID PROJECT				

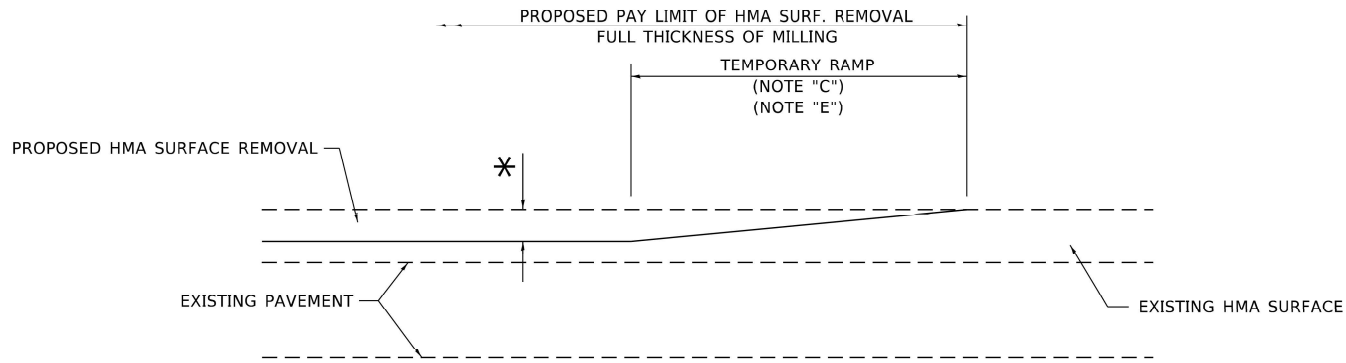

MILLED TEMPORARY RAMP

(FOR BUTT JOINT AND HMA TAPER SEE DETAIL BELOW)

OPTION 1

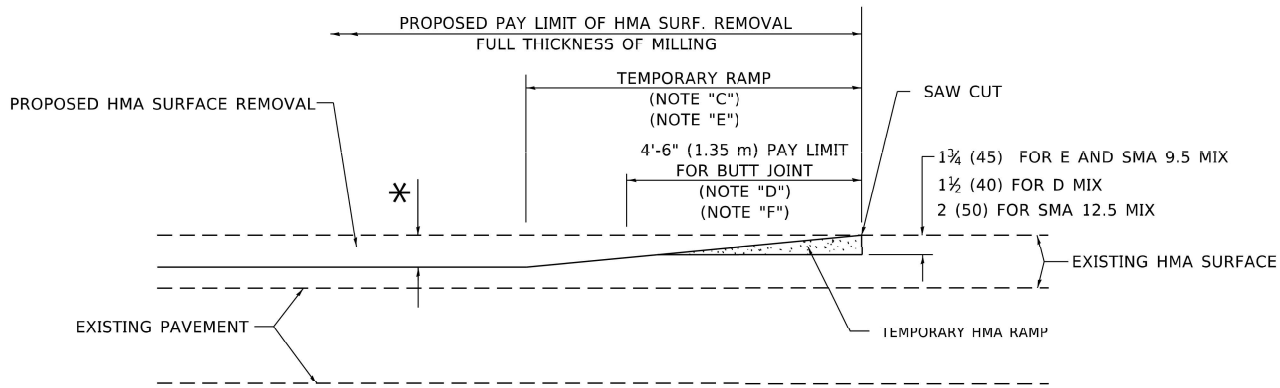


HMA CONSTRUCTED TEMPORARY RAMP


(FOR BUTT JOINT AND HMA TAPER SEE DETAIL BELOW)

OPTION 2

TYPICAL TEMPORARY RAMP

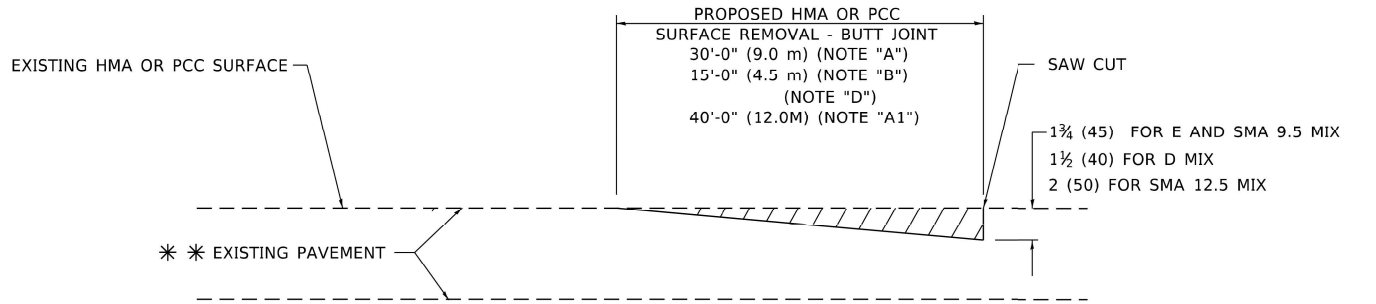

BUTT JOINT DETAIL

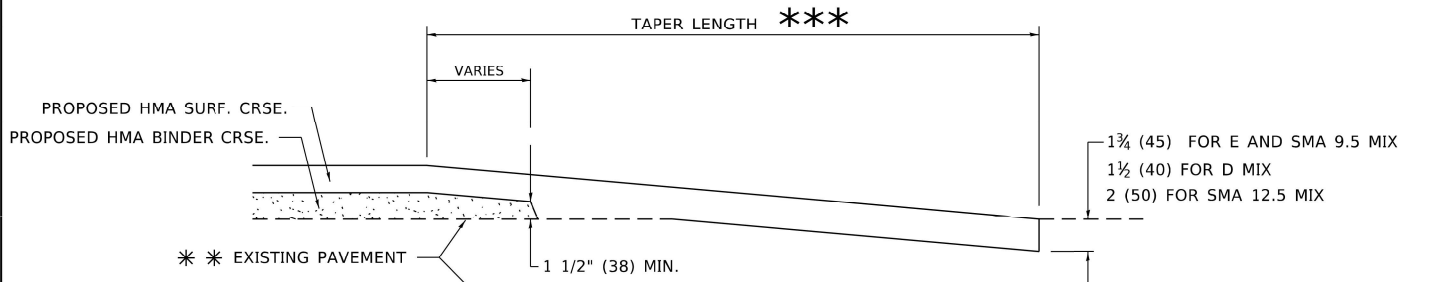

HMA TAPER DETAIL

**TYPICAL BUTT JOINT AND HMA TAPER
FOR RESURFACING ONLY**

** PC CONCRETE, HMA OR HMA RESURFACED PAVEMENT.


GENERAL NOTES

- MAINLINE ARTERIAL ROADWAYS AND MAJOR SIDE ROADS.
- INTERSTATES
- MINOR SIDE ROADS.
- THE TEMP. RAMP SHALL BE CONSTRUCTED IMMEDIATELY UPON REMOVAL OF THE EXISTING HMA SURFACE.
- THE BUTT JOINT SHALL BE CONSTRUCTED IMMEDIATELY PRIOR TO PLACING THE PROPOSED HMA COURSES.
- TAPER THE TEMP. RAMP AT A RATE OF 3' - 4" (1.02m) PER 1 INCH (25 mm) OF MILLING THICKNESS.
* SEE TYPICAL SECTIONS FOR MILLING THICKNESS.
- SEE ARTICLE 406.08 AND 406.14 OF THE STANDARD SPECIFICATIONS FOR "HMA AND/OR PCC SURFACE REMOVAL, BUTT JOINT".
*** 20'-0" (6.1 m) PER 1 (25) RESURFACING (NOTE "A")
10'-0" (3.0 m) PER 1 (25) RESURFACING (NOTE "B")

BASIS OF PAYMENT

- THE BUTT JOINT WILL BE PAID FOR AT THE CONTRACT UNIT PRICE PER SQUARE YARD (SQUARE METER) FOR "HOT-MIX ASPHALT SURFACE REMOVAL - BUTT JOINT" OR FOR "PORTLAND CEMENT CONCRETE SURFACE REMOVAL- BUTT JOINT".
- THE TEMPORARY RAMP AND SAW CUT SHALL BE INCLUDED IN THE UNIT COST FOR HMA OR PCC SURFACE REMOVAL-BUTT JOINT.

ALL DIMENSIONS ARE IN INCHES (MILLIMETERS) UNLESS OTHERWISE SHOWN.

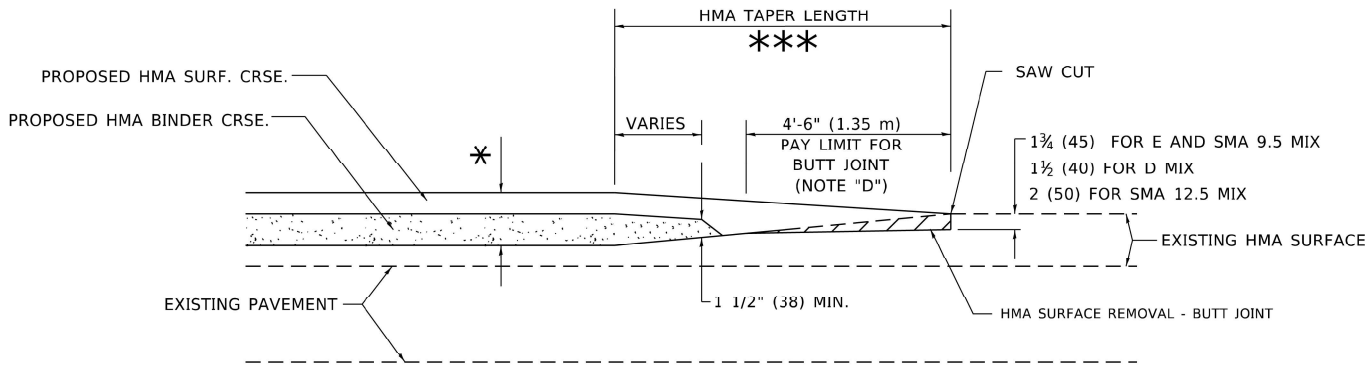

**BUTT JOINT AND
HMA TAPER**

**TYPICAL BUTT JOINT AND HMA TAPER
FOR MILLING AND RESURFACING**


USER NAME = Lawrence.DeManche	DESIGNED - M. DE YONG	REVISED - A. ABBAS 03-21-97
	DRAWN -	REVISED - M. GOMEZ 04-06-01
PLOT SCALE = 100.0000 ' / in.	CHECKED -	REVISED - R. BORO 01-01-07
PLOT DATE = 11/18/2022	DATE - 06-13-90	REVISED - K. SMITH 11-18-22

**STATE OF ILLINOIS
DEPARTMENT OF TRANSPORTATION**


**BUTT JOINT AND
HMA TAPER DETAILS**

SCALE: NONE SHEET 1 OF 1 SHEETS STA. TO STA.


MUN RTE.	SECTION	COUNTY	TOTAL SHEETS	SHEET NO.
XX	24-00144-00-MS	COOK	22	18
FIELD BOOK NO. : - BD400-05 BD32		CONTRACT NO. 61L76		
FED. ROAD DIST. NO. 1 ILLINOIS		FED. AID PROJECT		

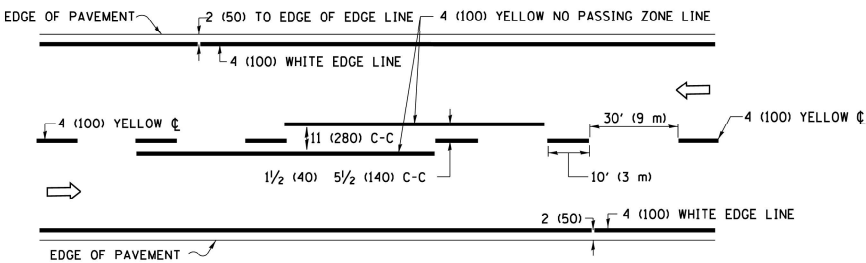

2-LANE ROADWAY


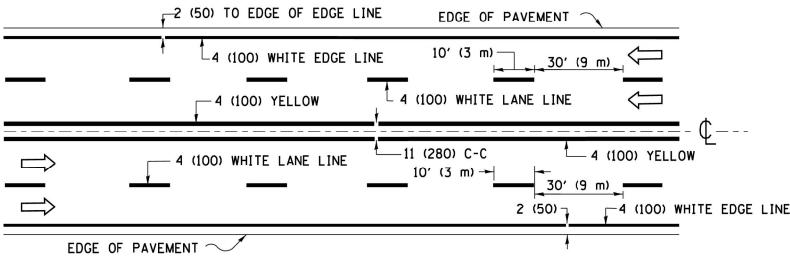


MULTI-LANE UNDIVIDED

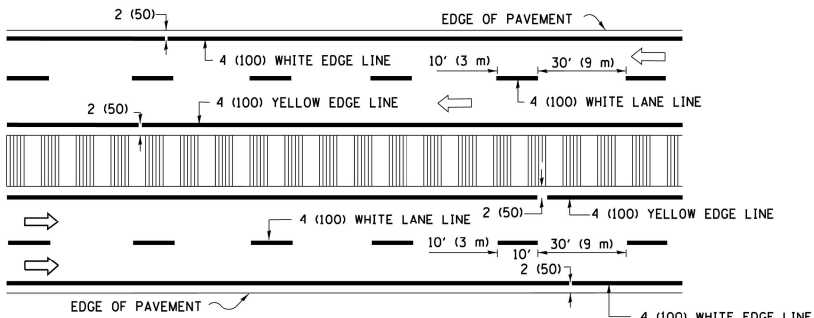

MULTI-LANE DIVIDED
WITH MEDIAN

TYPICAL LANE AND EDGE LINE MARKING

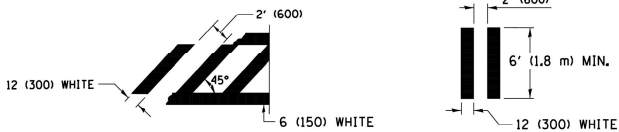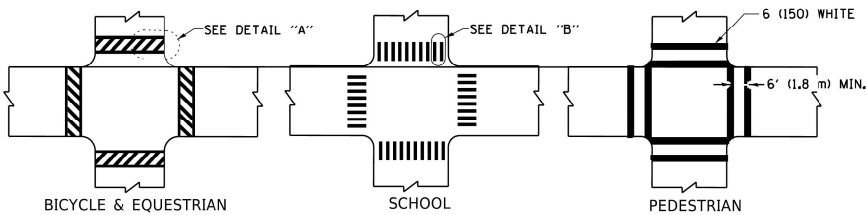


DETAIL "A"


DETAIL "B"

TYPICAL CROSSWALK MARKING

* MARKINGS SHALL BE INSTALLED PARALLEL TO THE CENTERLINE OF THE ROAD WHICH IT CROSSES

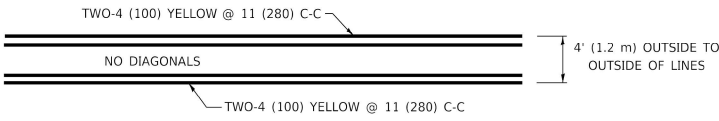


4' (1.2 m) WIDE MEDIANS ONLY

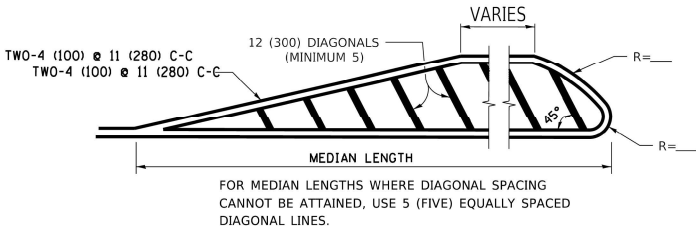


DIAGONAL LINE SPACING: 50' (15 m) C-C (LESS THAN 30MPH (50 km/h))
75' (25 m) C-C 30MPH (50 km/h) TO 45MPH (70 km/h))
150' (45 m) C-C (MORE THAN 45MPH (70 km/h))

MEDIANS OVER 4' (1.2 m) WIDE

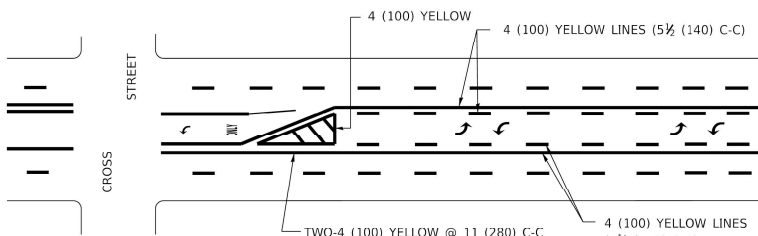


A MINIMUM OF TWO PAIRS OF TURN ARROWS SHALL BE USED, WHITE IN COLOR. ADDITIONAL PAIRS SHALL BE PLACED AT 200' (60 m) TO 300' (90 m) INTERVALS.

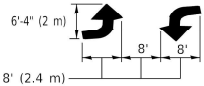

MEDIAN WITH TWO-WAY LEFT TURN LANE

TYPICAL PAINTED MEDIAN MARKING

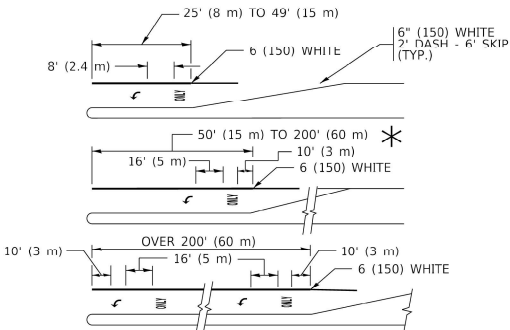


FULL SIZE LETTERS 8' (2.4 m) AND ARROWS SHALL BE USED.
AREA = 15.6 SQ. FT. (1.5 m²) ONLY AREA = 20.8 SQ. FT. (1.9 m²)


* TURN LANES IN EXCESS OF 400' (120 m) IN LENGTH MAY HAVE AN ADDITIONAL SET OF ARROW - "ONLY" INSTALLED MIDWAY BETWEEN THE OTHER TWO SETS OF ARROW - "ONLY".

TYPICAL LEFT (OR RIGHT) TURN LANE

TYPICAL TURN LANE MARKING

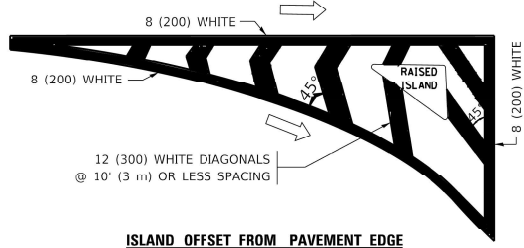


ISLAND OFFSET FROM PAVEMENT EDGE

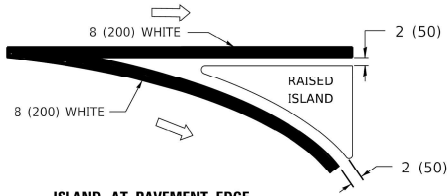


ISLAND AT PAVEMENT EDGE


TYPICAL ISLAND MARKING

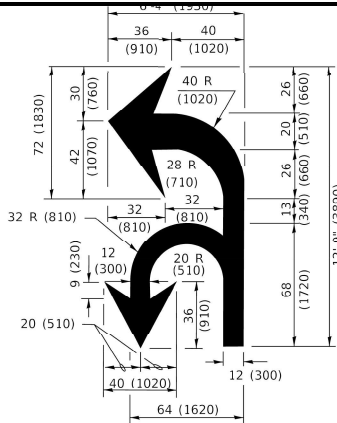

COMBINATION
LEFT AND U-TURN

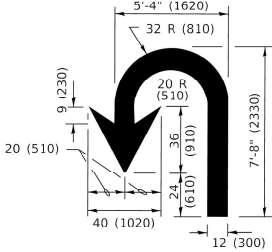

U-TURN

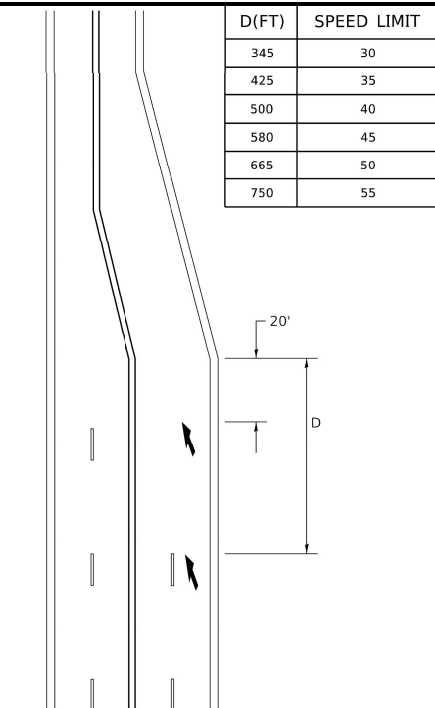

LANE REDUCTION TRANSITION

* LANE REDUCTION ARROWS REQUIRED AT SPEEDS OF 45 MPH OR GREATER OR WHEN SPECIFIED IN PLANS.

TYPE OF MARKING	WIDTH OF LINE	PATTERN	COLOR	SPACING / REMARKS
CENTERLINE ON 2 LANE PAVEMENT	4 (100)	SKIP-DASH	YELLOW	10' (3 m) LINE WITH 30' (9 m) SPACE
CENTERLINE ON MULTI-LANE UNDIVIDED PAVEMENT	2 @ 4 (100)	SOLID	YELLOW	11 (280) C-C
NO PASSING ZONE LINES: FOR ONE DIRECTION FOR BOTH DIRECTIONS	4 (100) 2 @ 4 (100)	SOLID SOLID	YELLOW YELLOW	5 1/2 (140) C-C FROM SKIP-DASH CENTERLINE 11 (280) C-C OMIT SKIP-DASH CENTERLINE BETWEEN
LANE LINES	4 (100) 5 (125) ON FREEWAYS	SKIP-DASH SKIP-DASH	WHITE WHITE	10' (3 m) LINE WITH 30' (9 m) SPACE
DOTTED LINES (EXTENSIONS OF CENTER, LANE OR TURN LANE MARKINGS)	SAME AS LINE BEING EXTENDED	SKIP-DASH	SAME AS LINE BEING EXTENDED	2' (600) LINE WITH 6' (1.8 m) SPACE
EDGE LINES	4 (100)	SOLID	YELLOW-LEFT WHITE-RIGHT	OUTLINE MEDIANS IN YELLOW
TURN LANE MARKINGS	6 (150) LINE; FULL SIZE LETTERS & SYMBOLS (8' (2.4m))	SOLID	WHITE	SEE TYPICAL TURN LANE MARKING DETAIL
TWO WAY LEFT TURN MARKING	2 @ 4 (100) EACH DIRECTION 8' (2.4m) LEFT ARROW	SKIP-DASH AND SOLID IN PAIRS	YELLOW WHITE	10' (3 m) LINE WITH 30' (9 m) SPACE FOR SKIP-DASH; 5 1/2 (140) C-C BETWEEN SOLID LINE AND SKIP-DASH LINE SEE TYPICAL TWO-WAY LEFT TURN MARKING DETAIL
CROSSWALK LINES (PEDESTRIAN) A. DIAGONALS (BIKE & EQUESTRIAN) B. LONGITUDINAL BARS (SCHOOL)	2 @ 6 (150) 12 (300) @ 45° 12 (300) @ 90°	SOLID SOLID SOLID	WHITE WHITE WHITE	NOT LESS THAN 6' (1.8 m) APART 2' (600) APART 2' (600) APART SEE TYPICAL CROSSWALK MARKING DETAILS.
STOP LINES	24 (600)	SOLID	WHITE	PLACE 4' (1.2 m) IN ADVANCE OF AND PARALLEL TO CROSSWALK, IF PRESENT. OTHERWISE, PLACE AT DESIRED STOPPING POINT. PARALLEL TO CROSSROAD CENTERLINE, WHERE POSSIBLE
PAINTED MEDIANS	2 @ 4 (100) WITH 12 (300) DIAGONALS @ 45° NO DIAGONALS USED FOR 4' (1.2 m) WIDE MEDIANS	SOLID	YELLOW; TWO WAY TRAFFIC WHITE; ONE WAY TRAFFIC	11 (280) C-C FOR THE DOUBLE LINE SEE TYPICAL PAINTED MEDIAN MARKING.
GORE MARKING AND CHANNELIZING LINES	8 (200) WITH 12 (300) DIAGONALS @ 45°	SOLID	WHITE	DIAGONALS: 15' (4.5 m) C-C (LESS THAN 30MPH (50 km/h)) 20' (6 m) C-C 30MPH (50 km/h) TO 45MPH (70 km/h)) 30' (9 m) C-C (OVER 45MPH (70 km/h))
RAILROAD CROSSING	24 (600) TRANSVERSE LINES; "RR" IS 6' (1.8 m) LETTERS; 16 (400) LINE FOR "X"	SOLID	WHITE	SEE STATE STANDARD 780001 AREA OF: *R*=3.6 SQ. FT. (0.33 m ²) EACH *X*=54.0 SQ. FT. (5.0 m ²)
SHOULDER DIAGONALS (REQUIRED FOR SHOULDERS ≥ 8')	12 (300) @ 45°	SOLID	WHITE - RIGHT YELLOW - LEFT	50' (15 m) C-C (LESS THAN 30MPH (50 km/h)) 75' (25 m) C-C 30 MPH (50 km/h) TO 45MPH (70 km/h)) 150' (45 m) C-C (OVER 45MPH (70 km/h))
U TURN ARROW	SEE DETAIL	SOLID	WHITE	16.3 SF
2 ARROW COMBINATION LEFT AND U TURN	SEE DETAIL	SOLID	WHITE	30.4 SF

FOR FURTHER DETAILS ON PAVEMENT MARKING REFER TO
STANDARD SPECIFICATIONS FOR ROAD AND BRIDGE
CONSTRUCTION AND STATE STANDARD 780001.


All dimensions are in inches (millimeters)
unless otherwise shown.

USER NAME = footemj	DESIGNED - EVERS	REVISED - C. JUCIUS 09-09-09
	DRAWN -	REVISED - C. JUCIUS 07-01-13
PLOT SCALE = 50.0000 ' / in.	CHECKED -	REVISED - C. JUCIUS 12-21-15
PLOT DATE = 3/4/2019	DATE - 03-19-90	REVISED - C. JUCIUS 04-12-16



STATE OF ILLINOIS
DEPARTMENT OF TRANSPORTATION

DISTRICT ONE TYPICAL PAVEMENT MARKINGS		MUN RTE.	SECTION	COUNTY	TOTAL SHEETS	SHEET NO.
		XX	24-00144-00-MS	COOK	22	20
		FIELD BOOK NO.: -TC-13		CONTRACT NO. 61L76		
		FED. ROAD DIST. NO. 1		ILLINOIS		
		FED. AID PROJECT				


SCALE: NONE SHEET 1 OF 2 SHEETS STA. TO STA.

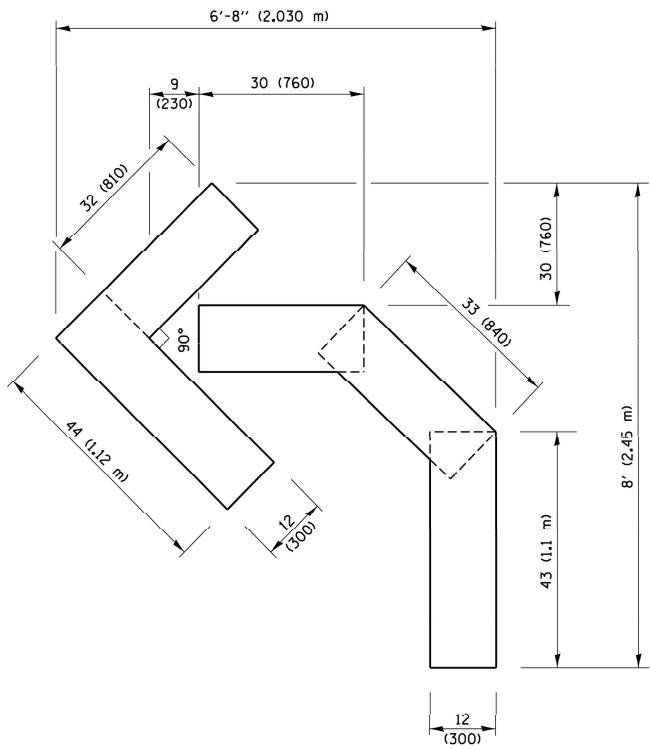

QUANTITY
4 (100) LINE = 45.5 ft. (13.9 m)
15.2 sq. ft. (1.41 sq. m)

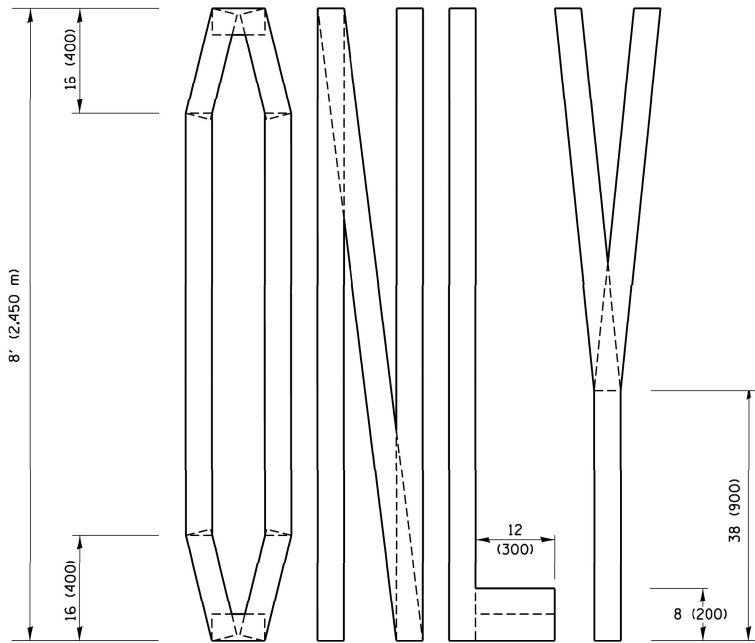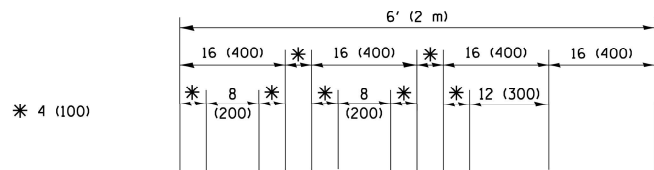


QUANTITY
4 (100) LINE = 64.1 ft. (19.5 m)
21.4 sq. ft. (1.99 sq. m)

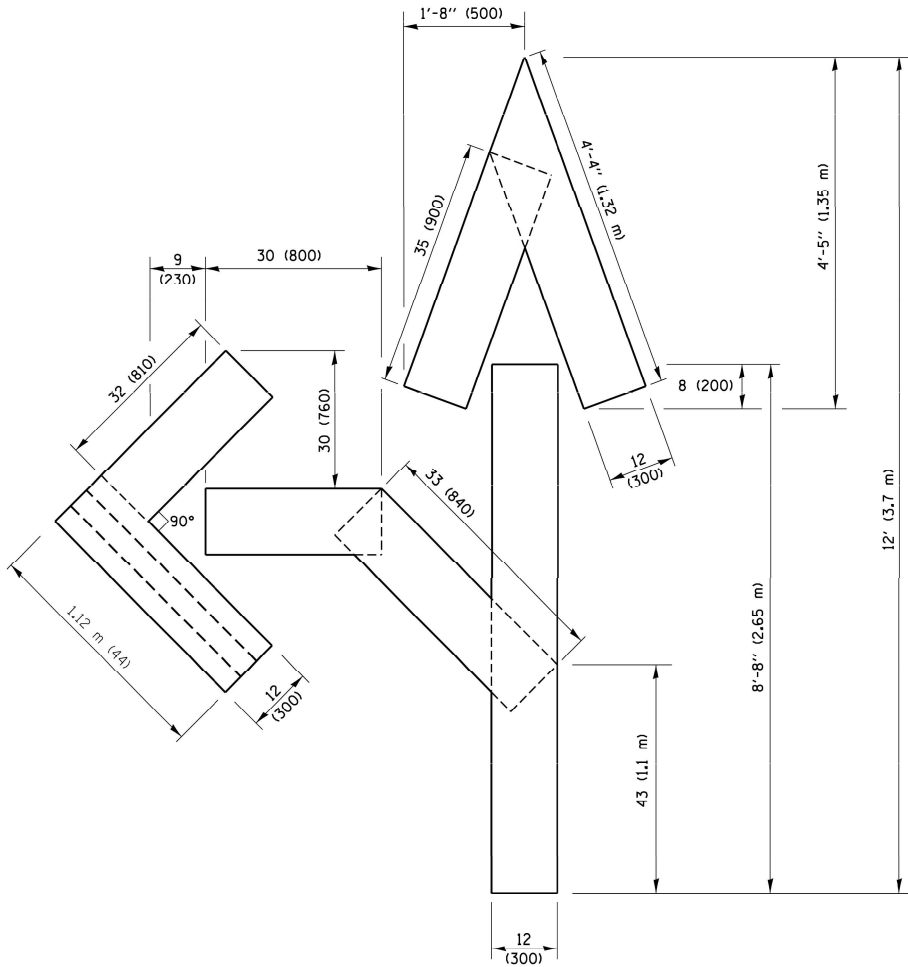

QUANTITY
4 (100) LINE = 82.5 ft. (25.1 m)
27.5 sq. ft. (2.53 sq. m)

NOTE:

ALL QUANTITIES OF PLACEMENT ARE REPRESENTED IN LINEAR FEET OF 4" LINES TO MATCH THE 4" TEMPORARY TAPE PAY ITEM AND REPRESENTS THE TOTAL QUANTITY OF 4" TAPE REQUIRED.

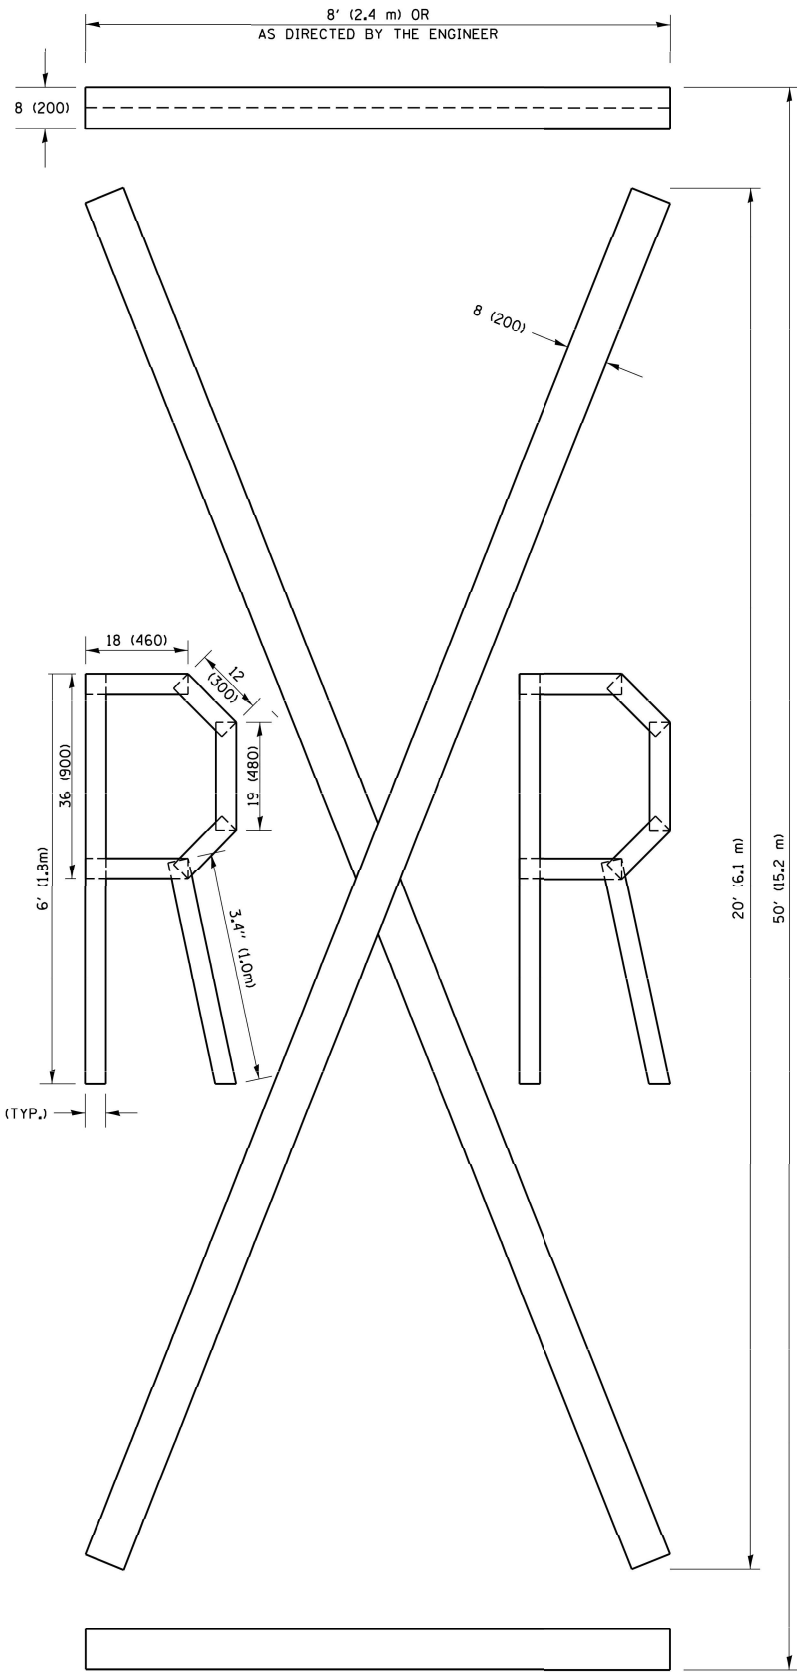

QUANTITY
4 (100) LINE = 225.9 ft. (68.9 m)
75.3 sq. ft. (6.99 sq. m)

All dimensions are in inches (millimeters) unless otherwise shown.

FILE NAME =	USER NAME = footemj	DESIGNED -	REVISED - T. RAMMACHER 03-02-98
pwt:\IL084EBIDINTEG\Illinois.gov\PI\DOT Documents\DOT Offices\District 1\Projects\District 1\DOT Data\CAD\Sheets\tol6.dgn		DRAWN -	REVISED - E. GOMEZ 08-28-00
PLOT SCALE = 50,0000 ' / in.		CHECKED -	REVISED - E. GOMEZ 08-28-00
PLOT DATE = 9/15/2016		DATE - 09-18-94	REVISED - A. SCHUETZE 09-15-16


**STATE OF ILLINOIS
DEPARTMENT OF TRANSPORTATION**

SHORT TERM PAVEMENT MARKING LETTERS AND SYMBOLS

SCALE: NONE SHEET NO. 1 OF 1 SHEETS STA. TO STA.

MUN. RTE.	SECTION	COUNTY	TOTAL SHEETS	SHEET NO.
XX	24-00144-00-MS	COOK	22	21
FIELD BOOK NO.: -TC-16		CONTRACT NO. 61L76		
FED. ROAD DIST. NO. 1		ILLINOIS	FED. AID PROJECT	

Drawing file: W:\projects_by_village\Maywood\56524168 - pedestrian safety improvements\DOT Standard.dwg Sep 11, 2025 - 9:41am

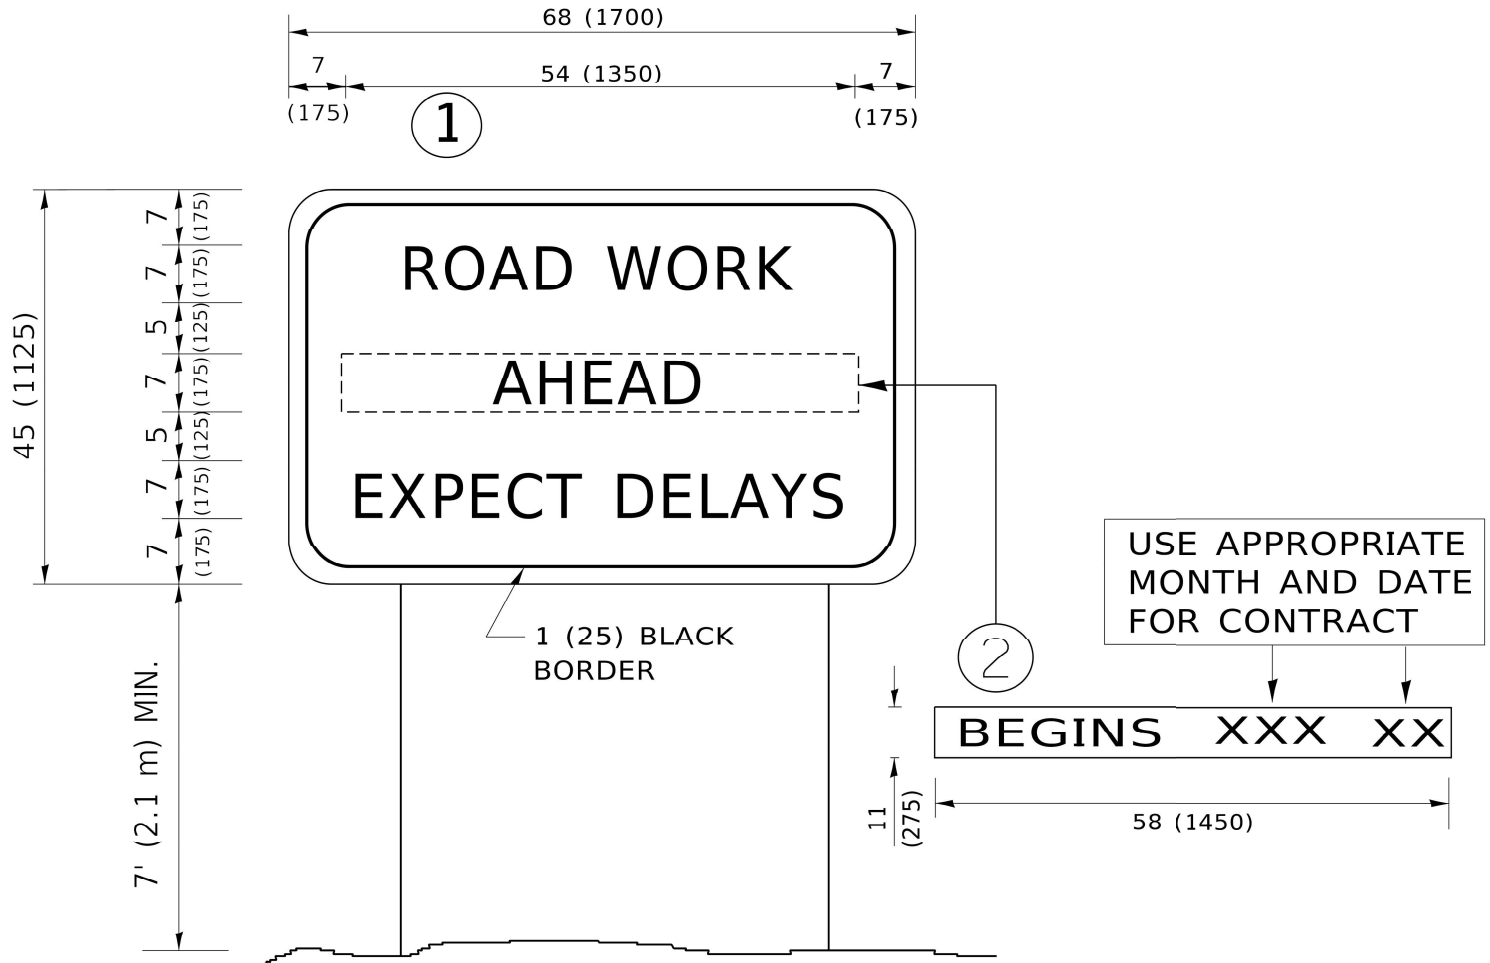

NOTES:

1. USE BLACK LETTERING ON ORANGE BACKGROUND.
2. ERECT SIGNS IN ADVANCE OF THE LOCATION FOR THE "ROAD CONSTRUCTION AHEAD" SIGN AT LOCATIONS AS DIRECTED BY THE ENGINEER.
3. ERECT SIGN①WITH INSTALLED PANEL②ONE WEEK PRIOR TO THE START OF CONSTRUCTION.
4. REMOVE PANEL②SOON AFTER THE START OF CONSTRUCTION.
5. SEE SPECIAL PROVISION FOR "TEMPORARY INFORMATION SIGNING" FOR ADDITIONAL INFORMATION.
6. ONE SIGN ASSEMBLY EQUALS 25.70 SQ. FT. (2.3 SQ. M.)
7. SHALL BE PAID FOR AS TEMPORARY INFORMATION SIGNING.

ALL DIMENSIONS ARE IN INCHES (MILLIMETERS)
UNLESS OTHERWISE SHOWN.

USER NAME	= footemj	DESIGNED	-	REVISED	- R. MIRS 09-15-97
		DRAWN	-	REVISED	- R. MIRS 12-11-97
PLOT SCALE	= 50.0000 ' / in.	CHECKED	-	REVISED	-T. RAMMACHER 02-02-99
PLOT DATE	= 3/4/2019	DATE	-	REVISED	- C. JUCIUS 01-31-07

STATE OF ILLINOIS
DEPARTMENT OF TRANSPORTATION

ARTERIAL ROAD
INFORMATION SIGN

SCALE: NONE SHEET 1 OF 1 SHEETS STA. TO STA.

MUN RTE.	SECTION	COUNTY	TOTAL SHEETS	SHEET NO.
XX	24-00144-00-MS	COOK	22	22
FIELD BOOK NO. : - TC-22		CONTRACT NO. 61L76		
FED. ROAD DIST. NO. 1		ILLINOIS	FED. AID PROJECT	