11/07/2025 LETTING ITEM 102

FOR INDEX OF SHEETS, SEE SHEET NO. 2 FOR LIST OF HIGHWAY STANDARDS SEE SHEET NO. 2

FUNCTIONAL CLASSIFICATION STONEBRIDGE BLVD - MAJOR COLLECTOR

TRAFFIC DATA STONEBRIDGE BLVD - NORTH OF SHEFFER RD 2023 ADT = 700STONEBRIDGE BLVD - SOUTH OF SHEFFER RD 2023 ADT = 1.550

POSTED SPEED LIMIT STONEBRIDGE BLVD = 25 MPH

DESIGN SPEED LIMIT STONEBRIDGE BLVD = 25 MPH

STATE OF ILLINOIS **DEPARTMENT OF TRANSPORTATION**

PLANS FOR PROPOSED FEDERAL AID HIGHWAY


FAU ROUTE 3826 & MUN ROUTE 0250 (STONEBRIDGE BLVD) INDIAN TRAIL TO EOLA ROAD ROADWAY RESURFACING

SECTION NO.: 24-00370-00-RS

PROJECT NO.: SDI4(603)

CITY OF AURORA DUPAGE COUNTY

C-91-124-25

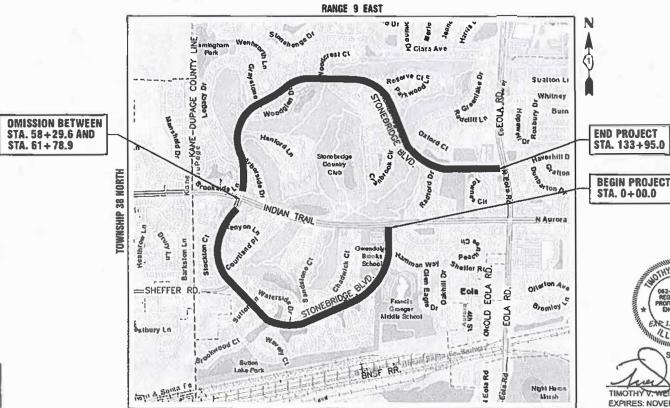

DUPAGE COUNTY - WAPERVILLE TOWNSHIP

LOCATION MAP

CONTRACT NO. 61L57

FULL SIZE PLANS HAVE BEEN PREPARED USING STANDARD ENGINEERING SCALES. REDUCED SIZED PLANS WILL NOT

ON REDUCED PLANS, THE ABOVE SCALES MAY BE USED.

811 OR 1-800-892-0123 Dial 811 or 1-800-892-0123

Know what's below.

Callbefore you dig.

CONFORM TO STANDARD SCALES. IN MAKING MEASUREMENTS

JOINT UTILITY LOCATION INFORMATION FOR EXCAVATION

JULIE DESIGN TICKET NUMBER: # XXXX


CITY-TOWNSHIP NAPERVILLE TOWNSHIP
SEC. & 1/4 SEC NO. 7. 18-38 N.-9 E.

(2) Working Days before you dig (Excluding Sal., Sun. & Halidays)

GROSS LENGTH OF PROJECT = 13,329.5 FEET (2.52 MILES) NET LENGTH OF PROJECT = 12,980 0 FEET (2 46 MILES)

SECTION SHEETS NO. 24-00370-00-RS DUPAGE ILLINOIS CONTRACT NO. 61L57



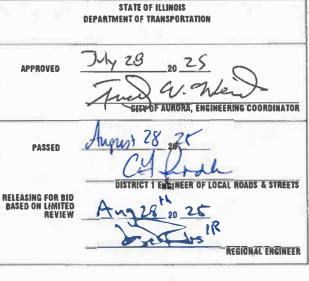

PLANS PREPARED BY THE CITY OF AURORA

PRINTED BY THE AUTHORITY OF THE STATE OF ILLINOIS

ENGINEER: CARMEN PROGRAM

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INDEX OF SHEETS

	SHEET NO.	DESCRIPTION
1		COVER SHEET
2		INDEX OF SHEETS, DETAILS, HIGHWAY STANDARDS AND GENERAL NOTES
3	- 5	SUMMARY OF QUANTITIES
6	- 8	TYPICAL SECTIONS
9	- 22	RESURFACING PLANS
23	;	EROSION CONTROL DETAILS
24	- 32	I.D.O.T. DISTRICT 1 DETAILS

ILLINOIS URBAN MANUAL EROSION CONTROL DETAILS

IUM-561C	INLET PROTECTION - PAVED AREAS CURB PROTECTION
IUM-561D	INLET PROTECTION - PAVED AREAS DROP-IN PROTECTION

DISTRICT ONE DETAILS

BD-08	DETAILS FOR FRAMES AND LIDS ADJUSTMENT WITH MILLING
BD-22	PAVEMENT PATCHING FOR HMA SURFACED PAVEMENT
BD-24	CURB OR CURB AND GUTTER REMOVAL AND REPLACEMENT
BD-32	BUTT JOINT AND HMA TAPER DETAILS
TC-10	TRAFFIC CONTROL AND PROTECTION FOR SIDE ROADS, INTERSECTIONS, AND DRIVEWAYS
TC-13	DISTRICT ONE TYPICAL PAVEMENT MARKINGS
TC-16	SHORT TERM PAVEMENT MARKING LETTERS AND SYMBOLS
TC-22	ARTERIAL ROAD INFORMATION SIGN
TC-26	DRIVEWAY ENTRANCE SIGNING

HIGHWAY STANDARDS

000001-08	STANDARD SYMBOLS, ABBREVIATIONS AND PATTERNS
001006	DECIMAL OF AN INCH AND OF A FOOT
280001-07	TEMPORARY EROSION CONTROL SYSTEMS
420001-10	PAVEMENT JOINTS
424001-12	PERPENDICULAR CURB RAMPS FOR SIDEWALKS
424006-06	DIAGONAL CURB RAMPS FOR SIDEWALKS
424011-05	CORNER PARALLEL CURB RAMPS FOR SIDEWALKS
424021-07	DEPRESSED CORNER FOR SIDEWALKS
424031-03	MEDIAN PEDESTRIAN CROSSINGS
442201-03	CLASS C AND D PATCHES
604001-05	FRAME AND LIDS TYPE 1
604051-04	FRAME AND LIDS TYPE 11
606001-08	CONCRETE CURB TYPE B AND COMBINATION CONCRETE CURB AND GUTTER
701001-02	OFF-RD OPERATIONS, 2L, 2W, MORE THAN 15' (4.5 m) AWAY
701101-05	OFF-RD OPERATIONS, MULTILANE, 15' (4.5 m) TO 24" (600 mm) FROM PAVEMENT EDGE
701106-02	OFF-RD OPERATIONS, MULTILANE, MORE THAN 15' (4.5 m) AWAY
701301-04	LANE CLOSURE, 2L, 2W, SHORT TIME OPERATIONS
701311-03	LANE CLOSURE, 2L, 2W, MOVING OPERATIONS-DAY ONLY
701427-05	LANE CLOSURE, MULTILANE, INTERMITTENT OR MOVING OPER., FOR SPEEDS ≤ 40 MPH
701501-06	URBAN LANE CLOSURE, 2L, 2W, UNDIVIDED
701601-09	URBAN LANE CLOSURE, MULTILANE, 1W OR 2W WITH NONTRAVERSABLE MEDIAN
701701-10	URBAN LANE CLOSURE, MULTILANE INTERSECTION
701801-06	SIDEWALK, CORNER OR CROSSWALK CLOSURE
701901-10	TRAFFIC CONTROL DEVICES
780001-05	TYPICAL PAVEMENT MARKING

GENERAL NOTES

- ALL REFERENCES TO "STANDARD SPECIFICATIONS" IN THESE GENERAL NOTES SHALL BE INTERPRETED TO MEAN THE ILLINOIS DEPARTMENT OF TRANSPORTATION "STANDARD SPECIFICATIONS FOR ROAD AND BRIDGE CONSTRUCTION", JANUARY 1, 2022 AND SUPPLEMENTAL SPECIFICATIONS AND RECURRING SPECIAL PROVISIONS.
- 2. IT SHALL BE THE CONTRACTOR'S RESPONSIBILITY TO VERIFY ALL DIMENSIONS AND CONDITIONS EXISTING IN THE FIELD PRIOR TO CONSTRUCTION AND ORDERING OF MATERIALS. IN ADDITION, THE CONTRACTOR MUST VERIFY THE ENGINEER'S LINE AND GRADE STAKES. IN THE EVENT OF A DISCREPANCY BETWEEN THE PLANS AND FIELD CONDITIONS, THE CONTRACTOR SHALL SECURE WRITTEN INSTRUCTIONS FROM THE ENGINEER PRIOR TO PROCEEDING WITH ANY PART OF THE WORK AFFECTED BY THE IDENTIFIED DISCREPANCIES.
- BEFORE STARTING ANY EXCAVATION, THE CONTRACTOR SHALL CALL "JULIE" (JOINT UTILITY LOCATION INFORMATION FOR EXCAVATION) AT (800) 892-0123 FOR FIELD LOCATIONS OF BURIED UTILITIES (48 HOURS NOTIFICATION IS REQUIRED).
- 4. THE CONTRACTOR SHALL BE RESPONSIBLE FOR CONTACTING THE OWNER OF ALL EXISTING UTILITIES FACILITIES SO THAT THE UTILITIES AND THEIR APPURTENANCES MAY BE LOCATED AND ADJUSTED OR MOVED, IF NECESSARY, PRIOR TO THE START OF CONSTRUCTION OPERATIONS.
- 5. THE CONTRACTOR WILL NOT BE ALLOWED TO SET UP A YARD OR FIELD OFFICE ON CITY, STATE, OR PRIVATE PROPERTY WITHOUT WRITTEN PERMISSION FROM THE ENGINEER.
- 6. THE STORAGE OF EQUIPMENT AND/OR MATERIALS WITHIN THE RIGHT-OF-WAY OF ANY STREET AND/OR PARK PROPERTY SHALL REQUIRE PRIOR APPROVAL OF THE ENGINEER.
- 7. OFFSET LOCATIONS GIVEN IN THE PLANS FOR STRUCTURES, EDGE OF PAVEMENT, ETC. ARE FROM THE ROADWAY CENTERLINE.
- 8. SIDEWALK REMOVAL AND REPLACEMENT AND COMBINATION CONCRETE CURB AND GUTTER REMOVAL AND REPLACEMENT AS SHOWN ON THE PLANS IS FOR INFORMATIONAL PURPOSES ONLY. ACTUAL LOCATIONS AND QUANTITIES ARE TO BE DETERMINED AND MARKED BY THE ENGINEER PRIOR TO CONSTRUCTION.
- THE CONTRACTOR SHALL BE RESPONSIBLE FOR THE REPLACEMENT OF ANY DETECTOR LOOPS DAMAGED DURING CONSTRUCTION.
- 10. BUTT JOINTS WILL BE INSTALLED AT THE ENDS OF RESURFACING (WHERE RESURFACING MEETS EXISTING PAVEMENT) IN ACCORDANCE WITH THE "BUTT JOINT AND HMA TAPER DETAILS" SHEET INCLUDED IN THE PLANS.
- 11. THE CONTRACTOR SHALL VERIFY THAT ALL CRACKS, JOINTS, AND FLANGEWAYS ARE CLEAN AND DRY PRIOR TO PLACEMENT OF MIXTURE FOR CRACKS, JOINTS, AND FLANGEWAYS.
- 12. THE CONTRACTOR SHALL MAINTAIN THE SITE IN A CLEAN AND ORDERLY MANNER. DEBRIS AND SURPLUS MATERIAL SHALL BE REMOVED AND RESTORATION SHALL PROCEED AS THE WORK PROCEEDS. IF THE ENGINEER SO DIRECTS, THE CONTRACTOR SHALL STOP ALL OTHER WORK AND CONCENTRATE ON CLEAN—UP AND RESTORATION. DEBRIS AND SURPLUS MATERIAL SHALL BE DISPOSED BY THE CONTRACTOR OFF—SITE.
- 13. DRIVEWAY ENTRANCES WILL BE KEPT OPEN TO TRAFFIC AT ALL TIMES. THE CONTRACTOR WILL BE ALLOWED TO CLOSE A MAXIMUM OF HALF THE AREA OF ANY ONE ENTRANCE AT ANY TIME. IT IS ESSENTIAL THAT THE ENTRANCES REMAIN OPEN AND 'DRIVE-ABLE' FOR TWO-WAY TRAFFIC AT ALL TIMES. THE CONTRACTOR WILL BE RESPONSIBLE FOR MAINTAINING TRAFFIC CONTROL AND PROTECTION. WHERE NEW CURB AND GUTTER IS TO BE INSTALLED ACROSS A DRIVEWAY, IT IS EXPECTED THAT ONLY HALF OF THE DRIVEWAY ENTRANCE MAY BE REMOVED AND REPLACED AT ANY ONE TIME. ONLY AFTER PROPER CONCRETE CURE TIME HAS OCCURRED MAY THE CONTRACTOR BEGIN REMOVAL AND REPLACEMENT OPERATIONS ON THE REMAINING HALF OF THE CURB AND GUTTER. THE CONTRACTOR WILL NOT BE ALLOWED TO CLOSE A HALF OF DRIVEWAY ENTRANCE FOR MORE THAN 48 HOURS UNDER ANY CIRCUMSTANCE.
- 14. CONTRACTOR SHALL TAKE PRECAUTION BY PRESERVING EXISTING TREES WITHIN THE RIGHT OF WAY. IF ANY DAMAGE OCCURS, TREES SHALL BE REPLACED IN KIND PER ARTICLE 201.07 REPAIR OR REPLACEMENT OF EXISTING PLANT MATERIAL REQUIREMENTS STATED HEREIN
- 15. WHEN MILLED PAVEMENT IS OPEN TO TRAFFIC, THE MAXIMUM GRADE DIFFERENTIAL BETWEEN PASSES OF THE MILLING MACHINE SHALL NOT EXCEED 1.5 INCHES WHERE THE SPEED IS 45 MPH OR LESS, WITH WRITTEN APPROVAL FROM THE RESIDENT ENGINEER, A MAXIMUM GRADE DIFFERENTIAL OF 3 INCHES MAY BE ALLOWED IF THE EDGE OF THE MILLING IS SLOPED A MINIMUM OF 14:35H.
- 16. PHOSPHOROUS FERTILIZER HAS BEEN INTENTIONALLY OMITTED FROM THE CONTRACT DUE TO THE PROXIMITY TO THE EXISTING PONDS. A PHOSPHORUS—FREE FERTILIZER SHALL BE USED (MIDDLE NUMBER SHOULD EQUAL 0).
- 17. THE CONTRACTOR SHALL CONTACT KALPANA KANNAN-HOSADURGA, THE DISTRICT ONE TRAFFIC CONTROL SUPERVISOR AT KALPANA.KANNAN-HOSADURGA@ILLINOIS.GOV A MINIMUM 72 HOURS IN ADVANCE OF BEGINNING WORK.
- 18. ANY TREE LIMBS THAT ARE BROKEN BY CONSTRUCTION EQUIPMENT MUST BE PRUNED CORRECTLY WITHIN 72 HOURS.
- 19. NO GRADING OR ADDITIONAL SOIL WILL BE ALLOWED WITHIN THE DRIPLINE OF ANY TREE UNLESS DIRECTED BY THE ENGINEER.
- 20. EXISTING VEGETATED AREAS (TREES, SHRUBS, VEGETATIVE BUFFERS, TURF AREAS, ETC.) WHERE DISTURBANCE IS NOT OCCURRING (INCLUDING AREAS OUTSIDE OF THE PROJECT LIMITS) SHALL NOT BE DISTURBED TO ENSURE THAT EXISTING VEGETATION IS PRESERVED HEALTHY TO MINIMIZE SOIL EROSION AND TO ELIMINATE SOIL COMPACTION. NO MATERIALS ARE TO BE STORED OR VEHICLES DRIVEN OR PARKED WITHIN THESE UNDISTURBED AREAS AT ANY TIME.

UTILITIES

- ALL UTILITY COMPANIES AND THE CITY OF AURORA SHALL BE NOTIFIED AT LEAST 3 DAYS PRIOR TO THE START OF CONSTRUCTION.
- EXISTING BROKEN FRAMES AND LIDS SHALL BE REMOVED AND DISPOSED OF BY THE CONTRACTOR AND SHALL BE REPLACED AS DIRECTED BY THE ENGINEER.
- ONLY PRECAST CONCRETE ADJUSTMENT RINGS, MAXIMUM OF 12 INCHES IN HEIGHT, WILL BE ALLOWED IN THE ADJUSTMENT OF CATCH BASINS, MANHOLES, INLETS AND VALVE VAULT STRUCTURES. COMMON BRICK WILL NOT BE ALLOWED.
- 4. THE CONTRACTOR SHALL ENSURE THAT ALL WATER SYSTEM VALVES (IN VALVE BOXES AND VALVE VAULTS) SHALL REMAIN READILY ACCESSIBLE TO THE CITY FOR EMERGENCY OPERATIONS AND NOT BURIED DURING CONSTRUCTION, UNLESS APPROVED BY THE ENGINEER. THE LOCATIONS OF ALL WATER FACILITIES SHALL BE MARKED AND READILY VISIBLE AT ALL TIMES. FOR ALL OTHER STRUCTURES THAT NEED TO BE ADJUSTED THAT ARE NOT WATER, THE CONTRACTOR CAN CHOOSE TO ADJUST THEM ACCORDING TO BD-08. THE CONTRACTOR CAN ALSO CHOOSE TO BURY WATER STRUCTURES ACCORDING TO BD-08 WITH APPROVAL BY THE ENGINEER. THE CONTRACTOR WOULD NEED TO PROVIDE A DETAILED SCHEDULE OF MILLING, PAVING, AND ADJUSTMENT TIMELINES FOR THE ENGINEER'S REVIEW. APPROVAL BY THE ENGINEER IS NOT GUARANTEED AND WOULD BE CONTINGENT ON THE CONTRACTOR BURYING WATER STRUCTURES LAST AND ADJUSTING THEM FIRST. THE CONTRACTOR IS TO DETERMINE ANY PROTECTION OR RAMPING THAT IS REQUIRED AROUND STRUCTURES IF THEY ARE NOT BURIED. OPEN LID STORM MANHOLE STRUCTURES IN THE PAVEMENT MAY NOT BE ABLE TO BE ADJUSTED ACCORDING TO BD-08.
- 5. THE INDISCRIMINATE USE OF FIRE HYDRANTS OR EXISTING STREAMS, CREEKS, WETLANDS OR PONDS IS STRICTLY PROHIBITED. THE CONTRACTOR SHALL PROVIDE A WATER TRUCK AND DRIVER AS REQUIRED TO OBTAIN AND TRANSPORT THIS WATER. THE CONTRACTOR SHALL BE RESPONSIBLE FOR OBTAINING WATER FROM AN APPROVED SOURCE. IF THIS WATER IS FROM A SOURCE OTHER THAN THEIR YARD, WRITTEN APPROVAL FROM THE AGENCY HAVING JURISDICTION FOR THE SOURCE OF THE WATER MUST BE RECEIVED BY THE ENGINEER PRIOR TO USE OF THE WATER.

SIGNING AND STRIPING

- ALL EXISTING SIGNS (INCLUDING THOSE LOCATED ON UTILITY/LIGHT POLES) THAT DO NOT
 CONFLICT WITH THE IMPROVEMENTS SHALL REMAIN IN PLACE UNLESS DIRECTED BY THE ENGINEER.
- 2. SIGNS SHALL NOT BE MOVED OR COVERED UNTIL PROGRESS OF WORK NECESSITATES IT.
- SEE IDOT DISTRICT ONE DETAILS TC-13 (DISTRICT ONE TYPICAL PAVEMENT MARKINGS), AND TC-16 (SHORT TERM PAVEMENT MARKINGS LETTERS AND SYMBOLS) AND PLAN SHEETS FOR PAVEMENT MARKING DETAILS.
- GRINDING OF PAVEMENT MARKINGS ON NEWLY CONSTRUCTED HOT-MIX ASPHALT SHALL NOT BE PERMITTED.

COMMITMENTS

- 1. ALL SOILS GENERATED FROM CURB AND SIDEWALK REPAIRS MUST REMAIN WITHIN THE RIGHT-OF-WAY
- 2. WORK HOURS ARE LIMITED DURING THE SCHOOL YEAR NEAR BROOKS ELEMENTARY AND GRANGER MIDDLE SCHOOLS. SEE SPECIAL PROVISIONS FOR DETAILS.
- CONTRACTOR SHALL COORDINATE WORK OPERATIONS AS NEEDED WITH AURORA SAFE ROUTES TO SCHOOL PROJECT 22-00349-00-SW.

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FILE NAME = Stonebridge-Cover-Ph2	DRAWN - MH	REVISED	-
PLOT SCALE = N.T.S.	CHECKED - TW	REVISED	-
PLOT DATE = 9/2/2025	DATE - 12/	/11/2024 REVISED	_

į	CODE NUMBER	ITEM DESCRIPTION	UNIT	QUANTITY ROADWAY 75% FEDERAL 25% LOCAL 0005
t	20101100	TREE TRUNK PROTECTION	EACH	42
t	20101200	TREE ROOT PRUNING	EACH	42
	21101615	TOPSOIL FURNISH AND PLACE, 4"	SQ YD	2928
	25000400	NITROGEN FERTILIZER NUTRIENT	POUND	37
	25000600	POTASSIUM FERTILIZER NUTRIENT	POUND	37
31	25200110	SODDING, SALT TOLERANT	SQ YD	2928
	25200200	SUPPLEMENTAL WATERING	UNIT	158.2
	28000510	INLET FILTERS	EACH	66
	31101000	SUBBASE GRANULAR MATERIAL, TYPE B	TON	249
	40600290	BITUMINOUS MATERIALS (TACK COAT)	POUND	40921
	40600370	LONGITUDINAL JOINT SEALANT	FOOT	9813
	40600400	MIXTURE FOR CRACKS, JOINTS, AND FLANGEWAYS	TON	24,2
	40600982	HOT-MIX ASPHALT SURFACE REMOVAL - BUTT JOINT	SQ YD	440
	40603200	POLYMERIZED HOT-MIX ASPHALT BINDER COURSE, IL-4.75, N50	TON	3335
	40604060	HOT-MIX ASPHALT SURFACE COURSE, IL-9.5, MIX "D", N50	TON	6790
	42400200	PORTLAND CEMENT CONCRETE SIDEWALK 5 INCH	SQ FT	7100

t INDICATES SPECIALTY ITEM

PROJECT CONSIGNATION OF THE NAME: Stonebridge PLOT DRIVER: DWG TO PD PEUT DRIVER: DWG TO PD PEUT DRIVER: LUOT-Stone

USER NAME = HOPPM	DESIGNED	-	AN	REVISED	_
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STATE OF ILLINOIS	
DEPARTMENT OF TRANSPORTATION	

SUMMARY OF QUANTITIES					SECTION
	SUMM	3826/0250	24-00370-00-RS		
CALE: N.T.S. S	MEET NO. OT OF	03 SHEETS STA.	TO STA.		ILLINOIS FED. A

COUNTY TOTAL SHEET NO.

DUPAGE 32 3

CONTRACT NO. 61L57

	CODE NUMBER	ITEM DESCRIPTION	UNIT	QUANTITY ROADWAY 75% FEDERAL 25% LOCAL 0005
	42400800	DETECTABLE WARNINGS	SQ FT	465
	44000161	HOT-MIX ASPHALT SURFACE REMOVAL, 3"	SQYD	60623
	44000600	SIDEWALK REMOVAL	SQ FT	7100
	44201681	CLASS D PATCHES, TYPE I, 3 INCH	SQYD	360
	44201682	CLASS D PATCHES, TYPE II, 3 INCH	SQYD	730
	44201683	CLASS D PATCHES, TYPE III, 3 INCH	SQYD	1450
	44201684	CLASS D PATCHES, TYPE IV, 3 INCH	SQ YD	1090
	67100100	MOBILIZATION	L SUM	1
	70102620	TRAFFIC CONTROL AND PROTECTION, STANDARD 701501	L SUM	1
	70102630	TRAFFIC CONTROL AND PROTECTION, STANDARD 701601	L SUM	1
	70102640	TRAFFIC CONTROL AND PROTECTION, STANDARD 701801	L SUM	1
	70300100	SHORT TERM PAVEMENT MARKING	FOOT	4213
	70300150	SHORT TERM PAVEMENT MARKING REMOVAL	SQ FT	1405
t	78000100	THERMOPLASTIC PAVEMENT MARKING - LETTERS AND SYMBOLS	SQ FT	146
t	78000200	THERMOPLASTIC PAVEMENT MARKING - LINE 4"	FOOT	8050
t	78000400	THERMOPLASTIC PAVEMENT MARKING - LINE 6"	FOOT	2046

t INDICATES SPECIALTY ITEM

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STATE OF ILLINOIS	
DEPARTMENT OF TRANSPORTATION	

		SUMMARY OF QUANTITIES									RTE. 3826/0250	
_	SCALE:	N.T.S.	SHEET	NO.	02	OF	03	SHEETS	STA,	το sta.		

	FAU/MUN RTE.	SECTION	COUNTY	TOTAL SHEETS	SHEET NO.	
	3826/0250		DUPAGE	32	4	
_			CONTRA	CT NO.	61L57	
			. AID PROJECT			

	CODE NUMBER	ITEM DESCRIPTION	UNIT	QUANTITY ROADWAY 75% FEDERAL 25% LOCAL 0005
t	78000600	THERMOPLASTIC PAVEMENT MARKING - LINE 12"	FOOT	2732
t	78000650	THERMOPLASTIC PAVEMENT MARKING - LINE 24"	FOOT	368
t	78011000	GROOVING FOR RECESSED PAVEMENT MARKING, LETTERS AND SYMBOLS	SQ FT	146
t	78011025	GROOVING FOR RECESSED PAVEMENT MARKING 5"	FOOT	8050
t	78011035	GROOVING FOR RECESSED PAVEMENT MARKING 7"	FOOT	2046
t	78011065	GROOVING FOR RECESSED PAVEMENT MARKING 13"	FOOT	2732
t	78011125	GROOVING FOR RECESSED PAVEMENT MARKING 25"	FOOT	368
t	K1004595	PRUNING FOR SAFETY AND EQUIPMENT CLEARANCE	LSUM	1
	X0327611	REMOVE AND REINSTALL BRICK PAVER	SQ FT	600
	X4400501	COMBINATION CURB AND GUTTER REMOVAL AND REPLACEMENT LESS THAN OR EQUAL TO 10 FEET	FOOT	200
	X4400503	COMBINATION CURB AND GUTTER REMOVAL AND REPLACEMENT GREATER THAN 10 FEET	FOOT	1015
	X6026050	SANITARY MANHOLES TO BE ADJUSTED	EACH	1
	X6030310	FRAMES AND LIDS TO BE ADJUSTED (SPECIAL)	EACH	75
	X7200061	TEMPORARY INFORMATION SIGNING	SQ FT	179
	Z0012500	CONCRETE CURB REPAIR	FOOT	160


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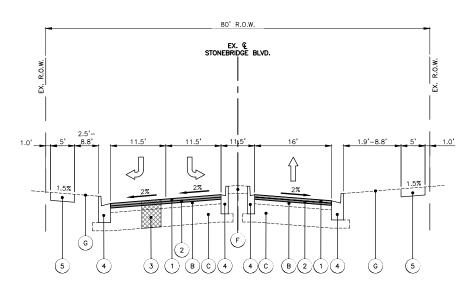
STATE OF ILLINOIS
DEPARTMENT OF TRANSPORTATION

		RTE.	RTE. SECTION			NO.	
	SUMMARY OF QUANTITIES	3826/0250	24-00370-00-RS	DUPAGE	32	5	
					CONTRA		61L57
SCALE: N.T.S.	SHEET NO. 03 OF 03 SHEETS STA.	TO STA.	ILLINOIS FED. AID PROJECT				



EXISTING TYPICAL SECTION - STONEBRIDGE BLVD.

STA: 0+00.0 - STA: 1+40.0

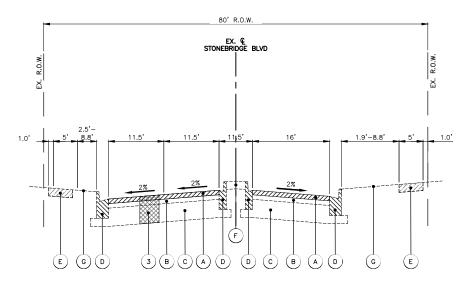


PROPOSED TYPICAL SECTION - STONEBRIDGE BLVD.

STA: 0+00.0 - STA: 1+40.0

17.2'-21.0' 13.5'-15.0' (D) (G) (E) (G) (G) (3) (C) (B) (A)

EXISTING TYPICAL SECTION - STONEBRIDGE BLVD.

STA: 1+40.0 - STA: 3+10.0

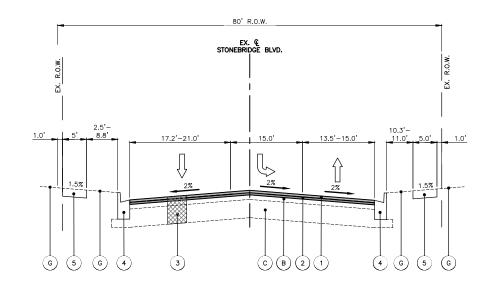

PROPOSED TYPICAL SECTION - STONEBRIDGE BLVD.

STA: 1+40.0 - STA: 3+10.0

EXISTING LEGEND

(A) HOT-MIX ASPHALT SURFACE REMOVAL, 3.0"

EXISTING HMA PAVEMENT, 6" (ESTIMATED TOP OF SURFACE TO TOP OF SUBBASE)

AGGREGATE SUBBASE, 12"

COMBINATION CONCRETE CURB & GUTTER, B-6.12 ALONG MEDIAN, B-6.24 ALONG OUTSIDE EDGE OF PAVEMENT

PORTLAND CEMENT CONCRETE SIDEWALK, 5"

LANDSCAPED MEDIAN

(G) EXISTING GROUND

HOT-MIX ASPHALT MIXTURE REQUIREMENTS

OPERATION	MIXTURE TYPE	AIR VOIDS	OMP		
OFERATION	MIXTORE TIFE	@ NDES	QIVIF		
PAVEMENT RESURFACING	HOT-MIX ASPHALT SURFACE COURSE, MIX "D", IL-9.5, N50, 2"	4% @ 50 GYR.	LR1030-2		
PAVEMENT RESURFACING	POLYMERIZED HOT-MIX ASPHALT BINDER COURSE, IL-4.75, N50, 1"	3.5% @ 50 GYR.	LR1030-2		
CLASS D PATCHES	HOT-MIX ASPHALT BINDER COURSE, IL-19.0, N50, 3"	4% @ 50 GYR.	LR1030-2		
QMP DESIGNATION: QUALIT					

THE UNIT WEIGHT USED TO CALCULATE ALL HMA SURFACE MIXTURE QUANTITIES IS 112 LBS/SQ YD/IN

THE "AC TYPE" FOR POLYMERIZED HMA MIXES SHALL BE "SBS/SBR PG 76-22" AND FOR NON-POLYMERIZED HMA THE "AC TYPE" SHALL BE "PG64-22" UNLESS MODIFIED BY RÉCLAIMED MATERIALS SPECIFICATIONS.

THE LONGITUDINAL JOINT SEALANT SHALL BE PLACED OVER THE P HMA BC IL-4.75 N50.

PROPOSED LEGEND

HOT-MIX ASPHALT SURFACE COURSE, MIX "D", IL-9.5, N50, 2"

POLYMERIZED HOT-MIX ASPHALT BINDER COURSE, IL-4.75, N50, 1"

CLASS D PATCHES 3" WITH SUBBASE GRANULAR MATERIAL 12", TYPE B AS NEEDED (SPOT REMOVAL & REPLACEMENT AS DIRECTED BY THE ENGINEER)

COMBINATION CONCRETE CURB & GUTTER, VARIES FROM TYPE B-6.12 TO B-6.24 (SPOT REMOVAL & REPLACEMENT AS DIRECTED BY THE ENGINEER)

ILLINOIS FED. AID PROJECT

PCC SIDEWALK, 5" (SPOT REMOVAL & REPLACEMENT AS DIRECTED BY THE ENGINEER)

SCALE: N.T.S. SHEET NO. 01 OF 03 SHEETS STA.

NOTES:

• THE PATCHING QUANTITIES HAVE BEEN ESTIMATED BASED ON FIELD OBSERVATIONS DURING DESIGN. ACTUAL QUANTITIES TO BE DETERMINED DURING CONSTRUCTION BY THE ENGINEER.


- . NO PROPOSED WORK WILL TAKE PLACE OUTSIDE OF THE EXISTING R.O.W.
- TOPSOIL FURNISH AND PLACE, 4" AND SODDING, SALT TOLERANT SHALL BE USED TO RESTORE ANY TURF AREAS DAMAGED DURING CONSTRUCTION.

USER NAME = HOPPM	DESIGNED	-	AN	REVISED -	
FILE NAME = Stonebridge-Typ Sections	DRAWN	-	НМ	REVISED -	
PLOT SCALE = N.T.S.	CHECKED	-	TW	REVISED -	
PLOT DATE = 8/25/2025	DATE	-	12/11/2024	REVISED -	

STATE OF ILLINOIS **DEPARTMENT OF TRANSPORTATION**


	FAU/MUN RTE.	SECTION	COUNTY	TOTAL SHEETS	SHEET NO.
TYPICAL SECTIONS	3826/0250	24-00370-00-RS	DUPAGE	32	6
THIORE DESTIONS			CONTRA	CT NO.	61L57

TO STA.

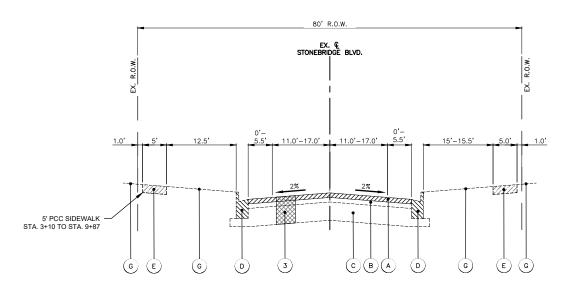

EXISTING TYPICAL SECTION - STONEBRIDGE BLVD.

STA: 3+10.0 - STA: 14+44.0

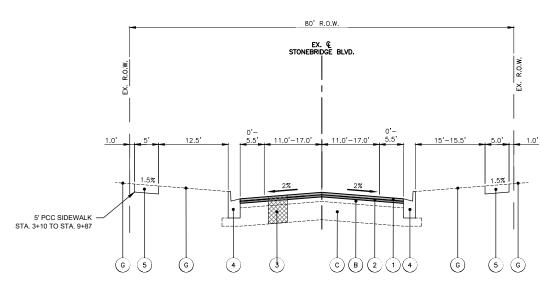

PROPOSED TYPICAL SECTION - STONEBRIDGE BLVD.

STA: 3+10.0 - STA: 14+44.0

EXISTING LEGEND

(A) HOT-MIX ASPHALT SURFACE REMOVAL, 3.0"

EXISTING HMA PAVEMENT, 6" (ESTIMATED TOP OF SURFACE TO TOP OF SUBBASE)


AGGREGATE SUBBASE, 12"

COMBINATION CONCRETE CURB & GUTTER, B-6.12 ALONG MEDIAN, B-6.24 ALONG OUTSIDE EDGE OF PAVEMENT

PORTLAND CEMENT CONCRETE SIDEWALK, 5"


(F) LANDSCAPED MEDIAN

EXISTING GROUND

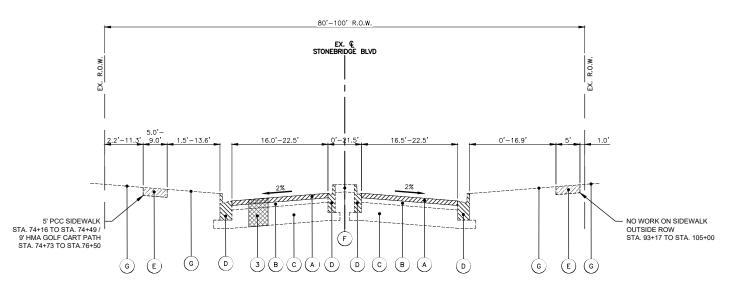

EXISTING TYPICAL SECTION - STONEBRIDGE BLVD.

STA: 14+44.0 - STA: 58+29.6 AND STA: 61+78.9 - STA. 100+75.0

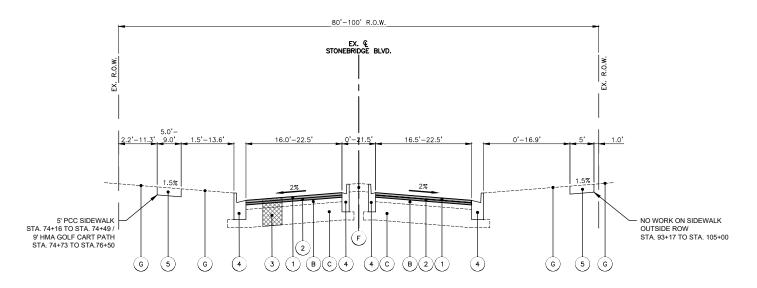

PROPOSED TYPICAL SECTION - STONEBRIDGE BLVD.

STA: 14+44.0 - STA: 58+29.6 AND STA: 61+78.9 - STA: 100+75.0 OMISSION BETWEEN STA: 58+29.6 AND STA: 61+78.9

PROPOSED LEGEND

- HOT-MIX ASPHALT SURFACE COURSE, MIX "D", IL-9.5, N50, 2"
- POLYMERIZED HOT-MIX ASPHALT BINDER COURSE, IL-4.75, N50, 1"
- CLASS D PATCHES 3" WITH SUBBASE GRANULAR MATERIAL 12", TYPE B AS NEEDED (SPOT REMOVAL & REPLACEMENT AS DIRECTED BY THE ENGINEER)
 - COMBINATION CONCRETE CURB & GUTTER, VARIES FROM TYPE B-6.12 TO B-6.24 (SPOT REMOVAL & REPLACEMENT AS DIRECTED BY THE ENGINEER)

 - PCC SIDEWALK, 5" (SPOT REMOVAL & REPLACEMENT AS DIRECTED BY THE ENGINEER)


NOTES:

- THE PATCHING QUANTITIES HAVE BEEN ESTIMATED BASED ON FIELD OBSERVATIONS DURING DESIGN. ACTUAL QUANTITIES TO BE DETERMINED DURING CONSTRUCTION BY THE ENGINEER.
- NO PROPOSED WORK WILL TAKE PLACE OUTSIDE OF THE EXISTING R.O.W.
- OMISSION BETWEEN STA. 58+29.6 AND 61+78.9

USER NAME = HOPPM	DESIGNED	-	AN	REVISED	-
FILE NAME = Stonebridge-Typ Sections	DRAWN	-	MH	REVISED	-
PLOT SCALE = N.T.S.	CHECKED	-	TW	REVISED	-
PLOT DATE = $8/25/2025$	DATE	_	12/11/2024	REVISED	_


STATE OF ILLINOIS	STONE TY
DEPARTMENT OF TRANSPORTATION	111

			FAU/MUN RTE.	SECTION			COUNTY	TOTAL SHEETS	SHEET NO.			
	TYPICAL SECTIONS						3826/0250 24-00370-00-RS			DUPAGE	32	7
										CONTRA	ACT NO.	61L57
	SCALE:	N.T.S.	SHEET NO. 02 OF 03 SHEETS	STA.	TO STA.	ILLINOIS FED. AID PROJECT						

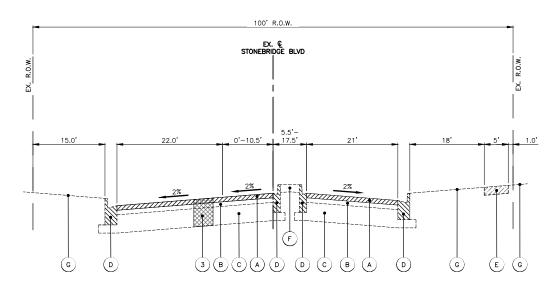

EXISTING TYPICAL SECTION - STONEBRIDGE BLVD.

STA: 100+75.0 - STA: 102+30.0

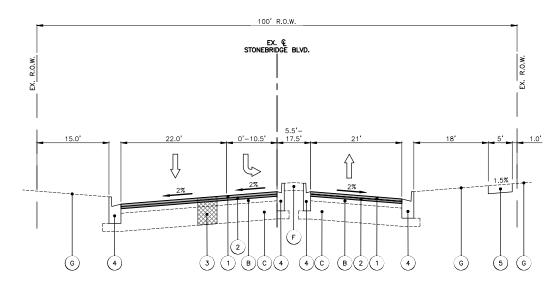

PROPOSED TYPICAL SECTION - STONEBRIDGE BLVD.

STA: 100+75.0 - STA: 102+30.0

EXISTING LEGEND

A HOT-MIX ASPHALT SURFACE REMOVAL, 3.0"


EXISTING HMA PAVEMENT, 6" (ESTIMATED TOP OF SURFACE TO TOP OF SUBBASE)

COMBINATION CONCRETE CURB & GUTTER, B-6.12 ALONG MEDIAN, B-6.24 ALONG OUTSIDE EDGE OF PAVEMENT

PORTLAND CEMENT CONCRETE SIDEWALK, 5"


(F) LANDSCAPED MEDIAN

EXISTING GROUND

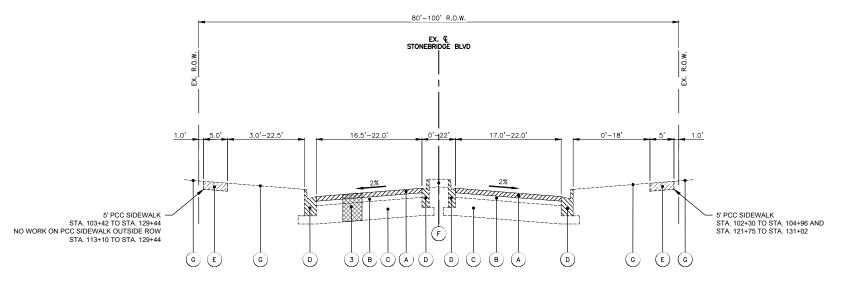

EXISTING TYPICAL SECTION - STONEBRIDGE BLVD.

STA: 102+30.0 - STA: 133+95.0

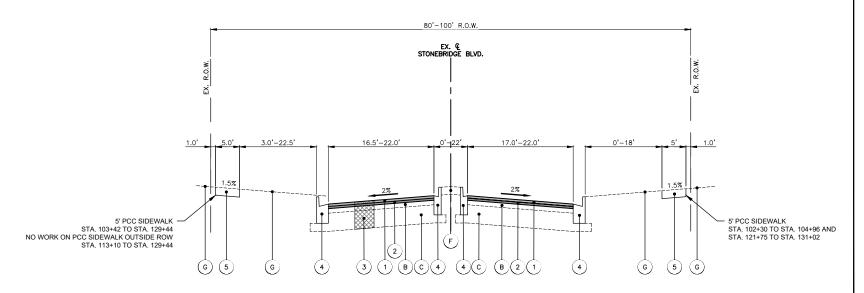

PROPOSED TYPICAL SECTION - STONEBRIDGE BLVD.

STA: 102+30.0 - STA: 133+95.0

- THE PATCHING QUANTITIES HAVE BEEN ESTIMATED BASED ON FIELD OBSERVATIONS DURING DESIGN. ACTUAL QUANTITIES TO BE DETERMINED DURING CONSTRUCTION BY THE ENGINEER.
- NO PROPOSED WORK WILL TAKE PLACE OUTSIDE OF THE EXISTING R.O.W.
- OMISSION BETWEEN STA. 58+29.6 AND 61+78.9

PROPOSED LEGEND

- HOT-MIX ASPHALT SURFACE COURSE, MIX "D", IL-9.5, N50, 2"
- POLYMERIZED HOT-MIX ASPHALT BINDER COURSE, IL-4.75, N50, 1"
- CLASS D PATCHES 3" WITH SUBBASE GRANULAR MATERIAL 12", TYPE B AS NEEDED (SPOT REMOVAL & REPLACEMENT AS DIRECTED BY THE ENGINEER)

 - COMBINATION CONCRETE CURB & GUTTER, VARIES FROM TYPE B-6.12 TO B-6.24 (SPOT REMOVAL & REPLACEMENT AS DIRECTED BY THE ENGINEER)
 - PCC SIDEWALK, 5" (SPOT REMOVAL & REPLACEMENT AS DIRECTED BY THE ENGINEER)


USER NAME = HOPPM DESIGNED - AN REVISED -FILE NAME = Stonebridge-Typ Section REVISED PLOT SCALE = N.T.S. CHECKED - TW REVISED PLOT DATE = 8/25/2025DATE - 12/11/2024 REVISED

STATE OF ILLINOIS **DEPARTMENT OF TRANSPORTATION**

STONEBRIDGE BOULEVARD TYPICAL SECTIONS SCALE: N.T.S. SHEET NO. 03 OF 03 SHEETS STA. TO STA.

DUPAGE 32 8 CONTRACT NO. 61L57

HOT-MIX ASPHALT SURFACE REMOVAL 3" - HOT-MIX ASPHALT SURFACE COURSE, IL-9.5, MIX "D", N50; 2" - POLYMERIZED HOT-MIX ASPHALT BINDER COURSE, IL-4.75, N50; 1" THPL PVT MK LTR & SYM, THPL PVT MK LINE 4 W (TYP) (DOUBLE SOLID, Y) (TYP) THPL PVT MK LINE 6 THPL PVT MK LINE 6 THPL PVT MK LINE 4 (SOLID, W) (TYP) **(**) (SKIP-DASH 2'-6', W) (SOLID, W) (TYP) ☐ THPL PVT MK LINE 6 THPL PVT MK LINE 12 __ x __ 0 (SOLID, W) (TYP) (SOLID, Y (TYP) ш BUTT JOINT 4+00 CORNER \odot \odot \odot **S** BEGIN MILLING AND RESURFACING EXISTING Q 68+ہ +007 LINE r+68 THPL PVT MK LINE 12 (SOLID, W) (TYP) **BEGIN PROJECT** STONEBRIDGE BLVD. BEGIN MILLING AND RESURFACING STONEBRIDGE BLVD. BUTT JOINT STA: 0+00.0 0 L+39 L_{50.3}' R Z THPL PVT MK LTR & SYM, L_{58.1}, R ∟BUTT JOINT BUTT JOINT ENTRANCE TO A STREET OF THE STREET OF T 0 THPL PVT MK LINE 24 (SOLID, W) (TYP) THPL PVT MK LINE 24 THPL PVT MK LINE 12 (SOLID, W) (TYP) (SOLID, W) (TYP) SCALE: 1"=20'-0 LEGEND: O '\\ THPL PVT MK LINE 24 HOT-MIX ASPHALT SURFACE REMOVAL 3" (SOLID, W) (TYP) EX. CONCRETE SIDEWALK - HOT-MIX ASPHALT SURFACE COURSE, IL-9.5, MIX "D", N50; 2" HAMMAN WAY - POLYMERIZED HOT-MIX ASPHALT BINDER COURSE, IL-4.75, N50; 1" CURB RAMP REMOVAL AND REPLACEMENT ENTRANCE TO GRANGER MIDDLE ADA DETECTABLE WARNINGS SCHOOL 52.1 EX. CONC. SIDEWALK == CONCRETE CURB & GUTTER THPL PVT MK LINE 4 -BUTT JOINT REMOVAL AND REPLACEMENT (SOLID, W) (TYP) (<u>O</u>) \odot \odot (c) DEPRESSED CURB THPL PVT MK LINE 12 (SOLID, W) (TYP) EXISTING Q (C) T EXISTING ADA COMPLIANT CURB RAMP TO REMAIN IN PLACE REMOVE CURB RAMP
AND DO NOT REPLACE STONEBRIDGE BLVD. г23.3' L THPL PVT MK LINE 12 CORNER 4+00 (SOLID, W) (TYP) TREE TRUNK PROTECTION AND TREE ROOT PRUNING THPL PVT MK LINE 12 (SOLID, W) (TYP) RIGHT STA. ANY SOILS GENERATED FROM CURB AND SIDEWALK REPAIRS SHALL REMAIN ON SITE IN THE RIGHT-OF-WAY. ANY SUCH SOIL THPL PVT MK LINE 4 SHALL BE PLACED AROUND LANDSCAPED 2 (SOLID, W) (TYP) RADIUS RETURNS OR WITHIN LANDSCAPED DITCH AREAS AS DIRECTED BY THE ENGINEER AND RESTORED THPL PVT MK LINE 12 THPL PVT MK LINE 4 (SOLID, W) (TYP) (DOUBLE SOLID, Y) (TYP) THPL PVT MK LINE 12 THPL PVT MK LINE 4 (SOLID, W) (TYP) (SOLID, W) (TYP) ENTRANCE TO GWENDOLYN BROOKS ELEMENTARY SCHOOL BUTT JOINT THPL PVT MK LINE 4 THPL PVT MK LINE 24 (DOUBLE SOLID, Y) (TYP) (SOLID, W) (TYP) FAU/MUN USER NAME = HOPPM DESIGNED - AN REVISED -SECTION STONEBRIDGE BOULEVARD FILE NAME = Stonebridge_Resurf PI_Ph 2 DRAWN REVISED STATE OF ILLINOIS 3826/0250 24-00370-00-RS DUPAGE 32 9 RESURFACING AND PAVEMENT MARKING PLAN PLOT SCALE = 1"=20' CHECKED - TW **DEPARTMENT OF TRANSPORTATION** REVISED CONTRACT NO. 61L57 SCALE: 1"=20' SHEET NO. 1 OF 14 SHEETS STA. 0+00 TO STA. 9+00 PLOT DATE = 8/25/2025DATE - 12/11/2024 REVISED

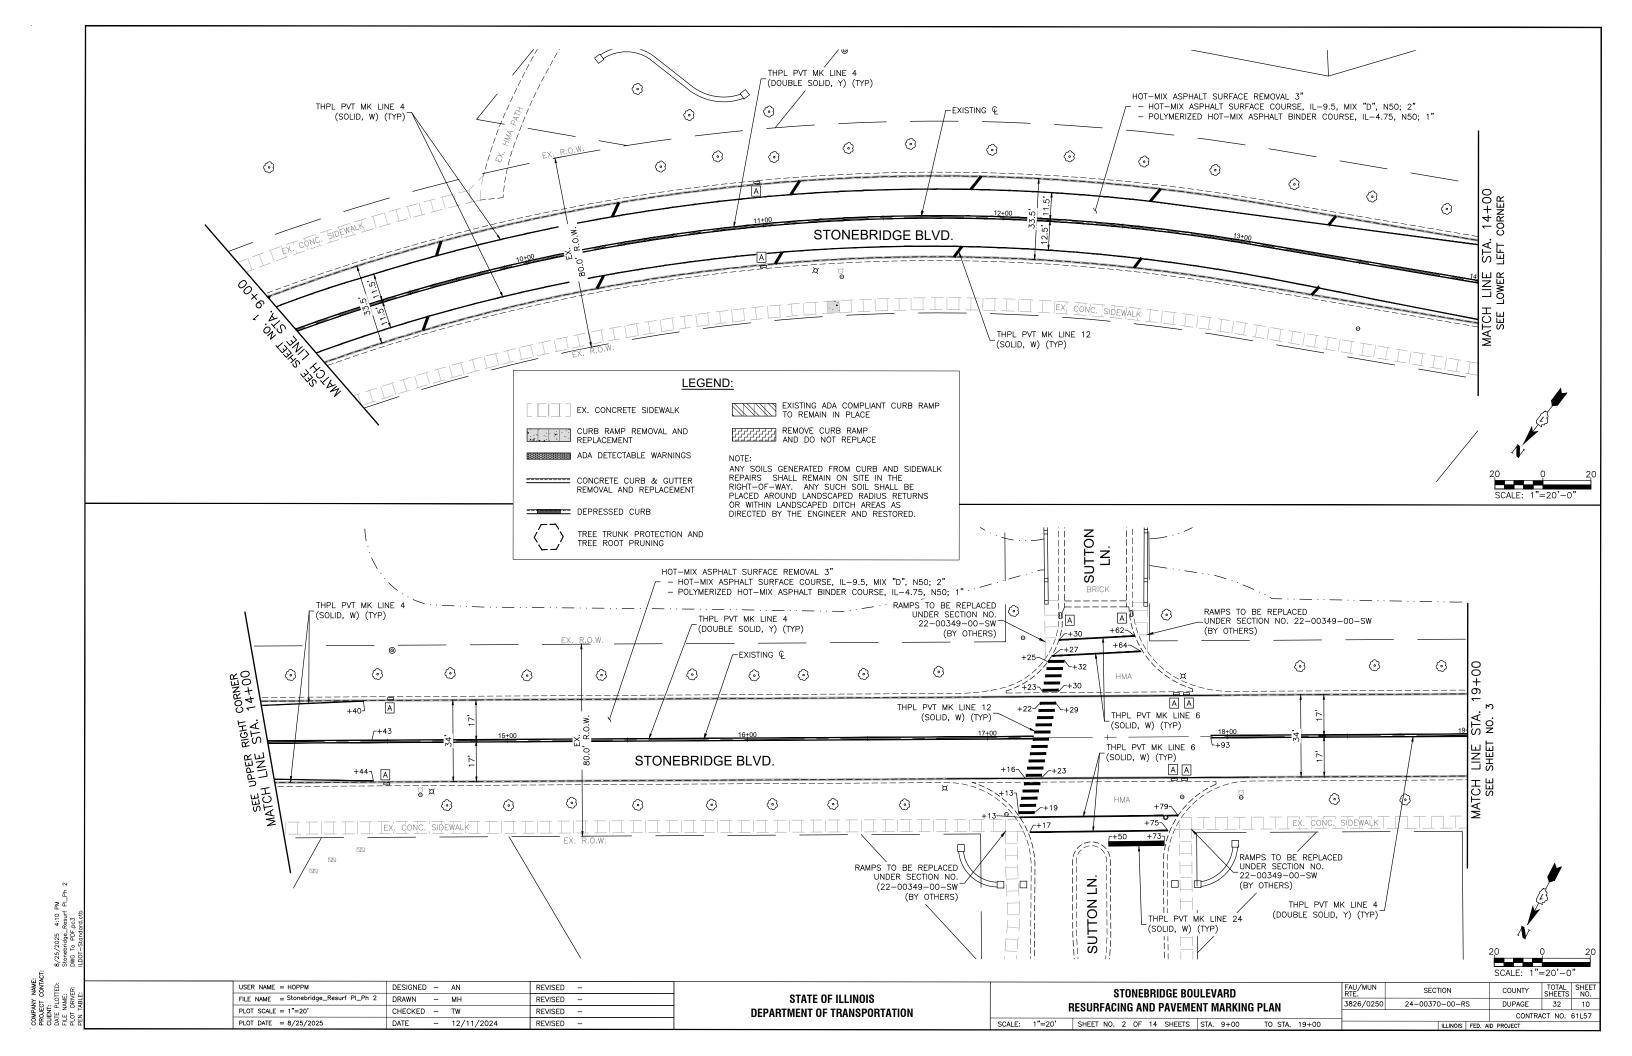



HOT-MIX ASPHALT SURFACE REMOVAL 3" - HOT-MIX ASPHALT SURFACE COURSE, IL-9.5, MIX "D", N50; 2" - POLYMERIZED HOT-MIX ASPHALT BINDER COURSE, IL-4.75, N50; 1" THPL PVT MK LINE 4 (SKIP-DASH 10'-30', Y) THPL PVT MK LINE 4 © [©] OF EXISTING & ⊙ _⊚ \odot \odot (DOUBLE SOLID, Y) (TYP) \odot \odot \odot \odot . 24+5(corner LINE LOWER MATCH SEE 1 \odot \odot 0 \odot \odot \odot \odot EX. CONC. SIDEWALK LEGEND: EXISTING ADA COMPLIANT CURB RAMP TO REMAIN IN PLACE \odot EX. CONCRETE SIDEWALK \odot CURB RAMP REMOVAL AND REPLACEMENT REMOVE CURB RAMP AND DO NOT REPLACE ADA DETECTABLE WARNINGS ANY SOILS GENERATED FROM CURB AND SIDEWALK REPAIRS SHALL REMAIN ON SITE IN THE RIGHT-OF-WAY. ANY SUCH SOIL SHALL BE CONCRETE CURB & GUTTER REMOVAL AND REPLACEMENT PLACED AROUND LANDSCAPED RADIUS RETURNS OR WITHIN LANDSCAPED DITCH AREAS AS DEPRESSED CURB DIRECTED BY THE ENGINEER AND RESTORED. TREE TRUNK PROTECTION AND TREE ROOT PRUNING HOT-MIX ASPHALT SURFACE REMOVAL 3" - HOT-MIX ASPHALT SURFACE COURSE, IL-9.5, MIX "D", N50; 2" - POLYMERIZED HOT-MIX ASPHALT BINDER COURSE, IL-4.75, N50; 1" THPL PVT MK LINE 4 (SKIP-DASH_10'-30', Y) EXISTING Q **③** \odot \odot \odot \odot THPL PVT MK LINE 6 STONEBRIDGE BLVD. 「(SOLID, W) (TYP) THPL PVT MK LINE 6 (SOLID, W) (TYP) \odot \odot \odot (<u>©</u>) CT WA TERSIDE SANDSTONE THPL PVT MK LINE 24 ¹56.0'R (SOLID, W) (TYP) BUTT JOINT SCALE: 1"=20'-0 DESIGNED - AN COUNTY TOTAL SHEETS NO.

DUPAGE 32 11 USER NAME = HOPPM REVISED -FAU/MUN RTE. SECTION STONEBRIDGE BOULEVARD FILE NAME = Stonebridge_Resurf PI_Ph 2 DRAWN REVISED STATE OF ILLINOIS 3826/0250 24-00370-00-RS RESURFACING AND PAVEMENT MARKING PLAN PLOT SCALE = 1"=20" CHECKED - TW REVISED **DEPARTMENT OF TRANSPORTATION** CONTRACT NO. 61L57 PLOT DATE = 8/25/2025DATE - 12/11/2024 REVISED SCALE: 1"=20' SHEET NO. 3 OF 14 SHEETS STA. 19+00 TO STA. 30+00

HOT-MIX ASPHALT SURFACE REMOVAL 3" HOT-MIX ASPHALT SURFACE COURSE, IL-9.5, MIX "D", N50; 2" - POLYMERIZED HOT-MIX ASPHALT BINDER COURSE, IL-4.75, N50; 1" WATER -EXISTING Q \odot \odot \odot THPI PVT MK LINE 4 (SKIP-DASH 10'-30', Y) 0 A A \odot \odot \odot STONEBRIDGE BLVD. \odot AA 3 \odot (Ô) \odot \odot WATER (Ô) \odot LEGEND: EXISTING ADA COMPLIANT CURB RAMP TO REMAIN IN PLACE EX. CONCRETE SIDEWALK CURB RAMP REMOVAL AND REPLACEMENT REMOVE CURB RAMP AND DO NOT REPLACE 0 ADA DETECTABLE WARNINGS ANY SOILS GENERATED FROM CURB AND SIDEWALK REPAIRS SHALL REMAIN ON SITE IN THE 0 ====== CONCRETE CURB & GUTTER RIGHT-OF-WAY. ANY SUCH SOIL SHALL BE PLACED AROUND LANDSCAPED RADIUS RETURNS REMOVAL AND REPLACEMENT OR WITHIN LANDSCAPED DITCH AREAS AS DIRECTED BY THE ENGINEER AND RESTORED. DEPRESSED CURB TREE TRUNK PROTECTION AND TREE ROOT PRUNING HOT-MIX ASPHALT SURFACE REMOVAL 3" -BUTT JOINT - HOT-MIX ASPHALT SURFACE COURSE, IL-9.5, MIX "D", N50; 2" - POLYMERIZED HOT-MIX ASPHALT BINDER COURSE, IL-4.75, N50; 1" THPL PVT MK LINE 24 62.8' L-(SOLID, W) (TYP) RAMPS TO BE REPLACED UNDER SECTION NO. 22-00349-00-SW THPL PVT MK LINE 4 RAMPS TO BE REPLACED UNDER SECTION NO. 22-00349-00-SW (DOUBLE SOLID, Y) (TYP) SU (BY OTHERS) THPL PVT MK LINE 12 (SOLID, W) (TYP) 0 (BY OTHERS) L₊₁₂ -EXISTING € \odot \odot \odot \odot \odot \odot \odot \odot \odot +73 CORN THPL PVT MK LINE 12 RIGHT (SOLID, W) (TYP) LINE SHEET UH H \odot \odot \odot 0 \odot (O) \odot \odot \odot \odot \odot EX. CONC. SIDEWALK +72¬ EX. CONC. SIDEWALK r+47 +697 RAMPS TO BE REPLACED UNDER SECTION NO. 22-00349-00-SW (BY OTHERS) THPL PVT MK LINE 4 SUTTON (DOUBLE SOLID, Y) (TYP) RAMPS TO BE REPLACED UNDER SECTION NO. THPL PVT MK LINE 4 THPL PVT MK LINE 24 0 (SKIP-DASH 10'-30', Y) (SOLID, W) (TYP) 22-00349-00-SW (BY OTHERS) FAU/MUN RTF: DESIGNED - AN REVISED SECTION COUNTY STONEBRIDGE BOULEVARD STATE OF ILLINOIS FILE NAME = Stonebridge_Resurf PI_Ph 2 REVISED -24-00370-00-RS DRAWN DUPAGE 32 12 3826/0250 RESURFACING AND PAVEMENT MARKING PLAN **DEPARTMENT OF TRANSPORTATION** PLOT SCALE = 1"=20' CHECKED - TW REVISED CONTRACT NO. 61L57 SCALE: 1"=20' SHEET NO. 4 OF 14 SHEETS STA. 30+00 TO STA. 40+50 PLOT DATE = 8/25/2025 - 12/11/2024


// -BUTT JOINT HOT-MIX ASPHALT SURFACE REMOVAL 3" \odot ∠79.9' L LEGEND: - HOT-MIX ASPHALT SURFACE COURSE, IL-9.5, MIX "D", N50; 2" - POLYMERIZED HOT-MIX ASPHALT BINDER COURSE, IL-4.75, N50; 1" EX. CONCRETE SIDEWALK В. THPL PVT MK LINE 4 (DOUBLE SOLID, Y) (TYP) CURB RAMP REMOVAL AND REPLACEMENT HEFFE \odot ADA DETECTABLE WARNINGS THPL PVT MK LINE 4 (DOUBLE SOLID, Y) (TYP) CONCRETE CURB & GUTTER
REMOVAL AND REPLACEMENT THPL PVT MK LINE 24 0 (SOLID, W) (TYP) (⊙) -EXISTING Q DEPRESSED CURB \odot EXISTING ADA COMPLIANT CURB RAMP TO REMAIN IN PLACE \odot 0 THPL PVT MK LINE 12 REMOVE CURB RAMP 0 (SOLID, W) (TYP) AND DO NOT REPLACE \odot TREE TRUNK PROTECTION AND TREE ROOT PRUNING Α ANY SOILS GENERATED FROM CURB AND SIDEWALK REPAIRS SHALL REMAIN ON SITE IN **(⊙**) **(**⊙) **(**⊙)> **(**⊙) THE RIGHT-OF-WAY. ANY SUCH SOIL SHALL BE PLACED AROUND LANDSCAPED RADIUS RETURNS \odot \odot \odot EX. CONC. SIDEWALK DIRECTED BY THE ENGINEER AND RESTORED. \odot MATCH 0 į BUTT JOINT HOT-MIX ASPHALT SURFACE REMOVAL 3" THPL PVT MK LINE 24 STOCKTON -BUTT JOINT - HOT-MIX ASPHALT SURFACE COURSE, IL-9.5, MIX "D", N50; 2" - POLYMERIZED HOT-MIX ASPHALT BINDER COURSE, IL-4.75, N50; 1" (SOLID, W) (TYP) 59.6' Ln THPL PVT MK LINE 4 EXISTING & iiot (DOUBLE SOLID, Y) (TYP) THPL PVT MK LINE 4 THPL PVT MK LINE 12 (DOUBLE SOLID, Y) (TYP) (SOLID, W) (TYP) 0 \odot (e) THPL PVT MK LINE 12 (SOLID, W) (TYP) 0 \odot CORNER 44+50 Α THPL PVT MK LINE 6 +35-(SOLID, W) (TYP) \odot \odot \odot \odot EX, CONC. SIDEWALK (<u>©</u>) +90¬ 0 COURTLAND THPL PVT MK LINE 4 THPL PVT MK LINE 24 (DOUBLE SOLID, Y) (TYP) (SOLID, W) (TYP) BUTT JOINT FAU/MUN USER NAME = HOPPM DESIGNED - AN REVISED -SECTION STONEBRIDGE BOULEVARD FILE NAME = Stonebridge_Resurf PI_Ph 2 REVISED STATE OF ILLINOIS 3826/0250 24-00370-00-RS DUPAGE 32 13 RESURFACING AND PAVEMENT MARKING PLAN PLOT SCALE = 1"=20' **DEPARTMENT OF TRANSPORTATION** CHECKED - TW REVISED CONTRACT NO. 61L57 SCALE: 1"=20' SHEET NO. 5 OF 14 SHEETS STA. 40+50 TO STA. 50+00 PLOT DATE = 8/25/2025DATE - 12/11/2024 REVISED

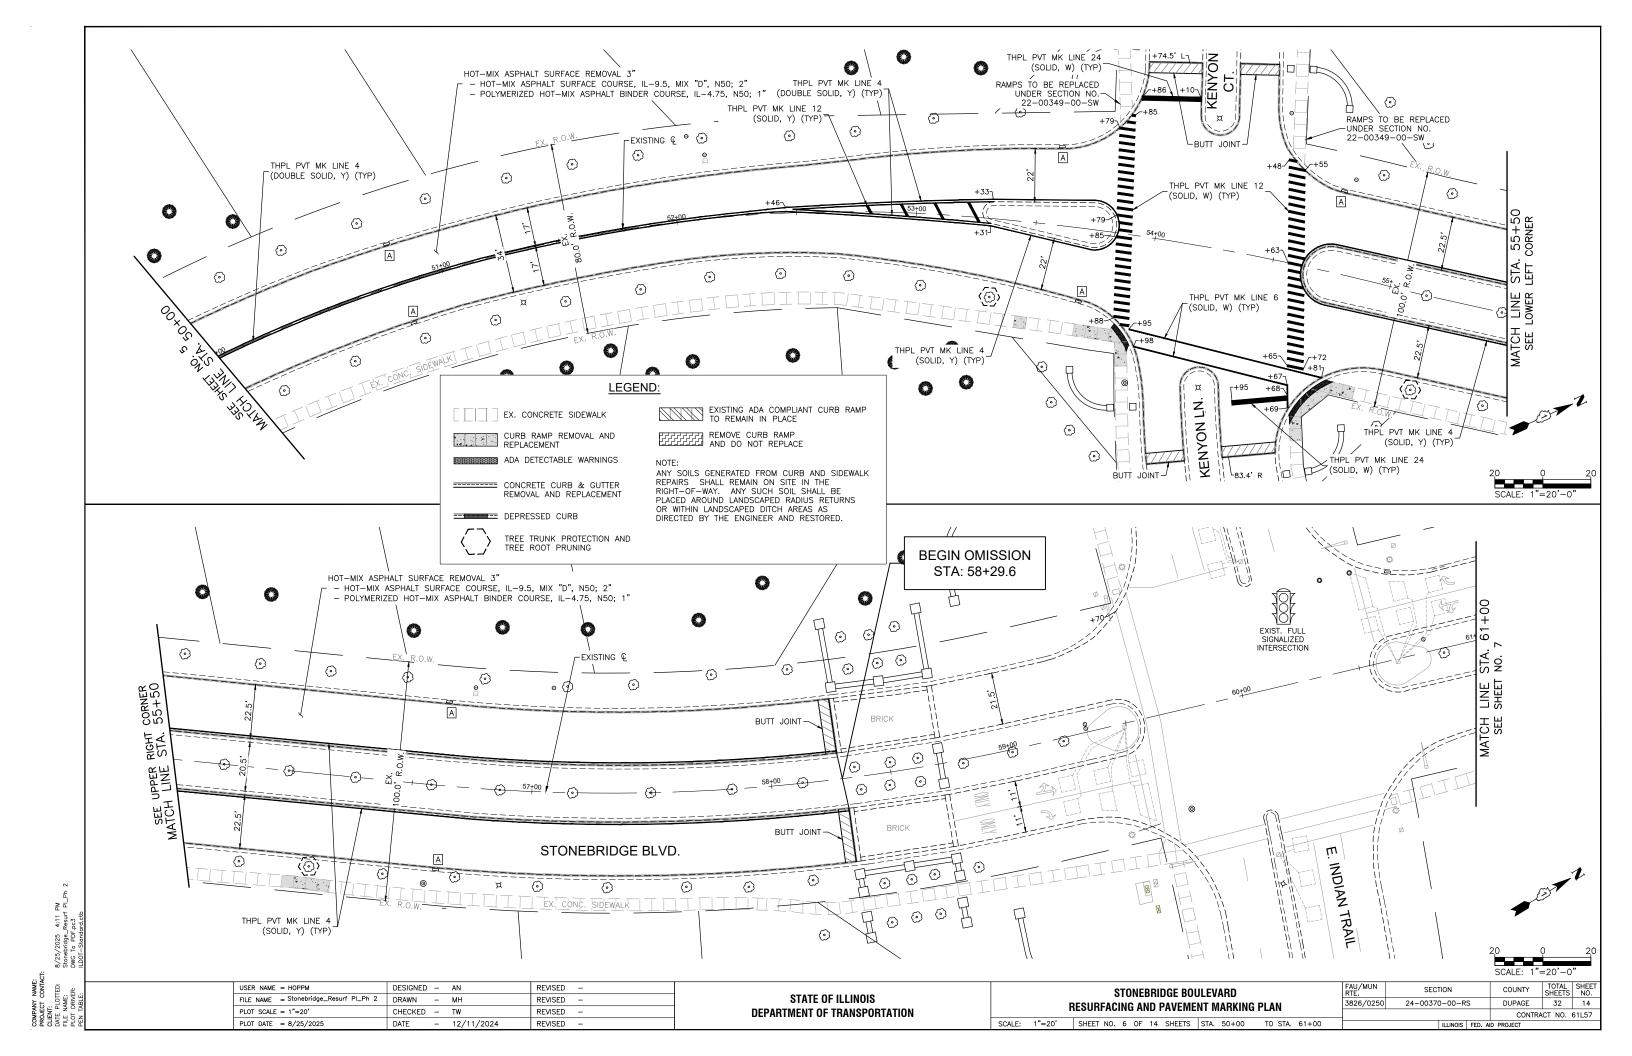

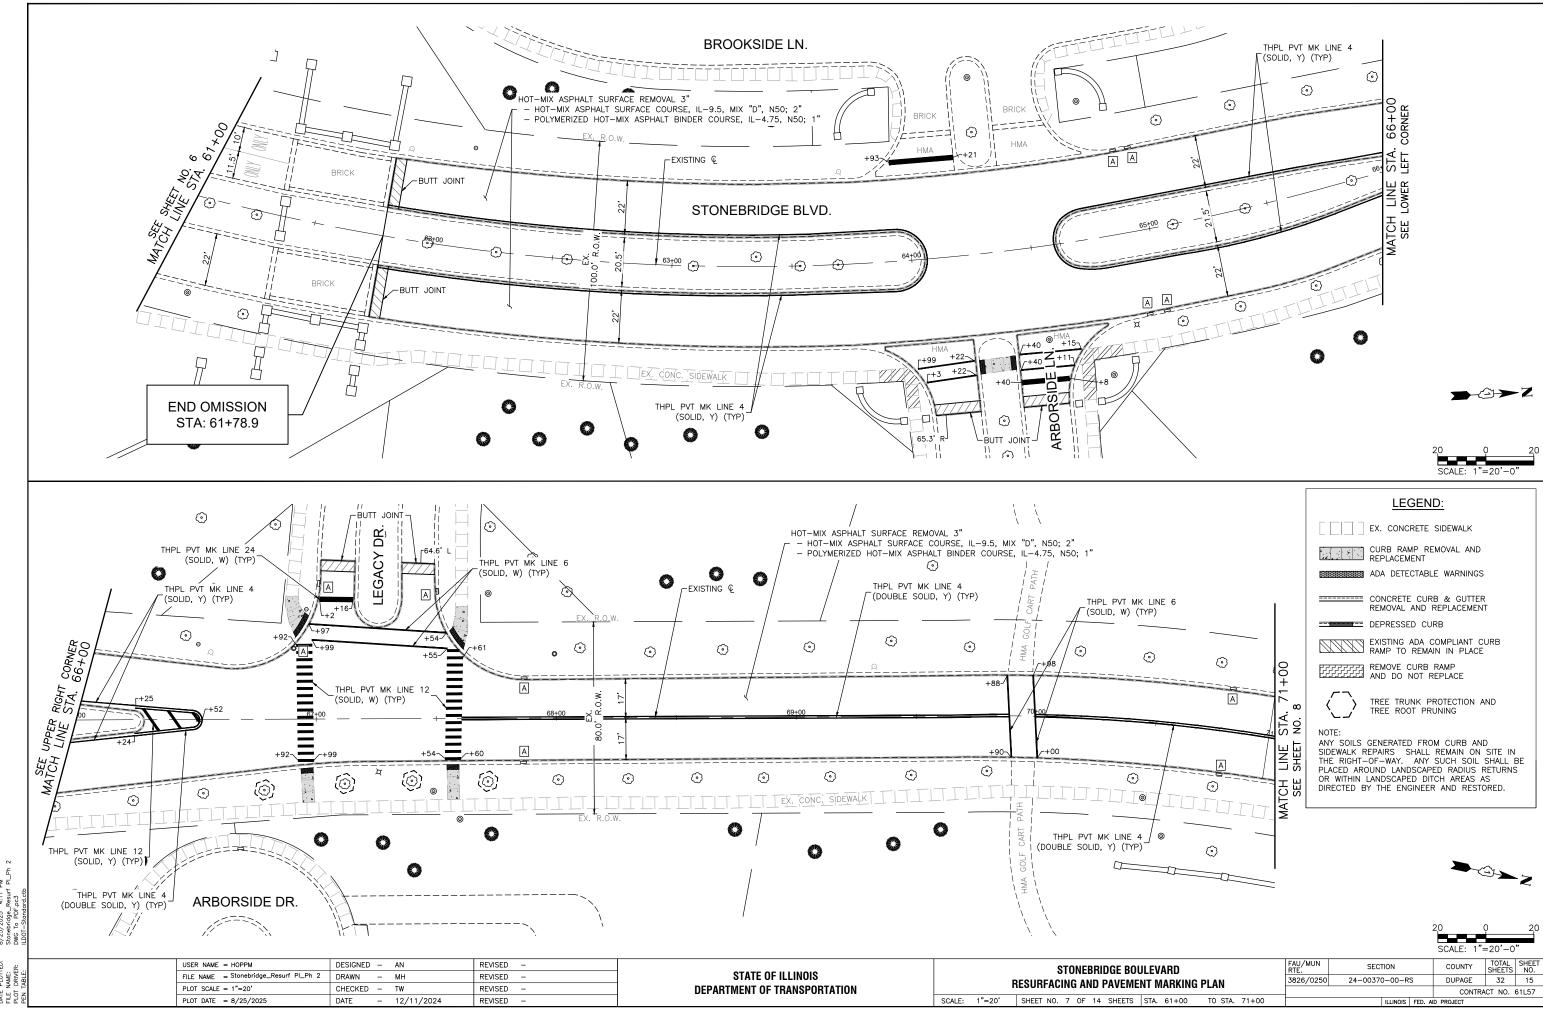



LEGEND: HOT-MIX ASPHALT SURFACE REMOVAL 3" HOT-MIX ASPHALT SURFACE COURSE, IL-9.5, MIX "D", N50; 2" EX. CONCRETE SIDEWALK - POLYMERIZED HOT-MIX ASPHALT BINDER COURSE, IL-4.75, N50; 1" THPL PVT MK LINE 4 CURB RAMP REMOVAL AND REPLACEMENT (DOUBLE SOLID, Y) (TYP) O-EXISTING & 0 THPL PVT MK LINE 4 ADA DETECTABLE WARNINGS 0 0 (DOUBLE SOLID, Y) (TYP) \odot CONCRETE CURB & GUTTER Α REMOVAL AND REPLACEMENT +13- \odot DEPRESSED CURB THPL PVT MK LINE 0 EXISTING ADA COMPLIANT CURB RAMP TO REMAIN IN PLACE (SOLID, W) (TYP) 0 \odot REMOVE CURB RAMP AND DO NOT REPLACE (<u>@</u>) (O) 764 CORN \odot TREE TRUNK PROTECTION AND 0 TREE ROOT PRUNING \odot EX. CONC. SIDEWALK ANY SOILS GENERATED FROM CURB AND SIDEWALK REPAIRS SHALL REMAIN ON SITE IN THE RIGHT-OF-WAY. ANY SUCH SOIL SHALL BE \odot 0 PLACED AROUND LANDSCAPED RADIUS RETURNS OR WITHIN LANDSCAPED DITCH AREAS AS **(**) DIRECTED BY THE ENGINEER AND RESTORED. 0 **(**) **(**) DR. HOT-MIX ASPHALT SURFACE REMOVAL 3" - HOT-MIX ASPHALT SURFACE COURSE, IL-9.5, MIX "D", N50; 2" BUTT JOINT-- POLYMERIZED HOT-MIX ASPHALT BINDER COURSE, IL-4.75, N50; 1" THPL PVT MK LINE 4 THPL PVT MK LINE 6 THPL PVT MK LINE 24 (DOUBLE SOLID, Y) (TYP) (SOLID, W) (TYP) (SOLID, W) (TYP) THPL PVT MK LINE 4 THPL PVT MK LINE 4 (SKIP-DASH 10'-30', Y) (SKIP-DASH 10'-30', Y) EXISTING Q \odot \odot \odot \odot \odot 0 \odot \odot \odot \odot LINE SHEET (·) \odot \odot 띥 EX. CONC, SIDEWALK WOODGLEN [.//======== SCALE: 1"=20'-0 COUNTY TOTAL SHEETS NO.

DUPAGE 32 16 FAU/MUN RTE. USER NAME = HOPPM DESIGNED - AN REVISED -SECTION STONEBRIDGE BOULEVARD FILE NAME = Stonebridge_Resurf PI_Ph 2 DRAWN REVISED STATE OF ILLINOIS 3826/0250 24-00370-00-RS RESURFACING AND PAVEMENT MARKING PLAN PLOT SCALE = 1"=20' CHECKED - TW REVISED **DEPARTMENT OF TRANSPORTATION** CONTRACT NO. 61L57 PLOT DATE = 8/25/2025DATE - 12/11/2024 REVISED SCALE: 1"=20' SHEET NO. 8 OF 14 SHEETS STA. 71+00 TO STA. 81+50 ILLINOIS FED. AID PROJECT

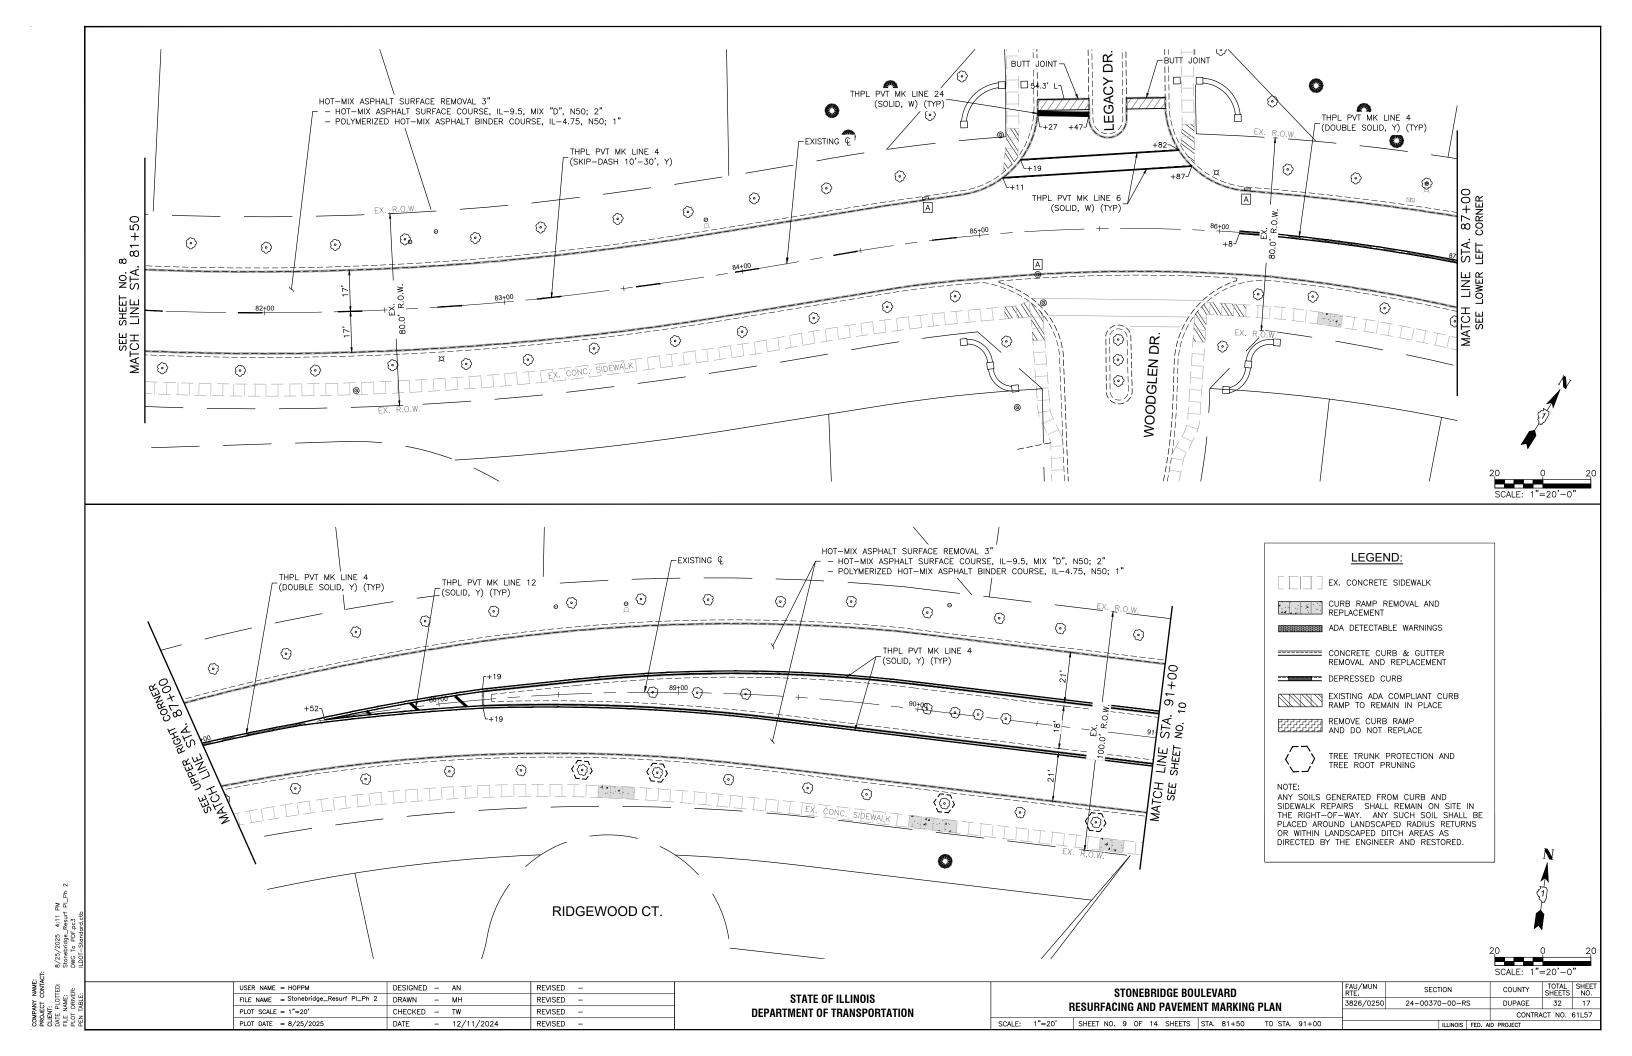


WOODCREST CT. THPL PVT MK LINE 24/ ۲72.4° HOT-MIX ASPHALT SURFACE REMOVAL 3" - HOT-MIX ASPHALT SURFACE COURSE, IL-9.5, MIX "D", N50; 2" (SOLID, W) (TYP) - POLYMERIZED HOT-MIX ASPHALT BINDER COURSE, IL-4.75, N50; 1" THPL PVT MK LINE 4 THPL PVT MK LINE 6 (SOLID, Y) (TYP) (SOLID, W) (TYP) THPL PVT MK LINE 12 (SOLID, W) (TYP) THPL PVT MK LINE 4 \odot \odot +38- \odot \odot EXISTING & \odot \odot (SOLID, Y) (TYP) \odot THPL PVT MK LINE 6 9 (SOLID, W) (TYP) +39-STA. LEFT SEE MATCH THPL PVT MK LINE 12 THPL PVT MK LINE 4 (SOLID, W) (TYP) (SOLID, Y) (TYP) +92√ 0 0 0 \odot \odot \odot 0 \odot 0 \odot \odot 0 \odot \odot \odot EX. CONC. SIDEWALK LEGEND: 0 EXISTING ADA COMPLIANT CURB RAMP TO REMAIN IN PLACE EX. CONCRETE SIDEWALK REMOVE CURB RAMP AND DO NOT REPLACE CURB RAMP REMOVAL AND REPLACEMENT ADA DETECTABLE WARNINGS ANY SOILS GENERATED FROM CURB AND SIDEWALK REPAIRS SHALL REMAIN ON SITE IN THE RIGHT-OF-WAY. ANY SUCH SOIL SHALL BE ====== CONCRETE CURB & GUTTER REMOVAL AND REPLACEMENT PLACED AROUND LANDSCAPED RADIUS RETURNS OR WITHIN LANDSCAPED DITCH AREAS AS DEPRESSED CURB DIRECTED BY THE ENGINEER AND RESTORED. THPL PVT MK LINE 4 HOT-MIX ASPHALT SURFACE REMOVAL 3" THPL PVT MK LINE 6 (SOLID, W) (TYP) TREE TRUNK PROTECTION AND TREE ROOT PRUNING (SOLID, Y) (TYP) HOT-MIX ASPHALT SURFACE COURSE, IL-9.5, MIX "D", N50; 2" POLYMERIZED HOT-MIX ASPHALT BINDER COURSE, IL-4.75, N50; 1" \odot \odot \odot THPL PVT MK LTR & SYM, \odot \odot \odot 「W (TYP) rEXISTING € THPL PVT MK LINE 6 (SKIP-DASH 2'-6', W) \odot \odot \odot **(**) \odot \odot \odot \odot THPL PVT MK LINE 4 (SOLID, Y) (TYP) STONEBRIDGE COUNTRY CLUB USER NAME = HOPPM DESIGNED - AN REVISED -FAU/MUN STONEBRIDGE BOULEVARD FILE NAME = Stonebridge_Resurf PI_Ph 2 REVISED STATE OF ILLINOIS 3826/0250 24-00370-00-RS DUPAGE 32 18 RESURFACING AND PAVEMENT MARKING PLAN PLOT SCALE = 1"=20' **DEPARTMENT OF TRANSPORTATION** CHECKED - TW REVISED CONTRACT NO. 61L57 SCALE: 1"=20' SHEET NO. 10 OF 14 SHEETS STA. 91+00 TO STA. 102+00 PLOT DATE = 8/25/2025DATE - 12/11/2024 REVISED

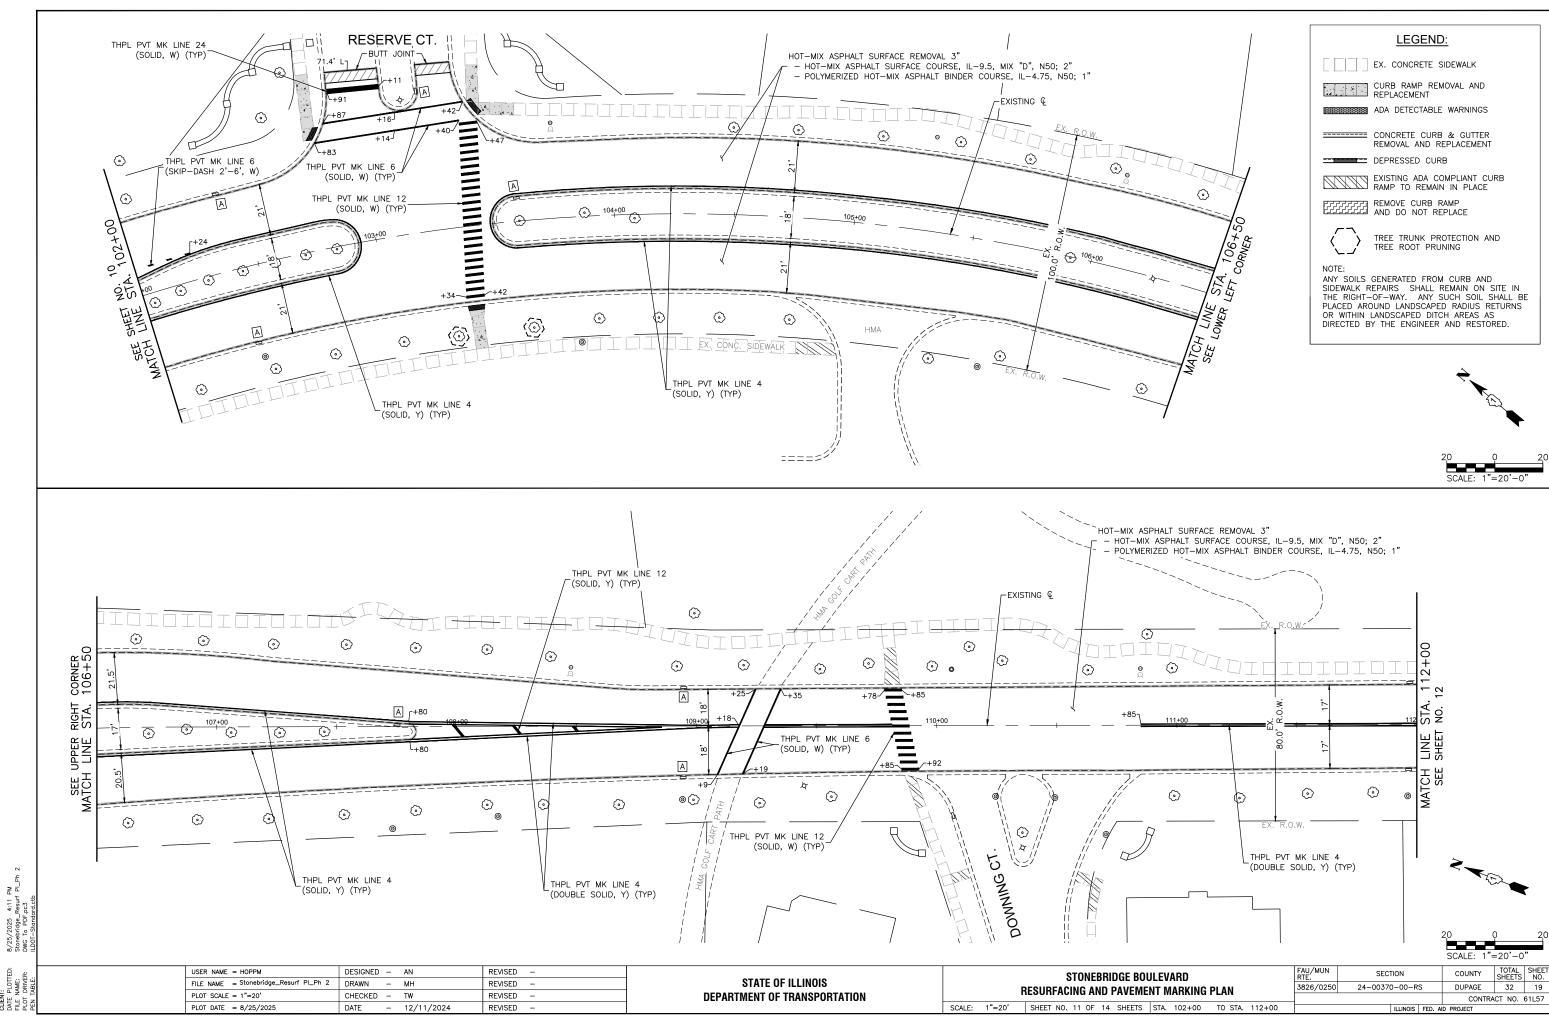

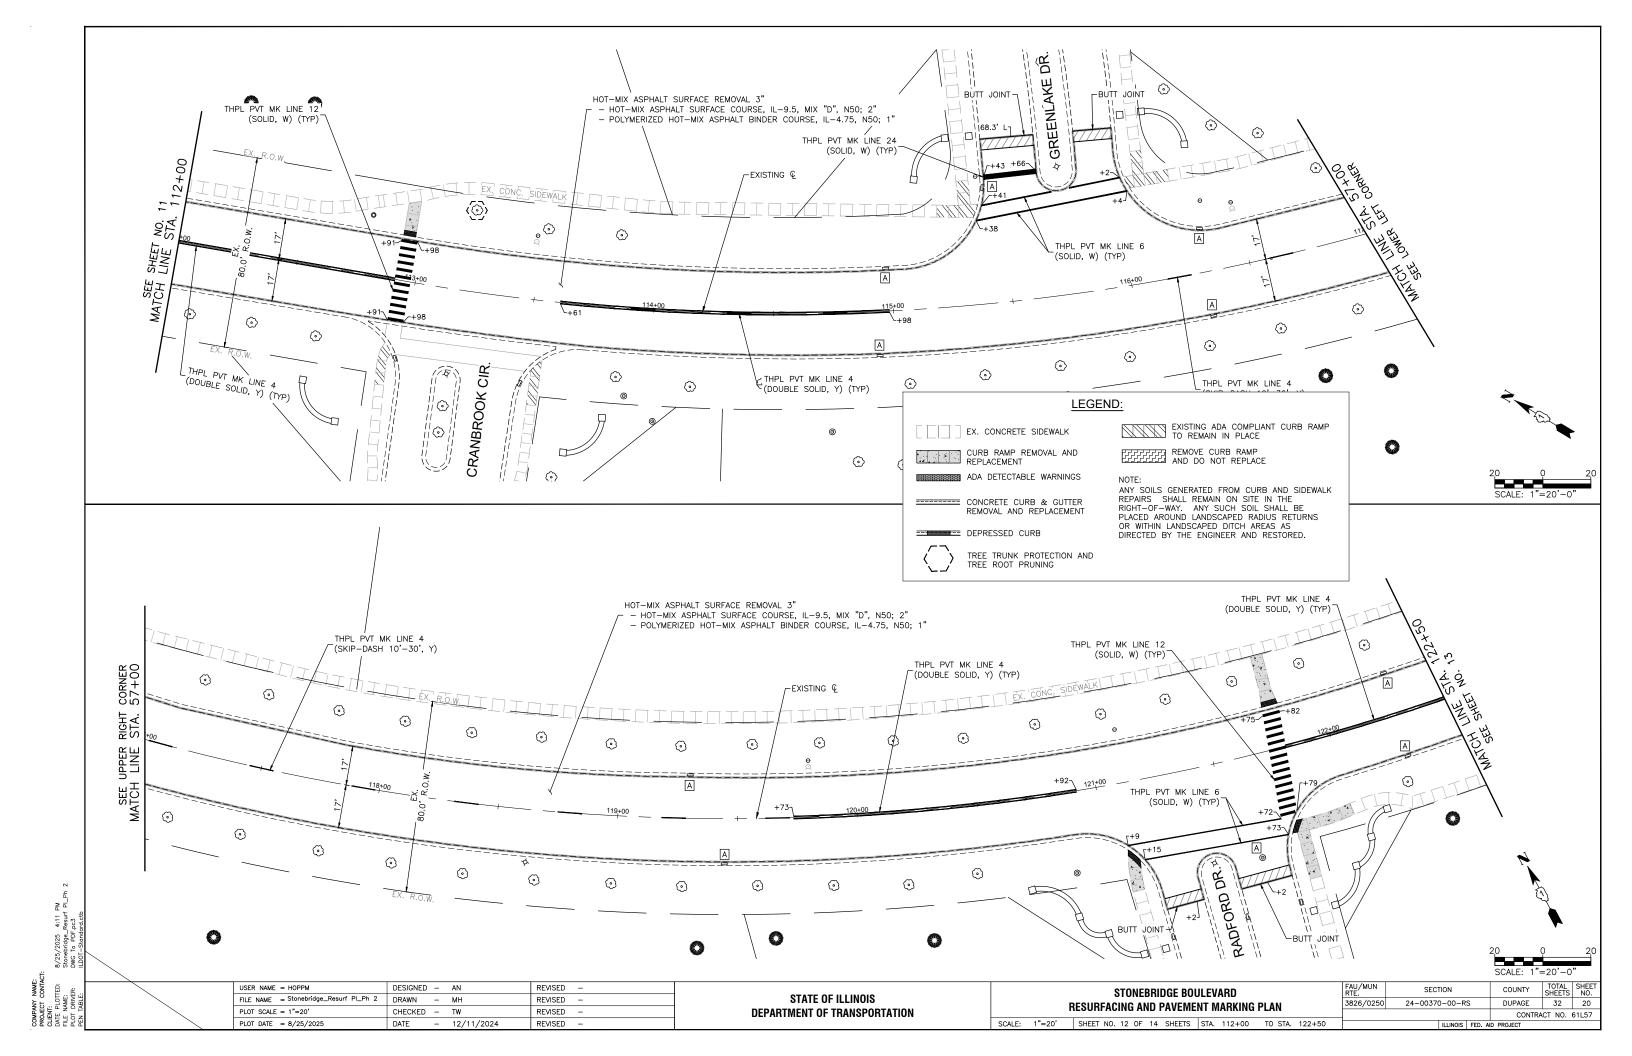


HOT-MIX ASPHALT SURFACE REMOVAL 3" - - HOT-MIX ASPHALT SURFACE COURSE, IL-9.5, MIX "D", N50; 2" - POLYMERIZED HOT-MIX ASPHALT BINDER COURSE, IL-4.75, N50; 1" LEGEND: EX. CONCRETE SIDEWALK THPL PVT MK LINE 4
(DOUBLE SOLID, Y) (TYP) CURB RAMP REMOVAL AND REPLACEMENT ADA DETECTABLE WARNINGS CONCRETE CURB & GUTTER REMOVAL AND REPLACEMENT \odot \odot \odot **③** \odot EXISTING & \odot DEPRESSED CURB 12 EXISTING ADA COMPLIANT CURB RAMP TO REMAIN IN PLACE REMOVE CURB RAMP SHEET TREE TRUNK PROTECTION AND TREE ROOT PRUNING \odot NOIL:
ANY SOILS GENERATED FROM CURB AND
SIDEWALK REPAIRS SHALL REMAIN ON SITE IN
THE RIGHT—OF—WAY. ANY SUCH SOIL SHALL BE
PLACED AROUND LANDSCAPED RADIUS RETURNS \odot \odot \odot 0 0 EX. CONC. SIDEWALK OR WITHIN LANDSCAPED DITCH AREAS AS DIRECTED BY THE ENGINEER AND RESTORED. 0 THPL PVT MK LINE 24 (SOLID, W) (TYP) BUTT JOINT HOT-MIX ASPHALT SURFACE REMOVAL 3" - HOT-MIX ASPHALT SURFACE COURSE, IL-9.5, MIX "D", N50; 2" \odot 0 - POLYMERIZED HOT-MIX ASPHALT BINDER COURSE, IL-4.75, N50; 1" \odot (2) \odot THPL PVT MK LINE 12 (SOLID, Y) (TYP) -EXISTING Q \odot EX. CONC. SIDEWALK \odot \odot **(**) \odot \odot \odot \odot RIGHT STA. \odot \odot 0 129+00 Α \odot \odot 0 0 \odot ⊙ _⊚ 0 EX. CONC. SIDEWALK \odot \odot **(**) <o} \odot THPL PVT MK LINE 4 (DOUBLE SOLID, Y) (TYP) THPL PVT MK LINE 4 (SOLID, Y) (TYP) TOWNES CIR. USER NAME = HOPPM DESIGNED - AN REVISED -FAU/MUN STONEBRIDGE BOULEVARD STATE OF ILLINOIS 3826/0250 24-00370-00-RS DUPAGE 32 21 RESURFACING AND PAVEMENT MARKING PLAN PLOT SCALE = 1"=20' **DEPARTMENT OF TRANSPORTATION** CHECKED - TW REVISED CONTRACT NO. 61L57 SCALE: 1"=20' SHEET NO. 13 OF 14 SHEETS STA. 122+50 TO STA. 130+50 PLOT DATE = 8/25/2025- 12/11/2024 REVISED

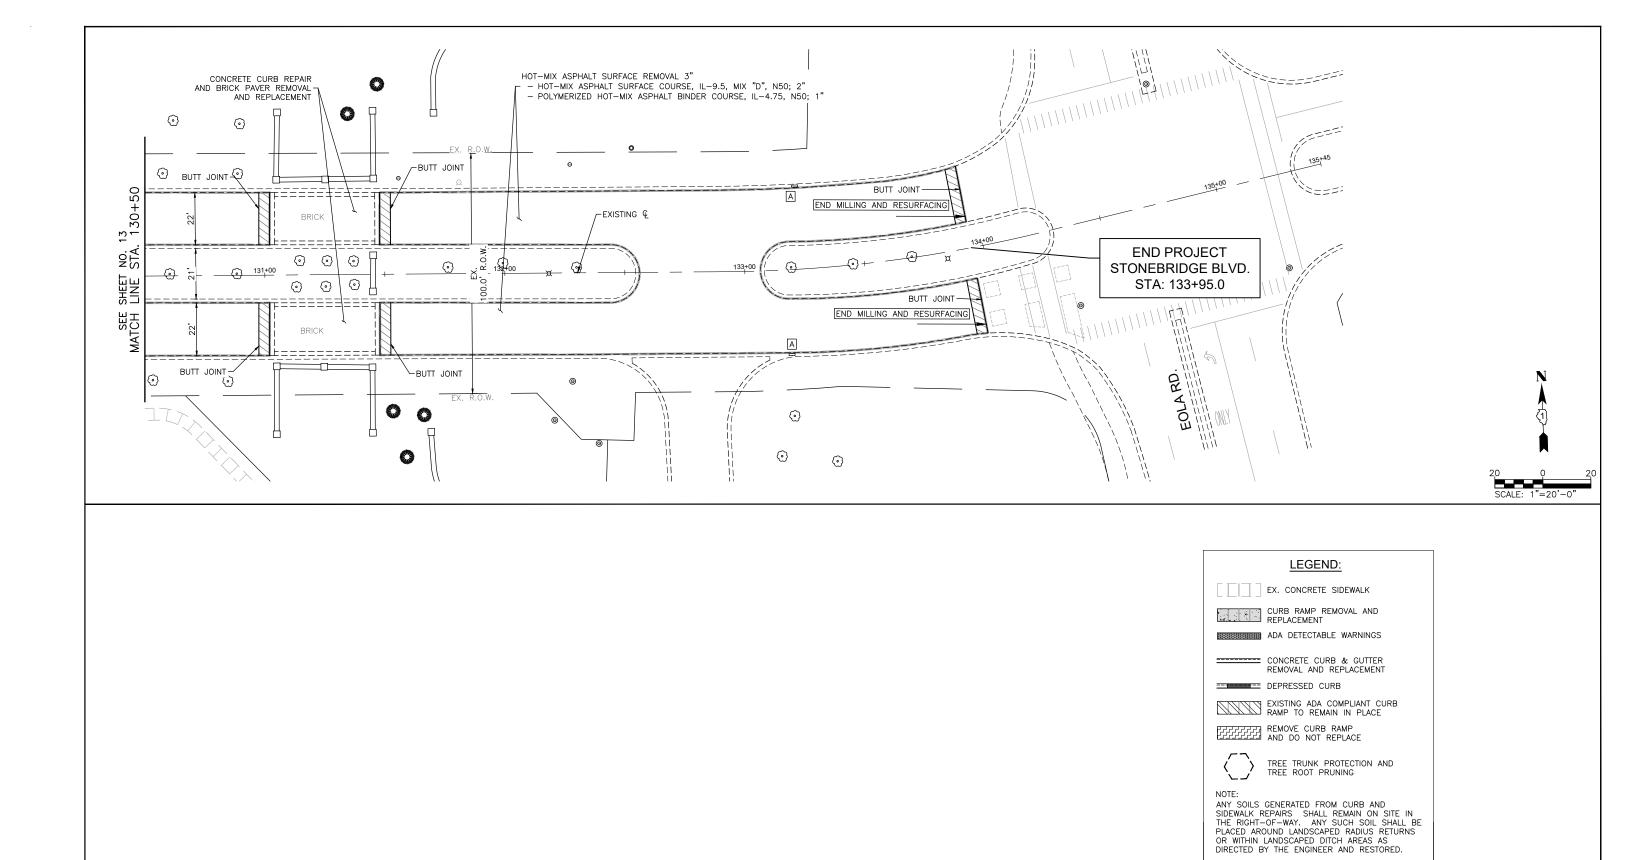

STATE OF ILLINOIS
DEPARTMENT OF TRANSPORTATION

STONEBRIDGE BOULEVARD
RESURFACING AND PAVEMENT MARKING PLAN

SCALE: 1"=20' SHEET NO. 14 OF 14 SHEETS STA. 130+50 TO STA. 133+95

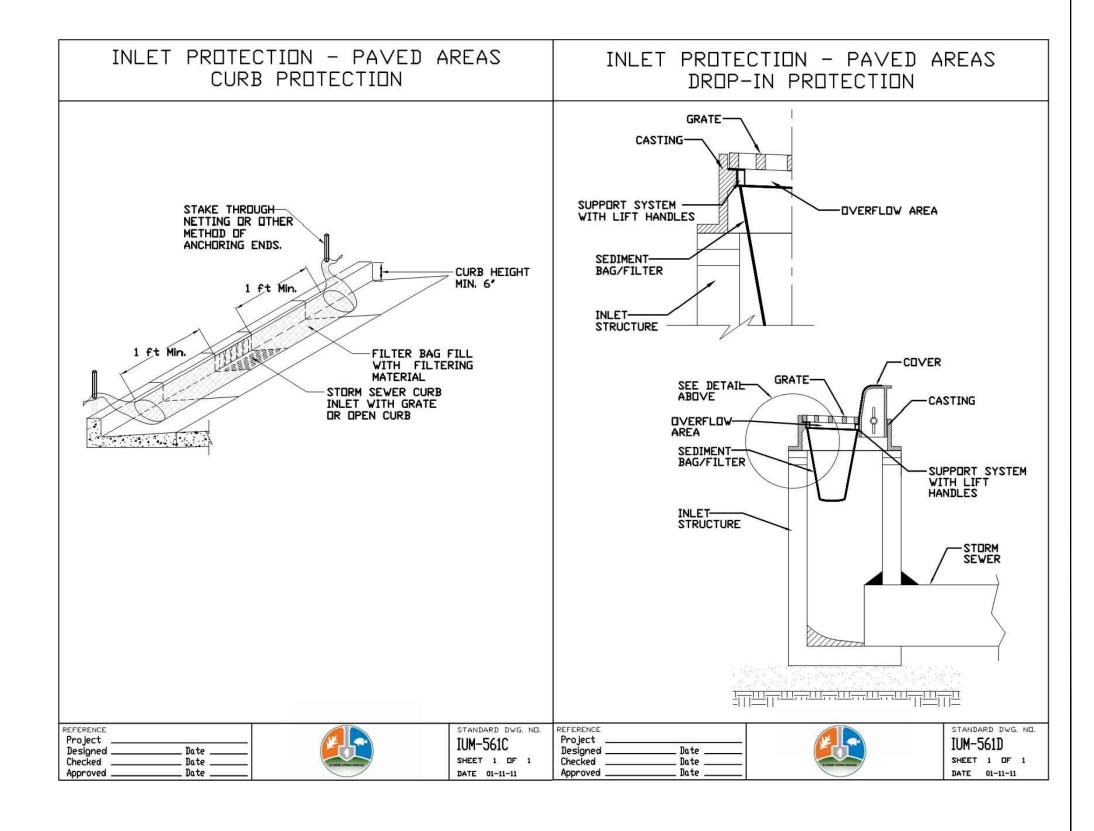

9/2/2025 2:39 PM Stonebridge—Details DWG To PDF.pc3 SEC—Standard.ctb

 USER NAME
 = HOPPM
 DESIGNED
 AN
 REVISED

 FILE NAME
 = Stonebridge-Details
 DRAWN
 MH
 REVISED

 PLOT SCALE
 = N.T.S.
 CHECKED
 TW
 REVISED

 PLOT DATE
 = 9/2/2025
 DATE
 12/11/2024
 REVISED

STATE OF ILLINOIS
DEPARTMENT OF TRANSPORTATION


SCALE: N.T.S. SHEET NO. 01 OF 01 SHEETS STA. TO STA.

 FAU/MUN RTE.
 SECTION
 COUNTY SHEETS NO.
 SHEETS NO.

 3826/0250
 24-00370-00-RS
 DUPAGE
 32
 23

 CONTRACT NO. 61L57

 ILLINOIS FED. AID PROJECT

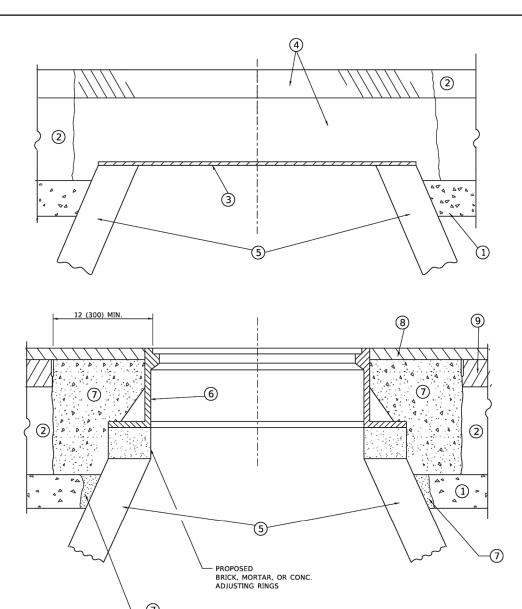

DETAILS FOR FRAMES AND LIDS ADJUSTMENT WITH MILLING

NOTES

- 1. EXISTING BROKEN FRAMES AND LIDS SHALL BE REMOVED AND DISPOSED OF BY THE CONTRACTOR AND SHALL BE REPLACED AS DIRECTED BY THE ENGINEER. REPLACEMENT FRAMES AND LIDS WILL BE PAID FOR IN ACCORDANCE WITH ARTICLE 109.04 OF THE STANDARD SPECIFICATIONS UNLESS A SEPARATE PAY ITEM HAS BEEN PROVIDED.
- IF THE EXISTING LIDS ARE OPEN, THE FRAME WILL BE ADJUSTED TO THE ELEVATION OF THE MILLED PAVEMENT SURFACE PRIOR TO THE MILLING OPERATION. THE FRAME WILL NOT BE REMOVED AND COVERED BY THE METAL PLATE.
- CITY OF CHICAGO CASTINGS ARE THE PROPERTY OF THE CITY AND THE CONTRACTOR SHALL NOTIFY THE CITY FOR REMOVAL AND DISPOSITION OF THE CASTINGS.
- 4. THE METAL PLATE USED TO COVER THE STRUCTURE SHALL REMAIN THE PROPERTY OF THE CONTRACTOR.
- THE CONTRACTOR SHALL REMOVE ALL TRAFFIC CONTROL DEVICES BY THE END OF EACH WORK SHIFT.

CONSTRUCTION PROCEDURES

STAGE 1 (BEFORE PAVEMENT MILLING)

- A) REMOVE A MINIMUM OF 12 (300) OF THE PAVEMENT FROM AROUND THE STRUCTURE.
- B) REMOVE THE EXISTING FRAME AND LID FROM THE STRUCTURE.

 C) COVER THE STRUCTURE OPENING WITH A 36 (900) DIAMETER
- METAL PLATE.

 D) BACKFILL WITH CRUSHED STONE AND HMA SURFACE MIX APPROVED BY THE ENGINEER. (MIN. 3 (80) HMA TO REMAIN

STAGE 2 (AFTER PAVEMENT MILLING)

AFTER MILLING).

- A) REMOVE THE HMA SURFACE MIX AND CRUSHED STONE.
- B) INSTALL THE FRAME AND LID; ADJUST THE FRAME TO ITS FINAL SURFACE ELEVATION.
- C) THE SURROUNDING SPACE SHALL BE FILLED WITH CLASS PP-2* CONCRETE TO THE ELEVATION OF THE SURFACE OF THE EXISTING BASE COURSE OR THE BINDER COURSE.
- *UNLESS OTHERWISE SPECIFIED IN THE PLANS.

THE PROCEDURE EXPLAINED ABOVE SHALL CONFORM TO THE APPLICABLE PORTIONS OF SECTIONS 353, 406, 602, AND 603 OF THE STANDARD SPECIFICATIONS EXCEPT THAT "THE CONTRACTOR SHALL ADJUST THE STRUCTURES TO THE FINISHED PAVEMENT ELEVATION NO MORE THAN 5 CALENDAR DAYS PRIOR TO PLACEMENT OF THE FINAL LIFT OF SURFACE UNLESS APPROVED BY THE ENGINEER."

LEGEND

- ① SUB-BASE GRANULAR ⑥ FRAME AND LID (SEE NOTES) MATERIAL
- (2) EXISTING PAVEMENT
- (7) CLASS PP-2* CONCRETE
- 3 36 (900) DIAMETER METAL PLATE
 - PLATE (8) P
- 4 PROPOSED CRUSHED STONE AND HMA SURFACE MIX
- 8 PROPOSED HMA SURFACE COURSE
- (5) EXISTING STRUCTURE
- (9) PROPOSED HMA BINDER COURSE

LOCATION OF STRUCTURES

THE CONTRACTOR WILL BE REQUIRED TO KEEP A RECORD OF THE LOCATIONS OF THE BURIED STRUCTURES ACCORDING TO THE STATION AND DISTANCE LEFT OR RIGHT OF THE CENTERLINE OF PAVEMENT. UPON COMPLETION OF THE WORK, THE CONTRACTOR WILL DELIVER THE RECORD TO THE ENGINEER.

BASIS OF PAYMENT

- 1. REMOVING FRAMES AND LIDS ON DRAINAGE AND UTILITY STRUCTURES IN THE PAVEMENT PRIOR TO MILLING, AND ADJUSTING TO FINAL GRADE PRIOR TO PLACING THE SURFACE COURSE, WILL BE PAID FOR AT THE CONTRACT UNIT PRICE EACH FOR "FRAMES AND LIDS TO BE ADJUSTED (SPECIAL)."
- 2. THIS WORK WILL NOT BE PAID FOR WHEN DRAINAGE AND UTILITY STRUCTURES ARE SPECIFIED FOR PAYMENT AS STRUCTURE RECONSTRUCTION.
- 3. NEW FRAMES AND LIDS, WHEN SPECIFIED, WILL BE PAID FOR SEPARATELY.
- 4. WHEN STRUCTURES ARE TO BE ADJUSTED OR RECONSTRUCTED, THE LOWERING AND RAISING OF THE FRAMES AND LIDS WILL NOT BE PAID FOR SEPARATELY BUT WILL BE INCLUDED IN THE COST OF THE CORRESPONDING PAY ITEM.

ALL DIMENSIONS ARE IN INCHES (MILLIMETERS) UNLESS OTHERWISE SHOWN

USER NAME = Lawrence.DeManche	DESIGNED - R. SHAH	REVISED - R. BORO 03-09-11		DETAILS FOR	F.A. RTF	SECTION	COUNTY	TOTAL S	HEET NO.
	DRAWN -	REVISED - R. BORO 12-06-11	STATE OF ILLINOIS		3826	24-00370-00-RS	DUPAGE	32	24
PLOT SCALE = 100.0000 ' / in.	CHECKED -	REVISED - K. SMITH 11-18-22	DEPARTMENT OF TRANSPORTATION	FRAMES AND LIDS ADJUSTMENT WITH MILLING		BD600-03 (BD-08)	CONTRACT	F NO. 61	57
PLOT DATE = 9/15/2023	DATE - 10-25-94	REVISED - K. SMITH 09-15-23		SCALE: NONE SHEET 1 OF 1 SHEETS STA. TO STA.		ILLINOIS FED. A	AID PROJECT		\neg

METHOD OF MEASUREMENT


REFER TO SECTION 442 OF THE STANDARD SPECIFICATIONS FOR ROAD AND BRIDGE CONSTRUCTION AND THE RECURRING SPECIAL PROVISION "PATCHING WITH HOT-MIX ASPHALT OVERLAY REMOVAL."

BASIS OF PAYMENT

- 1. REFER TO SECTION 442 OF THE STANDARD SPECIFICATIONS FOR ROAD AND BRIDGE CONSTRUCTION AND THE RECURRING SPECIAL PROVISION "PATCHING WITH HOT-MIX ASPHALT OVERLAY REMOVAL."
- SAW CUT/SCORING OF EXISTING HMA OVERLAY IS INCLUDED IN THE COST OF PAVEMENT PATCHING.
- 3. SAW CUT/SCORING OF EXISTING PAVEMENT IS INCLUDED IN THE COST OF PAVEMENT PATCHING.

★ SEE TYPICAL SECTIONS FOR

THICKNESS AND MATERIALS

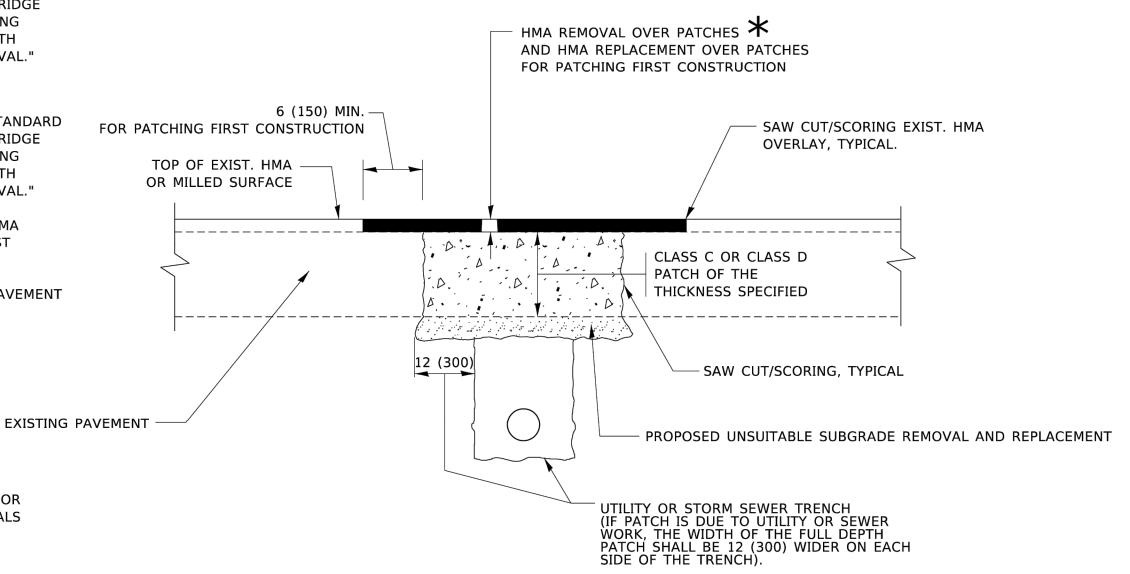

SEQUENCE OF CONSTRUCTION (PATCHING FIRST)


- 1. REMOVE THE EXISTING HMA MATERIAL OVER THE AREA TO BE PATCHED.
- 2. REMOVE AND REPLACE WITH CLASS C OR D PATCH.
- 3. REPLACE HMA MATERIAL OVER THE AREA TO BE PATCHED.

SEQUENCE OF CONSTRUCTION (MILLING FIRST)

- 1. MILL HMA FIRST IF THERE IS AT LEAST 4½ INCHES OR MORE OF HMA MATERIAL ON TOP OF THE EXISTING PAVEMENT OR IF THE PAVEMENT IS FULL DEPTH HMA. A MINIMUM OF 2 INCHES OF HMA MATERIAL SHALL BE IN PLACE AFTER MILLING.
- 2. REMOVE AND REPLACE WITH FULL DEPTH CLASS D PATCHES TO TOP OF MILLED SURFACE.

ALL DIMENSIONS ARE IN INCHES (MILLIMETERS) UNLESS OTHERWISE SHOWN.

USER NAME = Lawrence.DeManche	DESIGNED - R. SHAH	REVISED - R. BORO 01-01-07		PAVEMENT PATCHING FOR	F.A.	SECTION	COUNTY	TOTAL SHEET
	DRAWN -	REVISED - R. BORO 09-04-07	STATE OF ILLINOIS		3826	24-00370-00-RS	DUPAGE	32 25
PLOT SCALE = 100.0000 ' / in.	CHECKED -	REVISED - K. ENG 10-27-08	DEPARTMENT OF TRANSPORTATION	HMA SURFACED PAVEMENT	-	BD400-04 (BD-22)		NO. 61L57
PLOT DATE = 11/18/2022	DATE - 10-25-94	REVISED - K. SMITH 11-18-22		SCALE: NONE SHEET 1 OF 1 SHEETS STA. TO STA.	—	ILLINOIS FED. A	ID PROJECT	

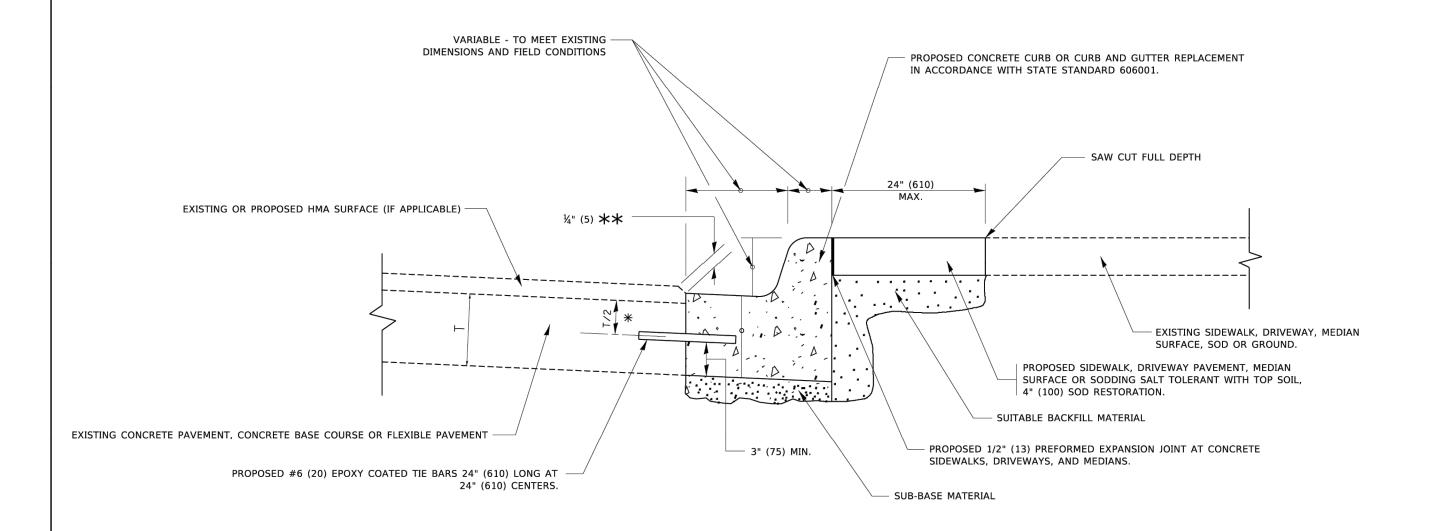


- * 3" (75) MINIMUM FROM TOP AND BOTTOM OF THE CONCRETE PAVEMENT OR BASE COURSE.
- $\star\star$ IF THE FINAL SURFACE OF THE PAVEMENT IS CONCRETE, THE GUTTER IS TO BE FLUSH WITH THE PAVEMENT.

CURB OR CURB AND GUTTER REMOVAL AND REPLACEMENT

ALL DIMENSIONS ARE IN INCHES (MILLIMETERS) UNLESS OTHERWISE SHOWN.


USER NAME = footemj	DESIGNED - A. HOUSEH	REVISED - A. ABBAS 03-21-97	STATE OF ILLINOIS	CURB OR CURB AND GUTTER			F.A. RTE.	SECTION	COUNTY	TOTAL SHEET SHEETS NO.
	DRAWN -	REVISED - M. GOMEZ 01-22-01		REMOVAL AND REPLACEMENT				24-00370-00-RS	DUPAGE	32 26
PLOT SCALE = 50.0000 ' / in.	CHECKED -	REVISED - R. BORO 12-15-09	DEPARTMENT OF TRANSPORTATION REMOVAL AND REPLACEMENT		NEIVIOVAL AIND NEPLAGEIVIENT		BD600-06 (B		3D-24) CONTRACT NO. 61L5	
PLOT DATE = 7/11/2019	DATE - 03-11-94	REVISED - K. SMITH 07-11-19		SCALE: NONE	SHEET 1 OF 1 SHEETS STA.	TO STA.		ILLINOIS FED. AI	D PROJECT	

FILE NAME: pw:\\planroom

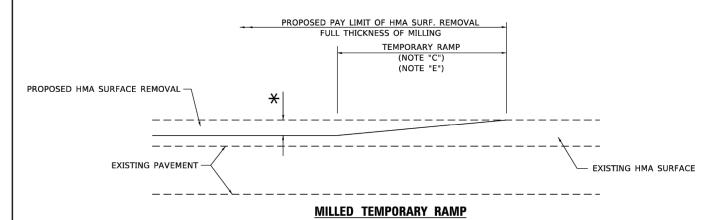

(FOR BUTT JOINT AND HMA TAPER SEE DETAIL BELOW)

OPTION 1

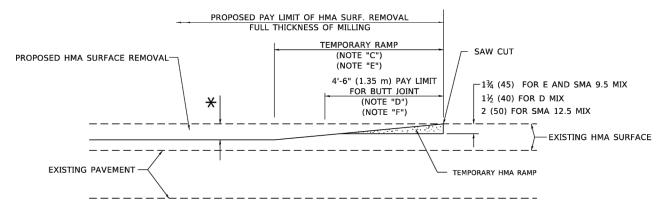


HMA CONSTRUCTED TEMPORARY RAMP


(FOR BUTT JOINT AND HMA TAPER SEE DETAIL BELOW)


OPTION 2

TYPICAL TEMPORARY RAMP

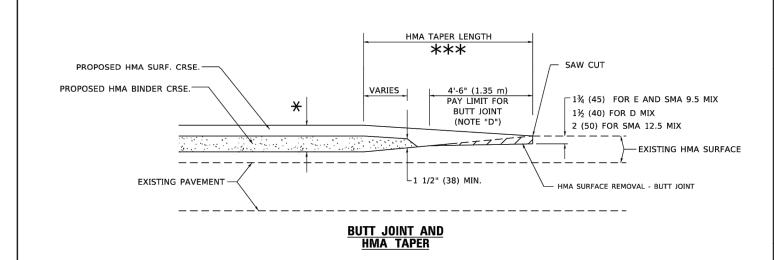

TYPICAL BUTT JOINT AND HMA TAPER FOR MILLING AND RESURFACING

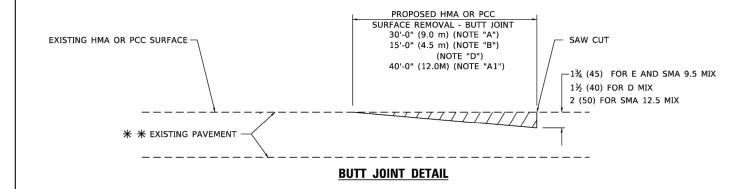

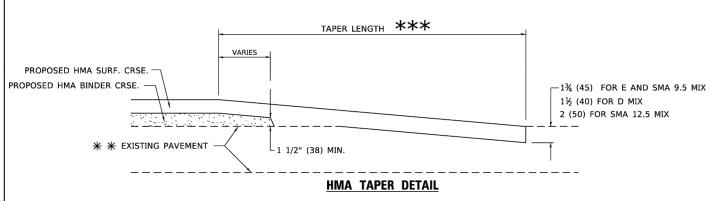

TYPICAL BUTT JOINT AND HMA TAPER FOR RESURFACING ONLY

** PC CONCRETE, HMA OR HMA RESURFACED PAVEMENT.

GENERAL NOTES

- A. MAINLINE ARTERIAL ROADWAYS AND MAJOR SIDE ROADS.
- A1. INTERSTATES
- B. MINOR SIDE ROADS.
- C. THE TEMP. RAMP SHALL BE CONSTRUCTED IMMEDIATELY UPON REMOVAL OF THE EXISTING HMA SURFACE.
- D. THE BUTT JOINT SHALL BE CONSTRUCTED IMMEDIATELY PRIOR TO PLACING THE PROPOSED HMA COURSES.
- E. TAPER THE TEMP. RAMP AT A RATE OF 3' 4" (1.02m) PER 1 INCH (25 mm) OF MILLING THICKNESS.
 - $m{ imes}$ see typical sections for milling thickness.
- F. SEE ARTICLE 406.08 AND 406.14 OF THE STANDARD SPECIFICATIONS FOR "HMA AND/OR PCC SURFACE REMOVAL, BUTT JOINT".

*** 20'-0" (6.1 m) PER 1 (25) RESURFACING (NOTE "A") 10'-0" (3.0 m) PER 1 (25) RESURFACING (NOTE "B")

BASIS OF PAYMENT


- THE BUTT JOINT WILL BE PAID FOR AT THE CONTRACT UNIT PRICE PER SQUARE YARD (SQUARE METER) FOR "HOT-MIX ASPHALT SURFACE REMOVAL - BUTT JOINT" OR FOR "PORTLAND CEMENT CONCRETE SURFACE REMOVAL- BUTT JOINT".
- THE TEMPORARY RAMP AND SAW CUT SHALL BE INCLUDED IN THE UNIT COST FOR HMA OR PCC SURFACE REMOVAL-BUTT JOINT.

ALL DIMENSIONS ARE IN INCHES (MILLIMETERS) UNLESS OTHERWISE SHOWN.

USER NAME = demanchelt	DESIGNED -	M. DE YONG	REVISED	-	A. ABBAS 03-21-97
	DRAWN -		REVISED	-	M. GOMEZ 04-06-0
PLOT SCALE = 100.0000 ' / in.	CHECKED -		REVISED	-	R. BORO 01-01-07
PLOT DATE = 2/2/2022	DATE -	06-13-90	REVISED	_	K. SMITH 02-01-22

STAT	E 0	F ILLINOIS
DEPARTMENT	0F	TRANSPORTATION

BUTT JOINT AND							F.A. RTE.	SECTION	COUNTY	TOTAL SHEETS			
	HMA TAPER DETAILS							24-00370-00-RS	DUPAGE	32	27		
	NIVIA TAPEN DETAILS								-32 CONTRACT NO. 61L				
SCALE: NONE	SHEET 1	OF	1	SHEETS	STA.	TO STA.	ILLINOIS FED. AID PROJECT						

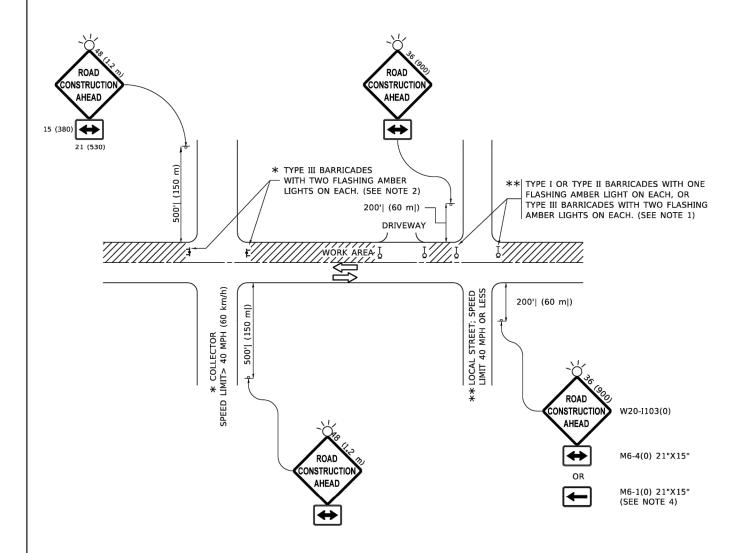

NOTES:

- 1. SIDE ROAD WITH A SPEED LIMIT OF 40 MPH (60 km/h) OR LESS AS SHOWN ON THE DRAWING AND AS DIRECTED BY THE ENGINEER:
- a) ONE "ROAD CONSTRUCTION AHEAD" SIGN 36 x 36 (900x900) WITH A FLASHER MOUNTED ON IT APPROXIMATELY 200' (60 m) IN ADVANCE OF THE MAIN ROUTE.
- b) THE CLOSED PORTION OF THE MAIN ROUTE SHALL BE PROTECTED BY BLOCKING WITH TYPE I, TYPE II OR TYPE III BARRICADES, 1/3 OF THE CROSS SECTION OF THE CLOSED PORTION.
- SIDE ROAD WITH A SPEED LIMIT GREATER THAN 40 MPH (60 km/h) AS SHOWN ON THE DRAWING AND AS DIRECTED BY THE ENGINEER:
 - a) ONE "ROAD CONSTRUCTION AHEAD" SIGN 48 x 48 (1.2 m x 1.2 m) WITH A FLASHER MOUNTED ON IT APPROXIMATELY 500' (150 m) IN ADVANCE OF THE MAIN ROUTE.
- THE CLOSED PORTION OF THE MAIN ROUTE SHALL BE PROTECTED BY
 b) BLOCKING WITH TYPE III BARRICADES, 1/2 OF THE CROSS SECTION
 OF THE CLOSED PORTION.
- 3. CONES MAY BE SUBSTITUTED FOR BARRICADES OR DRUMS AT HALF THE SPACING DURING DAY OPERATIONS. CONES SHALL BE A MINIMUM OF 28 (710) IN HEIGHT
- WHEN THE SIDE ROAD LIES BETWEEN THE BEGINNING OF THE MAINLINE
 4. SIGNING AND THE WORK ZONE, A SINGLE HEADED ARROW (M6-1) SHALL
 BE USED IN LIEU OF THE DOUBLE HEADED ARROW (M6-4).

SCALE: NONE

- WHEN WORK IS BEING PERFORMED ON A SIDE ROAD OR DRIVEWAY, FOLLOW THE APPLICABLE STANDARD(S). THE DIRECTIONAL ARROW (M6-1 OR M6-4) SHALL BE COVERED OR REMOVED WHEN NO LONGER CONSISTENT WITH THE TRAFFIC CONTROL SET-UP.
- 6. ADVANCE WARNING SIGNS ARE TO BE OMITTED ON DRIVEWAYS UNLESS OTHERWISE SPECIFIED IN THE PLANS OR BY THE ENGINEER
- THE TRAFFIC CONTROL AND PROTECTION FOR SIDE ROADS, INTERSECTIONS, AND DRIVEWAYS SHALL BE INCLUDED IN THE COST OF SPECIFIED TRAFFIC CONTROL STANDARDS OR ITEMS.

All dimensions are in inches (millimeters) unless otherwise shown.

STATE OF ILLINOIS
DEPARTMENT OF TRANSPORTATION


TRAFFIC CONTROL AND PROTECTION FOR SIDE ROADS, INTERSECTIONS, AND DRIVEWAYS

SHEET 1 OF 1 SHEETS STA. TO 9

 F.A. RTE.
 SECTION
 COUNTY
 TOTAL SHEETS
 SHEET NO.

 3826
 24-00370-00-RS
 DUPAGE
 32
 28

 TC-10
 CONTRACT
 NO.
 61L57

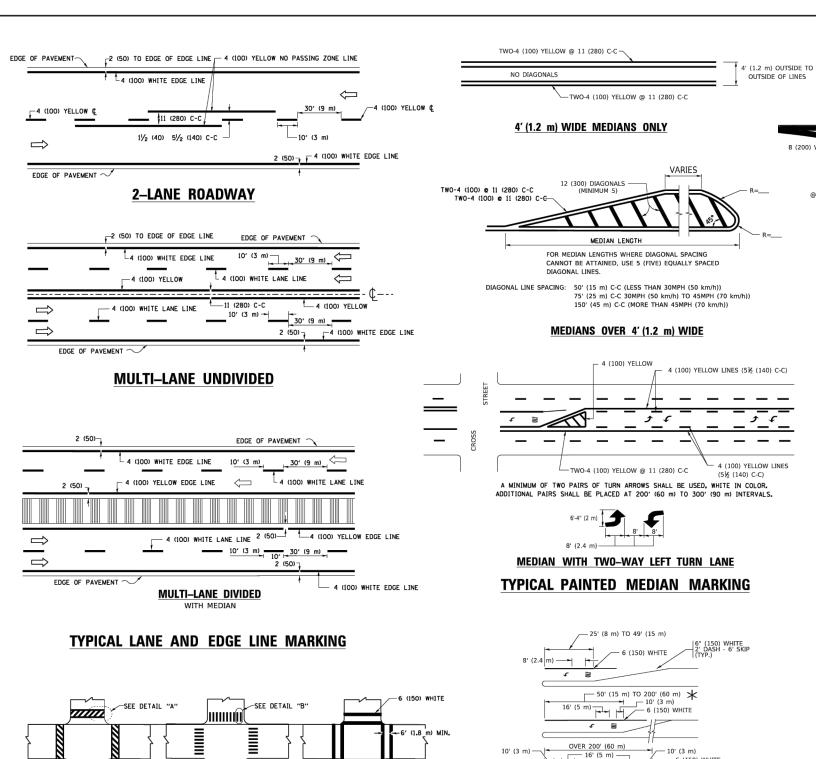

///////

BICYCLE & EQUESTRIAN PEDESTRIAN 2' (600) -6 (150) WHITE 12 (300) WHITE DETAIL "A" DETAIL "B"

TYPICAL CROSSWALK MARKING

 $m{\star}$ MARKINGS SHALL BE INSTALLED PARALLEL TO THE CENTERLINE OF THE ROAD WHICH IT CROSSES

6 (150) WHITE * TURN LANES IN EXCESS OF 400' (120 m) IN LENGTH MAY HAVE AN ADDITIONAL SET OF ARROW - "ONLY" INSTALLED MIDWAY BETWEEN THE OTHER TWO SETS OF

TYPICAL LEFT (OR RIGHT) TURN LANE

TYPICAL TURN LANE MARKING


@ 10' (3 m) OR LESS SPACING

- 2 (50) 8 (200) WHITE -RAISED ISLAND 8 (200) WHITE -2 (50) ISLAND AT PAVEMENT EDGE TYPICAL ISLAND MARKING

ISLAND OFFSET FROM PAVEMENT EDGE

6'-4" (1930) 40 (1020)

COMBINATION LEFT AND U-TURN

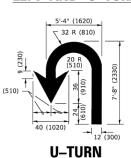

665 50 750

D(FT)

425

500

580

SPEED LIMIT

45

LANE REDUCTION TRANSITION

* LANE REDUCTION ARROWS REQUIRED AT SPEEDS OF 45 MPH OR GREATER OR WHEN SPECIFIED IN PLANS.

WIDTH OF LINE PATTERN TYPE OF MARKING COLOR SPACING / REMARKS CENTERLINE ON 2 LANE PAVEMENT 10' (3 m) LINE WITH 30' (9 m) SPACE SOLID rellow 11 (280) C-C NO PASSING ZONE LINES: FOR ONE DIRECTION FOR BOTH DIRECTIONS 4 (100) 2 @ 4 (100) 5½ (140) C-C FROM SKIP-DASH CENTERLINE 11 (280) C-C OMIT SKIP-DASH CENTERLINE BETWEEN LANE LINES SKIP-DASH SKIP-DASH 10' (3 m) LINE WITH 30' (9 m) SPACE 4 (100) 5 (125) ON FREEWAYS DOTTED LINES (EXTENSIONS OF CENTER, LANE OR TURN LANE MARKINGS) SAME AS LINE BEING EXTENDED SKIP-DASH SAME AS LINE BEING EXTENDED 2' (600) LINE WITH 6' (1.8 m) SPACE EDGE LINES 4 (100) SOLID OUTLINE MEDIANS IN YELLOW YELLOW-LEFT WHITE-RIGHT 6 (150) LINE; FULL SIZE LETTERS & SYMBOLS (8' (2.4m)) TURN LANE MARKINGS SOLID SEE TYPICAL TURN LANE MARKING DETAIL 10' (3 m) LINE WITH 30' (9 m) SPACE FOR SKIP-DASH; 5½ (140) C-C BETWEEN SOLID TWO WAY LEFT TURN MARKING **YELLOW** LINE AND SKIP-DASH LINE SEE TYPICAL TWO-WAY LEFT TURN MARKING DETAIL 8' (2.4m) LEFT ARROW CROSSWALK LINES (PEDESTRIAN) A. DIAGONALS (BIKE & EQUESTRIAN) B. LONGITUDINAL BARS (SCHOOL) NOT LESS THAN 6' (1.8 m) APART 2' (600) APART 2' (600) APART 12 (300) @ 45° 12 (300) @ 90° SOLID WHITE WHITE SEE TYPICAL CROSSWALK MARKING DETAILS PLACE 4' (1.2 m) IN ADVANCE OF AND
PARALLEL TO CROSSWALK, IF PRESENT.
OTHERWISE, PLACE AT DESIRED STOPPING
POINT. PARALLEL TO CROSSROAD CENTERLINE, WHERE
POSSIBLE STOP LINES 24 (600) SOLID WHITE 11 (280) C-C FOR THE DOUBLE LINE SEE TYPICAL PAINTED MEDIAN MARKING. PAINTED MEDIANS SOLID 2 @ 4 (100) WITH 12 (300) DIAGONALS YELLOW: TWO WAY TRAFFIC @ 45° NO DIAGONALS USED FOR 4' (1.2 m) WIDE MEDIANS WHITE: ONE WAY TRAFFIC GORE MARKING AND CHANNELIZING LINES DIAGONALS: 15' (4.5 m) C-C (LESS THAN 30MPH (50 km/h)) 20' (6 m) C-C 30MPH (50 km/h) TO 45MPH (70 km/h)) 30' (9 m) C-C (OVER 45MPH (70 km/h)) SOLID 24 (600) TRANSVERSE LINES; "RR" IS 6' (1.8 m) LETTERS; 16 (400) LINE FOR "X" RAILROAD CROSSING SOLID WHITE SEE STATE STANDARD 780001 AREA OF: "R"=3.6 SQ. FT. (0.33 m)2EACH
"X"=54.0 SQ. FT. (5.0 m)2 50' (15 m) C-C (LESS THAN 30MPH (50 km/h)) 75' (25 m) C-C (30 MPH (50 km/h) TO 45MPH (70 km/h)) 150' (45 m) C-C (OVER 45MPH (70 km/h)) SHOULDER DIAGONALS (REQUIRED FOR 12 (300) @ 45 SOLID WHITE - RIGHT YELLOW - LEFT SHOULDERS > 8') U TURN ARROW SEE DETAIL SOLID WHITE 2 ARROW COMBINATION SEE DETAIL SOLID WHITE


FOR FURTHER DETAILS ON PAVEMENT MARKING REFER TO STANDARD SPECIFICATIONS FOR ROAD AND BRIDGE CONSTRUCTION AND STATE STANDARD 780001.

All dimensions are in inches (millimeters) unless otherwise shown.

USER NAME = footemj EVERS DESIGNED -C. JUCIUS 09-09-09 DRAWN REVISED C. JUCIUS 07-01-13 CHECKED PLOT DATE = 3/4/2019 DATE REVISED -


STATE OF ILLINOIS **DEPARTMENT OF TRANSPORTATION**

DISTRICT ONE						F.A. RTE.	SEC	ΠΟΝ	COUNTY	TOTAL SHEETS	SHEET NO.
	TYPICAL PAVEMENT MARKINGS						24-0037	0-00-RS	DUPAGE 32		29
	TITIOAL TAYLWLINI WANKINGS								CONTRACT NO. 61L57		
SCALE: NONE SHEET 1 OF 2 SHEETS STA. TO STA.								ILLINOIS FED 4	AID PROJECT		

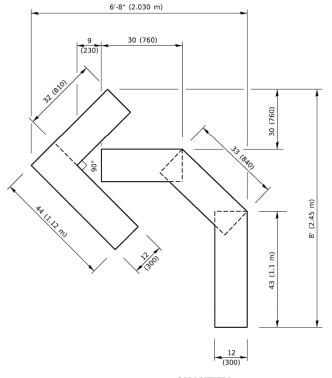


QUANTITY

4 (100) LINE = 45.5 ft. (13.9 m) 15.2 sq. ft. (1.41 sq. m)

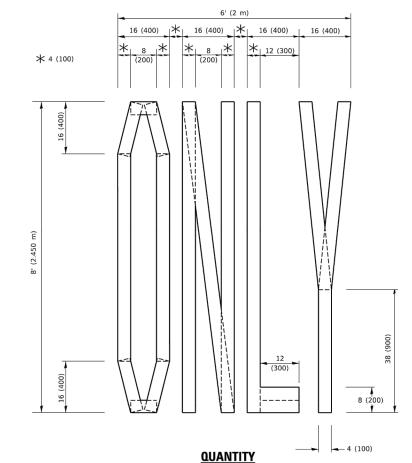

4 (100) LINE = 64.1 ft. (19.5 m) 21.4 sq. ft. (1.99 sq. m)

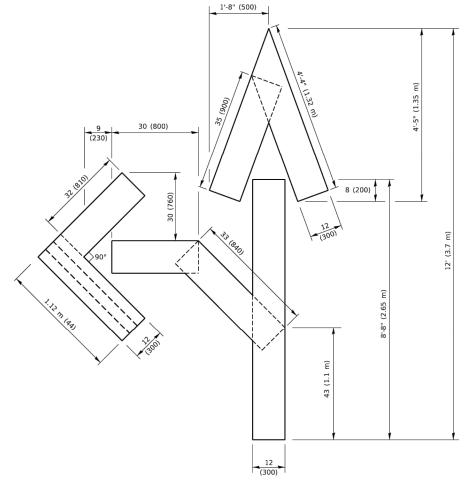


QUANTITY

4 (100) LINE = 82.5 ft. (25.1 m) 27.5 sq. ft. (2.53 sq. m)

NOTE:

ALL QUANTITIES OF PLACEMENT ARE REPRESENTED IN LINEAR FEET OF 4" LINES TO MATCH THE 4" TEMPORARY TAPE PAY ITEM AND REPRESENTS THE TOTAL QUANTITY OF 4" TAPE REQUIRED.

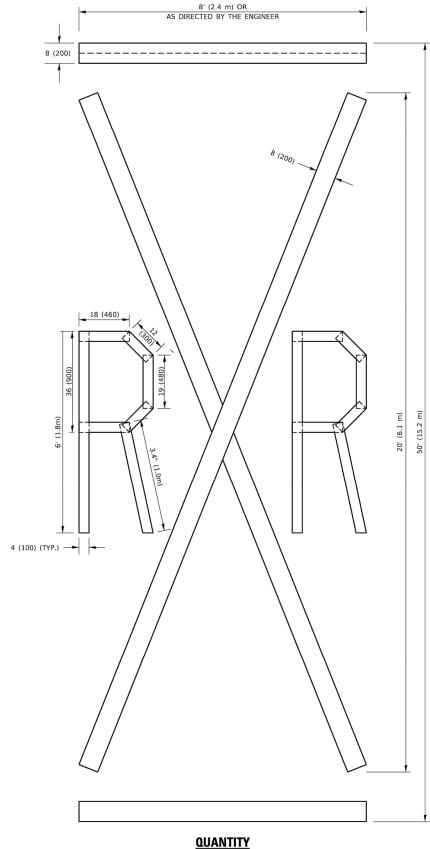

4 (100) LINE = 225.9 ft. (68.9 m) 75.3 sq. ft. (6.99 sq. m)

> All dimensions are in inches (millimeters) unless otherwise shown.


USER NAME = footemi	DESIGNED			REVISED	- T. RAMMACHER 03-02-98
OSEK WARE = lootelij	DESIGNED			KLVIJLD	- 1. KAMMACHER 03-02-96
	DRAWN	-		REVISED	- E. GOMEZ 08-28-00
PLOT SCALE = 50.0068 ' / in.	CHECKED	-		REVISED	- E. GOMEZ 08-28-00
PLOT DATE = 3/4/2019	DATE	-	09-18-94	REVISED	- A. SCHUETZE 09-15-16

DEPARTMENT OF TRANSPORTATION

COUNTY TOTAL SHEET NO.

DUPAGE 32 30 SECTION 24-00370-00-RS

F.A. RTE. 3826 STATE OF ILLINOIS SHORT TERM PAVEMENT MARKING LETTERS AND SYMBOLS TC-16 CONTRACT NO. 61L57 SCALE: NONE SHEET 1 OF 1 SHEETS STA.

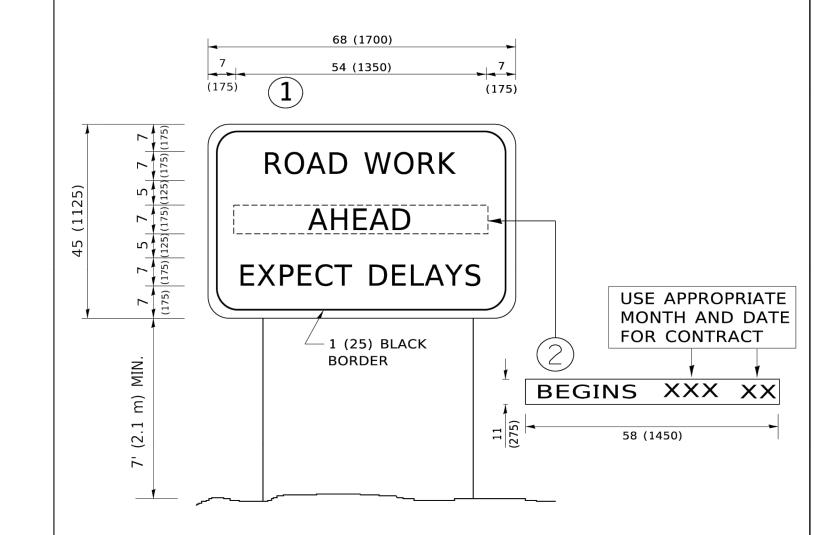


NOTES:

- 1. USE BLACK LETTERING ON ORANGE BACKGROUND.
- 2. ERECT SIGNS IN ADVANCE OF THE LOCATION FOR THE "ROAD CONSTRUCTION AHEAD" SIGN AT LOCATIONS AS DIRECTED BY THE ENGINEER.
- 3. ERECT SIGN 1 WITH INSTALLED PANEL 2 ONE WEEK PRIOR TO THE START OF CONSTRUCTION.
- 4. REMOVE PANEL(2)SOON AFTER THE START OF CONSTRUCTION.
- 5. SEE SPECIAL PROVISION FOR "TEMPORARY INFORMATION SIGNING" FOR ADDITIONAL INFORMATION.
- 6. ONE SIGN ASSEMBLY EQUALS 25.70 SQ. FT. (2.3 SQ. M.)
- 7. SHALL BE PAID FOR AS TEMPORARY INFORMATION SIGNING.

ALL DIMENSIONS ARE IN INCHES (MILLIMETERS) UNLESS OTHERWISE SHOWN.

USER NAME = footemj	DESIGNED -	REVISED - R. MIRS 09-15-97	·	ARTERIAL ROAD	F.A. RTF	SECTION	COUNTY TOTA	
	DRAWN -	REVISED - R. MIRS 12-11-97	STATE OF ILLINOIS		3826	24-00370-00-RS	DUPAGE 32	
PLOT SCALE = 50.0000 ' / in.	CHECKED -	REVISED -T. RAMMACHER 02-02-99	DEPARTMENT OF TRANSPORTATION	INFORMATION SIGN		TC-22	CONTRACT NO.	61L57
PLOT DATE = 3/4/2019	DATE -	REVISED - C. JUCIUS 01-31-07		SCALE: NONE SHEET 1 OF 1 SHEETS STA. TO STA.			D. AID PROJECT	

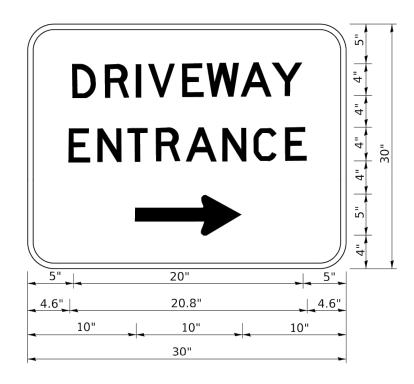

3.0" RADIUS, 0.5" BORDER, WHITE ON GREEN; REFLECTORIZED "DRIVEWAY" D; "ENTRANCE" D; STANDARD ARROW CUSTOM 12.0" x 5.0"

NOTES:

- 1. HALF OF THE SIGNS WILL REQUIRE A LEFT HAND FACING ARROW.
- 2. TWO SIGNS SHALL BE USED AT EACH COMMERCIAL ENTRANCE PLACED BACK-TO-BACK: ONE WITH A RIGHT HAND ARROW (SHOWN) SHALL BE PLACED ON THE NEAR RIGHT SIDE THE DRIVEWAY AND ONE WITH A LEFT HAND ARROW SHALL BE PLACED ON THE FAR LEFT SIDE OF THE DRIVEWAY.
- 3. SIGNS TO BE PAID FOR AS ITEM "TEMPORARY INFORMATION SIGNING".

STATE OF ILLINOIS
DEPARTMENT OF TRANSPORTATION