**DEPARTMENT OF TRANSPORTATION** FOR LIST OF HIGHWAY STANDARDS, SEE SHEET NO. 2 PLANS FOR PROPOSED 87TH STREET (WEST LEG) = CH 31 83RD STREET (EAST LEG) = CH 31 FEDERAL AID HIGHWAY TRAFFIC DATA FAU ROUTE 2612 (CH 9) (LEMONT ROAD) LEMONT ROAD ADT = 24,400(2018)/24,400(2019) 87TH STREET ADT = 18,000(2018) /18,000(2019) 87TH STREET TO 83RD STREET OLDFIELD ROAD ADT= 2,600(2018) /2,600(2019) **ROADWAY WIDENING AND RESURFACING** 83RD STREET ADT = 13,200(2018) /13,200(2019) SECTION NO.: 16-00232-00-CH SPEED LIMIT: PROJECT NO.: X6UK(066) END IMPROVEMENT 40 MPH (POSTED) - LEMONT ROAD **DUPAGE COUNTY** STA 311+40.00 40 MPH (POSTED) - 87TH STREET END IMPROVEMENT 25 MPH (POSTED) - OLDFIELD ROAD C-91-081-21 BEGIN IMPROVEMENT STA 27 + 85.00 30 MPH (POSTED) - 83RD STREET 16 + 00.003rd PM **DESIGN DESIGNATION:** LEMONT ROAD: MINOR ARTERIAL 87TH STREET: MINOR ARTERIAL (WEST OF LEMONT RD) OLDFIELD ROAD: MINOR COLLECTOR (EAST OF LEMONT RD) LOCATION OF SECTION INDICATED THUS: - -83RD STREET: MINOR ARTERIAL BEGIN IMPROVEMENT 302+66.36 BACK = 302+89.14 FORWARD STA 78 + 56.00 END IMPROVEMENT ENGINEERING SCALES, REDUCED SIZED PLANS WILL NOT STA 24+24.00 CONFORM TO STANDARD SCALES. IN MAKING MEASUREMENTS 100+00 BACK = 10+00 FORWARD ON REDUCED PLANS, THE ABOVE SCALES MAY BE USED. R11E LEMONT ROAD LENGTH = 4124.0 FT. = 0.78 MILE J.U.L.I.E. BEGIN IMPROVEMENT 87H STREET LENGTH = 3566.9 FT. = 0.676 MILE JOINT UTILITY LOCATION INFORMATION FOR EXCAVATION 1-800-892-0123 STA 270+16.00 BORD STREET LENGTH = 1049.6 FT. = 0.199 MILE OR 811 NET LENGTH = 8717.0 FT. = 1.651 MIL BLA, Inc. LICENSED 25 DATE 3 33 RE RICERCAD SUITE2 JUST ASCA, ILG 0 to 3 P :630 )436 5403 F | 630)438 6444 wa waayi ng com MATTHEW T. CESARIO ER DOMBROWSKI BLA. INC. NO.: 062-066160 CONTRACT NO. 61J01 EXP. DATE: 11-30-2025 SHEETS: 1-209, 215-248

01-16-2026 LETTING ITEM 206

FOR INDEX OF SHEETS, SEE SHEET NO. 2

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STATE OF ILLINOIS

SECTION COUNTY SHEETS 16-00232-00-CH OUPAGE

STATE OF ILLINOIS

SEPTEMBER 18, 2025 William C. Eilen DUPAGE COUNTY DIVISION OF TRANSPORTATION, COUNTY ENGINEER

PRINTED BY THE AUTHORITY OF THE STATE OF ILLINOIS

### GENERAL NOTES

- 1. NO WORK SHALL COMMENCE UNTIL TRAFFIC CONTROL REQUIREMENTS ARE MET.
- 2. ALL CONSTRUCTION SHALL BE IN ACCORDANCE WITH THE STANDARD SPECIFICATIONS FOR ROAD AND BRIDGE CONSTRUCTION ADOPTED JANUARY 1, 2022 (HEREIN AFTER REFERRED TO AS THE STANDARD SPECIFICATIONS; THE SUPPLEMENTAL SPECIFICATIONS AND RECURRING SPECIAL PROVISIONS ADOPTED JANUARY 1, 2023; THE LATEST EDITION OF THE ILLINOIS MANUAL ON UNIFORM TRAFFIC CONTROL DEVICES FOR STREETS AND HIGHWAYS; THE STANDARD SPECIFICATIONS FOR WATER & SEWER MAIN CONSTRUCTION IN ILLINOIS, LATEST EDITION; THE DETAILS IN THE PLANS; AND THE SPECIAL PROVISIONS INCLUDED IN THE CONTRACT DOCUMENTS.
- 3. ANY REFERENCE TO STANDARDS THROUGHOUT THE PLANS OR SPECIAL PROVISIONS SHALL BE INTERPRETED AS THE LATEST STANDARD OF THE ILLINOIS DEPARTMENT OF TRANSPORTATION STANDARD SPECIFICATIONS.
- 4. BEFORE STARTING ANY EXCAVATION, THE CONTRACTOR SHALL CALL "J.U.L.I.E." AT (800) 892-0123 OR 811 FOR FIELD LOCATIONS OF BURIED ELECTRIC, TELEPHONE AND GAS UTILITIES. 48 HOURS NOTIFICATION IS REQUIRED.
- 5. ALL UTILITIES, SCHOOL DISTRICTS, LOCAL POLICE, AND FIRE DEPARTMENTS SHALL BE NOTIFIED BY THE CONTRACTOR PRIOR TO THE START OF CONSTRUCTION.
- 6. UNLESS AUTHORIZED BY THE ENGINEER, ALL EXISTING ACCESS POINTS SHALL BE MAINTAINED AT ALL TIMES BY THE CONTRACTOR.
- 7. DURING THE CONSTRUCTION, THE CONTRACTOR WILL BE REQUIRED TO HAVE AVAILABLE A WATER TRUCK OR SIMILAR EQUIPMENT TO CONTROL DUST. IF NECESSARY, THE CONTRACTOR SHALL BE REQUIRED TO CONTROL DUST DURING NON-WORKING HOURS.
- 8. ALL EXCESS MATERIAL (BROKEN CONCRETE, CULVERT PIPE, WASTE ROADWAY EXCAVATION, SURPLUS MATERIAL FROM SEWER TRENCHES, ETC.) SHALL BE LEGALLY DISPOSED OF OUTSIDE THE LIMITS OF THE RIGHT-OF-WAY. IT SHALL BE THE CONTRACTOR'S RESPONSIBILITY TO SELECT DUMP SITES AND OBTAIN PERMISSION AND ALL NECESSARY PERMITS TO USE SUCH DUMP SITES.
- 9. A TEN (10) FOOT TRANSISTION SHALL BE USED TO MATCH PROPOSED CURB AND GUTTER ITEMS OF WORK TO EXISTING CURB AND GUTTER IN THE FIELD UNLESS OTHERWISE INDICATED.

### TREE REMOVAL, CLEARING, HEDGE REMOVAL

- 1. CONTRACTOR SHALL TAKE PRECAUTION BY PRESERVING EXISTING TREES WITHIN THE RIGHT OF WAY. IF ANY DAMAGE OCCURS, TREES SHALL BE REPLACED IN KIND PER ARTICLE 201.07 REPAIR OR REPLACEMENT OF EXISTING PLANT MATERIAL REQUIREMENTS SHATED HEREIN.
- ALL LIMBS, BRANCHES, AND OTHER DEBRIS RESULTING FROM THIS WORK SHALL BE DISPOSED OF BY THE CONTRACTOR OUTSIDE THE LIMITS OF THE RIGHT-OF-WAY.
- 3. ALL CLEARING, REMOVAL OF BUSHES, HEDGES AND TREES UNDER SIX (6) INCHES IN DIAMETER SHALL BE REMOVED PER THE STANDARD SPECIFICATIONS.

### TRENCH BACKFILL

 WHERE TRENCH BACKFILL IS REQUIRED, THE MATERIAL USED SHALL BE COMPACTED AS SPECIFIED IN ARTICLE 550.07 OF THE STANDARD SPECIFICATIONS USING METHOD ONE.

### HOT-MIX ASPHALT SURFACE AND HOT-MIX ASPHALT BASE COURSE

- 1. HOT-MIX ASPHALT SURFACE COURSE SHALL NOT BE PLACED UNTIL ALL EARTH EXCAVATION, TOPSOIL PLACEMENT, BASE COURSE, AND HOT-MIX ASPHALT BINDER COURSE HAVE BEEN COMPLETED TO THE SATISFACTION OF THE ENGINEER.
- 2. HOT-MIX ASPHALT BASE COURSE SHALL NOT BE PLACED ADJACENT TO CURB AND GUTTER UNTIL THE CURB AND GUTTER HAS BEEN BACKFILLED TO THE SATISFACTION OF THE ENGINEER.

### **DUPAGE COUNTY DETAILS**

SAG FRAME AND LID TEMPORARY DITCH CHECK (SPECIAL) COMMERCIAL DRIVEWAY DETAIL

BLA, Inc
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604001-05 FRAME AND LIDS TYPE 1

604051-04 FRAME AND GRATE TYPE 11

604061-03 FRAME AND GRATE TYPE 12

604086-05 FRAME AND GRATE TYPE 23

604091-05 FRAME AND GRATE TYPE 24

606001-09 CONCRETE CURB TYPE B COMBINATION CURB AND GUTTER
606006-04 OUTLETS FOR CONCRETE CURB AND GUTTER TYPE B-6. 24

604036-03 GRATE TYPE 8

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STATE OF ILLINOIS
DEPARTMENT OF TRANSPORTATION

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SCALE: N

877001-08 STEEL MAST ARM ASSEMBLY AND POLE 16' THROUGH 55'

878001-11 CONCRETE FOUNDATION DETAILS

880006-01 TRAFFIC SIGNAL MOUNTING DETAILS

877011-10 STEEL COMB. MAST ARM ASSEMBLY AND POLE 16' THROUGH 55'

880001-01 SPAN WIRE MOUNTED SIGNALS AND FLASHING BEACON INSTALLATION

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### **ROADWAY EXCAVATION**

- 1. ALL EXISTING CULVERTS, STORM SEWERS, OR DRAINAGE STRUCTURES MARKED FOR REMOVAL ON THE PLANS OR DESIGNATED IN THE FIELD BY THE ENGINEER TO BE REMOVED SHALL BE REMOVED AND ANY EXCAVATION SHALL BE BACKFILLED WITH A GRANULAR MATERIAL MEETING THE SPECIFICATIONS FOR FA-1 OR FA-2.
- 2. ALL EXISTING GRANULAR AND HOT-MIX ASPHALT PAVEMENT TO BE REMOVED AND NOT PAID AS A SPECIFIC ITEM SHALL BE CONSIDERED EARTH EXCAVATION AND WILL BE PAID FOR AT THE CONTRACT UNIT PRICE FOR EARTH EXCAVATION. THE CONTRACTOR WILL HAVE THE OPTION OF REMOVING THE EXISTING HOT-MIX ASPHALT PAVEMENT BY GRINDING OR EXCAVATION, IF THE HOT-MIX ASPHALT PAVEMENT IS REMOVED BY EXCAVATION, IT MAY NOT BE USED IN EMBANKMENT AREAS UNLESS SPECIFICALLY AUTHORIZED BY THE ENCINEER HOT-MIX ASPHALT PAVEMENT REMOVED BY GRINDING MAY BE USED AS EMBANKMENT MATERIAL. NO HOT-MIX ASPHALT PAVEMENT SHALL BE REMOVED IN AREAS TO BE USED FOR TEMPORARY ROADWAY.
- 3. THE CONTRACTOR SHALL NOT CROSS COMPLETED BASE COURSE OR EXISTING PAVEMENT, NOT SCHEDULED TO BE REMOVED, WITH TRACK EQUIPMENT OR LOADED
- 4. ALL EMBANKMENTS AND SUB-GRADE SHALL BE COMPACTED TO THE SATISFACTION OF THE ENGINEER PRIOR TO PLACING AGGREGATE SUBGRADE OR SUB-BASE GRANULAR MATERIAL.

### STORM SEWER, STRUCTURES, UTILITIES

- THE CONTRACTOR SHALL MAINTAIN CONVEYANCE OF ALL FLOWS DURING CONSTRUCTION OF THIS PROJECT. WHEN EXISTING DRAINAGE FACILITIES ARE DISTURBED, THE CONTRACTOR SHALL PROVIDE AND MAINTAIN TEMPORARY OUTLETS AND CONNECTIONS FOR ALL PRIVATE AND PUBLIC DRAINS, SEWERS, CULVERTS, AND OTHER DRAINAGE FACILITIES. THE CONTRACTOR SHALL PROVIDE FACILITIES TO TAKE IN ALL STORM WATER WHICH WILL BE RECEIVED BY THESE DRAINS AND SEWERS, AND DISCHARGE THE SAME. THE CONTRACTOR SHALL PROVIDE AND MAINTAIN A PUMPING PLANT, IF NECESSARY, AND A TEMPORARY OUTLET AND BE PREPARED AT ALL TIMES TO DISPOSE OF WATER RECEIVED FROM THESE TEMPORARY CONNECTIONS UNTIL SUCH TIME THAT THE PERMANENT DRAINAGE FACILITIES ARE IN SERVICE
- 2. THE STATION / OFFSET / ELEVATIONS NOTED FOR ALL DRAINAGE STRUCTURES LOCATED IN THE CURB LINE REFER TO THE POSITION OF THE ADJACENT PROPOSED EDGE OF PAVEMENT. THE CONTRACTOR SHALL BE RESPONSIBLE FOR DETERMINING THE OFFSET NECESSARY FOR THE STRUCTURES TO SET THE FRAME AND GRATES IN THE PROPER LOCATION. ALL OTHER STRUCTURES ARE DIMENSIONED TO THE CENTER OF THE STRUCTURE; ELEVATION INDICATES RIM GRADES.
- 3. THE CONTRACTOR SHALL BE RESPONSIBLE FOR CONTACTING LOCAL AGENCIES MAINTAINING SANITARY SEWERS, WATERMAINS, AND STREET LIGHTS TO VERIFY THE MATERIALS AND METHODS ALLOWED FOR THE ADJUSTMENT, RELOCATION, OR EXTENSION OF THE UTILITY INVOLVED.
- 4. THE LOCATION AND ELEVATION OF EXISTING UTILITIES ARE APPROXIMATE AND ARE PROVIDED BY THE OWNERS. THE EXACT LOCATIONS AND ELEVATIONS ARE TO BE VERIFIED BY THE CONTRACTOR THROUGH THE OWNERS OF THE UTILITIES.
- 5. EMBANKMENTS SHALL BE COMPLETED TO THE SATISFACTION OF THE ENGINEER PRIOR TO EXCAVATION FOR STORM SEWER.
- 6. MANHOLES AND CATCH BASINS SHALL BE CONSTRUCTED WITH FLAT TOPS WHERE THE DIFFERENCE BETWEEN THE RIM ELEVATION AND THE INVERT ELEVATION IS LESS THAN SIX (6) FEET).
- 7. ALL ADJUSTMENTS OR RECONSTRUCTIONS SHALL INCLUDE THE REMOVAL AND REPLACEMENT, AT THE CONTRACTOR'S EXPENSE, OF ALL UNSUITABLE TWO (2) FOOT INSIDE DIAMETER ADJUSTING RINGS.
- 8. ADJUSTMENT OF STRUCTURES MAINTAINED BY OTHER AGENCIES SHALL BE MADE TO THE SATISFACTION OF THE ENGINEER AND THE AGENCY MAINTAINING THE STRUCTURE INVOLVED.
- 9. ALL FIELD TILES ENCOUNTERED SHALL BE CAREFULLY PRESERVED AND CONNECTED TO PROPOSED DRAINAGE STRUCTURES, SEWERS, OR DITCHES, AS DIRECTED BY THE ENGINEER THIS WORK SHALL BE IN ACCORDANCE WITH ARTICLE 109.04 OF THE

### TOPSOIL

- 1. TOPSOIL SHALL BE PLACED TO A DEPTH OF SIX (6) INCHES AND BE MEASURED IN
- 2. THE CROSS SECTIONS INDICATE THE FINISHED GRADE OF TOPSOIL.
- 3. TOPSOIL SHALL NOT BE STOCKPILED WITHIN THE LIMITS OF CONSTRUCTION; THE LOCATIONS OF TOPSOIL STOCKPILES WITHIN THE RIGHT-OF-WAY MUST BE APPROVED BY THE ENGINEER.

### TRAFFIC SIGNAL NOTES

- 1. THE REMOVAL AND REPLACEMENT OF SIDEWALK, DRIVEWAY, MEDIAN AND ISLAND SURFACE PAVING AT HANDHOLES, JACKING PITS AND INSPECTION OPENINGS SHALL BE SAW CUT AROUND THE AREA TO BE REMOVED.
- 2. THE EXACT LOCATION OF ALL UTILITIES SHALL BE FIELD VERIFIED BY THE CONTRACTOR BEFORE THE INSTALLATION OF ANY COMPONENTS OF THE TRAFFIC SIGNAL SYSTEM, FOR LOCATION OF UTILITIES, CALL J.U.L.I.E. TOLL FREE NUMBER 1-800-892-0123.
- 3. ALL SIGNAL POSTS AND MAST ARM POLES SHALL BE LOCATED WITH THEIR CENTERLINES A MINIMUM OF FOUR (4) FEET AND SIX (6) FEET RESPECTIVELY FROM THE BACK OF CURB UNLESS NOTED OR DIMENSIONED TO THE CONTRARY ON THE DRAWINGS. IN NON-CURBED AREAS THE MAST ARM POLE SHALL BE LOCATED A MINIMUM OF TEN (10) FEET BEHIND THE EDGE OF PAVEMENT OR TWO (2) FEET BEHIND THE EDGE OF SHOULDER, WHICHEVER DISTANCE IS GREATER. SIGNAL POSTS SHALL BE PLACED AT A MINIMUM OF TWO (2) FEET BEHIND THE EDGE OF SHOULDER.
- 4. THE CONTRACTOR SHALL CONTACT THE DUPAGE COUNTY DIVISION OF TRANSPORTATION (630/407-6900) FOR TRAFFIC SIGNAL CABLE LOCATION, A MINIMUM OF 48 HOURS IN ADVANCE (SATURDAYS, SUNDAYS, AND HOLIDAYS EXCLUDED) AT ANY LOCATION WITHIN THE RIGHT- OF-WAY.
- 5. CONTACT THE DU PAGE COUNTY TRAFFIC SIGNAL COORDINATOR (630/407-6900) TO APPROVE LOCATIONS OF LOOPS, SIGNAL FOUNDATIONS AND SIGNAL HEADS.
- 6. LEAD WIRE AND DETECTOR LOOPS SHALL BE SAWCUT 40 DEEP INTO THE PAVE-MENT WHERE BITUMINOUS SURFACE COURSE IS NOT A PART OF THE CONTRACT.
- 7. ALL PRESENCE LOOPS SHALL BE EQUIPPED WITH AN INDUCTIVE LOOP DETECTOR WITH SYSTEM OUTPUT.
- 8. ALL LUMINAIRE ARMS SHALL BE 15 FEET LONG UNLESS OTHERWISE NOTED.
- 9. ALL LUMINAIRES SHALL BE MOUNTED AT 40 FOOT HEIGHT UNLESS OTHERWISE

### MISCELLANEOUS

- 1. MAILBOXES WITHIN THE PROJECT LIMITS THAT WILL BE AFFECTED BY THE IMPROVEMENTS AND AS DIRECCTED BY THE ENGINEER SHALL BE REMOVED AND TEMPORARILY RELOCATED AT A SAFE LOCATION OUTSIDE OF THE IMPACT ZONE. THE ENGINEER SHALL ASSIST THE CONTRACTOR ON THE TEMPORARY LOCATION WITH THE INPUT AND COORDINATION OF THE LOCAL POSTAL AUTHORITY. ACCESS SHALL BE MAINTAINED AT ALL TIMES TO THE EXISTING OR TEMPORARY MAILBOX LOCATION. THE PERMANENT LOCATION SHALL BE DIRECTED BY THE ENGINEER.
- 2. A NOMINAL QUANTITY OF AGGREGATE SUBGRADE IMPROVEMENT (CY) AND GEOTEXTILE FABRIC (SY) HAS BEEN INCLUDED IN THE CONTRACT TO BE UTILIZED IN LOCATIONS WHERE UNSUITABLE SOILS / UNDERCUTS ARE ENCOUNTERED. THESES ITEMS ARE TO BE UTILIZED AT THE DISCRETION AND DIRECTION OF THE ENGINEER.
- 3. SPEEDWAY'S CONTRACTOR SHALL HAVE PERMISSION TO STORE MATERIALS AND EQUIPMENT WITHIN THE TEMPORARY EASEMENT. COORDINATION SHOULD BE ANTICIPATED TO MITIGATE ANY CONFLICTS WITH SPEEDWAY'S CONTRACTOR AND THE GENERAL CONTRACTOR SELECTED FOR THIS PROJECT.
- 4. THE SUBGRADE STABILITY SHALL BE VERIFIED BY PROOF ROLLING WITH A FULLY LOADED TANDEM-AXLE TRUCK.
- 5. GEOTECHNICAL FABRIC FOR GROUND STABILIZATION AND/OR AGGREGATE SUBGRADE IMPROVEMENT (CU YD) HAVE BEEN PROVIDED FOR USE AT THE LOCATIONS INDICATED FOR SOILS THAT TEND TO BE UNSTABLE AND/OR UNSUITABLE. THE ACTUAL NEED FOR REMOVAL AND REPLACEMENT WITH ABOVE ITEM WILL BE DETERMINED IN THE FIELD AT THE TIME OF CONSTRUCTION BY THE WILL BE DETERMINED IN THE FIELD AT THE TIME OF CONSTRUCTION BY THE GEOTECHNICAL ENGINEER. ALL POTENTIALLY UNSTABLE SOILS SHOULD BE TESTED WITH A STATIC OR DYNAMIC CONE PENETROMETER AND TREATED IN ACCORDANCE WITH ARTICLE 301.04 OF THE SSRBC AND IDOT SUBGRADE STABILITY MANUAL. IF UNSTABLE AND/OR UNSUITABLE SOILS ARE NOT ENCOUNTERED THEN THE QUANTITY SHALL BE DEDUCTED AND NO ADDITIONAL COMPENSATION WILL BE DUE TO THE CONTROLOGRAP COMPENSATION WILL BE DUE TO THE CONTRACTOR
- 6. ANY AGGREGATE SHUBGRADE IMPROVEMENT CONTAMINATED AND/OR DAMAGED BY THE CONTRACTOR'S VEHICLE AND/OR EQUIPMENTS IS TO BE REMOVED AND REPLACED AS DIRECTED BY THE ENGINEER AT THE CONTRACTOR'S EXPENSE.
- 7. THE AGGREGATE GRADATION FOR THE AGGREGATE SUBGRADE IMPROVEMENT 12 INCH LOWER LIFT SHALL BE CS 1 OR RR 1.
- 8. PIPE UNDERDRAINS SHALL BE INSTALLED ACCORDING TO SECTION 601 OF THE SSRBC AND STANDARD 601001-05. TOP OF PIPE UNDERDRAINS SHALL BE PLACED MINIMUM 6 INCHES BELOW THE AGGREGATE SUBGRADE IMPROVEMENT LAYER. THE COST OF MAKING PIPE UNDERDRAINS CONNECTIONS TO THE DRAINAGE STRUCTURES SHALL BE INCLUDED IN THE COST OF THE PIPE UNDERDRAINS.
- 9. THE CONTRACTOR SHALL BE AWARE THAT COORDINATION WITH ADJACENT PROPERTY S CONTRACTOR AND WORK SHALL BE CONSIDERED NECESSARY FOR THIS PROJECT.
- 10.THE CONTRACTOR SHALL BE AWARE THAT THE EXISTING WOODEN SHED AND STORAGE RACKS LOCATED WITHIN THE TEMPORARY EASEMENT ON THE PROPERTY AT THE SOUTHWEST CORNER OF LEMONT ROAD AND 87° STREET ARE REMAINING. THE CONTRACTOR SHALL COORDINATE WITH THE PROPERTY OWNER AND CONSIDER THESE ITEMS NECESSARY TO WORK AROUND.
- 11.PEDESTRIAN ACCESS ACROSS AT THE INTERSECTIONS SHALL BE MAINTAINED THROUGHOUT CONSTRUCTION. IF TEMPORARY RAMPS, TEMPORARY STONE, OR OTHER METHODS APPROVED BY THE ENGINEER ARE NECESSARY THESE SHALL BE CONSIDERED IN THE COST FOR TRAFFIC CONTROL AND PROTECTION SPECIAL.
- 12. PHOSPHORUS FERTILIZER HAS BEEN INTENTIONALLY OMITTED FROM THE CONTRACT. A PHOSPHORUS-FREE FERTILIZED SHALL BE USED (MIDDLE NUMBER
- 13. THE COMMERCIAL DRIVEWAYS SHALL HAVE 6 INCH AGGREGATE BASE COURSE, TYPE B

### **COMMITMENTS**

TREES THREE (3) INCHES OR GREATER IN DIAMETER AT BREAST HEIGHT SHALL NOT BE CLEARED FROM APRIL 1 TO OCTOBER 31 OF ANY GIVEN YEAR

SHOULD THE PROJECT REQUIRE NEW/ADDITIONAL TEMPORARY OR PERMANENT LIGHTING, OR REPLACING EXISTING PERMANENT LIGHTS, ALL LIGHTING SHALL BE INSTALLED IN ACCORDANCE WITH IDOT BDE MANUAL-CHAPTER 56 AND WITH THE USFWS PBO FOR IBAT, NLEB AND TRICOLORED BAT. THIS INCLUDES THE

- \* DIRECT TEMPORARY LIGHTING AWAY FROM SUITABLE HABITAT DURING THE
- ACTIVE SEASON.

   UTILIZING THE BUG SYSTEM, THE PROJECT SHOULD BE AS CLOSE TO 0 FOR ALL THREE RATINGS WITH A PRIORITY OF "UPLIGHT" OF 0 AND "BACKLIGHT" AS LOW AS PRACTICABLE.

THIS PROJECT SHALL BE RE-SEEDED IN ACCORDANCE WITH IDOT'S STANDARD SPECIFICATIONS FOR ROAD AND BRIDGE CONSTRUCTION AS WITH A CLASS 5 5B SEED MIX, AS APPROPRIATE, WHICH CONTAIN NATIVE FORBS AND



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	CODE			TOTAL	ROADWAY 0004	ROADWAY 0004	ROADWAY 0005	ROADWAY 0005	TRAFFIC SIGNALS 0021	TRAFFIC SIGNALS 0021	TRAFFIC SIGNALS 0021	RETAINING WALL 0044	HIGHWAY LIGHTING 0021	ROADWAY 0042
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	20101000	TEMPORARY FENCE	FOOT	260	140	120								
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										<u> </u>				
#	20101300	TREE PRUNING (1 TO 10 INCH DIAMETER)	EACH	7	4	3				<u> </u>				1000
#	20101350	TREE PRUNING (OVER 10 INCH DIAMETER)	EACH	6	3	3								
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DEPARTMENT	OF	TRANSPORTATION

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		1		ROADWAY	ROADWAY	ROADWAY	ROADWAY	TRAFFIC SIGNALS	TRAFFIC SIGNALS	TRAFFIC SIGNALS	RETAINING WALL	HIGHWAY LIGHTING	ROADWAY
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NO.	ITEM	UNIT	QUANTITY	URBAN	URBAN	URBAN	URBAN	URBAN	URBAN	URBAN	URBAN	URBAN	URBAN
25200100 S	SODDING	SQYD	3653	2462	805	361	25						
23200100  3	SODDING										***************************************		
25200110 S	SODDING, SALT TOLERANT	SQYD	3238	1706	987	424	121			•			
25200200 S	SUPPLEMENTAL WATERING	UNIT	370	227	92	43	8						
28000250 T	TEMPORARY EROSION CONTROL SEEDING	POUND	226.4	163.7	47,4	12.3	3						
28000305 T	TEMPORARY DITCH CHECKS	FOOT	260	250		10							
								-					
28000400 P	PERIMETER EROSION BARRIER	FOOT	5149	3577	1376	146	50						
													Lanunca
28000510 IN	NLET FILTERS	EACH	109	58	17	30	4						
28001100 T	TEMPORARY EROSION CONTROL BLANKET	SQYD	10959	7922	2296	595	146			*******			
	***************************************								1862				**********
28100105 S	STONE RIPRAP, CLASS A3	SQYD	59	59	1 1 1 1 1 1 1 1 1 1 1 1 1 1 1 1 1 1 1								
		SQYD	59	59									
28200200 FI	FILTER FABRIC	3010	59	39									
		CUYD	1085	933	152								Marrow .
30300001 A	AGGREGATE SUBGRADE IMPROVEMENT						·						,
Boossate	ACCOPICATE CURCOADE INFOCUENCIA	SQYD	12839	7588	3410	1841			<u> </u>				<del></del>
a0300115 A	AGGREGATE SUBGRADE IMPROVEMENT 16"												
35101600 A	AGGREGATE BASE COURSE, TYPE B 4"	SQYD	1474	334	984	88	68						
CO TO TOUCH	SOMEONIE DAVE GOODINGE, I TEE D. 4												
35101800 A	AGGREGATE BASE COURSE, TYPE 8 6"	SQ YD	1035	355	680					Jestonom			
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В	BLA,	Inc.
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	USER NAME = thestor	DESIGNED	-	GJE	REVISED	*	2025-07-02
		DRAWN	-	GJE	REVISED	-	
.A. Inc.	PLOT SCALE = 100.0000 '/ in.	CHECKED	-	MTC	REVISED	-	
,	PLOT DATE : 11/3/2025	DATE		09/08/2023	REVISED	~	

STATE OF ILLINOIS										
DEPARTMENT	OF	TRANSPORTATION								

	SUMMARY OF QUANTITIES											SECTION
		LEMONT ROAD										16-00232-00-CH
i					FEIAL	JINI DO	MD				CH 9	
	SCALE:	N.T.S	SHEET	2	OF 16	SHEETS	STA.	N/A	TO STA,	N/A T		ILL INDIS FED

F.A.U RTE.	SECTION	COUNTY	TOTAL SHEETS	SHEET NO.
2612	16-00232-00-CH	DUPAGE	248	5
СН 9		CONTRAC	T NO.	61J01
	THE THOIS FED. A	ID PROJECT		

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Quentities	
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				80% FEDERAL FUNDING / 20% LOCAL (COUNTY) FUNDING  CONSTRUCTION CODE									
				····				CONSTRUC	CTION CODE	1	1		
				LEMONT AT 87th WIDENING	LEMONT AT 83rd WIDENING	LEMONT RD. RESURFACING	87th ST. RESURFACING	87th ST.	83rd ST,	INTERCONNECT	STRUCTURAL	INTERSECTION LIGHTING	TRAINEES
0005				ROADWAY	ROADWAY	ROADWAY	ROADWAY	TRAFFIC SIGNALS	· <del>[···································</del>	TRAFFIC SIGNALS	RETAINING WALL	HIGHWAY LIGHTING	ROADWAY 0042
CODE NO.	ITEM	TIMU	TOTAL QUANTITY	0004 URBAN	0004 URBAN	0005 URBAN	0005 URBAN	0021 URBAN	0021 URBAN	0021 URBAN	0044 URBAN	0021 URBAN	URBAN
NO.	ITEM	UNII	QUANTITY	URBAN	URBAN	URBAN	URBAN	URBAN	URBAN	URBAN	UKBAN	URBAN	URDAN
35102000	AGGREGATE BASE COURSE, TYPE B 8"	SQYD	756	537	31		188				:		
33102000	ACCRECATE BAGE COOKSE, TIFE 0 0												
35300400	PORTLAND CEMENT CONCRETE BASE COURSE 9"	SQYD	5490	2297	1990	1203							
			***************************************										
35400400	PORTLAND CEMENT CONCRETE BASE COURSE WIDENING 9"	SQYD	1387	867	238	282					ARRADON CONTRACTOR CON		
		SQYD	1027	347	680				All residents				
35501316	HOT-MIX ASPHALT BASE COURSE, 8"	30,70	1021	347	550								
35501320	HOT-MIX ASPHALT BASE COURSE. 9"	SQYD	3334	2931	403				**************************************				
30301320	TOTAL GOODE, U						······································		***				
40201000	AGGREGATE FOR TEMPORARY ACCESS	TON	40	10	10	10	10						
									with the control of t				
40600275	BITUMINOUS MATERIALS (PRIME COAT)	POUND	38111	10090	9832	8539	9650						
40600290	BITUMINOUS MATERIALS (TACK COAT)	POUND	38111	10090	9832	8539	9650						
		FOOT	33577	7449	8936	7100	10092		l				
40600370	LONGITUDINAL JOINT SEALANT	,,,,,		.,,,,									
40600400	MIXTURE FOR CRACKS JOINTS AND FLANGEWAYS	тон	74	15	20	17	22		<u> </u>	A-Markett Markett Mark			
12000100													
40600982	HOT-MIX ASPHALT SURFACE REMOVAL - BUTT JOINT	SQYD	1521	434	618	181	288						
	••••••								I				
40603080	HOT-MIX ASPHALT BINDER COURSE, IL-19 0 N50	TON	97	68	5		24			1			
		TON	7371	1951	1972	1610	1838						
40603085	HOT-MIX ASPHALT BINDER COURSE, IL-19 0 N70	13.7		5.	/2				-				
40604060	HOT-MIX ASPHALT SURFACE COURSE, IL-9.5, MIX "D", N50	TON	93	74	3		16		The state of the s				
40004000	TO THIS TOTAL OUTS OF THE TOTAL		-										
								<u> </u>					

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	USER NAME = thestor	DESIGNED	-	GJE	REVISED	-	2025-07-02
		DRAWN	-	GJE	REVISED	-	
nc.	PLOT SCALE = 100.0000 '/ in.	CHECKED	-	MTC	REVISED	-	
	PLOT DATE = 11/3/2025	DATE	_	09/08/2023	REVISED	-	

STATE	: OF	ILLINOIS
DEPARTMENT	0F	TRANSPORTATION

			5	SUMMARY	OF QU	ANTIT	IES			
				LEMO	ONT RO	AD				
SCALE:	N.T.S	SHEET	3	OF 16	SHEETS	STA.	N/A	TO STA.	N/A	

٦	F,A,U	SECTION	COUNTY	TOTAL	SHEE NO.
	2612	16-00232-00-CH	DUPAGE	248	6
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				80% FEDERAL FUNDING / 20% LOCAL (COUNTY) FUNDING									
								CONSTRUC	TION CODE	1	1	•	
				LEMONT AT 87th WIDENING	LEMONT AT 83rd WIDENING	LEMONT RD. RESURFACING	87th ST RESURFACING	87th ST.	83rd ST.	INTERCONNECT	STRUCTURAL	INTERSECTION LIGHTING	TRAINEES
				ROADWAY	ROADWAY	ROADWAY	ROADWAY	TRAFFIC SIGNALS	TRAFFIC SIGNALS	TRAFFIC SIGNALS	RETAINING WALL	HIGHWAY LIGHTING	ROADWAY
CODE			TOTAL	0004	0004	0005	0005	0021	0021	0021	0044	0021	0042
NO.	ITEM	UNIT	QUANTITY	URBAN	URBAN	URBAN	URBAN	URBAN	URBAN	URBAN	URBAN	URBAN	URBAN
													ļ
40604062	HOT-MIX ASPHALT SURFACE COURSE, IL-9.5, MIX "D", N70	TON	4912	1300	1314	1073	1225						
40004002	HOTHINA ASFRACE GOOKSE, IC-3.3, MIX. D., NYO												
42001300	PROTECTIVE COAT	SQYD	5226	2619	2119	289	199						
42.5010.50			İ	***************************************									
42300500	PORTLAND CEMENT CONCRETE DRIVEWAY PAVEMENT. 9 INCH	SQ YD	8	8									
42400200	PORTLAND CEMENT CONCRETE SIDEWALK 5 INCH	SQFT	13255	3004	8852	788	611						
42400800	DETECTABLE WARNINGS	SQFT	320	64	136	80	40						
44000100	PAVEMENT REMOVAL	SQYD	7287	4083	2187	1017							
44000163	HOT-MIX ASPHALT SURFACE REMOVAL 3 1/2*	SQYD	47412	9374	13292	10629	14117						
		SQYD	1712	933	586		193						
44000200	DRIVEWAY PAVEMENT REMOVAL	1 30 10	17.12	555	300		153				***************************************		
44000600	COMBINATION CURB AND GUTTER REMOVAL	FOOT	10447	3870	4109	2248	220						
44000000	COMMINATION CONTRACTOR AND CONTRACTO				***************************************			5					
44000600	SIDEWALK REMOVAL	SQ FT	13007	5013	6916	637	441				***************************************		
					and a company of the								
44003100	MEDIAN REMOVAL	SQFT	3662	1552	307	1803							
		ļ			***************************************								
44201785	CLASS D PATCHES, TYPE I. 12 INCH	SQYD	238	47	64	56	71			*			
		-											
44201789	CLASS D PATCHES, TYPE II. 12 INCH	SQYD	417	71	95	144	107						
		00.70	4000	2/2	500	070	200						
44201794	CLASS D PATCHES, TYPE III. 12 INCH	SQYD	1090	212	286	270	322						



	USER NAME = thestor	DESIGNED	-	GJÉ	REVISED	-	2025-07-02
		DRAWN	-	GJE	REVISED	-	
_	PLOT SCALE = IBBLEBSB '/ In.	CHECKED	-	MTC	REVISED	-	
	PLOT DATE : 11/3/2025	DATE	-	09/08/2023	REVISED	-	

STATE	OF ILLINOIS	
DEPARTMENT (	OF TRANSPORTATION	

		S	UMMARY	OF QU	ANTIT	IES		
			LEMO	NT RO	AD			
SCALE: N.T.S	SHEET	4	OF 16	SHEETS	STA.	N/A	TO STA.	N/A

F.A.U RTE.	SECTION		COUNTY	TOTAL SHEETS	SHEET NO.
2612	16-00232-00-Сн		DUPAGE	248	7
 CH 9			CONTRAC	T NO. (	51J01
	ILL INGIS FED.	. AID	PROJECT		

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				80% FEDERAL FUNDING / 20% LOCAL (COUNTY) FUNDING									
				, 54,017		15M01		CONSTRUC	TION CODE			I INTERCEPTION I	TRANSCO
		ı	ì	LEMONT AT 87th WIDENING	LEMONT AT 83rd WIDENING	LEMONT RD. RESURFACING	87th ST RESURFACING	87th ST.	83rd ST.	INTERCONNECT	STRUCTURAL	INTERSECTION LIGHTING	TRAINEES ROADWAY
CODE			TOTAL	ROADWAY 0004	ROADWAY 0004	ROADWAY 0005	ROADWAY 0005	TRAFFIC SIGNALS 0021	TRAFFIC SIGNALS 0021	TRAFFIC SIGNALS 0021	RETAINING WALL 0044	HIGHWAY LIGHTING 0021	0042
NO.	ITEM	UNIT	QUANTITY	URBAN	URBAN	URBAN	URBAN	URBAN	URBAN	URBAN	URBAN	URBAN	URBAN
44201796	CLASS D PATCHES, TYPE IV. 12 INCH	SQYD	939	367	191	167	214						
ANN		SOYD	122	122									
48101600	AGGREGATE SHOULDERS, TYPE B 8"	3415	122	124									
50100100	REMOVAL OF EXISTING STRUCTURES	EACH	1								1		
					The second secon								
50105220	PIPE CULVERT REMOVAL	FOOT	202	202									
52200700	PRECAST MODULAR RETAINING WALL	SQFT	385								385		
		SQFT	1263								1263		
52200800	SEGMENTAL CONCRETE BLOCK WALL												
542A1057	PIPE CULVERTS, CLASS A, TYPE 2 12"	FOOT	75	75									
542A1060	PIPE CULVERTS CLASS A. TYPE 2 15"	FOOT	148	148									
		EACH	1	1	7								
54213657	PRECAST REINFORCED CONCRETE FLARED END SECTIONS 12"			·									
54213660	PRECAST REINFORCED CONCRETE FLARED END SECTIONS 15"	EACH	5	5				***				LLWAIN BANKE	
								***************************************					
54213669	PRECAST REINFORCED CONCRETE FLARED END SECTIONS 24"	EACH	2	2									
		EACH	1	4									
54214503	PRECAST REINFORCED CONCRETE FLARED END SECTIONS, EQUIVALENT ROUND-S	IZ	- Constitution of the cons	1				Verification					
550A0050	STORM SEWERS CLASS A TYPE 1 12"	FOOT	325	325									
550A0070	STORM SEWERS, CLASS A, TYPE 1 15"	FOOT	45	10	35	***************************************							
		1											

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	USER NAME = thestor	DESIGNED	-	GJE	REVISED	-	2025-07-02
_		DRAWN	-	GJE	REVISED	-	
lnc.	PLOT SCALE = 188.8888 '/ in.	CHECKED	-	MTC	REVISED	-	
	PLOT DATE = 11/3/2025	DATE	-	09/08/2023	REVISED	-	

STATE OF ILLINOIS
DEPARTMENT OF TRANSPORTATION

SUMMARY OF QUANTITIES											
					LEMO	NT RO	AD				
ĺ	SCALE:	N.T.5	SHEET	5	OF 16	SHEETS	STA.	N/A	TO STA.	N/A	

_	F.A.U RTE.	SECTION	COUNTY	TOTAL SHEETS	SHEE NO.
	2612	16-00232-00-CH	DUPAGE	248	8
_	CH 9		CONTRAC	T NO.	51J01
_	i	STLL INDIS FED. AL	D PROJECT		

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RAYCADD.Sheets\16-88232-88-CH.sht.Summory	•
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							80%	FEDERAL FUNDING / 20		UNDING			
								CONSTRUC	TION CODE				
,	·			LEMONT AT 87th WIDENING	LEMONT AT 83rd WIDENING	LEMONT RD, RESURFACING	87th ST. RESURFACING	87th ST.	83rd ST.	INTERCONNECT	STRUCTURAL	INTERSECTION LIGHTING	TRAINEES
				ROADWAY	ROADWAY	ROADWAY	ROADWAY	TRAFFIC SIGNALS	TRAFFIC SIGNALS	TRAFFIC SIGNALS	RETAINING WALL	HIGHWAY LIGHTING	ROADWAY
CODE			TOTAL	0004	0004	0005	0005	0021	0021	0021	0044	0021	0042
NO.	ITEM	UNIT	QUANTITY	URBAN	URBAN	URBAN	URBAN	URBAN	URBAN	URBAN	URBAN	URBAN	URBAN
550A0340	STORM SEWERS CLASS A TYPE 2 12"	FOOT	866	568	298								
550A0360	STORM SEWERS CLASS A, TYPE 2 15"	FOOT	37	22		15							
55040000		FOOT	241	208	33								
550A0380	STORM SEWERS CLASS A, TYPE 2 18"												
55100400	STORM SEWER REMOVAL 10"	FOOT	227	227									
			045	100									
55100500	STORM SEWER REMOVAL 12"	FOOT	315	192	31	92							<u></u>
55100700	STORM SEWER REMOVAL 15"	FOOT	645	630		15							
											***************************************		
55100900	STORM SEWER REMOVAL 18"	FOOT	91	58	33								
		EACH	3	2	1	<u> </u>							
56400400	FIRE HYDRANTS TO BE RELOCATED												
58700300	CONCRETE SEALER	SQFT	983								983		
60108204	PIPE UNDERDRAINS, TYPE 2.4"	FOOT	652	652			***************************************						
60146304	PIPE UNDERDRAINS FOR STRUCTURES 4"	FOOT	443								443		
60200105	CATCH BASINS, TYPE A. 4'-DIAMETER, TYPE 1 FRAME, OPEN LID	EACH	2	2									
60201330	CATCH BASINS, TYPE A. 4'-DIAMETER, TYPE 23 FRAME AND GRATE	EACH	20	17	3								
			-										
60201340	CATCH BASINS, TYPE A.4'-DIAMETER, TYPE 24 FRAME AND GRATE	EACH	1	0	1								
			***		:								

B BLA, Inc.

USER NAME = tnestor	DESIGNED	-	GJE	REVISED	-	2025-07-02
	DRAWN	-	GJE	REVISED	-	
PLOT SCALE = 180,8880 '/ in.	CHECKED	-	MTC	REVISED	-	
 PLOT DATE = 11/3/2025	DATE	-	09/08/2023	REVISED		

STATE OF ILLINOIS
DEPARTMENT OF TRANSPORTATION

			S	UMMARY	OF QU	ANTIT	IES			
				LEMO	ONT RO	AD				
SCALE:	N.T.5	SHEET	6	OF 16	SHEETS	STA.	N/A	TO STA.	N/A	=

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							80% 1		% LOCAL (COUNTY) FI	JNDING			
	<u> </u>	<del></del>	· · · · · · · · · · · · · · · · · · ·	LEMONT AT 87th WIDENING	LEMONT AT 83rd WIDENING	LEMONT RD. RESURFACING	87th ST. RESURFACING	87th ST.	83rd ST.	INTERCONNECT	STRUCTURAL RETAINING WALL	INTERSECTION LIGHTING HIGHWAY LIGHTING	TRAINEES
CODE NO.	ITEM	UNIT	TOTAL QUANTITY	ROADWAY 0004 URBAN	ROADWAY 0004 URBAN	ROADWAY 0005 URBAN	ROADWAY 0005 URBAN	TRAFFIC SIGNALS 0021 URBAN	TRAFFIC SIGNALS 0021 URBAN	TRAFFIC SIGNALS 0021 URBAN	0044 URBAN	0021 URBAN	0042 URBAN
		EACH	3	3			····						
60205030	CATCH BASINS, TYPE A. 5'-DIAMETER, TYPE 23 FRAME AND GRATE	-											
60218400	MANHOLES, TYPE A, 4'-DIAMETER, TYPE 1 FRAME, CLOSED LID	EACH	3	3								***************************************	
60219530	MANHOLES, TYPE A, 4-DIAMETER, TYPE 23 FRAME AND GRATE	EACH	1	1									
69221100	MANHOLES, TYPE A, 5'-DIAMETER. TYPE 1 FRAME. CLOSED LID	EACH	4	1	1	2		200					
60236200	INLETS. TYPE A TYPE & GRATE	EACH	7	7									
60237460	INLETS TYPE A, TYPE 23 FRAME AND GRATE	EACH	14	11	3								
60237470	INLETS, TYPE A, TYPE 24 FRAME AND GRATE	EACH	2	1	¶.								
60256930	MANHOLES TO BE ADJUSTED WITH NEW TYPE 23 FRAME AND GRATE	EACH	1		1							-	
60500040	REMOVING MANHOLES	EACH	4	1	1	2							
60500050	REMOVING CATCH BASINS	EACH	21	16		5							
60500060	REMOVING INLETS	EACH	13	6	6	1							
60600095	CLASS SI CONCRETE (OUTLET)	CUYD	20	20									
60600605	CONCRETE CURB, TYPE B	FOOT	40	40									
60603800	COMBINATION CONCRETE CURB AND GUTTER, TYPE B-6.12	FOOT	991	113	363	295	220						

	B BLA, Inc.		
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	USER NAME = tnestor	DESIGNED	-	GJE	REVISED - 2025-07-	02
		DRAWN	4	GJE	REVISED ~	
_	PLOT SCALE = 100.0000 ' / in.	CHECKED	-+	MTC	REVISED -	
•	PLOT 09TE = 11/3/2025	DATE	-	09/08/2023	REVISED -	

STATE OF ILLINOIS
DEPARTMENT OF TRANSPORTATION

			8	UMMARY	OF QU	ANTIT	IES				
				LEMO	NT RO.	AD					
SCALE:	۲,۲,۸	SHEET	7	OF 16	SHEETS	STA.	N/A	TO	STA.	N/A	

								80%	FEDERAL FUNDING / 20	0% LOCAL (COUNTY) F	UNDING			
									CONSTRUC	TIONCODE				
Lucano			·····	T	LEMONT AT 87th WIDENING	LEMONT AT 83rd WIDENING	LEMONT RD. RESURFACING	87th ST. RESURFACING	87th ST.	83rd ST.	INTERCONNECT	STRUCTURAL	INTERSECTION LIGHTING	TRAINEES
	ODE			TOTAL	ROADWAY	ROADWAY	ROADWAY	ROADWAY	TRAFFIC SIGNALS	TRAFFIC SIGNALS	TRAFFIC SIGNALS	RETAINING WALL	HIGHWAY LIGHTING	ROADWAY
1	NO.	ITEM	UNIT	TOTAL	0004 URBAN	0004 URBAN	0005 URBAN	0005 URBAN	0021 URBAN	0021 URBAN	0021 URBAN	0044 URBAN	0021 URBAN	0042 URBAN
<u> </u>	110.	11 2 20	UNI	GOANTITI	ORBAN	UKOAN	ONDAN	URBAN	UNDAN	URDAIN	URDAN	UNDAN	URDAN	UNDAN
			FOOT	4187	2768	1029	240	150						
6060	04400	COMBINATION CONCRETE CURB AND GUTTER, TYPE B-6.18												
606	เกรดกก	COMBINATION CONCRETE CURB AND GUTTER, TYPE B-6.24	FOOT	1095	191	904							7-10-10-10-10-10-10-10-10-10-10-10-10-10-	
		S												
606	19600	CONCRETE MEDIAN, TYPE SB-6 12	SQFT	5161	2359	2802			***************************************	**************************************		***************************************		
				-										
606	22310	CONCRETE MEDIAN. TYPE SM-4.18	SQFT	12402	5578	3988	2836							
			***************************************		-									
6640	00305	CHAIN LINK FENCE 6'	FOOT	200	200									
6690	00200	NON-SPECIAL WASTE DISPOSAL	CUYD	4535	2267	2268								···
.		WITH THE PARTY OF												
6690	00530	SOIL DISPOSAL ANALYSIS	EACH	10	5	5	***************************************				~~~~~~~~~~~~~~~~~~~~~~~~~~~~~~~~~~~~~~			
.			1 0 1 5 1	1	0.5	0.5								
6690	01001	REGULATED SUBSTANCES PRE-CONSTRUCTION PLAN	LSUM	<u>'</u>	0.5	0.5		***************************************						,
.			LSUM	1	0.5	0.5								
6690	01003	REGULATED SUBSTANCES FINAL CONSTRUCTION REPORT												
eenr	04006	REGULATED SUBSTANCES MONITORING	ÇAL DA	180	90	90		***************************************						
0091	01000	REDULA JEU SUBSTANCES MUNITURING		-										
671	00100	MOBILIZATION	LSUM	1	0.25	0.25	0 25	0.25						
										-				
701	07025	CHANGEABLE MESSAGE SIGN	CAL DA	1080	540	540								
703	00100	SHORT TERM PAVEMENT MARKING	FOOT	103035	23877	29826	20397	28935						
# 7030	00150	SHORT TERM PAVEMENT MARKING REMOVAL	SQFT	44819	11671	15059	7948	10141						
									-		;			

	B	BLA,	Inc.
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	USER NAME = thestor	DESIGNED	-	GJE	REVISED	+-	2025-07-02
		DRAWN	-	GJE	REVISED	-	
1C.	PLOT SCALE = 189.8828 '/ in.	CHECKED	-	MTC	REVISED	-	
	PLOT DATE = 11/3/2825	DATE	_	09/08/2023	REVISED	~	

STATI	E OI	F ILLINOIS
DEPARTMENT	OF	TRANSPORTATION

		S	SUMMARY	OF QU	ANTIT	IES		
			LEM	ONT RO.	AD			
SCALE: N.T.S	SHEE	т 8	OF 16	SHEETS	STA.	N/A	TO STA.	N/A

F.A.U RTE.	SECTION	COUNTY	TOTAL SHEETS	SHE
2615	16-00232-00-CH	DUPAGE	248	11
CH 9		CONTRAC	T NO.	6110
	ER LINOIS FED. A	ID PROJECT		

Quantities,REV.dgn	
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				80% FEDERAL FUNDING / 20% LOCAL (COUNTY) FUNDING									
								CONSTRUC	TION CODE				
			*	LEMONT AT 87th WIDENING ROADWAY	LEMONT AT 83rd WIDENING ROADWAY	LEMONT RD. RESURFACING ROADWAY	87th ST. RESURFACING ROADWAY	87th ST. TRAFFIC SIGNALS	83rd ST. TRAFFIC SIGNALS	INTERCONNECT TRAFFIC SIGNALS	STRUCTURAL RETAINING WALL	INTERSECTION LIGHTING HIGHWAY LIGHTING	ROADWAY
CODE			TOTAL	0004	0004	0005	0005	0021	0021	0021	0044	0021	0042
NO.	ITEM	דואט	QUANTITY	URBAN	URBAN	URBAN	URBAN	URBAN	URBAN	URBAN	URBAN	URBAN	URBAN
70307100	TEMPORARY PAVEMENT MARKING LETTERS AND SYMBOLS - TYPE IV TAPE	SQFT	982	400	291	182	109						
70307120	TEMPORARY PAVEMENT MARKING - LINE 4" - TYPE IV TAPE	FOOT	40260	17484	14046	8054	676						
											November - November - November - November - November - November - November - November - November - November -		
70307130	TEMPORARY PAVEMENT MARKING - LINE 6" - TYPE IV TAPE	<b>FOOT</b>	3973	1907	1596	392	78						
70307210	TEMPORARY PAVEMENT MARKING - LINE 24"- TYPE IV TAPE	FOOT	411	230	181	1-1-1-1-1-1-1-1-1-1-1-1-1-1-1-1-1-1-1-					***************************************		
		ļ											
70400100	TEMPORARY CONCRETE BARRIER	FOOT	400	400									
70600255	IMPACT ATTENUATORS TEMPORARY (FULLY REDIRECTIVE, NARROW), TEST LEVEL	EACH	1	1									
72000100	SIGN PANEL - TYPE 1	SQFT	338.75	142.5	150			26	20.25				
72000200	SIGN PANEL - TYPE 2	SOFT	112.5	50	50				12.5				
				200	950								
72800100	TELESCOPING STEEL SIGN SUPPORT	FOOT	500	250	250								
78000100	THERMOPLASTIC PAVEMENT MARKING - LETTERS AND SYMBOLS	SQFT	1332	437	437	182	276						b-L-00000000000000000000000000000000000
78000200	THERMOPLASTIC PAVEMENT MARKING - LINE 4"	FOOT	24218	4310	5459	5630	8819						
		-										1	*******
78000400	THERMOPLASTIC PAVEMENT MARKING - LINE 6"	FOOT	6484	2576	2618	739	551						
78000500	THERMOPLASTIC PAVEMENT MARKING - LINE 8"	FOOT	840	840									
- 5555555	THE STATE OF THE S												
78000600	THERMOPLASTIC PAVEMENT MARKING - LINE 12"	FOOT	2706	755	1509	307	135						
					Cumulater								

B	BLA,	inc.
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	USER NAME = tnestor	DESIGNED	-	GJE	REVISED	-	2025-07-02
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nc.	PLOT SCALE = 100.0000 '/ in.	CHECKED	-	MTC	REVISED	-	
	PLOT DATE = 11/3/2825	DATE	-	09/08/2023	REVISED	_	

STATE	: OF	ILLINOIS
DEPARTMENT	OF	TRANSPORTATION

	SU	IMMARY	OF QUA	ANTIT	IES			R
		LEMO	ONT RO	AD				21
SCALE: N.T.S	SHEET 9	OF 16	SHEETS	STA.	N/A	TO STA.	N/A	<u> </u>

-		ILLINOIS   FED. AI	D PROJECT		
	CH 9	***	CONTRAC	T NO.	61J01
	2612	16-00232-00-CH	DUPAGE	248	12
	F.A.U RYE.	SECTION	COUNTY	TOTAL SHEETS	SHEET NO.

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.emport Rd/CADD_Sheats/16-88232-88-CH_sht_Summory of
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							80% (	FEDERAL FUNDING / 20		UNDING			
							1	CONSTRUC	TION CODE				TO 1 11/2 CO
		T	<b></b>	LEMONT AT 87th WIDENING	LEMONT AT 83rd WIDENING	LEMONT RD.  RESURFACING	87th ST. RESURFACING	87th ST.	83rd ST.	INTERCONNECT	STRUCTURAL	INTERSECTION  LIGHTING	ROADWAY
CODE			TOTAL.	ROADWAY 0004	ROADWAY 0004	ROADWAY 0005	ROADWAY 0005	TRAFFIC SIGNALS 0021	TRAFFIC SIGNALS 0021	TRAFFIC SIGNALS 0021	RETAINING WALL 0044	HIGHWAY LIGHTING 0021	0042
NO.	ITEM	UNIT	QUANTITY	URBAN	URBAN	URBAN	URBAN	URBAN	URBAN	URBAN	URBAN	URBAN	URBAN
# 78000650	THERMOPLASTIC PAVEMENT MARKING - LINE 24"	FOOT	440	186	191	48	15						
										***************************************			
78300200	RAISED REFLECTIVE PAVEMENT MARKER REMOVAL	EACH	10			10							
	***************************************									***************************************			
78300201	PAVEMENT MARKING REMOVAL - GRINDING	SQFT	3191	1585	878	238	490			***************************************			
78300202	PAVEMENT MARKING REMOVAL - WATER BLASTING	SQFT	240		240								
		FOOT	473	***				367	106				
# 81028200	UNDERGROUND CONDUIT, GALVANIZED STEEL 2" DIA.	FOOT	413	And the second s				30,	100				
<u></u>		FOOT	150					57	93				
# 81028220	UNDERGROUND CONDUIT, GALVANIZED STEEL. 3" DIA												
# 04020240	UNDERGROUND CONDUIT, GALVANIZED STEEL, 4" DIA.	FOOT	1969			<b>-</b>		860	483			626	Lantinovi
61028240	ONDERGROUND CONDUIT, GALVANIZED STEEL, 4 D/A										***************************************		
# 81028750	UNDERGROUND CONDUIT, COILABLE NONMETALLIC CONDUIT. 2" DIA	FOOT	1447							1447			
# 81400100	HANDHOLE	EACH	7					2	3	2			
						LUNDANASATATA							· · · · · · · · · · · · · · · · · · ·
# 81400300	DOUBLE HANDHOLE	EACH	4					2	2				
	18-2100000000000000000000000000000000000					***************************************							
# 81603000	UNIT DUCT, 600V 2-1C NO.8, 1/C NO.8 GROUND, (XLP-TYPE USE), 3/4" DIA. POLYETHY	FOOT LEN	1961									1961	
												220	
# 81603085	UNIT DUCT, 600V, 3-1C NO 4, 1/C NO 4 GROUND, (XLP-TYPE USE), 11/4" DIA POLYETH	VLEN .	230									230	Lucion
		FOOT	1330									1330	
# 81702120	ELECTRIC CABLE IN CONDUIT, 600V (XLP-TYPE USE) 1/C NO. 8												
		FOOT	1290					695				595	
# 81800320	AERIAL CABLE 3-1/C NO. 4 WITH MESSENGER WIRE					,,,,,,			<u> </u>				
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USER NAME = theater	DESIGNED	-	GJĒ	REVISED	-	2025-07-02
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PLOT SCALE = 100,0000 '/ in.	CHECKED	-	MTC	REVISED	-	
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				1	E N	AONT RO	AD						2612	16-
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SCALE:	N.T.S	SHEET	10	OF :	16	SHEETS	STA.	N/A	TØ	STA.	N/A		***	

_	CH 9		CONTRAC	T NO.	61J01
	2612	16-00232-00-CH	DUPAGE	248	13
	F.A.U RTE.	SECTION	COUNTY	TOTAL SHEETS	SHEET NO.

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					LEMONT AT ATA	LEISONE AT 03-1	LEMONTOD	974L AT	CONSTRUC				INTERSECTION	TRAINEES
					LEMONT AT 87th WIDENING	LEMONT AT 83rd WIDENING	LEMONT RD. RESURFACING	87th ST. RESURFACING	87th ST.	83rd ST	INTERCONNECT	STRUCTURAL	LIGHTING	
	0005			TOTAL	ROADWAY	ROADWAY	ROADWAY	ROADWAY	TRAFFIC SIGNALS	TRAFFIC SIGNALS	TRAFFIC SIGNALS	RETAINING WALL 0044	HIGHWAY LIGHTING 0021	ROADWAY 0042
	CODE NO.	ITEM	UNIT	TOTAL QUANTITY	0004 URBAN	0004 URBAN	0005 URBAN	0005 URBAN	0021 URBAN	0021 URBAN	0021 URBAN	URBAN	URBAN	URBAN
#			EACH	14									14	
#	82110008	LUMINAIRE LED, ROADWAY, OUTPUT DESIGNATION H	EACH	1			_						17	
	***************************************													
#	83009500	LIGHT POLE, ALUMINUM, 45 FT, M.H., 12 FT, MAST ARM	EACH	13					4				9	
	00003000	CONTROL OF THE PROPERTY OF THE												
#			EACH	4									4	
#	83057295	LIGHT POLE, WOOD, 50 FOOT, CLASS 4, WITH 15FT MAST ARM	EACG	4										*****
#	83600200	LIGHT POLE FOUNDATION, 24" DIAMETER	FOOT	90			:						90	
	OCCUPA	50011 002 00300711011, 24 077110121												
			F0011										9	
#	83800205	BREAKAWAY DEVICE: TRANSFORMER BASE: 15 INCH BOLT CIRCLE	EACH	9				<del></del>					3	
#	E4100140	REMOVAL OF TEMPORARY LIGHTING UNIT	EACH	5									5	
	84100110	REMOVAL OF TEMPORARY LIGHTING UNIT												
			+											
#	84200500	REMOVAL OF LIGHTING UNIT, SALVAGE	EACH	13		·····							13	
#	94400405	BELODATE EXICTING WOOD POLEC	EACH	1									1	
Ì	84400405	RELOCATE EXISTING WOOD POLES												
		And de .									_			
#	85000200	MAINTENANCE OF EXISTING TRAFFIC SIGNAL INSTALLATION	EACH	2					1		2			
#	07200040	COOLINDING EVICTING HANDHOLE COAME AND COVER	EACH	7					1		6			
	37300010	GROUNDING EXISTING HANDHOLE FRAME AND COVER	***************************************		-									
											50772			
#	87300925	ELECTRIC CABLE IN CONDUIT, TRACER, NO. 14 1C	FOOT	5070							5070			
"	P7204045	ELECTRIC CABLE IN CONDUIT. SIGNAL NO 14 2C	FOOT	2048					693	1355				
"	67301215	ELECTRIC CABLE IN CONDUIT. SIGNAL NO. 14 2C	***											
	<del></del>		-											
#	87301225	ELECTRIC CABLE IN CONDUIT, SIGNAL NO. 14 3C	FOOT	6698					4059	2639				
_			FOOT	6155					3132	3023				
"	87301245	ELECTRIC GABLE IN CONDUIT, SIGNAL NO. 14 SC	1				<u>.                                    </u>							
			1		****				]					



USER NAME = tnestor	DESIGNED	-	GJE	REVISED	•	2025-07-02
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 PLOT DATE = 11/3/2025	DATE	-	09/08/2023	REVISED	-	

STAT	E OI	F ILLINOIS
DEPARTMENT	OF	TRANSPORTATION

			su	MMARY	OF QU	ANTIT	IES				F.A.U RYE.	SECTION	COUNTY	SHEETS	SHEET NO.
			-		ONT RO						2612	16-00232-00-CH	DUPAGE	248	14
				FEIA1.	טת ווווע	Αυ					_ CH 9		CONTRA	CT NO.	61J01
SCALE:	N.T.S	SHEET	)!	OF 16	SHEETS	STA.	N/A	TO :	STA.	N/A "		LLINGIS FED.	AID PROJECT		

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		,			LEMONT AT 87th WIDENING	LEMONT AT 83rd WIDENING	LEMONT RD. RESURFACING	87th ST. RESURFACING	87th ST.	83rd ST.	INTERCONNECT	STRUCTURAL	INTERSECTION LIGHTING	TRAINEES
	CODE			TOTAL	ROADWAY 0004	ROADWAY 0004	ROADWAY 0005	ROADWAY 0005	TRAFFIC SIGNALS 0021	TRAFFIC SIGNALS 0021	TRAFFIC SIGNALS 0021	RETAINING WALL 0044	HIGHWAY LIGHTING 0021	ROADWAY 0042
	NO.	ITEM	UNIT	QUANTITY	URBAN	URBAN	URBAN	URBAN	URBAN	URBAN	URBAN	URBAN	URBAN	URBAN
#			FOOT	1483					485	998				
	87301255	ELECTRIC CABLE IN CONDUIT, SIGNAL NO 14 7C		····								-		
#	87301615	ELECTRIC CABLE IN CONDUIT, COMMUNICATION NO. 16 6 PAIR	FOOT	1549					735	814		4.0000		
#	87301805	ELECTRIC CABLE IN CONDUIT, SERVICE, NO. 6 2 C	FOOT	258					125	133				
44			FOOT	1400					885	611				
#	87301900	ELECTRIC CABLE IN CONDUIT, EQUIPMENT GROUNDING CONDUCTOR, NO. 6 1C	FOOT	1496				Luaimanaman	305	311				
#	87502500	TRAFFIC SIGNAL POST, GALVANIZED STEEL 16 FT	EACH	6					2	4			***	
#	87502520	TRAFFIC SIGNAL POST GALVANIZED STEEL 18 FT	EACH	1					1					
#	87702900	STEEL COMBINATION MAST ARM ASSEMBLY AND POLE 34 FT.	EACH	1					1					
#	87702910	STEEL COMBINATION MAST ARM ASSEMBLY AND POLE 36 FT.	EACH	1						1				
#	B*************************************		EACH	1	***************************************					1				
	61102900	STEEL COMBINATION MAST ARM ASSEMBLY AND POLE 46 FT												
#	87702980	STEEL COMBINATION MAST ARM ASSEMBLY AND POLE 50 FT.	EACH	1	***************************************					1				
#	87702990	STEEL COMBINATION MAST ARM ASSEMBLY AND POLE 54 FT.	EACH	2					1	1				
#	87703020	STEEL COMBINATION MAST ARM ASSEMBLY AND POLE 58 FT.	EACH	1			***************************************		1					
#		STEEL COMBINATION MAST ARM ASSEMBLY AND POLE WITH DUAL MAST ARMS, 20 FT. AND 54 FT	EACH	1					1					
#	87704319	20 F 1. AND 34 F 1												
#	87800100	CONCRETE FOUNDATION, TYPE A	FOOT	32					16	16				



	USER NAME = tnestor	DESIGNED	-	GJE	REVISED	-	2025-07-02
		DRAWN	-	GJE	REVISED	-	
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•	PLOT DATE : 11/18/2025	DATE	_	09/08/2023	REVISED	-	

STATE OF ILLINOIS
DEPARTMENT OF TRANSPORTATION

	SU	IMMARY	OF QU	ANTITIE	ES			F.A.U RTE.	SE
		LEM	ONT RO	۸D				2612	16-00
		FEIRI		AU			,	CH 9	
SCALE: N.T.S	SHEET 12	OF 16	SHEETS	STA.	N/A	TO STA.	N/A ^		

	F.A RTI		SECTION	COUNTY	TOTAL SHEETS	SHEET NO.
	26	2	16-00232-00-CH	DUPAGE	248	15
	СН	9		CONTRAC	T NO.	61J01
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								80% F	FEDERAL FUNDING / 20		JNDING			
					LEMONT AT 87th	LEMONT AT 83rd	LEMONT RD.	87th ST.	CONSTRUC				INTERSECTION	TRAINEES
					WIDENING	WIDENING	RESURFACING	RESURFACING	87th ST.	83rd ST.	INTERCONNECT	STRUCTURAL	LIGHTING	
	CODE			TOTAL	ROADWAY 0004	ROADWAY 0004	ROADWAY 0005	ROADWAY 0005	TRAFFIC SIGNALS 0021	TRAFFIC SIGNALS 0021	TRAFFIC SIGNALS 0021	RETAINING WALL 0044	HIGHWAY LIGHTING 0021	ROADWAY 0042
	NO	ITEM	UNIT	QUANTITY	URBAN	URBAN	URBAN	URBAN	URBAN	URBAN	URBAN	URBAN	URBAN	URBAN
							Name of the second seco							
#			FOOT	8					4	4				
	87800150	CONCRETE FOUNDATION, TYPE C	1001						-				- LANGER	
										····				······································
#	87800415	CONCRETE FOUNDATION, TYPE E 36-INCH DIAMETER	FOOT	90					30	60				
									, , , , , , , , , , , , , , , , , , ,					
#			FOOT	37					37					
"	87800420	CONCRETE FOUNDATION, TYPE E 42-INCH DIAMETER												
#	87900200	DRILL EXISTING HANDHOLE	EACH	7					1		6			
#			EACH	22					11	11				
"	88030020	SIGNAL HEAD, LED, 1-FACE, 3-SECTION MAST-ARM MOUNTED	CACII	22					, , ,	• • • • • • • • • • • • • • • • • • • •				
									***************************************					
#	88030050	SIGNAL HEAD, LED, 1-FACE, 3-SECTION, BRACKET MOUNTED	EACH	12					6	6				
Ì														
			EACH	5					2	3				Limenno
#	88030100	SIGNAL HEAD, LED, 1-FACE, 5-SECTION, BRACKET MOUNTED	EVO!	3					-					
#	88030110	SIGNAL HEAD, LED, 1-FACE, 5-SECTION, MAST-ARM MOUNTED	EACH	4					2	2			İ	
Ì			***************************************	·····										
}			EACU	13					4	8				
#	88102717	PEDESTRIAN SIGNAL HEAD. LED. 1-FACE BRACKET MOUNTED WITH COUNTDOWN T	ME	12					** 					
				www	,,,,,,,,,,,,,,,,,,,,,,,,,,,,,,,,,,,,,,	,								
#	88200410	TRAFFIC SIGNAL BACKPLATE, LOUVERED, FORMED PLASTIC	EACH	12					-	12				
İ														
			EACH	9					5	4				
#	88700200	LIGHT DETECTOR	LACH	ø					,	-				
#	88700300	LIGHT DETECTOR AMPLIFIER	EACH	2					1	1				
		OTTONIA CONTINUE OF THE												
}			EACH	2					1	1				
#	89000100	TEMPORARY TRAFFIC SIGNAL INSTALLATION	EACH	2						'				
•														
#	89502300	REMOVE ELECTRIC CABLE FROM CONDUIT	FOOT	27556					10183	12312	5061			
		LEED THIS GROLE (TOM, SORROLL)												
l					l				1			l		

LE NAME *	B	BLA,	Inc.
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	USER NAME = tnestor	DESIGNED	*	GJE	REVISED	~	2025-07-02
		DRAWN	-	GJE	REVISED	-	
.	PLOT SCALE = 100.0000 '/ in.	CHECKED	-	MTC	REVISED	-	
•	PLOT DATE = 11/7/2025	DATE	-	09/08/2023	REVISED	_	

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DEPARTMENT	OF	TRANSPORTATION

			SL	MM	ARY	F.A.U RTE.	SECTION	COUNTY	TOTAL					
				1		NT RO					2612	16-00232-00-CH	DUPAGE	248
				1	FINIT	NI NU	ΑU				CH 9		CONTRAC	T NO.
SCALE:												(ILLINOIS FEO. A	D PROJECT	

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								80% (	FEDERAL FUNDING / 20	0% LOCAL (COUNTY) F	UNDING			
								·	CONSTRUC	TION CODE				
					LEMONT AT 87th WIDENING	LEMONT AT 83rd WIDENING	LEMONT RD. RESURFACING	87th ST. RESURFACING	87th ST.	83rd ST.	INTERCONNECT	STRUCTURAL	INTERSECTION LIGHTING	TRAINEES
					ROADWAY	ROADWAY	ROADWAY	ROADWAY	TRAFFIC SIGNALS	TRAFFIC SIGNALS	TRAFFIC SIGNALS	RETAINING WALL	HIGHWAY LIGHTING	ROADWAY
	CODE			TOTAL	0004	0004	0005	0005	0021	0021	0021	0044	0021	0042
	NO.	ITEM	UNIT	QUANTITY	URBAN	URBAN	URBAN	URBAN	URBAN	URBAN	URBAN	URBAN	URBAN	URBAN
#			EACH	2					1	1				
	89502375	REMOVE EXISTING TRAFFIC SIGNAL EQUIPMENT		Acceptance			***************************************	***************************************	***************************************			,		
#	89502380	REMOVE EXISTING HANDHOLE	EACH	15			***************************************		9	6				
#	89502382	REMOVE EXISTING DOUBLE HANDHOLE	EACH	3					1	2				
#			EACH	18					9					
,	89502385	REMOVE EXISTING CONCRETE FOUNDATION	EACH	16					9	9				
#	A2006546	TREE QUERCUS BICOLOR (SWAMP WHITE OAK), 2" CALIPER BALLED AND BURLAPP	EACH	5	5									
	A2006516	TREE QUERCUS BICOLOR (SWAMP WHITE DAK), 2" CALIPER BALLED AND BURLAPP	<del></del>											
#	C2C0335G	SHRUB HAMMAMELIS VIRGINIANA (COMMON WITCHHAZEL), CONTAINER GROWN 5-	EACH GALLO	24	24									
							<u></u>							
#	K0029634	WEED CONTROL PRE-EMERGENT GRANULAR HERBICIDE	POUND	6	6									
#			SQ YD	19	5	5	2	7	***************************************					
,,	K0036120	MULCH PLACEMENT 4"			-	_	<del>-</del>							
#	X0324085	EMERGENCY VEHICLE PRIORITY SYSTEM LINE SENSOR CABLE, NO. 20 3/C	FOOT	3190					2281	909			-	
#	X0324599	ROD AND CLEAN EXISTING CONDUIT	FOOT	2922							2922			
						_ <b>_</b>								
	X0326806	WASHOUT BASIN	LSUM	1	0.5	0,5	<del></del>							
#	V0222600	LED INTERNALLY ILLUMINATED STREET NAME SIGN	EACH	8					4	4				
	V037108Q	ELONITEMPER (ELONINATED STREET NAME SIGN												
	X1200023	CATCH BASINS. TYPE A. 5'-DIAMETER, DUPAGE SAG FRAME AND GRATE	EACH	3	1	2								
#	X1400150	SERVICE INSTALLATION, GROUND MOUNTED, METERED	EACH	2					1	1				***************************************
									<u> </u>	***************************************	Source Control of the			

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	USER NAME = tnestor	DESIGNED	-	GJE	REVISED	~	2025-07-02
		DRAWN	-	GJE	REVISED	-	
,	PLOT SCALE = 188.8888 '/ in.	CHECKED	-	MTC	REVISED	-	
_	PLOT DATE = 11/3/2025	DATE	-	09/08/2023	REVISED	-	

STATE	E OF	ILLINOIS
DEPARTMENT	OF	TRANSPORTATION

			S	UMMARY	OF QU	ANTIT	IES		
					ONT RO				
SCALE:	N.T.S	SHEET	14	OF 16	SHEETS	STA.	N/A	TO STA.	N/A

	F.A.U RTE.	SECTION	COUNTY	TOTAL SHEETS	SHEET NO.
	2612	16-00232-00-CH	DUPAGE	248	17
	CH 9		CONTRAC	T NO.	61J01
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					80% FEDERAL FUNDING / 20% LOCAL (COUNTY) FUNDING									
									CONSTRUC	TION CODE			,	
					LEMONT AT 87th WIDENING	LEMONT AT 83rd WIDENING	LEMONT RD RESURFACING	87th ST. RESURFACING	87th ST.	83rd ST.	INTERCONNECT	STRUCTURAL	INTERSECTION LIGHTING	TRAINEES
					ROADWAY	ROADWAY	ROADWAY	ROADWAY	TRAFFIC SIGNALS	TRAFFIC SIGNALS	TRAFFIC SIGNALS	RETAINING WALL	HIGHWAY LIGHTING	ROADWAY
	CODE			TOTAL	0004	0004	0005	0005	0021	0021	0021	0044	0021	0042
<u> </u>	NO.	ITEM	UNIT	QUANTITY	URBAN	URBAN	URBAN	URBAN	URBAN	URBAN	URBAN	URBAN	URBAN	URBAN
# X1.	1400215	REMOTE CONTROLLED VIDEO SYSTEM	EACH	2					1	1		WWW. W. W. W. W. W. W. W. W. W. W. W. W.		
_		THE STREET STREE												······································
# X1	1400216	LAYER II (DATALINK) SWITCH	EACH	1					1					
# X1	1400378	PEDESTRIAN SIGNAL POST, 5 FT.	EACH	1					1					
# 1			FOOT	1523				789	734					
X1.	1400424	ELECTRIC CABLE IN CONDUIT STREET NAME SIGN, NO. 143C TYPE SOOW												
# X1	1400460	LAYER III (NETWORK) SWITCH	EACH	1						1				v-
Х2	2130010	EXPLORATION TRENCH (SPECIAL)	FOOT	150	75	75								
		9994119444111			***************************************							***************************************		
# X2	2501820	SEEDING CLASS 5 (MODIFIED)	ACRE	0 02	0.02							***************************************		
_			ACRE	0.02	0.02		. ,				······································			
# X2	2502014	SEEDING CLASS 4A (MODIFIED)												
# X2!	2511630	EROSION CONTROL BLANKET (SPECIAL)	SQYD	1113	1113									
				***************************************				***************************************						
X28	2800304	BEST MANAGEMENT PRACTICES DITCH CHECK	EACH	50	50									
_														***************************************
X40	4021000	TEMPORARY ACCESS (PRIVATE ENTRANCE)	EACH	14	11	1		2						
			EACH	10	3	7								
X40	4022000	TEMPORARY ACCESS (COMMERCIAL ENTRANCE)	2.211		· •									
X40	4024100	TEMPORARY ACCESS (WINTERIZE)	SQYD	24	14	8		2						
X41	4060995	TEMPORARY RAMP (SPECIAL)	SQ YD	260	129	105	26							

1	B	BLA,	Inc.	
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	USER NAME = thestor	DESIGNED	-	GJE	REVISED	-	2025-07-02
		DRAWN	-	GJE	REVISED	-	
.	PLOT SCALE = 100.0000 '/ in.	CHECKED	-	MTC	REVISED	~	
	PLGT DATE : 11/3/2025	DATE	~	09/08/2023	REVISED	-	

STATE	OF	ILLINOIS
DEPARTMENT O	)F 7	RANSPORTATION

	S		OF QUANTIT	TIES		
SCALE: N.T.S	SHEET 15	OF 16	SHEETS STA.	N/A	TO STA.	N/A

 CD 3	HLLINOIS FED. AT		. 110.	0.001
CH 9		CONTRAC	T NO.	61.101
2612	16-00232-00-CH	DUPAGE	248	18
F.A.U RTE.	SECTION .	COUNTY	TOTAL SHEETS	SHEET NO.

Quantities.REV.cgr
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Rd\CnDD_Sheqta\16-88232-88-CH_sht_Summery
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				80% FEDERAL FUNDING / 20% LOCAL (COUNTY) FUNDING  CONSTRUCTION CODE									
				LEMONT AT 87th WIDENING	LEMONT AT 83rd WIDENING	LEMONT RD.	87lh ST. RESURFACING	87th ST.	83rd ST.	INTERCONNECT	STRUCTURAL	INTERSECTION LIGHTING	TRAINEES
CODE NO.	(ТЕМ	UNIT	TOTAL QUANTITY	ROADWAY 0004 URBAN	ROADWAY 0004 URBAN	ROADWAY 0005 URBAN	ROADWAY 0005 URBAN	TRAFFIC SIGNALS 0021 URBAN	TRAFFIC SIGNALS 0021 URBAN	TRAFFIC SIGNALS 0021 URBAN	RETAINING WALL 0044 URBAN	HIGHWAY LIGHTING 0021 URBAN	ROADWAY 0042 URBAN
		SQFT	41	41									
X5220096	TIMBER RETAINING WALL	GGTT	7'	41									
X5427602	REMOVE EXISTING FLARED END SECTION	EACH	11	11		-							
X5509900	ABANDON AND FILL EXISTING STORM SEWER	FOOT	170	29		141							
X6030310	FRAMES AND LIDS TO BE ADJUSTED (SPECIAL)	EACH	25	7	13	5							
X6060300	CONCRETE MEDIAN, TYPE SB-6.24 (SPECIAL)	SOFT	1434	1434									
X6640104	FENCE REMOVAL	FOOT	191	191									
X6700407	ENGINEER'S FIELD OFFICE, TYPE A (D1)	CAL MO	18	9	9								
X7010216	TRAFFIC CONTROL AND PROTECTION (SPECIAL)	LSUM	1	0.25	0 25	0.25	0.25						
X7200061	TEMPORARY INFORMATION SIGNING	SQFT	576	166	220	96	94						
X7810300	RECESSED REFLECTIVE PAVEMENT MARKER	EACH	1008	210	205	207	386						
X8000003	MAINTENANCE OF LIGHTING SYSTEM	CALMO	12									12	
X8211008	TEMPORARY LUMINAIRE, LED. ROADWAY, OUTPUT DESIGNATION H	EACH	8					4				4	
X8250091	COMBINATION LIGHTING CONTROLLER	EACH	1									1	
X8250500	LIGHTING UNIT COMPLETE (SPECIAL)	EACH	1		PARTICLE				MINIOTONIA LA CONTRACTOR LA CONTRACTOR LA CONTRACTOR LA CONTRACTOR LA CONTRACTOR LA CONTRACTOR LA CONTRACTOR L			1	-
·····									***************************************				

	${f B}$	BLA,	inc.
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USER NAME = tnestor	DESIGNED	-	GJE	REVISED	-	2025-07-02
	DRAWN	-	GJE	REVISED	-	
PLOT SCALE = 188,8888 17 in.	CHECKED	-	MTC	REVISED	-	
PLOT DATE = 11/3/2025	DATE	-	09/08/2023	REVISED	-	

STATE	OF	ILLINOIS
DEPARTMENT	OF 1	TRANSPORTATION

SUMMARY OF QUANTITIES											
LEMONT ROAD											
 SCALE: N.T.S	SHEET	16	OF 16	SHEETS	STA.	N/A	TO	STA,	N/A	CH 9	

 F.A.U RYE.	SECTION	COUNTY	TOTAL	SHEET NO.
2612	16-00232-00-CH	DUPAGE	248	19
 CH 9		CONTRAC	NO.	51J0)
	(ILLINOIS) FED. AL	O PROJECT		

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				80% FEDERAL FUNDING / 20% LOCAL (COUNTY) FUNDING  CONSTRUCTION CODE									
				LEMONT AT 87th WIDENING	LEMONT AT 83rd WIDENING	LEMONT RD. RESURFACING	87th ST. RESURFACING	87th ST.	83rd ST.	INTERCONNECT	STRUCTURAL	INTERSECTION LIGHTING	TRAINEES
2005				ROADWAY	ROADWAY	ROADWAY	ROADWAY	TRAFFIC SIGNALS	TRAFFIC SIGNALS	TRAFFIC SIGNALS	RETAINING WALL	HIGHWAY LIGHTING	ROADWAY
CODE NO.	Į ITEM	UNIT	TOTAL QUANTITY	0004 URBAN	0004 URBAN	0005 URBAN	0005 URBAN	0021 URBAN	0021 URBAN	0021 URBAN	0044 URBAN	0021 URBAN	0042 URBAN
													***************************************
									<u> </u>				
X8301042	MAST ARM, ALUMINUM, 12 FT	EACH	1									1	
¥		EACH	2		***************************************	***************************************		1	1		-		*****
X8570226	FULL-ACTUATED CONTROLLER AND TYPE IV CABINET (SPECIAL)												
									***************************************				
* _X8620200	UNINTERRUPTABLE POWER SUPPLY (SPECIAL)	EACH	2					1	1				
									-				
,		FOOT	5070						nt .	5070			
X8710024	FIBER OPTIC CABLE IN CONDUIT, NO. 62.5/125, MM12F, SM24F								<u> </u>	33.0			
·····													
X8760200	ACCESSIBLE PEDESTRIAN SIGNALS	EACH	12					4	8			!	
		FOOT	4					4					
X8780012	CONCRETE FOUNDATION TYPE A 12-INCH DIAMETER							4					
Yeennin	TRAFFIC SIGNAL BACKPLATE SPECIAL	EACH	13					13			***************************************		
X3020010	THE TO STORE DAVID BY E. ST. ESTAL		***************************************										
						***************************************	-						
X8900104	TEMPORARY TRAFFIC SIGNAL TIMING	EACH	2					1	1				
									**************************************				
Y8050077		EACH	1									1	
X8950077	REMOVE AND RELOCATE EXISTING LIGHTING CONTROLLER								-				
					]								
Z0013797	STABILIZED CONSTRUCTION ENTRANCE	SQYD	480	240	240			**	***************************************				
									REPORTED TO THE PARTY OF THE PA				
		L SUM	1	0.25	0.25	0.25	0.25						
Z0013798	CONSTRUCTION LAYOUT							-					
Z0018501	DRAINAGE STRUCTURES TO BE CLEANED (SPECIAL)	EACH	40	10	10	10	10		**************************************				
								-					
#		EACH	14									14	
Z0033020	LUMINAIRE SAFETY CABLE ASSEMBLY								Average Averag				
	THE PROPERTY WAS A STATE OF THE PROPERTY AND A STATE OF TH						a de la constanta de la consta	1	94444444444444444444444444444444444444				
# Z0033044	RE-OPTIMIZE TRAFFIC SIGNAL SYSTEM LEVEL 1	EACH	7				Account		-	7			
<u> </u>	1								1		<u> </u>	<u>.</u>	



	USER NAME = tnestor	DESIGNED	-	GJE	REVISED	-	2025-07-02
		DRAWN	-	GJE	REVISED	-	
C.	PLOT SCALE = 100.0000 1/ in.	CHECKED	-	MTC	REVISED	-	
	PLOT DATE = 11/3/2025	DATE	-	09/08/2023	REVISED	-	

STATE (	OF ILLINOIS
DEPARTMENT OF	TRANSPORTATION

SUMMARY OF QUANTITIES											F.A.U RTE.	SECTION	COUNTY	TOTAL	SHEET NO.	
LEMONT ROAD												16-00232-00-CH	DUPAGE	248	20	
LEWOUT ROAD													CONTRACT NO. 61		61J01	
SCALE:	N.T.S	SHEET	16	CF	16	SHEETS	STA,	N/A	TO STA,	N/A	ILLINOIS FED. AND PROJECT					

					1		F	1	1	1	<del></del>	r	
		•		LEMONT AT 87th WIDENING	LEMONT AT 83rd WIDENING	LEMONT RD. RESURFACING	87th ST RESURFACING	87th ST.	83rd ST.	INTERCONNECT	STRUCTURAL	INTERSECTION LIGHTING	TRAINEES
				ROADWAY	ROADWAY	ROADWAY	ROADWAY	TRAFFIC SIGNALS	TRAFFIC SIGNALS	TRAFFIC SIGNALS	RETAINING WALL	HIGHWAY LIGHTING	ROADWAY
CODE			TOTAL	0004	0004	0005	0005	0021	0021	0021	0044	0021	0042
NO.	ITEM	UNIT	QUANTITY	URBAN	URBAN	URBAN	URBAN	URBAN	URBAN	URBAN	URBAN	URBAN	URBAN
20056608	STORM SEWER (WATER MAIN REQUIREMENTS) 12 INCH	F00T	679	526	79	74						***************************************	
													······································
70055610	CTODIA SEMED MAIATED MAIA DEGLEDERACATO 45 INCL.	FOOT	8	8									***************************************
20036610	STORM SEWER (WATER MAIN REQUIREMENTS) 15 INCH												
		FOOT	98	98			4		·····	, ,		<u> </u>	
Z0056612	STORM SEWER (WATER MAIN REQUIREMENTS) 18 INCH												
		FOOT	255	055									
Z0056616	STORM SEWER (WATER MAIN REQUIREMENTS) 24 INCH	FOOT	255	255				-				***************************************	
						*****			• •				
Z0062456	TEMPORARY PAVEMENT	SQYD	298	298						•			
20076600	TRAINEES	HOUR	1500										1500
Z0076604	TRAINEES TRAINING PROGRAM GRADUATE	HOUR	1500										1500
					····		***************************************						
XX000503	SPLIT RAIL FENCE	FOOT	267	267									
70700000	OI 11 11 11 11 11 11 11 11 11 11 11 11 11				111	**************************************			·····		***************************************		<u> </u>
UV6555		EACH	20	10	10						***************************************		
XX003338	TEST HOLE				****								
	11000000000	FOOT	491					404	200				
XX008392	OUTDOOR RATED NETWORK CABLE	FOOT	<b>→</b> 31				:	191	300				
XX009046	VEHICLE DETECTION SYSTEM (SPECIAL)	EACH	2					1	1				

80% FEDERAL FUNDING / 20% LOCAL (COUNTY) FUNDING
CONSTRUCTION CODE


# SPECIALTY ITÉM


B BLA, Inc.

	USER NAME = tnestor	DESIGNED	-	GJE	REVISED	-	2025-07-02
		DRAWN	-	GJE	REVISED	-	
į	PLOT SCALE = 188,8888 '/ in.	CHECKED	-	мTC	REVISED	-	
	PLOT DATE = 11/3/2025	DATE	-	09/08/2023	REVISED	_	


STATE OF ILLINOIS
DEPARTMENT OF TRANSPORTATION

		SUMMARY	OF QU	F.A.U RTE.	SECTION	COUNTY	TOTAL SHEETS	SHEET NO.	
		LENA	ONT RO	2612	16-00232-00-CH	DUPAGE	248	21	
	,	LL IY	ONI NO	 TO STA.	CH 9		CONTRAC	T NO. (	61J01
SCALE:	SHEET	OF	SHEETS	ILLINOIS FED. AND PROJECT					

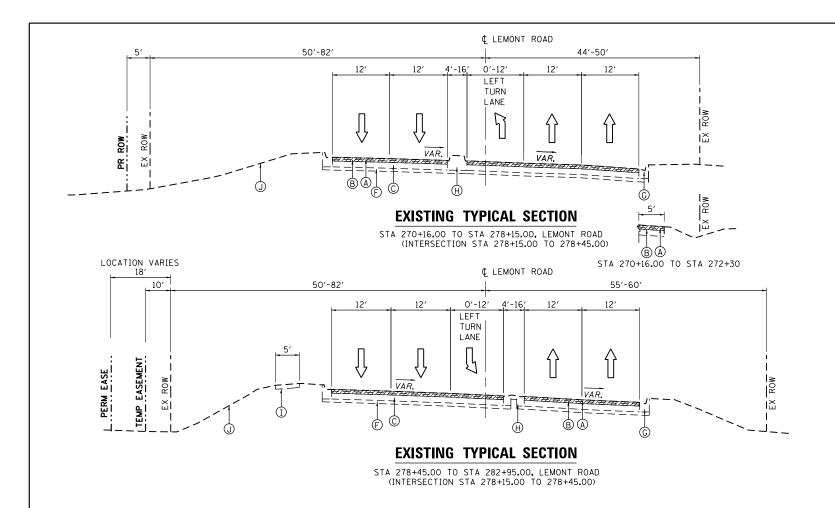

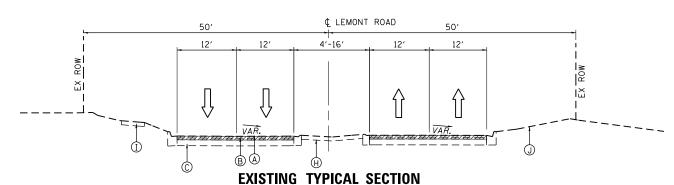


STA 282+95.00 TO STA 300+46.00, LEMONT ROAD

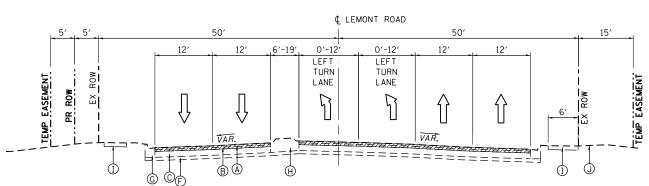


### **EXISTING TYPICAL SECTION**

STA 300+46.00 TO STA 305+03.43, LEMONT ROAD (INTERSECTION STA 305+03.43 TO 305+60.00) (STATION EQUATION: 302+66.36 BACKWARD = 302+89.14 FORWARD)


# BLA, Inc.

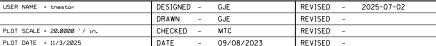

## STATE OF ILLINOIS DEPARTMENT OF TRANSPORTATION

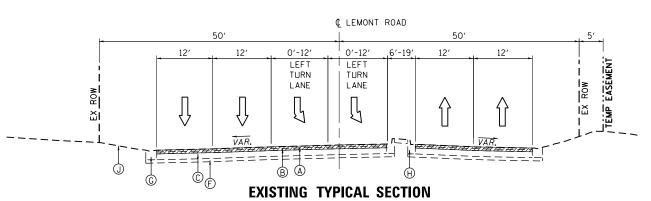

STA 305+60.00 TO STA 307+48.24, LEMONT ROAD STA 308+79.12 TO STA 311+40.00, LEMONT ROAD

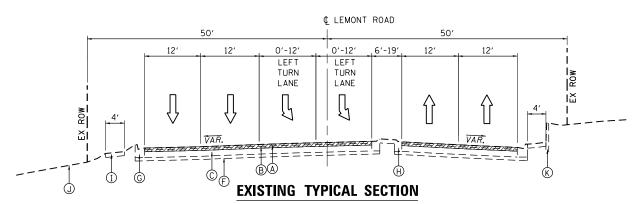


STA 307+48.24 TO STA 308+79.12, LEMONT ROAD

### **EXISTING LEGEND**

- (A) HOT-MIX ASPHALT SURFACE COURSE, 1.5"
- B) HOT-MIX ASPHALT BINDER COURSE, 2"
- C PCC BASE COURSE, 9"
- D) HOT-MIX ASPHALT BASE COURSE, 9"
- (E) AGGREGATE BASE COURSE, 12"
- F) SUBBASE GRANULAR MATERIAL, TYPE B, 4"
- (G) COMB. CONCRETE CURB & GUTTER, TY B-6.18
- H) CONCRETE MEDIAN, TYPE SB-6.12 OR
  COMB. CONCRETE CURB & GUTTER, TY M-6.18 & HMA MEDIAN SURFACE
- I P.C.C. SIDEWALK
- J) TOPSOIL, 6" AND VARIES
- (K) RETAINING WALL
- AGGREGATE SHOULDER
- M SHARED-USE PATH




HOT-MIX ASPHALT SURFACE REMOVAL, 3.5"

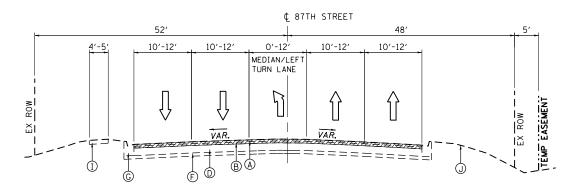


### **EXISTING TYPICAL SECTION**

STA 78+56.00 TO STA 100+00.00, 87TH STREET STA 10+00.00 TO STA 13+80.25, 87TH STREET (STATION EQUATION: 100+00 BACKWARD = 10+00 FORWARD)

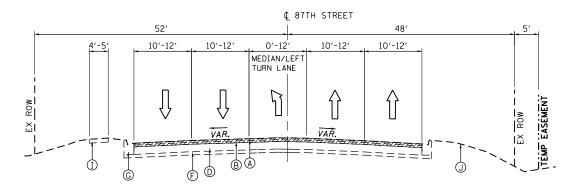


### **EXISTING TYPICAL SECTION**

STA 13+80.25 TO STA 17+20.00, 87TH STREET STA 18+75.00 TO STA 20+24.66, 87TH STREET (INTERSECTION STA 20+24.66 TO 21+01.00)

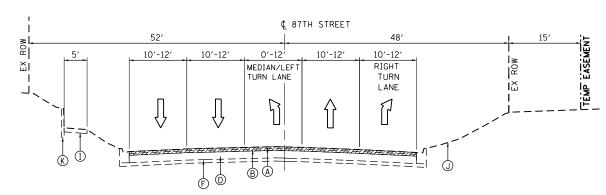


### **EXISTING TYPICAL SECTION**

STA 17+20.00 TO STA 18+75.00, 87TH STREET

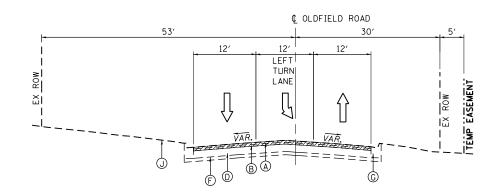

### **EXISTING TYPICAL SECTION**

STA 21+01.00 TO STA 22+59.47, OLDFIELD ROAD

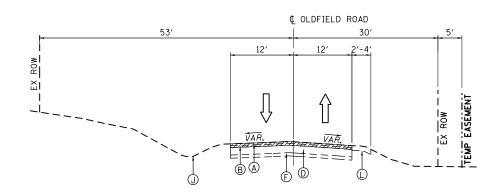

### **EXISTING TYPICAL SECTION**

STA 22+59.47 TO STA 24+24.00, OLDFIELD ROAD

### **EXISTING LEGEND**

- (A) HOT-MIX ASPHALT SURFACE COURSE, 1.5"
- B) HOT-MIX ASPHALT BINDER COURSE, 2"
- C PCC BASE COURSE, 9"
- D HOT-MIX ASPHALT BASE COURSE, 9"
- E AGGREGATE BASE COURSE, 12"
- F SUBBASE GRANULAR MATERIAL, TYPE B, 4"
- G COMB. CONCRETE CURB & GUTTER, TY B-6.18
- (H) CONCRETE MEDIAN, TYPE SB-6.12 OR COMB. CONCRETE CURB & GUTTER, TY M-6.18 & HMA MEDIAN SURFACE
- I P.C.C. SIDEWALK
- J TOPSOIL, 6" AND VARIES
- (K) RETAINING WALL
- (L) AGGREGATE SHOULDER
- M) SHARED-USE PATH



HOT-MIX ASPHALT SURFACE REMOVAL, 3.5"



USER NAME = tnestor	DESIGNED	-	GJE	REVISED	-	2025-07-02
	DRAWN	-	GJE	REVISED	-	
PLOT SCALE = 20.0000 '/ in.	CHECKED	-	MTC	REVISED	-	
PLOT DATE = 11/3/2025	DATE	-	09/08/2023	REVISED	-	


COUNTY

DUPAGE 248 23

CONTRACT NO. 61J01

EXISTING TYPICAL SECTION

STA 16+00.00 TO STA 21+63.52, 83RD STREET (INTERSECTION STA 21+63.52 TO 22+38.52)

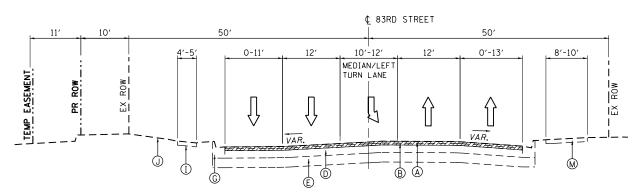

### **EXISTING TYPICAL SECTION**

STA 22+38.52 TO STA 27+85.00, 83RD STREET

### **EXISTING LEGEND**

- A HOT-MIX ASPHALT SURFACE COURSE, 1.5"
- B HOT-MIX ASPHALT BINDER COURSE, 2"
- C PCC BASE COURSE, 9"
- D HOT-MIX ASPHALT BASE COURSE, 9"
- E AGGREGATE BASE COURSE, 12"
- (F) SUBBASE GRANULAR MATERIAL, TYPE B, 4"
- G COMB. CONCRETE CURB & GUTTER, TY B-6.18
- CONCRETE MEDIAN, TYPE SB-6.12 OR COMB. CONCRETE CURB & GUTTER, TY M-6.18 & HMA MEDIAN SURFACE
- I P.C.C. SIDEWALK
- J TOPSOIL, 6" AND VARIES
- (K) RETAINING WALL
- L AGGREGATE SHOULDER
- M SHARED-USE PATH





HOT-MIX ASPHALT SURFACE REMOVAL, 3.5"

USER NAME = tnestor	DESIGNED	-	GJE	REVISED	-	2025-07-02
	DRAWN	-	GJE	REVISED	-	
PLOT SCALE = 20.0000 '/ in.	CHECKED	-	MTC	REVISED	-	
PLOT DATE = 11/3/2025	DATE	-	09/08/2023	REVISED	-	

STATE	OF ILLINOIS	
DEPARTMENT	OF TRANSPORTATION	N

			EXIS	STINO	G T	YPICAL	SECTIO	ONS			F.A.U RTE.	SECTION	COUNTY	TOTAL SHEETS	
				,	83 <b>B</b> I	) STRF	FT				2612	16-00232-00-CH	DUPAGE	248	24
	83RD STREET												CONTRAC	T NO.	61J01
SCALE:	NTS	SHEET	3	OF	6	SHEETS	STA.	N/A	TO STA.	N/A		ILLINOIS FED. A	ID PROJECT		

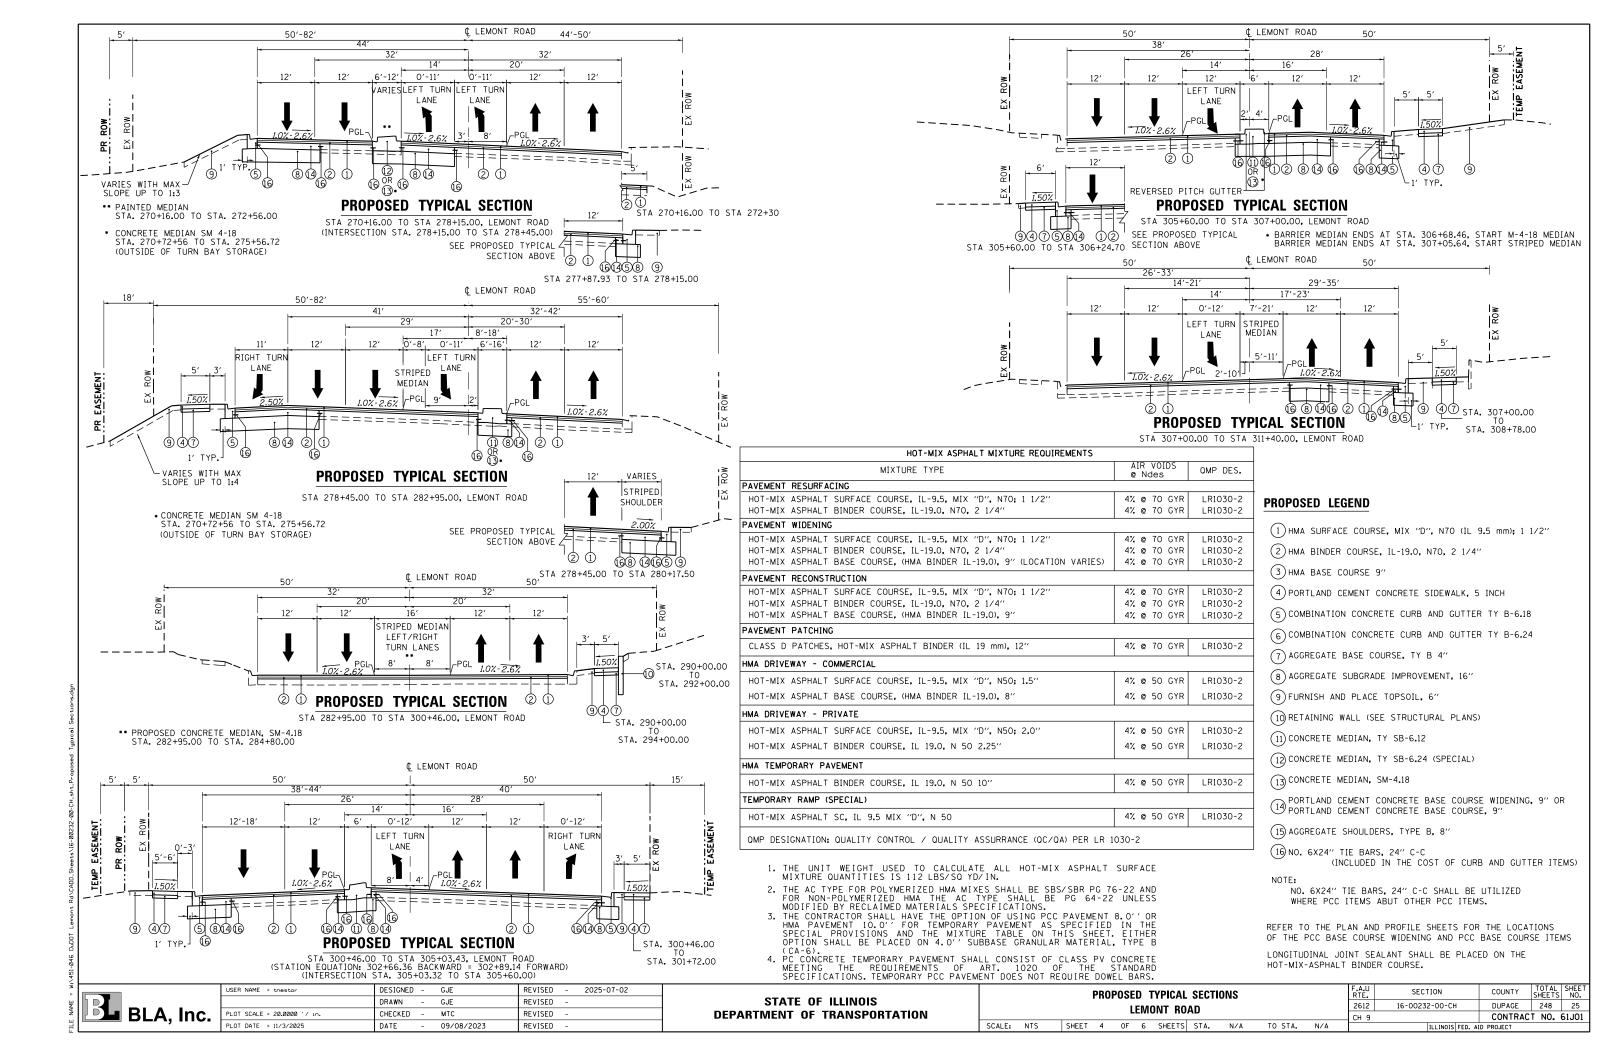


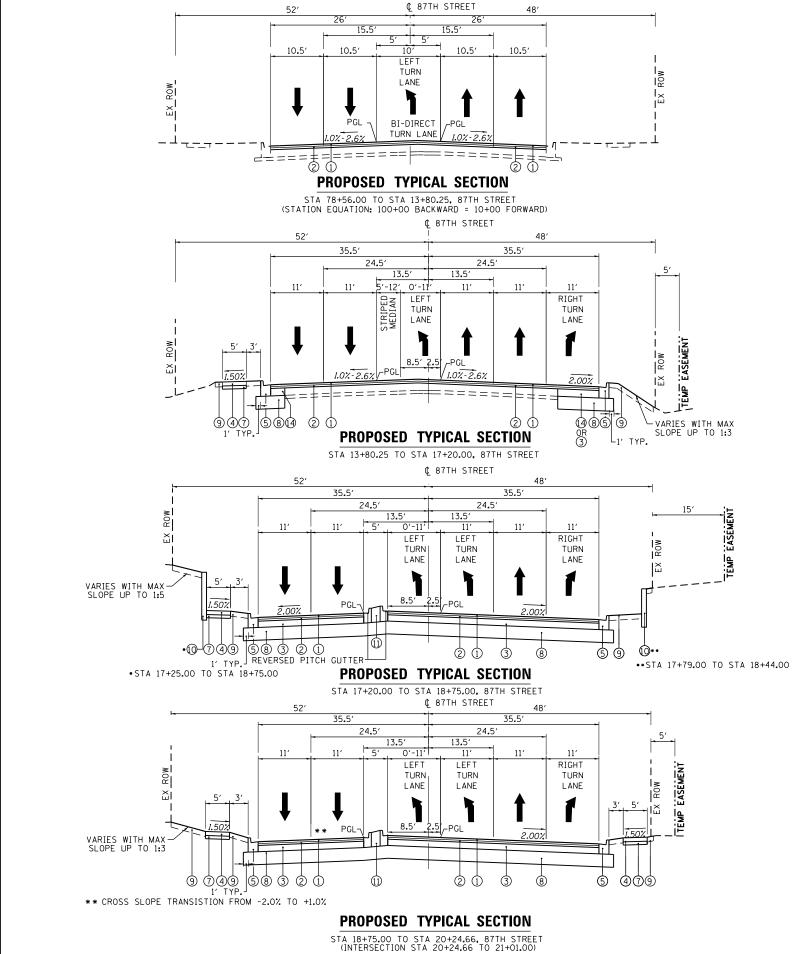

# \$\text{\$\text{COLDFIELD ROAD}}\$ \$\text{\$\text{30'}}\$ \$\text{\$\text{\$\text{12'}}\$} \text{\$\text{\$\text{\$\text{6'-9.5'}}\$}}\$ \$\text{\$\tex

### PROPOSED TYPICAL SECTION

STA 21+01.00 TO STA 21+58.00, OLDFIELD ROAD

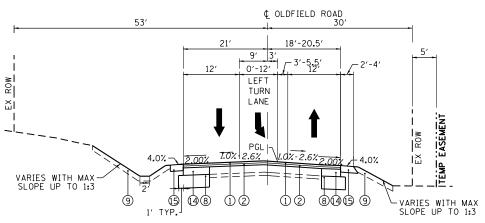

SCALE: NTS SHEET 5

### PROPOSED TYPICAL SECTION

STA 21+58.00 TO STA 24+24.00, OLDFIELD ROAD

### PROPOSED LEGEND


- (1) HMA SURFACE COURSE, MIX "D", N70 (IL 9.5 mm); 1 1/2"
- 2 HMA BINDER COURSE, IL-19.0, N70, 2 1/4"
- (3) HMA BASE COURSE 9"
- 4) PORTLAND CEMENT CONCRETE SIDEWALK, 5 INCH
- (5) COMBINATION CONCRETE CURB AND GUTTER TY B-6.18
- (6) COMBINATION CONCRETE CURB AND GUTTER TY B-6.24
- 7) AGGREGATE BASE COURSE, TY B 4"
- (8) AGGREGATE SUBGRADE IMPROVEMENT, 16"
- 9 FURNISH AND PLACE TOPSOIL, 6"
- 10 RETAINING WALL (SEE STRUCTURAL PLANS)
- 11) CONCRETE MEDIAN, TY SB-6.12
- (12) CONCRETE MEDIAN, TY SB-6.24 (SPECIAL)
- (13) CONCRETE MEDIAN, SM-4.18
- PORTLAND CEMENT CONCRETE BASE COURSE WIDENING, 9" OR PORTLAND CEMENT CONCRETE BASE COURSE, 9
- (15) AGGREGATE SHOULDERS, TYPE B, 8"
- (16) NO. 6X24" TIE BARS, 24" C-C (INCLUDED IN THE COST OF CURB AND GUTTER ITEMS)


LONGITUDINAL JOINT SEALANT SHALL BE PLACED ON THE HOT-MIX-ASPHALT BINDER COURSE PRIOR TO THE PLACEMENT OF THE HOT-MIX ASPHALT SURFACE COURSE




USER NAME = tnestor	DESIGNED	-	GJE	REVISED	-	2025-07-02
	DRAWN	-	GJE	REVISED	-	
PLOT SCALE = 20.0000 ' / in.	CHECKED	-	MTC	REVISED	-	
PLOT DATE = 11/3/2025	DATE	-	09/08/2023	REVISED	-	

	PROPOSED TYPICAL SECTIONS								F.A.U RTE.	SECTION	COUNTY	TOTAL SHEETS	SHEET NO.
	87TH	т у	RFF	T/OLDFII	FID R	nλn			2612	16-00232-00-CH	DUPAGE	248	26
	0/111		IILL	/OLDI II	LLD III	שאט			CH 9		CONTRAC	T NO.	61J01
Т	5	OF	6	SHEETS	STA.	N/A	TO STA.	N/A		TILLINOIS FED. A	D PROJECT		

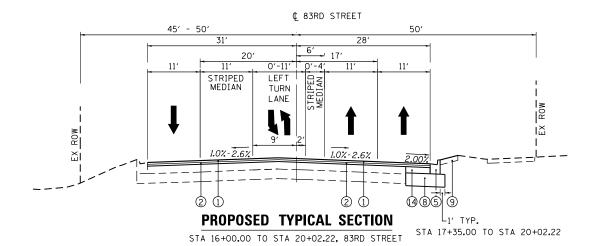

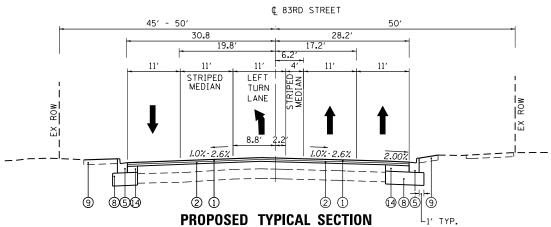


STA 20+02.22 TO STA 21+63.52, 83RD STREET (INTERSECTION STA 21+63.52 TO 22+38.52)

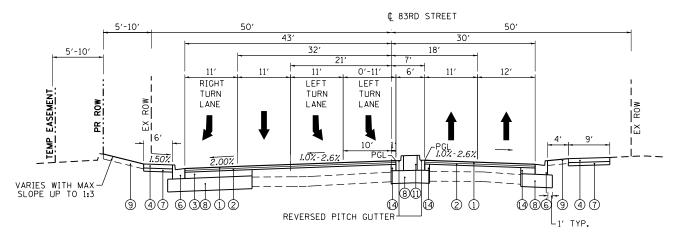

### PROPOSED TYPICAL SECTION

STA 22+38.52 TO STA 23+82.54, 83RD STREET

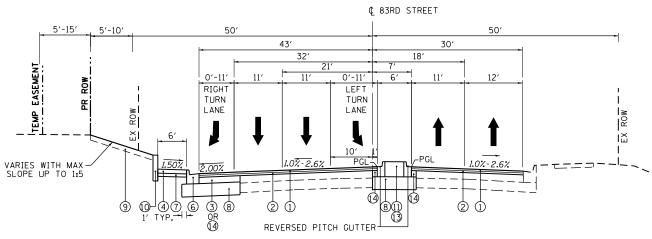

### PROPOSED TYPICAL SECTION

STA 23+82.54 TO STA 27+85.00, 83RD STREET

### PROPOSED LEGEND

- 1) HMA SURFACE COURSE, MIX "D", N70 (IL 9.5 mm); 1 1/2"
- (2) HMA BINDER COURSE, IL-19.0, N70, 2 1/4"
- (3) HMA BASE COURSE 9"
- 4) PORTLAND CEMENT CONCRETE SIDEWALK, 5 INCH
- (5) COMBINATION CONCRETE CURB AND GUTTER TY B-6.18
- (6) COMBINATION CONCRETE CURB AND GUTTER TY B-6.24
- 7) AGGREGATE BASE COURSE, TY B 4"
- 8) AGGREGATE SUBGRADE IMPROVEMENT, 16"
- 9) FURNISH AND PLACE TOPSOIL, 6"
- 10 RETAINING WALL (SEE STRUCTURAL PLANS)
- (11) CONCRETE MEDIAN, TY SB-6.12
- (12) CONCRETE MEDIAN, TY SB-6.24 (SPECIAL)
- (13) CONCRETE MEDIAN, SM-4.18
- $\ensuremath{ \bigcirc 19}$  Portland cement concrete base course widening, 9" or portland cement concrete base course, 9
- 15) AGGREGATE SHOULDERS, TYPE B, 8"
- (16) NO. 6X24" TIE BARS, 24" C-C (INCLUDED IN THE COST OF CURB AND GUTTER ITEMS)

NO. 6X24" TIE BARS, 24" C-C SHALL BE UTILIZED WHERE PCC ITEMS ABUT OTHER PCC ITEMS.

LONGITUDINAL JOINT SEALANT SHALL BE PLACED ON THE HOT-MIX-ASPHALT BINDER COURSE PRIOR TO THE PLACEMENT OF THE HOT-MIX ASPHALT SURFACE COURSE



USER NAME = thestor	DESIGNED	-	GJE	KENIZED	-	2025-07-02
	DRAWN	-	GJE	REVISED	-	
PLOT SCALE = 20.0000 '/ in.	CHECKED	-	MTC	REVISED	-	
PLOT DATE = 11/3/2025	DATE	-	09/08/2023	REVISED	-	

TE	MPORARY FE	NCE
87TH STREET V	VIDENING	
STATION	OFFSET	QUANTITY
STATION	OFFSEI	(EA)
271+43.69	50.95' LT	20
271+86.97	51.37' LT	20
271+96.78	50.00' LT	20
272+14.48	50.41' LT	20
272+27.81	47.24' LT	20
272+28.97	50.00' LT	20
272+64.92	54.33' LT	20
•	SUBTOTAL:	140
83RD STREET V	WIDENING	
17+35.00	32.34' RT	20
17+76.50	30.31' RT	20
18+24.38	31.29' RT	20
19+95.50	32.61' RT	20
20+35.78	34.03' RT	20
23+36.50	48.95' RT	20
	SUBTOTAL:	120
PAY CODI	E 20101000	260

				LANDSCAPING								
STATION	STATION	TOPSOIL FURNISH & PLACE, 6" (21101625) (SQ YD)	SODDING (25200100) (SQ YD)	SODDING, SALT TOLERANT (25200110) (SQ YD)	SEEDING, CLASS 2A (25000210) (ACRE)	SEEDING, CLASS 4A (MODIFIED) (X2502014) (ACRE)	SEEDING, CLASS 5 (MODIFIED) (X2501820) (ACRE)					
87TH STREET W	/IDENING											
270+16	276+00	969	0	0	0.20	0	0					
276+00	282+00	1,759	1,162	564	0.01	0.00	0.00					
282+00	282+95	160	141	20	0	0	0					
13+80.25	19+50	1,493	714	600	0	0	0					
21+50	24+24	969	446	523	0	0.01	0.01					
	SUBTOTAL:	5,351	2,462	1,706	0.21	0.02	0.02					
83RD STREET V	3RD STREET WIDENING											
300+68	306+25	504	279	225	0	0	0					
306+25	311+40	354	202	152	0	0	0					
16+00	21+00	472	0	472	0	0	0					
23+00	27+85	461	324	138	0	0	0					
	SUBTOTAL:	1,792	805	987	0	0	0					
LEMONT ROAD	RESURFACING											
282+95	288+00	21	0	21	0	0	0					
288+00	294+00	595	336	259	0	0	0					
294+00	300+00	116	0	116	0	0	0					
300+00	300+68	3	0	3	0	0	0					
AS DIRECTED	BY ENGINEER	25	25	25	0	0	0					
	SUBTOTAL:	760	361	424	0	0	0					
87TH STREET R	ESURFACING											
78+56	83+00	0	0	0	0	0	0					
83+00	88+00	45	0	45	0	0	0					
88+00	93+00	0	0	0	0	0	0					
93+00	98+00	0	0	0	0	0	0					
98+00	13+80.25	51	0	51	0	0	0					
AS DIRECTED	BY ENGINEER	25	25	25	5 0 0		0					
	SUBTOTAL:	121	25	121	0	0	0					
	TOTAL:	8,024	3,653	3,238	0.21	0.02	0.02					

STONE RIPRAP, CLASS A3					
87TH STREET	WIDENING				
STATION	OFFSET	QUANTITY			
STATION	OFFSEI	(SQ YD)			
270+48.15	38.39' LT	16			
272+30.57	45.36' RT	16			
15+18	59.0' RT	18			
22+00	29.0' RT	9			
PAY COD	E 28100105	59			

AGGREGATE SHOULDERS, TYPE B 8"					
STATION	STATION	OFFSET	QUANTITY		
STATION	STATION	(LT / RT)	(SQ YD)		
7TH STREET W	/IDENING				
270+16	270+68	LT	10		
21+56	24+24	RT	91		
22+65	23+02	LT	8		
23+33	23+79	LT	10		
24+10	24+24	LT	3		
P/	Y CODE 481016	00	122		

TREER	EMOVAL (6 TO DIAMETER)	O 15 UNIT
87TH STREET V	WIDENING '	
STATION	OFFSET	QUANTITY
STATION	OFFSEI	(UNIT)
272+28	47.29 LT	6
	SUBTOTAL:	6
83RD STREET	WIDENING	
17+76	29.72 RT	10
18+24	30.97 RT	10
19+95	32.94 RT	6
20+37	33.69 RT	6
20+48	33.46 RT	6
20+75	32.89 RT	5
23+30	52.53 LT	6
24+58	56.21LT	6
24+63	53.74 LT	8
24+72	56.37 LT	12
24+89	51.42 LT	8
24+90	51.42 LT	13
25+14	54.25 LT	6
•	SUBTOTAL:	102
PAY COD	E 20100110	108

SCALE: N.T.S.

TREE RE	MOVAL (OVE DIAMETER)	R 15 UNIT
TH STREET V	VIDENING	
STATION	OFFSET	QUANTITY
STATION	OFFSEI	(UNIT)
3RD STREET V	VIDENING	
24+73	48.38 LT	17
•	SUBTOTAL:	17
PAY CODE	E 20100210	17

	TEMPORARY WIDENING	Di i Oi i Oi i Loi	
			QUANTITY
STAGE	STATION	OFFSET	(FT)
1	271+11.34	41.65' LT	10
1	271+38.94	44.47' RT	10
1	271+84.10	42.80' LT	10
1	272+28.43	42.80' LT	10
1	272+68.82	42.64' LT	10
1	273+33.60	45.72' LT	10
1	274+28.70	47.21' LT	10
1	274+60.50	48.95' LT	10
1	280+29.28	81.69' LT	10
1	280+91.19	65.56' LT	10
1	282+33.72	48.12' LT	10
1	282+39.36	56.79' LT	10
1	14+34.12	40.87' LT	10
1	15+20.15	44.30' LT	10
1	16+22.78	45.23' LT	10
1	17+10.88	44.56' LT	10
1	22+53.68	25.80' LT	10
1	22+98.67	22.28' LT	10
1	23+74.08	20.14' LT	10
2	14+33.85	46.39' LT	10
2	15+20.15	44.30' LT	10
2	16+22.78	45.23' LT	10
2	17+10.88	44.56' LT	10
2	22+53.38	25.85' LT	10
2	22+98.99	24.53' LT	10
		SUBTOTAL:	250
IONT ROA	D RESURFACING	•	
1	289+84.40	43.39' RT	10
		SUBTOTAL:	10
P	AY CODE 280003	05	260

PERIMETER EROSION BARRIER (28000400) (FOOT)

943

636

62

519

411

240

604 162

3,577

294

556

103

251

172

1,376

0

96

50

146

0

50

50

5,149

EROSION CONTROL BLANKET (SPECIAL) (X2511630) (SQ YD)

973

36

52

52

1113

0

0

1113

B BLA, Inc.

USER NAME = tnestor	DESIGNED	-	GJE	REVISED	-	2025-07-02
	DRAWN	-	GJE	REVISED	-	
PLOT SCALE = 100.0000 ' / 10.	CHECKED	-	MTC	REVISED	-	
PLOT DATE = 11/3/2025	DATE	-	09/08/2023	REVISED	-	

SCHEDULE OF QUANTITIES	F.A.U RTE.	SECTION	COUNTY	TOTAL SHEETS	SHEET NO.
LEMONT ROAD	2612	16-00232-00-CH	DUPAGE	248	28
LEIVIUNI NUAD	CH 9		CONTRAC	T NO.	61J01
SHEET 1 OF 5 SHEETS STA. N/A TO STA. N/A		ILLINOIS FED. AI	D PROJECT		

**EROSION CONTROL** 

CONTROL SEEDING (28000250) (POUND)

32.0

34.7

3.3

30.8

20.8

9.5

14.2

8.2

4.5

8.5

166.7

10.8

7.3

9.8

10.1

2.4

7.1

47.4

0.4 10.8

0.1

1.0

12.3

0.9

1.1

1.0

3.0

226.4

TEMPORARY EROSION | TEMPORARY EROSION

CONTROL BLANKET

(28001100) (SQ YD)

1,681

161

1,493

1,008

459

686

399

413

7,922

521

354

472

490

114

345

2,296

521

50

595

45

51

50

146

10,959

STATION

270+16

276+00

282+00

13+80.25

21+50

276+00

13+80.25

21+50

276+00

21+50

300+68

306+25

16+00

23+00

306+25

288+00

294+00

83+00

98+00

300+68

STATION

276+00

282+00

282+95

19+50

24+24

282+00

19+50

24+24

282+00

24+24

306+25

311+40

21+00

27+85

306+25

SUBTOTAL:

311+40

294+00

SUBTOTAL:

300+00

88+00

13+80.25

SUBTOTAL

TOTAL:

SUBTOTAL:

87TH STREET WIDENING - STAGE 1

87TH STREET WIDENING - STAGE 2

83RD STREET WIDENING - STAGE 1

83RD STREET WIDENING - STAGE 2

LEMONT ROAD RESURFACING 282+95 288+00

AS DIRECTED BY ENGINEER

87TH STREET RESURFACING

AS DIRECTED BY ENGINEER

**INLET FILTERS** 

271+45.45 30.48' LT

OFFSET

30.14' LT

32.54' LT

STATION

271+25.46

271+85.07

QUANTITY

(EA)

87TH STREET WIDENING

STAGE

	INLET FILT	ERS (CONT.)	
EMONT RO	AD RESURFACING	3	
1	283+95.12	6.33' LT	1
1	283+97.80	33.39' RT	1
1	286+61.05	33.50' LT	1
1	287+00.31	33.50' RT	1
1	288+00.43	33.60' LT	1
1	288+98.91	0.37 LT	1
1	289+20.11	33.55' RT	1
1	289+84.40	43.39' RT	1
1	289+97.69	33.46' LT	1
1	290+50.73	33.50' RT	1
1	291+50.83	33.28' LT	1
1	291+94.06	50.76' LT	1
1	292+00.30	33.43' RT	1
1	292+37.19	49.74' LT	1
1	292+74.55	33.19' LT	1
1	293+50.01	33.40' RT	1
1	293+69.37	0.64' RT	1
1	294+34.16	33.48' LT	1
1	294+73.63	33.45' RT	1
1	295+89.08	33.41' RT	1
1	295+91.67	33.36' LT	1
1	295+98.63	33.47' RT	1
1	295+99.73	4.68' RT	1
1	296+00.95	33.36' LT	1
1	297+38.91	33.47' LT	1
1	297+44.96	CL	1
1	297+50.32	33.48' RT	1
1	298+98.78	33.40' RT	1
1	298+99.58	33.48' LT	1
2	283+95.12	7.10' LT	1
	200 00.12	SUBTOTAL:	30
TH STREE	T RESURFACING	0021017121	
1	10+66.56	51.37' LT	1
1	10+98.38	49.39' LT	1
1	13+23.62	28.94' LT	1
1	13+27.64	27.00' RT	1
· ·	1 2	SUBTOTAL:	4
	PAY CODE 280005		109

CONCRETE MEDIAN, TYPE SB-6.24 (SPECIAL)					
STATION STATION OFFSET QUANTITY					
STATION	STATION	(LT / RT)	(SQ FT)		
87TH STREET W	/IDENING				
275+57	276+00	LT	262		
276+00	277+95	LT	1,172		
P#	Y CODE X60603	00	1,434		

CONCRETE MEDIAN, TYPE SM-4.18					
STATION	STATION	OFFSET	QUANTITY		
STATION	STATION	(LT / RT)	(SQ FT)		
7TH STREET W	/IDENING				
272+50	275+57	LT / RT	3,391		
280+95	282+00	LT / RT	900		
282+00	282+95	LT / RT	1,287		
		SUBTOTAL:	5,578		
3RD STREET V	VIDENING				
306+68	307+06	LT / RT	236		
24+73	27+82	LT / RT	3,752		
		SUBTOTAL:	3,988		
EMONT ROAD	RESURFACING				
282+95	284+80	LT / RT	2,836		
		SUBTOTAL:	2,836		
P/	AY CODE 606223	10	12,402		

AGGREGATE SUBGRADE IMPROVEMENT 16"				
STATION	CTATION	QUANTITY		
STATION	STATION	(SQ YD)		
87TH STREET W	VIDENING			
270+16	276+00	1660		
276+00	282+00	2862		
282+00	282+95	231		
13+80	19+50	2526		
21+50	24+24	309		
	SUBTOTAL:	7588		
83RD STREET V	VIDENING			
300+00	306+25	776		
306+25	311+40	1034		
16+00	21+00	351		
23+00	27+85	1248		
	SUBTOTAL:	3410		
LEMONT ROAD	RESURFACING			
282+95	288+00	593		
288+00	294+00	591		
294+00	300+00	658		
	SUBTOTAL:	1841		
PAY CODE	E 30300116	12839		

HOT-MIX ASPHALT BASE COURSE, 9"				
STATION	STATION	OFFSET	QUANTITY (SQ YD)	
87TH STREET W	 VIDENING		(30 10)	
15+15	17+20	RT	246	
17+20	19+50	LT/RT	1822	
19+50	20+25	LT/RT	863	
	SUBTOTAL:		2931	
87TH STREET W	VIDENING	•		
22+50	23+00	LT	68	
23+00	25+30	LT	335	
	SUBTOTAL:		403	
PAY CODE	E 35501320		3,334	

			QUANTITY
STATION	STATION	OFFSET	(SQ YD)
87TH STREET V	VIDENING		(
271+32	276+00	LT	493
273+48	276+00	LT / RT	432
276+00	277+98	LT	406
276+00	277+97	LT	305
279+34	281+67	LT	417
278+62	279+72	RT	28
280+67	282+00	LT	216
SUBTOTAL:			2,297
83RD STREET V	VIDENING		
300+70	304+66	LT /RT	356
305+93	306+25	LT / RT	42
304+55	305+08	LT	88
306+25	311+20	LT / RT	832
22+70	23+00	RT	28
23+00	27+85	LT /RT	645
	SUBTOTAL:		1,990
LEMONT ROAD	RESURFACING		
286+60	288+00	LT / RT	167
288+00	289+26	LT / RT	234
292+54	293+91	LT / RT	242
295+32	299+38	LT /RT	560
	SUBTOTAL:		1,203
PAY CODI	E 35300400		5,490

			QUANTITY
STATION	STATION	OFFSET	(SQ YD)
7TH STREET V	/IDENING	•	
270+16	271+32	LT	47
272+40	273+48	RT	80
273+48	276+00	LT	55
278+95	280+67	RT	152
279+72	280+17	LT	17
281+67	282+00	LT	16
282+00	282+70	LT	20
282+00	282+95	RT	47
13+80	15+15	RT	51
13+80	17+20	LT	65
21+00	21+50	RT	40
21+50	24+24	RT	154
21+50	24+24	LT	123
	SUBTOTAL:		867
3RD STREET V	VIDENING		
303+50	304+55	LT	33
17+35	21+00	RT	189
19+71	21+00	LT	17
	SUBTOTAL:		238
EMONT ROAD	RESURFACING		
285+57	286+60	RT	69
290+04	291+76	LT	114
294+67	295+32	RT	68
299+38	299+81	LT	30
	SUBTOTAL:		282
PAY CODI	35400400		1,387

CONCRETE MEDIAN, TYPE SB-6.12				
07471011	STATION	OFFSET	QUANTITY	
STATION	SIATION	(LT / RT)	(SQ FT)	
87TH STREET V	VIDENING			
19+50	19+74	LT	118	
279+08	280+95	RT	1,105	
17+27	19+50	LT	1,136	
		SUBTOTAL:	2,359	
83RD STREET V	VIDENING			
302+47	304+66	LT	1,142	
22+70	23+00	RT	178	
305+93	306+25	LT / RT	185	
306+25	306+68	LT / RT	261	
23+00	24+73	RT	1,036	
		SUBTOTAL:	2,802	
P	AY CODE 606196	500	5,161	

COMBINAT		ETE CURB AN B-6.24	ID GUTTER,	
CTATION	CTATION	OFFSET	QUANTITY	
STATION	STATION	(LT / RT)	(FOOT)	
B7TH STREET	WIDENING			
276+00	277+91	LT	191	
		SUBTOTAL:	191	
83RD STREET	WIDENING			
304+37	23+00	RT	99	
23+00	306+25	RT	96	
306+25	308+79	RT	140	
23+00	23+83	RT	83	
23+00	27+85	LT	486	
		SUBTOTAL:	904	
PA	Y CODE 60605	000	1,095	

COMBINATION	ON CONCRET TYPE B		GUTTER,
CTATION	CTATION	OFFSET	QUANTITY
STATION	STATION	(LT / RT)	(FOOT)
7TH STREET W	IDENING		
270+52	276+00	LT	573
276+00	19+50	LT	280
277+88	21+50	RT	64
21+50	280+17	RT	200
19+50	282+00	LT	320
282+00	282+70	LT	72
13+80	19+50	LT	570
13+82	19+50	RT	568
21+50	22+66	LT	116
21+50	21+55	RT	5
		SUBTOTAL:	2,768
3RD STREET V	/IDENING		
300+81	301+01	LT	20
303+50.00	21+00	LT	186
21+00	306+25	LT	101
308+79	309+94	RT	229
17+35	21+00	RT	365
19+72	21+00	LT	128
		SUBTOTAL:	1,029
EMONT ROAD	RESURFACING		
289+78	289+99	RT	30
296+22	296+52	RT	30
297+42	297+72	RT	30
AS DIF	RECTED BY ENG	NEER	150
		SUBTOTAL:	240
7TH STREET R	ESURFACING		
	RECTED BY ENGI	NEER	150
, .5 5.1		SUBTOTAL:	150
P/	Y CODE 606044		4,187

OTATION	OTATIO:	OFFSET	QUANTIT
STATION	STATION	(LT / RT)	(FOOT)
TH STREET W	IDENING		
18+36	18+49	RT	25
18+81	18+92	RT	26
21+50	21+64	LT	23
22+40	22+65	LT	39
	•	SUBTOTAL:	113
3RD STREET V	VIDENING		
300+71	300+81	LT	18
301+03	301+23	RT	27
301+60	301+75	RT	23
22+80	22+80	LT	20
306+07	306+17	RT	20
306+44	306+74	RT	35
306+77	307+04	RT	35
307+37	307+60	RT	35
18+48	18+70	RT	23
19+21	19+46	RT	23
23+21	23+59	LT	77
24+06	24+12	LT	27
		SUBTOTAL:	363
EMONT ROAD	RESURFACING	ì	
284+63	284+71	LT	26
285+02	285+14	LT	27
291+78	291+94	LT	23
292+37	292+51	LT	20
293+00	294+17	RT	28
299+92	300+09	LT	21
AS DIF	RECTED BY ENG	SINEER	150
		SUBTOTAL:	295
7TH STREET R	ESURFACING		
84+78	84+84	LT	17
85+13	85+18	LT	17
10+62	10+67	LT	19
10+97	11+02	LT	17
AS DIF	RECTED BY ENG	SINEER	150
		SUBTOTAL:	220
PA	AY CODE 60603	800	991

USER NAME = tnestor	DESIGNED	-	GJE	REVISED	-	2025-07-02
	DRAWN	-	GJE	REVISED	-	
PLOT SCALE = 100.0000 ' / in.	CHECKED	-	MTC	REVISED	-	
PLOT DATE = 11/3/2025	DATE	-	09/08/2023	REVISED	-	

KLINIO	VING CATCH	DASINS	
7TH STREET	WIDENING		
STATION	OFFSET	QUANTITY	
STATION	OFFSEI	(EA)	
273+31.78	CL	1	
273+40.90	3.06 LT	1	
274+65.65	6.32 LT	1	
275+91.97	6.96 LT	1	
279+03.90	4.78 RT	1	
280+48.54	49.62' LT	1	
280+66.25	4.78 RT	1	
14+33.05	30.90 LT	1	
14+26.27	28.58 RT	1	
15+20.15	44.32' LT	1	
15+31.56	29.12 RT	1	
16+22.65	45.36' LT	1	
16+25.34	29.95 RT	1	
17+11.92	29.51RT	1	
17+11.06	33.34 LT	1	
17+10.81	44.56 LT	1	
	SUBTOTAL:	16	
EMONT ROA	D RESURFACIN	IG	
283+95.27	6.25' LT	1	
288+99.00	CL	1	
293+69.43	0.54 RT	1	
295+99.73	4.74 RT	1	
297+44.96	CL	1	
	SUBTOTAL:	5	
PAY CODE	60500050	21	

REMOVE EXISTING FLARED END SECTION		
87TH STREET	WIDENING	
STATION	OFFSET	QUANTITY
STATION	OFFSEI	(EA)
271+48.09	42.12' LT	1
271+80.11	42.97' LT	1
271+89.37	41.89' LT	1
272+21.56	41.47' LT	1
272+35.47	43.33' LT	1
272+68.83	42.82' LT	1
273+97.92	45.24' LT	1
281+45.28	48.62' LT	1
15+24.56	56.45 RT	1
22+53.66	26.05' LT	1
22+99.02	22.30' LT	1
PAY CODE	X5427602	11

REMOVING INLETS		
7TH STREET	WIDENING	
STATION	OFFSET	QUANTITY
STATION	STATION OFFSET	(EA)
278+60.20	51.58 RT	. 1
279+02.12	33.33 RT	1
282+50.69	7.21 LT	1
14+34.13	41.00 LT	1
15+21.61	34.12' LT	1
16+22.70	34.02' LT	1
	SUBTOTAL:	6
3RD STREET	WIDENING	
307+94.35	41.35' RT	1
19+83.01	25.13 RT	1
19+84.24	32.40 LT	1
19+93.07	25.43' RT	1
19+94.54	32.41' LT	1
25+00	31.76' LT	1
	SUBTOTAL:	6
EMONT ROA	D RESURFACII	NG
297+47	33.00' RT	. 1
	SUBTOTAL:	1
PAY CODE	60500060	13

REM	OVING MAN	HOLES
87TH STREET	WIDENING	
STATION	OFFSET	QUANTITY
STATION	OFFSET	(EA)
278+71.28	49.82 RT	1
	SUBTOTAL:	1
83RD STREET	WIDENING	
24+42.72	41.40 LT	1
,	SUBTOTAL:	1
LEMONT ROA	D RESURFACI	NG
290+60.55	40.76' RT	1
292+07.83	40.63' RT	1
	SUBTOTAL:	2
PAY CODE	60500040	4

STATION	OFFSET	OFFSET STATION C		QUANITITY	
STATION	(LT / RT)	STATION	(LT / RT)	(FOOT)	
7TH STREET W	IDENING				
279+03.90	4.78' RT	279+02.12	33.33' RT	29	
			SUBTOTAL:	29	
EMONT ROAD	RESURFACING				
288+98.96	CL	289+20.01	33.48' RT	40	
293+69.36	CL	293+50.07	33.30' RT	38	
295+99.73	4.74' RT	295+98.63	33.56' RT	29	
297+44.96	CL	297+50.32	33.48' RT	34	
÷			SUBTOTAL:	141	
	170				

	STOR	I SEWER REI	MOVAL 18"		
STATION	OFFSET	STATION	OFFSET	QUANTITY	
STATION	(LT / RT)	STATION	(LT / RT)	(FOOT)	
87TH STREET W	IDENING				
15+32	RT	15+26	RT	24	
278+71	RT	278+63	RT	34	
	SUBTOTAL:				
83RD STREET W	/IDENING				
19+83	RT	19+50	RT	33	
			SUBTOTAL:	33	
	PAY CODE 55100900				

STATION	OFFSET	STATION	OFFSET	QUANTITY		
STATION	(LT / RT)	STATION	(LT / RT)	(FOOT)		
87TH STREET W	IDENING					
279+03	RT	279+12	RT	40		
14+26	RT	15+32 RT		15+32 RT	15+32 RT	105
16+25	RT	15+32 RT	RT	94		
15+32	RT	15+30	15+30 RT			
17+12	RT 16+	RT	16+25	16+25 RT		
17+12	LT	17+12	17+12 RT 17+12 LT			
17+12	LT	17+12				
UNKNOWN	LT	17+12	LT	225		
			SUBTOTAL:	630		
LEMONT ROAD	RESURFACING					
290+61	RT	290+66	RT	5		
292+03	RT	292+13	RT	10		
			SUBTOTAL:	15		
	PAY CODE	55100700	-	645		

STATION	OFFSET	STATION	OFFSET	QUANTITY	
STATION	(LT / RT)	STATION	(LT / RT)	(FOOT)	
TH STREET W	IDENING	-			
273+32	CL	273+41	LT	10	
273+41	LT	273+41	RT	9	
278+60	RT	278+71	RT	11	
279+04	RT	279+02	RT	29	
279+02	RT	278+71	RT	35	
280+66	RT	280+72	RT	6	
281+48	LT	281+36	LT	90	
282+51	LT	282+51	LT	2	
			SUBTOTAL:	192	
RD STREET W	/IDENING				
19+93	RT	19+83	RT	10	
19+95	LT	19+84	LT	10	
307+94	RT	308+05	RT	11	
			SUBTOTAL:	31	
MONT ROAD	RESURFACING				
289+84	RT	290+61	RT	77	
290+56	RT	290+61	RT	5	
297+51	RT	297+61	RT	10	
			SUBTOTAL:	92	
	PAY CODI	E 55100500		315	

STORM SEWER REMOVAL 10"					
STATION	OFFSET	STATION	OFFSET	QUANTITY	
STATION	(LT / RT)	STATION	(LT / RT)	(FOOT)	
7TH STREET V	VIDENING				
14+34	LT	14+33	LT	8	
14+33	LT	14+33	LT	10	
14+33	LT	14+26	RT	60	
15+20	LT	15+20	LT	10	
15+22	LT	15+32	RT	64	
16+23	LT	16+23	LT	11	
16+23	LT	16+25	RT	64	
	PAY COD	E 55100400	,	227	

PIPE CULVERT REMOVAL							
STATION OFFSET STATION OFFSET QUANTIT							
STATION	(LT / RT)	STATION	(LT / RT)	(FOOT)			
7TH STREET W	IDENING						
271+49	LT	271+80	LT	33			
271+89	LT	272+21	LT	32			
272+35	LT	272+69	LT	33			
273+98	LT		LT	29			
23+00	LT	23+74	LT	75			
	PAY CODE 50105220						

STATION	CTATION	OFFSET	QUANTITY	
STATION	STATION	(LT / RT)	(SQFT)	
7TH STREET W	/IDENING			
270+16	276+00		0	
276+00	282+00	LT	2,028	
282+00	282+95	LT	142	
13+80	19+50	LT	2,843	
21+50	24+24		0	
_		SUBTOTAL:	5,013	
3RD STREET V	VIDENING			
300+00	306+25	LT / RT	3,979	
306+25	311+40	RT	1,384	
16+00	21+00	RT	248	
23+00	27+85	LT	1305	
-:		SUBTOTAL:	6,916	
EMONT ROAD	RESURFACING			
282+95	288+00	LT	98	
288+00	294+00	LT	451	
294+00	300+00	LT	88	
		SUBTOTAL:	637	
7TH STREET R	ESURFACING			
78+56	83+00		0	
83+00	88+00	LT	230	
88+00	93+00		0	
93+00	98+00		0	
98+00	13+50	LT	211	
		SUBTOTAL:	441	
P/	Y CODE 440006	000	13,007	

		OFFSET	QUANTITY
STATION	STATION	(LT / RT)	(FOOT)
TH STREET W	IDENING		
270+16	276+00	LT / RT	1,080
276+00	282+00	LT / RT	1,184
282+00	282+95	LT / RT	261
13+80	19+50	LT / RT	1,182
21+50	24+24	LT	163
		SUBTOTAL:	3,870
BRD STREET V	VIDENING		
300+00	306+25	LT / RT	1,436
306+25	311+40	LT / RT	1,417
17+35	21+00	LT / RT	551
23+00	27+85	LT / RT	705
		SUBTOTAL:	4,109
EMONT ROAD	RESURFACING		
282+95	288+00	LT / RT	701
288+00	294+00	LT / RT	592
294+00	300+00	LT / RT	793
300+00	300+68	LT	12
AS DIRE	CTED BY THE EN	IGINEER	150
		SUBTOTAL:	2,248
TH STREET R	ESURFACING	-	
83+00	88+00	LT	34
98+00	13+50	LT	36
AS DIRE	CTED BY THE EN	IGINEER	150
		SUBTOTAL:	220
PAY CODE 44000500			10,447

	MEDIAN REMOV	'AL
STATION	STATION	QUANTITY
STATION	STATION	(SQFT)
TH STREET V	VIDENING	
276+11	277+97	773
278+97	8+97 280+77	
SUBTOTAL:		1,552
RD STREET V	VIDENING	
304+43	304+58	80
306+16	306+29	71
311+11	311+17	56
18+86	19+03	100
	SUBTOTAL:	307
MONT ROAD	RESURFACING	
285+58	286+60	416
290+05	291+75	677
294+67	296+03	585
299+52	299+80	125
	SUBTOTAL:	1,803
PAY CODE	E 44003100	3,662

FENCE REMOVAL						
STATION OFFSET QUANI						
STATION	(FOOT)					
EMONT ROAD	WIDENING			•		
280+25	71.38' LT	281+84	53.15' LT	191		
-	PAY CODE	X6640104		191		

		QUANTITY
STATION	STATION	(SQ YD)
87TH STREET WIDE	NING	
270+16	276+00	317
276+00	282+00	0
282+00	282+95	0
13+80	19+50	0
21+50	24+24	117
	SUBTOTAL:	434
83RD STREET WIDE	NING	
300+00	306+25	32
306+25	311+40	347
16+00	21+00	66
23+00	27+85	173
	SUBTOTAL:	618
LEMONT ROAD RES	URFACING	
282+95	288+00	64
288+00	294+00	83
294+00	300+00	33
	SUBTOTAL:	181
87TH STREET RESU	RFACING	
78+56	83+00	288
83+00	88+00	0
88+00	93+00	0
93+00	98+00	0
98+00	13+50	0
	SUBTOTAL:	288
PAY CODI	E 40600982	1521

B BLA, Inc.

USER NAME = tnestor	DESIGNED	9	GJE	REVISED	-	2025-07-02
	DRAWN	-	GJE	REVISED	-	
PLOT SCALE = 100.0000 ' / in.	CHECKED	-	MTC	REVISED	-	
PLOT DATE = 12/1/2025	DATE	-	09/08/2023	REVISED	-	

	LENGTH		QUANTITY	SHORT TERM PAVEMENT MARKINGS
TYPE	(FOOT)	APPLICATIONS	(FOOT)	REMOVAL (70300150) (SQ FT)
7TH STREET V	/IDENING		, ,	1
L&S	165	3	495	165
4" LINE	4310	3	12,930	4,310
6" LINE	2543	3	7,629	3,815
12" LINE	755	3	2,265	2,265
24" LINE	186	3	558	1,116
		SUBTOTAL:	23,877	11,671
3RD STREET V	VIDENING			
L&S	165	3	495	165
4" LINE	5459	3	16,377	5,459
6" LINE	2618	3	7,854	3,927
12" LINE	1509	3	4,527	4,527
24" LINE	191	3	573	1,146
		SUBTOTAL:	29,826	15,059
EMONT ROAD	RESURFACING	3		
L&S	75	3	225	75
4" LINE	5630	3	16,890	5,630
6" LINE	739	3	2,217	1,109
12" LINE	307	3	921	921
24" LINE	48	3	144	288
		SUBTOTAL:	20,397	7,948
7TH STREET R	ESURFACING			
L&S	125	3	375	125
4" LINE	8819	3	26,457	8,819
6" LINE	551	3	1,653	827
12" LINE	135	3	405	405
24" LINE	15	3	45	90
		SUBTOTAL:	28,935	10,141
		TOTAL:	103,035	44,819

		TEMPORARY	PAVEMENT MARKIN	GS	
STATION	STATION	LETTERS & SYMBOLS (70307100) (SQ FT)	LINE 4" (70307120) (FOOT)	LINE 6" (70307130) (FOOT)	LINE 24" (70307210) (FOOT)
	VIDENING - STAC	SE1	1 4 000	I	1
270+16	276+00		1,268		
276+00	282+00		1,533	308	104
282+00	282+95		190		
13+80.25	19+50	109.2	2,190	358	
21+50	24+24		1,122		
	VIDENING - STAC	E 2			
270+16	276+00		1,894	24	
276+00	282+00	72.8	2,241	562	91
282+00	282+95		285		
13+80.25	19+50	109.2	1,529	316	
21+50	24+24		1,596		
87TH STREET V	VIDENING - STAC	E3			
270+16	276+00		614		
276+00	282+00		989	23	35
282+00	282+95				
13+80.25	19+50	109.2	915	316	
21+50	24+24		1,118		
	SUBTOTAL:	400	17,484	1907	230
83RD STREET V	WIDENING - STAC		,,,,,,,,,,,,,,,,,,,,,,,,,,,,,,,,,,,,,,,		
300+68	306+25	72.8	2,242	396	90
306+25	311+40	36.4	2,206	193	
16+00	21+00	00. <del>-</del> 1	1,388	100	
23+00	27+85		995		
	WIDENING - STAC	2E 2	1 000		
300+68	306+25	109.2	1,951	377	91
306+25	311+40	109.2	1,809	207	31
		20.4	<del>-</del>		
16+00	21+00	36.4	1,498	210	
23+00	27+85	36.4	1,957	213	101
	SUBTOTAL:	291	14,046	1,596	181
	RESURFACING	- STAGE 1		Ī	
282+95	288+00		1,027		
288+00	294+00		1,247		
294+00	300+00	36.4	1,967	18	
300+00	300+68				
LEMONT ROAD	RESURFACING	- STAGE 2			
282+95	288+00	36.4	1,355	20	
288+00	294+00	36.0	1,071	107	
294+00	300+00	72.8	1,347	247	
300+00	300+68		40		
	SUBTOTAL:	182	8,054	392	0
87TH STREET F	RESURFACING - S	STAGE 1			
78+56	83+00				
83+00	88+00				
88+00	93+00				
93+00	98+00				
98+00	13+80.25	36.4	341	42	
	RESURFACING - S		1 2	·	1
78+56	83+00		235		
83+00	88+00		200		<u> </u>
88+00	93+00				+
93+00	98+00				+
98+00	13+80.25	36.4		18	-
				10	
	RESURFACING - S	DIAGE 3	1	I	T
78+56	83+00				-
83+00	88+00				-
88+00	93+00				
93+00	98+00				
98+00	13+80.25	36.4	100	18	
	SUBTOTAL:	109	676	78	0
	TOTAL:	982	40,260	3,973	411

B BLA, Inc.	
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USER NAME = tnestor	DESIGNED	-	GJE	KENIZED	-	2025-07-02
	DRAWN	-	GJE	REVISED	-	
PLOT SCALE = 100.0000 ' / 10.	CHECKED	-	MTC	REVISED	-	
PLOT DATE = 11/3/2025	DATE	-	09/08/2023	REVISED	-	

	00112022 01 0071111120								F.A.U RTE.	SECTION	COUNTY	TOTAL SHEETS	SHEET NO.
ı									2612	16-00232-00-CH	DUPAGE	248	31
LEMONT ROAD									CH 9		CONTRAC	T NO.	61J01
	SCALE: N.T.S. SHEET 4 OF 5 SHEETS STA. N/A TO STA. N/A								ILLINOIS FED. A	ID PROJECT			

HOT-MIX ASPHALT BINDER COURSE, IL-19.0,								
		QUANTITY						
STATION	STATION	(TON)						
87TH STREET W	VIDENING							
270+16	276+00	494						
276+00	282+00	742						
282+00	282+95	68						
13+80	19+50	520						
21+50	24+24	127						
	SUBTOTAL:	1951						
83RD STREET V	VIDENING							
300+68	306+25	715						
306+25	311+40	493						
16+00	17+35	103						
17+35	21+00	296						
23+00	27+85	364						
	SUBTOTAL:	1972						
LEMONT ROAD	RESURFACING							
282+95	288+00	426						
288+00	294+00	559						
294+00	300+00	551						
300+00	300+68	74						
	SUBTOTAL:	1610						
87TH STREET R	ESURFACING							
78+56	83+00	323						
83+00	88+00	364						
88+00	93+00	364						
93+00	98+00	364						
98+00	13+50	401						
13+50	13+80	23						
	SUBTOTAL:	1838						
PAY CODE	E 40603085	7371						

	07471011	QUANTITY	
STATION	STATION	(TON)	
TH STREET WIDE	NING		
270+16	276+00	329	
276+00	282+00	494	
282+00	282+95	46	
13+80	19+50	347	
21+50	24+24	85	
	SUBTOTAL:	1300	
3RD STREET WIDE	NING		
300+68	306+25	477	
306+25	311+40	329	
16+00	17+35	69	
17+35	21+00	197	
23+00	27+85	243	
	SUBTOTAL:	1314	
EMONT ROAD RES	URFACING		
282+95	288+00	284	
288+00	294+00	373	
294+00	300+00	367	
300+00	300+68	49	
	SUBTOTAL:	1073	
7TH STREET RESU	RFACING		
78+56	83+00	215	
83+00	88+00	243	
88+00	93+00	243	
93+00	98+00	243	
98+00	13+50	267	
13+50	13+80	15	
	SUBTOTAL:	1225	
PAY CODI	E 40604062	4912	

OFFSET QUANTIT								
STATION	STATION	(LT / RT)	(SQ YD)					
7TH STREET WIDENING								
270+16	276+00	LT / RT	2,563					
276+00	282+00	LT / RT	3,705					
282+00	282+95	LT / RT	482					
13+80	19+50	LT / RT	2,304					
21+50	24+24	LT / RT	319					
SUBTOTAL: 9,374								
RD STREET V	VIDENING	'						
300+00	306+25	LT / RT	5,638					
306+25	311+40	311+40 LT / RT						
16+00	21+00	LT / RT	2,680					
23+00	27+85	LT / RT 2						
		SUBTOTAL:	13,292					
MONT ROAD	RESURFACING							
282+95	288+00	LT / RT	3,142					
288+00	294+00	LT / RT	3,799					
294+00	300+00	LT / RT	3,688					
		SUBTOTAL:	10,629					
TH STREET F	RESURFACING							
78+56	83+00	LT / RT	2,272					
83+00	88+00	LT / RT	2,887					
88+00	93+00	LT / RT	2,889					
93+00	98+00	LT / RT	2,889					
98+00	13+50	LT / RT	3,180					
		SUBTOTAL:	14,117					
P	AY CODE 440001	63	47,412					

	PCC SI	DEWALK 5 INCH			
STATION	STATION	PORTLAND CEMENT CONCRETE	AGGREGATE BASE		
FROM	то	SIDEWALK 5 INCH (SQ FT) (42400200)	(SQ YD) (35101600		
87TH STREET W	/IDENING				
270+16	276+00	0	0		
276+00	282+00	2,518	280		
282+00	282+95	0	0		
13+80	19+50	434	48		
21+50	24+24	52	6		
	SUBTOTAL:	3,004	334		
83RD STREET V	VIDENING				
300+00	306+25	4,339	482		
306+25	311+40	2,108	234		
16+00	21+00	254	28		
23+00	27+85	2,151	240		
	SUBTOTAL:	8,852	985		
LEMONT ROAD	RESURFACING				
282+95	288+00	94	10		
288+00	294+00	456	51		
294+00	300+00	88	10		
AS DIRECTED	BY ENGINEER	150	17		
	SUBTOTAL:	788	88		
87TH STREET R	ESURFACING				
78+56	83+00	0	0		
83+00	88+00	224	25		
88+00	93+00	0	0		
93+00	98+00	0	0		
98+00	13+50	237	26		
AS DIRECTED	BY ENGINEER	150	17		
	SUBTOTAL:	611	68		
	TOTAL:	13,255	1,474		

		QUANTITY	
STATION	STATION	LOCATION	(SQ YD)
7TH STREET V	VIDENING		
270+16	276+00	CURB	204
272+44	276+00	WIDENING	469
276+00	277+98	CURB	22
276+00	277+98	MEDIAN	312
276+00	276+11	MEDIAN	3
19+50	20+25	ROAD	639
277+88	21+50	CURB	8
21+50	280+15	CURB	24
278+95	282+00	MEDIAN	103
279+34	282+00	CURB	30
280+77	282+00	MEDIAN	134
282+00	282+71	CURB	8
282+00	282+95	CURB	11
282+00	282+95	MEDIAN	134
282+00	282+95	CURB	11
13+80	17+20	CURB	38
13+82	17+20	CURB	38
17+20	19+50	ROAD	1,534
21+00	24+24	TEMP. PAVE.	298
21+50	24+24	CURB	31
21+50	24+24	CURB	33
21.00	1 27124	SUBTOTAL:	4,083
3RD STREET V	WIDENING	OUDIVIAL.	4,000
300+70	304+66	CURB	93
300+70	304+66	MEDIAN	129
300+71	19+50	CURB	22
			34
304+37	304+95	CURB	
22+69	23+00	MEDIAN	28
305+61	306+25	WIDENING	35
305+68	306+25	WIDENING	43
306+25	311+20	CURB	223
306+29	311+11	MEDIAN	421
306+25	309+94	WIDENING	343
17+35	21+00	CURB	41
19+72	21+00	CURB	35
33100	23+82	CURB	36
23+00			
23+00	27+85	MEDIAN	650
	27+85 27+85	MEDIAN CURB	650 54
23+00 23+00	27+85	MEDIAN	650
23+00 23+00 emont Road R	27+85 esurfacing	MEDIAN CURB SUBTOTAL:	650 54 2,187
23+00 23+00 emont Road R 285+57	27+85 esurfacing 288+00	MEDIAN CURB SUBTOTAL: CURB	650 54 2,187
23+00 23+00 emont Road R	27+85 esurfacing	MEDIAN CURB SUBTOTAL:	650 54 2,187
23+00 23+00 emont Road R 285+57	27+85 esurfacing 288+00	MEDIAN CURB SUBTOTAL: CURB	650 54 2,187
23+00 23+00 emont Road R 285+57 286+60	27+85 esurfacing 288+00 288+00	MEDIAN CURB SUBTOTAL: CURB MEDIAN	650 54 2,187 54 86
23+00 23+00 emont Road R 285+57 286+60 288+00	27+85  esurfacing	MEDIAN CURB SUBTOTAL:  CURB MEDIAN MEDIAN	54 2,187 54 86 159
23+00 23+00 .emont Road R 285+57 286+60 288+00 288+00	27+85  esurfacing	MEDIAN CURB SUBTOTAL:  CURB MEDIAN MEDIAN CURB	54 2,187 54 86 159
23+00 23+00 .emont Road R 285+57 286+60 288+00 288+00 290+04	27+85 esurfacing 288+00 288+00 289+27 289+27 291+76	MEDIAN CURB SUBTOTAL:  CURB MEDIAN MEDIAN CURB CURB	650 54 2,187 54 86 159 29 39
23+00 23+00 .emont Road R 285+57 286+60 288+00 288+00 290+04 292+55	27+85  esurfacing 288+00 288+00 289+27 289+27 291+76 293+90	MEDIAN CURB SUBTOTAL:  CURB MEDIAN MEDIAN CURB CURB CURB	650 54 2,187 54 86 159 29 39 32
23+00 23+00 28+50 285+57 286+60 288+00 288+00 290+04 292+55 292+55	27+85  esurfacing 288+00 288+00 289+27 289+27 291+76 293+90 293+90	MEDIAN CURB SUBTOTAL:  CURB MEDIAN MEDIAN CURB CURB CURB MEDIAN	650 54 2,187 54 86 159 29 39 32 161
23+00 23+00 28+00 285+57 286+60 288+00 289+04 292+55 292+55 294+67	27+85  esurfacing 288+00 288+00 289+27 289+27 291+76 293+90 293+90 299+81	MEDIAN CURB SUBTOTAL:  CURB MEDIAN MEDIAN CURB CURB CURB CURB MEDIAN CURB MEDIAN CURB	650 54 2,187 54 86 159 29 39 32 161 115
23+00 23+00 emont Road R 285+57 286+60 288+00 290+04 292+55 292+55 292+55 294+67 296+03	27+85  esurfacing 288+00 288+00 289+27 289+27 291+76 293+90 293+90 299+81 299+52	MEDIAN CURB SUBTOTAL:  CURB MEDIAN MEDIAN CURB CURB CURB CURB MEDIAN CURB MEDIAN CURB	650 54 2,187 54 86 159 29 39 32 161 115 335
23+00 23+00 28+57 286+60 288+00 288+00 290+04 292+55 292+55 294+67 296+03 299+92	27+85  esurfacing 288+00 288+00 289+27 289+27 291+76 293+90 293+90 299+81 299+52 300+11	MEDIAN CURB SUBTOTAL:  CURB MEDIAN MEDIAN CURB CURB CURB MEDIAN CURB MEDIAN CURB MEDIAN CURB MEDIAN CURB	650 54 2,187 54 86 159 29 39 32 161 115 335 3


				D	RIVEWAYS				
STATION	MATERIAL	OFFSET	TYPE (PE / CE)	DRIVEWAY PAVEMENT REMOVAL (SQ YD) (44000200)	PORTLAND CEMENT CONCRETE DRIVEWAY	AGGREGATE BASE COURSE, TYPE B 6" (SQ YD) (35101800)	AGGREGATE BASE COURSE, TYPE B 8" (SQ YD) (35102000)	HOT-MIX ASPHALT BASE COURSE, 8" (SQ YD) (35501316)	HOT-MIX ASPHALT BINDER COURSE, IL 19.0, N50 (TON)
		(2171(1)	(12702)	(44000200)	PAVEMENT, 9 INCH	(35101600)	(35102000)	10) (35501316)	(40603080)
87TH STREET V					1				
271+63.02	HMA	LT	PE	36	0	0	45	0	6
272+05.59	HMA	LT	PE	26	0	0	33	0	4
272+52.19	HMA	LT	PE	37	0	0	34	0	4
274+14.27	HMA	LT	PE	34	0	0	26	0	3
274+95.80	HMA	LT	PE	32	0	0	20	0	3
279+69.10	HMA	LT	PE	76	0	0	117	0	15
282+21.95	HMA	LT	PE	42	0	0	45	0	6
15+66.46	HMA	RT	PE	32	0	0	30	0	4
16+95.66	HMA	RT	PE	29	0	0	20	0	3
17+67.53	HMA	RT	CE	123	8	112	0	104	0
18+65.39	HMA	RT	CE	129	0	98	0	98	0
22+01.98	HMA	LT	CE	185	0	145	0	145	18
23+17.73	HMA	LT	PE	76	0	0	81	0	10
23+94.15	HMA	LT	PE	77	0	0	87	0	11
			SUBTOTAL:	933	8	355	537	347	68
83RD STREET V	VIDENING								
301+40.49	HMA	RT	CE	44	0	133	0	133	0
303+66.92	HMA	RT	CE	18	0	35	0	35	0
306+30.37	HMA	RT	CE	47	0	88	0	88	0
307+20.40	HMA	RT	CE	46	0	103	0	103	0
18+95.38	HMA	RT	CE	129	0	119	0	119	0
20+27.52	HMA	LT	PE	28	0	0	31	0	5
23+02.78	HMA	LT	CE	117	0	90	0	90	0
23+86.11	HMA	LT	CE	157	0	112	0	112	0
			SUBTOTAL:	586	0	680	31	680	5
87TH STREET R	ESURFACING			<u> </u>	<u> </u>				
84+98.53	НМА	LT	PE	104	0	0	99	0	12
10+82.83	HMA	LT	PE	89	0	0	89	0	11
			SUBTOTAL:	193	0	0	188	0	24
			TOTAL:	1,712	8	1,032	756	1,027	97


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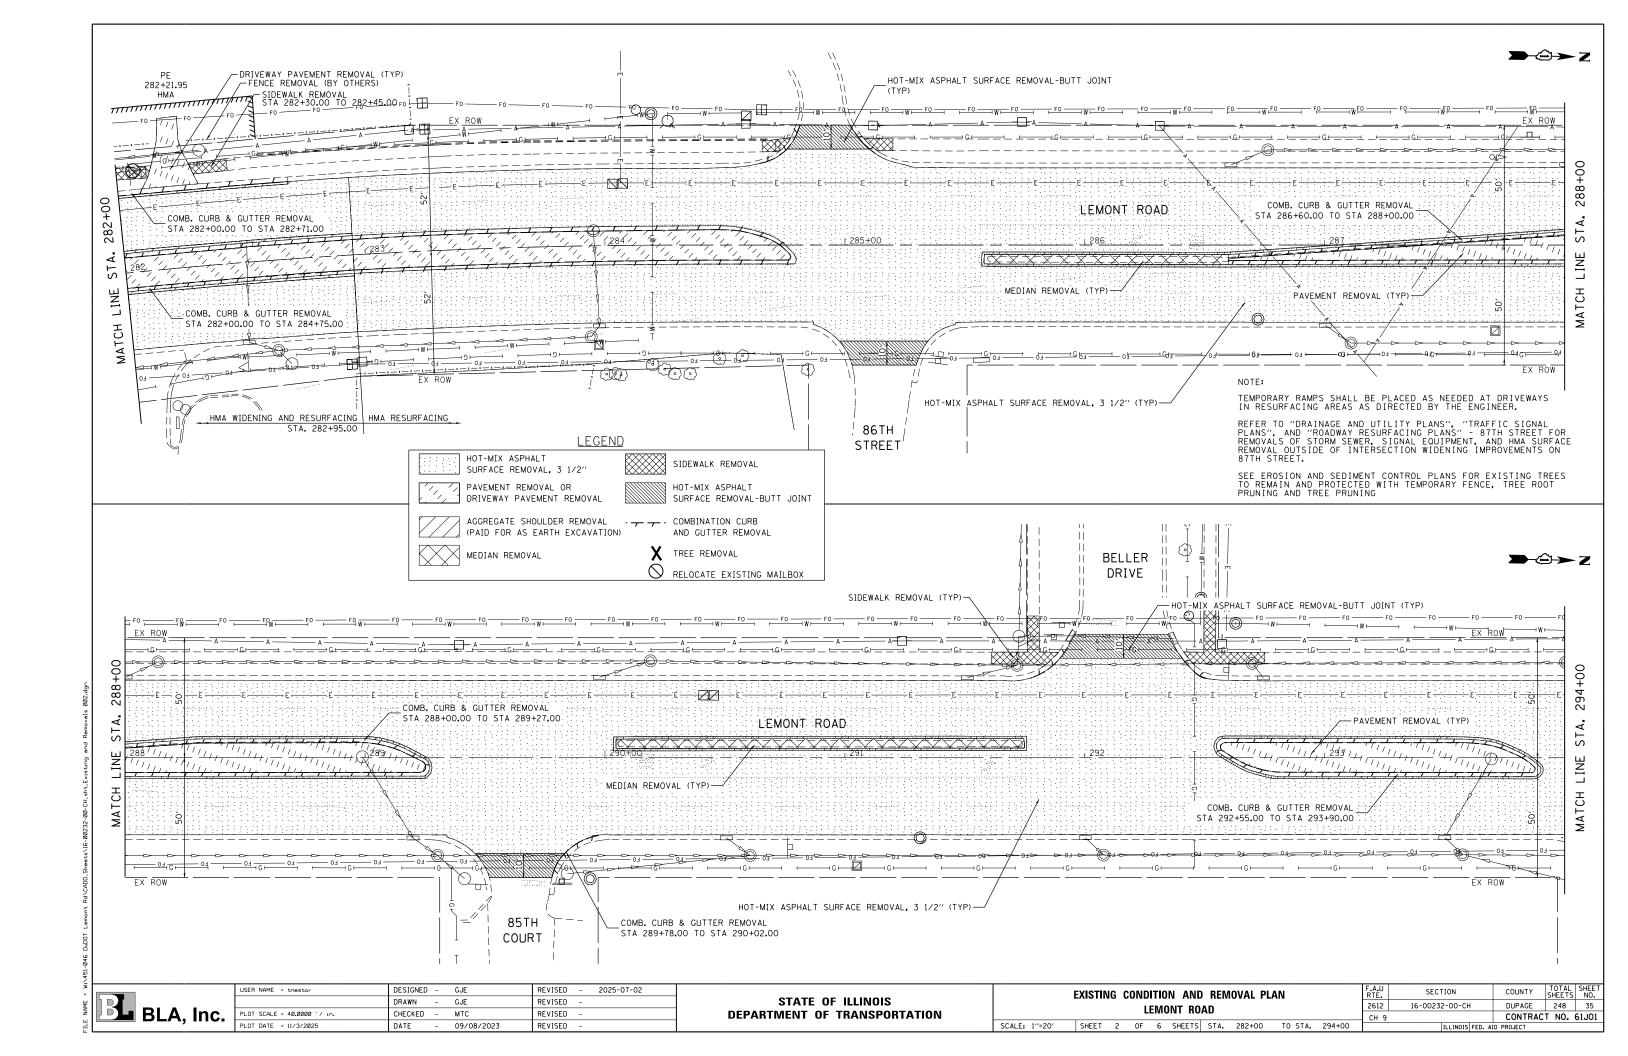
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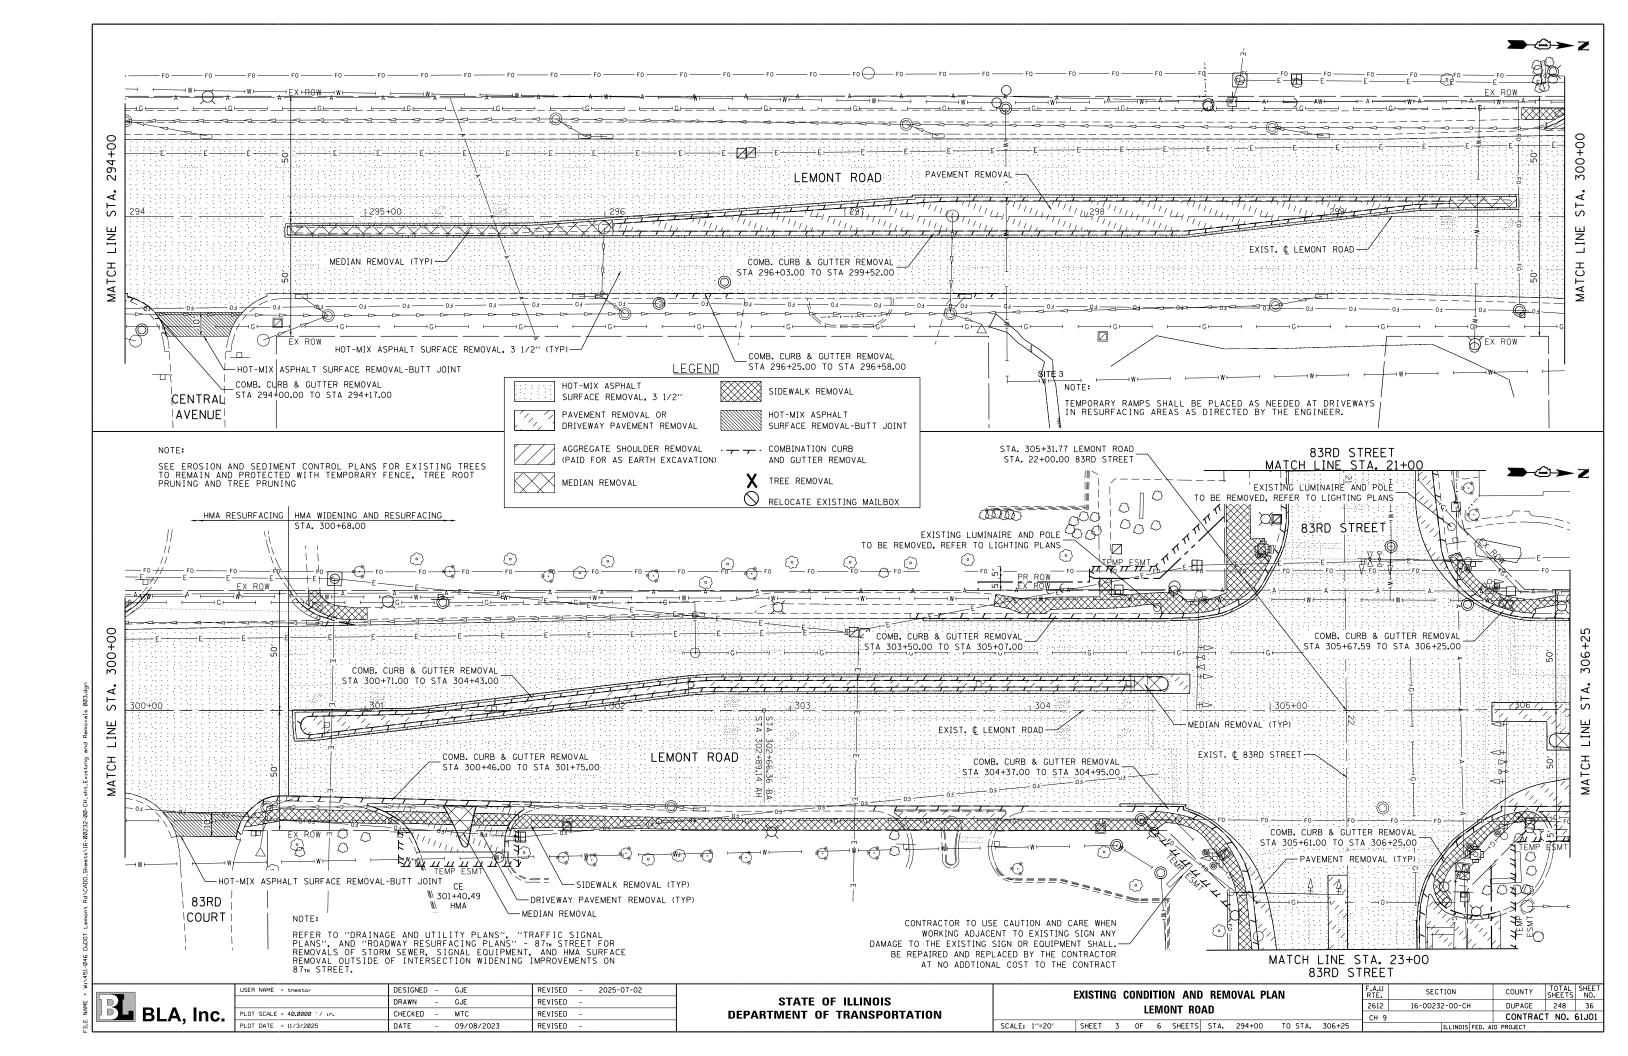
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ı		LEMONT ROAD	CH 9	10 00232 00 01	CONTRAC		
ı	SCALE: N.T.S.	SHEET 5 OF 5 SHEETS STA. N/A TO STA. N/A		ILLINOIS FED. A	ID PROJECT		


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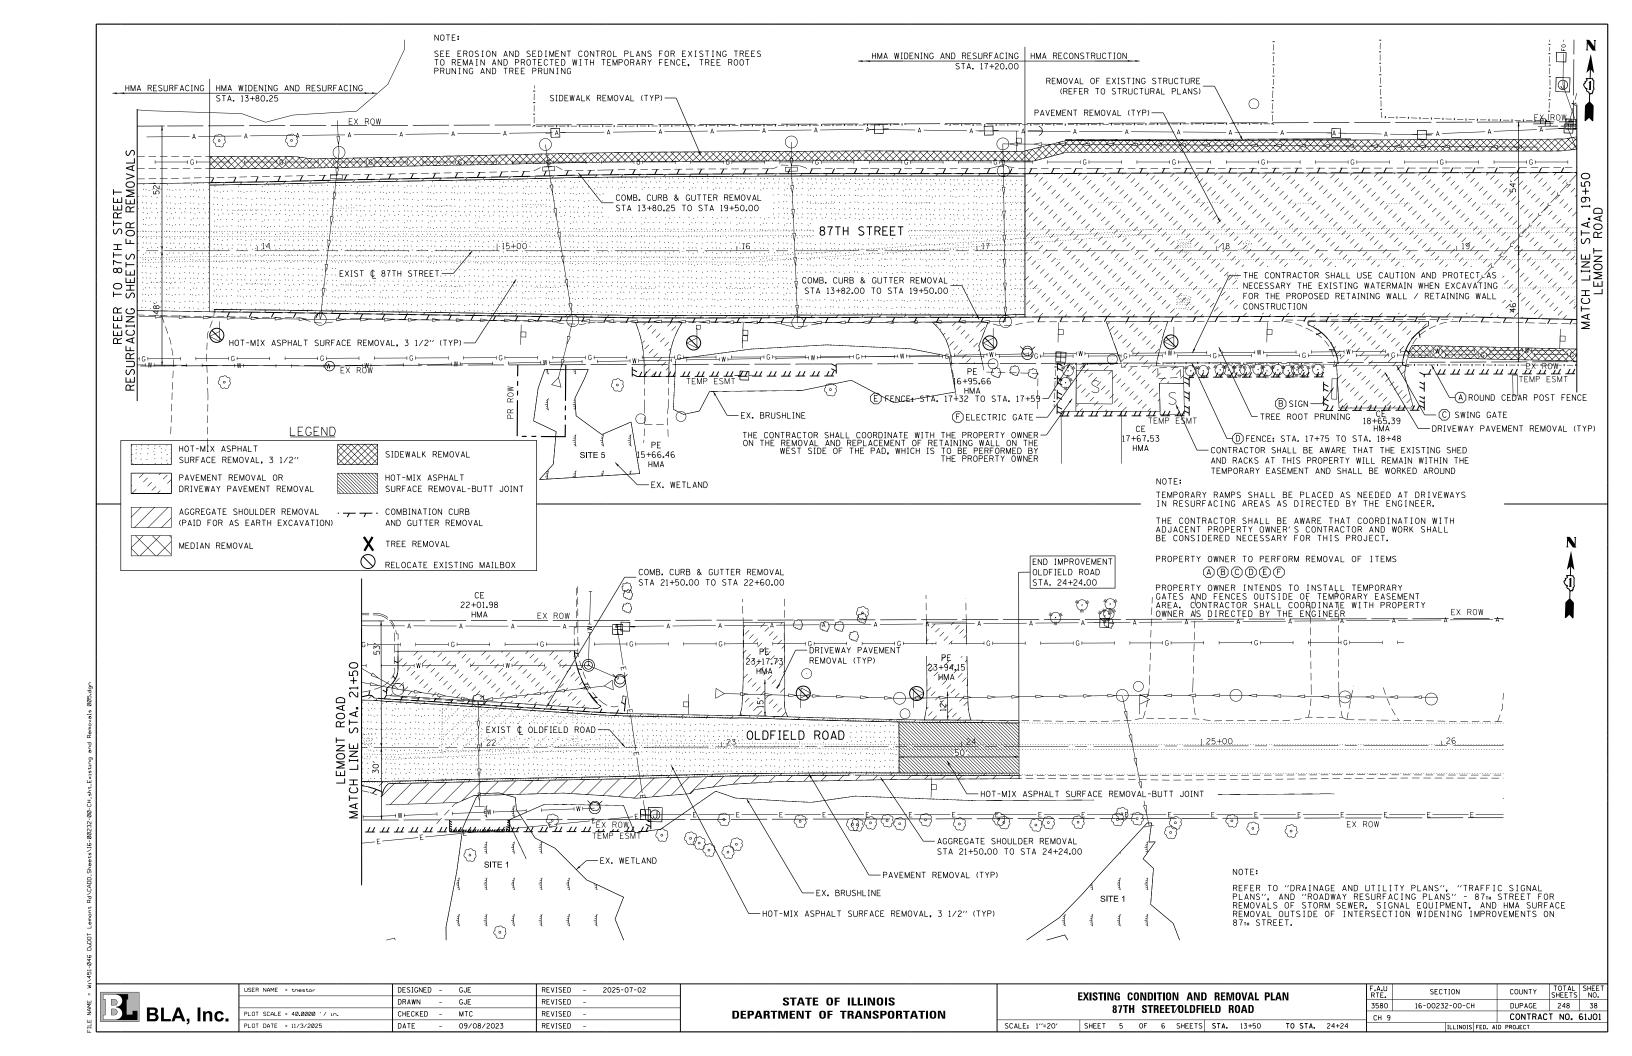






BLA, Inc.

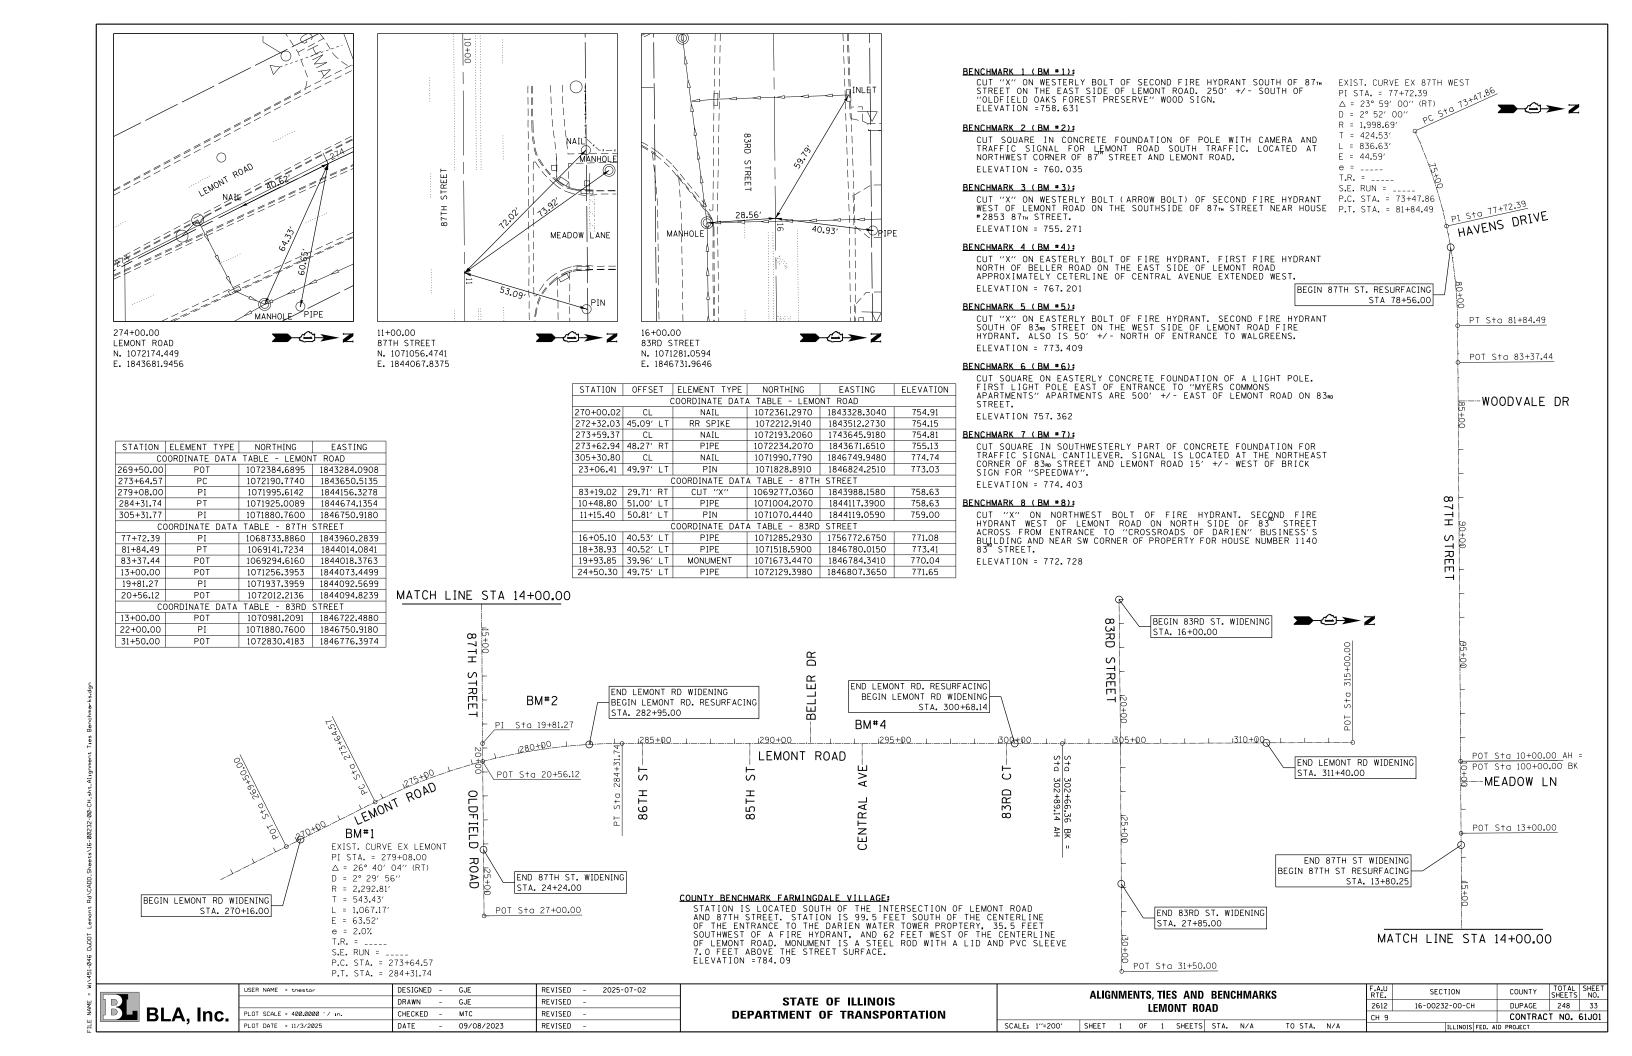
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	PLOT DATE = 11/3/2025	DATE	-	09/08/2023	REVISED	-	

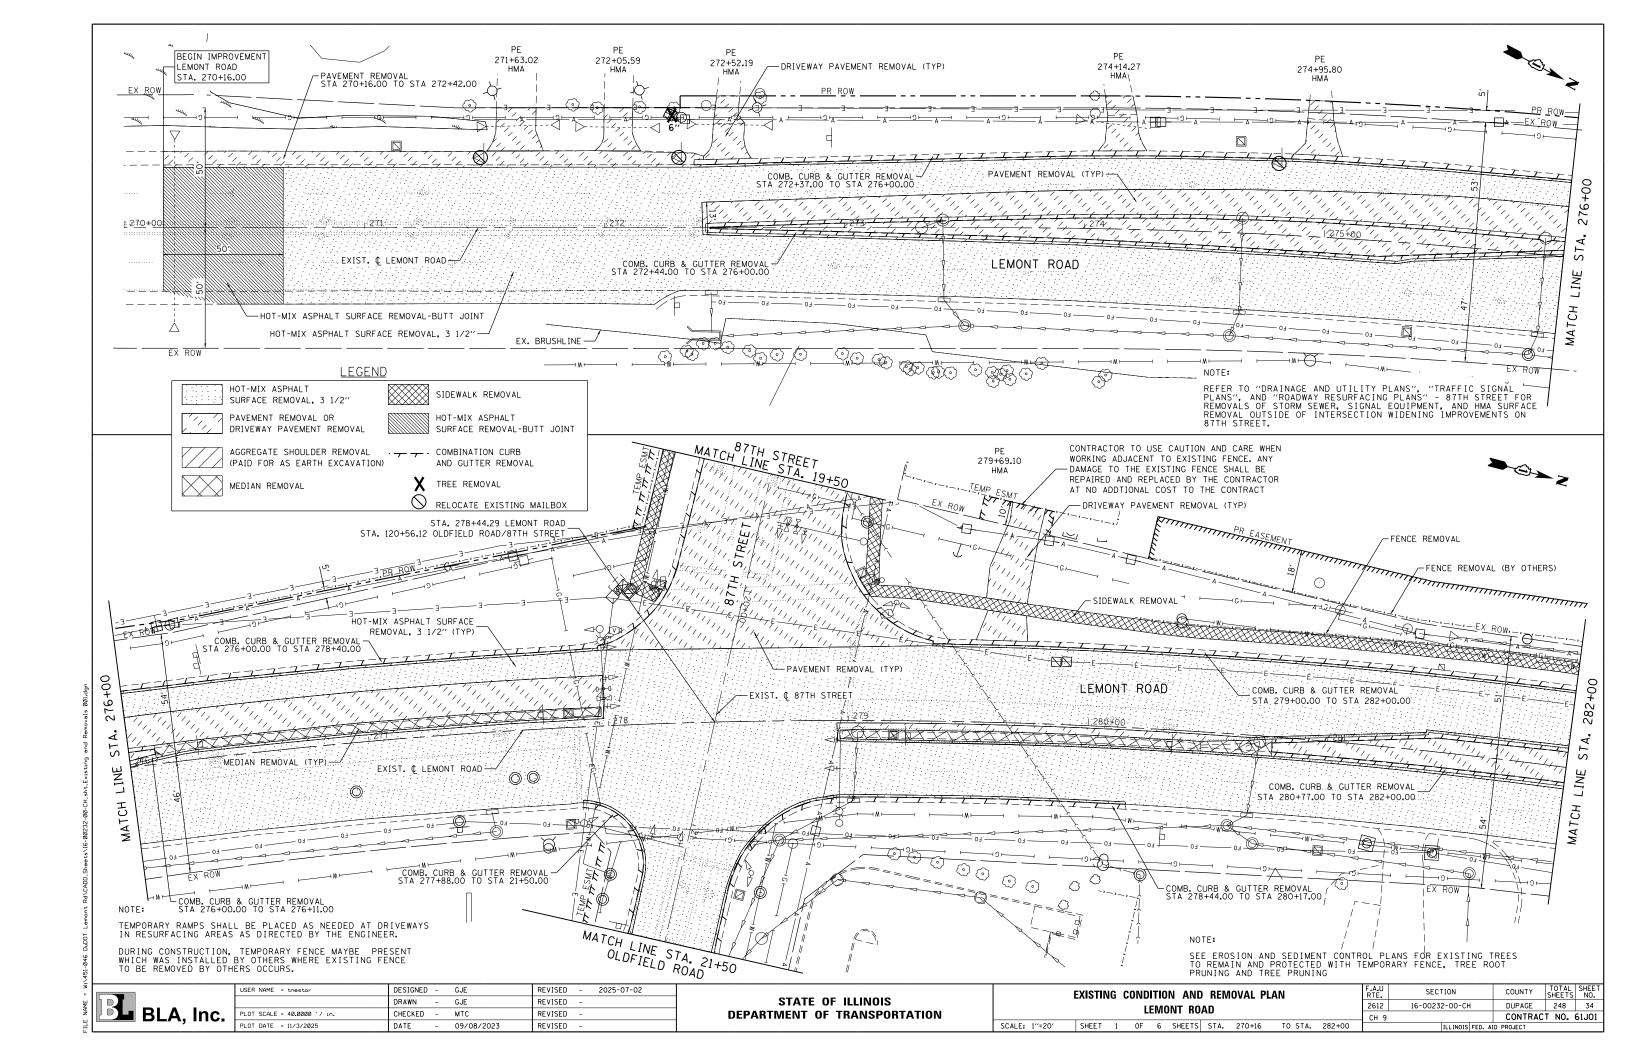
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I	LEMONT ROAD										2612 16-00232-00-CH		DUPAGE	248	37
ļ					LIVIO	11111110	CH 9		CONTRAC	T NO.	61J01				
ı	SCALE: 1"=20"	SHEET	4	OF	6	SHEETS	STA.	306+25	TO STA.	311+40		ILLINOIS FED. A	D PROJECT		

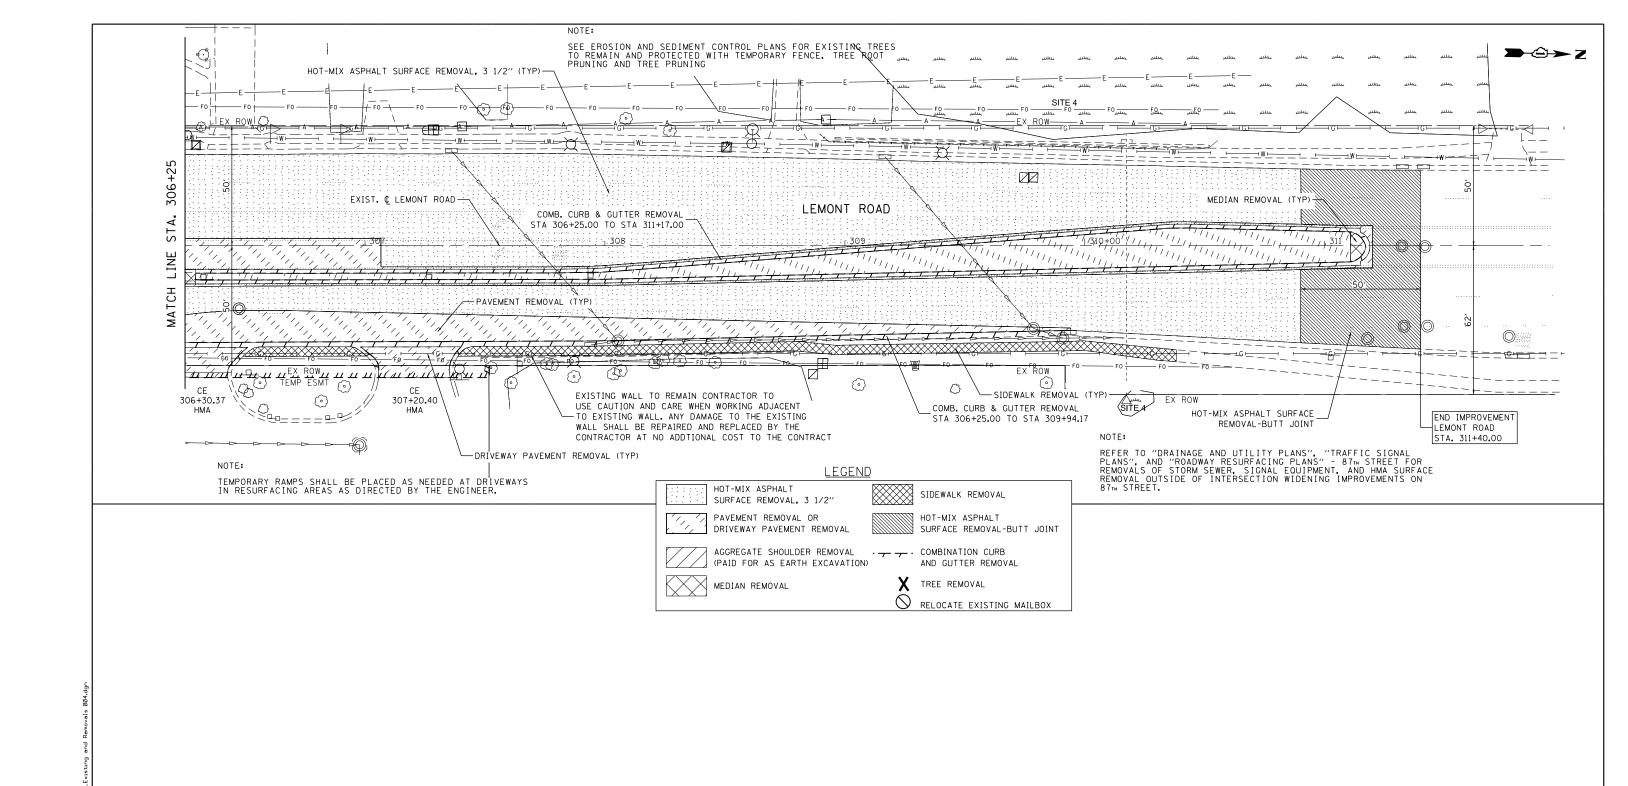


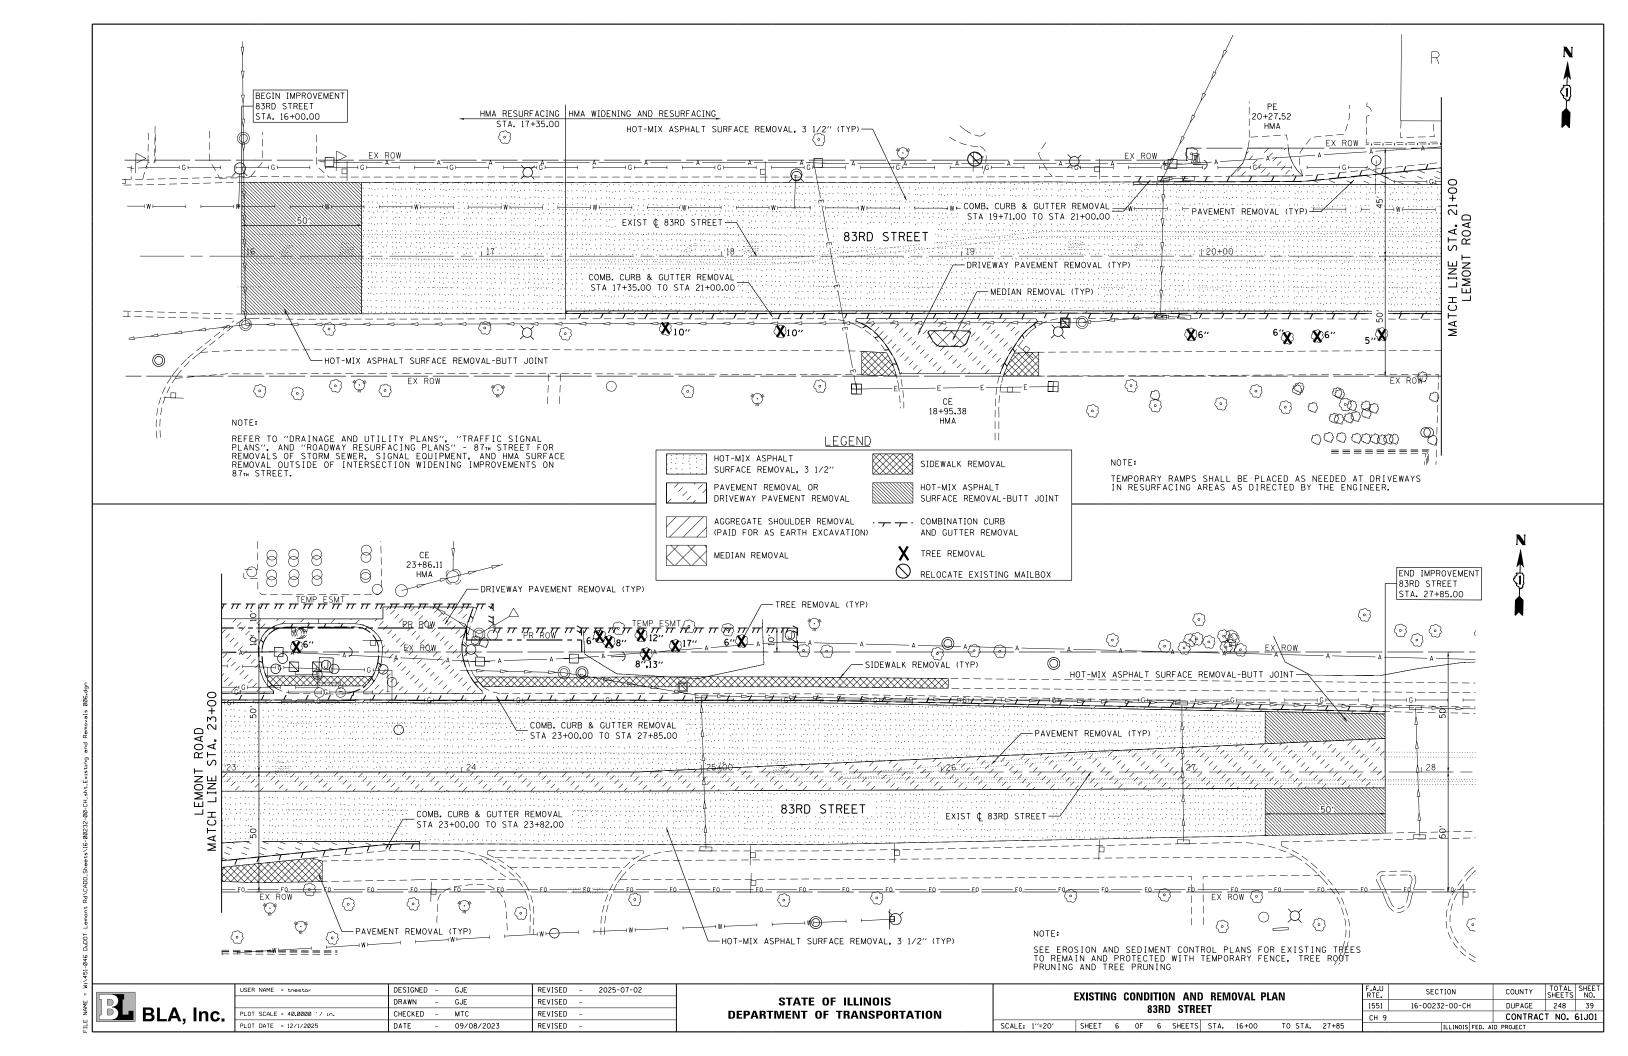


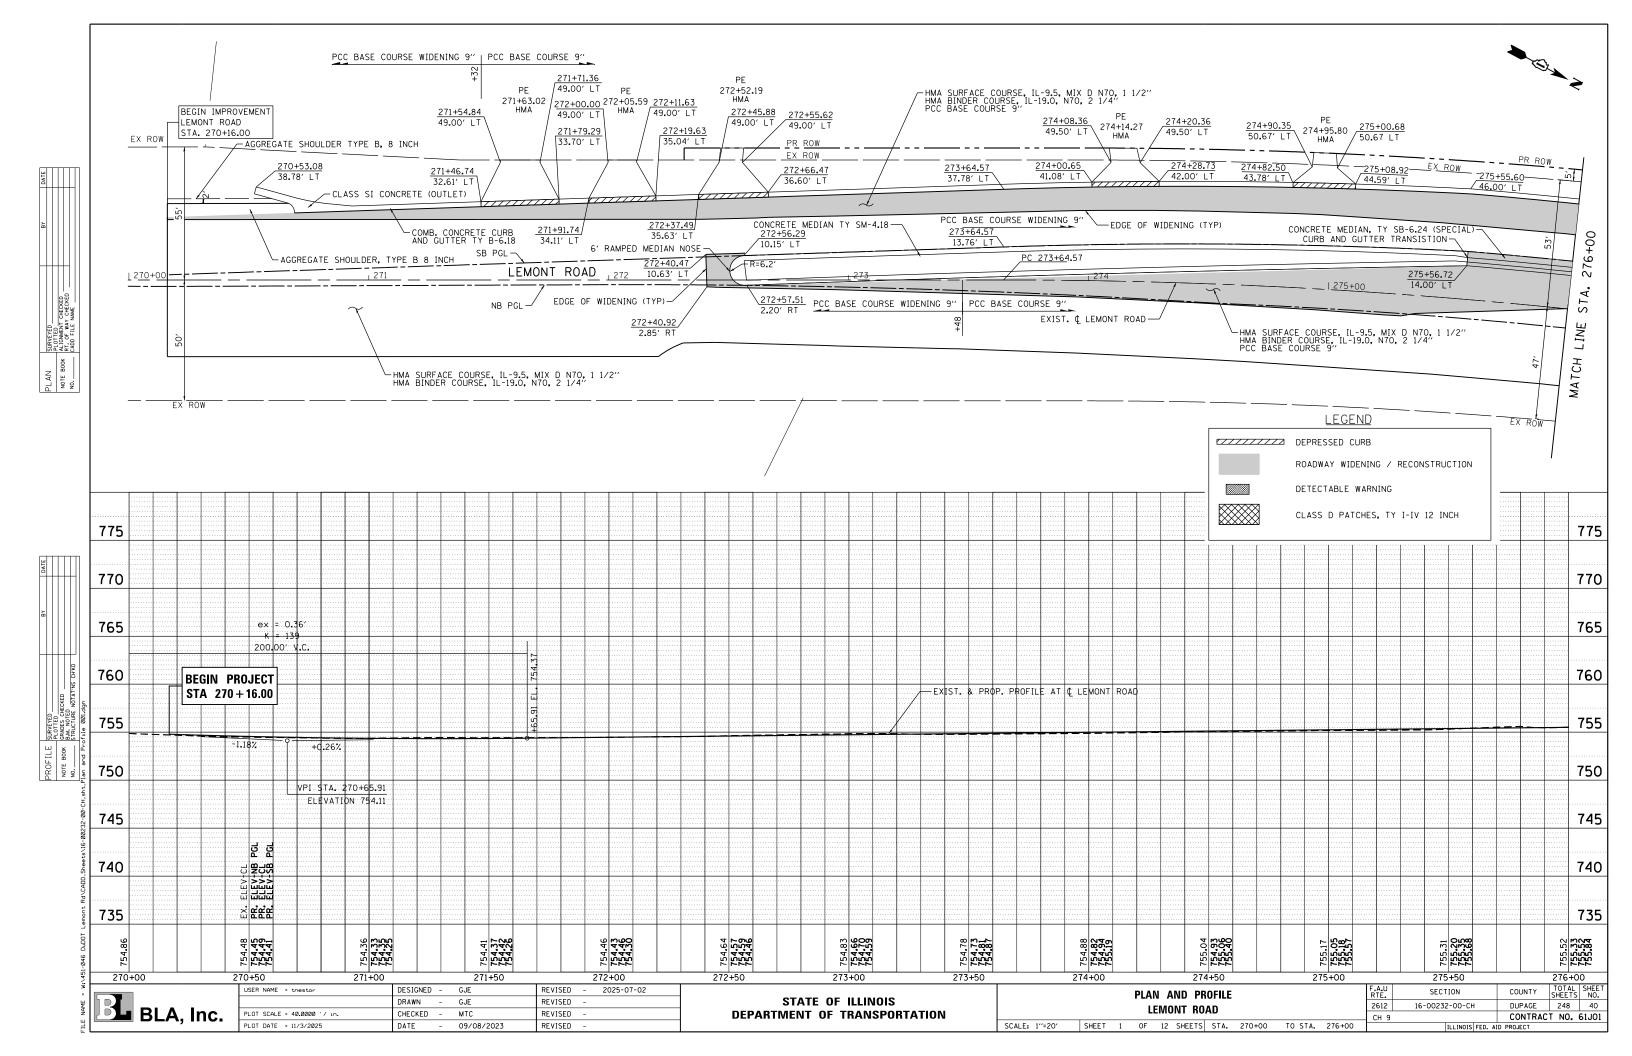


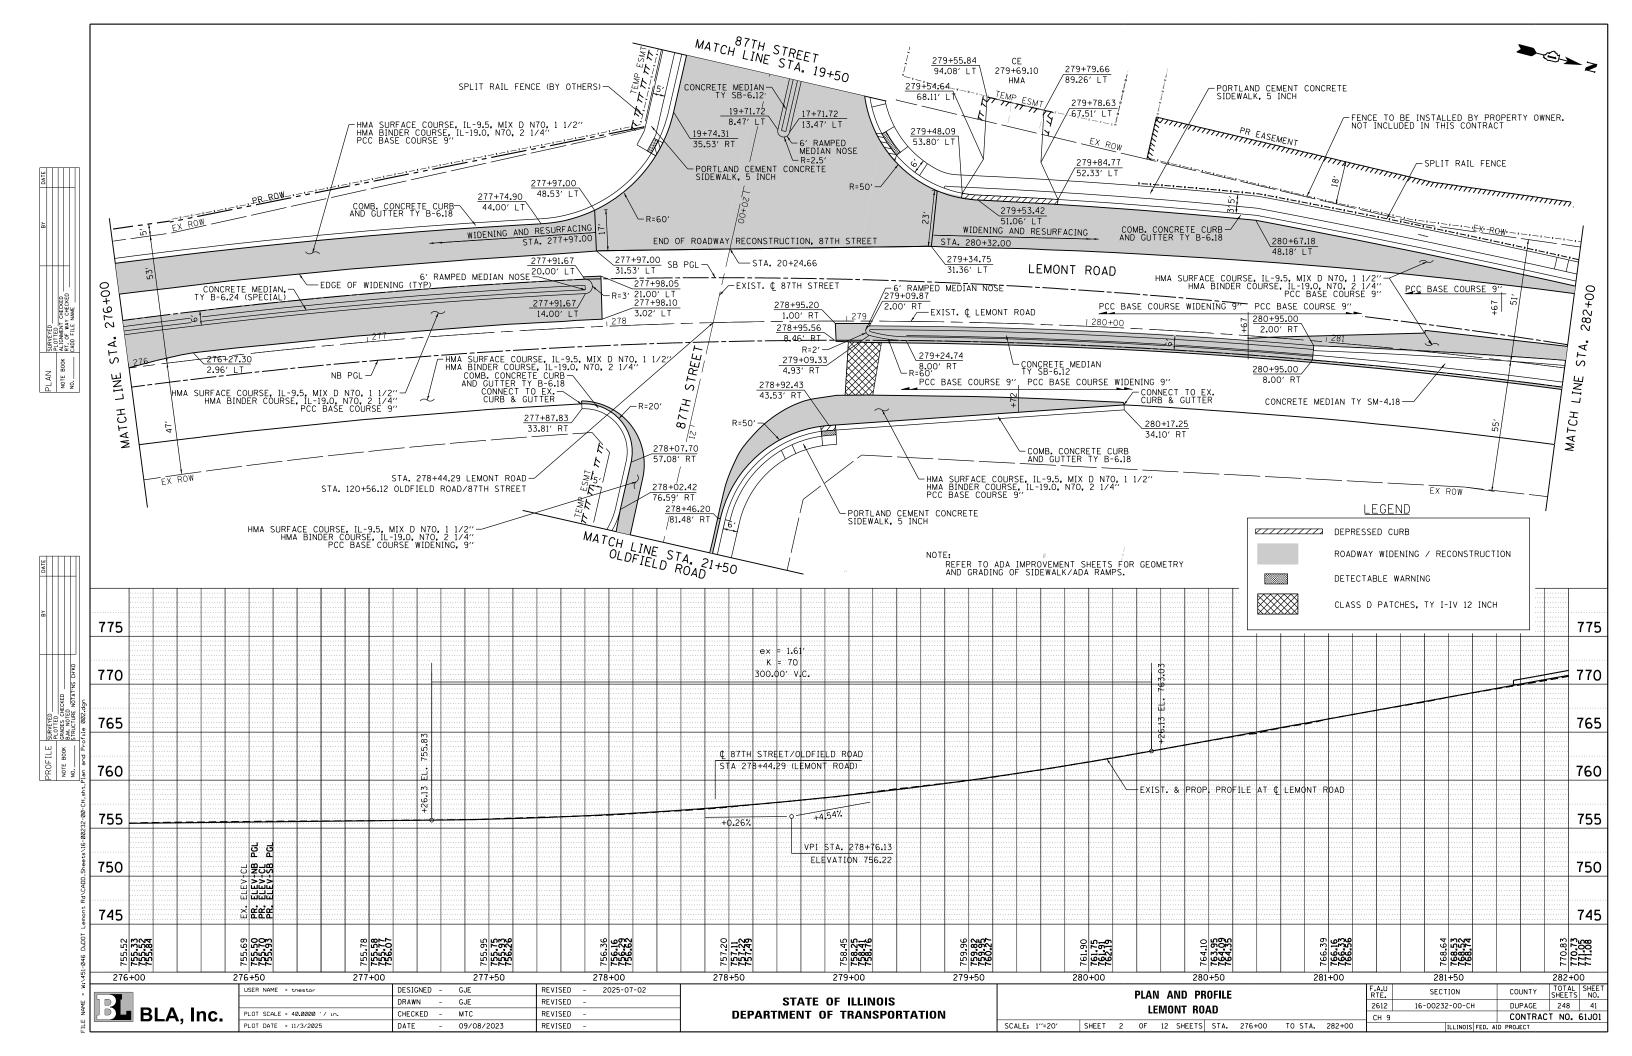


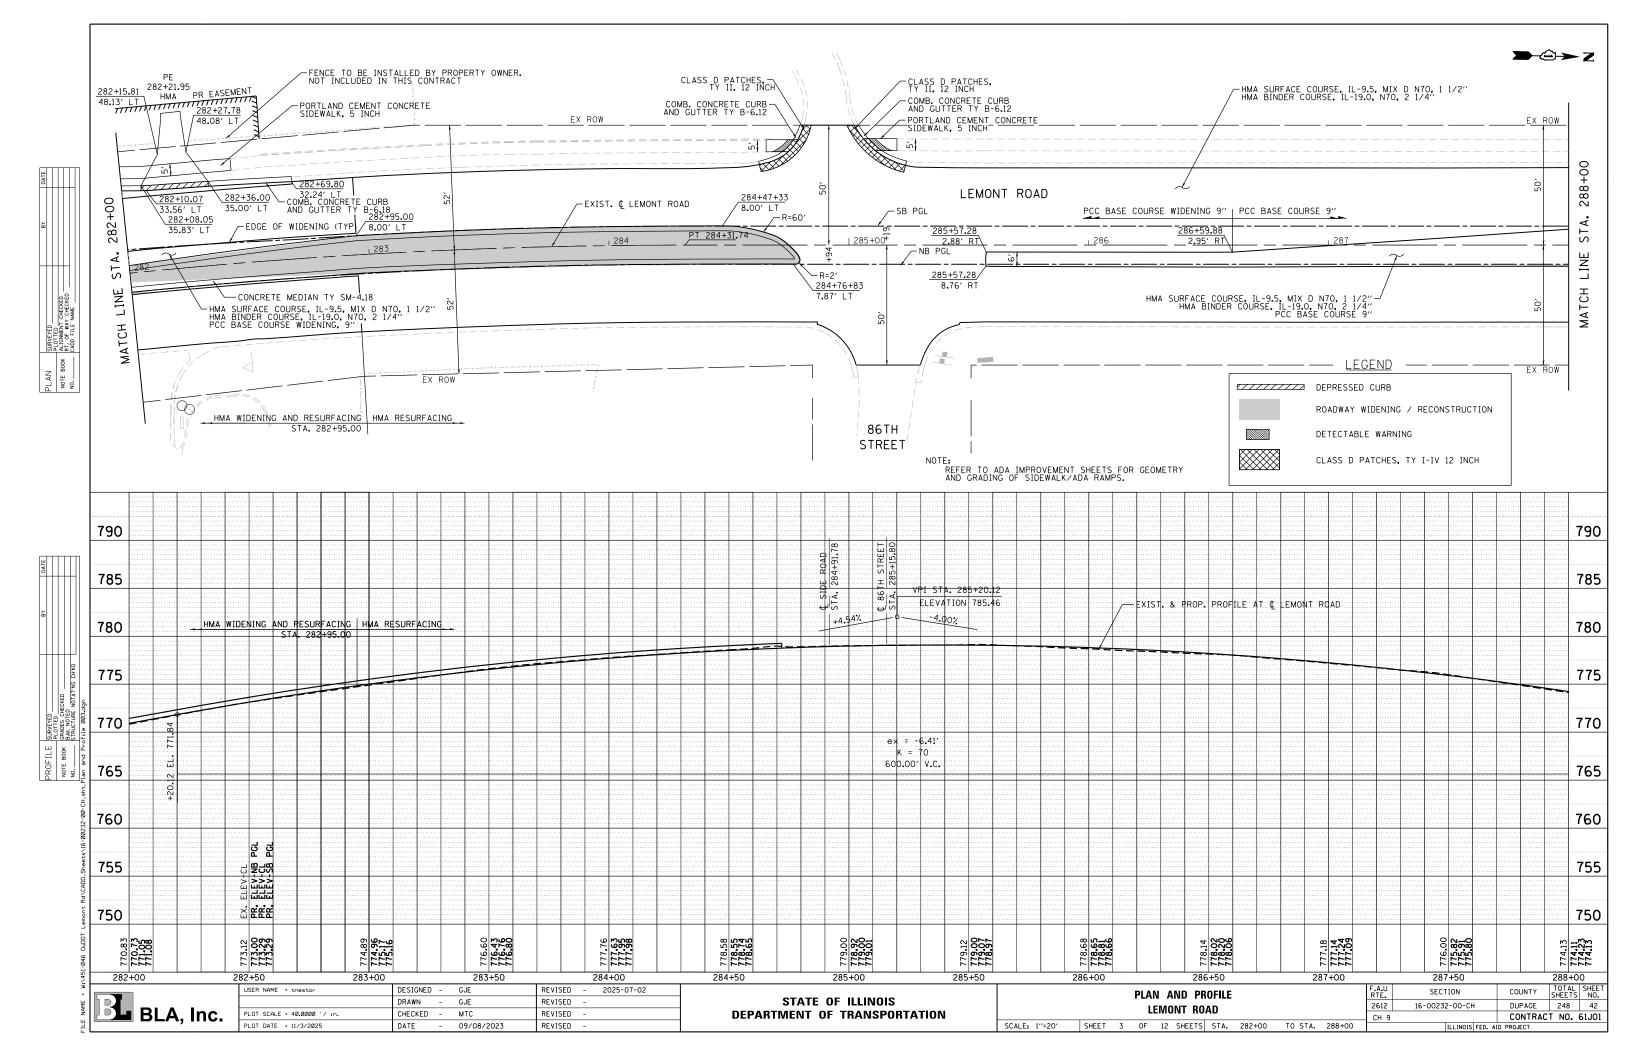


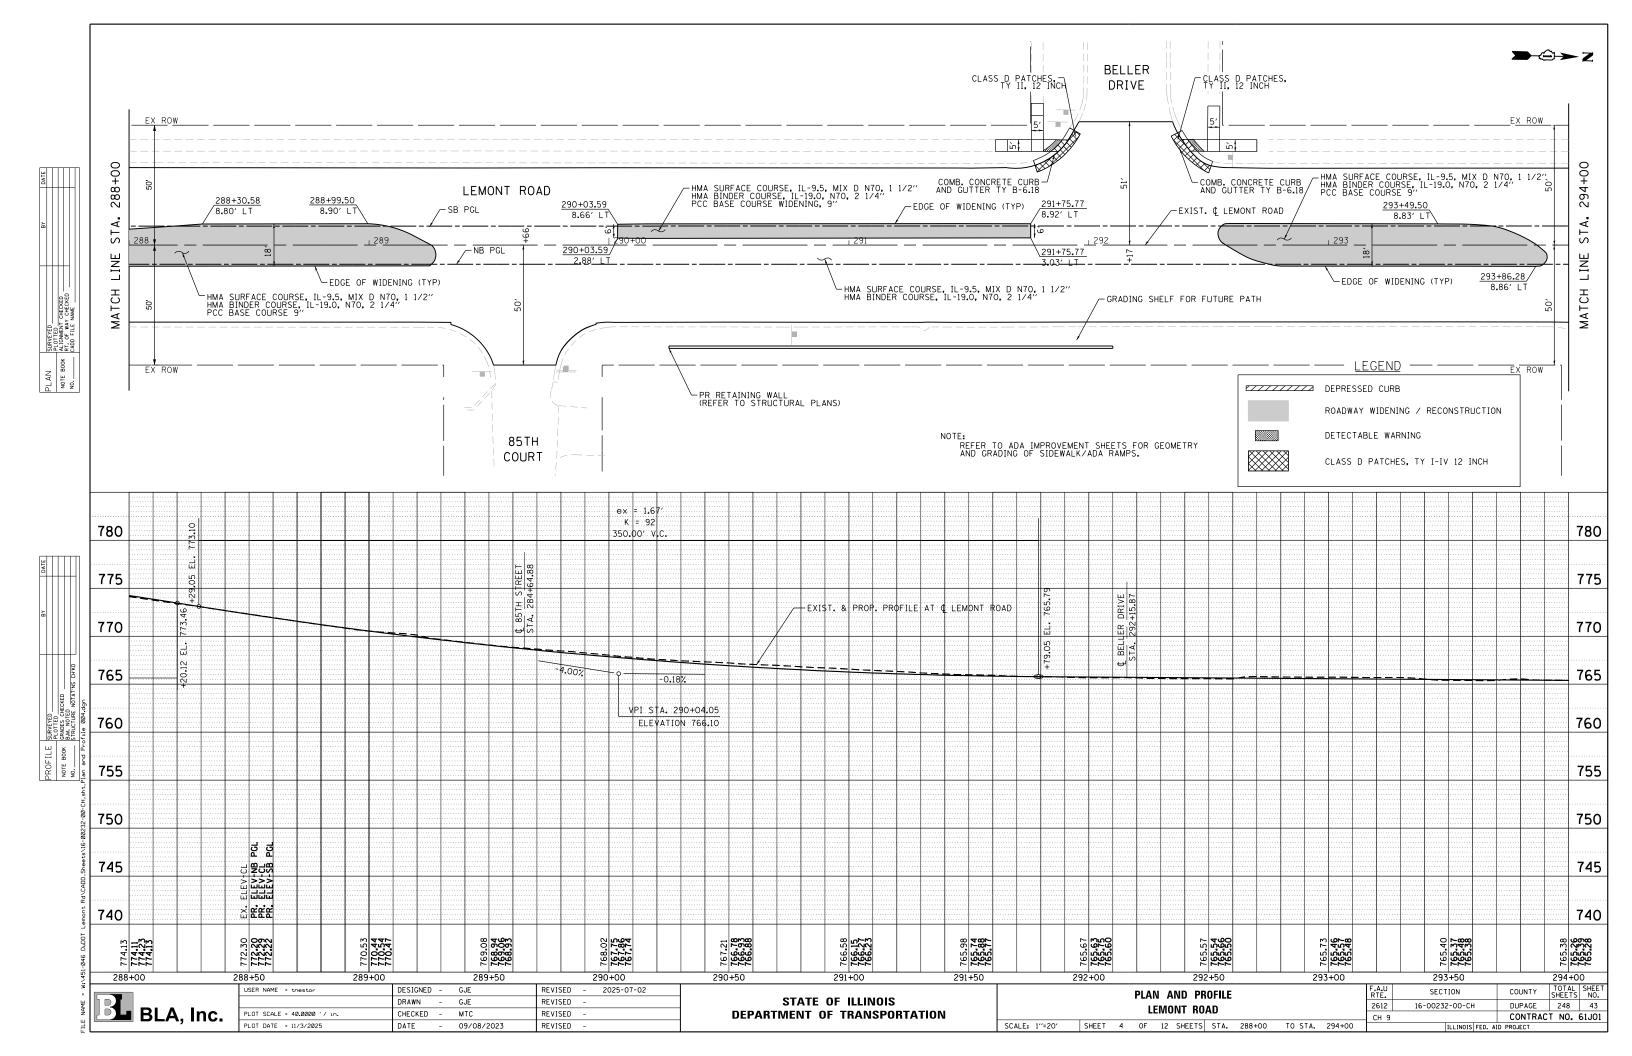


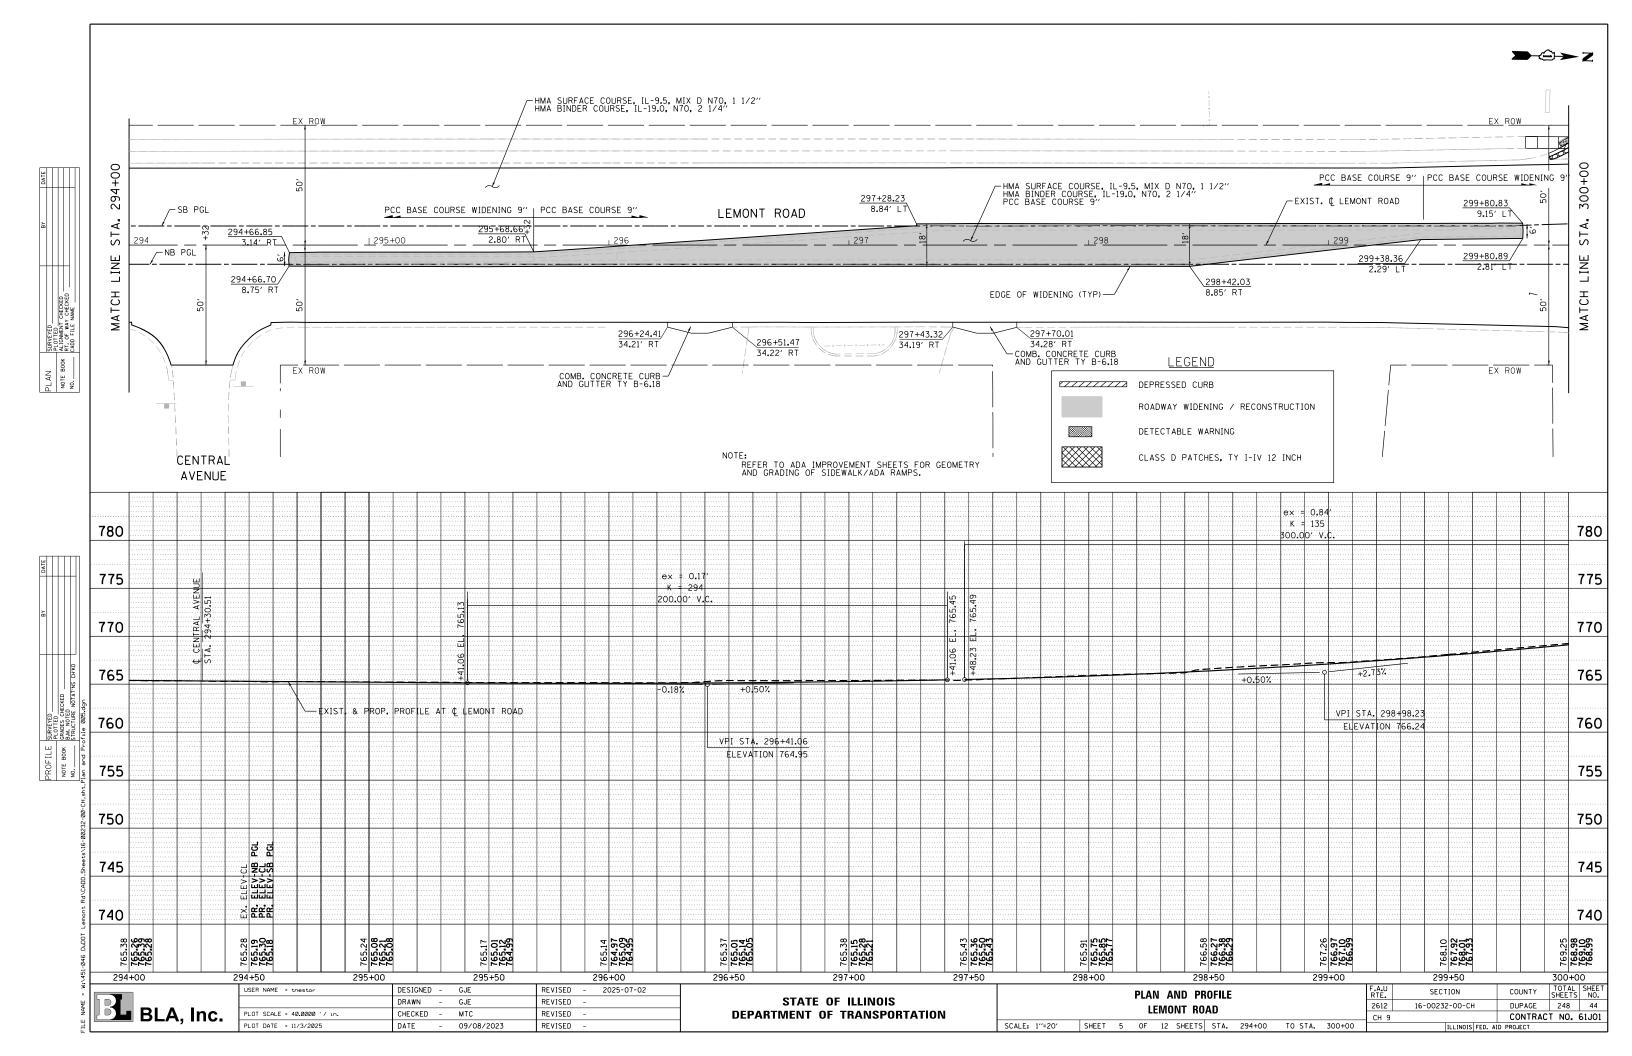


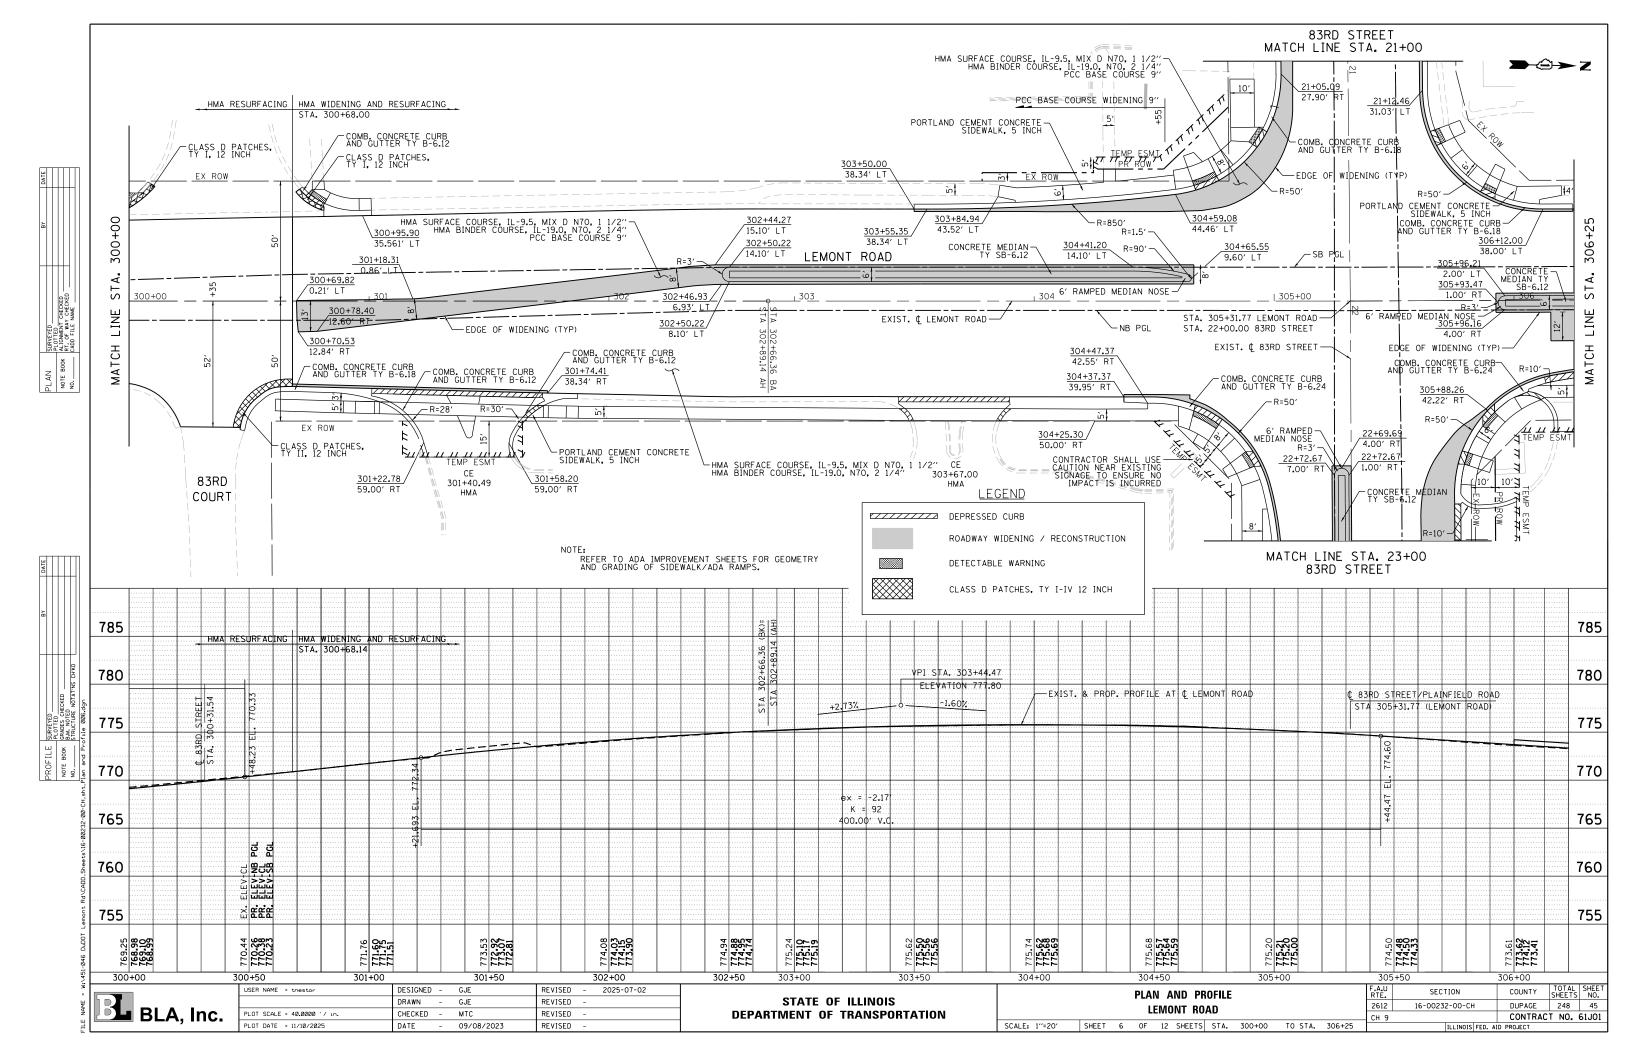


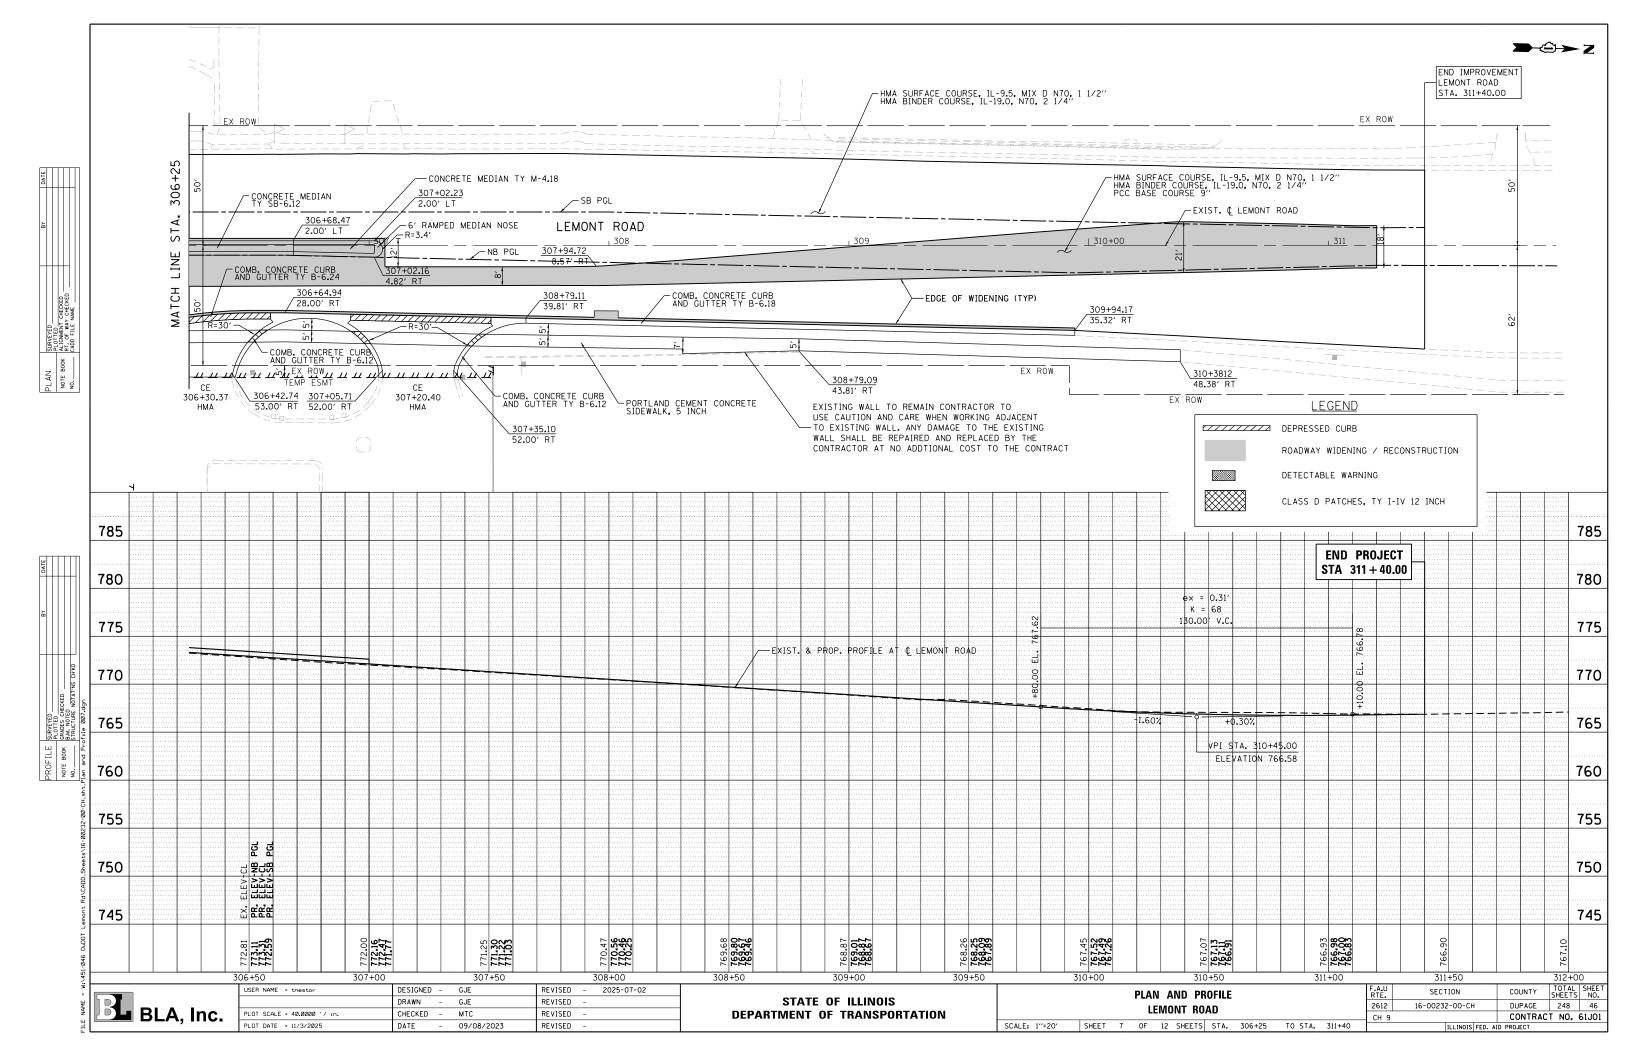


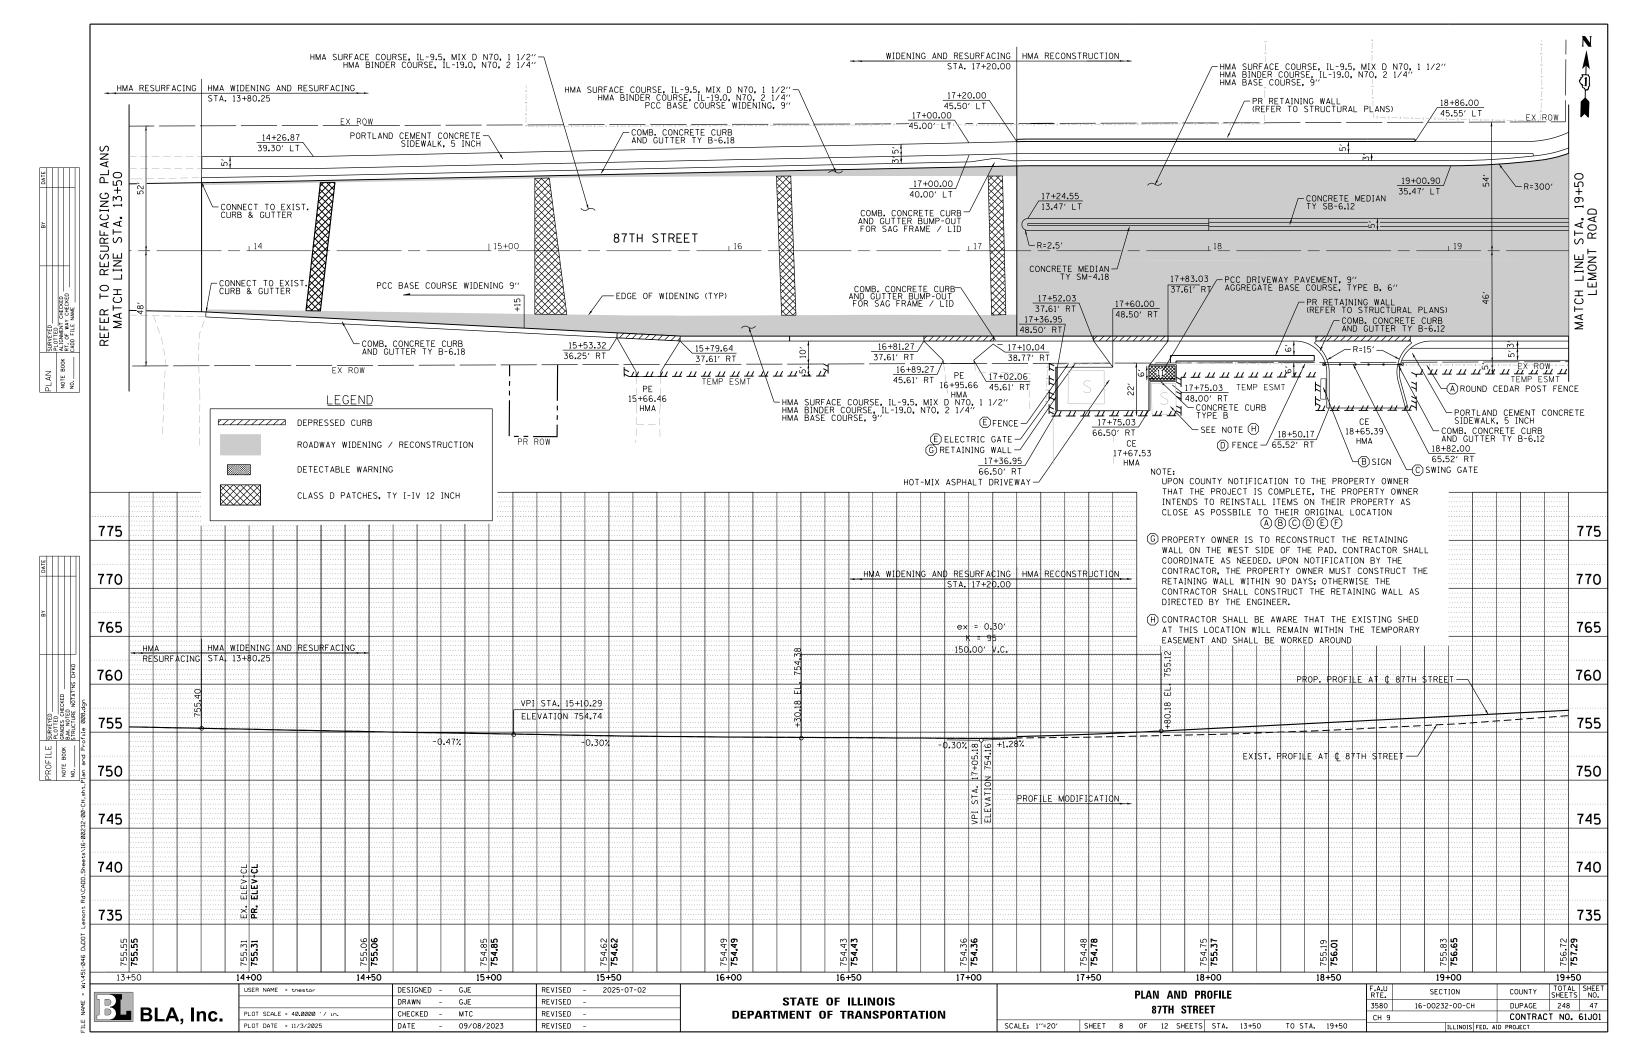


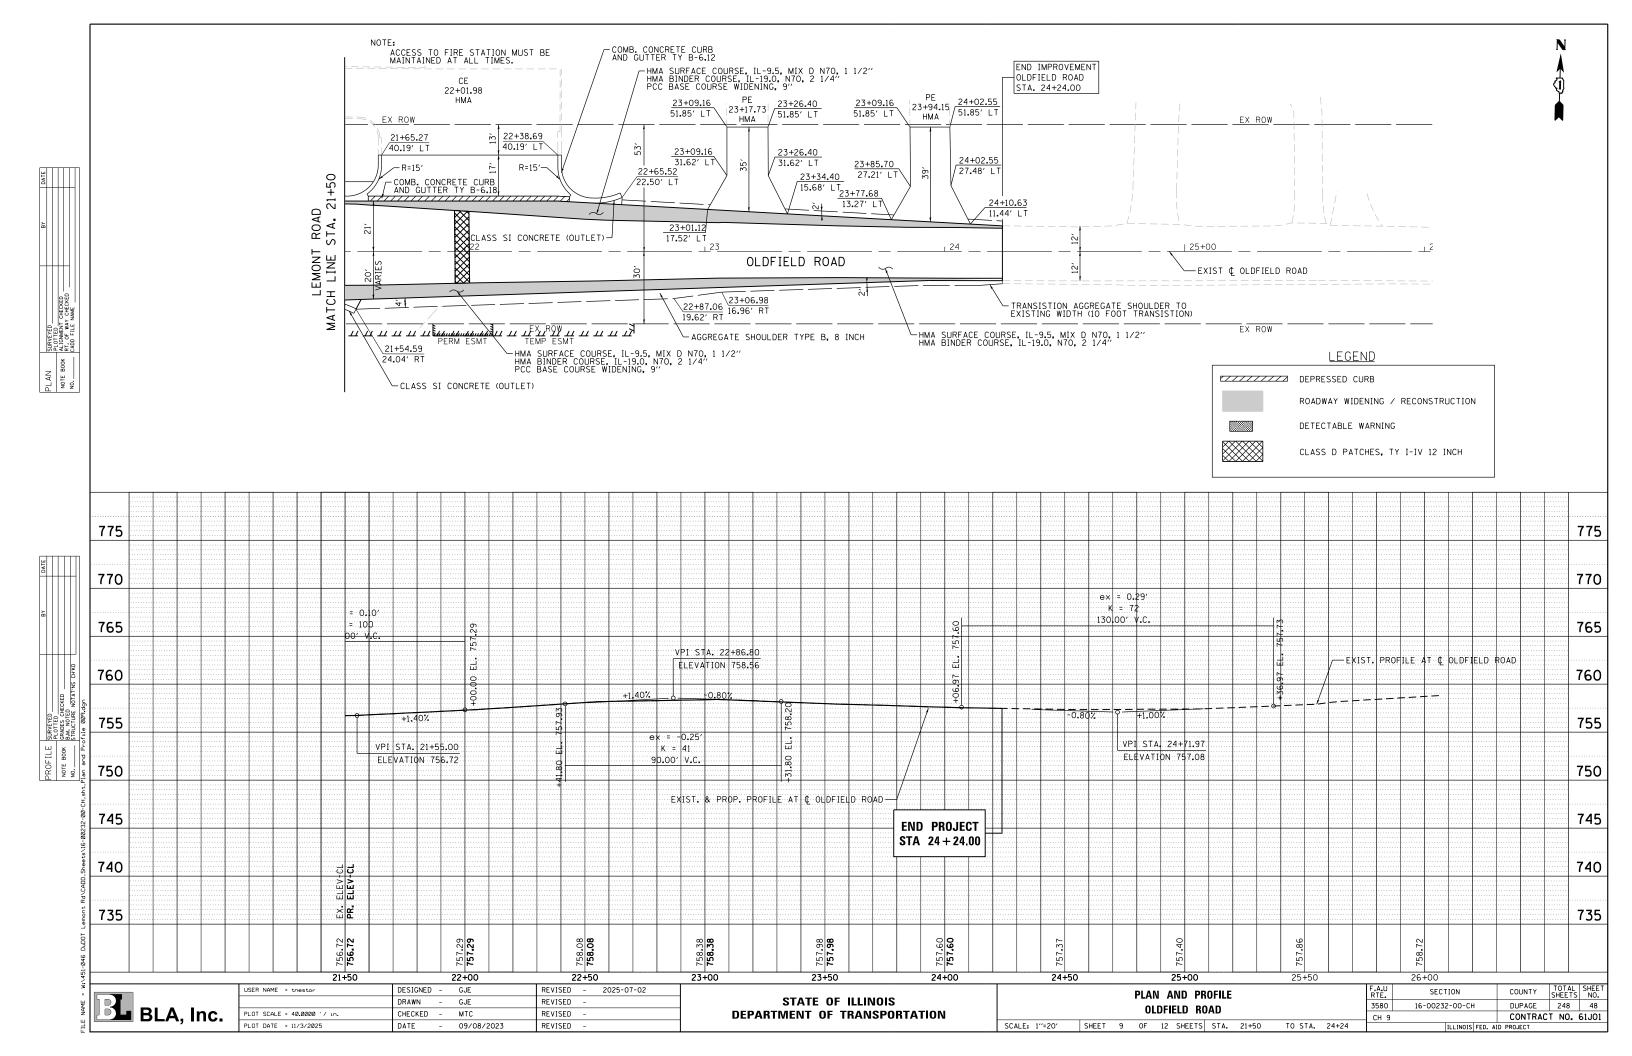


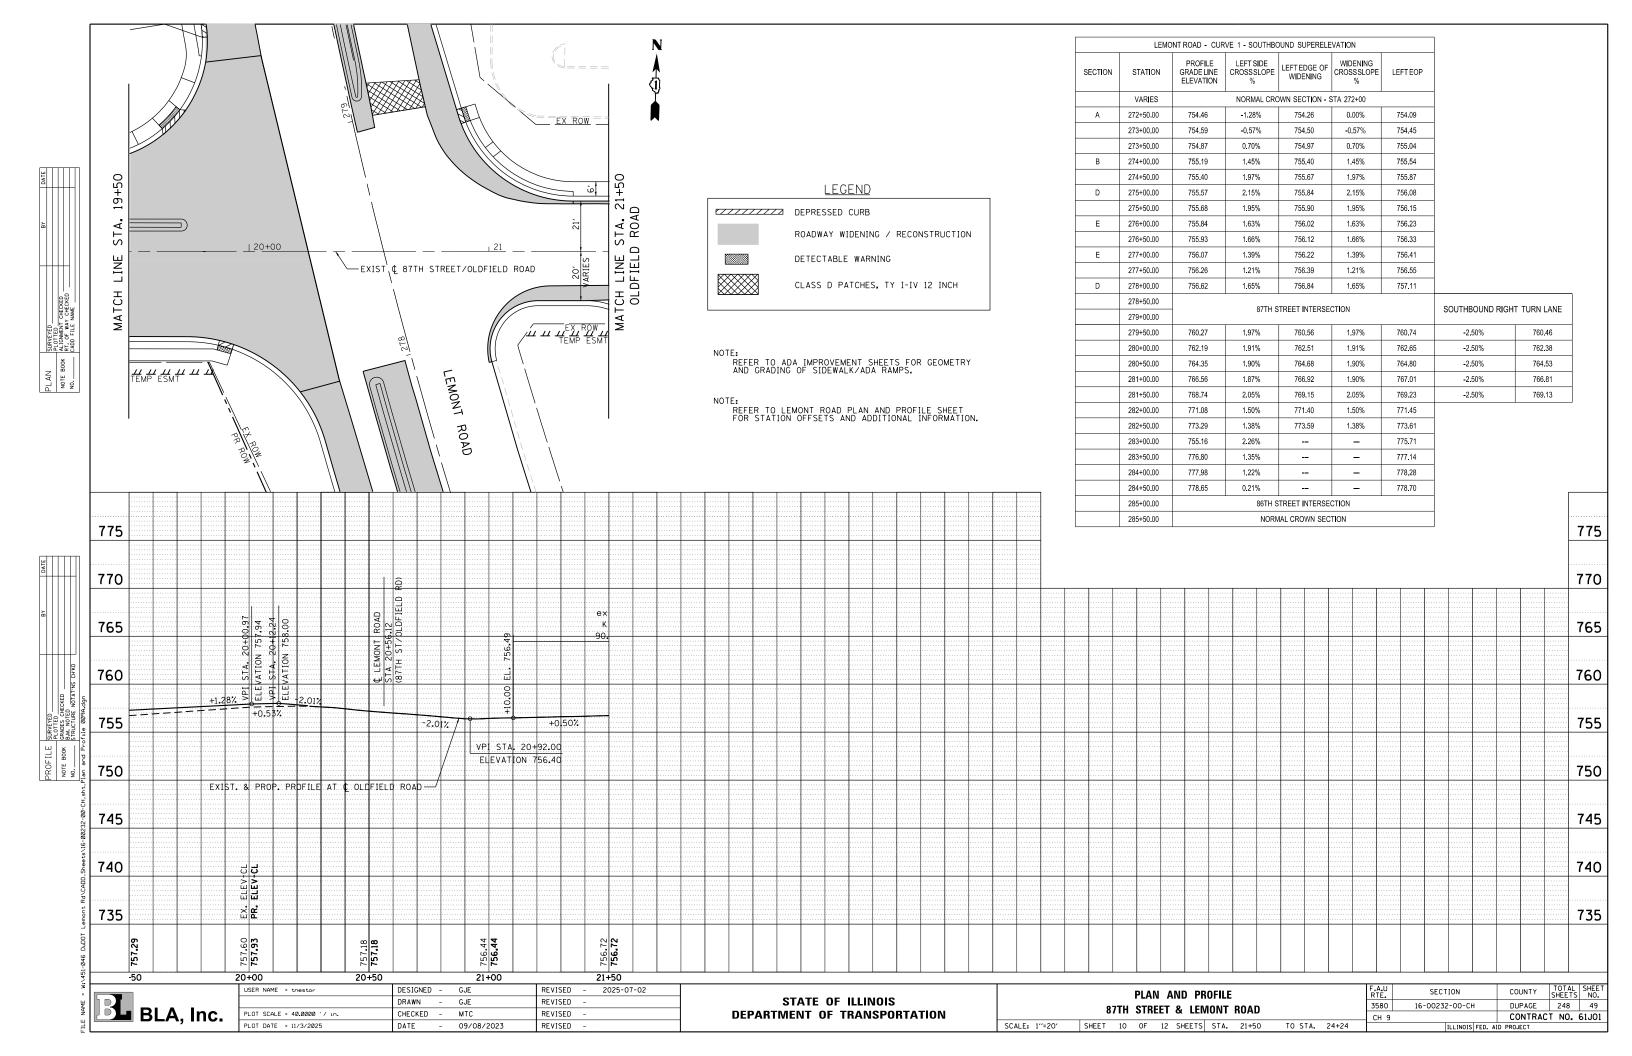


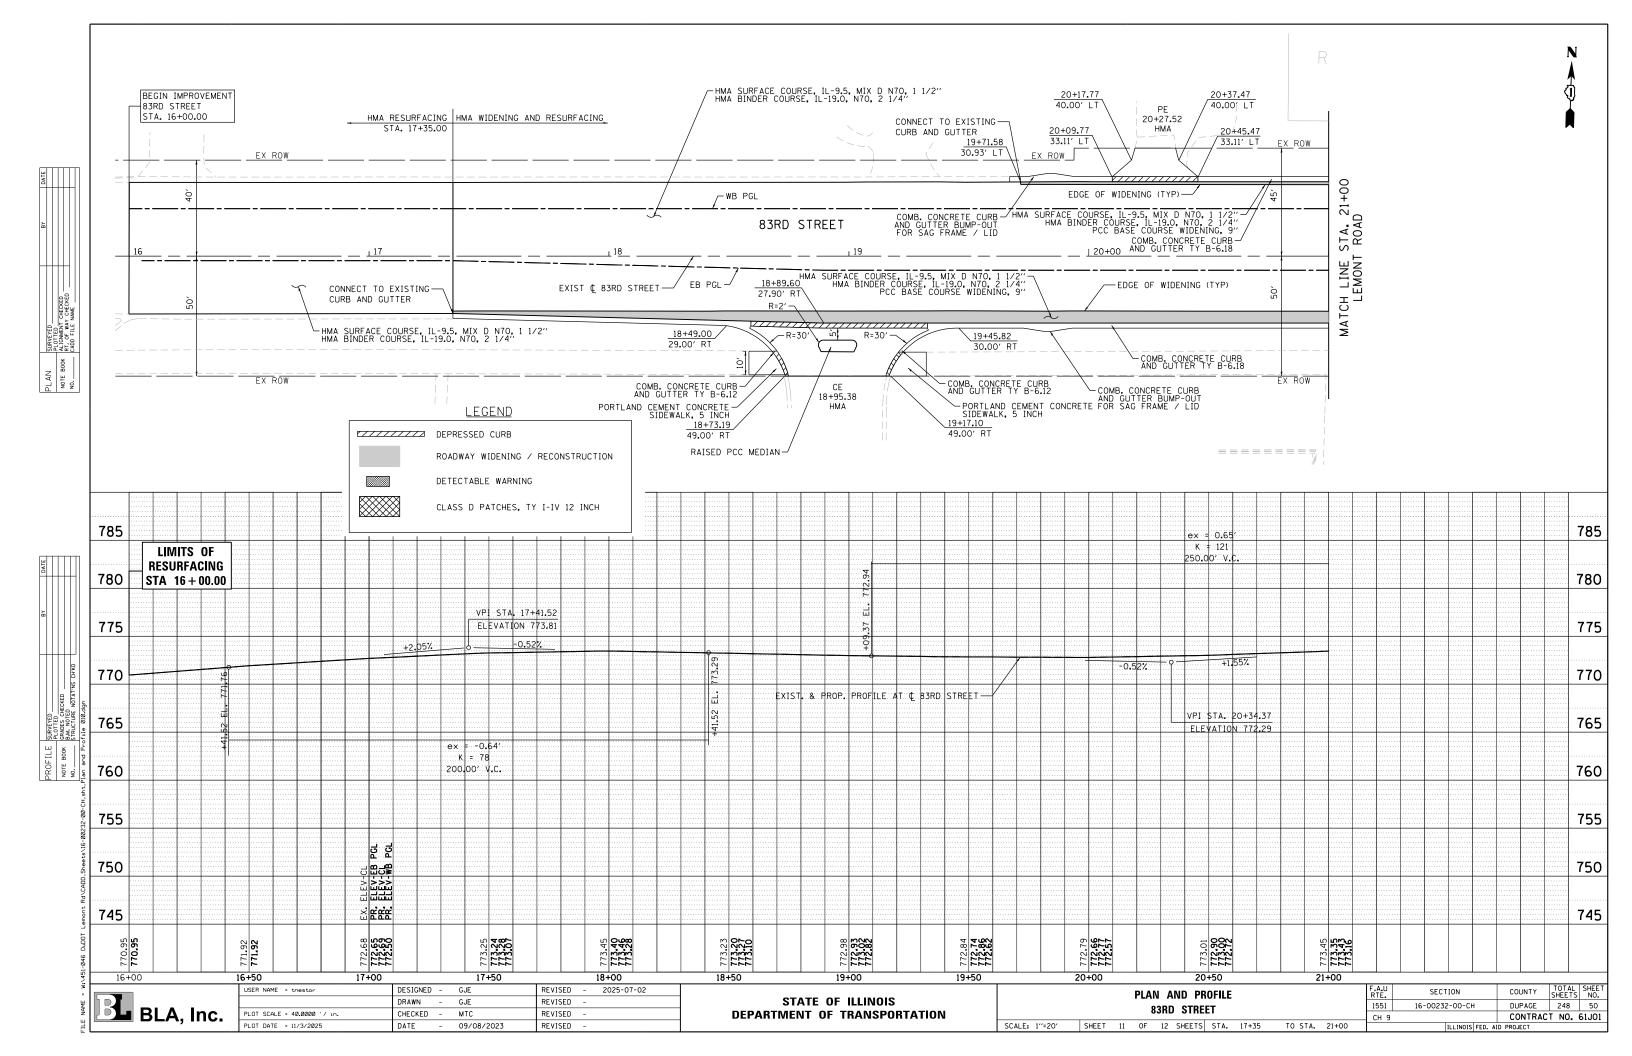

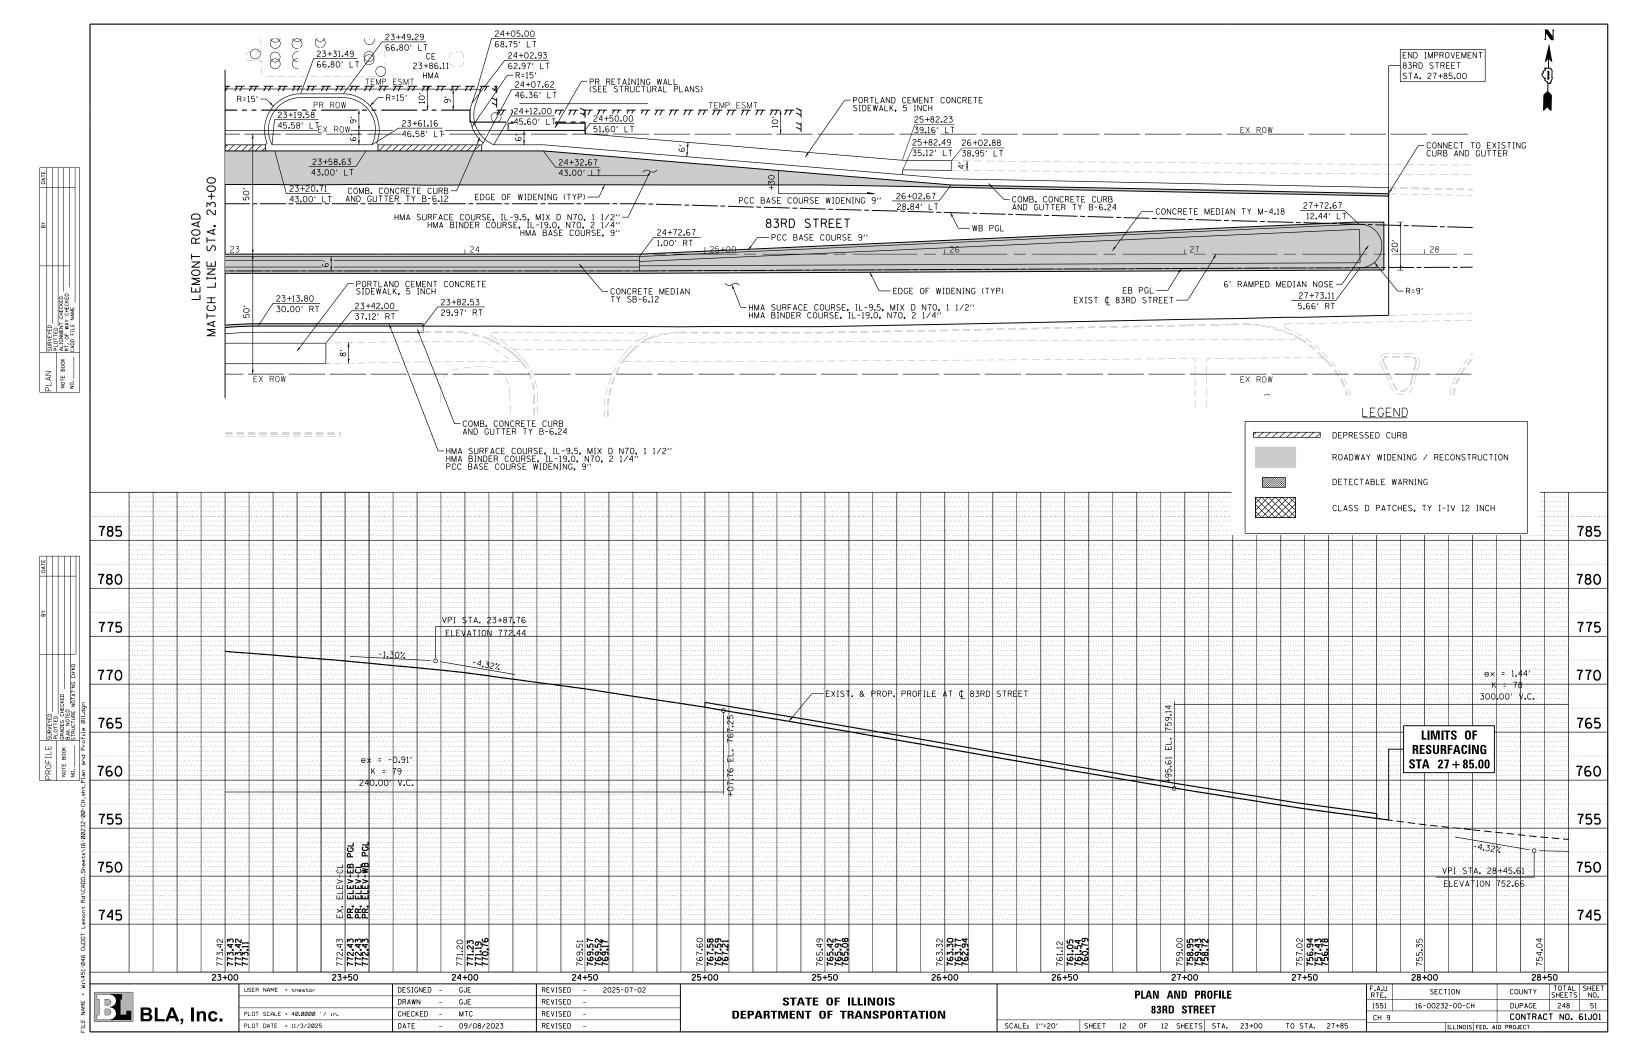

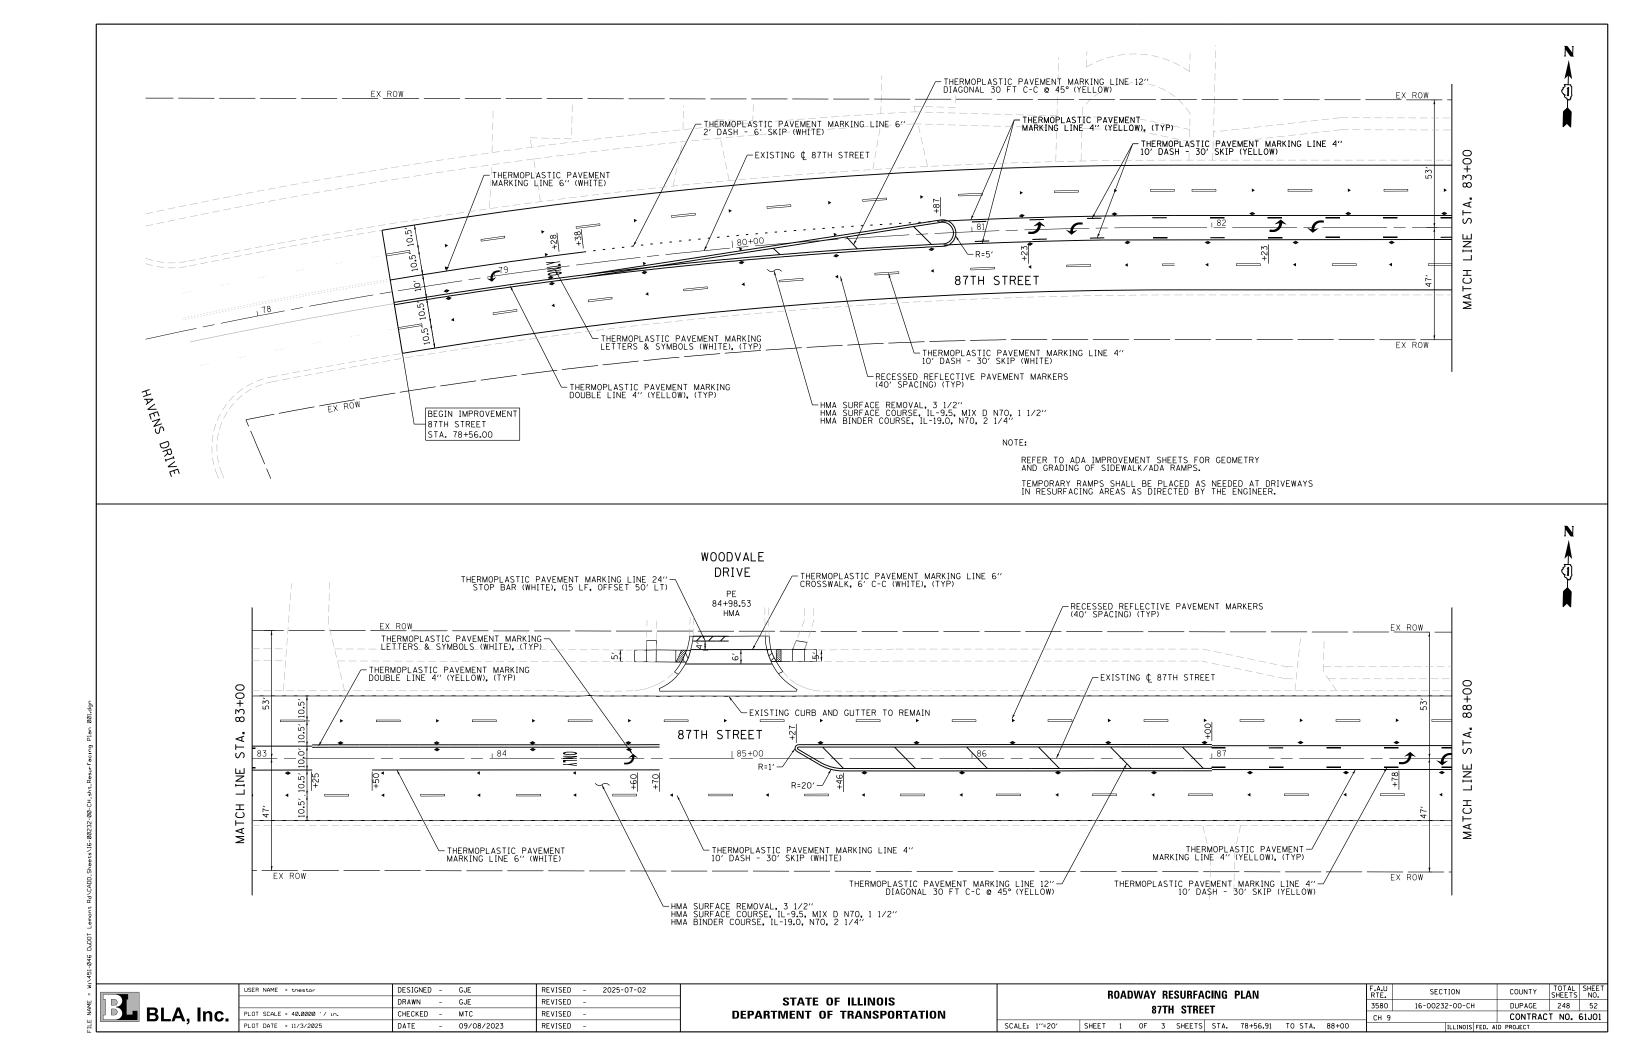

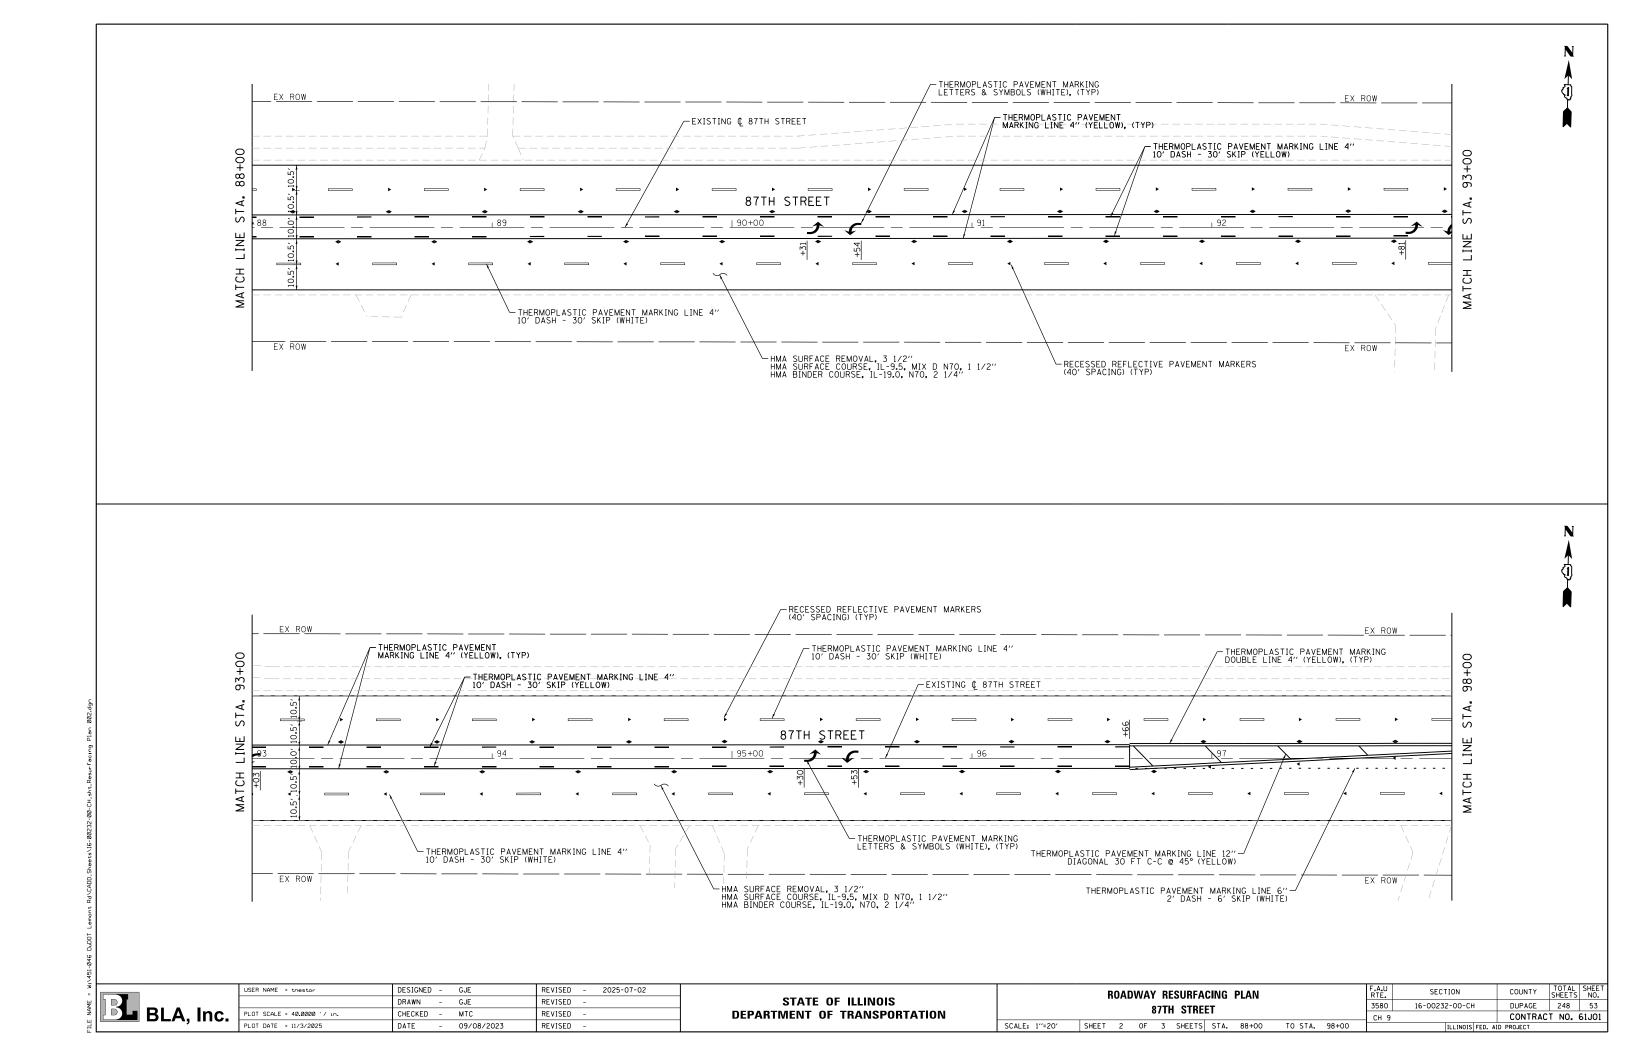

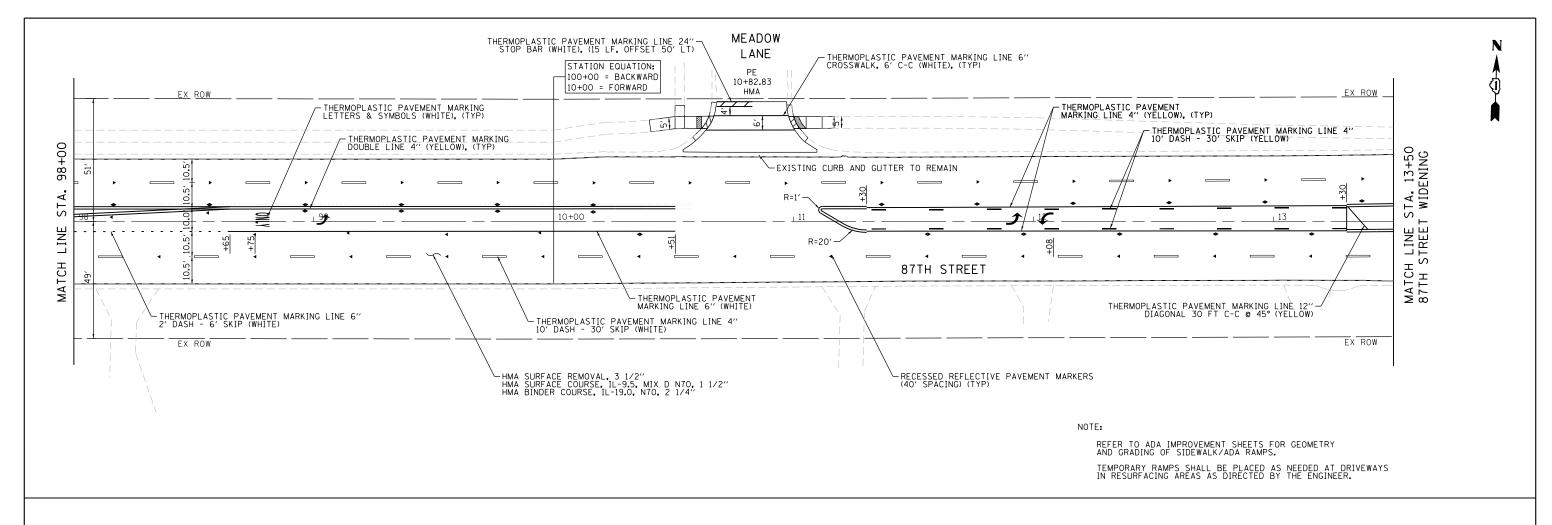

- 1. PAVEMENT MARKING AND RECESSED REFLECTIVE MARKERS SHALL BE IN CONFORMANCE WITH THE ILLINOIS MANUAL ON UNIFORM TRAFFIC CONTROL DEVICES, STANDARD DETAIL 780001, DISTRICT ONE STANDARDS, THE PLAN DETAILS AND THE STANDARD SPECIFICATIONS FOR TRAFFIC CONTROL ITEMS.
- 2. ALL FINAL PAVEMENT MARKING SYMBOLS SHALL BE OF LARGE SIZE.
- 3. STOP BARS SHALL BE PLACED 4' BEHIND CROSSWALK LINES AS SHOWN.
- 4. BEFORE BEGINNING ANY WORK, THE CONTRACTOR SHALL RETAIN AND RECORD FOR FUTURE REFERENCE, ALL EXISTING PAVEMENT MARKING LINES (AND RAISED REFLECTIVE MARKINGS) IN ORDER THAT THESE LOCATIONS CAN BE RE-ESTABLISHED FOR STRIPING. EXACT LOCATIONS OF ALL PAVEMENT MARKINGS SHALL BE AS DIRECTED BY THE FNGINFFR.
- 5. STATION AND OFFSET MEASUREMENTS AS SHOWN ON THE PLANS FOR 24" WHITE STOP BARS ARE TAKEN AT THE ENDS OF THE MARKINGS ALONG THE LONGITUDINAL CENTERLINES.
- 6. THERE SHALL BE A MINIMUM OF 5 DIAGONAL STRIPES IN THE PAINTED MEDIANS AT EACH LOCATION WHERE INDICATED IN THE PLANS.

BLA, Inc.
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PLOT DATE = 11/3/2025	DATE	_	09/08/2023	REVISED	-	

ROADWAY RESURFACING PLAN													
	87TH STREET												
SCALE: 1"=20"	SHEET	3	OF	3	SHEETS	STA.	98+00	TO STA.	13+50				

F.A.U RTE.	SECTION	COUNTY	TOTAL SHEETS	SHEET NO.
3580	16-00232-00-CH	DUPAGE	248	54
CH 9		CONTRAC	T NO.	61J01
	ILLINOIS FED.	AID PROJECT		

## STAGE CONSTRUCTION GENERAL NOTES

ALL OF THE TRAFFIC CONTROL DEVICES SHALL BE IN PLACE BEFORE CONSTRUCTION IS STARTED FOR EACH APPLICABLE PHASE. THE TRAFFIC CONTROL PLANS SHALL SERVE AS A GUIDE FOR THE SAFE DIVERSION OF TRAFFIC DURING THE EXECUTION OF

A MINIMUM OF ONE LANE (11 FEET) IN EACH DIRECTION OF LEMONT ROAD AND ALL SHOWN TURN LANES SHALL BE KEPT OPEN TO THROUGH TRAFFIC AT ALL TIMES EXCEPT AS NOTED IN PLANS. ANY LANE CLOSURES MUST BE APPROVED BY THE ENGINEER. ANY WORK THAT RESTRICTS CONTINUOUS TWO-WAY TRAFFIC THRU MAJOR OR SIGNALIZED INTERSECTIONS SHALL BE COORDINATED BY THE CONTRACTOR UNLESS APPROVED AND DIRECTED BY THE ENGINEER. THE COST FOR THIS NECESSARY COORDINATION AND EXECUTION SHALL BE INCLUDED IN THE LUMP SUM COST FOR TRAFFIC CONTROL &

IT WILL BE THE CONTRACTOR'S RESPONSIBILITY TO PROVIDE INFORMATIONAL SIGNS ON TEMPORARY SUPPORTS FOR EACH ENTRANCE IN CONSTRUCTION AREA, THESE SIGNS SHALL BE WHITE ON GREEN IN ACCORDANCE WITH THE MANUAL FOR UNIFORM TRAFFIC CONTROL DEVICES, ALSO, "CAUTION NEW LANES OPEN STOP HERE" SIGNS WILL BE THE CONTRACTOR'S RESPONSIBILITY TO PROVIDE AT THE APPROPRIATE LOCATIONS. THIS WORK WILL BE PAID FOR UNDER THE CONTRACT WORK FOR TEMPORARY INFORMATION

DROP OFF'S NOT PROTECTED BY TEMPORARY CONCRETE BARRIER SHALL B BACKFILLED TO 12" BEFORE ANY TRAFFIC IS ALLOWED BACK IN THE ADJACENT LANE.

### TRAFFIC CONTROL AND PROTECTION

TRAFFIC CONTROL AND PROTECTION SHALL BE PERFORMED IN ACCORDANCE WITH THE TRAFFIC CONTROL PLAN, TRAFFIC SIGNAL PLANS, THESE NOTES, APPLICABLE SPECIAL PROVISIONS, AND SECTION 701 OF THE STANDARD SPECIFICATIONS AS AMENDED BY THE SPECIAL PROVISION FOR WORK ZONE TRAFFIC CONTROL CHECK SHEET LRS 3).

THE TYPE III BARRICADES ARE TO BE PLACED IN ACCORDANCE WITH STANDARD TO 1901 UNLESS AUTHORIZED BY THE ENGINEER TO USE AN ALTERNATE ARRANGEMENT.

EXISTING TRAFFIC CONTROL SIGNS AND DEVICES WILL BE REMOVED BY THE CONTRACTOR AFTER THE TRAFFIC CONTROL REQUIREMENTS ARE MET OR AS AUTHORIZED BY THE ENGINEER; ANY SIGNS OR DEVICES LEFT IN PLACE AT THIS TIME ARE TO BE RELOCATED, MAINTAINED AND PROTECTED FROM DAMAGE BY THE CONTRACTOR AND ANY DAMAGED OR LOST SIGNS WILL BE REPLACED BY THE CONTRACTOR.

TYPE I OR TYPE II BARRICADES, DRUMS, OR VERTICAL PANELS WITH MONDDIRECTIONAL STEADY-BURN LIGHTS SHALL BE REQUIRED ALONG TEMPORARY ROADS, DETOURS, AND SIDE STREETS TO DELINEATE THE TRAVELED WAY WITHIN THE CONSTRUCTION ZONE. THE MAXIMUM SPACING FOR THESE DEVICES SHALL BE 100

ANY DROP OFF GREATER THAN THREE (3) INCHES BUT LESS THAN SIX (6) INCHES, WITHIN EIGHT (8) FEET OF THE PAVEMENT EDGE, SHALL BE PROTECTED BY TYPE I OR TYPE II BARRICADES, DRUMS OR VERTICAL PANELS WITH MONODIRECTIONAL STEADY- BURN LIGHTS AT 100 FOOT CENTER TO CENTER SPACING. IF THE DROP OFF WITHIN EIGHT (8) FEET OF THE PAVEMENT EDGE EXCEEDS SIX (6) INCHES, THE BARRICADES, DRUMS OR VERTICAL PANELS MENTIONED ABOVE SHALL BE PLACED AT FIFTY (50) FOOT CENTER TO CENTER SPACING. BARRICADES THAT MUST BE PLACED IN EXCAVATED AREAS SHALL HAVE LEG EXTENSIONS INSTALLED SUCH THAT THE TOP OF THE BARRICADE IS IN COMPLIANCE WITH THE HEIGHT REQUIREMENTS OF STANDARD 701901.

TYPE I OR TYPE II BARRICADES WITH TWO-WAY FLASHING LIGHTS SHALL BE REQUIRED AT ALL OPEN TRENCHES, EXCAVATIONS, OPEN OR EXPOSED SEWER STRUCTURES, TRANSVERSE PAVEMENT JOINTS, MATERIALS OR EQUIPMENT WITHIN THE RIGHT-OF- WAY (NUMBER AND SPACING DEPENDS ON THE CONDITIONS); AND AT LOCATIONS DESIGNATED BY THE ENGINEER OR LOCAL LAW ENFORCEMENT AGENCIES.

TYPE I, II AND / OR III BARRICADES WITH TWO-WAY FLASHING LIGHTS WILL BE REQUIRED TO GUIDE TRAFFIC AWAY FROM PAVEMENT AREAS CLOSED FOR CONSTRUCTION.

THE COST OF SUPPLYING, ERECTING, AND MAINTAINING BARRICADES, WARNING LIGHTS, AND SIGNS WILL BE INCLUDED IN THE CONTRACT LUMP SUM PRICE FOR TRAFFIC CONTROL AND PROTECTION (SPECIAL).

WHERE REQUIRED, TRAFFIC SIGNS SHALL BE RELOCATED FOR EACH STAGE OF

ARROW BOARDS WILL BE REQUIRED WHEN IMPLEMENTING ALL LANE CLOSURES.

ALL EXISTING PEDESTRIAN CROSSINGS MUST BE MAINTAINED WITH FULL ADA ACCESSIBILITY DURING ALL STAGES OF CONSTRUCTION. ANY TEMPORARY ACCOMMODATIONS SHALL BE INCLUDED IN COST OF TRAFFIC CONTROL & PROTECTION (SPECIAL) UNLESS APPROVED AND DIRECTED BY THE ENGINEER.

THE FOLLOWING TRAFFIC CONTROL STANDARDS ARE THE MINIMUM REQUIREMENTS FOR THE TRAFFIC CONTROL FOR THIS PROJECT:

TRAFFIC CONTROL DEVICES
OFF-RD OPERATIONS, 2L, 2W, 15' TO 24' FROM EDGE OF PVMT
OFF-RD OPERATIONS, MULTILANE, 15' TO 24" FROM PAVEMENT EDGE
LANE CLOSURE, 2L, 2W, SHORT TIME OPERATIONS
LANE CLOSURE 2L, 2W MOVING OPERATIONS - DAY ONLY
LANE CLOSURE, MULTILANE, INTERMITTENT OR MOVING OPER, FOR SPEEDS-40 MPH
URBAN LANE CLOSURE, 2L, 2W, UNDIVIDED
URBAN LANE CLOSURE, MULTILANE, 2W WITH BIDIRECTIONAL LEFT TURN LANE
URBAN SINGLE LANE CLOSURE, MULTILANE, 2W WITH MOUNTABLE MEDIAN
URBAN LANE CLOSURE, MULTILANE, 12W WITH MOUNTABLE MEDIAN
URBAN LANE CLOSURE, MULTILANE TOTALENE, 2W WITH MOUNTABLE MEDIAN
URBAN LANE CLOSURE, MULTILANE TOTALENE, 2W WITH MOUNTABLE MEDIAN
URBAN LANE CLOSURE, MULTILANE TOTALENE, 2W WITH MOUNTABLE MEDIAN
URBAN LANE CLOSURE, MULTILANE TOTALENE, 2W WITH MOUNTABLE MEDIAN
URBAN LANE CLOSURE, MULTILANE TOTALENE, 2W WITH MOUNTABLE MEDIAN
URBAN LANE CLOSURE, MULTILANE TOTALENE, 2W WITH MOUNTABLE MEDIAN
URBAN LANE CLOSURE, MULTILANE TOTALENE, 2W WITH MOUNTABLE MEDIAN
URBAN LANE CLOSURE, MULTILANE, 2W WITH MOUNTABLE MEDIAN 701006-05 701101-05 701606-10 701801-06

### CONSTRUCTION STAGING

THE FOLLOWING IS THE CONSTRUCTION STAGING FOR THIS PROJECT. THE PURPOSE OF THIS STAGING IS TO MINIMIZE DELAYS TO THE MOTORIST. THE CONTRACTOR MAY ALTER THE SEQUENCE OF CONSTRUCTION WITH THE PRIOR APPROVAL OF THE ENGINEER, PRIOR TO THE START OF CONSTRUCTION, REQUIRED TRAFFIC CONTROL DEVICES SHALL BE IN PLACE.

# LEMONT ROAD: STAGE 1:

- A. INSTALL STAGE 1 EROSION AND SEDIMENT CONTROL.
- B. PLACE TEMPORARY TRAFFIC CONTROL AND SIGNING. INSTALL TEMPORARY
- PROVIDE ONE 12' LANE IN EACH DIRECTION, NORTHBOUND AND SOUTHBOUND. AFTER CENTRAL AVENUE (APPROX. STATION 297+00) TRANSITIONS LANE WIDTHS FROM 12' TO 11' IN THE NORTHBOUND AND SOUTHBOUND DIRECTIONS. ALSO, PROVIDE ONE LEFT TURN LANE IN THE NORTHBOUND AND SOUTHBOUND DIRECTIONS ALONG LEMONT ROAD.
- D. CONSTRUCT THE WEST WIDENINGS ALONG LEMONT ROAD AT 87TH STREET TO BASE COURSE.
- E. CONSTRUCT THE EAST AND WEST WIDENINGS ALONG LEMONT ROAD AT 83RD STREETTO BASE COURSE EXCEPT FOR THE NORTHEAST CORNER LANE
- F. REMOVE THE EXISTING MEDIANS ALONG LEMONT ROAD AT 83RD STREET.
- G. CONSTRUCT THE PROPOSED MEDIANS ALONG LEMONT ROAD AT 83RD
- H. CONSTRUCT THE PROPOSED RETAINING WALL ALONG LEMONT ROAD (290+01 TO 292+01).

- I. INSTALL STAGE 2 EROSION AND SEDIMENT CONTROL.
- J. UTILIZING DAYTIME CLOSURES, MILL 3.5" OF EXISTING PAVEMENT (EXCLUDES RECONSTRUCTION AREA).
- K. PLACE TEMPORARY TRAFFIC CONTROL AND SIGNING. SWITCH TEMPORARY TRAFFIC SIGNALS TO STAGE 2 CONFIGURATION.
- L. PROVIDE ONE 11' LANE IN EACH DIRECTION, NORTHBOUND AND SOUTHBOUND.
  PROVIDE ONE LEFT TURN LANE IN THE NORTHBOUND AND SOUTHBOUND DIRECTIONS ALONG LEMONT ROAD.
- M. REMOVE THE EXISTING MEDIANS ALONG LEMONT ROAD AT 87TH STREET.
- N. CONSTRUCT THE PROPOSED MEDIANS ALONG LEMONT ROAD AT 87TH
- O. CONSTRUCT THE WEST WIDENINGS ALONG LEMONT ROAD AT THE NORTHEAST CORNER OF 83RD STREET UP TO BASE COURSE.
- P. UTILIZING DAYTIME CLOSURES, PLACE BINDER COURSE THROUGHOUT ENTIRE PROJECT.
- O. REMOVE EXISTING DEPRESSED MEDIANS BETWEEN STATION 285+00 TO
- R. PLACE NEW PAVEMENT AT THE ABOVE LOCATIONS.

- A. INSTALL STAGE 1 EROSION AND SEDIMENT CONTROL.
- B. PLACE TEMPORARY TRAFFIC CONTROL AND SIGNING. INSTALL TEMPORARY TRAFFIC SIGNALS.
- C. PROVIDE ONE 11' LANE IN EACH DIRECTION, EASTBOUND AND WESTBOUND. PROVIDE ONE LEFT TURN LANE IN THE EASTBOUND AND WESTBOUND DIRECTIONS ALONG 83RD STREET.
- D. CONSTRUCT THE NORTH AND SOUTH WIDENINGS ALONG 83RD STREET AT LEMONT ROAD UP TO BINDER COURSE.
- E. CONSTRUCT THE PROPOSED RETAINING WALL ALONG 83RD STREET (24+06 TO 24+50).

- F. INSTALL STAGE 2 EROSION AND SEDIMENT CONTROL.
- G. UTILIZING DAYTIME CLOSURES, MILL 3.5" OF EXISTING PAVEMENT (EXCLUDES RECONSTRUCTION AREA).
- H. PLACE TEMPORARY TRAFFIC CONTROL AND SIGNING. SWITCH TEMPORARY TRAFFIC SIGNALS TO STAGE 2 CONFIGURATION.
- I. PROVIDE ONE I LANE IN EACH DIRECTION, EASTBOUND AND WESTBOUND. PROVIDE ONE LEFT TURN LANE IN THE EASTBOUND AND WESTBOUND DIRECTIONS ALONG 83RD STREET.
- J. CONSTRUCT THE PROPOSED MEDIAN ALONG THE EAST LEG 83RD STREET.
- K. UTILIZING DAYTIME CLOSURES, PLACE BINDER COURSE THROUGHOUT ENTIRE PROJECT.

# 87TH STREET : STAGE 1:

- A. INSTALL STAGE 1 EROSION AND SEDIMENT CONTROL.
- B. PLACE TEMPORARY TRAFFIC CONTROL AND SIGNING. INSTALL TEMPORARY
- C. PROVIDE ONE 10' LANE IN WESTBOUND DIRECTION; PROVIDE A THRU/LEFT LANE AND A RIGHT TURN LANE (10' WIDE) IN THE WESTBOUND DIRECTIONS ALONG 87TH STREET.
- D. CONSTRUCT THE EASTBOUND WIDENINGS ALONG 87TH STREET STATION 13+80 TO 17+20) UPT TO BASE COURSE.
- E. RECONSTRUCT THE SOUTH HALF OF 87TH STREET (APPROX. STATION 17+20
- F. CONSTRUCT TEMPORARY PAVEMENT ALONG OLDFIELD ROAD.
- G. CONSTRUCT THE PROPOSED RETAINING WALLS ALONG 87TH STREET (17+79 TO 18+84 OFFSET RIGHT).

- H. INSTALL STAGE 2 EROSION AND SEDIMENT CONTROL.
- I. UTILIZING DAYTIME CLOSURES, MILL 3.5" OF EXISTING PAVEMENT (EXCLUDES RECONSTRUCTION AREA).
- S. PLACE TEMPORARY TRAFFIC CONTROL AND SIGNING. SWITCH TEMPORARY TRAFFIC SIGNALS TO STAGE 2 CONFIGURATION.
- J. PROVIDE ONE 10' LANE IN WESTBOUND DIRECTION; PROVIDE A THRU/LEFT LANE AND A RIGHT TURN LANE (10' WIDE) IN THE WESTBOUND DIRECTIONS ALONG 87TH STREET.
- K. RECONSTRUCT NORTH HALF OF 87TH STREET (APPROX. STATION 17+20 TO
- L. CONSTRUCT THE WESTBOUND WIDENINGS (APPROX. STATION 13+80 TO 17+20 & 21+00 TO 24+24) ALONG 87TH STREET UP TO BASE COURSE.
- M. CONSTRUCT THE PROPOSED RETAINING WALL ALONG 87TH STREET (17+25 TO
- N. UTILIZING DAYTIME CLOSURES, PLACE BINDER COURSE THROUGHOUT ENTIRE

- O. INSTALL STAGE 3 EROSION AND SEDIMENT CONTROL.
- P. PLACE TEMPORARY TRAFFIC CONTROL AND SIGNING. SWITCH TEMPORARY TRAFFIC SIGNALS TO STAGE 3 CONFIGURATION.
- O. PROVIDE ONE 10' LANE IN WESTBOUND DIRECTION; PROVIDE A THRU/LEFT LANE AND A RIGHT TURN LANE (10' WIDE) IN THE WESTBOUND DIRECTIONS ALONG 87TH STREET.
- R. REMOVE TEMPORARY PAVMENT ALONG OLDFIELD ROAD
- S. CONSTRUCT THE EASTBOUND WIDENINGS (APPROX. STATION 21+00 TO 24+24) ALONG OLDFIELD ROAD.


- STAGE 3 (ALL STREETS):

  A. UTILIZING DAYTIME CLOSURES SURFACE COURSES (NCLUDES RECONSTRUCTION AREA).
  - B. PLACE NEW PAVEMENT MARKINGS.
  - C. REMOVE ALL TEMPORARY EROSION CONTROL MEASURES AND TEMPORARY TRAFFIC CONTROL DEVICES.

NOTE: WIDENING AREAS TO HAVE BASE COURSE PLACED DURING STAGE 1 CONSTRUCTION BINDER COURSE DURING STAGE 2 CONSTRUCTION AND SURFACE COURSE WILL BE PLACED

SCALE: NTS

SHEET 1 OF 26 SHEETS STA. N/A TO STA. N/A

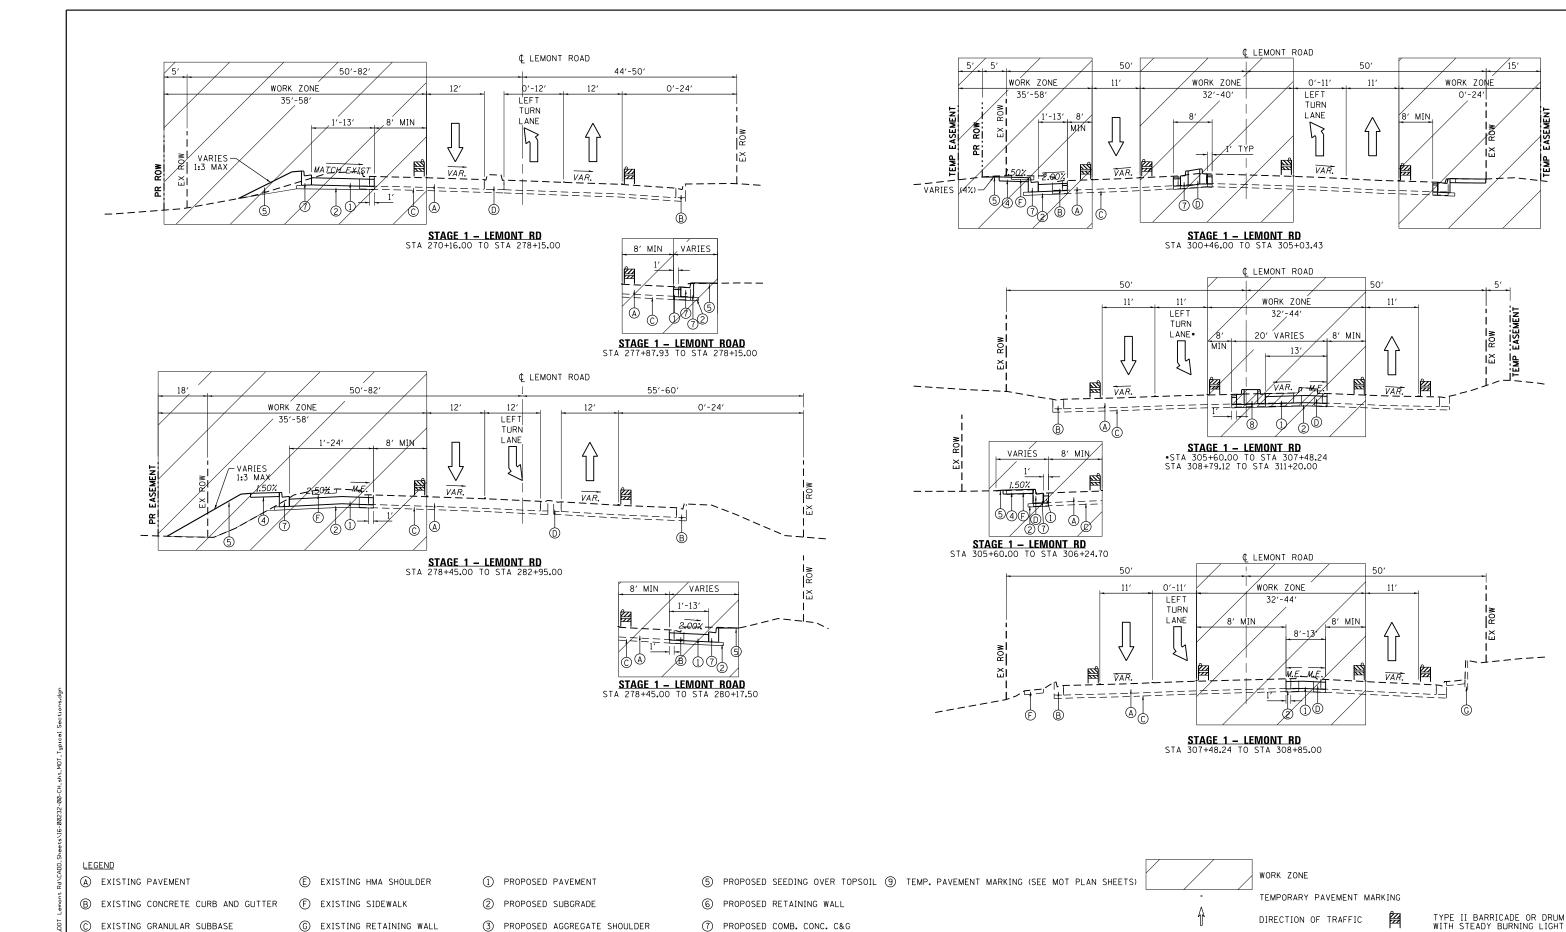

D EXISTING MEDIAN

USER NAME = tnestor DESIGNED - GJE REVISED - 2025-07-02 DRAWN GJE REVISED LOT SCALE = 20.0000 '/ in. CHECKED мтс REVISED PLOT DATE = 11/3/2025 DATE 09/08/2023 REVISED

(4) PROPOSED PCC SIDEWALK

STATE OF ILLINOIS

MAINTENANCE OF TRAFFIC - TYPICAL SECTIONS - STAGE 1 LEMONT ROAD

SECTION COUNTY 16-00232-00-CH

VERTICAL PANEL WITH STEADY BURNING LIGHT


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**DEPARTMENT OF TRANSPORTATION** 

8 PROPOSED MEDIAN

2612 DUPAGE 248 56 CONTRACT NO. 61J01 CH 9 SCALE: NTS SHEET 2 OF 26 SHEETS STA. N/A TO STA. N/A



F EXISTING SIDEWALK

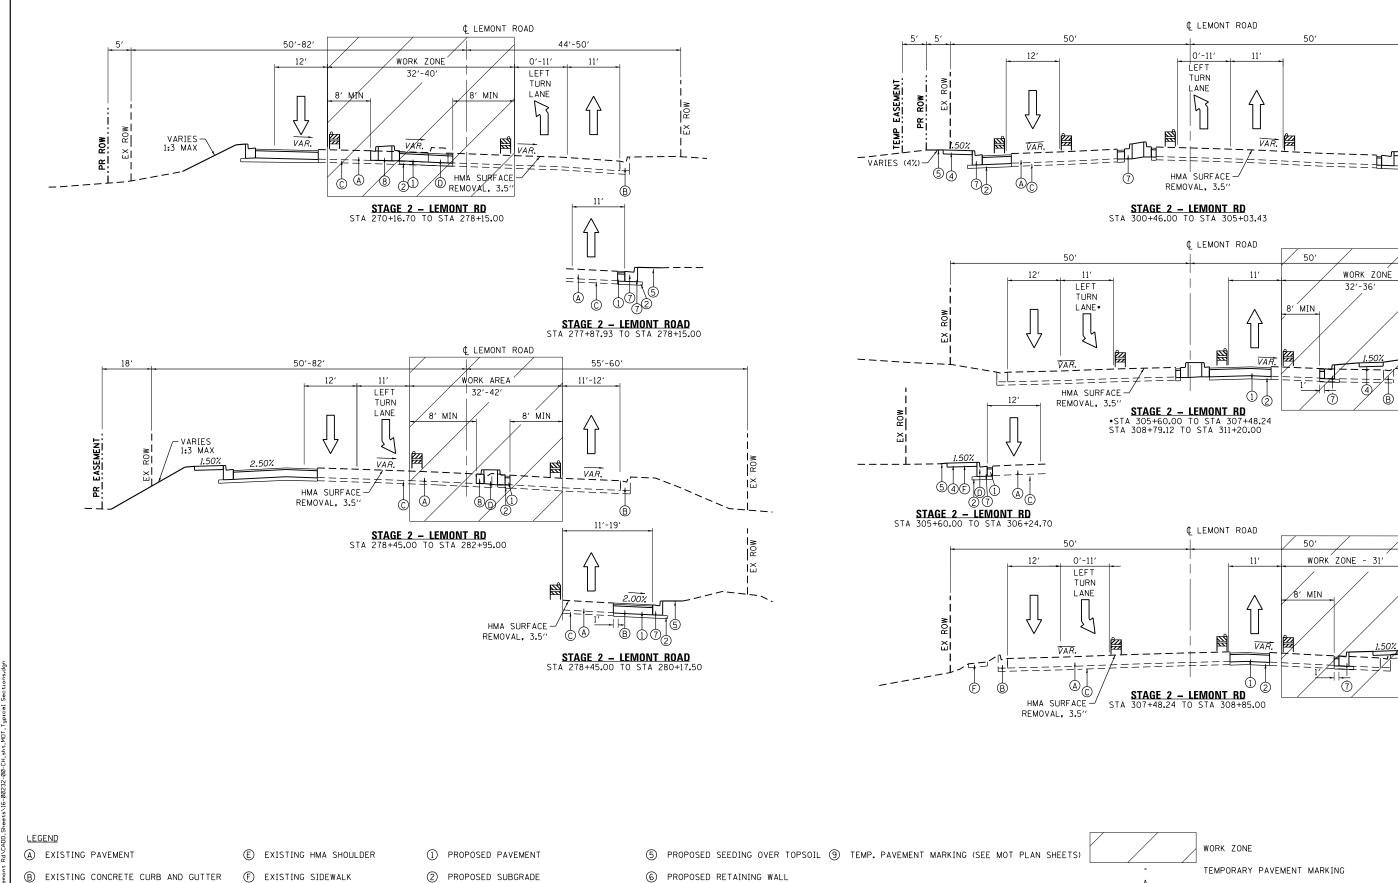© EXISTING RETAINING WALL

2 PROPOSED SUBGRADE

③ PROPOSED AGGREGATE SHOULDER

D EXISTING MEDIAN 4 PROPOSED PCC SIDEWALK 6 PROPOSED RETAINING WALL

7 PROPOSED COMB. CONC. C&G

8 PROPOSED MEDIAN

DIRECTION OF TRAFFIC

TYPE II BARRICADE OR DRUM WITH STEADY BURNING LIGHT VERTICAL PANEL WITH STEADY BURNING LIGHT


© EXISTING GRANULAR SUBBASE


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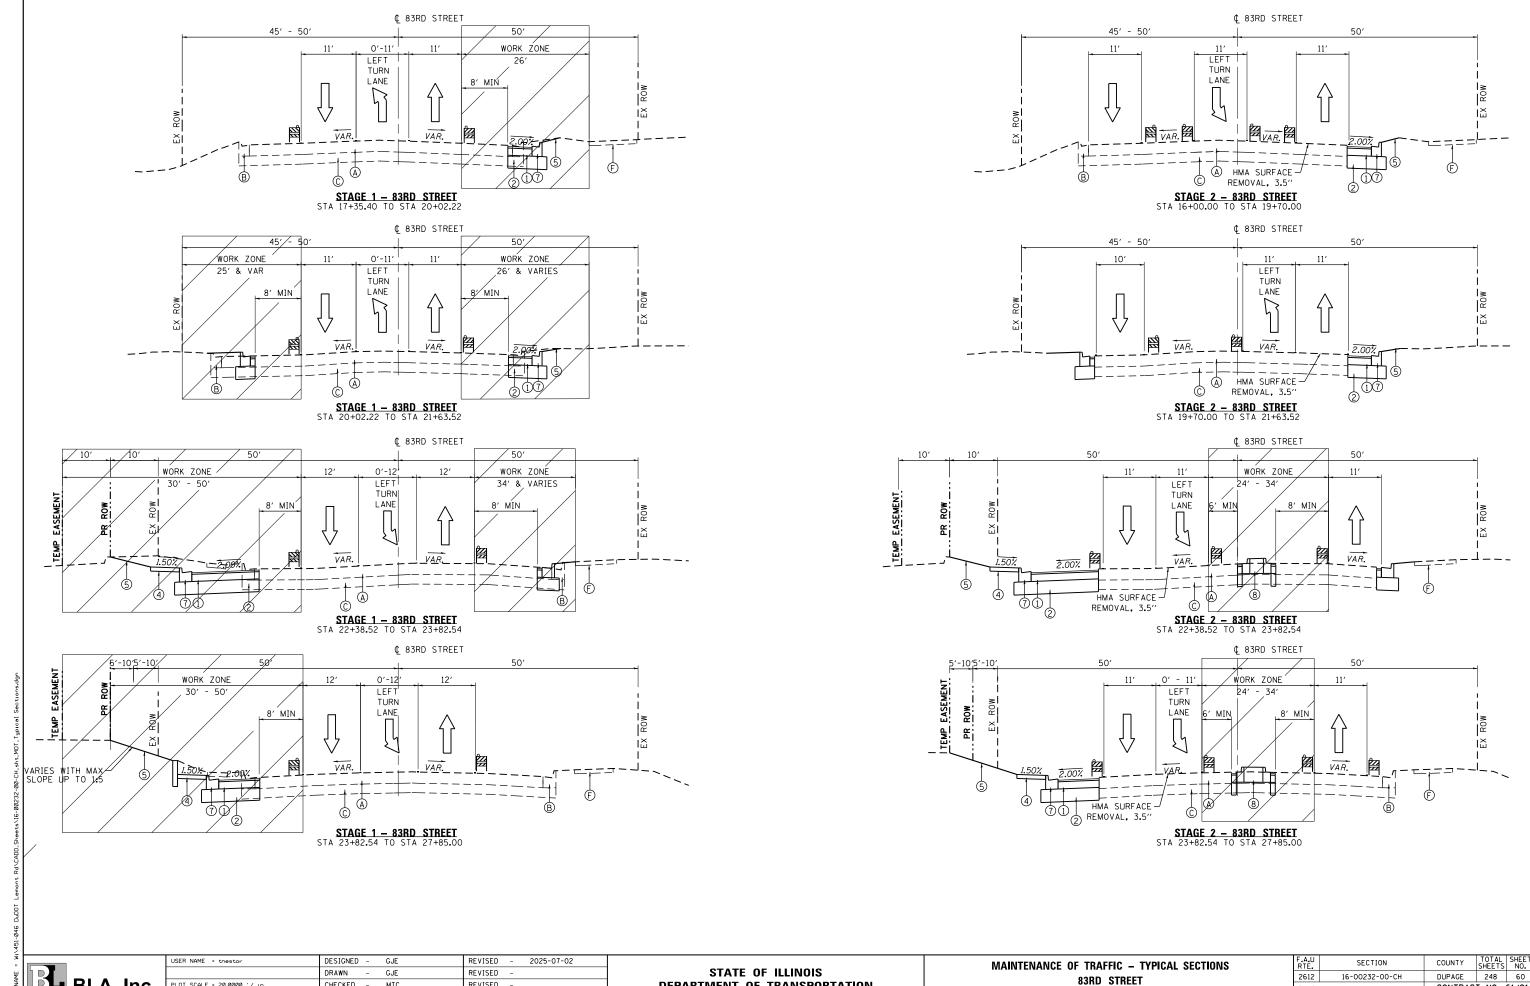
STATE OF ILLINOIS **DEPARTMENT OF TRANSPORTATION** 

MAINTENANCE OF TRAFFIC - TYPICAL SECTIONS - STAGE 2 LEMONT ROAD SCALE: NTS SHEET 3 OF 26 SHEETS STA. N/A TO STA. N/A

SECTION COUNTY 2612 16-00232-00-CH DUPAGE 248 57 CONTRACT NO. 61J01 CH 9



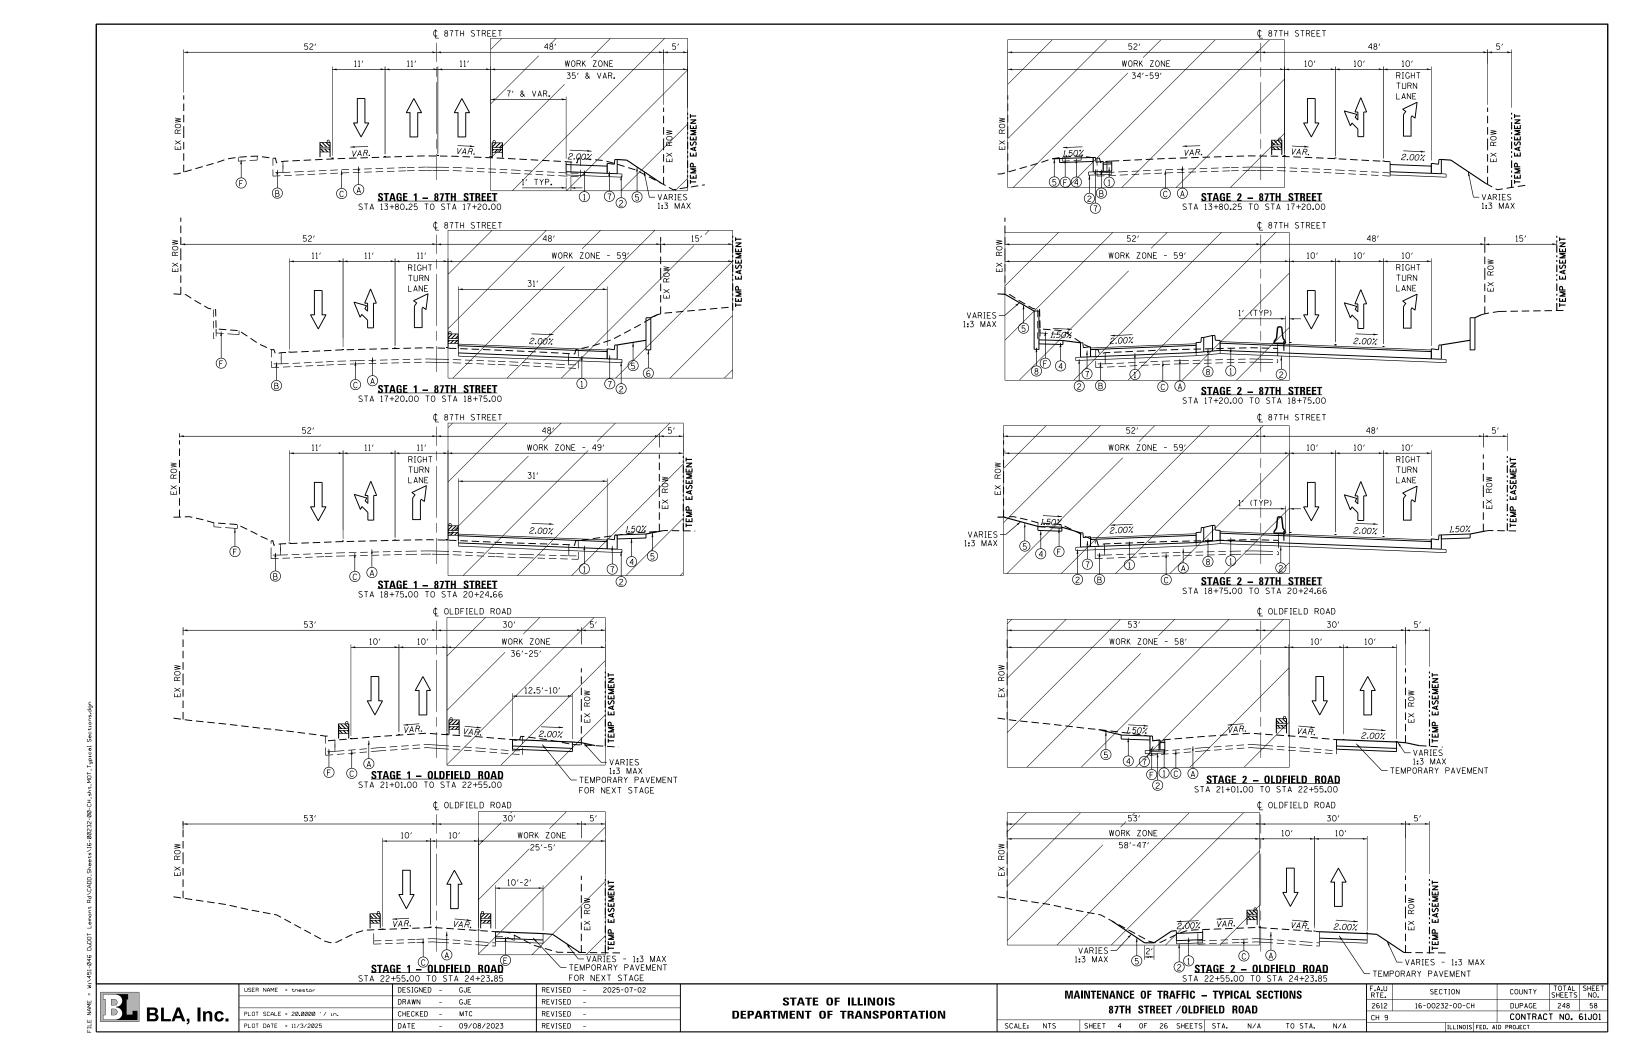


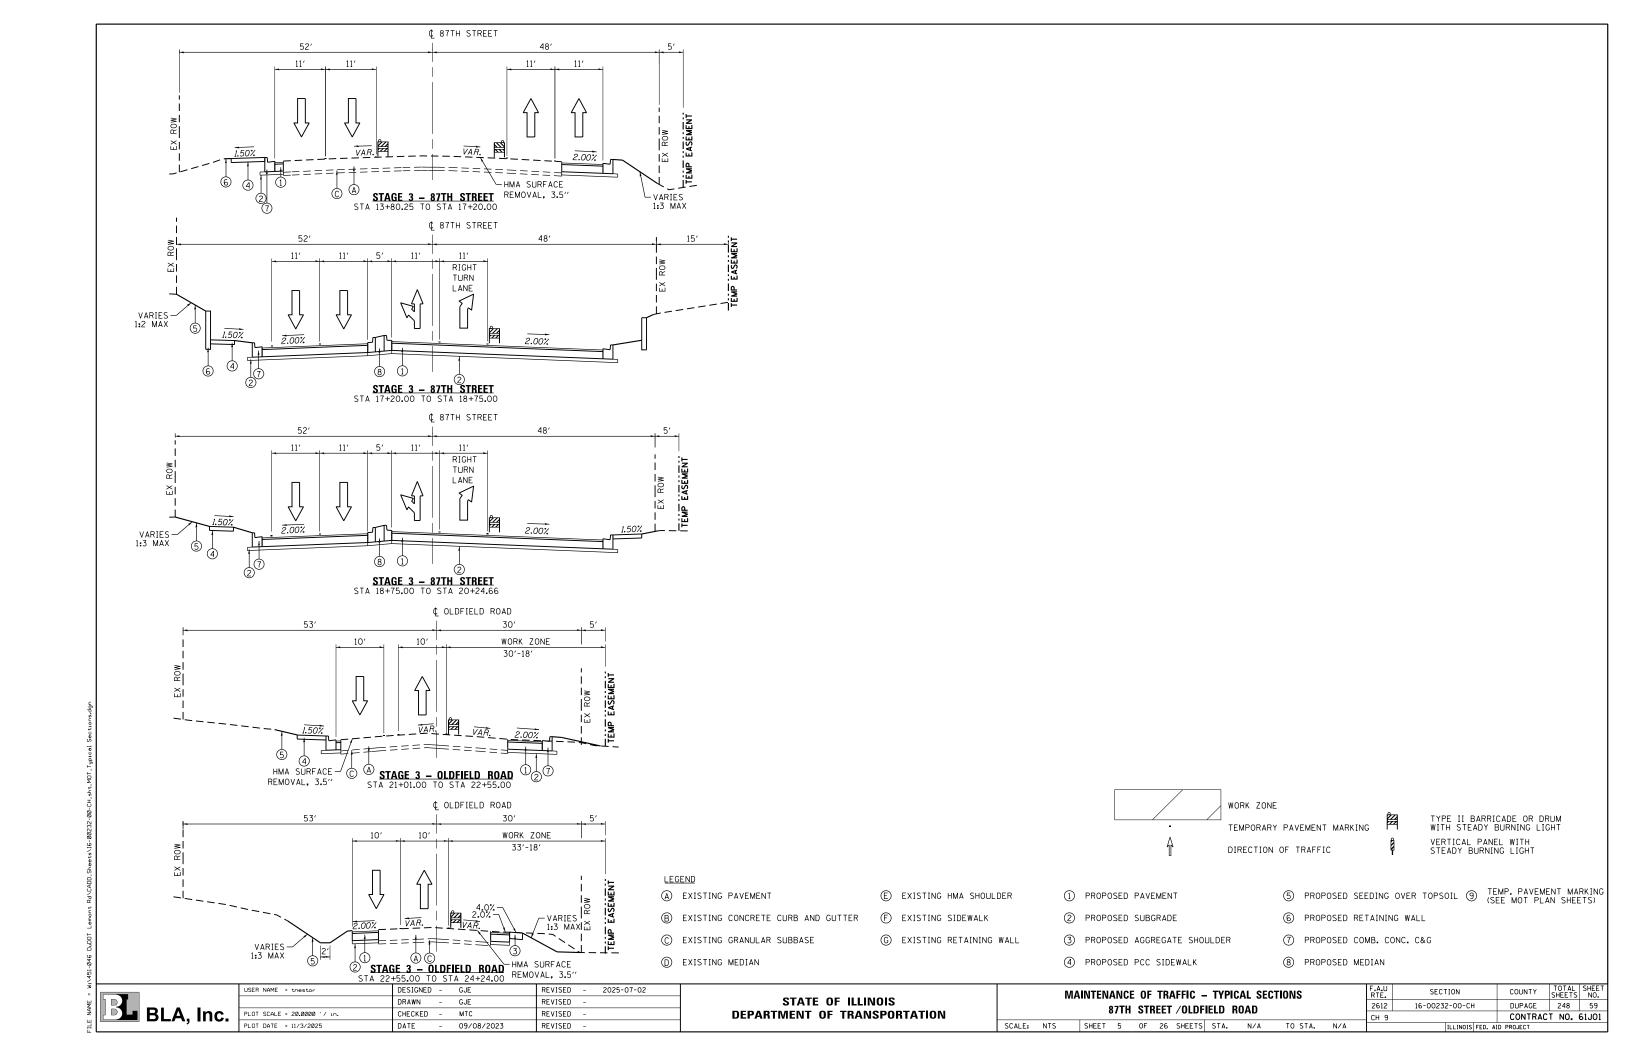



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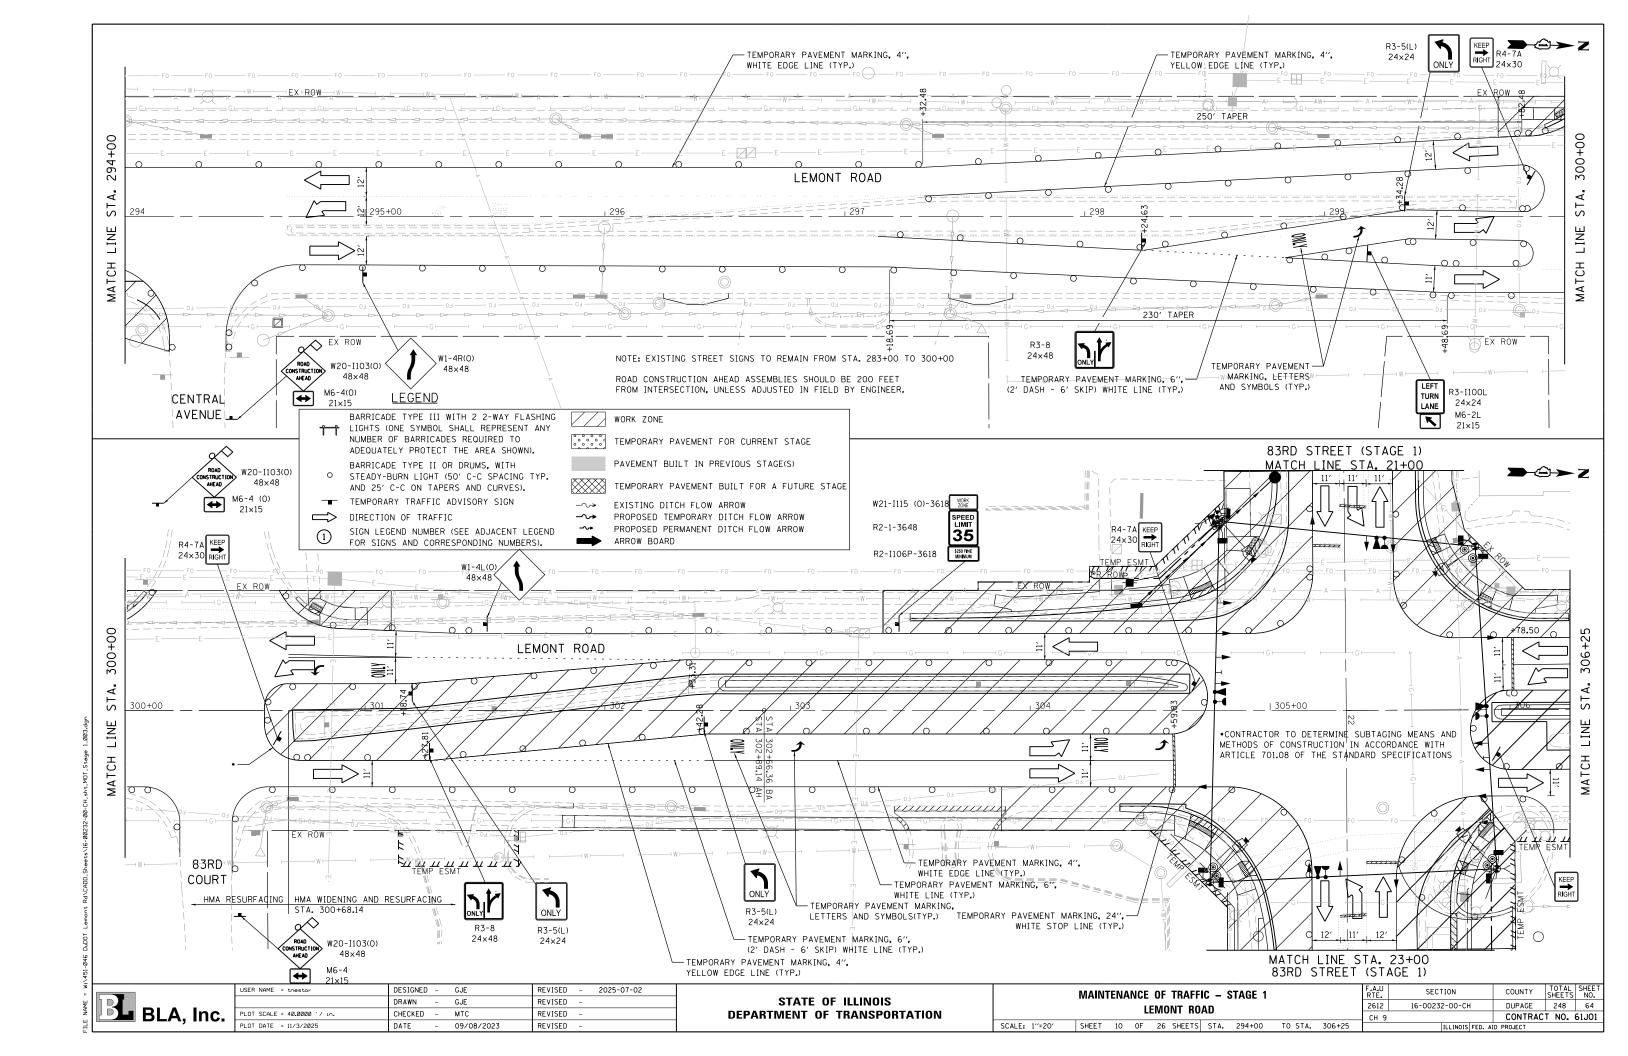
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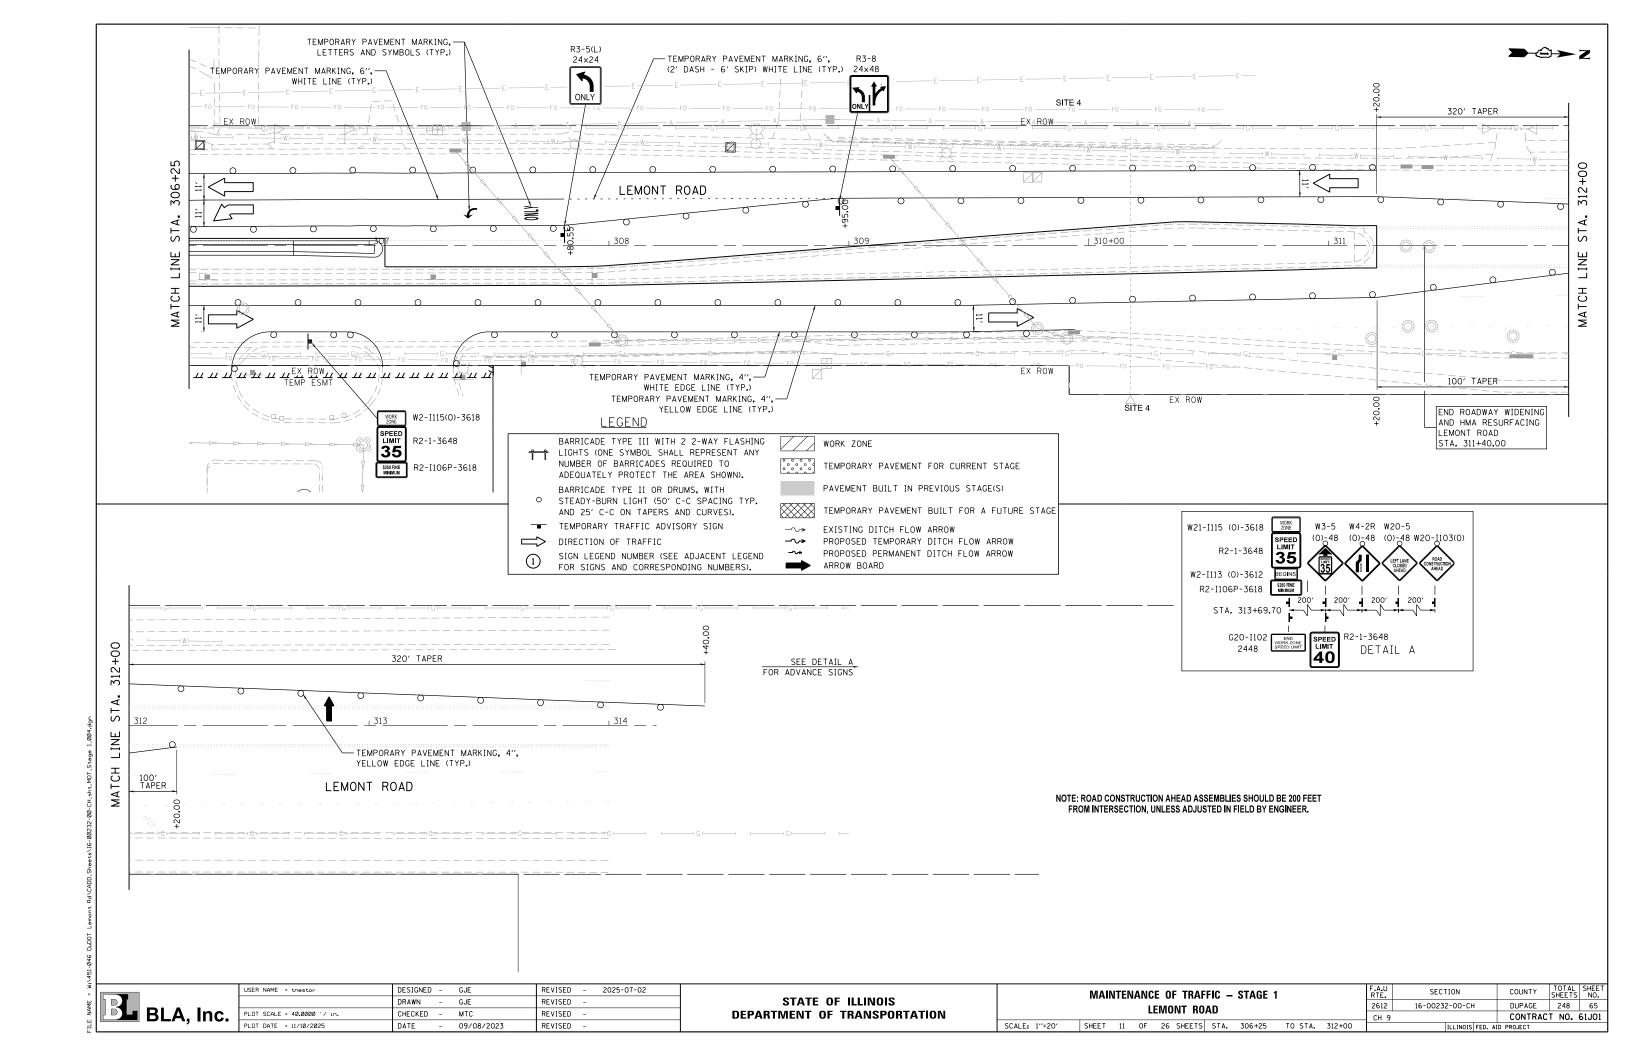
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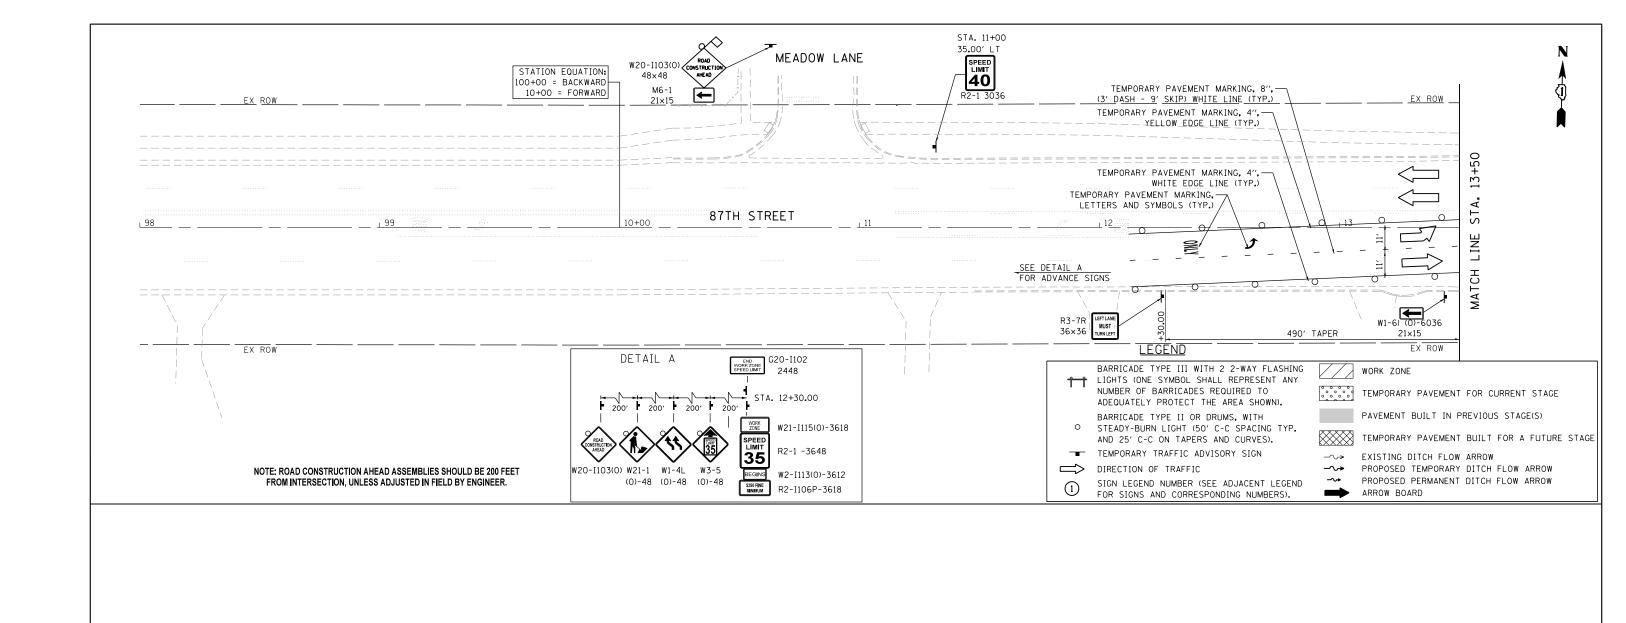






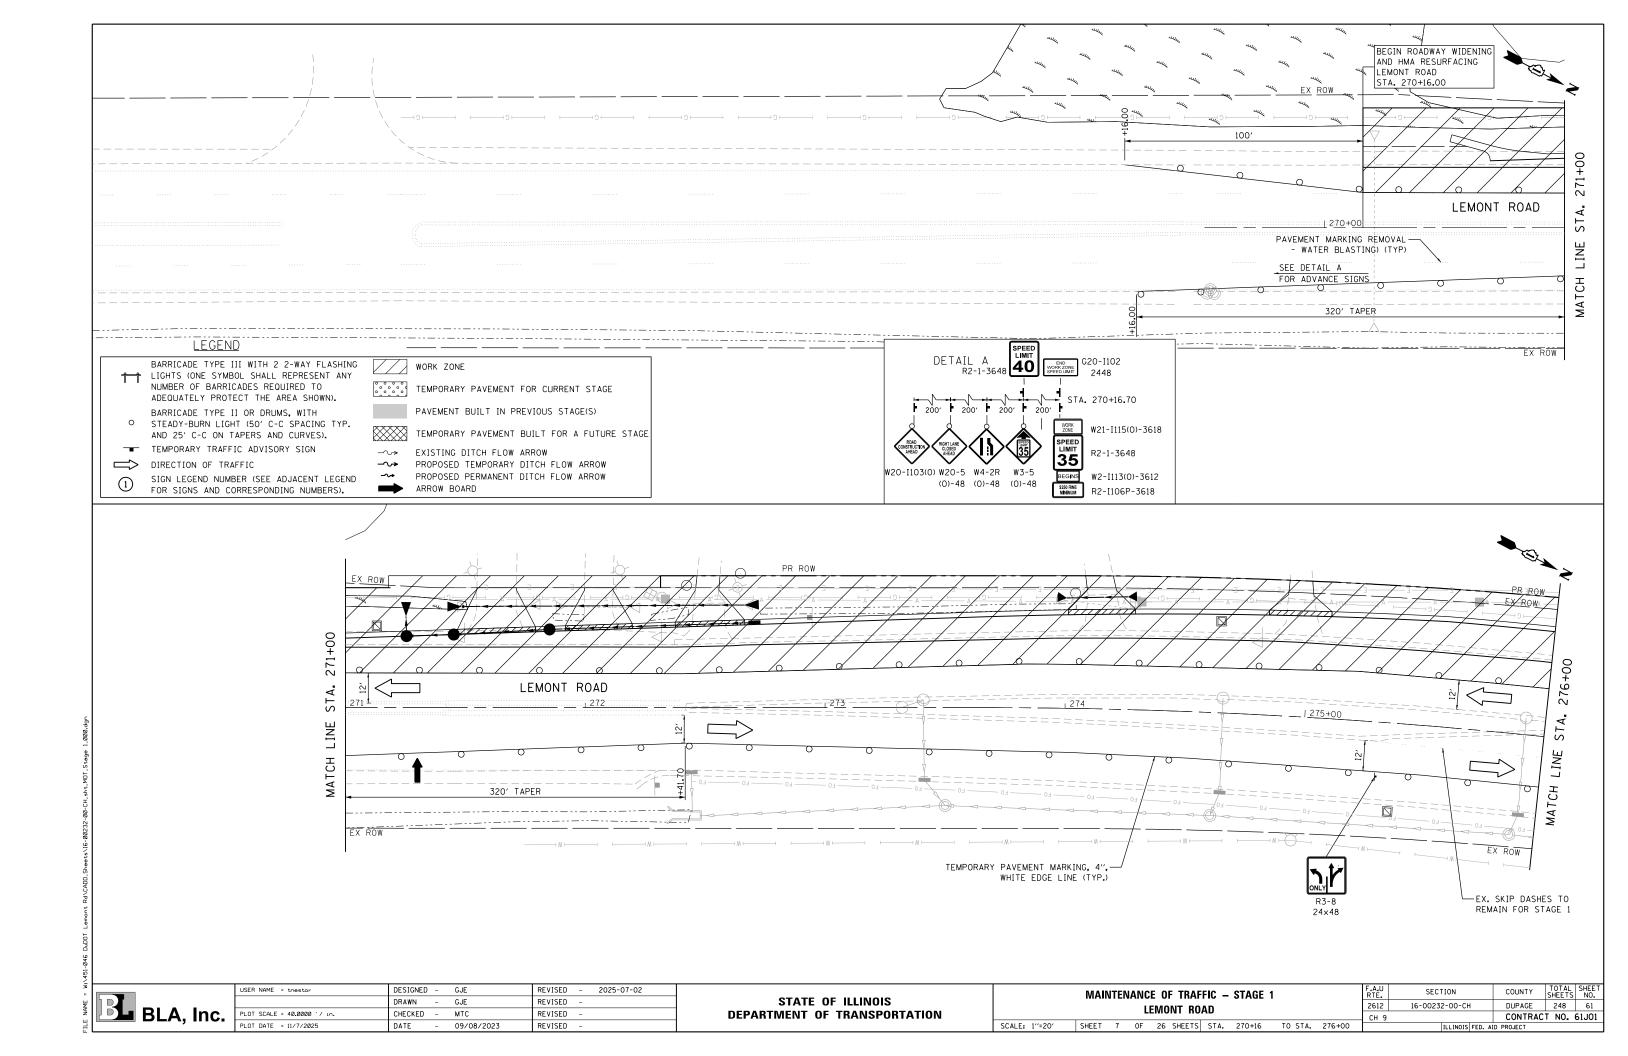

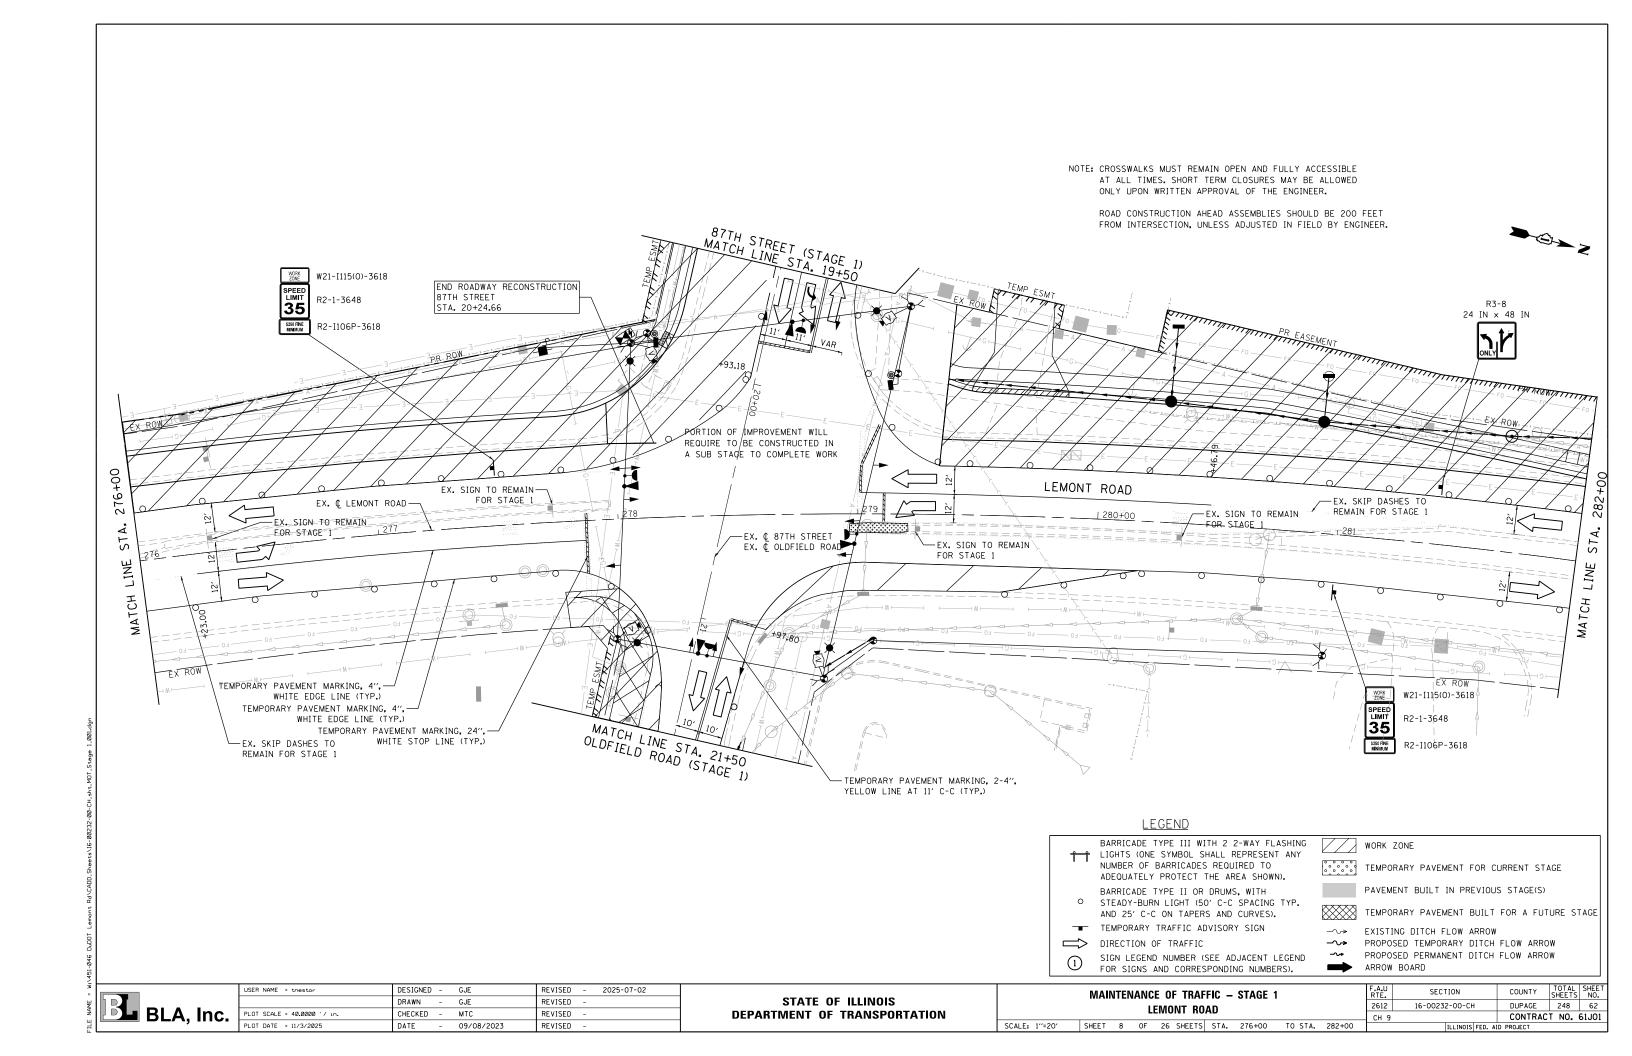

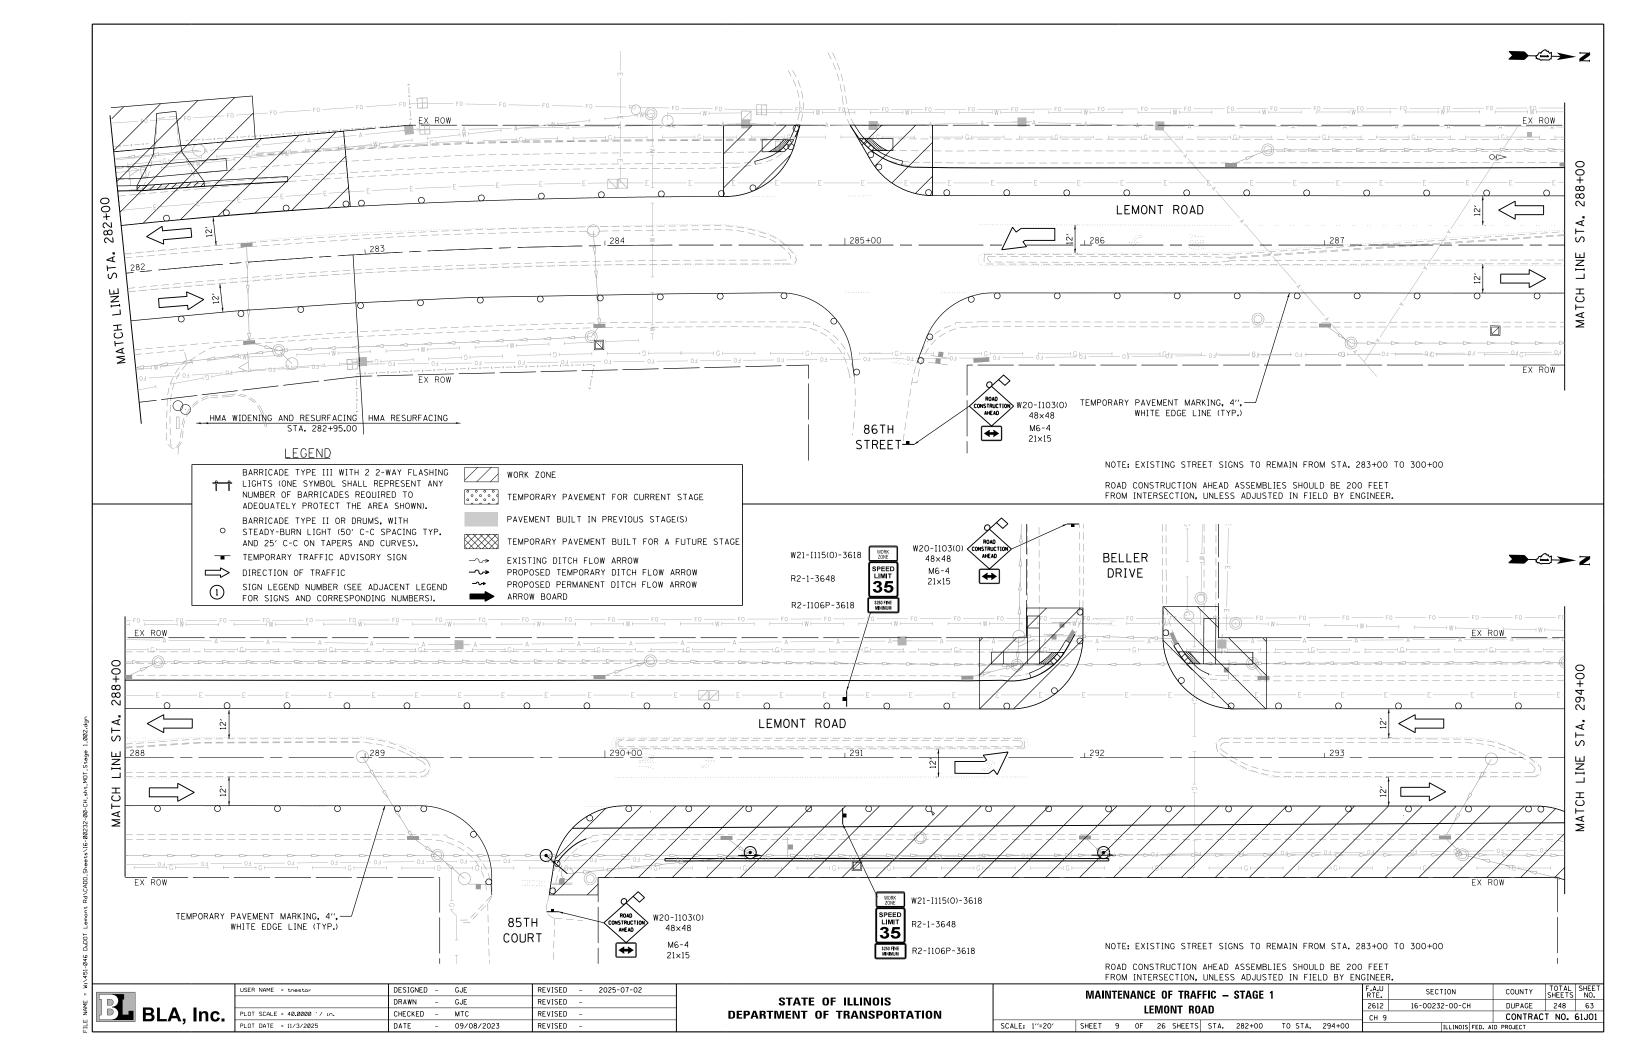


BLA, Inc.


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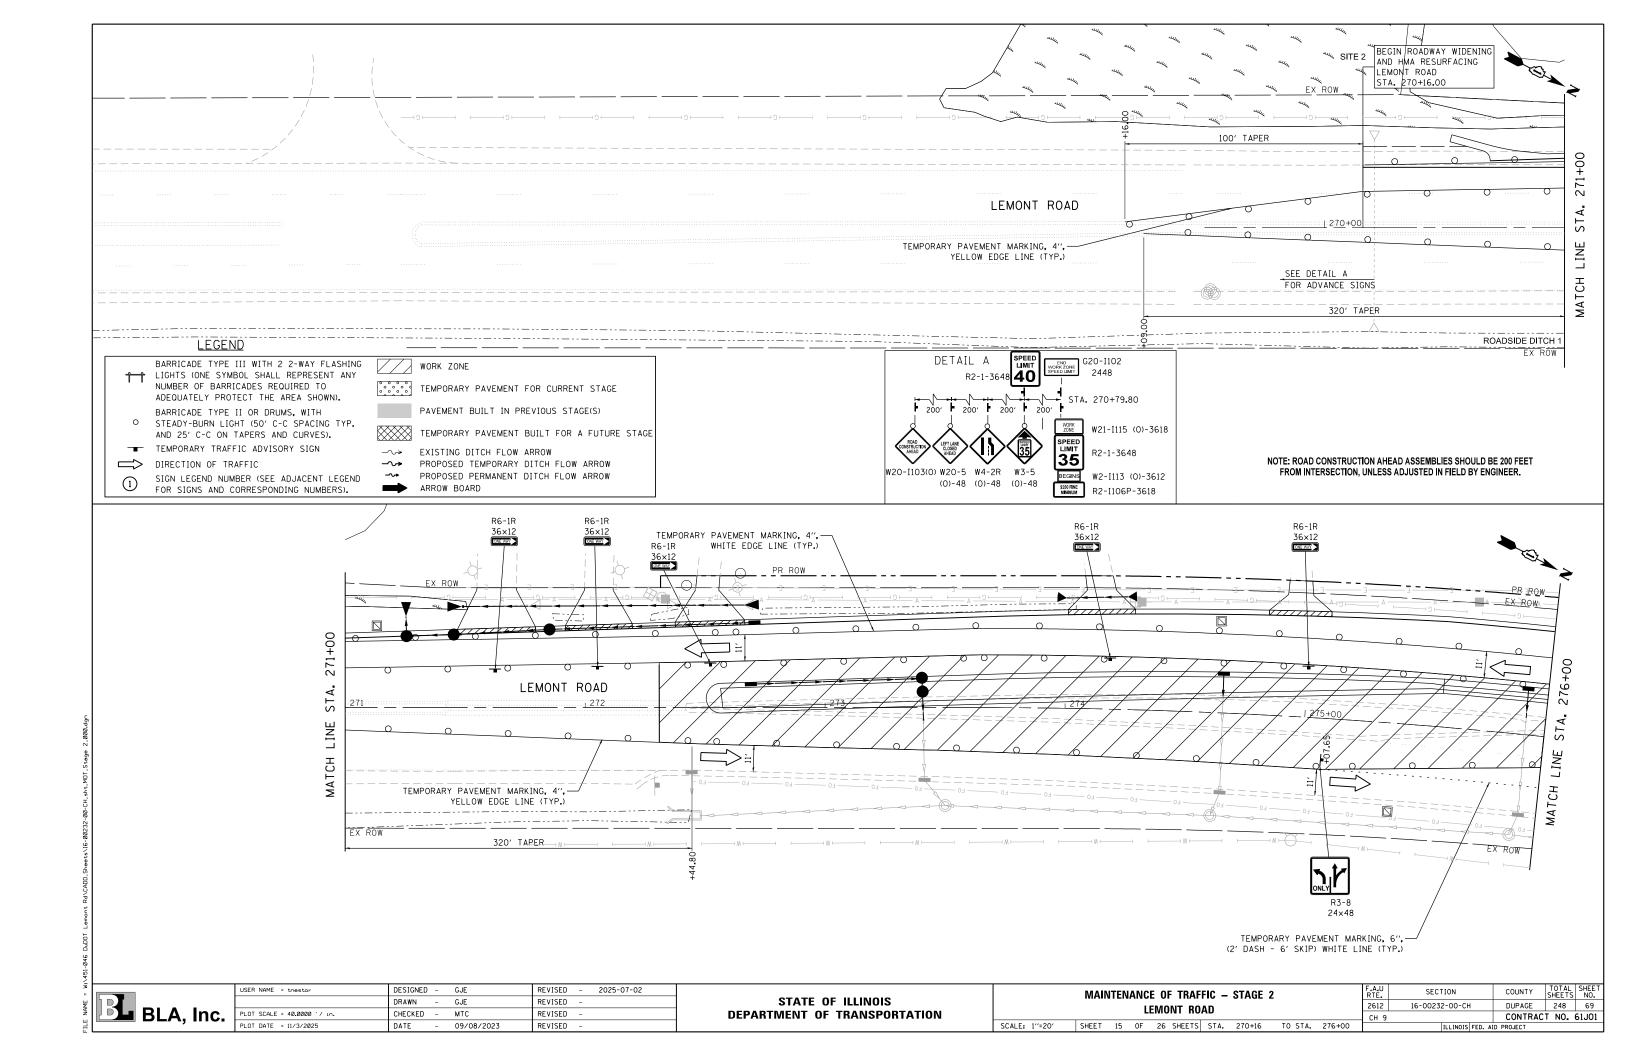
STATE OF	: ILLINOIS
DEPARTMENT OF	TRANSPORTATION

SCALE: 1"=20"


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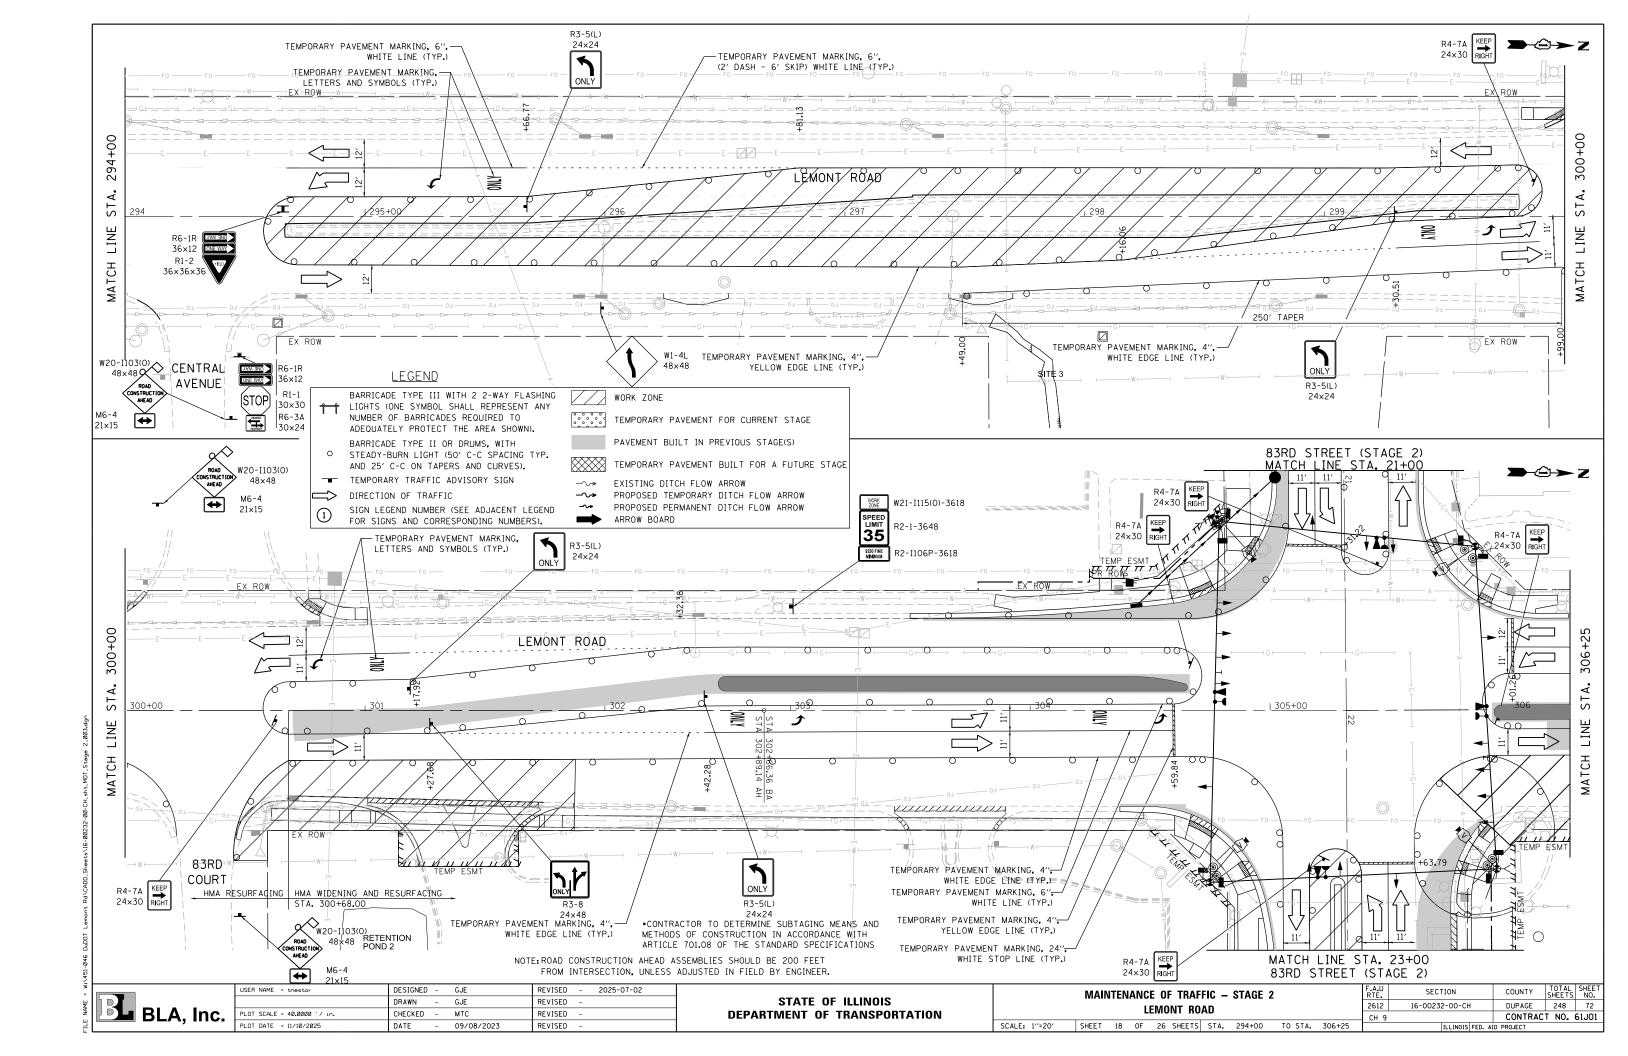





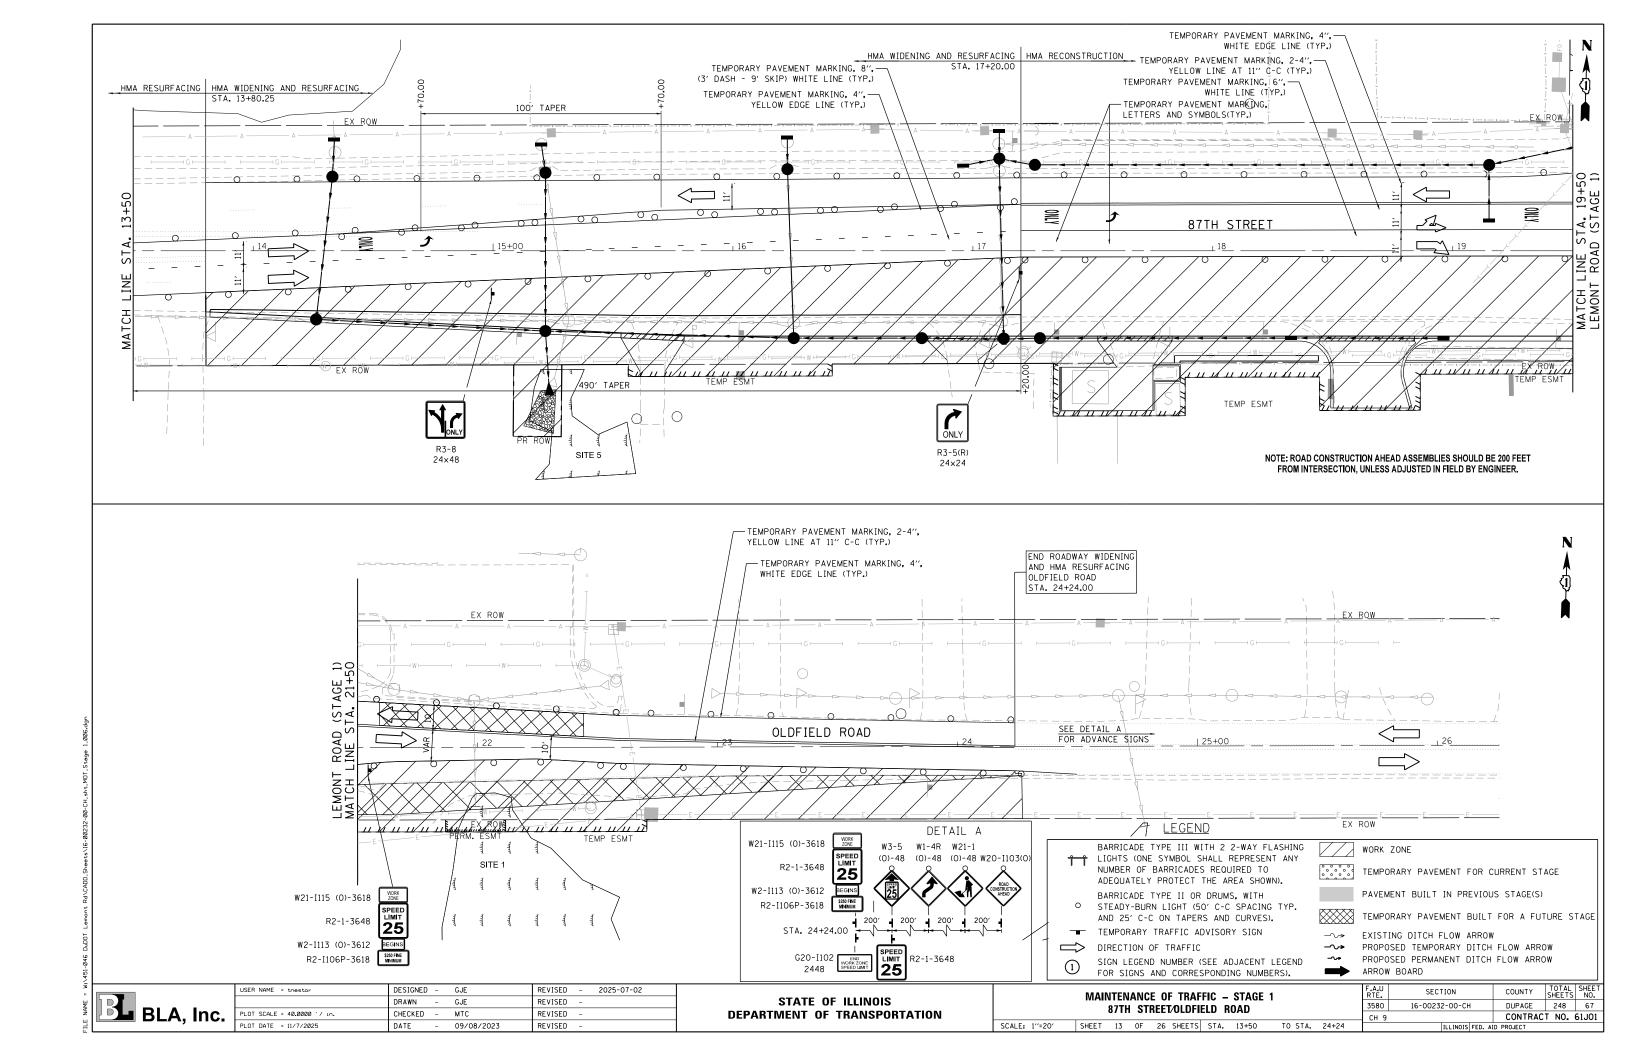


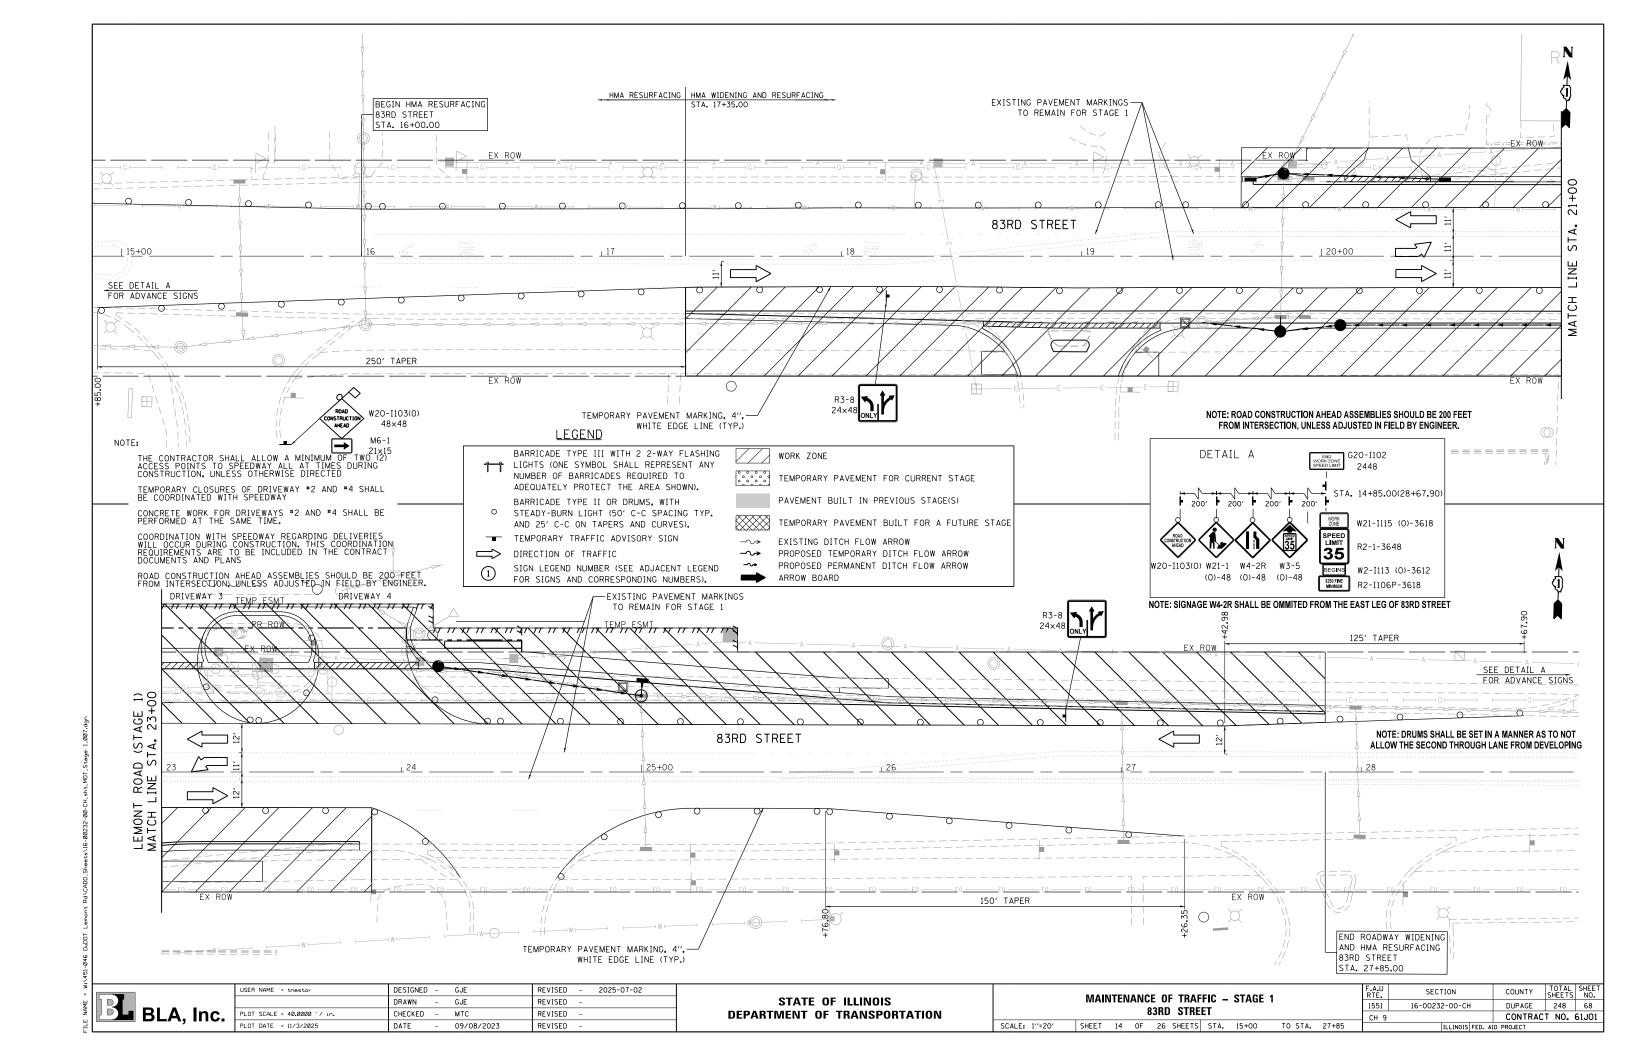CROSSWALKS MUST REMAIN OPEN AND FULLY ACCESSIBLE NOTE: AT ALL TIMES, SHORT TERM CLOSURES MAY BE ALLOWED ONLY UPON WRITTEN APPROVAL OF THE ENGINEER. ROAD CONSTRUCTION AHEAD ASSEMBLIES SHOULD BE 200 FEET FROM INTERSECTION, UNLESS ADJUSTED IN FIELD BY ENGINEER. \*CONTRACTOR TO DETERMINE SUBTAGING MEANS AND METHODS OF CONSTRUCTION THAT WILL BE IN ACCORDANCE WITH ARTICLE 701.08 TEMPORARY PAVEMENT MARKING, 4", WHITE EDGE LINE (TYP.) END ROADWAY RECONSTRUCTION 87TH STREET STA. 20+24.66 24×24 PR EASEMENT ONLY | ONLY | ONLY W21-I115(0)-3618 R4-7A KEEP RIGHT SPEED LIMIT 35 R2-1-3648 24×48 \$250 FINE MINIMUM R2-I106P-3618 +08.9 CONTRACTOR TO SUB-STAGE THIS AREA 276+00 LEMONT ROAD 🗲 TEMPORARY PAVEMENT MARKING, 24", WHITE STOP LINE (TYP.) STA. STA. 1 MATCH W21-I115(0)-3618 MATCH LINE STA. 21+50 OLDFIELD ROAD (STAGE 2) R2-1-3648 48×48 TEMPORARY PAVEMENT MARKING, 6", R3-5(L) TEMPORARY PAVEMENT MARKING, 4",-WHITE LINE (TYP.) R2-I106P-3618 YELLOW EDGE LINE (TYP.) -TEMPORARY PAVEMENT MARKING, LETTERS AND SYMBOLS (TYP.) TEMPORARY PAVEMENT MARKING, 6". (2' DASH - 6' SKIP) WHITE LINE (TYP.) **LEGEND** BARRICADE TYPE III WITH 2 2-WAY FLASHING WORK ZONE LIGHTS (ONE SYMBOL SHALL REPRESENT ANY NUMBER OF BARRICADES REQUIRED TO TEMPORARY PAVEMENT FOR CURRENT STAGE ADEQUATELY PROTECT THE AREA SHOWN). PAVEMENT BUILT IN PREVIOUS STAGE(S) BARRICADE TYPE II OR DRUMS, WITH STEADY-BURN LIGHT (50' C-C SPACING TYP. TEMPORARY PAVEMENT BUILT FOR A FUTURE STAGE AND 25' C-C ON TAPERS AND CURVES). TEMPORARY TRAFFIC ADVISORY SIGN EXISTING DITCH FLOW ARROW DIRECTION OF TRAFFIC PROPOSED TEMPORARY DITCH FLOW ARROW PROPOSED PERMANENT DITCH FLOW ARROW SIGN LEGEND NUMBER (SEE ADJACENT LEGEND ARROW BOARD FOR SIGNS AND CORRESPONDING NUMBERS). REVISED -2025-07-02 USER NAME = tnestor DESIGNED - GJE SECTION COUNTY MAINTENANCE OF TRAFFIC - STAGE 2 STATE OF ILLINOIS DRAWN GJE REVISED 2612 16-00232-00-CH DUPAGE 248 70 LEMONT ROAD PLOT SCALE = 40.0000 '/ in. CHECKED - MTC REVISED **DEPARTMENT OF TRANSPORTATION** CONTRACT NO. 61J01 SCALE: 1"=20" SHEET 16 OF 26 SHEETS STA. 276+00 TO STA. 282+00 09/08/2023 REVISED



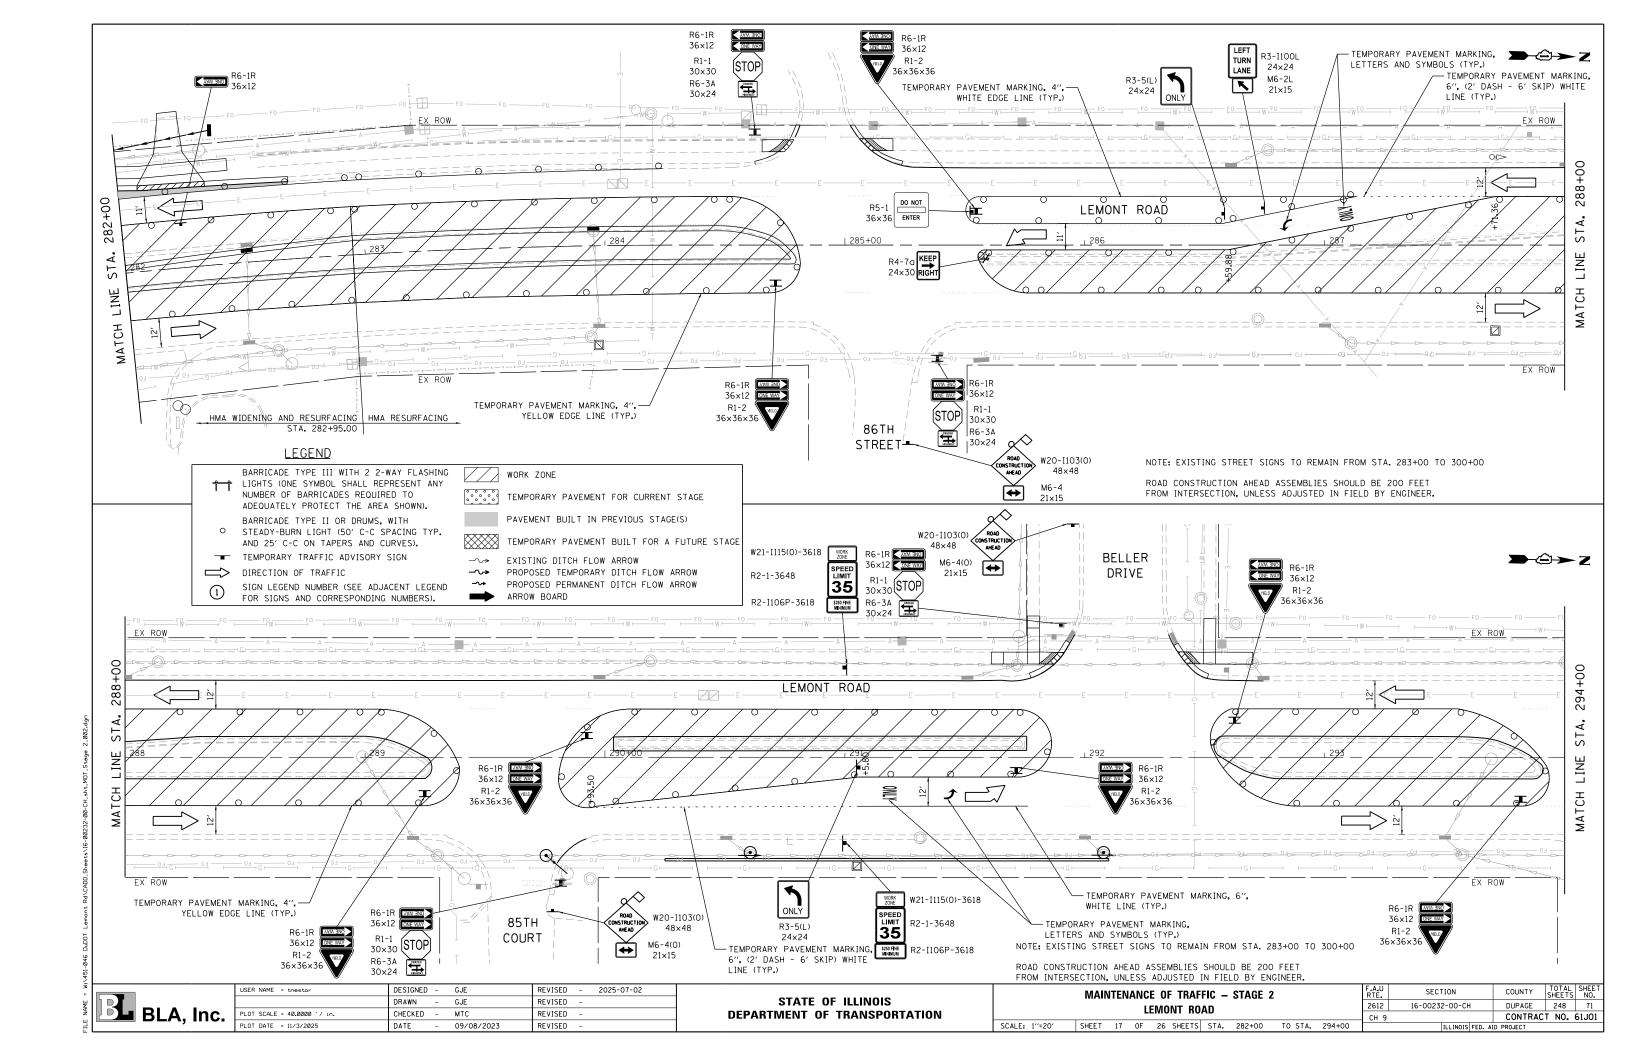

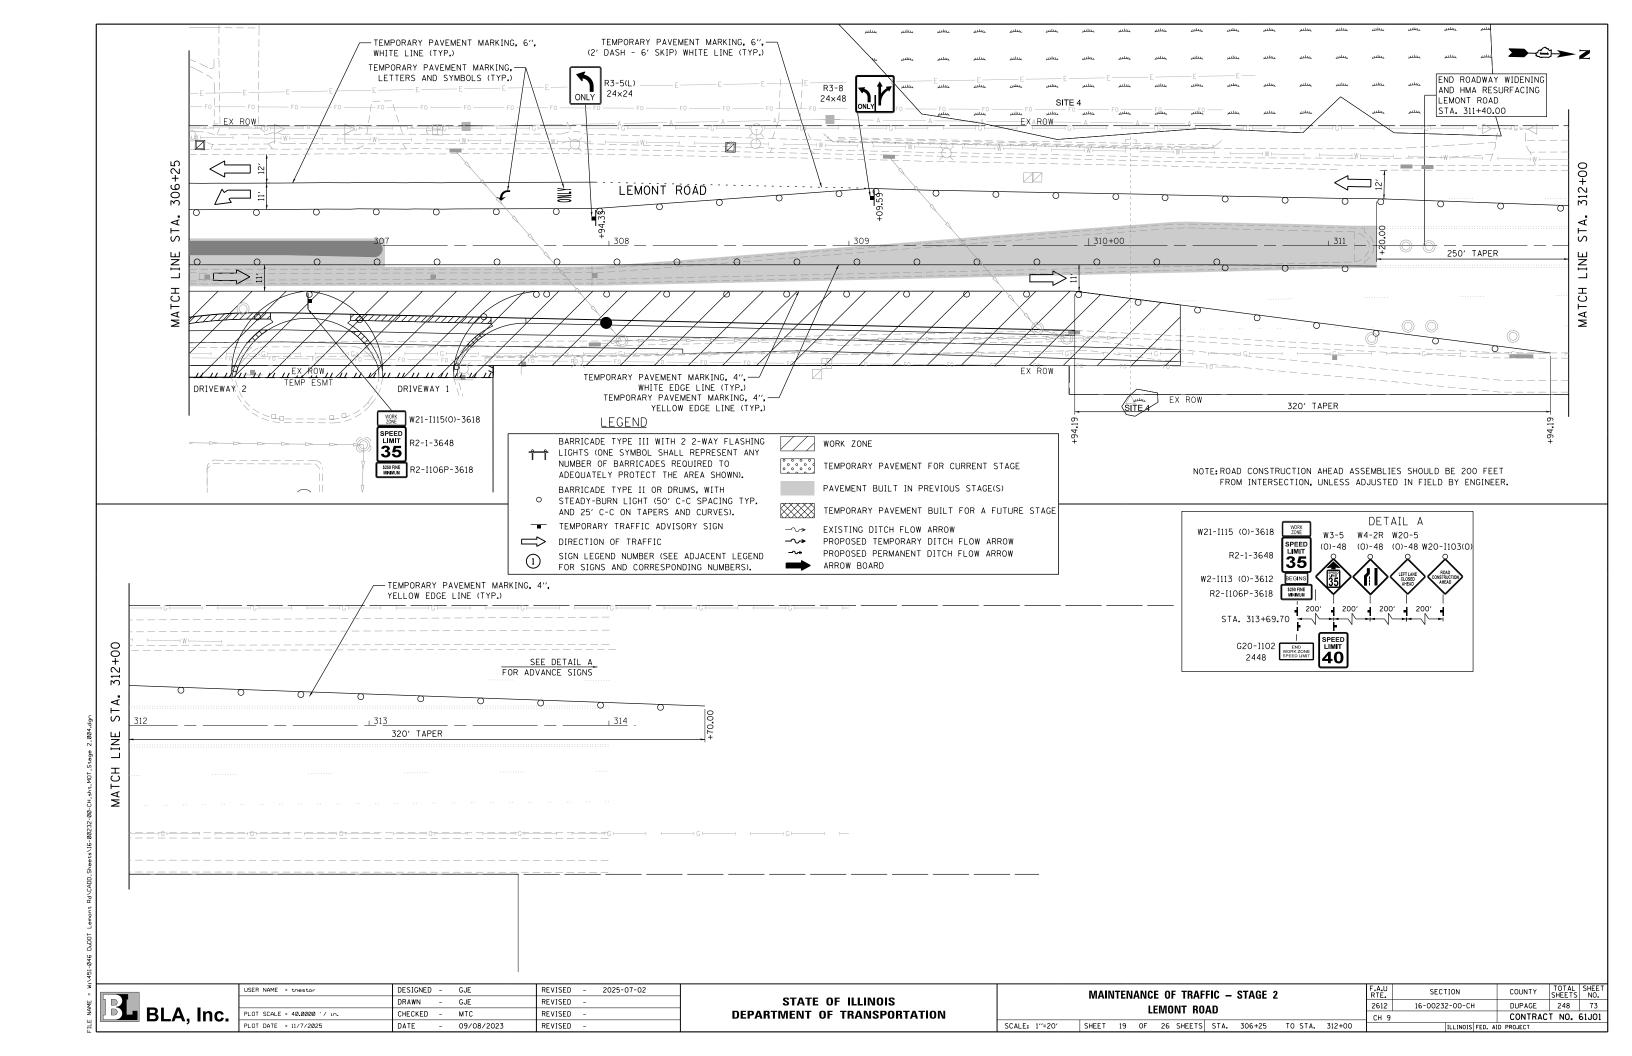

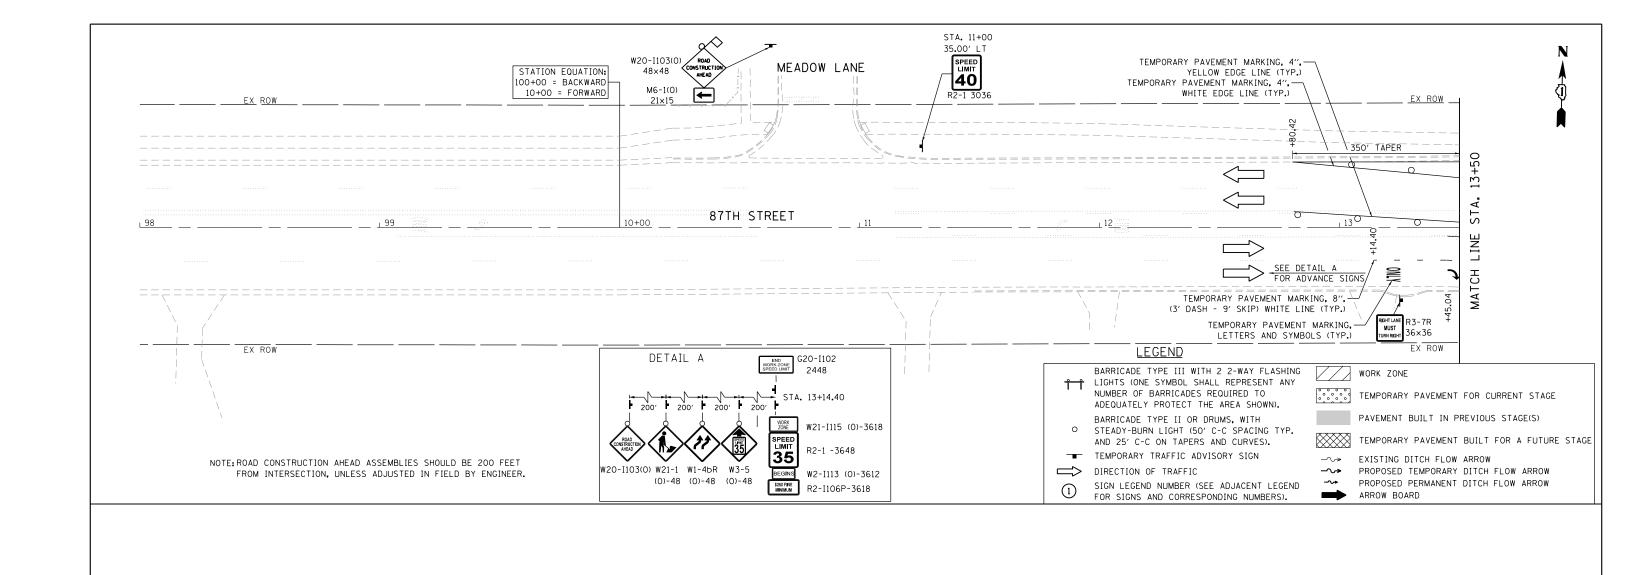



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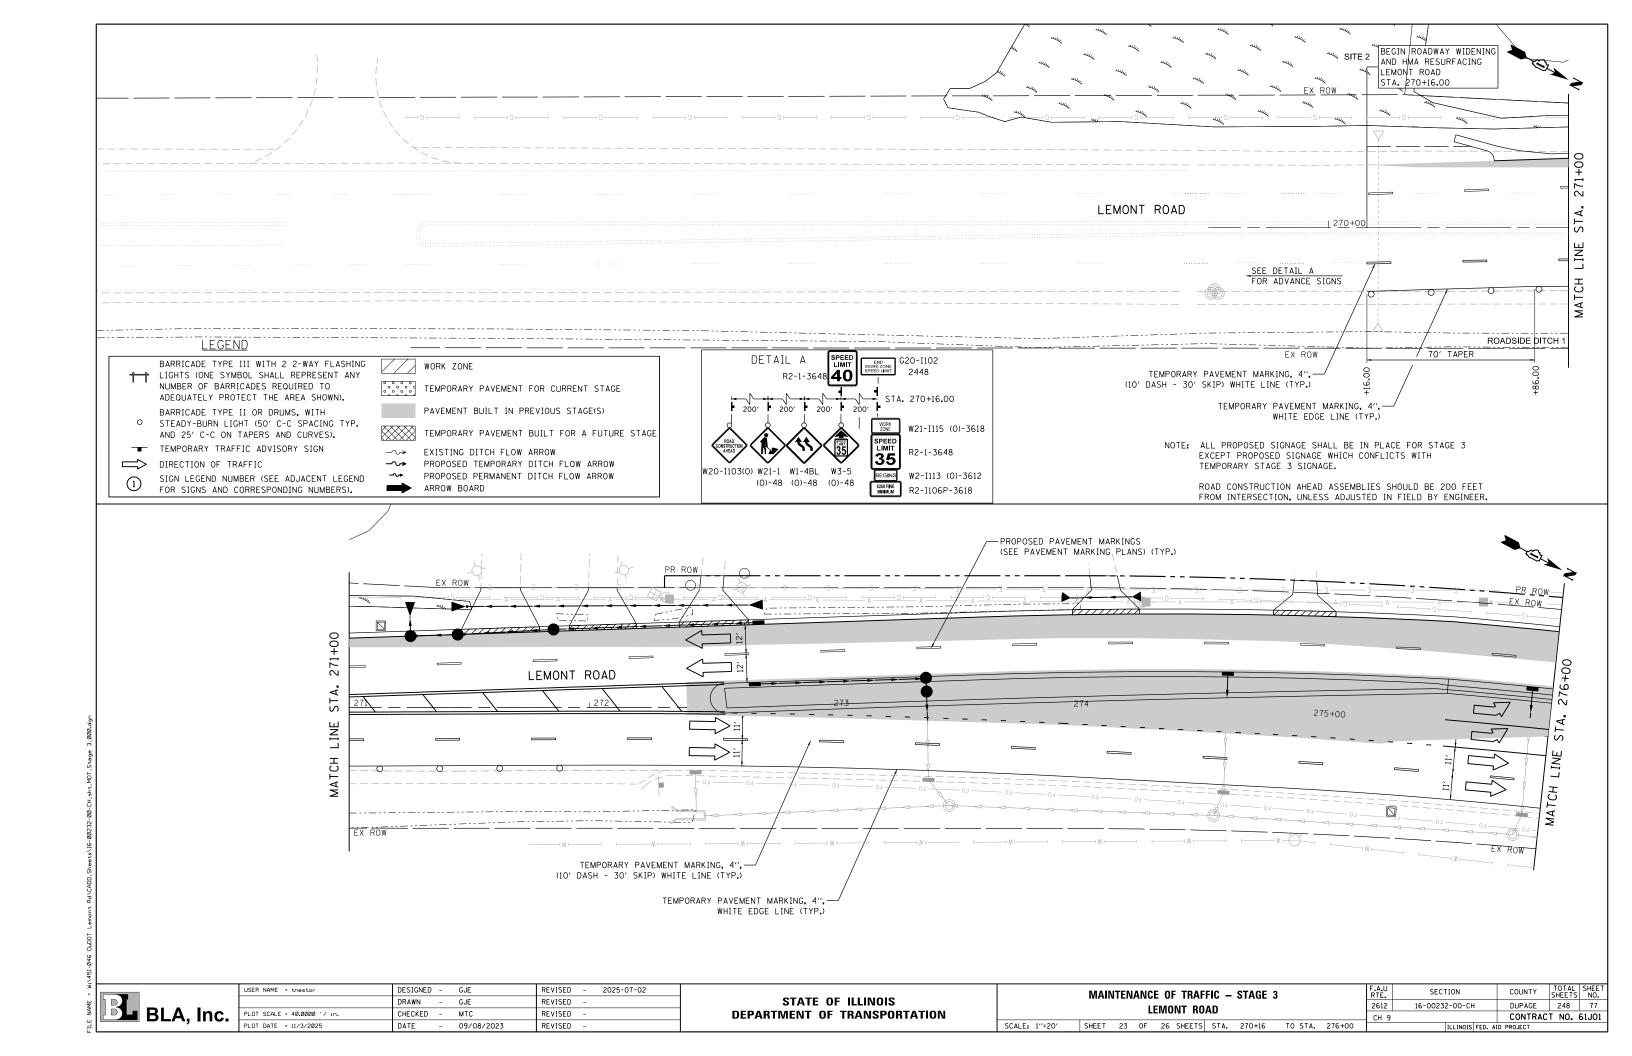
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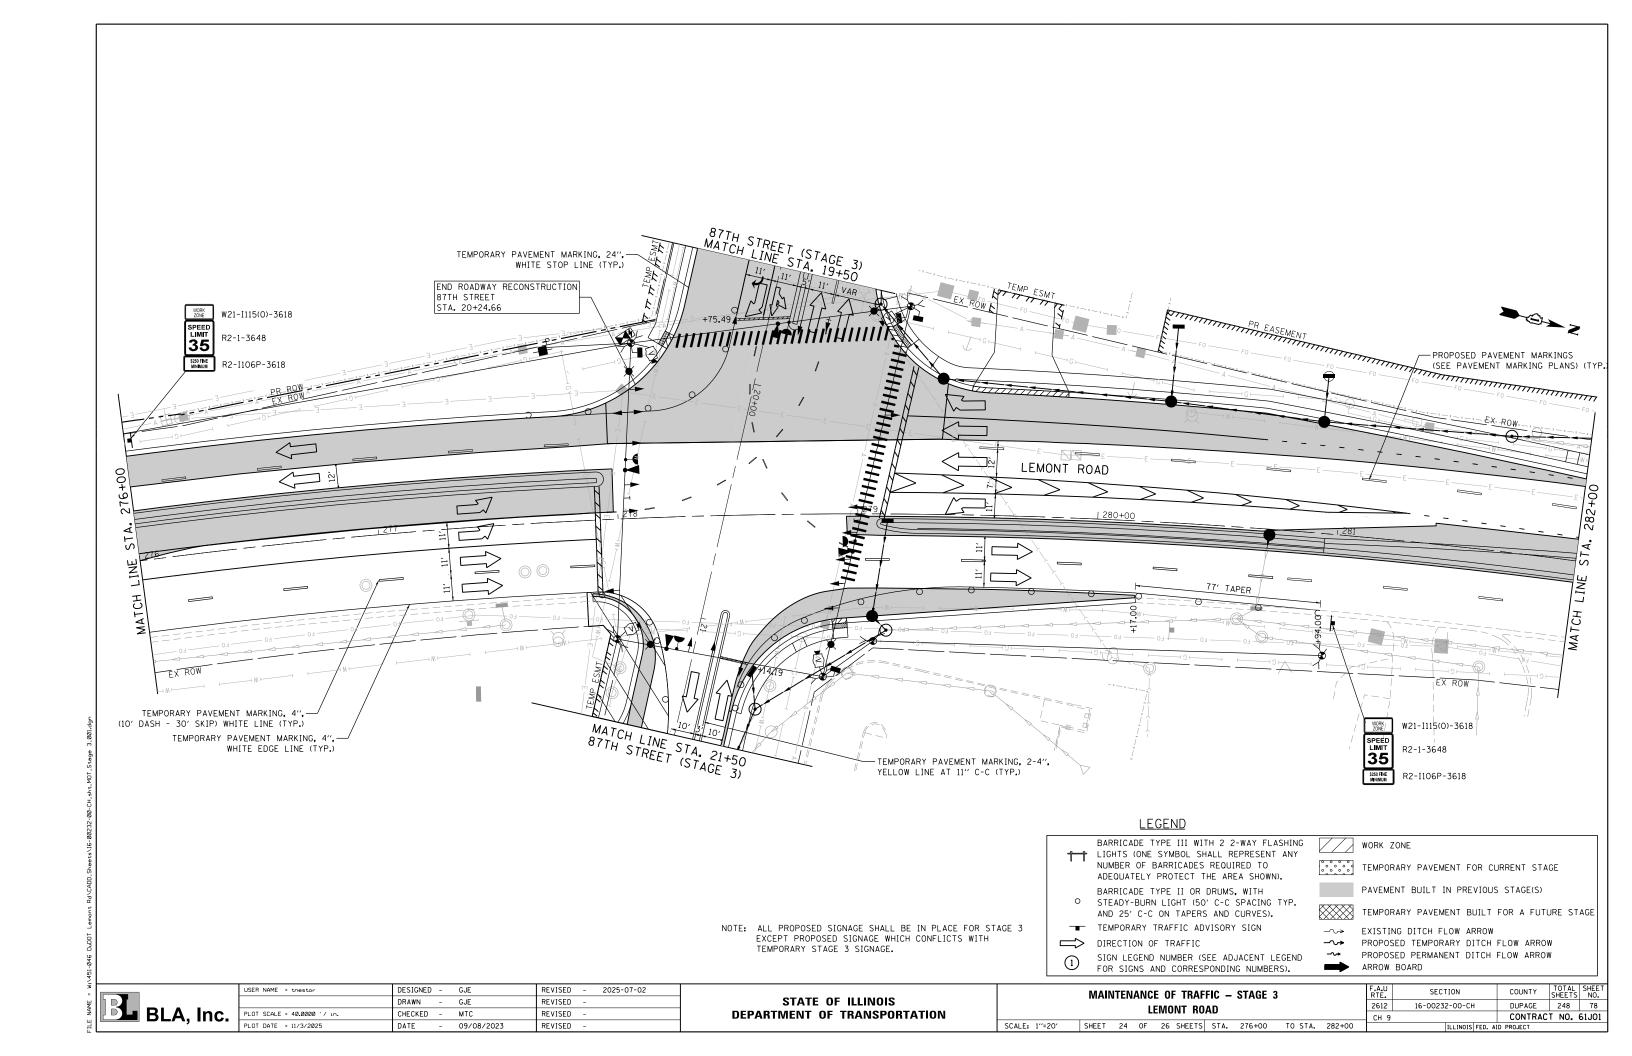
MAINTENANCE OF TRAFFIC – STAGE 2											
87TH STREET											
SCALE: 1"=20"	SHEET	20	OF	26	SHEETS	STA.	98+00	TO STA.	13+50		


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CH 9			CONTRAC	T NO.	61J
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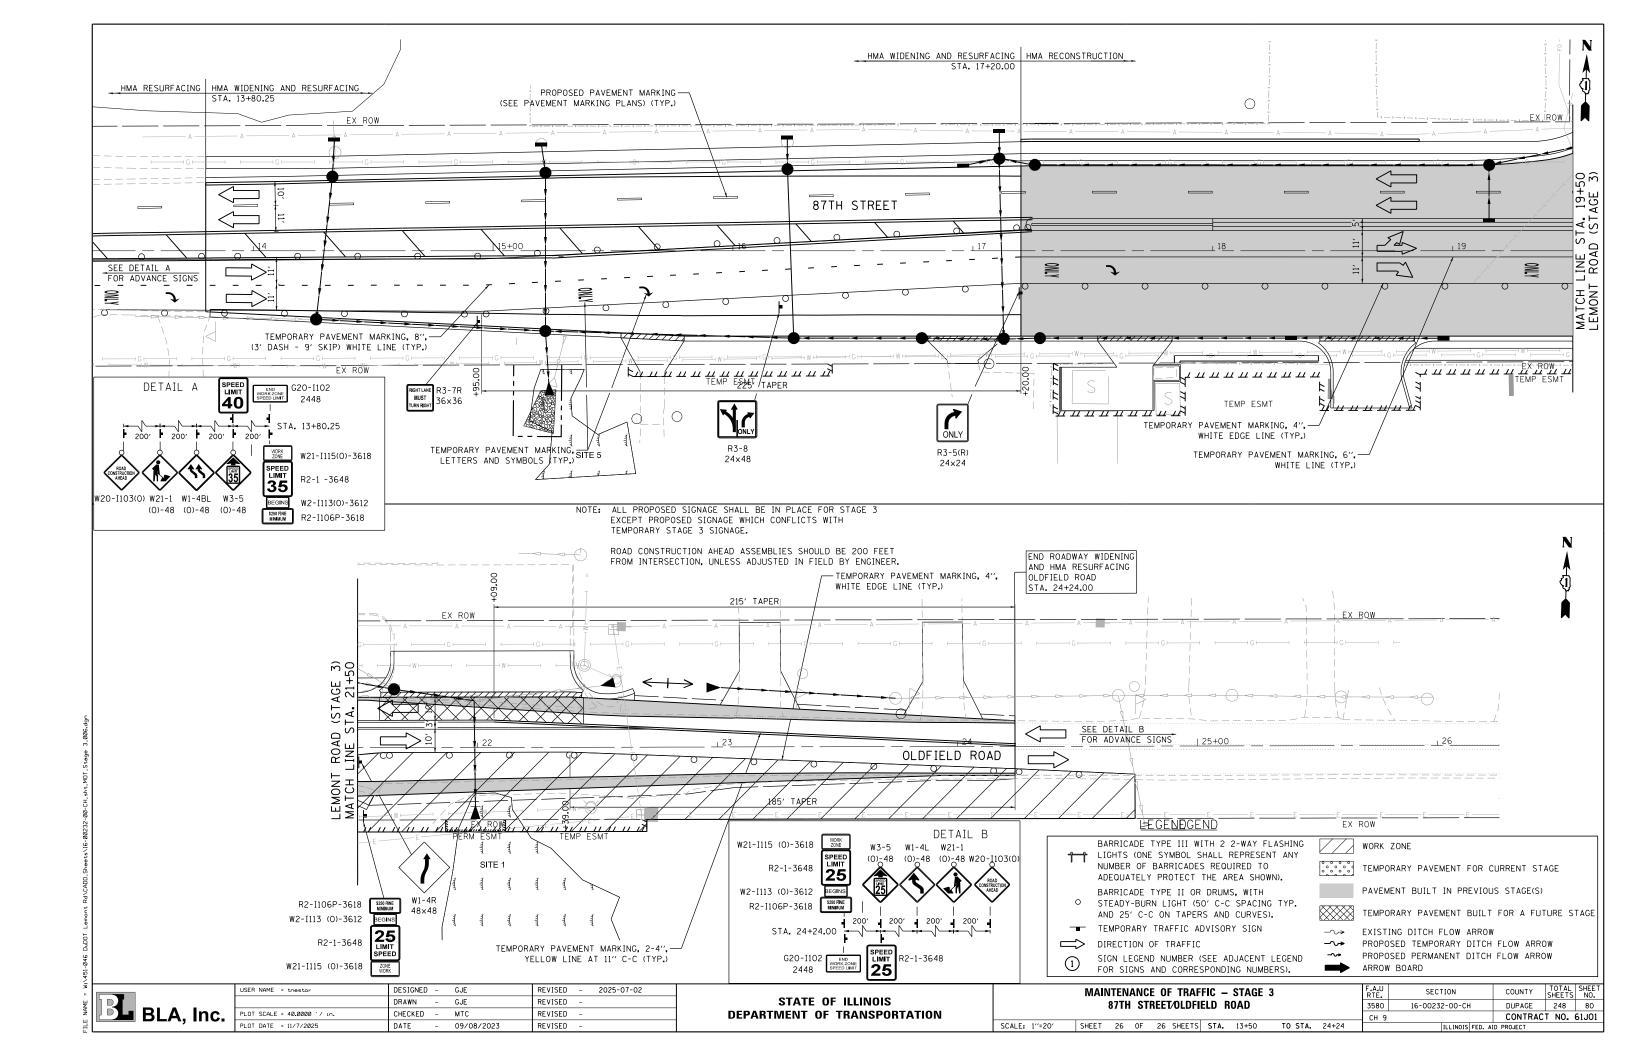




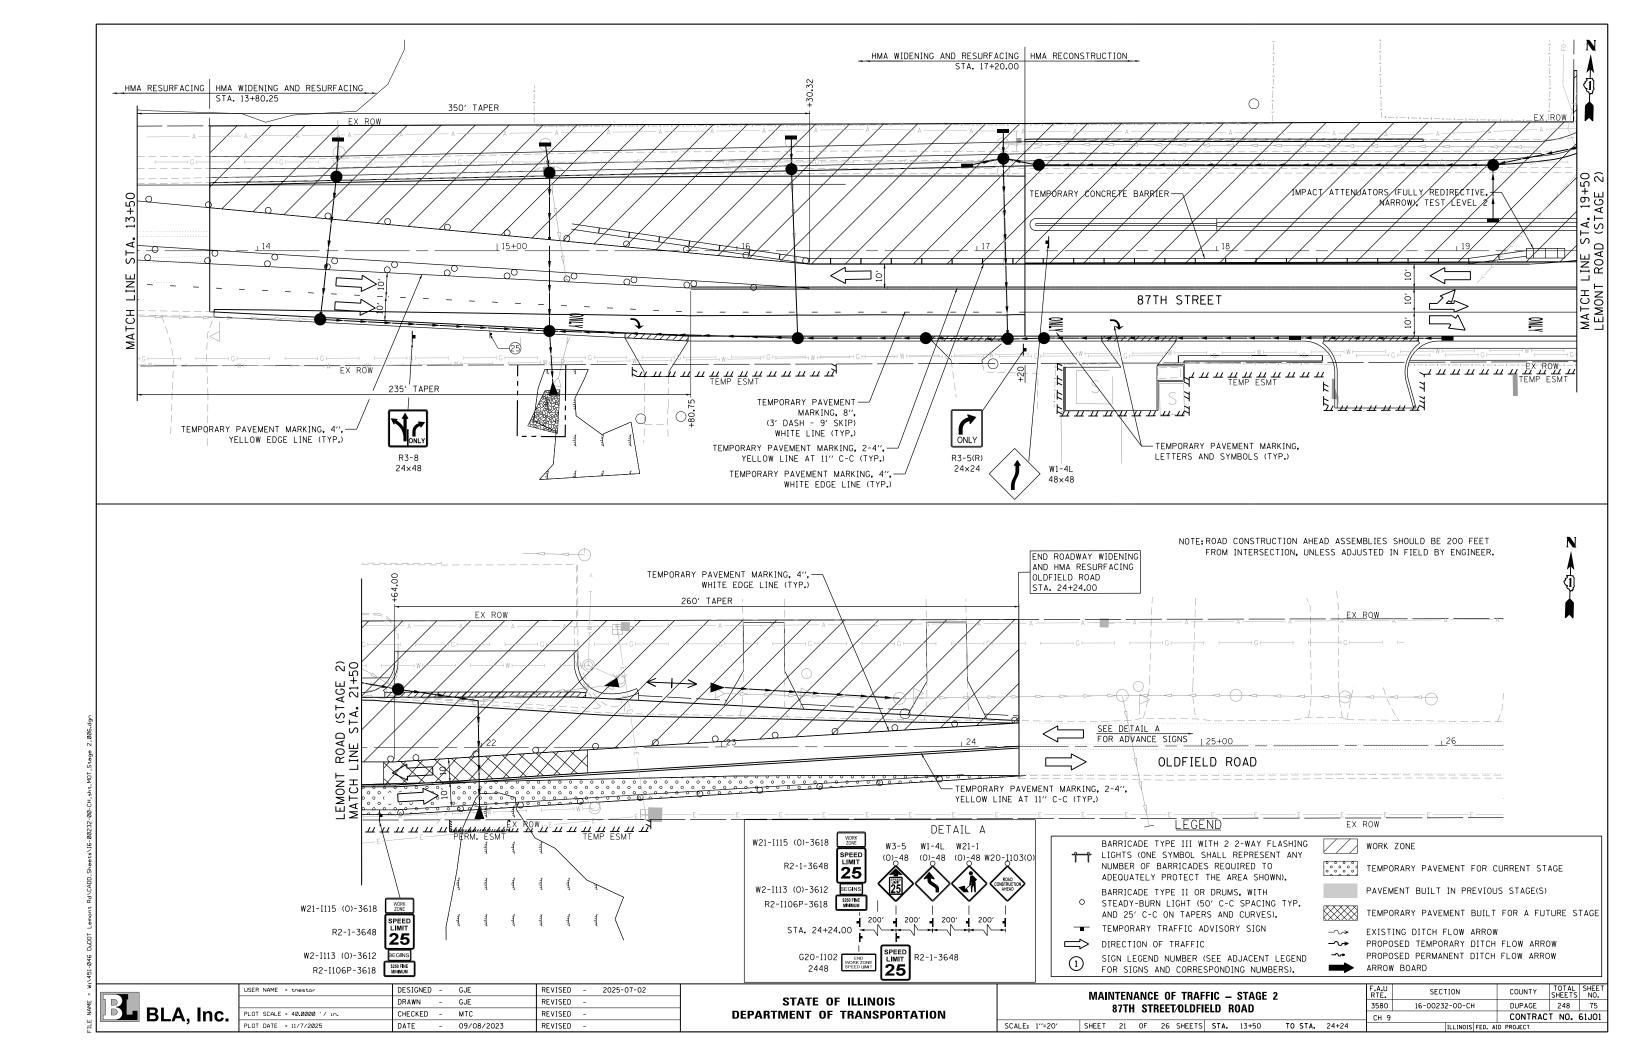

BLA, Inc.

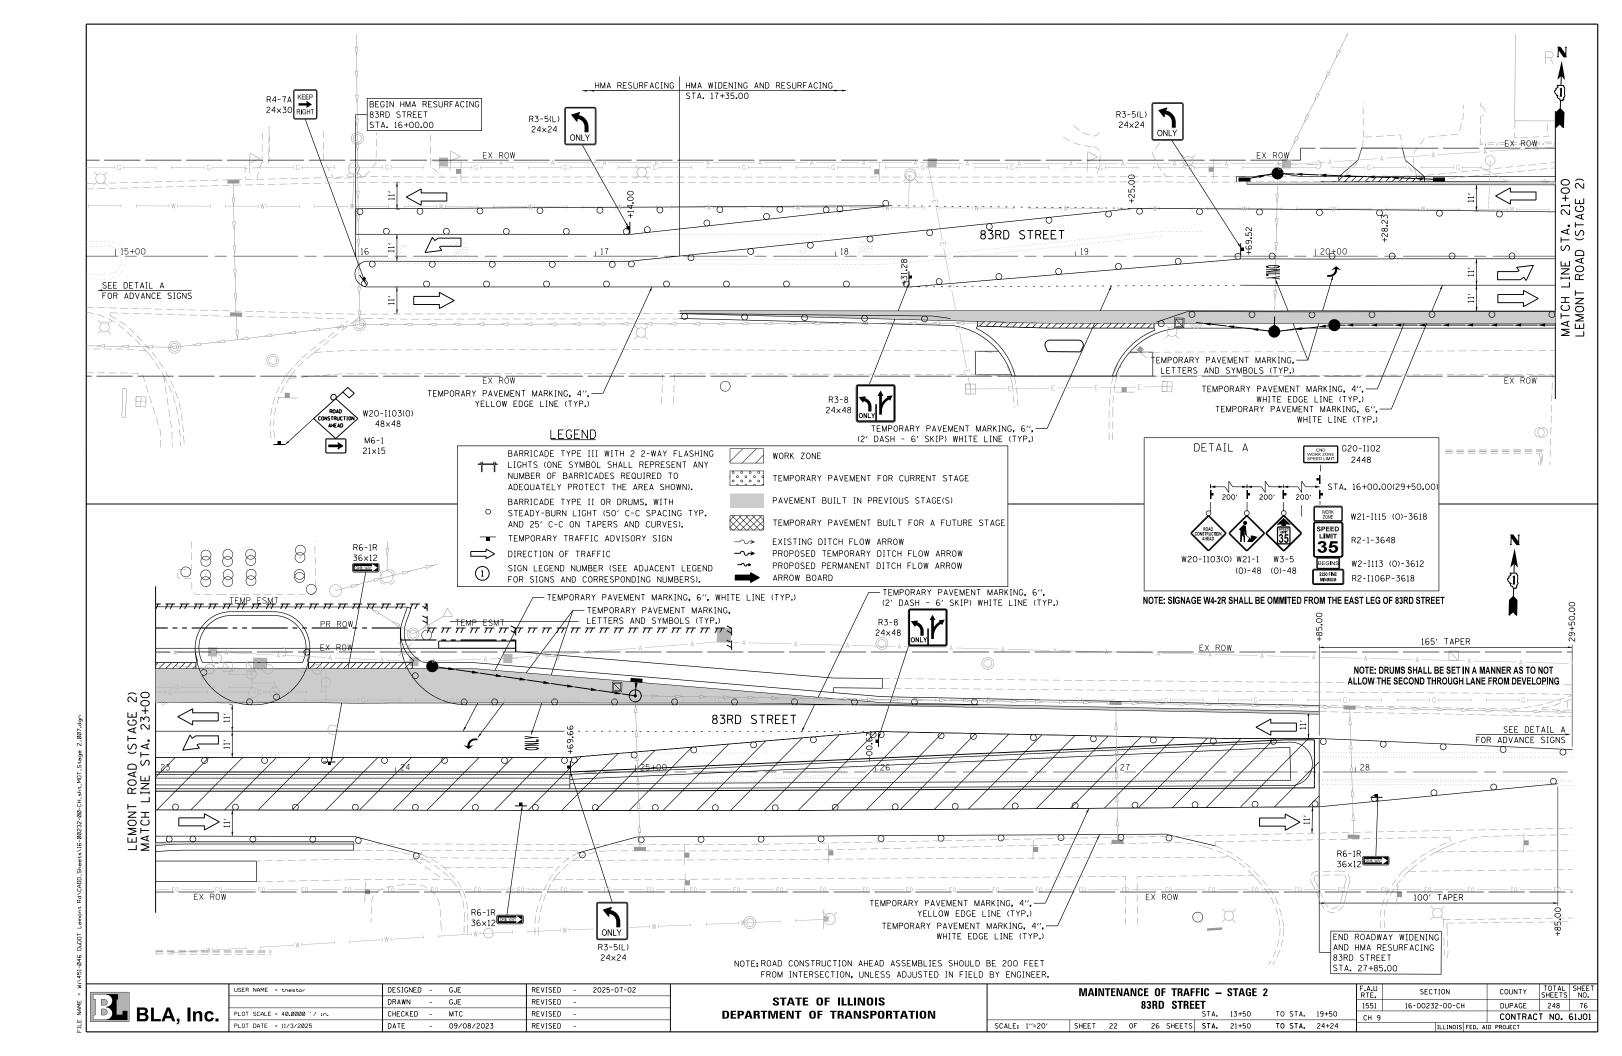STATE OF ILLINOIS
DEPARTMENT OF TRANSPORTATION

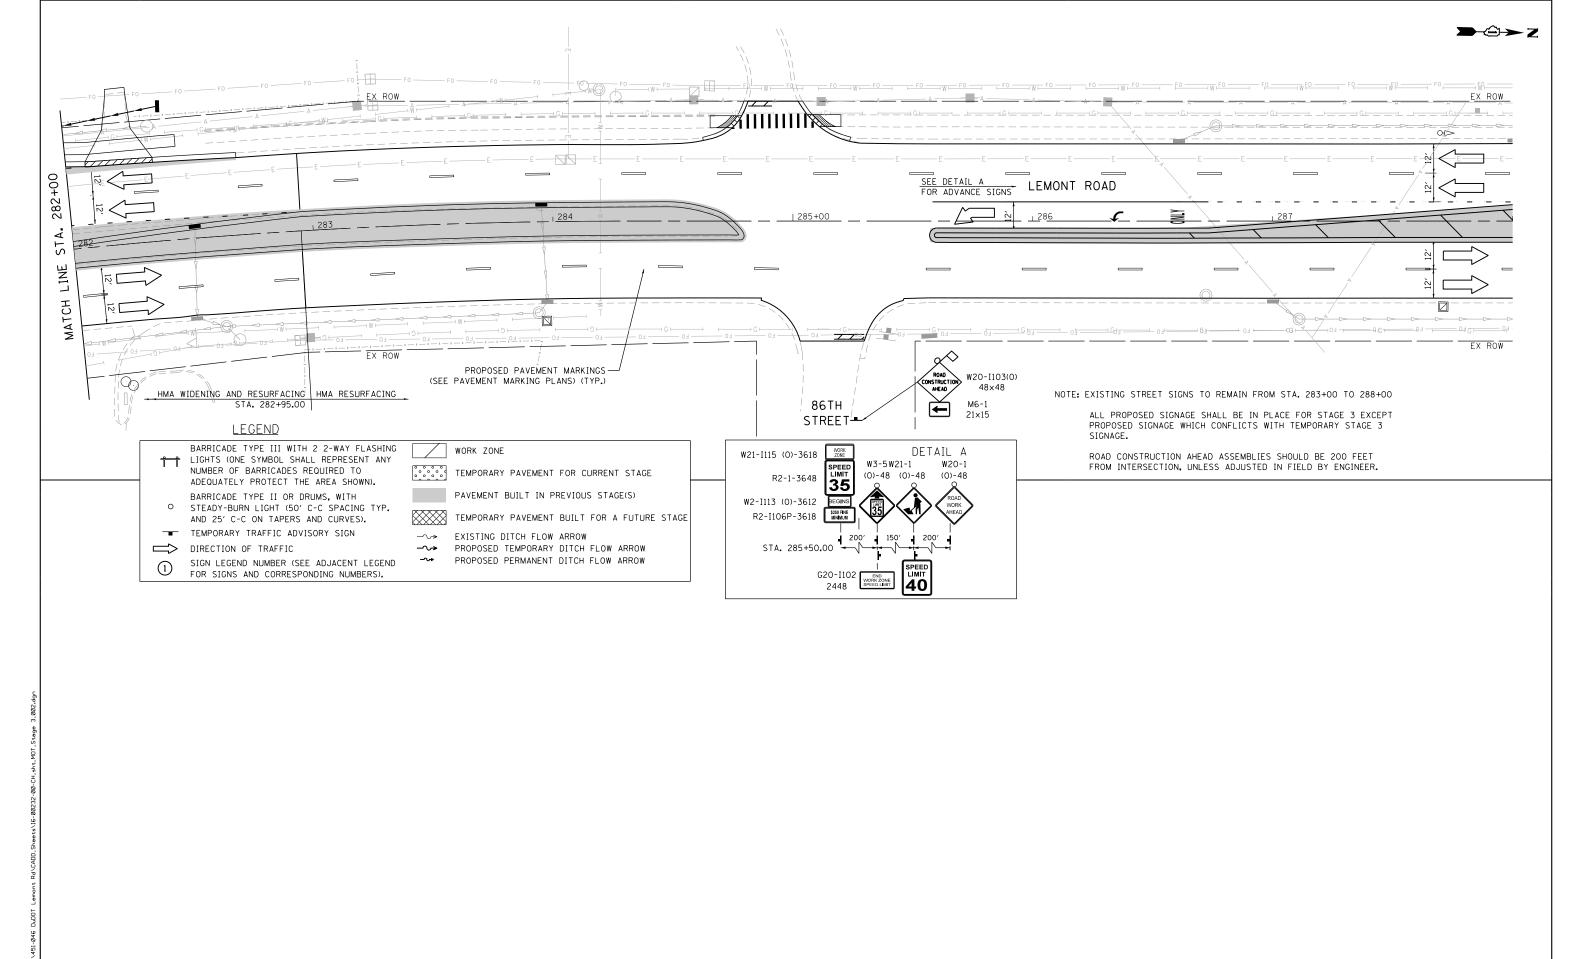

### **SOIL EROSION AND SEDIMENT CONTROL NOTES:**

- ALL WORK SHALL BE DONE IN ACCORDANCE WITH ARTICLE VII OF THE DUPAGE COUNTY COUNTYWIDE STORMWATER AND FLOOD PLAIN ORDINANCE, EFFECTIVE MAY 2019 AND ALL SUBSEQUENT REVISIONS. ALL SEDIMENT AND EROSION CONTROL MEASURES WILL BE INSTALLED PER IDOT STANDARD 280001 OR AS SPECIFIED HEREIN AND PAID FOR IN ACCORDANCE WITH SECTION 280 OF THE STANDARD SPECIFICATIONS. ALL CONSTRUCTION ACTIVITIES WILL BE IN ACCORDANCE WITH THE NATIONAL POLLUTANT DISCHARGE ELIMINATION SYSTEM STORM WATER PERMITS ILRIO AND ILR40.
- EROSION CONTROL SHALL BE PROVIDED IN ACCORDANCE WITH THE SEQUENCE OF STAGE CONSTRUCTION. THE CONTRACTOR SHALL SUBMIT A DETAILED SCHEDULE FOR APPROVAL.
- SEDIMENT AND EROSION CONTROL DEVICES SHALL BE FUNCTIONAL BEFORE THE PROJECT SITE IS OTHERWISE DISTURBED.
- ALL DISTURBED AREAS SHALL BE SEEDED OR SODDED AS SOON AS PRACTICAL AFTER CONSTRUCTION ACTIVITIES IN THAT AREA HAVE CONCLUDED. ALL 4. ERODABLE/BARE AREAS SHALL BE SEEDED EVERY 7 DAYS WITH TEMPORARY EROSION CONTROL SEEDING. IF A TOPSOIL STOCKPILE IS TO REMAIN IN PLACE FOR MORE THAN THREE DAYS, EROSION CONTROL MEASURES WILL BE PROVIDED.
- WHERE WETLANDS ARE TO REMAIN, THE CONTRACTOR SHALL TAKE ALL PRECAUTIONS TO PROTECT WETLANDS FROM DAMAGE BY SEDIMENT, CONSTRUCTION EQUIPMENT OR BY HIS WORK CREWS. THE CONTRACTOR SHALL ASSURE THAT DEBRIS OR ANY CONSTRUCTION MATERIAL IS NOT DISPOSED OF OR STOCKPILED IN WETLANDS.
- STOCKPILES AND MATERIAL STORAGE ARE PROHIBITED IN SPECIAL MANAGEMENT AREAS INCLUDING WETLANDS, WETLAND BUFFERS, AND FLOOD PLAINS, LOCATIONS OF STOCKPILES MUST BE APPROVED BY THE ENGINEER AND HAVE PROPER EROSION CONTROL MEASURES.
- RECEPTACLES FOR CONSTRUCTION DEBRIS, INCLUDING CONCRETE TRUCK WASHOUT WASTE, SHALL BE PROVIDED AND MAINTAINED BY THE CONTRACTOR. THESE WILL NOT BE ALLOWED IN SPECIAL MANAGEMENT AREAS. RECEPTACLES AND THEIR LOCATIONS MUST BE APPROVED BY THE ENGINEER AND HAVE PROPER EROSION CONTROL MEASURES. THIS WORK WILL NOT BE PAID FOR SEPERATELY, BUT SHALL BE INCLUDED IN THE APPLICABLE ITEMS OF WORK.
- HAY OR STRAW BALES WILL NOT BE ALLOWED AS PERIMITER EROSION BARRIER OR AS A DITCH CHECK. 8.
- WATER PUMPED OR OTHERWISE DISCHARGED FROM THE SITE DURING CONSTRUCTION DEWATERING SHALL BE FILTERED. 9.
- 10. WHEN TEMPORARY DRAINAGE IS ESTABLISHED, EROSION CONTROL MEASURES MAY BE REQUIRED BY THE ENGINEER.
- GRAVEL ROADS, ACCESS DRIVES, PARKING AREAS OF SUFFICIENT WIDTH AND LENGTH, AND VEHICLE WASH DOWN FACILITIES IF NECESSARY, SHALL BE PROVIDED TO 11. PREVENT SOIL FROM BEING TRACKED ONTO PUBLIC OR PRIVATE ROADWAYS. ANY SOIL REACHING A PUBLIC OR PRIVATE ROADWAY SHALL BE REMOVED BEFORE THE END
- CLEANING OF VEHICLES AND EQUIPMENT, INCLUDING CONCRETE MIXERS, SHALL BE PERFORMED IN A MANNER TO REDUCE THE AMOUNT OF POLLUTANTS TRIBUTARY TO 12. STORM SEWERS AND OPEN WATERS TO THE MAXIMUM EXTENT PRACTICAL.
- 13. ALL NECESSARY MEASURES SHALL BE TAKEN TO CONTAIN ANY FUEL OR POLLUTION RUNOFF. LEAKING EQUIPMENT OR SUPPLIES SHALL BE IMMEDIATELY REPAIRED OR REMOVED FROM THE SITE.
- SEDIMENT COLLECTED DURING CONSTRUCTION BY THE VARIOUS TEMPORARY EROSION CONTROL SYSTEMS SHALL BE DISPOSED OF ON A REGULAR BASIS. SEDIMENT SHALL BE REMOVED FROM EROSION CONTROL SYSTEMS WHEN THE HEIGHT OF THE SEDIMENT EXCEEDS ONE-HALF OF THE HEIGHT OF THE FILTER DEVICE.
- ALL EROSION CONTROL MEASURES SHALL BE KEPT OPERATIONAL AND MAINTAINED CONTINUOUSLY THROUGHOUT THE PERIOD OF LAND DISTURBANCE UNTIL PERMANENT SEDIMENT AND EROSION CONTROL MEASURES ARE OPERATIONAL.
- ALL TEMPORARY EROSION AND SEDIMENT CONTROL MEASURES SHALL BE REMOVED WITHIN 30 DAYS AFTER FINAL STABILIZATION IS ACHIEVED.
- THE ENGINEER SHALL INSPECT EROSION CONTROL MEASURES PERIODICALLY AND WITHIN 24 HOURS OF ANY STORM EXCEEDING 🐪 INCH PRECIPITATION. DAMAGED AND INEFFECTIVE EROSION CONTROL MEASURES SHALL BE REPAIRED OR REPLACED BY THE CONTRACTOR WITHIN 24 HOURS. EROSION CONTROL SYSTEMS REPLACED DUE TO SEDIMENT LOADING WILL BE PAID FOR AT THE CONTRACT UNIT PRICE FOR THE APPLICABLE EROSION CONTROL ITEM.
- THE COST OF REMOVING SEDIMENT OR REPAIRING FROSION CONTROL SYSTEMS SHALL BE INCLUDED IN THE CONTRACT UNIT PRICE FOR THE APPLICABLE FROSION CONTROL ITEM.
- THE CONTRACTOR WILL ASSUME RESPONSIBILITY FOR MAINTENANCE OF ALL SOIL EROSION CONTROL DURING CONSTRUCTION.
- "WETLANDS NO INTRUSION" SIGNAGE SHALL BE PROVIDED AT THE BOUNDARY OF ALL UN-IMPACTED WETLANDS AND / OR WATERS OF THE U.S. THE CONTRACTOR SHALL CONTACT THE COUNTY TO OBTAIN APPROPRIATE SIGNAGE.
- IN LOCATIONS ADJACENT TO WETLANDS AND / OR WATERS OF THE U.S. PERIMETER EROSION BARRIER ADJACENT SHALL BE INSTALLED AS A DOUBLE ROW AND SHALL 21. BE OF HIGH VISIBILITY MATERIAL.
- IF A STOCKPILE IS TO REMAIN IN PLACE FOR MORE THAN 14 DAYS, SEDIMENT AND EROSION CONTROL SHALL BE PROVIDED AROUND SUCH STOCKPILE. ANY PART OF THE STOCKPILE TO REMAIN UNTOUCHED FOR 14 DAYS MUST BE PROTECTED WITH TEMPORARY SOIL AND EROSION CONTROL MEASURES WITHIN 7 DAYS OF THE LAST DAY THE STOCKPILE WAS DISTURBED. TEMPORARY COVER SHALL BE MAINTAINED CONTINUOUSLY UNTIL PERMANENT COVER IS ESTABLISHED.
- THIS PROJECT REQUIRES A US ARMY CORPS OF ENGINEERS (USACE) 404 PERMIT THAT WILL BE SECURED BY THE DEPARTMENT. AS A CONDITION OF THIS PERMIT, THE CONTRACTOR WILL NEED TO SUBMIT AN IN-STREAM WORK PLAN (INCLUDING WORK WITHIN WETLANDS) TO THE DEPARTMENT FOR APPROVAL GUIDELINES ON ACCEPTABLE IN-STREAM WORK TECHNIQUES (INCLUDING WORK WITHIN WETLANDS) CAN BE FOUND ON THE USACE WEBSITE. THE USACE DEFINES AND DETERMINES IN-STREAM WORK. THE COST OF ALL MATERIALS AND LABOR NECESSARY TO COMPLY WITH THE ABOVE PROVISIONS TO PREPARE AND IMPLEMENT AN IN-STREAM WORK PLAN (INCLUDING WORK WITHIN WETLANDS) WILL NOT BE PAID FOR SEPARATELY, BUT SHALL BE CONSIDERED INCLUDED IN THE UNIT BID PRICES OF THE CONTRACT AND NO ADDITIONAL COMPENSATION WILL BE ALLOWED WITH THE EXCEPTION OF COFFERDAMS WHICH WILL BE PAID FOR AS COFFERDAM (TYPE 1) (IN-STREAM/WETLAND WORK) WITH A BASIS
- IT IS THE RESPONSIBILITY OF THE CONTRACTOR TO INFORM ANY-SUB-CONTRACTOR(S) WHO MAY PERFORM WORK ON THIS PROJECT, OF THE REQUIREMENTS IN IMPLEMENTING AND MAINTAINING THESE EROSION CONTROL PLANS AND THE NATIONAL POLLUTANT DISCHARGE ELIMINATION SYSTEM (NPDES) PERMIT REQUIREMENTS



TEMPORARY EROSION CONTROL BLANKET TEMPORARY EROSION CONTROL SEEDING



TEMPORARY DITCH CHECK



EXISTING DITCH FLOW ARROW PROPOSED DITCH FLOW ARROW



PERIMETER EROSION BARRIER TREE PROTECTION (TEMPORARY FENCE) TREE ROOT PRUNING / TREE PRUNING



INLET FILTERS (FROM PREVIOUS STAGE)



STONE RIP RAP, CLASS A3



STAGED WORK ZONE

REFER TO LANDSCAPING PLANS FOR PERMANENT SEEDING AND RESTORATION

### SOIL EROSION AND SEDIMENT CONTROL CONSTRUCTION SEQUENCE:

### STAGE 1:


- 1. INSTALL PERIMETER EROSION BARRIER AS SHOWN IN THE PLANS OR DIRECTED BY THE ENGINEER.
- 2. PERFORM ANY TREE REMOVAL OR CLEARING NEEDED FOR STAGE 1 WORK.
- 3. CONSTRUCT PROPOSED ROADWAY WIDENING AND IMPROVEMENTS PER PLANS IN STAGE 1 AND INSTALL DITCH CHECKS, INLET FILTERS AND BLANKET/SEED AS NECESSARY OR AS WORK ALLOWS
- 4. PROVIDE TEMPORARY DRAINAGE AS CALLED FOR IN THE PLANS AND AS NEEDED
- 5 PERFORM ONGOING MAINTENANCE ON FROSION CONTROL DEVICES


- 1. RETAIN AND MAINTAIN DEVICES FROM PREVIOUS STAGES AS SHOWN ON THE PLANS OR AS DIRECTED BY THE
- 2. INSTALL PERIMETER EROSION BARRIER AS SHOWN IN THE PLANS OR DIRECTED BY THE ENGINEER
- 3. INSTALL DITCH CHECKS, INLET FILTERS, AND SEED AS NECESSARY OR AS WORK ALLOWS
- 4. PROVIDE TEMPORARY DRAINAGE AS SHOWN IN THE PLANS OR AS DIRECTED BY THE ENGINEER.
- 5. PERFORM ONGOING MAINTENANCE ON EROSION CONTROL DEVICES.


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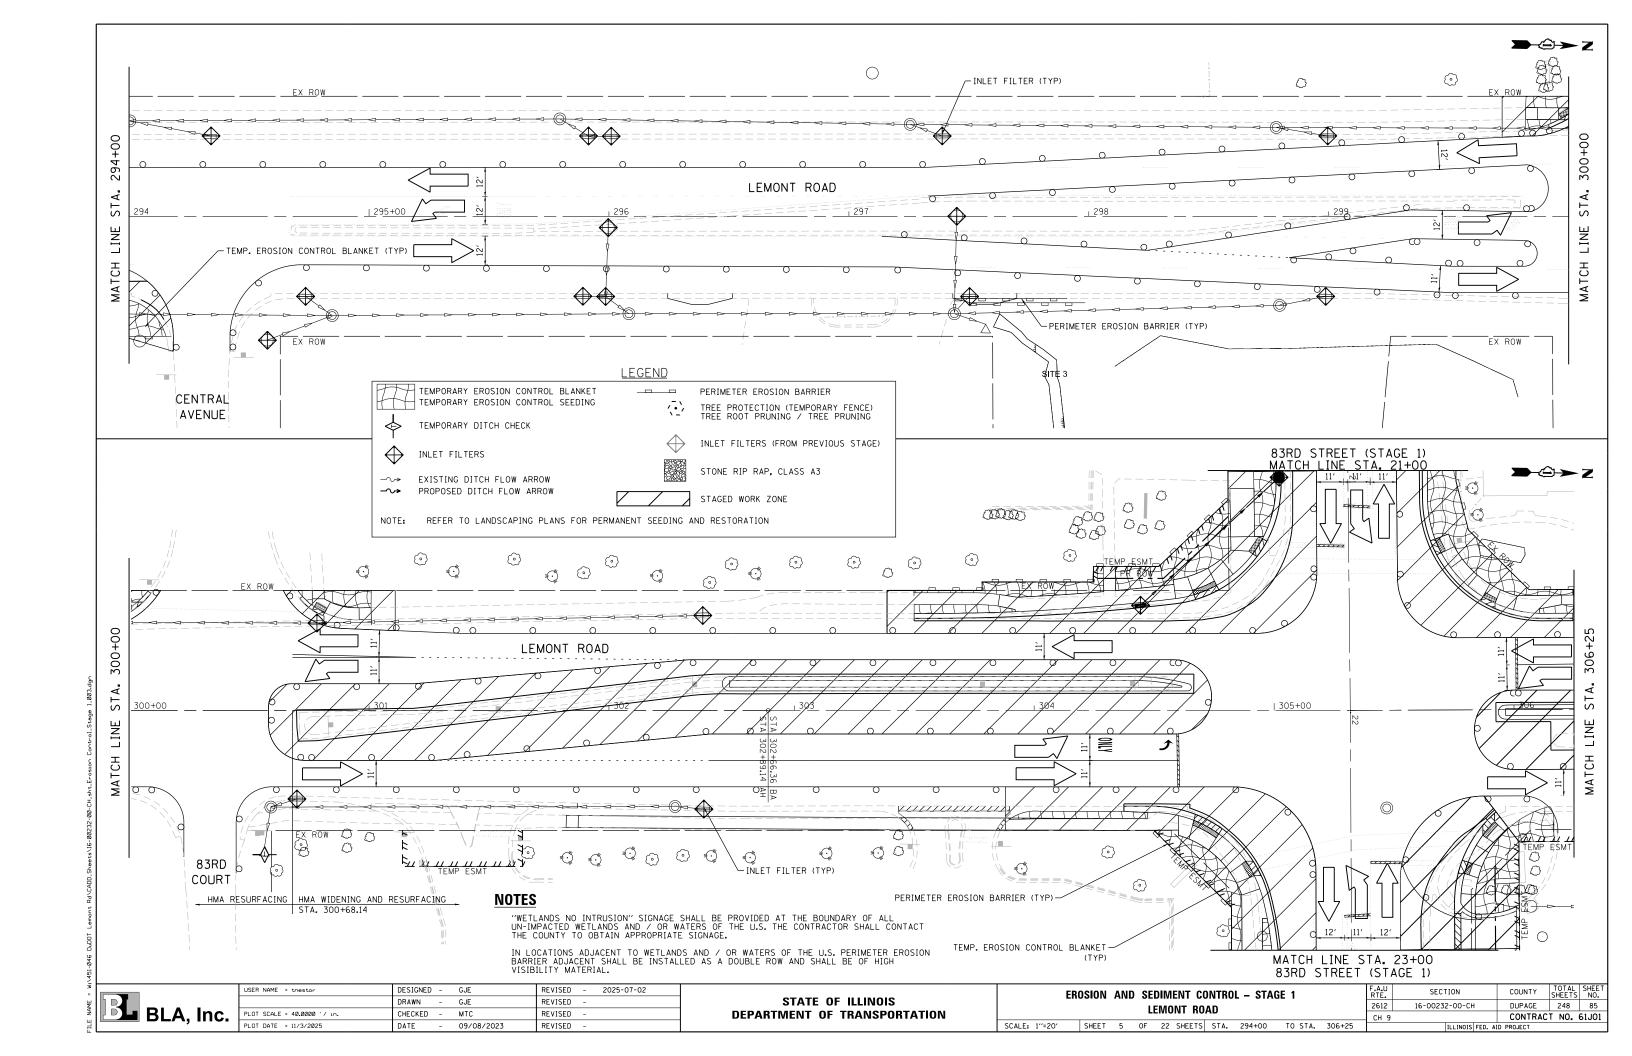
- 1. RETAIN AND MAINTAIN DEVICES FROM PREVIOUS STAGES AS SHOWN ON THE PLANS OR AS DIRECTED BY THE
- 2. INSTALL PERIMETER EROSION BARRIER AS SHOWN IN THE PLANS OR DIRECTED BY THE ENGINEER
- 3. INSTALL DITCH CHECKS, INLET FILTERS AND BLANKET/SEED AS NECESSARY OR AS WORK ALLOWS.
- 4. PERFORM ONGOING MAINTENANCE ON EROSION CONTROL DEVICES


TO STA. N/A



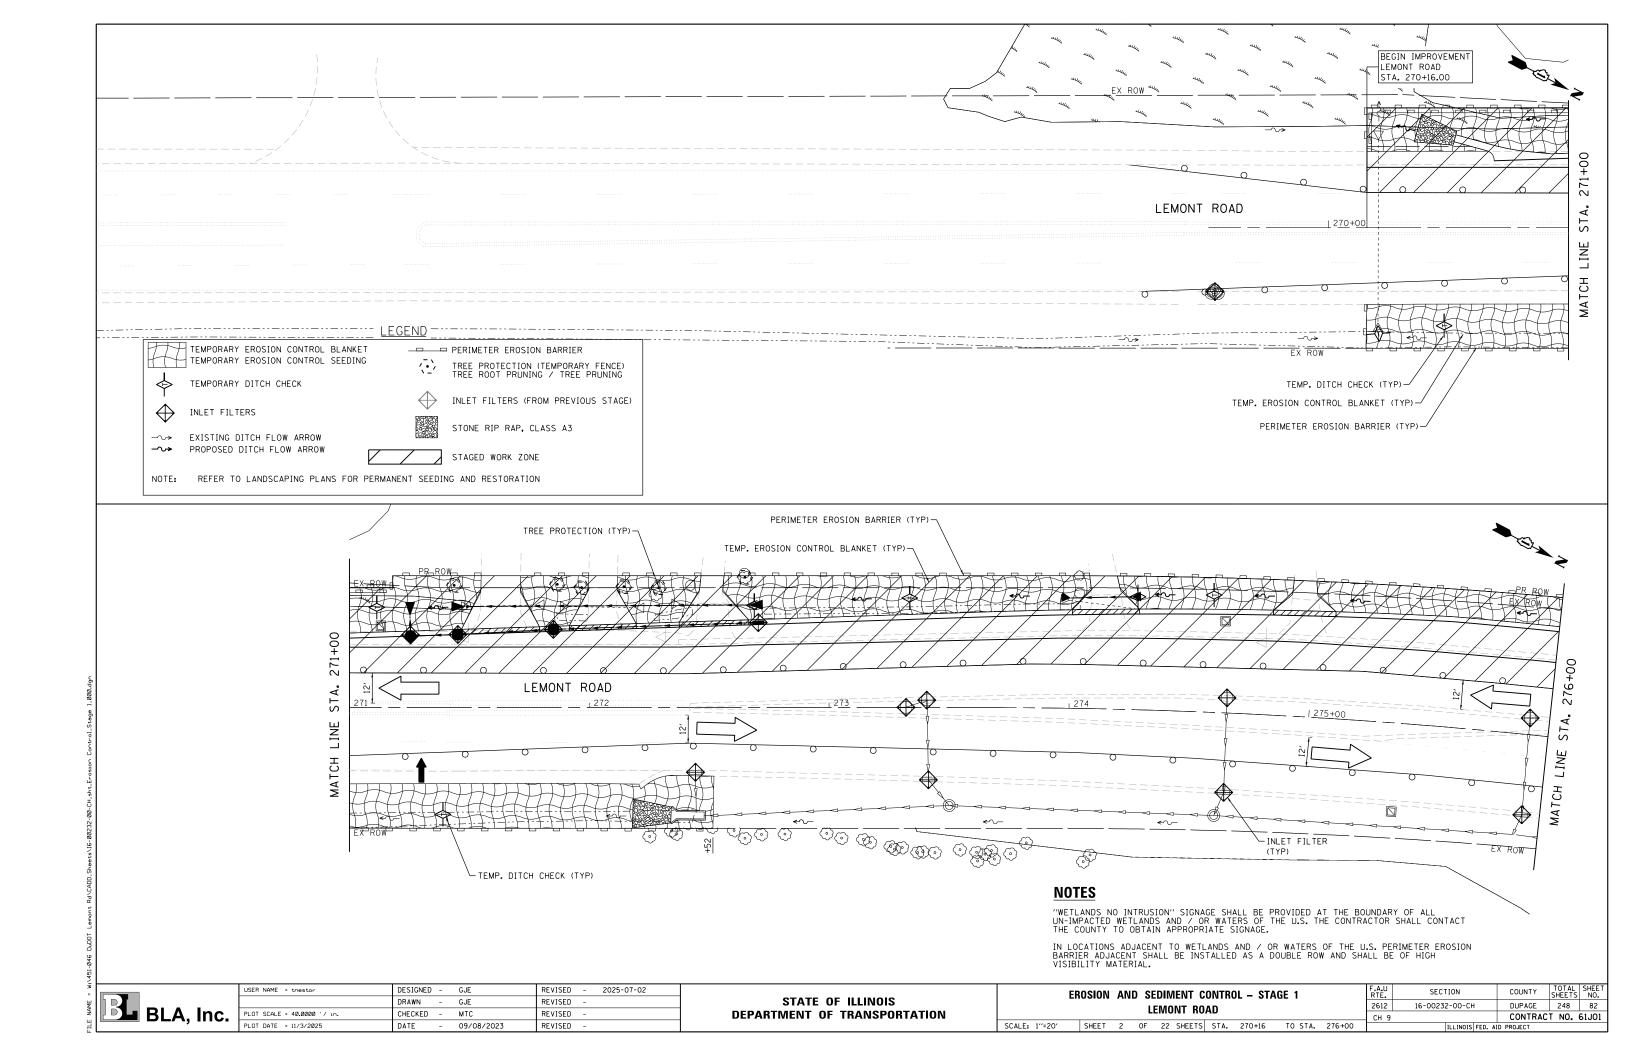

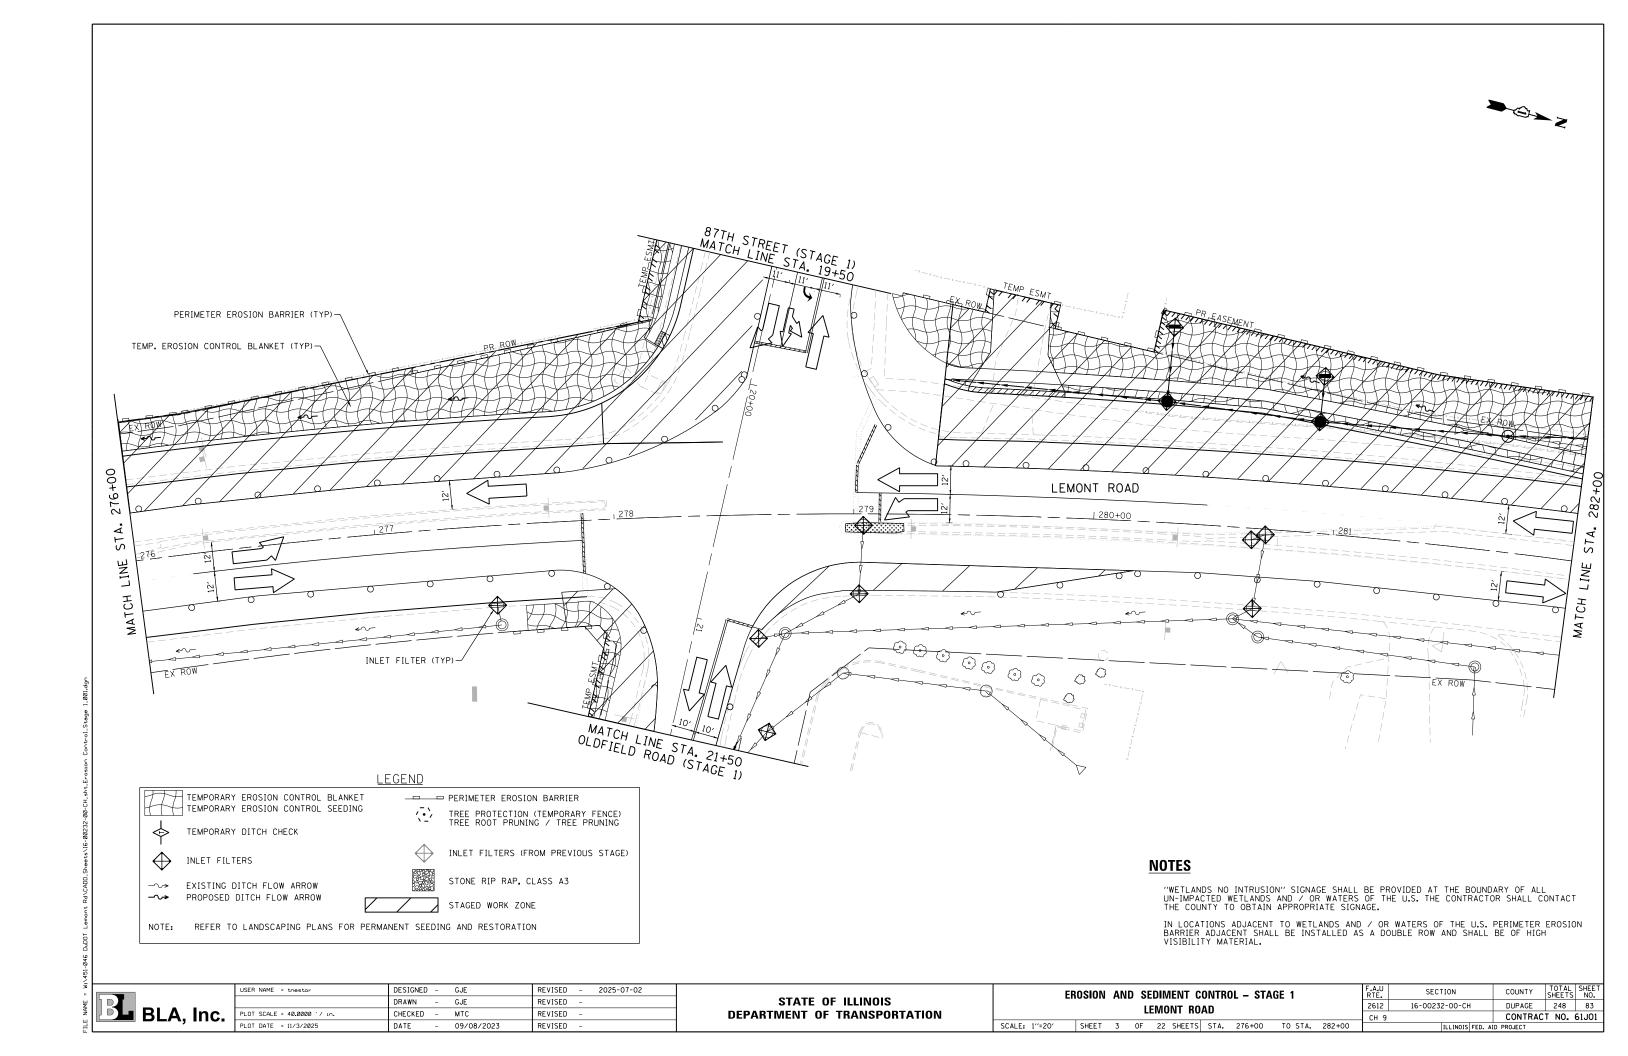

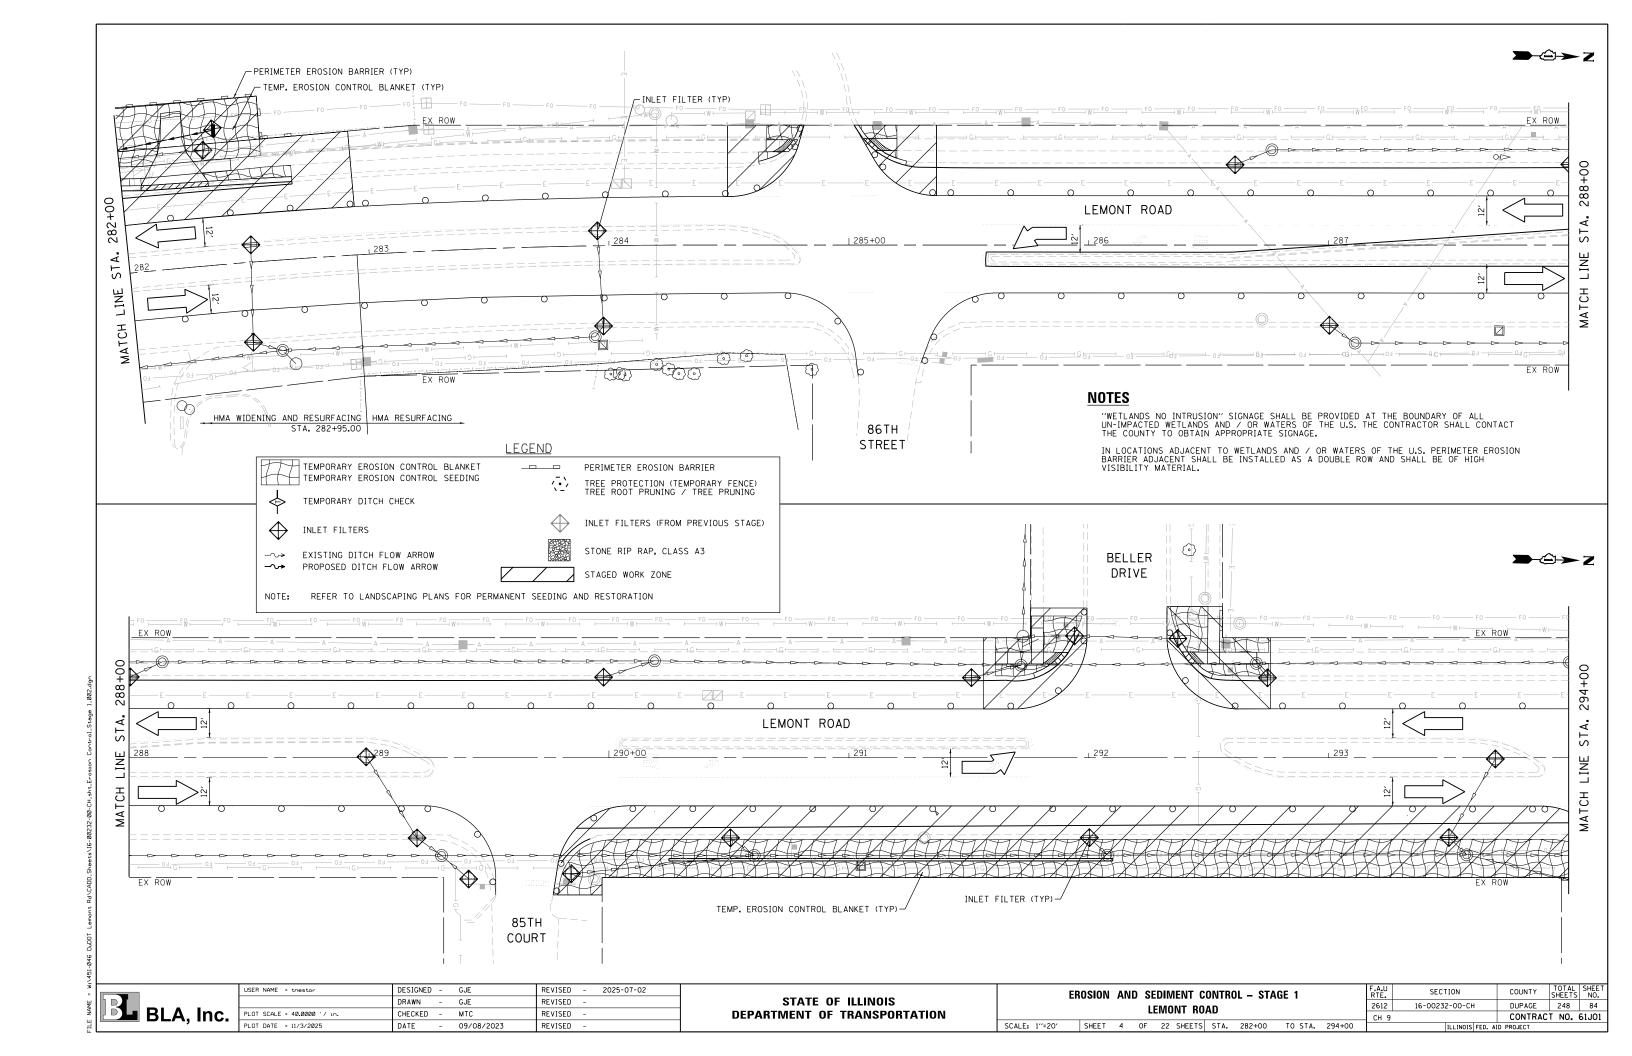

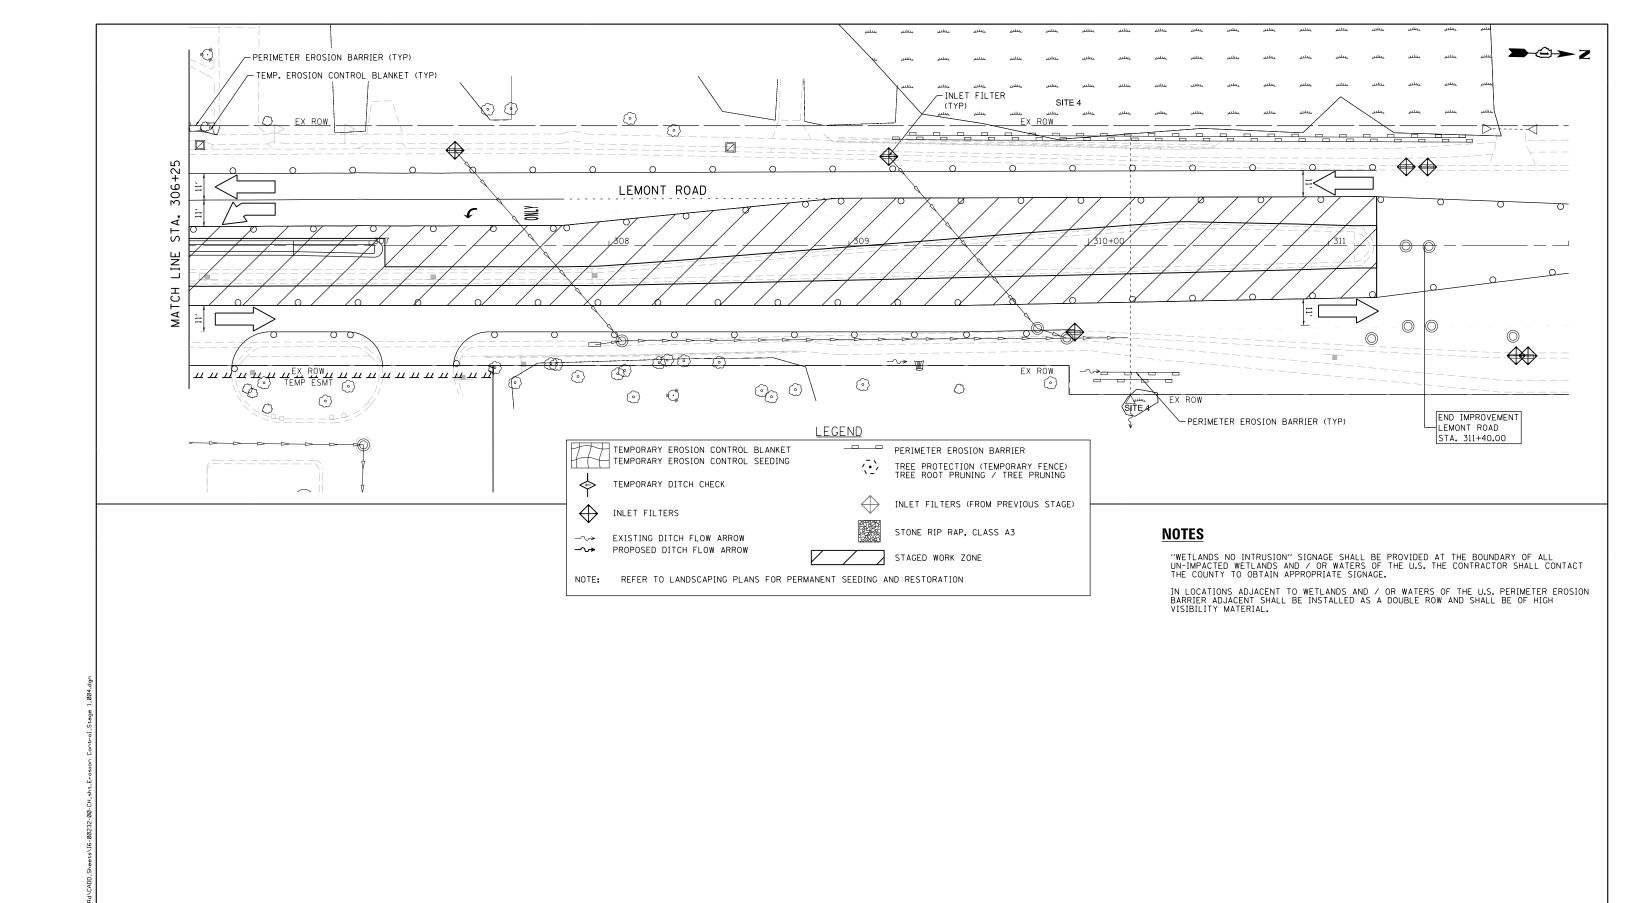


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BLA, Inc.	-
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	USER NAME = tnestor	DESIGNED	-	GJE	KENIZED	-	2025-07-02
		DRAWN	-	GJE	REVISED	-	
<b>)</b> .	PLOT SCALE = 40.0000 '/ in.	CHECKED	-	MTC	REVISED	-	
-	PLOT DATE = 11/3/2025	DATE	-	09/08/2023	REVISED	-	

EROSION AND SEDIMENT CONTROL – STAGE 1	RTE.												
LEMONT ROAD													
LLINOWI HOAD	СН												
SCALE: 1"=20' SHEET 6 OF 22 SHEETS STA. 306+25 TO STA. 312+00													


- [		ILLINOIS FED. A	D PROJECT		
_	CH 9		CONTRAC	T NO.	61J01
	2612	16-00232-00-CH	DUPAGE	248	86
	F.A.U RTE.	SECTION	COUNTY	TOTAL SHEETS	SHEE NO.

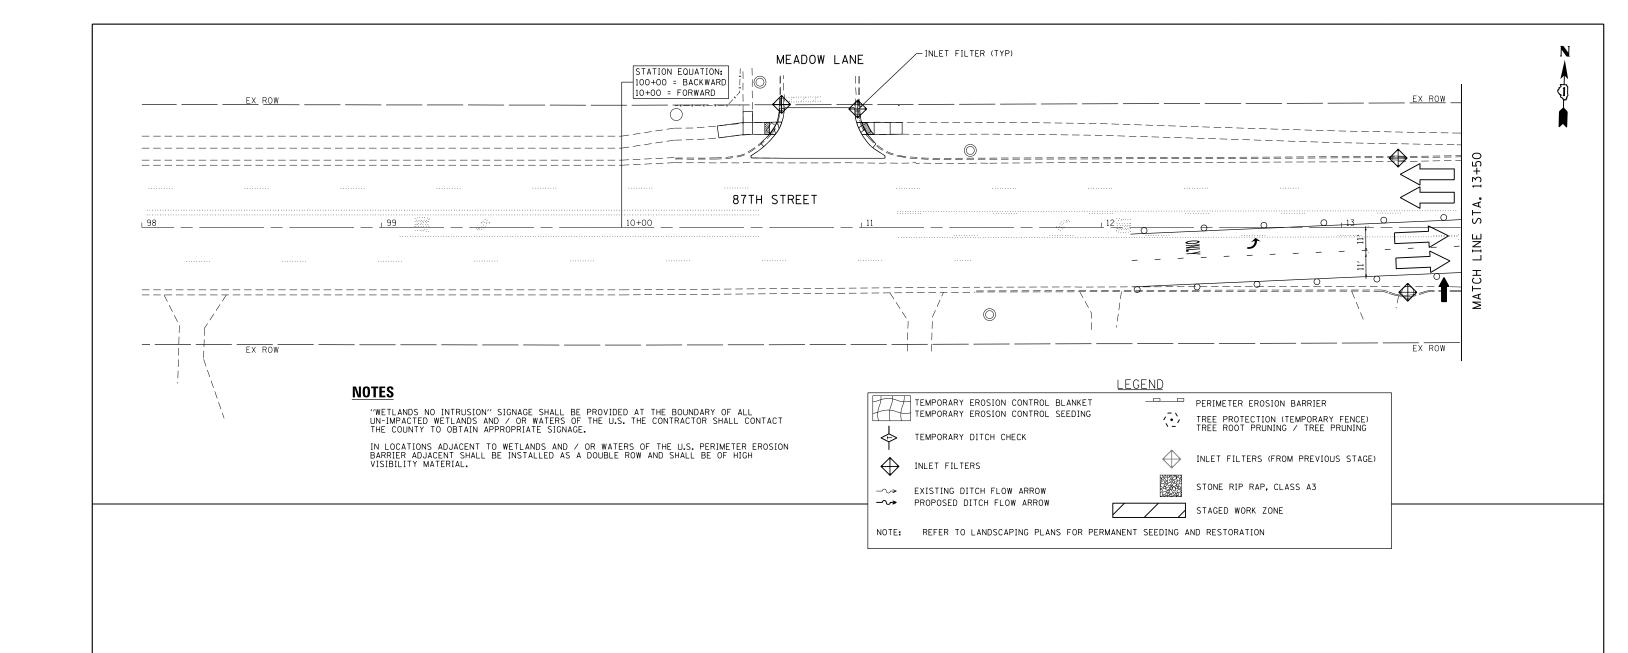



BLA, Inc.


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PLOT DATE = 11/3/2025	DATE	-	09/08/2023	REVISED	-	


ER	OSION	AND	SEDI	MENT	CONTRO	L – ST	AGE 1	
			87T	H STR	EET			
SCALE: 1"=20"	SHEET	7 (	OF 2:	2 SHEET	S STA.	98+00	TO STA.	13+50

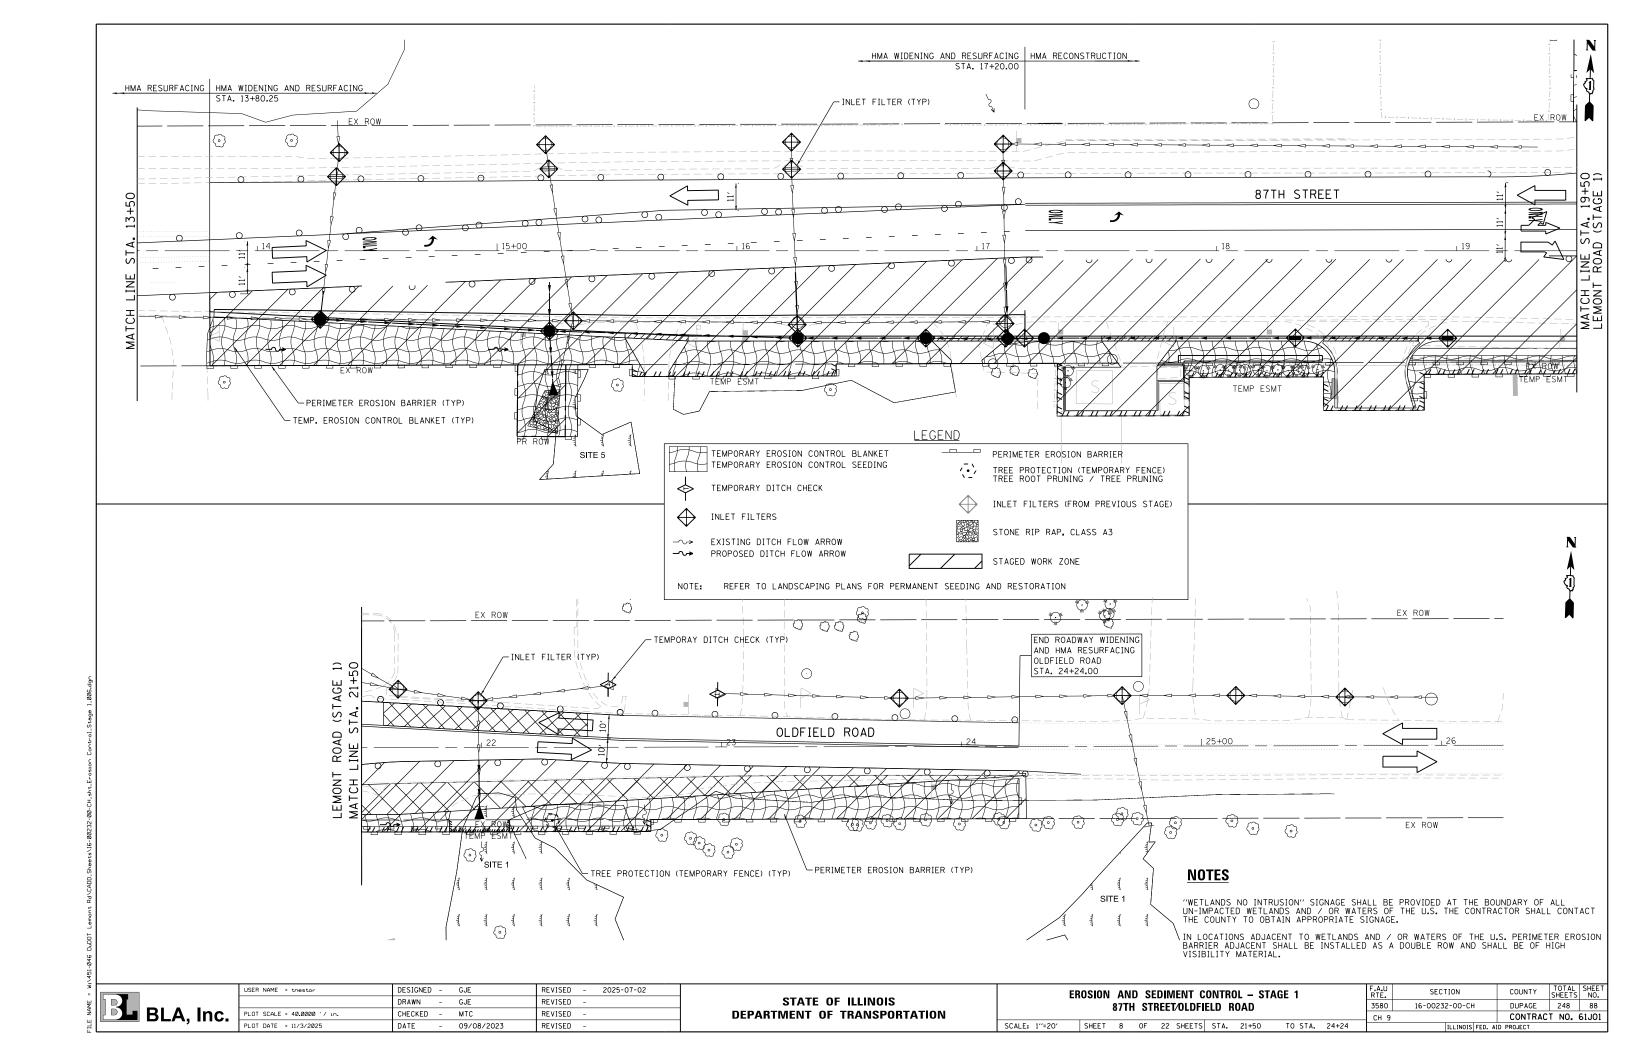


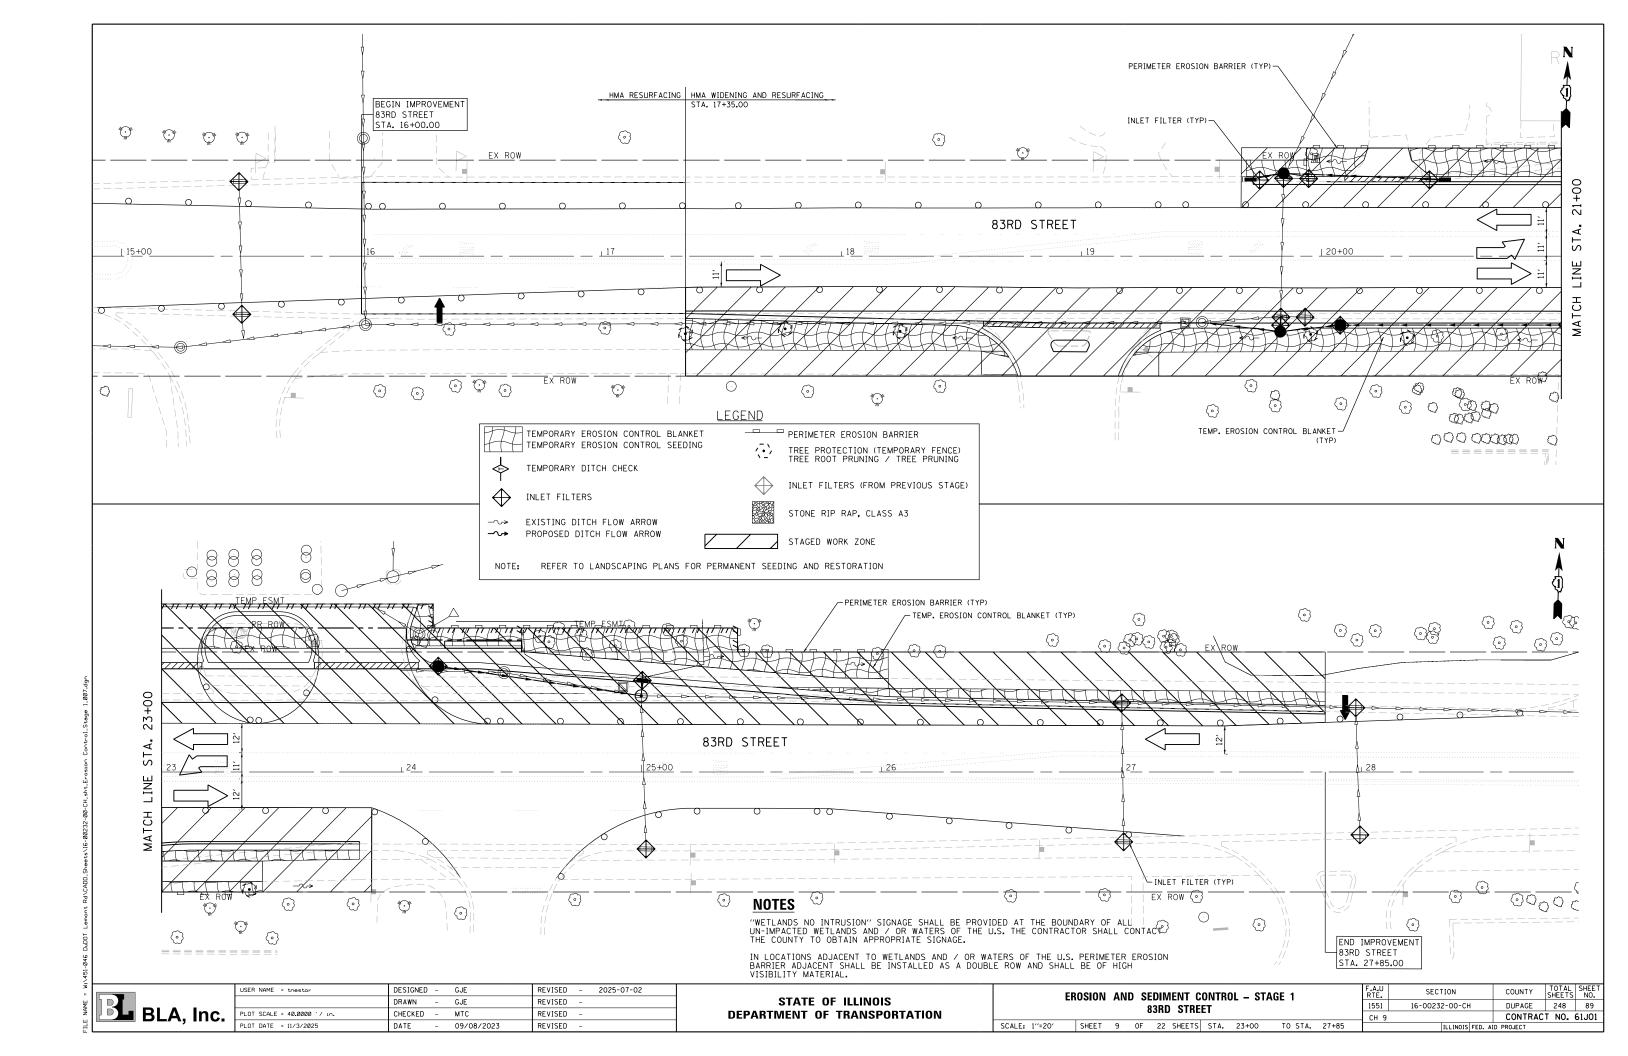


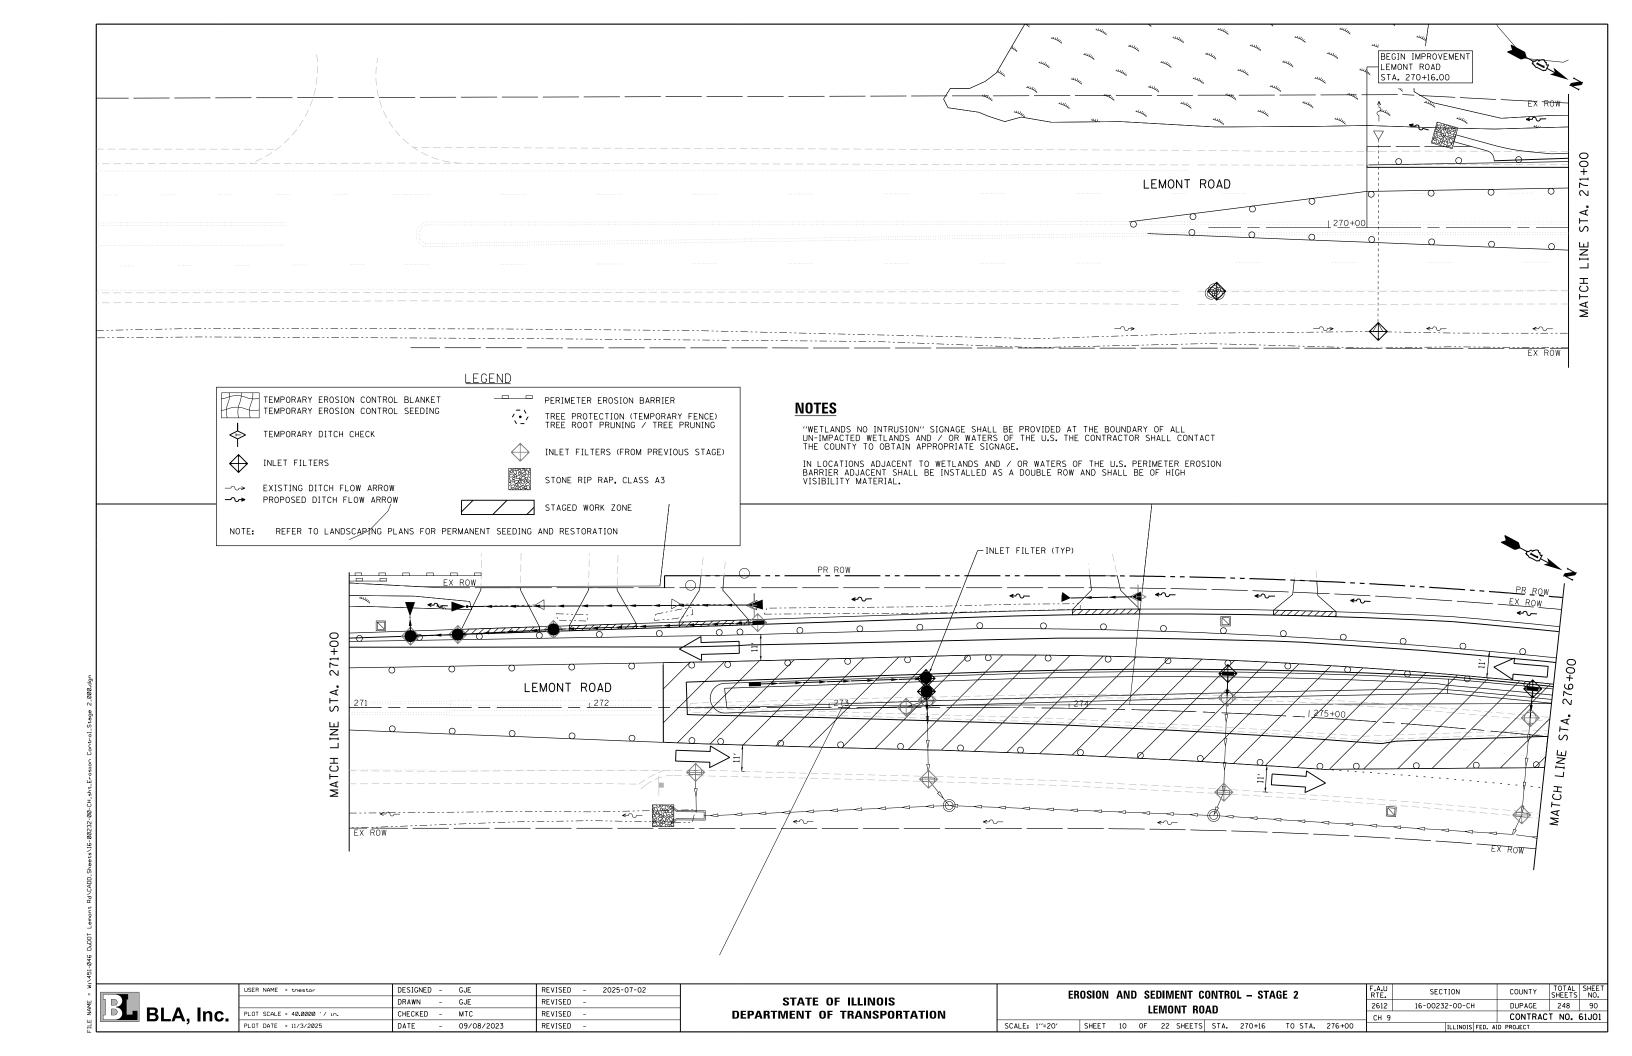

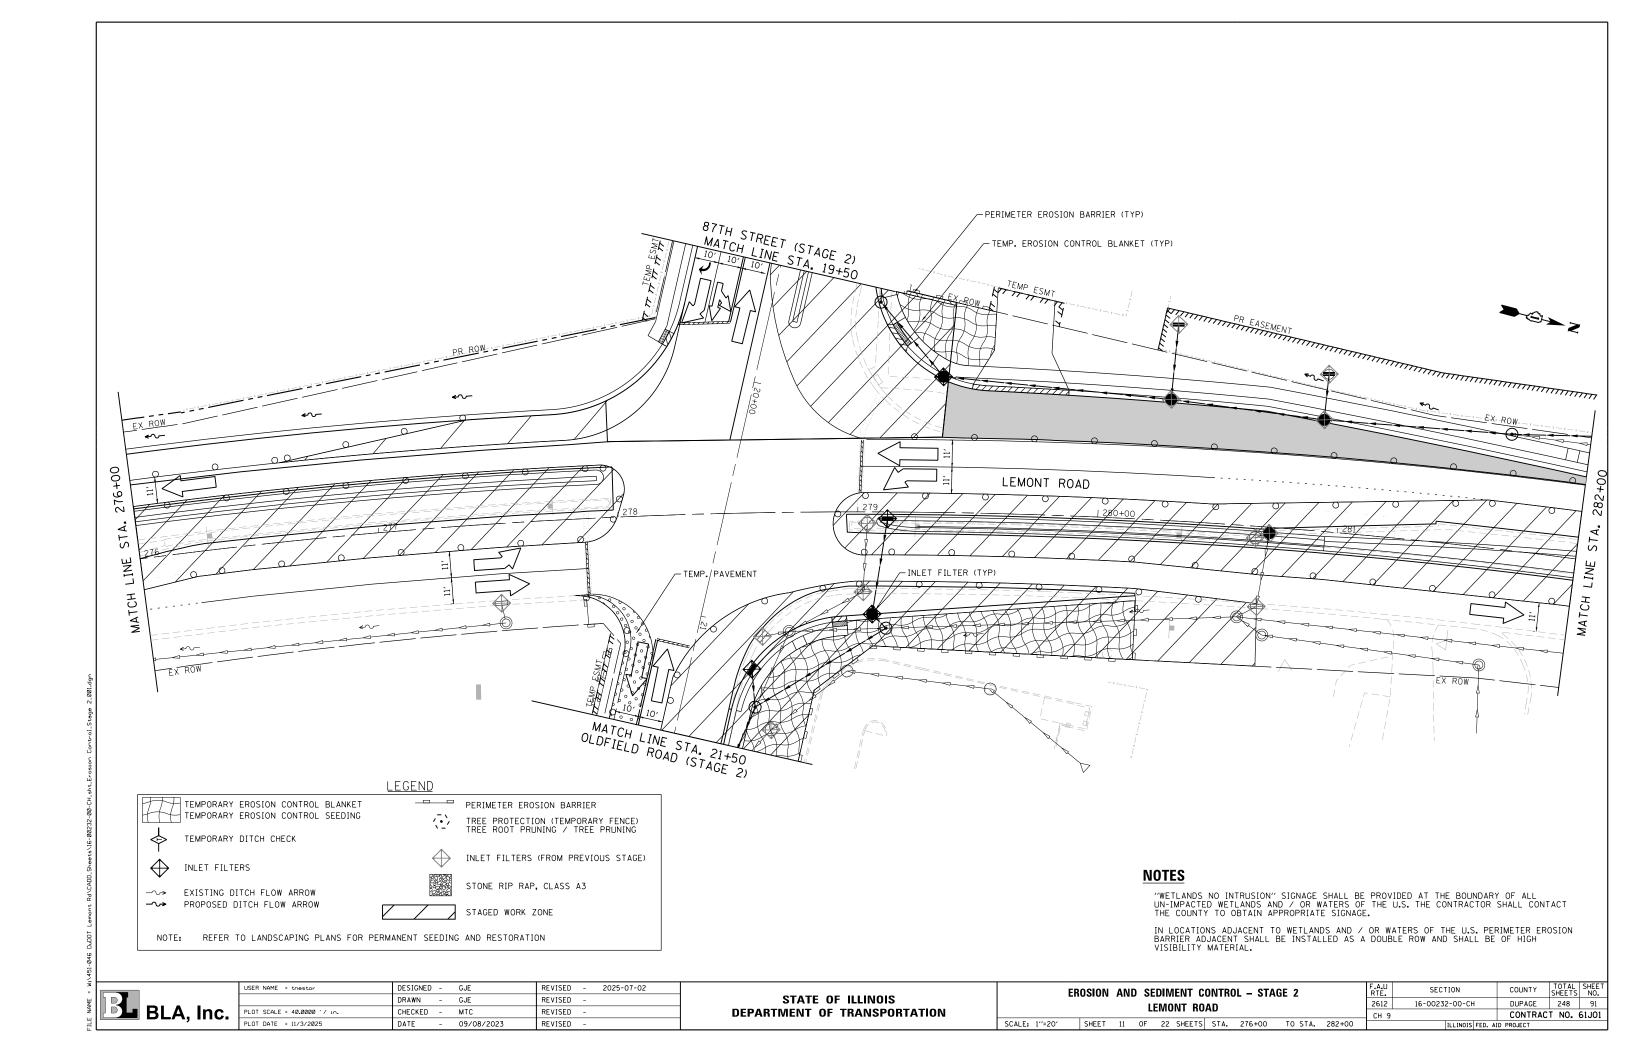

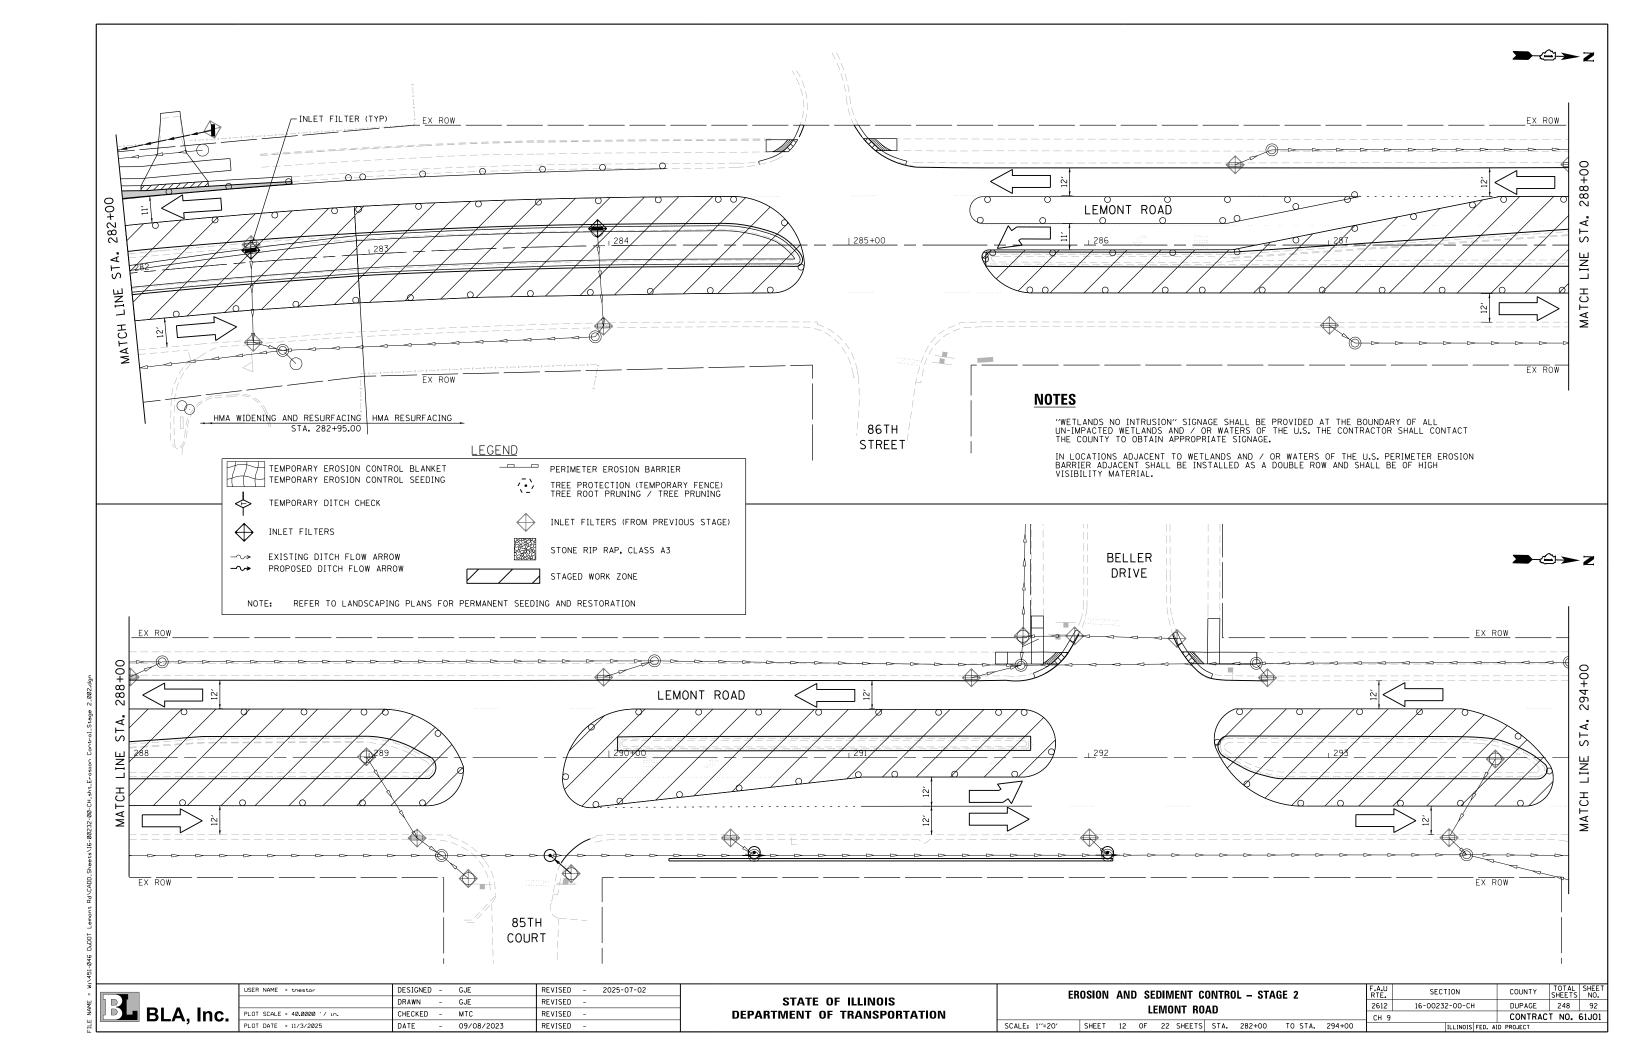

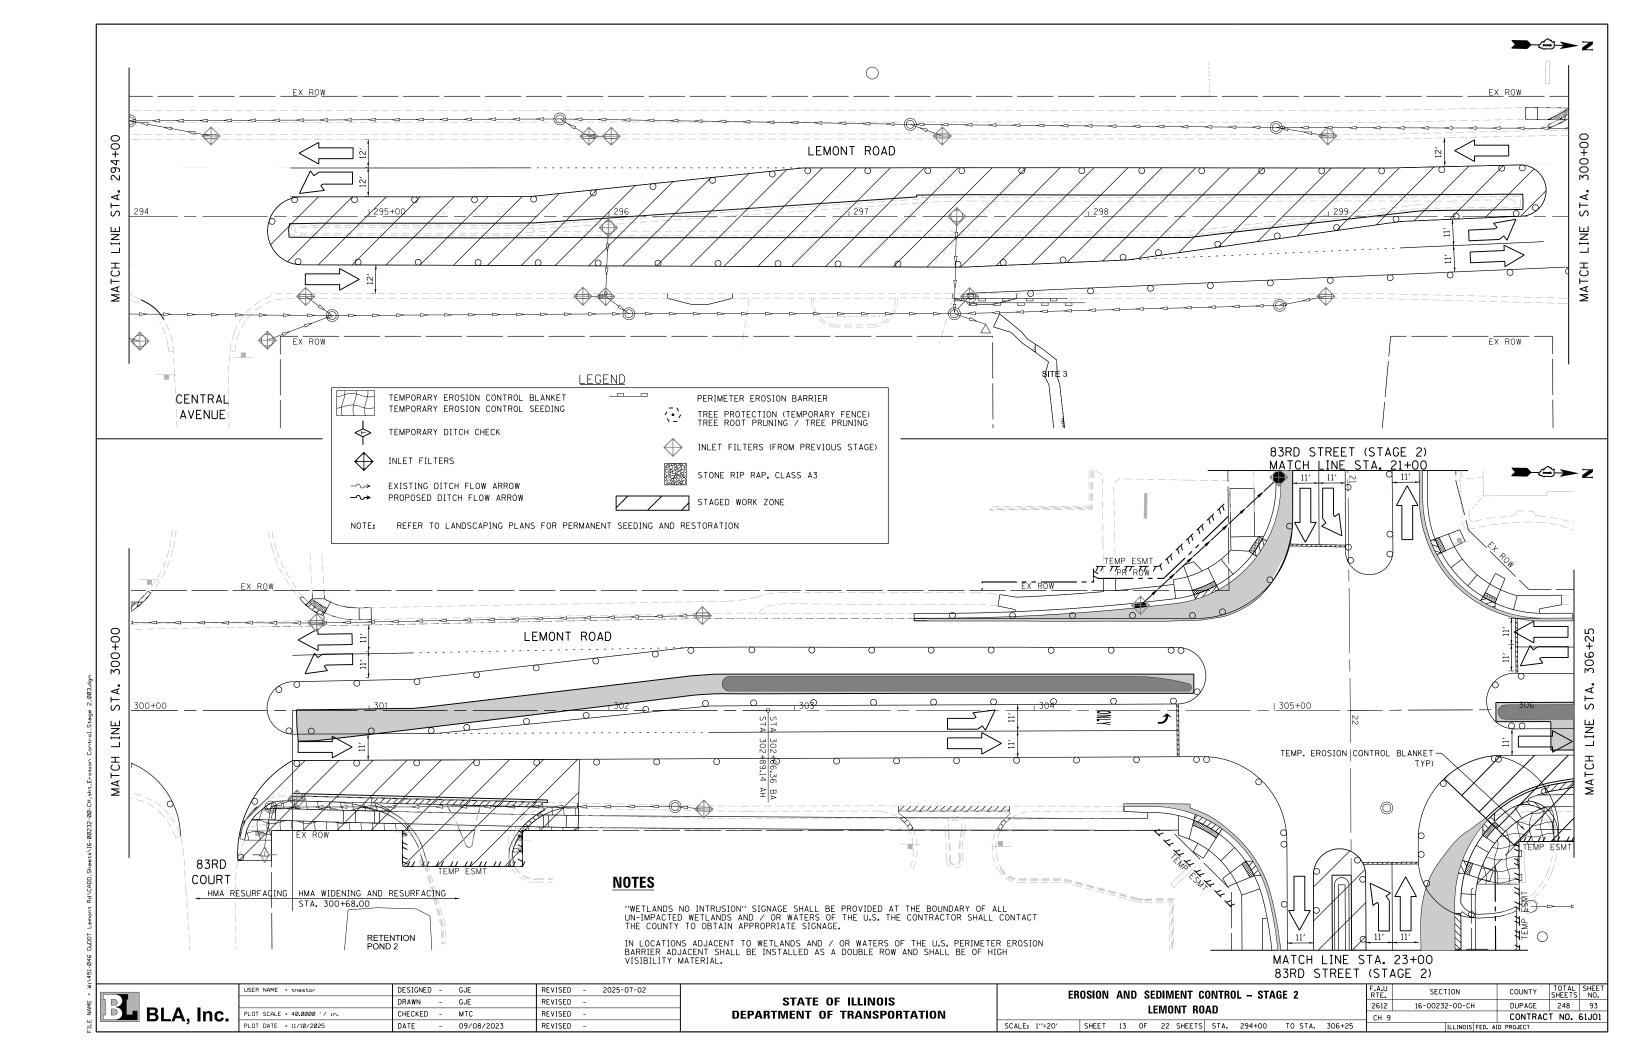


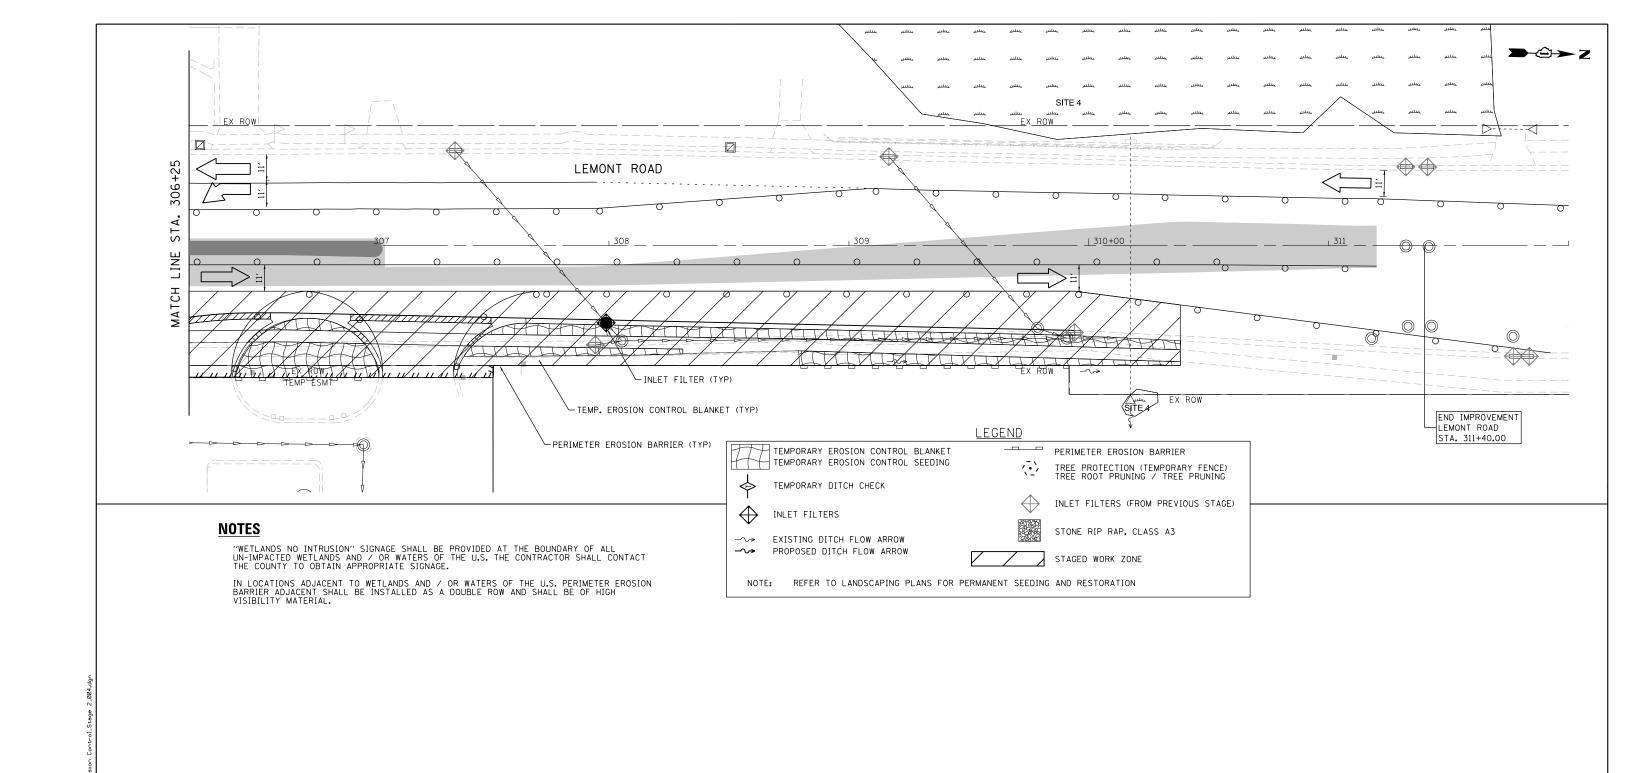



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	DRAWN	-	GJE	REVISED	-	
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PLOT DATE = 11/3/2025	DATE	-	09/08/2023	REVISED	-	


EROSION AND SEDIMENT CONTROL – STAGE 2 $\frac{F_0}{R}$												
	LEMONT ROAD											
LEMUNI KUAD												
SCALE: 1"=20"	SHEET	14	OF	22	SHEETS	STA.	306+25	TO STA.	312+00			

F.A.U RTE.	SECTION	COUNTY	TOTAL SHEETS	SHEI NO
2612	16-00232-00-CH	DUPAGE	248	94
CH 9		CONTRAC	T NO.	61J0
	ILLINOIS FED.	AID PROJECT		

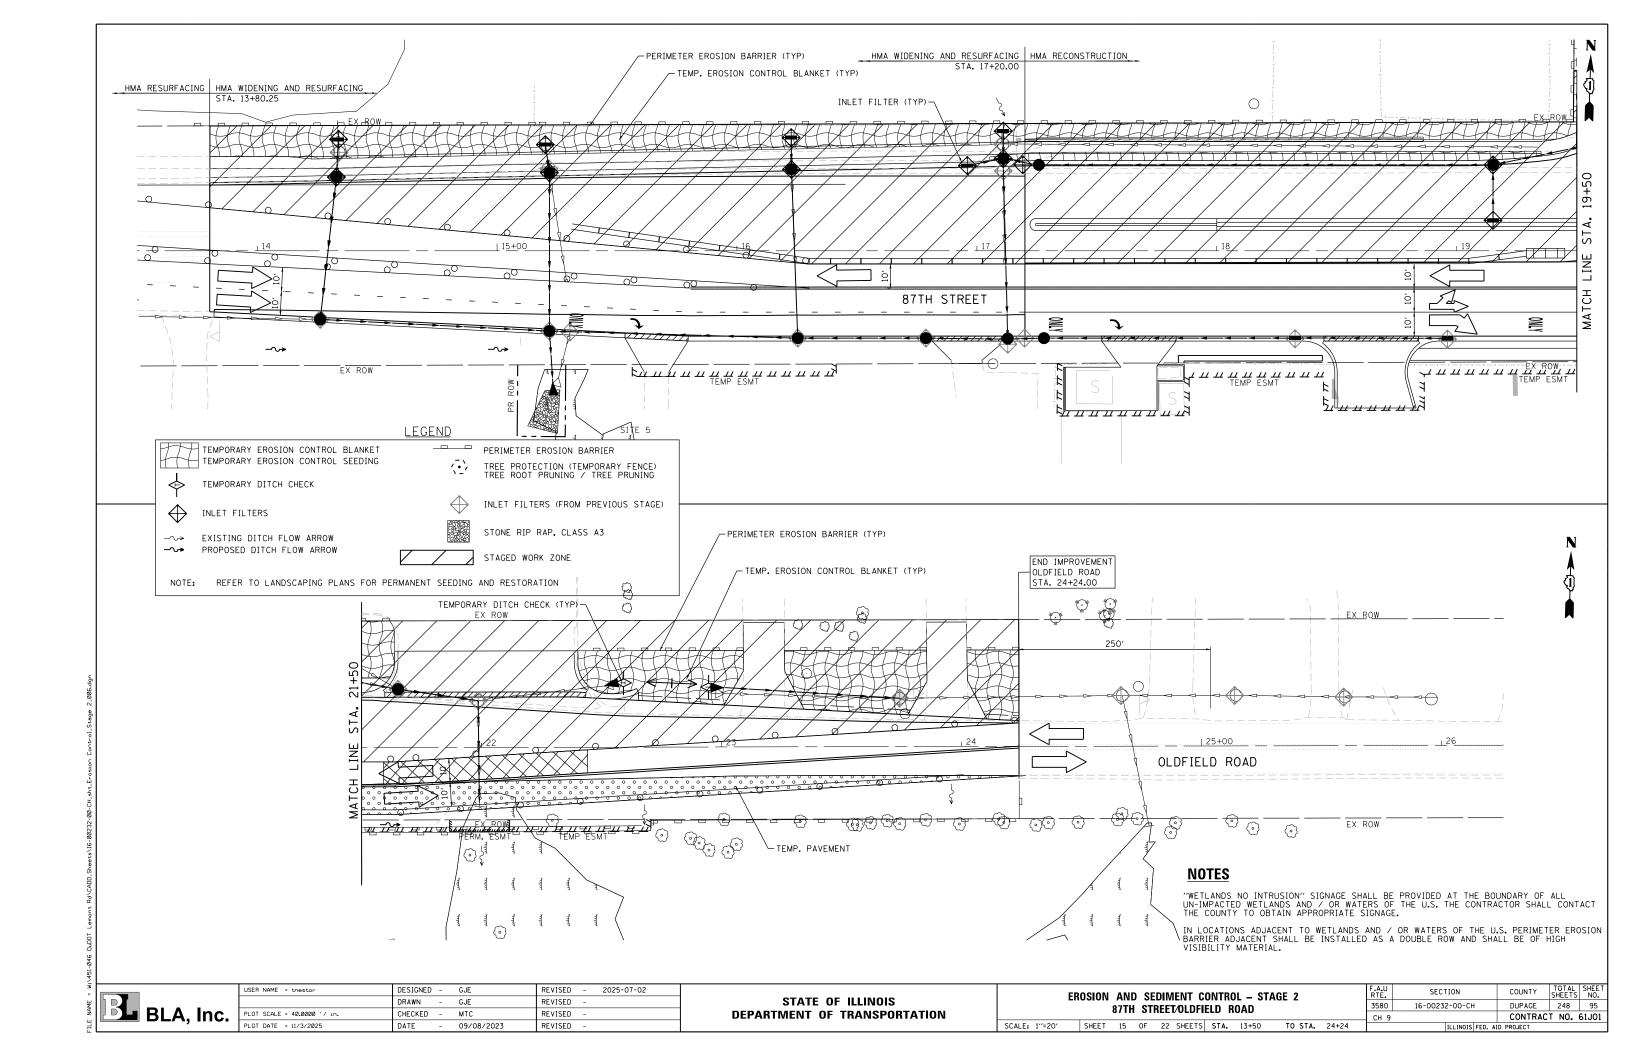

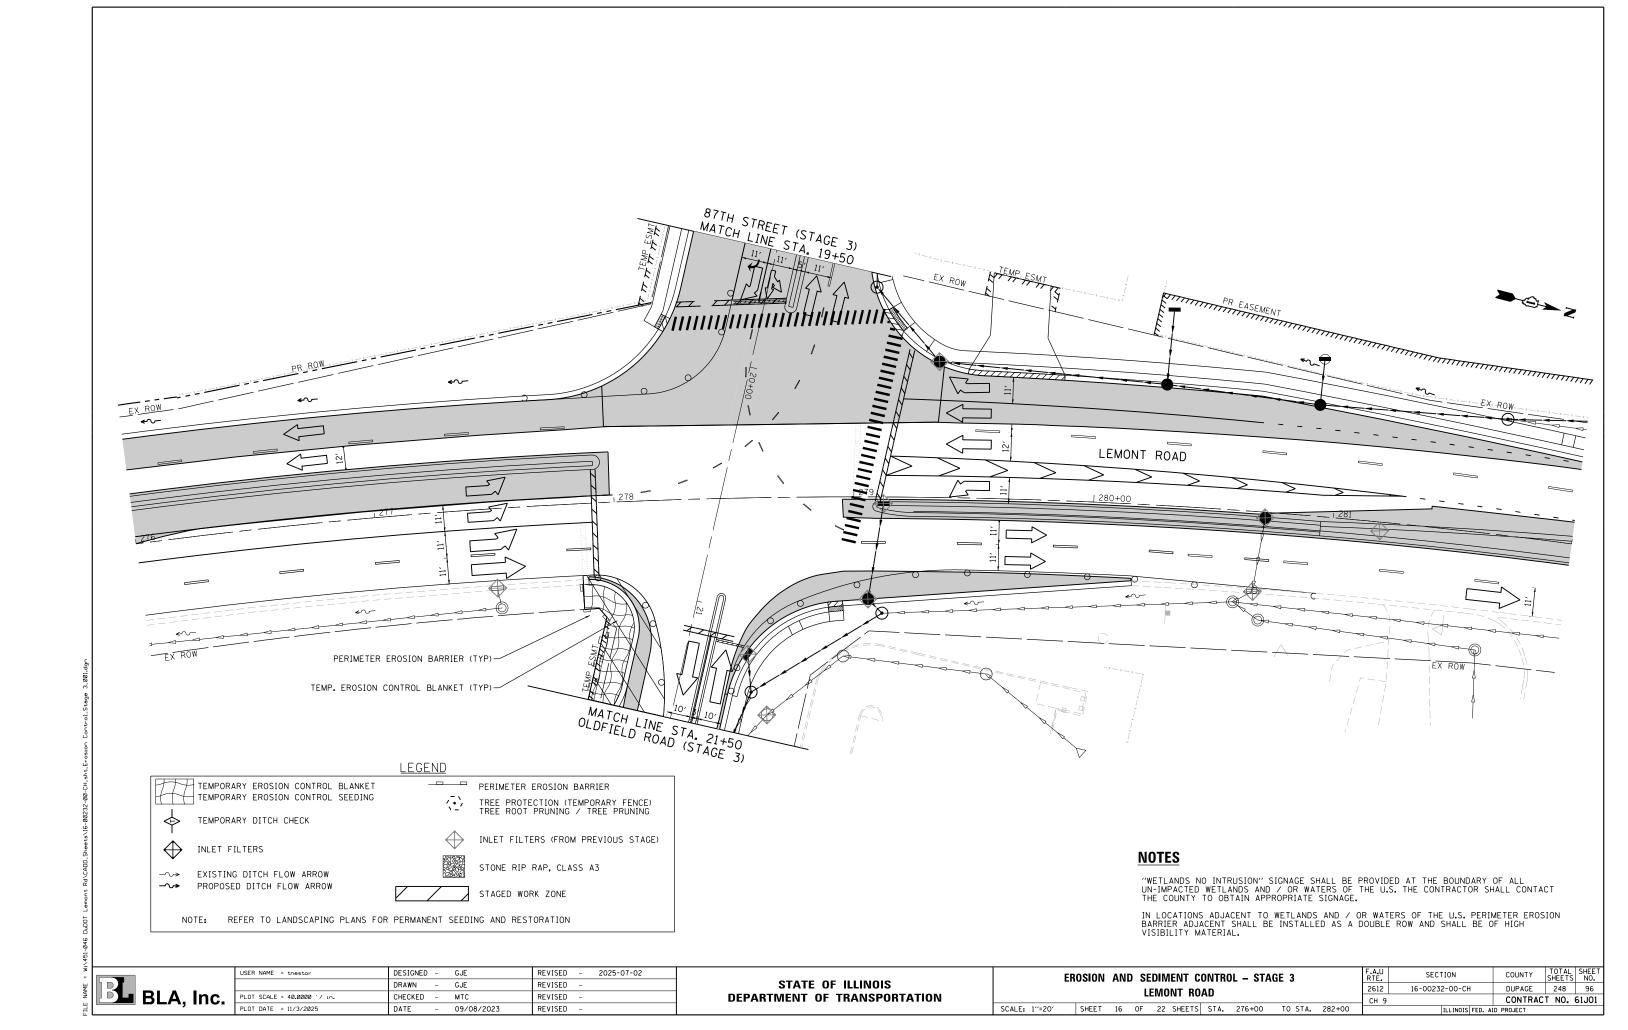


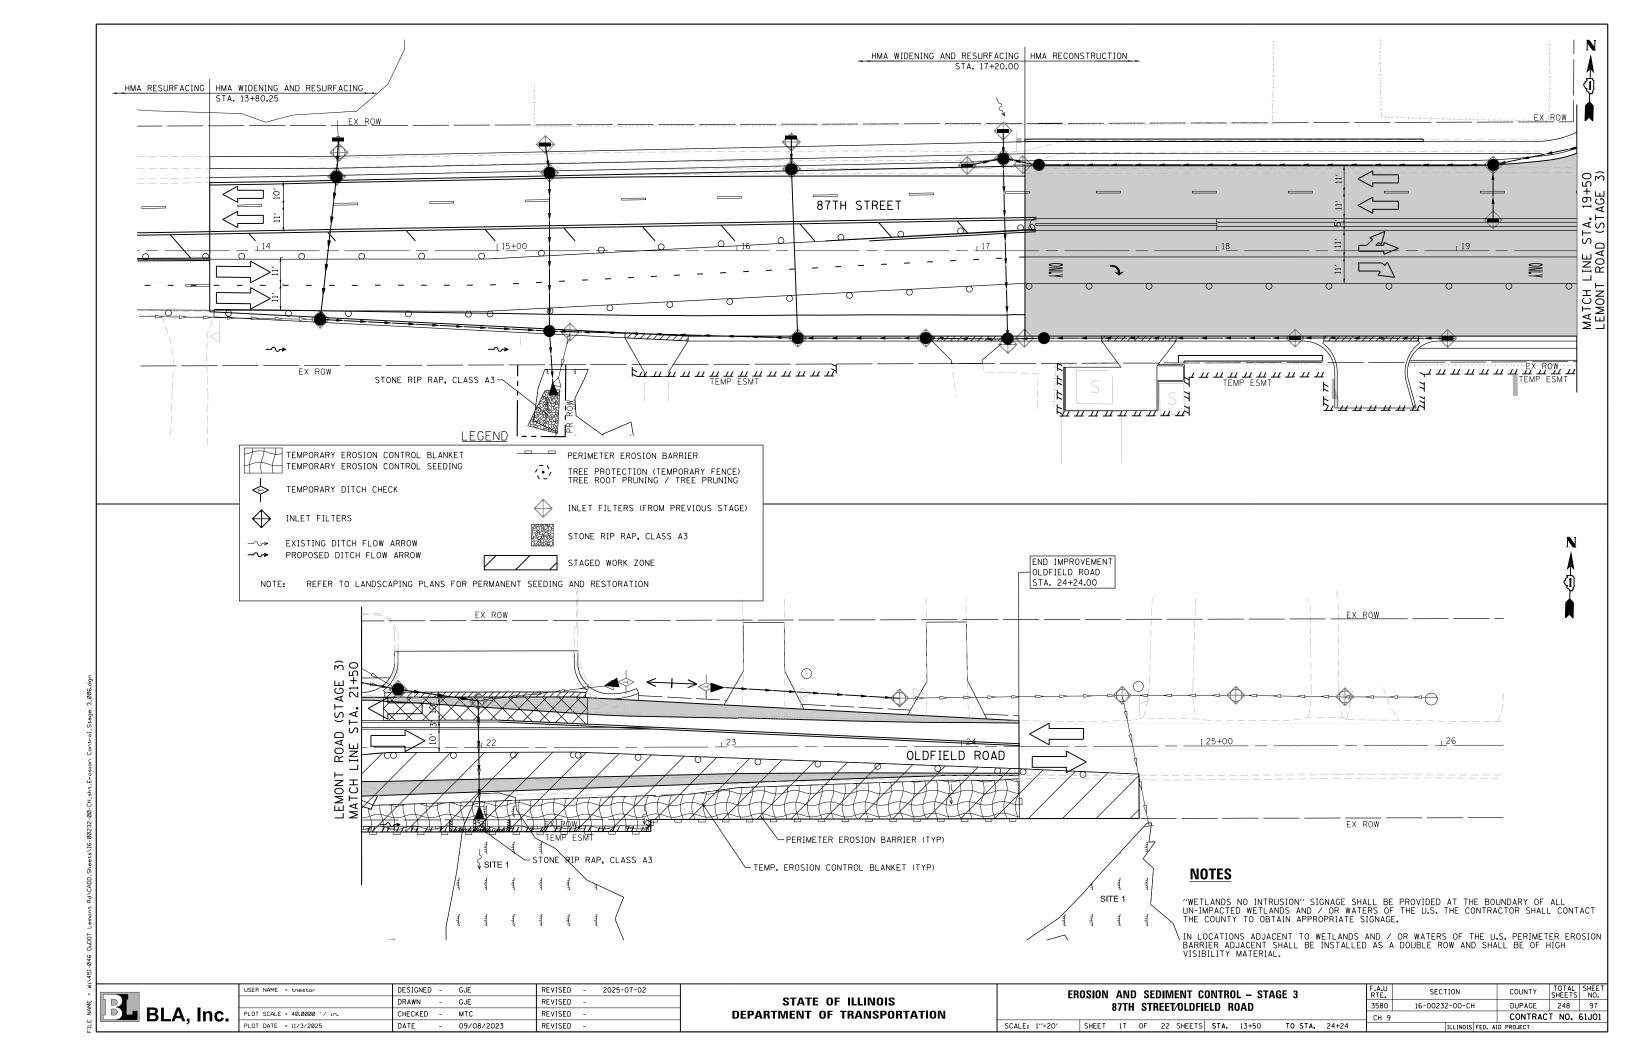

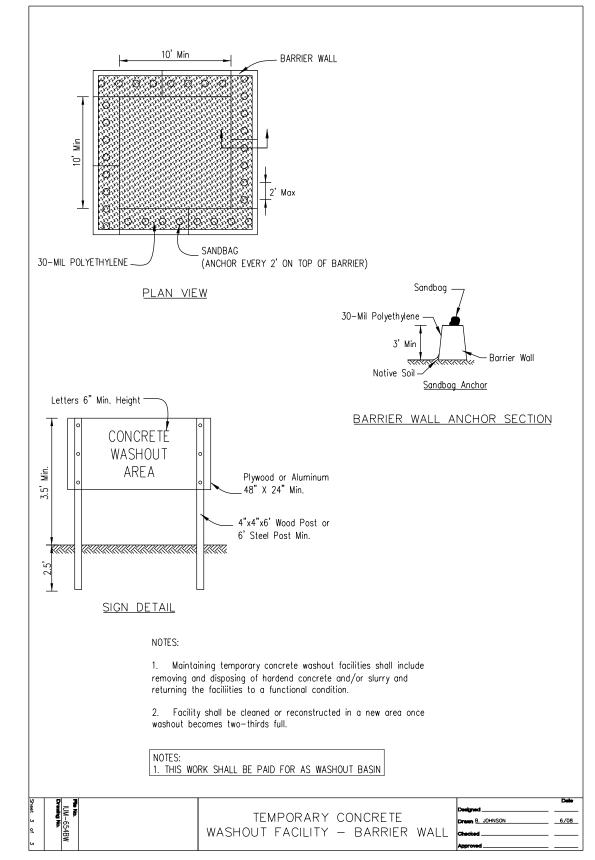


THE COST OF CONCRETE WASHOUTS SHALL BE INCLUDED IN THE COST OF THE STABILIZED CONSTRUCTION ENTRANCE

# TREE PROTECTION - FENCING

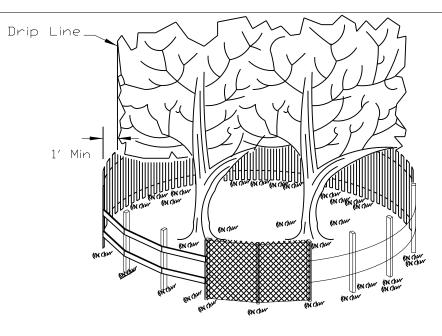

# SIDE VIEW

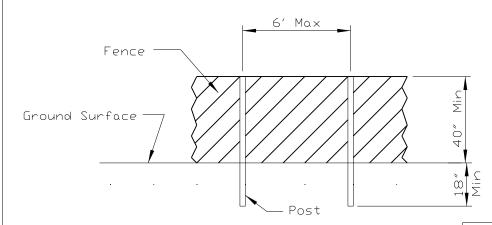

# POST AND FENCE DETAIL

NOTES: 1. THIS WORK SHALL BE PAID FOR AS TEMPORARY FENCE

- 1. The fence shall be located a minimum of 1 foot outside the drip line of the tree to be saved and in no case closer than 5 feet to the trunk of any tree.
- 2. Fence posts shall be either standard steel posts or wood posts with a minumum cross sectional area of 3.0 sq. in.
- 3. The fence may be either 40" high snow fence, 40" plastic web fencing or any other material as approved by the engineer/inspector.

REFERENCE		
Project		
Designed	Date	
Checked	Date	
Approved	Date	



IL-690 SHEET 1 OF 1 DATE 4-7-94

DUPAGE 248 98

CONTRACT NO. 61J01

STANDARD DWG. NO.

USER NAME = tnestor	DESIGNED	-	GJE	REVISED	-	2025-07-02
	DRAWN	-	GJE	REVISED	-	
PLOT SCALE = 100.0000 '/ 10.	CHECKED	-	MTC	REVISED	-	
PLOT DATE = 11/3/2025	DATE	-	09/08/2023	REVISED	-	

# ROLLED EROSION CONTROL PRODUCTS


# Staking Pattern Guide Straw Wattle or Rolled Excelsior — in 3" Deep Trench Stake within 2" of Wood Stake the end of Wattle -2" or less Min.

#### Notes:


- Overlap minimum is the diameter of the roll.
- 4' spacing for wattles.
- 2' spacing for rolled excelsion.
- Or space according to manufacturer's specifications.

1. THIS WORK SHALL BE PAID FOR AS TEMPORARY DITCH CHECK

## Stake Detail

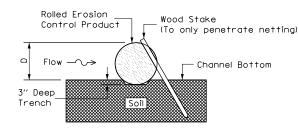

# Compost Filter Sock Detail

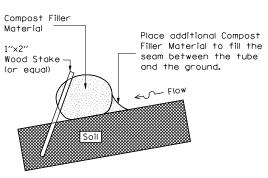

When compost filter sock ditch check is used. place a compost berm upstream of the filter sock (see IUM 805). A trench is not required.

### Notes:

- Drawings are not to scale. Ends of wattles or rolled excelsior shall be turned at least 6" upslope. Recommended stakes are 1 1/8" wide x 1 1/8" thick x 30" long
- Stakes shall not extend above the straw wattle more than 2".
- Spacing: The toe of the upstream ditch check shall create a horizontal line with the top of the downstream ditch check.
- When compost filter sock ditch check is used, place a compost berm upstream of the filter sock (see IUM 805). A trench is not required.

REFERENCE Project Date Designed Checked Date Approved Date





STANDARD DWG. NO. IUM-514

SHEET 1 OF 1

DATE 8 - 19 - 11

# PIPE DUTLET TO FLAT AREA

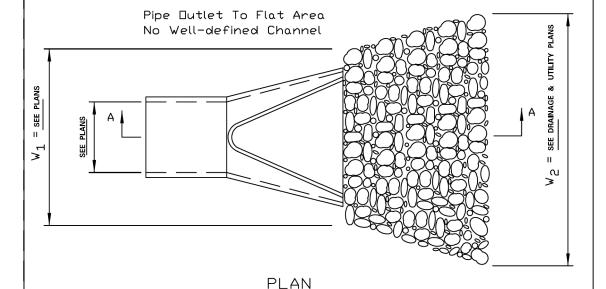

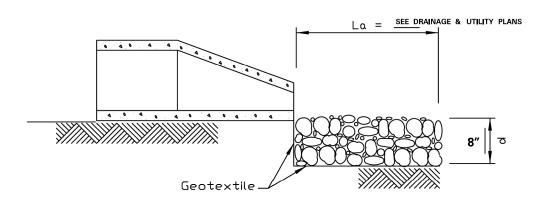

# SECTION A-A

- 1. The filter fabric shall meet the requirements in material specifications 592 GEOTEXTILE Table 1 or 2, class I, II or III.
- 2 The rock riprap shall shall meet the IDOT requirements for the following gradation: RR  $\frac{3 \text{ (CLASS A3)}}{4 \text{ (CLASS A3)}}$ , Quality  $\frac{A}{4}$
- 3. The riprap shall be placed according to construction specification 61 LOOSE ROCK RIPRAP. The rock may be equipment placed.

REFERENCE Project		<b>^</b>
Designed	Date	
Checked	Date	
Approved	Date	Natural R

STANDARD DWG. NO. IL-610 SHEET 1 OF 1 DATE 9-15-93

USER NAME = tnestor	DESIGNED	-	GJE	REVISED	-	2025-07-02
	DRAWN	-	GJE	REVISED	-	
PLOT SCALE = 100.0000 '/ in.	CHECKED	-	MTC	REVISED	-	
PLOT DATE = 11/3/2025	DATE	-	09/08/2023	REVISED	-	


STATE OF ILLINOIS **DEPARTMENT OF TRANSPORTATION** 


EROSION & SEDIMENT CONTROL – DETAILS  LEMONT ROAD									
SCALE: N.T.S.	SHEET 19	OF	22 SI	EETS S	TA. N/A	TO	STA.	N/A	

SECTION COUNTY 16-00232-00-CH DUPAGE 248 99 2612 CONTRACT NO. 61J01


NONES

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DETAIL 3

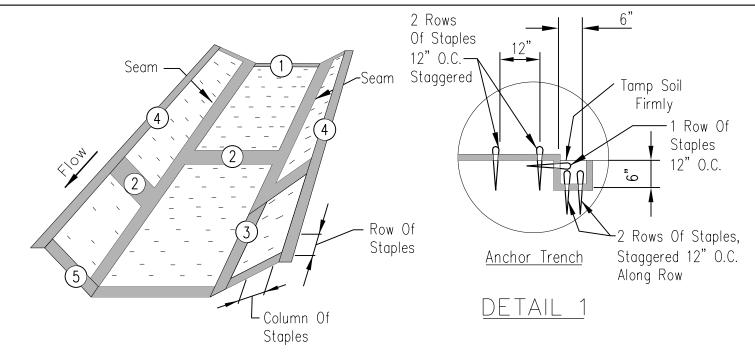

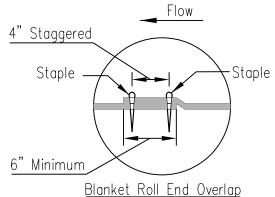
1" Min

Waterwo	y #			
Waterwo	ıy Width (ft)			
ECB Wid	Ith (ft)			
Length	(ft)			
Stations	3	to	to	to
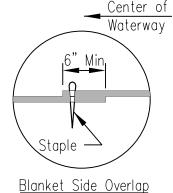
# NOTES:

- 1. The erosion control blanket consists of a machine produced mat of specified material. The product must meet the minimum requirements specified in Table 1, below. Ensure that the product is new and unused, and is furnished in rolls. Alternative materials may be used upon approval by the designer.
- 2. Prepare soil prior to installing erosion control blanket, including seeding, fertilizing, and lime application.
- 3. The erosion control blanket is to be placed in firm contact with the soil and not be allowed to bridge over surface irregularities. The blanket can not be stretched.
- 4. Install the erosion control blanket according to manufacturer's instructions. If no manufacturer's instructions are available, install the blanket as follows:
- a. Use "U" shaped staples, 0.12 in diameter wire or greater (#11 gauge). See Staple Detail for dimensions.
- b. Bury upstream end of blanket in a trench 6 inch wide by 6 inch deep and stapled in staggered rows across the width as shown in Detail 1.
- c. For joining ends of rolls, overlap end of upslope blanket a minimum of 6 inches over downslope blanket (shingle style). Use a double row of staggered staples 4 inches apart, as shown in Detail 2.
- d. Overlap blankets on side slopes a minimum 6 inches over the blanket below (shingle style). Staple overlap at 12 inch intervals. See Detail 3.
- e. Staple the outer edge along sides of the blanket every 12 inches. See Detail 4.
- f. Staples are to be placed alternately in columns (in the direction of the waterway) 2 feet apart and in rows (across the waterway) 3 feet apart, throughout the area covered by erosion blanket.
- g. Downstream (terminal) end of blanket are to be stapled with a double row of staggered staples 12 inches apart. See Detail 5.
- 5. Start laying the blankets by rolling center blanket in the direction of flow, centered on the centerline of waterway. No overlap of blankets at the center of the waterway.

TABLE 1. MINIMUM REQUIREMENTS FOR EROSION CONTROL BLANKET									
(See Note 1)	Coconut Blanket	Wood Fiber Blanket							
Type of Fiber	100% coconut fibers	100% curled wood fibers							
Weight, Ibs/sq. yd.	0.50	0.63							
Life Expectancy									
Fiber Length	N/A	80% of fibers $> 6$ in.							
Fiber Dimensions	N/A	0.021 in. x 0.042 in.							
Netting  Netting Required ?  9 Yes 9 No	Cover Top and bottom of blanket with a max. 5/8" x 5/8" opening size netting, bound to the mat on max. 1.5" centers.	Cover Top and bottom of blanket with a max. 5/8" x 5/8" opening size netting							

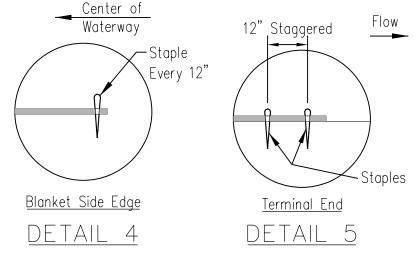

Not To Scale

BLA, Inc.

USER NAME = tnestor	DESIGNED	-	GJE	REVISED	-	2025-07-02
	DRAWN	-	GJE	REVISED	-	
PLOT SCALE = 100.0000 '/ in.	CHECKED	-	MTC	REVISED	-	
PLOT DATE = 11/3/2025	DATE	-	09/08/2023	REVISED	-	

STATE OF ILLINOIS **DEPARTMENT OF TRANSPORTATION** 

**EROSION & SEDIMENT CONTROL - DETAILS** LEMONT ROAD SHEET 20 OF 22 SHEETS STA. N/A TO STA. N/A

SCALE: N.T.S.

SECTION COUNTY 16-00232-00-CH DUPAGE 248 100 2612 CONTRACT NO. 61J01

United States Department of Agriculture

File No. IL ENG-61 Drawing No.

Page 1 of 1