# STATE OF ILLINOIS

# **DEPARTMENT OF TRANSPORTATION**

#### 60-7BJR-BDR MADISON 26 ILLINOIS CONTRACT NO. 76U07

### INDEX OF SHEETS

COVER SHEET

0

0

0

0

GENERAL NOTES

SUMMARY OF QUANTITIES 3 - 5

TYPICAL SECTIONS

SCHEDULE OF QUANTITIES

PLAN SHEETS

TRAFFIC CONTROL

DETOUR PLAN

16 - 17 **DETAILS** 

STRUCTURE REPAIR PLANS

# **PROPOSED HIGHWAY PLANS**

**FAI ROUTE 70 (I-55/I-70/US40) SECTION 60-7BJR-BDR** PROJECT NHPP-UL93(962) BRIDGE JOINT REPLACE/REPAIR, BRIDGE DECK OVERLAY **MADISON COUNTY** 


C-98-161-24



DESIGN FIRM REGISTRATION NUMBER

184004564-0014

CONSULTING ENGINEERS 1401 BRANDING AVENUE, SUITE 365 DOWNERS GROVE, ILLINOIS 60515 :: (312) 621-8777

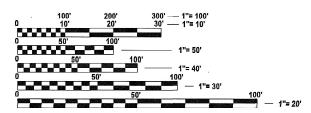


**ENGINEERING SCALES. REDUCED SIZED PLANS WILL NOT CONFORM TO STANDARD SCALES. IN MAKING MEASUREMENTS** ON REDUCED PLANS, THE ABOVE SCALES MAY BE USED.

J.U.L.I.E.

**JOINT UTILITY LOCATION INFORMATION FOR EXCAVATION** 1-800-892-0123

PROJECT ENGINEER: BILLIE OWEN, P.E. PROJECT MANAGER: MEIWU AN, P.E.

**CONTRACT NO. 76U07** 

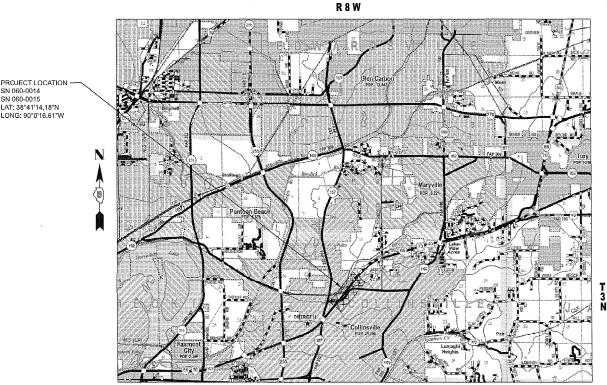


NOT TO SCALE

PROJECT AREA -

GROSS LENGTH = 525 FT. = 0.099 MILE **NET LENGTH = 525 FT. = 0.099 MILE** 




DATE: 07/24/24 SEAL EXPIRES: 11/30/25 APPLIES TO SHEETS: 1-17

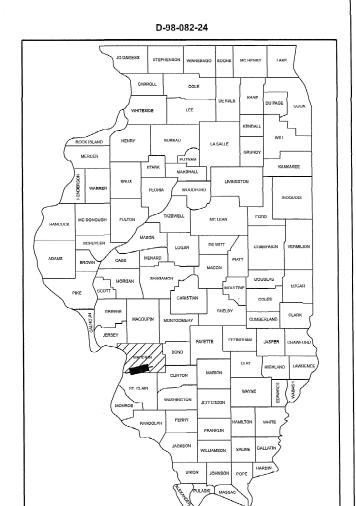

TRAFFIC DATA: 2023 ADT = 46,000 (ACTUAL) 2045 ADT = 57.3002025 ADT = 47,000PV = 74.2% SU = 3.0% MU = 22.8%FUNCTIONAL CLASS = INTERSTATE

LOCATION OF SECTION INDICATED THUS: -

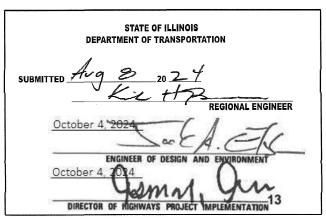

PRINTED BY THE AUTHORITY OF THE STATE OF ILLINOIS

### **GENERAL NOTES**

- "ROAD CONSTRUCTION AHEAD" SIGNS SHALL BE PLACED AT INTERCHANGES, ENTRANCES, AND SIDE STREETS WHERE WORK IS BEING CONDUCTED AS DIRECTED BY THE RESIDENT ENGINEER. ALL CONSTRUCTION SIGNS SHALL BE FLUORESCENT ORANGE. THIS SHALL BE INCLUDED IN THE COST OF THE TRAFFIC CONTROL AND PROTECTION. THESE SIGNS SHALL BE 48" X 48".
- IN ADDITION TO THE REQUIREMENTS OF ARTICLE 107.16, THE CONTRACTOR SHALL PROTECT THE SURFACE OF ALL BRIDGE DECKS AND BRIDGE APPROACH PAVEMENTS IN A MANNER SATISFACTORY TO THE ENGINEER BEFORE ANY EQUIPMENT IS ALLOWED TO CROSS THE STRUCTURE. PROTECTION SHALL BE PROVIDED FOR ALL EQUIPMENT AS DEFINED IN ARTICLE 107.16 REGARDLESS IF TRACK MOUNTED OR WHEELED.
- THE CONTRACTOR AND THE ENGINEER SHALL BE AWARE THAT NO SURVEY WAS PERFORMED FOR THIS PROJECT. THE STATIONING AND TOPO SHOWN IN THE PLANS WERE CREATED USING MICROFILM AND FIELD MEASUREMENTS MADE BY DESIGN PERSONNEL. BOTH SHALL BE CONSIDERED APPROXIMATE.
- THE RESIDENT ENGINEER SHALL VERIFY THE EXISTENCE OF HIGHWAY LIGHTING, INTELLIGENT TRANSPORTATION SYSTEMS (I.T.S.) UTILITIES, AND/OR ELECTRICAL CABLES ASSOCIATED WITH TRAFFIC SIGNALS WITHIN THE PROJECT LIMITS. IF ANY OF THESE EXIST WITHIN THE PROJECT LIMITS, AND IF THESE ITEMS REQUIRE LOCATING, THE CONTRACTOR SHALL BE DIRECTED TO DO SO ACCORDING TO SECTION 803 OF THE STANDARD SPECIFICATIONS. THIS WORK SHALL BE PAID FOR ACCORDING TO ARTICLE 109.04 OF THE STANDARD SPECIFICATIONS.
- THE DEPARTMENT STRONGLY ENCOURAGES THE PRIME CONTRACTOR AND THEIR APPROVED SUB-CONTRACTORS TO HIRE MINORITY, WOMEN AND DISADVANTAGED INDIVIDUALS FROM ITS FEDERALLY FUNDED HIGHWAY CONSTRUCTION CAREERS TRAINING PROGRAM (HCCTP) TO HELP MEET WORKFORCE AND TRAINEE GOALS, THIS PROGRAM IS TRAINING MINORITIES, WOMEN AND DISADVANTAGED INDIVIDUALS IN HIGHWAY CONSTRUCTION-RELATED SKILLS, E.G., MATH FOR THE TRADES, JOB READINESS, TECHNICAL SKILLS COURSEWORK (CARPENTRY, CONCRETE FLATWORK, BLUEPRINT READING, SITE PLANS, SITE WORK, TOOLS USE, ETC.) AND OSHA 10 HOUR CERTIFICATION, TO PREPARE THEM FOR A CAREER IN THE HIGHWAY CONSTRUCTION TRADES, GRADUATES ARE WELL-TRAINED AND READY TO BECOME PRODUCTIVITY ENTRY-LEVEL CONSTRUCTION WORKERS. CONTACT THE DISTRICT 8 EEO OFFICE AT 618-346-3360 AND/OR THE HCCP COORDINATOR AT 618-874-6528 TO LEARN MORE ABOUT THE PROGRAM AND FOR ASSISTANCE IN MEETING WORKFORCE AND TRAINEE GOALS.
- ALL TURF AREAS DISTURED BY THE CONTRACTOR SHALL BE SEEDED WITH THE APPROPRIATE EROSION CONTROL, AS DIRECTED BY THE ENGINEER, AT THE CONTRACTOR'S EXPENSE.
- THE INTENT OF THE MILLING IS TO REMOVE THE HMA RESURFACING ONLY. THE UNDERLYING CONCRETE SHALL NOT
- THE PROPOSED PAVEMENT MARKING SHALL MATCH THE LOCATIONS OF THE EXISTING PAVEMENT MARKING, AS DIRECTED
- UTILITIES KNOWN TO HAVE FACILITIES WITHIN THE PROJECT AREA:

AMEREN ILLINOIS CHARTER COMMUNICATIONS, INC. CLEARWAVE FIBER LLC DEPARTMENT OF CENTRAL MANAGEMENT SERVICES CITY OF COLLINSVILLE VERIZON BUSINESS CITY OF TROY WINDSTREAM KDL, INC.

### **MIXTURE REQUIREMENTS**

MIXTURE USE(S):	POLYMERIZED SURFACE	POLYMERIZED BINDER	SHOULDER (SURFACE)
AC/PG:	SBS PG 70-28	SBS PG 70-28	PG 64-22
DESIGN AIR VOIDS:	4.0% @ Ndes = 90	4.0% @ Ndes = 90	4.0% @ Ndes = 30
MIXTURE COMPOSITION: (GRADATION MIXTURE)	IL 9.5	IL 19.0	IL 9.5L
FRICTION AGGREGATE	MIXTURE "E"	MIXTURE "B"	
QUALITY MGMT PROGRAM	QC/QA	QC/QA	QC/QA
MATTRANDEV REQUIRED?	NO	NO	NO

PLAN QUANTITIES FOR HOT-MIX ASPHALT ITEMS ARE CALCULATED USING A UNIT WEIGHT OF 112 LB/SQ YD/IN (59.8 KG/SQ M/25MM THICKNESS).

ANY QCP PAY ITEM THAT HAS A QUANTITY OF 1600 TONS OR LESS WILL HAVE TWO SUBLOTS EACH OF WHICH WILL BE HALF OF THE PLAN QUANTITY OR HALF OF THE ADJUSTED QUANTITY BY THE RESIDENT ENGINEER/TECHNICIAN.

### **HIGHWAY STANDARDS**

701411-09	LANE CLOSURE, MULTILANE, AT ENTRANCE OR EXIT RAMP, FOR SPEEDS > 45 MPH
782006-01	GUARDRAIL AND BARRIER WALL REFLECTOR MOUNTING DETAILS
781001-04	TYPICAL APPLICATIONS RAISED REFLECTIVE PAVEMENT MARKERS
780001-05	TYPICAL PAVEMENT MARKINGS
701901-09	TRAFFIC CONTROL DEVICES
701606-10	URBAN SINGLE LANE CLOSURE, MULTILANE, 2W WITH MOUNTABLE MEDIAN
701451-05	RAMP CLOSURE FREEWAY EXPRESSWAY
701446-11	TWO LANE CLOSURE FREEWAY EXPRESSWAY
701428-01	TRAFFIC CONTROL SETUP REMOVAL FREEWAY EXPRESSWAY
701401-13	LANE CLOSURE FREEWAY/EXPRESSWAY
701400-12	APPROACH TO LANE CLOSURE FREEWAY EXPRESSWAY
701106-02	OFF-RD OPERATIONS, MULTILANE, MORE THAN 15' (4.5m) AWAY
701101-05	OFF-RD OPERATIONS, MULTILANE, MORE THAN 15' (4.5m) TO 24" (600mm) FROM PAVEMENT EDGE
642001-03	SHOULDER RUMBLE STRIPS, 16 IN.
610001-09	SHOULDER INLET WITH CURB
420001-10	PAVEMENT JOINTS
001006	DECIMAL OF AN INCH AND OF A FOOT
001001-02	AREAS OF REINFORCEMENT BARS
000001-08	STANDARD SYMBOLS, ABBREVIATIONS AND PATTERNS

### **COMMITMENTS**

NONE

_			_			
7	USER NAME = therrmann	DESIGNED	-	TH	REVISED	-
, -:		DRAWN	-	TH	REVISED	-
	PLOT SCALE = 4.99999000 ' / in.	CHECKED	-	PM	REVISED	-
	PLOT DATE = 10/1/2024	DATE	-	10/01/2024	REVISED	-

STATE OF ILLINOIS **DEPARTMENT OF TRANSPORTATION** 

SCALE:

				2	F.A.I. RTE.	SECTION	COUNTY	TOTAL SHEETS	SHEET NO.	
GENERAL NOTES					70	60-7BJR-BDR	MADISON	26	2	
							CONTRACT	ΓNO.	76U07	
SHEET 1	OF 1	SHEETS	STA	TO STA.		LILINOIS LEED AL	D PROJECT		$\overline{}$	

**REV - MS** 

				90% FED	90% FED
	1			10% STATE BRIDGE	10% STATE BRIDGE
CODE			TOTAL	0047	0047
NO.	ITEM	UNIT	QUANTITY	060-0014	060-0015
10600982	HOT-MIX ASPHALT SURFACE REMOVAL - BUTT JOINT	SQ YD	912	456	456
40603240	POLYMERIZED HOT-MIX ASPHALT BINDER COURSE, IL-19.0, N90	TON	180.5	90.2	90.3
40604174	POLYMERIZED HOT-MIX ASPHALT SURFACE COURSE, IL-9.5, MIX "E", N90	TON	160.5	80.2	80.3
40800029	BITUMINOUS MATERIALS (TACK COAT)	POUND	1137	577	560
44000158	HOT-MIX ASPHALT SURFACE REMOVAL, 2 1/4"	SQ YD	1433	716	717
48203100	HOT-MIX ASPHALT SHOULDERS	TON	109.1	56.9	52.2
50102400	CONCRETE REMOVAL	CUYD	89.4	44.7	44.7
50157300	PROTECTIVE SHIELD	SQ YD	1054	527	527
50300255	CONCRETE SUPERSTRUCTURE	CU YD	101.2	50.6	50.6
50300300	PROTECTIVE COAT	SQYD	2768	1384	1384
50800205	REINFORCEMENT BARS, EPOXY COATED	POUND	8230	4115	4115
52000110	PREFORMED JOINT STRIP SEAL	FOOT	474	237	237
54200116	SHOULDER RUMBLE STRIPS, 16 INCH	FOOT	960	480	480

REV - MS

<b>A</b> qonzalez
GONZALEZ COMPANIES, LLC PRO. ENGINEER 184004564-0014

	USER NAME = therrmann	DESIGNED	-	H	REVISED	-
$I \cup Z$		DRAWN	-	TH	REVISED	-
LLC	PLOT SCALE = 0.99999800 ' / in.	CHECKED	-	PM	REVISED	-
-0014	PLOT DATE = 7/24/2024	DATE	-	07/26/2024	REVISED	-

SCALE:

ÇI.	IMMAAD	V NE NII	ANTITIES		F.A.I. RTE.	SECTION	COUNTY	TOTAL SHEETS	SHEET NO.	
SUMMARY OF QUANTITIES					70	60-7BJR-BDR	MADISON	MADISON 26		
							CONTRACT	NO.	76U07	
SHEET 1	OF 3	SHEETS	STA.	TO STA.		ILLINOIS FED. A	ND PROJECT			

CONSTRUCTION CODE

TTED=	7/24/2024	1:10:58 PM	
	SPEN-BLSS		
FIG *	<b>SPLTDRVS</b> \$		

<b>_</b> qonzalez	_
GONZALEZ COMPANIES, LLC	
PRO. ENGINEER 184004564-0014	1

00070107	USER NAME = therrmann	DESIGNED - TH	REVISED -
<u> </u>		DRAWN - TH	REVISED -
NZALEZ COMPANIES, LLC	PLOT SCALE = 0.99999800 ' / in.	CHECKED - PM	REVISED -
ENGINEER 184004564-0014	PLOT DATE = 7/24/2024	DATE = 07/26/2024	REVISED -

\* SPECIALTY ITEM

CONSTRUCTION LAYOUT

20013798

CODE

NO.

67000400

ENGINEER'S FIELD OFFICE, TYPE A

# STATE OF ILLINOIS DEPARTMENT OF TRANSPORTATION

LSUM

							F.A.I. RTE.	SECTION		COUNTY	TOTAL SHEETS	SHEET NO.
SUMMARY OF QUANTITIES					70 60-7BJR-BDR			MADISON	26	4		
								CONTRACT	NO.	76U07		
 SHEET	2	OF	3	SHEETS	STA.	TO STA.	ILLINOIS   FED. AID PROJECT					

CONSTRUCTION CODE

90% FED 10% STATE BRIDGE

0047

060-0014

3

0.5

SCALE:

0.5

TOTAL

QUANTITY

UNIT

CAL MO

90% FED 10% STATE

BRIDGE

0047

060-0015

3

67100100	MOBILIZATION	LSUM	1	0.5	0.5
70102625	TRAFFIC CONTROL AND PROTECTION, STANDARD 701606	LSUM	1	0.5	0.5
70300100	SHORT TERM PAVEMENT MARKING	FOOT	152	76	76
70300150	SHORT TERM PAVEMENT MARKING REMOVAL	SQFT	50	25	25
78004630	PREFORMED PLASTIC PAVEMENT MARKING, TYPE D - STANDARD - LINE 6"	FOOT	2368	1184	1184
78011035	GROOVING FOR RECESSED PAVEMENT MARKING 7"	FOOT	2368	1184	1184
78100100	RAISED REFLECTIVE PAVEMENT MARKER	EACH	32	16	16
78200011	BARRIER WALL REFLECTORS, TYPE C	EACH	28	14	14
78300200	RAISED REFLECTIVE PAVEMENT MARKER REMOVAL	EACH	52	26	26
Z0012132	BRIDGE DECK SCARIFICATION 1"	SQ YD	2132	1066	1066
Z0012168	BRIDGE DECK MICROSILICA CONCRETE OVERLAY 3"	SQ YD	2132	1066	1066
Z0012754	STRUCTURAL REPAIR OF CONCRETE (DEPTH EQUAL TO OR LESS THAN 5 INCHES)	SQFT	97.3	40.5	56.8

ITEM

REV - MS

					0011011100	TION OODL
					90% FED 10% STATE	90% FED 10% STATE
					BRIDGE	BRIDGE
	CODE			TOTAL	0047	0047
	NO.	ITEM	UNIT	QUANTITY	060-0014	060-0015
	Z0016001	DECK SLAB REPAIR (FULL DEPTH, TYPE I)	SQ YD	2.6	0.7	1.9
	Z0016002	DECK SLAB REPAIR (FULL DEPTH, TYPE II)	SQ YD	80.2	36.1	44.1
	Z0016702	DETOUR SIGNING	LSUM	1	0.5	0.5
	X6020050	NLET BOXES TO BE ADJUSTED (SPECIAL)	EACH	4	2	2
	Z0029090	DIAMOND GRINDING (BRIDGE SECTION)	SQ YD	2088	1044	1044
Ø	Z0076600	TRAINEES	HOUR	1000	1000	
	X5030250	BRIDGE DECK GROOVING (LONGITUDINAL)	SQ YD	1359	679.5	679.5
Ø	Z0076604	TRAINEES TRAINING PROGRAM GRADUATE	HOUR	1000	1000	
	X0325494	NTERSTATE DIRECTIONAL CLOSURE	EACH	2	1	1

CONSTRUCTION CODE

Ø 0042

FIG \* SPENTBLSS
FIG \* SPLTERVSS

GONZALEZ COMPANIES, LLC
PRO. ENGINEER 184004564-0014

	USER NAME = therrmann	DESIGNED - TH	REVISED -
.dlez		DRAWN - TH	REVISED -
S. LLC	PLOT SCALE = 0.99999800 ' / in.	CHECKED - PM	REVISED -
4564-0014	PLOT DATE = 7/24/2024	DATE = 07/26/2024	REVISED -

STATI	E OI	F ILLINOIS
DEPARTMENT	0F	TRANSPORTATION

SCALE:

SUMMARY OF QUANTITIES		SECTION	COUNTY	TOTAL SHEETS	SHEET NO.
		60-7BJR-BDR	MADISON	26	5
			CONTRACT	NO.	76U07
SHEET 3 OF 3 SHEETS STA. TO STA.		ILLINOIS FED A	ID PROJECT		


REV - MS

### **EXISTING TYPICAL SECTION**

NOT TO SCALE

(E.B. LANES - LOOKING EAST, W.B. LANES - LOOKING WEST)

\* SEE NOTE 1

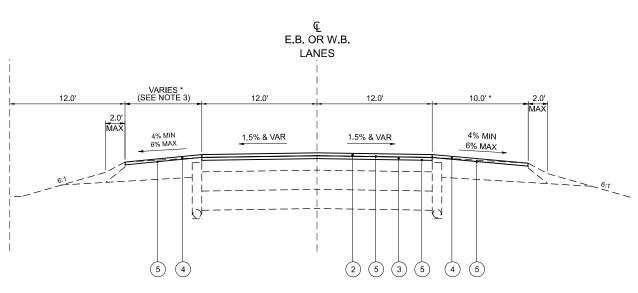

# **PROPOSED TYPICAL SECTION**

NOT TO SCALE

(E.B. LANES - LOOKING EAST, W.B. LANES - LOOKING WEST)

\* SEE NOTE 1

## **LEGEND**

- EXISTING P.C.C. CONCRETE
- (B) EXISTING 8" SUB-BASE GRANULAR MATERIAL TYPE A
- (C) EXISTING HMA SURFACE
- D EXISTING HMA SHOULDERS
- E EXISTING AGGREGATE SHOULDERS
- EXISTING PIPE UNDERDRAINS

### PROPOSED HOT-MIX ASPHALT SURFACE REMOVAL, 2 1/4"

- 2 PROPOSED POLYMERIZED HOT-MIX ASPHALT SURFACE COURSE, STONE MATRIX ASPHALT, N80, 2"
- (3) PROPOSED POLYMERIZED HOT-MIX ASPHALT BINDER COURSE, IL-19.0, N90, 2  $^{1}\!4$ "
- 4 PROPOSED HOT-MIX ASPHALT SHOULDERS, 2"
- (5) PROPOSED BITUMINOUS MATERIALS (TACK COAT)

### NOTES:

- PCC SHOULDER EXISTS IN EACH QUADRANT OF BOTH BRIDGES. THE SOUTHWEST AND SOUTHEAST QUADRANTS OF BOTH BRIDGES HAVE EXISTING INLETS.
- 2. SEE SHEET 16 FOR BUTT JOINT DETAILS
- INSIDE SHOULDER WIDTHS ARE 6.0' BEFORE THE BRIDGE OMISSION AND 8.0' AFTER THE BRIDGE OMISSION ALONG EACH DIRECTION OF TRAFFIC. SEE SHEET 8 .

<b>_</b> aqonzalez	
GONZALEZ COMPANIES, LLC	-

. 00073/07	USER NAME = therrmann	DESIGNED -	TH	REVISED -
<u>,</u> 40112dle21		DRAWN -	TH	REVISED -
NZALEZ COMPANIES, LLC ENGINEER 184004564-0014	PLOT SCALE = 0.083333317 ' / in.	CHECKED -	PM	REVISED -
	PLOT DATE = 10/1/2024	DATE -	10/01/2024	REVISED -

STATI	E OI	F ILLINOIS
DEPARTMENT	OF	TRANSPORTATION

SCALE:

					F.A.I. RTE	SECTION		COUNTY	TOTAL SHEETS	SHEET NO.
TYPICAL SECTIONS		70	60-7BJR-BDR		MADISON	26	6			
								CONTRACT	NO.	76U07
SHEET 1	OF 1	SHEETS	STA.	TO STA.		ILLINOIS I	FED. All	D PROJECT		

	PAVING SCHEDULE						
	HOT-MIX ASPHALT SURFACE REMOVAL, 2 1/4"	HOT-MIX ASPHALT SURFACE REMOVAL - BUTT JOINT	BITUMINOUS MATERIALS (TACK COAT)	POLYMERIZED HOT-MIX ASPHALT SURFACE COURSE, IL-9.5, MIX "E" N90	POLYMERIZED HOT-MIX ASPHALT BINDER COURSE, IL-19.0, N90	HOT-MIX ASPHALT SHOULDERS	SHOULDER RUMBLE STRIP, 16"
	(SQ YD)	(SQ YD)	(POUND)	(TON)	(TON)	(TON)	(FOOT)
EB I-70 NORTH APPROACH	362	234	304	40.5	45.6	29.5	242
EB I-70 SOUTH APPROACH	354	222	273	39.7	44.6	27.4	238
WB I-70 NORTH APPROACH	345	220	249	38.7	43.5	22.2	238
WB I-70 SOUTH APPROACH	372	236	311	41.6	46.8	30.0	242
TOTAL:	1433	912	1137	160.5	180.5	109.1	960

	PAVEMENT MARKING SCHEDULE						
	PREFORMED PLASTIC PAVEMENT MARKING, TYPE D - STANDARD - LINE 6"	SHORT TERM PAVEMENT MARKING REMOVAL	SHORT TERM PAVEMENT MARKING	GROOVING FOR RECESSED PAVEMENT MARKING 7"	RAISED REFLECTIVE PAVEMENT MARKER REMOVAL	RAISED REFLECTIVE PAVEMENT MARKER	BARRIER WALL REFLECTORS, TYPE C
	(FOOT)	(SQ FT)	(FOOT)	(FOOT)	(EACH)	(EACH)	(EACH)
EB I-70	1184	25	76	1184	26	16	14
WB I-70	1184	25	76	1184	26	16	14
TOTAL:	2368	50	152	2368	52	32	28

INLET BOXES TO BE ADJUSTED			
EB I-70	2		
WB I-70	2		
TOTAL:	4		

ONFIG = SPLTDRVSS SCHEDULES 1 ME: pw///gocos-pw.donfley.com/gocos-pw.d/1/Documents/Projec
---

<b>-</b> : 00070107	USER NAME = therrmann	DESIGNED - TH	REVISED -
<b>-</b> 401  2012		DRAWN - TH	REVISED -
GONZALEZ COMPANIES, LLC	PLOT SCALE = 0.083333317 ' / in.	CHECKED - PM	REVISED -
PRO. ENGINEER 184004564-0014	PLOT DATE = 10/1/2024	DATE - 10/01/2024	REVISED -

STATE OF ILLINOIS
<b>DEPARTMENT OF TRANSPORTATION</b>

SCALE: NONE


SCHEDULES OF QUANTITIES					F.A.I. RTE			COUNTY TOTAL SHEETS	SHEET NO.	
	001120220 01 0071111120					/0	60-7BJK-BDK	MADISON	26	/
							CONTRACT	NO.	76U07	
	SHEET 1	OF 1	SHEETS	STA.	TO STA.	ILLINOIS FED. AID PROJECT				


DRAWN -REVISED CHECKED - PM REVISED -- 10/01/2024 REVISED -


STATE OF ILLINOIS **DEPARTMENT OF TRANSPORTATION** 


**ROADWAY PLAN** SCALE: 1" = 50' SHEET 1 OF 1 SHEETS STA.


60-7BJR-BDR CONTRACT NO. 76U07

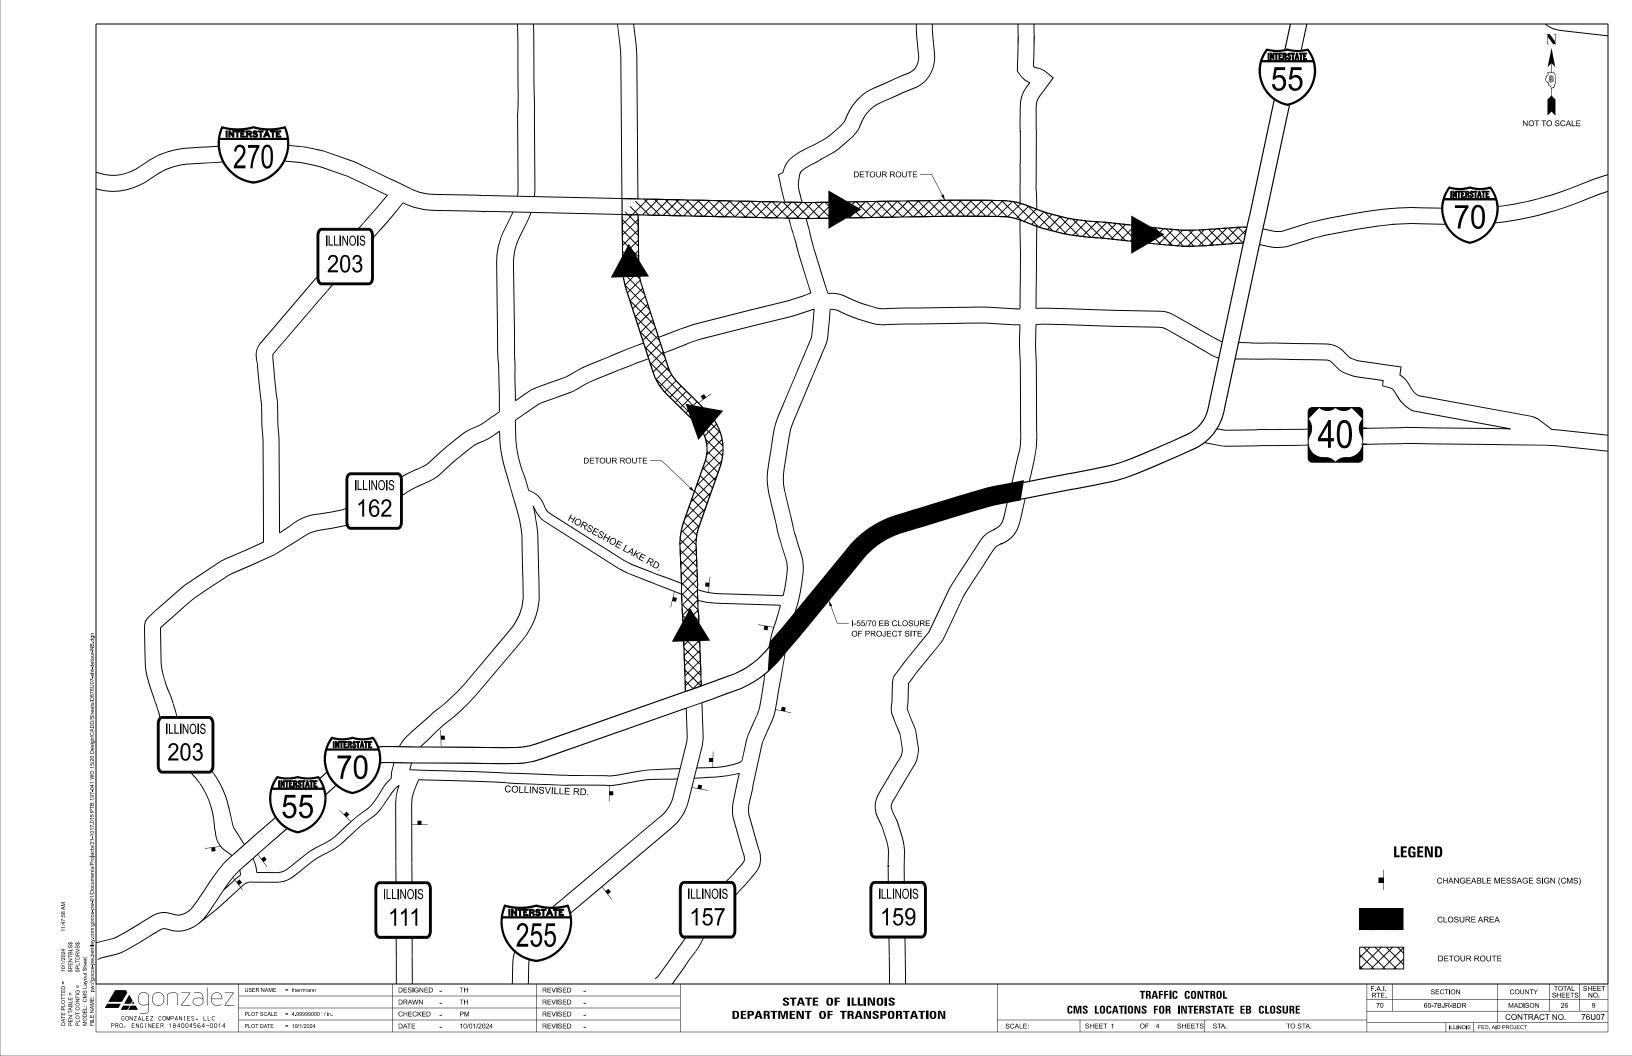

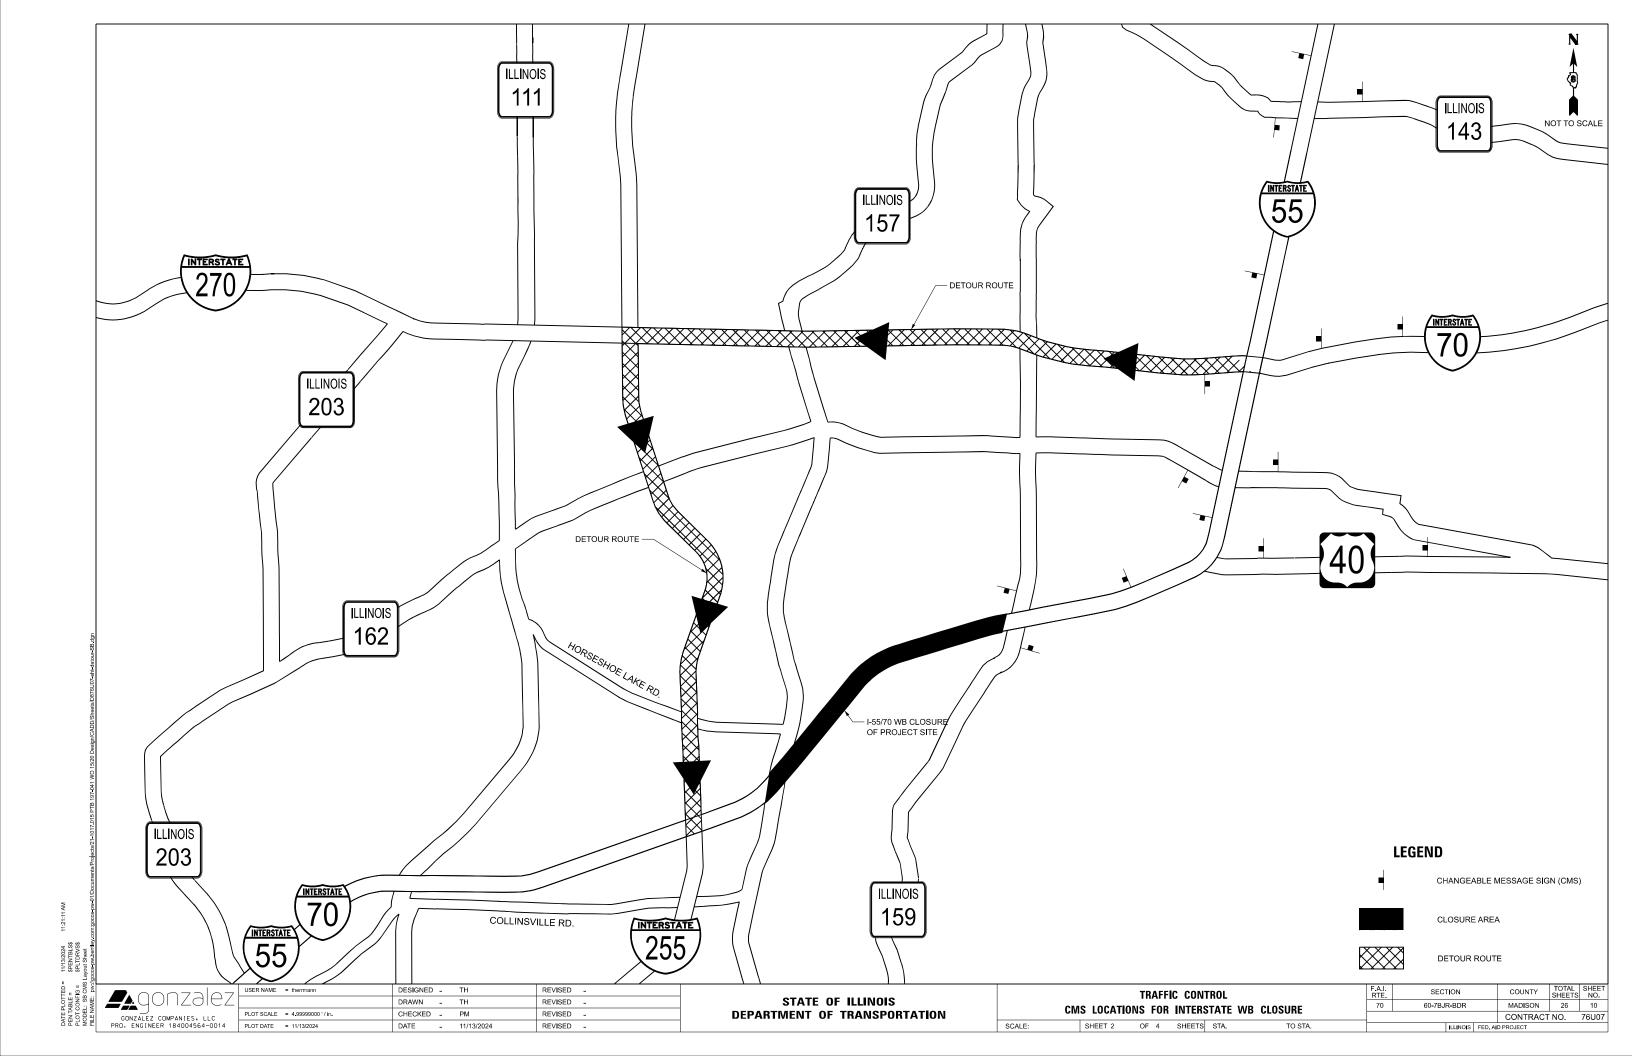

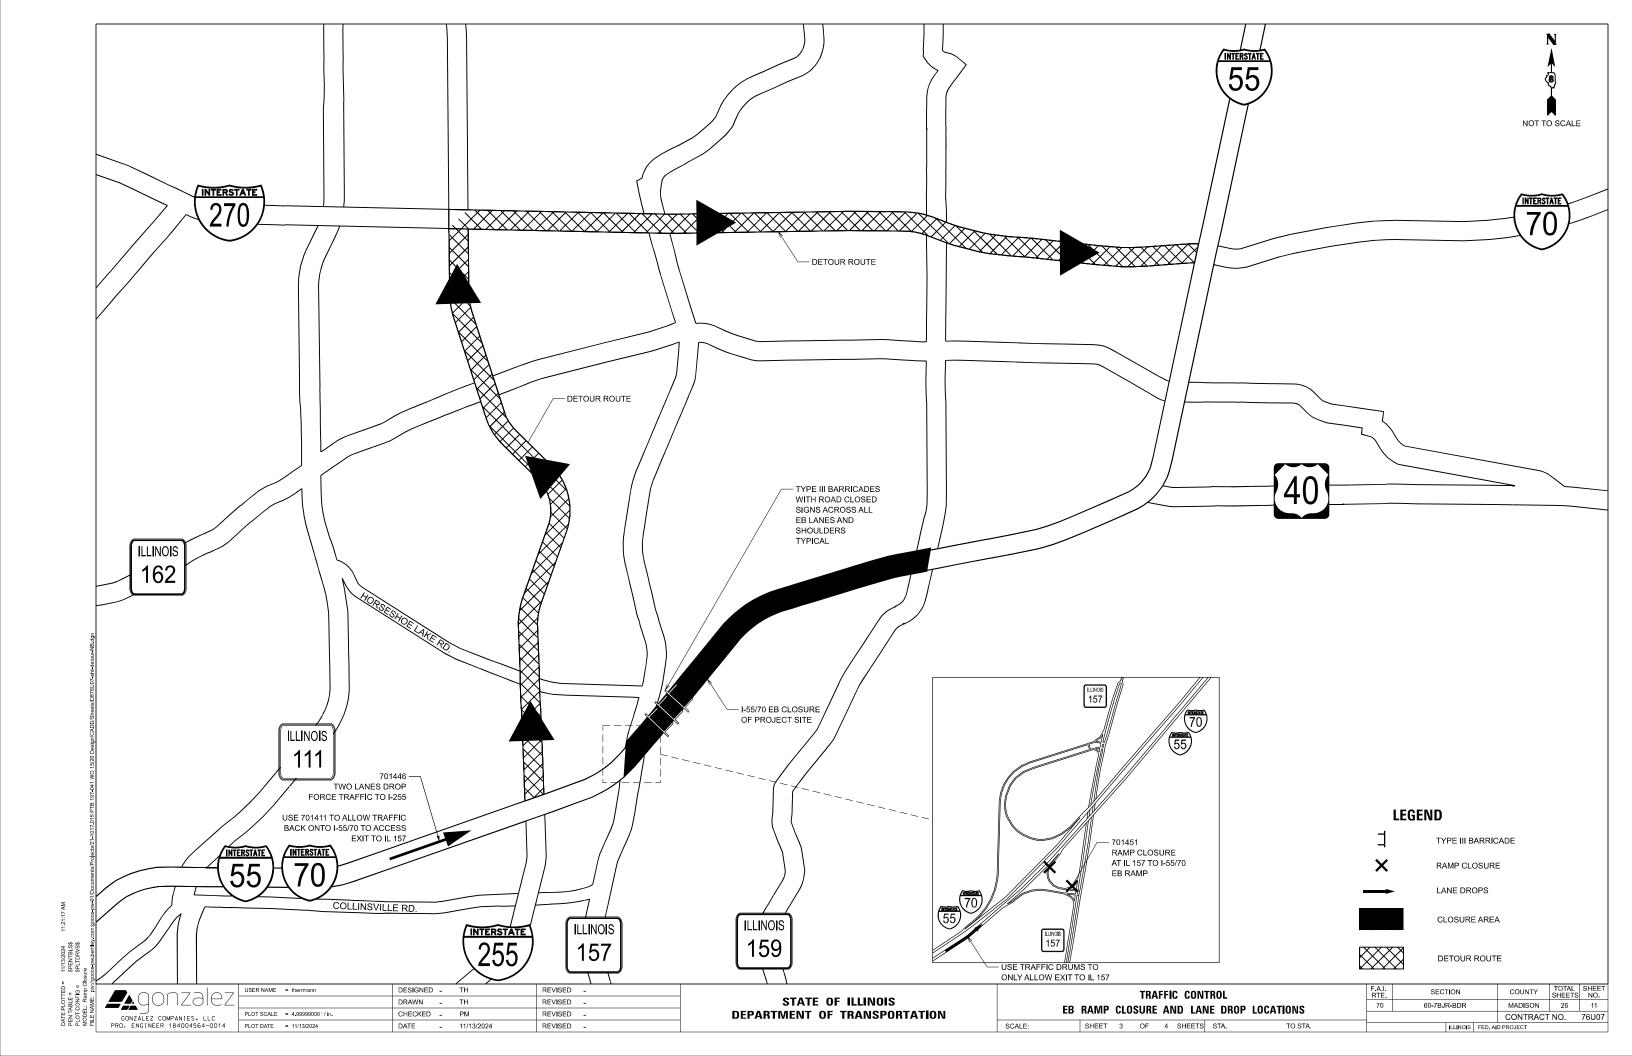

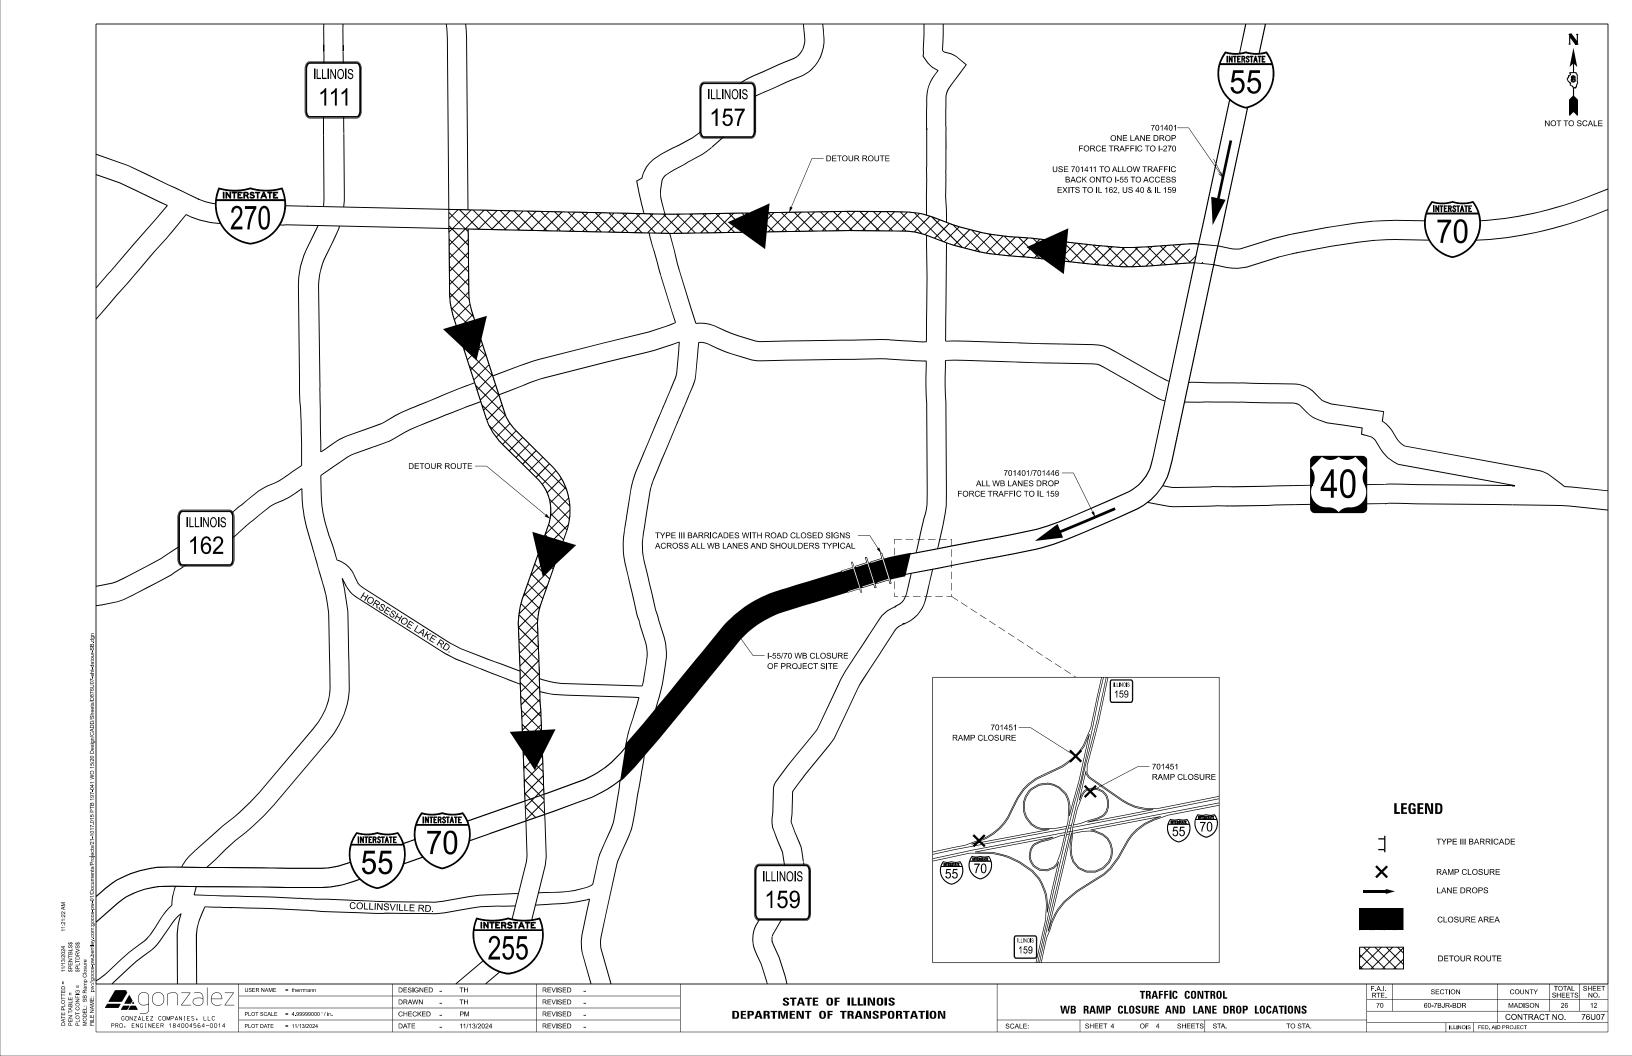

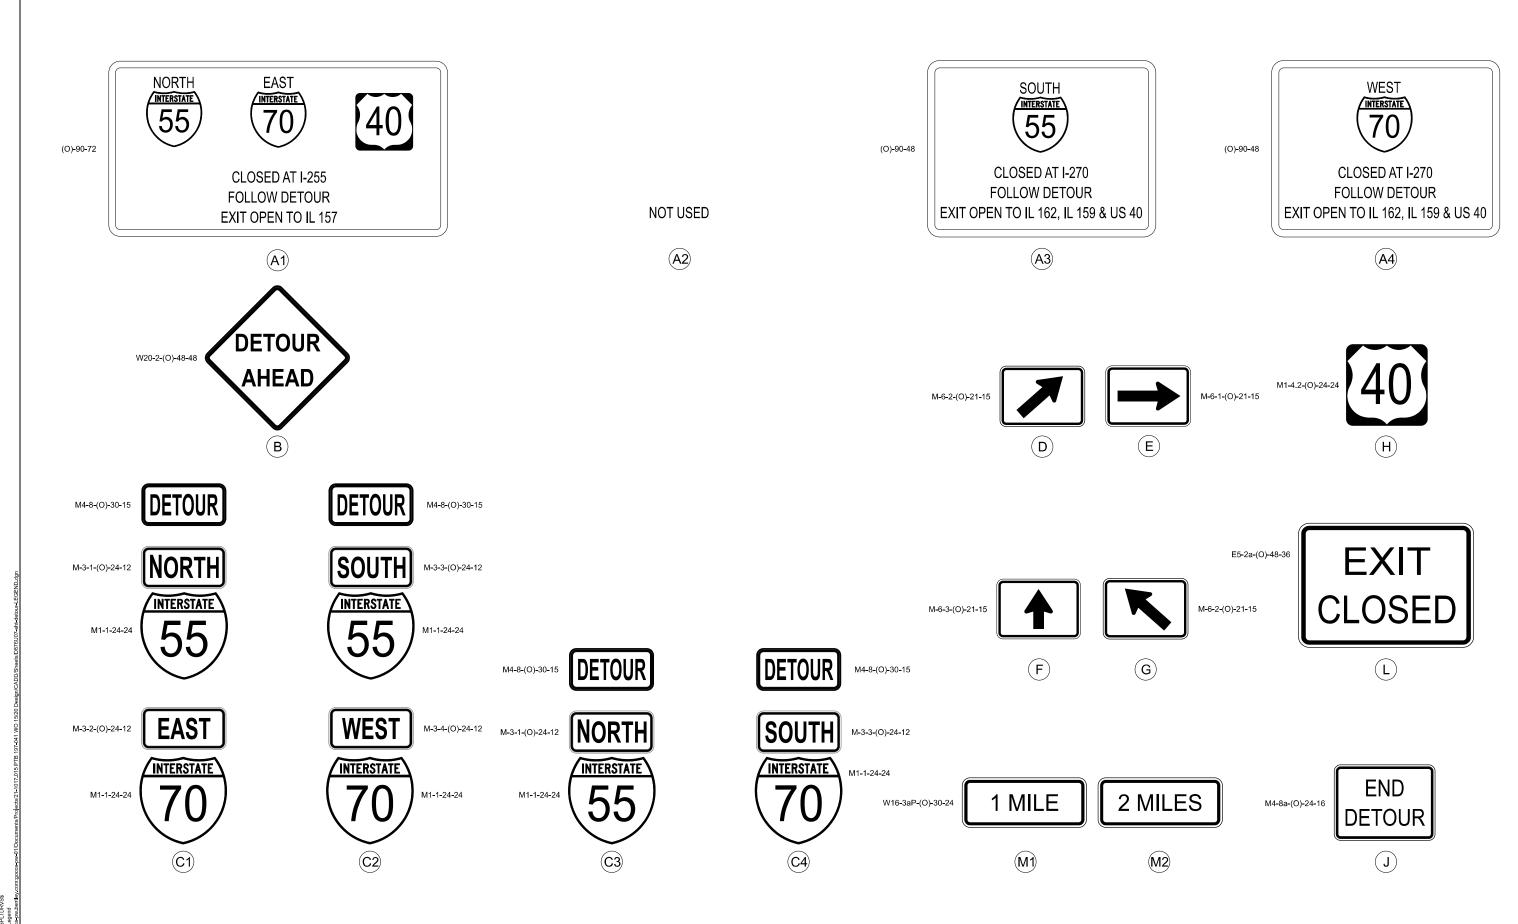


DALE PLOTTED = 10/1/2024 11:48:18
PENTRABLE = SPENTBLS\$
PLOT CONFIG = SPLTDRVS\$
FILE NAME: beyun Sign Legend
FILE NAME: by//loccos-pw.bentlev.com;gocos-


STATE OF ILLINOIS
DEPARTMENT OF TRANSPORTATION


SCALE:

 DETOUR PLAN SIGNING LEGEND
 F.A.I. RTE. RTE. 70
 SECTION 60-7BJR-BDI


 SHEET 1 OF 3 SHEETS STA. TO STA.
 ILLING

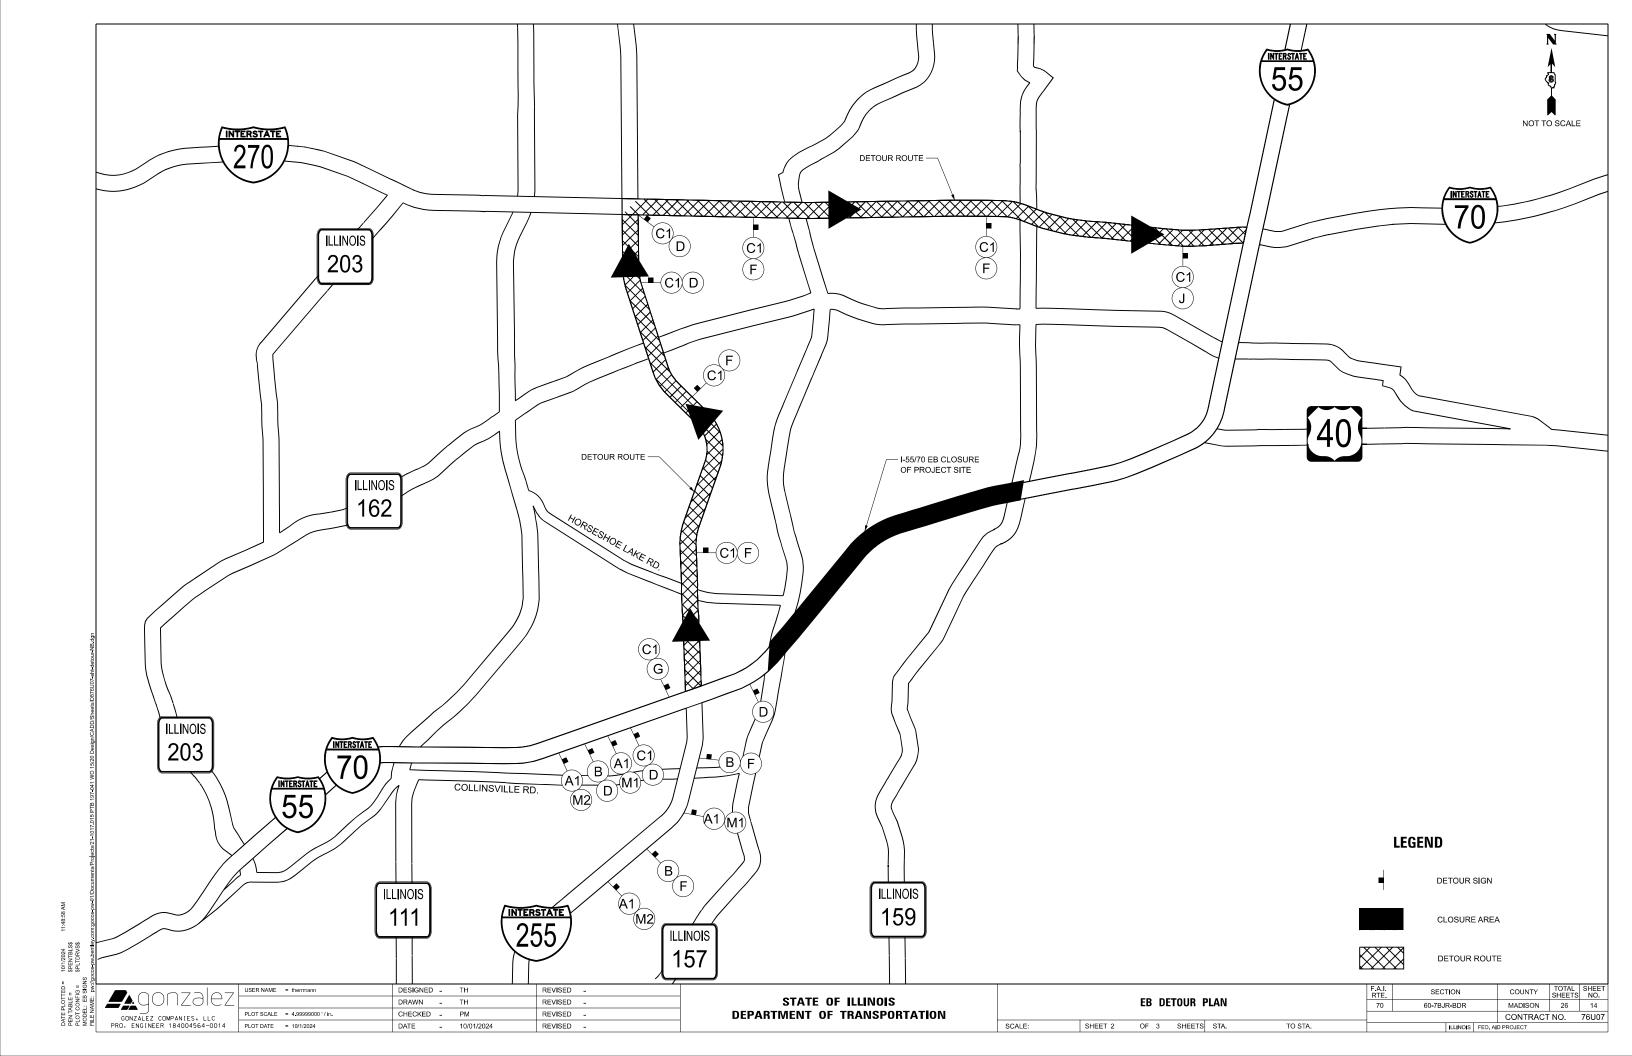

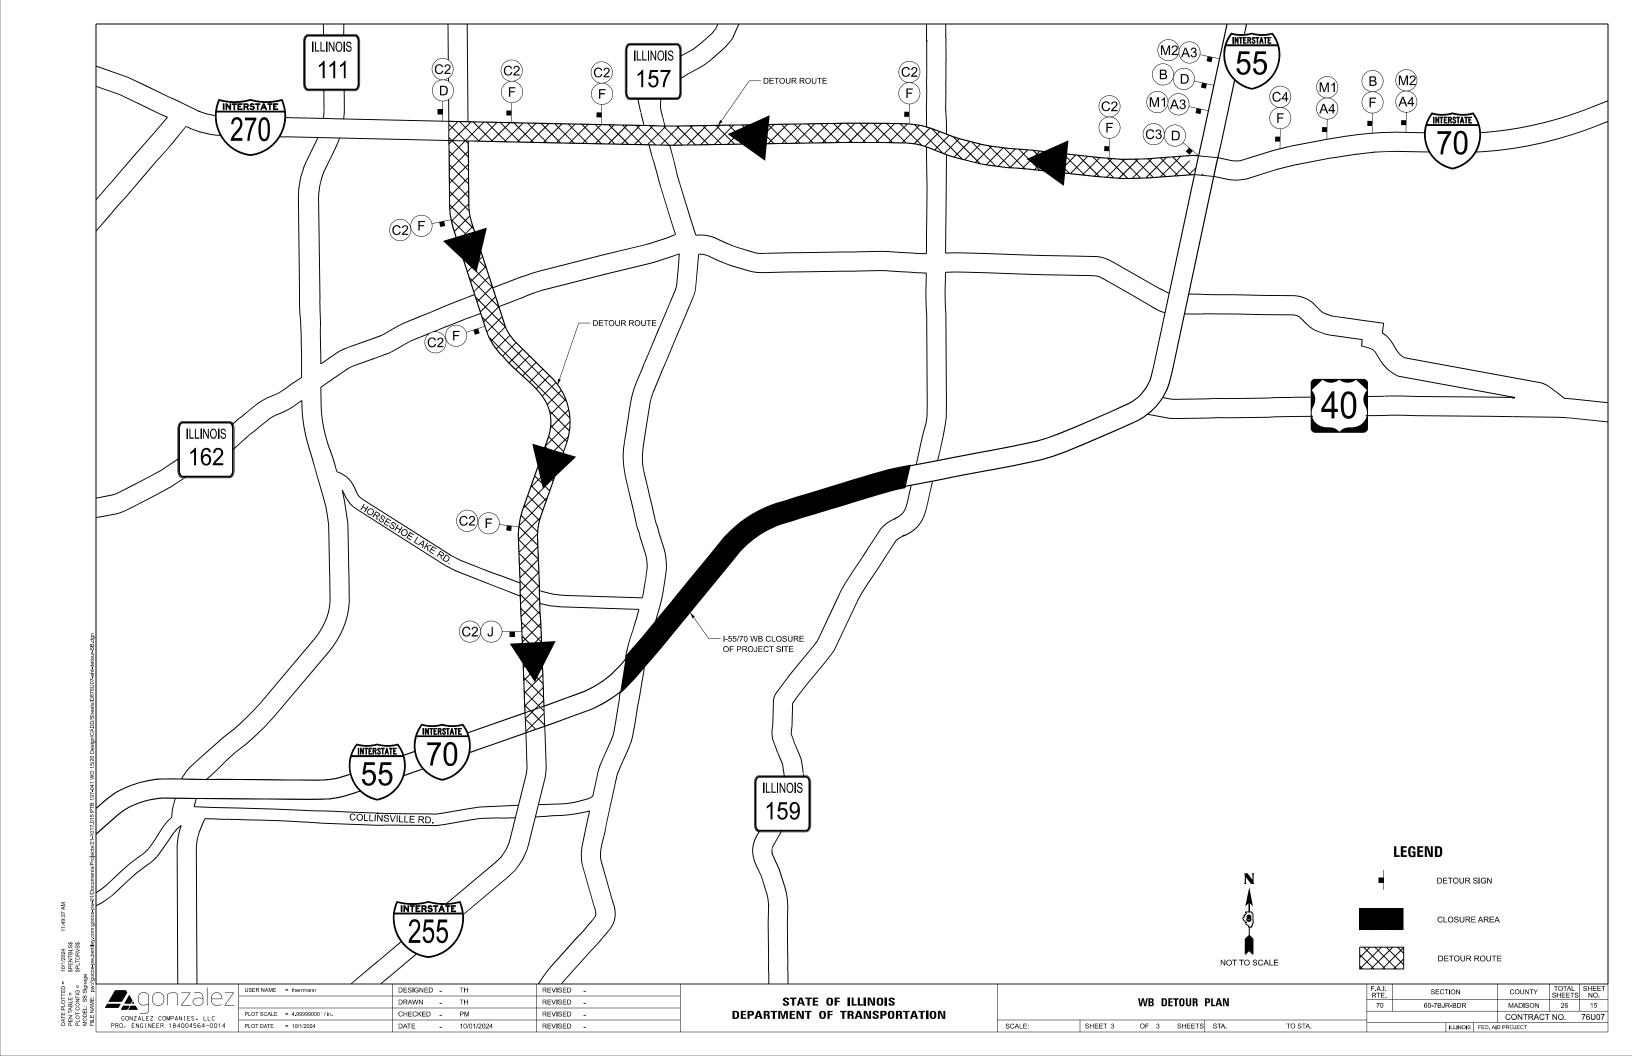

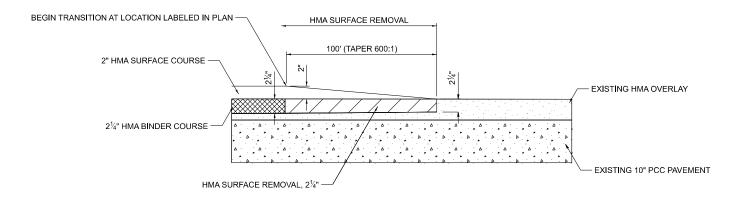

# BUTT JOINT DETAIL MAINLINE WITH HOT-MIX ASPHALT SURFACE REMOVAL NOT TO SCALE

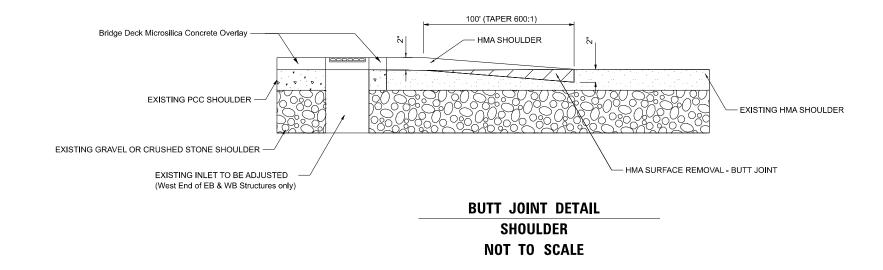



DATE PLOTTED = 10/1/2024 11:50:12
PEN TABLE = \$PENTBLS\$
PLOT CONFIG = \$PLTDRVS\$
MODEL: Detail Sheet
FILE NAME: pw//goosepw.bentley.com;goose

<b>P</b> : 00070107	USER NAME = therrmann	DESIGNED - TH	REVISED -
<b>4</b> 401 12a1821		DRAWN - TH	REVISED -
GONZALEZ COMPANIES, LLC	PLOT SCALE = 0.08333317 '/in.	CHECKED - PM	REVISED -
PRO. ENGINEER 184004564-0014	PLOT DATE = 10/1/2024	DATE - 10/01/2024	REVISED -

STATE OF ILLINOIS							
DEPARTMENT OF TRANSPORTATION							

	DETAILO					SECTION		COUNTY	TOTAL SHEETS	SHEET NO.
DETAILS				70	60-7BJR-BDR		MADISON	26	16	
								CONTRACT	NO.	76U07
SHEET 1	OF 2	SHEETS	STA.	TO STA.		ILLINOIS	FED. AII	D PROJECT		

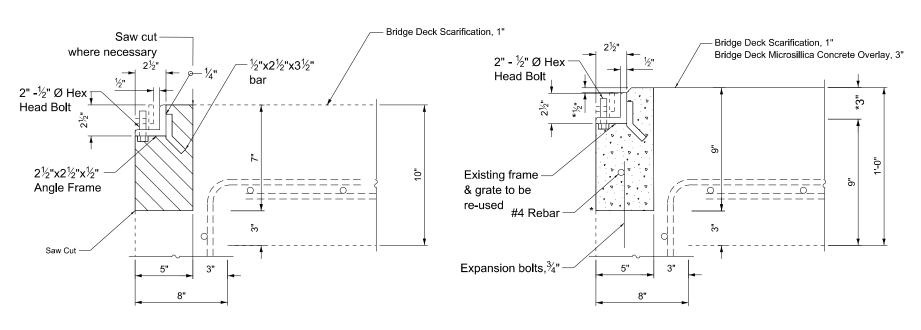

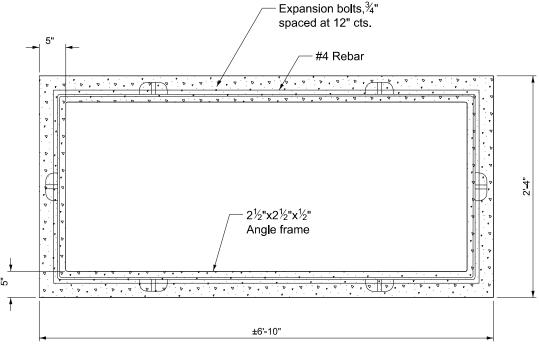

### **DETAIL "A" - EXISTING**


Concrete Removal

### **DETAIL "A" - PROPOSED**

Class S.I. Concrete


\* Prior to Diamond Grinding

# <u>PLAN - PROPOSED</u> (GRATING OMITTED FOR CLARITY)

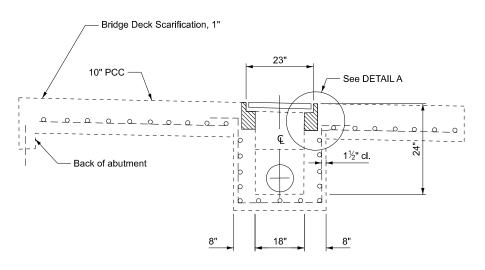

# EXISTING TYPE D INLET BOX PROFILE BRIDGE APPROACH SHOULDER PAVEMENT AND DRAIN

(Existing Approach Shoulder Pavement Std. 2324-6)

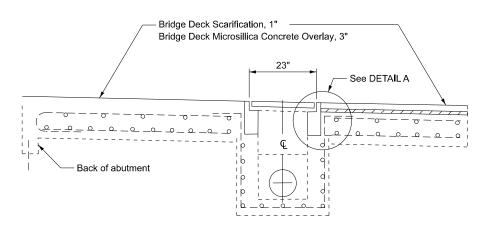

# PROPOSED PROFILE BRIDGE APPROACH SHOULDER PAVEMENT AND DRAIN

SCALE:

#### Notes:

Expansion bolts shall extend a minimum of 4" into the proposed concrete.

All work and materials shall be in accordance with applicable portions of Section 602.

This work will be paid for at the Contract unit price each for "Inlet Boxes to be Adjusted (Special)" which shall include all labor, equipment and material necessary to complete the work.

# ESTIMATED QUANTITIES (for information only)

	<i>,</i>	
ITEM	UNIT	
Concrete Removal	Cu Yd	0.13
Reinforcement Bars (Epoxy)	Pound	11.4
Class S.I. Concrete	Cu Yd	0.16
Expansion Bolts,¾"	Each	18

Note: Above quantities are for one (1) inlet box.


# **BILL OF MATERIALS**

ITEM	UNIT	TOTAL
Inlet Boxes to be Adjusted (Special)	Each	4

GONZALEZ COMPANIES. PRO. ENGINEER 18400456

00070107	USER NAME = therrmann	DESIGNED - TH	REVISED -
<u>401 1281621</u>		DRAWN - TH	REVISED -
ALEZ COMPANIES, LLC	PLOT SCALE = 0.083333317 ' / in.	CHECKED - PM	REVISED -
NGINEER 184004564-0014	PLOT DATE = 10/1/2024	DATE - 10/01/2024	REVISED -

INICT AD HICTMENT DETAILS					SECTION		COUNTY	TOTAL SHEETS	SHEET NO.
INLET ADJUSTMENT DETAILS				70	60-7BJR-BDR		MADISON	26	17
							CONTRACT	NO.	76U07
SHEET 2 OF 2	SHEETS	STA.	TO STA.		ILLINOIS FED, AID PROJECT				

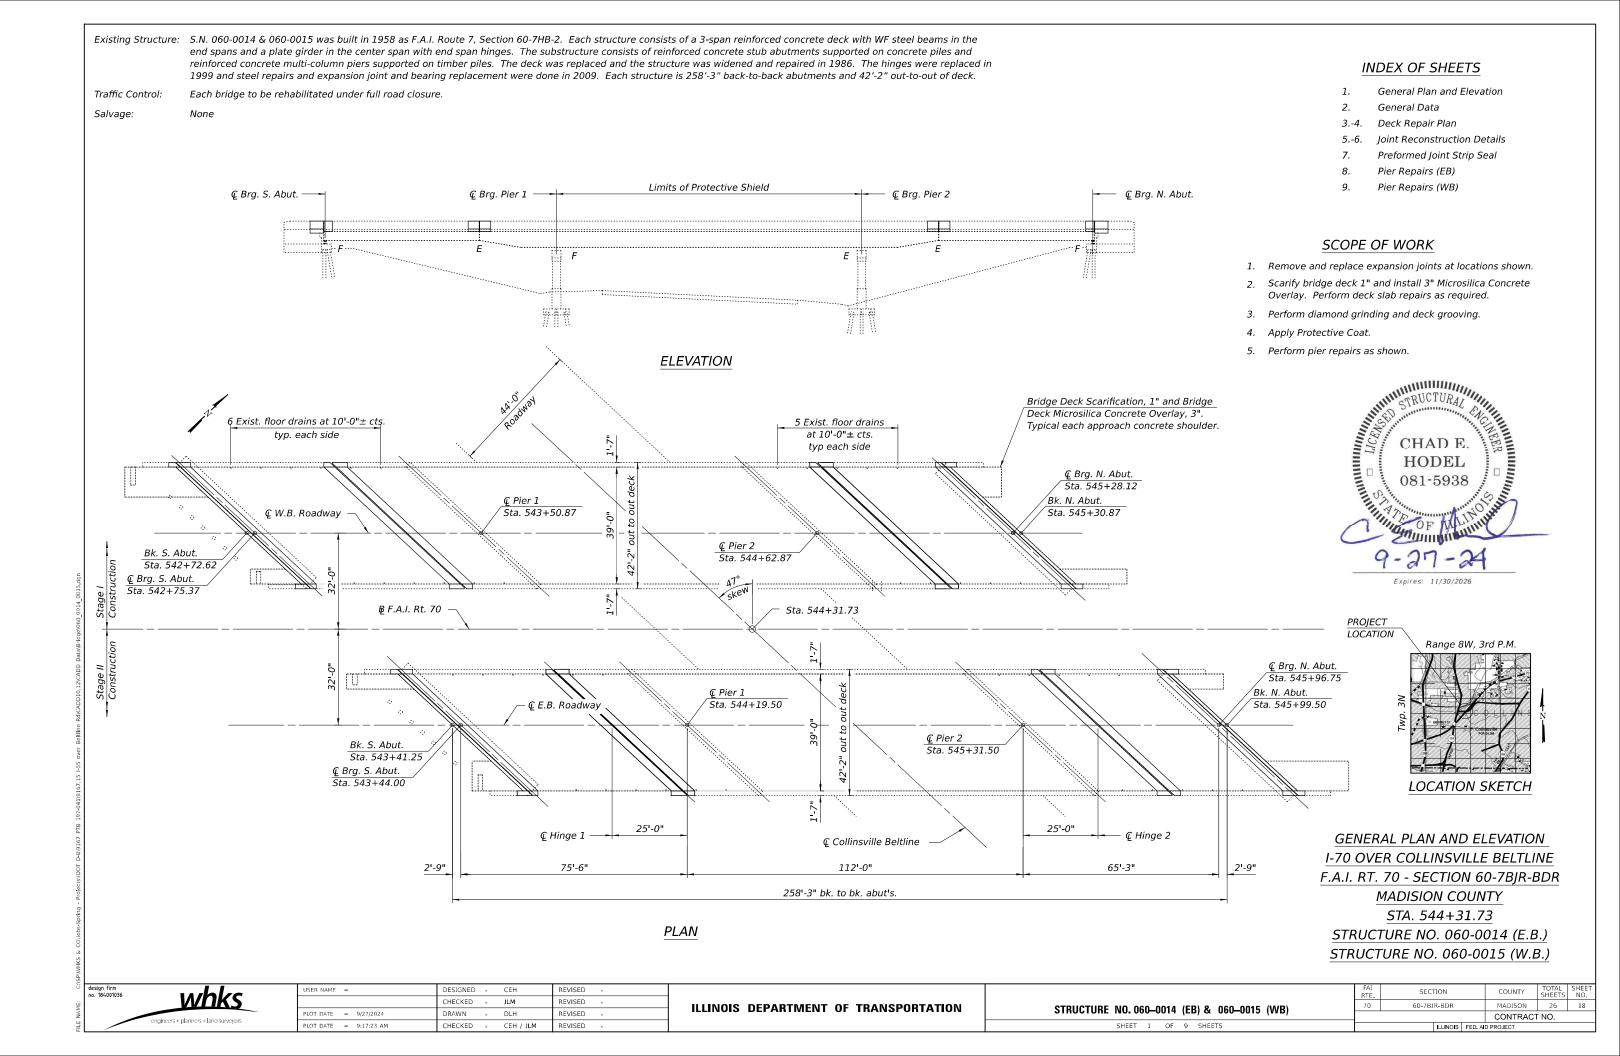

#### GENERAL NOTES


- Plan dimensions and details relative to the existing structure have beeen taken from existing plans and are subject to nominal construction variations. The Contactor shall field verify existing dimensions and details affecting new construction and make necessary approved adjustments prior to construction or ordering of materials. Such variations shall not be cause for additional compensation for a change in scope of the work, however, the Contractor will be paid for the quantity actually furnished at the unit price bid for the work.
- 2. The existing structural steel coating contains lead. The Contractor shall take appropriate precautions to deal with the presence of lead on this project.
- 3. Prior to pouring the new concrete deck, all heavy or loose rust, loose mill scale, and other loose detrimental foreign material shall be removed from the surfaces in contact with concrete (SSPC SP3 standards). Tightly adhered paint may remain unless otherwise noted. Removal shall be accomplished by methods that will not damage the steel and the cost will be paid for according to Article 109.04 of the Standard Specifications.

As directed by the Engineer, existing construction accessories welded to the top flange of beams and girders shall be removed. The weld areas shall be ground flush and inspected for cracks using magnetic particle testing (MT) or dye penetrant testing (PT) by qualified personnel approved by the Engineer. Any cracks that cannot be removed by grinding 1/4 in. deep shall be identified and reported to the Bureau of Bridges and Structures for further disposition. The cost of removing welded accessories, grinding and inspecting weld areas and grinding cracks will be paid for according to Article 109.04 of the Standard Specifications.


- 4. No field welding is permitted except as specified in the contract documents.
- 5. Reinforcement bars designated (E) shall be epoxy coated.
- 6. Up to 1/4" to be ground off the bridge deck and adjacent bridge approaches. The diamond grinding and surface testing for the bridge section shall extend from back of abutment to back of abutment (provide 1:240 taper on approach slabs).
- 7. Existing reinforcement extending into the removal area shall be cleaned, straightened, and incorporated into the new construction. Any existing reinforcement bars intended for reuse and damaged during the concrete removal operations shall be repaired or replaced using an approved bar splicer or anchor system to the satisfaction of the Engineer. Cost included with Concrete Removal.
- 8. The Contractor shall take appropriate measures to ensure that Protective Coat is not applied to the floor drains and drainage inlets.
- Dirt and debris shall be cleaned from the drainage inlets and floor drains. Cost included with Bridge Deck Scarification.

### TOTAL BILL OF MATERIAL

Item	Unit	Super	Sub	Total
Concrete Removal	Cu. Yd.	89.4	-	89.4
Protective Shield	Sq. Yd.	1,054	-	1,054
Concrete Superstructure	Cu. Yd.	101.2	-	101.2
Protective Coat	Sq. Yd.	2,768	-	2,768
Reinforcement Bars, Epoxy Coated	Pound	8,230	-	8,230
Preformed Joint Strip Seal	Foot	474	-	474
Bridge Deck Scarification 1"	Sq. Yd.	2,132	-	2,132
Bridge Deck Microsilica Concrete Overlay 3"	Sq. Yd.	2,132	-	2,132
Structural Repair of Concrete (Depth Equal to or Less Than 5 Inches)	Sq. Ft.	-	97.3	97.3
Deck Slab Repair (Full Depth, Type I)	Sq. Yd.	2.6	-	2.6
Deck Slab Repair (Full Depth, Type II)	Sq. Yd.	80.2	-	80.2
Diamond Grinding (Bridge Section)	Sq. Yd.	2,088	-	2,088
Bridge Deck Grooving (Longitudinal)	Sq. Yd.	1,359	-	1,359

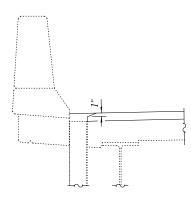


#### SECTION AT DRAINS

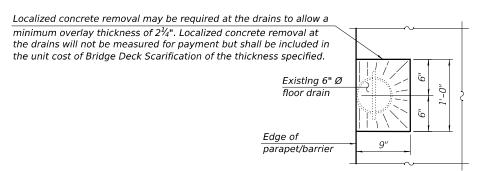

### **OVERLAY TREATMENT AT DRAINS**

(44 drains total)

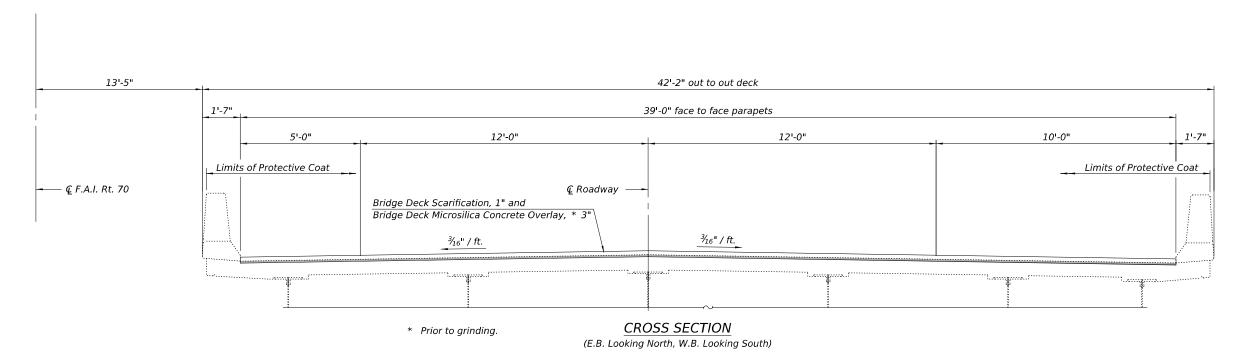

en firm
84001036

whks

cngincers + planners + land surveyors


| DESIGNED - CEH | REVISED - CHECKED - JLM | REVISED - CHECKED - JLM | REVISED - CHECKED - JLM | REVISED - CHECKED - CHECKED - CEH / JLM | REVISED - CHECKED - CHECKED - CEH / JLM | REVISED - CHECKED -

ILLINOIS DEPARTMENT OF TRANSPORTATION

GENERAL DATA

STRUCTURE NO. 060–0014 (EB) & 060–0015 (WB)

SHEET 2 OF 9 SHEETS

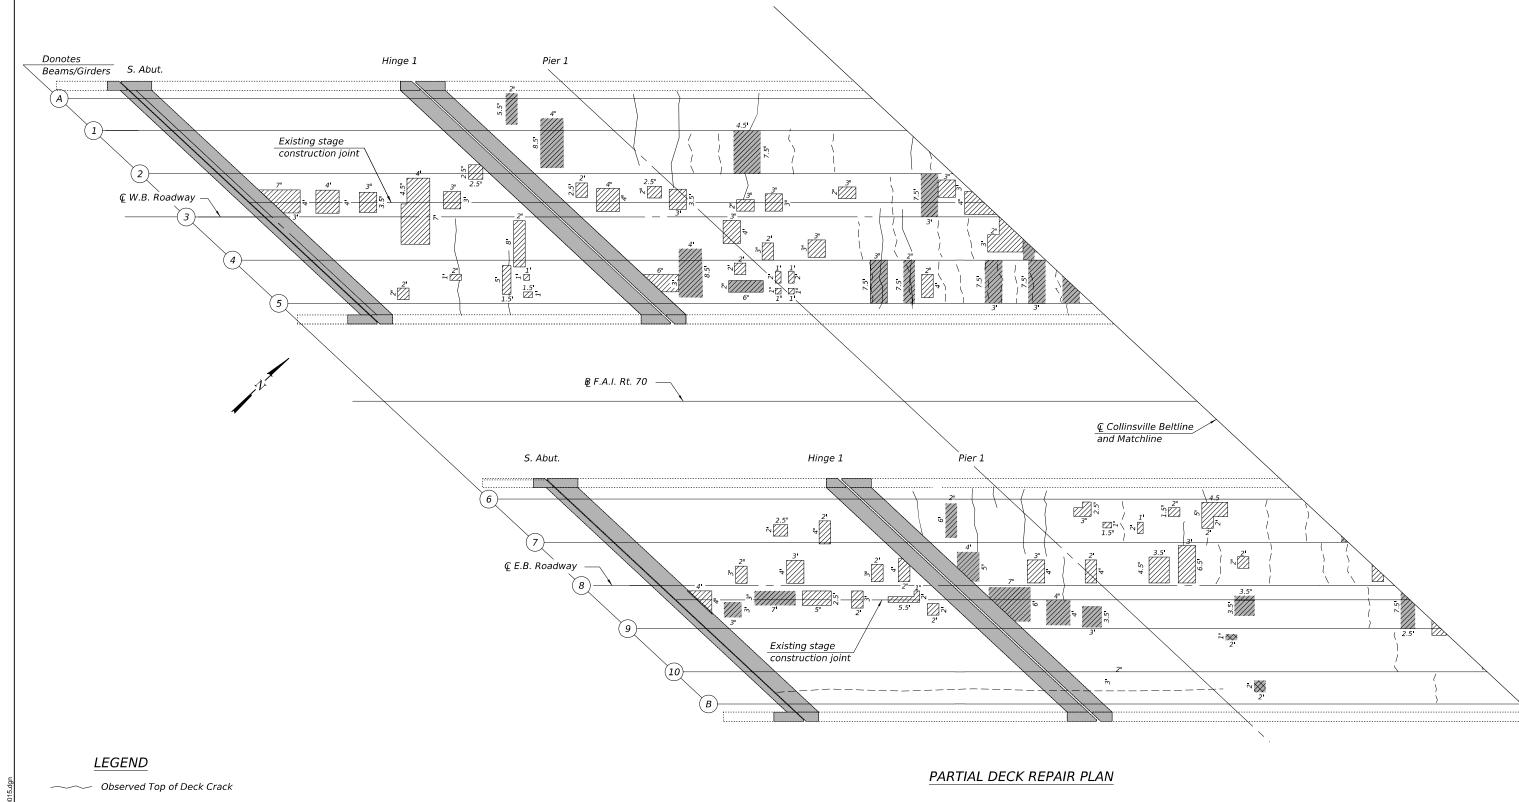

---- Observed Bottom of Deck Crack

Expansion Joint Removal

Deck Slab Repair (Partial)

Deck Slab Repair (Full Depth, Type I)

Deck Slab Repair (Full Depth, Type II)

#### Notes:

- Deck Slab Repair (Partial) locations and quantities shown are for information only and will not be measured for payment but shall be included in the cost of Bridge Deck Microsilica Concrete Overlay 3". See special provision for Bridge Deck Microsilica Concrete Overlay 3".
- 2. Quantities and limits of Deck Slab Repairs shown are estimated from an April 2024 inspection. Actual limits shall be determined in the field and noted in the As-Built Plans. See special provision for Deck Slab Repair.
- 3. For expansion joint reconstruction details, see sheets 5 and 6.


(Sheet 1 of 2)

n firm 34001036	whlee
	VVIIKS
	engineers + planners + land surveyors

USER NAME = \$USER\$	DESIGNED	-	SBC	REVISED	-
	CHECKED	-	JLM	REVISED	-
PLOT DATE = 9/27/2024	DRAWN	-	DLH	REVISED	-
PLOT TIME = 8:05:28 AM	CHECKED	-	SBC / JLM	REVISED	-

ILLINOIS	DEPARTMENT	OF	TRANSPORTATION

DECK REPAIR PLAN STRUCTURE NO. 060-0014 (EB) & 060-0015 (WB)		SECTION	COUNTY	TOTAL SHEETS	SHEET NO.
		60-7BJR-BDR	MADISON	26	20
31100101L 140.000-0014 (LD) & 000-0015 (WD)			CONTRACT	NO.	
SHEET 3 OF 9 SHEETS	SHEETS		ID PROJECT		

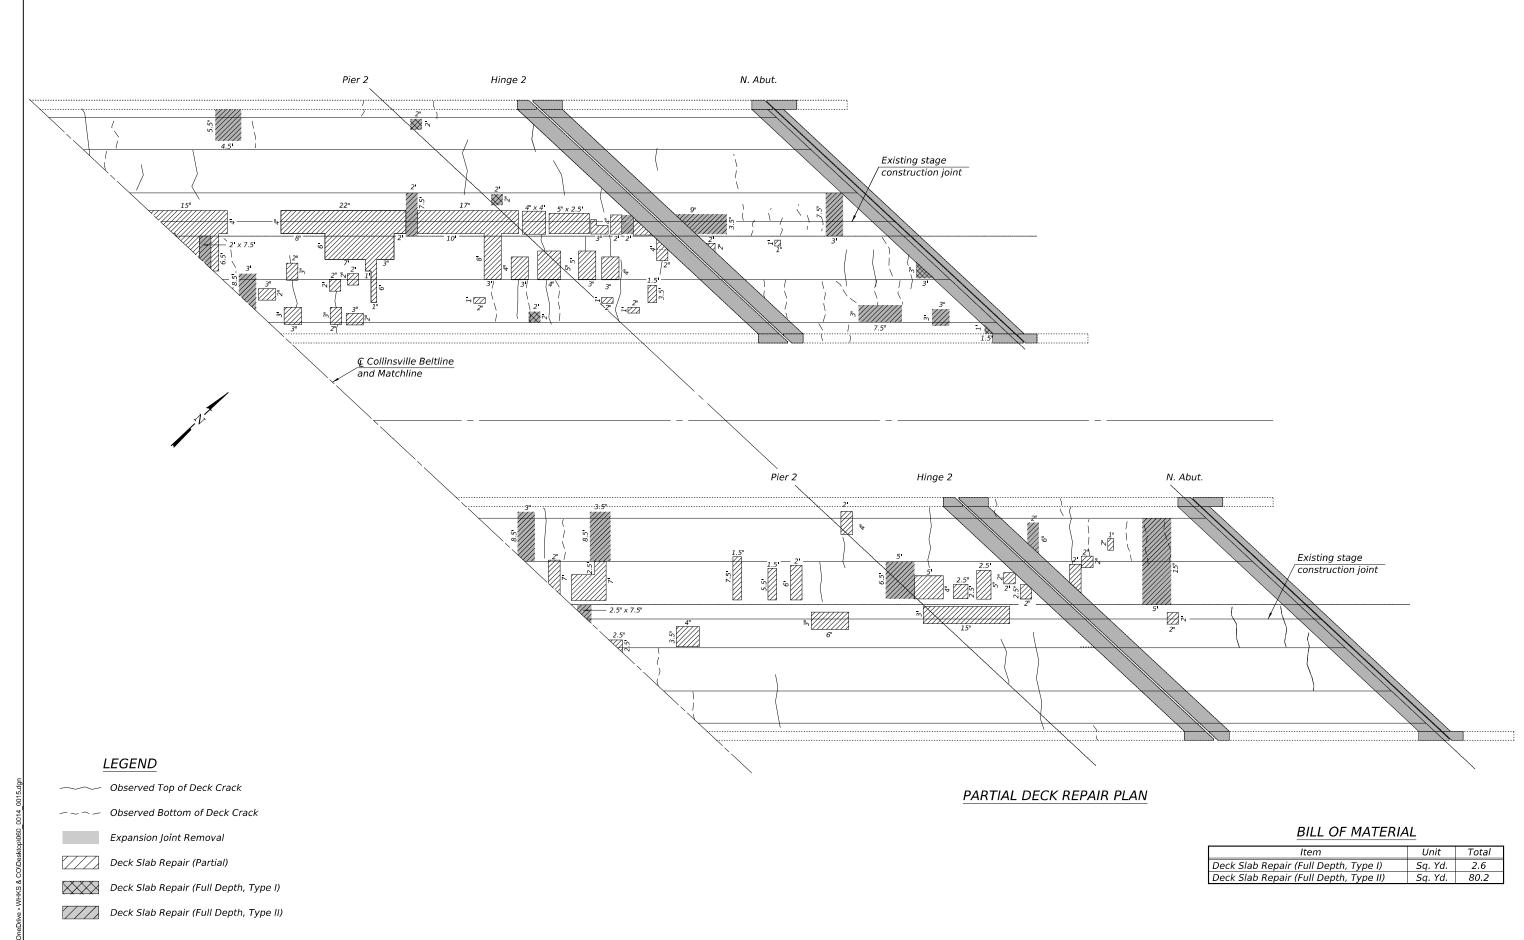



(Sheet 2 of 2)


whks engineers + planners + land surveyors

ILLINOIS DEPARTMENT OF TRANSPORTATION

| STEETS | NO. | STEE

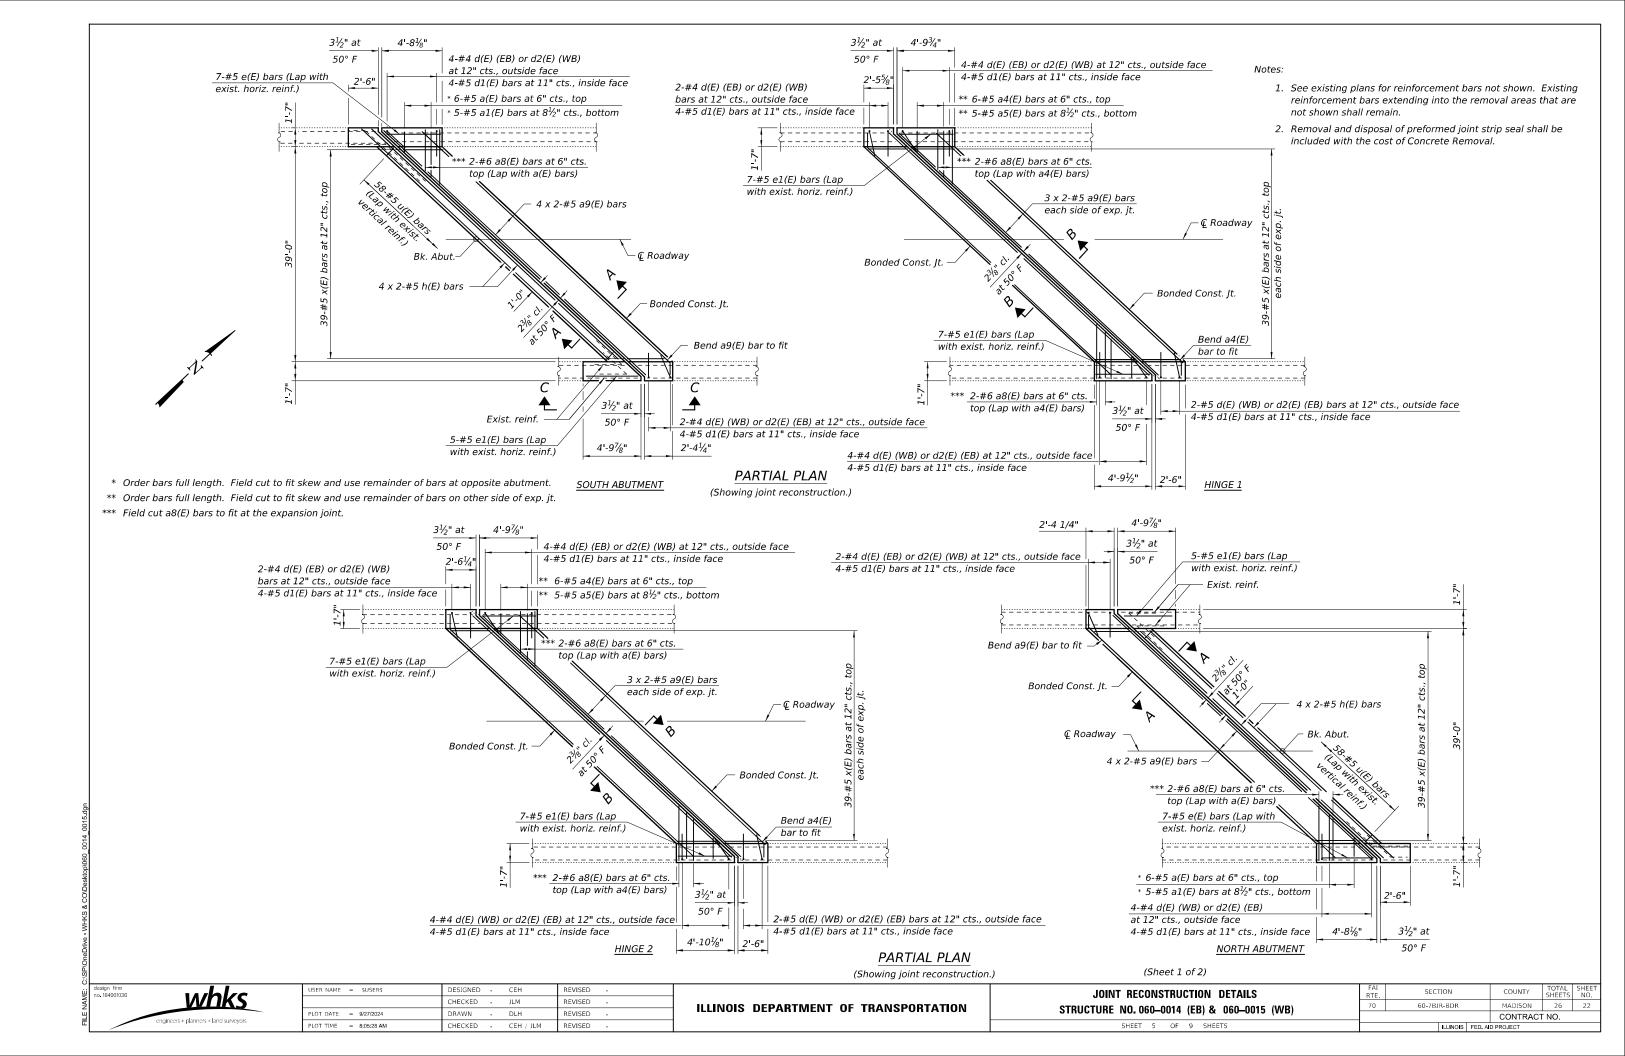

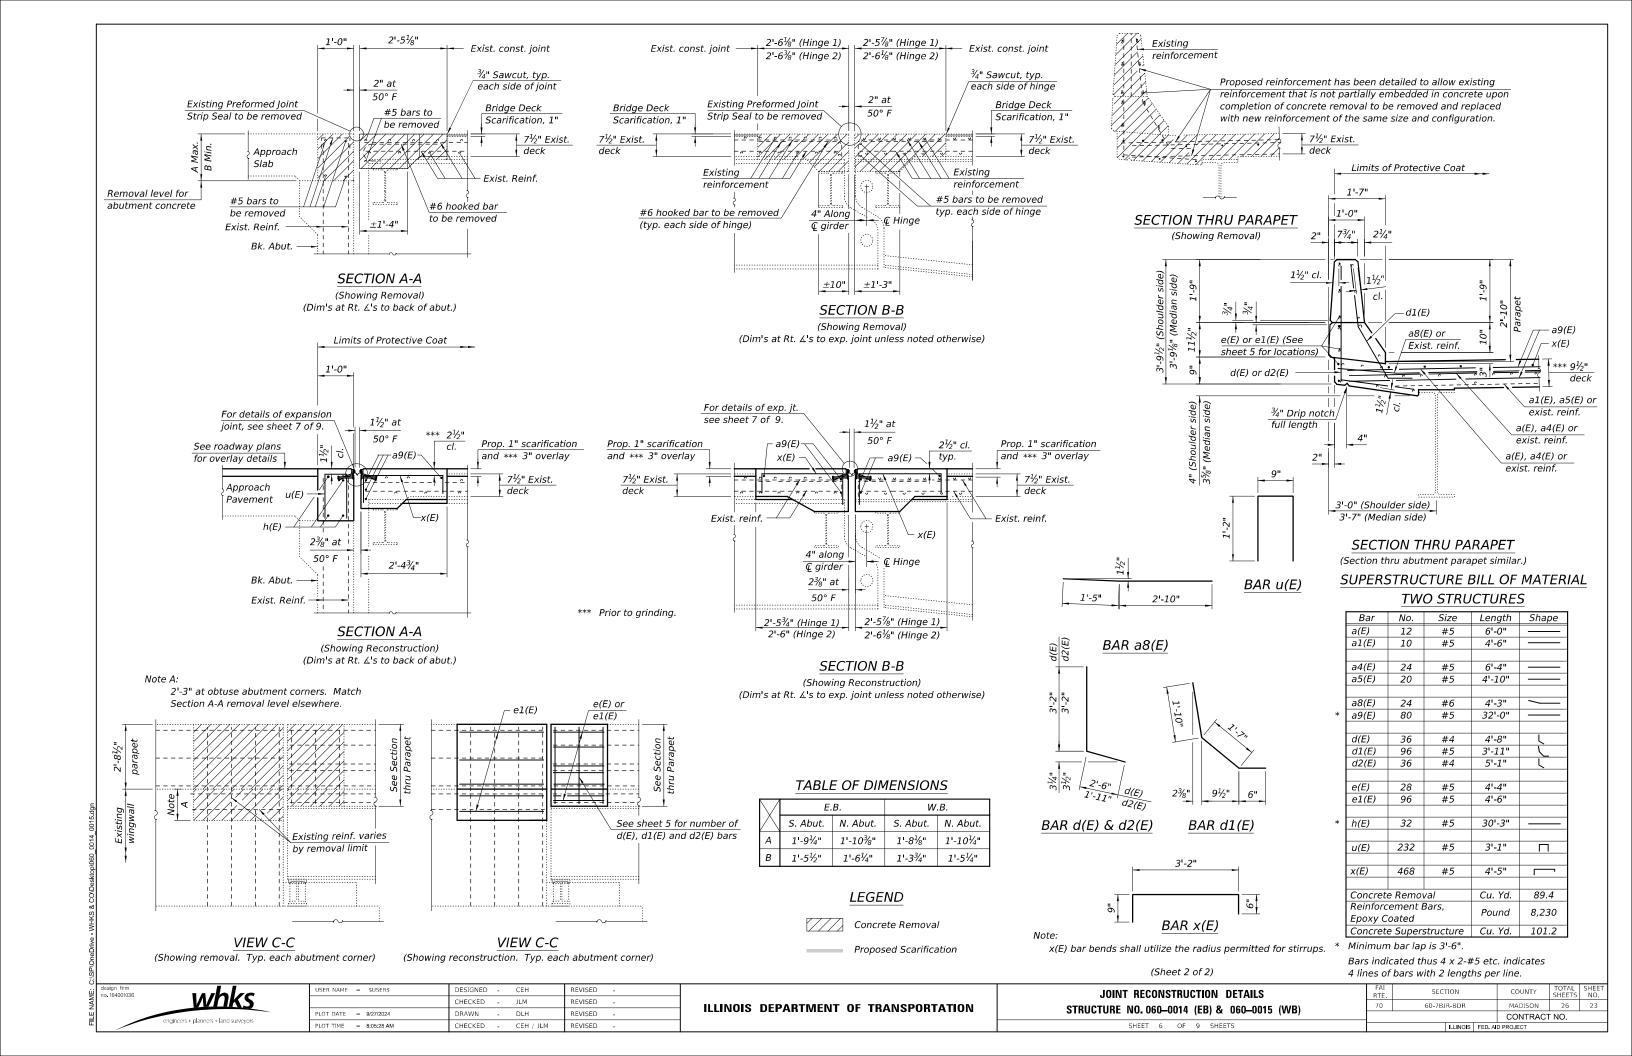

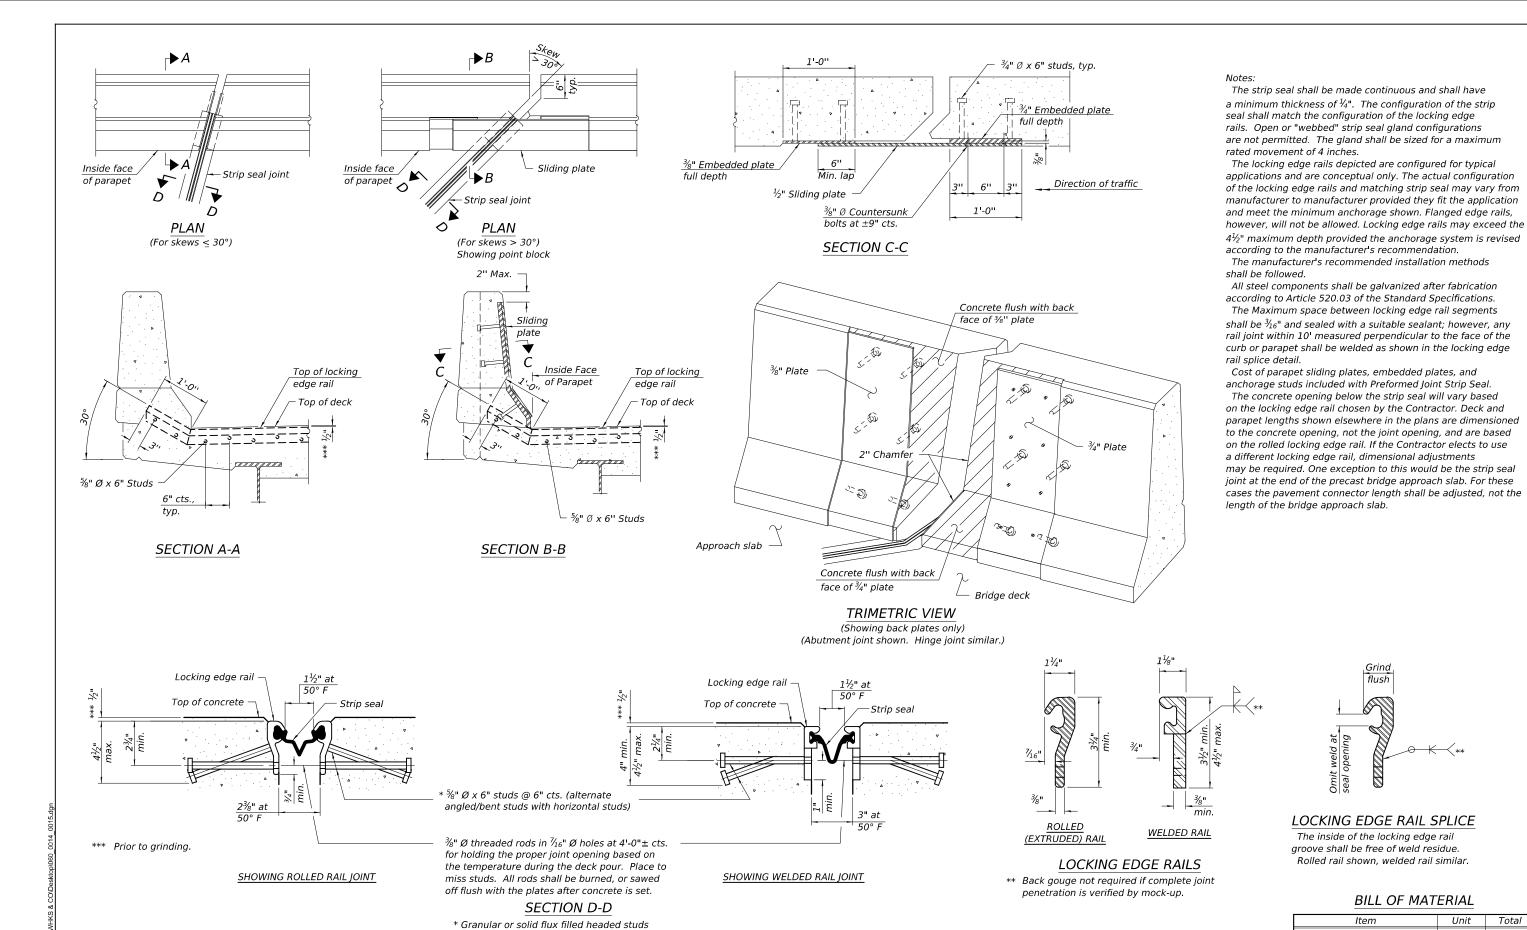

conforming to Article 1006.32 of the Std. Specs., automatically end welded.

EJ-SS

whks

# LOCKING EDGE RAIL SPLICE


flush

The inside of the locking edge rail groove shall be free of weld residue. Rolled rail shown, welded rail similar.

#### BILL OF MATERIAL


Item	Unit	Total
Preformed Joint Strip Seal	Foot	474

5-15-2023 (Modified) DESIGNED -CEH REVISED SECTION PREFORMED JOINT STRIP SEAL CHECKED JLM REVISED 60-7RIR-RDE 26 ILLINOIS DEPARTMENT OF TRANSPORTATION STRUCTURE NO. 060-0014 (EB) & 060-0015 (WB) REVISED CONTRACT NO. SHEET 7 OF 9 SHEETS LOT TIME = 8:05:28 AM CHECKED -CEH / JLM REVISED

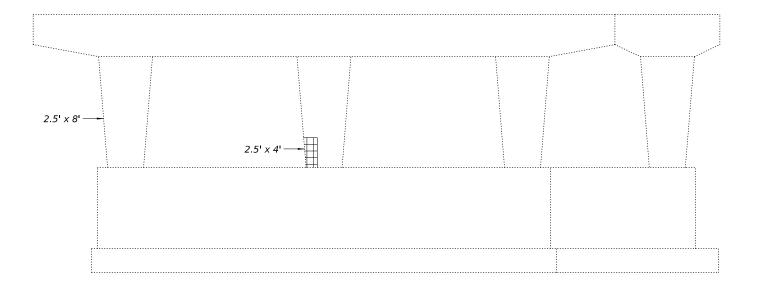

PIER 1 - SOUTH ELEVATION

(Looking North)

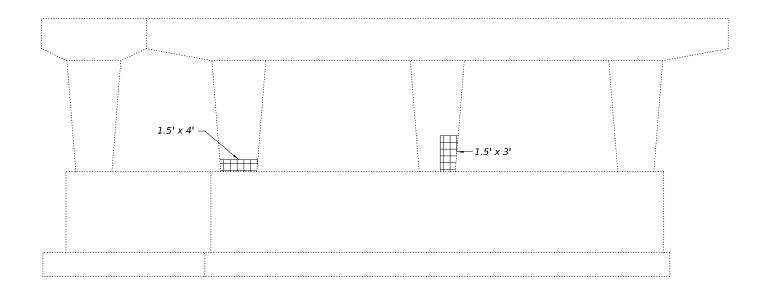

### LEGEND

Structural repair of concrete ≤ 5".

# PIER 1 - NORTH ELEVATION

(Looking South)

#### Note:

Pier repairs may be done under full traffic or as directed by the Engineer.

## BILL OF MATERIAL

Item	Unit	Total
Structural Repair of Concrete (Depth equal to or less than 5 inches)	Sq. Ft.	40.5

design firm no. 184001086 whks engineers + planners + land surveyors | DESIGNED - CEH REVISED - | CHECKED - | DESIGNED - CHECKED - JLM REVISED - | PLOT DATE = 9/27/2024 | DRAWN - DLH REVISED - | PLOT TIME = 8:05:28 AM | CHECKED - CEH / JLM REVISED - | |

ILLINOIS DEPARTMENT OF TRANSPORTATION


PIER REPAIRS (EB)

STRUCTURE NO. 060-0014 (EB) & 060-0015 (WB)


 FAI
 SECTION
 COUNTY
 TOTAL SHEETS
 SHEETS NC

 70
 60-7BJR-BDR
 MADISON
 26
 25


 CONTRACT NO.

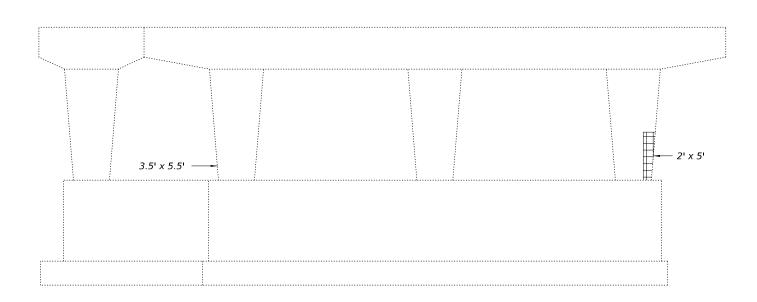

PIER 1 - SOUTH ELEVATION (Looking North)

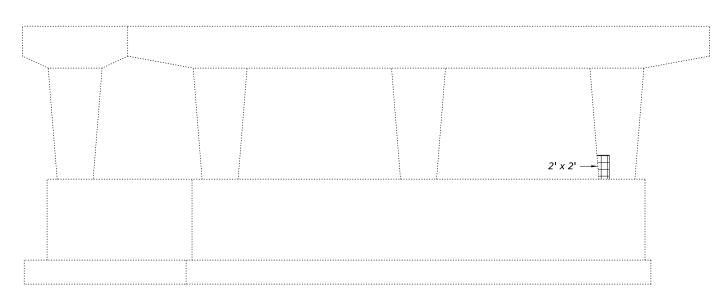

PIER 2 - SOUTH ELEVATION (Looking North)

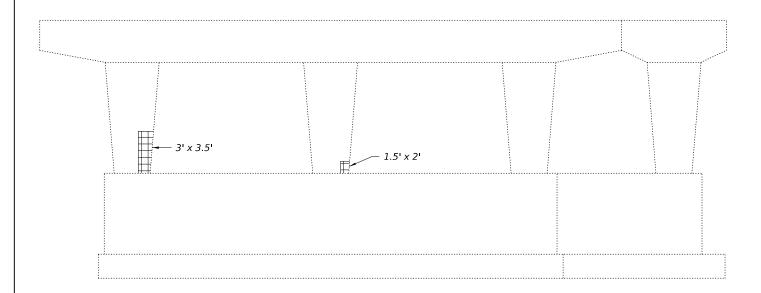

PIER 1 - NORTH ELEVATION (Looking South)

1.5' x 2' — 1' x 1'

PIER 2 - NORTH ELEVATION

(Looking South)

LEGEND

Structural repair of concrete  $\leq 5$ ".

Pier repairs may be done under full traffic or as directed by the Engineer.

BILL OF MATERIAL

Item	Unit	Total
Structural Repair of Concrete (Depth	Sa. Ft.	56.8
egual to or less than 5 inches)	3q. rt.	50.0

whks

USER NAME = \$USER\$	DESIGNED	-	CEH	REVISED	-
	CHECKED	-	JLM	REVISED	-
PLOT DATE = 9/27/2024	DRAWN	-	DLH	REVISED	-
PLOT TIME = 8:05:28 AM	CHECKED	-	CEH / JLM	REVISED	-

ILLINOIS DEPARTMENT OF TRANSPORTATION

PIER REPAIRS (WB)									
STRUCTURE NO. 060-0014 (EB) & 060-0015 (WB)									
	SHEET	9	OF	9	SHEETS				

		CONTRACT	NO.						
70	) 60-7BJR-BDR		MADISON	26	26				
AI TE.	SECTION		COUNTY	TOTAL SHEETS	SHEET NO.				