11/18/2022 LETTING ITEM 089

FOR LIST OF HIGHWAY STANDARDS SEE SHEET NO. 2

STATE OF ILLINOIS DEPARTMENT OF TRANSPORTATION

| F.AU. | SECTION | COUNTY | TOTAL SHEET | RTE. | 087 | 20-00087-00-RS | MCHENRY | 43 | 1 | FED. ROAD DIST. NO 1 | ILLINOIS | CONTRACT | NO. 61J03

TRAFFIC DATA

0

0

0

0

ADT: GREEN STREET 2017 TRAFFIC 5.250 VPD

FOR INDEX OF SHEETS, SEE SHEET NO. 2

2017 TRUCK %

ROADWAY
GREEN STREET

SPEED POSTED DESIGN SPEED

25 MPH


25 MPH

DESIGN DESIGNATION

FAU 087 (GREEN STREET) - MAJOR COLLECTOR

J.U.L.I.E.
JOINT
UTILITY
LOCATION
INFORMATION FOR
EXCAVATION
CALL 811

Know what's below. Call before you dig.

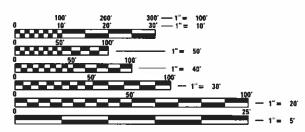

FULL SIZE PLANS HAVE BEEN PREPARED USING STANDARD ENGINEERING SCALES. REDUCED SIZED PLANS WILL NOT CONFORM TO STANDARD SCALES. IN MAKING MEASUREMENTS ON REDUCED PLANS, THE ABOVE SCALES MAY BE USED.

PROJECT ENGINEER: B. HARTMAN PROJECT MANAGER: A. CHAUDHRY

CONTRACT NO. 61J03


PLANS FOR PROPOSED FEDERAL-AID HIGHWAY

FAU 087 (GREEN STREET)
MUNICIPAL DRIVE TO ILLINOIS ROUTE 120 (FAP 333)
ROADWAY IMPROVEMENTS

SECTION: 20-00087-00-RS
PROJECT: KVGS(364)
CITY OF MCHENRY
MCHENRY COUNTY
C-91-081-22

GROSS LENGTH OF PROJECT = 8.193 FT. = 1.55 MILES

NET LENGTH OF PROJECT = 8,067 FT. = 1.53 MILES

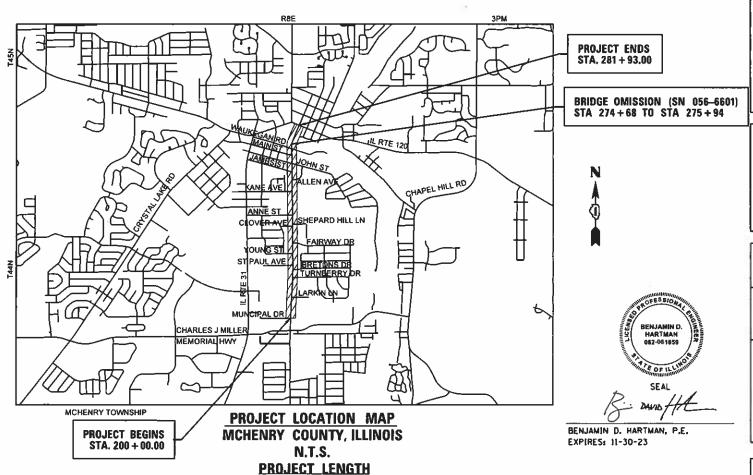

LOCATION OF SECTION INDICATED THUS: - -1391 CORPORATE DRIVE, SUITE 203 | McHENRY, ILLINOIS 60050 815.385.1778 | Toll Free: 800.728.7805 | Fax: 815.385.1781 | HRGreen.com ILLINOIS PROFESSIONAL DESIGN FIRM #184-001322 STATE OF ILLINOIS
DEPARTMENT OF TRANSPORTATION

MUC WORKS CITY OF MICHENRY

GINEER OF LOCAL ROADS AND STREETS

PRINTED BY THE AUTHORITY

OF THE STATE OF ILLINOIS

REGIONAL ENGINEER

PASSED

INDEX OF SHEETS

COVER SHEET

INDEX OF SHEETS AND LIST OF HIGHWAY STANDARDS

GENERAL NOTES

SUMMARY OF QUANTITIES

TYPICAL SECTIONS

12 - 30 SIDEWALK PLANS

13 - 33 LANDSCAPING PLANS

14 - 43 DISTRICT ONE DETAILS

DISTRICT ONE DETAILS

STANDARD NO.	LIST OF DESCRIPTION
BD-08	DETAILS FOR FRAMES AND LIDS ADJUSTMENT WITH MILLING
BD-22	PAVEMENT PATCHING FOR HMA SURFACED PAVEMENT
BD-32	BUTT JOINT AND HMA TAPER DETAILS
TC-10	TRAFFIC CONTROL AND PROTECTION FOR
	SIDE ROADS, INTERSECTIONS, AND DRIVEWAYS
TC-13	DISTRICT ONE TYPICAL PAVEMENT MARKINGS
TC-14	TRAFFIC CONTROL AND PROTECTION AT TURN BAYS (TO REMAIN OPEN TO TRAFFIC)
TC-16	SHORT TERM PAVEMENT MARKING LETTERS AND SYMBOLS
TC-22	ARTERIAL ROAD INFORMATION SIGN
TC-26	DRIVEWAY ENTRANCE SIGNING
TS-07	DETECTOR LOOP INSTALLATION DETAILS FOR ROADWAY RESURFACING

STATE STANDARDS STANDARD NO. LIS

<u> </u>	7.1.1.5 · C
STANDARD NO.	LIST OF DESCRIPTION
000001-08	STANDARD SYMBOLS, ABBREVIATIONS AND PATTERNS
001006-00	DECIMAL OF AN INCH AND OF A FOOT
442201-04	CLASS C AND D PATCHES
701001-02	OFF-ROAD OPERATIONS, 2L, 2W, MORE THAN 15' (4.5 M) AWAY
701006-05	OFF-ROAD OPERATIONS, 2L, 2W, 15' (4.5 M) TO 24" (600 MM) FROM PAVEMENT EDGE
701301-04	LANE CLOSURE, 2L, 2W, SHORT TIME OPERATIONS
701311-03	LANE CLOSURE, 2L, 2W, MOVING OPERATIONS - DAY ONLY
701501-06	URBAN LANE CLOSURE, 2L, 2W, UNDIVIDED
701701-10	URBAN LANE CLOSURE, MULTILANE INTERSECTION
701801-06	SIDEWALK, CORNER OR CROSSWALK CLOSURE
701901-08	TRAFFIC CONTROL DEVICES
720001-01	SIGN PANEL MOUNTING DETAILS
720006-04	SIGN PANEL ERECTION DETAILS
728001-01	TELESCOPING STEEL SIGN SUPPORT
780001-05	TYPICAL PAVEMENT MARKINGS

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||Illnois Professional Design Firm # 184-001322

USER NAME = bhartma	DESIGNED	-	CW	REVISED -
	DRAWN	-	CW	REVISED -
PLOT SCALE = 2.0000 '/ in.	CHECKED	-	ВН	REVISED -
PLOT DATE = 9/6/2022	DATE	-	9/1/2022	REVISED -

STATE OF ILLINOIS							
DEPARTMENT	0F	TRANSPORTATION					

l Rī									F.A.U RTE. SECTION NO.			COUNTY	TOTAL SHEETS	SHEET NO.	
INDEX OF SHEETS AND STATE STANDARDS								87	20-00087-00-RS		MCHENRY	43	2		
													CONTRACT	NO.	61J03
SCALE: N.T.S.	SHEET	1	OF	1	SHEETS	STA.		TO STA.		FED. ROAD DIST. NO. ILLINOIS FED. AID PROJECT					

GENERAL NOTES

- ALL REFERENCES TO "STANDARD SPECIFICATIONS" IN THESE GENERAL NOTES SHALL BE INTERPRETED TO MEAN "STANDARD SPECIFICATIONS FOR ROAD AND BRIDGE CONSTRUCTION" ADOPTED BY THE ILLINOIS DEPARTMENT OF TRANSPORTATION, JANUARY 1, 2022. ALL WORK TO BE COMPLETED IN ACCORDANCE WITH THE STANDARD SPECIFICATIONS.
- PRIOR TO COMMENCEMENT OF CONSTRUCTION, THE CONTRACTOR SHALL VERIFY ALL DIMENSIONS AND CONDITIONS AFFECTING THEIR WORK WITH THE ACTUAL CONDITIONS AT THE JOB SITE. IF THERE ARE ANY DISCREPANCIES FROM WHAT IS SHOWN ON THE CONSTRUCTION PLANS, HE MUST IMMEDIATELY REPORT THEM TO THE ENGINEER BEFORE DOING ANY WORK, OTHERWISE THE CONTRACTOR ASSUMES FULL RESPONSIBILITY. IN THE EVENT OF DISAGREEMENT BETWEEN THE CONSTRUCTION PLANS, STANDARD SPECIFICATIONS AND/OR SPECIAL DETAILS, THE CONTRACTOR SHALL SECURE WRITTEN INSTRUCTIONS FROM THE ENGINEER PRIOR TO PROCEEDING WITH ANY PART OF THE WORK AFFECTED BY OMISSIONS OR DISCREPANCIES. FAILING TO SECURE SUCH INSTRUCTIONS, THE CONTRACTOR WILL BE CONSIDERED TO HAVE PROCEEDED AT HIS OWN RISK. IN THE EVENT OF ANY DOUBT OR QUESTION ARISING WITH RESPECT TO THE TRUE MEANING OF THE CONSTRUCTION PLANS OR SPECIFICATIONS, THE DECISION OF THE ENGINEER SHALL BE FINAL AND CONCLUSIVE.
- IT IS THE CONTRACTOR' S RESPONSIBILITY TO ASCERTAIN EXISTING FIELD CONDITIONS PRIOR TO BIDDING
- BEFORE STARTING ANY EXCAVATION, THE CONTRACTOR SHALL CALL "JULIE" (JOINT UTILITY LOCATION INFORMATION FOR EXCAVATION) AT 8-1-1 FOR FIELD LOCATIONS OF BURIED UTILITIES (48 HOURS NOTIFICATION IS REQUIRED).
- ALL ELEVATIONS SHOWN ON THE PLANS ARE ON THE NAVD88 DATUM.
- SAW CUTTING WILL BE REQUIRED FOR ALL REMOVAL ITEMS AND SHALL BE TO FULL DEPTH AND SHALL RESULT IN A CLEAN STRAIGHT EDGE IN THE PORTION REMAINING
- ABANDONED UNDERGROUND UTILITIES THAT CONFLICT WITH CONSTRUCTION SHALL BE DISPOSED OF OUTSIDE THE LIMITS OF THE RIGHT OF WAY ACCORDING TO ARTICLE 202.03 OF THE STANDARD SPECIFICATIONS AND AS DIRECTED BY THE ENGINEER.
- THE ELEVATIONS SHOWN ON THE PLANS ARE FINISHED GRADES OF PROPOSED PAVEMENT, UNLESS
- ALL SIGNS TO BE REMOVED ALONG THE PROJECT SHALL REMAIN THE PROPERTY OF THE CITY OF MCHENRY AND SHALL BE RETURNED TO THE CITY (1415 INDUSTRIAL DRIVE) UPON REMOVAL
- THE CONTRACTOR WILL NOT BE ALLOWED TO SET UP A YARD OR FIELD OFFICE ON CITY PROPERTY 10. WITHOUT WRITTEN CONSENT FROM THE CITY OF MCHENRY.
- HOT-MIX ASPHALT MATERIAL RESULTING FROM MILLING OPERATIONS WILL NOT BE ALLOWED TO BE USED AS FILL MATERIAL.
- ALL CURB AND GUTTER THAT IS CURRENTLY OVERLAID WITH ASPHALT MATERIAL WILL BE REMOVED DURING MILLING OPERATIONS.
- CONTRACTOR SHALL TAKE PRECAUTION BY PRESERVING EXISTING TREES WITHIN THE RIGHT OF WAY. IF ANY DAMAGE OCCURS, TREES SHALL BE REPLACED IN KIND PER ARTICLE 201.07 REPAIR OR REPLACEMENT OF EXISTING PLANT MATERIAL REQUIREMENTS STATED HEREIN.

STORM SEWERS, SANITARY SEWER, AND UTILITIES

- THE CONTRACTOR SHALL BE RESPONSIBLE FOR CONTACTING THE OWNERS OF ALL LITLLITIES PRIOR TO CONSTRUCTION TO DETERMINE THE LOCATION OF ALL UTILITY EQUIPMENT. THE CONTRACTOR SHALL COOPERATE WITH ALL UTILITY OWNERS IN ACCORDANCE WITH THE STANDARD SPECIFICATIONS IF UTILITY ELOCATION, ADJUSTMENT, OR PROTECTION IS NECESSARY.
- THE LOCATION OF EXISTING DRAINAGE STRUCTURES, STORM SEWERS, WATER MAINS, SANITARY SEWERS, AND ANY OTHER PUBLIC OR PRIVATE UTILITIES AS SHOWN ON THE PLANS IS APPROXIMATE AND THEIR EXACT LOCATION IS TO BE DETERMINED IN THE FIELD BY THE CONTRACTOR.
- THE CONTRACTOR SHALL BE RESPONSIBLE FOR THE PROTECTION OF ALL UNDERGROUND AND SURFACE UTILITIES EVEN THOUGH THEY MIGHT NOT BE SHOWN ON THE PLANS. ANY UTILITY PROPERTY DAMAG DURING CONSTRUCTION SHALL BE REPAIRED OR REPLACED TO THE SATISFACTION OF THE ENGINEER.
- ALL UTILITY COMPANIES SHALL BE NOTIFIED AT LEAST 3 DAYS PRIOR TO THE START OF CONSTRUCTION.
- THE CONTRACTOR SHALL COOPERATE WITH THE CITY OF MCHENRY IF ANY UTILITY IMPROVEMENTS ARE REQUIRED BY THE CITY WITHIN THE DURATION OF THE CONTRACT.
- OFFSET LOCATIONS GIVEN IN THE PLANS FOR STRUCTURES, EDGE OF PAVEMENT, ETC. ARE FROM THE
- ANY LOOSE MATERIAL DEPOSITED IN THE FLOW LINE OF DRAINAGE STRUCTURES, WHICH OBSTRUCTS THE NATURAL FLOW OF WATER. SHALL BE REMOVED AT THE CLOSE OF EACH WORKING DAY. PRIOR TO
- WHEN EXISTING DRAINAGE FACILITIES ARE DISTURBED, THE CONTRACTOR SHALL PROVIDE AND MAINTAIN, IN AN OPERATING CONDITION, TEMPORARY OUTLETS AND CONNECTIONS FOR ALL DRAINS, SEWERS, AND CATCH BASINS. THE CONTRACTOR SHALL PROVIDE FACILITIES WHICH HAVE THE CAPACITY TO RECEIVE AND DISCHARGE THE STORM WATER FLOW RATES NORMALLY ACCEPTED AND RELEASED BY THE EXISTING DRAINAGE FACILITIES.
- THE INDISCRIMINATE USE OF FIRE HYDRANTS, EXISTING STREAMS, CREEKS, WETLANDS, OR PONDS IS STRICTLY PROHIBITED. THE CONTRACTOR SHALL PROVIDE A WATER TRUCK AND DRIVER AS REQUIRED TO OBTAIN AND TRANSPORT THIS WATER. THE CONTRACTOR SHALL BE RESPONSIBLE FOR OBTAINING WATER FROM AN APPROVED SOURCE. IF THIS WATER IS FROM A SOURCE OF THE THAN HIS YARD, WRITTEN APPROVAL FROM THE AGENCY HAVING JURISDICTION FOR THE SOURCE OF THE WATER MUST BE RECEIVED BY THE CONTRACTOR PRIOR TO THE USE OF THE WATER

SIGNING AND STRIPING

- SEE IDOT DISTRICT ONE DETAILS AND PLAN SHEETS FOR PAVEMENT MARKING DETAILS.
- SIGNS SHALL NOT BE MOVED OR COVERED UNTIL PROGRESS OF WORK NECESSITATES IT
- THE CONTRACTOR WILL BE REQUIRED TO TEMPORARILY RESET ALL SUCH SIGNS THAT INTERFERE WITH HIS THE CONTRATOR WILL BE REQUIRED TO TEMPORABLE RESET ALL SOCIETIONS THAT INTERTINE WITH THE TEMPORARY CONSTRUCTION OF PERATIONS. ALL SUCH SIGNS MUST BE MAINTAINED STRAIGHT AND CLEAN FOR THE DURATION OF THE TEMPORARY SETTING AND MUST BE RE-ERECTED AT A TEMPORARY LOCATION IN A WORKMANLIKE MANNER AND BE VISIBLE TO THE TRAFFIC FOR WHICH IT IS INTENDED.
- LONGER POSTS MAY BE REQUIRED AT SOME TEMPORARY OR PERMANENT SIGN LOCATIONS TO MAINTAIN PROPER SIGN ELEVATIONS. THIS WORK SHALL BE COMPLETED IN ACCORDANCE WITH SECTION 729 OF THE STANDARD SPECIFICATIONS.
- ALL SIGNS SHALL BE INSTALLED IN PERMANENT LOCATIONS AS THE ROADWAY IS COMPLETED.
- THE CONTRACTOR SHALL BE RESPONSIBLE FOR POSTING "FRESH OIL" W21-2(0) SIGNS (48"X48" MINIMUM) AS NEEDED FOR THE PROJECT. THE CONTRACTOR SHALL INSTALL AND MAINTAIN TEMPORARY SIGNS IN THE PARKWAY TWENTY-FOUR (24) HOURS PRIOR TO STARTING WORK. THE SIGNS SHALL READ "FRESH OIL, TRAVEL AT YOUR OWN RISK." THE CONTRACTOR SHALL REMOVE THE SIGNS AND REINSTALL THEM AS
- THE CONTRACTOR SHALL CONTACT KALPANA KANNAN-HOSADURGA, THE DISTRICT ONE TRAFFIC CONTROL SUPERVISOR AT KALPANA KANNAN-HOSADURGA@ILLINOIS.GOV A MINIMUM OF 72 HOURS IN ADVANCE OF

SEDIMENTATION AND EROSION CONTROL

- CONTROL MEASURES SHALL MEET THE MINIMUM STANDARDS AND SPECIFICATIONS OF THE ILLINOIS URBAN MANUAL (WWW.AISWCD.ORG/IUM) DATED FEBRUARY 2020, UNLESS STATED OTHERWISE.
- SOIL DISTURBANCE SHALL BE CONDUCTED IN SUCH A MANNER AS TO MINIMIZE EROSION. AREAS OF THE DEVELOPMENT SITE THAT ARE NOT TO BE DISTURBED SHALL BE PROTECTED FROM CONSTRUCTION TRAFFIC OR OTHER DISTURBANCE UNTIL FINAL STABILIZATION IS ACHIEVED.
- SOIL STABILIZATION MEASURES SHALL CONSIDER THE TIME OF YEAR, DEVELOPMENT SITE CONDITIONS AND THE USE OF TEMPORARY OR PERMANENT MEASURES.
- STABILIZATION BY SEEDING SHALL INCLUDE TOPSOIL PLACEMENT AND FERTILIZATION, AS NECESSARY,
- NATIVE SEED MIXTURES SHALL INCLUDE RAPID-GROWING ANNUAL GRASSES OR SMALL GRAINS TO PROVIDE
- OFFSITE PROPERTY SHALL BE PROTECTED FROM EROSION AND SEDIMENTATION. VELOCITY DISSIPATION DEVICES SHALL BE PLACED AT CONCENTRATED DISCHARGE LOCATIONS AND ALONG THE LENGTH OF ANY OUTFALL CHANNEL, AS NECESSARY TO PREVENT EROSION.
- SEDIMENT CONTROL MEASURES SHALL BE INSTALLED PRIOR TO THE DISTURBANCE OF TRIBUTARY AREAS.
- STABILIZATION OF DISTURBED AREAS SHALL BE INITIATED IMMEDIATELY WHENEVER ANY CLEARING GRADING, EXCAVATING OR OTHER EARTH DISTURBING ACTIVITIES HAVE PERMANENTLY CEASED ON ANY PORTION OF THE DEVELOPMENT SITE, OR TEMPORARILY CEASED ON ANY PORTION OF THE DEVELOPMENT SITE AND WILL NOT RESUME FOR A PERIOD EXCEEDING 14 CALENDAR DAYS. STABILIZATION OF DISTURBED AREAS SHALL BE INITIATED WITHIN 1 WORKING DAY OF PERMANENT OR TEMPORARY CESSATION OF EARTH DISTURBING ACTIVITIES AND SHALL BE COMPLETED AS SOON AS POSSIBLE, BUT NOT LATER THAN 14 CALENDAR DAYS FROM THE INITIATION OF STABILIZATION WORK IN AN AREA. EXCEPTIONS TO THESE TIME FRAMES ARE SPECIFIED BELOW: A) WHERE THE INITIATION OF STABILIZATION MEASURES IS PRECLUDED BY SNOW COVER, STABILIZATION MEASURES SHALL BE INITIATED AS SOON AS PRACTICABLE; AND B) IN AREAS WHERE CONSTRUCTION ACTIVITY HAS TEMPORARILY CEASED AND WILL RESUME AFTER 14 DAYS, A TEMPORARY STABILIZATION METHOD MAY BE USED.
- DISTURBANCE OF STEEP SLOPES SHALL BE MINIMIZED. AREAS OR EMBANKMENTS HAVING SLOPES STEEPER THAN 3:1 SHALL BE STABILIZED WITH STAKED IN PLACE SOD, EROSION CONTROL BLANKET IN COMBINATION WITH SEEDING, OR AN EQUIVALENT CONTROL MEASURE.
- PERIMETER CONTROL MEASURES SHALL BE PROVIDED DOWNSLOPE AND PERPENDICULAR TO THE FLOW OF RUNOFF FROM DISTURBED AREAS, WHERE THE TRIBUTARY AREA IS GREATER THAN 5,000 SQUARE FEET, AND WHERE RUNOFF WILL FLOW IN A SHEET FLOW MANNER. PERIMETER EROSION CONTROL SHALL ALSO BE PROVIDED AT THE BASE OF SOIL STOCKPILES.
- THE STORMWATER MANAGEMENT SYSTEM SHALL BE PROTECTED FROM EROSION AND SEDIMENTATION DOWNSLOPE FROM DISTURBED AREAS. INLET PROTECTION THAT REDUCES SEDIMENT LOADING, WHILE ALLOWING RUNOFF TO ENTER THE INLET SHALL BE REQUIRED FOR ALL STORM SEWERS. CHECK DAMS, OR AN EQUIVALENT CONTROL MEASURE, SHALL BE REQUIRED FOR ALL CHANNELS. FILTER FABRIC INLET PROTECTION AND STRAW BALE DITCH CHECKS ARE NOT ACCEPTABLE CONTROL MEASURES.
- IF DEWATERING SERVICES ARE USED, DISCHARGES SHALL BE ROUTED THROUGH AN EFFECTIVE SEDIMENT CONTROL MEASURE (E.G., SEDIMENT TRAP OR AN EQUIVALENT CONTROL MEASURE). THE ENFORCEMENT OFFICER SHALL BE NOTIFIED PRIOR TO THE COMMENCEMENT OF DEWATERING ACTIVITIES.
- ALL TEMPORARY SOIL EROSION AND SEDIMENT CONTROL MEASURES SHALL BE REMOVED WITHIN 30 DAYS AFTER FINAL STABILIZATION OF THE DEVELOPMENT SITE IS ACHIEVED OR AFTER THE TEMPORARY MEASURES ARE NO LONGER NECESSARY. TRAPPED SEDIMENT SHALL BE REMOVED AND DISTURBED AREAS SHALL BE PERMANENTLY STABILIZED.
- STOCKPILED SOIL AND MATERIALS SHALL BE REMOVED FROM FLOOD HAZARD AREAS AT THE END OF EACH WORK DAY. SOIL AND MATERIALS STOCKPILED IN IWMC OR BUFFER AREAS SHALL BE PLACED ON TIMBER MATS, OR AN EQUIVALENT CONTROL MEASURE.
- EFFECTIVE CONTROL MEASURES SHALL BE UTILIZED TO MINIMIZE THE DISCHARGE OF POLLUTANTS FROM THE DEVELOPMENT SITE. AT A MINIMUM, CONTROL MEASURES SHALL BE IMPLEMENTED IN ORDER TO: A) MINIMIZE THE DISCHARGE OF POLLUTANTS FROM EQUIPMENT AND VEHICLE WASHING, WHEEL WASH WATER, AND OTHER WASH WATER; AND B) MINIMIZE THE EXPOSURE OF BUILDING MATERIALS, BUILDING PRODUCTS, CONSTRUCTION WASTES, TRASH, LANDSCAPE MATERIALS, FERTILIZERS, PESTICIDES, HERBICIDES, DETERGENTS, VEHICLE FLUIDS, SANITARY WASTE, AND OTHER MATERIALS PRESENT ON THE DEVELOPMENT SITE TO PRECIPITATION AND TO STORMWATER.
- ADEQUATE RECEPTACLES SHALL BE PROVIDED FOR THE DEPOSITING OF ALL CONSTRUCTION MATERIAL DEBRIS GENERATED DURING THE DEVELOPMENT PROCESS. THE APPLICANT SHALL NOT CAUSE OR PERMIT THE DUMPING, DEPOSITING, DROPPING, THROWING, DISCARDING OR LEAVING OF CONSTRUCTION MATERIAL DEBRIS UPON OR INTO ANY DEVELOPMENT SITE, CHANNEL, OR IWMC. THE DEVELOPMENT SITE SHALL BE MAINTAINED FREE OF CONSTRUCTION MATERIAL DEBRIS.
- THE ENFORCEMENT OFFICER MAY REQUIRE ADDITIONAL OR ALTERNATE SOIL EROSION AND SEDIMENT CONTROL MEASURES, BASED ON DEVELOPMENT SITE SPECIFIC CONSIDERATIONS AND THE EFFECTIVENESS OF THE INSTALLED CONTROL MEASURES.

SCALE: N.T.S.

HRGreen

				CONSTR. CODE
CODE			TOTAL	80% FED (STP) 20% LOCAL
NO.	ITEM	UNIT	QUANTITY	0005 URBAN
20101000	TEMPORARY FENCE	FOOT	125	125
20101300	TREE PRUNING (1 TO 10 INCH DIAMETER)	EACH	5	5

20200100	EARTH EXCAVATION	CU YD	25	25
21101615	TOPSOIL FURNISH AND PLACE, 4"	SO YD	574	574
25200110	SODDING, SALT TOLERANT	SO YD	574	574
		V W		
25200200	SUPPLEMENTAL WATERING	UNIT	18	18
28000510	INLET FILTERS	EACH	25	25
40600290	BITUMINOUS MATERIALS (TACK COAT)	POUND	21,477	21,477
40600370	LONGITUDINAL JOINT SEALANT	F00T	8,194	8,194
				,
40600400	MIXTURE FOR CRACKS, JOINTS, AND FLANGEWAYS	TON	39	39
		50.40	277	
40600982	HOT-MIX ASPHALT SURFACE REMOVAL - BUTT JOINT	50 YD	377	377
40603200	POLYMERIZED HOT-MIX ASPHALT BINDER COURSE, IL-4.75, N50	TON	1,337	1,337
40803200	TOETMENTZED HOT MITA ASITIACT BINDER COUNCE, TE 47/5, NOO	1011	1,551	1,55.
40604060	HOT-MIX ASPHALT SURFACE COURSE, IL-9.5, MIX "D", N50	TON	2,673	2,673
		-		<u> </u>
40800050	INCIDENTAL HOT-MIX ASPHALT SURFACING	TON	61	61

42400200	PORTLAND CEMENT CONCRETE SIDEWALK 5 INCH	SO FT	5,550	5,550
42400800	DETECTABLE WARNINGS	SQ FT	639	639
44000157	HOT-MIX ASPHALT SURFACE REMOVAL, 2"	Sa YD	31,817	31,817
44000500	COMBINATION CURB AND GUTTER REMOVAL	FOOT	2,364	2,364
44000600	SIDEWALK REMOVAL	SO FT	5,658	5,658

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150-00 Professional Design Firm

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 DESIGNED
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 BH

 DATE
 9/1/2022
 REVISEO -USER NAME = bhartma REVISED -PLOT SCALE * 100,0000 '/ in. REVISED -PLOT DATE = 9/6/2022 REVISED -

STATE OF ILLINOIS
DEPARTMENT OF TRANSPORTATION

SUMMARY OF QUANTITIES SCALE: N.T.S. SHEET 1 OF 4 SHEETS STA.

+ SPECIALTY ITEM

TO STA.

SPECIAL PROVISION

				CONSTR. CODE
CODE			TOTAL	80% FED (STP) 20% LOCAL
NO.	ITEM	UNIT	QUANTITY	0005 URBAN
44201690	CLASS D PATCHES, TYPE I, 4 INCH	SQ YD	162	162
44201692	CLASS D PATCHES, TYPE II, 4 INCH	SQ YD	162	162
44201694	CLASS D PATCHES, TYPE III, 4 INCH	SO YD	325	325
44201696	CLASS D PATCHES, TYPE IV. 4 INCH	SQ YD	325	325
	•			
44201785	CLASS D PATCHES, TYPE I, 12 INCH	SO YD	73	73
44201789	CLASS D PATCHES, TYPE II, 12 INCH	SO YD	73	73
44201794	CLASS D PATCHES, TYPE III, 12 INCH	SQ YD	145	145
44201796	CLASS D PATCHES, TYPE IV, 12 INCH	SO YD	145	145
60266600	VALVE BOXES TO BE ADJUSTED	EACH	5	5
60300105	FRAMES AND GRATES TO BE ADJUSTED	EACH	70	70
60603800	COMBINATION CONCRETE CURB AND GUTTER, TYPE B-6.12	FOOT	2,364	2,364
66900200	NON-SPECIAL WASTE DISPOSAL	CU YD	5	5
66900530	SOIL DISPOSAL ANALYSIS	EACH	1	1

66901001	REGULATED SUBSTANCES PRE-CONSTRUCTION PLAN	L SUM	1	1
66901003	REGULATED SUBSTANCES FINAL CONSTRUCTION REPORT	L SUM	1	1
		1		
66901006	REGULATED SUBSTANCES MONITORING	CAL DA	5	5
67100100	MOBILIZATION	L SUM	1	1
70102620	TRAFFIC CONTROL AND PROTECTION, STANDARD 701501	L SUM	1	1
_				
70102635	TRAFFIC CONTROL AND PROTECTION, STANDARD 701701	L SUM	1	1

USER NAME = bhartma	DESIGNED	-	CW	REVISED	-
	DRAWN	-	CW	REVISED	-
PLOT SCALE = 100.0000 '/ in.	CHECKED	-	BH	REVISED	-
PLOT DATE ± 9/6/2022	DATE	-	9/1/2022	REVISED	•

STATE OF ILLINOIS DEPARTMENT OF TRANSPORTATION

		SU	MM	ARY	OF QU	ANTITIES	
SCALE: N.T.S.	SHEET	2	0F	4	SHEETS	STA.	TO STA.

+ SPECIALTY ITEM

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DESIGNED - CW REVISED -USER NAME = bhartma DRAWN - CW REVISED -PLOT SCALE = 100.0000 '/ in. CHECKED - BH REVISED -PLOT DATE = 9/6/2022 REVISED -DATE - 9/1/2022

CODE

70102640

70107025

70300100

70300150

72000100

72400310

72400500

72800100

78000100

78000200

78000400

78000600

78000650

78001100

78011025

88600600

A2002516

A2002879

TRAFFIC CONTROL AND PROTECTION, STANDARD 701801

CHANGEABLE MESSAGE SIGN

SIGN PANEL - TYPE 1

REMOVE SIGN PANEL - TYPE 1

SHORT TERM PAVEMENT MARKING

SHORT TERM PAVEMENT MARKING REMOVAL

RELOCATE SIGN PANEL ASSEMBLY - TYPE A

THERMOPLASTIC PAVEMENT MARKING - LINE 4"

THERMOPLASTIC PAVEMENT MARKING - LINE 6"

THERMOPLASTIC PAVEMENT MARKING - LINE 12"

THERMOPLASTIC PAVEMENT MARKING - LINE 24"

PAINT PAVEMENT MARKING - LETTERS AND SYMBOLS

GROOVING FOR RECESSED PAVEMENT MARKING 5"

DETECTOR LOOP REPLACEMENT

THERMOPLASTIC PAVEMENT MARKING - LETTERS AND SYMBOLS

TELESCOPING STEEL SIGN SUPPORT

DEPARTMENT OF TRANSPORTATION

		SI	JMM/	ARY	OF	QU.	ANTITIE	S
 SCALE: N.T.S.	SHEET	3	OF	4	SHE	ETS	STA.	

CONSTR. CODE 80% FED (STP) 20% LOCAL

0005 URBAN

1

80

7,342

5,256

30

1

795

110

15,626

923

1,398

309

448

13,880

234

33

8

QUANTITY

80

7,342

5,256

166

30

1

110

15,626

923

1,398

309

448

13,880

234

L SUM

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FOOT

SQ FT

SQ FT

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EACH

FOOT

SQ FT

FOOT

FOOT

FOOT

FOOT

SQ FT

FOOT

FOOT

COUNTY TOTAL SHEET NO.

MCHENRY 43 6 SECTION NO. 87 20-00087-00-RS CONTRACT NO. 61J03 FED. ROAD DIST. NO. | ILLINOIS FED. AID PROJECT

+ SPECIALTY ITEM

TO STA.

SPECIAL PROVISION

	STATE OF ILLINOIS	รบ	MMARY 0	OF QU
_		L	L	.L
	TREE, CELTIS OCCIDENTALIS CHICAGOLAND, (CHICAGOLAND COMMON HACKBERRY), 2" CALIPER, BALLED AND BURLAPPED	EACH	8	
	TREE, CARPINUS CAROLINIANA (AMERICAN HORNBEAM), 2" CALIPER, BALLED AND BURLAPPED	EACH	33	

	CODE			TOTAL	80% FED (STP) 20% LOCAL
	NO.	ITEM	UNIT	QUANTITY	0005 URBAN
+	A2004416	TREE, GINKGO BILOBA (GINKGO), 2" CALIPER, BALLED AND BURLAPPED	EACH	13	13
-					
+	A2005956	TREE, PLATANUS X ACERIFOLIA MORTON CIRCLE (EXCLAMATION LONDON PLANETREE), 2" CALIPER, TREE FORM, BALLED AND BURLAPPED	ЕАСН	7	7
+	A2006416	TREE, QUERCUS ALBA (WHITE OAK), 2" CALIPER, BALLED AND BURLAPPED	EACH	3	3
+	A2006816	TREE, OUERCUS MUEHLENBERGII (CHINKAPIN OAK), 2" CALIPER, BALLED AND BURLAPPED	EACH	12	12
+	A2007116	TREE, OUERCUS RUBRA (RED OAK), 2" CALIPER, BALLED AND BURLAPPED	EACH	3	3
+	A2018718	TREE, ULMUS CARPINIFOLIA MORTON, (ACCOLADE ELM), 2" CALIPER, BALLED AND BURLAPPED	EACH	9	9
+	A2C050G5	TREE, QUERCUS BICOLOR (SWAMP WHITE OAK), CONTAINER GROWN, 5-GALLON	EACH	3	3
+	B2001616	TREE, CRATAEGUS CRUSGALLI INERMIS (THORN LESS COCKSPUR HAWTHORN), 2" CALIPER, TREE FORM, BALLED AND BURLAPPED	EACH	34	34
+	B2006216	TREE, SYRINGA RETICULATA (JAPANESE TREE LILAC), 2" CALIPER, TREE FORM, BALLED AND BURLAPPED	EACH	37	37
•	X6030310	FRAMES AND LIDS TO BE ADJUSTED (SPECIAL)	EACH	42	42
	Z0004510	HOT-MIX ASPHALT DRIVEWAY PAVEMENT, 3"	SO YD	100	100
•	Z0013798	CONSTRUCTION LAYOUT	L SUM	1	1
	Z0017400	DRAINAGE & UTILITY STRUCTURES TO BE ADJUSTED	EACH	64	64
	Z0018600	DRAINAGE STRUCTURES TO BE RECONSTRUCTED	EACH	10	10
	Z0030850	TEMPORARY INFORMATION SIGNING	SQ FT	52	52
Ø	Z0076600	TRAINEES	HOUR	500	500
ø	Z0076604	TRAINEES TRAINING PROGRAM GRADUATE	HOUR	500	500
1					

Ø CODE 0042

+ SPECIALTY ITEM

SPECIAL PROVISION


HRGreen.com Illinois Professional Design Firm # 184-001322


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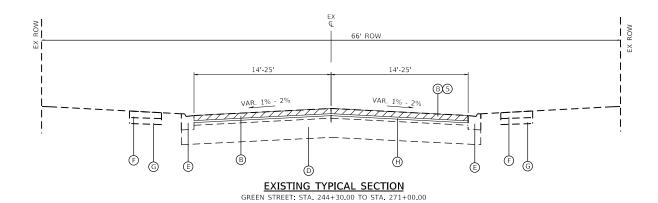
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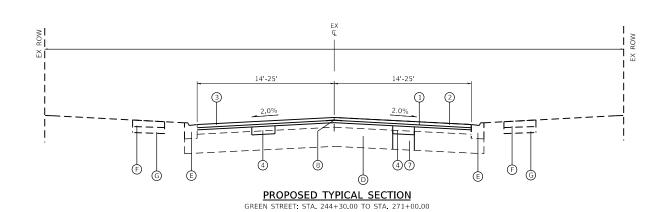
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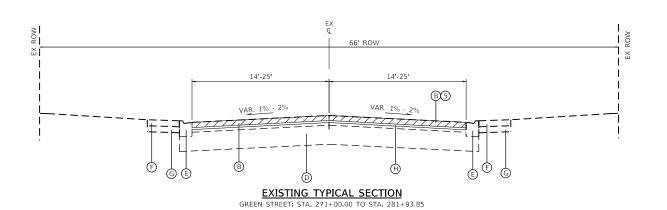
STATE OF ILLINOIS DEPARTMENT OF TRANSPORTATION


SUMMARY OF QUANTITIES SCALE: N.T.S. SHEET 4 OF 4 SHEETS STA. TO STA. 





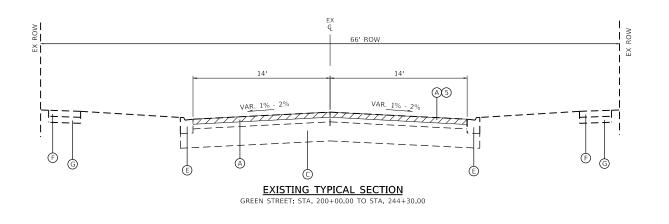

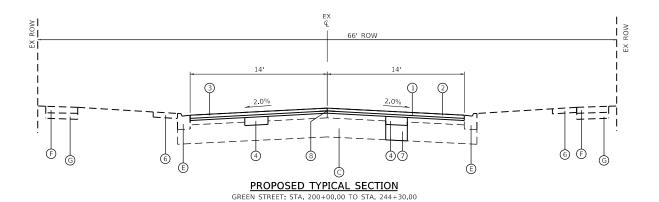

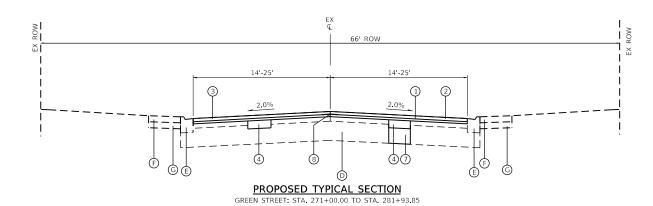

HOT-MIX ASPHALT MIXTURE REQUIREMEN	ITS	OMP
MIXTURE TYPE	AIR VOIDS @ Ndes	ΨР
PAVEMENT RESURFACING		
HMA SURFACE COURSE, MIX "D", IL-9.5, N50	4% @ 50 GYR.	LR1030-2
POLYMERIZED HMA BINDER COURSE, IL-4.75, N50	3.5% @ 50 GYR.	LR 1030-2
PATCHING		
CLASS D PATCHES (HMA BINDER IL-19 mm)	4% @ 50 GYR.	LR1030-2
INCIDENTAL HMA SURFACING		
HMA SURFACE COURSE, MIX "D", IL-9.5, N50	4% @ 50 GYR.	LR1030-2
HMA DRIVEWAY PAVEMENT 3"		
HMA SURFACE COURSE, MIX "D", IL-9.5, N50; 3" (IN 2 LIFTS)	4% @ 50 GYR.	LR1030-2
QMP DESIGNATION: QUALITY CONTROL/QUALITY ASSURANCE (QC/QA)		

THE UNIT WEIGHT TO CALCULATE ALL HMA SURFACE MIXTURE QUATITIES IS 112 LBS/SQ YD/IN

THE "AC TYPE" FOR POLYMERIZED HMA MIXES SHALL BE "SBS/SBR PG 76-22" AND FOR NON-POLYMERIZED HMA THE "AC TYPE" SHALL BE "PG 64-22" UNLESS MODIFIED BY RECLAIMED MATERIALS SPECIFICATIONS.

CONTRACTOR SHALL MILL BEFORE PATCHING.

THE LONGITUDINAL JOINT SEALANT SHALL BE PLACED OVER THE POLYMERIZED HMA BINDER.

EXISTING LEGEND

- A EXISTING HMA SURFACE AND BINDER 13.0" +/- TOTAL
- B EXISTING HMA SURFACE AND BINDER 6.0" +/- TOTAL
- C EXISTING AGGREGATE BASE COURSE 4" +/-
- D EXISTING PCC BASE 8" +/-
- E EXISTING COMBINATION CURB AND GUTTER
- F EXISTING PCC SIDEWALK
- G EXISTING SUBBASE GRANULAR MATERIAL
- H PAVEMENT FABRIC

PROPOSED LEGEND

- 1 POLYMERIZED HOT-MIX ASPHALT BINDER COURSE, IL-4.75 N50 0.75"
- 2 HOT-MIX ASPHALT SURFACE COURSE, MIX 'D', IL 9.5 N50 1.5"
- 3 BITUMINOUS MATERIALS (TACK COAT)
- * 4 CLASS D PATCHES 4" OR 12" (MIN. WIDTH 4')
- 5 HMA SURFACE REMOVAL 2"
- 6 TOPSOIL 4", SODDING
- * 7 AGG. BASE REPAIR 12"
- 8 LONGITUDINAL JOINT SEALANT
- * SPOT LOCATIONS TO BE DETERMINED IN THE FIELD BY ENGINEER

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USER NAME = bhartma	DESIGNED	-	CW	REVISED -
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PLOT SCALE = 12.0000 '/ in.	CHECKED	-	ВН	REVISED -
PLOT DATE = 9/6/2022	DATE	-	9/1/2022	REVISED -

STATE OF ILLINOIS	
DEPARTMENT OF TRANSPORTATION	

TYPICAL SECTION SCALE: N.T.S. SHEET 1 OF 1 SHEETS STA. TO STA.											
SCALE: N.T.S.	SHEET	1	OF	1	SHEETS	STA.	TO STA.				

F.A.U RTE.	SECTI	ON NO.		COUNTY	TOTAL SHEETS	SHEE NO.
87	20-000	87-00-RS		MCHENRY	43	8
				CONTRACT	NO.	61J03
FED. RO	DAD DIST. NO.	ILLINOIS	FED. A	D PROJECT		

→②→ Z PNNOA AVENUE STREET - THPL PVT MK - BUTT JOINT (TYP) LINE 24" (W, TYP) THPL PVT MK LINE 6" (W, TYP) EX/PR Q GREEN STREET — $=\frac{1}{7}=\frac{1}{250}=\frac{1}{250}=\frac{1}{11}=\frac{1}{11}$ GREEN STREET THPL PVT MK LINE 12" (W, TYP) **IEPHERD** - PT PVT MK HOT-MIX ASPHALT RESURFACING (STA 226+00 TO STA 240+00) -LTRS & SYMB (TYP) -POLYMERIZED HMA BINDER COURSE, IL-4.75, N50; 0.75" -THPL PVT MK LINE 4" (SOLID, DBL Y)(TYP) -HMA SURFACE COURSE, MIX 'D', IL-9.5, N50; 1.5" HILL GRV RCSD PVT MRKG 5 (TYP) SIGN LEGEND Moralne Hills State Park 1 Mi Prairie Path 1 MI BIKE ROUTE BIKE ROUTE AHEAD D1-2b varies x 12 SHARROW DETAIL (1L) 4 (1R) (8) (3) (5) 6 1 /2 Downtown 1 1/2 W2-2 30x30 W2-2 30x30 W11-1 30x30 D11-1 24x18 W11-2 24x24 W16-8P 24x8 7 D1-1b varies x 6 W16-1P 24x8 W16-9P 24x12 W16-7P 24x12 BUTT JOINT (TYP) -KANE **AVENUE** STREET THPL PVT MK - THPL PVT MK THPL PVT MK LINE 6" (W, TYP) LINE 24" (W, TYP) LINE 12" (W, TYP) (4) - PT PVT MK EX/PR Q GREEN STREET -LTRS & SYMB (TYP) (6)THPL PVT MK LINE 4" (SOLID, DBL Y)(TYP) GRV RCSD PVT MRKG 5 (TYP) HOT-MIX ASPHALT RESURFACING (STA 240+00 TO STA 254+00) — -POLYMERIZED HMA BINDER COURSE, IL-4.75, N50; 0.75 -HMA SURFACE COURSE, MIX 'D', IL-9.5, N50; 1.5" DESIGNED -REVISED USER NAME = bhartma CW SECTION NO. COUNTY HRGreen.com STATE OF ILLINOIS DRAWN CW REVISED **RESURFACING PLAN** MCHENRY 43 10

HRGreen

CHECKED REVISED REVISED PLOT DATE = 9/6/2022 DATE 9/1/2022

DEPARTMENT OF TRANSPORTATION

SCALE: 50' = 1" SHEET 2 OF 3 SHEETS STA. 226+00.00 TO STA. 254+00.00 FED. ROAD DIST. NO. | ILLINOIS | FED. AID PROJECT

20-00087-00-RS CONTRACT NO. 61J03

BUTT JOINT (TYP) -THPL PVT MK LINE 24" (W, TYP) THPL PVT MK LINE 12" (W, TYP) ______ °€ [GREEN STREET EX/PR Q GREEN STREET PT PVT MK LTRS & SYMB (TYP) THPL PVT MK LINE 4" (SOLID, DBL Y)(TYP) HOT-MIX ASPHALT RESURFACING (STA 254+00 TO STA 268+00) -- POLYMERIZED HMA BINDER COURSE, IL-4.75, N50; 0.75" GRV RCSD PVT MRKG 5 (TYP) -HMA SURFACE COURSE, MIX D, IL-9.5, N50, 1.5" SIGN LEGEND Moralne Hills State Park 1 Mi BIKE ROUTE Prairie Path 1 Mi BIKE ROUTE AHEAD D1-2b varies x 12 SHARROW DETAIL (1L) (1R) 4 (8) (3) (5) (6) SIGNS TO BE MOUNTED ON EXISTING POSTS/POLES (2 AT EACH LOCATION) 1 /2 Downtown 1 1/2 W2-2 30x30 W2-2 30x30 W11-1 30x30 D11-1 24x18 D11-1 24x18 W11-2 24x24 HOT-MIX ASPHALT RESURFACING (STA 268+00 TO STA 281+93) -POLYMERIZED HMA BINDER COURSE, IL-4.75, N50; 0.75" W16-8P 24x8 7 D1-1b varies x 6 W16-1P 24x8 W16-9P 24x12 W16-7P 24x12 -HMA SURFACE COURSE, MIX 'D', IL-9.5, N50; 1.5" EX/PR @ GREEN STREET * (6 PT PVT MK LTRS & SYMB (TYP) GREEN STREET - THPL PVT MK LINE 24" (W, TYP) END PROJECT THPL PVT MK STA 281+93 LINE 12" (W, TYP) THPL PVT MK LTR & SYM (W, TYP) BRIDGE OMMISSION EXIST. CURVE PRCL_GREEN_27 STA 274+68 TO STA 275+94 120 .M STREET PI STA. = 273+54.80 THPL PVT MK \triangle = 23° 44′ 00′′ (RT) LINE 4" (W, TYP) D = 14° 33′ 31′′ R = 393.55'T = 82.70'- BUTT JOINT (TYP) L = 163.02'E = 8.59'e = ____ T.R. = ____ S.E. RUN = ____ P.C. STA. = 272+72.10 P.T. STA. = 274+35.12 - THPL PVT MK LINE 4" (SOLID, DBL Y)(TYP) GRV RCSD PVT MRKG 5 (TYP) DESIGNED - CW REVISED USER NAME = bhartma SECTION NO. COUNTY HRGreen.com STATE OF ILLINOIS DRAWN CW REVISED **RESURFACING PLAN** 20-00087-00-RS MCHENRY 43 11 PLOT SCALE = 100.0000 '/ in. CHECKED ВН REVISED **DEPARTMENT OF TRANSPORTATION**

CONTRACT NO. 61J03

SCALE: 50' = 1" SHEET 3 OF 3 SHEETS STA. 254+00.00 TO STA. 281+93.00 FED. ROAD DIST. NO. | ILLINOIS FED. AID PROJECT


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PLOT DATE = 9/6/2022

DATE

9/1/2022

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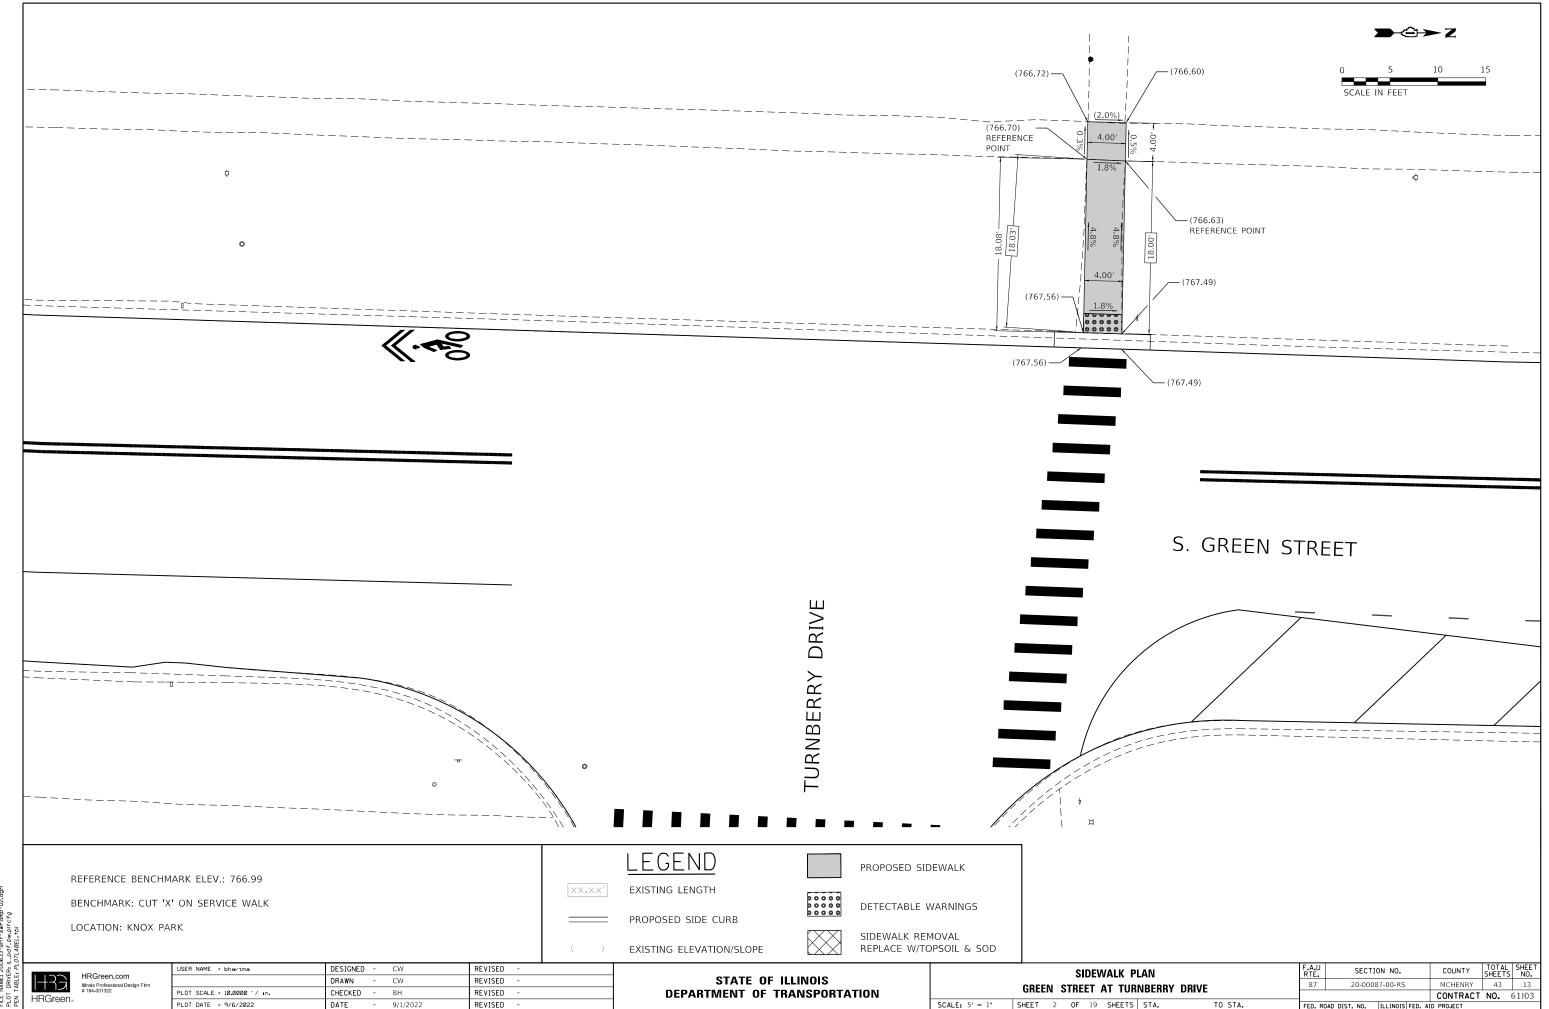


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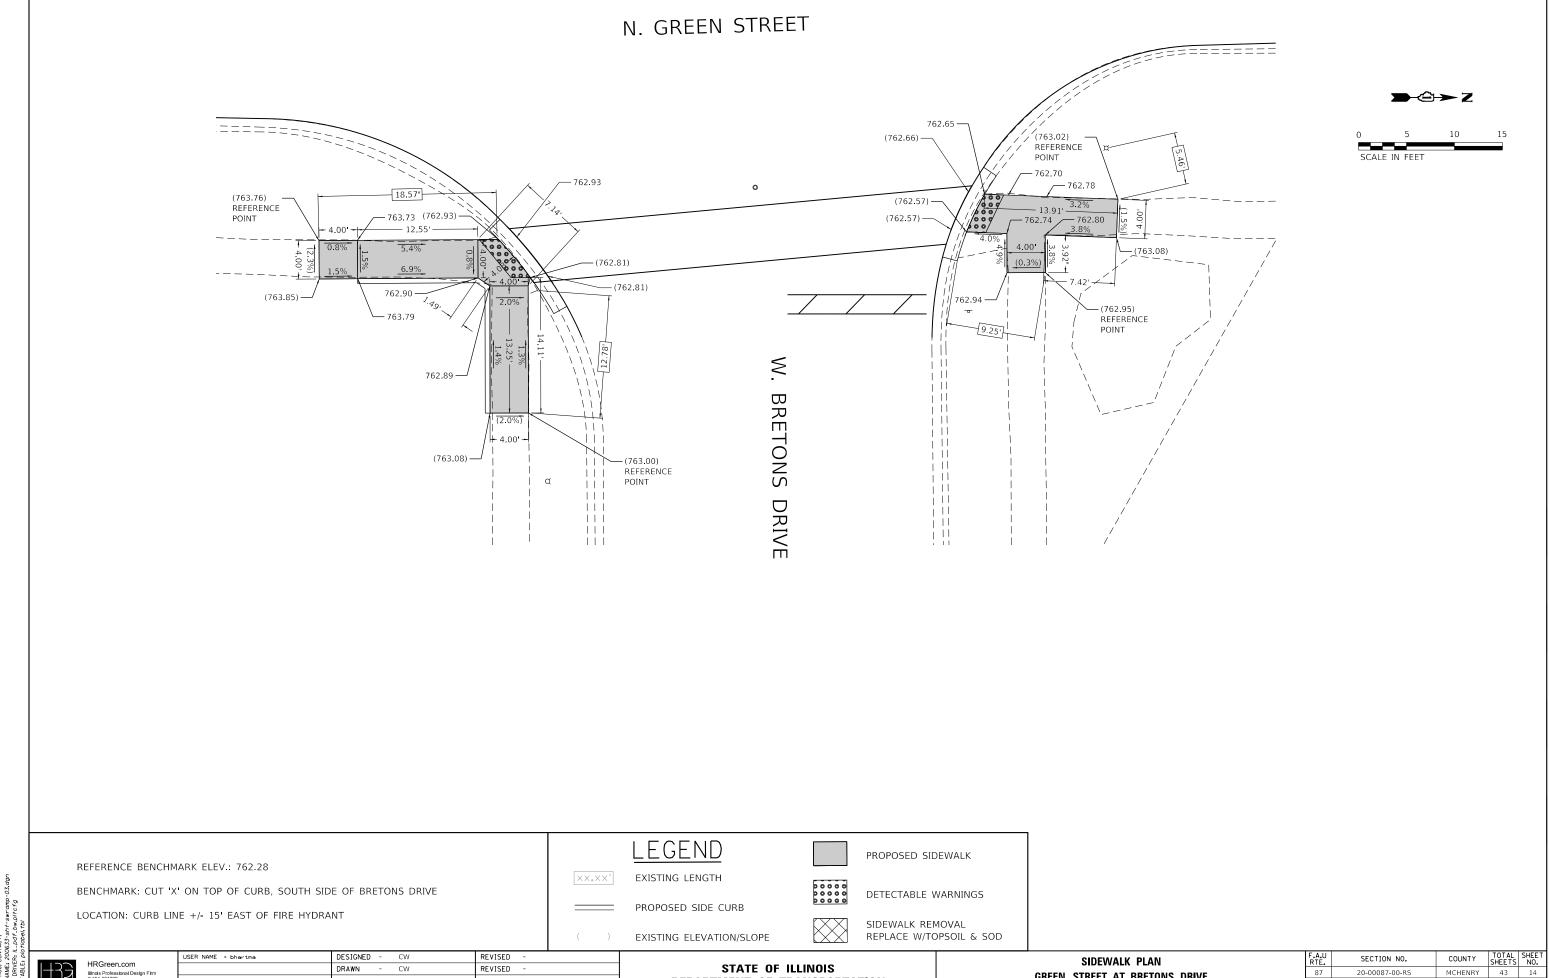
CHECKED -REVISED PLOT DATE = 9/6/2022 DATE REVISED

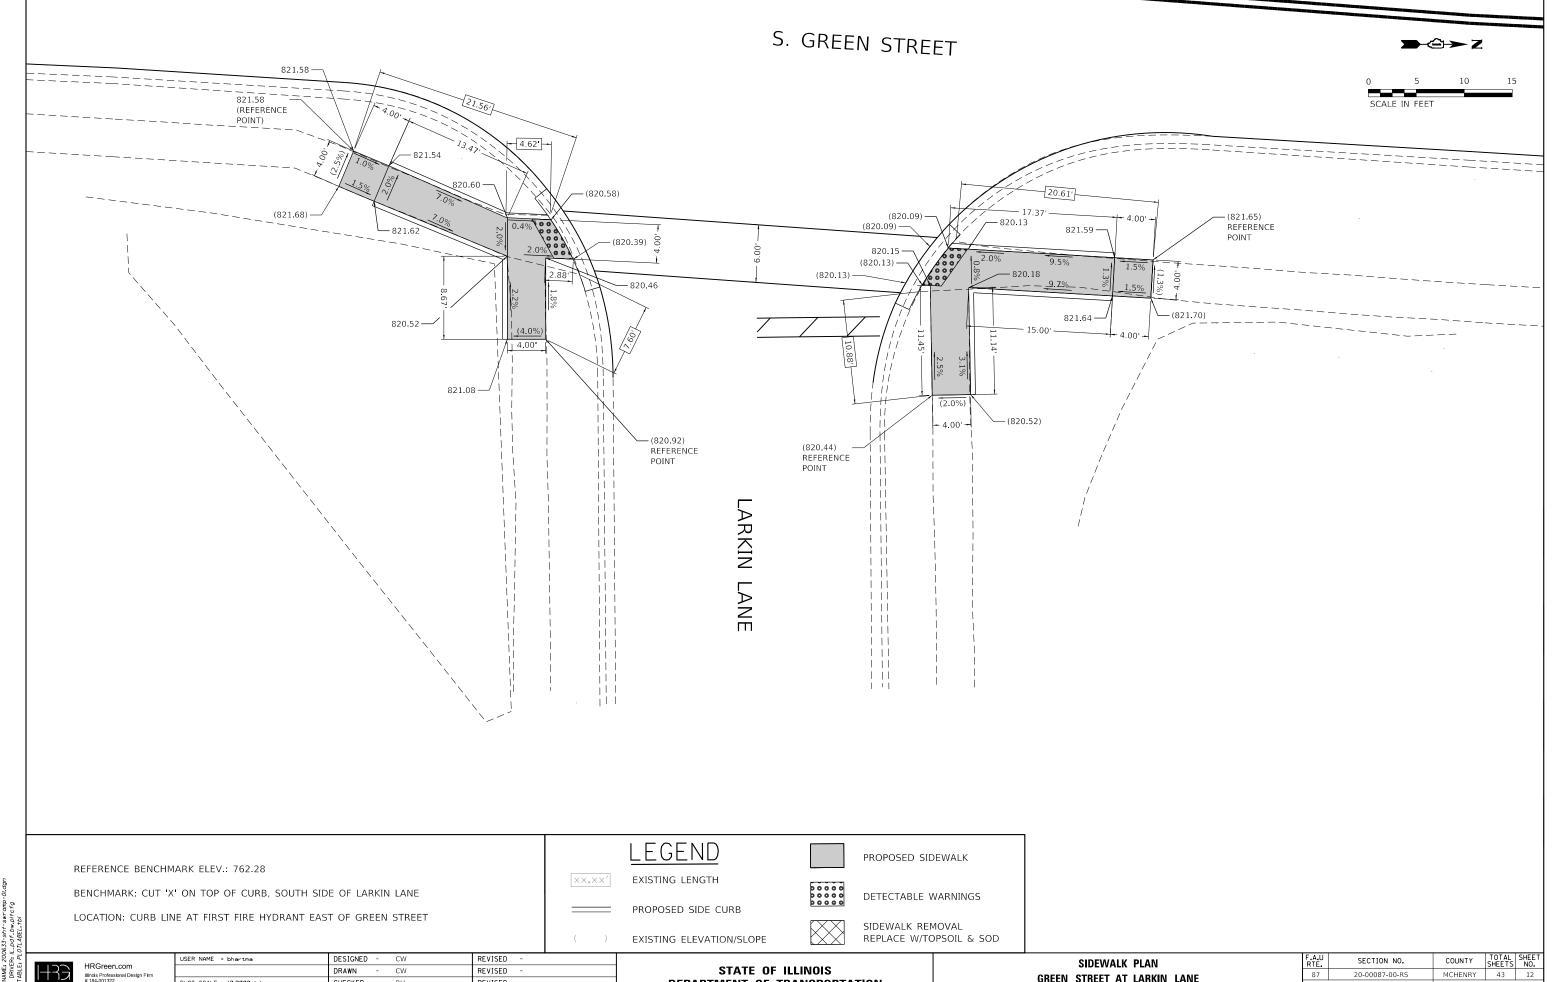DEPARTMENT OF TRANSPORTATION

GREEN STREET AT LARKIN LANE CONTRACT NO. 61J03 SCALE: 5' = 1" SHEET 1 OF 19 SHEETS STA. TO STA.



PLOT DATE = 9/6/2022




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USER NAME = bhartma	DESIGNED	-	CW	REVISED	-
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PLOT SCALE = 10.0000 '/ in.	CHECKED	-	BH	REVISED	-
PLOT DATE = 9/6/2022	DATE	-	9/1/2022	REVISED	-

DEPARTMENT OF TRANSPORTATION

I	SIDEWALK PLAN										SECTI	ON NO.	COUNTY	SHEETS	NO.
I	GREEN STREET AT BRETONS DRIVE									87	20-0008	37-00-RS	MCHENRY	43	14
I	GUECIA SINEEL AL DUELONS DUIVE												CONTRACT	NO.	61J03
SCALE: 5' = 1" SHEET 3 OF 19 SHEETS STA. TO STA.						FED. R	DAD DIST. NO.	ILLINOIS FED. A	ID PROJECT						

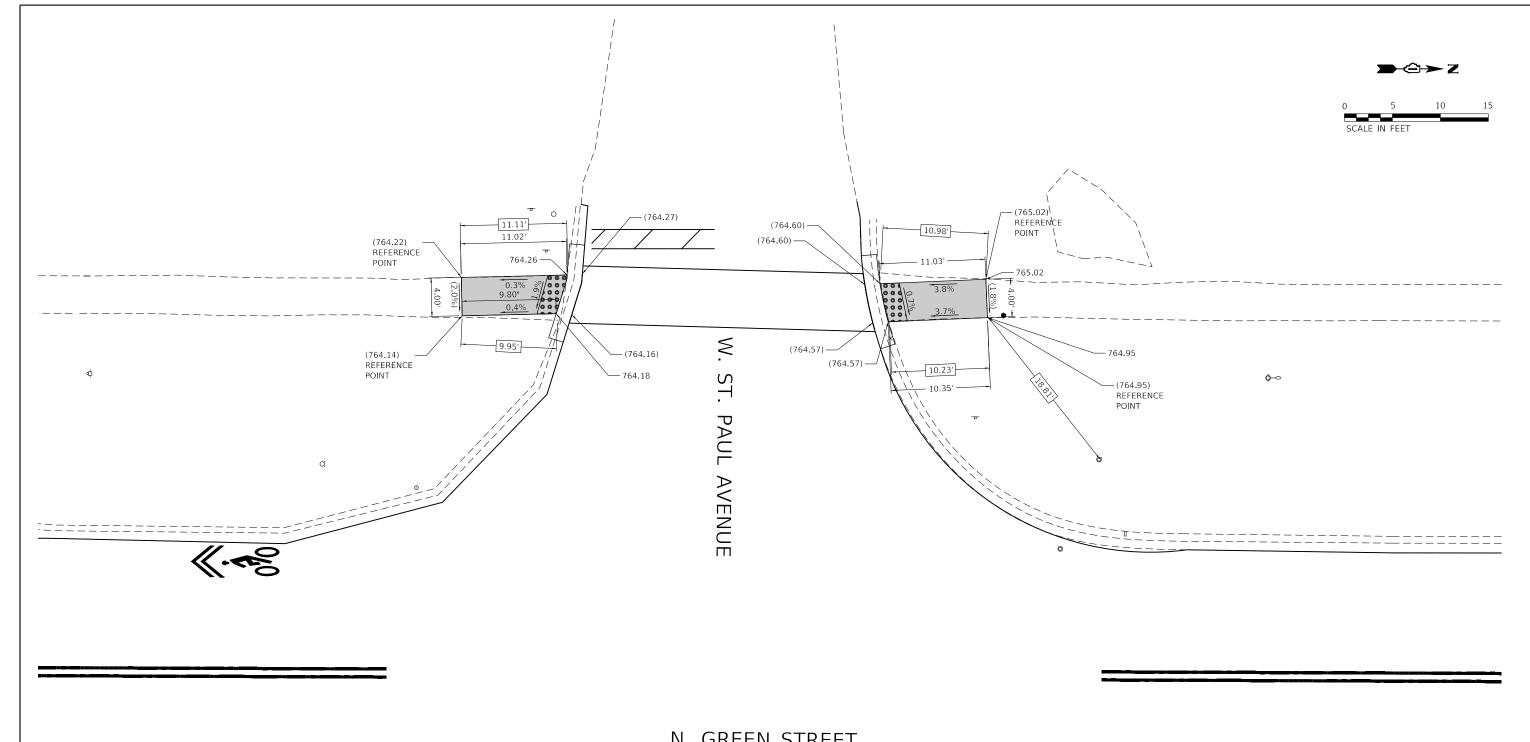

N. GREEN STREET

LEGEND PROPOSED SIDEWALK REFERENCE BENCHMARK ELEV.: 764.95 $\times \times ... \times \times '$ EXISTING LENGTH BENCHMARK: CUT 'X' ON TOP OF SIDEWALK, NORTH SIDE SOUTH SIDE OF ST. PAUL AVENUE DETECTABLE WARNINGS PROPOSED SIDE CURB LOCATION: NORTHWEST OF ST. PAUL AVENUE +10' NORTH OF BL SIDEWALK REMOVAL REPLACE W/TOPSOIL & SOD EXISTING ELEVATION/SLOPE


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1	USER NAME = bhartma	DESIGNED	-	CW	REVISED	-	
		DRAWN	-	CW	REVISED	-	
	PLOT SCALE = 10.0000 ' / in.	CHECKED	-	ВН	REVISED	-	
	PLOT DATE = 9/6/2022	DATE	-	9/1/2022	REVISED	-	

STATE OF ILLINOIS
DEPARTMENT OF TRANSPORTATION

SCALE: 5' = 1"

	SIDEWALK PLAN								F.A.U RTE. SECTION NO.			SHEET NO.
CREE	GREEN STREET AT ST. PAUL AVENUE							20-0008	7-00-RS	MCHENRY	43	15
UIILL										CONTRACT	NO.	61J03
SHEET	4	OF	19	SHEETS	STA.	TO STA.	FED. RO	FED. ROAD DIST. NO. ILLINOIS FED.		D PROJECT		

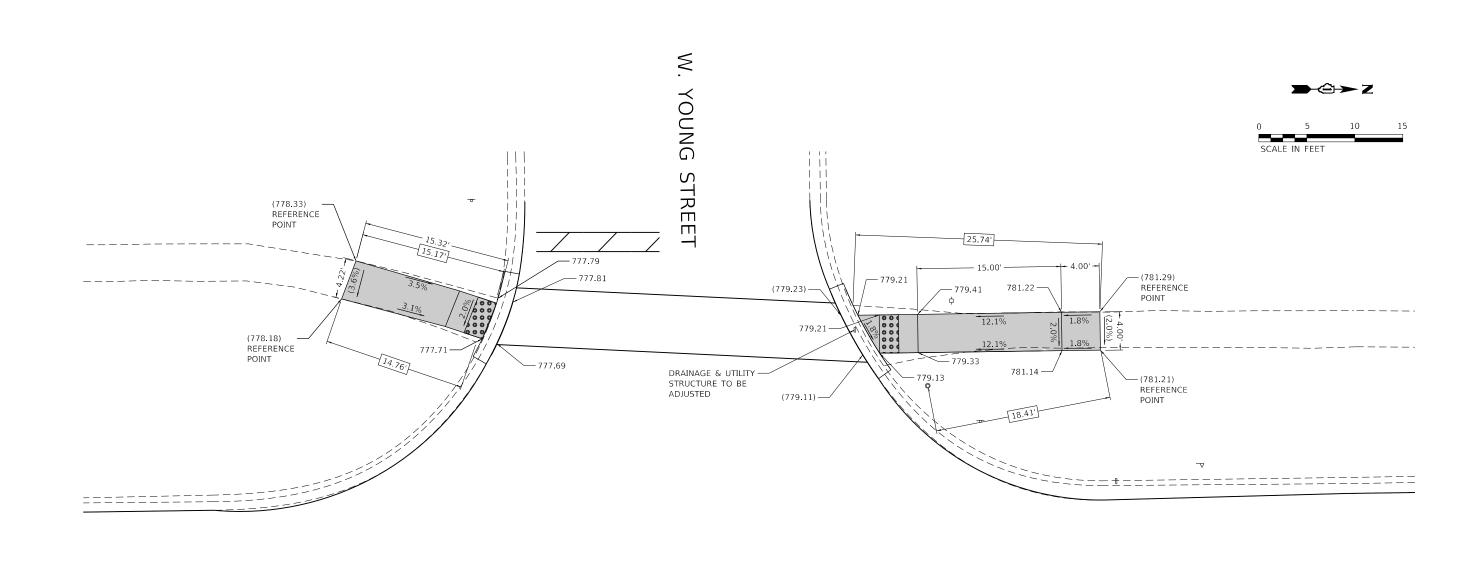

N. GREEN STREET

REFERENCE BENCHMARK ELEV.: 776.95
BENCHMARK: CUT 'X' ON SIDEWALK, EAST SIDE OF GREEN STREET

LOCATION: CENTERLINE OF YOUNG STREET EXTENSION

LEGEND

PROPOSED SIDEWALK

××°××′ EXISTING LENGTH

DETECTABLE WARNINGS

PROPOSED SIDE CURB

EXISTING ELEVATION/SLOPE

SIDEWALK REMOVAL REPLACE W/TOPSOIL & SOD

SCALE: 5' = 1"


G PROJECT NO.: 20063; G PROJ. CONTACT: E NAME: 200633-sht-s OT DRIVER: (L.DOF.DW.) N TABLE: PLOTLABEL: H


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illinois Professional Design Fir
#184-001322

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PLOT DATE = 9/6/2022	DATE	-	9/1/2022	REVISED	-	

STATE OF ILLINOIS
DEPARTMENT OF TRANSPORTATION

SIDEWALK PLAN	F.A.U RTE.	SECTION NO.	COUNTY	TOTAL SHEETS	SHEET NO.
GREEN STREET AT YOUNG STREET	87	20-00087-00-RS	MCHENRY	43	16
UNLER STREET AT TOORG STREET			CONTRACT	NO.	61J03
SHEET 5 OF 19 SHEETS STA. TO STA.	FED. RO	DAD DIST. NO. ILLINOIS FED. A	ID PROJECT		

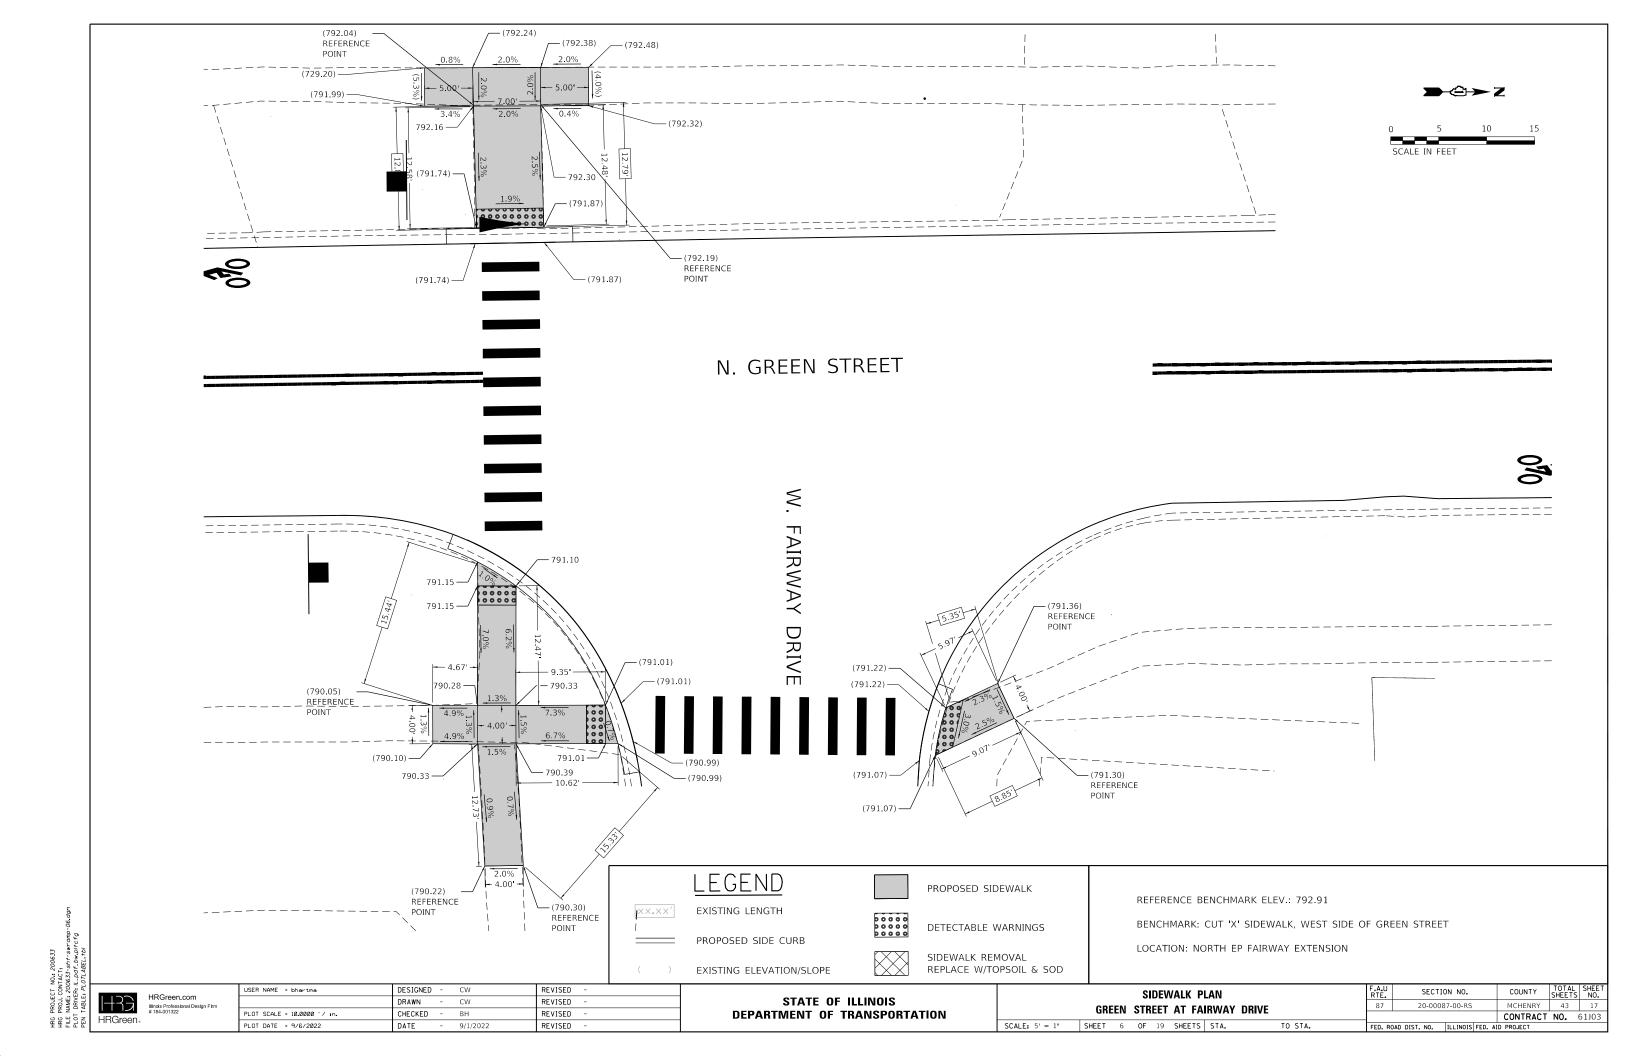

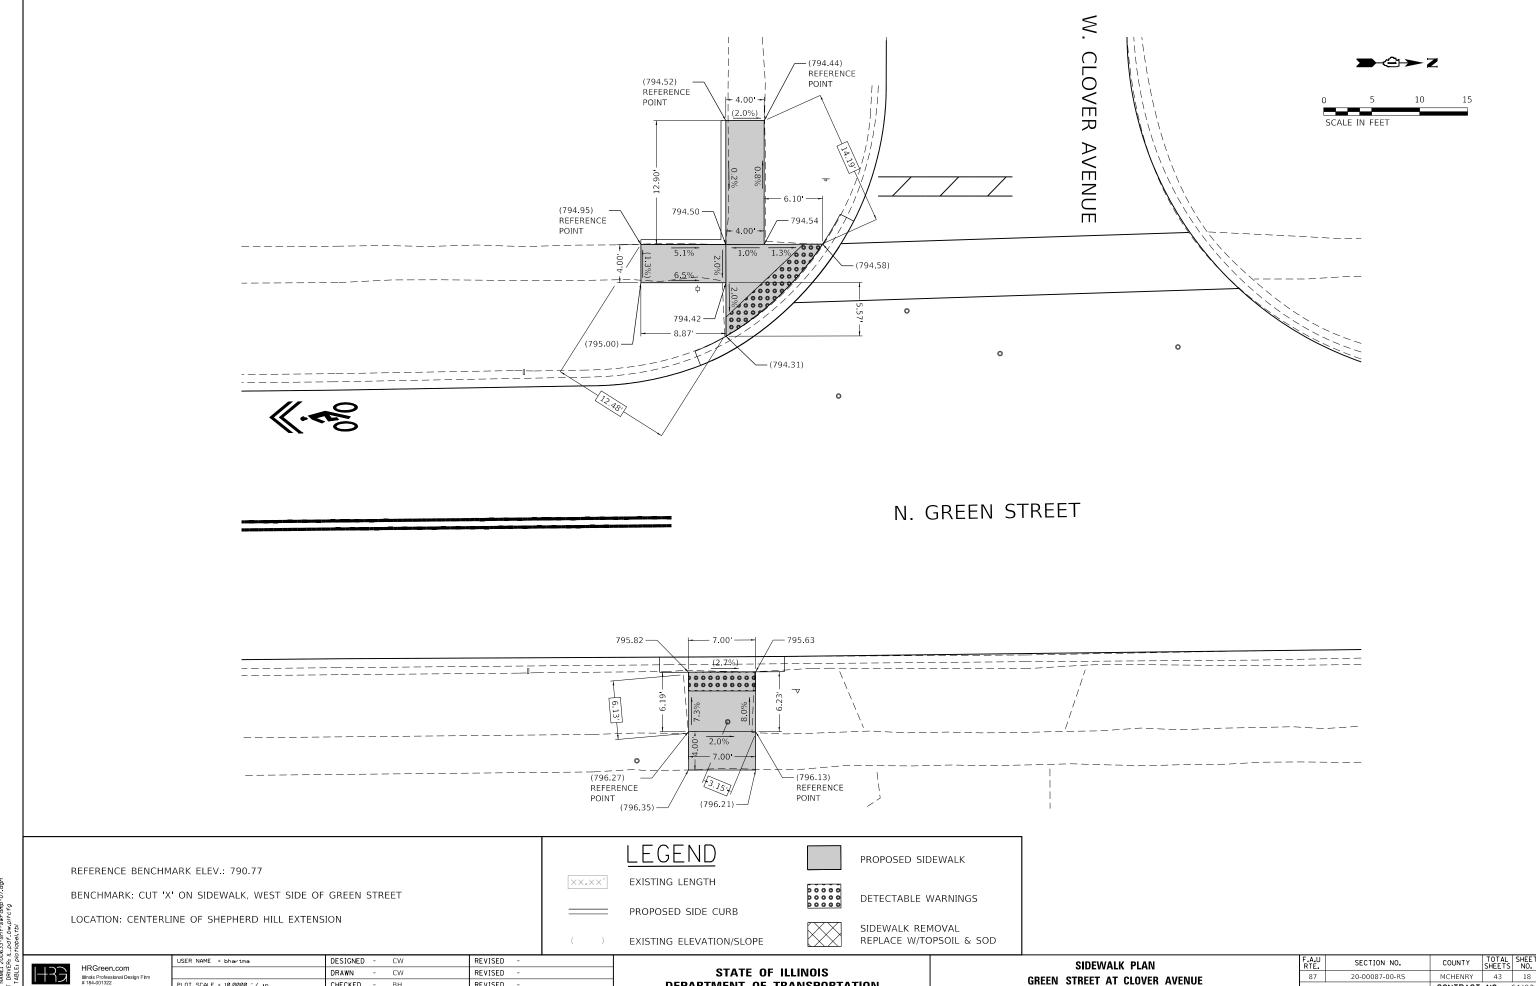

DEPARTMENT OF TRANSPORTATION

SCALE: 5' = 1" SHEET 7 OF 19 SHEETS STA.

CONTRACT NO. 61J03

HRGreen.

PLOT SCALE = 10.0000 '/ in.


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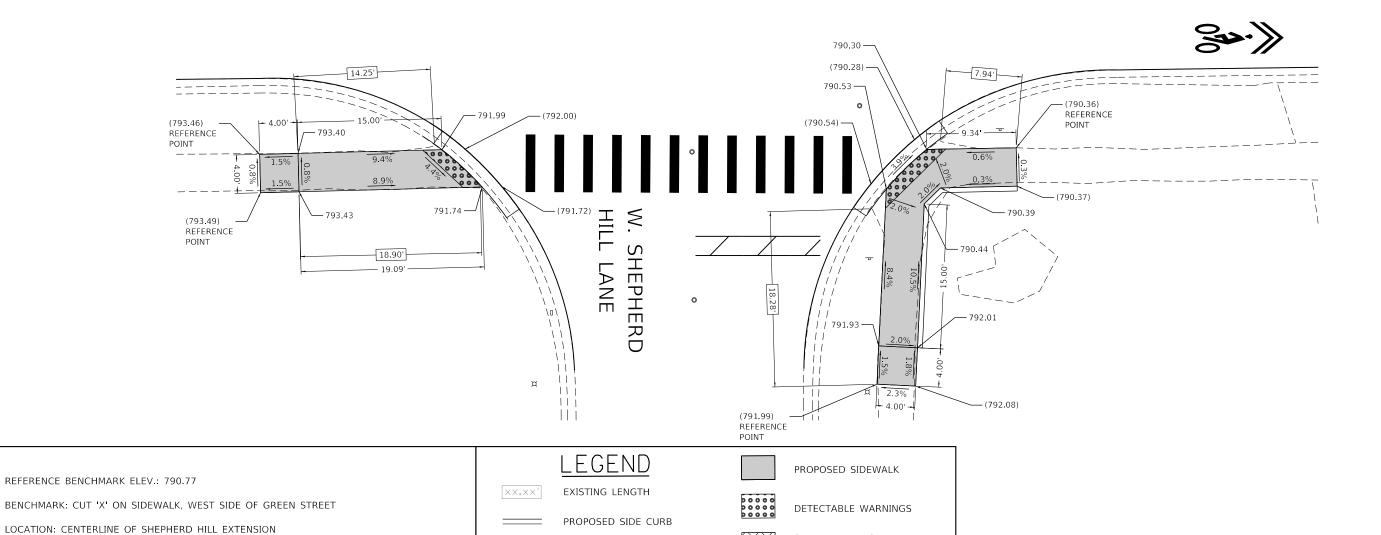
DATE

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REVISED



N. GREEN STREET

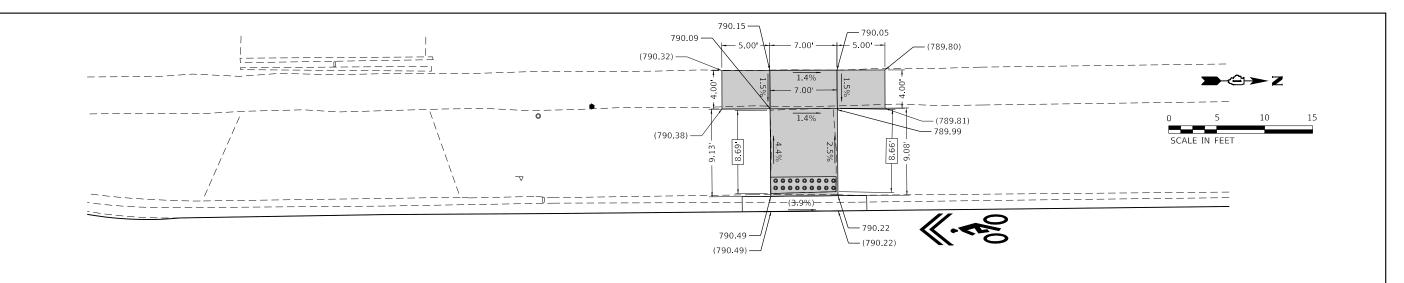

SIDEWALK REMOVAL REPLACE W/TOPSOIL & SOD

SCALE: 5' = 1"

PROJECT NO. 200633 PROJ. CONTACT. NAME: 200633-sht-swramp-08.dgn TABI E. DPT. bw.plt.cfg


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PLOT DATE = 9/6/2022	DATE	-	9/1/2022	REVISED -		
						_

STATE OF ILLINOIS	
DEPARTMENT OF TRANSPORTAT	ION

EXISTING ELEVATION/SLOPE

SIDEWALK PLAN							RTE.				COUNTY	SHEETS	
GREEN STREET AT SHEPHERD HILL LANE						87	20-0008	37-00-RS		MCHENRY	43	19	
GIILLIN	SUCCIN SINCEL AT SUCPEIEND HILL LANC										CONTRACT	NO.	61J03
SHEET	8	OF	19	SHEETS	STA.	TO STA.	FED. ROAD DIST. NO. ILLINOIS FED. AI		D PROJECT				

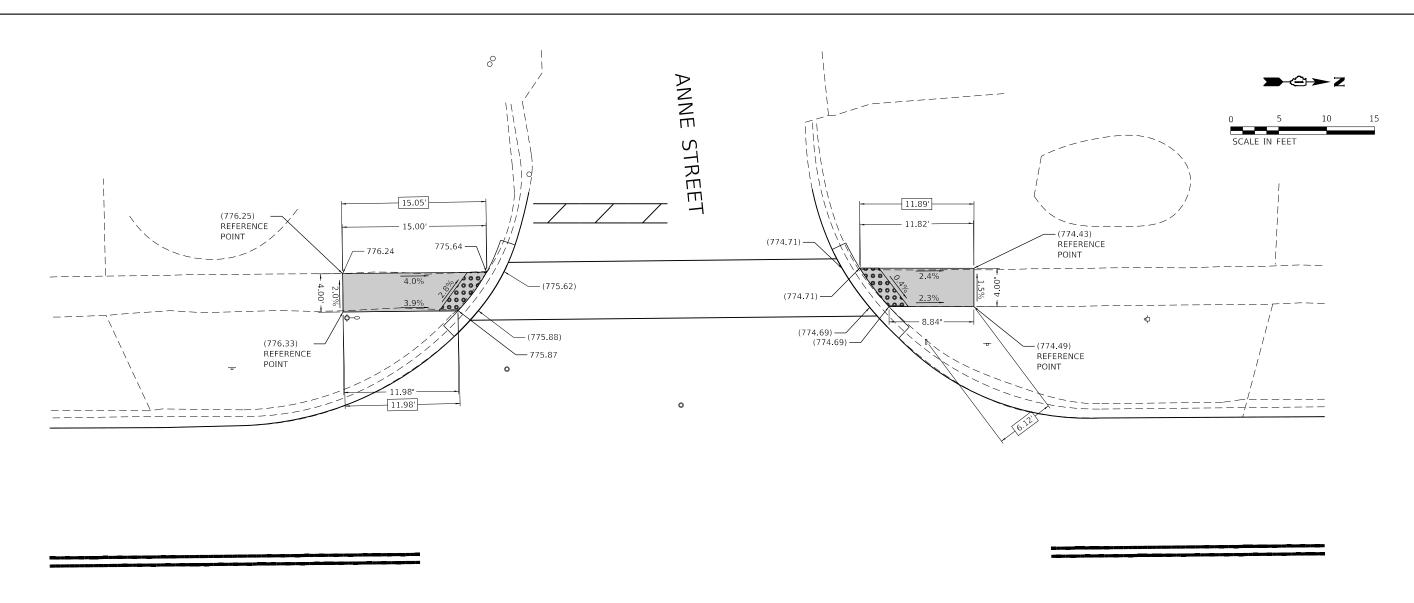

N. GREEN STREET



BENCHMARK: CUT 'X' ON SIDEWALK, EAST SIDE OF GREEN STREET

LOCATION: CENTERLINE OF ANNE EXTENSION

EXISTING LENGTH

PROPOSED SIDEWALK

DETECTABLE WARNINGS

SIDEWALK REMOVAL
REPLACE W/TOPSOIL & SOD




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Illinois Professional Design Firm
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PLOT DATE = 9/6/2022	DATE	-	9/1/2022	REVISED -	
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STATE OF ILLINOIS
DEPARTMENT OF TRANSPORTATION

SCALE: 5' = 1"

SIDE	WALK PLAN		F.A.U RTE.	SECTION NO.	COUNTY	TOTAL SHEETS	SHEET NO.
GREEN STREE	T AT ANNE STREET	87	20-00087-00-RS	MCHENRY	43	20	
UILLIN STILL	I AI AIVIVE STILLET				CONTRACT	NO.	61J03
SHEET 9 OF 19	SHEETS STA.	TO STA.	FED. RC	AD DIST. NO. ILLINOIS FED. AI	D PROJECT		




REVISED PLOT DATE = 9/6/2022 DATE

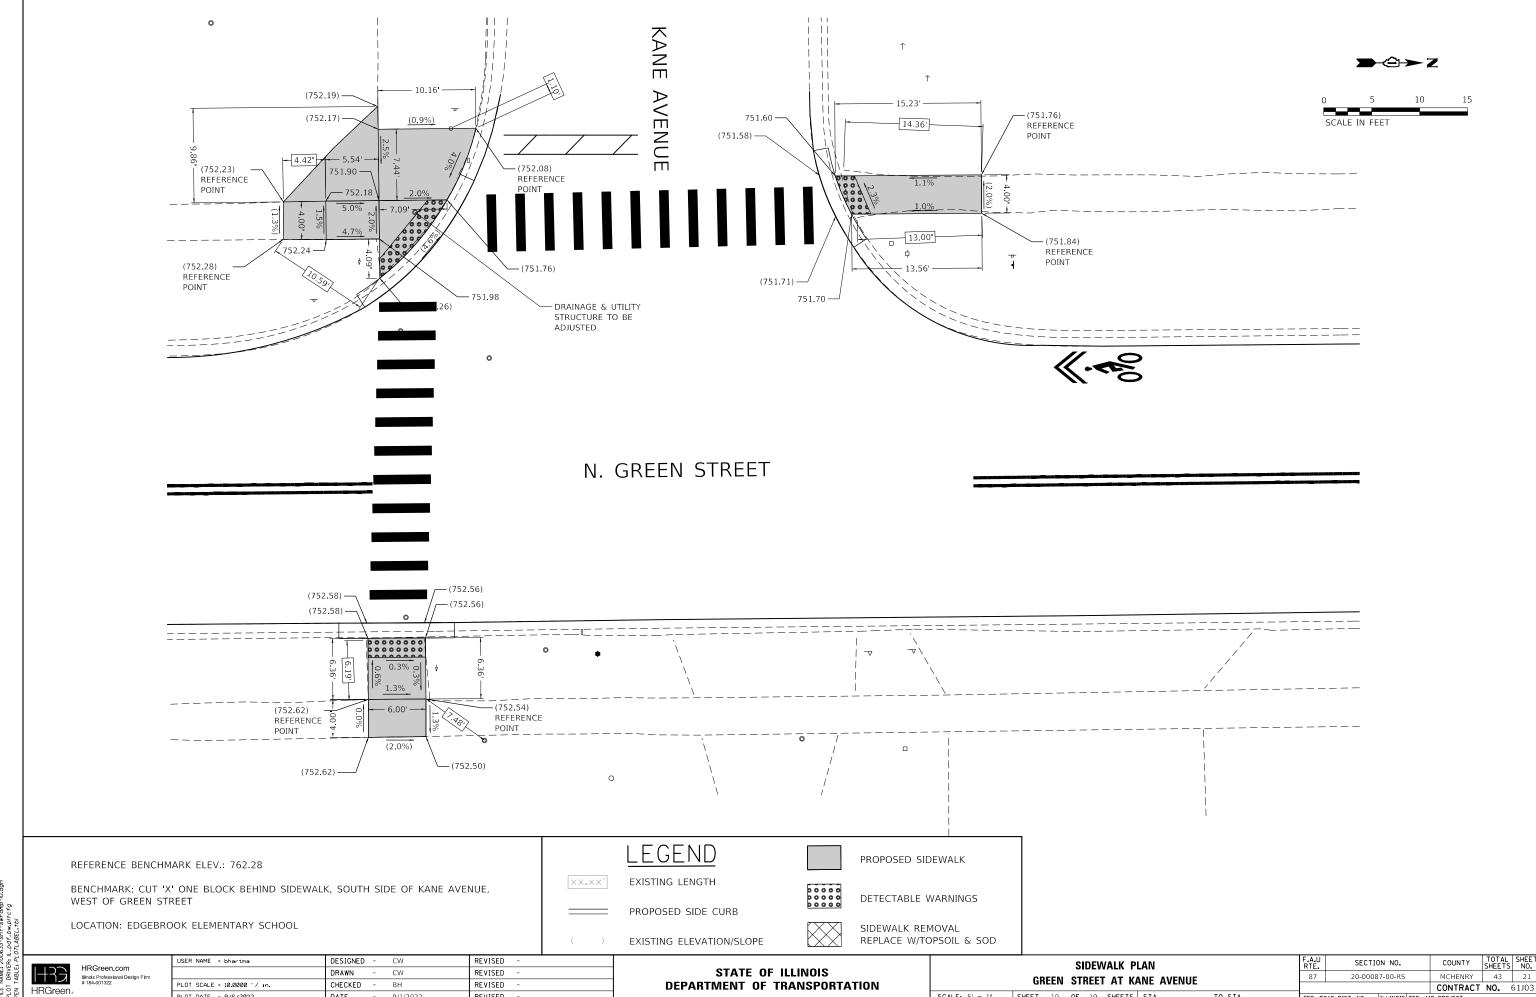SCALE: 5' = 1" SHEET 10 OF 19 SHEETS STA.

N. GREEN STREET





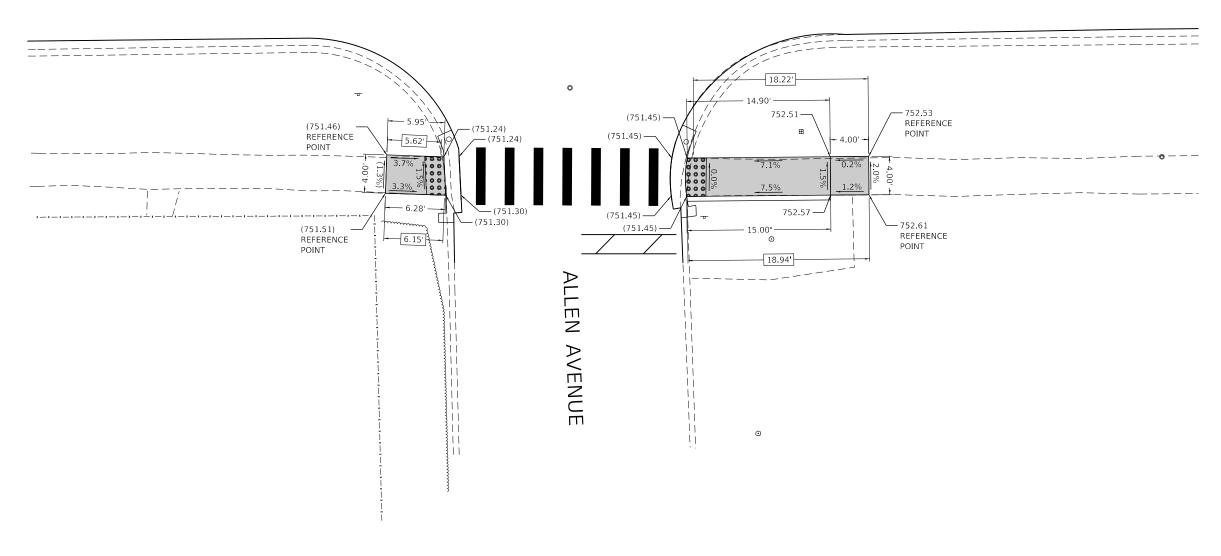

REFERENCE BENCHMARK ELEV.: 752.36

BENCHMARK: CUT 'X' ON SIDEWALK, WEST SIDE OF GREEN STREET

LOCATION: ALLEN AVENUE +/- 7' NORTH OF DRIVEWAY OF 813 GREEN STREET

LEGEND

EXISTING LENGTH

PROPOSED SIDE CURB

PROPOSED SIDEWALK

DETECTABLE WARNINGS

)	EXISTING	ELEVATION/SLO




SIDEWALK REMOVAL REPLACE W/TOPSOIL & SOD



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PLOT SCALE = 10.0000 '/ in.	CHECKED	-	вн	REVISED -	1
PLOT DATE = 9/6/2022	DATE	-	9/1/2022	REVISED -	1

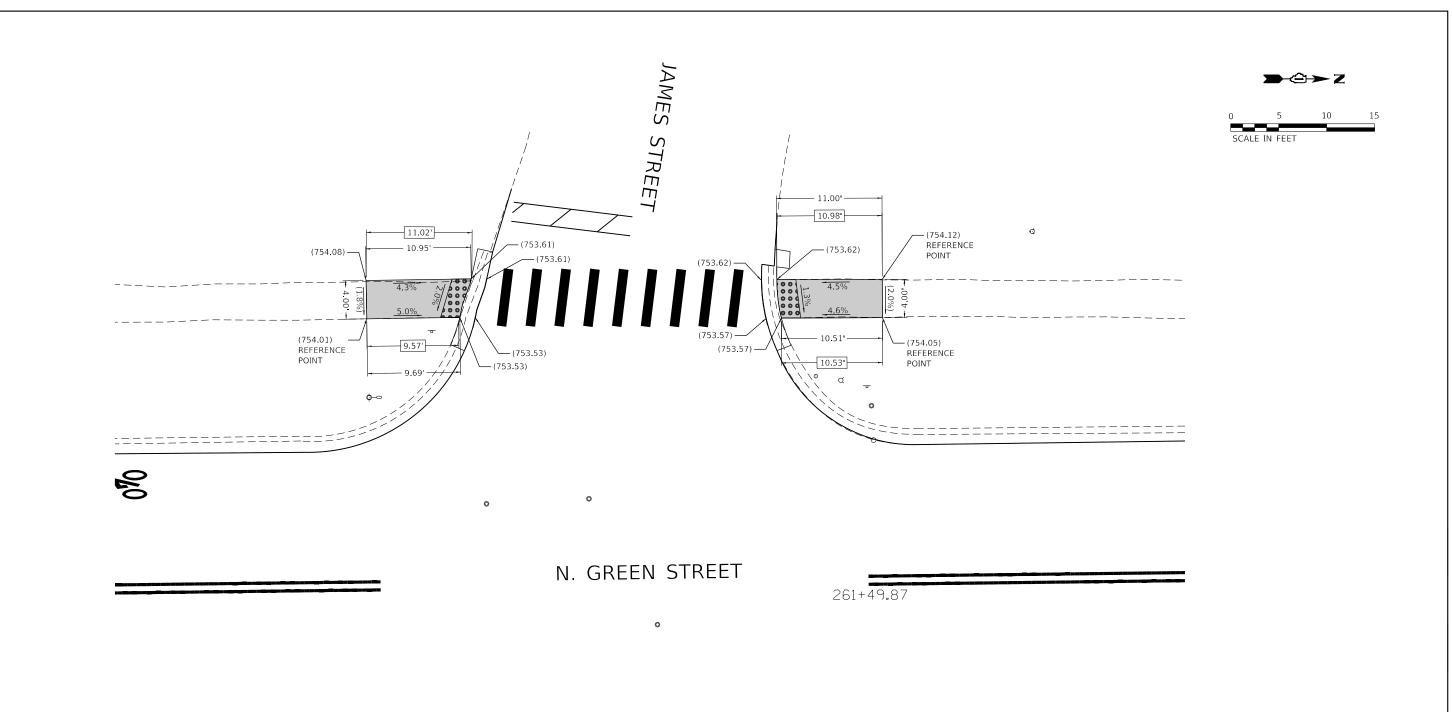

REFERENCE BENCHMARK ELEV.: 754.74

BENCHMARK: CUT 'X' ON SIDEWALK, EAST SIDE OF GREEN STREET

LOCATION: JAMES STREET 15' SOUTH OF DRIVEWAY FOR 902 GREEN STREET

LEGEND $\times \times$, $\times \times'$

EXISTING LENGTH

PROPOSED SIDEWALK

PROPOSED SIDE CURB

DETECTABLE WARNINGS

EXISTING ELEVATION/SLOPE




SIDEWALK REMOVAL REPLACE W/TOPSOIL & SOD

SCALE: 5' = 1"


CT NO.: 20 CONTACT: 200633-SI R: IL.DOF.	
PROJECT I PROJ. CON NAME: 20C DRIVER: A	H33
HRC H	HRGreen.

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PLOT SCALE = 10.0000 '/ in.	CHECKED	-	вн	REVISED -	1
PLOT DATE = 9/6/2022	DATE	-	9/1/2022	REVISED -	1

SIDEWALK PLAN Green Street at James Street					F.A.U RTE.	SECTION NO.	COUNTY	TOTAL SHEETS	SHEET NO.			
					87	20-00087-00-RS	MCHENRY	43	23			
UIIL	GREEN SIREEL AL JAMES SIREEL								CONTRACT	NO.	61J03	
SHEET	12	OF	19	SHEETS	STA.		TO STA.	FFD. RO	AD DIST. NO. TILLINGIS FED. AT	D PROJECT		

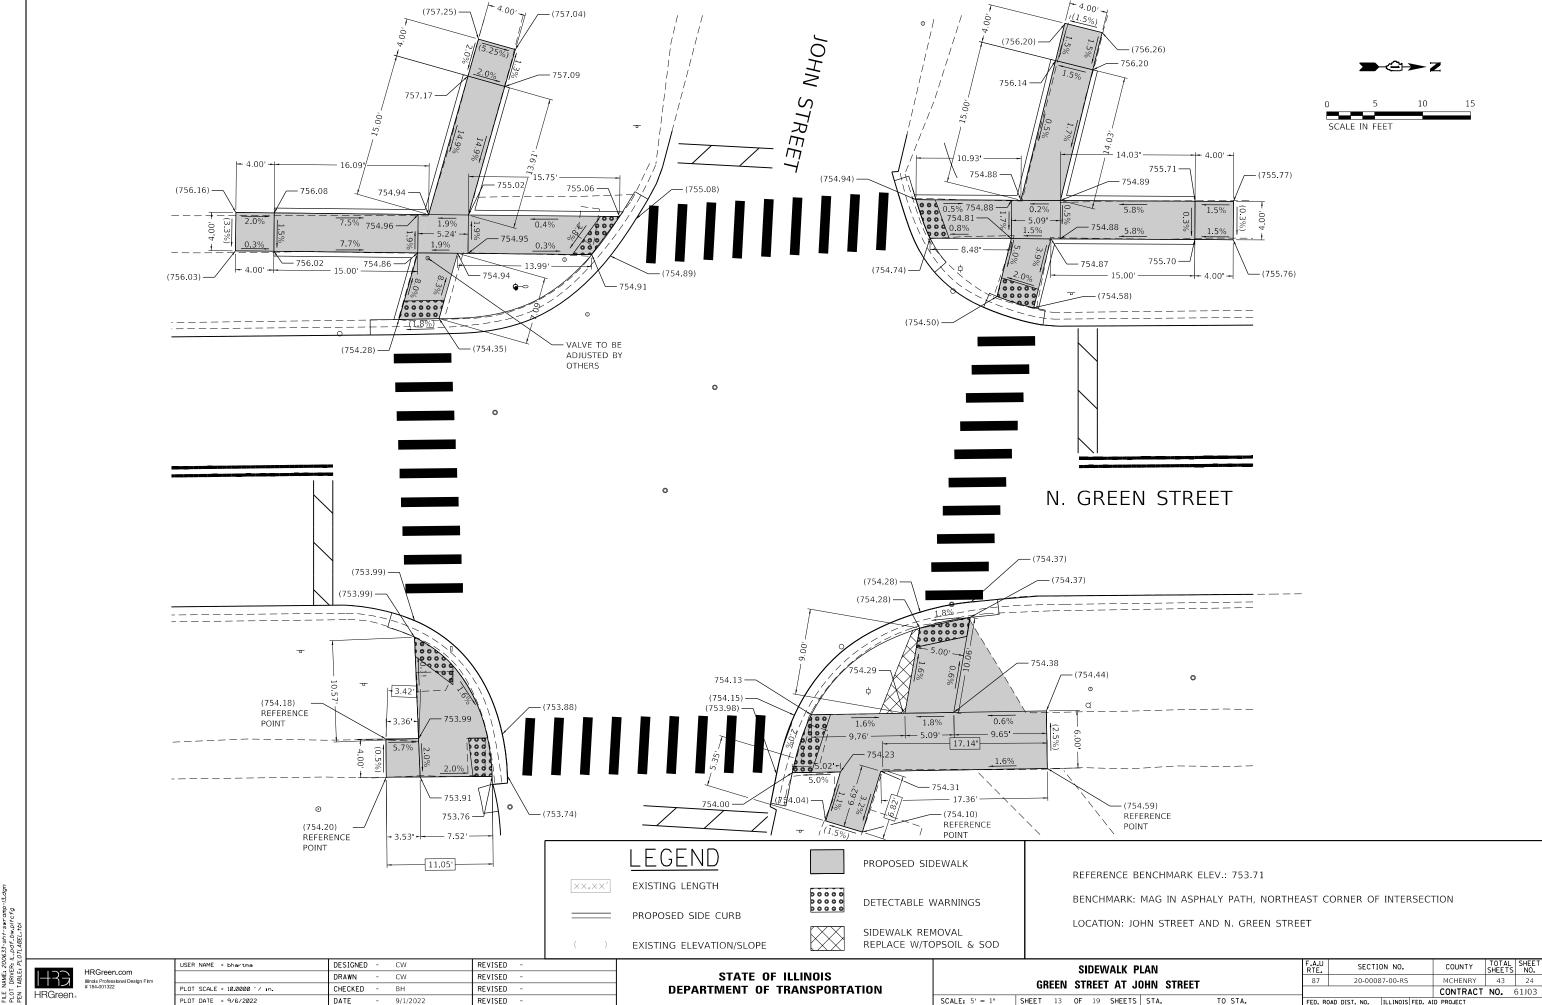

PLOT DATE = 9/6/2022 DATE REVISED

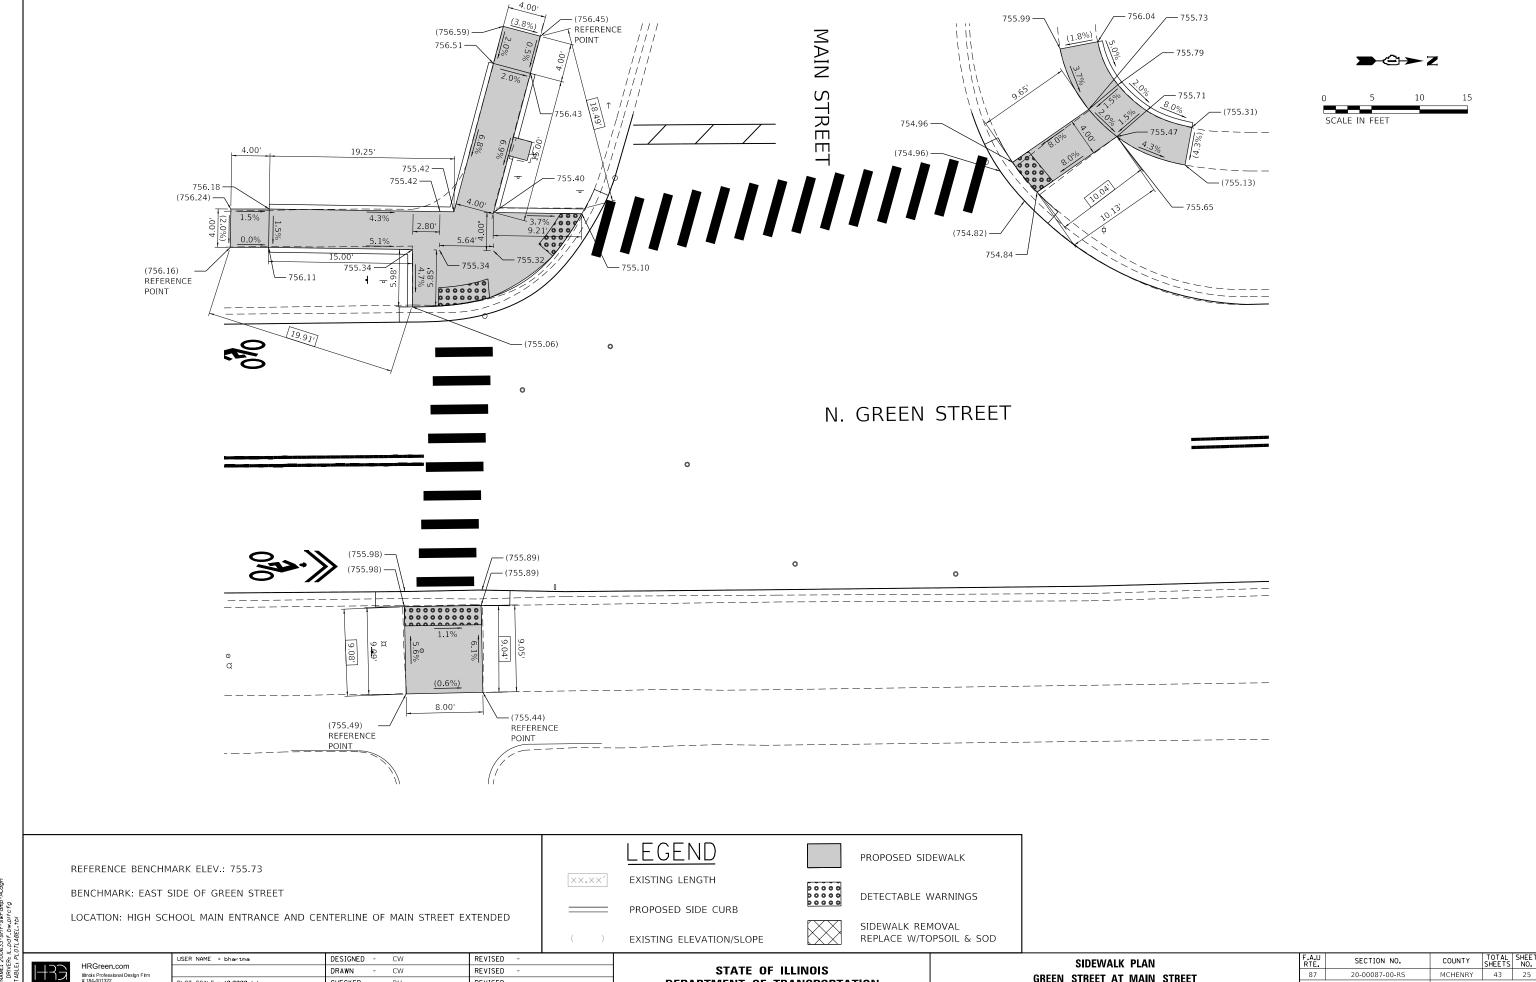


PLOT SCALE = 10.0000 '/ in. CHECKED REVISED PLOT DATE = 9/6/2022 DATE REVISED

DEPARTMENT OF TRANSPORTATION

SCALE: 5' = 1"

		SI	DEV	VALK P	LAN		RTE.	SECTION	ON NO.	COUNTY	SHEETS	NO.
CR	EEN	СŢ	REE.	Т АТ М	AIN STREET	-	87	20-0008	37-00-RS	MCHENRY	43	25
UII	LLIV	31	IILL	1 A1 W	AIN SINEE					CONTRACT	NO.	61J03
SHEET	14	OF	19	SHEETS	STA.	TO STA.	FED. R	DAD DIST. NO.	ILLINOIS FED. A	D PROJECT		

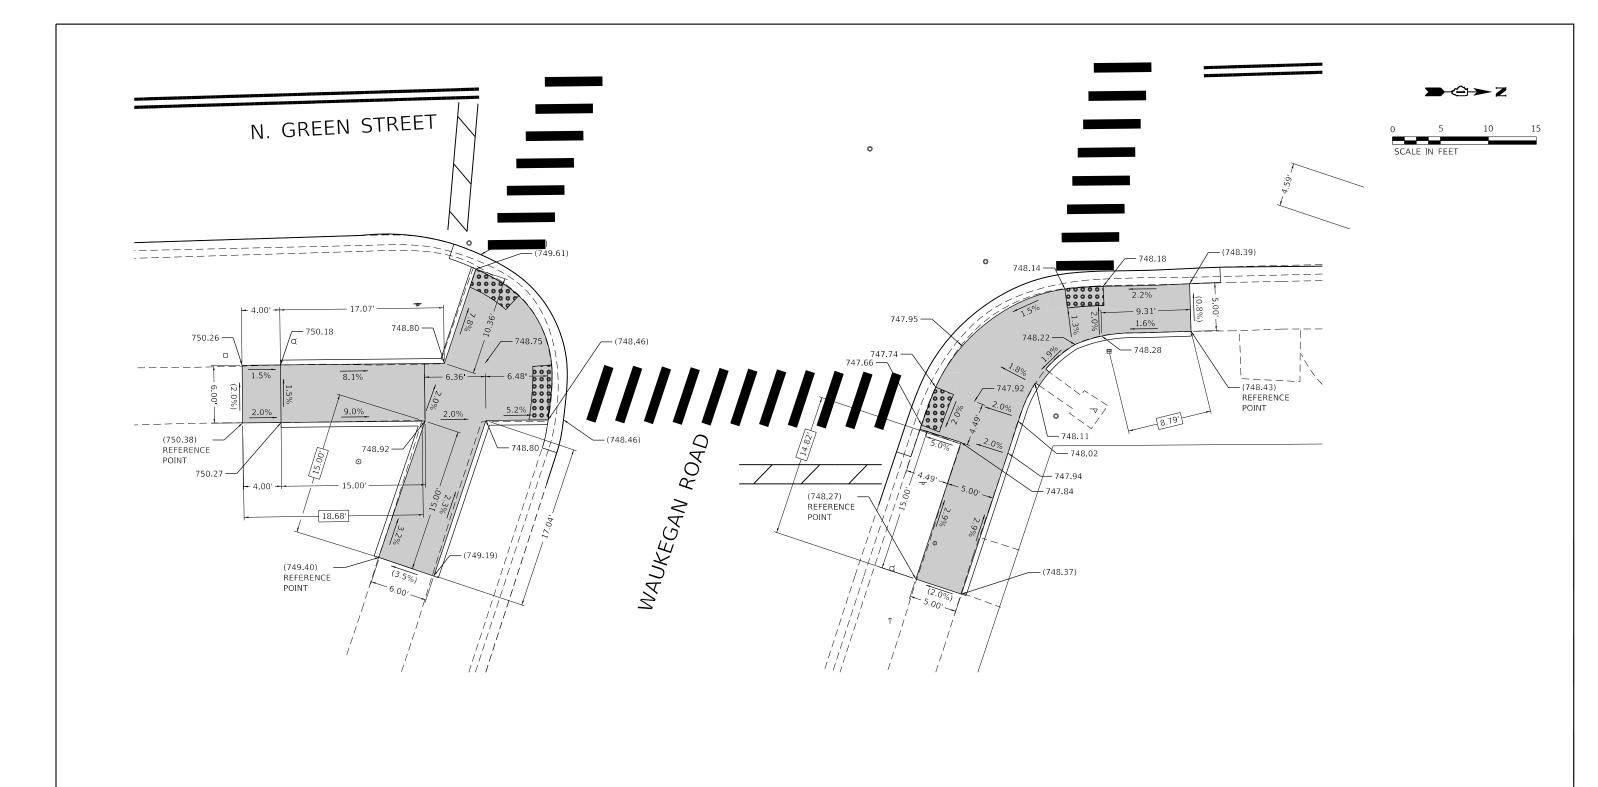

REFERENCE BENCHMARK ELEV.: 750.71

BENCHMARK: CUT 'X' ON SIDEWALK IN THE MEDIAN

LOCATION: NORTHWEST OF MEDIAN OF INTERSECTION

LEGEND

EXISTING LENGTH

PROPOSED SIDEWALK

××.××′ EXISTIN

DETECTABLE WARNINGS

()

EXISTING ELEVATION/SLOPE

PROPOSED SIDE CURB



SIDEWALK REMOVAL REPLACE W/TOPSOIL & SOD

SCALE: 5' = 1"




HRGreen.com Illinois Professional Design Firm # 184-001322

USER NAME = bhartma	DESIGNED	-	CW	REVISED	-
	DRAWN	-	CW	REVISED	-
PLOT SCALE = 10.0000 '/ in.	CHECKED	-	BH	REVISED	-
PLOT DATE = 9/6/2022	DATE	-	9/1/2022	REVISED	-

STATE OF ILLINOIS	S
DEPARTMENT OF TRANSPO	ORTATION

SIDEWALK PLAN	RTE.	SECTION NO.	COUNTY	SHEETS	NO.
GREEN STREET AT WAUKEGAN ROAD	87	20-00087-00-RS	MCHENRY	43	27
UNLEW STREET AT WACKEDAM HOAD			CONTRACT	NO.	61J03
SHEET 16 OF 19 SHEETS STA. TO ST	A. FED. RO	OAD DIST. NO. ILLINOIS FED. AI	D PROJECT		

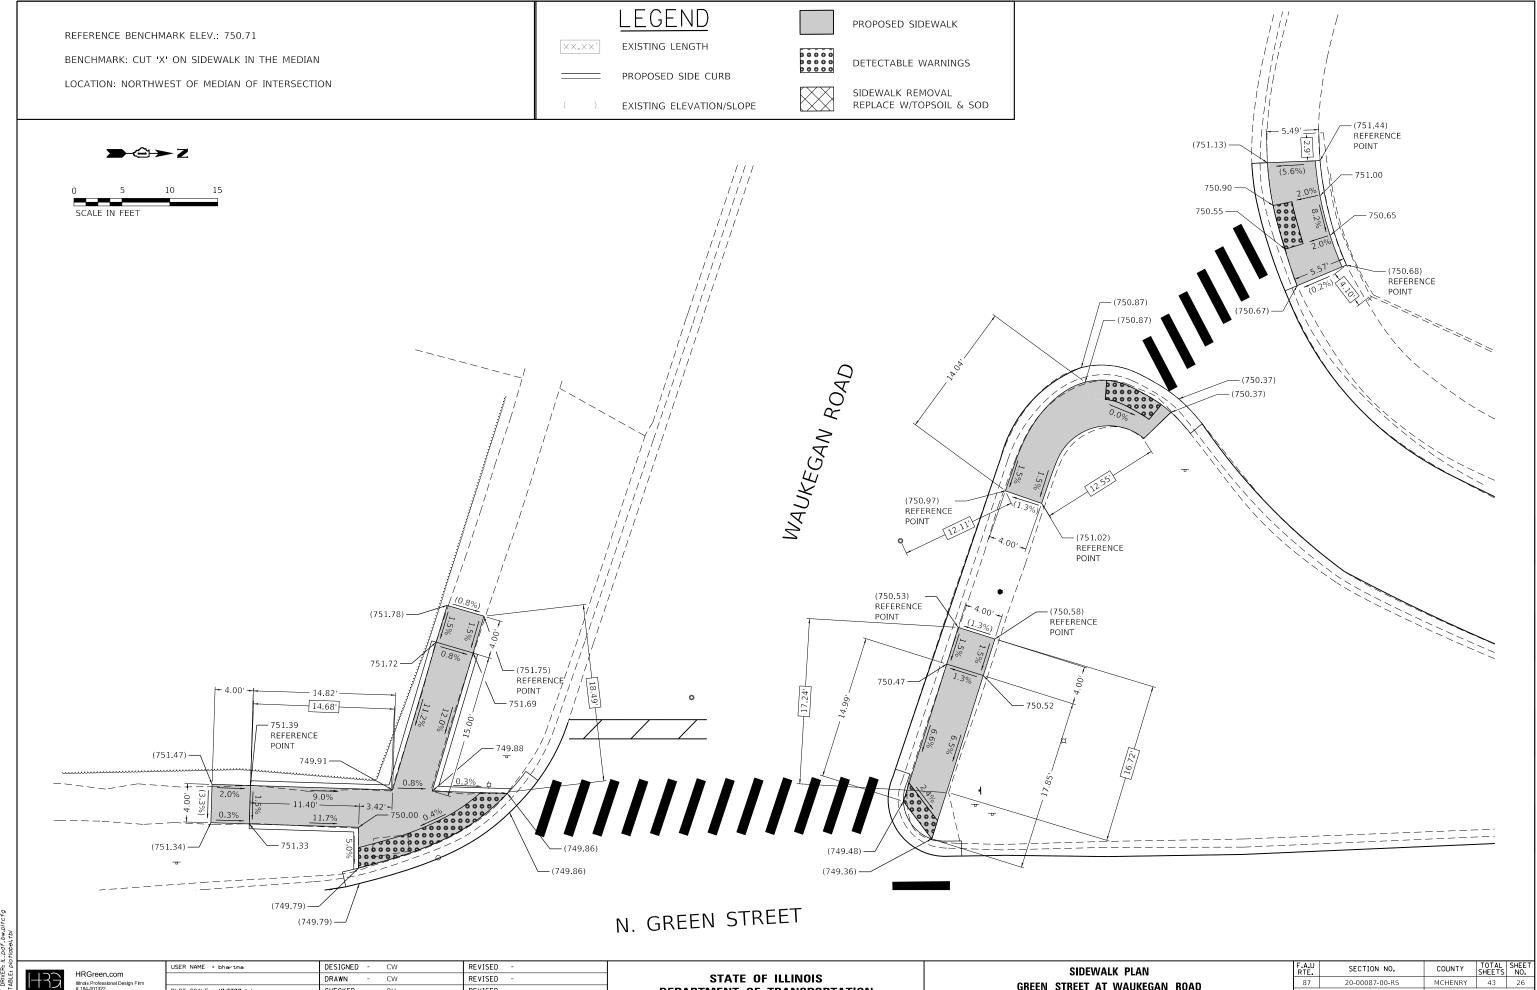


HRGreen

PLOT SCALE = 10.0000 '/ in. CHECKED REVISED PLOT DATE = 9/6/2022 DATE REVISED

DEPARTMENT OF TRANSPORTATION

GREEN STREET AT WAUKEGAN ROAD CONTRACT NO. 61J03 SCALE: 5' = 1" SHEET 15 OF 19 SHEETS STA.

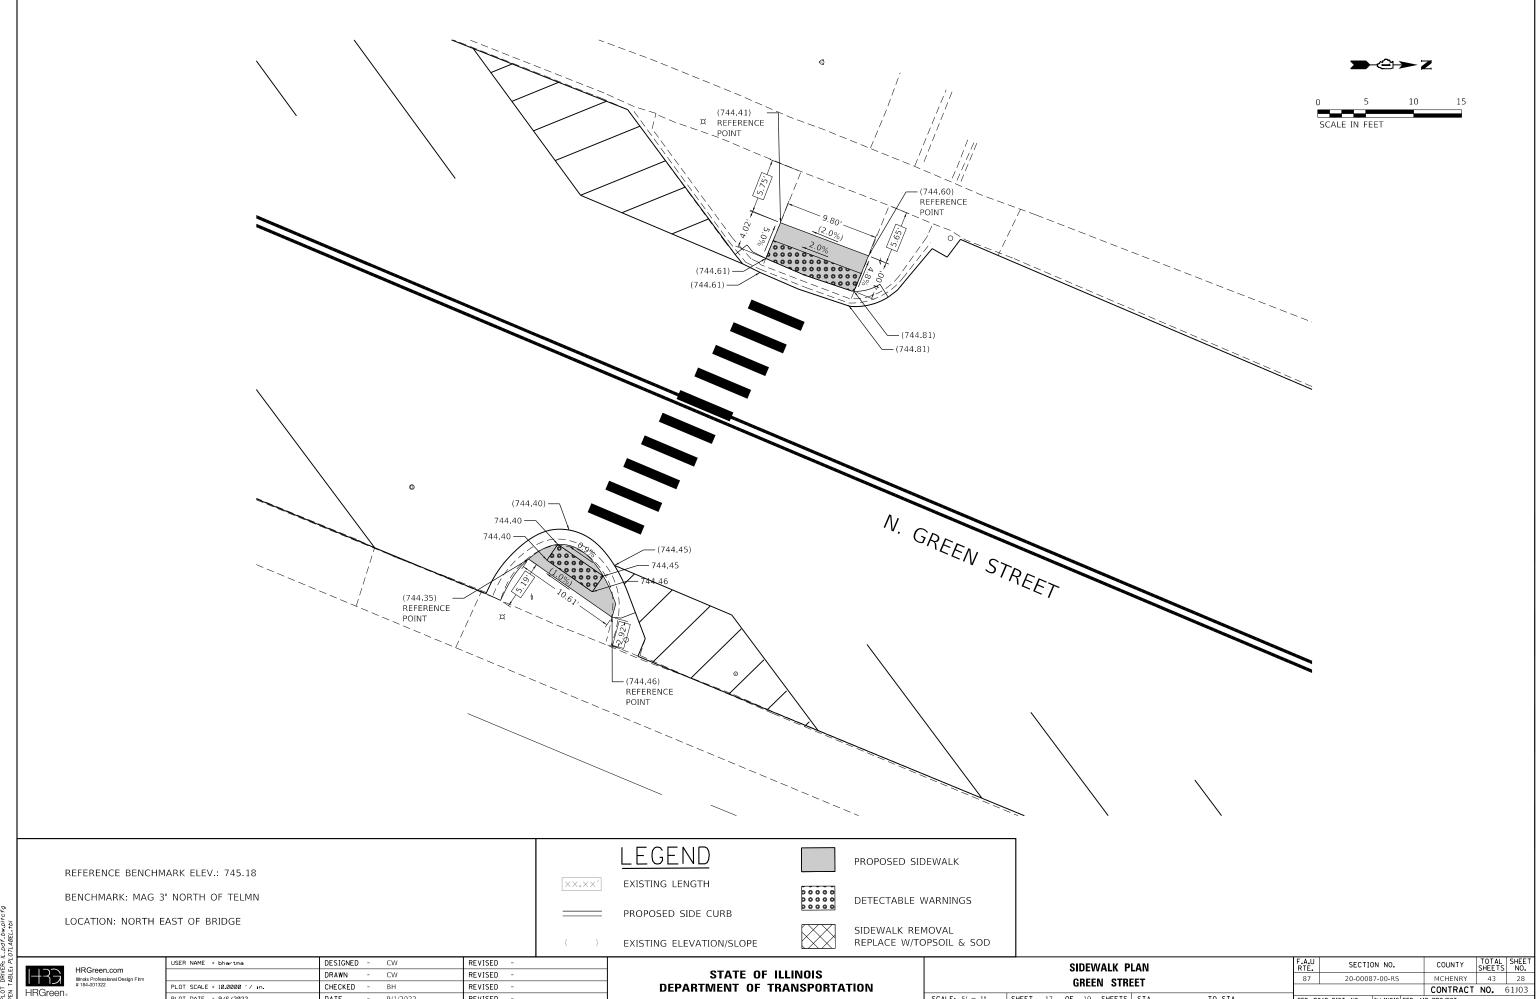

SCALE: 5' = 1" SHEET 17 OF 19 SHEETS STA.

TO STA.


FED. ROAD DIST. NO. | ILLINOIS | FED. AID PROJECT

PLOT DATE = 9/6/2022

DATE

9/1/2022


REVISED

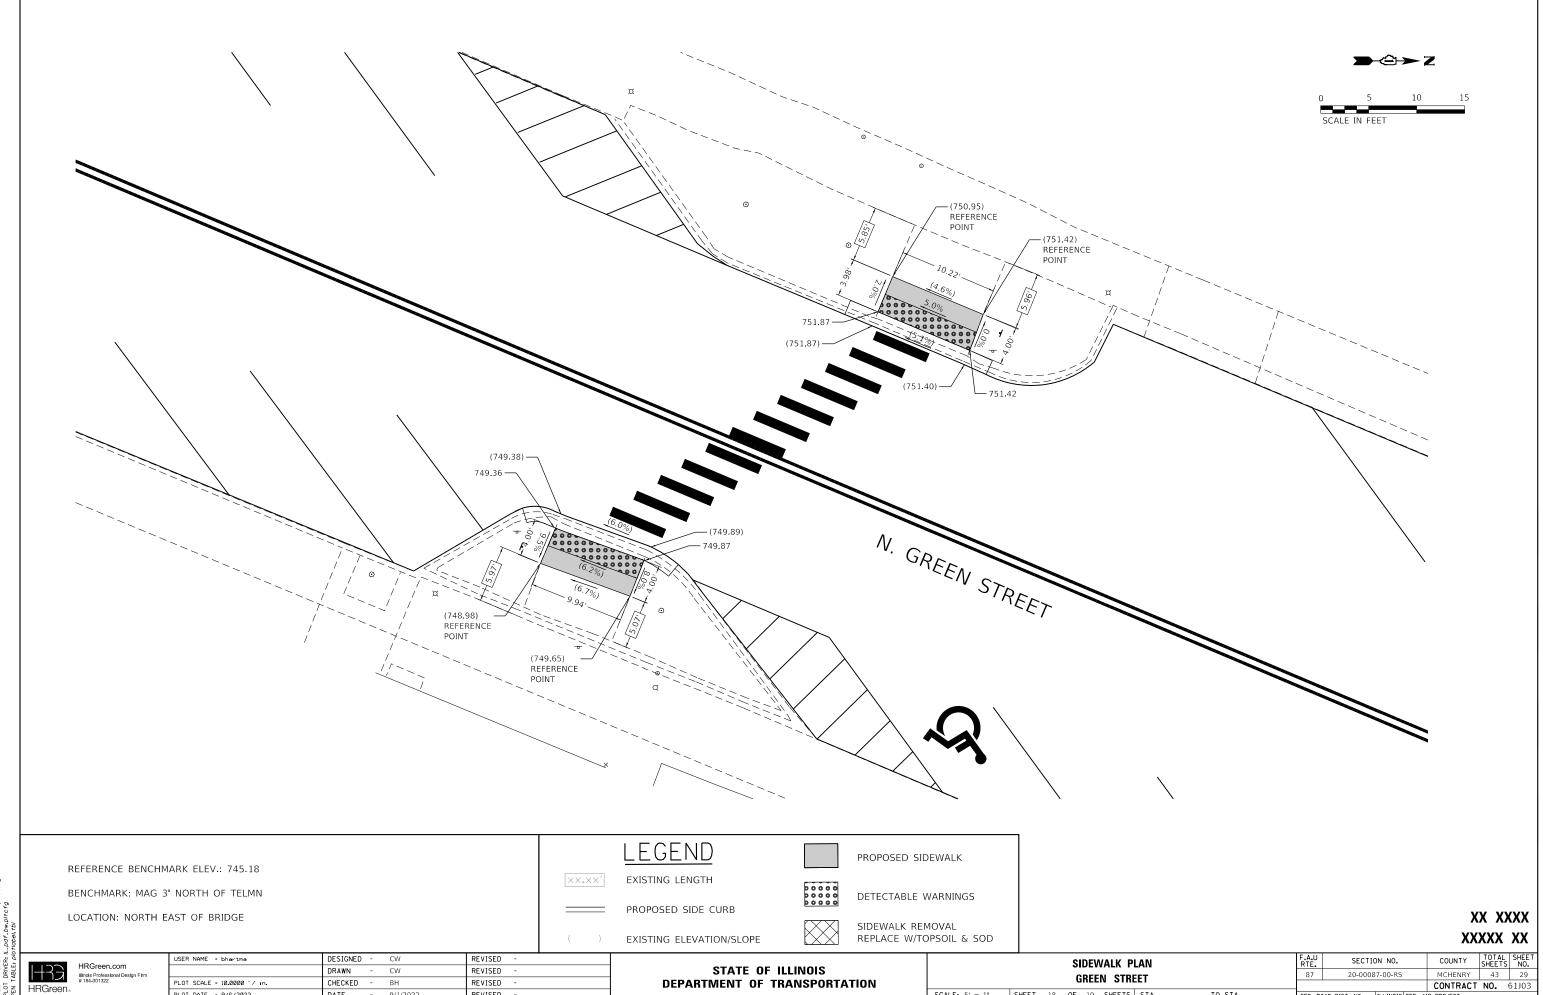

PLOT SCALE = 10.0000 '/ in. CHECKED -REVISED PLOT DATE = 9/6/2022 DATE REVISED 9/1/2022

DEPARTMENT OF TRANSPORTATION


CONTRACT NO. 61J03 SCALE: 5' = 1" SHEET 18 OF 19 SHEETS STA. TO STA.

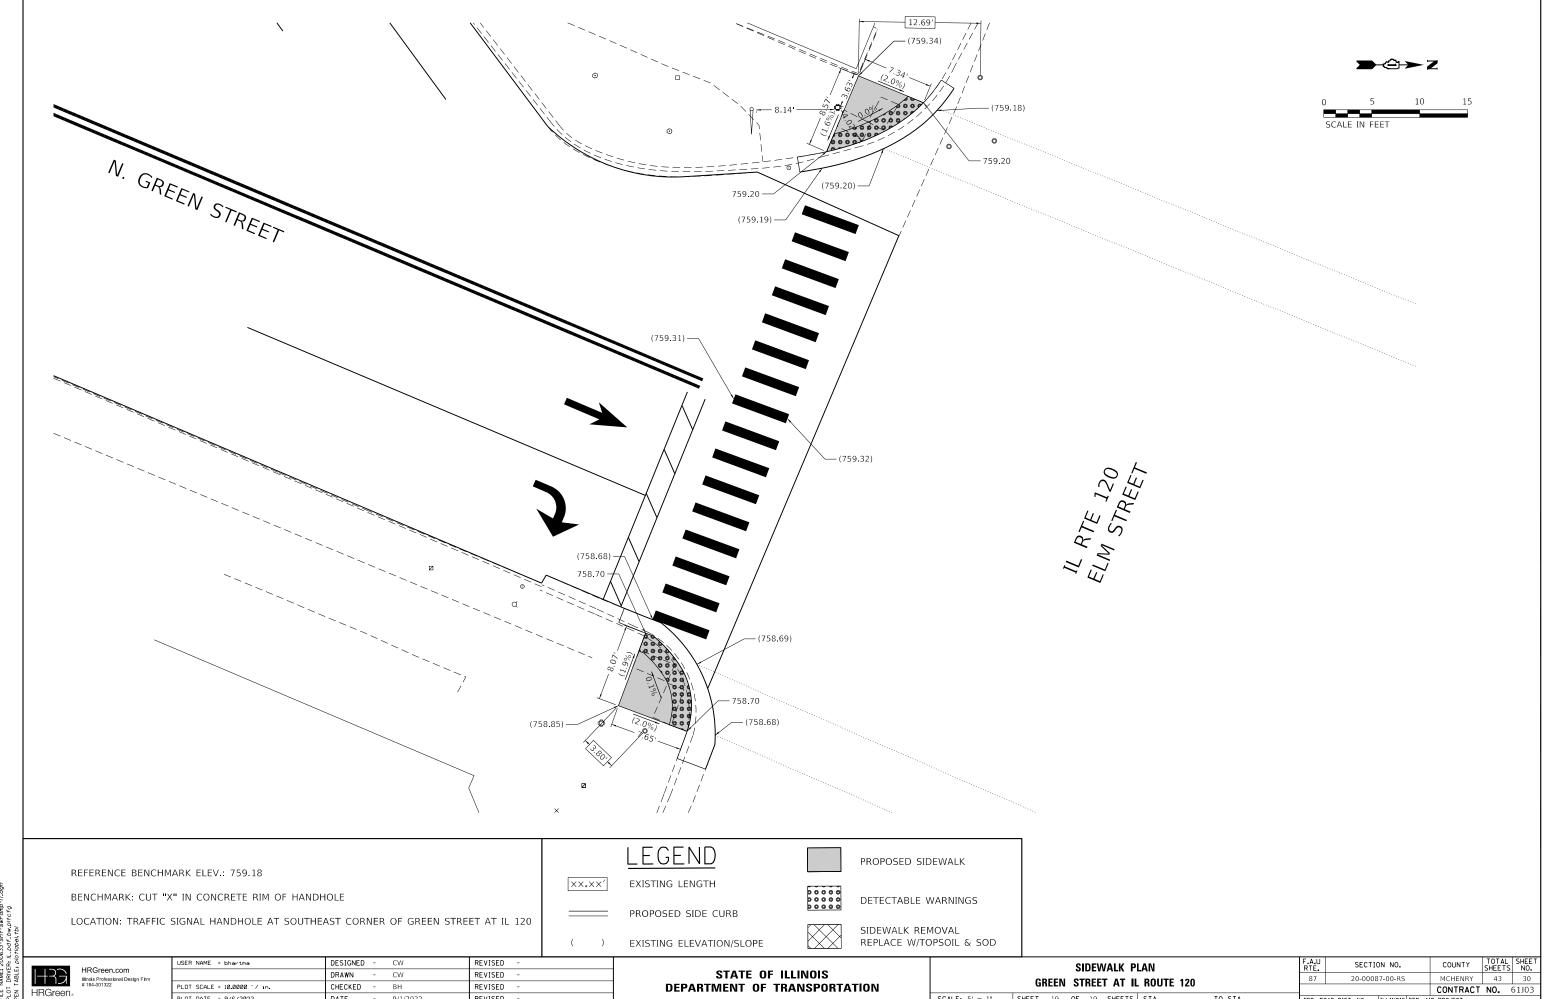


PLOT SCALE = 10.0000 '/ in. CHECKED -REVISED PLOT DATE = 9/6/2022 DATE REVISED

DEPARTMENT OF TRANSPORTATION

CONTRACT NO. 61J03 SCALE: 5' = 1" SHEET 19 OF 19 SHEETS STA. TO STA.

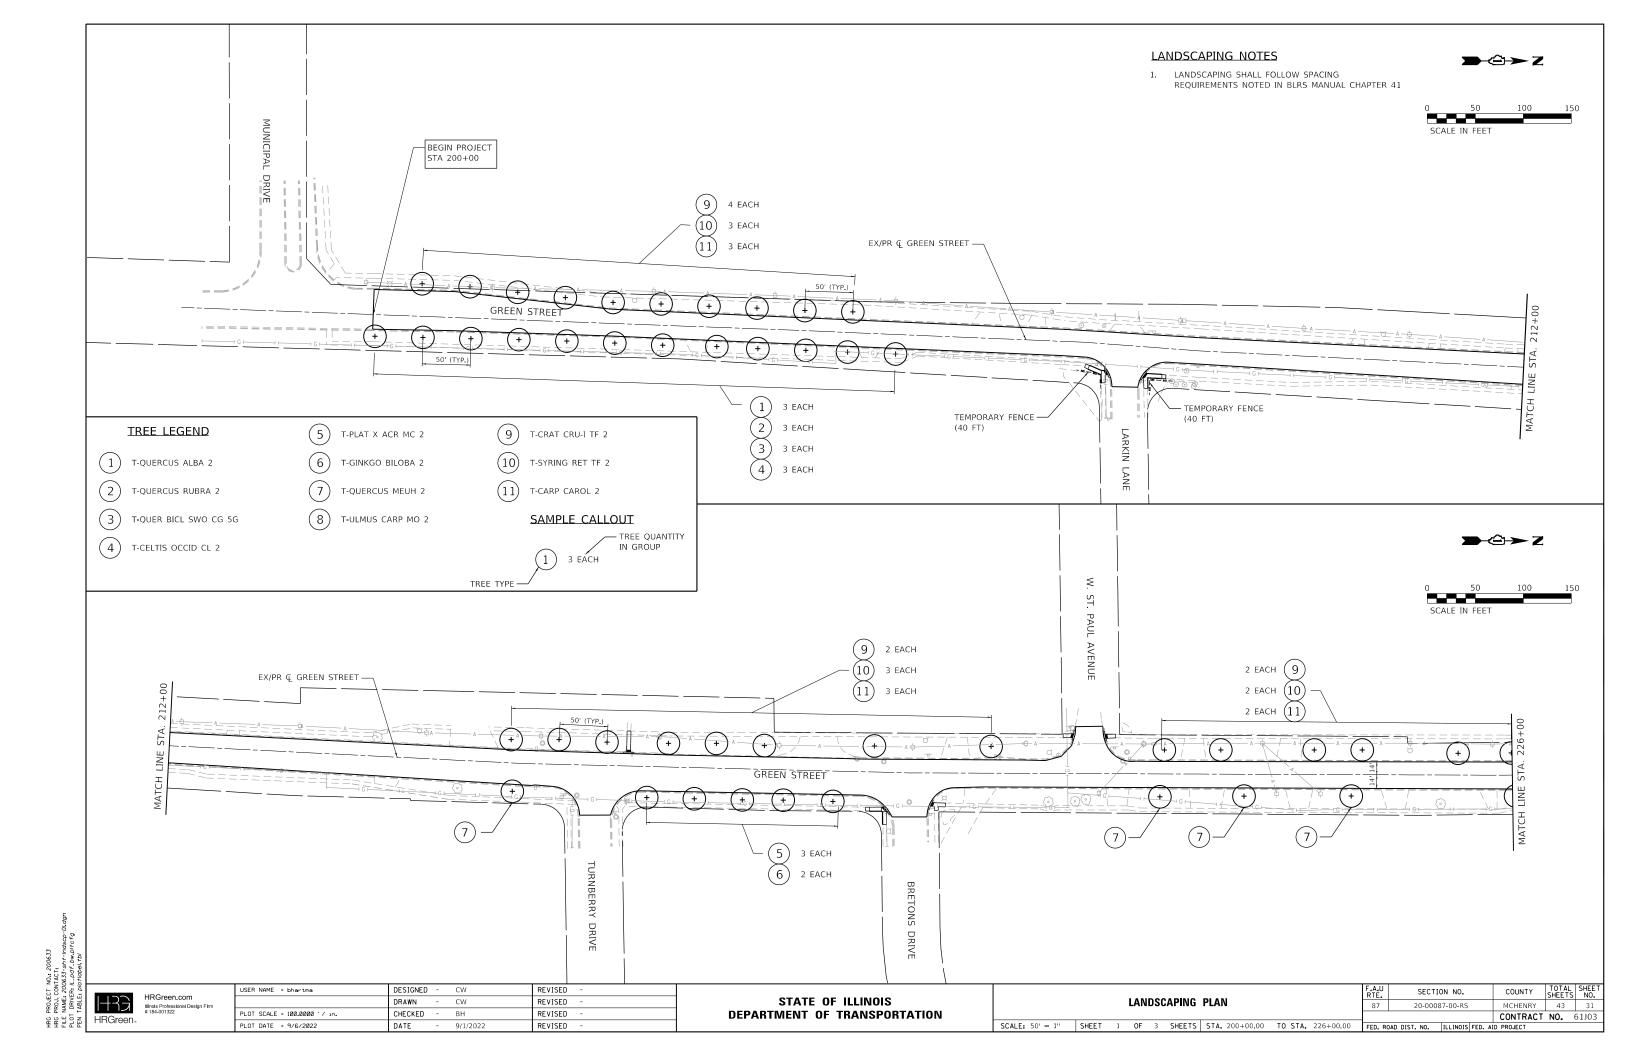

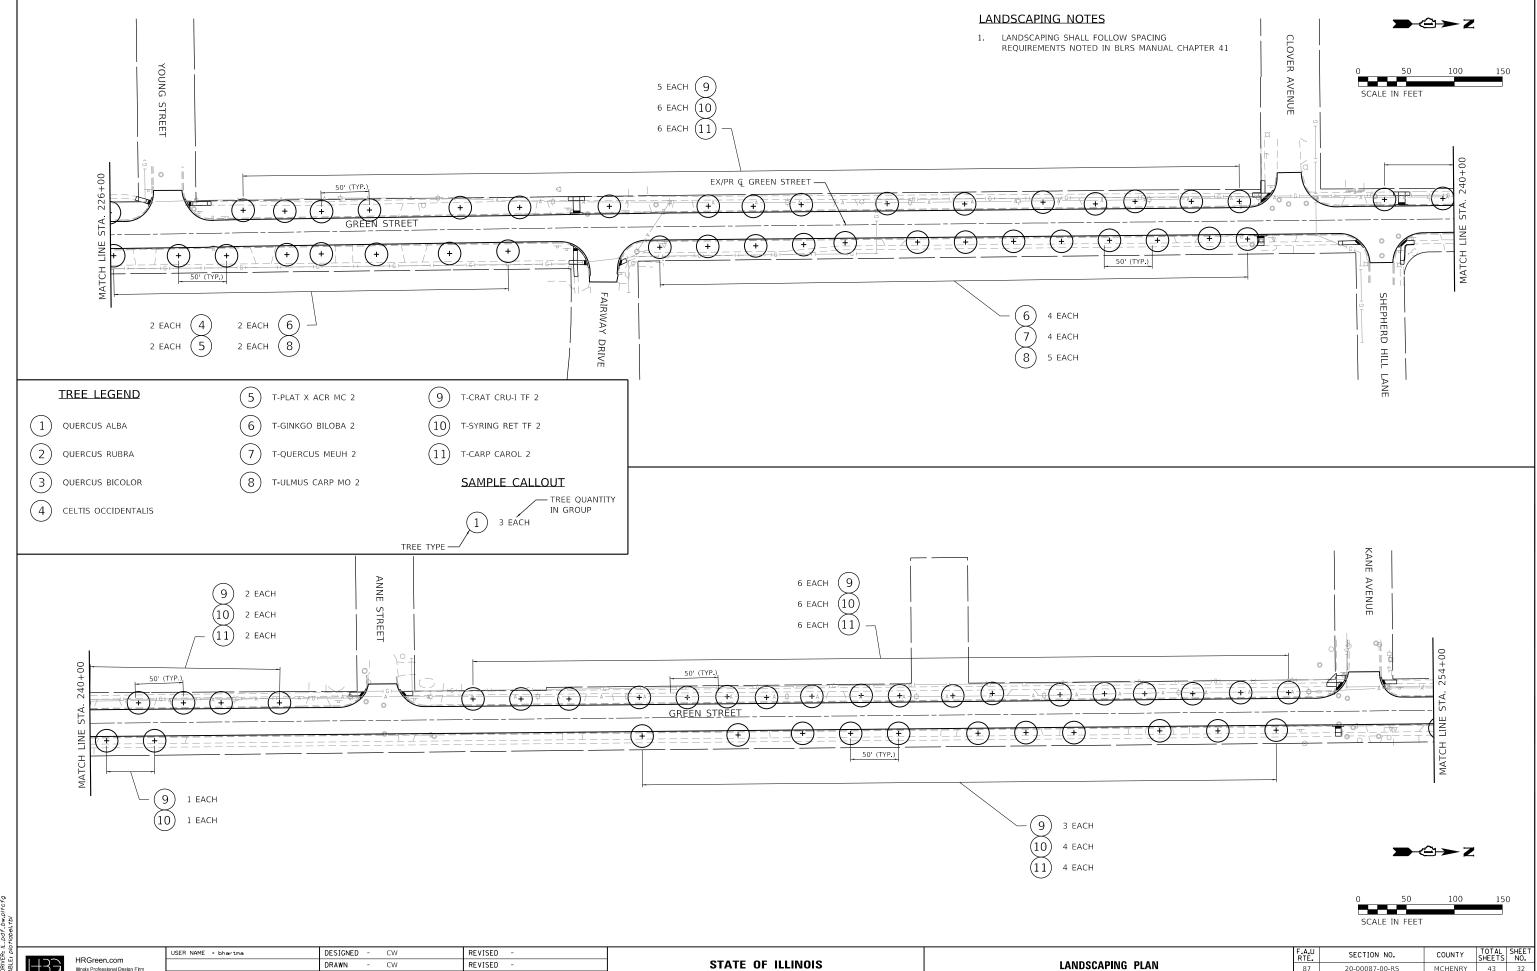


HRGreen.

REVISED PLOT SCALE = 100.0000 '/ in. CHECKED ВН REVISED PLOT DATE = 9/6/2022 DATE REVISED 9/1/2022

DEPARTMENT OF TRANSPORTATION

LANDSCAPING PLAN 20-00087-00-RS SCALE: 50' = 1" | SHEET | 2 OF 3 | SHEETS | STA. 226+00.00 | TO STA. 254+00.00 | FED. ROAD DIST. NO. | ILLINOIS | FED. AID PROJECT

MCHENRY 43 32 CONTRACT NO. 61J03

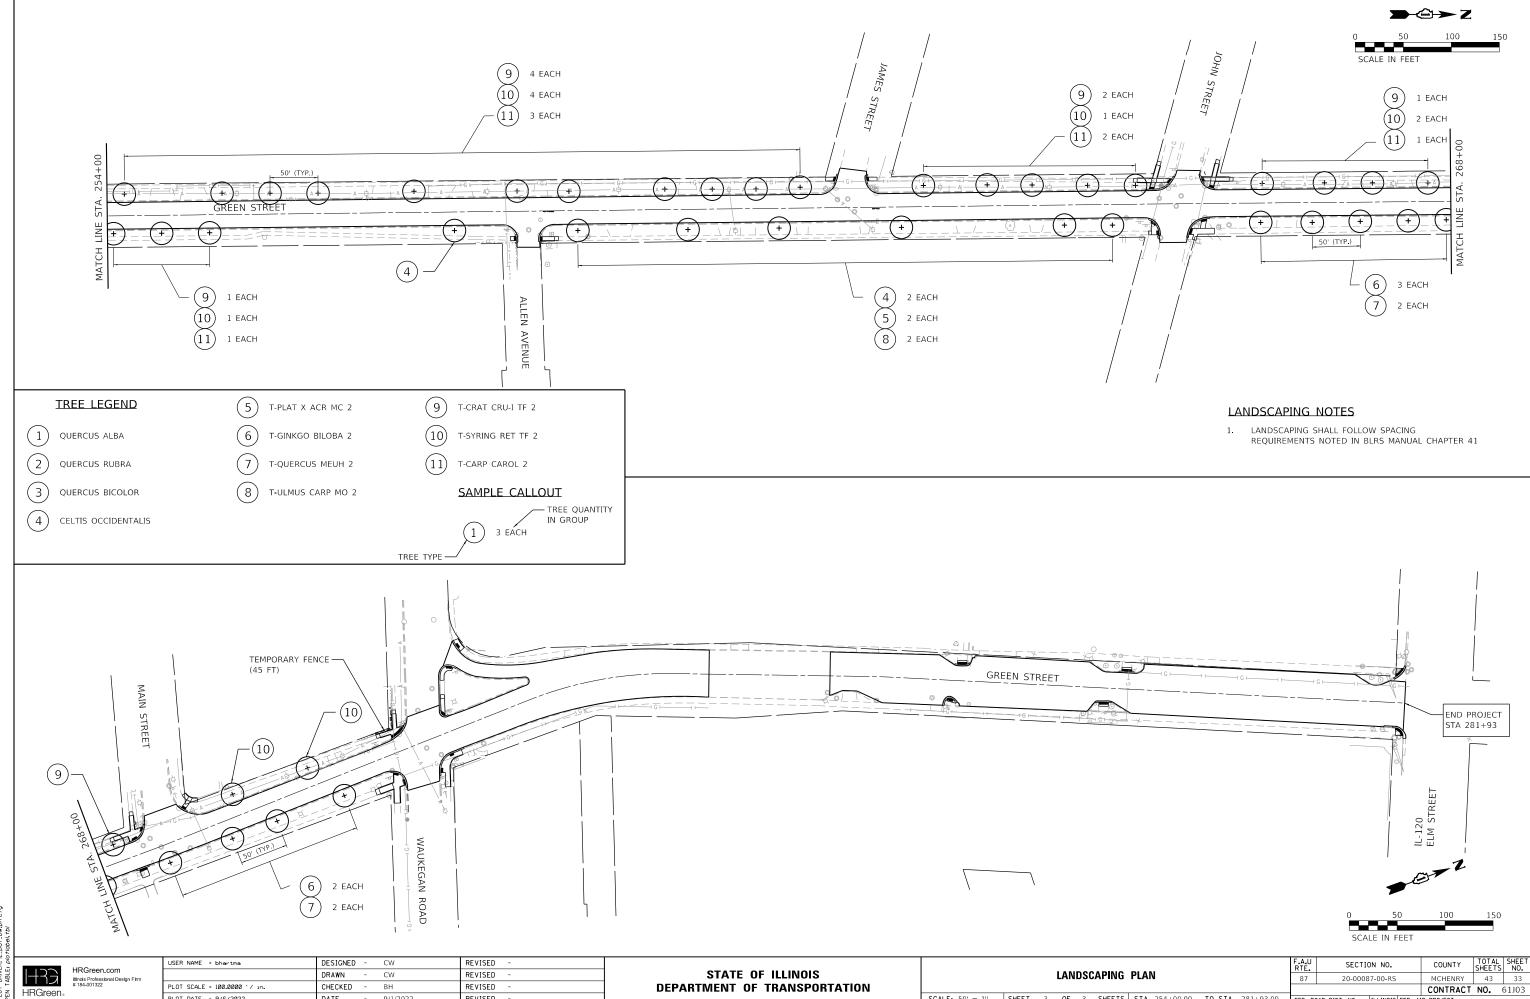


PLOT SCALE = 100.0000 '/ in. CHECKED ВН REVISED PLOT DATE = 9/6/2022 DATE REVISED 9/1/2022

DEPARTMENT OF TRANSPORTATION

SCALE: 50' = 1" SHEET 3 OF 3 SHEETS STA. 254+00.00 TO STA. 281+93.00 FED. ROAD DIST. NO. | ILLINOIS | FED. AID PROJECT

CONTRACT NO. 61J03

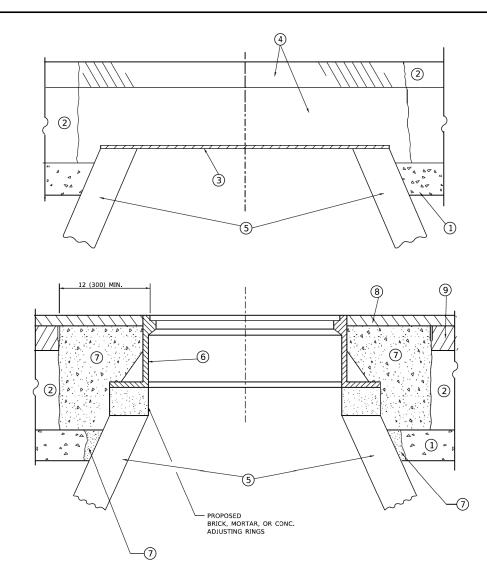

DETAILS FOR FRAMES AND LIDS ADJUSTMENT WITH MILLING

- 1. EXISTING BROKEN FRAMES AND LIDS SHALL BE REMOVED AND DISPOSED OF BY THE CONTRACTOR AND SHALL BE REPLACED AS DIRECTED BY THE ENGINEER. REPLACEMENT FRAMES AND LIDS WILL BE PAID FOR IN ACCORDANCE WITH ARTICLE 109.04 OF THE STANDARD SPECIFICATIONS UNLESS A SEPARATE PAY ITEM HAS BEEN PROVIDED.
- 2. IF THE EXISTING LIDS ARE OPEN, THE FRAME WILL BE ADJUSTED TO THE ELEVATION OF THE MILLED PAVEMENT SURFACE PRIOR TO THE MILLING OPERATION. THE FRAME WILL NOT BE REMOVED AND COVERED BY THE METAL PLATE.
- 3. CITY OF CHICAGO CASTINGS ARE THE PROPERTY OF THE CITY AND THE CONTRACTOR SHALL NOTIFY THE CITY FOR REMOVAL AND DISPOSITION OF THE CASTINGS.
- 4. THE METAL PLATE USED TO COVER THE STRUCTURE SHALL REMAIN THE PROPERTY OF THE CONTRACTOR.

CONSTRUCTION PROCEDURES

STAGE 1 (BEFORE PAVEMENT MILLING)

- A) REMOVE A MINIMUM OF 12 (300) OF THE PAVEMENT FROM AROUND THE STRUCTURE.
- B) REMOVE THE EXISTING FRAME AND LID FROM THE STRUCTURE.
- C) COVER THE STRUCTURE OPENING WITH A 36 (900) DIAMETER METAL PLATE.
- D) BACKFILL WITH CRUSHED STONE AND HMA SURFACE MIX APPROVED BY THE ENGINEER. (MIN. 1 1/2 (40) HMA TO REMAIN AFTER MILLING).

STAGE 2 (AFTER PAVEMENT MILLING)

- A) REMOVE THE HMA SURFACE MIX AND CRUSHED STONE.
- B) INSTALL THE FRAME AND LID; ADJUST THE FRAME TO ITS FINAL SURFACE ELEVATION.
- C) THE SURROUNDING SPACE SHALL BE FILLED WITH CLASS*PP-1 CONCRETE TO THE ELEVATION OF THE SURFACE OF THE EXISTING BASE COURSE OR THE BINDER COURSE.
- *UNLESS OTHERWISE SPECIFIED IN THE PLANS.

THE PROCEDURE EXPLAINED ABOVE SHALL CONFORM TO THE APPLICABLE PORTIONS OF SECTIONS 353, 406, 602, AND 603 OF THE STANDARD SPECIFICATIONS EXCEPT THAT "THE CONTRACTOR SHALL ADJUST THE STRUCTURES TO THE FINISHED PAVEMENT ELEVATION NO MORE THAN 5 CALENDAR DAYS PRIOR TO PLACEMENT OF THE FINAL LIFT OF SURFACE UNLESS APPROVED BY THE ENGINEER."

LEGEND

SUB-BASE GRANULAR MATERIAL

(6) FRAME AND LID (SEE NOTES)

2 EXISTING PAVEMENT

5 EXISTING STRUCTURE

7 CLASS*PP-1 CONCRETE

3 36 (900) DIAMETER METAL PLATE

8 PROPOSED HMA SURFACE COURSE

4 PROPOSED CRUSHED STONE AND HMA SURFACE MIX

9 PROPOSED HMA BINDER COURSE

LOCATION OF STRUCTURES

THE CONTRACTOR WILL BE REQUIRED TO KEEP A RECORD OF THE LOCATIONS OF THE BURIED STRUCTURES ACCORDING TO THE STATION AND DISTANCE LEFT OR RIGHT OF THE CENTERLINE OF PAVEMENT. UPON COMPLETION OF THE WORK, THE CONTRACTOR WILL DELIVER THE RECORD TO THE ENGINEER.

BASIS OF PAYMENT

SCALE: N.T.S.

- 1. REMOVING FRAMES AND LIDS ON DRAINAGE AND UTILITY STRUCTURES IN THE PAVEMENT PRIOR TO MILLING, AND ADJUSTING TO FINAL GRADE PRIOR TO PLACING THE SURFACE COURSE, WILL BE PAID FOR AT THE CONTRACT UNIT PRICE EACH FOR "FRAMES AND LIDS TO BE ADJUSTED
- 2. THIS WORK WILL NOT BE PAID FOR WHEN DRAINAGE AND UTILITY STRUCTURES ARE SPECIFIED FOR PAYMENT AS STRUCTURE RECONSTRUCTION.
- 3. NEW FRAMES AND LIDS, WHEN SPECIFIED, WILL BE PAID FOR SEPARATELY.
- 4. WHEN STRUCTURES ARE TO BE ADJUSTED OR RECONSTRUCTED. THE LOWERING AND RAISING OF THE FRAMES AND LIDS WILL NOT BE PAID FOR SEPARATELY BUT WILL BE INCLUDED IN THE COST OF THE CORRESPONDING PAY ITEM.

ALL DIMENSIONS ARE IN INCHES (MILLIMETERS) UNLESS OTHERWISE SHOWN

JSER NAME = demanchelt DESIGNED - R. SHAH REVISED - R. BORO 01-01-07 **DETAILS FOR** DRAWN REVISED - R. BORO 03-09-11 STATE OF ILLINOIS FRAMES AND LIDS ADJUSTMENT WITH MILLING PLOT SCALE = 100.0000 ' / in. CHECKED -REVISED - R. BORO 12-06-11 **DEPARTMENT OF TRANSPORTATION** BD600-03 (BD-08) CONTRACT NO SCALE: NONE SHEET 1 OF 1 SHEETS STA.

DESIGNED -REVISED CW USER NAME = bhartma DRAWN CW REVISED CHECKED REVISED PLOT DATE = 9/6/2022 REVISED DATE 9/1/2022

STATE OF ILLINOIS **DEPARTMENT OF TRANSPORTATION**

	D	ISTR	ICT	ONE D	ETAILS		F.A.U RTE.	SECTION NO.	COUNTY	TOTAL	
			1	BD-08			87	20-00087-00-RS	MCHENRY	43	34
				DD-00					CONTRACT	NO.	61J03
SHEET	1	OF	9	SHEETS	STA.	TO STA.	FED. RC	DAD DIST. NO. ILLINOIS FED.	AID PROJECT		

METHOD OF MEASUREMENT


REFER TO SECTION 442 OF THE STANDARD SPECIFICATIONS FOR ROAD AND BRIDGE CONSTRUCTION AND THE RECURRING SPECIAL PROVISION "PATCHING WITH HOT-MIX ASPHALT OVERLAY REMOVAL."

BASIS OF PAYMENT

- 1. REFER TO SECTION 442 OF THE STANDARD SPECIFICATIONS FOR ROAD AND BRIDGE CONSTRUCTION AND THE RECURRING SPECIAL PROVISION "PATCHING WITH HOT-MIX ASPHALT OVERLAY REMOVAL."
- 2. SAW CUT/SCORING OF EXISTING HMA OVERLAY IS INCLUDED IN THE COST OF PAVEMENT PATCHING.
- 3. SAW CUT/SCORING OF EXISTING PAVEMENT IS INCLUDED IN THE COST OF PAVEMENT PATCHING.

★ SEE TYPICAL SECTIONS FOR

THICKNESS AND MATERIALS

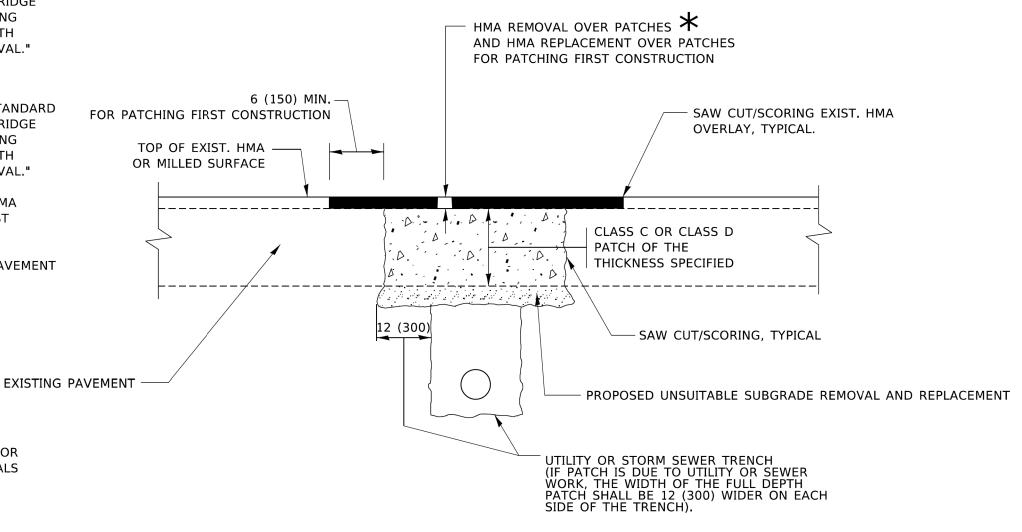

SEQUENCE OF CONSTRUCTION (PATCHING FIRST)

- 1. REMOVE THE EXISTING HMA MATERIAL OVER THE AREA TO BE PATCHED.
- 2. REMOVE AND REPLACE WITH CLASS C OR D PATCH.
- 3. REPLACE HMA MATERIAL OVER THE AREA TO BE PATCHED.

SEQUENCE OF CONSTRUCTION (MILLING FIRST)

- 1. MILL HMA FIRST IF THERE IS AT LEAST 4½ INCHES OR MORE OF HMA MATERIAL ON TOP OF THE EXISTING PAVEMENT OR IF THE PAVEMENT IS FULL DEPTH HMA. A MINIMUM OF 2 INCHES OF HMA MATERIAL SHALL BE IN PLACE AFTER MILLING.
- 2. REMOVE AND REPLACE WITH FULL DEPTH CLASS D PATCHES TO TOP OF MILLED SURFACE.

ALL DIMENSIONS ARE IN INCHES (MILLIMETERS) UNLESS OTHERWISE SHOWN.

	USER NAME = demanchelt	DESIGNED - R. SHAH DRAWN -	REVISED - R. BORO 01-01-07 REVISED - R. BORO 09-04-07	STATE OF ILLINOIS		PAVEMENT PATCH			RTE.	SECTION	COUNTY	SHEETS N	10.
	PLOT SCALE = 100.0000 ' / in.	CHECKED -	REVISED - K. ENG 10-27-08	DEPARTMENT OF TRANSPORTATION		HMA SURFACED P	AVENIENI			BD400-04 (BD-22)	CONTRAC	T NO.	
1	PLOT DATE = 2/2/2022	DATE - 10-25-94	REVISED - K. SMITH 02-01-22		SCALE: NONE	SHEET 1 OF 1 SHEETS	STA.	TO STA.		ILLINOIS F	ED. AID PROJECT		


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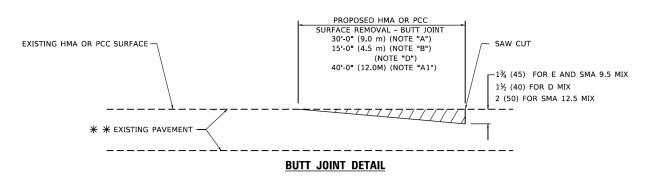



USER NAME = bhartma	DESIGNED	-	CW	REVISED -	
	DRAWN	-	CW	REVISED -	
PLOT SCALE = 33.3330 '/ in.	CHECKED	-	ВН	REVISED -	
PLOT DATE = 9/6/2022	DATE	-	9/1/2022	REVISED -	

STATE OF ILLINOIS
DEPARTMENT OF TRANSPORTATION

	DISTRICT ONE DETAILS BD-22								SECTION NO.	COUNTY	TOTAL SHEETS	SHEET NO.
									20-00087-00-RS	MCHENRY	43	35
					DD-22					CONTRACT	NO.	61J03
	SHEET 2 OF 9 SHEETS STA. TO STA.						TO STA.	FED. RO	AD DIST. NO. ILLINOIS FED. A	ID PROJECT		



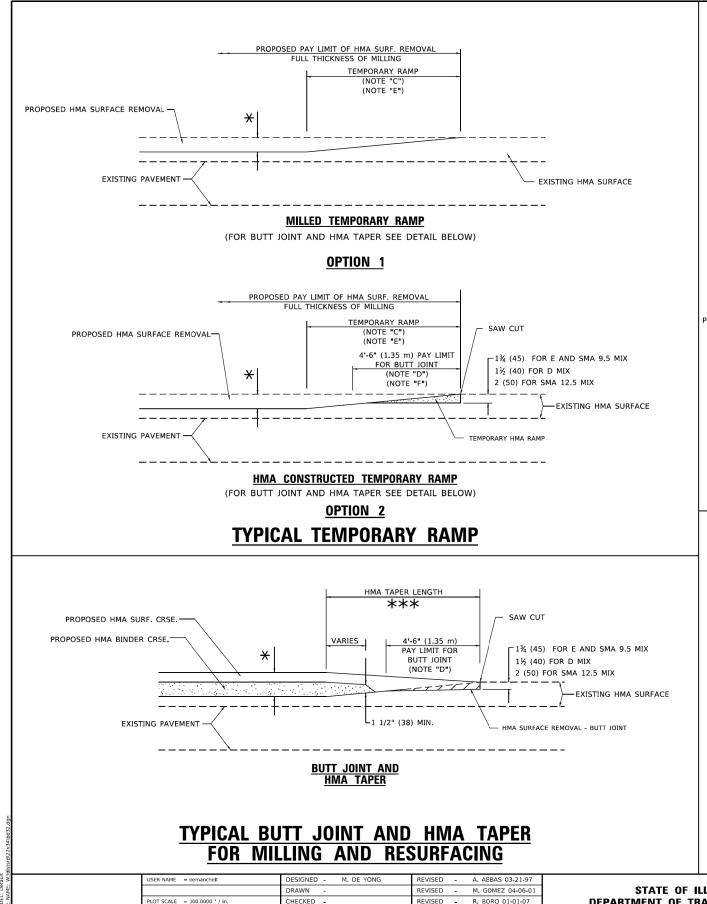

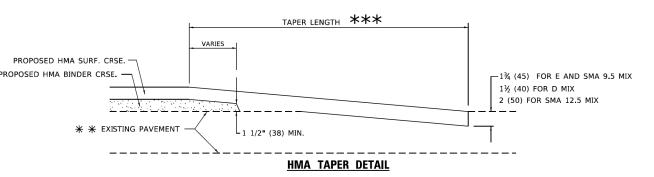

TYPICAL BUTT JOINT AND HMA TAPER FOR RESURFACING ONLY

 $\star\star$ pc concrete, hma or hma resurfaced pavement.

GENERAL NOTES

- A. MAINLINE ARTERIAL ROADWAYS AND MAJOR SIDE ROADS.
- A1. INTERSTATES
- B. MINOR SIDE ROADS.
- C. THE TEMP, RAMP SHALL BE CONSTRUCTED IMMEDIATELY UPON REMOVAL OF THE EXISTING HMA SURFACE.
- D. THE BUTT JOINT SHALL BE CONSTRUCTED IMMEDIATELY PRIOR TO PLACING THE PROPOSED HMA COURSES.
- E. TAPER THE TEMP. RAMP AT A RATE OF 3' 4" (1.02m) PER 1 INCH (25 mm) OF MILLING THICKNESS.

* SEE TYPICAL SECTIONS FOR MILLING THICKNESS.

F. SEE ARTICLE 406.08 AND 406.14 OF THE STANDARD SPECIFICATIONS FOR "HMA AND/OR PCC SURFACE REMOVAL, BUTT JOINT".

*** 20'-0" (6.1 m) PER 1 (25) RESURFACING (NOTE "A") 10'-0" (3.0 m) PER 1 (25) RESURFACING (NOTE "B")

BASIS OF PAYMENT

- THE BUTT JOINT WILL BE PAID FOR AT THE CONTRACT UNIT PRICE PER SQUARE YARD (SQUARE METER) FOR "HOT-MIX ASPHALT SURFACE REMOVAL - BUTT JOINT" OR FOR "PORTLAND CEMENT CONCRETE SURFACE REMOVAL- BUTT JOINT".
- 2. THE TEMPORARY RAMP AND SAW CUT SHALL BE INCLUDED IN THE UNIT COST FOR HMA OR PCC SURFACE REMOVAL-BUTT JOINT.

SCALE: N.T.S.

ALL DIMENSIONS ARE IN INCHES (MILLIMETERS) UNLESS OTHERWISE SHOWN.


USER NAME = cemancheit	DESIGNED - M. DE YONG	REVISED - A. ABBAS 03-21-97			BUTT JOINT	AND		RTE	SECTI	ION	COUNTY SHEETS	S NO
	DRAWN -	REVISED - M. GOMEZ 04-06-01	STATE OF ILLINOIS								SHEETS	3
PLOT SCALE = 100.0000 ' / in.	CHECKED -	REVISED - R. BORO 01-01-07	DEPARTMENT OF TRANSPORTATION		HMA TAPER	DETAILS		—	BD400-05 B	3D-32	CONTRACT NO.	
PLOT DATE = 2/2/2022	DATE - 06-13-90	REVISED - K. SMITH 02-01-22		SCALE: NONE	SHEET 1 OF 1 SHEET	S STA.	TO STA.		1	ILLINOIS FED. AI	D PROJECT	

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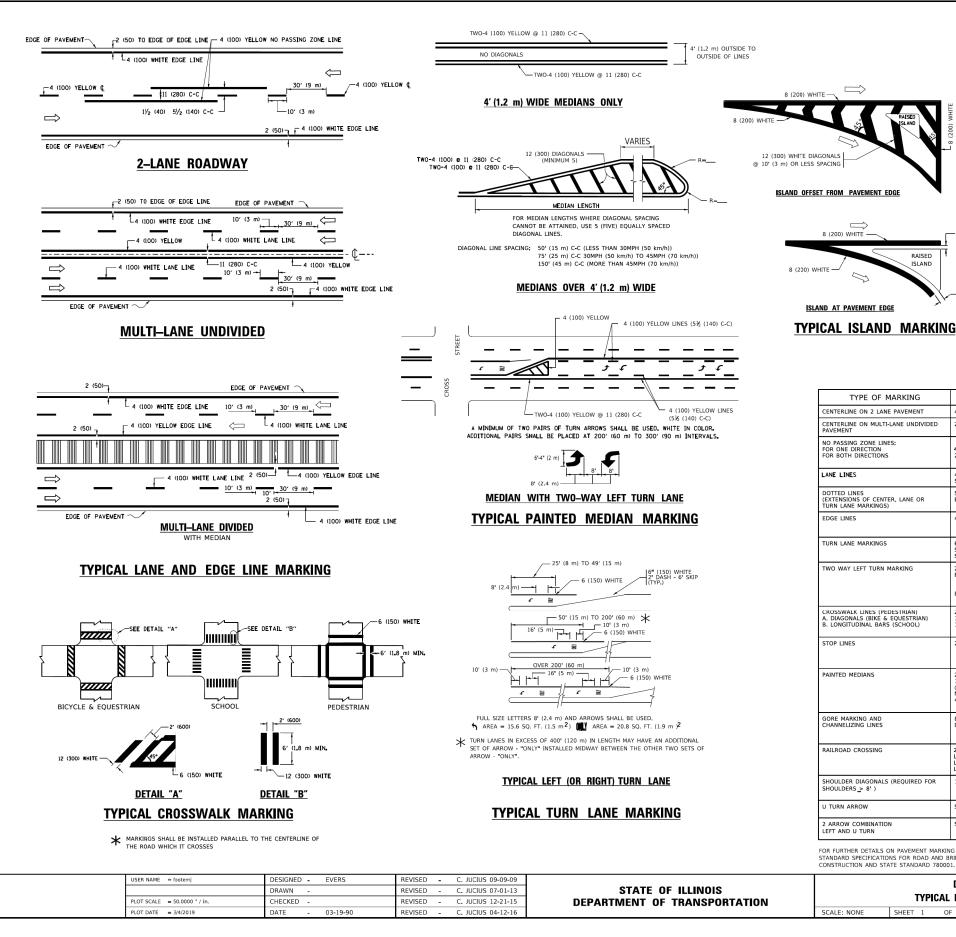
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PLOT DATE = 9/6/2022	DATE	-	9/1/2022	REVISED -


STATE OF ILLINOIS
DEPARTMENT OF TRANSPORTATION

DISTRICT ONE DETAILS						F.A.U RTE.	SECTI	ON NO.	COUNTY	TOTAL	SHEET NO.	
			1	BD-32			87	20-000	87-00-RS	MCHENRY	43	36
			'	DD-32						CONTRACT	NO.	61J03
SHEET	3	OF	9	SHEETS	STA.	TO STA.	FED. RO	DAD DIST. NO.	ILLINOIS FED. AI	D PROJECT		

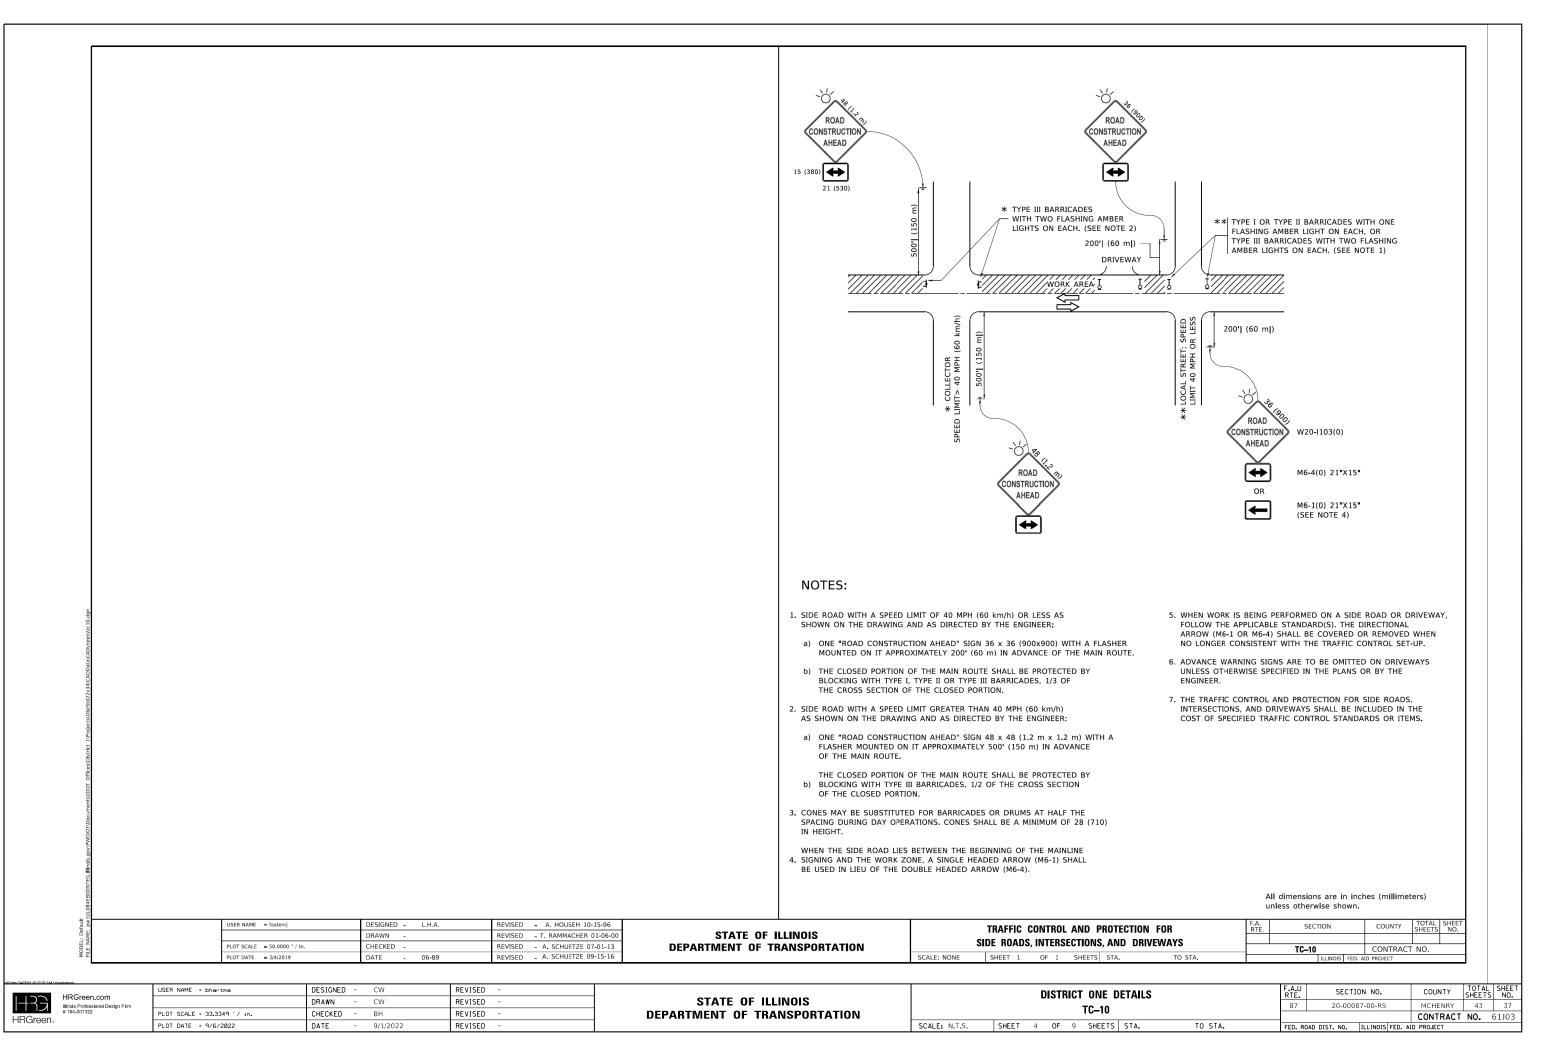

HRG PROJECT NO.: 200633 HRG PROJ. CONTACT: FILE NAME: 200633-sht-def. tcl0.0 PLOT DRIVER: (L.-bdf.-bw.pitcfg PEN TABLE: plottobel.tbi



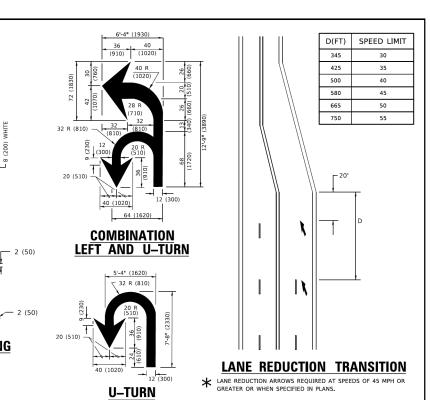

PATTERN TYPE OF MARKING WIDTH OF LINE COLOR SPACING / REMARKS ENTERLINE ON 2 LANE PAVEMENT 4 (100) SKIP-DASH 10' (3 m) LINE WITH 30' (9 m) SPACE 2 @ 4 (100 SOLID ENTERLINE ON MULTI-LANE UNDIVIDED AVEMENT 11 (280) C-C NO PASSING ZONE LINES: 5½ (140) C-C FROM SKIP-DASH CENTERLINE 11 (280) C-C FOR ONE DIRECTION FOR BOTH DIRECTIONS 4 (100) 2 @ 4 (100) rellow rellow SKIP-DASH SKIP-DASH 10' (3 m) LINE WITH 30' (9 m) SPACE 4 (100) 5 (125) ON FREEWAYS OOTTED LINES EXTENSIONS OF CENTER, LANE OR FURN LANE MARKINGS) SAME AS LINE BEING EXTENDED SAME AS LINE BEING (100) TURN LANE MARKINGS 6 (150) LINE; FULL SIZE LETTERS & SYMBOLS (8' (2.4m)) SOLID SEE TYPICAL TURN LANE MARKING DETAIL 10' (3 m) LINE WITH 30' (9 m) SPACE FOR SKIP-DASH; 5½ (140) C-C BETWEEN SOLID LINE AND SKIP-DASH LINE SEE TYPICAL TWO-WAY LEFT TURN MARKING DETAIL TWO WAY LEFT TURN MARKING SKIP-DASH AND SOLID 2 @ 4 (100) EACH DIRECTIO YELLOW 8' (2.4m) LEFT ARROV ROSSWALK LINES (PEDESTRIAN) A. DIAGONALS (BIKE & EQUESTRIAN) B. LONGITUDINAL BARS (SCHOOL) 2 @ 6 (150) 12 (300) @ 45° 12 (300) @ 90° NOT LESS THAN 6' (1.8 m) APART 2' (600) APART 2' (600) APART 5' (600) APART 5' (FOR THE TOTAL STANDARD PLACE 4' (1,2 m) IN ADVANCE OF AND PARALLEL TO CROSSWALK, IF PRESENT. OTHERWISE, PLACE AT DESIRED STOPPING POINT. PARALLEL TO CROSSROAD CENTER POSSIBLE 24 (600) SOLID WHITE 2 @ 4 (100) WITH 12 (300) DIAGONALS @ 45° NO DIAGONALS USED FO 4' (1.2 m) WIDE MEDIANS PAINTED MEDIANS SOLID YELLOW: TWO WAY TRAFFIC 11 (280) C-C FOR THE DOUBLE LINE SEE TYPICAL PAINTED MEDIAN MARKING. WHITE: ONE WAY TRAFFIC DIAGONALS: 15' (4.5 m) C-C (LESS THAN 30MPH (50 km/h)) 20' (6 m) C-C 30MPH (50 km/h) TO 45MPH (70 km/h)) 30' (9 m) C-C (OVER 45MPH (70 km/h)) GORE MARKING AND CHANNELIZING LINES SOLID 24 (600) TRANSVERSE LINES; "RR" IS 6' (1.8 m) LETTERS; 16 (400) LINE FOR "X" RAILROAD CROSSING SOLID WHITE SEE STATE STANDARD 780001 AREA OF: "R"=3.6 SQ. FT. (0.33 m) EACH "X"=54.0 SQ. FT. (5.0 m) 50' (15 m) C-C (LESS THAN 30MPH (50 km/h)) 75' (25 m) C-C (30 MPH (50 km/h) TO 45MPH (70 km/h)) 150' (45 m) C-C (OVER 45MPH (70 km/h)) SHOULDER DIAGONALS (REQUIRED FOR SHOULDERS > 8') 12 (300) @ 45 SOLID WHITE - RIGHT YELLOW - LEFT 2 ARROW COMBINATION LEFT AND U TURN SEE DETAIL SOLID 30.4 SF

FOR FURTHER DETAILS ON PAVEMENT MARKING REFER TO STANDARD SPECIFICATIONS FOR ROAD AND BRIDGE CONSTRUCTION AND STATE STANDARD 780001.

SCALE: N.T.S.

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	T\	/PICA	ι ΡΔ	VEMENT	MARKING	e l							
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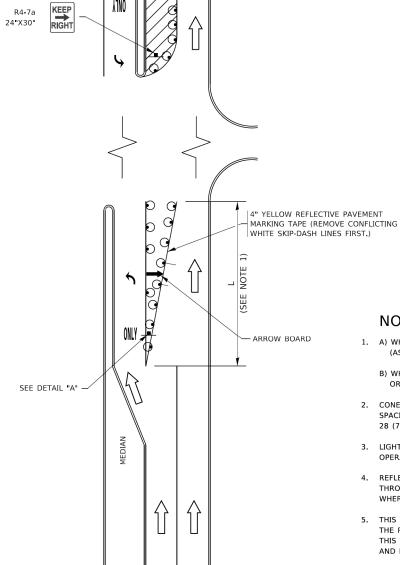
HRGreen.com **HRGreen**


USER NAME = bhartma	DESIGNED	-	CW	REVISED	-
	DRAWN	-	CW	REVISED	-
PLOT SCALE = 33.3349 '/ in.	CHECKED	-	ВН	REVISED	-
PLOT DATE = 9/6/2022	DATE	-	9/1/2022	REVISED	-

STATE OF ILLINOIS **DEPARTMENT OF TRANSPORTATION**

	D	OISTE	RICT	ONE D	ETAILS		F.A.U RTE.	SECTI	ON NO.	COUNTY	TOTAL SHEETS	SHEET NO.
				TC-13			87	20-0008	37-00-RS	MCHENRY	43	38
										CONTRACT	NO.	61J03
SHEET	5	OF	9	SHEETS	STA.	TO STA.	FED. RO	DAD DIST, NO.	ILLINOIS FED. A	D PROJECT		

TURN BAY ENTRANCE AT START OF LANE CLOSURE TAPER




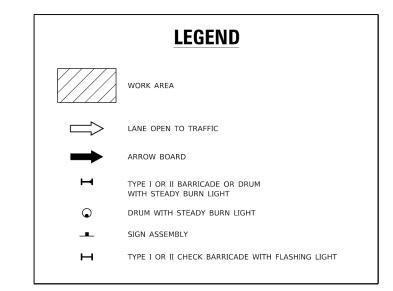

NOTES:

- 1. A) WHEN "L" IS \leq THE STORAGE LENGTH OF THE TURN LANE (AS SHOWN IN FIG. 1), USE FIGURE 1.
 - B) WHEN "L" IS > THE STORAGE LENGTH OF THE TURN LANE OR THE TURN LANE IS WITHIN THE LANE CLOSURE, USE FIGURE 2.
- 2. CONES MAY BE SUBSTITUTED FOR BARRICADES OR DRUMS AT HALF THE SPACING DURING DAY OPERATIONS. CONES SHALL BE A MINIMUM OF 28 (710) IN HEIGHT.
- 3. LIGHTS WILL NOT BE REQUIRED ON BARRICADES OR DRUMS FOR DAY OPERATIONS. ALL LIGHTS SHALL BE MONODIRECTIONAL.
- 4. REFLECTIVE TEMPORARY PAVEMENT MARKINGS SHALL BE PLACED THROUGHOUT THE BARRICADED AREAS OF EACH TURN BAY AS SHOWN WHERE THE CLOSURE TIME IS GREATER THAN FOURTEEN (14) DAYS.
- 5. THIS APPLICATION ALSO APPLIES WHEN WORK IS BEING PERFORMED IN THE RIGHT LANE(S) AND THE RIGHT TURN BAY IS TO REMAIN OPEN. UNDER THIS CONDITION, "RIGHT TURN LANE" R3-I100R 24 x 24 (600 x 600) AND M6-2R 21 \times 15 (530 \times 380) SHALL BE USED.
- THESE CONTROLS SHALL SUPPLEMENT MAINLINE TRAFFIC CONTROL FOR LANE CLOSURES.
- 7. THE SIGNS SHALL BE MOUNTED ABOVE THE BARRICADES/DRUMS ON SEPARATE SIGN SUPPORTS THAT MEET NCHRP 350 OR MASH
- 8. TRAFFIC CONTROL AND PROTECTION AT TURN BAYS (TO REMAIN OPEN TO TRAFFIC) SHALL BE INCLUDED IN THE COST OF SPECIFIED TRAFFIC CONTROL STANDARDS OR ITEMS.

TURN BAY ENTRANCE WITHIN A LANE CLOSURE

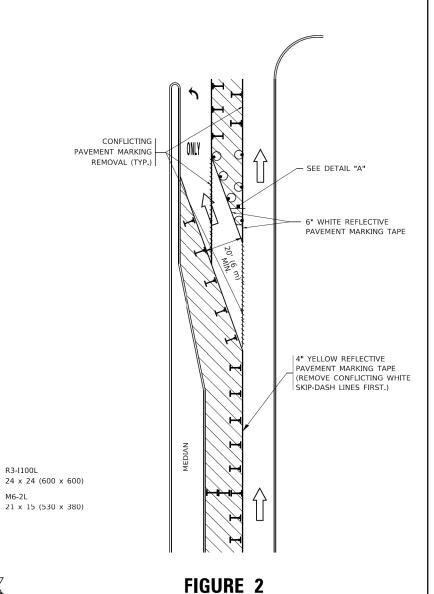

DETAIL A

SCALE: N.T.S.

STABILIZE SIGN SUPPORT WITH

SANDBAGS AS

NECESSARY

TURN

LANE

All dimensions are in inches (millimeters) unless otherwise shown.

USER NAME = footemj	DESIGNED -T. RAMMACHER 09-08-9	4 REVISED			l trafi	FIC CONTR	OL AND	PROTE	CTION AT TUR	N BAYS	RTE.	SECTION	COUNTY	SHEETS	NO.
	DRAWN - A. HOUSEH 11-07-95	REVISED	- A. SCHUETZE 07-01-13	STATE OF ILLINOIS					TO TRAFFIC)						
PLOT SCALE = 50.0000 ' / in.	CHECKED - A. HOUSEH 10-12-96	REVISED	- A. SCHUETZE 09-15-16	DEPARTMENT OF TRANSPORTATION		(10 1	TEIVIAIN	UPEN	IU INAFFIC)			TC-14	CONTRACT	T NO.	
PLOT DATE = 3/4/2019	DATE -T. RAMMACHER 01-06-0	0 REVISED	-		SCALE: NONE	SHEET 1	OF 1	SHEETS	STA.	TO STA.		ILLINOIS FED.	ID PROJECT		

HRGreen


HRGreen.com

USER NAME = bhartma	DESIGNED	-	CW	REVISED	-
	DRAWN	-	CW	REVISED	-
PLOT SCALE = 33.3349 '/ in.	CHECKED	-	ВН	REVISED	-
PLOT DATE = 9/6/2022	DATE	-	9/1/2022	REVISED	-

FIGURE 1

STATE OF ILLINOIS **DEPARTMENT OF TRANSPORTATION**

	D	ISTR	RICT	ONE D	ETAILS		F.A.U RTE.	SECTIO	ON NO.	COUNTY	TOTAL SHEETS	SHEET NO.
				TC-14			87	20-0008	7-00-RS	MCHENRY	43	39
				10-17						CONTRACT	NO.	61J03
CHEET	6	OE	0	CHEETC	CTA	TO STA		ALD DICT NO	TILL THOSE FED. AT	O DDO FOT		

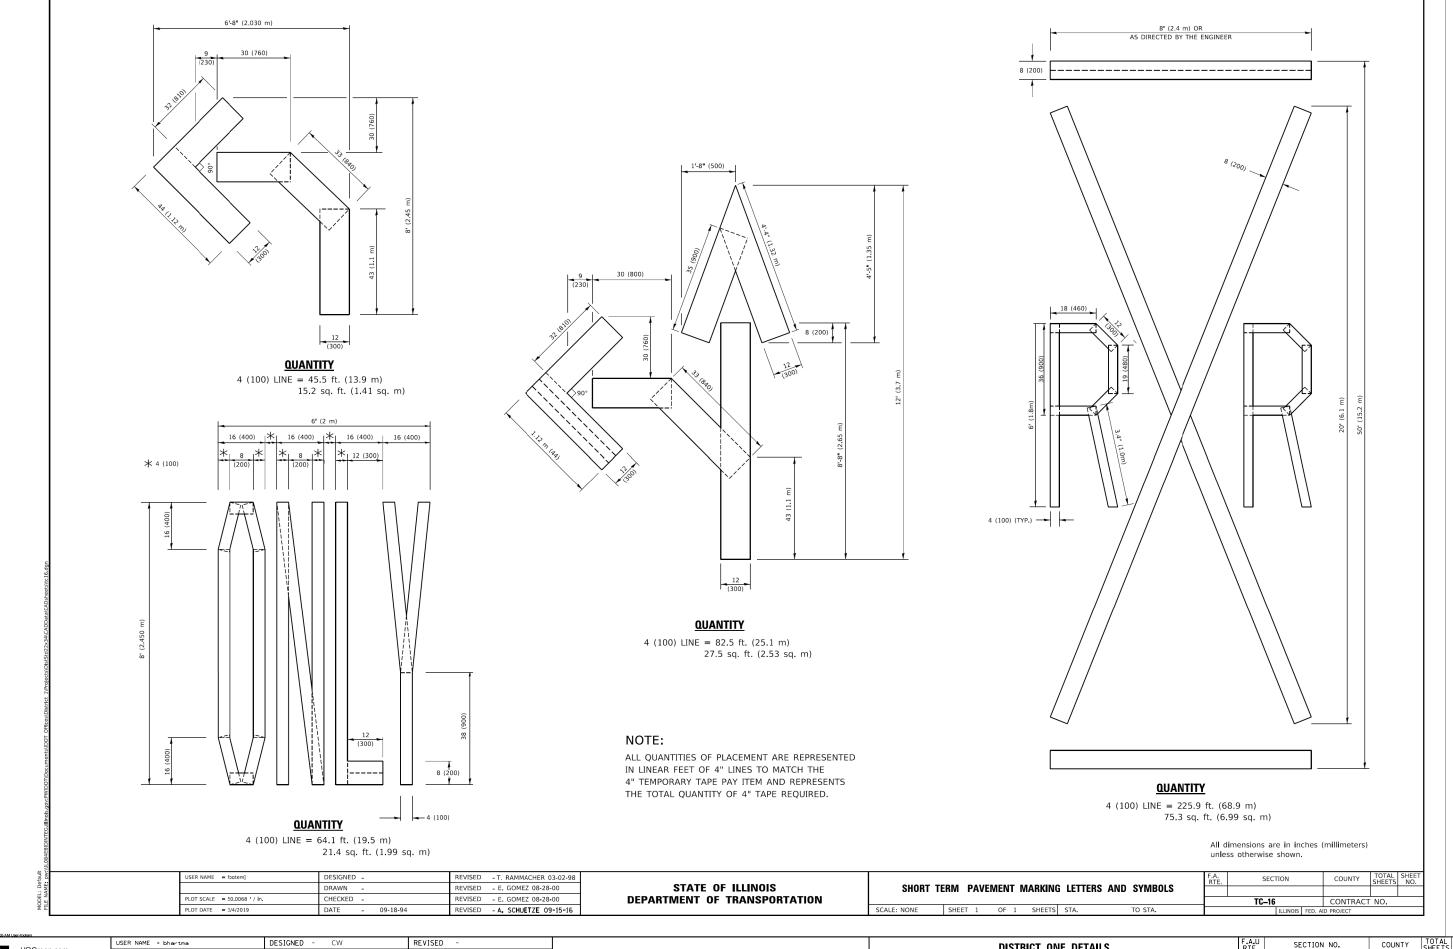

HRGreen.com HRGreen.


DRAWN CW REVISED PLOT SCALE = 33.3335 '/ in. CHECKED REVISED REVISED PLOT DATE = 9/6/2022 DATE - 9/1/2022

STATE OF ILLINOIS **DEPARTMENT OF TRANSPORTATION**

SECTION NO. DISTRICT ONE DETAILS 20-00087-00-RS TC-16 SCALE: N.T.S. SHEET 7 OF 9 SHEETS STA. TO STA.

COUNTY TOTAL SHEET NO.

MCHENRY 43 40 CONTRACT NO. 61J03 FED. ROAD DIST. NO. | ILLINOIS FED. AID PROJECT

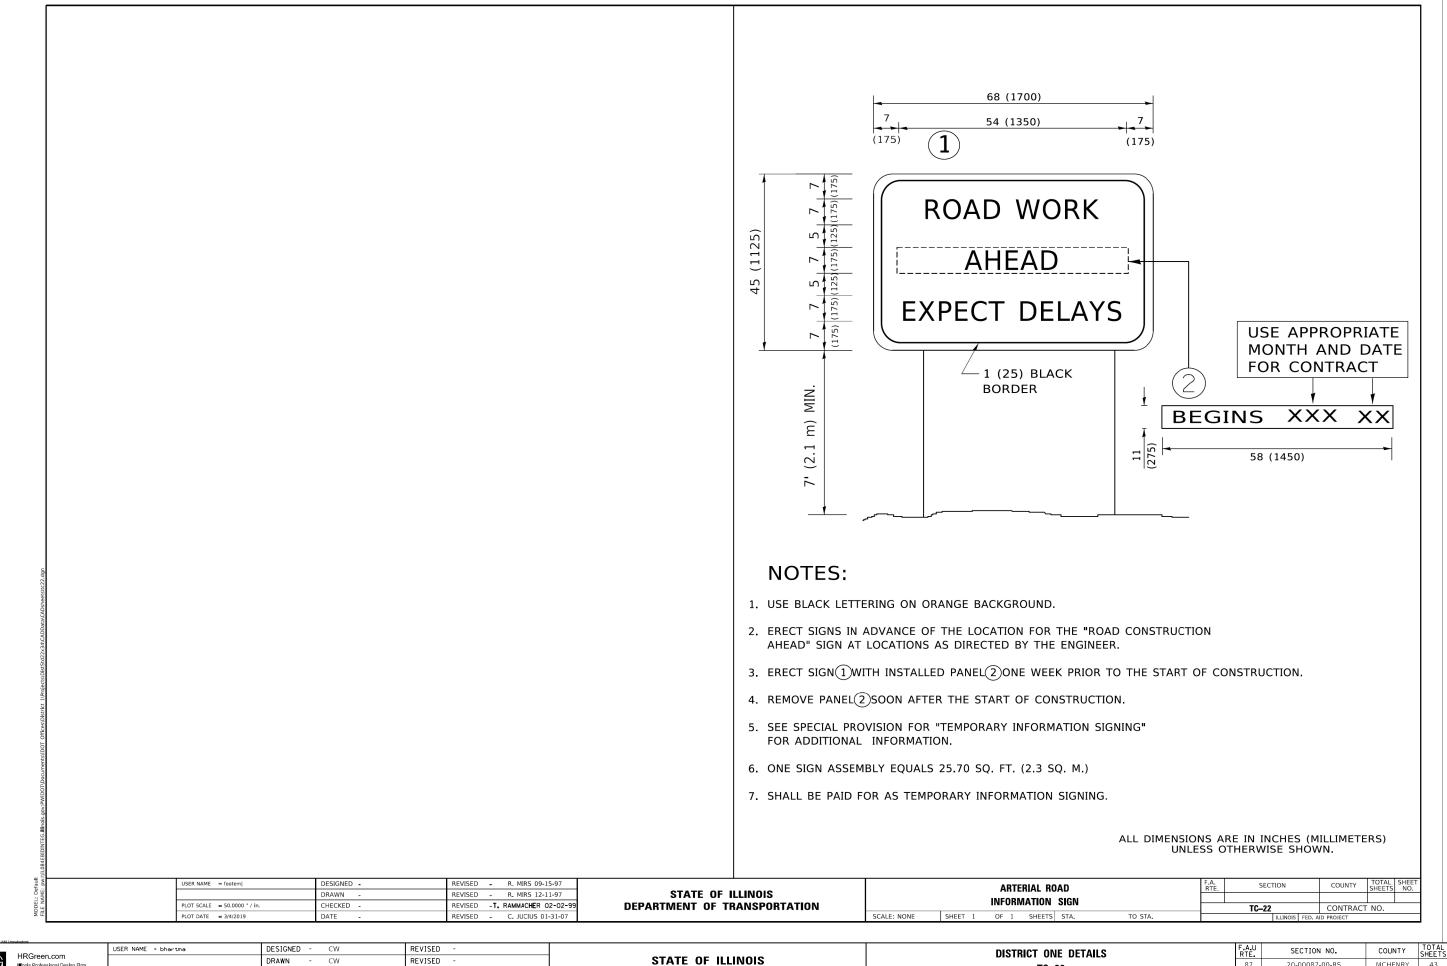

HRGreen


CHECKED REVISED REVISED PLOT DATE = 9/6/2022 DATE 9/1/2022

DEPARTMENT OF TRANSPORTATION

SCALE: N.T.S.

TC-22 SHEET 8 OF 9 SHEETS STA. TO STA.

43 41 20-00087-00-RS MCHENRY CONTRACT NO. 61J03

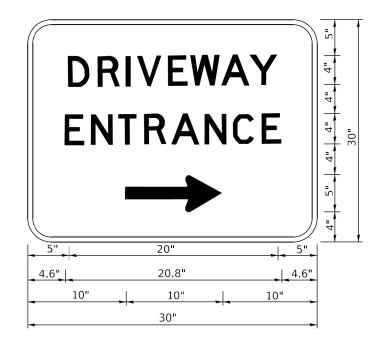

3.0" RADIUS, 0.5" BORDER, WHITE ON GREEN; REFLECTORIZED "DRIVEWAY" D; "ENTRANCE" D; STANDARD ARROW CUSTOM 12.0" x 5.0"

NOTES:

- 1. HALF OF THE SIGNS WILL REQUIRE A LEFT HAND FACING ARROW.
- 2. TWO SIGNS SHALL BE USED AT EACH COMMERCIAL ENTRANCE PLACED BACK-TO-BACK: ONE WITH A RIGHT HAND ARROW (SHOWN) SHALL BE PLACED ON THE NEAR RIGHT SIDE THE DRIVEWAY AND ONE WITH A LEFT HAND ARROW SHALL BE PLACED ON THE FAR LEFT SIDE OF THE DRIVEWAY.
- 3. SIGNS TO BE PAID FOR AS ITEM "TEMPORARY INFORMATION SIGNING".

USER NAME = leysa	DESIGNED -	REVISED	-	C. JUCIUS 02-15-07
	DRAWN -	REVISED	-	
PLOT SCALE = 50.0000 ' / in.	CHECKED -	REVISED	-	
PLOT DATE = 8/6/2021	DATE -	REVISED	-	

STATE OF ILLINOIS
DEPARTMENT OF TRANSPORTATION

	_							RTE.	SEC	TION		COUNTY	SHEETS	
	L	RIVE	:WA	YE	NIKANO	E SIGNING								
									TC-26			CONTRACT	NO.	
CALE: NONE	SHEET	1	OF	1	SHEETS	STA.	TO STA.			ILLINOIS	FED. A	ID PROJECT		

HRG PROJECT NO. 200633
RRG PROJ. CONTACT:
"ILE NAME, 200633-sht-det_t28.c.
LUT DRNYER: L.Ddf.bw.pitcfg
PEN TABLE: plot/dobel.tb/

USER NAME = bhartma	DESIGNED	-	CW	REVISED -
	DRAWN	-	CW	REVISED -
PLOT SCALE = 33.3349 '/ in.	CHECKED	-	ВН	REVISED -
PLOT DATE = 9/6/2022	DATE	-	9/1/2022	REVISED -


STATE OF ILLINOIS	
DEPARTMENT OF TRANSPORTATION	

		DIS	RICT	ONE D	ETAILS		F.A.U RTE.	SECTIO	ON NO.	COUNTY	TOTAL SHEETS	SHEET NO.
				TC-26			87	20-0008	7-00-RS	MCHENRY	43	42
				10-20						CONTRACT	NO.	61J03
SCALE: N.T.S. SF	HEET	9 O F	9	SHEETS	STA.	TO STA.	FED. RC	DAD DIST. NO.	ILLINOIS FED. AI	D PROJECT		

LOOPS NEXT TO SHOULDERS PROVIDE A PAVEMENT REPLACEMENT NOTE WHICH SHOULD EQUAL 3' (900 mm) X WIDTH OF PAVED SHOULDER. NON-PAVED SHOULDER (1.5 m) (1.8 m) (1.5 m) > | 1" (25 mm) UNI DUCT-TRENCHED (3.0 m) (3.0 m) TO E/P ** * = (600 mm) * * UNIT DUCT IS TO BE SHOWN ON PLAN SHEETS BUT SHALL NOT BE INCLUDED IN THE PAY ITEMS ARTERIAL-VOLUME DENSITY ("FAR OUT" DETECTION)

LEFT TURN LANES WITH MEDIANS VOLUME DENSITY ("FAR OUT" DETECTION) ON SAME APPROACH (PROTECTED / PERMITTED LEFT TURN PHASING)


HANDHOLE LOCATION MAY VARY DEPENDING ON GEOMETRICS AND DESIGN OF TRAFFIC SIGNALS. HEAVY-DUTY HANDHOLES TO BE USED WHEN THE MEDIAN IS MOUNTABLE. REFER TO STANDARD 814001 TO ENSURE THAT HANDHOLE FITS IN MEDIAN.

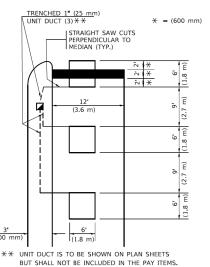

LEFT TURN LANES WITHOUT MEDIANS

VOLUME DENSITY ("FAR OUT" DETECTION) ON SAME APPROACH

(PROTECTED / PERMITTED LEFT TURN PHASING)

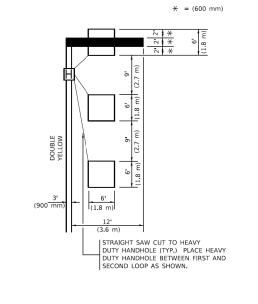


NOTE: DUAL LEFT TURNS NOT SHOWN REFER TO PLAN SHEET FOR DETECTOR LOOP REPLACEMENT

SCALE: NONE

SCALE: N.T.S.

SHEET 1

NOTE: DUAL LEFT TURNS NOT SHOWN REFER TO PLAN SHEET FOR DETECTOR LOOP REPLACEMENT ARTERIAL-VOLUME DENSITY ("FAR OUT" DETECTION)

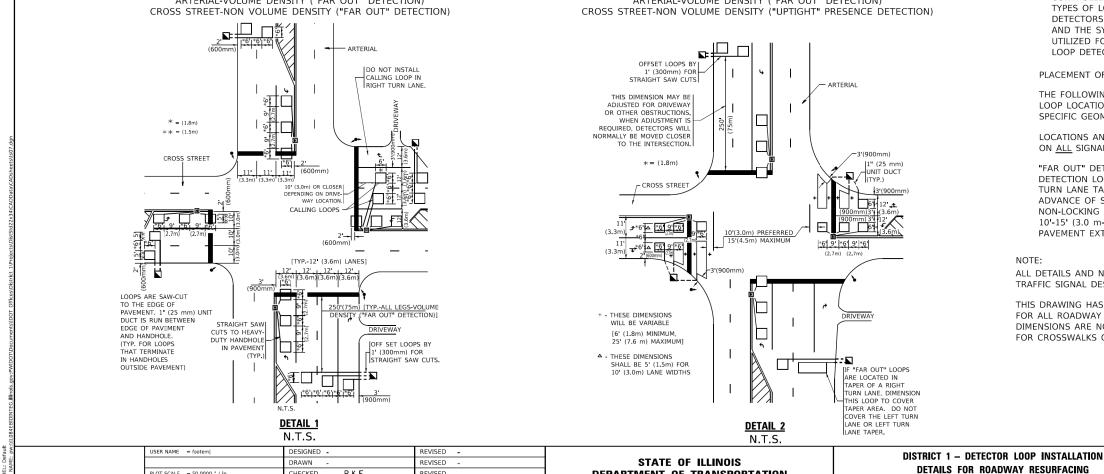

REVISED

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NOTES:

VEHICLES LOOP DETECTORS

- * ALL LEAD IN CABLE SHALL BE TWO CONDUCTOR NO. 14 TWISTED, SHIELDED.
- * FACH DETECTOR LOOP SHALL HAVE ITS OWN SAW CUT FROM THE LOOP TO THE EDGE OF PAVEMENT OR TO A HANDHOLE IN THE PAVEMENT
- * EACH DETECTOR LOOP SHALL HAVE ITS OWN ONE INCH (25 mm) UNIT DUCT BETWEEN THE EDGE OF PAVEMENT AND THE FIRST HANDHOLE OR JUNCTION BOX. EACH UNIT DUCT RUN SHALL BE SHOWN ON THE PLANS BY THE DESIGNER, BUT SHALL NOT BE PAID FOR SEPARATLY. THIS ITEM IS INCIDENTAL TO THE PAY ITEM FOR DETECTOR LOOPS.
- st One dimension of <u>all</u> detector loops shall be six feet
- * EACH LANE OF NON-LOCKING, PRESENCE DETECTION AND EACH LANE OF A DOUBLE LEFT TURN LANE REQUIRES A SEPARATE INDUCTIVE LOOP DETECTOR AND LEAD IN CABLE.
- * WHEN NON-LOCKING, PRESENCE DETECTION IS USED, MORE THAN ONE LOOP PER LANE IS REQUIRED BEHIND THE STOP BAR (i.e. 1-1/2, 1-3/4, 2).
- * WHEN SYSTEM LOOPS ARE REQUIRED ON AN APPROACH OF AN INTERSECTION, THE LOOPS USED FOR VOLUME DENSITY AND INTERSECTION TIMING SHALL ALSO BE USED AS SYSTEM DETECTORS. EACH ONE OF THESE TYPE OF LOOPS REQUIRES A SEPARATE TWO CONDUCTOR NO. 14 TWISTED SHIELDED CABLE AND A SEPARATE INDUCTIVE LOOP DETECTOR WHEN NEW CONTROLLERS ARE UTILIZED. THE DESIGNER SHALL LABEL THESE TYPES OF LOOPS AS "INTERSECTION AND SAMPLING (SYSTEM) DETECTORS" ON THE SIGNAL LAYOUT, THE INTERCONNECT PLAN AND THE SYSTEM CABLE PLAN. WHEN AN EXISTING CONTROLLER IS UTILIZED FOR THIS TYPE OF DETECTION, THE PAY ITEM "INDUCTIVE LOOP DETECTOR WITH SYSTEM OUTPUT" SHOULD BE USED.

PLACEMENT OF DETECTORS

THE FOLLOWING FIGURES REPRESENT THE MOST COMMON DETECTOR LOOP LOCATIONS AND SIZES. ADJUSTMENTS WILL BE NECESSARY FOR SPECIFIC GEOMETRIC CONSIDERATIONS.

LOCATIONS AND DEMENSIONS OF DETECTOR LOOPS ARE REQUIRED ON ALL SIGNAL LAYOUT PLAN SHEETS.

"FAR OUT" DETECTION REFERS TO LOCKING, PRESENCE TYPE DETECTION LOCATED IN THRU LANES, RIGHT TURN LANES, AND RIGHT TURN LANE TAPER AREAS (IF APPLICABLE), USUALLY 250' (75 m) IN ADVANCE OF STOP BARS. "UPTIGHT" DETECTION REFERS TO NON-LOCKING PRESENCE TYPE DETECTION LOCATED IN ALL LANES AND 10'-15' (3.0 m-4.5 m) BEHIND THE CROSSING STREET'S EDGE OF PAVEMENT EXTENDED.

NOTE:

ALL DETAILS AND NOTES SHOWN ARE FROM THE I.D.O.T. DISTRICT 1 TRAFFIC SIGNAL DESIGN GUIDELINES DATED JANUARY 1995

TO STA.

THIS DRAWING HAS BEEN PREPARED TO ASSIST THE RESIDENT ENGINEER FOR ALL ROADWAY RESURFACING OR S.M.A.R.T. PROJECTS WHERE THE DIMENSIONS ARE NOT SHOWN ON THE PLANS AND THE FINAL LOCATIONS FOR CROSSWALKS OR STOP BARS ARE NOT DETERMINED.

SECTION

TS-07

T NO.: 2 DNTACT: 200633-: 1: /L_Dd1 plo flabe	x07.don 3W/2010 12:50:10 PM Llon	c=fo
PROJEC PROJ. CO NAME: 2 DRIVER TABLE:	H33	H #
HRC HRC FLE PLOT	HRGreen₅	

HRGreen.com

USER NAME = bhartma	DESIGNED	-	CW	REVISED	-
	DRAWN	-	CW	REVISED	-
PLOT SCALE = 33.3349 '/ in.	CHECKED	-	ВН	REVISED	-
PLOT DATE = 9/6/2022	DATE	-	9/1/2022	REVISED	-

HECKED R.K.F.

PLOT SCALE = 50.0000 ' / ir

STATE OF ILLINOIS

DEPARTMENT OF TRANSPORTATION

DISTRICT ONE DETAILS TS-07							
SHEET	9	OF	9	SHEETS	STA.		

F.A.U RTE.	SECTI	ON NO.			COUNTY	TOTAL SHEETS	SHEE NO.
87	20-000	87-00-RS		MCHENRY	43	43	
				Т	CONTRACT	NO.	61J03
FED. RO	DAD DIST. NO.	ILLINOIS	FED.	AID	PROJECT		

COUNTY

CONTRACT NO

DEPARTMENT OF TRANSPORTATION