FOR INDEX OF SHEETS, SEE SHEET NO. 2

FUNCTIONAL CLASSIFICATION: INTERSTATE F.A.I. ADT: 59,850 (2005), 74,480 (2021)

DESIGN SPEED LIMIT: 50 MPH POSTED SPEED LIMIT: 50 MPH

SCOPE OF WORK

WITHIN THE PROJECT LIMITS SIX (6) BRIDGE STRUCTURES WILL HAVE INTERIM REPAIRS TO THE BRIDGE DECKS. TWO (2) BRIDGES WILL HAVE REPAIRS TO THE PIERS.

IMPROVEMENTS LOCATED IN THE CITY OF CHICAGO, COOK COUNTY

LOCATION OF WORK: F.A.I. 55 AT U.S. 41 SN 016-0036, SN 016-1045 SN 016-1048, SN 016-1052 SN 016-1055, SN 016-1075

100' 200' 300' -- 1" = 100'
0 10' 20' 30' -- 1" = 10'
0 50' 100' -- 1" = 50'
0 50' 100' -- 1" = 30'
0 50' 100' -- 1" = 30'

FULL SIZE PLANS HAVE BEEN PREPARED USING STANDARD ENGINEERING SCALES. REDUCED SIZED PLANS WILL NOT CONFORM TO STANDARD SCALES. IN MAKING MEASUREMENTS ON REDUCED PLANS, THE ABOVE SCALES MAY BE USED.

C.U.A.N. CHICAGO UTILITY ALERT NETWORK 1-312-744-7000

PROJECT MANAGER: ISSAM RAYYAN (842) 705–4178 PROJECT ENGINEER: ROBERT BORO (847) 705–4237

CONTRACT NO. 60P37

STATE OF ILLINOIS DEPARTMENT OF TRANSPORTATION DIVISION OF HIGHWAYS


PROPOSED HIGHWAY PLANS

F.A.I. RTE. 55 / I-55 (STEVENSON EXPRESSWAY)


SECTION: 2011–031–BR
PRAIRIE AVE. TO ICG RR
BRIDGE DECK REPAIRS
COOK COUNTY

C-91-522-11

SOUTH TOWNSHIP R. 14 E.

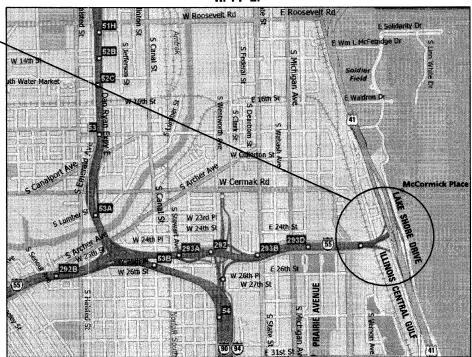


GROSS & NET LENGTH = 7,796 FEET = 1.478 MILES

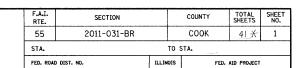

D-91-522-11 $\frac{441+2=43}{}$



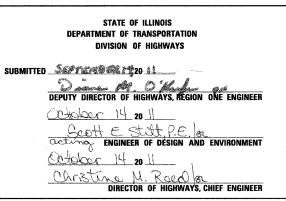



BHADRESH N. SHAH
LICENSED STRUCTURAL ENGINEER
STATE OF ILLINOIS LIC. No. 081-004476
EXPIRES: 11-30-12



CHRISTIAN-ROGE & ASSOCIATES, INC.
ENGINEERS / PLANNERS / SURVEYORS
211 W. WACKER DRIVE CHICAGO, IL. 60606
TELEPHONE: 312-372-2023

PRINTED BY THE AUTHORITY OF THE STATE OF ILLINOIS

INDEX OF SHEETS LIST OF STATE STANDARDS SHEET NO. DESCRIPTION STANDARD NO. DESCRIPTION COVER SHEET 701400*-05* APPROACH TO LANE CLOSURE. INDEX OF SHEETS, LIST OF STATE FREEWAY/EXPRESSWAY STANDARDS AND GENERAL NOTES SUMMARY OF QUANTITIES 701401-*0*6 LANE CLOSURE, FREEWAY/EXPRESSWAY SITE PLAN SUGGESTED STAGE IA CONSTRUCTION 701411**-07** LANE CLOSURE, MULTILANE, AT ENTRANCE OR EXIT RAMP. FOR SPEEDS > 45 MPH 6 SUGGESTED STAGE IB CONSTRUCTION SUGGESTED STAGE II CONSTRUCTION 701422**-03** LANE CLOSURE. MULTILANE, FOR SPEEDS 8 SUGGESTED STAGE IIIA CONSTRUCTION >= 45 MPH TO 55 MPH 9 SUGGESTED STAGE IIIB CONSTRUCTION 701446-02 TWO LANE CLOSURE FREEWAY/EXPRESSWAY DETOUR PLAN - STAGE IIIB 11 DETOUR PLAN - STAGE IIIB 701901-01 TRAFFIC CONTROL DEVICES S.N. 016-0036 704001**-06** TEMPORARY CONCRETE BARRIER 12 GENERAL PLAN & ELEVATION 13 DECK CONCRETE PATCHING 780001-02 TYPICAL PAVEMENT MARKINGS 13A PIER E12 REPAIRS S.N. 016-1045 14 GENERAL PLAN & ELEVATION 15 DECK CONCRETE PATCHING 16 PIER ES3 REPAIRS 17 PIER ES6 REPAIRS 18 PIER ES7 REPAIRS S.N. 016-1048 19 GENERAL PLAN & ELEVATION 20 DECK CONCRETE PATCHING S.N. 016-1052 21 GENERAL PLAN & ELEVATION

23 GENERAL PLAN & ELEVATION 24 DECK CONCRETE PATCHING GENERAL PLAN & ELEVATION DECK CONCRETE PATCHING

29 BAR SPLICER ASSEMBLY AND MECHANICAL SPLICER DETAILS

30 EXISTING PLANS - PIERS ES1, ES2 & ES3

31 EXISTING PLANS - PIER ES6

22 DECK CONCRETE PATCHING

PIER E15 REPAIRS

PIFR F16 REPAIRS

S.N. 016-1055

S.N. 016-1075

26

27

28

32 EXISTING PLANS - PIER ES7

33 EXISTING PLANS - PIER E12

34 EXISTING PLANS - PIERS E14 & E15

35 EXISTING PLANS - PIERS E16 & E17

36 FREEWAY ENTRANCE AND EXIT RAMP CLOSURE DETAIL

TRAFFIC CONTROL DETAILS FOR FREEWAY SINGLE & MULTI-LANE WEAVE 37

38 TRAFFIC CONTROL DETAILS FOR FREEWAY SHOULDER CLOSURES AND PARTIAL RAMP CLOSURES

39 TRAFFIC CONTROL DETAILS FOR FREEWAY CENTER LANE CLOSURE SHOULDER LANE

MULTI-LANE FREEWAY PAVEMENT MARKING DETAILS 40

MULTI-LANE FREEWAY PAVEMENT MARKING DETAILS

GENERAL NOTES:

- 1. THESE PLANS HAVE BEEN PREPARED FROM NOTES RECEIVED FROM I.D.O.T. FIELD MAINTENANCE ENGINEERS.
- 2. THE CONTRACTOR MUST USE EXTREME CAUTION DURING FULL DEPTH DECK SLAB REPAIR AND MUST NOT NICK, CUT OR DAMAGE, IN ANY WAY, ANY OF THE STEEL BEAMS. THE EXISTING REINFORCEMENT BARS SHALL BE CLEANED. IF ANY OF THESE REINFORCEMENT BARS ARE DAMAGED THEY MUST BE REPLACED WITH AN APPROVED BAR SPLICER OR ANCHORAGE SYSTEM. THE COST OF THIS WORK IS INCLUDED WITH DECK SLAB REPAIR (FULL DEPTH, TYPE II) .
- 3. THE CONTRACTOR SHALL CONTACT THE TRAFFIC CONTROL SUPERVISOR AT (847) 705-4151 AT LEAST 72 HOURS PRIOR TO INSTALLATION OF THE TEMPORARY TRAFFIC CONTROL DEVICES.
- 4. THERE ARE ELECTRICAL CONDUITS AND/OR FIBERGLASS DRAIN PIPES ATTACHED TO THE BOTTOM OF THE BRIDGE DECK. THE CONTRACTOR MAY MODIFY THE FORMING AND MUST EXERCISE EXTREME CAUTION DURING FULL DEPTH REPAIR BREAK OUT AND SHALL TEMPORARILY SUPPORT THE CONDUITS AND/OR DRAIN PIPES IF NEED BE, AT NO ADDITIONAL COST TO THE DEPARTMENT.
- 5. WHEN ARTIFICIAL LIGHTING IS UTILIZED IN NIGHT OPERATIONS, THE CONTRACTOR MUST EXERCISE THE UTMOST PRECAUTIONS IN PREVENTING ADVERSE VISIBILITY TO THE MOTORING PUBLIC.
- 6. PLAN DIMENSIONS AND DETAILS RELATIVE TO EXISTING PLANS ARE SUBJECT TO ROUTINE VARIATIONS. THE CONTRACTOR SHALL FIELD VERIFY EXISTING DIMENSIONS AND DETAILS AFFECTING NEW CONSTRUCTION AND MAKE NECESSARY APPROVED ADJUSTMENTS PRIOR TO CONSTRUCTION OR ORDERING OF MATERIALS. SUCH VARIATIONS SHALL NOT BE CAUSE FOR ADDITIONAL COMPENSATION FOR A CHANGE IN THE SCOPE OF THE WORK, HOWEVER, THE CONTRACTOR WILL BE PAID FOR THE QUANTITY ACTUALLY FURNISHED BASED UPON THE UNIT PRICE BID FOR THE WORK.
- 7. BEFORE STARTING ANY EXCAVATION, THE CONTRACTOR SHALL CALL C.U.A.N. AT (312) 744-7000 FOR FIELD LOCATIONS OF BURIED ELECTRIC, TELEPHONE AND GAS UTILITIES (48 HOURS NOTIFICATION IS REQUIRED).
- 8. THE CONTRACTOR WILL NOT BE ALLOWED TO SET UP A YARD OR FIELD OFFICE ON STATE PROPERTY WITHOUT WRITTEN PERMISSION FROM THE DEPARTMENT.
- 9. TO COORDINATE ACCESS TO THE McCORMICK PLACE PARKING LOT CALL EUGENE HARTISON AT (312) 791-6081.
- 10. DURING ANY WORK WITHIN THE McCORMICK PLACE PARKING LOT, THE CONTRACTOR MUST COORDINATE WITH THE McCORMICK PLACE PARKING LOT AUTHORITY AS TO AVOID ANY AND ALL CONFLICTS DURING THIS CONTRACT.
- 11. DO NOT SCALE PLANS FOR CONSTRUCTION DIMENSIONS.
- 12. ANY DAMAGES TO THE CONDUITS OR PIPES CAUSED BY THE CONTRACTOR'S OPERATIONS SHALL BE REPLACED OR REPAIRED BY THE CONTRACTOR AT HIS/HER EXPENSE.
- 13. ALL PROPOSED RAISED REFLECTIVE PAVEMENT MARKERS (BRIDGE) SHALL BE LOW PROFILE.
- 14. THE CONTRACTOR SHALL COORDINATE AND/OR MODIFY THE WORK SCHEDULE AS DIRECTED BY THE DEPARTMENT TO ACCOMMODATE SPECIAL EVENTS.
- 15. THE CONTRACTOR SHALL PLACE TEMPORARY CONCRETE BARRIER ADJACENT TO TEMPORARY SHORING AND CRIBBING TO PROVIDE A BARRIER FROM PARKING LOT TRAFFIC. AN ESTIMATED THREE (3) SECTIONS OF TEMPORARY CONCRETE BARRIER WILL BE NEEDED AT EACH SHORING AND CRIBBING LOCATIONS.
- 16. THE CONTRACTOR SHALL USE PP3 CONCRETE FOR ALL DECK PATCHES.
- 17. AS PART OF THIS PROJECT, ALL BRIDGE DECKS SHALL BE RE-STRIPED AND RAISED REFLECTIVE PAVEMENT MARKERS SHALL BE REMOVED AND REPLACED.
- 18. THE CONTRACTOR WILL BE ALLOWED ADDITIONAL LANE CLOSURES TO MEASURE AND SAWCUT PATCHING AREAS AND TO LAYOUT WEAVE LOCATIONS.

	US
C'R CHRISTIAN-ROGE &	
ASSOCIATES, INC.	PL
	PI

SER NAME = IDOT DESIGNED - J.C.N./B.N.S. REVISED CHECKED - B.N.S./J.C.N. REVISED LOT SCALE = 50.0000 '/ IN. DRAWN - F.M. REVISED LDT DATE = 10/12/2011 DATE OCTOBER 12, 2011 REVISED

STATE OF ILLINOIS **DEPARTMENT OF TRANSPORTATION** INDEX OF SHEETS, LIST OF STATE STANDARDS AND GENERAL NOTES F.A.I. RTE. I-55 OVER U.S. 41 / LAKE SHORE DRIVE

SHEET NO. S2 OF S41 SHEETS

SECTION 2011-031-BR COOK 41 2 CONTRACT NO. 60P37

	SUMMARY OF QUANTITII	_ ~							
	SOMMAN OF QUANTITIES	<u>-</u> S	URBAN	S.N. 016-0036 FUNDS	S.N. 016-1045 FUNDS	S.N. 016-1048 FUNDS	S.N. 016-1052 FUNDS	S.N. 016-1055 FUNDS	S.N. 016-1075 FUNDS
CODE NO.	DESCRIPTION	UNIT	TOTAL QUANTITIES	0014	0014	0014	0014	0014	0014
44200581	CLASS A PATCHES, TYPE III, 12 INCH	SQ YD	15	15					
44213000	PATCHING REINFORCEMENT	SQ YD	15	15					
44213200	SAW CUTS	FOOT	68	68					
44213202	TIE BARS, 1"	EACH	10	10					
50102400	CONCRETE REMOVAL	CU YD	24		18				6,
50300225	CONCRETE STRUCTURES	CU YD	24		18				6
50800205	REINFORCEMENT BARS, EPOXY COATED	POUND	7,230		5,800				1,430
52100520	ANCHOR BOLTS, 1"	EACH	6	2	2				2
52100530	ANCHOR BOLTS, 1 1/4"	EACH	14		8				6
67100100	MOBILIZATION	L SUM	1	0.17	0.17	0.17	0.17	0.16	0.10
70102625	TRAFFIC CONTROL AND PROTECTION, STANDARD 701606	L SUM	1,		1				
70106800	CHANGEABLE MESSAGE SIGN	CAL MO	9	2	2	2	1	1	1
70300520	PAVEMENT MARKING TAPE, TYPE III, 4"	FOOT	5,000	1,800	*	800	2,400		
70300550	PAVEMENT MARKING TAPE, TYPE III, 8"	FOOT	7,000	2,500		2,100	2,400		
70301000	WORK ZONE PAVEMENT MARKING REMOVAL	SQ FT	7,878	3,828		1,650	2,400	,	
70400100	TEMPORARY CONCRETE BARRIER	FOOT	475	75	250				150
78008210	POLYUREA PAVEMENT MARKING, TYPE I - LINE 4"	FOOT	16,400	2,800	3,000	4,500	1,600	2,100	2,400
78008220	POLYUREA PAVEMENT MARKING, TYPE I - LINE 5"	FOOT	1,780	720			210	540	310
78008240	POLYUREA PAVEMENT MARKING, TYPE I - LINE 8"	FOOT	1,890	1,590	300				
78008250	POLYUREA PAVEMENT MARKING, TYPE I - LINE 12"	FOOT	1,812	900	40	440		192	240
78008300	POLYUREA PAVEMENT MARKING, TYPE II - LETTERS AND SYMBOLS	FOOT	36	36					
78100105	RAISED REFLECTIVE PAVEMENT MARKER (BRIDGE)	EACH	356	144			42	108	62
78300100	PAVEMENT MARKING REMOVAL	SQ FT	200	80		80	40		
78300200	RAISED REFLECTIVE PAVEMENT MARKER REMOVAL	EACH	356	144			42	108	62
X5080600	MECHANICAL SPLICERS	EACH	64		32				32
X7011015	TRAFFIC CONTROL AND PROTECTION (EXPRESSWAYS)	L SUM	. 1	0.17	0.17	0.17	0.17	0.16	0.1
X7013820	TRAFFIC CONTROL SURVEILLANCE, EXPRESSWAYS	CAL DA	60	10	10	10	10	10	10
Z0001700	APPROACH SLAB REPAIR (FULL DEPTH)	SQ YD	7					7	
Z0001800	APPROACH SLAB REPAIR (PARTIAL DEPTH)	SQ YD	7					7	
Z0012754	STRUCTURAL REPAIR OF CONCRETE (DEPTH EQUAL TO OR LESS THAN 5 INCHES)	SQ FT	54	54		,			
Z0012755	STRUCTURAL REPAIR OF CONCRETE (DEPTH GREATER THAN 5 INCHES)	SQ FT	11	. 11	Y .				
Z0016002	DECK SLAB REPAIR (FULL DEPTH, TYPE II)	SQ YD	33	7	2	2	5	. 4	13
Z0016200	DECK SLAB REPAIR (PARTIAL)	SQ YD	212	50	13	13	35	- 24	77
Z0030240	IMPACT ATTENUATORS, TEMPORARY (NON- REDIRECTIVE), TEST LEVEL 2	EACH	2	1	1				
Z0048665	RAILROAD PROTECTIVE LIABILITY INSURANCE	L SUM	1	0.25	0.25		0.25	0.25	
Z0073200	TEMPORARY SHORING AND CRIBBING	EACH	15	2	8				5
		i							

* SPECIALTY ITEM

CHRISTIAN-ROGE & ASSOCIATES, INC.

PLOT SCALE = 50.0000 // IN.
PLOT DATE = 10/12/2011


DESIGNED - J.C.N./B.N.S. USER NAME = IDOT REVISED -CHECKED - B.N.S./J.C.N. REVISED -DRAWN - F.M. REVISED -- OCTOBER 12, 2011 REVISED


STATE OF ILLINOIS DEPARTMENT OF TRANSPORTATION


SUMMARY OF QUANTITIES F.A.I. RTE. I–55 OVER U.S. 41 / LAKE SHORE DRIVE SHEET NO. S3 OF S41 SHEETS


-90% FED. |10% STATE -


SECTION 2011-031-BR

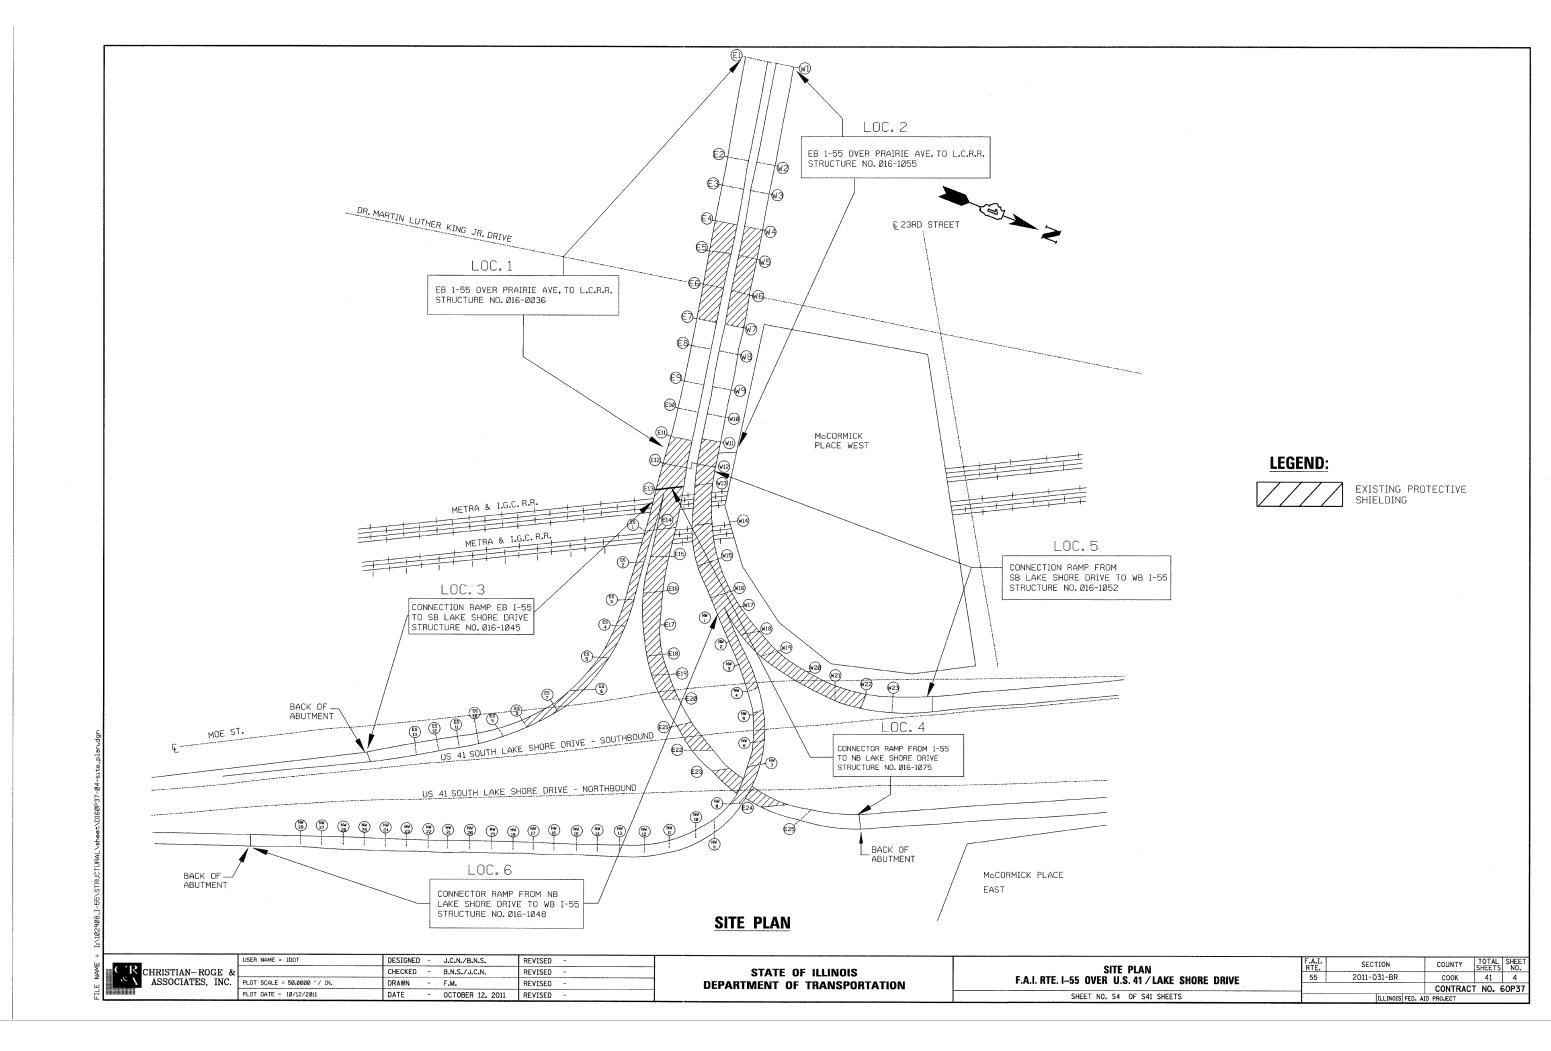


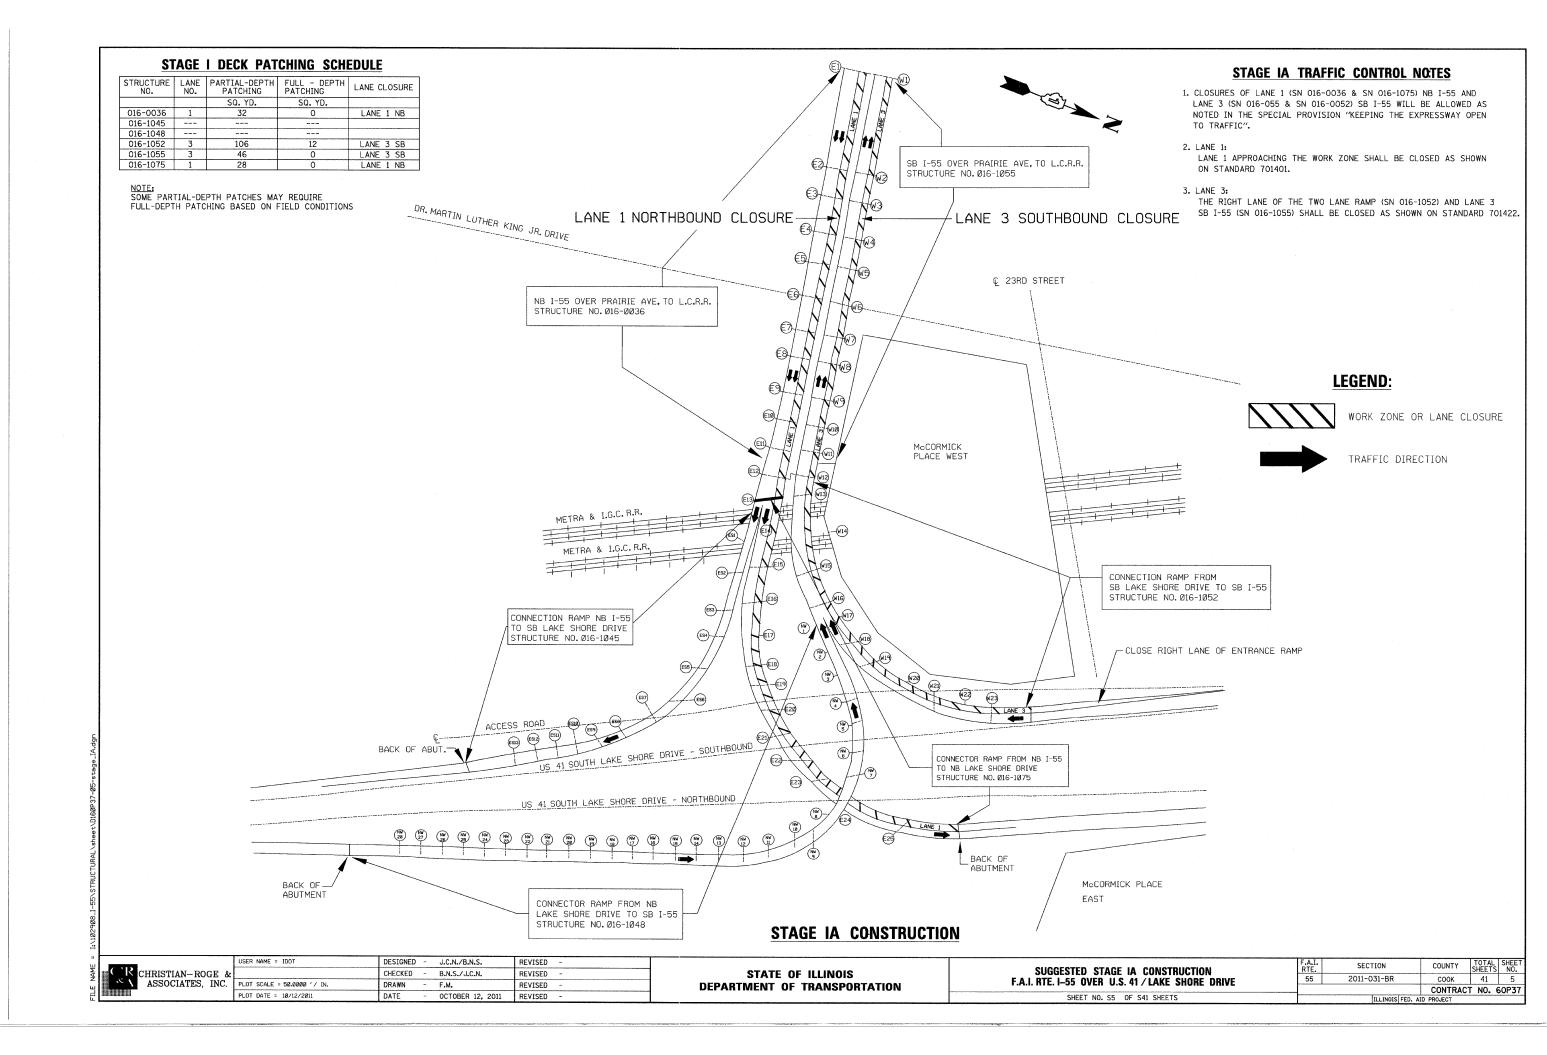


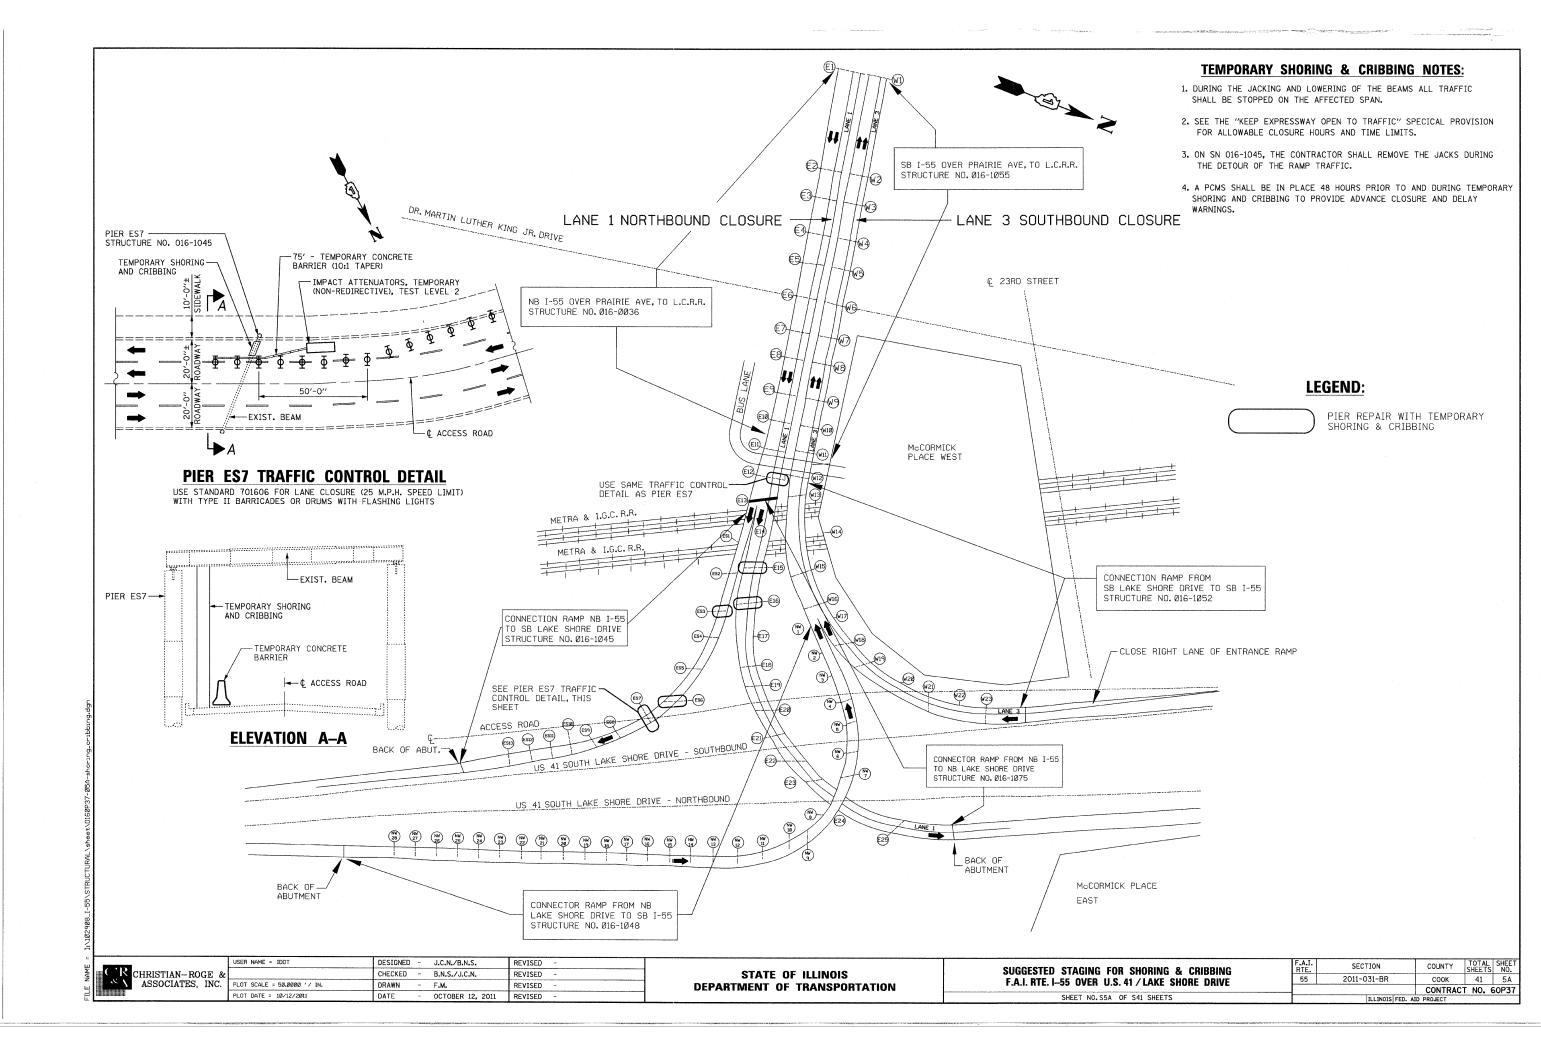


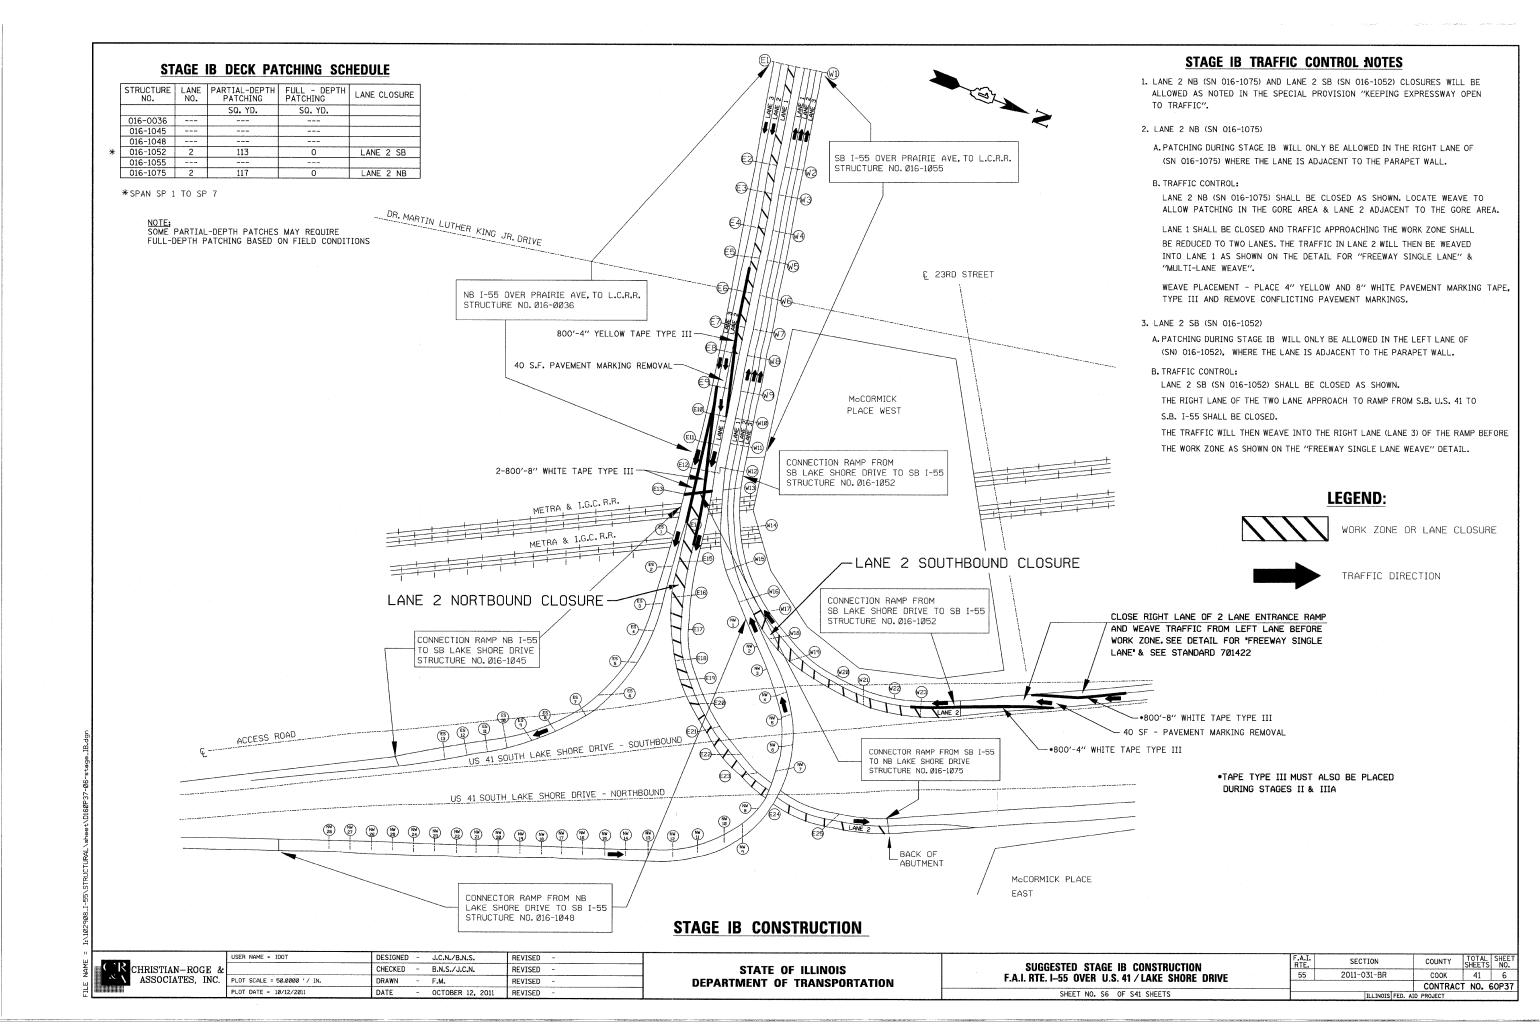


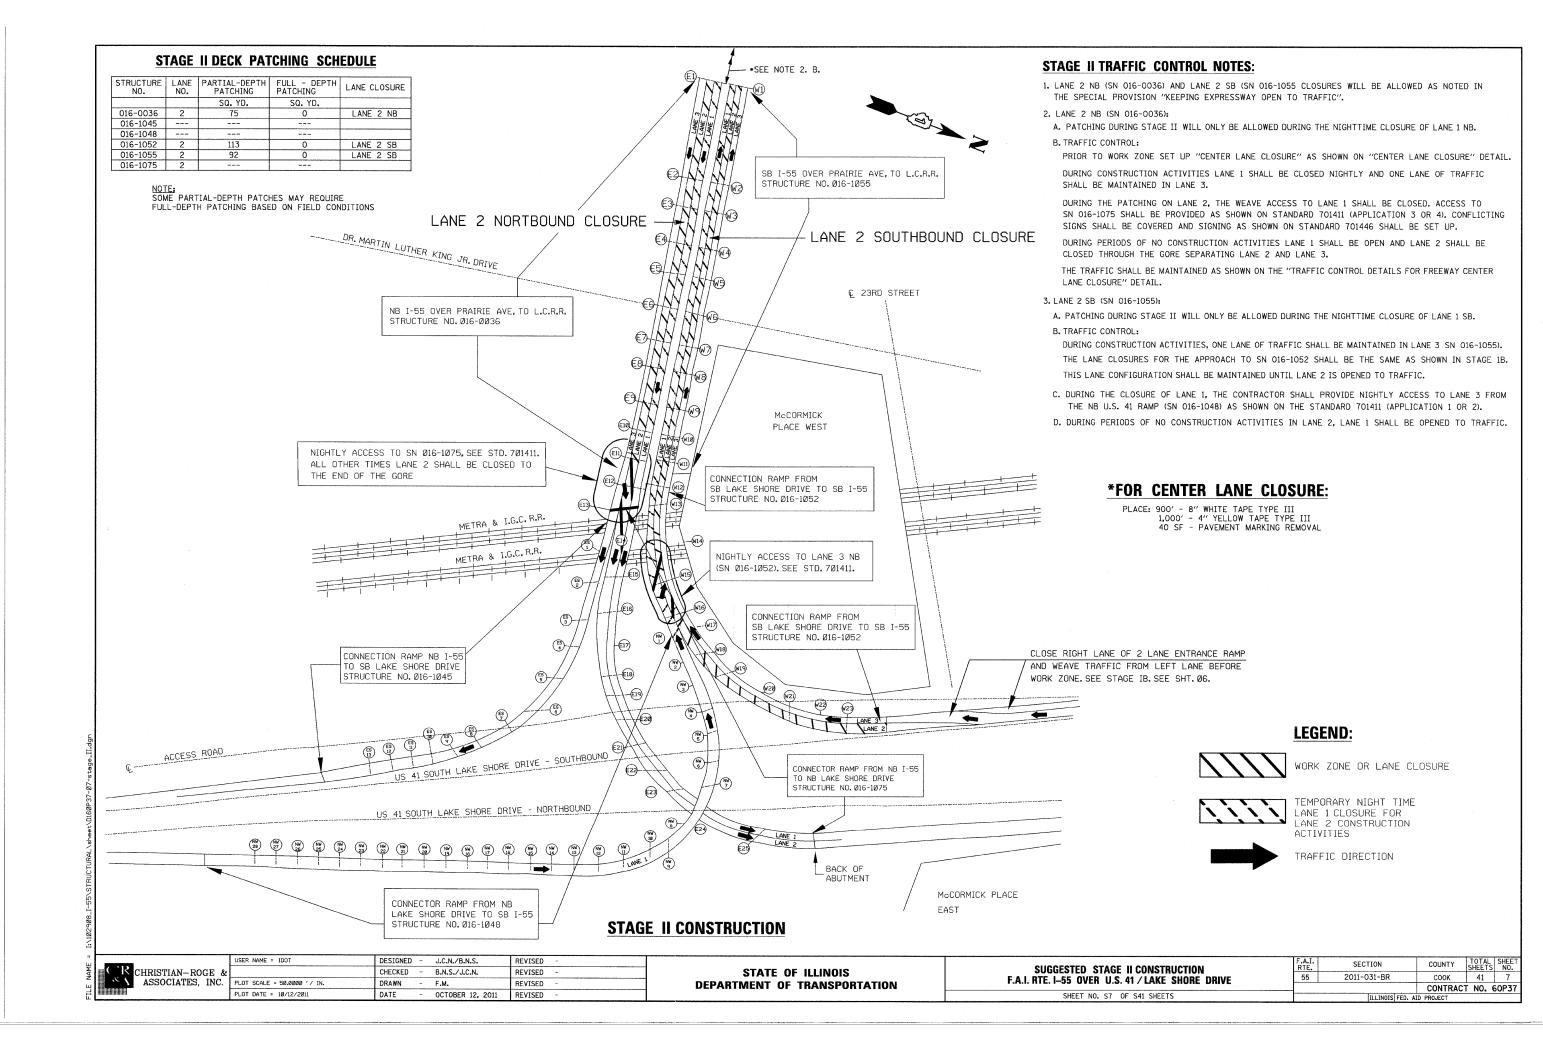


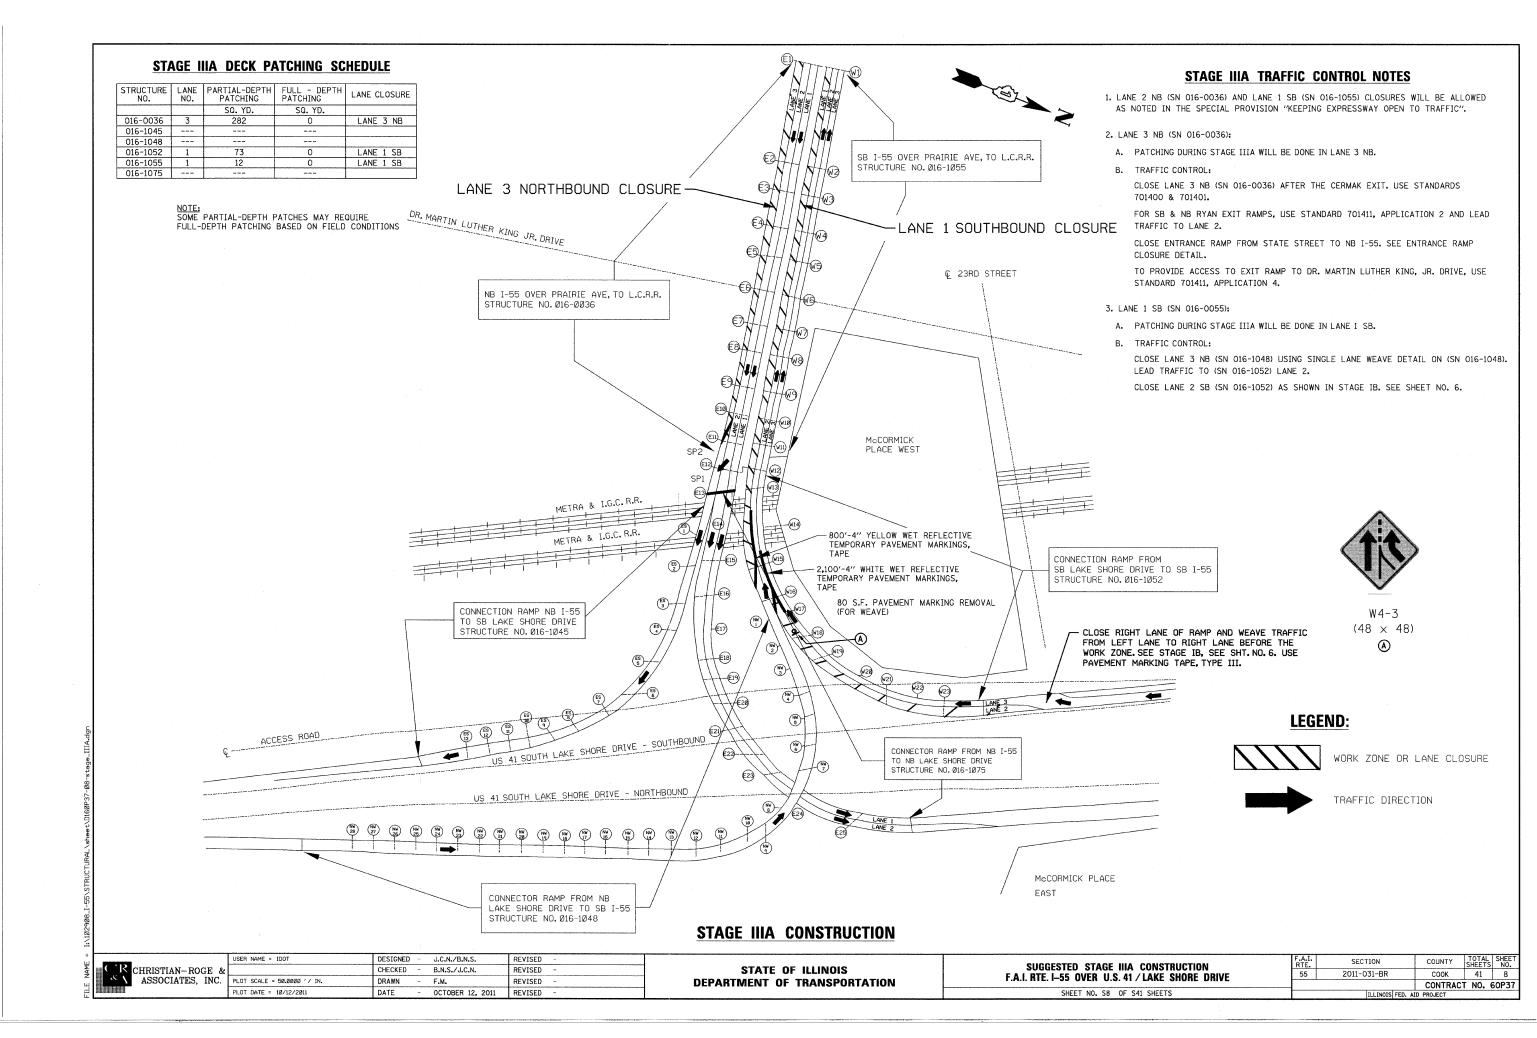


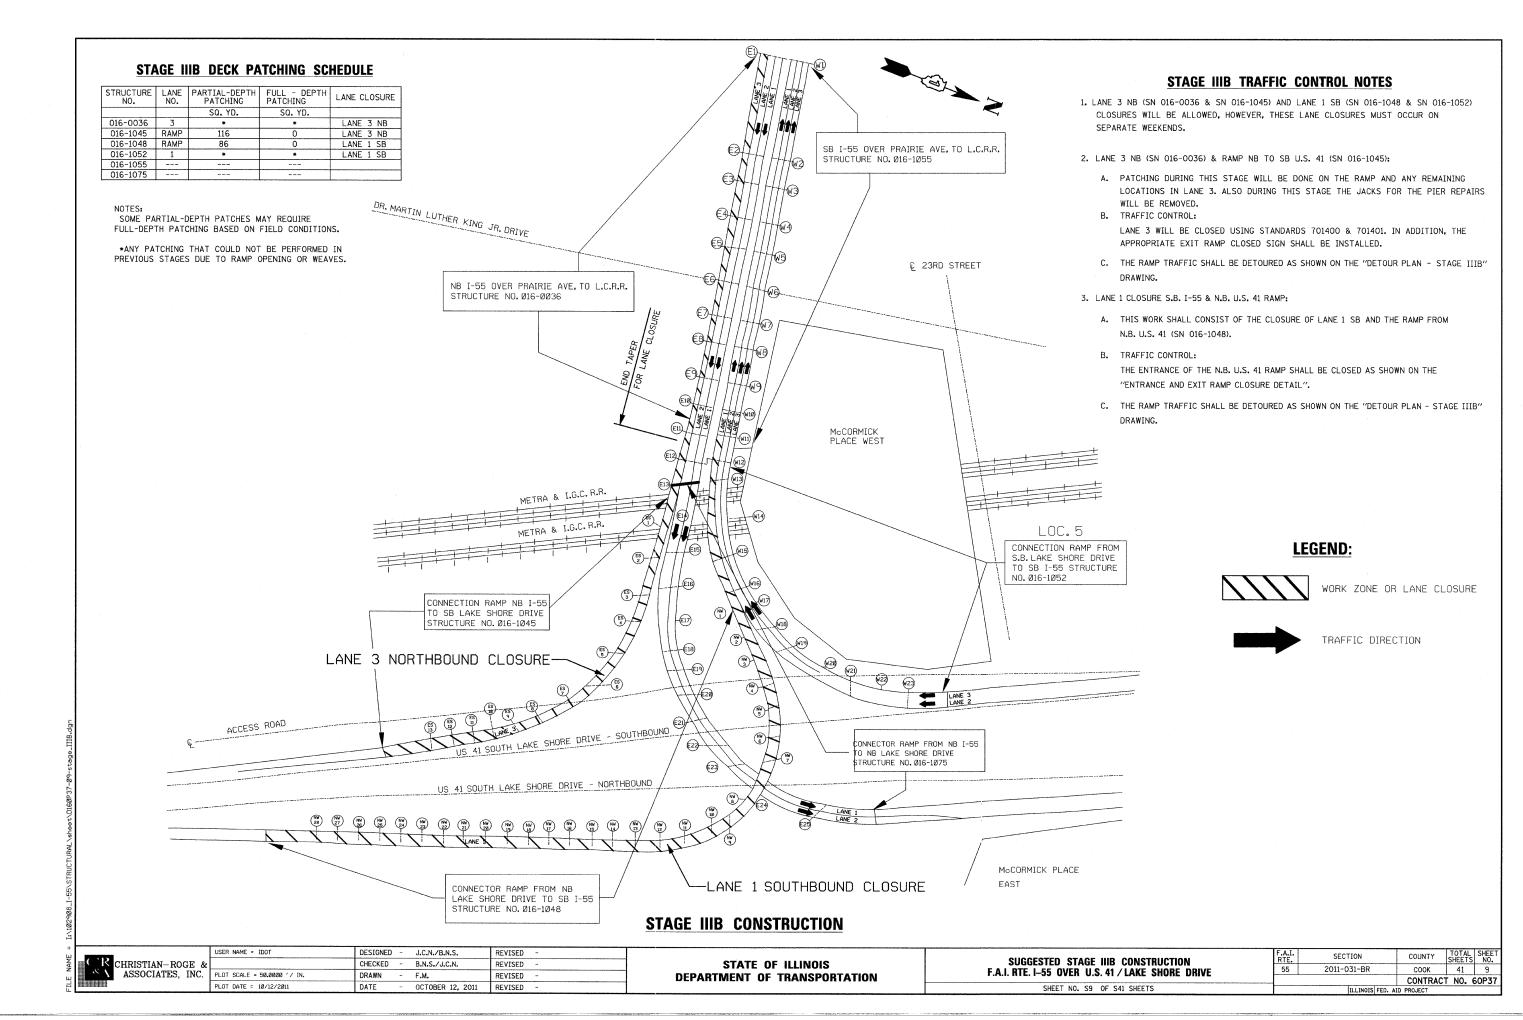

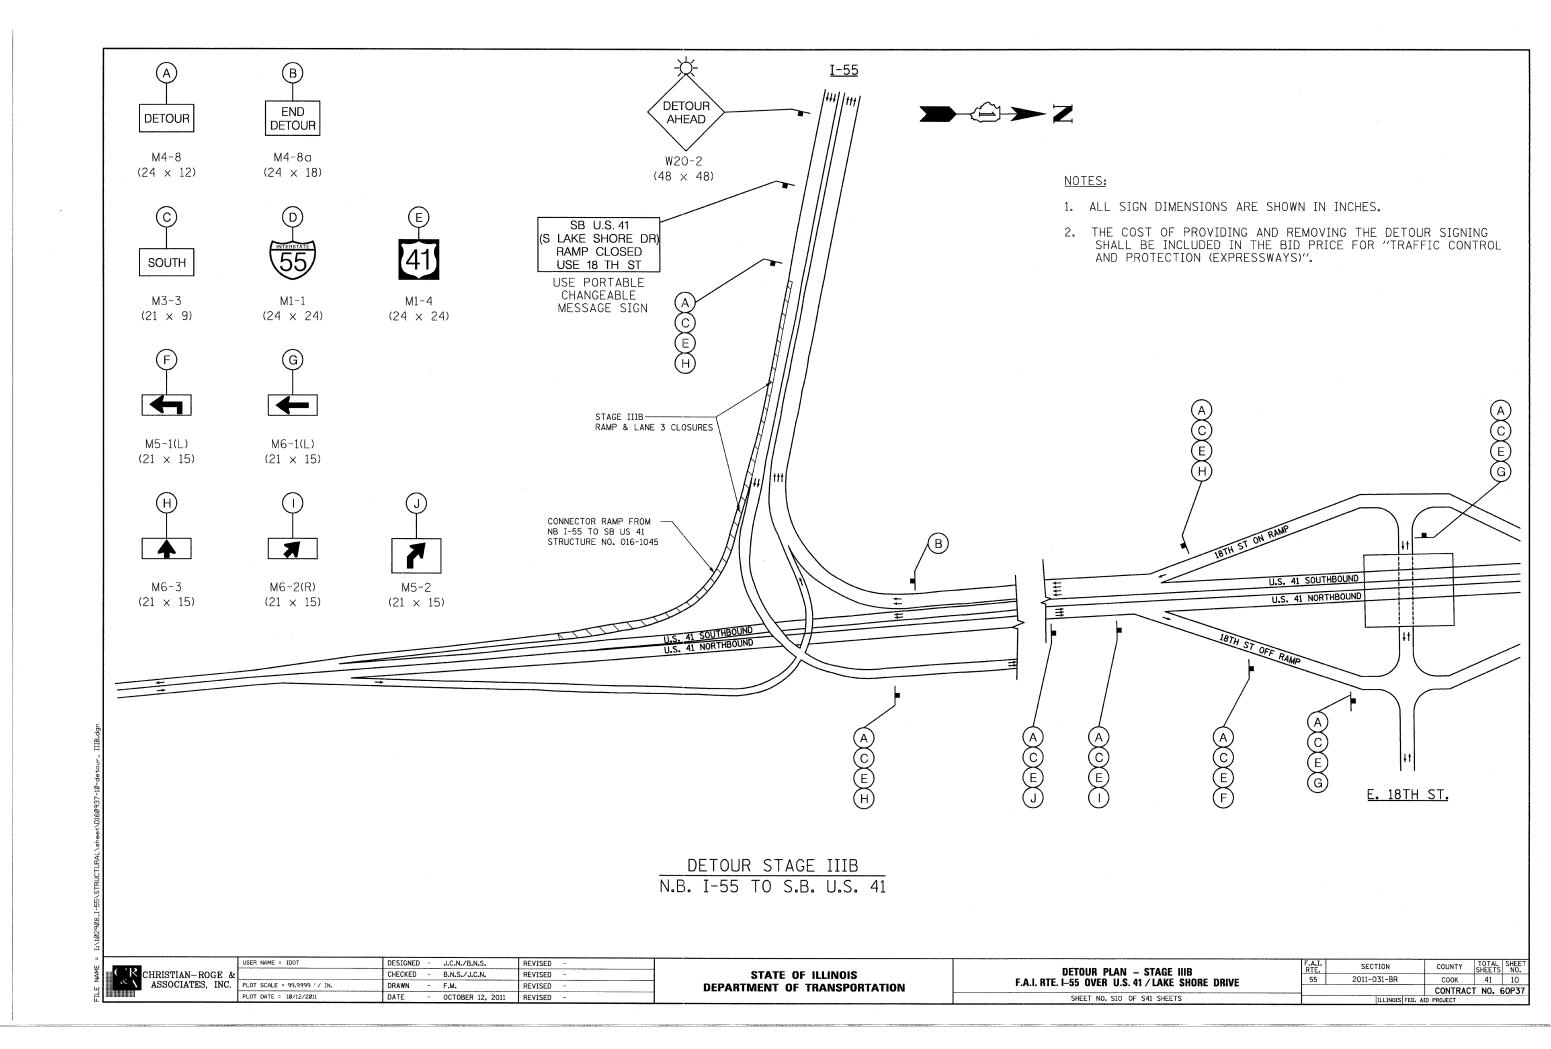

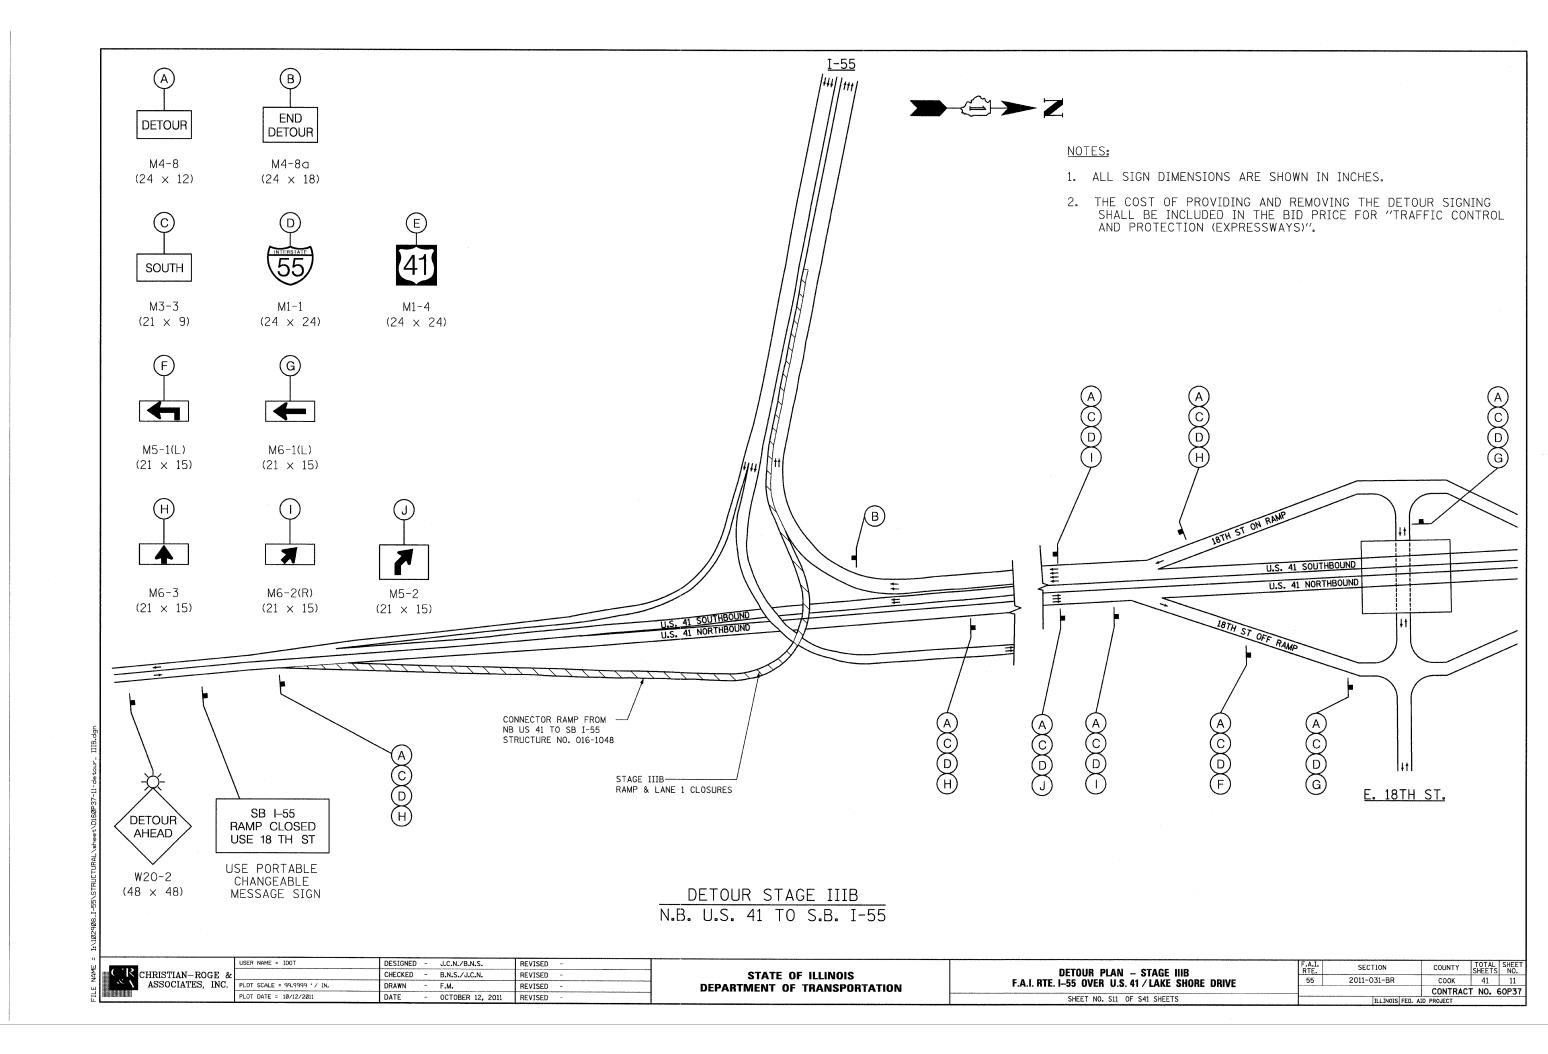

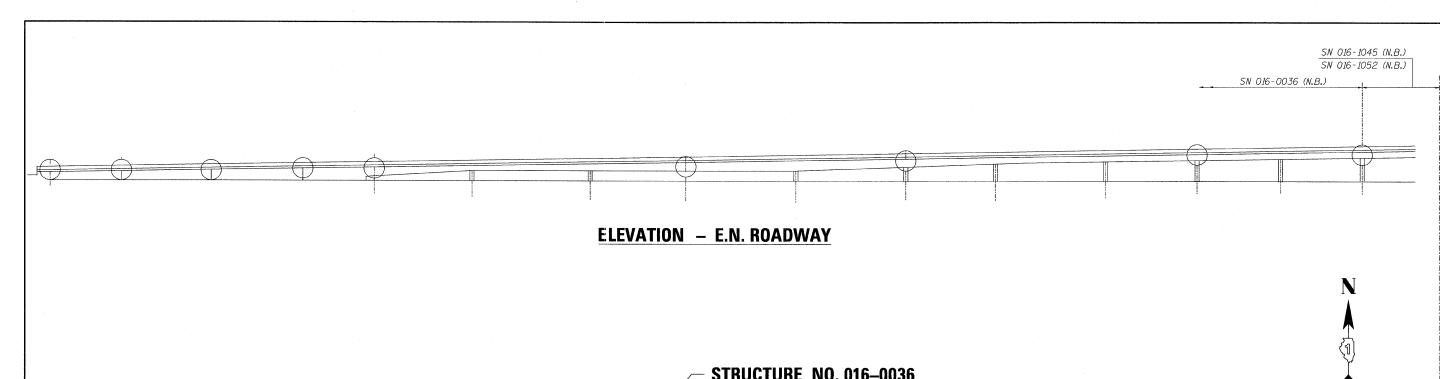

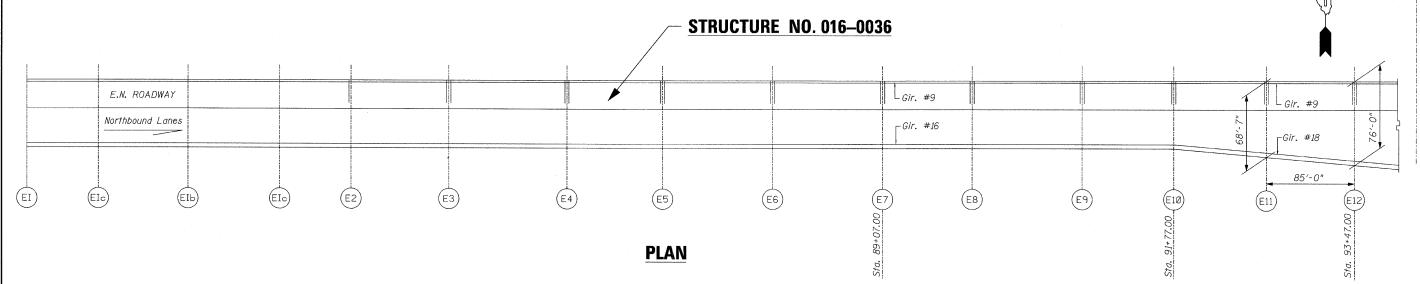

PAVEMENT PATCHING NOTE:

15 SY(±) PAVEMENT PATCHING IS REQUIRED IN LANE 2 WEST OF THE APPROACH PAVEMENT.

SHEET NO. S12 OF S41 SHEETS

ESTIMATED QUANTITIES ARE AS FOLLOWS:

15 SY - CLASS A PATCHES, TYPE III 12 INCH.

15 SY - PATCHING REINFORCEMENT

68 FT - SAWCUTS


10 EACH - TIE BARS, 1"


GENERAL PLAN & ELEVATION
F.A.I. RTE. I-55 OVER
U.S. 41/LAKE SHORE DRIVE
COOK COUNTY
STRUCTURE NO. 016-0036

1		
1	CHRISTIAN-ROGE & ASSOCIATES, INC.	
1		P

	USER NAME == IDOT	DESIGNED	-	J.C.N./B.N.S.	REVISED	-	
&		CHECKED	-	B.N.S./J.C.N.	REVISED	-	
C.	PLOT SCALE = 50.0000 '/ IN.	DRAWN	-	F.M.	REVISED	~	
	PLOT DATE == 10/12/2011	DATE	-	OCTOBER 12, 2011	REVISED	-	
							-

STATE	0F	ILLINOIS	
DEPARTMENT (OF 1	TRANSPORTATION	

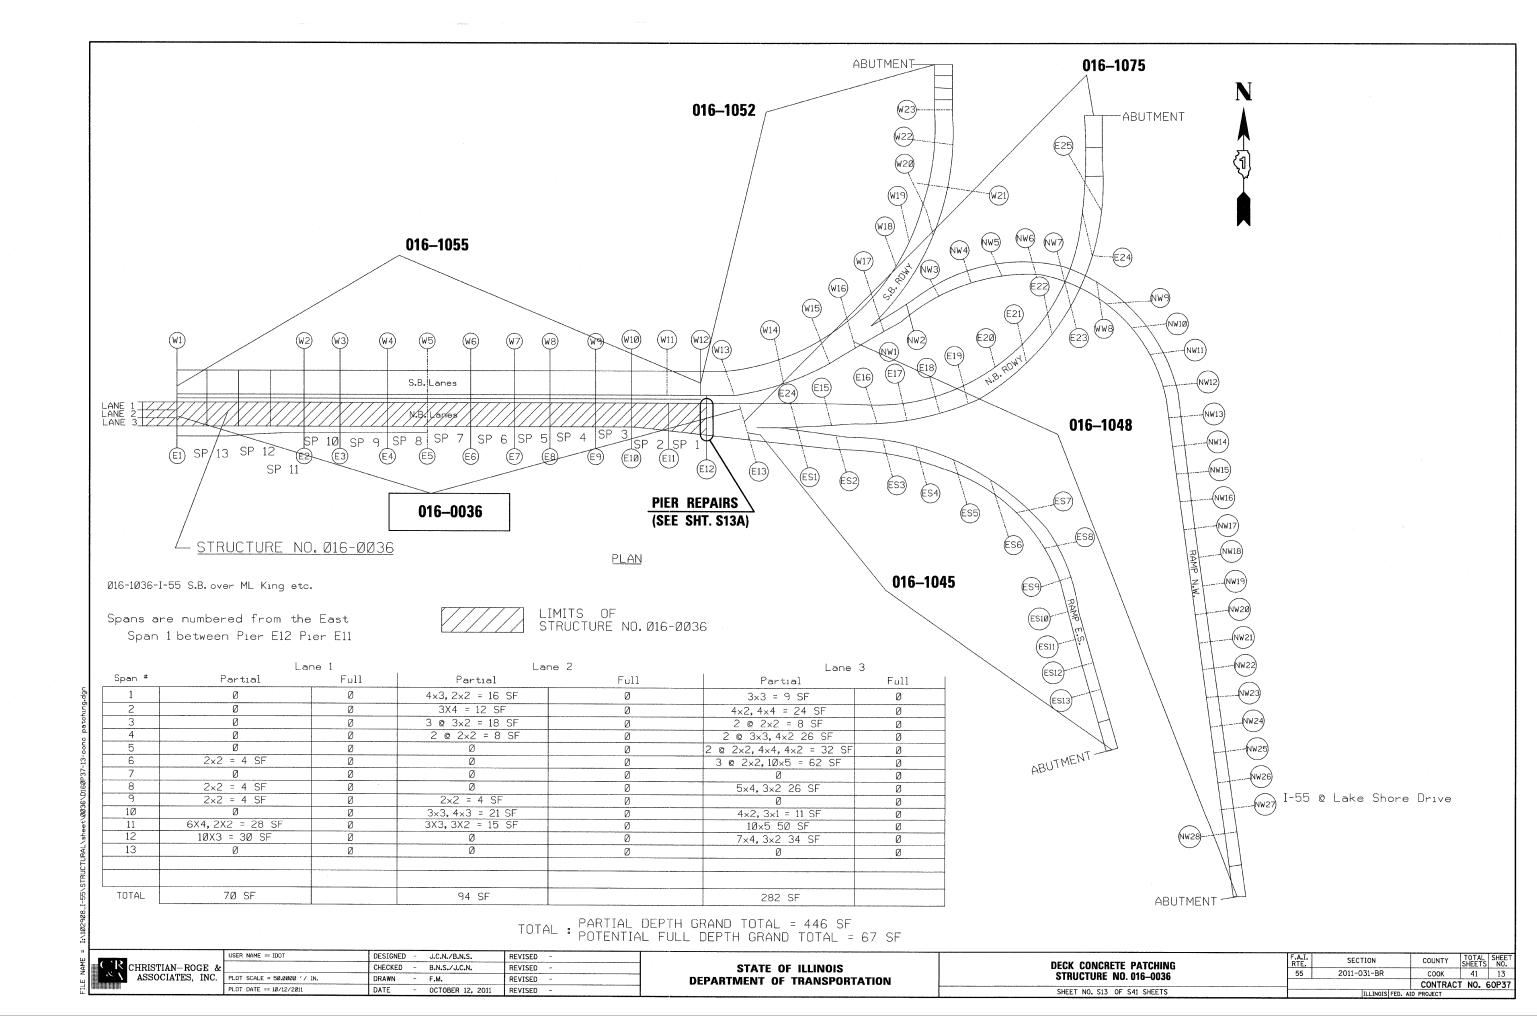

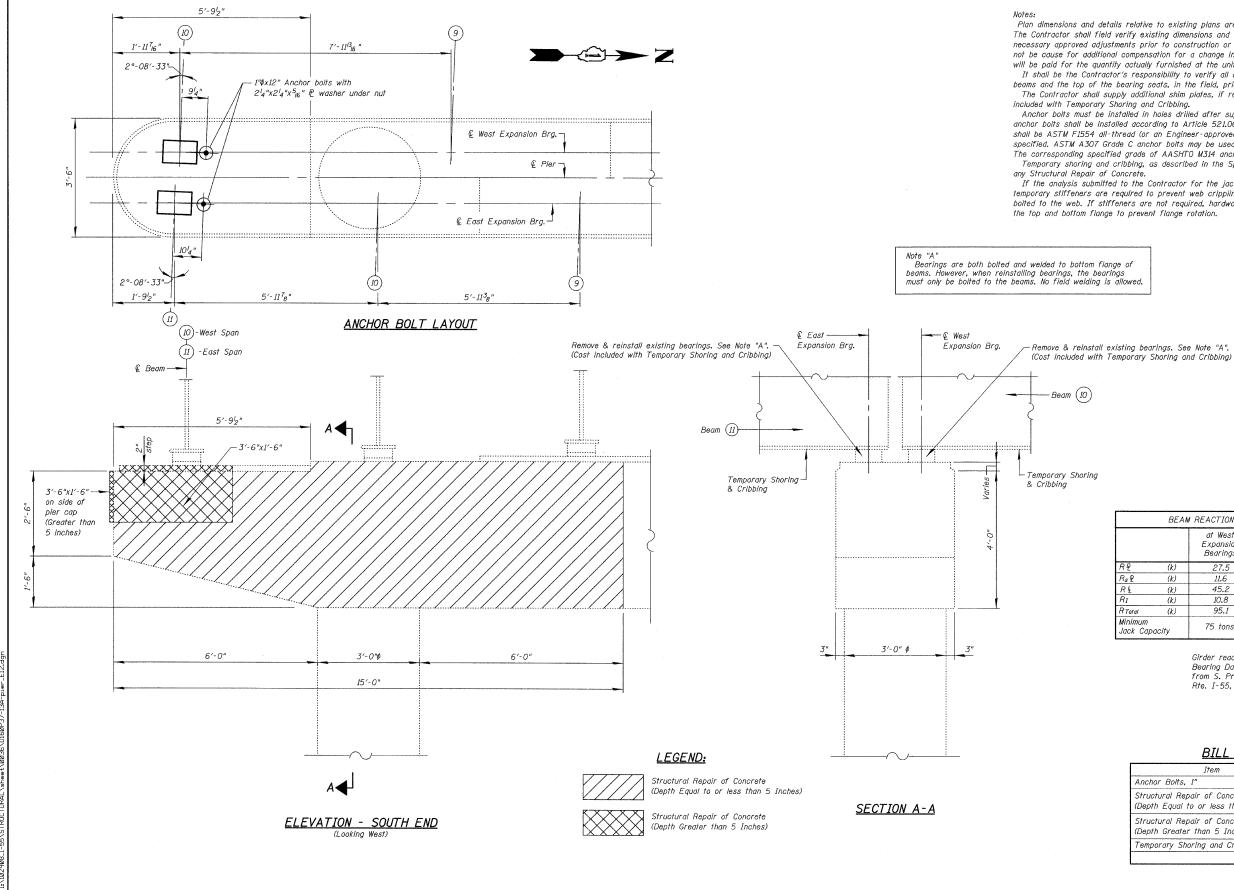

Plan dimensions and details relative to existing plans are subject to nominal construction variations. The Contractor shall field verify existing dimensions and details affecting new construction and make necessary approved adjustments prior to construction or ordering of materials. Such variations shall not be cause for additional compensation for a change in scope of the work, however, the Contractor will be paid for the quantity actually furnished at the unit price bid for the work.

It shall be the Contractor's responsibility to verify all dimensions between the bottom of the bridge beams and the top of the bearing seats, in the field, prior to construction or ordering of materials. The Contractor shall supply additional shim plates, if required, to bring devices to grade. Cost included with Temporary Shoring and Cribbing.

Anchor bolts must be installed in holes drilled after supported member is in place. Drilled and set anchor bolts shall be installed according to Article 521.06 of the Standard Specifications. Anchor bolts shall be ASTM F1554 all-thread (or an Engineer-approved alternate material) of the grade and diameter specified. ASTM A307 Grade C anchor bolts may be used in lieu of ASTM F1554 Grade 36 (Fy-36ksi). The corresponding specified grade of AASHTO M314 anchor bolts may be use in lieu of ASTM F1554. Temporary shoring and cribbing, as described in the Special Provisions, is to be installed prior to

If the analysis submitted to the Contractor for the jacking/temporary support system to be used shows temporary stiffeners are required to prevent web crippling or buckling, the stiffeners shall be steel and bolted to the web. If stiffeners are not required, hardwood timbers shall be installed tightly between

	BEAM REACTION TABLE							
		at West Expansion Bearings	at East Expansion Bearings					
R P	(k)	27.5	38.6					
Rs &	(k)	11.6	14.7					
R Ł	(k)	45.2	46.6					
R_I	(k)	10.8	11.1					
RTotal	(k)	95.1	111.0					
Minimum Jack Capacity		75 tons	85 tons					

Girder reactions shown are from the existing plan Bearing Data Tables, At Roadway E.N. & Ramp E.S. from S. Prairie Ave. to S. Lake Shore Dr. F.A.I. Rte. I-55, dated June 18, 1991

BILL OF MATERIAL

Item	Unit	Quantity
Anchor Bolts, 1"	Each	2
Structural Repair of Concrete (Depth Equal to or less than 5 Inches)	Sq. Ft.	54
Structural Repair of Concrete (Depth Greater than 5 Inches)	Sq. Ft.	11
Temporary Shoring and Cribbing	Each	2

CR CHRISTIAN-ROGE & ASSOCIATES, INC.


USER NAME == IDOT DESIGNED - J.C.N./B.N.S. REVISED CHECKED - B.N.S./J.C.N. REVISED PLOT SCALE = 50.0000 '/ IN. DRAWN - F.M. REVISED PLOT DATE == 10/12/2011 DATE OCTOBER 12, 2011 REVISED


STATE OF ILLINOIS **DEPARTMENT OF TRANSPORTATION**


PIER E12 REPAIRS STRUCTURE NO. 016-0036 SHEET NO. S13A OF S41 SHEETS

COUNTY TOTAL SHEET NO.

COOK 41 13A SECTION 2011-031-BR CONTRACT NO. 60P37 ILLINOIS FED. AID PROJECT

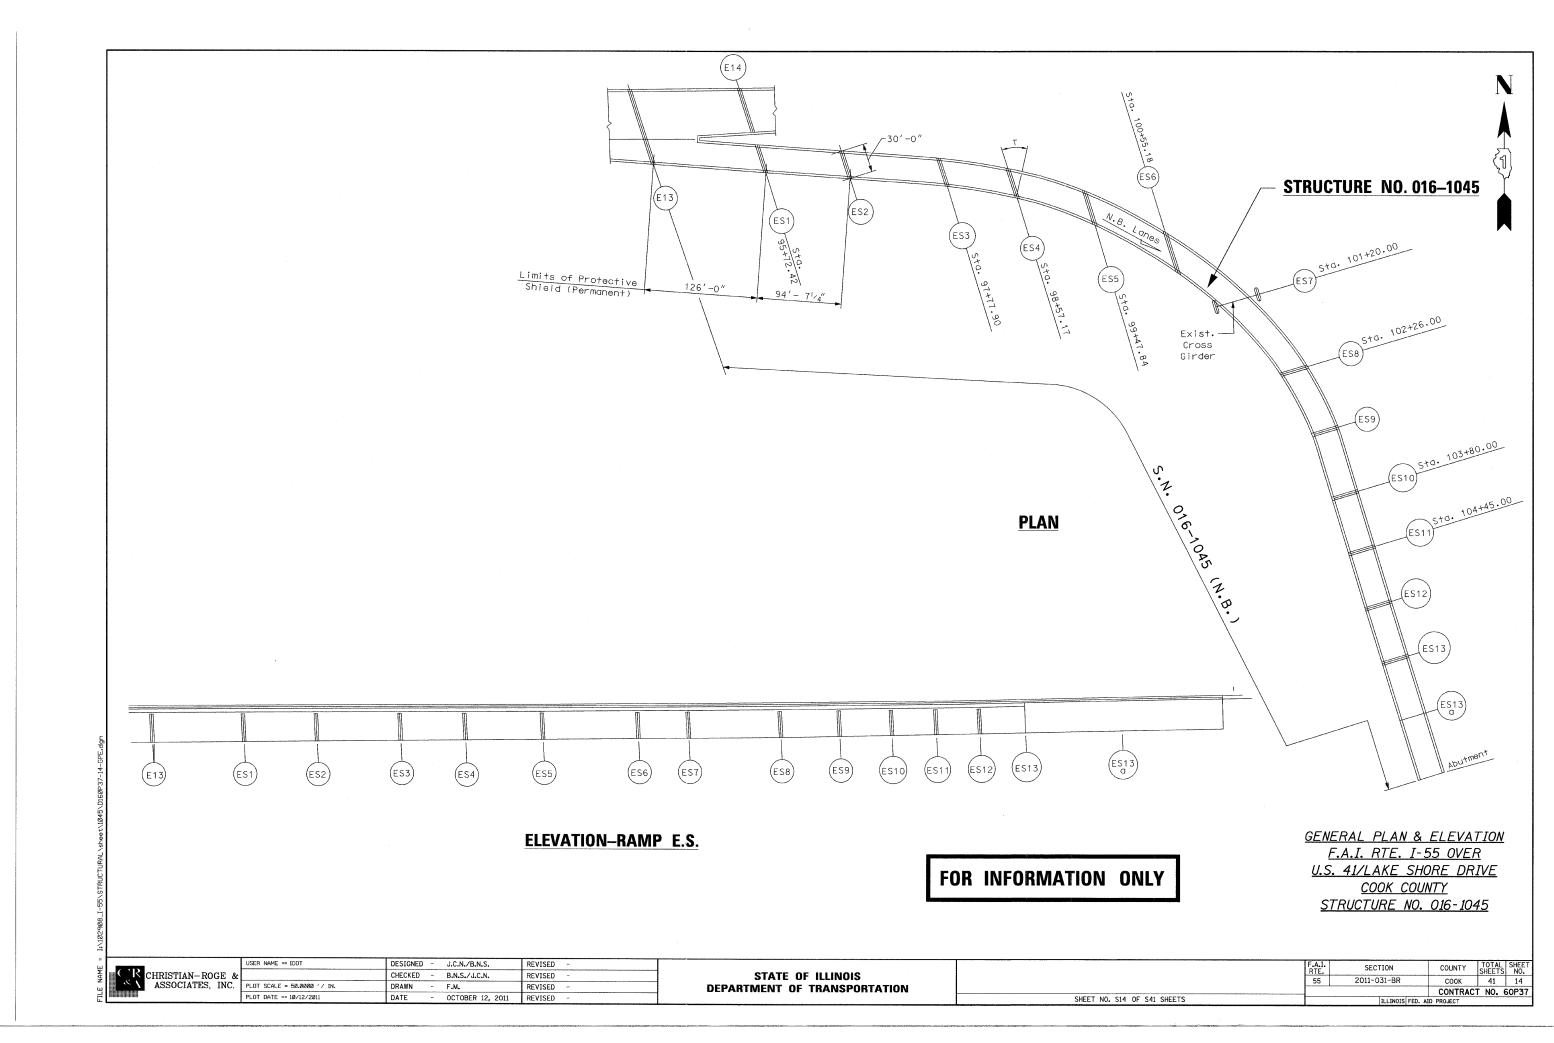

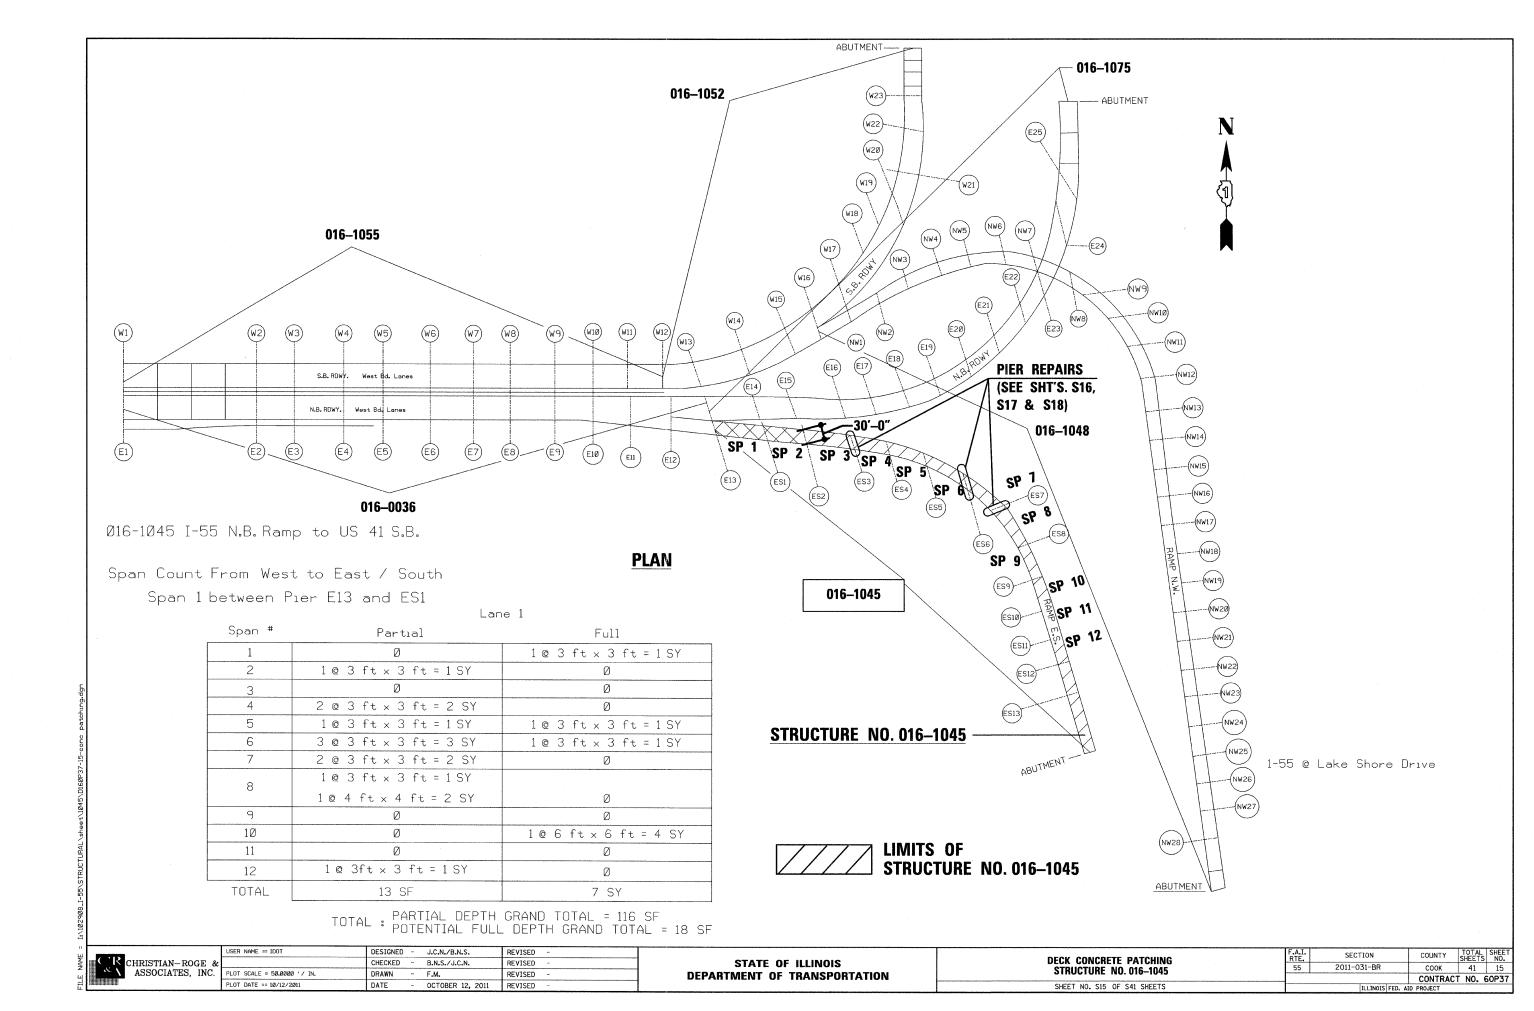

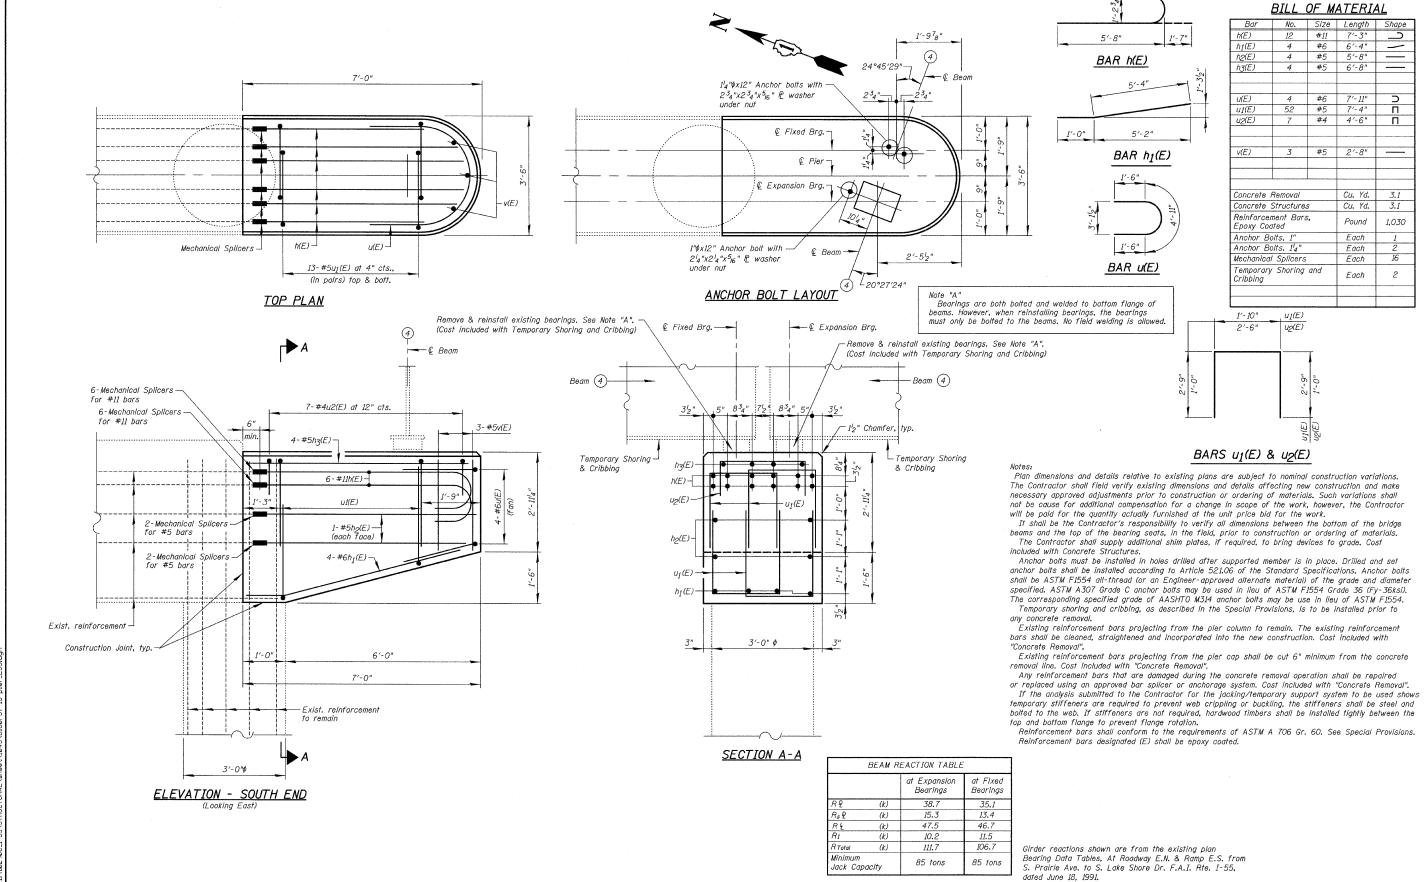

STATE OF ILLINOIS

DEPARTMENT OF TRANSPORTATION

SECTION

2011-031-BR

ILLINOIS FED. AID PROJECT

PIFR FS3 RFPAIRS

STRUCTURE NO. 016-1045

SHEET NO. S16 OF S41 SHEETS

COUNTY TOTAL SHEE

CONTRACT NO. 60P37

COOK 41 16

TILE NAME = II

CHRISTIAN-ROGE & ASSOCIATES, INC.

JSER NAME == IDOT

PLOT SCALE = 50.0000 '/ IN.

PLOT DATE == 10/12/2011

DESIGNED - J.C.N./B.N.S.

CHECKED - B.N.S./J.C.N.

- F.M.

OCTOBER 12, 2011

DRAWN


DATE


REVISED

REVISED

REVISED

REVISED

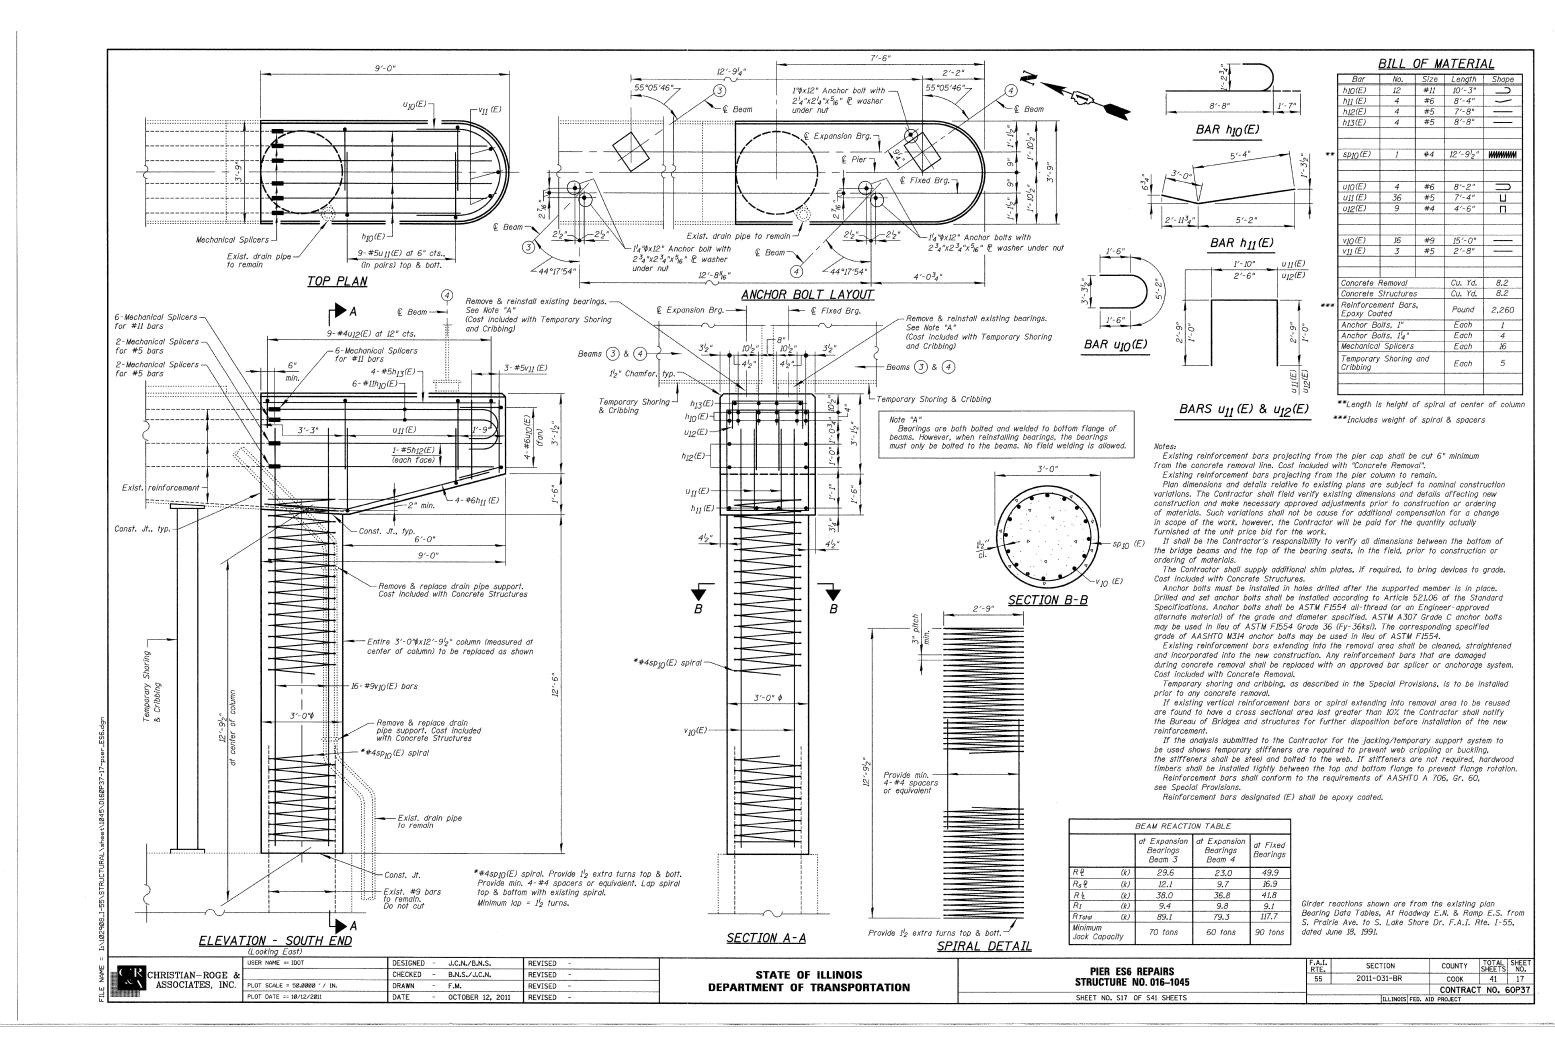

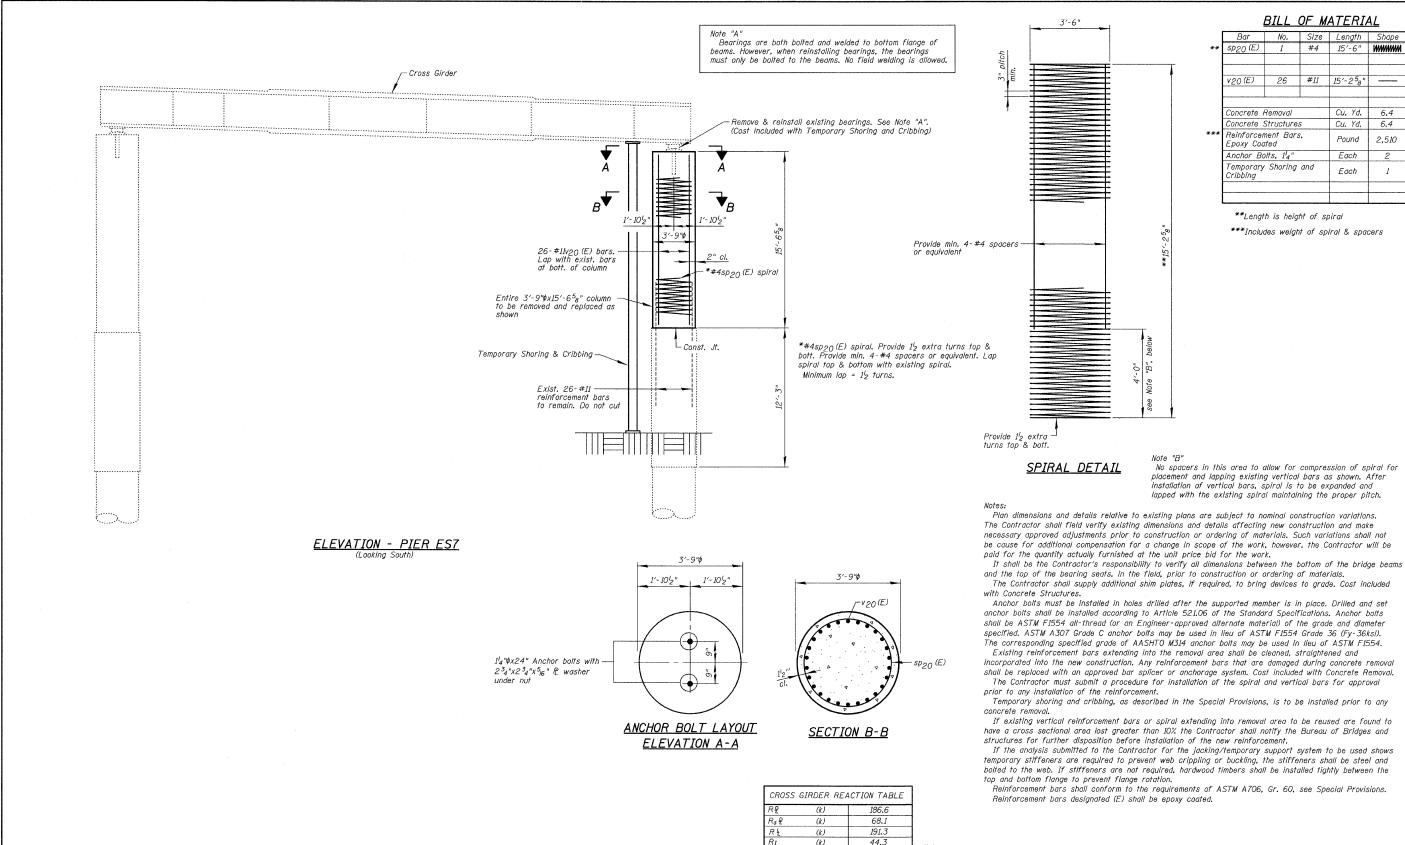

490.3

370 tons

Temporary Shoring & Cribbing at this location must be designed to carry all the column loads, which includes portions of reactions from all eight (8) girders supported by the cross girder (shown) plus lonaitudinal and transverse loads (not shown). The Temporary Shoring & Cribbing will be in place under traffic for an extended period of time.

USER NAME == IDOT DESIGNED -J.C.N./B.N.S. REVISED CHRISTIAN-ROGE & ASSOCIATES, INC. CHECKED - B.N.S./J.C.N. REVISED PLOT SCALE = 50.0000 '/ IN. DRAWN - F.M. REVISED PLOT DATE == 10/12/2011 DATE OCTOBER 12, 2011 REVISED

STATE OF ILLINOIS **DEPARTMENT OF TRANSPORTATION**

R Total

Jack Capacity

(k)

COUNTY TOTAL SHEE SHEETS NO. SECTION PIER ES7 REPAIRS 2011-031-BR COOK 41 18 55 **STRUCTURE NO. 016-1045** CONTRACT NO. 60P37 SHEET NO. S18 OF S41 SHEETS ILLINOIS FED. AID PROJECT

#4 15'-6" W

Cu. Yd.

Pound

Each


Fach


6.4

6.4

2,510

1

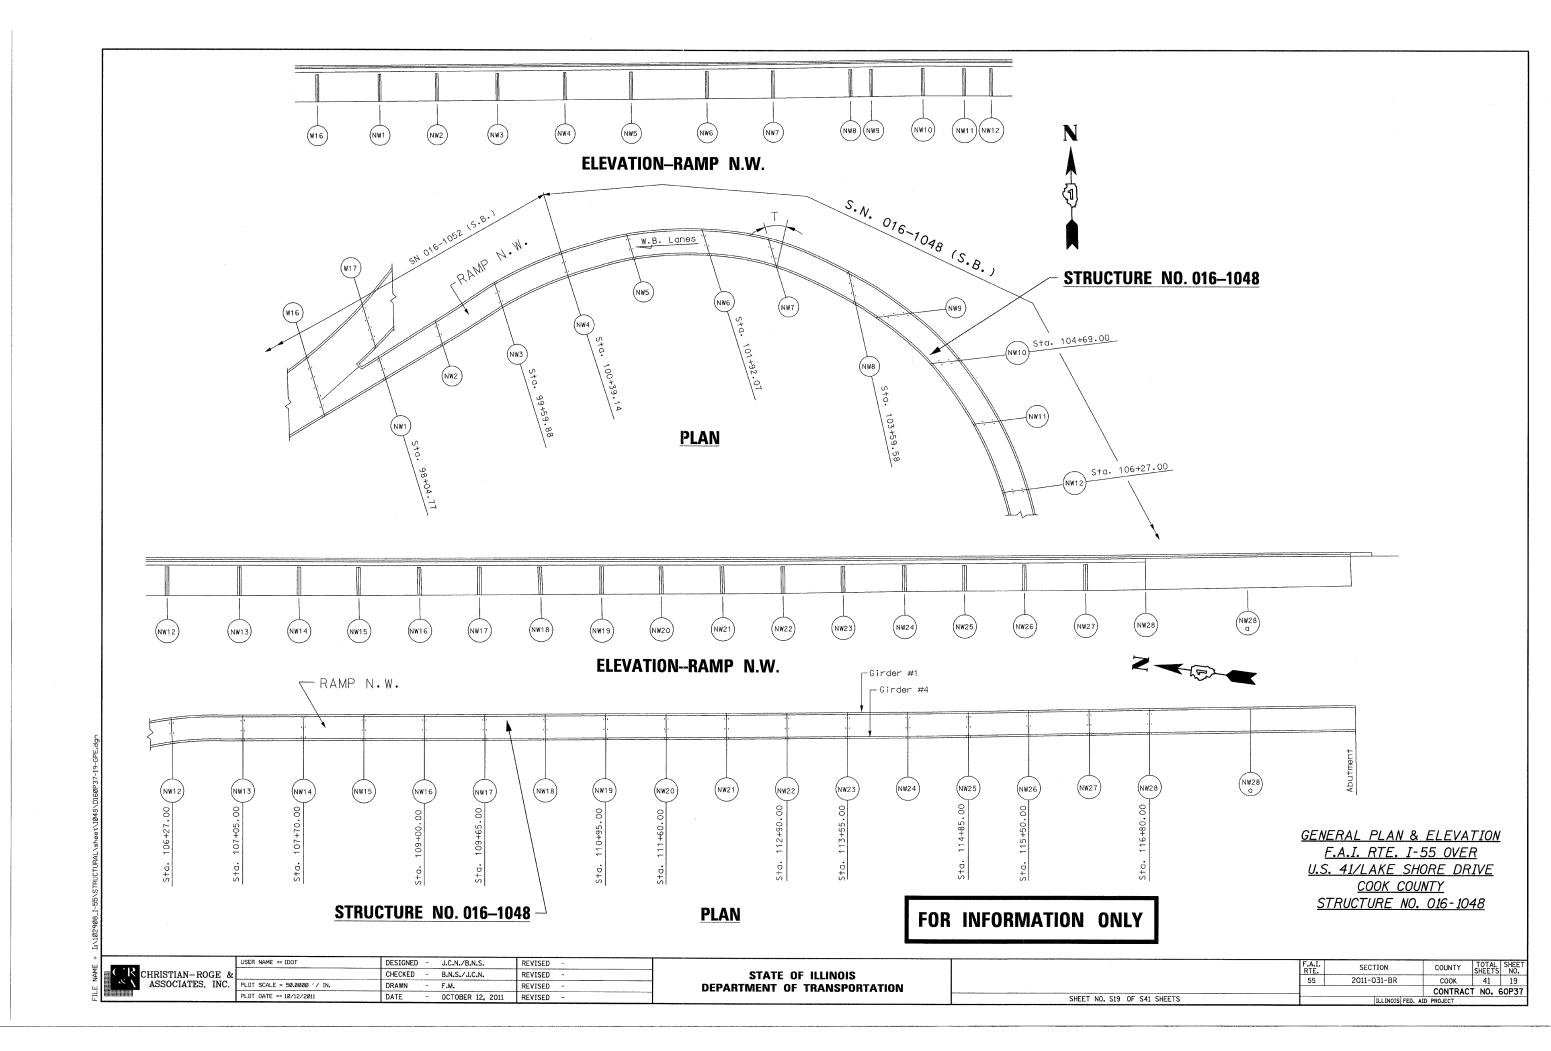

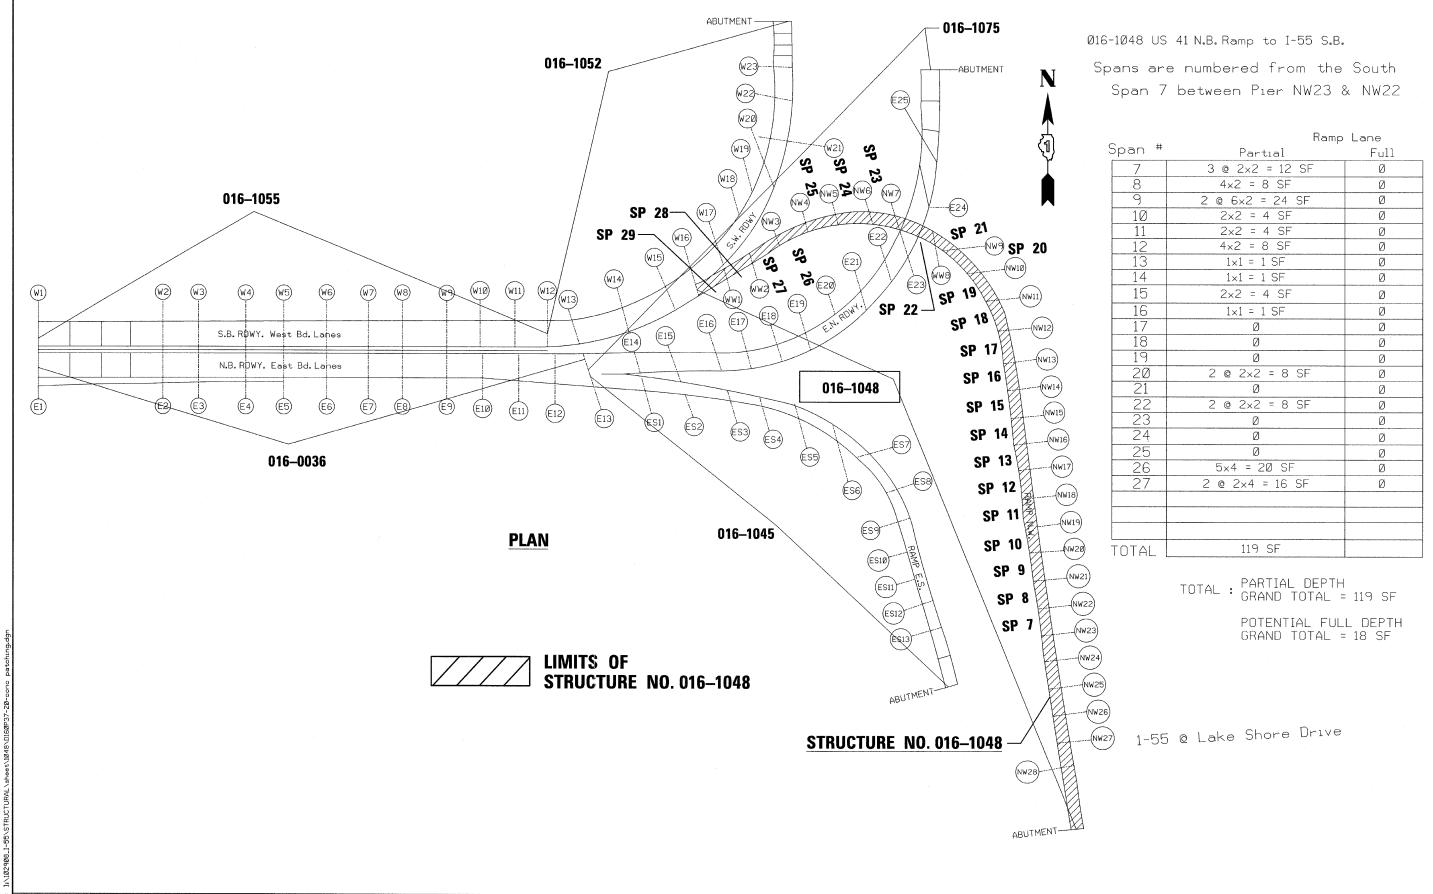

FILE NAME = I:\10

CHRISTIAN-ROGE & ASSOCIATES, INC.

 &
 USER NAME == IDOT
 DESIGNED - J.C.N./B.N.S.
 REVISED


 &
 CHECKED - B.N.S./J.C.N.
 REVISED


 PLOT SCALE = 56.0800 '/ IN.
 DRAWN - F.M.
 REVISED

 PLOT DATE == 10/12/2011
 DATE - OCTOBER 12, 2011
 REVISED

STATE OF ILLINOIS
DEPARTMENT OF TRANSPORTATION

DECK CONCRETE PATCHING STRUCTURE NO. 016-1048 SHEET NO. S20 OF S41 SHEETS

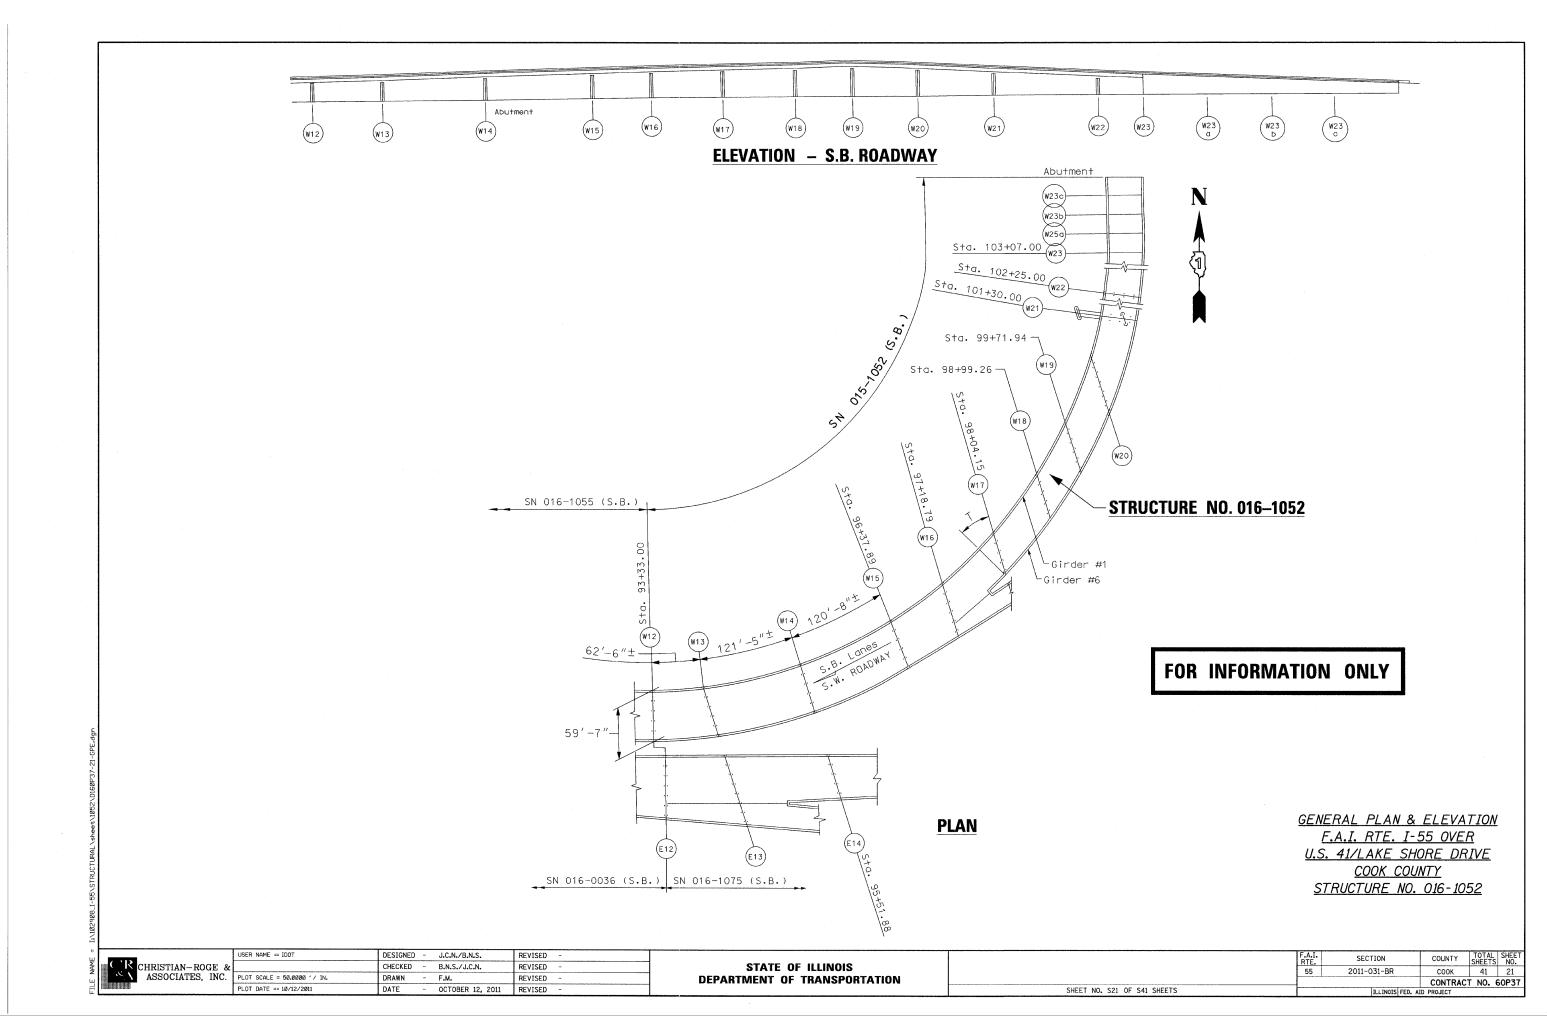

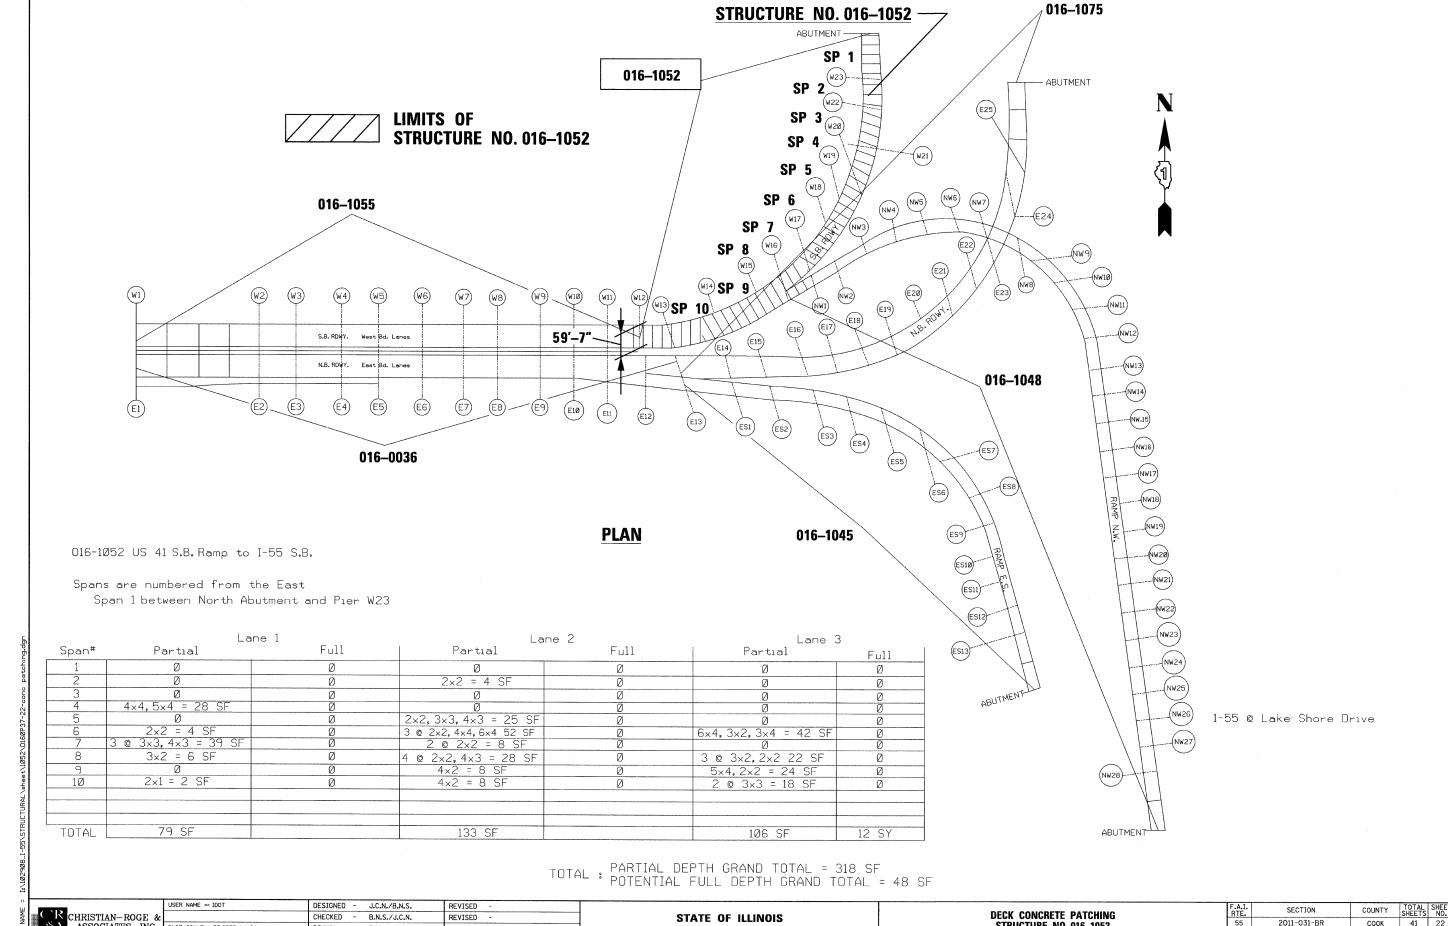


CHRISTIAN-ROGE & ASSOCIATES, INC. ASSOCIATES, INC.

PLOT SCALE = 50.0000 '/ IN. DRAWN - F.M. REVISED -PLOT DATE == 10/12/2011 OCTOBER 12, 2011 REVISED DATE

DEPARTMENT OF TRANSPORTATION

STRUCTURE NO. 016-1052 SHEET NO. S22 OF S41 SHEETS

2011-031-BR COOK 41 22 CONTRACT NO. 60P37

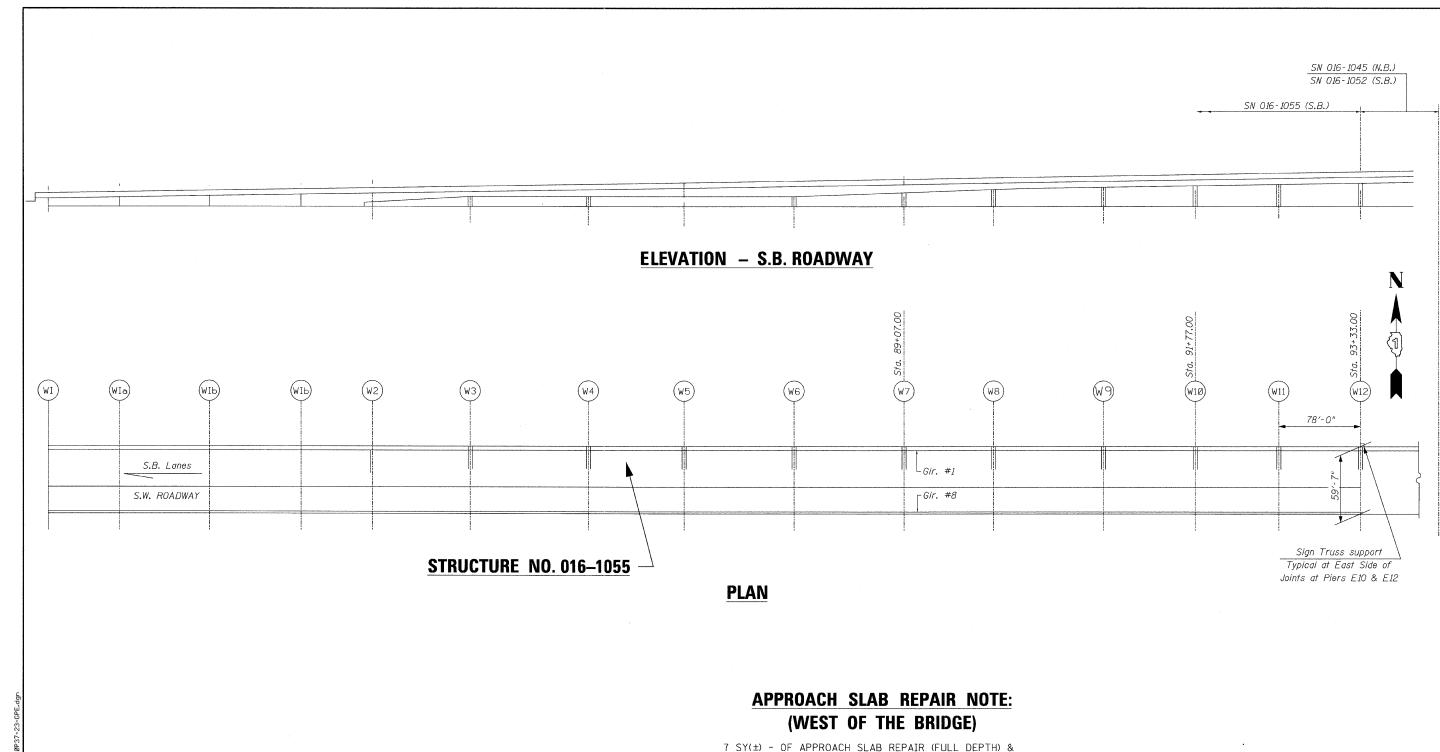

7 SY(±) - OF APPROACH SLAB REPAIR (FULL DEPTH) &
7 SY(±) - OF APPROACH SLAB REPAIR (PARTIAL DEPTH) IS REUUIRED

SHEET NO. S23 OF S41 SHEETS


GENERAL PLAN & ELEVATION
F.A.I. RTE. I-55 OVER
U.S. 41/LAKE SHORE DRIVE
COOK COUNTY
STRUCTURE NO. 016-1055

Ц	7.505	_
Ī	∰ CHRISTIAN−ROGE &	
	CHRISTIAN-ROGE & ASSOCIATES, INC.	Р
4		Р

	USER NAME == IDOT	DESIGNED	-	J.C.N./B.N.S.	REVISED	-
&		CHECKED	-	B.N.S./J.C.N.	REVISED	~
C.	PLOT SCALE = 50.0000 '/ IN.	DRAWN	-	F.M.	REVISED	-
	PLOT DATE == 10/12/2011	DATE	-	OCTOBER 12, 2011	REVISED	=

STATE	OF	ILLINOIS
DEPARTMENT	OF	TRANSPORTATION

F.A.I. RTE.	SECTION	COUNTY	TOTAL SHEETS	SHEET NO.
55	2011-031-BR	COOK	41	23
		CONTRACT	NO. 6	50P37
	THE INOIS EED A	ID PROJECT		

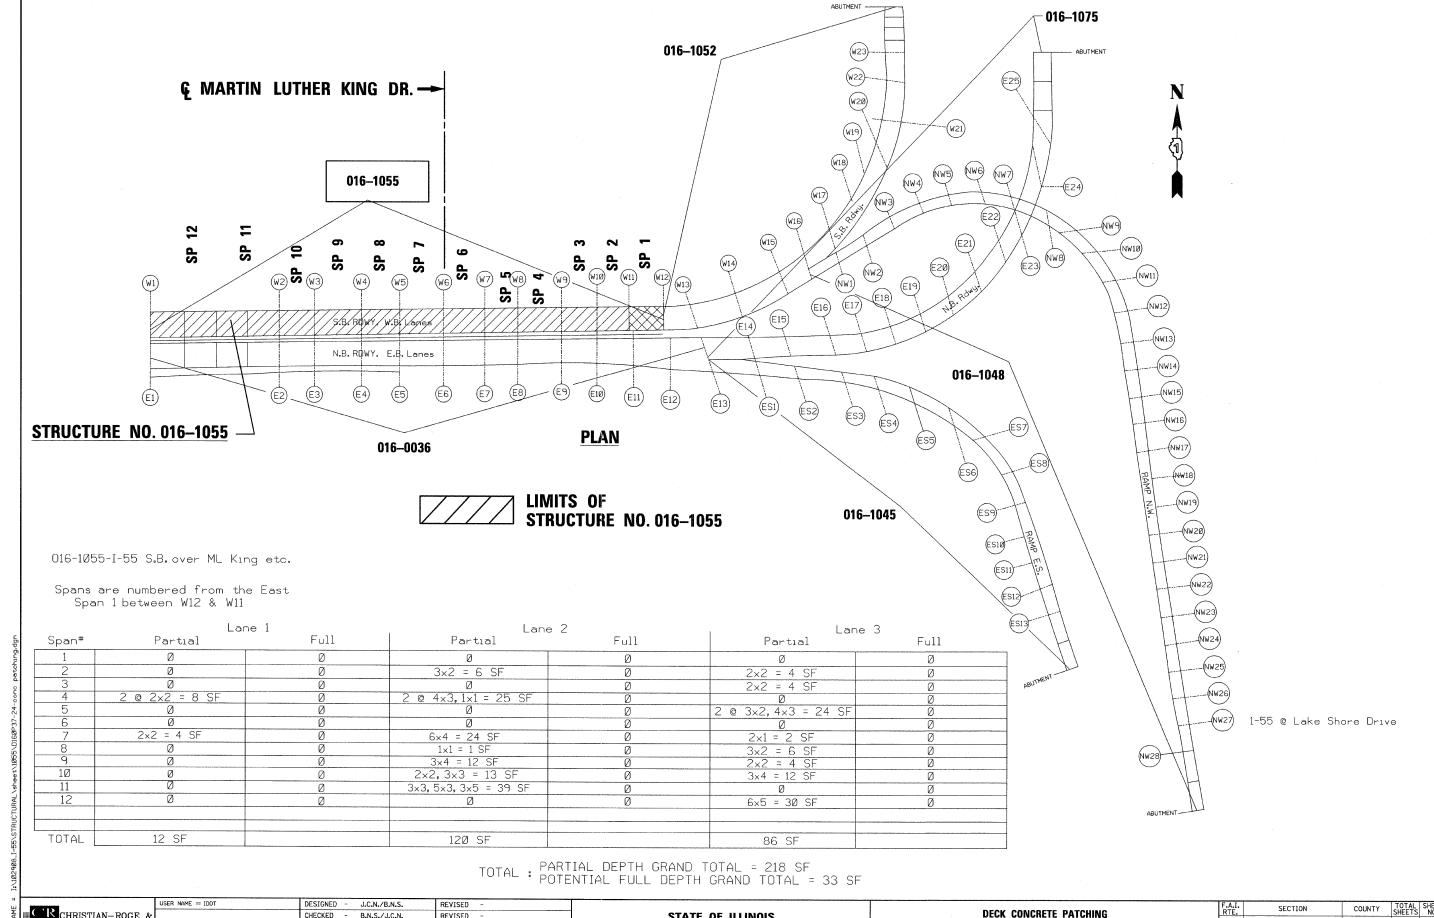


CR CHRISTIAN-ROGE & ASSOCIATES, INC.

CHECKED - B.N.S./J.C.N. REVISED PLOT SCALE = 50.0000 '/ IN. DRAWN F.M. REVISED PLOT DATE == 10/12/2011 DATE OCTOBER 12, 2011 REVISED

STATE OF ILLINOIS **DEPARTMENT OF TRANSPORTATION** STRUCTURE NO. 016-1055 SHEET NO. S24 OF S41 SHEETS

COUNTY TOTAL SHEETS NO.
COOK 41 24

CONTRACT NO. 60P37 2011-031-BR

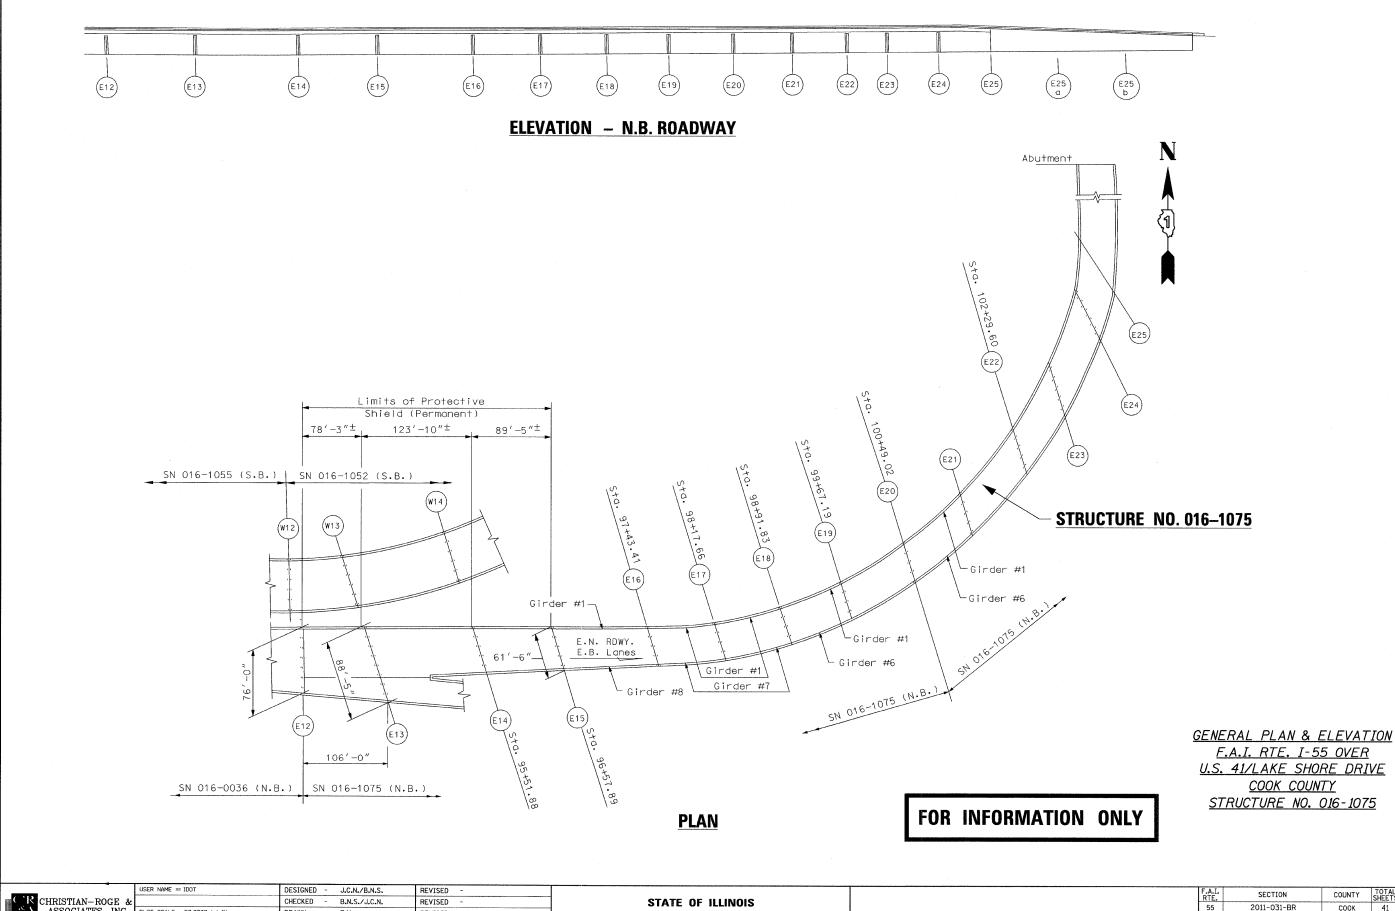



CHRISTIAN-ROGE & ASSOCIATES, INC. PLOT SCALE = 56.60000 '/ IN. DRAWN F.M. REVISED -PLOT DATE == 10/12/2011 OCTOBER 12, 2011 REVISED


DEPARTMENT OF TRANSPORTATION

2011-031-BR

SHEET NO. S25 OF S41 SHEETS

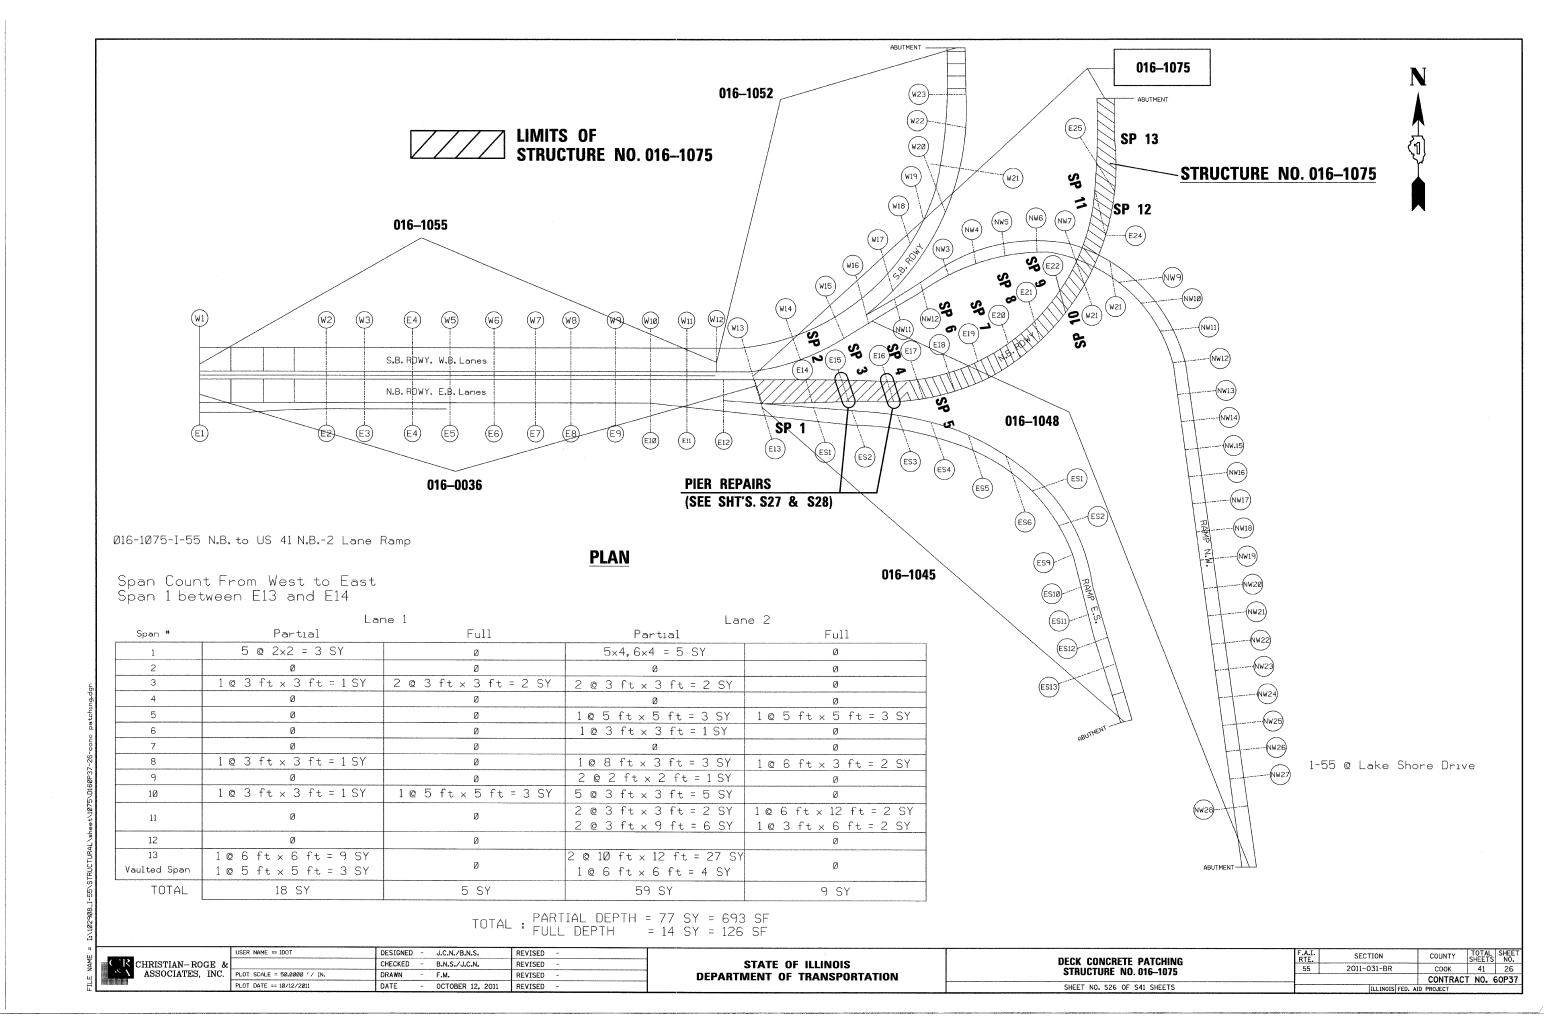

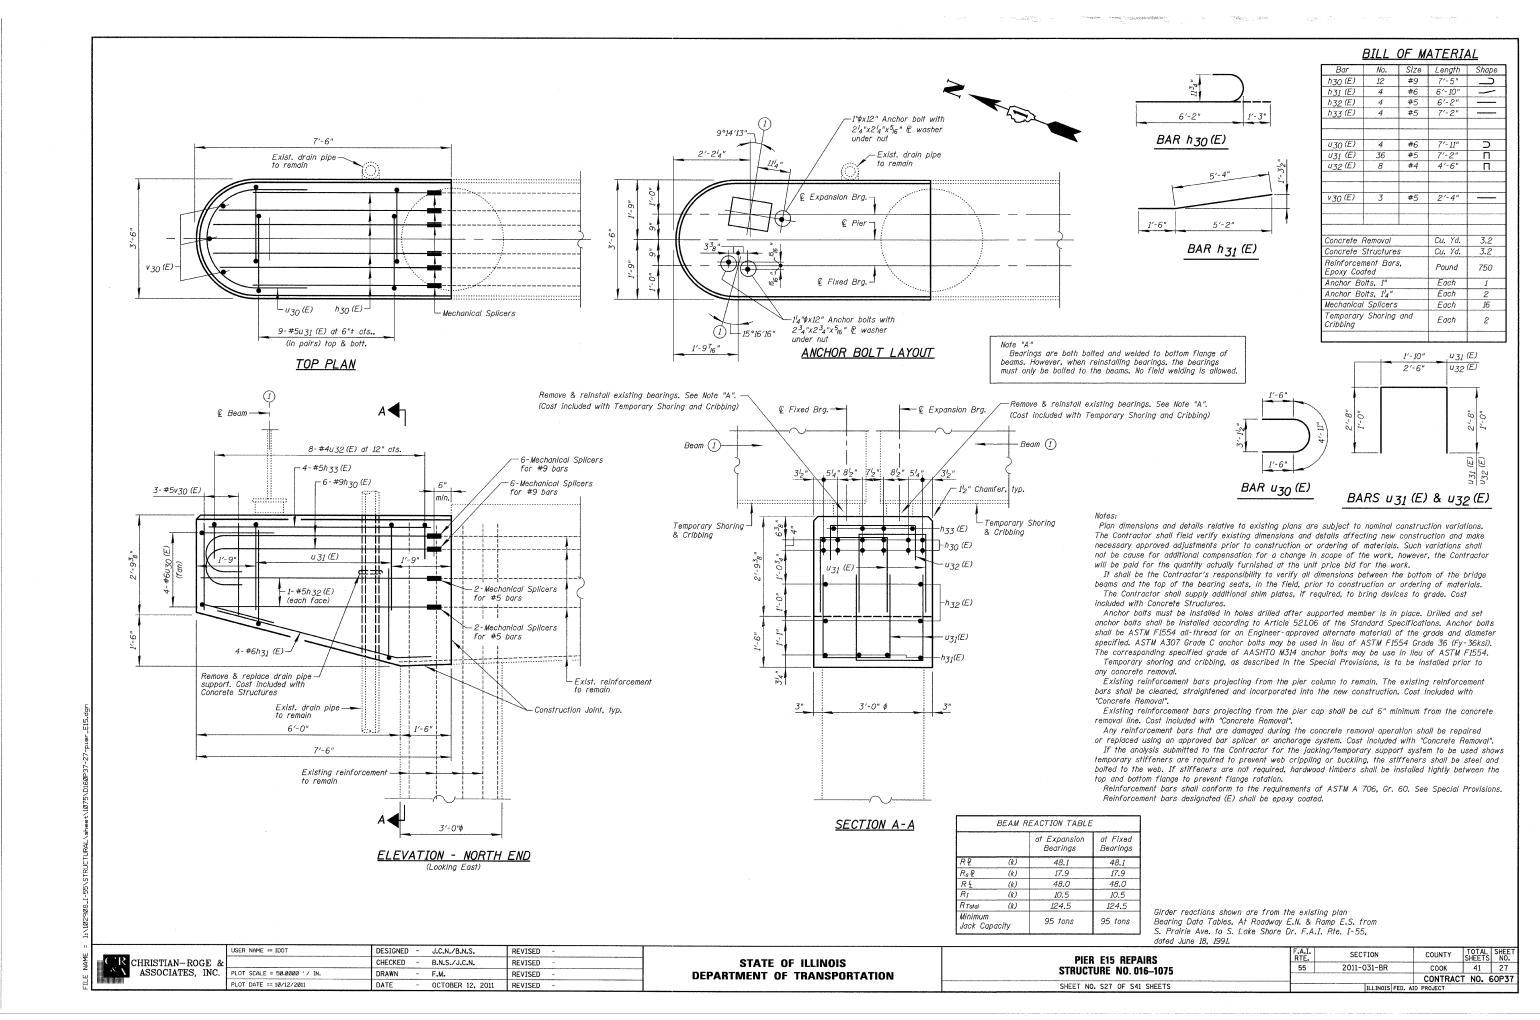

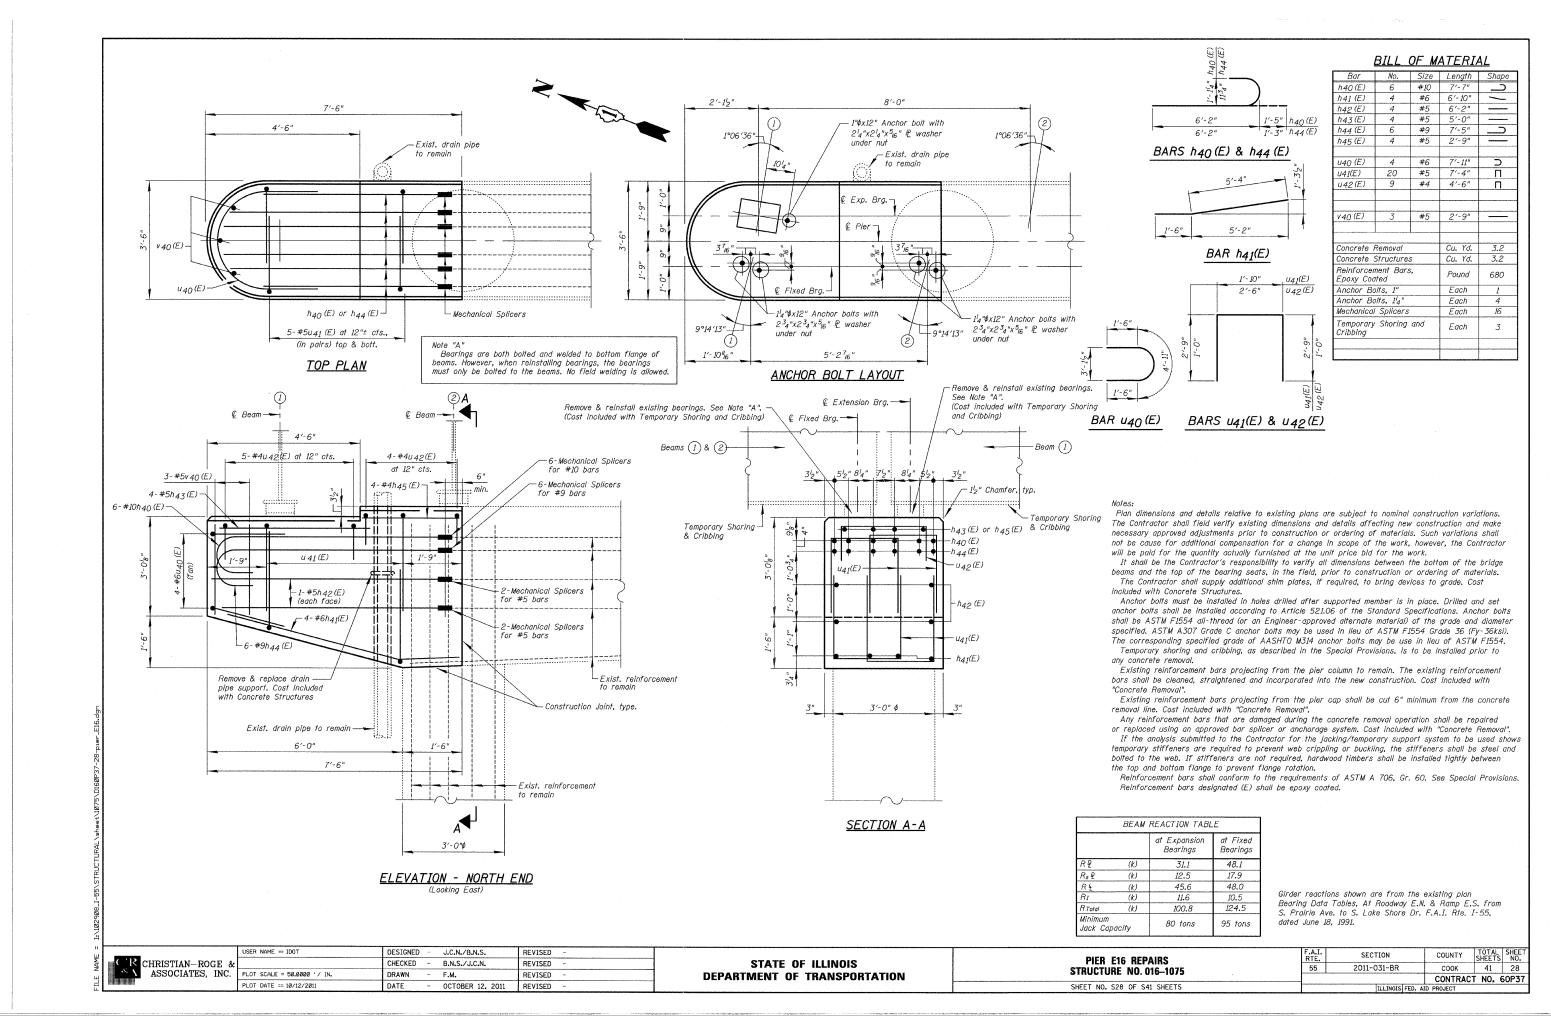

STANDARD BAR SPLICER ASSEMBLY

Minimum Lap Lengths									
Bar size to be spliced	Table 1	Table 2	Table 3	Table 4	Table 5				
3, 4	1'-5''	1'-11''	2'-1"	2'-4"	2'-3"				
5	1'-9''	2'-5"	2'-7"	2'-11''	2'-10''				
6	2'-1"	2'-11''	3'-1''	3'-6''	3'-4''				
7	2'-9"	3'-10''	4'-2"	4'-8''	4'-6"				
8	3'-8"	5'-1"	5′-5′′	6'-2''	5′-10′′				
9	4'-7"	6'-5"	6'-10''	7'-9"	7′-5′′				

Table 1: Black bar, 0.8 Class C


Table 2: Black bar, Top bar lap, 0.8 Class C Table 3: Epoxy bar, 0.8 Class C

Table 4: Epoxy bar, Top bar lap, 0.8 Class C Table 5: Epoxy bar, Top bar lap, Class B

Threaded splicer bar length = min. lap length + 1_2^{l} " + thread length

* Epoxy not required on Bar Splicer Assembly components used in conjunction with black bars.

Location	Location Bar size		Table for minimum lap length			
		'				
######################################						

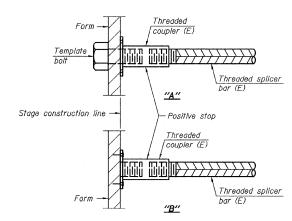

INSTALLATION AND SETTING METHODS


"A" : Set bar splicer assembly by means of a template bolt.
"B" : Set bar splicer assembly by nalling to wood forms or cementing to steel forms.


(E): Indicates epoxy coating.

-	Bridge Deck	Approach Slab
Reinforcement bars	Threaded couplers (E)	Threaded splicer
Threaded	44444444444444444444444444444444444444	***************************************
bar (E)	4'-0''	6′-0′′

BAR SPLICER ASSEMBLY FOR #5 BAR ON INTEGRAL OR SEMI-INTEGRAL ABUTMENTS

No. required = -

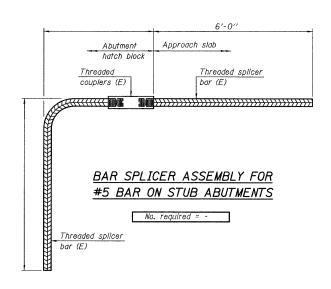

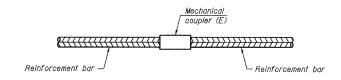

STANDARD MECHANICAL SPLICER

STANDARD MEGHANICAL SI LICEN								
Structure number	Location	Bar size	No. assemblies required					
016-1045	Pier ES3 Top of Pier	#11	12					
	Pier ES3 East & West Faces of Pier	#5	4					
	Pier ES6 Top of Pier	#11	12					
	Pier ES6 East & West Faces of Pier	#5	4					
	Pier ES6 Column	#9	16					

Structure number	Location	Bar size	No. assemblies required		
	Pier E15 Top of Pier	#9	12		
016-1075	Pier E15 East & West Faces of Pier	#5	4		
	Pier E16 Top of Pier	#9	6		
	Pier E16 Top of Pier	#10	6		
	Pler E16 East & West Faces of Pier	#5	4		

<u>NOTES</u>

Splicer bars shall be deformed with threaded ends and have a minimum 60 ksi yield strength.

All reinforcement shall be lapped and tied to the splicer bars.

Bar splicer assemblies shall be epoxy coated according to the requirements for reinforcement bars. See Section 508 of the Standard Specifications. See special provision for Mechanical Splicers.

See approved list of bar splicer assemblies and mechanical splicers for alternatives.


BSD-1 7-1-10


CHRISTIAN-ROGE & ASSOCIATES, INC. ASSOCIATES, INC.


	USER NAME == IDOT	DESIGNED	-	J.C.N./B.N.S.	REVISED -
:		CHECKED	_	B.N.S./J.C.N.	REVISED -
	PLOT SCALE = 50.0000 '/ IN.	DRAWN	-	F.M.	REVISED ~
	PLOT DATE == 10/12/2011	DATE	-	OCTOBER 12, 2011	REVISED -


STATE OF ILLINOIS **DEPARTMENT OF TRANSPORTATION** BAR SPLICER ASSEMBLY AND MECHANICAL SPLICER DETAILS STRUCTURE NO'S. 016-1045 & 016-1075 SHEET NO. S29 OF S41 SHEETS


	F.A.I. RTE.	SECTION	COUNTY	TOTAL SHEETS	SHEET NO.			
	55	2011-031-BR	соок	41	29			
CONTRACT NO. 60P37								
		ILLINOIS FED.	AID PROJECT					

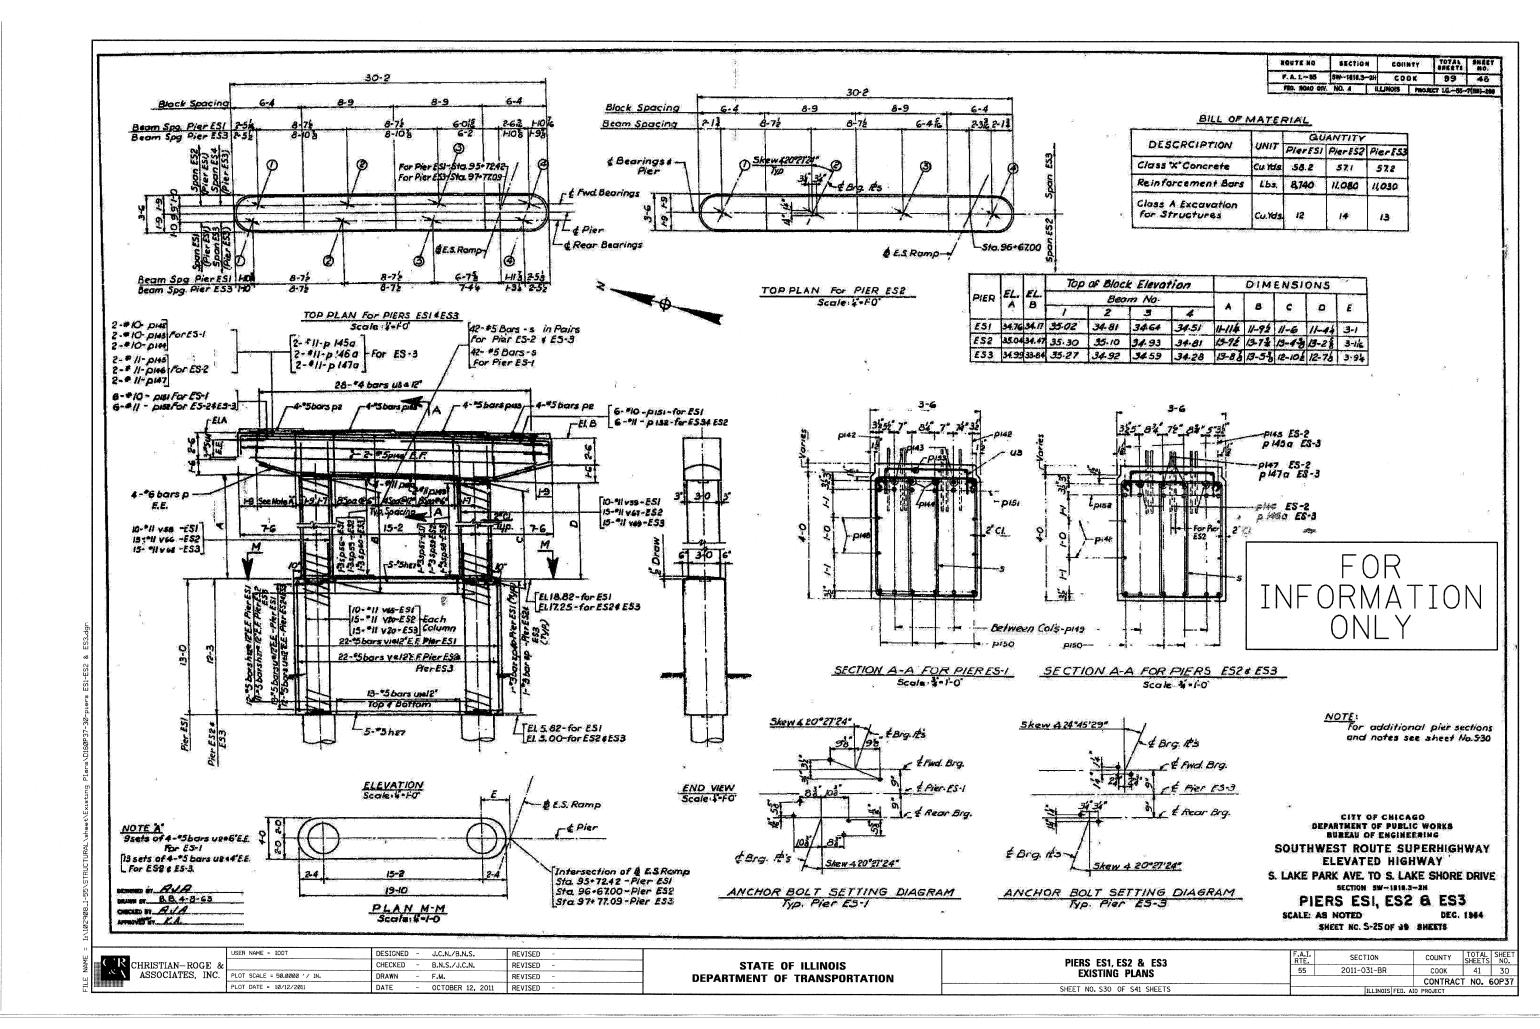


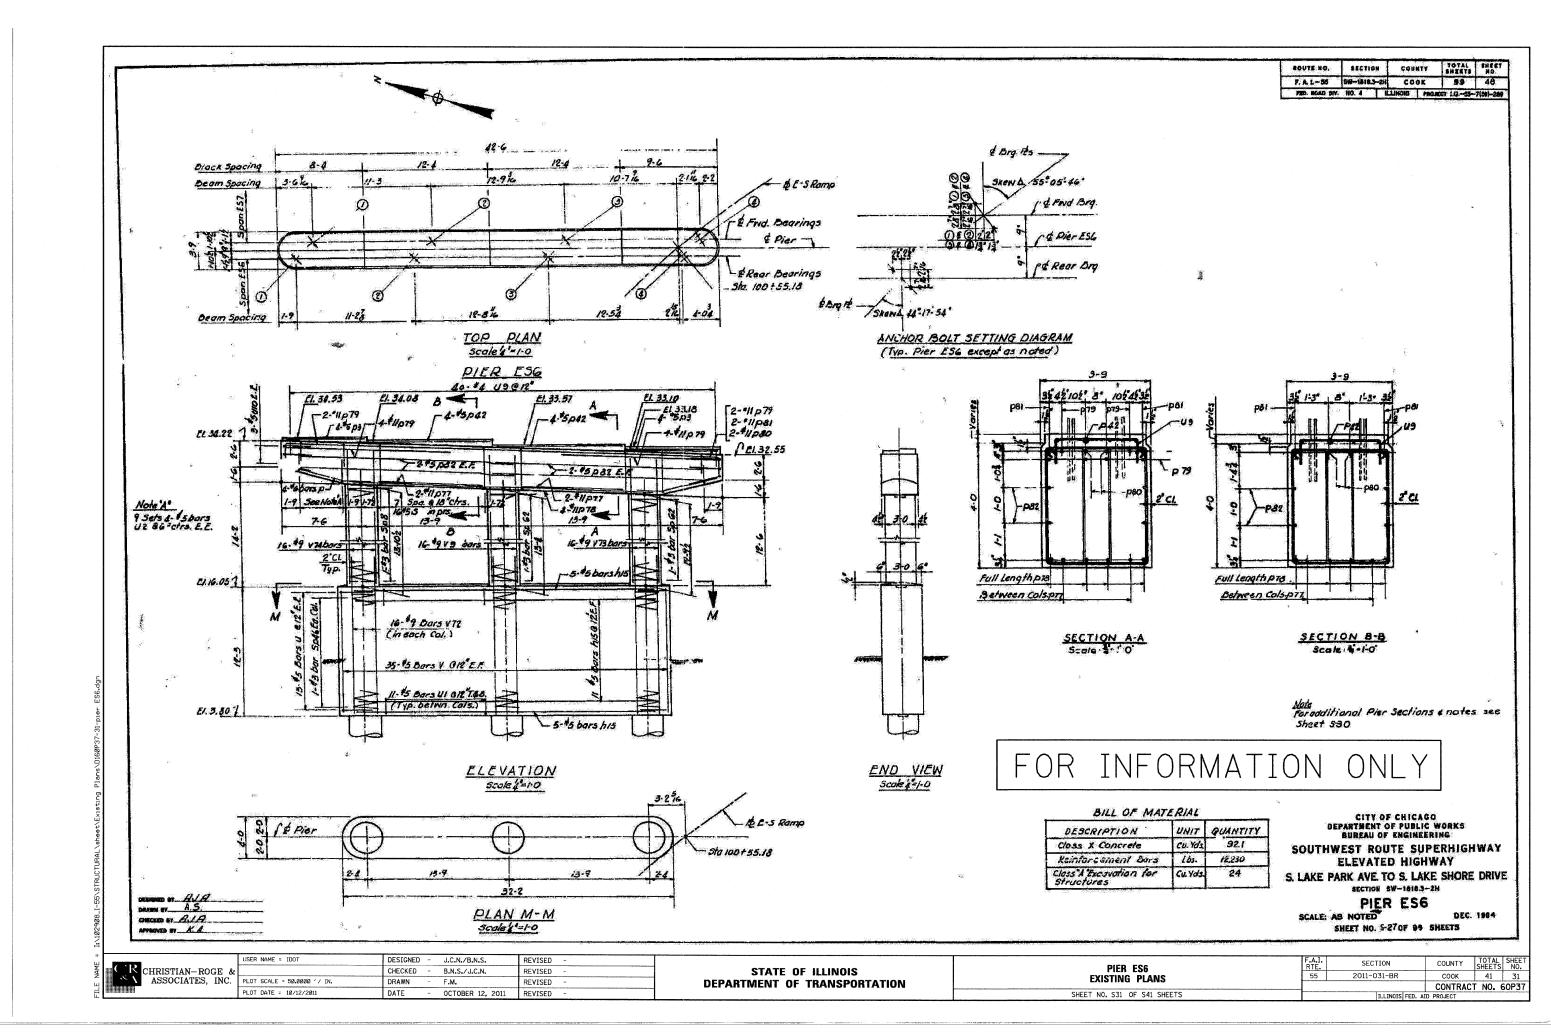

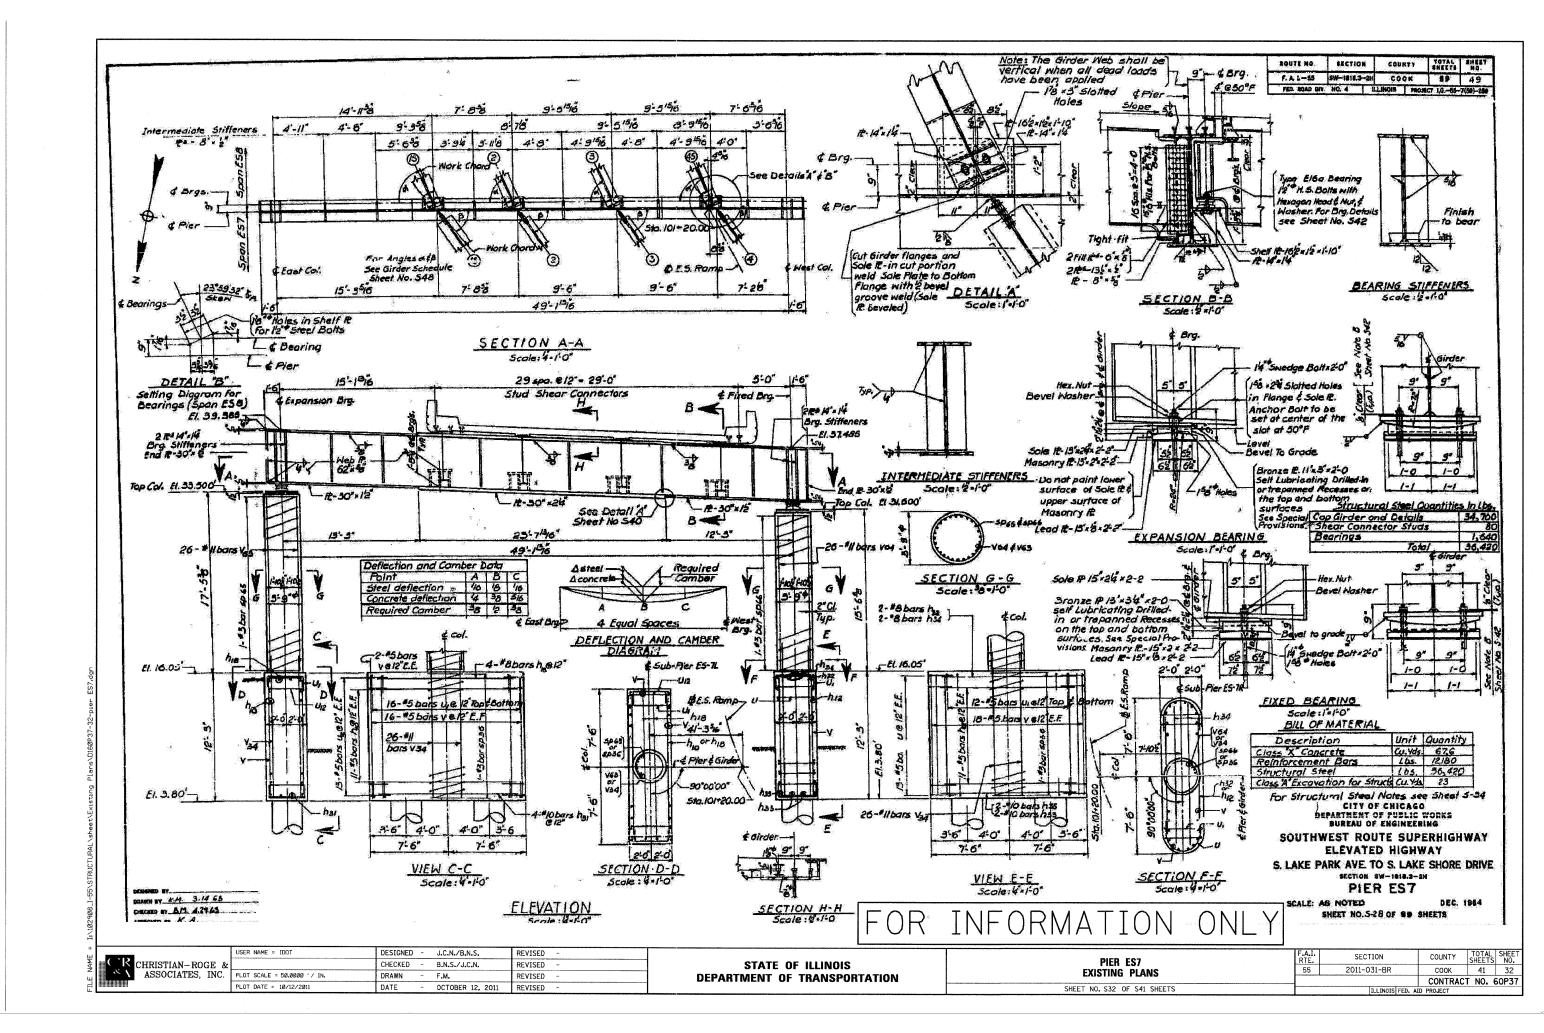

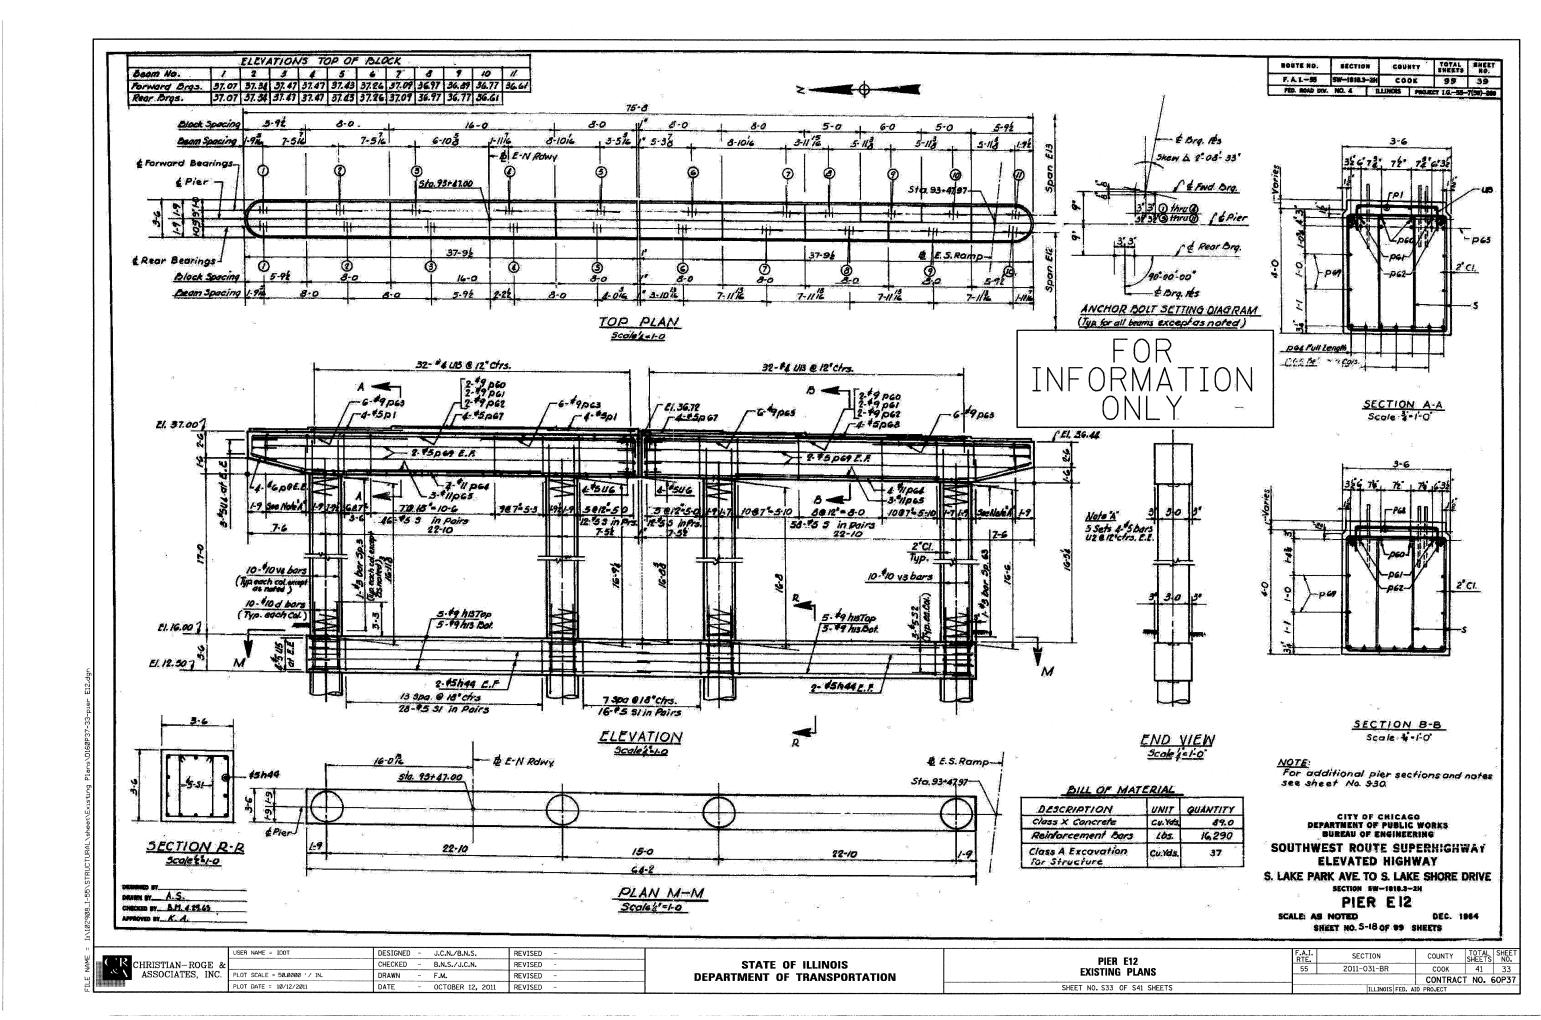

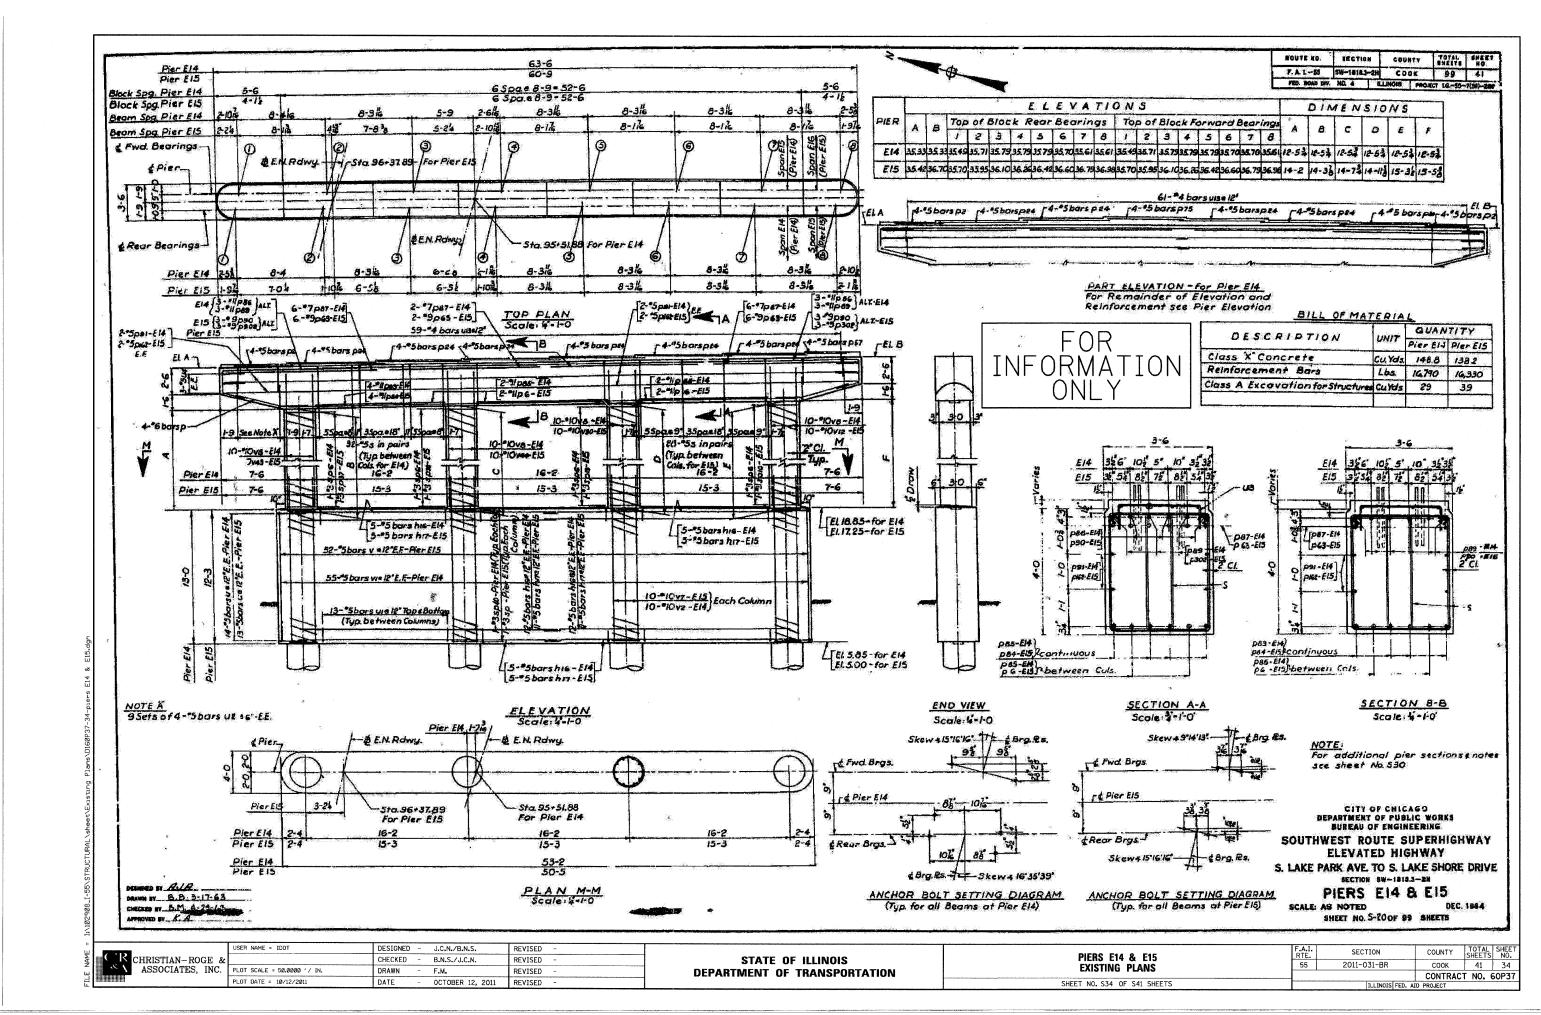

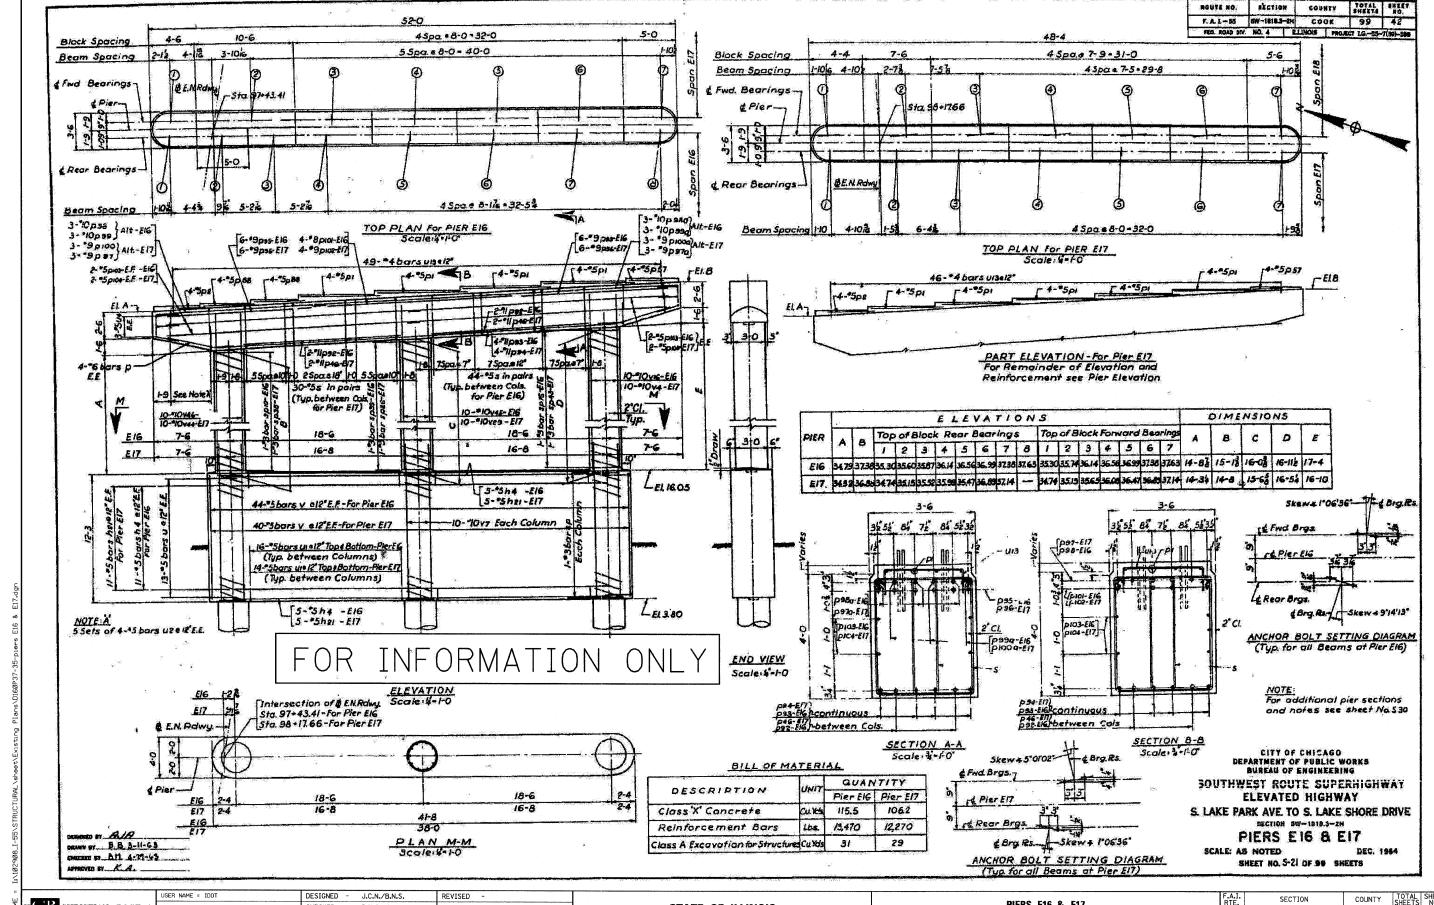


CHRISTIAN-ROGE & ASSOCIATES, INC.

STATE OF ILLINOIS
DEPARTMENT OF TRANSPORTATION


PIERS E16 & E17 EXISTING PLANS SHEET NO. S35 OF S41 SHEETS F.A.I. SECTION COUNTY TOTAL SHEETS NO. 55 2011-031-BR COOK 41 35

CONTRACT NO. 60P37

| ILLLINOIS| FED. AID PROJECT

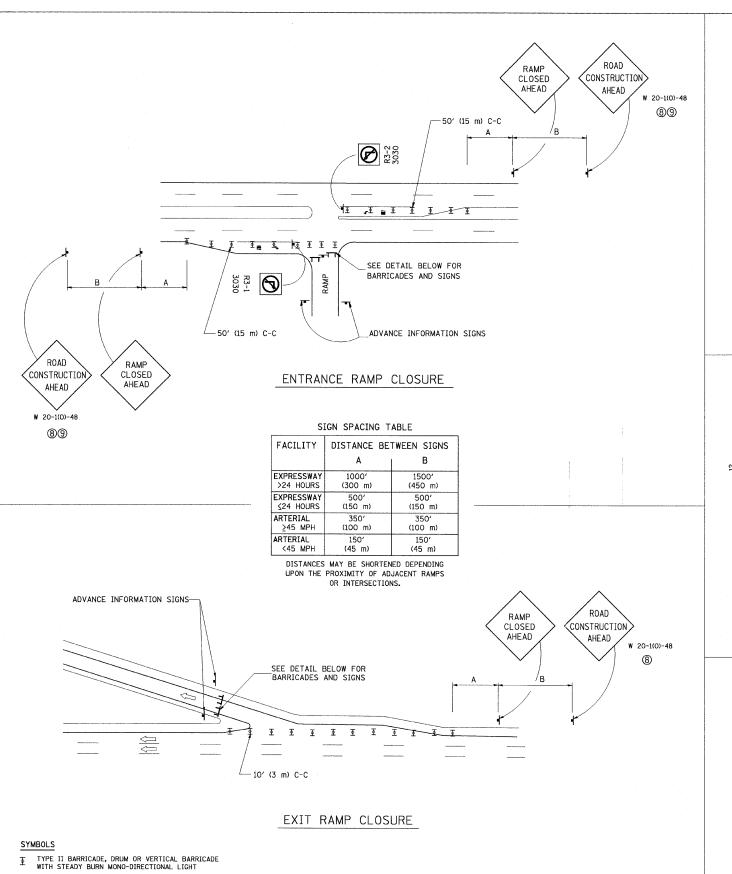

TYPE III BARRICADE WITH FLASHING LIGHT

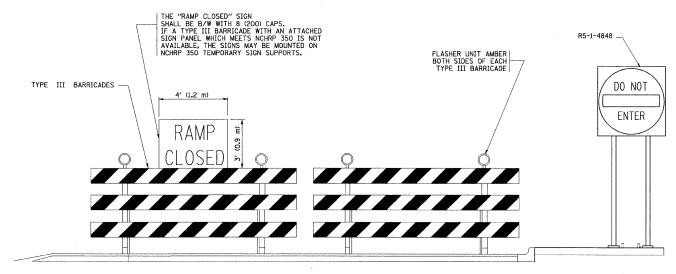

DETAIL FOR REQUIRED BARRICADES & SIGNS

RAMP CLOSURE ADVANCE WARNING SIGN




BLACK LEGEND ON ORANGE REFLECTORIZED BACKGROUND

1 (25) BORDER

THESE SIGNS ARE REQUIRED ON ALL THE EXIT GUIDE SIGNS FOR THE CLOSED EXIT RAMPS.

RAMP CLOSURE ADVANCE INFORMATION SIGN

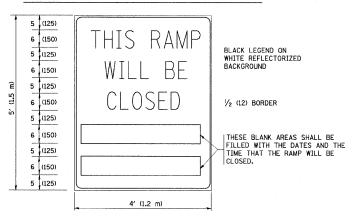


THESE SIGNS ARE REQUIRED ON BOTH SIDES OF THE RAMP, MINIMUM OF 1 WEEK IN ADVANCE OF THE CLOSURE.


GENERAL NOTES:

- (1) CONES MAY BE SUBSTITUTED FOR DRUMS OR TYPE II BARRICADES DURING DAY OPERATIONS, CONES SHALL BE A MINIMUM OF 28 (700) HIGH.
- ② STEADY BURN LIGHTS WILL NOT BE REQUIRED FOR DAY OPERATIONS.
- $\begin{tabular}{ll} \hline \end{tabular} \begin{tabular}{ll} \end{tabular} A FLAGGER SHALL BE POSITIONED AT EACH CLOSED RAMP THAT IS OPEN TO CONSTRUCTION VEHICLES. \\ \hline \end{tabular}$
- 4 ALL ROUTE MARKERS AND TRAILBLAZER ASSEMBLIES WHICH DIRECT MOTORISTS TO A CLOSED ENTRANCE RAMP SHALL BE COVERED.
- (5) THE SIGNING AND BARRICADING WHICH IS REQUIRED BY THIS DETAIL SHALL BE INCLUDED IN THE COST OF TRAFFIC CONTROL AND PROTECTION (EXPRESSWAYS).
- AUTHORIZATION FROM THE DISTRICT'S BUREAU OF TRAFFIC IS REQUIRED FOR ALL RAMP CLOSURES.
- THE RAMP CLOSURE ADVANCE INFORMATION SIGNS SHALL BE ERECTED IF THE CLOSURE TIME EXCEEDS TWENTY- FOUR 24 HOURS. ADDITIONAL ADVANCE WARNING SIGNS ON EXIT GUIDE SIGNING WILL BE REQUIRED FOR EXIT RAMP CLOSURES THAT EXCEED TWENTY FOUR 24 HOURS IN LENGTH.
- (8) ROAD CONSTRUCTION AHEAD SIGNS MAY BE OMITTED WHEN THIS DETAIL IS USED IN CONJUNCTION WITH OTHER TRAFFIC CONTROL THAT ALREADY INCLUDES A ROAD CONSTRUCTION AHEAD SIGN.
- ARTERIAL ROAD CONSTRUCTION AHEAD SIGNS MAY BE OMITTED ON CLOSURES LESS THAN 24 HOURS IN DURATION.

ALL DIMENSIONS ARE IN INCHES (MILLIMETERS)
UNLESS OTHERWISE SHOWN.

USER NAME = leusa DESIGNED - DWS REVISED - DWS/JAF 12-02 TOTAL SHEET SHEETS NO. SECTION COUNTY FREEWAY ENTRANCE AND EXIST RAMP vi\diststd\22x34\tc08.dqr DRAWN REVISED JAF 02-06 STATE OF ILLINOIS 2011-031-BR соок CLOSURE DETAILS PLOT SCALE = 50.000 '/ IN. CHECKED REVISED SPB 01-07 **DEPARTMENT OF TRANSPORTATION** TC-08 CONTRACT NO. 60P37 PLOT DATE = 1/26/2010 DATE 02~83 REVISED SPB 12-09 SCALE: NONE SHEET NO. 1 OF 1 SHEETS STA. TO STA.

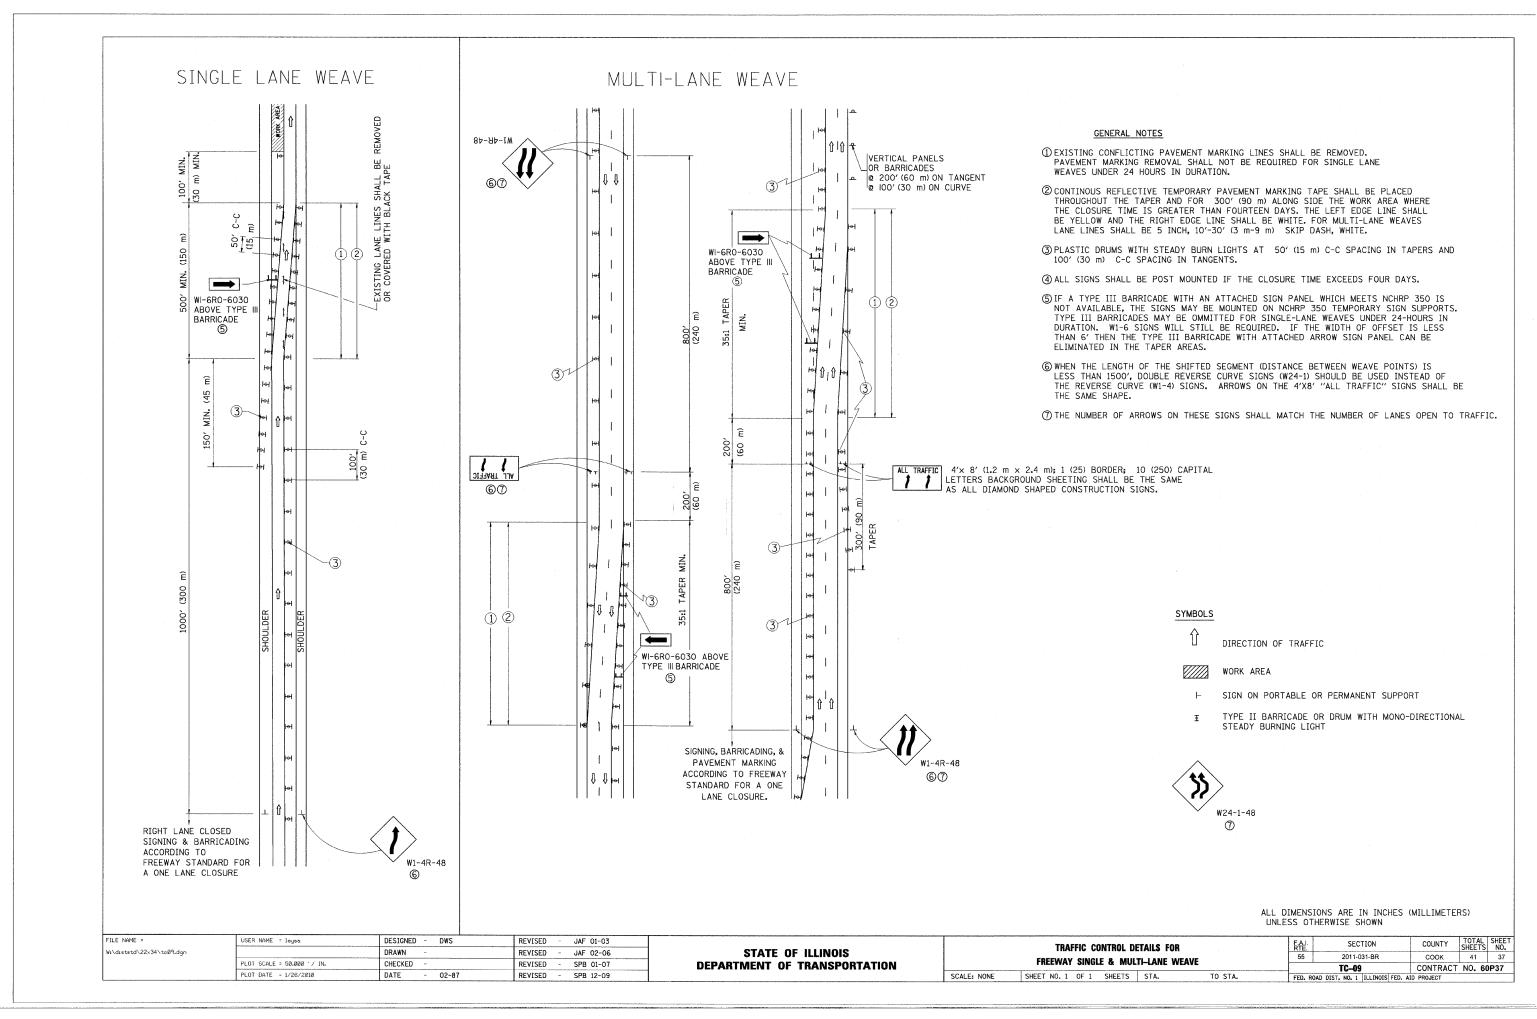

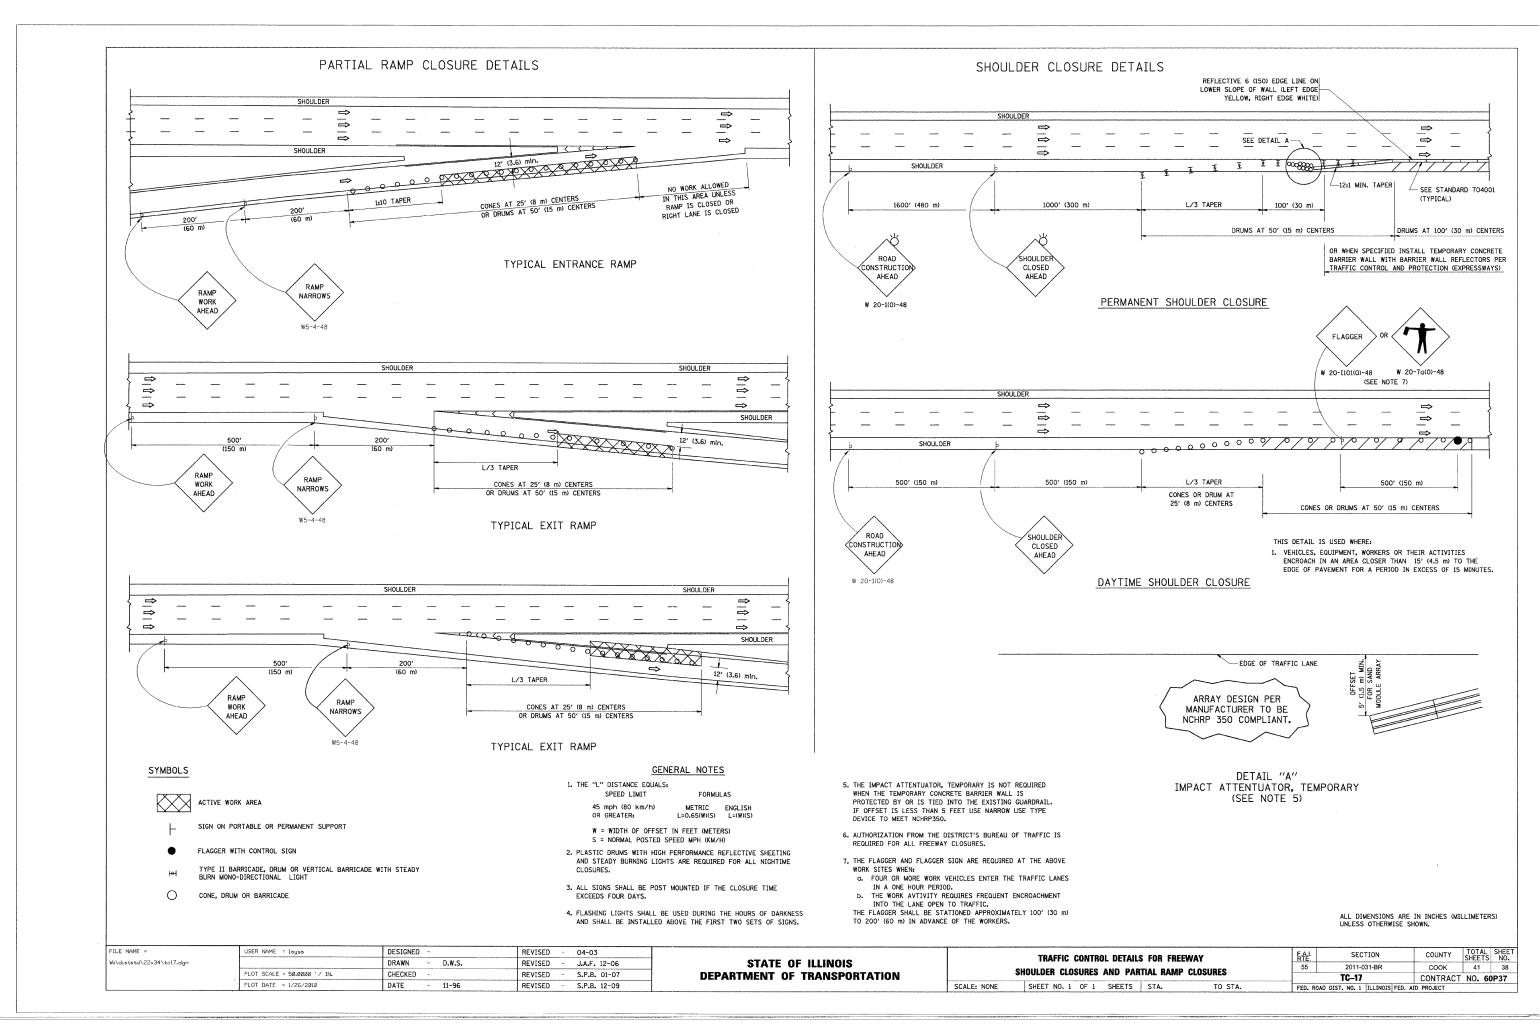

CENTER LANE CLOSURE TYPE I CHECK BARRICADES— AT 100' (30 m) CENTERS DRUMS AT 50' (15 m) CENTERS ARROW BOARD DISPLAYING-DOUBLE ARROW PATTERN 1010 LANE CLOSED AHEAD ′* w9-3-48 * ₩9-3a-48 SIGNING & BARRICADING ACCORDING TO FREEWAY STANDARD FOR A ONE LANE CLOSURE INSTALLATION SEQUENCE 1. CLOSE LANES 1&2 ACTIVE NOTES WORK AREA 1. DRUMS WITH STEADY BURN LIGHTS SHALL BE USED AT 50' (15 m) CENTERS ON ALL TAPERS AND TANGENTS IN 2. ERECT INSIDE LANE 2 TAPER ADVANCE OF WORK AREA. 2. CLOSURE SHALL BE USED ONLY FOR OPERATIONS LASTING 72 HOURS OR LESS. 3. OPEN LANE 2 BY RELOCATING FIRST TAPER 3. CENTER LANE CLOSURE CONFIGURATION NON-ACTIVE WORK AREA IS NOT TO BE USED WITH WORKERS 4. REMOVE CLOSURE IN REVERSE ORDER FILE NAME = USER NAME = leusa DESIGNED REVISED - J.A.F. 04-03 /i\diststd\22×34\tc25.dor DRAWN REVISED S.P.B. 01-07

CHECKED

DATE

PLOT SCALE = 50.000 ' / IN


PLOT DATE = 1/26/2010


S.P.B. 12-09


REVISED

SHOULDER LANE

NOTE: CLOSURE SHALL BE USED ONLY FOR OPERATIONS LASTING 72 HOURS OR LESS.

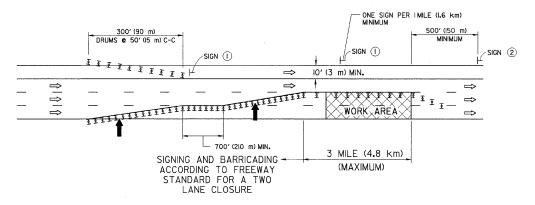

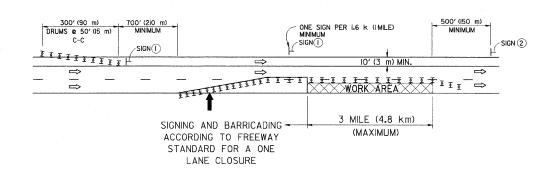

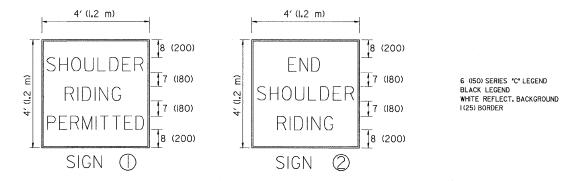

SYMBOLS

DIRECTION OF TRAFFIC

ARROWBOARD

ACTIVE WORK AREA

- ⊢ SIGN ON PORTABLE OR PERMANENT SUPPORT ★
- TYPE #BARRICADE, OR DRUM WITH MONO-DIRECTIONAL STEADY BURN LIGHT

ALL DIMENSIONS ARE IN INCHES (MILLIMETERS) UNLESS OTHERWISE SHOWN

* ALL SIGNS SHALL BE MOUNTED AT A MINIMUM HEIGHT OF 5' (I.5 m).

STATE OF ILLINOIS DEPARTMENT OF TRANSPORTATION	TRAFFIC CONTROL DETAILS FOR FREEWAY						E.A.J. SECTION		COUNTY TOTAL SHI SHEETS N		SHEET NO.
	CENTER LANE CLOSURE SHOULDER LANE					55	2011-031-BR	COOK	41	39	
	SCALE: NONE	SHEET NO. 1	0F 1	SHEETS	STA.	TO STA.	FED. ROA	TC-25 D DIST. NO. 1 ILLINOIS FED. AI	CONTRACT D PROJECT	NO. 60	0P37

