11-17-2023 LETTING ITEM 054

INDEX OF SHEETS

- COVER SHEET AND INDEX OF SHEETS GENERAL NOTES & LIST OF STANDARDS & COMMITMENTS
- SUMMARY OF QUANTITIES
- TYPICAL SECTIONS
- SCHEDULE OF QUANTITIES 26-27 ROADWAY REMOVAL PLANS
- 28-30 PLAN SHEETS

0

0

0

- 31-36 STAGING SHEETS
- STRUCTURAL PLANS
- STRUCTURE NO. 062-0059 41-48 STRUCTURE NO. 062-0056
- 49-57 STRUCTURE NO. 062-0057 GUARDRAIL LENGTH OF NEED SHEETS 58-59
- PAVEMENT MARKING AND SIGNAGE SHEET
- MISCELLANEOUS DETAILS
- DISTRICT DETAILS
- TRAFFIC BARRIER TERMINAL TYPE 6 (MODIFIED) SHEETS

FOR LIST OF HIGHWAY STANDARDS, SEE SHEET NO. 2

TRAFFIC DATA

1L 29 (S.N. 062-0056) ADT = 325050% = 4.31%MU% = 9.23%

IL 29 (S.N. 062-0057) 2021 ADT = 7150 SU% = 4.55%

MU% = 5.24%

50% = 6.36%MU% = 22.73%


5.N. 062-0059

STA. 253+10.71

IL 17 (S.N. 062-0059) 2021 ADT = 1100 (2023)

FUNCTIONAL CLASSIFICATION

IL 29: OTHER PRINCIPAL ARTERIAL IL 17: MINOR ARTERIAL

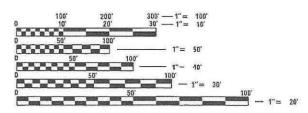

FULL SIZE PLANS HAVE BEEN PREPARED USING STANDARD ENGINEERING SCALES. REDUCED SIZED PLANS WILL NOT CONFORM TO STANDARD SCALES, IN MAKING MEASUREMENTS ON REDUCED PLANS, THE ABOVE SCALES MAY BE USED.

JOINT UTILITY LOCATION INFORMATION FOR EXCAVATION 1-800-892-0123 OR 811

PROJECT ENGINEER: NICOLE FAYANT (309-671-3454) PROJECT MANAGER: KYLE HARRISON (309-671-3462)

CATALOG NO. 036205-00D


CONTRACT NO. 68G39

STATE OF ILLINOIS **DEPARTMENT OF TRANSPORTATION**

PROPOSED HIGHWAY PLANS

FAP ROUTE 318 (IL 29), FAP 645 (IL 17) SECTION (3B-BR, BR-1; (104B) BR-1) BDR, BRR PROJECT NHPP-HBFP-TQG7(735) **BRIDGE PRESERVATION** MARSHALL COUNTY

C-94-060-21

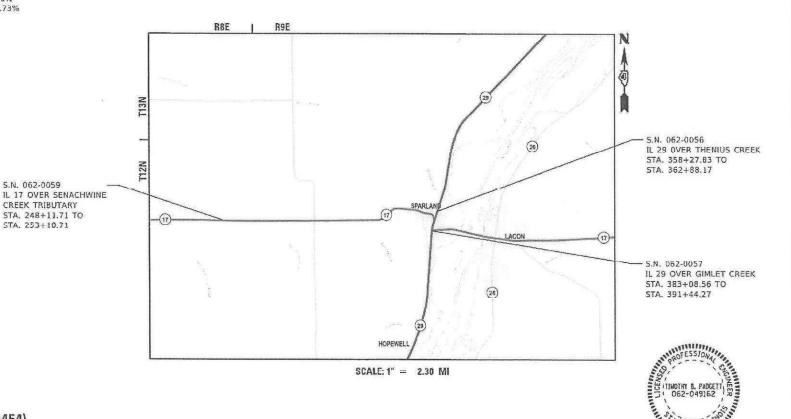


GROSS LENGTH = 499.00 FT. + 460.34 FT. + 835.71 FT. = 0.340 MILE NET LENGTH = 79.00 FT. + 137.00 FT. + 78.00 FT. = 0.056 MILE

318 *(38-88,98-1;(104b)98-1)8DR,9RR MARSHALL 72 1 ILLINOIS CONTRACT NO. 68G39

D-94-041-21

SECTION

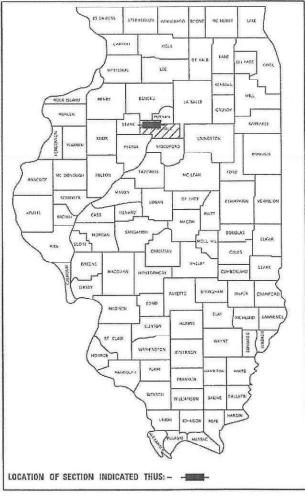

PLANS PREPARED BY:



4940 Old Collinsville Road Swansea, Illinois 62226 Tel: 618.624.4468

Illinois Professional Design Firm No. 184-001220 www.twm-inc.com License Expires: 04/30/2025

ILLINOIS - MISSOURI - TENNESSEE

STATE OF ILLINOIS DEPARTMENT OF TRANSPORTATION October 13, 20 ENGINEER OF DESIGN AND ENVIRONMENT October 13, 2023 DIRECTOR OF HIGHWAYS PROJECT IMPLEMENTATION

PRINTED BY THE AUTHORITY OF THE STATE OF ILLINOIS

AVAILABILITY OF ELECTRONIC FILES

MICROSTATION AND GEOPAK FILES OF THIS PROJECT WILL BE MADE AVAILABLE TO THE CONTRACTOR AFTER CONTRACT AWARD. IF THERE IS A CONFLICT BETWEEN THE ELECTRONIC FILES AND THE PRINTED CONTRACT PLANS AND DOCUMENTS, THE PRINTED CONTRACT PLANS AND DOCUMENTS SHALL TAKE PRECEDENCE OVER THE ELECTRONIC FILES. THE CONTRACTOR SHALL ACCEPT ALL RISK ASSOCIATED WITH USING THE ELECTRONIC FILES AND SHALL HOLD THE DEPARTMENT HARMLESS FOR ANY ERRORS OR OMISSIONS IN THE ELECTRONIC FILES AND THE DATA CONTAINED THEREIN. ERRORS OR DELAYS RESULTING FROM THE USE OF THE ELECTRONIC FILES BY THE CONTRACTOR SHALL NOT RESULT IN AN EXTENSION OF TIME FOR ANY INTERIM OR FINAL COMPLETION DATE OR SHALL NOT BE CONSIDERED CAUSE FOR ADDITIONAL COMPENSATION, THE CONTRACTOR SHALL NOT USE. SHARE, OR DISTRIBUTE THESE ELECTRONIC FILES EXCEPT FOR THE PURPOSE OF CONSTRUCTING THIS CONTRACT. ANY CLAIMS BY THIRD PARTIES DUE TO USE OR ERRORS SHALL BE THE SOLE RESPONSIBILITY OF THE CONTRACTOR. THE CONTRACTOR SHALL INCLUDE THIS DISCLAIMER WITH THE TRANSFER OF THESE ELECTRONIC FILES TO ANY OTHER PARTIES AND SHALL INCLUDE APPROPRIATE LANGUAGE BINDING THEM TO SIMILAR RESPONSIBILITIES.

ENVIRONMENTAL REVIEWS

PRIOR TO THE USE OF ANY PROPOSED BORROW AREAS, USE AREAS (TEMPORARY ACCESS ROADS, DETOURS, RUN-AROUNDS, ETC.) AND/OR WASTE AREAS, THE CONTRACTOR SHALL FILE THE REQUIRED ENVIRONMENTAL RESOURCE REQUEST SURVEYS ACCORDING TO SECTION 107.22 OF THE STANDARD SPECIFICATIONS. THESE SURVEYS ARE REQUIRED IN ORDER FOR THE DEPARTMENT TO CONDUCT CULTURAL AND BIOLOGICAL RESOURCE SURVEYS FOR THE PROPOSED SITE.

THE REQUIRED ENVIRONMENTAL RESOURCE DOCUMENTATION SHALL INCLUDE THE FOLLOWING:

BDE FORM 2289 (BORROW SITE REVIEW) BDE FORM 2290 (WASTE/USE AREA REVIEW) A LOCATION MAP SHOWING THE SIZE LIMITS AND LOCATION OF THE USE AREA COLOR PHOTOGRAPHS DEPICTING THE USE AREA BORROW AREA ENTRY AGREEMENT FORM D4 PI0101

PRIOR TO ANY WASTE MATERIALS BEING REMOVED FROM THE CONSTRUCTION SITE THE REQUIRED ENVIRONMENTAL RESOURCE SURVEYS SHALL BE OBTAINED AND FILED BY THE CONTRACTOR. EXCESS WASTE PRODUCTS REMOVED FROM THE CONSTRUCTION SITE SHALL BE DISPOSED OF AS REQUIRED IN SECTION 202.03 OF THE STANDARD SPECIFICATIONS.

ANY PROTRUDING METAL BARS SHALL BE REMOVED PRIOR TO THE DISPOSAL OF BROKEN CONCRETE AT APPROVED DISPOSAL SITES.

PLEASE NOTE THAT A MINIMUM OF FOUR WEEKS SHALL BE ALLOWED FOR THE DISTRICT TO OBTAIN THE REQUIRED WASTE SITE ENVIRONMENTAL CLEARANCES AND SIX WEEKS FOR THE REQUIRED BORROW SITE ENVIRONMENTAL CLEARANCES.

AGGREGATE FOR DRIVEWAY REPLACEMENT

THE MATERIAL USED FOR CONSTRUCTION OF PERMANENT AGGREGATE DRIVEWAYS SHALL BE GRAVEL OR CRUSHED STONE, AS DIRECTED BY THE ENGINEER, TO REPLACE IN KIND THE EXISTING AGGREGATE

NO ADDITIONAL COMPENSATION SHALL BE PROVIDED FOR THIS REQUIREMENT BUT SHALL BE CONSIDERED AS INCLUDED IN THE COST OF THE PAY ITEM FOR THE AGGREGATE AS SPECIFIED ON THE PLANS.

STATUS OF UTILITIES

COMPANY	LOCATION	TYPE OF UTILITY	TYPE OF CONFLICT	DISPOSITION
	SN 062-0056	ELECTRIC	STRUCTURE / GUARDRA I L	CAUTION
AMEREN ILLINOIS	SN 062-0057	OVERHEAD	STRUCTURE/GUARDRAIL	CAUTION
	SN 062-0059	LINES	STRUCTURE/GUARDRAIL	CAUTION
METRO COMMUNICATIONS	SN 062-0056	FIBER OPTICS	STRUCTURE/GUARDRAIL	CAUTION
CO.	SN 062-0057	FIDER OFFICS	STRUCTURE/GUARDRAIL	CAUTION
WINDSTREAM	SN 062-0057	FIBER OPTICS	STRUCTURE / GUARDRA I L	CAUTION

DROPOFFS

THE CONTRACTOR SHALL ORGANIZE THE WORK ON THIS PROJECT TO ELIMINATE ANY OVERNIGHT DROPOFFS GREATER THAN 9 INCHES AND WITHIN 8 FEET OF THE EDGE OF TRAVEL LANE.

BRIDGE OVERLAY NOTIFICATION

AFTER PLACEMENT OF THE BRIDGE DECK OVERLAY, THE RESIDENT ENGINEER SHALL NOTIFY THE DISTRICT BRIDGE MAINTENANCE ENGINEER OF THE "AS CONSTRUCTED" MILLING DEPTH AND OVERLAY THICKNESS FOR UPDATING THE ILLINOIS HIGHWAY INFORMATION SYSTEM.

BUTT JOINT CUTTING TIME RESTRICTION

BUTT JOINTS SHALL NOT BE MILLED MORE THAN THREE (3) DAYS PRIOR TO PLACEMENT OF THE HMA SURFACE COURSE

PAVING SURFACE COURSE

CONTINUOUS PAVING OPERATIONS ON THE MAIN ROADWAY SHALL BE MAINTAINED AT ALL TIMES DURING THE CONSTRUCTION OF THE HOT-MIX ASPHALT SURFACE, NO INTERRUPTIONS FOR SIDE ROADS, ENTRANCES, TURN LANES, ETC. WILL BE ALLOWED.

ORDERING LENGTH CONFIRMATION - DRAINAGE ITEMS

THE CONTRACTOR SHALL CONSULT WITH THE ENGINEER IN REGARD TO THE EXACT LENGTH OF THE BOX/ PIPE CULVERTS, STORM SEWERS, AND/ OR PIPE DRAINS REQUIRED TO ORDERING THESE ITEMS.

SECURING DRAINAGE STRUCTURE GRATES

PRIOR TO ROUTING TRAFFIC ONTO THE SHOULDERS AS SHOWN IN THE STAGING PLANS, THE CONTRACTOR SHALL SECURE GRATINGS ON SHOULDER INLETS AS DIRECTED BY THE ENGINEER. THIS WORK WILL NOT BE PAID FOR SEPARATELY, BUT SHALL BE INCLUDED IN THE COST OF THE TRAFFIC CONTROL PAY ITEM.

HIGHWAY STANDARDS

000001-08	STANDARD SYMBOLS, ABBREVIATIONS AND PATTERNS
001001-02	AREAS OF REINFORCEMENT BARS
001006	DECIMAL OF AN INCH AND OF A FOOT
280001-07	TEMPORARY EROSION CONTROL SYSTEMS
420001-10	PAVEMENT JOINTS
420701-03	PAVEMENT WELDED WIRE REINFORCEMENT
442201-03	CLASS C & D PATCHES
482001-02	HMA SHOULDER ADJACENT TO FLEXIBLE PAVEMENT
542401-04	METAL FLARED END SECTION FOR PIPE CULVERTS
604006-05	FRAME AND GRATE TYPE 3
606001-08	CONCRETE CURB TYPE B & COMBINATION CONCRETE CURB & GUTTER
606301-04	PC CONCRETE ISLANDS & MEDIANS
630001-12	STEEL PLATE BEAM GUARDRAIL
630301-09	SHOULDER WIDENING FOR TYPE 1 (SPECIAL) GUARDRAIL TERMINALS
631031-18	TRAFFIC BARRIER TERMINAL, TYPE 6
701001-02	OFF-ROAD OPERATIONS, 2L, 2W, MORE THAN 15 FT AWAY
701006-05	OFF-ROADOPERATIONS, 2L, 2W, 15 FT TO 24 IN FROM PAVEMENT EDGE
701011-04	OFF-ROAD MOVING OPERATIONS, 2L, 2W, DAY ONLY
701201-05	LANE CLOSURE, 2L, 2W, DAY ONLY, FOR SPEEDS 45 MPH OR MORE
701301-04	LANE CLOSURE, 2L, 2W, SHORT TIME OPERATIONS
701306-04	LANE CLOSURE, 2L, 2W, SLOW-MOVING OPERATIONS DAY ONLY FOR SPEEDS ≥ 45 MI
701311-03	LANE CLOSURE, 2L, 2W, MOVING OPERATIONS - DAY ONLY
701321-18	LANE CLOSURE, 2L, 2W, BRIDGE REPAIR WITH BARRIER
701326-04	LANE CLOSURE, 2L, 2W, PAVEMENT WIDENING, FOR SPEEDS 45 MPH OR MORE
701501-06	URBAN LANE CLOSURE, 2L, 2W, UNDIVIDED
701502 - 09	URBAN LANE CLOSURE, 2L, 2W, WITH BIDIRECTIONAL LEFT TURN LANE
701701-10	URBAN LANE CLOSURE, MULTILANE INTERSECTION
701801-06	SIDEWALK, CORNER OR CROSSWALK CLOSURE
701901-08	TRAFFIC CONTROL DEVICES
704001 - 08	TEMPORARY CONCRETE BARRIER
720001-01	SIGN PANEL MOUNTING DETAILS
720006-04	SIGN PANEL ERECTION DETAILS
725001-01	OBJECT AND TERMINAL MARKERS
728001-01	TELESCOPING STEEL SIGN SUPPORT
731001-01	BASE FOR TELESCOPING STEEL SIGN SUPPORT
780001-05	TYPICAL PAVEMENT MARKINGS
781001-04	TYPICAL APPLICATIONS RAISED REFLECTIVE PAVEMENT MARKERS
782001-01	CURB REFLECTORS
782006-01	GUARDRAIL AND BARRIER WALL REFLECTOR MOUNTING DETAILS
BLR21 - 9	TYPICAL APPLICATION OF TRAFFIC CONTROL DEVICES FOR CONSTRUCTION ON RURAL LOCAL HWYS
SURVEY	

NO SURVEY WAS PERFORMED ON THIS PROJECT. ALL INFORMATION WAS OBTAINED FROM OLD PLANS AND THE INTERNET

HOT-MIX ASPHALT MIXTURE REQUIREMENTS

LOCATION(S):	MAINLINE	SHOULDERS	MAINLINE	MAINLINE	WIDENING	WIDENING
MIXTURE USE(S):	SURFACE 2"	SURFACE 2"	PARTIAL DEPTH PATCHES	FULL DEPTH PATCHES	LOWER LIFT	UPPER LIFT
AC/PG:	PG 58-28	PG 58-28	PG 58-28	PG 58-28	PG 58-28	PG 58-28
DESIGN AIR VOIDS:	4.0% @ N=50	4.0% @ N=50	4.0% @ N=50	4.0% @ N=50	4.0% @ N=50	4.0% @ N=50
MIXTURE COMPOSITION (MIXTURE GRADATION):	IL 9.5	IL 9.5	IL 9.5	IL 19.0	IL 19.0	IL 9.5
FRICTION AGGREGATE:	MIX D	MIX D	MIX D	N/A	N/A	MIX D
QUALITY MANAGEMENT PROGRAM:	QCP	QC/QA	QC/QA	QC/QA	QC/QA	QC/QA
MTD:	YES	YES	NO	NO	NO	YES

- INDIVIDUAL LIFT THICKNESS OF EACH MIX TYPE WILL BE NO LESS THAN 3 TIMES NOMINAL MAXIMUM AGGREGATE SIZE AND NO MORE THAN 6 TIMES NOMINAL MAXIMUM AGGREGATE SIZE, UNLESS OTHERWISE APPROVED BY THE ENGINEER.
- FOR DESIGN PURPOSES, MIXTURE WEIGHT FOR ALL MIXES IS DETERMINED TO BE 112.0 LB/S.Y./IN., UNLESS OTHERWISE
- SUBLOT SIZES FOR PFP AND QCP MIXES WILL BE 1000 TONS, UNLESS OTHERWISE AGREED TO BY THE ENGINEER AND THE PAVING CONTRACTOR.



TWM. INC.

SER NAME = \$USER\$ DRAWN I OT DATE = 8/23/2023 DATE

DESIGNED REVISED REVISED HECKED REVISED REVISED

STATE OF ILLINOIS **DEPARTMENT OF TRANSPORTATION** **GENERAL NOTES, COMMITMENTS, AND HIGHWAY STANDARDS** MARSHALL 72 *(3B-BR,BR-1;(104b)BR-1)BDR,BRR | CONTRACT NO. 68G39 SHEET 1 OF 1 SHEETS STA.

				IL 17	IL 29	IL 29
				S.N. 062-0059	S.N. 062-0056	S.N. 062-0057
	T	I		MARSHALL COUNTY	MARSHALL COUNTY	MARSHALL COUNTY
CODE			TOTAL	80% FEDERAL / 20% STATE		
NO.	PAY ITEM	UNIT	QUANTITY	0047	0047	0047
				RURAL	URBAN	URBAN
25000210	SEEDING, CLASS 2A	ACRE	0.25	0.1	0.1	0.05
25000400	NITROGEN FERTILIZER NUTRIENT	POUND	10	5	3	2
25000500	PHOSPHORUS FERTILIZER NUTRIENT	POUND	10	5	3	2
	THOSTHOROS TERTIFIZER NOTRIENT	1 00110	10	3		2
25000600	POTASSIUM FERTILIZER NUTRIENT	POUND	10	5	3	2
23000000	POTASSIUM FERTILIZER NOTRIENT	POUND	10	3	<u> </u>	2
25000750	MOWING	ACRE	1.25	0.4	0.4	0.45
25100115	MULCH, METHOD 2	ACRE	0.25	0.1	0.1	0.05
28200200	FILTER FABRIC	SQ YD	72	28	44	
35100100	AGGREGATE BASE COURSE, TYPE A	TON	101		14	87
35501320	HOT-MIX ASPHALT BASE COURSE, 9"	SQ YD	479	93	386	
35600712	HOT-MIX ASPHALT BASE COURSE WIDENING, 9"	SQ YD	537	199		338
40200800	AGGREGATE SURFACE COURSE, TYPE B	TON	10	3		7
40201000	AGGREGATE FOR TEMPORARY ACCESS	TON	28	13		15
40600275	BITUMINOUS MATERIALS (PRIME COAT)	POUND	961		122	839
	· · · · · · · · · · · · · · · · · · ·					
40600290	BITUMINOUS MATERIALS (TACK COAT)	POUND	856	188	198	470
	1	1	I.			

TWM, INC.
WWW.TMM-INC.COM

IL DESIGN FIRM
LICENSE NO:
184-001220

USER NAM
PLOT SCAL
PLOT DATE

c.	USER NAME = \$USER\$	DESIGNED -	REVISED -
ОМ		DRAWN -	REVISED -
RM	PLOT SCALE = 1:40	CHECKED -	REVISED -
):)	PLOT DATE = 9/1/2023	DATE -	REVISED -

STATI	E 01	F ILLINOIS
DEPARTMENT	0F	TRANSPORTATION

SCALE:

-						F.A.P. RTE	SECTION		COUNTY	TOTAL SHEETS	SHEET NO.
SU	JIVIIVIA	٩KY	OF QU	ANTITIES	5	318	318 * MARSHALL		72	3	
						*(3B-E	BR,BR-1;(104b)BR-1)BDF	R,BRR	CONTRACT	NO. 68	3G39
SHEET 1	OF	9	SHEETS	STA.	TO STA.		ILLINOIS	FED. A	ID PROJECT		

IL 29

IL 29

				IL 17	IL 29	1L 29
				S.N. 062-0059	S.N. 062-0056	S.N. 062-0057
	I			MARSHALL COUNTY	MARSHALL COUNTY	MARSHALL COUNTY
CODE			TOTAL			80% FEDERAL / 20% STATE
NO.	PAY ITEM	UNIT	QUANTITY	0047	0047	0047
				RURAL	URBAN	URBAN
40600982	HOT-MIX ASPHALT SURFACE REMOVAL - BUTT JOINT	SQ YD	1164	213	267	684
40600990	TEMPORARY RAMP	SQ YD	350	89	111	150
	TEPH ORANGE RAPH	30 15	330	0.3		130
			105	1.0		
40604060	HOT-MIX ASPHALT SURFACE COURSE, IL-9.5, MIX "D", N50	TON	105	18	22	65
40800029	BITUMINOUS MATERIALS (TACK COAT)	POUND	73			73
40800050	INCIDENTAL HOT-MIX ASPHALT SURFACING	TON	11			11
42400100	PORTLAND CEMENT CONCRETE SIDEWALK 4 INCH	SQ FT	100			100
44000200	DRIVEWAY PAVEMENT REMOVAL	SQ YD	18			18
44000600	SIDEWALK REMOVAL	SQ FT	100			100
44000000	STOCWACK REMOVAL	30 11	100			100
44004250	DAVED CHOULDED DEMOVAL	60.1/5	700	272	100	126
44004250	PAVED SHOULDER REMOVAL	SQ YD	700	372	192	136
44200168	PAVEMENT PATCHING, TYPE II, 14 INCH	SQ YD	23			23
44200180	PAVEMENT PATCHING, TYPE II, 15 INCH	SQ YD	23		23	
48101200	AGGREGATE SHOULDERS, TYPE B	TON	8	4	4	
48102100	AGGREGATE WEDGE SHOULDER, TYPE B	TON	62	22	21	19
48203100	HOT-MIX ASPHALT SHOULDERS	TON	21	6	12	3
	1		1			

TWM, INC.

).	USER NAME = \$USER\$	DESIGNED -	REVISED -
ОМ		DRAWN -	REVISED -
M	PLOT SCALE = 1:40	CHECKED -	REVISED -
í	PLOT DATE = 9/1/2023	DATE -	REVISED -

STATI	E 01	F ILLINOIS
DEPARTMENT	0F	TRANSPORTATION

SCALE:

					F.A.P. RTE	SECT	ΓΙΟΝ		COUNTY	TOTAL SHEETS	
SUMMARY OF QUANTITIES						318 * MARSHALL		MARSHALL	72	4	
					*(3B-F	BR,BR-1;(104b)B	R-1)BDF	R,BRR	CONTRACT	NO. 6	8G39
SHEET 2	OF 9	SHEETS	STA.	TO STA.			ILLINOIS	FED. AI	D PROJECT		

IL 29

IL 29

				IL 1/	IL 29	IL 29
				S.N. 062-0059	S.N. 062-0056	S.N. 062-0057
				MARSHALL COUNTY	MARSHALL COUNTY	MARSHALL COUNTY
CODE			TOTAL		80% FEDERAL / 20% STATE	
NO.	PAY ITEM	UNIT	QUANTITY	0047	0047	0047
				RURAL	URBAN	URBAN
50102400	CONCRETE REMOVAL	CU YD	29.2	0.8	11.7	16.7
50105220	PIPE CULVERT REMOVAL	FOOT	25	25		
50300255	CONCRETE SUPERSTRUCTURE	CU YD	31.4	0.8	12.4	18.2
50300260	BRIDGE DECK GROOVING	SQ YD	1929	463	744	722
50300300	PROTECTIVE COAT	SQ YD	2046	494	791	761
50800205	REINFORCEMENT BARS, EPOXY COATED	POUND	4260	100	1640	2520
50800515	BAR SPLICERS	EACH	48		24	24
52000110	PREFORMED JOINT STRIP SEAL	FOOT	212		84	128
54213450	END SECTIONS 15"	EACH	2	2		
542D0220	PIPE CULVERTS, CLASS D, TYPE 1 15"	FOOT	48	48		
63000001	STEEL PLATE BEAM GUARDRAIL, TYPE A, 6 FOOT POSTS	FOOT	368	238	130	
63000003	STEEL PLATE BEAM GUARDRAIL, TYPE A, 9 FOOT POSTS	FOOT	88	88		
63100085	TRAFFIC BARRIER TERMINAL, TYPE 6	EACH	4	4		
63100167	TRAFFIC BARRIER TERMINAL, TYPE 1 (SPECIAL) TANGENT	EACH	7	3	4	

*= SPECIALTY ITEM

	TWM
1	ENGINEERING
1	GEOSPATIAÏ SERVICES

TWM, INC. WWW.TWM-INC.COM IL DESIGN FIRM LICENSE NO: 184-001220

IC.	USER NAME = \$USER\$	DESIGNED -	REVISED -
IC.		DRAWN -	REVISED -
IRM	PLOT SCALE = 1:40	CHECKED -	REVISED -
10: 20	PLOT DATE = 9/1/2023	DATE -	REVISED -

	-	F.A.P. RTE	F.A.P. SECTION		TOTAL SHEETS	SHEET NO.				
	SU	JIMIMAKY	OF QU	ANTITIES	i	318	*	MARSHALL	72	5
						*(3B-E	BR,BR-1;(104b)BR-1)BDR,BRR	CONTRACT	NO. 68	3G39
SCALE: SHEET 3 OF 9 SHEETS STA. TO STA.							ILLINOIS FED.	AID PROJECT		

IL 29

IL 29

				IL 17	IL 29	IL 29
				S.N. 062-0059	S.N. 062-0056	S.N. 062-0057
				MARSHALL COUNTY	MARSHALL COUNTY 80% FEDERAL / 20% STATE	MARSHALL COUNTY 80% FEDERAL / 20% STATE
CODE	PAY ITEM	UNIT	TOTAL	0047	0047	0047
NO.			QUANTITY	RURAL	URBAN	URBAN
63200310	GUARDRAIL REMOVAL	FOOT	1151	643	508	
		1	1131	0.0		
63302700	REMOVE AND REERECT TRAFFIC BARRIER TERMINALS, TYPE 6	EACH	1			1
67000400	ENGINEER'S FIELD OFFICE, TYPE A	CAL MO	6	2	2	2
67100100	MOBILIZATION	L SUM	1	0.33	0.33	0.34
0/100100	WOBILIZATION	L 30M	1	0.33	U.33	0.34
70100450	TRAFFIC CONTROL AND PROTECTION, STANDARD 701201	L SUM	1	0.5	0.5	
70100460	TRAFFIC CONTROL AND PROTECTION, STANDARD 701306	L SUM	1	0.5	0.5	
70100500	TRAFFIC CONTROL AND PROTECTION STANDARD 701226	I CUM	1	0.22	0.22	0.24
70100500	TRAFFIC CONTROL AND PROTECTION, STANDARD 701326	L SUM	1	0.33	0.33	0.34
70102620	TRAFFIC CONTROL AND PROTECTION, STANDARD 701501	L SUM	1			1
70102622	TRAFFIC CONTROL AND PROTECTION, STANDARD 701502	L SUM	1			1
70400505						
70102635	TRAFFIC CONTROL AND PROTECTION, STANDARD 701701	L SUM	1			1
70102640	TRAFFIC CONTROL AND PROTECTION, STANDARD 701801	L SUM	1			1
	·					
70103815	TRAFFIC CONTROL SURVEILLANCE	CAL DA	15	5	5	5
			_			
70106500	TEMPORARY BRIDGE TRAFFIC SIGNALS	EACH	3	1	1	1
70106700	TEMPORARY RUMBLE STRIPS	EACH	18	6	6	6
					<u> </u>	

IL 17

IL 29

IL 29

JSER NAME = \$USER\$ DESIGNED -TWM, INC. DRAWN CHECKED DATE

REVISED

REVISED

REVISED

REVISED

STATE OF ILLINOIS
DEPARTMENT OF TRANSPORTATION

SCALE:

SECTION SUMMARY OF QUANTITIES SHEET 4 OF 9 SHEETS STA. TO STA.

COUNTY TOTAL SHEET NO.

MARSHALL 72 6 *(3B-BR,BR-1;(104b)BR-1)BDR,BRR CONTRACT NO. 68G39

				S.N. 062-0059	S.N. 062-0056	S.N. 062-0057
				MARSHALL COUNTY 80% FEDERAL / 20% STATE	MARSHALL COUNTY 80% FEDERAL / 20% STATE	MARSHALL COUNTY
CODE	PAY ITEM	UNIT	TOTAL	0047	0047	0047
NO.	FAI IILM	ONTI	QUANTITY			
				RURAL	URBAN	URBAN
70107005	PAVEMENT MARKING BLACKOUT TAPE, 5"	FOOT	6045	738	1765	3542
70107007	PAVEMENT MARKING BLACKOUT TAPE, 7"	FOOT	106			106
70107012	PAVEMENT MARKING BLACKOUT TAPE, 12"	FOOT	367			367
70107024	PAVEMENT MARKING BLACKOUT TAPE, 24"	FOOT	44			44
70300100	SHORT TERM PAVEMENT MARKING	FOOT	244	36	87	121
70300100	SHORT TERM PAVEMENT MARKING	1001	244	30	07	121
70200150		60.57	2127	210	7.10	2051
70300150	SHORT TERM PAVEMENT MARKING REMOVAL	SQ FT	3127	318	748	2061
	TEMPORARY PAVEMENT MARKING LETTERS AND SYMBOLS - MODIFIED					
70303100	URETHANE	SQ FT	31			31
70303120	TEMPORARY PAVEMENT MARKING - LINE 4" - MODIFIED URETHANE	FOOT	4421	444	944	3033
70303160	TEMPORARY PAVEMENT MARKING - LINE 12"- MODIFIED URETHANE	FOOT	206			206
70303210	TEMPORARY PAVEMENT MARKING - LINE 24"- MODIFIED URETHANE	FOOT	54			54
70400100	TEMPORARY CONCRETE BARRIER	FOOT	1175	400.0	462.5	312.5
70400200	RELOCATE TEMPORARY CONCRETE BARRIER	FOOT	1050	400.0	437.5	212.5
70600251	IMPACT ATTENUATORS, TEMPORARY (NON- REDIRECTIVE, NARROW),	EACH	9	4	4	1
	TEST LEVEL 3		-			
70600255	IMPACT ATTENUATORS, TEMPORARY (FULLY REDIRECTIVE, NARROW), TEST LEVEL 2	EACH	1			1
	TEST LEVEL 2	27,011	•			•
		l .	l .			

IL 17

IL 29

(TWM)	ν
ENGINEERING	I.

IL DESIGN FIRM LICENSE NO: 184-001220

C.	USER NAME = \$USER\$	DESIGNED -	REVISED -
ОМ		DRAWN -	REVISED -
RM	PLOT SCALE = 1:40	CHECKED -	REVISED -
):)	PLOT DATE = 9/1/2023	DATE -	REVISED -

SCALE:

	-					F.A.P. RTE	SECTIO	ON		COUNTY	TOTAL SHEETS	SHEET NO.
SUMMARY OF QUANTITIES					318	318 * MARSHALL		72	7			
					*(3B-F	BR,BR-1;(104b)BR	R-1)BDR	,BRR	CONTRACT	NO. 68	3G39	
SHEET 5 OF 9 SHEETS STA.		TO STA.		Il	LLINOIS	FED. AI	D PROJECT					

CODE				T0741	80% FEDERAL / 20% STATE 80% FEDERAL / 20% STATE 80% FEDERAL / 20% STATE				
	CODE NO.	PAY ITEM	UNIT	TOTAL QUANTITY	0047	0047	0047		
				40/	RURAL	URBAN	URBAN		
_	70600322	IMPACT ATTENUATORS, RELOCATE (FULLY REDIRECTIVE, NARROW), TEST LEVEL 2	EACH	1			1		
-	70600352	IMPACT ATTENUATORS, RELOCATE (NON- REDIRECTIVE, NARROW), TEST LEVEL 3	EACH	5	2	2	1		
*	72000100	SIGN PANEL - TYPE 1	SQ FT	6			6		
*	72400100	REMOVE SIGN PANEL ASSEMBLY - TYPE A	EACH	1			1		
*	72501000	TERMINAL MARKER - DIRECT APPLIED	EACH	7	3	4			
	72800100	TELESCOPING STEEL SIGN SUPPORT	FOOT	10			10		
-	73100100	BASE FOR TELESCOPING STEEL SIGN SUPPORT	EACH	1			1		
*	78009000	MODIFIED URETHANE PAVEMENT MARKING - LETTERS AND SYMBOLS	SQ FT	31			31		
*	78009004	MODIFIED URETHANE PAVEMENT MARKING - LINE 4"	FOOT	4706	444	944	3318		
*	78009012	MODIFIED URETHANE PAVEMENT MARKING - LINE 12"	FOOT	206			206		
*	78009024	MODIFIED URETHANE PAVEMENT MARKING - LINE 24"	FOOT	68			68		
*	78100100	RAISED REFLECTIVE PAVEMENT MARKER	EACH	7		1	6		
*	78200005	GUARDRAIL REFLECTORS, TYPE A	EACH	32	16	16			
*	78200011	BARRIER WALL REFLECTORS, TYPE C	EACH	143	49	56	38		

IL 17

S.N. 062-0059

MARSHALL COUNTY

IL 29

S.N. 062-0056

MARSHALL COUNTY

IL 29

S.N. 062-0057

MARSHALL COUNTY

*= SPECIALTY ITEM

NAME: S:\(TWM
HE	ENGINEERING GEOSPATIAL SERVICES

TWM, INC. WWW.TWM-INC.COM IL DESIGN FIRM LICENSE NO: 184-001220

STATE OF ILLINOIS
DEPARTMENT OF TRANSPORTATION

SCALE:

				_ Ш 1/	Ш 29	Ш 29
				S.N. 062-0059	S.N. 062-0056	s.N. 062-0057
0		- T	ř-	MARSHALL COUNTY	MARSHALL COUNTY	MARSHALL COUNTY
2005			moma.	80% FEDERAL I 20% STATE	80% FEDERAL I 20% STATE	80% FEDERAL I 20% STATE
CODE NO.	PAY ITEM	UNIT	TOTAL QUANTITY	0047	0047	0047
			2011(1111	RURAL	URBAN	URBAN
78300200	RAISED REFLECTIVE PAVEMENT MARKER REMOVAL	EACH	7		1	6
5000000			1010	110	015	105.6
78300202	PAVEMENT MARKING REMOVAL - WATER BLASTING	SQ FT	1819	148	315	1356
X0326444	SURFACE FILLER (SPECIAL)	GALLON	1.7	1.7	7	
X4421002	PARTIAL DEPTH PATCHING (SPECIAL)	SQ YD	67	44		23
X1700005	ISLAND PAVEMENT (SPECIAL)	SQ FT	130			130
X1700108	CURB AND GUTTER (SPECIAL)	FOOT	29		14	15
X1700108	CORD AND GUITER (SPECIAL)	rwi	25		14	15)
X2810808	STONE DUMPED RIPRAP, CLASS A4 (SPECIAL)	TON	76	76		
X2810812	STONE DUMPED RIPRAP, CLASS B4 (SPECIAL)	TON	48	18	30	1
X4400196	HOT-MIX ASPHALT SURFACE REMOVAL, SPECIAL	SQ YD	12	3	3	6
X4420201	PAVEMENT PATCHING (SPECIAL)	SQ YD	21			21
X4421000	PARTIAL DEPTH PATCHING	TON	7	4		3
X4811900	AGGREGATE SHOULDERS (SPECIAL)	TON	16	6	6	4
	11001 TOUR (OLDOTAL)	100	10	Ŭ		7
X5015225	PIPE CULVERT REMOVAL (SPECIAL)	FOOT	28	28		
X5030550	PROTECTIVE COAT (SPECIAL)	SQ YD	112	11.2		
5						

TWM,INC. DESIGNED REV[SED DRAWN REV[SED CHECKED -REV[SED DATE REV[SED -

STATE OF ILLINOIS
DEPARTMENT OF TRANSPORTATION

SUMMARY OF QUANTITIES SCALE: TSHEET 7 OF 9 SHEETS! STA, TO STA.

_					MAKSHALL COUNTY	MARSHALL COUNTY	MAKSHALL COUNTY
					80% FEDERAL / 20% STATE	80% FEDERAL / 20% STATE	80% FEDERAL / 20% STATE
	CODE NO.	PAY ITEM	UNIT	TOTAL QUANT I TY	0047	0047	0047
	NO.			QUANTITI	RURAL	URBAN	URBAN
	X6050310	FILLING INLETS, SPECIAL	EACH	4	2	2	
*	X6310187	TRAFFIC BARRIER TERMINAL, TYPE 6 (MODIFIED)	EACH	4		4	
*	X6330725	STEEL PLATE BEAM GUARDRAIL (SHORT RADIUS)	FOOT	90	25	65	
	X7010202	TRAFFIC CONTROL AND PROTECTION, STANDARD 701321 (SPECIAL)	EACH	2	1	1	
-	X7010216	TRAFFIC CONTROL AND PROTECTION, (SPECIAL)	L SUM	1			1
	X7011800	TRAFFIC CONTROL AND PROTECTION, STANDARD BLR 21	L SUM	1		0.5	0.5
-	Z0001002	GUARDRAIL AGGREGATE EROSION CONTROL	TON	259	141	118	
	Z0012130	BRIDGE DECK SCARIFICATION 3/4"	SQ YD	1967	494	759	714
-	Z0012162	BRIDGE DECK MICROSILICA CONCRETE OVERLAY 2 1/4"	SQ YD	1967	494	759	714
	Z0013798	CONSTRUCTION LAYOUT	L SUM	1	0.33	0.33	0.34
ø	Z0076600	TRAINEES	HOUR	1,000	1,000		
ø	Z0076604	TRAINEES - TRAINING PROGRAM GRADUATE	HOUR	1,000	1,000		

Ø 0042 *= SPECIALTY ITEM

DESIGNED -

CHECKED

DRAWN

DATE



REVISED

REVISED

REVISED

REVISED

STATE OF ILLINOIS
DEPARTMENT OF TRANSPORTATION

SUMMARY OF QUANTITIES

SCALE: SHEET 8 OF 9 SHEETS STA. TO STA.

IL 29

S.N. 062-0056

MARSHALL COUNTY


IL 17 S.N. 062-0059

MARSHALL COUNTY

IL 29

S.N. 062-0057


MARSHALL COUNTY

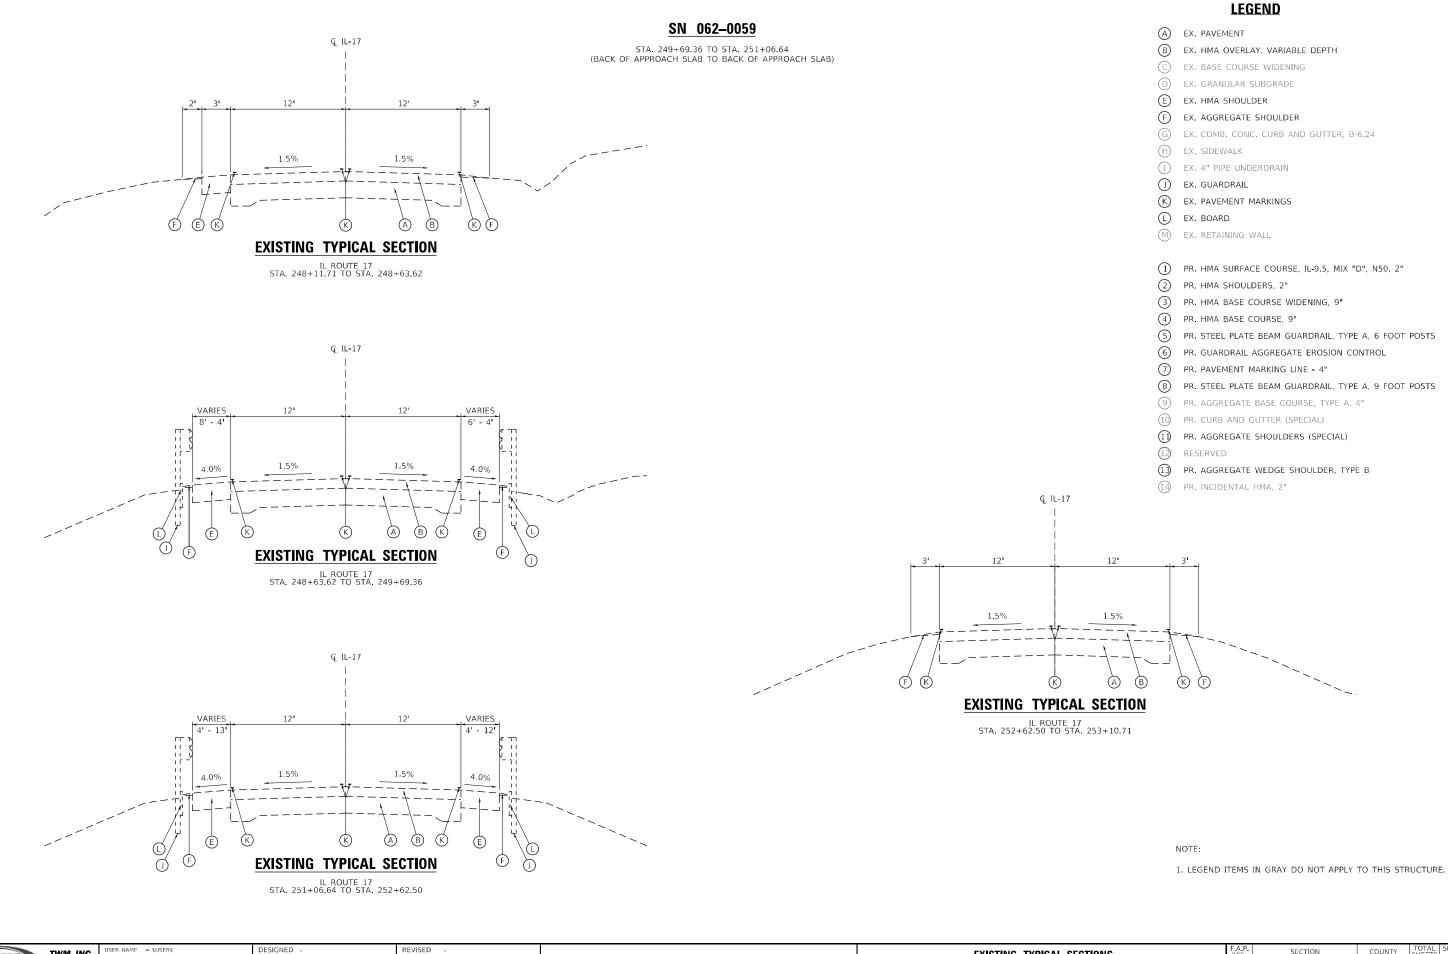

MODEL: Defau FILE NAME: S: ENGINEER GEOSPATIALS STATE OF ILLINOIS DEPARTMENT OF TRANSPORTATION

EXISTING TYPICAL SECTIONS
IL ROUTE 17 - S.N. 062-0059
EET 1 OF 2 SHEETS STA.

TO STA.

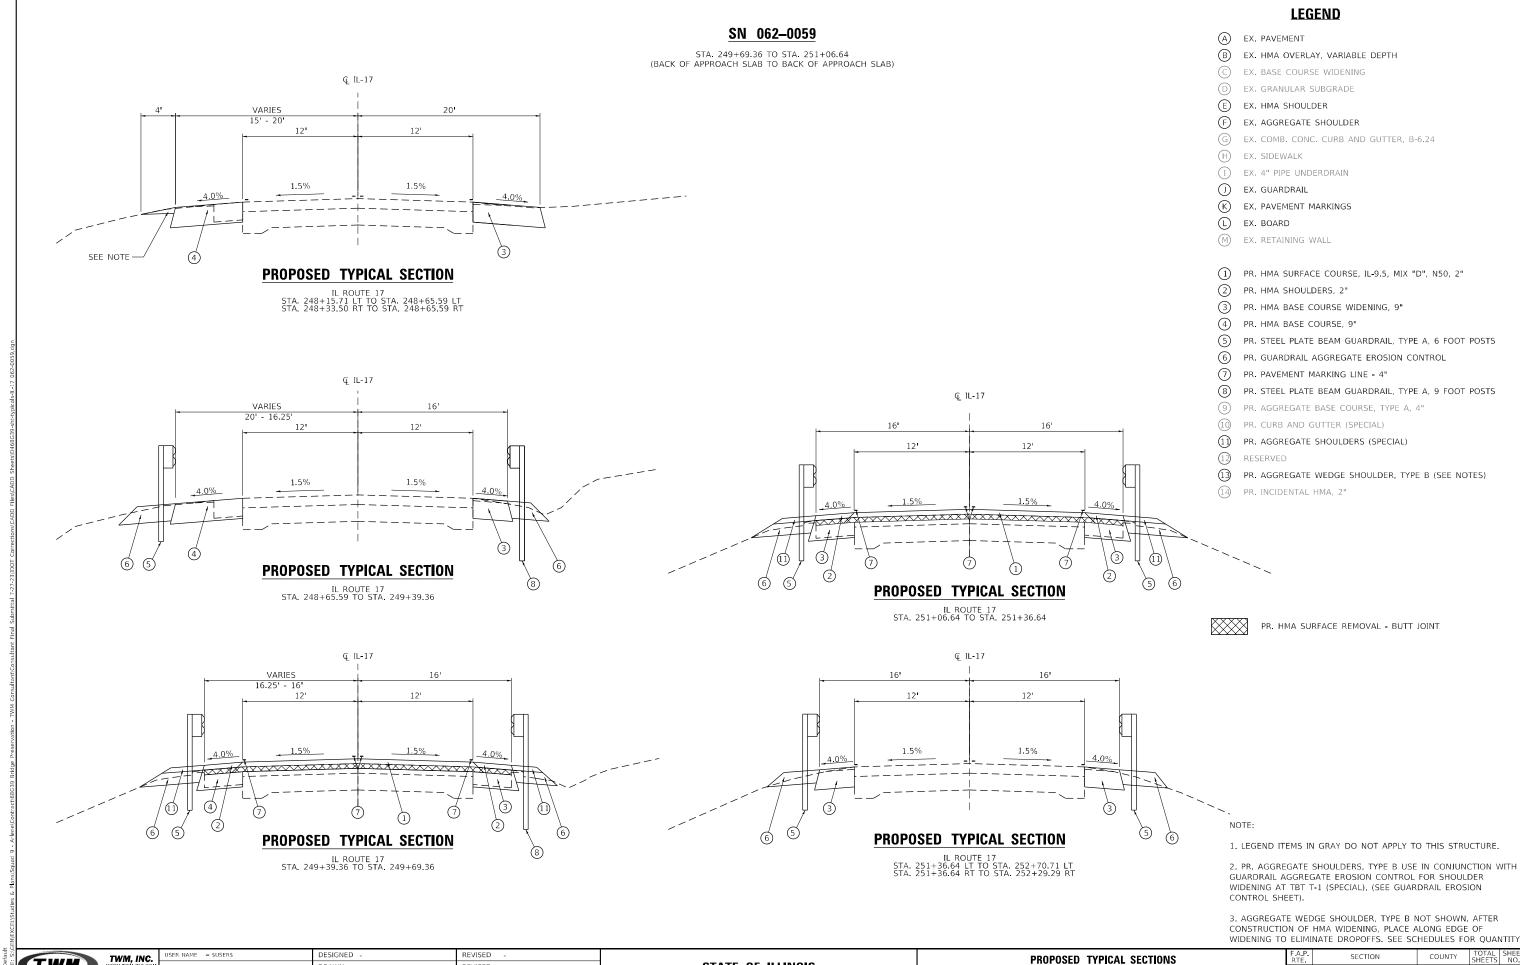

STATE OF ILLINOIS

DEPARTMENT OF TRANSPORTATION

MARSHALL

*(3B-BR,BR-1;(104b)BR-1)BDR,BRR | CONTRACT NO. 68G39

IL ROUTE 17 - S.N. 062-0059

SHEET 2 OF 2 SHEETS STA.

MODEL: Default

DRAWN

DATE


PLOT DATE = 8/23/2023

HECKED

REVISED


REVISED


STA. 359+70.00 TO STA. 361+46.00 (BACK OF APPROACH SLAB TO BACK OF APPROACH SLAB)

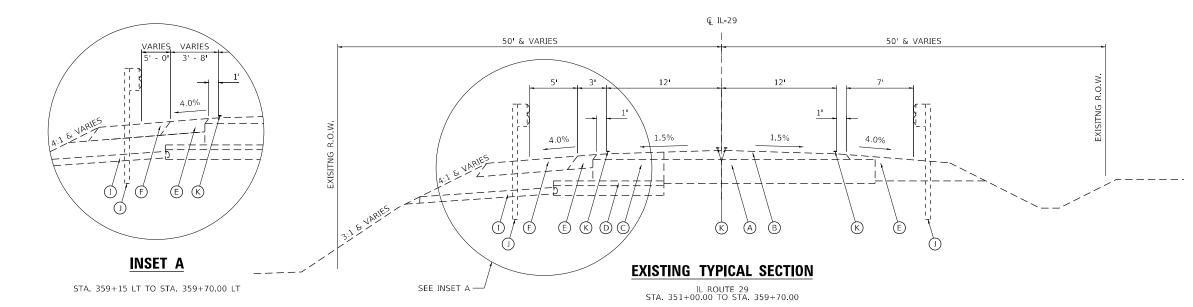

LEGEND

- A EX. PAVEMENT
- B EX. HMA OVERLAY, VARIABLE DEPTH
- © EX. BASE COURSE WIDENING
- D EX. GRANULAR SUBGRADE
- (E) EX. HMA SHOULDER
- (F) EX. AGGREGATE SHOULDER
- EX. COMB. CONC. CURB AND GUTTER, B-6.24
- EX. SIDEWALK
- (I) EX. 4" PIPE UNDERDRAIN
- (J) EX. GUARDRAIL
- K EX. PAVEMENT MARKINGS
- L EX. BOARD
- M EX. RETAINING WALL
- 1 PR. HMA SURFACE COURSE, IL-9.5, MIX "D", N50, 2"
- (2) PR. HMA SHOULDERS, 2"
- 3) PR. HMA BASE COURSE WIDENING, 9"
- 4) PR. HMA BASE COURSE, 9"
- PR. STEEL PLATE BEAM GUARDRAIL, TYPE A, 6 FOOT POSTS
- (6) PR. GUARDRAIL AGGREGATE EROSION CONTROL
- 7) PR. PAVEMENT MARKING LINE 4"
- (8) PR. STEEL PLATE BEAM GUARDRAIL, TYPE A, 9 FOOT POSTS
- 9 PR. AGGREGATE BASE COURSE, TYPE A, 4"
- 10) PR. CURB AND GUTTER (SPECIAL)
- 11 PR. AGGREGATE SHOULDERS (SPECIAL)
- (12) RESERVED
- 13 PR. AGGREGATE WEDGE SHOULDER, TYPE B
- (14) PR. INCIDENTAL HMA, 2"

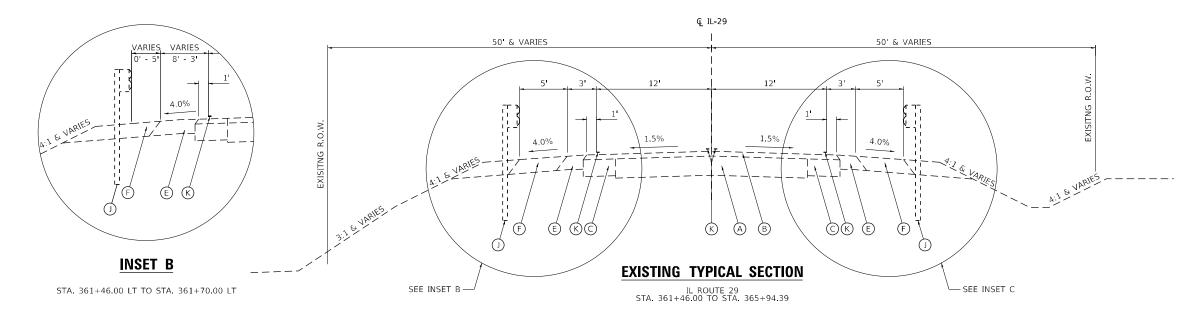

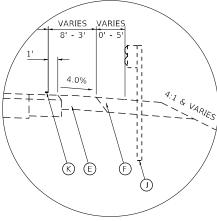

INSET C

STA. 361+46.00 RT TO STA. 361+90.00 RT

NOTE:

1. LEGEND ITEMS IN GRAY DO NOT APPLY TO THIS STRUCTURE

NAME: S:\C	TWM	ı
FILE	ENGINEERING GEOSPATIAL SERVICES	1


TWM. INC.	USER NAME = \$USER\$	DESIGNED -	REVISED -
vww.twm-inc.com		DRAWN -	REVISED -
LICENSE NO:	PLOT SCALE = 1:10	CHECKED -	REVISED -
	PLOT DATE = 8/23/2023	DATE -	REVISED -

			_		SECTIONS . 062–0056	
SHEET	1	OF	3	SHEETS	STA.	TO STA.


SCALE: N.T.S.

F.A.P. RTE	SECT	ПОИ		COUNTY	TOTAL SHEETS	SHI
318	*			MARSHALL	72	1
*(3B-E	BR,BR-1;(104b)BR-1)BDR,BRR			CONTRACT	NO. 68	3G3
		ILLINOIS	FED. A	D PROJECT		

STA. 359+70.00 TO STA. 361+46.00 (BACK OF APPROACH SLAB TO BACK OF APPROACH SLAB)

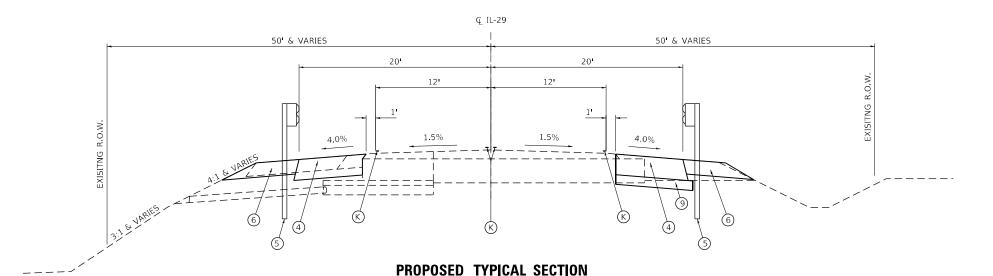

IL ROUTE 29 STA. 358+27.83 LT TO STA. 359+40.00 LT STA. 358+00.41 RT TO STA. 359+40.00 RT

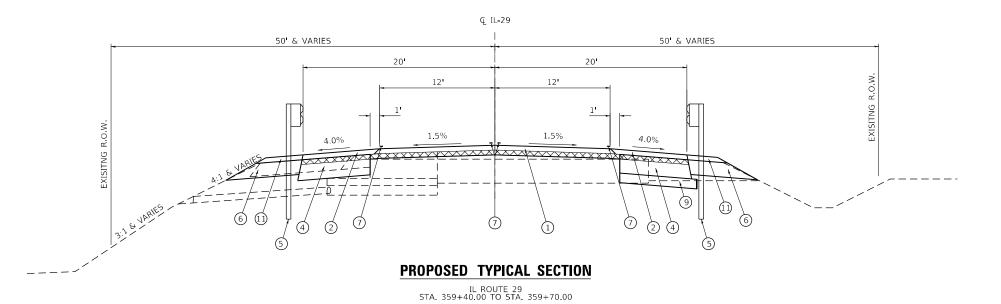

LEGEND

A EX. PAVEMENT

B EX. HMA OVERLAY, VARIABLE DEPTH

© EX. BASE COURSE WIDENING

D EX. GRANULAR SUBGRADE

(E) EX. HMA SHOULDER

EX. AGGREGATE SHOULDER

G EX. COMB. CONC. CURB AND GUTTER, B-6.24

(H) EX. SIDEWALK

(I) EX. 4" PIPE UNDERDRAIN

(J) EX. GUARDRAIL

K) EX. PAVEMENT MARKINGS

(L) EX. BOARD

EX. RETAINING WALL

1 PR. HMA SURFACE COURSE, IL-9.5, MIX "D", N50, 2"

(2) PR. HMA SHOULDERS, 2"

3) PR. HMA BASE COURSE WIDENING, 9"

PR. HMA BASE COURSE, 9"

PR. STEEL PLATE BEAM GUARDRAIL, TYPE A, 6 FOOT POSTS

6 PR. GUARDRAIL AGGREGATE EROSION CONTROL

7) PR. PAVEMENT MARKING LINE - 4"

8) PR. STEEL PLATE BEAM GUARDRAIL, TYPE A, 9 FOOT POSTS

PR. AGGREGATE BASE COURSE, TYPE A, 4" (SEE NOTE 3)

10) PR. CURB AND GUTTER (SPECIAL)

(1) PR. AGGREGATE SHOULDERS (SPECIAL)

(12) RESERVED

PR. AGGREGATE WEDGE SHOULDER, TYPE B (SEE NOTES)

(14) PR. INCIDENTAL HMA, 2"

PR. HMA SURFACE REMOVAL - BUTT JOINT

NOTE:

TO STA.

1. LEGEND ITEMS IN GRAY DO NOT APPLY TO THIS STRUCTURE

2. PR. AGGREGATE SHOULDERS, TYPE B USE IN CONJUNCTION WITH GUARDRAIL AGGREGATE EROSION CONTROL FOR SHOULDER WIDENING AT TBT T-1 (SPECIAL). (SEE GUARDRAIL EROSION CONTROL SHEET)

3. THICKNESS BASED ON ASSUMED THICKNESS FROM MICROFILM.

 AGGREGATE WEDGE SHOULDER, TYPE B NOT SHOWN. AFTER CONSTRUCTION OF HMA WIDENING, PLACE ALONG EDGE OF WIDENING TO ELIMINATE DROPOFFS. SEE SCHEDULES FOR QUANTITY.





WM, INC. w.twm-inc.com	USER NAME = \$USER\$	DESIGNED -	REVISED -
		DRAWN -	REVISED -
	PLOT SCALE = 1:10	CHECKED -	REVISED -
84-001220	PLOT DATE = 8/23/2023	DATE -	REVISED -
CENSE NO:			

STATE OF ILLINOIS
DEPARTMENT OF TRANSPORTATION

			_		SECTIONS . 062–0056
SCALE: N.T.S.	SHEET 2	OF	3	SHEETS	STA.

STA. 359+70.00 TO STA. 361+46.00 (BACK OF APPROACH SLAB TO BACK OF APPROACH SLAB)

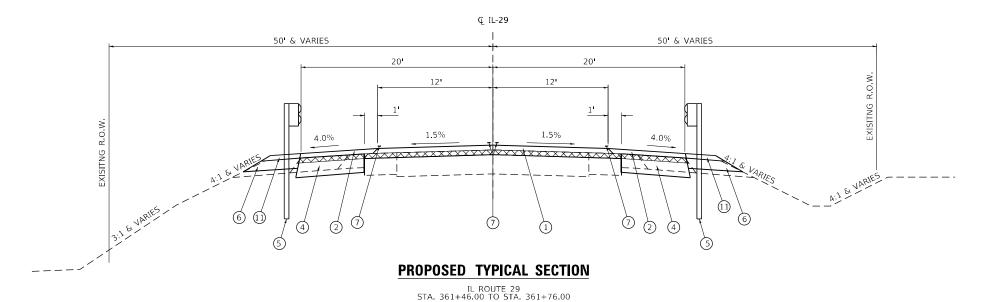

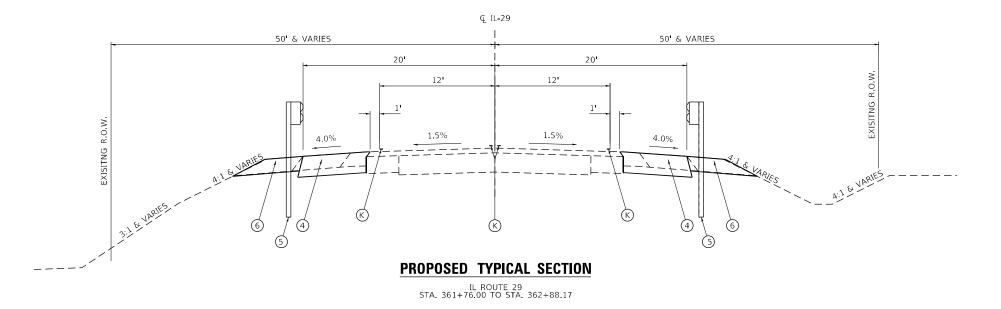

LEGEND

A EX. PAVEMENT

(B) EX. HMA OVERLAY, VARIABLE DEPTH

© EX. BASE COURSE WIDENING

EX. GRANULAR SUBGRADE

(E) EX. HMA SHOULDER

) EX. AGGREGATE SHOULDER

EX. COMB. CONC. CURB AND GUTTER, B-6.24

EX. SIDEWALK

(I) EX. 4" PIPE UNDERDRAIN

(J) EX. GUARDRAIL

EX. PAVEMENT MARKINGS

(L) EX. BOARD

EX. RETAINING WALL

1 PR. HMA SURFACE COURSE, IL-9.5, MIX "D", N50, 2"

(2) PR. HMA SHOULDERS, 2"

3) PR. HMA BASE COURSE WIDENING, 9"

(4) PR. HMA BASE COURSE, 9"

PR. STEEL PLATE BEAM GUARDRAIL, TYPE A, 6 FOOT POSTS

(6) PR. GUARDRAIL AGGREGATE EROSION CONTROL

PR. PAVEMENT MARKING LINE - 4"

8) PR. STEEL PLATE BEAM GUARDRAIL, TYPE A, 9 FOOT POSTS

9) PR. AGGREGATE BASE COURSE, TYPE A, 4"

PR. CURB AND GUTTER (SPECIAL)

11) PR. AGGREGATE SHOULDERS (SPECIAL)

(12) RESERVED

PR. AGGREGATE WEDGE SHOULDER, TYPE B (SEE NOTES)

(14) PR. INCIDENTAL HMA, 2"

PR. HMA SURFACE REMOVAL - BUTT JOINT

NOTE:

TO STA.

1. LEGEND ITEMS IN GRAY DO NOT APPLY TO THIS STRUCTURE

2. PR. AGGREGATE SHOULDERS, TYPE B USE IN CONJUNCTION WITH GUARDRAIL AGGREGATE EROSION CONTROL FOR SHOULDER WIDENING AT TBT T-1 (SPECIAL). (SEE GUARDRAIL EROSION CONTROL SHEET)


3. AGGREGATE WEDGE SHOULDER, TYPE B NOT SHOWN. AFTER CONSTRUCTION OF HMA WIDENING, PLACE ALONG EDGE OF WIDENING TO ELIMINATE DROPOFFS. SEE SCHEDULES FOR QUANTITY.



VM, INC.	USER NAME = \$USER\$	DESIGNED -	REVISED -
		DRAWN -	REVISED -
ESIGN FIRM ENSE NO:	PLOT SCALE = 1:10	CHECKED -	REVISED -
4-001220	PLOT DATE = 8/23/2023	DATE -	REVISED -


F.A.P. RTE	SECTION		COUNTY	TOTAL SHEETS	SHE
318	*	MARSHALL	72	15	
*(3B-E	BR,BR-1;(104b)BR-1)BDR	,BRR	CONTRACT	NO. 68	3G39
	ILLINOIS	FED. A	D PROJECT		

STA. 386+34.50 TO STA. 387+51.50 (BACK OF APPROACH SLAB TO BACK OF APPROACH SLAB)

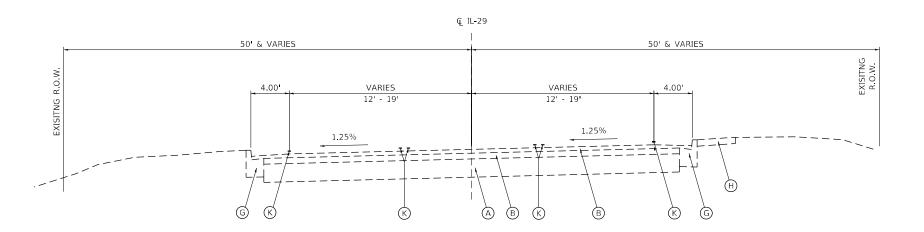

EXISTING TYPICAL SECTION

IL ROUTE 29
STA. 383+08.56 TO STA. 385+60.00

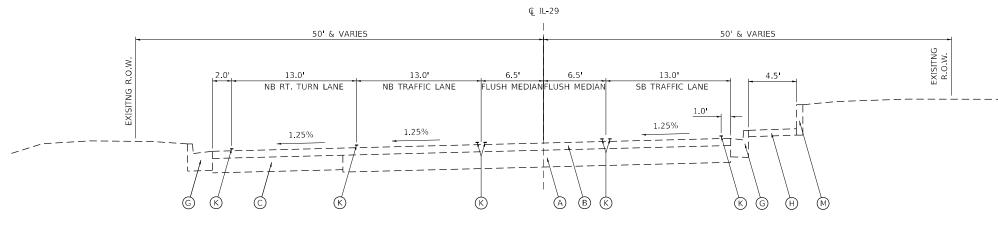

EXISTING TYPICAL SECTION

IL ROUTE 29 STA. 385+60.00 TO STA. 386+34.50

LEGEND

- A EX. PAVEMENT
- B EX. HMA OVERLAY, VARIABLE DEPTH
- (C) EX. BASE COURSE WIDENING
 - EX. GRANULAR SUBGRADE
 - EX. HMA SHOULDER
- (F) EX. AGGREGATE SHOULDER
- G EX. COMB. CONC. CURB AND GUTTER, B-6.24
- EX. SIDEWALK
- (I) EX. 4" PIPE UNDERDRAIN
- (J) EX. GUARDRAIL
- K EX. PAVEMENT MARKINGS
- L EX. BOARD
- M EX. RETAINING WALL
- 1 PR. HMA SURFACE COURSE, IL-9.5, MIX "D", N50, 2"
- 2) PR. HMA SHOULDERS, 2"
- 3) PR. HMA BASE COURSE WIDENING, 9"
- (4) PR. HMA BASE COURSE, 9"
- 5) PR. STEEL PLATE BEAM GUARDRAIL, TYPE A, 6 FOOT POSTS
- 6 PR. GUARDRAIL AGGREGATE EROSION CONTROL
- PR. PAVEMENT MARKING LINE 4"
- (8) PR. STEEL PLATE BEAM GUARDRAIL, TYPE A, 9 FOOT POSTS
- (9) PR. AGGREGATE BASE COURSE, TYPE A
- PR. CURB AND GUTTER (SPECIAL)
- 11) PR. AGGREGATE SHOULDERS (SPECIAL)
- (12) RESERVED
- 13 PR. AGGREGATE WEDGE SHOULDER, TYPE B
- 14) PR. INCIDENTAL HMA, 2"

NOTE:

TO STA.

1. LEGEND ITEMS IN GRAY DO NOT APPLY TO THIS STRUCTURE


ENGINEERING GEOSPATIAL SERVICES

VM. INC.	USER NAME = \$USER\$	DESIGNED -	REVISED
v.TWM-INC.COM		DRAWN -	REVISED
ESIGN FIRM	PLOT SCALE = 1:10	CHECKED -	REVISED
CENSE NO: 84-001220	PLOT DATE = 8/23/2023	DATE -	REVISED


SCALE: N.T.S.

F.A.P. RTE	SECTION	COUNTY	TOTAL SHEETS	SH	
318	*		MARSHALL	72	
*(3B-E	BR,BR-1;(104b)BR-1)BDR	CONTRACT	NO. 68	3G	
	TUTNOIS	FFD Δ	ID PROJECT		_

STA. 386+34.50 TO STA. 387+51.50 (BACK OF APPROACH SLAB TO BACK OF APPROACH SLAB)

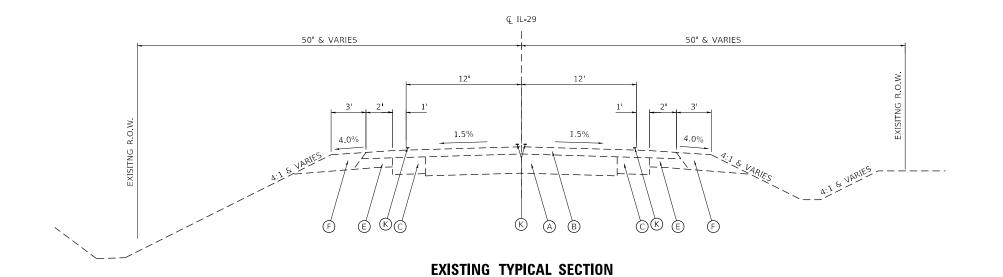


IL ROUTE 29 STA. 390+31.50 TO STA. 391+44.27

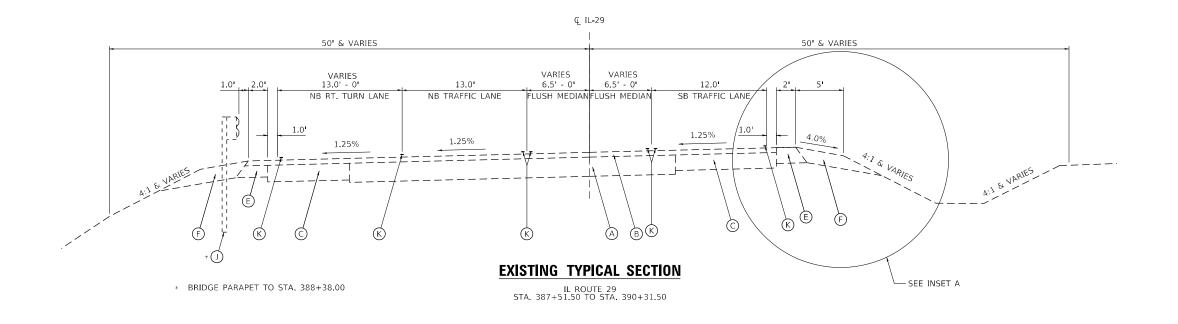

LEGEND

- A EX. PAVEMENT
- B EX. HMA OVERLAY, VARIABLE DEPTH
- (C) EX. BASE COURSE WIDENING
- (D) EX. GRANULAR SUBGRADE
- (E) EX. HMA SHOULDER
-) EX. AGGREGATE SHOULDER
- EX. COMB. CONC. CURB AND GUTTER, B-6.24
- H) EX. SIDEWALK
- 1) EX. 4" PIPE UNDERDRAIN
- (J) EX. GUARDRAIL
- K EX. PAVEMENT MARKINGS
- L EX. BOARD
- M EX. RETAINING WALL
- 1 PR. HMA SURFACE COURSE, IL-9.5, MIX "D", N50, 2"
- (2) PR. HMA SHOULDERS, 2"
- 3) PR. HMA BASE COURSE WIDENING, 9"
- (4) PR. HMA BASE COURSE, 9"
- (5) PR. STEEL PLATE BEAM GUARDRAIL, TYPE A, 6 FOOT POSTS
- 6) PR. GUARDRAIL AGGREGATE EROSION CONTROL
- PR. PAVEMENT MARKING LINE 4"
- (8) PR. STEEL PLATE BEAM GUARDRAIL, TYPE A, 9 FOOT POSTS
- (9) PR. AGGREGATE BASE COURSE, TYPE A
- 10) PR. CURB AND GUTTER (SPECIAL)
- 11) PR. AGGREGATE SHOULDERS (SPECIAL)
- (12) RESERVED
- 13 PR. AGGREGATE WEDGE SHOULDER, TYPE B
- 14) PR. INCIDENTAL HMA, 2"

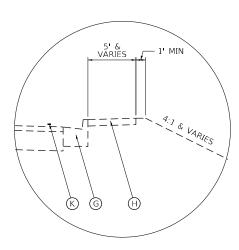

INSET A

STA. 387+51.50 RT TO STA. 367+64.50 RT

NOTE:

TO STA.

1. LEGEND ITEMS IN GRAY DO NOT APPLY TO THIS STRUCTURE

ENGINEERING GEOSPATIAL SERVICES


VM, INC.	USER NAME = \$USER\$	DESIGNED -	REVISED -
		DRAWN -	REVISED -
ESIGN FIRM ENSE NO: 4-001220	PLOT SCALE = 1:10	CHECKED -	REVISED -
	PLOT DATE = 8/23/2023	DATE -	REVISED -

STATE OF ILLINOIS
DEPARTMENT OF TRANSPORTATION

	_		-		SECTIONS . 062–0057
SCALE: N.T.S.	SHEET 2	OF	5	SHEETS	STA.


F.A.P. RTE	SECTION		COUNTY	TOTAL SHEETS	SHE
318	*		MARSHALL	72	1
*(3B-E	BR,BR-1;(104b)BR-1)BD	R,BRR	CONTRACT	NO. 68	3G39
	TILLINOI	FED. A	ID PROJECT		

STA. 386+34.50 TO STA. 387+51.50 (BACK OF APPROACH SLAB TO BACK OF APPROACH SLAB)

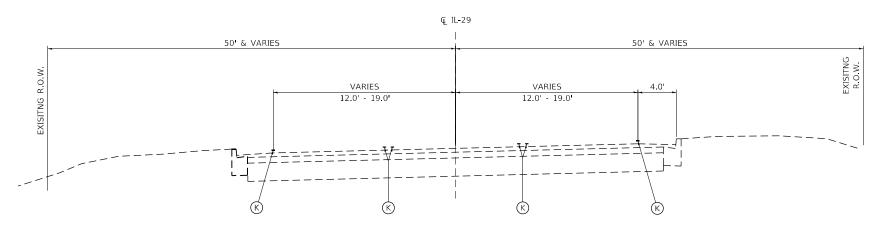

PROPOSED TYPICAL SECTION

IL ROUTE 29 STA. 383+08.56 TO STA. 386+08.50

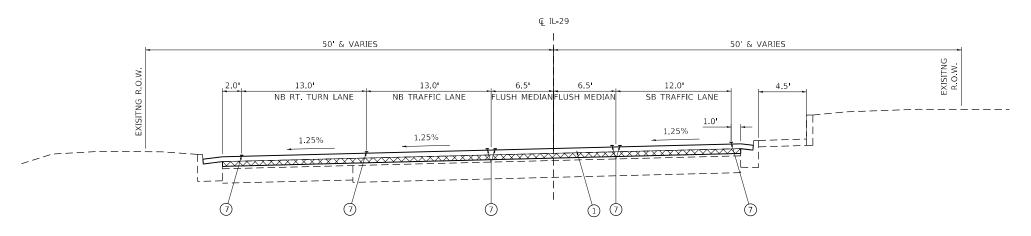

REVISED

REVISED

REVISED

REVISED

PROPOSED TYPICAL SECTION

IL ROUTE 29 STA. 386+08.50 TO STA. 386+34.50

LEGEND

(A)	EV	PAVEMEN
(A)	EA.	PAVEMEN

B EX. HMA OVERLAY, VARIABLE DEPTH

(C) EX. BASE COURSE WIDENING

D EX. GRANULAR SUBGRADE

(E) EX. HMA SHOULDER

EX. AGGREGATE SHOULDER

G EX. COMB. CONC. CURB AND GUTTER, B-6.24

(H) EX. SIDEWALK

(I) EX. 4" PIPE UNDERDRAIN

(J) EX. GUARDRAIL

K) EX. PAVEMENT MARKINGS

L EX. BOARD

M) EX. RETAINING WALL

1 PR. HMA SURFACE COURSE, IL-9.5, MIX "D", N50, 2"

(2) PR. HMA SHOULDERS, 2"

PR. HMA BASE COURSE WIDENING, 9"

(4) PR. HMA BASE COURSE, 9"

5) PR. STEEL PLATE BEAM GUARDRAIL, TYPE A, 6 FOOT POSTS

(6) PR. GUARDRAIL AGGREGATE EROSION CONTROL

PR. PAVEMENT MARKING LINE - 4"

8) PR. STEEL PLATE BEAM GUARDRAIL, TYPE A, 9 FOOT POSTS

9) PR. AGGREGATE BASE COURSE, TYPE A

PR. CURB AND GUTTER (SPECIAL)

11) PR. AGGREGATE SHOULDERS (SPECIAL)

(12) RESERVED

R. AGGREGATE WEDGE SHOULDER, TYPE B (SEE NOTE 2)

14 PR. INCIDENTAL HMA, 2"

PR. HMA SURFACE REMOVAL - BUTT JOINT

NOT

TO STA.


1. LEGEND ITEMS IN GRAY DO NOT APPLY TO THIS STRUCTURE.

2. AFTER CONSTRUCTION OF HMA WIDENING, PLACE AGGREGATE WEDGE SHOULDER, TYPE B ALONG EDGE OF WIDENING TO ELIMINATE DROPOFFS. SEE SCHEDULES FOR QUANTITY.

NAME: 5:\0	TWM	и
H	ENGINEERING GEOSPATIAL SERVICES	IL

/M, INC.	USER NAME = \$USER\$	DESIGNED -
TWM-INC.COM		DRAWN -
ESIGN FIRM	PLOT SCALE = 1:10	CHECKED -
ENSE NO: 4-001220	PLOT DATE = 8/23/2023	DATE -

	F.A.P. RTE	SECTION	COUNTY	TOTAL SHEETS	SHE	
ı	318	*	MARSHALL	72	1	
l	*(3B-BR,BR-1;(104b)BR-1)BDR,BRR			CONTRACT	NO. 68	3G3
ı		ILLINOIS	FED. A	ID PROJECT		

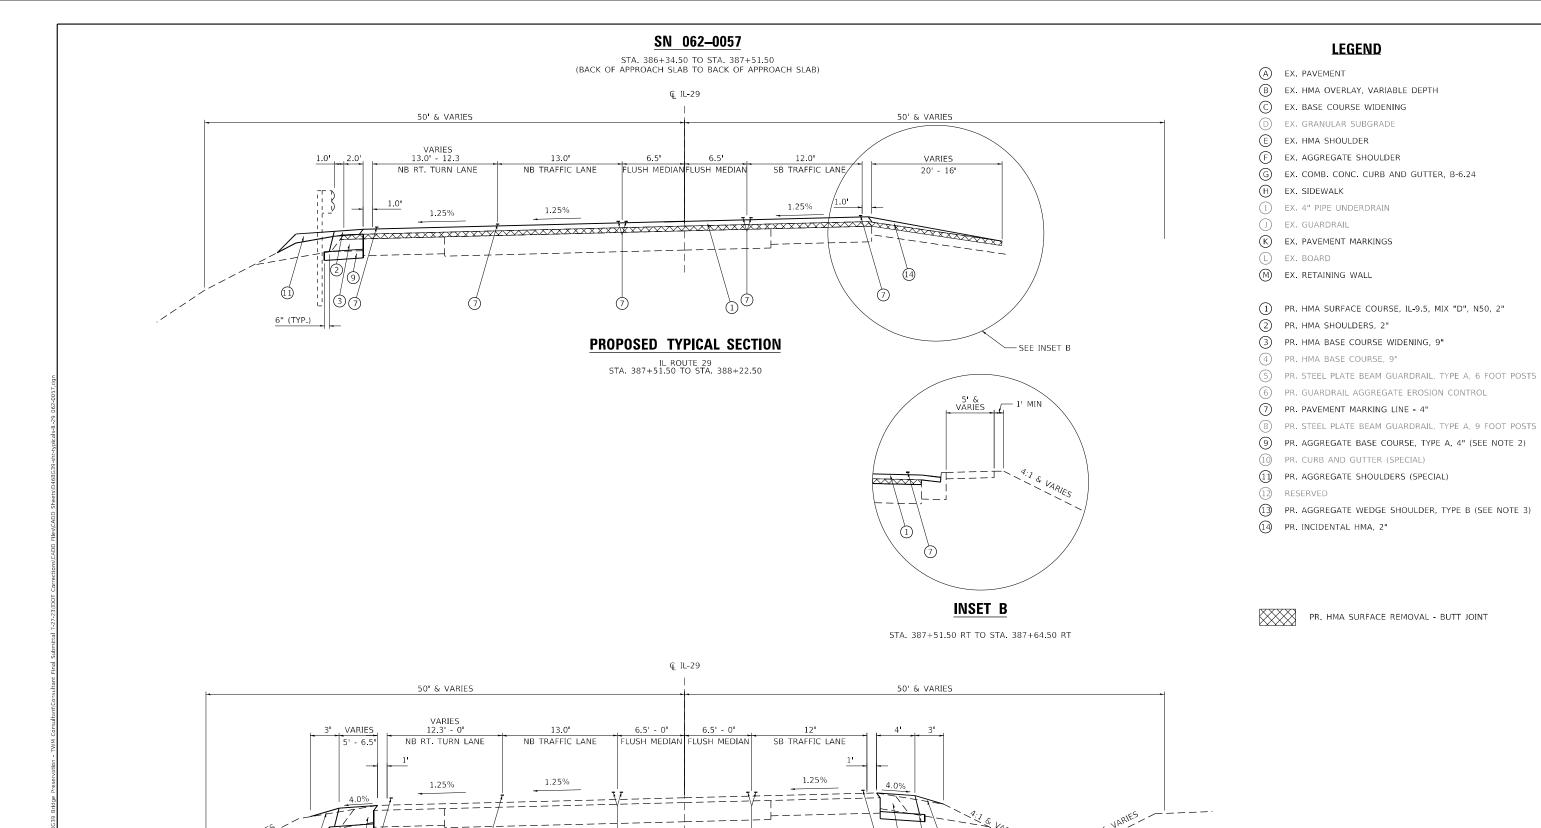

NOTE:

- 1. LEGEND ITEMS IN GRAY DO NOT APPLY TO THIS STRUCTURE.
- 2. THICKNESS BASED ON ASSUMED THICKNESS FROM MICROFILM.
- 3. AFTER CONSTRUCTION OF HMA WIDENING, PLACE AGGREGATE WEDGE SHOULDER, TYPE B ALONG EDGE OF WIDENING TO ELIMINATE DROPOFFS. SEE SCHEDULES FOR QUANTITY.

Š		-
NAME:	CTWM	w
A		//
I.E	ENGINEERING	
Ξ	GEOSPATIAÎ SERVICES	

WM. INC.	USER NAME = \$USER\$	DESIGNED -	REVISED -
W.TWM-INC.COM		DRAWN -	REVISED -
	PLOT SCALE = 1:10	CHECKED -	REVISED -
ICENSE NO: 184-001220	PLOT DATE = 8/23/2023	DATE -	REVISED -

6" (TYP.)

STATE	OF	: ILLINOIS
DEPARTMENT	0F	TRANSPORTATION

SCALE: N.T.S.


PROPOSED TYPICAL SECTION

IL ROUTE 29 STA. 388+22.50 TO STA. 390+31.50

				F.A. RTE			
11 5	OUTF 20	N 2 _ G	. 062–0057		31	8	
, , , , , , , , , , , , , , , , , , ,	IUUIL Z) — J.IV.	002-0037		*(3	B-E	BR,BR-1;(10
SHEET 4	OF 5	SHEETS	STA.	TO STA.			

F.A.P. RTE	SECT	ПОИ		COUNTY	TOTAL SHEETS	SHE
318	*	:		MARSHALL	72	19
*(3B-E	BR,BR-1;(104b)B	R-1)BDF	,BRR	CONTRACT	NO. 68	3G39
		ILLINOIS	FED. A	ID PROJECT		

STA. 386+34.50 TO STA. 387+51.50 (BACK OF APPROACH SLAB TO BACK OF APPROACH SLAB)

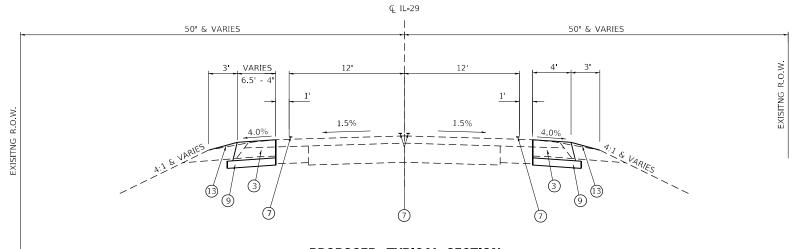

PROPOSED TYPICAL SECTION

IL ROUTE 29 STA. 390+31.50 TO STA. 391+44.27 LT STA. 390+31.50 TO STA. 390+60.88 RT

LEGEND

\sim		
(A)	ΓV	PAVEME
(A)	EA.	PAVEIVIC

EX. HMA OVERLAY, VARIABLE DEPTH

(C) EX. BASE COURSE WIDENING

EX. GRANULAR SUBGRADE

(E) EX. HMA SHOULDER

F EX. AGGREGATE SHOULDER

G EX. COMB. CONC. CURB AND GUTTER, B-6.24

 \oplus EX. SIDEWALK

EX. 4" PIPE UNDERDRAIN

EX. GUARDRAIL

 $\langle K \rangle$ EX. PAVEMENT MARKINGS

L EX. BOARD

EX. RETAINING WALL

PR. HMA SURFACE COURSE, IL-9.5, MIX "D", N50, 2"

(2) PR. HMA SHOULDERS, 2"

3 PR. HMA BASE COURSE WIDENING, 9"

PR. HMA BASE COURSE, 9"

(5) PR. STEEL PLATE BEAM GUARDRAIL, TYPE A, 6 FOOT POSTS

6 PR. GUARDRAIL AGGREGATE EROSION CONTROL

PR. PAVEMENT MARKING LINE - 4"

PR. STEEL PLATE BEAM GUARDRAIL, TYPE A, 9 FOOT POSTS

PR. AGGREGATE BASE COURSE, TYPE A, 4" (SEE NOTE 2)

(10) PR. CURB AND GUTTER (SPECIAL)

11) PR. AGGREGATE SHOULDERS (SPECIAL)

(12)

13 PR. AGGREGATE WEDGE SHOULDER, TYPE B (SEE NOTE 3)

14) PR. INCIDENTAL HMA, 2"

- 1. LEGEND ITEMS IN GRAY DO NOT APPLY TO THIS STRUCTURE.
- 2. THICKNESS OF AGGREGATE BASE COURSE, TYPE A BASED ON ASSUMED THICKNESS FROM MICROFILM.
- 3. AFTER CONSTRUCTION OF HMA WIDENING, PLACE AGGREGATE WEDGE SHOULDER, TYPE B ALONG EDGE OF WIDENING TO ELIMINATE DROPOFFS. SEE SCHEDULES FOR QUANTITY.



M. INC.	USER NAME = \$USER\$	DESIGNED -	REVISED -
WM-INC.COM		DRAWN -	REVISED -
SIGN FIRM NSE NO:	PLOT SCALE = 1:10	CHECKED -	REVISED -
-001220	PLOT DATE = 8/23/2023	DATE -	REVISED -

SCALE: N.T.S.

						GUA	RDRAIL SC	HEDULE						
				63000001	63000003	63100085	63100167	63200310	63302700	72501000	78200005	X6310187	X6330725	Z0001002
	L	OCATION		STEEL PLATE BEAM GUARDRAIL, TYP A, 6 FOOT POSTS	STEEL PLATE BEAM E GUARDRAIL, TYPE A, 9 FOOT POSTS	TRAFFIC BARRIER TERMINAL, TYPE 6	TRAFFIC BARRIER TERMINAL, TYPE 1 (SPECIAL) TANGENT	GUARDRA I L REMOVAL	REMOVE AND REERECT TRAFFIC BARRIER TERMINALS, TYPE 6	TERMINAL MARKER - DIRECT APPLIED	GUARDRAIL REFLECTORS, TYPE A	TRAFFIC BARRIER TERMINAL, TYPE 6 (MODIFIED)	STEEL PLATE BEAM GUARDRAIL (SHORT RADIUS)	GUARDRAIL AGGREGATE EROSION CONTROL
STATION	ТО	STATION	LT/RT	FOOT	FOOT	EACH	EACH	FOOT	EACH	EACH	EACH	EACH	FOOT	TON
IL ROUTE 17 0	62-00!	59			•									
248+46.71	ТО	249+96.71	LT	62.5		1	1	148.0		1	4			33.1
248+63.84	ТО	250+05.29	RT		87.5	1		146.0			4		25.0	30.5
250+70.71	ТО	252+70.71	LT	112.5		1	1	196.6		1	4			44.1
250+79.29	ТО	252+29.29	RT	62.5		1	1	152.6		1	4			33.5
IL ROUTE 29 0	62-00!	56												
358+81.64	ТО	359+93.14	RT	55.2			1	103.9		1	4	1	65.4	43.7
358+93.14	ТО	359+93.14	LT	12.5			1	110.8		1	4	1		22.1
361+22.85	ТО	362+22.85	RT	12.5			1	111.7		1	4	1		21.7
361+22.85	ТО	362+60.35	LT	50.0			1	181.4		1	4	1		29.8
IL ROUTE 29 0	62-00	57												
38	7+25.1	15	LT						1					
			PAY TOTAL	: 368	88	4	7	1151	1	7	32	4	90	259

				S	TAGING SC	HEDULE S	N. 062-0	059			
			40600990	70106500	70106700	70107005	70400100	70400200	70600251	70600352	78200011
LOCATION		TEMPORARY RAMP * TAPER RATE 1:40	TEMPORARY BRIDGE TRAFFIC SIGNALS *	TEMPORARY RUMBLE STRIPS *	PAVEMENT MARK I NG BLACKOUT TAPE, 5"	TEMPORARY CONCRETE BARRIER *	RELOCATE TEMPORARY CONCRETE BARRIER *	IMPACT ATTENUATORS, TEMPORARY (NON-REDIRECT IVE, NARROW), TEST LEVEL 3	IMPACT ATTENUATORS, RELOCATE (NON-REDIRECT IVE, NARROW), TEST LEVEL 3	BARRIER WALL REFLECTORS, TYPE C *	
STATION	ТО	STATION	SQ YD	EACH	EACH	FOOT	FOOT	FOOT	EACH	EACH	EACH
STAGE I						499.8		1	1		
WEST END				_	3						
EAST END				1	3						
247+56.30									1		
247+73.07	ТО	248+10.94					37.5				49
248+27.72									1		
248+57.72									1		
248+74.50	TO	252+41.43					362.5				
252+58.20		•							1		
STAGE II						238.30					
248+34.57	TO	252+39.37						400.0			
248+17.80										1	
249+64.36	TO	249+69.36	8.9								
251+06.64	ТО	251+11.64	8.9								
252+56.15										1	
	ST ST	1									
249+39.36	ТО	249+44.36	17.8								
249+64.36	TO	249+69.36	17.8								
251+06.64	ТО	251+11.64	17.8								
251+31.64	TO	251+36.64	17.8								
		PAY TOTAL:	89	1	6	738	400	400	4	2	49

^{*} SEE STAGING SCHEDULE S.N. 062-0056 AND STAGING SCHEDULE S.N. 062-0057 FOR ADDITIONAL QUANTITIES

		MAINLII	VE REM	MOVAL SCHED	ULE	
				40600982	44004250	X4400196
	LOCA	.TION		HOT-MIX ASPHALT SURFACE REMOVAL - BUTT JOINT	PAVED SHOULDER REMOVAL	HOT-MIX ASPHALT SURFACE REMOVAL, SPECIAL
						QTY FOR JOINT TREATMENT ON CL
STATION	то	STATION	LT/RT	SQ YD	SQ YD	SQ YD
SN 062-0059						
248+15.71	ТО	249+65.15	LT		105.2	
248+33.50	ТО	249+73.65	RT		70.9	
249+39.36	ТО	249+69.36	LT/RT	106.7		1.7
251+06.64	ТО	251+36.64	LT/RT	106.7		1.7
251+02.43	TO	251+70.71	LT		124.7	
251+10.85	TO	252+29.29	RT		71.4	
SN 062-0056						
358+27.83	TO	359+70.00	LT		47.7	
359+00.41	TO	359+70.00	RT		54.1	
359+40.00	ТО	359+70.00	LT/RT	133.3		1.7
361+46.00	ТО	361+76.00	LT/RT	133.3		1.7
361+46.00	TO	362+88.17	LT		42.6	
361+46.00	ТО	362+88.17	RT		47.7	
SN 062-0057						
386+08.50	ТО	386+34.50	LT/RT	157.5		1.4
387+51.50	ТО	388+22.50	LT/RT	526.6		3.9
387+51.50	ТО	388+56.41	LT		26.2	
388+15.47	ТО	390+60.88	RT		53.9	
388+91.94	ТО	391+44.27	LT		55.9	
		PAY	TOTAL:	1164	700	12

	TWM
1	ENGINEERING
1	GEOSPATIAL SERVICES

STATE OF ILLINOIS DEPARTMENT OF TRANSPORTATION

SCALE:

						_	F.A.P. RTE.	SECTION	COUNTY	TOTAL SHEETS	SHEET NO.
	SCH	:มน	JLE	OF QU	ANIIIIE	S	318	*	MARSHALL	72	21
							*(3B-F	BR,BR-1;(104b)BR-1)BDR,BRR	CONTRACT	NO. 68	3G39
SHEET 1	()F	5	SHEETS	STA.	TO STA.		ILLINOIS FED. A	ID PROJECT		

^{**} SEE STAGING SCHEDULE S.N. 062-0056 FOR ADDITIONAL QUANTITIES

						SH	OULDER SCHEDU	JLE				
				35100100	35501320	35600712	40600275	40600290	48101200	48102100	48203100	X4811900
	LOC	CATION		AGGREGATE BASE COURSE, TYPE A	HOT-MIX ASPHALT BASE COURSE, 9"	HOT-MIX ASPHALT BASE COURSE WIDENING, 9"	BITUMINOUS MATERIALS (PRIME COAT)	BITUMINOUS MATERIALS (TACK COAT) *	AGGREGATE SHOULDERS, TYPE B	AGGREGATE WEDGE SHOULDER, TYPE B	HOT-MIX ASPHALT SHOULDERS	AGGREGATE SHOULDERS (SPECIAL)
				4 "	-		0.25 LBS/SQ FT	0.08 LBS/SQ FT			2 "	
STATION	ТО	STATION	LT/RT	TON	SQ YD	SQ YD	POUND	POUND	TON	TON	TON	TON
062-0059												
248+11.71	ТО	248+35.71	LT						1.6			
248+15,71	ТО	249+65.07	LT		93.3					5.9		
249+39.36	ТО	249+69.36	LT					8.5			1.3	1.3
249+39.36	ТО	249+69.36	RT					10.8			1.7	1.8
248+33.50	ТО	249+73.57	RT			71.7				4.7		
251+02.35	ТО	252+70.71	LT			74.6				6.6		
251+06.64	ТО	251+36.44	LT					10.8			1.7	1.6
251+06.64	ТО	251+36.64	RT					8.4			1.3	1.1
251+10.93	TO	252+29.29	RT			52.8				4.6		
252+39.29	TO	252+69.29	RT						1.5			
252+80.71	ТО	253+10.71	LT						1.5			
062-0056												
358+27.83	ТО	359+70.00	LT		110.6				0.93	7.4		
358+59.14	TO	358+83.14	LT						0.93			
358+84.58	ТО	358+91.63	RT									
359+00.41	ТО	359+70.00	RT	13.5	54.1		121.8			2.7		
359+40.00	ТО	359+70.00	LT					19.1			3.0	1.6
359+40.00	ТО	359+70.00	RT					19.1			3.0	1.6
361+46.00	ТО	361+76.00	LT					19.1			3.0	1.6
361+46.00	ТО	361+76.00	RT					19.1			3.0	1.6
361+46.00	ТО	362+88.17	LT		110.6					5.5		
361+46.00	ТО	362+88.17	RT		110.6					5.5		
362+70.35	ТО	362+94.35	LT						0.93			
362+32.85	ТО	362+56.85	RT						0.93			
062-0057			1 .	T	T	T						
387+51.50	ТО	388+22.50	LT					22.6			3.5	4.1
387+51.50	TO	391+44.27	LT	58.6		229.1	564.9					
388+14.59	TO	390+60.88	RT							9.6		
388+15.47	TO	390+60.88	RT	28.5		108.3	274.5					
388+85.63	ТО	391+44.27	LT	4.0.5	4=0		0.5.5	4.2		10.0		
		PA	Y TOTAL:	101	479	537	961	137	8	62	21	16

^{*} SEE MAINLINE PAVING AND PATCHING SCHEDULES FOR ADDITIONAL QUANTITIES

SIGNAGE SCHEDULE									
			72000100	72400100	72800100	73100100			
LOCATION	DESCRIPTION			REMOVE SIGN PANEL ASSEMBLY - TYPE A	TELESCOPING STEEL SIGN SUPPORT	BASE FOR TELESCOPING STEEL SIGN SUPPORT			
	SIGN SIZE			EACH	FOOT	EACH			
SN 062-0057	N 062-0057								
NE QUAD - ISLAND PAVEMENT (SPECIAL) STOP SIGN 30" X 30" 6.25 1.0 10.0									
		PAY TOTAL:	6	1	10	1			

MOWING SCHEDULE										
LC	MOWING									
			ASSUMING 2 MOWINGS							
STATION	ТО	STATION	ACRE							
SN 062-0059		'								
248+11.71	ТО	253+10.71	0.38							
SN 062-0056										
358+27.83	ТО	363+24.35	0.38							
SN 062-0057										
383+08.56	383+08.56 TO 391+57.38									
	SUB-TOTAL									
PAY TOTAL: 1.25										

CU	RB A	ND GUTTER	(SPECI	AL)						
	CURB AND GUTTER (SPECIAL)									
STATION	ТО	STATION	LT/RT	FOOT						
SN 062-0056										
361+26.50	TO	361+40.50	RT	14.0						
SN 062-0057		-		-						
387+42.12	ТО	385+57.12	LT	15.0						
·		PAY	TOTAL:	29						
		·								

WM. INC.	USER NAME = \$USER\$	DESIGNED -	REVISED -
W.TWM-INC.COM		DRAWN -	REVISED -
	PLOT SCALE = 1:2	CHECKED -	REVISED -
ICENSE NO: 184-001220	PLOT DATE = 8/23/2023	DATE -	REVISED -

			STAGING S	CHEDULE S	S.N. 062-	0056			
	40600990	70106500	70106700	70107005	70400100	70400200	70600251	70600352	78200011
LOCATION	TEMPORARY RAMP *	TEMPORARY BRIDGE TRAFFIC SIGNALS	TEMPORARY RUMBLE STRIPS *	PAVEMENT MARKING BLACKOUT TAPE, 5"	TEMPORARY CONCRETE BARRIER *	RELOCATE TEMPORARY CONCRETE BARRIER *	IMPACT ATTENUATORS, TEMPORARY (NON-REDIRECT IVE, NARROW), TEST LEVEL 3	IMPACT ATTENUATORS, RELOCATE (NON-REDIRECT IVE, NARROW), TEST LEVEL 3	BARRIER WALL REFLECTORS TYPE C
	1:40	5.00		5007	5007	5007	5.00	5.00	54.611
STATION TO STATION	SQ YD	EACH	EACH	FOOT	FOOT	FOOT	EACH	EACH	EACH
STAGE I			_	1480.3					
NORTH END		1	3						
SOUTH END			3						
357+19.78							1		
357+29.28 TO 358+05.55					75.0				56
358+15.74							1		
358+76.94							1		
358+87.17 TO 362+79.32					387,5				
362+89.56							1		
STAGE II				284.4					
358+26.45								1	
358+36.68 TO 362+79.32	11.1					437.5			
359+95.00 TO 359+70.00	11.1								
361+46.00 TO 361+51.00									
362+89.55								1	
POST STAGE									
359+40.00 TO 359+45.00	22.2								
359+65.00 TO 359+70.00	22.2								
361+46.00 TO 361+51.00	22.2								
361+71.00 TO 361+76.00	22.2								
PAY TOTAL	: 111	1	6	1765	463	438	4	2	56
* SEE STAGING SCHEDULE S	.N. 062-0059	AND STAGING	SCHEDULE S.	N. 062-0057	FOR ADDITIO	NAL QUANTIT	IES		1

^{**} SEE STAGING SCHEDULE S.N. 062-0059 FOR ADDITIONAL QUANTITIES

		ERG	OSION SCHEDUL	E	
		28200200	X2810812	X5015225	X6050310
LOCATION	N	FILTER FABRIC	STONE DUMPED RIPRAP, CLASS B4 (SPECIAL)	PIPE CULVERT REMOVAL (SPECIAL)	FILLING INLETS, SPECIAL
STATION	LT/RT	SQ YD	TON	FOOT	EACH
SN 062-0059					
250+88.00	LT			12.0	1
250+97.00	RT			16.0	1
251+02.43	LT	11.9	7.9		
251+10.85	RT	15.8	10.6		
SN 062-0056					
359+70.00	LT	14.8	9.9		
359+70.00	RT	29.7	19.8		
359+75.00	LT				1
359+75.00	RT				1
PAY	TOTAL:	72	48	28	4

	PIPE CULVERT SCHEDULE											
				50105220	54213450	542D0220						
	LOCA	TION		PIPE CULVERT REMOVAL	END SECTIONS, 15 INCH	PIPE CULVERTS CLASS D, TYPE 1, 15 INCH						
STATION	ТО	STATION	LT/RT	FOOT	EACH	FOOT						
SN 062-0059												
248+34.50	ТО	248+59.50	RT	25.0								
248+34.50	ТО	248+82.50	RT		2	48.0						
		PAY	TOTAL:	25	2	48						

ENTRANCE SCHEDULE										
		40200800	40201000	44000200						
LOCATIO	NC	AGGREGATE SURFACE COURSE, TYPE B	AGGREGATE FOR TEMPORARY ACCESS	DRIVEWAY PAVEMENT REMOVAL						
STATION	LT/RT	TON	TON	SQ YD						
062-0059										
258+51.50	RT	3.5	13.0							
062-0057										
388+75.92	LT	6.5	15.0	17.6						
	PAY TOTAL:	10	28	18						

ISLAND PAVEMENT (SPECIAL) SCHEDULE										
			X1700005	X4420201						
	LOCA	TION	ISLAND PAVEMENT (SPECIAL)	PAVEMENT PATCHING (SPECIAL)						
STATION	то	STATION	LT/RT	SQ FT	SQ YD					
SN 062-0057										
385+32.47	TO	385+44.92	LT	130.0	21.4					
		PAY	TOTAL:	130	21					

TWM	
ENGINEERING GEOSPATIAL SERVICES	•

M. INC.	USER NAME = \$USER\$	DESIGNED -	REVISED -
TWM-INC.COM		DRAWN -	REVISED -
ESIGN FIRM	PLOT SCALE = 1:2	CHECKED -	REVISED -
ENSE NO: 4-001220	PLOT DATE = 8/23/2023	DATE -	REVISED -

STATE OF ILLINOIS	
EPARTMENT OF TRANSPORTATION	

				05 011	4 N.T.T.I.F.O.		F.A.P. RTE	SECTION	COUNTY	TOTAL SHEETS	SHEET NO.
	5	CHED	ULE	OF QU	ANTITIES		318	*	MARSHALL	72	23
							*(3B-F	BR,BR-1;(104b)BR-1)BDR,BRR	CONTRACT	NO. 68	3G39
SHEET	3	OF	5	SHEETS	STA.	TO STA.		ILLINOIS FED. A	ID PROJECT		

					DATCHIA	IG SCHEDULE				
					FAICHIN		I			
						40600290	44200168	44200180	X0556100	X4421000
		LOCATIO	ON			BITUMINOUS MATERIALS (TACK COAT)	PAVEMENT PATCHING TYPE II 14"	PAVEMENT PATCHING TYPE II 15"	PARTIAL DEPTH PATCHING (SPECIAL)	PARTIAL DEPTH PATCHING
						0.08 LBS/SQ FT				
STATION	ТО	STATION	DIRECTION	LENGTH	WIDTH	POUND	SQ YD	SQ YD	SQ YD	TON
SN 062-0059										
241+61.36	ТО	249+69.36	WB	8	12	8.0			11.0	1.2
241+61.36	ТО	249+69.36	EB	8	12	8.0			11.0	1.2
251+06.64	ТО	251+14.64	WB	8	12	8.0			11.0	1.2
251+06.64	ТО	251+14.64	EB	8	12	8.0			11.0	1.2
SN 062-0056										
359+66.00	ТО	359+70.00	NB	4	13	1.0		5.8		
359+66.00	ТО	359+70.00	SB	4	13	1.0		5.8		
361+46.00	TO	361+50.00	NB	4	13	1.0		5.8		
361+46.00	ТО	361+50.00	SB	4	13	1.0		5.8		
SN 062-0057										
386+30.50	ТО	386+34.50	SB THRU	4	12	3.8	5.3			
386+30.50	ТО	386+34.50	MEDIAN	4	13	4.2	5.8			
386+30.50	ТО	386+34.50	NB THRU	4	13	4.2	5.8			
386+30.50	ТО	386+34.50	NB RT	4	13	4.2	5.8			
387+51.50	ТО	387+55.50	SB THRU	4	12	3.8			5.3	0.6
387+51.50	ТО	387+55.50	MEDIAN	4	13	4.2			5.8	0.7
387+51.50	ТО	387+55.50	NB THRU	4	13	4.2			5.8	0.7
387+51.50	ТО	387+55.50	NB RT	4	13	4.2			5.8	0.7
				P.A	Y TOTAL:	69	23	23	67	7

*SEE MAINLINE PAVING AND SHOULDE	RS SCHEDULE FOR ADDITIONAL QUANTITIES
----------------------------------	---------------------------------------

			SEED	ING SCHED	ULE			
				25000210	25000400	25000500	25000600	25100115
	LOCATION			SEEDING, CLASS 2A	NITROGEN FERTILIZER NUTRIENT	PHOSPHORUS FERTILIZER NUTRIENT	POTASSIUM FERTILIZER NUTRIENT	MULCH, METHOD 2
STATION	ТО	STATION	LT/RT	ACRE	POUND	POUND	POUND	ACRE
SN 062-0059								
248+11.71	TO	253+10.71	LT/RT	0.049	4.4	4.4	4.4	0.049
SN 062-0056								
358+27.83	TO	362+88.17	LT/RT	0.034	3.1	3.1	3.1	0.034
SN 062-0057								
383+08.56	ТО	391+44.27	LT/RT	0.018	1.6	1.6	1.6	0.018
			SUB - TOTAL :	0.101	9.1	9.1	9.1	0.101
			PAY TOTAL:	0.25	10	10	10	0.25

		CIDEWAL	r ccn	EDIII E								
	SIDEWALK SCHEDULE											
			42400100	44000600								
	LOCA	TION	PORTLAND CEMENT CONCRETE SIDEWALK 4"	SIDEWALK REMOVAL								
STATION	то	STATION	LT/RT	SQ FT	SQ FT							
SN 062-0057												
386+45.19	ТО	386+55.19	RT	50.0	50.0							
387+31.85	ТО	387+41.85	RT	50.0	50.0							
		PAY	TOTAL:	100	100							

					STAGING	SCHEDULE	S.N. 062	-0057							
	40600990	70106500	70106700	70107005	70107007	70107012	70107024	70400100	70400200	70600251	70600255	70600322	78200011		
LOCATION	TEMPORARY RAMP *	RAMP	RAMP *	TEMPORARY BRIDGE TRAFFIC SIGNALS	TEMPORARY RUMBLE STR1PS *	PAVEMENT MARKING BLACKOUT TAPE, 5"	PAVEMENT MARKING BLACKOUT TAPE, 7"	PAVEMENT MARKING BLACKOUT TAPE, 12"	PAVEMENT MARKING BLACKOUT TAPE, 24"	TEMPORARY CONCRETE BARRIER *	RELOCATE TEMPORARY CONCRETE BARRIER *	IMPACT ATTENUATORS, TEMPORARY (NON-REDIRECT IVE, NARROW), TEST LEVEL 3	IMPACT ATTENUATORS, TEMPORARY (FULLY REDIRECTIVE, NARROW), TEST LEVEL 2	IMPACT ATTENUATORS, RELOCATE (FULLY REDIRECTIVE, NARROW), TEST LEVEL 2	BARRIER WALL REFLECTORS, TYPE C
	TAPER RATE 1:40									*	LEVEL 2	LEVEL 2			
STATION TO STATION	SQ YD	EACH	EACH	FOOT	FOOT	FOOT	FOOT	FOOT	FOOT	EACH	EACH	EACH	EACH		
STAGE I				2552.6		366.6									
NORTH END		1	3												
SOUTH END		1	3												
384+60.82											1				
386+22.17 TO 388+37.40								212.5					26.0		
388+47.51										1					
STAGE II	25.6			990	106		44								
386+11.95												1			
384+71.00 TO 387+86.58								100	212.5				12.0		
POST STAGE	124.4														
PAY TOTAL:	150	1	6	3542	106	367	44	312	212	1	1	1	38		

^{*} SEE STAGING SCHEDULE S.N. 062-0059 AND STAGING SCHEDULE S.N. 062-0056 FOR ADDITIONAL QUANTITIES

TWM	
ENGINEERING GEOSPATIAL SERVICES	

VM. INC.	USER NAME = \$USER\$	DESIGNED -	REVISED -
v.TWM-INC.COM		DRAWN -	REVISED -
ESIGN FIRM	PLOT SCALE = 1:2	CHECKED -	REVISED -
CENSE NO: 34-001220	PLOT DATE = 8/23/2023	DATE -	REVISED -

STATI	OF	ILLINOIS
DEPARTMENT	OF	TRANSPORTATION

				F.A.P. RTE				TOTAL SHEETS	SHEET NO.			
SCHEDULE OF QUANTITIES								*		MARSHALL	72	24
							*(3B-F	BR,BR-1;(104b)B	R-1)BDR,BRR	CONTRACT	NO. 68	3G39
	SCALE:	SHEET 4	OF 5	SHEETS	STA.	TO STA.			AID PROJECT			

						PAVEM	IENT MARKI	NG SCH	EDULE								
				70300100	70300	0150	70303100	70303	3120	70303160	70303210	78009000	78009	9004	78009012	78009024	78300202
		LOCATION	SHORT TERM PAVEMENT MARK I NG	IENT MARKING KLMOVAL		TEMPORARY PAVEMENT MARKING LETTERS AND SYMBOLS - MODIFIED URETHANE	IENT MARK ING - ING LINE 4" - 5 AND MODIFIED LS - URETHANE		TEMPORARY PAVEMENT MARKING - LINE 12" - MODIFIED URETHANE	PAVEMENT MARKING - LINE 24" - MODIFIED	MODIFIED URETHANE PAVEMENT MARKING MARKING LETTERS & SYMBOLS	E MODIFIED T URETHANE G PAVEMENT G MARKING - LIN 5 4"		MODIFIED URETHANE PAVEMENT MARKING - LINE 12"	MODIFIED URETHANE PAVEMENT MARKING - LINE 24"	PAVEMENT MARKING REMOVAL - WATER BLASTING	
					SHORT TERM	BLACKOUT		YELLOW	WHITE	WHITE	WHITE	WHITE	YELLOW	WHITE	YELLOW	WHITE	
STATION TO	STATION	LOCATION	TYPE	FOOT	SQ FT	SQ FT	SQ FT	FOOT	FOOT	FOOT	FOOT	SQ FT	FOOT	FOOT	FOOT	FOOT	SQ FT
SN 060-0059									1				I.				
249+39.36 TO	251+36.64	EDGELINE, LT	SINGLE						197.3					197.3			65.8
249+39.36 TO	251+36.64	EDGELINE, RT	SINGLE			307.5			197.3					197.3			65.8
249+36.36 TO	251+36.64	CENTERLINE	35.7	10.8			49.3					49.3				16.4	
SN 060-0056																	
359+40.00 TO	361+76.00	EDGELINE, LT	SINGLE	24.0	2.7				236.0					236.0			78.7
359+40.00 TO	361+76.00	EDGELINE, RT	SINGLE	24.0	2.7	735.2			236.0					236.0			78.7
359+40.00 TO	361+76.00	CENTERLINE DOUBLE		39.6	7.9	7.9		472.0					472.0				157.3
SN 060-0057																	
383+08.56 TO	384+57.40	EDGELINE, LT	SINGLE						148.8					148.8			49.6
385+26.46 TO	385+28.46	SB STOP BAR	SINGLE								26.4			284.8		40.4	52.7
386+11.50 TO	386+13.50	NB STOP BAR	SINGLE								27.6					27.6	55.3
386+12.50 TO		EDGELINE, RT	SINGLE						139.0					139.0			46.3
386+12.50 TO		EDGELINE, LT	SINGLE	34.1	8.6				181.4					181.4			60.5
386+12.50 TO	391+44.27	EDGELINE, LT	SINGLE			2029.6			531.8					531.8			177.2
386+26.18 TO		CENTER MEDIAN DIAGONALS	SINGLE			2029.0				206.2					206.2		206.2
386+43.90 TO	386+43.90	RIGHT TURN ARROW				_	15.6					15.6					15.6
388+22.50 TO	390+60.88	EDGELINE, RT	SINGLE						238.4					238.4			79.5
386+13.45 TO	391+44.27	STRIPED CENTER MEDIAN	DOUBLE	86.92	16.9			1793.9					1793.9				597.9
387+51.50 TO	388+22.50	CENTERLINE	DOUBLE		4.7]											
387+68.90 TO	387+68.90	RIGHT TURN ARROW					15.6					15.6					15.6
			PAY TOTAL:	244	54	3072	31	2315	2106	206	54	31	2315	2391	206	68	1819
					312	27		442	21				470	06			

						MAINLINE PAVIN	G SCHED	ULE				
								40604060	40800029	40800050	RAISED REFLECTIVE PAVEMENT MARKER	78300200
		LOCATION	N					IX ASPHALT SURFACE , IL-9.5, MIX "D", N50	BITUMINOUS MATERIALS (TACK COAT)	INCIDENTAL HOT-MIX ASPHALT SURFACING		RAISED REFLECTIVE PAVEMENT MARKER REMOVAL
					0.08 LBS/ SQ FT	QTY FOR JOINT TREATMENT ON CL	2 "	QTY FOR JOINT TREATMENT ON CL	0.08 LBS/SQ FT	2 "		
STATION	то	STATION	LT/RT	MAINLINE WIDTH	POUND	POUND	TON	TON	POUND	TON	EACH	EACH
SN 062-0059				ı	,							1
249+39.36	ТО	249+69.36		24.0	57.6	1.2	9.0	0.2				
251+06.64	ТО	251+36.64		24.0	57.6 1.2		9.0	0.2				
SN 062-0056												
359+40.00	ТО	359+70.00		24.0	57.6	1.2	10.8	0.2				
359+46.00	ТО	359+76.00		24.0	57.6	1.2	10.8	0.2			1	1
SN 062-0057		<u> </u>	<u> </u>									
386+08.50	ТО	386+34.50		51.0	121.8	1.0	18.9	0.2				
387+51.50	ТО	388+22.50		51.0	288.7	2.8	44.9	0.4			6	6
387+51.50	ТО	388+22.50	RT						72.8	11.3		
				PAY TOTAL:	641	9	103	1	73	11	7	7
	* SEE PATCHING AND SHOULDERS SCHEDULES FOR ADDITIONAL QUANTITIES				6	550		105				


ENGINEERING GEOSPATIAL SERVICES


STATE OF ILLINOIS
DEPARTMENT OF TRANSPORTATION


SCALE:


							F.A.P. RTE	SECTION	COUNTY	TOTAL SHEETS	SHEET NO.	
SCHEDULE OF QUANTITIES								318 * MARSHALL 72				
							*(3B-E	BR,BR-1;(104b)BR-1)BDR,BRR	CONTRACT	NO. 68	3G39	
	SHEET 5	OF	5	SHEETS	STA.	TO STA.		TILLINOIS FED AID PROJECT				



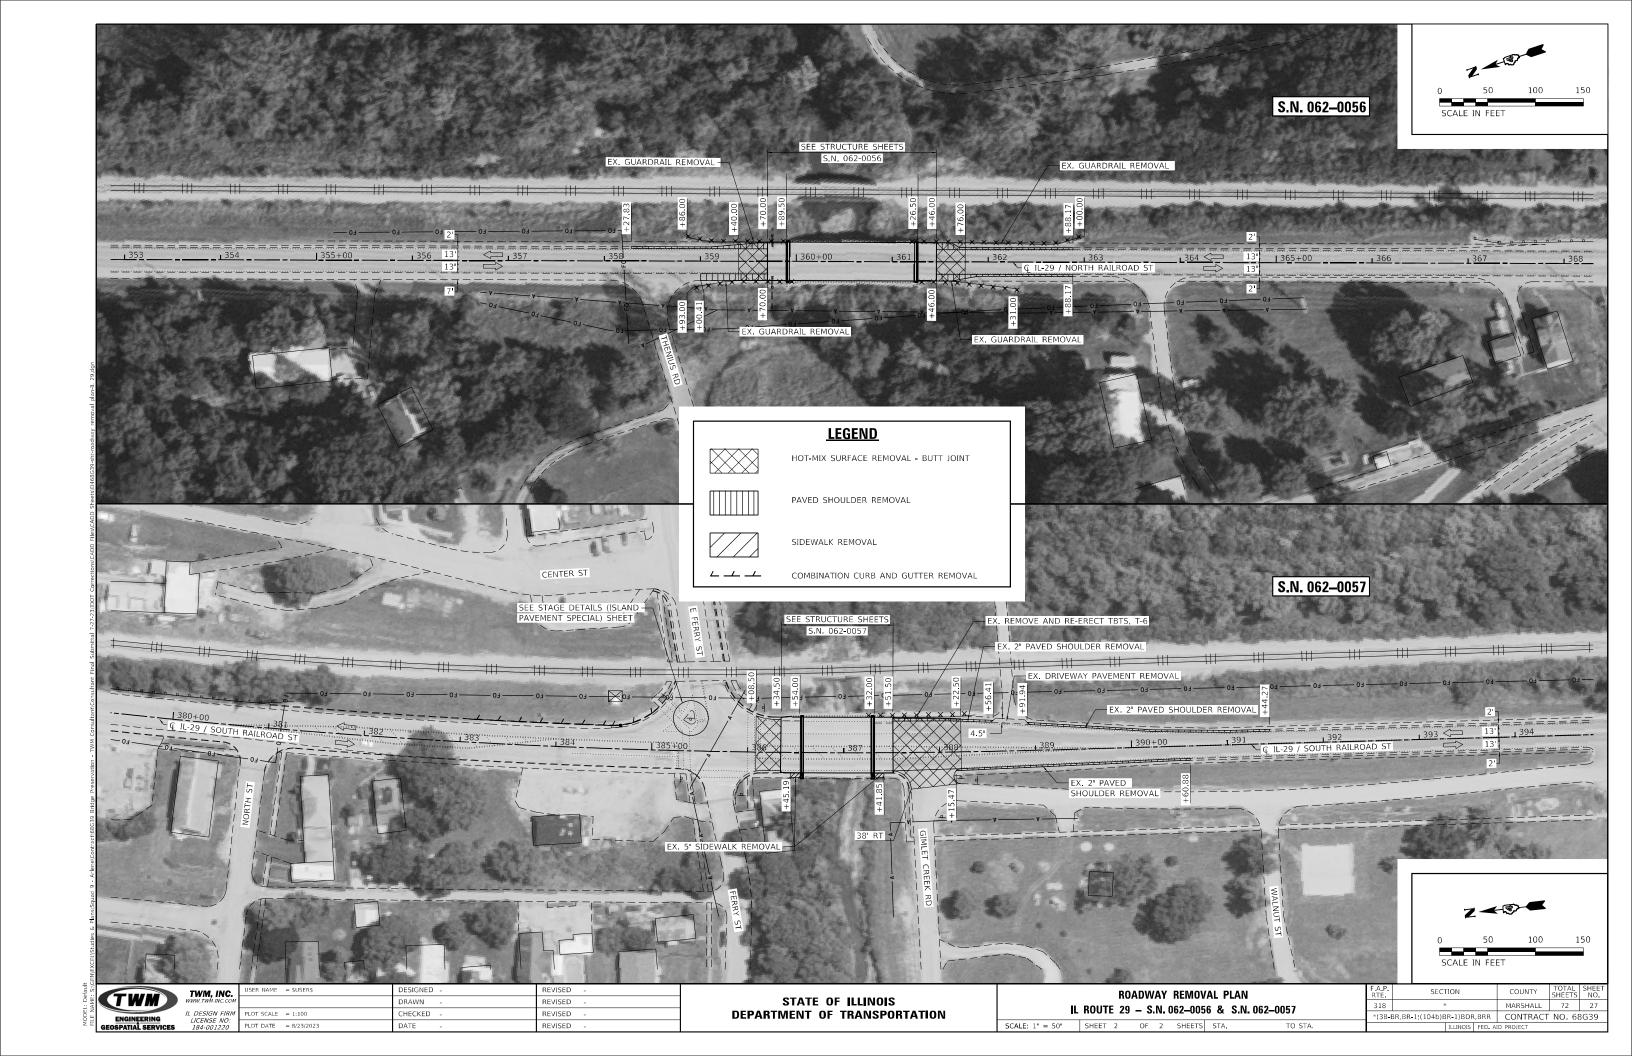

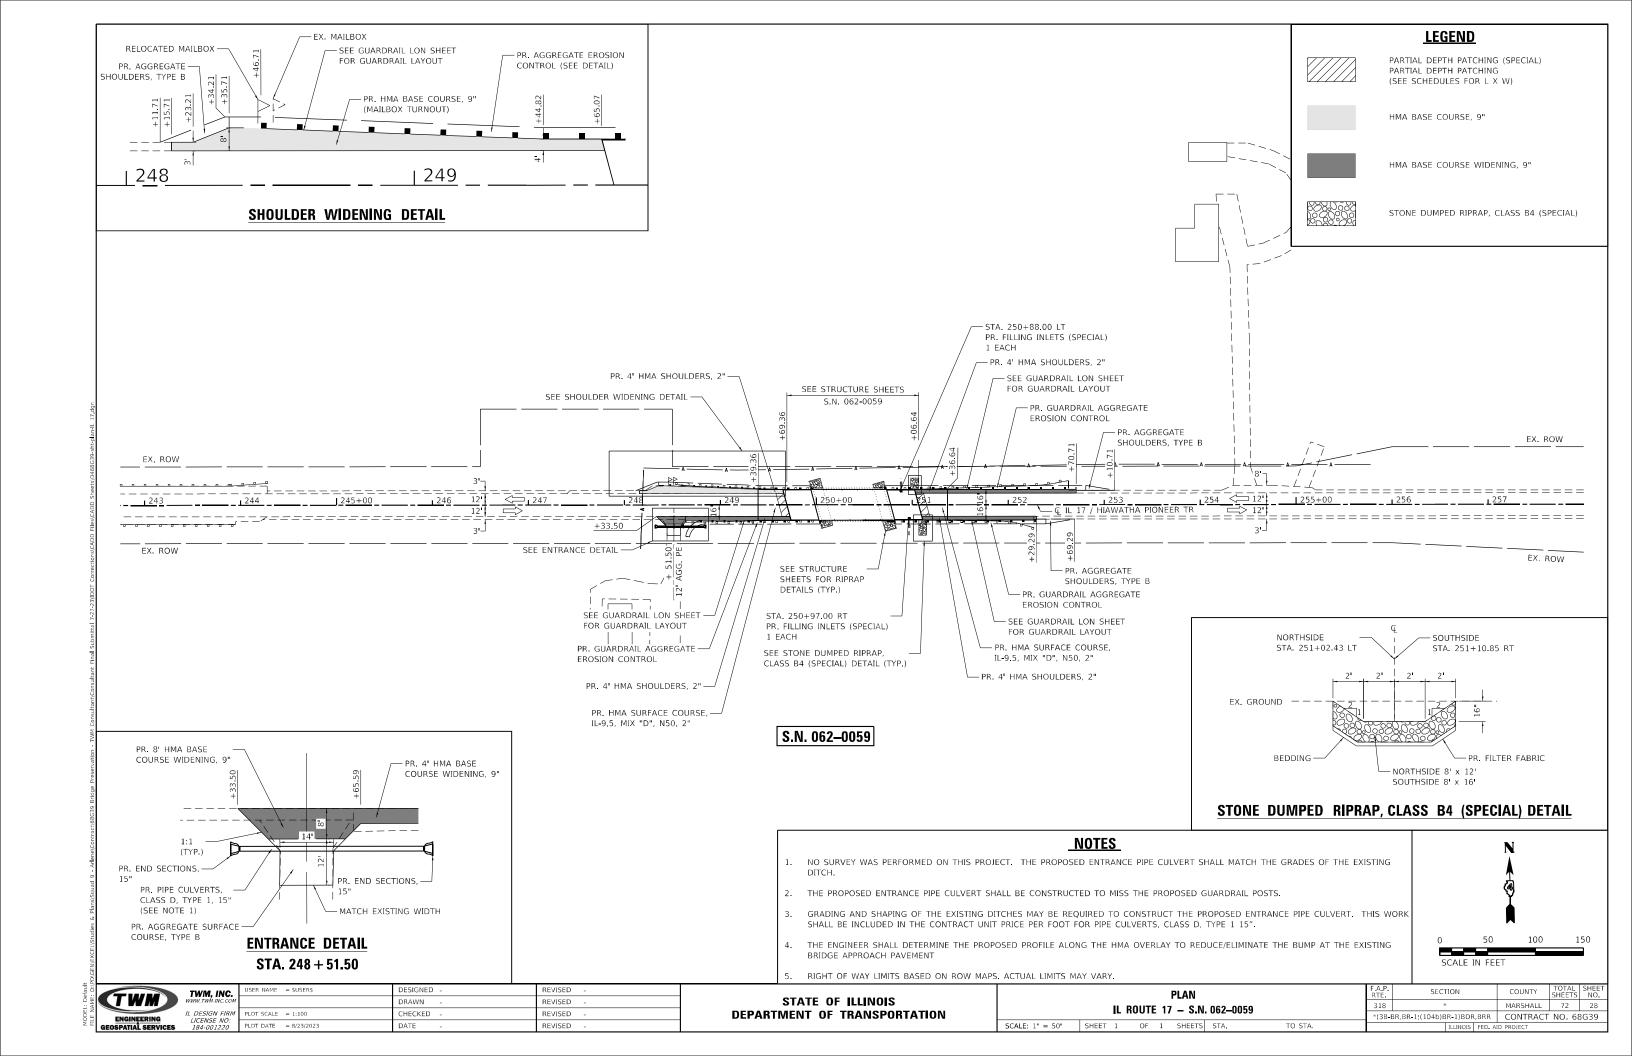

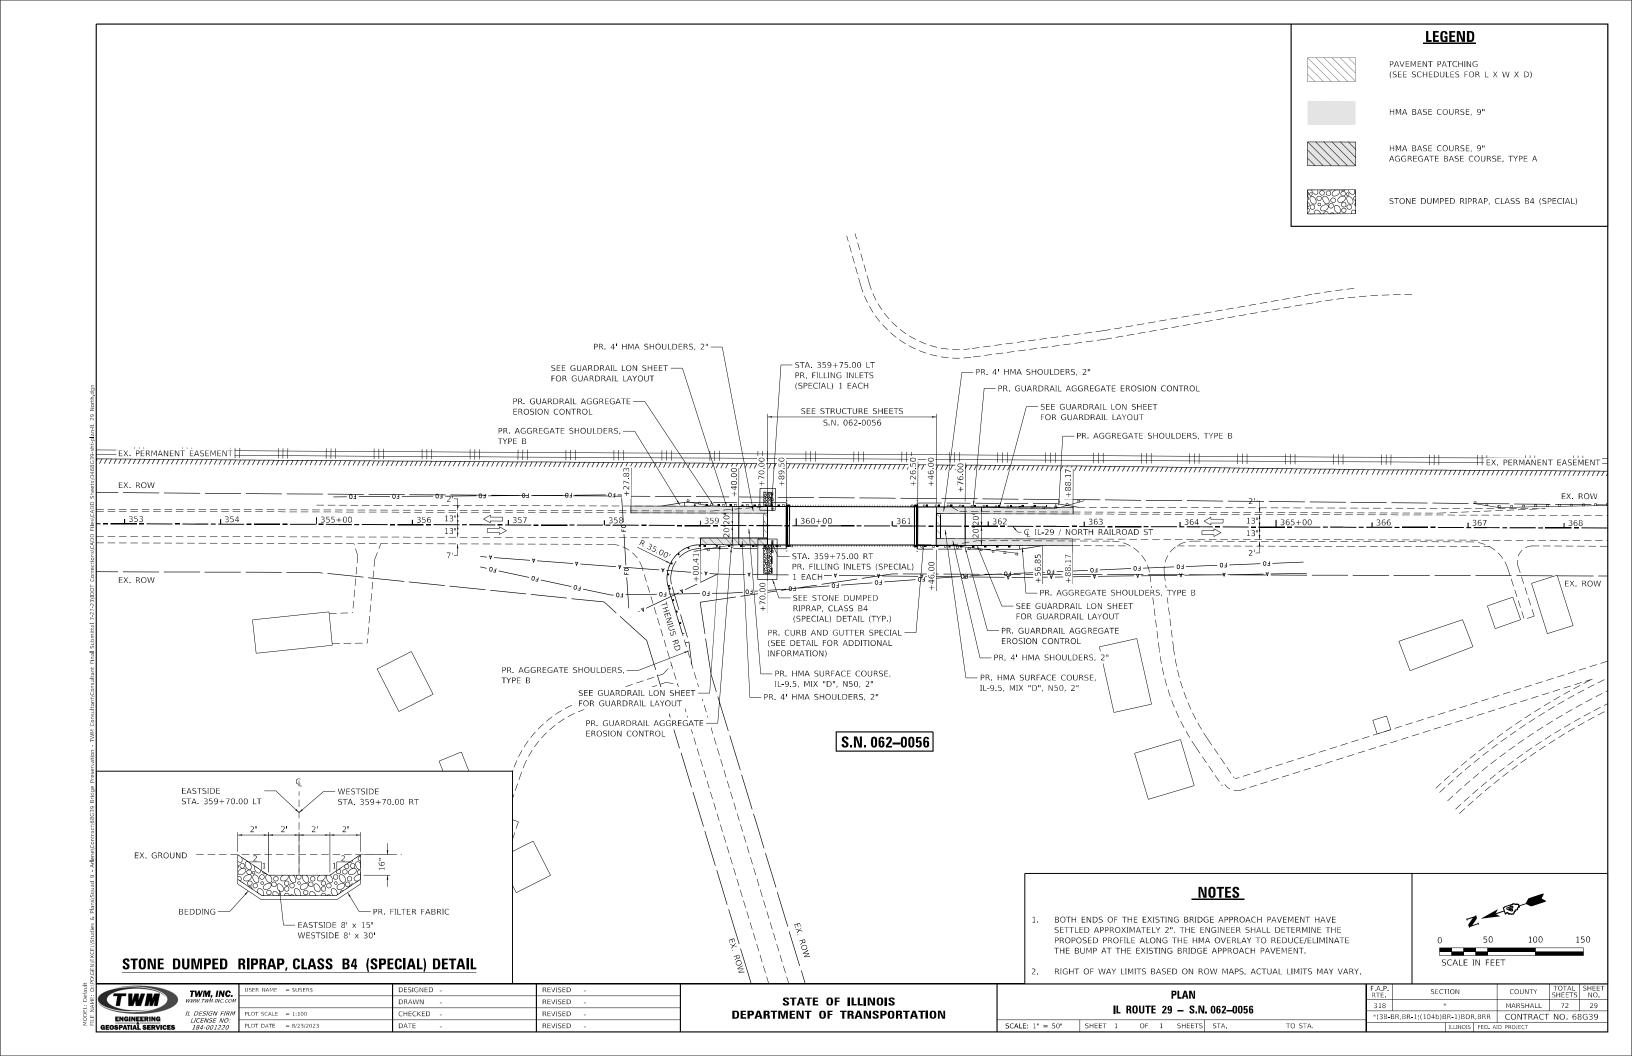

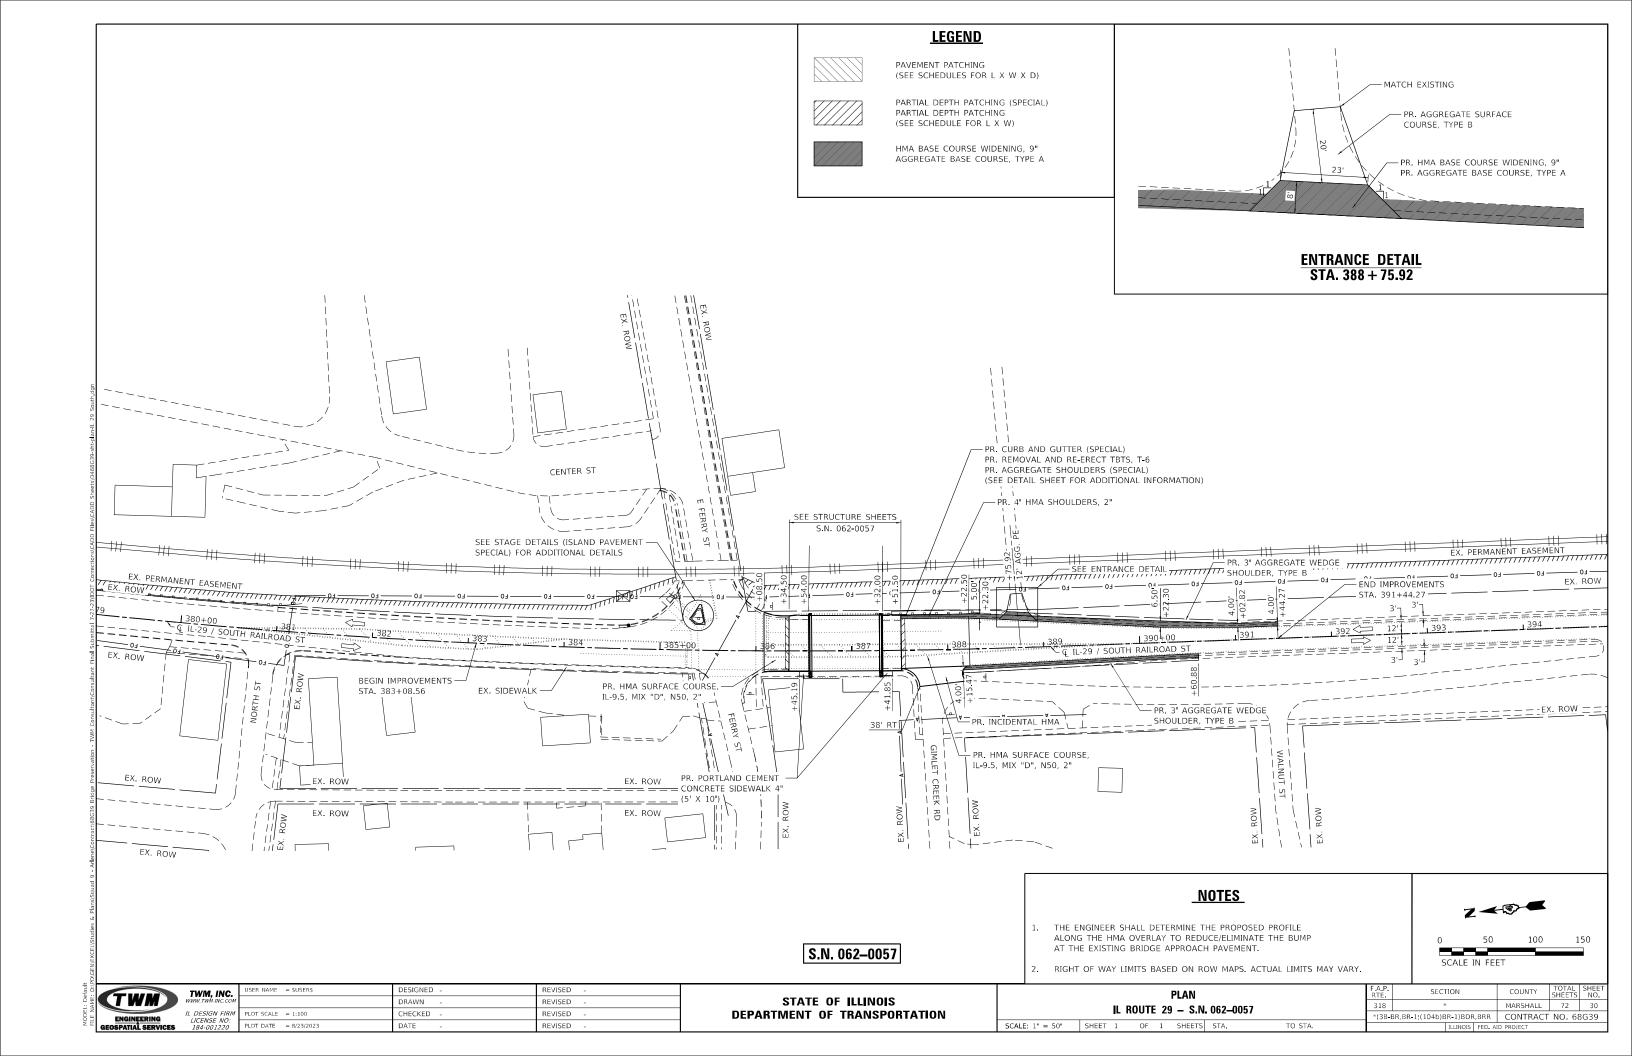

SUGGESTED STAGE CONSTRUCTION SEQUENCE

S.N. 062-0059 (IL 17)

PRE-STAGE

- 1. REMOVE EXISTING SHOULDERS.
- 2. WIDEN EXISTING ROADWAY FOR STAGE I AND II TRAFFIC.
- 3. RECONSTRUCT ENTRANCE.
- 4. PLACE AGGREGATE WEDGE SHOULDER ALONG PROPOSED WIDENING.
- 5. TRAFFIC CONTROL SHALL BE IN ACCORDANCE WITH STANDARD 701306 AND 701326.

STAGE I AND II

1. ALL OTHER WORK (SEE STAGING PLAN)

STAGE III

- 1. PATCH ROADWAY.
- 2. MILL EXISTING ROADWAY AND SHOULDERS FOR PROPOSED HMA RESURFACING.
- 3. HMA ROADWAY AND SHOULDER RESURFACING.
- 4. PLACE AGGREGATE SHOULDERS (SPECIAL).
- 5. TRAFFIC CONTROL SHALL BE IN ACCORDANCE WITH STANDARD 701201 AND 701306.

S.N. 062-0056 (IL 29)

PRE-STAGE

- 1. REMOVE EXISTING SHOULDERS.
- 2. WIDEN EXISTING ROADWAY FOR STAGE I AND II TRAFFIC.
- 3. PLACE AGGREGATE WEDGE SHOULDER ALONG PROPOSED WIDENING.
- 4. TRAFFIC CONTROL SHALL BE IN ACCORDANCE WITH STANDARD 701306 AND 701326.

STAGE I AND II

1. ALL OTHER WORK (SEE STAGING PLAN)

STAGE III

- 1 PATCH ROADWAY
- 2. MILL EXISTING ROADWAY AND SHOULDERS FOR PROPOSED HMA RESURFACING.
- 3. HMA ROADWAY AND SHOULDER RESURFACING.
- 4. PLACE AGGREGATE SHOULDERS (SPECIAL).
- 5. TRAFFIC CONTROL SHALL BE IN ACCORDANCE WITH STANDARD 701201 AND 701306.

S.N. 062-0057 (IL 29)

PRE-STAGE

- 1.REMOVE EXISTING SHOULDERS.
- 2.RECONSTRUCT ENTRANCE.
- 3. REMOVE EXISTING ISLAND AND REPLACE PAVEMENT PORTION.
- 4.PLACE AGGREGATE WEDGE SHOULDER ALONG PROPOSED WIDENING.
- 5.TRAFFIC CONTROL SHALL BE IN ACCORDANCE WITH STANDARD 701306 AND 701326.

STAGE I AND II

1. ALL OTHER WORK (SEE STAGING PLAN)

STAGE III

- 1.PATCH ROADWAY.
- 2, MILL EXISTING ROADWAY AND SHOULDERS FOR PROPOSED HMA RESURFACING.
- 3.HMA ROADWAY AND SHOULDER RESURFACING.
- 4. PLACE AGGREGATE SHOULDERS (SPECIAL).
- 5.RECONSTRUCT RAISED PORTION OF ISLAND.
- 6.TRAFFIC CONTROL SHALL BE IN ACCORDANCE WITH STANDARD 701501, 701502 AND 701701.


TWM, INC.


SER NAME = \$USER\$ DESIGNED REVISED DRAWN REVISED HECKED REVISED PLOT DATE = 8/23/2023 DATE REVISED


STATE OF ILLINOIS **DEPARTMENT OF TRANSPORTATION** SUGGESTED STAGE CONSTRUCTION SEQUENCE SHEET 1 OF 1 SHEETS STA.


SCALE:


COUNTY MARSHALL 72 31 *(3B-BR,BR-1;(104b)BR-1)BDR,BRR | CONTRACT NO. 68G39

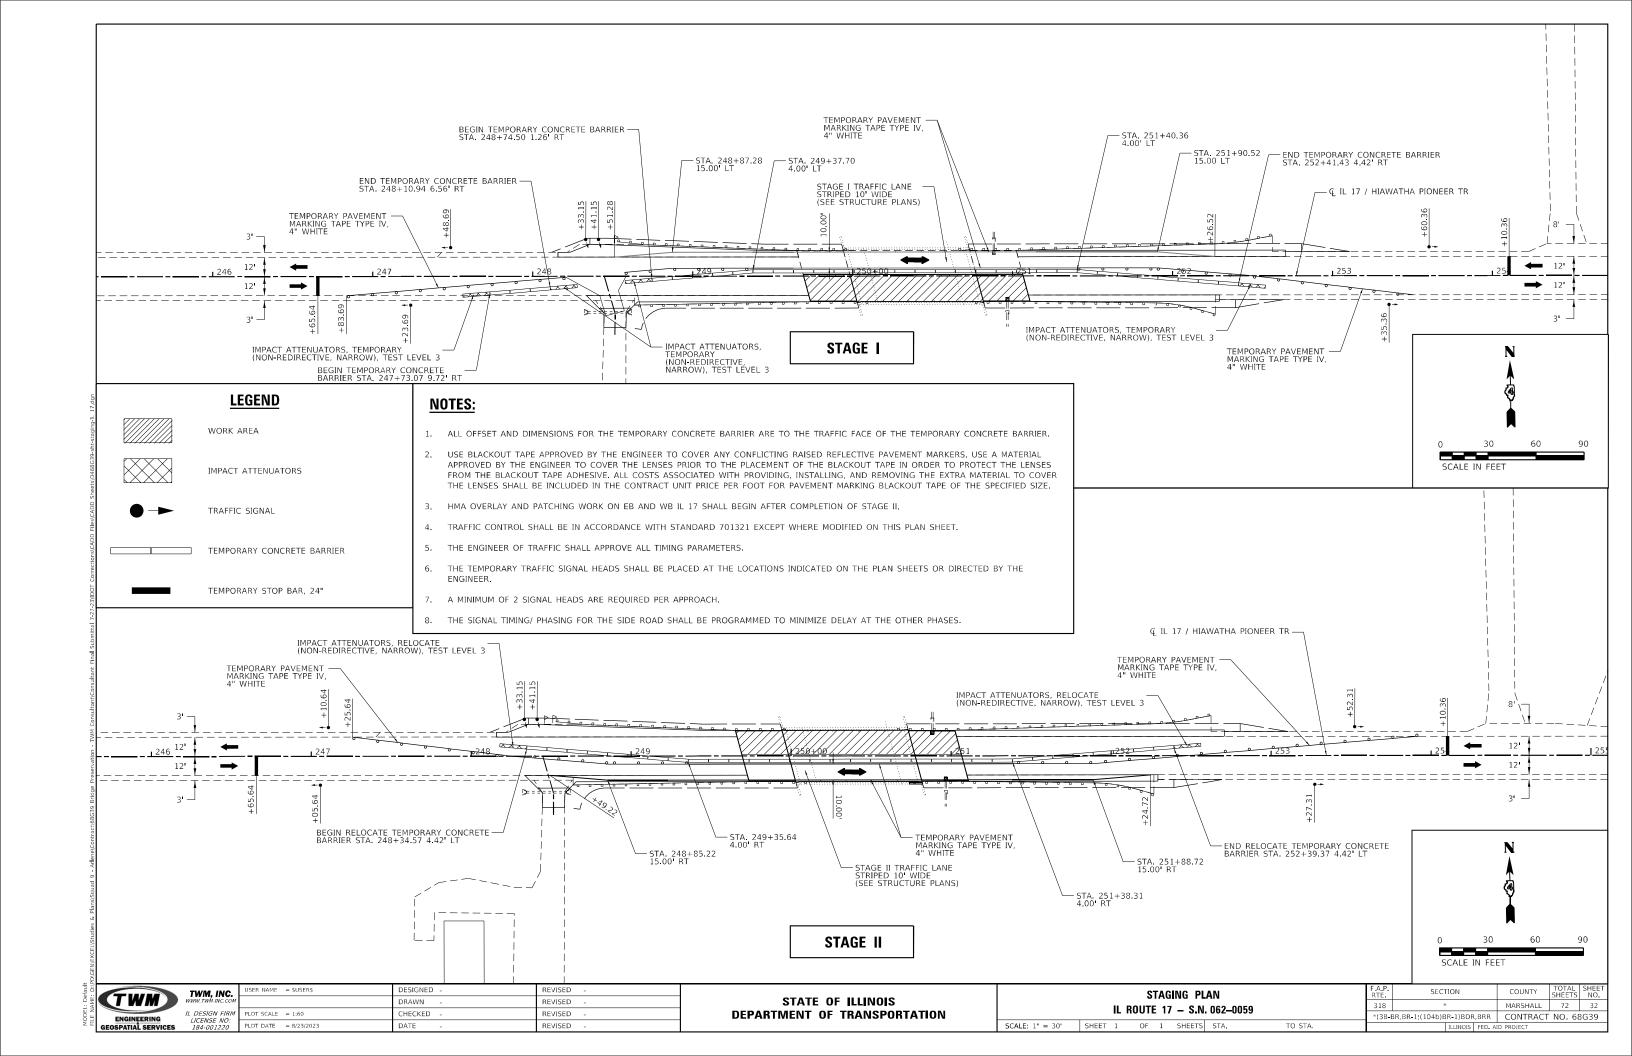


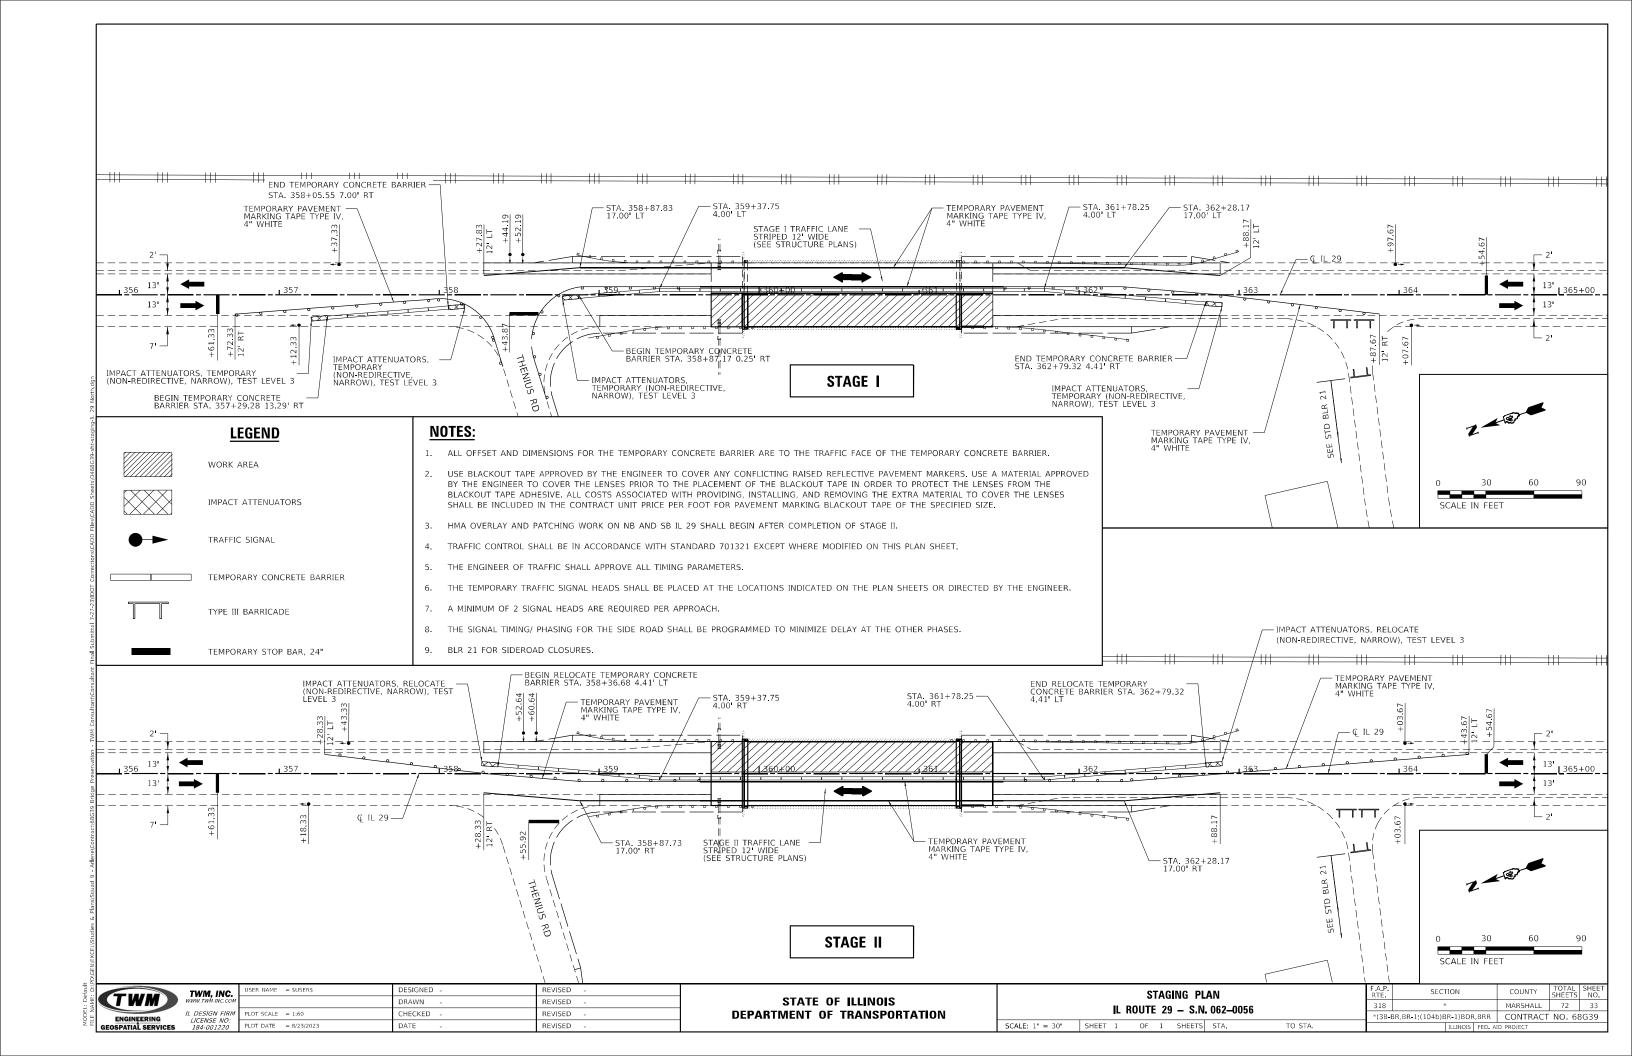

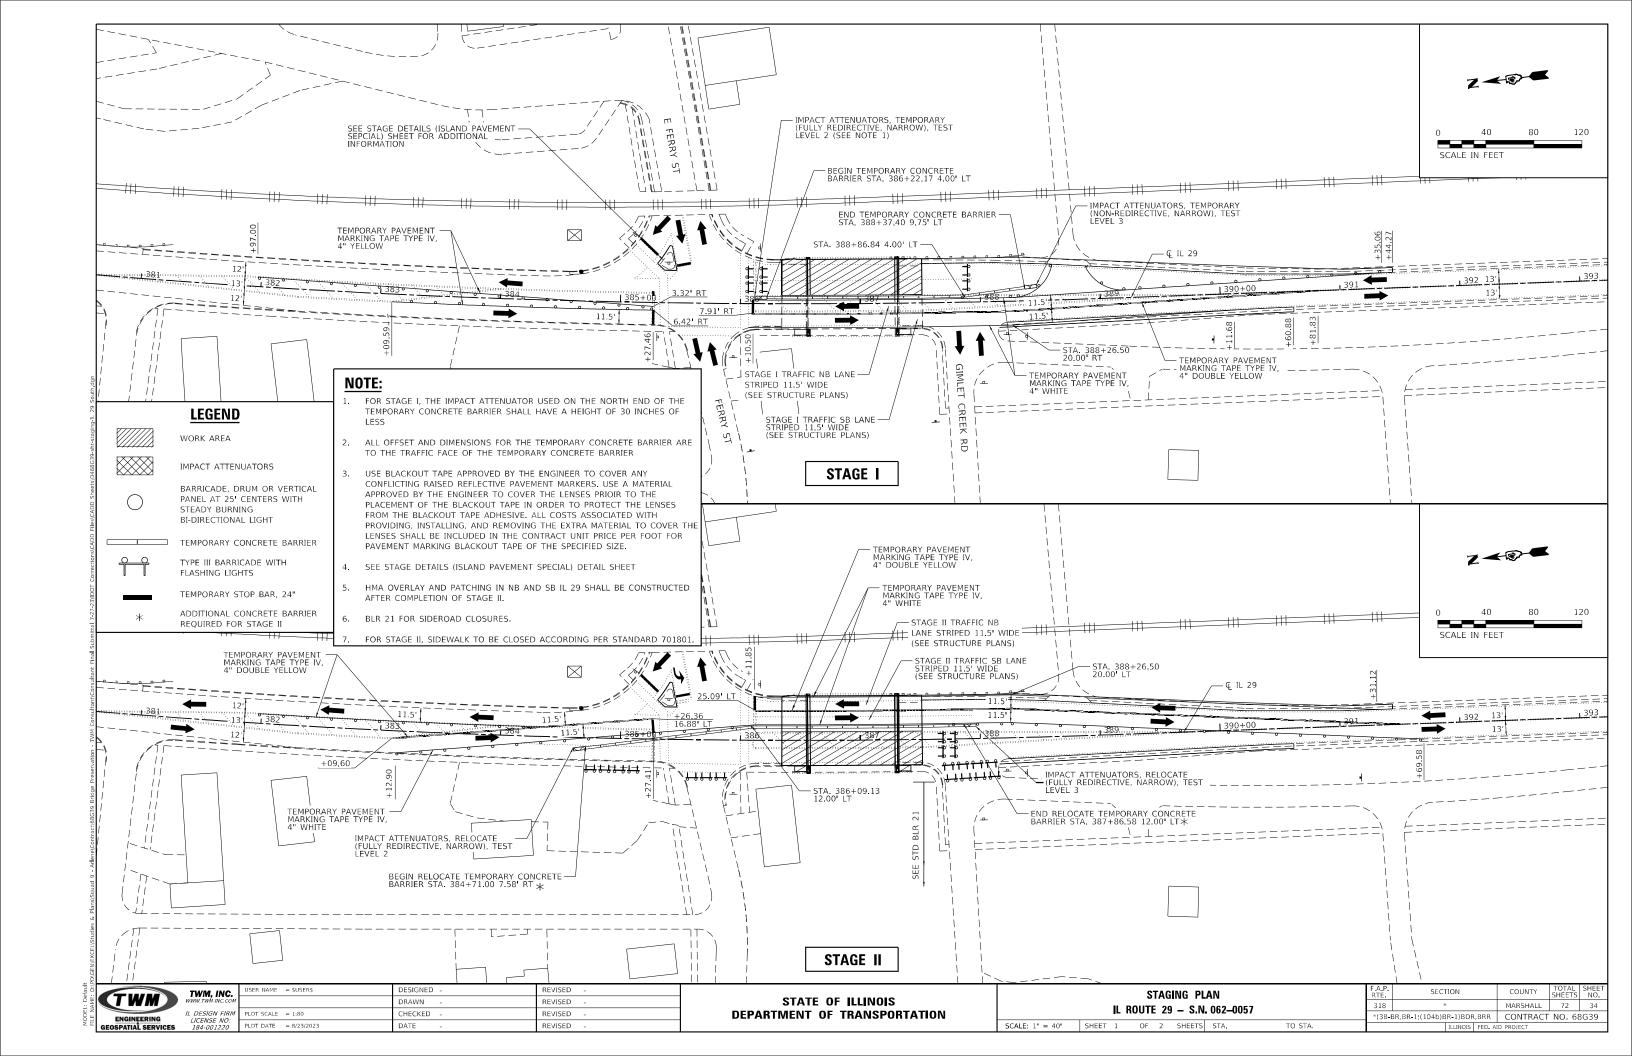

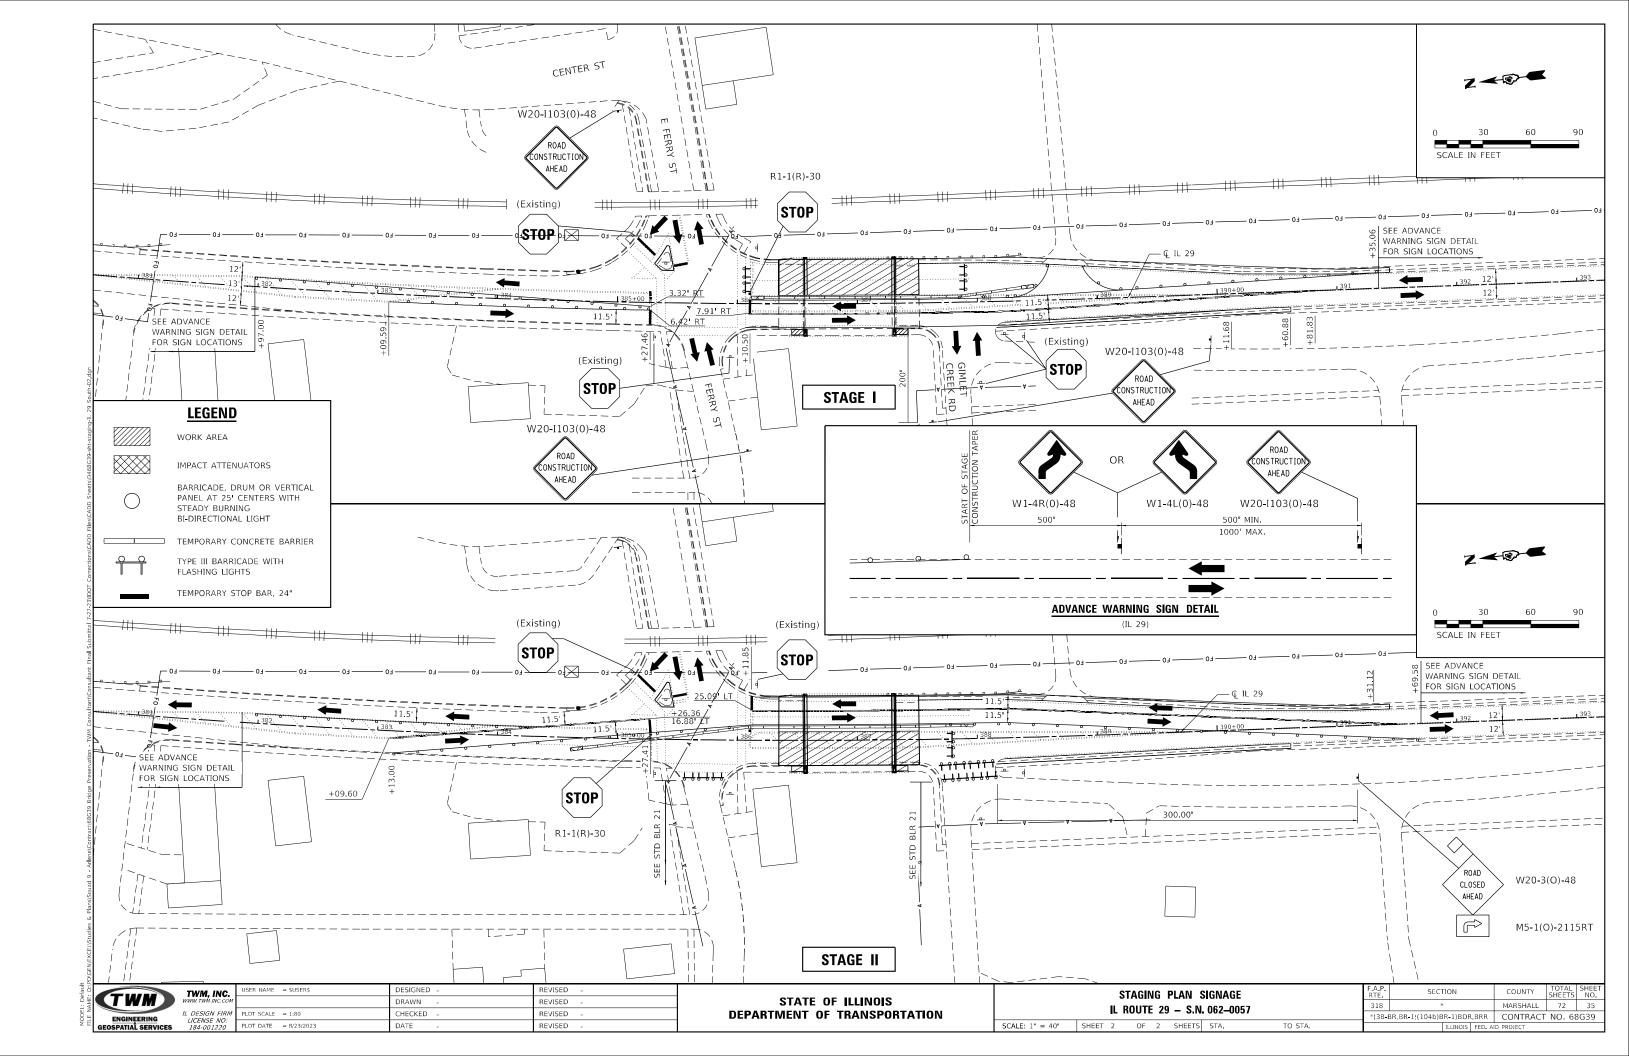

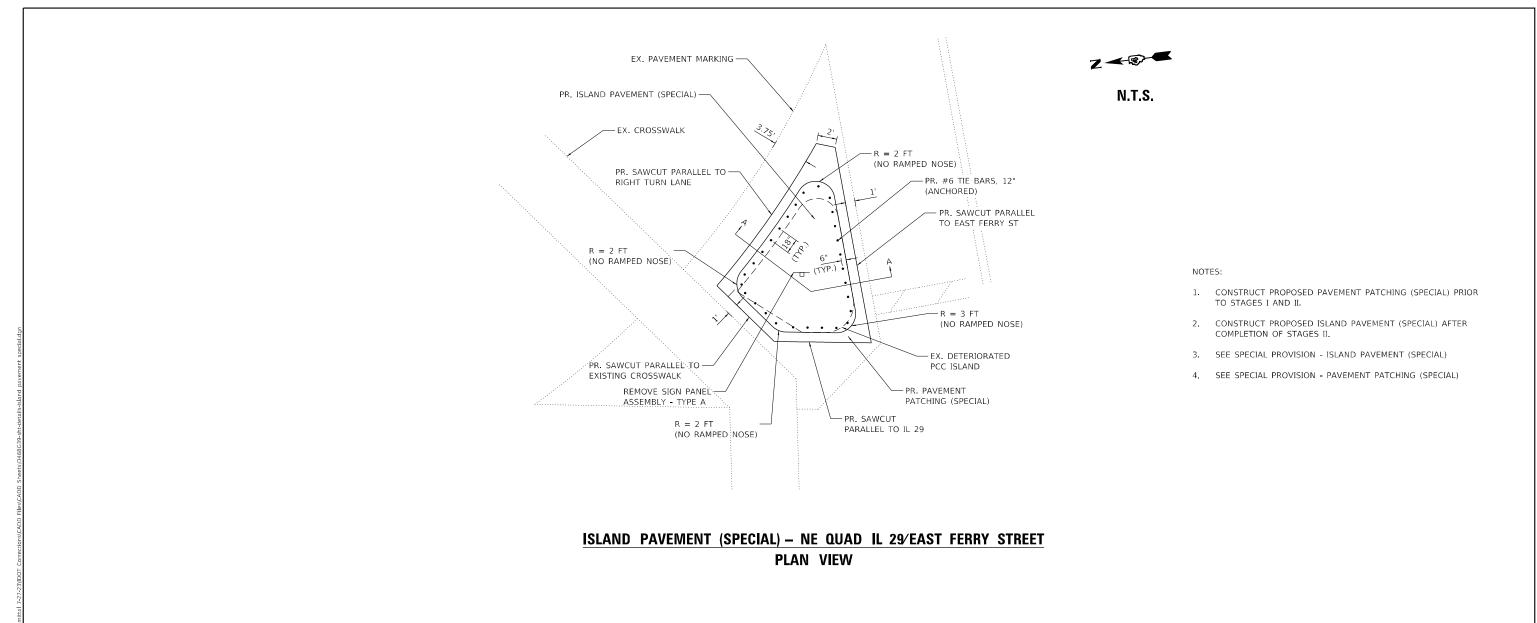

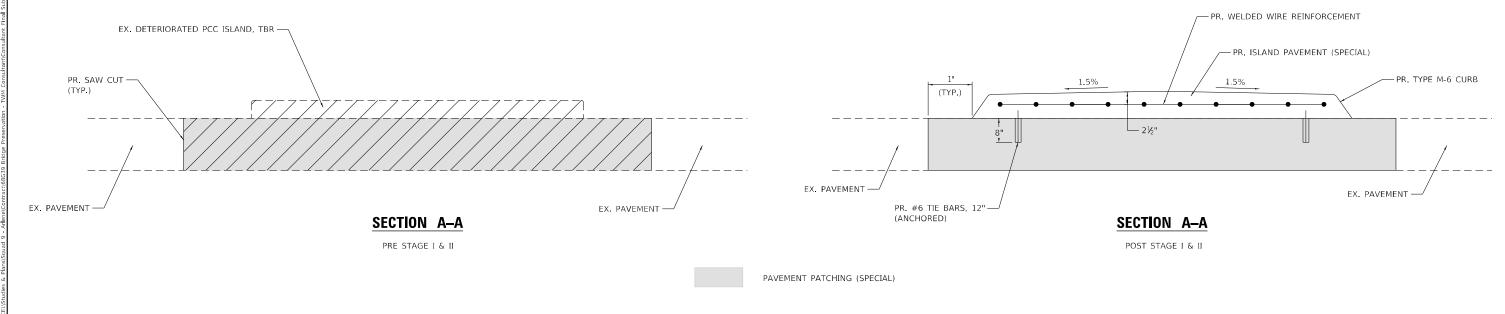

ENGINEERING GEOSPATIAL SERVICES

STATE OF ILLINOIS
DEPARTMENT OF TRANSPORTATION

SCALE: N.T.S.

STAGE DETAILS (ISLAND PAVEMENT SPECIAL)

IL ROUTE 29 - S.N. 062-0057

| SHEET 1 OF 1 SHEETS STA. TO STA.

$rac{3}{4}$ " Bridge Deck Scarification, $2rac{1}{4}$ " Microsilica Concrete Overlay to Bridge deck and approach slab

- Remove and Replace Parapet
- Protective Coat (Special) and Surface Filler (Special) applied to all surfaces of the parapets (See Parapet Sealing Detail on Sheet 2 of 4)
- $\langle D \rangle$ Stone Dumped Riprap, Class A4 (Special) in front of abutments and wingwalls.
- $\langle E \rangle$ HMA transitions to roadway. (See Roadway Plans for details)

GENERAL NOTES

Plan dimensions and details relative to existing plans are subject to nominal construction variations. The Contractor shall field verify existing dimensions and details affecting new construction and make necessary approved adjustments prior to construction or ordering of materials. Such variations shall not be cause for additional compensation for a change in scope of work, however, the Contractor will be paid for the quantity actually furnished at the unit price bid for the work.

Reinforcement bars designated (E) shall be epoxy coated. Existing reinforcement bars extending into the removal area shall be cleaned, straightened, and incorporated into the new construction. Any reinforcement bars that are damaged during concrete removal shall be replaced with an approved bar splicer or anchorage system. Cost included with Concrete Removal.

Synthetic fibers are not required for the Bridge Deck Microsilica Concrete Overlay.

INDEX OF SHEETS

- General Plan and Elevation
- Proposed Cross Section & Stage Construction Details
- Temporary Concrete Barrier
- Parapet Replacement Details

TOTAL BILL OF MATERIAL

ITEM	UNIT	SUPER	SUB	TOTAL
Stone Dumped Riprap, Class A4 (Special)	Ton	-	76	76
Concrete Removal	Cu. Yd.	0.8	-	0.8
Concrete Superstructure	Cu. Yd.	0.8	-	0.8
Bridge Deck Grooving	Sq. Yd.	463	-	463
Protective Coat	Sq. Yd.	494	-	494
Reinforcement Bars, Epoxy Coated	Pound	100	-	100
Surface Filler (Special)	Gallon	1.7	-	1.7
Protective Coat (Special)	Sq. Yd.	112	-	112
Bridge Deck Scarification, ¾"	Sq. Yd.	494	-	494
Bridge Deck Microsilica Concrete Overlay, 21/4"	Sq. Yd.	494	-	494
Apply to available and (Dridge C Appr Clab)	'			

Apply to overlay only. (Bridge & Appr. Slab)

DESIGN STRESSES

FIELD UNITS (New Const.)

f'c = 4,000 psi (Concrete Superstructure) fy = 60,000 psi (Reinforcement)



EXPIRES: 11/30/2024


TWM, INC. ENGINEERING LICENSE NO:
GEOSPATIAL SERVICES 184-001220

DESIGNED - CAJ REVISED JSER NAME = ckoltveit CHECKED - CDK REVISED . DRAWN REVISED PLOT DATE = 7/21/2023 CHECKED -CDK REVISED .

STATE OF ILLINOIS DEPARTMENT OF TRANSPORTATION GENERAL PLAN & ELEVATION
IL ROUTE 17 OVER SENACHWINE CREEK TRIBUTARY STRUCTURE NO. 062 - 0059 SHEET NO. 1 OF 4 SHEETS


COUNTY MARSHALL (3B-BR,BR-1;(104b)BR-1)BDR,BRR CONTRACT NO. 68G39 ILLINOIS FED. AID


^{**} Apply to parapets only. (Bridge)

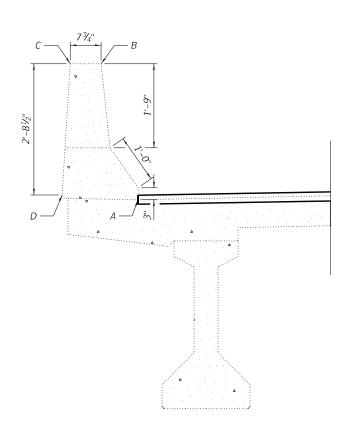

PARAPET SEALING DETAIL

Protective Coat (Special) to cover from Point A through Points B, C, and D of the existing Parapet

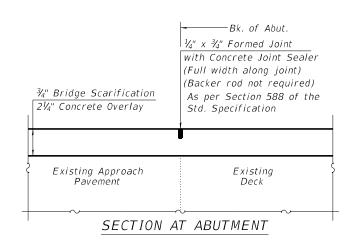

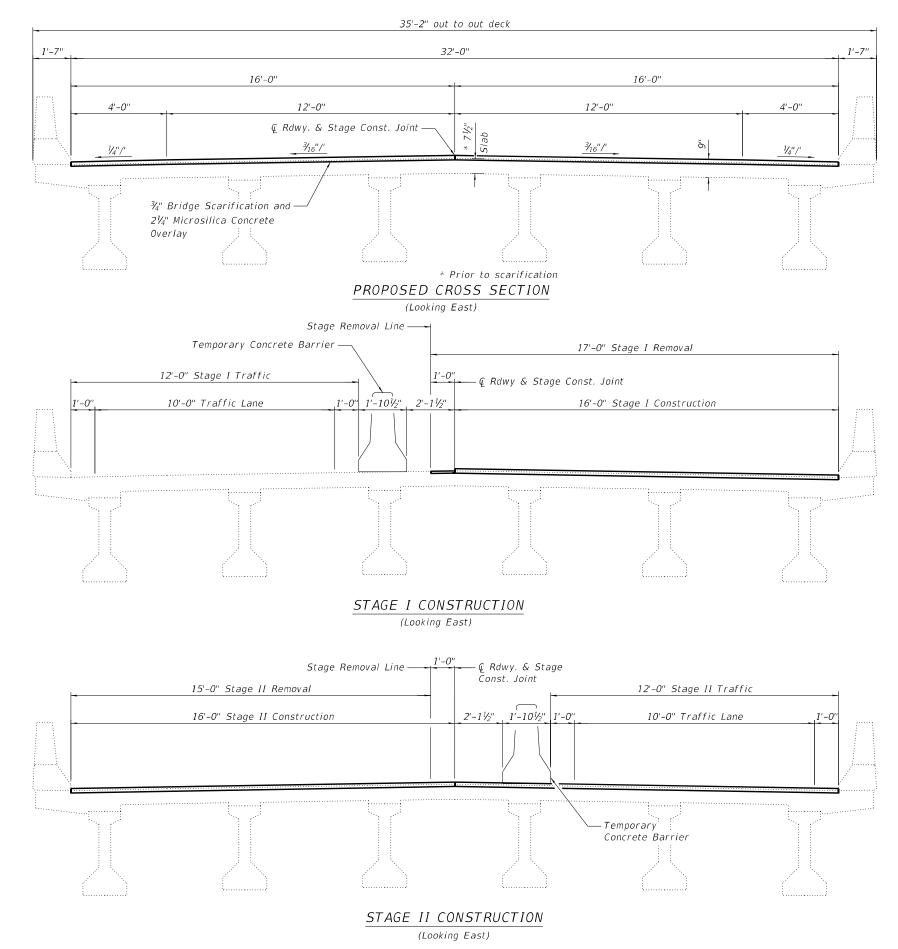


TWM, INC.

USER NAME = \$USER\$ LICENSE NO: 184-001220 PLOT DATE = \$DATE\$

DESIGNED - CAJ REVISED -CHECKED - CDK REVISED -DRAWN - CAJ REVISED CHECKED - CDK REVISED -

STATE OF ILLINOIS DEPARTMENT OF TRANSPORTATION PROPOSED CROSS SECTION & STAGE CONSTRUCTION DETAILS **STRUCTURE NO. 062 - 0059** SHEET NO. 2 OF 4 SHEETS

MARSHALL 72 38 * (3B-BR,BR-1;(104b)BR-1)BDR,BRR CONTRACT NO. 68G39

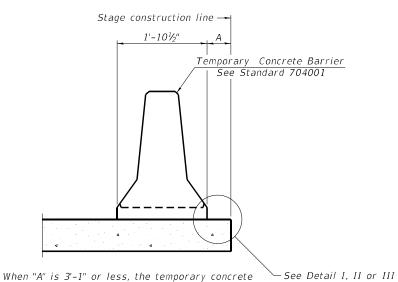

barrier shall be restrained to the new slab according to Detail I, II or III. No restraint is required when "A" is greater than 3'-1".

NEW SLAB OR NEW DECK BEAM

Temporary Concrete Barrier See Standard 704001 min. min. Drill 3-11/4" Ø Holes in existing slab for 1" Ø restraining pins. Traffic side only. Cost of restraining pins are included with Temporary Concrete Barrier. No restraint

* When hot-mix asphalt wearing surface is present, embedment shall be 3" plus the wearing surface depth.

├── Stage removal line


EXISTING DECK BEAM


– Ç ¾" Ø Holes

is required when "A" is greater than 3'-1". EXISTING SLAB

► Stage removal line

SECTIONS THRU SLAB OR DECK BEAM

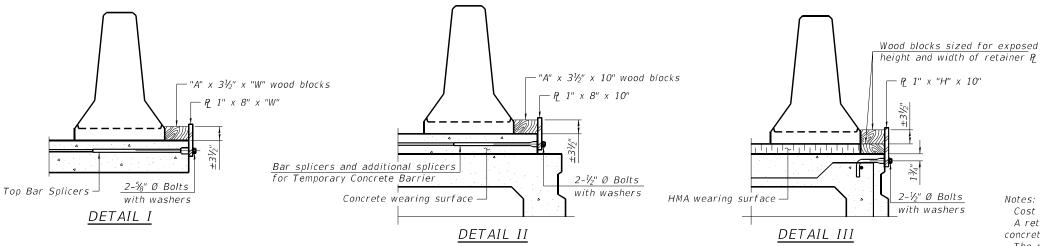

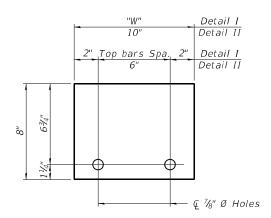


RAILING CRITERIA

NCHRP 350 Test Level

STEEL RETAINER P 1" x 8" x "W"

STEEL RETAINER P 1" x "H" x 10" (Detail III) (Detail I and II)

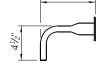

RESTRAINING PIN

BAR SPLICER FOR #4 BAR - DETAIL III

Cost of retainer assembly is included with Temporary Concrete Barrier. A retainer assembly shall be located at the approximate © of each temporary concrete barrier.

The retainer plate shall not be removed until the concrete on the adjacent stage is ready to be poured. For Detail III applications the retainer plate shall not be removed until just prior to placing the adjacent beam.

When the 'A' dimension is less than $1\frac{1}{2}$ ", the wood block shall be omitted and the barrier shall be placed in direct contact with the steel retainer plate. For deck beam applications the minimum required 'A' distance is 6" to accommodate the shear key clamping device.

Detail I - Installation for a new bridge deck or bridge slab.

US Std. 11/16" I.D. x 21/2" O.D. x approx. 8 gauge thick washer

1" Ø pin -

Detail II - Installation for a new deck beam with an initial concrete wearing surface. Additional bar splicers shall be provided at 6'-0" centers and paired with the bar splicers of the concrete wearing surface reinforcement to accommodate the installation of the retainer assemblies. The cost of the additional bar splicers is included with the concrete wearing surface.

Detail III - Installation for a new deck beam with no initial wearing surface or with an initial hot-mix asphalt (HMA) wearing surface present. The deck beam directly beneath the temporary concrete barrier shall be fabricated with bar splicer inserts in the side of the beam, as detailed, to accommodate the installation of the retainer assemblies. A pair of bar splicers, 6" apart, shall be placed at 6'-0" centers along the length of the beam. The cost of the bar splicers is included with the deck beam.


10-12-2021 USER NAME = \$USER\$ TWM, INC. DESIGNED - CAJ REVISED -CHECKED - CDK REVISED -CAJ REVISED LICENSE NO: 184-001220 PLOT DATE = 8/23/2023 CHECKED - CDK REVISED -

STATE OF ILLINOIS DEPARTMENT OF TRANSPORTATION

TEMPORARY CONCRETE BARRIER FOR STAGE CONSTRUCTION STRUCTURE NO. 062 - 0059 SHEET NO. 3 OF 4 SHEETS

MARSHALL + (3B-BR,BR-1;(104b)BR-1)BDR,BRR CONTRACT NO. 68G39

7∕16" Ø hole

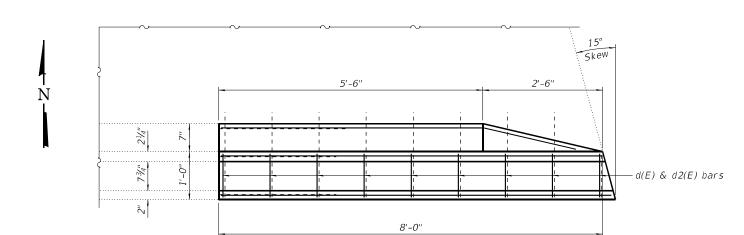

SECTION A-A

1 - #5 e1(E) bar each face — PARTIAL INSIDE ELEVATION OF PARAPET

3 - #4 e(E) bars each face

5'-6'' 10-#5 d(E) bars @ 11" cts. Inside Face


9-#4 d2(E) bars @ 12" cts. Outside Face

 $\triangleright B$

2'-8" min. lap

3'-0" min. lap

Note: Reinforcement extending into removed area shall be cleaned straightened and incorporated into the new construction.

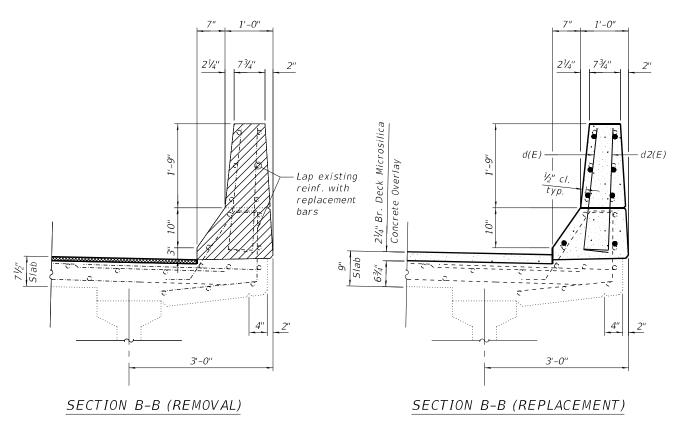

REVISED -

REVISED -

REVISED

REVISED -

BAR d(E) & d2(E)

10 #5 3'-0" d2(E) #4 3'-0" #4 e1(E) #5 7'-8" Concrete Superstructure 0.8 Concrete Removal Cu. Yd. 0.8 Reinforcement Bars, Pound 100 Epoxy Coated

SUPERSTRUCTURE

BILL OF MATERIAL

-Existing #8 bar E.F. to remain

1" min. thickness at edge of drain Edge of parapet DRAIN DETAIL * slope to drain



TWM, INC.


USER NAME = \$USER\$ DESIGNED - CAJ CHECKED - CDK DRAWN CAJ LICENSE NO: 184-001220 PLOT DATE = 8/23/2023 CHECKED - CDK

¾" Bridge Deck Scarification

Concrete Removal

STATE OF ILLINOIS DEPARTMENT OF TRANSPORTATION PARAPET REPLACEMENT DETAILS STRUCTURE NO. 062 - 0059 SHEET NO. 4 OF 4 SHEETS

MARSHALL 72 40 * (3B-BR,BR-1;(104b)BR-1)BDR,BRR CONTRACT NO. 68G39

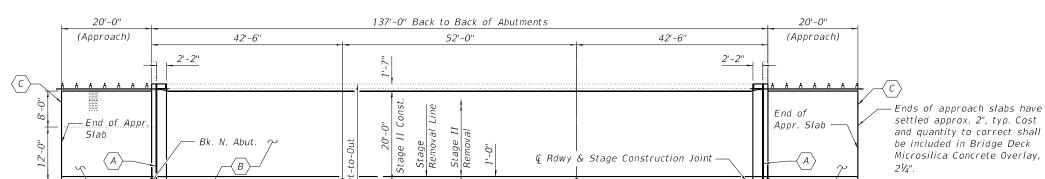

GENERAL NOTES

Plan dimensions and details relative to existing plans are subject to nominal construction variations. The Contractor shall field verify existing dimensions and details affecting new construction and make necessary approved adjustments prior to construction or ordering of materials. Such variations shall not be cause for additional compensation for a change in scope of work, however, the Contractor will be paid for the quantity actually furnished at the unit price bid for the work.

Reinforcement bars designated (E) shall be epoxy coated.

Prior to pouring new concrete, all heavy or loose rust, loose mill scale, and other loose or potentially detrimental foreign material shall be removed from the surfaces in contact with concrete. Tightly adhered paint may remain unless otherwise noted. Removal shall be accomplished by methods that will not damage the steel and the cost will be included in the pay item covering removal of existing concrete.

Existing reinforcement bars extending into the removal area shall be cleaned, straightened, and incorporated into the new construction. Any reinforcement bars that are damaged during concrete removal shall be replaced with an approved bar splicer or anchorage system. Cost included

Joint openings shall be adjusted according to Article 520.04 of the Std. Specs. when the deck is poured at an ambient temperature other than 50° F. Synthetic fibers are not required for the Bridge Deck Microsilica Concrete Overlay.

INDEX OF SHEETS

- General Plan and Elevation Proposed Cross Sections
- Stage Construction Details
- Temporary Concrete Barrier Abutment Joint Removal & Replacement Details
- Preformed Joint Strip Seal Bar Splicer Assembly Details

TOTAL BILL OF MATERIAL

ITEM	UNIT	SUPER	SUB	TOTAL
Concrete Removal	Cu. Yd.	11.7	-	11.7
Concrete Superstructure	Cu. Yd.	12.4	-	12.4
Bridge Deck Grooving	Sq. Yd.	744	-	744
Protective Coat	Sq. Yd.	791	-	791
Reinforcement Bars, Epoxy Coated	Pound	1640	-	1640
Bar Splicers	Each	24	-	24
Preformed Joint Strip Seal	Foot	84	-	84
Bridge Deck Scarification, ¾"	Sq. Yd.	759	-	759
Bridge Deck Microsilica	Sg. Yd.	759	_	759
Concrete Overlay, 21/4"	, , , , , , , , , , , , , , , , , , ,			

DESIGN STRESSES

FIELD UNITS (New Const.)

f'c = 4,000 psi (Concrete Superstructure) fy = 60,000 psi (Reinforcement)



A - Remove	and repla	ce expansion	joints	at	abutments
------------	-----------	--------------	--------	----	-----------

 $\langle B \rangle$ – $\frac{3}{4}$ " Bridge Deck Scarification, 2½" Microsilica Concrete Overlay to Bridge deck and approach slab

PLAN

 $\langle c \rangle$ - HMA transitions to roadway. (See Roadway Plans for details)

20'-0" Stage I Const.

Stage Const.

ENGINEERING LICENSE NO:
GEOSPATIAL SERVICES 184-001220

TWM, INC. JSER NAME = ckoltveit PLOT DATE = 7/20/2023

Fill inlet and cover

Overlay, typ. (See

Roadway Plans for filling inlet) —

with Microsilica

1'-0"

DESIGNED - CAJ REVISED . CHECKED - ALN/CDK REVISED -REVISED CHECKED - ALN/CDK REVISED -

STATE OF ILLINOIS DEPARTMENT OF TRANSPORTATION

-Ç Pier 2 Bk. S. Abut.

1'-0"

- See Roadway Plans


for Curb and


Gutter (Special)

GENERAL PLAN & ELEVATION IL ROUTE 29 OVER THENIUS CREEK **STRUCTURE NO. 062 - 0056** SHEET NO. 1 OF 8 SHEETS

Traffic Barrier

COUNTY MARSHALL * (3B-BR,BR-1;(104b)BR-1)BDR,BRR CONTRACT NO. 68G39 ILLINOIS FED. AID PROJECT

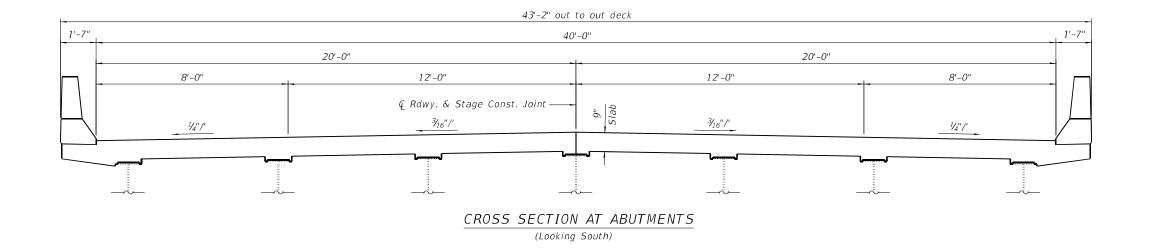

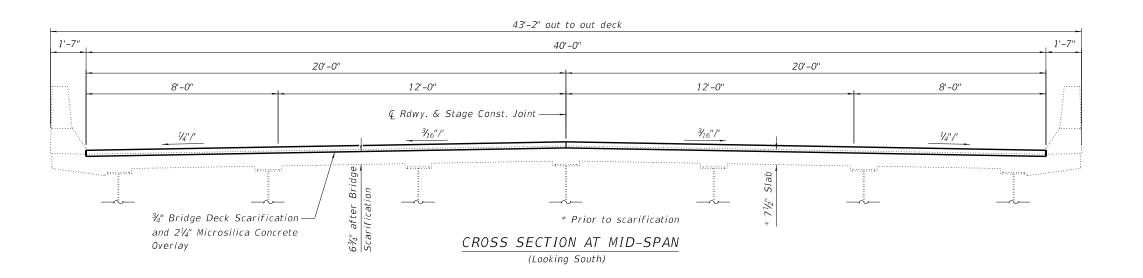

TWM, INC.

USER NAME = \$USER\$
 IL DESIGN FIRM
 PLOT SCALE
 =


 LICENSE NO:
 184-001220
 PLOT DATE
 =
 8/23/2023


DESIGNED - CAJ REVISED -CHECKED - CDK/ALN REVISED -DRAWN - CAJ REVISED -REVISED -CHECKED - CDK/ALN

STATE OF ILLINOIS **DEPARTMENT OF TRANSPORTATION** PROPOSED CROSS SECTIONS STRUCTURE NO. 062 - 0056 SHEET NO. 2 OF 8 SHEETS

COUNTY TOTAL SHEETS NO.

MARSHALL 72 42 *(3B-BR,BR-1;(104b)BR-1)BDR,BRR CONTRACT NO. 68G39 ILLINOIS FED. AID PROJECT

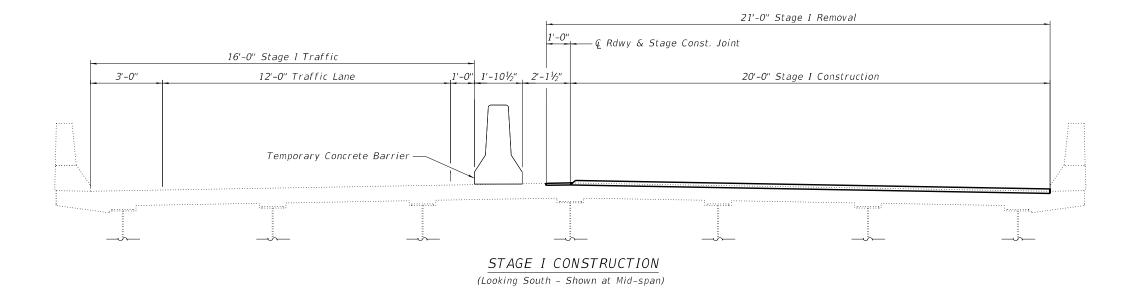

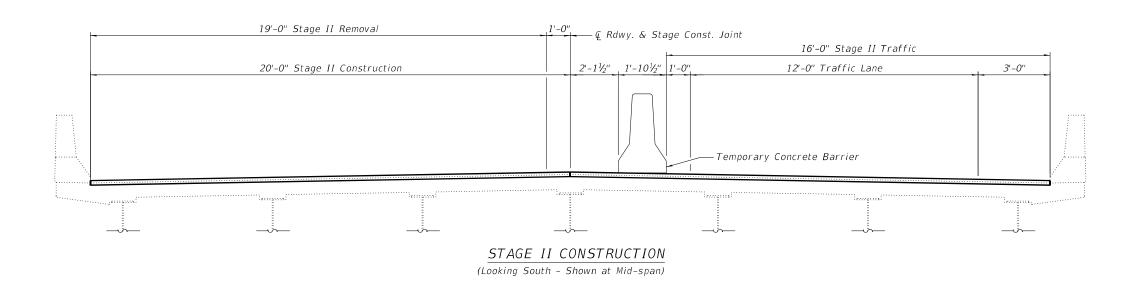

TWM, INC.

USER NAME = \$USER\$ LICENSE NO: 184-001220 PLOT DATE = 8/23/2023

DESIGNED - CAJ REVISED -CHECKED - ALN/CDK REVISED -DRAWN - CAJ REVISED -CHECKED - ALN/CDK REVISED -

STATE OF ILLINOIS **DEPARTMENT OF TRANSPORTATION** STAGE CONSTRUCTION DETAILS STRUCTURE NO. 062 - 0056 SHEET NO. 3 OF 8 SHEETS

COUNTY TOTAL SHEETS NO.

MARSHALL 72 43 *(3B-BR,BR-1;(104b)BR-1)BDR,BRR CONTRACT NO. 68G39 ILLINOIS FED. AID PROJECT

When "A" is 3'-1" or less, the temporary concrete — See Detail I, II or III barrier shall be restrained to the new slab according to Detail I, II or III. No restraint is required when "A" is greater than 3'-1".

NEW SLAB OR NEW DECK BEAM

— Stage removal line -Stage removal line 1'-101/2" 1'-101/2" Temporary Concrete Barrier See Standard 704001 min. min. Drill 3-11/4" Ø Holes in existing slab for 1" Ø restraining pins. Traffic side only. Cost of restraining pins are included with Temporary Concrete Barrier. No restraint


* When hot-mix asphalt wearing surface is present, embedment shall be 3" plus the wearing surface depth.


EXISTING DECK BEAM

SECTIONS THRU SLAB OR DECK BEAM

is required when "A" is greater than 3'-1".

EXISTING SLAB

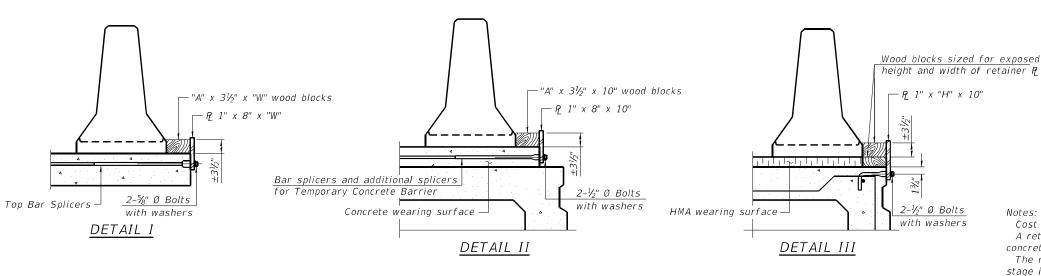

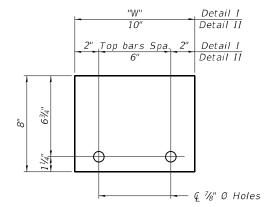


STEEL RETAINER P 1" x 8" x "W"

(Detail I and II)


RAILING CRITERIA

NCHRP 350 Test Level Railing Weight (plf) 440

R-27 10-12-2021

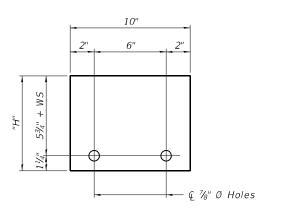

STEEL RETAINER P 1" x "H" x 10" (Detail III)

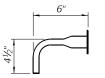

RESTRAINING PIN

BAR SPLICER FOR #4 BAR - DETAIL III

Notes:

Cost of retainer assembly is included with Temporary Concrete Barrier. A retainer assembly shall be located at the approximate Q of each temporary concrete barrier

The retainer plate shall not be removed until the concrete on the adjacent stage is ready to be poured. For Detail III applications the retainer plate shall not be removed until just prior to placing the adjacent beam.

1x8 UNC

US Std. 11/16" I.D. x 21/2" O.D. x approx. 8 gauge thick washer 7/₁₆" Ø hole


When the 'A' dimension is less than $1\frac{1}{2}$ ", the wood block shall be omitted and the barrier shall be placed in direct contact with the steel retainer plate. For deck beam applications the minimum required 'A' distance is 6" to accommodate the shear key clamping device.

- Detail I Installation for a new bridge deck or bridge slab.
- Detail II Installation for a new deck beam with an initial concrete wearing surface. Additional bar splicers shall be provided at 6'-0" centers and paired with the bar splicers of the concrete wearing surface reinforcement to accommodate the installation of the retainer assemblies. The cost of the additional bar splicers is included with the concrete wearing surface.
- Detail III Installation for a new deck beam with no initial wearing surface or with an initial hot-mix asphalt (HMA) wearing surface present. The deck beam directly beneath the temporary concrete barrier shall be fabricated with bar splicer inserts in the side of the beam, as detailed, to accommodate the installation of the retainer assemblies. A pair of bar splicers, 6" apart, shall be placed at 6'-0" centers along the length of the beam. The cost of the bar splicers is included with the deck beam.


USER NAME = \$USER\$ DESIGNED - CAJ TWM, INC. REVISED CHECKED - ALN/CDK REVISED -CAJ REVISED LICENSE NO: 184-001220 PLOT DATE = 8/23/2023 CHECKED - ALN/CDK REVISED -

STATE OF ILLINOIS DEPARTMENT OF TRANSPORTATION TEMPORARY CONCRETE BARRIER FOR STAGE CONSTRUCTION STRUCTURE NO. 062 - 0056 SHEET NO. 4 OF 8 SHEETS


COUNTY MARSHALL 72 44 *(3B-BR,BR-1;(104b)BR-1)BDR,BRR CONTRACT NO. 68G39 ILLINOIS FED. AID PROJECT

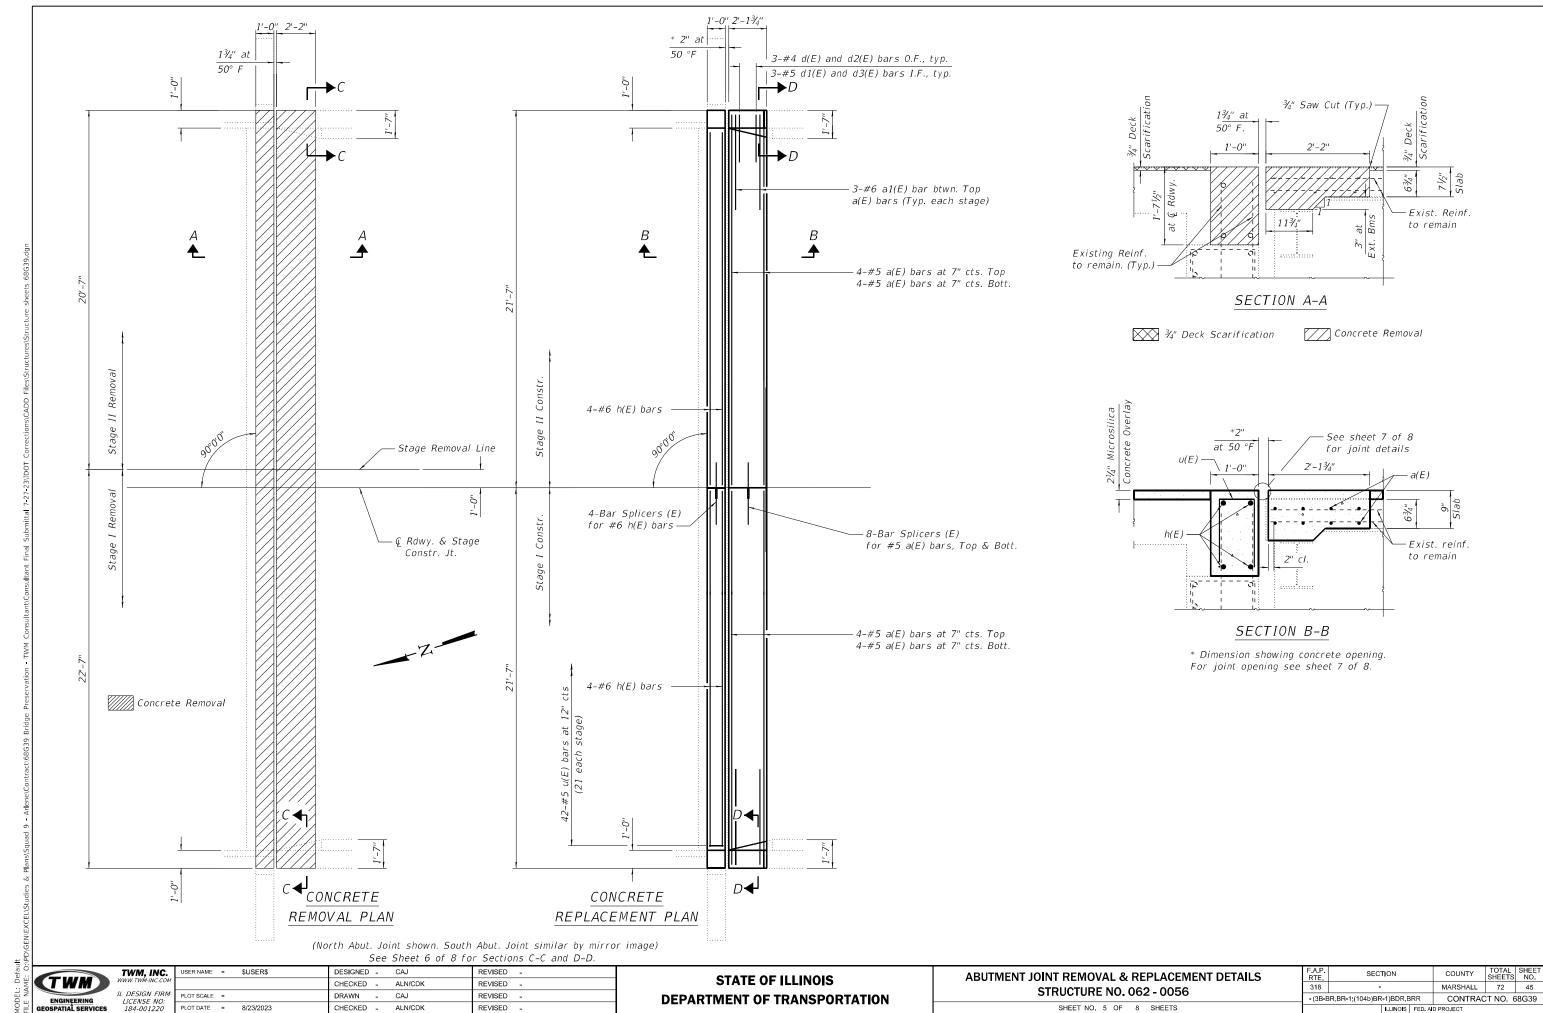


8/23/2023 10:52:52 AM

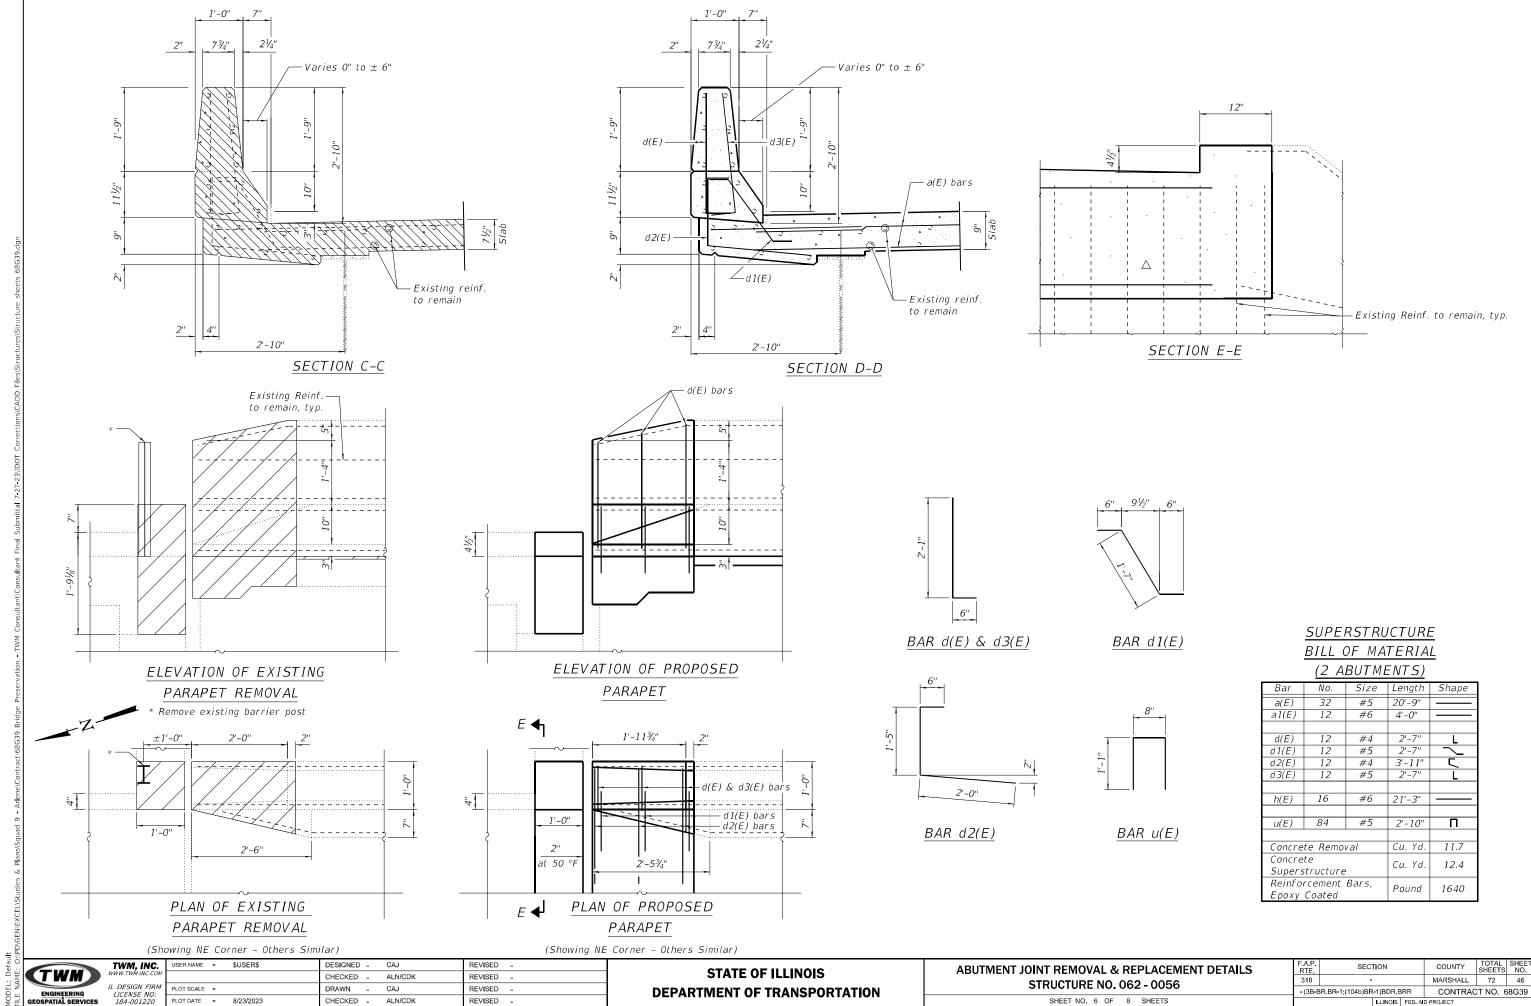

8/23/2023 10:52:53 A

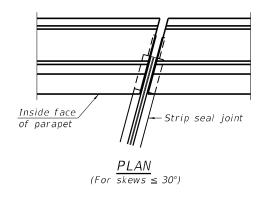

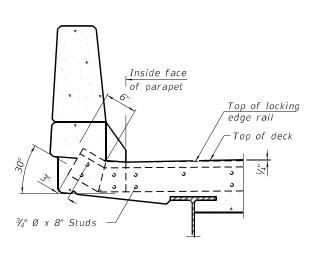

PARAPET ELEVATION AT ABUTMENTS

The strip seal shall be made continuous and shall have a minimum thickness of $\frac{1}{4}$ ". The configuration of the strip seal shall match the configuration of the Locking Edge Rails. Open or "webbed" strip seal gland configurations are not permitted. The gland shall be sized for a maximum rated movement of 4 inches.


The Locking Edge Rails depicted are conceptual only, except for the minimum dimensions shown. The actual configuration of the Locking Edge Rails and matching strip seal may vary from manufacturer to manufacturer. Flanged edge rails will not be allowed.

The manufacturer's recommended installation methods shall be followed.

The joint opening and deck dimensions detailed on the superstructure are based on a rolled rail expansion joint. If the Contractor elects to use the welded rail expansion joint, the opening and deck dimensions shall be modified according to the dimensions detailed on this sheet. Required modifications shall be made at no additional cost to the State.

All steel components shall be galvanized after fabrication according to Article 520.03 of the Standard Specifications.

Maximum space between rail segments shall be $\frac{3}{16}$ ", sealed with a suitable sealant. Joints in rails within 10 ft. of curbs shall be welded.

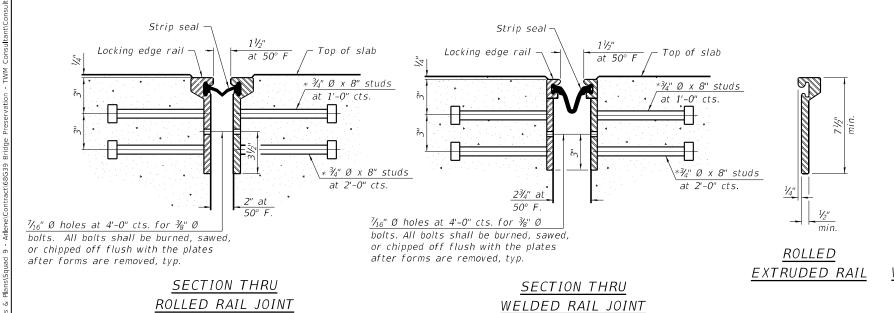

REVISED -

REVISED -

REVISED -

REVISED

* Granular or solid flux filled headed studs conforming to Article 1006.32

 $of \ the \ Std. \ Specs., \ automatically$

end welded.

Grind Flush Omit seal

*** Back gouge not required if complete joint penetration is verified by mock-up.

WELDED RAIL

LOCKING EDGE RAIL SPLICE

The inside of the locking edge rail groove shall be free of weld residue.

Rolled rail shown, welded rail similar.

LOCKING EDGE RAILS

BILL OF MATERIAL

Item	Unit	Total
Preformed Joint Strip Seal	Foot	84

TWM, INC. LICENSE NO: 184-001220

USER NAME = \$USER\$ DESIGNED - CAJ CHECKED - ALN/CDK CAJ PLOT DATE = 8/23/2023 CHECKED - ALN/CDK

STATE OF ILLINOIS DEPARTMENT OF TRANSPORTATION PREFORMED JOINT STRIP SEAL STRUCTURE NO. 062 - 0056 SHEET NO. 7 OF 8 SHEETS

COUNTY 72 47 MARSHALL * (3B-BR,BR-1;(104b)BR-1)BDR,BRR CONTRACT NO. 68G39


STANDARD BAR SPLICER ASSEMBLY PLAN

(All components shall be provided from one supplier)

Threaded splicer bar length = min. lap length + $1\frac{1}{2}$ " + thread length

* Epoxy not required on Bar Splicer Assembly components used in conjunction with black bars.


Location	Bar size	No. assemblies required	Minimum Iap length
Bridge Deck	#5	16	3'-6"
Hatch Block	#6	8	4'-0"

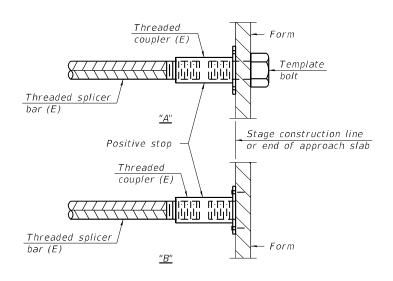

INSTALLATION AND SETTING METHODS

"A": Set bar splicer assembly by means of a template bolt"B": Set bar splicer assembly by nailing to wood forms or cementing to steel forms.

(E): Indicates epoxy coating.

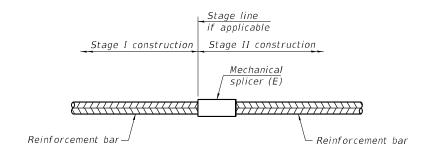

STANDARD MECHANICAL SPLICER

Location	Bar size	No. assemblies required

Notes:

Splicer bars shall be deformed with threaded ends and have a minimum 60 ksi yield strength.

All reinforcement shall be lapped and tied to the splicer bars.

Bar splicer assemblies shall be epoxy coated according to the requirements for reinforcement bars. See Section 508 of the Standard Specifications. See approved list of bar splicer assemblies and mechanical splicers for alternatives.

BSD-1

1-1-2020

5	
ANIE:	TWM
5	ENGINEERING

TWM, INC.	USER NAME = \$USER\$	DESIGNED - CAJ	REVISED -
WWW.TWM-INC.COM		CHECKED - ALN/CDK	REVISED -
IL DESIGN FIRM LICENSE NO:	PLOT SCALE =	DRAWN - CAJ	REVISED -
184-001220	PLOT DATE = 8/23/2023	CHECKED - ALN/CDK	REVISED -

GENERAL NOTES

Plan dimensions and details relative to existing plans are subject to nominal construction variations. The Contractor shall field verify existing dimensions and details affecting new construction and make necessary approved adjustments prior to construction or ordering of materials. Such variations shall not be cause for additional compensation for a change in scope of work, however, the Contractor will be paid for the quantity actually furnished at the unit price bid for the work.

Reinforcement bars designated (E) shall be epoxy coated.

Prior to pouring new concrete, all heavy or loose rust, loose mill scale and other loose or potentially detrimental foreign material shall be removed from the surfaces in contact with concrete. Tightly adhered paint may remain unless otherwise noted. Removal shall be accomplished by methods that will not damage the steel and the cost will be included in the pay item covering removal of existing concrete.

Existing reinforcement bars extending into the removal area shall be cleaned, straightened, and incorporated into the new construction. Any reinforcement bars that are damaged during concrete removal shall be replaced with an approved bar splicer or anchorage system. Cost included

The N. Abutment joint opening shall be adjusted according to Article 520.04 of the Std. Specs. when the deck is poured at an ambient temperature

Synthetic fibers are not required for the Bridge Deck Microsilica Concrete Overlay.

INDEX OF SHEETS

- General Plan and Elevation
- Proposed Cross Sections
- Stage Construction Details
- Temporary Concrete Barrier
- Abutment Joint Removal & Replacement Details
- Preformed Joint Strip Seal Sidewalk
- Bar Splicer Assembly Details

DESIGN STRESSES

FIELD UNITS (New Const.)

f'c = 4,000 psi (Concrete Superstructure) fy = 60,000 psi (Reinforcement)

TOTAL BILL OF MATERIAL

ITEM	UNIT	SUPER	SUB	TOTAL
Concrete Removal	Cu. Yd.	16.7	-	16.7
Concrete Superstructure	Cu. Yd.	18.2	-	18.2
Bridge Deck Grooving	Sq. Yd.	722	-	722
Protective Coat	Sq. Yd.	761	-	761
Reinforcement Bars, Epoxy Coated	Pound	2520	-	2520
Bar Splicers	Each	24	-	24
Preformed Joint Strip Seal	Foot	128	-	128
Bridge Deck Scarification, ¾"	Sq. Yd.	714	-	714
Bridge Deck Microsilica Concrete Overlay, 21/4"	Sq. Yd.	714	-	714

*Protective Coat shall be applied to all new concrete superstructure and all new concrete overlays as specified in Article 503.19 of the Standard Specifications




EXPIRES: 11/30/2024


DESIGNED - CAJ JSER NAME = ckoltveit REVISED TWM, INC. CHECKED - ALN/CDK REVISED . REVISED ENGINEERING LICENSE NO:
GEOSPATIAL SERVICES 184-001220 PLOT DATE = 7/20/2023 CHECKED - ALN/CDK REVISED .

STATE OF ILLINOIS DEPARTMENT OF TRANSPORTATION

GENERAL PLAN & ELEVATION IL ROUTE 29 OVER GIMLET CREEK STRUCTURE NO. 062 - 0057 SHEET NO. 1 OF 9 SHEETS

COUNTY MARSHALL (3B-BR,BR-1;(104b)BR-1)BDR,BRR CONTRACT NO. 68G39

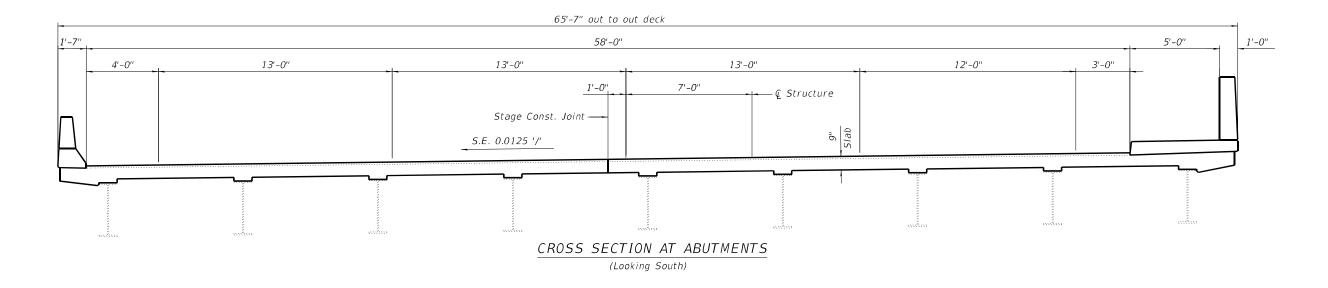

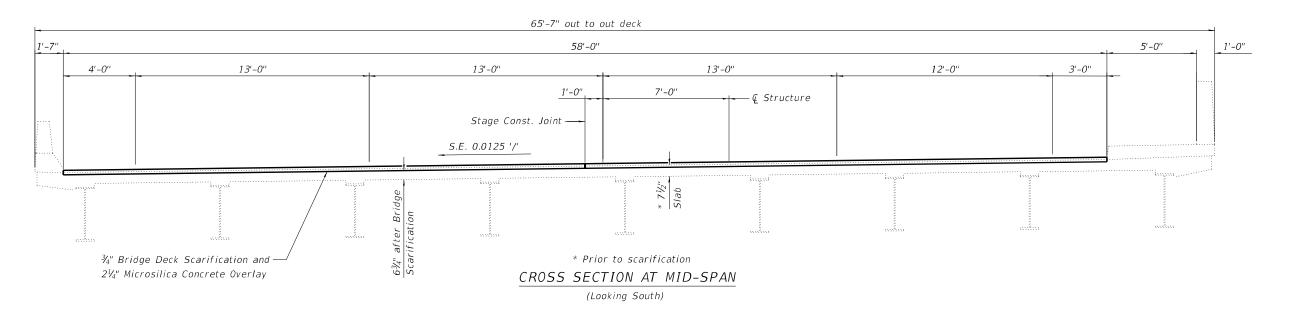

TWM, INC.

USER NAME = \$USER\$ DESIGNED - CAJ CHECKED - ALN/CDK DRAWN - CAJ CHECKED - ALN/CDK REVISED -

REVISED -


REVISED -

REVISED -

STATE OF ILLINOIS **DEPARTMENT OF TRANSPORTATION** PROPOSED CROSS SECTIONS STRUCTURE NO. 062 - 0057 SHEET NO. 2 OF 9 SHEETS


COUNTY TOTAL SHEETS NO.

MARSHALL 72 50 * (3B-BR,BR-1;(104b)BR-1)BDR,BRR CONTRACT NO. 68G39

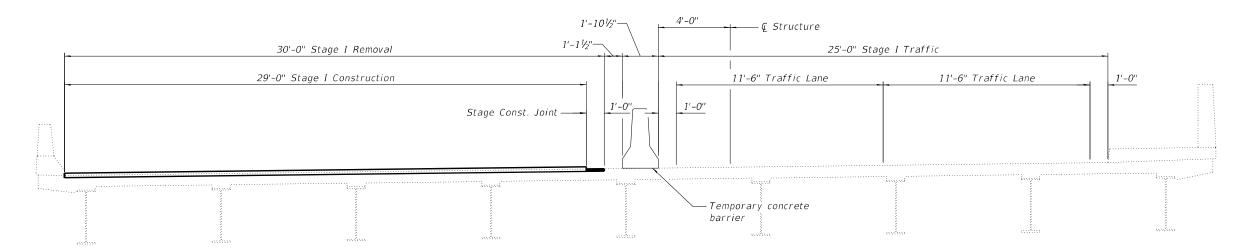

STAGE I CONSTRUCTION

(Looking South - Shown at Mid-Span)

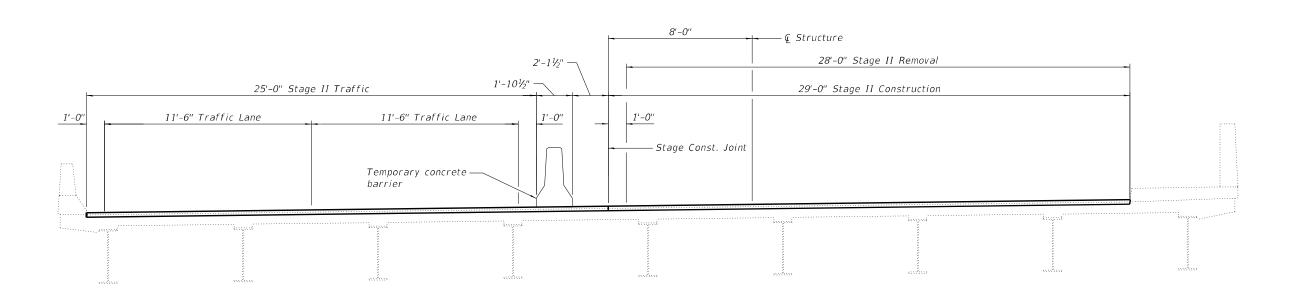

STAGE II CONSTRUCTION


(Looking South - Shown at Mid-Span)

TWW	и
	IL
GEOSPATIAL SERVICES	
	ENGINEERING GEOSPATIAL SERVICES

	TWM, INC.	-
)	WWW.TWM-INC.COM	
	IL DESIGN FIRM LICENSE NO:	Г
	184-001220	-

F.A.P. RTE	SECTION		COUNTY	TOTAL SHEETS	SHEET NO.
318	*		MARSHALL	72	51
* (3B-BR,BR-1;(104b)BR-1)BDR,BRR			CONTRAC	T NO. 6	8G39
	ILLINOIS	FED. All	D PROJECT		

8/23/2023 10:52:56 AM

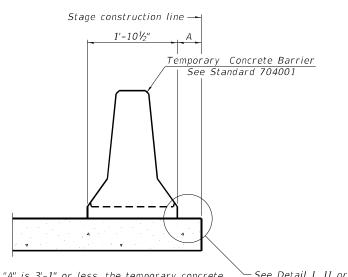

- See Detail I, II or III When "A" is 3'-1" or less, the temporary concrete barrier shall be restrained to the new slab according to Detail I, II or III. No restraint is required when "A" is greater than 3'-1".

1'-101/2" Temporary Concrete Barrier See Standard 704001 6' min. min. Drill 3-11/4" Ø Holes in existing slab for 1" Ø restraining pins. Traffic side only. Cost of restraining pins are included with Temporary Concrete Barrier. No restraint is required when "A" is greater than 3'-1".

* When hot-mix asphalt wearing surface is present, embedment shall be 3" plus the wearing surface depth.

→ Stage removal line


EXISTING DECK BEAM


NEW SLAB OR NEW DECK BEAM

SECTIONS THRU SLAB OR DECK BEAM

Stage removal line

EXISTING SLAB

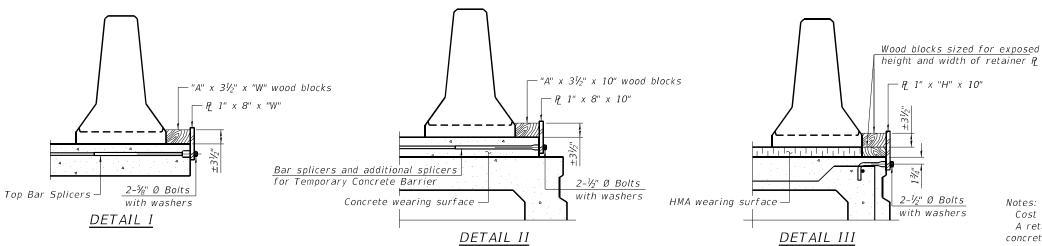

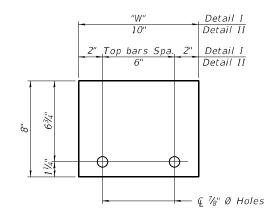


STEEL RETAINER P 1" x 8" x "W"


(Detail I and II)

RAILING CRITERIA

NCHRP 350 Test Level Railing Weight (plf)

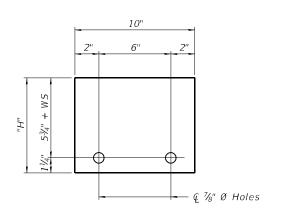

STEEL RETAINER P 1" x "H" x 10" (Detail III)

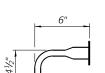

RESTRAINING PIN

BAR SPLICER FOR #4 BAR - DETAIL III

Cost of retainer assembly is included with Temporary Concrete Barrier. A retainer assembly shall be located at the approximate \cite{Q} of each temporary

1x8 UNC

US Std. 11/16" I.D. x 21/2" O.D. x approx. 8 gauge thick washer

The retainer plate shall not be removed until the concrete on the adjacent stage is ready to be poured. For Detail III applications the retainer plate shall not be removed until just prior to placing the adjacent beam.

When the 'A' dimension is less than $1\frac{1}{2}$ ", the wood block shall be omitted and the barrier shall be placed in direct contact with the steel retainer plate. For deck beam applications the minimum required 'A' distance is 6" to accommodate the shear key clamping device.


- Detail I Installation for a new bridge deck or bridge slab.
- Detail II Installation for a new deck beam with an initial concrete wearing surface. Additional bar splicers shall be provided at 6'-0" centers and paired with the bar splicers of the concrete wearing surface reinforcement to accommodate the installation of the retainer assemblies. The cost of the additional bar splicers is included with the concrete
- Detail III Installation for a new deck beam with no initial wearing surface or with an initial hot-mix asphalt (HMA) wearing surface present. The deck beam directly beneath the temporary concrete barrier shall be fabricated with bar splicer inserts in the side of the beam, as detailed, to accommodate the installation of the retainer assemblies. A pair of bar splicers, 6" apart, shall be placed at 6'-0" centers along the length of the beam. The cost of the bar splicers is included with the deck beam.

R-27


10-12-2021 USER NAME = \$USER\$ TWM, INC. DESIGNED - CAJ REVISED . CHECKED - CDK REVISED . CAJ REVISED LICENSE NO: 184-001220 PLOT DATE = 8/23/2023 CHECKED - CDK REVISED .

STATE OF ILLINOIS DEPARTMENT OF TRANSPORTATION TEMPORARY CONCRETE BARRIER FOR STAGE CONSTRUCTION STRUCTURE NO. 062 - 0057 SHEET NO. 4 OF 9 SHEETS

COUNTY MARSHALL 72 52 * (3B-BR,BR-1;(104b)BR-1)BDR,BRR CONTRACT NO. 68G39 ILLINOIS FED. AID PROJECT

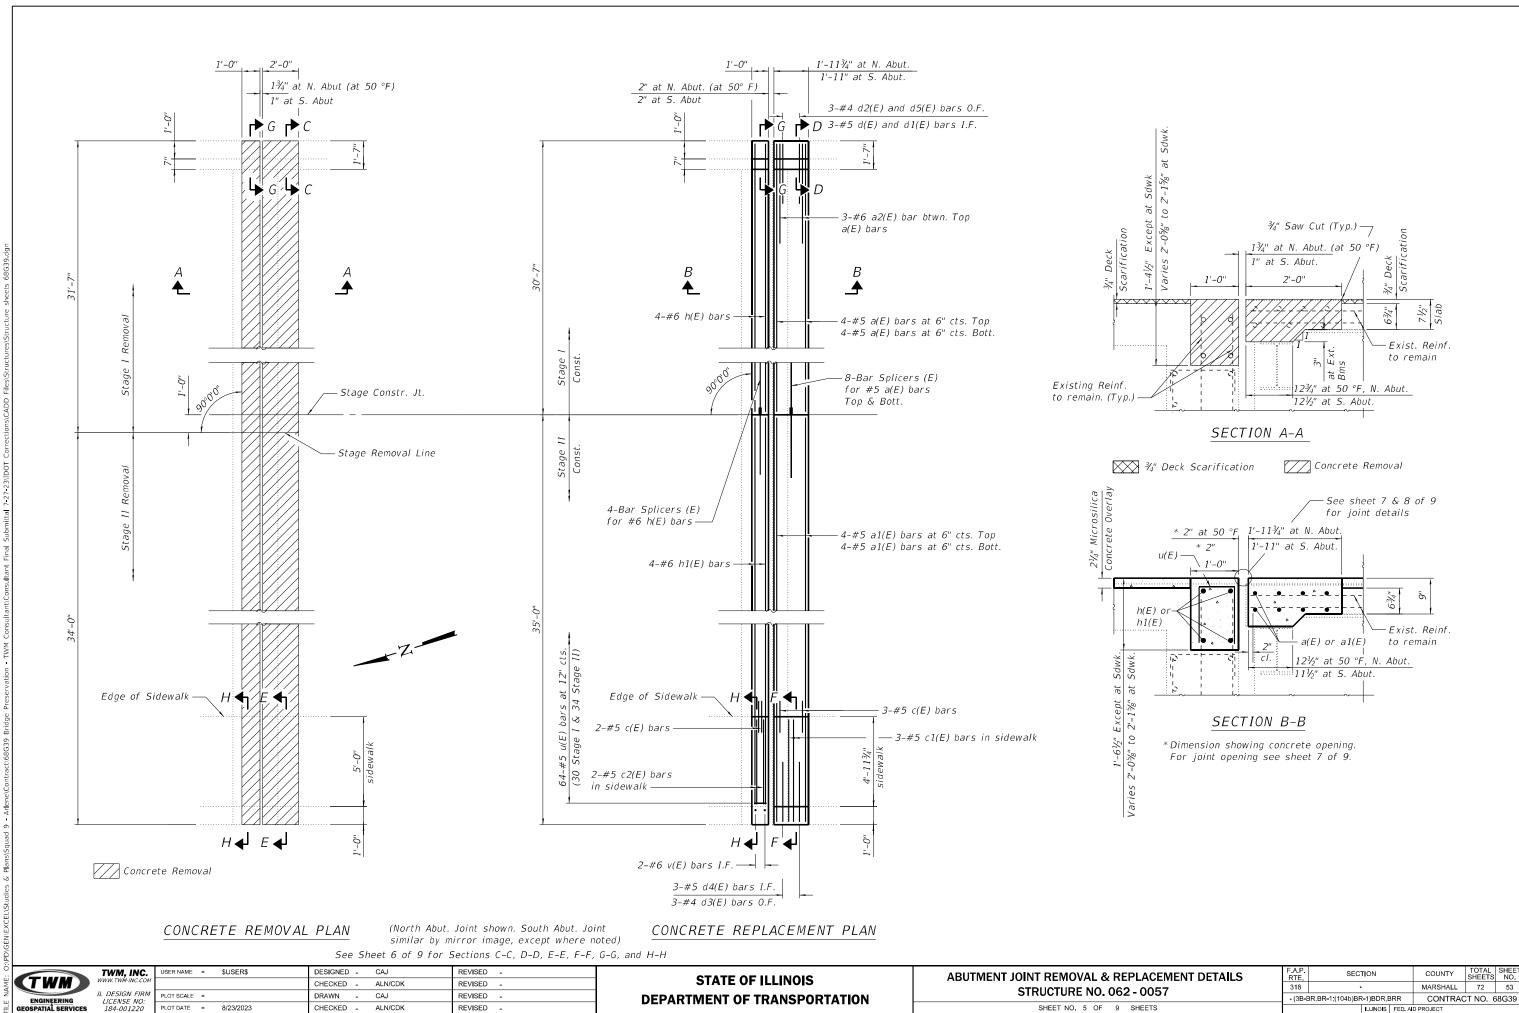


8/23/2023 10:52:57 AM

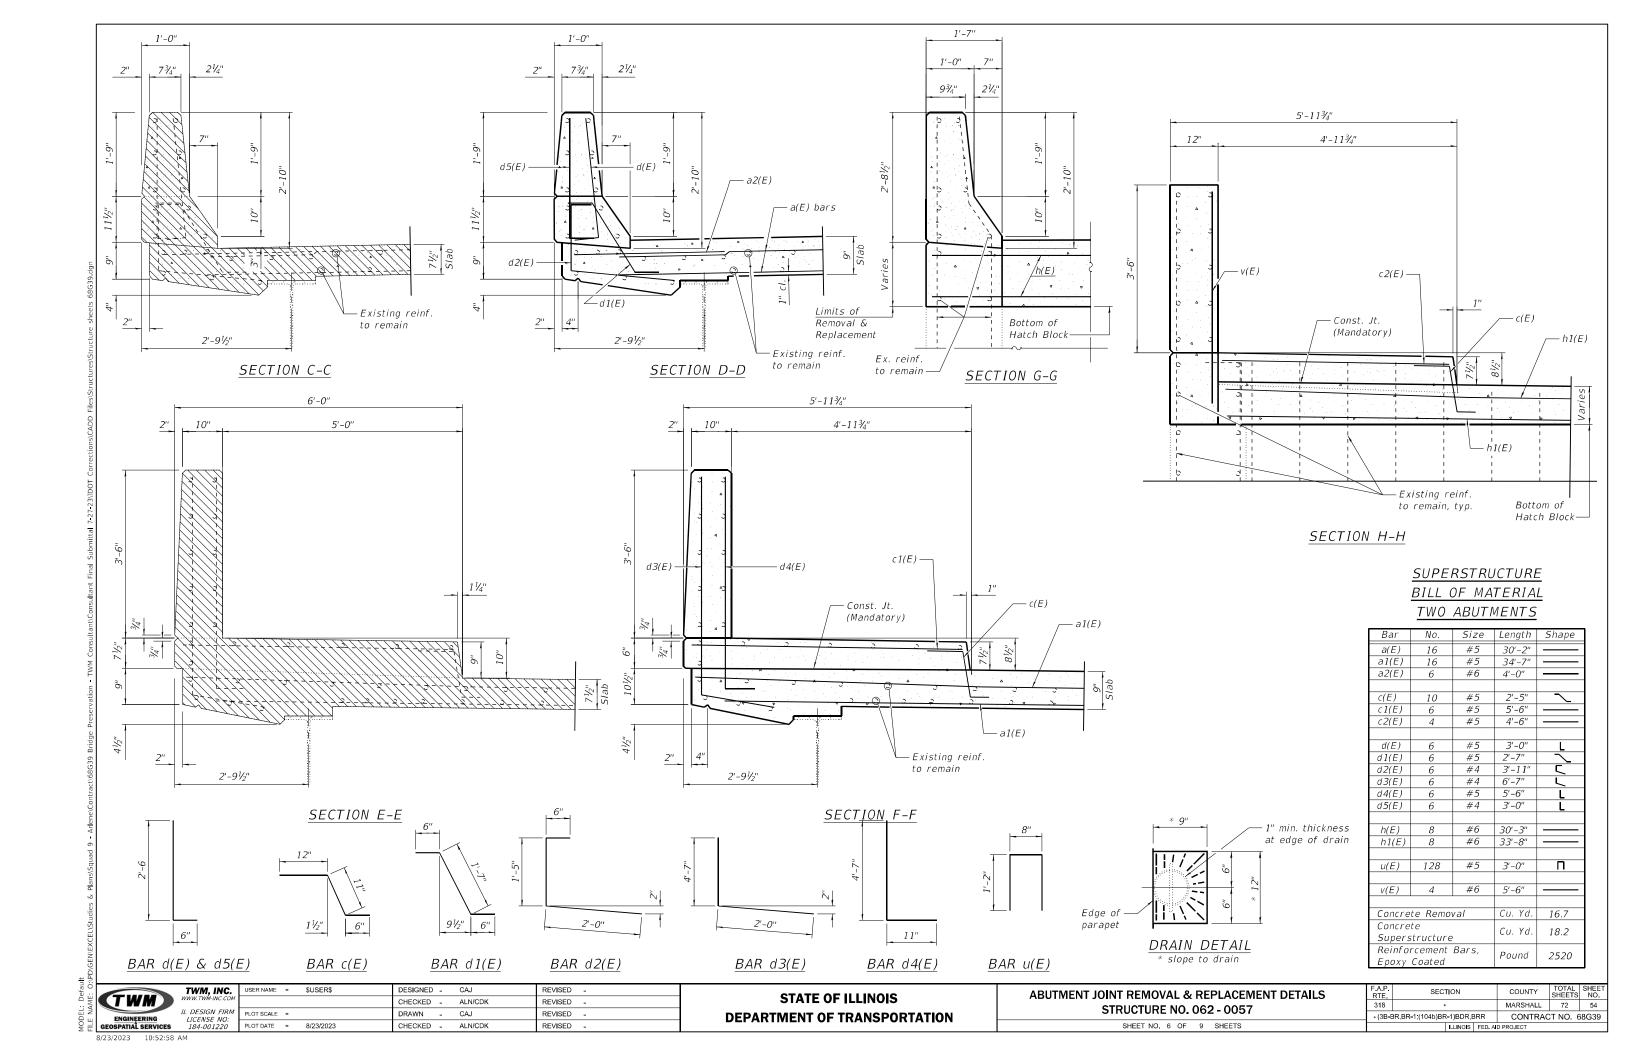

SECTION THRU

ROLLED RAIL JOINT

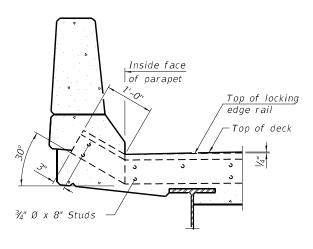

SECTION A-A

Notes:

The strip seal shall be made continuous and shall have a minimum thickness of $\frac{1}{4}$ ". The configuration of the strip seal shall match the configuration of the Locking Edge Rails. Open or "webbed" strip seal gland configurations are not permitted. The gland shall be sized for a maximum rated movement of 4 inches.

The Locking Edge Rails depicted are conceptual only, except for the minimum dimensions shown. The actual configuration of the Locking Edge Rails and matching strip seal may vary from manufacturer to manufacturer. Flanged edge rails will not be allowed.


The manufacturer's recommended installation methods shall be followed.

The joint opening and deck dimensions detailed on the superstructure are based on a rolled rail expansion joint. If the Contractor elects to use the welded rail expansion joint, the opening and deck dimensions shall be modified according to the dimensions detailed on this sheet. Required modifications shall be made at no additional cost

All steel components shall be galvanized after fabrication according to Article 520.03 of the Standard Specifications.

Maximum space between rail segments shall be $rac{3}{16}$ ", sealed with a suitable sealant. Joints in rails within 10 ft. of curbs shall be welded.

Cost of sidewalk sliding plates, anchorage studs, and expansion anchors included with Preformed Joint Strip Seal.

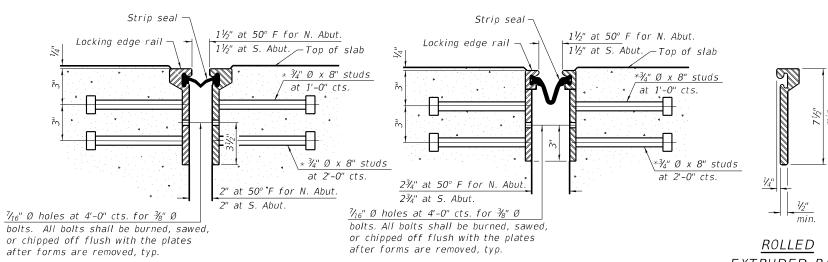


* Granular or solid flux filled headed studs conforming to Article 1006.32

of the Std. Specs., automatically

SECTION THRU

WELDED RAIL JOINT

EXTRUDED RAIL WELDED RAIL

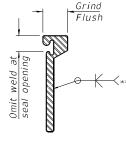

*** Back gouge not required if complete joint penetration is verified by mock-up.

LOCKING EDGE RAIL SPLICE

The inside of the locking edge rail groove shall be free of weld residue. Rolled rail shown, welded rail

similar.

LOCKING EDGE RAILS

BILL OF MATERIAL

Item	Unit	Total
Preformed Joint Strip Seal	Foot	128

TWM, INC. LICENSE NO: 184-001220

JSER NAME = \$USER\$ DESIGNED - CAJ REVISED -CHECKED - ALN/CDK REVISED -CAJ REVISED PLOT DATE = 8/23/2023 CHECKED - ALN/CDK REVISED .


end welded.

STATE OF ILLINOIS DEPARTMENT OF TRANSPORTATION PREFORMED JOINT STRIP SEAL - SIDEWALK STRUCTURE NO. 062 - 0057 SHEET NO. 7 OF 9 SHEETS

(Sheet 1 of 2)

COUNTY MARSHALL 72 55 (3B-BR,BR-1;(104b)BR-1)BDR,BRR CONTRACT NO. 68G39 ILLINOIS FED. AID PROJECT

ELEVATION AT RAISED SIDEWALK

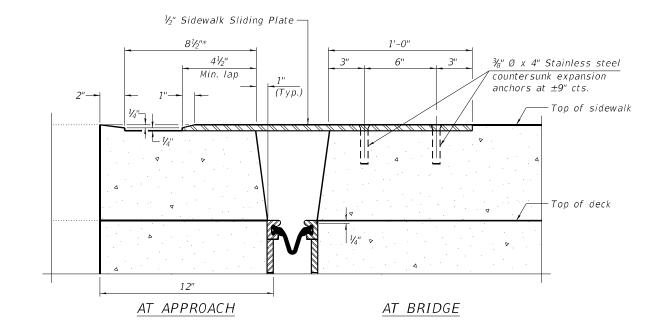

SECTION C-C


REVISED -

REVISED -


REVISED -

REVISED -

*Dimensions are based on a Welded Rail Strip Seal Joint. If the contractor elects to use the Rolled Rail Strip Seal Joint, dimensions may require adjustment.

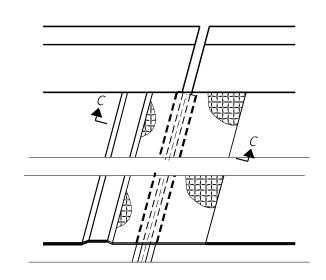

 $(FOR SKEWS \le 30^{\circ})$ PLAN AT RAISED SIDEWALK

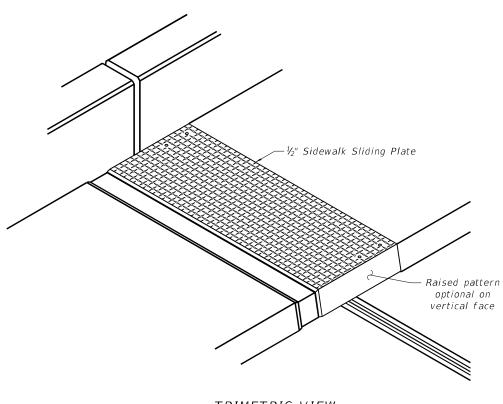

TRIMETRIC VIEW

(Sheet 2 of 2)

TWM, INC.

USER NAME = \$USER\$ DESIGNED - CAJ CHECKED - ALN/CDK DRAWN - CAJ LICENSE NO: 184-001220 PLOT DATE = 8/23/2023 CHECKED - ALN/CDK

STATE OF ILLINOIS DEPARTMENT OF TRANSPORTATION PREFORMED JOINT STRIP SEAL - SIDEWALK STRUCTURE NO. 062 - 0057 SHEET NO. 8 OF 9 SHEETS

* (3B-BR,BR-1;(104b)BR-1)BDR,BRR CONTRACT NO. 68G39 ILLINOIS FED. AID PROJECT


STANDARD BAR SPLICER ASSEMBLY PLAN

(All components shall be provided from one supplier)

Threaded splicer bar length = min. lap length + $1\frac{1}{2}$ " + thread length

* Epoxy not required on Bar Splicer Assembly components used in conjunction with black bars.


Location	Bar size	No. assemblies required	Minimum Iap length
Bridge Deck	#5	16	3'-6"
Hatch Block	#6	8	4'-0"

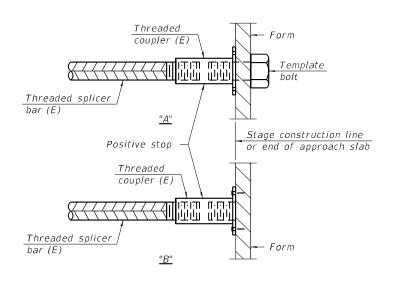

INSTALLATION AND SETTING METHODS

"A": Set bar splicer assembly by means of a template bolt"B": Set bar splicer assembly by nailing to wood forms or cementing to steel forms.

(E): Indicates epoxy coating.

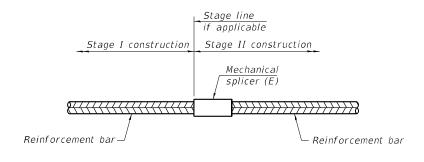

STANDARD MECHANICAL SPLICER

Location	Bar size	No. assemblies required

Notes:

Splicer bars shall be deformed with threaded ends and have a minimum $60\ ksi$ yield strength.

All reinforcement shall be lapped and tied to the splicer bars.

Bar splicer assemblies shall be epoxy coated according to the requirements for reinforcement bars. See Section 508 of the Standard Specifications.

See approved list of bar splicer assemblies and mechanical splicers for

alternatives.


BSD-1

1-1-2020




TWM, INC.	USER NAME = \$USER\$	DESIGNED - CAJ	REVISED -
		CHECKED - ALN/CDK	REVISED -
L DESIGN FIRM LICENSE NO: 184-001220	PLOT SCALE =	DRAWN - CAJ	REVISED -
	PLOT DATE = 8/23/2023	CHECKED - ALN/CDK	REVISED -

NOTE: AT THE POINT WHERE TANGENT GUARDRAIL MEETS FLARED GUARDRAIL, A 12.5 FT SECTION OF SPBGR SHALL BE INSTALLED ON A SLIGHT CURVE BY ADJUSTING THE POST BACK A SMALL DISTANCE.

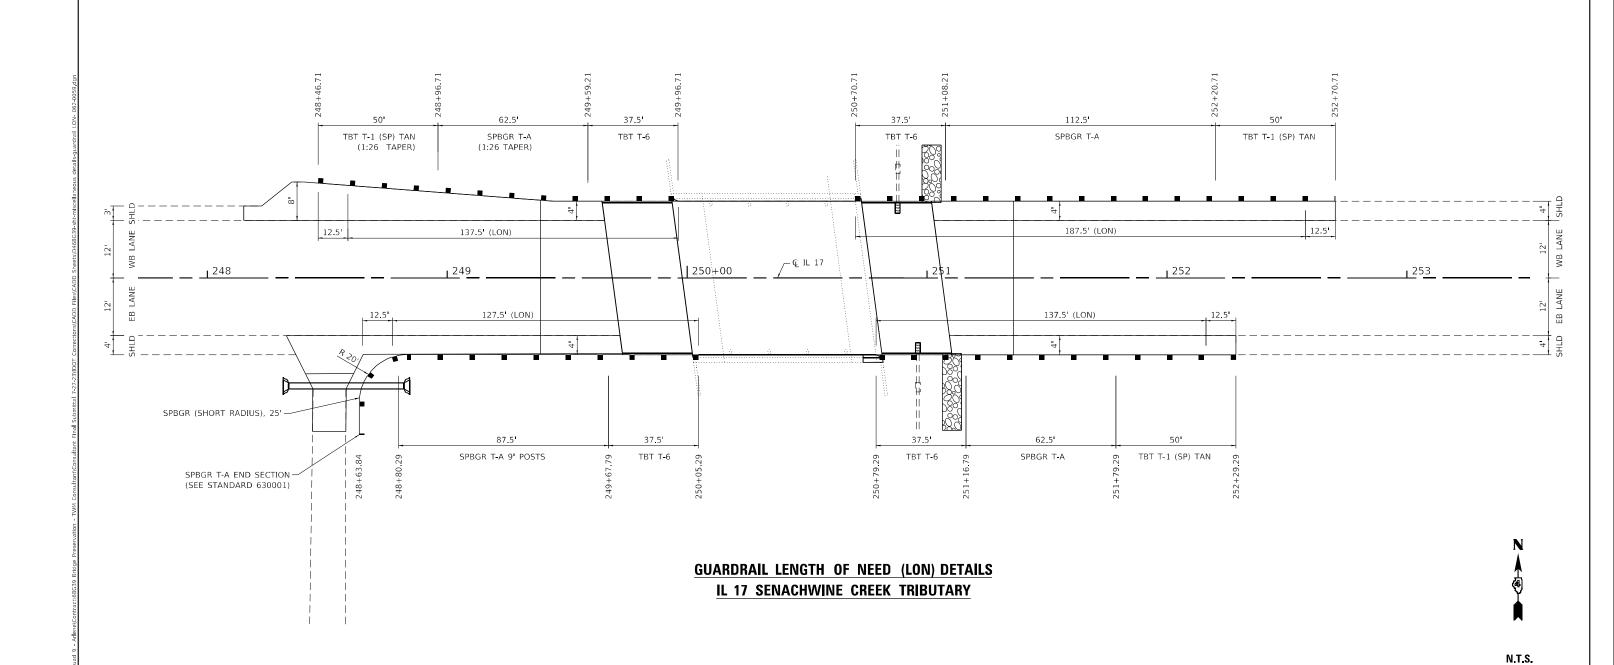

ENGINEERING GEOSPATIAL SERV

STATE OF ILLINOIS
DEPARTMENT OF TRANSPORTATION

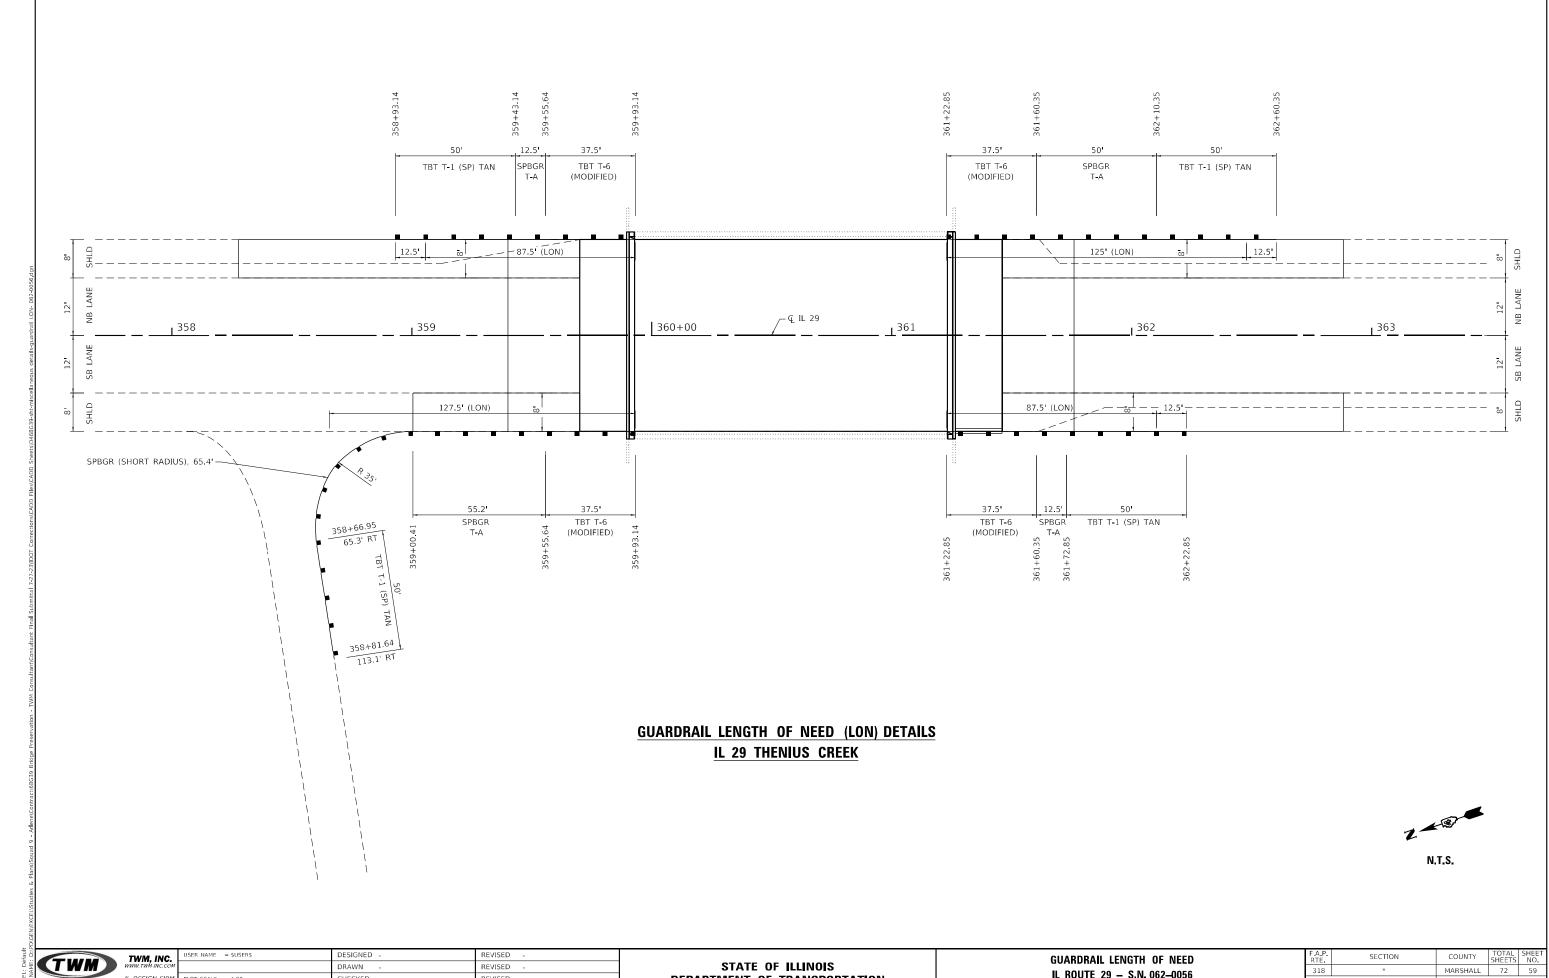



CHECKED REVISED


DEPARTMENT OF TRANSPORTATION

IL ROUTE 29 - S.N. 062-0056 SCALE: N.T.S. SHEET 1 OF 1 SHEETS STA.

*(3B-BR,BR-1;(104b)BR-1)BDR,BRR CONTRACT NO. 68G39

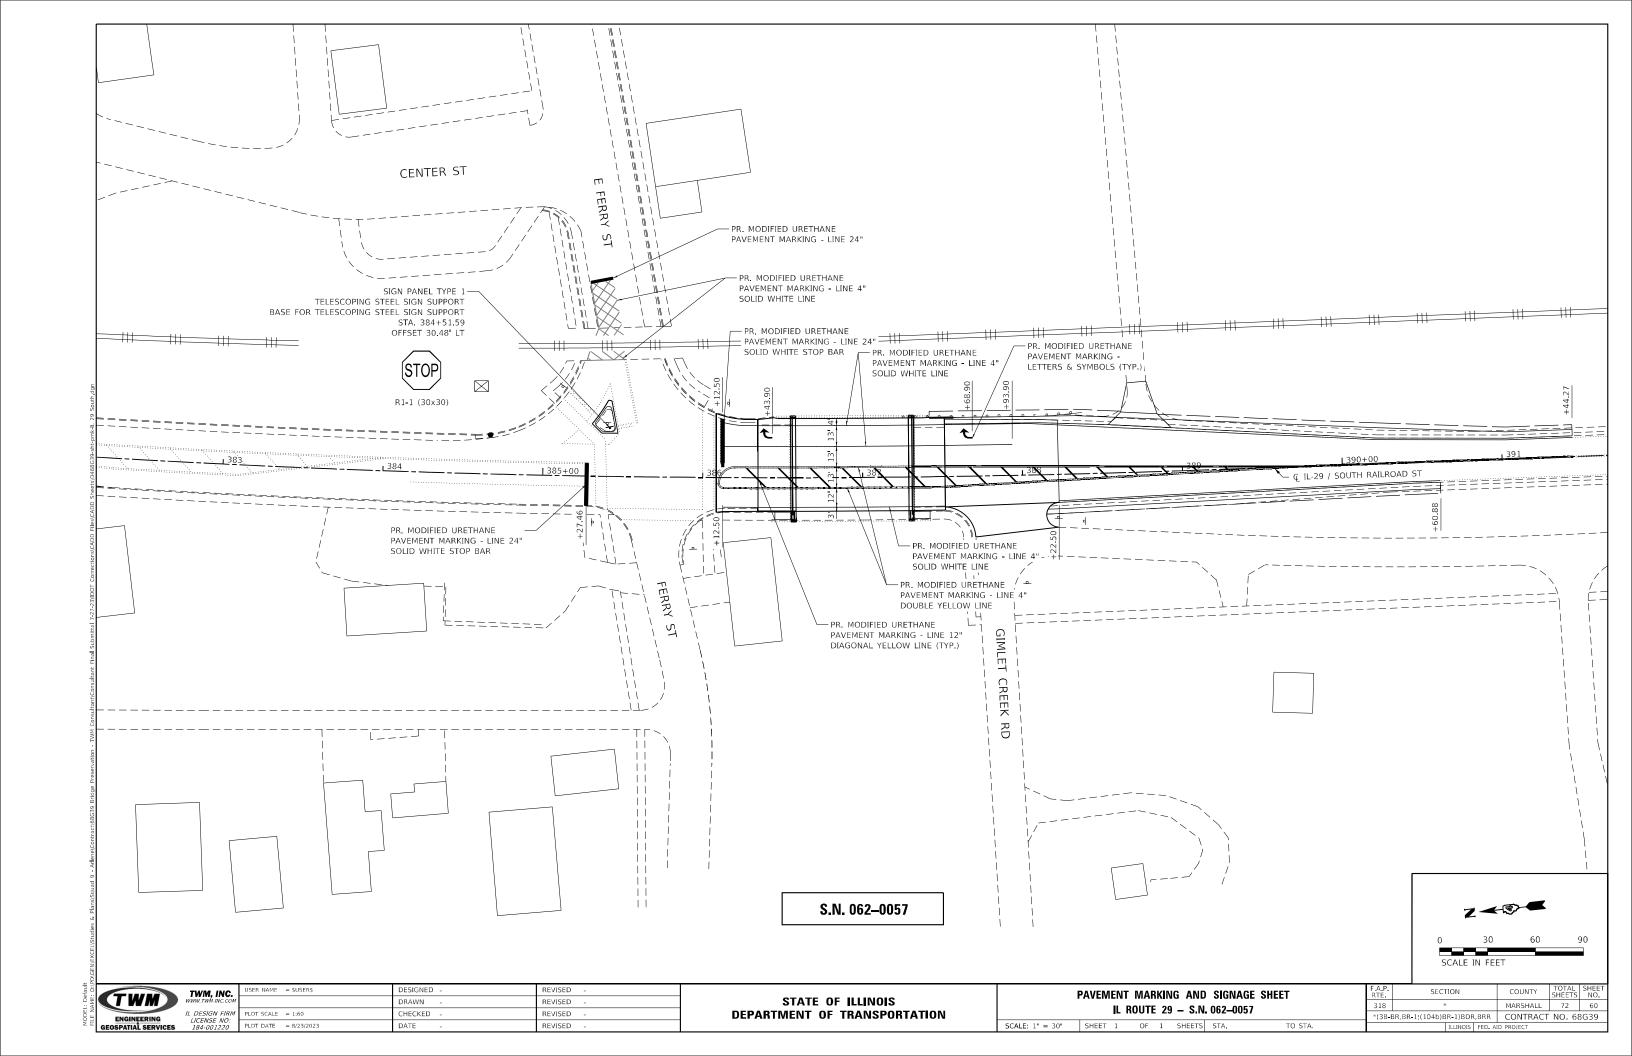

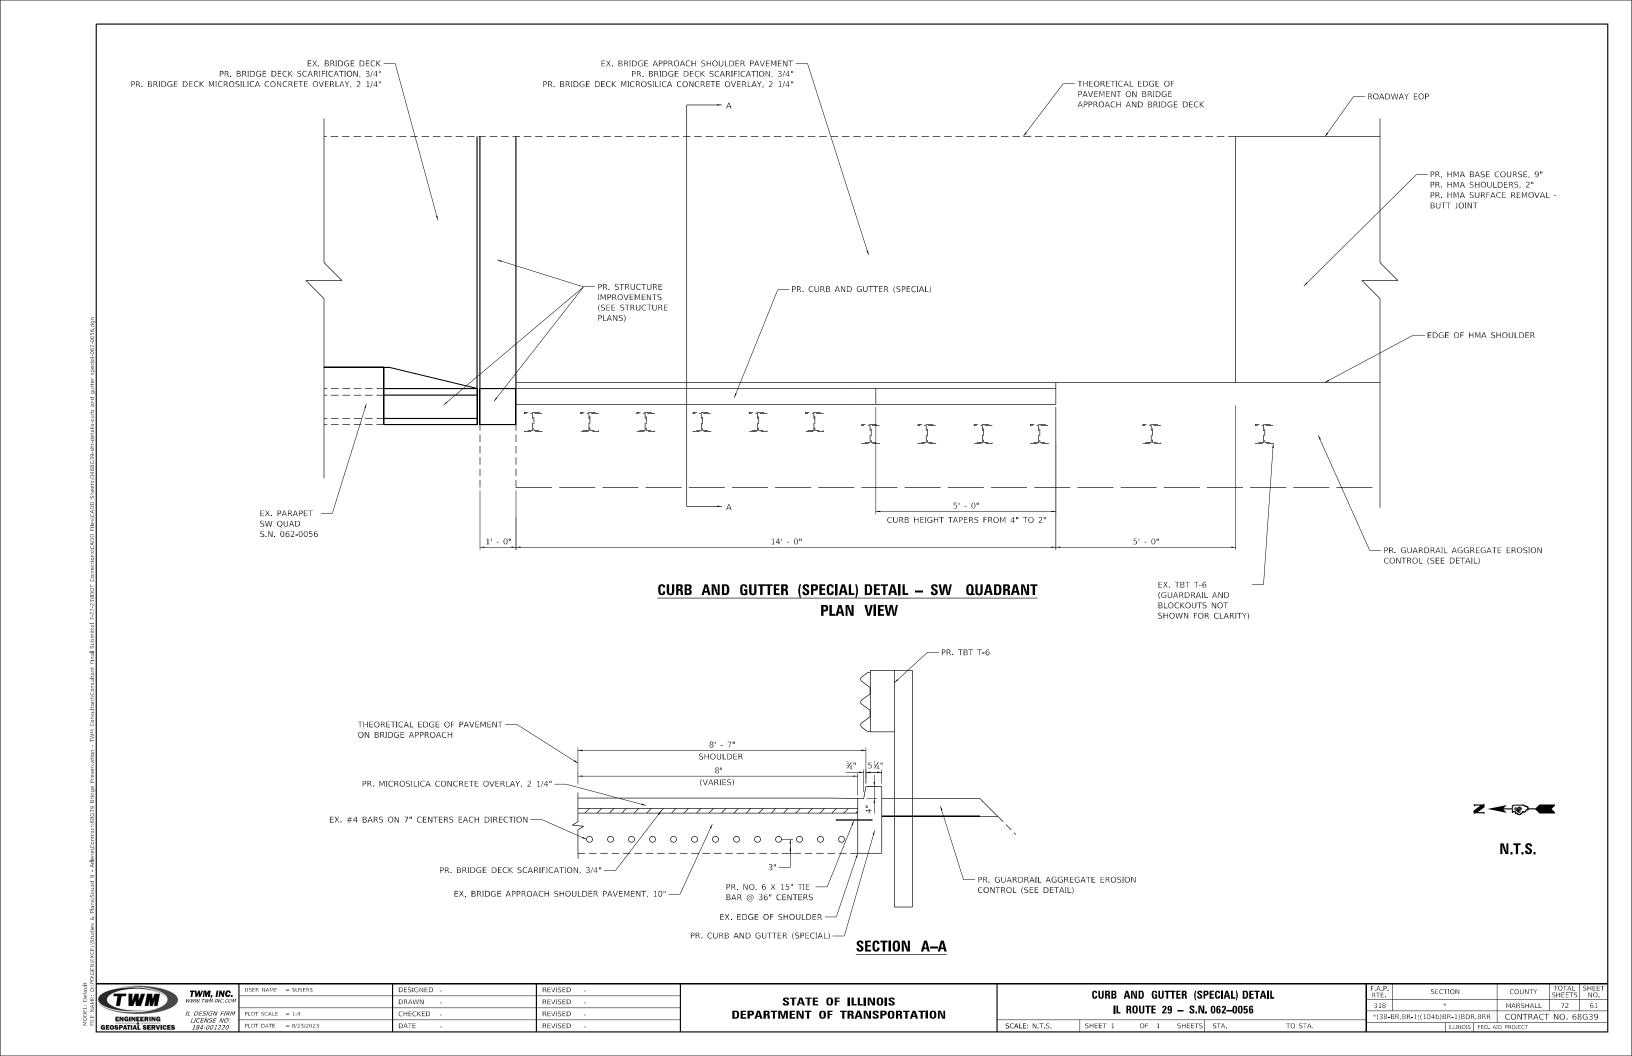

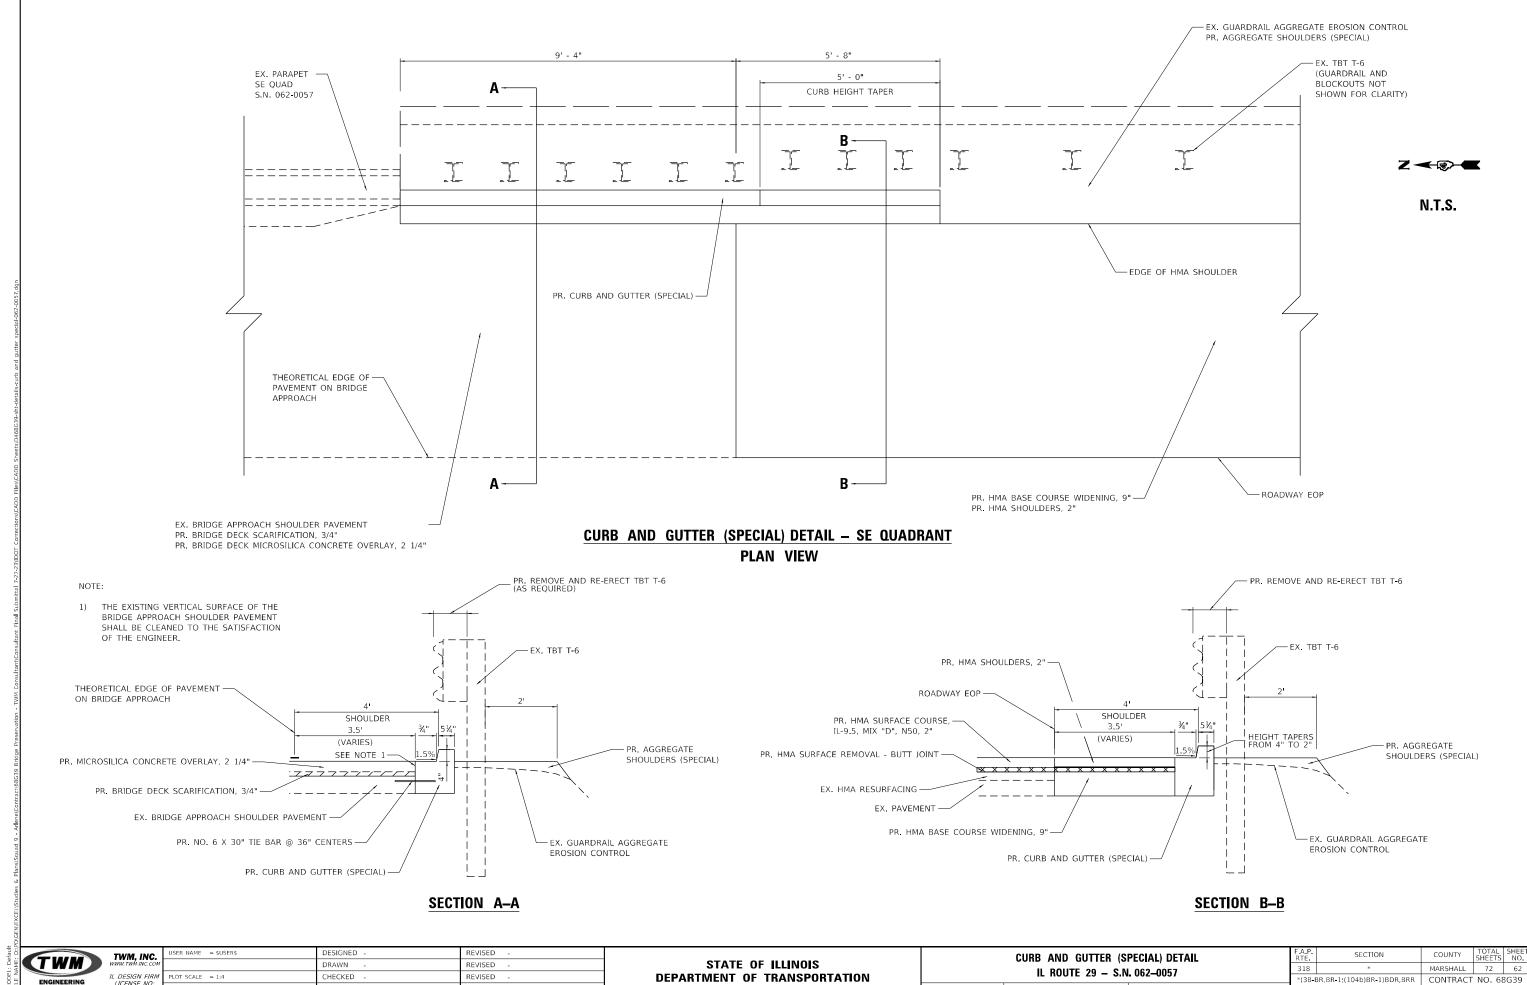

SCALE: N.T.S.

OF 1 SHEETS STA.

TO STA.

PLOT DATE = 8/23/2023

DATE

* ITEMS CONSTRUCTED PREVIOUSLY PRIOR TO CONSTRUCTING HMA ROADWAY APPROACH TAPERS

AGGREGATE SHOULDERS (SPECIAL) DETAIL

S.N. 062-0059

STA. 249+39.36 TO STA. 249+69.36 STA. 251+06.64 TO STA. 251+36.64

S.N. 062-0056

STA. 359+40.00 TO STA. 359+70.00 STA. 361+46.00 TO STA. 361+76.00

S.N. 062-0057

SEE CURB AND GUTTER (SPECIAL) DETAIL


ENGINEERING GEOSPATIAL SERVICES

. INC.	USER NAME = \$USER\$	DESIGNED -	REVISED -
N-INC.COM		DRAWN -	REVISED -
SN FIRM	PLOT SCALE = 1:40	CHECKED -	REVISED -
SE NO: 01220	PLOT DATE = 8/23/2023	DATE -	REVISED -


SCALE: N.T.S.

ACCRECATE CHOIL DEDC (CRECIAL) DETAIL		F.A.P. SECTION		COUNTY	TOTAL SHEETS	SHEET NO.				
AGGREGATE SHOULDERS (SPECIAL) DETAIL			318	318 * MAF		72	63			
		*(3B-BR,BR-1;(104b)BR-1)BDR,BRR CONTRACT NO.				3G39				
SHEET 1	OF	1	SHEETS	STA.	TO STA.	ILLINOIS FED. AID PROJECT				


CASE 1: HOT MIX ASPHALT SURFACE REMOVAL - BUTT JOINT

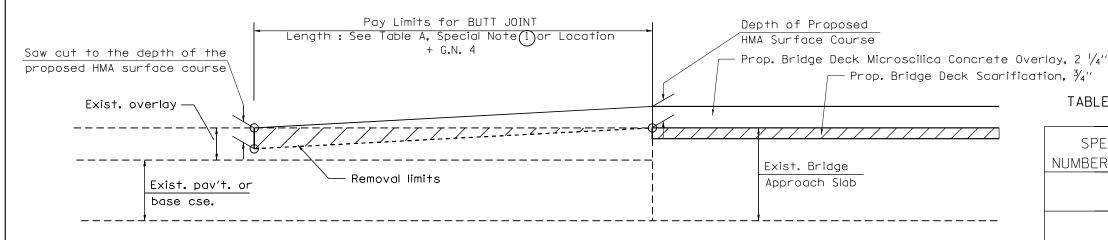

CASE 1: TEMPORARY RAMP DETAIL

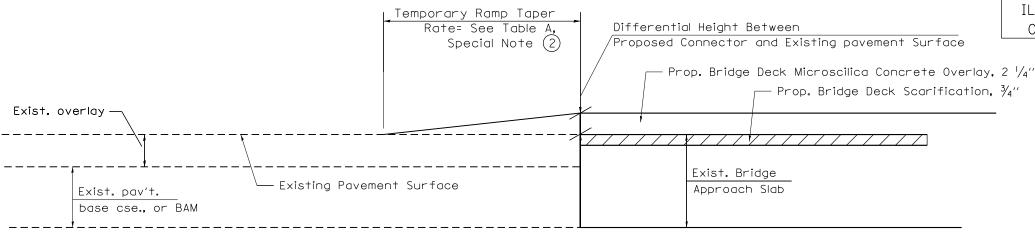

CASE 2: TEMPORARY RAMP DETAIL

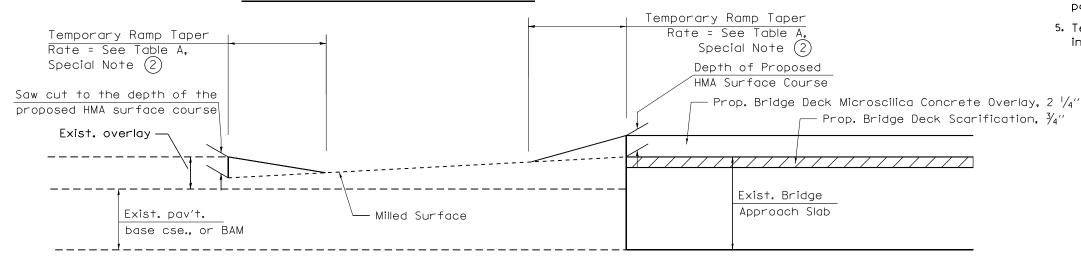

REVISED

REVISED

REVISED

REVISED

TABLE A

TAPER RATES

SPECIAL NOTE NUMBER OR LOCATION	ELEMENT	IL 29 & IL 17
	BUTT JOINT TAPER RATE	1:240
2	TEMPORARY RAMP TAPER RATE	1:40
IL 29 NORTH SIDE OF SN 062-0057	BUTT JOINT TAPER RATE	1:208
IL 29 SOUTH SIDE OF SN 062-0057	BUTT JOINT TAPER RATE	1:568

GENERAL NOTES

- 1. The work shall be done in accordance with Article 406.08 and the Special Provision for Butt Joints.
- 2. The pavement surface to be removed may be either bituminous or P.C. concrete. The work shall be performed in accordance with Article 440.04 and the Special Provisions for Butt Joints.
- 3. The saw cut joints shall be primed just prior to the placing of bituminous material. The work will be in accordance with the applicable portions of Article 406.05.
- 4. The length of butt joint is based on the taper rate times change in cold milling depth within the butt joint pay limits, unless otherwise indicated.
- 5. Temporary ramps are paid for separately and not included in the cost of the butt joints.

All dimensions are in inches (millimeters) unless otherwise noted.

	DISTRICT 4 DETAIL NO	D. 406101 M	ODIFIE	D
F.A.P. RTE	SECTION		TOTAL SHEETS	SHEET NO.

NAME: 0	TWM
FILE	ENGINEERING GEOSPATIAL SERVICES

SER NAME = \$USER\$ TWM. INC. PLOT DATE = 8/23/2023 DESIGNED -

HECKED

DRAWN

DATE


DEPARTMENT OF TRANSPORTATION

STATE OF ILLINOIS

SCALE: N.T.S.

BUTT JOINT AND TEMPORARY RAMP DETAILS SHEET 1 OF 1 SHEETS STA.

MARSHALL 72 64

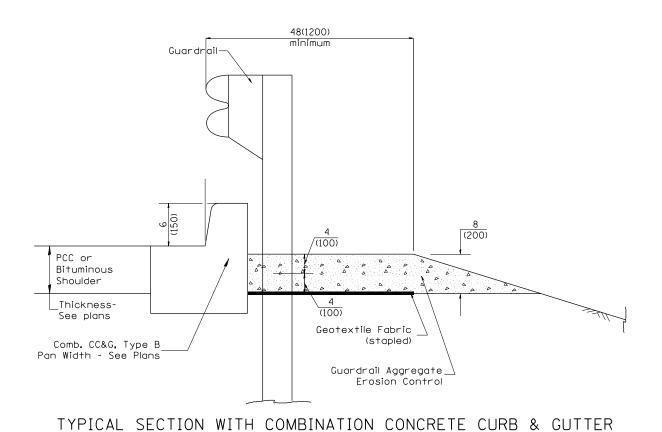

SER NAME = \$USER\$

PLOT DATE = 8/23/2023

TWM. INC.

DESIGNED -

HECKED

DRAWN

DATE

REVISED

REVISED

REVISED

REVISED

GENERAL NOTES: GUARDRAIL AGGREGATE EROSION CONTROL

- 1. This work shall consist of grading as needed, furnishing and installing geotextile fabric and staples, and furnishing, placing and shaping crushed aggregate around and behind Steel Plate Beam Guardrail posts in accordance with Plan Details.
- 2. Before placing the aggregate and the Geotextile Fabric, weeds and grass shall be removed from the area to be covered.
- 3. After the area has been prepared, and in a dry condition, the Geotextile fabric shall be placed with a 12(300) minimum overlap. A knife cut for guardrail post installation is necessary.
- 4. The aggregate shall be deposited, compacted and shaped by either mechanical or hand methods, in a manner reasonably true to line and grade.
- 5. The Contractor shall have the option of placing the guardrail before or after the Geotextile Fabric and Aggregate are in place. If the guardrail is placed after the Geotextile Fabric and Aggregate, then any voids must be filled and the aggregate returned to line and grade.

All dimensions are in inches (millimeters) unless otherwise noted.

DISTRICT 4 DETAIL NO. 630101

MARSHALL

72 65


- 6. Materials shall meet the following requirements:
- A. The crushed aggregate shall be CA1 gradation in accordance with Article 1004.01(c) of the Standard Specifications.
- B. The Geotextile Fabric shall be nonwoven fabric in accordance with Article 1080.02 of the Standard Specifications.

GUARDRAIL EROSION CONTROL TREATMENTS

TO STA.


SHEET 1 OF 2 SHEETS STA.


SCALE: N.T.S.

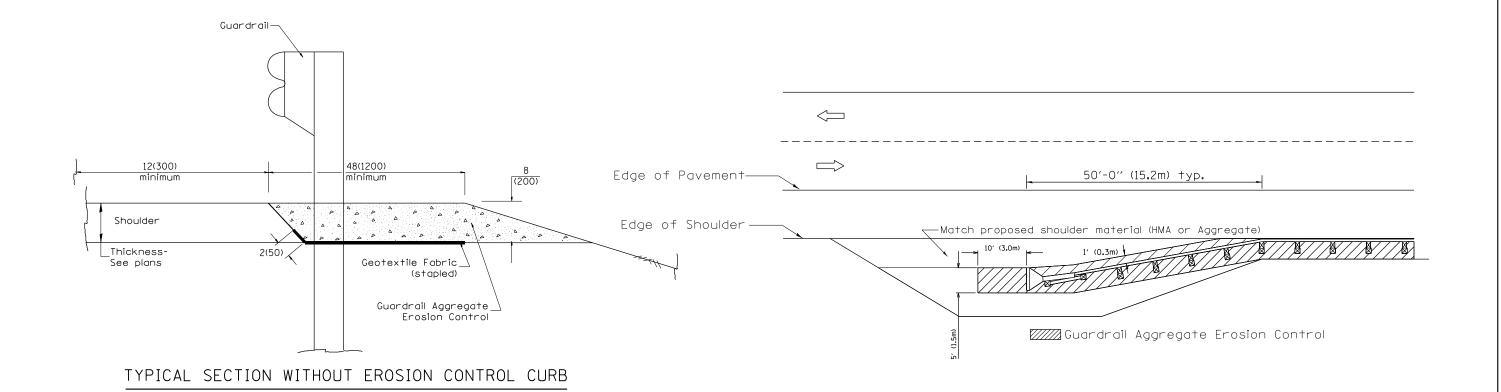


STATE OF ILLINOIS

DEPARTMENT OF TRANSPORTATION

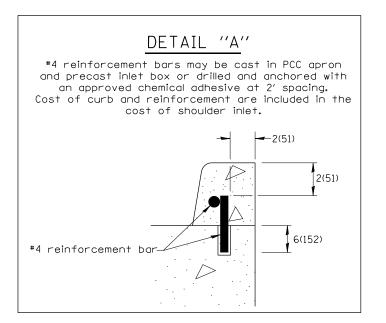


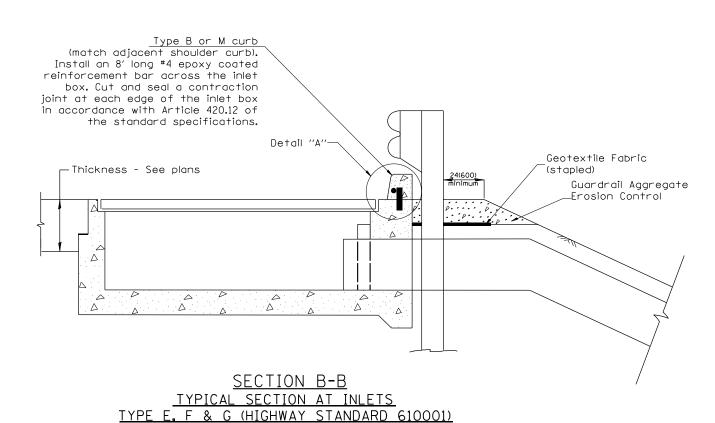

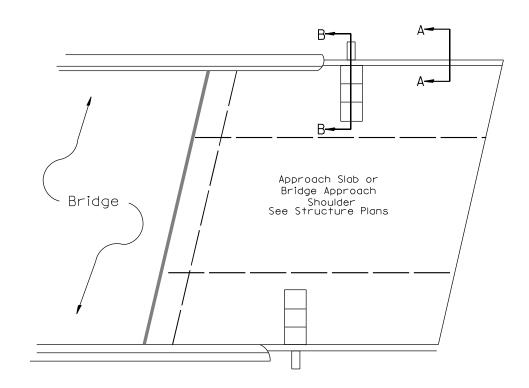

PLAN VIEW

APPROACH SLAB OR SHOULDER PLACEMENT

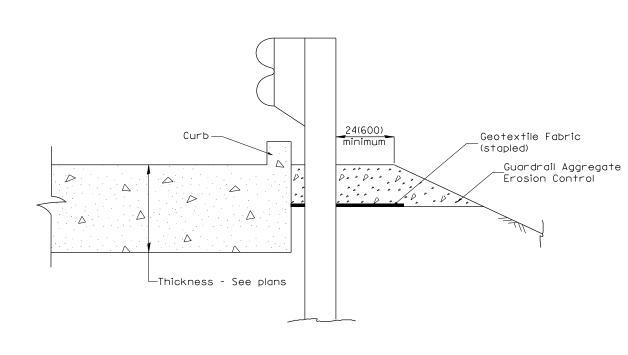

SECTION A-A

TYPICAL SECTION WITH BRIDGE APPROACH CURB

All dimensions are in inches (millimeters) unless otherwise noted.


DISTRICT 4 DETAIL NO. 630101									
F.A.P. RTE	SECTION			COUNTY	TOTAL SHEETS	SHEE NO.			
318	*			MARSHALL	72	66			
*(3B-BR,BR-1;(104b)BR-1)BDR,BRR			CONTRACT	NO. 68	3G39				
ILLINOIS FED. A			D PROJECT						

WM. INC.	USER NAME = \$USER\$	DESIGNED -	REVISED -
vw.twm-inc.com		DRAWN -	REVISED -
DESIGN FIRM ICENSE NO: 184-001220	PLOT SCALE = 1:100	CHECKED -	REVISED -
	PLOT DATE = 8/23/2023	DATE -	REVISED -

STATE OF ILLINOIS
DEPARTMENT OF TRANSPORTATION

GUARDRAIL EROSION CONTROL TREATMENTS

SCALE: N.T.S. SHEET 2 OF 2 SHEETS STA. TO S

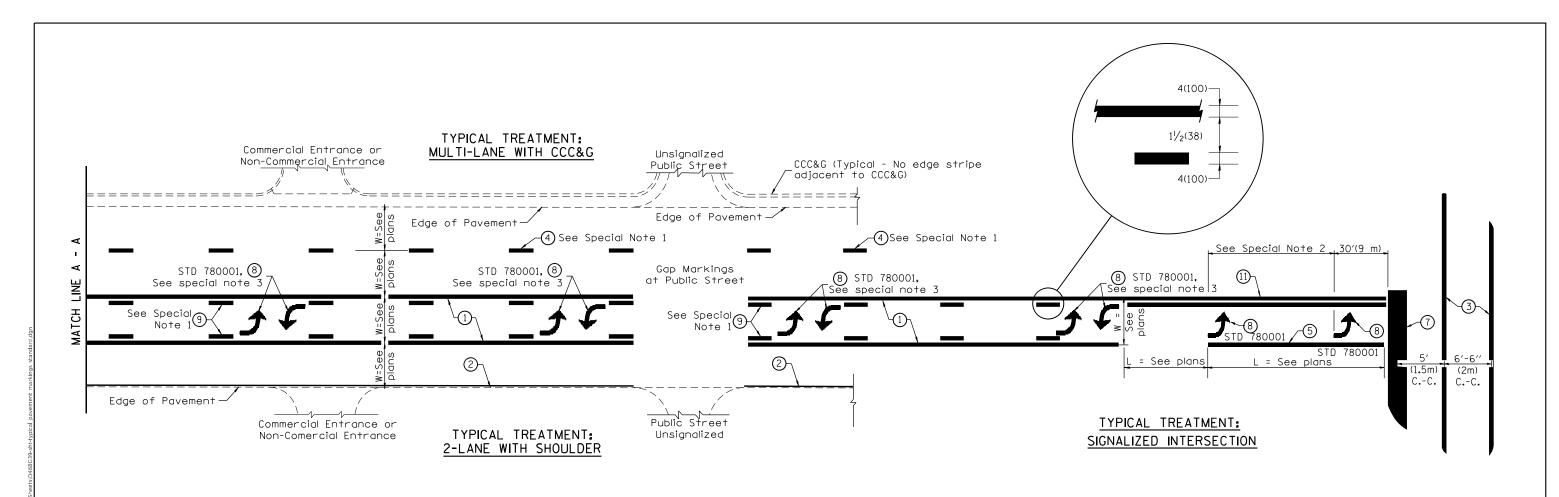


FLUSH PAVED MEDIAN: TWO-WAY LEFT TURN LANE WITH ONE-WAY LEFT TURN LANE AT SIGNALIZED INTERSECTION

TYPICAL PAVEMENT MARKING LEGEND

(Note: This is a District Standard Legend. Some elements may not apply to specific project.)

- 4(100) Solid (Yellow)
- 2 4(100) Solid (White)
- 2-6(150) Crosswalk @ 6'-6" (2m)min C.-C. (White) 2-8(200) Crosswalk @ 6'-6" (2m)min C.-C. (White) (When traffic signals are present.)
- 6(150) Skip-Dash (White)

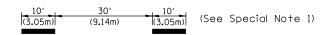

- 8(200) Solid (White)
- 12(300) Diagonal (White) (Item 6) is shown on Std. 780001
- 24(600) Stop Bar (White)
- Letters & Arrows (See Std. 780001 and Special Notes 2 & 3)
- 4(100) Skip-Dash (Yellow) (See Special Note 1)
- 12(300) Diagonal (Yellow) (See Table A)

4(100) Double Solid (Yellow) 11(280) C.-C.

SPECIAL NOTES

- 1. Skip-Dash markings will be centered between both ends of city blocks and shall be placed in alignment transversely across the pavement.
- 2. The following shall apply to arrows located in one-way left turn lanes:
 - A. A minimum of two (2) arrows is required.
 - The maximum spacing between arrows is 80' (24 m).
 - C. Arrows shall be evenly spaced if three (3) or more are required.
- 3. The following shall apply to arrow pairs located in two-way left turn lanes:
 - A minimum of two (2) arrow pairs is required. The maximum spacing between arrow pairs
 - is 200' (61 m). Arrow pairs shall be evenly spaced if three (3) or more are required.
- D. The spacing between Bi Directional Left Turn Arrows is 33' (10 m).

GENERAL NOTES


- Refer to State Standard 780001 for additional Pavement Markings including letters & arrows.
- 2. See Plans for Pavement Markings adjacent to curbed islands and medians, and through lane reductions.
- 3. Refer to Article 780.13 for letter, number and symbol areas (sq. ft.)
- 4. Areas are grooved $1^{\prime\prime}$ beyond each edge for the following symbols: Through Arrow= 14.8 sq. ft. Large Left or Right Arrow= 21.9 sq. ft. 2 Arrow Combination Left (or Right) and Through= 34.9 sq. ft. Wrong Way Arrow= 29.5 sq. ft. Railroad Crossing Symbol= 69.8 sq. ft. (For further information, refer to BDE Special Provision: Grooving for Recessed Pavement Markings)

DISTRICT 4 DETAIL NO. 780001 MARSHALL *(3B-BR,BR-1;(104b)BR-1)BDR,BRR | CONTRACT NO. 68G39

DESIGNED SER NAME = \$USER\$ REVISED TWM. INC. DRAWN REVISED HECKED REVISED PLOT DATE = 8/23/2023 DATE


STATE OF ILLINOIS **DEPARTMENT OF TRANSPORTATION**


TYPICAL PAVEMENT MARKINGS SHEET 1 OF 2 SHEETS STA.

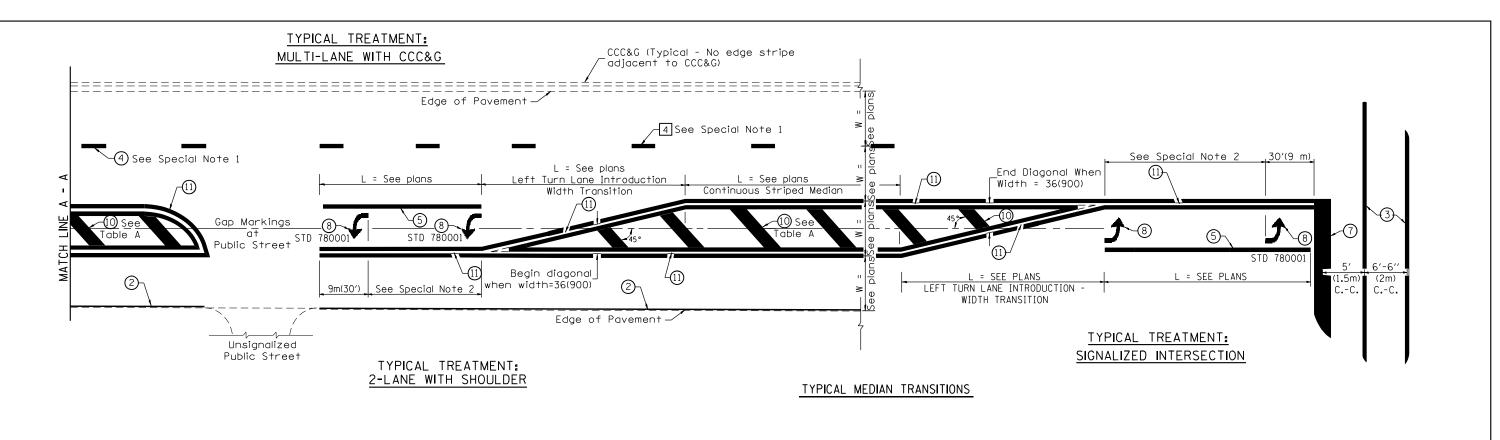

FLUSH PAVED MEDIAN: RESTRICTED LEFT TURN LANE

TABLE A RECOMMENDED SPACING BETWEEN DIAGONAL LINES

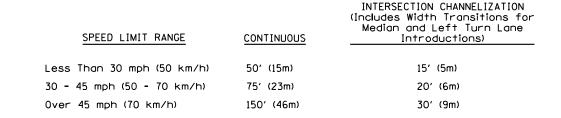


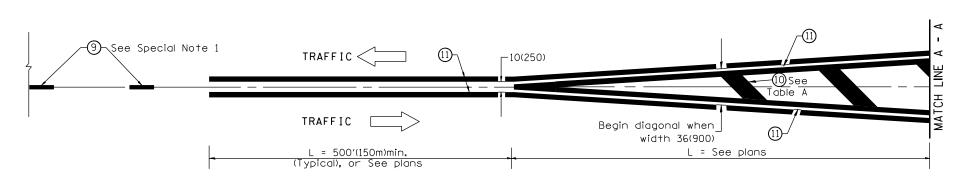

MEDIAN INTRODUCTION - WIDTH TRANSITIONS

All dimensions are in inches (millimeters) unless otherwise noted.

							DISTRICT 4 DETAIL NO. 780001					
FWW	TWM, INC. USER NAME = \$L	SER\$ DESIGNED -	REVISED -					F.A.P. RTE	SECTION	COUNTY	TOTAL SHEF	ET O.
TWM)	WWW.TWM-INC.COM	DRAWN -	REVISED -	STATE OF ILLINOIS	TYPICAL PAVEMENT MARKINGS				*	MARSHALL	72 68	3
NGINEERING	IL DESIGN FIRM PLOT SCALE = 1:	CHECKED -	REVISED -	DEPARTMENT OF TRANSPORTATION				*(3B-BF	R,BR-1;(104b)BR-1)BDR,BRR	CONTRACT	NO. 68G39	<u>-</u>
PATIAL SERVICES	LICENSE NO: 184-001220 PLOT DATE = 8/	23/2023 DATE -	REVISED -		SCALE:	SHEET 2 OF 2 SHEETS	STA. TO STA.		ILLINOIS FED.	AID PROJECT		

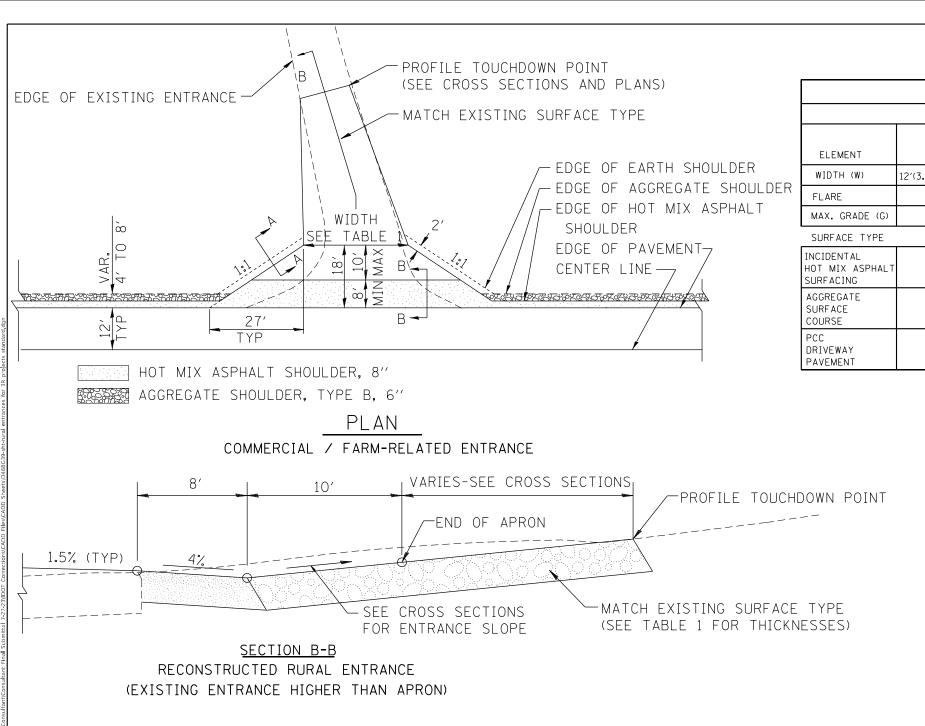

VARIES-SEE CROSS SECTIONS

PROFILE HINGE POINT

└SEE CROSS SECTIONS


END OF APRON


1.5% (TYP)

4%

<u>SECTION B-B</u> RECONSTRUCTED RURAL ENTRANCE

(EXISTING ENTRANCE LOWER THAN APRON)

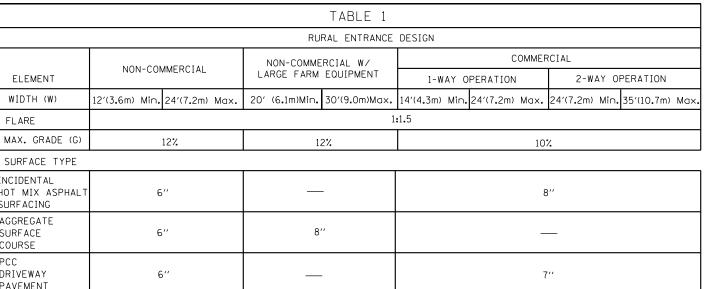

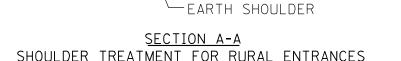

GENERAL NOTES

1. ENTRANCES SHALL SLOPE AWAY FROM THE PAVEMENT AT A RATE EQUAL TO THE SHOULDER SLOPE FOR A MINIMUM DISTANCE OF 8'.

← PROPOSED ENTRANCE

SEE TABLE 1 FOR SURFACE TYPE


- 2. A MINIMUM 8' PAVED SHOULDER SHALL BE CONSTRUCTED BETWEEN LOCATIONS WHERE THE RURAL ENTRANCE IS LESS THAN 50' FROM AN ADJACENT SIDEROAD, ENTRANCE OR MAILBOX TURNOUT.
- 3. A TAPER RATE OF 5:1 IS DESIRABLE WHEN TRANSITING FROM THE RURAL ENTRANCE WIDTH SHOWN IN TABLE 1, TO THE EXISTING ENTRANCE WIDTH.


All dimensions are in inches (millimeters) unless otherwise noted.


FOR ENTRANCE SLOPE (SEE TABLE 1 FOR THICKNESSES) DISTRICT 4 DETAIL NO. 406301 REVISED DESIGNED TWM. INC. STATE OF ILLINOIS **RURAL ENTRANCES FOR "3R" PROJECTS** DRAWN REVISED CHECKED REVISED **DEPARTMENT OF TRANSPORTATION** PLOT DATE = 8/23/2023 SHEET 1 OF 2 SHEETS STA.

- MATCH EXISTING SURFACE TYPE

PROFILE TOUCHDOWN POINT

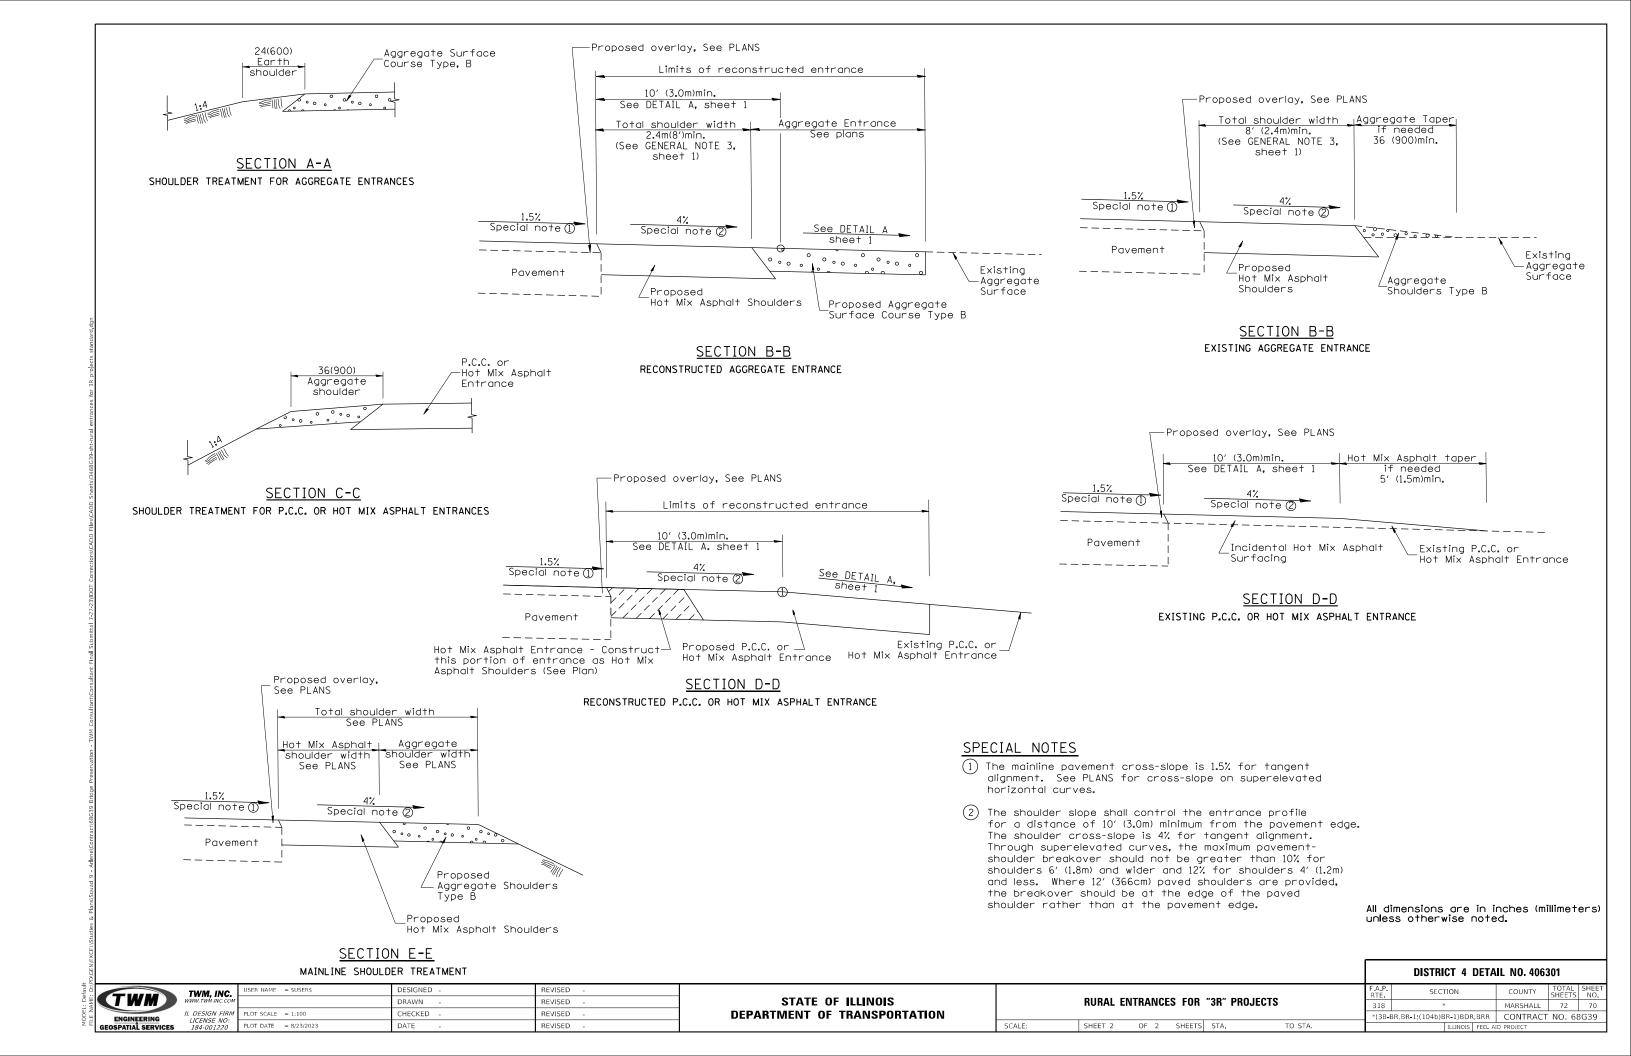


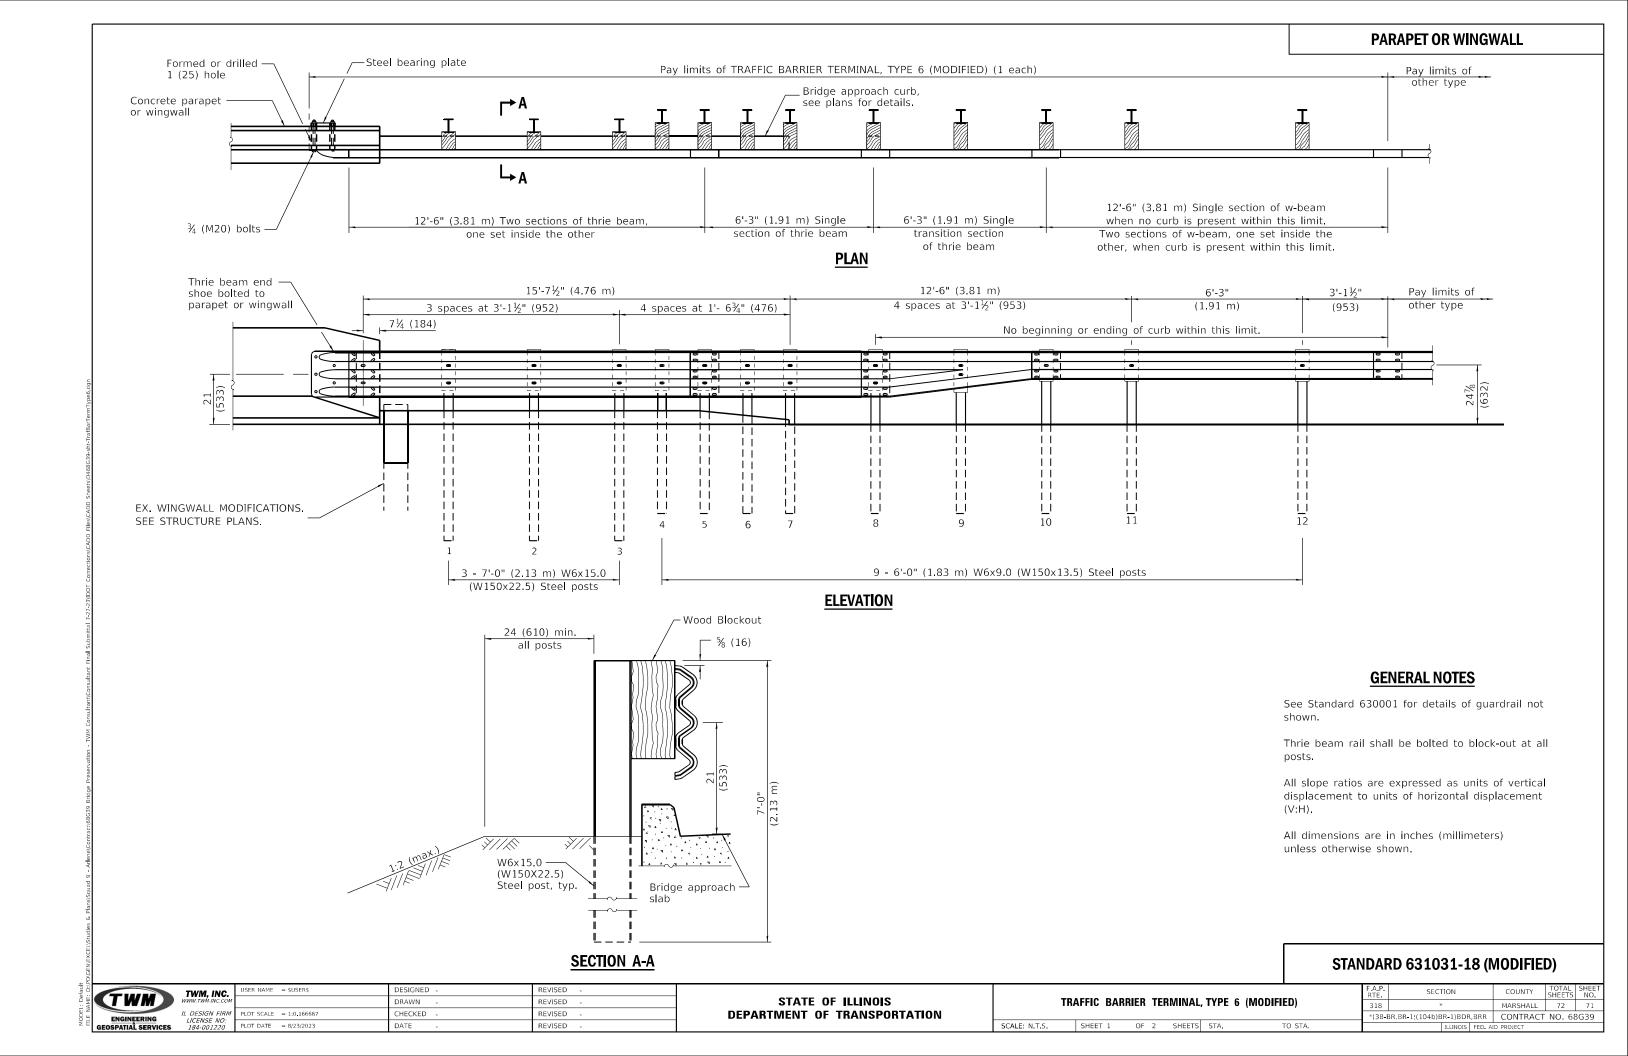

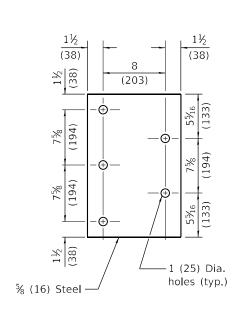


STEEL BEARING PLATE FOR F-SHAPE PARAPET


(5 each individual 5x5x\% (125x125x16) steel plates with centered 1 (25) holes may be substituted for the plate shown.)

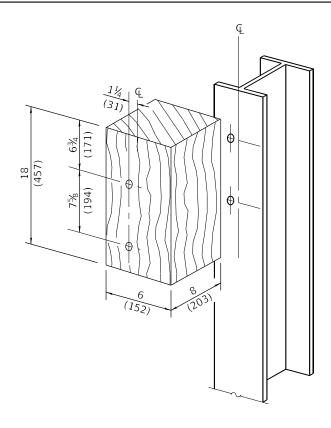


POSTS 1-6 WOOD BLOCKOUT DETAIL

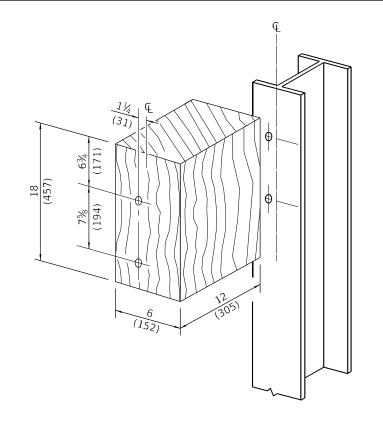


POSTS 7-11 WOOD BLOCKOUT DETAIL

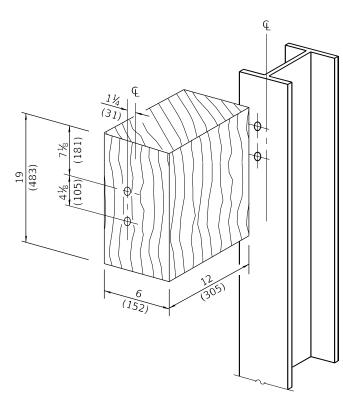

POST 12 WOOD BLOCKOUT DETAIL

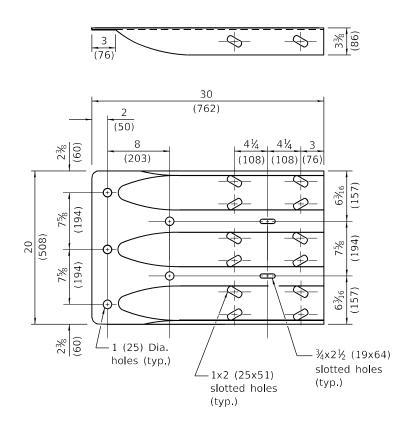

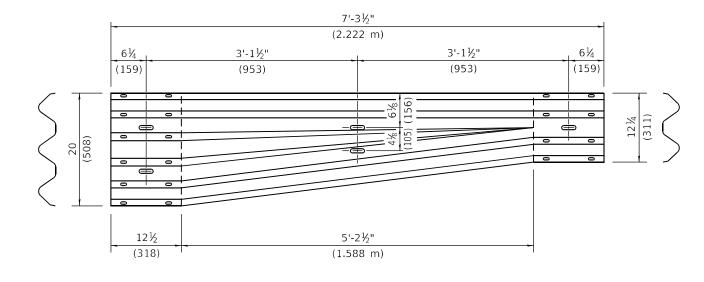

TRANSITION SECTION

(10 gauge (3.4) rail element)

THRIE BEAM END SHOE DETAIL

STANDARD 631031-18 (MODIFIED)



TWM, INC.

DESIGNED DRAWN REVISED CHECKED REVISED PLOT DATE = 8/23/2023 DATE REVISED

STATE OF ILLINOIS DEPARTMENT OF TRANSPORTATION

TRAFFIC BARRIER TERMINAL, TYPE 6 (MODIFIED) SCALE: N.T.S. SHEET 2 OF 2 SHEETS STA.

MARSHALL *(3B-BR,BR-1;(104b)BR-1)BDR,BRR CONTRACT NO. 68G39