11-17-2023 LETTING ITEM 043

FOR INDEX OF SHEETS, SEE SHEET NO. 2
FOR STATE STANDARDS. SEE SHEET NO. 2

0

0

0

0

#### STATE OF ILLINOIS

#### **DEPARTMENT OF TRANSPORTATION**

**DIVISION OF HIGHWAYS** 

# PROPOSED HIGHWAY PLANS

FAI ROUTE 88 (I–88)
SECTION (195–3HB–4)BDR
PROJECT NHPP-02D6(056)
TYPE of IMPROVEMENT: BRIDGE REPAIR
SN 098–0086 IL 40 OVER I–88

#### WHITESIDE COUNTY

C-92-136-23

GROSS LENGTH = 340.83 FT. = 0.065 MILE

NET LENGTH = 340.83 FT. = 0.065 MILE

MONTMORENCY TOWNSHIP
T20N R7E, SEC. 3 & 4, 4TH PM

SN 098-0086

SN 098

SCALE

062-048736

\* PROFESSIONAL \*\*
ENGINEER
OF

DATE: O

JAMES R. PUSH. P.E.
LICENSE NO.: 062-048736
EXPIRES: NOVEMBER 30, 2023

D-92-070-23

| D-92-070-23 | STEP-6/SON | SINDE BLOD | DOOR | SIC VENTY | LATE | DOOR | SINDE BLOD | DOOR | SINDE BLOD | DOOR | SINDE BLOD | SINDE B

WHITESIDE



DEPARTMENT OF TRANSPORTATION
DIVISION OF HIGHWAYS

SUBMITTED 41914 25 20 23

DEPARTMENT OF HIGHWAYS, REGION ENGINEER
October 13, 2023

ENGINEER OF DESIGN AND ENVIRONMENT
October 13, 2023

DIRECTOR OF HIGHWAYS PROJECT IMPLEMENTATION

PRINTED BY THE AUTHORITY OF THE STATE OF ILLINOIS

CONTRACT NO. 64S39

PROJECT ENGINEER: JAMES R. PUSH, PE (630) 930-6420 PROJECT MANAGER: MAHMOUD ETEMADI (815) 284-5393

REV. 9/5/23 REV. 8/31/23

#### **INDEX OF SHEETS**

- 1 COVER SHEET
- 2 INDEX OF SHEETS, STATE STANDARDS & GENERAL NOTES
- 3 5 SUMMARY OF QUANTITIES
- 6 10 TRAFFIC CONTROL PLANS
- 11 29 STRUCTURE REPAIR PLANS SN 098-0086
- 30 33 WORK ZONE SIGN DETAILS (DISTRICT STD 34.1)
- 34 36 TYPICAL PAVEMENT MARKINGS (DISTRICT STD 41.1)
  - 37 GUARDRAIL REFLECTORS, TYPE C (SPECIAL) (DISTRICT STD 55.1)

#### STATE STANDARDS

000001-08	STANDARD SYMBOLS, ABBREVIATIONS AND PATTERNS
001001-02	AREAS OF REINFORCEMENT BARS
001006	DECIMAL OF AN INCH AND OF A FOOT
482006-03	HMA SHOULDER ADJACENT TO RIGID PAVEMENT
606001-08	CONCRETE CURB TYPE B AND COMBINATION CONCRETE CURB AND GUTTER
610001-09	SHOULDER INLET WITH CURB
701201-05	LANE CLOSURE, 2L, 2W, DAY ONLY, FOR SPEEDS $\geq$ 45 MPH
701311-03	LANE CLOSURE, 2L, 2W, MOVING OPERATIONS - DAY ONLY
701326-04	LANE CLOSURE, 2L, 2W, PAVEMENT WIDENING, FOR SPEEDS $\geq$ 45 MPH
701331-05	LANE CLOSURE, 2L, 2W, WITH RUN-AROUND, FOR SPEEDS $\geq$ 45 MPH
701423-10	LANE CLOSURE, MULTILANE, WITH BARRIER, FOR SPEEDS $\geq$ 45 MPH TO 55 MP
701901-  08	TRAFFIC CONTROL DEVICES
704001-08	TEMPORARY CONCRETE BARRIER
780001-05	TYPICAL PAVEMENT MARKINGS
781001-04	TYPICAL APPLICATIONS RAISED REFLECTIVE PAVEMENT MARKERS
782006-01	GUARDRAIL AND BARRIER WALL REFLECTOR MOUNTING DETAILS



USER NAME = Jpush	DESIGNED	-	JRP	REVISED -
	DRAWN	-	JRP	REVISED -
PLOT SCALE = 40.0000 ' / 10.	CHECKED	-	JRP	REVISED -
PLOT DATE = 10/6/2023	DATE	-	08/23/2023	REVISED -

### STATE OF ILLINOIS DEPARTMENT OF TRANSPORTATION

# INDEX OF SHEETS, STATE STANDARDS & GENERAL NOTES SCALE: N.T.S. | SHEET 1 OF 1 SHEETS | STA. TO STA.

#### 

**GENERAL NOTES** 

ALL BORROW/WASTE/USE SITES MUST BE APPROVED BY THE DEPARTMENT PRIOR TO REMOVING ANY MATERIAL FROM THE PROJECT OR INITIATING ANY EARTHMOVING ACTIVITIES, INCLUDING TEMPORARY STOCKPILING OUTSIDE THE LIMITS OF CONSTRUCTION.

THE CONTRACTOR SHALL SUBMIT A SEQUENCE OF CONSTRUCTION OPERATIONS TO THE RESIDENT ENGINEER FOR APPROVAL BEFORE THIS PROJECT IS STARTED.

THE CONTRACTOR SHALL BE RESPONSIBLE FOR PROTECTING UTILITY PROPERTY DURING CONSTRUCTION OPERATIONS AS OUTLINED IN ARTICLE 107.31 OF THE STANDARD SPECIFICATIONS. A MINIMUM OF 48 HOURS ADVANCE NOTICE IS REQUIRED FOR NON-EMERGENCY WORK. THE JULIE NUMBER IS 800-892-0123.

ALL ELEVATIONS SHOWN IN PLANS ARE BASED ON NORTH AMERICAN VERTICAL DATUM OF 1988 (NAVD 88).

THERE ARE NO COMMITMENTS ASSOCIATED WITH THIS PROJECT.

ALL SAW CUTS NECESSARY TO COMPLETE THE WORK DETAILED IN THESE PLANS SHALL BE INCLUDED IN THE COST FOR THE VARIOUS PAY ITEMS INVOLVED.

PAVEMENT MARKING SHALL BE DONE ACCORDING TO STANDARD 780001. EXCEPT AS FOLLOWS:

- ALL WORDS, SUCH AS ONLY, SHALL BE 8 FEET HIGH.
- ALL NON-FREEWAY ARROWS SHALL BE THE LARGE SIZE.
- THE DISTANCE BETWEEN YELLOW NO-PASSING LINES SHALL BE 8 INCHES, NOT 7 INCHES, AS SHOWN IN THE DETAIL OF TYPICAL LANE AND EDGE LINES.
- CENTERLINE SKIP DASH PAVEMENT MARKING ON MULTI-LANE DIVIDED, MULTI-LANE UNDIVIDED, AND ONE-WAY ROADWAY SHALL BE ACCORDING TO DISTRICT STANDARD 41.1.

UNLESS DIRECTED BY THE ENGINEER, PAVEMENT MARKING LINES SHALL NOT BE LAID DIRECTLY OVER A LONGITUDINAL CRACK OR JOINT NOR OVER A TAR OR ASPHALT PAINTED LINE.

- THE EDGE OF A CENTERLINE OR LANE LINE SHALL BE OFFSET A MINIMUM DISTANCE OF 2" FROM A LONGITUDINAL CRACK OR JOINT.
- EDGE LINES SHALL BE APPROXIMATELY 2" FROM THE EDGE LINE OF PAVEMENT. SEE SECTION 780 OF THE STANDARD SPECIFICATIONS FOR TRAFFIC CONTROL ITEMS.

AREAS OF DECK REPAIRS SHOWN ARE ESTIMATED. THE ENGINEER SHALL SHOW ACTUAL LOCATIONS OF DECK REPAIRS ON AS-BUILT PLANS.

MICROSILICA CONCRETE SHALL INCLUDE MACRO-SIZE, TYPE III, SYNTHETIC FIBERS MEETING THE 'BRIDGE DECK MICROSILICA CONCRETE OVERLAY' SPECIAL PROVISION.

#### MAINTENANCE OF TRAFFIC NOTES

SHOULDER REMOVAL AND REPLACEMENT

EXISTING STABILIZED SHOULDERS 10' WIDE AT STA. 602+83 TO STA. 606+48 AND STA. 609+23 TO STA. 612+88 SHALL BE EXCAVATED BY MILLING 9-INCH DEEP IN ACCORDANCE WITH SECTION 202 OF THE STANDARD SPECIFICATIONS AND FOLLOWING IDOT STANDARD 482006. THIS WORK SHALL BE MEASURED AND PAID FOR AS EXCAVATING AND GRADING EXISTING SHOULDER, WHICH SHALL INCLUDE ALL WORK REQUIRED TO RESHAPE THE SHOULDERS TO THE NEW GRADE LINE FOR PAVEMENT RESURFACING.

SHOULDERS SHALL BE REPLACED WITH HMA IN ACCORDANCE WITH IDOT STANDARD 482006. PRIME AND TACK SHALL BE INCLUDED IN COST OF HOT-MIX ASPHALT SHOULDERS, 9".

THE FOLLOWING MIXTURE REQUIREMENTS ARE APPLICABLE FOR THIS PROJECT:

MIXTURE USE(S): SHOULDERS	SURFACE	LOWER LIFTS
LIFT THICKNESS:	2"	3.5" / 2 LIFTS
PG:	PG 58 -28	PG 58 -28
DESIGN AIR VOIDS:	4.0% @ Ndes - 50	4.0% @ Ndes - 50
MIXTURE COMPOSITION:	IL-9.5 or IL-9.5FG	IL-19.0
FRICTION AGGREGATE:	MIX "D"	NA
QUALITY MANAGEMENT PROGRAM:	QC / QA	QC / QA
SUBLOT SIZE:	NA	NA

THE FOLLOWING RATES OF APPLICATION HAVE BEEN USED TO CALCULATE PLAN QUANTITIES: BITUMINOUS MATERIALS (TACK COAT) 0.05 LBS / SQ FT (ON PAVEMENT)

HOT-MIX ASPHALT MATERIAL 112 LBS / SQ YD PER 1"

CONSTRUCTION CODE
BRIDGE 00 47
90% FED / 10% STATE

				1 70 70 120 7 10 70 317 112
CODE NO.	ITEM	UNIT	TOTAL QUANTITY	SN 098-0086 WHITESIDE COUNTY
20200600	EXCAVATING AND GRADING EXISTING SHOULDER	UNIT	15	15
50102400	CONCRETE REMOVAL	CU YD	91.5	91.5
48203033	HOT-MIX ASPHALT SHOULDERS, 9"	SQ YD	1,623	1,623
50157300	PROTECTIVE SHIELD	SQ YD	859	859
50300255	CONCRETE SUPERSTRUCTURE	CU YD	101.7	101.7
50300300	PROTECTIVE COAT	SQ YD	2,324	2,324
50500405	FURNISHING AND ERECTING STRUCTURAL STEEL	POUND	3,080	3,080
50800205	REINFORCEMENT BARS, EPOXY COATED	POUND	17,060	117,060
50800515	BAR SPLICERS	EACH	16	16
52000110	PREFORMED JOINT STRIP SEAL	FOOT	181	181
52100400	STEEL BEARING ASSEMBLY	EACH	4	4
52100520	ANCHOR BOLTS, 1"	EACH	16	16
67000400	ENGINEER'S FIELD OFFICE, TYPE A	CAL MO	4	4
67100100	MOBILIZATION	L SUM	1	1
70100200	TRAFFIC CONTROL AND PROTECTION, STANDARD 701331	EACH	2	2
70100325	TRAFFIC CONTROL AND PROTECTION, STANDARD 701423	EACH	2	2
70100450	TRAFFIC CONTROL AND PROTECTION, STANDARD 701201	L SUM	1	1
70100500	TRAFFIC CONTROL AND PROTECTION, STANDARD 701326	L SUM	1	1
70103815	TRAFFIC CONTROL SURVEILLANCE	CAL DA	90	90

<sup>\*</sup> DENOTES SPECIALTY ITEM



USER NAME = Jpush	DESIGNED	-	BMW	REVISED	-
	DRAWN	-	BMW	REVISED	=
PLOT SCALE = 40.0000 '/ in.	CHECKED	-	JRP	REVISED	=
PLOT DATE = 8/24/2023	DATE	-	08/23/2023	REVISED	=

	SUMMARY OF QUANTITIES								SECTION	COUNTY	TOTAL SHEETS	SHEET NO.
									(195-3HB-4)BDR	WHITESIDE	37	3
										CONTRACT	NO. 6	4539
	SCALE: N.T.S.	SHEET 1	OF	3	SHEETS	STA.	TO STA.		ILLINOIS FED. AID PROJECT			

CONSTRUCTION CODE BRIDGE 0047 90% FED / 10% STATE

CODE NO.	ITEM	UNIT	TOTAL QUANTITY	SN 098-0086 WHITESIDE COUNTY
70107025	CHANGEABLE MESSAGE SIGN	CAL DA	104	104
70300150	SHORT TERM PAVEMENT MARKING REMOVAL	SQ FT	2 <b>,</b> 657	2,657
70307100	TEMPORARY PAVEMENT MARKING LETTERS AND SYMBOLS - TYPE IV TAPE	SQ FT	2	2
70307120	TEMPORARY PAVEMENT MARKING - LINE 4" - TYPE IV TAPE	FOOT	7,971	7,971
70400100	TEMPORARY CONCRETE BARRIER	FOOT	1,320	1,320
70400200	RELOCATE TEMPORARY CONCRETE BARRIER	FOOT	1,320	1,320
70600250	IMPACT ATTENUATORS, TEMPORARY (NON- REDIRECTIVE), TEST LEVEL 3	EACH	2	2
70600350	IMPACT ATTENUATORS, RELOCATE (NON- REDIRECT IVE) , TEST LEVEL 3	EACH	2	2
78009004	MODIFIED URETHANE PAVEMENT MARKING - LINE 4"	FOOT	2,688	2,688
78300202	PAVEMENT MARKING REMOVAL - WATER BLASTING	SQ FT	670	670
X0325748	ACRYLIC COATING	SQ YD	387	387
X5030250	BRIDGE DECK GROOVING (LONGITUDINAL)	SQ YD	1,317	1,317
X7820007	GUARDRAIL REFLECTORS, TYPE C (SPECIAL)	EACH	64	64
20001899	JACK AND REMOVE EXISTING BEARINGS	EACH	4	4
20001905	STRUCTURAL STEEL REPAIR	POUND	60	60
20005880	BRIDGE HANDRAIL REMOVAL	FOOT	494	494
DENOTIES SDESS				

\* DENOTES SPECIALTY ITEM



STATE OF ILLINOIS
DEPARTMENT OF TRANSPORTATION

 SUMMARY OF QUANTITIES
 30L I 88 I

 SCALE: N.T.S. I SHEET 2 OF 3 SHEET S STA. TO STA.
 TO STA.

CONSTRUCTION CODE BRIDGE 0047 90% FED / 10% STATE


CODE NO.	ITEM	UNIT	TOTAL QUANTITY	SN 098-0086 WHITESIDE COUNTY
>				
20007101	CONTAINMENT AND DISPOSAL OF LEAD PAINT CLEANING RESIDUES NO. 1	L SUM	1	1
20010501	CLEANING AND PAINTING STEEL BRIDGE NO. 1	L SUM	1	1
20012144	BRIDGE DECK SCARIFICATION 2 1/2"	SQ YD	1,934	1,934
20012166	BRIDGE DECK MICROSILICA CONCRETE OVERLAY 2 3/4"	SQ YD	1,934	1,934
20012754	STRUCTURAL REPAIR OF CONCRETE (DEPTH EQUAL TO OR LESS THAN 5 INCHES)	SQ FT	113	113
20016001	DECK SLAB REPAIR (FULL DEPTH, TYPE I)	SQ YD	24	24
20029090	DIAMOND GRINDING (BRIDGE SECTION)	SQ YD	1,714	1,714
-				
		-		
DEMORES CDECT				


\* DENOTES SPECIALTY ITEM

QUANDEI)

STATE OF ILLINOIS
DEPARTMENT OF TRANSPORTATION

SCALE: N.T.S. I SHEET 3 OF 3 SHEETS STA. TO STA.

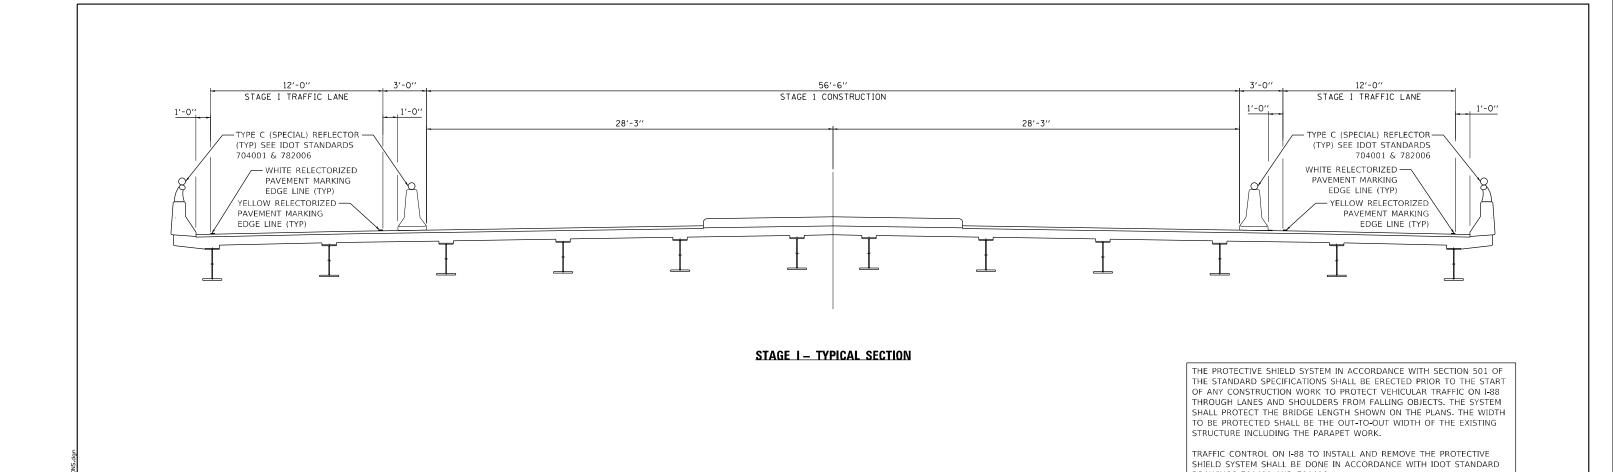

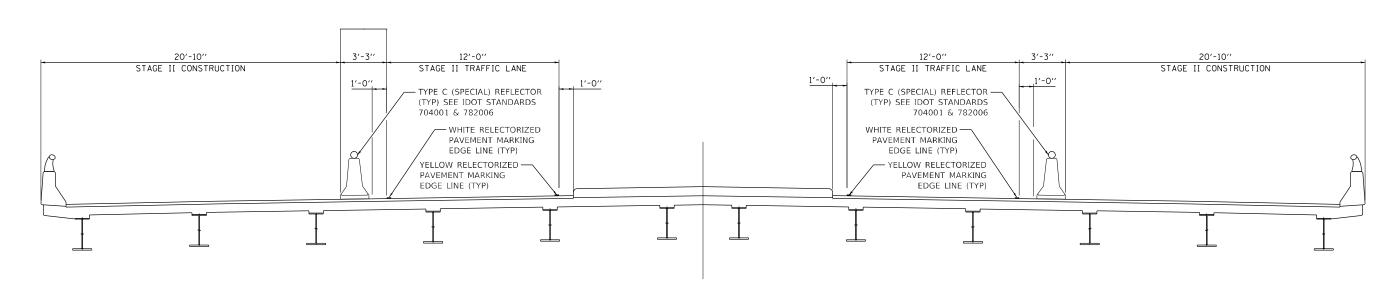

STAGE II - TYPICAL SECTION

CHANDE!
GUANDEL


USER NAME = Jpush	DESIGNED	-	BMW	REVISED -	
MOT CROSSECTIONS.dgn	DRAWN	-	BMW	REVISED -	ĺ
PLOT SCALE = 100.0000 '/ in.	CHECKED	-	JRP	REVISED -	i
PLOT DATE = 8/24/2023	DATE	-	08/21/2023	REVISED -	ı

STATE OF ILLINOIS	
DEPARTMENT OF TRANSPORTATION	


STAGE (	CONSTI	RUCTIO	NC	TRAFF	C CON	ITROL SN	- 098-0	086
		STA	GIN	G TYPI	CAL SE	CTIONS		
SCALE: N.T.S.	SHEET	1	0F	5 SHE	ETS S1	Α.	TO ST	A.

DRAWINGS 701400 AND 701406.

	ILLINOIS	FED. Al	ID PROJECT		
			CONTRACT	NO. 6	453
88	(195-3HB-4)BDR		WHITESIDE	37	6
F.A.I. RTE.	SECTION	COUNTY	TOTAL SHEETS	SHE	

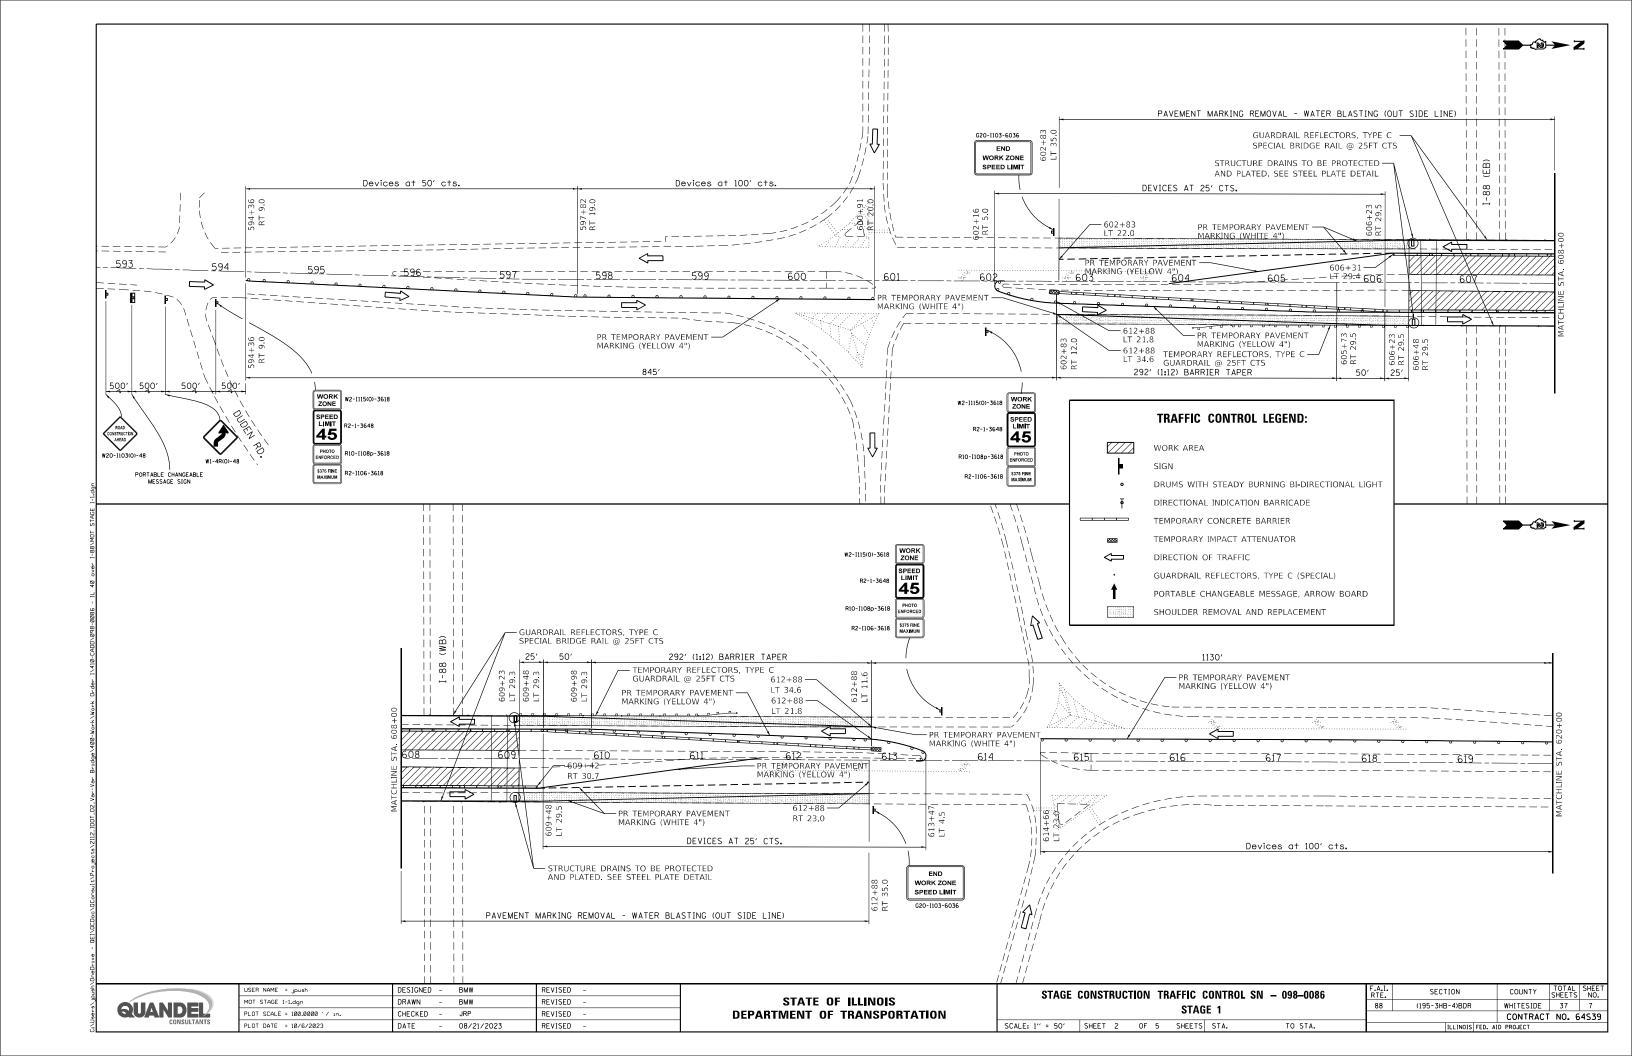



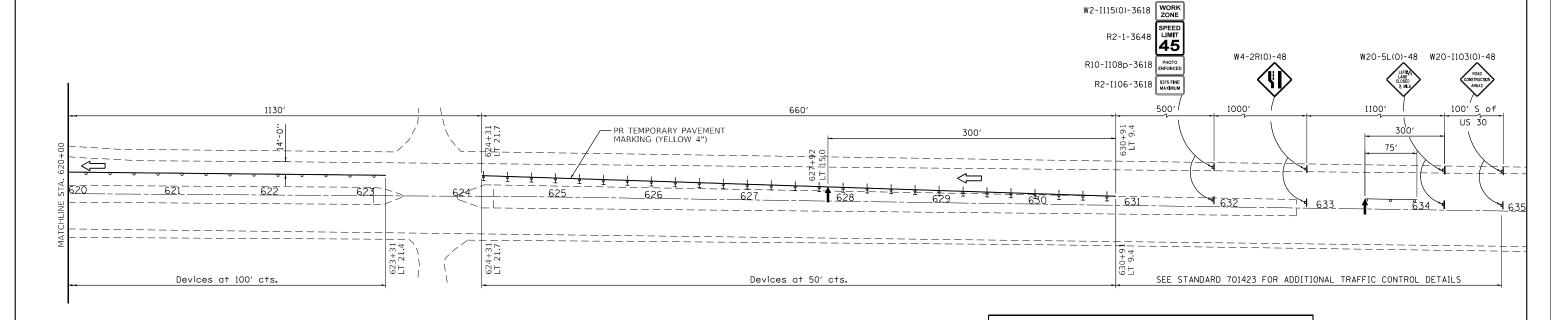

#### **GENERAL NOTES**

ALL TEMPORARY PAVEMENT MARKINGS SHALL BE TYPE IV TAPE. EXISTING PAVEMENT MARKINGS THAT CONFLICT WITH STAGED TRAFFIC MARKINGS SHALL BE REMOVED AND PAID FOR AS "PAVEMENT MARKING REMOVAL - WATER BLASTING".

THE CONTRACTOR SHALL MAKE EVERY EFFORT DURING CONSTRUCTION TO PROTECT BRIDGE SCUPPERS AND APPROACH DRAINS WITH STEEL PLATE OR APPROVED EQUIVALENT. SEE STEEL PLATE DETAIL, THIS WORK SHALL BE INCLUDED IN THE COST OF TRAFFIC CONTROL AND PROTECTION, STANDARD 701331.

GUARD RAIL REFLECTORS, TYPE C SHALL BE PLACED ALONG THE EXISTING NORTH AND SOUTH GUARD RAIL AND BRIDGE RAIL PER IDOT STANDARD 782006. THEY SHALL BE SPACED AT 25 FT CENTERS TO COINCIDE WITH THE OTHER TEMPORARY TRAFFIC CONTROL DEVICES. THE MOUNTING METHOD SHALL ALLOW FOR THE REFLECTORS TO BE REMOVED WITHOUT DAMAGE TO THE EXISTING GUARD RAIL.

#### STAGE I SPECIFIC NOTES /CONSTRUCTION SEQUENCE

ALL EXISTING PAVEMENT MARKINGS THAT CONFLICT WITH THE PROPOSED STAGE TRAFFIC CONTROL SHALL BE REMOVED PRIOR TO IMPLEMENTING STAGE I. EXISTING PAVEMENT MARKINGS SHALL BE REMOVED USING THE PAY ITEM PAVEMENT MARKING REMOVAL - WATER BLASTING. DURING THE PRE-STAGE 1 PAVEMENT MARKING REMOVAL AND INSTALLATION WORK. TRAFFIC SHALL BE MAINTAINED BY THE CONTRACTOR UTILIZING IDOT STANDARD 701423 AND 701311 DURING DAY AND MOVING OPERATIONS.

INSTALL STAGE I TRAFFIC CONTROL DEVICES, PAVEMENT MARKINGS, AND PROTECTIONS TO THE LINES AND GRADES SHOWN ON TRAFFIC CONTROL PLAN, OR AS SPECIFIED BY ENGINEER.

COMPLETE ALL BRIDGE AND ROADWAY WORK ON THE OUTSIDE SHOULDER AND LANES OF THE STRUCTURE.

OPEN TRAFFIC TO THE OUTSIDE SHOULDER AND INSTALL STAGE II TRAFFIC CONTROL PER THE TRAFFIC

# 3/4" OR GREATER 8'-0"

#### STEEL PLATE DETAIL

N.T.S.

#### TRAFFIC CONTROL LEGEND: WORK AREA

DRUMS WITH STEADY BURNING BI-DIRECTIONAL LIGHT

DIRECTIONAL INDICATION BARRICADE TEMPORARY CONCRETE BARRIER

TEMPORARY IMPACT ATTENUATOR

DIRECTION OF TRAFFIC  $\triangleleft$ 

GUARDRAIL REFLECTORS, TYPE C (SPECIAL)

PORTABLE CHANGEABLE MESSAGE, ARROW BOARD

#### NOTES

DURING MOT STAGE I, THE APPROACH DRAIN AT THE CORNERS OF THE BRIDGE NEED TO BE PROTECTED WITH  $\ensuremath{\mathfrak{A}}\xspace$ " (MIN.) STEEL PLATE ANCHORED WITH 4 ANCHOR BOLTS


THE EDGES OF THE STEEL PLATE SHALL BE TAPERED WITH HMA TO AVOID BUMP FOR TRAFFIC.  $\,$ 

CONTRACTOR SHALL MAKE EVERY EFFORT DURING CONSTRUCTION TO PROTECT BRIDGE SCUPPERS AND APPROACH DRAINS WITH STEEL PLATE OR APPROVED EQUIVALENT. SEE PLATE DETAILS. THIS WORK SHALL BE INCIDENTAL AND INCLUDED AS PART OF " TRAFFIC CONTROL AND PROTECTION (SPECIAL)"


QUAN	DEL
CO	ONSULTANTS

USER NAME = Jpush	DESIGNED	-	BMW	REVISED -
MOT STAGE 1-2.dgn	DRAWN	-	BMW	REVISED -
PLOT SCALE = 100.0000 ' / 10.	CHECKED	-	JRP	REVISED -
PLOT DATE = 8/24/2023	DATE	-	08/21/2023	REVISED -

	STAGE CONS	TRUC	TION	TRA	FFIC C	ONTROL SN	I - 098-0086	F.A.I. RTE.	SECTION	COUNTY	TOTAL SHEETS	SHEET NO.
ı					STAG	F 1		88	(195-3HB-4)BDR	WHITESIDE	37	8
ı		STAGE I								CONTRAC	NO. 6	4539
ı	SCALE: 1" = 50'   SHEE	T 3	OF	5	SHEETS	STA.	TO STA.		ILLINOIS FED. A	ID PROJECT		

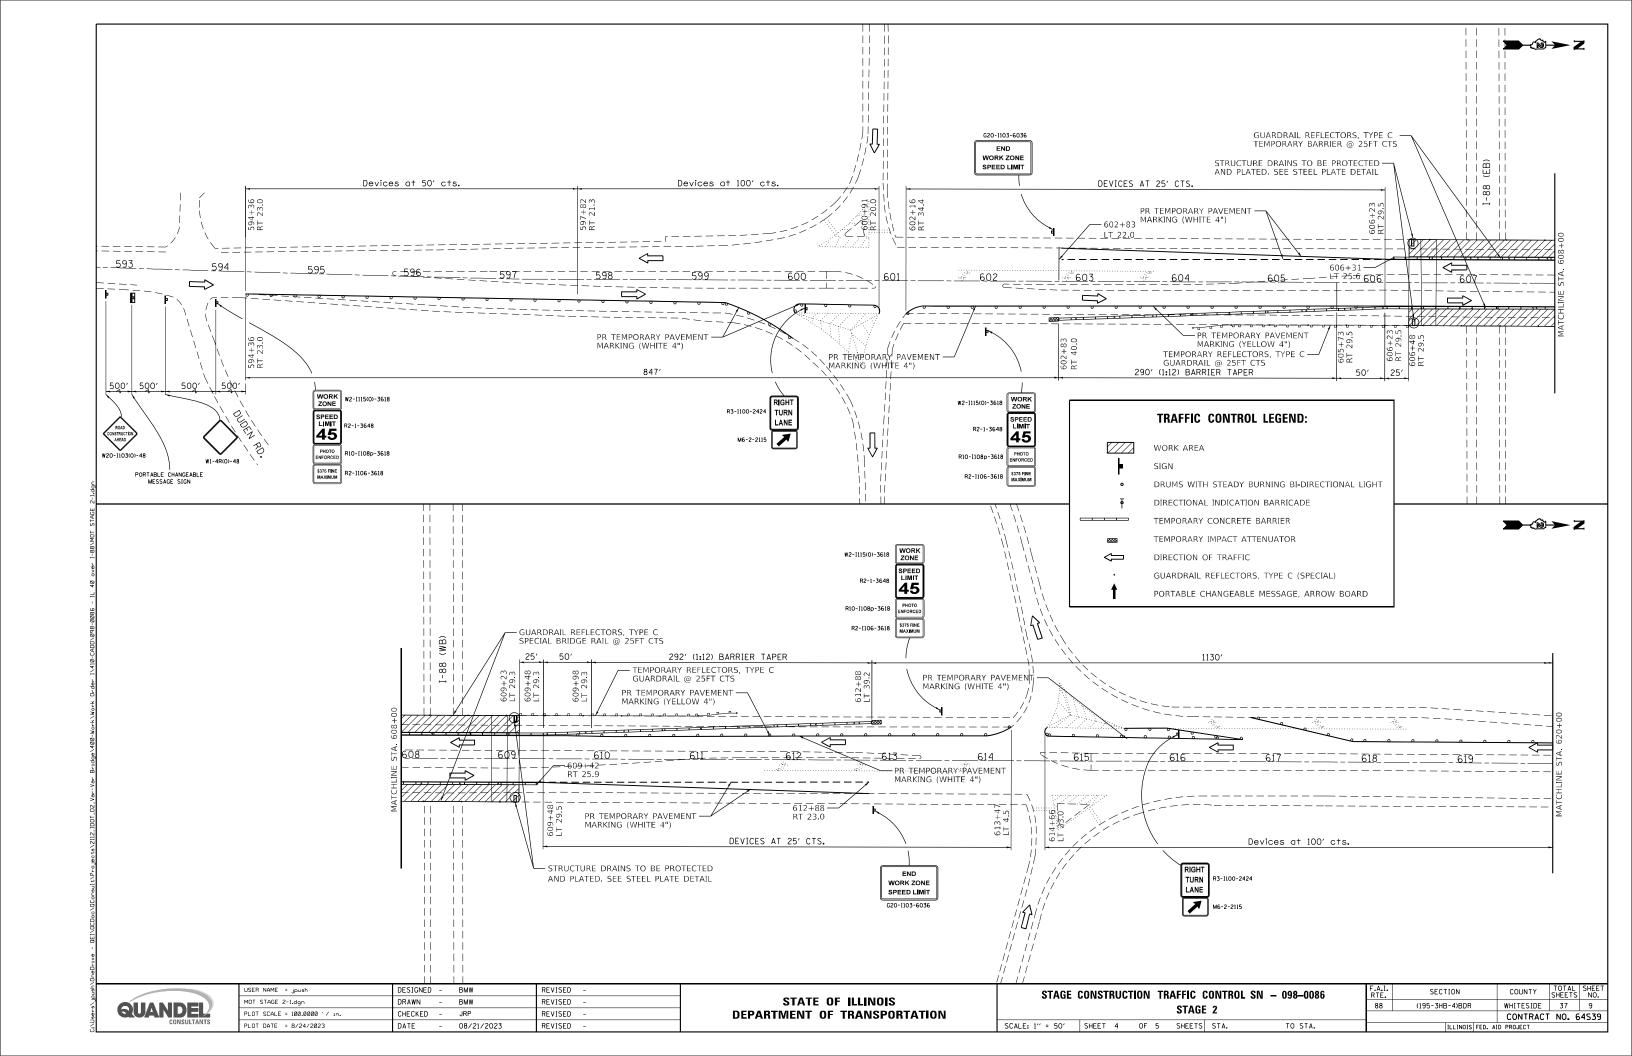



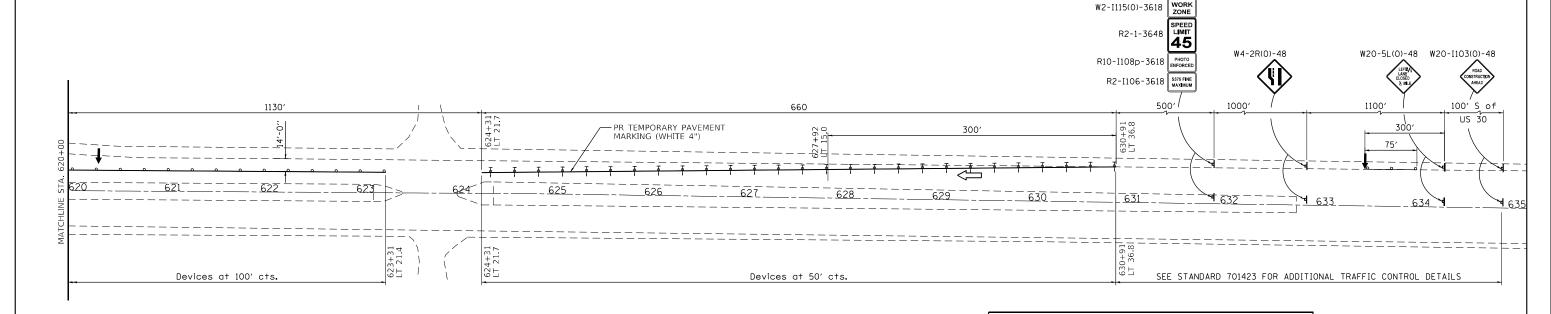

#### **GENERAL NOTES**

ALL TEMPORARY PAVEMENT MARKINGS SHALL BE TYPE IV TAPE.

THE CONTRACTOR SHALL MAKE EVERY EFFORT DURING CONSTRUCTION TO PROTECT BRIDGE SCUPPERS AND APPROACH DRAINS WITH STEEL PLATE OR APPROVED EQUIVALENT. SEE STEEL PLATE DETAIL, THIS WORK SHALL BE INCLUDED IN THE COST OF TRAFFIC CONTROL AND PROTECTION, STANDARD 701331.

GUARD RAIL REFLECTORS, TYPE C SHALL BE PLACED ALONG THE TEMPORARY BARRIER PER IDOT STANDARD 782006. THEY SHALL BE SPACED AT 25 FT CENTERS AND TO NOT COINCIDE WITH THE OTHER TEMPORARY TRAFFIC CONTROL DEVICES.

#### STAGE II SPECIFIC NOTES / CONSTRUCTION SEQUENCE

ALL EXISTING PAVEMENT MARKINGS THAT CONFLICT WITH THE PROPOSED STAGE TRAFFIC CONTROL SHALL BE REMOVED PRIOR TO IMPLEMENTING STAGE II. EXISTING PAVEMENT MARKINGS SHALL BE REMOVED USING THE PAY ITEM PAVEMENT MARKING REMOVAL - WATER BLASTING. DURING THE TRANSITION PAVEMENT MARKING REMOVAL AND INSTALLATION WORK. TRAFFIC SHALL BE MAINTAINED BY THE CONTRACTOR UTILIZING IDOT STANDARD 701423 AND 701311 DURING DAY AND MOVING OPERATIONS.

INSTALL STAGE II TRAFFIC CONTROL DEVICES, PAVEMENT MARKINGS, AND PROTECTIONS TO THE LINES AND GRADES SHOWN ON TRAFFIC CONTROL PLAN, OR AS SPECIFIED BY ENGINEER.

COMPLETE ALL BRIDGE AND ROADWAY WORK ON THE INSIDE LANES OF THE STRUCTURE.

REMOVE TRAFFIC CONTROL DEVICES AND RESTORE ROADWAY TO EXISTING TRAFFIC CONFIGURATION, AND COMPLETE ALL FINAL PAVEMENT MARKINGS.

# WORK AREA SIGN DRUMS WITH STEADY BURNING BI-DIRECTIONAL LIGHT DIRECTIONAL INDICATION BARRICADE TEMPORARY CONCRETE BARRIER TEMPORARY IMPACT ATTENUATOR DIRECTION OF TRAFFIC GUARDRAIL REFLECTORS, TYPE C (SPECIAL) PORTABLE CHANGEABLE MESSAGE, ARROW BOARD

TRAFFIC CONTROL LEGEND:

# 34" OR GREATER

#### STEEL PLATE DETAIL

8'-0"

N.T.S.

#### NOTES

DURING MOT STAGE II, THE APPROACH DRAIN PROTECTION STEEL PLATES WILL BE REMOVED.

QUAN	DEL
	CONSULTANTS

USER NAME = Jpush	DESIGNED	-	BMW	REVISED -	Ī
MOT STAGE 2-2.dgn	DRAWN	-	BMW	REVISED -	
PLOT SCALE = 100.0000 ' / 10.	CHECKED	-	JRP	REVISED -	
PLOT DATE = 8/24/2023	DATE	-	08/21/2023	REVISED -	

STATE OF ILLINOIS
DEPARTMENT OF TRANSPORTATION

STAGE (	CONSTRUC	TION	TRAFFIC (	CONTROL	. SN - 098-0086	F.A.I. RTE.	SECTION	COUNTY	TOTA
	STAGE 2						(195-3HB-4)BDR	WHITESIDE	37
			SIAGE	. 4				CONTRAC	NO.
SCALE: 1" = 50"	SHEET 5	OF 5	5 SHEETS	STA.	TO STA.		ILLINOIS FED. A	D PROJECT	

Existing Structure: S.N. 098-0086 (IL 40), originally built in 1972, as a two-span, continuous steel plate girder superstructure with vaulted abutments and multi-column piers. The back to back length = 220'-2" and the out to out width = 92'-0". Structure is to be repaired as detailed in these plans. Stage construction will be used to maintain traffic. No Salvage SCOPE OF WORK 1. Replace transverse expansion joints Bk. of S. Abut. -→ Bk. of S. - Bk. of N. Abut. Bk. of N. located at the end of the bridge deck. Appr. Bent Appr. Bent 2. Eliminate the longitudinal deck joint. 3. Concrete repair of parapets. 4. Concrete parapet extensions. 5. Concrete repair of median. -Ex. 48" P. Girder 6. Deck scarification and microsilica concrete overlay. 7. Replace select bearings. 8. Steel beam end repairs. I-88 (WB) I-88 (EB) 9. Paint beam ends. 10. Concrete repair of abutments. Up to 1/4" may be ground off the bridge deck. INDEX OF SHEETS ELEVATION 1. General Plan and Elevation 2. General Details 3. Stage Construction Details 220'-2" Bk. to Bk. Abut. 4. Temporary Concrete Barrier for Stage Construction 108'-31/2" 108'-31/2" 5. Deck Overlay Plan 6-7. Parapet Details 8. Deck Removal and Repair Details 1'-91/2" 1'-91/2" 9. Deck Details 10-11. Expansion Joint Details 15'-81/2" 15'-8½" 12. Longitudinal Joint and Expansion Joint Details 13. Preformed Joint Strip Seal 14. Bearing Removal and Replacement - Ç Brg. N. Abut. € Brg. S. Abut. 15-16. Steel Details 17. Abutment Repairs 18. Bar Splicer Assembly and Mechanical Splicer Details 19. Existing Plans Reference Sheet 90°, typ. STRUCTURA € IL 40 - Bk. of N. Abut. − Bk. of S. Abut. ROBERT WHITESIDE 081-008015 ⊈ Pier -− Bk. of S. Appr. Bent Bk. of N. Appr. Bent 10/5/2023 Robert Whiteside, Illinois S.E. 081-008015 Expires 11/30/2024 Stage Const. Range 7E, 3rd P.M. DESIGN STRESSES FIELD UNITS (NEW) f'c = 4,000 psi (Superstructure)Limits of Protective Shield = 42'-0" Limits of Protective Shield = 42'-0" fy = 60,000 psi (Reinforcement)GENERAL PLAN & ELEVATION fy = 36,000 psi (M270 Grade 36)PLANFIELD UNITS (EXISTING) IL 40 OVER I-88 f'c = 3,000 psi (Deck)SECTION (195-3HB-4)BDR f'c = 3,500 psi (Approach Slab, Parapet, DESIGN SPECIFICATIONS LOADING HS20-44 Median, Sub) WHITESIDE COUNTY fy = 40,000 psi (Reinforcement)Existing and Proposed 2002 AASHTO Standard Specifications Project fy = 36,000 psi (M270 Grade 36) LOCATION SKETCH Location for Highway Bridges (Proposed) SN 098-0086 SER NAME = zdavidson DESIGNED - SDY REVISED -SECTION **GENERAL PLAN AND ELEVATION** COUNTY **STATE OF ILLINOIS** CHECKED - ZQ 980086-64N01-Sht-001-GPE.dan REVISED -WHITESIDE 37 11 (195-3HB-4)BDR **STRUCTURE NO. 098-0086** 25:0.0000 ':" / in ZQ/CFS REVISED **DEPARTMENT OF TRANSPORTATION** CONTRACT NO. 64S39 QUIGG ENGINEERING INC SHEET 1 OF 19 SHEETS PLOT DATE = CHECKED - MDC REVISED .

10/5/2023 7:44:38 AM

Calculated weight of Structural Steel = 3,140 lbs.

All structural steel shall be AASHTO M 270 Grade 36.

No field welding is permitted except as specified in the contract documents.

Reinforcement bars designated (E) shall be epoxy coated.

Prior to pouring the new concrete deck, all heavy or loose rust, loose mill scale, and other loose or potentially detrimental foreign material shall be removed from the surfaces in contact with concrete. Tightly adhered paint may remain unless otherwise noted. Removal shall be accomplished by methods that will not damage the steel and the cost will be included in the pay item covering removal of the existing concrete.

Plan dimensions and details relative to existing plans are subject to nominal construction variations. The Contractor shall field verify existing dimensions and details affecting new construction and make necessary approved adjustments prior to construction or ordering of materials. Such variations shall not be cause for additional compensation for a change in scope of the work, however, the Contractor will be paid for the quantity actually furnished at the unit price bid

The existing structural steel coating contains lead. The Contractor shall take

The Organic Zinc Rich Primer / Epoxy / Urethane Paint System shall be used for painting of new structural steel except where otherwise noted. The entire system shall be shop applied, with the exception of the exterior surface and the bottom of the bottom flange of fascia beams, masked off connection surfaces, field installed fasteners and damaged areas shall be touched up in the field. The color of the final finish coat for all interior steel surfaces shall be Gray, Munsell No. 5B 7/1. The color of the final finish coat for the exterior and bottom flange of the fascia beams shall be Blue, Munsell No. 10B 3/6.

construction. Cost included with Concrete Removal.

the beam) of either side of the transverse deck joints shall be cleaned per Near White Blast Cleaning (SSPC-SP10).

The designated areas cleaned per Near White Blast Cleaning (SSPC-SP10) shall be painted according to the requirements of Paint System 1 - OZ/E/U. The color of the final finish coat for all interior steel surfaces shall be Gray, Munsell No. 5B 7/1. The color of the final finish coat for the exterior and bottom flange of the fascia beams shall be Blue, Munsell No. 10B 3/6.

Existing structural steel that will be in contact with new structural steel shall be cleaned and painted prior to erection as required by the special provision "Cleaning and Painting Contact Surface Areas of Existing Steel Structures". Cost included in

A minimum of 2 air monitor(s) will be required to monitor abrasive blasting operations at this site. See special provision for "Containment and Disposal of Lead Paint Cleaning Residues."

galvanized per the special provision "Hot Dip Galvanizing for Structural Steel."

Protective coat shall be applied to bridge deck microsilica concrete overlay, new bridge deck concrete, new vault slab concrete, top and vertical face of new concrete at median and top and inside face of new concrete at parapets.

Fasteners shall be ASTM A325 Type 1, mechanically galvanized bolts. Bolts ¾" Ø, holes

for the work.

appropriate precautions to deal with the presence of lead on this project.

Existing reinforcement shall be cleaned and incorporated into the new

Cleaning and painting of the existing structural steel shall be as specified in the special provision for "Cleaning and Painting Existing Steel Structures". All beams, bearings and other structural steel within 10 ft (measurement along

Structural Steel Repair.

SSPC QP1 and SSPC QP2 Certification is required for this Contract.

All repairs including structural steel angles, wide flanges, bolts, nuts and washers shall be Cost included in Structural Steel Repair.

# QUIGG ENGINEERING INC

USER NAME = zdavidson	DESIGNED -	SDY	REVISED -
0980086-64N01-Sht-002-General Details.dgn	CHECKED -	ZQ	REVISED -
PLOT SCALE = 0:2.0000 ':" / in.	DRAWN -	ZQ/CFS	REVISED -
PLOT DATE =	CHECKED -	MDC	REVISED -

#### STATE OF ILLINOIS **DEPARTMENT OF TRANSPORTATION**

#### TOTAL BILL OF MATERIAL


Item	Unit	Super	Sub	Total
Protective Coat	Sq. Yd.	2324	0	2324
Concrete Removal	Cu. Yd.	91.5	0	91.5
Protective Shield	Sq. Yd.	859	0	859
Concrete Superstructure	Cu. Yd.	101.7	0	101.7
Furnishing and Erecting Structural Steel	Pound	3080	0	3080
Reinforcement Bars, Epoxy Coated	Pound	17060	0	17060
Bar Splicers	Each	16	0	16
Preformed Joint Strip Seal	Foot	181	0	181
Steel Bearing Assembly	Each	4	0	4
Anchor Bolts, 1"	Each	16	0	16
Jack and Remove Existing Bearings	Each	4	0	4
Structural Steel Repair	Pound	60	0	60
Bridge Handrail Removal	Foot	494	0	494
Containment and Disposal of Lead Paint Cleaning Residues No. 1	L. Sum	1	0	1
Cleaning and Painting Steel Bridge No. 1	L. Sum	1	0	1
Bridge Deck Scarification 21/2"	Sq. Yd.	1934	0	1934
Bridge Deck Microsilica Concrete Overlay 2¾"	Sq. Yd.	1934	0	1934
Structural Repair of Concrete (Depth Equal to or less than 5")	Sq. Ft.	36	77	113
Deck Slab Repair (Full Depth, Type I)	Sq. Yd.	24	0	24
Diamond Grinding (Bridge Section)	Sq. Yd.	1714	0	1714
Acrylic Coating	Sq. Yd.	387	0	387
Bridge Deck Grooving (Longitudinal)	Sq. Yd.	1317	0	1317

\* Deck Slab Repair areas are estimated and will be field verified and approved by the engineer prior to starting patching.

**GENERAL DETAILS** 


**STRUCTURE NO. 098-0086** 

SHEET 2 OF 19 SHEETS

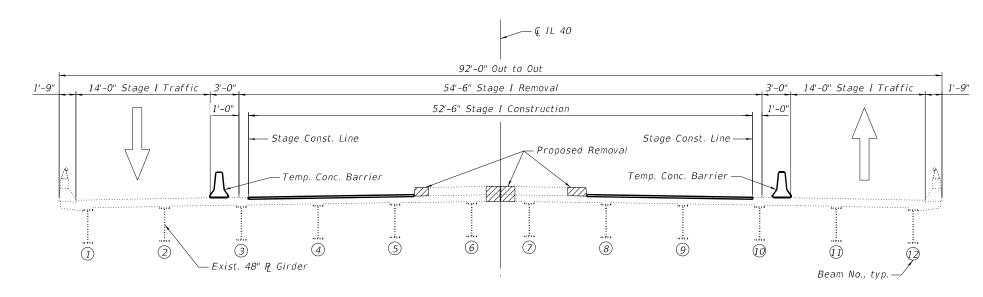


#### STAGE I REMOVAL AND CONSTRUCTION

(Looking North)

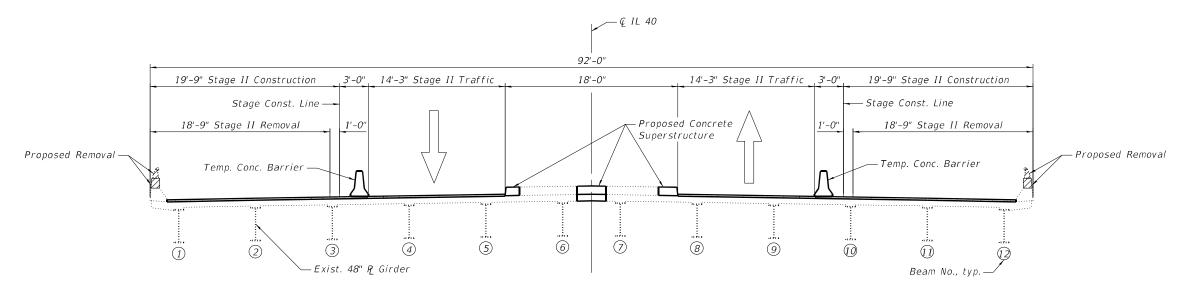

#### STAGE II REMOVAL AND CONSTRUCTION

(Looking North)

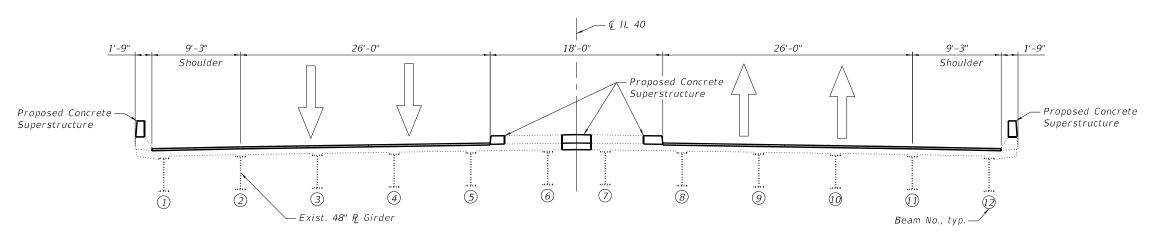

LEGEND

Concrete Removal


#### PROPOSED SECTION

(Looking North)

QUIGG ENGINEERING IN

USER NAME = zdavidson	DESIGNED -	SDY	REVISED -
0980086-64N01-Sht-003-Stage Constr.dgn	CHECKED -	ZQ	REVISED -
PLOT SCALE = 10:0.0000 ':" / in.	DRAWN -	ZQ/CFS	REVISED -
PLOT DATE =	CHECKED -	MDC	REVISED -

						SB-03
STAGE CONSTRUCTION DETAILS	F.A.I. RTE	SECTION		COUNTY	TOTAL SHEETS	SHEET NO.
STRUCTURE NO. 098-0086		(195-3HB-4)BDR		WHITESIDE	37	13
311(00101)L 110: 030-0000				CONTRA	CT NO.	64S39
SHEET 3 OF 19 SHEETS		ILLINOIS	FED. All	PROJECT		

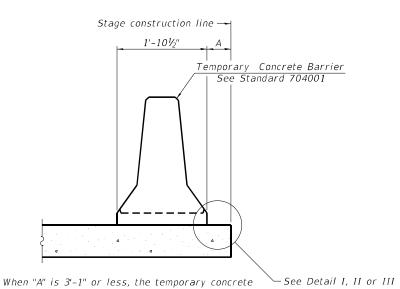

barrier shall be restrained to the new slab according to Detail I, II or III. No restraint is required when "A" is greater than 3'-1".

#### - Stage removal line ← Stage removal line 1'-101/2" 1'-101/2" Temporary Concrete Barrier See Standard 704001 6" min. min. Drill 3-11/4" Ø Holes in existing slab for 1" Ø restraining pins. Traffic side only. Cost of restraining pins are included with Temporary Concrete Barrier. No restraint is required when "A" is greater than 3'-1".

\* When hot-mix asphalt wearng surface is present, embedment shall be 3" plus the wearing surface depth.


#### EXISTING DECK BEAM


#### NEW SLAB OR NEW DECK BEAM

2-17-2017

#### SECTIONS THRU SLAB OR DECK BEAM


EXISTING SLAB

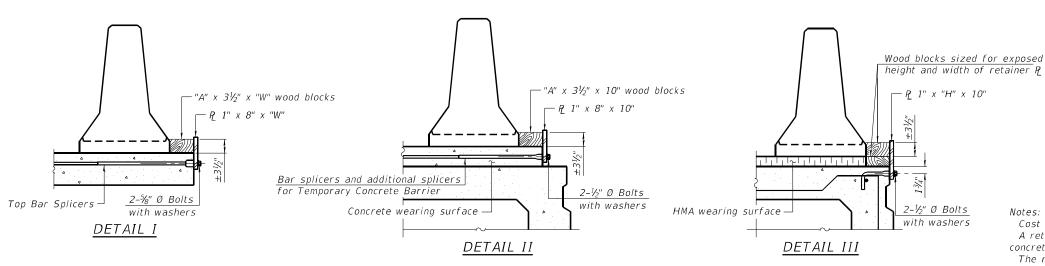

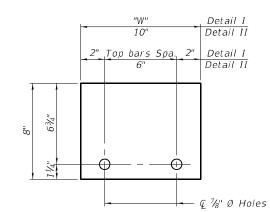


#### STEEL RETAINER P 1" x 8" x "W"

(Detail I and II)

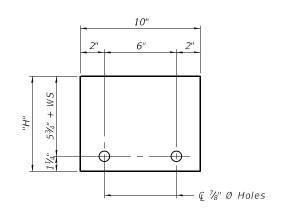

STEEL RETAINER P 1" x "H" x 10" (Detail III)

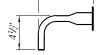

RESTRAINING PIN

#### BAR SPLICER FOR #4 BAR - DETAIL III

Cost of retainer assembly is included with Temporary Concrete Barrier. A retainer assembly shall be located at the approximate ( of each temporary concrete barrier.

The retainer plate shall not be removed until the concrete on the adjacent stage is ready to be poured. For Detail III applications the retainer plate shall not be removed until just prior to placing the adjacent beam.

1x8 UNC

1" Ø pin

US Std. 11/16" I.D. x 21/2" O.D. x approx. 8 guage thick washer

When the 'A' dimension is less than  $1\frac{1}{2}$ ", the wood block shall be omitted and the barrier shall be placed in direct contact with the steel retainer plate. For deck beam applications the minimum required 'A' distance is 6" to accommodate the shear key clamping device.


- Detail I Installation for a new bridge deck or bridge slab.
- Detail II Installation for a new deck beam with an initial concrete wearing surface. Additional bar splicers shall be provided at 6'-0" centers and paired with the bar splicers of the concrete wearing surface reinforcement to accommodate the installation of the retainer assemblies. The cost of the additional bar splicers is included with the concrete wearing surface.
- Detail III Installation for a new deck beam with no initial wearing surface or with an initial hot-mix asphalt (HMA) wearing surface present. The deck beam directly beneath the temporary concrete barrier shall be fabricated with bar splicer inserts in the side of the beam, as detailed, to accommodate the installation of the retainer assemblies. A pair of bar splicers, 6" apart, shall be placed at 6'-0" centers along the length of the beam. The cost of the bar splicers is included with the deck beam.

DESIGNED - SDY REVISED -980086-64N01-Sht-004-TCB.dgn CHECKED - ZQ REVISED -OT SCALE = 0:2.0000 ':" / in. ZQ/CFS REVISED CHECKED - MDC REVISED -


**STATE OF ILLINOIS DEPARTMENT OF TRANSPORTATION**  TEMPORARY CONCRETE BARRIER FOR STAGE CONSTRUCTION **STRUCTURE NO. 098-0086** SHEET 4 OF 19 SHEETS

SECTION COUNTY (195-3HB-4)BDR WHITESIDE 37 14 CONTRACT NO. 64S39


QUIGG ENGINEERING INC

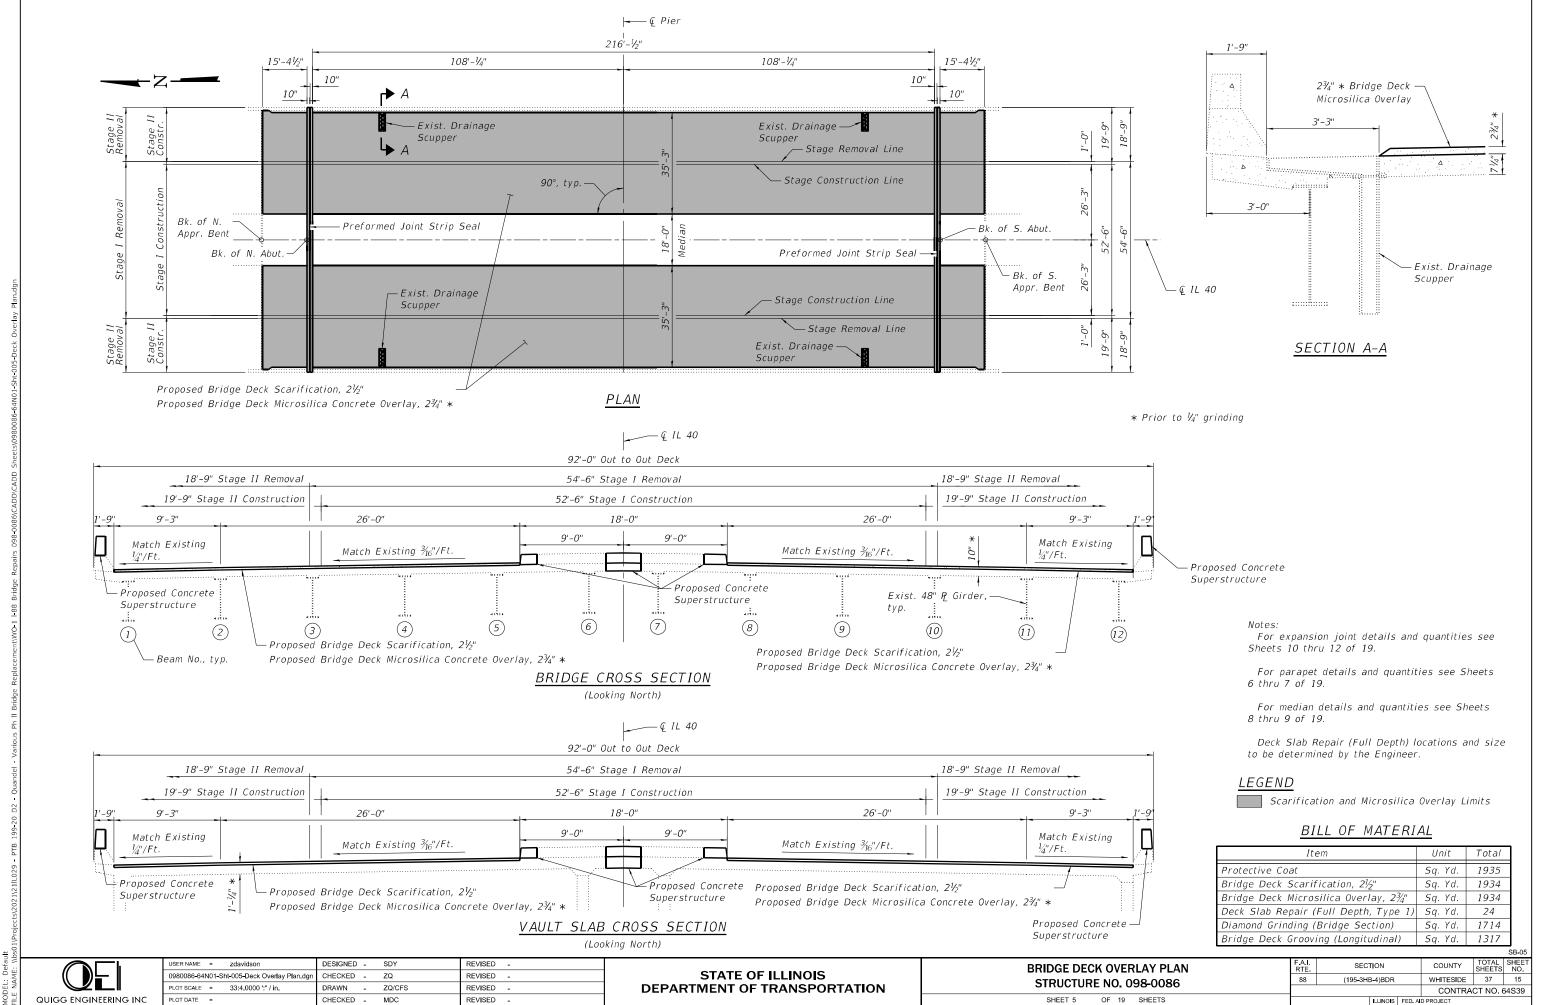


10/5/2023 7:44:44 AM

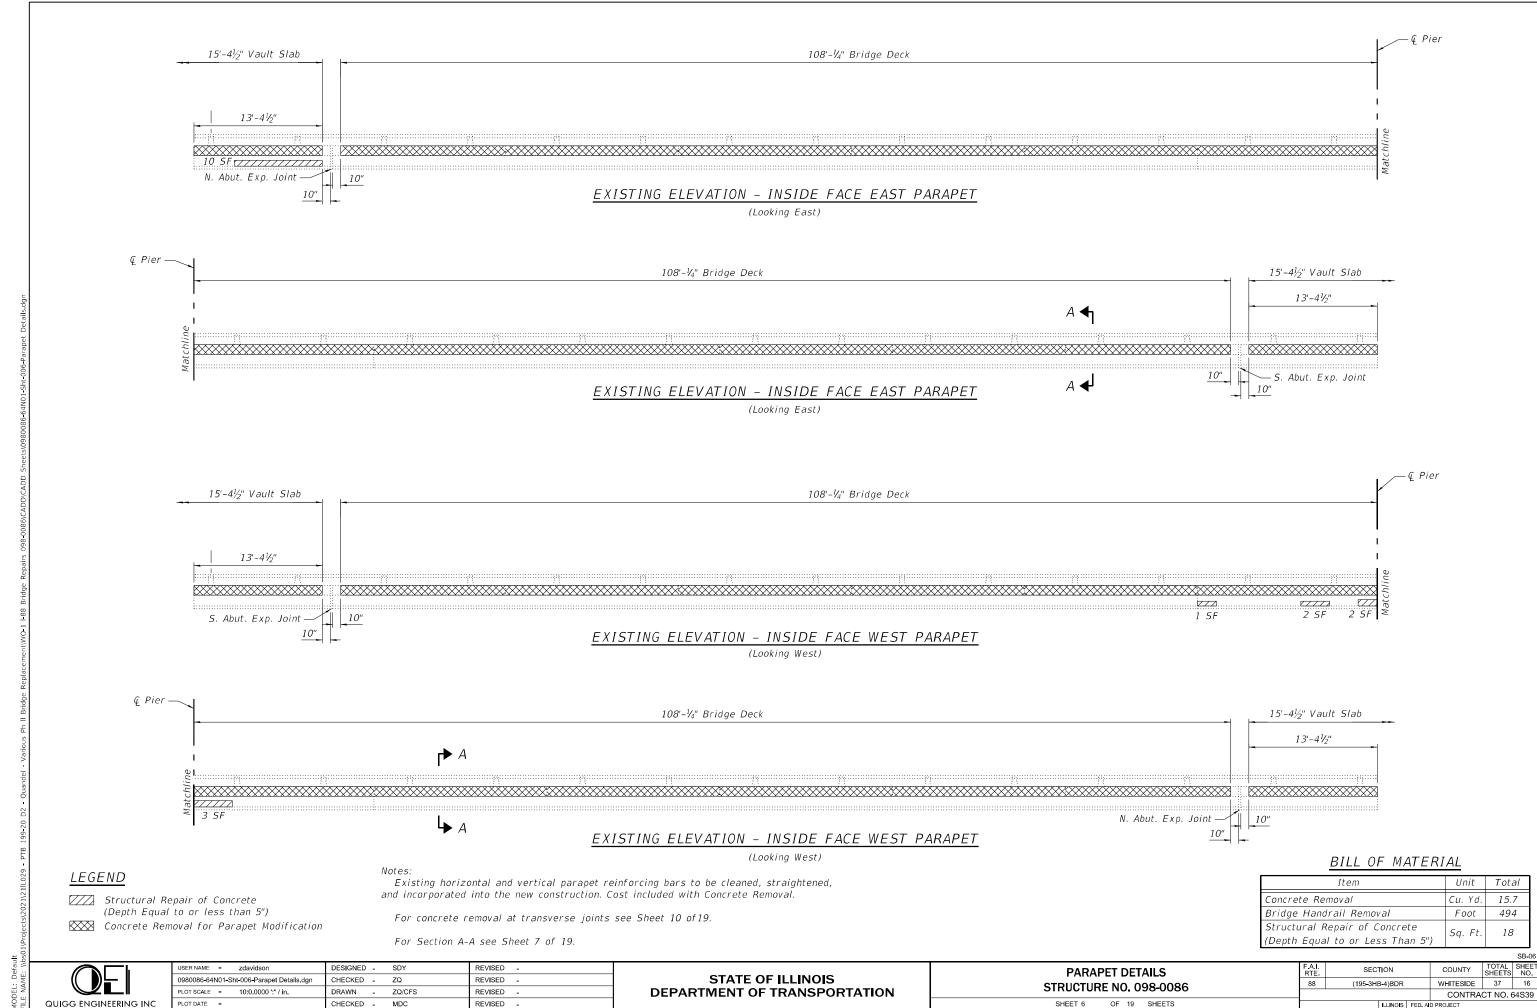


10/5/2023 7:44:46 AM

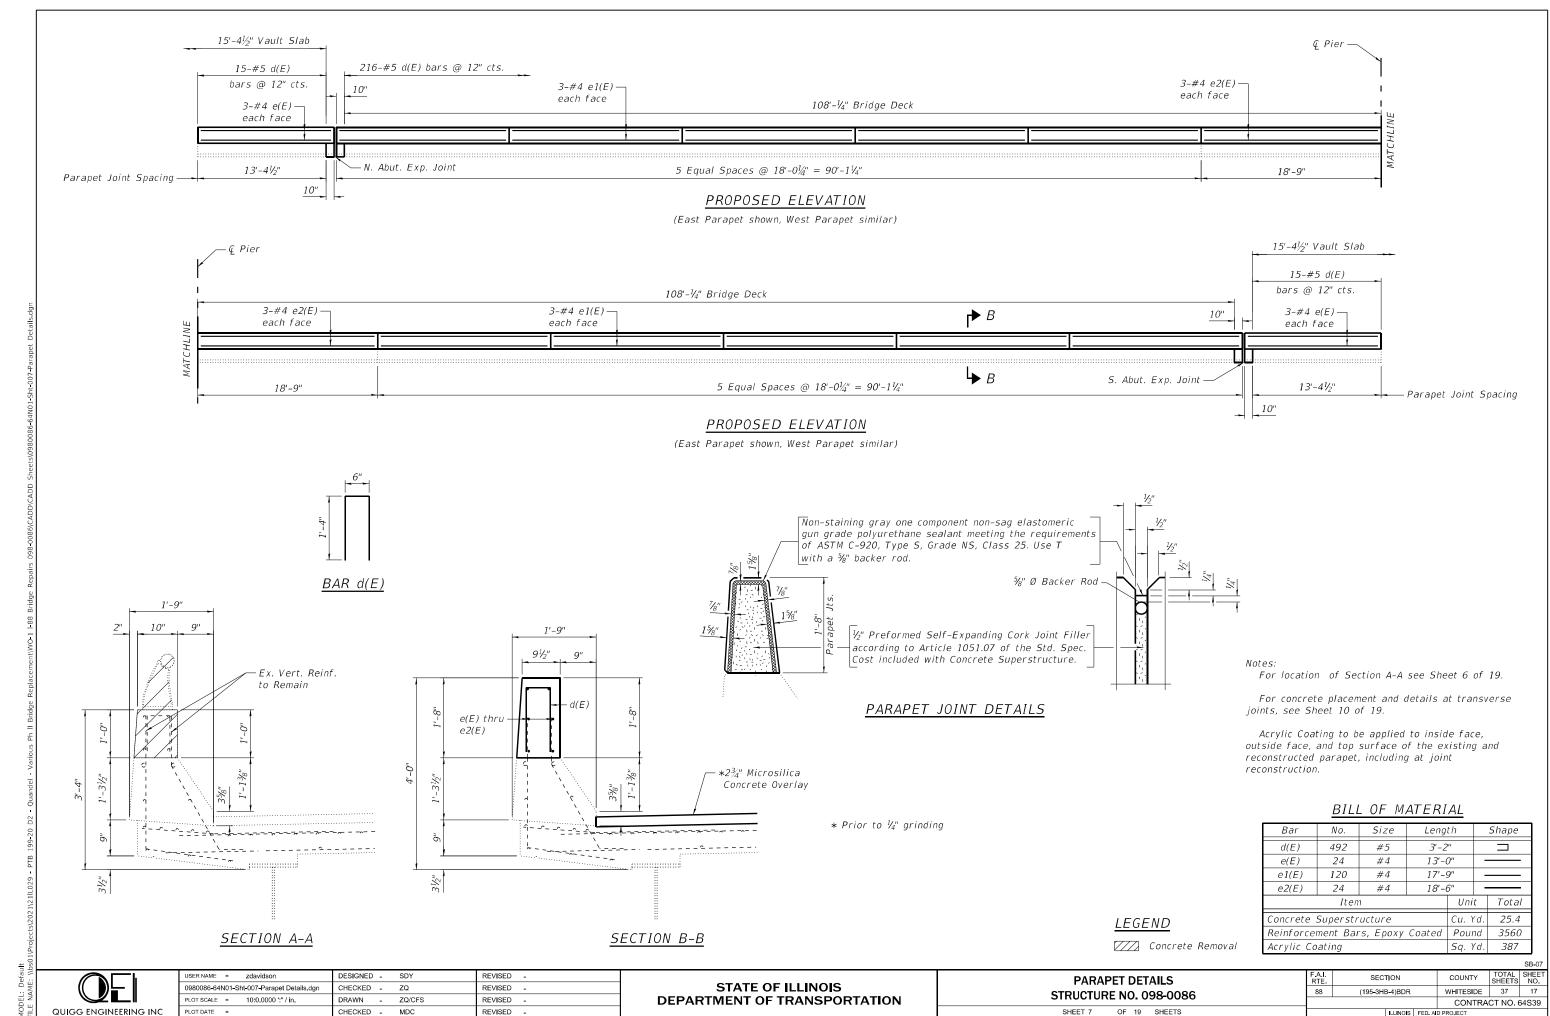

10/5/2023 7:44:47 AM

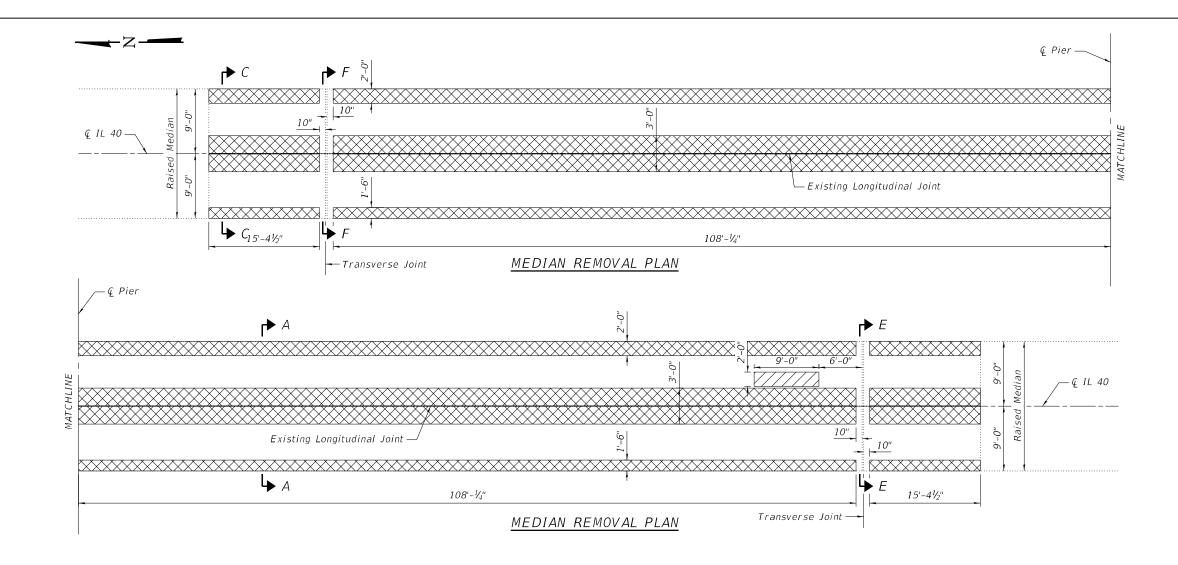

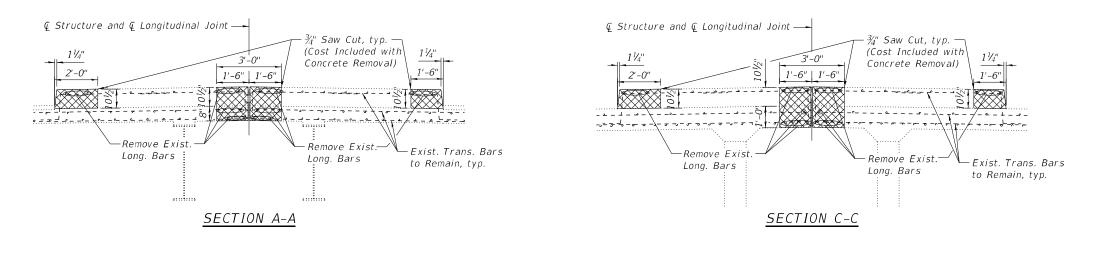

#### Notes:

Existing reinforcement shall be cleaned and incorporated into the new construction. Cost included with Concrete Removal.

For concrete removal at joints see Sheet 10 of 19.

For Sections E-E and F-F see Sheet 12 of 19.

#### LEGEND

Concrete Removal for Longitudinal Joint
Closure and Median Repairs

#### BILL OF MATERIAL

Item	Unit	Total
Concrete Removal	Cu. Yd.	67.3
Structural Repair of Concrete (Depth Equal to or Less than 5")	Sq. Ft.	18

SB-08



 USER NAME
 =
 zdavidson
 DESIGNED
 SDY
 REVISED

 0980086-64N01-Sht-008-Deck Removal.dgn
 CHECKED
 ZQ
 REVISED


 PLOT SCALE
 =
 13:4,0000 "." / in.
 DRAWN
 ZQ/CFS
 REVISED

 PLOT DATE
 =
 CHECKED
 MDC
 REVISED


STATE OF ILLINOIS
DEPARTMENT OF TRANSPORTATION

DECK REMOVAL AND REPAIR DETAILS
STRUCTURE NO. 098-0086

SHEET 8 OF 19 SHEETS

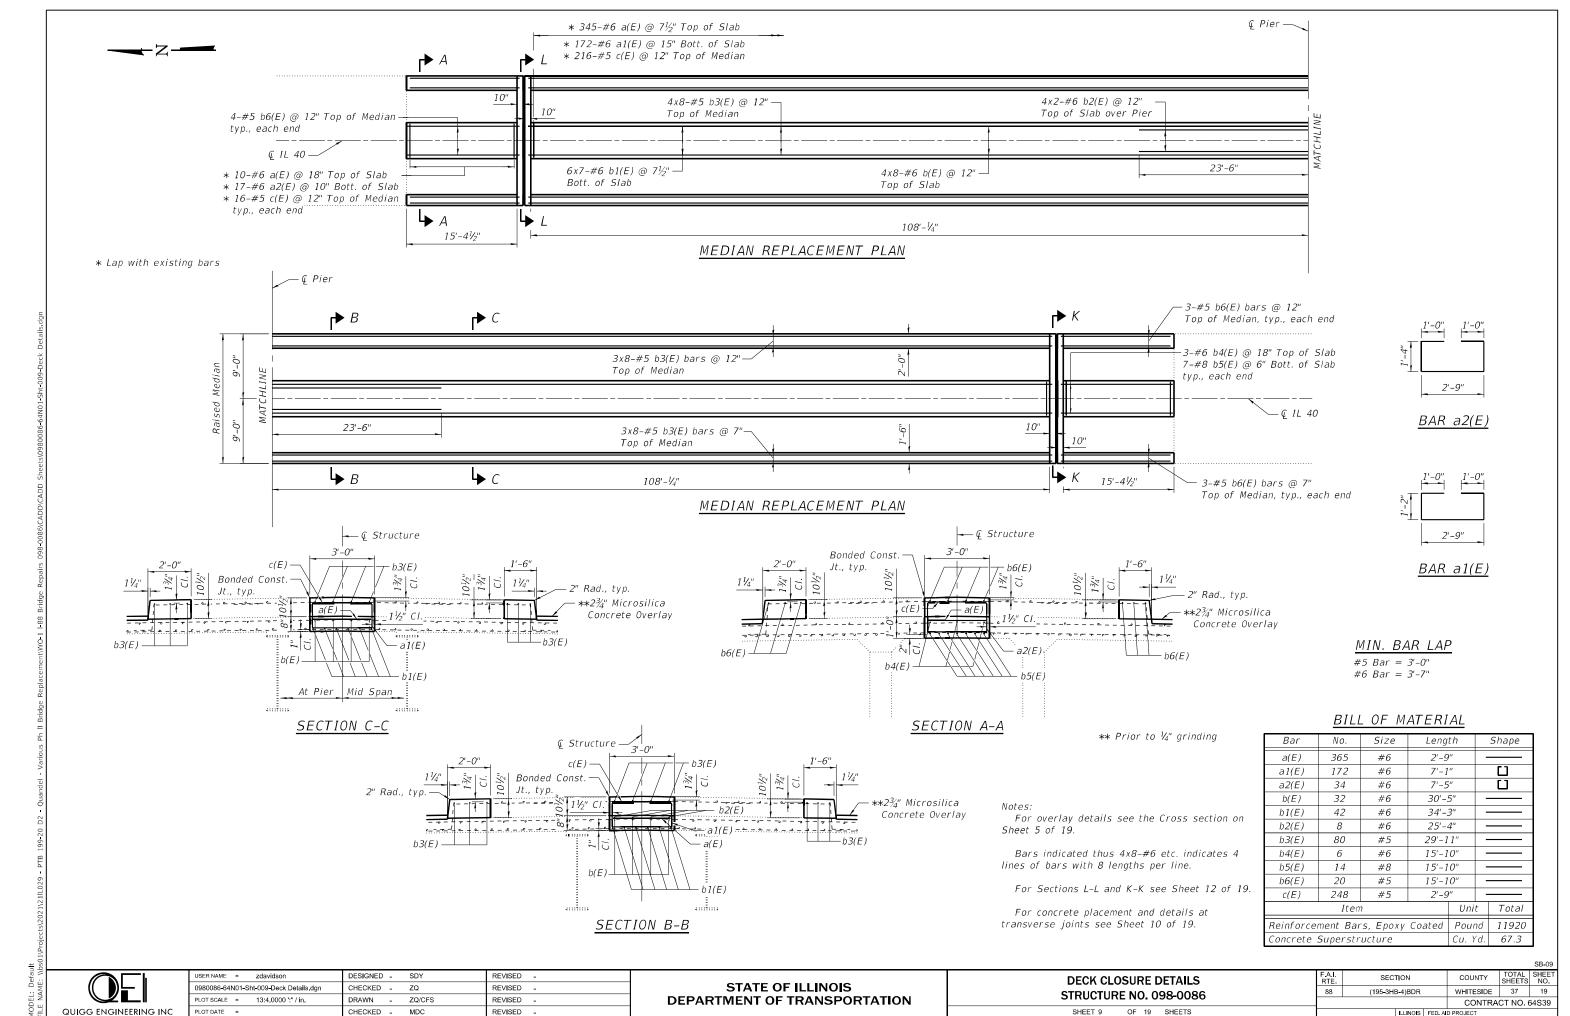

10/5/2023 7:44:50 Al

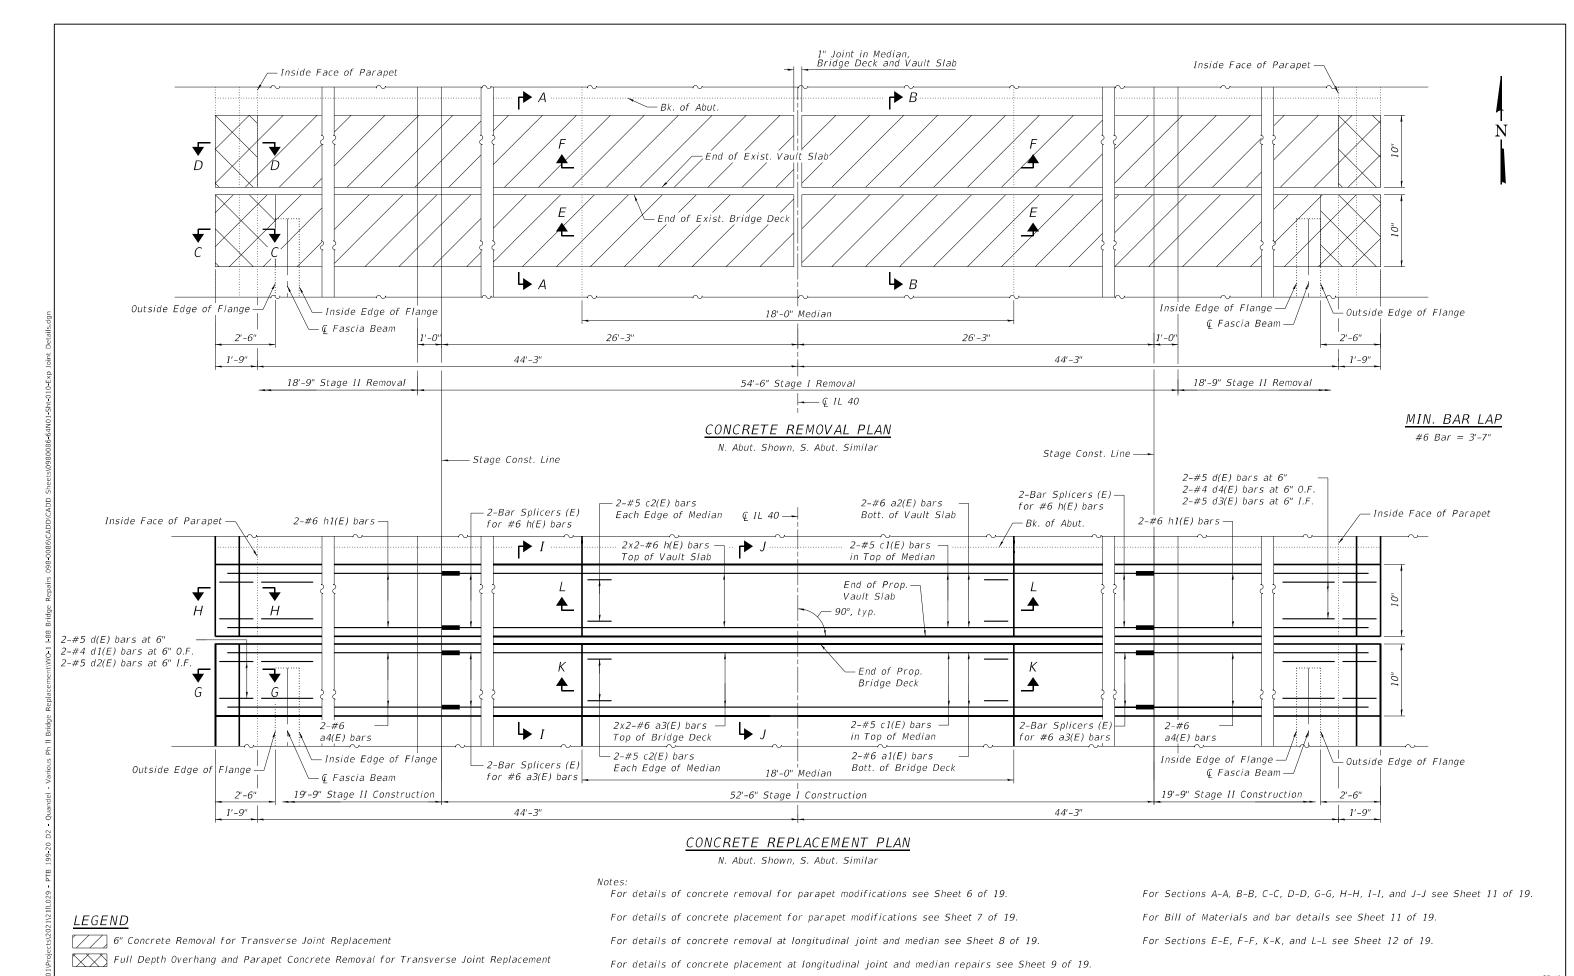


QUIGG ENGINEERING INC

DESIGNED - SDY REVISED . 980086-64N01-Sht-010-Exp Joint Details.don CHECKED -ZQ REVISED -ZQ/CFS REVISED PLOT DATE = CHECKED -REVISED MDC

**STATE OF ILLINOIS DEPARTMENT OF TRANSPORTATION**  **EXPANSION JOINT DETAILS STRUCTURE NO. 098-0086** SHEET 10 OF 19 SHEETS

SECTION COUNTY (195-3HB-4)BDR WHITESIDE 37 20 CONTRACT NO. 64S39

10/5/2023 7:44:52 AM

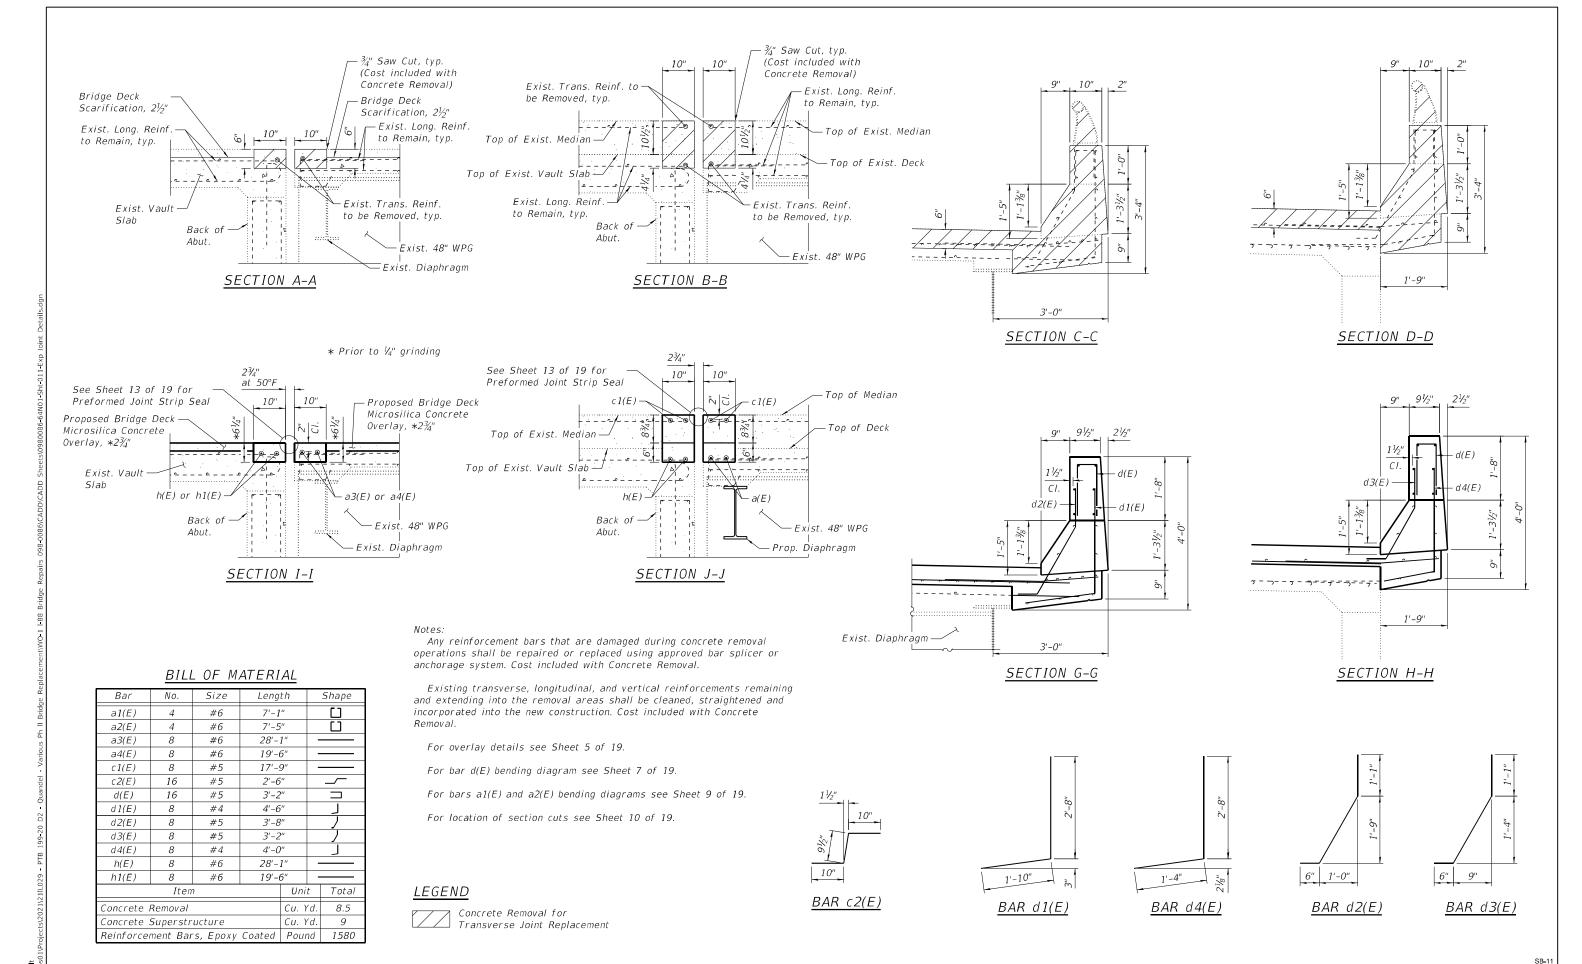

QUIGG ENGINEERING INC

 USER NAME
 =
 zdavidson
 DESIGNED
 SDY
 REVISED

 0980086-64N:01-Sh-011-Exp Joint Details.dgn
 CHECKED
 ZQ
 REVISED

 PLOT SCALE
 =
 2:6.0000 '." / in.
 DRAWN
 ZQ/CFS
 REVISED

 PLOT DATE
 =
 CHECKED
 MDC
 REVISED

STATE OF ILLINOIS
DEPARTMENT OF TRANSPORTATION


EXPANSION JOINT DETAILS STRUCTURE NO. 098-0086 SHEET 11 OF 19 SHEETS


 
 F.A.I. RTE.
 SECTION
 COUNTY SHEETS
 TOTAL SHEETS NO.
 SHEETS NO.


 88
 (195-3HB-4)BDR
 WHITESIDE
 37
 21


 CONTRACT NO. 64S39

 ILLINOIS FED. AID PROJECT

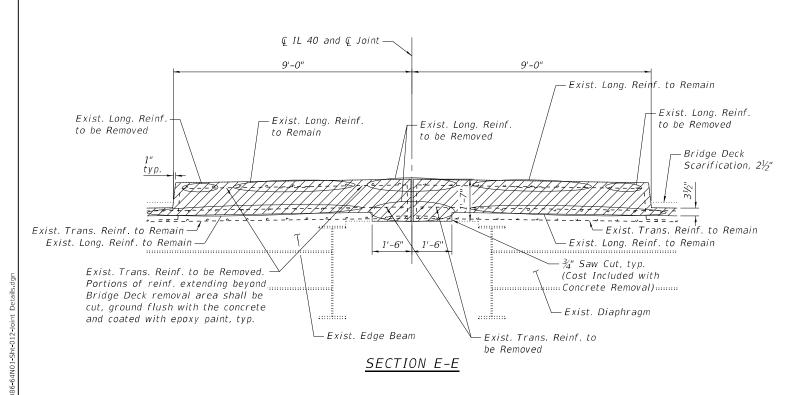

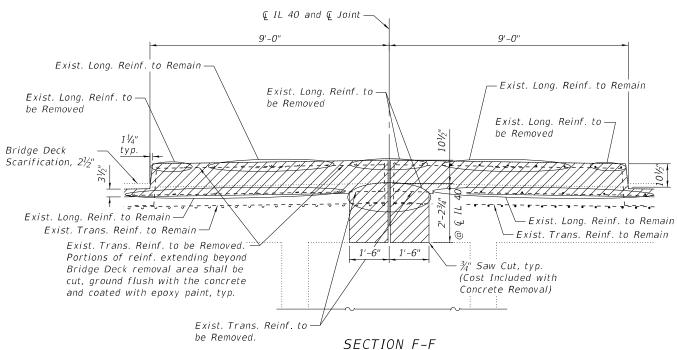

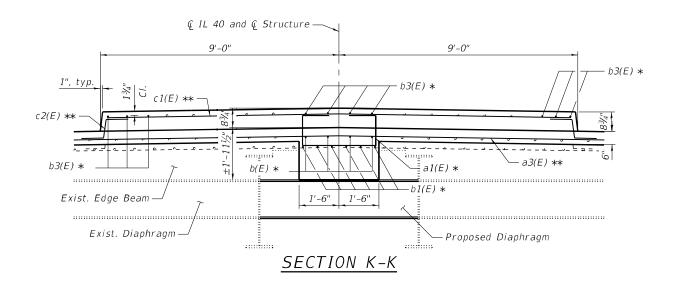

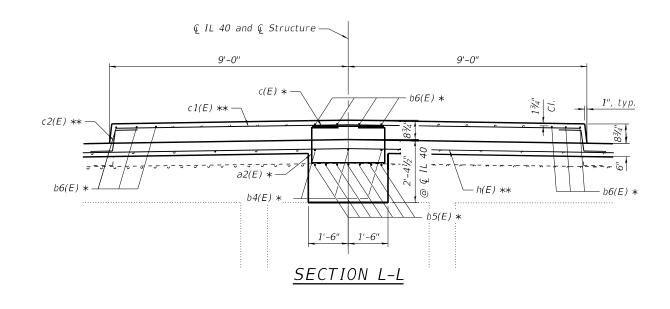

Notes:

For section cut locations see Sheets 8 thru 10 of 19.

For Bill of Material see Sheet 11 of 19.

For details of longitudinal reinforcement in median to remain and to be removed see Sheets 8 and 9 of 19.

\* See Sheet 9 of 19 for bar details

\*\* See Sheet 11 of 19 for bar details

 USER NAME
 =
 zdavidson
 DESIGNED
 SDY
 REVISED

 0980086-64N01-Sht-012-Joint Details.dgn
 CHECKED
 ZQ
 REVISED

 PLOT SCALE
 =
 10:10.0000 "" / in.
 DRAWN
 ZQ/CFS
 REVISED


 PLOT DATE
 =
 CHECKED
 MDC
 REVISED

STATE OF ILLINOIS
DEPARTMENT OF TRANSPORTATION


ONGITUDINAL JOINT AND EXPANSION JOINT DETAILS								
STRUCTURE NO. 098-0086								
CHEET 12 OF 10 CHEETC								

FILE NAME: \\bso

QUIGG ENGINEERING INC 10/5/2023 7:44:55 AM

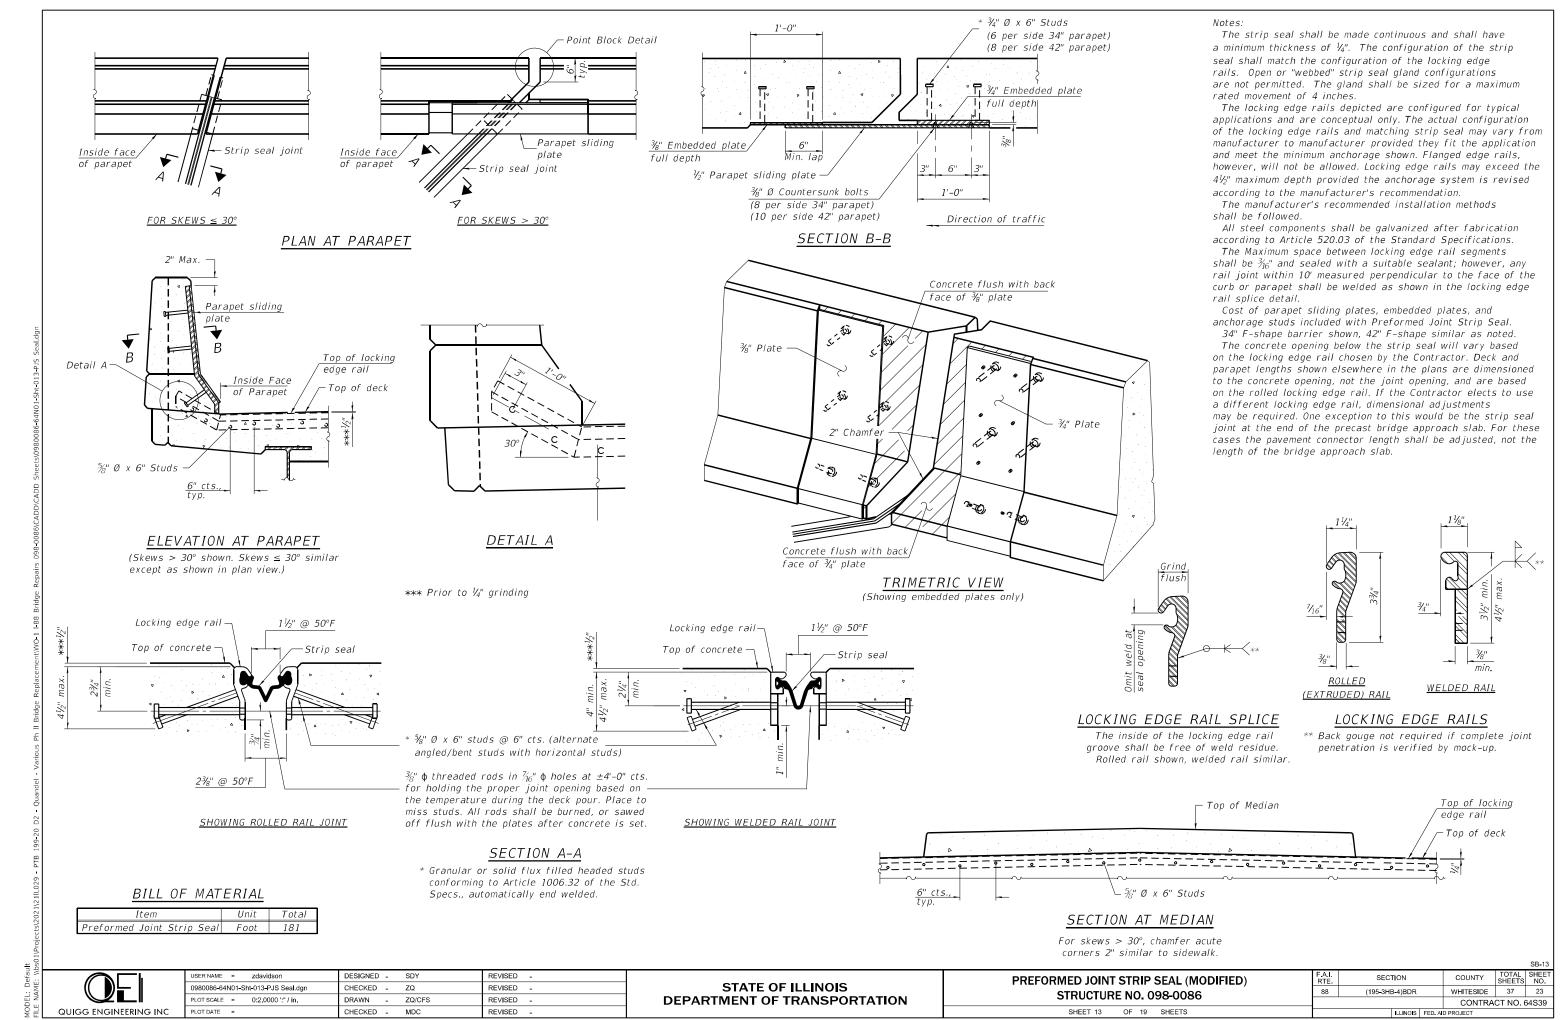

10/5/2023 7:44:56 AM

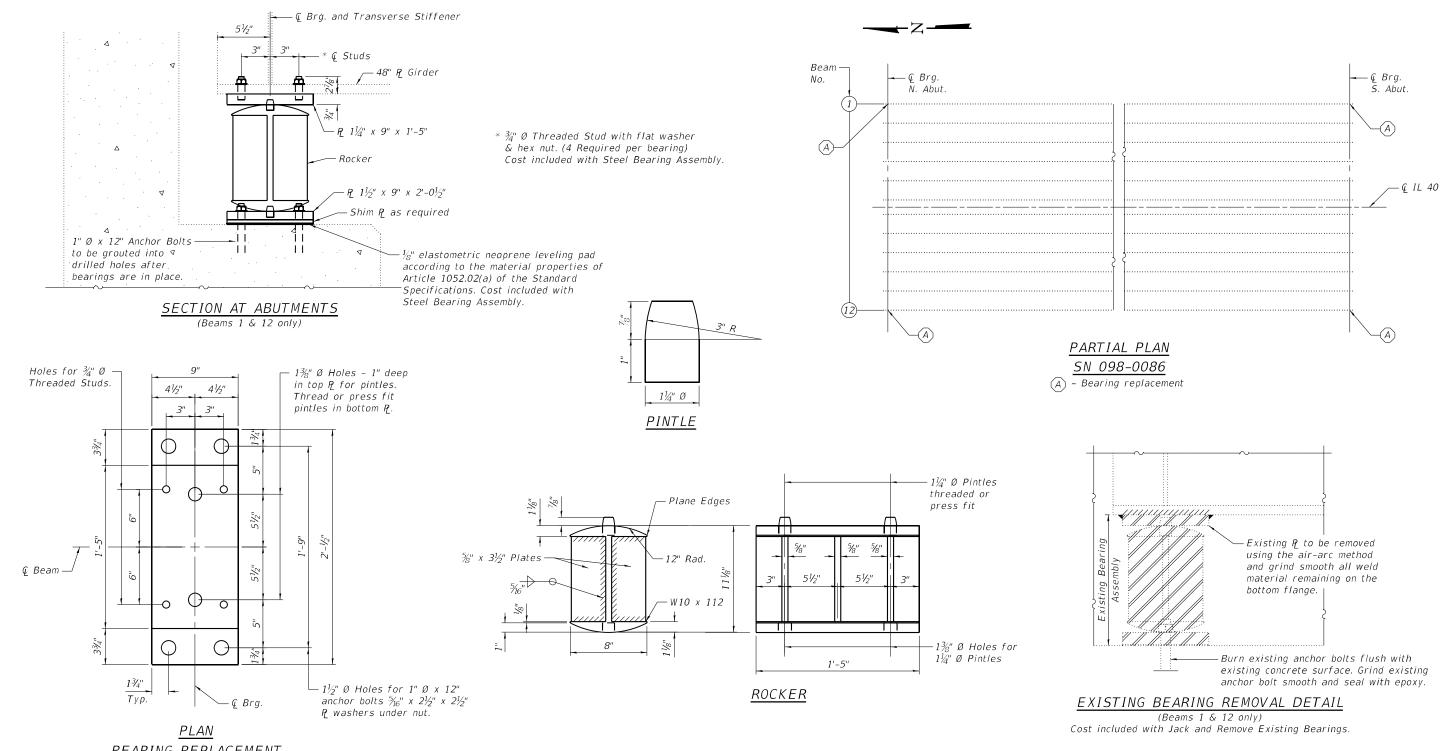

#### BEARING REPLACEMENT

Cost included with Steel Bearing Assembly.

#### Notes

Two  $\frac{1}{8}$  in. adjusting shims shall be provided for each bearing in addition to all other plates or shims and placed as shown on bearing details.

Anchor bolts shall be ASTM F1554 all-threaded (or an Engineer-approved alternate material) of the grade(s) and diameter(s) specified. The corresponding specified grade of AASHTO M314 anchor bolts may be used in lieu of ASTM F1554.

Anchor bolts shall be placed in holes drilled in the concrete through holes in the

bottom bearing plate after bearings are in place.

Drilled and set anchor bolts shall be installed according to Article 521.06 of the

Standard Specifications.

Min. jack capacity = 95 tons.

#### BEAM REACTIONS

		Abut.
R 12	(K)	58.6
R 4	(K)	51.6
Imp.	(K)	11.1
R (Total)	(K)	1213

#### BILL OF MATERIAL

88

Item	Unit	Total
Steel Bearing, Assembly	Each	4
Jack and Remove Existing Bearings	Each	4
Anchor Bolts, 1" Ø	Each	16

SB-14

QUIGG ENGINEERING INC


USER NAME = zdavidson	DESIGNED -	SDY	REVISED -
0980086-64N01-Sht-014-Bearings.dgn	CHECKED -	ZQ	REVISED -
PLOT SCALE = 0:10.0000 ':" / in.	DRAWN -	ZQ/CFS	REVISED -
PLOT DATE =	CHECKED -	MDC	REVISED -

STATE OF ILLINOIS
DEPARTMENT OF TRANSPORTATION

BEARING REMOVAL AND REPLACEMENT STRUCTURE NO. 098-0086

SHEET 14 OF 19 SHEETS

SECTION		COUNTY	TOTAL SHEETS	SHE
(195-3HB-4)BDR		WHITESIDE	37	24
		CONTRA	CT NO. 6	64S3
ILLINOIS	FED. A	D PROJECT		

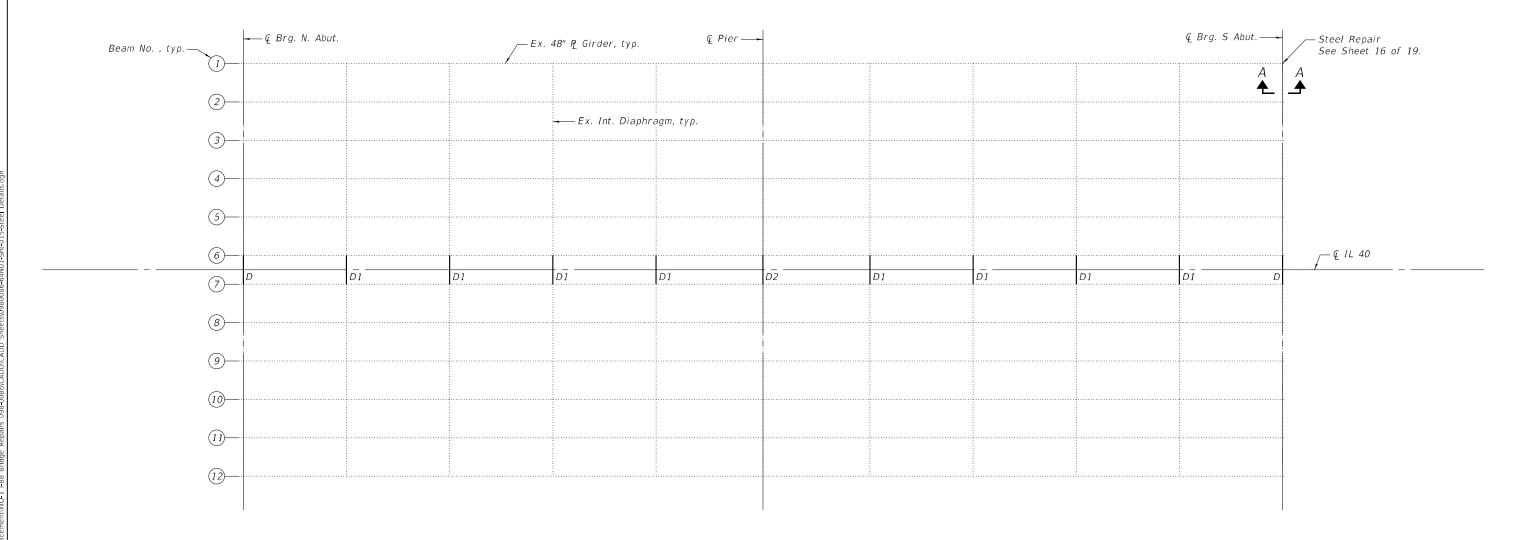

D – Location of new diaphragm type D D1 – Location of new diaphragm type D1 D2 – Location of new diaphragm type D2

FRAMING PLAN

For section A-A and diaphragms details see Sheet 16 of 19.

For new intermediate diaphragms match spacing of existing intermediate diaphragms.

BILL OF MATERIAL

Item	Unit	Total
Furnishing and Erecting Structural Steel	Pound	3080
Structural Steel Repair	Pound	60




DESIGNED - SDY REVISED -0980086-64N01-Sht-015-Steel Details.dgn CHECKED - ZQ REVISED -DRAWN - ZQ/CFS REVISED -CHECKED - MDC REVISED -

STATE OF ILLINOIS DEPARTMENT OF TRANSPORTATION

STEEL DETAILS **STRUCTURE NO. 098-0086** SHEET 15 OF 19 SHEETS

COUNTY TOTAL SHEET NO.
WHITESIDE 37 25 SECTION (195-3HB-4)BDR CONTRACT NO. 64S39

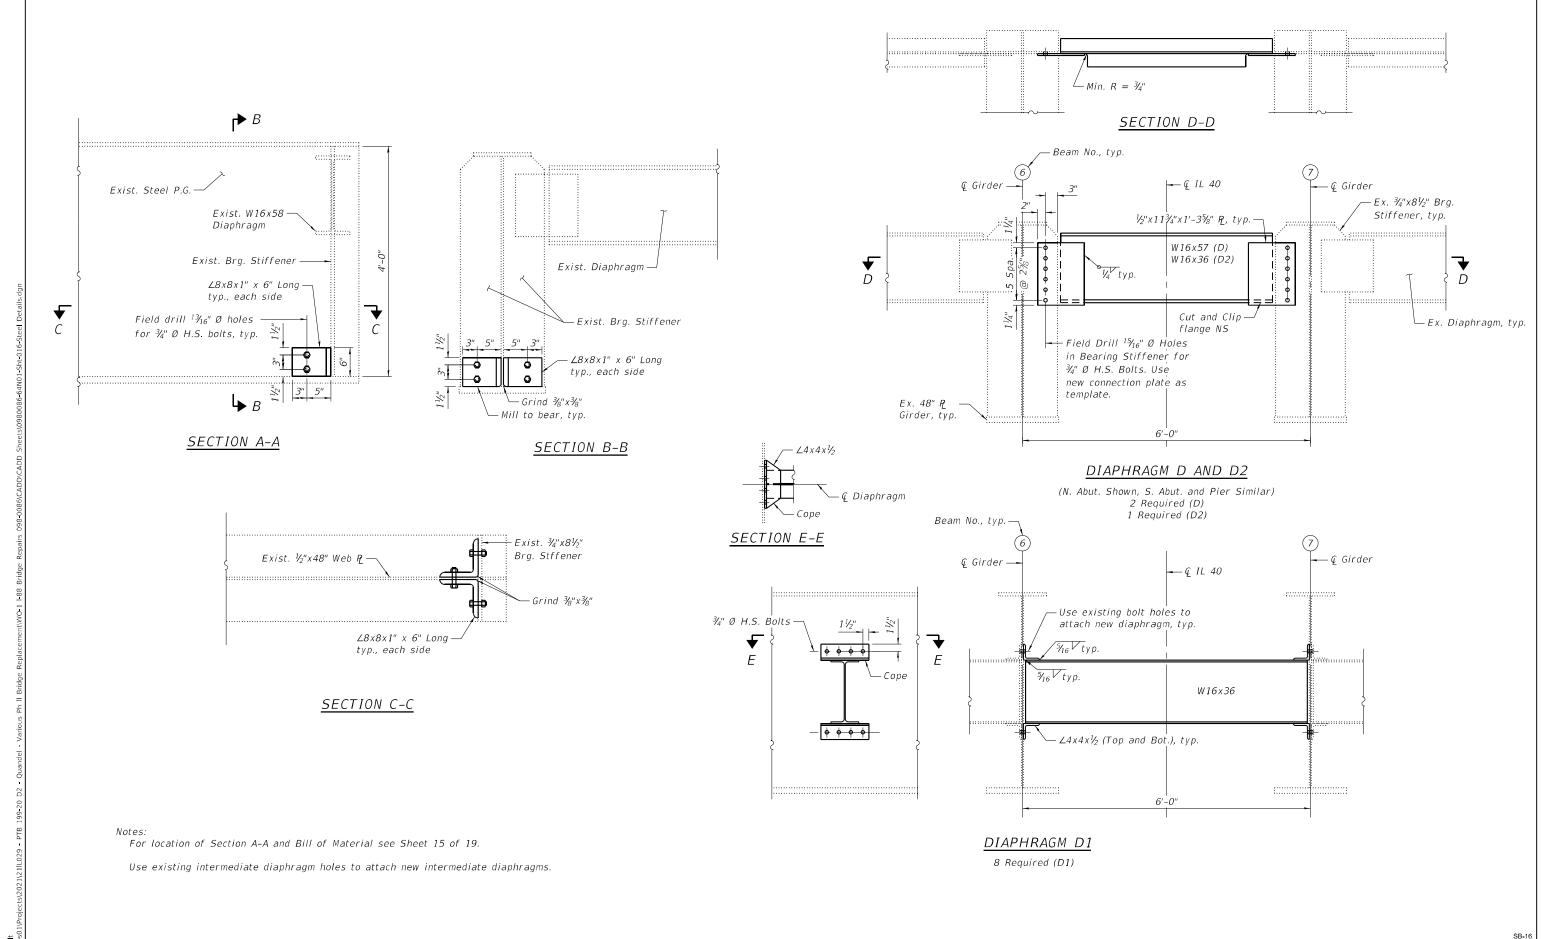

QUIGG ENGINEERING INC 10/5/2023 7:45:00 AM DESIGNED - SDY

CHECKED - ZQ

CHECKED - MDC

980086-64N01-Sht-016-Steel Details.don

LOT SCALE = 0:2.0000 ':" / in.

REVISED -

REVISED -

REVISED -


REVISED -

STATE OF ILLINOIS DEPARTMENT OF TRANSPORTATION

STEEL DETAILS

STRUCTURE NO. 098-0086

SHEET 16 OF 19 SHEETS

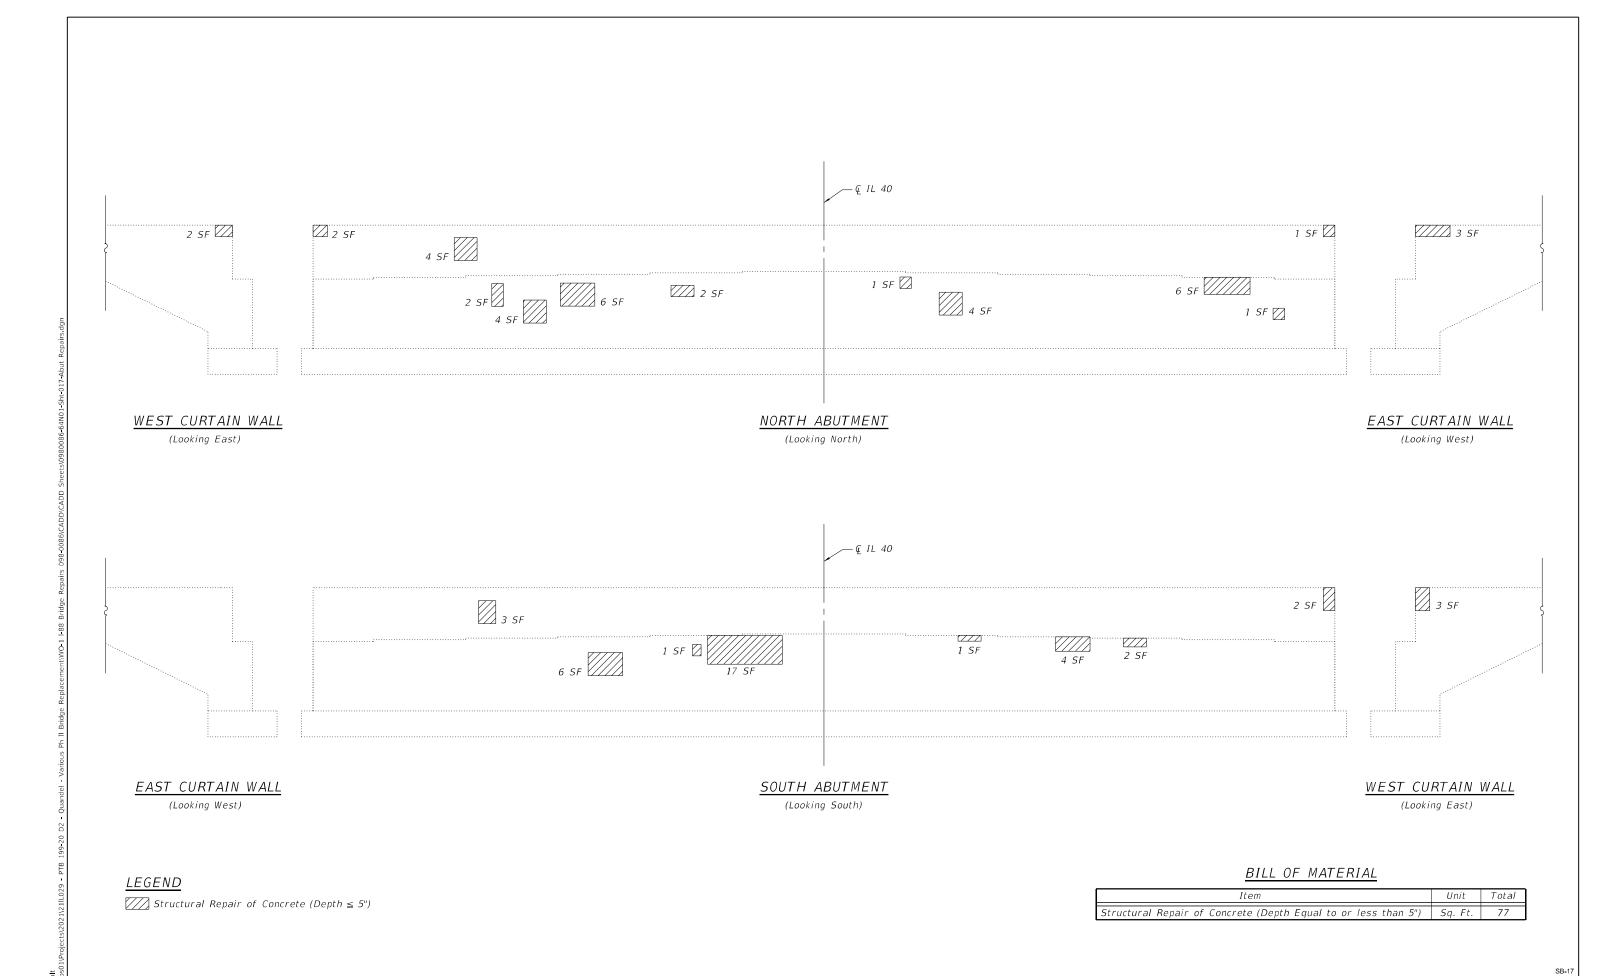

QUIGG ENGINEERING INC

 USER NAME
 =
 zdavidson
 DESIGNED
 SDY
 REVISED

 0980086-64N01-Sht-017-Abut Repairs.dgn
 CHECKED
 ZQ
 REVISED

 PLOT SCALE
 8:4.0000 "" / in.
 DRAWN
 ZQ/CFS
 REVISED

 PLOT DATE
 CHECKED
 MDC
 REVISED

STATE OF ILLINOIS DEPARTMENT OF TRANSPORTATION

ABUTMENT REPAIRS
STRUCTURE NO. 098-0086

SHEET 17 OF 19 SHEETS

10/5/2023 7:45:01 AM


#### STANDARD BAR SPLICER ASSEMBLY PLAN

(All components shall be provided from one supplier)

Threaded splicer bar length = min. lap length +  $1\frac{1}{2}$ " + thread length

\* Epoxy not required on Bar Splicer Assembly components used in conjunction with black bars.


Location	Bar size	No. assemblies required	Minimum Iap length
Bridge Deck Side of Exp. Joint	#6	8	3'-7"
Appr. Side of Exp. Joint	#6	8	3'-7"

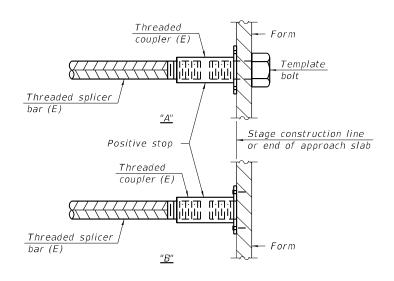

#### INSTALLATION AND SETTING METHODS

"A": Set bar splicer assembly by means of a template bolt"B": Set bar splicer assembly by nailing to wood forms or cementing to steel forms.

(E): Indicates epoxy coating.

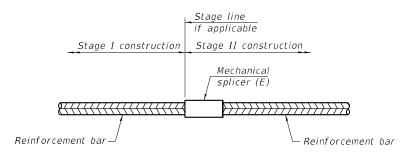

#### STANDARD MECHANICAL SPLICER

Location	Bar size	No. assemblies required

Notes:

Splicer bars shall be deformed with threaded ends and have a minimum 60 ksi yield strength.

All reinforcement shall be lapped and tied to the splicer bars. Bar splicer assemblies shall be epoxy coated according to the requirements for reinforcement bars. See Section 508 of the Standard Specifications.

See approved list of bar splicer assemblies and mechanical splicers for alternatives.

BSD-1

QUIGG ENGINEERING INC

1-1-2020

 USER NAME
 =
 zdavidson
 DESIGNED
 SDY
 REVISED

 0980086-64N01-ShI-018-Bar Splicer.dgn
 CHECKED
 ZQ
 REVISED

 PLOT SCALE
 =
 0:2,0000 '." / in.
 DRAWN
 ZQ/CFS
 REVISED


 PLOT DATE
 =
 CHECKED
 MDC
 REVISED

STATE OF ILLINOIS
DEPARTMENT OF TRANSPORTATION

BAR SPLICER ASSEMBLY AND MECHANICAL SPLICER DETAILS
STRUCTURE NO. 098-0086

SHEET 18 OF 19 SHEETS


10/5/2023 7:45:02 AM

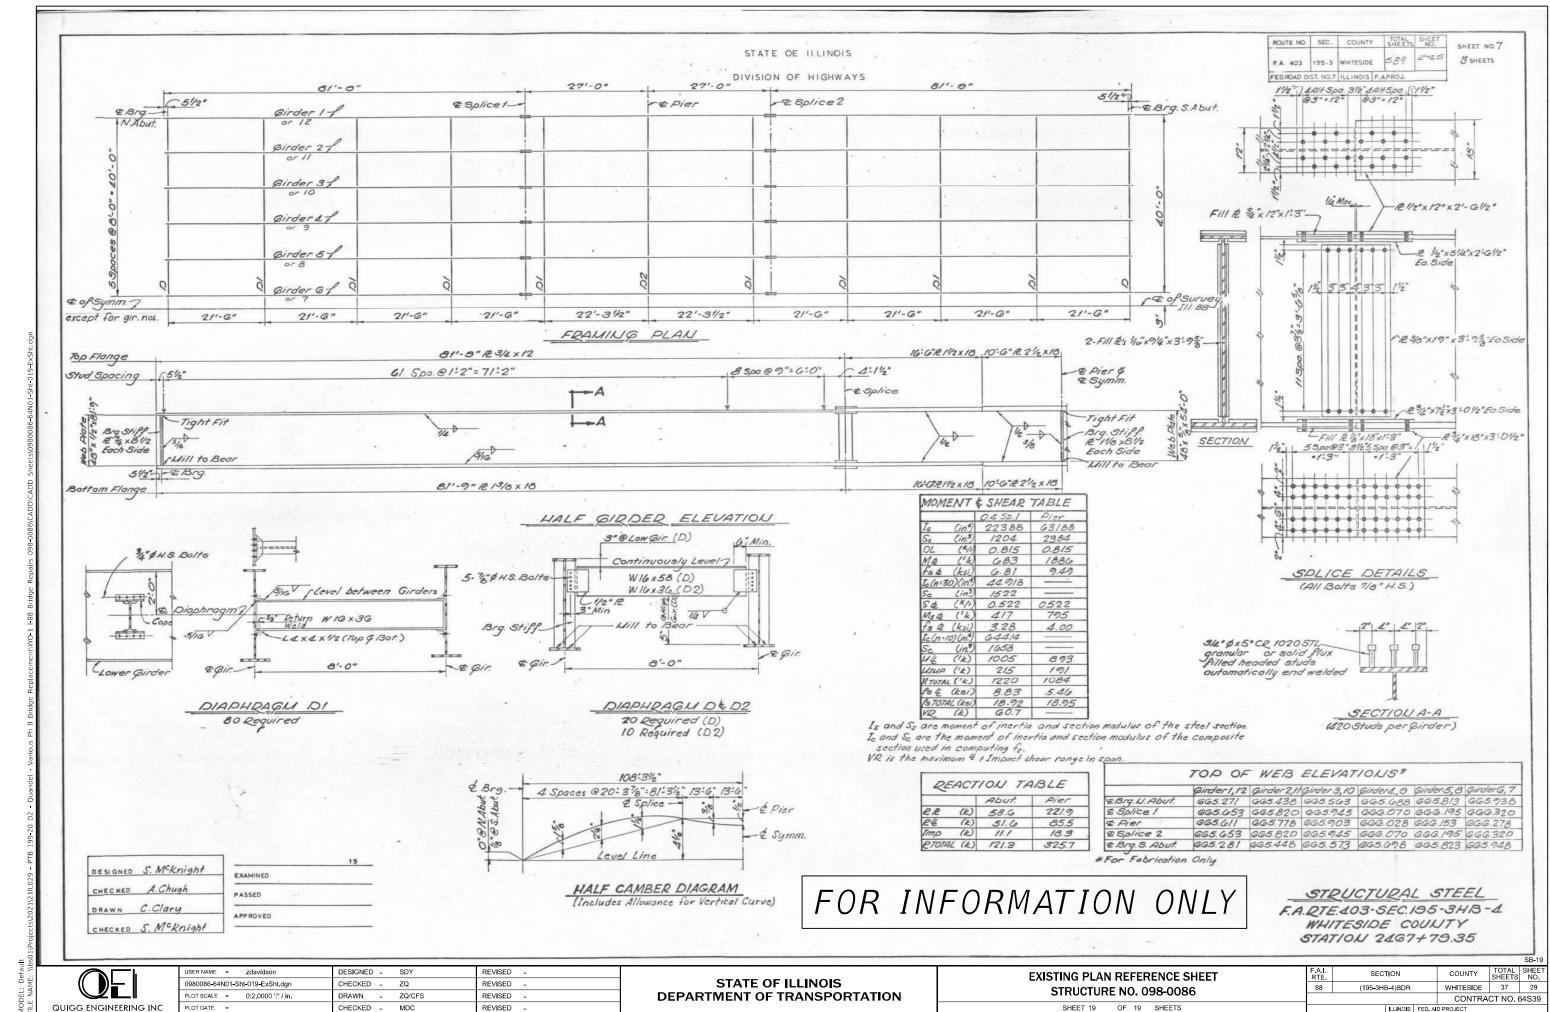

0/5/2023 7:45:02 AM

# **WORK ZONE SIGN DETAILS**

#### **ILLINOIS STANDARD G20–I100**

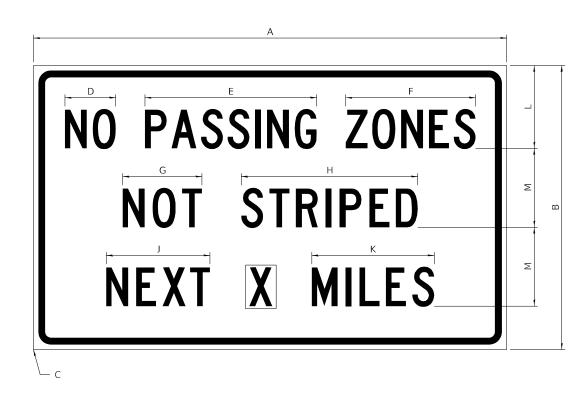

LEGEND AND BORDER BACKGROUND

BLACK ORANGE

NON-REFLECTORIZED REFLECTORIZED

SIGN SIZE		DIMENSIONS										
SIGN SIZE	А	В	С	D	Е	F	G	Η	J	K	L	М
60 x 36	60.00	36.00	2,25	6.4	21.80	16.40	10.00	22,40	13,20	15,50	10.50	10.00

SIGN SIZE	SER	IES BY	LINE	MARGIN	PODDED	
SIGN SIZE	1	2	3	MARGIN	BORDER	
60 x 36	5C	5C	5C	0.625	0.875	

Sign not to scale

#### **GENERAL NOTES**


All work to furnish and install these signs shall be included in the cost of the specified traffic control standards and shall not be paid separately.

All Illinois Standard signs shall conform to the latest edition of the "Illinois Standard Highway Signs Book" in effect on the date of invitation for bids.

Signs shall meet the applicable portions of Sections 701 and 720 of the Standard Specifications.

All dimensions are in inches unless otherwise noted.

#### **ILLINOIS STANDARD W8–I107**

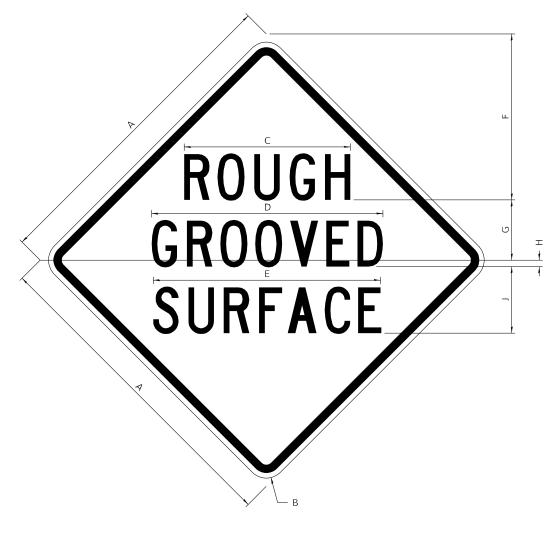

LEGEND AND BORDER BACKGROUND

BLACK

NON-REFLECTORIZED REFLECTORIZED

SIGN SIZE		DIMENSIONS									
SIGN SIZE	А	В	С	D	Е	F	G	Н	J		
48 x 48	48.00	3.00	25.00	34.80	34.20	24.94	9.00	1.00	10.00		


SIGN SIZE	SER	IES BY	LINE	MARGIN	BORDER
SIGN SIZE	1	2	3	MARGIN	BURDER
48 x 48	7C	7C	7C	1.250	0.750

Sign not to scale

	USER NAME = joush	DESIGNED -	REVISED - 3-02-16				F.A.I. BTF	SECTION	COUNTY TOTAL SHI
FILE NAME: 64S39_99_D2Details.dgn		DRAWN -	REVISED -	STATE OF ILLINOIS		REGION 2/DISTRICT 2 STANDARD	88	(195-3HB-4)BDR	WHITESIDE 37
	PLOT SCALE = 100.0000 / in.	CHECKED -	REVISED -	DEPARTMENT OF TRANSPORTATION				, ,	CONTRACT NO. 6453
	PLOT DATE = 8/24/2023	DATE -	REVISED -		SCALE: N.T.S.	SHEET 1 OF 4 SHEETS STA. TO STA.		ILLINOIS FED. A	.ID PROJECT

# **WORK ZONE SIGN DETAILS**

#### **ILLINOIS STANDARD W12–I102**

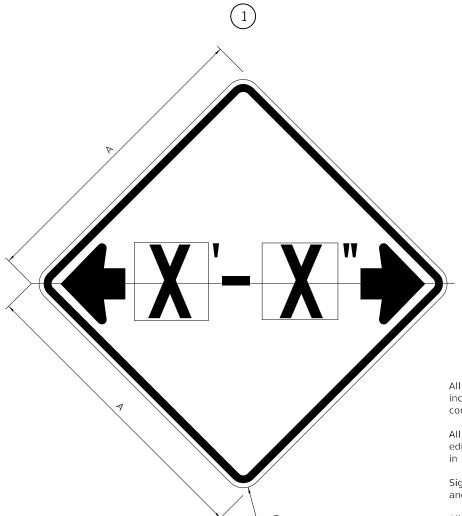

#### **GENERAL NOTES**

All work to furnish and install these signs shall be included in the cost of the specified traffic control standards and shall not be paid separately.

All Illinois Standard signs shall conform to the latest edition of the "Illinois Standard Highway Signs Book" in effect on the date of invitation for bids.

Signs shall meet the applicable portions of Sections 701 and 720 of the Standard Specifications.

**DEPARTMENT OF TRANSPORTATION** 

All dimensions are in inches unless otherwise noted.

COLOR LEGEND AND BORDER BACKGROUND

PLOT DATE = 8/24/2023

FILE NAME: 64S39\_99\_D2Details.dgn

BLACK FL ORANGE NON-REFLECTORIZED REFLECTORIZED

SIGN SIZE	DIMEN	ISIONS
SIGN SIZE	А	В
48 x 48	48.00	3.00

 $\underbrace{1} \ \, \text{Illinois Standard signs W12-I102 and W12-I103 shall be used as described in the special provisions.}$ 

SIGN SIZE	SERIES BY LINE	MARGIN	BORDER	
SIGN SIZE	1	MARGIN	DURDER	
48 x 48	12C	0.750	1,250	

Sign not to scale

REVISED

DESIGNED -


DRAWN

DATE

HECKED

# REVISED - 3-02-16 REVISED - STATE OF ILLINOIS

#### **ILLINOIS STANDARD W12–I103**

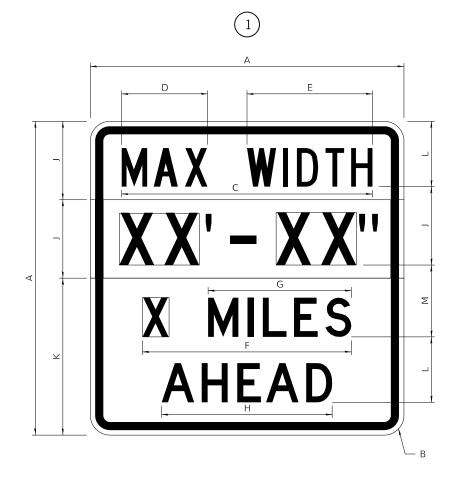

COLOR

LEGEND AND BORDER BACKGROUND BACKGROUND (WIDTH) BLACK WHITE FL ORANGE NON-REFLECTORIZED REFLECTORIZED REFLECTORIZED

SIGN SIZE		DIMENSIONS										
	А	В	С	D	Е	F	G	Н	J	K	L	М
48 x 48	48.00	3.00	38.40	13.20	19.20	32.00	22.00	26.20	12.00	24.00	10.00	11.00

SIGN SIZE	,	SERIES	BY LINE	MARGIN	BORDER	
SIGN SIZE	1	2	3	4	MARGIN	BORDER
48 x 48	6C	8D	6D	6D	0.750	1.250


Sign not to scale

XX'-XX" WIDTH AND X MILES ARE VARIABLE TOP AND BOTTOM OF BACKGROUND WHITE

	2501011				F.A.I. RTE.	SECTION	COUNTY	TOTAL SHEETS	SHEET NO.			
REGION 2/DISTRICT 2 STANDARD									(195-3HB-4)BDR	WHITESIDE	37	31
										CONTRACT	NO. 64	1539
CALE: N.T.S.	SHEET 2	OF	4	SHEETS	STA.	TO STA.			ILLINOIS FED. AI	D PROJECT		

# **WORK ZONE SIGN DETAILS**

#### **ROAD CLOSED TO OVERSIZED LOADS**

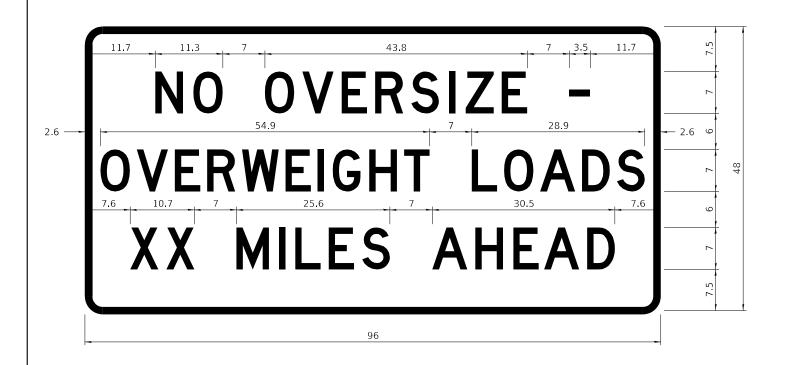

COLOR


LEGEND AND BORDER BACKGROUND BLACK ORANGE NON-REFLECTORIZED REFLECTORIZED

Permit Loads - Loads Over 13 Feet; 3.0" Radius, 1.3" Border; [NO OVERSIZE -] D; [OVERWEIGHT LOADS] D 85% spacing; [XX MILES AHEAD] D; Table of letter and object lefts.

N 11.7	O 18.1	O 30.0	V 36.2	E 42.8	R 48.4	S 54.4	I 60.7	Z 63.5	E 69.5	- 80.8				
O 2.6	V 8.6	E 15.0	R 20.4	W 26.2	E 33.4	I 38.8	G 41.3	H 47.4	T 53.2	L 64.5	O 69.9	<b>A</b> 75.9	D 82.9	S 88.7
X 7.6	X 13.6	M 25.3	I 32.3	L 35.1	E 40.6	S 46.2	<b>A</b> 57.9	H 65.1	E 71.4	A 76.6	D 83.7			

Sign not to scale

#### STOP LINE SIGN FOR TEMPORARY SIGNALS

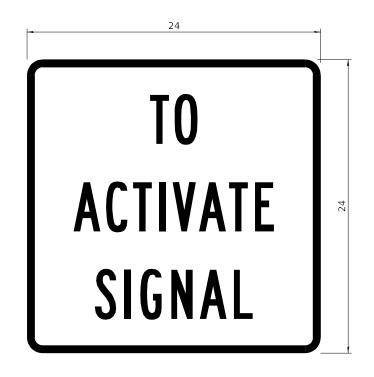

COLOR

LEGEND AND BORDER BACKGROUND

BLACK WHITE NON-REFLECTORIZED REFLECTORIZED

SIGN SIZE	SER	IES BY	LINE
SIGN SIZE	1	2	3
24 x 24	4C	4C	4C

Sign not to scale

#### **GENERAL NOTES**

All work to furnish and install these signs shall be included in the cost of the specified traffic control standards and shall not be paid separately.

All Illinois Standard signs shall conform to the latest edition of the "Illinois Standard Highway Signs Book" in effect on the date of invitation for bids.


Signs shall meet the applicable portions of Sections 701 and 720 of the Standard Specifications.

All dimensions are in inches unless otherwise noted.

	USER NAME = jpush	DESIGNED -	REVISED - 3-02-16			F.A.I SECTION	COUNTY TOTAL SHEET
FILE NAME: 64S39_99_D2Details.dgn		DRAWN -	REVISED -	STATE OF ILLINOIS	REGION 2 / DISTRICT 2 STANDARD	88 (195-3HB-4)BDR	WHITESIDE 37 32
	PLOT SCALE = 100.0000 / in.	CHECKED -	REVISED -	DEPARTMENT OF TRANSPORTATION			CONTRACT NO. 64539
	PLOT DATE = 8/24/2023	DATE -	REVISED -		SCALE: N.T.S. SHEET 3 OF 4 SHEETS STA. TO STA.	ILLINOIS FED. A	ID PROJECT

#### **ENTRANCE SIGN FOR USE WITH TEMPORARY SIGNALS**

# **WORK ZONE SIGN DETAILS**

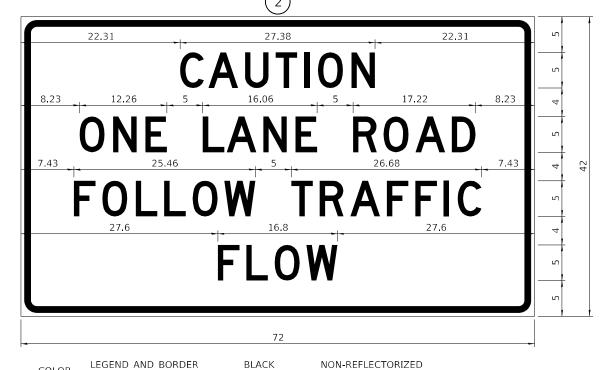

BACKGROUND

COLOR

ORANGE

NON-REFLECTORIZED REFLECTORIZED

2.25" Radius, 0.88" Border, 0.50" IndenT; [CAUTION] D; [ONE LANE ROAD] D; [FOLLOW TRAFFIC] D; [FLOW] D

This sign shall be installed at entrances located between the temporary signals as shown in the staging plans.


#### **Table Of Widths And Spaces**

22	3.1	C 3.36	0.62	A 4.18	0.94	U 3.36	0.94	T 3.04	0.94	I 0.78	1 17	O 3.52	1 17	N 3.36	22.31
~~'	21	5.50	0.02	7.10	0.54	3.50	0.54	3.04	0.54	0.70	1.17	3.32	1.1/	5.50	22.51

	0		Ν		Е
8.23	3.51	1.17	3.36	1.18	3.04

	L		Α		N		Е
5.00	3,05	0.31	4.18	0.94	3,36	1,17	3.05

	R		0		Α		D	
5.00	3.36	0.93	3.52	0.94	4.18	0.93	3.36	8.23

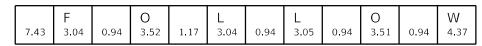


5.00	T 3,05	0.94	R 3.36	0.94	A 4.18	0.93	F 3.05	0.94	F 3.04	0.94	I 0.78	1.18	C 3.35	7.43
------	-----------	------	-----------	------	-----------	------	-----------	------	-----------	------	-----------	------	-----------	------

	F		L		0		W	
27.60	3.05	0.94	3.04	0.94	3.52	0.93	4.38	27.60

Sign not to scale

# STAY IN YOUR LANE

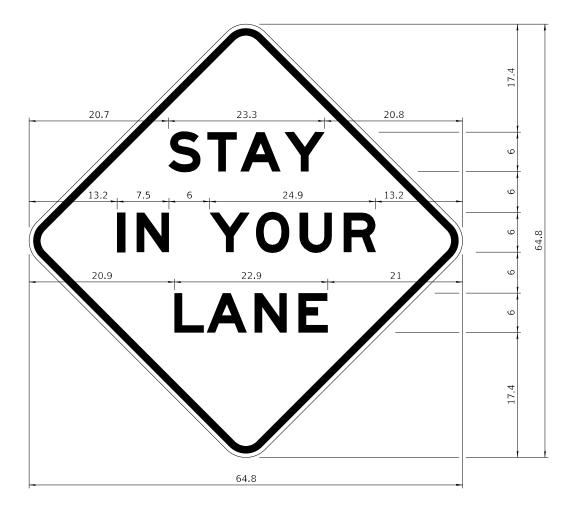

COLOR

LEGEND AND BORDER BACKGROUND

BLACK ORANGE

NON-REFLECTORIZED REFLECTORIZED

48.0" across sides 3.8" Radius, 1.0" Border, 0.6" Indent; "STAY" E Mod; "IN YOUR" E Mod; "LANE" E Mod;

#### Table of Letter and Object Lefts

S	Т	Α	Υ
20.7	26.8	31.6	38.0

I	Ν	Υ	0	$\cup$	R
13.2	15.9	26.7	33.9	40.5	46.8

L	Α	N	Е
20.9	25.8	33.1	39.4

Sign not to scale

	USER NAME = jpush	DESIGNED -	REVISED - 3-02-16				F.A.I. RTF	SECTION	COUNTY TO	OTAL SHEET
FILE NAME: 64S39_99_D2Details.dgn		DRAWN -	REVISED -	STATE OF ILLINOIS		REGION 2 / DISTRICT 2 STANDARD	88	(195-3HB-4)BDR	WHITESIDE	37 33
	PLOT SCALE = 100.0000 / in.	CHECKED -	REVISED -	DEPARTMENT OF TRANSPORTATION				,	CONTRACT N	O. 64539
	PLOT DATE = 8/24/2023	DATE -	REVISED -		SCALE: N.T.S.	SHEET 4 OF 4 SHEETS STA. TO STA.		ILLINOIS FED. A	ID PROJECT	

**GENERAL NOTES** 

All work to furnish and install these signs shall be included in the cost of the specified traffic control standards and shall not be paid separately.

All Illinois Standard signs shall conform to the latest edition of the "Illinois Standard Highway Signs Book"

Signs shall meet the applicable portions of Sections 701

All dimensions are in inches unless otherwise noted.


in effect on the date of invitation for bids.


and 720 of the Standard Specifications.

# **TYPICAL PAVEMENT MARKINGS**

#### **MEDIAN PAVEMENT MARKING**

# TYPICAL PAVEMENT MARKING FOR FLUSH MEDIAN AT LEFT TURN LANE

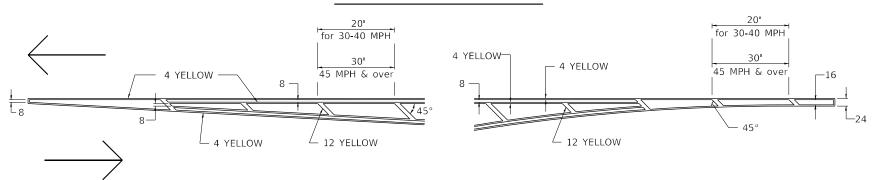

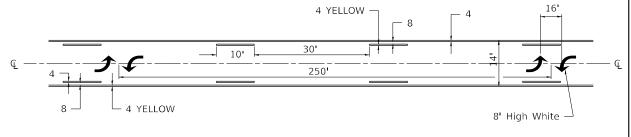


\*\* ALL DIMENSIONS ARE IN INCHES UNLESS OTHERWISE NOTED.


# TYPICAL ISLAND OFFSET SHOULDER WIDTH


# TYPICAL MARKING FOR PAINTED ISLANDS

# STANDARD CROSSWALK MARKING

See Schedules for Locations

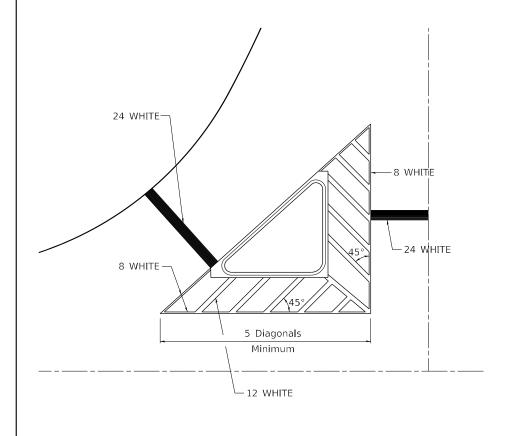

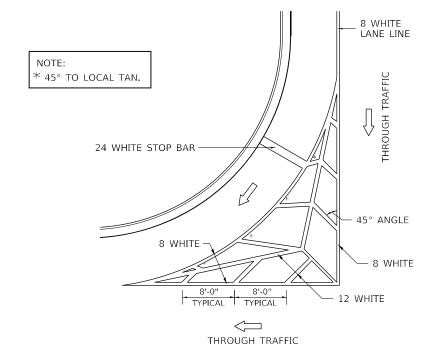

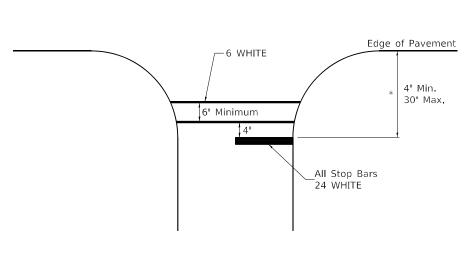

 Distance to the nearest edge of the intersecting roadway in the absence of a marked crosswalk.

	USER NAME = jpush	DESIGNED -	REVISED - 6-27-14
FILE NAME: 64S39_99_D2Details.dgn		DRAWN -	REVISED - 3-05-12
	PLOT SCALE = 100.0000 / in.	CHECKED -	REVISED -
	PLOT DATE = 8/24/2023	DATE -	REVISED -

STATE OF ILLINOIS
DEPARTMENT OF TRANSPORTATION


REGION 2 / DISTRICT 2 STANDARD

ALE: N.T.S. SHEET 1 OF 3 SHEETS STA. TO STA.

 
 F.A.I. RTE.
 SECTION
 COUNTY SHEETS
 TOTAL NO.
 SHEETS NO.


 88
 (195-3HB-4)BDR
 WHITESIDE
 37
 34

 CONTRACT NO. 64S39

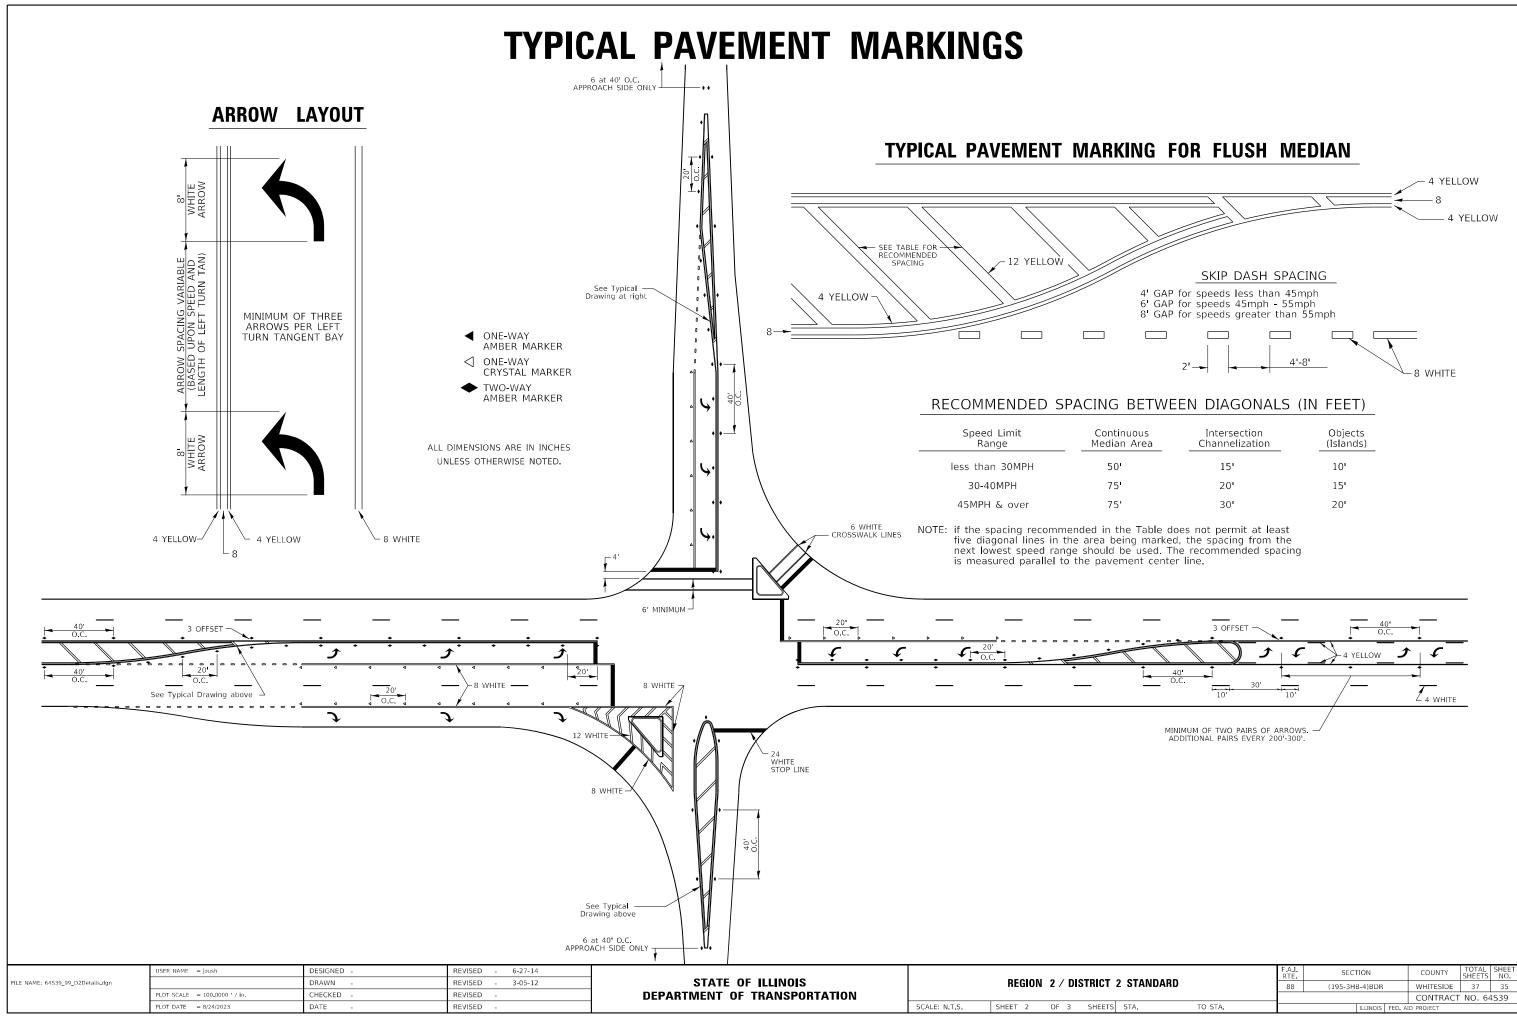


# **TYPICAL PAVEMENT MARKINGS**

#### TYPICAL PARKING SPACING

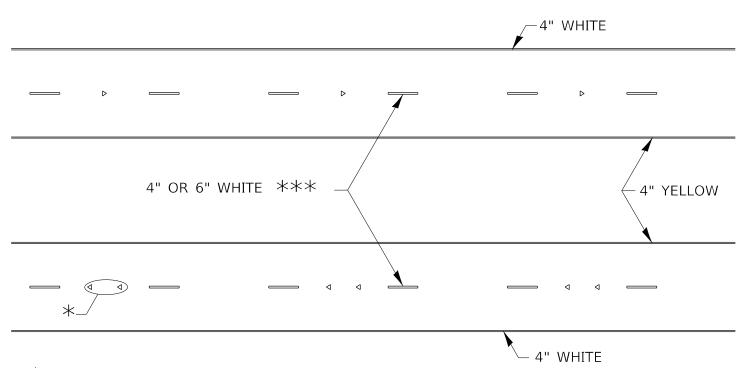

\* SEE HIGHWAY STANDARD 781001 FOR SPACING DETAILS. USE DOUBLE MARKERS WHEN ADT ≥ 20,000.

#### MULTI-LANE / DIVIDED

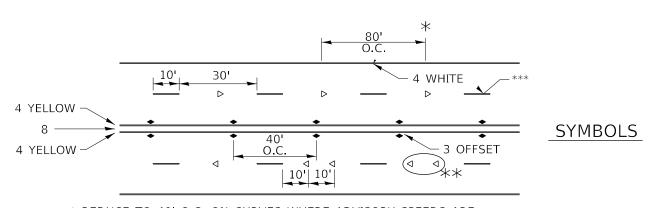

- \* REDUCE TO 40' O.C. ON CURVES WHERE ADVISORY SPEEDS ARE 10 MPH LOWER THAN POSTED SPEEDS.
- \*\* USE DOUBLE MARKERS WHEN ADT ≥ 20,000

\*\*\* CENTERLINE SKIP DASH PAVEMENT MARKING SPEED LIMIT LESS THAN 40 MPH USE 4" LINE. SPEED LIMIT 40 MPH AND OVER USE 6" LINE.

#### MULTI-LANE / UNDIVIDED & ONE WAY

(FOR MULTI-LANE UNDIVIDED HIGHWAYS USE THIS DETAIL NOT HIGHWAY STANDARD 781001)

	USER NAME = jpush	DESIGNED -	REVISED - 6-27-14
FILE NAME: 64S39_99_D2Details.dgn		DRAWN -	REVISED - 8-27-13
	PLOT SCALE = 100.0000 / in.	CHECKED -	REVISED - 11-28-12
	PLOT DATE = 8/24/2023	DATE -	REVISED -


# STATE OF ILLINOIS DEPARTMENT OF TRANSPORTATION

#### 


# 22'-25' A WHITE 20' Min. No Parking Zone 22'-25' 20' Min. Face of Curb 30' Min. Approach to Signal 20' Min. Face of Curb 20' Min. Approach to Signal

#### TYPICAL PAVEMENT MARKING FOR TWO LANE SECTION - NO PASSING ZONES

No Parking Zone

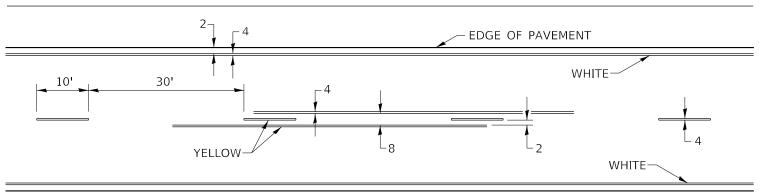

# GUARDRAIL AND BARRIER WALL REFLECTORS, TYPE C (SPECIAL)

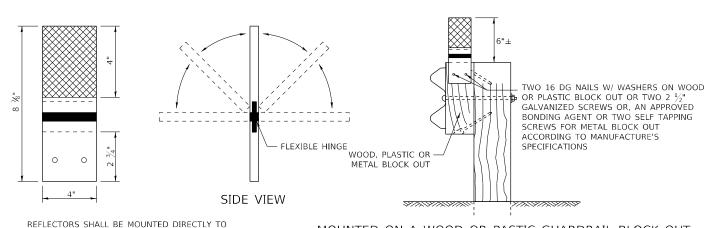

REFLECTORS MOUNTED ON WOODEN OR PLASTIC BLOCK OUT SHALL BE MOUNTED USING TWO 16 DG NAILS AND TWO  $\frac{3}{16}$ " WASHERS OR TWO 2  $\frac{1}{2}$ " GALVANIZED SCREWS

WOOD OR PLASTIC BLOCK OUTS.

#### MOUNTED ON A WOOD OR PASTIC GUARDRAIL BLOCK OUT

TO METAL BLOCK OUT.


REFLECTORS MOUNTED ON METAL BLOCK OUT


SHALL BE MOUNTED USING AN APPROVED

BONDING AGENT PER THE MANUFACTURE'S SPECIFICATIONS OR TWO SELF TAPPING GALVANIZED SCREWS WITH WASHERS.

#### ATTACH REFLECTOR WITH AN APPROVED BONDING AGENT ACCORDING TO MANUFACTURE'S SPECIFICATIONS OR TWO SELF TAPPING SCREWS METAL BLOCK OUT SIDE VIEW MOUNTED ON A METAL GUARDRAIL BLOCK OUT REFLECTORS SHALL BE MOUNTED DIRECTLY

#### REFLECTORS MOUNTED ON METAL GUARDRAIL BLOCK OUT

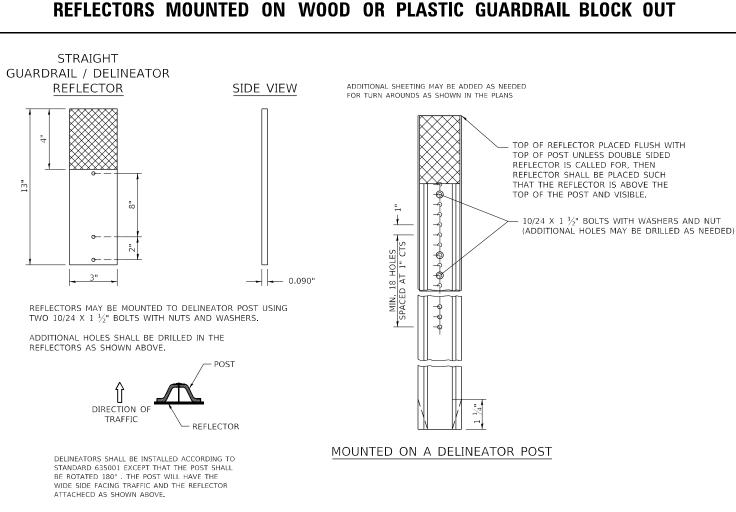

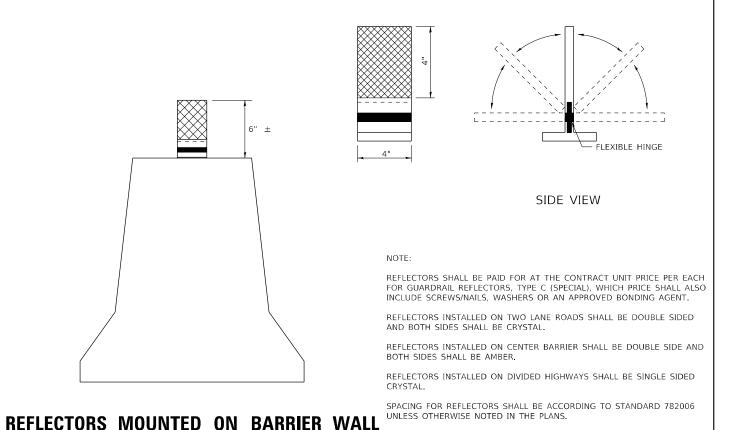

DESIGNED 4-27-23 REVISED onsult\Projects\2112 IDOT D2 Var-Var Bridge\400 MAXVONder 1\410-CADD\098-0086 - JL 40 ov R68935ED D2Details,d6#21-21 REVISED

STATE OF ILLINOIS **DEPARTMENT OF TRANSPORTATION** 

SECTION REGION 2 / DISTRICT 2 STANDARD WHITESIDE (195-3HB-4)BDR 37 37 CONTRACT NO. 64539 OF SHEETS STA. TO STA.