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KUTTAB, P.E. (847)705-4431 SCHAUMBURG, ILLINOIS

SERVICES: BRIAN

/CONSULTANT

ISTRICT

PROJECT MANAGER: BRIAN KUTTAB. P.E.

CONTRACT NO. 60X95

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GROSS LENGTH = 725.00 FT (0.137 MILES) NET LENGTH = 725.00 FT (0.137 MILES)

LOCATION MAP

COUNTY COOK 2014-016R&B 378 1 CONTRACT NO. 60X95 •378+ 46 = 42⁴

PROJECT LOCATED IN CITY OF CHICAGO

D-91-227-13





DEPARTMENT OF TRANSPORTATION SUBMITTED JULY 26 20 17

STATE OF ILLINOIS

PRINTED BY THE AUTHORITY OF THE STATE OF ILLINOIS

PLOT DATE: 7/11/2017

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=		USER NAME = domehueki	DESIGNED	-	MMA	REVISED	-
뿦	PAR S ON S		DRAWN	-	MMA	REVISED	-
ž	BRINCKERHOFF	PLOT SCALE = 1"=50"	CHECKED	-	RT	REVISED	-
3		PLOT DATE - 9/29/2017	DATE	_	09 (01 (2017	DEVICED	

STATE OF ILLINOIS
DEPARTMENT OF TRANSPORTATION

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		90/94 1	2014 010/02	CONTRACT	NO. 6	0X95
SHEET NO. 1 OF 1 SHEETS S	TA. TO STA.		ILLINOIS FED	. AID PROJECT		

DISTRICT 1 STANDARDS

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TY-ITSC-400*18	EXPANSION FITTING DETAIL SHEET
TY-ITSC-400#41	FIBER OPTIC SPLICING TYPICAL
TY-ITSC-400#42	FIBER OPTIC SPLICING DETAIL

BY						
	SURVEYED	PLOTTED	GRADES CHECKED	B.M. NOTED	STRUCTURE NOTATING CHIKD	
1	7.5		MOTE BOOK	100	Q	

PARSONS BRINCKERHOFF

USER NAME = Kucharski	DESIGNED		MMA	REVISED -
	DRAWN	-	MMA	REVISED -
PLOT SCALE = 1"=50"	CHECKED	-	RT	REVISED -
PLOT DATE = 4/18/2017	DATE	-	05/02/2017	REVISED -

STATE OF ILLINOIS DEPARTMENT OF TRANSPORTATION

COMMITMENTS

- CONSTRUCTION NOISE AND CONSTRUCTION VIBRATION SHALL FOLLOW THE ENVIRONMENTAL COMMITMENT OUTLINED IN THE ENVIRONMENTAL ASSESSMENT INCLUDED IN THE CONTRACT DOCUMENTS.
- PROVISIONS FOR THE AIR QUALITY MONITORING PROGRAM SHALL FOLLOW THE ENVIRONMENTAL COMMITMENT OUTLINED IN THE ENVIRONMENTAL ASSESSMENT AND ERRATA INCLUDED IN THE CONTRACT DOCUMENTS.

	D.I	OTDIOT 4 AND				F.A.I. RTE.	SECTION	COUNTY	TOTAL SHEETS	SHEET NO.
RTATION	DISTRICT 1 AND IDOT TSC STANDARDS			FAI 90/94	2014-016R&B	COOK	378	3		
								CONTRACT	NO. 60	X95
	SCALE:	SHEET NO. 1 OF 1	SHEETS	STA.	TO STA.		ILLINOIS FED. AI	O PROJECT		

GENERAL NOTES

- SEVENTY-TWO (72) HOURS BEFORE STARTING EXCAVATION, THE CONTRACTOR SHALL CALL DIGGER (CHICAGO UTILITY ALERT NETWORK) AT (312) 744-7000 TO HAVE THE LOCATION OF EXISTING UNDERGROUND UTILITIES MARKED IN THE FIELD.
- A MINIMUM OF SEVENTY-TWO (72) HOURS PRIOR TO ANY PLACEMENT OR RELOCATION OF MAINTENANCE OF TRAFFIC DEVICES, CONTACT ILLINOIS DEPARTMENT OF TRANSPORTATION (IDOT) DISTRICT 1 BUREAU OF TRAFFIC AT (847) 705-4151.
- 3. THE CONTRACTOR IS RESPONSIBLE FOR OBTAINING ALL NECESSARY PERMITS TO PERFORM WORK,
- 4. TEN FOOT TRANSITIONS SHALL BE USED TO MATCH PROPOSED ITEMS OF WORK TO EXISTING ITEMS IN THE FIELD UNLESS OTHERWISE SHOWN. THE TRANSITIONS SHALL BE PAID FOR AT THE CONTRACT UNIT PRICE FOR THE PROPOSED ITEM OF WORK SPECIFIED.
- ALL ELEVATIONS IN THE PLANS ARE BASED UPON THE NORTH AMERICAN VERTICAL DATUM OF 1988 (NAVD88), UNLESS OTHERWISE NOTED.
- 6. THE CONVERSION OF THE NORTH AMERICAN VERTICAL DATUM OF 1988 (NAVD 1988) TO THE CHICAGO DATUM IS APPROXIMATELY 579,19 FEET.
- 7. THE CONTRACTOR WILL NOT BE ALLOWED TO SET UP A YARD OR FIELD OFFICE ON STATE OR CITY PROPERTY WITHOUT WRITTEN PERMISSION FROM THE DEPARTMENT OR CITY OF CHICAGO.
- 8. THE IDOT HIGHWAY STANDARDS LATEST REVISION NUMBERS SHALL APPLY TO THIS PROJECT.
- 9. CONFLICTS MAY OCCUR BETWEEN THE ROADWAY PLANS AND RIGHT-OF-WAY PLANS, THE RIGHT-OF-WAY PLANS SHALL TAKE PRECEDENCE IN CONFLICTS IN RIGHT-OF-WAY OR EASEMENTS. THE ROADWAY PLANS SHALL TAKE PRECEDENCE IN ITEMS FOR CONSTRUCTION.
- 10. EXCEPT WHERE DESIGNATED OTHERWISE, THE LOCATIONS AND/OR DEPTHS OF UNDERGROUND UTILITIES SHOWN HAVE BEEN TAKEN FROM OFFICE RECORD INFORMATION FURNISHED BY THE UTILITY OWNERS AND THE SUE SURVEYS. ALL UNDERGROUND UTILITIES MUST BE CONSIDERED APPROXIMATE.
- 11. THE CONTRACTOR SHALL BE RESPONSIBLE FOR THE PROTECTION OF ALL UNDERGROUND OR SURFACE UTILITIES EVEN THOUGH THEY MAY NOT BE SHOWN IN THE PLANS. ANY UTILITY THAT IS DAMAGED DURING CONSTRUCTION SHALL BE REPAIRED OR REPLACED TO THE SATISFACTION OF THE ENGINEER, THIS WORK WILL BE AT THE CONTRACTOR'S EXPENSE.
- 12. THE CONTRACTOR SHALL COORDINATE WORK WITH UTILITIES IN ADVANCE OF WORKING IN THE VICINITY OF THEIR FACILITIES, AND ALLOW SUFFICIENT TIME FOR THEM TO PERFORM ADJUSTMENTS TO THEIR FACILITIES IN ACCORDANCE WITH THE CONTRACTOR'S SCHEDULE, COORDINATION EFFORTS SHALL BE INCLUDED IN THE COST OF THE CONTRACT BID PRICE.
- 13. THE CONTRACTOR MUST CALL THE IDOT ELECTRICAL MAINTENANCE CONTRACTOR TO LOCATE IDOT FACILITY CABLES.
- 14. AGGREGATE SUBGRADE IMPROVEMENT (CU YD) HAS BEEN PROVIDED FOR USE AT THE LOCATIONS INDICATED FOR SOILS THAT TEND TO BE UNSTABLE AND/OR UNSUITABLE. THE ACTUAL NEED FOR REMOVAL AND REPLACEMENT WITH AGGREGATE SUBGRADE IMPROVEMENT (CU YD) WILL BE DETERMINED IN THE FIELD AT THE TIME OF CONSTRUCTION BY THE GEOTECHNICAL ENGINEER. ALL POTENTIALLY UNSTABLE SOILS SHOULD BE TESTED WITH A STATIC AND/OR DYNAMIC CONE PENETROMETER AND TREATED IN ACCORDANCE WITH ARTICLE 301.04 OF THE STANDARD SPECIFICATIONS FOR ROAD AND BRIDGE CONSTRUCTION AND THE 100T SUBGRADE STABILITY MANUAL. IF UNSTABLE AND/OR UNSUITABLE SOILS ARE NOT ENCOUNTERED, THE QUANTITY SHALL BE DEDUCTED AND NO EXTRA COMPENSATION WILL BE DUE TO THE CONTRACTOR.
- 15. ALL ROADWAY WIDTHS AND RADII SHOWN ON THE PLANS ARE TO THE EDGE OF PAVEMENT UNLESS OTHERWISE NOTED.
- 16. DRAINAGE
 - a. ALL STORM SEWER CONNECTIONS WITH PIPES 27 INCHES IN DIAMETER AND SMALLER SHALL BE MADE WITH PRECAST TEES OR ELBOW PIPES. FOR PROPOSED STORM SEWERS LARGER THAN 27 INCHES IN DIAMETER, OPENINGS OF THE SPECIFIED DIAMETER SHALL BE IN THE PIPE AT THE TIME IT IS MANUFACTURED, PRECAST "TEE" AND "ELBOW" PIPE CONNECTIONS FOR PROPOSED STORM SEWER WILL NOT BE PAID FOR SEPARATELY BUT WILL BE INCLUDED IN THE COST FOR THE STORM SEWERS.
 - b. COMBINED SEWER, (WATER MAIN REQUIREMENTS) SHALL BE USED AT LOCATIONS WHERE LATERAL SEPARATION BETWEEN THE SEWER AND WATER MAIN IS LESS THAN 10 FT AND THE VERTICAL SEPARATION IS LESS THAN 1.5 FT. DUCTILE IRON PIPE WITH RUBBER GASKET JOINTS SHALL BE USED FOR ALL COMBINED SEWER, (WATER MAIN REQUIREMENTS).
 - C. TOP OF FRAME OR LID ELEVATIONS FOR STRUCTURES WHICH ARE LOCATED ADJACENT TO CURB AND GUTTER OR CURB ARE GIVEN AT THE EDGE OF PAVEMENT. OFFSETS AND TOP OF FRAME OR LID ELEVATIONS FOR STRUCTURES NOT LOCATED IN THE GUTTER ARE GIVEN TO THE CENTER OF THE GRATE OR LID. STRUCTURES ADJACENT TO CURB SHALL BE TURNED SO THAT THE FRAME IS CLOSEST TO THE CENTER LINE OF THE ROAD UNLESS OTHERWISE NOTED ON THE PLANS.
 - d. DRAINAGE GRADES SHALL BE VERIFIED IN FIELD PRIOR TO INSTALLATION OF DRAINAGE ITEMS.
 - e. CARE SHALL BE TAKEN BY THE CONTRACTOR TO NOT DAMAGE THE EXISTING DRAINAGE SYSTEMS. ANY DAMAGE CAUSED BY THE CONTRACTOR TO THE EXISTING DRAINAGE SYSTEMS SHALL BE REPAIRED OR REPLACED BY THE CONTRACTOR AT THE CONTRACTOR'S OWN EXPENSE AND TO THE SATISFACTION OF THE ENGINEER. NO ADDITIONAL COMPENSATION SHALL BE PROVIDED.
 - f. THE CONTRACTOR IS RESPONSIBLE FOR MAINTAINING POSITIVE DRAINAGE ON THE JOB SITE DURING CONSTRUCTION.
- 17. THE CONTRACTOR SHALL VERIFY ALL DIMENSIONS AND CONDITIONS IN THE FIELD PRIOR TO CONSTRUCTION AND ORDERING OF MATERIALS.
- 18. THE THICKNESS OF THE HOT-MIX ASPHALT MIXTURE SHOWN ON THE PLANS IS THE NOMINAL THICKNESS. DEVIATIONS FROM THE NOMINAL THICKNESS WILL BE PERMITTED WHEN SUCH DEVIATIONS OCCUR DUE TO IRREGULARITIES IN THE EXISTING SURFACE OR BASE ON WHICH THE HOT-MIX ASPHALT MIXTURE IS PLACED.
- 19. WHEN THE PAVEMENT CONSTRUCTED IS PORTLAND CEMENT CONCRETE BASE COURSE OR PORTLAND CEMENT CONCRETE PAVEMENT, IT SHALL NOT BE OPENED TO TRAFFIC, INCLUDING CONSTRUCTION TRAFFIC, UNTIL AFTER THE SPECIFIED CURING PERIOD AS DEFINED IN ARTICLE 701.17(c) OF THE STANDARD SPECIFICATIONS AND UNTIL THE JOINTS HAVE BEEN SEALED.

- 20. PROTECTIVE COAT SHALL BE APPLIED IN ACCORDANCE WITH ARTICLE 420.18 OF THE STANDARD SPECIFICATIONS TO CONCRETE MEDIAN SURFACES AND BARRIER AND ALL EXPOSED SURFACES OF CURBS AND GUTTERS.
- 21. THE ENTIRE AREA WHICH IS TO RECEIVE BITUMINOUS MATERIALS (TACK COAT)' SHALL BE SWEPT CLEAN BEFORE THE MATERIAL APPLICATION, SWEEPINGS SHALL NOT BE DEPOSITED IN THE GUTTER OR ON THE CURB, PARKWAY, OR SIDEWALK, BUT SHALL BE PICKED UP AND DISPOSED OF PROPERLY BEYOND THE LIMITS OF THE PROJECT ON THE SAME DAY THAT SWEEPING IS DONE. THIS WORK SHALL BE INCLUDED IN THE COST OF BITUMINOUS MATERIALS (TACK COAT) AND NO ADDITIONAL COMPENSATION SHALL BE ALLOWED.
- 22. ALL REINFORCEMENT BARS, DOWEL BARS, AND TIE BARS SHALL BE EPOXY COATED UNLESS OTHERWISE NOTED IN THE PLANS.
- 23. IF ANY UNUSUAL MATERIALS ARE UNCOVERED OR THERE ARE SUSPICIONS OF EXISTING UNDERGROUND STORAGE TANKS, THE GENERAL CONTRACTOR IS REQUIRED TO HIRE AN ENVIRONMENTAL FIRM WITH AT LEAST FIVE (5) DOCUMENTED LEAKING UNDERGROUND STORAGE TANK (LUST) CLEANUPS OR THAT IS PREQUALIFIED IN HAZARDOUS WASTE BY THE DEPARTMENT TO REMEDIATE THE SOIL CONTAMINATION AND MONITOR FOR WORKER PROTECTION.
- 24. THE CONTRACTOR IS RESPONSIBLE FOR PROTECTING EXISTING PLANT MATERIAL AS SHOWN ON THE PLANS.
- 25. AN ESTIMATED QUANTITY OF 250 TONS OF AGGREGATE FOR TEMPORARY ACCESS HAS BEEN INCLUDED IN THIS CONTRACT FOR THE PURPOSE OF MAINTAINING CONSTRUCTION POINTS OF ACCESS IN THE MONROE STREET AREA AND FOR MAINTAINING ANY NECESSARY ACCESS TO PRIVATE PROPERTIES AND SIDE STREETS DURING THIS CONTRACT.
- 26. WHERE SECTION, SUBSECTION, SUBDIVISION OR PROPERTY MONUMENTS ARE ENCOUNTERED. THE ENGINEER SHALL BE NOTIFIED BEFORE SUCH MONUMENTS ARE REMOVED. THE CONTRACTOR SHALL PROTECT AND CAREFULLY PRESERVE ALL PROPERTY MARKERS AND MONUMENTS UNTIL THE OWNER, AN AUTHORIZED SURVEYOR, OR AGENT HAS WITNESSED OR OTHERWISE REFERENCED THEIR LOCATION.
- 27. FOR STORM SEWER CONSTRUCTED UNDER THE ROADWAY, BACKFILLING METHODS TWO AND THREE AUTHORIZED UNDER THE PROVISIONS OF ARTICLE 550.07 OF THE STANDARD SPECIFICATIONS WILL NOT BE ALLOWED.
- 28. ABANDONED UNDERGROUND UTILITIES THAT CONFLICT WITH CONSTRUCTION SHALL BE DISPOSED OF OUTSIDE THE LIMITS OF THE RIGHT-OF-WAY ACCORDING TO ART. 202.03 OF THE STANDARD SPECIFICATIONS AND AS DIRECTED BY THE ENGINEER. THIS WORK WILL NOT BE PAID FOR SEPARATELY BUT WILL BE INCLUDED IN THE COST OF FARTH FXCAVATION.
- 29. A QUANTITY OF 100 FEET OF EXPLORATION TRENCH 52" DEPTH HAS BEEN INCLUDED IN THE PLANS FOR THE PURPOSE OF IDENTIFYING ANY BURIED OBSTACLE. THE ENGINEER SHALL APPROVE THE LOCATIONS OF EXPLORATION TRENCH 52" DEPTH BEFORE ANY EXCAVATION MAY BEGIN.
- 30. SAW CUT (FULL DEPTH) SHALL BE REQUIRED AT THE JOINT BETWEEN PAVEMENT, SIDEWALK, CURB, CURB AND GUTTER, MEDIAN, DRIVEWAY PAVEMENT, HOT-MIX ASPHALT SURFACES TO BE REMOVED AND THAT LEFT IN PLACE OR AS DIRECTED BY THE ENGINEER, THIS WORK WILL NOT BE PAID FOR SEPARATELY BUT SHALL BE INCLUDED IN THE COST OF THE REMOVAL ITEMS.
- 31. THE DEPARTMENT HAS NOT OBTAINED ANY PERMITS FOR OFFSITE BORROW OR WASTE/USE (BWU) AREAS. PRIOR TO WORKING IN BWU AREAS, IF THE CONTRACTOR CHOOSES TO USE ACTIVITIES REQUIRING PERMITS IT IS THE CONTRACTOR'S RESPONSIBILITY TO SECURE THE PROPER PERMITS. IN ADDITION TO THE BORROW REVIEW (BDE 2289) AND USE/WASTE REVIEW (BDE 2290) SUBMITTALS, THE CONTRACTOR WILL NEED TO SUBMIT AN EROSION AND SEDIMENT CONTROL (ESC) PLAN FOR EVERY BWU SITE TO THE DEPARTMENT FOR ACCEPTANCE. GUIDELINES FOR ACCEPTABLE BWU PRACTICES CAN BE FOUND IN SECTION II.5.A AND B OF THE SWPPP. THE COST OF ALL MATERIALS AND LABOR NECESSARY TO COMPLY WITH THE ABOVE PROVISIONS TO PREPARE AND IMPLEMENT ESC PLANS WILL NOT BE PAID FOR SEPARATELY, BUT SHALL BE CONSIDERED AS INCLUDED IN THE UNIT BID PRICES OF THE CONTRACT AND NO ADDITIONAL COMPENSATION WILL BE ALLOWED.
- 32. THE DEPARTMENT WILL REQUIRE A MINIMUM OF THREE (3) WEEKS TO REVIEW ANY SUBMITTALS REQUIRING THE DEPARTMENT'S APPROVAL.

 NO ADDITIONAL COMPENSATION AND NO EXTENSION OF CALENDAR DAYS WILL BE MADE DUE TO THE DEPARTMENT REQUIRING MORE TIME TO REVIEW SUBMITTALS.
- 33. THE CONTRACTOR SHALL ENSURE THAT NO CONSTRUCTION ACTIVITY OCCURS BEYOND THE TEMPORARY CHAIN LINK FENCE AND/OR LIMITS OF CONSTRUCTION ALONG MONROE STREET.
- 34. COOPERATION BETWEEN CONTRACTORS SHALL BE IN ACCORDANCE WITH THE SPECIAL PROVISIONS.
- 35. THE CONTRACTOR'S ATTENTION IS CALLED TO THE FACT THAT THE PRESERVATION OF EXISTING TREES IS OF UTMOST IMPORTANCE TO THE CITY OF CHICAGO. ALL TREE PROTECTION, TREE REMOVAL, PRUNING AND ROOT PRUNING SHALL BE COMPLETED BEFORE CONSTRUCTION OPERATIONS COMMENCE IN ANY AREA. AT NO TIME SHALL THE CONTRACTOR PRUNE OR REMOVE ANY TREES UNLESS SPECIFICALLY DIRECTED BY THE ROADSIDE DEVELOPMENT UNIT.
- 36. THE CONTRACTOR SHALL TAKE EXTRA CARE IN GRADING AND EXCAVATING NEAR TREES WHICH ARE NOT MARKED FOR REMOVAL SO AS NOT TO CAUSE INJURY TO THE ROOT SYSTEM OR TRUNKS. ANY DAMAGE TO EXISTING TREES BY THE CONTRACTOR SHALL BE REPAIRED OR REPLACED BY THE CONTRACTOR AT THE CONTRACTOR'S OWN EXPENSE.
- 37. TREE ROOT PRUNING IS TO BE USED ON EXISTING TREES/SHRUBS WHEN NECESSARY TO CUT MAJOR TREE/SHRUB ROOTS TO PREVENT THE RIPPING UP OF ROOTS WHEN TRENCHING OR EXCAVATION IS WITHIN THE ROOT ZONE OF ADJACENT TREES TO REMAIN. SUPPLEMENTAL WATERING IS SPECIFIED FOR TREES AND SHRUBS THAT WILL BE DISTURBED BY CONSTRUCTION BUT WILL REMAIN. SUPPLEMENTAL WATERING OF TREES/SHRUBS SHALL BEGIN IMMEDIATELY AFTER ROOT PRUNING OF THE TREES HAS OCCURRED.
- 38. THE CONTRACTOR SHALL ERECT A TEMPORARY FENCE AROUND ALL TREES WITHIN THE CONSTRUCTION AREA TO ESTABLISH A "TREE PROTECTION ZONE" BEFORE ANY WORK BEGINS OR MATERIAL IS DELIVERED TO THE JOB SITE. NO WORK IS TO BE PERFORMED (OTHER THAN ROOT PRUNING), MATERIALS STORED OR VEHICLES DRIVEN OR PARKED WITHIN THE "TREE PROTECTION ZONE". REMOVE PROTECTIVE TEMPORARY FENCE ONLY AFTER ALL CONSTRUCTION WORK HAS BEEN COMPLETED.
- 39. THE CONTRACTOR SHALL SCHEDULE A WALK THROUGH WITH THE ROADSIDE DEVELOPMENT UNIT A MINIMUM OF ONE WEEK PRIOR TO THE START OF CONSTRUCTION TO MARK TREES FOR PROTECTION AND EXACT LOCATION FOR PLACEMENT OF TEMPORARY FENCE.
- 40. THE CONTRACTOR WILL BE RESPONSIBLE FOR TAKING MEASURES TO PROTECT ALL EXISTING TRESS WITHIN THE SIDEWALKS ON MONROE STREET. REFER TO THE ABOVE NOTES AND THE SPECIAL PROVISION "PROTECTION OF EXISTING TREES" FOR DETAILS AND REQUIREMENTS.
- 41. CONTRACT 60X95 WILL PROVIDE THE ENGINEER'S FIELD OFFICE TYPE A (SPECIAL) TO BE SHARED WITH CONTRACT 62A75.

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PAR SONS	Γ
BRINCKERHOFF	

USEK NAME = Doghman	DESIGNED	-	MMA	KFAIZFD -	
	DRAWN	-	MMA	REVISED -	
PLOT SCALE = 1"=50"	CHECKED	~	RT	REVISED -	
PLOT DATE = 7/12/2017	DATE	-	07/14/2017	REVISED -	

STATE	10	ILLINOIS
DEPARTMENT	0F	TRANSPORTATION

SCAL

	OFNEDAL MOTEO		F.A.I. RTE.	SECTION	COUNTY	TOTAL SHEETS	SHEET NO.
	GENERAL NOTES	FAI 90/94	2014-016R&B	COOK	378	4	
					CONTRACT		X95
LE:	SHEET NO. 1 OF 2 SHEETS STA.	TO STA.		TILL INDIS FED. AL	D PROJECT		

GENERAL NOTES (CONTINUED)

- 42. CHICAGO TRANSIT AUTHORITY (CTA) REPRESENTATIVE WILL BE MR. ABDIN CARRILLO, MANAGER, PROJECT CONSTRUCTION OVERSIGHT. CONTRACTOR SHALL NOTIFY CTA REPRESENTATIVE AT 312-681-3913 AT LEAST 72 HOURS IN ADVANCE OF THE TIME HE INTENDS TO ENTER UPON THE CTA RIGHT-OF-WAY FOR THE PERFORMANCE OF
- 43. WORK AREA IS IN CLOSE PROXIMITY TO RECENT IMPROVEMENTS. THE CONTRACTOR SHALL PROTECT THESE IMPROVEMENTS INCLUDING BUT NOT LIMITED TO THE PLAZA WALKWAY AREA, RETAINING WALL, UNDERGROUND SPRINKLER SYSTEM AND PLANTINGS. THIS WORK WILL NOT BE PAID FOR SEPARATELY, BUT SHALL BE INCLUDED IN THE COST OF THE CONTRACT.
- 44. ALL EXCAVATED MATERIAL SHALL BE USED AS BACKFILL. NO EXCAVATED MATERIAL SHALL LEAVE THE SITE.
- 45. THE RESIDENT ENGINEER WILL CONTACT THE ROADSIDE DEVELOPMENT UNIT AT (847) 705-4171 TO APPROVE THE LAYOUT OF ALL TREES, SHRUBS, AND PERENNIALS PRIOR TO THEIR INSTALLATION. ALLOW A MINIMUM NOTICE OF 7 DAYS PRIOR TO INSTALLATION FOR APPROVAL.
- 46. THE CONTRACTOR SHALL ENSURE THAT NO CONSTRUCTION ACTIVITY, STORING, OR PARKING OF EQUIPMENT OR VEHICLES OCCURS BEYOND THE PERIMETER EROSION CONTROL BARRIER AND/OR PEORIA STREET SIPHON LINING LIMITS OF CONSTRUCTION. THE CONTRACTOR SHALL MAINTAIN ACCESS TO THE CTA STATION AND DRIVEWAY ACCESS TO ABUTTING PROPERTIES AT ALL TIMES. THE CONTRACTOR SHALL ACCESS THE WORK ZONE AS SHOWN ON THE PLANS AND NOT PARK VEHICLES ON, OR OBSTRUCT ACCESS TO ABUTTING PROPERTIES.

CITY OF CHICAGO **GENERAL NOTES:**

- THE CONVERSION OF NORTH AMERICAN VERTICAL DATUM OF 1988 (NAVD88) TO CITY OF CHICAGO DATUM IS APPROXIMATELY 579.19 FEET.
- 2. ALL WORK MUST CONFORM TO THE MOST CURRENT CITY OF CHICAGO STANDARDS FOR CONSTRUCTION IN COMPLIANCE WITH THE AMERICANS WITH DISABILITIES ACT, (ADA) AVAILABLE ON THE CITY OF CHICAGO WEBSITE.
- 3. PAVEMENT CROSS SLOPES SHALL VARY FROM A MINIMUM OF 1.4% TO A MAXIMUM OF 3.6%. CURB AND GUTTER CONSTRUCTION SHALL PROVIDE A MINIMUM CURB HEIGHT OF 3 INCHES AND A MAXIMUM OF 9 INCHES. THE LONGITUDINAL SLOPE ALONG A STRAIGHT CONCRETE GUTTER SECTION AND CURVED GUTTER SECTION SHALL BE A MINIMUM OF 0.4% AND 0.65%, RESPECTIVELY.
- 4. TEMPORARY HOT-MIX ASPHALT RAMPS MUST BE CONSTRUCTED AROUND ALL UTILITY STRUCTURES REGARDLESS OF SHAPE WHEN THE ROAD IS OPEN TO TRAFFIC PRIOR TO PLACEMENT OF BINDER AND/OR SURFACE COURSE. THE RAMPS MUST BE CONSTRUCTED IN ACCORDANCE WITH THE TEMPORARY HMA RAMP DETAILS AND REMOVED PRIOR TO PLACEMENT OF BINDER AND/OR SURFACE COURSE. THIS WORK WILL NOT BE PAID FOR SEPARATELY BUT SHALL BE CONSIDERED INCLUDED IN THE COST OF THE UTILITY STRUCTURES.
- 5. THE LOCATIONS AND ELEVATIONS OF EXISTING SEWERS AND SEWER STRUCTURES SHOWN ON THE PLANS AND PROFILES HAVE BEEN OBTAINED FROM DRAWINGS AND ATLASES AND THE INFORMATION IS NOT GUARANTEED. THE RESIDENT ENGINEER AND THE CONTRACTOR SHALL FIELD VERIFY THE CITY'S EXISTING SEWER FACILITIES INCLUDING PUBLIC AND PRIVATE DRAIN CONNECTIONS IN THE LIMITS OF THE REFERENCED PROJECT FOR AN CONFLICTS DUE TO THE PROPOSED IMPROVEMENTS. ANY CONFLICT SHOULD BE RESOLVED WITH THE DEPARTMENT OF WATER MANAGEMENT PRIOR TO START OF CONSTRUCTION.
- 6. IN LOCATIONS WHERE THE MAIN SEWER IS NOT BEING REPLACED AND THE EXISTING DRAINAGE FACILITIES ARE DISTURBED OR DAMAGED DURING CONSTRUCTION BY THE CONTRACTOR, IT WILL BE THE CONTRACTOR'S RESPONSIBILITY TO RESTORE AND REPLACE THE DAMAGED FACILITIES AT HIS/HER EXPENSE TO THE SATISFACTION OF THE DEPARTMENT OF WATER MANAGEMENT. THE SEWER FLOWS MUST BE MAINTAINED AT ALL TIMES.
- IN CASE OF ANY DAMAGE TO THE CITY'S SEWER SYSTEM, PRIVATE AND PUBLIC DRAIN CONNECTIONS, THE CONTRACTOR SHALL CONTACT THE CHICAGO DEPARTMENT OF WATER MANAGEMENT IMMEDIATELY AT (312) 747-8117 OR (312) 747-7893. THE CONTRACTOR SHALL AT HIS/HER OWN EXPENSE, REPLACE THE AFFECTED SEWERS, DRAIN CONNECTIONS, AND SEWER STRUCTURES AS NECESSARY. THE SEWER FLOW MUST BE MAINTAINED AT ALL TIMES.
- 8. CITY OF CHICAGO WATER VALVE VALUES AND SEWER STRUCTURES SHALL NOT BE CLOSED, COVERED OR OTHERWISE OBSTRUCTED DURING CONSTRUCTION WITHOUT WRITTEN PERMISSION FROM THE CITY OF CHICAGO DEPARTMENT OF WATER MANAGEMENT UNLESS SPECIFICALLY IDENTIFIED FOR REMOVAL, RECONSTRUCTION OR ADJUSTMENT WITHIN
- 9. AS-BUILT PLANS MUST BE SUBMITTED RIGHT AFTER WORK COMPLETION. FINAL PAYMENT SHALL NOT BE MADE TO THE CONTRACTOR UNTIL THE DEPARTMENT OF WATER MANAGEMENT ACKNOWLEDGES RECEIPT OF AS-BUILT PLANS.
- 10. THE CONTRACTOR SHALL IMMEDIATELY NOTIFY THE DEPARTMENT OF TRANSPORTATION OF ANY DAMAGE TO CITY OWNED AND MAINTAINED TRAFFIC SIGNS, SIGNALS, GUARDRAILS, FENCES, ETC.
- 11. THE CONTRACTOR SHALL SAWCUT A MINIMUM DEPTH OF ONE AND A HALF INCHES (1 1/2") WITH A CONCRETE SAWING MACHINE, TO PREVENT THE SURFACE FROM SPALLING WHEN THE SURFACE COURSE AND THE BASE COURSE ARE BROKEN. THE WORK SHALL BE DONE IN SUCH A MANNER THAT A STRAIGHT JOINT IS SECURED. THE CONTRACTOR SHALL SAWCUT THE PAVEMENT FULL DEPTH FOR PATCHES AND AROUND STRUCTURES. AT CONCRETE CURB AND GUTTER, CONTRACTOR SHALL SAWCUT TO THE BASE OF THE CURB AND GUTTER. ALL SAWCUTTING REQUIRED WHETHER OR NOT SPECIFIED ON THE PLANS SHALL BE INCLUDED IN THE COST OF THE ADJACENT REMOVAL PAY ITEMS. NO ADDITIONAL COMPENSATION SHALL BE ALLOWED.
- 12. 1/2-INCH THICK EXPANSION JOINTS SHALL BE PLACED BETWEEN THE SIDEWALK AND ALL STRUCTURES SUCH AS LIGHT STANDARDS, TRAFFIC LIGHT STANDARDS, AND MANHOLES WHICH EXTEND THROUGH THE SIDEWALK UNLESS OTHERWISE NOTED ON THE PLANS. THIS WORK SHALL BE INCLUDED IN THE COST OF THE PORTLAND CEMENT CONCRETE SIDEWALK PAY ITEM. NO ADDITIONAL COMPENSATION SHALL BE ALLOWED.

- 13. THERE ARE NUMEROUS MANHOLES, CATCH BASINS, AND INLETS, WHICH MUST BE PROTECTED FROM ENTRY OF ASPHALT/DEBRIS INTO THE SEWER SYSTEM DURING CONSTRUCTION. THE CONTRACTOR MUST MARK THE LOCATIONS OF ALL SEWER STRUCTURES ON THE SIDEWALK BEFORE STARTING PAVEMENT REMOVAL/REPLACEMENT. ALL NECESSARY ADJUSTMENTS TO SEWER FACILITIES, INCLUDING VERTICAL ADJUSTMENT OF FRAMES AND LIDS, MUST BE INCLUDED IN THE CONTRACT AND PERFORMED BY IDOT'S CONTRACTOR PRIOR TO STREET RESURFACING. PLEASE NOTE THAT A PERMIT WILL BE REQUIRED FROM THE SEWER SECTION FOR THE ABOVE-MENTIONED ADJUSTMENT WORK.
- 14. A PERMIT FROM THE DEPARTMENT OF WATER MANAGEMENT SHOULD BE OBTAINED IN ADVANCE FOR ANY UNDERGROUND SEWER WORK INCLUDING ADJUSTMENT OF STRUCTURES, REMOVAL/REPLACEMENT OF FRAMES AND LIDS, TELEVISION SURVEYS, CLEANING, LINING AND INSPECTIONS BY A LICENSED SEWER CONTRACTOR AT 333 S. STATE STREET, SUITE 410, CHICAGO, ILLINOIS 60604.
- 15. IF CONSTRUCTION REQUIRES THE USE OF WATER FROM A CITY FIRE HYDRANT, OR ADJUSTMENT REPAIRS ARE REQUIRED TO ANY CITY SEWER FACILITIES IN PROXIMITY TO THE PROJECT SITE, PERMITS MUST BE OBTAINED FROM THE DEPARTMENT OF WATER MANAGEMENT, WATER AND SEWER SECTIONS.
- 16. EXTREME CAUTION IS TO BE TAKEN TO ENSURE THAT NO FACILITY OWNED AND MAINTAINED BY THIS DEPARTMENT IS DAMAGED DURING CONSTRUCTION. IF DAMAGE OCCURS TO ANY FACILITIES, THE CONTRACTOR WILL BE HELD RESPONSIBLE FOR THE COST OF REPAIRING OR REPLACING THEM.

CITY OF CHICAGO DIVISION OF TRANSPORTATION STANDARD CONSTRUCTION DETAILS

- TYPICAL JOINT LAYOUT FOR P.C. CONCRETE PAVEMENTS
- P.C.C BASE COURSE JOINT DETAILS A-2-3C
- CONCRETE CURB AND GUTTER DETAIL
- PORTLAND CEMENT CONCRETE ALLEY A-2-9
- DETAILS OF STRUCTURE CASTING ISOLATION BOX
- DETAILS OF STRUCTURE CASTING ISOLATION BOX FOR P.C.C. PAVEMENT AND BASE COURSES 4-2-10B
- DETAILS OF PORTLAND CEMENT CONCRETE CONSTRUCTION A-3-2
- TREE PLT DETAIL A-5-2
- TREE PIT DETAIL
- TRENCH GUIDELINES FOR INSTALLATION OF UNDERGROUND UTILITIES ADJACENT TO TREES
- CROSSWALK MARKING DETAIL Δ-7-1A
- CROSSWALK MARKING DETAIL A-7-1B

CITY OF CHICAGO DIVISION OF TRANSPORTATION ADA STANDARDS

- ALLEY RETURN PLAN VIEW
- ALLEY RETURN SECTIONS B-2-2
- DRIVEWAY CONSTRUCTION PLAN VIEWS
- DRIVEWAY CONSTRUCTION SECTIONS
- B-3-2 GENERAL NOTES
- GENERAL NOTES (CONTINUED)
- ADA COMPLIANCE AND TRANSITION GUIDELINES B-3-4
- CURB & GUTTER DETAILS

CITY OF CHICAGO DIVISION OF WATER MANAGEMENT STANDARD DETAILS

- VITRIFIED CLAY PIPE DRAIN CONNECTIONS
- MANHOLES LIDS AND FRAMES A.3
- TYPE "A" MANHOLE PRECAST BASES AND RINGS
- TYPE "B" MANHOLE
- DRAINAGE STRUCTURE DETAILS A.15
- LADDER RUNGS

FOLLOW CDOT STANDARDS FOR MONROE STREET. FOLLOW IDOT STANDARDS FOR I-90 / 94

COUNTY SHEETS NO.

COOK 378 5 SECTION CITY OF CHICAGO 2014-016R&B STATE OF ILLINOIS **GENERAL NOTES AND COMMITMENTS** CONTRACT NO. 60X95 DEPARTMENT OF TRANSPORTATION SHEET NO. 2 OF 2 SHEETS STA. ILLINOIS FED. AID PROJECT SCALE:

PARSONS BRINCKERHOFF PLOT SCALE = 1"=58"

REVISED . DESIGNED - MMA USER NAME : Kucharski DRAWN - MMA REVISED REVISED CHECKED - RT - 07/14/2017 REVISED PLOT DATE = 7/13/2017 DATE

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BY DATE				
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	PROFILE	MOTE BOOK	9	

		1		90% FED 10% STATE	90% FED 10% STATE UTILITIES	90% FED 10% STATE BRIDGE	90% FED 10% STATE	90% FED 10% STATE	90% FED 10% STATE ROADWAY LIGHTING
CODE	PAY ITEM	UNIT	TOTAL	ROADWAY 0004	₩ 0043	BRIDGE	0044	0021	0021
NUMBER			QUANTITY	URBAN	URBAN	016-1700	016-Z017	URBAN	URBAN
20100110	TREE REMOVAL (6 TO 15 UNITS DIAMETER)	UNIT	53	35	18				
20100210	TREE REMOVAL (OVER 15 UNITS IN DIAMETER)	UNIT	68	68				<u>,,,</u>	
20101000	TEMPORARY FENCE	FOOT	540	220	320				
20101100	TREE TRUNK PROTECTION	EACH	10	10					
20101200	TREE ROOT PRUNING	EACH	21	11	10				
20101300	TREE PRUNING (1 TO 10 INCH DIAMETER)	EACH	19	11	8				
20101350	TREE PRUNING (OVER 10 INCH DIAMETER)	EACH	2		2				
21101505	TOPSOIL EXCAVATION AND PLACEMENT	CU YD	113		113				
21101800	COMPOST FURNISH AND PLACE, 1"	SY YD	228		228				
20101700	SUPPLEMENTAL WATERING	UNIT	5	5					
20200100	EARTH EXCAVATION	CU YD	976	976					
20201200	REMOVAL AND DISPOSAL OF UNSUITABLE MATERIAL	CU YD	172	172		1			
		OH VO	104	124					
20800150	TRENCH BACKFILL	CU YD	124	124					
21101615	TOPSOIL FURNISH AND PLACE, 4"	SO YD	4840	4840					
21301052	EXPLORATION TRENCH 52" DEPTH	FOOT	100	100					
21301032	EXPLORATION FRENCH 32 DEPTH	1007	100	100					
25000210	SEEDING, CLASS 2A	ACRE	1	1					
25000400	NITROGEN FERTILIZER NUTRIENT	POUND	99	90	9			- 141114	
25000600	POTASSIUM FERTILIZER NUTRIENT	POUND	99	90	9				
							1		
25100115	MULCH METHOD 2	ACRE	1	1					
25100630	EROSION CONTROL BLANKET	SQ YD	4840	4840					
25200110	SODDING, SALT TOLERANT	SQ YD	688		688			- Andrews - Andr	

* DENOTES SPECIALTY ITEM

DENOTES NON-PARTICIPATING ITEM

CONSTRUCTION CODE

- 1		USER NAME = Kucherski	DESIGNED - WWA	REVISED -				Į F	RTE. SECT	TON COUNTY TOTAL SHEET NO.
¥ P	AR SONS		DRAWN - MMA	REVISED -	STATE OF ILLINOIS		SUMMARY OF QUANTITIES		FAI 2014-0	16R&B COOK 378 6
5 8	RINCKERHOFF	PLOT SCALE = NO SCALE	CHECKED - RT	REVISED -	DEPARTMENT OF TRANSPORTATION					CONTRACT NO. 60X95
<u> </u>		PLDT CATE = 7/13/2017	DATE - 07/14/2017	REVISED -		SCALE:	SHEET NO. 1 OF 14 SHEETS STA.	TO STA.		ILLINOIS FED. AID PROJECT

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CODE	DAY ITEM	TINU	TOTAL	ROADWAY 0004	UTILITIES 0043	BRIDGE 0010	RETAINING WALL	0021	0021
NUMBER	PAY ITEM	UNI	QUANTITY	URBAN	URBAN	016~1700	00-44 016-2017	URBAN	URBAN
25200200	SUPPLEMENTAL WATERING	UNIT	5		5				
28000250	TEMPORARY EROSION CONTROL SEEDING	POUND	118	100	18	<i>y.</i> ,			
28000400	PERIMETER EROSION BARRIER	FOOT	1449	970	479				
28000510	INLET FILTERS	EACH	39	38	1	~			
									-
30300001	AGGREGATE SUBGRADE IMPROVEMENT	CU YD	30	30					
30300112	AGGREGATE SUBGRADE IMPROVEMENT 12"	SQ YD	229	229					
31101200	SUBBASE GRANULAR MATERIAL, TYPE B 4"	SQ YD	1550	1550			·		
31101200									
31101400	SUBBASE GRANULAR MATERIAL, TYPE B 6"	SQ YD	1823	1823		***************************************	-		
31101100	SOURCE STRATEGICALLY THE B		1023	.023					
31101600	SUBBASE GRANULAR MATERIAL, TYPE B 8"	SQ YD	116	116					
31101000	SOURCE STRAIGHT WATER THE STORY								
35300500	PORTLAND CEMENT CONCRETE BASE COURSE 10"	SQ YD	1576	1576			****		
	TOTAL COMMENT CONTACT DATE COUNTY TO	54.15	1310						
40201000	AGGREGATE FOR TEMPORARY ACCESS	TON	250	250					
70201000	AND THE PORT OF THE START AND COST			130					
40600290	BITUMINOUS MATERIALS (TACK COAT)	POUND	1481	1481		· · · · · · · · · · · · · · · · · · ·			
10000230	BY OWN TOOL STATES THE COURT	7,50.0							
40600635	LEVELING BINDER (MACHINE METHOD), N70	TON	132	132					
									·····
40603340	HOT-MIX ASPHALT SURFACE COURSE, MIX "D", N70	TON	154	154					
100000	THE THINK ASSITIVE SOUTH OF CONTROL OF THE STATE OF THE S						<u> </u>		
42000070	PAVEMENT CONNECTOR (HMA) FOR BRIDGE APPROACH SLAB	SO YO	93	93					
42000010	PAYEMENT CONNECTION GIMMATTON BILLDOC ATTENDACT SEAD	30.10		3,3			<u> </u>		
42000301	PORTLAND CEMENT CONCRETE PAVEMENT 8" (JOINTED)	SQ YD	97	97					
42000301	PONTEAND CEMENT CONCRETE TAVEMENT & COORTED	34.15	3,	J					
42000501	PORTLAND CEMENT CONCRETE PAVEMENT 10" (JOINTED)	SQ YD	188	188					.,
-,2000J0I	ONTEND CONCRETE PAREMENT TO MOINTED	32 (8	155	130					
42001300	PROTECTIVE COAT	SQ YD	1163	1163					
		34 15	11(0.3	(140.3			 		
42300400	PORTLAND CEMENT CONCRETE DRIVEWAY PAVEMENT, 8 INCH	SO YD	158	158					
72300400	TOTAL CONCILL DISTENSE LANGUAGE, O 1901	34 10	130	130					
43400300	DODTI AND CENENT CONCRETE SIDEWALK & INCH	SO FT	4660	4660			+		
42400200	PORTLAND CEMENT CONCRETE SIDEWALK 5 INCH	SUFI	4000	1000					•
44000100	PAVEMENT REMOVAL	SQ YD	2194	2194		L			

	USER NAME = Kucharski	DESEGNED - MMA	REVISED -				F.A.I.	SECTION	COUNTY SHEETS	SHEET NO.
PARSONS		DRAWN - MMA	REVISED -	STATE OF ILLINOIS		SUMMARY OF QUANTITIES	FAI 90/94	2014-016R&B	COOK 378	7
* BRINCKERHOFF	PLOT SCALE = NO SCALE	CHECKED - RT	REVISED -	DEPARTMENT OF TRANSPORTATION			30734		CONTRACT NO. CO	50X95
=	PLOT DATE = 7/13/2817	DATE - 07/14/2017	REVISED -		SCALE:	SHEET NO. 2 OF 14 SHEETS STA. TO STA.		ILLINOIS FED. AI	PROJECT	

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'	PLDT DATE = 7/13/2017	DATE	-	07/14/2017	REVISED -	

STATE (OF ILLINOIS
DEPARTMENT O	OF TRANSPORTATION

	SUMMARY OF QUANTITIES	
SCALE:	SHEET NO. 3 OF 14 SHEETS STA.	TO STA.

CONSTRUCTION CODE
ED 90% FED
ATE 10% STATE

SECTION

* DENOTES SPECIALTY ITEM

DENOTES NON-PARTICIPATING ITEM

21

		٦				CONS		90% FED	
				90% FED 10% STATE	90% FED 10% STATE	90% FED 10% STATE	90% FED 10% STATE	90% FED 10% STATE	10% STAT
		T	TOTAL	ROADWAY	UTILITIES	BRIDGE	RETAINING WALL	HIGHWAY LIGHTING	ROADWAY LIG
CODE	PAY ITEM	UNIT	1	0004	0043	0100	0044	0021	0021
NUMBER			CUANTITY	URBAN	URBAN	016-1700	016-Z017	URBAN	URBAN
4000200	DRIVEWAY PAVEMENT REMOVAL	SQ YD	145	145					
44000500	COMBINATION CURB AND GUTTER REMOVAL	FOOT	864	864					1
44000600	SIDEWALK REMOVAL	SQ FT	4418	4418					
			1 3 1 4	111-					
44001980	CONCRETE BARRIER REMOVAL	FOOT	363	363		 			
		1							
44004250	PAVED SHOULDER REMOVAL	SQ YD	211	311					
44004250	FAVEO SHOULDER REMOVAL	30 10	316	316					
10007001	UNDER VIEW ARROWS TO COMPANY TO C	CO VO	610	C10		1	-		
48203021	HOT-MIX ASPHALT SHOULDERS, 6"	SQ YD	610	610	1			 	
									
50100300	REMOVAL OF EXISTING STRUCTURES NO. 1	EACH	1			1			
						V			
50100400	REMOVAL OF EXISTING STRUCTURES NO. 2	EACH	1				1		
50102400	CONCRETE REMOVAL	CU YD	2.4		2.4				
50104650	SLOPE WALL REMOVAL	SQ YD	161			161			

50157300	PROTECTIVE SHIELD	SQ YD	2714			2714			
30131300	THOTESTIFE STILLED	+							<u> </u>
50200100	STRUCTURE EXCAVATION	CU YD	1780.1		 	1457	323.1	·	
30200100	STAUCTURE EXCAVATION		1100.1			1.31	32311	-	
		00.40	010.7	***************************************	2.1	700	102.6		
50300225	CONCRETE STRUCTURES	CU YD	810.7		2.1	706	102.6		
			ļ						
50300254	RUBBED FINISH	SQ FT	10760	:		10760			
						ļ			
50300255	CONCRETE SUPERSTRUCTURE	CU YD	989.2			956	33.2		ļ
50300260	BRIDGE DECK GROOVING	SQ YD	1814			1814			
50300285	FORM LINER TEXTURED SURFACE	SQ FT	836			836			
50300300	PROTECTIVE COAT	SQ YD	3327			3173	154		
50301350	CONCRETE SUPERSTRUCTURE (APPROACH SLAB)	CU YD	197			197			
		+				1			
ENERGIA	CHIDATCUING AND EDECTING STRUCTURAL STEEL	LSUM	1			1			
50500105	FURNISHING AND ERECTING STRUCTURAL STEEL	LOUM	+			•			
		F.6	0770	 		0.450	007		
50500505	STUD SHEAR CONNECTORS	EACH	8739	ŀ	1	8452	287	1	1

50800105 REINFORCEMENT BARS POUND 350760 970 50800205 REINFORCEMENT BARS, EPOXY COATED POUND 448830 50800515 BAR SPLICERS EACH 140 50800530 MECHANICAL SPLICERS EACH 16 16 NAME PLATES EACH 2 51602000 PERMANENT CASING FOOT 3832 51603000 DRILLED SHAFT IN SOIL CU YD 1835 51604000 DRILLED SHAFT IN ROCK CU YD 42.5 52000110 PREFORMED JOINT STRIP SEAL F00T 138 52100010 ELASTOMERIC BEARING ASSEMBLY, TYPE I EACH 36 52100505 ANCHOR BOLTS, 5/8" EACH 36 52100520 ANCHOR BOLTS, 1" EACH 54 52200020 TEMPORARY SOIL RETENTION SYSTEM SO FT 1660 135 52200105 FURNISHING SOLDIER PILES (W SECTION) FOOT 2097 52200200 DRILLING AND SETTING SOLDIER PILES (IN SOIL) CU FT 31285 UNTREATED TIMBER LAGGING 52200250 50 FT 32 52200265 SECANT LAGGING CU FT 5611 550A0340 STORM SEWERS, CLASS A, TYPE 2 12" FOOT 47 47 55100400 STORM SEWER REMOVAL 10" FOOT 18 18

PAY ITEM

* DENOTES SPECIALTY ITEM
DENOTES NON-PARTICIPATING ITEM

CONSTRUCTION CODE

90% FED

10% STATE

RETAINING WALL

0044

016-Z017

14600

1

1826

1826

30702

32

5611

1738

167

10% STATE

0021

URBAN

10% STATE

0021

URBAN

HIGHWAY LIGHTING | ROADWAY LIGHTING

90% FED

10% STATE

BRIDGE

0010

016-1700

349790

434230

140

1

2006

1835

42.5

138

36

36

54

1525

271

583

12393

388

90% FED

10% STATE

ROADWAY

0004

URBAN

TOTAL

QUANTITY

UNIT

90% FED

10% STATE

UTILITIES 0043

URBAN

<i>:</i> [USER NAME = Kucherska	DESEGNED -	MMA	REVISED -				*****		F.A.I.	SECTION	COUNTY	TOTAL SI	EET
	PAR \$ ON \$		DRAWN -	MMA	REVISED -	STATE OF ILLINOIS	ĺ	SUMMARY (OF QUANTIT	TES	FAL	2014-016R&B	СООК	378	9
* i	DNINGKENNGFF		CHECKED -	RT	REVISED -	DEPARTMENT OF TRANSPORTATION					30/34 ;		CONTRACT	NO. 60X	95
∉L		PLOT DATE = 7/13/2017	DATE -	07/14/2017	REVISED -		SCALE:	SHEET NO. 4 OF 14 S	HEETS STA.	TO STA.		ILLINGIS FEO. A	ID PROJECT		=

14131

555

SQ FT

SQ YD

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CONCRETE SEALER

59100100 GEOCOMPOSITE WALL DRAIN

CODE

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	SURVEYED	GRADES CHECKED	STAL.
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				90% FED 10% STATE					
CODE		T	TOTAL	ROADWAY	UTILITIES	BRIDGE	RETAINING WALL	HIGHWAY LIGHTING	ROADWAY LIGHTING
NUMBER	PAY ITEM	UNIT	OUANTITY	0004	0043	0010	0044	0021	0021
		+	GOASTILIT	URBAN	URBAN	016-1700	016-Z017	URBAN	URBAN
50100100	DIDE UNDERDOATNE AU COPELALY	7007	-		 				
60108100	PIPE UNDERORAINS 4" (SPECIAL)	FOOT	68	68			-		
		<u> </u>					-		
60200205	CATCH BASINS, TYPE A, 4'-DIAMETER, TYPE 1 FRAME, CLOSED LID	EACH	1	1			1		
								_	
60255500	MANHOLES TO BE ADJUSTED	EACH	2	2					
60258200	MANHOLES TO BE RECONSTRUCTED WITH NEW TYPE 1 FRAME, CLOSED LID	EACH	1		1				
60300305	FRAMES AND LIDS TO BE ADJUSTED	EACH	10	10					
60500040	REMOVING MANHOLES	EACH	2	2					
							1		
60500050	REMOVING CATCH BASINS	EACH	5	5	 				
60600605	CONCRETE CURB, TYPE B	FOOT	55	55	1		+		
	SWIND TO SWIND THE S	1	 		 		+		
60602800	CONCRETE GUTTER, TYPE B	FOOT	170	170					
80802800	CONCRETE GUSTER, TIPE B	FOOT	170	170			1		
					 		-		
60603800	COMBINATION CONCRETE CURB AND GUTTER, TYPE B-6.12	FOOT	146	146					
		<u> </u>							
60610400	COMBINATION CONCRETE CURB AND GUTTER, TYPE M-6.24	FOOT	183	183					ļ
							1		
63200310	GUARDRAIL REMOVAL	FOOT	150	150					Tanana and an analas an analas and an analas an analas and an analas and an analas and an analas and an analas an analas and an analas and an analas and an analas and an analas an analas and an analas analas an anala
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							-		
		† —							
64300260	IMPACT ATTENUATORS (FULLY REDIRECTIVE, NARROW), TEST LEVEL 3	EACH	1	1					
64300370	IMPACT ATTENUATORS (FULLY REDIRECTIVE, WIDE), TEST LEVEL 3	EACH	2	2					
			-						
66900200	NON-SPECIAL WASTE DISPOSAL	CU YD	2790	2605	185				
00300200	THE STATE WAS EDUCATED AND THE STATE OF THE	30 10	2,30	2003	103		+	 	
CERODAEO	SPECIAL WASTE PLANS AND REPORTS	LCIM	 , 	•			1		
66900450	DECUME THADIC FLAND REFUNCTS	LSUM	1	1			-		
***********	CAN DISCOUNT AND VOIC	F	 _ 				-		
66900530	SOIL DISPOSAL ANALYSIS	EACH	7	6	1				
67100100	MOBILIZATION	LSUM	1	1					
		1	+ +						

7

* DENOTES SPECIALTY ITEM
DENOTES NON-PARTICIPATING ITEM

CONSTRUCTION CODE

	USER NAME = Kucharakı	DESIGNED - MMA	REVISED -				F.A.I.	SECTION	COUNTY	TOTAL SHEET
PARSONS		DRAWN - MMA	REV[SED -	STATE OF ILLINOIS		SUMMARY OF QUANTITIES	FAI	2014-016R&B	соок	378 10
* BRINCKERHOFF	PLOT SCALE = NO SCALE	CHECKED - RT	REVISED -	DEPARTMENT OF TRANSPORTATION			30235	4017 0101100	CONTRACT	NO. 60X95
#[PLOT DATE = 7/13/2017	DATE - 07/14/2017	REVISED ~		SCALE:	SHEET NO. 5 OF 14 SHEETS STA. TO STA.		ILLINOIS FED. A	ID PROJECT	

					90% FED	90% FED	90% FED	TRUCTION CODE 90% FED	90% FED	90% FED
					10% STATE	10% STATE	10% STATE	10% STATE	10% STATE	10% STATE
	CODE			TOTAL	ROADWAY	UTILITIES	BRIDGE	RETAINING WALL	HIGHWAY LIGHTING	ROADWAY LIGHTING
	NUMBER	PAY ITEM	UNIT	1	0004	0043	0010	0044	0021	0021
	NOWBER			OUANTITY	URBAN	URBAN	016-1700	016-Z017	URBAN	URBAN
	70300520	DAVENCAT MARKING TARE TYPE III 40	5007	1005		1005		<u></u>		
	70300520	PAVEMENT MARKING TAPE, TYPE III 4"	FOOT	1925		1925		***		
	70400100	TEMPORARY CONCRETE BARRIER								
	70400100	TEMPORARY CONCRETE BARRIER	FOOT	3250	2875	375	-			
	70400200	RELOCATE TEMPORARY CONCRETE BARRIER	5007	200			 			
	10400200	RECOGNIC TEMPORARY CONCRETE BARRIER	FOOT	800	800					
	70600260	IMPACT ATTENUATORS, TEMPORARY (FULLY REDIRECTIVE, NARROW), TEST LEVEL 3	EACH	5	4	1				
	10000200	THE ACT ATTENDATIONS, TERM CHART IN DEET ALBINEOTIVE, MARKOWN, TEST LEVEL S	EACT		+	1		1		
	70600330	IMPACT ATTENUATORS, RELOCATE (FULLY REDIRECTIVE), TEST LEVEL 3	EACH	2	2					
	- 10000000	The state of the s	LACI		-					
*	72000100	SIGN PANEL - TYPE 1	SO FT	45	45		-	-		
			3011	1	73					
*	72000200	SIGN PANEL - TYPE 2	SQ FT	32	32	<u> </u>				***************************************
				 						
*	72100100	SIGN PANEL OVERLAY	SO FT	21	9	12				
				 	1					
*	72400100	REMOVE SIGN PANEL ASSEMBLY - TYPE A	EACH	4	4					
				· · · · · · · · · · · · · · · · · · · 						···
*	72400310	REMOVE SIGN PANEL - TYPE 1	SO FT	25	25			1		

*	72400320	REMOVE SIGN PANEL - TYPE 2	SO FT	32	32		4.0	***************************************		

*	72400330	REMOVE SIGN PANEL - TYPE 3	SQ FT	36	36					
*	73304000	OVERHEAD SIGN STRUCTURE - BRIDGE MOUNTED	FOOT	97	97					•
							<u> </u>			
*	78000100	THERMOPLASTIC PAVEMENT MARKING - LETTERS AND SYMBOLS	SO FT	321	321					
		**************************************			ļ					
*	78000200	THERMOPLASTIC PAVEMENT MARKING - LINE 4"	FOOT	3719	3719					
					<u> </u>					
*	78000650	THERMOPLASTIC PAVEMENT MARKING - LINE 24"	FOOT	67	67					
	70005120	EDAVY DAYSUSAIT HADVING A THE EX		ļ				ļ		
*	78005120	EPOXY PAVEMENT MARKING - LINE 5"	FOOT	482		482			15.00.00	•
u.	70000000	DOLYINGA DAVENTAT MADVING TYPE I LETTEDE ING COMPAGE	nun-							
*	78008200	POLYUREA PAVEMENT MARKING TYPE I - LETTERS AND SYMBOLS	SO FT	177	177		ļ			
عد ا	79000010	POLYLIGEA DAVENENT MADVING TYPE I I INF 40		1710	1212					**************************************
*	78008210	POLYUREA PAVEMENT MARKING TYPE I - LINE 4"	FOOT	1316	1316		-			·
ا ب	70000000	DOLYHDEA BAVENENT MADVING TYPE I 1 TAG 520								
*	78008250	POLYUREA PAVEMENT MARKING TYPE I - LINE 12"	FOOT	200	200		-			
. w	70000070	DOLVIDES DAVENENT MADVING TYPE I - LINE GAV.		ļ			 		·	
11*	78008270	POLYUREA PAVEMENT MARKING TYPE I - LINE 24"	FOOT	54	54		1			

* DENOTES SPECIALTY ITEM

DENOTES NON-PARTICIPATING ITEM

<u>.</u> [USER NAME = Kucharski	DESIGNED	- Nus	REVISED -				F.A.I.	SECTION	COUNTY	TOTAL SHEET
	PARSONS		ORAWN -	- NAA	REVISED -	STATE OF ILLINOIS	SUMMARY	OF QUANTITIES	FAI CONTA	2014-016R&8	соок	378 II
ᆲ	BRINCKERHOFF		CHECKED	- RT	REVISED -	DEPARTMENT OF TRANSPORTATION			90/94	2011 0101100	CONTRACT	NO. 60X95
ŧι		PLOT DATE = 7/13/2017	DATE	- 07/14/2017	REVISED -		SCALE: SHEET NO. 6 OF 14	SHEETS STA. TO STA.		ILLINDIS FED. A	ID PROJECT	

				90% FED	90% FED	90% FED	STRUCTION CODE 90% FED	90% FED	90% FED
	•			10% STATE	10% STATE	10% STATE	10% STATE	10% STATE	10% STATE
CODE			TOTAL	ROADWAY	UTILITIES	BRIDGE		HICHWAY LIGHTING	
NUMBER	PAY ITEM	UNIT	QUANTITY	0004 URBAN	0043 URBAN	00 <i>10</i> 016-1700	0044 016-2017	0021 URBAN	0021 URBAN
				01107111	3.137.1	010 1100	010 2011	3000	BNDAN
78009000	MODIFIED URETHANE PAVEMENT MARKING - LETTERS AND SYMBOLS	SO FT	182	182					
78009004	MODIFIED URETHANE PAVEMENT MARKING - LINE 4"	FOOT	4903	4903					

78009005	MODIFIED URETHANE PAVEMENT MARKING - LINE 5"	FOOT	2142	2142					
78009006	MODIFIED URETHANE PAVEMENT MARKING - LINE 6"	FOOT	40	40					
78009008	MODIFIED URETHANE PAVEMENT MARKING - LINE 8"	FOOT	7651	7651					
78009012	MODIFIED URETHANE PAVEMENT MARKING - LINE 12"	FOOT	612	612		M			
78009024	MODIFIED URETHANE PAVEMENT MARKING - LINE 24"	FOOT	23	23					
79100100	DAISED DEELECTIVE DAVEMENT NADVED	F.M.	700	720					
78100100	RAISED REFLECTIVE PAVEMENT MARKER	EACH	320	320		,			
78100300	REPLACEMENT REFLECTOR	EACH	5		5	***			
78200011	BARRIER WALL REFLECTORS, TYPE C	EACH	374	344	30				
78300200	RAISED REFLECTIVE PAVEMENT MARKER REMOVAL	EACH	399	399		<u> </u>			
80400100	ELECTRIC SERVICE INSTALLATION	EACH	1					1	
001000-000	CECOTIO SENTICE INSTACEATION	EACH	I					1	
80400200	ELECTRIC UTILITY SERVICE CONNECTION	LSUM	1					1	
81028200	UNDERGROUND CONDUIT, GALVANIZED STEEL, 2" DIA.	FOOT	470					470	
81028220	UNDERGROUND CONDUIT, GALVANIZED STEEL, 3" DIA.	FOOT	50					50	
01040440	DIRECTOROGRA COMBOLL, GALTANIZED STEEL, S. DIA.	1001	50					50	
81028370	UNDERGROUND CONDUIT, PVC, 3" DIA.	FOOT	40					40	
81100320	CONDUIT ATTACHED TO STRUCTURE, 1" DIA., PVC COATED GALVANIZED STEEL	FOOT	1420			,—, <u>, .</u>	***	1420	
81100605	CONDUIT ATTACHED TO STRUCTURE 2" DIA DVC COATED CALVANIZED STEES	FOOT	1660					1660	
01100000	CONDUIT ATTACHED TO STRUCTURE, 2" DIA., PYC COATED GALVANIZED STEEL	FOOT	Vaar					1660	
81100805	CONDUIT ATTACHED TO STRUCTURE, 3" DIA., PVC COATED GALVANIZED STEEL	FOOT	410			- vinor		410	
						<i></i>			
81300220	JUNCTION BOX, STAINLESS STEEL, ATTACHED TO STRUCTURE, 6" X 6" X 4"	EACH	24					24	
OZZUUCED	JUNE TION BOA, STAINLESS STEEL, ATTACHED TO STRUCTURE, 6" X 6" X 4"	EACH	24				1	24	

* DENOTES SPECIALTY ITEM
DENOTES NON-PARTICIPATING ITEM

-	USER NAME = Kucherski	DESIGNED - MA		-					F.A.I. RTE.	SECTION	COUNTY	TOTAL SHEET
PARSONS		DRAWN - MN		-	STATE OF ILLINOIS		SUMMARY OF QUANTITIES		FA] 90/94	2014-016R&B	соок	378 12
BRINCKERHOFF	PLOT SCALE = NO SCALE	CHECKED - RT	REVISED	-	DEPARTMENT OF TRANSPORTATION		***************************************			***************************************	CONTRACT	NO. 60X95
2	PLOT DATE * 7/13/2017	DATE - 07	714/2017 REVISED	-		SCALE:	SHEET NO. 7 OF 14 SHEETS STA.	TO STA.		ILLINOIS FED. AI	D PROJECT	

SIRVETED FLOTTED ALLOWINN CHECKED RT, OF WAY CHECKED RT, OF WAY CHECKED
VEYED CHARAT CHECKED OF WAY CHECKED OF WAY CHECKED

			Г			CONS	TRUCTION CODE		
				90% FED	90% FED	90% FED	90% FED	90% FED	90% FED
				10% STATE ROADWAY	10% STATE UTILITIES	10% STATE BRIDGE	10% STATE	10% STATE HIGHWAY LIGHTING	10% STATE
CODE	PAY ITEM	UNIT	TOTAL -	0004	0043	0010	0044	0021	0021
NUMBER	PATTICM	- CATT	QUANTITY	URBAN	URBAN	016-1700	016-Z017	URBAN	URBAN
81300530	O JUNCTION BOX, STAINLESS STEEL, ATTACHED TO STRUCTURE, 12" X 10" X 6"	EACH	18					18	
-					1				
B170003	O JUNCTION BOX, STAINLESS STEEL, ATTACHED TO STRUCTURE, 18" X 18" X 8"	EACH	16			<u> </u>		16	
81300830	O SUNCTION BOX, STAINLESS STEEL, ATTACHED TO STRUCTURE, TO X TO X O	- Cron	1						
			 		 				
8140020	HEAVY-DUTY HANDHOLE	EACH	2					2	
8140030	O DOUBLE HANDHOLE	EACH	2					2	
					,				
8160308	UNIT DUCT, 600V, 3-1C NO.2, 1/C NO.4 GROUND, (XLP-TYPE USE), 1 1/2" DIA. POLYETHYLENE	FOOT	3030				1	3030	
2:20208	Controlling to the control of the co								
		5007	E1.45		 	\$P.	1	5145	
81702110	0 ELECTRIC CABLE IN CONDUIT, 600V (XLP-TYPE USE) 1/C NO. 10	FOOT	5145					5145	
L									
81702120	0 ELECTRIC CABLE IN CONDUIT, 600V (XLP-TYPE USE) 1/C NO. 8	FOOT	541					541	
81702140	O ELECTRIC CABLE IN CONDUIT, 600V (XLP-TYPE USE) 1/C NO. 4	FOOT	245					245	
01702170	de EEEE Mile CABEE IV GONDEN, GOOT MEET THE GOED IN STANT		+ +						
		FOOT	775				-	735	
81702150	0 ELECTRIC CABLE IN CONDUIT, 600V (XLP-TYPE USE) 1/C NO. 2	FOOT	735				<u> </u>	133	1
8180030	AERIAL CABLE, 3-1/C NO. 2 WITH MESSENGER WIRE	F00T	3965					3965	
						1			
8420050	OO REMOVAL OF LIGHTING UNIT, SALVAGE	EACH	18					18	
0.420000	04 REMOVAL OF POLE FOUNDATION	EACH	3						3
8420080	74 REMOVAL OF POLE FOUNDATION	LACII							
			 						
8720040	SPAN WIRE	FOOT	1300					1300	
8730122	ELECTRIC CABLE IN CONDUIT, SIGNAL NO. 14 3C	F00T	541		-			541	
8730179	00 ELECTRIC CABLE IN CONDUIT, SERVICE, NO. 2 2 C	F00T	1082					1082	<u>†</u>
9130119	DO ELECTRIC CABLE IN CONDUIT, SERVICE, NO. 2 20		1000	.	†		-	1000-	
			+		 	1		1,000	
8730180	24 ELECTRIC CABLE IN CONDUIT, SERVICE NO. 6 1C	FOOT	1082			ļ		1082	
							1		
8730181	5 ELECTRIC CABLE IN CONDUIT, SERVICE, NO. 6 3 C	FOOT	161					161	
8730270	D5 ELECTRIC CABLE AERIAL SUSPENDED, EQUIPMENT GROUNDING CONDUCTOR, NO. 6 1C	FOOT	1600					1600	
0130270			 		1				
	AS CONCERTS FOUND LINE TYPE A	FOOT	4			 		4	
8780010	DO CONCRETE FOUNDATION, TYPE A	FOOT	+ +					"	
									1
8790020	DRILL EXISTING HEAVY DUTY HANDHOLE	EACH	1.1						
8950238	85 REMOVE EXISTING CONCRETE FOUNDATION	EACH	1					1	
0330230						·	1		<u> </u>

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Ě		USER NAME = Kucharski	DESIGNED	- MMA	REVISED -					F.A.I. RTE.	SECTION	COUNTY	SHEETS N	EET
· PAI	r s ons		ORAWN	- MMA	REVISED -	STATE OF ILLINOIS		SUMMARY OF QUANTITIES		FAE 90/94	2014-016R&B	COOK	378 1	13
₹ BR	INCKERHOFF	PLDT SCALE = NO SCALE	CHECKED	- RT	REVISED -	DEPARTMENT OF TRANSPORTATION						CONTRACT	r No. 60X9	9 5
3		PLDT DATE = 7/13/2017	DATE	- 07/14/2017	REVISED -		SCALE:	SHEET NO. 8 OF 14 SHEETS STA.	TO STA.		ILLINOIS FED. Al	PROJECT		\Box

-		87	DATE
1	-KUFILE SURVEYED		
	COADEC PURCES		
NO IE 6008	B.M. MOTED		
	STRUCTURE NOTATING CHKD		

				90% FED	90% FED	90% FED	TRUCTION CODE 90% FED	90% FED	90% FED
				10% STATE	10% STATE	10% STATE	10% STATE	10% STATE	90% FED 10% STATE
CODE			TOTAL	ROADWAY	UTILITIES	BRIDGE		HIGHWAY LIGHTING	
	PAY ITEM	UNIT		0004	0043	0010	0044	0021	0021
NUMBER			YTITMAUD	URBAN	URBAN	016-1700	016-2017	URBAN	URBAN
]						
A2002009	TREE, AESCULUS FLAVEA (YELLOW SWEET BUCKEYE), 2-1/2" CALIPER, BALLED AND BURLAPPED	EACH	3		3				
C2000138	SHRUB, AESCULUS PARVIFLORA (BOTTLEBRUSH BUCKEYE), 3 1/2' HEIGHT, BALLED AND BURLAPPED	EACH	3		3				
			<u> </u>			~	1		
C2003936	SHRUB, ILEX VERTICILLATA WINTER RED (WINTER RED WINTERBERRY), 3' HEIGHT, BALLED AND BURLAPPED	EACH	35		35				
			ļ				7		
C2015312	SHRUB, JUNIPERUS CHINENSIS KALLAY'S COMPACT, (KALLAY'S PFITZER JUNIOR), 18" WIDTH, CONTAINER GROWN, 3-GALLON	EACH	290		290			P-P-rise	
K0029634	WEED CONTROL, PRE-EMERGENT GRANULAR HERBICIDE	POUND	7		7				

X0320051	CROSSHOLE SONIC LOGGING ACCESS DUCTS	FOOT	405)			4051			
X0320052	CROSSHOLE SONIC LOGGING TESTING	EACH	10			10			
X0322463	CONNECTION TO EXISTING SEWER	EACH	7	7		*****			
								<u> </u>	
X0324198	REMOVAL OF ASBESTOS CEMENT CONDUIT	FOOT	1380						1380
X0324599	ROD AND CLEAN EXISTING CONDUIT	FOOT	595		***************************************			75	520
			† · · · · · · · · · · · · · · · · · · ·	- -					
X0325143	FILLING EXISTING VAULT	EACH	1	1					

X0325207	TELEVISION INSPECTION OF SEWER	FOOT	620	620					
				· · · · · · · · · · · · · · · · · · ·		4			
X0325318	LIGHTWEIGHT CELLULAR CONCRETE FILL	CU YD	1066			1066			
		+	1			1000		*****	
X0325349	TEMPORARY CONCRETE BARRIER (TO REMAIN PERMANENTLY)	FOOT	(2)						
X0323313	TOWN OWNER DESIGNATION REPORTS FEMALUATED	1001	526	526					
Y0325815	REMOVE EXISTING CABLE	FOOT	1870					300	1570
X0323013	NEWOYE EXISTING GADE.	1001	1010					300	1510
X0326094	RELOCATE EXISTING ITS CONTROLLER CABINET	EACH	1			···			
X0326034	RELOCATE EXISTING ITS CONTROLLER CABINE!	EACH	1					1	
V0726726	CARLS IN CONDUIT TRIPLEY 2 1/C NO. S. AND 1 1/O 1/2 A CROUND	5007							
X0326326	CABLE IN CONDUIT, TRIPLEX, 2-1/C NO. 6 AND 1-1/C NO. 8 GROUND	F00T	980						980
VAZOCICI	CONCRETE DADRIED BACE (CDECIAL)		1						
X0326382	CONCRETE BARRIER BASE (SPECIAL)	FOOT	100	100		<u> </u>			
V0700 11 1	OFFICE PARTIES AND AND ADDET HOWEVER.							***************************************	
XU326486	DECORATIVE RAILING (PARAPET MOUNTED)	FOOT	724			724			
X0326664	CURED-IN-PLACE PIPE LINER, 36"	FOOT	413		413				
			ļ						*
Y0326665	6 CURED-IN-PLACE PIPE LINER, 42"	FOOT	408		408				

	USER NAME : Kucherski	DESIGNED - MMA	REVISED -				F.A.I. SECTION	COUNTY TOTAL SHEET
PARSONS		DRAWN - MMA	REVISED -	STATE OF ILLINOIS	İ	SUMMARY OF QUANTITIES	7014-016R&B	COOK 378 14
BRINCKERHOFF	PLOT SCALE = NO SCALE	CHECKED - RT	REVISED -	DEPARTMENT OF TRANSPORTATION			2014 010300	CONTRACT NO. 60X95
	PLDT DATE * 7/13/2017	DATE - 07/14/2017	REVISED -		SCALE:	SHEET NO. 9 OF 14 SHEETS STA. TO STA.	ILLINOIS FED.	ALD PROJECT

					90% FED 10% STATE	90% FED 10% STATE	90% FED 10% STATE	90% FED 10% STATE	90% FED 10% STATE	_
	CODE		-	TOTAL	ROADWAY	UTILITIES	BRIDGE		HIGHWAY LIGHTING	;
	NUMBER	PAY ITEM	UNIT	QUANTITY	0004	0043	0010	00 44	0021	_
	740141027			GUANTITT	URBAN	URBAN	016-1700	016-Z017	URBAN	_
D *	X0326801	COMBINED SEWERS TO BE CLEANED	FOOT	310	310	+				
.	X0320001	COMMINED SERVING TO BE CEENIED	1001	1 310	1 210		<u> </u>			
*	X0327004	TEMPORARY WOOD POLE, 60 FT., CLASS 4	EACH	7					7	_
,,-	, NOSE1007	TEMPORAL HOUSE GEEL GO THE GERSS T	CACII	 		 			ľ	_
*	X0327236	TEMPORARY WOOD POLE, 50 FT., CLASS 4	EACH	13					13	_
				1				<u> </u>		
	X0327267	SLOPE INCLINOMETER	EACH	3			2	1		_
			-							_
	X0327348	COMBINED SEWER REMOVAL 10"	FOOT	96	96					_
	X0327357	CONSTRUCTION VIBRATION MONITORING	LSUM	1	1			1		
										_
*	X0327552	TREE GRATE REMOVAL	EACH	11	11					
*	X0327607	FIBER OPTIC SPLICE-MAINLINE	EACH	2					2	
	X0327615	COMBINED SEWER REMOVAL 8"	FOOT	39	39	1				
			-	ļ						_
*	X0327616	MAINTAINING ITS DURING CONSTRUCTION	CAL MO	21					21	_
	V0303600	ANURDING COMERC TA OF ALCENICA COCATA								_
]*	X0327689	COMBINED SEWERS TO BE CLEANED, SPECIAL	FOOT	1231		1231				_
*	X0327965	ELECTRIC CABLE NO. 19 50-PAIR	FOOT	250					250	_
•	X0321363	ELECTRIC GABLE NO. 15 JOT AIR	F001	250			 		250	_
*	X0327980	PAVEMENT MARKING REMOVAL - WATER BLASTING	SO FT	32074	31432	642		1	•	_
			3611	32011	31132	0.12	-			
*	X0370008	BREAKDOWN MANHOLE (CDOT)	EACH	2		<u> </u>				_
							-			_
*	X0370049	UNDERGROUND CONDUIT, PVC, 2" DIA., SCHEDULE 80 (CDOT)	FOOT	95				 		_
İ										_
*	X0370068	CONCRETE FOUNDATION, 24" DIAMETER, 1 1/4" ANCHOR RODS, 15" BOLT CIRCLE (CPOT)	EACH	3						
		PIPE								
	X0370069	COMBINED SEWER (EXTRA STRENGTH VIRTIFIED CLAY), 8 INCH (CDOT)	FOOT	53	53					
	X0370070	COMBINED SEWERS, WATER MAIN REQUIREMENTS, 8 INCH (CDOT)	FOOT	33	33					
										_
*	X0370074	RACKING CABLES IN MANHOLE OR HANDHOLE (CDOT)	EACH	8						_
	VA22000	HARTOCOCOUNT CONDUCT DUC 44 DIA SOUSOUS CO COCOT		075						_
*	X0370075	UNDERGROUND CONDUIT, PVC, 4" DIA., SCHEDULE 80 (CDOT)	F00T	970 -					190	_
	X0370080	COMBINATION CURB AND GUTTER TYPE B V.12 (CDOT)	FOOT	676	676	1				_
	חפתחורמע	COMMUNICATION COUNT AND GOTTEN THE B 4-12 (CDOT)	FOOT	010	010		L	1		

		USER NAME = Kucharski	DESIGNED	- MMA	REVISED -				F.	.A.I.	SECTION	COUNTY	TOTAL SHEET
PARS(DRAWN	- MWA	REVISED -	STATE OF ILLINOIS		SUMMARY OF QUANTITIES	<u> </u>	FAL	2014-016R&B	соок	378 15
BRINC	CKERHOFF	PLOT SCALE = NO SCALE	CHECKED	- RT	REVISED +	DEPARTMENT OF TRANSPORTATION			- 9	10/94	2014 Oldinab	CONTRACT	NO. 60X95
\$		PLOT DATE = 7/13/2017	DATE	- 07/14/2017	REVISED -		SCALE:	SHEET NO. 10 OF 14 SHEETS STA. TO S	STA.		ILLINOIS FED.	AID PROJECT	1101 001132

	SURVEYED	2	CADD FILE NAME	
14 10	FLAN	NOTE BOOK	Ğ.	
DATE	П	Τ		
F	H	t	H	

							TRUCTION CODE	201/ 550	004 550
				90% FED	90% FED	90% FED	90% FED	90% FED	90% FED
				10% STATE	10% STATE	10% STATE	10% STATE	10% STATE HIGHWAY LICHTING	10% STATE
CODE	211.7251	LIAST T	TOTAL	ROADWAY 0004	UTILITIES 0043	BRIDGE 0010	00-44	0021	0021
NUMBER	PAY ITEM	UNIT	OUANTITY	URBAN	URBAN	016-1700	016-20.7	URBAN	URBAN
0370084	DRILL MANHOLE OR HANDHOLE (CDOT)	EACH	3				<u> </u>		3
0370085	CLEAN MANHOLE OR HANDHOLE (CDOT)	EACH	7						7
			•						
(0370139	MAINTENANCE OF LIGHTING SYSTEM (CDOT)	CAL MO	21						21
(0370186	ELECTRICAL MANHOLE, 3' X 4' X 4', 30" FRAME AND LID (CDOT)	EACH	1		-				1
(0539800	TREE GRATES	EACH	11	11					
X1200011	STORM SEWERS, TYPE 2, DUCTILE IRON PIPE 8"	FOOT	58	58					
									- -
X1200012	STORM SEWERS, TYPE 2, DUCTILE IRON PIPE 10"	F00T	29	29					
X1200102	CURED-IN-PLACE PIPE LINER, 14"	F00T	410		410				
	SE,AL,								
X1200103	HYDROPHILIC END SEAL SLEEVES, 36"	EACH	2		2				
	SEAL								
X1200104	HYDROPHILIC END SEAL SLEEVES, 42"	EACH	2		2		1000		
	ACCESS								
X1200105	REMOVE AND REPLACE BLIND FLANGE	EACH	3		3				
X1200106	TEMPORARY PUMPING SYSTEM	CAL DAY	9		9				
X1400013	REMOVAL OF CABLE IN CONDUIT	FOOT	10607					10607	
AT 100015			1				and the same of th		
X1800003	PLANTING SOIL MIX FURNISH & PLACE	CU YO	371		371				-
X1800004	SHRUB, ILEX VERTICILLATA SOUTHERN GENTLEMAN (SOUTHERN GENTLEMAN WINTERBERRY), 36" HEIGHT, BALLED AND BURLAPPED	EACH	7		7		1		
									
X1800005	REPAIR IRRIGATION SYSTEM	LSUM	1		1				
X2020410	EARTH EXCAVATION (SPECIAL)	CU YD	68		68				
75050410	EACH ENGLAND OF COLO							J. J. 1	
X2200003	FENCE (SPECIAL)	FOOT	39	39					
~E200003				-	1				
x2600022	REMOVE, STORE, AND RE-ERECT SIGN PANEL ASSEMBLY (SPECIAL)	EACH	1	1			 		
^20UUU22	NEMOVE, STORE, AND RETERED STORY AND ASSEMBLE OF COTACY	1	-	-	-	1			
V4000000	TEMPORARY ACCESS (COMMERCIAL ENTRANCE)	EACH	4	4			1		
X4022000	TEMPORARY ACCESS (COMMERCIAL ENTRANCE)	LACIS	 	<u> </u>	 		 		
	DODY, MA OF USAY CONODETS STORMAN STORMAN	SOFT	112.7	"	 	 	+ +		
X4240430	PORTLAND CEMENT CONCRETE SIDEWALK 5 INCH, SPECIAL	SQ FT	1102	1102	I	I	1		1

2	USER NAME = Kucharsks	DESIGNED - MAKA	REVISEO -				F.A.I. SECTION	COUNTY SHEETS NO.
# PARSONS		DRAWN - MAKA	REVISED +	STATE OF ILLINOIS		SUMMARY OF QUANTITIES	FAI 2014-016R&B	COOK 378 16
BRINCKERHOFF	PLOT SCALE 2 NO SCALE	CHECKED - RT	REVISED -	DEPARTMENT OF TRANSPORTATION				CONTRACT NO. 60X95
3	PLOT DATE = 7/13/2017	DATE - 07/14/2017	REVISED -		SCALE:	SHEET NO. 11 OF 14 SHEETS STA. TO STA.	ILL INDIS F	ED. AID PROJECT

		ΒY	DATE
LAN SURVEYED	, Leb		L
TTO PLOT	03		L
MOTE GOOD ALIGH	KENT CHECKED		L
œ	WAY CHECKED		
NO. CADO FILE	JUE NAME		

PROFILE SIRVEYED BY ADDRESS OFFICED NOTE BOOK BANADIS OFFICED NOTE BOOK BANADIS OFFICED NOTE THE SURFINE SURFACE FORTON

				004 550	00% 550		TRUCTION CODE	001/ 555	000 550
				90% FED 10% STATE	90% FED 10% STATE	90% FED 10% STATE	90% FED 10% STATE	90% FED 10% STATE	90% FED 10% STATE
				ROADWAY	UTILITIES		RETAINING WALL	HICHWAY LIGHTING	
CODE	PAY ITEM	UNIT	TOTAL	0004	0043	0010	0044 Phoo	0021	0021
NUMBER		0/11	YTITMAUO	URBAN	URBAN	016-1700	016-Z017	URBAN	URBAN
X4240800	DETECTABLE WARNINGS (SPECIAL)	SO FT	68	68					
X4402020	CONCRETE MEDIAN SURFACE REMOVAL	SO FT	694	694					
X5610651	ABANDON EXISTING WATER MAIN, FILL WITH CLSM	FOOT	399	399					
X5610712	WATER MAIN REMOVAL,12"	FOOT	107	107			10 H		ļ
				_				And the state of t	
X6020083	INLETS, TYPE A, TYPE 1 FRAME, OPEN LID (CITY OF CHICAGO)	EACH	4	4				-	<u> </u>
				_	The state of the s				
X6020270	MANHOLES, TYPE B, 4' DIA, TYPE 1 FRAME, CLOSED LID (CITY OF CHICAGO)	EACH	1	1	and the state of t				-
			_	_	***************************************				
X6022505	CATCH BASINS, TYPE A, 4'-DIAMETER, TYPE 1 FRAME, OPEN LID (CITY OF CHICAGO)	EACH	5	5					
		5100			ļ				
	STEEL POSTS, SPECIAL	EACH	6	6				<u> </u>	ļ
	CONCRETE BARRIER WALL (SPECIAL)	FOOT	50	50					
X6370700	CONCRETE BARRIER TRANSITION (SPECIAL)	FOOT	50	50					
X6430120	REMOVE IMPACT ATTENUATORS, NO SALVAGE	EACH	1	1					
x6431120	REMOVE IMPACT ATTENUATOR SAND MODULE	EACH	1	1		Avenue			ļ
			2.2		247	-			
X6640200	TEMPORARY CHAIN LINK FENCE	FOOT	813		813	-			-
			01	21					<u> </u>
X6700410	ENGINEER'S FIELD OFFICE, TYPE A (SPECIAL)	CAL MO	21	21		<u> </u>			1
W3040046	TRAFFIC CONTROL AND PROTECTION (CRECIA)	1.5194	4						
X7010216	TRAFFIC CONTROL AND PROTECTION (SPECIAL)	LSUM	1	1					1
×3044045	TRIFFIC CONTROL AND SPOTFOTION (CVSPSCCWAVE)) Cini		•					1
X / 011015	TRAFFIC CONTROL AND PROTECTION (EXPRESSWAYS)	LSUM	1	1		<u> </u>	10 mm		
V3013000	TO LEGIC CONTROL CURVETILLANCE EVERESCHAVE	CAL DA	640	640			- Andreas		1
X7013820	TRAFFIC CONTROL SURVEILLANCE, EXPRESSWAYS	CAL DA	640	640		···-			1
X7015005	CHANGEABLE MESSAGE SIGN	CAL DA	1280	1280				-	
X1012002	CHANGEADLE MESSAGE SIGN	CAL DA	1260	1280				A CONTRACTOR OF THE CONTRACTOR	
X7030005	TEMPORARY PAVEMENT MARKING REMOVAL	SO FT	642		642				
V1020003	TEM VIGALLI ATEMICIT MANUFOUND INCOME.	3011	772					-	
X7035100	TEMPORARY EPOXY PAVEMENT MARKING - LETTERS AND SYMBOLS	SQ FT	144	144			 	1	
21033100	TEM VIVIL CLOSE LATERETT REPORTED SELECTED MID STREETS	3311		• • • • • • • • • • • • • • • • • • • •	 				
X7035104	TEMPORARY EPOXY PAVEMENT MARKING - LINE 4"	FOOT	12557	12557				1	
X1000101	CATE I	1,001	12001	100,	 				
X7035105	TEMPORARY EPOXY PAVEMENT MARKING - LINE 5"	FOOT	6993	6993					
		1		1	1		.L	I .	

	USER NAME : Kucherskii	DESIGNED - NIMA	REVISED -				İ	F.A.I. RTF.	SECTION	COUNTY	TOTAL SHEET SHEETS NO.
PARSONS		DRAWN - MMA	REVISED -	STATE OF ILLINOIS		SUMMARY OF QUANTITIES		FA]	2014-016R&B	соок	378 17
* BRINCKERHOFF	PLDT SCALE = NO SCALE	CHECKED - RT	REVISED -	DEPARTMENT OF TRANSPORTATION				3073.		CONTRACT	NO. 60X95
	PLOT DATE = 7/13/2017	DATE - 07/14/2017	REVISED -		SCALE:	SHEET NO. 12 OF 14 SHEETS STA. TO S	TA.		ELLENGES FED. A	IO PROJECT	

DATE						
4						
		PLOTTED	GRADES CHECKED	B.M. NOTED	STRUCTURE NOTATINS CHIKD	
2000	740F1LE		NOTE ROOK		₹ 1	

					90% FED	90% FED	90% FED	TRUCTION CODE 90% FED	90% FED	90% FED
					10% STATE	10% STATE	10% STATE	10% STATE	10% STATE	10% STATE
	CODE	I		TOTAL	ROADWAY	UTILITIES			HIGHWAY LIGHTING	ROADWAY LIGH
	CODE	PAY ÎTEM	UNIT	TOTAL	0004	0043	0010	0044	0021	0021
	NUMBER			GUANTITY	URBAN	URBAN	016-1700	016-Z017	URBAN	URBAN
		·								
	X7035108	TEMPORARY EPOXY PAVEMENT MARKING - LINE 8"	F00T	22113	22113					
			1,000							
	X7035112	TEMPORARY EPOXY PAVEMENT MARKING - LINE 12"	FOOT	810	810					
			1 1 2 2 1	1						+
	X7040125	DIAMING TEMPODADY CONCOUTE GARDIED	FACU	525	F2F		 			+
	X10401Z5	PINNING TEMPORARY CONCRETE BARRIER	EACH	323	525					
- 1	x7200053	REMOVE, STORE AND RE-ERECT SIGN PANEL (SPECIAL)	EACH	5	5					
7	x7830050	RAISED REFLECTIVE PAVEMENT MARKER, REFLECTOR REMOVAL	EACH	5		5				
										+
	X8100863	INTERCEPT EXISTING CONDUIT	EACH	8					8	+
	V-100000	BITCHOCK CALLETTO COMOUNT	EACH	•					٥	 •
					, <u>,</u>					+
	X8130115	DRILL EXISTING JUNCTION BOX	EACH	7					7	
	X8440120	REMOVE AND RE-ERECT EXISTING LIGHTING UNIT	EACH	3			•"			3
	X8730312	ELECTRIC CABLE IN CONDUIT, LEAD-IN, NO. 18 4/C, TWISTED, SHIELDED	FOOT	5290					5290	
	X0130312	ELECTRIC GADLE IN CONDUCT, ELAD IN, NO. 10 470, THISTED, SINCEBED	7 30 1	3230			 		25.30	+
	X8951011	REMOVE AERIAL CABLE	FOOT	5785					5500	285
X	2200020	FENCE REMOVAL AND REINISALLATION	FOOT	65	65					
	Z0004552	APPROACH SLAB REMOVAL	SQ YD	319	319		<u> </u>			
			***************************************		2/4/					
_	70010614	CLEANING EXISTING MANHOLE OR HANDHOLE	EACH	10			7		10	+
_	Z0010614	CCENTIAG EXIZITING WANHOLE OK HANDHOLE	EACH	10		1			10	
	Z0013797	STABILIZED CONSTRUCTION ENTRANCE	SQ YD	3367	3367					
	Z0013798	CONSTRUCTION LAYOUT	LSUM	1	1			-		
	70017400	DRAINAGE & UTILITY STRUCTURES TO BE ADJUSTED	EACH	8	8		 			+
	20011 100	DIATING & GIZZIT STROUGHES TO SE ACCUSTED	EACH	 					····	
				1		1				
	20018002	DRAINAGE SCUPPERS, DS-11	EACH	16			16	-		
_ :	20018500	DRAINAGE STRUCTURES TO BE CLEANED	EACH	21	21					
								-		
	Z0018800	DRAINAGE SYSTEM	LSUM	1			1	1		1
				+ -			 			+
	70010500	DUCT CONTROL WITTENING		1.		-		1		
<u> </u>	20019600	DUST CONTROL WATERING	UNIT	10	5	5				
	70030850	TEMPORARY INFORMATION SIGNING	SQ FT	1157	1157		1	}		

I NON- PARTICIPATING

	USER NAME = Kucharski	DESIGNED - H	MMA	REVISED -			·-				F.A.I.	SECTION	COUNTY	TOTAL SHEET
PARSONS		DRAWN - I	MMA	REVISED -	STATE OF ILLINOIS	1	SUMMARY	OF QU	JANTITIES		FAI 90/94	2014-016R&B	соок	378 L7A
* BRINCKERHOFF	PLOT SCALE = NO SCALE	CHECKED - F	RT	REVISED -	DEPARTMENT OF TRANSPORTATION						30/34		CONTRACT	NO. 60X95
3	PLDT DATE = 7/13/2817	DATE - C	07/14/2017	REVISED -		SCALE:	SHEET NO. 13 OF 14	SHEETS	STA.	TO STA.		ILLINOIS FED. A	D PROJECT	

		-B	DATE
PLAN	CURVEYED.		
	PI DITED		
NOTE BOOK	ALIGNMENT CHECKED		
	RT. OF WAY CHECKED		I
į	CADO FILE NAME		
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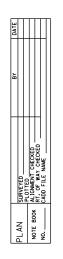



								TRUCTION CODE	1 404 ===	1 001: 550
					90% FED 10% STATE	90% FED 10% STATE	90% FED 10% STATE	90% FED 10% STATE	90% FED 10% STATE	90% FED 10% STATE
	CODE	PAY ITEM	UNIT	TOTAL	ROADWAY 0004 URBAN	UTILITIES 0043 URBAN	0010 016-1700	0044 016-Z017	HIGHWAY LIGHTING 0021 URBAN	0021 URBAN
ļ	NUMBER				URBAN	UNDAN	016-1100	016-2017	ORBAN	ON SHAT
L			CAL MO	21					21	
L	Z0033028	MAINTENANCE OF LIGHTING SYSTEM	CAL MU	21				-		
L	Z0046304	PIPE UNDERDRAINS FOR STRUCTURES, 4"	FOOT	361			211	150		
\vdash	20046304	FIFE UNDERDINATION STRUCTURES, 4								
-	Z0048665	RAILROAD PROTECTIVE LIABILITY INSURANCE	LSUM	1		1				
\vdash								are a second		
r	Z0062456	TEMPORARY PAVEMENT	SQ YD	223	223			<u> </u>		*
r	*									
	Z0076600	TRAINEES	HOUR	2000	2000			<u> </u>		
_			HOUR"	2000	a000			-		
٦	Z0076604	TRAINEES TRAINING PROGRAM GRADUATE	noac	2000	auco			 		
\ \	Y140x740	LUMINAIRE, UNDERPASS, LEO, TYPE C	EACH	24		-			24	
X	x1400272	COMMUT 4" DID DV CONTEN GOLVANIZED STEEL	FOOT	a520						2520
x	X1400269	CONDUIT, 4" DIA., PYC COATED GALVANIZED STEEL ELECTRIC CABLE IN CONDUIT, NO. 14 6/C	FOOT	848					848	
ľ						2011			ļ	
þ	X1400270	ELECTRIC CABLE, AERIAL INSTALLATION, NO. 14 6/C	FOOT	900		<u> </u>	<u> </u>	ļ	900	-
				1 200				-	700	
2	X1400242	ELECTRIC CABLE, AERIAL INSTALLATION, NO. 19 50-PAIR	FOOT	700		 		-	100	
Ļ	New 1 2 2 5	The second secon	FOOT	1600		<u> </u>			1600	
	X19 00 2/1	ELECTRIC CABLE, AERIAL INSTALLATION, NO. 2 2/C	1001	1000					· · · · · · · · · · · · · · · · · · ·	
,	Yulaa 201	FIBER OPTIC CABLE, AERIAL, 96 FIBERS, SINGLE MODE	FOOT	700					700	
ľ	MINAMI									
\ \	X1400290	FIBER OPTIC CABLE, IN CONDUIT, 96 FIBERS, SINGLE MODE	FOOT	300					300	
				 						
Ź	X1200159	MANHOLES TO BE ADJUSTED WITH NEW TYPE 1 FRAME, CLOSED LID (CITY OF CHICAGO)	EACH		1				-	
	X1200 160	CONNECTION TO EXISTING DRAINAGE STRUCTURE	EACH	2	2					
Ľ	11200 100	CONTROL TO EXISTING BINAMAC STREET							.	1


NOTE:

TRAINEES AND TRAINEES TRAINING PROGRAM GRADUATE FUND NUMBER 0042

	USER NAME = Kucharski	DESIGNED - NMA	REVISED -			RTE. SECTION	COUNTY SHEETS NO.
PARSONS		DRAWN - MMA	REVISED -	STATE OF ILLINOIS	SUMMARY OF QUANTITIES	90/94 2014-016R&B	COOK 310 TUB
	PLOT SCALE = NO SCALE	CHECKED - RT	REVISED -	DEPARTMENT OF TRANSPORTATION	SCALE: SHEET NO. 14 OF 14 SHEETS STA. TO STA.	Toursel	CONTRACT NO. 60X95
Dimitorial interior .	PLOT DATE = 7/13/2017	DATE - 07/14/2017	REVISED -		SCALE: SHEET NO. 14 OF 14 SHEETS STA. TO STA.	ILLINOIS	EB. AID PROJECT




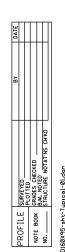

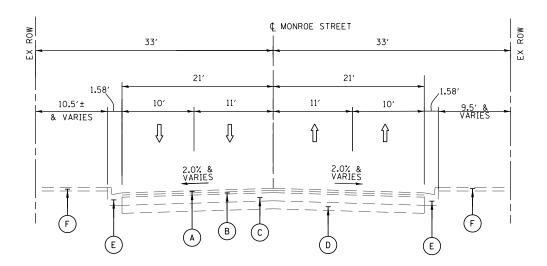

EXISTING TYPICAL SECTION MONROE STREET

STA. 8409+80 TO STA. 8411+68.80 STA. 8415+45.88 TO STA. 8417+05.00

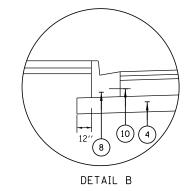

EXISTING


- A 11/2" HMA SURFACE COURSE
- B 1" LEVEL AND BINDER
- © 10" PCC BASE
- SUBBASE
- E COMB. CURB AND GUTTER TYPE
- BV.12 (SPECIAL) F PCC SIDEWALK (5")

PROPOSED

- 1 HOT-MIX ASPHALT SURFACE COURSE, MIX "D", N70, 1 3/4"
- (2) LEVELING BINDER (MACHINE METHOD), N70, 1 1/2"
- 3 PORTLAND CEMENT CONCRETE BASE COURSE 10"
- (4) SUBBASE GRANULAR MATERIAL, TYPE B 6" (5) PORTLAND CEMENT CONCRETE SIDEWALK 5 INCH
- 6 PORTLAND CEMENT CONCRETE SIDEWALK, SPECIAL
- SUBBASE GRANULAR MATERIAL, TYPE B 4"
- 8 COMBINATION CURB AND GUTTER TYPE B V.12 (CDOT)
- 9 #4 TIE BARS, 30" LONG AT 30" C-C (INCLUDED IN PRICE
- BID FOR PCC BASE COURSE)
- () *5 TIE BARS, 18" LONG AT 30" C-C (INCLUDED IN PRICE BID FOR PCC CURB AND GUTTER)

NOTES

- 1. TYPICAL SECTIONS ARE NOT TO SCALE
- 2. AS INDICATED ON THE ROADWAY PLANS, TYPICALLY 6' MIN OF PROPOSED SIDEWALK WIDTH MUST HAVE A CROSS SLOPE OF
- 3. TYPICAL LOCAL ROADWAY CROSS SLOPE VARIES BETWEEN 1.4% AND 3.6% AS INDICATED ON THE PLANS. SEE ROADWAY AND GRADING PLAN DETAILS FOR ROADWAY SLOPE TRANSITIONS.
- 4. PCC BASE COURSE SHALL HAVE TRANSVERE CONTRACTION JOINTS AT A 20' MAXIMUM SPACING. (INCLUDED IN PRICE FOR BID FOR PCC BACE COURSE)

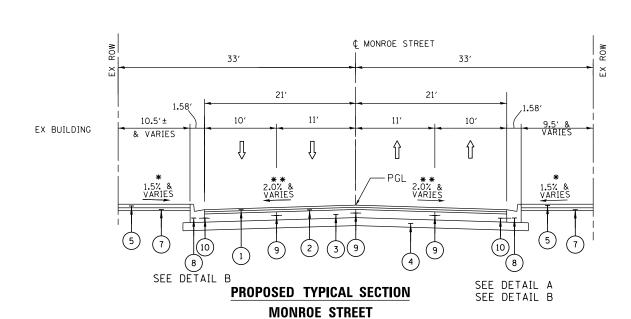

STA. 8409+80.00 TO STA. 8411+68.80

* SEE NOTE 2

** SEE NOTE 3

-EXISTING

DETAIL A

LEFT SIDE SHOWN

RIGHT SIDE OPPOSITE

STA. 8411+46.64 RT TO STA. 8411+68.80 RT

STA. 8415+45.88 LT TO STA. 8416+52.52 LT

/ARIES

¢ MONROE STREET 33′ 33′ 21′ 21' EX BUILDING 11' 10' 11′ 10.5′± 9.5′ & VARIES & VARIES 1.5% & VARIES 1.5% & VARIES (5) SEE DETAIL A SEE DETAIL B PROPOSED TYPICAL SECTION **MONROE STREET**

STA. 8415+45.88 TO STA. 8417+05.00

- * SEE NOTE 2
- ** SEE NOTE 3


BRIDGE OMISSION (STA. 8411+98.80 TO 8415+15.88) WEST APPROACH SLAB STA. 8411+68.80 TO STA. 8411+98.80 EAST APPROACH SLAB STA. 8415+15.88 TO STA. 8415+45.88 WEST PAVEMENT CONNECTOR (HMA) STA. 8411+58.80 TO 8411+68.80 EAST PAVMENT CONNECTOR (HMA) STA. 8415+45.88 TO 8415+55.88

PARSONS BRINCKERHO

	USER NAME = Kucharskı	DESIGNED	-	MMA	REVISED	-
		DRAWN	-	MMA	REVISED	-
OFF	PLOT SCALE = NO SCALE	CHECKED	-	RT	REVISED	-
	PLOT DATE = 4/18/2017	DATE	-	05/02/2017	REVISED	-

STATE OF ILLINOIS **DEPARTMENT OF TRANSPORTATION**

	TYPICAL SECTIONS MONROE STREET						SECTI	ON	COUNTY	TOTAL SHEETS	SHEET NO.
							2014-016	SR&B	COOK	373	18
					CONTRACT	NO. 60	X95				
	SCALE: NOT TO SCALE	SHEET NO. 1 OF 5 SHE	rs st	4. 8409+80.00 TO STA	8417+05.00		It	LLINOIS FED. AI	D PROJECT		

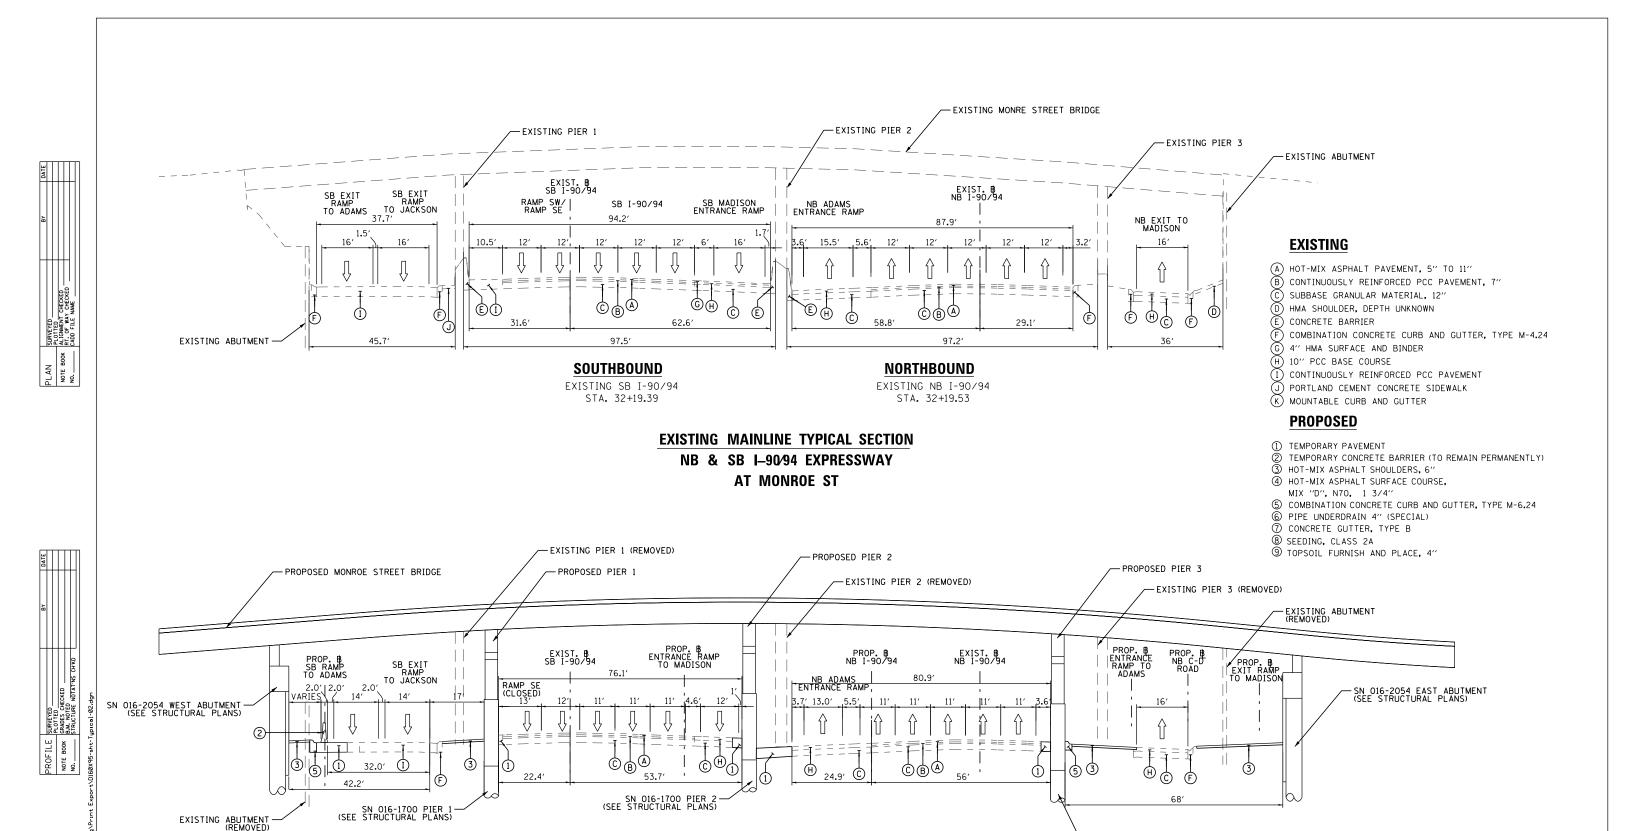

PROPOSED MAINLINE TYPICAL SECTION

NB & SB I-90/94 EXPRESSWAY

AT MONROE ST

SOUTHBOUND

EXISTING SB I-90/94

STA. 32+19.39

 PROPOSED BASELINES (NB & SB I-90/94, SB RAMP TO ADAMS, RAMP SW, EXIT RAMP TO MADISON AND ENTRANCE RAMP TO ADAMS) ARE SHOWN FOR INFORMAION ONLY AND WILL BE USED IN FUTURE BY OTHERS.

		U:
	PARSONS BRINCKERHOFF	
	BRINCKERHOFF	Pι
1		

	USER NAME = Kucharskı	DESIGNED	-	MMA	REVISED -
		DRAWN	-	MMA	REVISED -
F	PLOT SCALE = NO SCALE	CHECKED	-	RT	REVISED -
	PLOT DATE = 4/18/2017	DATE	-	05/02/2017	REVISED -

STATE OF ILLINOIS
DEPARTMENT OF TRANSPORTATION

NORTHBOUND

EXISTING NB I-90/94


STA. 32+19.53


SCALE: N.T.S.


TYPICAL SECTIONS MAINLINE I-90 /94				F.A.I. RTE.	SECTION	COUNTY	TOTAL SHEETS	SHEET NO.	
				FAI 90/94	2014-016R&B	COOK	373	19	
	IVIAIIVLIIVE 1-30 / 34					NO. 60	0X95		
	SHEET NO. 2 OF 5	SHEETS	STA.	TO STA.		ILLINOIS FED. AI	D PROJECT		

NOTES

SN 016-1700 PIER 3 (SEE STRUCTURAL PLANS)

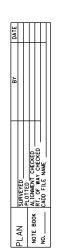

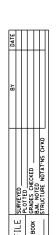


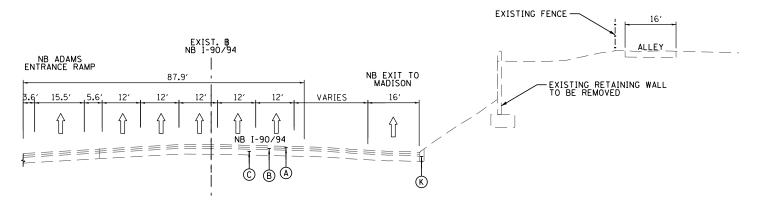

NORTHBOUND

STA. 30+34.85 TO 31+84.26 (EXIST. I-90/94 NB)

EXISTING MAINLINE TYPICAL SECTION NB I-90/94 EXPRESSWAY

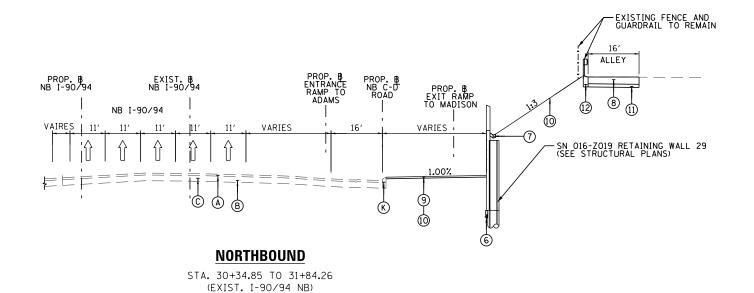

PROPOSED MAINLINE TYPICAL SECTION NB I-90/94 EXPRESSWAY

EXISTING

- (A) HOT-MIX ASPHALT PAVEMENT, 5" TO 11"
 (B) CONTINUOUSLY REINFORCED PCC PAVEMENT, 7"
- C) SUBBASE GRANULAR MATERIAL, 12"
- (D) HMA SHOULDER, DEPTH UNKNOWN
- (E) CONCRETE BARRIER
- (F) COMBINATION CONCRETE CURB AND GUTTER, TYPE M-4.24
- (G) 4" HMA SURFACE AND BINDER
- H) 10" PCC BASE COURSE
- (I) CONTINUOUSLY REINFORCED PCC PAVEMENT
- J PORTLAND CEMENT CONCRETE SIDEWALK

 K MOUNTABLE CURB AND GUTTER

PROPOSED

- TEMPORARY PAVEMENT
- TEMPORARY CONCRETE BARRIER (TO REMAIN PERMANENTLY)
- HOT-MIX ASPHALT SHOULDERS, 6"
- HOT-MIX ASPHALT SURFACE COURSE, MIX "D", N70, 1 3/4"
- COMBINATION CONCRETE CURB AND GUTTER, TYPE M-6.24
- 6 PIPE UNDERDRAIN 4" (SPECIATION CONCRETE GUTTER, TYPE B PIPE UNDERDRAIN 4" (SPECIAL)
- (8) PORTLAND CEMENT CONCRETE PAVEMENT 8" (JOINTED)
- (9) SEEDING, CLASS 2A
- (10) TOPSOIL FURNISH AND PLACE, 4"
- (11) SUBBASE GRANULAR MATERIAL, TYPE B 4"
- (12) CONCRETE CURB, TYPE B

NOTES

- 1. PROPOSED BASELINES (NB & SB I-90/94, SB RAMP TO ADAMS, RAMP SW, EXIT RAMP TO MADISON AND ENTRANCE RAMP TO ADAMS) ARE SHOWN FOR INFORMAION ONLY AND WILL BE USED IN FUTURE BY OTHERS.
- 2. SEE CROSS SECTIONS AND PROPOSED GRADING DETAIL FOR GRADING LIMITS AND SLOPE.


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1	<i>PARSONS</i>	
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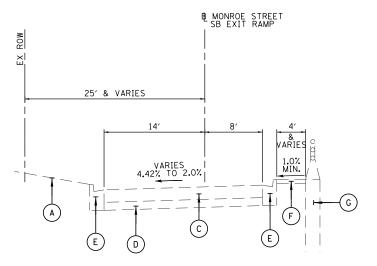
USER NAME = Kucharskı	DESIGNED	-	MMA	REVISED	-
	DRAWN	-	MMA	REVISED	-
PLOT SCALE = NO SCALE	CHECKED	-	RT	REVISED	-
PLOT DATE = 4/18/2017	DATE	-	05/02/2017	REVISED	-
	PLOT SCALE = NO SCALE	PLOT SCALE = NO SCALE CHECKED	DRAWN - PLOT SCALE = NO SCALE CHECKED -	DRAWN - MMA PLOT SCALE = NO SCALE CHECKED - RT	DRAWN - MMA REVISED PLOT SCALE = NO SCALE CHECKED - RT REVISED

STATE OF ILLINOIS **DEPARTMENT OF TRANSPORTATION**

TYPICAL SECTIONS MAINLINE I-90 /94 AT RETAINING WALL 29						
SCALE: N.T.S.	SHEET NO.	3 ()F 5	SHEETS	STA.	TO STA.


SECTION COUNTY SHEETS NO. 2014-016R&B CONTRACT NO. 60X95



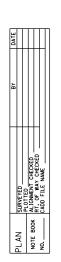


EXISTING TYPICAL SECTION MONROE STREET SB EXIT RAMP

LOOKING NORTH STA. 100+34.50 TO STA. 100+94.05

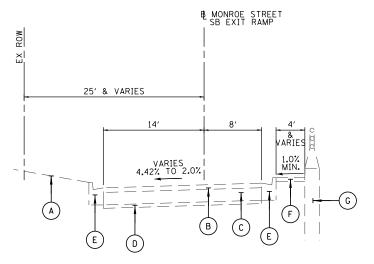


EXISTING TYPICAL SECTION MONROE STREET SB EXIT RAMP

LOOKING NORTH STA. 100+94.05 TO STA. 101+10.00

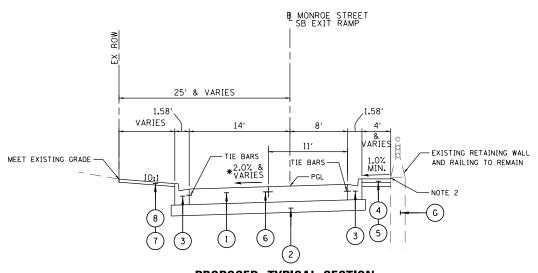

PROPOSED TYPICAL SECTION MONROE STREET SB EXIT RAMP

LOOKING NORTH STA. 100+34.50 TO STA. 101+10.00 * SEE NOTE 3

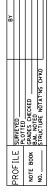

PARSONS BRINCKE

_	USER NAME = Kucharski	DESIGNED -	MMA	REVISED -	
5		DRAWN -	MMA	REVISED -	
RHOFF	PLOT SCALE = NO SCALE	CHECKED -	RT	REVISED -	
	PLOT DATE = 4/18/2017	DATE -	05/02/2017	REVISED -	

STATE OF ILLINOIS **DEPARTMENT OF TRANSPORTATION**

TYPICAL SECTIONS						SECTION	COUNTY	TOTAL SHEETS	SHEE NO.
MONROE STREET SB EXIT RAMP					FAI 90/94 2014-016R&B		COOK	373	21
							CONTRACT	NO. 60	0X95
SCALE: NOT TO SCALE	SHEET NO. 4 OF 5	SHEETS	STA. 100+34.50	TO STA. 101+10.00		ILLINOIS FED. A	ID PROJECT		

EXISTING

- A EXISTING GROUND
- B 1" LEVELING BINDER
 C 10" PCC BASE COURSE
- TO 4" SUBBASE GRANULAR MATERIAL
- © COMB. CONCRETE CURB AND GUTTER TYPE B V.12 (SPECIAL)
- E PCC SIDEWALK (5")
- © RETAINING WALL WITH RAILING

PROPOSED

- 1 PORTLAND CEMENT CONCRETE PAVEMENT 10" (JOINTED)
 2 AGGREGATE SUBGRADE IMPROVEMENT 12"
 3 COMBINATION CONCRETE CURB AND GUTTER, TYPE B-6.12

- 4 PORTLAND CEMENT CONCRETE SIDEWALK 5 INCH
- (5) SUBBASE GRANULAR MATERIAL, TYPE B 4"
- #6 TIE BARS, 36" LONG AT 18" C-C (INCLUDED IN PRICE BID FOR PCC PAVEMENT)
- 7 TOPSOIL FURNISH AND PLACE, 4"
 8 SEEDING, CLASS 2A


NOTES

- 1. TYPICAL SECTIONS ARE NOT TO SCALE
- 2. MINIMUM DISTANCE OF 2 INCHES SHALL BE MAINTAINED BETWEEN THE SIDEWALK AND THE TOP OF RETAINING WALL.
- 3. SEE ROADWAY AND GRADING PLAN DETAILS FOR RAMP SLOPE TRANSITIONS.

TEMPORARY PAVEMENT DETAILS:


I-90 /94 MAINLINE

DETAIL A: FULL DEPTH TEMPORARY HMA PAVEMENT

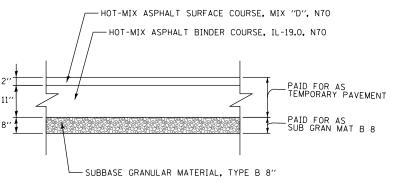


TEMPORARY HMA PAVEMENT FOR I-90/94

DETAIL B: TEMPORARY PCC PAVEMENT

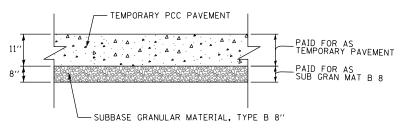


TEMPORARY PCC PAVEMENT FOR I-90/94

I-90 /94 AT MADISON STREET RAMPS & SHOULDERS

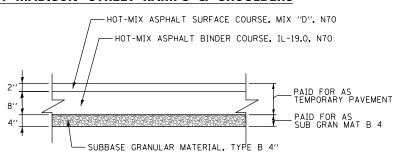


TEMPORARY HMA PAVEMENT FOR MADISON STREET RAMP

DETAIL B: TEMPORARY PCC PAVEMENT

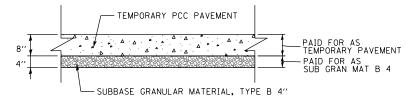


TEMPORARY PCC PAVEMENT FOR MADISON STREET RAMP

I-90 /94 AT ADAMS STREET RAMPS & SHOULDERS

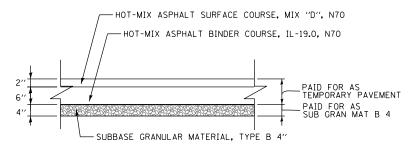

TEMPORARY HMA PAVEMENT FOR ADAMS STREET RAMP

DETAIL B: TEMPORARY PCC PAVEMENT

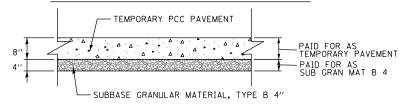

TEMPORARY PCC PAVEMENT FOR ADAMS STREET RAMP

TEMPORARY PAVEMENT GENERAL NOTES:

- 1. THE CONTRACTOR SHALL HAVE THE OPTION OF USING HMA OR PCC SECTION FOR TEMPORARY PAVEMENT.
- 2. TEMPORARY HMA PAVEMENT SHALL CONSIST OF TWO ITEMS: HMA BINDER COURSE AND HMA SURFACE
- 3. PORTLAND CEMENT CONCRETE TEMPORARY PAVEMENT SHALL CONSIST OF CLASS PV CONCRETE MEETING THE REQUIREMENTS OF ARTICLE 1020 OF THE STANDARD SPECIFICATIONS. TEMPORARY PCC PAVEMENT DOES NOT REQUIRE DOWEL BARS.

HOT MIX ASPHALT MIXTURE REQUIREMENTS

MIXTURE TYPE	AIR VOIDS (%) @NDES	QMP
TEMPORARY PAVEMENT (IF HMA OPTION IS SELECTED BY CONTRACTOR)		
I-90/94 AND INTERSTATE RAMPS		
HOT-MIX ASPHALT SURFACE COURSE, MIX "D", N70 (IL 9.5 MM): 2"	4% @ 70 GYR	QC/QA
HOT-MIX ASPHALT BINDER COURSE, IL-19.0, N70:	4% @ 70 GYR	QC/QA
PAVEMENT RECONSTRUCTION		
MONROE STREET		
HOT-MIX ASPHALT SURFACE COURSE, MIX "D", N70, (IL 9.5MM) 1 3/4".	4% @ 70 GYR	QC/QA
LEVELING BINDER (MACHINE METHOD) N70, 1 1/2"	4% @ 70 GYR	QC/QA
OMP DESIGNATION: QUALITY CONTROL/QUALITY ASSURANCE (QC/QA) CONTROL FOR PERFORMANCE	(QCP)	
I-90/94 AND RAMPS HMA SHOULDER 6"		
HOT-MIX ASPHALT SURFACE COURSE, MIX "D", N70, (IL 9.5MM) 2"	4% @ 70 GYR	QC/QA
HOT-MIX ASPHALT BINDER COURSE, IL-19.0, N70, 4"	4% @ 70 GYR	QC/QA

- 1. THE UNIT WEIGHT USED TO CALCULATE ALL HMA SURFACE MIXTURE QUANTITIES IS 112 LBS/SQ YD/IN.
- 2. THE AC TYPE FOR POLYMERIZED HMA MIXTURES SHALL BE "SBS/SBR PG 76-22" AND FOR NON-POLYMERIZED HMA THE "AC TYPE" SHALL BE "PG 64-22" UNLESS MODIFIED BY DISTRICT ONE SPECIAL PROVISIONS. FOR USE OF RECYCLED MATERIALS SEE DISTRICT ONE SPECIAL PROVISIONS.
- 3. QUALITY MANAGEMENT PROGRAM (OMP) IDENTIFIES THE PARTICULAR QUALITY CONTROL SPECIFICATION THAT APPLIES TO THE HMA MIXTURE.

PARSONS BRINCKERHOFF

	USER NAME = Kucharskı	DESIGNED	-	MMA	REVISED	-
		DRAWN	-	MMA	REVISED	-
•	PLOT SCALE = NO SCALE	CHECKED	-	RT	REVISED	-
	PLOT DATE = 4/18/2017	DATE	-	05/02/2017	REVISED	-

TUDIO III OFOTIONIO	F.A.I. RTE.	SEC.	TION	COUNTY	TOTAL SHEETS	SHEE NO.	
TYPICAL SECTIONS	FAI 90/94	2014-0	16R&B	COOK	373	22	
				CONTRACT	NO. 6	0X95	
SCALE:NOT TO SCALE SHEET NO. 5 OF 5 SHEETS STA. TO STA.				ILLINOIS FED. A	ID PROJECT		

REMOVAL SCHEDULE

ROADWAY LOCATION	TREE REMOVAL (6 TO 15 UNITS DIAMETER)	Z TREE REMOVAL (OVER 15 UNITS DIAMETER)	O PAVEMENT REMOVAL	O DRIVEWAY PAVEMENT REMOVAL	COMBINATION CURB AND GUTTER REMOVAL	SIDEWALK REMOVAL	CONCRETE BARRIER REMOVAL	S PAVED SHOULDER REMOVAL	GUARDRAIL REMOVAL	TREE GRATE REMOVAL	o APPROACH SLAB REMOVAL ŏ	FENCE REMOVAL AND RE-ERECTION	CONCRETE MEDIAN SURFACE REMOVAL
MONROE ST			1693	145	586	4123				11	319	65	
NB I-90/94	27	38	100		114		168	316					
SB I-90/94	8	30	213		90		195		150				694
MONROE ST EXIT RAMP			188		74	295							
REMOVAL TOTALS	35	68	2194	145	864	4418	363	316	150	11	319	65	694

SAFETY SCHEDULE

ROADWAY LOCATION	CONCRETE BARRIER WALL (SPECIAL)	IMPACT ATTENUATORS (FULLY P REDIRECTIVE, WIDE), TEST LEVEL 3	DEMPORARY CONCRETE BARRIER (TO REMAIN PERMANENTLY)	CONCRETE BARRIER TRANSITION (SPECIAL)	CONCRETE BARRIER BASE (SPECIAL)	MPACT ATTENUATORS (FULLY PROJECTIVE, NARROW), TEST LEVEL 3	BARRIER WALL REFLECTORS, TYPE C
MONROE ST							
NB I-90/94		1					
	F0	1		F0	100		
SB I-90/94	50	1	F06	50	100	1	8
MONROE ST EXIT RAMP			526		400		42
SAFETY TOTALS	50	2	526	50	100	1	50

B ₄					H'KD		
	PROFILE SURVEYED	- PLOTTED	NOTE BOOK GRADES CHECKED	B.M. NOTED	STRUCTURE NOTATINS C		SCHEDULE-01.dgn
1 0 0	PROFILE		NOTE BOOK	100	- ON		otting/Print Export/DI60X95-sht-SCHEDULE-01.dgn

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USER NAME = donahuek1	DESIGNED	-	MMA	REVISED -
	DRAWN	-	MMA	REVISED -
PLOT SCALE = 1"=50"	CHECKED	-	RT	REVISED -
PLOT DATE = 8/31/2017	DATE	-	09/01/2017	REVISED -

				F.A.I. RTE.	SECTION	COUNTY	TOTAL SHEETS	SHEET NO.			
		SCHEDUI	LE OF QU	ANTITIES		FAI 90/94	2014-016R&B	соок	378	23	
								CONTRACT	NO. 60	0X95	
SCALE: N.T.S. SHEET NO. 1 OF 3 SHEETS STA. TO STA. ILLINOIS FED. AID PROJECT											

LAN SIMPERS PLOTED PLOTED PLOTED NOTE BOOK ALIGNMENT OFFICKED NO. CADO FILE NAME			BY	DATE
	PLAN	SURVEYED		
		PLOTTED		
		AL IGNMENT CHECKED		
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	<u> </u>	CADO FILE NAME		

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	SURVEYED		
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	. NOTED		
No.	UCTURE NOTATINS CHIKD		

ROADWAY LOCATION	S AGGREGATE SUBGRADE IMPROVEMENT 12" ☐	SUBBASE GRANULAR MATERIAL, TYPE B 4"	SUBBASE GRANULAR MATERIAL, TYPE B 6"	SUBBASE GRANULAR MATERIAL, TYPE B 8"	S PORTLAND CEMENT CONCRETE BASE COURSE 10".	O BITUMINOUS MATERIALS (TACK COAT)	d LEVELING BINDER (MACHINE METHOD), N70	9 HOT-MIX ASPHALT SURFACE COURSE, MIX "D", N70	S PAVEMENT CONNECTOR (HMA) FOR BRIDGE APPROACH SLAB	PORTLAND CEMENT CONCRETE PAVEMENT 8" (JOINTED)	PORTLAND CEMENT CONCRETE PAVEMENT 10" (JOINTED)	S PORTLAND CEMENT CONCRETE DRIVEWAY PAVEMENT, 8 INCH S	א Portland Cement Concrete Sidewalk 5 inch	S DETECTABLE WARNINGS (SPECIAL)	CONCRETE CURB, TYPE B	COMBINATION CONCRETE CURB AND GUTTER, TYPE B-6.12	COMBINATION CONCRETE CURB AND GUTTER, TYPE M-6.24	S HOT-MIX ASPHALT SHOULDERS, 6"	COMBINATION CURB AND GUTTER TYPE B V.12 (CDOT)	PORTLAND CEMENT CONCRETE SIDEWALK 5 INCH, SPECIAL	FENCE (SPECIAL)	S TEMPORARY PAVEMENT
MONROE ST	+	861	1.823		1,576	1,324	132	154	93			158	4,660	68					676	1,293	39	\vdash
NB I-90/94		387	1,023	51	1,510	1,52	. 32	137	33			130	.,000	- 55			183	426	510	1,233	"	72
SB I-90/94		167		65													1	184				151
MONROE ST EXIT RAMP	229	33				157					188					146						
ALLEY		102								97					55							
ROADWAY TOTALS	229	1550	1823	116	1576	1481	132	154	93	97	188	158	4660	68	55	146	183	610	676	1293	39	223

TREE SCHEDULE

STATION	OFFSET (FEET)	LT/RT	NO. STEMS	SIZE DIAMETER	TREE REMOVAL 6-15 UNITS DIAMETER UNIT	TREE REMOVAL (OVER 15 UNITS IN DIAMETER) UNIT	TREE PRUNING 1-10 INCH DIAMETER EACH	TREE ROOT PRUNING EACH	TEMPORARY FENCE FOOT	TREE GRATES
NORTHBOUND I-90	/94		ı	1.10	0.11.	0.41	27,011	271011		
29+89.25	120.90	RT	1	20		20				
30+29.52	125.79	RT	1	12	12					
30+75.44	117.86	RT	1	15	15					
31+48.13	117.96	RT	1	18		18				
SOUTHBOUND I-90	/94									
31+63.02	103.22	LT	1	30		30				
31+48.76	115 . 54	LT	1	8	8					
MONROE STREET	05.47				T	T				
8409+87.03	25.43	RT	1	8			1	1	20	1
8410+17.87	25.77	RT	ļ <u> </u>	6			1	1	20	1
8410+44.38	25.41	RT	1	6			1	1	20	1
8410+49.82	25.83	RT	<u> </u>	8			1	1	20	1
8409+92.97	25.64	LT	1 1	6			1	1	20	1
8410+18.07	25.63	LT	1 1	1 7			1	1	20	1 1
8410+43.02	25.58	LT	1 1	6			1	1	20	1
8410+68.21	25 . 35 25 . 07	LT	<u> </u>	2 2			1	1	20 20	1 1
8410+97.85		LT LT	1 1	2			1	1	20	1 1
8411+23.09 8416+04.09	25 . 47 25 . 11	LT	1 1	2			1	1	20	1 1
CO*LO.101LO	C J.11		1	 		 	1	1		1
				TOTALS	35	68	11	11	220	11

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	USER NAME = ahmedmm	DESIGNED	-	MMA	REVISED -
		DRAWN	-	MMA	REVISED -
F	PLOT SCALE = 1"=50"	CHECKED	-	RT	REVISED -
	PLOT DATE = 6/29/2017	DATE	-	06/30/2017	REVISED -

				F.A.I. RTE.	SECTION	COUNTY	TOTAL SHEETS	SHEET NO.	
-	SCHEDULE OF QUANTITIES				FAI 90/94	2014-016R&B	COOK	378	24
ļ						CONTRACT	NO. 60	0X95	
-	SCALE: N.T.S.	SHEET NO. 2 OF 3 SHEETS	STA.	TO STA.		ILLINOIS FED. AI	D PROJECT		

EARTHWORK SCHEDULE

LOCATION	FROM STATION	TO STATION	EARTH EXCAVATION	•EMBANKMENT	*EXCAVATION TO BE USED IN EMBANKMENT (15% SHRINKAGE)	UNSUITABL EXISTING TOPSOIL	D DISPOSAL OF E MATERIALS UNDERCUT	•EARTHWORK BALANCE WASTE (+) OR SHORTAGE (-)
			CU. YD	CU. YD	CU. YD	CU. YD	CU. YD	CU. YD
I90/94 NB	6345+25.00	6345+50.00	25.4	1.4	1.6	6.2		23.8
Wall 29	6345+50.00	6345+60.43	39.6	0.5	0.6	6.4		39.0
	6345+60.43	6345+68.05	37.7	0.2	0.5	6.6		37.2
	6345+68.05	6345+75.00	33.4	0.4	0.5	6.0		32.9
	6345+75.00	6346+00.00	88.4	1.1	1.3	23.1		87.1
	6346+00.00	6346+25.00	91.9	1.2	1.4	20.8		90.5
	6346+25.00	6346+50.00	93.0	1.1	1.3	20.8		91.7
	6346+50.00	6346+75.00	99.4	0.9	1.0	20.0		98.4
	6346+75.00	6347+00.00	102.5	1.0	1.2	19.3		101.3
	6347+00.00	6347+16.15	61.3	1.9	2.2	12.4		59.1
MONDOE CT	0.400 + 00 00	0.410 + 00 00	16.7		0.0	0.0		16.7
MONROE ST.	8409+80.00	8410+00.00	16.7	0.0	0.0	0.0		16.7
	8410+00.00	8410+45.44	44.6	0.0	0.0	0.0		44.6
	8410+45.44	8410+50.00	4.0	0.0	0.0	0.0		4.0
	8410+50.00	8411+00.00	45.4	0.0	0.0	0.0		45.4
	8411+00.00	8411+26.16	23.7	0.0	0.0	0.0		23.7
	8411+26.16	8411+36.68	7.1	0.0	0.0	0.0		7.1
	8411+36.68	8411+50.00	6.3 11.6	1.7	2.0 27.8	0.0		4.3 -16.2
	8411+50.00	8411+98.30	11.6	24.2	21.8	0.0		-16.2
	BRIDGE OMISSION							
	8415+16.38	8417+05.00						
	0413+10.30	0411+03.00						
	8415+16.38	8415+50.00	4.4	29.3	33.7			-29.3
	8415+50.00	8415+53.06	0.9	3.0	3.5			-2.6
	8415+53.06	8416+00.00	29.6	26.1	30.0			-0.4
	8416+00.00	8416+19.88	18.0	0.0	0.0			18.0
	8416+19.88	8416+36.66	15.8	0.0	0.0			15.8
	8416+36.66	8416+50.00	14.3	0.0	0.0			14.3
	8416+50.00	8416+69.24	21.7	0.0	0.0			21.7
	8416+69.24	8417+00.00	34.7	0.0	0.0			34.7
	8417+00.00	8417+03.00	2.8	0.0	0.0			2.8
	8417+03.00	8417+05.00	1.6	0.0	0.0			1.6
	ESTIMATED UNDERC	UT (NOTE 4)					30.2	
	•	EARTHWORK						
		TOTALS	976	94	109	142	30	867

*SEE NOTES BELOW


NOTES:
1.ESTIMATED SHRINKAGE FACTOR 15%
2.APPROXIMATE EMBANKMENT OUANTITY IS SHOWN FOR INFORMATION ONLY.
3.APPROXIMATE EARTHWORK BALANCE IS SHOWN FOR INFORMATION ONLY.
4.REMOVAL OF UNSUITABLE MATERIALS IS INTENDED FOR TOPSOIL AND AN ESTIMATED 25' OF UNDERCUT 2' DEEP ON EACH MONROE ST. APPROACH. TOPSOIL DEPTH WAS ESTIMATED AT 4" THICKNESS.
5.WHERE AN ITEM IS DENOTED WITH AN ASTERISK (*), IT IS NOT A PAY ITEM.


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PARSONS	
BRINCKERHOFF	Г
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	USER NAME = Kucharskı	DESIGNED -	•	MMA	REVISED	-
		DRAWN -		MMA	REVISED	-
FF	PLOT SCALE = 1"=50"	CHECKED -		RT	REVISED	-
	PLOT DATE = 4/18/2017	DATE -		05/02/2017	REVISED	-

	F.A.I. SECTION COUNTY TOTAL SHEETS NO.
SCHEDULE OF QUANTITIES	FAI 90/94 2014-016R&B COOK 378 25
	CONTRACT NO. 60X95
SCALE: NONE SHEET NO. 3 OF 3 SHEETS STA. TO STA.	ILLINOIS FED. AID PROJECT



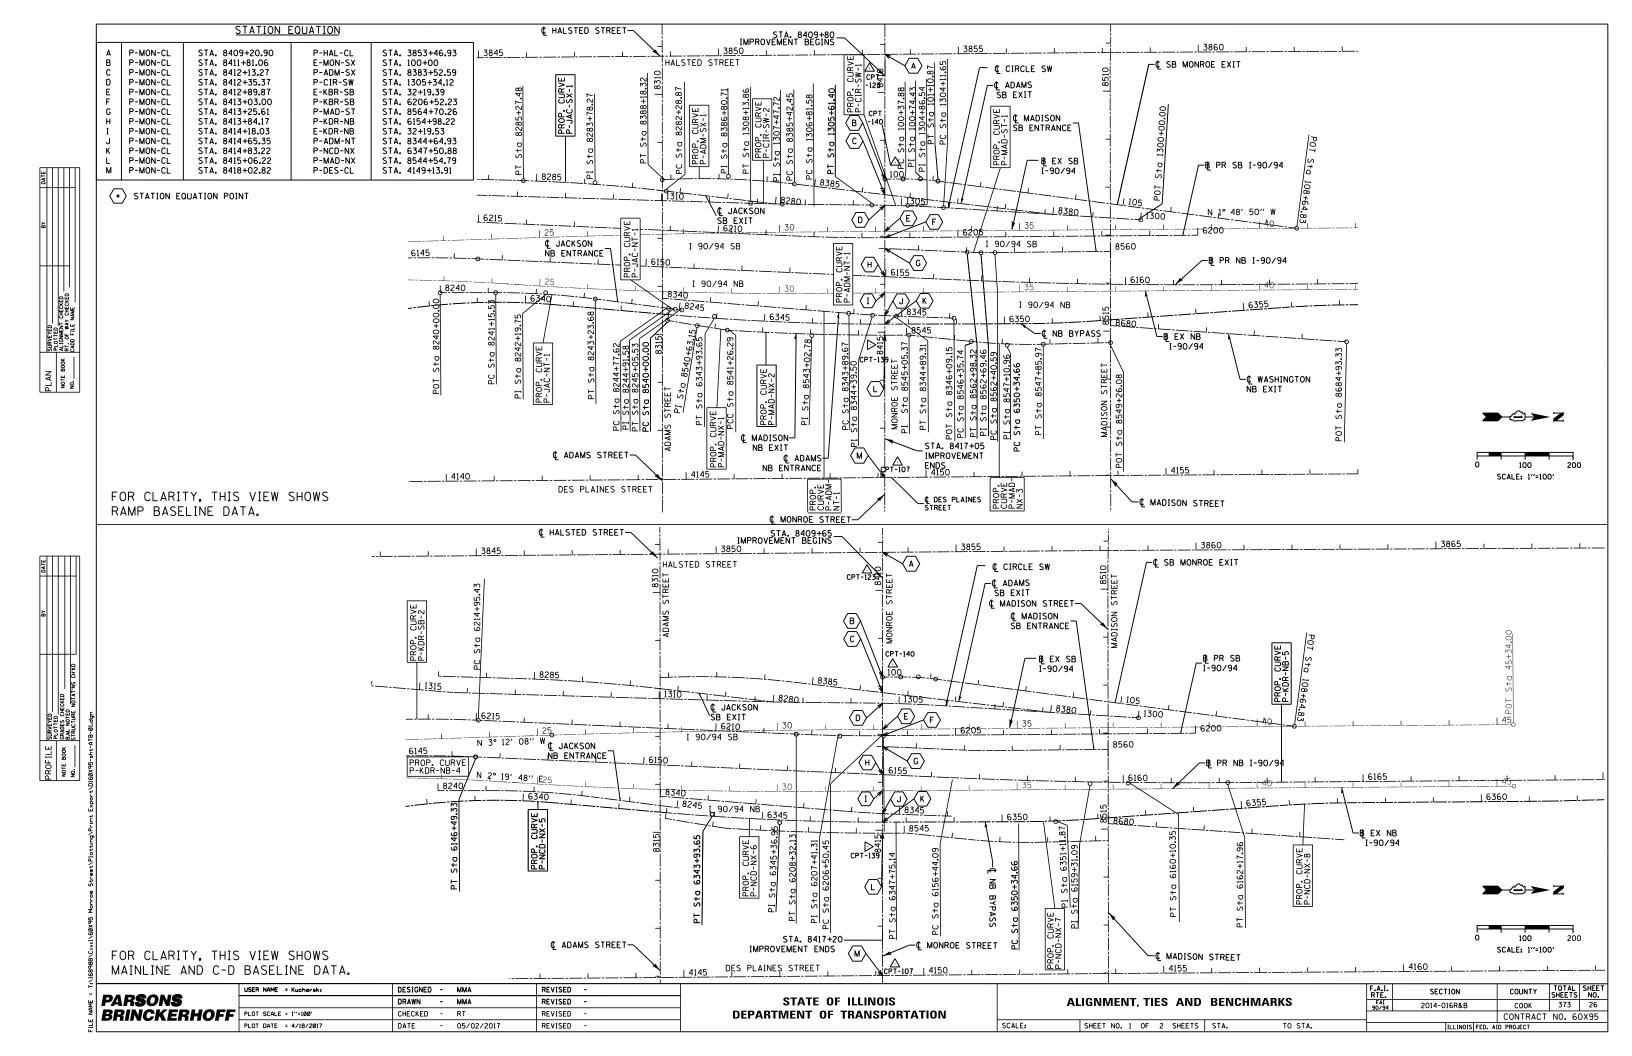

S.E. RUN = N/A P.C. STA. = 7301+72.03

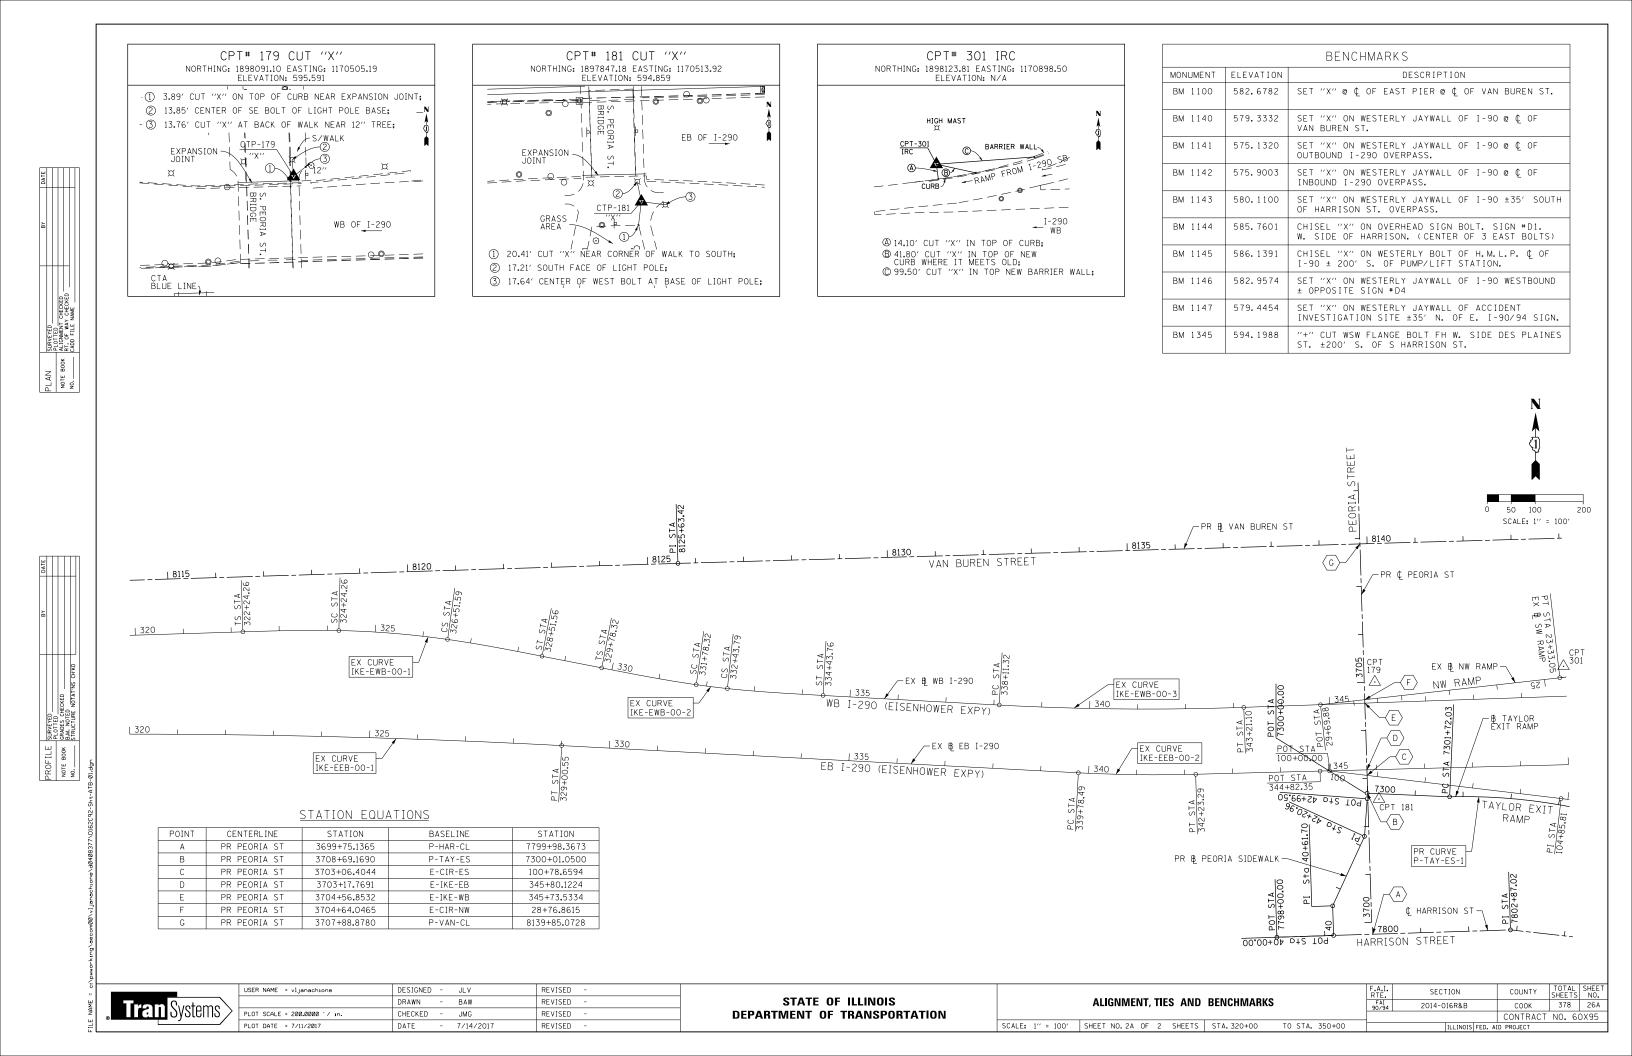P.T. STA. = 7304+67.59

 $\triangle = 14^{\circ} 41' 14'' (RT)$ D = 4° 58′ 09″ R = 1,153.00' T = 148.59'L = 295.56' E = 9.54' e = N/A T.R. = N/A

EXIST. CURVE IKE-EWB-00-2 EXIST. CURVE IKE-EWB-00-1 PI Sta. 323+57.62 PI Sta. 327+18.26 PI Sta. 331+11.67 PI Sta. 333+10.47 EXIST. CURVE IKE-EWB-00-3 Δs = 2° 59′ 59.83" Ds = 2° 59′ 59.83" ∆s = 2° 59′ 58.21″ Ds = 2° 59′ 59.83″ Δs = 2° 59′ 59.83" Ds = 2° 59′ 59.83" Δs = 2° 59′ 58.21″ Ds = 2° 59′ 59.83″ PI STA. = 332+11.06 PI STA. = 325+38.06 PI STA. = 340+66.38 $\Delta = 6^{\circ} 49' 10'' (RT)$ $\Delta = 1^{\circ} 57' 51'' (LT)$ $\Delta = 5^{\circ} \ 05' \ 52'' \ (LT)$ D = 3° 00′ 00′′ T1 = 133.35' T1 = 133.33' D = 3° 00′ 00′′ T1 = 133.35' T1 = 133.33' D = 1° 00′ 00′′ T2 = 66.68' R = 1,909.89' T2 = 66.68' R = 1,909.89' T2 = 66.67 T2 = 66.67' R = 5,729.58' T = 32.74'Rs = 1,909.89' Rs = 1,909.89' T = 255.06' T = 113.80' Rs = 1,909.89' Rs = 1,909.89' L = 227.32' Ls = 200.00' Ls = 199.97' L = 65.47' Ls = 200.00' Ls = 199.97' L = 509.78' E = 3.39' 326+51.59 E = 0.28' 329+78.32 332+43.79 E = 5.67' 322+24.26 P.C. STA. = 324+24.26 P.C. STA. = 331+78.32 P.C. STA. = 338+11.32 324+24.26 328+51.56 331+78.32 334+43.76 P.T. STA. = 332+43.79 P.T. STA. = 343+21.10 P.T. STA. = 326+51.59

EXIST. CURVE IKE-EEB-00-1 PI STA. = 321+86.75 \triangle = 4° 45′ 41′′ (RT) D = 0° 20′ 00″ R = 17,188.74' T = 714.62'L = 1,428.42' E = 14.85' P.C. STA. = 314+72.13

P.T. STA. = 329+00.55

CHECKED CHECKED

EXIST. CURVE IKE-EEB-00-2 PI STA. = 341+00.95 △ = 4° 29′ 17′′ (LT) D = 1° 50′ 00′′ R = 3,125.22'T = 122.46'L = 244.80' E = 2.40'P.C. STA. = 339+78.49 P.T. STA. = 342+23.29

EXIST. CURVE IKE-EEB-00-3 PI STA. = 354+82.42 \triangle = 2° 27′ 30′′ (LT) D = 1° 00′ 00′′ R = 5,729.65' T = 122.93'L = 245.82' E = 1.32'P.C. STA. = 353+59.49 P.T. STA. = 356+05.32

EXIST. CURVE CIR-EES-00-1 PI STA. = 107+84.38 $\Delta = 40^{\circ} 04' 47'' (RT)$ D = 11° 27′ 32′′ R = 500.01'T = 182.38'L = 349.77' E = 32.22'P.C. STA. = 106+02.00 P.T. STA. = 109+51.77

EXIST. CURVE CIR-ENW-00-3 PI STA. = 22+66.58 \triangle = 37° 04′ 01′′ (RT) D = 19° 53′ 40′′ R = 288.00'T = 96.55'L = 186.32' E = 15.75'P.C. STA. = 21+70.03 P.T. STA. = 23+56.35

EXISTING ALIGNMENTS

EX WB I-290 (EISENHOWER EXPY)						
POINT	DESCRIPTION	STATION	NORTHING	EASTING		
POT		293+90.95	1,898,109.2305	1, 165, 314. 6967		
TS	IKE-EWB-00-1B	322+24.26	1,898,195.6075	1,168,146.6931		
PIS	IKE-EWB-00-1B	323+57.62	1,898,199.6729	1,168,279.9836		
SC	IKE-EWB-00-1	324+24.26	1,898,198.2148	1,168,346.6517		
PΙ	IKE-EWB-00-1	325+38.06	1,898,195.7265	1,168,460.4198		
CS	IKE-EWB-00-1	326+51.59	1,898,179.7466	1,168,573.0875		
PIS	IKE-EWB-00-1A	327+18.26	1,898,170.3839	1, 168, 639. 1010		
ST	IKE-EWB-00-1A	328+51.56	1,898,144.7784	1, 168, 769. 9517		
TS	IKE-EWB-00-2B	329+78.32	1,898,120.4341	1,168,894.3575		
PIS	IKE-EWB-00-2B	331+11.67	1,898,094.8247	1,169,025.2278		
SC	IKE-EWB-00-2	331+78.32	1,898,085.4611	1,169,091.2512		
PΙ	IKE-EWB-00-2	332+11.06	1,898,080.8638	1, 169, 123. 6666		
CS	IKE-EWB-00-2	332+43.79	1,898,077.3803	1, 169, 156. 2204		
PIS	IKE-EWB-00-2A	333+10.47	1,898,070.2861	1, 169, 222. 5160		
ST	IKE-EWB-00-2A	334+43.76	1,898,063.0562	1, 169, 355. 6523		
PC	IKE-EWB-00-3	338+11.32	1,898,043.1252	1, 169, 722. 6716		
PΙ	IKE-EWB-00-3	340+66.38	1,898,029.2947	1, 169, 977. 3536		
PT	IKE-EWB-00-3	343+21.10	1,898,038.1489	1, 170, 232, 2572		
TS	IKE-EWB-00-4B	352+47.24	1,898,070.2993	1, 171, 157. 8387		
PIS	IKE-EWB-00-4B	353+47.25	1,898,073.7709	1,171,257.7841		

	EX EB I-290 (EISENHOWER EXPY)							
POINT	DESCRIPTION	STATION	NORTHING	EASTING				
POT		293+88.84	1,897,910.7311	1, 165, 300. 7513				
PC	IKE-EEB-00-1	314+72.13	1,897,974.3410	1,167,383.0682				
PΙ	IKE-EEB-00-1	321+86.75	1,897,996.1608	1,168,097.3549				
PT	IKE-EEB-00-1	329+00.55	1,897,958.6150	1,168,810.9878				
PC	IKE-EEB-00-2	339+78.49	1,897,901.9806	1,169,887.4363				
PΙ	IKE-EEB-00-2	341+00.95	1,897,895.5464	1, 170, 009. 7311				
PT	IKE-EEB-00-2	342+23.29	1,897,898.7017	1, 170, 132, 1545				
POT		344+82.35	1,897,905.3762	1, 170, 391. 1241				
PC	IKE-EEB-00-3	353+59.49	1,897,927.9756	1, 171, 267, 9805				
PΙ	IKE-EEB-00-3	354+82.42	1,897,931.1429	1, 171, 390. 8707				
PT	IKE-EEB-00-3	356+05.32	1,897,939.5781	1, 171, 513, 5119				

EX ES RAMP							
POINT	DESCRIPTION	STATION	NORTHING	EASTING			
POT		100+00.00	1,897,905.8769	1,170,411.1180			
PI		104+85.81	1,897,848.1878	1, 170, 893. 4859			
PC	CIR-EES-00-1	106+02.00	1,897,833.1375	1,171,008.7039			
PΙ	CIR-EES-00-1	107+84.38	1,897,812.0320	1, 171, 189. 8610			

		EX NW RAMP		
POINT	DESCRIPTION	STATION	NORTHING	EASTING
PC	CIR-ENW-00-3	21+70.03	1,898,189.5975	1, 171, 167. 5671
PΙ	CIR-ENW-00-3	22+66.58	1,898,123.1471	1,171,097.5218
PT	CIR-ENW-00-3	23+56.35	1,898,112.3438	1,171,001.5775
POT		29+69.88	1,898,043.6940	1, 170, 391. 8959

PROPOSED ALIGNMENTS

	PR TAYLOR EXIT RAMP								
POINT	DESCRIPTION	STATION	NORTHING	EASTING					
POT		7300+00.00	1,897,859.3643	1,170,489.3261					
PC	P-TAY-ES-1	7301+72.03	1,897,851.8722	1,170,661.1900					
PΙ	P-TAY-ES-1	7303+20.62	1,897,855.7720	1,170,809.7335					
PCC	P-TAY-ES-1/P-TAY-ES-2	7304+67.59	1,897,821.8823	1,170,954.4121					

PR PEORIA STREET								
POINT DESCRIPTION STATION NORTHING EASTIN								
POT		3700+00.00	1,897,590.2790	1,170,498.7199				
POT		3717+00.00	1,899,287.4618	1,170,446.0167				

PR HARRISON STREET						
POINT	DESCRIPTION	STATION	NORTHING	EASTING		
POT		7798+00.00	1,897,559.2104	1,170,301.2209		
PΙ		7802+87.02	1,897,574.4743	1,170,788.0041		
PC	P-HAR-CL-1	7805+53.90	1,897,545.0894	1, 171, 053. 2542		

PR PEORIA SIDEWALK							
POINT	POINT DESCRIPTION STATION NORTHING EAST						
POT		40+00.00	1,897,562.8859	1, 170, 418, 4372			
PΙ		40+63.78	1,897,626.6321	1, 170, 416. 4383			
POT		43+00.58	1,897,849.0192	1,170,497.7879			


PR VAN BUREN STREET						
POINT	DESCRIPTION	STATION	NORTHING	EASTING		
POT		8100+00.00	1,898,259.3220	1,166,490.9835		
PΙ		8125+63.42	1,898,338.2206	1,169,053.1845		
PΙ		8146+24.60	1,898,397.0221	1, 171, 113. 5263		
POT		8171+35.75	1,898,460.2841	1, 173, 623. 8877		



USER NAME = vljanachione	DESIGNED	-	JL V	REVISED -	Γ
	DRAWN	-	BAW	REVISED -]
PLOT SCALE = 200.0000 '/ in.	CHECKED	-	JMG	REVISED -]
PLOT DATE = 7/11/2017	DATE	-	7/14/2017	REVISED -	

SCALE: NONE

		F.A.I. RTE. FAI	SECTION	COUNTY	TOTAL SHEETS	SHEET NO.	
ALIGNMENT, TIES AND BENCHMARKS				2014-016R&B	COOK	378	26B
					CONTRACT	NO. 60	X95
SHEET NO. 2B OF 2 SHEETS	STA.	TO STA.		ILLINOIS FED. A	ID PROJECT		

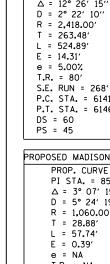

PROPOSED I-90/94 (KENNEDY) NB PROP. CURVE P-KDR-NB-4 PROP. CURVE P-KDR-NB-5 PI STA. = 6143+87.92 PI STA. = 6159+31.09 $\Delta = 12^{\circ} 26' 15'' (RT)$ Δ = 2° 57′ 23″ (LT) $D = 0^{\circ} 30' 55''$ R = 11.122.00T = 286.99'L = 573.86' E = 3.70'T.R. = N/A S.E. RUN = N/A P.C. STA. = 6141+24.44 P.C. STA. = 6156+44.09 P.T. STA. = 6146+49.33 P.T. STA. = 6162+17.96 DS = 60 PS = 45

PROPOSED I-90/94 (KENNEDY) SB PROP. CURVE P-KDR-SB-2 PI STA. = 6217+28.62 $\Delta = 10^{\circ} 41' 00'' (LT)$ D = 2° 17′ 50′ R = 2,494.00'T = 233.19'L = 465.03 E = 10.88' e = 5.00% T.R. = 107S.E. RUN = 268' P.C. STA. = 6214+95.43 P.T. STA. = 6219+60.46 DS = 60PS = 45

PROPOSED CIRCLE SW RAMP PROP. CURVE P-CIR-SW-1 PROP. CURVE P-CIR-SW-2 PI STA. = 1304+86.54 PI STA. = 1307+47.72 $\Delta = 3^{\circ} 00' 34'' (LT)$ $\Delta = 1^{\circ} 10' 04'' (RT)$ $D = 2^{\circ} 00' 35'$ D = 0° 52′ 58″ R = 2.851.00'R = 6.491.00'T = 74.89'T = 66.14'I = 149.75L = 132.28E = 0.98'E = 0.34'e = 3.00% e = NC T.R. = 67' T.R. = NA S.E. RUN = 100 S.E. RUN = NA P.C. STA. = 1304+11.65 P.C. STA. = 1306+81.58 P.T. STA. = 1305+61.40 P.T. STA. = 1308+13.86 DS = 45DS = 45 PS = 45 PS = 45

PROPOSED NB BYPASS PROP. CURVE P-NCD-NX-5 PROP. CURVE P-NCD-NX-6 PROP. CURVE P-NCD-NX-4 PROP. CURVE P-NCD-NX-7 PROP. CURVE P-NCD-NX-8 PI STA. = 6336+57.47 PI STA. = 6345+36.95 PI STA. = 6328+76.78 PI STA. = 6351+11.87 PI STA. = 6356+55.70 $\Delta = 5^{\circ} 12' 37'' (LT)$ $\Delta = 59^{\circ} 05' 41'' (LT)$ \triangle = 35° 13′ 41″ (RT) $\Delta = 3^{\circ} 37' 03'' (RT)$ $\Delta = 3^{\circ} 51' 44'' (LT)$ D = 4° 12′ 24″ D = 2° 30′ 07″ D = 1° 05′ 35″ D = 2° 31′ 27″ D = 14° 08′ 50′ R = 1.362.00'R = 405.00R = 5.242.00R = 2.290.00'R = 2.270.00'T = 238.51'T = 229.58T = 432.42'T = 77.21'T = 71.68'L = 837.42' L = 476.70'L = 417.72'L = 154.36 $L = 143.32^{\circ}$ E = 60.54'E = 67.00'E = 5.42'E = 1.30'E = 1.13'e = 4.20% e = 3.00% e = 3.00% e = ____ T.R. = 41' T.R. = NA T.R. = 41'T.R. = NA T.R. = ____ S.E. RUN = 87 S.E. RUN = NA S.E. RUN = 21' S.E. RUN = ____ S.E. RUN = 62'P.C. STA = 6326+47.20P.C. STA. = 6332+25.05 P.C. STA. = 6342+98.44 P.C. STA. = 6350+34.66 P.C. STA. = 6355+84.02 P.T. STA. = 6340+62.48 P.T. STA. = 6347+75.14 P.T. STA = 6330+64.91 P.T. STA. = 6351+89.02 P.T. STA. = 6357+27.34 DS = 30 DS = 40DS = 40DS = 40 DS = 40 PS = 40PS = 40

PROPOSED MADISON SB ENTRANCE PROP. CURVE P-MAD-ST-1

PI STA. = 8562+69.46 $\Delta = 3^{\circ} \ 07' \ 15'' \ (RT)$ D = 5° 24′ 19″ T.R. = NA S.E. RUN = NA P.C. STA. = 8562+40.59

P.T. STA. = 8562+98.32

PROPOSED JACKSON NB ENTRANCE PROP. CURVE P-JAC-NT-1 PROP. CURVE P-JAC-NT-2 PI STA. = 8242+19.75 PI STA. = 8244+91.58 $\Delta = 0^{\circ} 18' 21'' (LT)$ $\Delta = 7^{\circ} 19' 00'' (RT)$ D = 3° 30′ 54′ D = 1° 05′ 44′′ R = 1.630.00'R = 5.230.00 $T = 104.22^{\circ}$ T = 13.96L = 208.15L = 27.91E = 3.33'F = 0.02e = N/Ae = N/A $T_*R_* = N/A$ $T.R. = N/\Delta$ S.E. RUN = N/A S.E. RUN = N/A P.C. STA. = 8241+15.53P.C. STA. = 8244+77.62 P.T. STA. = 8243+23.68 P.T. STA. = 8245+05.53

PROPOSED JACKSON SB EXIT PROP. CURVE P-JAC-SX-1 PI STA. = 8283+78.27 $\Delta = 5^{\circ} \ 01' \ 56'' \ (LT)$ D = 1° 41' 07" $R = 3.400.00^{\circ}$ T = 149.40'L = 298.61' E = 3.28'T.R. = N/A

S.E. RUN = N/A

DS = 30

PS = 30

P.C. STA = 8282+28.87

P.T. STA = 8285+27.48

PROP. CURVE P-ADM-NT-1 PI STA. = 8344+39.50 Δ = 2° 32′ 55″ (LT) D = 2° 33′ 28′′ R = 2.240.00T = 49.83'L = 99.64 E = 0.55'e = N/A $T_R = N/A$ S.E. RUN = N/AP.C. STA. = 8343+89.67 P.T. STA. = 8344+89.31 DS = 30 PS = 30

PROPOSED ADAMS NB ENTRANCE

PROPOSED ADAMS SB EXIT PROP. CURVE P-ADM-SX-1 PI STA. = 8386+80.71 $\Delta = 9^{\circ} 39' 42'' (LT)$ D = 3° 30′ 08′ R = 1.636.00' T = 138.27L = 275.88 E = 5.83'e = 2.6%T.R. = 48 S.E. RUN = 97' P.C. STA = 8385 + 42.45P.T. STA = 8388+18.32 DS = 30 PS = 30

FUTURE CONTRACT (BY OTHERS) CURVE

DATA SHOWN FOR INFORMATION ONLY

PROPOSED MADISON NB EXIT PROP. CURVE P-MAD-NX-2 PROP. CURVE P-MAD-NX-3 PI STA. = 8543+02.78 PI STA. = 8547+10.96 $\Delta = 3^{\circ} 50' 23'' (LT)$ $\Delta = 7^{\circ} 10' 23'' (LT)$ D = 1° 05′ 18′′ D = 4° 46′ 29′′ R = 5.265.00'R = 1.200.00'T = 176.49' T = 75.21'L = 352.85'L = 150.23E = 2.96'E = 2.35'e = N/A e = N/A $T_R = N/A$ T.R. = N/A S.E. RUN = N/A S.E. RUN = N/A P.C. STA. = 8541+26.29 P.C. STA. = 8546+35.74 P.T. STA. = 8544+79.14 P.T. STA. = 8547+85.97

EXISTING MONROE SOUTHBOUND EXIT EXIST. CURVE E-MON-SX1 PI STA. = 100+74.43 $\Delta = 8^{\circ} \ 02' \ 32'' \ (RT)$ D = 11° 01′ 06′ R = 520.00'T = 36.55'L = 72.99' E = 1.28'e = NA T.R. = NA S.E. RUN = NA P.C. STA. = 100+37.88 P.T. STA. = 101+10.87

MONROE STREET SB EXIT RAMP BASELINE POINT DESCRIPTION STATION NORTHING EASTING POT STA, 100+00,00 1.899.793.93 1.171.324.99 E-MON-SX STA. 100+37.88 1.899.831.79 1.171.323.6 STA. 100+74.43 1,899,868.32 1,171,322.44 PΤ STA. 101+10.87 1,899,904.67 1,171,326.33 POT STA. 108+64.83 1.900.654.35 1.171.406.55

MONUMENT DESCRIPTION ELEVATION ET "X" SOUTH SIDE OF ADAMS ST @ CL OF I-90/94, PLUS OR MINUS BM 1103 592,8285 CHISEL "X" ON SOUTH SIDE OF MONROE ST., PLUS OR MINUS CL OF I-90/94 (CENTER OF WALK) BM 1110 600.8817 CUT BOX ON CONCRETE WALL ON NORTHERLY SIDE OF MONROE ST., EASTERLY OF RAMP FROM EASTBOUND I-90/94 BM 1328 CUT BOX ON CONCRETE WALL ON NORTHERLY SIDE OF ADAMS ST., EASTERLY OF RAMP FROM EASTBOUND I-90/94 BM 1329 595.9520 CHISEL "X" ON CHAINBOLT OF FIRE HYDRANT, NORTH SIDE OF MADISON ST., 1ST HYDRANT WEST OF DES PLAINES STREET BM 1391

BM 1397

BM 1400

594,7606

BENCHMARKS

CPT #123 CUT "X" NORTHING: 1899761.31 EASTING: 1171096.54 ELEVATION: 593.10 S. HALSTED 800 W 0 0 ŎĐ_ _0_ _0_ \sim \bigcirc W. MONROE ST. 100 S. -2 00 0 0 0 ♥ 🗇 0 0 0 STONE COLUMNS


1.40' E CORNER OF ADA RED TILE;


3 11.65' NW FACE OF LOWER STEP;

2 2.34' CENTER OF CITY MH;


DS = 30

PS = 30

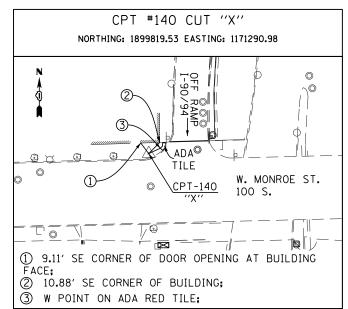

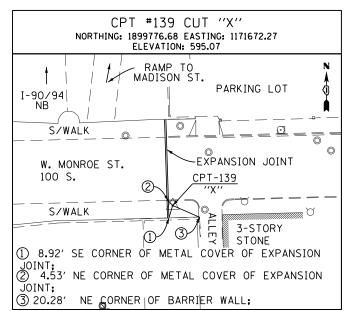

SCALE:

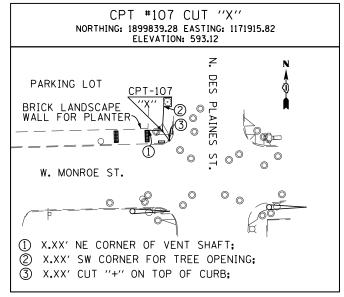

100

CUT BOX NORTH LINE OF ADAMS AT NORTHEAST QUADRANT OF I-90/94 WESTBOUND RAMP PLUS OR MINUS 0.8' ABOVE PAVEMENT

CHISEL "X" ON CHAIN BOLT OF FIRE HYDRANT, SOUTH SIDE OF MONROE, FIRST FIRE HYDRANT WEST OF DES PLAINES STREET


PARSONS BRINCKERHOFF


	USER NAME = Kucharskı	DESIGNED	-	MMA	REVISED	-
		DRAWN	-	MMA	REVISED	
F	PLOT SCALE = 1"=100"	CHECKED	-	RT	REVISED	
	PLOT DATE = 4/18/2017	DATE	-	05/02/2017	REVISED	


STATE OF ILLINOIS


SCALE: 1"=100" SECTION COUNTY ALIGNMENT, TIES AND BENCHMARKS COOK 373 27 2014-016R&B CONTRACT NO. 60X95 SHEET NO. 2 OF 2 SHEETS STA. TO STA.

DEPARTMENT OF TRANSPORTATION

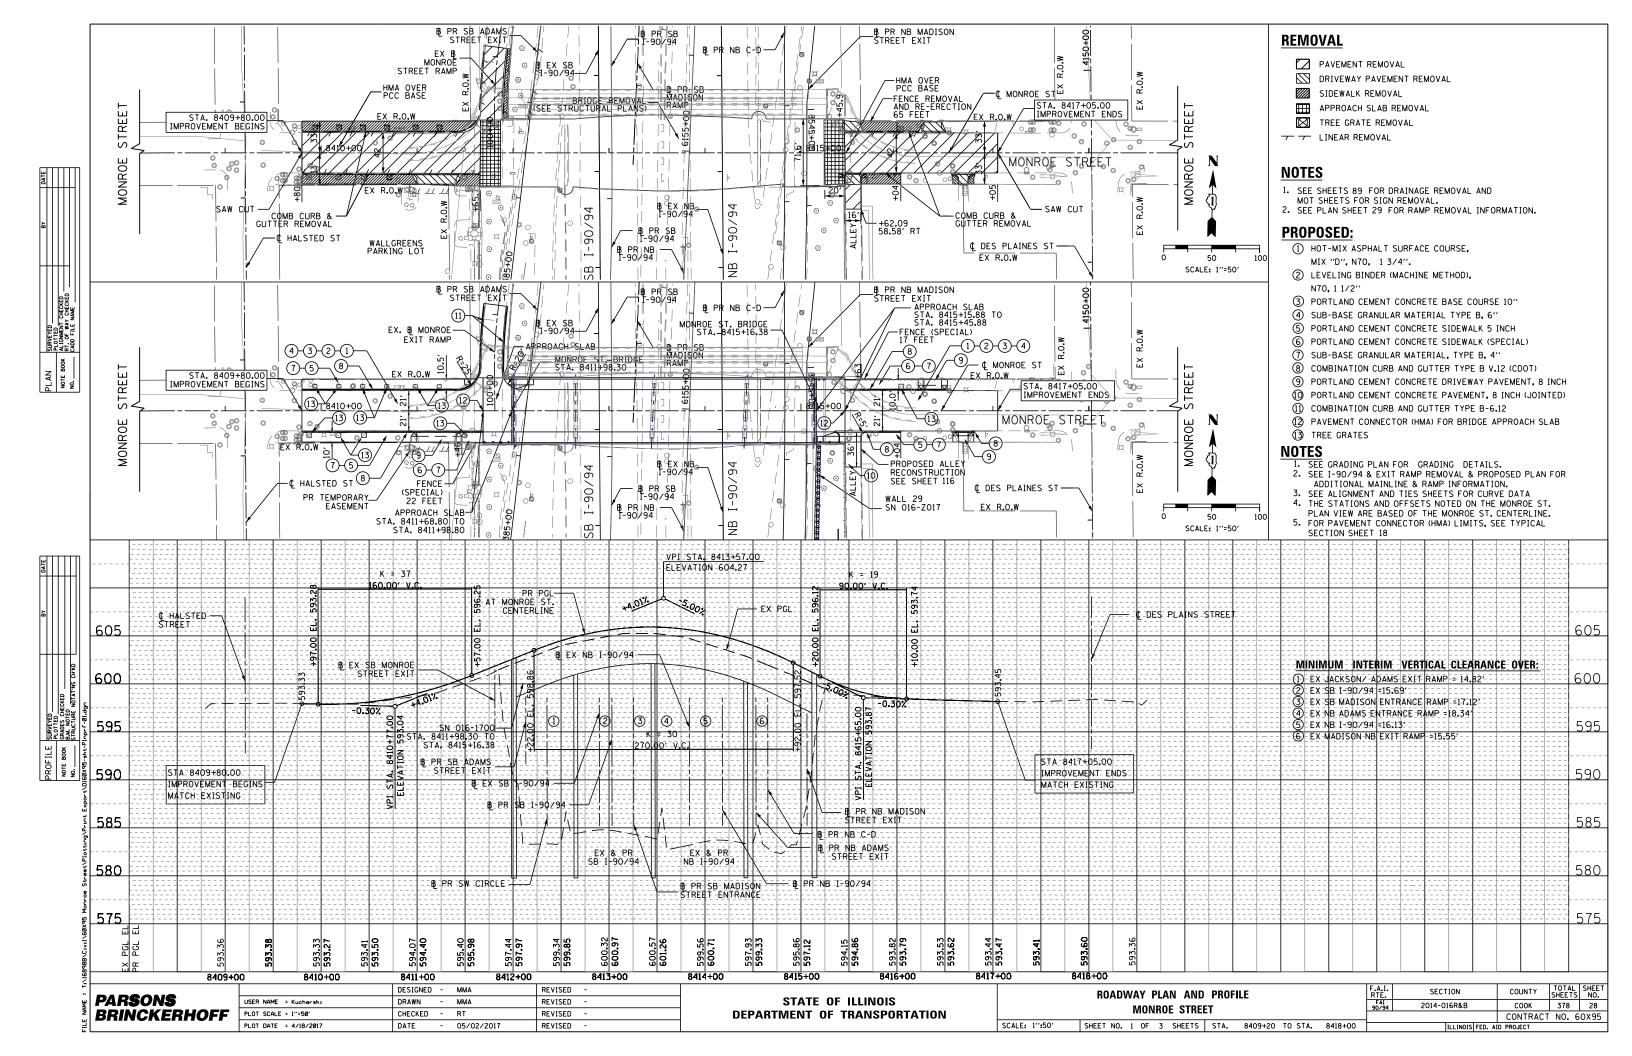


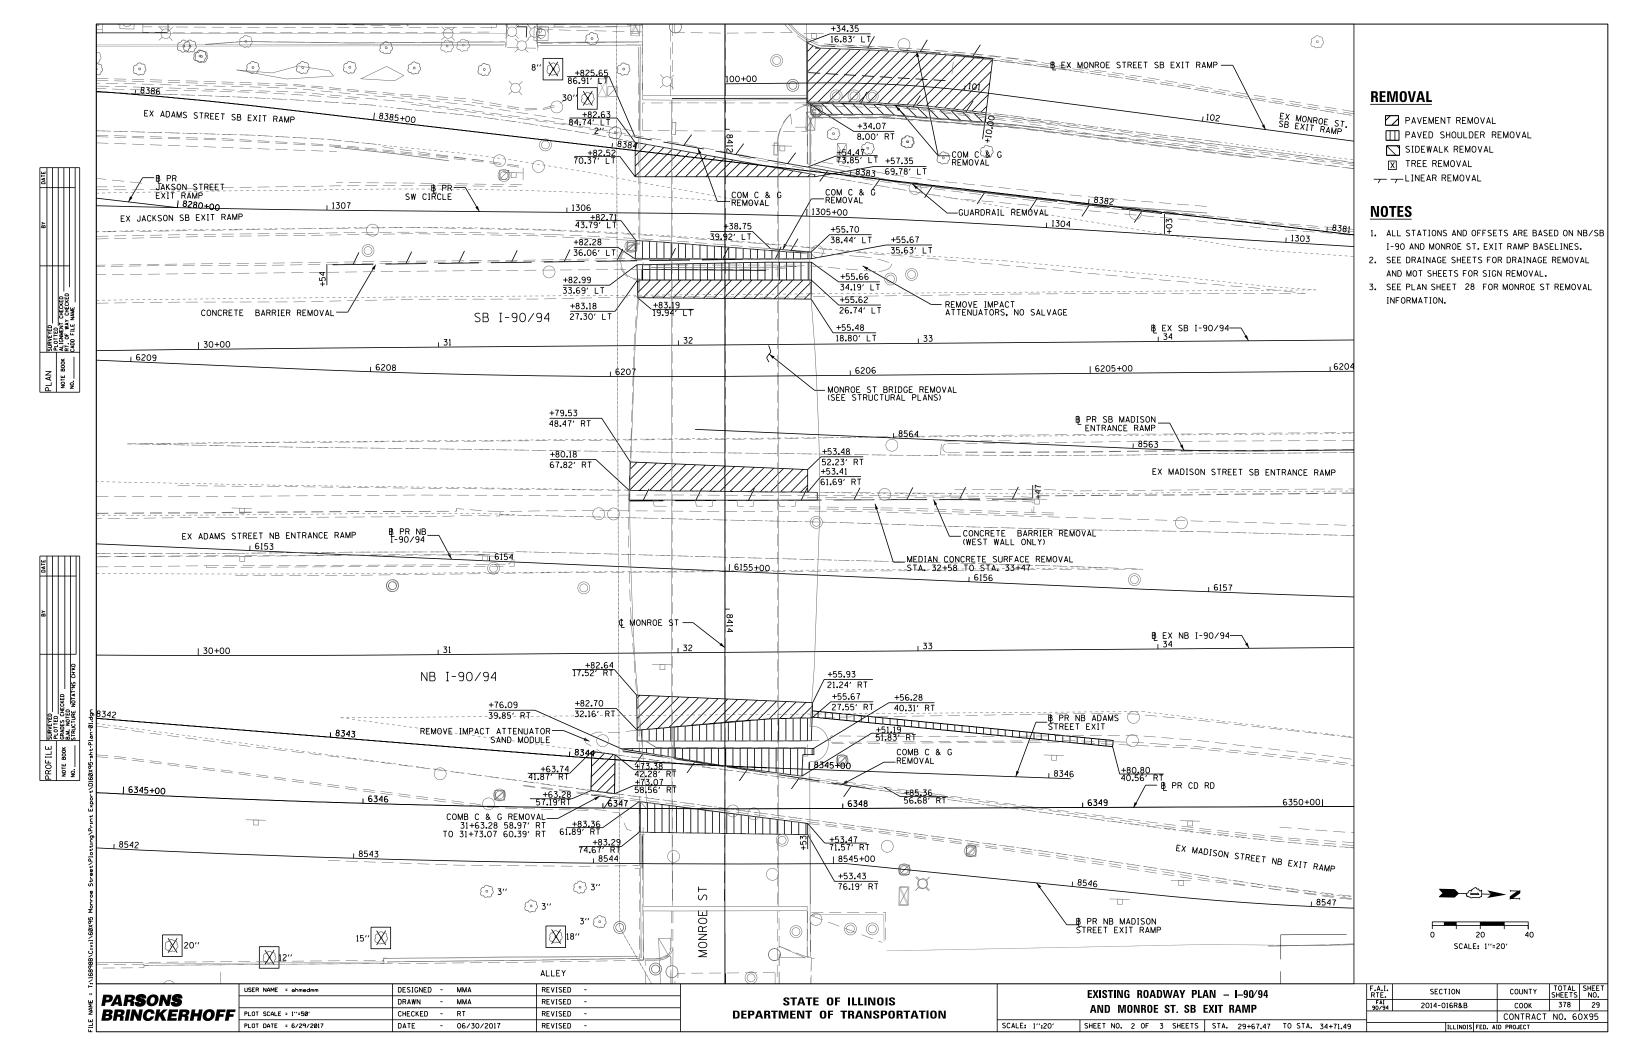

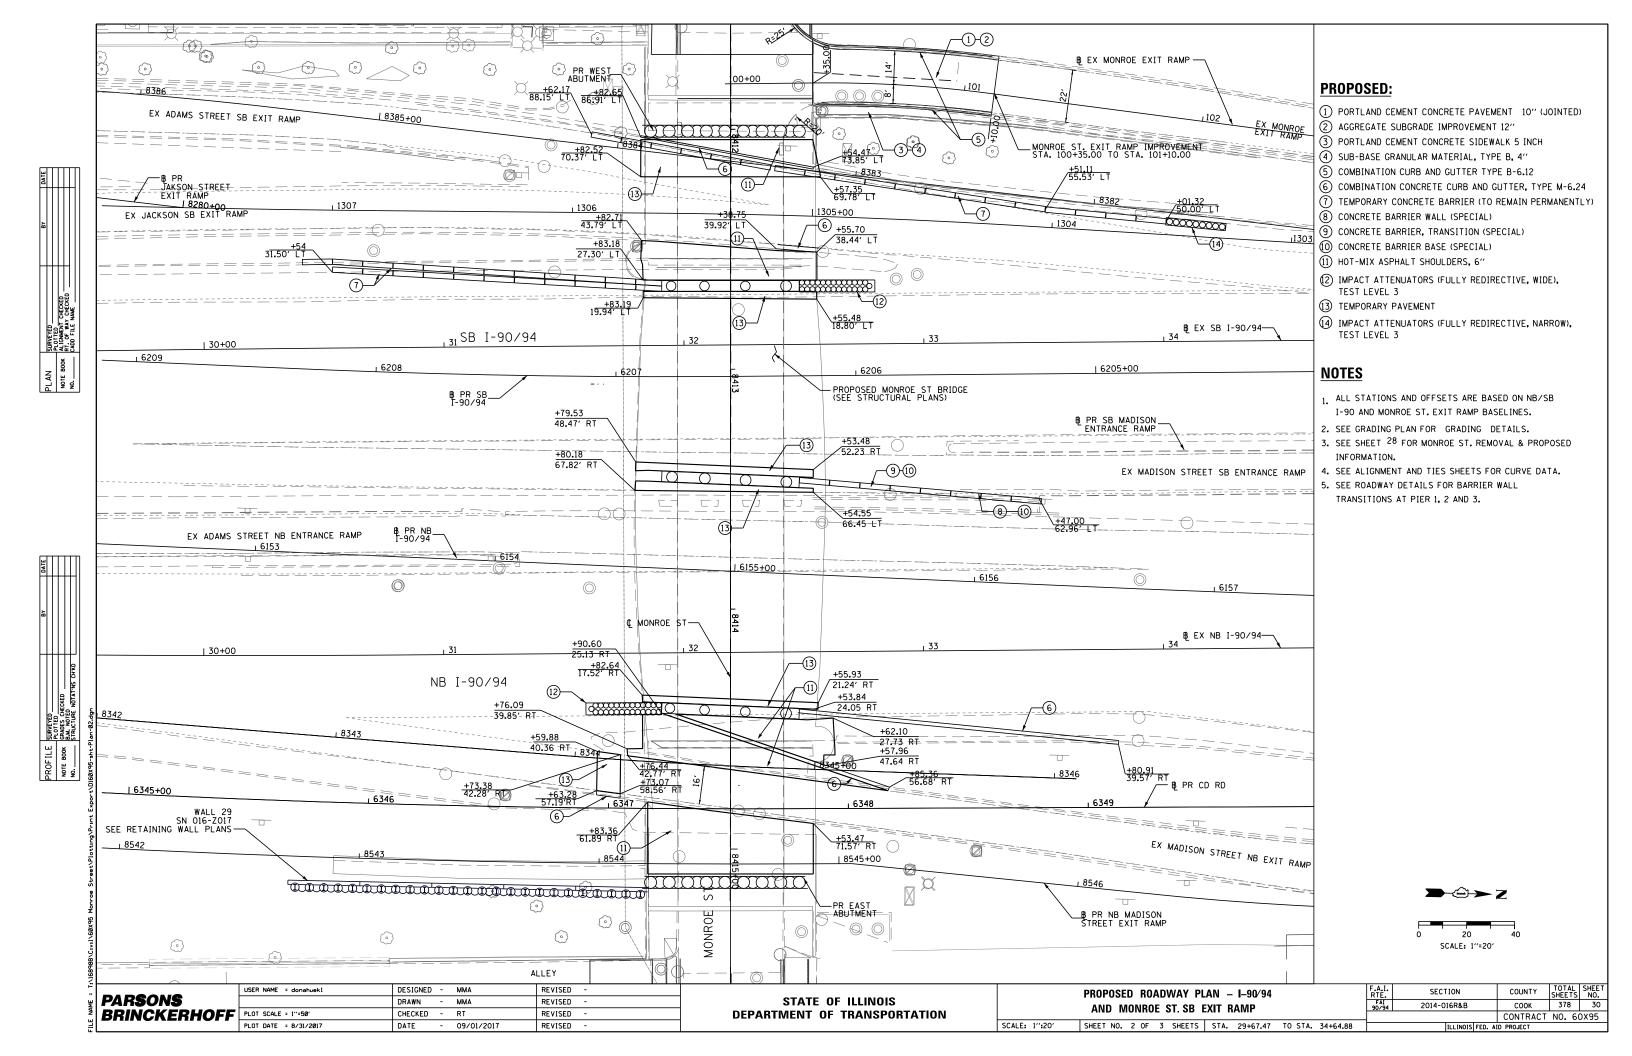

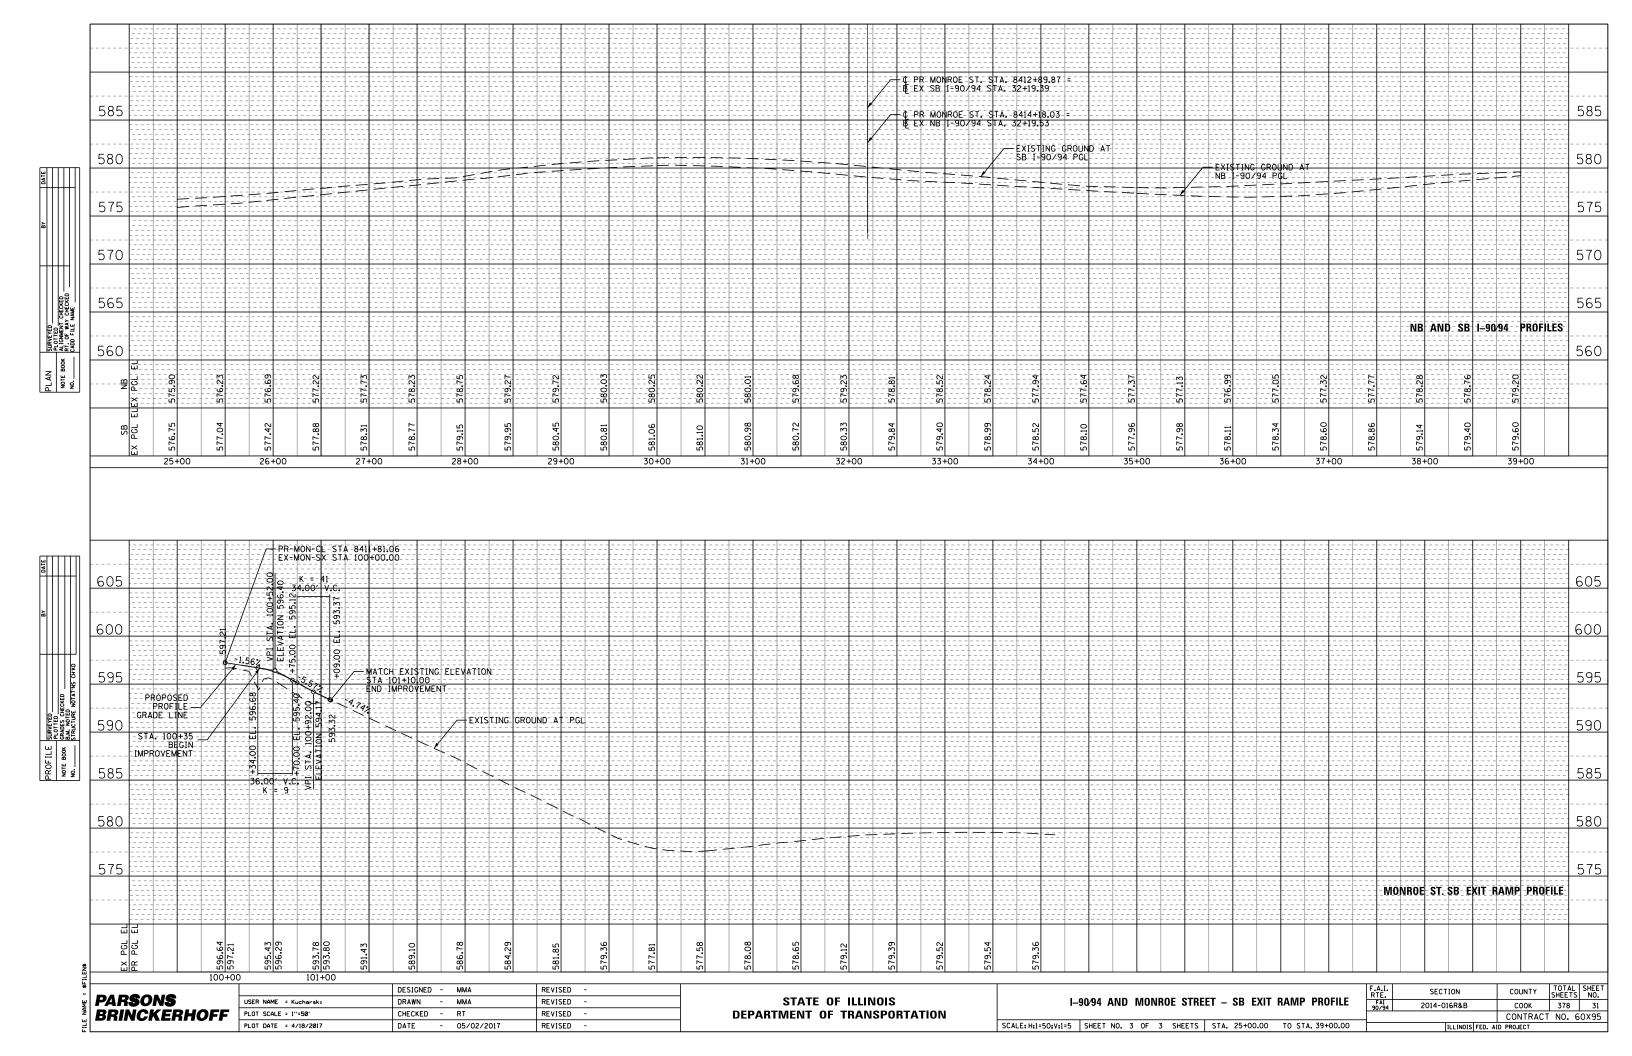

AN SURVEYED BY DATE 10.011E0 ALIGNER'S CHECKED 1. CALO FILE NAME 1

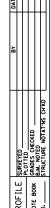

TRAFFIC CONTROL GENERAL NOTES

- TRAFFIC CONTROL AND PROTECTION SHALL BE PERFORMED IN ACCORDANCE WITH SECTION 701 OF THE STANDARD SPECIFICATIONS FOR ROAD AND BRIDGE CONSTRUCTION.
- TYPE III BARRICADES AND ROAD/RAMP CLOSURE SIGNS SHALL BE POSITIONED AS SHOWN, ACCORDING TO HIGHWAY STANDARD 701901, DISTRICT DETAIL TC-08, AND AS DIRECTED BY THE ENGINEER.
- TYPE A LOW INTENSITY FLASHING WARNING LIGHTS SHALL BE USED ON EACH SIGN IN ADVANCE OF THE WORK DURING HOURS OF DARKNESS.
- 4. ALL WARNING SIGNS SHALL BE A MINIMUM OF 48" × 48" AND HAVE A BLACK LEGEND AND BORDER ON A FLUORESCENT ORANGE REFLECTORIZED BACKGROUND.
- 5. ALL TYPE III BARRICADES UTILIZED FOR ROAD CLOSURES SHALL HAVE TWO LOW INTENSITY FLASHING LIGHTS MOUNTED ON TOP OF EACH BARRICADE.
- 6. FOR STABILIZATION, ALL TYPE III BARRICADES SHALL REQUIRE A MINIMUM OF FOUR SAND BAGS PER BARRICADE. THE CONTRACTOR SHALL PROVIDE AND INSTALL TWO (2) WEIGHTED SANDBAGS ON EACH TYPE I OR II BARRICADE USED.
- 7. WHERE ARTIFICIAL LIGHTING IS UTILIZED IN NIGHT OPERATIONS, THE CONTRACTOR SHALL EXERCISE THE UTMOST PRECAUTIONS IN PREVENTING ADVERSE VISIBILITY TO THE MOTORING PUBLIC AND ADJOINING RESIDENTIAL AREAS.
- 8. EXACT LOCATION OF ALL WARNING SIGNS AND BARRICADES SHALL BE STAKED IN THE FIELD FOR APPROVAL BY THE ENGINEER PRIOR TO INSTALLATION.
- PRIOR TO START OF CONSTRUCTION, ALL REQUIRED TRAFFIC CONTROL DEVICES SHALL BE IN PLACE.
- 10. COOPERATION BETWEEN CONTRACTORS WILL BE REQUIRED. THE CONTRACTOR SHALL COORDINATE TRAFFIC CONTROL WITH OTHER ADJACENT CONTRACTS WHICH MAY BE UNDER CONSTRUCTION DURING THE DURATION OF THIS PROJECT. NO ADDITIONAL COMPENSATION IS ALLOWED. ADJACENT CONTRACTS MAY CONSIST OF, BUT NOT LIMITED TO PROJECTS NEAR:
 - o CONTRACT 60X99 VAN BUREN STREET BRIDGE
 - O CONTRACT 62A75 JACKSON BOULEVARD UTILITY ADJUSTMENTS
 - O CONTRACT 60X75 CONGRESS PARKWAY BRIDGE (EB) AND I-290 EB BRIDGE
 - O CONTRACT 60X76 I-290 MAINLINE (EB) (I-90/94 TO LOOMIS STREET)
 - O CONTRACT 60X77 I-290 MAINLINE (WB) (I-90/94 TO RACINE AVE)
 - O CONTRACT 60X78 CONGRESS PARKWAY BRIDGE (WB) EAST OF DES PLAINES) AND I-290 BRIDGE OVER I-90/94 (WB)
 - o CONTRACT 62B76 RAMP NE
 - o CONTRACT 62D78 WB I-290 78" STORM SEWER
 - O CONTRACT 46358 KENNEDY BLANKET SIGN PANEL REPLACEMENT
 - o AND OTHERS.
- 11. THE CONTRACTOR SHALL NOTIFY THE ENGINEER 28 DAYS PRIOR TO ANY ANTICIPATED CLOSURES.
- 12. A MINIMUM 11' LANE WIDTH SHALL BE MAINTAINED ON ALL INTERSTATE LANES OPEN TO TRAFFIC DURING CONSTRUCTION.
- 13. OFFSETS BETWEEN THE EDGE OF TRAVEL LANE AND THE FACE OF TEMPORARY CONCRETE BARRIER ARE ASSUMED TO BE 2 FT UNLESS DESIGNATED OTHERWISE.
- 14. THE CONTRACTOR SHALL VERIFY LOCATION OF ALL BUILDING ACCESS, COORDINATE WITH BUILDING OWNERS AND LOCAL AUTHORITIES AND PROVIDE FULL ACCESS TO BUSINESSES OR PROPERTIES DURING THEIR NORMAL WORKING HOURS IN ACCORDANCE WITH ADA AND APPLICABLE CODE REQUIREMENTS.
- 15. THE CONTRACTOR SHALL MAINTAIN TRAFFIC ON ALL STREETS EXCEPT WHERE NOTED ON THE PLANS AND PROHIBIT PARKING WITHIN FIFTY (50) FEET OF THE CONSTRUCTION AREA AT ALL TIMES. CDOT AND OEMC SHALL BE NOTIFIED AT LEAST 72 HOURS BEFORE COMMENCING CONSTRUCTION.

- 16. PROVIDE CONTINUOUS TEMPORARY ACCESS TO ALL SIDE STREETS, ALLEYS,
 DRIVEWAYS, AND PARKING LOTS UNLESS SPECIFICALLY IDENTIFIED ON THE PLANS
 FOR TEMPORARY CLOSURE. LOTS WITH MORE THAN ONE DRIVEWAY MUST BE
 STAGED TO KEEP AT LEAST ONE DRIVEWAY OPEN AT ALL TIMES.
- 17. PROVIDE CONTINUOUS TEMPORARY ACCESS TO ALL DOORS AND BUILDING ENTRANCE AND EXITS UNLESS SPECIFICALLY IDENTIFIED ON THE PLANS FOR TEMPORARY CLOSURE. BUILDINGS WITH MORE THAN ONE ENTRANCE/EXIT MUST BE STAGED TO KEEP ALL ENTRANCE/EXIT OPEN UNLESS WRITTEN APPROVAL IS PROVIDED BY THE BUILDING OWNER.
- 18. MAINTAIN ACCESS TO FIRE HYDRANTS, BUILDING STANDPIPES AND OTHER EMERGENCY FACILITIES WITHIN THE CONSTRUCTION ZONE.
- 19. THE CONTRACTOR SHALL COORDINATE WORK WITH PRIVATE UTILITY COMPANIES AND THEIR CONTRACTORS FOR ADJUSTMENTS, SUPPORTS, AND RELOCATION.

 UTILITY WORK WILL GENERALLY BE CONDUCTED PRIOR TO ROADWAY WORK, BUT CERTAIN ITEMS MAY NEED TO PROCEED IN CONCERT WITH CONSTRUCTION OPERATIONS. IT IS THE CONTRACTOR'S RESPONSIBILITY TO CONTACT AFFECTED UTILITIES AND COORDINATE WORK WITHIN THE CONSTRUCTION SCHEDULE. THE EFFORT OF WHICH WILL BE CONSIDERED INCIDENTAL TO THE CONTRACT.
- 20. THE CONTRACTOR SHALL CONTACT THE DISTRICT OF ARTERIAL TRAFFIC CONTROL SUPERVISOR AT (847) 705-4470 AND THE EXPRESSWAYS TRAFFIC CONTROL SUPERVISOR AT (847) 705-4155 A MINIMUM OF 72 HOURS IN ADVANCE OF BEGINNING WORK.
- 21. SIGN W21-1 OR W20-7 SHALL BE TAKEN DOWN WHEN THE WORKERS ARE NOT PRESENT.
- 22. THE CONTRACTOR SHALL BE RESPONSIBLE FOR MAINTAINING ACCESS
 RESTRICTIONS TO THE SITE AS MAY BE REQUIRED BY THE ENGINEER. IN AREAS
 WHERE SILT FENCE IS NOT INSTALLED, ORANGE CONSTRUCTION FENCING MAY BE
 REQUIRED TO RESTRICT ACCESS TO WORK ZONES. THE ENGINEER SHALL BE THE
 SOLE JUDGE OF THE NEED FOR ACCESS RESTRICTIONS AND THEIR CONFIGURATION.
 ORANGE CONSTRUCTION FENCING (IF NECESSARY) WILL NOT BE MEASURED
 SEPARATELY FOR PAYMENT. BUT SHALL BE INCLUDED IN THE UNIT BID PRICES
 OF THE CONTRACT.
- 23. A 37" DEFLECTION AREA IS REQUIRED FROM THE BACK SIDE OF THE TEMPORARY BARRIER WALL TO ANY OBSTRUCTION OR DROP OFF IN THE WORK ZONE. IF THIS 37" DEFLECTION AREA CANNOT BE MAINTAINED, THE TEMPORARY CONCRETE BARRIER WALL SHALL BE ANCHORED TO THE PAVEMENT (EXCLUDING BRIDGE DECKS) IN ACCORDANCE WITH THE IDOT SAFETY ENGINEERING POLICY MEMORANDUM 4-15. THIS WORK SHALL BE PAID FOR AS PINNING TEMPORARY CONCRETE BARRIER.
- 24. ALL TEMPORARY PAVEMENT MARKINGS SHOWING DETERIORATION AFTER 7 DAYS
 SHALL BE REPLACED BY THE CONTRACTOR AS DIRECTED BY THE ENGINEER.
 SUFFICIENT QUANTITIES FOR ONE PLACEMENT AND ONE REPLACEMENT HAVE BEEN
 PROVIDED FOR EACH STAGE. ALL MARKINGS THAT REQUIRE REPLACEMENT AFTER
 THE FIRST REPLACEMENT SHALL BE REPLACED BY THE CONTRACTOR AT HIS OWN
 EXPENSE
- 25. THE FURNISHING, INSTALLING, AND RELOCATION OF ALL TRAFFIC SIGNS SHALL BE IN ACCORDANCE WITH THE MANUAL ON UNIFORM TRAFFIC CONTROL DEVICES AND THE STANDARD SPECIFICATIONS. THIS WORK SHALL BE INCLUDED IN THE COST FOR TRAFFIC CONTROL AND PROTECTION, (SPECIAL) FOR THOSE SIGNS ALONG LOCAL STREETS AND INCLUDED IN THE COST OF TRAFFIC CONTROL AND PROTECTION (EXPRESSWAYS) FOR THOSE SIGNS ALONG EXPRESSWAYS. ALL CONFLICTING TRAFFIC SIGNS SHALL BE COVERED AS DIRECTED BY THE ENGINEER.

- 26. THE CONTRACTOR SHALL ONLY SET UP AND STORE EQUIPMENT DURING CONSTRUCTION AT THE SUGGESTED STAGING AREAS AS APPROVED BY THE ENGINEER. THE SUGGESTED STAGING AREAS SHOWN IN THE PLANS ARE SUBJECT TO FIELD MODIFICATION AS DETERMINED BY THE ENGINEER. THE SUGGESTED STAGING AREAS MAY BE SHARED WITH OTHER ADJACENT CONTRACTS WHICH MAY BE UNDER CONSTRUCTION DURING THE DURATION OF THIS PROJECT. CONTRACTOR COOPERATION IS REQUIRED. ADDITIONALLY, UTILITIES AND UTILITY CONTRACTORS MAY PERFORM ASBESTOS ABATEMENT ON CONTRACTOR REMOVED CONDUITS WITHIN A SECURE AREA PROVIDED WITHIN THE STAGING AREAS.
- 27. TYPE III BARRICADES SHALL BE PLACED AT BOTH ENDS OF CLOSED PORTIONS OF ROAD UNDER CONSTRUCTION. THE CONTRACTOR SHALL PROVIDE ENOUGH TYPE III BARRICADES TO CROSS THE ENTIRE ROADWAY AS DEPICTED IN THE PLANS.
- 28. ALL TYPE II/III BARRICADES, DRUMS, AND VERTICAL PANELS SHALL HAVE MONO-DIRECTIONAL OR BI-DIRECTIONAL STEADY BURNING LIGHTS AS PER CURRENT IDOT STANDARDS.
- 29. ALL TRAFFIC CONTROL DEVICES SHALL BE REMOVED, COVERED OR TURNED AWAY FROM TRAFFIC AS SOON AS THEY ARE NO LONGER NECESSARY. WHEN A SIGN IS COVERED, ITS POST SHALL HAVE A REFLECTIVE 3 INCH X 6 INCH DELINEATOR INSTALLED.
- 30. ALL TEMPORARY INFORMATION SIGNS SHALL HAVE A BLACK LEGEND AND BORDER ON A FLUORESCENT ORANGE REFLECTORIZED BACKGROUND.
- 31. FOR MAINTENANCE OF TRAFFIC ALONG PEORIA STREET (SIPHON WORK) SEE SHEET 93F.

PARSONS
BRINCKERHOFF

 SCALE: SHEET NO. 1 OF 1 SHEETS STA. TO STA.

 F.A.I. RTE.
 SECTION
 COUNTY
 TOTAL SHEETS
 SHEET NO.

 90/34
 2014-016R&B
 COOK
 378
 32

 CONTRACT
 NO.
 60X95

STATE OF ILLINOIS
DEPARTMENT OF TRANSPORTATION

STAGING SEQUENCE

STAGE 1A

MAINTENANCE OF TRAFFIC ALONG MAINLINE AND RAMPS

- SOUTHBOUND I-90/94
 - O MAINTAIN ALL LANES OF TRAVEL
 - O INSTALL TEMPORARY BARRIER AND TEMPORARY PAVEMENT MARKINGS PER THE PLAN.
 - O TRAVEL LANES WILL BE SHIFTED ONTO THE OUTSIDE SHOULDER AND REDUCED TO 11' LANES. SHOULDERS WILL BE REDUCED TO 1 FOOT.
- SOUTHBOUND MONROE STREET EXIT RAMP
 - O EXISTING RAMP TO REMAIN OPEN. THE TRAVEL LANE WILL BE REDUCED TO 12 FEET. WESTBOUND TURNING TRAFFIC FROM THE RAMP TO MONROE STREET WILL NOT BE ALLOWED. WESTBOUND TRAFFIC WILL UTILIZE PROPOSED DETOUR PLAN.
- SOUTHBOUND MADISON STREET ENTRANCE RAMP
 - O EXISTING RAMP TO REMAIN CLOSED FOR THE DURATION OF THIS STAGE. TRAFFIC TO LITTLIZE PROPOSED DETOLIR PLAN.
- SOUTHBOUND ADAMS STREET EXIT RAMP
 - O EXISTING RAMP TO REMAIN CLOSED FOR THE DURATION OF THIS STAGE. TRAFFIC TO UTILIZE PROPOSED DETOUR PLAN.
- SOUTHBOUND JACKSON STREET EXIT RAMP
 - O EXISTING RAMP TO REMAIN OPEN. THE TRAVEL LANE WILL BE REDUCED TO 14 FEET.
- SE EXIT RAMP
 - o EXISTING RAMP TO REMAIN OPEN.
- NORTHBOUND I-90/94
 - O MAINTAIN EXISTING NUMBER AND LANE CONFIGURATION
 - O MAINLINE TO UTILIZE TEMPORARY NIGHT LANE CLOSURES FOR DEMOLITION OF MONROE STREET SUPERSTRUCTURE.
- NORTHBOUND JACKSON BOULEVARD ENTRANCE RAMP
- o EXISTING RAMP TO REMAIN OPEN.
- NORTHBOUND ADAMS STREET ENTRANCE RAMP
 - o EXISTING RAMP TO REMAIN OPEN.
- NORTHBOUND MADISON STREET EXIT RAMP
 - o EXISTING RAMP TO REMAIN OPEN.
- EASTBOUND I-290 AT PEORIA STREET
 - o INSTALL TEMPORARY BARRIER PER PLAN SHEET 93F.
 - o CONTRACTOR COOPERATION AND COORDINATION REQUIRED WITH CONTRACT 60X76.

MAINTENANCE OF TRAFFIC ALONG LOCAL STREETS

- MONROE STREET
 - O CLOSE THE MONROE STREET BRIDGE APPROACHES TO BOTH VEHICULAR AND PEDESTRIAN TRAFFIC. THE BRIDGE WILL REMAIN CLOSED FOR THE ENTIRE DURATION OF CONSTRUCTION.
 - O MONROE STREET APPROACH SHALL BE CONVERTED INTO LIMITED ACCESS TWO-WAY TRAFFIC.
 - O VEHICULAR AND PEDESTRIAN TRAFFIC WILL BE DETOURED UTILIZING THE DETOUR PLAN.
 - O MAINTAIN PEDESTRIAN AND VEHICULAR ACCESS TO THE DRIVEWAYS, BUILDINGS, AND ALLEY ALONG MONROE STREET.

CONSTRUCTION TO BE COMPLETED IN STAGE 1A

MAINLINE AND RAMPS

- REMOVE THE EXISTING BRIDGE MOUNTED SIGN PANELS ON MONROE STREET BRIDGE. RELOCATE SIGN STRUCTURES ACCORDING TO THE SIGNING PLAN.
- ALL COMED, AT&T, OUC, OEMC AND 911 EMERGENCY UNIT UTILITIES TO BE RELOCATED BY OTHERS. THE REMOVAL AND REPLACEMENT OF THE EXISTING UTILITIES SHALL BE COORDINATED AND AT THE DISCRETION OF UTILITY AGENCIES.
- REMOVE THE EXISTING WEST ABUTMENT. BEGIN CONSTRUCTION OF THE WEST ABUTMENT.
- REMOVE THE EXISTING CENTER PIER AS SHOWN ON THE PLANS AND CONSTRUCT THE PROPOSED PIER 2 CONSTRUCTION.

MONROE STREET

- DEMOLISH THE EXISTING MONROE STREET BRIDGE APPROACHES AND SUPERSTRUCTURE AS SHOWN IN THE PLANS. WORK INCLUDES BUT IS NOT LIMITED TO REMOVAL OF ALL APPURTENANCE FIXTURES ON THE BRIDGE.
- INSTALL TEMPORARY SOIL RETENTION SYSTEMS AS SHOWN ON THE PLANS.

PEORIA STREET

- BEGIN PEORIA SIPHON LINING WORK, SEE SHEET 93F FOR TRAFFIC CONTROL AND TRAVEL LANE CONFIGURATION.

STAGE 1A-1

STAGE 1A-1 IS A SUBSTAGE OF STAGE 1A. THE STAGE WILL BE USED FOR THE LIMITED CLOSURE OF NORTHBOUND ADAMS ENTRANCE RAMP FOR THE DEMOLITION OF THE EXISTING CENTER PIER AND THE CONSTRUCTION OF PIER 2.

MAINTENANCE OF TRAFFIC ALONG MAINLINE AND RAMPS

- MAINLINE AND RAMPS WILL MATCH THE PROPOSED MAINTENANCE OF TRAFFIC EXCEPT FOR NORTHBOUND ADAMS STREET ENTRANCE RAMP.
- NORTHBOUND ADAMS STREET ENTRANCE RAMP
 - O THE RAMP WILL BE FULLY CLOSED FOR A LIMITED DURATION FOR THE DEMOLITION OF THE EXISTING CENTER PIER. TRAFFIC TO UTILIZE PROPOSED DETOUR PLAN.
 - O MINIMIZE TIME OF CLOSURE BY REOPENING THE RAMP IMMEDIATELY UPON COMPLETION OF THE EXISTING PIER 2 DEMOLITION AND CONSTRUCTION ALONG THE INSIDE MEDIAN FACE.
 - O NORTHBOUND JACKSON BOULEVARD ENTRANCE SHALL NOT BE CLOSED DURING STAGE 1A-1.

MAINTENANCE OF TRAFFIC ALONG LOCAL STREETS

- MONROE STREET
 - O MAINTAIN PROPOSED MAINTENANCE OF THE TRAFFIC FROM STAGE 1A.

CONSTRUCTION TO BE COMPLETED IN STAGE 1A-1

MATNI INF AND RAMPS

- REMOVE THE EXISTING PIER 2 AND SUBSTRUCTRE AS SHOWN ON THE PLANS.
- INSTALL TEMPORARY BARRIER ALONG THE ADAMS ENTRANCE RAMPS AS SHOWN ON THE

STAGE 1B

MAINTENANCE OF TRAFFIC ALONG MAINLINE AND RAMPS

- SOUTHBOUND I-90/94
 - o MAINTAIN 5 LANES OF TRAVEL.
 - O TRAVEL LANES WILL BE SHIFTED BACK TO MAINLINE PAVEMENT. STAGE 1A LANES ARE MAINTAINED AND AN ADDITIONAL LANE TO BE ADDED ADJACENT TO THE CENTER MEDIAN. TRAFFIC LANES WILL UTILIZE REDUCED TO 11 FOOT LANES. SHOULDERS WILL BE REDUCED TO 1 FOOT.
- SOUTHBOUND MONROE STREET EXIT RAMP
 - O MAINTAIN MAINTENANCE OF TRAFFIC FROM STAGE 1A
- SOUTHBOUND MADISON STREET ENTRANCE RAMP
 - O RAMP TO BE OPENED WITH REDUCED LANE WIDTH AND LANE SHIFT AROUND THE PROPOSED PIER 2. THE TRAVEL LANE WILL BE REDUCED TO 12 FEET.
- SOUTHBOUND ADAMS STREET EXIT RAMP
 - O EXISTING RAMP TO REMAIN CLOSED FOR THE DURATION OF THIS STAGE. MAINTENANCE OF TRAFFIC MATCHES STAGE 1A.
- SOUTHBOUND JACKSON STREET EXIT RAMP
 - O EXISTING RAMP TO REMAIN OPEN. MAINTENANCE OF TRAFFIC MATCHES STAGE 1A.
- SE EXIT RAMP
 - O EXISTING RAMP TO REMAIN OPEN.
- NORTHBOUND I-90/94
- O MAINTENANCE OF TRAFFIC MATCHES STAGE 1A.
- NORTHBOUND JACKSON BOULEVARD ENTRANCE RAMP
 - O EXISTING RAMP TO REMAIN OPEN. MAINTENANCE OF TRAFFIC MATCHES STAGE 1A.
- NORTHBOUND ADAMS STREET ENTRANCE RAMP
 - O EXISTING RAMP TO REMAIN OPEN. MAINTENANCE OF TRAFFIC MATCHES STAGE 1A.
- O EXISTING RAMP TO REMAIN OPEN. MAINTENANCE OF TRAFFIC MATCHES STAGE 1A.
- EASTBOUND I-290 AT PEORIA STREET

- NORTHBOUND MADISON STREET EXIT RAMP

O MAINTAIN MAINTENANCE OF TRAFFIC FROM STAGE 1A AS NEEDED FOR THE COMPLETION OF THE PEORIA SIPHON LINING.

MAINTENANCE OF TRAFFIC ALONG LOCAL STREETS

- MONROF STREET
 - O MAINTENANCE OF TRAFFIC TO MATCH STAGE 1A.

CONSTRUCTION TO BE COMPLETED IN STAGE 1B

MAINLINE AND RAMPS

- ALL COMED, AT&T, OUC, OEMC AND 911 EMERGENCY UNIT UTILITIES TO BE RELOCATED BY OTHERS. THE REMOVAL AND REPLACEMENT OF THE EXISTING UTILITIES SHALL BE COORDINATED AND AT THE DISCRETION OF UTILITY AGENCIES.
- CONTINUE REMOVAL AND CONSTRUCTION OF THE WEST ABUTMENT.

PEORIA STREET

- COMPLETE PEORIA SIPHON LINING.

STAGE 1B-1

STAGE 1B-1 IS A SUBSTAGE OF STAGE 1B. THE STAGE WILL BE USED FOR THE LIMITED WEEKEND CLOSURE OF SOUTHBOUND JACKSON BOULEVARD ENTRANCE RAMP FOR THE DEMOLITION OF EXISTING PIER 1 AND CONSTRUCTION OF TEMPORARY PAVEMENT AT PIER 1.

MAINTENANCE OF TRAFFIC ALONG MAINLINE AND RAMPS

- MAINLINE AND RAMPS WILL MATCH THE PROPOSED MAINTENANCE OF TRAFFIC EXCEPT FOR JACKSON BOULEVARD ENTRANCE RAMP.
 - o TRAVEL LANES WILL MATCH STAGE 1B.
- SOUTHBOUND MONROE STREET EXIT RAMP
 - O MAINTAIN MAINTENANCE OF TRAFFIC FROM STAGE 1B.
- o RAMP SHALL NOT BE CLOSED DURING THIS SUBSTAGE.
- SOUTHBOUND JACKSON BOULEVARD EXIT RAMP
 - O EXISTING RAMP TO BE CLOSED FOR A LIMITED DURATION PER SPECIAL PROVISIONS TO COMPLETE THE DEMOLITION OF PIER 1 AND RECONSTRUCTION OF TEMPORARY PAVEMENT ASSOCIATED WITH THE PIER 1 REMOVAL. TRAFFIC TO UTILIZE PROPOSED DETOUR PLAN.
- O MINIMIZE TIME OF CLOSURE BY REOPENING THE RAMP IMMEDIATELY UPON COMPLETION OF WORK.
- O INSTALL TEMPORARY BARRIER AND DETOUR PLAN.

MAINTENANCE OF TRAFFIC ALONG LOCAL STREETS

- MONROF STREET
 - O MAINTENANCE OF TRAFFIC TO MATCH STAGE 1B.

CONSTRUCTION TO BE COMPLETED IN STAGE 1B-1

MAINLINE AND RAMPS

- CONTINUE REMOVAL AND CONSTRUCTION OF THE WEST ABUTMENT.
- DEMOLITION OF THE EXISTING PIER 1 AS SHOWN IN THE PLANS.
- CONSTRUCTION OF TEMPORARY PAVEMENT AND OTHER ASSOCIATED ITEMS DUE TO THE REMOVAL OF PIER 1.



DESIGNED -REVISED USER NAME = donahuek1 DRAWN AMK REVISED REVISED PLOT DATE = 8/30/2017 - 09/01/2017 REVISED DATE

STATE OF ILLINOIS **DEPARTMENT OF TRANSPORTATION**

SUGGESTED STAGES OF CONSTRUCTION AND TRAFFIC CONTROL PLAN STAGING SEQUENCE SCALE: SHEET NO. 1 OF 2 SHEETS STA. TO STA.

SECTION COUNTY COOK 378 33 2014-016R&B CONTRACT NO. 60X95

STAGE 2A

MAINTENANCE OF TRAFFIC ALONG MAINLINE AND RAMPS

- SOUTHBOUND I-90/94

STAGING SEQUENCE

- MAINTAIN 4 LANES OF TRAFFIC AND CLOSE THE RIGHT LANE FOR PIER 1 CONSTRUCTION AND RAMP SE PERMANENT CLOSURE.
- O TRAVEL LANES WILL MAINTAIN 11 FOOT THROUGH LANES AND A 12 FOOT EXIT ONLY LANE FOR RAMP SE. SHOULDERS WILL BE A MINIMUM OF 1'.
- o INSTALL TEMPORARY BARRIER PER PLANS.
- SOUTHBOUND MONROE STREET EXIT RAMP
 - O EXISTING RAMP TO CLOSE. TRAFFIC WILL UTILIZE PROPOSED DETOUR PLAN.
- SOUTHBOUND MADISON STREET ENTRANCE RAMP
 - o RAMP TO BE OPEN. CONFIGURATION MATCHES STAGE 1B.
 - o TRAVEL LANE UTILIZE 12 FEET LANES.
- SOUTHBOUND ADAMS STREET EXIT RAMP
 - O EXISTING RAMP OPEN TO TRAFFIC. TRAVEL LANE REDUCED TO 14 FEET.
- SOUTHBOUND JACKSON STREET EXIT RAMP
 - O EXISTING RAMP OPEN TO TRAFFIC. THE TRAVEL LANE WILL BE REDUCED TO 11
 - O INSTALL TEMPORARY BARRIER PER PLAN.
- SE EXIT RAMP
 - o EXIT RAMP IS PERMANENTLY CLOSED.
- NORTHBOUND I-90/94
 - O MAINTAIN 4 LANES OF TRAFFIC AND SHIFT TRAVEL LANES TO THE WEST. OUTSIDE LANE WILL BE CLOSED FOR CONSTRUCTION OF PIER 3.
 - O MAINLINE LANES WILL BE REDUCED TO 11 FOOT AND 1 FOOT SHOULDERS.
- NORTHBOUND JACKSON BOULEVARD ENTRANCE RAMP
 - O EXISTING RAMP TO BE CLOSED DURING THIS STAGE. TRAFFIC TO UTILIZE THE PROPOSED DETOUR PLAN.
- NORTHBOUND ADAMS STREET ENTRANCE RAMP
 - O EXISTING RAMP TO REMAIN OPEN.
- NORTHBOUND MADISON STREET EXIT RAMP
 - O EXISTING RAMP TO BE CLOSED DURING THIS STAGE. TRAFFIC TO UTILIZE THE PROPOSED DETOUR PLAN.

MAINTENANCE OF TRAFFIC ALONG LOCAL STREETS

- MONROE STREET
 - BRIDGE REMAINS CLOSED AND THE STREET IS CLOSED TO SOUTHBOUND RAMP TRAFFIC.
 - MAINTAIN PEDESTRIAN AND VEHICULAR ACCESS TO THE DRIVEWAYS, BUILDINGS, AND ALLEY ALONG MONROE STREET BY STAGED CONSTRUCTION OF MONROE STREET.

CONSTRUCTION TO BE COMPLETED IN STAGE 2A

MAINLINE AND RAMPS

- REMOVE AND COMPLETE CONSTRUCTION OF PIER 3.
- BEGIN CONSTRUCTION OF PIER 1.
- BEGIN REMOVAL AND CONSTRUCTION OF EAST ABUTMENT. INSTALL TEMPORARY SOIL RETENTION SYSTEMS AS SHOWN IN THE STRUCTURAL PLANS.
- BEGIN CONSTRUCTION OF RETAINING WALL 016-Z017.

MONROE STREET

- BEGIN REMOVAL AND RECONSTRUCTION OF THE EXISTING MONROE STREET PAVEMENT,
 SIDEWALK, AND DRAINAGE AS SHOWN IN THE PLANS.
- INSTALL AND MAINTAIN TEMPORARY DRIVEWAY ACCESS AS REQUIRED.

STAGE 2B

MAINTENANCE OF TRAFFIC ALONG MAINLINE AND RAMPS

- SOUTHBOUND MAINLINE AND RAMPS WILL MATCH STAGE 2A.
- SE EXIT RAMP
 - o EXISTING RAMP TO REMAIN CLOSED.
- NORTHBOUND I-90/94
 - o TRAVEL LANES TO INCREASE FROM 4 TO 5 LANES WITH THE OPENING OF LANE 5 ADJACENT TO PIER 3.
 - O TRAVEL LANES WILL UTILIZE 11' LANES. MAINLINE CENTER MEDIAN SHOULDER WILL BE 0.9 FEET AT MONROE STREET BRIDGE PER PLANS. SHOULDERS OTHERWISE WILL UTILIZE 1 FOOT MINIMUM SHOULDER.
- NORTHBOUND JACKSON BOULEVARD ENTRANCE RAMP
 - O EXISTING RAMP TO REOPEN AND REMAIN OPEN.
- NORTHBOUND ADAMS STREET ENTRANCE RAMP
 - O EXISTING RAMP TO REMAIN OPEN.
- NORTHBOUND MADISON STREET EXIT RAMP
 - o RAMP WILL REMAIN CLOSED AND MATCH STAGE 2A.

MAINTENANCE OF TRAFFIC ALONG LOCAL STREETS

- MONROE STREET
 - O BRIDGE REMAINS CLOSED AND THE STREET IS CLOSED TO SOUTHBOUND RAMP
 - O MAINTAIN PEDESTRIAN AND VEHICULAR ACCESS TO THE DRIVEWAYS, BUILDINGS, AND ALLEY ALONG MONROE STREET BY STAGED CONSTRUCTION OF MONROE STREET.

CONSTRUCTION TO BE COMPLETED IN STAGE 2B

MAINLINE AND RAMPS

- CONTINUE CONSTRUCTION OF PIER 1.
- CONTINUE REMOVAL AND CONSTRUCTION OF EAST ABUTMENT.
- CONTINUE CONSTRUCTION OF RETAINING WALL 016-Z017.

MONROE STREET

- CONTINUE REMOVAL AND RECONSTRUCTION OF THE EXISTING MONROE STREET PAVEMENT, SIDEWALK, AND DRAINAGE AS SHOWN IN THE PLANS.
- INSTALL AND MAINTAIN TEMPORARY DRIVEWAY ACCESS AS REQUIRED.

STAGE 3

MAINTENANCE OF TRAFFIC ALONG MAINLINE AND RAMPS

- SOUTHBOUND I-90/94 AND SOUTHBOUND RAMPS EXCEPT FOR SOUTHBOUND MONROE STREET EXIT RAMP.
 - o SHIFT TRAFFIC TO PERMANENT FINAL CONDITION. (4 LANES)
 - UTILIZE TEMPORARY NIGHT TIME LANE CLOSURES FOR THE SUPERSTRUCTURE BEAM PLACEMENT.
- SOUTHBOUND MONROE STREET EXIT RAMP
 - O EXISTING RAMP TO REMAIN CLOSED. WESTBOUND TRAFFIC WILL UTILIZE THE PROPOSED DETOUR PLAN.
 - MINIMIZE TIME OF CLOSURE BY REOPENING THE RAMP IMMEDIATELY UPON COMPLETION OF MONROE STREET PAVEMENT.
- SE EXIT RAMP (REFER TO CONTRACT 60X99)
 - o EXISTING RAMP TO REMAIN CLOSED.
- NORTHBOUND I-90/94
 - o MAINTAIN STAGE 2B.
 - O UTILIZE TEMPORARY NIGHT TIME LANE CLOSURES FOR THE SUPERSTRUCTURE BEAM PLACEMENT.
- NORTHBOUND JACKSON BOULEVARD ENTRANCE RAMP
 - o EXISTING RAMP TO REOPEN AND REMAIN OPEN.
- NORTHBOUND ADAMS STREET ENTRANCE RAMP
- O EXISTING RAMP TO REMAIN OPEN.
 NORTHBOUND MADISON STREET EXIT RAMP
 - O RAMP WILL REMAIN CLOSED AND MATCH STAGE 2A.

MAINTENANCE OF TRAFFIC ALONG LOCAL STREETS (STAGE 3 CONTINUED)

- MONROE STREET
 - O BRIDGE REMAINS CLOSED AND THE STREET IS CLOSED TO SOUTHBOUND RAMP
 - MAINTAIN PEDESTRIAN AND VEHICULAR ACCESS TO THE DRIVEWAYS, BUILDINGS, AND ALLEY ALONG MONROE STREET BY STAGED CONSTRUCTION OF MONROF STREET.
 - REMOVE DETOUR AND REOPEN TO TRAFFIC AFTER BRIDGE COMPLETION.
 RETURN TRAFFIC TO EXISTING LANE CONFIGURATION.

CONSTRUCTION TO BE COMPLETED IN STAGE 3

MAINLINE AND RAMPS

- COMPLETE PERMANENT EROSION CONTROL AND SEDIMENT CONTROL MEASURES.
- COMPLETE PERMANENT PAVEMENT MARKINGS AND SIGNING.

MONROE STREET

- COMPLETE CONSTRUCTION OF SUPERSTRUCTURE OF MONROE STREET BRIDGE
- COMPLETE CONSTRUCTION OF RETAINING WALL 016-Z017
- COMPLETE CONSTRUCTION OF EAST AND WEST APPROACHES OF MONROE STREET INCLUDING NOT LIMITED TO ROADWAY, SIDEWALK, SIGNING, PAVEMENT MARKING, AND ADA RAMPS.
- COMPLETE CONSTRUCTION OF ITS AND LIGHTING.

PAR SONS BRINCKERHOFF
BHINGKEHHOFF

USER NAME = Kucharskı	DESIGNED	-	AMK	REVISED -
	DRAWN	-	AMK	REVISED -
PLOT SCALE =	CHECKED	-	RPH	REVISED -
PLOT DATE = 7/13/2017	DATE	-	07/14/2017	REVISED -

STATE OF ILLINOIS
DEPARTMENT OF TRANSPORTATION

SUGGESTED S	TAGES	0F	-			UCTION IG SEQU		TRAFFIC	CONTROL PLAN
SCALE:	SHEET	NO.	2	OF	2	SHEETS	STA.		TO STA.

A.I. SECTION COUNTY TOTAL SHEET'S NO. FIFE O'SHEET'S NO. SHEET'S NO. GOVERNMENT OF THE O'SHEET'S NO. GOVERNMENT O

(ALL SIGN COLORS SHALL BE ACCORDING TO THE LATEST EDITION OF THE MUTCD)



W20-2 (48"×48")



W20-30-48 48"×48"



W20-I103-48

48''×48''

DETOUR

M4-9L 30''×24''



M4-9R 30''×24''



R3-1 24''×24''



30''×24''





ROAD CLOSED TO THRU TRAFFIC

R11-4 60''X30''



65"X48"



M4-10L 48''×18''





M4-8A 24''×18''





M3-4 24" X 12"




M5-1R 30''x24''



M5-1L 30''×24''

R3-2 24"x24"



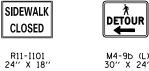

R11-2 48''×30''



















M3-2 24" X 12"





M1-1 (24"×24")







R5-1 (48"×48")



CUSTOM SPECIAL BLACK LETTERS ON ORANGE BACKGROUND 30"×18"

SCALE:



CUSTOM SPECIAL BLACK LETTERS ON ORANGE BACKGROUND 30"×18"

MADISON STREET

CUSTOM SPECIAL BLACK LETTERS ON ORANGE BACKGROUND 30"×18"




CUSTOM SPECIAL BLACK LETTERS ON ORANGE BACKGROUND 30"×18"

* TO BE PAID FOR AS TEMPORARY INFORMATION


PARSONS BRINCKERHOFF


USER NAME = Kucherski	DESIGNED	-	AMK	REVISED	-
	DRAWN	-	AMK	REVISED	-
PLOT SCALE =	CHECKED	-	RPH	REVISED	-
PLOT DATE = 4/18/2017	DATE	-	05/02/2017	REVISED	-


DETOUR GIOVA	F.A.I. RTE.	SECTION	COUNTY	TOTAL SHEETS	SHEET NO.
DETOUR SIGNS	FAI 90/94	2014-016R&B	соок	378	35
			CONTRACT	NO. 60	0X95
SHEET NO. 1 OF 14 SHEETS STA. TO STA.		II I INOIS FED. A	ID PROJECT		

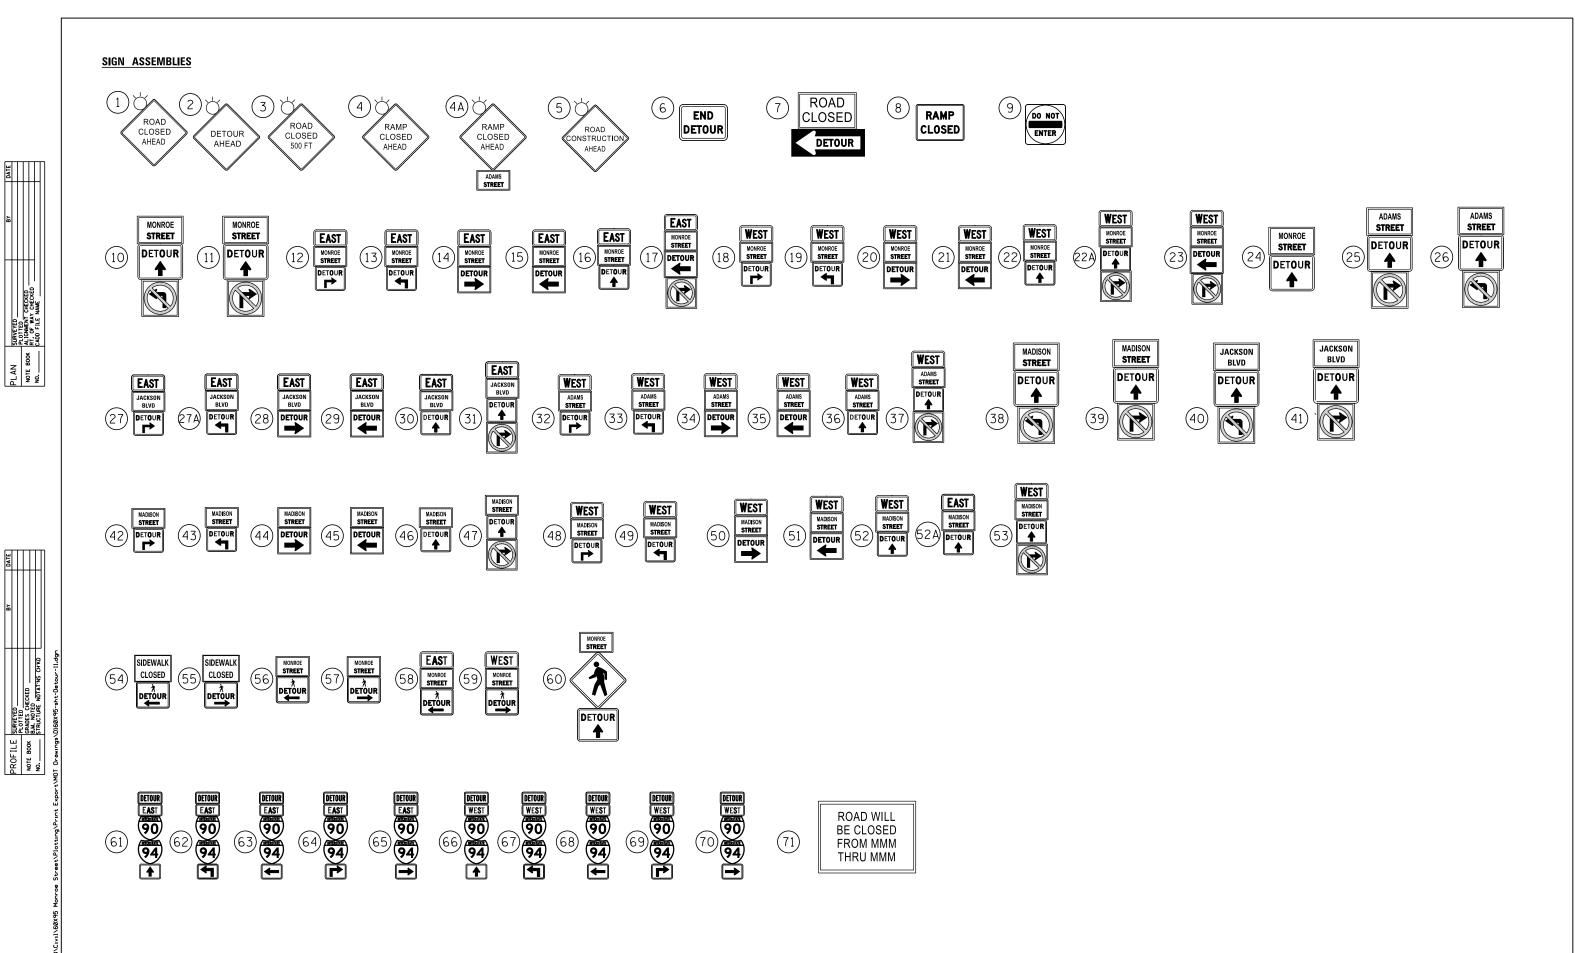



<u> </u>	USER NAME = Kucherski	DESIGNED - AMK	REVISED -					F.A.I.	SECTION	COUNTY	TOTAL SHEET
PARSON		DRAWN - AMK	REVISED -	STATE OF ILLINOIS		DETOUR SIGN ASSEMBLIES		FAI 90/94	2014-016R&B	соок	378 36
BRINCK!	ERHOFF PLOT SCALE :	CHECKED - RPH	REVISED -	DEPARTMENT OF TRANSPORTATION				307 34 1		CONTRACT	NO. 60X95
#	PLOT DATE = 4/18/2017	DATE - 05/02/2017	REVISED -		SCALE:	SHEET NO. 2 OF 14 SHEETS STA.	TO STA.		ILL INOIS FED.	AID PROJECT	

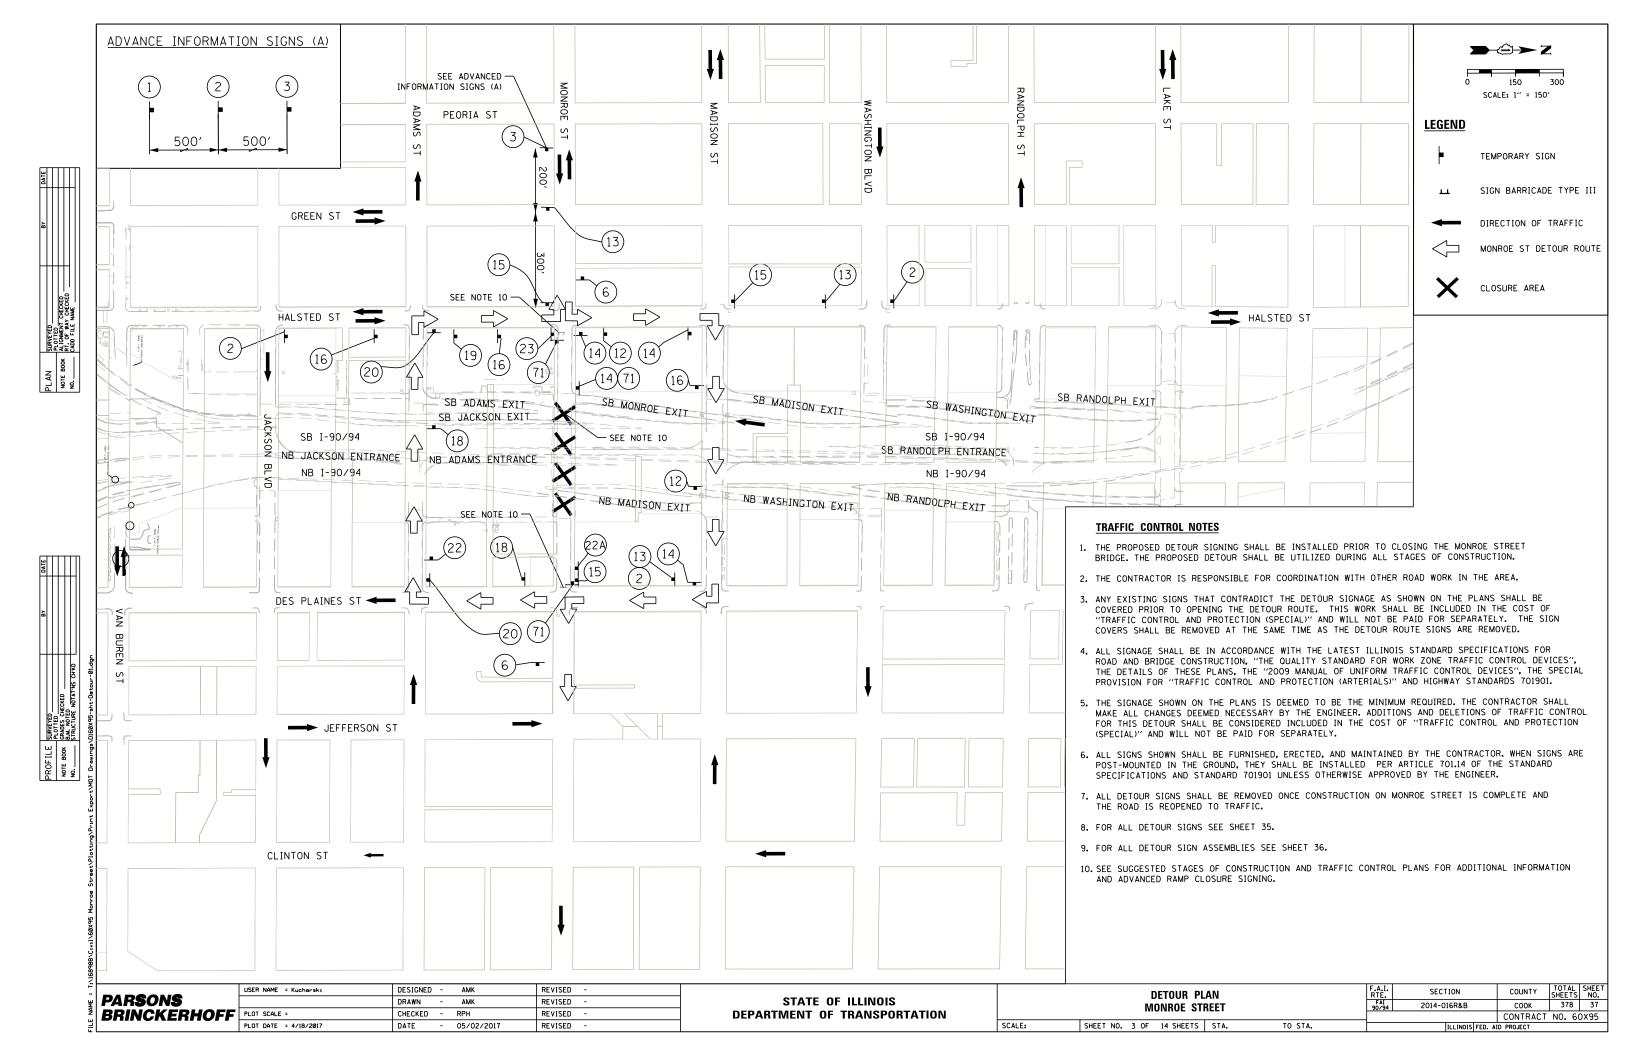


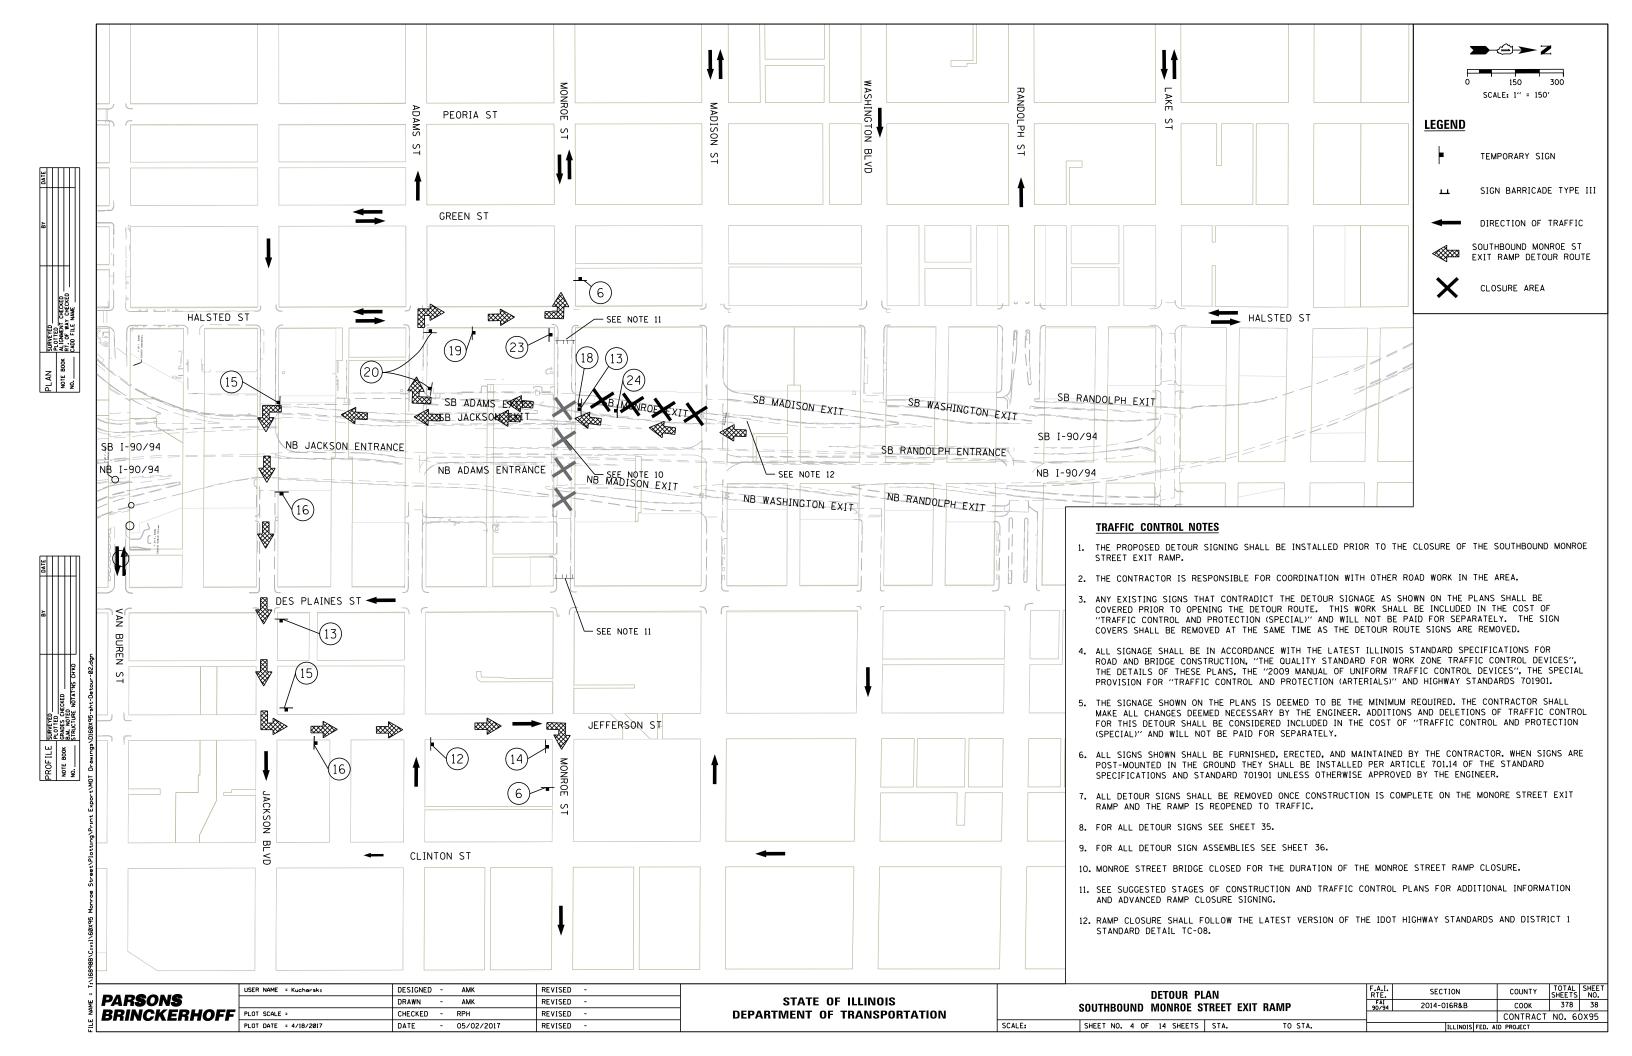


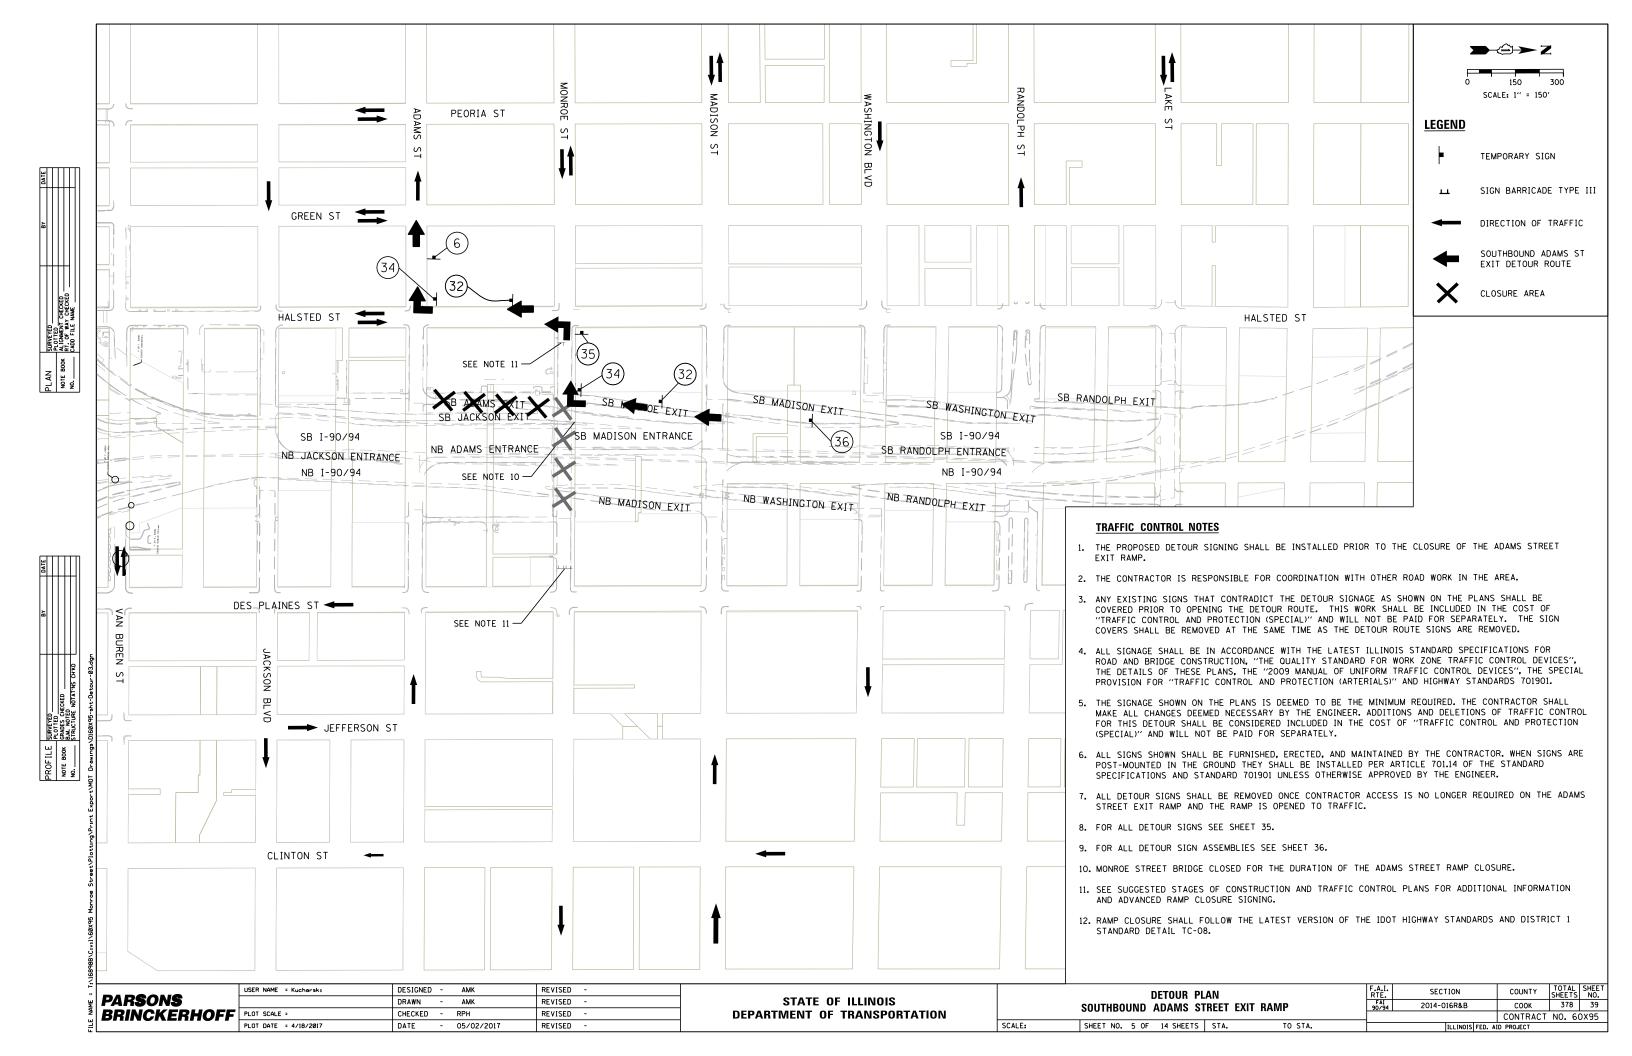


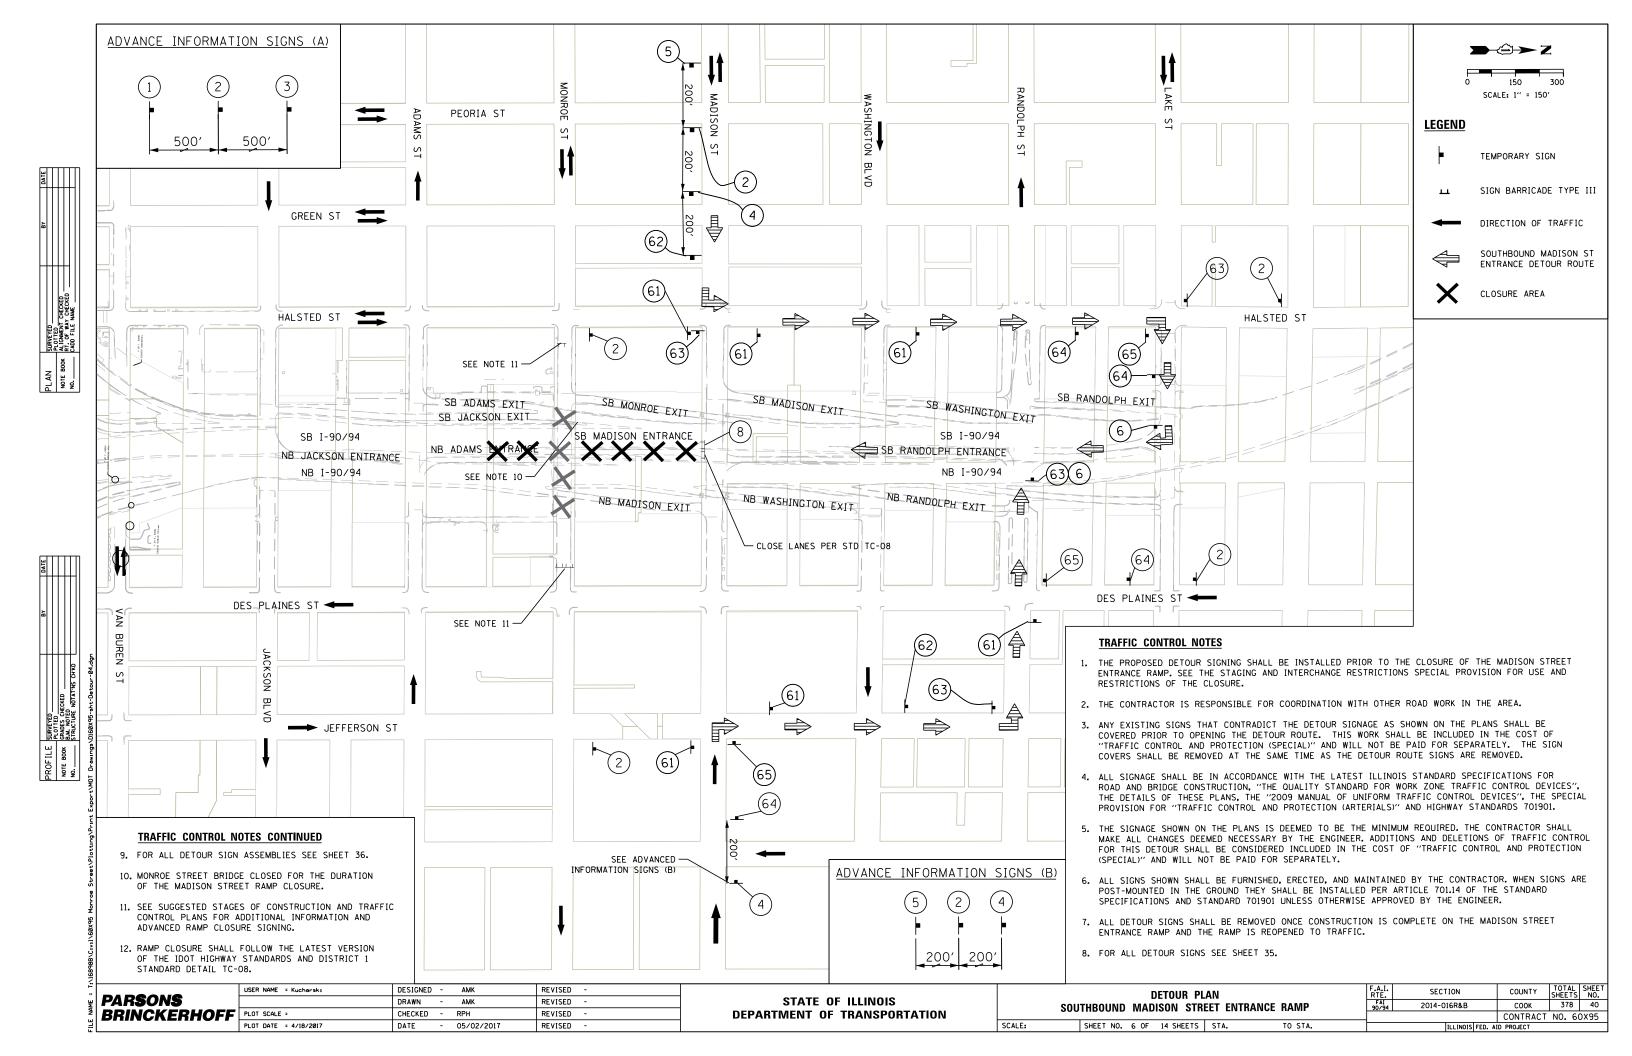


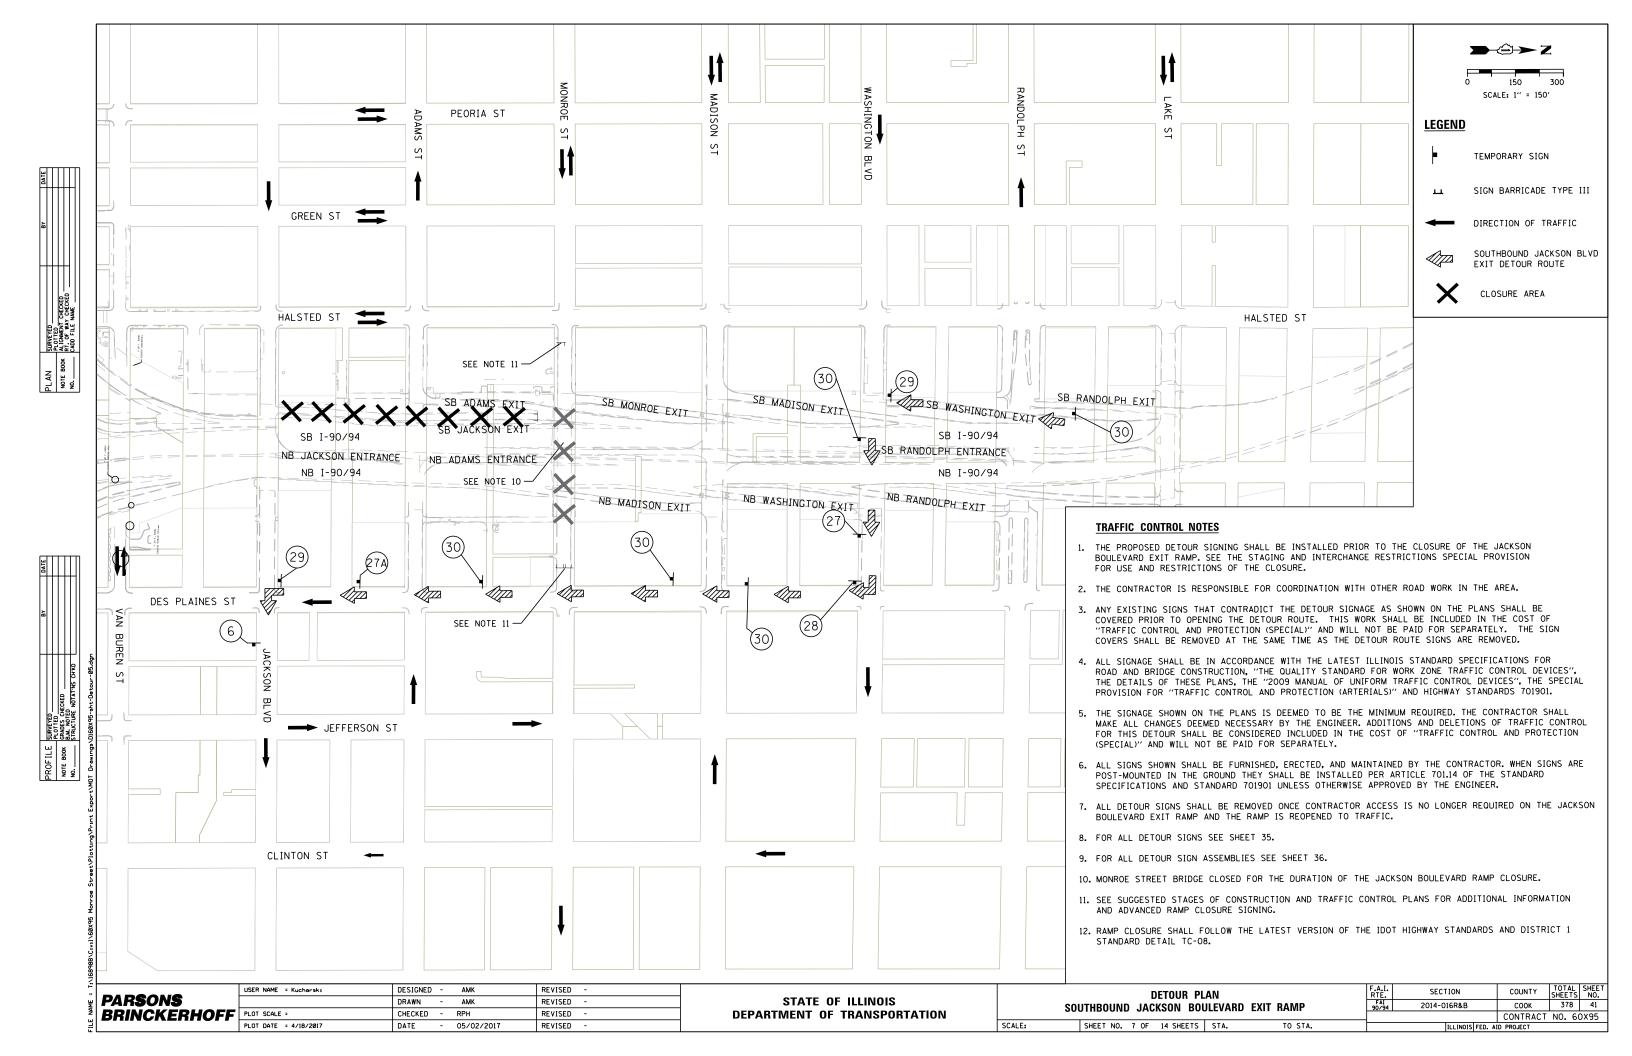

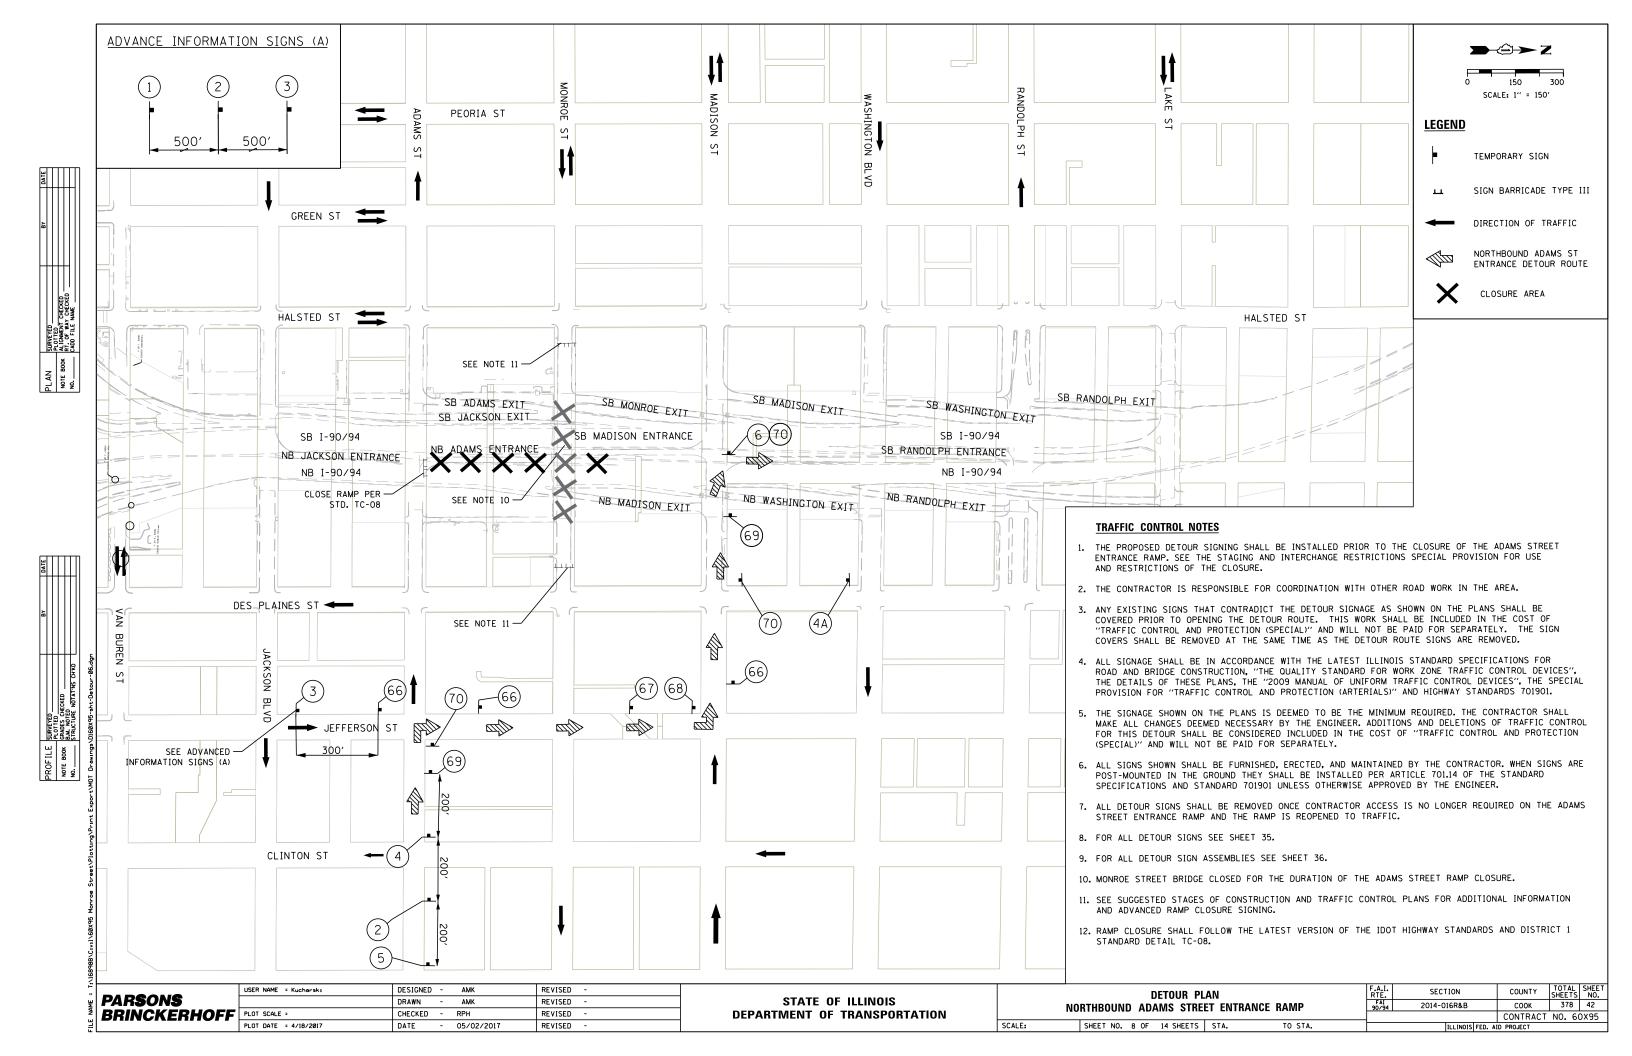

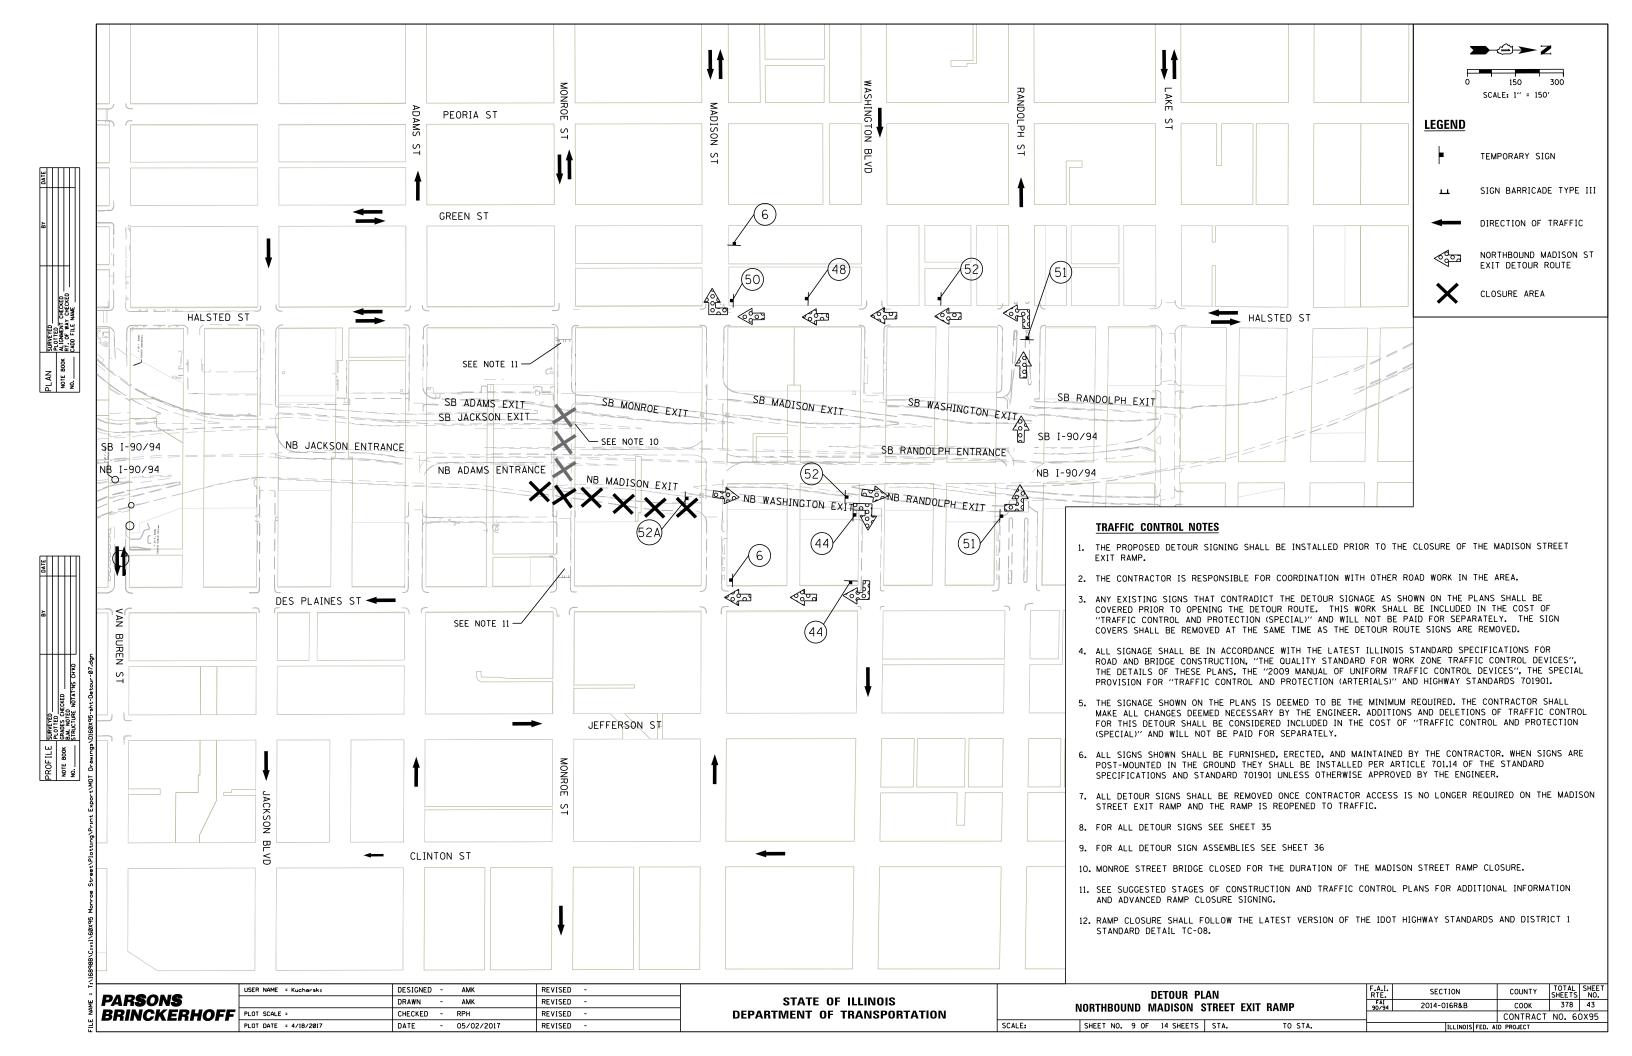

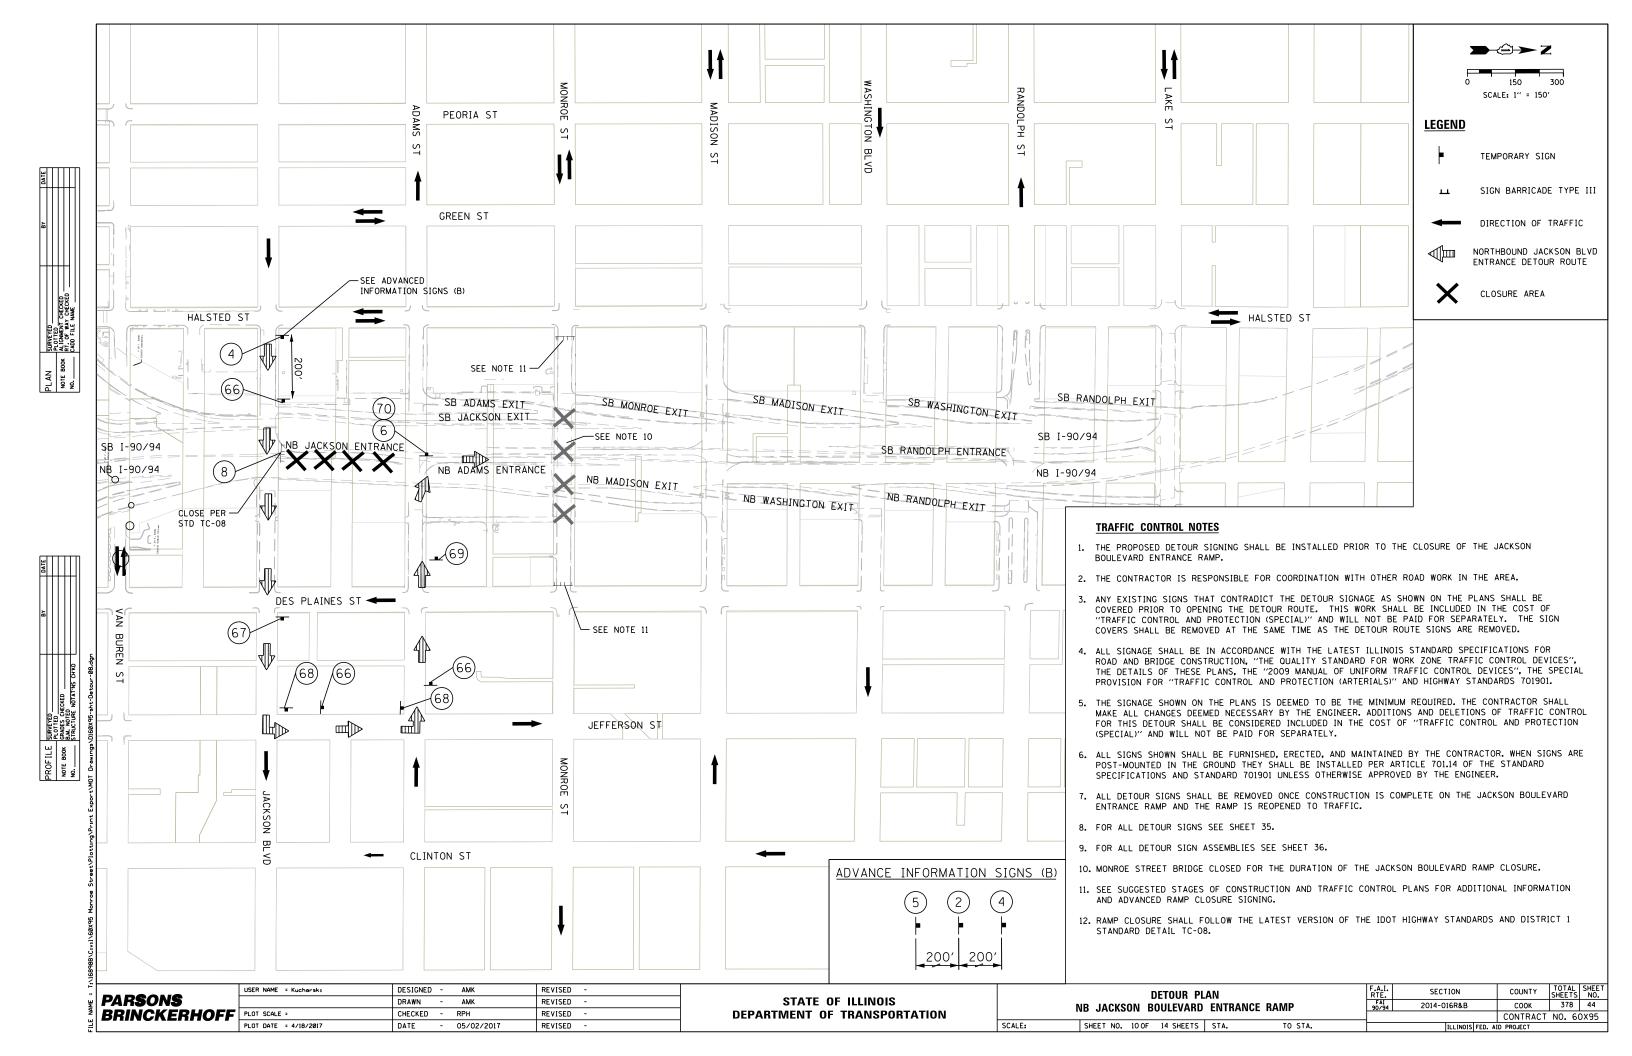

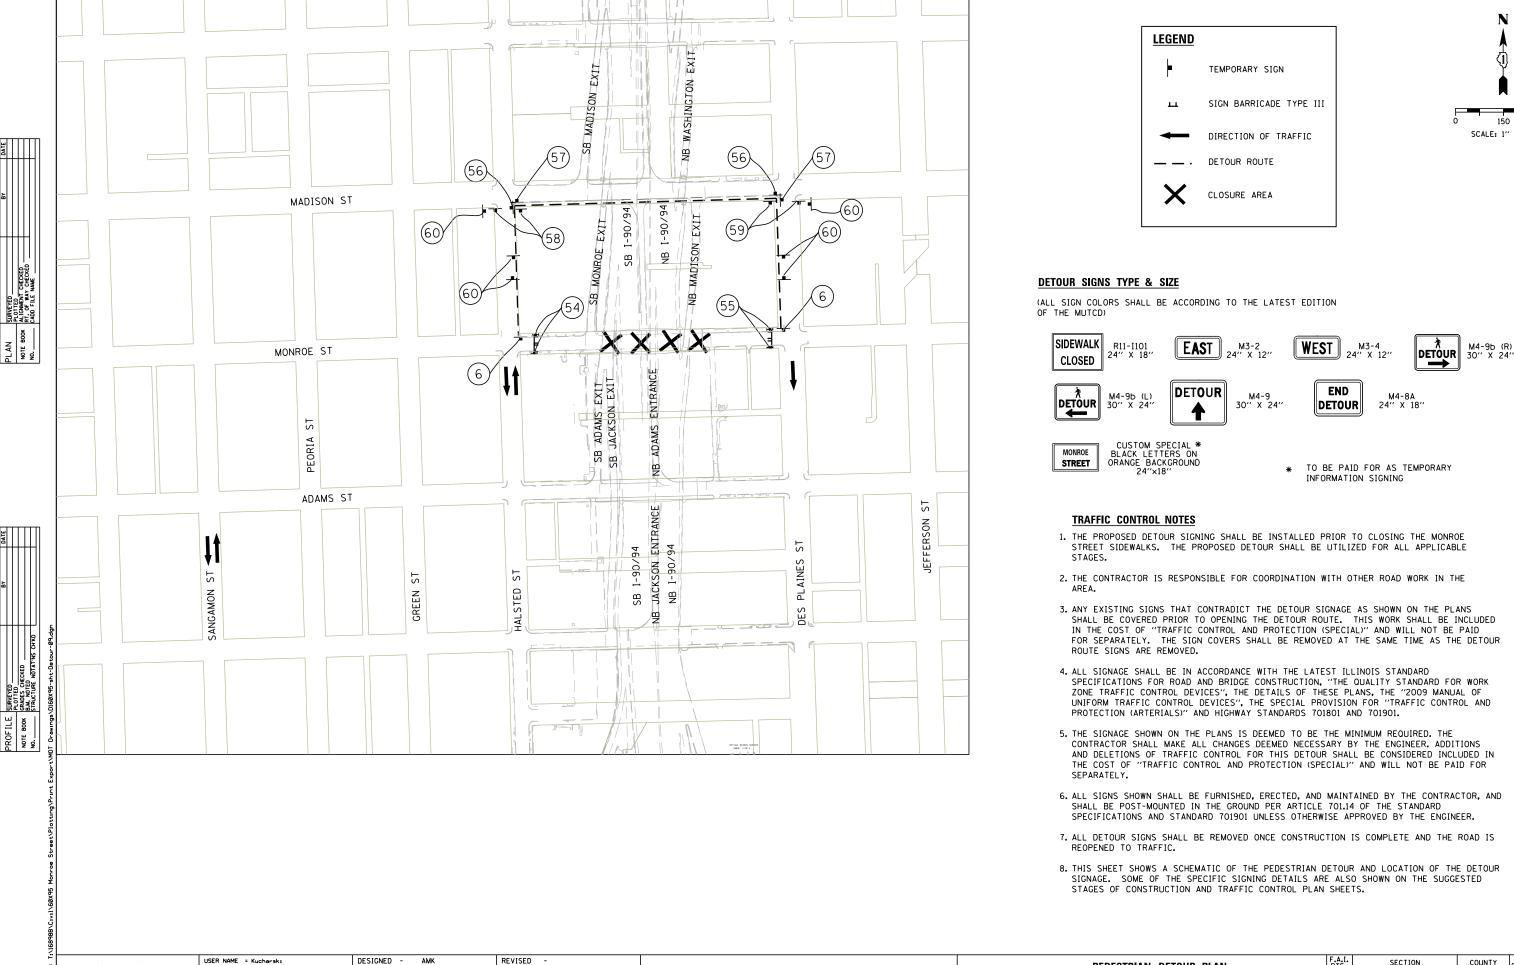

STATE OF ILLINOIS

DEPARTMENT OF TRANSPORTATION

PARSONS

BRINCKERHOFF PLOT SCALE =

PLOT DATE = 4/18/2017

DRAWN

DATE

CHECKED

AMK

- 05/02/2017

RPH

REVISED

REVISED


REVISED


SECTION COUNTY PEDESTRIAN DETOUR PLAN COOK 378 45 2014-016R&B MONROE STREET CONTRACT NO. 60X95 SCALE: SHEET NO. 11 OF 14 SHEETS STA. TO STA.

150

SCALE: 1" = 150"

300

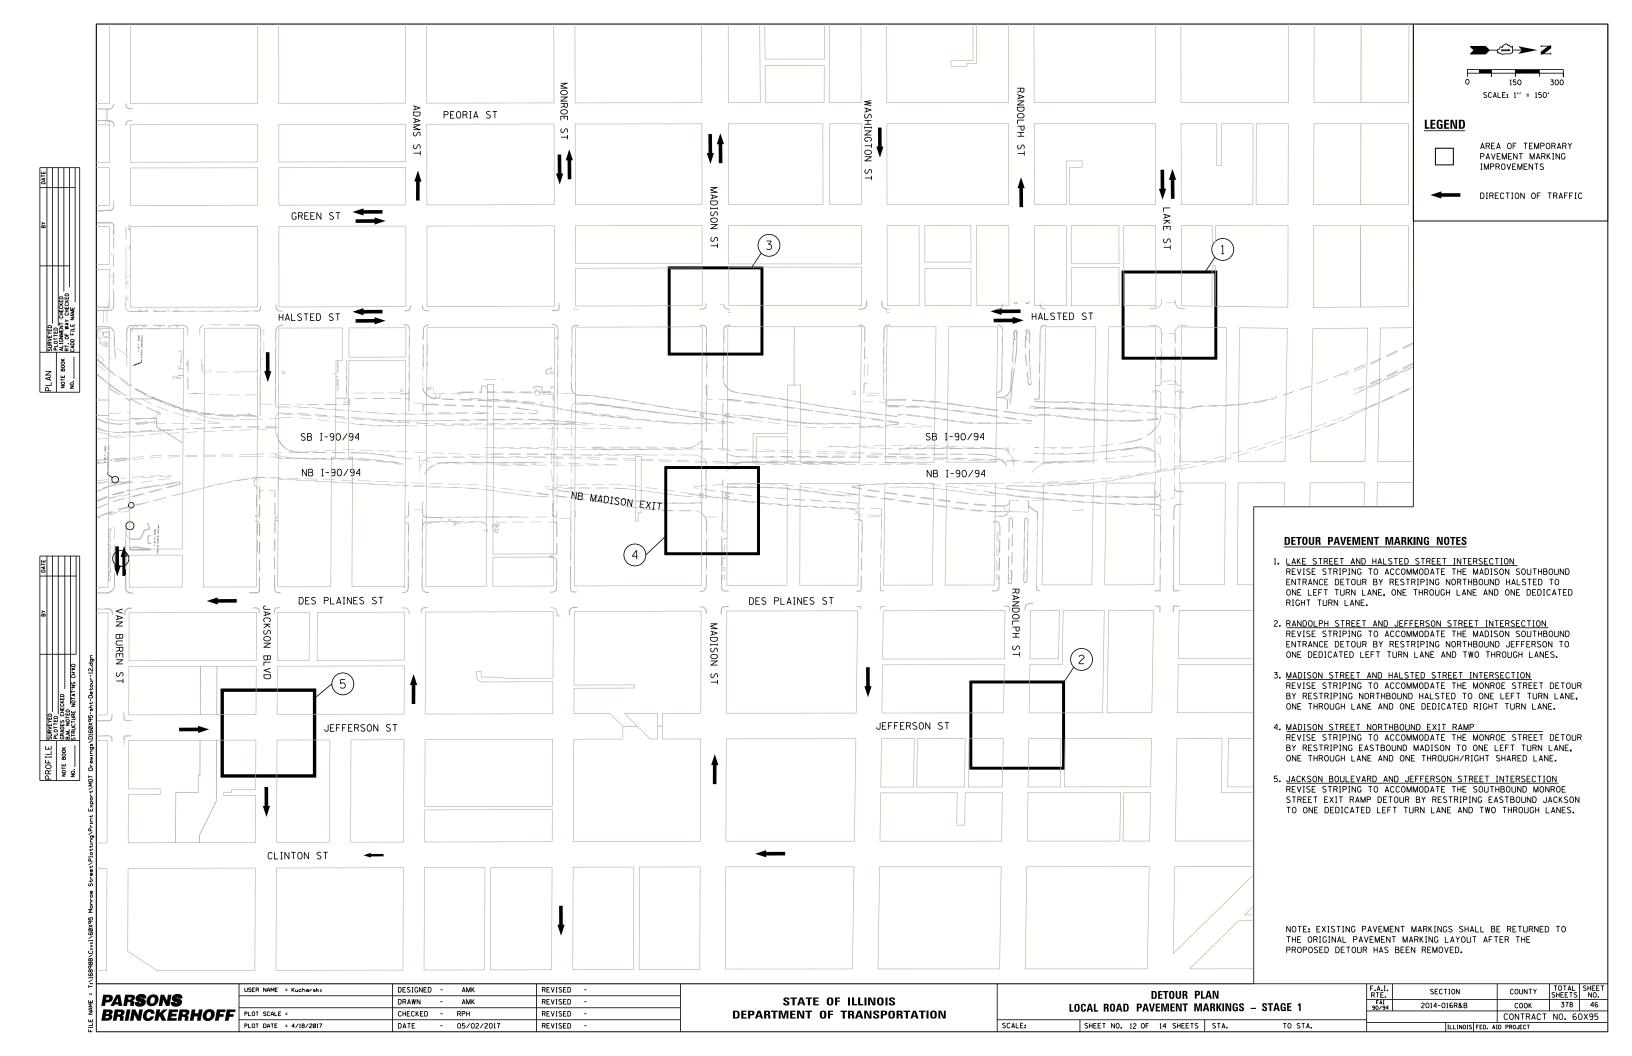

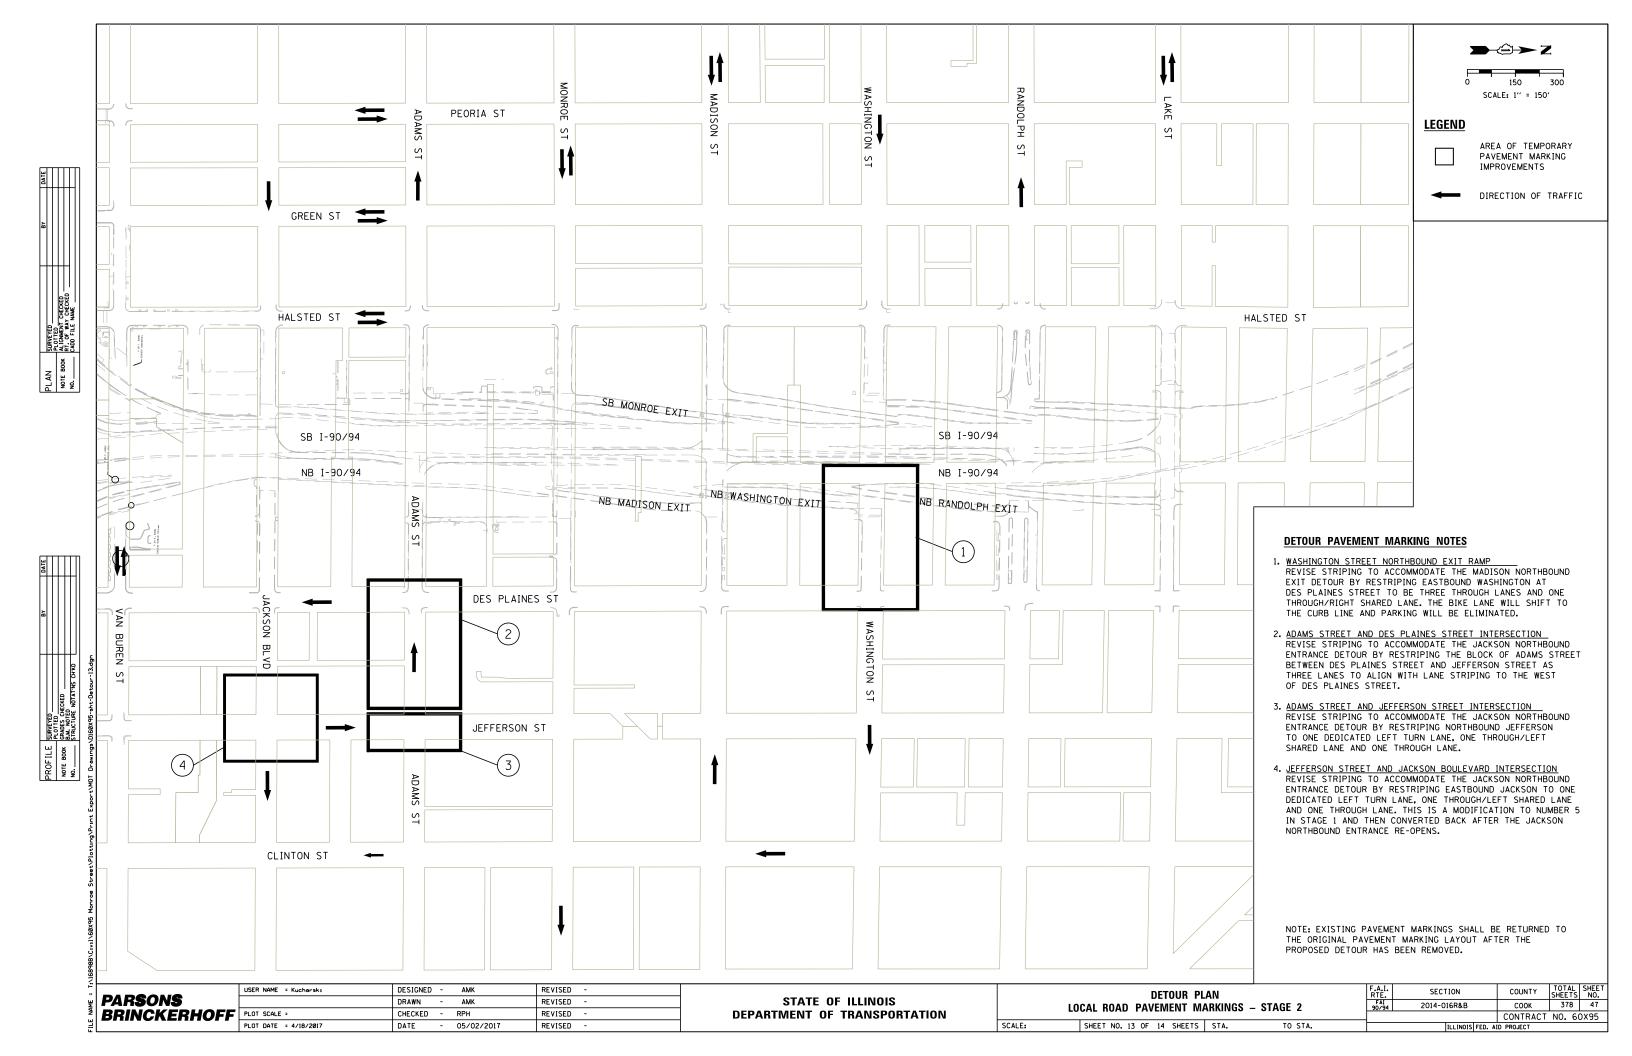

LOCAL ROAD PAVEMENT MARKING SCHEDULE

	THERMOPLASTIC PAVEMENT MARKING - LINE 4"	THERMOPLASTIC PAVEMENT MARKING - LETTERS AND SYMBOLS	POLYUREA PAVEMENT MARKING TYPE 1 - LINE 4"	POLYUREA PAVEMENT MARKING TYPE 1 - LINE 12"	POLYUREA PAVEMENT MARKING TYPE 1 - LETTERS AND SYMBOLS	PAVEMENT MARKING REMOVAL - WATER BLASTING
LOCATION	FOOT	SQ FOOT	FOOT	FOOT	SQ FOOT	SQ FOOT
LAKE STREET AND HALSTED STREET INTERSECTION	106		220		104	164
RANDOLPH STREET AND JEFFERSON STREET INTERSECTION	508	55				224
MADISON STREET AND HALSTED STREET INTERSECTION	324	55				163
MADISON STREET NB EXIT RAMP	203		153	200	55	422
JACKSON BOULEVARD AND JEFFERSON STREET INTERSECTION	396	52				239
WASHINGTON STREET NB EXIT RAMP	990	55				382
ADAMS STREET AND DES PLAINES STREET INTERSECTION	157					52
ADAMS STREET AND JEFFERSON STREET INTERSECTION		52				52
JEFFERSON STREET AND JACKSON BOULEVARD INTERSECTION		52				
TOTAL	2684	321	373	200	159	1698

NOTE: SUFFICIENT QUANTITIES FOR ONE PLACEMENT AND ONE REPLACEMENT OF LOCAL ROADWAY MARKINGS HAVE BEEN PROVIDED.

ВУ						
	SURVEYED	PLOTTED	GRADES CHECKED	B.M. NOTED	STRUCTURE NOTATINS CHIKD	
1	PROFILE SURVEYED		NOTE BOOK	101	ģ	


	Γ
PAR S ON S	r
BRINCKERHOFF	
	Γ

	USER NAME = donahuek1	DESIGNED	-	AMK	REVISED	-
		DRAWN	-	AMK	REVISED	-
OFF	PLOT SCALE =	CHECKED	-	RPH	REVISED	-
	PLOT DATE = 7/13/2017	DATE	-	07/14/2017	REVISED	-


STATE OF ILLINOIS
DEPARTMENT OF TRANSPORTATION

DETOUR PLAN	F.A.I. RTE.	SECTION	COUNTY	TOTAL SHEETS	
LOCAL ROAD PAVEMENT MARKINGS - SCHEDULE	FAI 90/94	2014-016R&B	COOK	378	48
			CONTRACT	NO. 60	X95
SHEET NO. 14 OF 14 SHEETS STA. TO STA.		ILLINOIS FED. AI	D PROJECT		



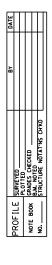



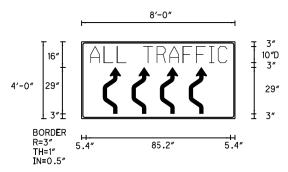

Panel Style: construction_guide.ssi
Dimensions are in inches.tenths
Letter locations are panel edge to lower left corner
M.U.T.C.D.: 2009 Edition

SIGN NUMBER	TIS 1				
WIDTH × HGHT.	8'-0" × 4'-0"				
BORDER WIDTH	1*				
CORNER RADIUS	3,				
MOUNTING	Ground				
BACKGROUND	TYPE: Reflective				
	COLOR: Orange				
LEGEND/BORDER	TYPE: Reflective				
	COLOR: Black				


SYMBOL	ROT	Х	Y	WID	НТ
W24_1bR	Ø	21.0	3	11.3	29
W24_1bR	Ø	39.0	3	11,3	29
W24_1bR	Ø	57.0	3	11.3	29
W24_1bR	Ø	75.0	3	11.3	29

LENGTH SERIES/SIZE

LETTER	POSITIONS	(X)

Α	L	L		Т	R	Α	F	F	I	С				D 2000
5.4	15.4	23.1	29.3	39.3	47	54.6	64.6	72.3	8Ø	83.8			85.2	10

SIGN DETAIL

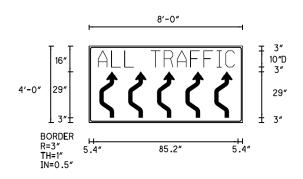

Panel Style: construction_guide.ssi
Dimensions are in inches.tenths
Letter locations are panel edge to lower left corner
M.U.T.C.D.: 2009 Edition

SIGN NUMBER	TIS 3
WIDTH × HGHT.	8'-0" × 4'-0"
BORDER WIDTH	1*
CORNER RADIUS	3"
MOUNTING	Ground
BACKGROUND	TYPE: Reflective
	COLOR: Orange
LEGEND/BORDER	TYPE: Reflective
	COLOR: Black

SYMBOL	ROT	Х	Υ	WID	HT
W24_1bR	Ø	15.2	3	11.3	29
W24_1bR	Ø	33.2	3	11.3	29
W24_1bR	Ø	51.2	3	11.3	29
W24_1bR	Ø	69.2	3	11.3	29
W24_1bR	Ø	87.2	3	11.3	29

LENGTH SERIES/SIZE

LETTER POSITIONS (X)


Α	L	L		T	R	Α	F	F	I	С				D 2000
5.4	15.4	23.1	29.3	39.3	47	54.6	64.6	72.3	8Ø	83.8			85.2	1Ø

PARSONS BRINCKERHOFF

USER NAME = Kucharskı	DESIGNED	-	•	MKW	REVISED	-	
	DRAWN	-	•	BAW	REVISED	-	
PLOT SCALE =	CHECKED	-	•	JLV	REVISED	-	
PLOT DATE = 4/18/2017	DATE	-	•	05/02/2017	REVISED	-	
•							

STATE OF ILLINOIS
DEPARTMENT OF TRANSPORTATION

SIGN DETAIL

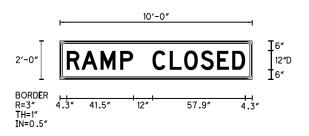


Panel Style: construction_guide.ssi
Dimensions are ininches.tenths
Letter locations are panel edge to lower left corner
M.U.T.C.D.: 2009 Edition

SIGN NUMBER	TIS 2
WIDTH × HGHT.	10'-0" × 2'-0"
BORDER WIDTH	1"
CORNER RADIUS	3"
MOUNTING	Overhead
BACKGROUND	TYPE: Reflective
	COLOR: Orange
LEGEND/BORDER	TYPE: Reflective
	COLOR: Black

SYMBOL	ROT	Х	Υ	WID	HT

	LETTER POSITIONS (X)											LENGT	H SERIES/SIZE	
R	Α	М	Р		С	L	0	S	E	D				D 2000
4.3	13.4	25.4	37.6	45.8	57.8	68.6	77.6	87.9	98.1	107.6			111.4	12

SUGGESTED	STAGING OF CONSTRUCT	F.A.I. RTE.	SECTION	COUNTY	TOTAL SHEETS	SHEET NO.		
	SIGN PANEL D	ETAILS		FAI 90/94	2014-016R&B	COOK	378	49
				CONTRACT	NO. 60	0X95		
SCALE: 1"=50"	SHEET NO. 1 OF 4 SHEETS	STA.	TO STA.		ILLINOIS FED. A	D PROJECT		

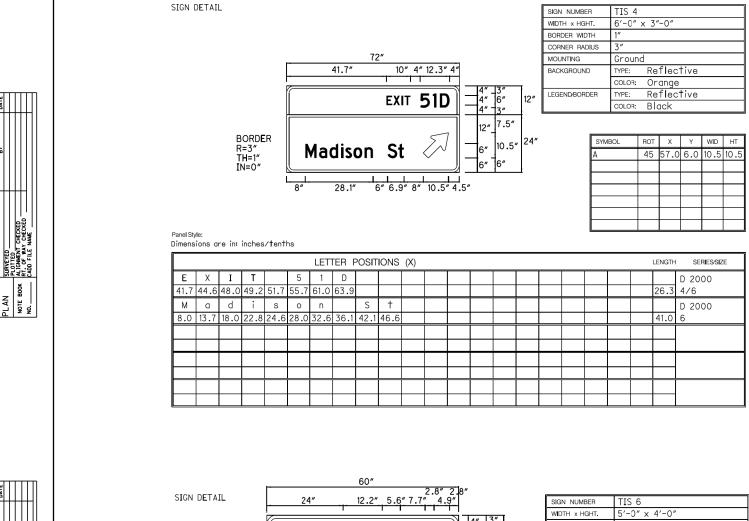


EXIT 51G

EAST

Jackson Blvd

STAY LEFT

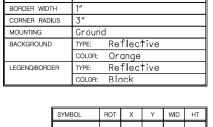

SYMBOL	ROT	Х	Υ	WID	HT

Panel Style: Dimensions are in: inches/tenths

USER NAME = Kucharskı

PLOT DATE = 4/18/2017

PARSONS

BRINCKERHOFF PLOT SCALE =

BORDER R=3" TH=1" IN=0"

						LET	ΓER F	POSIT	IONS	(X)						LENGTH	SERIES/SIZE
Ε	Χ	I	Т		5	1	G										E 2000
24.0	27.5	31.8	33.2	36.2	41.8	47.7	52.3									33.2	4/6
Ε	Α	S	T														D 2000
21.0	25.2	30.8	35.3													18.0	6
J	а	С	k	s	0	n		В	- 1	٧	d						D 2000
4.9	9.8	14.1	18.4	22.6	25.9	30.6	34.2	40.1	45.1	46.8	51.5					50.2	6
S	Т	Α	Υ		L	E	F	Т									D 2000
8.8	13.4	17.4	22.9	31.3	34.1	38.7	43.4	47.5								42.4	6

4.5"

4.5"

4.5″

36"

DESIGNED	-	•	MKW	REVISED	-	
DRAWN	-	•	BAW	REVISED	-	STA ⁻
CHECKED	-	•	JLV	REVISED	-	DEPARTMEN ⁻
DATE	-	•	05/02/2017	REVISED	-	

SUGGESTED STAGING OF CONSTRUCTION AND TRAFFIC CONTROL SIGN PANEL DETAILS SCALE: 1"=50' SHEET NO. 2 OF 4 SHEETS STA. TO STA.

COUNTY TOTAL SHEET NO.

COOK 378 50 SECTION 2014-016R&B CONTRACT NO. 60X95

Panel Style:

Dimens		re in:	inches	/tentl	าธ														
	LETTER POSITIONS (X) LENGTH															SERIES/SIZE			
Е	Χ	I	Т		5	1	F												D 2000
24.3	27.9	32.2	33.6	39.2	42.2	48.1	52.7											32.9	4/6
W	Ε	S	Т																D 2000
20.6	26.8	31.1	35.7															18.8	6
Α	d	а	m	S		S	†												D 2000
11.5	17.1	21.6	26.2	32.9	38.9	41.7	46.1											37.0	6
S	Т	Α	Υ		R	I	G	Н	T										D 2000
6.6	11.2	15.3	20.7	26.7	31.9	37.0	39.3	44.7	49.1									46.8	6

		+					
			LE	NGTH	SEI	RIES/SIZ	Έ
			3	2.9	D 20 4/6	00	
			1	8.8	D 20	00	
			3	7.0	D 20	00	
			4	6.8	D 20	00	
			T				

SIGN DETAIL

BORDER R=3" TH=1" IN=0"

EAST Washington Blvd **500 FEET** 40.2" | 6"| 15" | 5.4 16.9" 15" 6" 17.2" 16.9"

EXIT 51C

SIGN NUMBER TIS 5 BORDER WIDTH CORNER RADIUS 3' MOUNTING Ground BACKGROUND TYPE: Reflective COLOR: Orange
TYPE: Reflective LEGEND/BORDER color: Black

SYMBOL	ROT	Х	Υ	WID	HT

Panel Style: o in inchas/tanth

Dimens	ions ai	e in:	inches	/tent	ns														
	LETTER POSITIONS (X) LENGTH SERIESSI														SERIES/SIZE				
E	X	I	T		5	1	C 63.9											26.2	D 2000
41.8 E	44.7 A	48.1 S	49.3 T		55.6	01.1	63.9											26.2	4/6 D 2000
27.0	31.2	36.8	41.3															18.0	l
W	а	S	h	i	n	g	†	0	n		В	1	V	d					D 2000
5.4	11.2	15.4	19.0	23.7	25.9	30.3	34.6	37.4	42.0		51.6	56.5	58.2	63.0				61.2	16
5	0	0		F	Ε	E	Т												D 2000
16.9	22.1	27.6		37.9	42.5	47.2	51.4											38.2	12

SIGN DETAIL

BORDER R=3" TH=1" IN=0"

12.3" 5.6" 7.7" 4.5" EXIT 51F 4.5" **WEST** 4.5" Adams St 4.5" STAY RIGHT

6.6" 19.3" | 6" | 21.5"

"	12″	MOUNTING
"		BACKGROU
		LEGEND/BOR
	36″	

 SIGN NUMBER
 TIS 7

 WIDTH x HGHT.
 5'-0" x 4'-0"

Ground

BORDER WIDTH 1"

CORNER RADIUS 3"


SYMBOL	ROT	Х	Υ	WID	HT


TYPE: Reflective

COLOR: Orange
TYPE: Reflective

color: Black

ATE OF ILLINOIS NT OF TRANSPORTATION

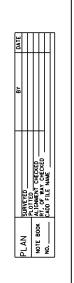

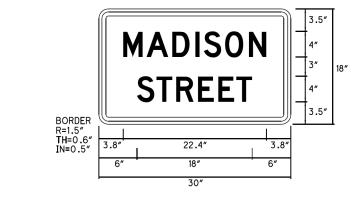


TTC 8	
2′-6″	× 1′-6″
0.6"	
1.5"	
GROUN	D
TYPE:	Reflective
COLOR:	Orange
TYPE:	Reflective
COLOR:	Black
	1.5" GROUN TYPE: COLOR: TYPE:

SYMBOL	ROT	Х	Υ	WID	HT

Panel Style: Dimensions are in: inches/tenths

SIGN DETAIL

	LETTER POSITIONS (X)														LENGTH	SERIES/SIZE			
М	Α	D	I	S	0	N													D 2000
3.8	7.5	11.5	15.1	16.4	19.8	23.5												22.4	4
S	Т	R	Ε	Ε	T														D 2000
6.0	9.1	12.1	15.5	18.7	21.5													18.0	4

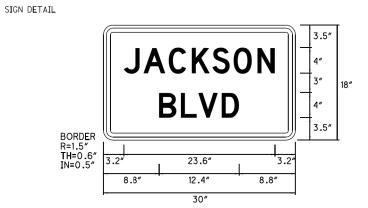

SIGN NUMBER	TIS 10	
WIDTH x HGHT.	2'-6"	× 1′-6″
BORDER WIDTH	0.6"	
CORNER RADIUS	1.5"	
MOUNTING	GROUN	D
BACKGROUND	TYPE:	Reflective
	COLOR:	Orange
LEGEND/BORDER	TYPE:	Reflective
	COLOR:	Black

SYMBOL	ROT	Х	Υ	WID	HT

Panel Style: Dimensions are in: inches/tenths

	LETTER POSITIONS (X)													LENGTH	LENGTH SERIES/SIZE				
J	Α	С	K	S	0	N													D 2000
3.2	6.3	10.3	13.9	17.1	20.4	24.1												23.6	4
В	L	٧	D																D 2000
8.8	12.2	14.9	18.5															12.4	4

PAR**S**ON**S** BRINCKERHOFF

L	USER NAME = Kucharskı	DESIGNED	-	•	MKW	REVISED	-
		DRAWN	-	•	BAW	REVISED	-
'[PLOT SCALE =	CHECKED	-	•	JLV	REVISED	-
	PLOT DATE = 4/18/2017	DATE	-	•	05/02/2017	REVISED	-

STATE OF ILLINOIS
DEPARTMENT OF TRANSPORTATION

BORDER		ONRO STREE		3.5" 4" 3" 4" 3.5"	18″
R=1.5" TH=0.6" IN=0.5"	4.5"	21" 18" 30"	4.5"		-

SIGN NUMBER	TIS 9	
WIDTH x HGHT.	2'-6"	× 1′-6″
BORDER WIDTH	0.6"	
CORNER RADIUS	1.5"	
MOUNTING	GROUN	D
BACKGROUND	TYPE:	Reflective
	COLOR:	Green
LEGEND/BORDER	TYPE:	Reflec t ive
	COLOR:	Whi t e


ROT	Х	Υ	WID	HT
	ROT	ROT X	ROT X Y	ROT X Y WID

PanelStyle: Dimensions are in: inches/tenths

SIGN DETAIL

	LETTER POSITIONS (X) LENGTH SERIESSIZ													SERIES/SIZE				
М	0	N	R	0	Е													D 2000
4.5	8.5	12.3	15.9	19.3	23.0												21.0	4
S	Т	R	E	E	Т													D 2000
6.0	9.1	12.1	15.5	18.7	21.5												18.0	4

SIGN DETAIL

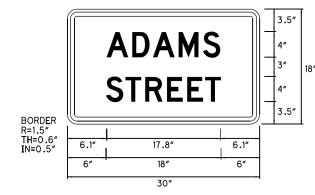

SIGN NUMBER	TIS 11	
WIDTH x HGHT.	2'-6"	× 1′-6″
BORDER WIDTH	0.6"	
CORNER RADIUS	1.5"	
MOUNTING	GROUN	D
BACKGROUND	TYPE:	Reflec t ive
	COLOR:	Orange
LEGEND/BORDER	TYPE:	Reflec t ive
	COLOR:	Black

SYMBOL	ROT	Х	Υ	WID	HT

Panel Style:
Dimensions are in: inches/tenths

Dilliella	iono di	0 1111	11101103	/ TOIII	10														
	LETTER POSITIONS (X) LENGTH SERIESSIZE														SERIES/SIZE				
Α	D	Α	М	S															D 2000
6.1	10.1	13.4	17.4	21.2														17.8	4
S	Т	R	Ε	Ε	Т														D 2000
6.0	9.1	12.1	15.5	18.7	21.5													18.0	4

SUGGESTED	STAGING OF CONSTRUCT	TON AND TRAFFI	C CONTROL	F.A.I. RTE.	SECTION	COUNTY	TOTAL SHEETS	SHEE NO.
	SIGN PANEL D	FAI 90/94	2014-016R&B	соок	378	51		
				CONTRACT	NO. 60	0X95		
SCALE: 1"=50"	SHEET NO. 3 OF 4 SHEETS	STA.		ILLINOIS FED.	AID PROJECT			

BORDI R=3" TH=1" IN=0.

SIGN DETAIL

MONROE EB CLOSED USE JACKSON

							_)
10.4"	52.3"	10′	14.7	10″	48	.3″ 10	.3
31.9"	23.2"	10"		59	9.1″	31.8	"
	-		156"				

SIGN NUMBER TIS 12

WIDTH x HGHT. 13'-0" x 3'-6"

BORDER WIDTH 1'

CORNER RADIUS 3'

MOUNTING Overhead

BACKGROUND TYPE: Reflective

COLOR: Orange

LEGEND/BORDER TYPE: Reflective

COLOR: Black

SYMBOL	ROT	Х	Y	WID	HT

LENGTH SERIES/SIZE

Panel Style: construction_guide.ssi
Dimensions are in inches.tenths
Letter locations are panel edge to lower left corner
M.U.T.C.D.: 2009 Edition

LETTER POSITIONS (X)


М	0	N	R	0	E		E	В		С	L	0	S	E	D	D 2000
10.4	20.4	29.7	38.9	47.2	56.5	66.5	72.7	80.6	90.6	97.4	106.4	113.9	122.5	131.0	138.9	10
U	S	E		J	А	С	K	S	0	N						D 2000
31.9	40.4	48.9	58.9	65.1	73.0	82.8	91.8	99.9	108.1	117.4						1Ø

10" 7.5" 10"

7.5"

SIGN DETAIL

BORDER R=3" TH=1" IN=0.0"

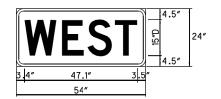

SIGN NUMBER	TIS 14
WIDTH × HGHT.	4'-6" × 2'-0"
BORDER WIDTH	1"
CORNER RADIUS	3 "
MOUNTING	Overlay
BACKGROUND	TYPE: Reflective
	COLOR: Orange
LEGEND/BORDER	TYPE: Reflective
	COLOR: Black

ROT	Χ	Υ	WID	HT
	ROT	ROT X	ROT X Y	ROT X Y WID

LENGTH SERIES/SIZE

Panel Style: construction_guide.ssi
Dimensions are in inches.tenths
Letter locations are panel edge to lower left corner
M.U.T.C.D.: 2009 Edition

LETTER POSITIONS (X)

					 	 . (-7				
W	E	S	Т								D 2000
3.4	19.0	29.8	41.2							47.1	15

PARSONS BRINCKERHOFF

	USER NAME = Kucharski	DESIGNED	-	٠	MKW	REVISED	-
		DRAWN	-	•	BAW	REVISED	-
•	PLOT SCALE =	CHECKED	-	•	JLV	REVISED	-
	PLOT DATE = 4/18/2017	DATE	-	•	05/02/2017	REVISED	-

STATE OF ILLINOIS
DEPARTMENT OF TRANSPORTATION

SIGN DETAIL

BORDER

MONROE WEST USE ADAMS MONROE EAST USE JACKSON 3.3" 8" 4.5" 4.5" 4.5"

7.5″	41.9"	7.5″	25.1"	7.5″
21.7"	13.9" 6"	26.7″	2	1.7″
8"	41.9″	8"	24.1″	8"
17.3″	13.9" 6"	35.5″	11	7.3″
		90"		

Panel Style: construction_guide.ssi
Dimensions are in inches.tenths
Letter locations are panel edge to lower left corner
M.U.T.C.D.: 2009 Edition

SIGN NUMBER TIS 13 WIDTH x HGHT. 9'-6" x 2'-0" BORDER WIDTH 1" CORNER RADIUS 3" MOUNTING Ground BACKGROUND TYPE: Reflective COLOR: Orange LEGEND/BORDER TYPE: Reflective COLOR: Black

ROT	Χ	Υ	WID	H
	ROT	ROT X	ROT X Y	ROT X Y WID

LENGTH SERIES/SIZE

LETTER POSITIONS (X)

										(- ')				
М	0	N	R	0	E		W	E	S	Т				D 2000
7.5	15.5	23.0	30.3	37.0	44.4	52.4	57.4	65.7	71.4	77.5			75.0	8
U	S	E		Α	D	Α	М	S						D 2000
21.7	26.8	31.9	38.9	41.6	47.6	52.5	58.5	64.2					46.6	6
М	0	N	R	0	E		E	Α	S	Т				D 2000
8.0	16.0	23.5	30.8	37.5	44.9	52.9	57.9	63.5	70.9	77.0			74.0	8
U	S	E		J	А	С	K	S	0	N				D 2000
17.3	22.4	27.5	33.5	37.2	42.0	47.8	53.2	58.0	63.0	68.6			55.4	6

SUGGESTED STAGING OF CONSTRUCTION AND TRAFFIC CONTROL

TEMPORARY INFORMATION SIGNING

SCALE: 1"=50" SHEET NO. 4 OF 4 SHEETS STA. TO STA.

SUGGESTED STAGING OF CONSTRUCTION AND TRAFFIC CONTROL

RTE. SECTION COUNTY SHEETS NO.

RTE. SECTION COUNTY SHEETS NO.

RTE. SECTION COUNTY SHEETS NO.

RTE. SECTION COUNTY SHEETS NO.

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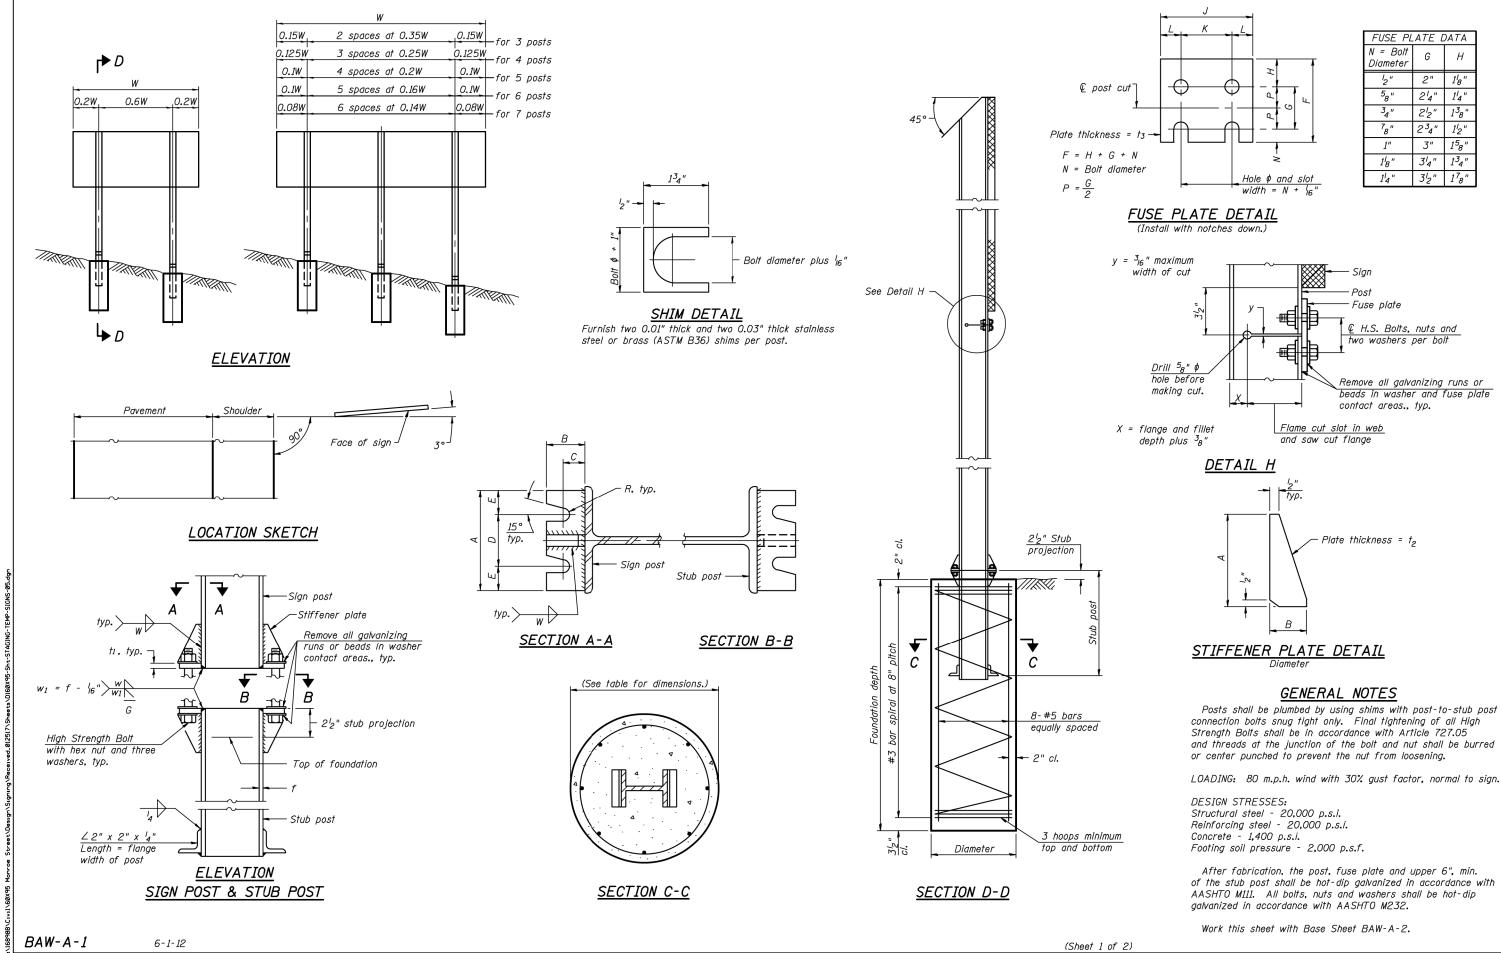
RTE. SECTION COUNTY SHEETS NO.

RTE. SECTION COUNTY SHEETS NO.

RTE. SECTION COUNTY SHEETS NO.

RTE. SECTION COUNTY SHEETS NO.

RTE. SECTION COUNTY SHEETS NO



PARSONS BRINCKERHOFF PLOT SCALE =

USER NAME = Kucharski DESIGNED -REVISED DRAWN REVISED CHECKED -REVISED PLOT DATE = 4/18/2017 REVISED DATE

STATE OF ILLINOIS **DEPARTMENT OF TRANSPORTATION**

BREAK AWAY WIDE FLANGE STEEL SIGN POST DETAIL SHEET NO. OF SHEETS STA.

SCALE:

COUNTY TOTAL SHEET NO.

COOK 378 53 SECTION 2014-016R&B CONTRACT NO. 60X95 TO STA.

FUSE PLATE DATA

G

24" 14"

212" 138"

 $2^{3}_{4}" | 1_{2}"$

3" 1⁵8"

34" 134"

3½" 178"

N = Bolt

Diameter

18"

14"

€ H.S. Bolts, nuts and

Remove all galvanizing runs or

beads in washer and fuse plate


two washers per bolt

Post Fuse plate

			CONCR	RETE FOUNDAT	ION TABL	.E				P0.	ST TO	STUB	POST (CONNEC	TION L	DATA			FU:	SE PLA	ATE DA	1TA
POST		Foundation		Re	einforceme	nt		Stub Post														
7 007	Diameter	* Minimum Depth	Concrete (1) cu. yds.)	Vertical Bars Length	Bar S Diameter	Spirals Length	Ibs. 2	Length	Bolt Size	Α	В	С	D	Ε	†1	† ₂	R	W	J	K	L	†3
W6x9	2'-0"	6'-0"	0.70	5′-9"	1'-8 ^l 2"	79′-0"	78	2'-3"	⁵ 8" x 3 ¹ 4"	6"	24"	14"	31/2"	14"	34"	2"	″32 "	4"	4"	24"	78"	4"
W6x15	2'-0"	6′-0"	0.70	5′-9"	1'-812"	79′-0"	78	2'-6"	⁵ 8" x 3 ¹ 4"	6"	24"	14"	31/2"	14"	34"	2"	″32 ″	4"	6"	3/2"	14"	³ 8"
W8x18	2′-0"	6′-0"	0.70	5′-9"	1'-8 ¹ 2"	79′-0"	78	2'-6"	3 ₄ " x 3 ³ 4"	6"	21/2"	138"	34"	138"	1"	2"	1332 "	⁵ 16 "	54"	234"	14"	38"
W10x22	2′-6"	6′-6"	1.18	6′-3"	2'-212"	105′-0"	92	3'-0"	3 ₄ " x 3 ³ 4"	6"	21/2"	138"	34"	138"	1"	12"	1332 "	⁵ 16 "	534"	234"	1/2"	12"
W10x26	2′-6"	7′-0"	1.27	6′-9"	2'-212"	112'-0"	98	3'-0"	⁷ 8" x 4"	7"	234"	1/2"	4"	12"	1"	34"	15 ₃₂ "	38"	5 ³ 4"	234"	1/2"	⁵ 8"
W12x26	2′-6"	7′-9"	1.41	7′-6"	2'-212"	119′-0"	107	3'-0"	⁷ 8" x 4"	7"	234"	12"	4"	12"	1"	³ 4"	1532 "	38"	62"	32"	1/2"	⁵ 8"
W14x30	3′-0"	7′-3"	1.90	7′-0"	2'-812"	145′-0"	113	3'-0"	⁷ 8" x 4"	7"	234"	1'2"	4"	1'2"	1"	34"	1532 "	38"	634"	32"	1 ⁵ 8"	2"
W14x38	3′-0"	8′-0"	2.09	7′-9"	2'-812"	153′-0"	122	3′-6"	1" x 4 ¹ 2"	71/2"	3"	134"	4"	134"	14"	34"	1732 "	38"	6 ³ 4"	31/2"	1 ⁵ 8"	12"
W16x45	3′-0"	8′-6"	2.23	8′-3"	2'-812"	162'-0"	130	3′-6"	1" x 41/2"	7/2"	3"	134"	4"	134"	14"	34"	17, "	38"	7"	32"	134"	12"

^{*}Dimensional changes required for varying site conditions shall be approved by the Engineer.

		FUSE PLATE BOLT SIZE Sign Height																			
POST	1	1						1					1					I	T	l	
	4'-0"	5′-0"	6′-0"	7′-0"	8′-0"	9′-0"	10′-0"	11'-0"	12'-0"	13′-0"	14′-0"	15′-0"	16′-0"	17'-0''	18'-0''	19'-0''	20′-0′′	21'-0''	22'-0"	23'-0''	24'-0''
W6x9	¹ 2" x 1 ¹ 2"	½" x 1½"	'2" x 1'2"	'2" x 1'2"																	
W6x15							3 ₄ " x 2"	³ 4" x 2"	3 ₄ " x 2"												
W8x18	¹ 2" x 1 ³ 4"	¹ 2" x 1 ³ 4"	$^{l}_{2}$ " \times 1 $^{3}_{4}$ "	½" x 1 ³ 4"	⁵ 8" x 2"	⁵ 8" x 2"	3 ₄ " x 2"	³ 4" x 2"	3 ₄ " x 2"	3 ₄ " x 2"		—									
W10x22	¹ 2" x 2"	¹ 2" x 2"	¹ 2" x 2"	¹ 2" x 2"	¹ 2" x 2"	⁵ 8" x 2"	⁵ 8" x 2"	3 _{4"} x 21 _{4"}	3 _{4"} x 21 _{4"}	3 ₄ " x 21 ₄ "	3 ₄ " x 2 ¹ 4"	3 _{4"} x 21 _{4"}	3 ₄ " x 21 ₄ "								
W10x26	¹ 2" x 2"	¹ 2" x 2"	½" x 2"	½" x 2"	½" x 2"	⁵ 8" x 2 ¹ 4"	⁵ 8" x 2 ¹ 4"	3 _{4"} x 2 ¹ 2"	3 _{4"} x 2½"	3 ₄ " x 2 ¹ 2"	3 _{4"} x 2 ¹ 2"	3 ₄ " x 2½"	3 ₄ " x 21 ₂ "	34" x 212"							
W12x26	¹ 2" x 2"	¹ 2" x 2"	½" x 2"	½" x 2"	½" x 2"	⁵ 8" x 2 ¹ 4"	⁵ 8" x 2 ¹ 4"	³ 4" x 2 ¹ 2"	3 ₄ " x 2½"	3 ₄ " x 2½"	3 ₄ " x 2 ¹ 2"	3 ₄ " x 2½"	3 ₄ " x 2 ¹ 2"	3 ₄ " x 2½"	3 ₄ " x 2 ¹ 2"						
W14x30	¹ 2" x 2"	¹ 2" x 2"	¹ 2" x 2"	¹ 2" x 2"	¹ 2" x 2"	⁵ 8" x 2"	⁵ 8" x 2"	3 ₄ " x 21 ₄ "	3 _{4"} x 21 _{4"}	3 ₄ " x 21 ₄ "	3 ₄ " x 21 ₄ "	3 _{4"} x 21 _{4"}	3 ₄ " x 21 ₄ "	3 ₄ " x 2 ¹ ₄ "	34" x 214"	34" x 214"	3 ₄ " x 2 ¹ ₄ "				
W14x38	¹ 2" x 2"	¹ 2" x 2"	¹ 2" x 2"	¹ 2" x 2"	¹ 2" x 2"	⁵ 8" x 2 ¹ 4"	⁵ 8" x 2 ¹ 4"	3 ₄ " x 21 ₂ "	³ 4" x 2 ¹ 2"	3 ₄ " x 21 ₂ "	³ 4" x 2 ¹ 2"	⁷ 8" x 2½"	⁷ 8" x 2 ¹ 2"	1" x 2 ³ 4"	1" x 2 ³ 4"	1" x 2 ³ 4"	1" x 2 ³ 4"	1" x 2 ³ 4"	1" x 2 ³ 4"	1" x 2 ³ 4"	1" x 2 ³ 4"
W16x45		½" x 2"	2" x 2"	2" x 2"	½" x 2"	½" x 2"	½" x 2"	⁵ 8" x 2 ¹ 4"	⁵ 8" x 2 ¹ 4"	⁵ 8" x 2 ¹ 4"	³ 4" x 2½"	³ 4" x 2 ¹ 2"	⁷ 8" x 2 ¹ 2"	⁷ 8" x 2 ¹ 2"	⁷ 8" x 2 ¹ 2"	1" x 2 ³ 4"	1" x 23 ₄ "	1" x 234"	1" x 2 ³ 4"	1" x 23 ₄ "	1" x 23 ₄ "

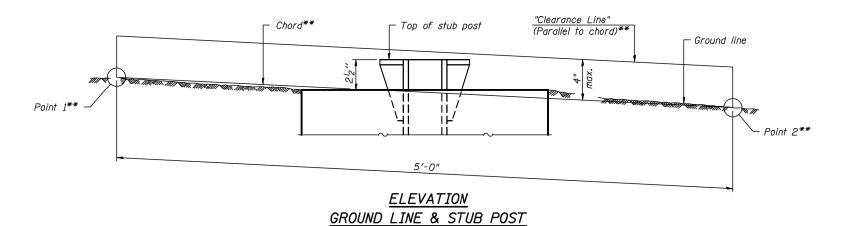

- Quantity includes all concrete necessary for one foundation.
- ② Includes reinforcement bars and spiral hooping for one foundation.

** For all "Point I" and "Point 2" locations, "Clearance Line" must be at or above top of stub post.

BAW-A-2 6-1-12

PAR**S**ON**S** BRINCKERHOFF

	USER NAME = Kucharski	DESIGNED - ·	REVISED -
		DRAWN -	REVISED -
•	PLOT SCALE =	CHECKED - ·	REVISED -
	PLOT DATE = 4/18/2017	DATE - ·	REVISED -

STATE OF ILLINOIS
DEPARTMENT OF TRANSPORTATION

SCALE:

	(S	heet 2 of	2)						
	BREAK A	AWAY WID	E FLANGE	F.A.I. RTE.	SECTION	COUNTY	TOTAL SHEETS	SHEE'	
STEEL SIGN POST DETAIL					FAI 90/94	2014-016R&B	соок	378	54
		SIGN FUS					CONTRACT	NO. 60	0X95
	SHEET NO. OF	SHEETS	STA.	TO STA.		ILLINOIS FED. A	ID PROJECT		

STAGING SCHEDULE

	TEMPORARY CONCRETE BARIER	BARRIER WALL REFLECTORS, TYPE C	RELOCATE TEMPORARY CONCRETE BARRIER	PINNING TEMPORARY CONCRETE BARRIER	IMPACT ATTENUATORS, TEMPORARY (FULLY REDIRECTIVE, NARROW) TEST LEVEL 3	IMPACT ATTENUATORS, RELOCATE (FULLY REDIRECTIVE) TEST LEVEL 3	TEMPORARY EPOXY PAVEMENT MARKING - LINE 4"	TEMPORARY EPOXY PAVEMENT MARKING - LINE 5"	TEMPORARY EPOXY PAVEMENT MARKING - LINE 8"	TEMPORARY EPOXY PAVEMENT MARKING - LINE 12"	TEMPORARY ACCESS (COMMERCIAL ENTRANCE)	TEMPORARY INFORMATION SIGNING	PAVEMENT MARKING REMOVAL - WATER BLASTING	TEMPORARY EPOXY PAVEMENT MARKINGS - LETTERS AND SYMBOLS	TEMPORARY PAVEMENT MARKING - LINE 6"	SIGN PANEL OVERLAY
LOCATION	FOOT	EACH	FOOT	EACH	EACH	EACH	FOOT	FOOT	FOOT	FOOT	EACH	SQ FT	SQ FT	SQ FT	FOOT	SQ FT
MONROE STREET BRIDGE	175	14					546				4	230	309			
STAGE 1A	1037.5	83		78	2		4574	2709	6949	100		373	11239	82		9
STAGE 1A-1	275	22										46				
STAGE 1B							2032	2438	7774	304			7344	41		
STAGE 1B-1		18	225	30	1				732			118				
STAGE 2A	1387.5	129	225	246	1	1	5405	1846	6658	406		390	488		908	
STAGE 2B		28	350	42		1							10313		608	
STAGE 3				129									41	21		
TOTAL	2875	294	800	525	4	2	12557	6993	22113	810	4	1157	29734	144	1516	9

NOTES

- 1. ALL TEMPORARY PAVEMENT MARKINGS SHOWING DETERIORATION AFTER 7 DAYS
 SHALL BE REPLACED BY THE CONTRACTOR AS DIRECTED BY THE ENGINEER. SUFFICIENT
 OUANTITIES FOR ONE PLACEMENT AND ONE REPLACEMENT OF MARKINGS HAVE BEEN
 PROVIDED FOR EACH STAGE.
- 2. WATER BLASTING QUANTITIES INCLUDE SUFFICIENT QUANTITIES FOR TWO FULL TEMPORARY PAVEMENT REMOVALS.
- 3. WATER BLASTING REMOVAL QUANTITIES SHOWN IN THE STAGE MARKINGS ARE PLACED. EXISTING SOUTHBOUND MARKING REMOVAL QUANTITIES INCLUDED IN STAGE 1A. EXISTING NORTHBOUND MARKING REMOVAL QUANTITIES INCLUDED IN STAGE 2A.

PINNING TEMPORARY CONCRETE BARRIER

	BEGIN		END	NUMBER OF			
STAGE	STATION	RT / LT	STATION	TRANSITIONS	ALIGNMENT	DESCRIPTION	PINS
1A	0031+35	RT	0032+94	2	E-KDR-SB		39
1A	0031+23	RT	0031+35		E-KDR-SB	TRANSITION	3
1A	0032+94	RT	0033+07		E-KDR-SB	TRANSITION	3
1A	0031+36	LT	0032+55	1	E-KDR-SB		30
1A	0032+55	LT	0032+67		E-KDR-SB	TRANSITION	3
1B-1	0031+84	LT	0033+08	0	E-KDR-SB		30
2A	0031+42	LT	0034+35	1	E-KDR-SB		72
2A	0034+35	LT	0034+48		E-KDR-SB	TRANSITION	3
2A	0031+48	LT	0034+09	1	E-KDR-SB		63
2A	0034+09	LT	0034+22		E-KDR-SB	TRANSITION	3
2A	0031+49	LT	0034+10	1	E-KDR-SB		63
2A	0034+10	LT	0034+23		E-KDR-SB	TRANSITION	3
2A	0031+57	RT	0032+88	2	E-KDR-NB		33
2A	0031+45	RT	0031+57		E-KDR-NB	TRANSITION	3
2A	0032+88	RT	0033+01		E-KDR-NB	TRANSITION	3
2B	0030+32	RT	0031+87	1	E-KDR-NB		39
2B	0030+20	RT	0030+32		E-KDR-NB	TRANSITION	3
PERMANENT PINNING							
3	0031+62	LT	0034+01	0	E-KDR-SB		60
3	0030+54	LT	0031+83	0	E-KDR-SB		33
3	0030+42	LT	0031+83	0	E-KDR-SB		36
						TOTAL	525

AA BA	''NS CH'KD	
SURVEYED	NOTE BOOK GRADES CHECKED NO. STRUCTURE NOTATINS CHIKD	
PROFILE SURVEYED_	NOTE BOOK NO.	


PARSONS BRINCKERHOFF


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		DRAWN -	· AMK	REVISED -
-	PLOT SCALE =	CHECKED -	RPH	REVISED -
	PLOT DATE = 7/13/2017	DATE -	07/14/2017	REVISED -

STATE OF ILLINOIS
DEPARTMENT OF TRANSPORTATION

SUGGESTED	STAGES OF	CONSTRUCTION	AND TRAFFIC	CONTROL PLAN	F					
	SCHEDULE									
SCALE: NONE	SHEET NO.	1 OF 1 SHEETS	STA.	TO STA.	-					

F.A.I. RTE.	SECTION		COUNTY	TOTAL SHEETS	SHEE NO.
FAI 90/94	2014-016R&B	COOK	378	5	
			CONTRACT	NO. 60	0X95
	ILLINOIS	FED. AI	D PROJECT		

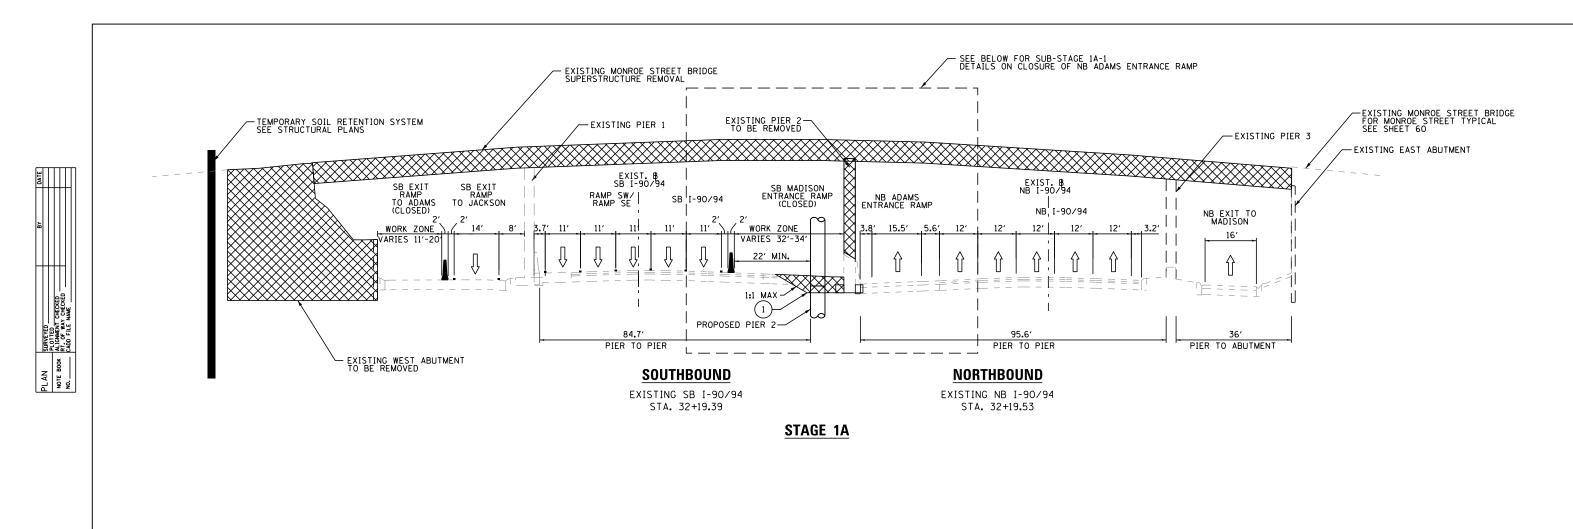

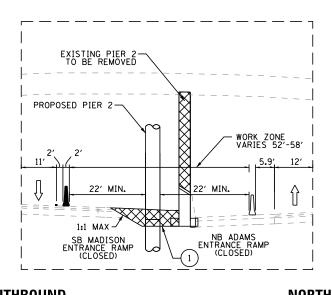

SOUTHBOUND

NORTHBOUND

STA. 32+19.53

EXISTING SB I-90/94 EXISTING NB I-90/94 STA. 32+19.39

STAGE 1A-1

NB ADAMS ENTRANCE RAMP TEMPORARY CLOSURE

P/ Bl

	USER NAME = Kucharskı	DESIGNED	-	AMK	REVISED	-
PAR SONS		DRAWN	-	AMK	REVISED	-
BRINCKERHOFF	PLOT SCALE =	CHECKED	-	RPH	REVISED	-
	PLOT DATE = 4/18/2017	DATE	_	05/02/2017	REVISED	-

STATE OF ILLINOIS **DEPARTMENT OF TRANSPORTATION**

							TRAFFIC CONTROL PLAN S 1A AND 1A-1
SCALE:	SHEET NO.	1	OF	5	SHEETS	STA.	TO STA.

	F.A.I. RTE.	SECTION	COUNTY	TOTAL SHEETS	SHEET NO.			
	FAI 90/94	2014-016R&B	соок	56				
			CONTRACT NO. 60X95					
TILLINOIS FED. AID PROJECT								

LEGEND


WORK ZONE


TEMPORARY
PAVEMENT MARKING

TEMPORARY CONCRETE BARRIER - UNPINNED


TEMPORARY CONCRETE

BARRIER - PINNED DIRECTION OF TRAFFIC PROPOSED PAVEMENT

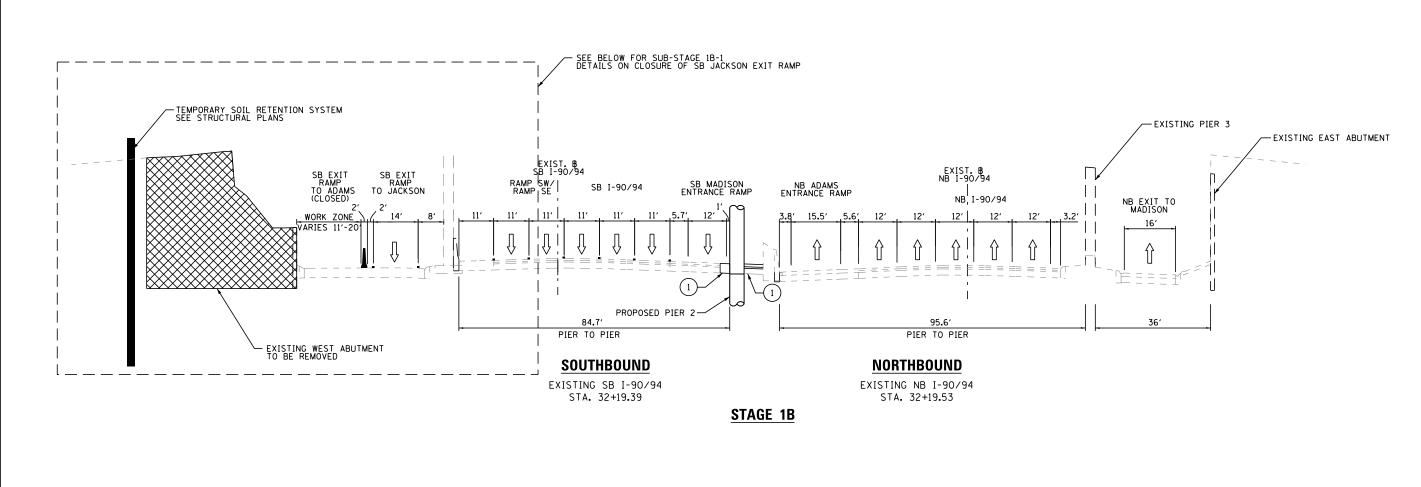

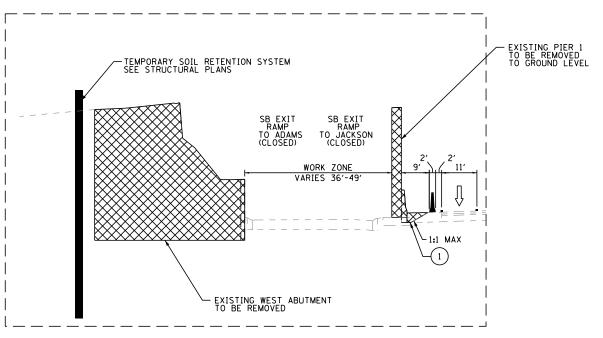

STAGE 1B-1 SB JACKSON EXIT RAMP TEMPORARY CLOSURE

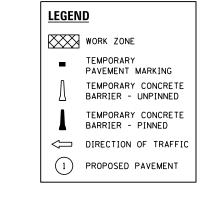


_		U
ΨE	PAR SONS BRINCKERHOFF	
ž	BRINCKERHOFF	Pl
۱۳		Б

	USER NAME = Kucharski	DESIGNED - AMK	KENIZED -
PAR SONS		DRAWN - AMK	REVISED -
BRINCKERHOFF	PLOT SCALE =	CHECKED - RPH	REVISED -
	PLOT DATE = 4/18/2017	DATE - 05/02/2017	REVISED -


STATE OF ILLINOIS **DEPARTMENT OF TRANSPORTATION**

SUGGESTED S	TAGES	0F	CO	NST	ſRΙ	UCTION	AND	TRAFFIC	CO	NTROL	PLAN
TYPICAL SECTIONS - MAINLINE STAGES 1B AND 1B-1											
CALE.	CHEET	NO	3 0		_	CHEETC	CTA		ΤO	CTA	

F.A.I. RTE.	SECTION	COUNTY	TOTAL SHEETS	SHEET NO.		
FAI 90/94	2014-016R&B	СООК	378	57		
		CONTRACT	NO. 60	0X95		
	ILLINOIS F	ED. AI	D PROJECT			

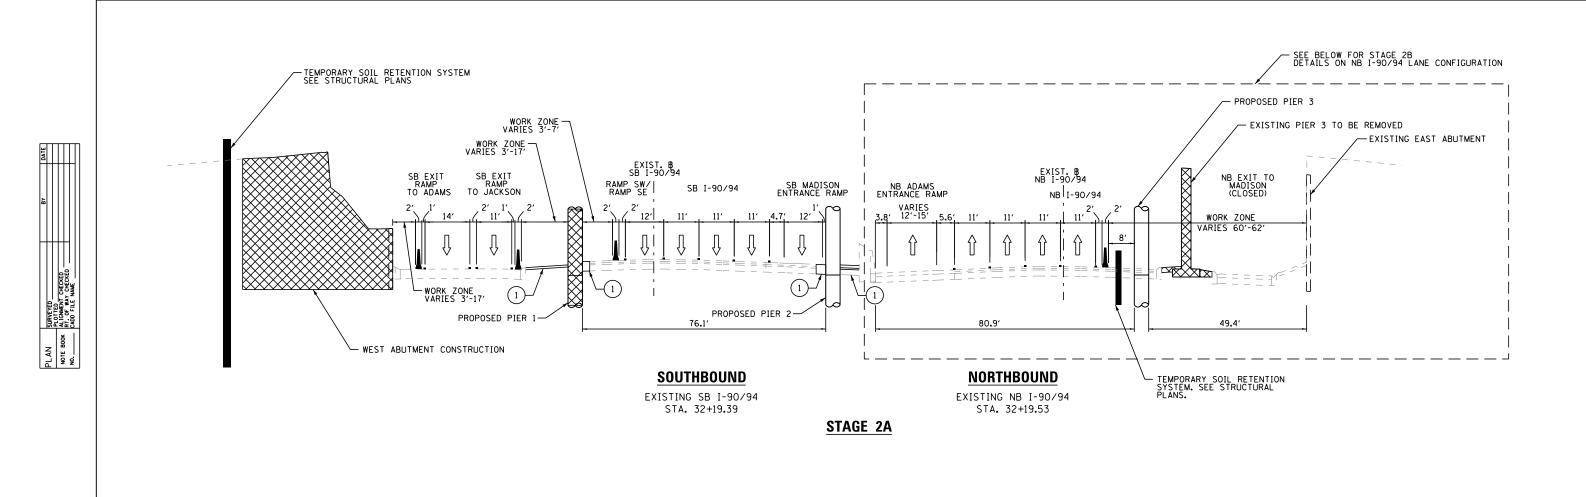



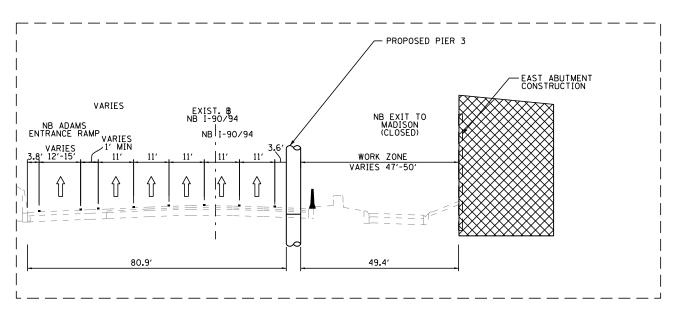


NORTHBOUND

EXISTING NB I-90/94 STA. 32+19.53


STAGE 2B

716													
<u>-</u> -		USER NAME = Kucharskı	DESIGNED - AMK	REVISED -		SUGGESTED ST	AGES OF CONSTRUCTION	AND TRAFFIC CONTROL PLAN	F.A.I.	SECTION	COUNTY	TOTAL	SHEET
Ā	PARSONS		DRAWN - AMK	REVISED -	STATE OF ILLINOIS	TYPIC		STAGES 2A AND 2B	FAI	2014-016R&B	соок	378	58
ž	BRINCKERHOFF	PLOT SCALE =	CHECKED - RPH	REVISED -	DEPARTMENT OF TRANSPORTATION	TTFICE	AL SECTIONS - MAINLINE	STAGES ZA AND ZB	30/34		CONTRACT	NO. 60	0X95
<u>"</u>		PLOT DATE = 4/18/2017	DATE - 05/02/2017	REVISED -		SCALE:	SHEET NO. 3 OF 5 SHEETS	STA. TO STA.		ILLINOIS FED.			

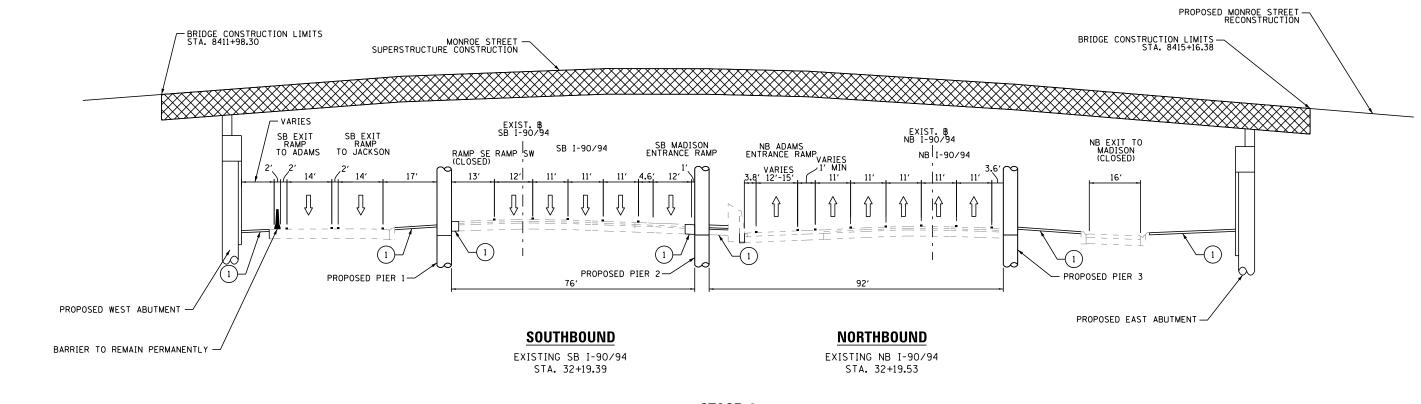

STAGE 3



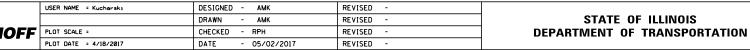



A.I. SECTION COUNTY TOTAL SHEETS NO.
FAL SHEETS NO.
2014-016R&B COOK 378 59
CONTRACT NO. 60X95

LEGEND


WORK ZONE


TEMPORARY
PAVEMENT MARKING
TEMPORARY CONCRETE
BARRIER - UNPINNED


TEMPORARY CONCRETE BARRIER - PINNED

DIRECTION OF TRAFFIC

1 PROPOSED PAVEMENT

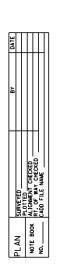

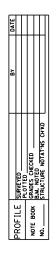

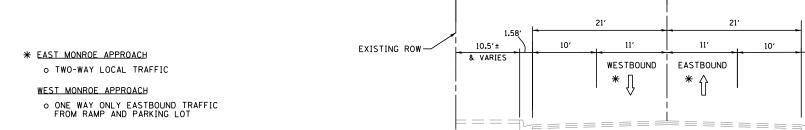

MONROE STREET TYPICAL SECTION

STAGE 1

¢ MONROE STREET


10'

9.5′ & VARIES

-EXISTING ROW

33'


WEST APPROACH STA. 8409+80.00 TO STA. 8411+68.80 EAST APPROACH STA. 8415+45.88 TO STA. 8417+05.00

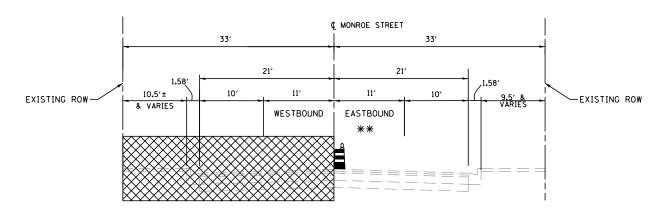

MONROE STREET TYPICAL SECTION

STAGE 2

WEST APPROACH STA. 8409+80.00 TO STA. 8411+68.80 EAST APPROACH STA. 8415+45.88 TO STA. 8417+05.00

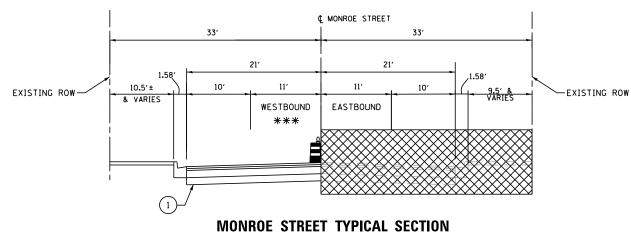

STAGE 3

WEST APPROACH STA. 8409+80.00 TO STA. 8411+68.80 EAST APPROACH STA. 8415+45.88 TO STA. 8417+05.00

LEGEND

NOTES:

WORK ZONE

BUILDING ENTRANCES.

BY THE ENGINEER.

TEMPORARY PAVEMENT MARKING

TEMPORARY CONCRETE BARRIER - UNPINNED

1. TYPICAL SECTIONS ARE NOT TO SCALE.

2. EXISTING BRIDGE WILL BE CLOSED AND UNDER CONSTRUCTION. SEE DETOUR SHEETS FOR DETOUR ROUTES.

3. LOCAL ACCESS SHALL BE MAINTAINED TO DRIVEWAYS AND ALLEYS UNLESS APPROVED

4. LOCAL ACCESS SHALL BE MAINTAINED TO SIDEWALKS AND ENTRANCES TO BUILDINGS UNLESS APPROVED BY THE ENGINEER. THE

CONTRACTOR SHALL ADJUST WORK AS NECESSARY TO MAXIMIZE SIDEWALK ACCESS

AND MINIMIZE DISRUPTION TO LOCAL

TEMPORARY CONCRETE BARRIER - PINNED

TYPE II DRUM WITH STEADY BURN MONODIRECTIONAL LIGHT

DIRECTION OF TRAFFIC

PROPOSED PAVEMENT, CURB AND GUTTER, SIDEWALK

PARSONS **BRINCKERHO**I

** EAST MONROE APPROACH

*** EAST MONROE APPROACH

WEST MONROE APPROACH

WEST MONROE APPROACH

O TWO-WAY LIMITED TRAFFIC TO PARKING LOTS.

O TWO-WAY LIMITED TRAFFIC TO PARKING LOT. ALLEY ACCESS CLOSED FOR A MINIMAL PERIOD.

o RAMP CLOSED. ONE WAY ONLY FROM FROM DRIVEWAYS TO HALSTED STREET.

o RAMP CLOSED. ONE WAY ONLY FROM FROM DRIVEWAYS TO HALSTED STREET.


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		DRAWN - AMK	REVISED -
FF	PLOT SCALE =	CHECKED - RPH	REVISED -
	PLOT DATE = 4/18/2017	DATE - 05/02/2017	REVISED -


STATE OF ILLINOIS **DEPARTMENT OF TRANSPORTATION**


SUGGESTED STAGES OF CONSTRUCTION AND TRAFFIC CONTROL PLAN TYPICAL SECTIONS - MONROE STREET SCALE: SHEET NO. 5 OF 5 SHEETS STA. TO STA.


COUNTY SHEETS NO.


COOK 378 60 SECTION 2014-016R&B CONTRACT NO. 60X95

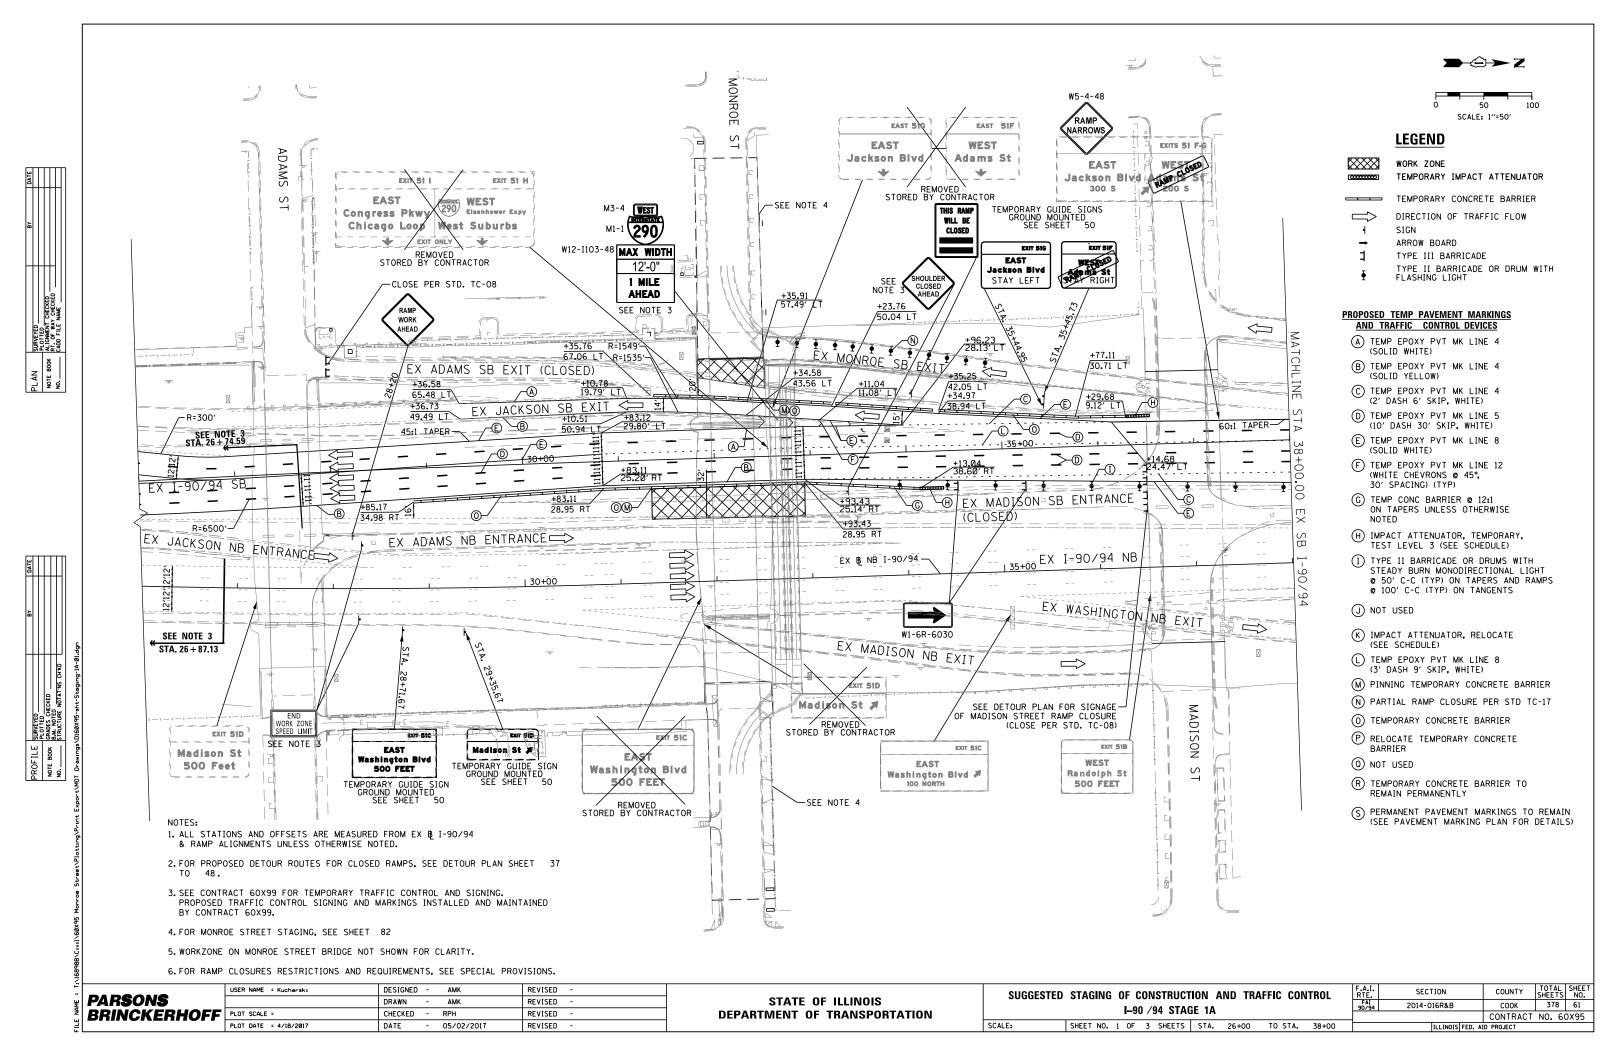


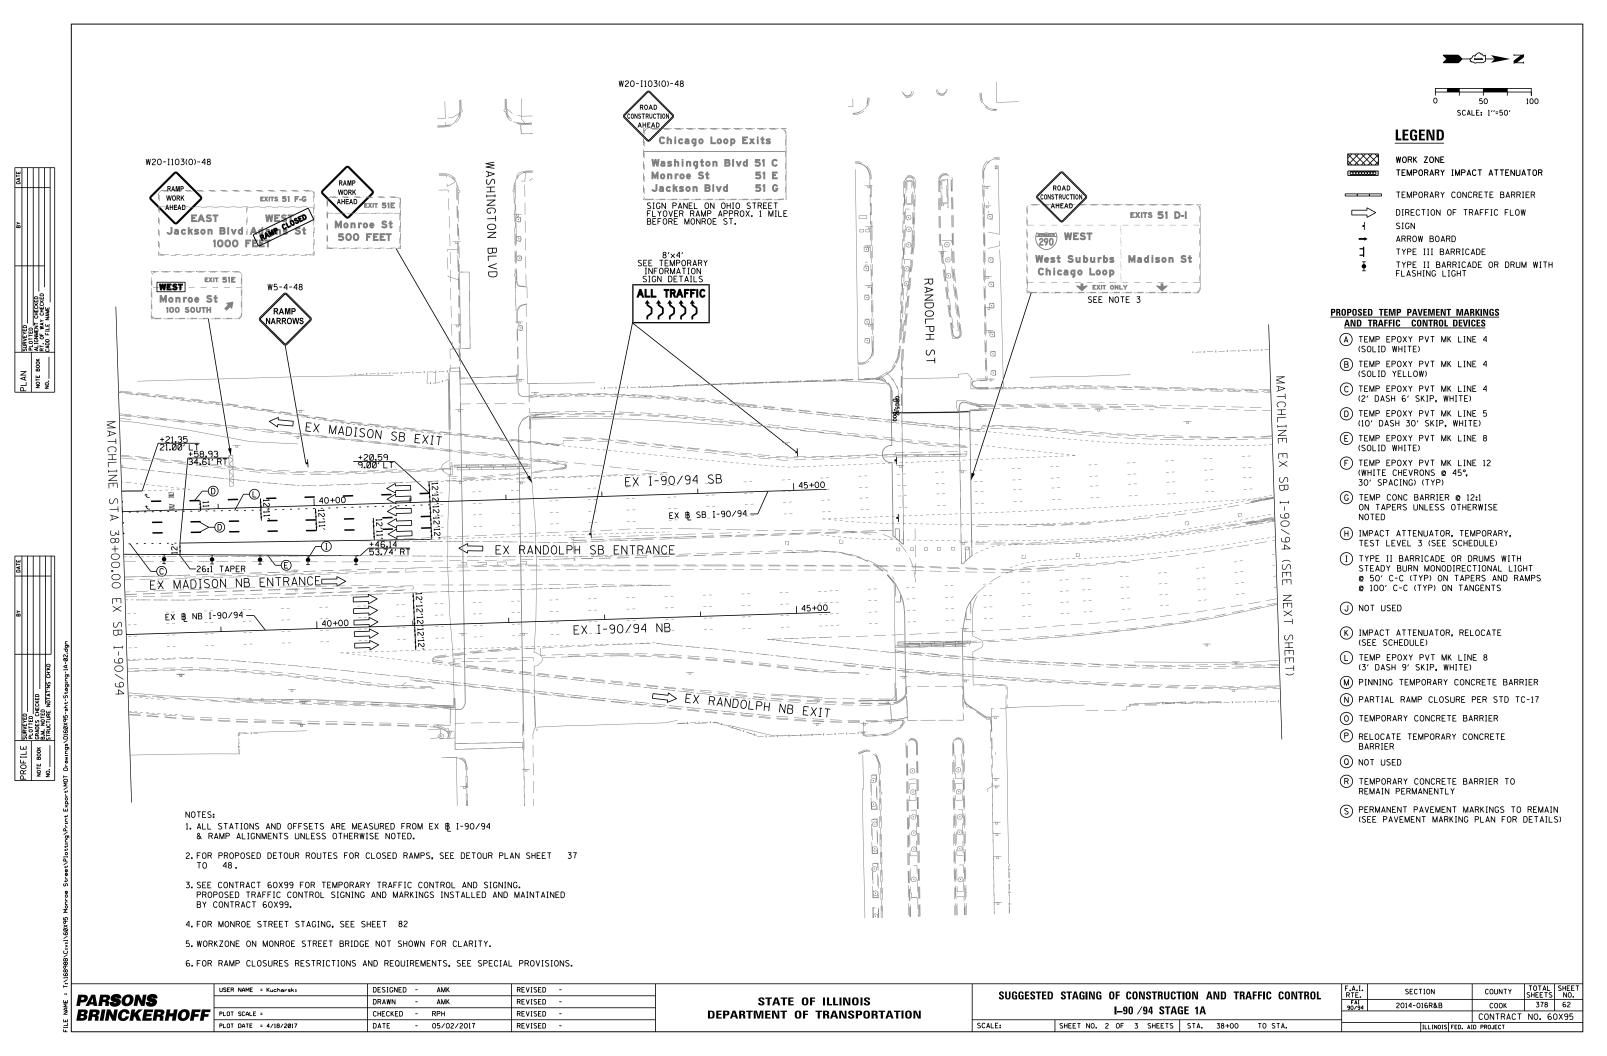


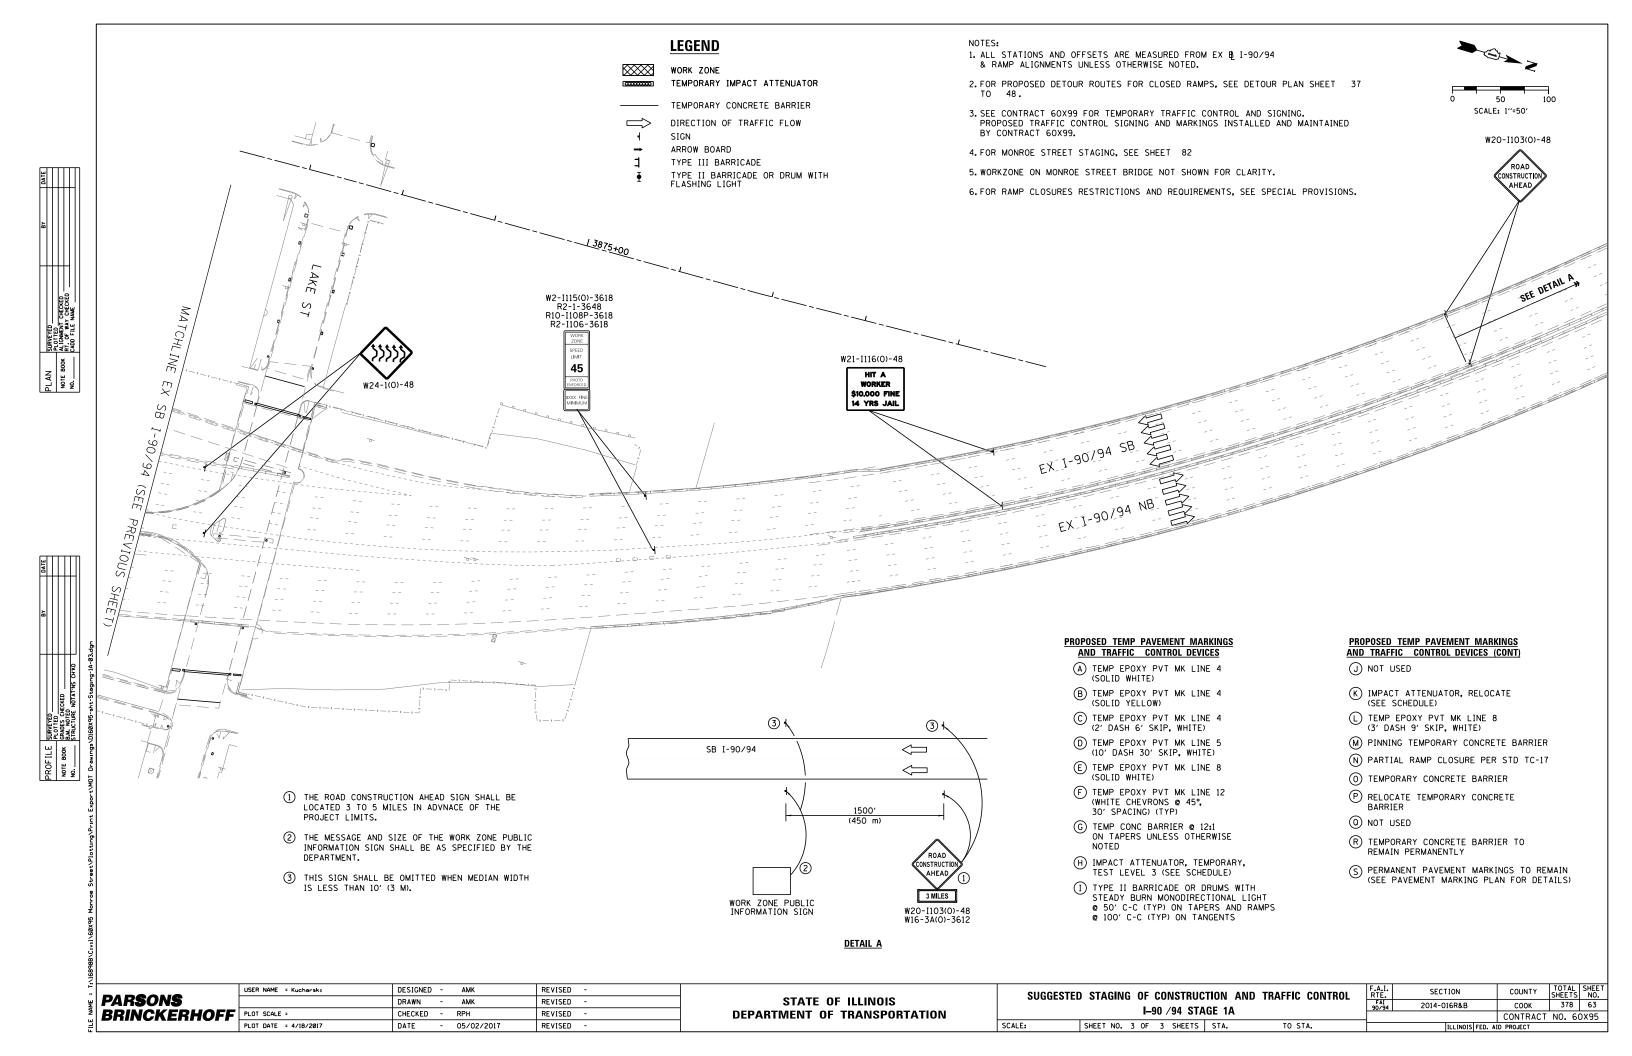


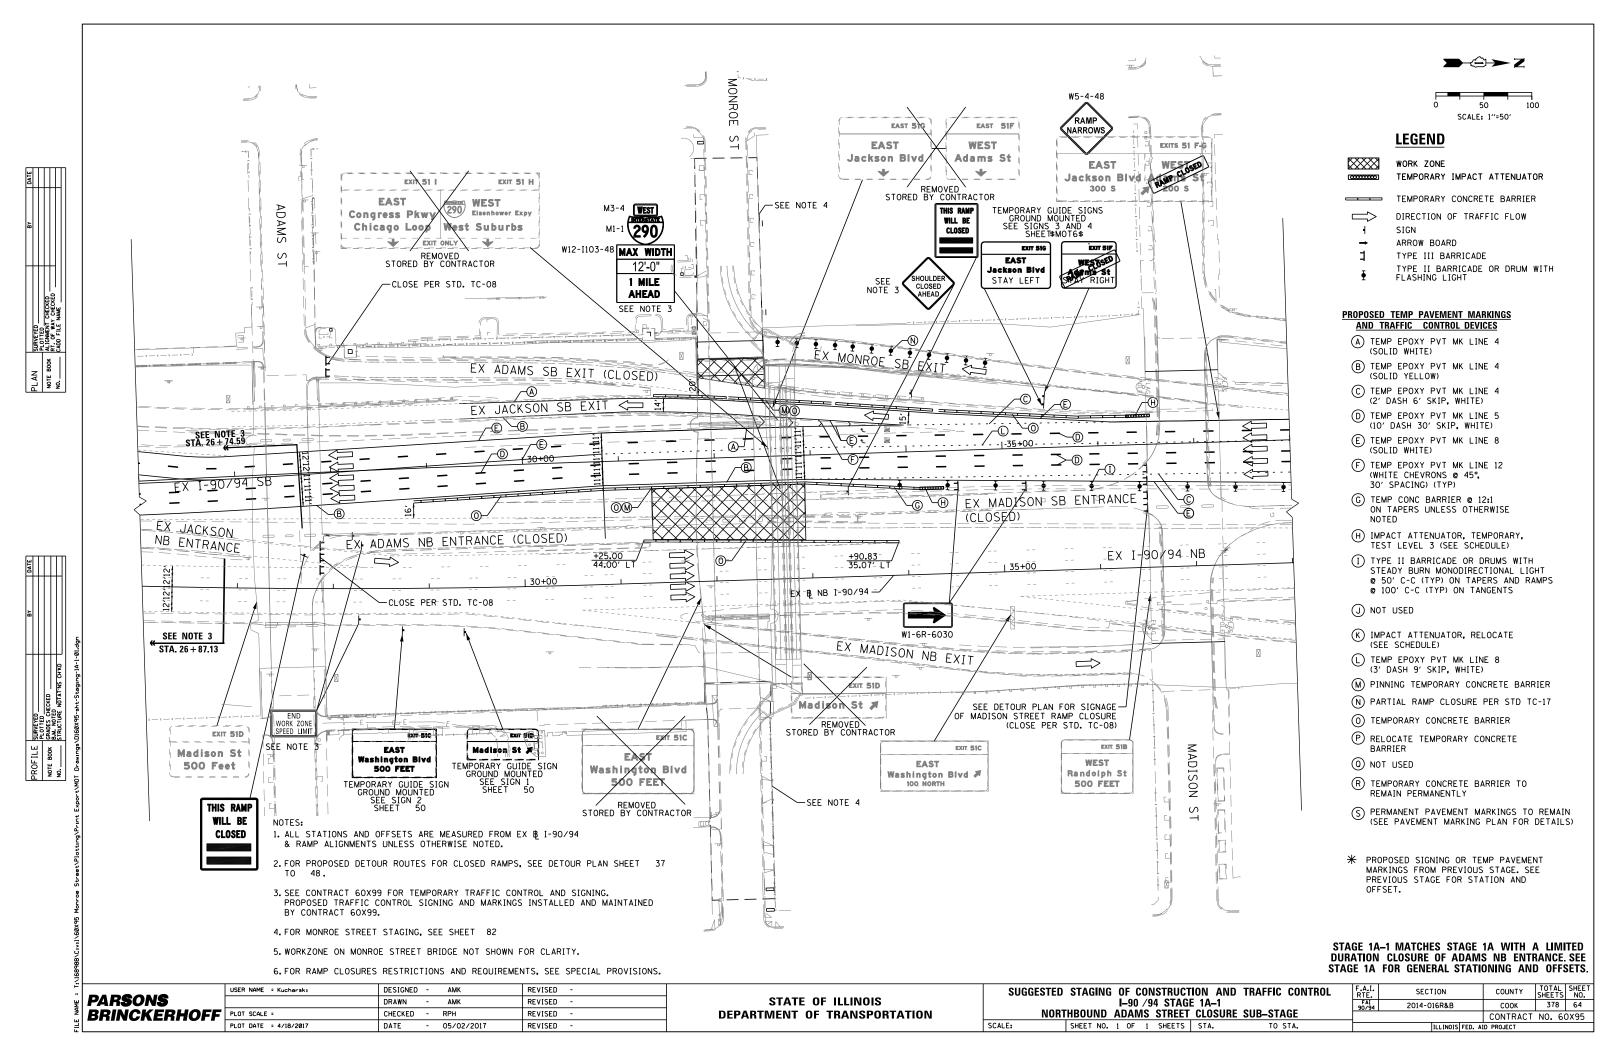


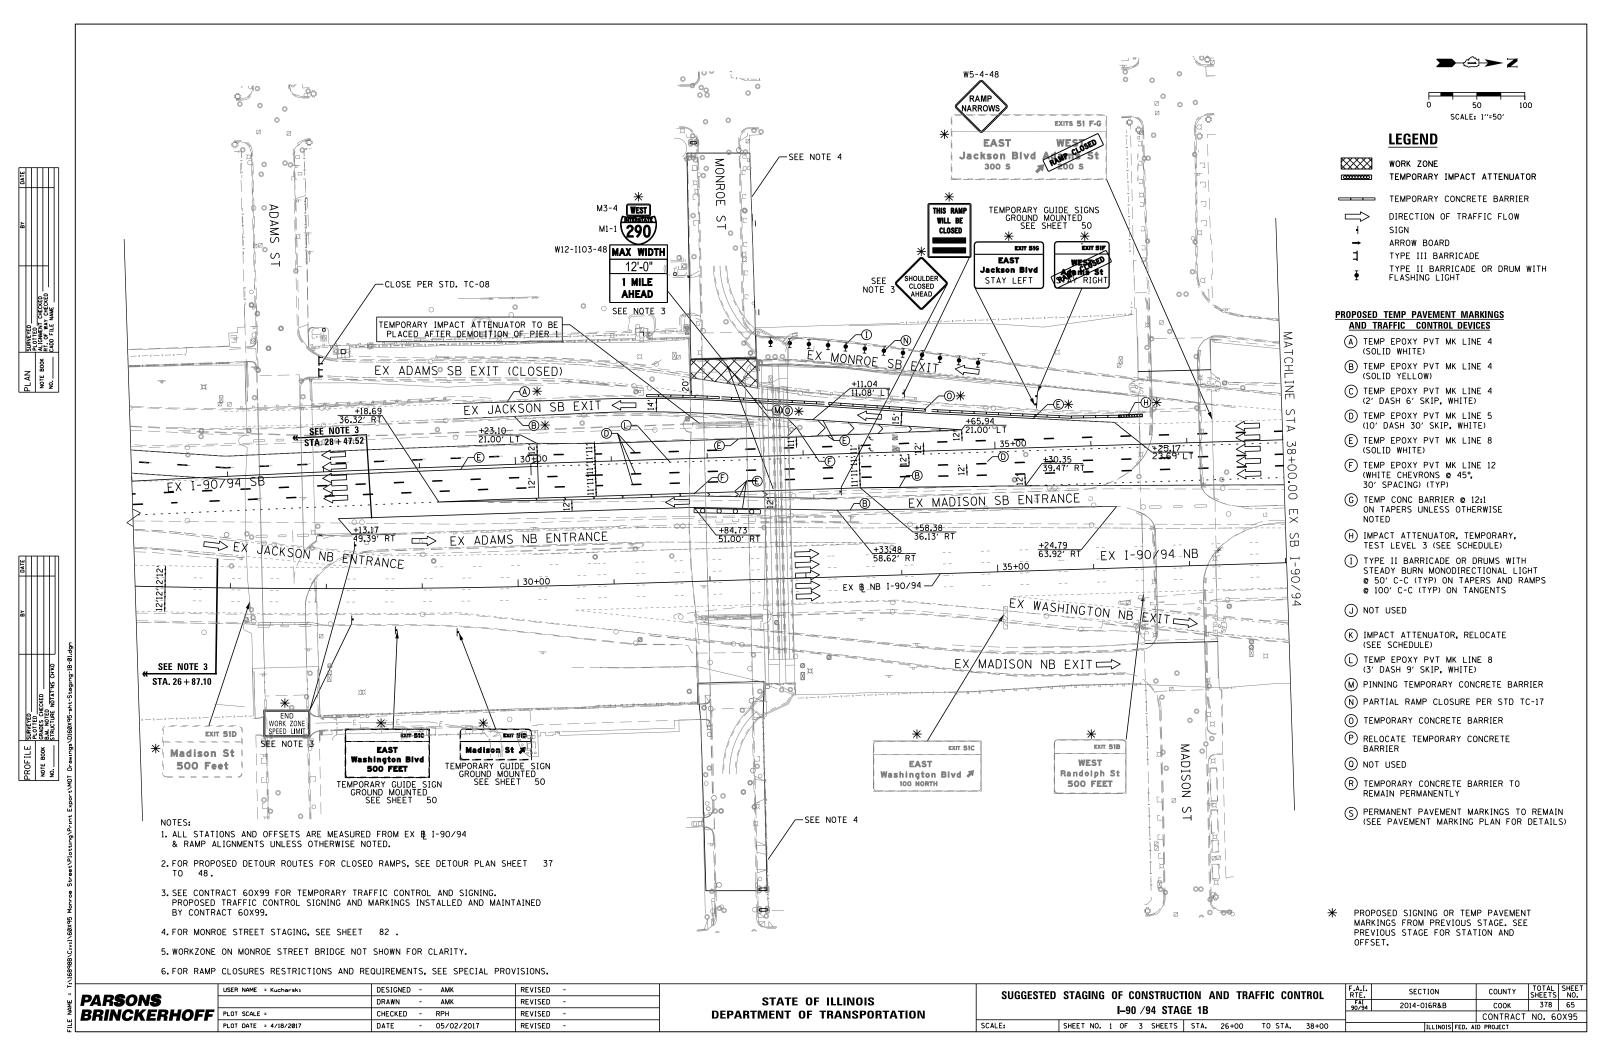


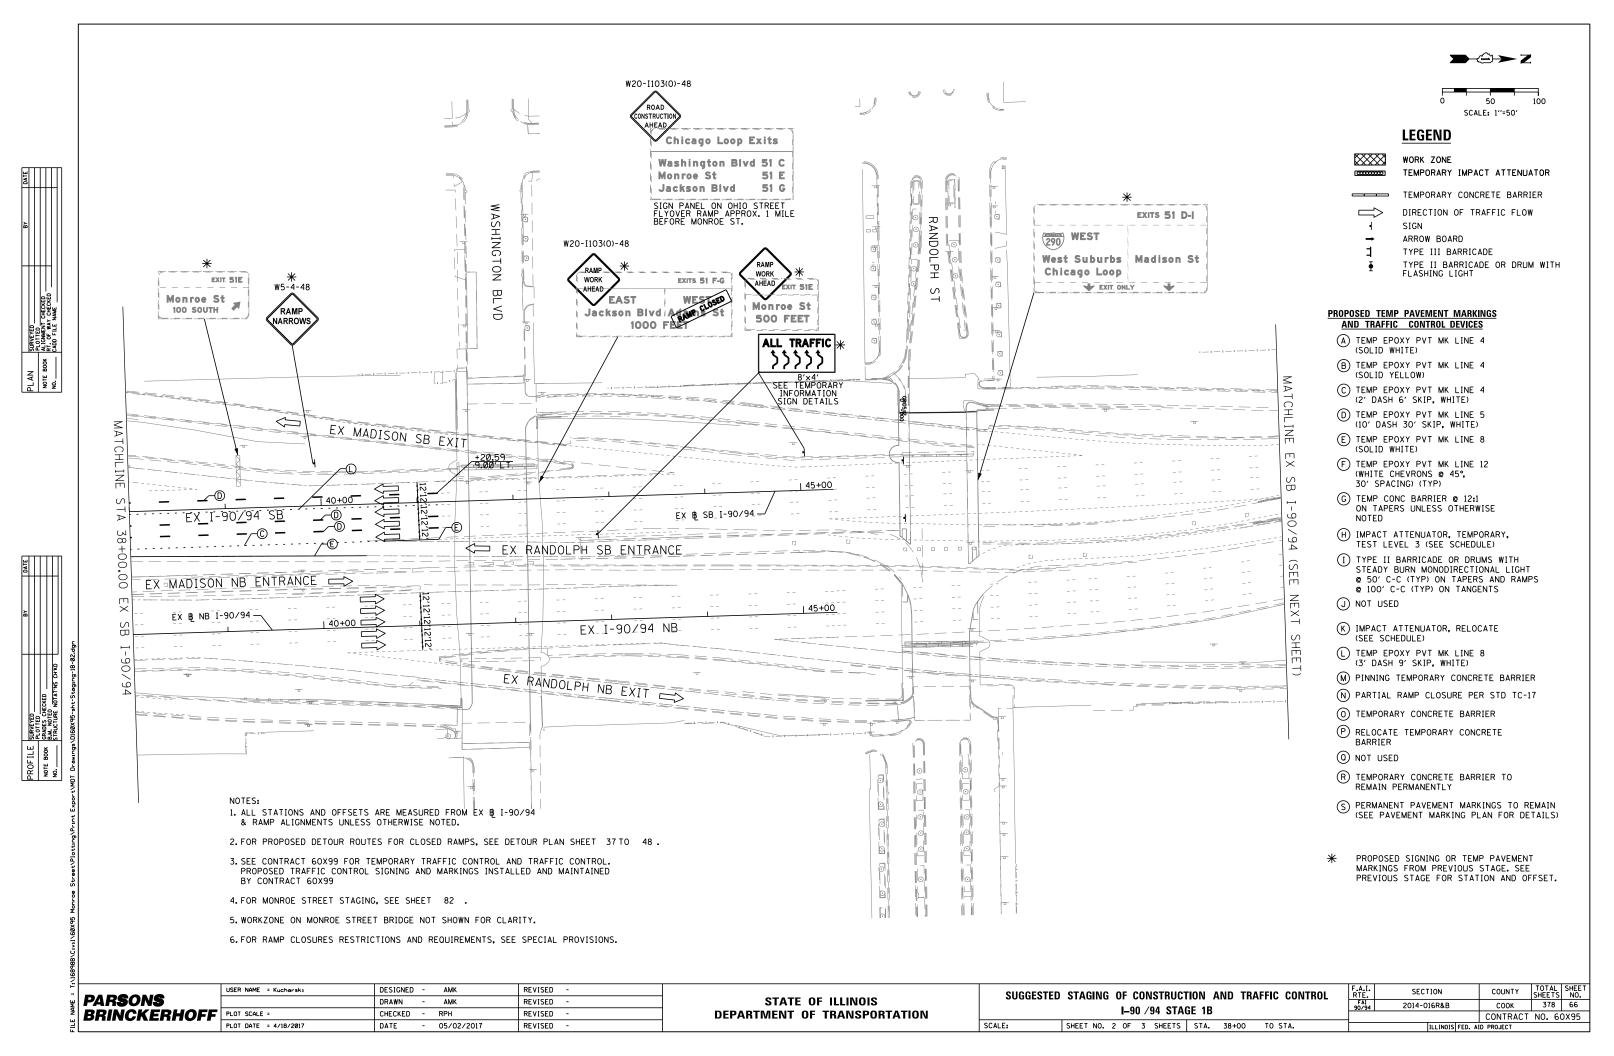


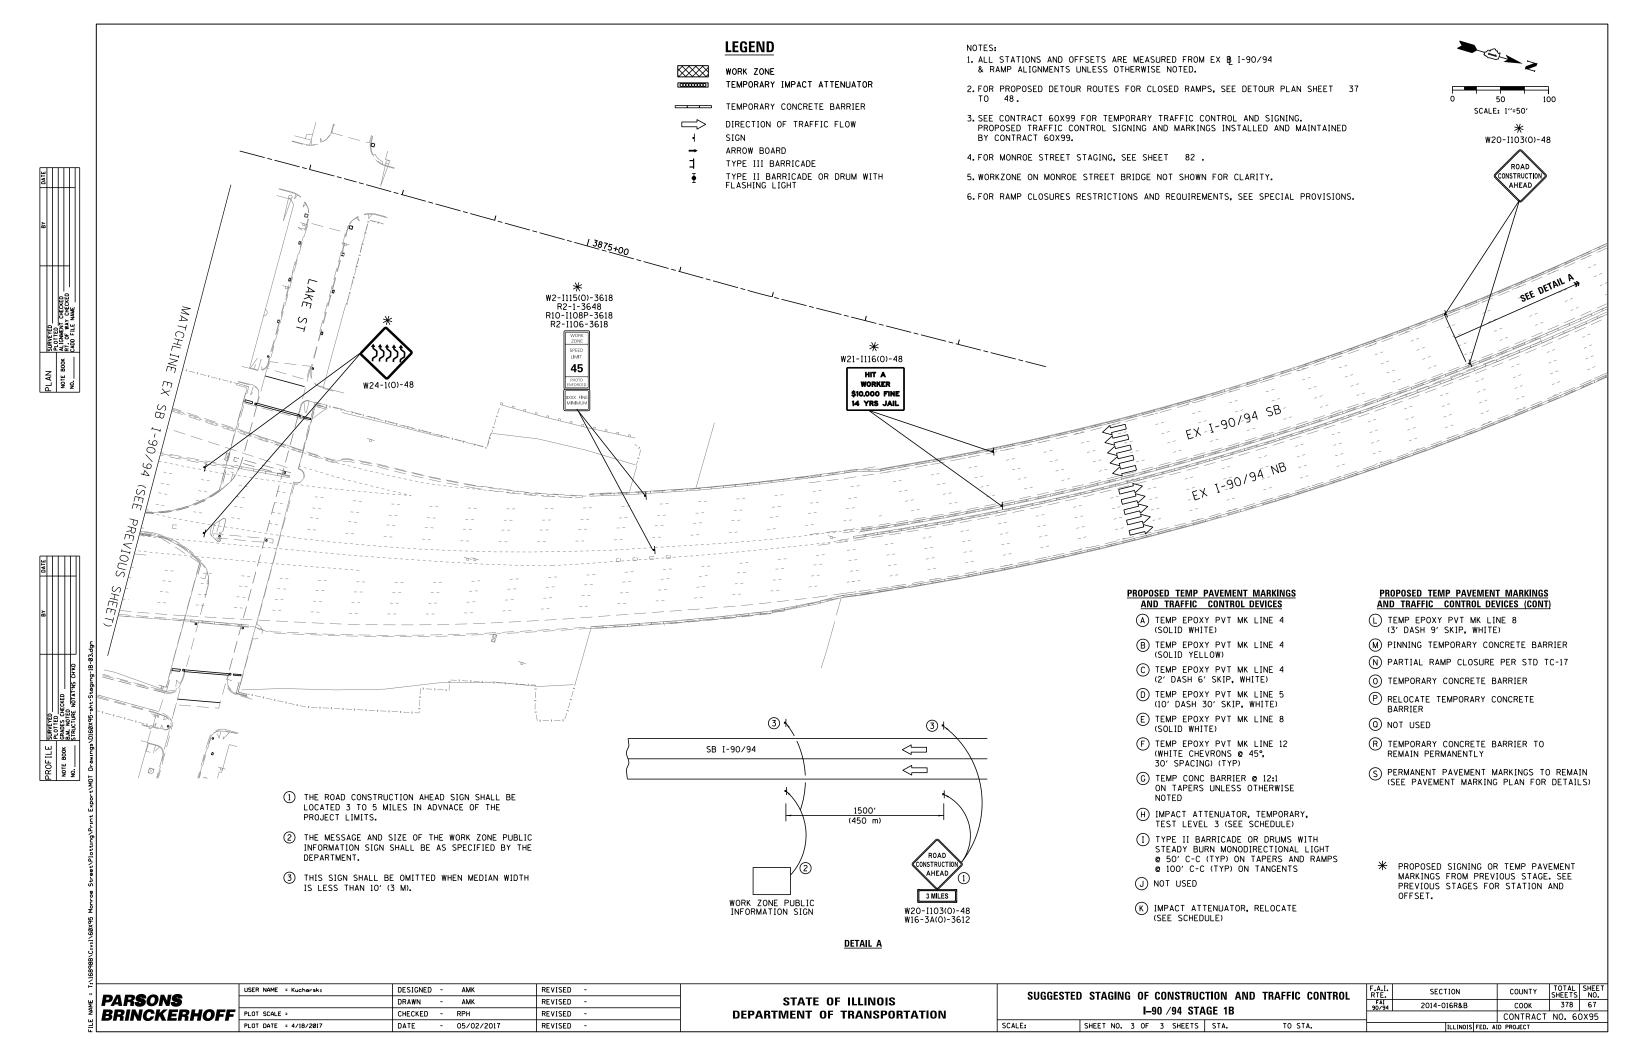


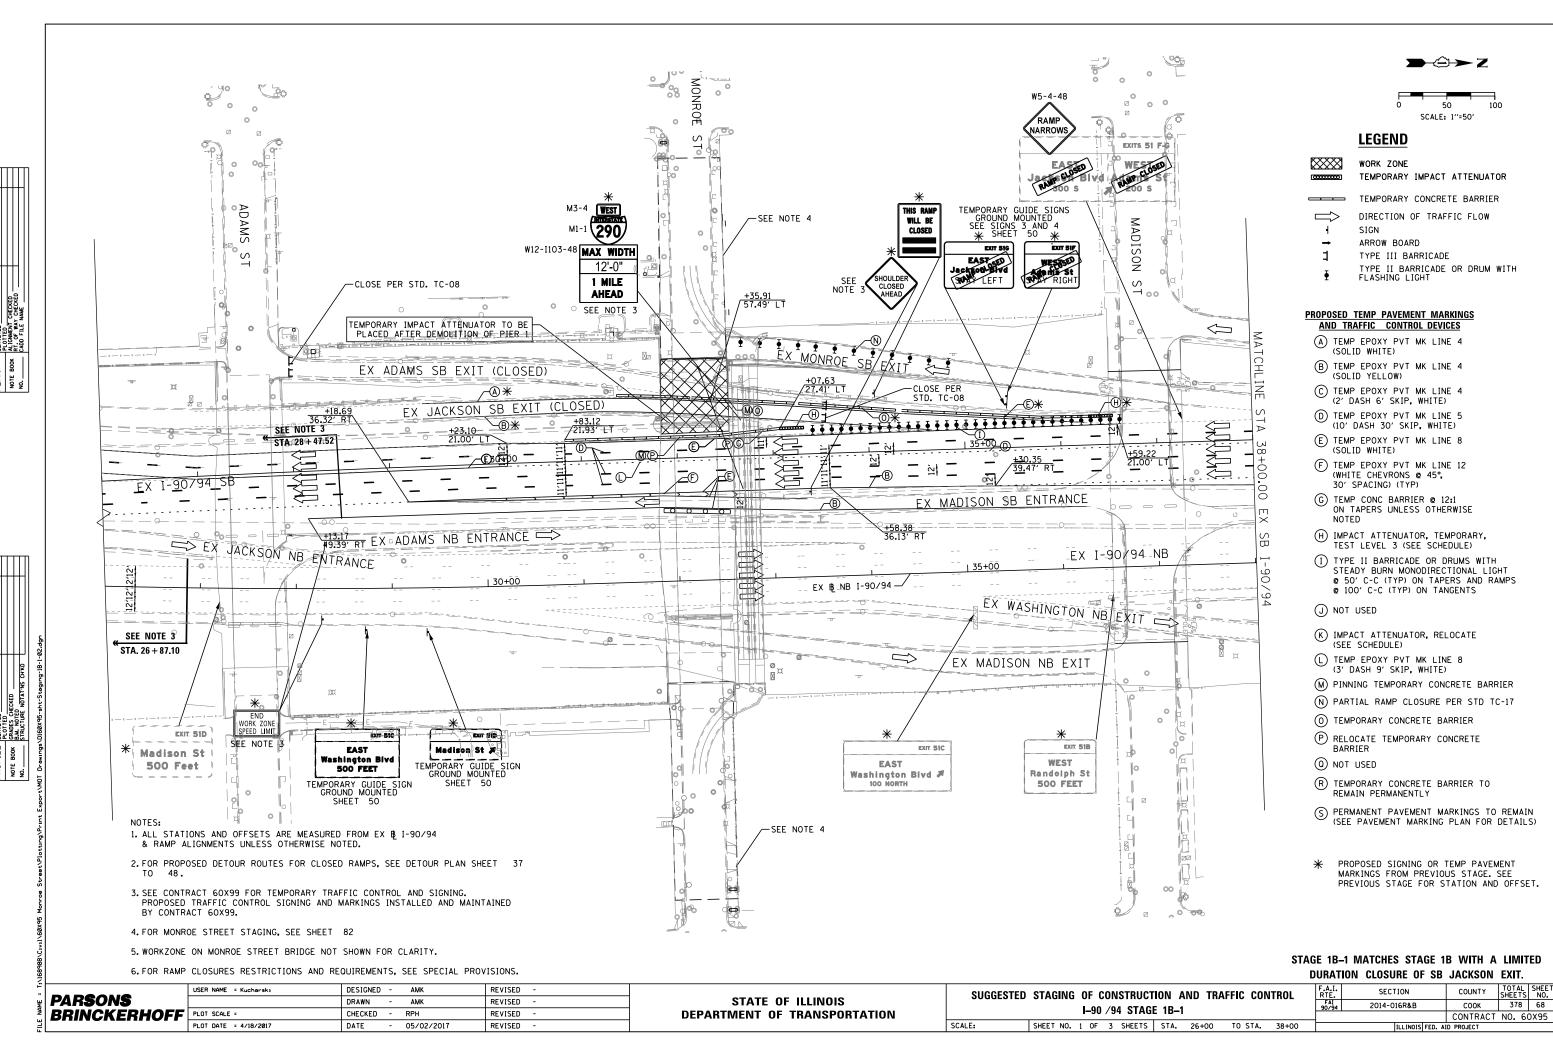


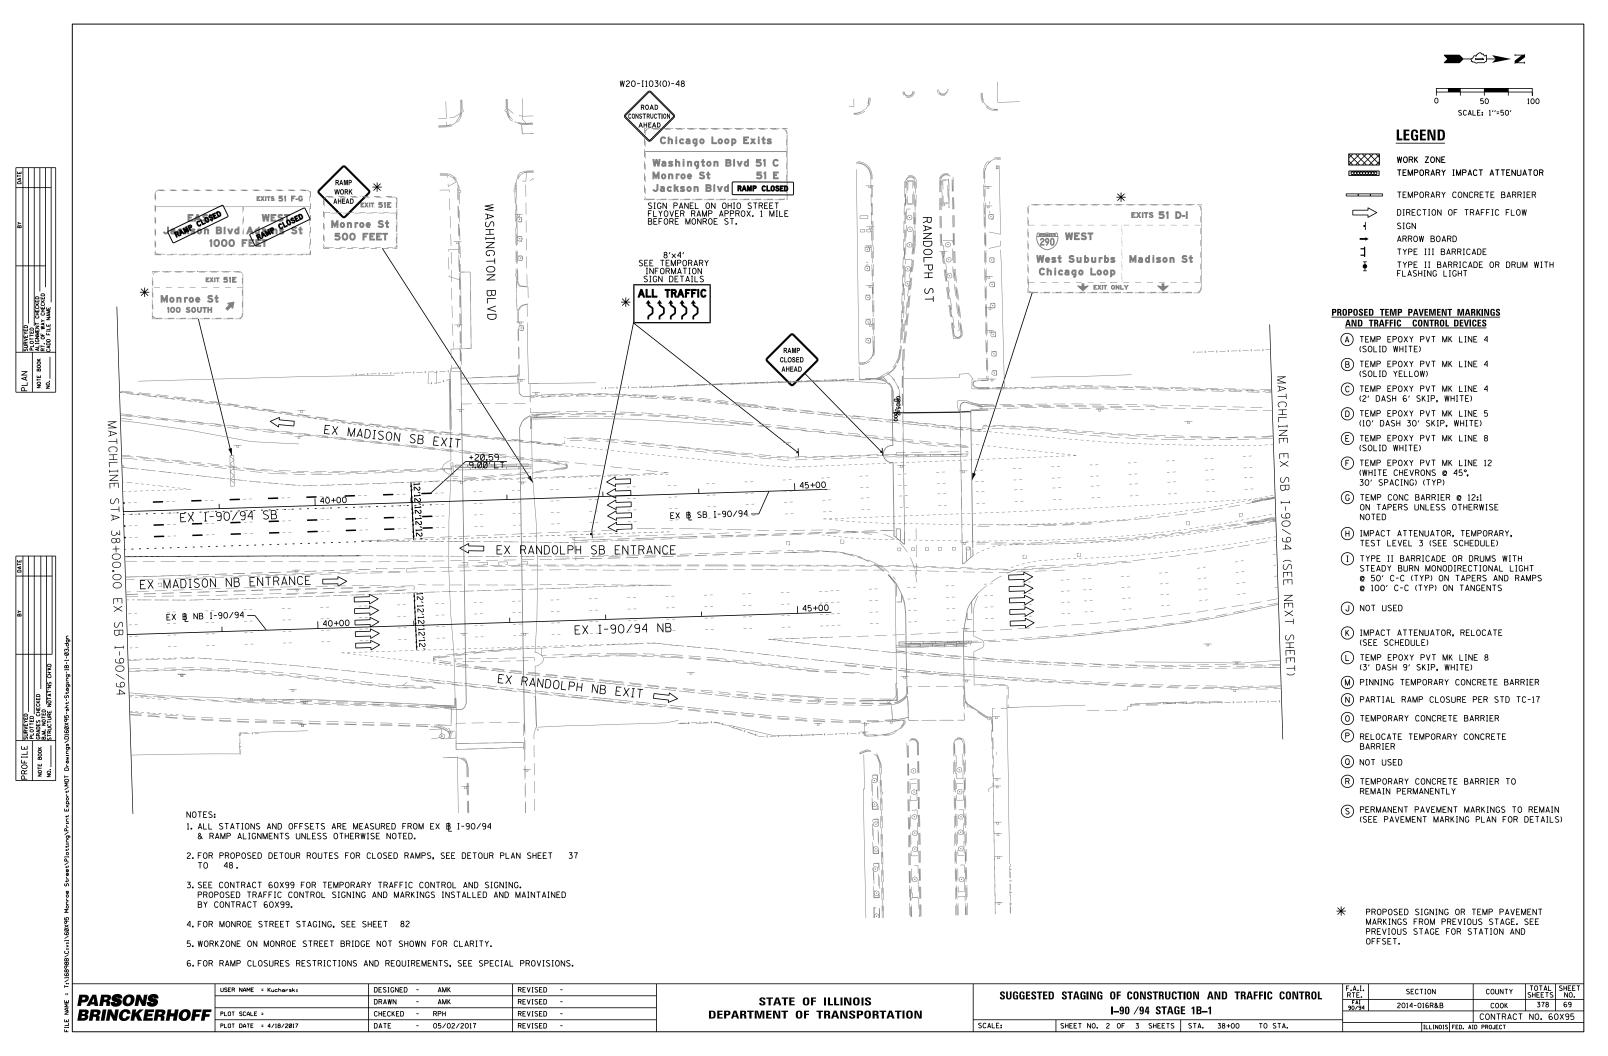


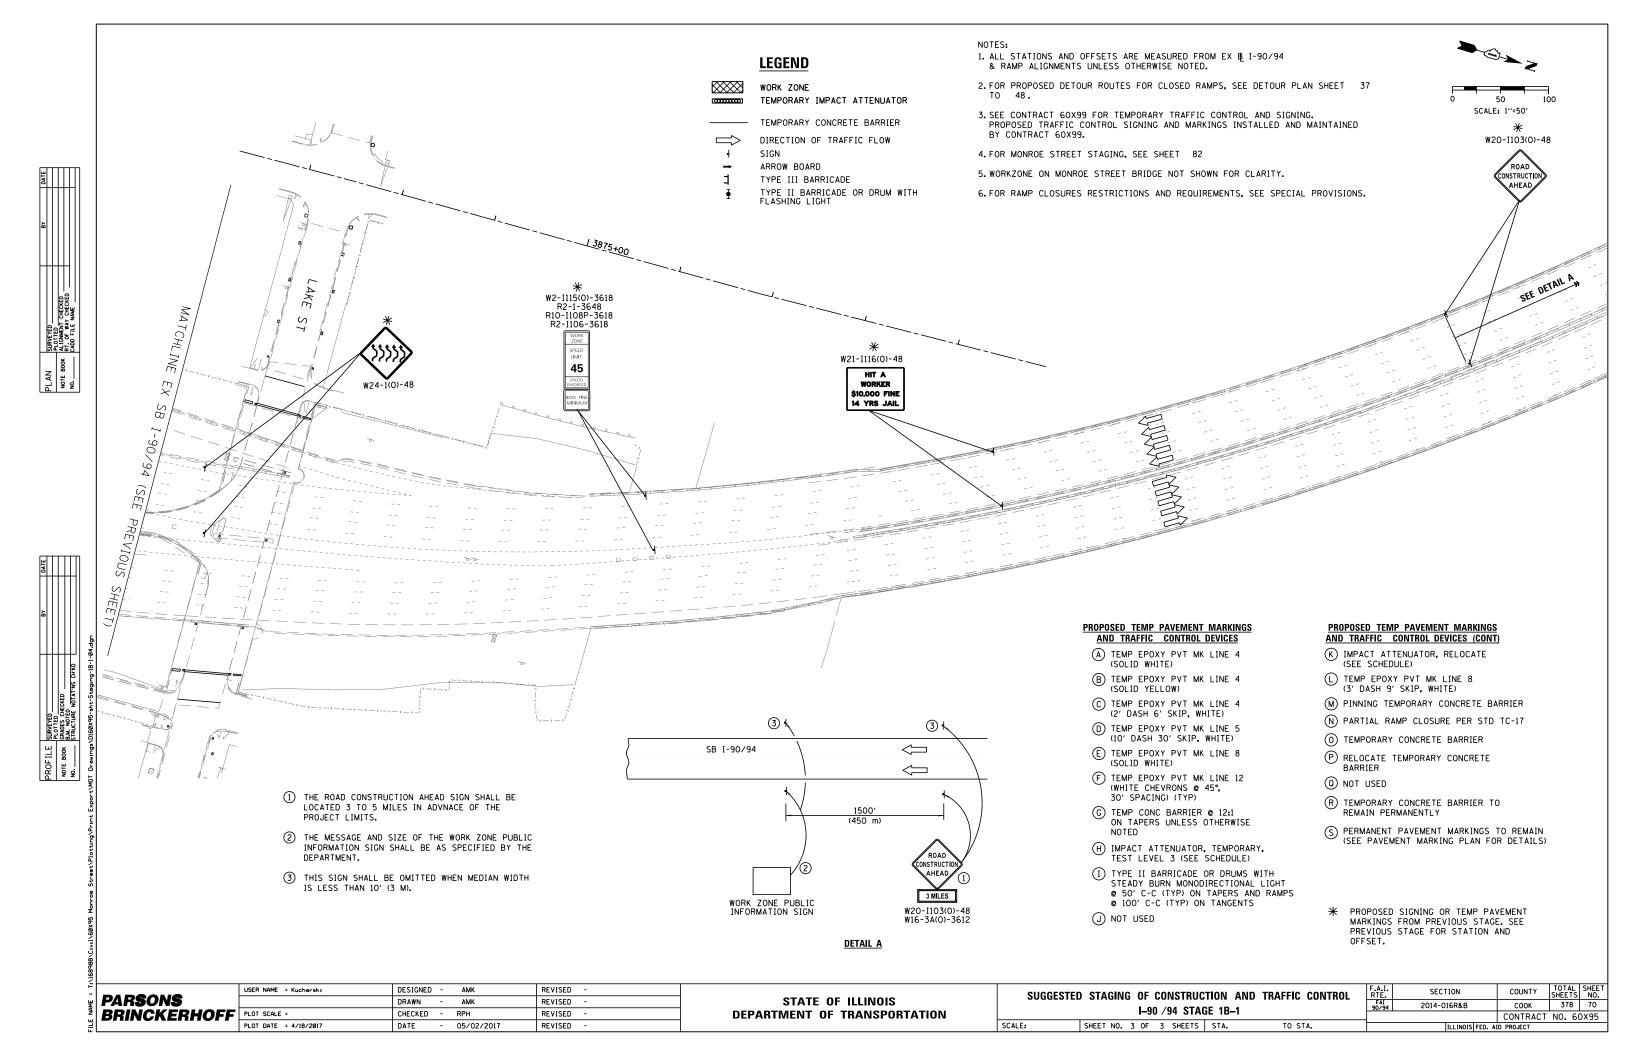


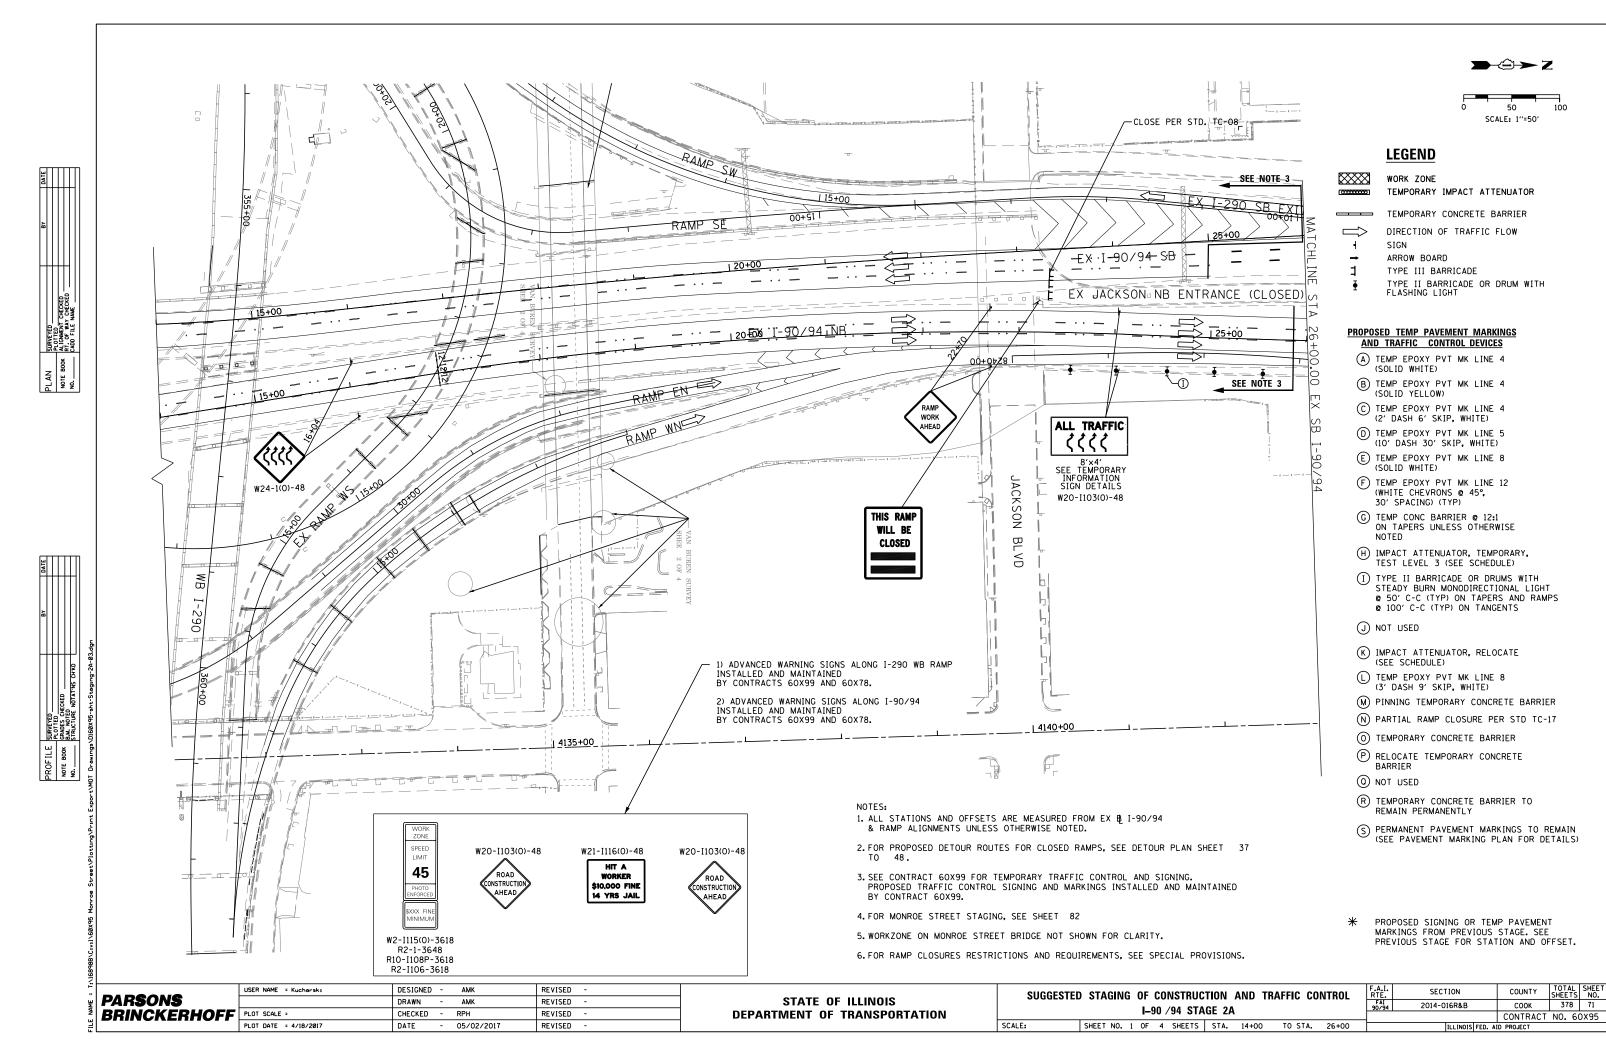

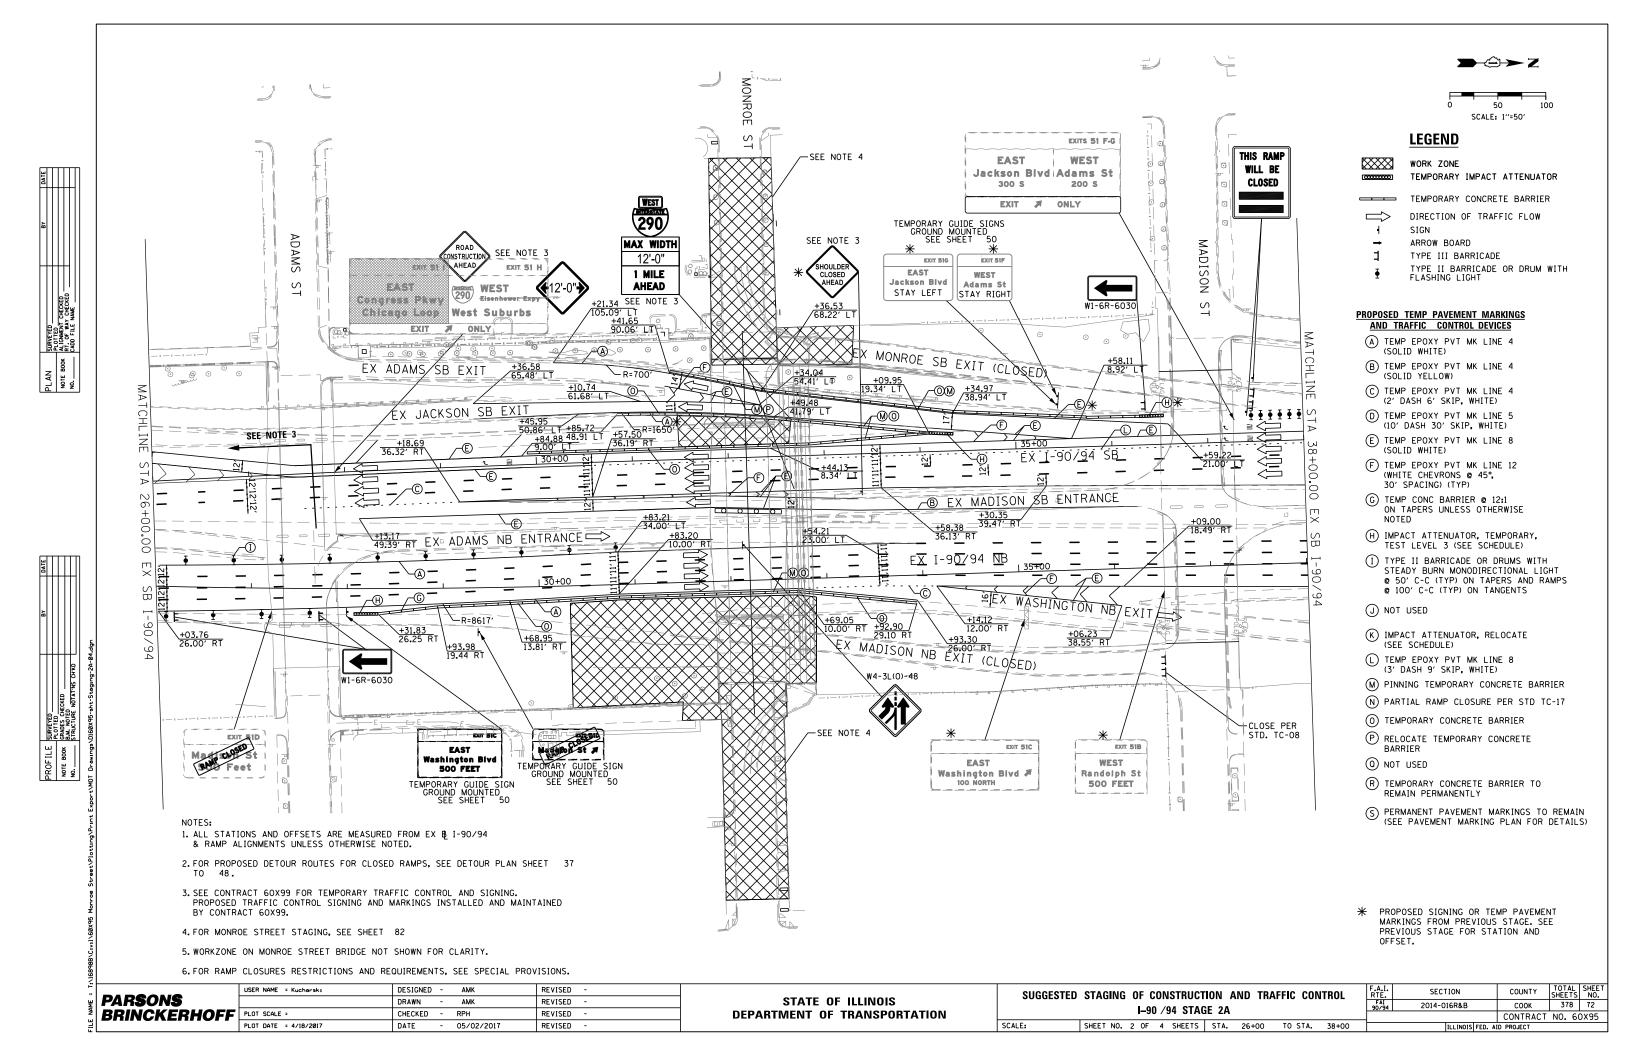

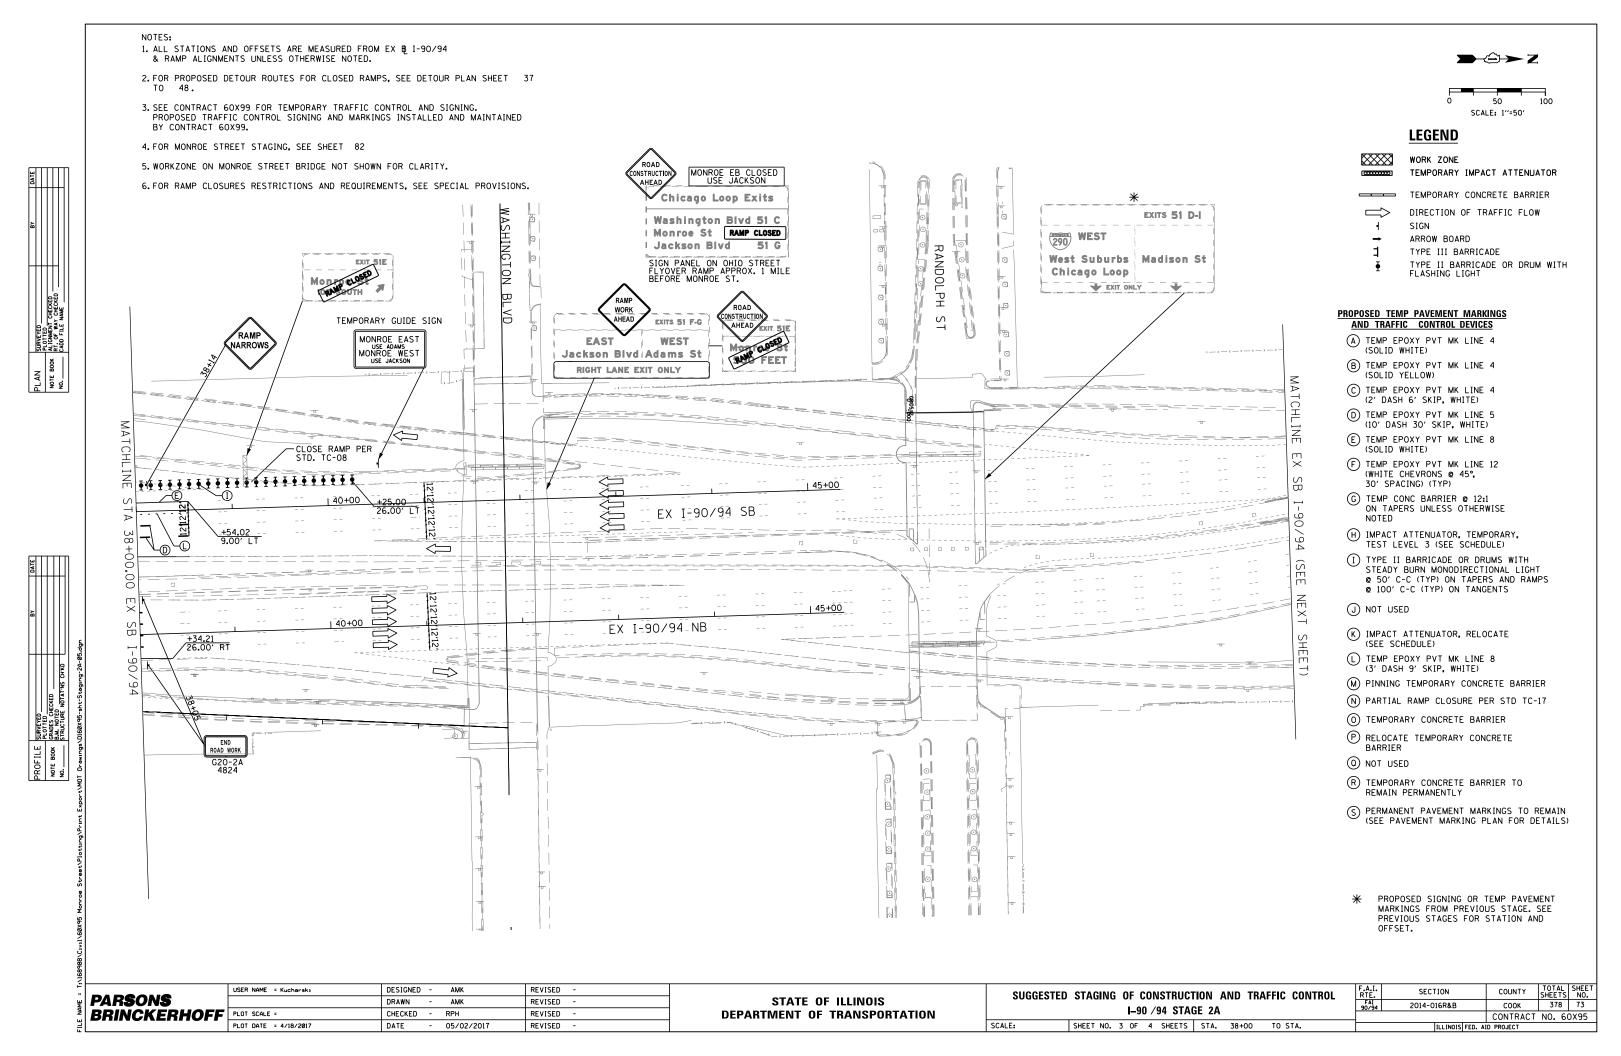

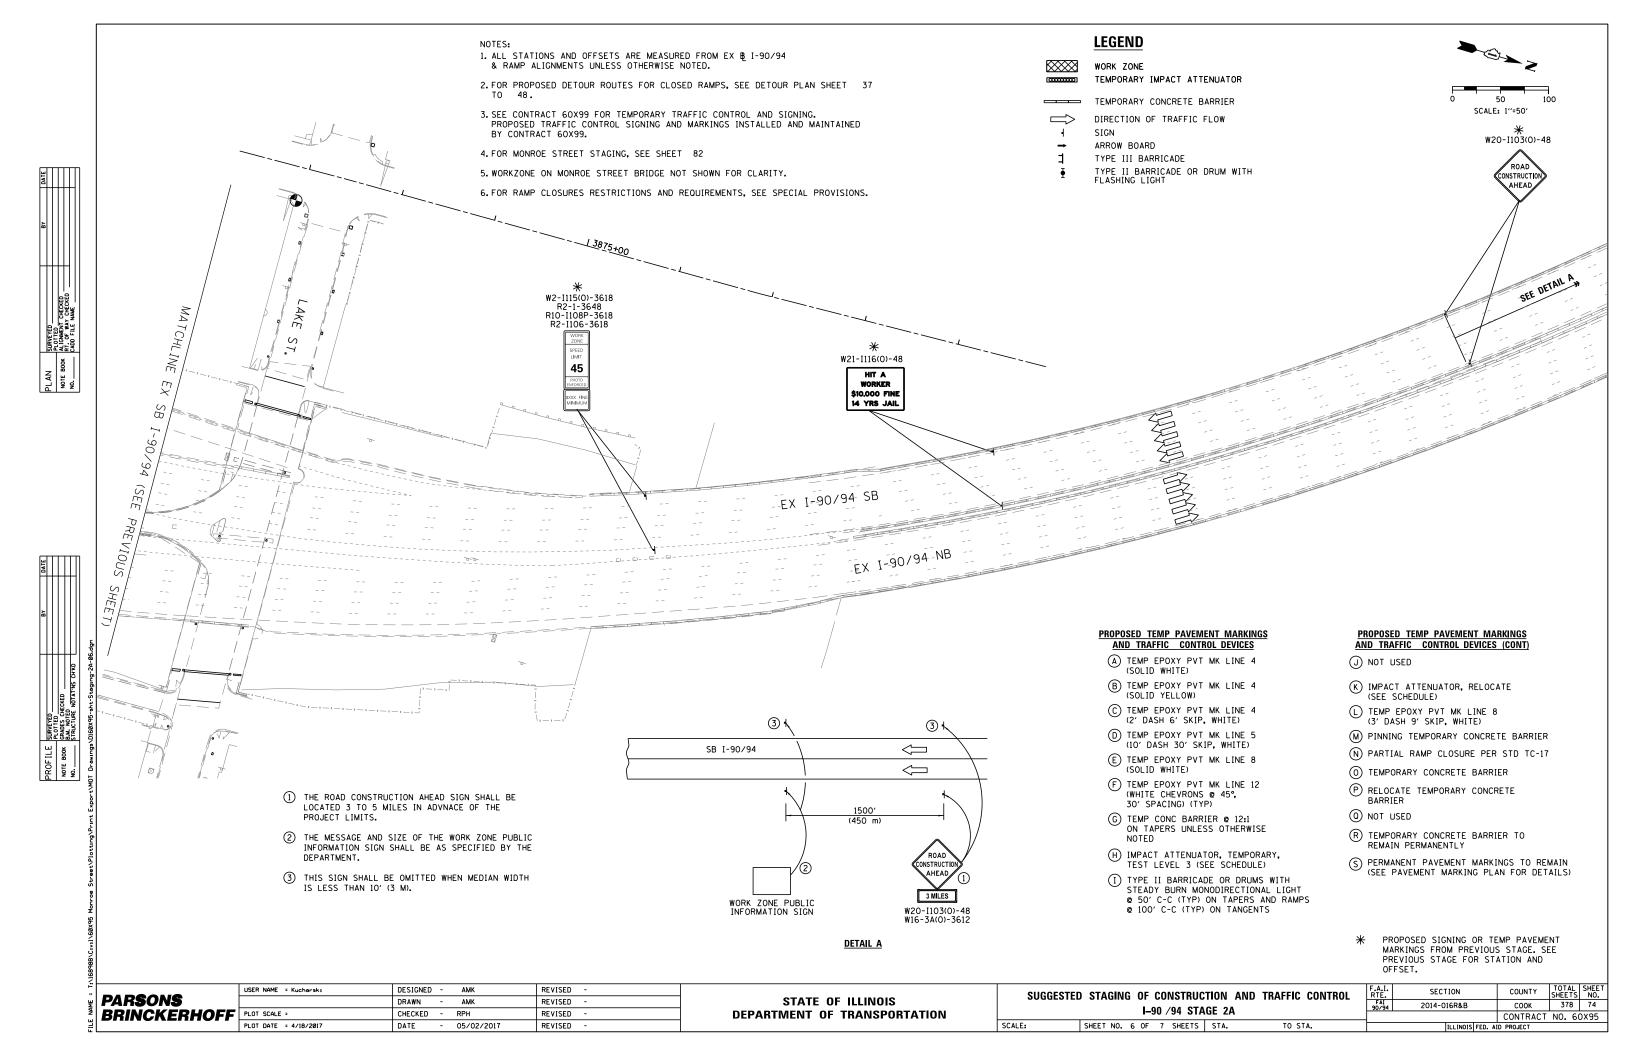

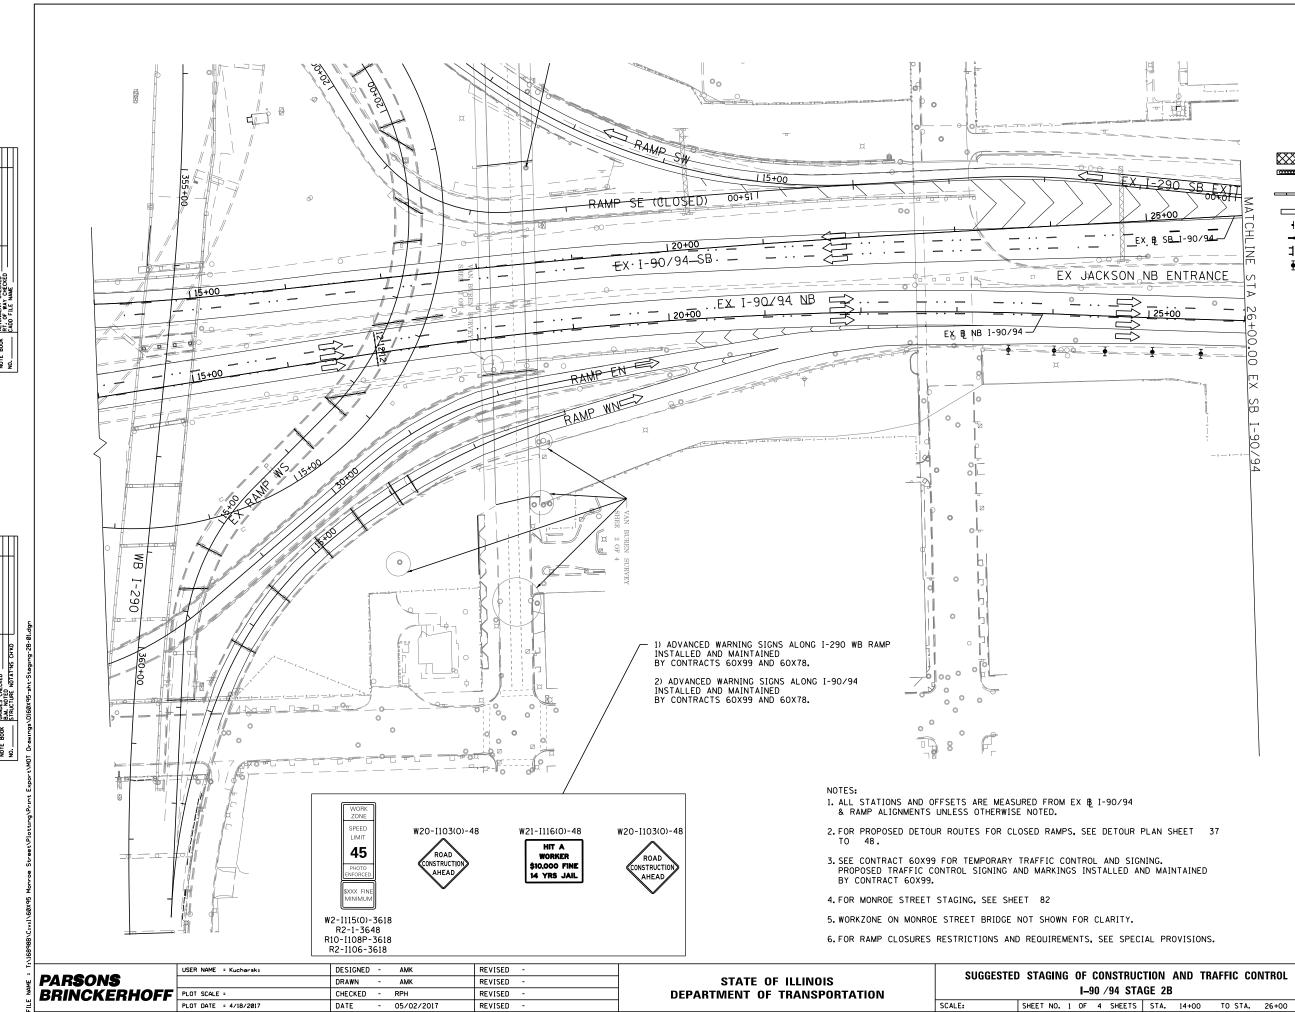

SCALE: 1"=50"

LEGEND

 \bowtie

WORK ZONE

TEMPORARY IMPACT ATTENUATOR

TEMPORARY CONCRETE BARRIER

DIRECTION OF TRAFFIC FLOW

ARROW BOARD

TYPE III BARRICADE

TYPE II BARRICADE OR DRUM WITH FLASHING LIGHT

PROPOSED TEMP PAVEMENT MARKINGS AND TRAFFIC CONTROL DEVICES

- (SOLID WHITE)
- B TEMP EPOXY PVT MK LINE 4 (SOLID YELLOW)
- C TEMP EPOXY PVT MK LINE 4 (2' DASH 6' SKIP, WHITE)
- (10' DASH 30' SKIP, WHITE)
- E TEMP EPOXY PVT MK LINE 8
- (SOLID WHITE)
- F TEMP EPOXY PVT MK LINE 12 (WHITE CHEVRONS @ 45°, 30' SPACING) (TYP) G TEMP CONC BARRIER @ 12:1 ON TAPERS UNLESS OTHERWISE
- (H) IMPACT ATTENUATOR, TEMPORARY, TEST LEVEL 3 (SEE SCHEDULE)
- (1) TYPE II BARRICADE OR DRUMS WITH STEADY BURN MONODIRECTIONAL LIGHT © 50' C-C (TYP) ON TAPERS AND RAMPS © 100' C-C (TYP) ON TANGENTS
- J NOT USED
- K IMPACT ATTENUATOR, RELOCATE (SEE SCHEDULE)
- (3' DASH 9' SKIP, WHITE)
- M PINNING TEMPORARY CONCRETE BARRIER
- N PARTIAL RAMP CLOSURE PER STD TC-17
- ① TEMPORARY CONCRETE BARRIER
- P RELOCATE TEMPORARY CONCRETE BARRIER
- O NOT USED
- R TEMPORARY CONCRETE BARRIER TO REMAIN PERMANENTLY
- S PERMANENT PAVEMENT MARKINGS TO REMAIN (SEE PAVEMENT MARKING PLAN FOR DETAILS)
- PROPOSED SIGNING OR TEMP PAVEMENT MARKINGS FROM PREVIOUS STAGE. SEE PREVIOUS STAGE FOR STATION AND OFFSET.

COUNTY


COUNTY SHEETS NO.


COOK 378 75


CONTRACT NO. 60X95


SECTION


2014-016R&B

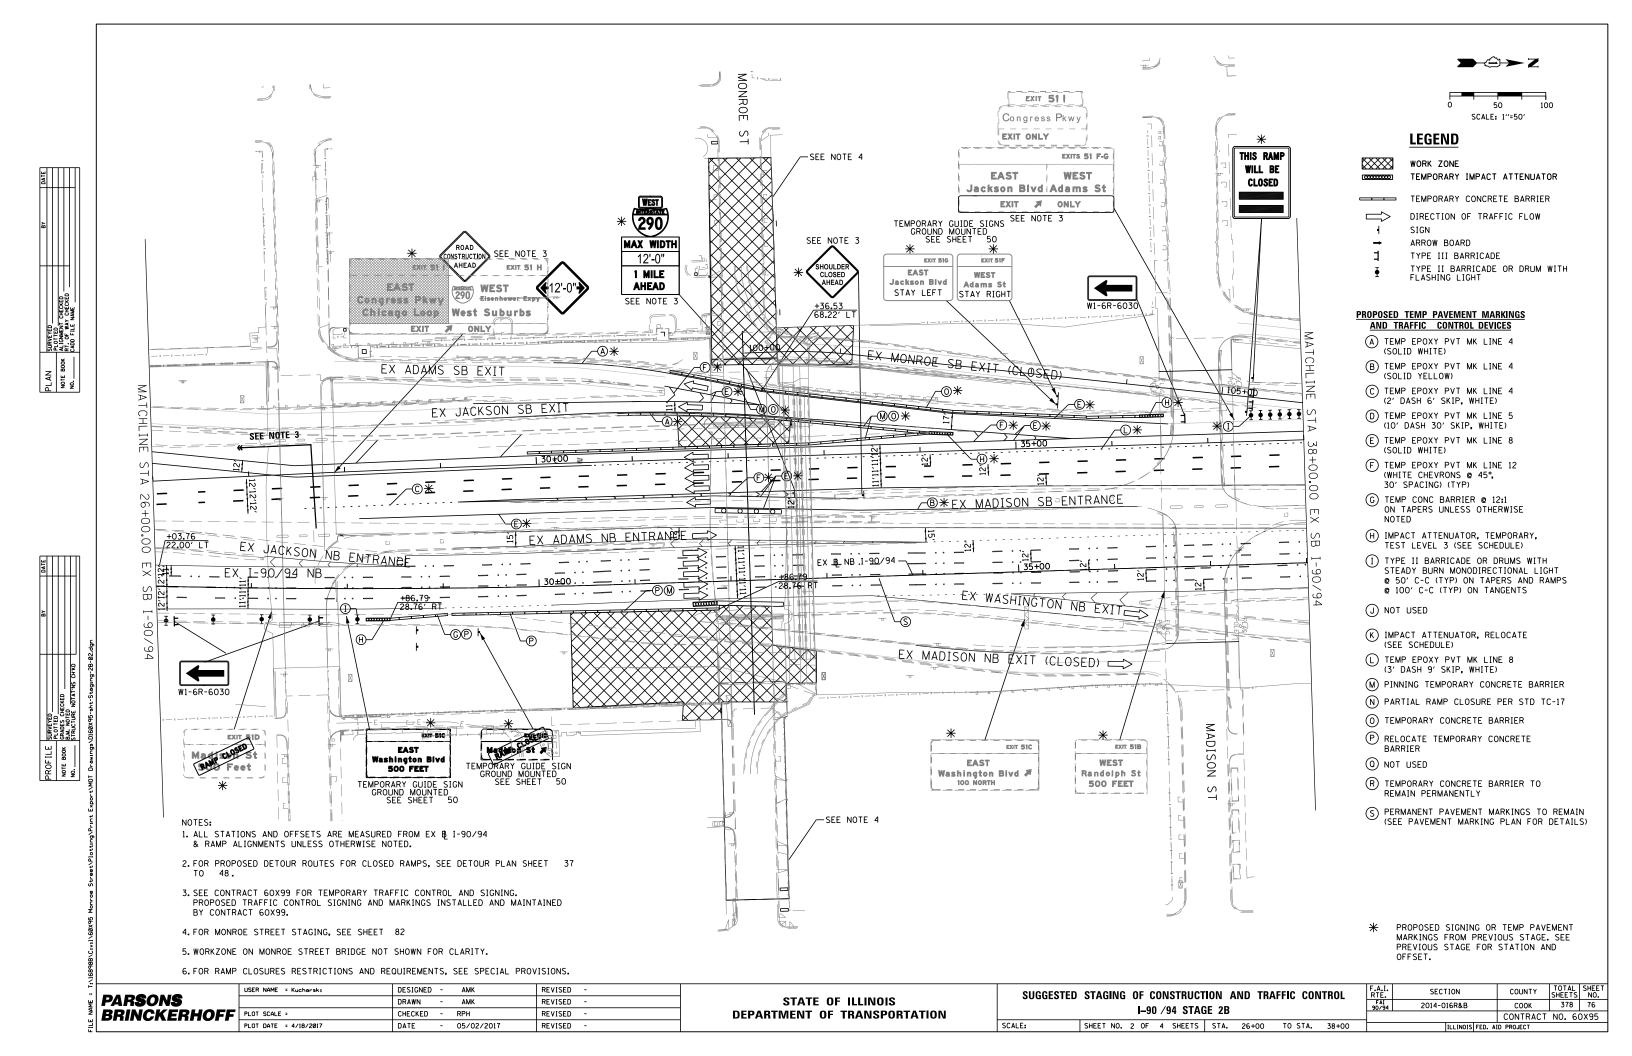


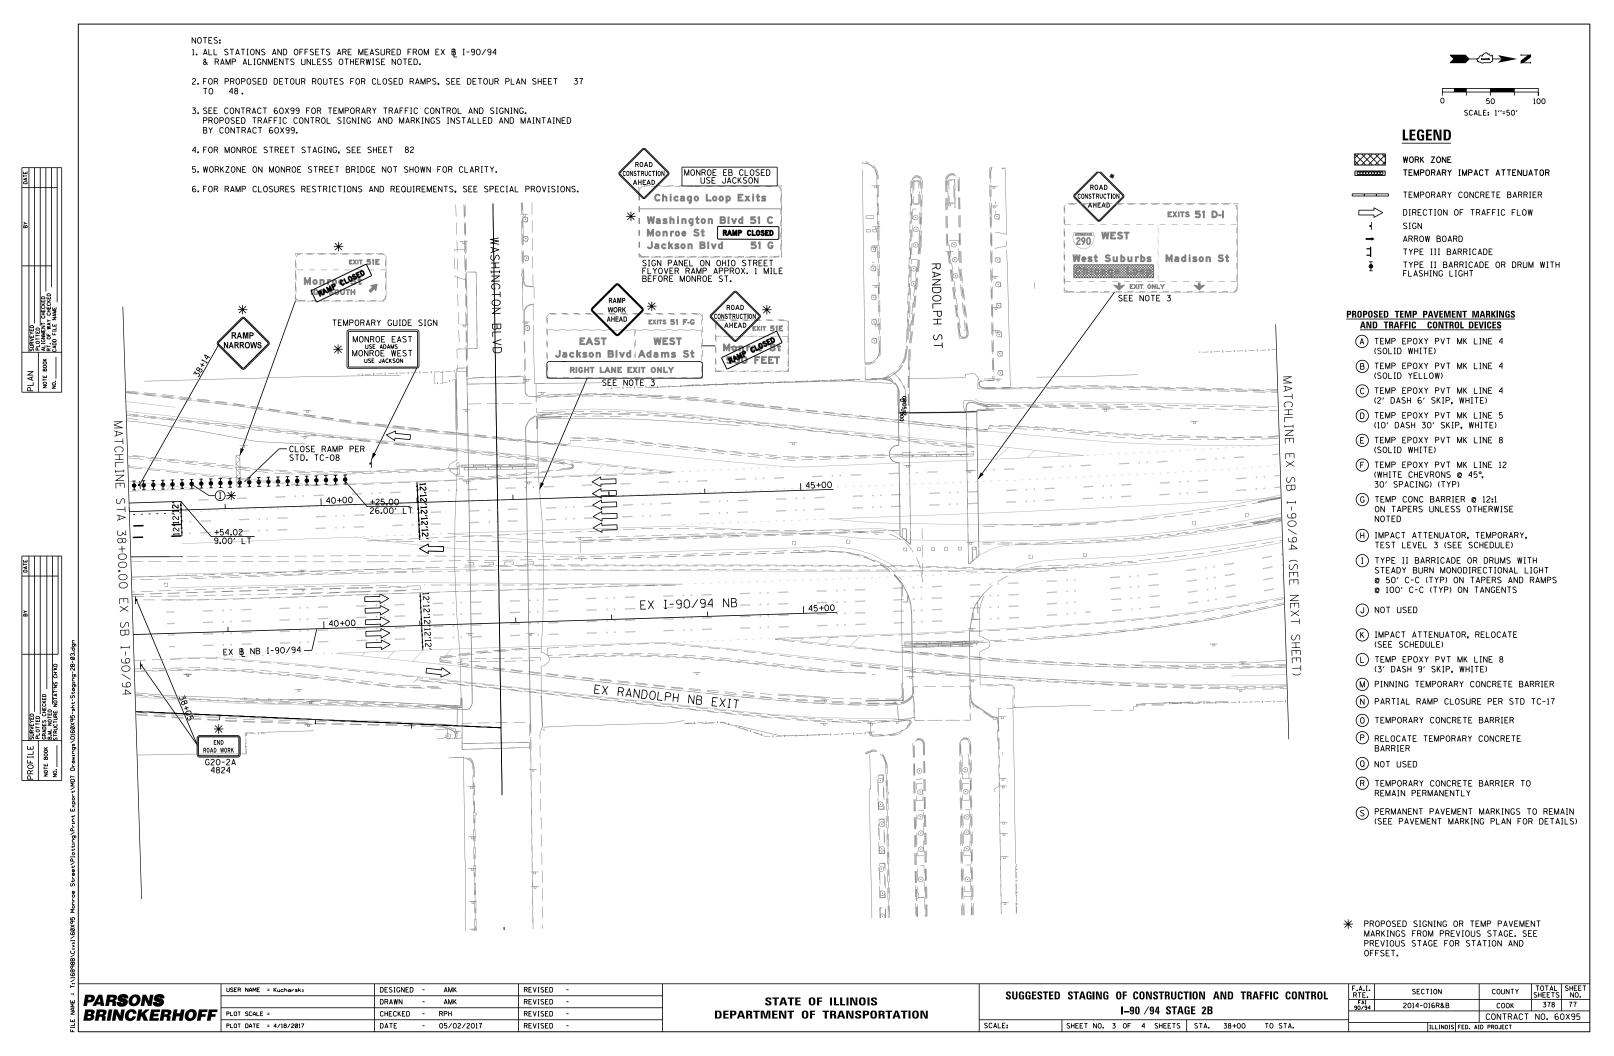


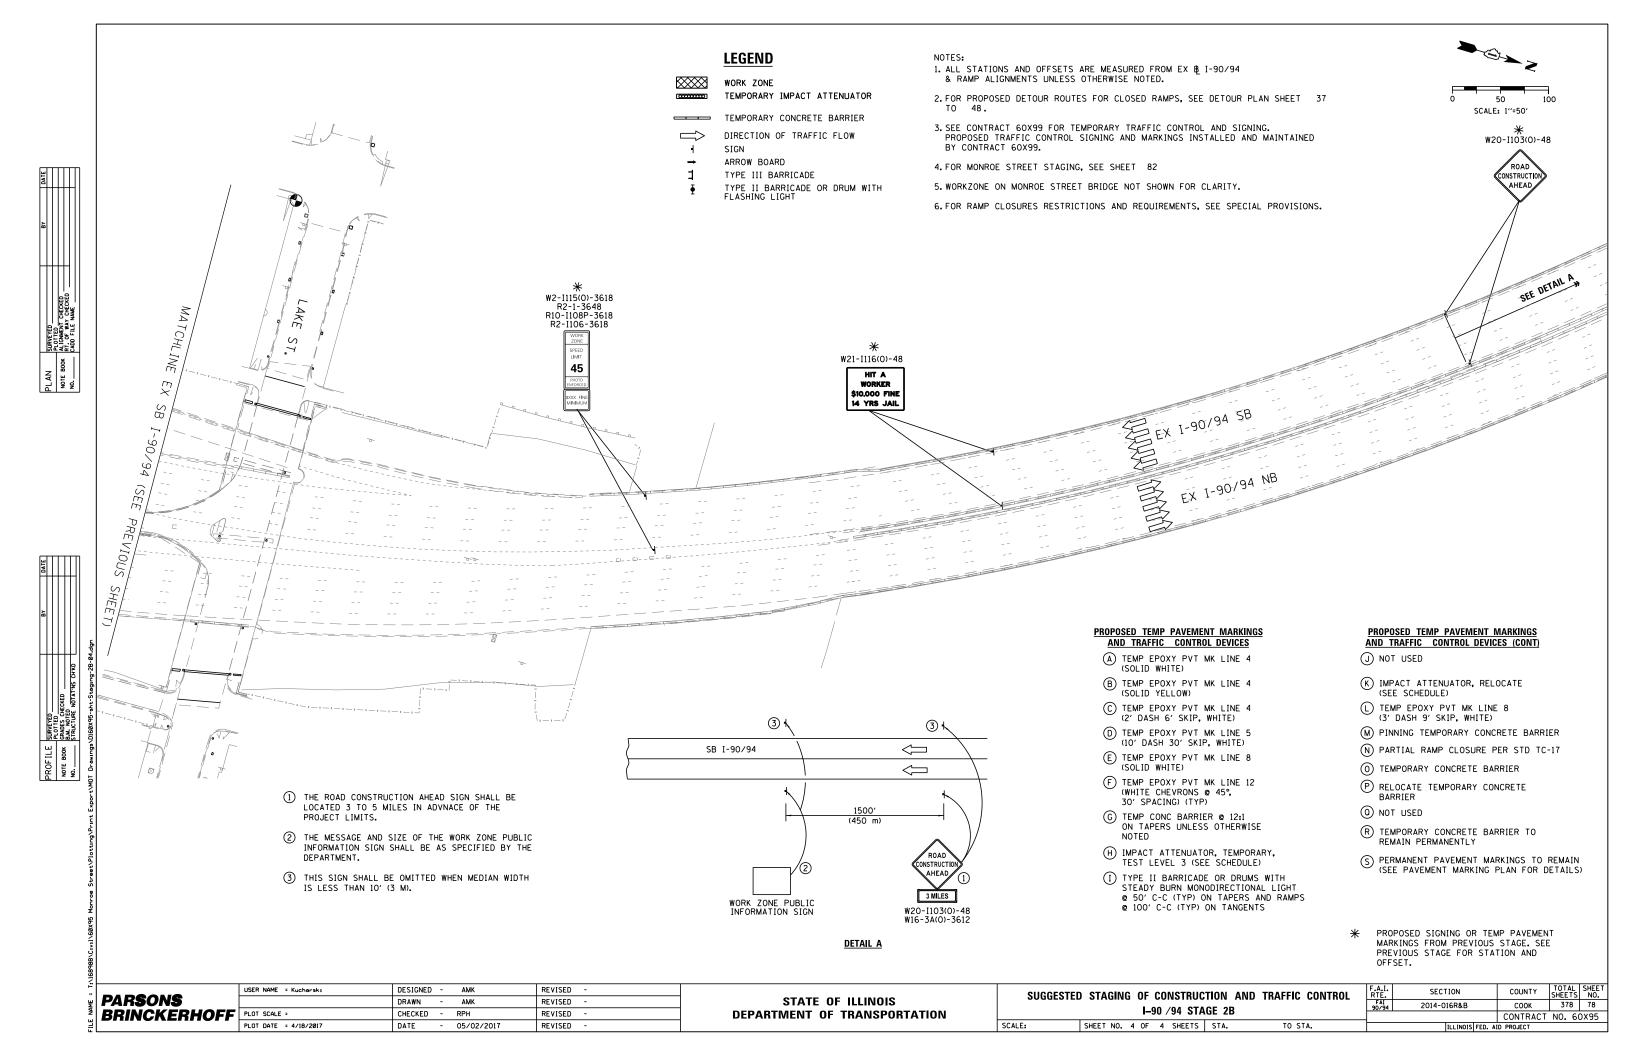


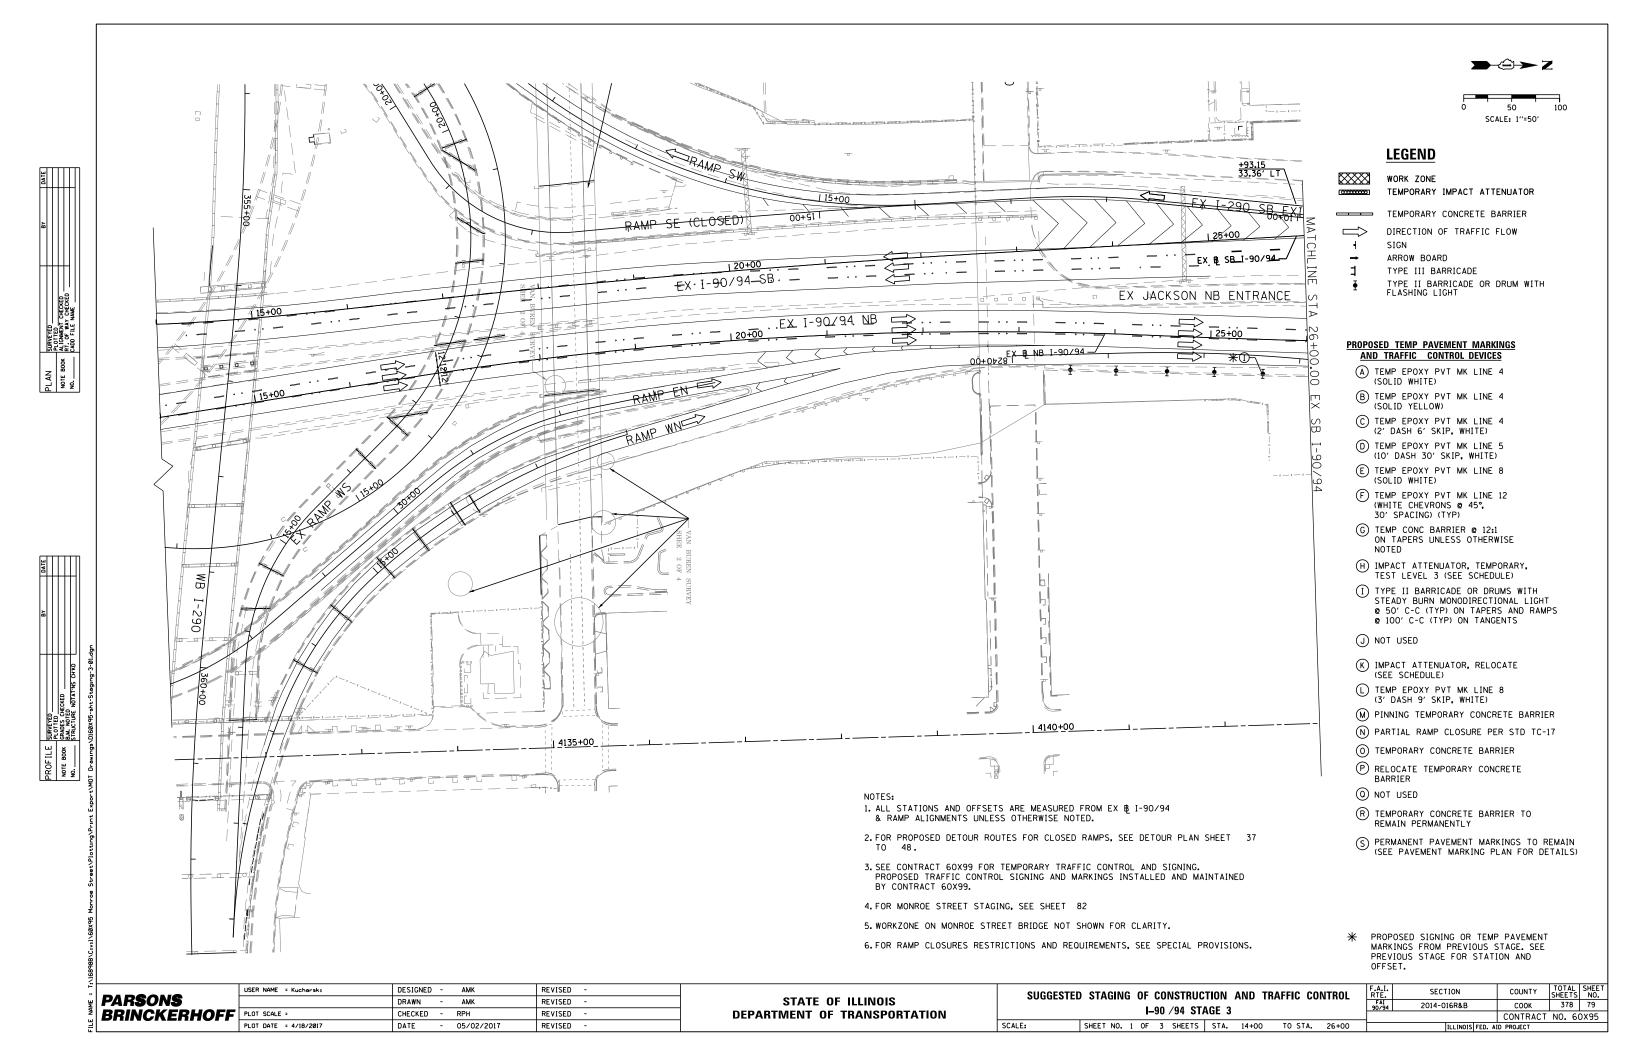

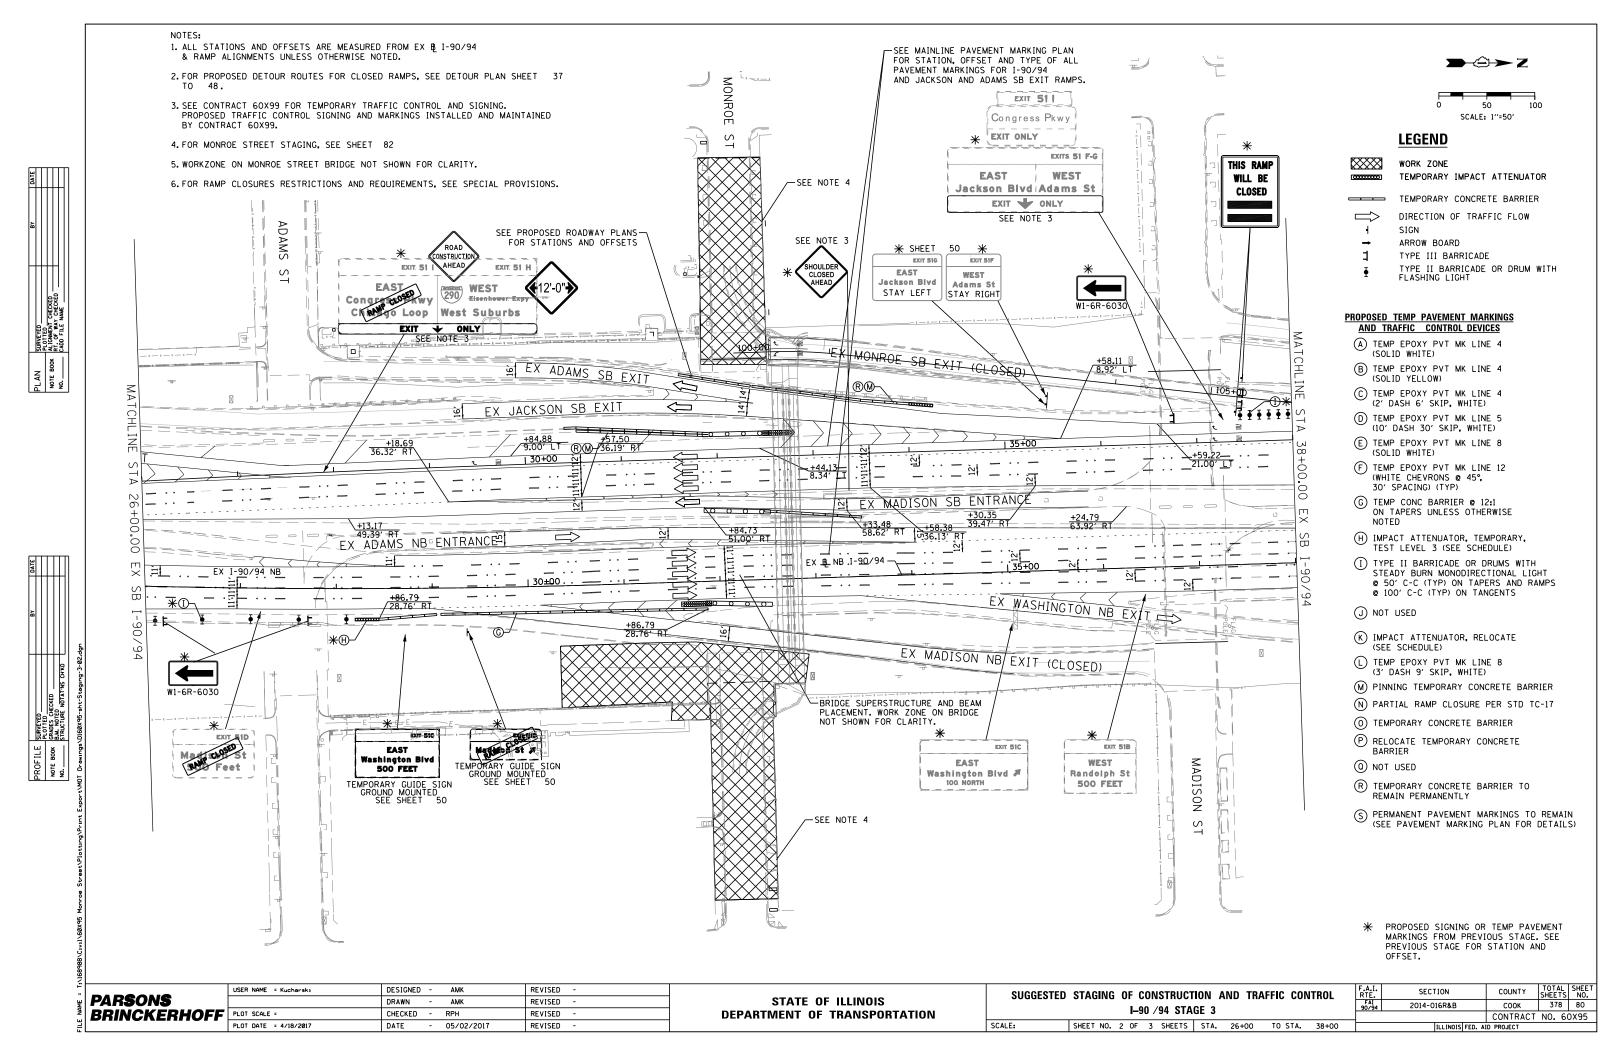

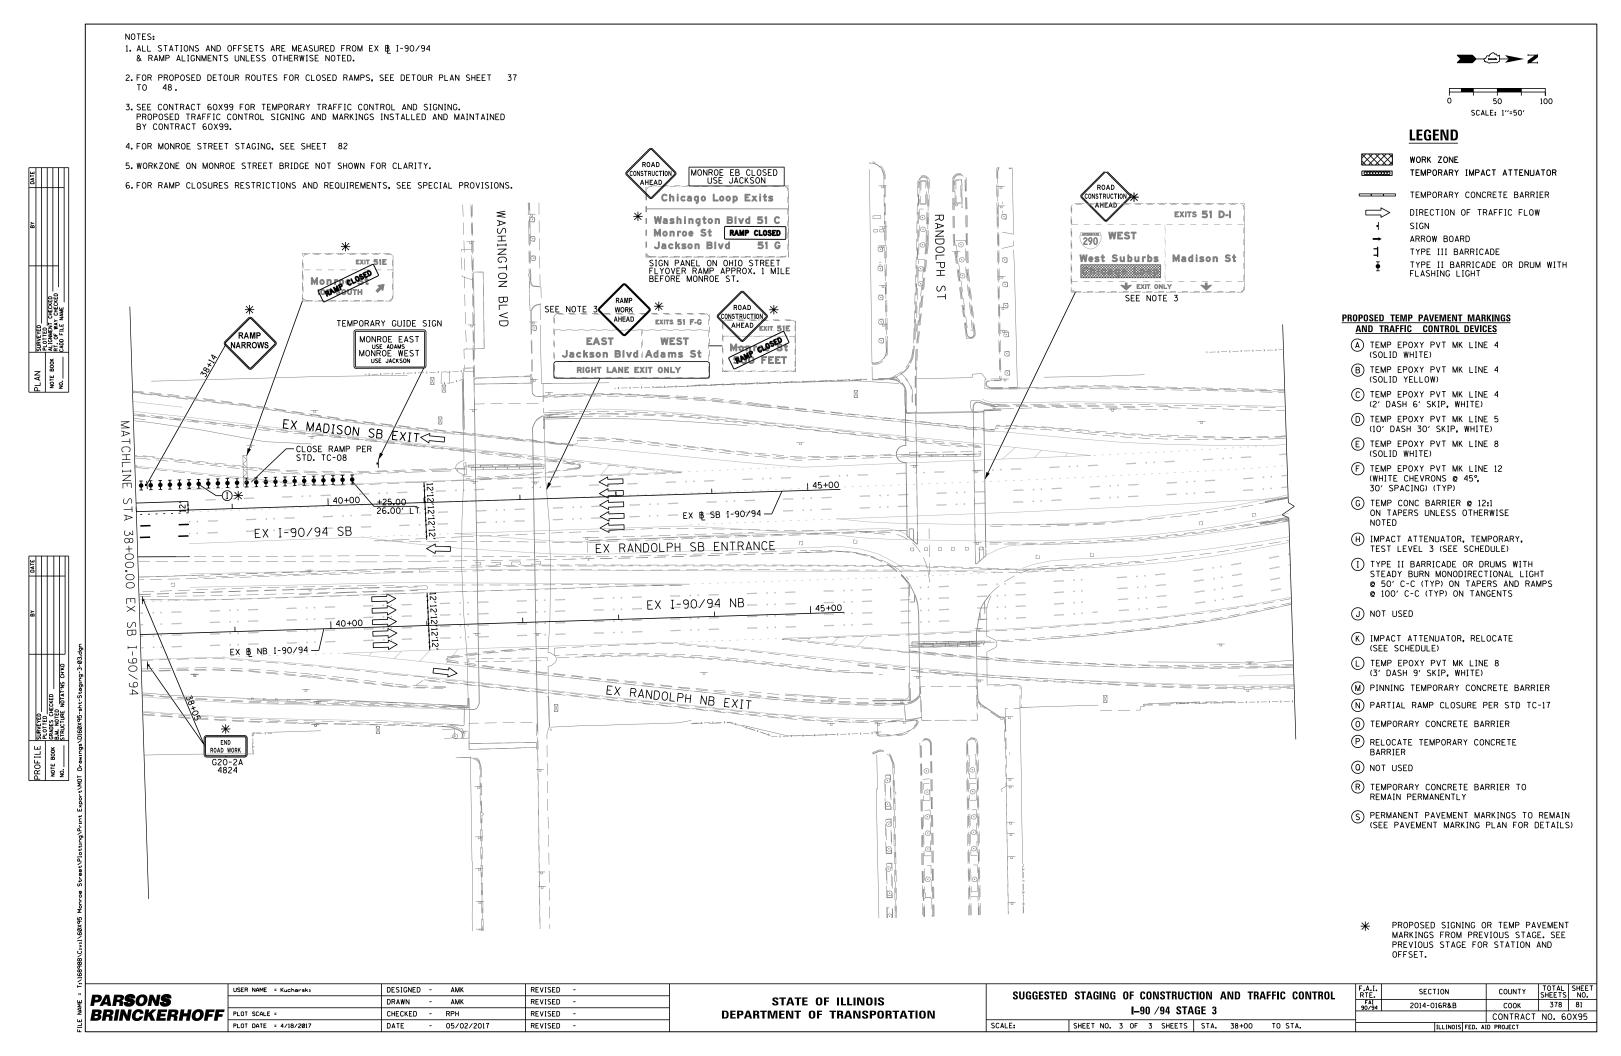

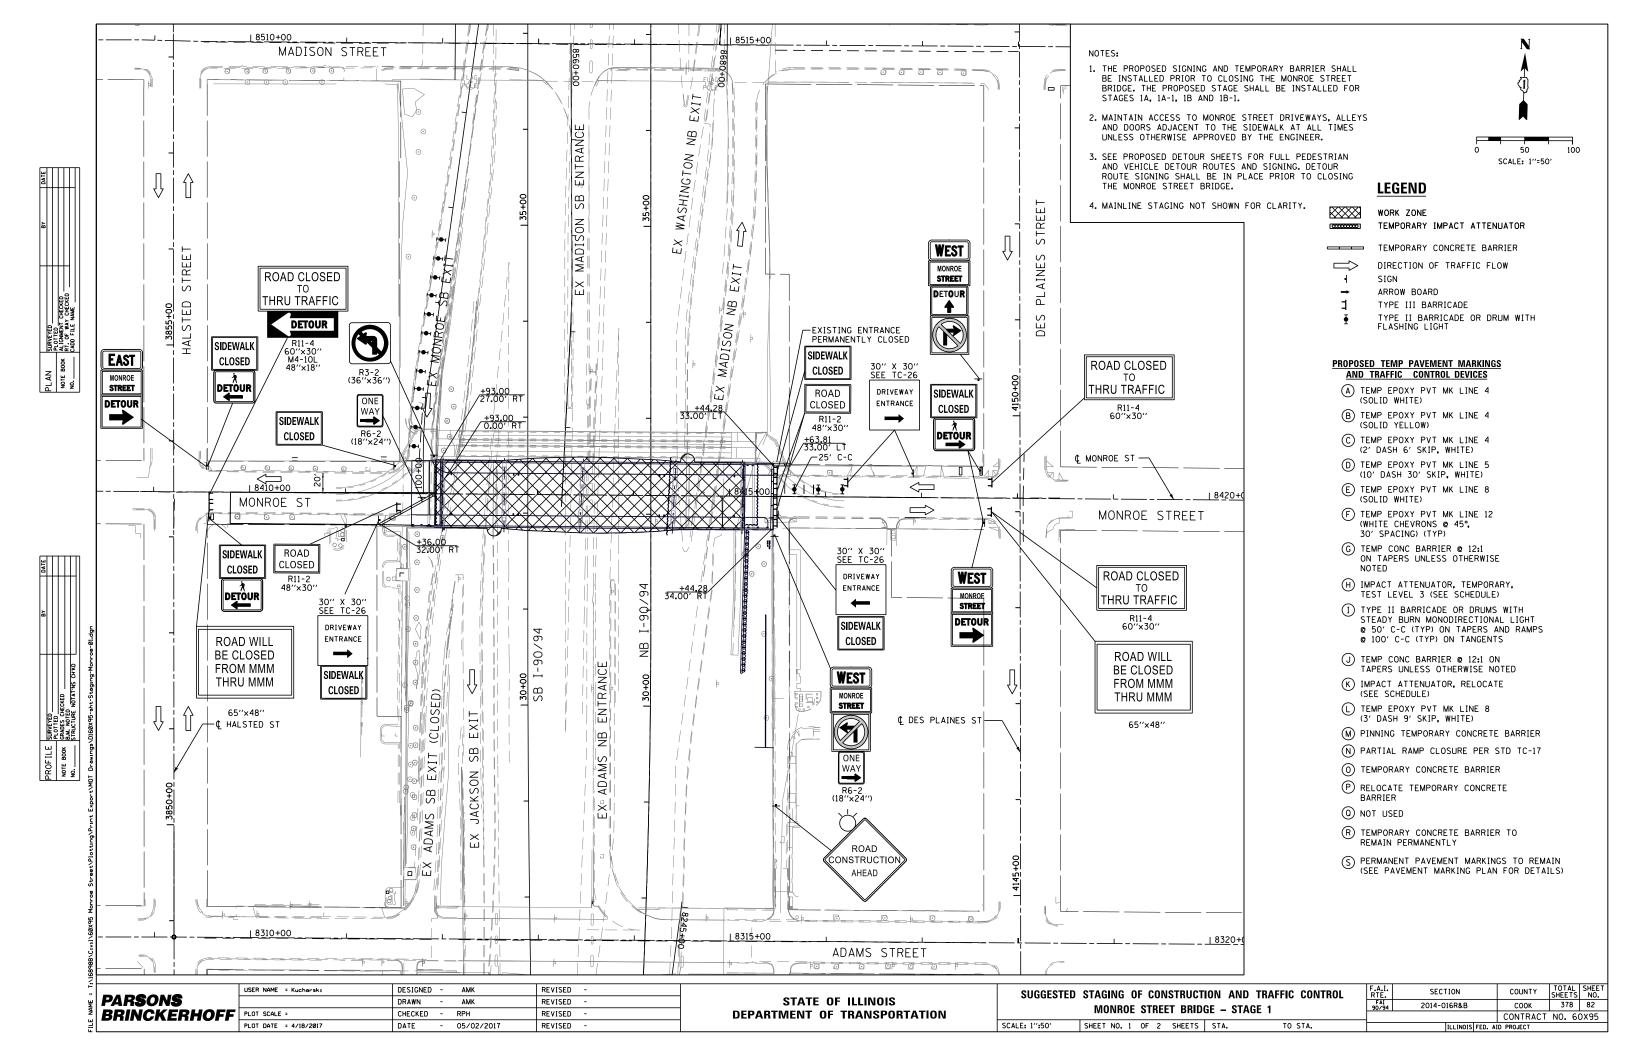

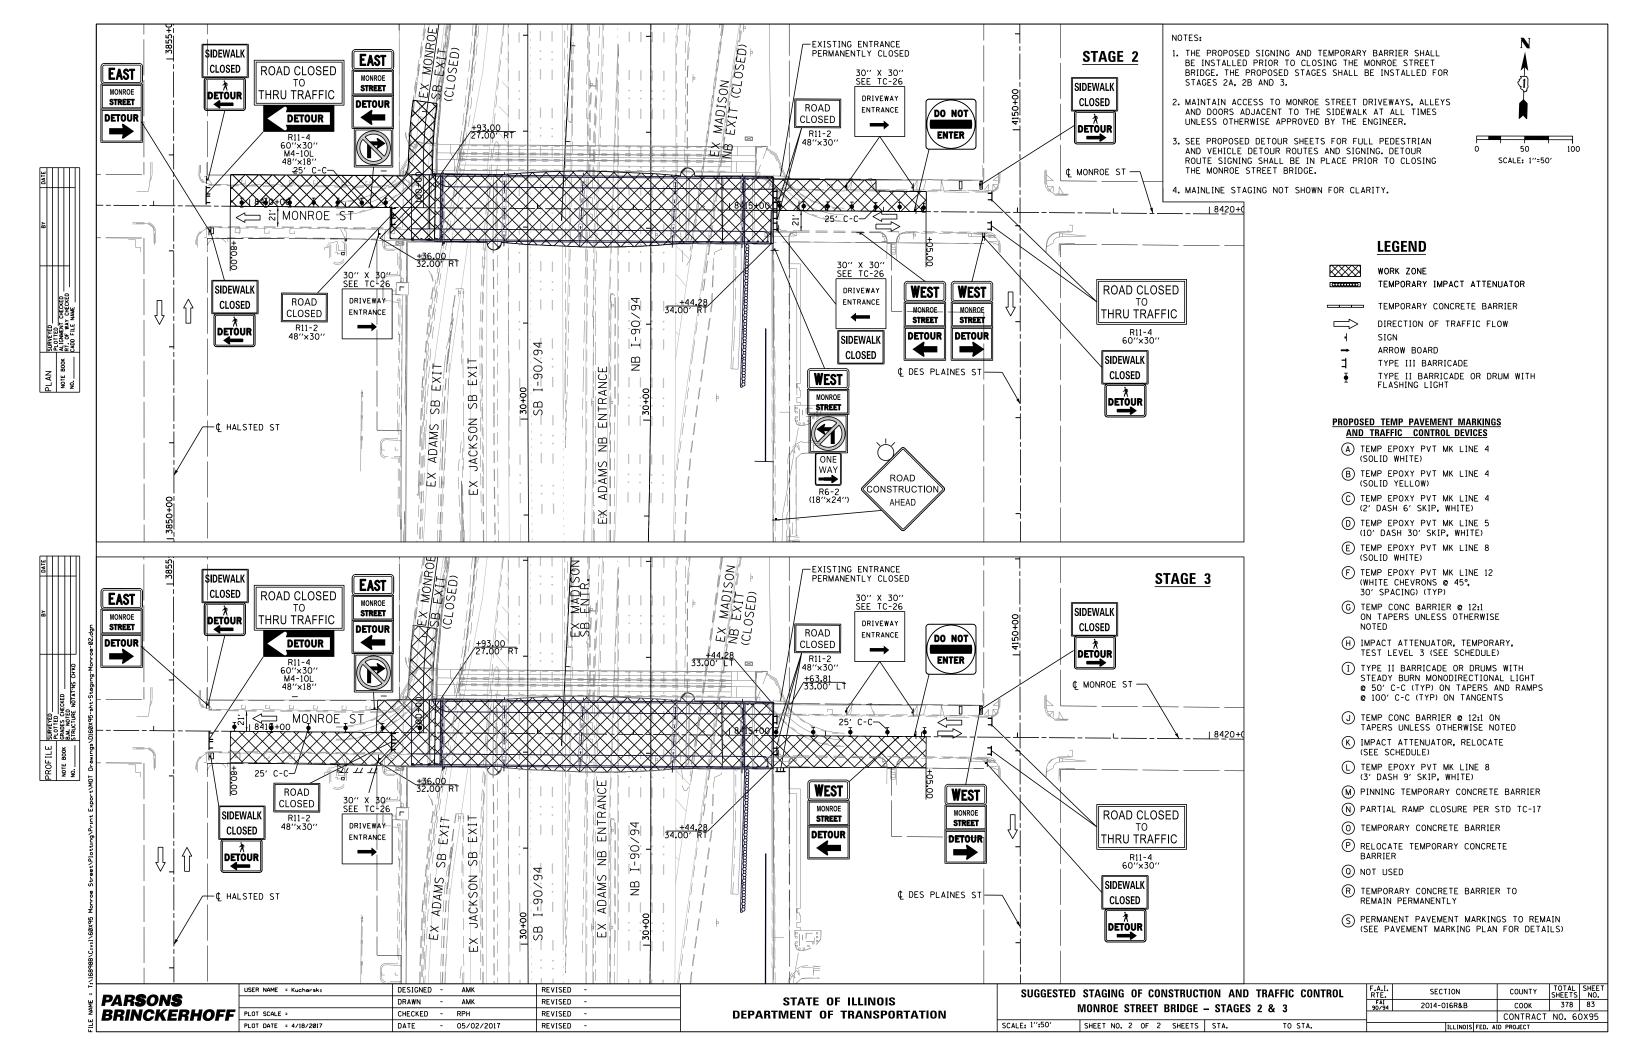



EROSION CONTROL GENERAL NOTES

- 1. THE CONSTRUCTION LIMITS WILL BE STAKED AND APPROVED BY THE ENGINEER PRIOR TO COMMENCING CONSTRUCTION. THE CONSTRUCTION LIMITS MAY BE ADJUSTED BY THE ENGINEER TO PRESERVE TREES AND NO ADDITIONAL COMPENSATION WILL BE PAID TO THE CONTRACTOR FOR CHANGES IN CONSTRUCTION LIMITS.
- 2. EROSION CONTROL ITEMS ARE CONSIDERED HIGH PRIORITY ITEMS IN THIS CONTRACT. THE ENGINEER WILL IMPLEMENT ALL PROVISIONS OF SPECIFICATION TO NECESSARY ASSURE THAT EROSION CONTROL ITEMS ARE CONSTRUCTED AND MAINTAINED IN A TIMELY MANNER. THE CONTRACTOR SHALL INSTALL TEMPORARY EROSION CONTROL MEASURES PRIOR TO THE START OF CONSTRUCTION OPERATIONS WHICH WILL POTENTIALLY CREATE ERODIBLE CONDITIONS. PLACEMENT AND MAINTENANCE OF TEMPORARY EROSION CONTROL SYSTEMS WILL BE UTILIZED THROUGHOUT THE CONSTRUCTION LIMITS.
- 3. TEMPORARY EROSION CONTROL MEASURES SHALL BE CONSTRUCTED AS SHOWN ON THE PLANS AND AS DIRECTED BY THE ENGINEER. THE WORK SHALL BE COMPLETED IN ACCORDANCE WITH SECTION 280 OF THE STANDARD SPECIFICATIONS, CONTRACT SPECIAL PROVISIONS AND THE STORM WATER POLLUTION PREVENTION PLAN (SWPPP).
- 4. THE CONTRACTOR SHALL UTILIZE THE GENERAL MAINTENANCE GUIDELINES AS OUTLINED IN THE SWPPP TO ENSURE GOOD AND EFFECTIVE OPERATING CONDITION OF THE VEGETATION AND EROSION AND SEDIMENT CONTROL MEASURES.
- 5. A COPY OF THE APPROVED EROSION AND SEDIMENT CONTROL PLAN SHALL BE MAINTAINED ON SITE. ALL CHANGES TO THE SOIL EROSION AND SEDIMENT CONTROL PLAN SHALL BE NOTED ON THE SITE.
- 6. THE CONTRACTOR SHALL PERFORM ALL WORK AS DIRECTED BY THE ENGINEER AND AS SHOWN IN HIGHWAY STANDARD 280001. STRAW BALES AND SILT FENCE SHOULD NOT BE USED AS INLET AND PIPE PROTECTION.
- 7. THE EROSION CONTROL MEASURES SHOWN ARE BUT A GRAPHICAL REPRESENTATION OF SUGGESTED MEASURES. DEVIATIONS FROM THIS PLAN ARE TO BE EXPECTED PENDING A JOBSITE INSPECTION BETWEEN THE CONTRACTOR AND THE DEPARTMENT.
- 8. THE CONTRACTOR WILL BE REQUIRED TO IMPLEMENT AND MAINTAIN SEDIMENT CONTROL MEASURES PRIOR TO STRIPPING EXISTING VEGETATION.
- 9. THE CONTRACTOR SHALL INSPECT ALL EROSION AND SEDIMENT CONTROL MEASURES WEEKLY AND AFTER EACH RAINFALL, 0.5 INCHES OR GREATER IN A 24 HOUR PERIOD, OR EQUIVALENT SNOWFALL. ADDITIONALLY DURING WINTER MONTHS, ALL MEASURES SHOULD BE CHECKED AFTER EACH SIGNIFICANT SNOWMELT. ANY NECESSARY REPAIRS OR CLEANUP TO MAINTAIN THE EFFECTIVENESS OF SAID MEASURES SHALL BE MADE IMMEDIATELY.
- 10. TEMPORARY EROSION CONTROL SEEDING SHALL BE APPROVED PER SUB-STAGE AS SOON AS ROUGH GRADING IS COMPLETED IN A SECTION. STABILIZATION OF DISTURBED AREAS MUST BE INITIATED WITHIN ONE WORKING DAY OF TEMPORARY OR PERMANENT CESSATION OF FARTH DISTURBING ACTIVITIES AND SHALL BE COMPLETED AS SOON AS POSSIBLE BUT NO LATER THAN 14 DAYS FROM THE INITIATION OF STABILIZATION OF WORK IN AN AREA.
- 11. MULCH, METHOD 2 AND SURFACE ROUGHENING SHALL BE USED FOR TEMPORARY STABILIZATION DURING WINTER IN ADDITION TO TEMPORARY EROSION CONTROL SEEDING WHEN GRADING WILL OCCUR WHILE THE GROUND IS SNOW COVERED WHEN TEMPORARY SEED WILL NOT GERMINATE AND PROVIDE EROSION CONTROL PROTECTION UNTIL THE FOLLOWING SPRING. SURFACE ROUGHENING WILL NOT BE PAID FOR SEPARATELY BUT SHALL BE INCLUDED IN THE COST OF MULCH, METHOD 2.
- 12. ANY AREA WHERE THERE IS NO PROPOSED GRADING THE EXISTING GROUND COVER SHALL REMAIN.

- 13. TEMPORARY STOCKPILE LOCATIONS SHALL BE APPROVED BY THE ENGINEER AND WILL REQUIRE SILT FENCE AND TEMPORARY SEEDING.
- 14. THE CONTRACTOR SHALL INSTALL, MAINTAIN AND ROUTINELY CLEAN INLET FILTERS AT ALL EXISTING INLETS ADJACENT TO THE EDGE OF PAVEMENT PRIOR TO THE START OF PRE-STAGE WORK. THE INLET FILTERS SHALL BE MAINTAINED AT EACH SUBSEQUENT STAGE UNTIL NO LONGER REQUIRED OR AS DIRECTED BY THE ENGINEER.
- 15. DURING CONSTRUCTION OPERATIONS, WHEN ANY LOOSE MATERIAL IS DEPOSITED IN THE FLOW LINE OF DITCHES, GUTTERS OR DRAINAGE STRUCTURES SO THAT THE NATURAL FLOW OF WATER IS OBSTRUCTED, THE MATERIAL SHALL BE REMOVED AT THE CLOSE OF EACH WORKING DAY.
- 16. THE CONTRACTOR SHALL IMMEDIATELY INSTALL AND MAINTAIN INLET FILTERS AT ALL NEW INLETS AND DRAINAGE STRUCTURES. THE INLET FILTERS SHALL BE MAINTAINED AT EACH SUBSEQUENT STAGE UNTIL COMPLETION OF STAGING OR UNTIL NO LONGER REQUIRED.
- 17. TEMPORARY OR PERMANENT STABILIZATION SHALL BE INSTALLED ON ALL AREAS DISTURBED DURING EACH STAGE OF CONSTRUCTION PRIOR TO SWITCHING TRAFFIC TO BEGIN THE SUBSEQUENT STAGE. ALSO, ALL EROSION CONTROL MEASURES PLACED DURING CONSTRUCTION SHALL REMAIN IN PLACE AND BE MAINTAINED UNTIL COMPLETION OF CONTRACT OR NO LONGER REQUIRED.
- 18. ALL EROSION AND SEDIMENT CONTROL MEASURES WILL BE MAINTAINED IN ACCORDANCE WITH THE IDOT EROSION AND SEDIMENT CONTROL FIELD GUIDE FOR CONSTRUCTION INSPECTION AND IDOT'S BEST MANAGEMENT PRACTICES MAINTENANCE GUIDE: (HTTP://WWW.IDOT.ILLINOIS.GOV/ TRANSPORTATION-SYSTEM/ENVIRONMENT/EROSION-AND-SEDIMENT-CONTROL).
- 19. THE CONTRACTOR SHALL PROVIDE TO THE RESIDENT ENGINEER A PLAN TO ENSURE THAT A STABILIZED FLOW LINE WILL BE PROVIDED DURING STORM SEWER CONSTRUCTION. THE USE OF A STABILIZED FLOW LINE BETWEEN INSTALLED STORM SEWER AND OPEN DISTURBANCE WILL REDUCE THE POTENTIAL FOR THE OFFSITE DISCHARGE OF SEDIMENT-BEARING WATERS. ESPECIALLY WHEN RAIN IS FORECASTED, SO THAT FLOW WILL NOT ERODE, LACK OF APPROVED PLAN OR FAILURE TO COMPLY WILL RESULT IN AN EROSION AND SEDIMENT CONTROL DEFICIENCY DEDUCTION.

FF

SCALE:

20. UNDER NO CIRCUMSTANCES SHALL THE CONTRACTOR PROLONG FINAL GRADING AND SHAPING SO THAT THE ENTIRE PROJECT CAN BE PERMANENTLY SEEDED AT ONE TIME.

PARSONS	ŀ
BRINCKERHOFF	ļ

USER NAME = Kucharski	DESIGNED	-	KD	REVISED -
	DRAWN	-	RD	REVISED -
PLOT SCALE = 1"=50"	CHECKED	-	SV	REVISED -
PLOT DATE = 4/28/2017	DATE	-	05/02/2017	REVISED -

_						F.A.I. RTE.	SECTION	COUNTY	TOTAL SHEETS	SHEET NO.
ROSION CONTROL GENERAL NOTES		NOTES	FAI 90/94	2014-016R&B	соок	378	84			
	1							CONTRACT	NO. 6	0X95
	SHEET NO	1 OF 1	SHEETS	STA	TO STA		THE TWO IS FED. A	TO DOO ICCT		

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PLAN SURVEYED			
PLOTTED			
NOTE BOOK ALIGNMENT CHECKED	CKED		
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D. CADD FILE NA			

TEMPORARY EROSION CONTROL									
STAGES	MULCH, METHOD 2	TEMPORARY EROSION CONTROL SEEDING	PERIMETER EROSION BARRIER	INLET FILTERS	STABILIZED CONSTRUCTION ENTRANCE	TREE TRUNK PROTECTION			
	ACRE	POUND	FOOT	EACH	SQ YD	EACH			
1	0.25	25	970	18	-	10			
2 AND 3	2 AND 3 0.75 75		-	20	3,367	0			
TOTAL	1.00	100	970	38	3,367	10			

INLET FILTER SCHEDULE											
STAGE 1											
STATION	OFFSET	ALIGNMENT	QUANTITY								
31+26.06	77 . 48 LT	EX SB I-90/94	1								
31+42.28	74 . 99 LT	EX SB I-90/94	1								
31+46.34	30.99 LT	EX SB I-90/94	1								
31+50.06	99.72 LT	EX SB I-90/94	1								
32+58.19	38.64 LT	EX SB I-90/94	1								
32+85.48	62.83 RT	EX SB I-90/94	1								
32+88.63	42.16 RT	EX SB I-90/94	1								
32+99.14	64 . 59 LT	EX SB I-90/94	1								
33+90.93	53 . 43 LT	EX SB I-90/93	1								
34+88.56	61.60 LT	EX SB I-90/94	1								
34+91.95	43 . 29 LT	EX SB I-90/94	1								
34+99.87	42.66 LT	EX SB I-90/94	1								
8409+69.97	21 . 00 LT	MONROE ST	1								
8409+94.63	20.88 RT	MONROE ST	1								
8411+57.36	20.63 LT	MONROE ST	1								
8411+64.68	74 . 54 LT	MONROE ST	1								
8411+99.58	21 . 00 RT	MONROE ST	1								
8412+08.21	21 . 00 LT	MONROE ST	1								
		TOTAL	18								

INLET FILTER SCHEDULE									
STAGES 2 AND 3									
STATION	OFFSET	ALIGNMENT	QUANTITY						
29+01.01	35 . 20 LT	EX NB I-90/94	1						
29+00.00	27 . 25 RT	EX NB I-90/94	1						
31+00.45	49.68 RT	EX NB I-90/94	1						
31+20.49	62.36 RT	EX NB I-90/94	1						
31+67.39	58.17 LT	EX NB I-90/94	1						
31+68.29	36.41 RT	EX NB I-90/94	1						
31+73.56	38.05 LT	EX NB I-90/94	1						
32+22.32	66.10 RT	EX NB I-90/94	1						
32+31.08	67.38 RT	EX NB I-90/94	1						
32+56.59	111 . 59 RT	EX NB I-90/94	1						
32+86.57	81.35 RT	EX NB I-90/94	1						
33+89.09	38.10 RT	EX NB I-90/94	1						
33+89.63	28.40 RT	EX NB I-90/94	1						
8415+53.98	20.67 LT	MONROE ST	1						
8415+51.11	22.00 RT	MONROE ST	1						
8416+16.68	20.43 LT	MONROE ST	1						
8417+35.00	17.67 RT	MONROE ST	1						
8417+35.40	21.00 RT	MONROE ST	1						
8417+36.38	21.26 LT	MONROE ST	1						
8417+61.34	19.60 LT	MONROE ST	1						
		TOTAL	20						


F	PERMANENT EROSION CONTROL										
	POTASSIUM FERTILIZER NUTRIENT	NITROGEN FERTILIZER NUTRIENT	SEEDING, CLASS 2A	EROSION CONTROL BLANKET							
	POUND	POUND	ACRE	SQ YD							
	90	90	1	4,840							
TOTAL	90	90	1	4,840							


PAR S ONS	
BRINCKERHOFF	


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		DRAWN	-	MMA	REVISED -
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-	PLOT DATE = 7/12/2017	DATE	-	07/14/2017	REVISED -


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DEPARTMENT (OF 1	RANSPORTATION


EDGGIGN, GONEDOL	F.A.I. RTE.	SECTION	COUNTY	TOTAL SHEETS	SHEET NO.	
EROSION CONTROL	FAI 90/94	2014-016R&B	СООК	378	85	
			CONTRACT	NO. 6	0X95	
SCALE: SHEET NO. 1 OF 1 SHEETS	STA. TO STA.		ILLINOIS FED.	AID PROJECT		

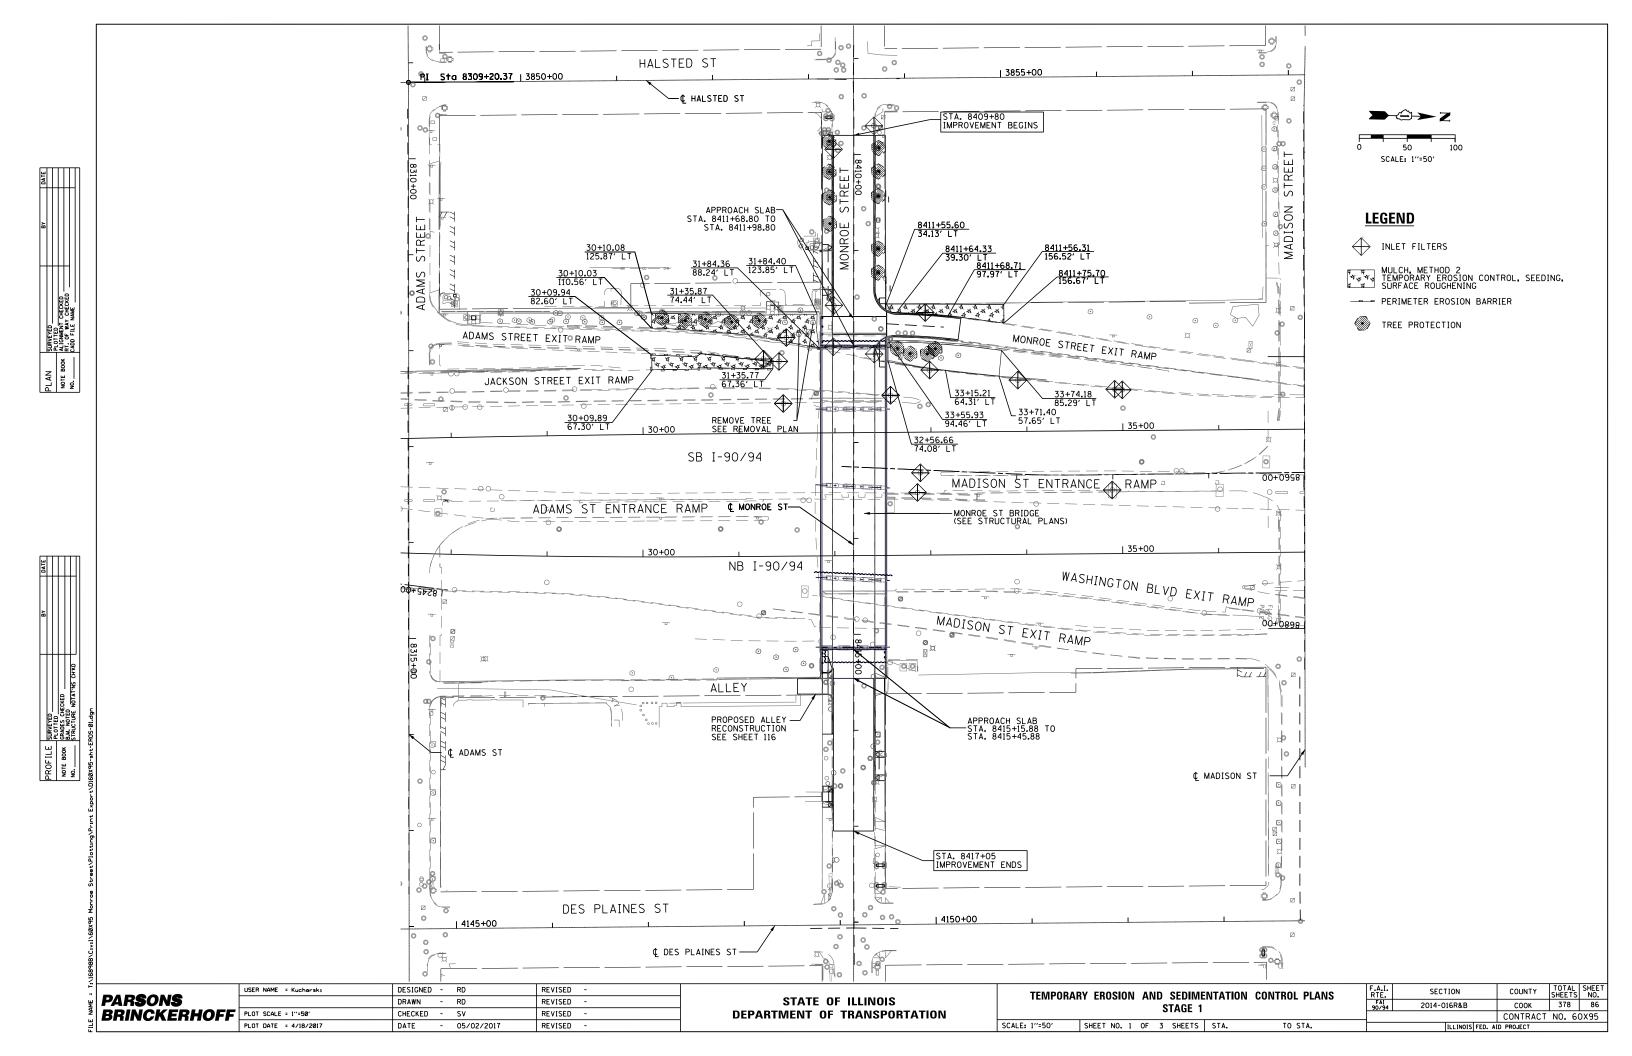

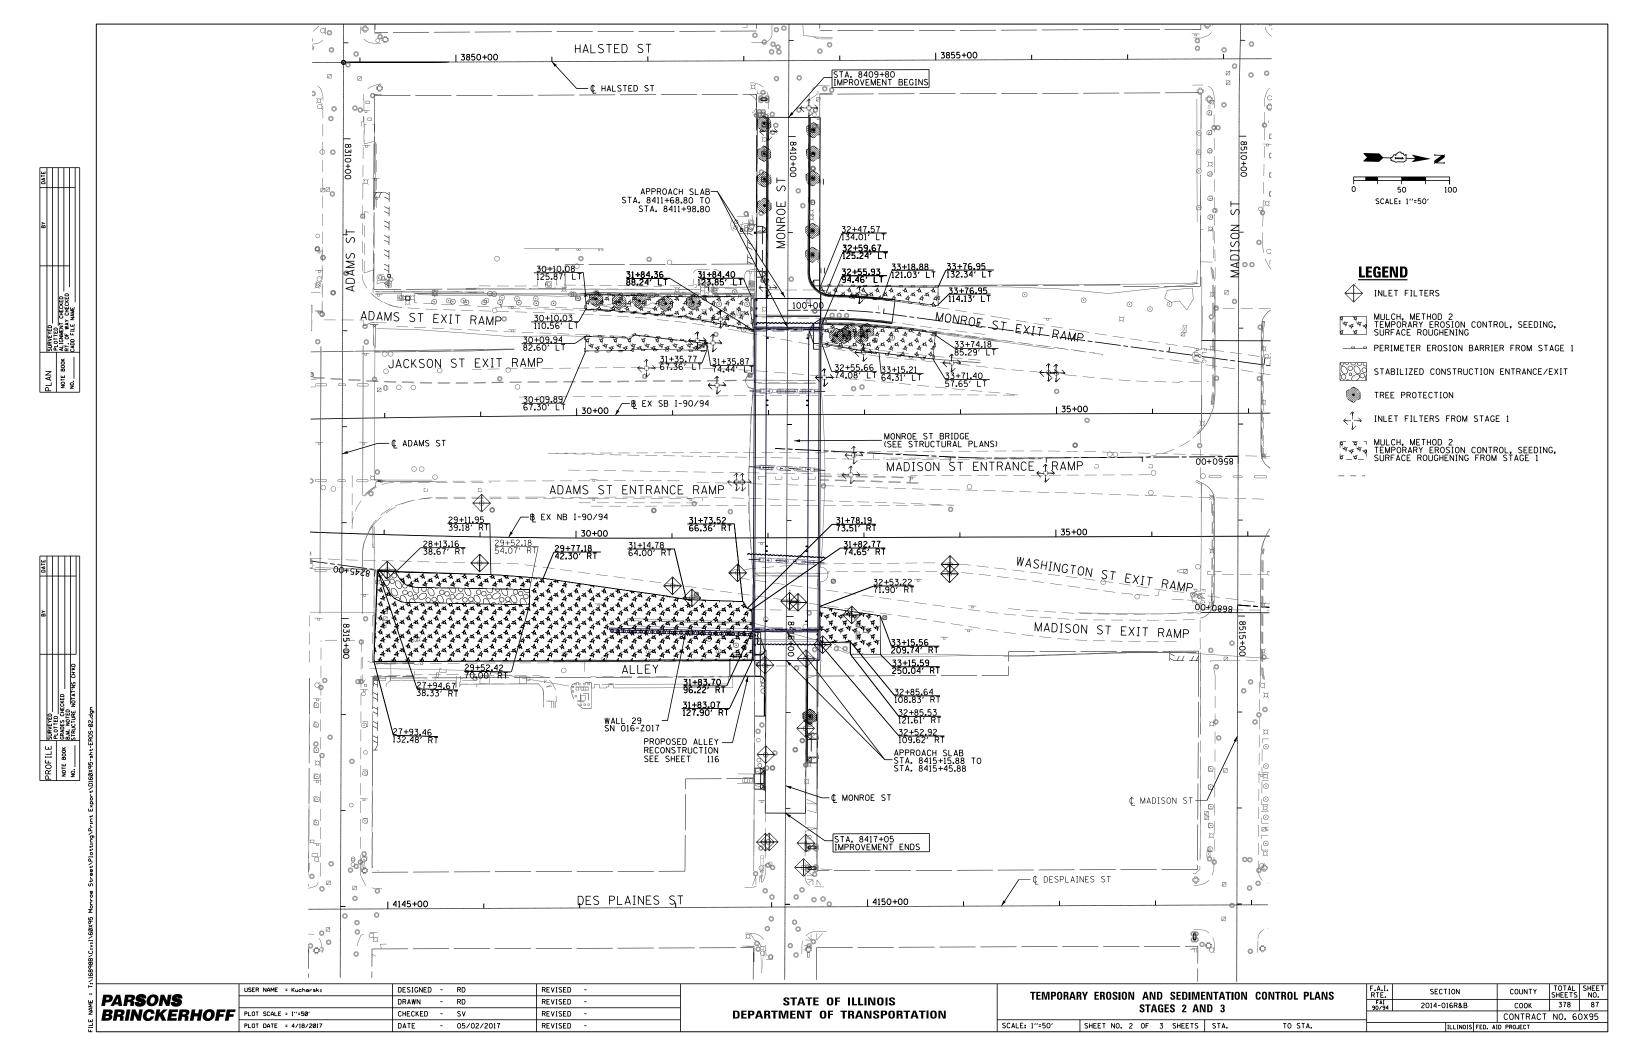

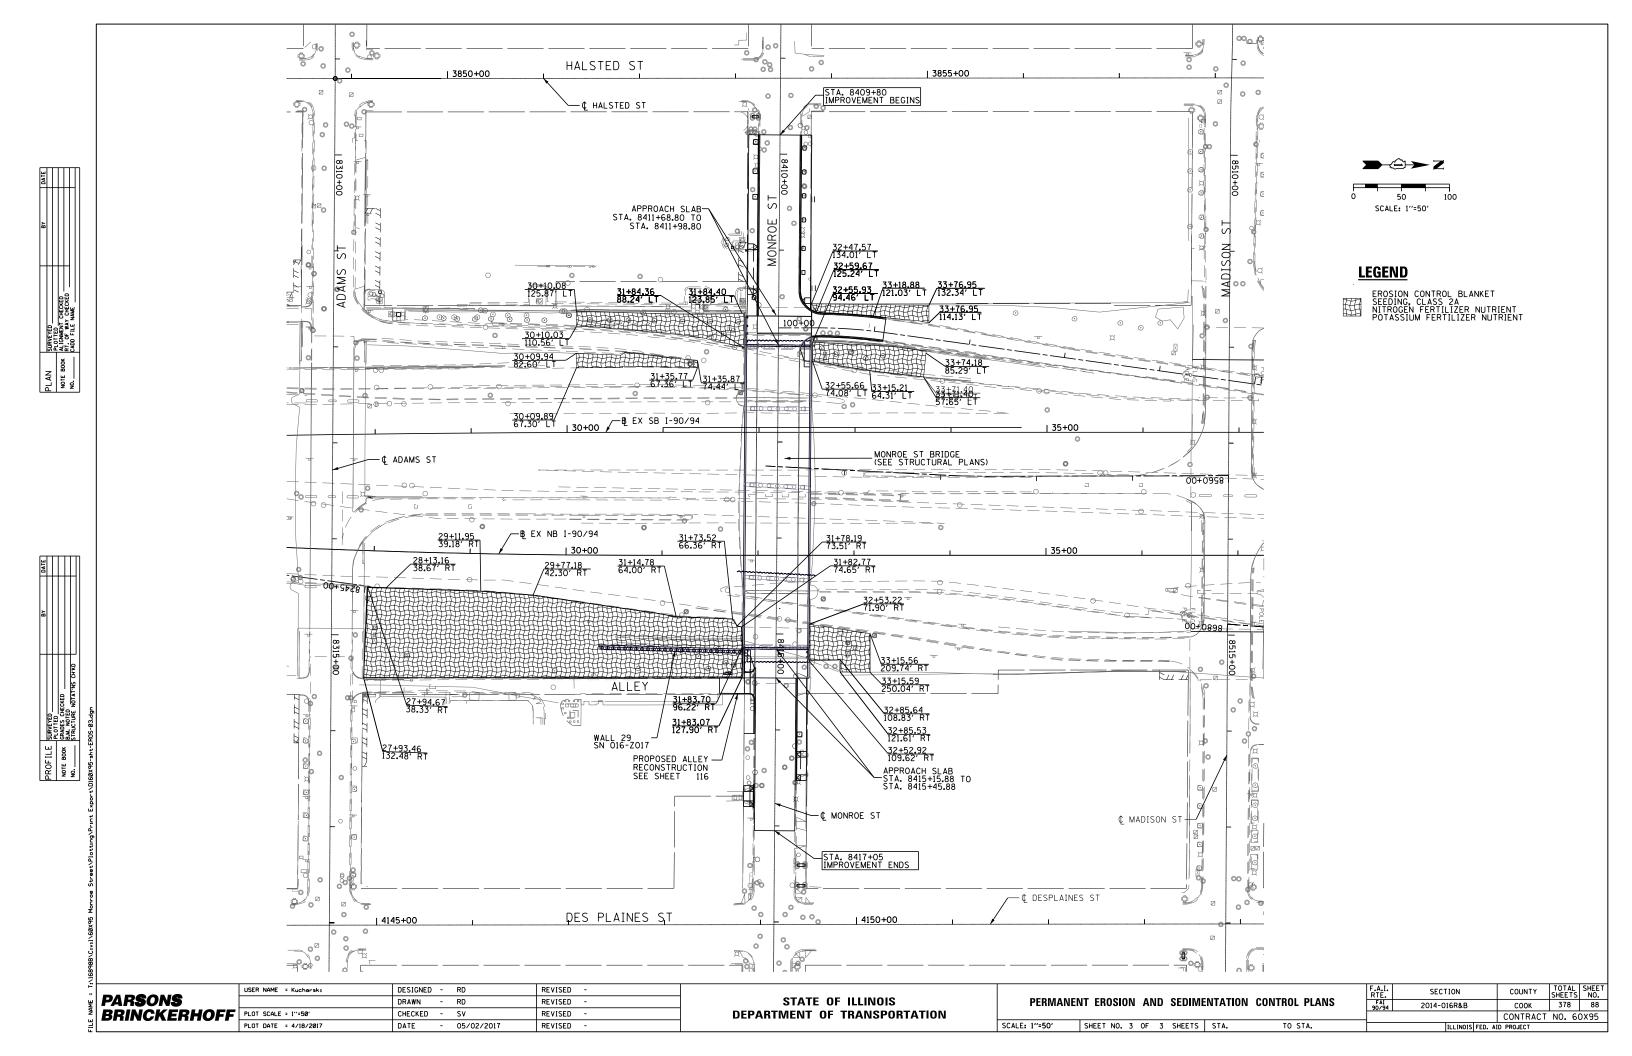

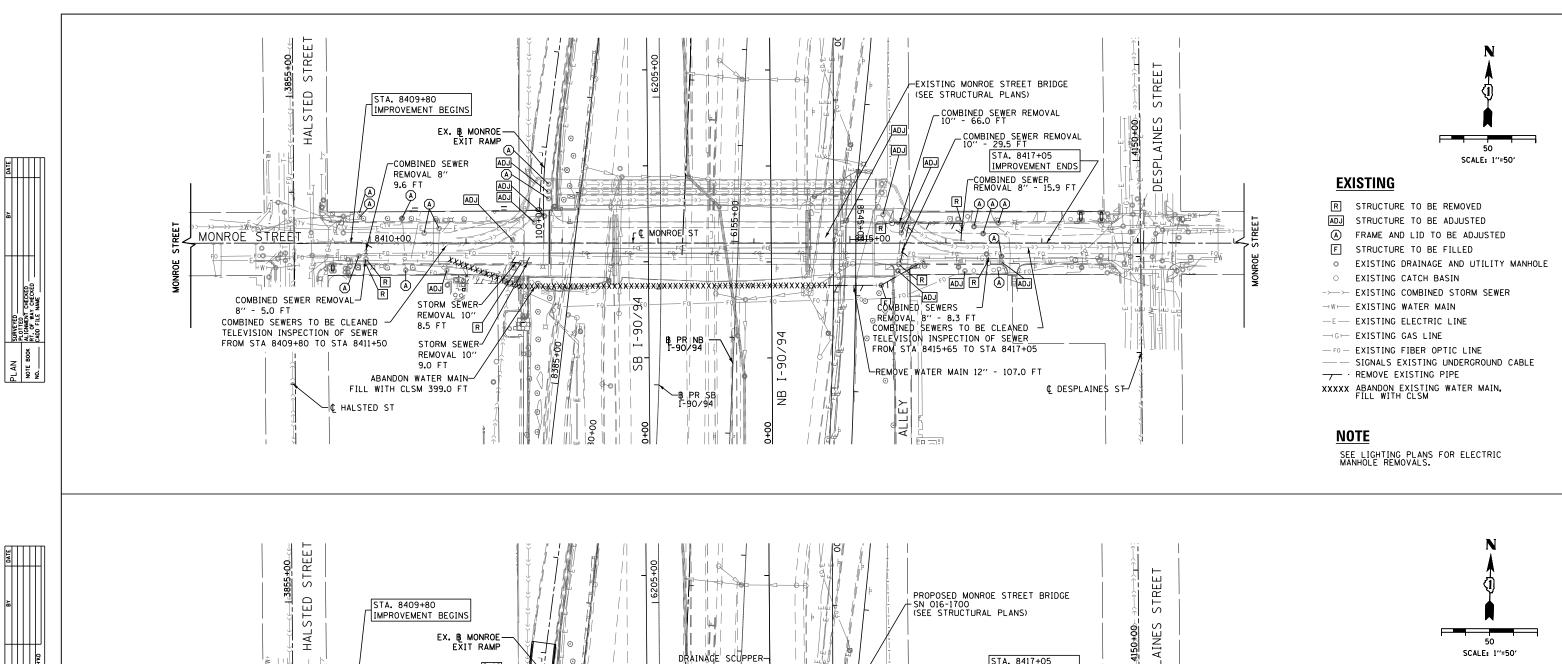

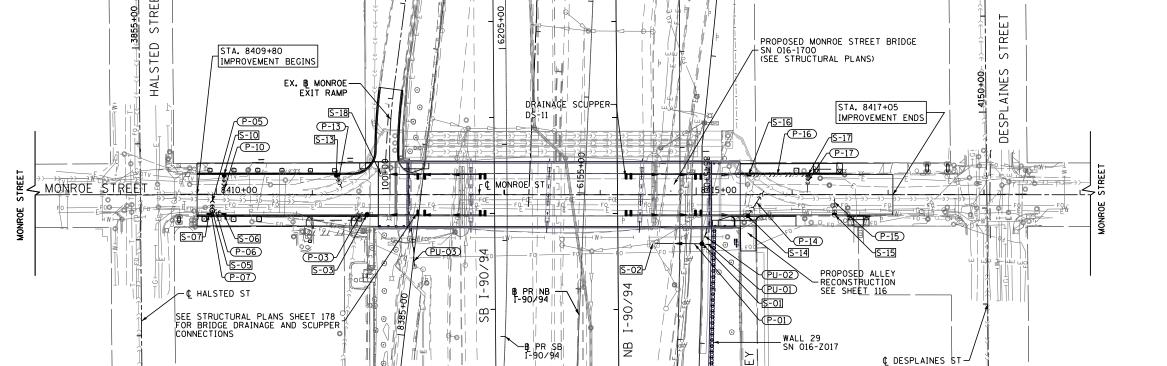


9



- PROPOSED MANHOLE
- PROPOSED CATCH BASIN
- PROPOSED INLET
- → PROPOSED COMBINED SEWER
- -- PROPOSED STORM SEWER
- PROPOSED PIPE UNDERDRAIN
- PROPOSED SCUPPER DS-11
- S-07 PROPOSED STRUCTURE NUMBER

P-07 PROPOSED PIPE NUMBER

91											
		USER NAME = Dughman	DESIGNED - MMA	REVISED -			DRAINAGE AND UTILITY PLAN	F.A.I.	SECTION	COUNTY TOTA	AL SHEET
F PARSO			DRAWN - MMA	REVISED -	STATE OF ILLINOIS			FAI	2014-016R&B	СООК 378	8 89
BRINCK	KERHOFF	PLOT SCALE = 1"=50"	CHECKED - RT	REVISED -	DEPARTMENT OF TRANSPORTATION		MONROE STREET	30/34			60X95
#		PLOT DATE = 7/12/2017	DATE - 07/14/2017	REVISED -		SCALE: 1":50"	SHEET NO. 1 OF 3 SHEETS STA. 8409+20 TO STA. 8418+00		ILLINOIS FED.	AID PROJECT	

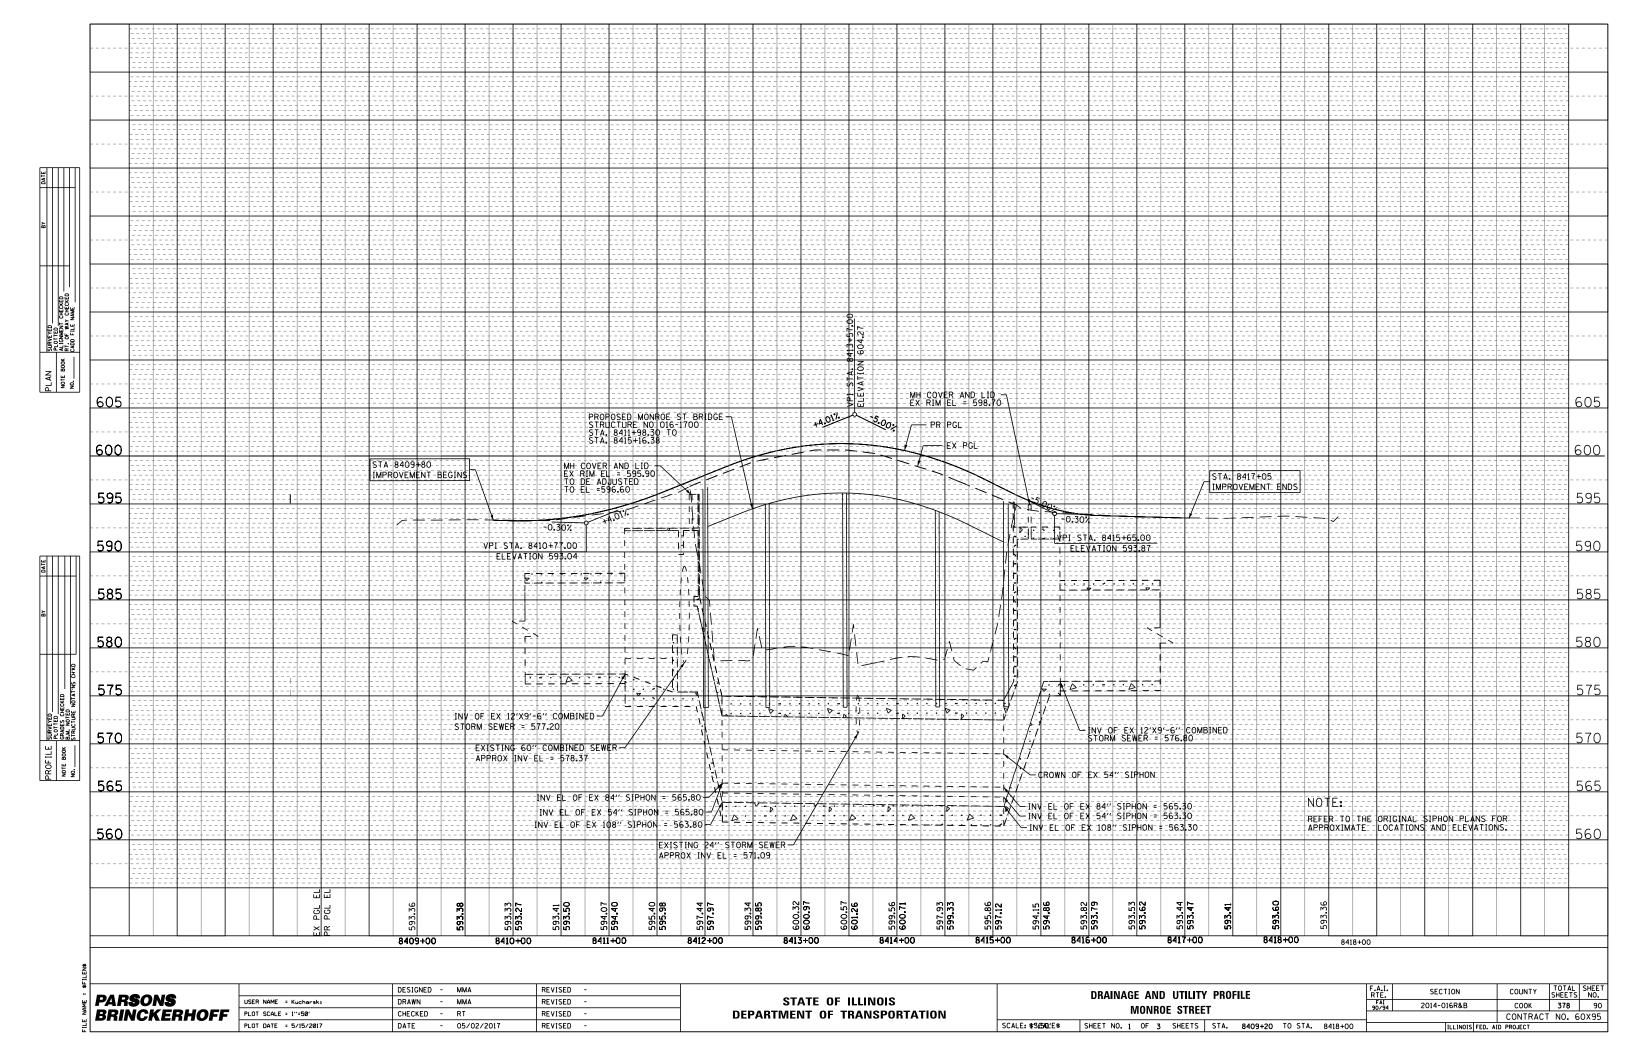

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				EXI	STING DRAII	NAGE STR	UCTURE SCI	HEDULE				
STATION	OFFSET	FRAMES AND LIDS TO BE ADJUSTED	DRAINAGE & UTILITY STRUCTURES TO BE ADJUSTED	MANHOLES TO BE ADJUSTED	MANHOLES TO BE ADJUSTED WITH NEW TYPE 1 FRAME, CLOSED LID (CITY OF CHICAGO)	REMOVING MANHOLES	REMOVING CATCH BASINS	FILLING EXISTING VAULT	DRAINAGE STRUCTURES TO BE CLEANED		СОММ	ENTS
		EACH	EACH	EACH	EACH	EACH	EACH	EACH	EACH	1		
MONROE STR	EET						•					
8409+94.7	20.88RT						1					
8409+95.7	16.37RT					1						
8410+37.2	28.08RT	1							1	EX RIM EL = 5	93.32	PR RIM EL = 593.5
8410+80.0	28.17RT		1						1	EX RIM EL = 5	93.76	PR RIM EL = 594.1
8411+57.36	20.63RT						1				•	
8415+50.0	28.91RT		1						1	EX RIM EL = 5	93.86	PR RIM EL = 594.5
8415+51.11	22.08RT					1						
8416+19.9	28.91RT		1						1	EX RIM EL = 5	93.50	PR RIM EL = 593.2
8416+55.4	26.99RT		1						1	EX RIM EL = 5	93.41	PR RIM EL = 592.3
8416+58.1	13.74RT	1							1	EX RIM EL = 5	93.18	PR RIM EL = 593.1
8409+89.0	31.49LT	1							1	EX RIM EL = 5	93.44	PR RIM EL = 593.5
8409+89.1	26.94LT	1							1	EX RIM EL = 5	93.22	PR RIM EL = 593.4
8410+32.9	25.52LT	1							1	EX RIM EL = 5	93.29	PR RIM EL = 593.4
8410+56.4	10.44LT	1							1	EX RIM EL = 5	93.25	PR RIM EL = 593.3
8410+72.0	15.22LT	1							1		93.33	PR RIM EL = 593.4
8410+78.9	23.71LT		1						1	EX RIM EL = 5	93.56	PR RIM EL = 593.9
8411+48.5	3.58LT			1					1	EX RIM EL = 5	95.17	PR RIM EL = 595.8
8411+57.4	20.78LT						1					
8411+71.3	21.56LT				1				1	EX RIM EL = 5	95.77	PR RIM EL = 596.6
8414+96.3	23.85LT		1						1	EX RIM EL = 5	96.44	PR RIM EL = 597.7
8415+34.4	29.61LT		1						1	EX RIM EL = 5		PR RIM EL = 597.3
8415+44.0	20.67 LT		-				1					
8416+16.7	20.43 LT						1	1				
8415+53.7	10.89LT		1				-		1	EX RIM EL = 5	93.79	PR RIM EL = 594.4
8416+29.3	17.28LT	1	1						1		93.19	PR RIM EL = 593.0
MONROE EXI		-	1	ı			1	1	-			
100+46.4	5.43RT	1							1	EX RIM EL = 5	95.90	PR RIM EL = 596.1
100+53.9	5.31RT	-		1					1		95.61	PR RIM EL = 596.1
100+61.6	5.22RT	1		<u> </u>					1	EX RIM EL = 5		PR RIM EL = 595.6
		T RAMP (BASELIN	IE: NB CD ROAD)				1			1 =	- 3.00	333.0
6347+07.5	49.67RT	IDAGEEN	12.12.00 10.00					1		EX RIM EL = 5	94.22	PR RIM EL = 591.0
23 11 10123	TOTAL	10	8	2	1	2	5	1	21			

		Ε	XISTIN	G WA	TE	R MAIN SC	HEDULE	
FRO	ом •		Т	0•		ALIGNMENT	WATER MAIN REMOVAL, 12'	ABANDON EXISTING WATER MAIN,
SATION	OFFSI	ΞT	SATION	OFFSI	ΞT		FOOT	FILL WITH CLSM FOOT
32+02.3	205.7	LT	31+75.0	132.9	LT	EX SB I-90/94		78.5
31+75.0	132.9	LT	31+74.6	0.0	LT	EX SB I-90/94		132.9
31+74.6	0.0	LT	31+75.2	128.2	RT	EX SB I-90/94		128.2
31+75.2	0.0	RT	31+75.0	58.8	RT	EX NB I-90/94		58.8
31+75.0	58.8	RT	31+99.7	159.1	RT	EX NB I-90/94	106.7	
						TOTAL	107.0	399.0

[•] STATIONS AND OFFSETS ARE APPROXIMATE AND MUST BE FIELD VERIFIED

	E	XISTING D	RAINAGE	PIPE	SCHE	DULE			
FROM	1 •	то	•	COMBINED SEWER	REMOVAL	STORM SEWER REMOVAL	TRENCH BACKFILL	TELEVISION INSPECTION OF SEWER	COMBINED SEWERS TO BE CLEANED
SATION	OFFSET	SATION	OFFSET	F0 8"	OT 10"	F00T 10"	CU YD	FOOT	FOOT
MONROE STREE		JATION	011321		10	1 10			
8409+80.0	0.00RT	8411+50.0	2.00RT					340.0	170.0
8415+65.0	0.00RT	8417+05.0	0.00RT					280.0	140.0
8409+94.6	20.88RT	8409+95.7	16.37RT	5			0.7		
840995.72	16.37RT	8409+95.7	5.065RT	9.6			1.3		
8411+46.4	19.60RT	8411+54.9	20.50RT			8.5	1.2		
8411+59.9	20 . 57RT	8411+68.8	20.57RT			9.0	1.2		
8415+52.5	20.00RT	8415+69.3	5.30LT		29.5		4.0		
8416+44.3	20.83RT	8416+44.3	10.00RT	8.3			1.1		
8415+46.5	20.75LT	8416+14.5	20.66LT		66		9.0		
8416+16.4	17.90LT	8416+15.7	2.00LT	15.9			2.2		
			TOTAL	39	96	18	21	620	310

[•] STATIONS AND OFFSETS ARE APPROXIMATED AND MUST BE FIELD VERIFIED 1-PIPE SIZE AND MATERIAL ARE ASSUMED. EXISTING INFORMATION NOT AVAILABLE

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BRINCKERHOFF	ŀ
	I

	USER NAME = Dughman	DESIGNED	-	MMA	REVISED	-
		DRAWN	-	MMA	REVISED	-
F	PLOT SCALE = 1"=50"	CHECKED	-	RT	REVISED	-
-	PLOT DATE = 7/12/2017	DATE	-	07/14/2017	REVISED	-

STATE OF ILLINOIS DEPARTMENT OF TRANSPORTATION

SCALE:

EVICTING DRAINIAGE COM		F.A.I. RTE.	SECTION	COUNTY	TOTAL SHEETS	SHEET NO.
EXISTING DRAINAGE SCHI	EDULES	FAI 90/94	2014-016R&B	СООК	378	91
				CONTRACT	NO. 60	0X95
SHEET NO 1 OF 1 SHEETS STA	TO STA		THE IMOUSE FED. AT	O DROJECT		

LAN SURVERS PLOTTED PLOTTED NOTE BOOK ALTOMENT CHECKED NOTE CADO FILE MANE			ВУ	DATE
VOTE BOOK ALIOWERN CHECKED NO. CAND FILE NAME CAND FILE NAME	LAN	SURVEYED		
NOTE BOOK ALIGNMENT CHECKED RT, OF WAY CHECKED W. CADD FILE NAME		PLOTTED		
NO. CADD FILE NAME	NOTE BOOK	ALIGNMENT CHECKED		
40. CADD FILE NAME	500	RT, OF WAY CHECKED		
	9	CADD FILE NAME		

				PROPOSED DRAI	NAGE F	PIPE SC	HEDUL	_E				
SIRVEYED BY DATE PROTED GRADES CVECKED STRUCTURE NOTATIVES CHIKD	le-02.dgn	PIPE	UPSTREAM STRUCTURE	DOWNSTREAM STRUCTURE	UPSTREAM INVERT ELEVATION	DOWNSTREAM INVERT ELEVATION	STORM SEWERS, CLASS A. TYPE 2	COMBINED SEWER (EXTRA S STRENGTH VIRTIFIED CLAY)	COMBINED SEWERS (WATER MAIN REQUIREMENTS)	STORM SEWERS, TYPE 2, DUCTILE IRON PIPE	STORM SEWERS, TYPE 2, DUCTILE IRON PIPE	
SURVEYED PLOTTED GRADES CHECI B.M. NOTED STRUCTURE N	sht-DRAIN-Schedule-02.dgn					0	12'' F00T	(CDOT) FOOT	(CDOT) FOOT	8" F00T	10'' F00T] (
	-ORA	MONROE S	TREET		1	1	I				I	_
PROFILE NOTE BOOK		P-03	S-03	CONNECTION TO EXISTING SEWER	590.00	578.38•		8				
NOTE NOTE	Export\D160x95-	P-05	S-05	CONNECTION TO EXISTING SEWER	588.09	585.50•			10			Г
	9	P-06	S-06	S-05	588.91	589.19			8			
	ř	P-07	S-07	S-05	589.10	589.19			5			
		P-10	S-10	CONNECTION TO EXISTING SEWER	588.80	585.50•		14				
	eet\Plotting\Print	P-13	S-13	CONNECTION TO EXISTING SEWER	590.00	585.50•		14				
	퉭	P-14	S-14	CONNECTION TO EXISTING SEWER	587.58	585.44•					29	L
	ğ	P-15	S-15	CONNECTION TO EXISTING SEWER	589.00	585.50•			10			\perp
	عِ ا	P-16	S-16	S-17	590.14	588.98				58		\perp
	ž	P-17	S-17	CONNECTION TO EXISTING SEWER	586.83	585.30•		17				

572.31

572.08

PROPOSED DRAINAGE STRUCTURE SCHEDULE MANHOLES, TYPE B, 4'-DIA, TYPE I FRAME, CLOSED LID (CITY OF CHICAGO) INLETS, TYPE A, TYPE 1 FRAME, OPEN LID (CITY OF CHICAGO) CATCH BASINS, TYPE A, 4'-DIAMETER, TYPE 1 FRACLOSED LID CONNECTION TO EXIST DRAINAGE STRUCTURE CATCH BASINS, TYPE , 4'-DIAMETER, TYPE 1 F OPEN LID (CITY OF C Š z EACH EACH EACH EACH EACH MONROE STREET S-03 8411+56.00 | 22.7 RT | 596.26 590.00 592.49• 1 CONICAL 8409+95.72 16.4 RT 592.96 588.09 589.19 589.19 FLAT SLAB S-05 8410+08.13 22 RT 589.58 FLAT SLAB S-06 592.83 FLAT SLAB S-07 8409+85.00 21 RT 592.88 589.63 1 8410+08.13 22 LT 588.80 FLAT SLAB S-10 592.83 1 FLAT SLAB 8411+25.00 | 21 LT 593.34 590.00 S-13 CONICAL S-14 8415+54.00 | 22 RT 594.30 589.72• 587.58 S-15 8416+44.25 21 RT 592.75 589.00 FLAT SLAB S-16 8415+55.00 21 LT 593.98 591.00• 590.73 FLAT SLAB S-17 8416+16.62 21 LT 593.42 588.98 586.83 CONICAL EXISTING S-18 8411+73.00 21.5 LT 596.68 592.00•

572.08-EX

PROPOSED DRAINAGE STRUCTURE SCHEDULE NOTES:

- •STORM SEWER FROM BRIDGE DRAIN
- 1- STRUCTURES MUST BE ROTATED TO AVOID CONFLICT WITH EXISTING UTILITIES
- 2- STATIONS AND OFFSETS ARE GIVEN AT THE CENTER OF THE STRUCTURE
- 3- RIM ELEVATIONS ARE GIVEN AT THE FLOW LINE EXCEPT FOR STRUCTURES S-05 AND S-18; RIM ELEVATION GIVEN AT THE CENTER OF THE LID
- 4- FOR FLAT SLAB STRUCTURES USE IDOT STANDARD 602601

DOWNSTREAM INVERT ELEVATION	STORM SEWERS, CLASS A, TYPE 2	COMBINED SEWER (EXTRA STRENGTH VIRTIFIED CLAY)	COMBINED SEWERS (WATER MAIN REOUIREMENTS)	STORM SEWERS, TYPE 2, DUCTILE IRON PIPE	STORM SEWERS, TYPE 2, DUCTILE IRON PIPE	TRENCH BACKFILL
OW.	12"	8′′	8′′	8"	10"	
	12	(CDOT)	(CDOT)	8	10	CU YD
	FOOT	FOOT	FOOT	FOOT	FOOT	
8.38•		8				11.0
5.50•			10			2.9
89.19			8			1.5
89.19			5			1.0
5.50•		14				3.4
5.50•		14				3.1
5.44•					29	23.8
5.50•			10			2.3
38.98				58		13.1
5.30•		17				12.8

TOTAL 47 53 33 58 29 103

572.18-EX

TOTAL

5

27.7

4

• PIPE DOWNSTREAM END CONNECTS TO THE EXISTING 12X9.5 EXISTING COMBINED STORM SEWER. INVERT ELEVATIONS MUST BE FIELD VERIFIED PRIOR TO CONSTRUCTION.

P-01 S-01 EXISTING DRAINAGE STRUCTURE (S-02) 571.53 571.43 47

PIPES THAT CONNECT TO THE EXISTING 12X9.5 STORM SEWER SHOULD BE CONSTRUCTED WITH AT A 2% MINIMUM GRADE TO MEET CAPACITY AND FULL VELOCITY REQUIREMENT

	u
PAR S ON S	
BRINCKERHOFF	F
	F

EX MADISON STREET EXIT RAMP (BASELINE: NB CD ROAD) 6347+00.00 23 RT 575.68

EX MADISON STREET EXIT RAMP (BASELINE: NB CD ROAD)

6347+00.00 28.1 LT

S-01

S-02

	USER NAME = Dughman	DESIGNED	-	MMA	REVISED -
		DRAWN	-	MMA	REVISED -
F	PLOT SCALE = 1"=50"	CHECKED	-	RT	REVISED -
	PLOT DATE = 6/29/2017	DATE	-	06/30/2017	REVISED -


DRODOGED DRAINIAGE COUEDINES		SECTION	COUNTY	TOTAL SHEETS	SHEET NO.
PROPOSED DRAINAGE SCHEDULES	FAI 90/94	2014-016R&B	COOK	378	92
			CONTRACT	NO. 60	X95
CUEET NO. 1 OF 1 CUEETS CTA TO CTA					$\overline{}$


	PROPOSE	D PIPE	UNDERDI	RAINS SC	HEDULE		
PIPE	UPSTI	REAM		PIPE			
INDERDRAIN	STATION	OFFSET	STRUCTURE	STATION OFFSET		UNDERDRAINS 4" (SPECIAL)	
MONROE S	FOOT						
PU-03	8412+03.3.	34.5 RT	EX MH	31+45.24	84.0 LT	40	
X MADISON							
PU-01	6347+00.00	32.8 RT	S-01	6347+00.00	23.0 RT	10	
PU-02	6347+17.75	27.8 RT	S-01	6347+00.00	23.0 RT	18	
					TOTAL	68	


SCALE:


FLAT SLAB

EXISTING

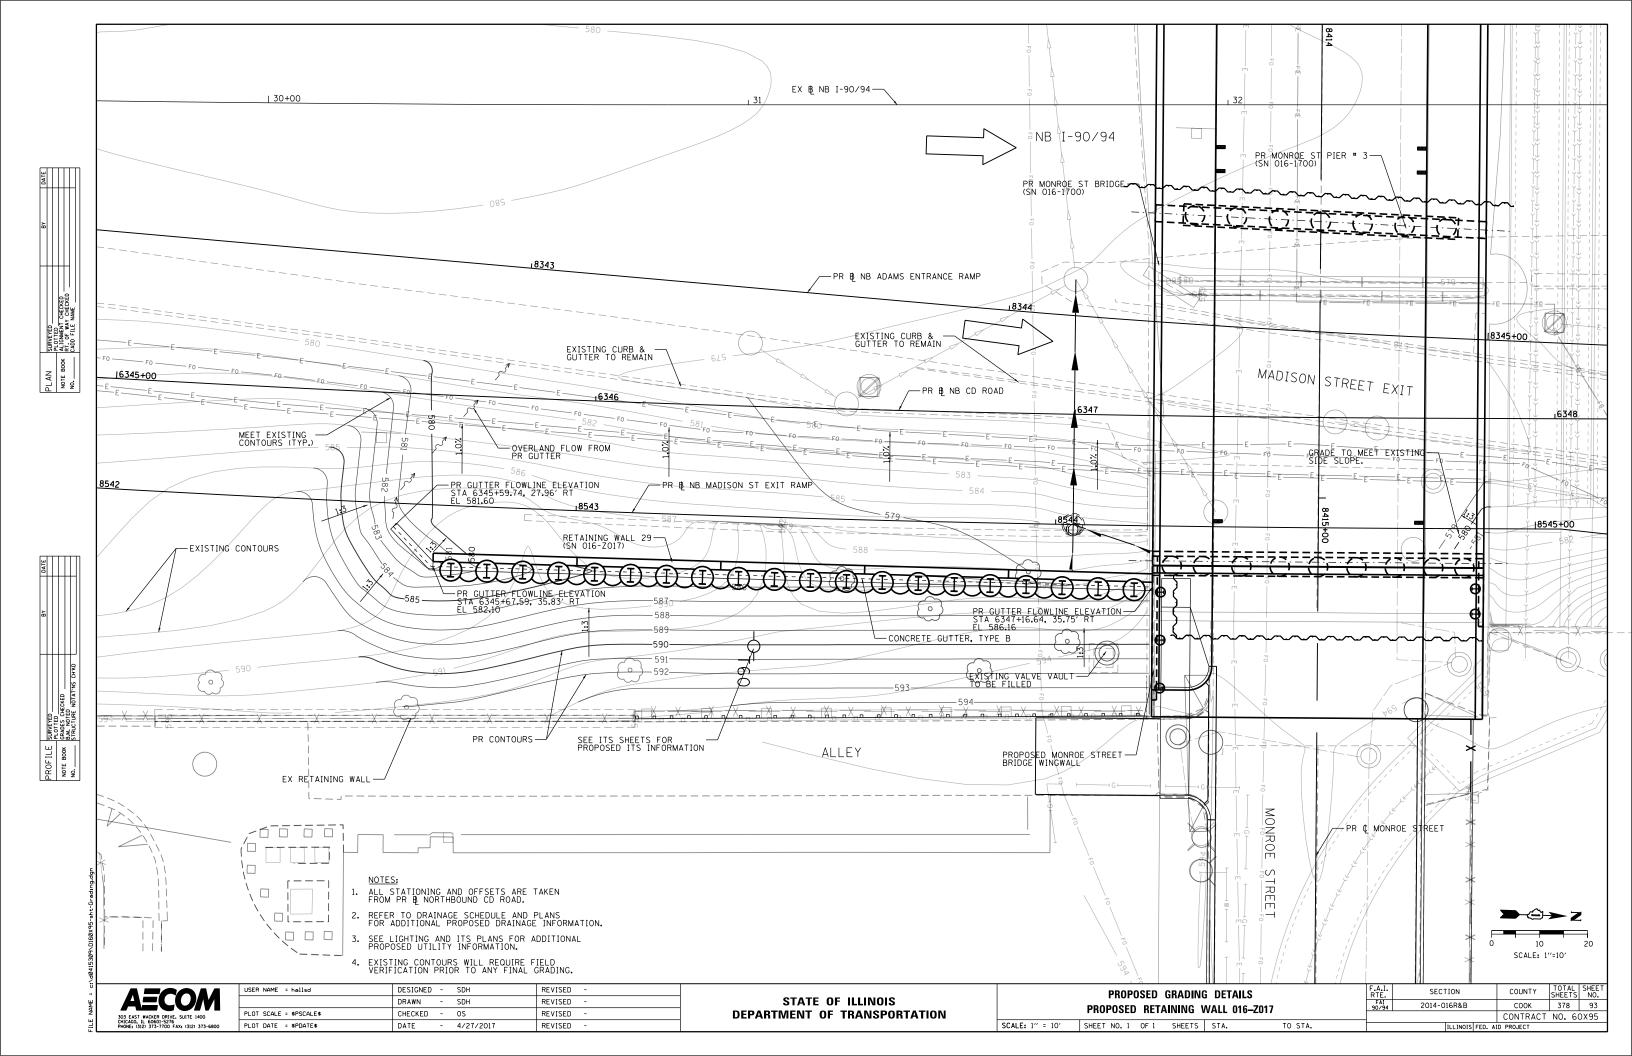

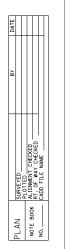


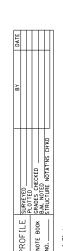

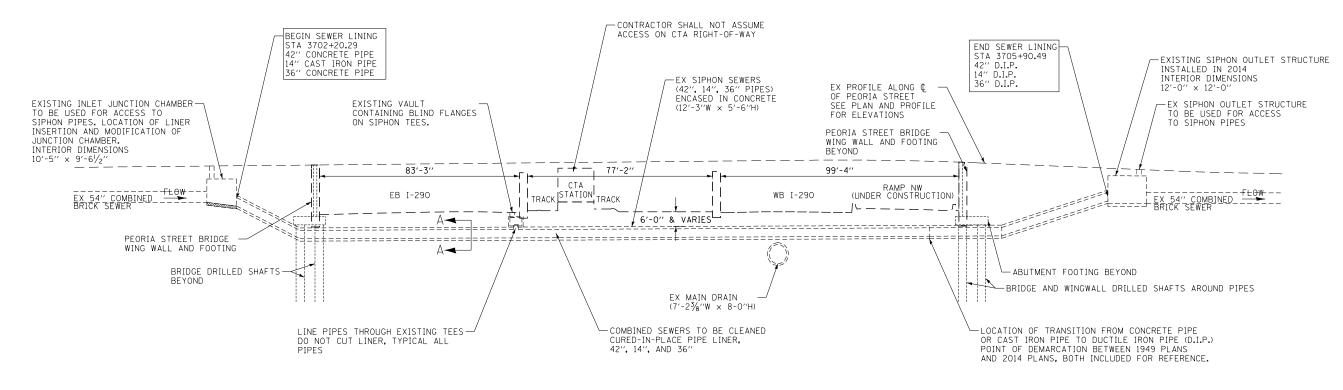

ELEVATION VIEW OF SIPHON

LOOKING WEST

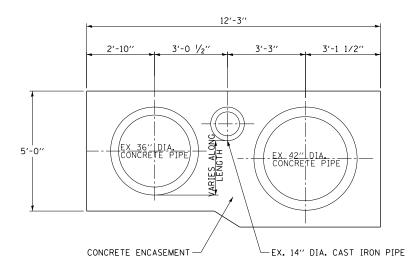

SECTION A-A

NOTES:

1. EXISTING VAULT ALONG EB I-290 SHALL NOT BE USED FOR LINER INSERTION OR TERMINATION.





USER NAME = vljanachione	DESIGNED	-	MFD	REVISED -
	DRAWN	-	BAW	REVISED -
PLOT SCALE = 40.0000 '/ in.	CHECKED	-	JMG	REVISED -
PLOT DATE = 7/11/2017	DATE	-	7/14/2017	REVISED -


STATE OF ILLINOIS
DEPARTMENT OF TRANSPORTATION


SCALE: NONE


	TYPICAL SEC	F.A.I. RTE. FAI	SECTION	COUNTY	TOTAL SHEETS	SHEET NO.		
PEORIA STREET SIPHON					2014-016R&B	COOK	378	93A
						CONTRACT	NO. 60	X95
	SHEET NO. 1 OF 33 SHEETS	STA.	TO STA.	ILLINOIS FED. AID PROJECT				

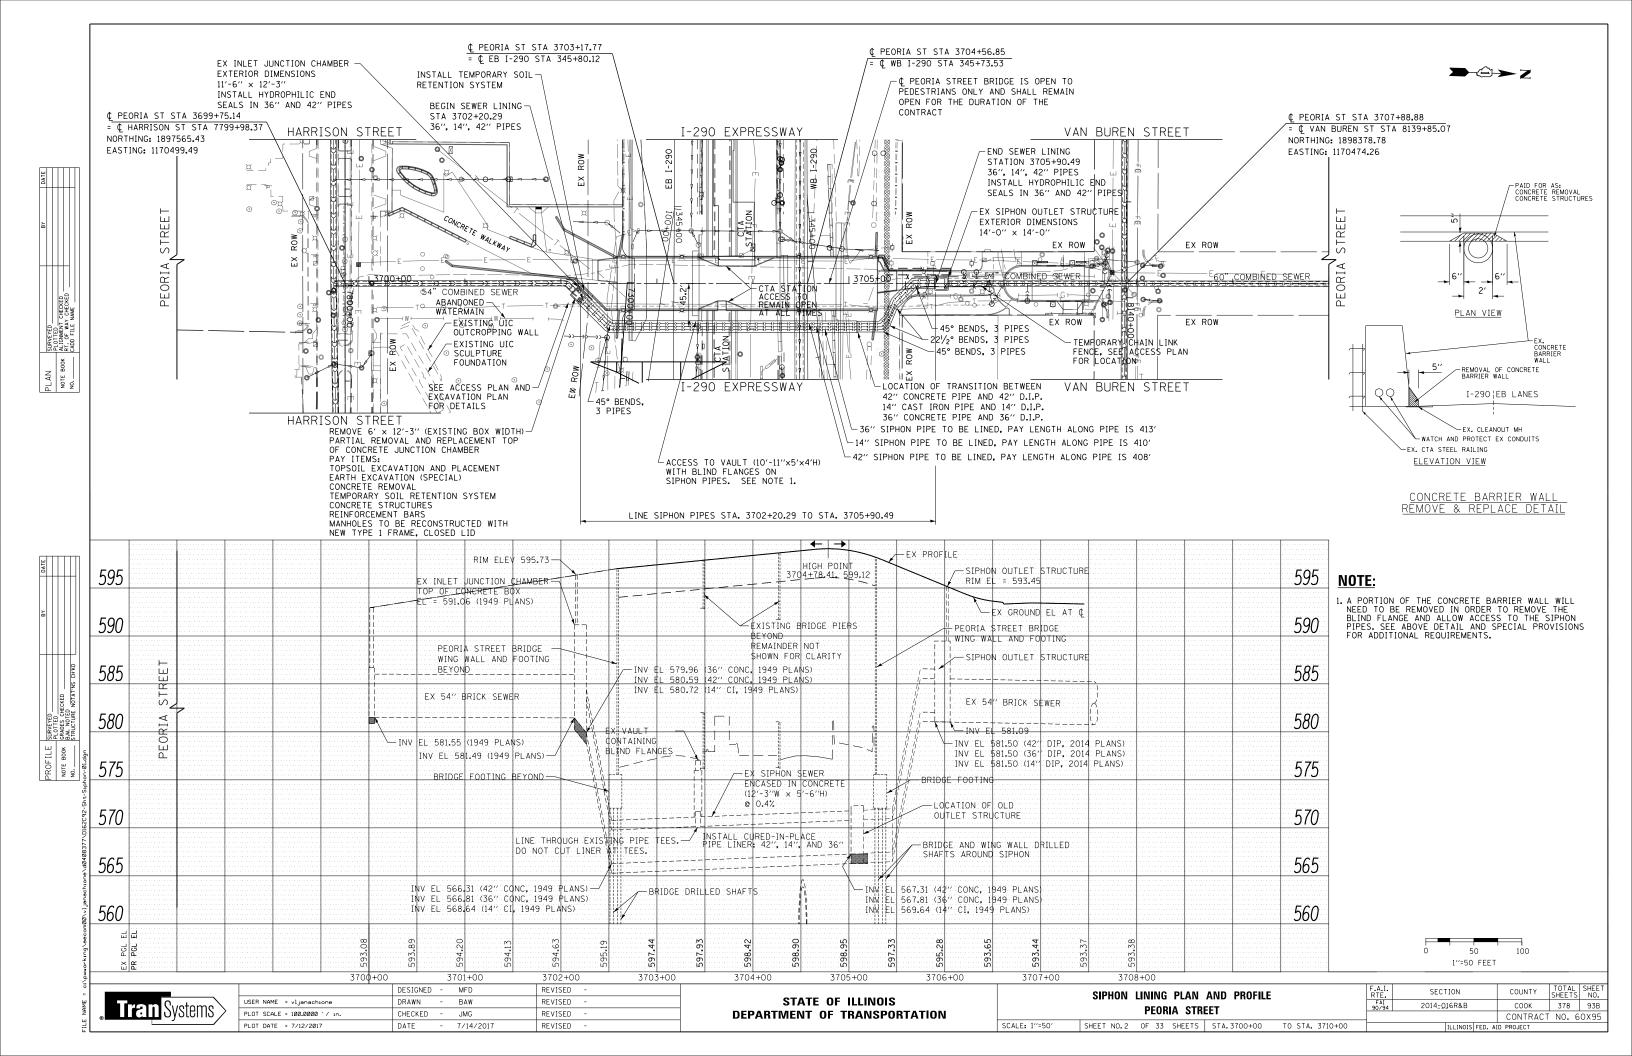


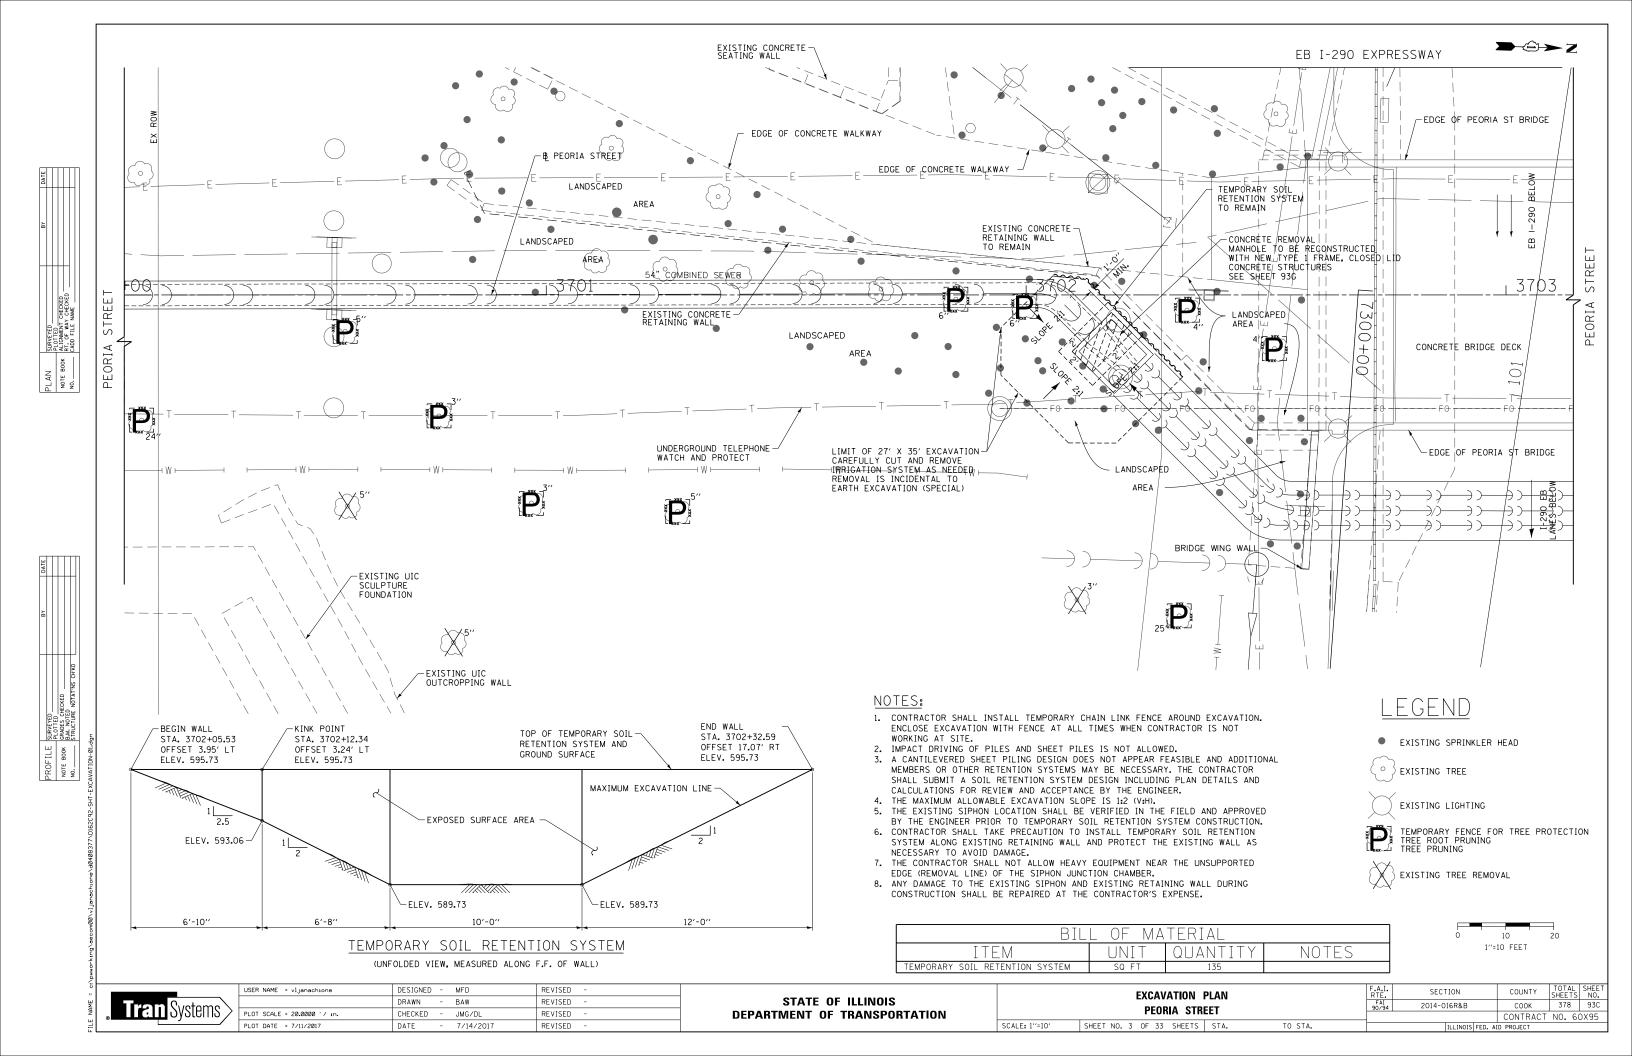


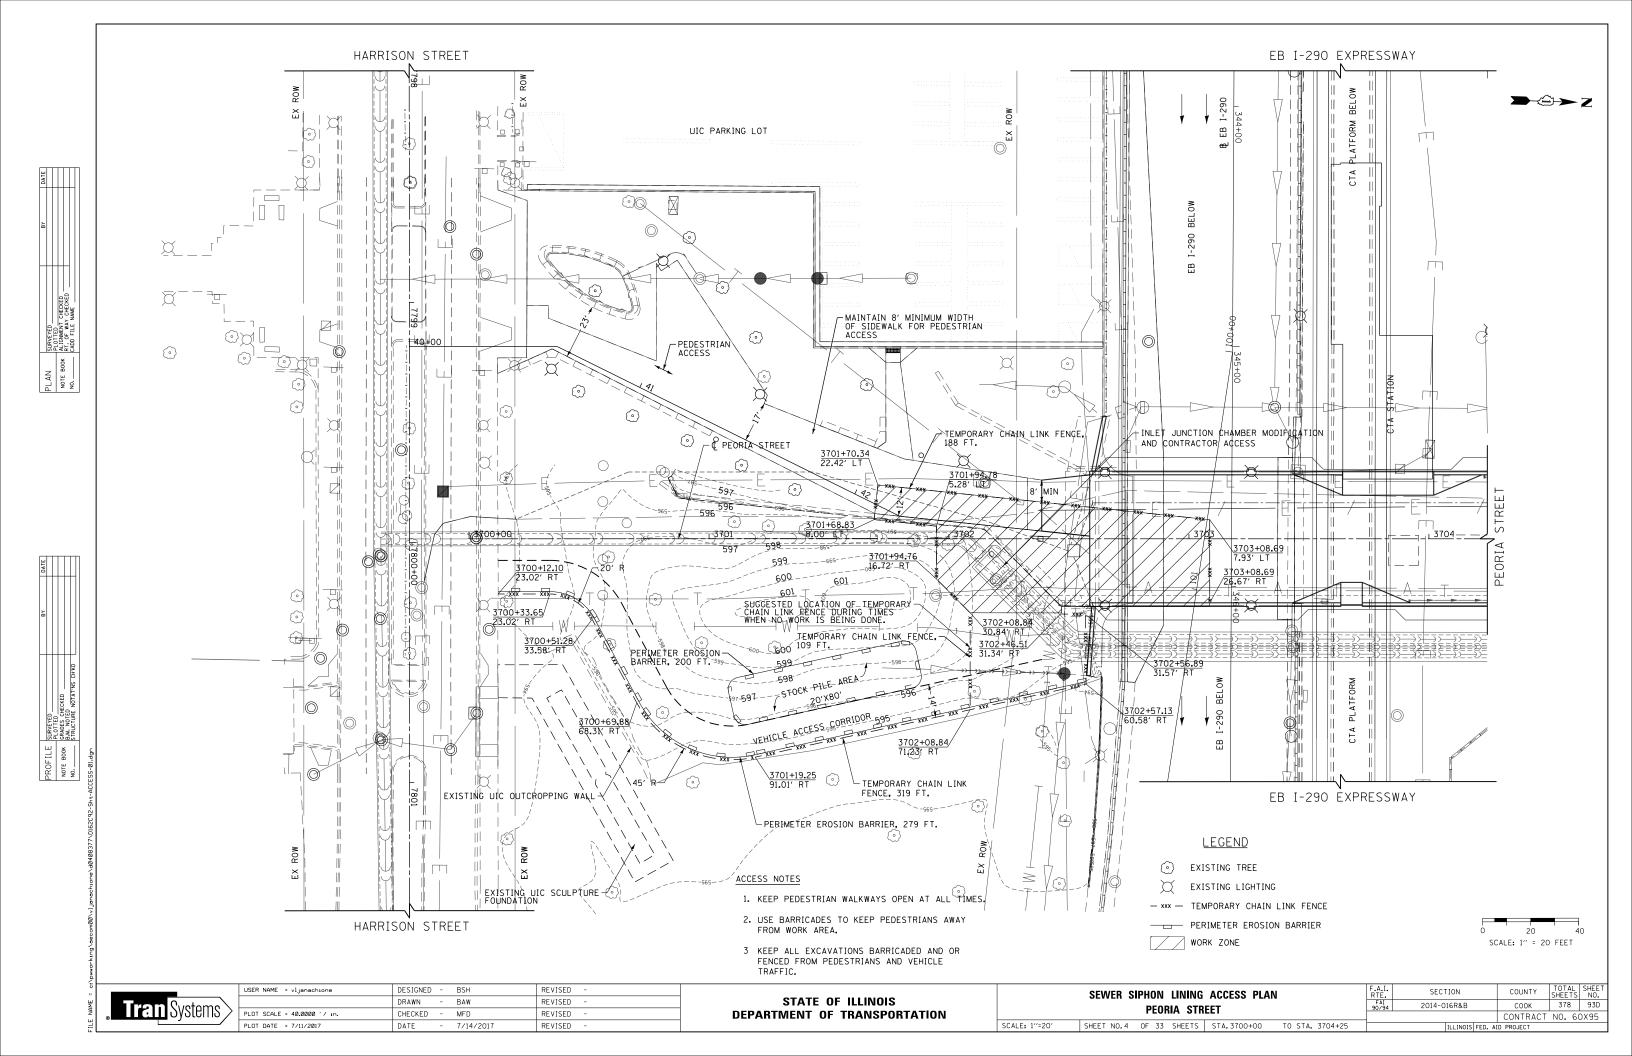


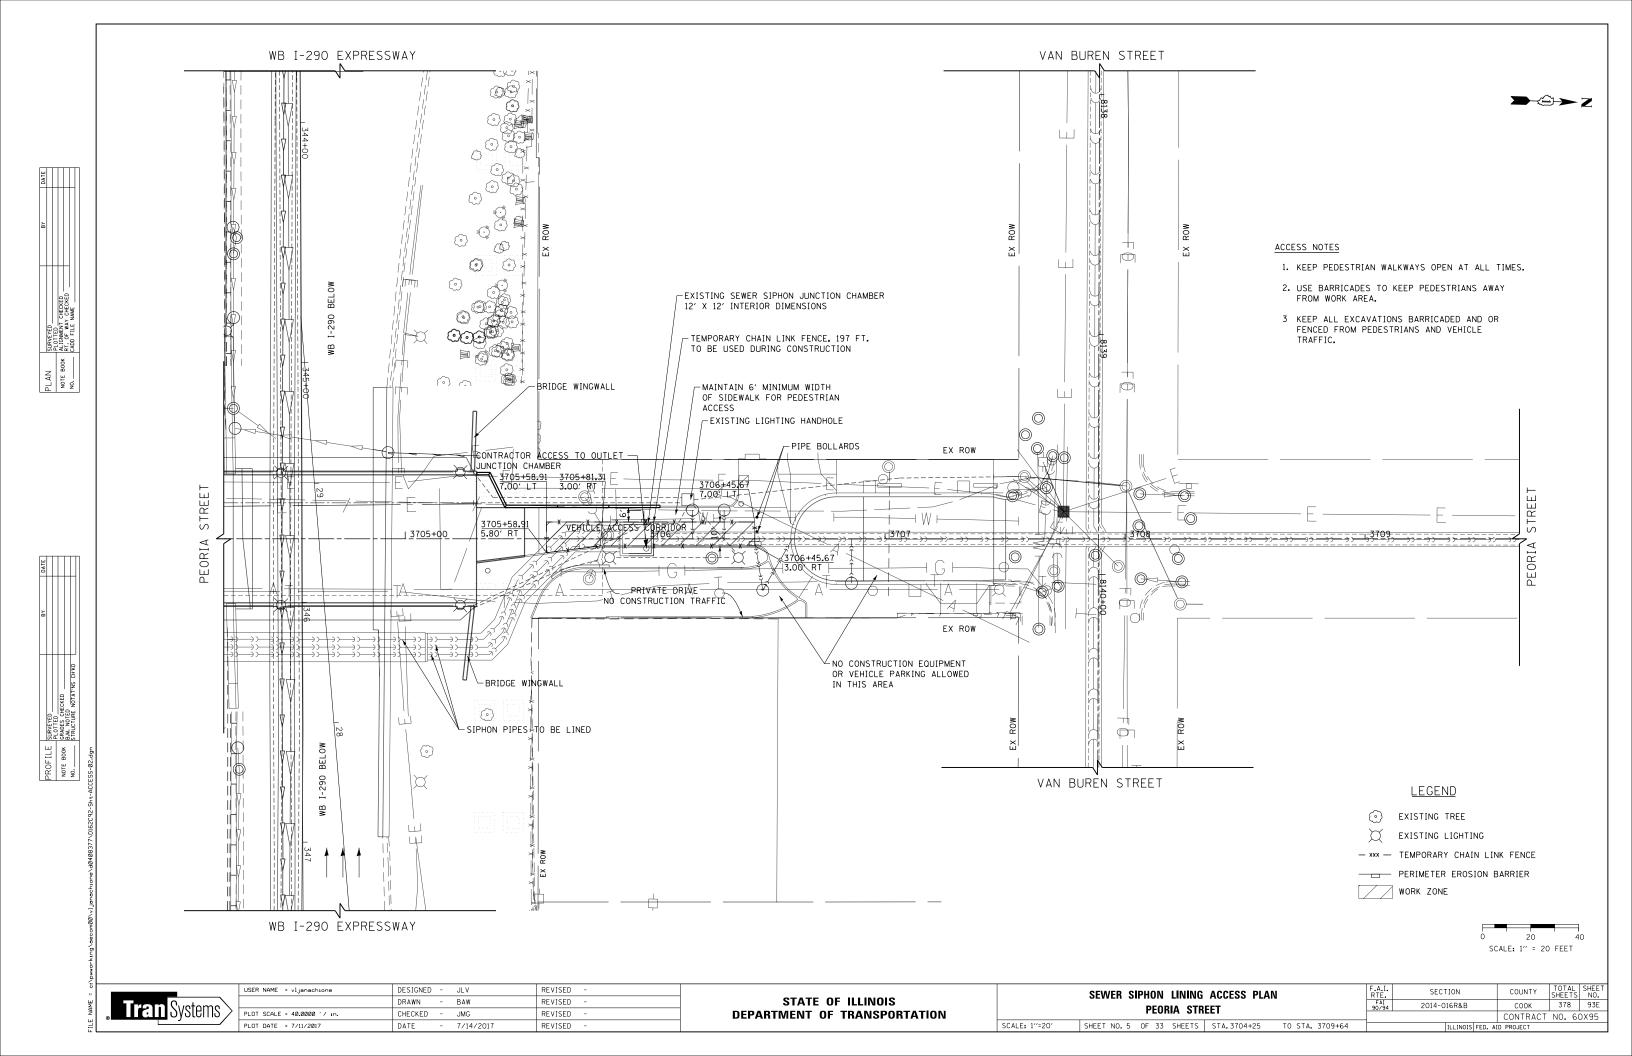


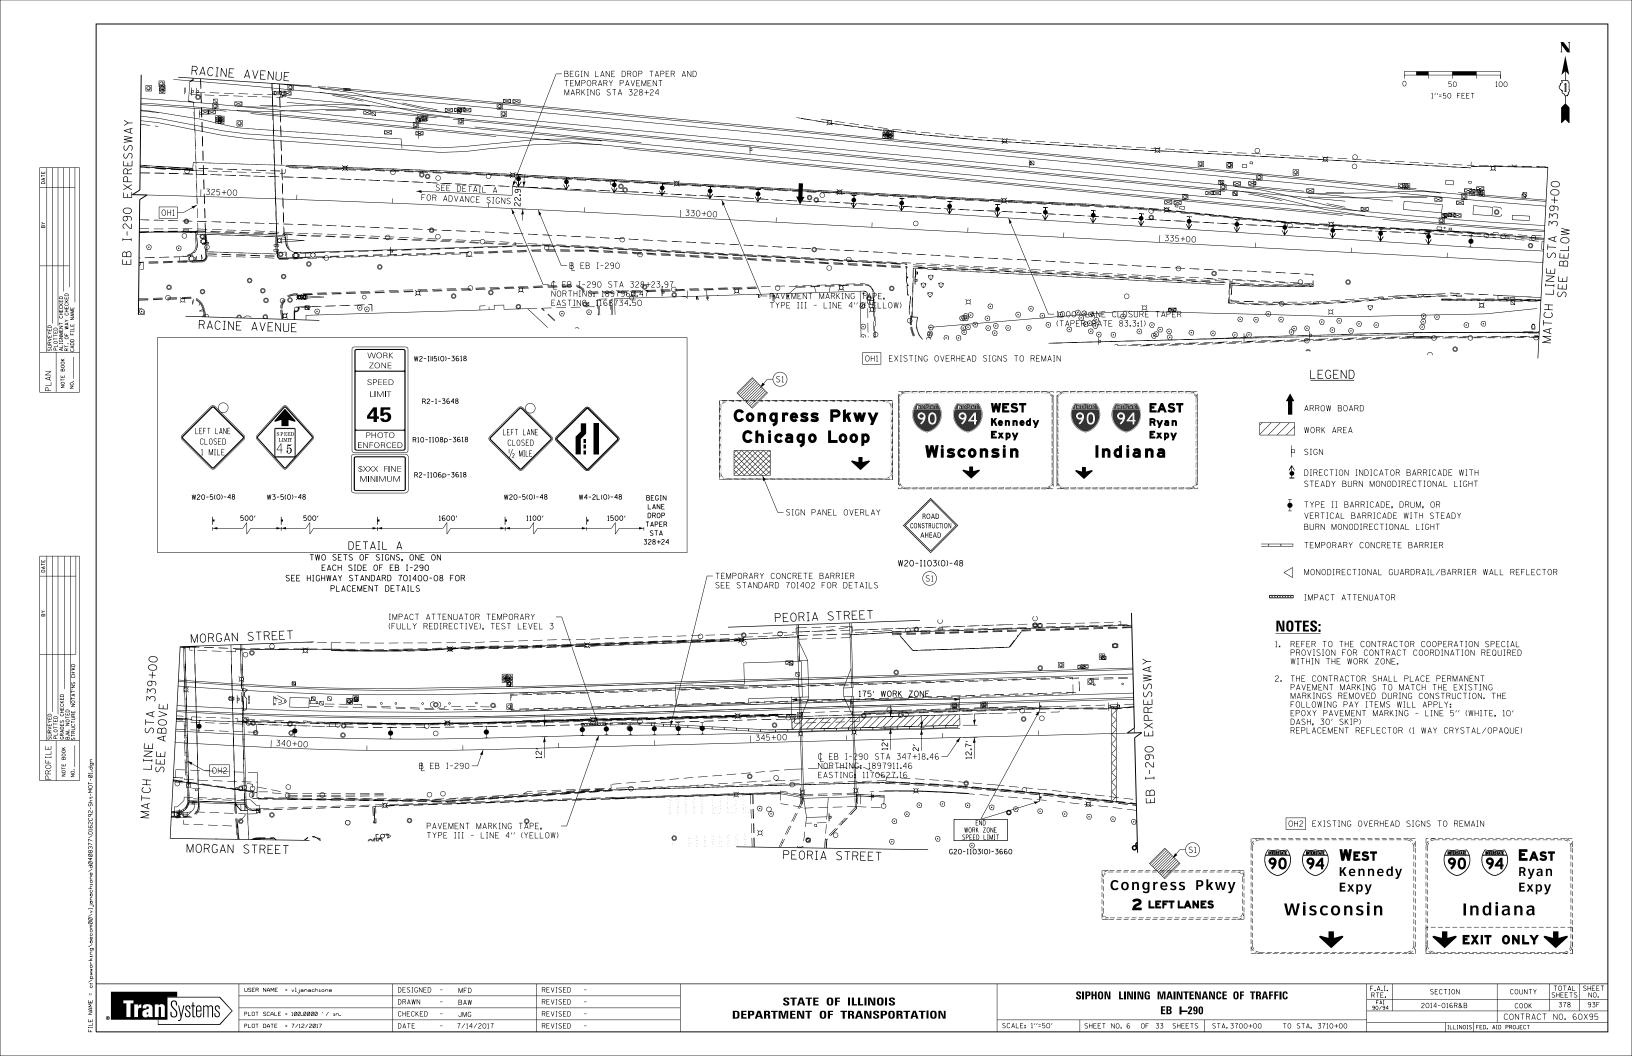

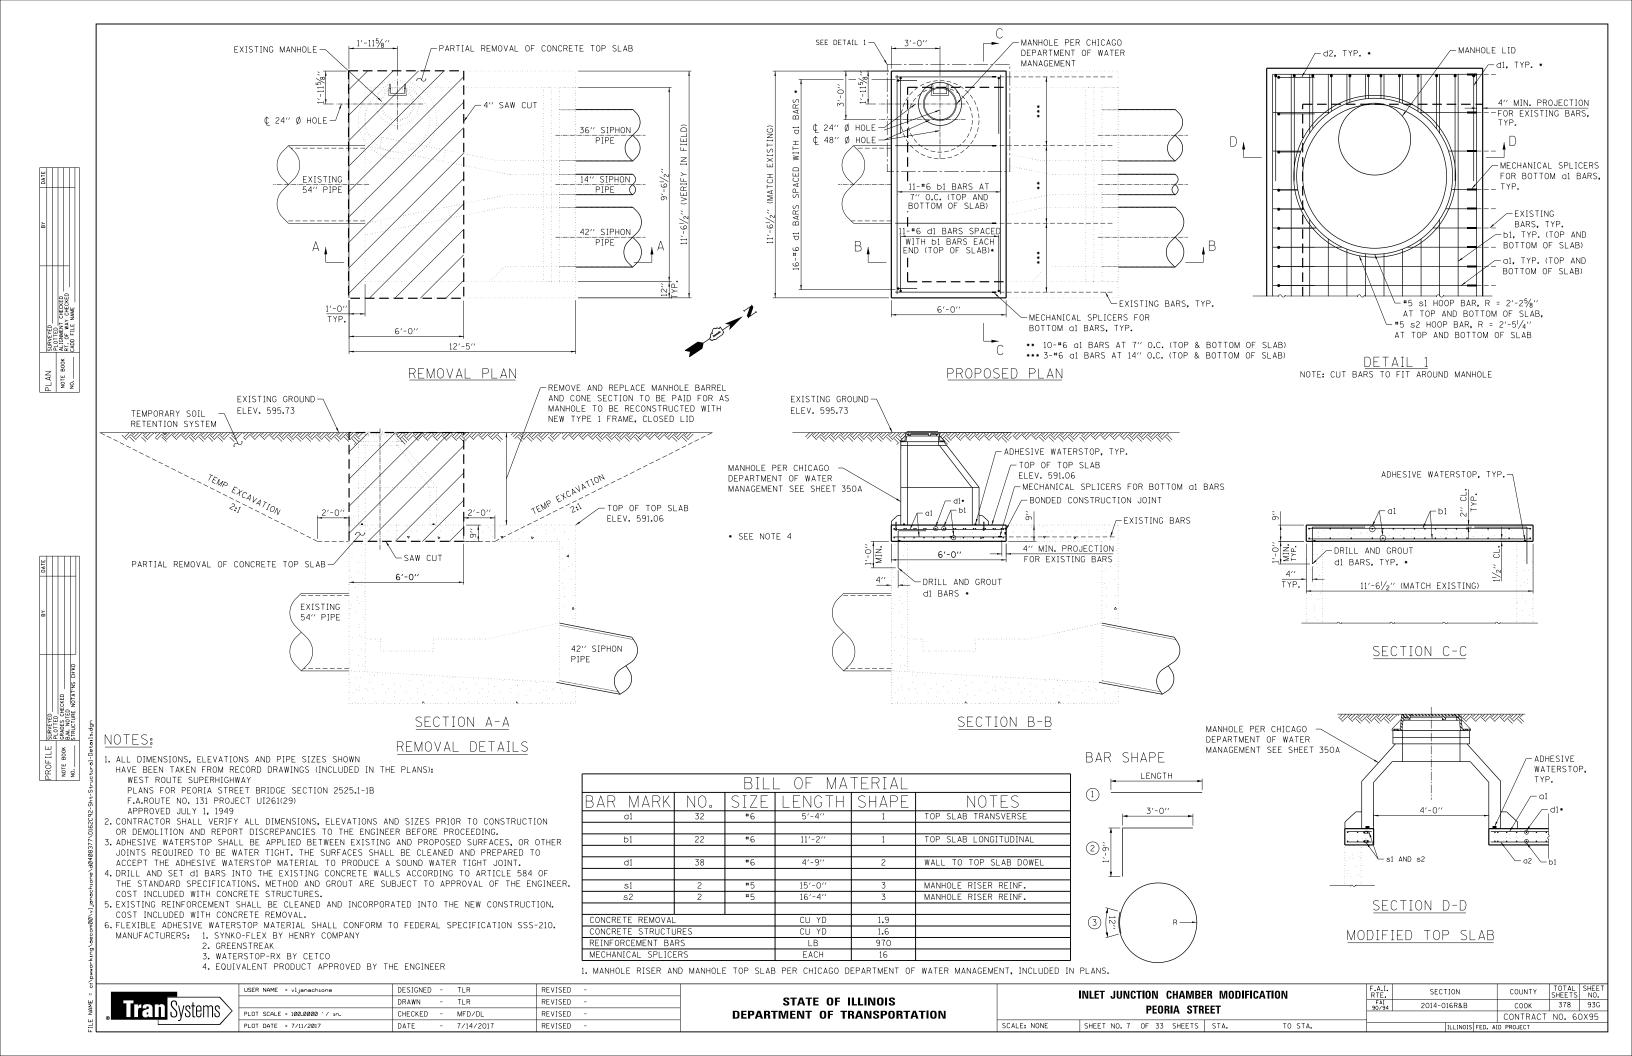

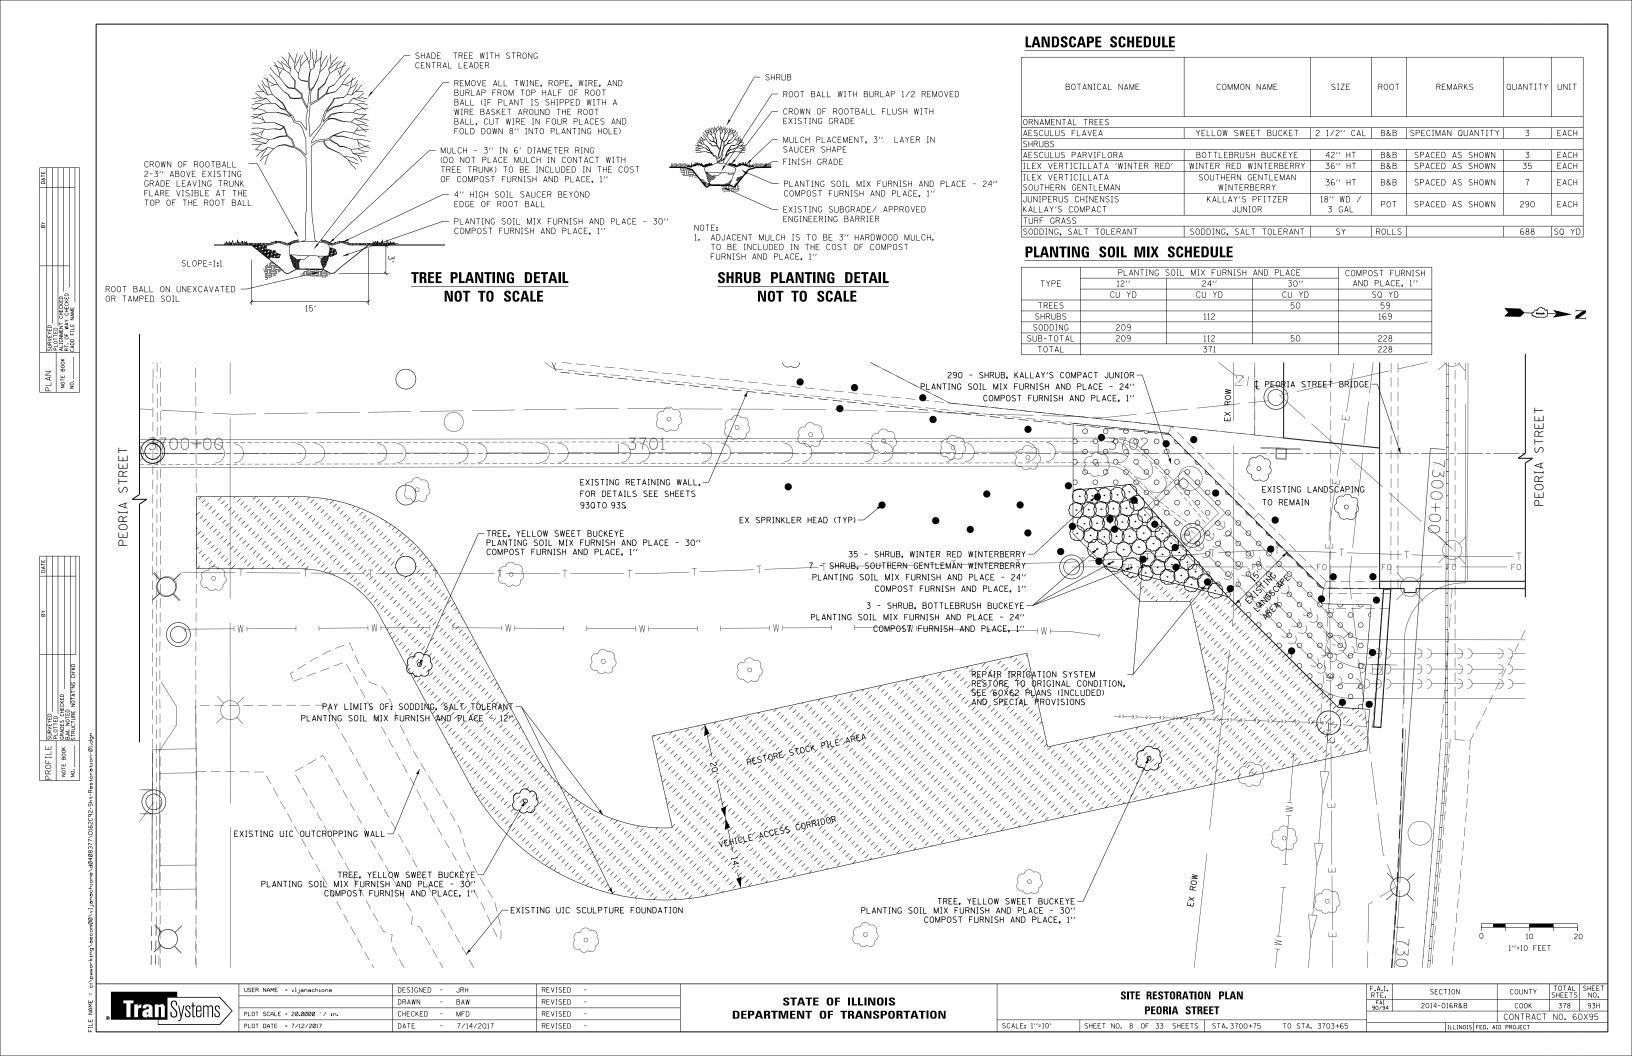

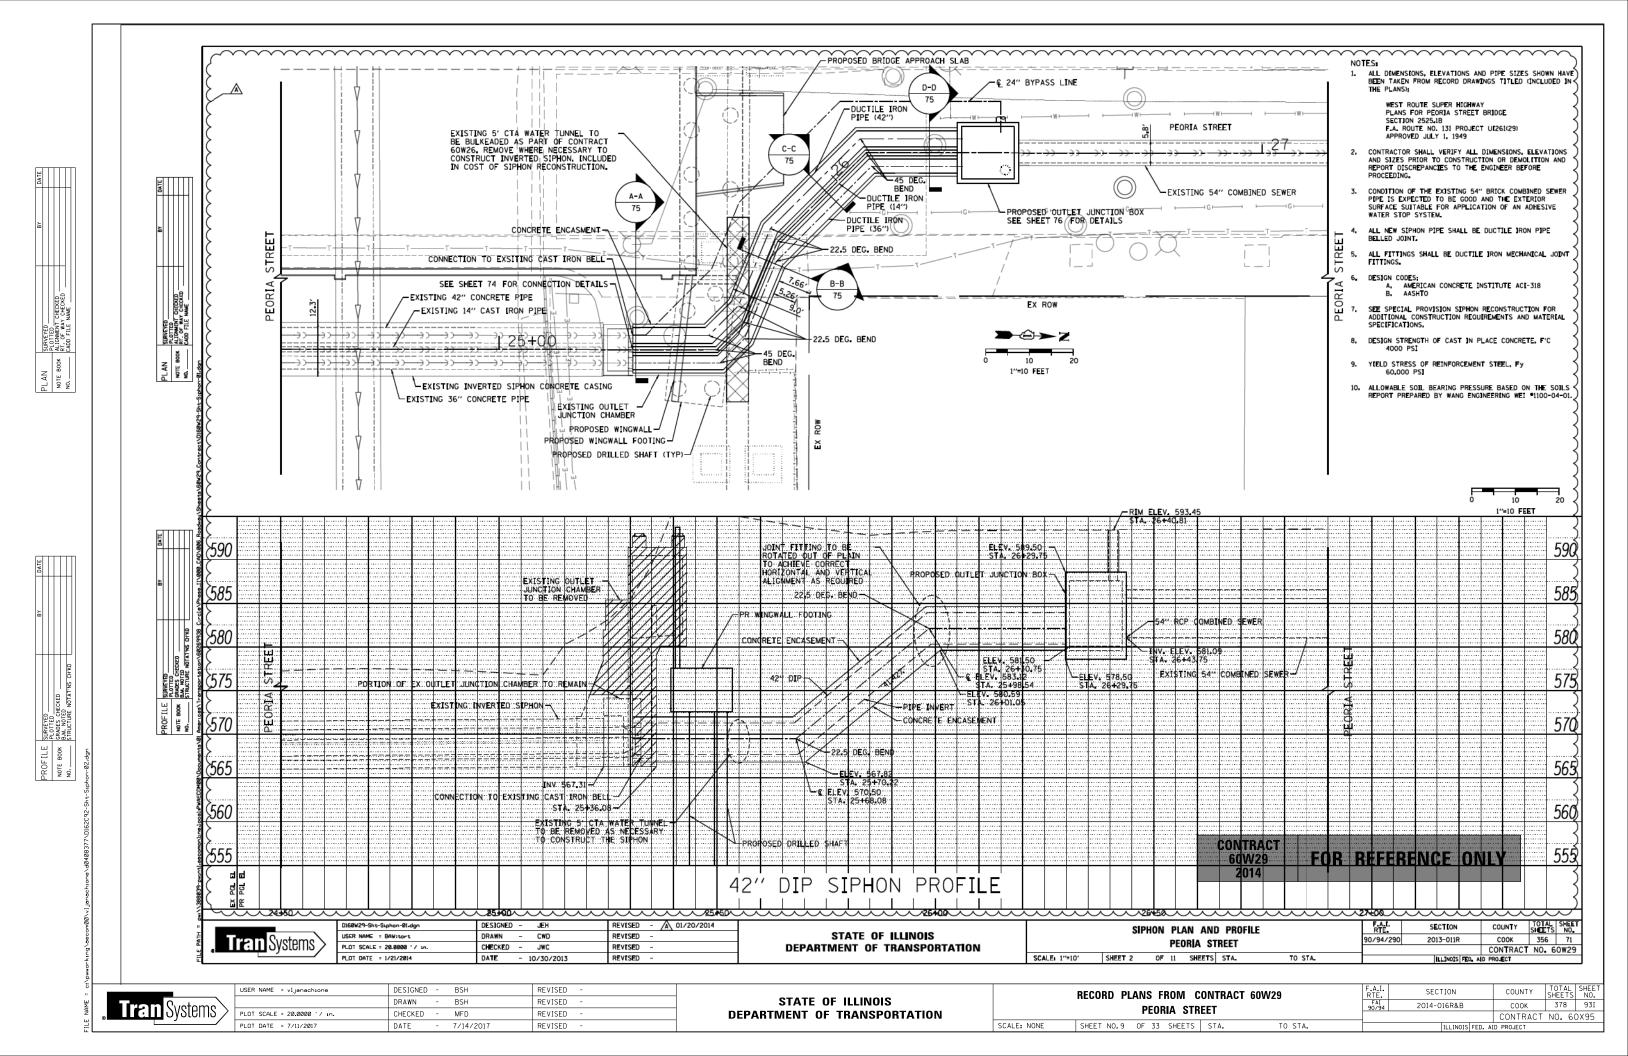

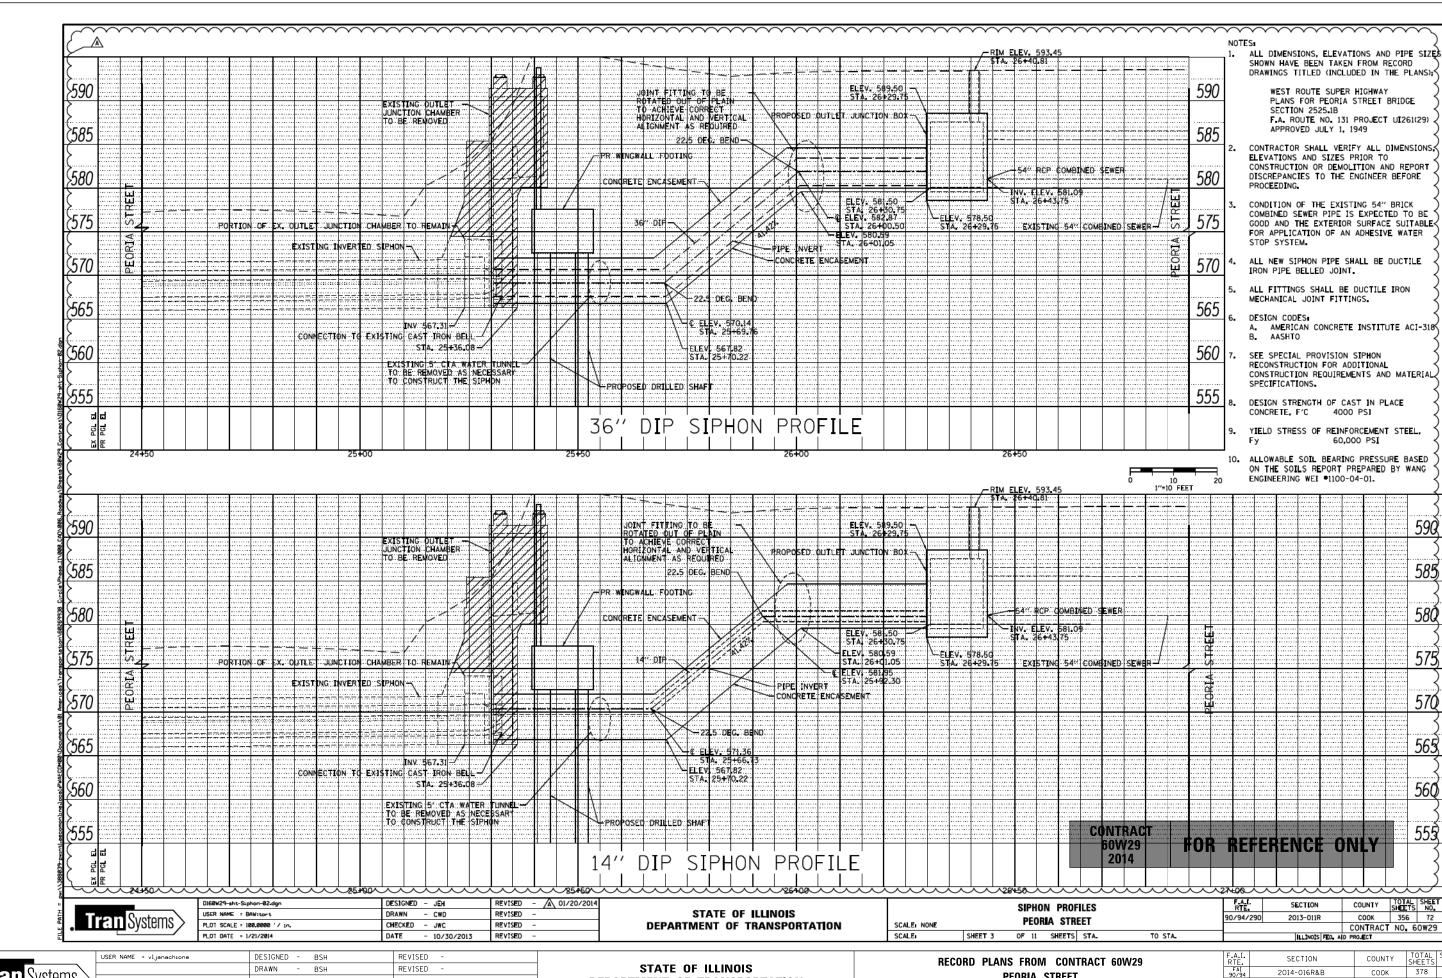

Tran Systems

CHECKED CHECKED NAME


PLOT SCALE = 100.0000 '/ 10. CHECKED MFD REVISED 7/14/2017 REVISED

DEPARTMENT OF TRANSPORTATION


PEORIA STREET SHEET NO. 10 OF 33 SHEETS STA TO STA.

SCALE: NONE

TOTAL SHEET SHEETS NO. 378 93J CONTRACT NO. 60X95

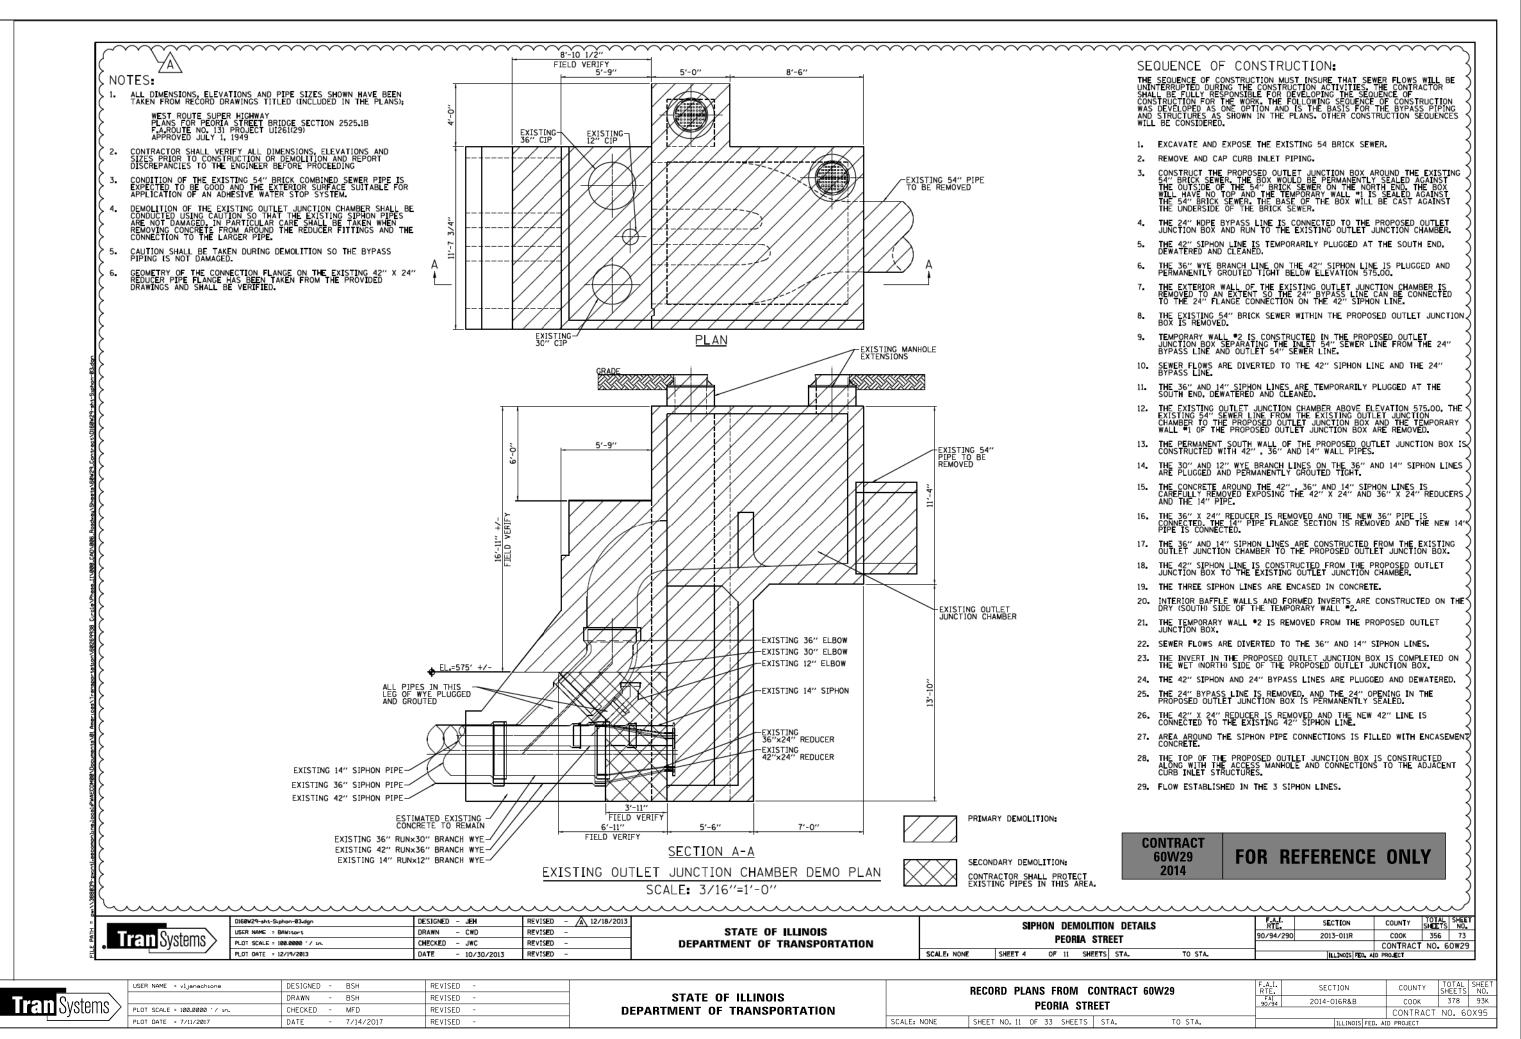


CHECKED CHECKED

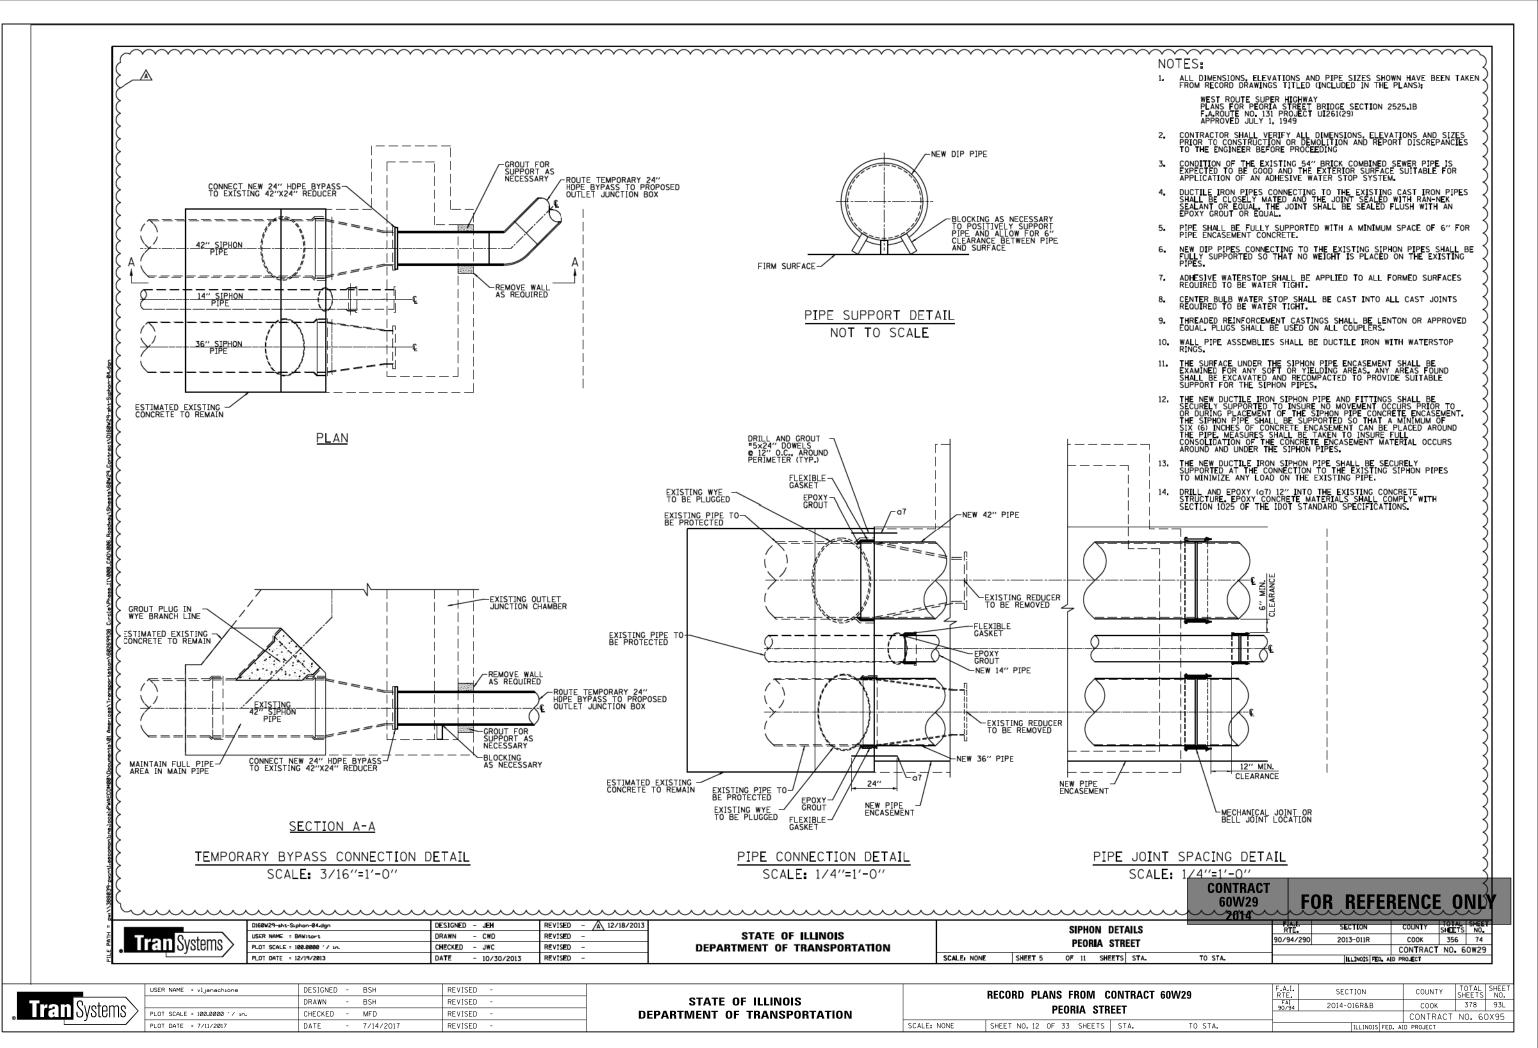

CHECKED Y CHECKED NAME

SURVEYED — PLOTTED — ALIGNMENT I RT. OF WAY

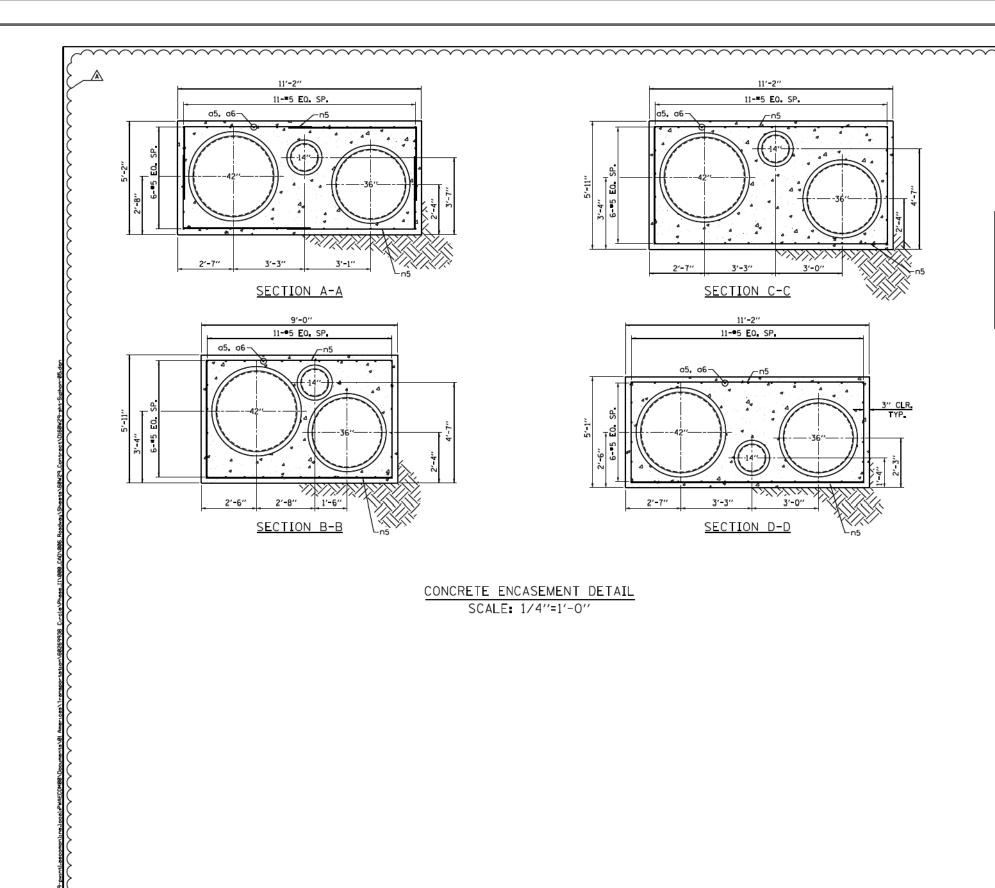


NOTES:

BILL OF MATERIAL (FOR INFORMATION ONLY)							
BAR MARK	NO.	SIZE	LENGTH	SHAPE	NOTES		
a5	60	* 5	40'-0"	1	LAP 2'-0" MIN.		
a6	30	●5	23′-0′′	1	LAP 2'-0" MIN.		
a 7	30	•5	2'-0"	1	DOWLES		
n5	384	●5	9'-2"	10	LAP 1'-0" MIN, 3'-2" MAX		
CONCRETE STRUCTU	JRES		CU YD	131.7	_		
REINFORCEMENT BA	RS		POUND	6954			

COST OF CONCRETE STRUCTURES AND REINFORCEMENT BARS IS INCLUDED WITH SIPHON RECONSTRUCTION.

> BAR SHAPE LENGTH 1

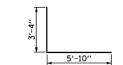

CONTRACT 60W29

FOR REFERENCE ONLY

Tran Systems

160W29-sht-Siphon-05-dgn	DESIGNED - JEH	REVISED - A 01/20/2014
SER NAME = BAWitort	DRAWN - CWD	REVISED -
LOT SCALE = 100.0000 ' / in.	CHECKED - JWC	REVISED -
LOT DATE = 1/21/2014	DATE - 10/30/2013	REVISED -

STATE OF ILLINOIS **DEPARTMENT OF TRANSPORTATION**


		SIPH	ON DET	AILS		F.A.I. RTE	SECTION
		PEOI	RIA STR	FFT		90/94/290	2013-011F
		1 201	un 0111				
SCALE: NONE	SHEET 6	OF 11	SHEETS	STA.	TO STAL		ILLINOIS

	F.A.I. RTE.	SECTION		COUNTY	TOTAL SHEETS	SHEET NO.
	FAI 90/94	2014-016R&B	COOK	378	93M	
_	·			CONTRACT	NO. 60	X95



PLAN SURVEYED
NOTE BOOK ALLOWENT CHECKED
NO. CADD FILE NAME

USER NAME = vljanachione	DESIGNED	-	BSH	REVISED -	
	DRAWN	-	BSH	REVISED -	
PLOT SCALE = 100.0000 ' / in.	CHECKED	-	MFD	REVISED -	
PLOT DATE = 7/11/2017	DATE	-	7/14/2017	REVISED -	

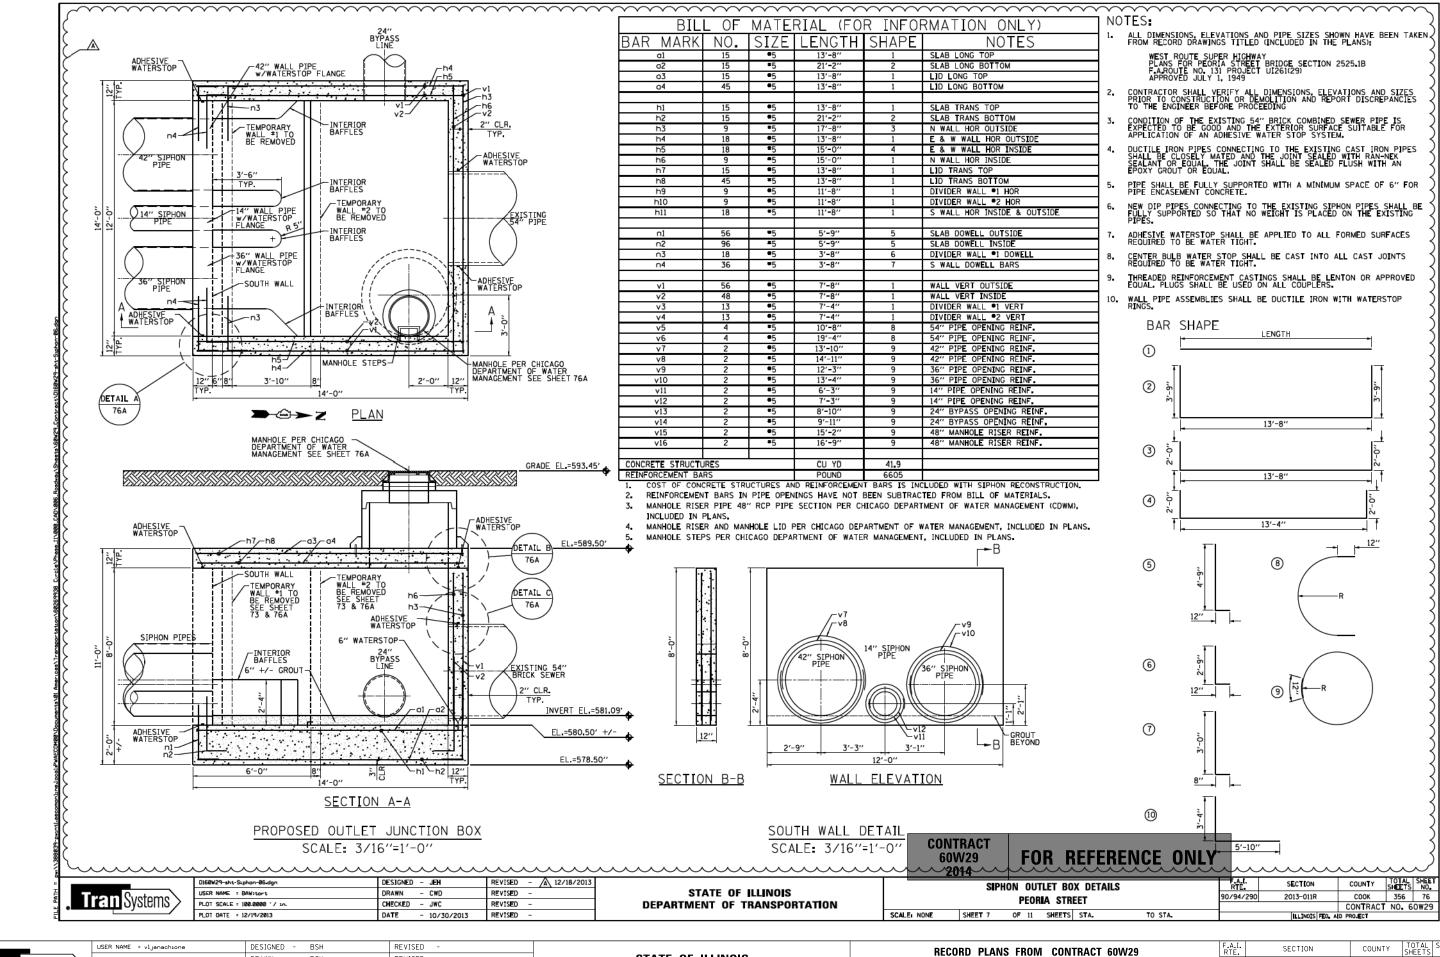

Tran Systems

CHECKED CHECKED

| DESIGNATE | DESIGNATION | DESIGNATION | DE

STATE OF ILLINOIS
DEPARTMENT OF TRANSPORTATION

SCALE: NONE

 RECORD PLANS FROM CONTRACT 60W29
 F.A.I. RTE. RTE. 90.794
 SECTION

 PEORIA STREET


 SHEET NO. 14 OF 33 SHEETS STA. TO STA.

 I.
 SECTION
 COUNTY SHEAL SHEET NO.


 94
 2014-016R&B
 COOK
 378
 93N

 CONTRACT
 NO.
 60X95

 |ILLINOIS | FED. AID PROJECT

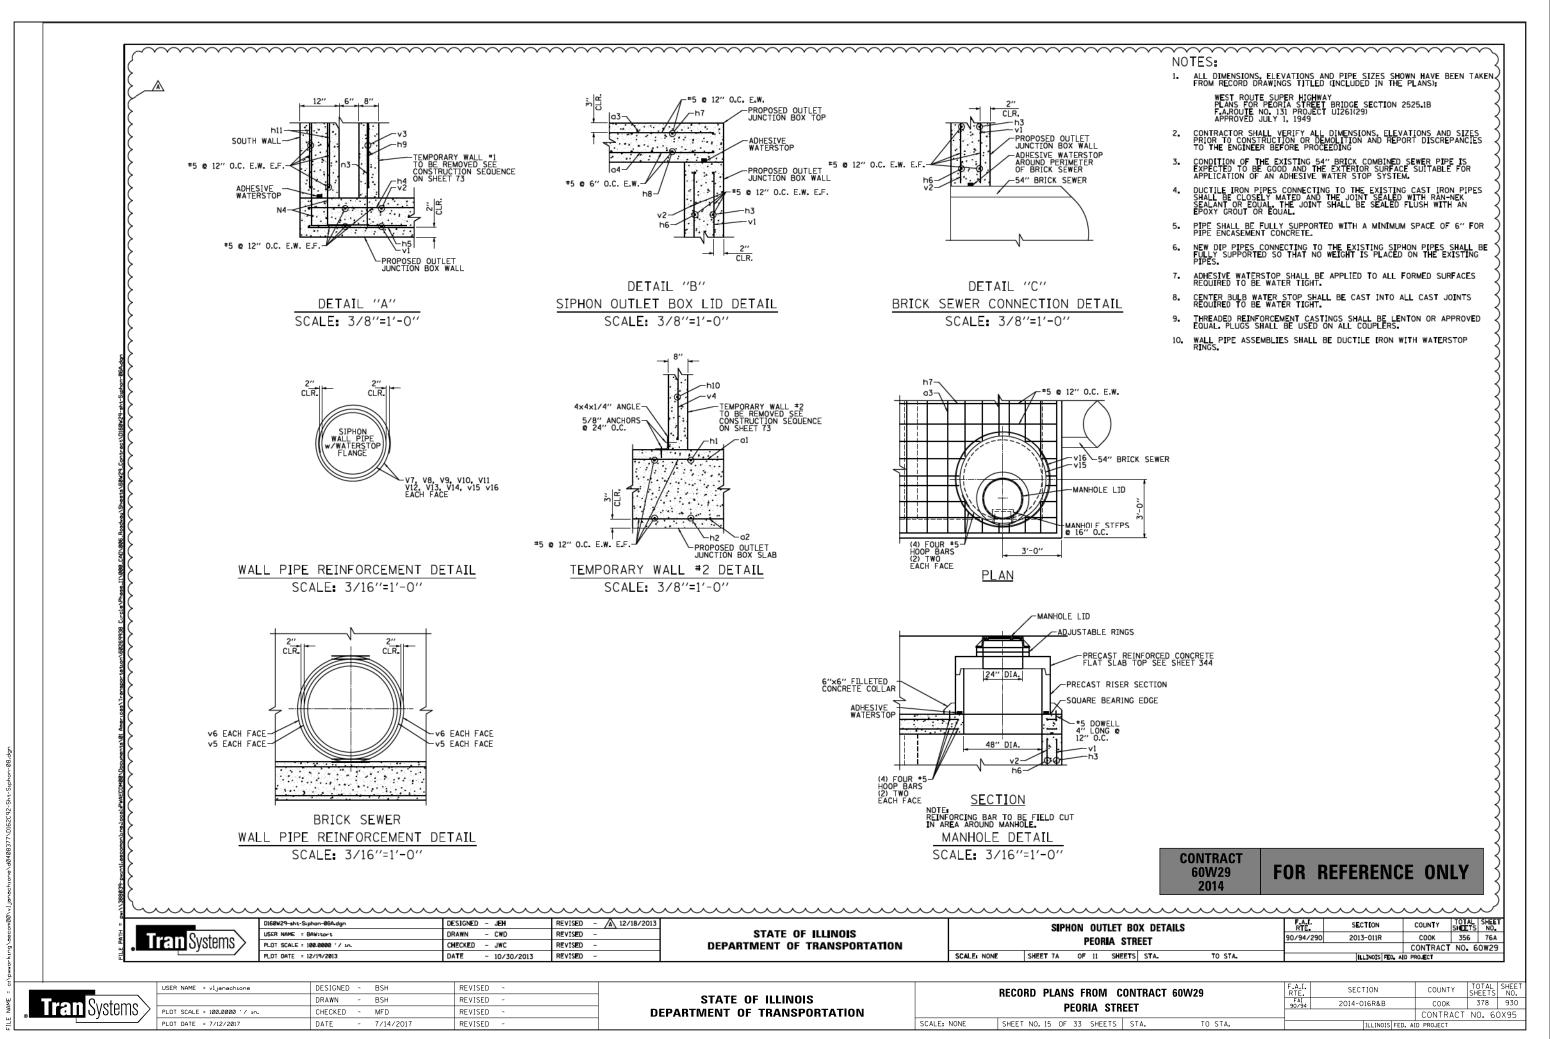

CHECKED Y CHECKED NAME

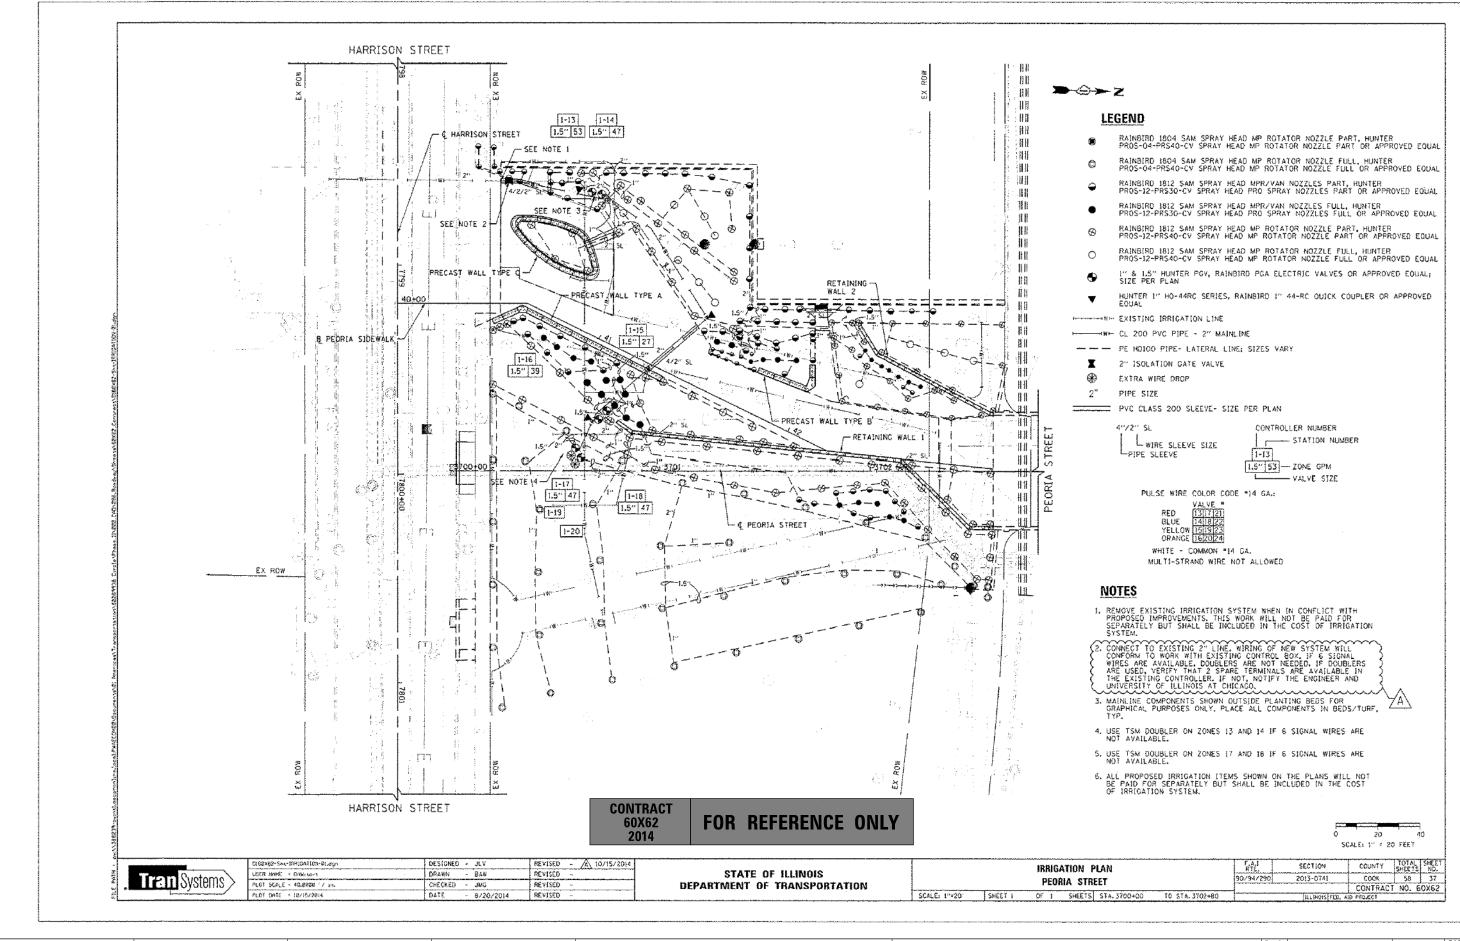


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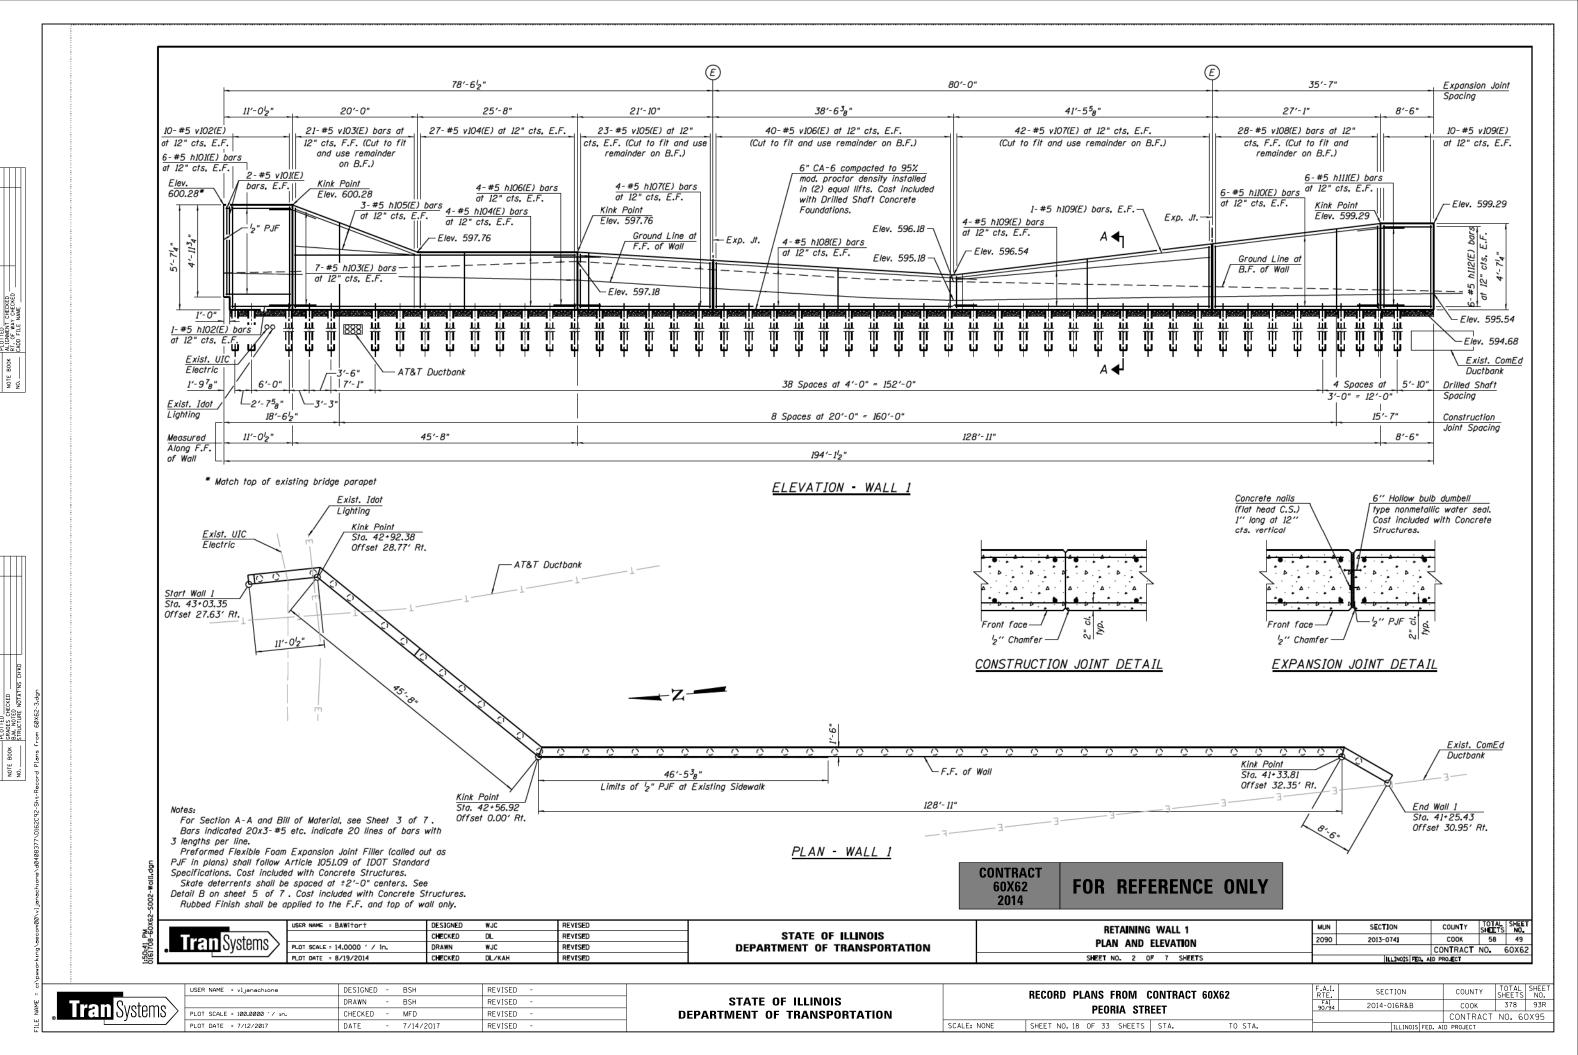
STATE OF ILLINOIS
DEPARTMENT OF TRANSPORTATION


RECORD PLANS FROM CONTRACT 60X62
PEORIA STREET

SHEET NO. 16 OF 33 SHEETS STA. 3700+00 TO STA. 3702+80

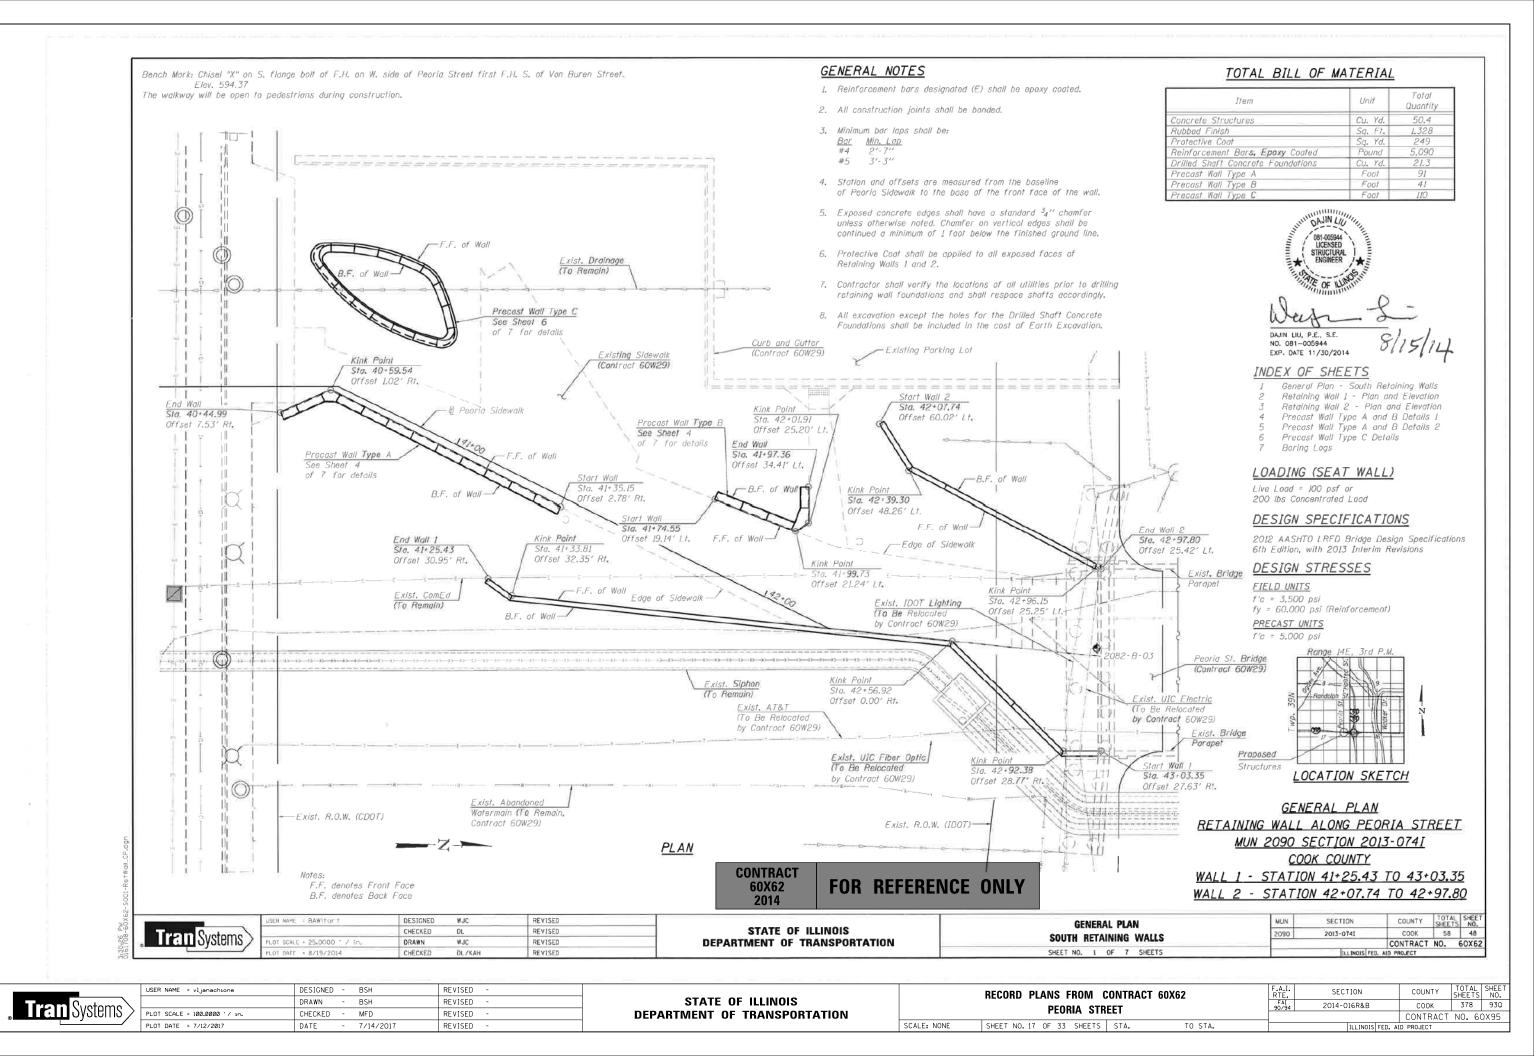

CHECKED



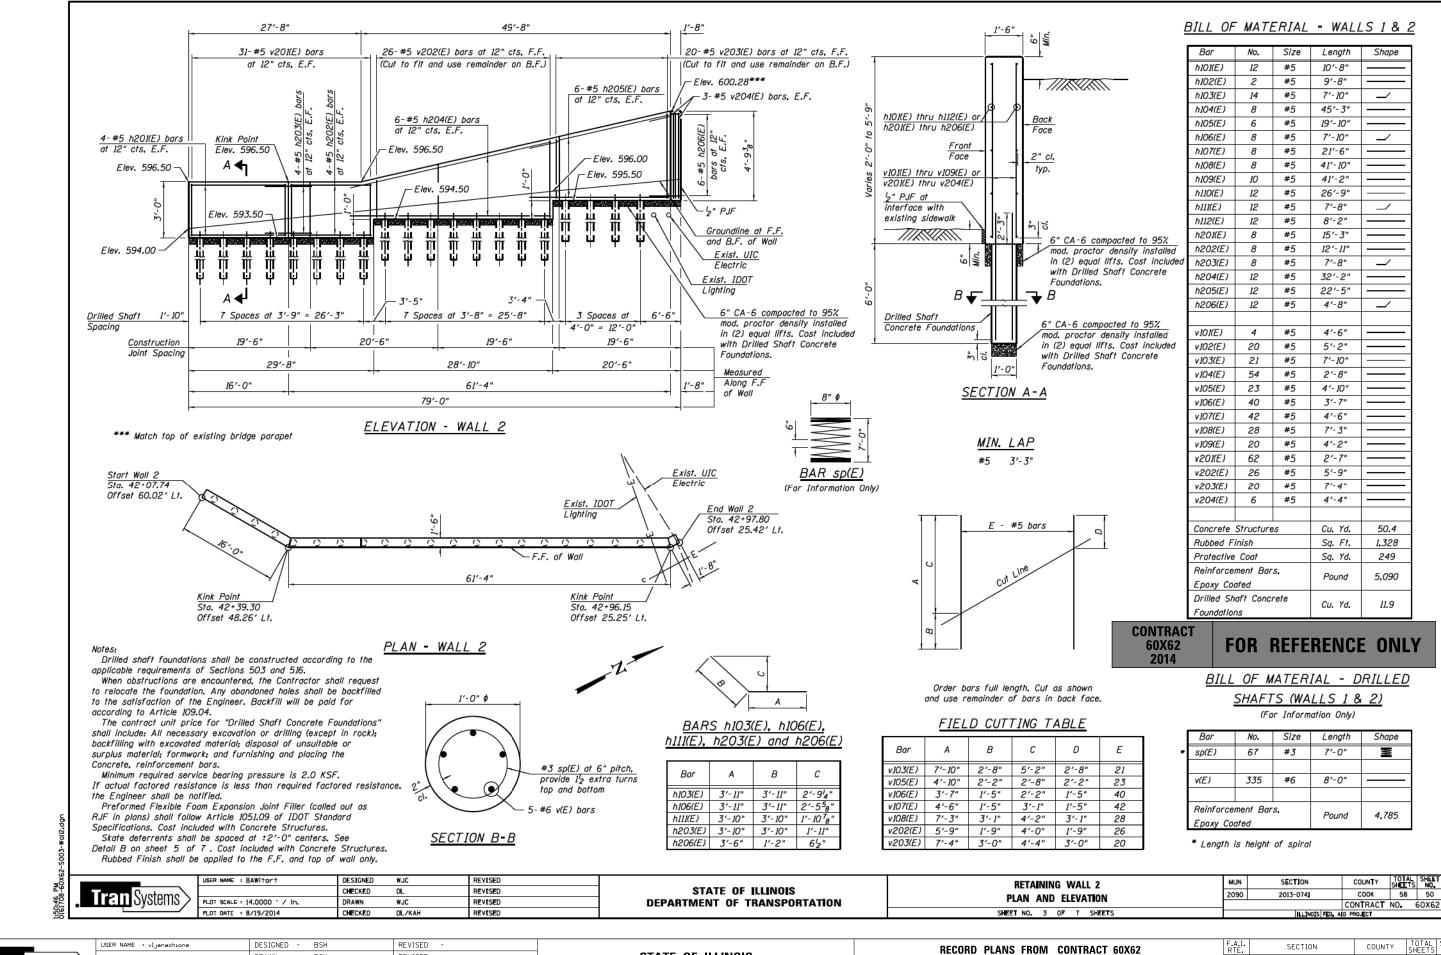

STATE OF ILLINOIS

DEPARTMENT OF TRANSPORTATION

378 935

CONTRACT NO. 60X95

COOK

2014-016R&B

PEORIA STREET

TO STA.

SHEET NO. 19 OF 33 SHEETS STA

SCALE: NONE

Tran Systems

PLOT DATE = 7/12/2017

DRAWN

DATE

CHECKED

BSH

MFD

7/14/2017

REVISED

REVISED

REVISED

CHECKED CHECKED

INDEX OF SHEETS

SHEET

TITLE SHEET LOCATION PLAN AND PROFILE EXCAVATION AND BACKFILL PAY LIMITS

DESIGN DATA

STEEL FRAMING PLAN GIRDER DETAILS

STRUCTURAL STEEL DETAILS

GIRDER BEARINGS

EXPANSION JOINTS

PILING PLAN

PIERS

SOUTH ABUTMENT NORTH ABUTMENT

SOUTH WING WALLS

CONCRETE DECK DETAILS DECK REINFORCEMENT

BAR LIST

ARCHITECTURAL FINISH

RAILING DETAILS

SEWER SIPHON GENERAL PLAN AND PROFILE

INLET JUNGTION CHAMBER SPECIAL PIPE FITTINGS

OUTLET JUNCTION CHAMBER

SEWER DETAILS

PAVEMENT DETAILS

MISCELLANEOUS TIMBER DETAILS


MANHOLE FRAMES AND COVERS MISCELLANEOUS STEEL

SEWER AND SIPHON CONCRETE AND REINFORCEMENT DETAILS

INLET JUNCTION CHAMBER REINFORCEMENT DETAILS

OUTLET JUNCTION CHAMBER REINFORCEMENT DETAILS

BAR LIST FOR SIPHON

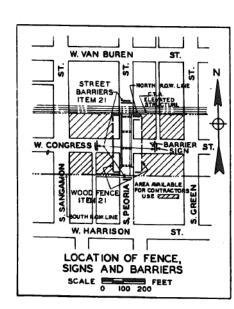

STATE OF ILLINOIS CITY OF CHICAGO DEPARTMENT OF SUBWAYS AND SUPERHIGHWAYS



PLANS FOR PEORIA STREET BRIDGE **SECTION 2525.1-1B**


F.A.ROUTE NO.131 PROJECT UI 261(29)

SUMMARY OF QUANTITIES

ITEM NO.	UNIT	QUANTITY	DESCRIPTION	
1	CU.YDS.	15,500	SPECIAL EXCAVATION	
2	CU.YDS.	1,550	BACKFILL	
3	CUYDS.	2,100	CLASS X CONCRETE	'
4	LBS.	200,000	REINFORCEMENT BARS	
5	LBS.	600,000	STRUCTURAL STEEL	
6	LIN.FT.	12,636	FURNISHING TREATED PILES, 20.1 TO 38 FEET LONG	
7	LIN.FT.	12,636	DRIVING TIMBER PILES, 36 FEET LONG	
8	EACH	4	TEST PILES	
9	LBS.	340,000	STEEL SHEETING AND BRACING	
10	LBS.	9,300	ALUMINUM RAILING	
11	TONS	80	BITUMINOUS CONCRETE BINDER COURSE	
12	TONS	80	SHEET ASPHALT SURFACE COURSE, SUBCLASS J-1	
13	SQ.YDS.	850	BITUMINOUS MACADAM PAVEMENT	
14	LBS.	24,000	CAST IRON PIPE, 12 FEET AND OVER IN LENGTH	
15	LBS.	2,500	CAST IRON PIPE, OVER 3 FEET AND LESS THAN 12 FEET IN LENGTH	1
16	LBS.	38,000	CAST IRON PIPE, 3 FEET OR LESS IN LENGTH, AND FITTINGS	
17	LIN. FT.	300	36-INCH REINFORCED CONCRETE PIPE	
18	LIN.FT.	300	42-INCH REINFORCED CONCRETE PIPE	Series and the second
19	LBS.	5,200	MISGELLANEOUS IRON CASTINGS	
20	LBS.	800	MISCELLANEOUS STEEL	
21	M. FT. B.M.	11	MISCELLANEOUS TIMBER	
22	EACH	2	SHORING OF ELEVATED COLUMNS	
23	LIN.FT.	5,600	35-INCH CONDUIT	
24	LIN.FT.	2,100		VAC
25	MONTHS	12	PUMPING	


PLANS APPROVED BY STATE DIVISION OF HIGHWAYS



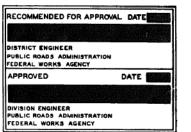

VENTIONAL SIGNS

COMMONWEALTH EDIS	ON CO	. —
WESTERN UNION CO.		
WATER		
GAS		
SEWER		
SEWER MANHOLE	®	
CATCH BASIN	Õ	
VALVE VAULT	Ğ	
	_	
LIGHT STANDARD	¤	
FIRE HYDRANT	8	
R.O.W. LINE		

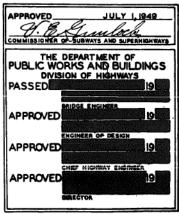

CONSTRUCTION FOR REFERENCE ONLY

TO STA.

SHEET NO 1

Tran Systems


USER NAME = vljanachione	DESIGNED -	REVISED -
	DRAWN -	REVISED -
PLOT SCALE = 100.0000 '/ in.	CHECKED -	REVISED -
PLOT DATE = 7/12/2017	DATE - 7/14/2017	REVISED -

STATE OF ILLINOIS **DEPARTMENT OF TRANSPORTATION**

AS BUILT SIPHON PLANS PEORIA STREET SCALE: NONE SHEET NO. 20 OF 33 SHEETS STA.

SECTION COUNTY COUNTY SHEETS NO.

COOK 378 93T 2014-016R&B CONTRACT NO. 60X95

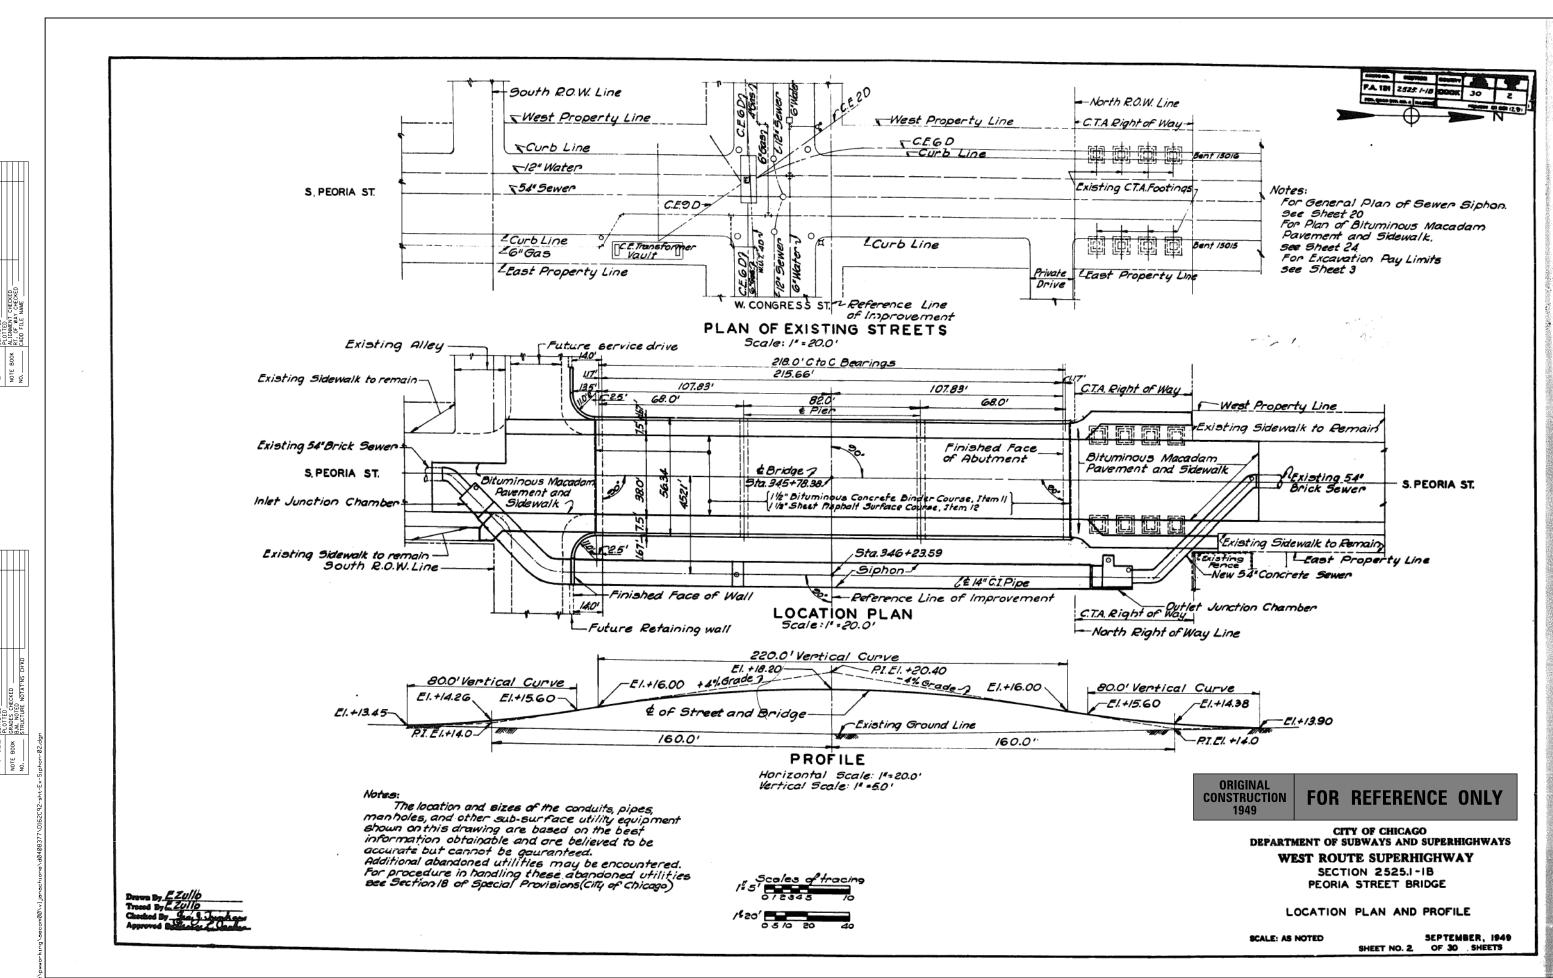


Tran Systems

STATE OF ILLINOIS
DEPARTMENT OF TRANSPORTATION

SCALE: NONE

AS BUILT SIPHON PLANS
PEORIA STREET

SHEET NO. 21 OF 33 SHEETS STA. TO STA.

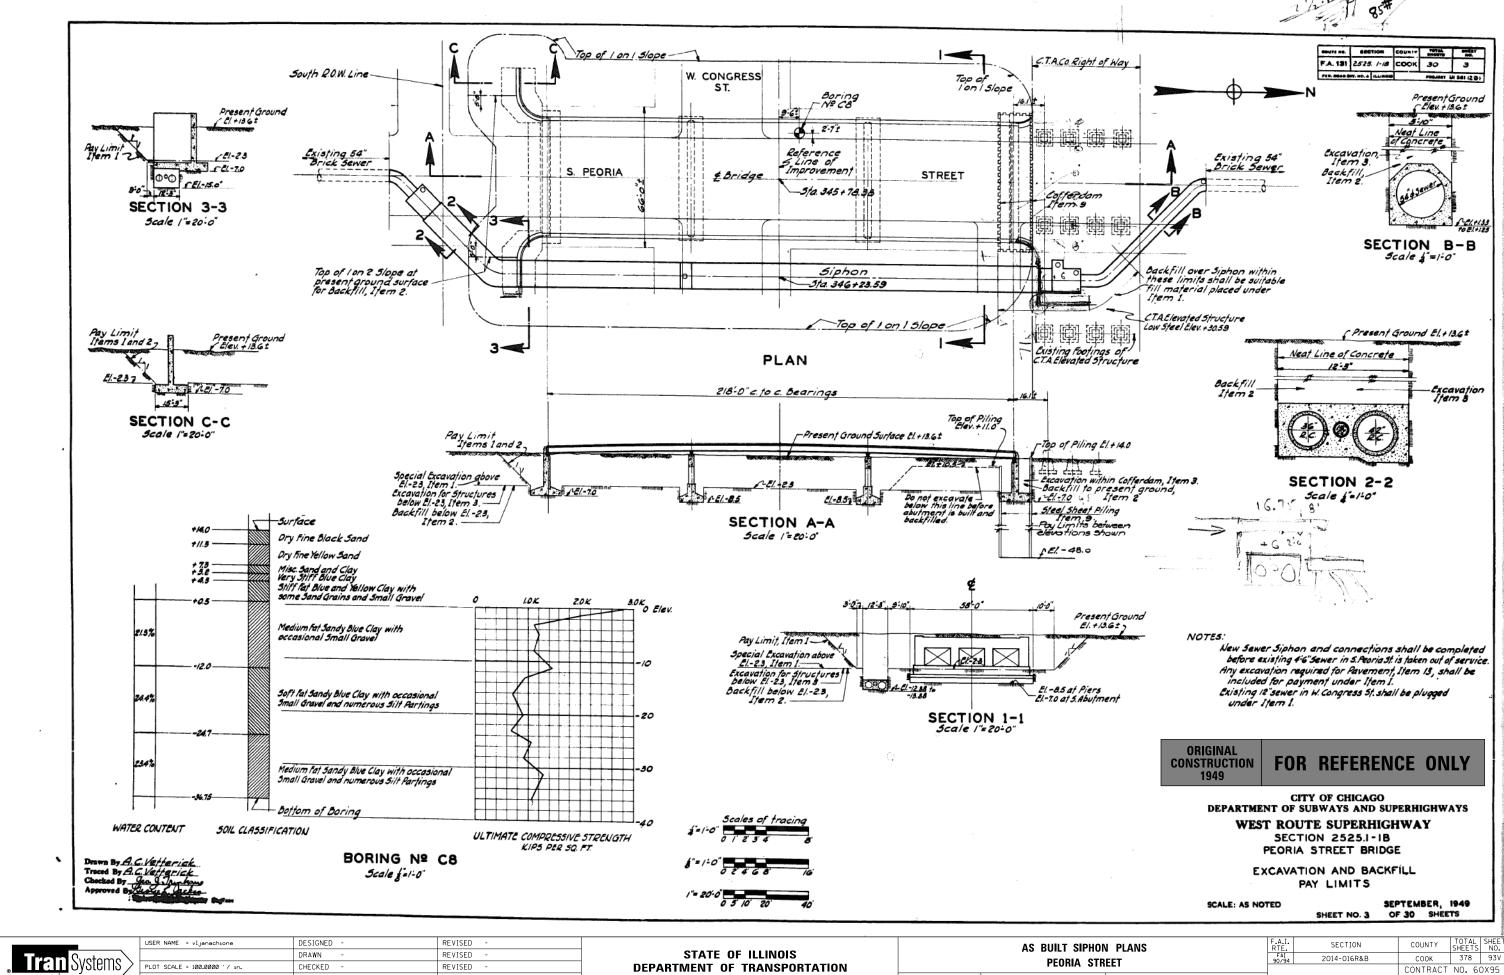

SCALE: NONE

SHEET NO. 22 OF 33 SHEETS STA.

TO STA.

Tran Systems

PLOT DATE = 7/12/2017


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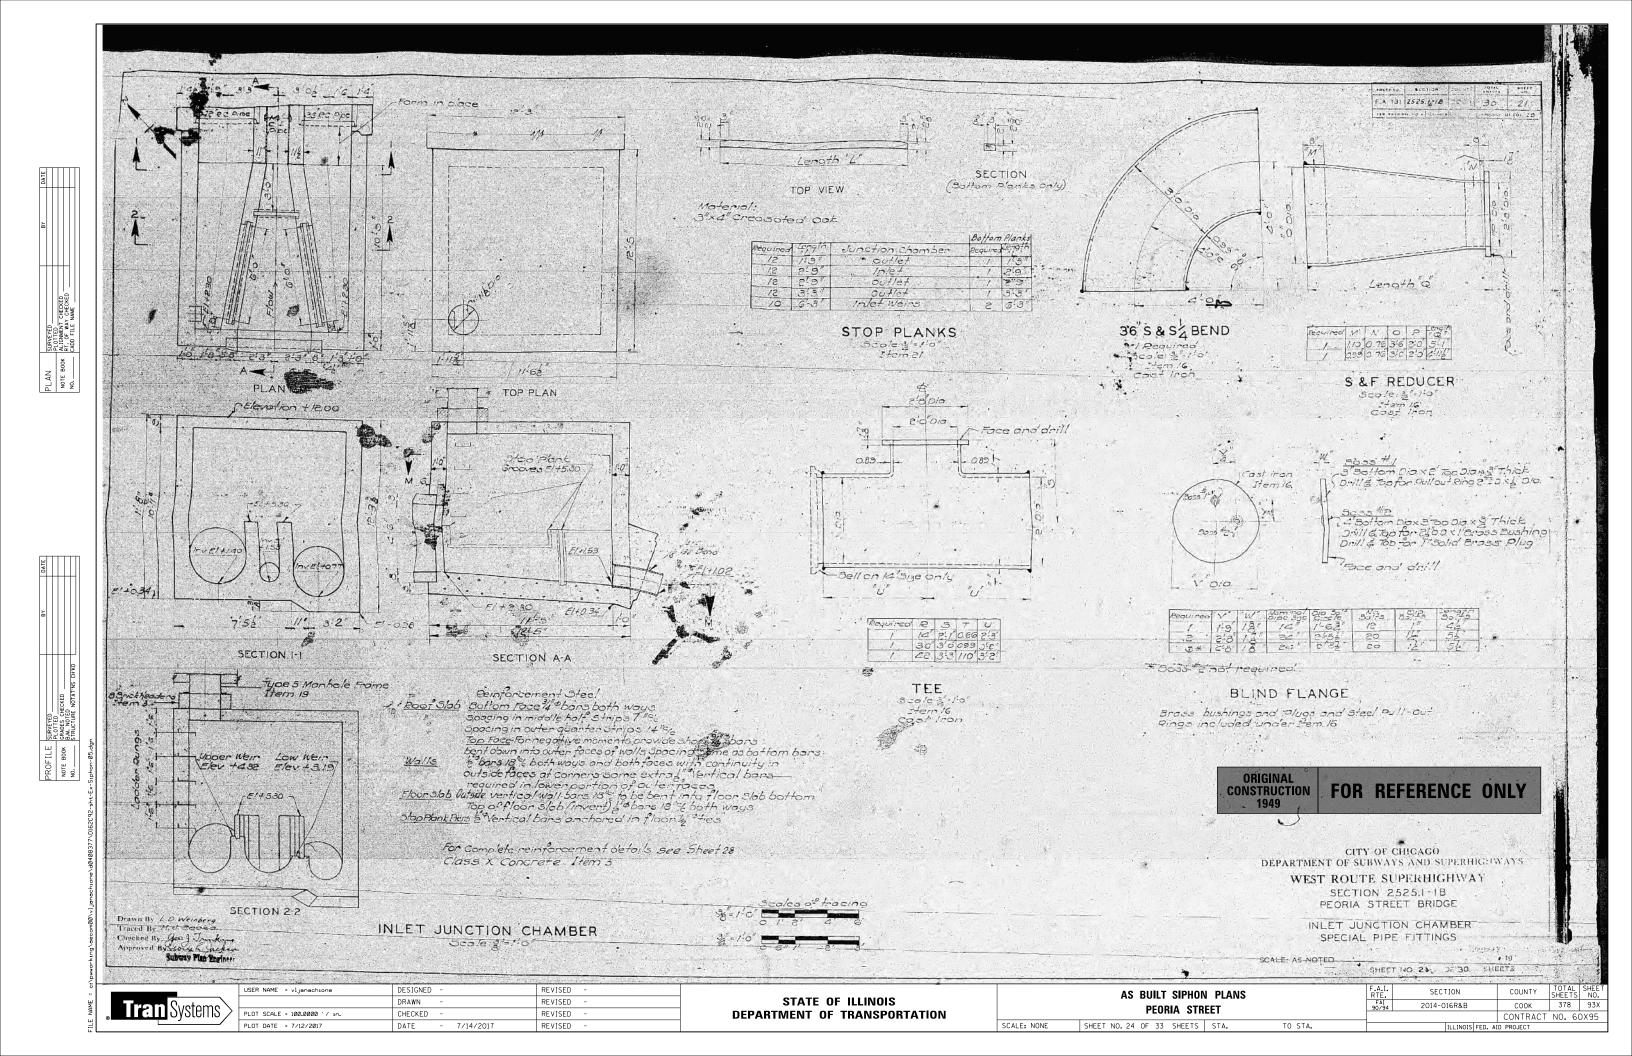
7/14/2017


REVISED


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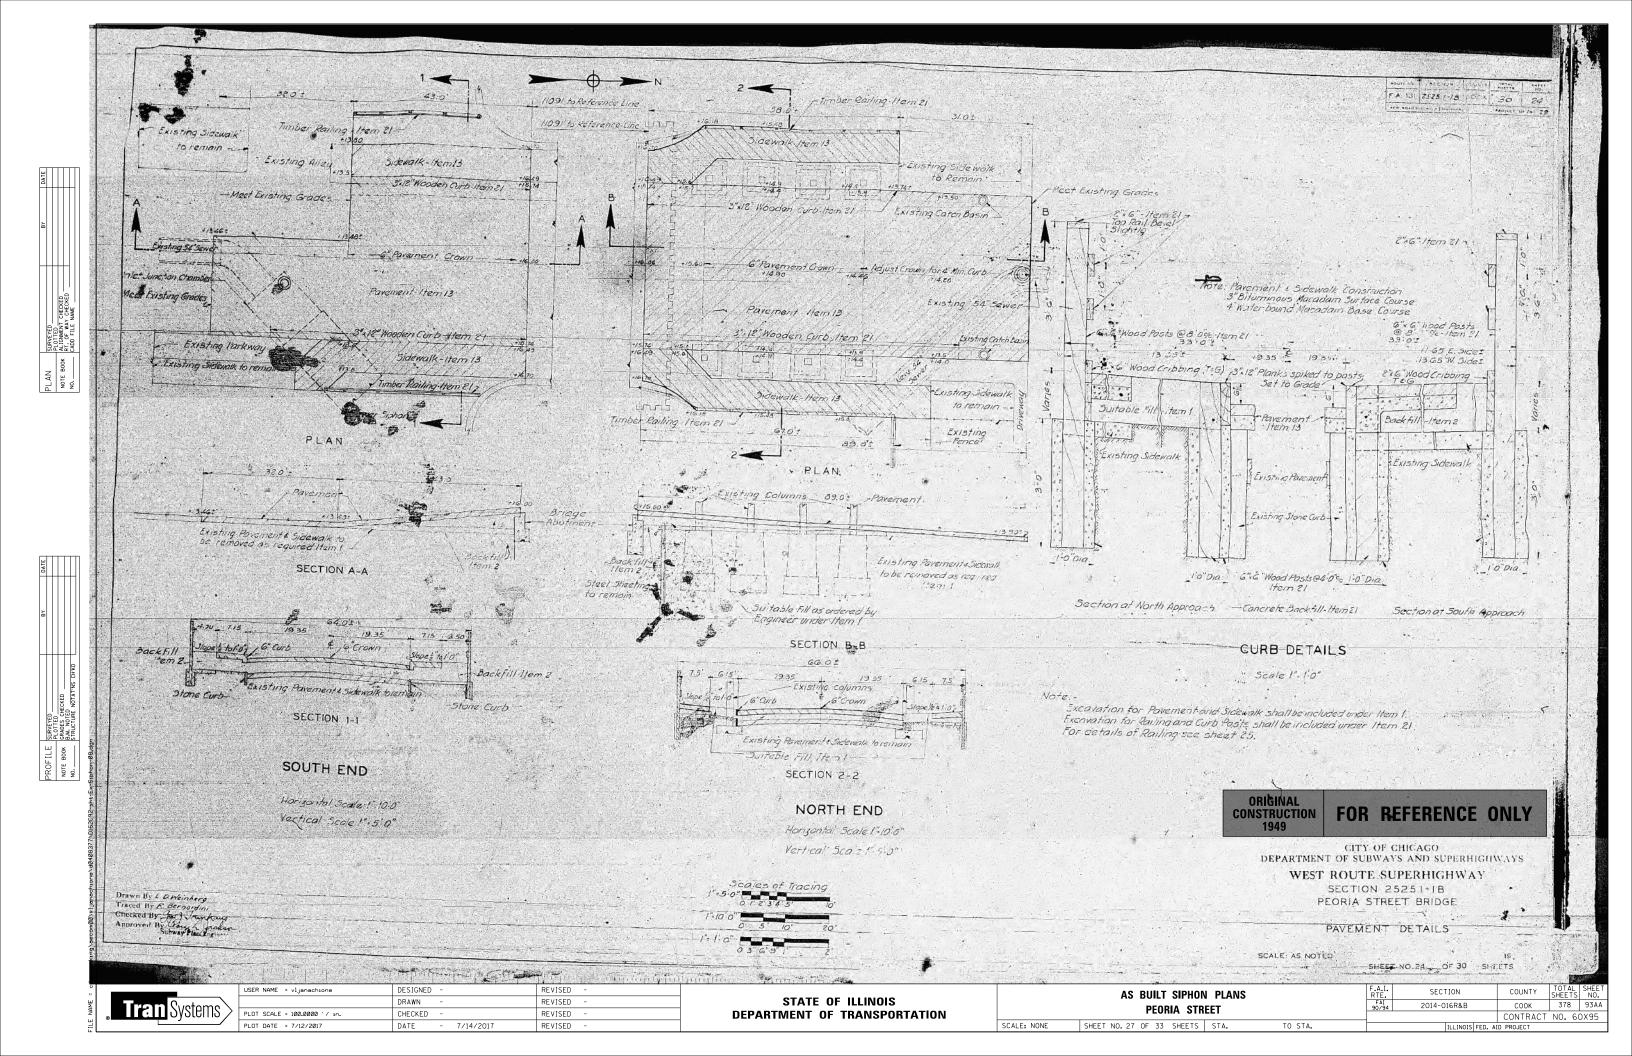
PROF NOTE







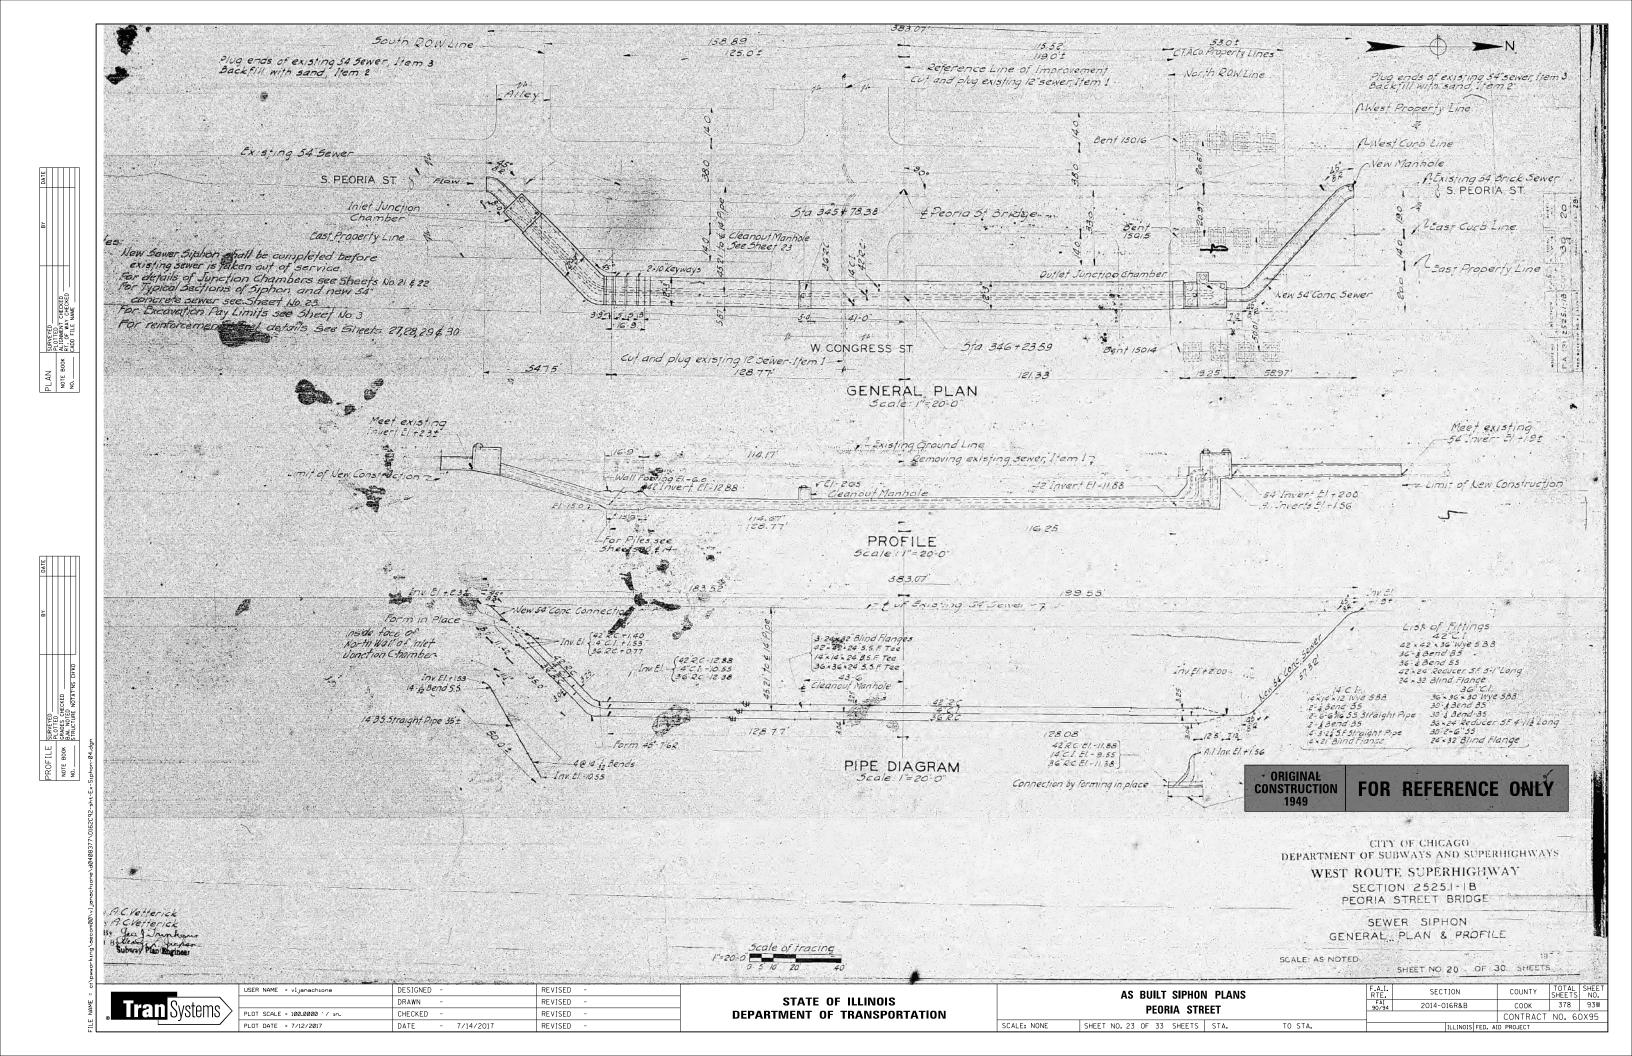


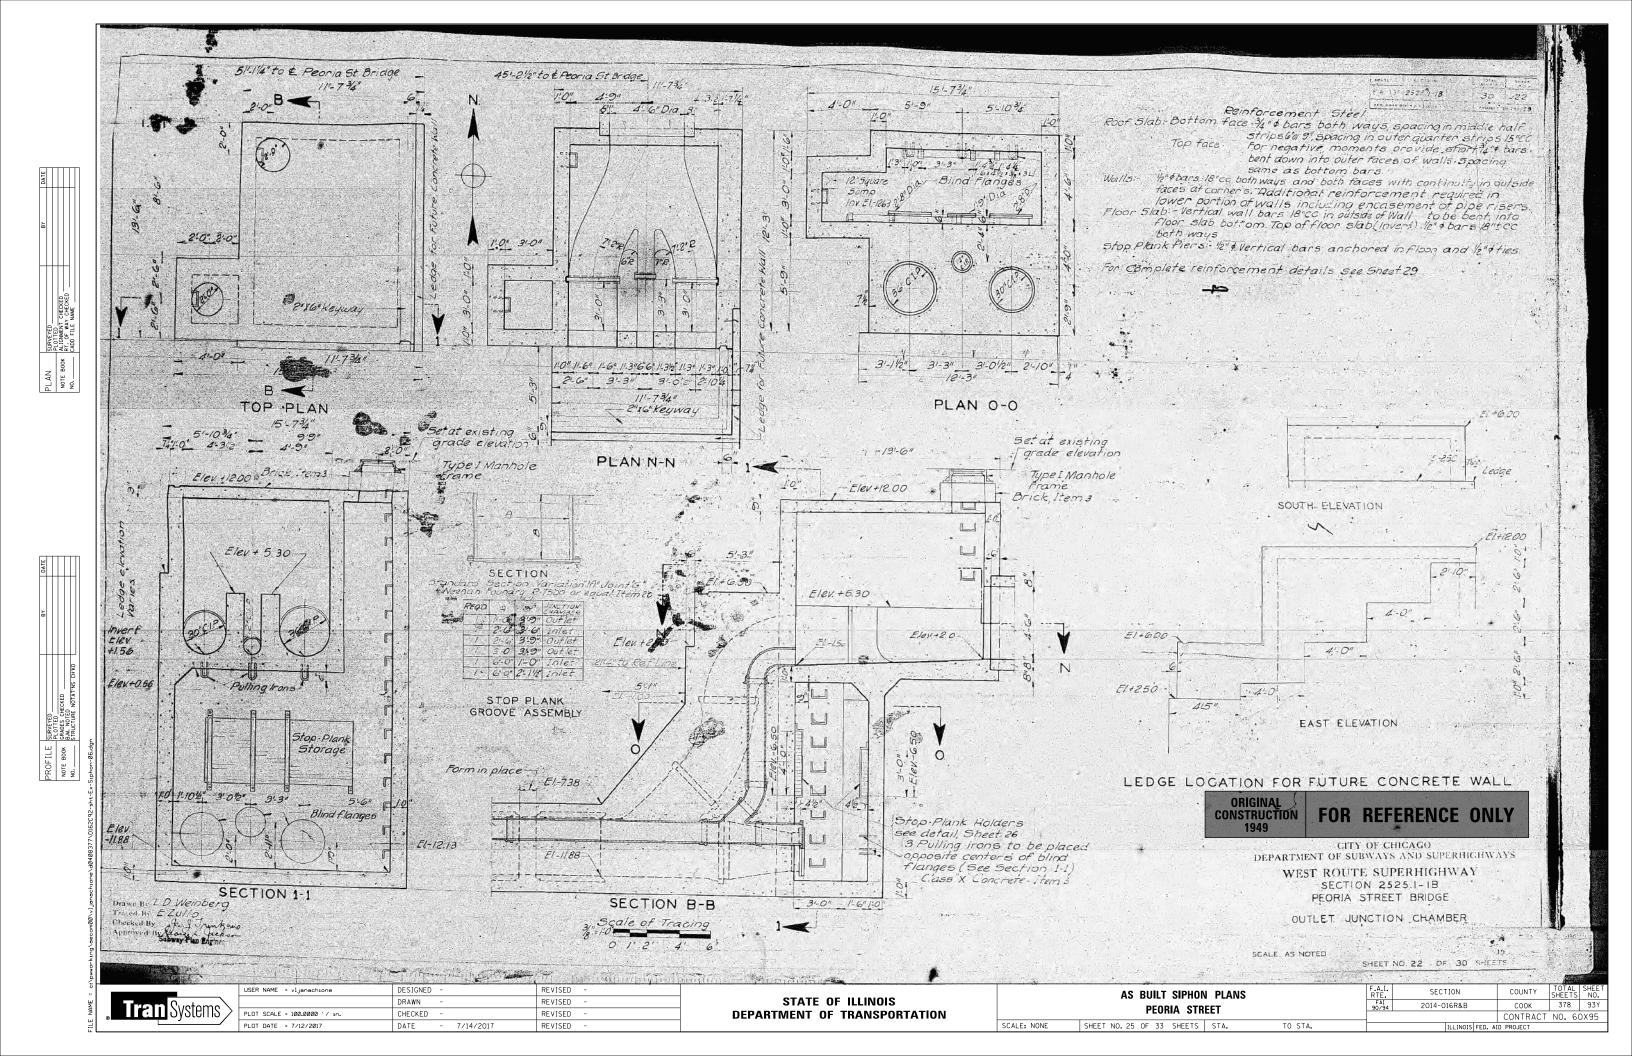


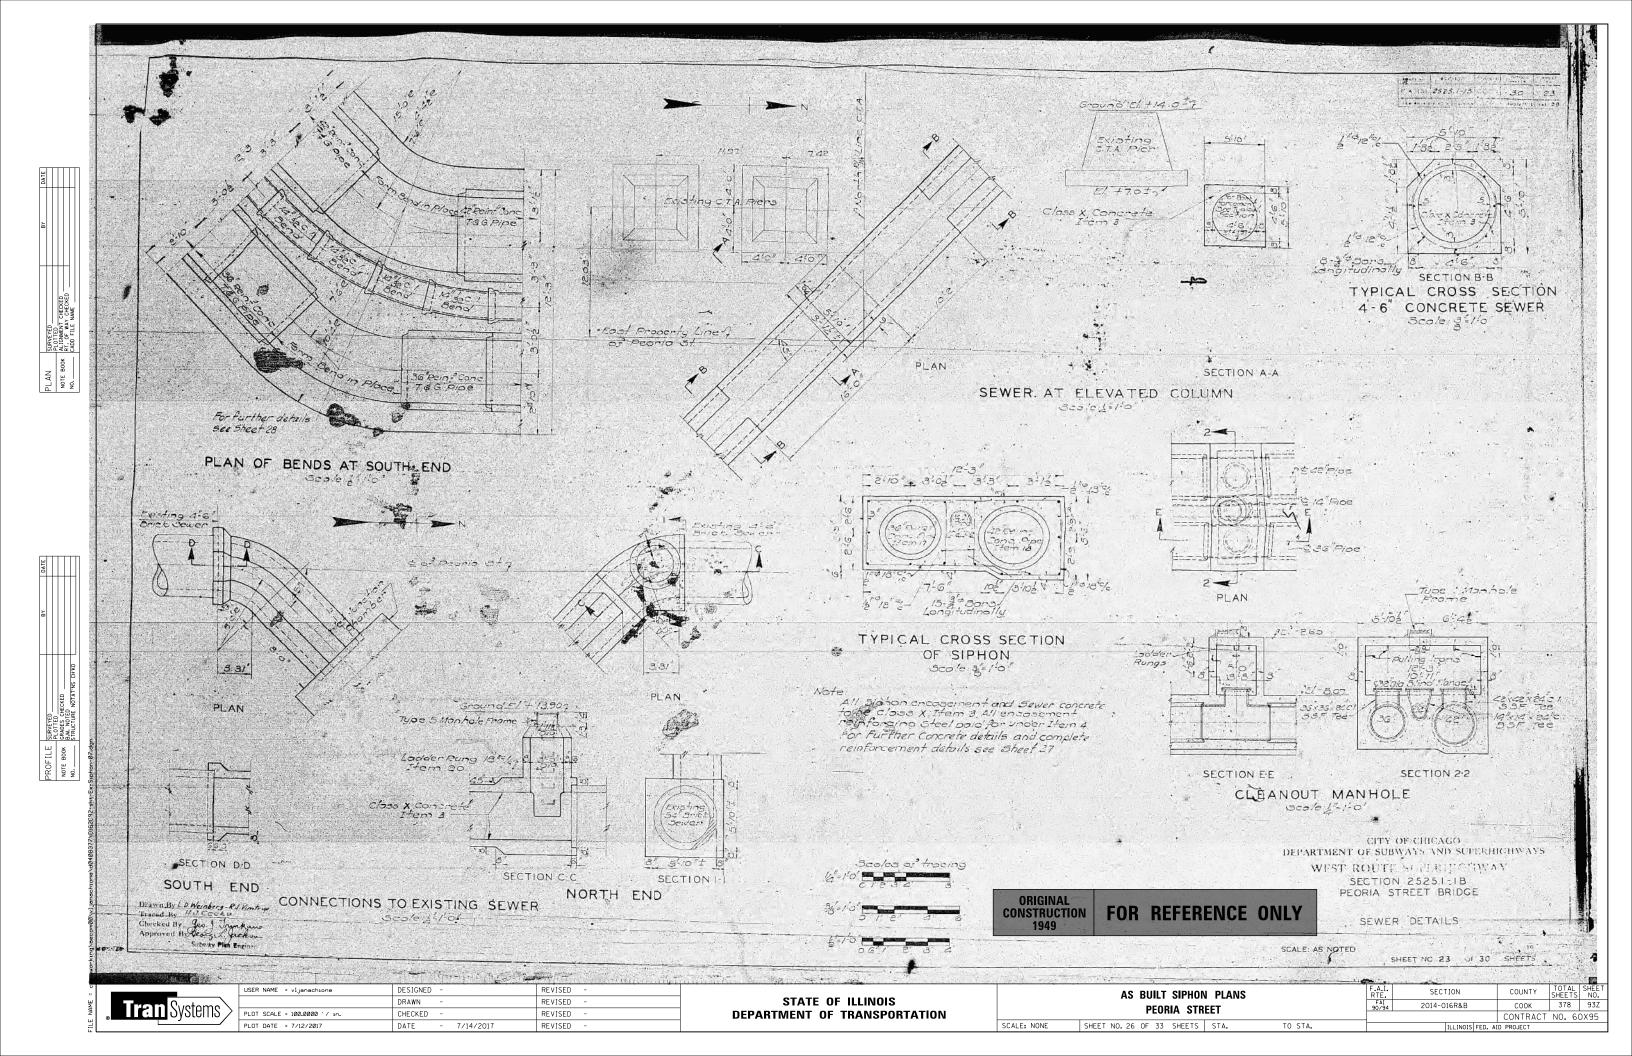


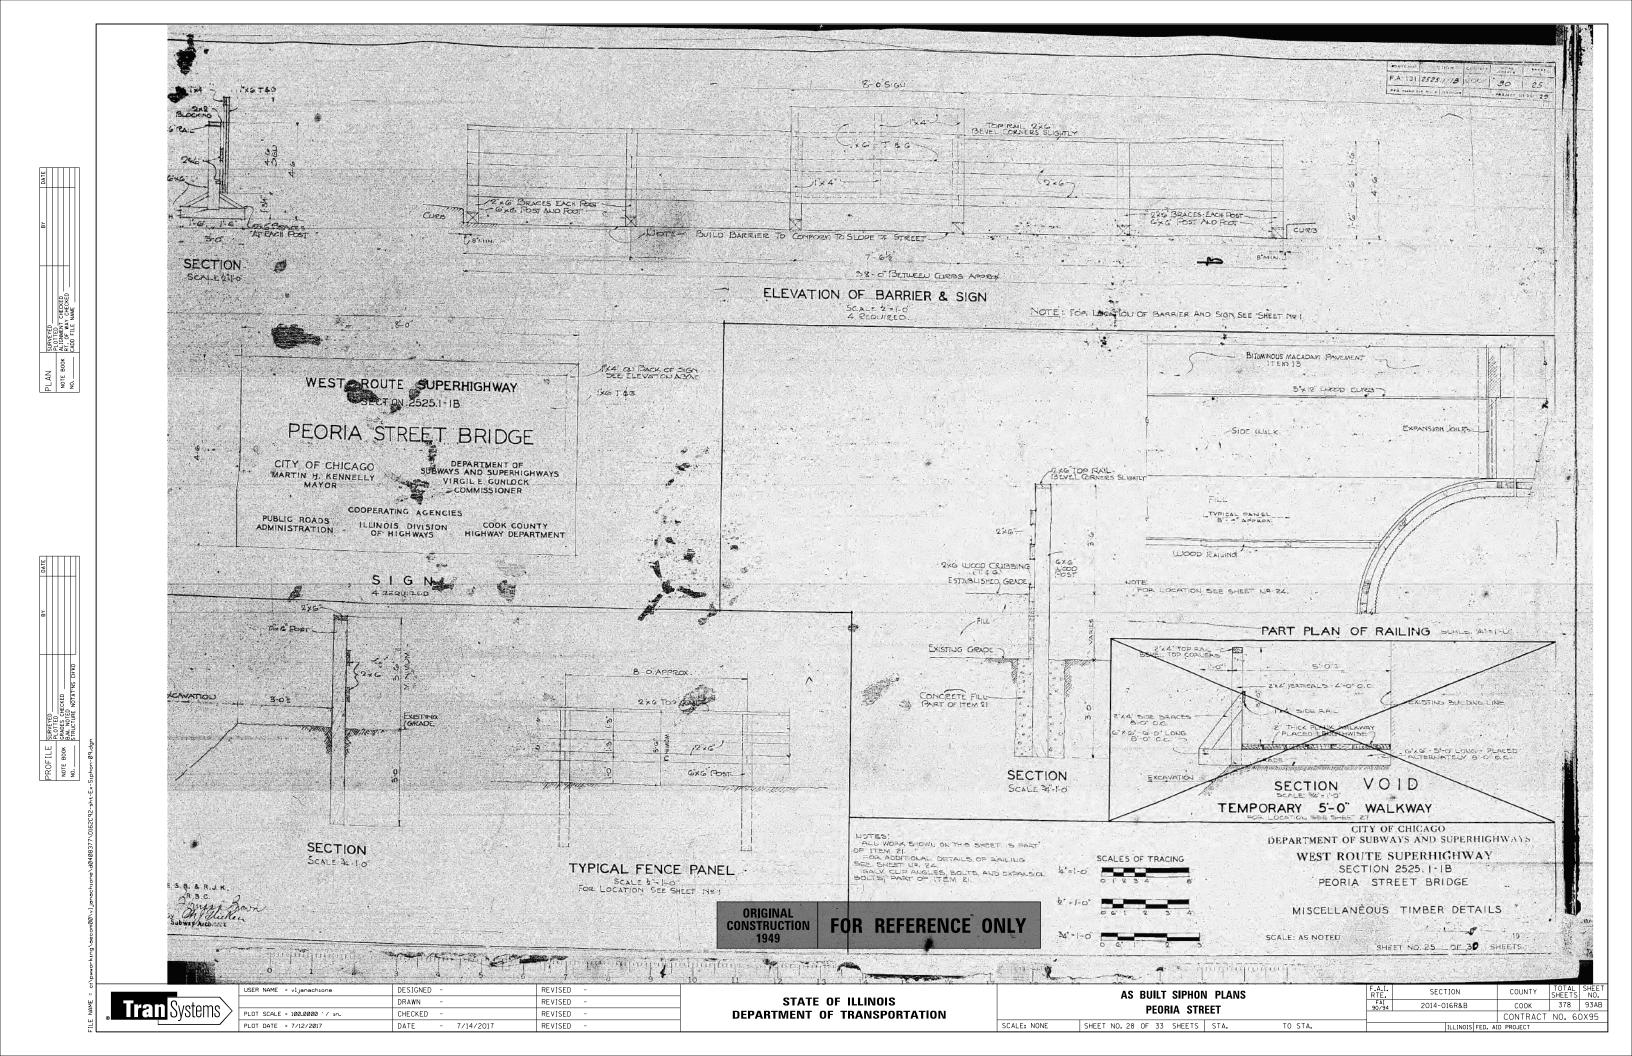


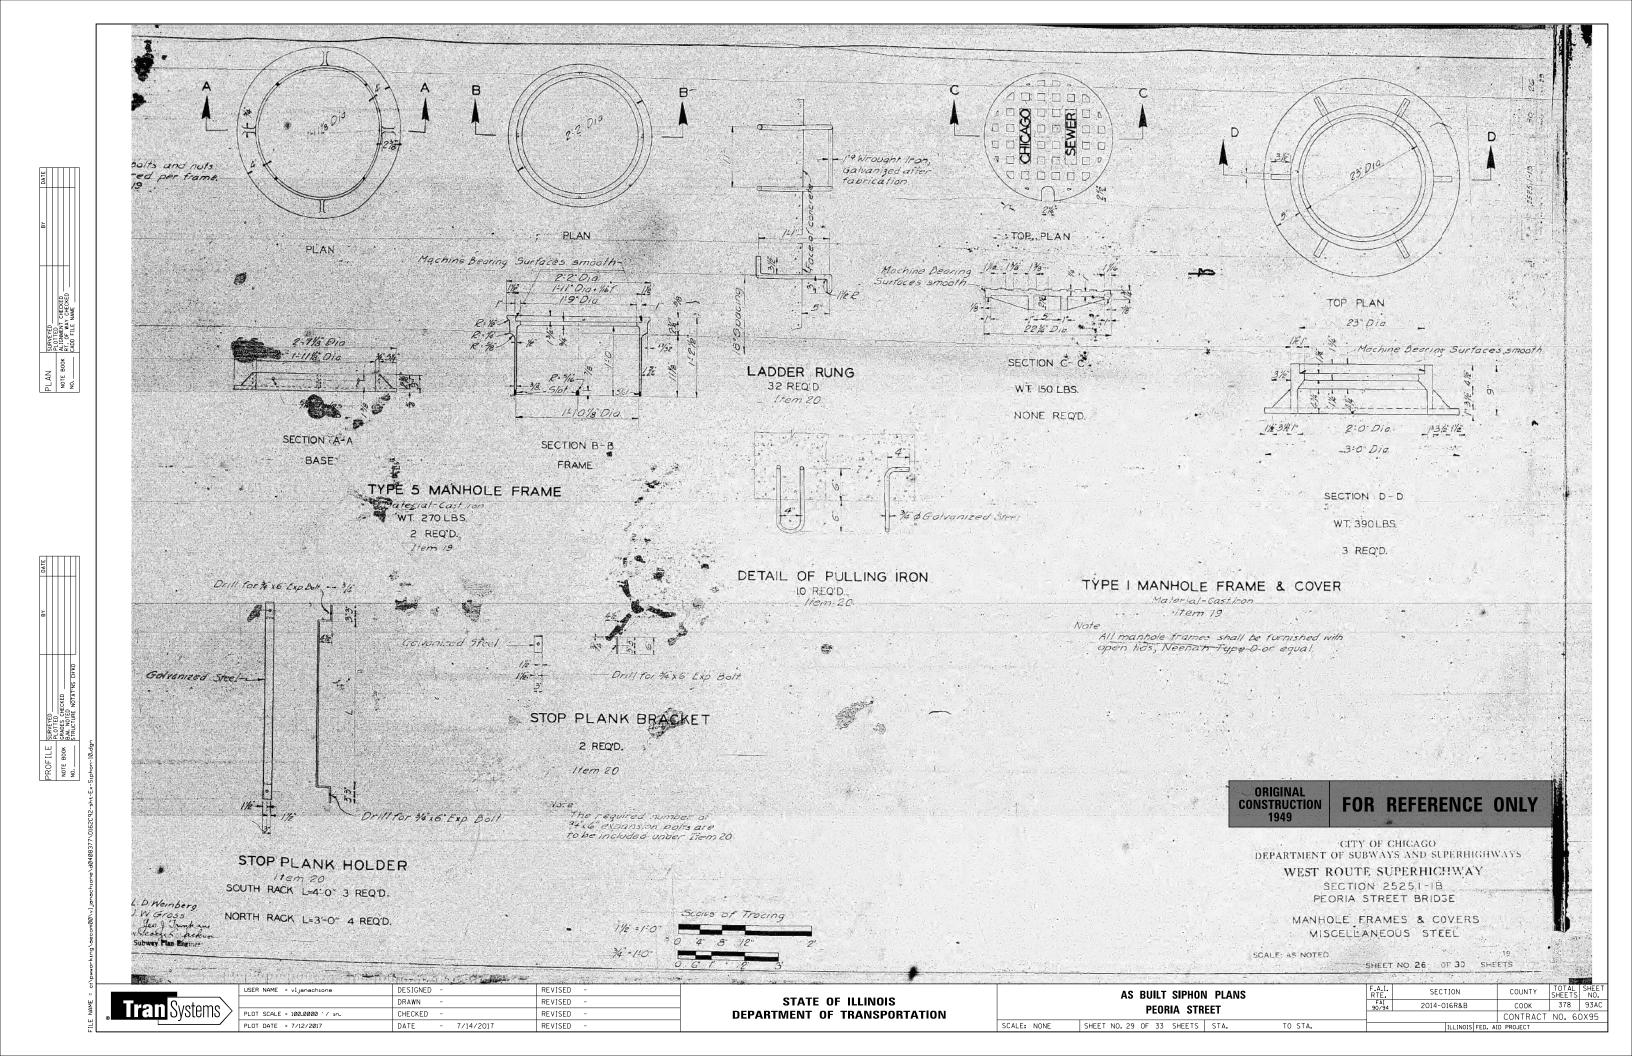


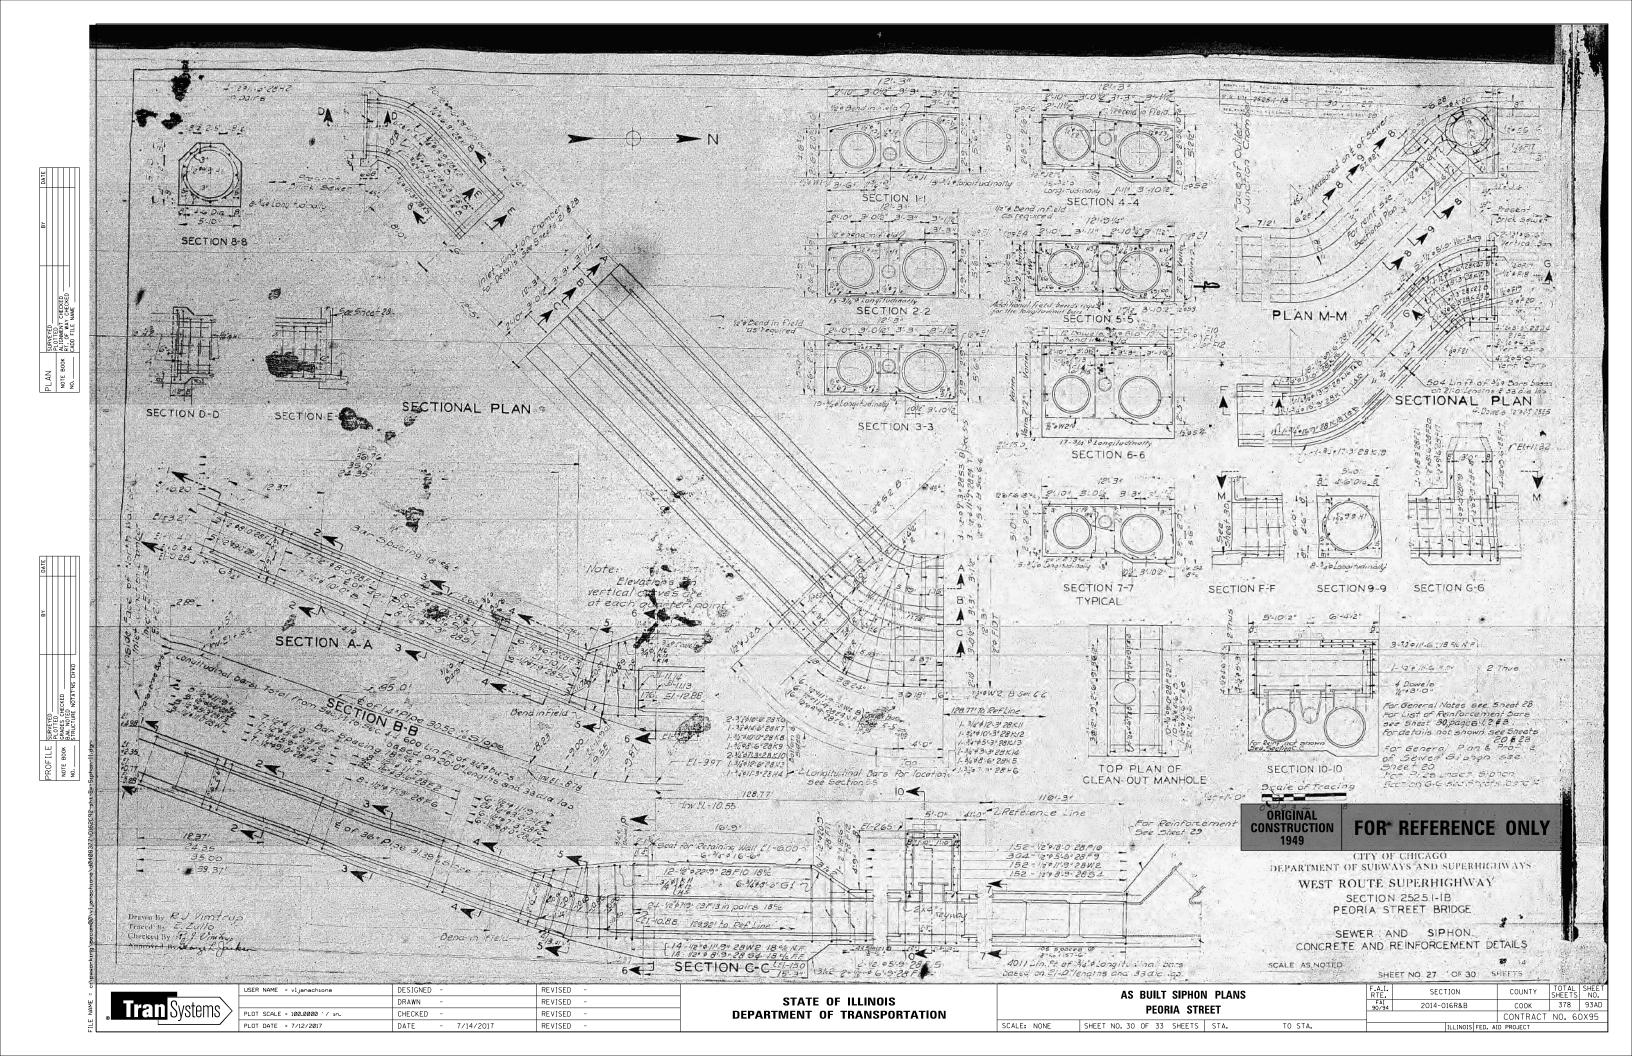


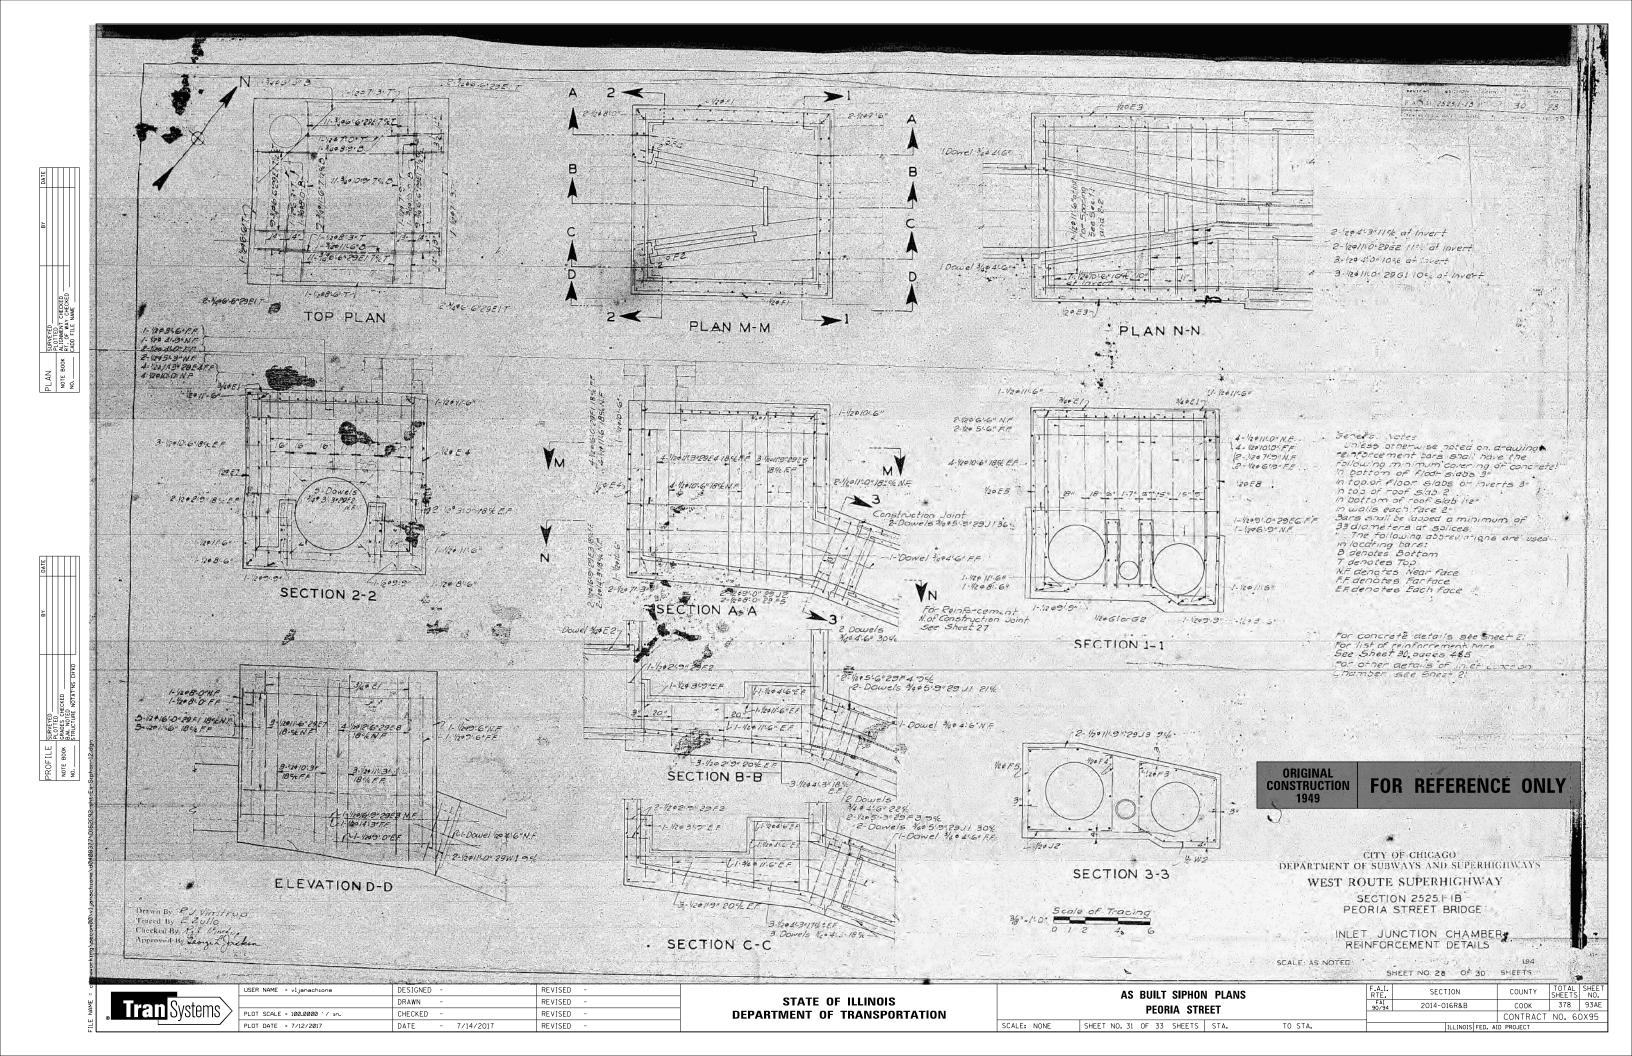


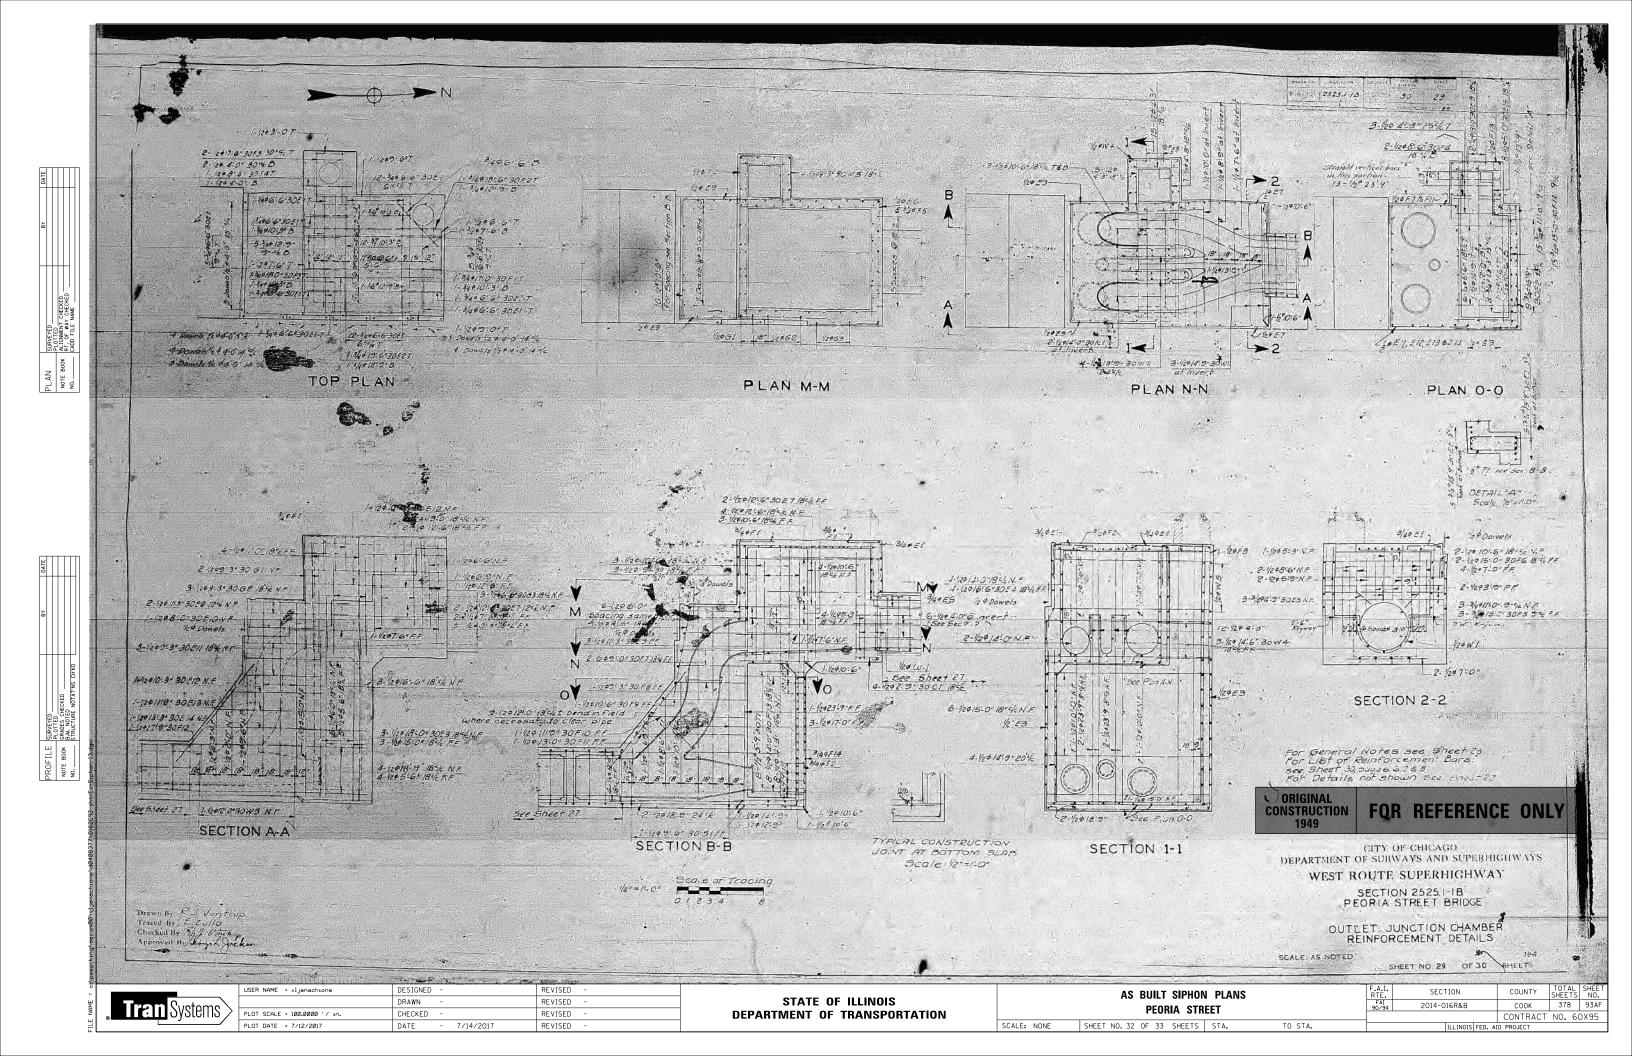


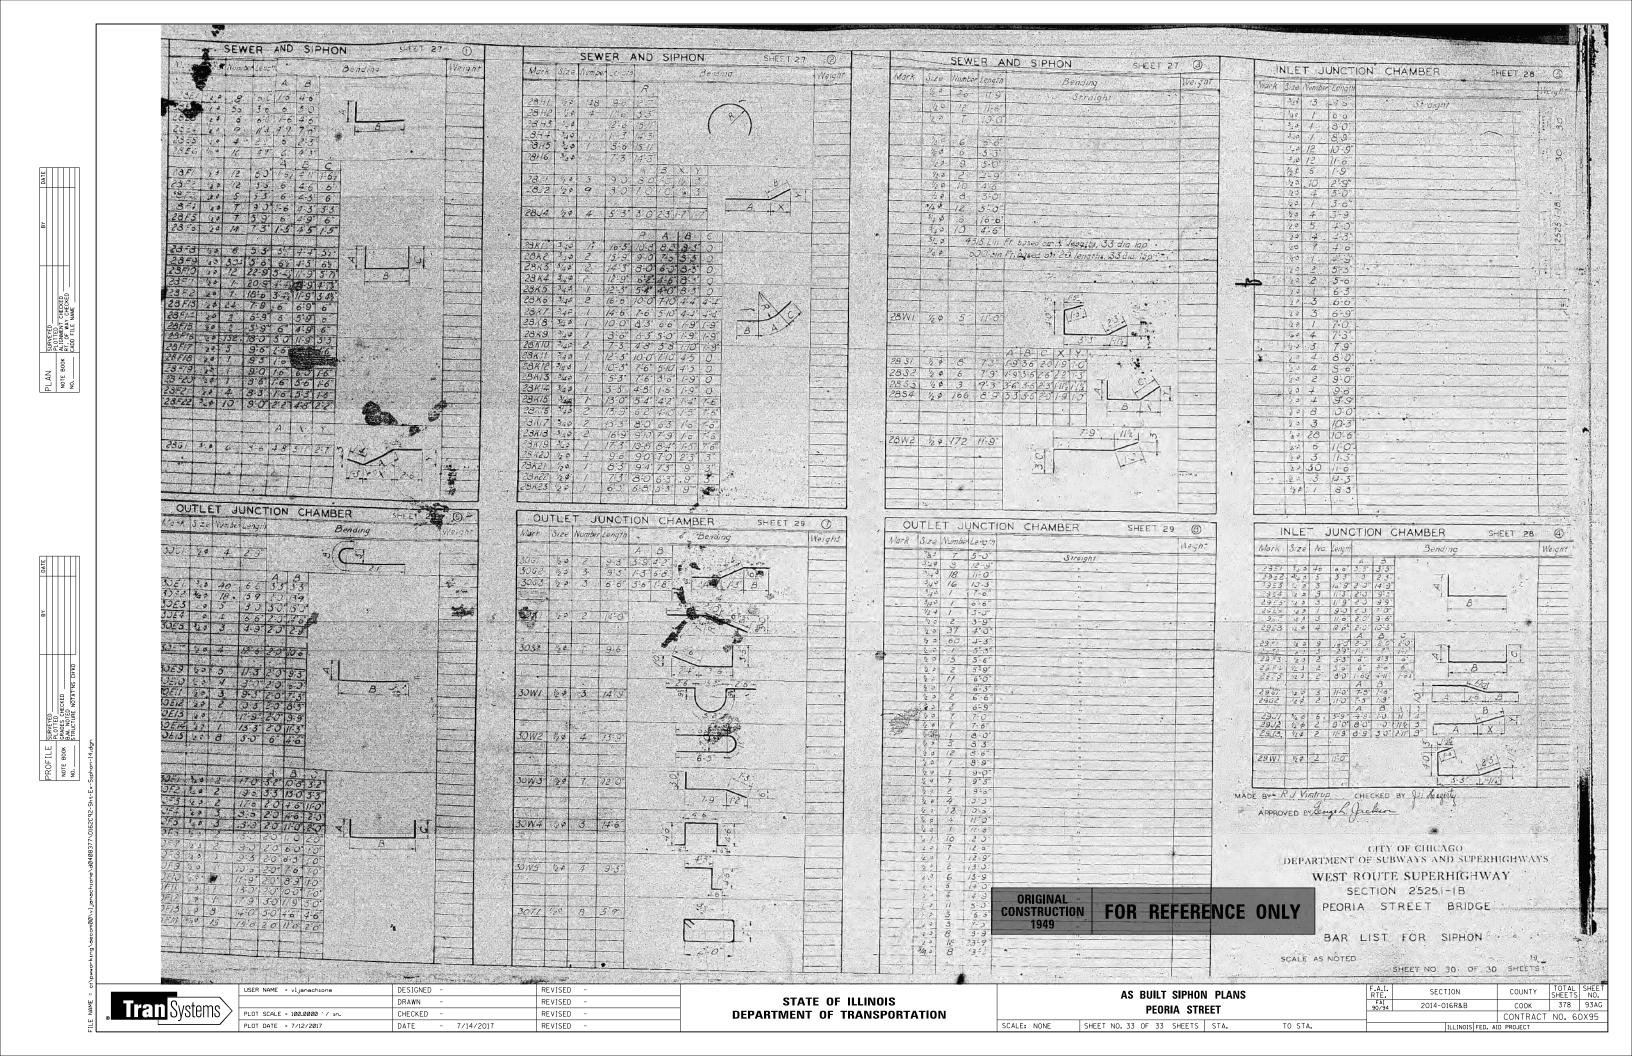


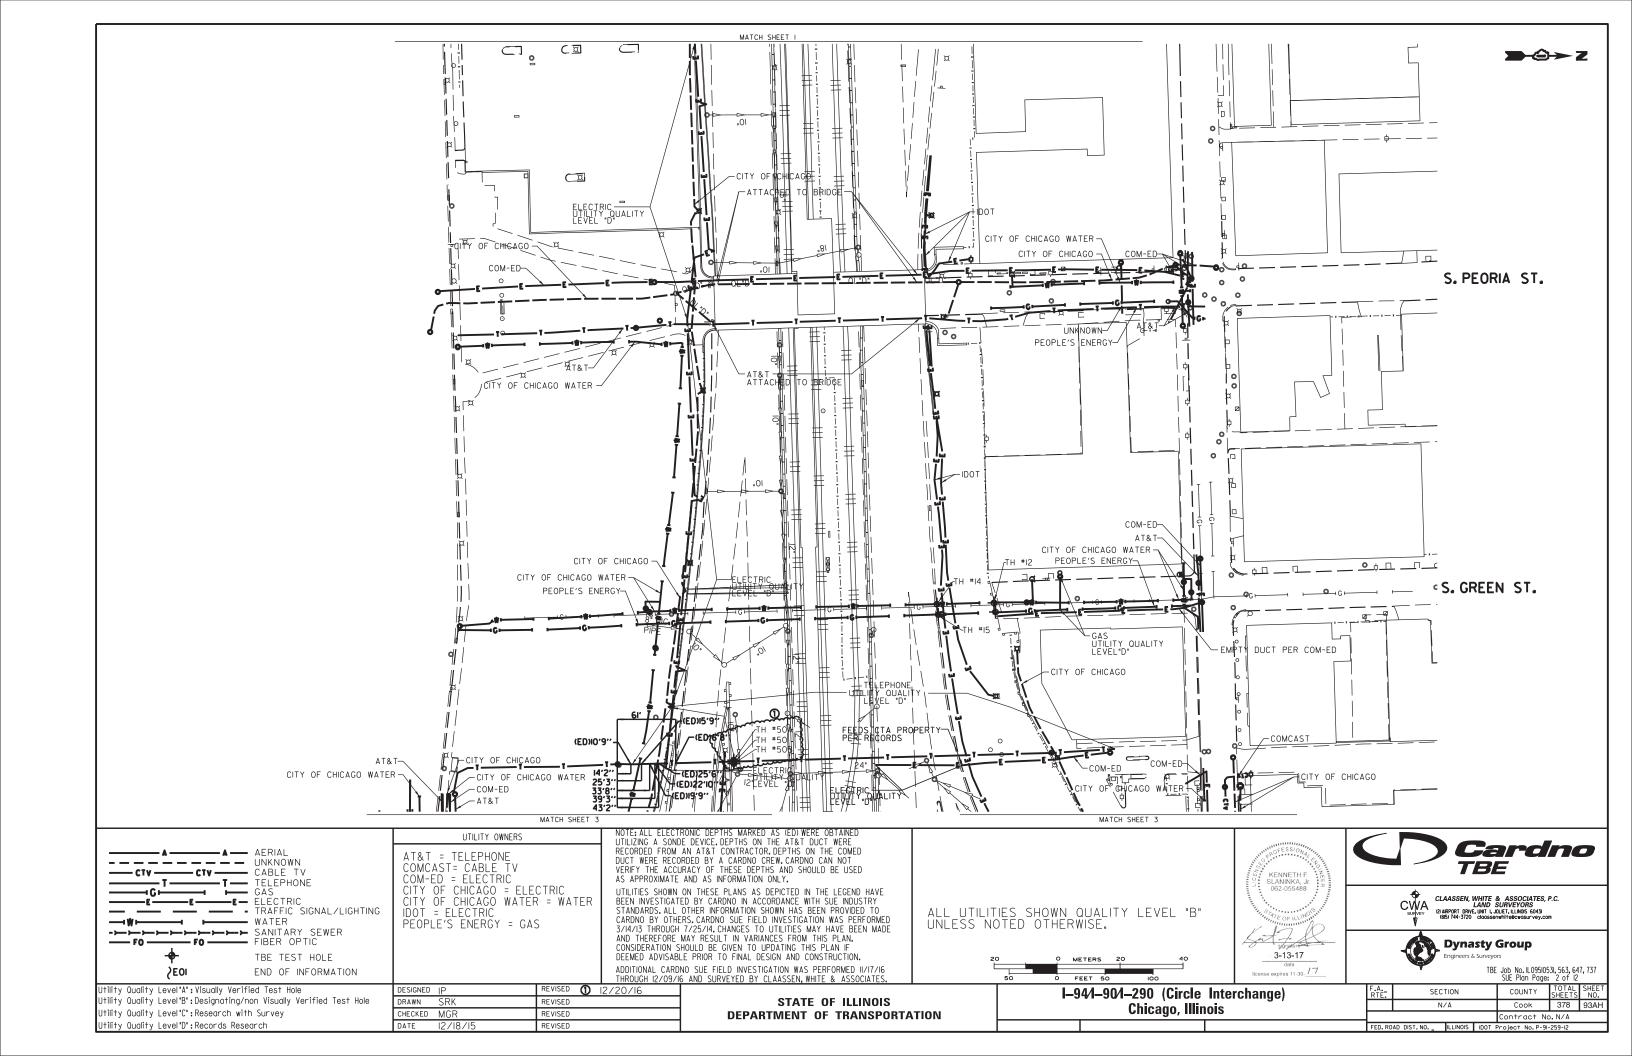


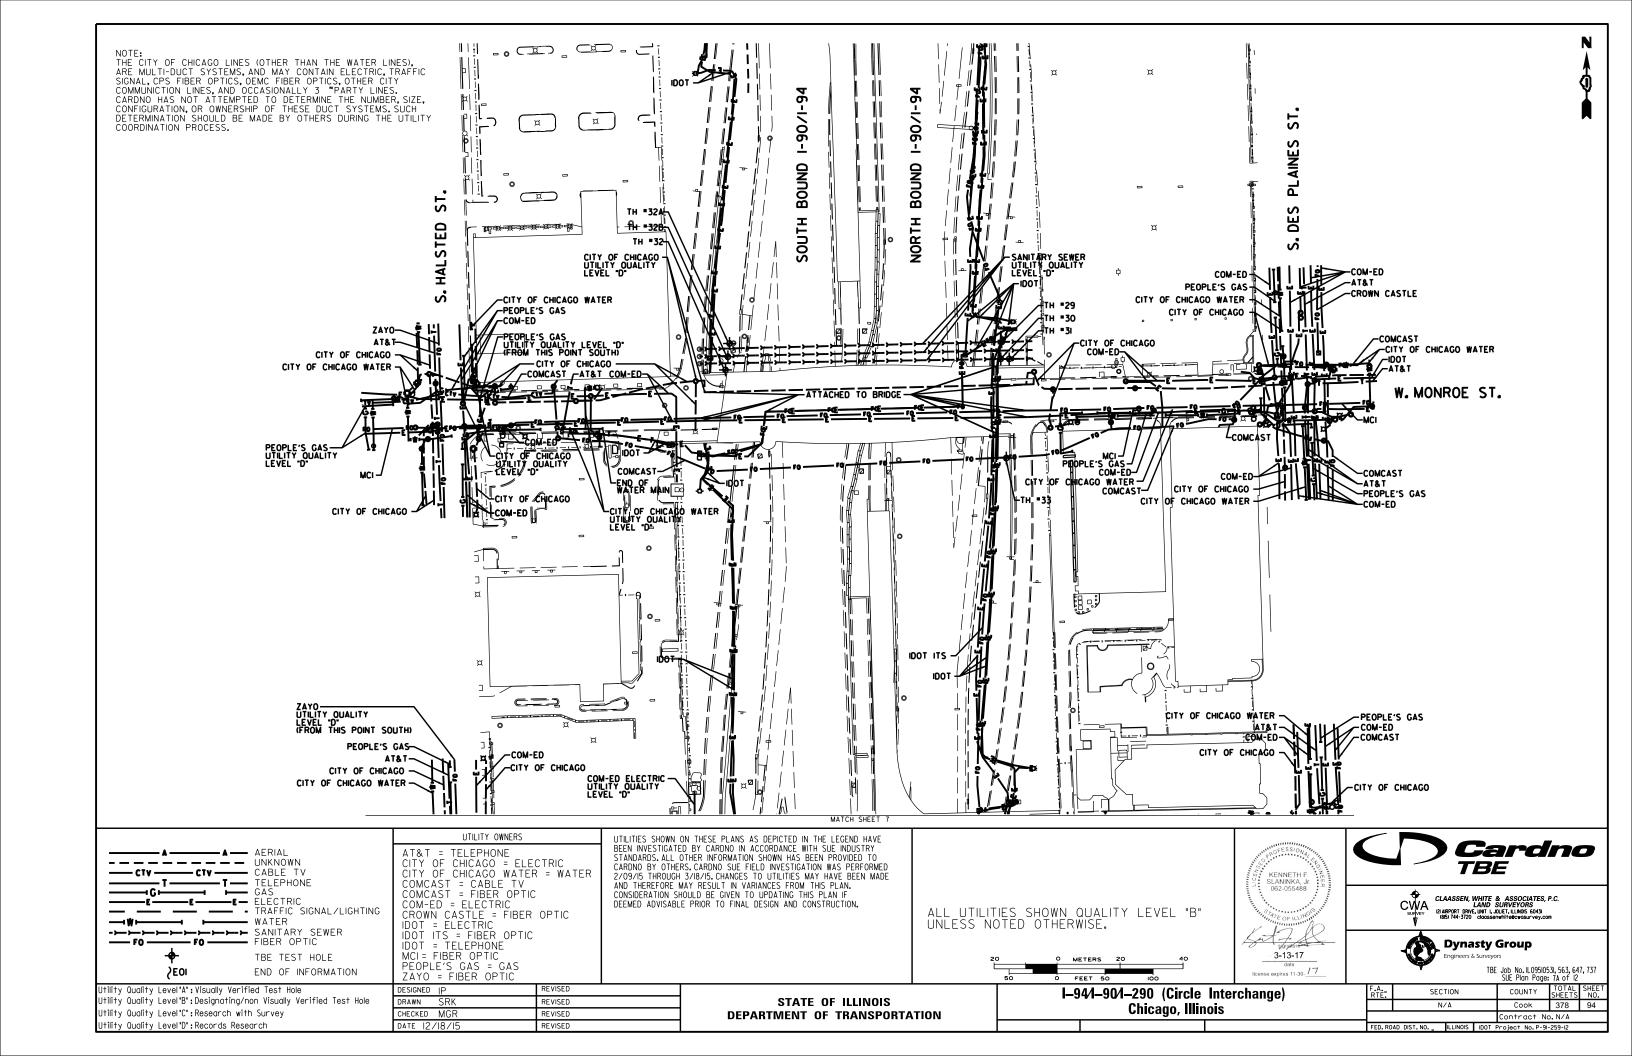


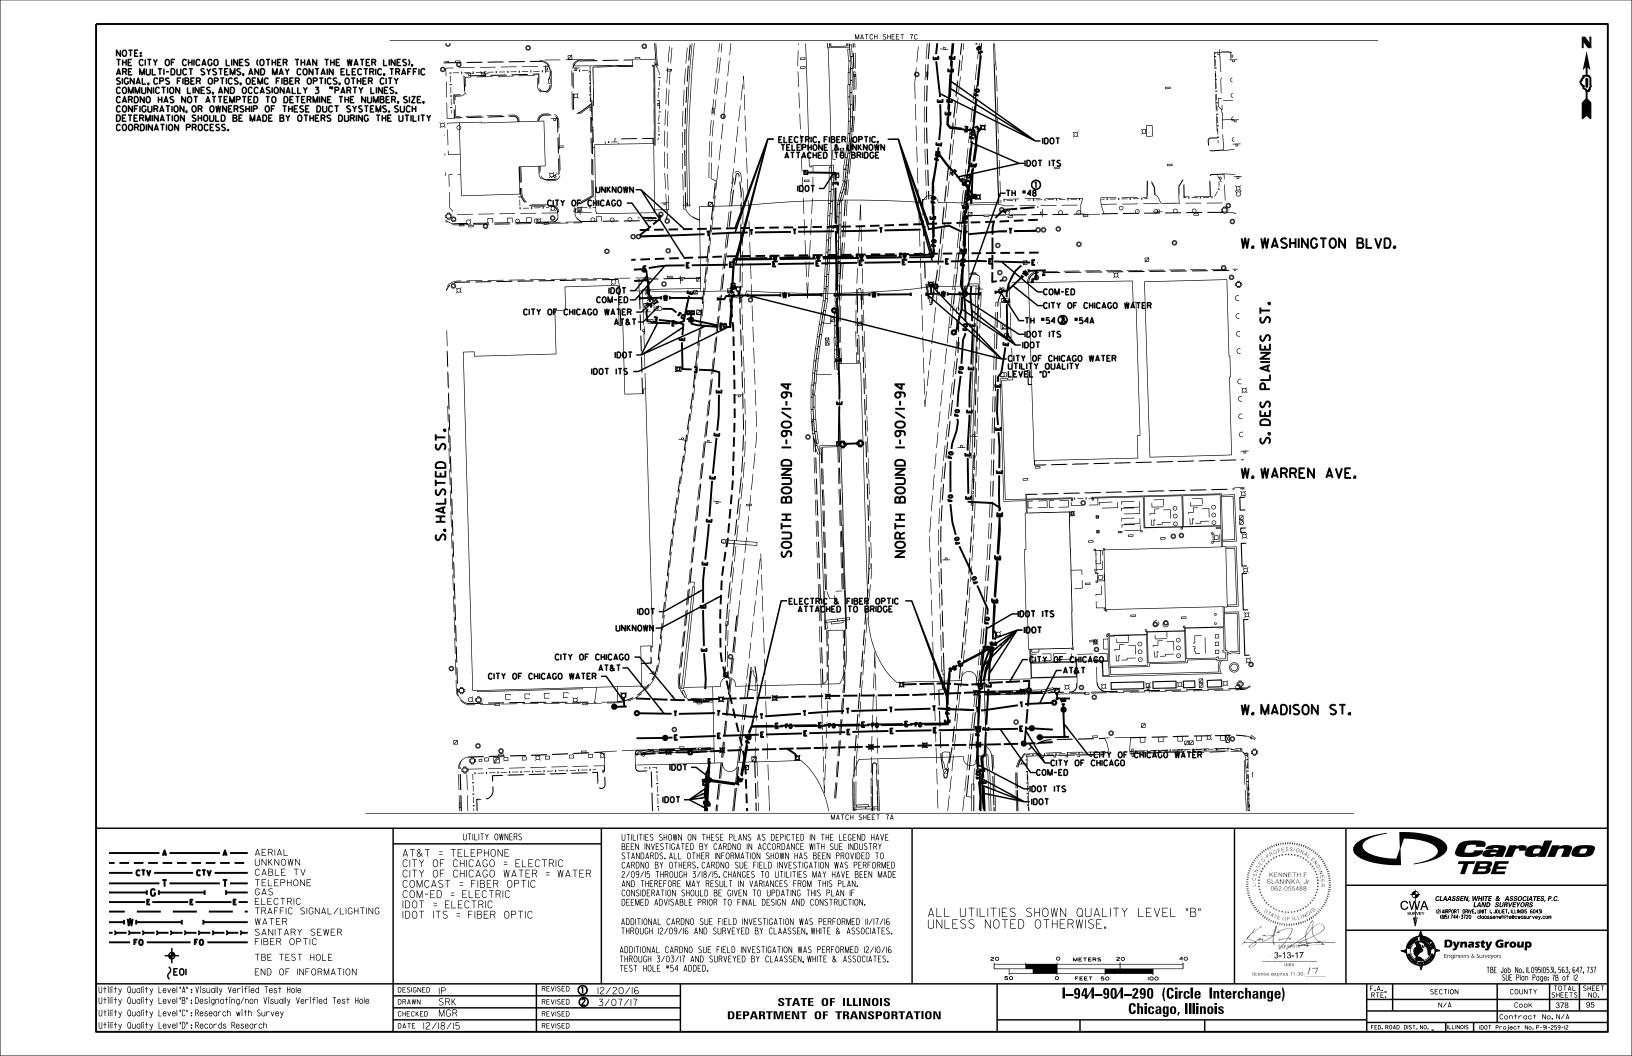


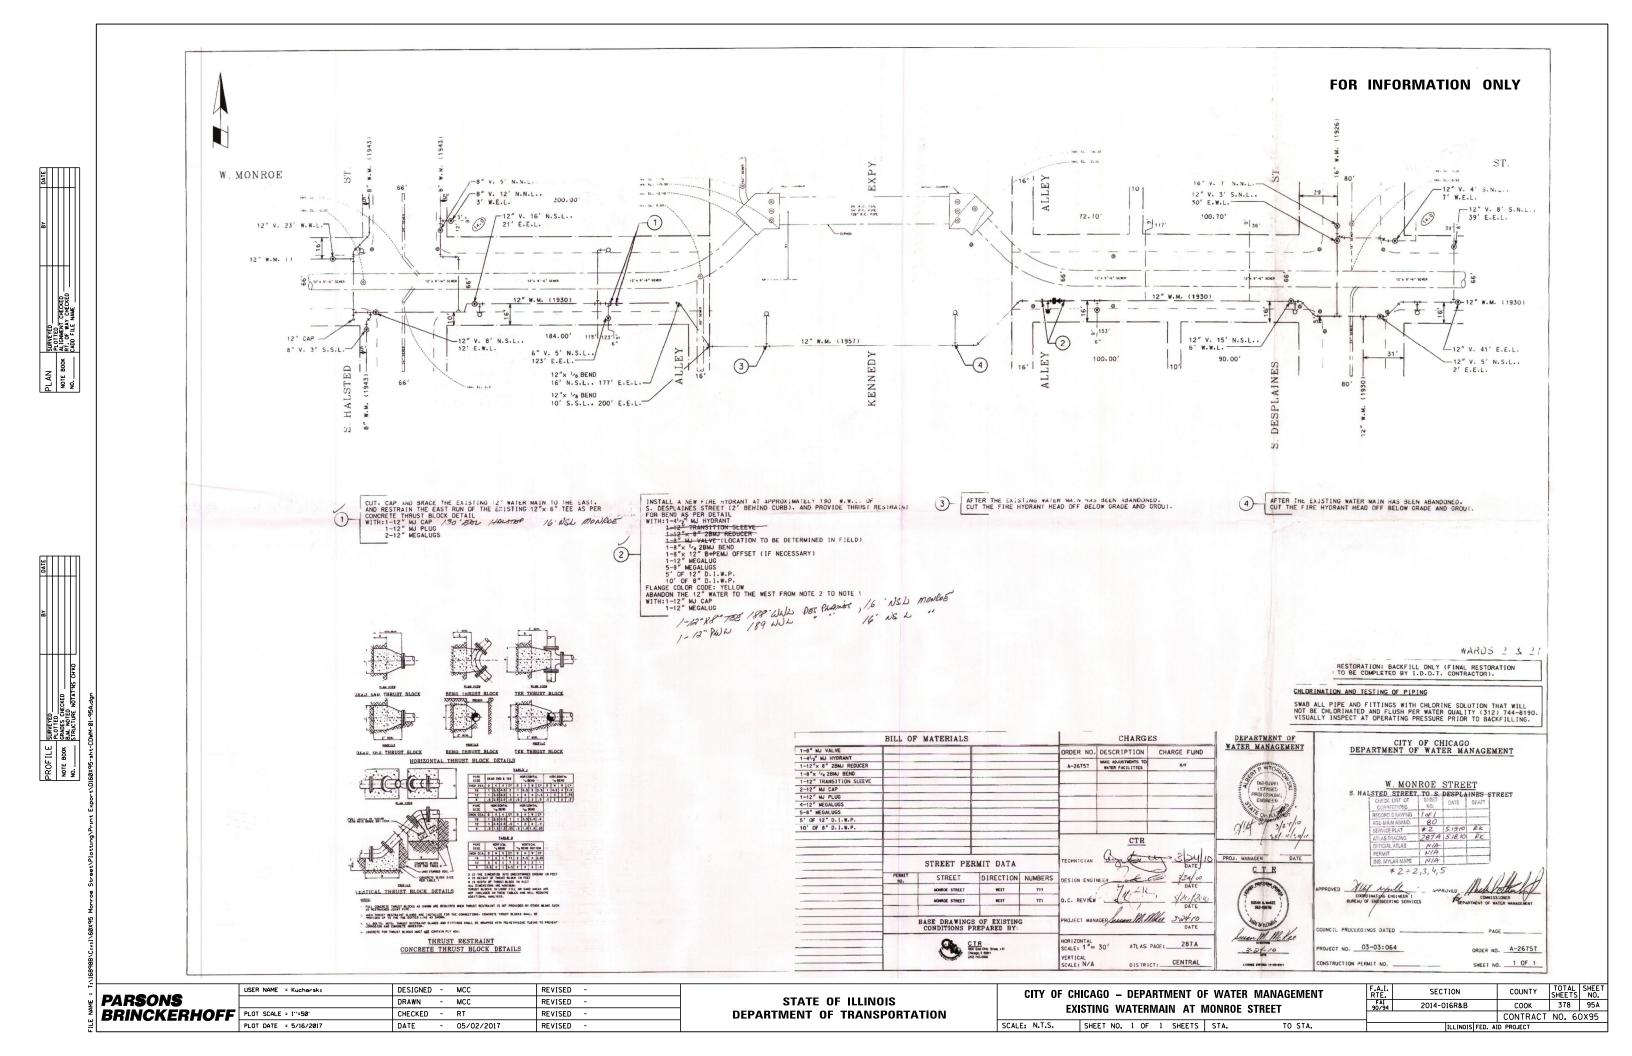

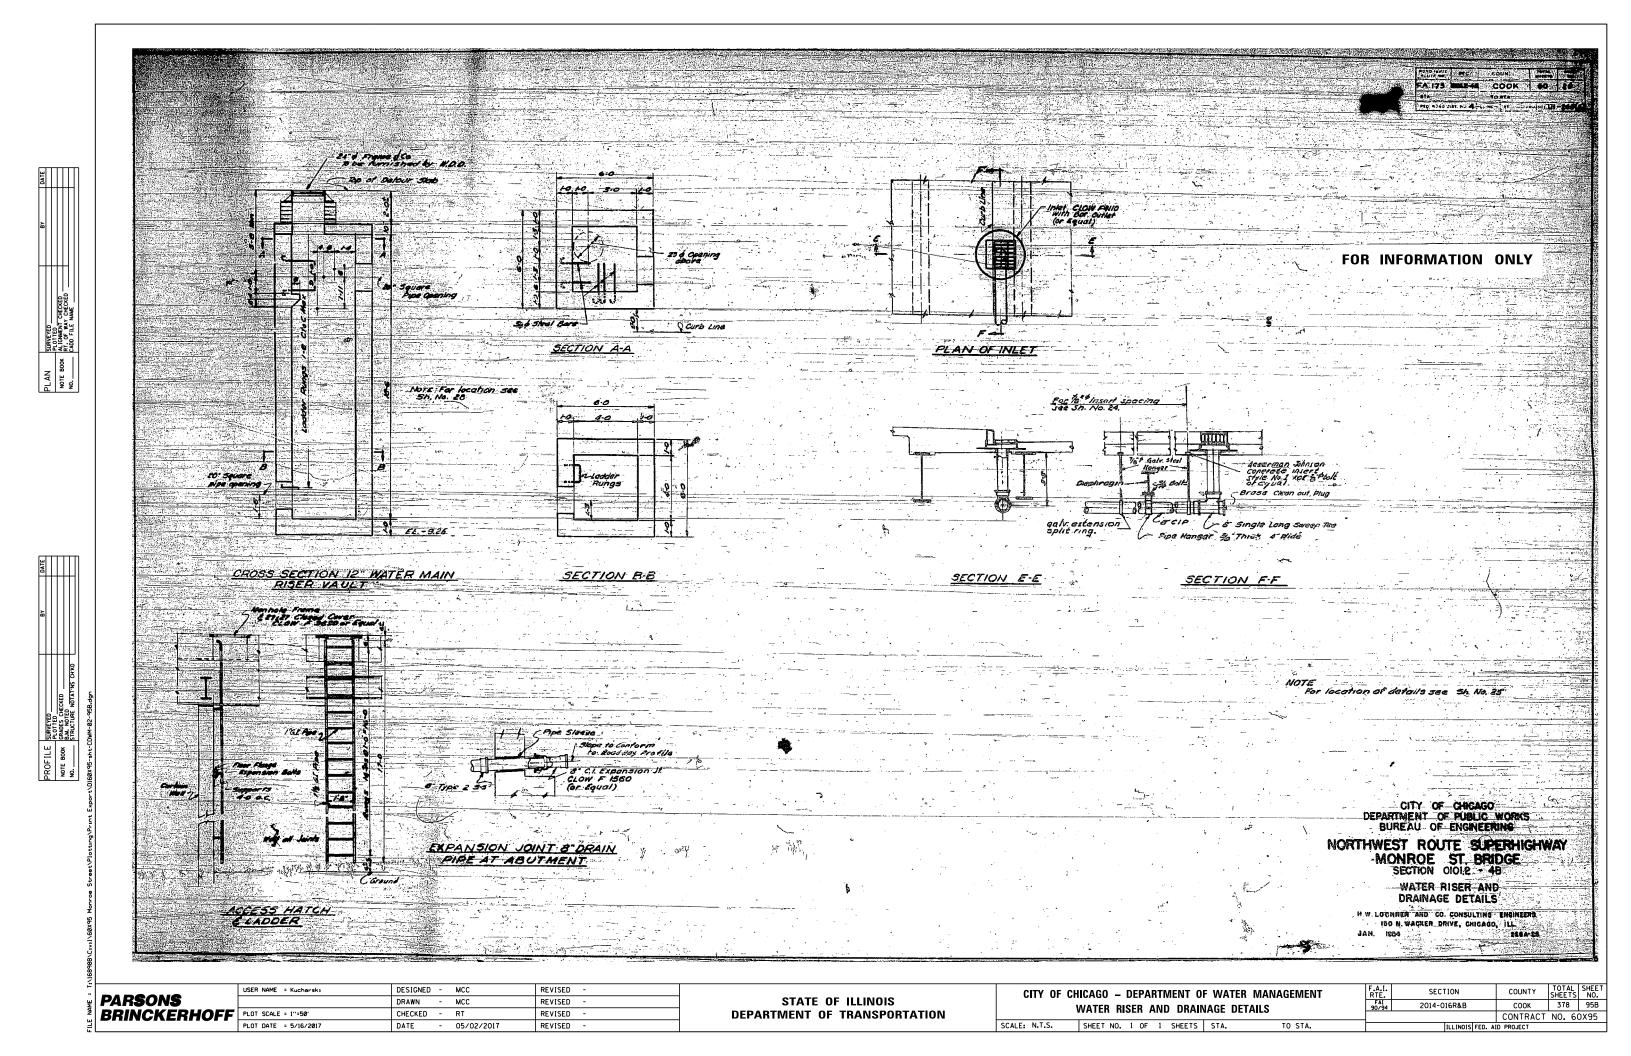

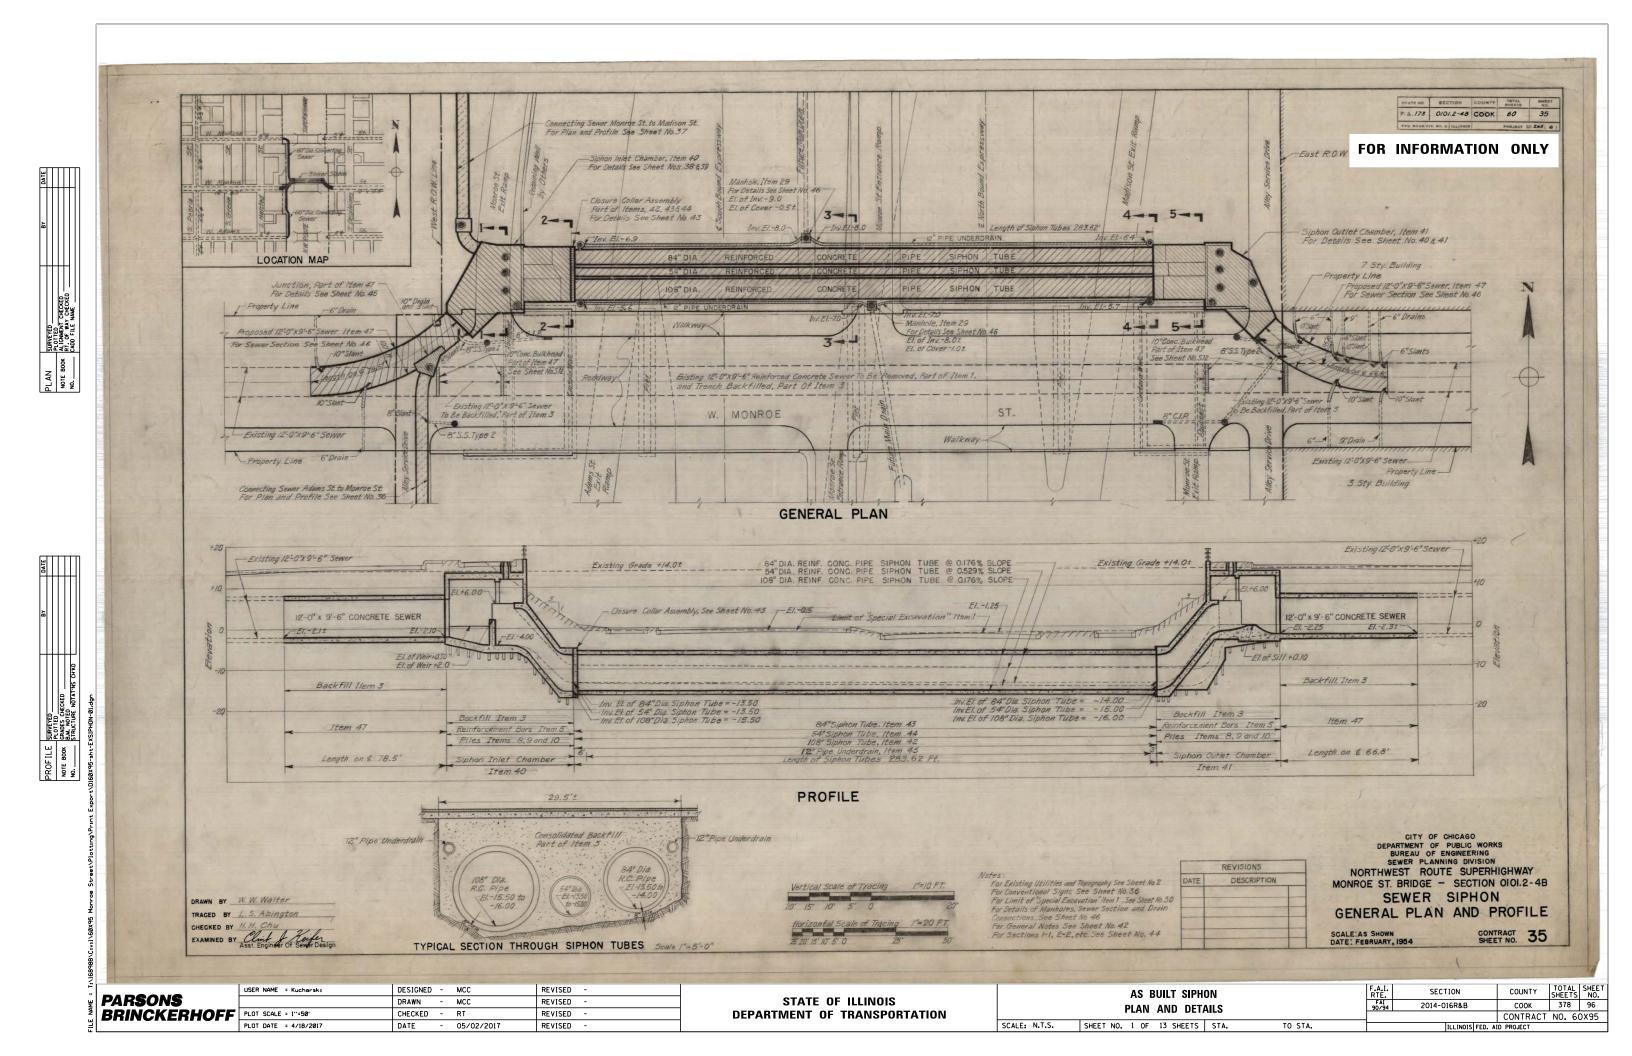

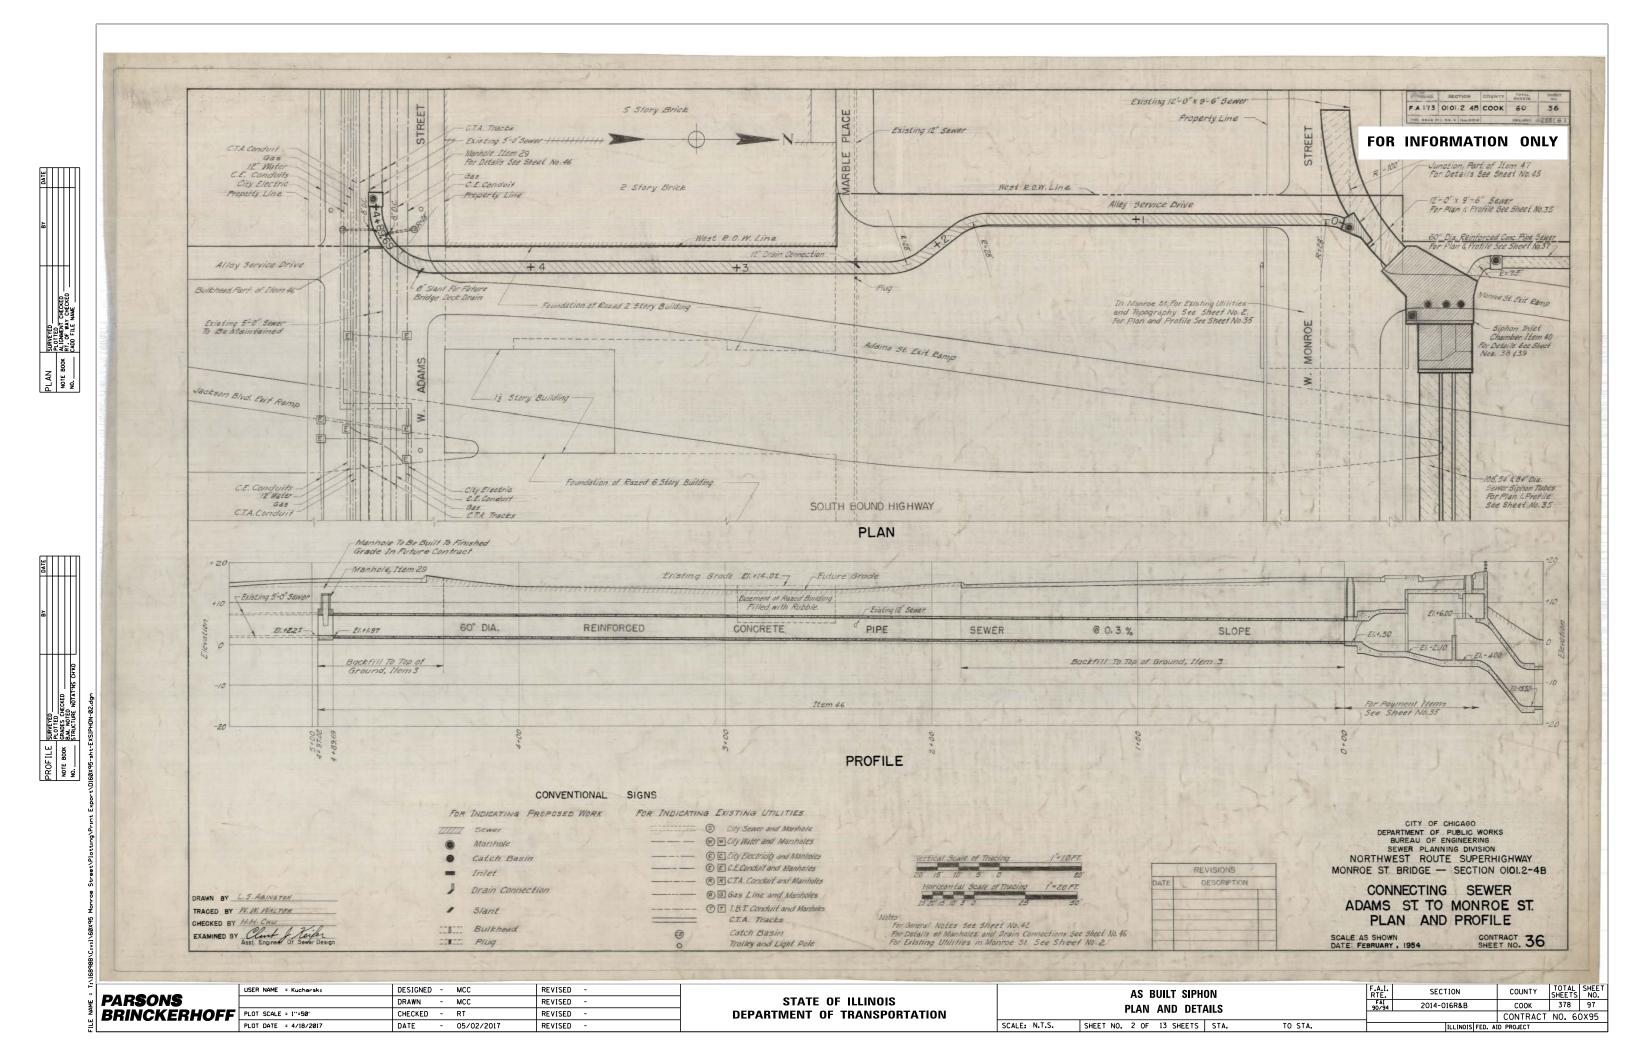

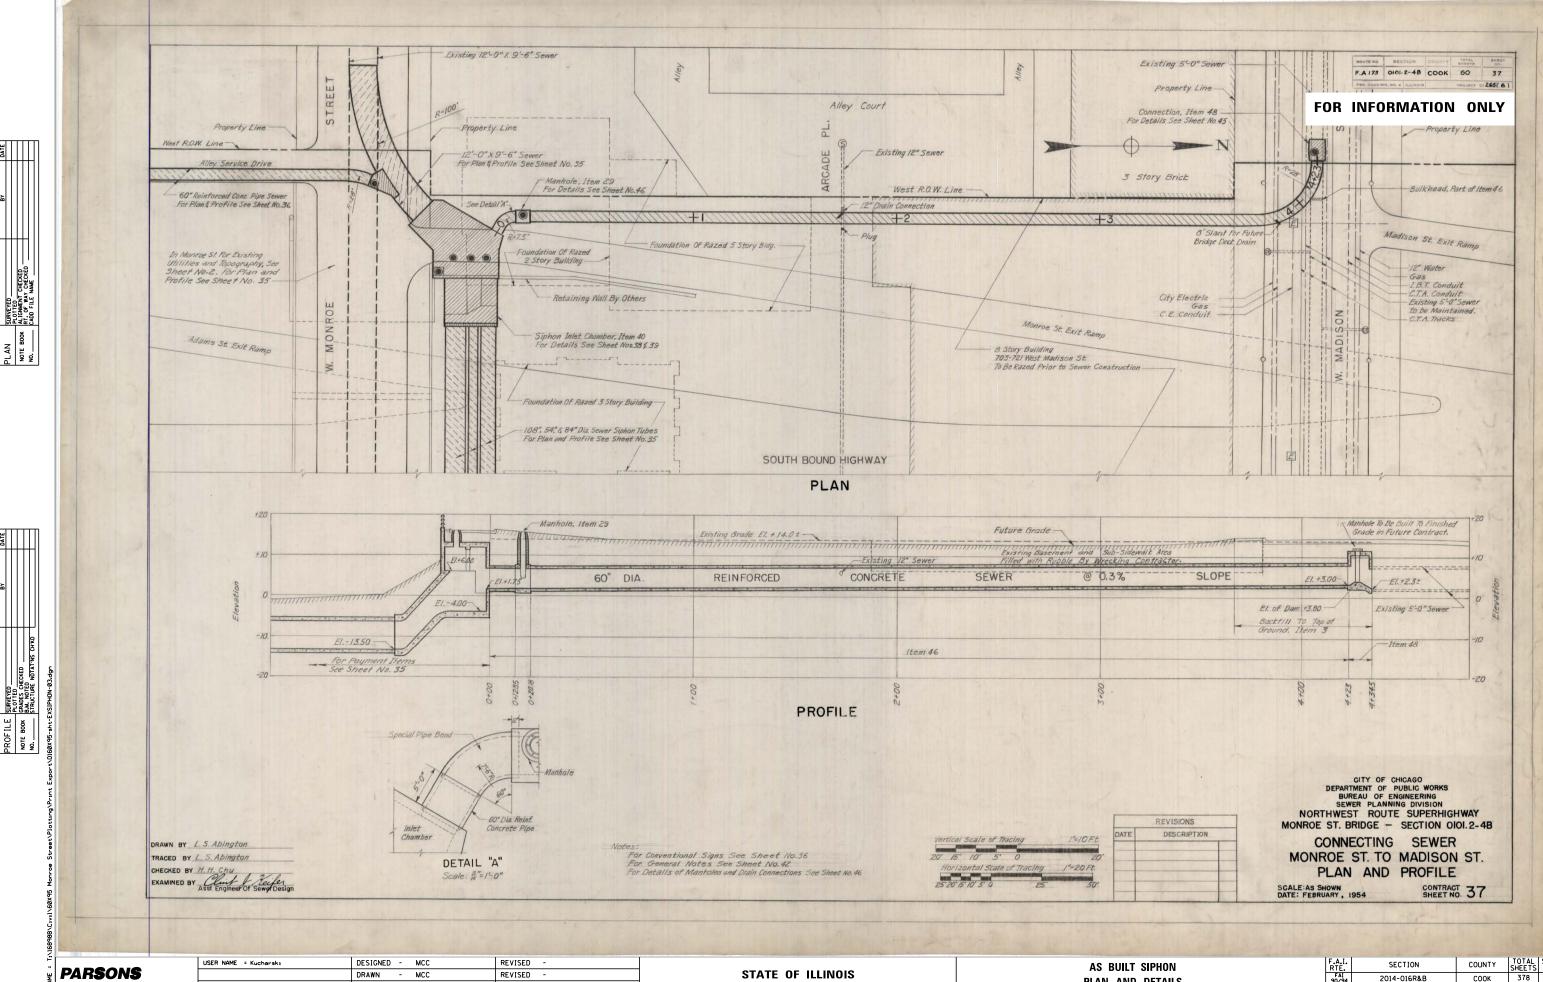


BRINCKERHOFF PLOT SCALE = 1"=50"


CHECKED - RT REVISED PLOT DATE = 4/18/2017 - 05/02/2017 DATE REVISED **DEPARTMENT OF TRANSPORTATION**

PLAN AND DETAILS SCALE: N.T.S. SHEET NO. 3 OF 13 SHEETS STA. TO STA.

COUNTY TOTAL SHEET NO.

COOK 378 98 2014-016R&B CONTRACT NO. 60X95

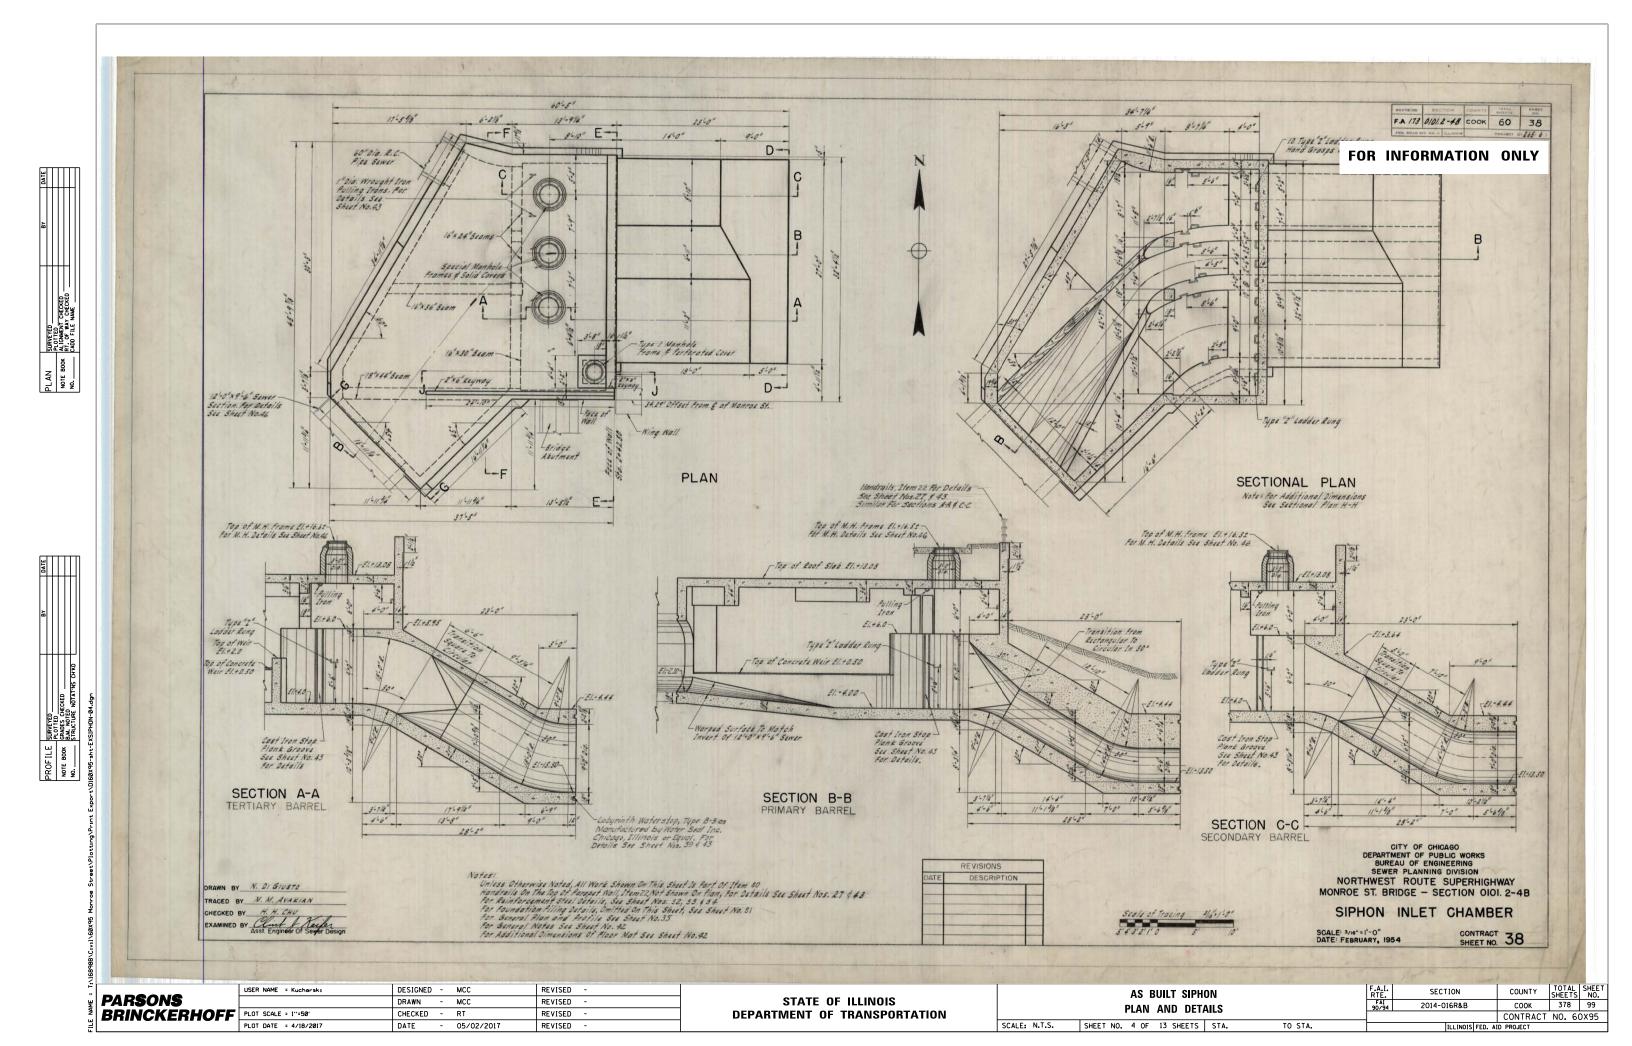

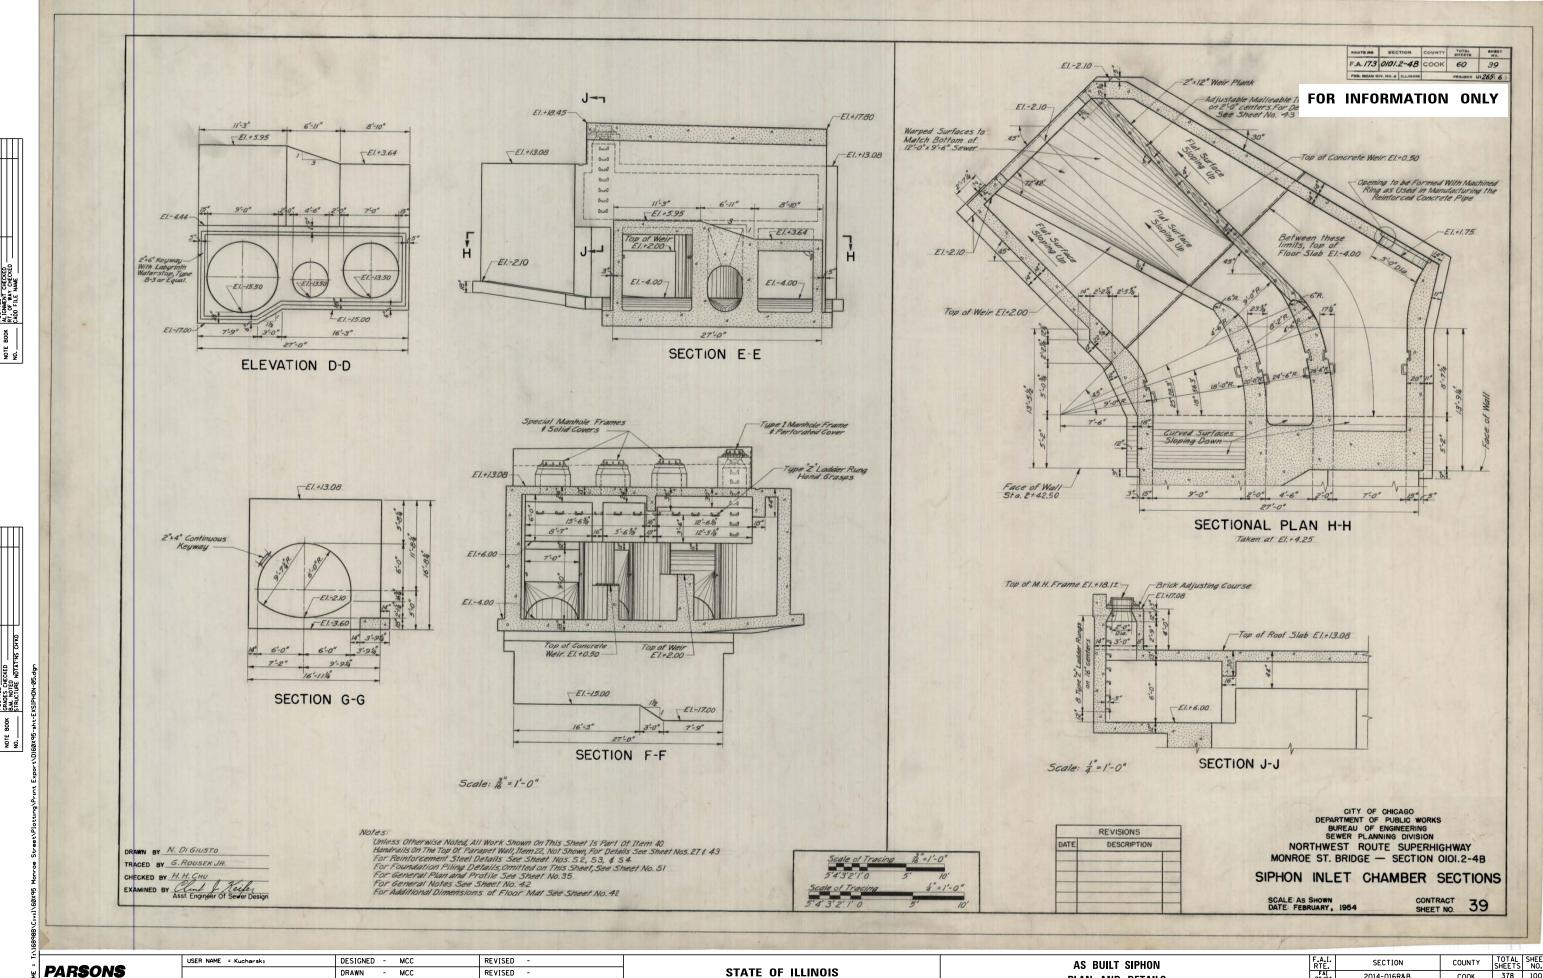

PARSONS
BRINCKERHOFF
PLOT SCALE = 1"=50"
PLOT DATE = 4/18/2

STATE OF ILLINOIS
DEPARTMENT OF TRANSPORTATION

	AS BUILT SIPHON				F.A.I. RTE.	SECTION	COUNTY	TOTAL SHEETS	SHEET NO.
	PLAN AND DETAILS					2014-016R&B	соок	378	100
							CONTRACT	NO. 60	X95
	SCALE: N.T.S. SHEET NO. 5 OF 13 SHEETS STA. TO STA.					ILLINOIS FED. A	D PROJECT		