11-17-2017 LETTING ITEM 005

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STATE OF ILLINOIS DEPARTMENT OF TRANSPORTATION

COOK

D-91-207-17



FOR INDEX OF SHEETS, SEE SHEET NO. 2

PROPOSED HIGHWAY PLANS

PROJECT LOCATED IN THE VILLAGES

OF WILMETTE AND WINNETKA

TRAFFIC DATA:


HIBBARD RD. SPEED LIMIT - 30MPH 2014 ADT - 6750

ILLINOIS RD. SPEED LIMIT - 30MPH 2014 ADT - 1800

F.A.U. 2807 (HIBBARD RD.) AT ILLINOIS RD. TREE PRUNING AND **ADA PEDESTRIAN RAMPS** SECTION NO.: 1819SW-TR

PROJECT: STP-2WWQ(001)

COOK COUNTY C-91-207-17

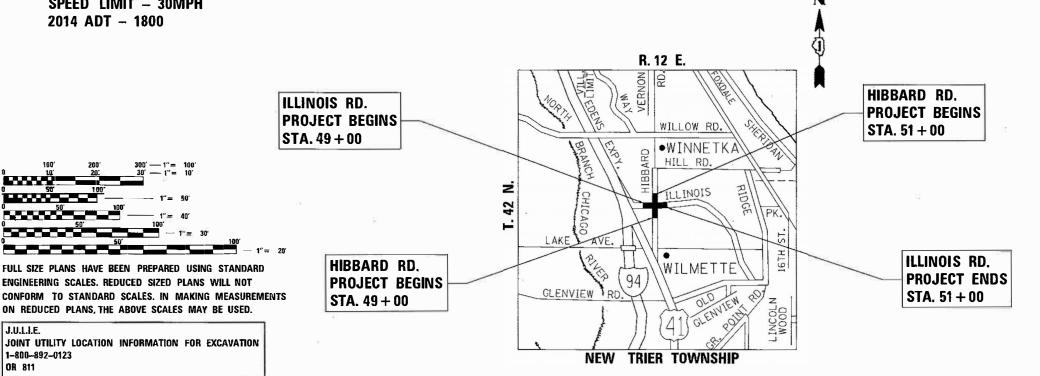

PROJECT ENGINEER: JENPAI CHANG (847) 705-4432 PROJECT MANAGER: FAWAD AQUEEL (847) 705-4247

GROSS AND NET LENGTH OF PROJECT - 200 FEET - .04 MILES

CONTRACT NO. 62F07

1-800-892-0123 OR 811

STATE OF ILLINOIS DEPARTMENT OF TRANSPORTATION SUBMITTED AUGUST ID 20 17

LOCATION OF SECTION INDICATED THUS: - -

PRINTED BY THE AUTHORITY OF THE STATE OF ILLINOIS

	INDEX OF SHEETS		
SHEET NO.	DESCRIPTION:		STATE STANDARDS
1	COVER SHEET	-000001-06	STANDARD SYMBOLS, ABBREVIATIONS AND PATTERNS
2	INDEX OF SHEETS, STATE STANDARDS, AND GENERAL NOTES	424001-09	PERPENDICULAR CURB RAMPS FOR SIDEWALKS
3-4	SUMMARY OF QUANTITIES	424021-03	DEPRESSED CORNER RAMPS FOR SIDEWALKS
5-8	EXISTING AND PROPOSED TYPICAL SECTIONS	442201-03	CLASS C AND D PATCHES
9-10	EXISTING AND PROPOSED ROADWAY PLAN AND PROFILE	606001-06	CONCRETE CURB TYPE B AND COMBINATION CONCRETE CURB AND CUTTER
11	PROPOSED PAVEMENT MARKING PLAN	701006-05	OFF-ROAD OPERATIONS, 2L, 2W, 15' (4,5m) TO 24" (600mm)
12	PROPOSED LANDSCAPING PLAN		FROM PAVEMENT EDGE
13	PROPOSED TRAFFIC PLAN	701301-04	LANE CLOSURE, 2L, 2W, SHORT TIME OPERATIONS
14-15	PROPOSED ADA SIDEWALK RAMP DETAILS	701311-03	LANE CLOSURE, 2L, 2W, MOVING OPERATIONS - DAY ONLY
16	PAVEMENT PATCHING FOR HMA SURFACED PAVEMENT (BD-22)	701501-06	URBAN LANE CLOSURE, 2L, 2W, UNDIVIDED
17	CURB OR CURB AND GUTTER REMOVAL AND REPLACEMENT (BD-24)	701801-06	LANE CLOSURE, MULTILANE, 1W OR 2W CROSSWALK OR SIDEWALK CLOSURE
18	TRAFFIC CONTROL AND PROTECTION FOR SIDE ROADS, INTERSECTIONS, AND DRIVEWAYS (TC-10)	701901-06	TRAFFIC CONTROL DEVICES
19	DISTRICT ONE TYPICAL PAVEMENT MARKINGS (TC-13)	720001-01	SIGN PANEL MOUNTING DETAILS
20	PRUNING FOR SAFETY AND EQUIPMENT CLEARENCE (BM-20)	720006-04	SIGN PANEL ERECTION DETAILS
21	DISTRICT ONE FLASHING BEACON INSTALLATION DETAILS (TS~04)	780001-05	TYPICAL PAVEMENT MARKINGS
22	ARTERIAL ROAD INFORMATION SIGNING (TC-22)		

GENERAL NOTES:

BEFORE STARTING ANY EXCAVATION THE CONTRACTOR SHALL CALL "JULIE" AT 800-892-0123 OR "CUAN" (CHICAGO UTILITY ALERT NETWORK) AT 312-744-7000 FOR FIELD LOCATIONS OF BURIED ELECTRIC, TELEPHONE AND GAS FACILITIES, (48 HOURS NOTIFICATION IS REQUIRED).

10 FEET (3 METERS) TRANSITION SHALL BE USED TO MATCH PROPOSED CURB AND GUTTER AND MEDIAN ITEMS OF WORK TO EXISTING CURBS AND GUTTERS AND MEDIANS IN THE FIELD, UNLESS OTHERWISE SHOWN. THE TRANSITION SHALL BE PAID FOR AT THE CONTRACT UNIT PRICE FOR THE PROPOSED ITEMS OF WORK SPECIFIED.

THE CONTRACTOR SHALL COORDINATE CONSTRUCTION ACTIVITIES WITH THE UTILITY COMPANIES AND THE VILLAGES OF WILMETTE AND WINNETKA.

THE CONTRACTOR WILL NOT BE ALLOWED TO SET UP A YARD OR FIELD OFFICE ON STATE PROPERTY WITHOUT WRITTEN PERMISSION FROM THE DEPARTMENT.

BEFORE BEGINNING ANY WORK, THE CONTRACTOR SHALL RETAIN AND RECORD FOR FUTURE REFERENCE, ALL EXISTING PAVEMENT MARKING LINES (RAISED REFLECTIVE PAVEMENT MARKERS) IN ORDER THAT THESE LOCATIONS CAN BE RE-ESTABLISHED FOR STRIPING. EXACT LOCATIONS OF ALL PAVEMENT MARKINGS SHALL BE AS DIRECTED BY THE ENGINEER.

ANY DAMAGE TO EXISTING PAVEMENT MARKINGS OR RAISED REFLECTIVE PAVEMENT MARKERS OUTSIDE THE REMOVAL LINE SHOWN ON THE PLANS SHALL BE REPLACED AT THE CONTRACTOR'S EXPENSE.

ALL PAVEMENT PATCHING LOCATIONS WILL BE DETERMINED IN THE FIELD BY THE ENGINEER.

DRAINAGE ADJUSTMENT OR RECONSTRUCTION LOCATIONS WILL BE DETERMINED IN THE FIELD BY THE ENGINEER.

LOCATION OF COMBINATION CONCRETE CURB AND GUTTER REMOVAL AND REPLACEMENT (OR COMBINATION CURB AND GUTTER, WITH THE TYPE SPECIFIED ON THE PLANS), WILL BE DETERMINED IN THE FIELD BY TH ENGINEER.

FRAMES AND GRATES ADJUSTMENT OF PRIVATE UTILITIES WITHIN THE PROJECT LIMITS SHALL BE DONE BY THEIR REPSECTIVE OWNERS AND ARE NOT PART OF THIS CONTRACT.

THE CONTRACTOR SHALL CONTACT THE DISTRICT ONE TRAFFIC CONTROL CENTER AT (847) 705-4470 A MINIMUM OF 72 HOURS IN ADVANCE OF BEGINNING WORK.

PERMANENT PAVEMENT MARKINGS SHALL BE THERMOPLASTIC (OF THE EXTRUDED TYPE) AND SHOULD BE PLACED IN ACCORDANCE WITH THE "DISTRICT ONE TYPICAL PAVEMENT MARKINGS" DETAIL. (TC-13)

THE RESIDENT ENGINEER SHALL CONTACT CORY JUCIUS, ARTERIAL TRAFFIC ENGINEER, AT CORY, JUCIUS , ILLINOIS, GOV, A MINIMUM OF TWO (2) WEEKS PRIOR TO THE PLACEMENT OF PERMANENT PAVEMENT MARKINGS.

THE CONTRACTOR SHALL MAINTAIN PEDESTRIAN ACCESS AT ALL TIMES DURING CONSTRUCTION.

THE CONTRACTOR SHALL ERECT A TEMPORARY FENCE AROUND ALL TREES WITHIN THE CONSTRUCTION AREA TO ESTABLISH A "TREE PROTECTION ZONE" BEFORE ANY WORK BEGINS OR ANY MATERIAL IS DELIVERED TO THE JOBSITE, (A TEMPORARY FENCE SHOULD BE ERECTED ALONG THE DRIPLINE OF THE TREES AND SHRUBS WITHIN THE LIMITS OF CONSTRUCTION DESIGNATED TO REMAIN, IF EXISTING TREES AND SHRUBS ARE ADJACENT TO THE R.O.W., SUCH VEGETATION SHALL BE PROTECTED BY THE TEMPORARY FENCE AS WELL, WITH THE TEMPORARY FENCE BEING ERECTED WITHIN THE CONSTRUCTION LIMITS,) NO WORK IS TO BE PERFORMED (OTHER THAN ROOT PRUNING), MATERIALS STORED OR VEHICLES DRIVEN OR PARKED WITHIN THE "TREE PROTECTION ZONE," REMOVE PROTECTIVE TEMPORARY FENCE ONLY AFTER ALL CONSTRUCTION WORK HAS BEEN COMPLETED.

THE CONTRACTOR SHALL USE CARE IN GRADING OR EXCAVATING NEAR ANY AND ALL EXISTING ITEMS WHICH WILL NOT BE REMOVED. ANY DAMAGE DONE TO EXISTING ITEMS BY THE CONTRACTOR SHALL BE REPAIRED BY THE CONTRACTOR AT THE CONTRACTOR'S OWN EXPENSE.

TREE ROOT PRUNING IS TO BE USED ON EXISTING TREES TO PREVENT THE RIPPING UP OF ROOTS WHEN TRENCHING OR EXCAVATION IS WITHIN THE ROOT ZONE OF ADJACENT TREES TO REMAIN, SUPPLEMENTAL WATERING OF TREES SHOULD BEGIN IMMEDIATELY AFTER ROOT PRUNING OF THE TREES HAS OCCURED.

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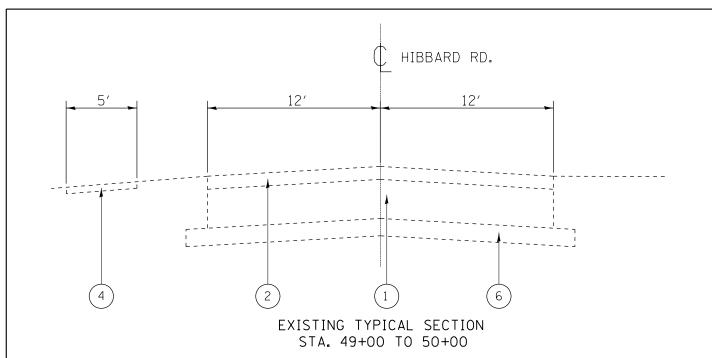
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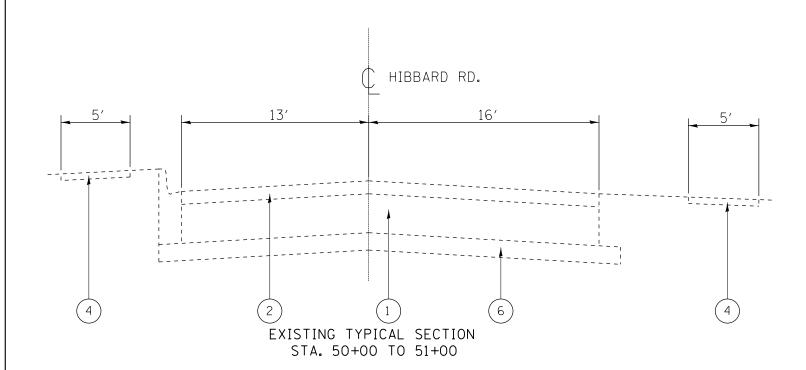
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		CONTRACT	NO. 6	2F0
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F.A.U. RTE.	SECTION	COUNTY	TOTAL SHEETS	SHEE NO.

				urban											URBAI	J			
	SUMMA	RY OF QUANTITIES				CO	NSTRUCTI	ON TYPE C	ODE			SUMMAI	RY OF QUANTITIES				CC	NSTRUCTION	TYPE CODE
CODE NO		ITEM	UNIT	TOTAL QUANTITIES	80% FED 20% STATE 0021	- - -					CODE NO		ITEM	UNIT	TOTAL QUANTITIES	80% FED 20% STATE 0021			
20101000	TEMPORARY FEN	ICE	FOOT	187	187	·					60300105	FRAMES AND G	RATES TO BE ADJUSTED	EACH	2	2			
20101200	TREE ROOT PRU	IN I NG	EACH	6	6						60300305	FRAMES AND L	IDS TO BE ADJUSTED	EACH	1	1			
20101700	SUPPLEMENTAL	WATERING	UNIT	1	1						* 66900200	NON-SPECIAL	WASTE DISPOSAL	CU YD	15	15	,		
20200100	EARTH EXCAVAT	ION	CU YD	15	15						* 66900450	SPECIAL WAST	E PLANS AND REPORTS	LSUM	1	1			
25,000,400	HITDOORN FERT	11 1250 MITDIENT	BOUND		20						50000570	SAL DISPOSA	. Ann vete	5.60					
25000400	NIIRUGEN FERI	ILIZER NUTRIENT	POUND	90	90					<u> </u>	66900530	SOIL DISPOSA	L ANALYSIS	EACH	1	1	·		
25000500	PHOSPHORUS FE	RTILIZER NUTRIENT	POUND	90	90						67000400	ENGINEER'S F	IELD OFFICE, TYPE A	CAL MO	6	6			
25000600	POTASSIÚM FER	TILIZER NUTRIENT	POUND	90	90						67100100	MOBILIZATION		LSUM	1	1			
25200110	SODDING, SALT	TOLERANT	SQ YD	97	97						70102620	TRAFFIC CONT	ROL AND PROTECTION.	LSUM	1	1			
	·											STANDARD 701	501						
40601005	HOT-MIX ASPHA	LT REPLACEMENT OVER	TON	15	15														
	PATCHES										70102640	TRAFFIC CONT	ROL AND PROTECTION.	LSUM	1	1			
42400200	PORT: AND FEME	NT CONCRETE SIDEWALK 5	SQ FT	465	465							STANDARD 701	801						
12100200	INCH	NI CONCRETE SIDERALN S	30 11	103	703						70300220	TEMPOŘARY PA	VEMENT MARKING - LINE 4"	FOOT	378	378			
42400800	DETECTABLE WA	RNINGS	SO FT	72	72		<u> </u>				70300260	TEMPORARY PA	VEMENT MARKING - LINE 12"	FOOT	246	246			
44000600	SIDEWALK REMO	WAL	SQ FT	342	342						70300280	TEMPORARY PA	VEMENT MARKING - LINE 24"	FOOT	60	60			
44002224	HOT-MIX ASPHA	LT REMOVAL OVER PATCHES.	SO YD	45	45						*72400200	REMOVE SIGN	PANEL ASSEMBLY - TYPE B	EACH	4	4			
	6"										*72400600	RELOCATE SIG	N PANEL ASSEMBLY - TYPE B	EACH	4	4			
44201741	CLASS D PATCH	ES. TYPE II. 8 INCH	SO YD	40	40							SELOCATE SIG	TOTAL ASSEMBLY 2 TIPE B	EACH	4	4			* SPECIALTY ITEMS
											* 73000100	WOOD SIGN SU	PPORT	FOOT	70	70			NON-PARTICIPATING ITEMS
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	SUMMARY OF QUANTITIES		ULCAN		CC	NSTRUCTIO	N TYPE C	ODE	1		SUMMARY OF QUA	ANTITIES				CONS	TRUCTION	TYPE COL	DE	
CODE NO	ITEM	UNIT	TOTAL QUANTITIES	80% FED 20% STATE						CODE NO	ITE		UNIT	TOTAL QUANTITIES						
				0021								<u>. </u>								
*78000200	THERMOPLASTIC PAVEMENT MARKING - LINE	FOOT	378	378		ļ														ļ
	4"																			
* 78000600	THERMOPLASTIC PAVEMENT MARKING - LINE	FOOT	246	246																
	12"																			
* 78000650	THERMOPLASTIC PAVEMENT MARKING - LINE	FOOT	60	60																
	24"																			
									-									:		
X0320050	CONSTRUCTION LAYOUT (SPECIAL)	LSUM	1	1	•															
*X0325714	FLASHING BEACON, POST MOUNTED, SOLAR	EACH	4	4																
	POWERED INSTALLATION																			
* X0327980	PAVEMENT MARKING REMOVAL - WATER	SO FT	492	492																
	BLASTING	-	<u> </u>		· 															
Z0004562	COMBINATION CONCRETE CURB AND GUTTER	FOOT	17	17																
	REMOVAL AND REPLACEMENT																			
Z0030850	TEMPORARY INFORMATION SIGNING	SO FT	102. 8	102.8		-														
20064800	SELECTIVE CLEARING	UNIT	1	1																
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LEGEND:

- (1) EXISTING P.C.C. PAVEMENT ±8"
- (2) EXISTING HOT-MIX ASPHALT SURFACE, ±6"
- (3) EXISTING COMBINATION CONCRETE CURB & GUTTER, TYPE B-6.24
- (4) EXISTING SIDEWALK
- 5) EXISTING AGGREGATE SHOULDER
- (6) EXISTING STABILIZED SUB-BASE
- (7) PROPOSED P.C.C. SIDEWALK, 5'
- (8) PROPOSED COMBINATION CONCRETE CURB & GUTTER, TYPE B-6.24

MIXTURE REQUIREMENTS

MIXTURE TYPE	AIR VOIDS & Ndes	QMP							
PAVEMENT PATCHING									
HOT-MIX ASPHALT BINDER COURSE, 8" (IL-19MM)	4% @ 70 GYR.	QC / QA							
HOT-MIX ASPHALT SURFACE COURSE, MIX "D", N70, 2" (IL-9.5MM)	4% @ 70 GYR.	QC / QA							
QMP DESIGNATION: QUALITY CONTROL/ QUALITY ASSURANCE (QC/ QA)									

NOTES:

THE UNIT WEIGHT USED TO CALCULATE ALL HOT-MIX ASPHALT QUANTITIES IS 112 LBS./SQ. YD./ IN.

THE "AC TYPE" FOR POLYMERIZED HMA MIXES SHALL BE
"SBS/SBR PG 76 -22" AND FOR NON-POLYMERIZED HMA THE
"AC TYPE" SHALL BE "PG 64 -22" UNLESS MODIFIED BY DISTRICT
ONE SPECIAL PROVISIONS.

QUALITY MANAGEMENT PROGRAM (QMP) IDENTIFIES THE PARTICULAR QUALITY CONTROL SPECIFICATION THAT APPLIES TO THE HMA MIXTURE

FOR USE OF RECYCLED MATERIALS SEE SPECIAL PROVISIONS


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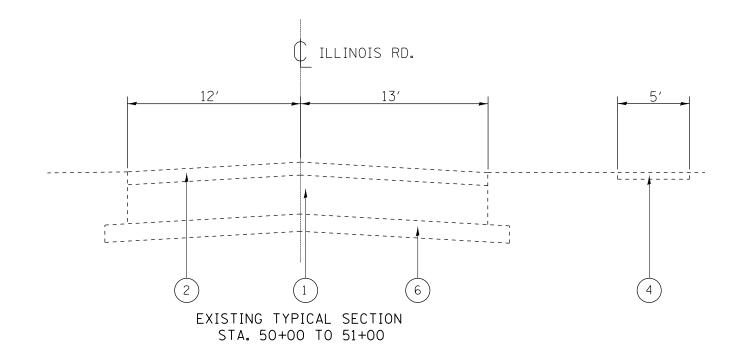
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F.A.U. RTE.	SECTION			COUNTY	TOTAL SHEETS	SHEE'
2807	1819SW-TR		Τ	соок	22	5
			Т	CONTRACT	NO. 6	2F07
	ILLINOIS	FED.	AID	PROJECT		





<u>LEGEND:</u>

- 1) EXISTING P.C.C. PAVEMENT ±8"
- (2) EXISTING HOT-MIX ASPHALT SURFACE, ±6"
- EXISTING COMBINATION CONCRETE CURB & GUTTER, TYPE B-6.24
- EXISTING SIDEWALK
- EXISTING AGGREGATE SHOULDER
- EXISTING STABILIZED SUB-BASE
- PROPOSED P.C.C. SIDEWALK, 5'
- PROPOSED COMBINATION CONCRETE CURB & GUTTER, TYPE B-6.24

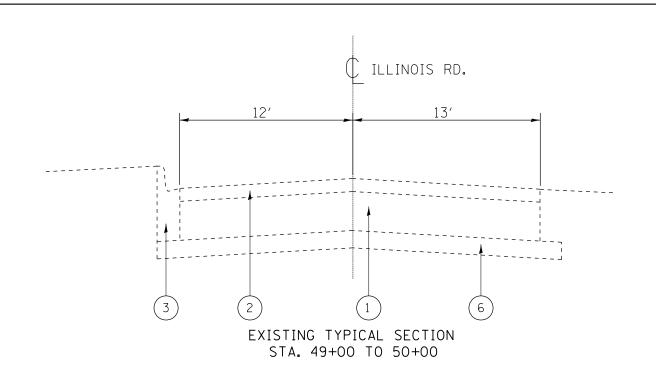SECTION

1819SW-TR


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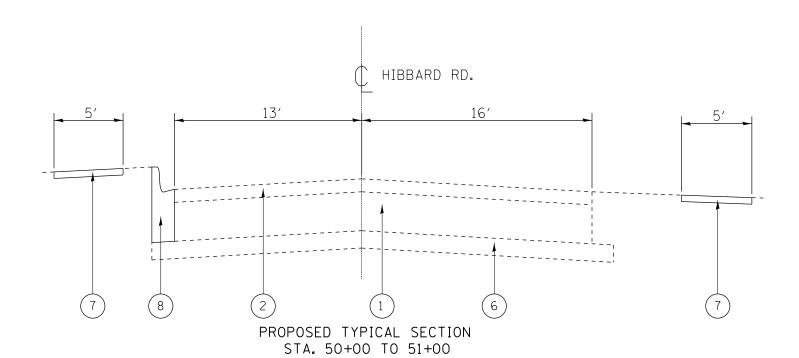
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CONTRACT NO. 62F07

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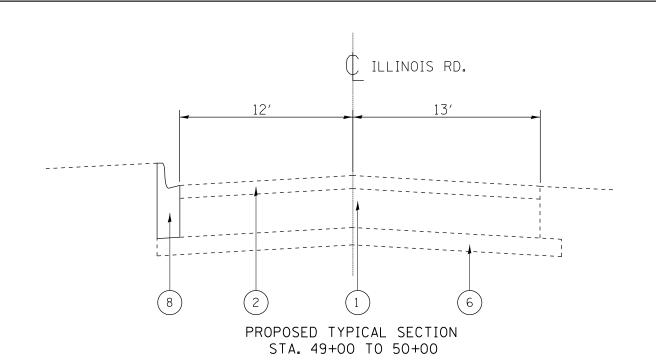
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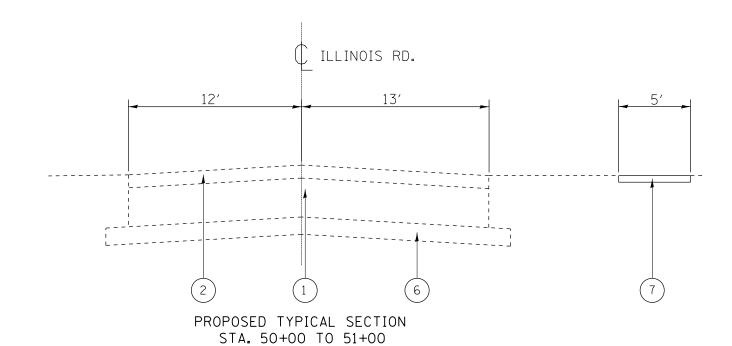
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STATE OF ILLINOIS	
DEPARTMENT OF TRANSPORTATION	

EXISTING AND PROPOSED TYPICAL SECTIONS								
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		CONTRACT	NO. 6	2F07
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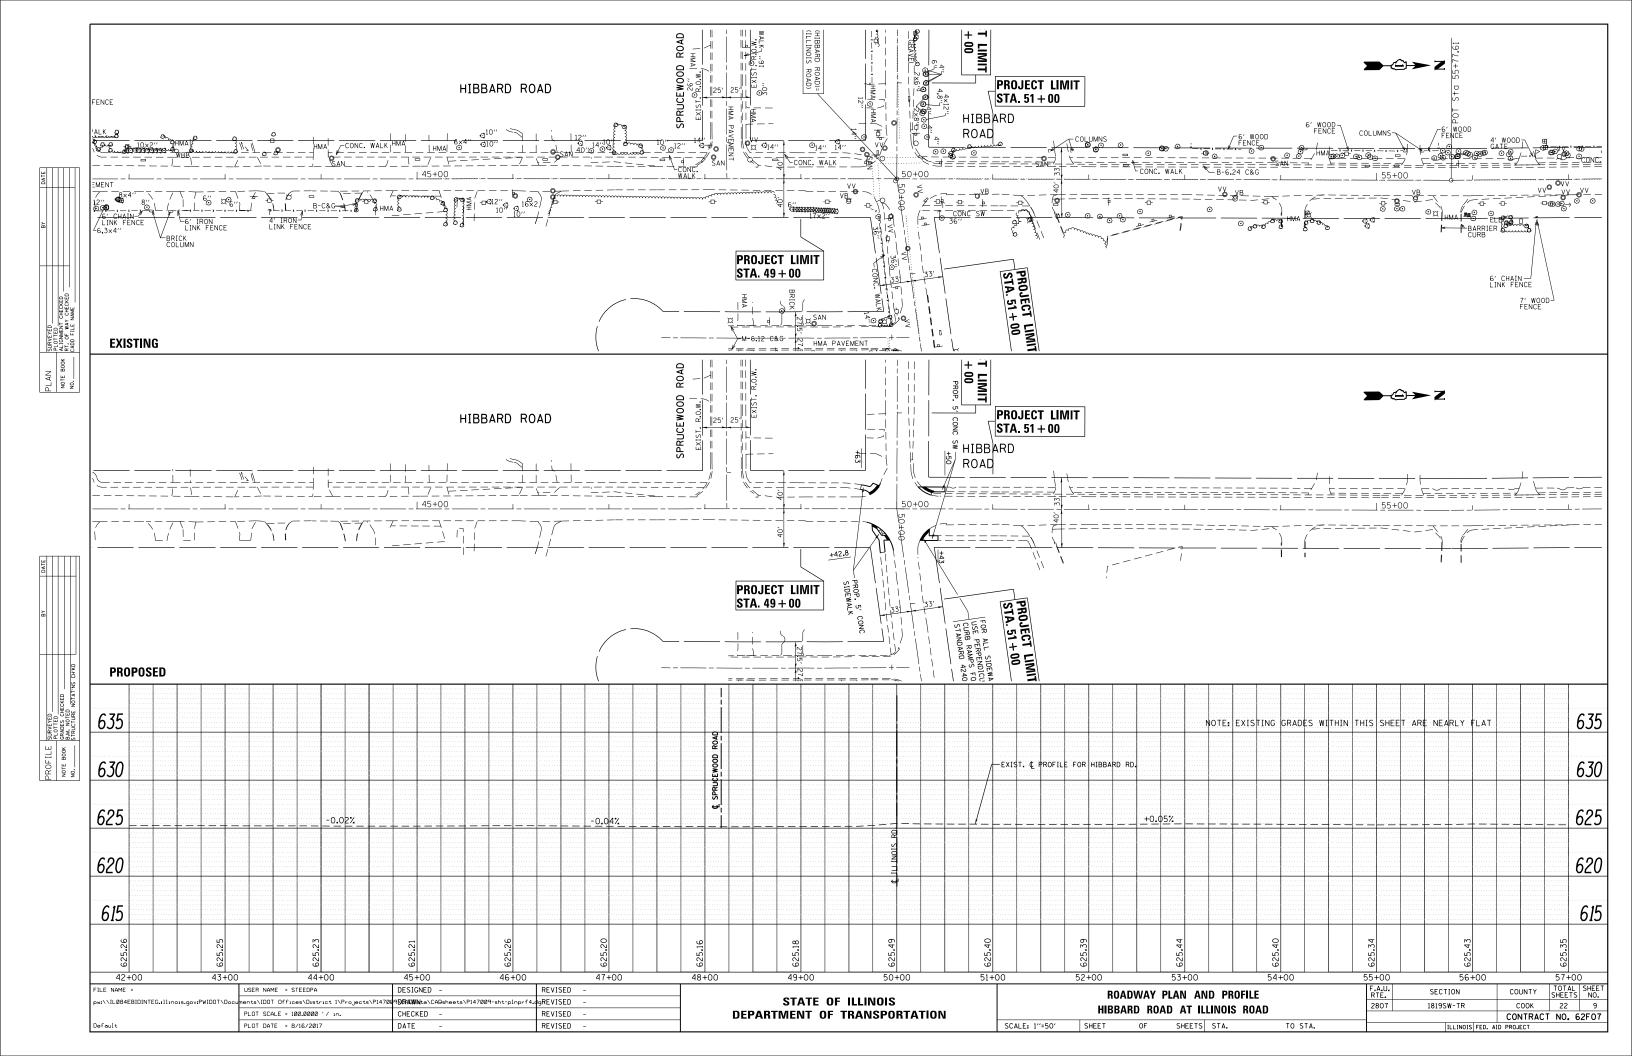
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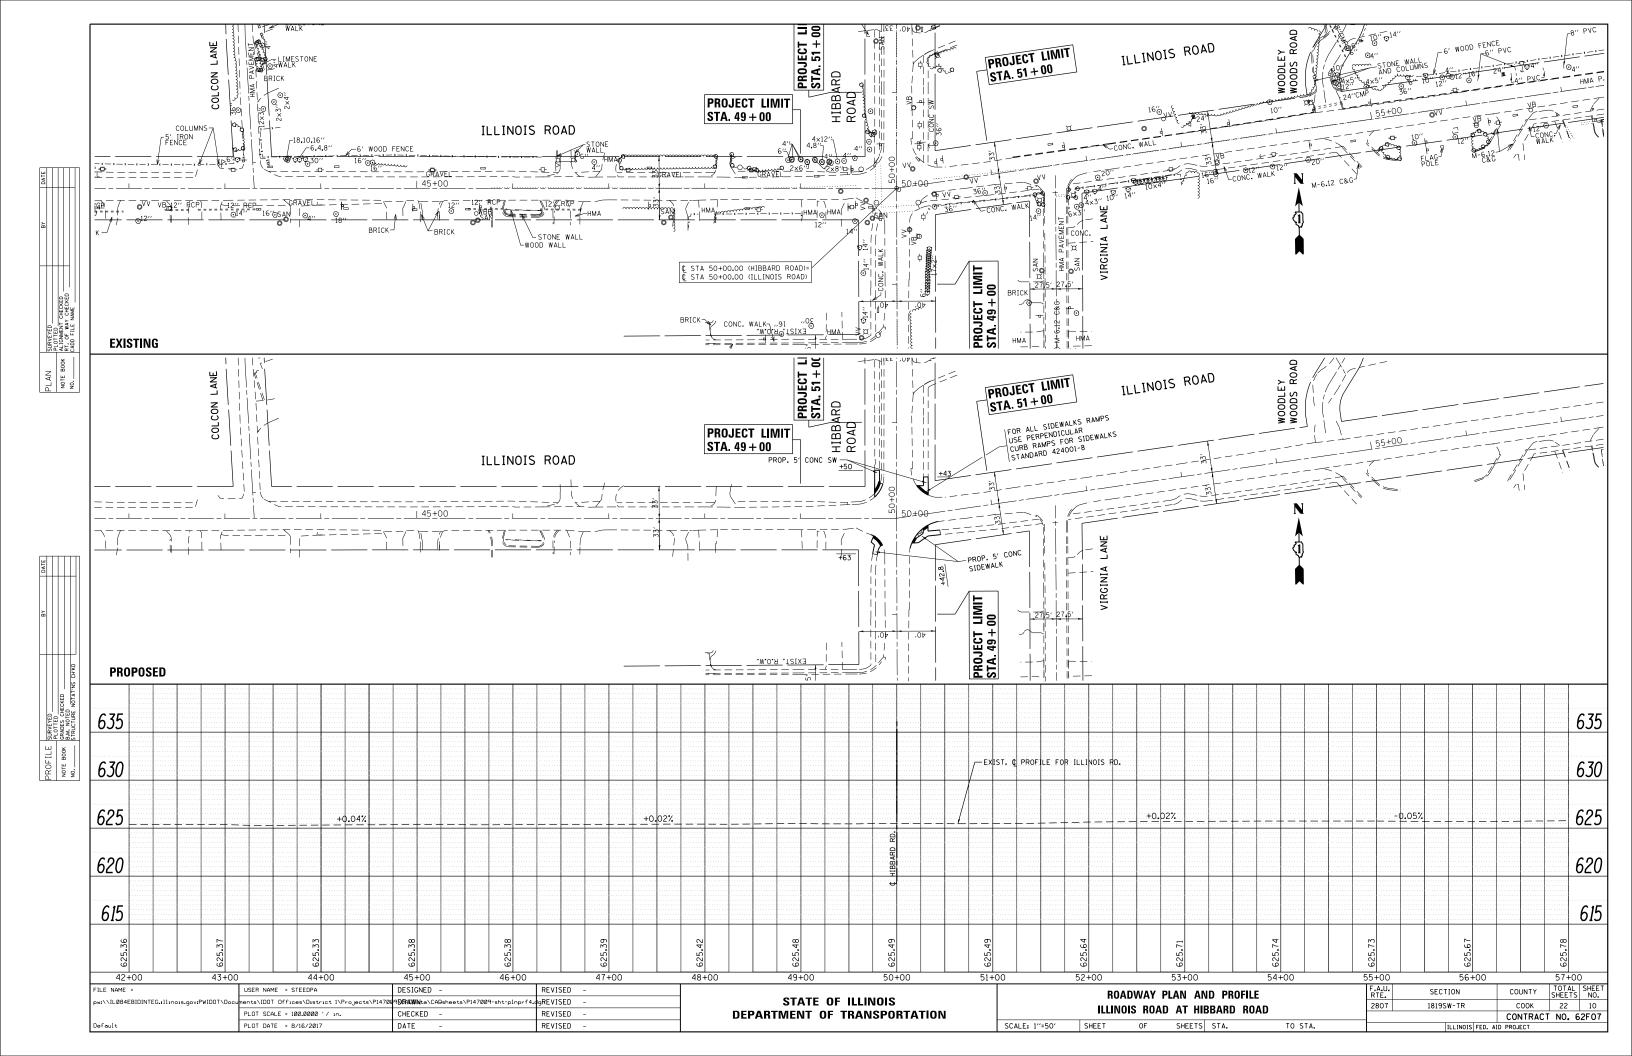
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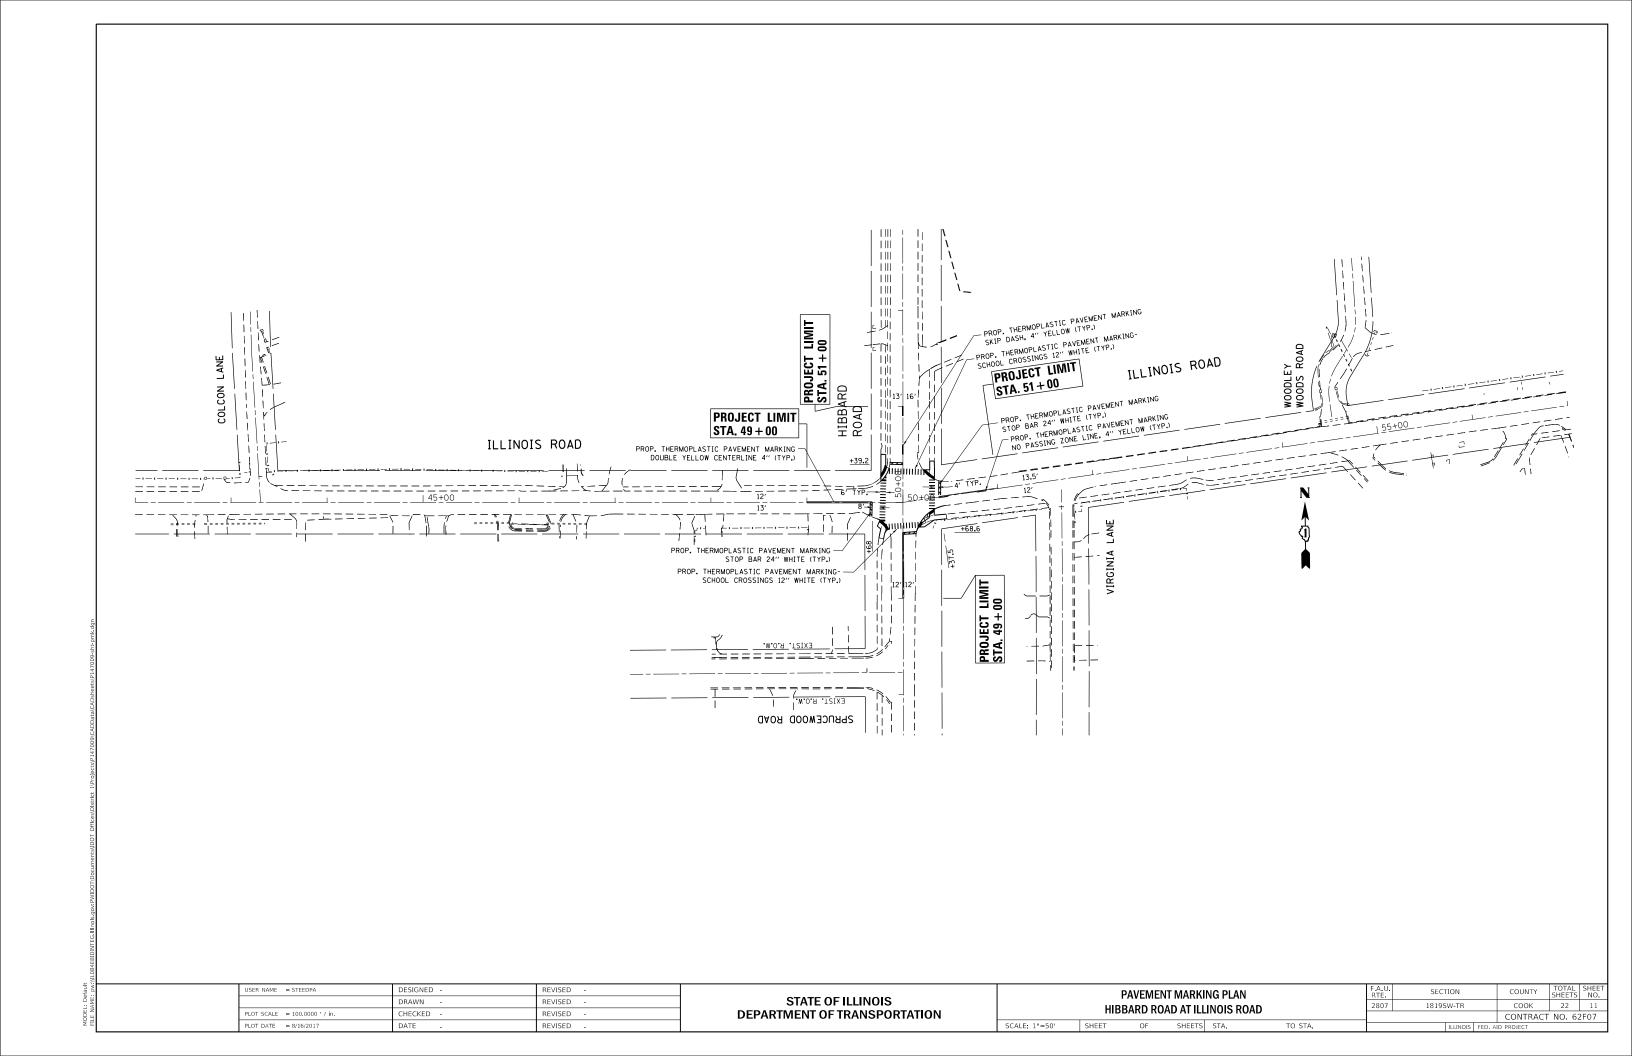
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DEPARTMENT OF	TRANSPORTATION


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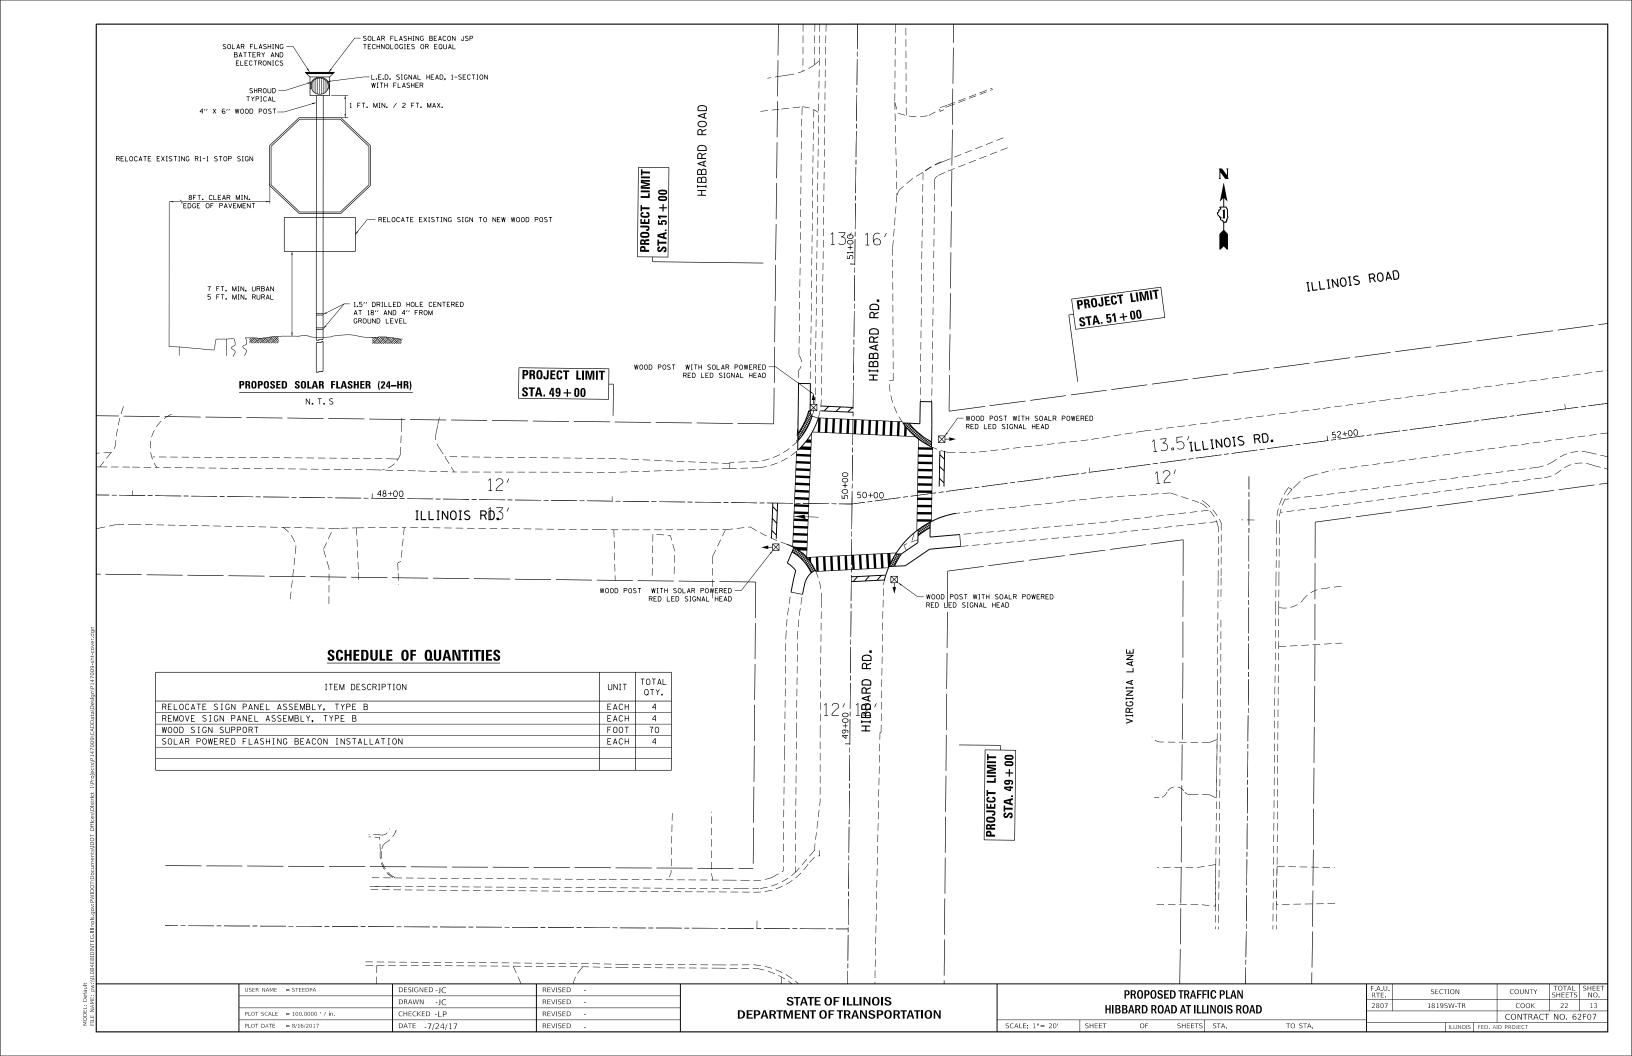



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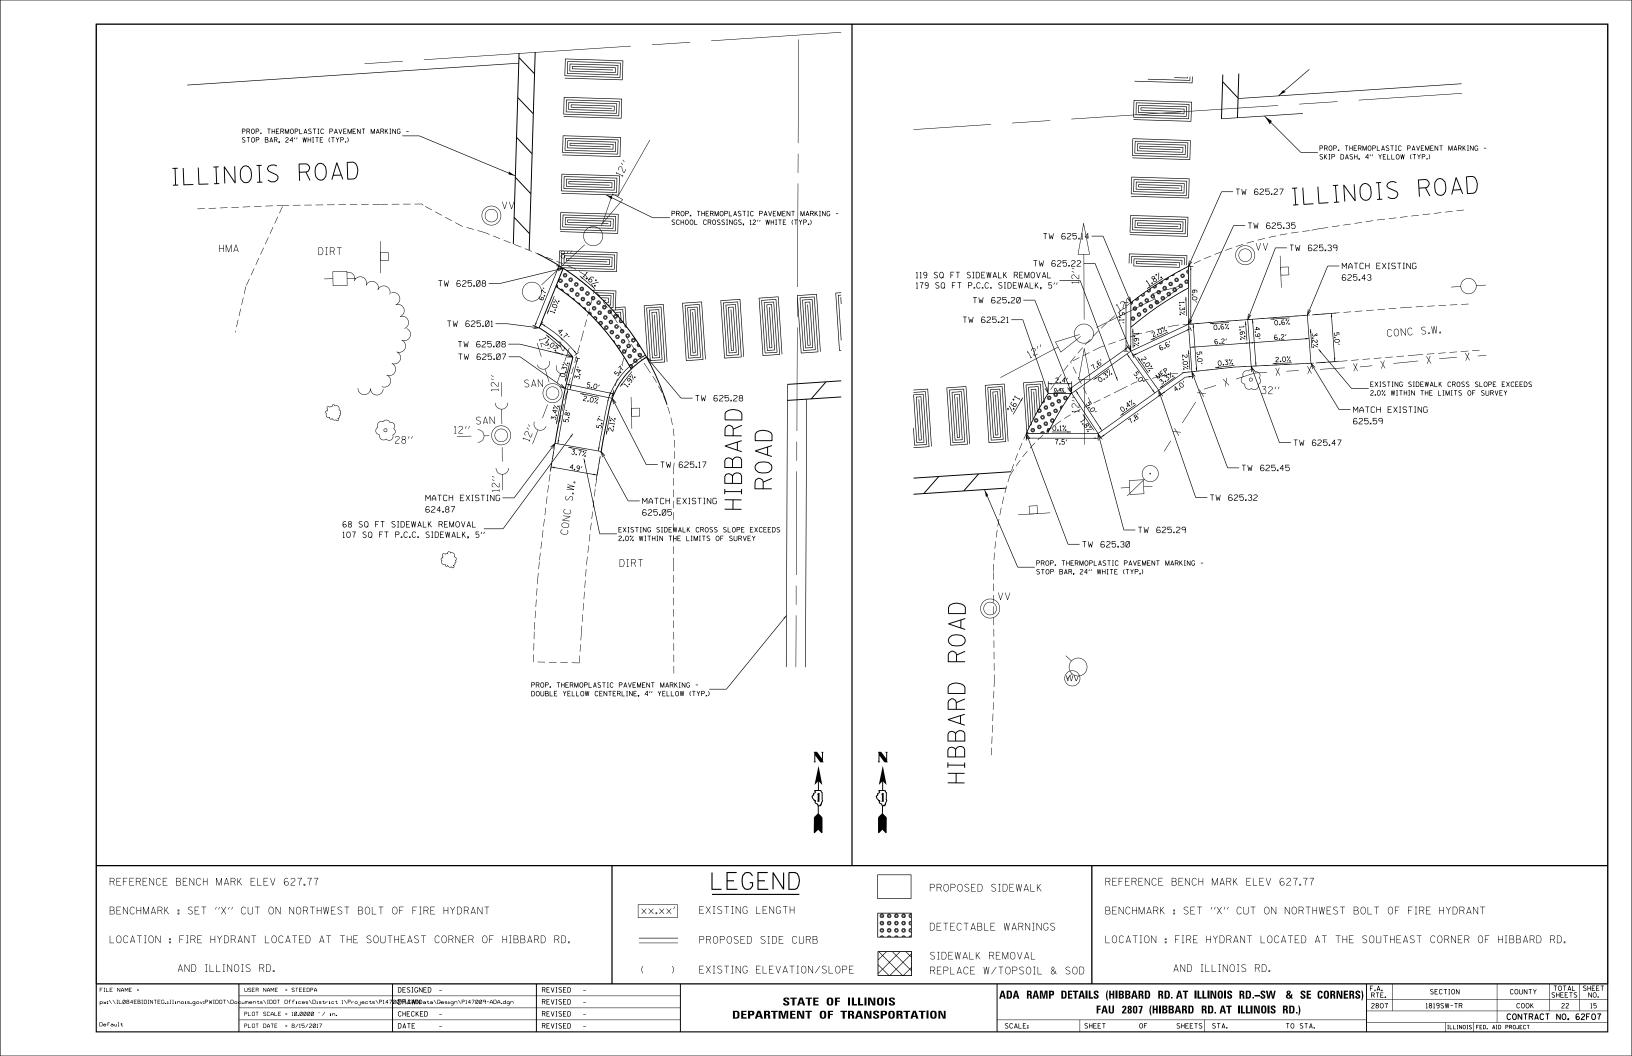
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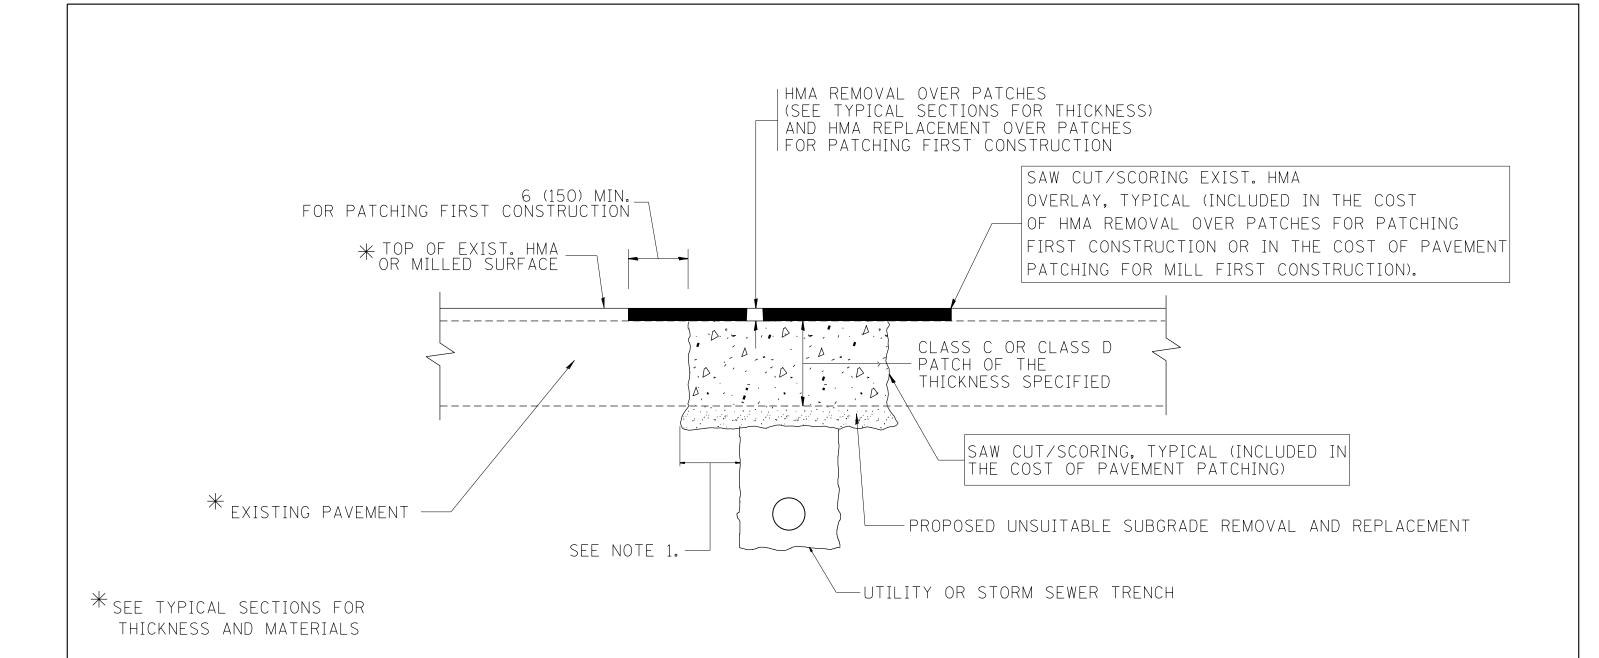
STATE OF ILLINOIS DEPARTMENT OF TRANSPORTATION

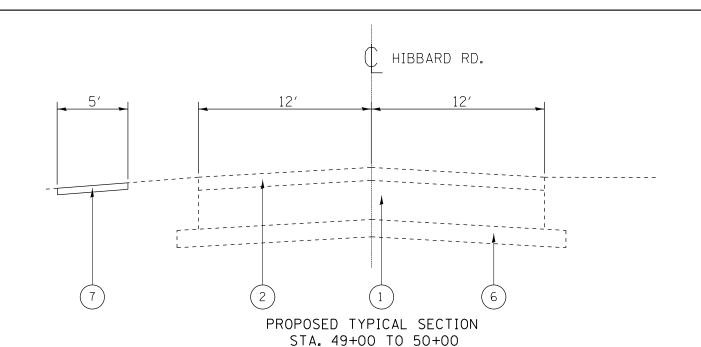HIBBARD ROAD AT ILLINOIS ROAD SCALE: 1"=50" SHEET OF SHEETS STA. TO STA.





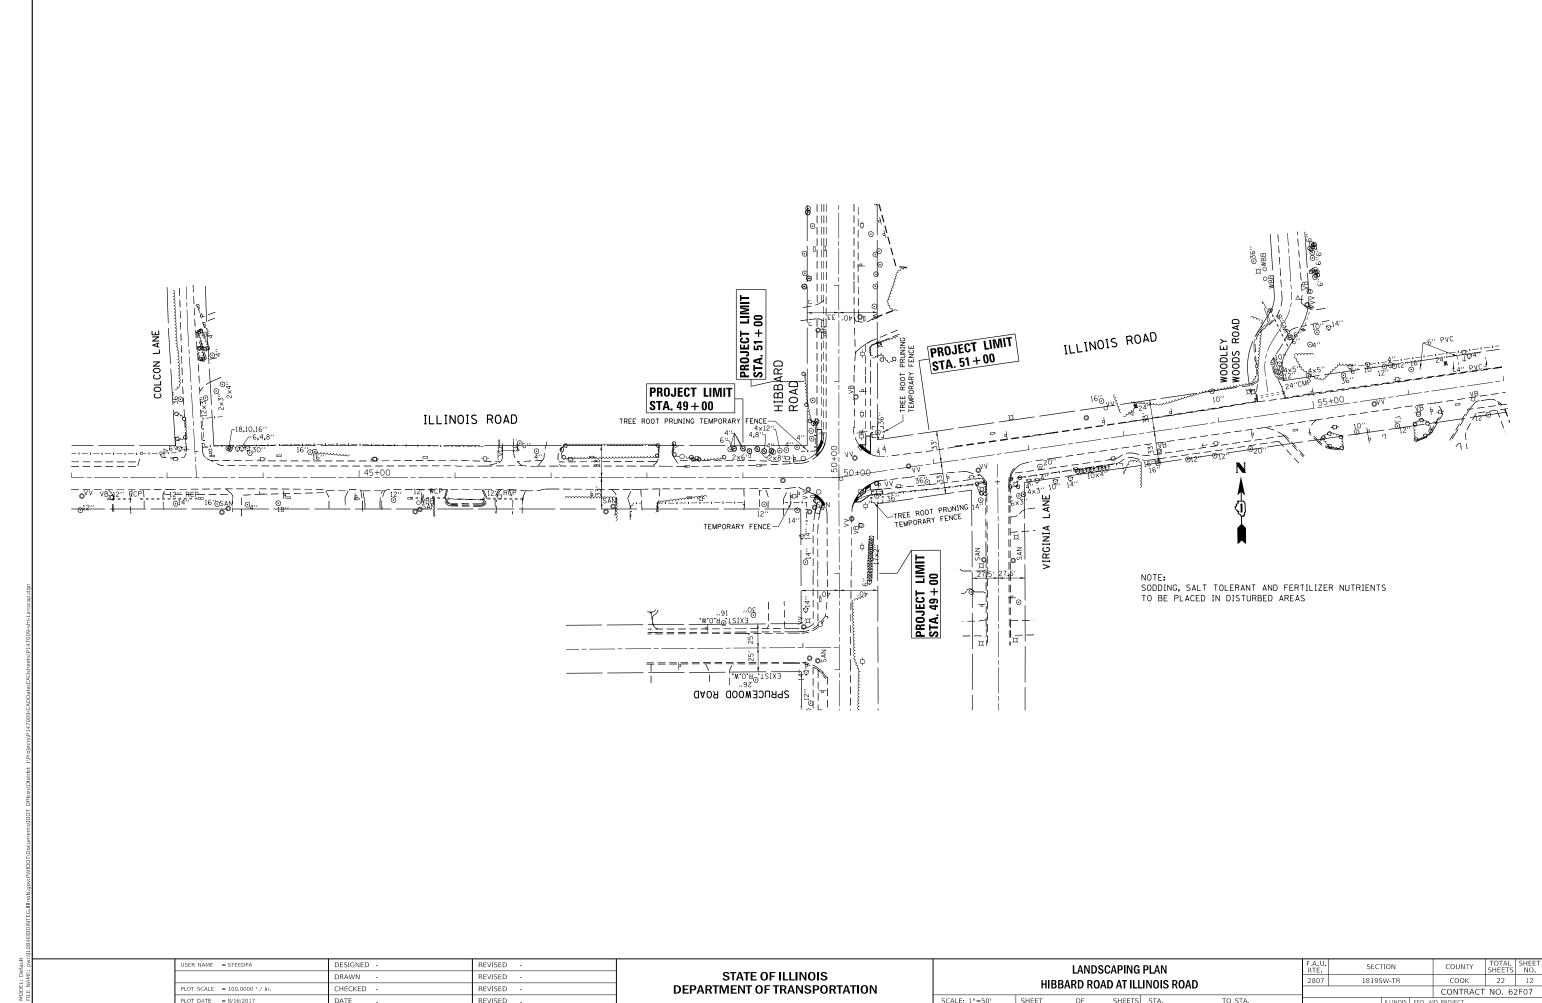

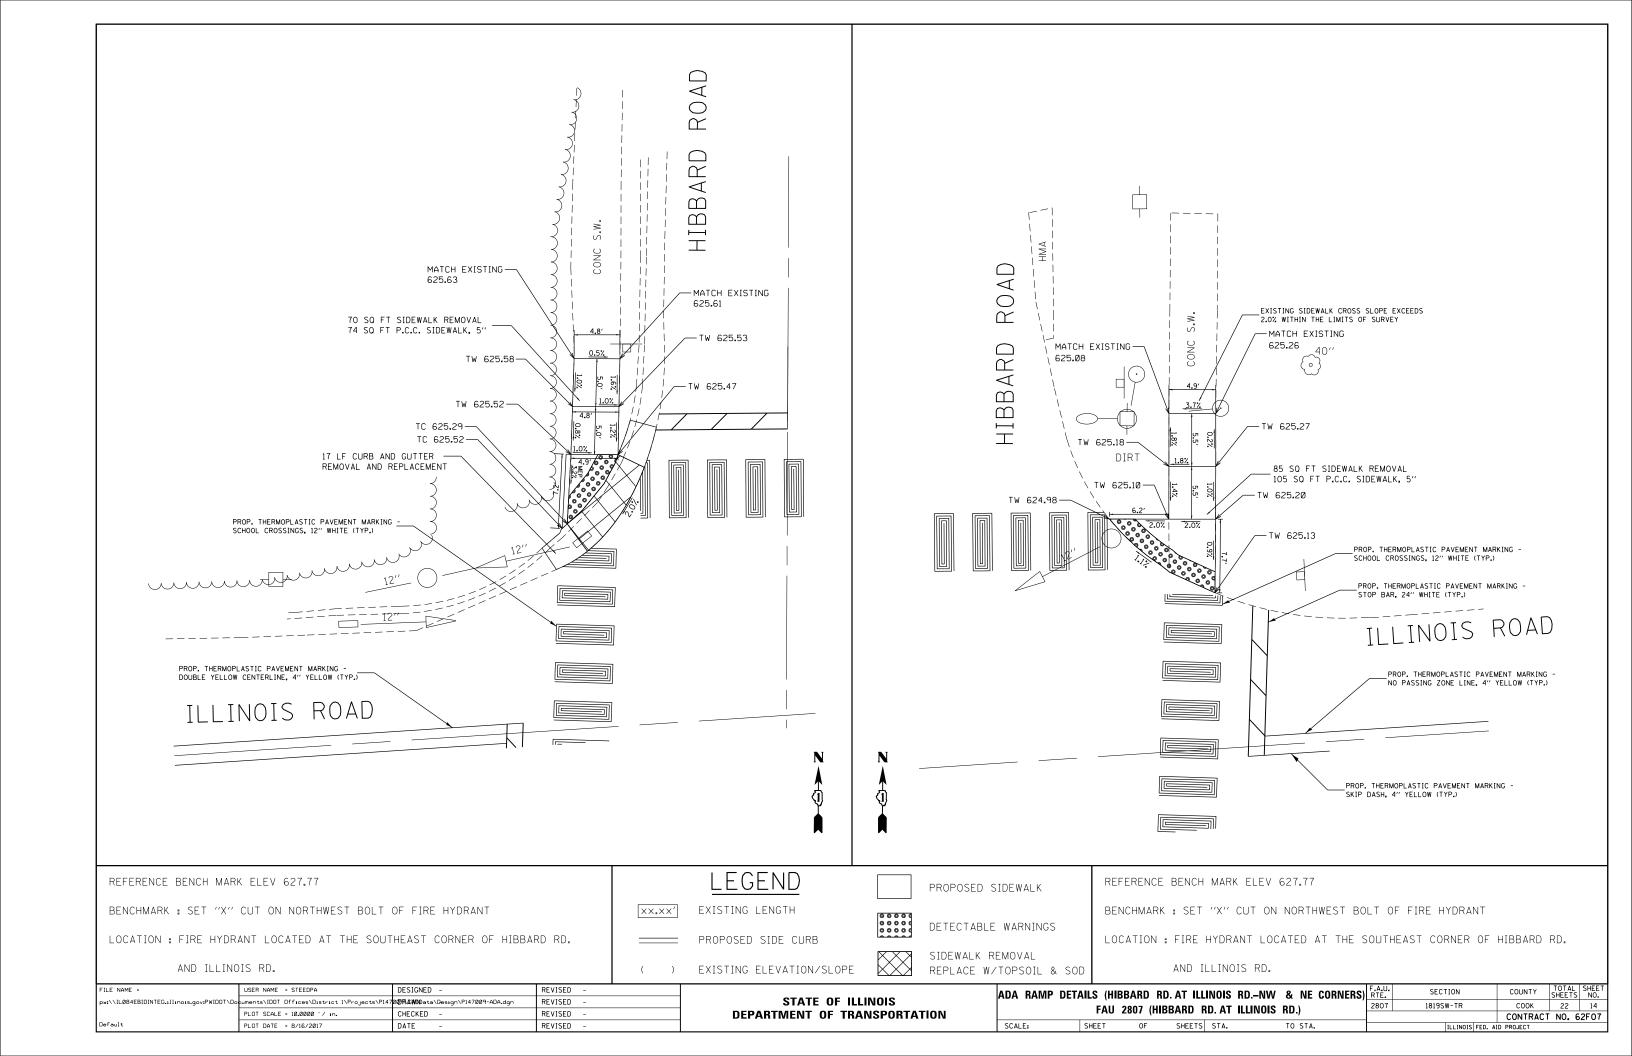

NOTES:

- 1. THE WIDTH OF THE FULL DEPTH PATCH OVER A TRENCH SHALL BE 12 (300) WIDER ON EACH SIDE OF THE TRENCH.
- 2. FOR METHOD OF MEASUREMENT AND BASIS OF PAYMENT, SEE RECURRING SPECIAL PROVISION "PATCHING WITH HOT-MIX ASPHALT OVERLAY REMOVAL".

SEQUENCE OF CONSTRUCTION (PATCHING FIRST)


- 1. REMOVE THE EXISTING HMA MATERIAL OVER THE AREA TO BE PATCHED.
- 2. REMOVE AND REPLACE WITH CLASS C OR D PATCH.
- 3. REPLACE HMA MATERIAL OVER THE AREA TO BE PATCHED.

SEQUENCE OF CONSTRUCTION (MILLING FIRST)

- 1. MILL HMA FIRST IF THERE IS AT LEAST 41/2 INCHES OR MORE OF HMA MATERIAL ON TOP OF THE EXISTING PAVEMENT OR IF THE PAVEMENT IS FULL DEPTH HMA. A MINIMUM OF 2 INCHES OF HMA MATERIAL SHALL BE IN PLACE AFTER MILLING.
- 2. REMOVE AND REPLACE WITH FULL DEPTH CLASS D PATCHES TO TOP OF MILLED SURFACE.

ALL DIMENSIONS ARE IN INCHES (MILLIMETERS) UNLESS OTHERWISE SHOWN.


	FILE NAME =	USER NAME = STEEDPA	DESIGNED - R. SHAH	REVISED -	A. ABBAS 04-27-98			PAVEMENT PATCHING FOR		F.A.U. RTF	SECTION	COUNTY	TOTAL S	HEET NO.
- 1	pw:\\IL084EBIDINTEG.:llinois.gov:PWIDOT\Do	cuments\IDOT Offices\District 1\Projects\P14	DORAMO Data\Design\DistStd.dgn	REVISED -	R. BORO 01-01-07	STATE OF ILLINOIS				2807	1819SW-TR	соок	22	16
		PLOT SCALE = 100.0000 '/ in.	CHECKED -	REVISED -	R. BORO 09-04-07	DEPARTMENT OF TRANSPORTATION		HMA SURFACED PAVEMENT		BD	400-04 (BD-22)	CONTRACT	NO. 62	-07
- 1		PLOT DATE = 7/28/2017	DATE - 10-25-94	REVISED -	K. ENG 10-27-08		SCALE: NONE	SHEET NO. 1 OF 1 SHEETS STA.	TO STA.	FED. ROAD I	DIST. NO. 1 ILLINOIS FED. A			\neg

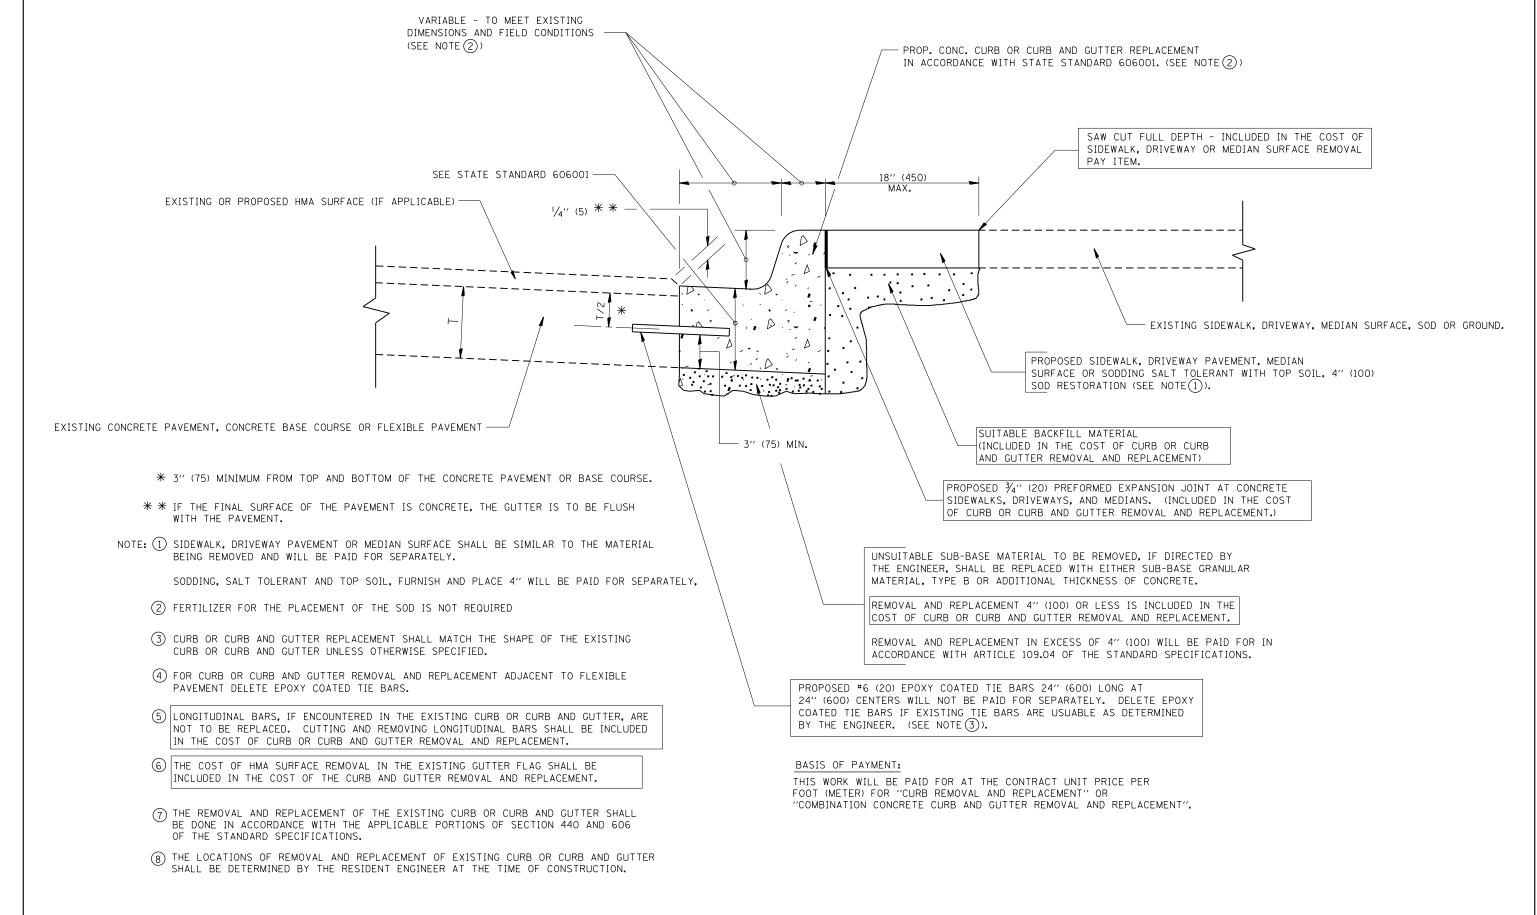

CURB OR CURB AND GUTTER REMOVAL AND REPLACEMENT

ALL DIMENSIONS ARE IN INCHES (MILLIMETERS) UNLESS OTHERWISE SHOWN.

FI	ILE NAME =	USER NAME = STEEDPA	DESIGNED - A. HOUSEH	REVISED - R. SHAH 10-03-96			CURB OR CURB AND GUTTER	F.A	SEC	TION COUNTY	, TOTAL	AL SHEET
Pw	w:\\IL084EBIDINTEG.:ll:no:s.gov:PWIDOT\Do	cuments\IDOT Offices\District 1\Projects\P147	OORANDOata\Design\DistStd.dgn	REVISED - A. ABBAS 03-21-97	STATE OF ILLINOIS			28	07 18199	SW-TR COOK	22	17
		PLOT SCALE = 100.0000 ' / in.	CHECKED -	REVISED - M. GOMEZ 01-22-01	DEPARTMENT OF TRANSPORTATION		REMOVAL AND REPLACEMENT	-	BD600-06 (CT NO.	62F07
		PLOT DATE = 7/28/2017	DATE - 03-11-94	REVISED - R. BORO 12-15-09		SCALE: NONE	SHEET NO. 1 OF 1 SHEETS STA. TO STA.	FE	D. ROAD DIST. NO. 1	ILLINOIS FED. AID PROJECT		

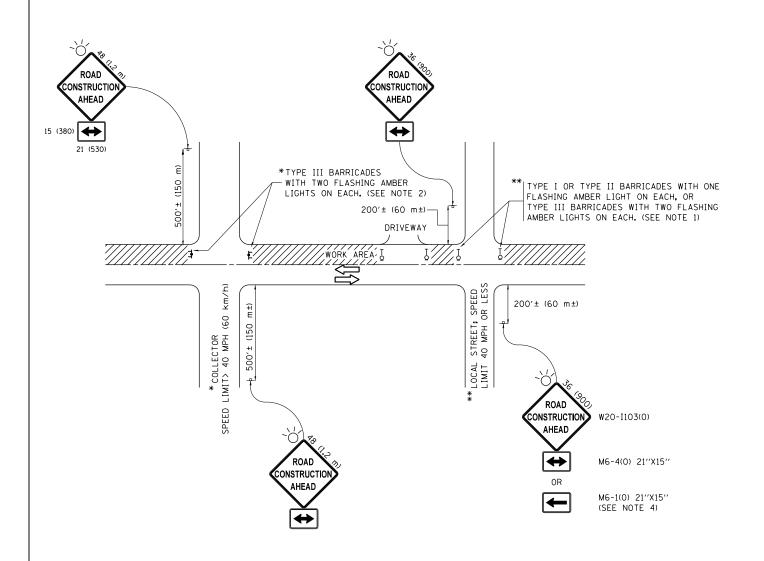

NOTES:

- SIDE ROAD WITH A SPEED LIMIT OF 40 MPH (60 km/h) OR LESS AS SHOWN ON THE DRAWING AND AS DIRECTED BY THE ENGINEER:
 - a) ONE "ROAD CONSTRUCTION AHEAD" SIGN 36 x 36 (900x900) WITH A FLASHER MOUNTED ON IT APPROXIMATELY 200" (60 m) IN ADVANCE OF THE MAIN ROUTE.
 - b) THE CLOSED PORTION OF THE MAIN ROUTE SHALL BE PROTECTED BY BLOCKING WITH TYPE I, TYPE II OR TYPE III BARRICADES, 1/3 OF THE CROSS SECTION OF THE CLOSED PORTION.
- 2. SIDE ROAD WITH A SPEED LIMIT GREATER THAN 40 MPH (60 km/h) AS SHOWN ON THE DRAWING AND AS DIRECTED BY THE ENGINEER:
 - a) ONE "ROAD CONSTRUCTION AHEAD" SIGN 48 \times 48 (1.2 m \times 1.2 m) WITH A FLASHER MOUNTED ON IT APPROXIMATELY 500" (150 m) IN ADVANCE OF THE MAIN ROUTE.
 - b) THE CLOSED PORTION OF THE MAIN ROUTE SHALL BE PROTECTED BY BLOCKING WITH TYPE III BARRICADES, 1/2 OF THE CROSS SECTION OF THE CLOSED PORTION.
- 3. CONES MAY BE SUBSTITUTED FOR BARRICADES OR DRUMS AT HALF THE SPACING DURING DAY OPERATIONS. CONES SHALL BE A MINIMUM OF 28 (710) IN HEICHT
- 4. WHEN THE SIDE ROAD LIES BETWEEN THE BEGINNING OF THE MAINLINE SIGNING AND THE WORK ZONE, A SINGLE HEADED ARROW (M6-1) SHALL BE USED IN LIEU OF THE DOUBLE HEADED ARROW (M6-4).

SCALE: NONE

- 5. WHEN WORK IS BEING PERFORMED ON A SIDE ROAD OR DRIVEWAY, FOLLOW THE APPLICABLE STANDARD(S). THE DIRECTIONAL ARROW (M6-1 OR M6-4) SHALL BE COVERED OR REMOVED WHEN NO LONGER CONSISTENT WITH THE TRAFFIC CONTROL SET-UP.
- 6. ADVANCE WARNING SIGNS ARE TO BE OMITTED ON DRIVEWAYS UNLESS OTHERWISE SPECIFIED IN THE PLANS OR BY THE ENGINEER
- 7. THE TRAFFIC CONTROL AND PROTECTION FOR SIDE ROADS, INTERSECTIONS, AND DRIVEWAYS SHALL BE INCLUDED IN THE COST OF SPECIFIED TRAFFIC CONTROL STANDARDS OR ITEMS.

All dimensions are in inches (millimeters) unless otherwise shown.

COUNTY TOTAL SHEETS NO.


COOK 22 18

CONTRACT NO. 62F07


FILE NAME =	USER NAME = STEEDPA	DESIGNED - L.H.A.	REVISED	- A. HOUSEH 10-15-96
pw:\\ILØ84EBIDINTEG.:ll:nois.gov:PWIDOT\Do	cuments\IDOT Offices\District 1\Projects\P147	Ø Ø₹AWD Data\Besign\DistStd.dgn	REVISED	-T. RAMMACHER 01-06-00
	PLOT SCALE = 100.0000 '/ in.	CHECKED -	REVISED	- A. SCHUETZE 07-01-13
Default	PLOT DATE = 7/28/2017	DATE - 06-89	REVISED	- A. SCHUETZE 09-15-16

STATE OF ILLINOIS	
DEPARTMENT OF TRANSPORTATION	

	TRAFFIC CONTROL AND PROTECTION FOR						SECTION	COUNTY
SIDE ROADS, INTERSECTIONS, AND DE					DRIVEWAVS	2807	1819SW-TR	СООК
SIDE HOADS, INTERSECTIONS, A				, AND L	DIIIVEVVAIS		TC-10	CONTRA
	SHEET 1	OF 1	SHEETS	STA.	TO STA.		ILLINOIS FED. A	ID PROJECT

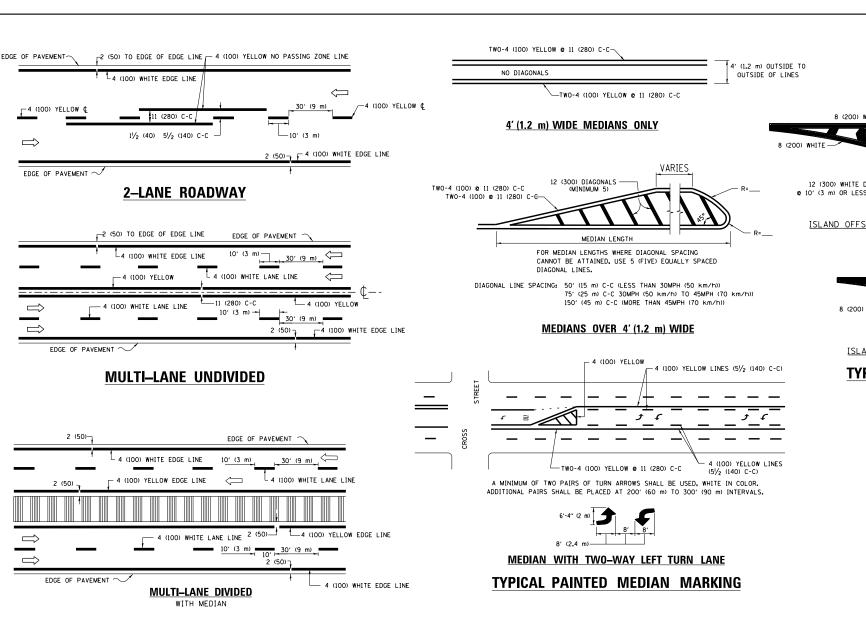

TYPICAL LANE AND EDGE LINE MARKING

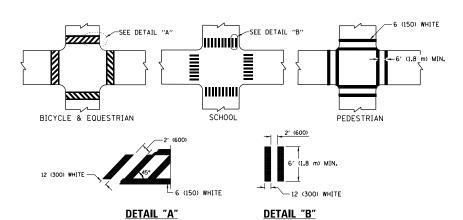

TYPICAL CROSSWALK MARKING

* MARKINGS SHALL BE INSTALLED PARALLEL TO THE CENTERLINE OF THE ROAD WHICH IT CROSSES


8' (2.4 m) — 25' (8 m) TO 49' (15 m) — 6' (150) WHITE — 2' DASH — 6' SKIF —

FULL SIZE LETTERS 8' (2.4 m) AND ARROWS SHALL BE USED. \P AREA = 15.6 SO. FT. (1.5 m²))


* TURN LANES IN EXCESS OF 400' (120 m) IN LENGTH MAY HAVE AN ADDITIONAL SET OF ARROW - "ONLY" INSTALLED MIDWAY BETWEEN THE OTHER TWO SETS OF ARROW - "ONLY".

TYPICAL LEFT (OR RIGHT) TURN LANE


TYPICAL TURN LANE MARKING

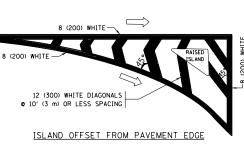



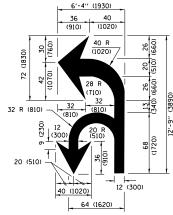

COMBINATION LEFT AND U-TURN

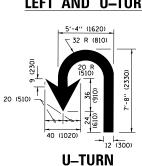

580 45 665 50 750 55

D(FT)

345

425

500

SPEED LIMIT

LANE REDUCTION TRANSITION

 \divideontimes LANE REDUCTION ARROWS REQUIRED AT SPEEDS OF 45 MPH OR GREATER OR WHEN SPECIFIED IN PLANS.

TYPE OF MARKING	WIDTH OF LINE	PATTERN	COLOR	SPACING /REMARKS
CENTERLINE ON 2 LANE PAVEMENT	4 (100)	SKIP-DASH	YELLOW	10' (3 m) LINE WITH 30' (9 m) SPACE
CENTERLINE ON MULTI-LANE UNDIVIDED PAVEMENT	2 @ 4 (100)	SOLID	YELLOW	11 (280) C-C
NO PASSING ZONE LINES: FOR ONE DIRECTION FOR BOTH DIRECTIONS	4 (100) 2 @ 4 (100)	SOLID SOLID	YELLOW YELLOW	5½ (140) C-C FROM SKIP-DASH CENTERLINE 11 (280) C-C OMIT SKIP-DASH CENTERLINE BETWEEN
LANE LINES	4 (100) 5 (125) ON FREEWAYS	SKIP-DASH SKIP-DASH	WHITE WHITE	10' (3 m) LINE WITH 30' (9 m) SPACE
DOTTED LINES (EXTENSIONS OF CENTER, LANE OR TURN LANE MARKINGS)	SAME AS LINE BEING EXTENDED	SKIP-DASH	SAME AS LINE BEING EXTENDED	2' (600) LINE WITH 6' (1.8 m) SPACE
EDGE LINES	4 (100)	SOLID	YELLOW-LEFT WHITE-RIGHT	OUTLINE MEDIANS IN YELLOW
TURN LANE MARKINGS	6 (150) LINE; FULL SIZE LETTERS & SYMBOLS (8' (2.4m))	SOLID	WHITE	SEE TYPICAL TURN LANE MARKING DETAIL
TWO WAY LEFT TURN MARKING	2 @ 4 (100) EACH DIRECTION 8' (2.4m) LEFT ARROW	SKIP-DASH AND SOLID IN PAIRS	YELLOW	10' (3 m) LINE WITH 30' (9 m) SPACE FOR SKIP-DASH; 5½ (140) C-C BETWEEN SOLID LINE AND SKIP-DASH LINE E SEE TYPICAL TWO-WAY LEFT TURN MARKING DETAIL
CROSSWALK LINES (PEDESTRIAN) A. DIAGONALS (BIKE & EOUESTRIAN) B. LONGITUDINAL BARS (SCHOOL)	2 e 6 (150) 12 (300) e 45° 12 (300) e 90°	SOLID SOLID SOLID	WHITE WHITE WHITE	NOT LESS THAN 6' (1.8 m) APART 2' (600) APART 2' (600) APART SEE TYPICAL CROSSWALK MARKING DETAILS.
STOP LINES	24 (600)	SOLID	WHITE	PLACE 4' (1.2 m) IN ADVANCE OF AND PARALLEL TO CROSSWALK, IF PRESENT. OTHERWISE, PLACE AT DESIRED STOPPING POINT. PARALLEL TO CROSSROAD CENTERLINE, WHERE POSSIBLE
PAINTED MEDIANS	2 @ 4 (100) WITH 12 (300) DIAGONALS @ 45° NO DIAGONALS USED FOR 4' (1.2 m) WIDE MEDIANS	SOLID	YELLOW: TWO WAY TRAFFIC WHITE: ONE WAY TRAFFIC	11 (280) C-C FOR THE DOUBLE LINE SEE TYPICAL PAINTED MEDIAN MARKING.
GORE MARKING AND CHANNELIZING LINES	8 (200) WITH 12 (300) DIAGONALS @ 45°	SOLID	WHITE	DIAGONALS: 15' (4.5 m) C-C (LESS THAN 30MPH (50 km/h)) 20' (6 m) C-C 30MPH (50 km/h) TO 45MPH (70 km/h)) 30' (9 m) C-C (OVER 45MPH (70 km/h))
RAILROAD CROSSING	24 (600) TRANSVERSE LINES; "RR" IS 6' (1.8 m) LETTERS; 16 (400) LINE FOR "X"	SOLID	WHITE	SEE STATE STANDARD 780001 AREA OF: "R"=3.6 SO. FT. (0.33 m²) EACH "X"=54.0 SO. FT. (5.0 m²)
SHOULDER DIAGONALS (REOUIRED FOR SHOULDERS ≥ 8′)	12 (300) © 45°	SOLID	WHITE - RIGHT YELLOW - LEFT	50' (15 m) C-C (LESS THAN 30MPH (50 km/h)) 75' (25 m) C-C (30 MPH (50 km/h) TO 45MPH (70 km/h 150' (45 m) C-C (0VER 45MPH (70 km/h))
U TURN ARROW	SEE DETAIL	SOLID	WHITE	16.3 SF
2 ARROW COMBINATION LEFT AND U TURN	SEE DETAIL	SOLID	WHITE	30.4 SF


FOR FURTHER DETAILS ON PAVEMENT MARKING REFER TO STANDARD SPECIFICATIONS FOR ROAD AND BRIDGE CONSTRUCTION AND STATE STANDARD 780001.

All dimensions are in inches (millimeters) unless otherwise shown.


FILE NAME = USER NAME = STEEDPA DESIGNED - EVERS REVISED - C. JUCIUS 09-09-09 ow:\\ILØ84EBIDINTEG.:ll:no: ments\IDOT Offices\District 1\Projects\P1470**0FRAMO**Data\Besign\DistStd.dgr REVISED -C. JUCIUS 07-01-13 CHECKED REVISED C. JUCIUS 12-21-15 PLOT DATE = 7/28/2017 DATE 03-19-90 REVISED -C. JUCIUS 04-12-16

STATE OF ILLINOIS
DEPARTMENT OF TRANSPORTATION


DISTRICT ONE	F.A.U RTE.	SECTION	COUNTY	TOTAL SHEETS	SHEET NO.
TYPICAL PAVEMENT MARKINGS	2807	1819SW-TR	COOK	22	19
TITIOAL LAVEWENT WANKINGS		TC-13	CONTRACT	NO.	62F07
SCALE: NONE SHEET 1 OF 1 SHEETS STA. TO STA.	ILLINOIS FED. AID PROJECT				

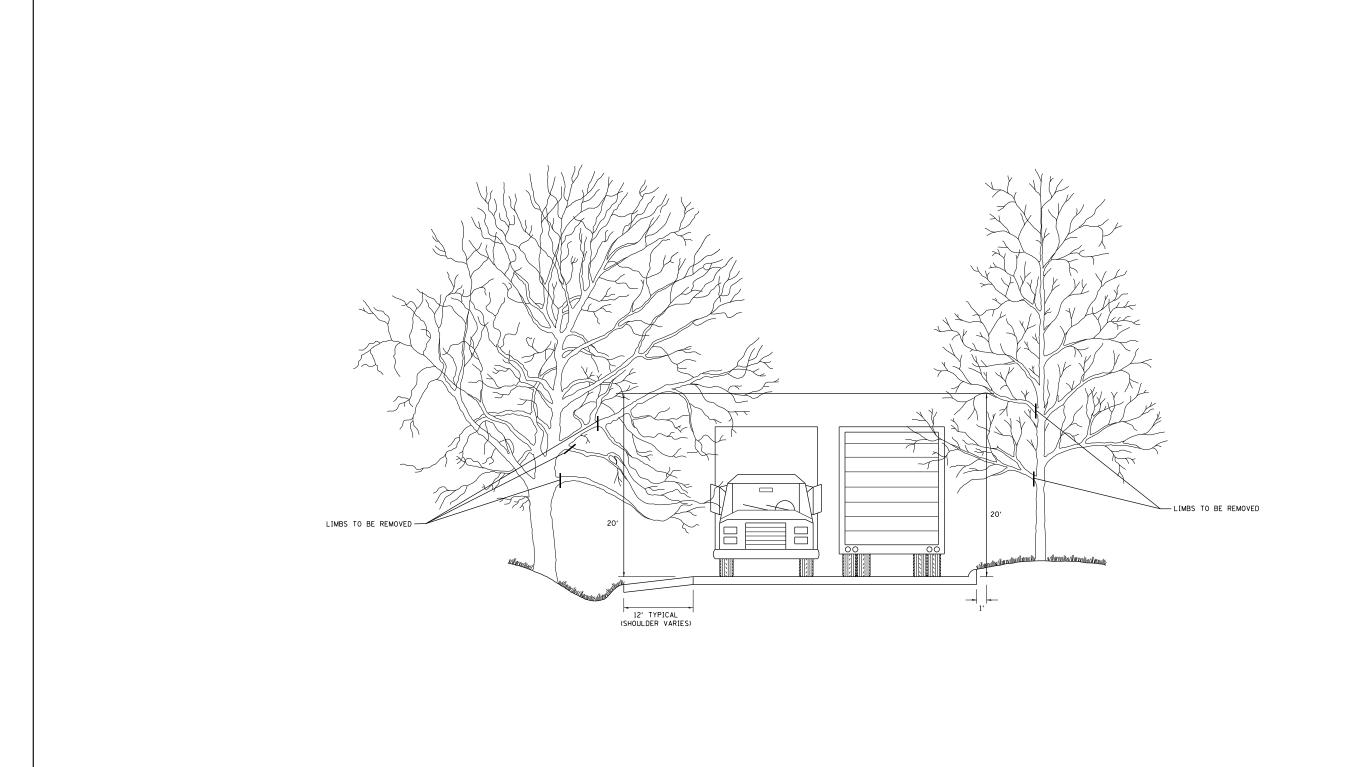

FILE NAME =	USER NAME = STEEDPA	DESIGNED -	REVISED - R. BORO 10-31-06			PRUNING FOR SAFETY	AND	F.A.U.	SECTION	COUNTY	TOTAL S	SHEET
pw:\\ILØ84EBIDINTEG.:ll:nois.gov:PWIDOT\Do	cuments\IDOT Offices\District 1\Projects\P14	70@RAWD Data\Design\DistStd.dgn	REVISED -	STATE OF ILLINOIS				2807	1819SW-TR	СООК	22	20
	PLOT SCALE = 100.0000 ' / in.	CHECKED -	REVISED -	DEPARTMENT OF TRANSPORTATION		EQUIPMENT CLEARAN	ICE	2001	BM-20	CONTRACT	NO. 62	2F07
	PLOT DATE = 7/28/2017	DATE -	REVISED -		SCALE: NONE	SHEET NO. 1 OF 1 SHEETS STA	A. TO STA.	FED. ROAD	DIST. NO. 1 ILLINOIS FED	. AID PROJECT		

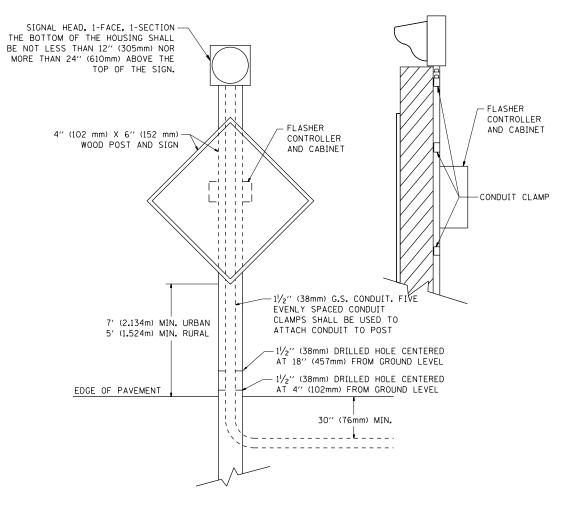


POST MOUNTED FLASHING BEACON WITH CONTROLLER AND CABINET

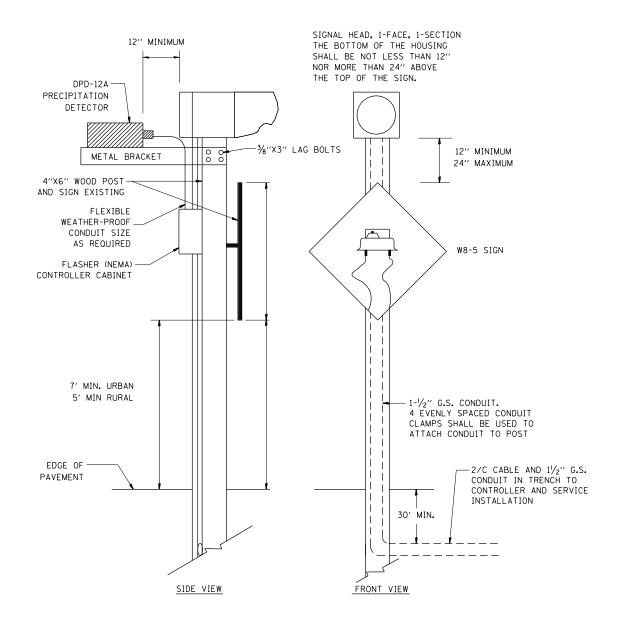

POST MOUNTED FLASHING BEACON WITH PRECIPITATION DETECTOR

- 1	FILE NAME =	USER NAME = STEEDPA	DESIGNED - TRF	REVISED - 01-01-2007
	pw:\\ILØ84EBIDINTEG.:ll:nois.gov:PWIDOT\Do	cuments\IDOT Offices\District 1\Projects\P147	Ø ØRAWM Data\Design\ UR stStd.dgn	REVISED - 07-01-2015
		PLOT SCALE = 100.0000 ' / in.	CHECKED -	REVISED -
	Default	PLOT DATE = 7/28/2017	DATE -	REVISED -

								F.A.U RTE.	SECTION	COUNTY	TOTAL SHEETS	
		EI V CHIVI	C RF	۱۸۲۸۱	TOME	ALLATION	DETAILS	2807	1819SW-TR	соок	22	21
FLASHING BEACON INSTALLATION									TS-04	CONTRACT	NO. (62F07
	SCALE: NTS	SHEET 1	OF	2	SHEETS	STA.	TO STA.		ILLINOIS FED. A	ID PROJECT		

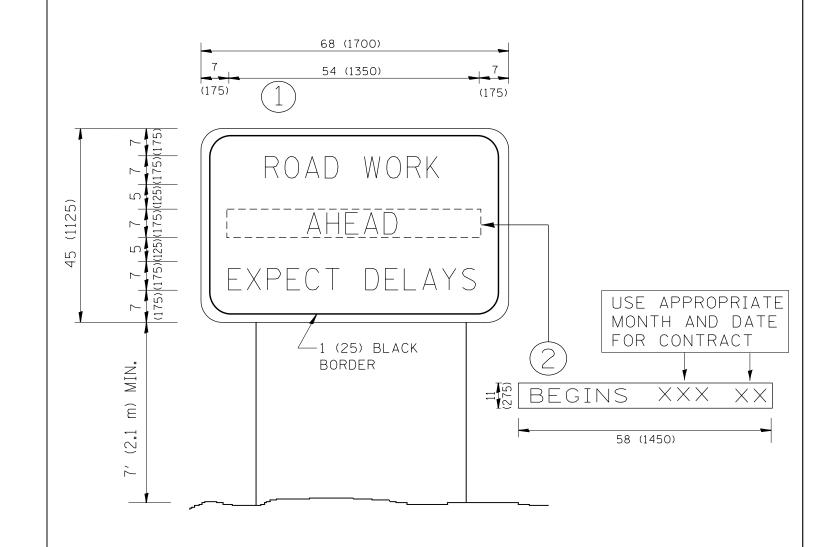

NOTES:

- 1. USE BLACK LETTERING ON ORANGE BACKGROUND.
- 2. ERECT SIGNS IN ADVANCE OF THE LOCATION FOR THE "ROAD CONSTRUCTION AHEAD" SIGN AT LOCATIONS AS DIRECTED BY THE ENGINEER.
- 3. ERECT SIGN (1) WITH INSTALLED PANEL (2) ONE WEEK PRIOR TO THE START OF CONSTRUCTION.
- 4. REMOVE PANEL (2) SOON AFTER THE START OF CONSTRUCTION.
- 5. SEE SPECIAL PROVISION FOR "TEMPORARY INFORMATION SIGNING" FOR ADDITIONAL INFORMATION.
- 6. ONE SIGN ASSEMBLY EQUALS 25.70 SQ. FT. (2.3 SQ. M.)
- 7. SHALL BE PAID FOR AS TEMPORARY INFORMATION SIGNING.

ALL DIMENSIONS ARE IN INCHES (MILLIMETERS) UNLESS OTHERWISE SHOWN.

FILE NAME = pw:\\IL084EBIDINTEG.illinois.gov:PWIDOT\De	USER NAME = STEEDPA	DESIGNED -	REVISED -	- R. MIRS 09-15-97 - R. MIRS 12-11-97	STATE OF ILLINOIS		ARTERIAL ROAD		F.A.U. RTE.	SECTION	COUNTY	TOTAL SHEETS	NO.
I'	PLOT SCALE = 100.0000 '/ in.	CHECKED -	REVISED -	- R. MIRS 12-11-97 -T. RAMMACHER 02-02-99	DEPARTMENT OF TRANSPORTATION		INFORMATION SIGN		2807	1819SW-TR TC-22	COOK CONTRACT	22 F NO. 6	22 2F 0 7
	PLOT DATE = 7/28/2017	DATE -	REVISED -	- C. JUCIUS 01-31-07		SCALE: NONE	SHEET NO. 1 OF 1 SHEETS STA.	TO STA.	FED. ROAD	D DIST. NO. 1 ILLINOIS FED. AI			