STATE OF ILLINOIS DEPARTMENT OF TRANSPORTATION

DIVISION OF HIGHWAYS

PLANS FOR PROPOSED FEDERAL AID HIGHWAY

PLAN - 1"=20'
PROFILE HORIZ. - 1"=50'
PROFILE VERT. - 1"=5'
CROSS SECTIONS - 1"=10'

INDEX OF SHEETS

- COVER SHEET
- **SUMMARY OF QUANTITIES, GENERAL NOTES** & TYPICAL CROSS SECTIONS
- 3.-5. PLAN SHEETS
- 6.-7. TRAFFIC SIGNALS
- **DISTRICT 1 TYPICAL PAVEMENT MARKINGS**

STATE STANDARDS

000001-04 STANDARD SYMBOLS, ABBREVIATIONS AND PATTERNS

280001-03 TEMPORARY EROSION CONTROL SYSTEMS

424001-04-CURB RAMPS FOR SIDEWALKS

606001-03 CONCRETE CURB TYPE B AND COMBINATION **CURB AND GUTTER**

701006-02 OFF-ROAD OPERATIONS, 2L, 2W, 4.5m(15') TO 600mm(24") FROM PAVEMENT EDGE

701201-02 LANE CLOSURE, 2L, 2W, DAY ONLY, FOR SPEEDS ≥ 45 MPH

701801-03 LANE CLOSURE. MULTI LANE 1W OR 2W CROSSWALK OR SIDEWALK CLOSURE

702001-06 TRAFFIC CONTROL DEVICES

FULL SIZE PLANS HAVE BEEN PREPARED USING STANDARD

ENGINEERING SCALES, REDUCED SIZED PLANS WILL NOT CONFORM TO STANDARD SCALES, IN MAKING MEASUREMENTS ON REDUCED PLANS, THE ABOVE SCALES MAY BE USED.


> **JOINT** UTILITY LOCATING INFORMATION FOR **EXCAVATORS**

48 hours before you dig

F.A.U. ROUTE 2860

ASHLAND AVENUE SIDEWALK IMPROVEMENT

C-91-134-06

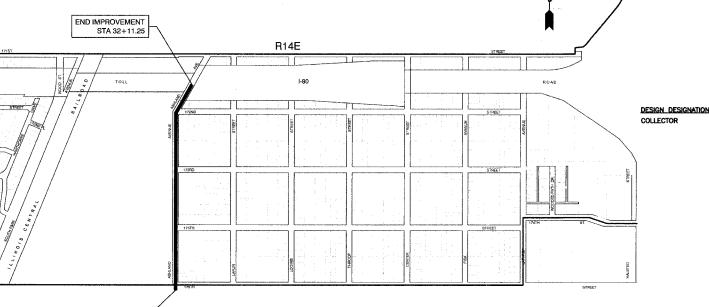

175TH STREET TO 172ND STREET PROJECT NO.: CMM-8003(558) SECTION NO.:05-00022-00-SW

VILLAGE OF EAST HAZEL CREST COOK COUNTY

STATE OF ILLINOIS DEPARTMENT OF TRANSPORTATION DIVISION OF HIGHWAYS Patrice Saylor VILLAGE OF EAST HAZEL CREST SEPTEMBER 13 2007 CHIUSTOPHER HOLT
REGION ONE ENGINEER OF LOCAL ROADS & STREETS Sept. 14 20 07 Diago / Leefs / L

PRINTED BY AUTHORITY OF THE STATE OF ILLINOIS

7-25-07

COUNTY TOTAL SHEETS

COOK 8

TO STA. FED. ROAD DIST. NO. ILLINOIS FED. AID PROJECT

CONTRACT NO. 83967

CONTRACT NO. 83967

LOCATION MAP-N.T.S. GROSS LENGTH=2.277 FEET=0.431 MILES NET LENGTH=2,277 FEET=0.431 MILES

BEGIN IMPROVEMENT

F.A.U. RTE.	SECTION NO.			COUNTY	TOTAL SHEETS	SHEET
2860 05-00022-00-SW			COOK		8	2
STA.			STA.			
FED. ROAD DIST, NO. ILUNOIS FED. AID PROJECT						

CONTRACT NO. 83967

GENERAL NOT	ES
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- ANY REFERENCE TO STANDARDS THROUGHOUT THE PLANS OR SPECIAL PROVISIONS SHALL BE INTERPRETED TO BE THE LATEST STANDARDS OF THE ILLINOIS DEPARTMENT OF TRANSPORTATION
- İTEMS OF WORK LISTED IN THE SUMMARY OF QUANTITIES WHICH ARE NOT SPECIFICALLY INDICATED IN THE PLANS SHALL BE PERFORMED AT LOCATIONS AS DIRECTED BY THE ENGINEER.
- 3. WHEN, IN THE CONSTRUCTION OPERATION, ANY LOOSE MATERIAL IS DEPOSITED IN THE FLOW LINE OF DITCHES, GUTTERS OR OTHER DRAINAGE STRUCTURES SO THAT THE NATURAL FLOW OF WATER IS OBSTRUCTED, IT SHALL BE REMOVED AT THE CLOSE OF EACH DAY BY THE CONTRACTOR AT HIS EXPENSE. AT THE CONCLUSION OF THE CONSTRUCTION OPERATIONS, ALL DRAINAGE STRUCTURES SHALL BE FREE FROM ALL DIRT AND DEBRIS. THIS WORK SHALL NOT BE PAID FOR SEPARATELY BUT SHALL BE CONSIDERED INCIDENTAL TO THE CONTRACT.
- 4. THE APPROXIMATE LOCATION OF KNOWN PUBLIC UTILITIES ARE SHOWN ON THE PLANS. HOWEVER, THE DEPARTMENT DOES NOT GUARANTEE ITS ACCURACY. PRIOR TO COMMENCING OPERATIONS ON THE PROJECT WHICH MAY IN ANY WAY CREATE THE POSSIBILITY OF INVOLVEMENT WITH EXISTING UTILITIES, THE CONTRACTOR SHALL CONTACT THE UTILITY COMPANY INVOLVED. ADJUSTMENT OF ALL PUBLIC UTILITIES WITHIN THE LIMITS OF THIS IMPROVEMENT WILL BE DONE BY THE RESPECTIVE OWNERS. NO ADDITIONAL COMPENSATION WILL BE ALLOWED DUE TO DELAYS OR INCONVENIENCE CAUSED BY THESE ADJUSTMENTS. IT SHALL BE THE CONTRACTOR'S RESPONSIBILITY TO VERIFY LOCATIONS OF UNDERGROUND INSTALLATION BEFORE STARTING CONSTRUCTION OPERATIONS. PLANS FOR THESE ADJUSTMENTS WILL BE ON FILE IN THE OFFICE OF THE COOK COUNTY HIGHWAY DEPARTMENT, BUREAU OF CONSTRUCTION FOR INFORMATION AND USE.
- BEFORE STARTING ANY EXCAVATION, THE CONTRACTOR SHALL CALL "JULIE" AT 800-892-0123 FOR FIELD LOCATIONS OF BURIED ELECTRIC, TELEPHONE AND GAS FACILITIES. (48 HOURS NOTIFICATION IS REQUIRED).
- 6. THE CONTRACTOR SHALL COORDINATE CONSTRUCTION ACTIVITIES WITH UTILITY COMPANIES.
- THE CONTRACTOR SHALL CONTACT THE DISTRICT ONE TRAFFIC CONTROL SUPERVISOR AT (847) 705-4150 A MINIMUM OF 5 WORKING DAYS IN ADVANCE OF BEGINNING WORK. THE CONTRACTOR SHALL ALSO CONTACT ROBINSON ENGINEERING (708) 331-6700, AND THE VILLAGE OF EAST HAZEL CREST (708) 957-7360 A MINIMUM OF 72 HOURS IN ADVANCE OF BEGINNING WORK.
- 8. ALL PAVEMENT, CURB AND SIDEWALK REMOVALS SHALL BE MADE BY MEANS OF STRAIGHT SAW CUT JOINT. THE COST FOR SAW CUTTING SHALL BE INCIDENTAL TO THE CONTRACT.
- 9. CONTRACTOR SHALL BE RESPONSIBLE AT ALL TIMES FOR TRAFFIC CONTROL AND PROTECTION IN ACCORDANCE WITH THE IDOT STANDARD SPECIFICATIONS ADOPTED JANUARY 1, 2007, THE LATEST EDITION OF THE ILLINOIS MANUAL ON UNIFORM TRAFFIC CONTROL DEVICES FOR STREETS AND HIGHWAYS, AND THE STANDARD SPECIFICATIONS FOR TRAFFIC CONTROL ITEMS.

REVISION


DATE

SIDEWALKS MARKINGS LANDSCAPE SIGNALS SUMMARY OF QUANTITIES CONSTRUCTION TYPE CODE S.I. CODE NO. PAY ITEM UNIT QUAN SFTY-1B | SFTY-1D | Y003 | Y031-1F TREE REMOVAL (OVER 15 UNITS DIAMETER) 20100210 UNIT 90 90 20200100 CU YD 285 285 21101615 TOPSOIL FURNISH AND PLACE. 4" SQ YD 2175 2175 SEEDING, CLASS 2A 25000210 0.5 0.5 NITROGEN FERTILIZER NUTRIENT 25000400 POUND 45 PHOSPHORUS FERTILIZER NUTRIENT 25000500 POUND POTASSIUM FERTILIZER NUTRIENT 25000600 POUND EROSION CONTROL BLANKET 25100630 SQ YD 2175 2175 SUB-BASE GRANULAR MATERIAL, TYPE B 4" 31101200 SQ YD 1140 1140 PORTLAND CEMENT CONCRETE SIDEWALK 5 INCH 42400200 SQ FT 8950 8950 PORTLAND CEMENT CONCRETE SIDEWALK 7 INCH 42400400 SQ FT 1305 1305 DETECTABLE WARNINGS 42400800 SQ FT DRIVEWAY PAVEMENT REMOVAL 44000200 SQ YD 145 145 63200310 FOOT 67100100 L SUM TRAFFIC CONTROL AND PROTECTION, STANDARD 701201 70100450 TRAFFIC CONTROL AND PROTECTION, STANDARD 701801 70102640 L SUM THERMOPLASTIC PAVEMENT MARKING - LINE 6" 78000400 FOOT 466 THERMOPLASTIC PAVEMENT MARKING — LINE 24" 78000650 FOOT 22 PAVEMENT MARKING REMOVAL 78300100 SQ FT 50 MAINTENANCE OF EXISTING TRAFFIC SIGNAL INSTALLATION 85000200 ELECTRIC CABLE IN CONDUIT, SIGNAL NO. 14 2C 87301215 FOOT 219 219 ELECTRIC CABLE IN CONDUIT, SIGNAL NO. 14 3C 87301225 238 238 PEDESTRIAN SIGNAL HEAD, L.E.D., 1 FACE, BRACKET MOUNTED 88102710 EACH 2 PEDESTRIAN PUSH-BUTTON 88800100 EACH 2

CURB AND GUTTER REMOVAL AND REPLACEMENT

XX003560

* - INDICATES SPECIALTY ITEMS

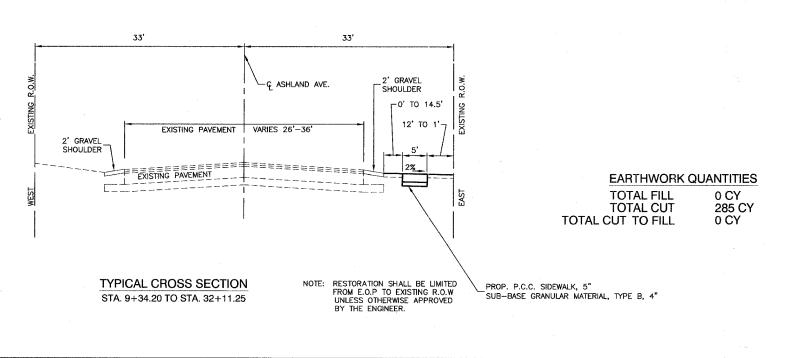


ILLINOIS DEPARTMENT OF TRANSPORTATION

ASHLAND AVENUE SIDEWALK IMPROVEMENT SUMMARY OF QUANTITIES, GENERAL NOTES, & TYPICAL SECTION

SCALE: VERT. NA HORIZ. NA DATE 07-27-07

DRAWN BY JZ CHECKED BY WPD

DBINSON ENGINEERING, LTD.
80 SOUTH PARK AVENUE SOUTH HOLLAND, ILLINOIS 60473
9 931-8709 PAX (700) 331-8826
ULDIOIS ORDINAL BIRLA DECISTRATION NO. 194001183

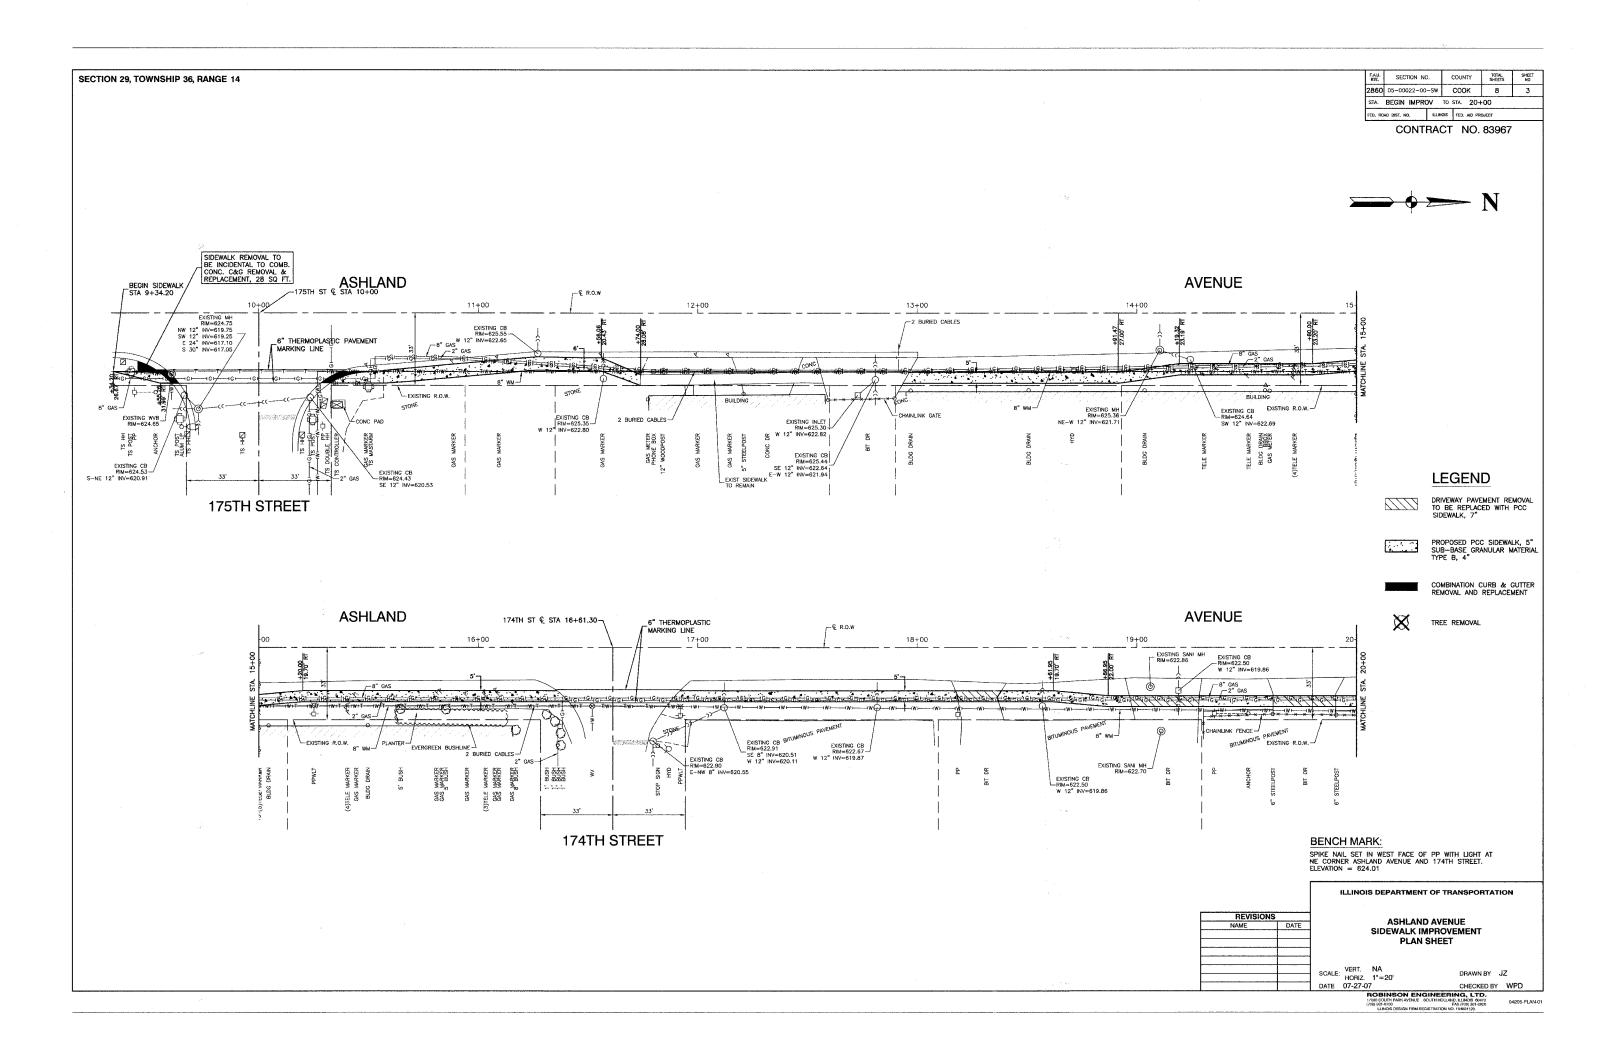



SECTION 29, TOWNSHIP 36, RANGE 14 F.A.U. SECTION NO. COUNTY TOTAL SHEET NO 2860 05-00022-00-5W COOK 8

STA 20+00 TO STA 29+00 FED. ROAD DIST. NO. ILLINOIS FED. AID PROJECT

CONTRACT NO. 83967




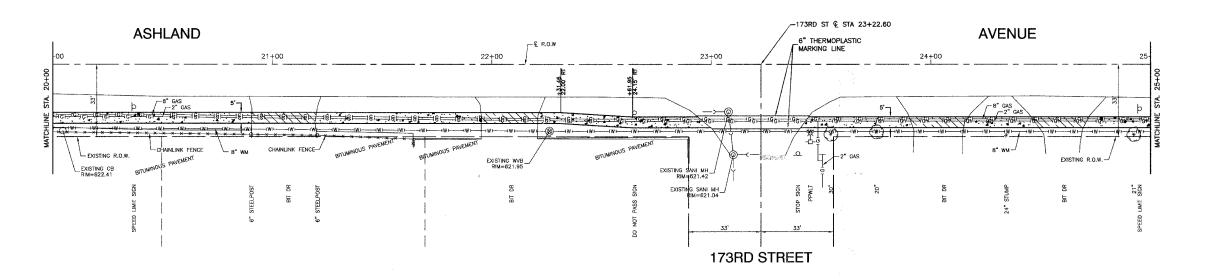


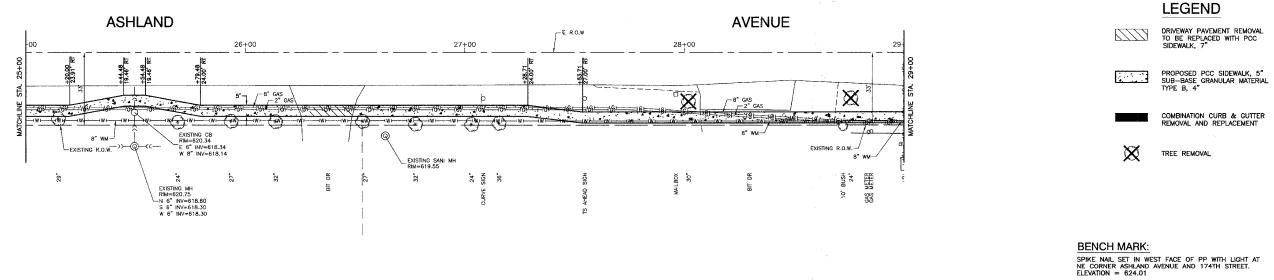



				ILLINOI	S DEPARTMENT	OF TRANSPORTATION
Г	REVISIONS				ASHLANE	AVENUE
-	NAME	DATE			SIDEWALK IN	
\vdash					PLAN	
r						
-			SCALE:	VERT.	NA 1"=20'	DRAWN BY JZ
			DATE	07-27-0		CHECKED BY WPD

SECTION 29, TOWNSHIP 36, RANGE 14 CONTRACT NO. 83967 EXISTING MH RIM=619.45 E 15" NV=616.24-NW 18" NV=614.65 172ND ST & STA 29+87.78-SW 24" NV=614.65 **AVENUE** ASHLAND 30+00 31+00 LEGEND DRIVEWAY PAVEMENT REMOVAL TO BE REPLACED WITH PCC SIDEWALK, 7" PROPOSED PCC SIDEWALK, 5" SUB-BASE GRANULAR MATERIAL TYPE B, 4" TREE REMOVAL BENCH MARK: SPIKE NAIL SET IN WEST FACE OF PP WITH LIGHT AT NE CORNER ASHLAND AVENUE AND 174TH STREET. ELEVATION = 624.01 ILLINOIS DEPARTMENT OF TRANSPORTATION REVISIONS NAME ASHLAND AVENUE SIDEWALK IMPROVEMENT PLAN SHEET SCALE: VERT. NA HORIZ. 1"=20' DATE 07-27-07 DRAWN BY JZ CHECKED BY WPD

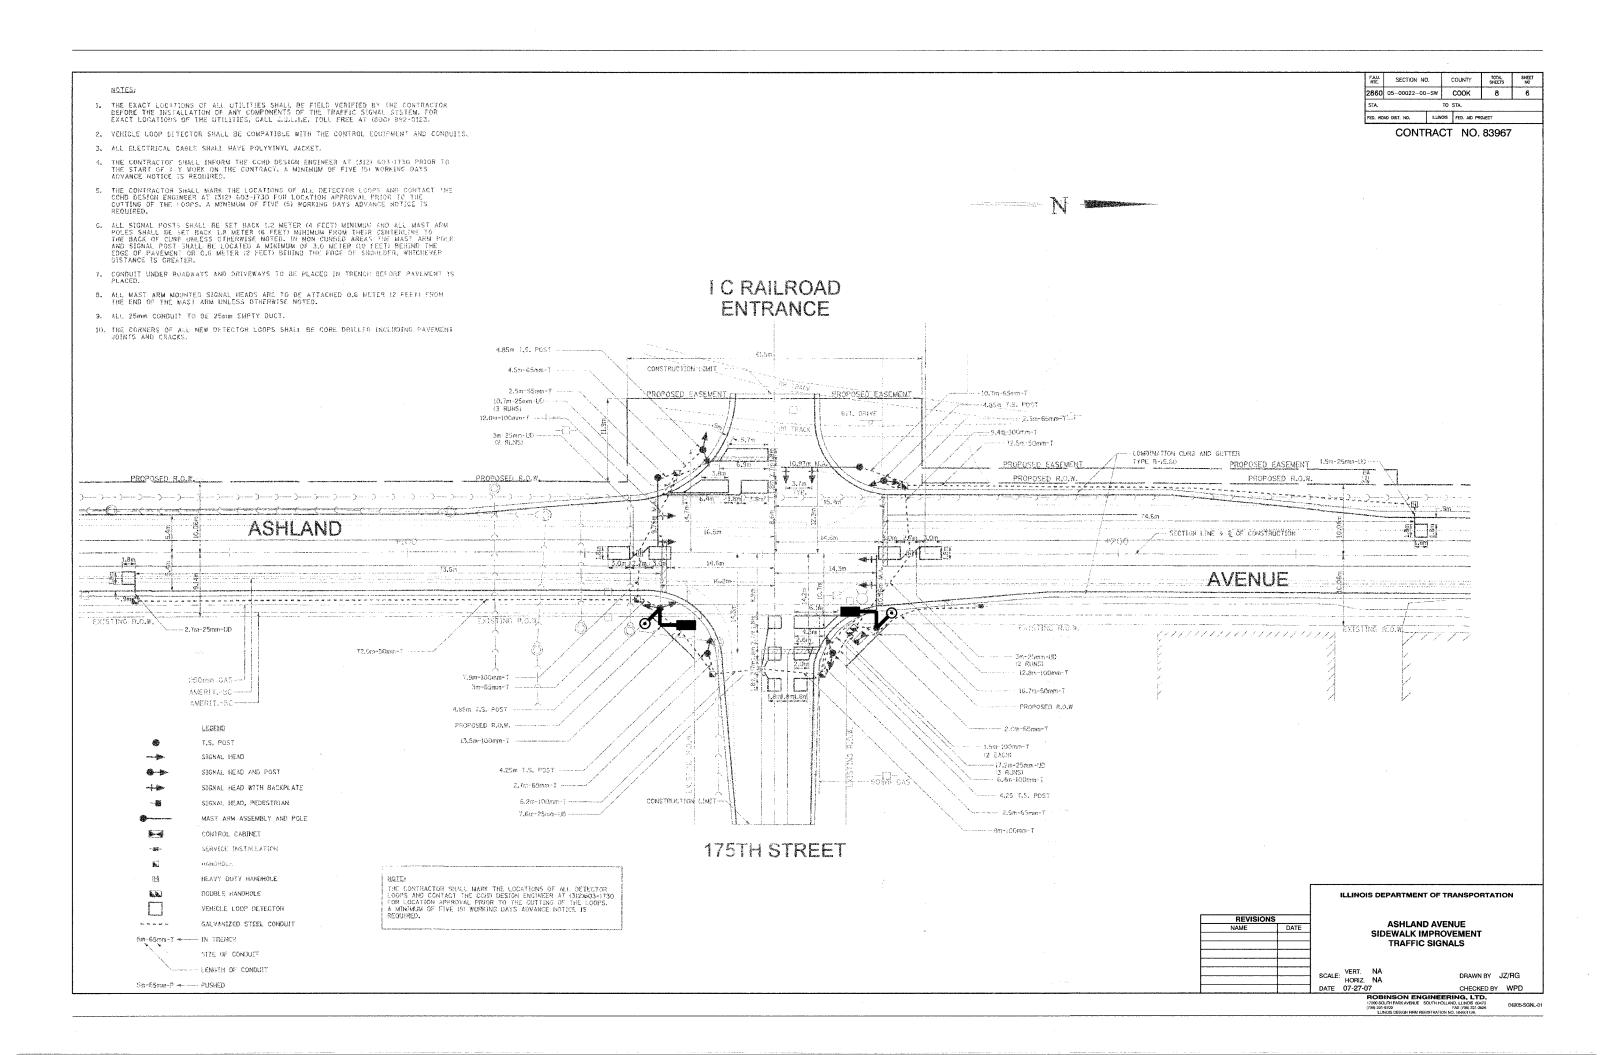


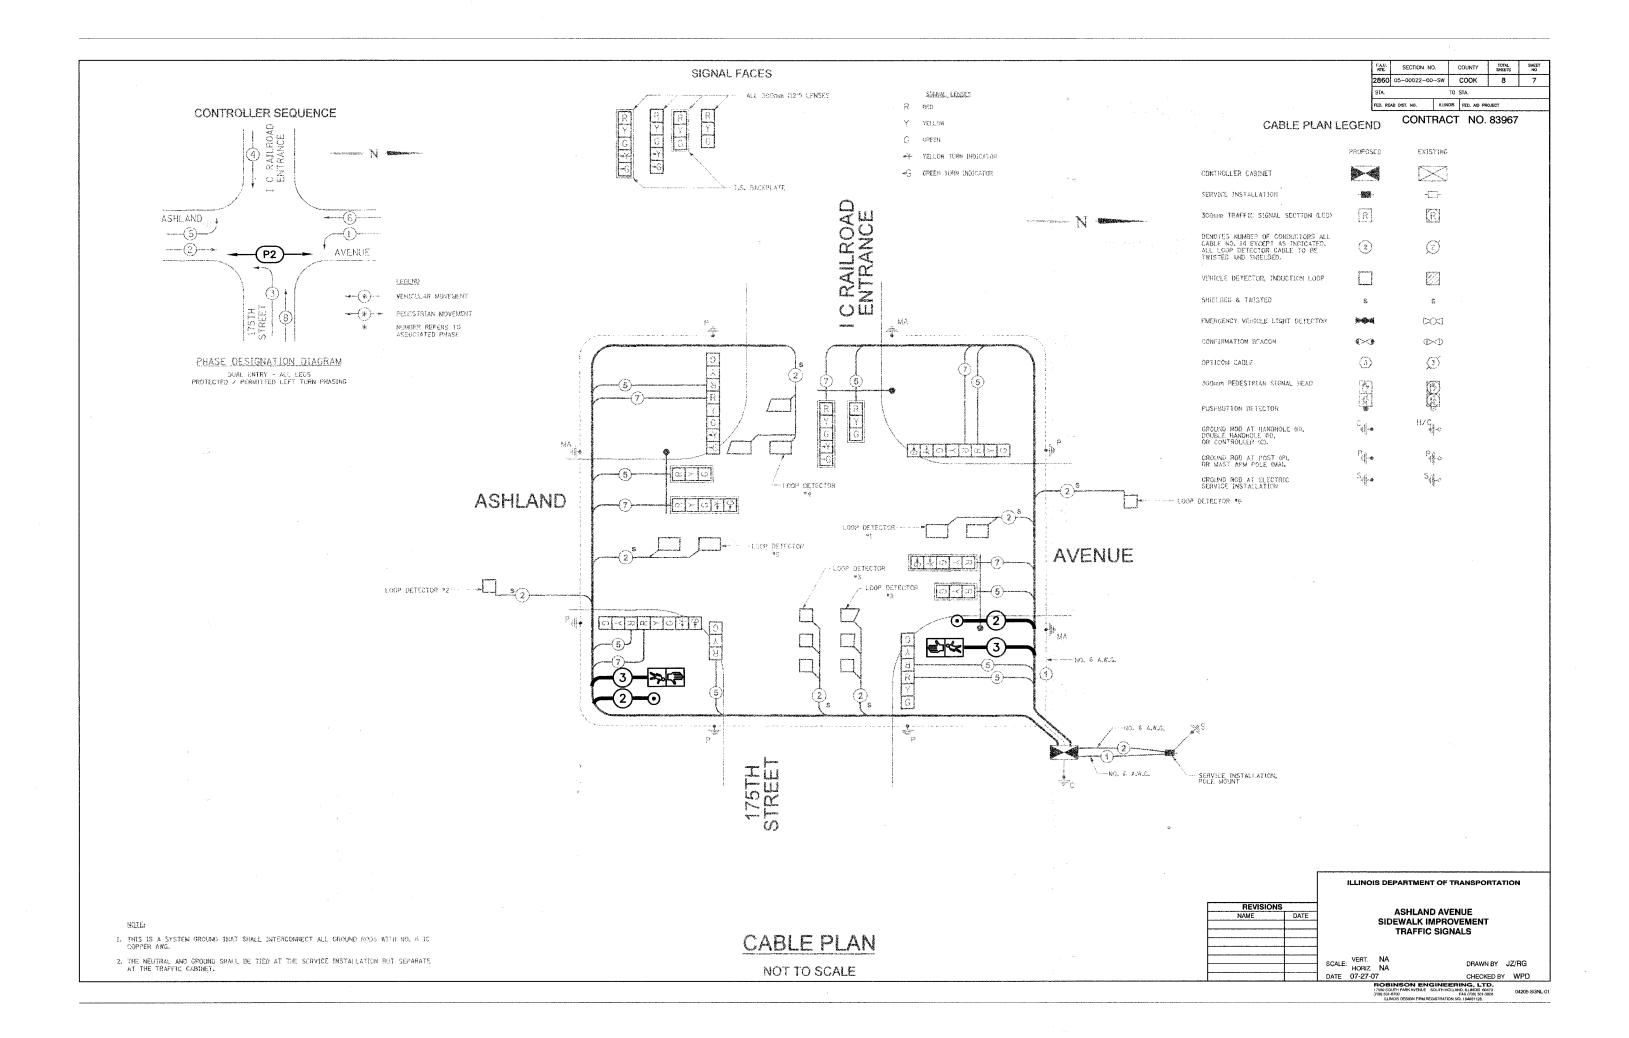

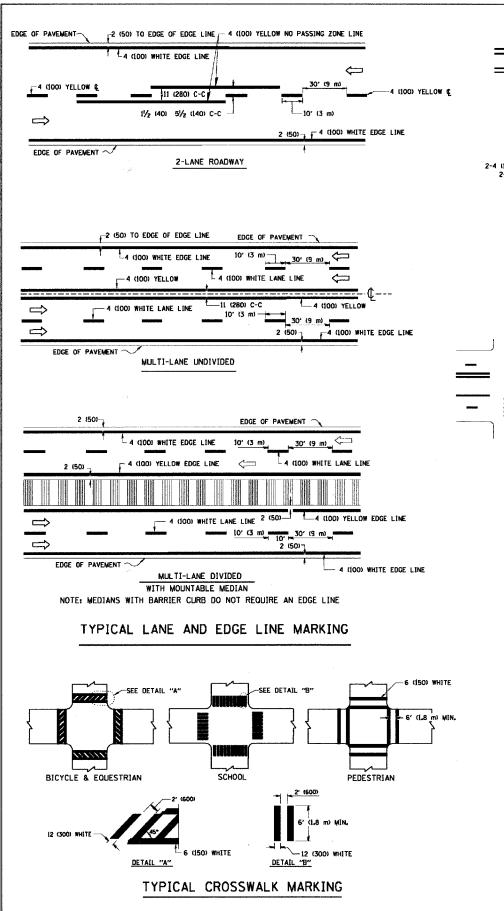

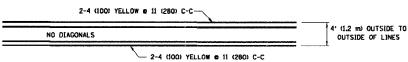


4' (1,2 m) WIDE MEDIANS ONLY

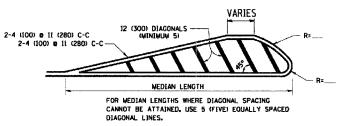

DIAGONAL LINE SPACING: 50° (15 m) C-C (LESS THAN 30MPH (50 km/h))
75° (25 m) C-C 30MPH (50 km/h) TO 45MPH (70 km/h))
150° (45 m) C-C (MORE THAN 45MPH (70 km/h))

MEDIANS OVER 4' (1.2 m) WIDE

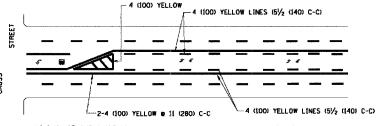


A MINIMUM OF TWO PAIRS OF TURN ARROWS SHALL BE USED, WHITE IN COLOR. ADDITIONAL PAIRS SHALL BE PLACED AT 200' (60 m) TO 300' (90 m) INTERVALS.



MEDIAN WITH TWO-WAY LEFT TURN LANE

TYPICAL PAINTED MEDIAN MARKING

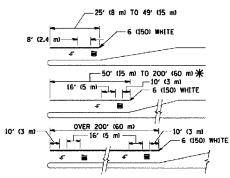


FULL SIZE LETTERS 8' (2.4 m) AND ARROWS SHALL BE USED.

\$\frac{1}{2}\text{AREA} = 15.6 SO. FT. (1.5 m²) \text{MLY AREA} = 20.8 SO. FT. (1.9 m²)

* TURN LANES IN EXCESS OF 400° (120 m) IN LENGTH MAY HAVE AN ADDITIONAL SET OF ARROW - "ONLY" INSTALLED MIDWAY BETWEEN THE OTHER TWO SETS OF ARROW - "ONLY".

TYPICAL LEFT (OR RIGHT) TURN LANE

TYPICAL TURN LANE MARKING

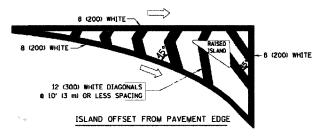

FAU. RTE.	SECTION NO.		COUNTY	TOTAL SHEETS	SHEET
2860	05-00022-00	-SW	соок	8	8
STA.	BEGIN IMPR	ov 1	O STA. 20	+00	
FED. RO	AD DIST. NO.	BLUND	S FED. AID F	PROJECT	

CONTRACT NO. 83967

8 (200) WHITE	2 (50)
8 (200) WHITE RAISED ISLAND	र्गे
	2 (50)
ISLAND AT PAVEMENT EDGE	•

TYPICAL ISLAND MARKING

TYPE OF MARKING WIDTH OF LINE		PATTERN	COLOR	SPACING / REMARKS
CENTERLINE ON 2 LANE PAVEMENT 4 (100)		SKIP-DASH	YELLOW	10' (3 m) LINE WITH 30' (9 m) SPACE
CENTERLINE ON MULTI-LANE UNDIVEDED 2 @ 4 (100)		SOLID	YELLOW	11 (280) C-C
NO PASSING ZONE LINES: FOR ONE DIRECTION FOR BOTH DIRECTIONS	4 (100) 2 to 4 (100)	SOLID SOLID	YELLOW YELLOW	5/2 (140) C-C FROM SKIP-DASH CENTERLINE 11 (280) C-C ONIT SKIP-DASH CENTERLINE BETWEEN
LANE LINES	4 (100) 5 (125) ON FREEWAYS	SKIP-DASH SKIP-DASH	WHITE WHITE	10' (3 m) LINE WITH 30' (9 m) SPACE
DOTTED LINES (EXTENSIONS OF CENTER, LANE OR TURN LANE MARKINGS)	SAME AS LINE BEING EXTENDED	SKIP-DASH	SAME AS LINE BEING EXTENDED	2' (600) LINE WITH 6' (1.8 m) SPACE
EDGE LINES	4 (100)	SOLID	YELLOW-LEFT WHITE-RIGHT	OUTLINE MOUNTABLE MEDIANS IN YELLOW: EDGE LINES ARE NOT USED NEXT TO BARRIER CURB
TURN LANE MARKINGS	6 (150) LINE, FULL SIZE LETTERS & SYMBOLS (8' (2,4m))	SOLID	WHITE	SEE TYPICAL TURN LANE MARKING DETAIL
TWO WAY LEFT TURN MARKING	2 6 4 (100) EACH DIRECTION	SKIP-DASH AND SOLID	YELLOW	10' (3 m) LINE WITH 30' (9 m) SPACE FOR SKIP-DASH: 5½ (140) C-C BETWEEN SOLID LINE AND SKIP-DASH LINE
	8' (2.4m) LEFT ARROW	IN PAIRS	WHITE	SEE TYPICAL TWO-WAY LEFT TURN MARKING DETAIL
CROSSWALK LINES (PEDESTRIAN) A. DIAGONALS (BIKE & EQUESTRIAN) B. LONGITUDINAL BARS (SCHOOL)	2 e 6 (150) 12 (300) e 45° 12 (300) e 90°	SOLID SOLID SOLID	WHITE WHITE WHITE	NOT LESS THAN 6' (L.8 m) APART 2' (500) APART 2' (500) APART SEE TYPICAL CROSSWALK MARKING DETAILS.
STOP LINES	24 (600)	SOLID	WHITE	PLACE 4" (1.2 m) IN ADVANCE OF AND PARALLEL TO (COSSMALK, IF PRESENT. OTHERNISE, PLACE AT DESIRED STOPPING POINT. PARALLEL TO CROSSROAD CENTERLINE, WHERE POSSIBLE
PAINTED MEDIANS	2 @ 4 (100) WITH 12 (300) DIAGONALS @ 45° NO DIAGONALS USED FOR 4' (1.2 m) WIDE MEDIANS	SOLID	YELLOW: TWO WAY TRAFFIC WHITE: ONE WAY TRAFFIC	II (280) C-C FOR THE DOUBLE LINE SEE TYPICAL PAINTED MEDIAN MARKING.
GORE MARKING AND CHANNELIZING LINES			WHITE	DIAGONALS: 15' (4.5 m) C-C (LESS THAN 30MPH (50 km/h)) 20' (6 m) C-C 30MPH (50 km/h) TO 45MPH (70 km/h)) 30' (9 m) C-C (OYER 45MPH (70 km/h))
RAJLROAD CROSSING 24 (600) TRANSVERSE LINES; "RR" IS 6' (1,8 m LETTERS; 16 (400) LINE FOR "X"		SOLID	WHITE	SEE STATE STANDARD 780001 AREA OF: "R"-3.6 SO. FT. (0.33 m²) EACH "X"-54.0 SO. FT. (5.0 m²)
SHOULDER DIAGONALS 12 (300) & 45°		SOLID	WHITE - RIGHT	50' (15 m) C-C (LESS THAN 30MPH (50 km/h)) 75' (25 m) C-C (30 MPH (50 km/h) TO 45MPH (70 km/h) 150' (45 m) C-C (0YER 45MPH (70 km/h))

FOR FURTHER DETAILS ON PAVEMENT MARKING REFER TO STANDARD SPECIFICATIONS FOR ROAD AND BRIDGE CONSTRUCTION AND STATE STANDARD 780001.

All dimensions are in inches (millimeters) unless otherwise shown,

REVISIO	N\$	TILINOIS DEBART	MENT OF TRANSPORTATION
NAME	DATE	ILLINOIS DELANI	MEN OF THANSPORTATION
EVERS	03-19-90		The state of the s
T. RAMMACHER	10-27-94	TZIG	RICT ONE
ALEX HOUSEH	10-09-96		
ALEX HOUSEH	10-17-96	TYPICA	L PAVEMENT
T. RAMMACHER	01-06-00	NA.	ARKINGS
		1917	ARKINGS
		SCALE: NONE	DRAWN BY CADD
			CHECKED BY

TC-13