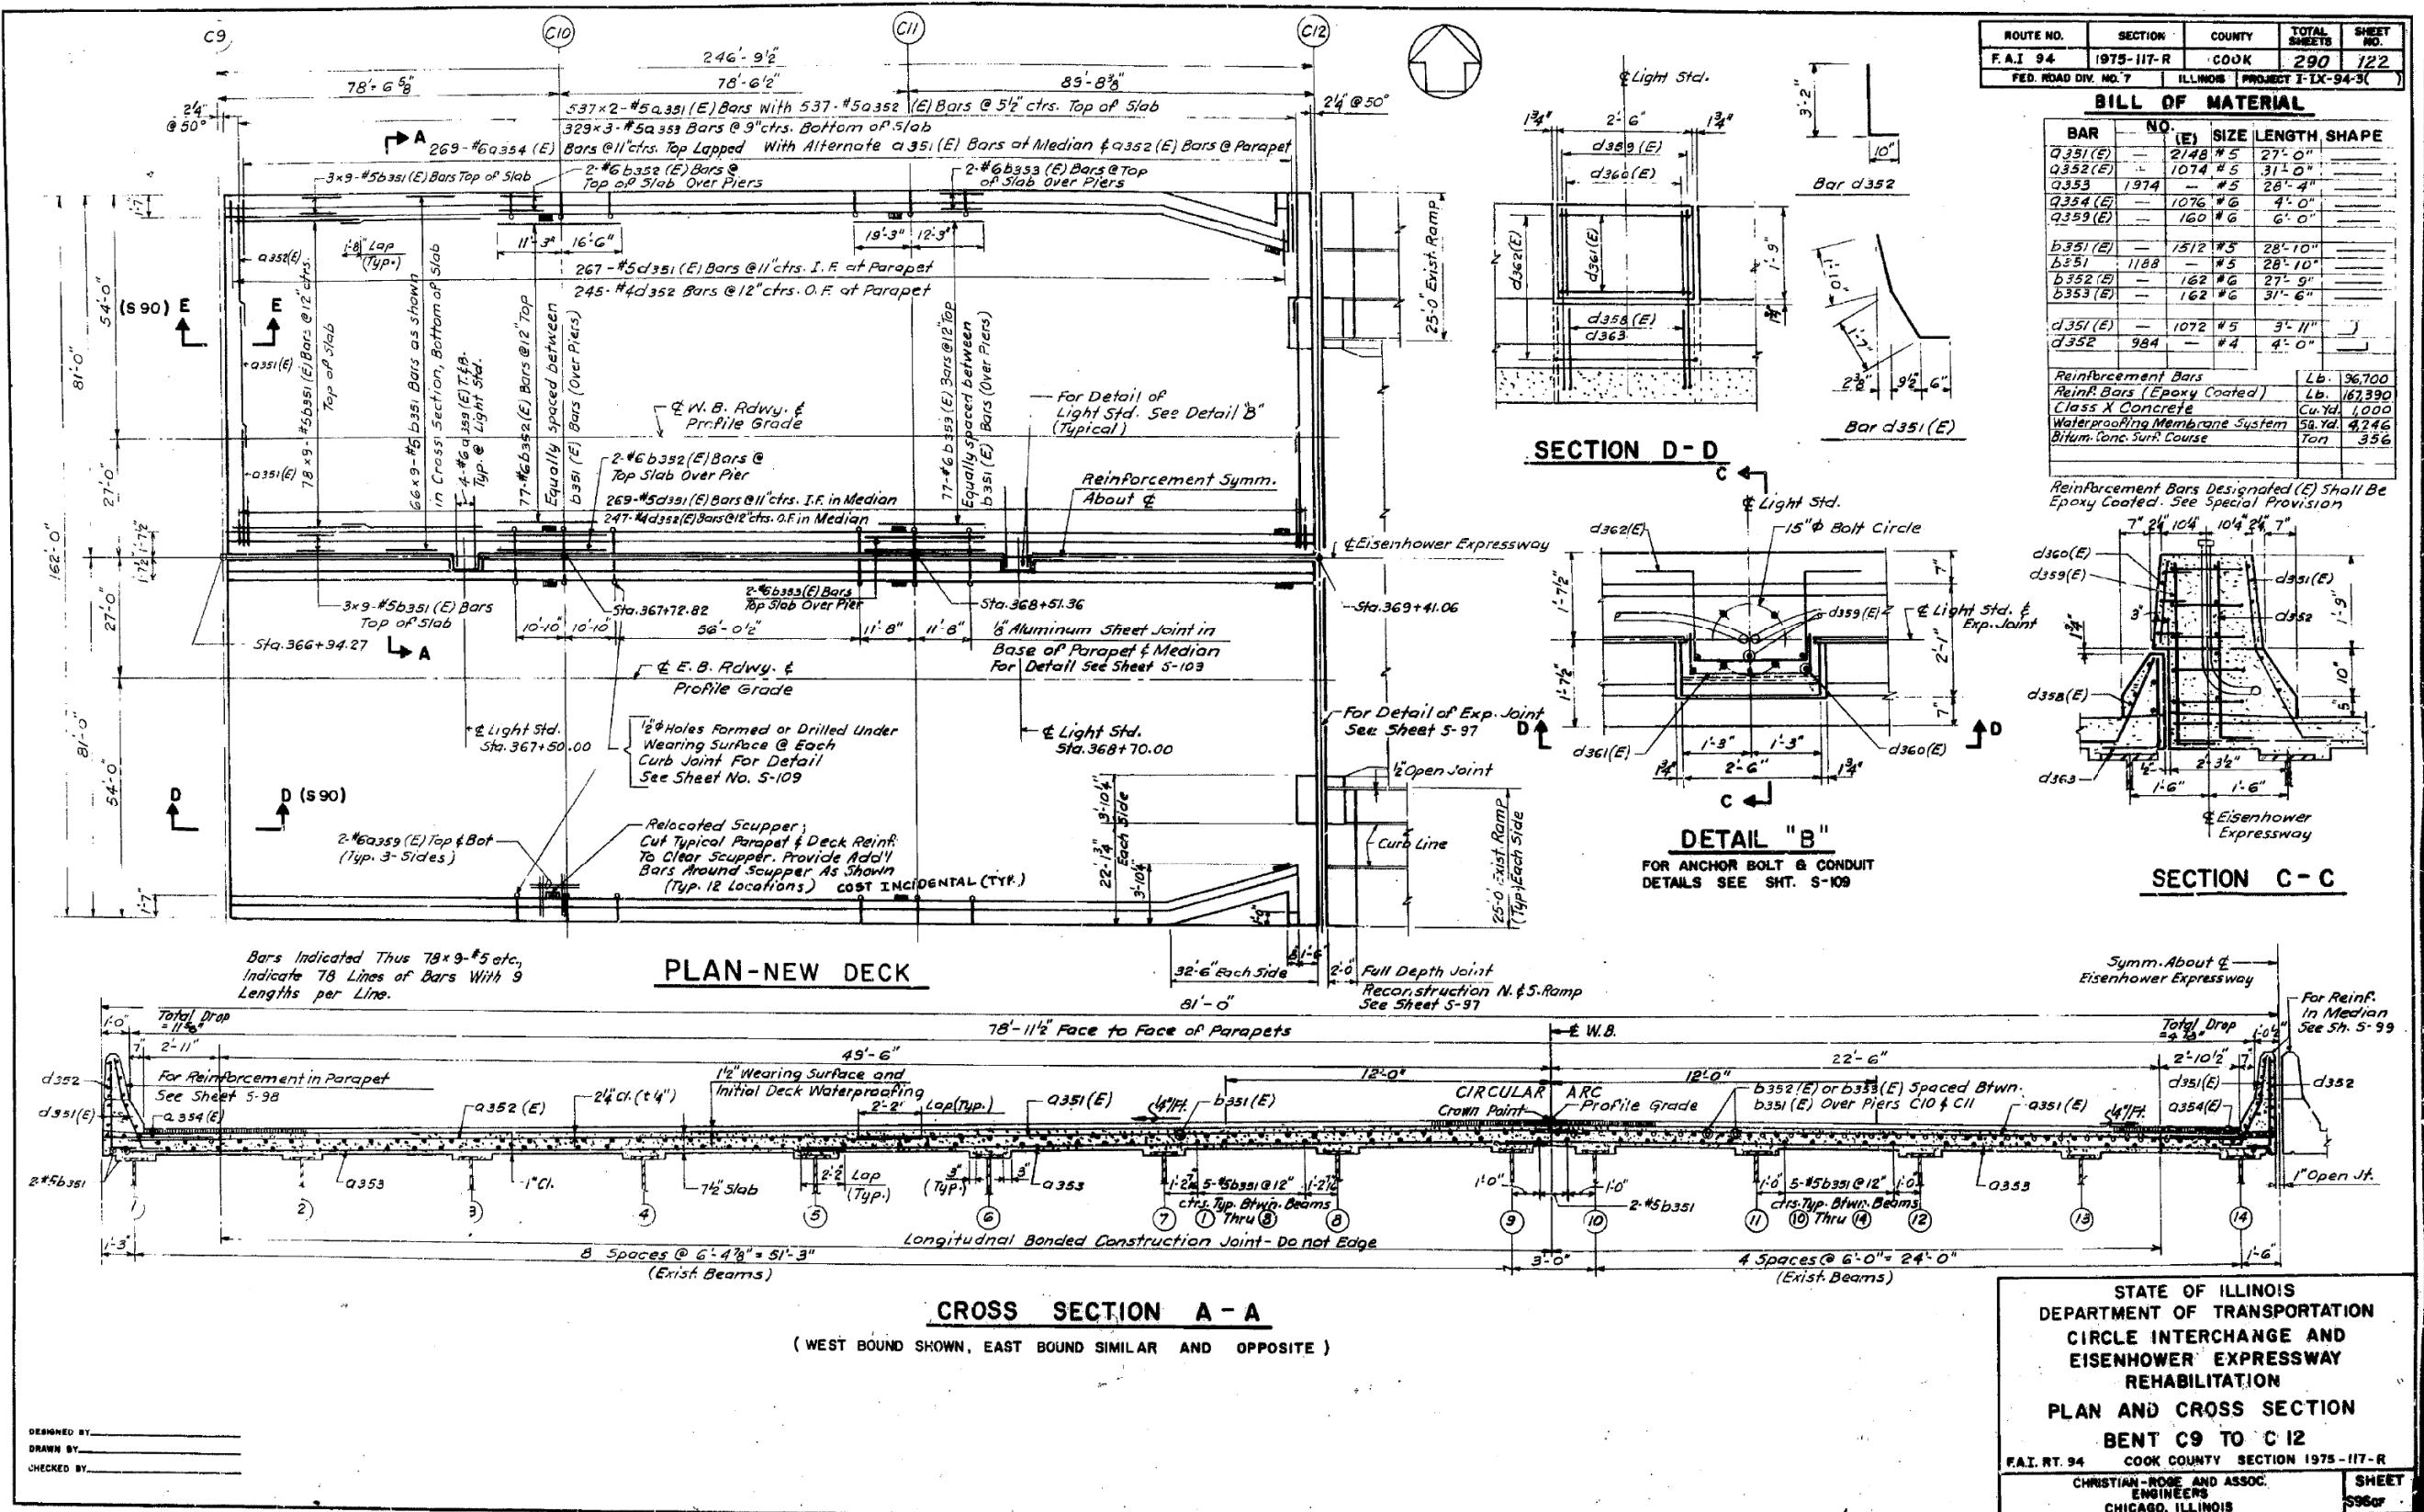
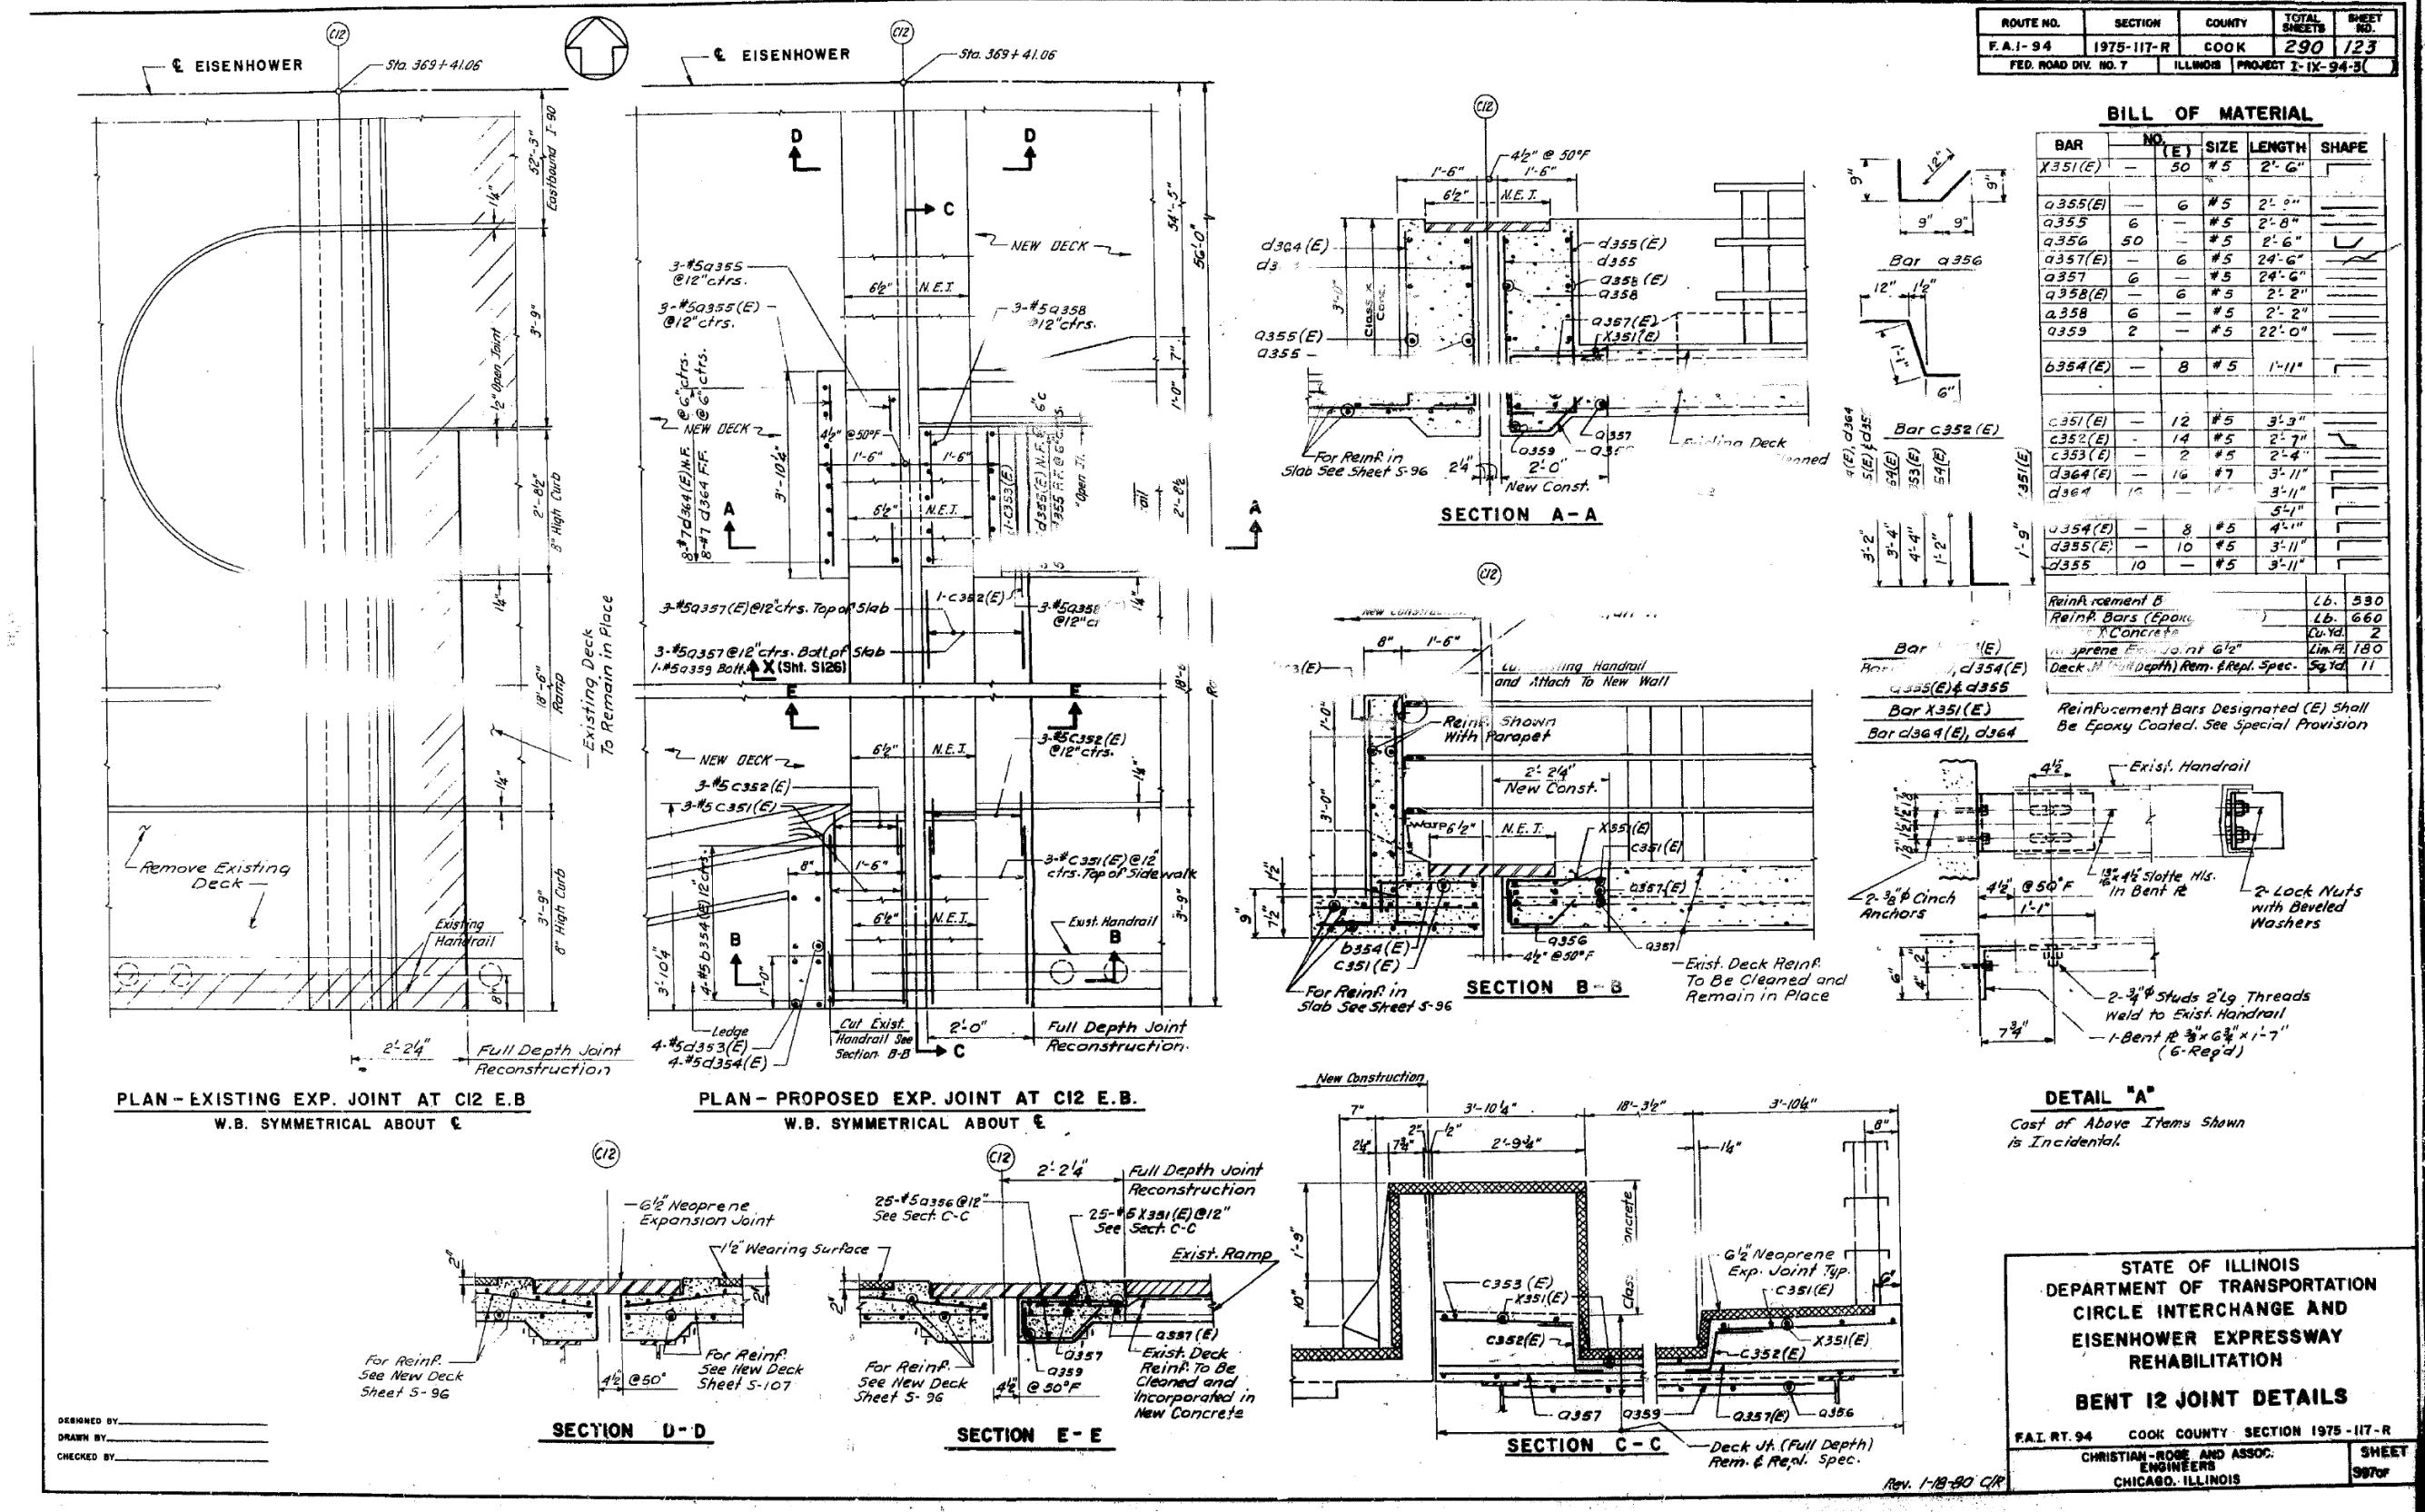



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Elevations given here									
New Wearing Surface									
New Concrete									
FILLET HEIGHTS									
To determine "t" as shown in DETAIL A: After all existing concrete superstructure has been demolished and removed from each span, elevations of the top flanges of the beams shall be determined. The difference between these elevations subtracted from the "Theoretical Grade Elevation Adjusted for Dead Load Deflection" shown in tables minus slab thickness, equals the fillet heights "t" above the top flange of beams.									
DETAILED INFORMATION									
ROUTE NO. SECTION COUNTY FED. AID NO.									
F.A.I. RT. 94 1975-117-R COOK 280 126									
FED. HIGHW. NO. 7 ILLINOIS PROJECT I-IX - 94-54									
DETAIL A									
<p>NOTE: All elevations in the tables are given at the top of the concrete deck as shown in DETAIL A.</p>									
<p>PLAN</p>									
<p>DESIGNED BY _____ DRAWN BY _____ CHECKED BY _____</p>									
<p>STATE OF ILLINOIS DEPARTMENT OF TRANSPORTATION CIRCLE INTERCHANGE AND EISENHOWER EXPRESSWAY REHABILITATION ELEVATIONS I-90 W.R. BENT C9 TO BENT C12</p>									
<p>F.A.I. RT. 94 COOK COUNTY SECTION 1975-117 CHRISTIANSEN & ASSOC. CHICAGO, ILLINOIS</p>									

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FILE NAME: dwg:1617479-PWINT_aecomonline.local:AECON\Documents\01 Americas\Transportation\60269938_CirclePhase II\000 CAD008 Structural Structure 016-1718\Existing Plans\33906-60935-XXX-Existing418

ROUTE NO. 1875-117-R SECTION COOK TOTAL SHEETS 290 SHEET NO. 127																							
F.A.I. RT. 94		ILLINOIS PROJECT I-IX-94-3(1)		FED. ROAD DIV. NO. 7		COUNTY		TOTAL SHEETS															
E	BRG PIER C9	36695.098	-39.937	32.442	32.442	E	BRG PIER C9	36695.098	-33.531	32.576	32.576	E	BRG PIER C9	36695.098	-27.125	32.709	32.709	E	BRG PIER C9	36695.098	-20.718	32.842	32.842
A		36705.098	-39.937	32.407	32.407	A	36705.098	-33.531	32.541	32.541	A	36705.098	-27.125	32.674	32.706	A	36705.098	-20.718	32.807	32.839			
B		36715.098	-39.937	32.372	32.372	B	36715.098	-33.531	32.506	32.506	B	36715.098	-27.125	32.639	32.702	B	36715.098	-20.718	32.772	32.835			
C		36725.098	-39.937	32.337	32.337	C	36725.098	-33.531	32.471	32.452	C	36725.098	-27.125	32.604	32.675	C	36725.098	-20.718	32.737	32.808			
D		36735.098	-39.937	32.302	32.302	D	36735.098	-33.531	32.436	32.512	D	36735.098	-27.125	32.569	32.645	D	36735.098	-20.718	32.702	32.778			
E		36745.098	-39.937	32.267	32.267	E	36745.098	-33.531	32.401	32.461	E	36745.098	-27.125	32.534	32.596	E	36745.098	-20.718	32.667	32.727			
F		36755.098	-39.937	32.232	32.232	F	36755.098	-33.531	32.366	32.408	F	36755.098	-27.125	32.499	32.542	F	36755.098	-20.718	32.632	32.675			
G		36765.098	-39.937	32.197	32.215	G	36765.098	-33.531	32.330	32.349	G	36765.098	-27.125	32.463	32.462	G	36765.098	-20.718	32.597	32.615			
E	PIER C10	36772.815	-39.937	32.169	32.169	E	PIER C10	36772.815	-33.531	32.307	32.302	E	PIER C10	36772.815	-27.125	32.436	32.436	E	PIER C10	36772.815	-20.718	32.569	32.569
H		36782.815	-39.937	32.133	32.131	H	36782.815	-33.531	32.266	32.264	H	36782.815	-27.125	32.400	32.397	H	36782.815	-20.718	32.533	32.530			
J		36792.815	-39.937	32.097	32.092	J	36792.815	-33.531	32.230	32.225	J	36792.815	-27.125	32.363	32.358	J	36792.815	-20.718	32.497	32.491			
K		36802.815	-39.937	32.060	32.052	K	36802.815	-33.531	32.194	32.186	K	36802.815	-27.125	32.327	32.319	K	36802.815	-20.718	32.460	32.452			
L		36812.815	-39.937	32.023	32.013	L	36812.815	-33.531	32.157	32.146	L	36812.815	-27.125	32.290	32.279	L	36812.815	-20.718	32.423	32.412			
M		36822.815	-39.937	31.986	31.973	M	36822.815	-33.531	32.119	32.106	M	36822.815	-27.125	32.253	32.239	M	36822.815	-20.718	32.386	32.373			
N		36832.815	-39.937	31.948	31.934	N	36832.815	-33.531	32.082	32.067	N	36832.815	-27.125	32.215	32.200	N	36832.815	-20.718	32.348	32.339			
O		36842.815	-39.937	31.911	31.904	O	36842.815	-33.531	32.044	32.037	O	36842.815	-27.125	32.177	32.170	O	36842.815	-20.718	32.310	32.304			
E	PIER C11	36851.355	-39.937	31.878	31.878	E	PIER C11	36851.355	-33.531	32.011	32.011	E	PIER C11	36851.355	-27.125	32.144	32.144	E	PIER C11	36851.355	-20.718	32.278	32.278
P		36861.355	-39.937	31.840	31.865	P	36861.355	-33.531	31.973	31.999	P	36861.355	-27.125	32.106	32.132	P	36861.355	-20.718	32.239	32.265			
Q		36871.355	-39.937	31.801	31.852	Q	36871.355	-33.531	31.934	31.986	Q	36871.355	-27.125	32.067	32.119	Q	36871.355	-20.718	32.200	32.252			
R		36881.355	-39.937	31.762	31.834	R	36881.355	-33.531	31.895	31.967	R	36881.355	-27.125	32.028	32.100	R	36881.355	-20.718	32.161	32.238			
S		36891.355	-39.937	31.722	31.813	S	36891.355	-33.531	31.855	31.946	S	36891.355	-27.125	31.989	32.079	S	36891.355	-20.718	32.122	32.123			
T		36901.355	-39.937	31.682	31.776	T	36901.355	-33.531	31.816	31.909	T	36901.355	-27.125	31.949	32.043	T	36901.355	-20.718	32.082	32.176			
U		36911.355	-39.937	31.642	31.727	U	36911.355	-33.531	31.776	31.860	U	36911.355	-27.125	31.909	31.993	U	36911.355	-20.718	32.042	32.127			
V		36921.355	-39.937	31.602	31.668	V	36921.355	-33.531	31.735	31.802	V	36921.355	-27.125	31.869	31.935	V	36921.355	-20.718	32.002	32.068			
W		36931.355	-39.937	31.561	31.593	W	36931.355	-33.531	31.685	31.726	W	36931.355	-27.125	31.828	31.859	W	36931.355	-20.718	31.961	31.992			
E	BRG PIER C12	36940.222	-39.937	31.525	31.525	E	BRG PIER C12	36940.222	-33.531	31.658	31.658	E	BRG PIER C12	36940.222	-27.125	31.792	31.792	E	BRG PIER C12	36940.222	-20.718	31.925	31.925

	LOCATION	STATION	OFFSET	THEORETICAL GRADE ELEVATION	THEO. GRADE ELEV. FOR Q DEFL.		LOCATION	STATION	OFFSET	THEORETICAL GRADE ELEVATION	THEO. GRADE ELEV. FOR Q DEFL.		LOCATION	STATION	OFFSET	THEORETICAL GRADE ELEVATION	THEO. GRADE ELEV. FOR Q DEFL.		LOCATION	STATION	OFFSET	THEORETICAL GRADE ELEVATION	THEO. GRADE ELEV. FOR Q DEFL.	
GIRDER 7	E BRG PIER C9	36695.098	-14.312	32.975	32.975		E BRG PIER C9	36695.098	-7.906	33.094	33.094	33.094		E BRG PIER C9	36695.098	-1.900	33.147	33.147		E BRG PIER C9	36695.098	-0.000	33.149	33.149
	A	36705.098	-14.312	32.970	32.973		A	36705.098	-7.906	33.099	33.099	33.099		A	36705.098	-1.900	33.112	33.114		A	36705.098	-0.000	33.114	33.114
	B	36715.098	-14.312	32.905	32.968		B	36715.098	-7.906	33.024	33.087	33.087		B	36715.098	-1.900	33.077	33.140		B	36715.098	-0.000	33.079	33.141
	C	36725.098	-14.312	32.870	32.941		C	36725.098	-7.906	32.989	33.060	33.060		C	36725.098	-1.900	33.042	33.113		C	36725.098	-0.000	33.044	33.115
	D	36735.098	-14.312	32.835	32.912		D	36735.098	-7.906	32.954	33.031	33.031		D	36735.098	-1.900	33.007	33.083		D	36735.098	-0.000	33.009	33.085
	E	36745.098	-14.312	32.800	32.861		E	36745.098	-7.906	32.919	32.979	32.979		E	36745.098	-1.900	32.972	33.032		E	36745.098	-0.000	32.973	33.034
	F	36755.098	-14.312	32.765	32.808		F	36755.098	-7.906	32.884	32.927	32.927		F	36755.098	-1.900	32.936	32.979		F	36755.098	-0.000	32.938	32.981
	G	36765.098	-14.312	32.730	32.748		G	36765.098	-7.906	32.849	32.867	32.867		G	36765.098	-1.900	32.901	32.920		G	36765.098	-0.000	32.903	32.922
	E PIER C10	36772.815	-14.312	32.702	32.702		E PIER C10	36772.815	-7.906	32.821	32.821	32.821		E PIER C10	36772.815	-1.900	32.873	32.873		E PIER C10	36772.815	-0.000	32.875	32.875
	H	36782.815	-14.312	32.666	32.664		H	36782.815	-7.906	32.785	32.782	32.782		H	36782.815	-1.900	32.837	32.835		H	36782.815	-0.000	32.839	32.837
GIRDERS	J	36792.815	-14.312	32.630	32.625		J	36792.815	-7.906	32.749	32.743	32.743		J	36792.815	-1.900	32.801	32.796		J	36792.815	-0.000	32.803	32.798
	K	36802.815	-14.312	32.593	32.585		K	36802.815	-7.906	32.712	32.704	32.704		K	36802.815	-1.900	32.764	32.756		K	36802.815	-0.000	32.766	32.757
	L	36812.815	-14.312	32.556	32.546		L	36812.815	-7.906	32.675	32.665	32.665		L	36812.815	-1.900	32.727	32.717		L	36812.815	-0.000	32.729	32.719
	M	36822.815	-14.312	32.519	32.506		M	36822.815	-7.906	32.638	32.625	32.625		M	36822.815	-1.900	32.690	32.677		M	36822.815	-0.000	32.692	32.679
	N	36832.815	-14.312	32.481	32.467		N	36832.815	-7.906	32.600	32.586	32.586		N	36832.815	-1.900	32.653	32.638		N	36832.815	-0.000	32.655	32.640
	O	36842.815	-14.312	32.444	32.427		O	36842.815	-7.906	32.562	32.556	32.556		O	36842.815	-1.900	32.619	32.608		O	36842.815	-0.000	32.621	32.610
	E PIER C11	36851.359	-14.312	32.411	32.411		E PIER C11	36851.359	-7.906	32.530	32.530	32.530		E PIER C11	36851.359	-1.900	32.582	32.582		E PIER C11	36851.359	-0.000	32.584	32.584
	P	36861.359	-14.312	32.373	32.398		P	36861.359	-7.906	32.491	32.517	32.517		P	36861.359	-1.900	32.544	32.569		P	36861.359	-0.000	32.546	32.571
GIRDERS	Q	36871.359	-14.312	32.334	32.385		Q	36871.359	-7.906	32.453	32.504	32.504		Q	36871.359	-1.900	32.505	32.556		Q	36871.359	-0.000	32.507	32.558
	R	36881.359	-14.312	32.295	32.367		R	36881.359	-7.906	32.413	32.485	32.485		R	36881.359	-1.900	32.466	32.538		R	36881.359	-0.000	32.468	32.540
	S	36891.359	-14.312	32.255	32.346		S	36891.359	-7.906	32.374	32.465	32.465		S	36891.359	-1.900	32.426	32.517		S	36891.359	-0.000	32.428	32.519
	T	36901.359	-14.312	32.215	32.309		T	36901.359	-7.906	32.336	32.428	32.428		T	36901.359	-1.900	32.387	32.480		T	36901.359	-0.000	32.389	32.482
	U	36911.359	-14.312	32.175	32.260		U	36911.359	-7.906	32.294	32.379	32.379		U	36911.359	-1.900	32.347	32.431		U	36911.359	-0.000	32.348	32.433
	V	36921.359	-14.312	32.139	32.201		V	36921.359	-7.906	32.254	32.320	32.320		V	36921.359	-1.900	32.306	32.373		V	36921.359	-0.000	32.308	32.375
	W	36931.359	-14.312	32.094	32.126		W	36931.359	-7.906	32.213	32.244	32.244		W	36931.359	-1.900	32.265	32.297		W	36931.359	-0.000	32.267	32.299
	E W BRG PIER C12	36940.222	-14.312	32.058	32.058		E W BRG PIER C12	36940.222	-7.906	32.177	32.177	32.177		E W BRG PIER C12	36940.222	-1.900	32.229	32.229		E W BRG PIER C12	36940.222	-0.000	32.231	32.231

NOTE: All elevations in the tables are given at the top of the concrete deck as shown in DETAIL A. On Sht. 9-100

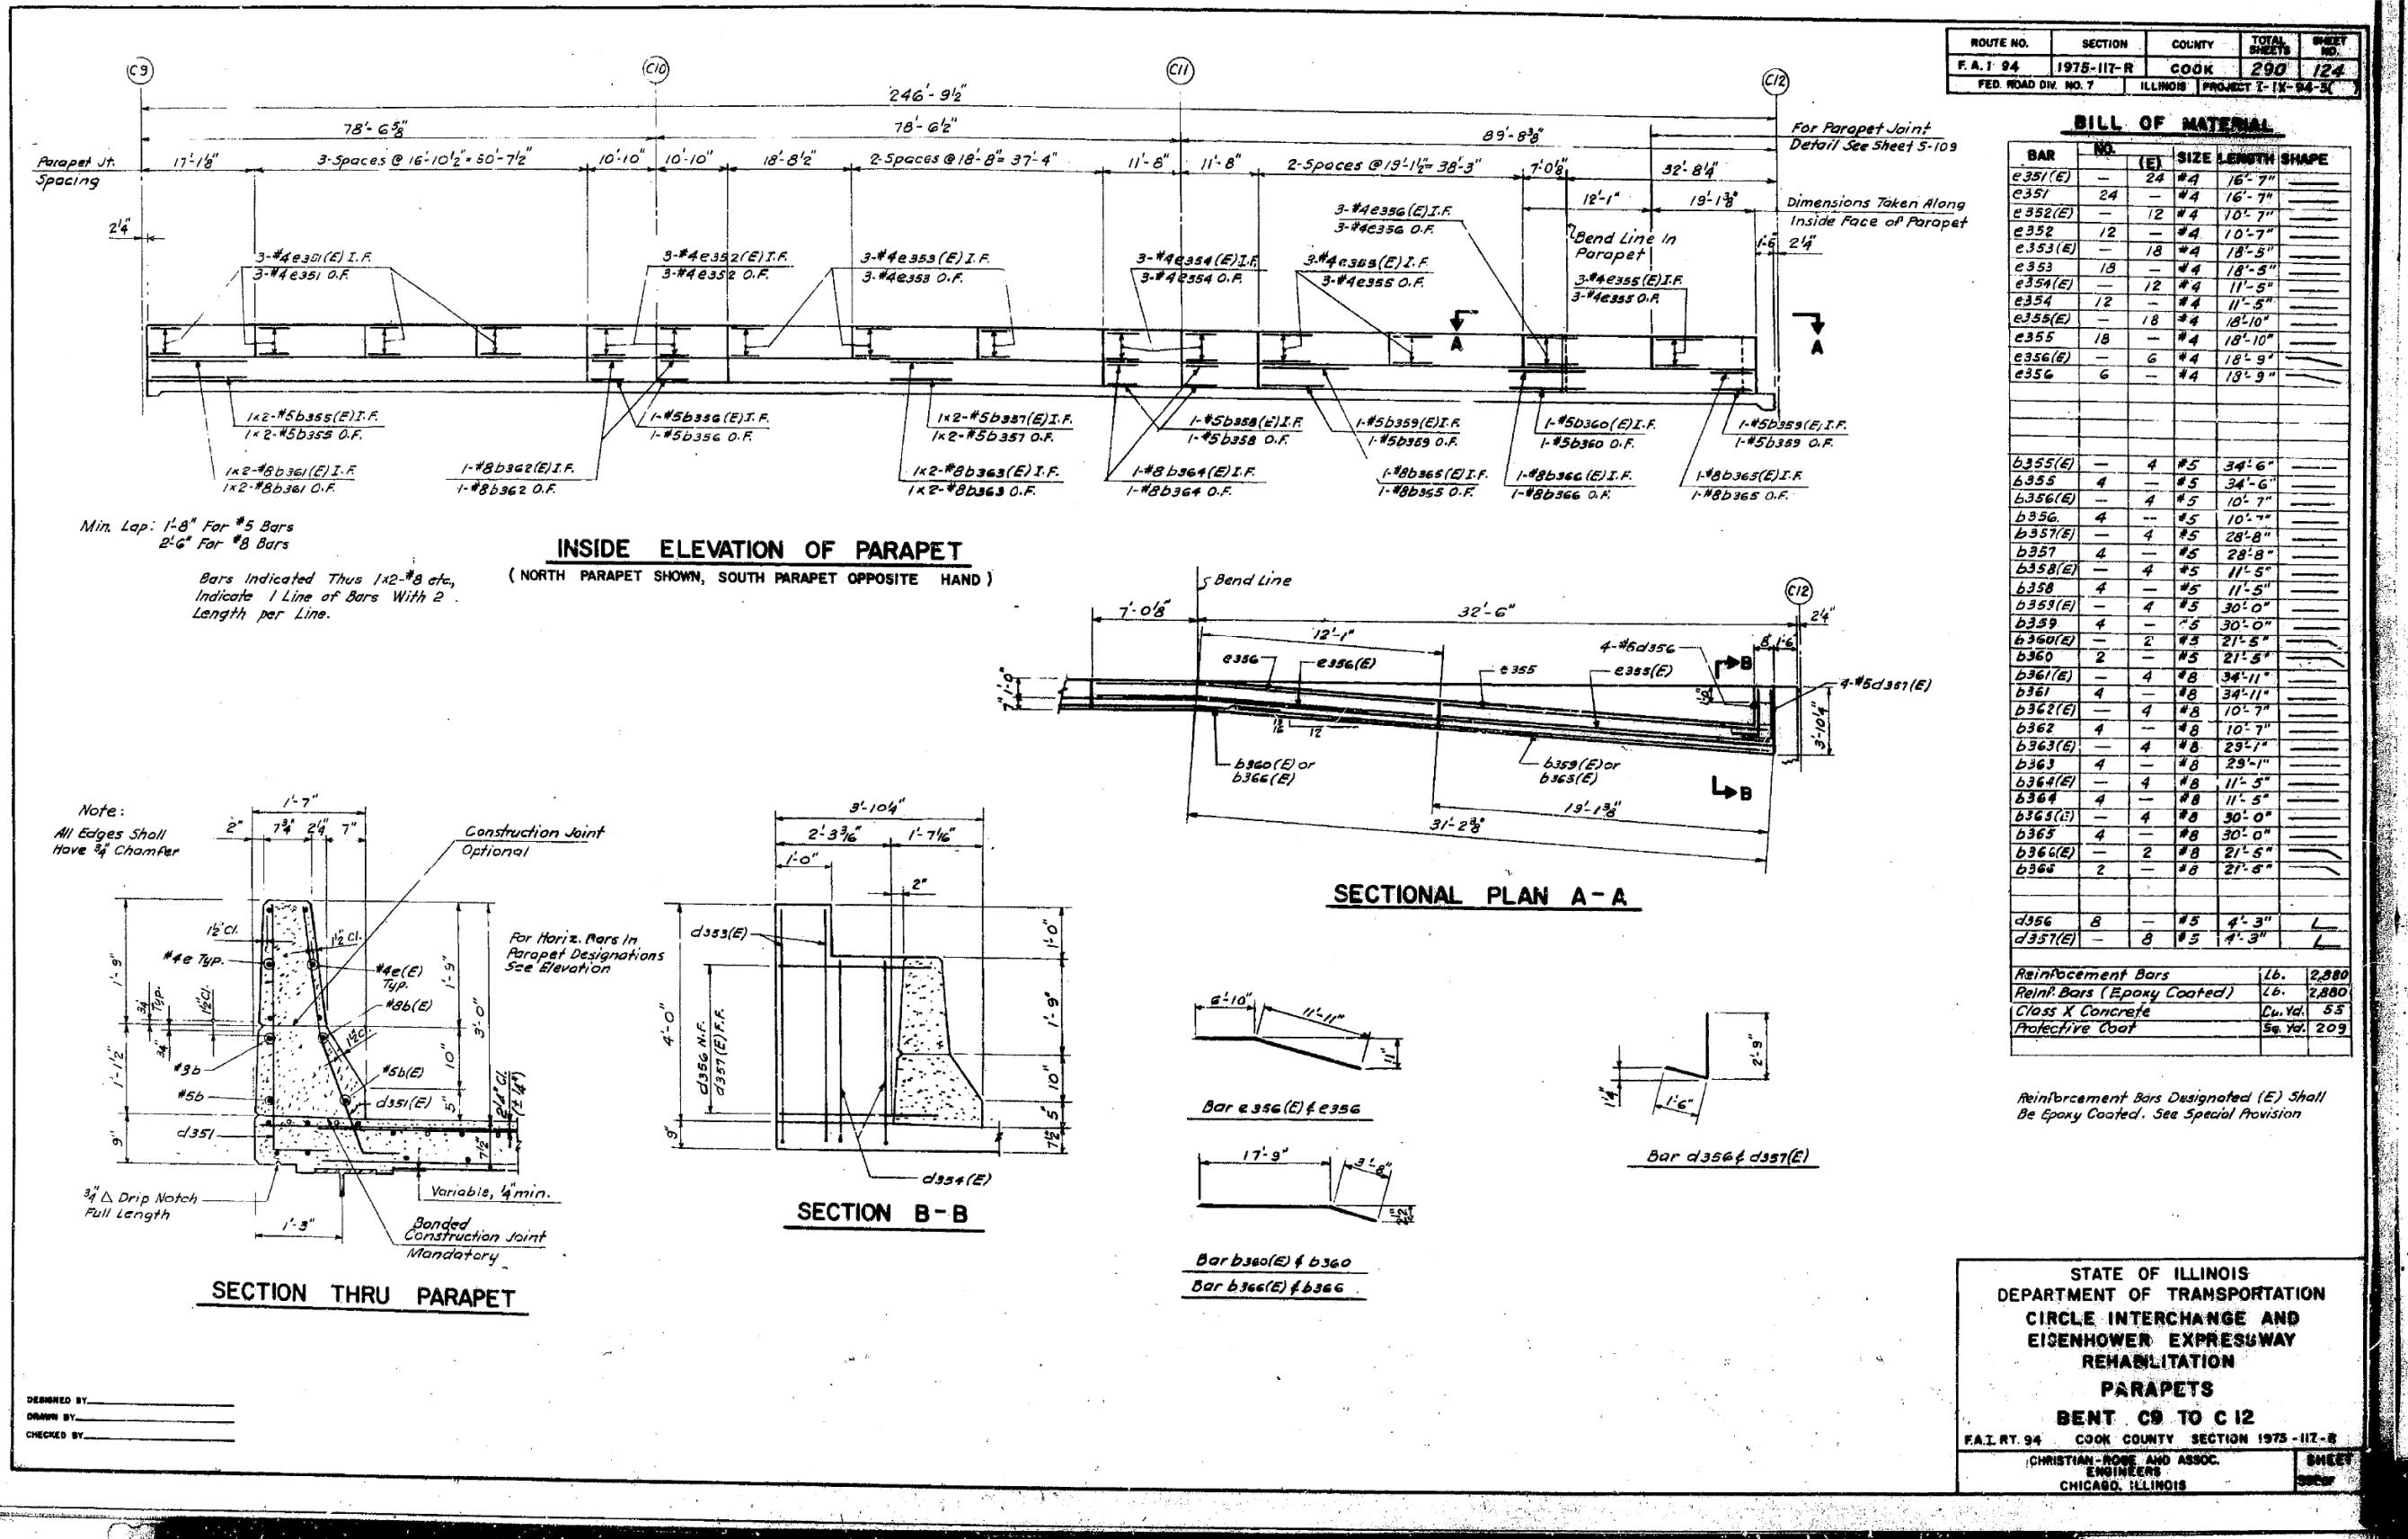DESIGNED BY _____
DRAWN BY _____


**STATE OF ILLINOIS
DEPARTMENT OF TRANSPORTATION
CIRCLE INTERCHANGE AND
EISENHOWER EXPRESSWAY
REHABILITATION
ELEVATIONS
I-90 W.B. BENT C9 TO BENT C12
A.I.RT. 84 COOK COUNTY SECTION 1078-117-B
CHRISTIAN-ROSE AND ASSOC.
ENGINEERS
CHICAGO, ILLINOIS**

				FILE NAME: DWG				FILE NAME: DWG								
 HBM ENGINEERING GROUP, LLC				USER NAME = ahmad.issa CHECKED - REVISED - PLOT SCALE = N.T.S DRAWN - REVISED - PLOT DATE = 7/26/2018 CHECKED - MI, MAI REVISED -				STATE OF ILLINOIS DEPARTMENT OF TRANSPORTATION				EXISTING RECORD DRAWINGS				
												F.A.I. RTE.	SECTION	COUNTY	TOTAL SHEETS	SEE NO.
												90/94/290	2014-013R&B-R	COOK	1972	1906
												CONTRACT NO. 60X93				
												ILLINOIS FED. AID PROJECT				

FOR INFORMATION ONLY

ROUTE NO. 290 SECTION 128																							
F.A.I. RT. 94		SECTION 1975-II7-R		COUNTY COOK		TOTAL SHEETS 128		OWNER NO.															
FED. ROAD DIV. NO. 7		ILLINOIS		PROJECT I-IX - 04-34																			
LOCATION	STATION	OFFSET	THEORETICAL GRADE ELEV.	THEO. ELEV. FOR DEF'L.	ADJ. ELEV.	LOCATION	STATION	OFFSET	THEORETICAL GRADE ELEV.	THEO. ELEV. FOR DEF'L.	ADJ. ELEV.												
E BRG PIER C9	36695.098	1.499	32.847	33.147		E BRG PIER C9	36695.098	7.499	33.100	33.100		E BRG PIER C9	36695.098	13.499	32.992	32.992		E BRG PIER C9	36695.098	19.499	32.668	32.668	
A	36705.098	1.499	33.112	33.144		A	36705.098	7.499	33.085	33.097		A	36705.098	13.499	32.957	32.989		A	36705.098	19.499	32.855	32.855	
B	36715.098	1.499	33.077	33.100		B	36715.098	7.499	33.082	33.093		B	36715.098	13.499	32.922	32.985		B	36715.098	19.499	32.798	32.860	
C	36725.098	1.499	33.082	33.113		C	36725.098	7.499	33.093	33.084		C	36725.098	13.499	32.887	32.958		C	36725.098	19.499	32.763	32.834	
D	36735.098	1.499	33.007	33.083		D	36735.098	7.499	32.960	32.985		D	36735.098	13.499	32.852	32.929		D	36735.098	19.499	32.763	32.804	
E	36745.098	1.499	32.971	33.032		E	36745.098	7.499	32.925	32.985		E	36745.098	13.499	32.817	32.878		E	36745.098	19.499	32.702	32.773	
F	36755.098	1.499	32.936	32.979		F	36755.098	7.499	32.890	32.932		F	36755.098	13.499	32.782	32.825		F	36755.098	19.499	32.657	32.700	
G	36765.098	1.499	32.901	32.920		G	36765.098	7.499	32.854	32.873		G	36765.098	13.499	32.747	32.765		G	36765.098	19.499	32.622	32.641	
E PIER C10	36772.815	1.499	32.873	32.873		E PIER C10	36772.815	7.499	32.827	32.827		E PIER C10	36772.815	13.499	32.719	32.719		E PIER C10	36772.815	19.499	32.594	32.594	
H	36782.815	1.499	32.837	32.835		H	36782.815	7.499	32.791	32.788		H	36782.815	13.499	32.683	32.680		H	36782.815	19.499	32.556	32.556	
J	36792.815	1.499	32.801	32.795		J	36792.815	7.499	32.749	32.749		J	36792.815	13.499	32.647	32.641		J	36792.815	19.499	32.522	32.517	
K	36802.815	1.499	32.745	32.745		K	36802.815	7.499	32.615	32.610		K	36802.815	13.499	32.610	32.602		K	36802.815	19.499	32.485	32.477	
L	36812.815	1.499	32.727	32.717		L	36812.815	7.499	32.681	32.670		L	36812.815	13.499	32.573	32.563		L	36812.815	19.499	32.459	32.459	
M	36822.815	1.499	32.690	32.677		M	36822.815	7.499	32.643	32.630		M	36822.815	13.499	32.536	32.523		M	36822.815	19.499	32.431	32.398	
N	36832.815	1.499	32.653	32.638		N	36832.815	7.499	32.606	32.601		N	36832.815	13.499	32.498	32.484		N	36832.815	19.499	32.374	32.359	
O	36842.815	1.499	32.615	32.608		O	36842.815	7.499	32.568	32.561		O	36842.815	13.499	32.461	32.454		O	36842.815	19.499	32.336	32.329	
E PIER C11	36851.355	1.499	32.582	32.582		E PIER C11	36851.355	7.499	32.535	32.535		E PIER C11	36851.355	13.499	32.428	32.428		E PIER C11	36851.355	19.499	32.303	32.303	
P	36861.355	1.499	32.546	32.569		P	36861.355	7.499	32.497	32.523		P	36861.355	13.499	32.389	32.415		P	36861.355	19.499	32.265	32.290	
Q	36871.355	1.499	32.508	32.556		Q	36871.355	7.499	32.455	32.510		Q	36871.355	13.499	32.351	32.402		Q	36871.355	19.499	32.226	32.277	
R	36881.355	1.499	32.468	32.538		R	36881.355	7.499	32.419	32.479		R	36881.355	13.499	32.312	32.383		R	36881.355	19.499	32.197	32.207	
S	36891.355	1.499	32.426	32.517		S	36891.355	7.499	32.379	32.470		S	36891.355	13.499	32.272	32.363		S	36891.355	19.499	32.147	32.238	
T	36901.355	1.499	32.387	32.480		T	36901.355	7.499	32.340	32.434		T	36901.355	13.499	32.232	32.326		T	36901.355	19.499	32.108	32.201	
U	36911.355	1.499	32.347	32.431		U	36911.355	7.499	32.300	32.384		U	36911.355	13.499	32.192	32.277		U	36911.355	19.499	32.067	32.192	
V	36921.355	1.499	32.308	32.373		V	36921.355	7.499	32.259	32.326		V	36921.355	13.499	32.152	32.218		V	36921.355	19.499	32.027	32.096	
W	36931.355	1.499	32.265	32.297		W	36931.355	7.499	32.219	32.250		W	36931.355	13.499	32.111	32.142		W	36931.355	19.499	31.986	32.018	
E BRG PIER C12	36940.222	1.499	32.229	32.229		E BRG PIER C12	36940.222	7.499	32.182	32.182		E BRG PIER C12	36940.222	13.499	32.075	32.075		E BRG PIER C12	36940.222	19.499	31.950	31.950	
NOTE: All elevations in the tables are given at the top of the concrete deck as shown in DETAIL A, On Sht. 5-00																							
E BRG PIER C9																							
E BRG PIER C10																							
E BRG PIER C11																							
E BRG PIER C12																							
E BRG PIER C13																							
E BRG PIER C14																							

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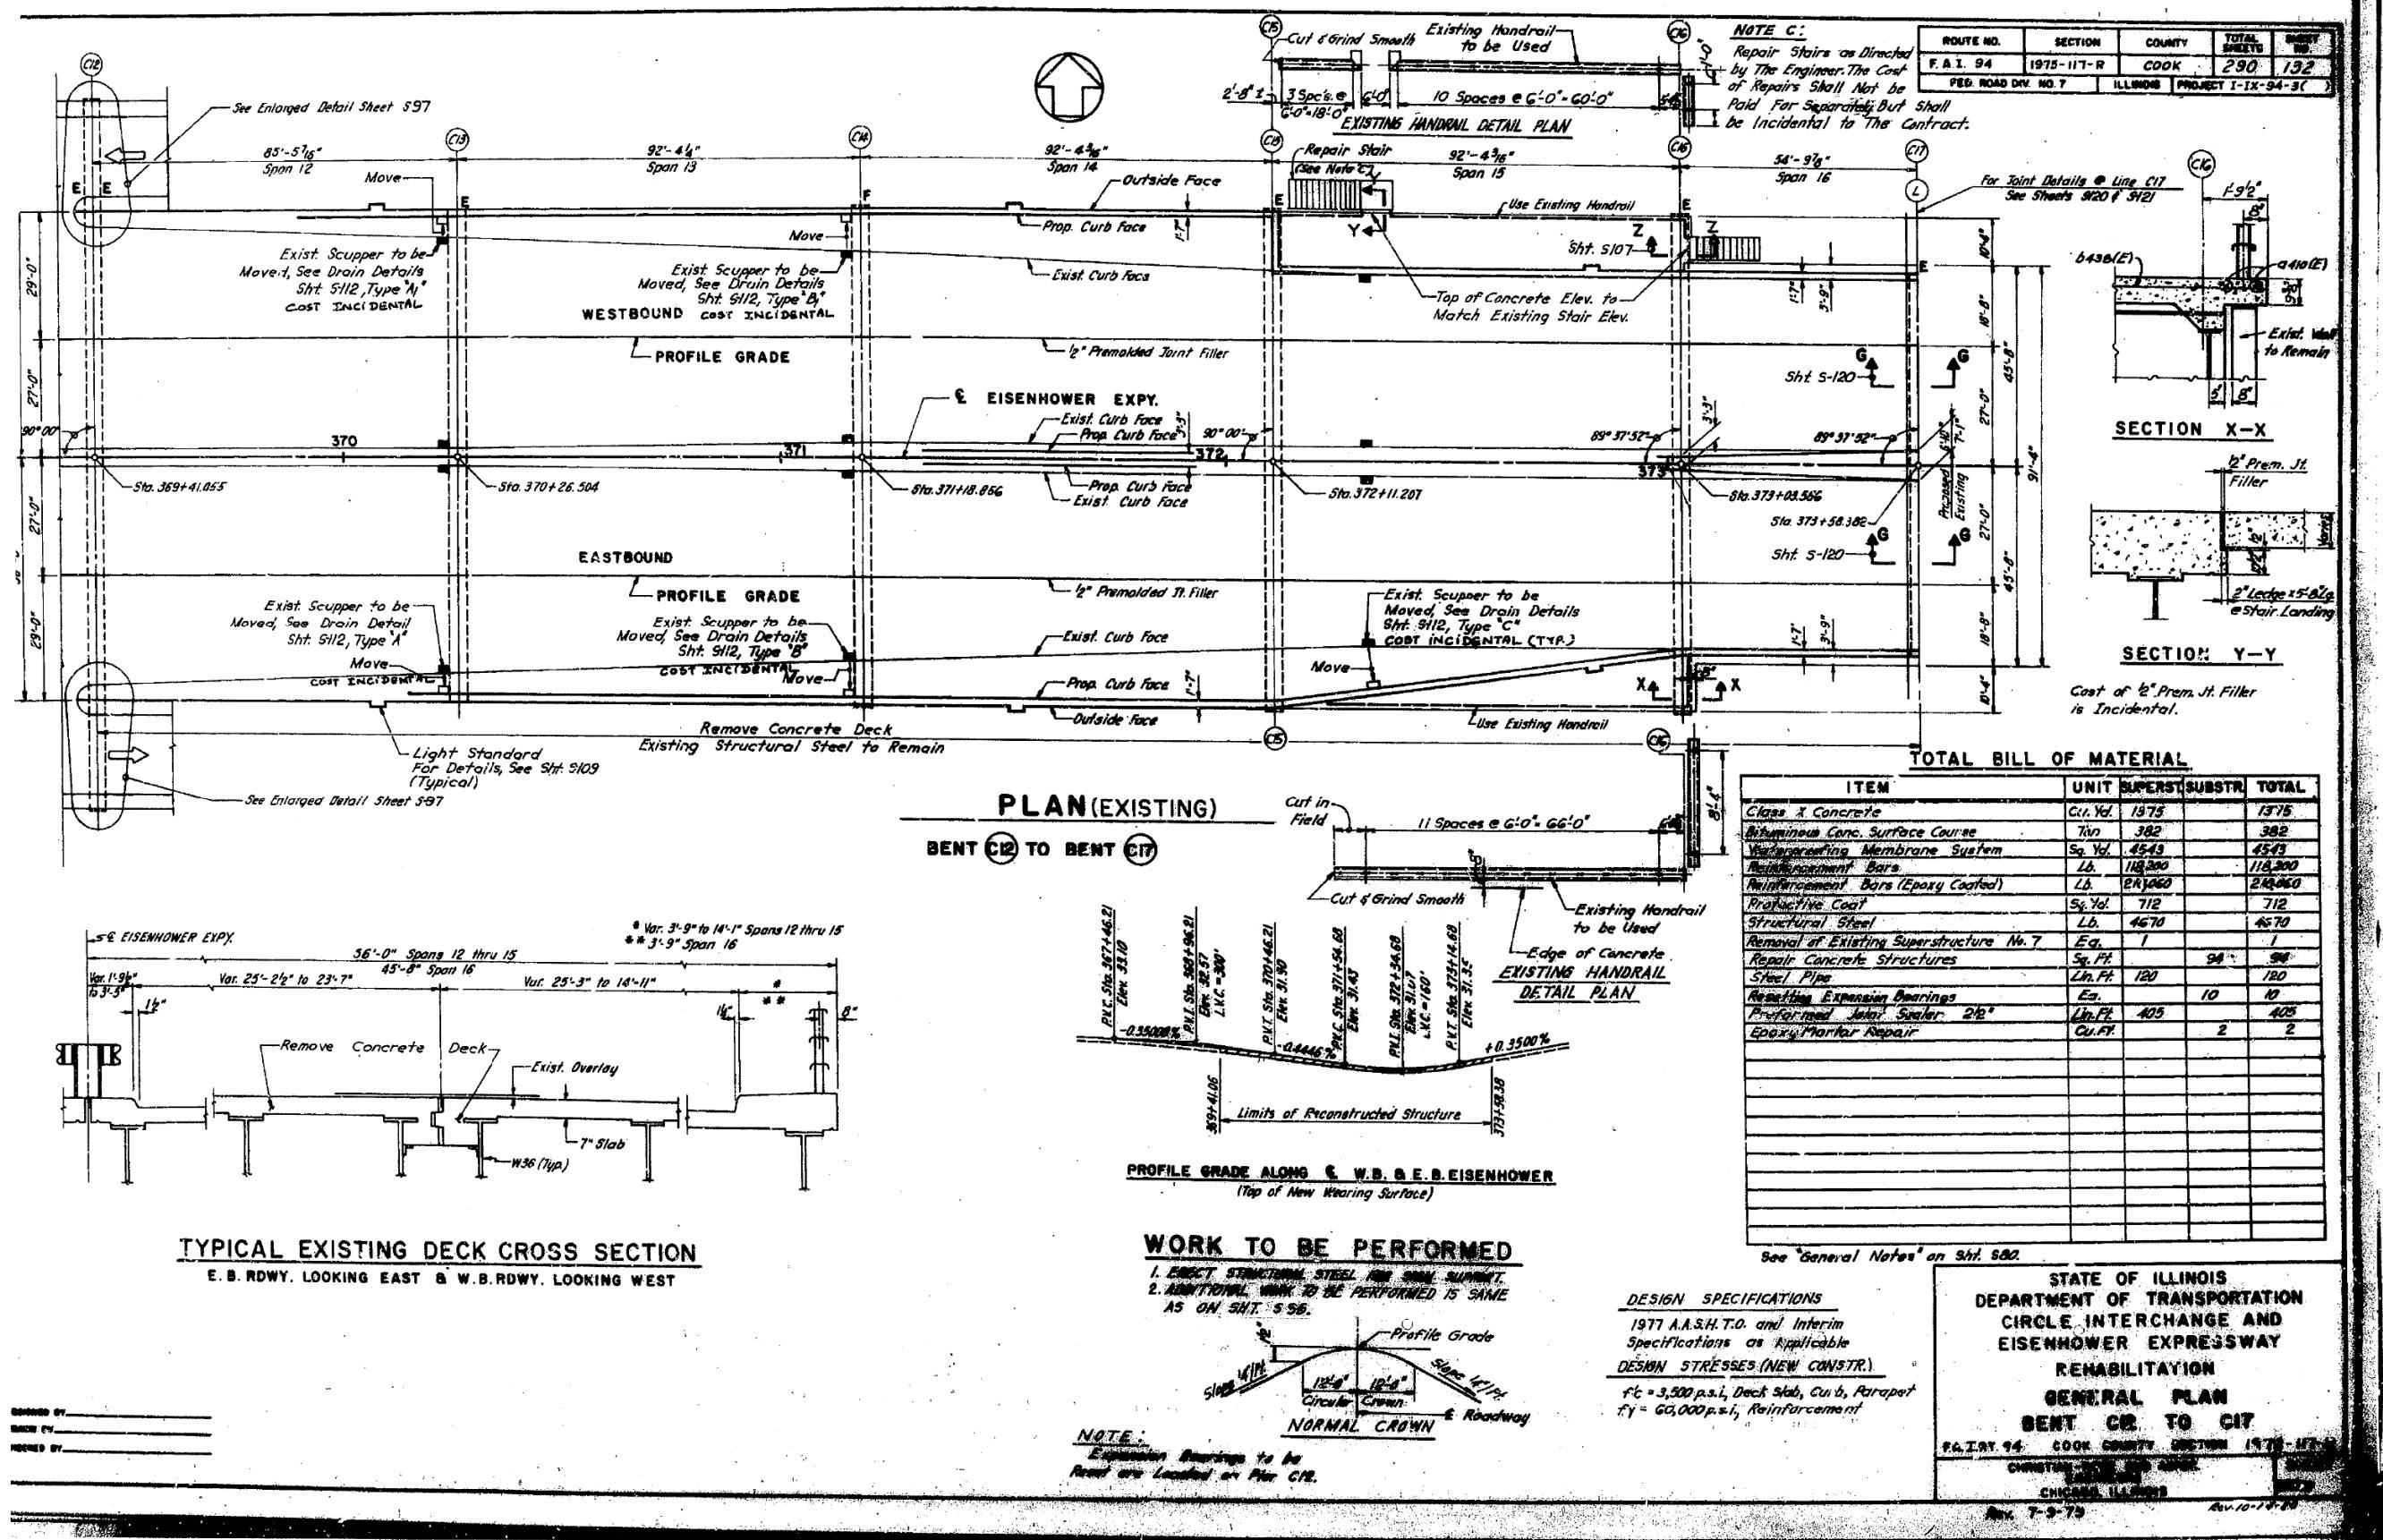
	LOCATION	STATION	OFFSET	THEORETICAL GRADE ELEVATION	THEO. ELEV. ADJ. FOR Q DEFL.		LOCATION	STATION	OFFSET	THEORETICAL GRADE ELEVATION	THEO. ELEV. ADJ. FOR Q DEFL.		LOCATION	STATION	OFFSET	THEORETICAL GRADE ELEVATION	THEO. ELEV. ADJ. FOR Q DEFL.		LOCATION	STATION	OFFSET	THEORETICAL GRADE ELEVATION	THEO. ELEV. ADJ. FOR Q DEFL.	
GIRDER 16	E BRG PIER C9	36695.098	-19.499	32.868	32.868		E BRG PIER C9	36695.098	-13.499	32.992	32.992		E BRG PIER C9	36695.098	-7.499	33.100	33.100		E BRG PIER C9	36695.098	-1.499	33.147	33.147	
	A	36705.098	-19.499	32.833	32.865		A	36705.098	-13.499	32.957	32.989		A	36705.098	-7.499	33.058	33.097		A	36705.098	-1.499	33.112	33.144	
	B	36715.098	-19.499	32.798	32.860		B	36715.098	-13.499	32.922	32.985		B	36715.098	-7.499	33.030	33.093		B	36715.098	-1.499	33.077	33.140	
	C	36725.098	-19.499	32.753	32.864		C	36725.098	-13.499	32.887	32.958		C	36725.098	-7.499	32.959	33.066		C	36725.098	-1.499	33.042	33.113	
	D	36735.098	-19.499	32.728	32.864		D	36735.098	-13.499	32.852	32.929		D	36735.098	-7.499	32.960	33.036		D	36735.098	-1.499	33.007	33.083	
	E	36745.098	-19.499	32.692	32.753		E	36745.098	-13.499	32.817	32.878		E	36745.098	-7.499	32.960	33.032		E	36745.098	-1.499	32.972	33.032	
	F	36755.098	-19.499	32.657	32.700		F	36755.098	-13.499	32.782	32.823		F	36755.098	-7.499	32.890	32.932		F	36755.098	-1.499	32.956	32.979	
	G	36765.098	-19.499	32.622	32.641		G	36765.098	-13.499	32.747	32.765		G	36765.098	-7.499	32.854	32.873		G	36765.098	-1.499	32.901	32.920	
	Q PIER C10	36772.815	-19.499	32.594	32.594		Q PIER C10	36772.815	-13.499	32.719	32.719		Q PIER C10	36772.815	-7.499	32.827	32.827		Q PIER C10	36772.815	-1.499	32.873	32.873	
	H	36782.815	-19.499	32.556	32.556		H	36782.815	-13.499	32.680	32.680		H	36782.815	-7.499	32.791	32.788		H	36782.815	-1.499	32.837	32.835	
	J	36792.815	-19.499	32.532	32.547		J	36792.815	-13.499	32.647	32.641		J	36792.815	-7.499	32.754	32.749		J	36792.815	-1.499	32.801	32.796	
	K	36802.815	-19.499	32.508	32.547		K	36802.815	-13.499	32.610	32.602		K	36802.815	-7.499	32.718	32.710		K	36802.815	-1.499	32.764	32.756	
	L	36812.815	-19.499	32.448	32.438		L	36812.815	-13.499	32.573	32.563		L	36812.815	-7.499	32.670	32.670		L	36812.815	-1.499	32.727	32.717	
	M	36822.815	-19.499	32.411	32.398		M	36822.815	-13.499	32.536	32.525		M	36822.815	-7.499	32.643	32.630		M	36822.815	-1.499	32.690	32.677	
	N	36832.815	-19.499	32.374	32.359		N	36832.815	-13.499	32.498	32.484		N	36832.815	-7.499	32.556	32.561		N	36832.815	-1.499	32.653	32.638	
	O	36842.815	-19.499	32.336	32.229		O	36842.815	-13.499	32.461	32.454		O	36842.815	-7.499	32.615	32.608		O	36842.815	-1.499	32.687	32.682	
	Q PIER C11	36851.355	-19.499	32.303	32.303		Q PIER C11	36851.355	-13.499	32.428	32.428		Q PIER C11	36851.355	-7.499	32.535	32.535		Q PIER C11	36851.355	-1.499	32.582	32.582	
	P	36861.355	-19.499	32.265	32.290		P	36861.355	-13.499	32.389	32.415		P	36861.355	-7.499	32.497	32.23		P	36861.355	-1.499	32.549	32.569	
	Q	36871.355	-19.499	32.226	32.277		Q	36871.355	-13.499	32.351	32.402		Q	36871.355	-7.499	32.458	32.510		Q	36871.355	-1.499	32.509	32.556	
	R	36881.355	-19.499	32.187	32.259		R	36881.355	-13.499	32.312	32.383		R	36881.355	-7.499	32.419	32.491		R	36881.355	-1.499	32.466	32.538	
	S	36891.355	-19.499	32.147	32.238		S	36891.355	-13.499	32.355	32.472		S	36891.355	-7.499	32.379	32.470		S	36891.355	-1.499	32.426	32.517	
	T	36901.355	-19.499	32.108	32.201		T	36901.355	-13.499	32.372	32.363		T	36901.355	-7.499	32.430	32.434		T	36901.355	-1.499	32.480	32.480	
	U	36911.355	-19.499	32.067	32.152		U	36911.355	-13.499	32.392	32.397		U	36911.355	-7.499	32.500	32.384		U	36911.355	-1.499	32.437	32.437	
	V	36921.355	-19.499	32.027	32.094		V	36921.355	-13.499	32.152	32.218		V	36921.355	-7.499	32.259	32.326		V	36921.355	-1.499	32.306	32.303	
	W	36931.355	-19.499	31.986	32.018		W	36931.355	-13.499	32.111	32.142		W	36931.355	-7.499	32.219	32.250		W	36931.355	-1.499	32.245	32.247	
	E W BRG PIER C12	36940.222	-19.499	31.950	31.950		E W BRG PIER C12	36940.222	-13.499	32.075	32.075		E W BRG PIER C12	36940.222	-7.499	32.182	32.182		E W BRG PIER C12	36940.222	-1.499	32.229	32.229	

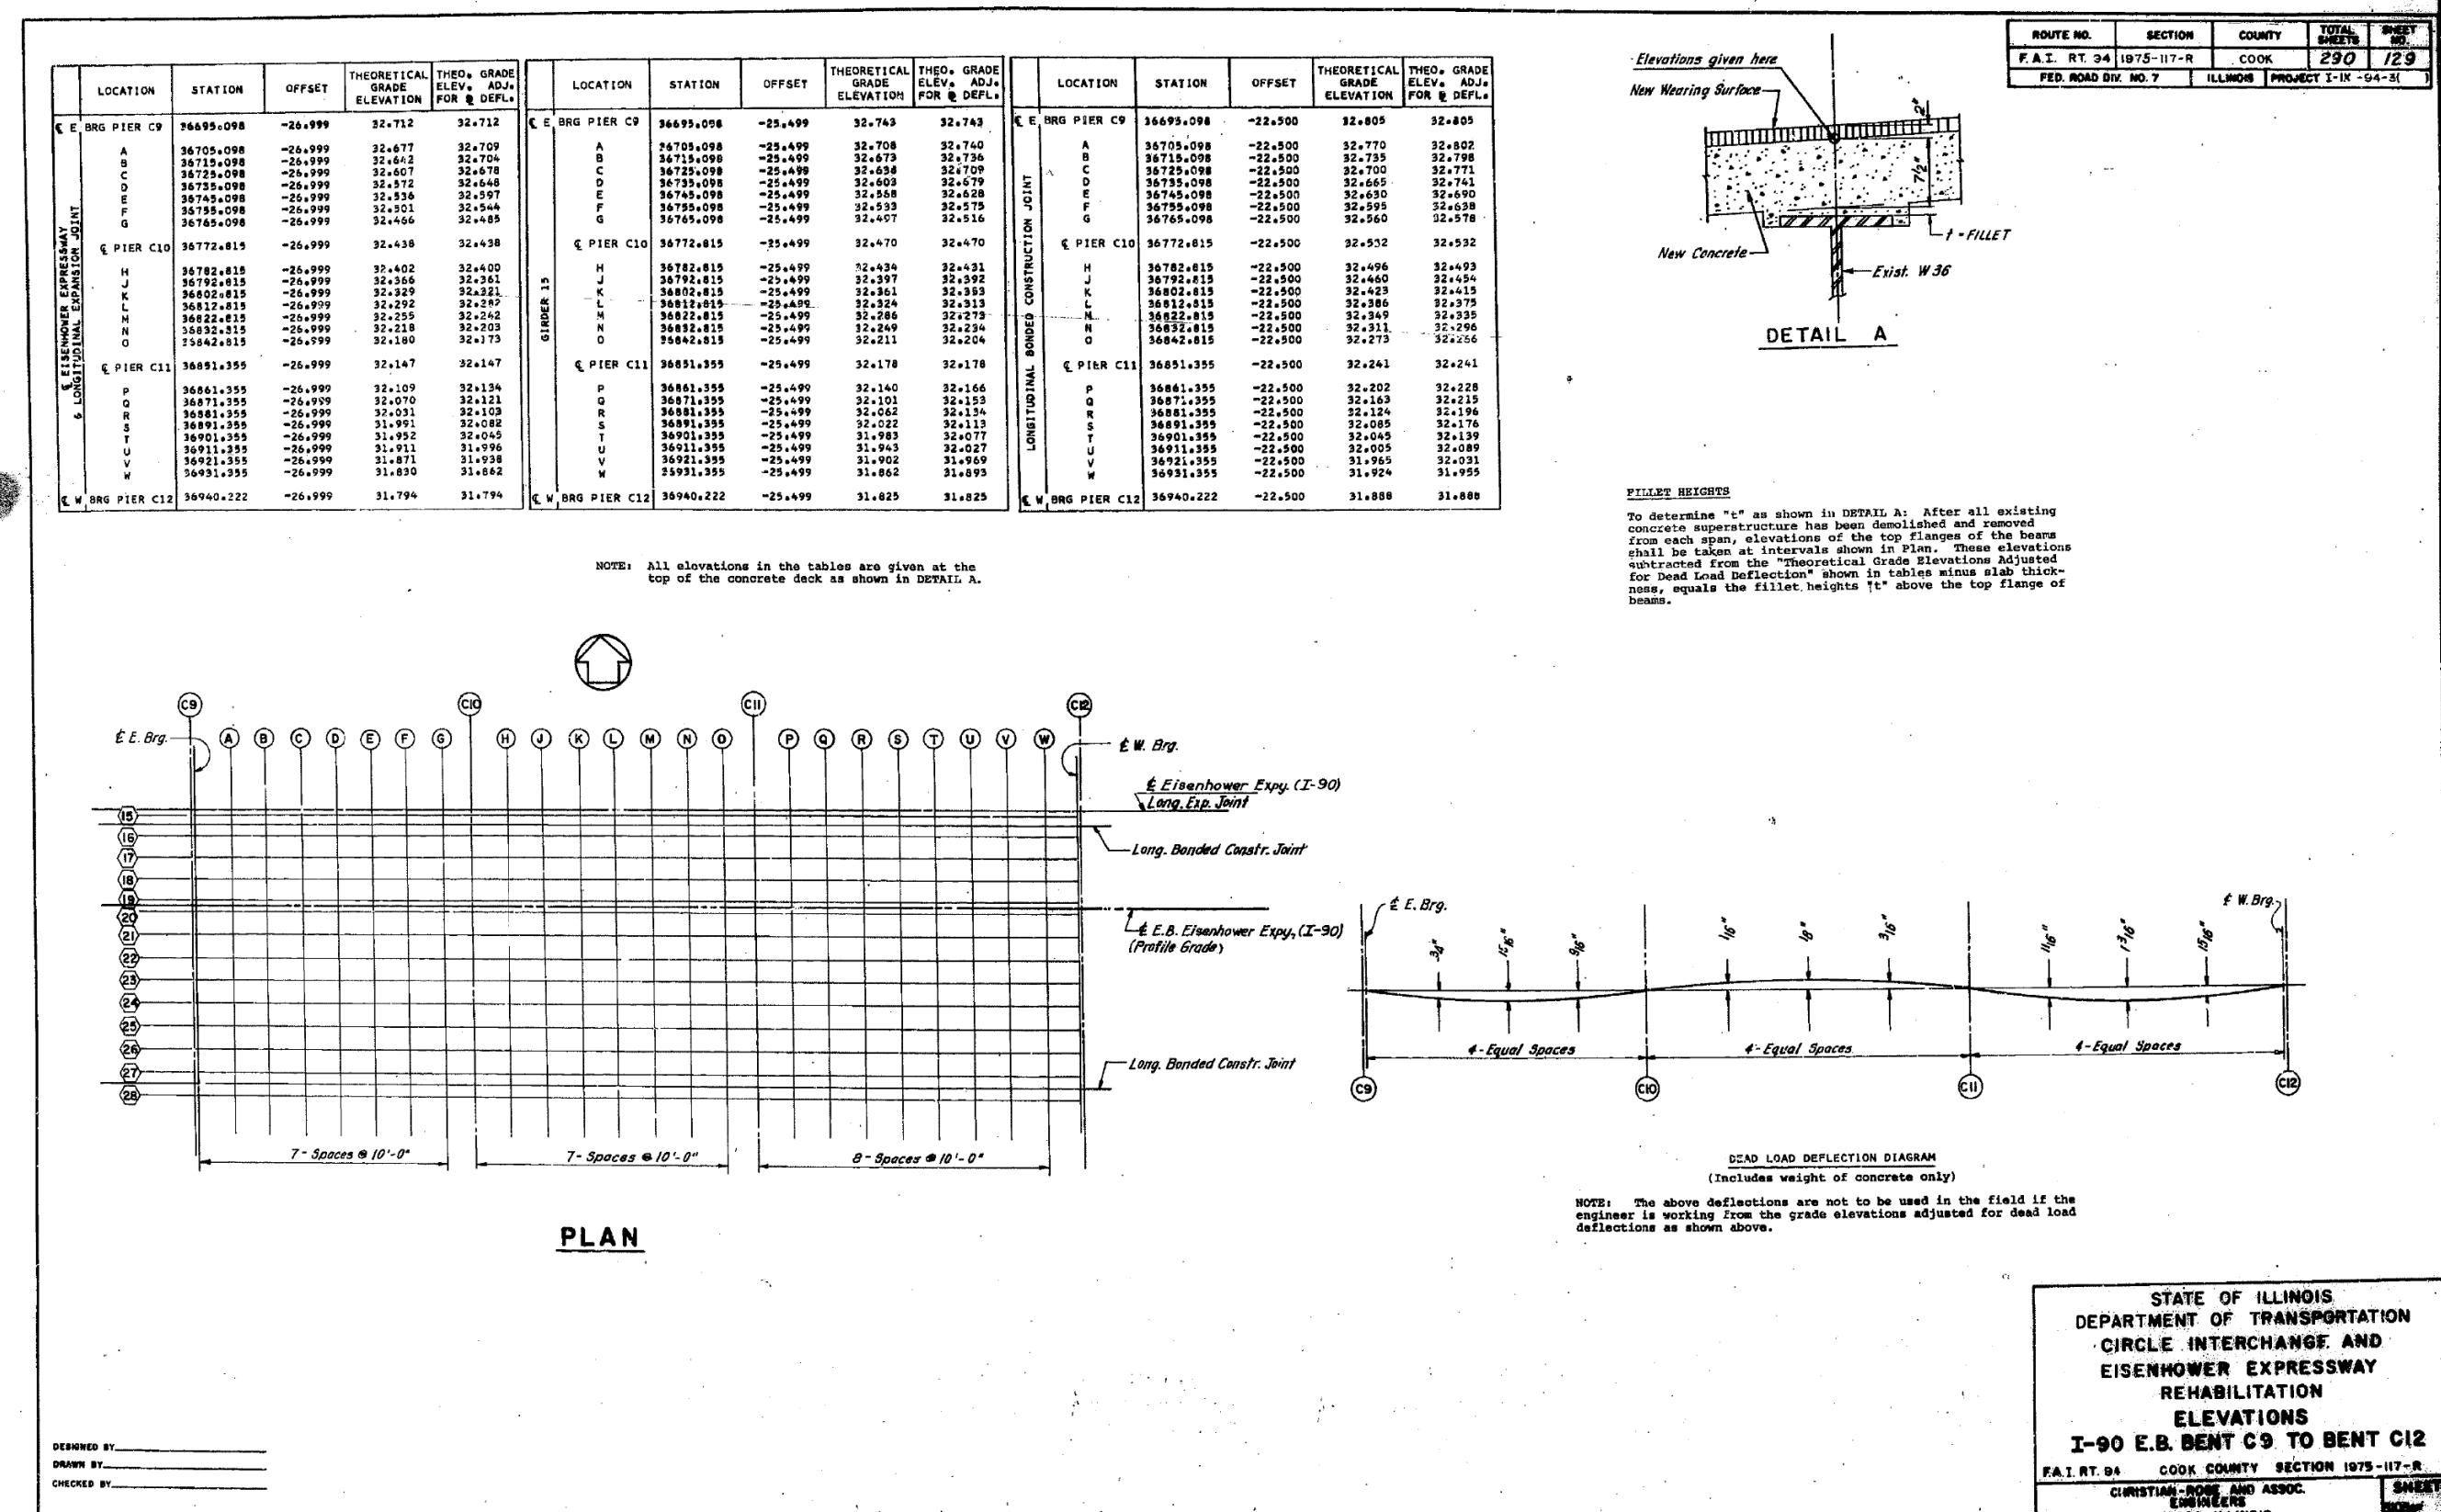	LOCATION	STATION	OFFSET	THEORETICAL GRADE ELEVATION	THEO. ELEV. ADJ. FOR Q DEFL.		LOCATION	STATION	OFFSET	THEORETICAL GRADE ELEVATION	THEO. ELEV. ADJ. FOR Q DEFL.		LOCATION	STATION	OFFSET	THEORETICAL GRADE ELEVATION	THEO. ELEV. ADJ. FOR Q DEFL.		LOCATION	STATION	OFFSET	THEORETICAL GRADE ELEVATION	THEO. ELEV. ADJ. FOR Q DEFL.	
GIRDER 17	E BRG PIER C9	36695.098	0.000	33.149	33.149		E BRG PIER C9	36695.098	1.500	33.147	33.147		E BRG PIER C9	36695.098	7.906	33.094	33.094		E BRG PIER C9	36695.098	14.31			


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	LOCATION	STATION	OFFSET	THEORETICAL GRADE ELEV.	THEO. GRADE ELEV. ADJ. FOR Q DEFL.		LOCATION	STATION	OFFSET	THEORETICAL GRADE ELEV.	THEO. GRADE ELEV. ADJ. FOR Q DEFL.		LOCATION	STATION	OFFSET	THEORETICAL GRADE ELEV.	THEO. GRADE ELEV. ADJ. FOR Q DEFL.		LOCATION	STATION	OFFSET	THEORETICAL GRADE ELEV.	THEO. GRADE ELEV. ADJ. FOR Q DEFL.			
E E	BRG PIER C9	36695.098	20.718	32.842	32.842		E E	BRG PIER C9	36695.098	27.125	32.709	32.709		E E	BRG PIER C9	36695.098	39.531	32.576	32.576		E E	BRG PIER C9	36695.098	39.937	32.442	32.442
A		36705.098	20.718	32.807	32.839		B		36715.098	27.125	32.639	32.702		C		36725.098	27.125	32.604	32.675		D		36735.098	27.125	32.569	32.595
B		36715.098	20.718	32.772	32.835		C		36725.098	27.125	32.537	32.778		D		36735.098	27.125	32.504	32.645		E		36745.098	27.125	32.434	32.727
C		36725.098	20.718	32.737	32.808		F		36745.098	27.125	32.494	32.737		G		36755.098	27.125	32.452	32.675		H		36765.098	27.125	32.415	32.608
D		36735.098	20.718	32.702	32.727		I		36765.098	27.125	32.463	32.597		J		36775.098	27.125	32.423	32.615		K		36785.098	27.125	32.384	32.559
E		36745.098	20.718	32.673	32.727		L		36785.098	27.125	32.494	32.559		M		36802.815	27.125	32.460	32.536		N		36812.815	27.125	32.424	32.500
F		36755.098	20.718	32.632	32.675		O		36812.815	27.125	32.494	32.536		P		36822.815	27.125	32.459	32.500		Q		36832.815	27.125	32.418	32.433
G		36765.098	20.718	32.597	32.615		R		36832.815	27.125	32.463	32.500		S		36842.815	27.125	32.421	32.434		T		36851.355	27.125	32.378	32.478
H		36772.815	20.718	32.569	32.569		U		36851.355	27.125	32.436	32.436		V		36861.355	27.125	32.397	32.436		W		36872.815	27.125	32.363	32.436
I		36782.815	20.718	32.533	32.530		X		36881.355	27.125	32.400	32.437		Y		36891.355	27.125	32.367	32.437		Z		36901.355	27.125	32.334	32.437
J		36792.815	20.718	32.497	32.491		AA		36881.355	27.125	32.337	32.419		BB		36891.355	27.125	32.304	32.425		CC		36901.355	27.125	32.271	32.425
K		36802.815	20.718	32.460	32.452		DD		36881.355	27.125	32.237	32.319		EE		36912.815	27.125	32.197	32.259		FF		36912.815	27.125	32.157	32.214
L		36812.815	20.718	32.423	32.412		GG		36881.355	27.125	32.215	32.200		HH		36912.815	27.125	32.119	32.106		II		36932.815	27.125	32.082	32.067
M		36822.815	20.718	32.386	32.373		JJ		36881.355	27.125	32.177	32.170		KK		36942.815	27.125	32.044	32.037		LL		36942.815	27.125	31.931	31.904
N		36832.815	20.718	32.348	32.333		MM		36881.355	27.125	32.144	32.144		NN		36951.355	27.125	31.931	31.878		OO		36961.355	27.125	31.865	31.865
O		36842.815	20.718	32.310	32.304		PP		36881.355	27.125	32.106	32.132		QQ		36881.355	27.125	31.931	31.865		RR		36881.355	27.125	31.895	31.865
P		36851.355	20.718	32.278	32.278		SS		36881.355	27.125	31.967	32.100		TT		36881.355	27.125	31.949	32.043		UU		36891.355	27.125	31.993	31.860
Q		36861.355	20.718	32.240	32.265		VV		36881.355	27.125	31.926	31.926		WW		36891.355	27.125	31.889	31.726		XX		36901.355	27.125	31.859	31.726
R		36871.355	20.718	32.200	32.232		YY		36881.355	27.125	31.897	32.079		ZZ		36911.355	27.125	31.776	31.682		AA		36921.355	27.125	31.746	31.658
S		36881.355	20.718	32.172	32.213		BB		36881.355	27.125	31.749	32.043		CC		36921.355	27.125	31.735	31.802		DD		36931.355	27.125	31.705	31.658
T		36891.355	20.718	32.142	32.142		EE		36881.355	27.125	31.705	31.705		FF		36931.355	27.125	31.679	31.658		GG		36940.222	31.925	31.658	31.658
U		36901.355	20.718	32.102	32.102		HH		36881.355	27.125	31.679	31.679		II		36940.222	31.925	31.658	31.658		JJ		36940.222	31.925	31.658	31.658
V		36911.355	20.718	32.062	32.062		KK		36881.355	27.125	31.641	31.641		LL		36940.222	31.925	31.658	31.658		MM		36940.222	31.925	31.658	31.658
W		36921.355	20.718	32.020	32.020		NN		36881.355	27.125	31.614	31.614		OO		36940.222	31.925	31.658	31.658		OO		36940.222	31.925	31.658	31.658
X		36931.355	20.718	31.961	31.992		PP		36881.355	27.125	31.589	31.658		QQ		36940.222	31.925	31.658	31.658		RR		36940.222	31.925	31.658	31.658
Y		36941.355	20.718	31.928	31.928		SS		36881.355	27.125	31.559	31.658		TT		36940.222	31.925	31.658	31.658		UU		36940.222	31.925	31.658	31.658
Z		36951.355	20.718	31.895	31.928		VV		36881.355	27.125	31.526	31.658		WW		36940.222	31.925	31.658	31.658		XX		36940.222	31.925	31.658	31.658
AA		36961.355	20.718	31.862	31.928		YY		36881.355	27.125	31.500	31.658		ZZ		36940.222	31.925	31.658	31.658		AA		36940.222	31.925	31.658	31.658
BB		36971.355	20.718	31.830	31.928		BB		36881.355	27.125	31.478	31.658		CC		36940.222	31.925	31.658	31.658		CC		36940.222			


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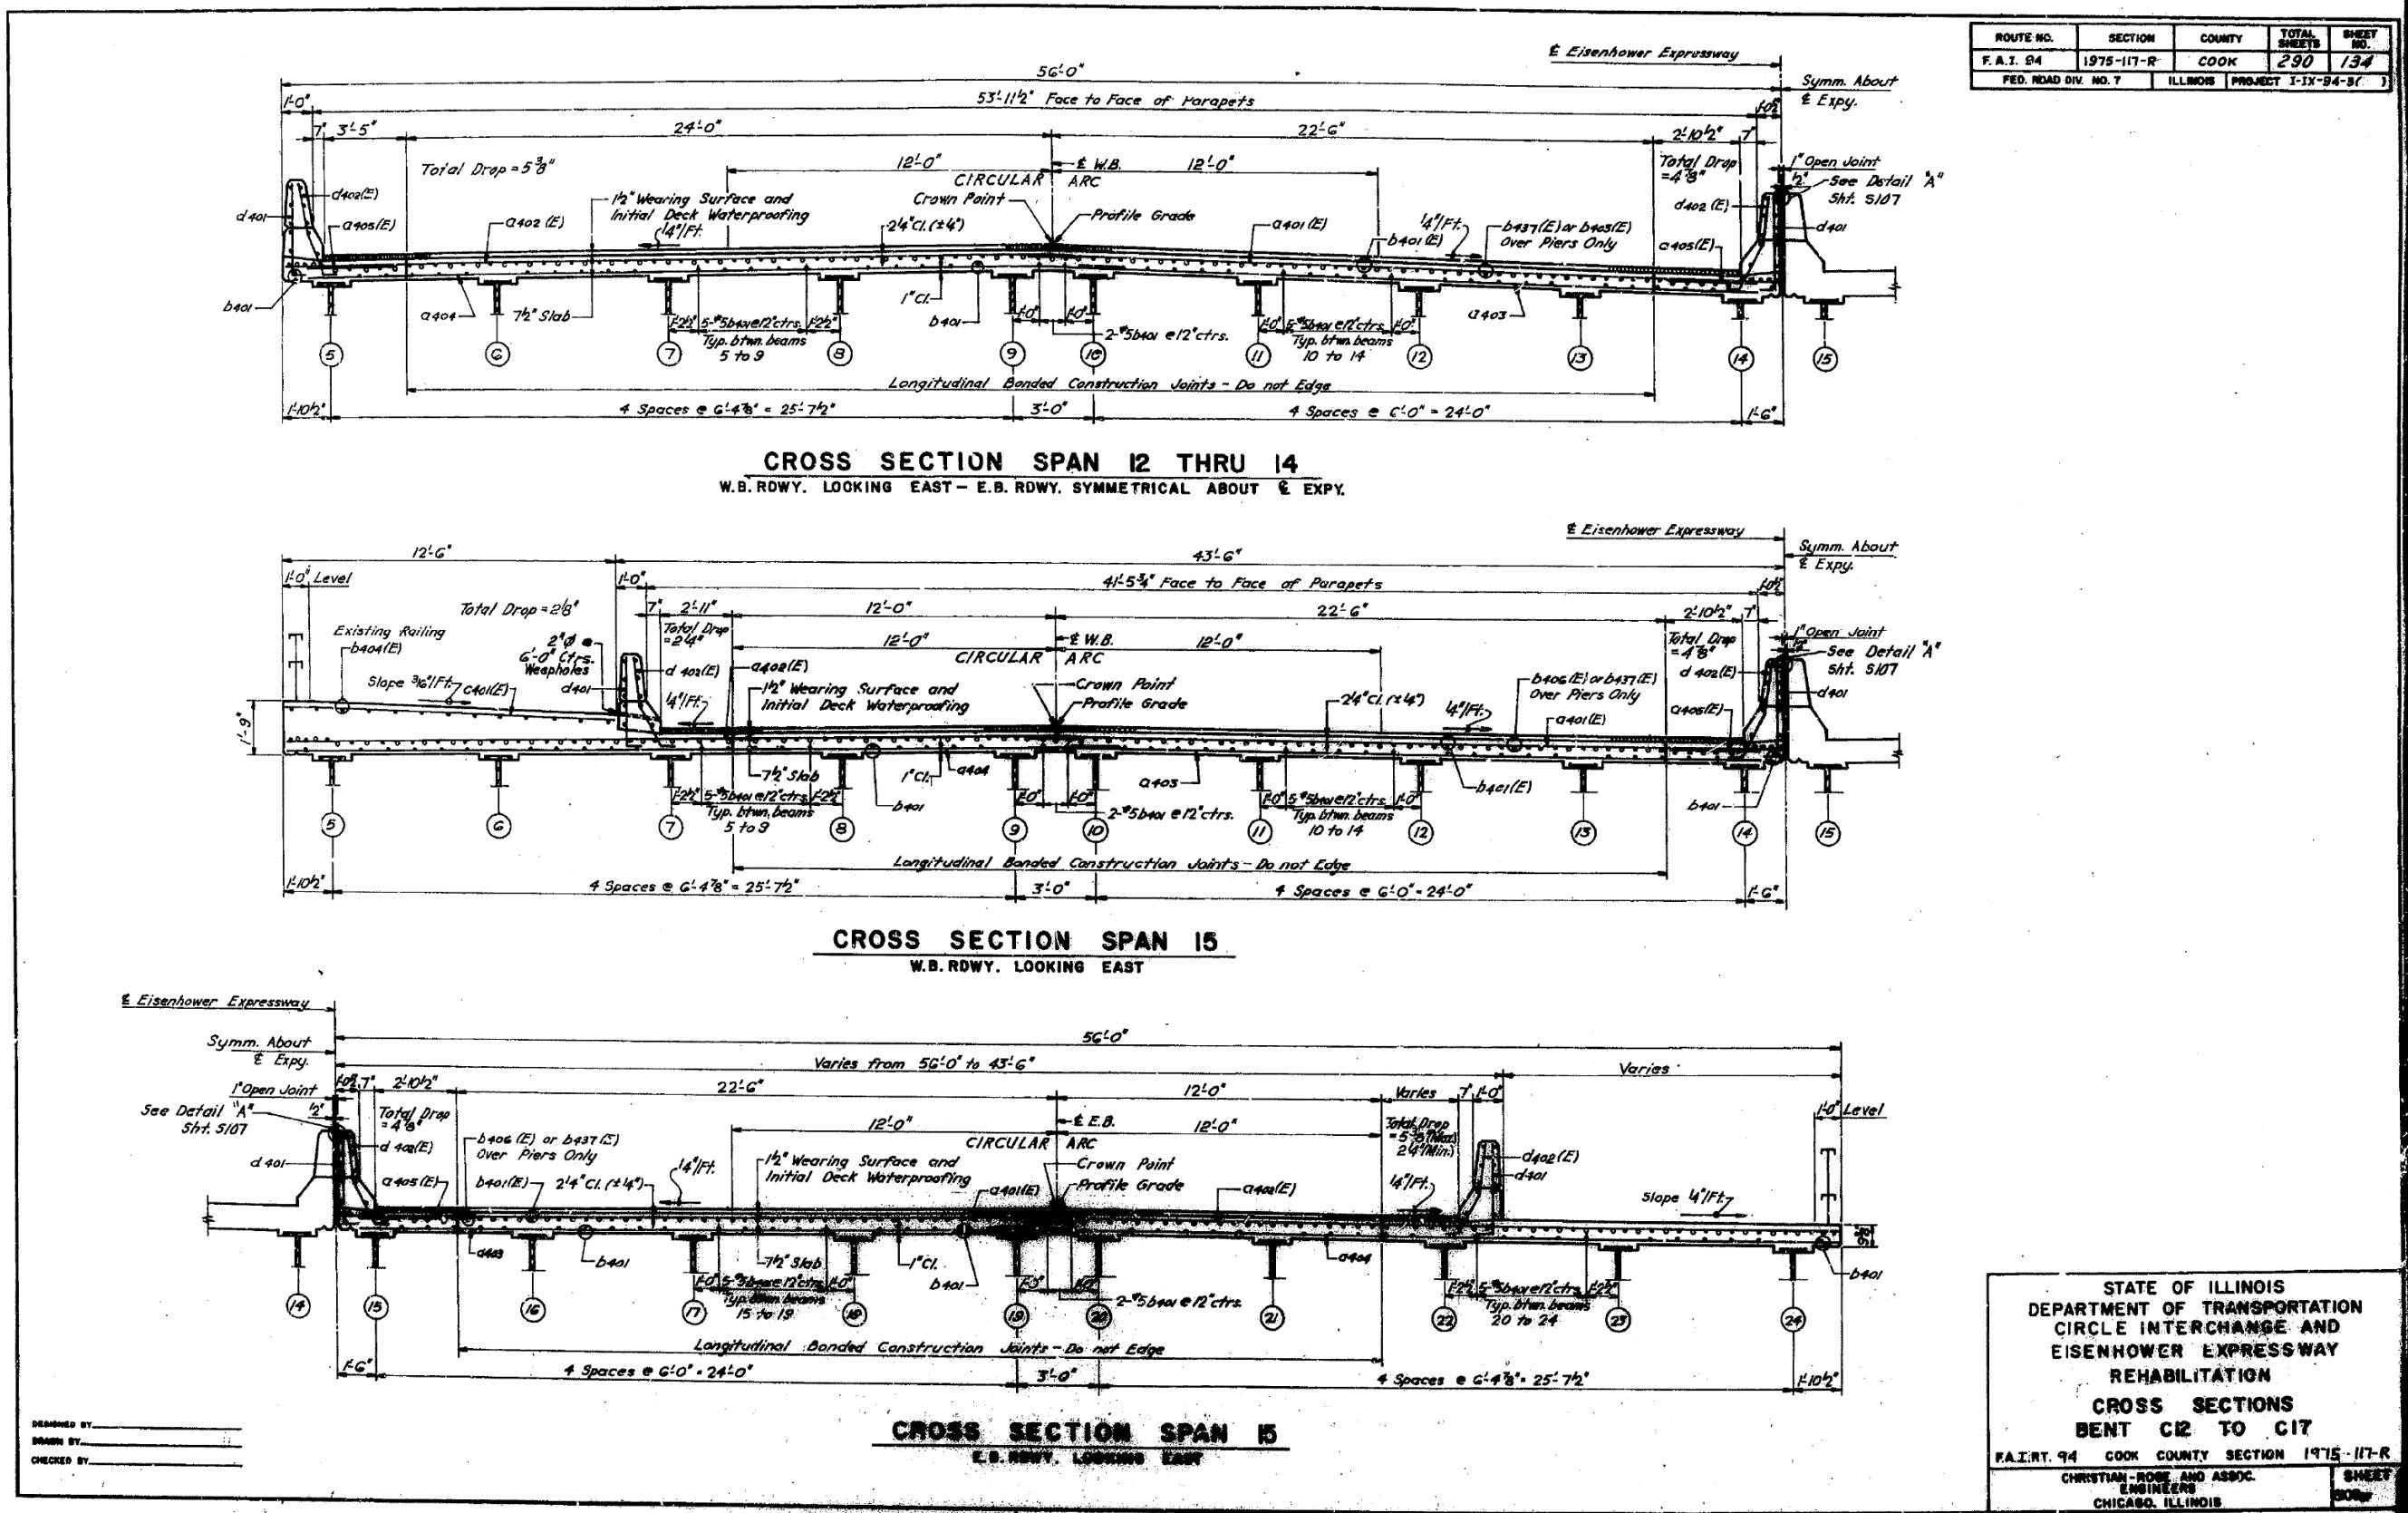
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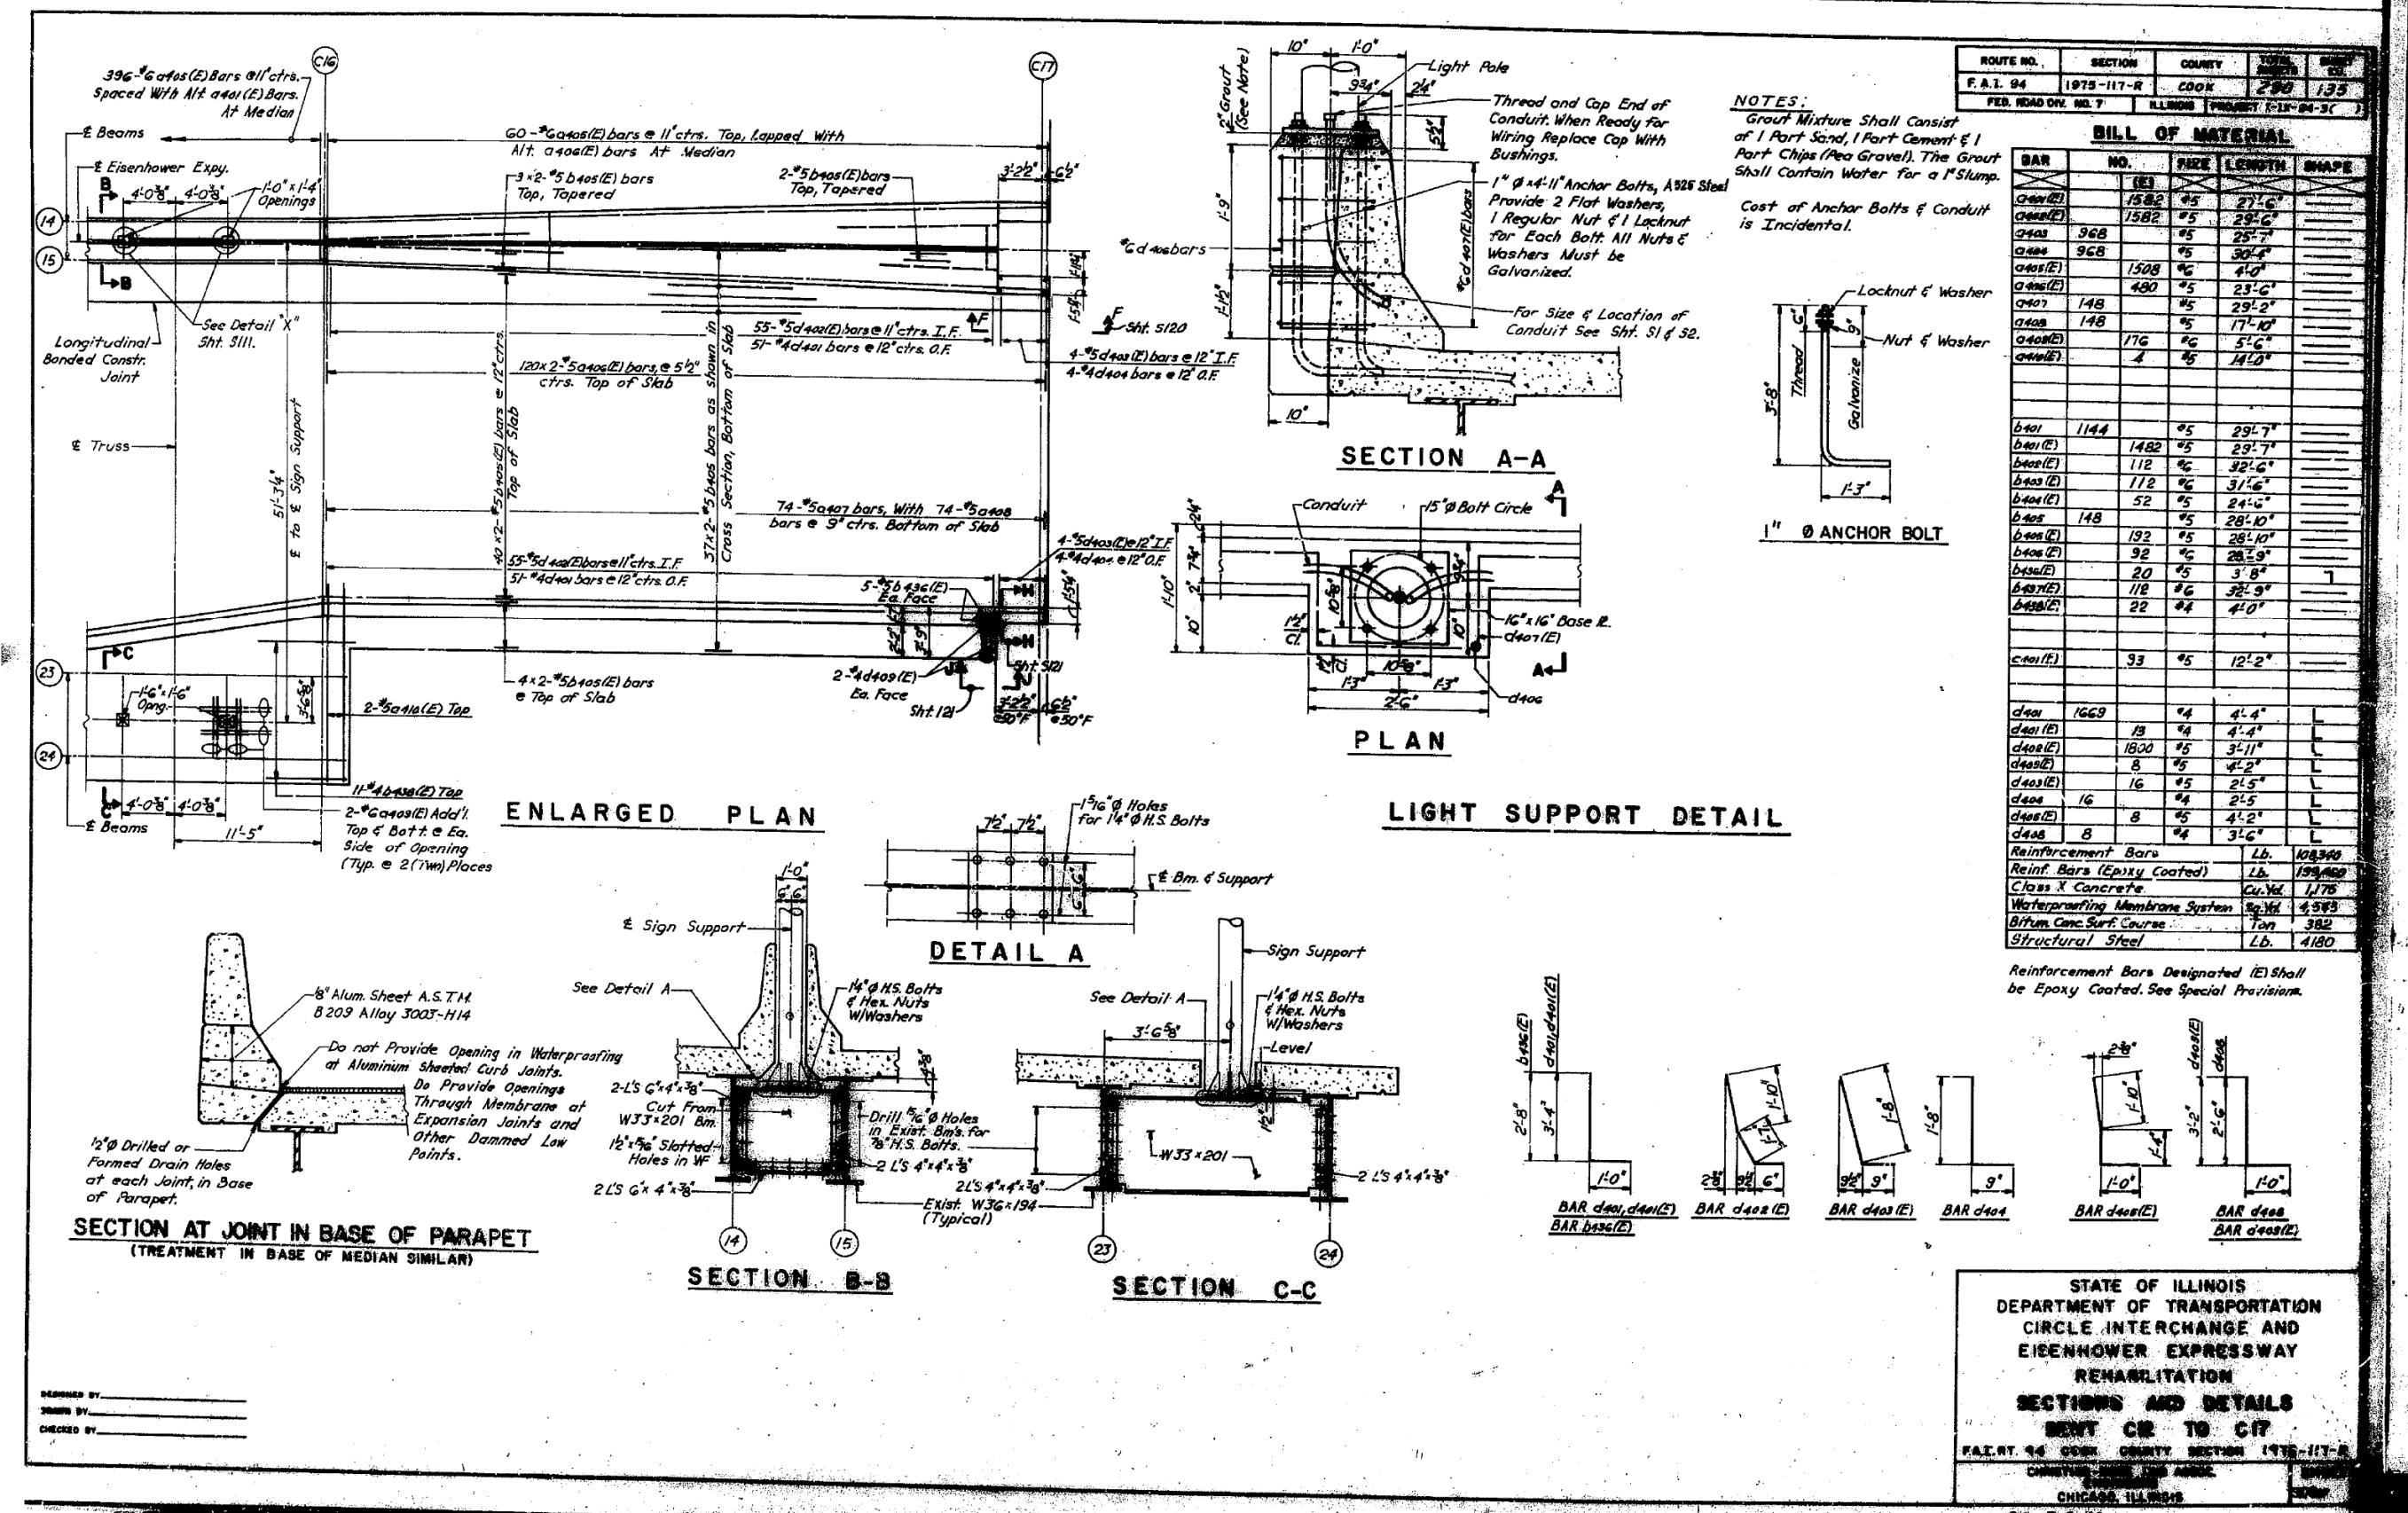
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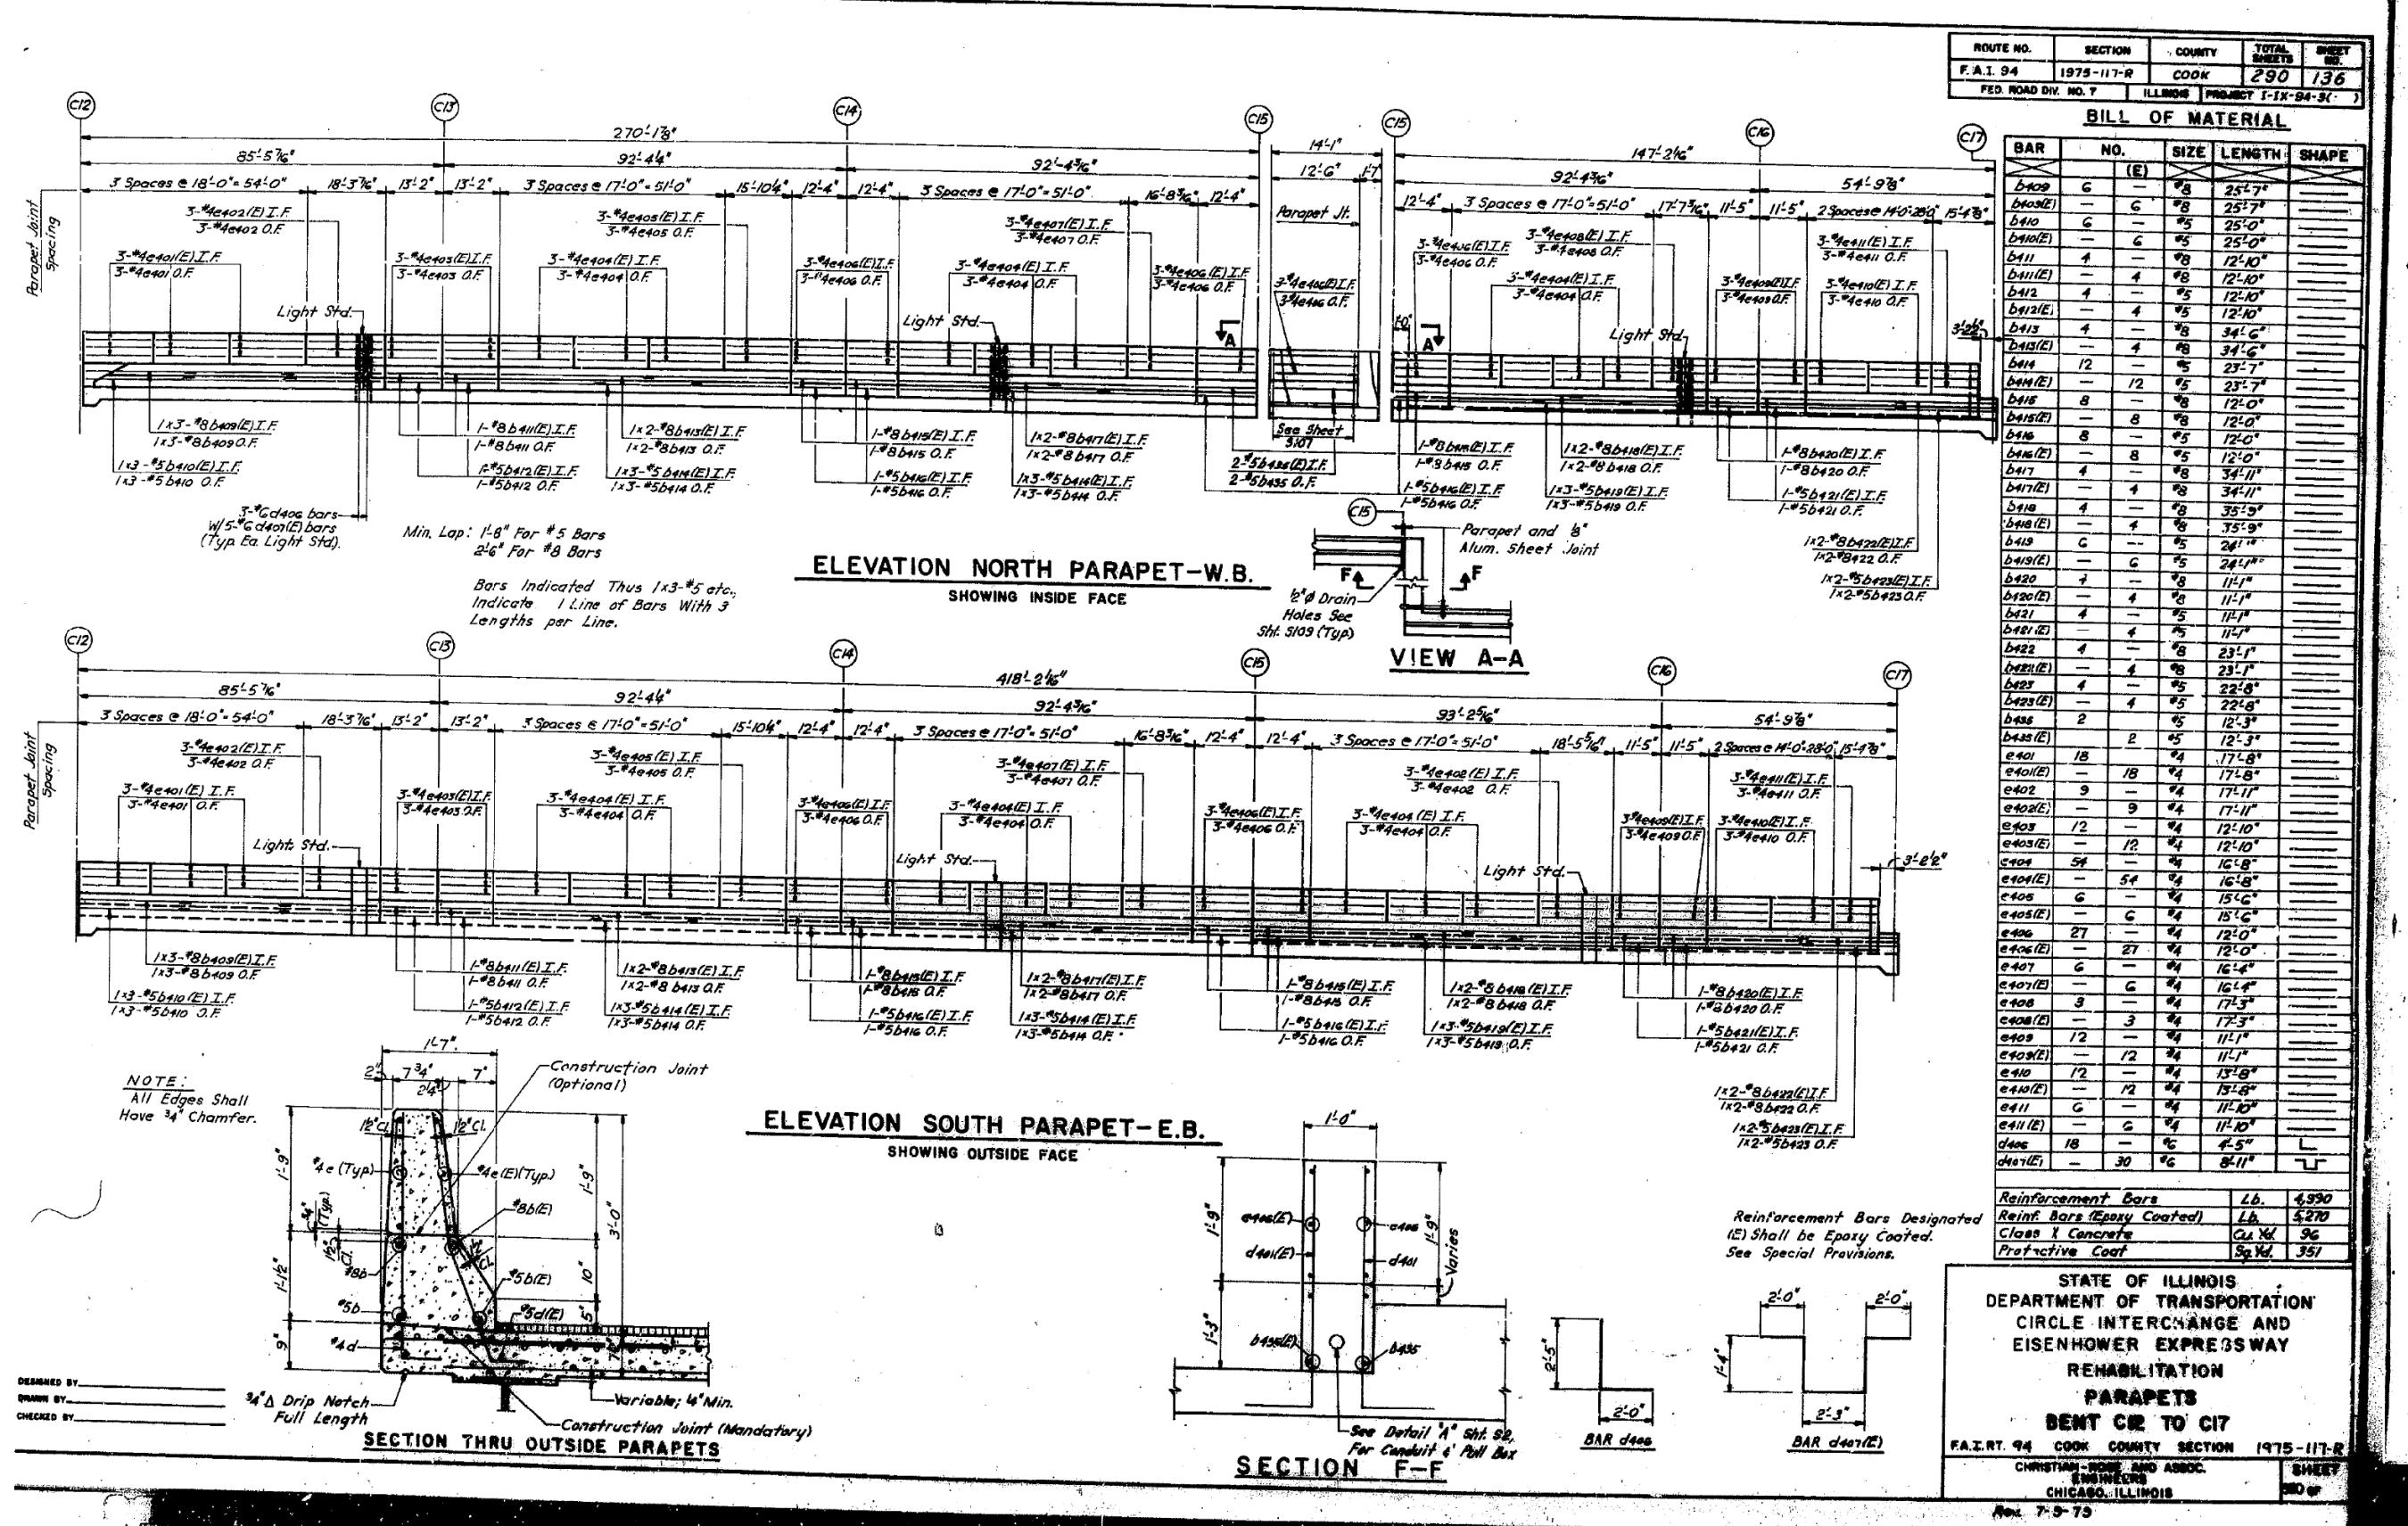
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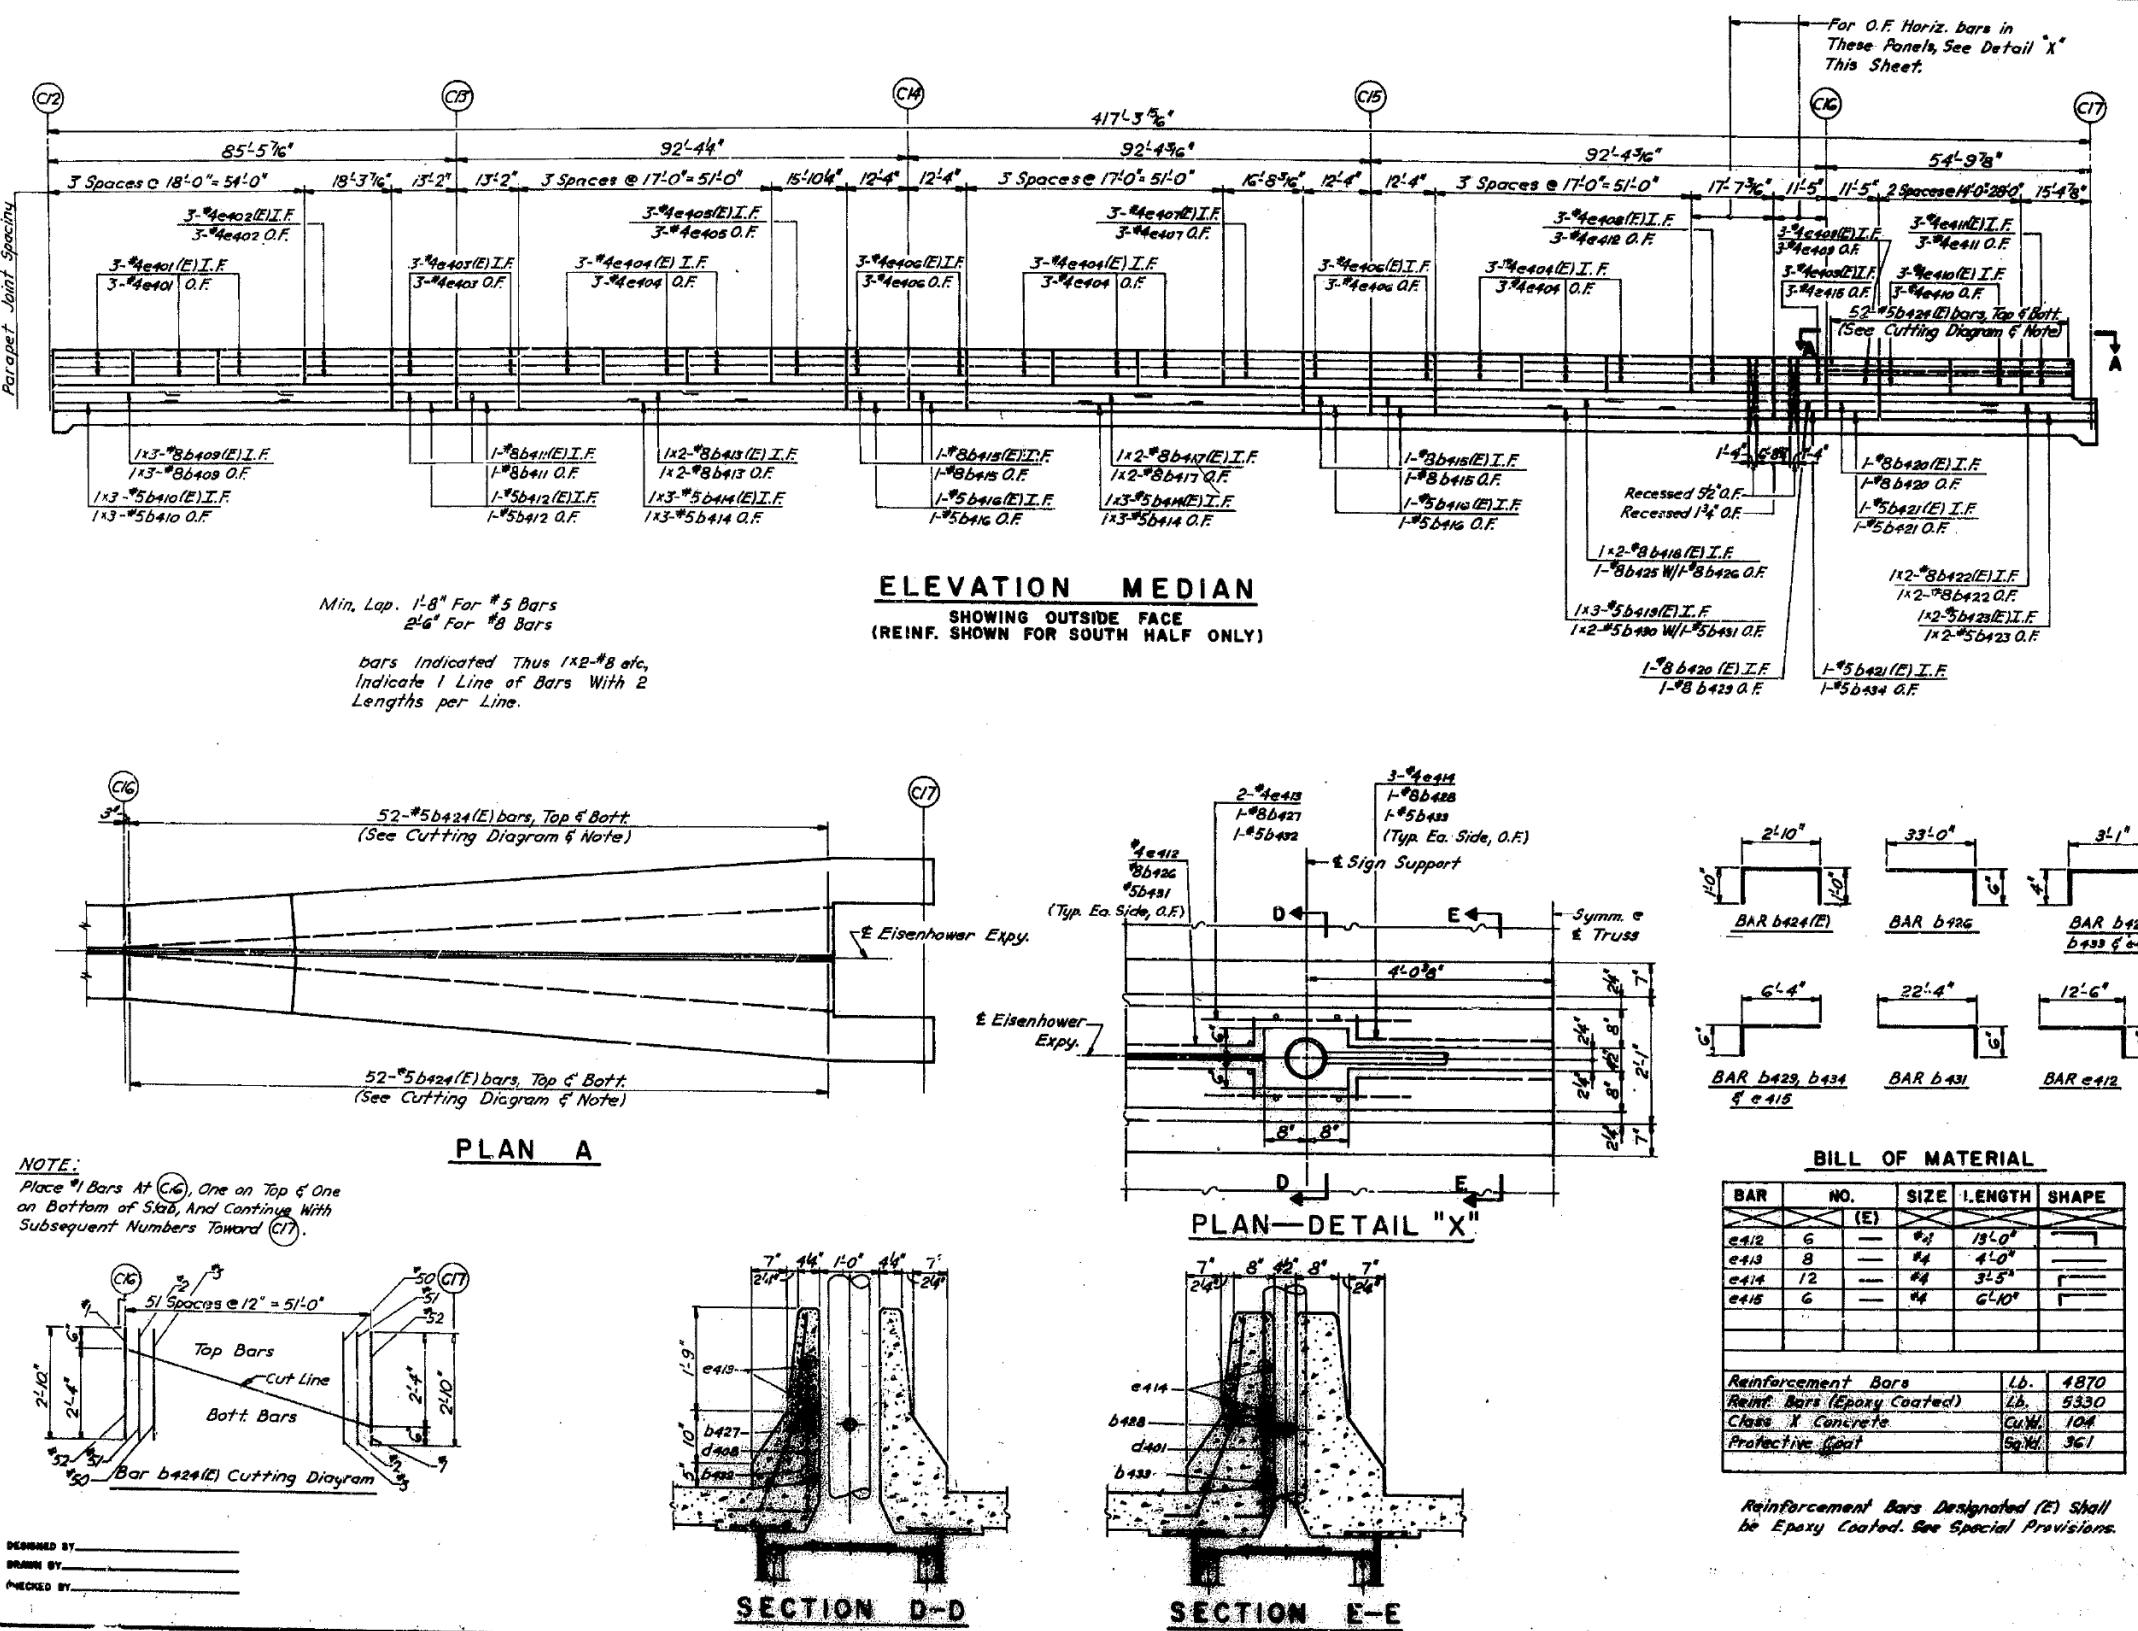
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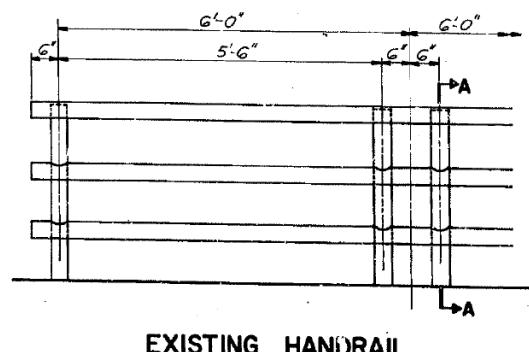
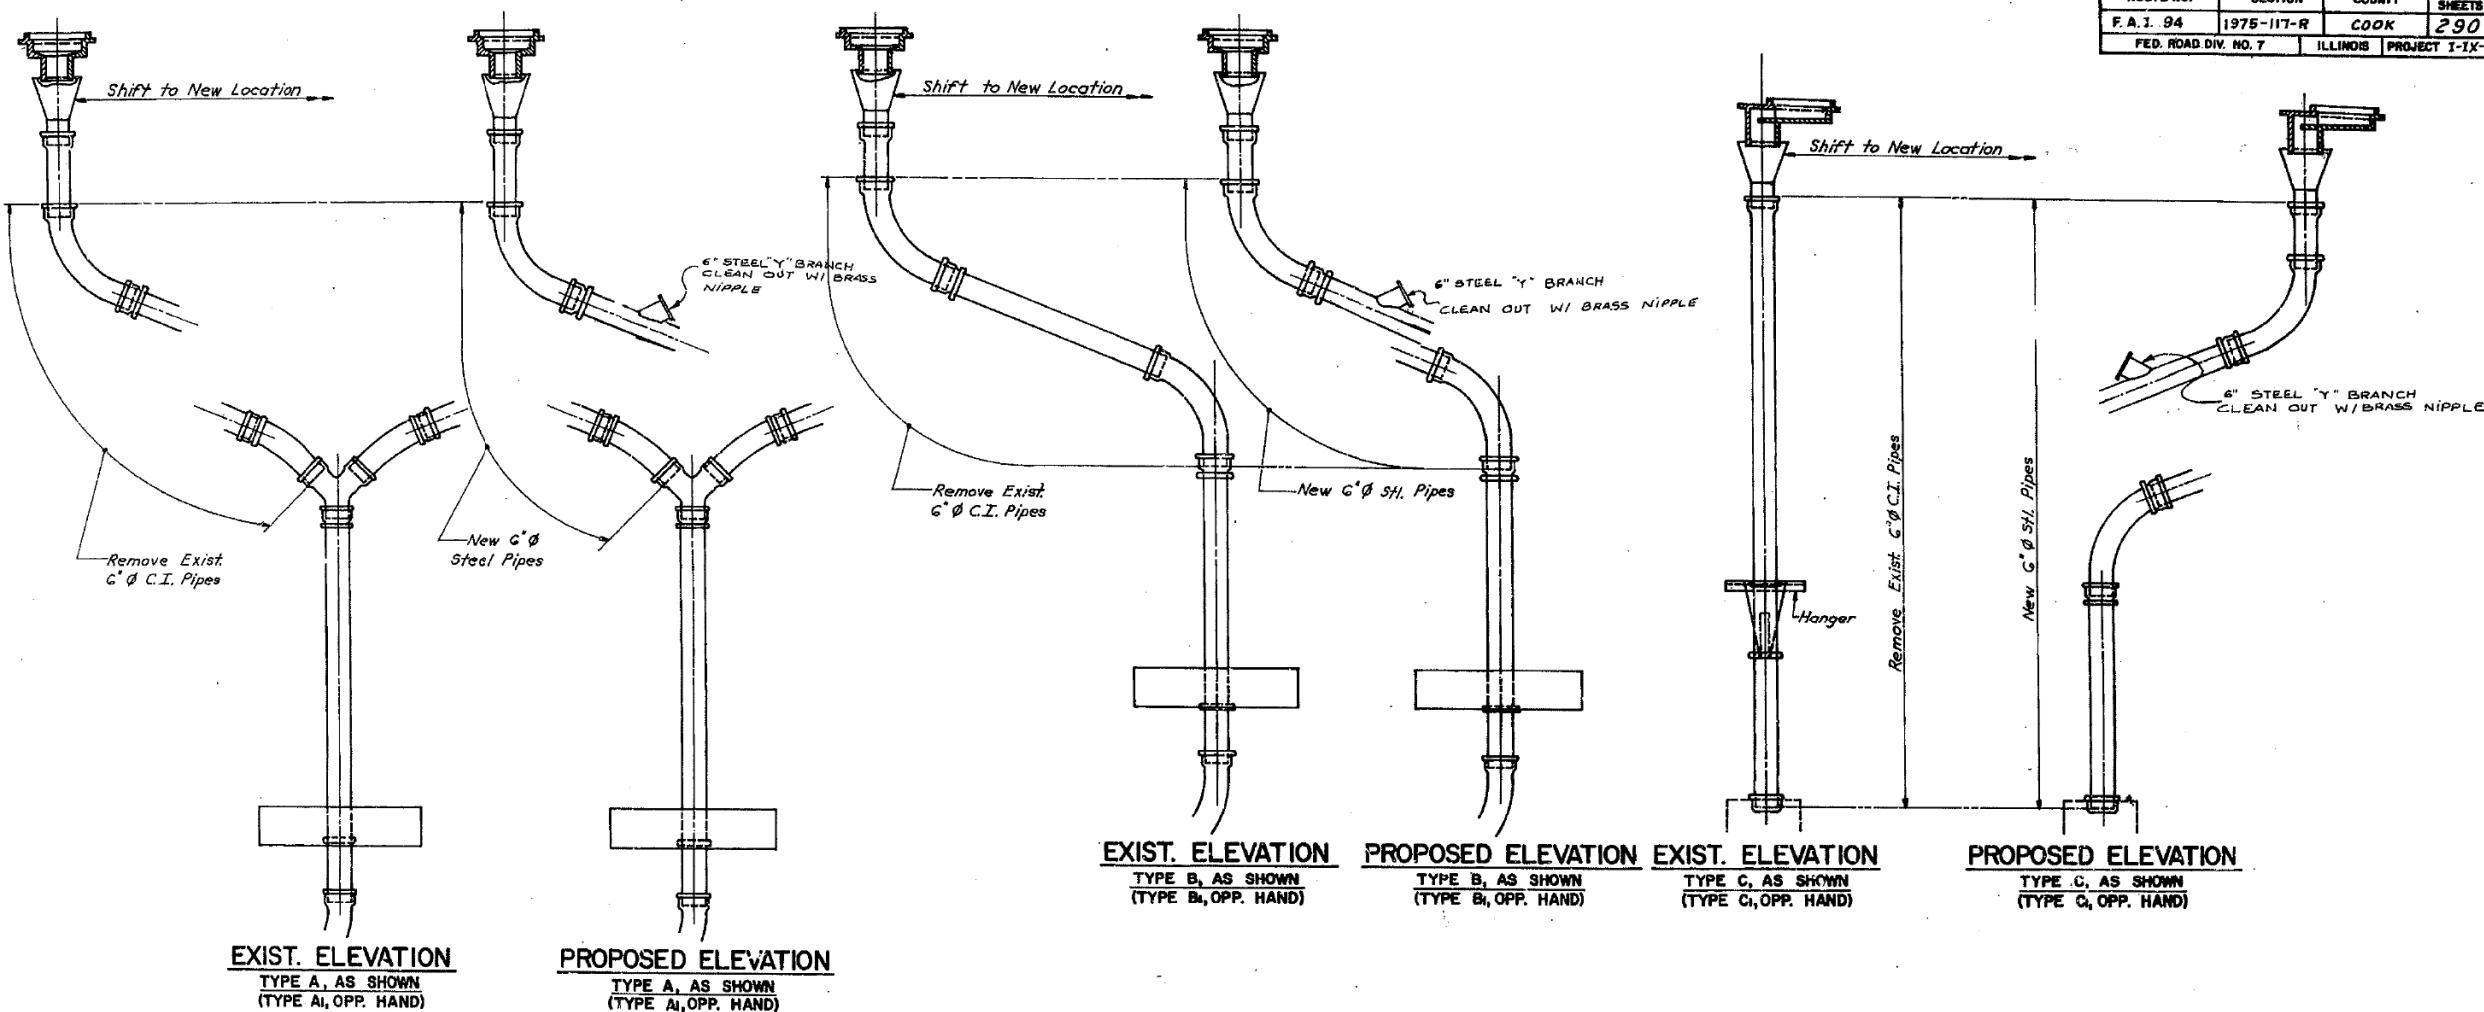
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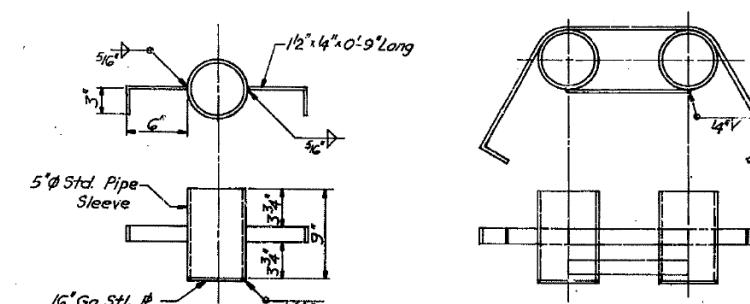
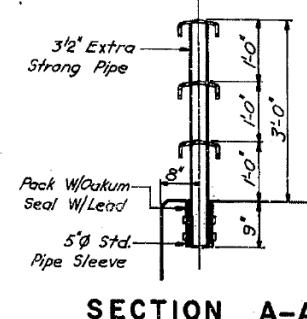
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DRAWN BY _____
CHECKED BY _____



EXISTING HANDRAIL
PIPE SLEEVE DETAILS

STATE OF ILLINOIS
DEPARTMENT OF TRANSPORTATION
CIRCLE INTERCHANGE AND
EISENHOWER EXPRESSWAY
REHABILITATION
DRAINAGE & HANDRAIL DETAILS
BENT C12 TO C17
F.A.I.R.T. 94 COOK COUNTY SECTION 1975-IIT-R
REV. 3/15/80 RCS
REV. 1/18/80 CIR
CHRISTIAN-ROSE AND ASSOC.
ENGINEERS
CHICAGO, ILLINOIS
SHEET
Rev. 10/17/80
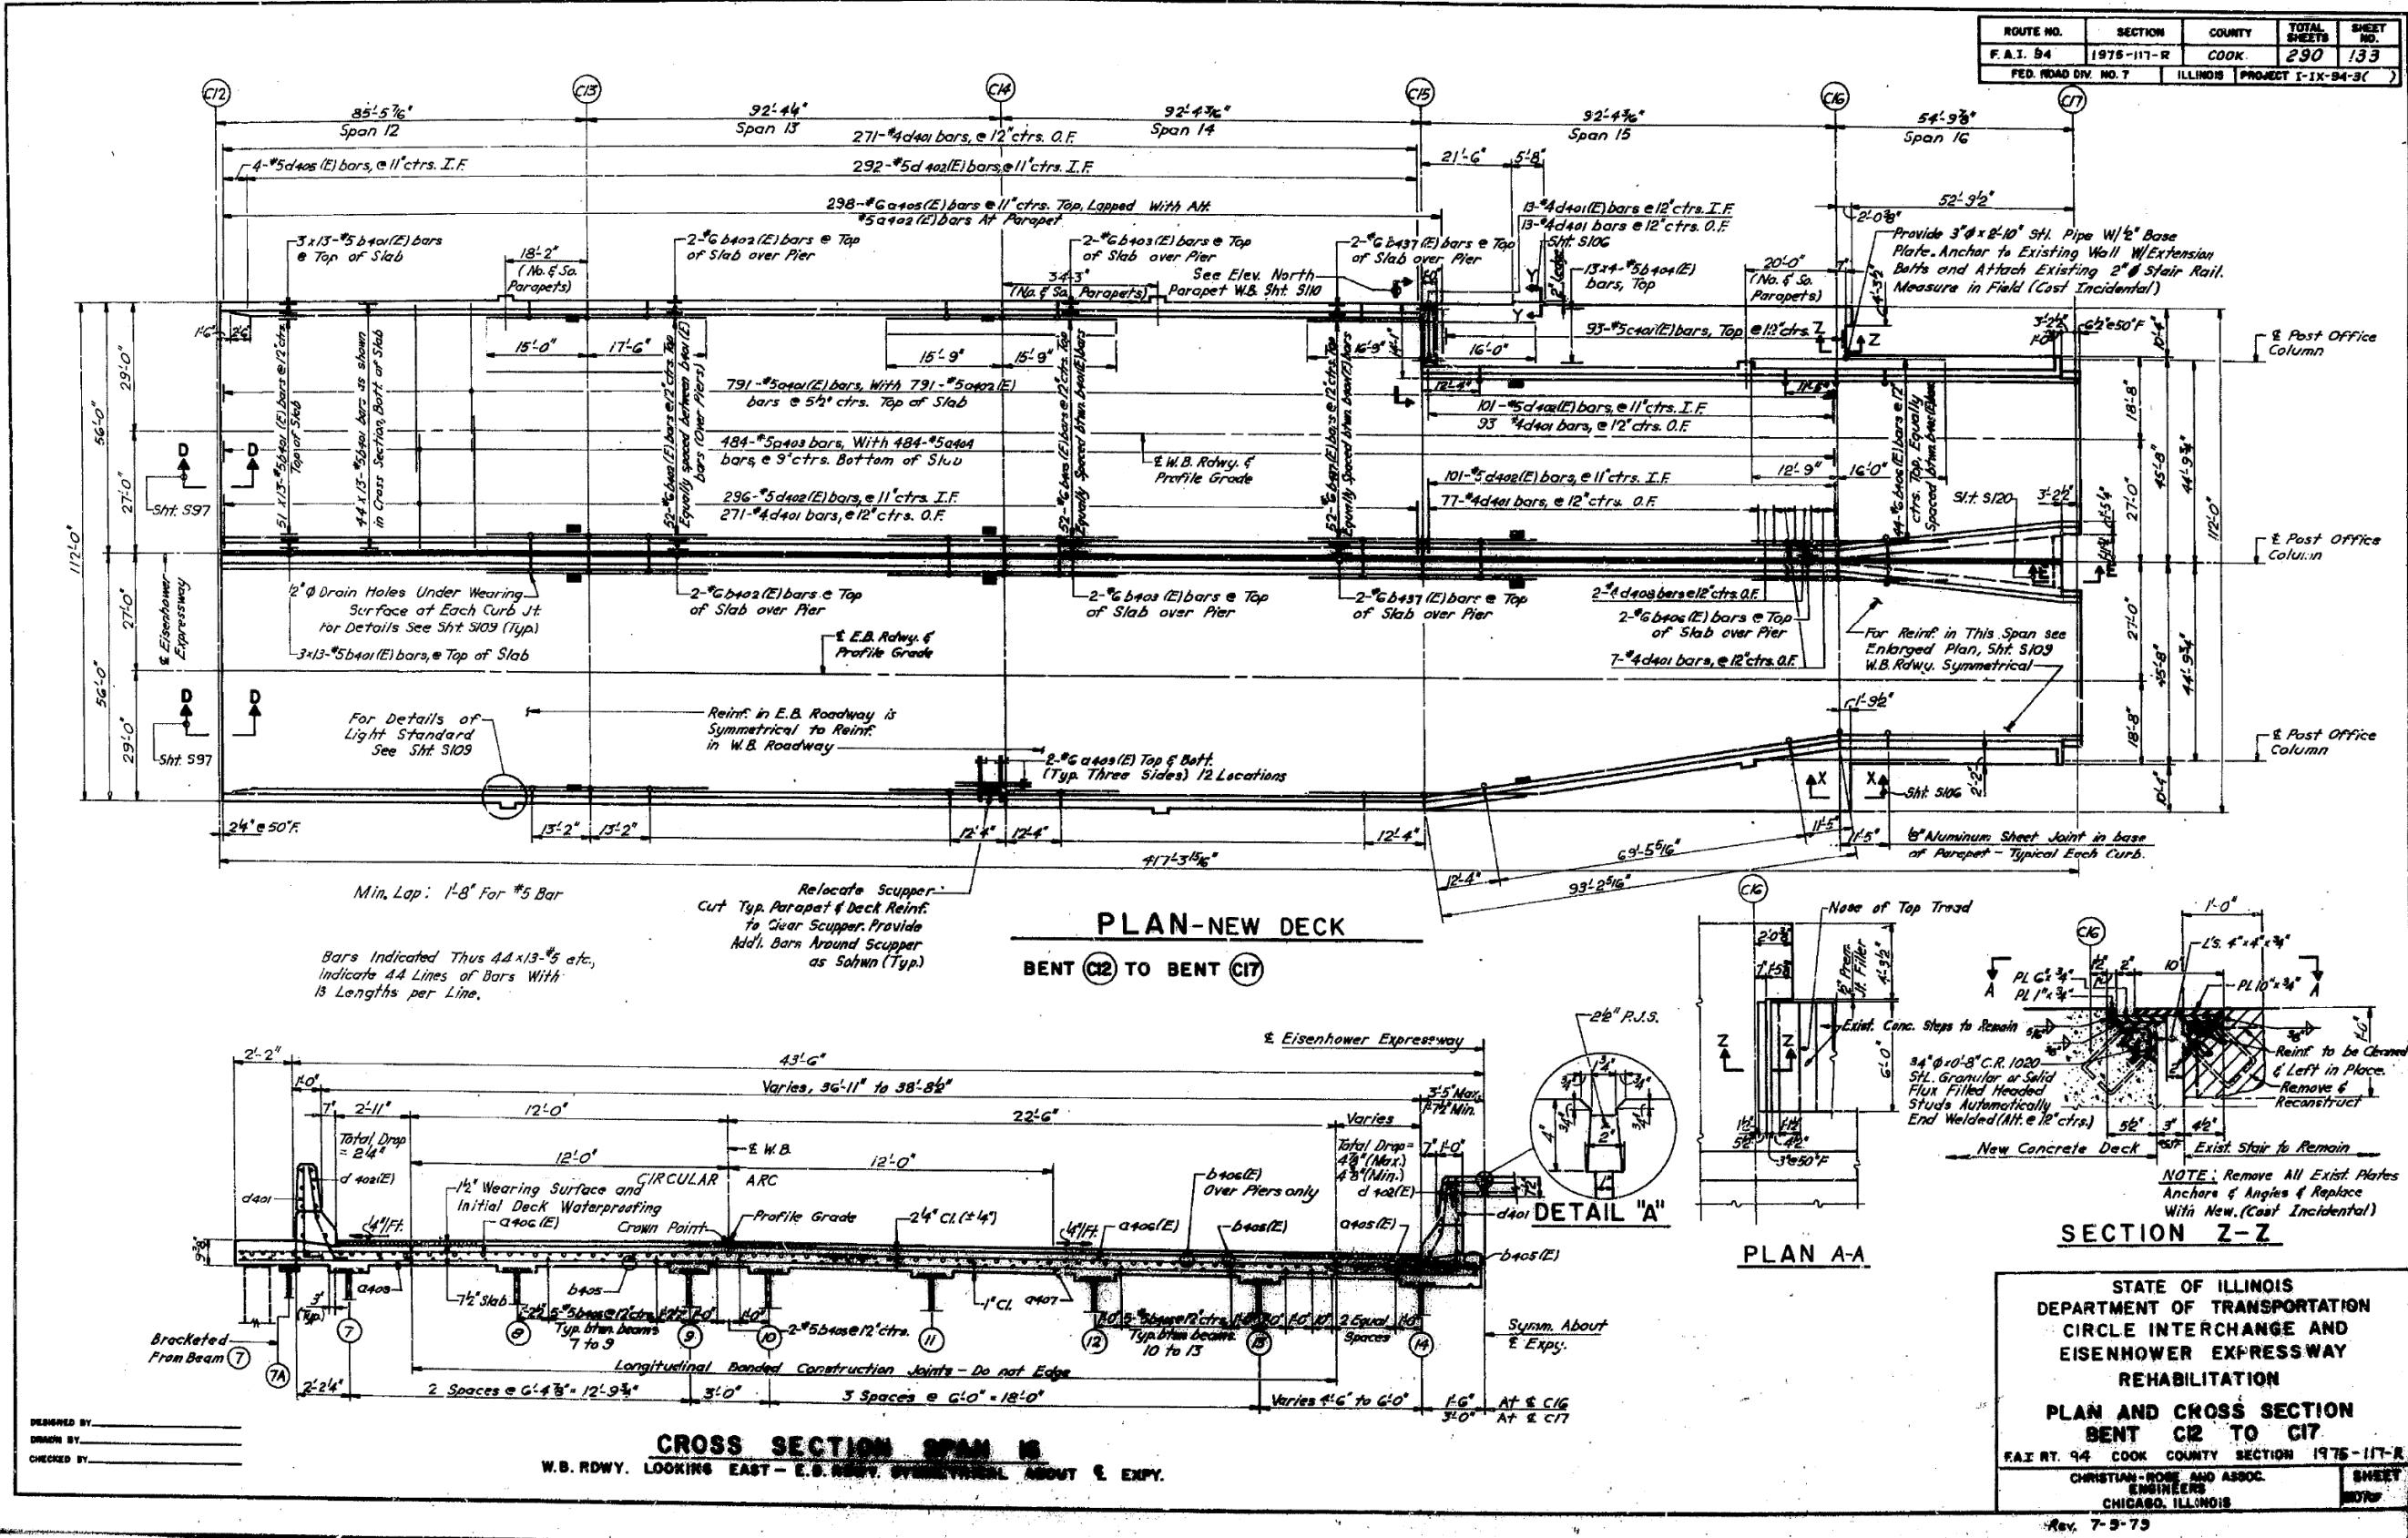
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	LOCATION	STATION	OFFSET	THEORETICAL GRADE ELEV.	THEO. ELEV. ADJ. FOR Q. DEFL.		LOCATION	STATION	OFFSET	THEORETICAL GRADE ELEV.	THEO. ELEV. ADJ. FOR Q. DEFL.		LOCATION	STATION	OFFSET	THEORETICAL GRADE ELEV.	THEO. ELEV. ADJ. FOR Q. DEFL.
E	BRG PIER C12	36941.888	-27+125	31.785	31.785	E	BRG PIER C12	36941.888	-24+000	31.850	31.850	E	BRG PIER C12	36941.888	-20+718	31.918	31.918
A		36951.888	-27+125	31.743	31.743	A		36951.888	-24+000	31.808	31.830	A		36951.888	-20+718	31.877	31.899
B		36961.888	-27+125	31.702	31.741	B		36961.888	-24+000	31.767	31.811	B		36961.888	-20+718	31.835	31.857
C		36971.888	-27+125	31.660	31.704	C		36971.888	-24+000	31.725	31.776	C		36971.888	-20+718	31.793	31.844
D		36981.888	-27+125	31.617	31.664	D		36981.888	-24+000	31.682	31.739	D		36981.888	-20+718	31.751	31.807
E		37001.888	-27+125	31.575	31.612	E		37001.888	-24+000	31.640	31.686	E		37001.888	-20+718	31.708	31.754
F		37001.888	-27+125	31.532	31.567	F		37001.888	-24+000	31.597	31.628	F		37001.888	-20+718	31.665	31.696
G		37001.888	-27+125	31.489	31.503	G		37001.888	-24+000	31.554	31.572	G		37001.888	-20+718	31.622	31.640
H		37021.888	-27+125	31.442	31.450	H		37021.888	-24+000	31.510	31.516	H		37021.888	-20+718	31.578	31.584
E	PIER C13	37026.504	-27+125	31.425	31.425	E	PIER C13	37026.504	-24+000	31.490	31.490	E	PIER C13	37026.504	-20+718	31.558	31.558
J		37036.504	-27+125	31.381	31.385	J		37036.504	-24+000	31.446	31.453	J		37036.504	-20+718	31.514	31.521
K		37046.504	-27+125	31.337	31.346	K		37046.504	-24+000	31.402	31.415	K		37046.504	-20+718	31.570	31.583
L		37056.504	-27+125	31.292	31.309	L		37056.504	-24+000	31.357	31.379	L		37056.504	-20+718	31.625	31.647
M		37066.504	-27+125	31.248	31.279	M		37066.504	-24+000	31.313	31.344	M		37066.504	-20+718	31.681	31.612
N		37076.504	-27+125	31.203	31.232	N		37076.504	-24+000	31.268	31.302	N		37076.504	-20+718	31.737	31.770
O		37086.504	-27+125	31.159	31.181	O		37086.504	-24+000	31.224	31.251	O		37086.504	-20+718	31.292	31.319
P		37096.504	-27+125	31.114	31.130	P		37096.504	-24+000	31.179	31.200	P		37096.504	-20+718	31.248	31.268
Q		37106.504	-27+125	31.070	31.078	Q		37106.504	-24+000	31.135	31.148	Q		37106.504	-20+718	31.203	31.214
R		37116.504	-27+125	31.025	31.027	R		37116.504	-24+000	31.090	31.093	R		37116.504	-20+718	31.159	31.161
E	PIER C14	37118.856	-27+125	31.015	31.015	E	PIER C14	37118.856	-24+000	31.080	31.080	E	PIER C14	37118.856	-20+718	31.148	31.148
S		37128.856	-27+125	30.971	30.973	S		37128.856	-24+000	31.036	31.038	S		37128.856	-20+718	31.104	31.106
T		37138.856	-27+125	30.926	30.926	T		37138.856	-24+000	30.991	30.996	T		37138.856	-20+718	31.059	31.064
U		37148.856	-27+125	30.882	30.882	U		37148.856	-24+000	30.947	30.953	U		37148.856	-20+718	31.015	31.022
V		37158.856	-27+125	30.838	30.848	V		37158.856	-24+000	30.903	30.912	V		37158.856	-20+718	30.971	30.978
W		37168.856	-27+125	30.793	30.806	W		37168.856	-24+000	30.863	30.871	W		37168.856	-20+718	30.931	30.939
X		37178.856	-27+125	30.763	30.764	X		37178.856	-24+000	30.828	30.829	X		37178.856	-20+718	30.896	30.897
Y		37188.856	-27+125	30.733	30.728	Y		37188.856	-24+000	30.798	30.793	Y		37188.856	-20+718	30.866	30.861
Z		37198.856	-27+125	30.708	30.705	Z		37198.856	-24+000	30.773	30.770	Z		37198.856	-20+718	30.841	30.836
AA		37208.856	-27+125	30.688	30.687	AA		37208.856	-24+000	30.739	30.732	AA		37208.856	-20+718	30.821	30.820
E	PIER C15	37211.207	-27+125	30.684	30.684	E	PIER C15	37211.207	-24+000	30.749	30.749	E	PIER C15	37211.207	-20+718	30.817	30.817
AB		37221.207	-27+125	30.670	30.673	AB		37221.207	-24+000	30.705	30.705	AB		37221.207	-20+718	30.805	30.833
AC		37231.207	-27+125	30.661	30.701	AC		37231.207	-24+000	30.705	30.744	AC		37231.207	-20+718	30.794	30.833
AD		37241.207	-27+125	30.657	30.722	AD		37241.207	-24+000	30.705	30.796	AD		37241.207	-20+718	30.790	30.876
AE		37251.207	-27+125	30.658	30.741	AE		37251.207	-24+000	30.705	30.791	AE		37251.207	-20+718	30.797	30.913
AF		37261.207	-27+125	30.664	30.754	AF		37261.207	-24+000	30.705	30.800	AF		37261.207	-20+718	30.812	30.912
AG		37271.207	-27+125	30.675	30.756	AG		37271.207	-24+000	30.705	30.824	AG		37271.207	-20+718	30.845	30.894
AH		37281.207	-27+125	30.691	30.761	AH		37281.207	-24+000	30.705	30.845	AH		37281.207	-20+718	30.824	30.914
AJ		37291.207	-27+125	30.712	30.750	AJ		37291.207	-24+000	30.705	30.845	AJ		37291.207	-20+718	30.845	30.894
AK		37301.207	-27+125	30.737	30.744	AK		37301.207	-24+000	30.705	30.871	AK		37301.207	-20+718	30.871	30.877
E	PIER C16	37303.208	-27+125	30.743	30.743	E	PIER C16	37303.276	-16+562	30.963	30.963	E	PIER C16	37303.249	-20+718	30.877	30.877
AL						AL		37313.276	-16+562	30.995	30.995	AL					
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ROUTE NO.	SECTION	COUNTY	TOTAL SHEETS	SHEET NO.																																																																																																																																																																																																																																																																																																																																																																																																																																																																																																																																																																																																																																					
E E BRG PIER C12	36941.888	-14.312	32.051	32.051	E E BRG PIER C12	A	36951.888	-14.312	32.010	32.034	E E BRG PIER C12	36941.888	-7.906	32.170	32.170	E E BRG PIER C12	36941.888	-1.500	32.222	32.222																																																																																																																																																																																																																																																																																																																																																																																																																																																																																																																																																																																																																					
A	36951.888	-14.312	31.968	32.017	B	36961.888	-7.906	32.045	32.036	C	36971.888	-7.906	32.049	32.036	D	36981.888	-7.906	32.003	32.060	E	36991.888	-7.906	32.008	32.047	F	37001.888	-7.906	31.960	31.974	G	37011.888	-7.906	31.874	31.953	H	37021.888	-7.906	31.831	31.837	J	37036.504	-7.906	31.647	31.771	K	37046.504	-7.906	31.603	31.612	L	37056.504	-7.906	31.559	31.575	M	37066.504	-7.906	31.514	31.540	N	37076.504	-7.906	31.470	31.498	O	37086.504	-7.906	31.425	31.447	P	37096.504	-7.906	31.381	31.396	Q	37106.504	-7.906	31.336	31.345	R	37116.504	-7.906	31.292	31.294	S	37128.856	-7.906	31.281	31.281	T	37138.856	-7.906	31.244	31.244	U	37148.856	-7.906	31.267	31.293	V	37158.856	-7.906	31.223	31.255	W	37168.856	-7.906	31.183	31.216	X	37178.856	-7.906	31.148	31.172	Y	37188.856	-7.906	31.118	31.133	Z	37198.856	-7.906	31.093	31.102	AA	37208.856	-7.906	31.073	31.075	AB	37211.207	-7.906	31.069	31.069	AC	37231.207	-12.000	30.996	30.996	AD	37241.207	-12.000	30.972	31.000	AE	37251.207	-12.000	30.973	31.013	AF	37261.207	-12.000	30.979	31.023	AG	37271.207	-12.000	30.989	31.027	AH	37281.207	-12.000	31.005	31.035	AJ	37291.207	-12.000	30.978	31.007	AK	37301.207	-12.000	31.004	31.027	AL	37303.290	-14.312	31.010	31.010	AM	37313.290	-14.312	31.042	31.042	AN	37323.290	-14.312	31.077	31.079	AO	37333.290	-14.312	31.112	31.117	AP	37343.290	-14.312	31.147	31.152	BRG PIER C17	37358.116	-14.312	31.199	31.199	BRG PIER C17	37358.131	-12.000	31.247	31.247	BRG PIER C17	37358.158	-7.906	31.318	31.318	BRG PIER C17	37358.199	-1.500	31.370	31.370	BRG PIER C12	36941.888	-14.312	32.051	32.051	BRG PIER C12	36951.888	-14.312	31.968	31.980	BRG PIER C12	36961.888	-14.312	31.941	31.941	BRG PIER C12	36971.888	-14.312	31.884	31.884	BRG PIER C12	36981.888	-14.312	31.841	31.849	BRG PIER C12	36991.888	-14.312	31.798	31.834	BRG PIER C12	37001.888	-14.312	31.755	31.777	BRG PIER C12	37011.888	-14.312	31.712	31.719	BRG PIER C12	37021.888	-14.312	31.672	31.719	PIER C13	37026.504	-14.312	31.691	31.691	PIER C13	37026.504	-7.906	31.810	31.810	PIER C13	37026.504	-1.500	31.863	31.863	PIER C13	37026.504	-14.312	31.652	31.652	PIER C13	37026.504	-7.906	31.771	31.771	PIER C13	37026.504	-1.500	31.823	31.823	PIER C13	37026.504	-14.312	31.612	31.612	PIER C13	37026.504	-7.906	31.659	31.678	PIER C13	37026.504	-1.500	31.783	31.783	PIER C13	37026.504	-14.312	31.575	31.575	PIER C13	37026.504	-7.906	31.689	31.694	PIER C13	37026.504	-1.500	31.743	31.743	PIER C13	37026.504	-14.312	31.540	31.540	PIER C13	37026.504	-7.906	31.659	31.669	PIER C13	37026.504	-1.500	31.703	31.703	PIER C13	37026.504	-14.312	31.498	31.498	PIER C13	37026.504	-7.906	31.617	31.617	PIER C13	37026.504	-1.500	31.660	31.660	PIER C13	37026.504	-14.312	31.447	31.447	PIER C13	37026.504	-7.906	31.566	31.566	PIER C13	37026.504	-1.500	31.611	31.611	PIER C13	37026.504	-14.312	31.396	31.396	PIER C13	37026.504	-7.906	31.515	31.500	PIER C13	37026.504	-1.500	31.562	31.562	PIER C13	37026.504	-14.312	31.345	31.345	PIER C13	37026.504	-7.906	31.464	31.442	PIER C13	37026.504	-1.500	31.463	31.463	PIER C14	37118.856	-14.312	31.281	31.281	PIER C14	37118.856	-7.906	31.400	31.400	PIER C14	37118.856	-1.500	31.453	31.453	PIER C14	37118.856	-14.312	31.244	31.244	PIER C14	37118.856	-7.906	31.356	31.329	PIER C14	37118.856	-1.500	31.415	31.415	PIER C14	37118.856	-14.312	31.207	31.207	PIER C14	37118.856	-7.906	31.299	31.275	PIER C14	37118.856	-1.500	31.259	31.259	PIER C14	37118.856	-14.312	31.172	31.172	PIER C14	37118.856	-7.906	31.217	31.200	PIER C14	37118.856	-1.500	31.217	31.217	PIER C15	37211.207	-7.906	31.069	31.069	PIER C15	37211.207	-12.000	30.998	30.998	PIER C15	37211.207	-7.906	31.059	31.066	PIER C15	37211.207	-1.500	31.117	31.117	PIER C15	37211.207	-14.312	30.963	30.963	PIER C15	37211.207	-7.906	31.046	31.046	PIER C15	37211.207	-1.500	31.117	31.117	PIER C15	37211.207	-14.312	30.923	30.923	PIER C15	37211.207	-7.906	31.042	31.071	PIER C15	37211.207	-1.500	31.120	31.120	PIER C15	37211.207	-14.312	30.975	30.975	PIER C15	37211.207	-7.906	31.043	31.083	PIER C15	37211.207	-1.500	31.128	31.128	PIER C15	37211.207	-14.312	30.930	30.930	PIER C15	37211.207	-7.906	31.049	31.094	PIER C15	37211.207	-1.500	31.136	31.136	PIER C15	37211.207	-14.312	30.981	30.981	PIER C15	37211.207	-7.906	31.060	31.098	PIER C15	37211.207	-1.500	31.135	31.135	PIER C15	37211.207	-14.312	30.957	30.957	PIER C15	37211.207	-7.906	31.076	31.106	PIER C15	37211.207	-1.500	31.153	31.153	PIER C15	37211.207	-14.312	30.992	30.992	PIER C15	37211.207	-7.906	31.097	31.113	PIER C15	37211.207	-1.500	31.149	31.163	PIER C15	37211.207	-14.312	31.004	31.004	PIER C15	37211.207	-7.906	31.123	31.126	PIER C15	37211.207	-1.500	31.178	31.178	PIER C16	37303.305	-12.000	31.058	31.058	PIER C16	37303.332	-7.906	31.129	31.129	PIER C16	37303.373	-1.500	31.181	31.181	PIER C16	37303.305	-1
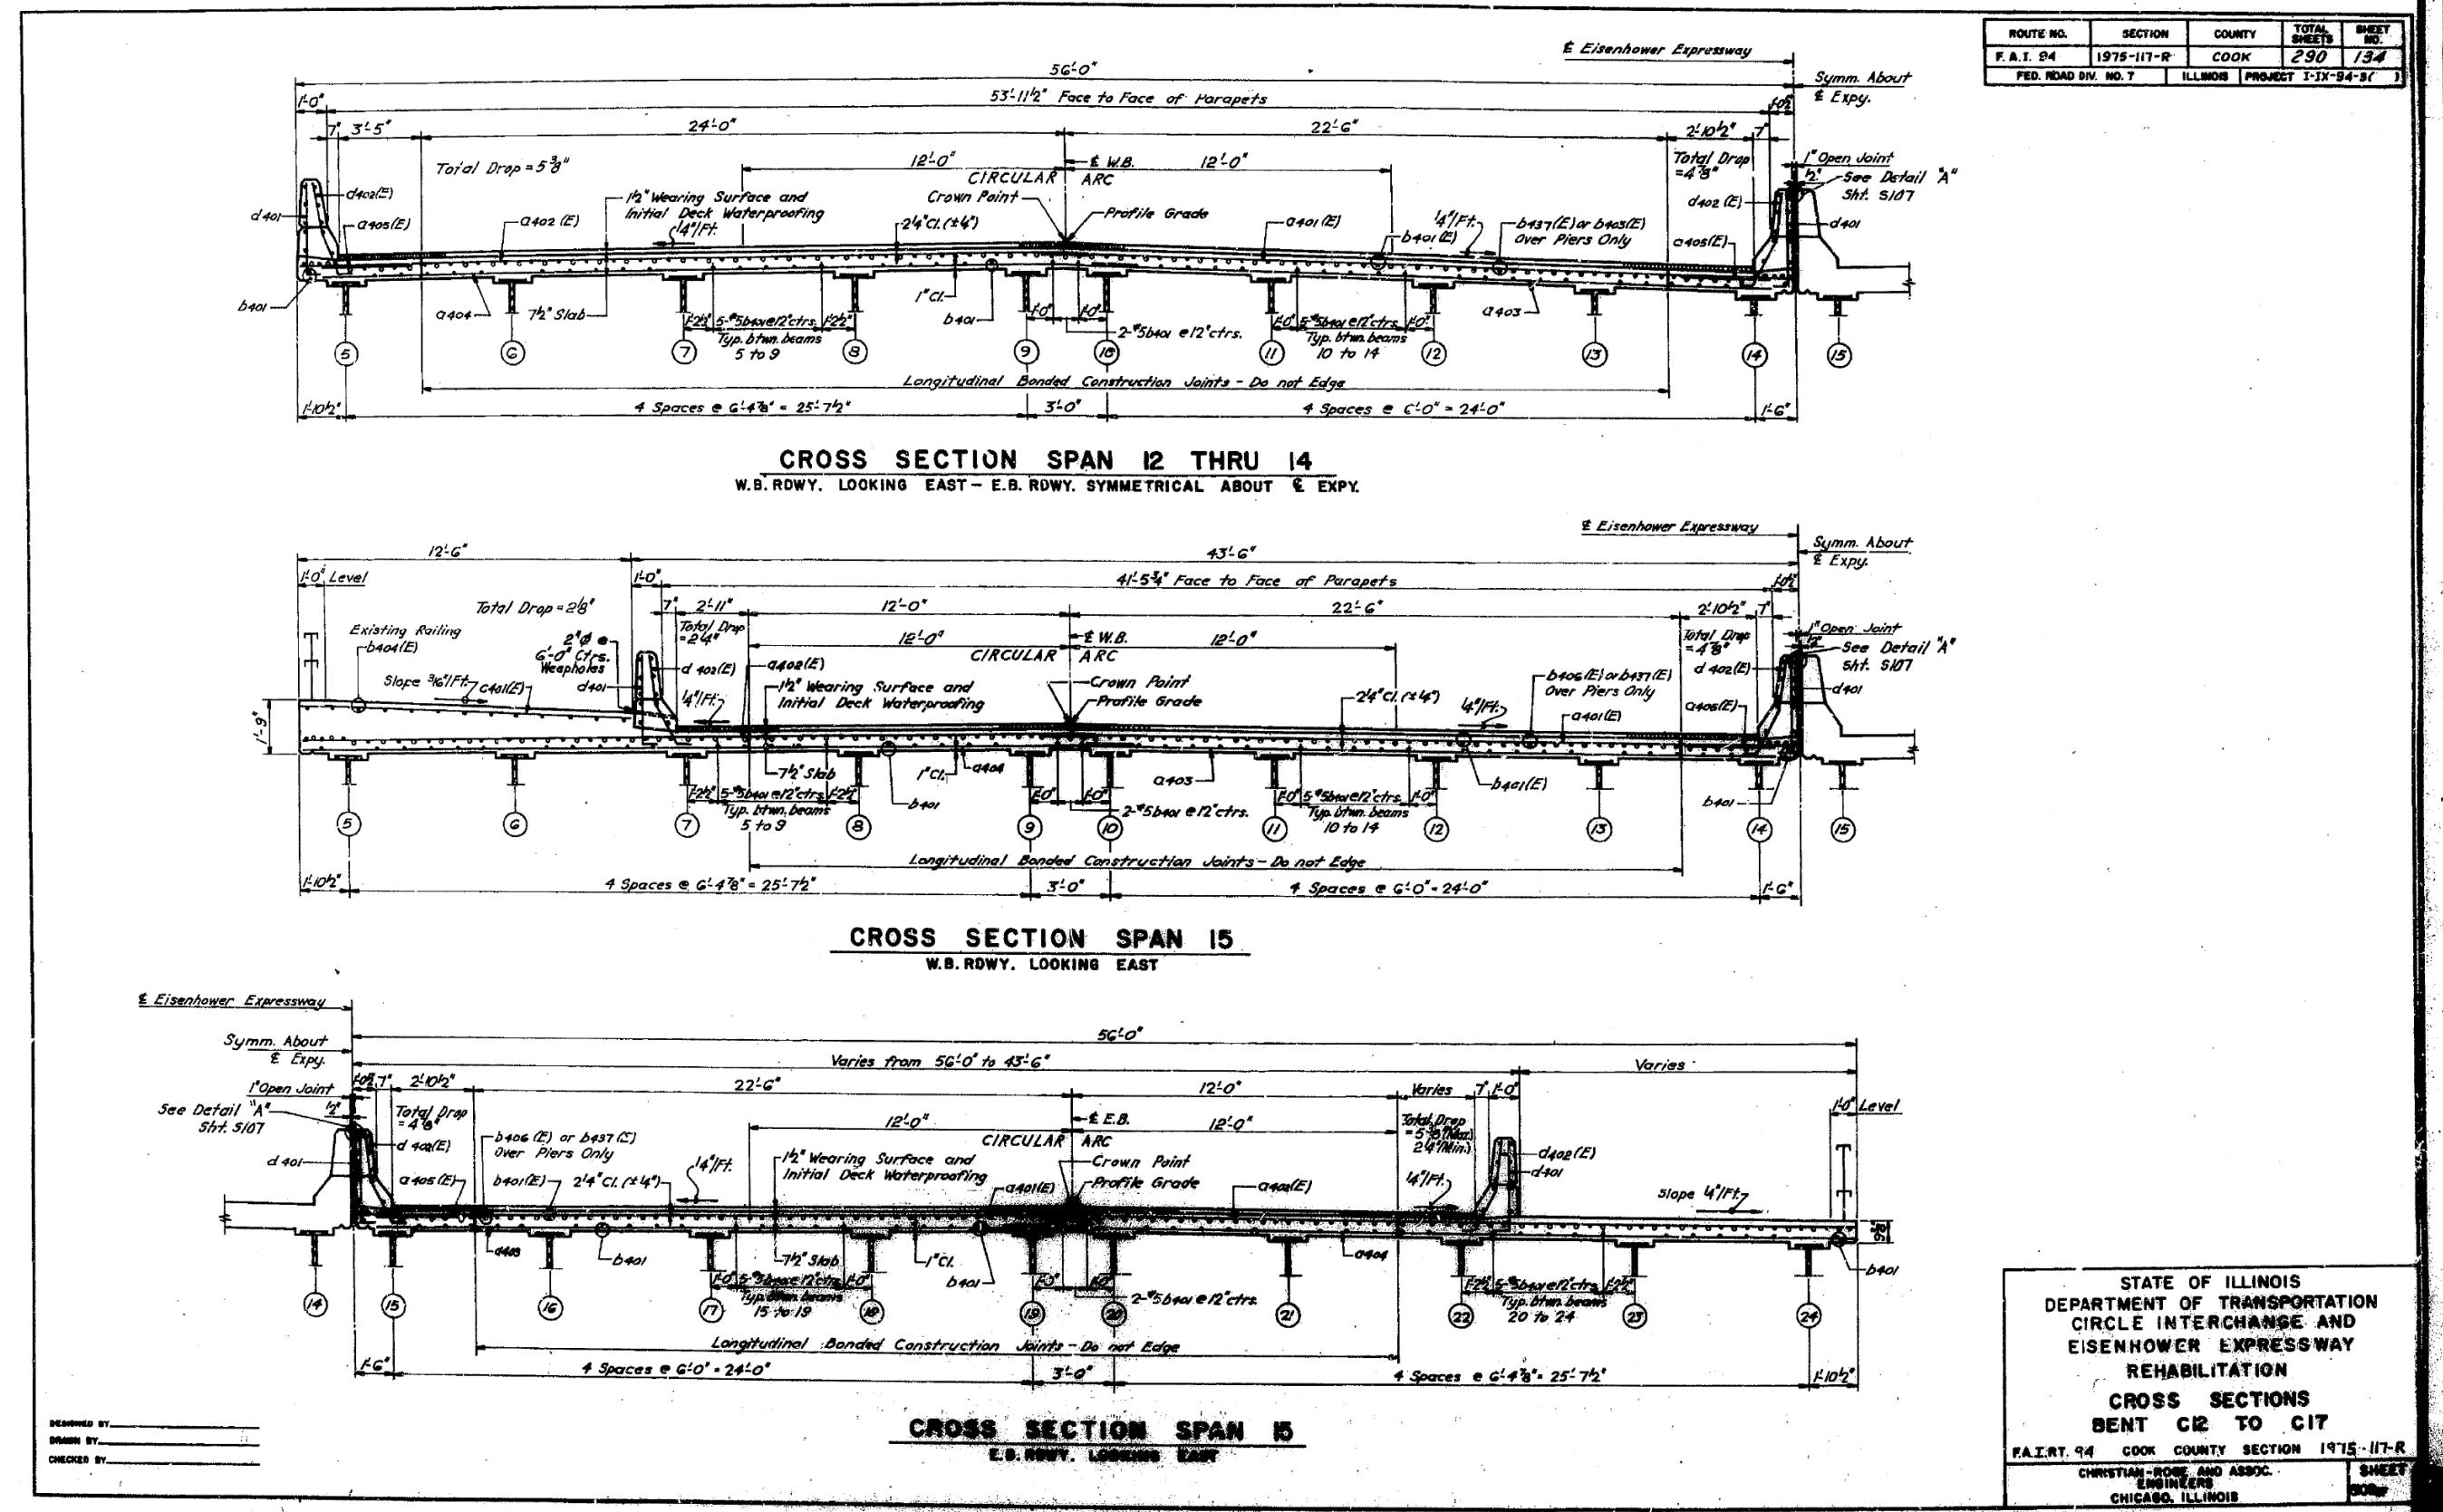
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ROUTE NO.	SECTION	COUNTY	TOTAL SHEETS	SHEET NO.					
FED. ROAD DIV. NO. 7 ILLINOIS PROJECT 1-IX-94-31									
E BRG PIER C12	36941.888	-0.000	32.224	32.224	E BRG PIER C12	36941.888	1.499	32.222	32.222
A	36951.888	-0.000	32.183	32.200	A	36951.888	1.499	32.181	32.198
B	36961.888	-0.000	32.141	32.176	B	36961.888	1.499	32.139	32.174
C	36971.888	-0.000	32.099	32.138	C	36971.888	1.499	32.097	32.136
D	35981.888	-0.000	32.057	32.096	D	36981.888	1.499	32.055	32.096
E	36991.888	-0.000	32.014	32.049	E	36991.888	1.499	32.012	32.047
F	37001.888	-0.000	31.972	31.996	F	37001.888	1.499	31.970	31.994
G	37011.888	-0.000	31.928	31.943	G	37011.888	1.499	31.926	31.941
H	37021.888	-0.000	31.885	31.899	H	37021.888	1.499	31.883	31.887
E PIER C13	37026.504	-0.000	31.865	31.865	E PIER C13	37026.504	1.499	31.863	31.863
J	37036.504	-0.000	31.821	31.825	J	37036.504	1.499	31.819	31.823
K	37046.504	-0.000	31.776	31.785	K	37046.504	1.499	31.774	31.783
L	37056.504	-0.000	31.732	31.745	L	37056.504	1.499	31.730	31.743
M	37066.504	-0.000	31.687	31.705	M	37066.504	1.499	31.685	31.703
N	37076.504	-0.000	31.643	31.662	N	37076.504	1.499	31.641	31.660
O	37086.504	-0.000	31.598	31.613	O	37086.504	1.499	31.596	31.611
P	37096.504	-0.000	31.554	31.569	P	37096.504	1.499	31.552	31.562
R	37106.504	-0.000	31.510	31.515	Q	37106.504	1.499	31.508	31.513
Q	37116.504	-0.000	31.465	31.466	R	37116.504	1.499	31.463	31.464
E PIER C14	37118.856	-0.000	31.455	31.455	E PIER C14	37118.856	1.499	31.453	31.453
S	37128.856	-0.000	31.410	31.417	S	37128.856	1.499	31.408	31.419
T	37138.856	-0.000	31.366	31.379	T	37138.856	1.499	31.364	31.377
U	37148.856	-0.000	31.321	31.340	U	37148.856	1.499	31.319	31.338
V	37158.856	-0.000	31.277	31.301	V	37158.856	1.499	31.275	31.299
W	37168.856	-0.000	31.237	31.261	W	37168.856	1.499	31.235	31.259
X	37178.856	-0.000	31.202	31.219	X	37178.856	1.499	31.200	31.217
Y	37188.856	-0.000	31.172	31.183	Y	37188.856	1.499	31.170	31.181
Z	37198.856	-0.000	31.147	31.153	Z	37198.856	1.499	31.145	31.151
AA	37208.856	-0.000	31.127	31.126	AA	37208.856	1.499	31.125	31.126
E PIER C15	37211.207	-0.000	31.123	31.123	E PIER C15	37211.207	1.499	31.121	31.121
AB	37221.207	-0.000	31.109	31.119	AB	37221.207	1.499	31.108	31.117
AC	37231.207	-0.000	31.101	31.119	AC	37231.207	1.499	31.099	31.117
AD	37241.207	-0.000	31.097	31.122	AD	37241.207	1.499	31.095	31.120
AE	37251.207	-0.000	31.098	31.130	AE	37251.207	1.499	31.096	31.128
AF	37261.207	-0.000	31.138	31.138	AF	37261.207	1.499	31.102	31.136
AG	37271.207	-0.000	31.114	31.145	AG	37271.207	1.499	31.113	31.143
AH	37281.207	-0.000	31.130	31.155	AH	37281.207	1.499	31.129	31.155
AJ	37291.207	-0.000	31.151	31.165	AJ	37291.207	1.499	31.149	31.163
AK	37301.207	-0.000	31.177	31.180	AK	37301.207	1.499	31.175	31.178
E PIER C16	37303.383	-0.000	31.183	31.183	E PIER C16	37303.392	1.499	31.181	31.181
AL	37313.383	-0.000	31.215	31.215	AL	37313.392	1.499	31.213	31.213
AM	37323.383	-0.000	31.250	31.250	AM	37323.392	1.499	31.248	31.248
AN	37333.383	-0.000	31.285	31.286	AN	37333.392	1.499	31.283	31.284
AO	37353.383	-0.000	31.320	31.325	AO	37343.392	1.499	31.318	31.323
AP	37353.383	-0.000	31.355	31.357	AP	37353.392	1.499	31.353	31.355
E BRG PIER C17	37358.209	-0.000	31.372	31.372	E BRG PIER C17	37358.218	1.499	31.370	31.370
E BRG PIER C17	37358.218	-0.000	31.372	31.372	E BRG PIER C17	37358.257	1.499	31.323	31.323
E BRG PIER C17	37358.257	-0.000	31.370	31.370	E BRG PIER C17	37358.295	1.499	31.323	31.323
E BRG PIER C17	37358.295	-0.000	31.372	31.372	E BRG PIER C17	37358.295	1.499	31.321	31.321
E BRG PIER C12	36941.888	19.499	31.943	31.943	E BRG PIER C12	36941.888	22.500	31.881	31.881
A	36951.888	19.499	31.902	31.924	A	36951.888	22.500	31.840	31.862
B	36961.888	19.499	31.860	31.905	B	36961.888	22.500	31.790	31.842
C	36971.888	19.499	31.818	31.870	C	36971.888	22.500	31.749	31.844
D	36981.888	19.499	31.799	31.832	D	36981.888	22.500	31.714	31.770
E	36991.888	19.499	31.765	31.779	E	36991.888	22.500	31.671	31.717
F	37001.888	19.499	31.691	31.722	F	37001.888	22.500	31.628	31.659
G	37011.888	19.499	31.647	31.665	G	37011.888	22.500	31.585	31.603
H	37021.888	19.499	31.604	31.609	H	37021.888	22.500	31.541	31.547
E PIER C13	37026.504	19.499	31.584	31.584	E PIER C13	37026.504	22.500	31.521	31.521
J	37036.504	19.499	31.540	31.544	J	37036.504	22.500	31.477	31.482
K	37046.504	19.499	31.495	31.504	K	37046.504	22.500	31.433	31.442
L	37056.504	19.499	31.451	31.466	L	37056.504	22.500	31.386	31.404
M	37076.504	19.499	31.406	31.428	M	37066.504	22.500	31.324	31.344
N	37086.504	19.499	31.317	31.385	N	37076.504	22.500	31.299	31.326
O	37096.504	19.499	31.273	31.288	O	37086.504	22.500	31.255	31.276
P	37106.504	19.49							

FOR INFORMATION ONLY

	LOCATION	STATION	OFFSET	THEORETICAL GRADE ELEV.	THEO. GRADE ELEV. FOR Q DEFL.		LOCATION	STATION	OFFSET	THEORETICAL GRADE ELEV.	THEO. GRADE ELEV. FOR Q DEFL.		LOCATION	STATION	OFFSET	THEORETICAL GRADE ELEV.	THEO. GRADE ELEV. FOR Q DEFL.
E	BRG PIER C12	36941.888	-27.000	31.787	31.787	E	BRG PIER C12	36941.888	-25.500	31.818	31.818	E	BRG PIER C12	36941.888	-22.500	31.881	31.881
A		36951.888	-27.000	31.746	31.763	A		36951.888	-25.500	31.777	31.794	A		36951.888	-22.500	31.840	31.862
B		36961.888	-27.000	31.704	31.739	B		36961.888	-25.500	31.735	31.770	B		36961.888	-22.500	31.798	31.842
C		36971.888	-27.000	31.662	31.703	C		36971.888	-25.500	31.694	31.734	C		36971.888	-22.500	31.756	31.807
D		36981.888	-27.000	31.620	31.666	D		36981.888	-25.500	31.651	31.697	D		36981.888	-22.500	31.714	31.750
E		36991.888	-27.000	31.577	31.615	E		36991.888	-25.500	31.609	31.646	E		36991.888	-22.500	31.671	31.717
F		37001.888	-27.000	31.535	31.560	F		37001.888	-25.500	31.566	31.591	F		37001.888	-22.500	31.628	31.659
G		37011.888	-27.000	31.491	31.505	G		37011.888	-25.500	31.523	31.537	G		37011.888	-22.500	31.585	31.603
H		37021.888	-27.000	31.448	31.452	H		37021.888	-25.500	31.479	31.484	H		37021.888	-22.500	31.541	31.547
E	PIER C13	37026.504	-27.000	31.428	31.428	E	PIER C13	37026.504	-25.500	31.459	31.459	E	PIER C13	37026.504	-22.500	31.521	31.521
J		37036.504	-27.000	31.384	31.388	J		37036.504	-25.500	31.415	31.419	J		37036.504	-22.500	31.477	31.482
K		37046.504	-27.000	31.339	31.348	K		37046.504	-25.500	31.370	31.379	K		37046.504	-22.500	31.433	31.442
L		37056.504	-27.000	31.295	31.308	L		37056.504	-25.500	31.326	31.340	L		37056.504	-22.500	31.388	31.404
M		37076.504	-27.000	31.250	31.268	M		37076.504	-25.500	31.282	31.300	M		37076.504	-22.500	31.346	31.366
N		37086.504	-27.000	31.200	31.225	N		37086.504	-25.500	31.237	31.256	N		37086.504	-22.500	31.299	31.314
O		37096.504	-27.000	31.161	31.176	O		37096.504	-25.500	31.193	31.207	O		37096.504	-22.500	31.255	31.275
P		37106.504	-27.000	31.117	31.127	P		37106.504	-25.500	31.148	31.158	P		37106.504	-22.500	31.211	31.226
Q		37116.504	-27.000	31.073	31.078	Q		37116.504	-25.500	31.104	31.109	Q		37116.504	-22.500	31.166	31.174
R		37116.504	-27.000	31.028	31.029	R		37116.504	-25.500	31.059	31.060	R		37116.504	-22.500	31.122	31.123
E	PIER C14	37118.856	-27.000	31.018	31.018	E	PIER C14	37118.856	-25.500	31.049	31.049	E	PIER C14	37118.856	-22.500	31.111	31.111
S		37128.856	-27.000	30.973	30.980	S		37128.856	-25.500	31.004	31.011	S		37128.856	-22.500	31.074	31.074
T		37138.856	-27.000	30.929	30.942	T		37138.856	-25.500	30.960	30.973	T		37138.856	-22.500	31.028	31.036
U		37148.856	-27.000	30.884	30.903	U		37148.856	-25.500	30.915	30.934	U		37148.856	-22.500	30.948	30.958
V		37158.856	-27.000	30.840	30.864	V		37158.856	-25.500	30.871	30.895	V		37158.856	-22.500	30.934	30.961
W		37178.856	-27.000	30.800	30.824	W		37178.856	-25.500	30.832	30.855	W		37178.856	-22.500	30.894	30.923
X		37188.856	-27.000	30.765	30.782	X		37188.856	-25.500	30.797	30.813	X		37188.856	-22.500	30.859	30.881
Y		37198.856	-27.000	30.735	30.746	Y		37198.856	-25.500	30.767	30.777	Y		37198.856	-22.500	30.829	30.844
Z		37208.856	-27.000	30.710	30.716	Z		37208.856	-25.500	30.742	30.752	Z		37208.856	-22.500	30.804	30.812
AA		37208.856	-27.000	30.690	30.691	AA		37208.856	-25.500	30.722	30.723	AA		37208.856	-22.500	30.784	30.786
E	PIER C15	37211.207	-27.000	30.686	30.686	E	PIER C15	37211.207	-25.500	30.718	30.718	E	PIER C15	37211.207	-22.500	30.780	30.780
AB		37221.207	-27.000	30.672	30.682	AB		37221.207	-25.500	30.704	30.713	AB		37221.207	-22.500	30.766	30.777
AC		37231.207	-27.000	30.664	30.662	AC		37231.207	-25.500	30.695	30.713	AC		37231.207	-22.500	30.757	30.760
AD		37241.207	-27.000	30.660	30.685	AD		37241.207	-25.500	30.691	30.716	AD		37241.207	-22.500	30.753	30.785
AE		37251.207	-27.000	30.661	30.693	AE		37251.207	-25.500	30.692	30.724	AE		37251.207	-22.500	30.754	30.775
AF		37261.207	-27.000	30.667	30.701	AF		37261.207	-25.500	30.698	30.733	AF		37261.207	-22.500	30.760	30.804
AG		37271.207	-27.000	30.677	30.708	AG		37271.207	-25.500	30.709	30.739	AG		37271.207	-22.500	30.771	30.809
AH		37281.207	-27.000	30.693	30.719	AH		37281.207	-25.500	30.725	30.750	AH		37281.207	-22.500	30.787	30.817
AJ		37291.207	-27.000	30.714	30.728	AJ		37291.207	-25.500	30.745	30.750	AJ		37291.207	-22.500	30.808	30.825
AK		37301.207	-27.000	30.740	30.743	AK		37301.207	-25.500	30.771	30.774	AK		37301.207	-22.500	30.834	30.837
E	PIER C16	37303.557	-27.000	30.747	30.747	E	PIER C16	37303.566	-25.500	30.778	30.778	E	PIER C16	37303.586	-22.500	30.841	30.841
AL		37313.557	-27.000	30.779	30.775	AL		37313.566	-25.245	30.815	30.812	AL		37313.586			

FOR INFORMATION ONLY

FED ROAD DIV NO. 7												ILLINOIS PROJECT I-IX-94-3K																
ROUTE NO.			SECTION			COUNTY			TOTAL SHEETS			SHEET NO.																
F.A.I. RT. 94			1975-I-7-R			COOK			290			143																
E	BRG PIER C12	36941.888	-19.500	31.943	31.943	E	BRG PIER C12	36941.888	-13.499	32.068	32.068	E	BRG PIER C12	36941.888	-7.499	32.175	32.175	E	BRG PIER C12	36941.888	-1.499	32.222	32.222	E	BRG PIER C12	36941.888	-1.499	32.222
A	36951.888	-19.500	31.902	31.924		A	36951.888	-13.499	32.027	32.049		A	36951.888	-7.499	32.134	32.156		A	36951.888	-1.499	32.131	32.198		A	36951.888	-1.499	32.131	
B	36961.888	-19.500	31.860	31.905		B	36961.888	-13.499	31.985	32.029		B	36961.888	-7.499	32.092	32.137		B	36961.888	-1.499	32.139	32.174		B	36961.888	-1.499	32.139	
C	36971.888	-19.500	31.818	31.850		C	36971.888	-13.499	31.943	31.994		C	36971.888	-7.499	32.050	32.102		C	36971.888	-1.499	32.097	32.136		C	36971.888	-1.499	32.097	
D	36981.888	-19.500	31.766	31.832		D	36981.888	-13.499	31.901	31.957		D	36981.888	-7.499	32.008	32.064		D	36981.888	-1.499	32.015	32.066		D	36981.888	-1.499	32.015	
E	36991.888	-19.500	31.725	31.779		E	36991.888	-13.499	31.850	31.934		E	36991.888	-7.499	31.966	32.012		E	36991.888	-1.499	32.012	32.067		E	36991.888	-1.499	32.012	
F	37001.888	-19.500	31.691	31.722		F	37001.888	-13.499	31.819	31.847		F	37001.888	-7.499	31.923	31.954		F	37001.888	-1.499	31.970	31.994		F	37001.888	-1.499	31.970	
G	37011.888	-19.500	31.667	31.695		G	37011.888	-13.499	31.772	31.790		G	37011.888	-7.499	31.879	31.898		G	37011.888	-1.499	31.926	31.941		G	37011.888	-1.499	31.926	
H	37021.888	-19.500	31.604	31.609		H	37021.888	-13.499	31.729	31.734		H	37021.888	-7.499	31.836	31.842		H	37021.888	-1.499	31.883	31.887		H	37021.888	-1.499	31.883	
Q	PIER C13	37026.504	-19.500	31.584	31.584	Q	PIER C13	37026.504	-13.499	31.708	31.708	Q	PIER C13	37026.504	-7.499	31.816	31.816	Q	PIER C13	37026.504	-1.499	31.863	31.863	Q	PIER C13	37026.504	-1.499	31.863
J	37036.504	-19.500	31.540	31.544		J	37036.504	-13.499	31.664	31.669		J	37036.504	-7.499	31.772	31.776		J	37036.504	-1.499	31.819	31.823		J	37036.504	-1.499	31.819	
K	37046.504	-19.500	31.495	31.504		K	37046.504	-13.499	31.620	31.629		K	37046.504	-7.499	31.727	31.736		K	37046.504	-1.499	31.774	31.785		K	37046.504	-1.499	31.774	
L	37056.504	-19.500	31.451	31.466		L	37056.504	-13.499	31.576	31.591		L	37056.504	-7.499	31.683	31.698		L	37056.504	-1.499	31.740	31.753		L	37056.504	-1.499	31.740	
M	37066.504	-19.500	31.406	31.424		M	37066.504	-13.499	31.531	31.553		M	37066.504	-7.499	31.639	31.660		M	37066.504	-1.499	31.641	31.660		M	37066.504	-1.499	31.641	
N	37076.504	-19.500	31.362	31.376		N	37076.504	-13.499	31.487	31.511		N	37076.504	-7.499	31.594	31.618		N	37076.504	-1.499	31.642	31.673		N	37076.504	-1.499	31.642	
O	37086.504	-19.500	31.317	31.337		O	37086.504	-13.499	31.492	31.502		O	37086.504	-7.499	31.550	31.569		O	37086.504	-1.499	31.596	31.611		O	37086.504	-1.499	31.596	
P	37096.504	-19.500	31.273	31.288		P	37096.504	-13.499	31.398	31.413		P	37096.504	-7.499	31.505	31.520		P	37096.504	-1.499	31.552	31.562		P	37096.504	-1.499	31.552	
Q	37106.504	-19.500	31.229	31.237		Q	37106.504	-13.499	31.353	31.362		Q	37106.504	-7.499	31.461	31.469		Q	37106.504	-1.499	31.508	31.513		Q	37106.504	-1.499	31.508	
R	37116.504	-19.500	31.184	31.186		R	37116.504	-13.499	31.309	31.310		R	37116.504	-7.499	31.416	31.418		R	37116.504	-1.499	31.463	31.464		R	37116.504	-1.499	31.463	
Q	PIER C14	37118.856	-19.500	31.174	31.174	Q	PIER C14	37118.856	-13.499	31.298	31.298	Q	PIER C14	37118.856	-7.499	31.406	31.406	Q	PIER C14	37118.856	-1.499	31.453	31.453	Q	PIER C14	37118.856	-1.499	31.453
S	37128.856	-19.500	31.129	31.136		S	37128.856	-13.499	31.254	31.261		S	37128.856	-7.499	31.361	31.368		S	37128.856	-1.499	31.408	31.415		S	37128.856	-1.499	31.408	
T	37138.856	-19.500	31.085	31.098		T	37138.856	-13.499	31.210	31.223		T	37138.856	-7.499	31.317	31.330		T	37138.856	-1.499	31.366	31.377		T	37138.856	-1.499	31.366	
U	37148.856	-19.500	31.040	31.061		U	37148.856	-13.499	31.165	31.185		U	37148.856	-7.499	31.226	31.242		U	37148.856	-1.499	31.319	31.338		U	37148.856	-1.499	31.319	
V	37158.856	-19.500	31.006	31.026		V	37158.856	-13.499	31.121	31.148		V	37158.856	-7.499	31.226	31.245		V	37158.856	-1.499	31.319	31.338		V	37158.856	-1.499	31.319	
W	37168.856	-19.500</																										

FOR INFORMATION ONLY

LOCATION	STATION	OFFSET	THEORETICAL GRADE ELEVATION	THEO. GRADE ELEV. ADJ. FOR Q DEFL.	LOCATION	STATION	OFFSET	THEORETICAL GRADE ELEVATION	THEO. GRADE ELEV. ADJ. FOR Q DEFL.	LOCATION	STATION	OFFSET	THEORETICAL GRADE ELEVATION	THEO. GRADE ELEV. ADJ. FOR Q DEFL.	LOCATION	STATION	OFFSET	THEORETICAL GRADE ELEVATION	THEO. GRADE ELEV. ADJ. FOR Q DEFL.	ROUTE NO.	SECTION	COUNTY	TOTAL SHEETS	SHEET NO.
E BRG PIER C12	36941.888	0.000	32.224	32.224	E BRG PIER C12	36941.888	1.500	32.222	32.222	E BRG PIER C12	36941.888	7.906	32.170	32.170	E BRG PIER C12					F.A.I. RT. 94	1975-II7-R	COOK	290	144
A	36951.888	0.000	32.183	32.200	A	36951.888	1.500	32.181	32.198	A	36951.888	7.906	32.129	32.153	A					FED ROAD DIV NO 7	ILLINOIS	PROJECT I-IX-94-3(1)		
B	35941.888	0.000	32.141	32.176	B	36961.888	1.500	32.139	32.174	B	36961.888	7.906	32.087	32.136	B									
C	35971.888	0.000	32.099	32.138	C	36971.888	1.500	32.097	32.136	C	36971.888	7.906	32.045	32.099	C									
D	35991.888	0.000	32.057	32.098	D	36981.888	1.500	32.055	32.096	D	36981.888	7.906	32.003	32.060	D									
E	35991.888	0.000	32.014	32.049	E	35991.888	1.500	32.012	32.047	E	35991.888	7.906	31.960	32.008	E									
F	37001.888	0.000	31.972	31.996	F	37001.888	1.500	31.970	31.994	F	37001.888	7.906	31.917	31.953	F									
G	37011.888	0.000	31.928	31.943	G	37011.888	1.500	31.926	31.941	G	37011.888	7.906	31.874	31.896	G									
H	37021.888	0.000	31.885	31.899	H	37021.888	1.500	31.883	31.887	H	37021.888	7.906	31.831	31.837	H									
Q PIER C13	37026.504	0.000	31.865	31.865	Q PIER C13	37026.504	1.500	31.863	31.863	Q PIER C13	37026.504	7.906	31.810	31.810	Q PIER C13									
J	37036.504	0.000	31.821	31.825	J	37036.504	1.500	31.819	31.823	J	37036.504	7.906	31.766	31.771	J									
K	37046.504	0.000	31.775	31.785	K	37046.504	1.500	31.774	31.783	K	37046.504	7.906	31.722	31.731	K									
L	37056.504	0.000	31.732	31.745	L	37056.504	1.500	31.730	31.743	L	37056.504	7.906	31.678	31.694	L									
M	37066.504	0.000	31.687	31.705	M	37066.504	1.500	31.685	31.703	M	37066.504	7.906	31.633	31.659	M									
N	37076.504	0.000	31.643	31.662	N	37076.504	1.500	31.641	31.660	N	37076.504	7.906	31.589	31.617	N									
O	37086.504	0.000	31.598	31.613	O	37086.504	1.500	31.596	31.611	O	37086.504	7.906	31.544	31.566	O									
P	37096.504	0.000	31.554	31.564	P	37096.504	1.500	31.552	31.562	P	37096.504	7.906	31.500	31.515	P									
Q	37106.504	0.000	31.510	31.515	Q	37106.504	1.500	31.508	31.513	Q	37106.504	7.906	31.455	31.464	Q									
R	37116.504	0.000	31.465	31.468	R	37116.504	1.500	31.463	31.464	R	37116.504	7.906	31.411	31.412	R									
Q PIER C14	37118.856	0.000	31.455	31.455	Q PIER C14	37118.856	1.500	31.453	31.453	Q PIER C14	37118.856	7.906	31.400	31.400	Q PIER C14									
S	37128.856	0.000	31.410	31.417	S	37128.856	1.500	31.408	31.415	S	37128.856	7.906	31.356	31.365	S									
T	37138.856	0.000	31.366	31.379	T	37138.856	1.500	31.364	31.377	T	37138.856	7.906	31.311	31.329	T									
U	37148.856	0.000	31.321	31.340	U	37148.856	1.500	31.319	31.338	U	37148.856	7.906	31.267	31.293	U									
V	37158.856	0.000	31.277	31.301	V	37158.856	1.500	31.275	31.299	V	37158.856	7.906	31.223	31.255	V									
W	37168.856	0.000	31.237	31.261	W	37168.856	1.500	31.235	31.259	W	37168.856	7.906	31.183	31.216	W									
X	37178.856	0.000	31.202	31.219	X	37178.856	1.500	31.200	31.217	X	37178.856	7.906	31.148	31.172	X									
Y	37188.856	0.000	31.172	31.185	Y	37188.856	1.500	31.170	31.181	Y	37188.856	7.906	31.118	31.133	Y									
Z	37198.856	0.000	31.147	31.153	Z	37198.856	1.500	31.145	31.151	Z	37198.856	7.906	31.093	31.102	Z									
AA	37208.856	0.000	31.127	31.128	AA	37208.856	1.500	31.125	31.126	AA	37208.856	7.906	31.073	31.075	AA									
Q PIER C15	37211.207	0.000	31.123	31.123	Q PIER C15	37211.207	1.500	31.121	31.121	Q PIER C15	37211.207	7.906	31.069	31.069	Q PIER C15									
AB	37221.207	0.000	31.109	31.119	AB	37221.207	1.500	31.108	31.117	AB	37221.207	7.906	31.055	31.064	AB									
AC	37231.207	0.000	31.101	31.119	AC	37231.207	1.500	31.099	31.117	AC	37231.207	7.906	31.046	31.064	AC									
AD	37241.207	0.000	31.097	31.122	AD	37241.207	1.500	31.095	31.120	AD	37241.207	7.906	31.042	31.071	AD									
AE	37251.207	0.000	31.098	31.130	AE	37251.207	1.500	31.096	31.128	AE	37251.207	7.906	31.043	31.083	AE									
AF	37261.207	0.000	31.091	31.145	AF																			


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STATE OF ILLINOIS
CITY OF CHICAGO
DEPARTMENT OF PUBLIC WORKS
BUREAU OF ENGINEERING

NORTHWEST ROUTE SUPERHIGHWAY

**PLANS FOR
HALSTED STREET INTERCHANGE
SECTION 0101.6-1P**

FAI ROUTE NO. 94 PROJECT I-94-3 (1)-51 (NEW NUMBER)
FAI ROUTE NO. 4 PROJECT I-04-8 (89) (OLD NUMBER)

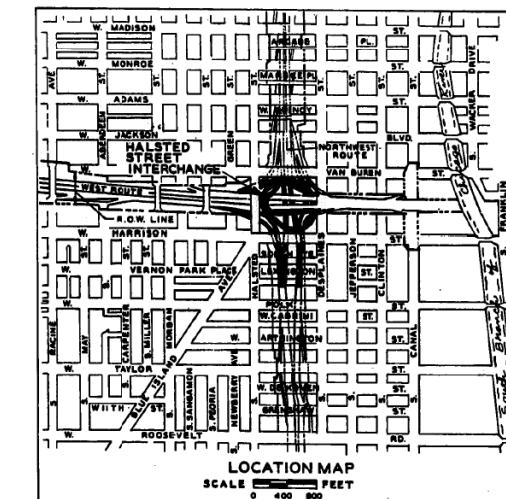

APPROVED AS TO SEWER ALTERATIONS AND ADDITION
Dobekbauer
CHIEF ENGINEER OF SEWERS
John E. Gaskill
DEPUTY FOR SEWERS

DEPARTMENT OF COMMERCE BUREAU OF PUBLIC ROADS		CITY OF CHICAGO DEPARTMENT OF PUBLIC WORKS BUREAU OF ENGINEERING	
APPROVED [REDACTED]		DATE AUGUST 13, 1959	
APPROVED [REDACTED] CHIEF SURVEY AND HIGHWAY ENGINEER		APPROVED [REDACTED] ASSISTANT CHIEF ENGINEER	
APPROVED [REDACTED] CHIEF ENGINEER		APPROVED [REDACTED] COMMISSIONER	
THE DEPARTMENT OF PUBLIC WORKS AND BUILDINGS DIVISION OF HIGHWAYS			
APPROVED [REDACTED] 19 [REDACTED]		APPROVED [REDACTED] 19 [REDACTED]	
APPROVED [REDACTED] 19 [REDACTED]		DIRECTOR [REDACTED]	
SHEET NO. G-1 OF 115 SHEETS			

USER NAME	= ahmad,issa	DESIGNED	-	REVISED	-
		CHECKED	-	REVISED	-
PLOT SCALE	= N.T.S	DRAWN	-	REVISED	-
PLOT DATE	= 7/26/2018	CHECKED	- MI, MAI	REVISED	-

**STATE OF ILLINOIS
DEPARTMENT OF TRANSPORTATION**


EXISTING RECORD DRAWINGS

F.A.I. RTE.	SECTION	COUNTY	TOTAL SHEETS	SHEET NO.
90/94/290	2014-013R&B-R	COOK	1972	1925
			CONTRACT NO. 60X93	
		ILLINOIS	FED. AID PROJECT	

FOR INFORMATION ONLY

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ITEM NO.	UNIT	QUANTITY	DESCRIPTION	ITEM NO.	UNIT	QUANTITY	DESCRIPTION	ITEM NO.	UNIT	QUANTITY	DESCRIPTION
1	CU. YDS.	23,000	SPECIAL EXCAVATION	37	EACH	19	MANHOLES,TYPE A, 4-FT. DIA.	73	EACH	91	JUNCTION BOXES
2	CU. YDS.	1,500	CLASS A EXCAVATION FOR STRUCTURES	38	EACH	2	INLETS TO BE ADJUSTED	74	LUMP SUM	-	SERVICE FOR SUBWAY PUMP ROOM
3	TONS	18,700	POROS GRANULAR EMBANKMENT	39	EACH	8	CATCH BASINS TO BE ADJUSTED	75	SQL.YDS.	18,300	SODDING
4	CU.YDS.	1,500	TRENCH BACKFILL	40	EACH	13	MANHOLES TO BE ADJUSTED	76	CU.YDS.	4,200	TOP SOIL
5	CU.YDS.	8,100	CLASS X CONCRETE	41	EACH	15	CATCH BASINS TO BE RECONSTRUCTED	77	ACRES	6.4	COMPLETE SEEDING
6	LBS.	1,600,000	REINFORCEMENT BARS	42	EACH	7	MANHOLES TO BE RECONSTRUCTED	78	TONS	11.7	PEAT MOSS
7	SQ.YDS.	33,000	PAVEMENT FABRIC	43	EACH	4	FILLING EXISTING INLETS	79	TONS	1.1	FERTILIZER NUTRIENTS
8	LBS.	3,400,000	STRUCTURAL STEEL	44	EACH	1	FILLING EXISTING CATCH BASINS	80	LONS	12.8	STRAW FOR ASPHALT-COATED MULCH
9	CU.FT.	66,000	SUB-PIER SHAFTS	45	LBS.	16,000	MISCELLANEOUS IRON CASTINGS	81	GALS.	1,280	EMULSIFIED ASPHALT
10	CU.FT.	5,600	SUB-PIER BELLS	46	LIN.FT.	2,050	STORM SEWERS, TYPE 1, 6-INCH	82	EACH	20	FRAXINUS AMERICANA, 5'-6'
11	TONS	16,300	6-INCH SUB-BASE GRANULAR MATERIAL ,TYPE A	47	LIN.FT.	400	STORM SEWERS, TYPE 2, 6-INCH	83	EACH	6	PLATANUS OCCIDENTALIS, 7'-6'
12	TONS	3,250	6-INCH SUB-BASE GRANULAR MATERIAL ,TYPE B	48	LIN.FT.	2,200	STORM SEWERS, TYPE 2, 10-INCH	84	EACH	10	CELTI S OCCIDENTALIS, 6'-10'
13	TONS	16,000	12-INCH SUB-BASE GRANULAR MATERIAL ,TYPE B	49	LIN.FT.	1,425	STORM SEWERS, TYPE 2, 12-INCH	85	EACH	25	GLEDTISIA TRIACANTHOS INERMIS, 7'-6'
14	SQ.YDS.	1,600	PORTLAND CEMENT CONCRETE PAVEMENT,6-INCH	50	LIN.FT.	350	STORM SEWERS, TYPE 2, 15-INCH	86	EACH	12	GLEDTISIA TRIACANTHOS INERMIS, 6'-10'
15	SQ.YDS.	30,000	PORTLAND CEMENT CONCRETE PAVEMENT,10-INCH	51	LIN.FT.	180	STORM SEWERS, TYPE 2, 18-INCH	87	EACH	7	CRATAEGUS CRUS-GALLI, 6'-10'
16	SQ.YDS.	2,100	PORTLAND CEMENT CONCRETE PAVEMENT,10-INCH (COLORED)	52	LIN.FT.	1,500	PIPE UNDERDRAINS, 6-INCH	8			

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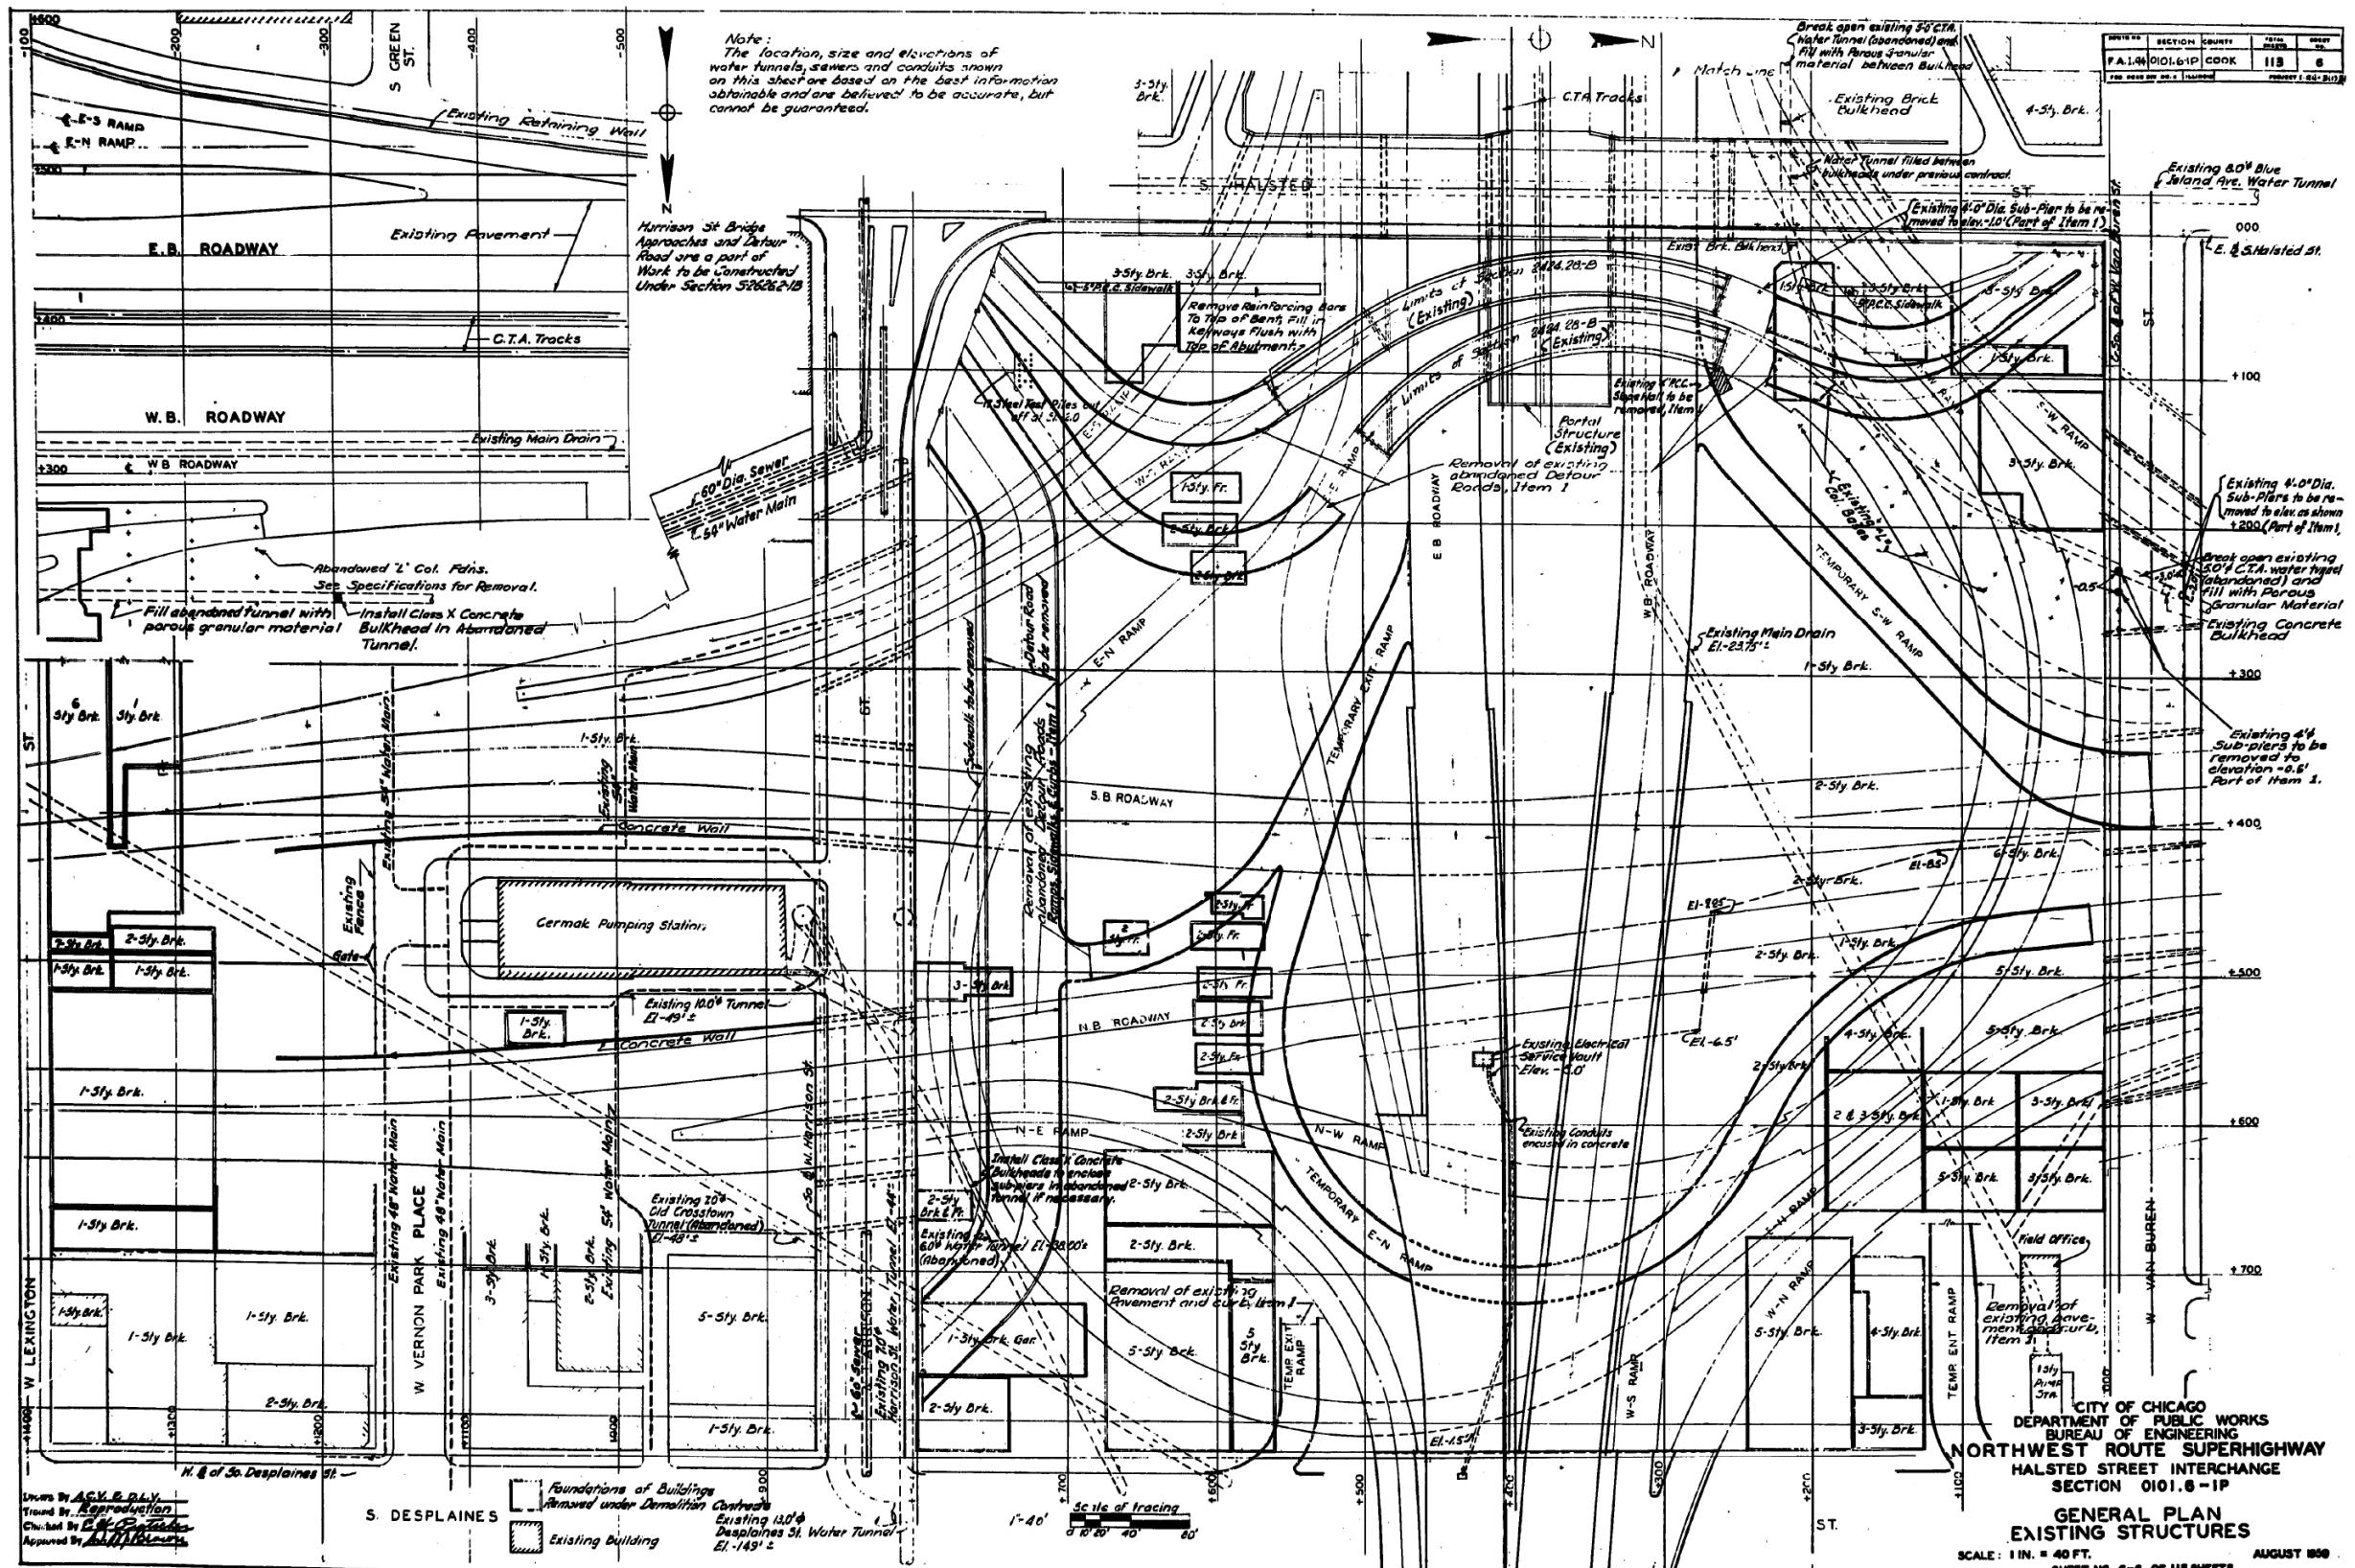
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PLOT SCALE =	N.T.S	DRAWN -	REVISED -
PLOT DATE =	7/26/2018	CHECKED - MI, MAI	REVISED -

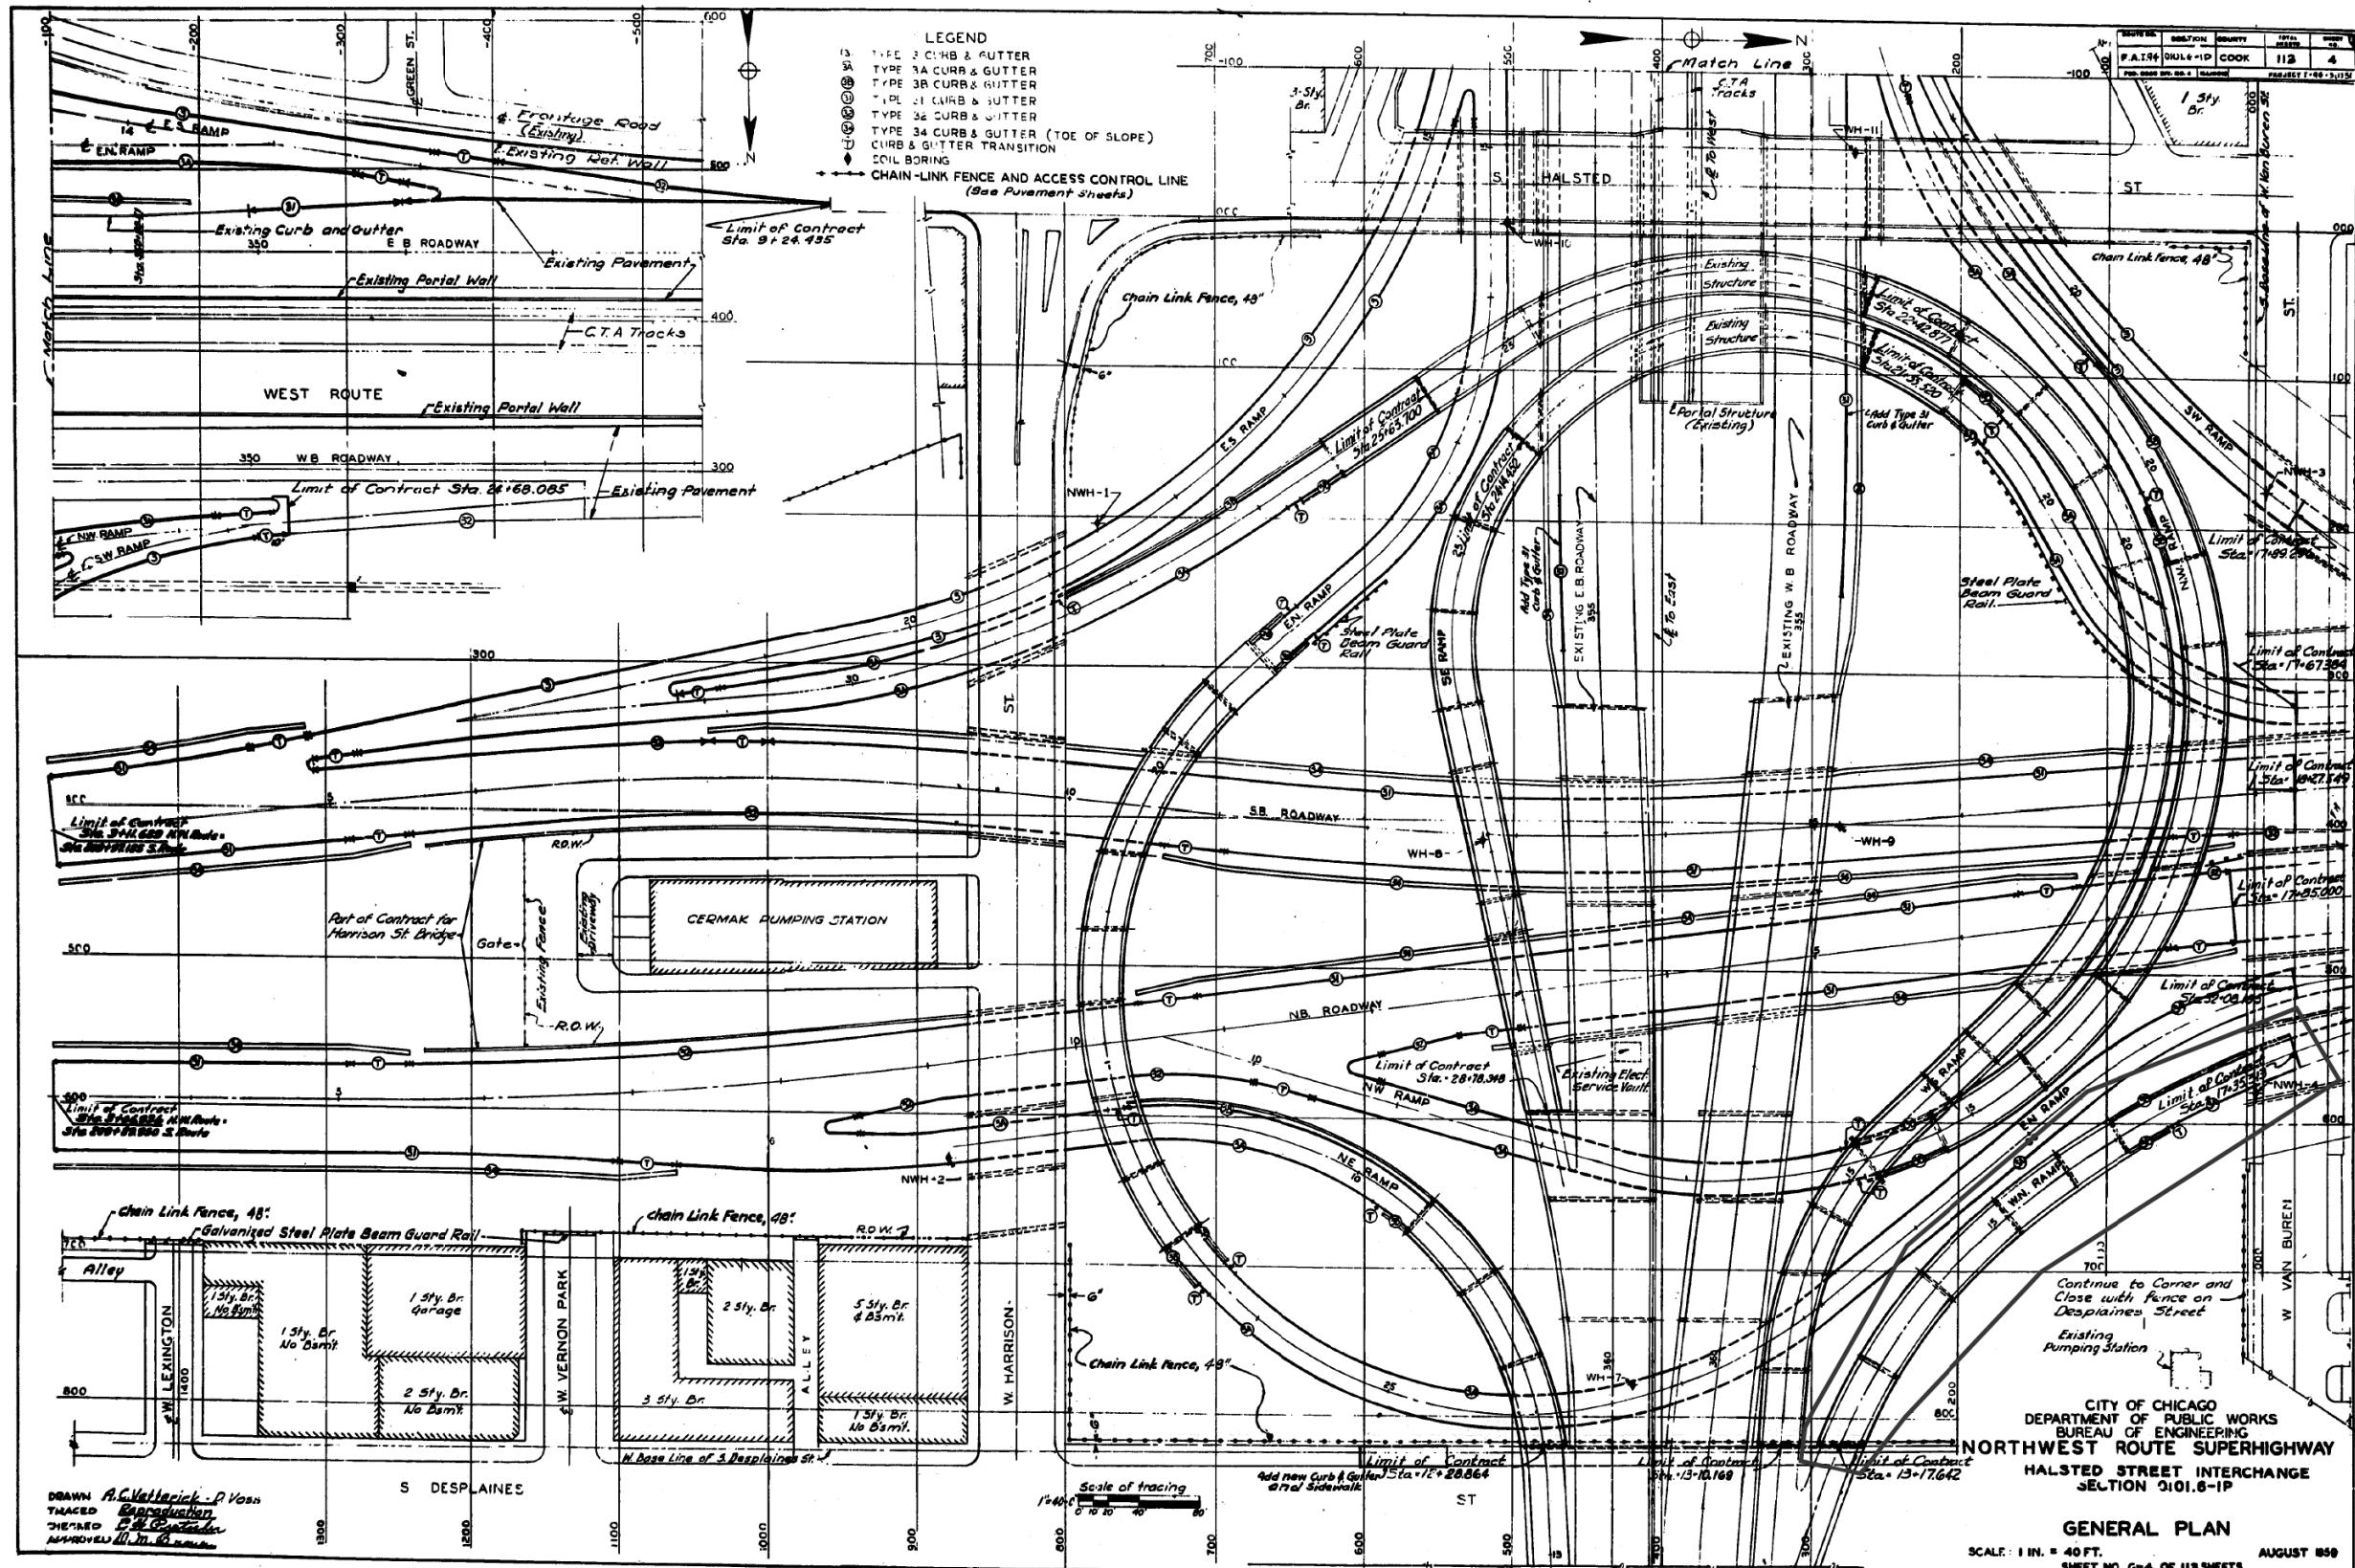STATE OF ILLINOIS
DEPARTMENT OF TRANSPORTATION

EXISTING RECORD DRAWINGS

F.A.I. RTE.	SECTION	COUNTY	TOTAL SHEETS	HEET NO.
90/94/290	2014-013R&B-R	COOK	1972	1927
			CONTRACT NO. 60X93	
	ILLINOIS	FED. AID PROJECT		

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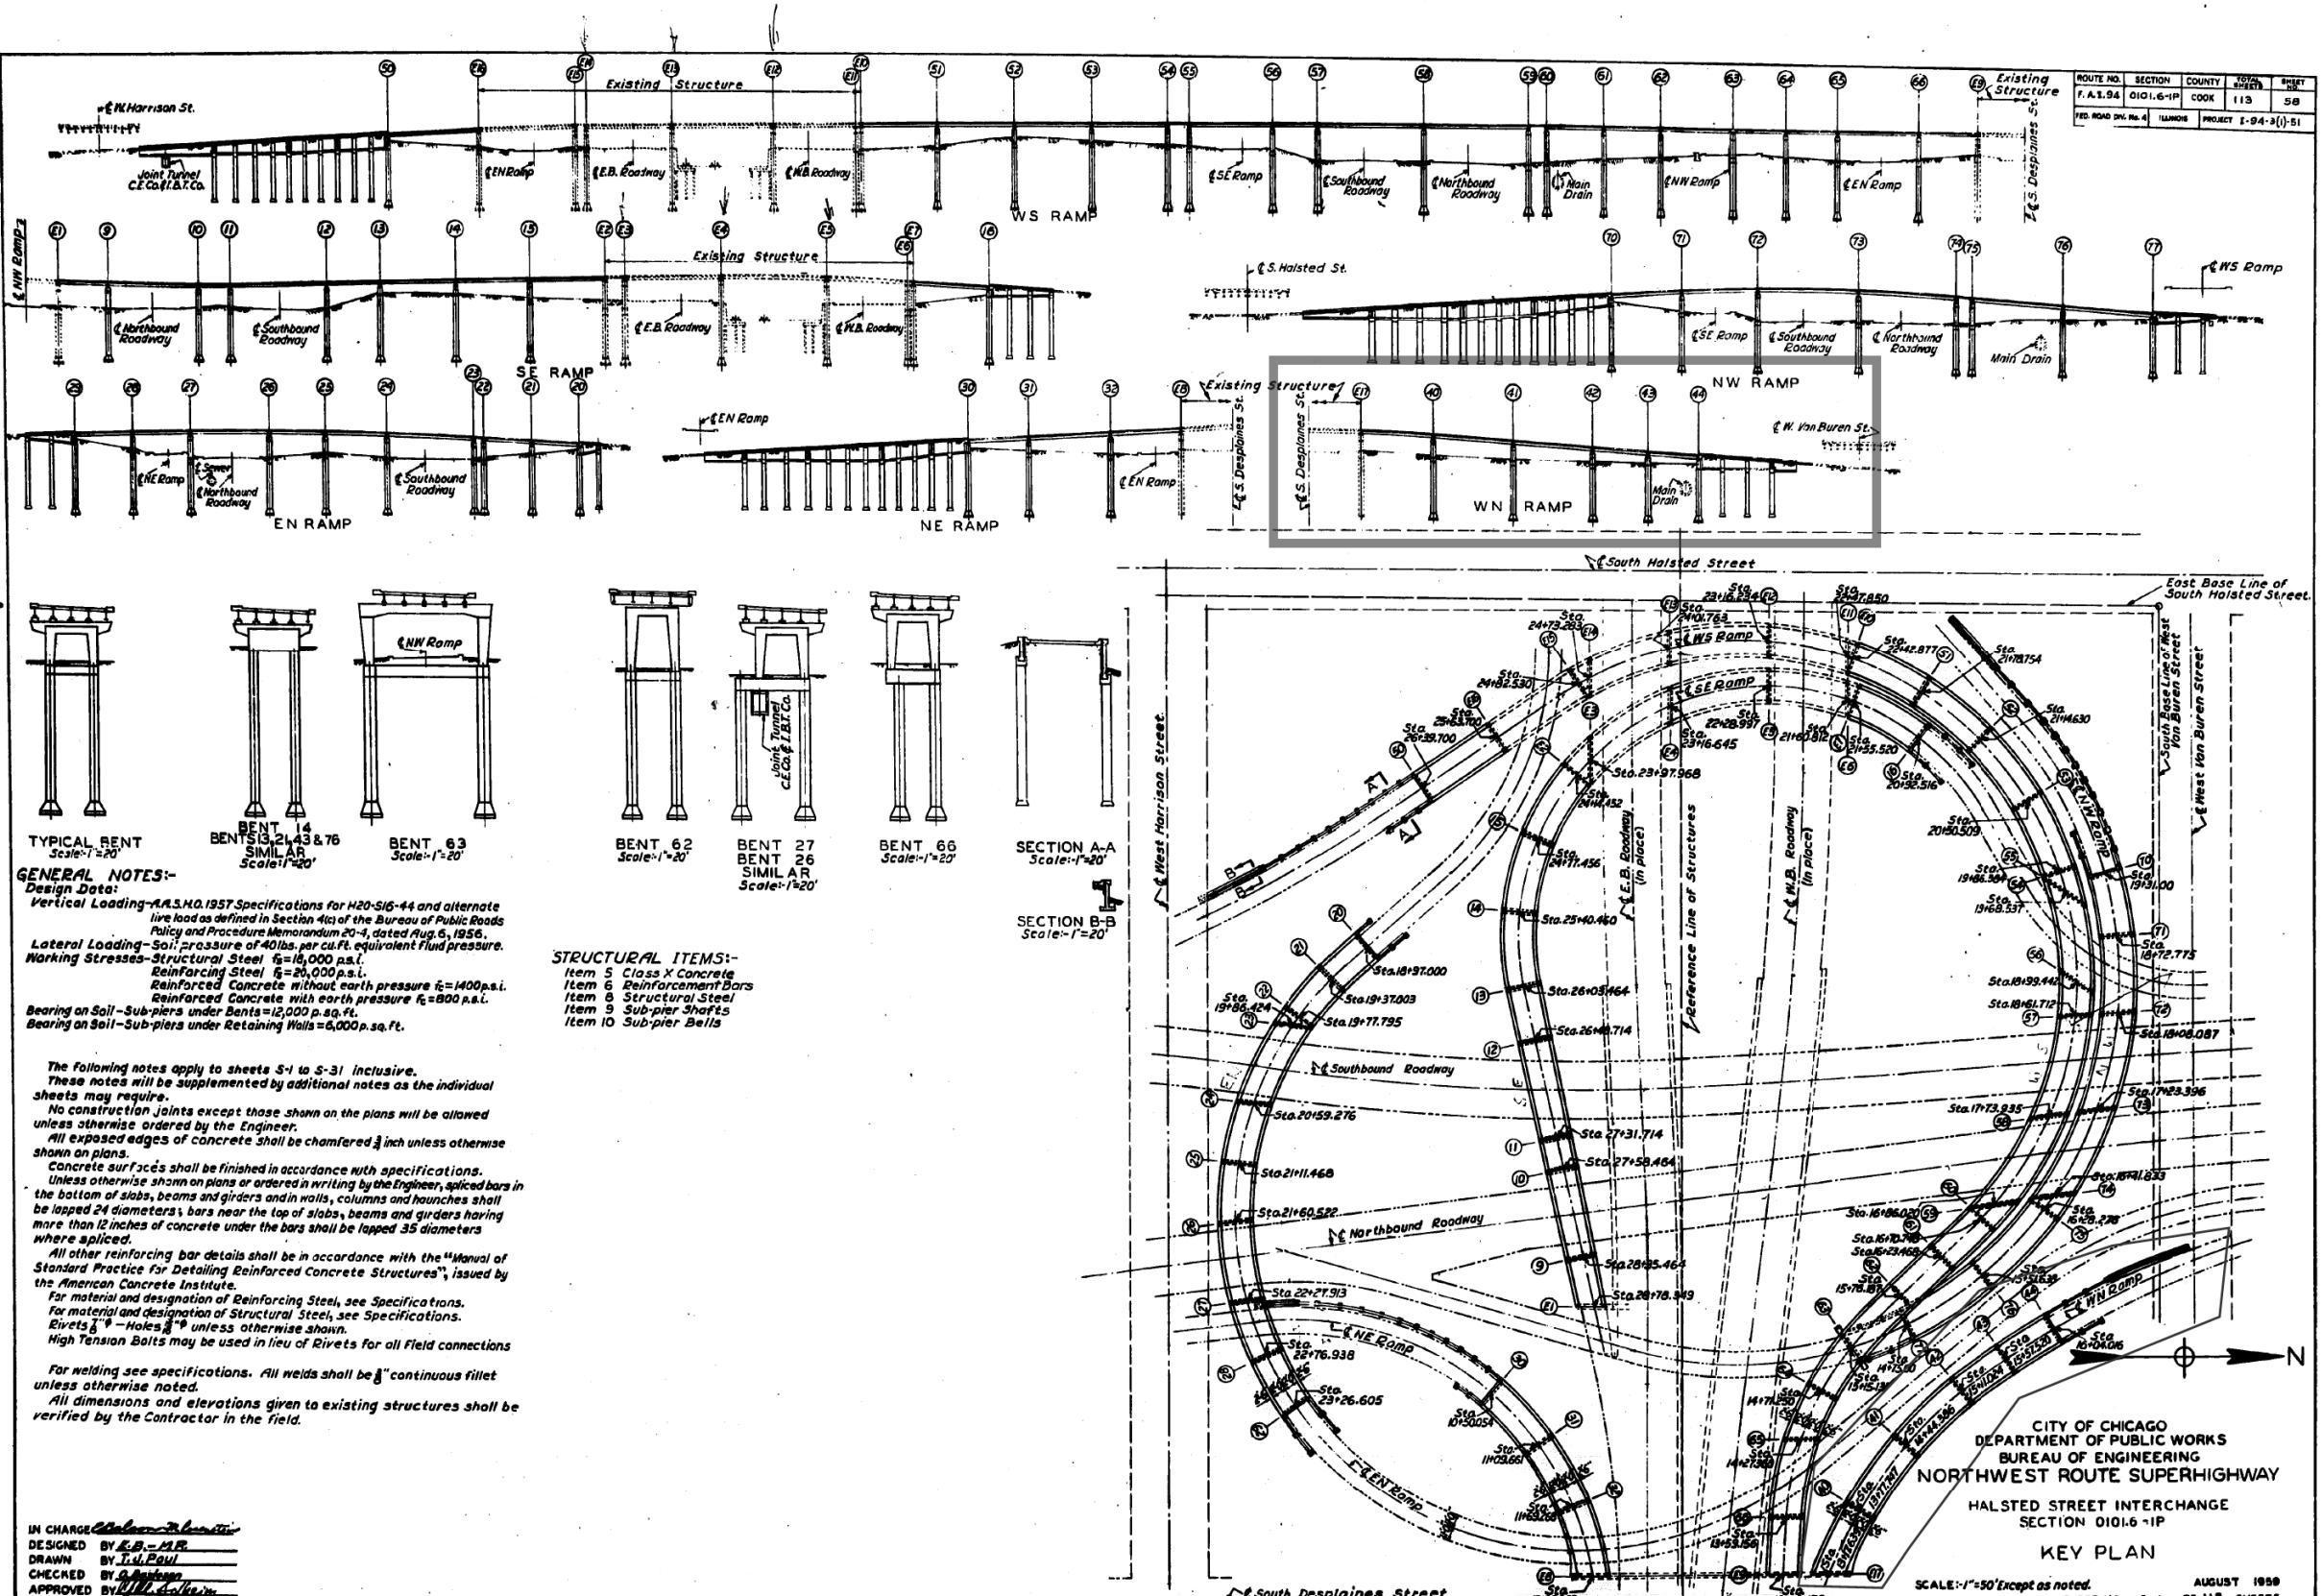


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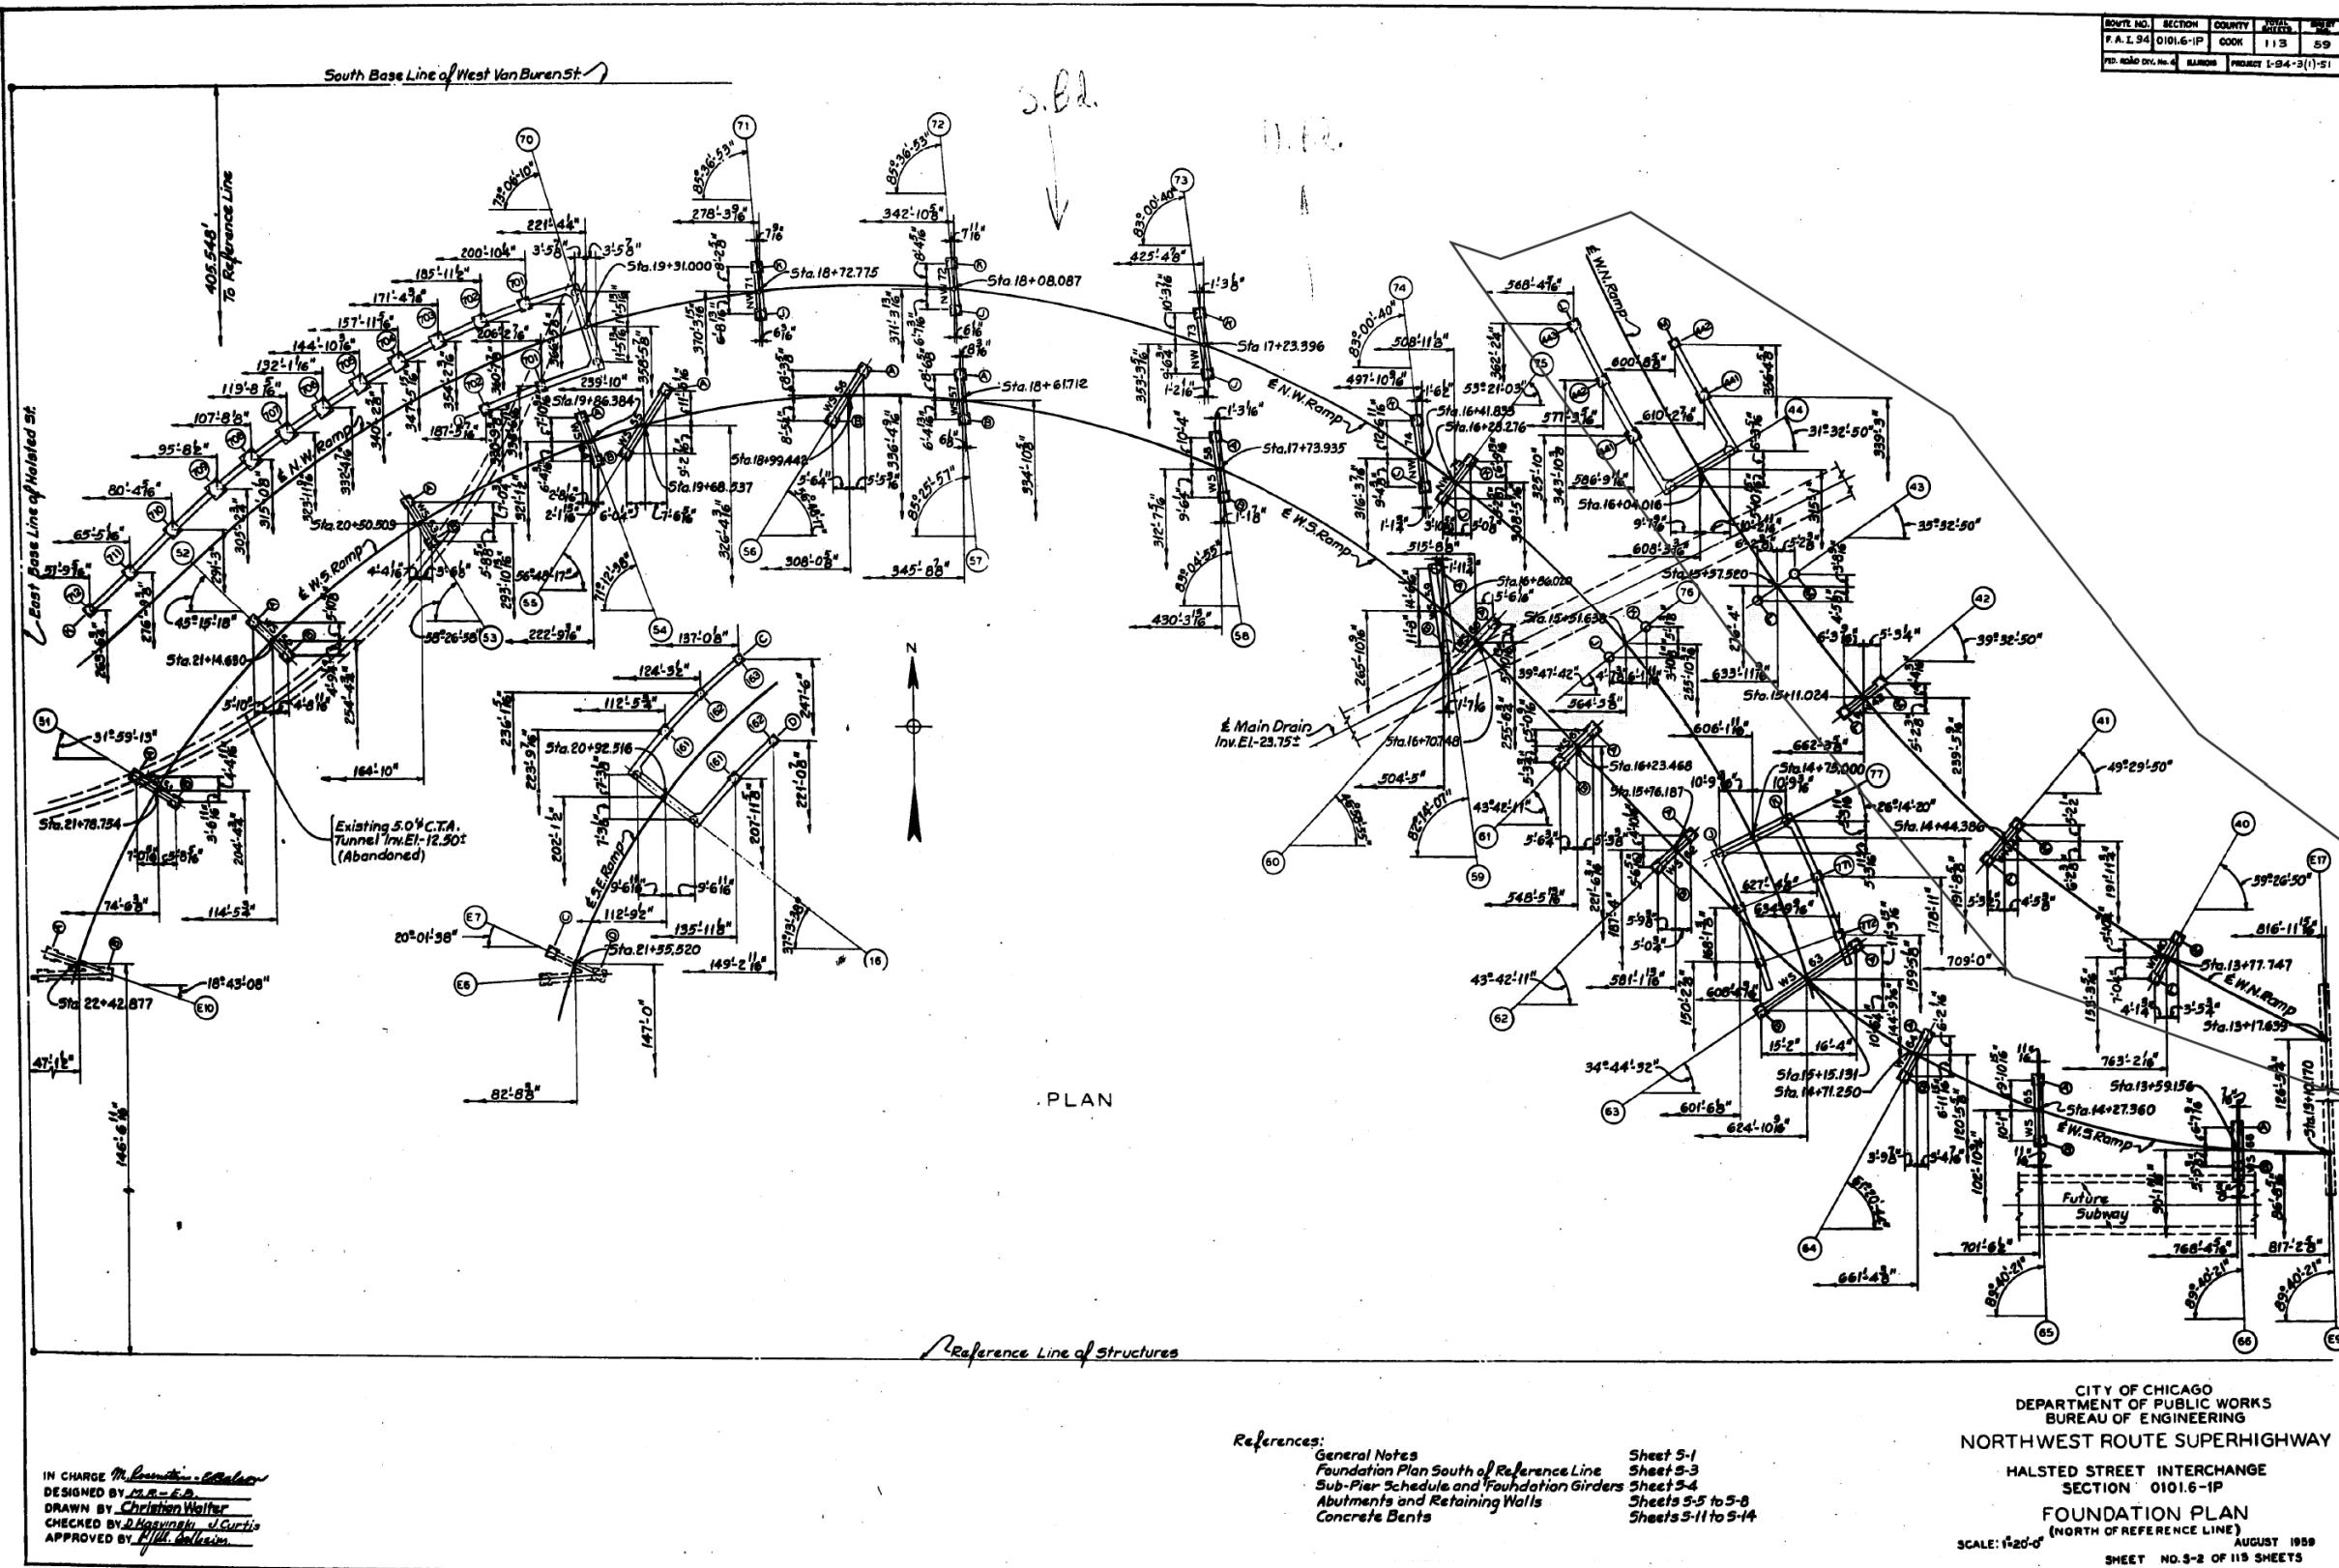
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90/94/290	2014-013R&B-R	COOK	1972	1928
	CONTRACT NO. 60X93			
	ILLINOIS	FED. AID PROJECT		

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IN CHARGE M. Rosentini - C. Salton
DESIGNED BY M.R. - F.D.
DRAWN BY Christian Walter
CHECKED BY D.Kasynski J.Curtis
APPROVED BY H.H. Colvin

References:	General Notes	Sheet 5-1
	Foundation Plan South of Reference Line	Sheet 5-3
	Sub-Pier Schedule and Foundation Girders	Sheet 5-4
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**CITY OF CHICAGO
DEPARTMENT OF PUBLIC WORKS
BUREAU OF ENGINEERING**

**HALSTED STREET INTERCHANGE
SECTION 01016-1B**

FOUNDATION PLAN

FOUNDATION PLAN
(NORTH OF REFERENCE LINE)
SCALE: 1"-20'-0" AUGUST 1959
SHEET NO. S-2 OF 113 SHEETS

				FILE NAME: pwv								
HBM ENGINEERING GROUP, LLC		USER NAME = ahmad.issa	DESIGNED -	REVISED -	STATE OF ILLINOIS DEPARTMENT OF TRANSPORTATION			F.A.I. RTE.	SECTION	COUNTY	TOTAL SHEETS	SHEET NO.
		CHECKED -	REVISED -					90/94/290	2014-013R&B-R	COOK	1972	1931
		PLOT SCALE = N.T.S	DRAWN -	REVISED -								CONTRACT NO. 60X93
		PLOT DATE = 7/26/2018	CHECKED - MI, MAI	REVISED -								ILLINOIS FED. AID PROJECT

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IN CHARGE ELEVATION -
DESIGNED BY H. Mackay - D. Hasby
DRAWN BY Vic. GRECO
CHECKED BY B. Vintrop - O. Anderson
APPROVED BY B. Vintrop - O. Anderson

APPROVED BY THE STATE

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USER NAME = ahmad.issa

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PLOT SCALE = N.T.S

PLOT DATE = 7/26/2018

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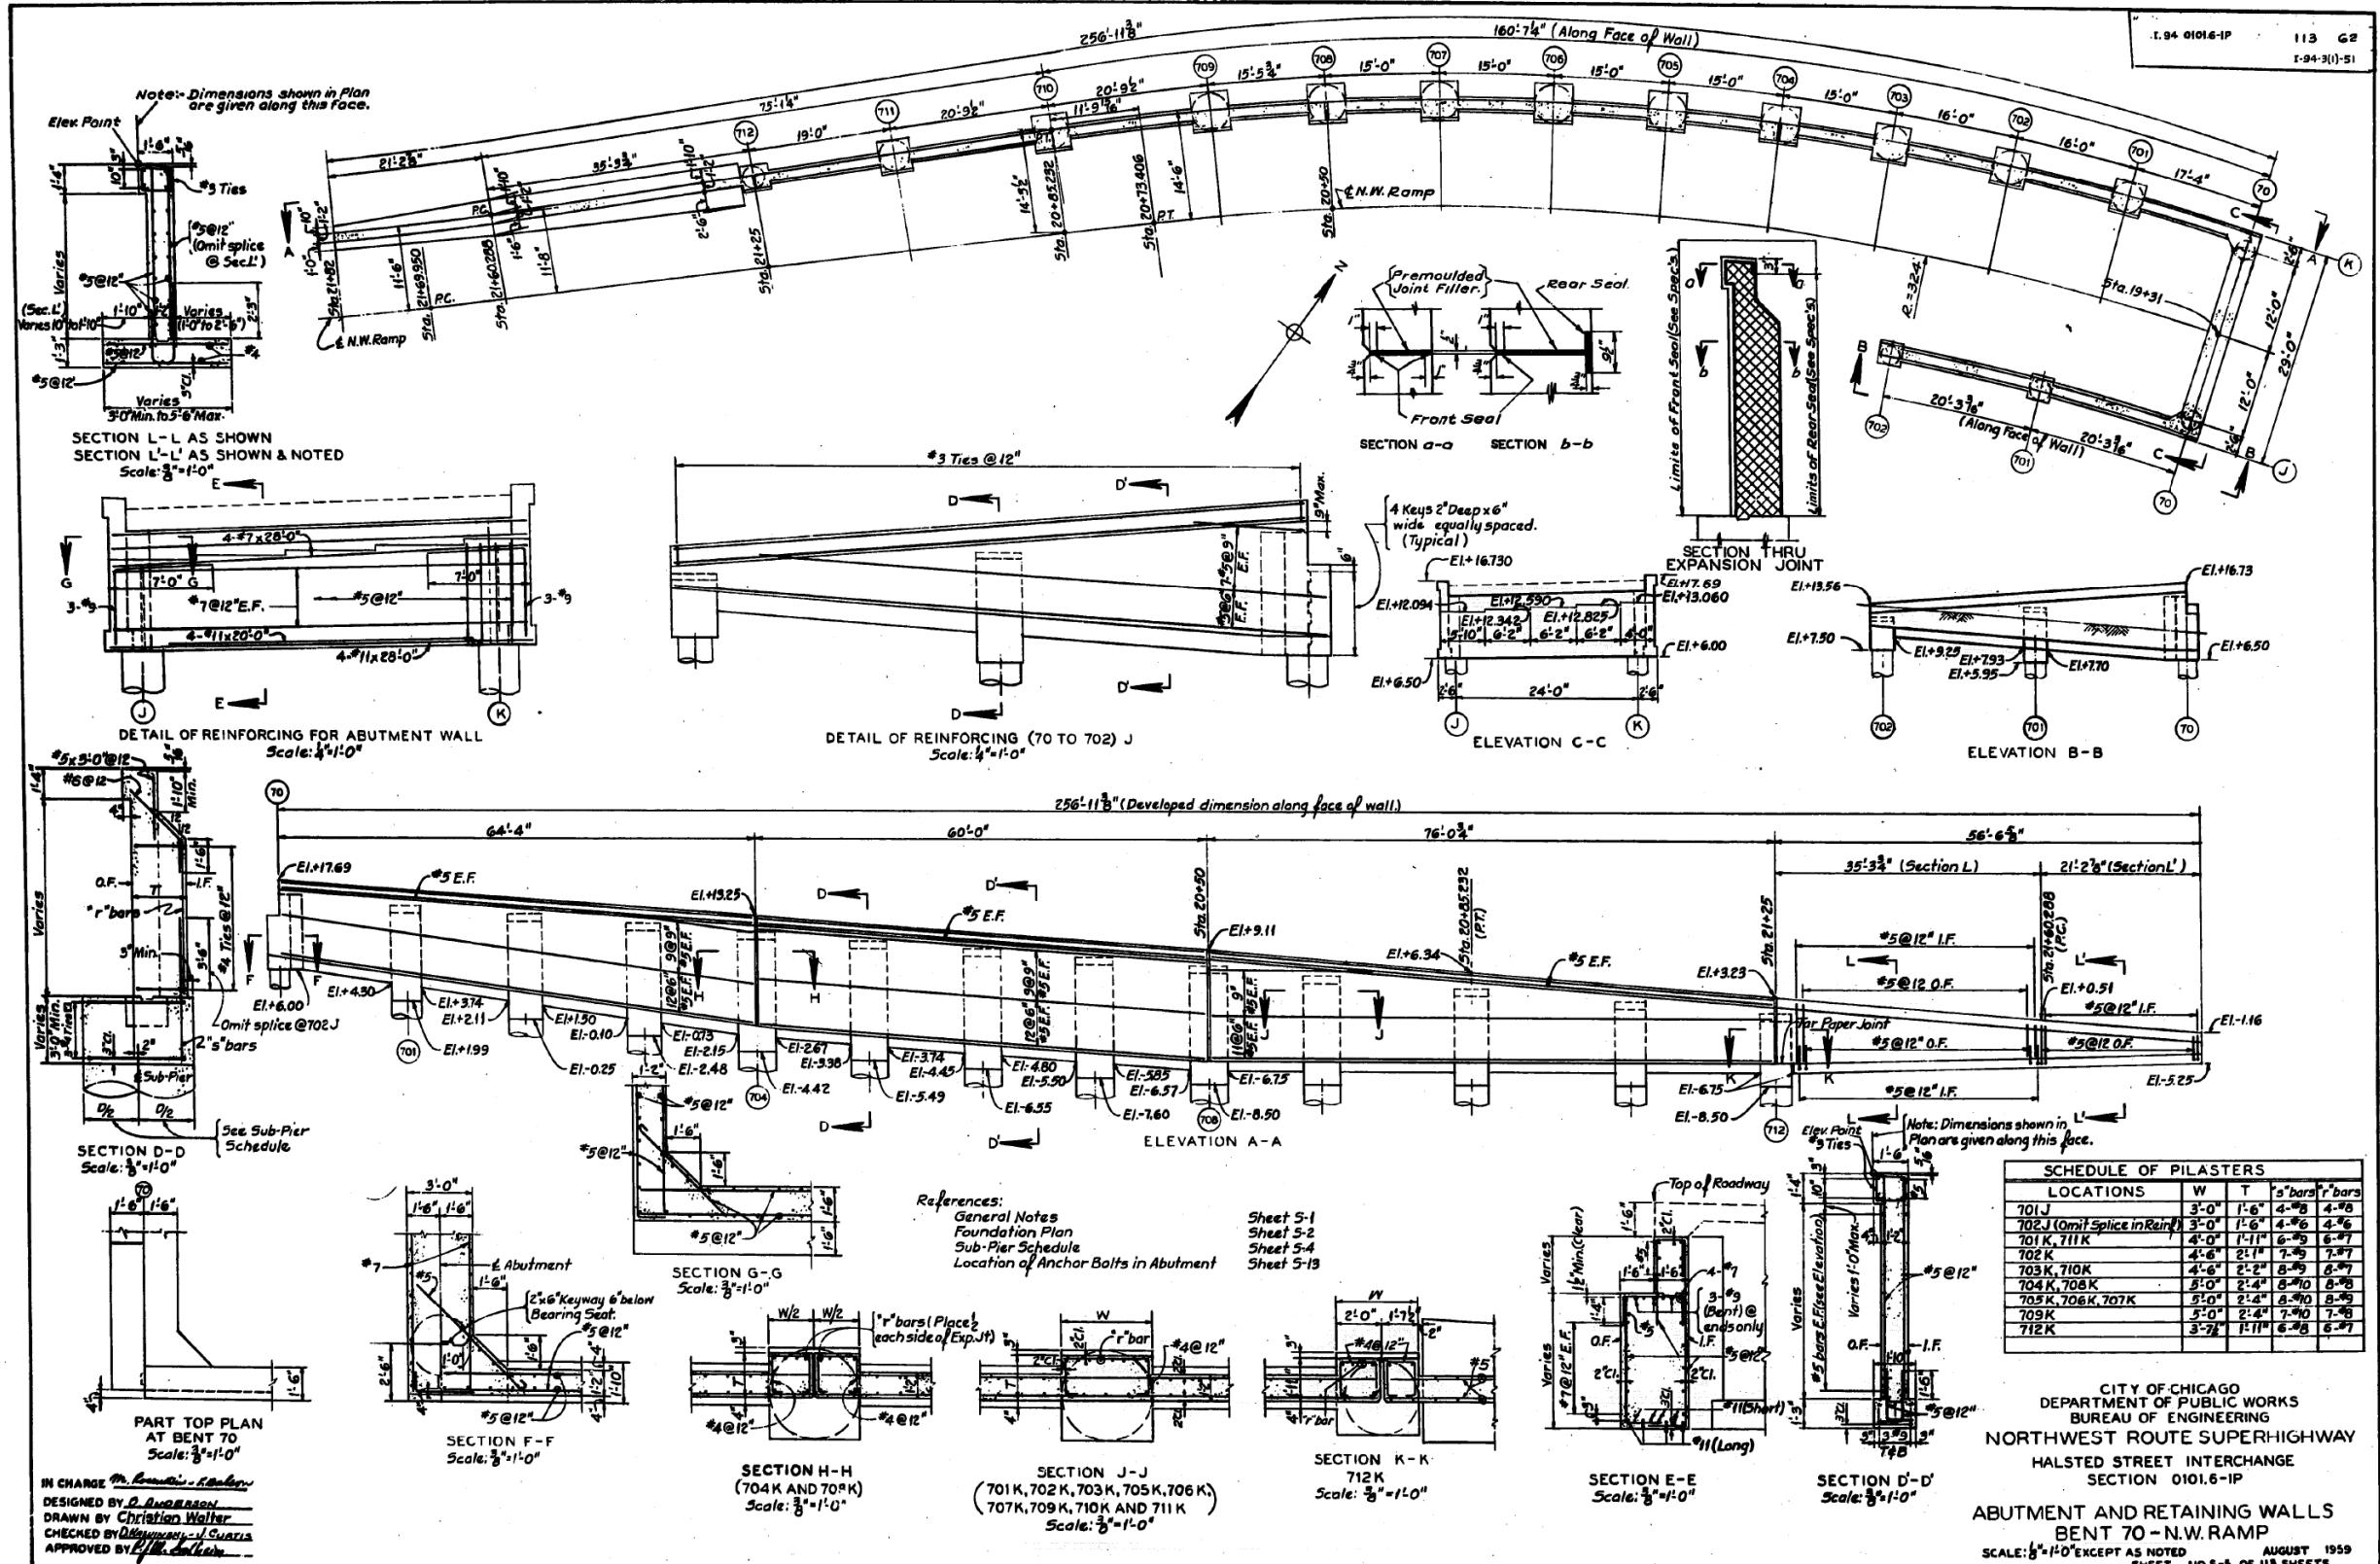
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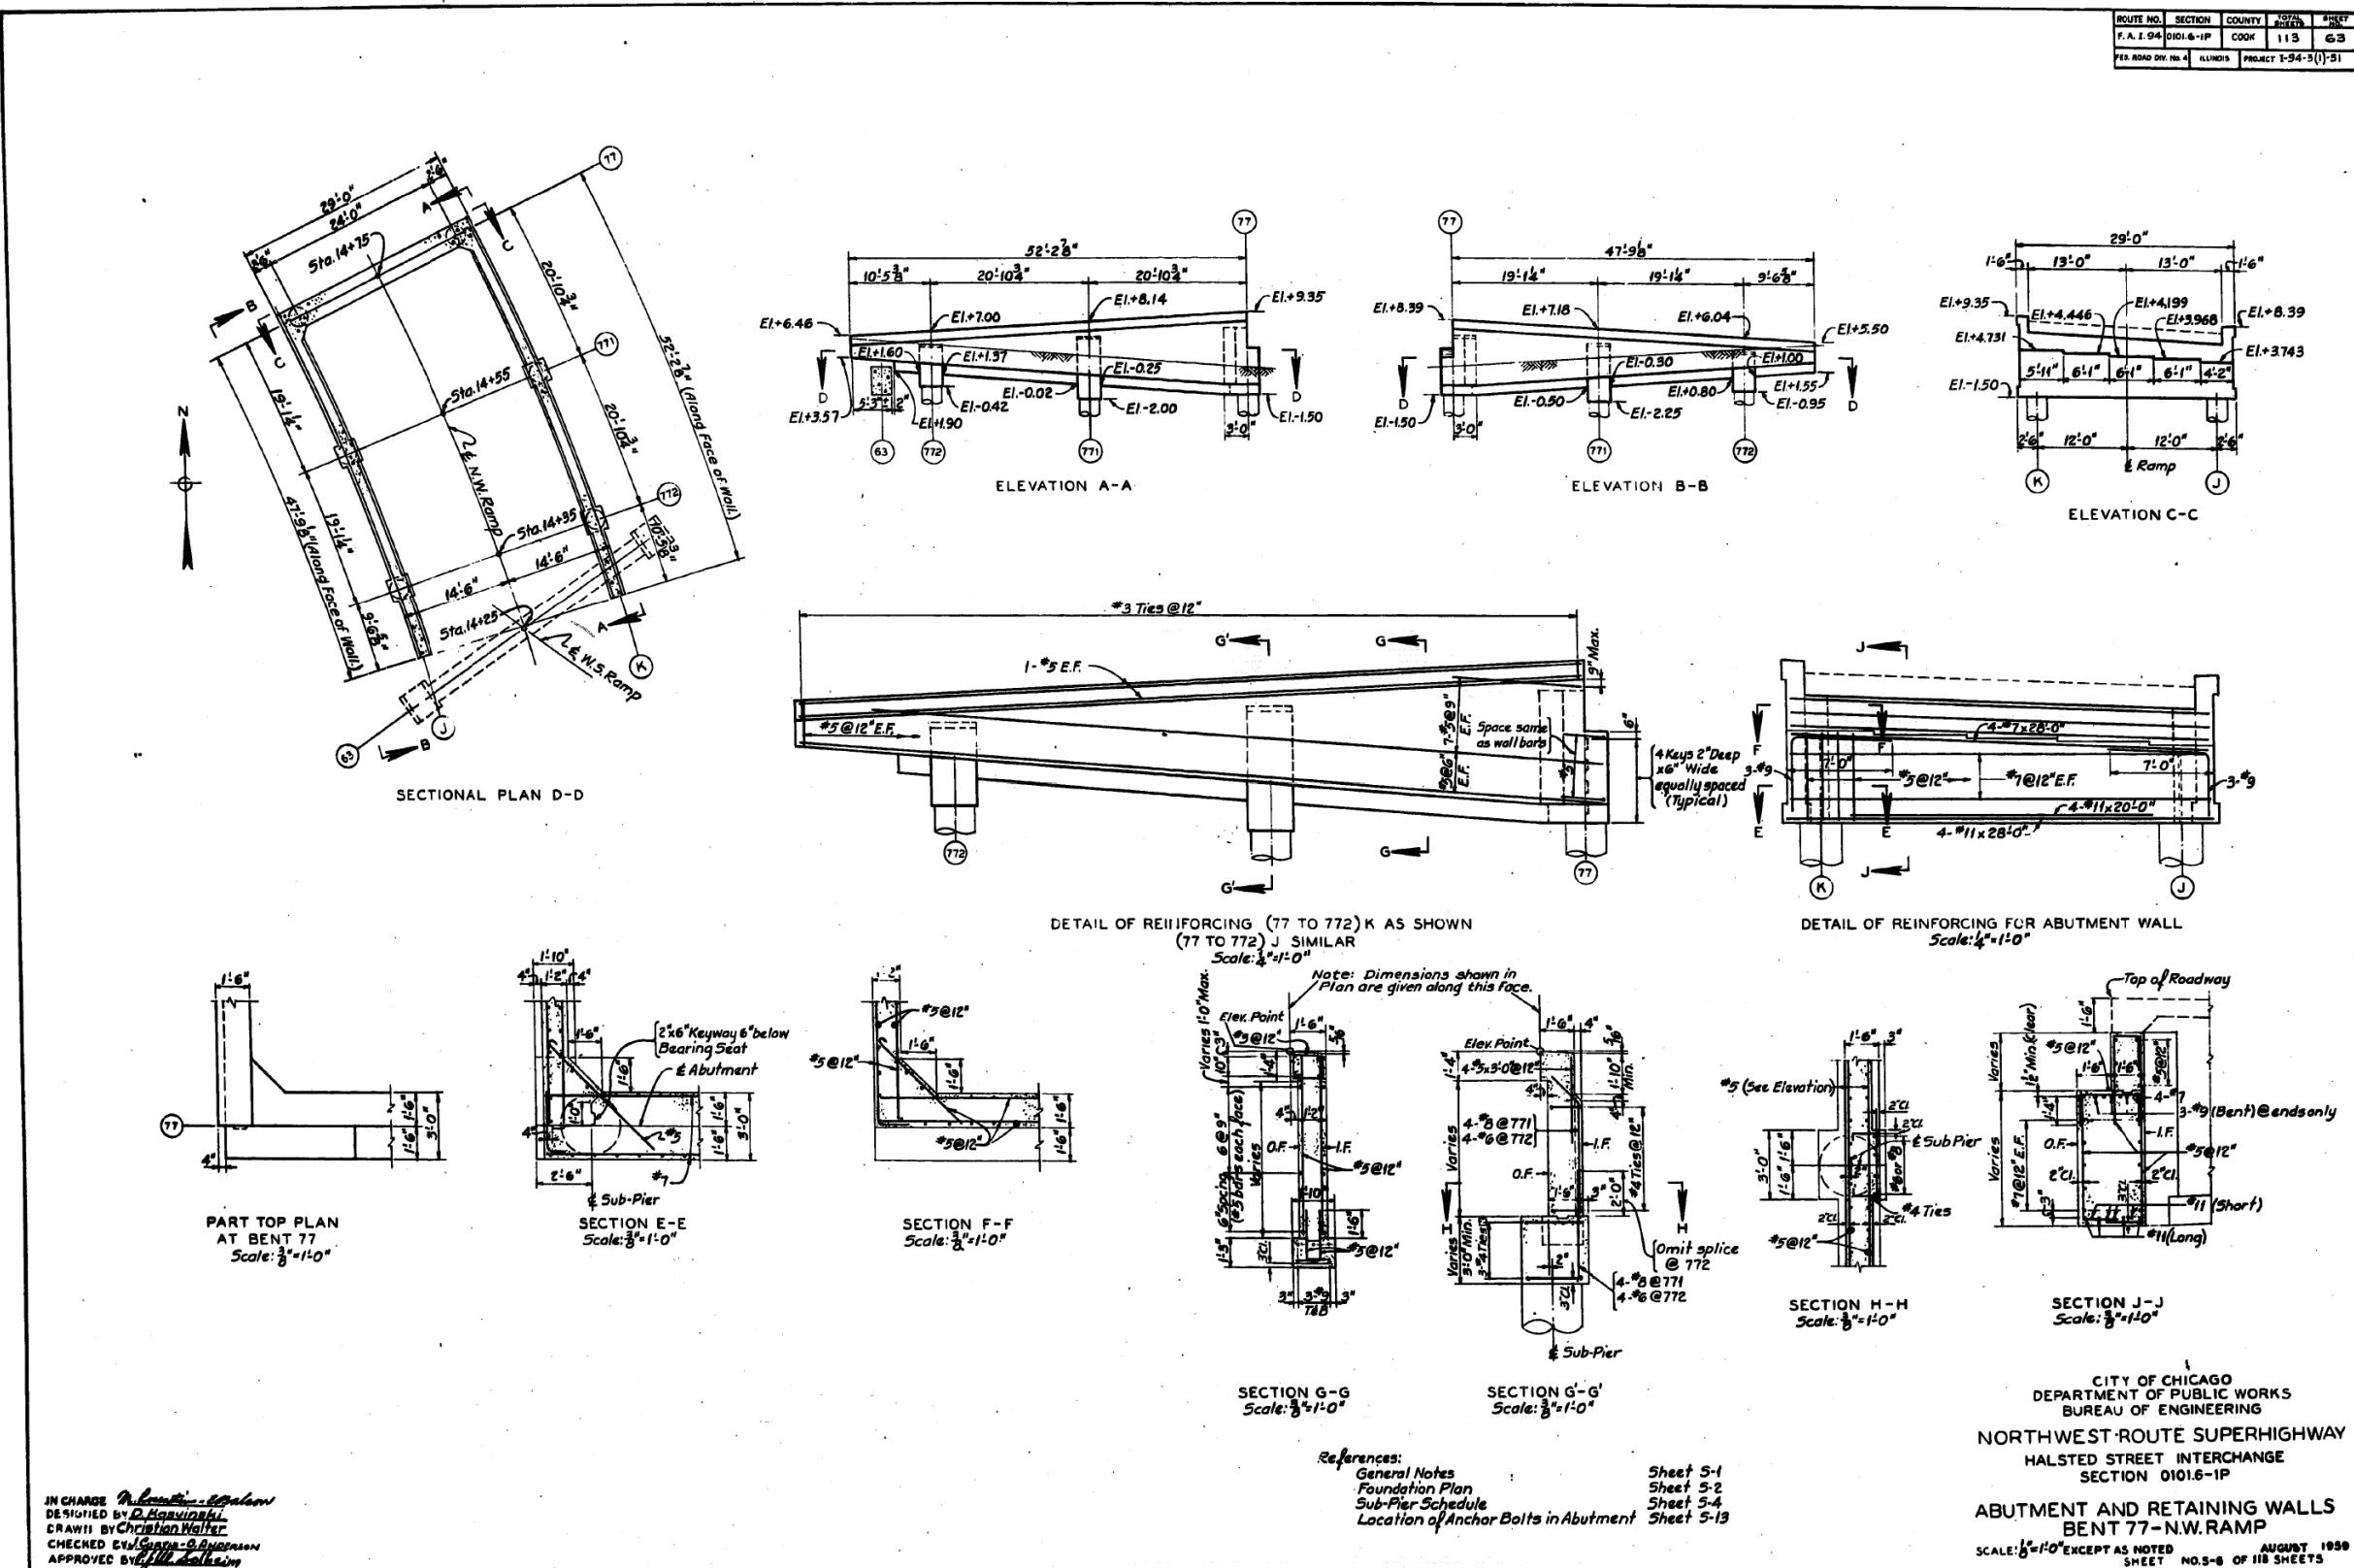
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90/94/290	2014-013R&B-R	COOK	1972	1933
			CONTRACT NO. 60X93	

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DRAFT - 17/07/2019 Page 38 of 38 Circular House, 11000 CANDON STRUCTURAL STRUCTURE 016.1712 Edition Bincy01060161 21 NOV 2019 Eviction666



IN CHARGE N. L. Cawelti - C. W. Carlson
DESIGNED BY D. Hayashi
CRAWL BY Christian Walter
CHECKED BY G. Gustafson - O. Anderson
APPROVED BY John T. Johnson

USER NAME = ahmad,issa	DESIGNED -	REVISED -
	CHECKED -	REVISED -
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PLOT DATE = 7/26/2018	CHECKED - MI, MAI	REVISED -


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DEPARTMENT OF TRANSPORTATION**

EXISTING RECORD DRAWINGS

F.A.I. RTE.	SECTION	COUNTY	TOTAL SHEETS	SHEET NO.
90/94/290	2014-013R&B-R	COOK	1972	1938
CONTRACT NO. 60X93				
	ILLINOIS	FED. AID PROJECT		

FOR INFORMATION ONLY

NAME: DWYV1617A9 DWYNTI according to local E&COM D502 NAVDocument01 Ameridact-Aranchortation50260932 CircularPhase II/00 CAN008 StructuralStructure 016 1718/Edition Branch160612 20 60903 Cvv Eviction661

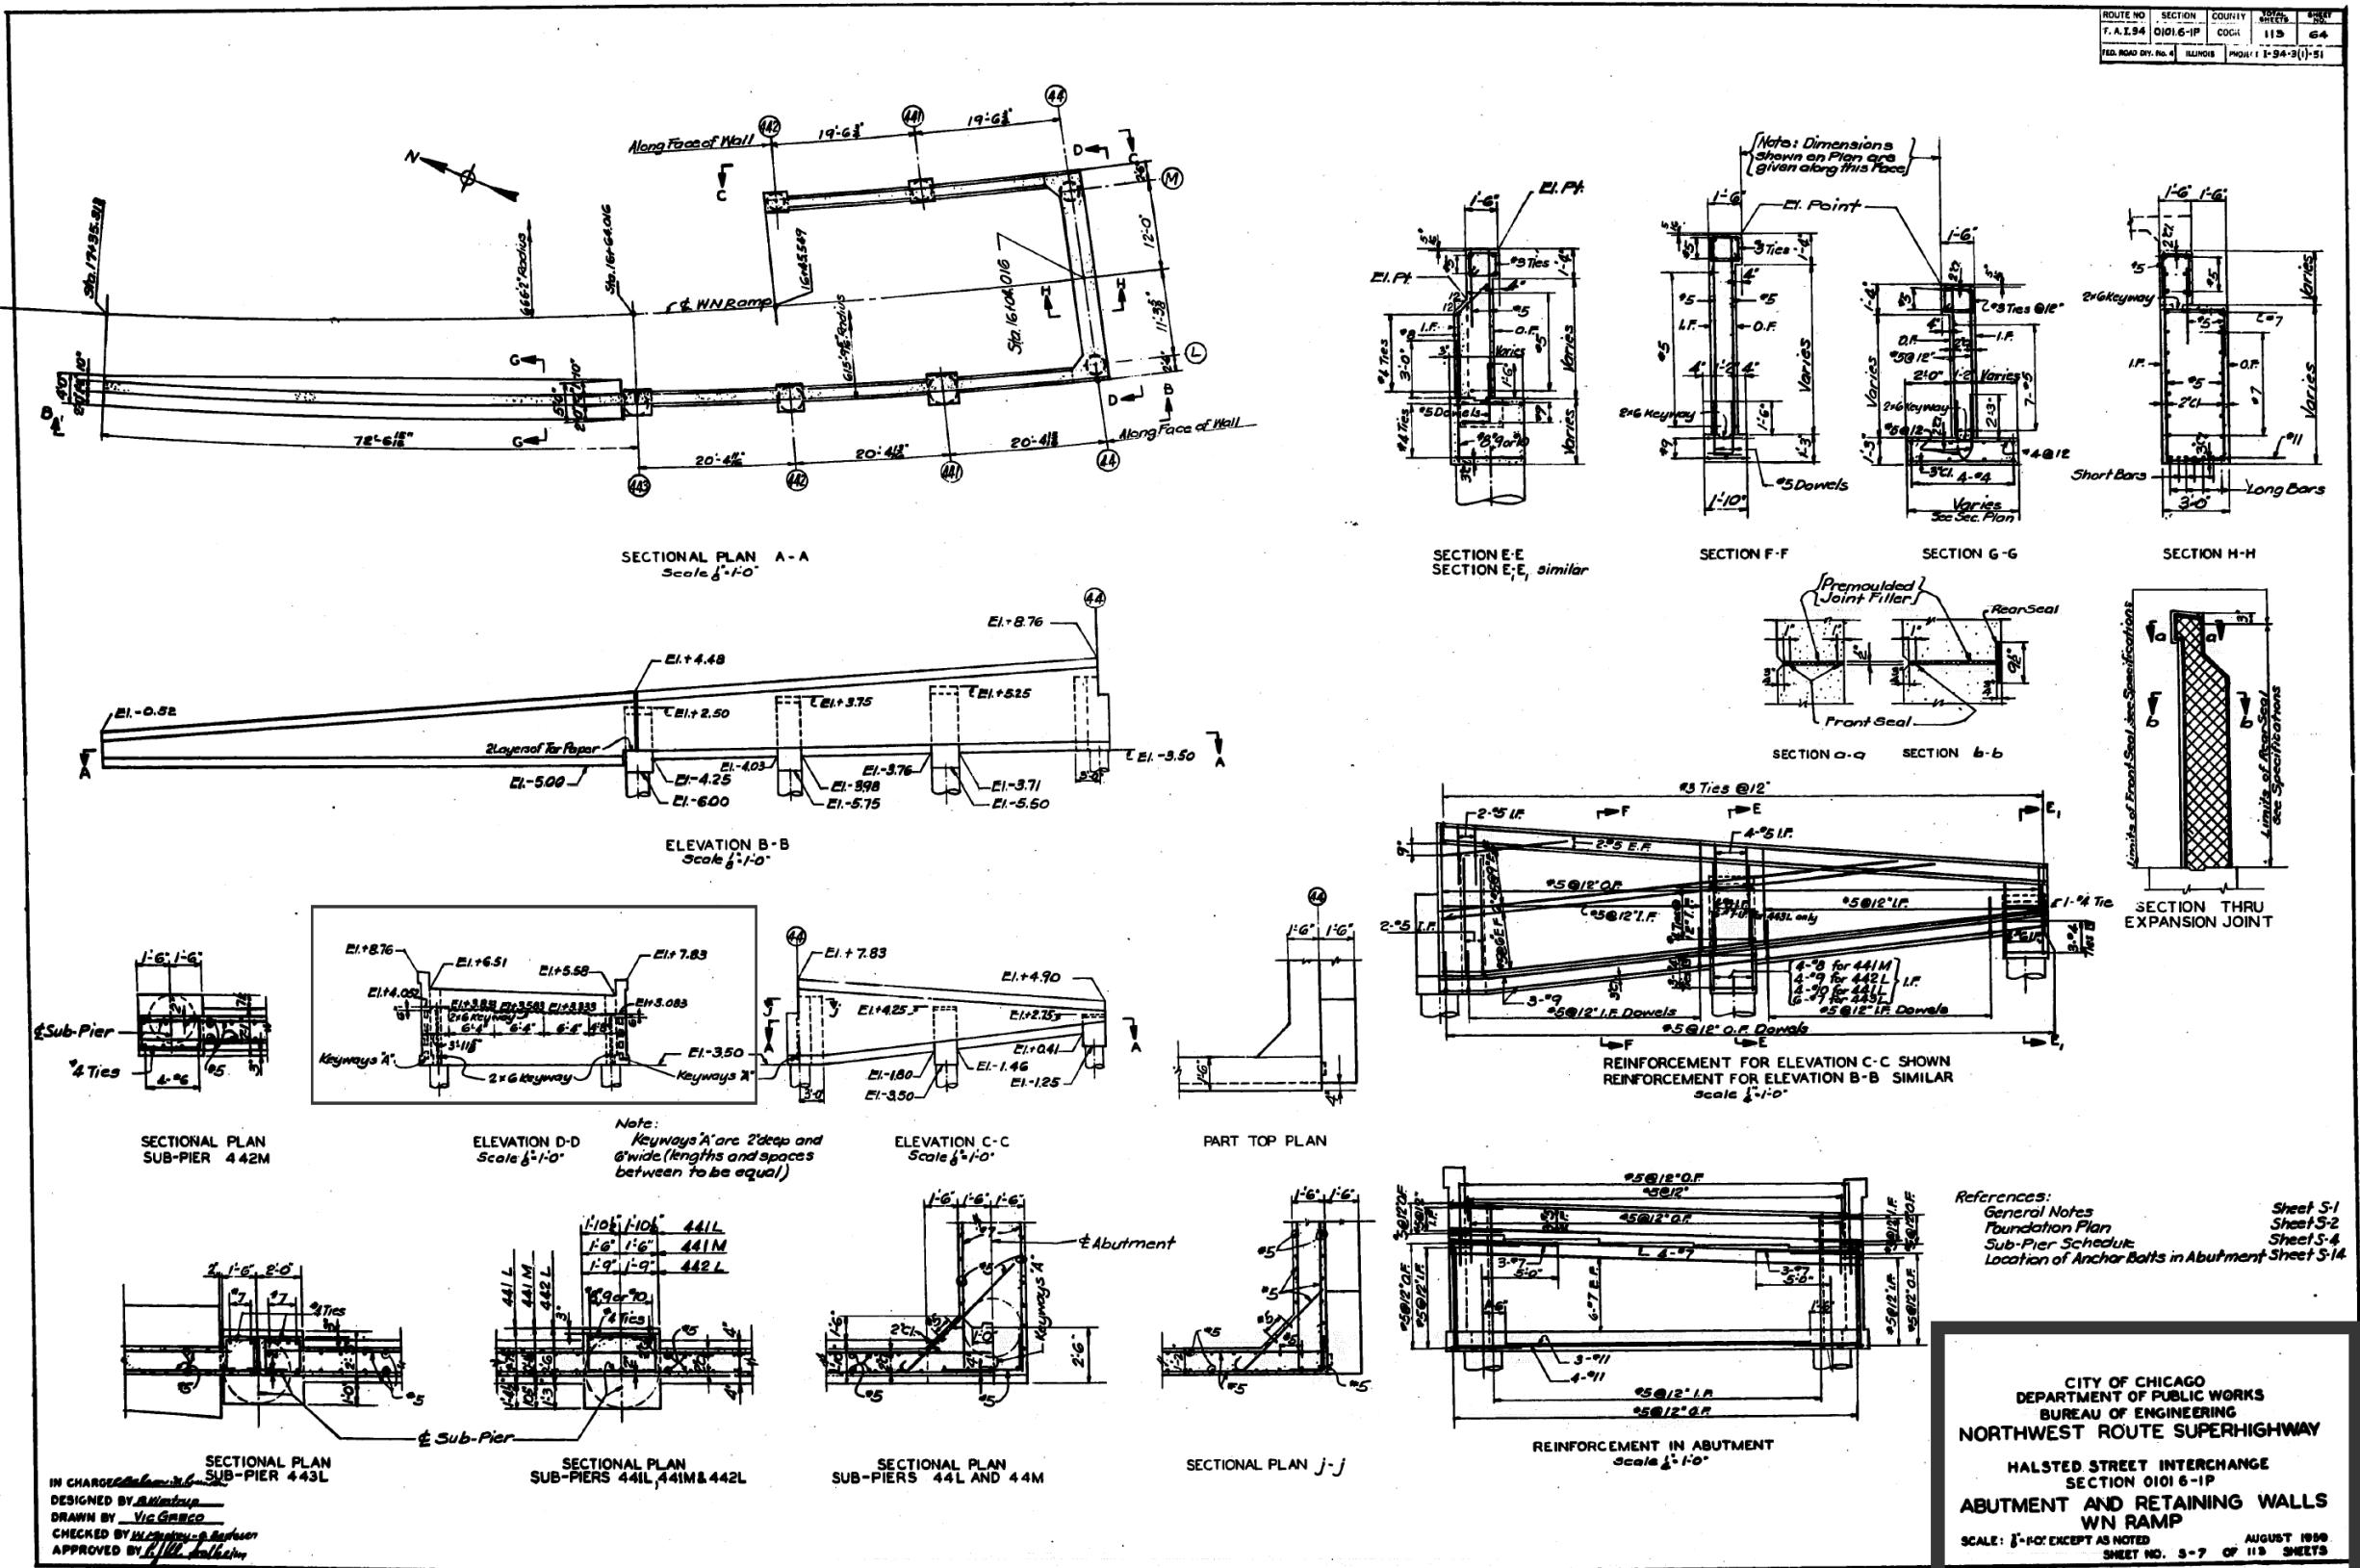

STATE OF ILLINOIS
DEPARTMENT OF TRANSPORTATION

EXISTING RECORD DRAWINGS

FILE NO.	SECTION	COUNTY	TOTAL SHEETS	SHEET NO.
I-94	0101.6-IP	COKI	113	64
DAD DIV. No. 4	ILLINOIS	PROJECT	I-94-3 (1)-51	

*Sheet S-1
Sheet S-2
Sheet S-4
Botts in Abutment Sheet S-14*

**CITY OF CHICAGO
DEPARTMENT OF PUBLIC WORKS
BUREAU OF ENGINEERING
NORTHWEST ROUTE SUPERHIGHWAY**

**HALSTED STREET INTERCHANGE
SECTION 01016-1P
ABUTMENT AND RETAINING WALLS
WN RAMP**

SCALE: 1"-100' EXCEPT AS NOTED AUGUST 1950
SHEET NO. 5-7 OF 113 SHEETS

FILE NAME: pw:
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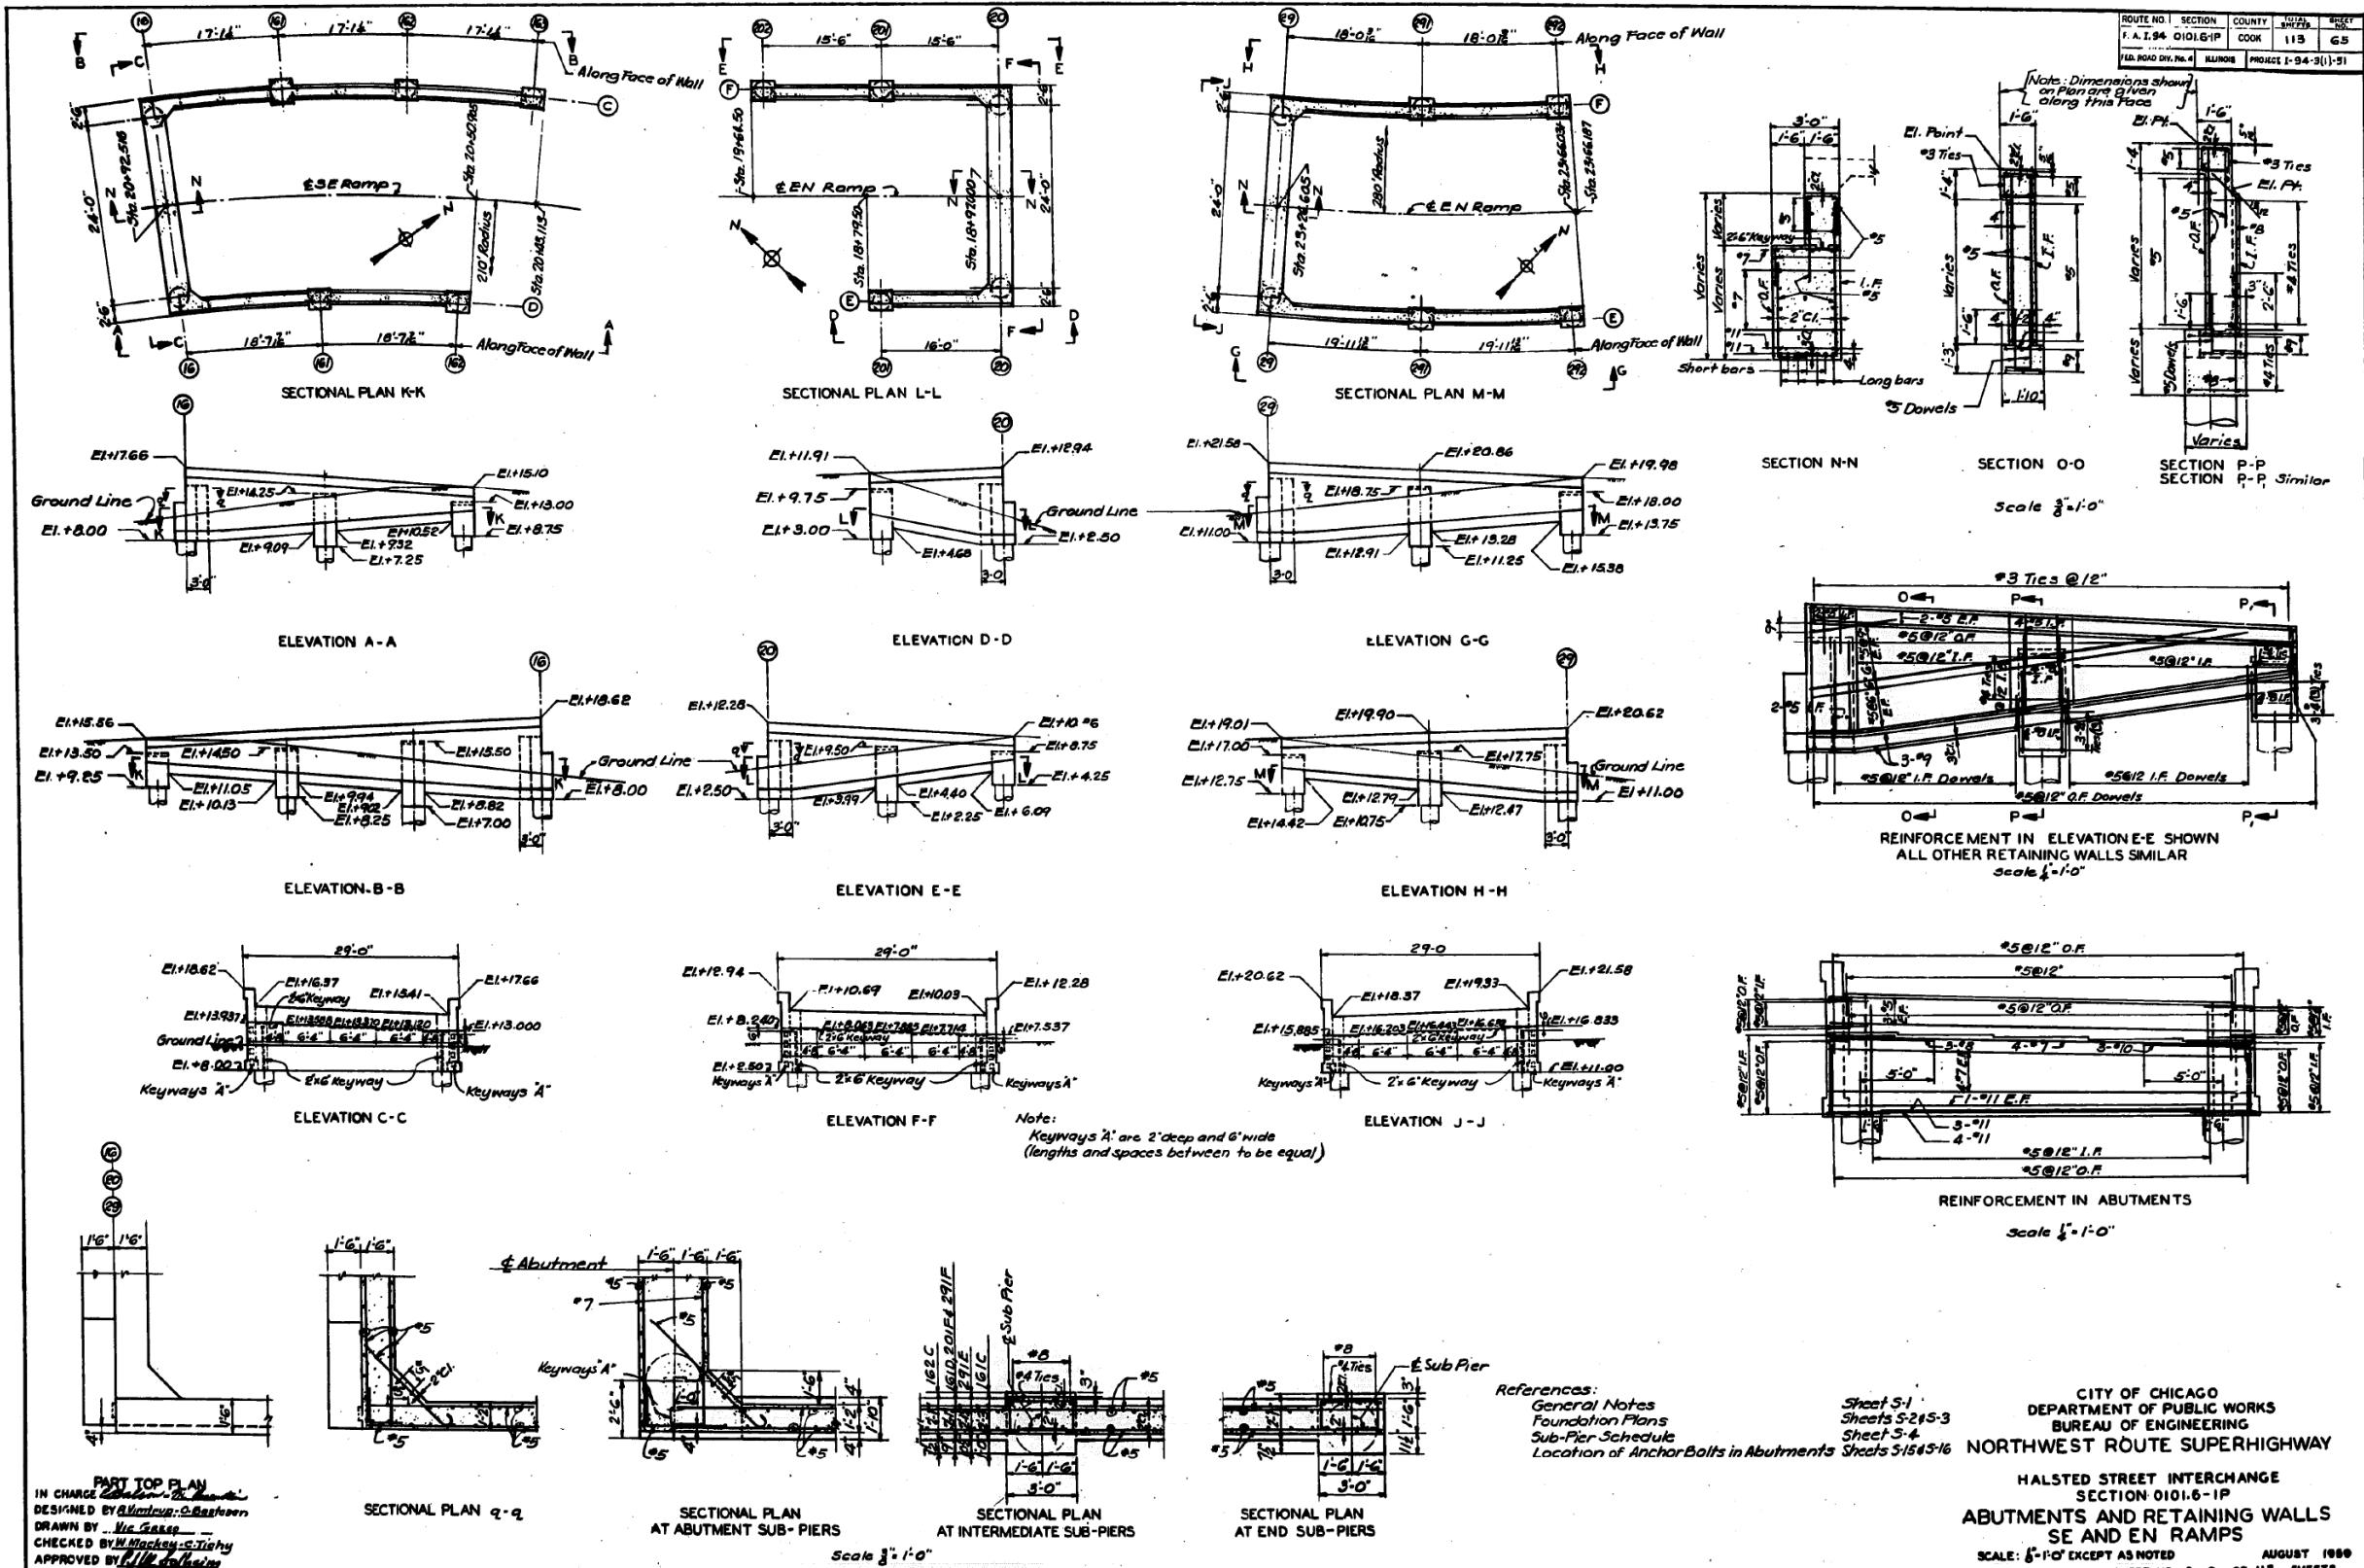
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PLOT SCALE	= N,T,S	DRAWN	-	REVISED	-
PLOT DATE	= 7/26/2018	CHECKED	- MI, MAI	REVISED	-

**STATE OF ILLINOIS
DEPARTMENT OF TRANSPORTATION**

EXISTING RECORD DRAWINGS		F.A.I. RTE.	
90/94/290	2		

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References:
General Notes
Foundation Plans
Sub-Pier Schedule
Location of Anchors

CITY OF CHICAGO
DEPARTMENT OF PUBLIC WORKS
BUREAU OF ENGINEERING
NORTHWEST ROUTE SUPERHIGHWAY

**HALSTED STREET INTERCHANGE
SECTION 0101.6-1P**

ABUTMENTS AND RETAINING WALLS SE AND EN RAMPS

SCALE: 6'-10" EXCEPT AS NOTED AUGUST 1966

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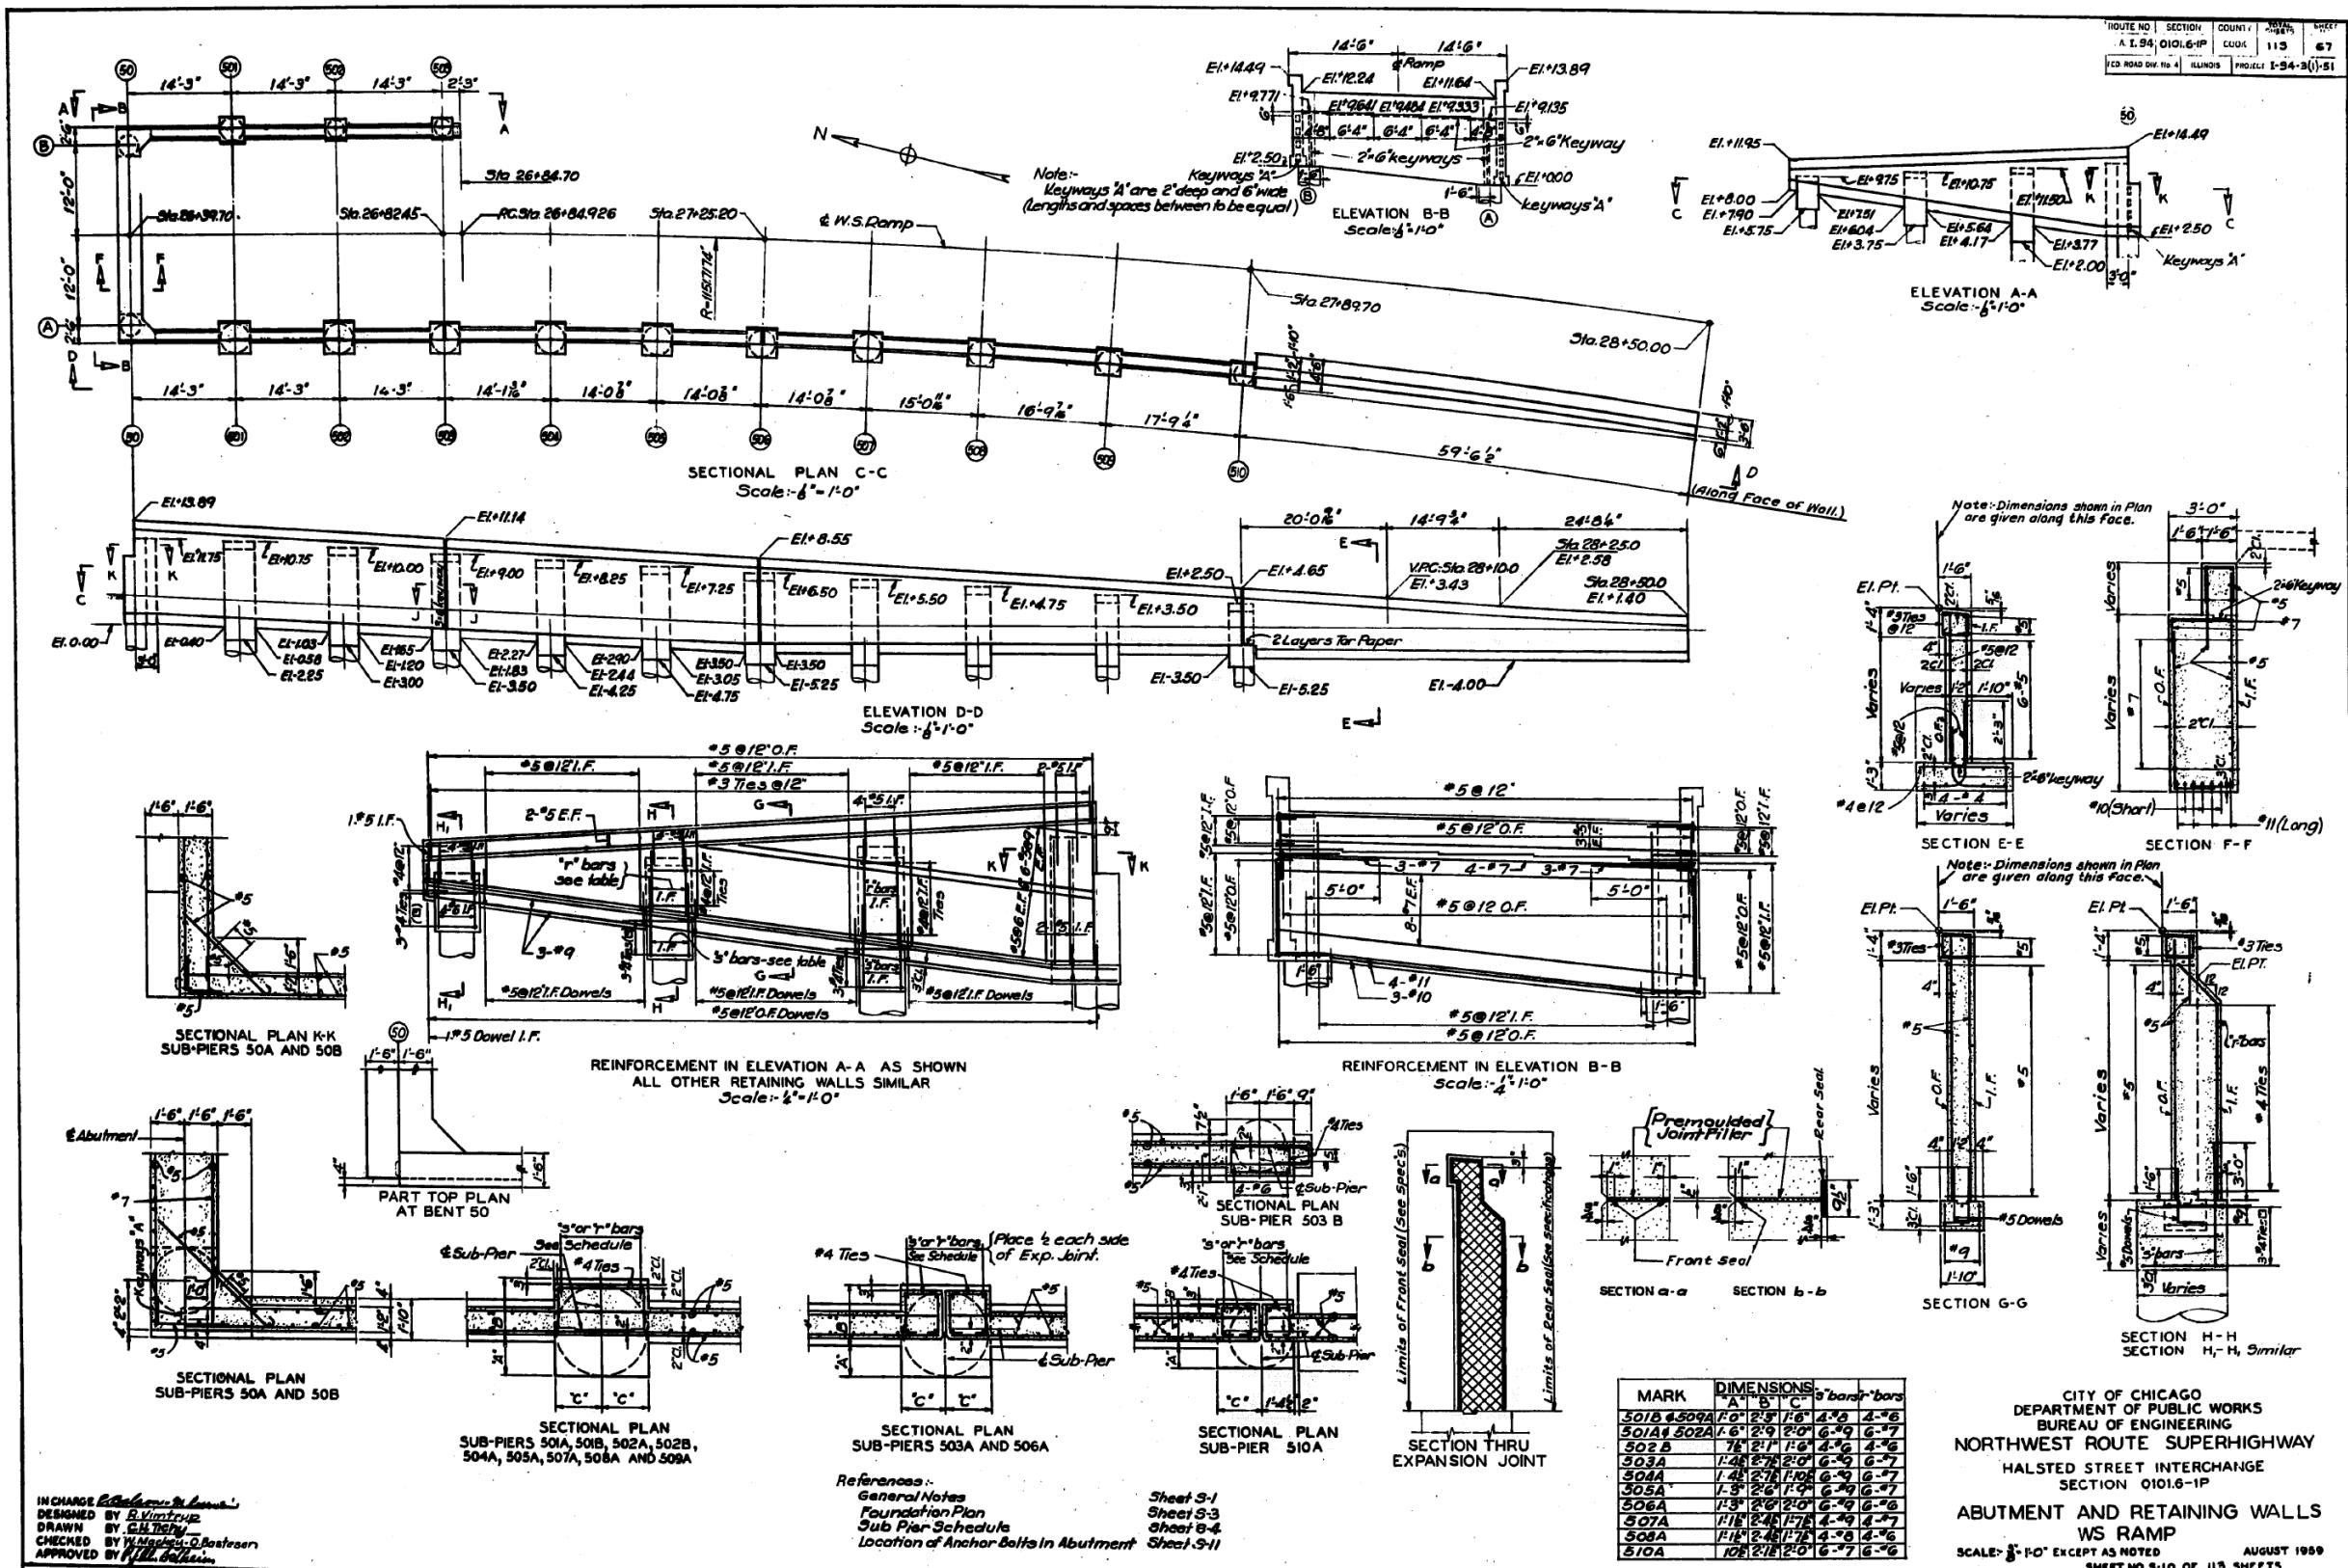
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PLOT DATE	= 7/26/2018	CHECKED - MI, MAI	REVISED -

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EXISTING RECORD DRAWINGS

F.A.I. RTE.	SECTION	COUNTY	TOTAL SHEETS	HEET NO.
90/94/290	2014-013R&B-R	COOK	1972	1937
			CONTRACT NO. 60X93	
		ILLINOIS	FED. AID PROJECT	

FOR INFORMATION ONLY



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DESIGNED BY *R. Vintcup*
DRAWN BY *C. H. Tracy*
CHECKED BY *W. Neely, O. Bostesem*
APPROVED BY *R. C. Galt*


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PLOT SCALE = N,T,S	DRAWN -	REVISED
PLOT DATE = 7/26/2018	CHECKED - MI, MAI	REVISED

**STATE OF ILLINOIS
DEPARTMENT OF TRANSPORTATION**

EXISTING RECORD DRAWINGS

EXISTING RECORD DRAWINGS	F.A.I. RTE.	SECTION	COUNTY	TOTAL SHEETS	SHEET NO.
	90/94/290	2014-013R&B-R	COOK	1972	1939
	CONTRACT NO. 60X93				
	ILLINOIS	FED. AID PROJECT			

FOR INFORMATION ONLY

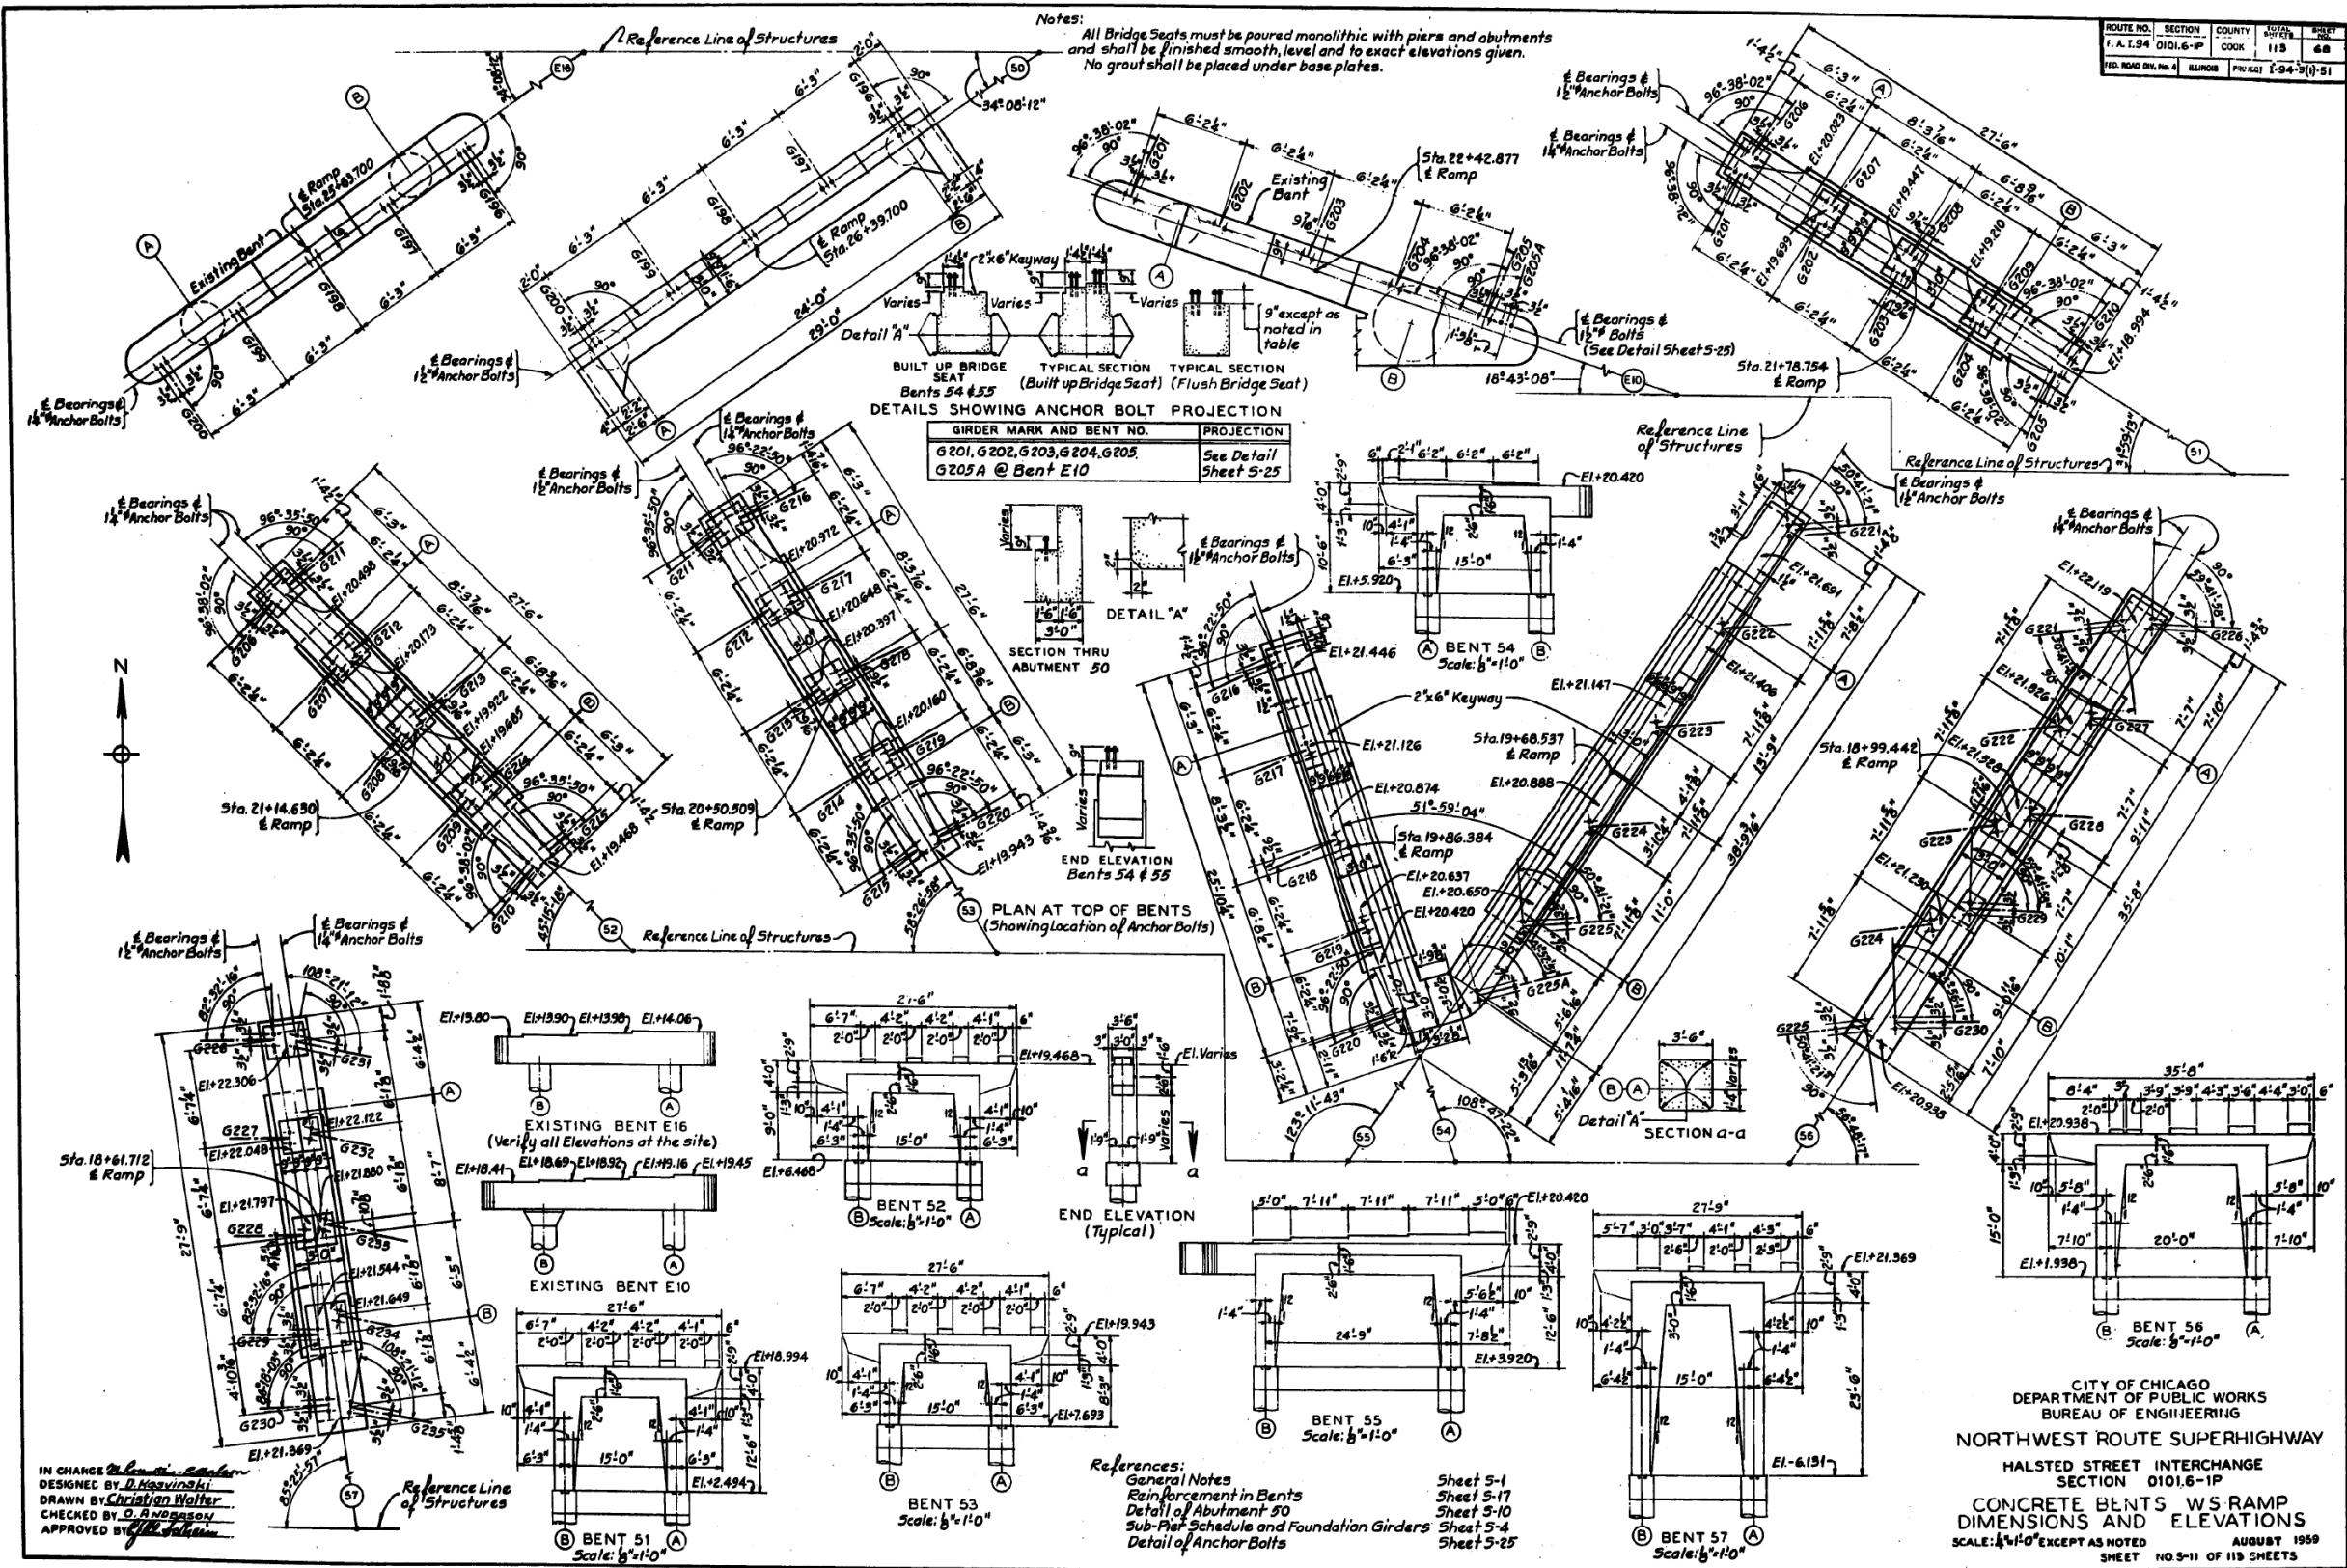

NAME: dw\161747-PWINT-aecomonline.local\AECON DS02 NAD\Documents\01 Americast\Transportation\0269938 CirclePhase II\000 CAD\008 Structural Structure 016-1718\Existing Plans\0160464 20-60x93-Sxx-Existingd65

HBM
ENGINEERING GROUP, LLC


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PLOT SCALE =	N.T.S	DRAWN -	REVISED -
PLOT DATE =	7/26/2018	CHECKED - MI, MAI	REVISED -

STATE OF ILLINOIS
DEPARTMENT OF TRANSPORTATION

EXISTING RECORD DRAWINGS

F.A.I. RTE.	SECTION	COUNTY	TOTAL SHEETS	HEET NO.
90/94/290	2014-013R&B-R	COOK	1972	1940
			CONTRACT NO. 60X93	
		ILLINOIS	FED. AID PROJECT	

FOR INFORMATION ONLY

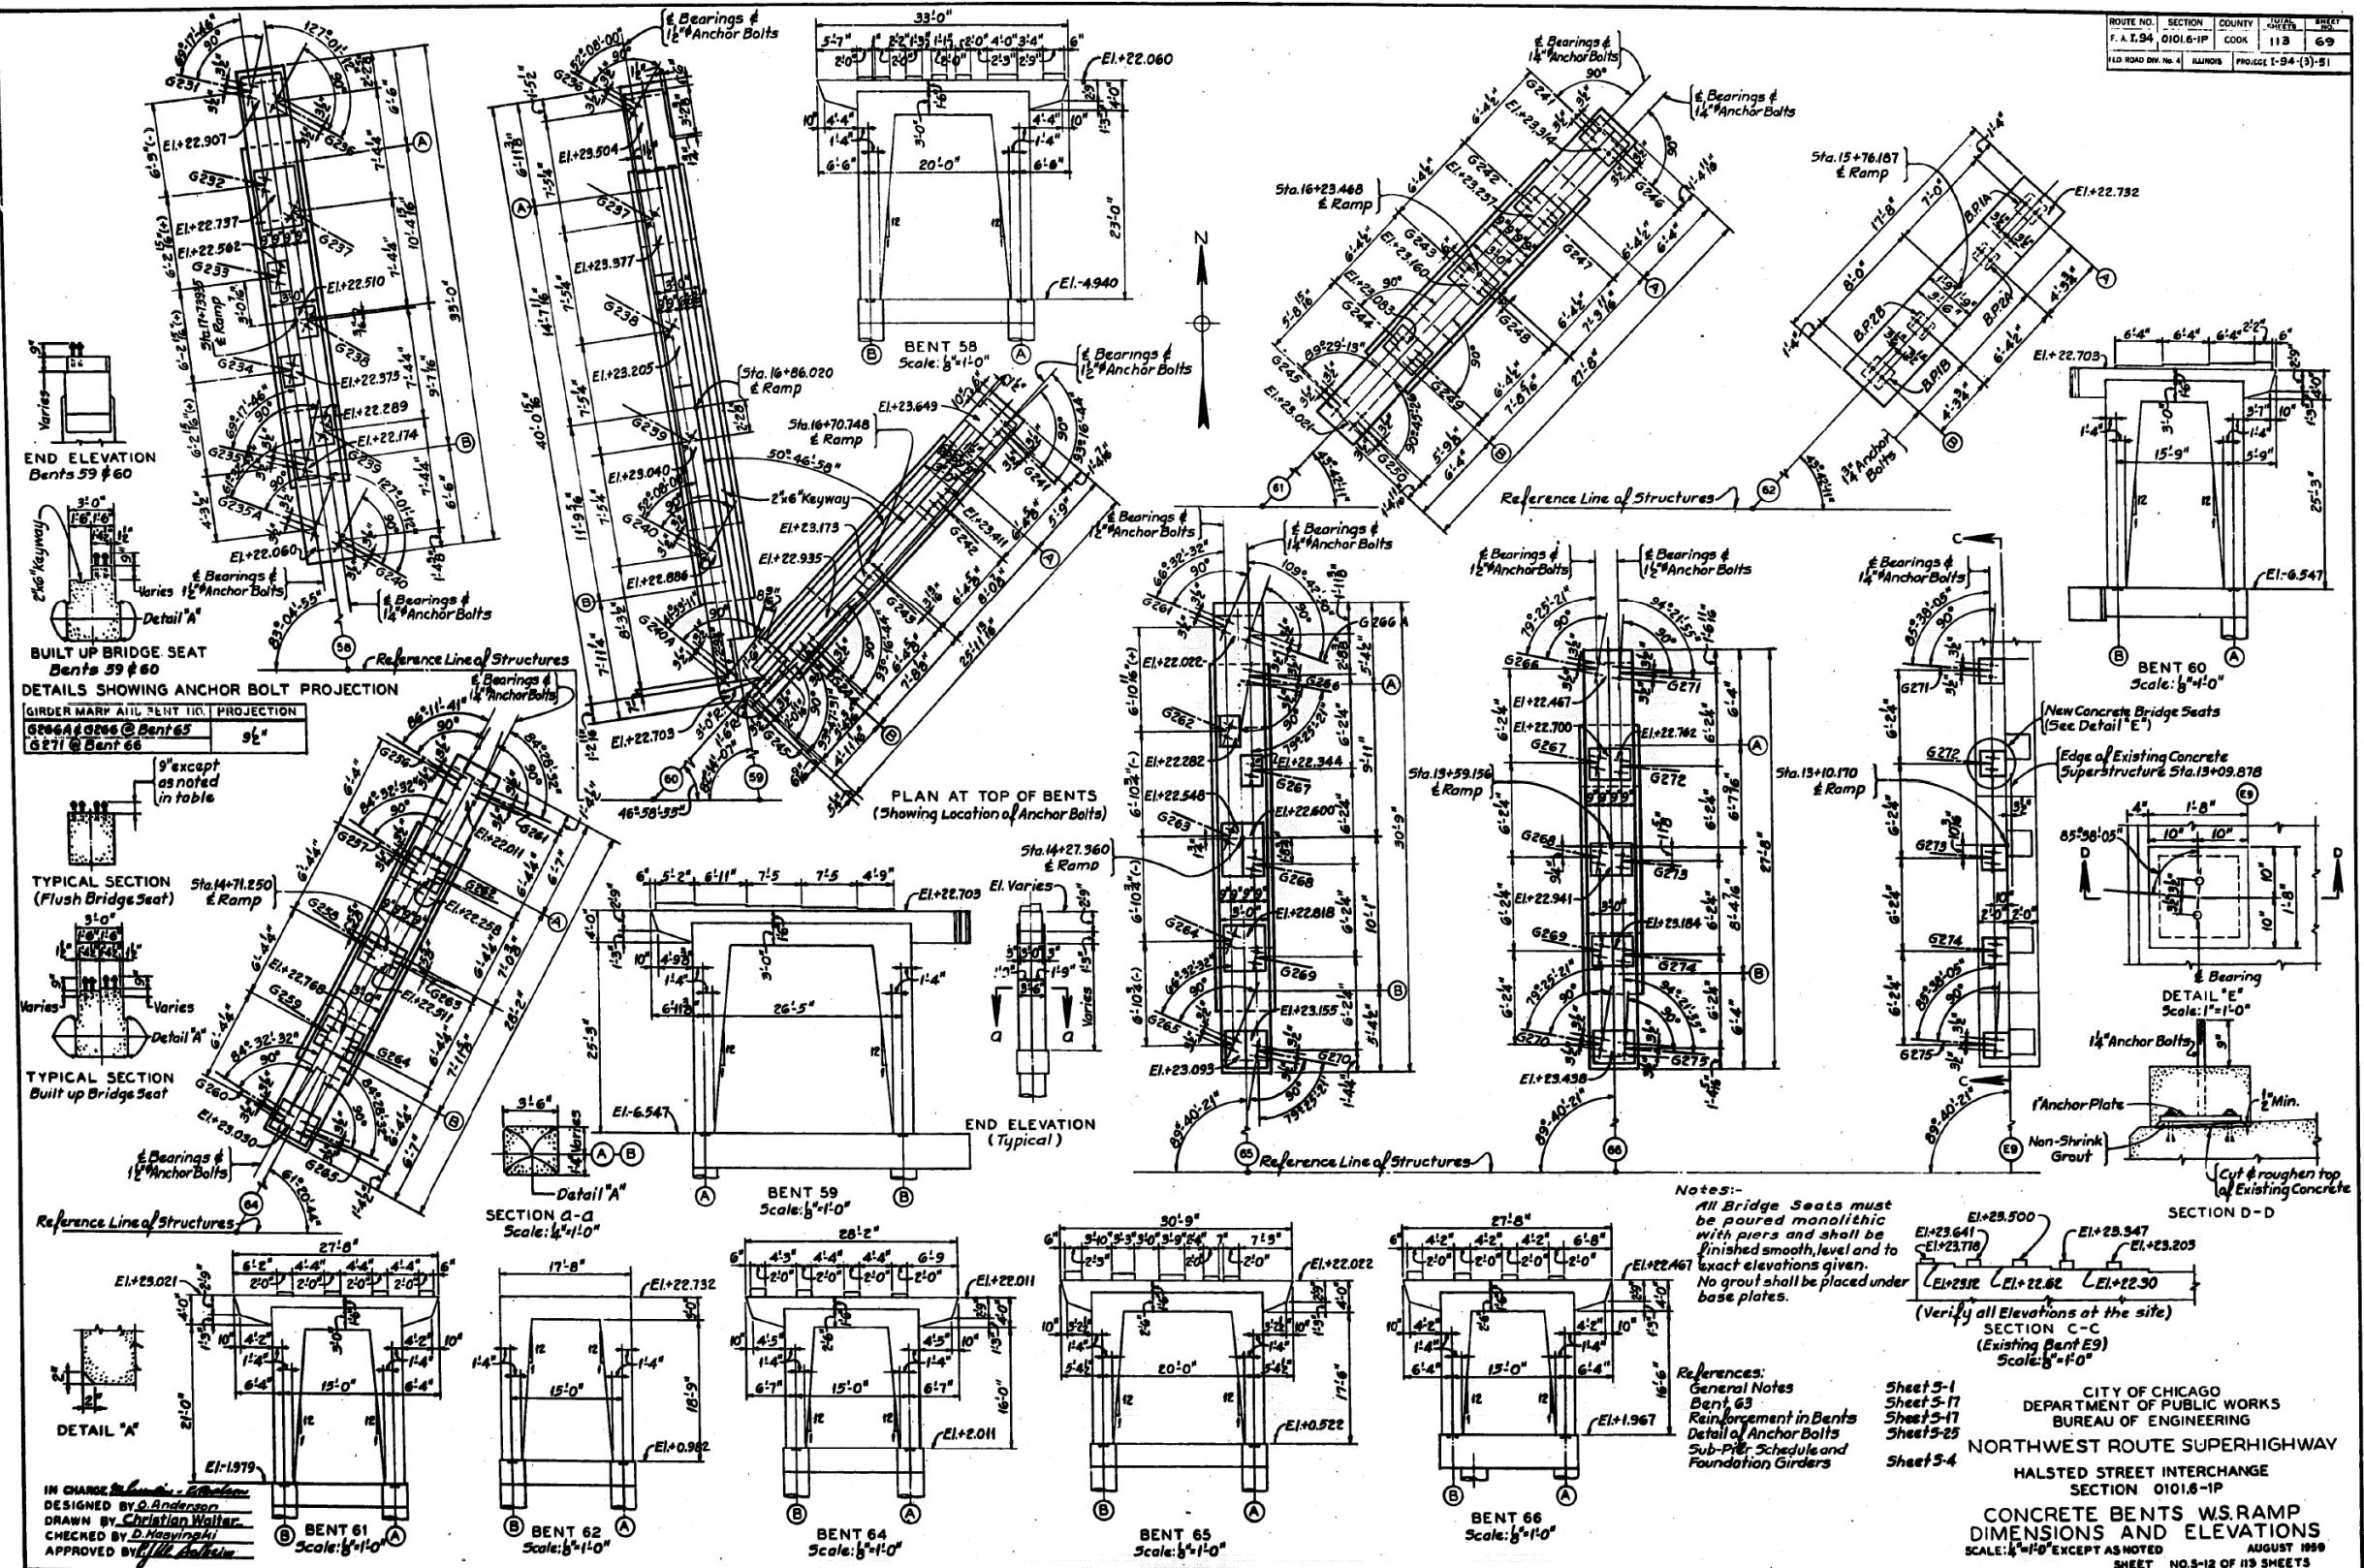

FILE NAME: pwa161747-PWINT.aecommobile;local:AECCOM_D502_NADocuments\01_Americas\Transportation\60269938_CirclePhase_I\000_CAD\008_Structural\Structure_016-1718\Existing Plans\0160461-20-60X93-Sxx-Existing666

HBM
ENGINEERING GROUP, LLC


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PLOT DATE =	7/26/2018	CHECKED - MI, MAI	REVISED -

**STATE OF ILLINOIS
DEPARTMENT OF TRANSPORTATION**

EXISTING RECORD DRAWINGS

F.A.I. RTE.	SECTION	COUNTY	TOTAL SHEETS	HEET NO.
90/94/290	2014-013R&B-R	COOK	1972	1941
CONTRACT NO. 60X93				
	ILLINOIS	FED. AID PROJECT		

FOR INFORMATION ONLY

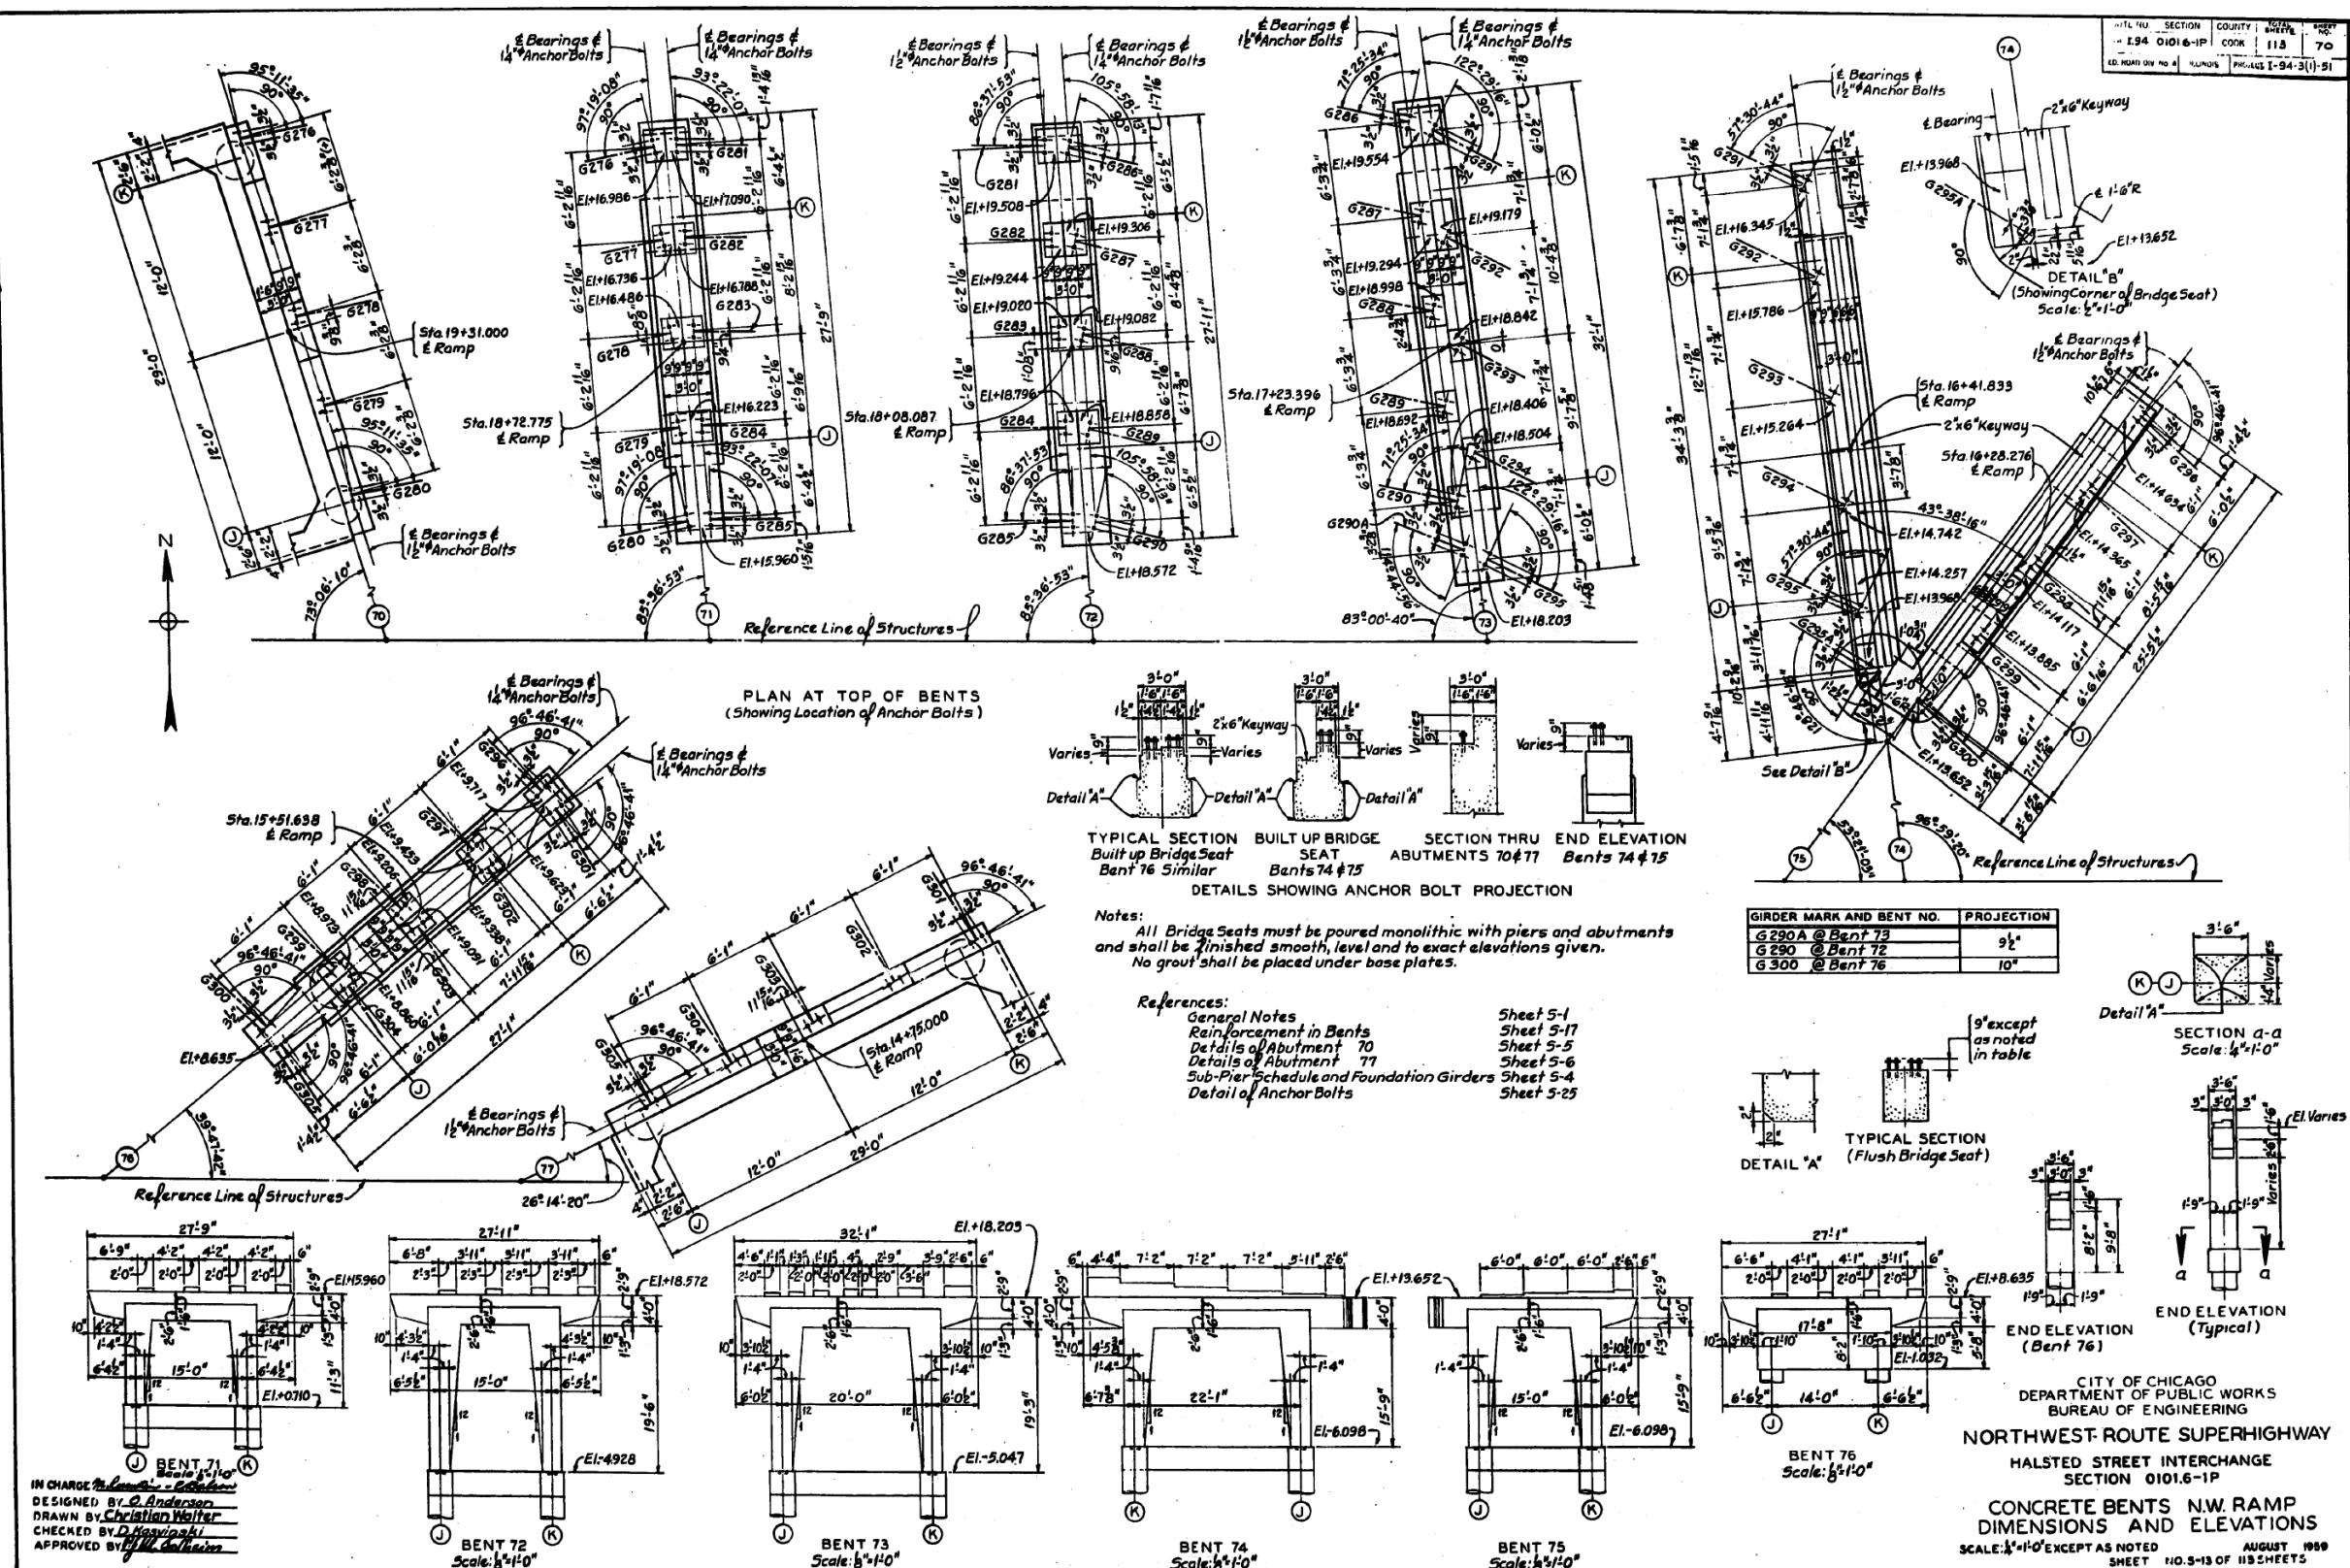

FILE NAME: PW\1617475-PWINT.acmonline\local\ACOM_D502\NA\Documents\01 Americas\Transportation\60269938\CirclePhase\J1000.CAD\008_Structural\Structure_016-1718\Existing_Plans\0160461\20-60X3-Sxx-Existing667

HBM
ENGINEERING GROUP, LLC

USER NAME	=	ahmad.issa
PLOT SCALE	=	N.T.S
PLOT DATE	=	7/26/2018


STATE OF ILLINOIS
DEPARTMENT OF TRANSPORTATION

EXISTING RECORD DRAWINGS

F.A.I. RTE.	SECTION	COUNTY	TOTAL SHEETS	HEET NO.
90/94/290	2014-013R&B-R	COOK	1972	1942
			CONTRACT NO. 60X93	

FOR INFORMATION ONLY

NAME: dwm61747-pwINT_aedonline-local@ECOM_D502_NA\Documents\01 America's Transportation\6259983_CirclePhase_1\P0000\ADAO088_Structural\Structures_016-1718\Existing_Plans\01610461_20-619x93-5x7-Existing668

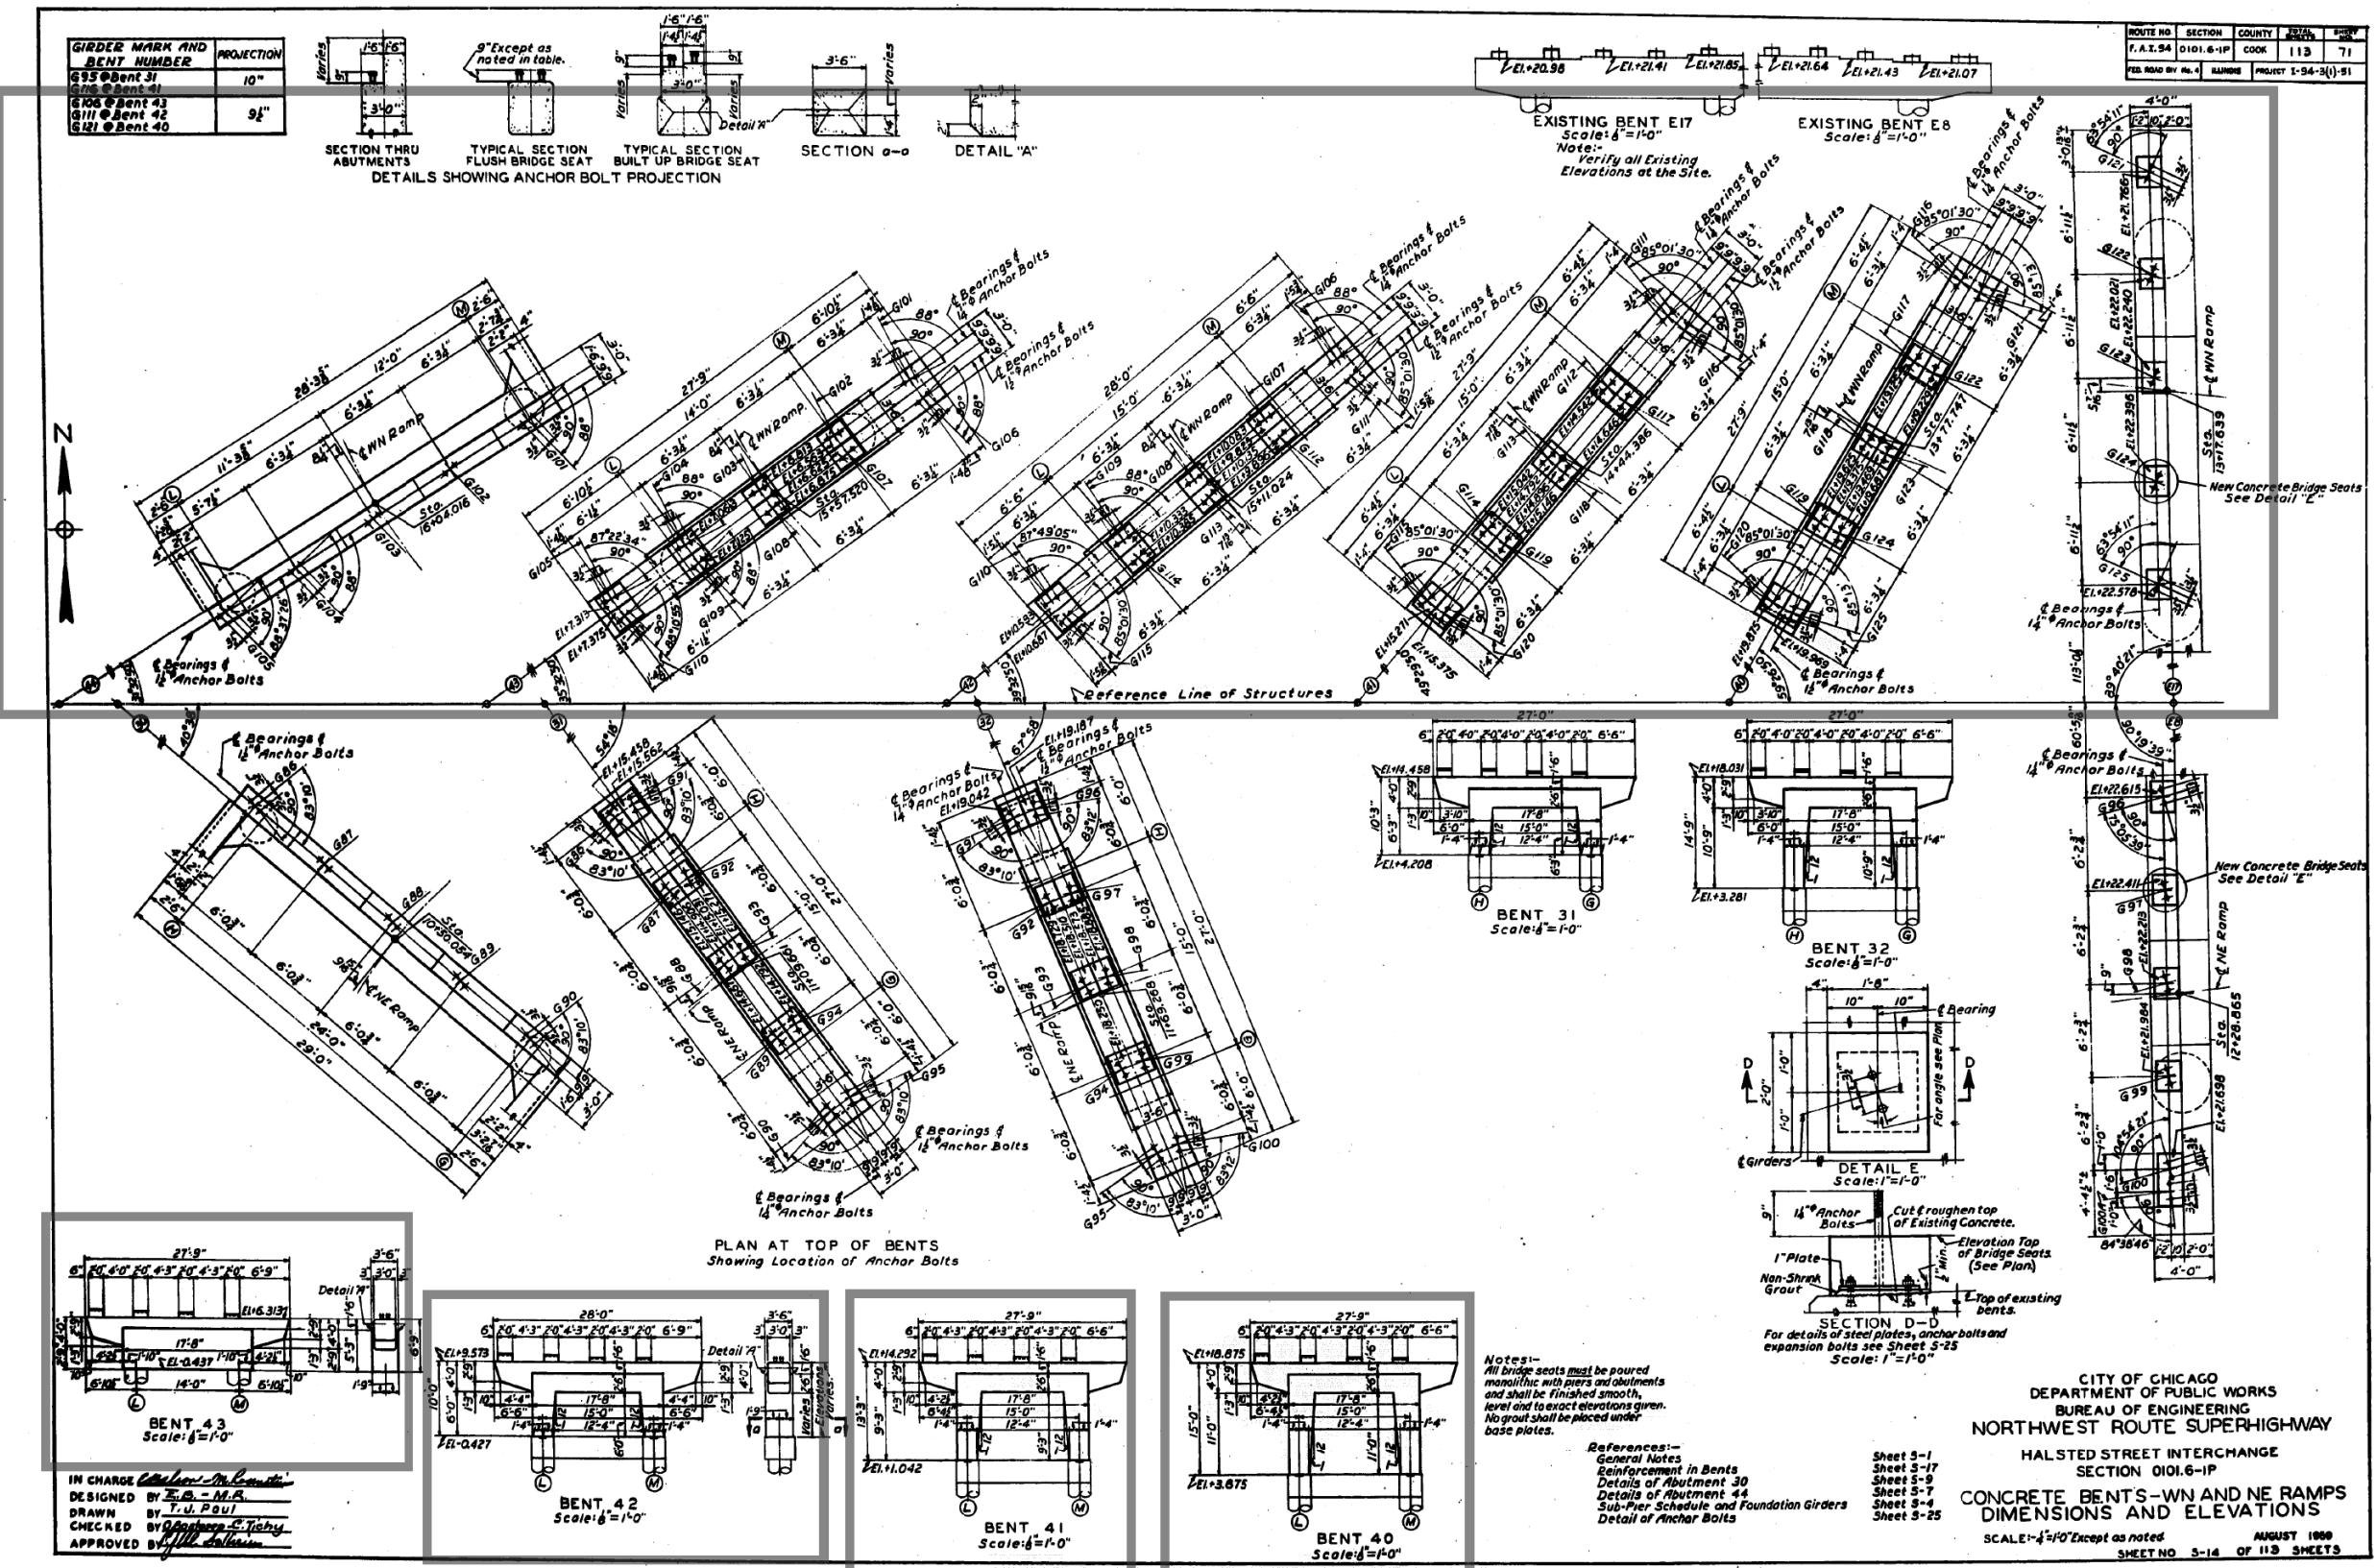

HBM
ENGINEERING GROUP, LLC

USER NAME	=	ahmad,issa
PLOT SCALE	=	N.T.S
PLOT DATE	=	7/26/2018


**STATE OF ILLINOIS
DEPARTMENT OF TRANSPORTATION**

EXISTING RECORD DRAWINGS

F.A.I. RTE.	SECTION	COUNTY	TOTAL SHEETS	SHEET NO.
90/94/290	2014-013R&B-R	COOK	1972	1943
			CONTRACT NO.	60X93
		ILLINOIS	FED. AID PROJECT	

FOR INFORMATION ONLY

FILE NAME: DWG1617A9 DWGINT secoundary localAE.COM D502 NAVDocument01 Amdec-ACT-annotation016500038 CircleDashed H100N CADWWS Structural|Structural 016 1718|Section Disney160612 20 60Y02 Svc Existing6669

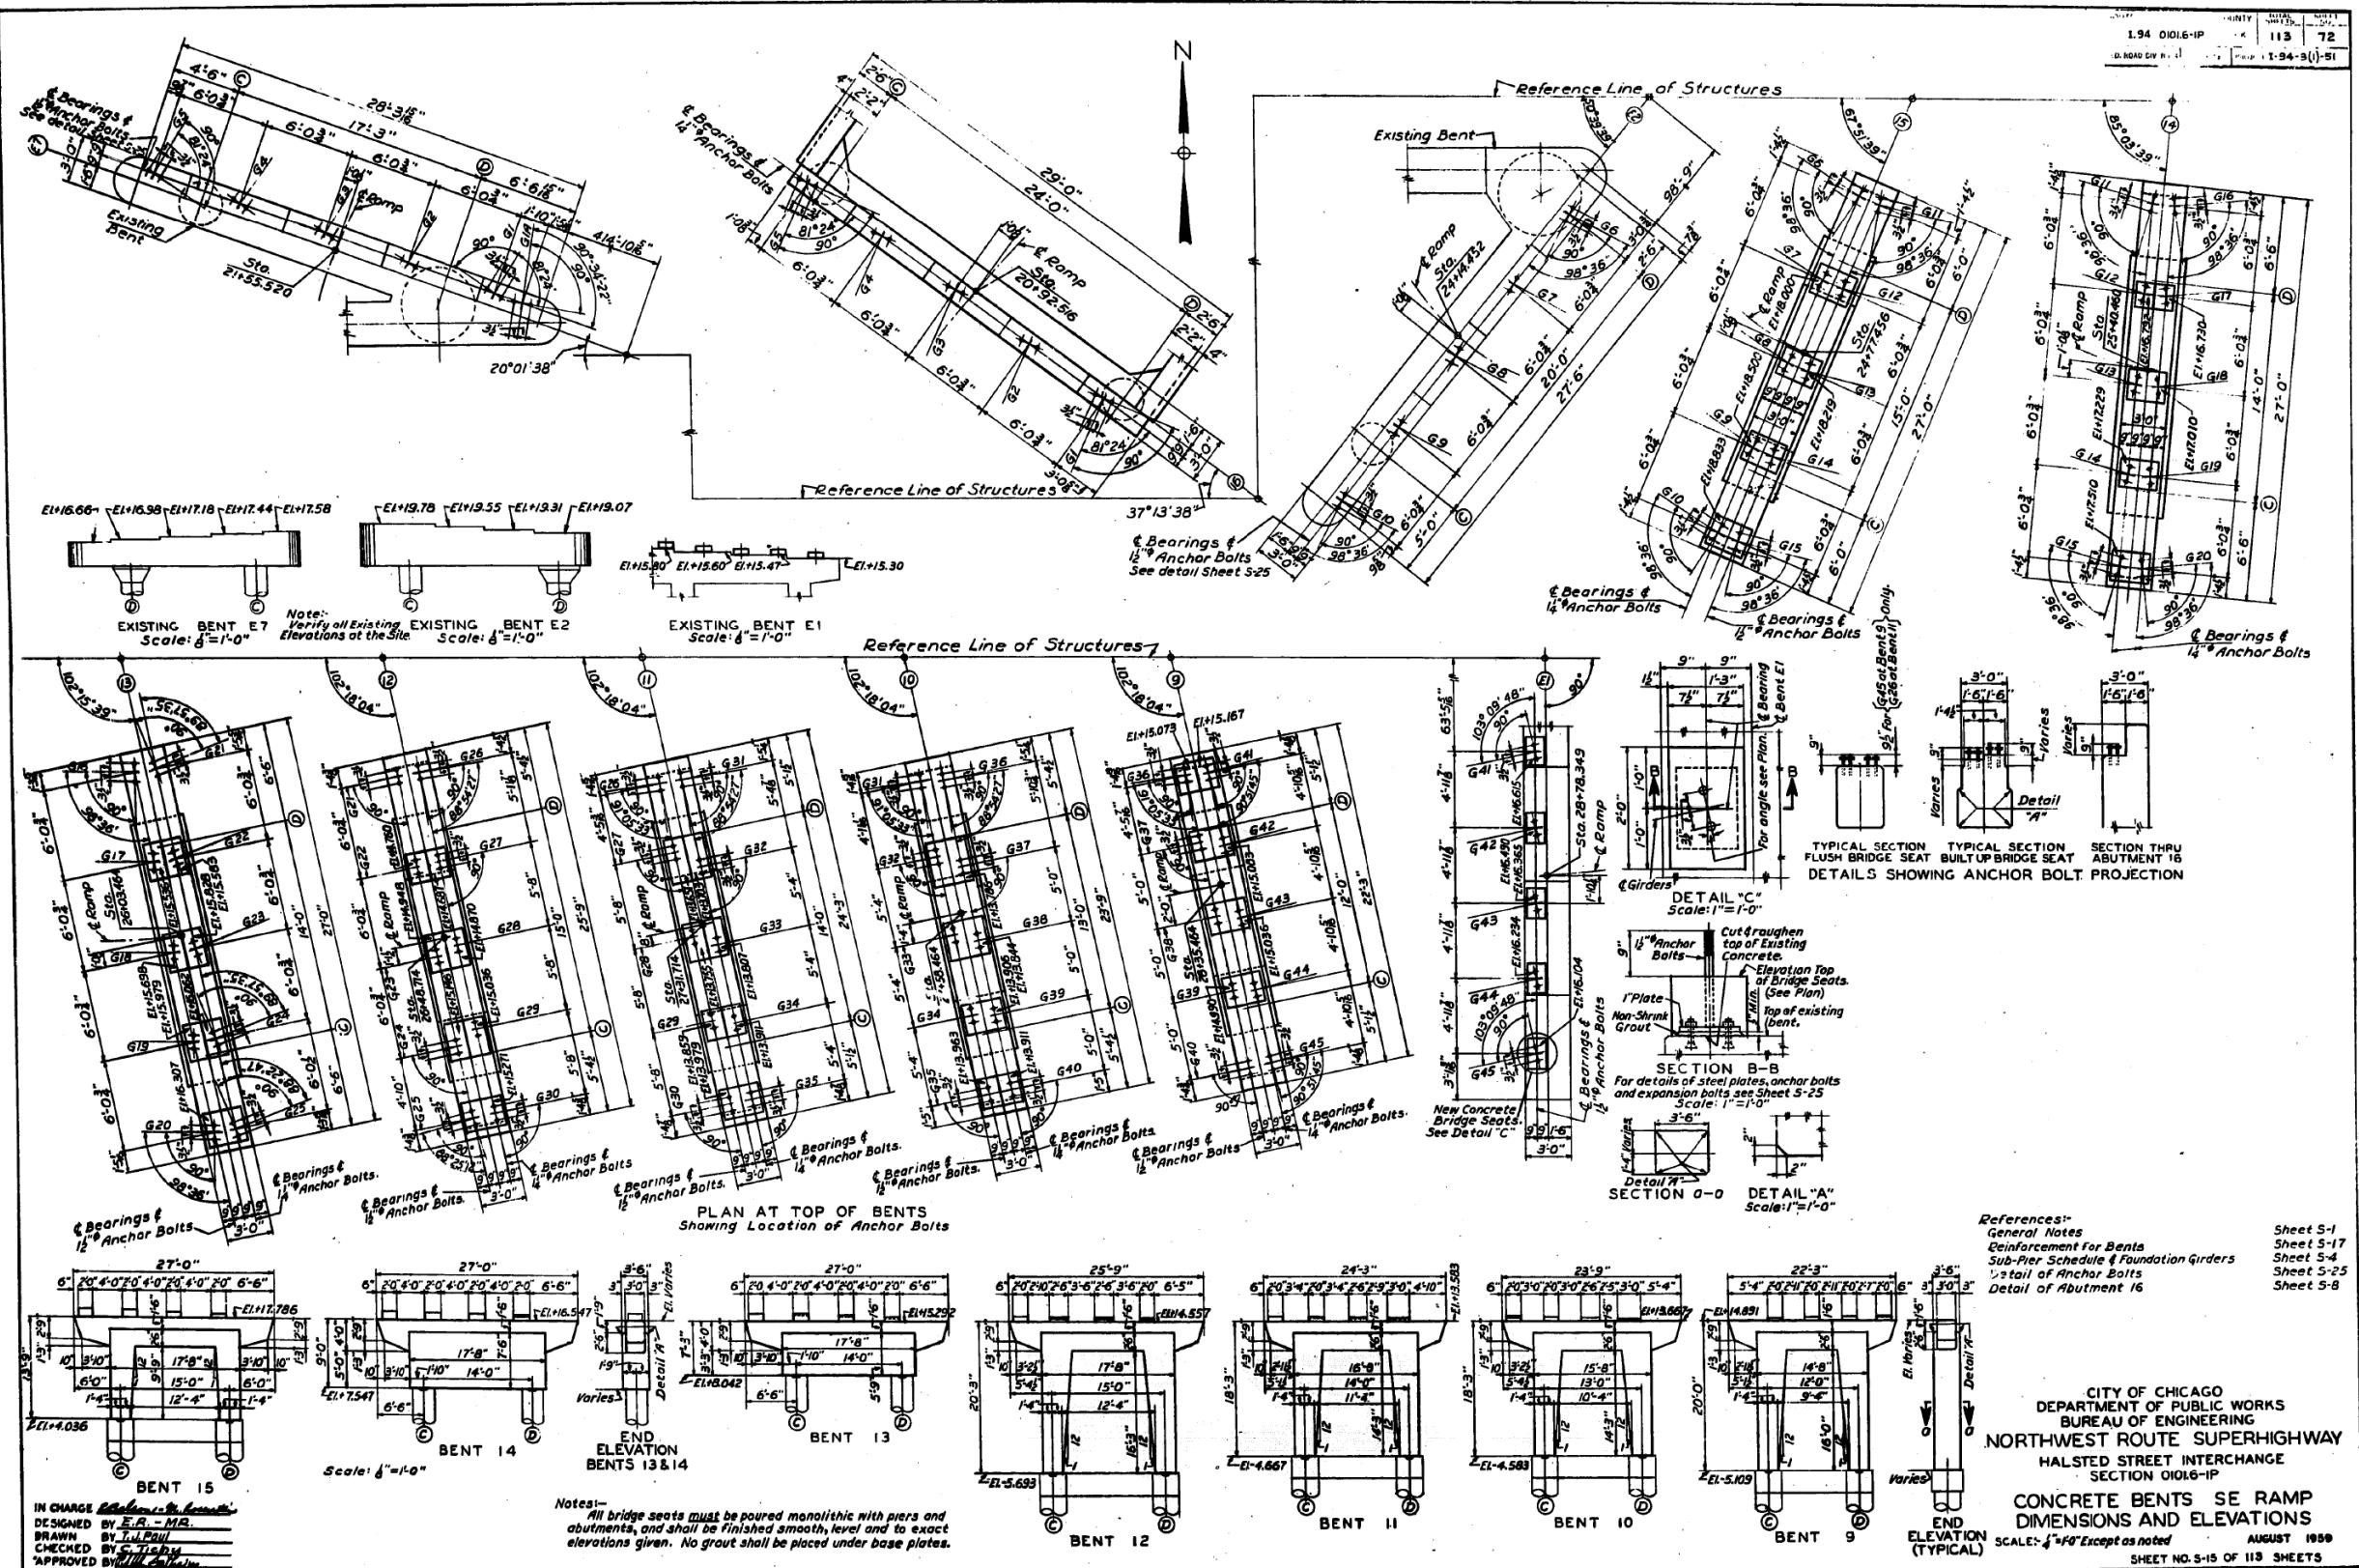

HBM
ENGINEERING GROUP, LLC


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PLOT SCALE	=	N.T.S
PLOT DATE	=	7/26/2018

STATE OF ILLINOIS
DEPARTMENT OF TRANSPORTATION

EXISTING RECORD DRAWINGS

F.A.I. RTE.	SECTION	COUNTY	TOTAL SHEETS	HEET NO.
90/94/290	2014-013R&B-R	COOK	1972	1944
CONTRACT NO. 60X93				
	ILLINOIS	FED. AID PROJECT		

FOR INFORMATION ONLY

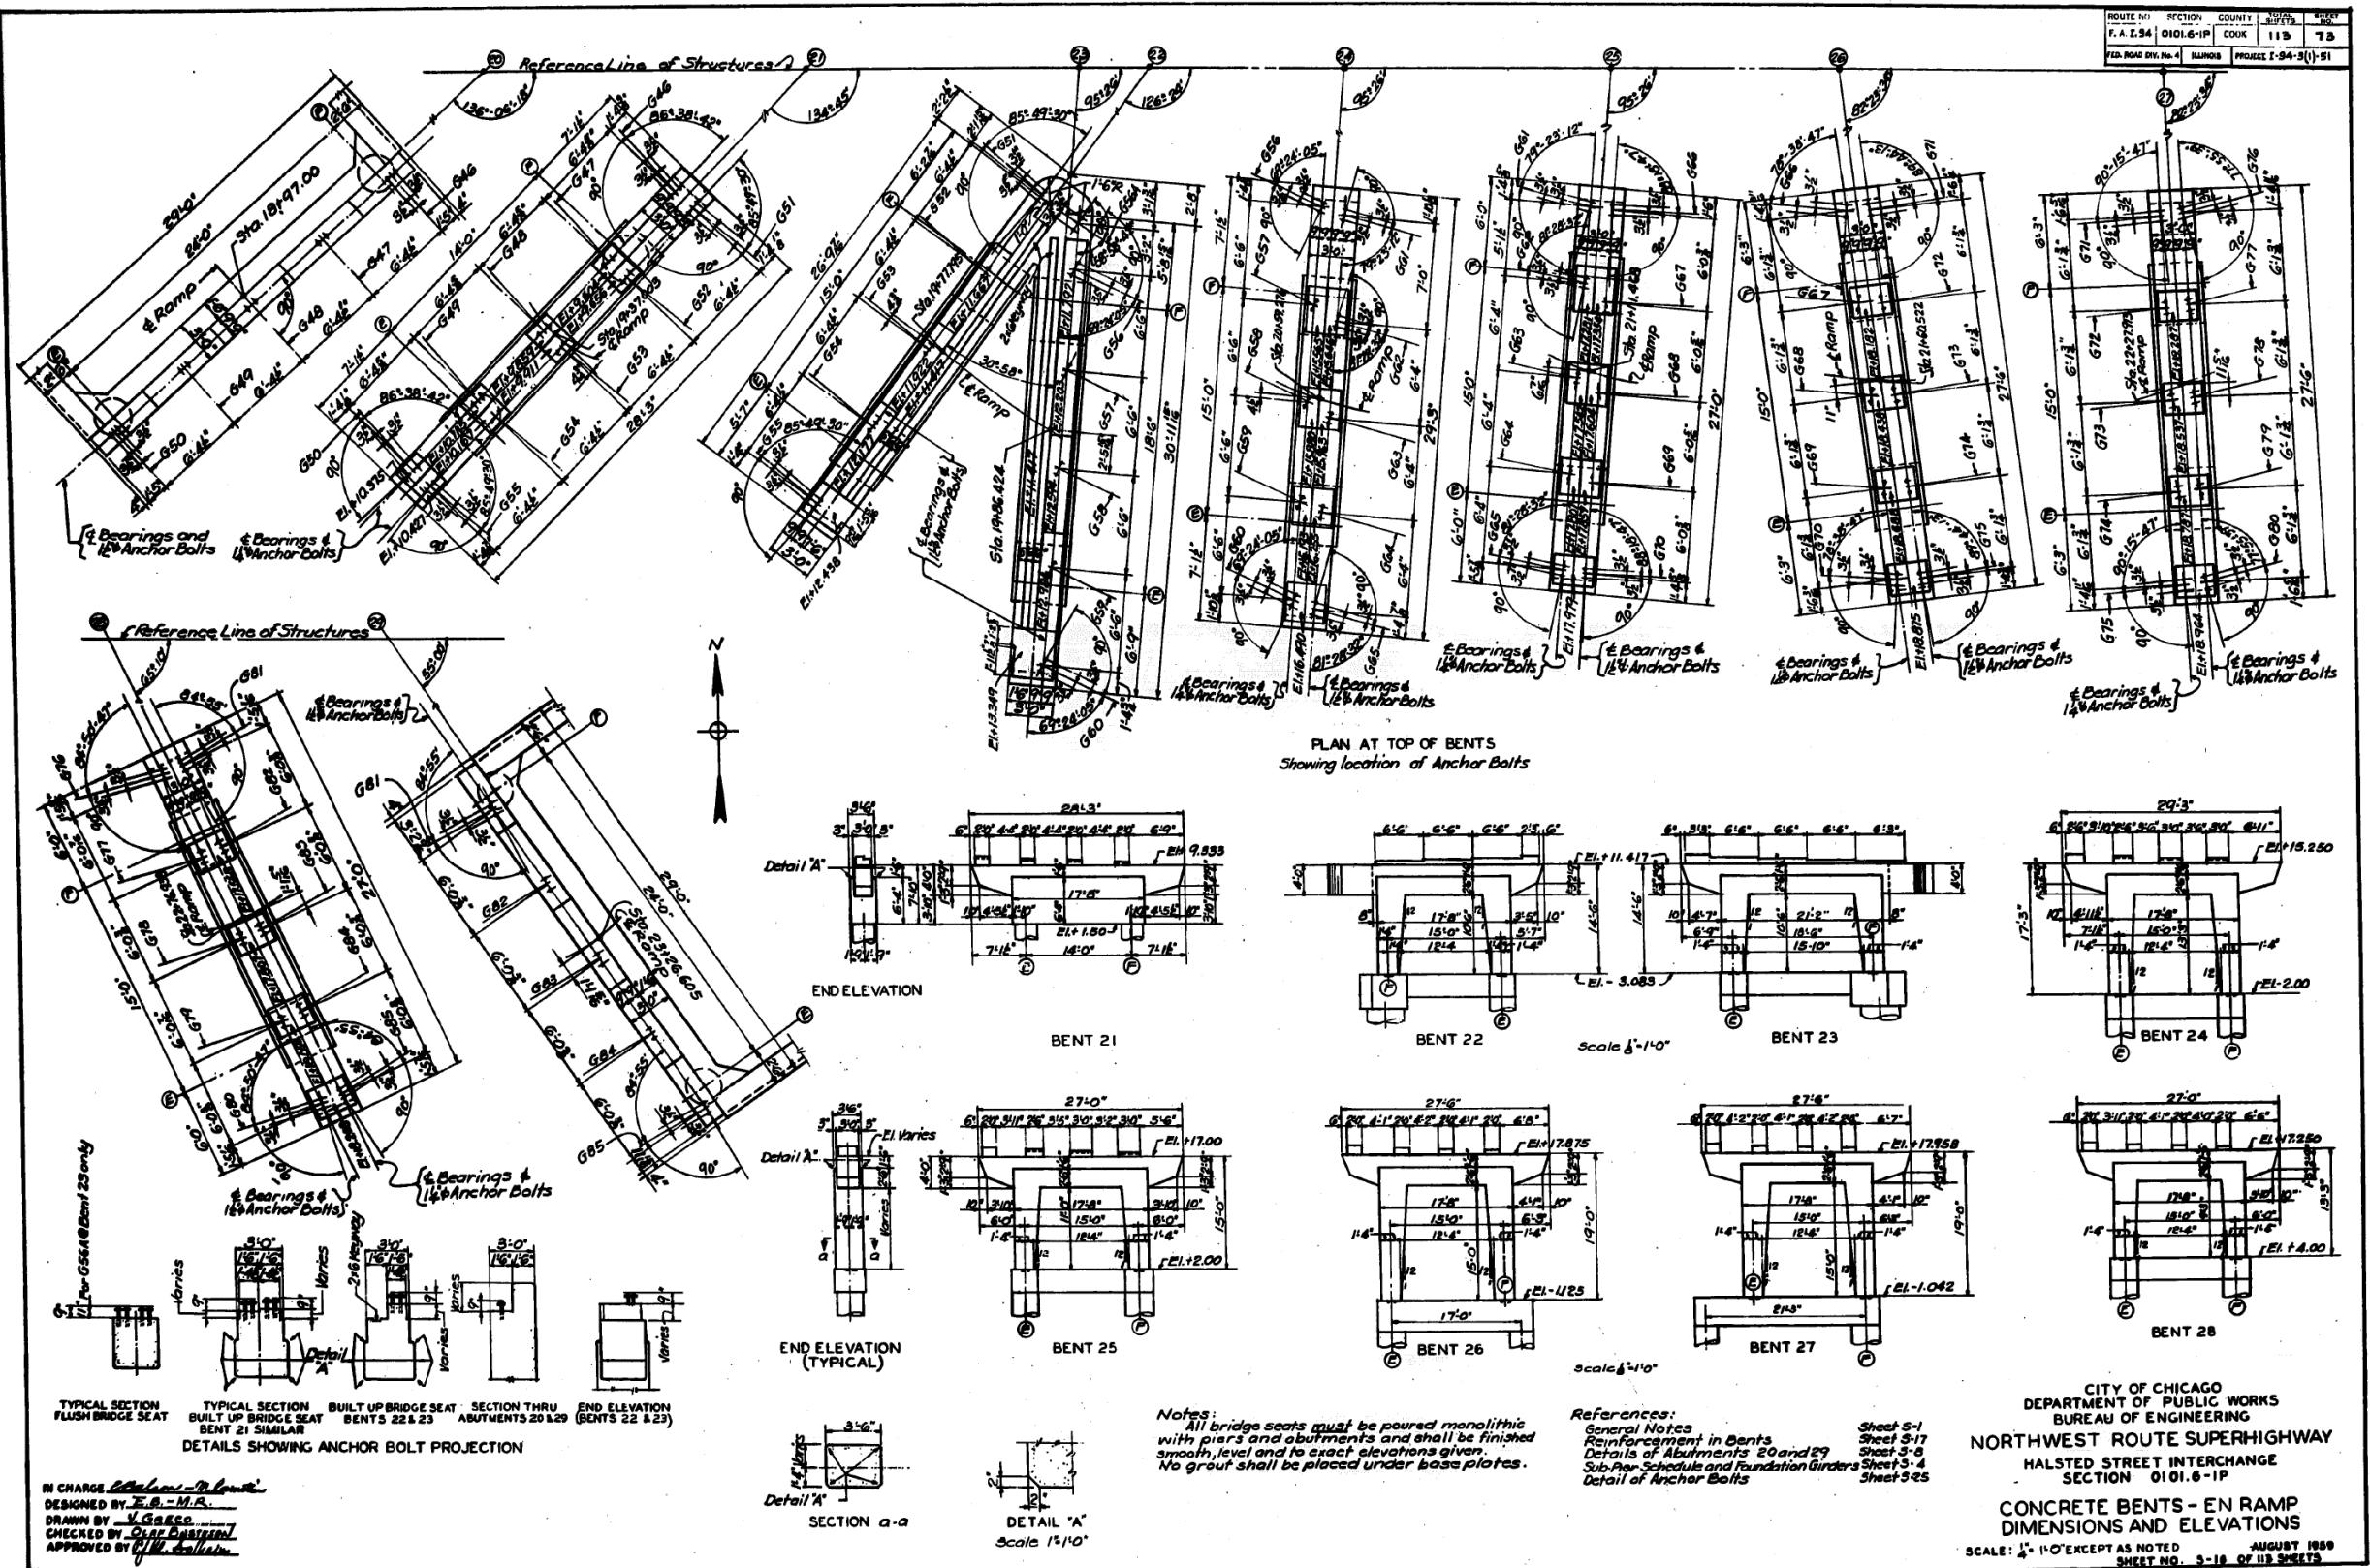

FILE NAME: pwi:61747-9P-WINT.aecommobile;local:AECOM DS02_NAD\Documents\01_Americas\Transportation\60269938_CirclePhase II\000 CAD\008_Structural\Structure_016-1718\Existing Plans\0160461-20-60X93-Sxx-Existing670

HBM
ENGINEERING GROUP, LLC


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PLOT DATE = 7/26/2018	CHECKED - MI, MAI	REVISED -

STATE OF ILLINOIS
DEPARTMENT OF TRANSPORTATION

EXISTING RECORD DRAWINGS

F.A.I. RTE.	SECTION	COUNTY	TOTAL SHEETS	SHEET NO.
90/94/290	2014-013R&B-R	COOK	1972	1945
CONTRACT NO. 60X93				
		ILLINOIS	FED. AID PROJECT	

FOR INFORMATION ONLY

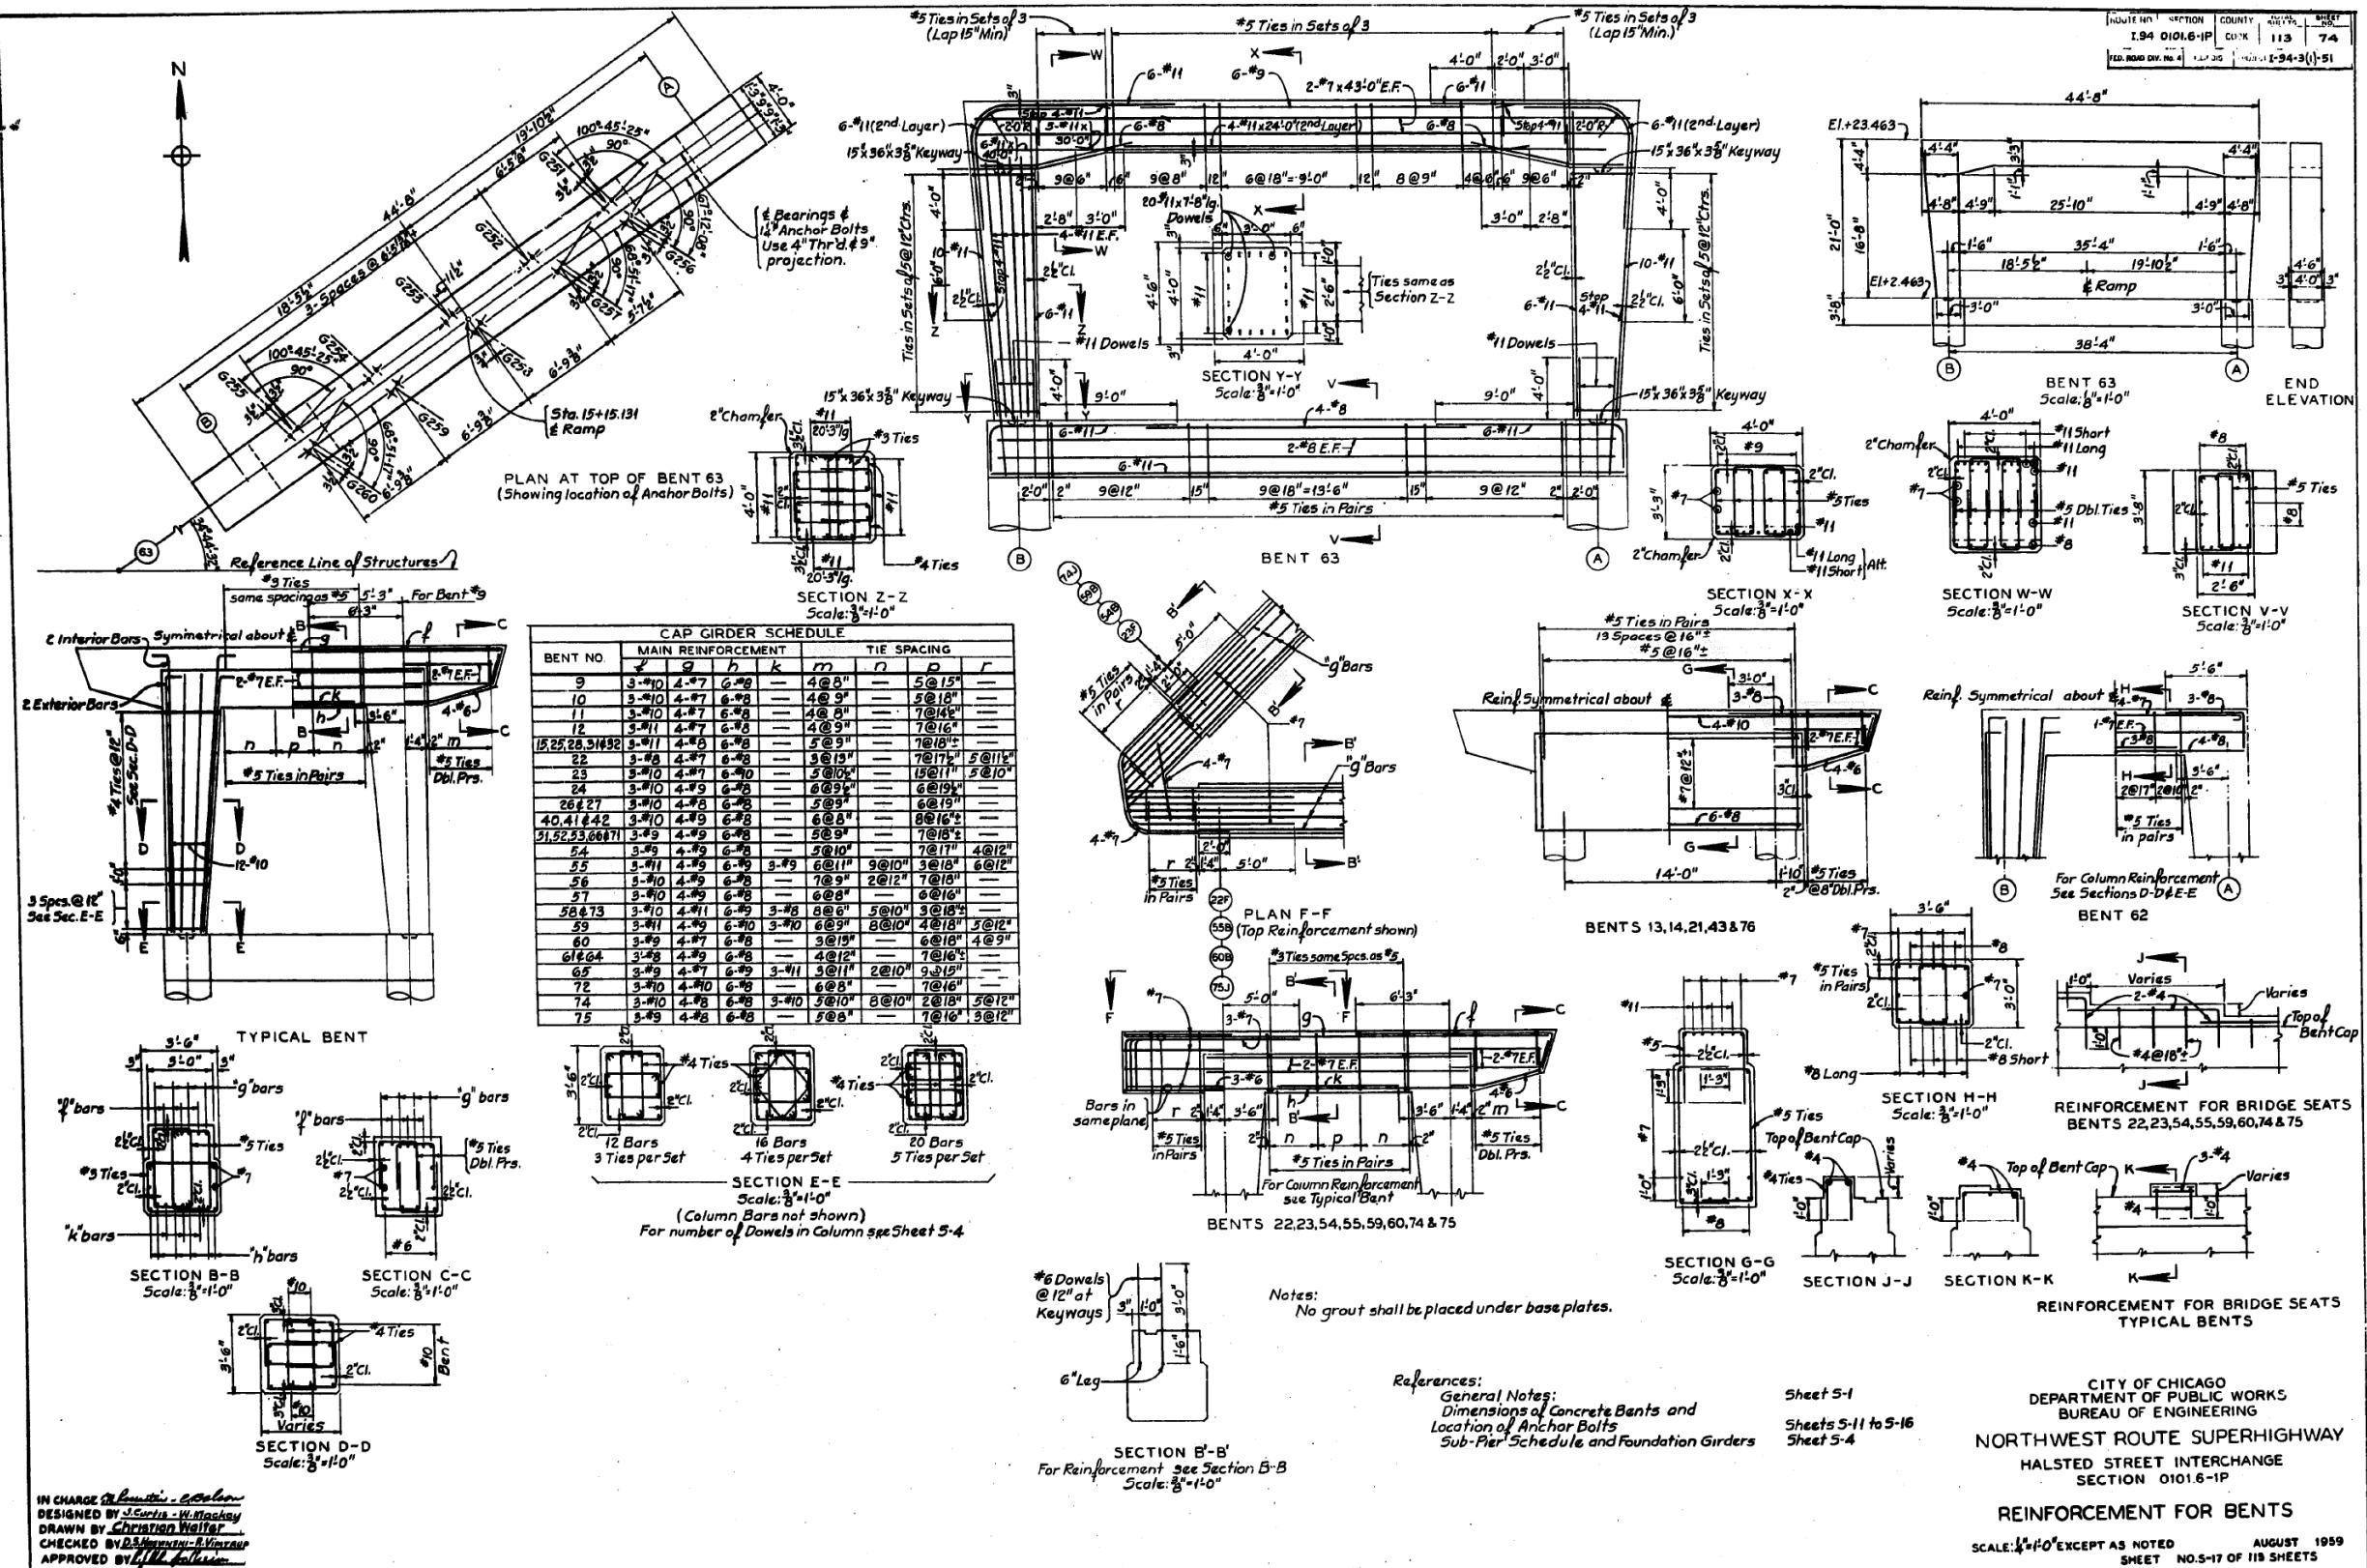

IN CHARGE J. Curtis - C. Balson
DESIGNED BY J. Curtis - W. Mackay
DRAWN BY Christian Walker
CHECKED BY D.S. Hoshino - R. Vintzka
APPROVED BY John G. Miller


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		CHECKED	-
PLOT SCALE	= N.T.S	DRAWN	-
PLOT DATE	= 7/26/2018	CHECKED	- MI, MA

STATE OF ILLINOIS
DEPARTMENT OF TRANSPORTATION

EXISTING RECORD DRAWINGS

F.A.I. RTE.	SECTION	COUNTY	TOTAL SHEETS	HEET NO.
90/94/290	2014-013R&B-R	COOK	1972	1946
			CONTRACT NO.	60X93
	ILLINOIS	FED. AID PROJECT		

FOR INFORMATION ONLY

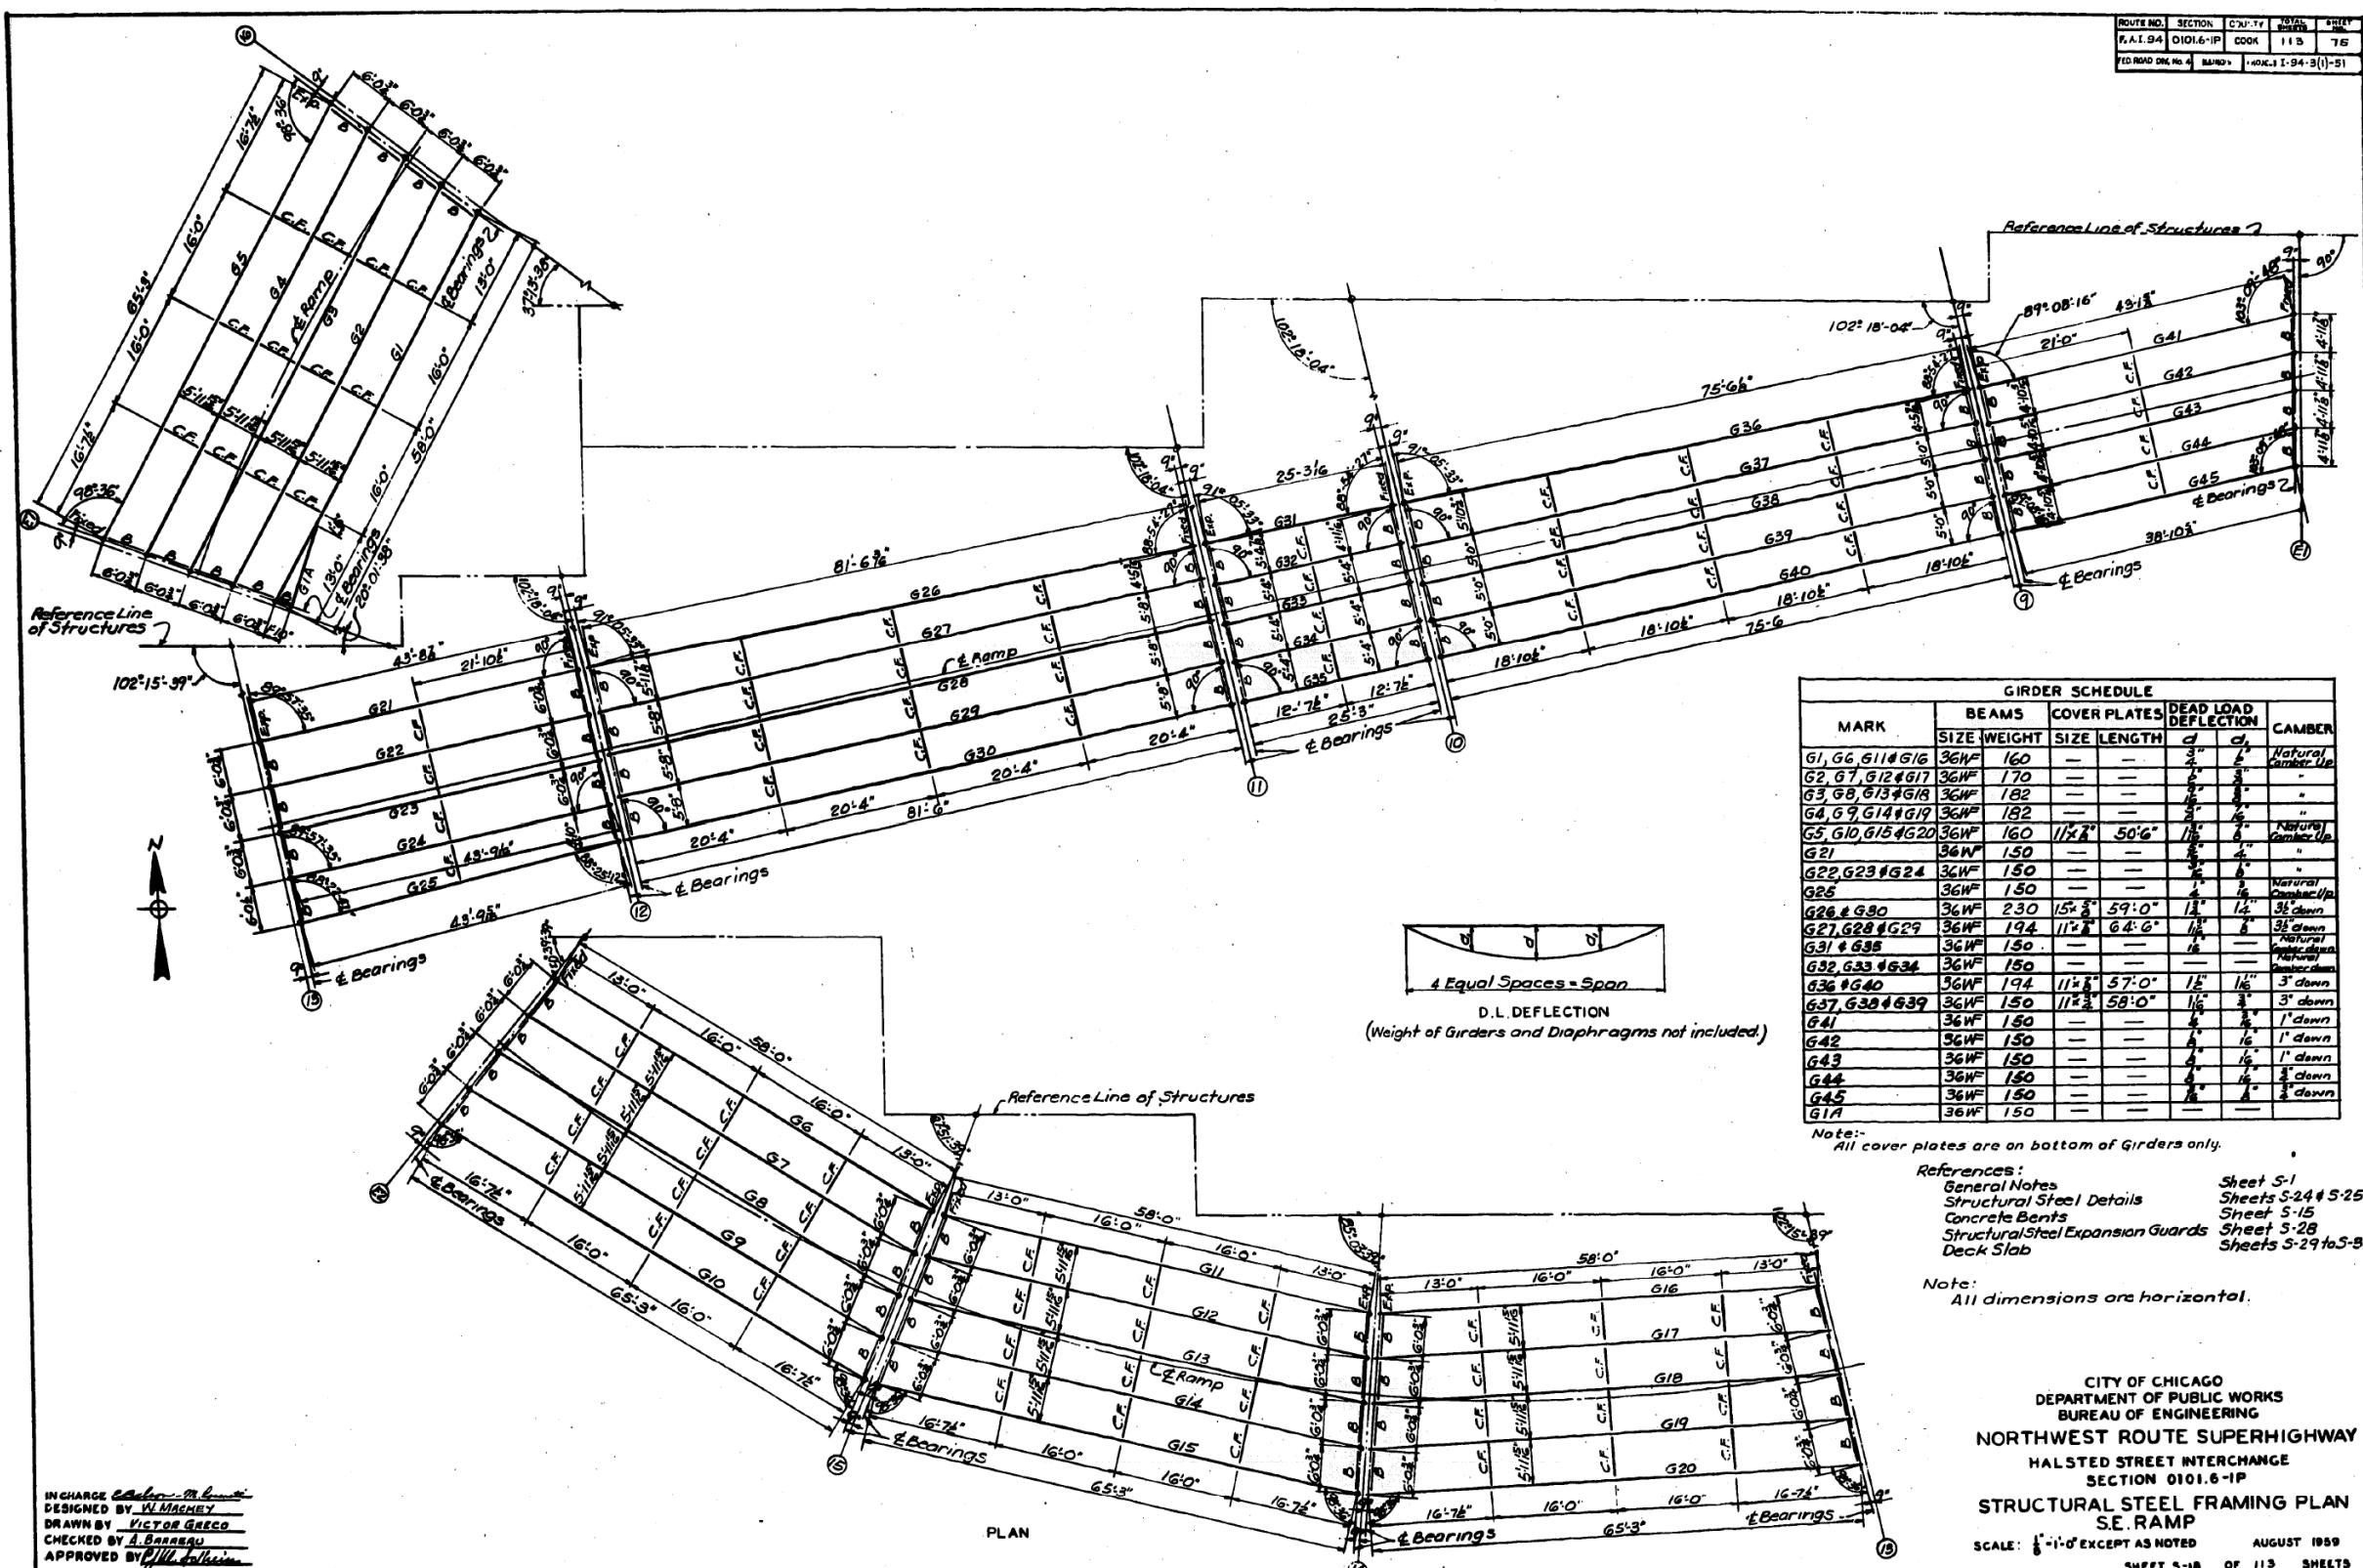

NAME: pwi:\61479-PWINT_aecomonline\local\AEOM_D502_NA\Documents\01_Americas\Transportation\60269938_CirclePhase_1000_CAD008_Structural\Structure_016-1718\Existing_Plans\016461-20-6093-S-xx-Existing672

HBM
ENGINEERING GROUP LLC

USER NAME	=	ahmad.issa	DESIGNED	-	REVISED	-
			CHECKED	-	REVISED	-
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PLOT DATE	=	7/30/2010	CHECKED	NL.MAJ	REVISED	-


STATE OF ILLINOIS
DEPARTMENT OF TRANSPORTATION

EXISTING RECORD DRAWINGS

F.A.I. RTE.	SECTION	COUNTY	TOTAL SHEETS	SHEET NO.
90/94/290	2014-013R&B-R	COOK	1972	1947
				CONTRACT NO. 60X93

FOR INFORMATION ONLY

FILE NAME: DWG1617A9 DWGINT secoundary localAE.COM D502 NAVDocument01 Amdec-ACT-annotation0165050038 CircleDashed H100N CADWWS Structural|Structural|Structure_01K_1718Eviction Disney160612 2n 60Y09 Sec Eviction673

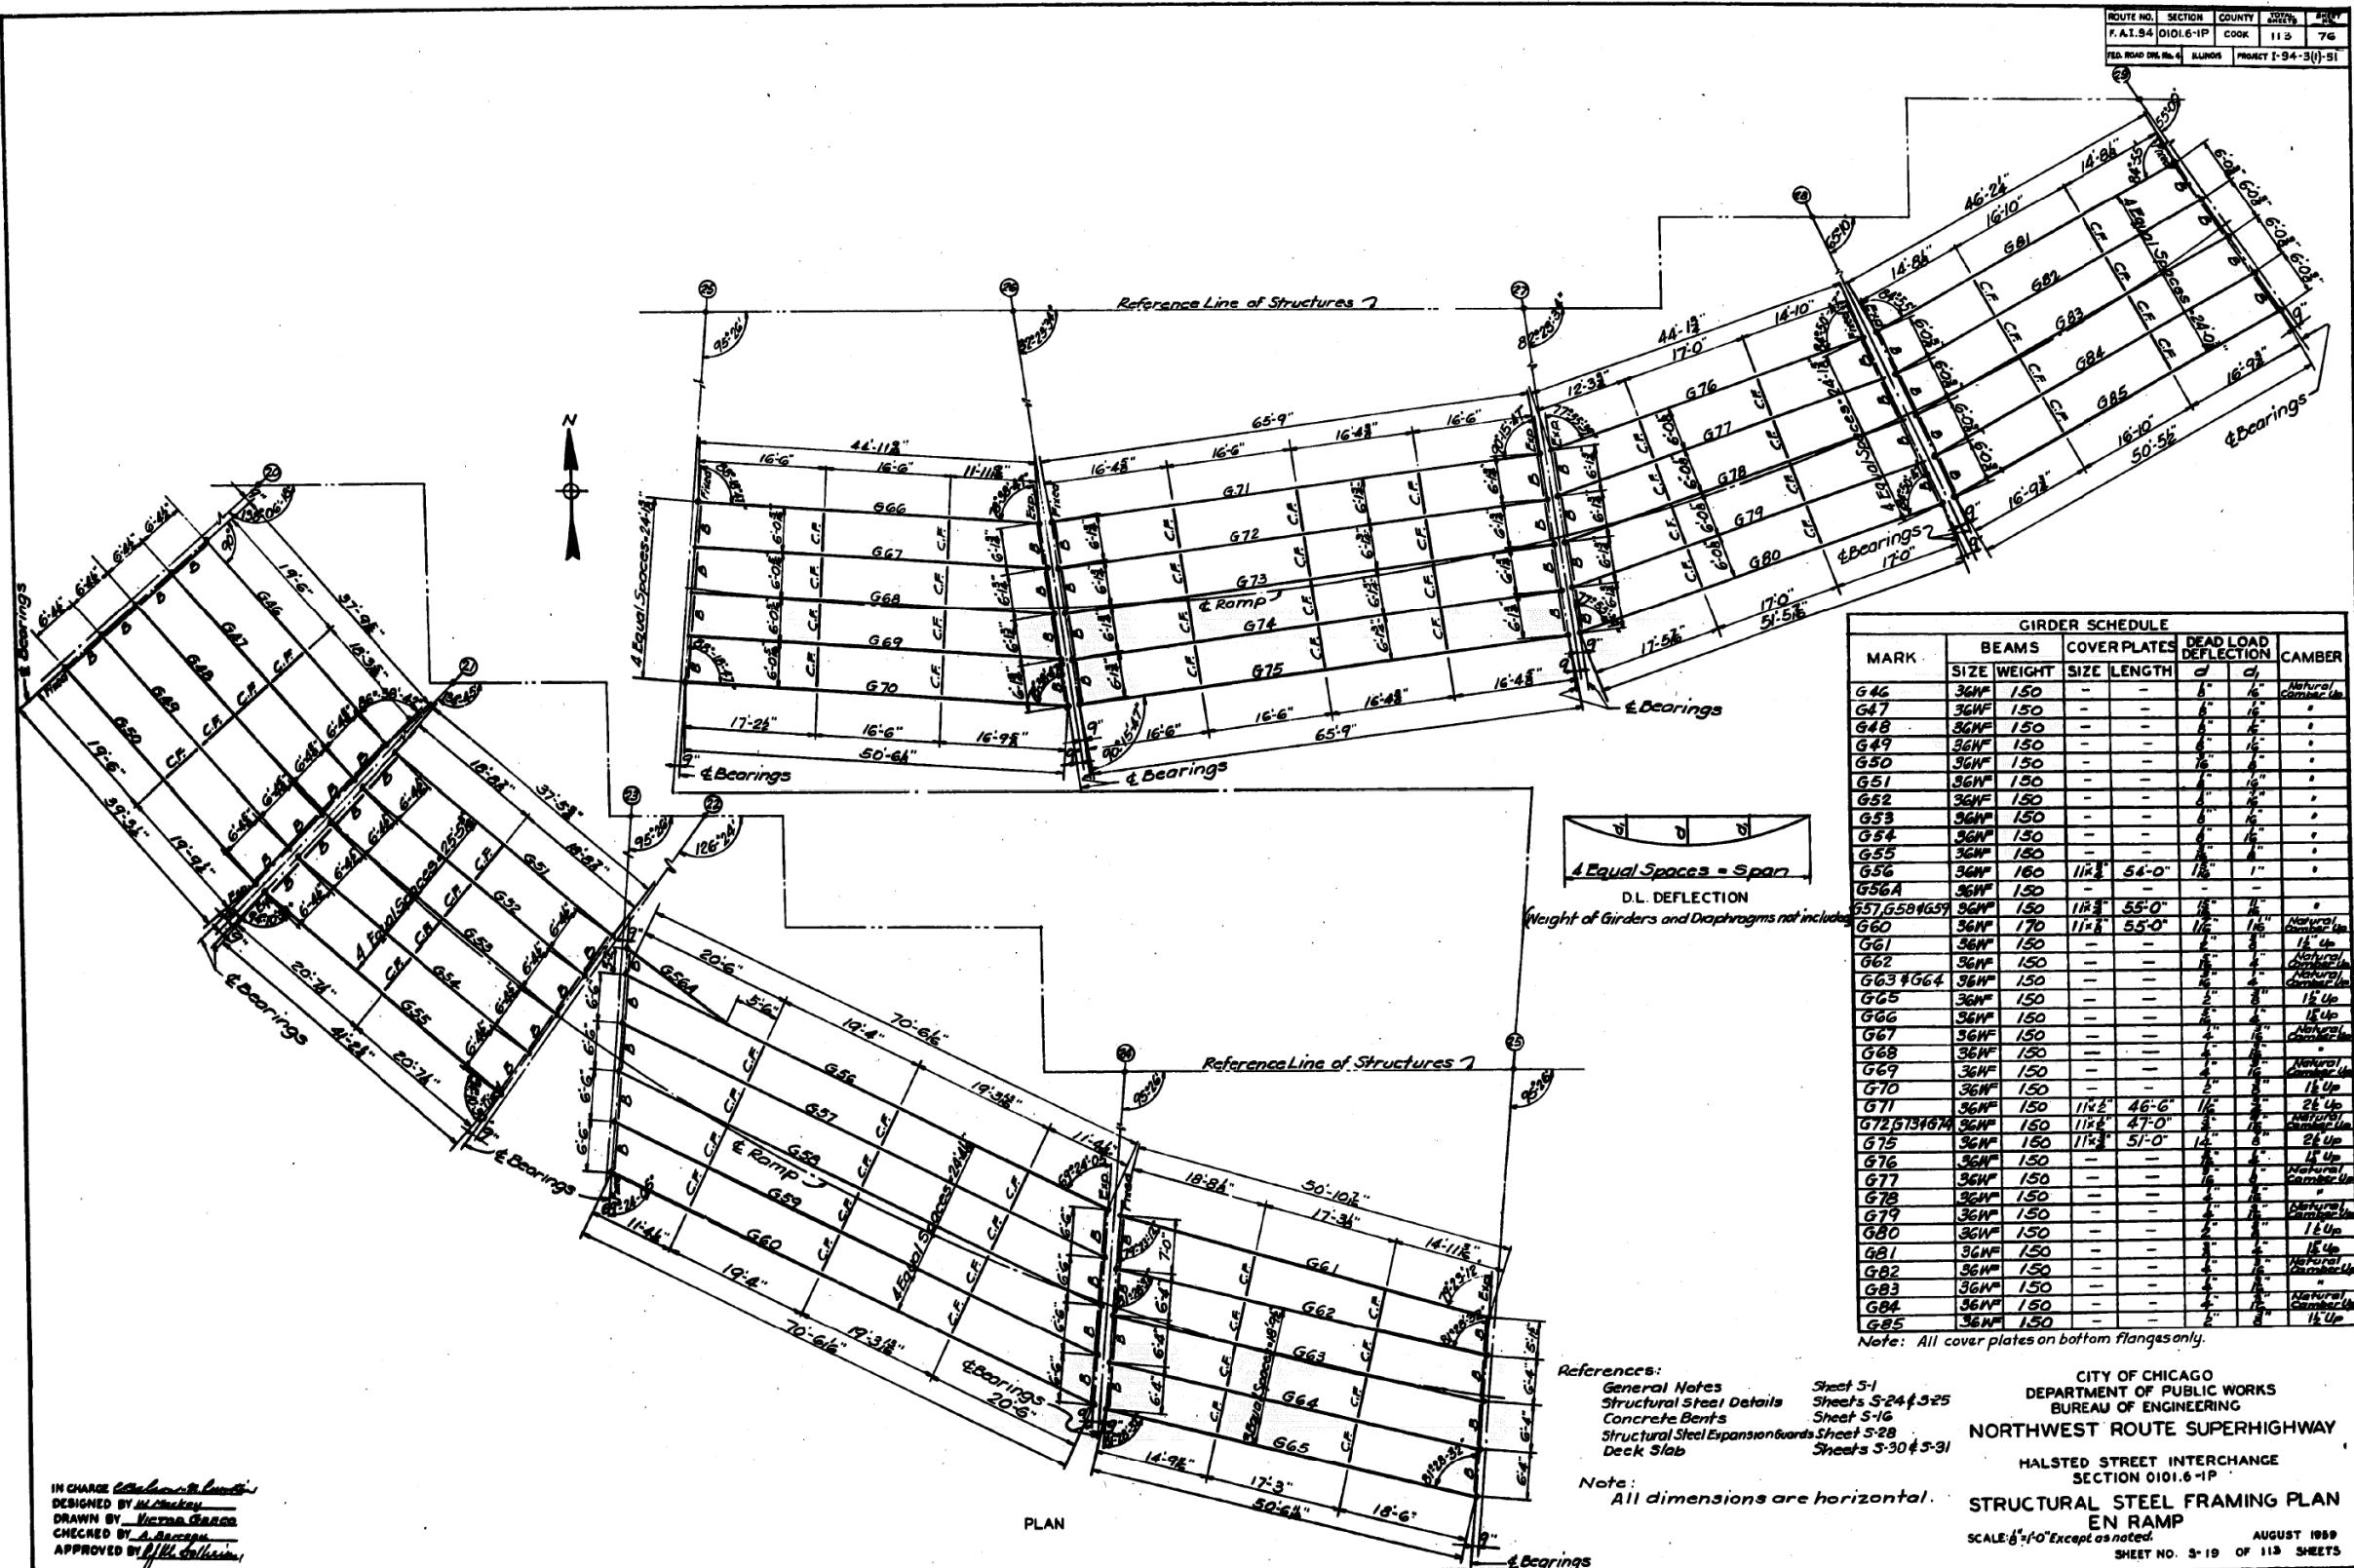

IN CHARGE C. L. Martin
DESIGNED BY M. McKinley
DRAWN BY Victor Garcia
CHECKED BY A. Baca
APPROVED BY J. H. Johnson

USER NAME	= ahmad,issa	DESIGNED	-	REVISED	-
		CHECKED	-	REVISED	-
PLOT SCALE	= N,T,S	DRAWN	-	REVISED	-
PLOT DATE	= 7/26/2018	CHECKED	- MI, MAI	REVISED	-


**STATE OF ILLINOIS
DEPARTMENT OF TRANSPORTATION**

EXISTING RECORD DRAWINGS

F.A.I. RTE.	SECTION	COUNTY	TOTAL SHEETS	HEET NO.
90/94/290	2014-013R&B-R	COOK	1972	1948
			CONTRACT NO.	60X93

FOR INFORMATION ONLY

NAME: DWYV17470 DWINTIACOM DSO2 NAVDocument001 Amherst Transection016020032 CircularPhase II/000 CADWWS Structural/Struct001 01718/Eiction Biscay160612 20 EN002 Svc Eiction67A

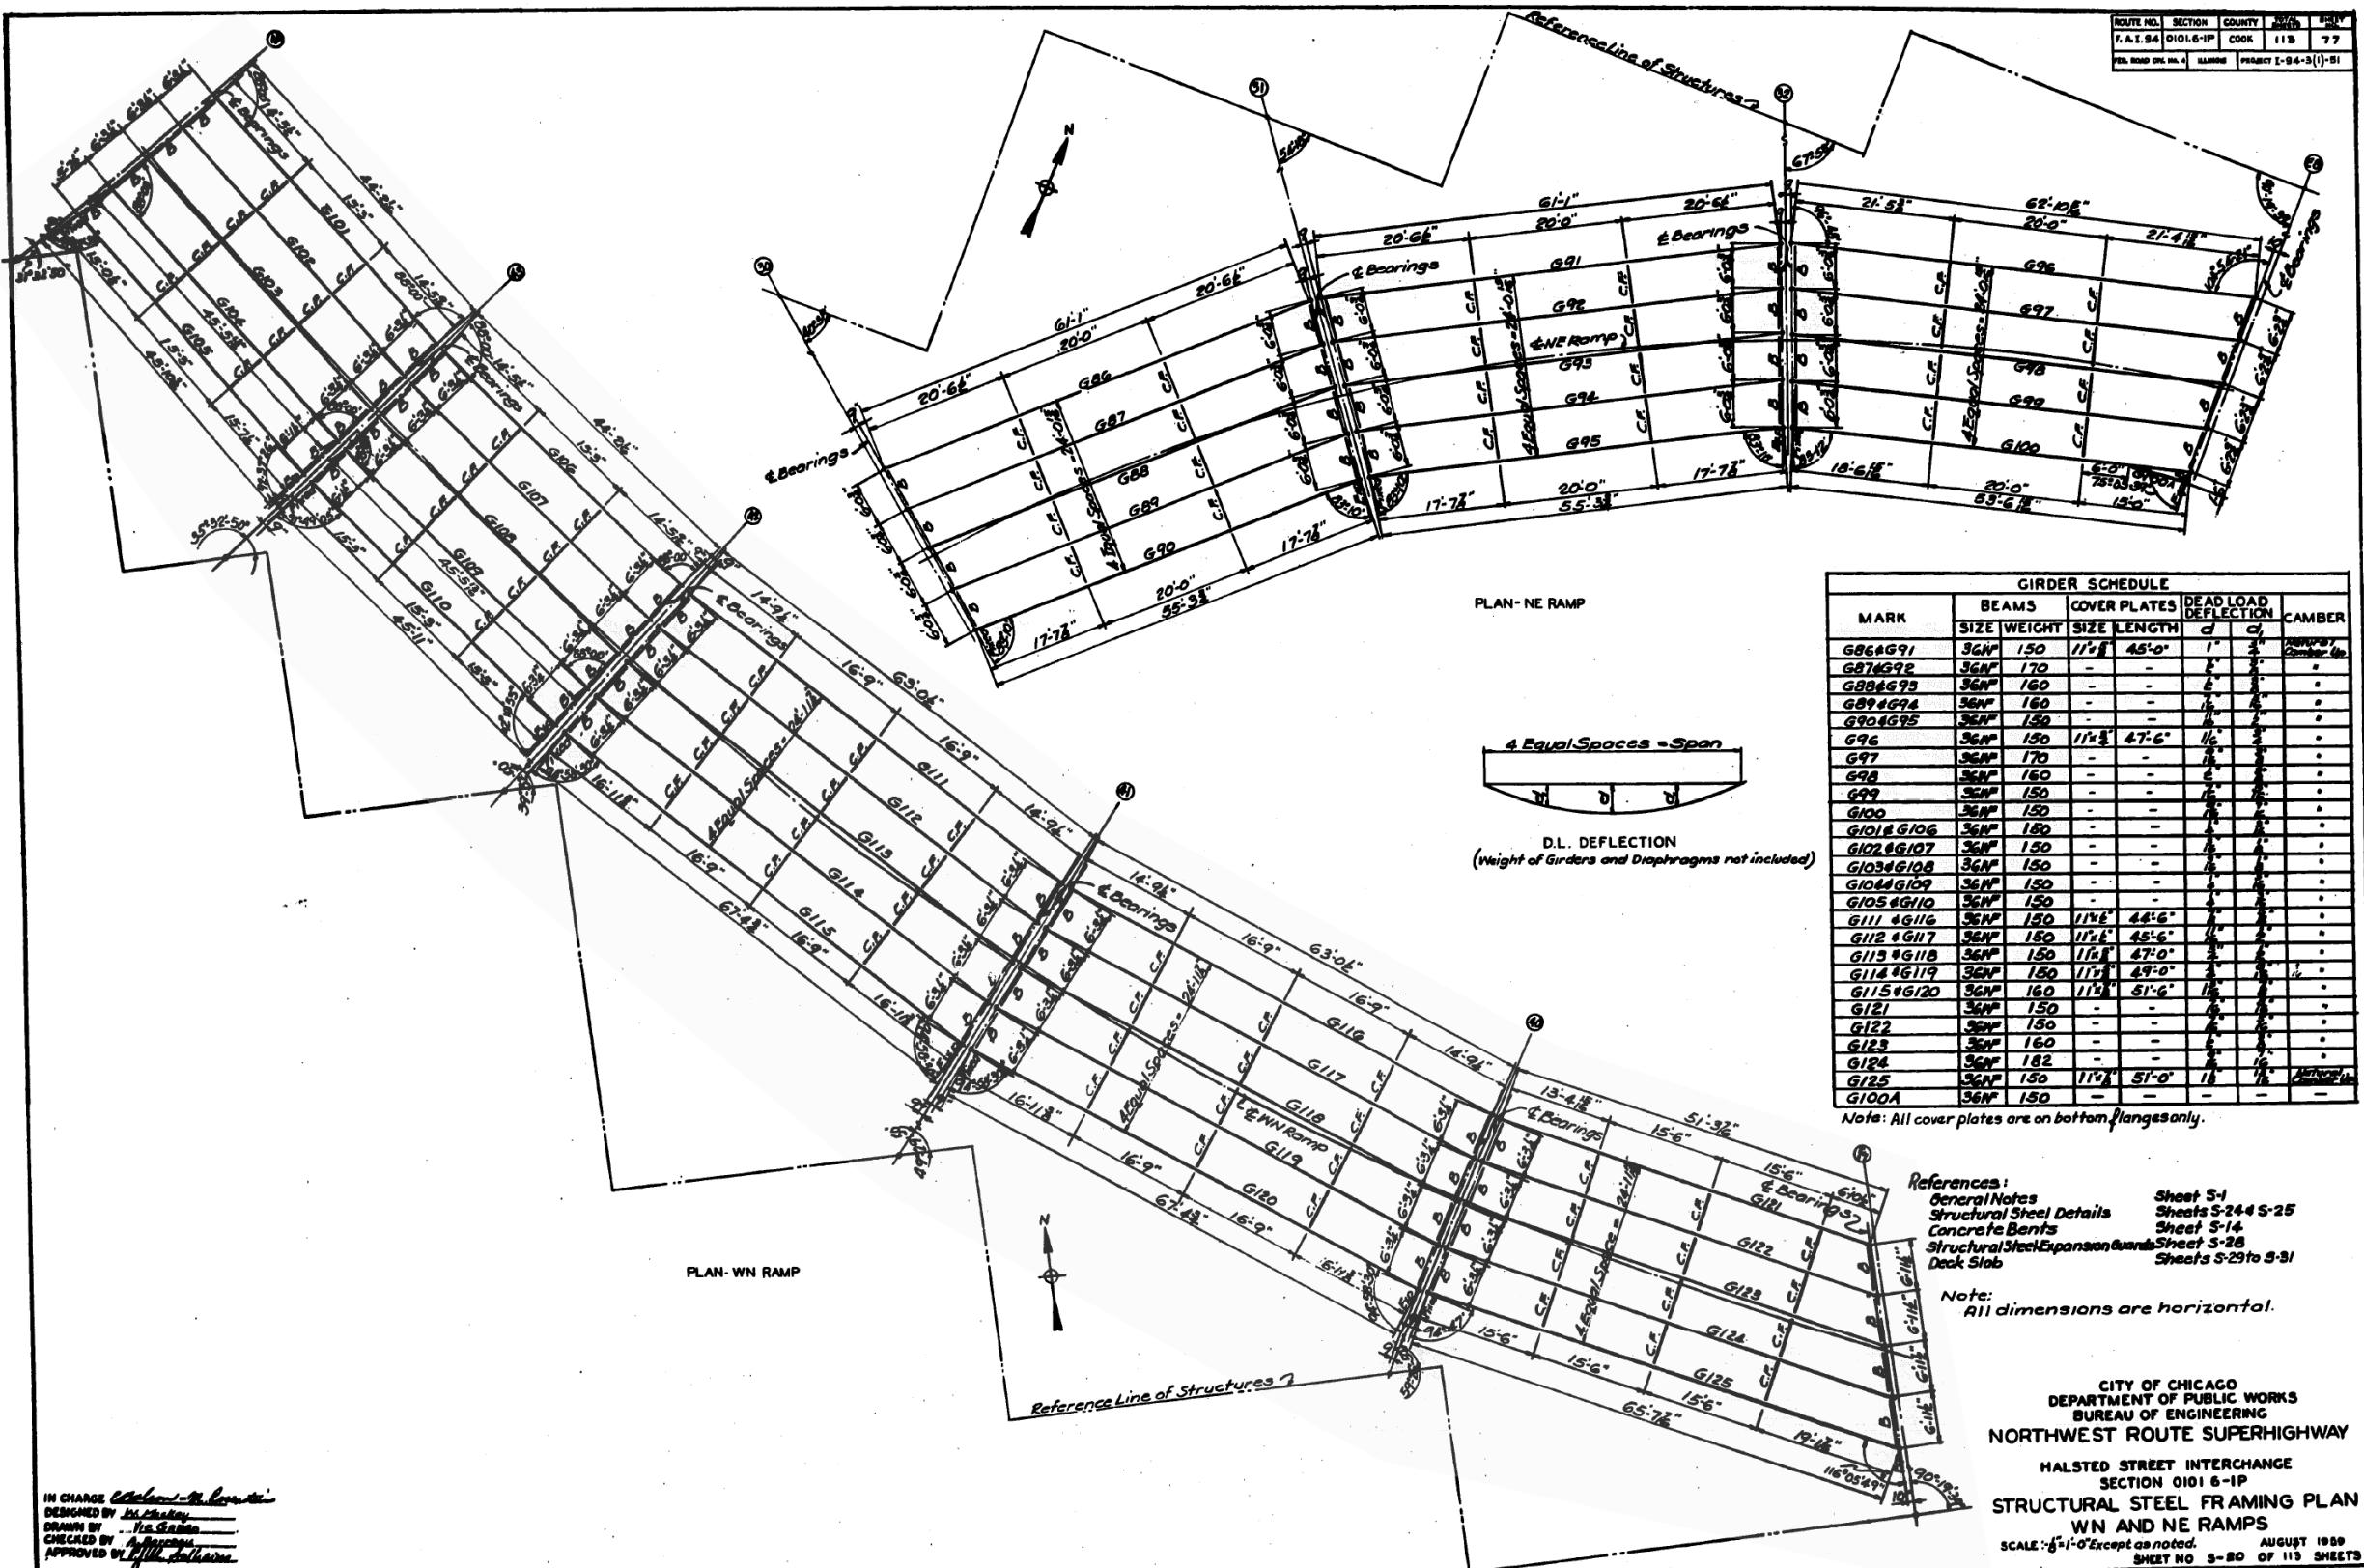

IN CHARGE C. L. Johnson - M. Corrigan
DESIGNED BY D. C. Mackay
DRAWN BY H. G. Griggs
CHECKED BY A. Ferguson
APPROVED BY J. W. Johnson

USER NAME	= ahmad,issa	DESIGNED	-	REVISED	-
		CHECKED	-	REVISED	-
PLOT SCALE	= N.T.S	DRAWN	-	REVISED	-
PLOT DATE	= 7/26/2018	CHECKED	M.L.MAL	REVISED	-


STATE OF ILLINOIS
DEPARTMENT OF TRANSPORTATION

EXISTING RECORD DRAWINGS

	F.A.I. RTE.	SECTION	COUNTY	TOTAL SHEETS	SHEE NO.
90/94/290	2014-013R&B-R	COOK	1972	1949	
			CONTRACT NO.	60X93	

FOR INFORMATION ONLY

E NAME: pwn617479-pwINT.aecommobile.local\AECDOM_D502_NA\Documents\01 Americas\Transportation\60269983 CirclePhase_01000_CAD008_Structural\Structure_0116-17\B1\Existing_Plans\0106041_20-60X93-5xx-Existing75

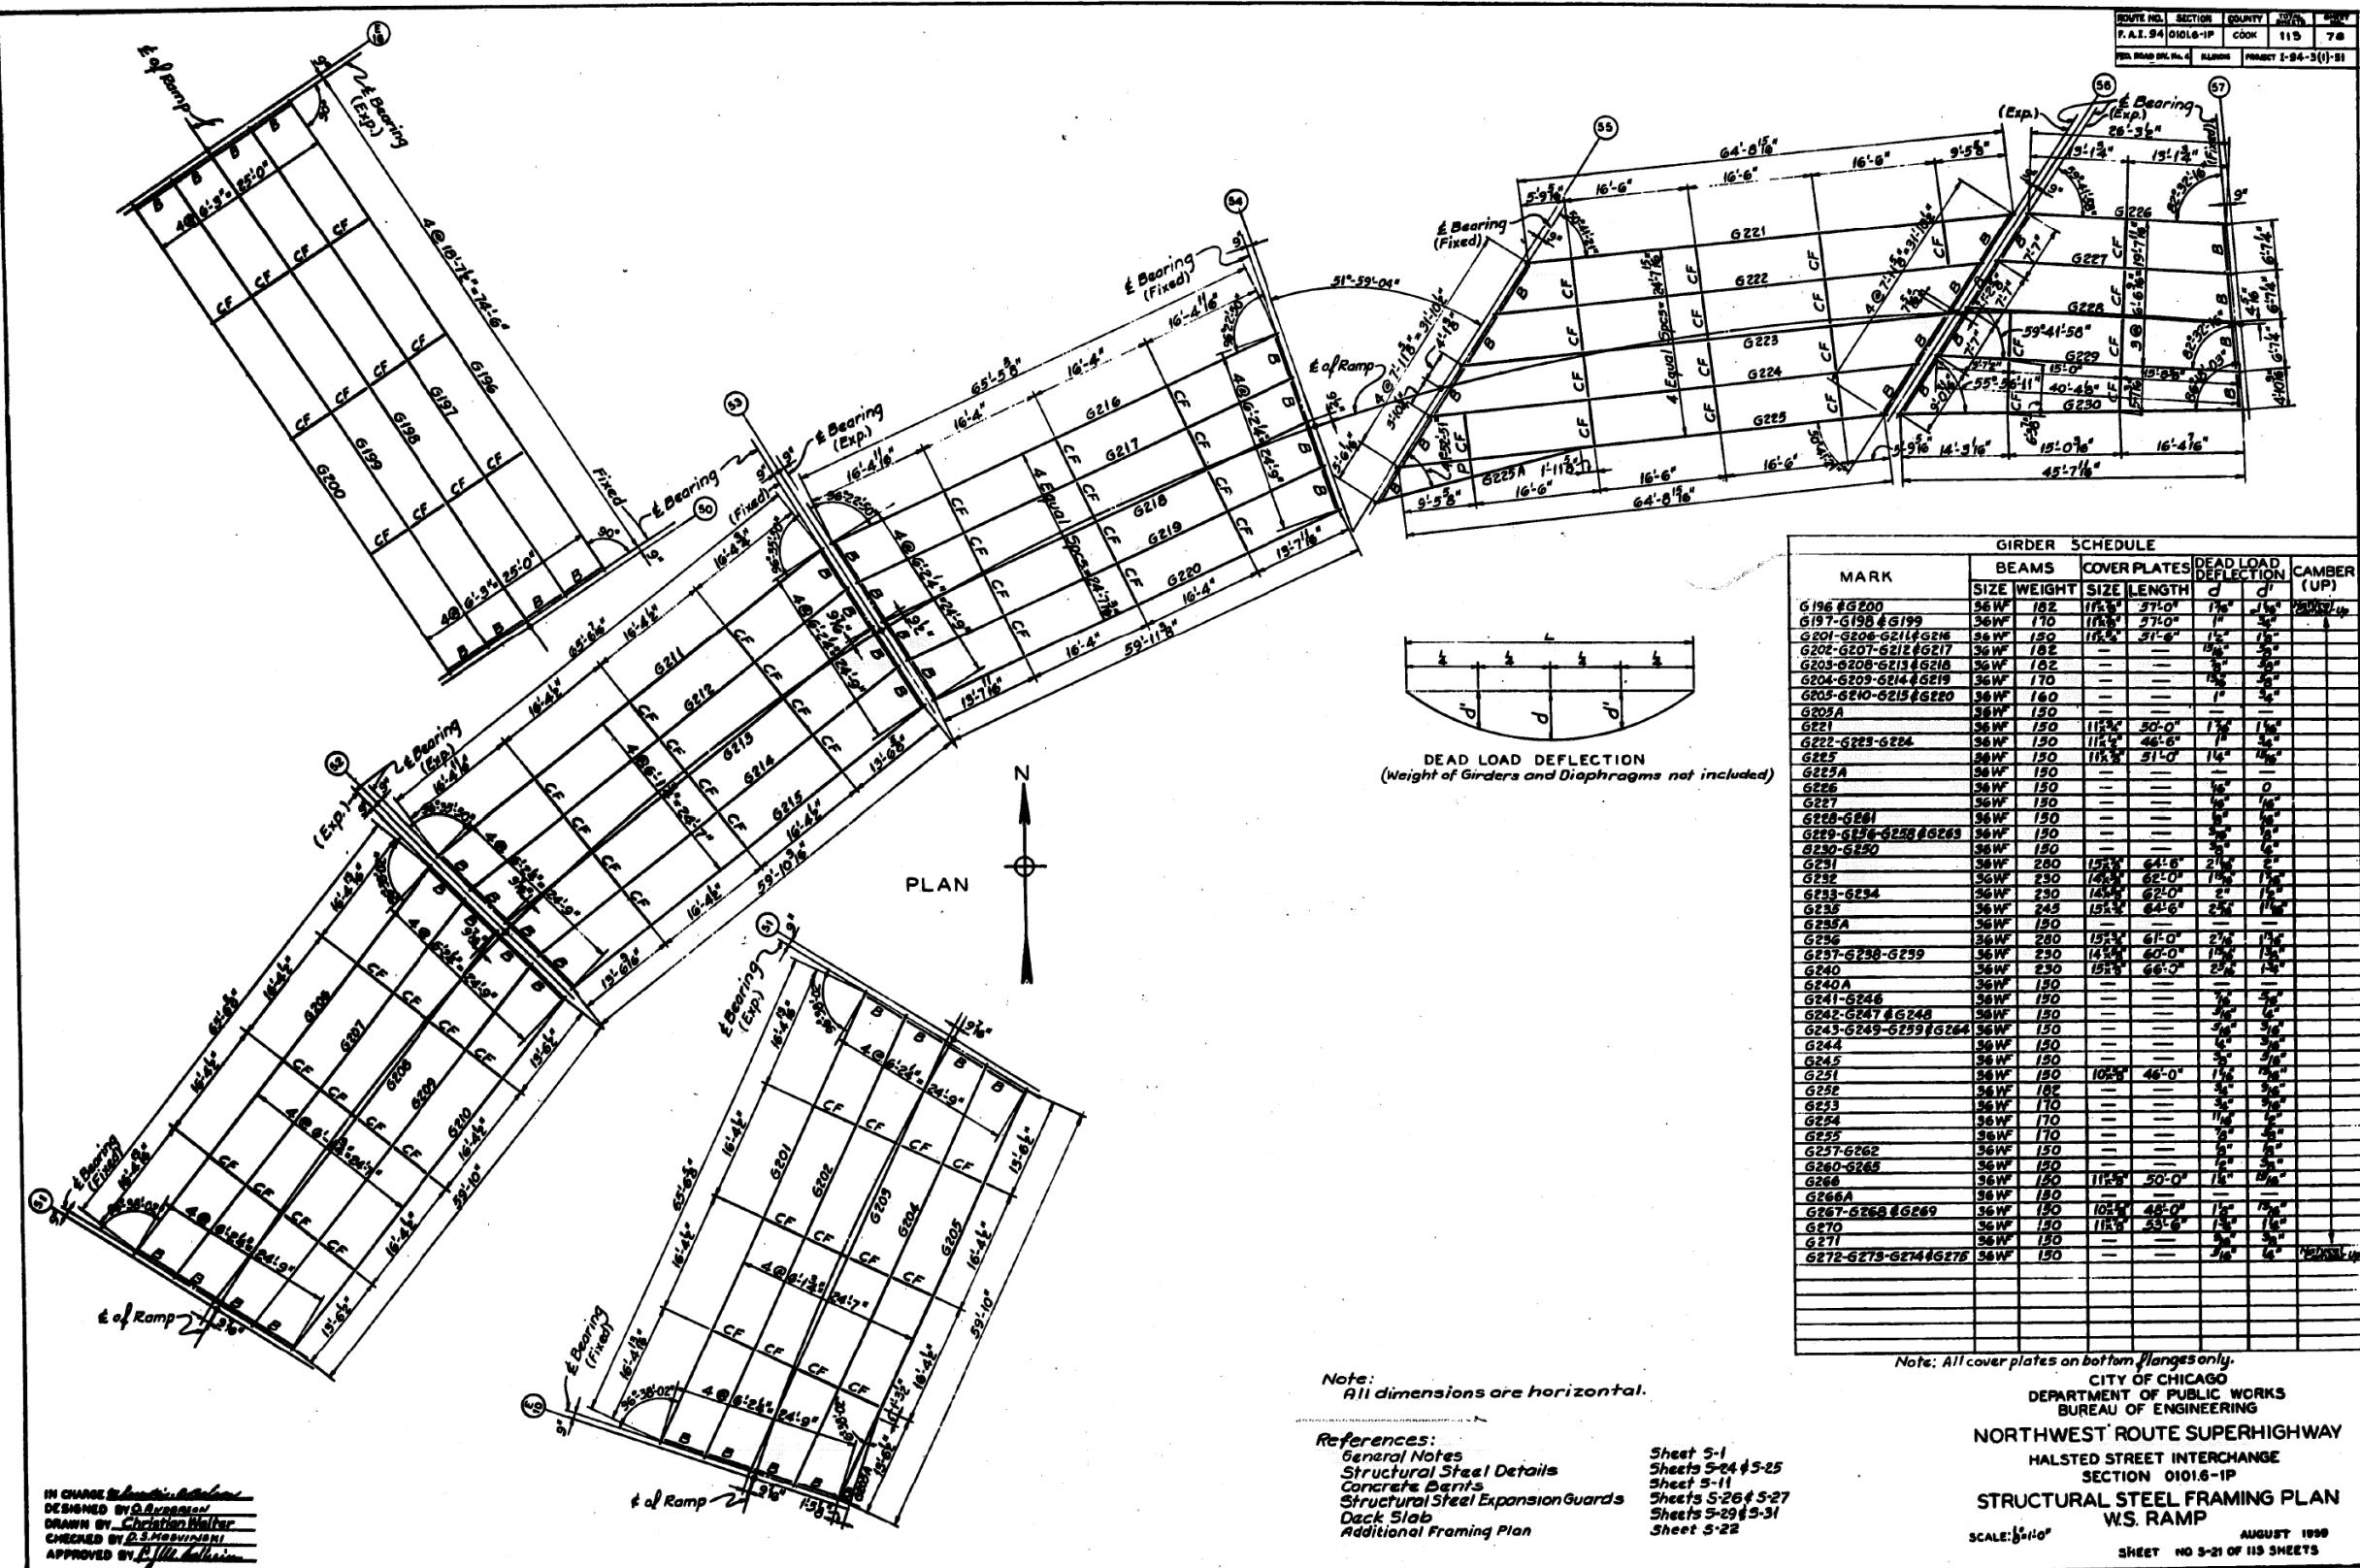

IN CHARGE *John G. Johnson*
DESIGNED BY *O. K. Johnson*
DRAWN BY *Christian Walter*
CHECKED BY *O. S. MacCormick*
APPROVED BY *C. H. Johnson*

USER NAME	=	ahmad.issa
PLOT SCALE	=	N.T.S
PLOT DATE	=	7/26/2018


STATE OF ILLINOIS
DEPARTMENT OF TRANSPORTATION

EXISTING RECORD DRAWINGS

F.A.I. RTE.	SECTION	COUNTY	TOTAL SHEETS	HEET NO.
90/94/290	2014-013R&B-R	COOK	1972	1950
				CONTRACT NO. 60X93
ILLINOIS		FED. AID PROJECT		

FOR INFORMATION ONLY

UTE NO.	SECTION	COUNTY	TOTAL ACRES	SHEET NO.
A. 1.94	0101.6-1P	COOK	115	79
ROAD CR. NO. 4	ILLINOIS	PROJECT I-94-3(I)-51		

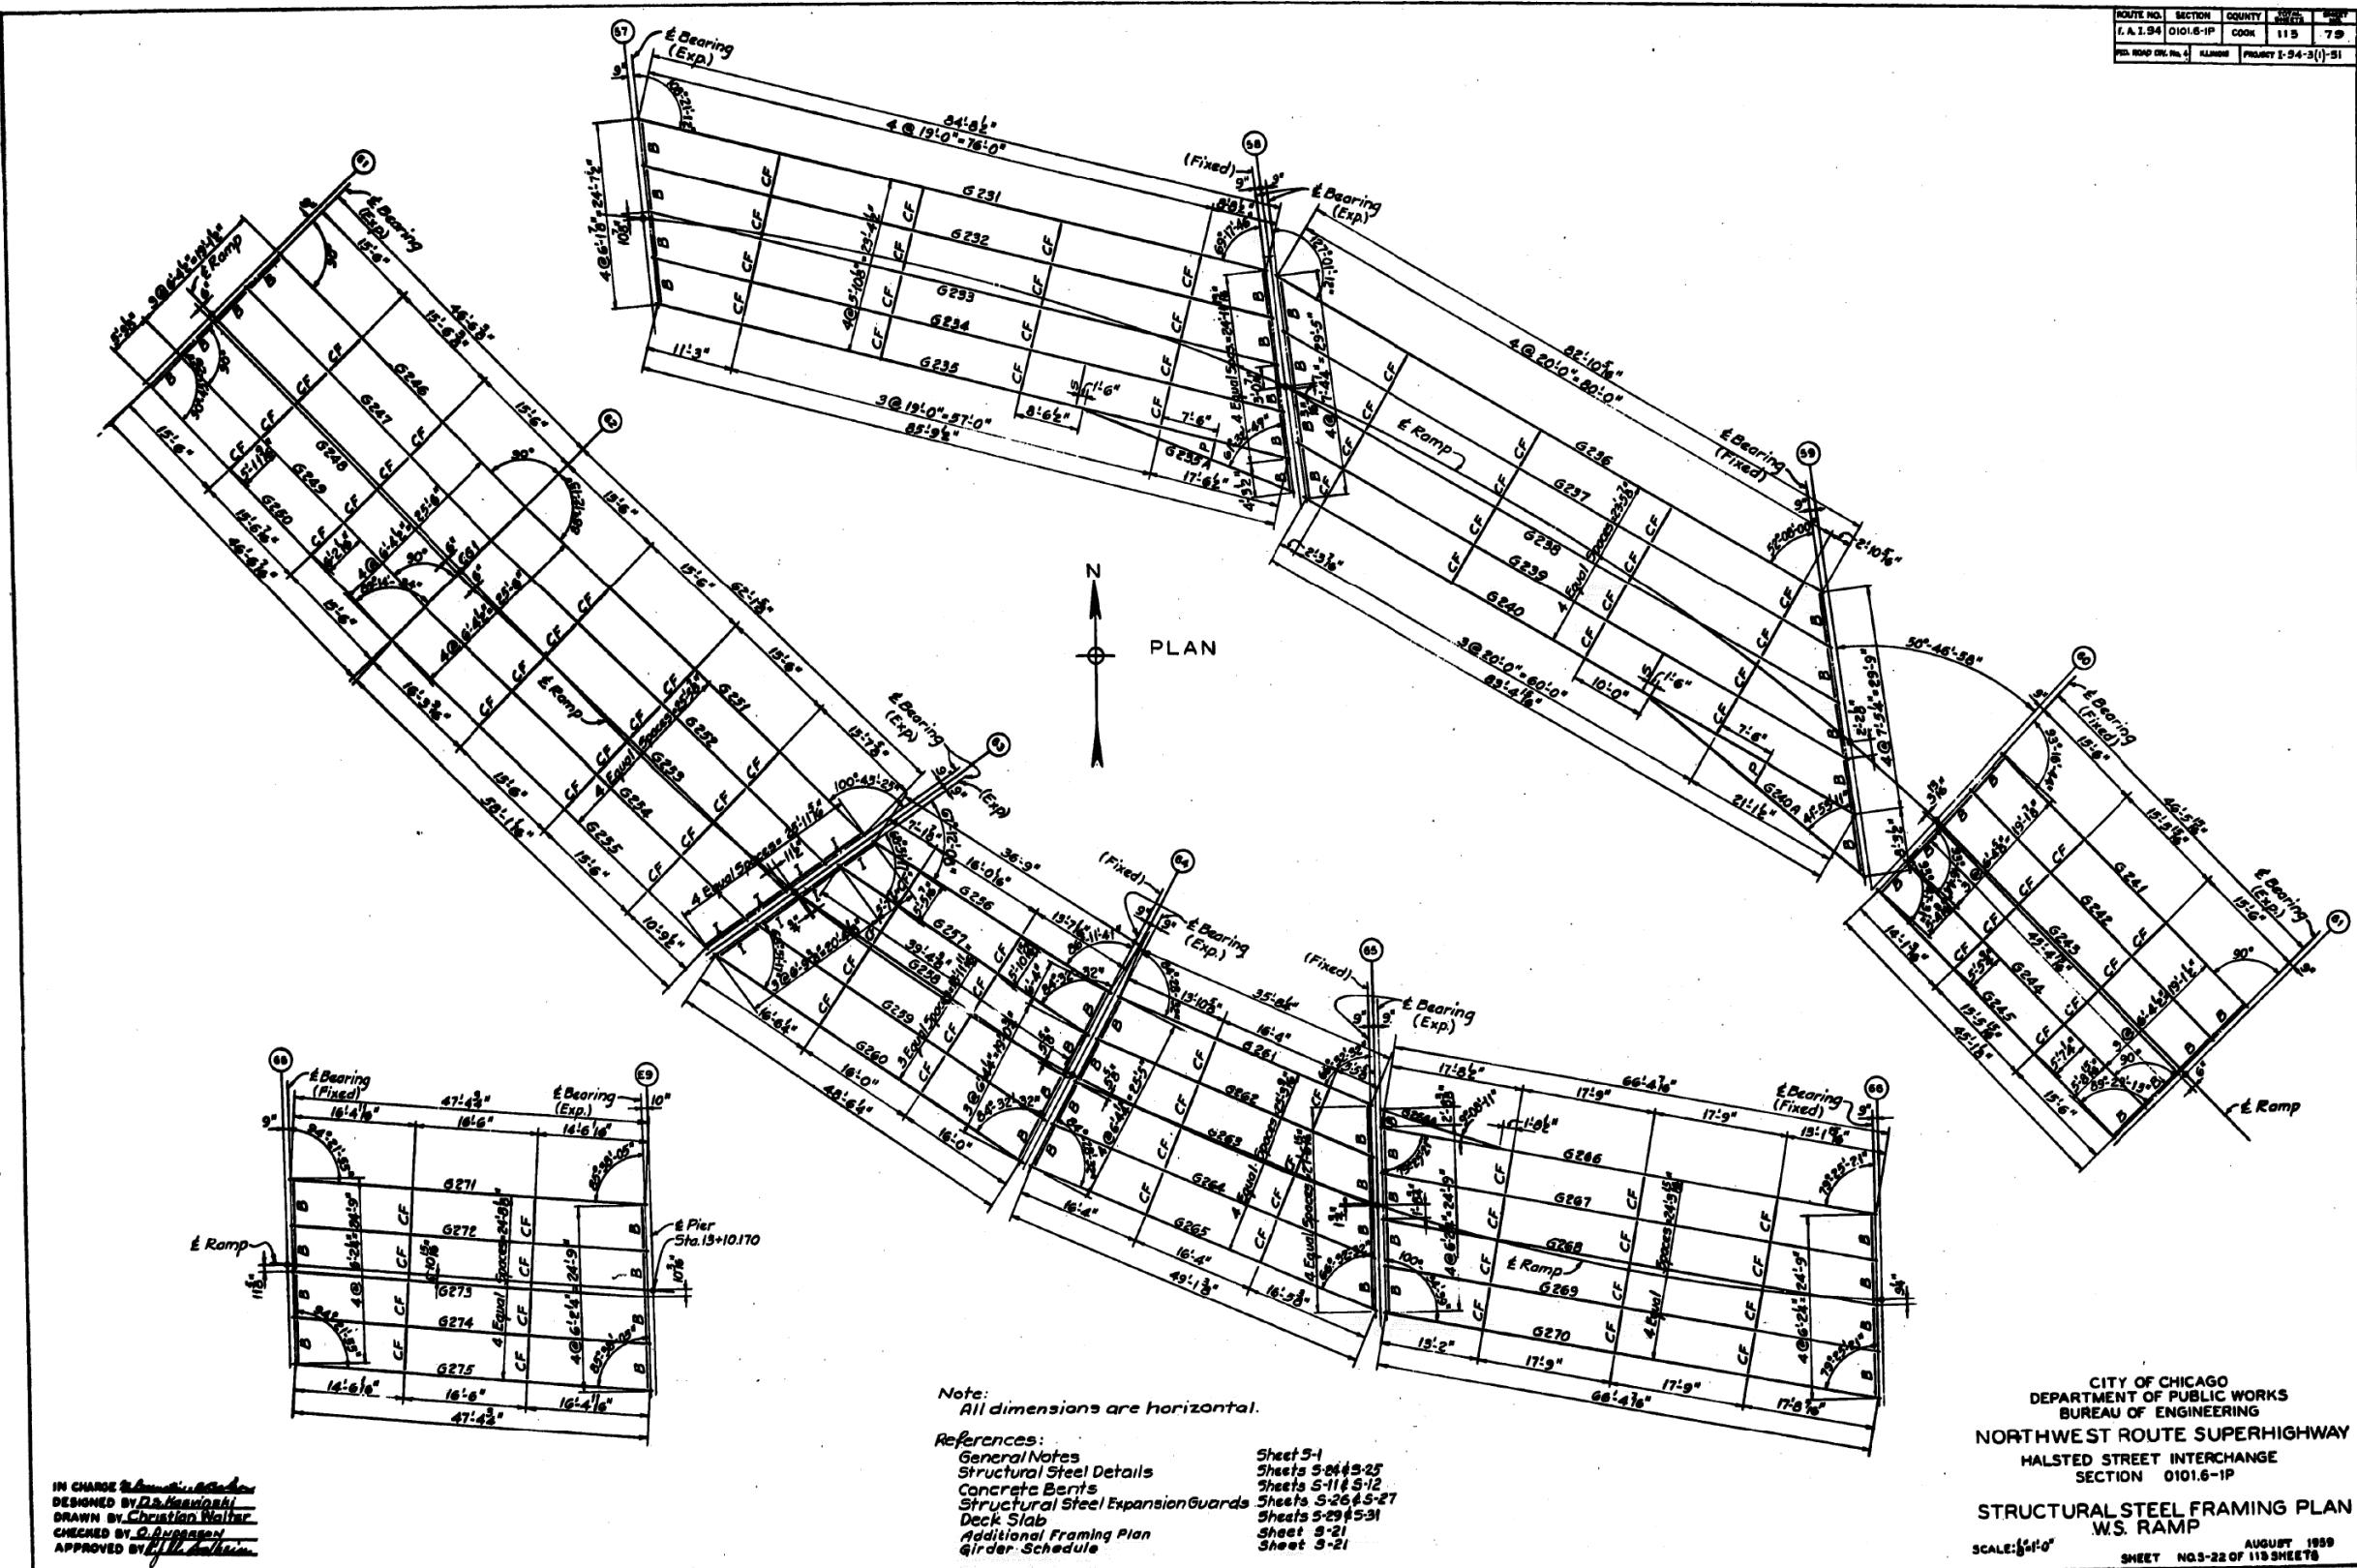

FILE NAME: pwi\617479-PWINT_aecomonline.local\AECOM DS02_NA\Documents\01_America's Transportation\60269938_CirclePhase_II\000_CAD008_Structural\Structure_016-1718Existing Plans\0160461-20-60X93-Sxx-Existing676

IN CHARGE 26-10-1944
DESIGNED BY Dr. Kenjiro Shiota
DRAWN BY Christian Walter
CHECKED BY O. Anderson
APPROVED BY P.H. T. Liao

USER NAME	= ahmad.issa	DESIGNED -	REVISED -
		CHECKED -	REVISED -
PLOT SCALE	= N.T.S	DRAWN -	REVISED -
PLOT DATE	= 7/26/2018	CHECKED - MI, MAI	REVISED -


STATE OF ILLINOIS
DEPARTMENT OF TRANSPORTATION

EXISTING RECORD DRAWINGS

F.A.J. RTE.	SECTION	COUNTY	TOTAL SHEETS	SHEET NO.
90/94/290	2014-013R&B-R	COOK	1972	195
			CONTRACT NO.	60X93
	ILLINOIS	FED. AID PROJECT		

FOR INFORMATION ONLY

FILE NAME: DWYNE_17479-PWINT.aecomonline.local\AE\COM_D52_NA\Documents\01_Americas\Transportation\60269938_CirclePhaseJ1000_CAD006_StructuralStructure_016-1718\Existing_Plans\016461_2061932-xx\Existing\677

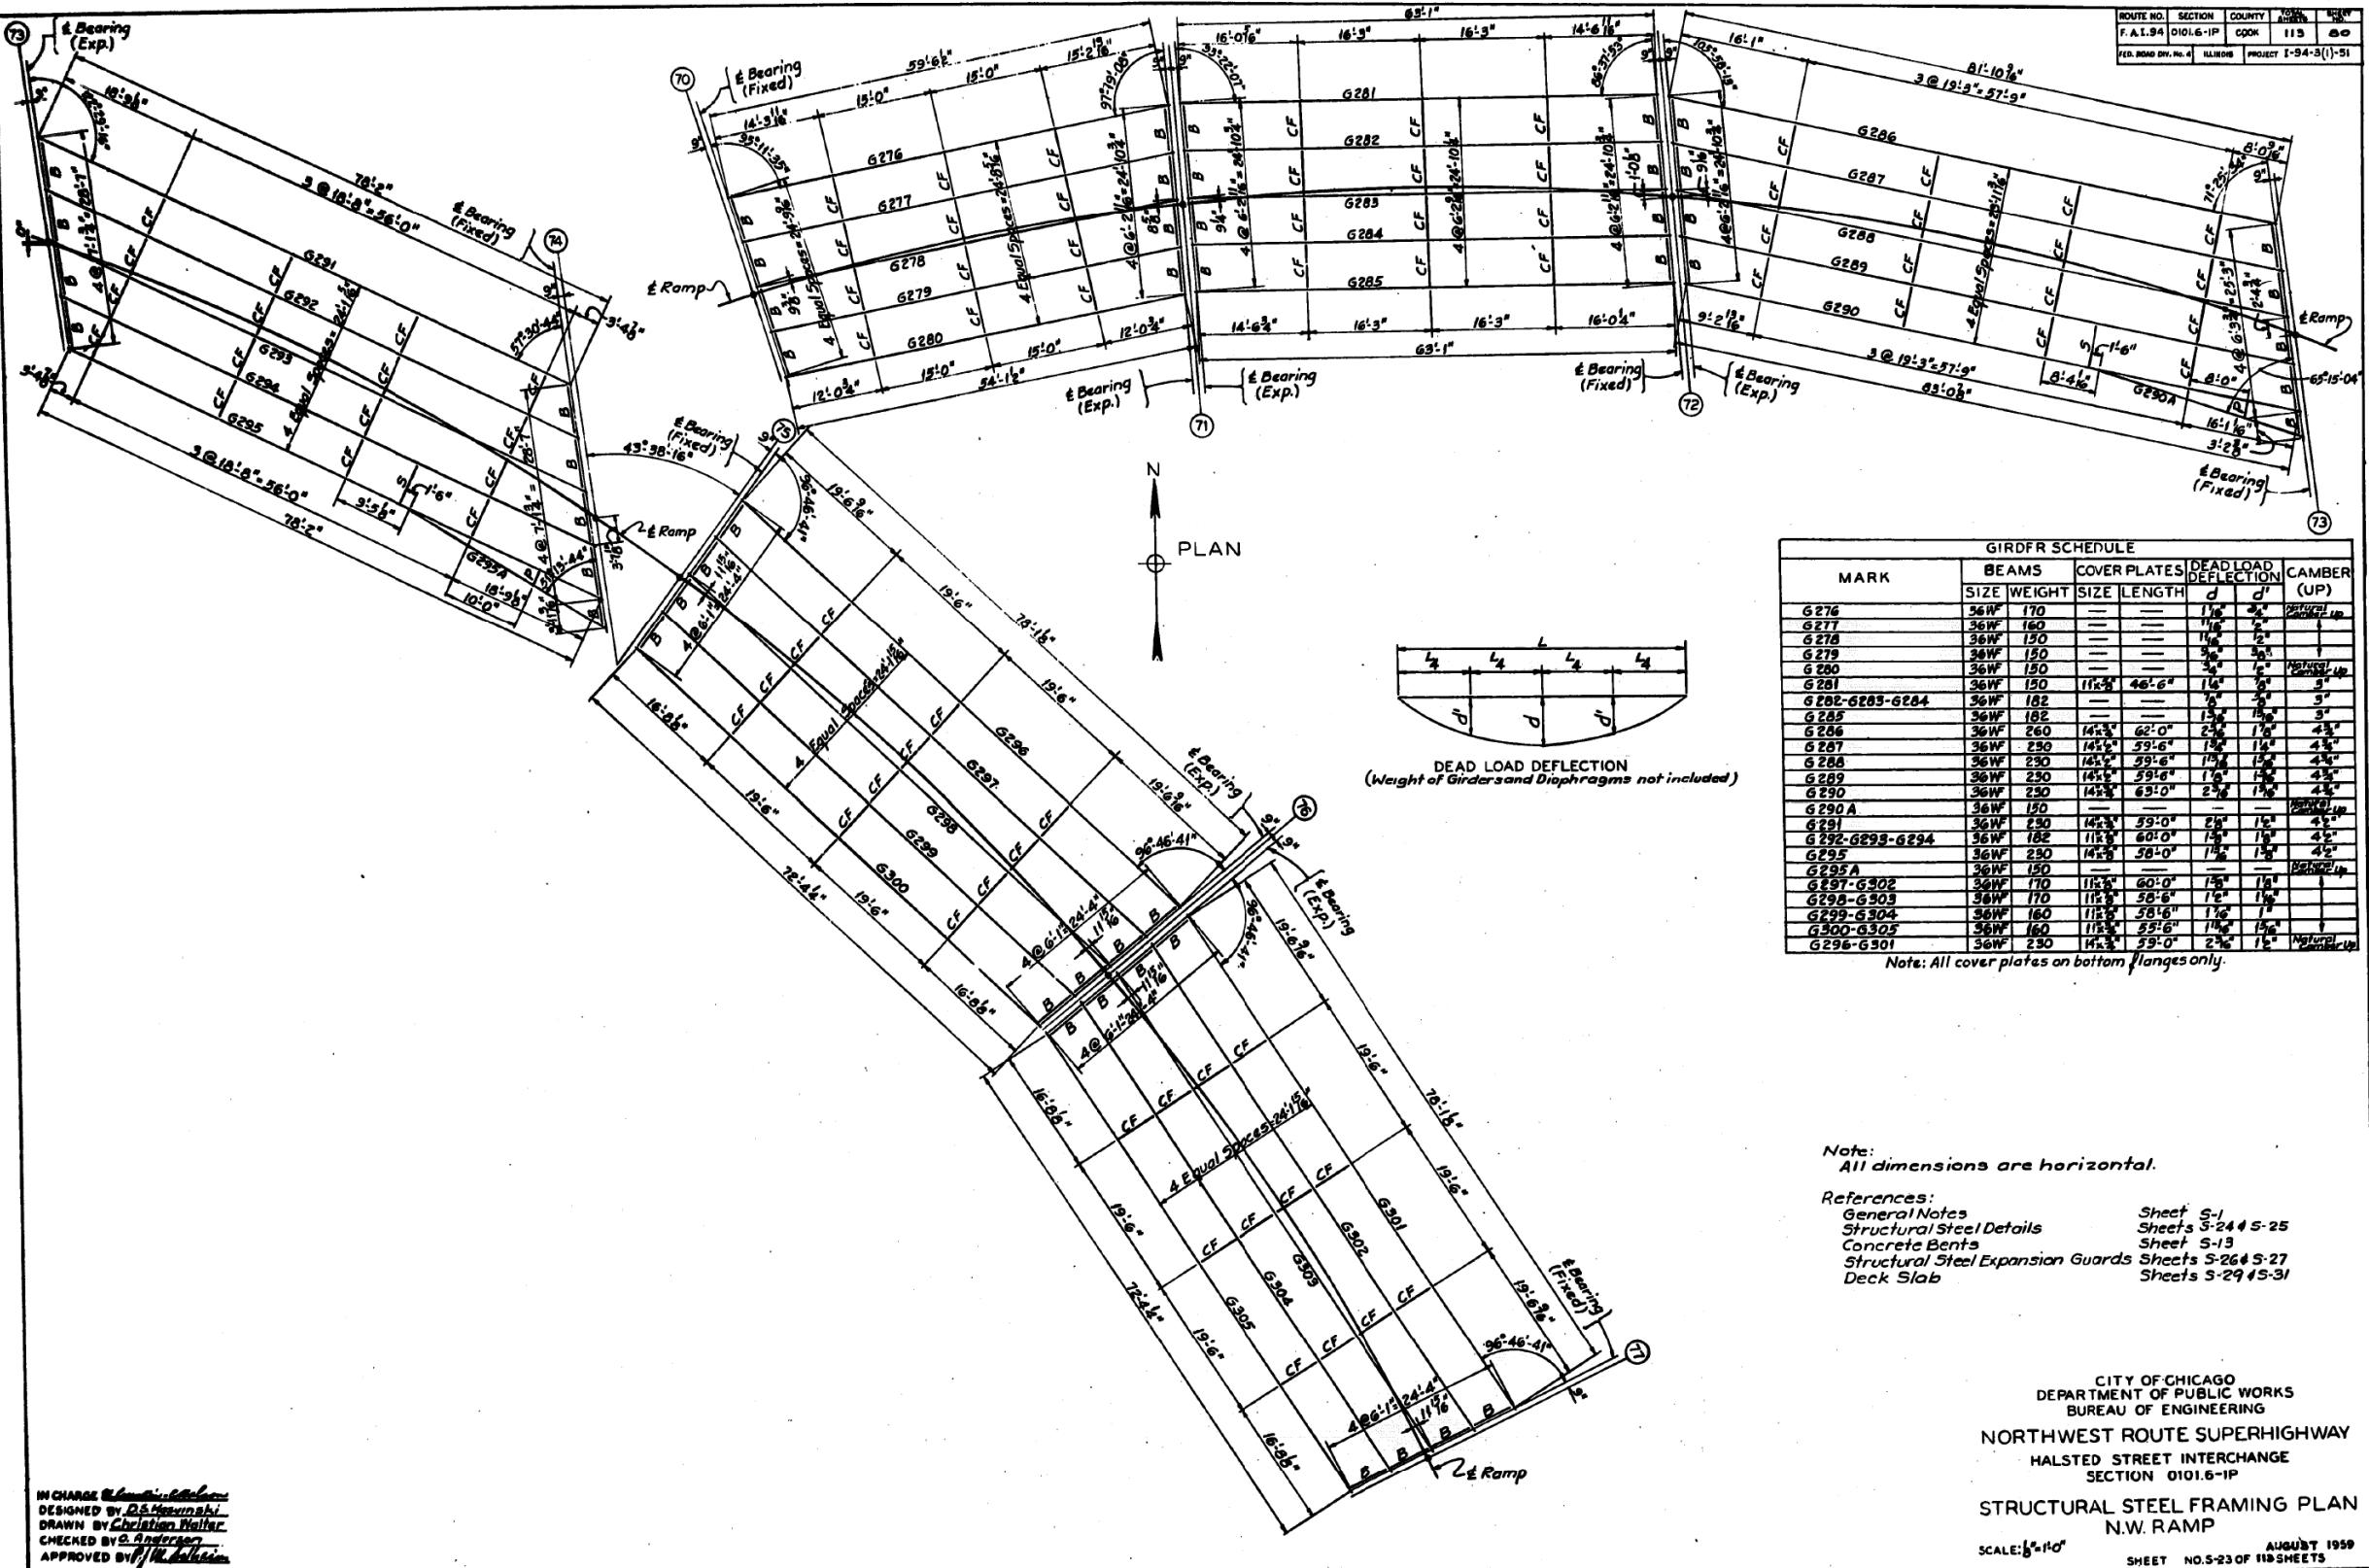

IN CHARGE Glenn C. Carlson
DESIGNED BY D.S. Kowinski
DRAWN BY Christian Walter
CHECKED BY G. Anderson
APPROVED BY W.H. Johnson

USER NAME	=	ahmad.issa
PLOT SCALE	=	N.T,S
PLOT DATE	=	7/26/2018

STATE OF ILLINOIS
DEPARTMENT OF TRANSPORTATION

EXISTING RECORD DRAWINGS

ROUTE NO.	SECTION	COUNTY	TOTAL LENGTH	LINK NO.
F.A.I.94	0101.6-IP	COOK	115	80
FED. ROAD DIV. NO. 4	ILLINOIS	PROJECT	I-94-3(1)-51	

MARK	GIRDFR SCHEDULE				DEAD LOAD DEFLECTION	CAMBER (UP)	
	BEAMS	COVER PLATES	SIZE	LENGTH			
	SIZE	WEIGHT	SIZE	LENGTH	d	d'	
G 276	36WF	170	—	—	1 1/8"	3/8"	PERMITTED UP
G 277	36WF	160	—	—	1 1/8"	3/8"	PERMITTED UP
G 278	36WF	150	—	—	1 1/8"	3/8"	PERMITTED UP
G 279	36WF	150	—	—	3/8"	3/8"	1
G 280	36WF	150	—	—	3/8"	1/8"	NOT PERMITTED UP
G 281	36WF	150	1 1/8"	46'-6"	1 1/8"	3/8"	3"
G 282-G285-G284		36WF	182	—	—	3/8"	3/8"
G 285	36WF	182	—	—	1 1/8"	1 1/8"	3"
G 286	36WF	260	1 1/8"	62'-0"	2 1/8"	1 1/8"	4 1/2"
G 287	36WF	230	1 1/8"	59'-6"	1 1/8"	1 1/8"	4 1/2"
G 288	36WF	230	1 1/8"	59'-6"	1 1/8"	1 1/8"	4 1/2"
G 289	36WF	230	1 1/8"	59'-6"	1 1/8"	1 1/8"	4 1/2"
G 290	36WF	230	1 1/8"	63'-0"	2 1/8"	1 1/8"	4 1/2"
G 290 A		36WF	150	—	—	PERMITTED UP	
G 291	36WF	230	1 1/8"	59'-0"	2 1/8"	1 1/8"	4 1/2"
G 292-G293-G294		36WF	182	—	60'-0"	1 1/8"	4 1/2"
G 295	36WF	230	1 1/8"	58'-0"	1 1/8"	1 1/8"	4 1/2"
G 295 A		36WF	150	—	—	NOT PERMITTED UP	
G 297-G302	36WF	170	1 1/8"	60'-0"	1 1/8"	1 1/8"	1
G 298-G303	36WF	170	1 1/8"	58'-6"	1 1/8"	1 1/8"	1
G 299-G304	36WF	160	1 1/8"	58'-6"	1 1/8"	1 1/8"	1
G 300-G305	36WF	160	1 1/8"	55'-6"	1 1/8"	1 1/8"	1
G 298-G301	36WF	230	1 1/8"	59'-0"	2 1/8"	1 1/8"	NOT PERMITTED UP

Note: All cover plates on bottom flanges only.


Note:
All dimensions are horizontal.

<u>References:</u>	
General Notes	Sheet S-1
Structural Steel Details	Sheets S-24 & S-25
Concrete Bents	Sheet S-13
Structural Steel Expansion Guards	Sheets S-26 & S-27
Deck Slab	Sheets S-29 & S-31

**CITY OF CHICAGO
DEPARTMENT OF PUBLIC WORKS
BUREAU OF ENGINEERING**
**NORTHWEST ROUTE SUPERHIGHWAY
HALSTED STREET INTERCHANGE
SECTION 0101.6-1P**
**STRUCTURAL STEEL FRAMING PLAN
N.W. RAMP**

FOR INFORMATION ONLY

E NAME: pwn17479-pWINT.aecommobile.local;AECON.DS02.NADocuments01 AmericanTransportation60269938.CirclesPhase_1000_CAD008_StructuralStructure_016-1718ExistingPlans016046120-60X93-Sxx-Existing678

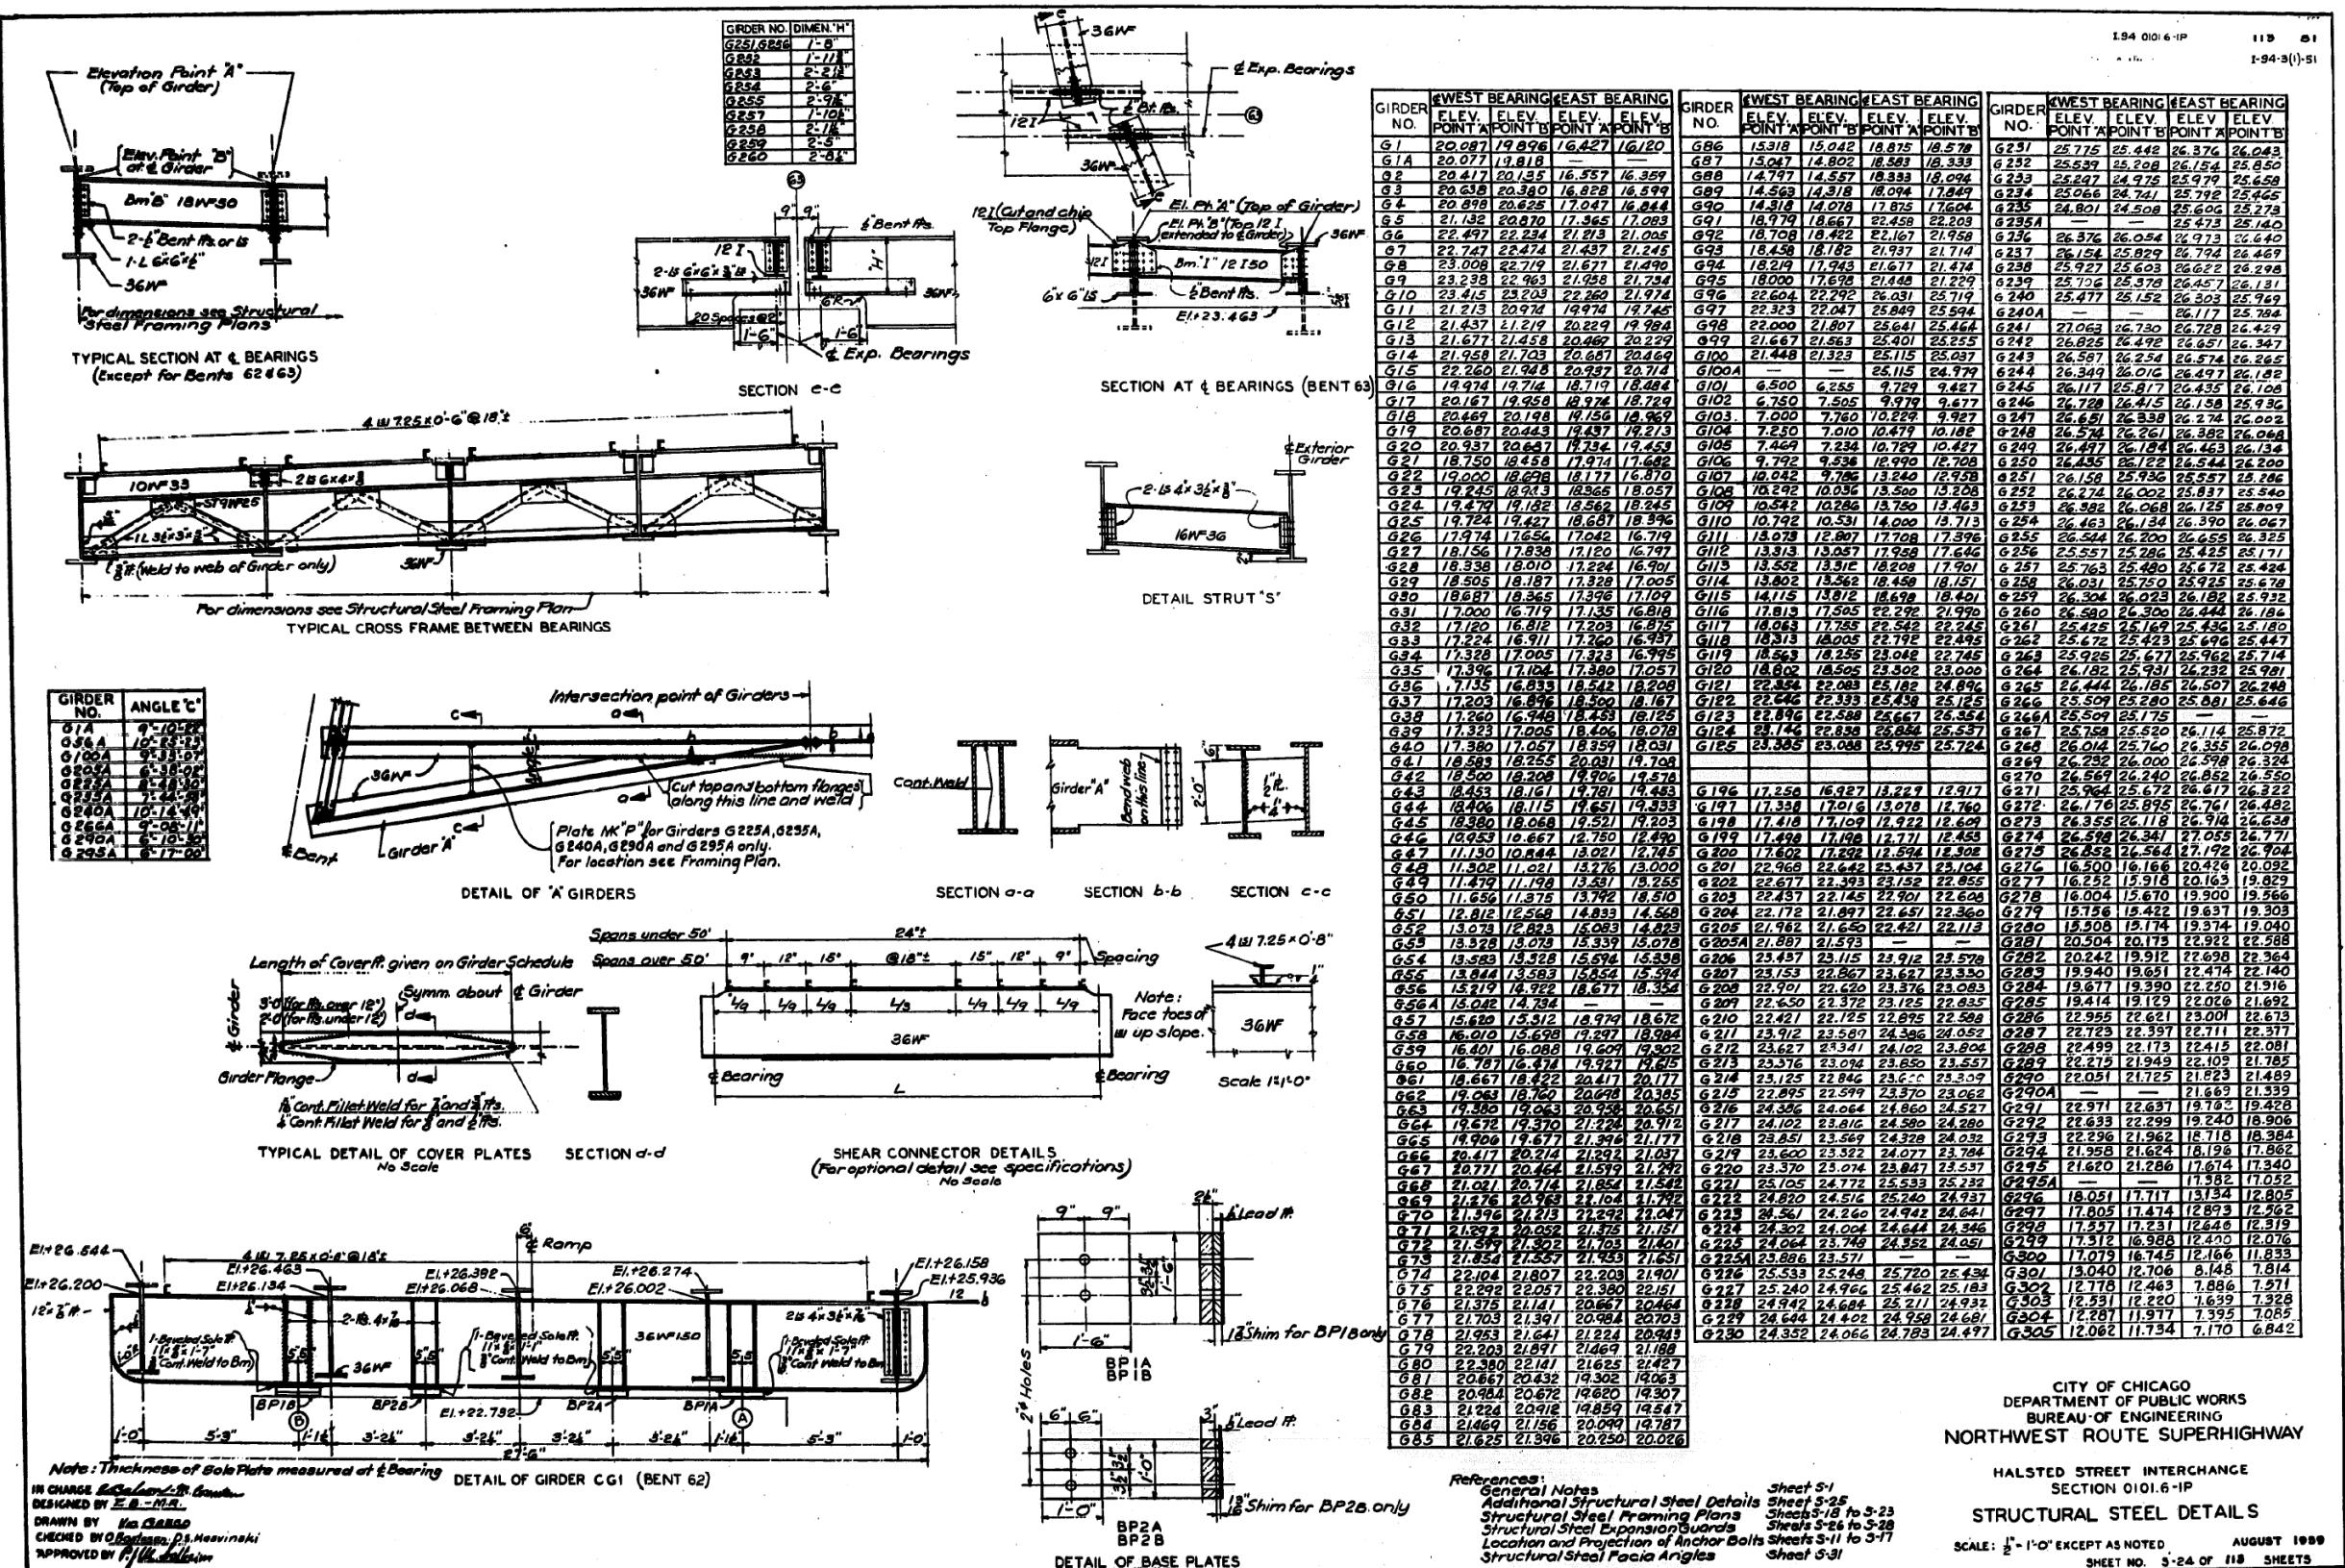

CITY OF CHICAGO
DEPARTMENT OF PUBLIC WORKS
BUREAU OF ENGINEERING
NORTHWEST ROUTE SUPERHIGHWAY

HALSTED STREET INTERCHANGE

STRUCTURAL STEEL DETAILS

SCALE: $\frac{1}{2}$ " - 1'-0" EXCEPT AS NOTED AUGUST 1989
SHEET NO. 5-24 OF 118 SHEETS


USER NAME	= ahmad,issa	DESIGNED	-	REVISED	-
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PLOT SCALE	= N.T.S	DRAWN	-	REVISED	-
PLOT DATE	= 7/26/2018	CHECKED	- MI, MAI	REVISED	-

**STATE OF ILLINOIS
DEPARTMENT OF TRANSPORTATION**

EXISTING RECORD DRAWINGS

F.A.I. RTE.	SECTION	COUNTY	TOTAL SHEETS	SHEET NO.
90/94/290	2014-013R&B-R	COOK	1972	1953
			CONTRACT NO. 60X93	
		ILLINOIS	FED. AID PROJECT	

FOR INFORMATION ONLY

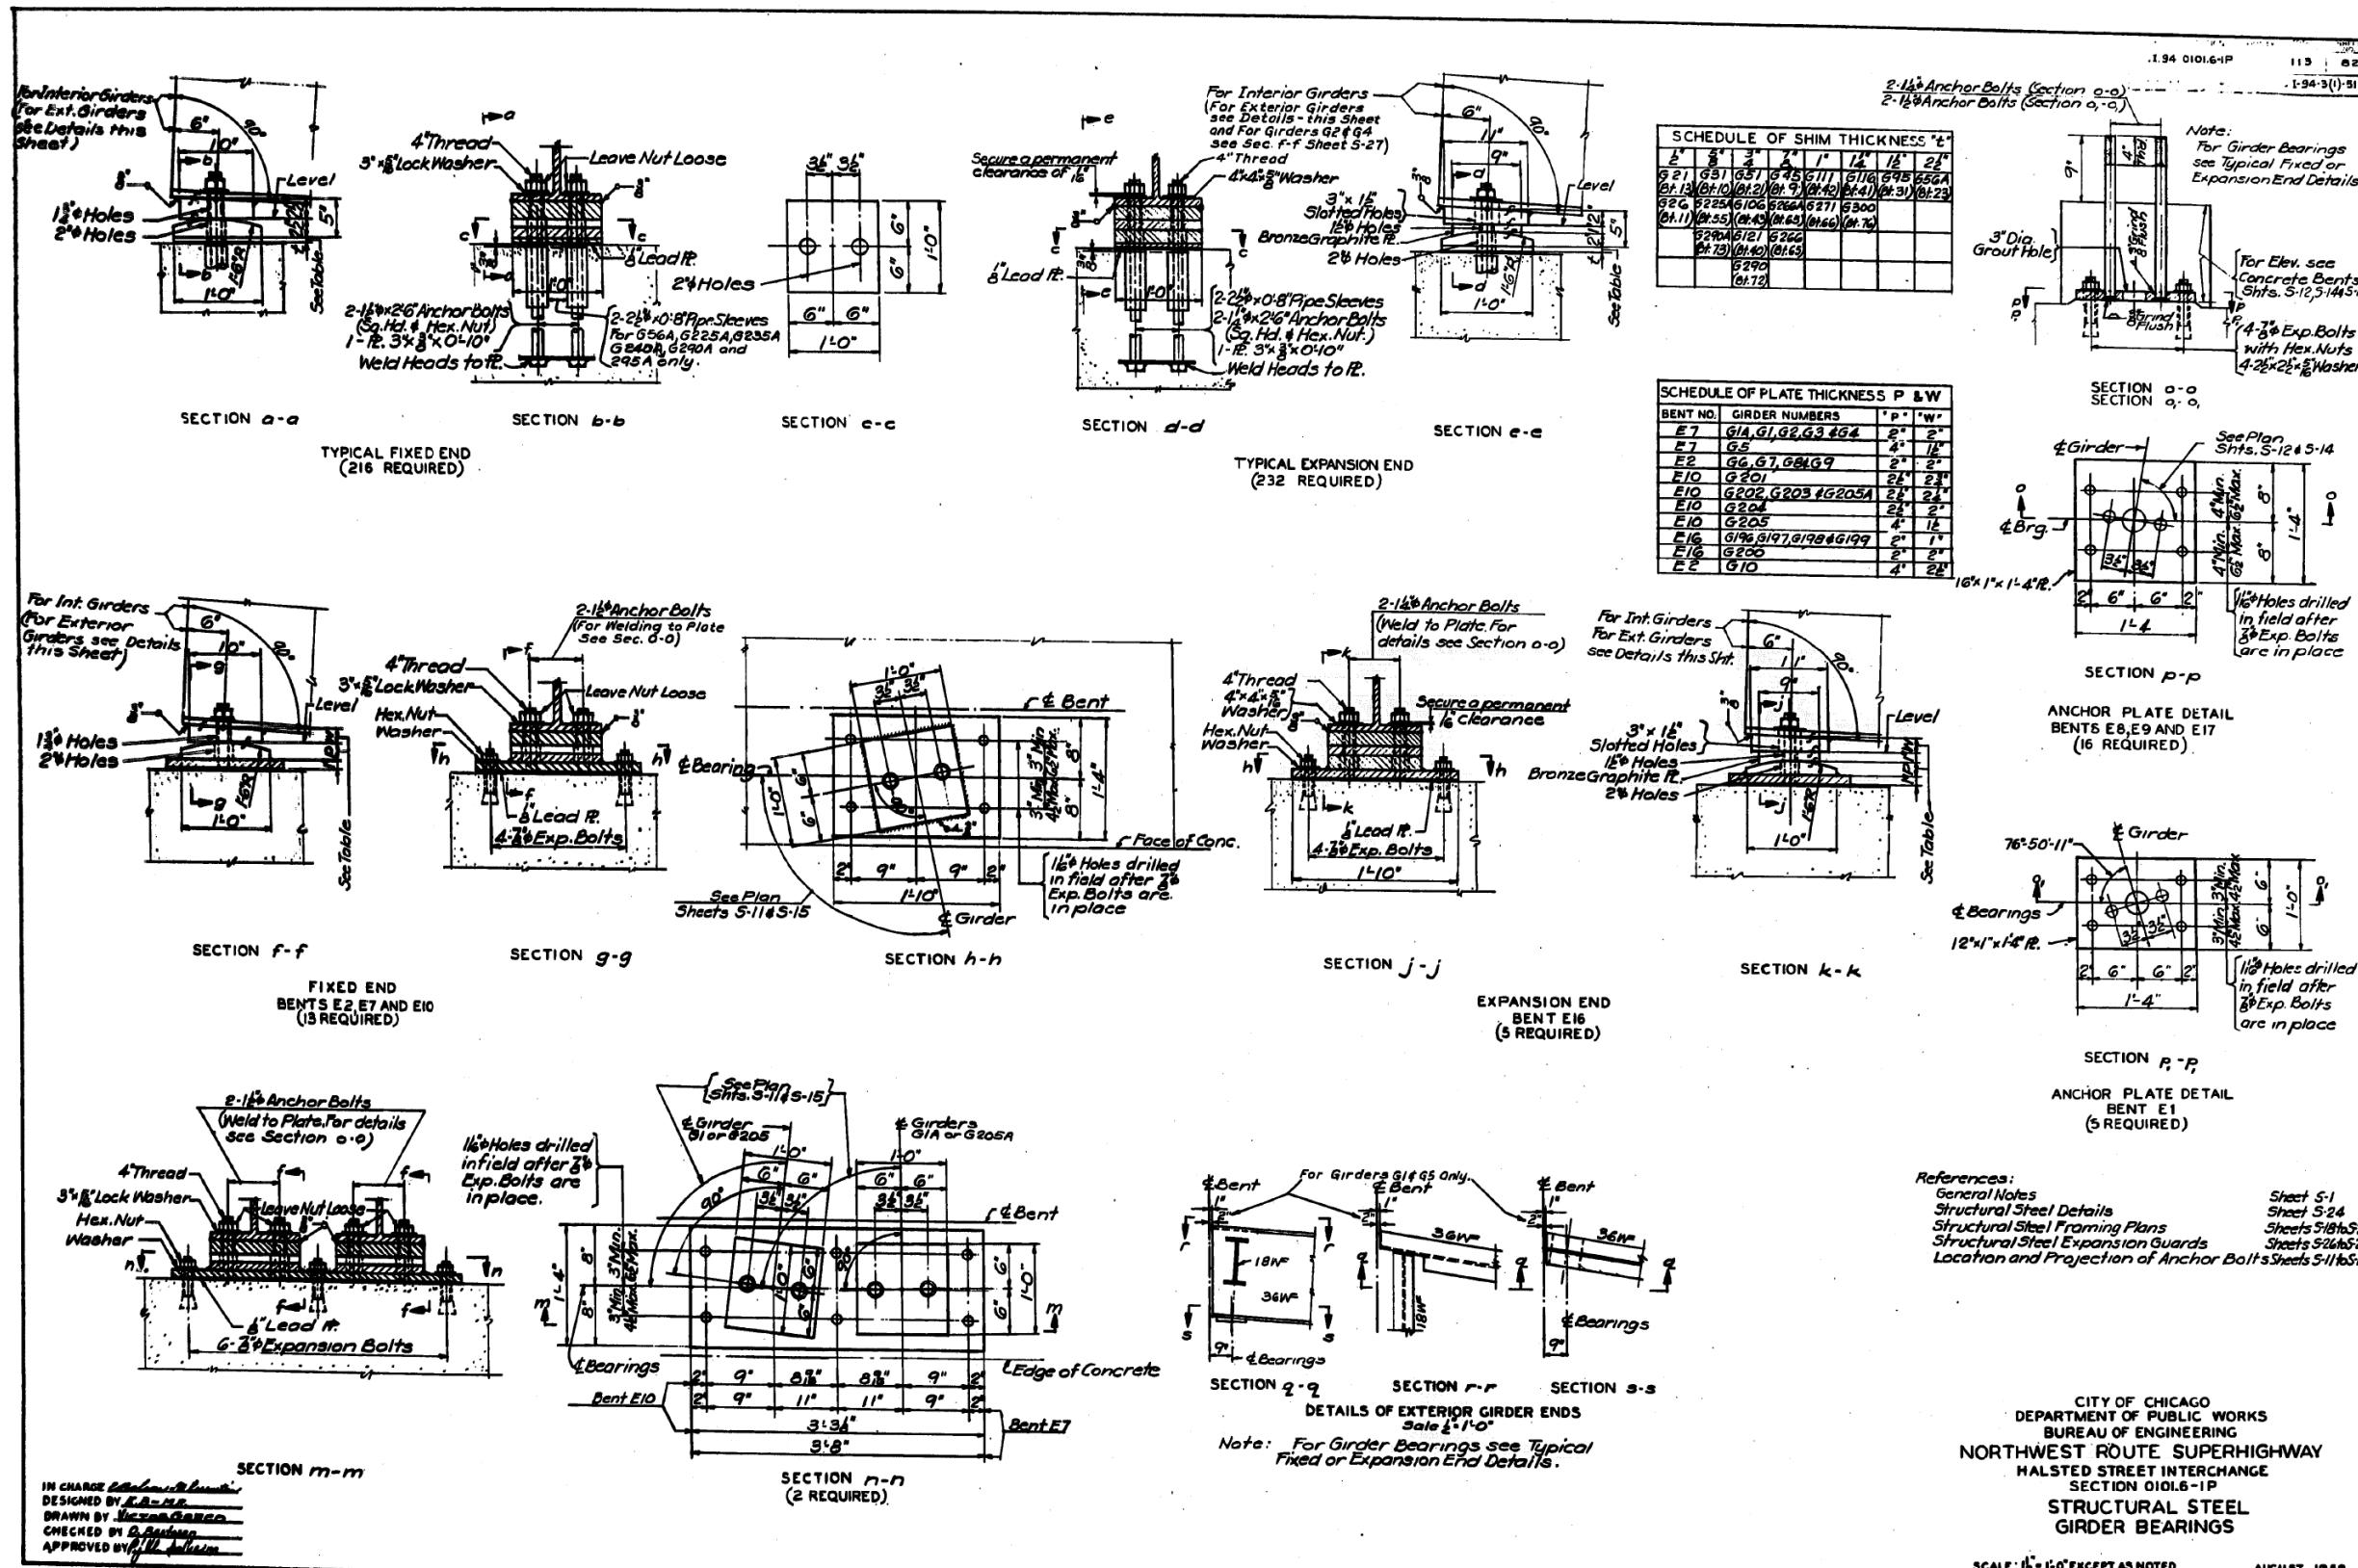

TITLE NAME: pwi:161749-PWINT,NAI|Documents\01 Americas\Transportation\60269938_CirclePhase_II|000_CAD008_StructuralStructure_016-1718\Existing_Plans\0160461-20-60X93-Sxx-Existing679

HBM
ENGINEERING GROUP, LLC


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PLOT SCALE	=	N.T.S	DRAWN	-	REVISED	-
PLOT DATE	=	7/26/2018	CHECKED	-	MI MAI	REVISED

STATE OF ILLINOIS
DEPARTMENT OF TRANSPORTATION

EXISTING RECORD DRAWINGS

F.A.I. RTE.	SECTION	COUNTY	TOTAL SHEETS	SHEET NO.
90/94/290	2014-013R&B-R	COOK	1972	1954
			CONTRACT NO. 60X93	

FOR INFORMATION ONLY

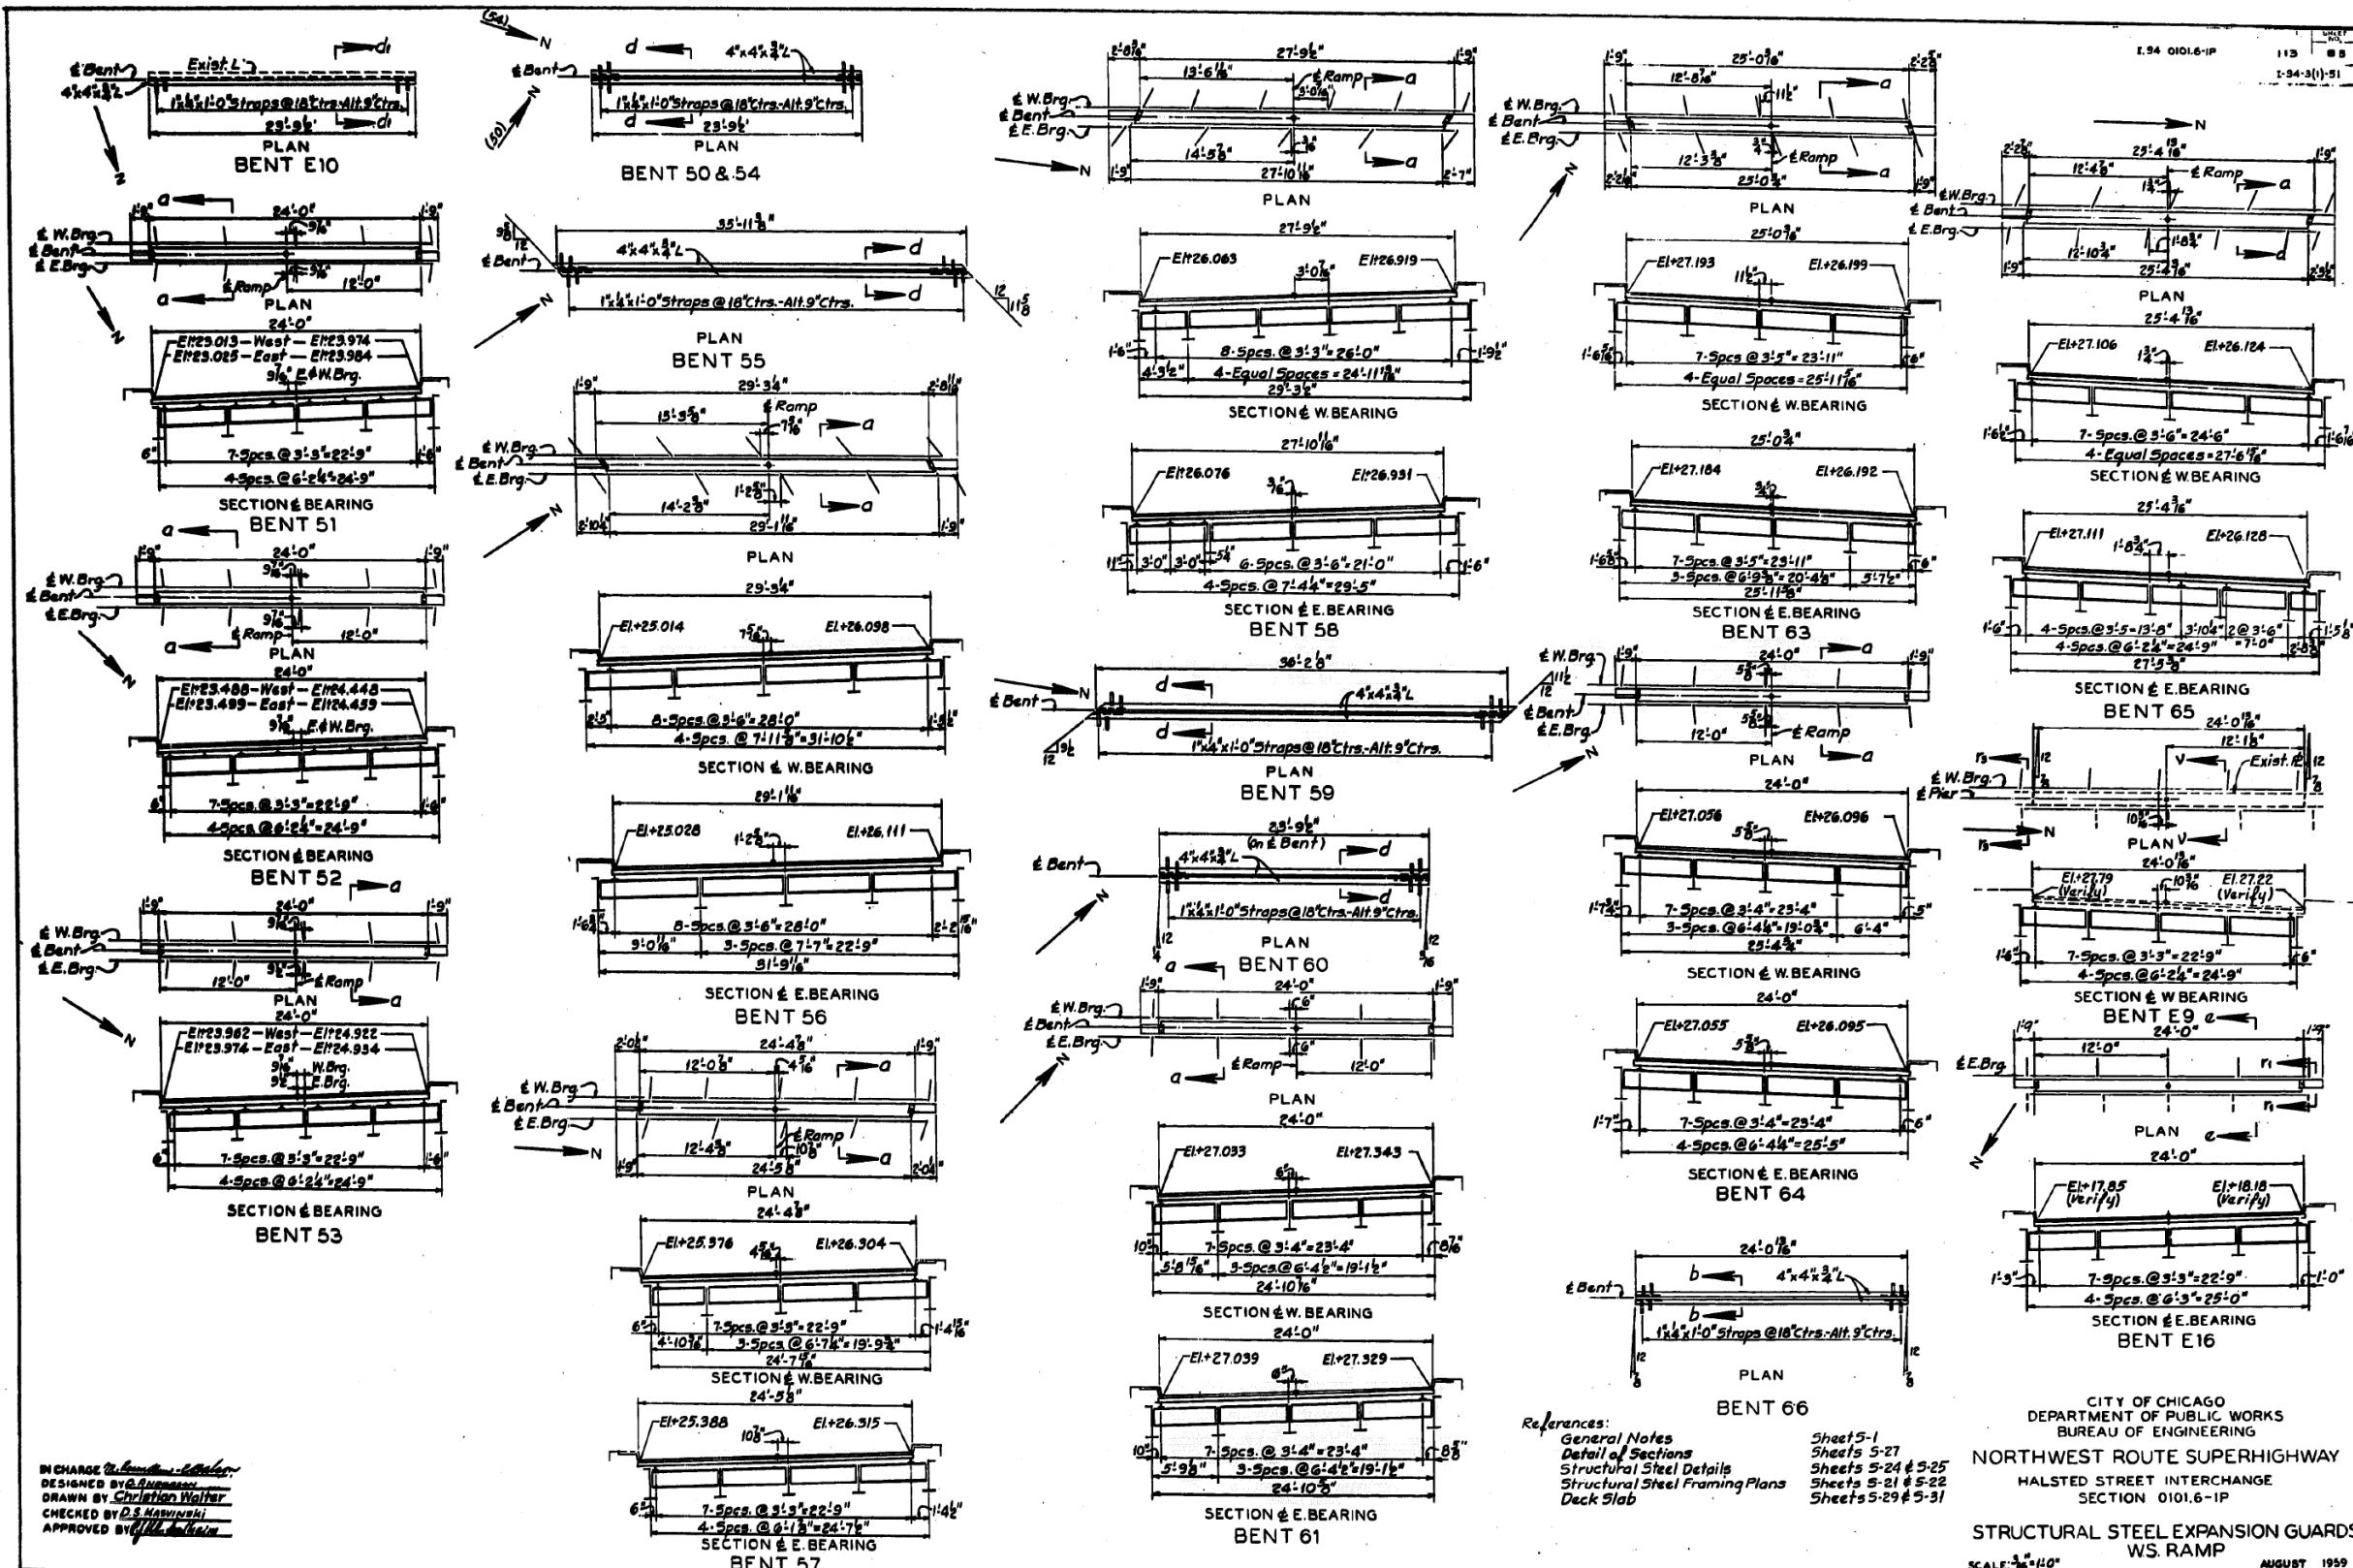

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BENT 66	
<u>References:</u>	
General Notes	Sheets 5-1
Detail of Sections	Sheets 5-27
Structural Steel Details	Sheets 5-24 & 5-25
Structural Steel Framing Plans	Sheets 5-21 & 5-22
Deck Slab	Sheets 5-29 & 5-31

**CITY OF CHICAGO
DEPARTMENT OF PUBLIC WORKS
BUREAU OF ENGINEERING**

**NORTHWEST ROUTE SUPERHIGHWAY
HALSTED STREET INTERCHANGE
SECTION 0101-1P**

**STRUCTURAL STEEL EXPANSION GUARDS
WS. RAMP**

SHEET NO.5-26 OF 113 SHEETS

HBM
ENGINEERING GROUP, LLC

USER NAME = ahmad,issa	DESIGNED -
	CHECKED -
PLOT SCALE = N.T.S	DRAWN -
PLOT DATE = 7/26/2018	CHECKED - MI, MA


STATE OF ILLINOIS
DEPARTMENT OF TRANSPORTATION

EXISTING RECORD DRAWINGS

F.A.I. RTE.	SECTION	COUNTY	TOTAL SHEETS	SHEET NO.
90/94/290	2014-013R&B-R	COOK	1972	1955
			CONTRACT NO. 60X93	
	ILLINOIS	FED. AID PROJECT		

FOR INFORMATION ONLY

NAME: DWINT SecondLineLocal-MEROM DSC0 NAVDocumentID: 602660032 CircularPhase IIWON CANYONS Structural Structure 016_1718EvictionPlan0160161_20_60x93_Sv Eviction681

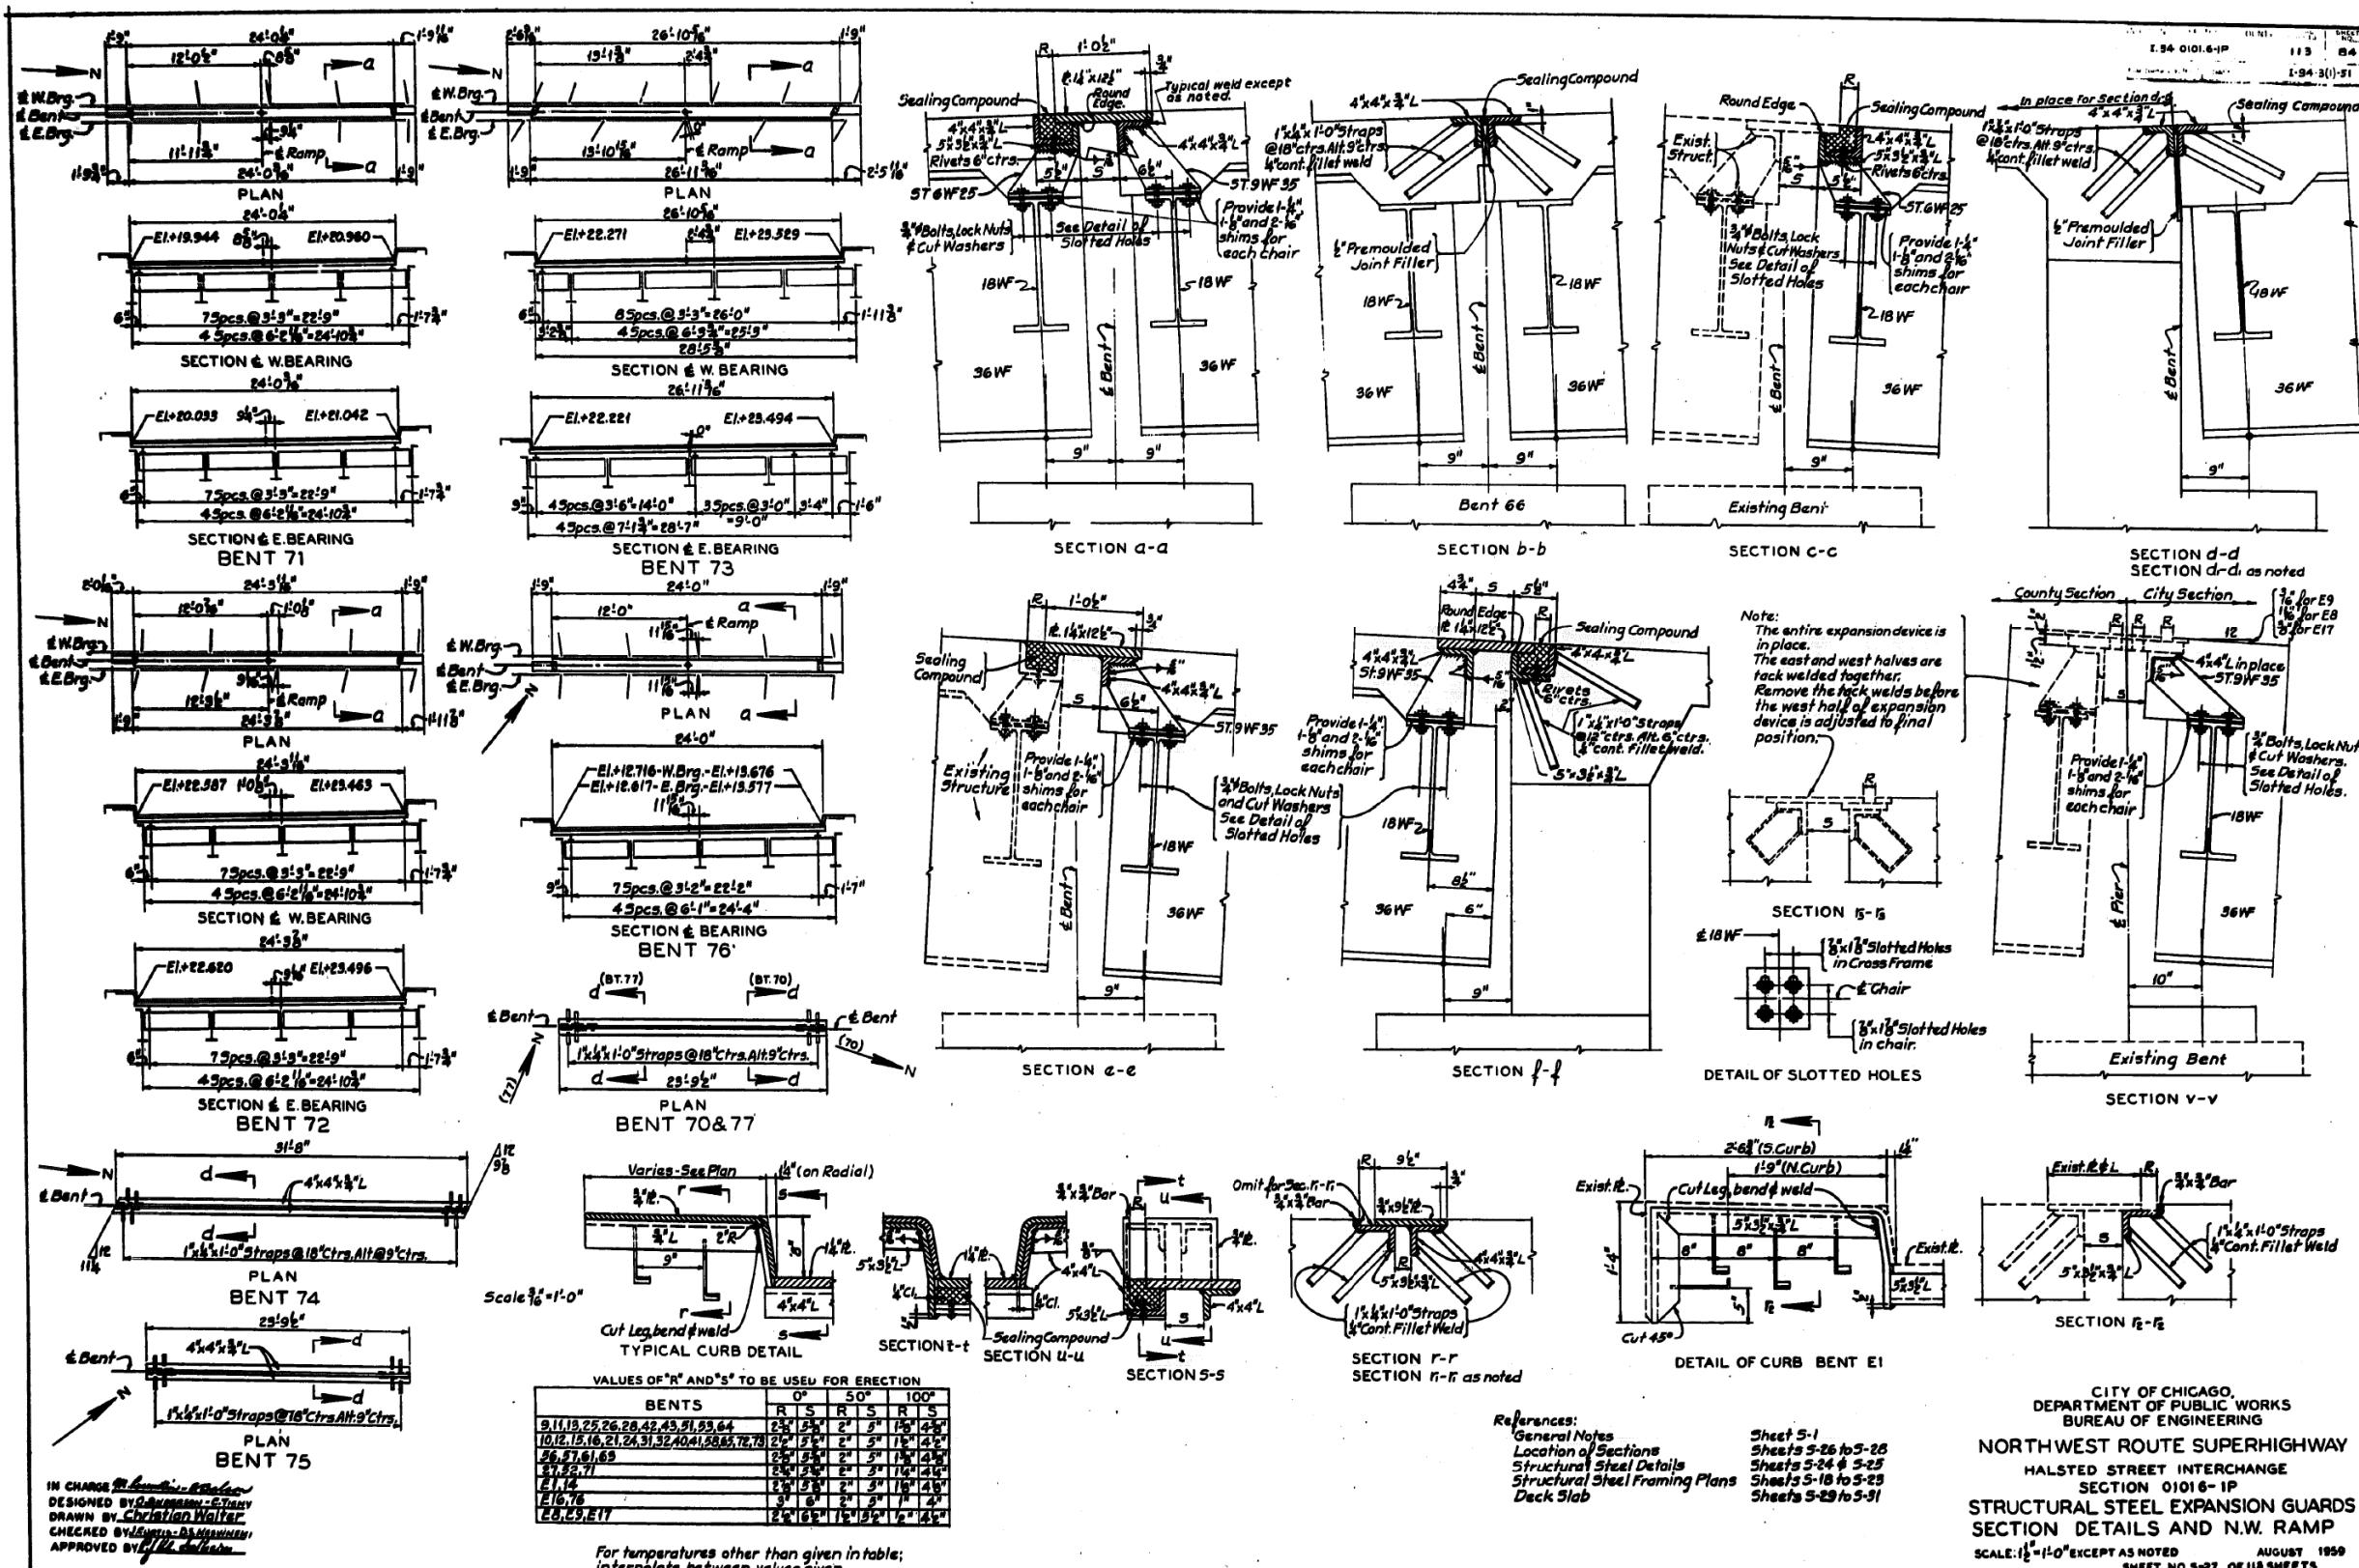

IN CHARGE *M. L. C. - B. A. L.*
DESIGNED BY *C. T. R.* C. T. R.
DRAWN BY *Christian Walter*
CHECKED BY *E. H. D. - A. M. H.*
APPROVED BY *W. H. H.*

For temperatures other than given in
interpolate between values given.

References:	Sheet 5-1
General Notes	Sheets 5-26 to 5-28
Location of Sections	Sheets 5-24 & 5-25
Structural Steel Details	Sheets 5-18 to 5-23
Structural Steel Framing Plans	Sheets 5-29 & 5-31
Deck Slab	

**CITY OF CHICAGO,
DEPARTMENT OF PUBLIC WORKS
BUREAU OF ENGINEERING**

**NORTHWEST ROUTE SUPERHIGHWAY
HALSTED STREET INTERCHANGE
SECTION 01016-1P
STRUCTURAL STEEL EXPANSION GUARDS
SECTION DETAILS AND N.W. RAMP**


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	R	S	R	S	R	S	R	S	R
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10.12.15.16.21.24.31.32.40.41.50.55.72.73	2 ¹	5 ¹	2 ¹	5 ¹	1 ¹	4 ¹	1 ¹	4 ¹	1 ¹
56.57.58.69	2 ¹	5 ¹	2 ¹	5 ¹	1 ¹	4 ¹	1 ¹	4 ¹	1 ¹
13.14.27.71	2 ¹	5 ¹	2 ¹	5 ¹	1 ¹	4 ¹	1 ¹	4 ¹	1 ¹
L1.14	2 ¹	5 ¹	2 ¹	5 ¹	1 ¹	4 ¹	1 ¹	4 ¹	1 ¹
L1.16	9 ¹	6 ¹	2 ¹	5 ¹	1 ¹	4 ¹	1 ¹	4 ¹	1 ¹
L1.19.21.27	2 ¹	5 ¹	2 ¹	5 ¹	1 ¹	4 ¹	1 ¹	4 ¹	1 ¹

STATE OF ILLINOIS
DEPARTMENT OF TRANSPORTATION

EXISTING RECORD DRAWINGS

HBM ENGINEERING GROUP, LLC				USER NAME = ahmad.issa	DESIGNED -	REVISED -	SECTION	COUNTY	TOTAL SHEETS	SHEET NO.
				CHECKED -	REVISED -		90/94/290	COOK	1972	1956
				PLOT SCALE = N.T.S	DRAWN -	REVISED -				CONTRACT NO. 60X93
				PLOT DATE = 7/26/2018	CHECKED - MI, MAI	REVISED -				ILLINOIS FED. AID PROJECT
STATE OF ILLINOIS DEPARTMENT OF TRANSPORTATION										
EXISTING RECORD DRAWINGS										

FOR INFORMATION ONLY

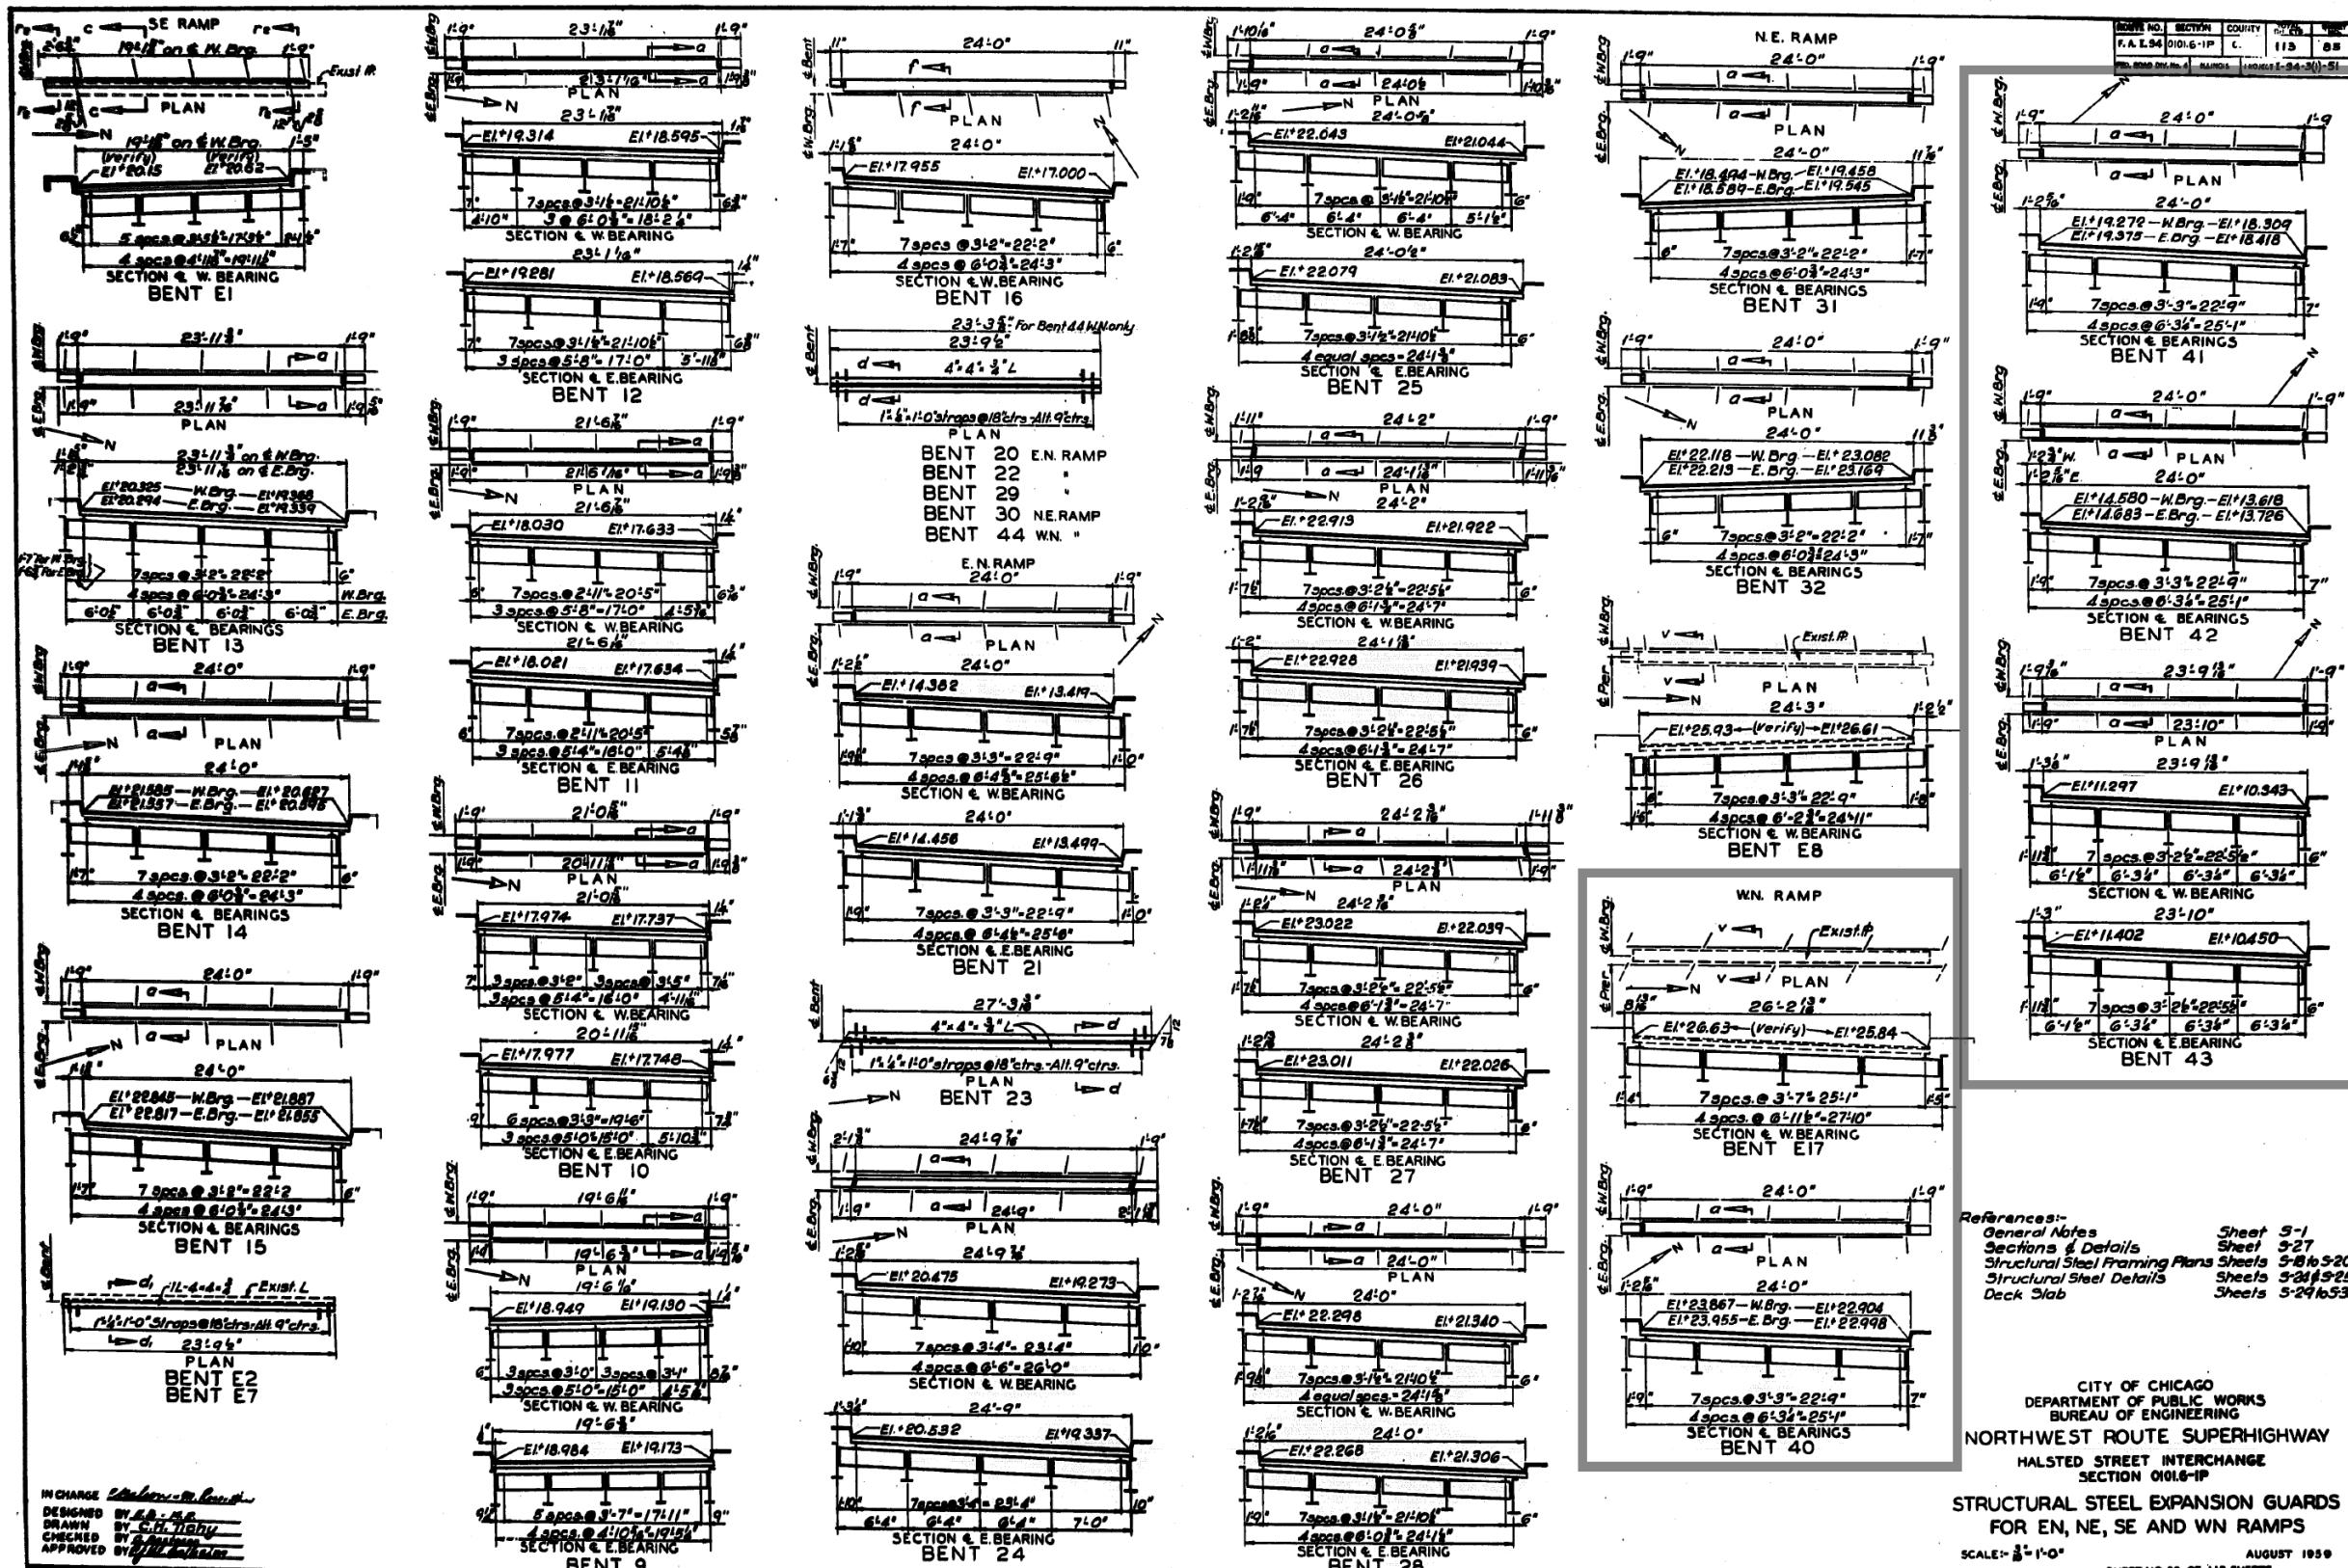

**STRUCTURAL STEEL EXPANSION GUARDS
FOR EN, NE, SE AND WN RAMPS**

General Notes	Sheet	5-1
Sections & Details	Sheet	5-27
Structural Steel Framing Plans	Sheets	5-18 to 5-20
Structural Steel Details	Sheets	5-24 & 5-25
Deck Slab	Sheets	5-29 to 53

CITY OF CHICAGO
DEPARTMENT OF PUBLIC WORKS
BUREAU OF ENGINEERING
NORTHWEST ROUTE SUPERHIGHWAY
HALSTED STREET INTERCHANGE
SECTION ONE&Four

STATE OF ILLINOIS
DEPARTMENT OF TRANSPORTATION

EXISTING RECORD DRAWINGS


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REVISED	-	

**STATE OF ILLINOIS
DEPARTMENT OF TRANSPORTATION**

EXISTING RECORD DRAWINGS		F.A.I. RTE.
		90/94/290

FOR INFORMATION ONLY

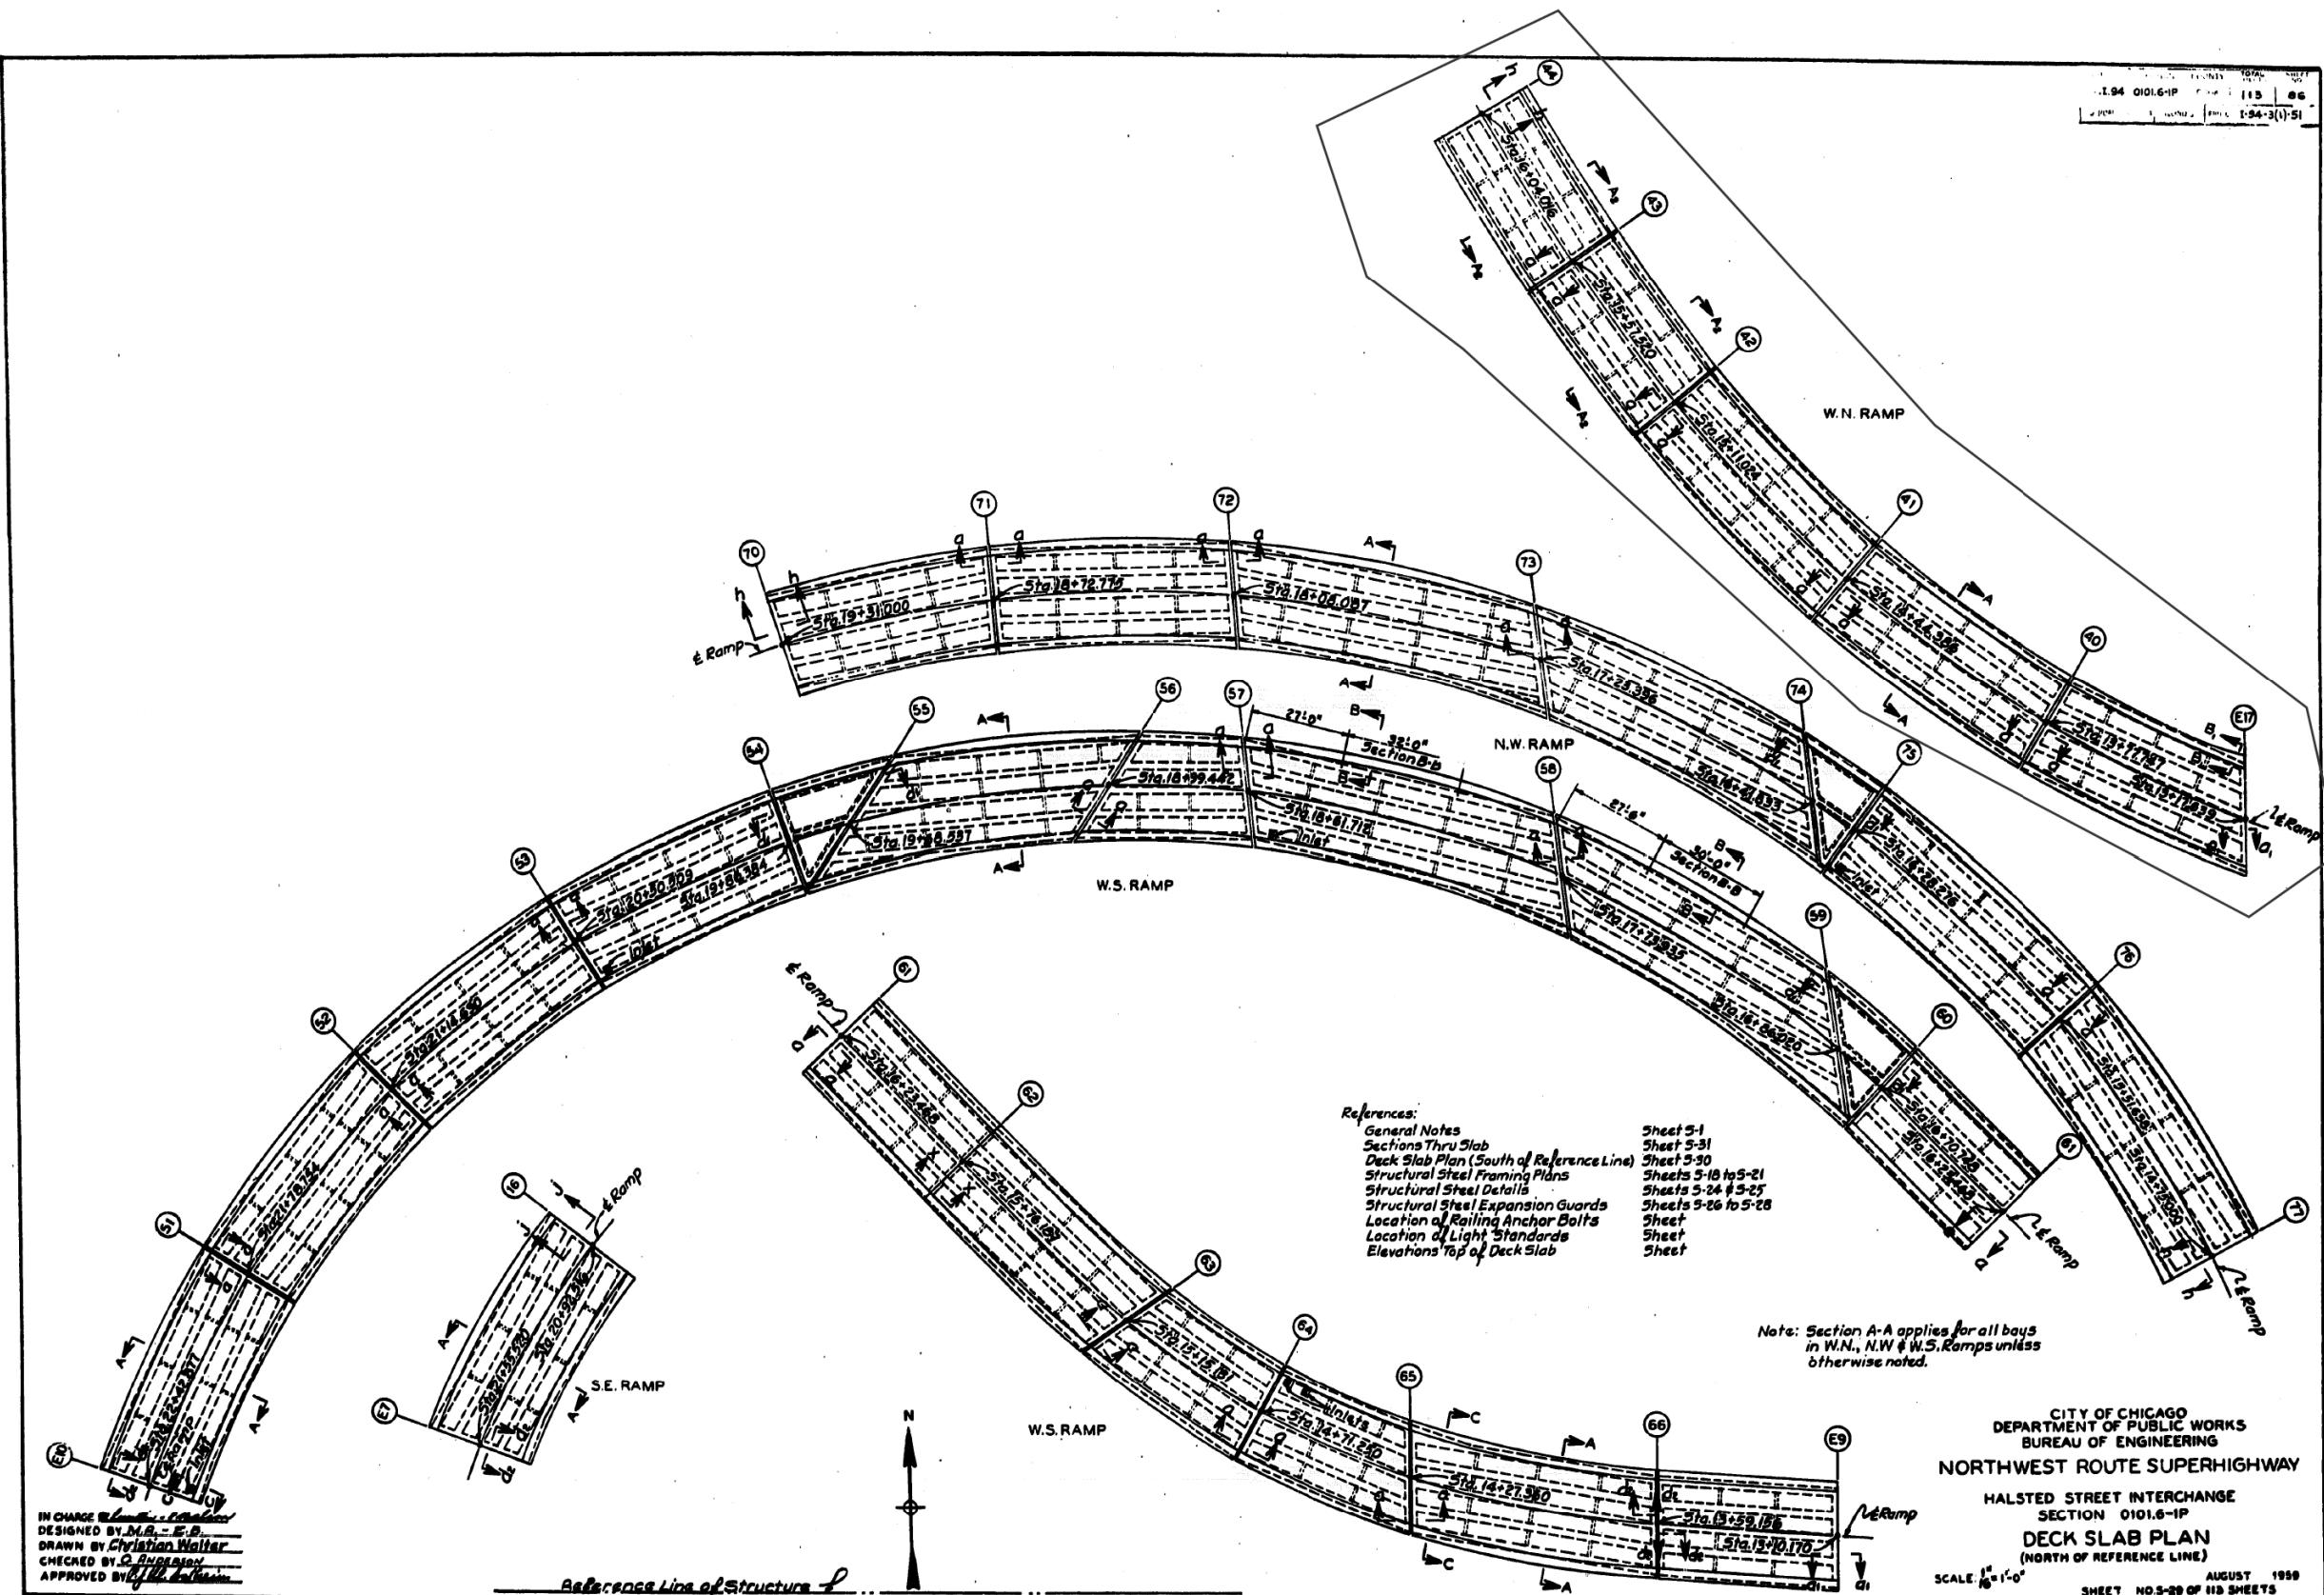

FILE NAME: pwa1617479-PWINT_aecomonline.local:AECCOM_D502_NA\Documents\01 American\Transportation\0269938_CirclePhase_1\000 Structural\Structure_016-1718\Existing Plans\016461-20-60X93-Sxx-Existing683
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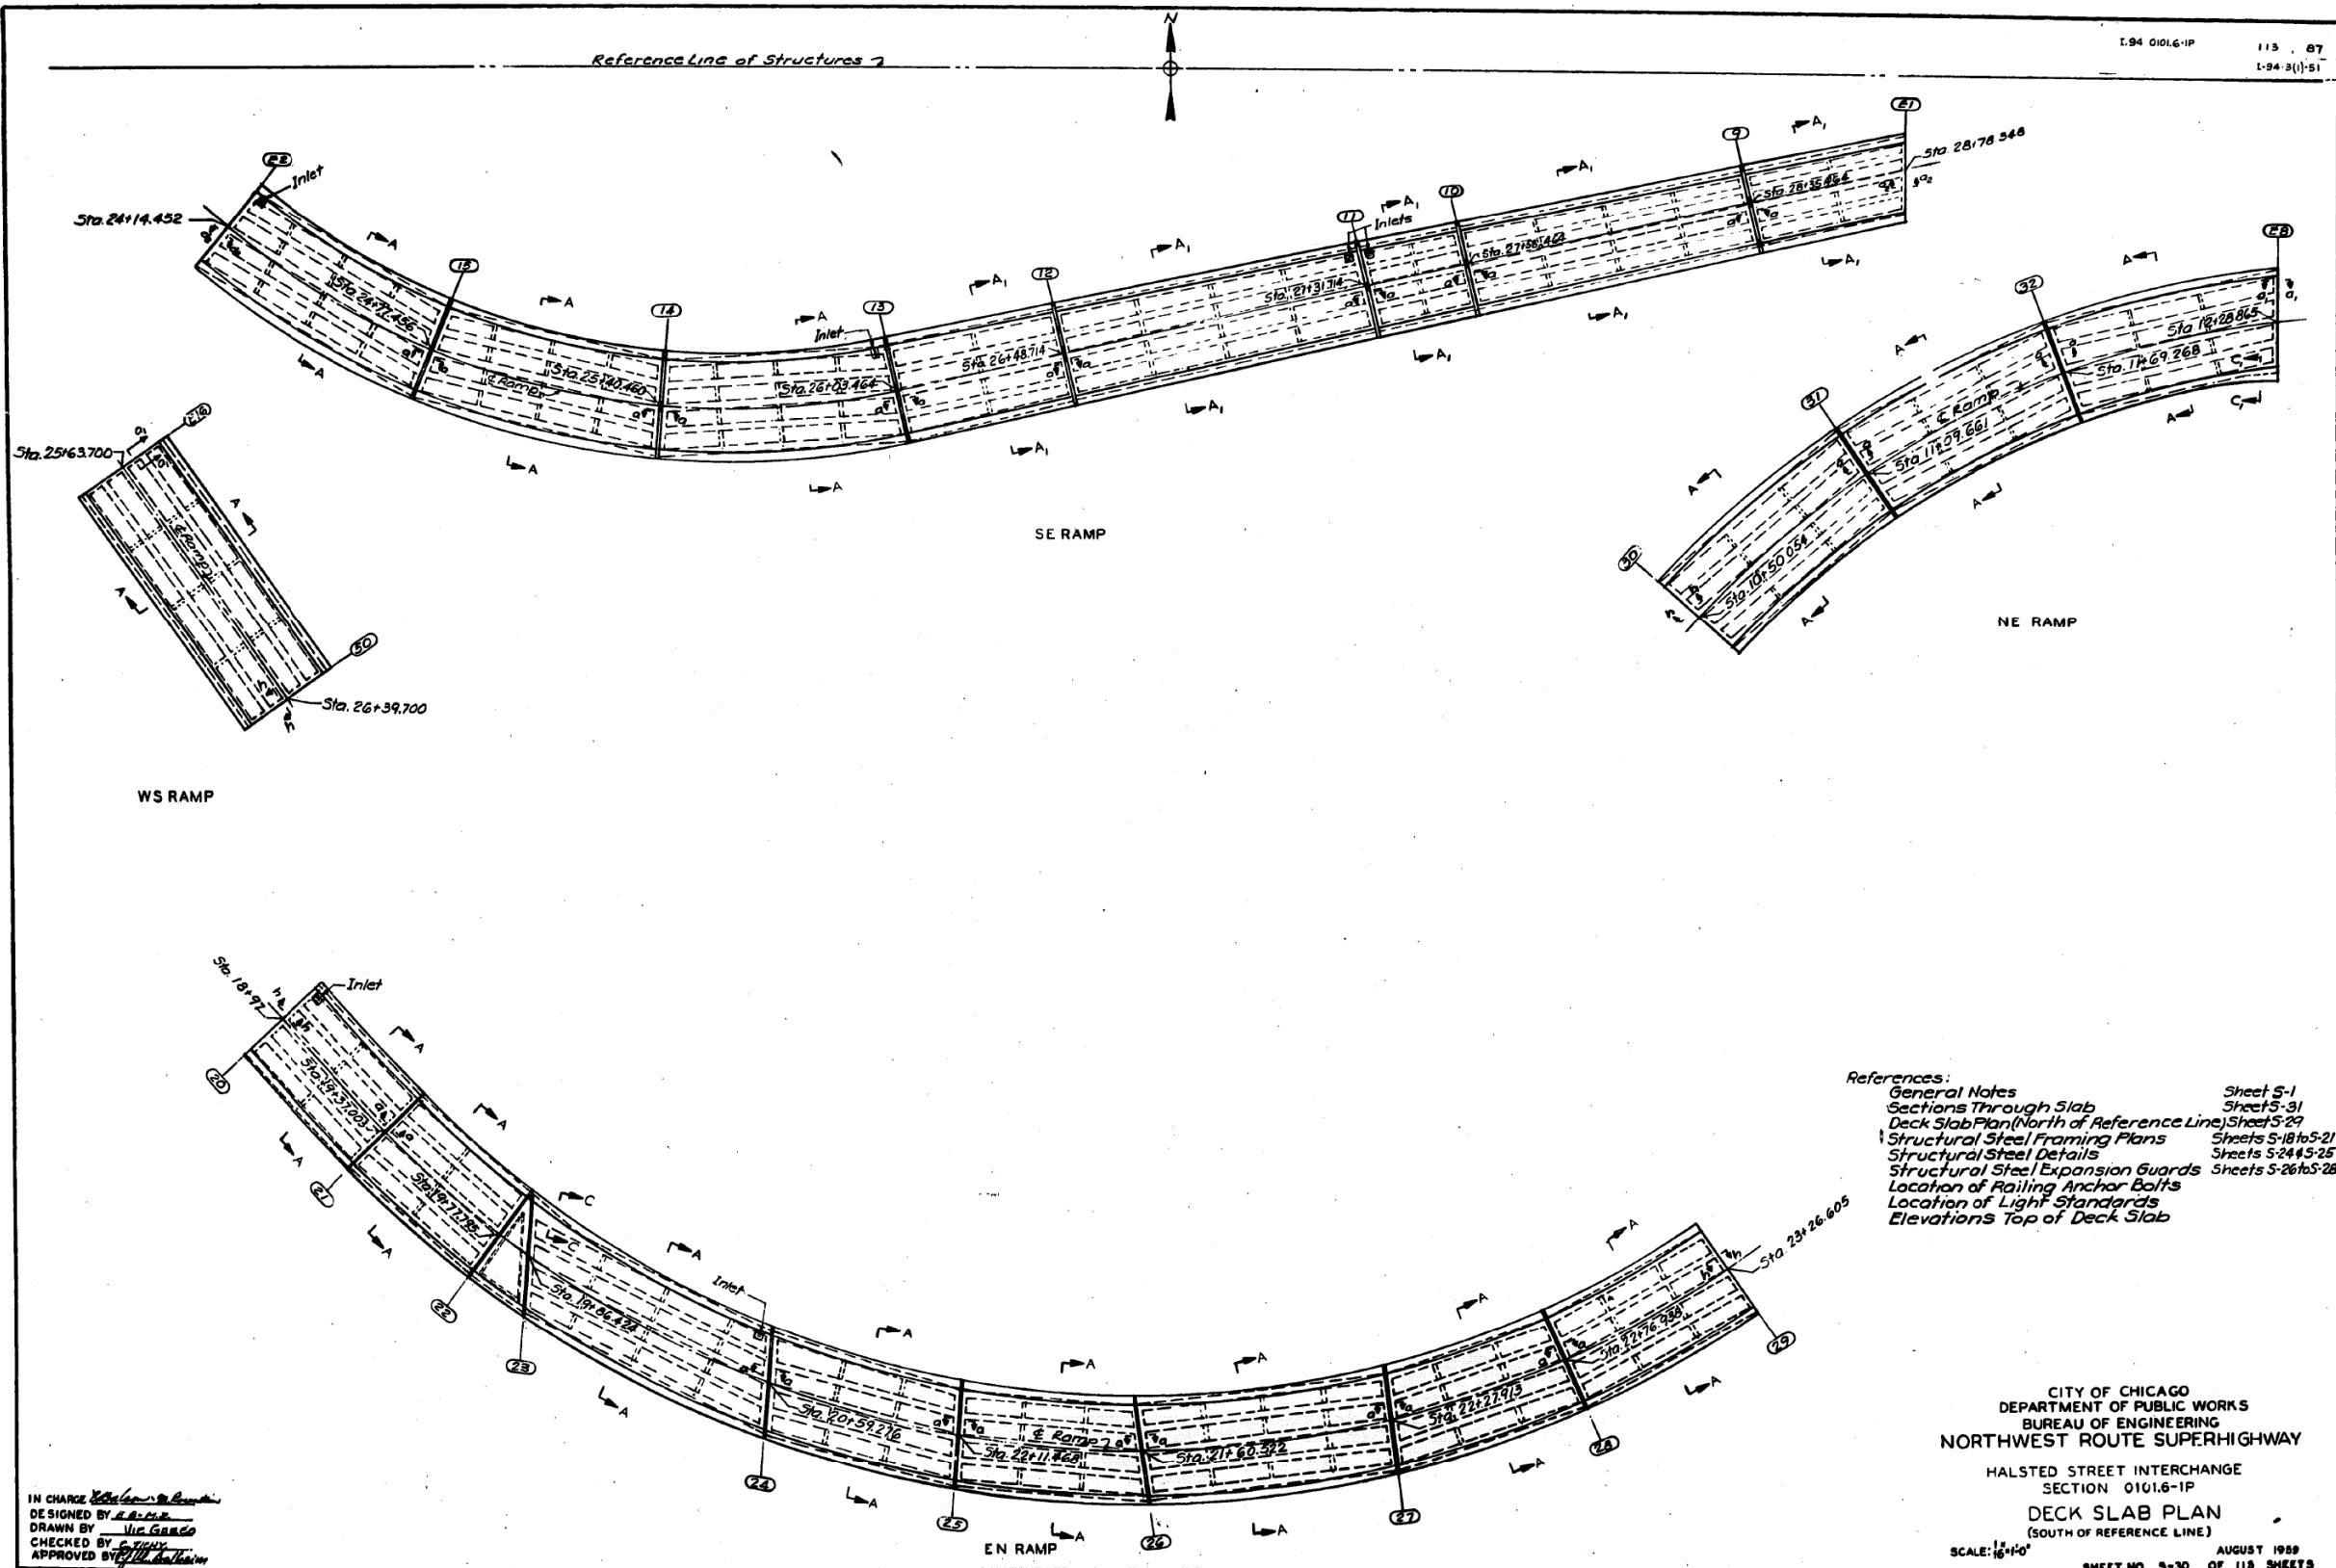
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**STATE OF ILLINOIS
DEPARTMENT OF TRANSPORTATION**


EXISTING RECORD DRAWINGS

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CONTRACT NO. 60X93				
		ILLINOIS	FED. AID PROJECT	

FOR INFORMATION ONLY



FOR INFORMATION ONLY

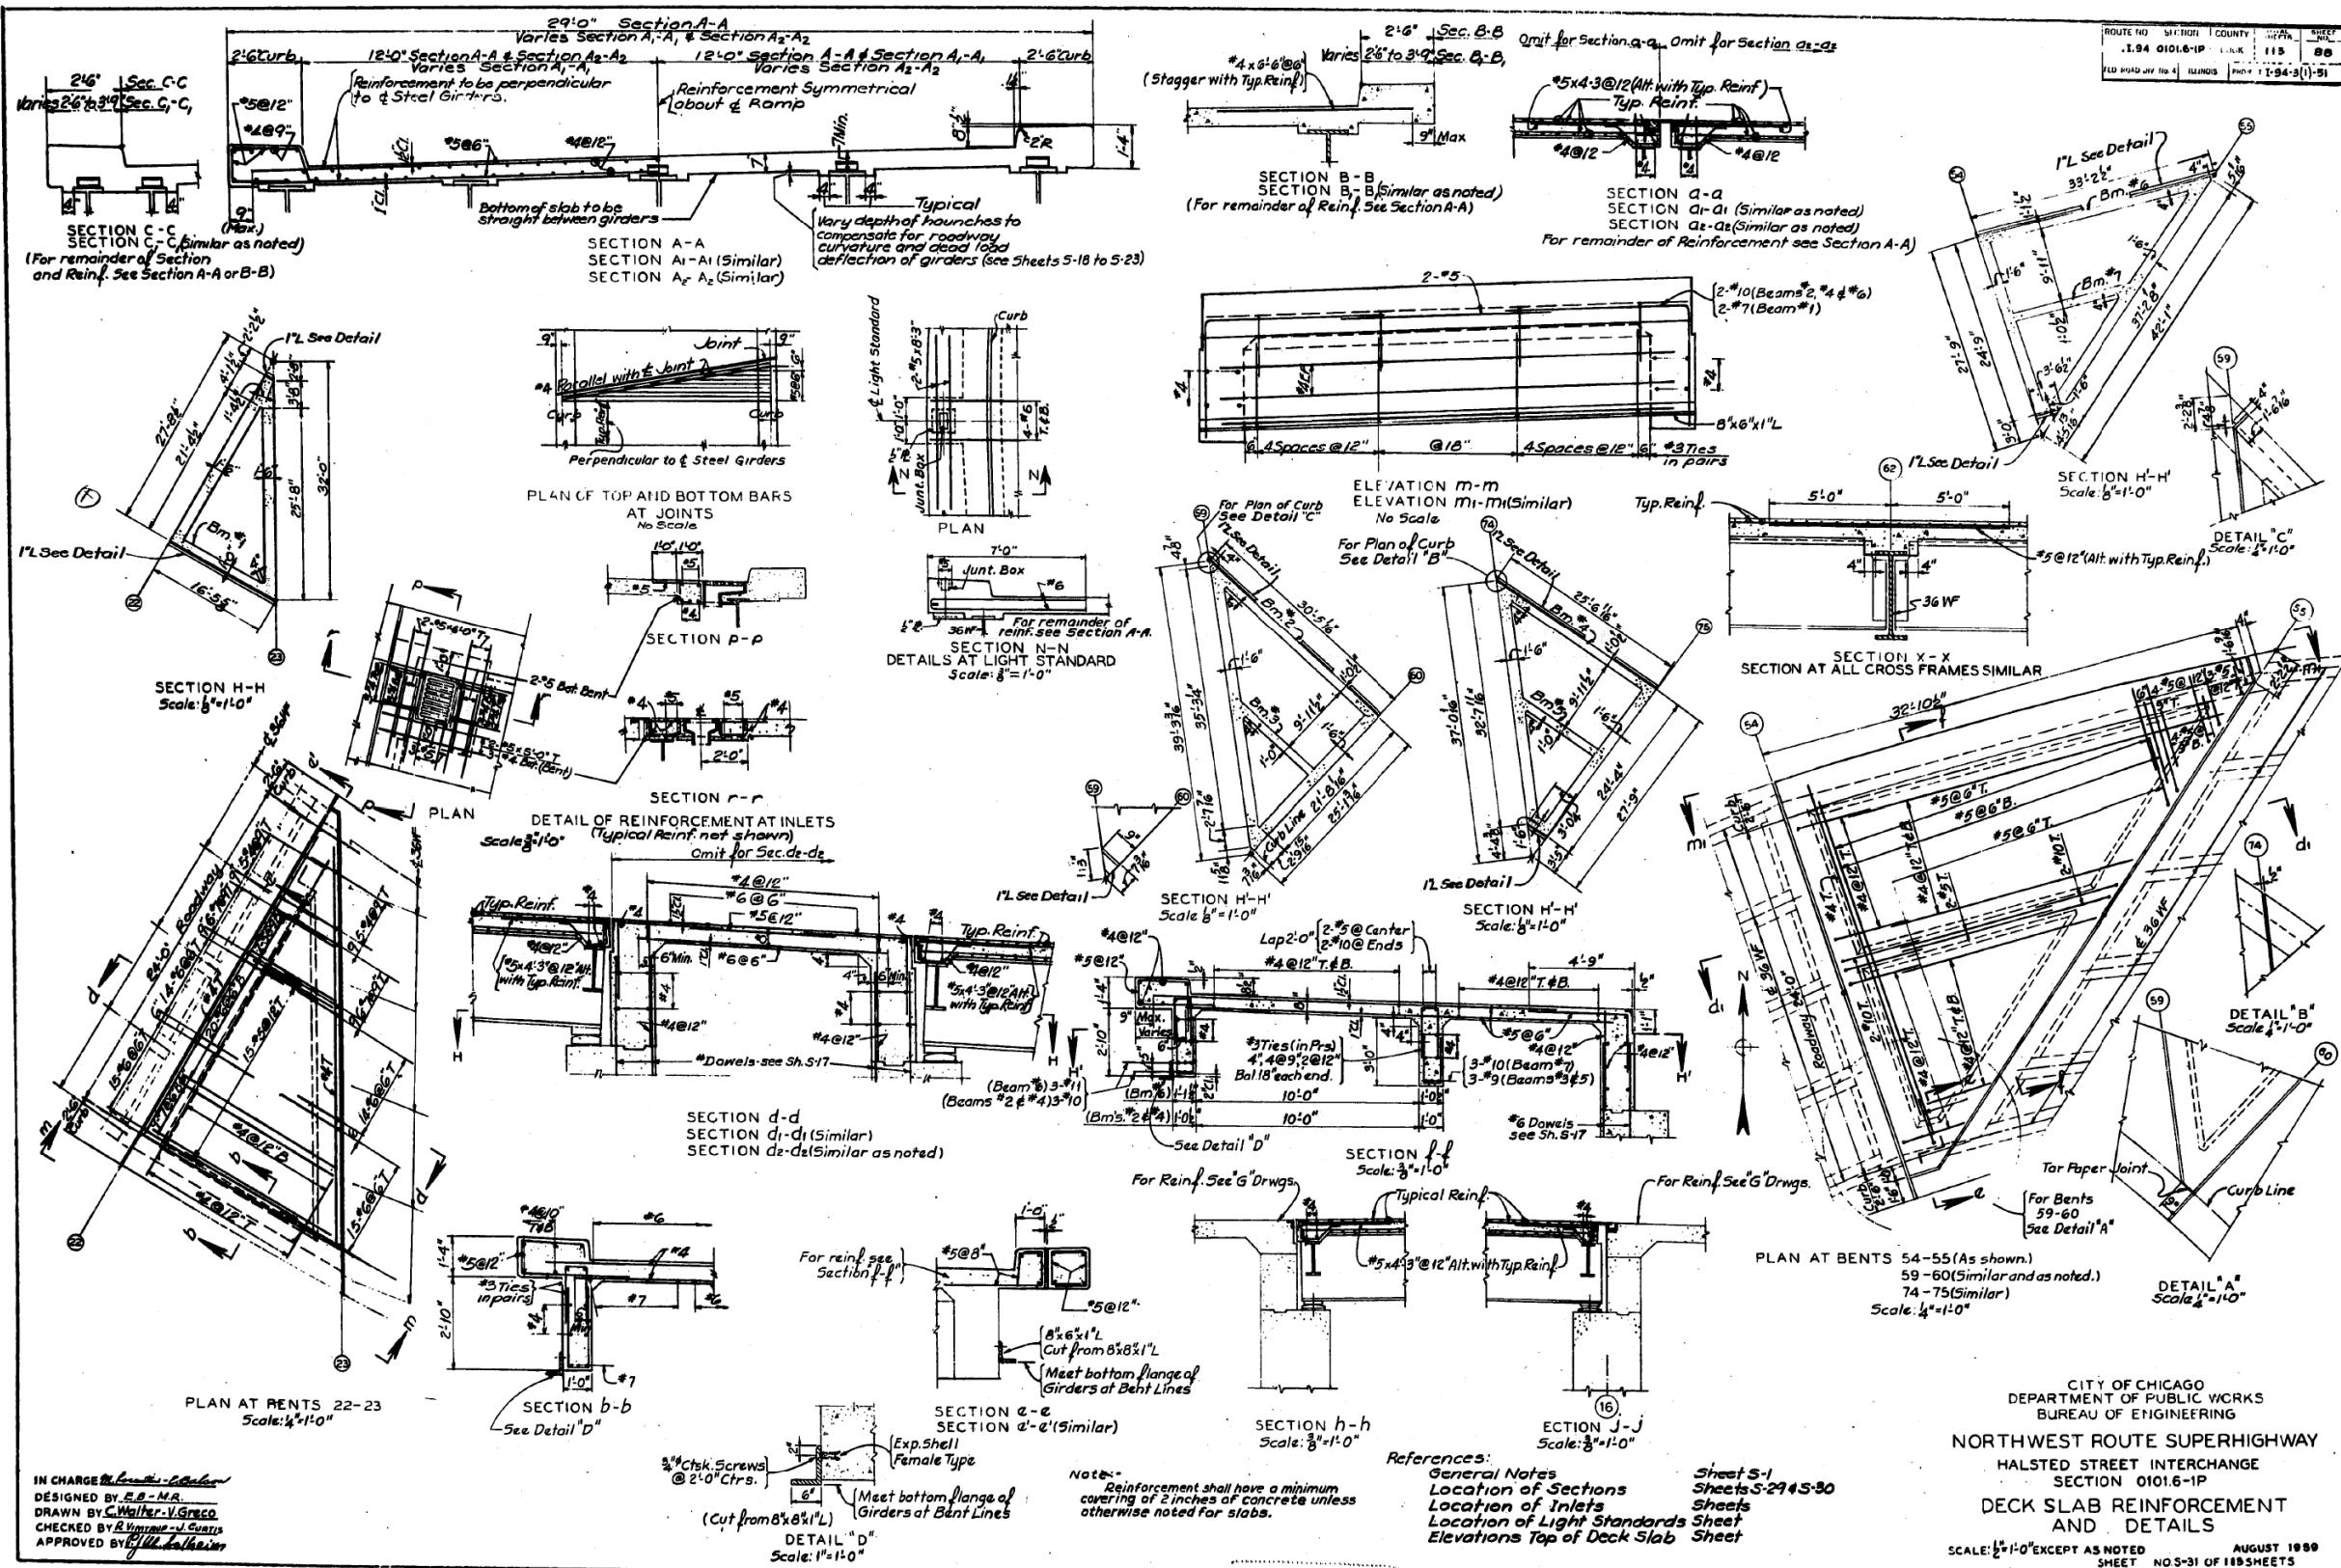

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HBM
ENGINEERING GROUP, LLC


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STATE OF ILLINOIS
DEPARTMENT OF TRANSPORTATION

EXISTING RECORD DRAWINGS

F.A.I. RTE.	SECTION	COUNTY	TOTAL SHEETS	SHEET NO.
90/94/290	2014-013R&B-R	COOK	1972	1960
			CONTRACT NO.	60X93
	ILLINOIS	FED. AID PROJECT		

FOR INFORMATION ONLY

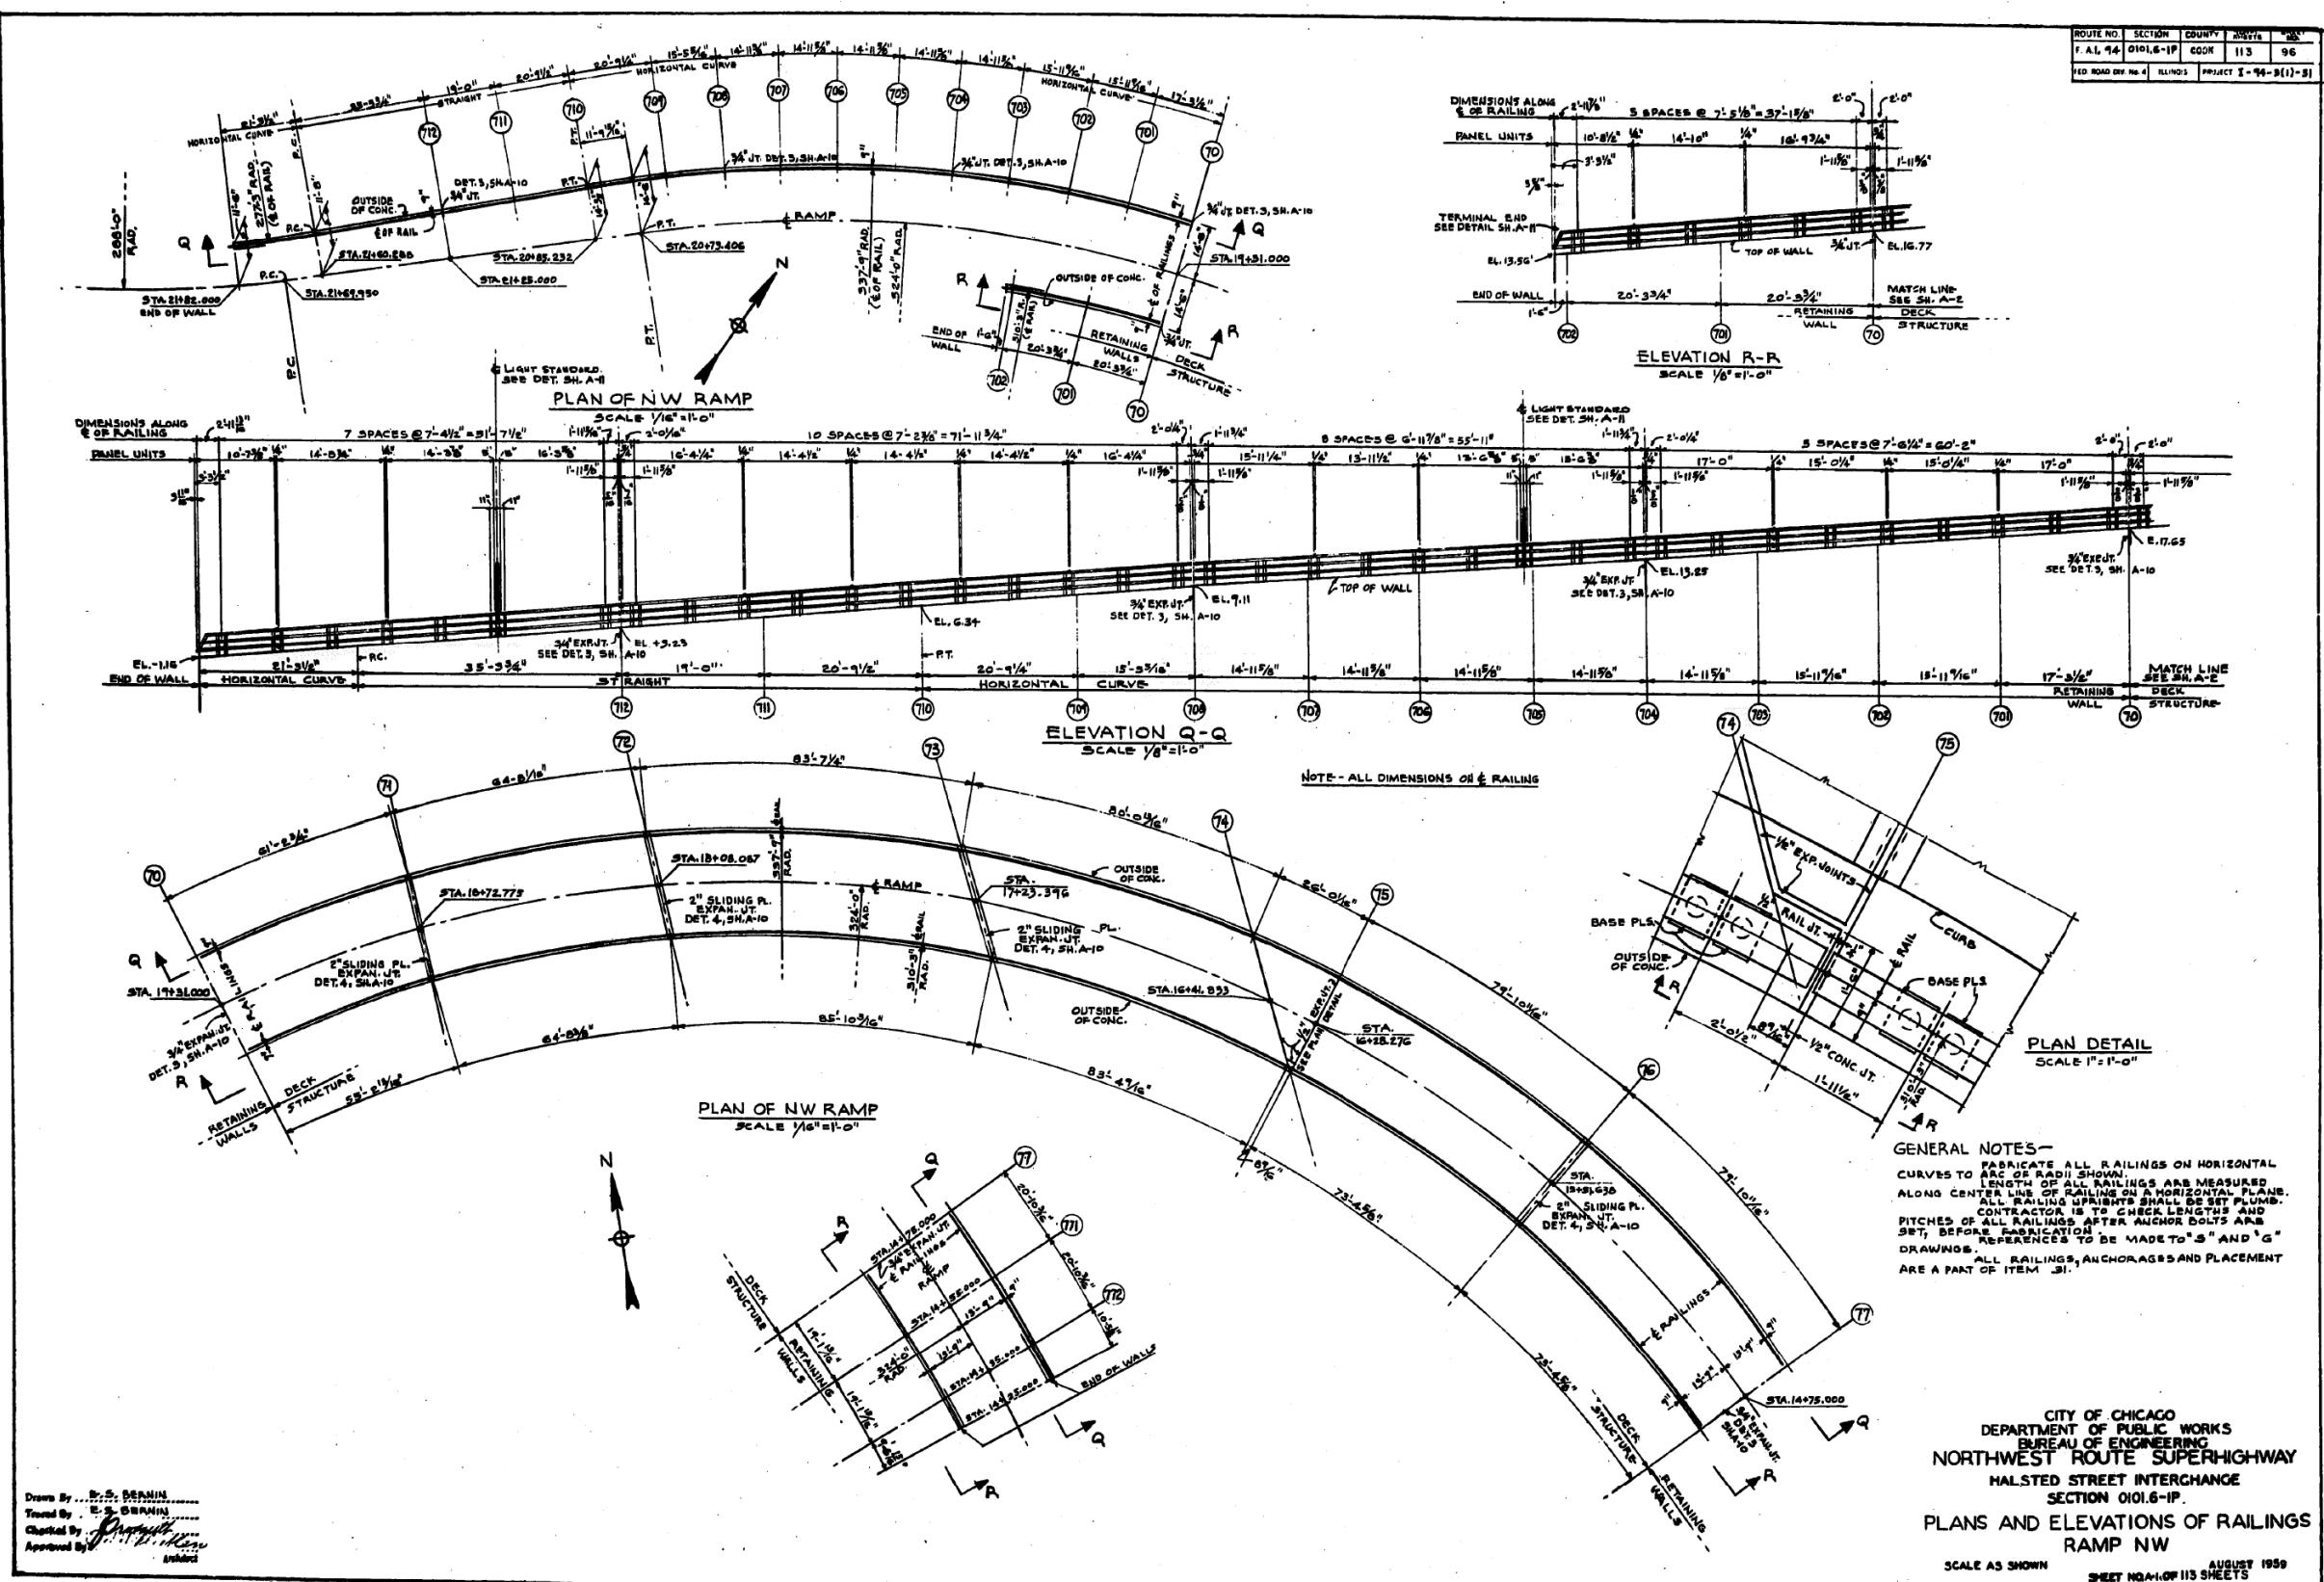

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Drawn By B. S. BERNIN
Traced By B. S. BERNIN
Checked By J. P. MURRAY
Approved By


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STATE OF ILLINOIS
DEPARTMENT OF TRANSPORTATION

EXISTING RECORD DRAWINGS

F.A.I. RTE.	SECTION	COUNTY	TOTAL SHEETS	SHEET NO.
90/94/290	2014-013R&B-R	COOK	1972	1961
CONTRACT NO. 60X93				

FOR INFORMATION ONLY

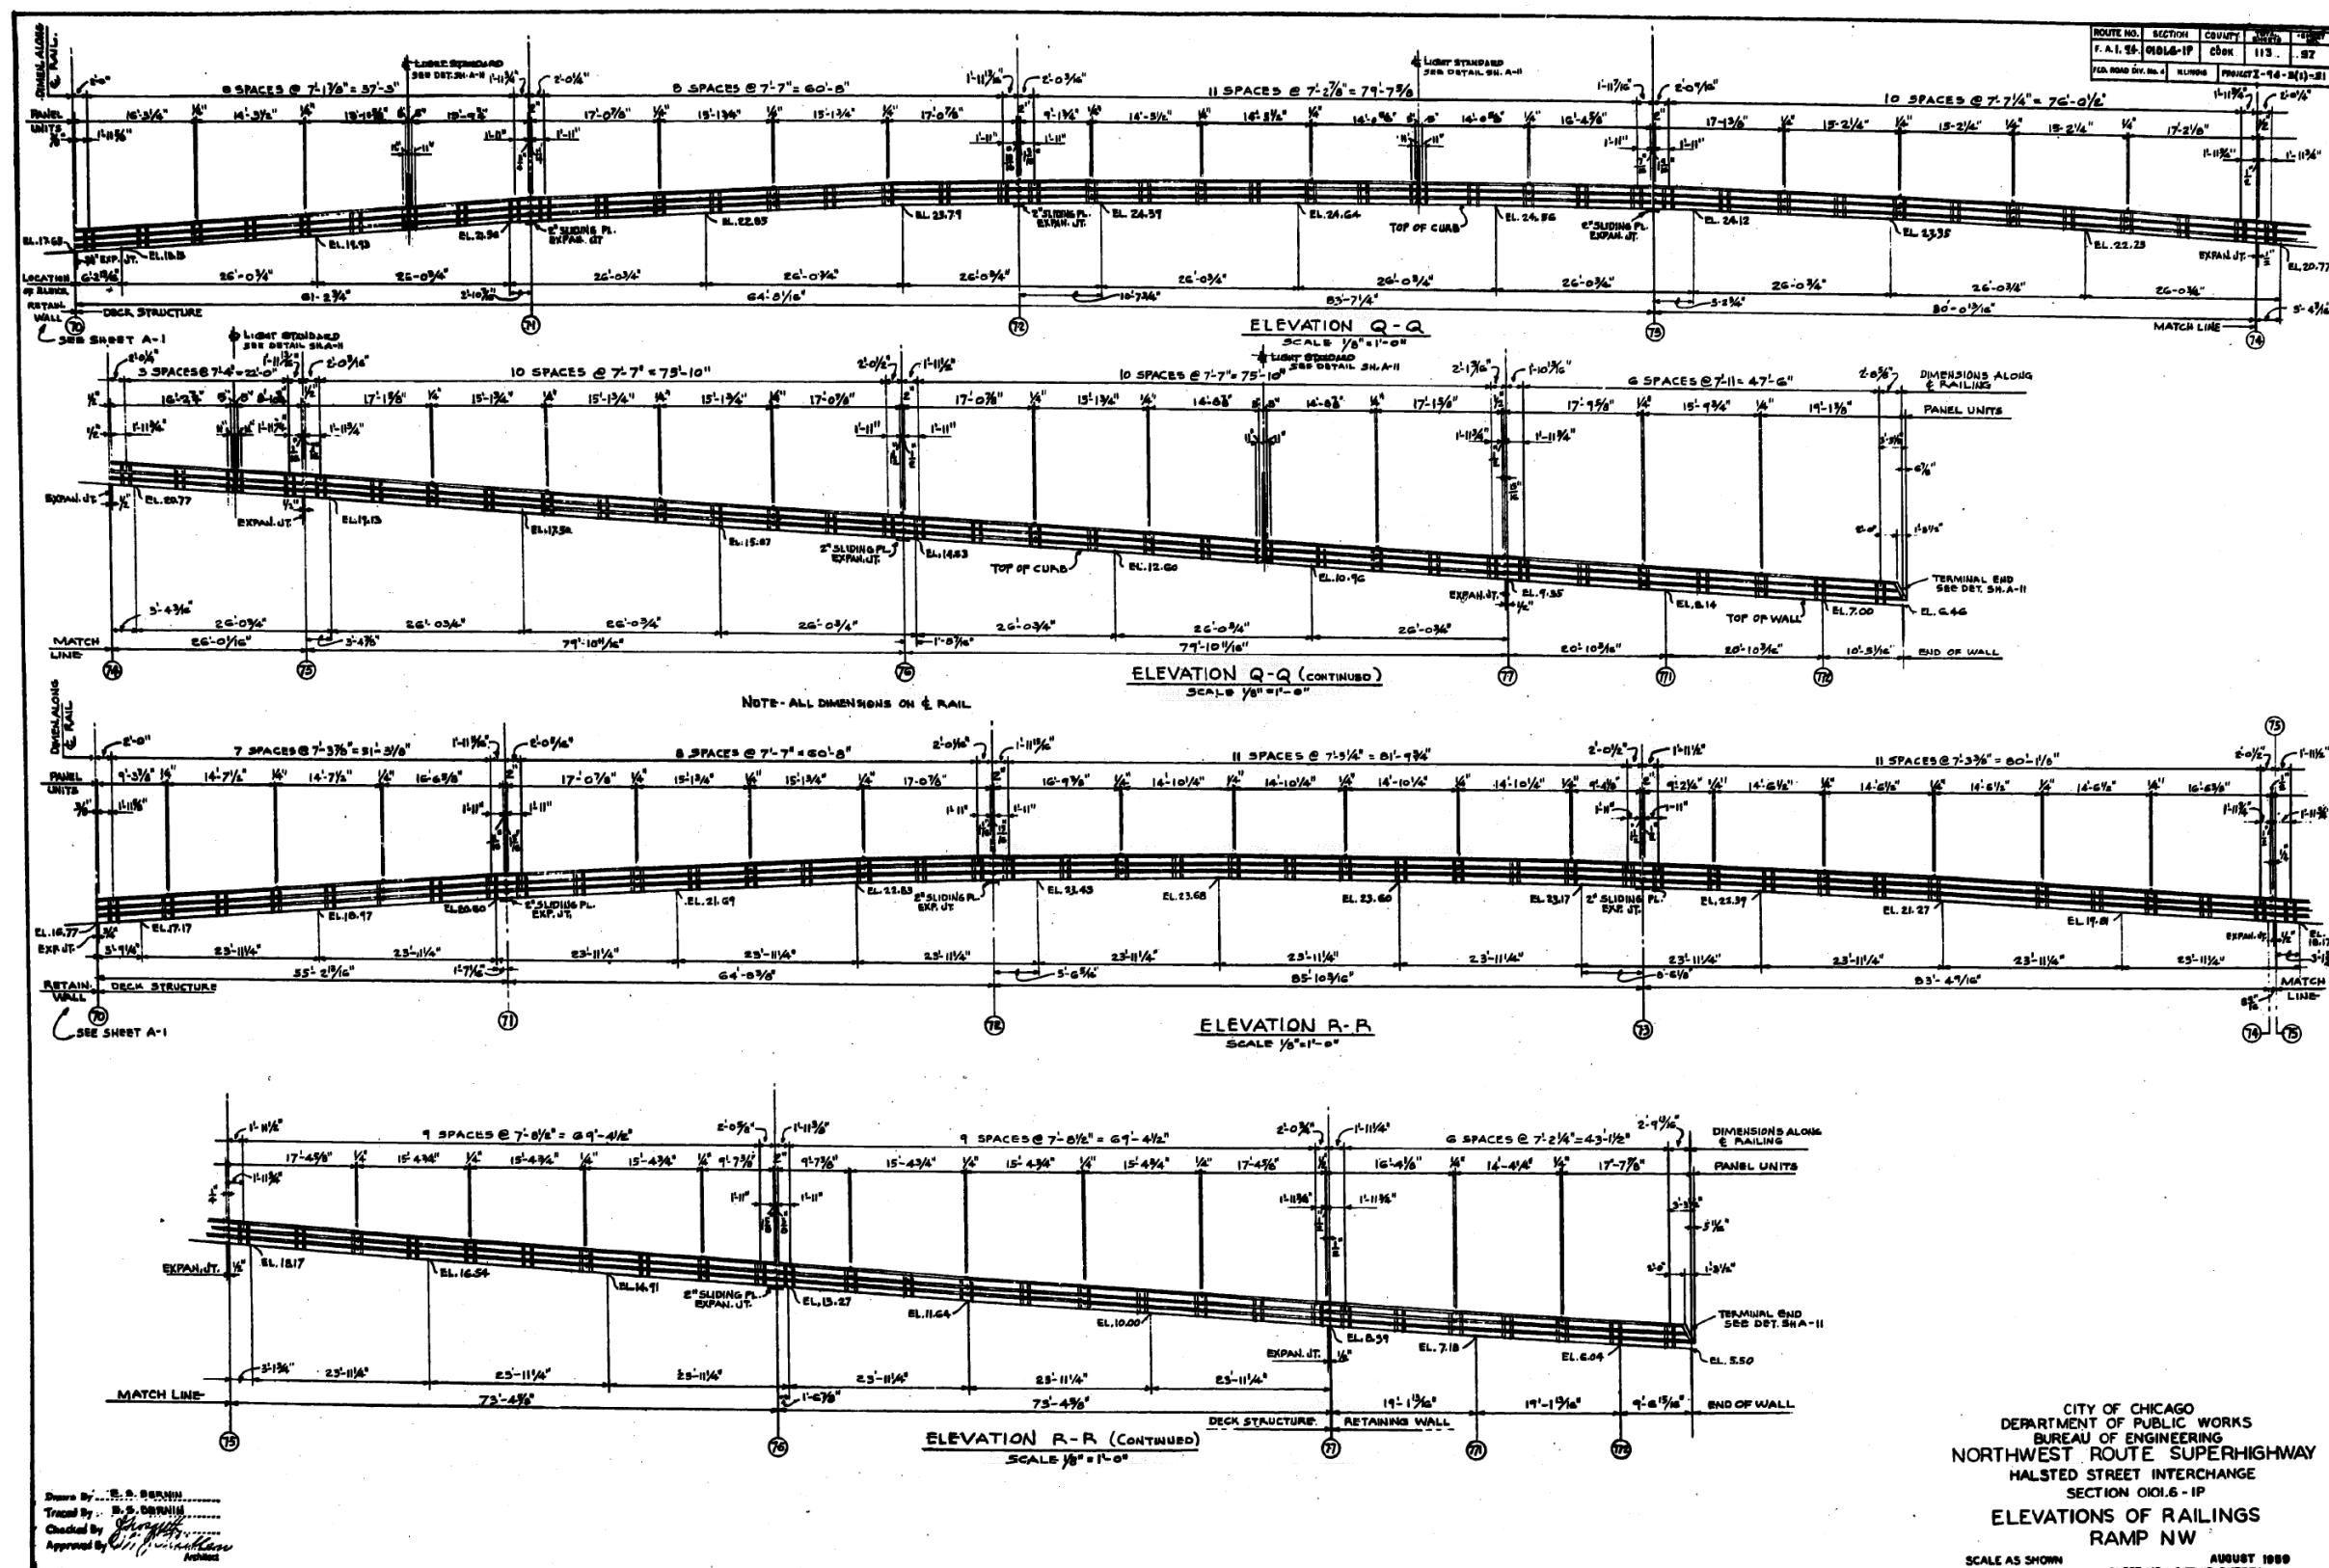

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BM
GROUP LLC


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STATE OF ILLINOIS
DEPARTMENT OF TRANSPORTATION

EXISTING RECORD DRAWINGS

	F.A.I. RTE.	SECTION	COUNTY	TOTAL SHEETS	SHEET NO.
	90/94/290	2014-013R&B-R	COOK	1972	1962
				CONTRACT NO. 60X93	

FOR INFORMATION ONLY

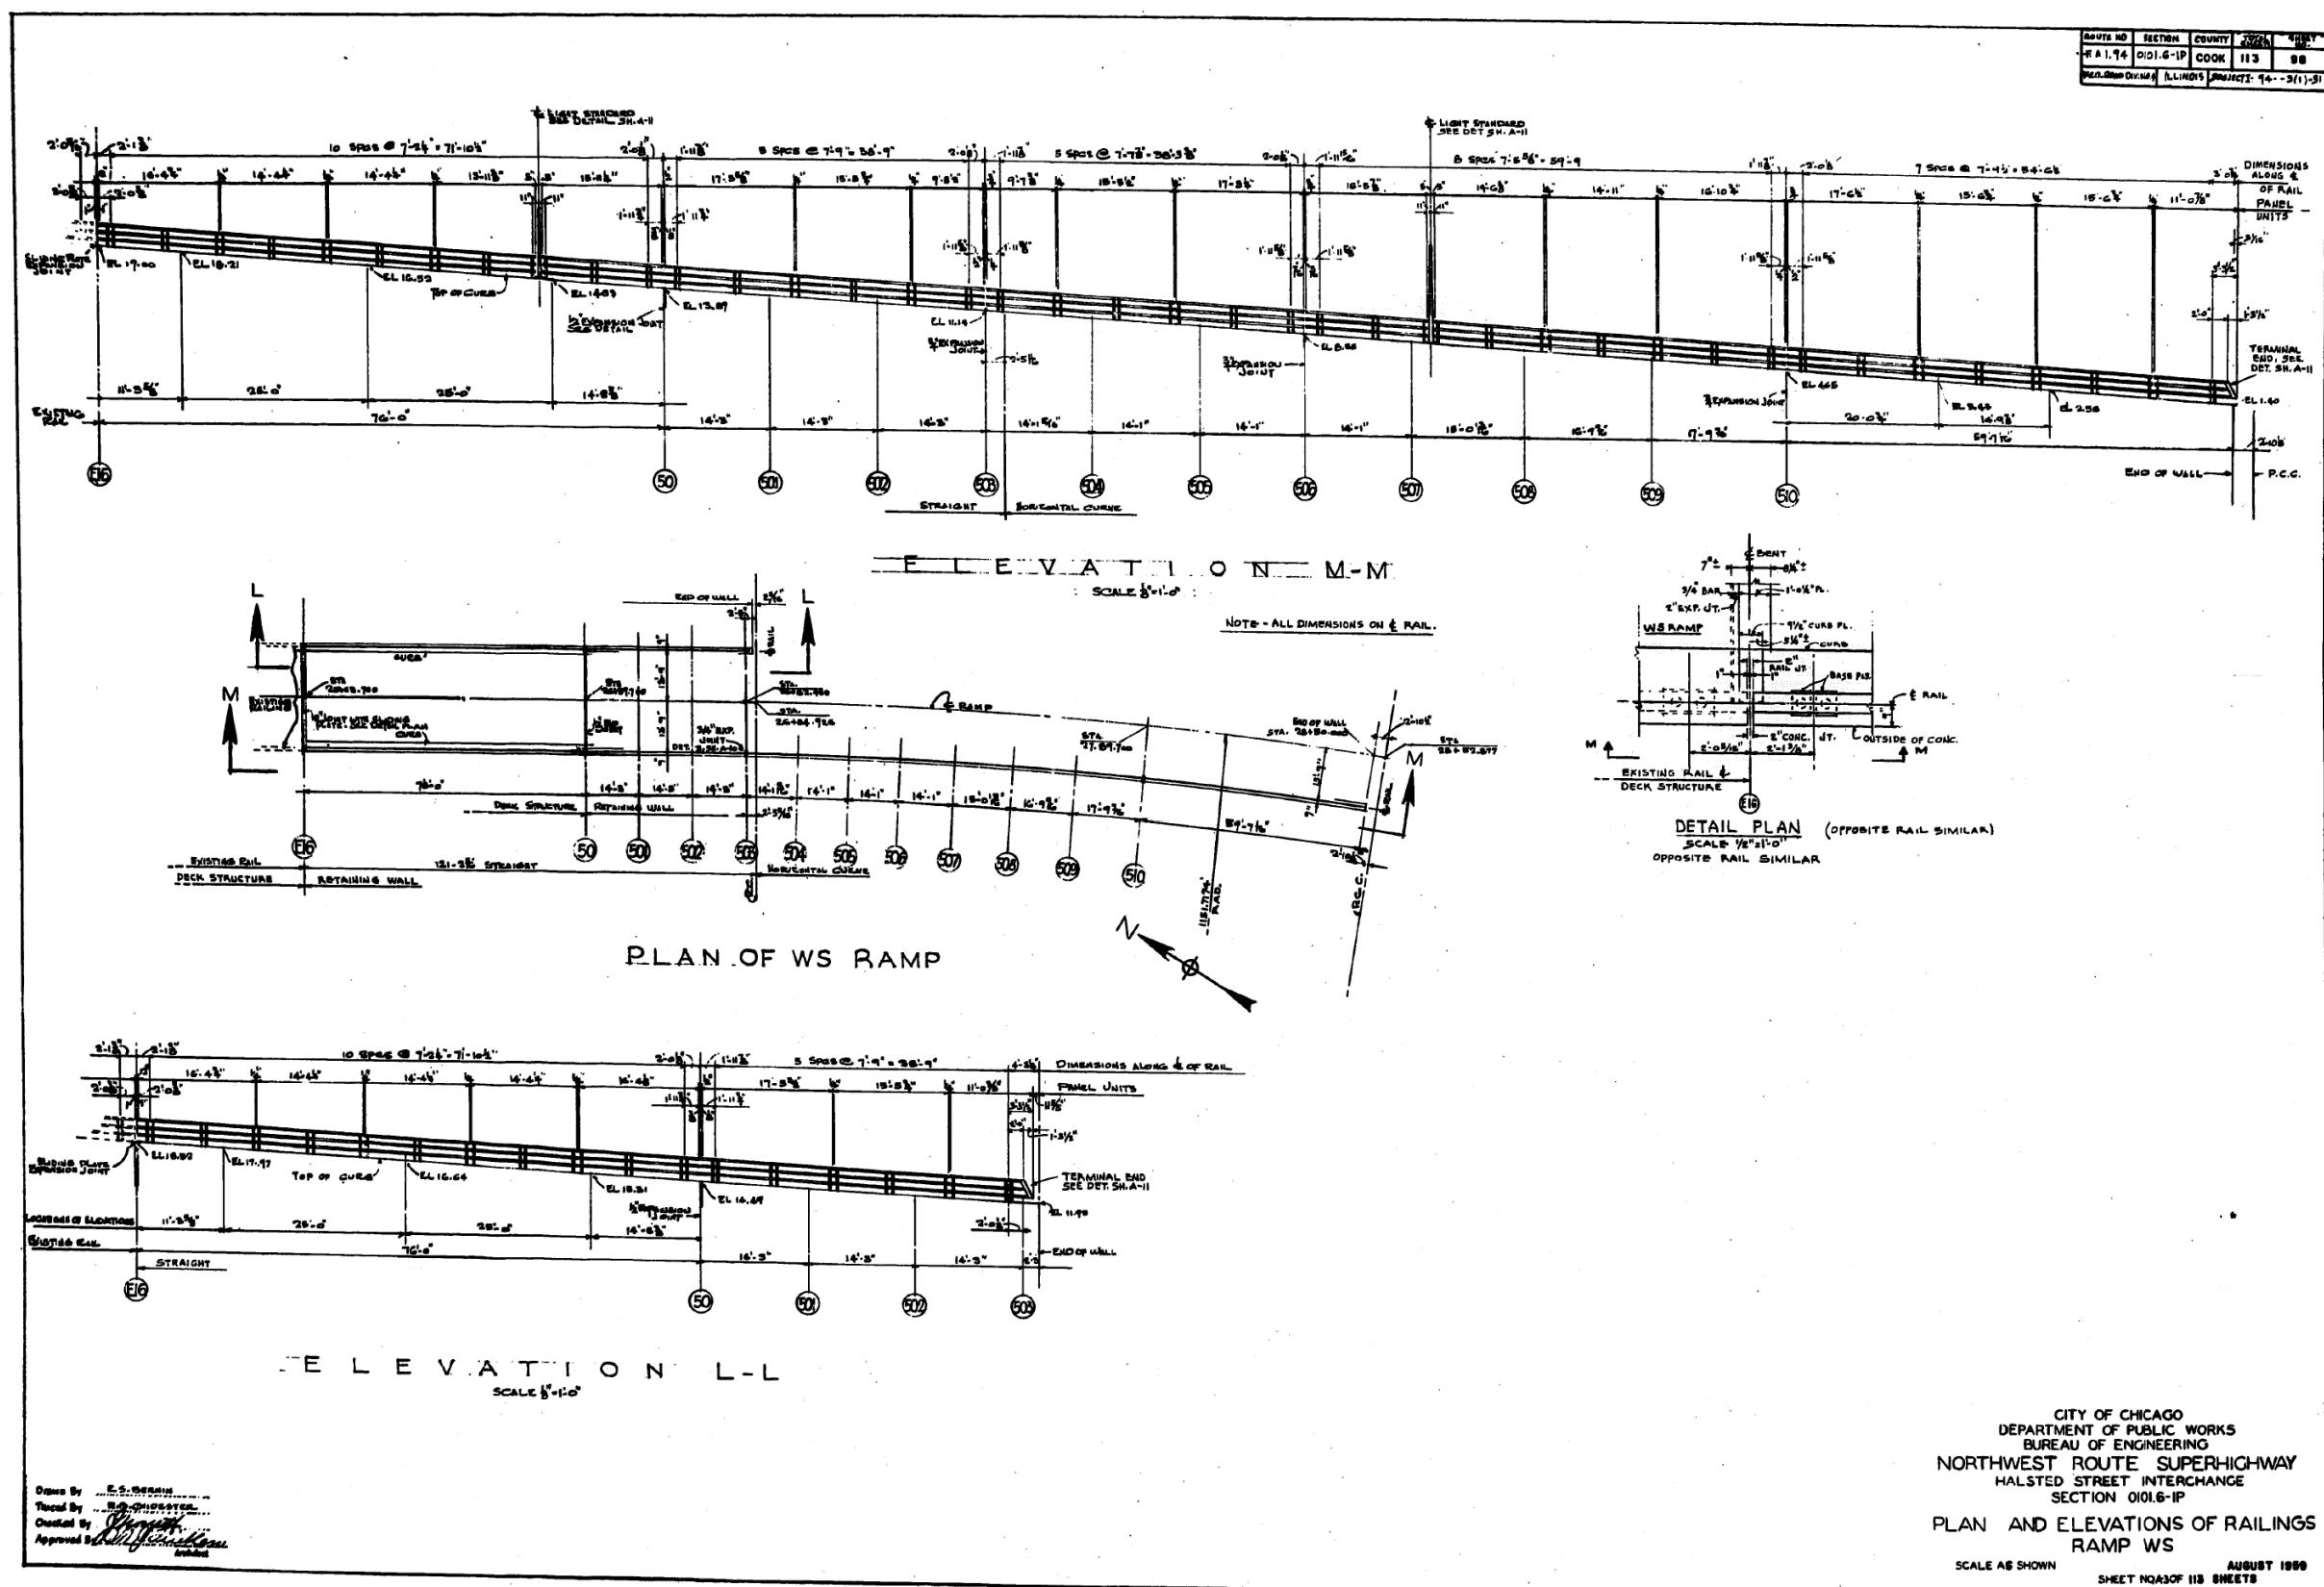

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ENGINEERING GROUP, LLC


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STATE OF ILLINOIS
DEPARTMENT OF TRANSPORTATION

EXISTING RECORD DRAWINGS

A.I. ITE.	SECTION	COUNTY	TOTAL SHEETS	SHEET NO.
04/290	2014-013R&B-R	COOK	1972	1963
CONTRACT NO. 60X93				
	ILLINOIS	FED. AID PROJECT		

FOR INFORMATION ONLY

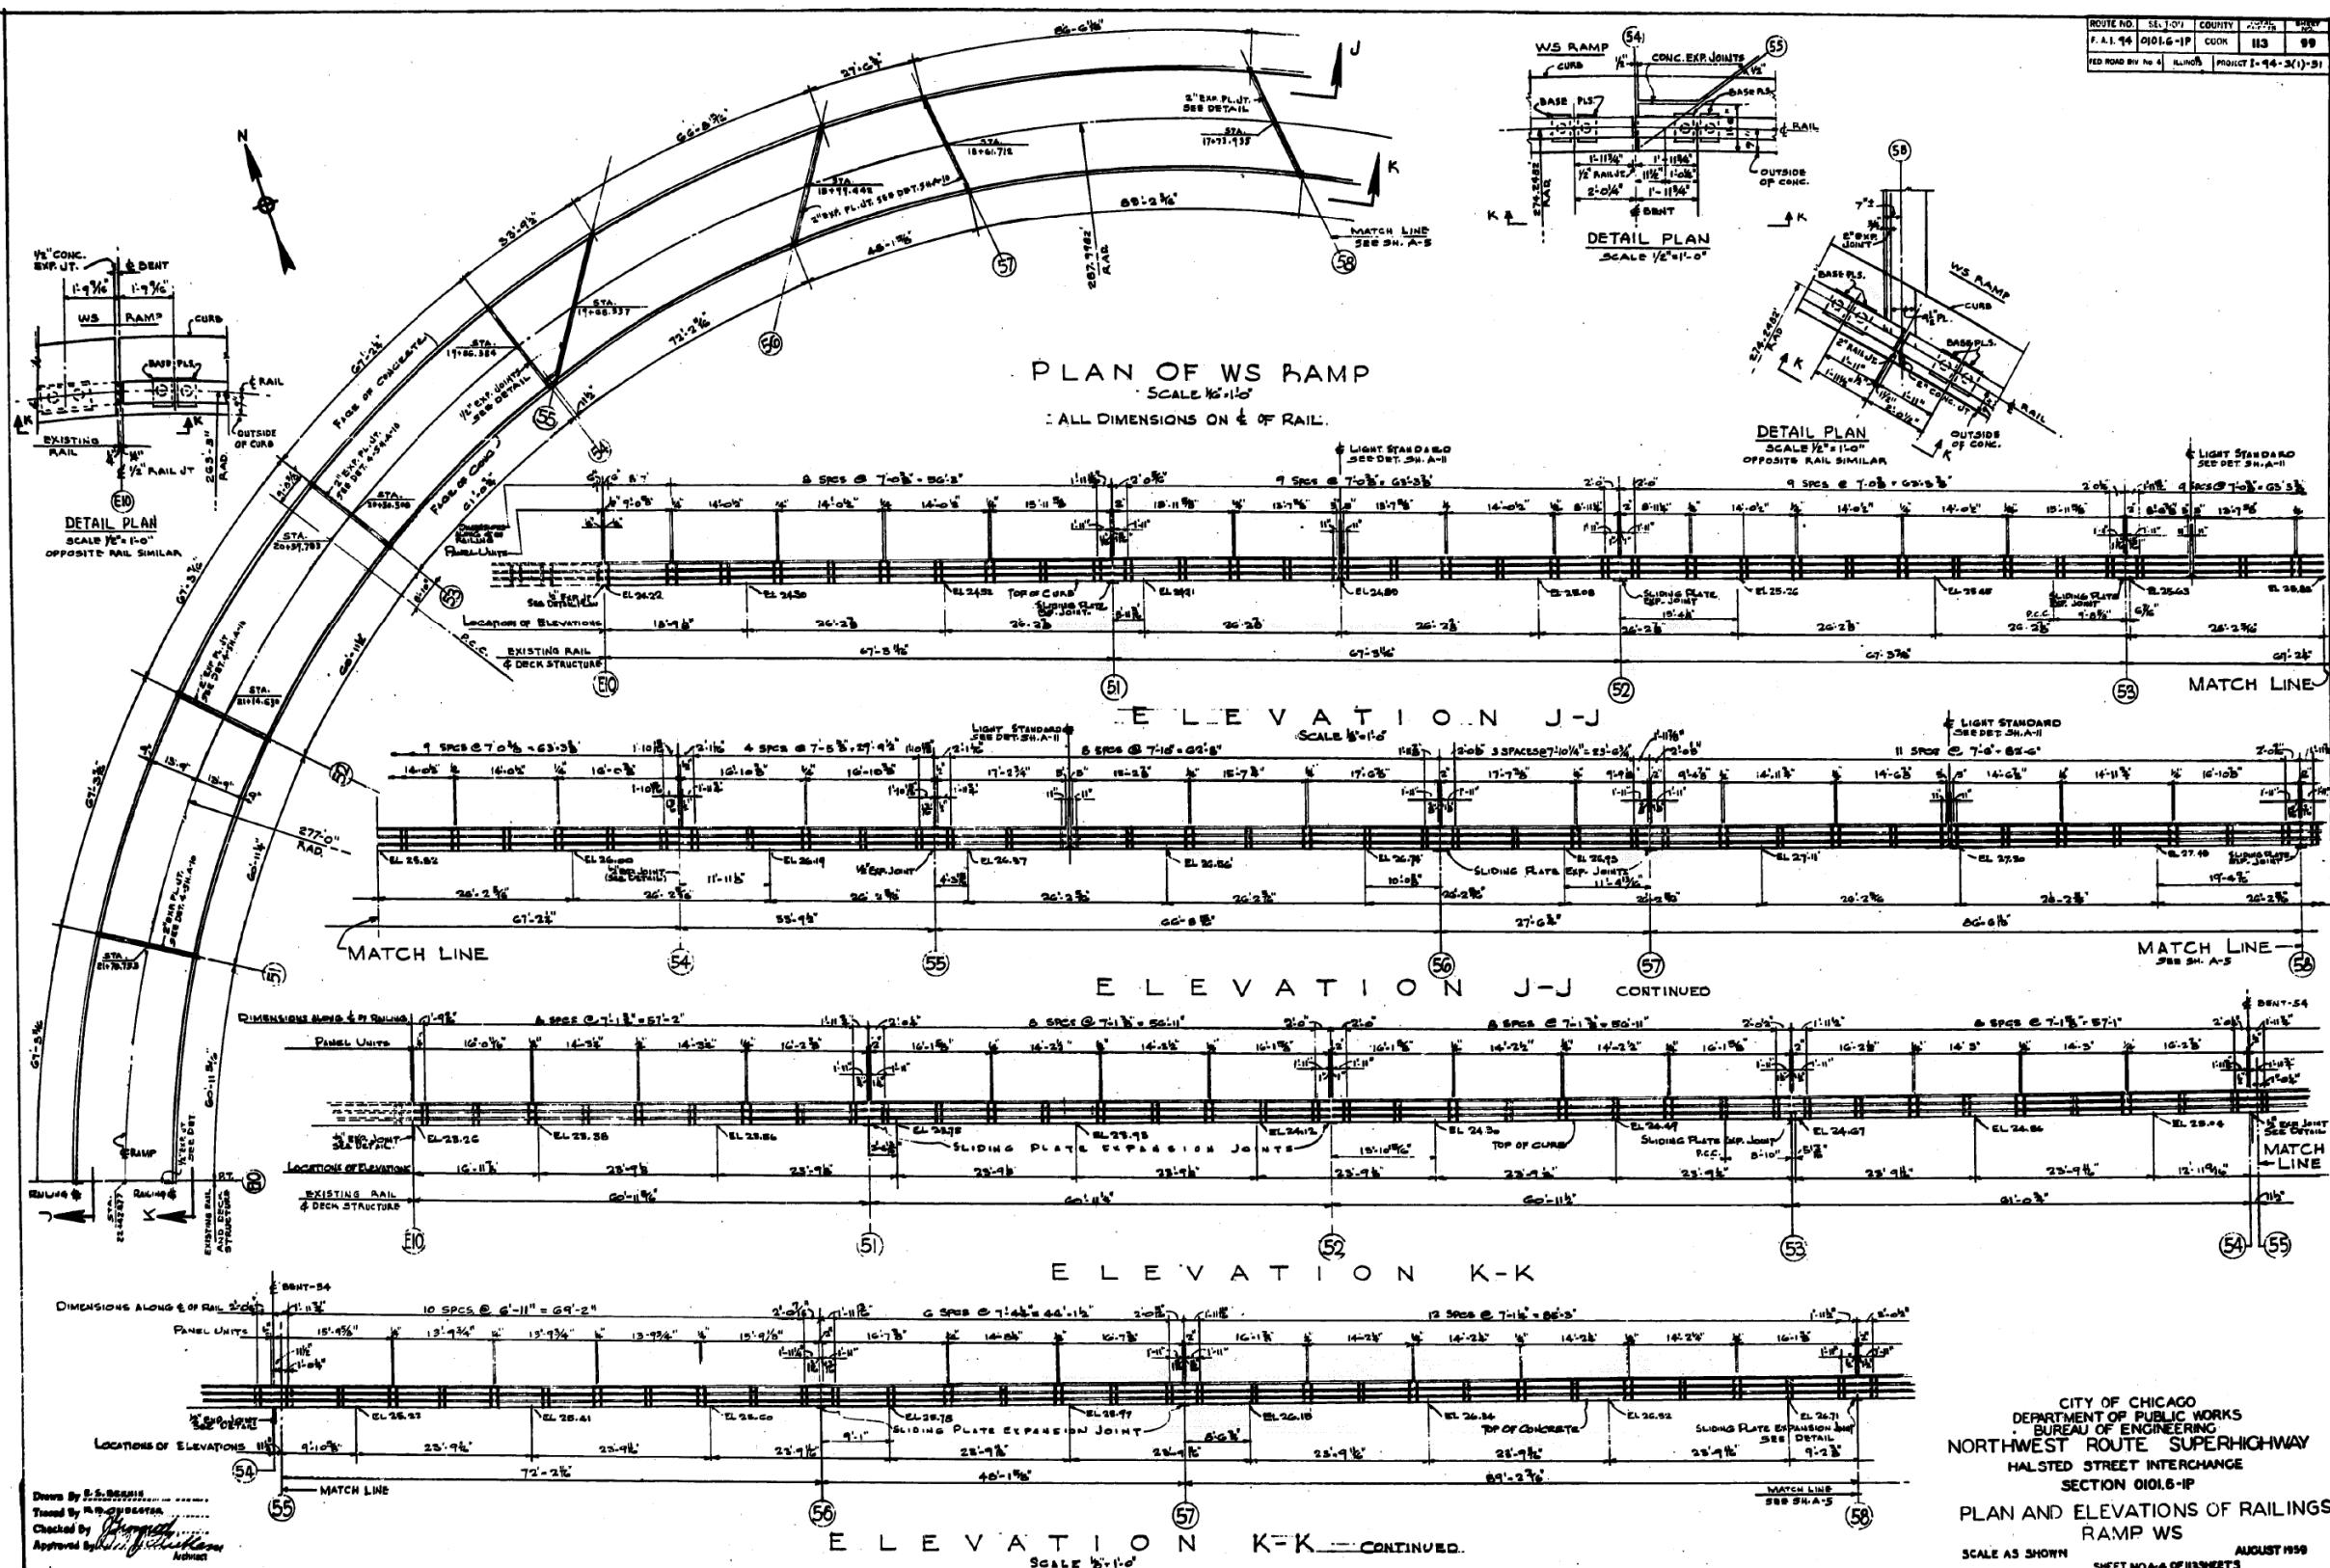

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ENGINEERING GROUP, LLC

USER NAME	= ahmad,issa	DESIGNED -	REVISED
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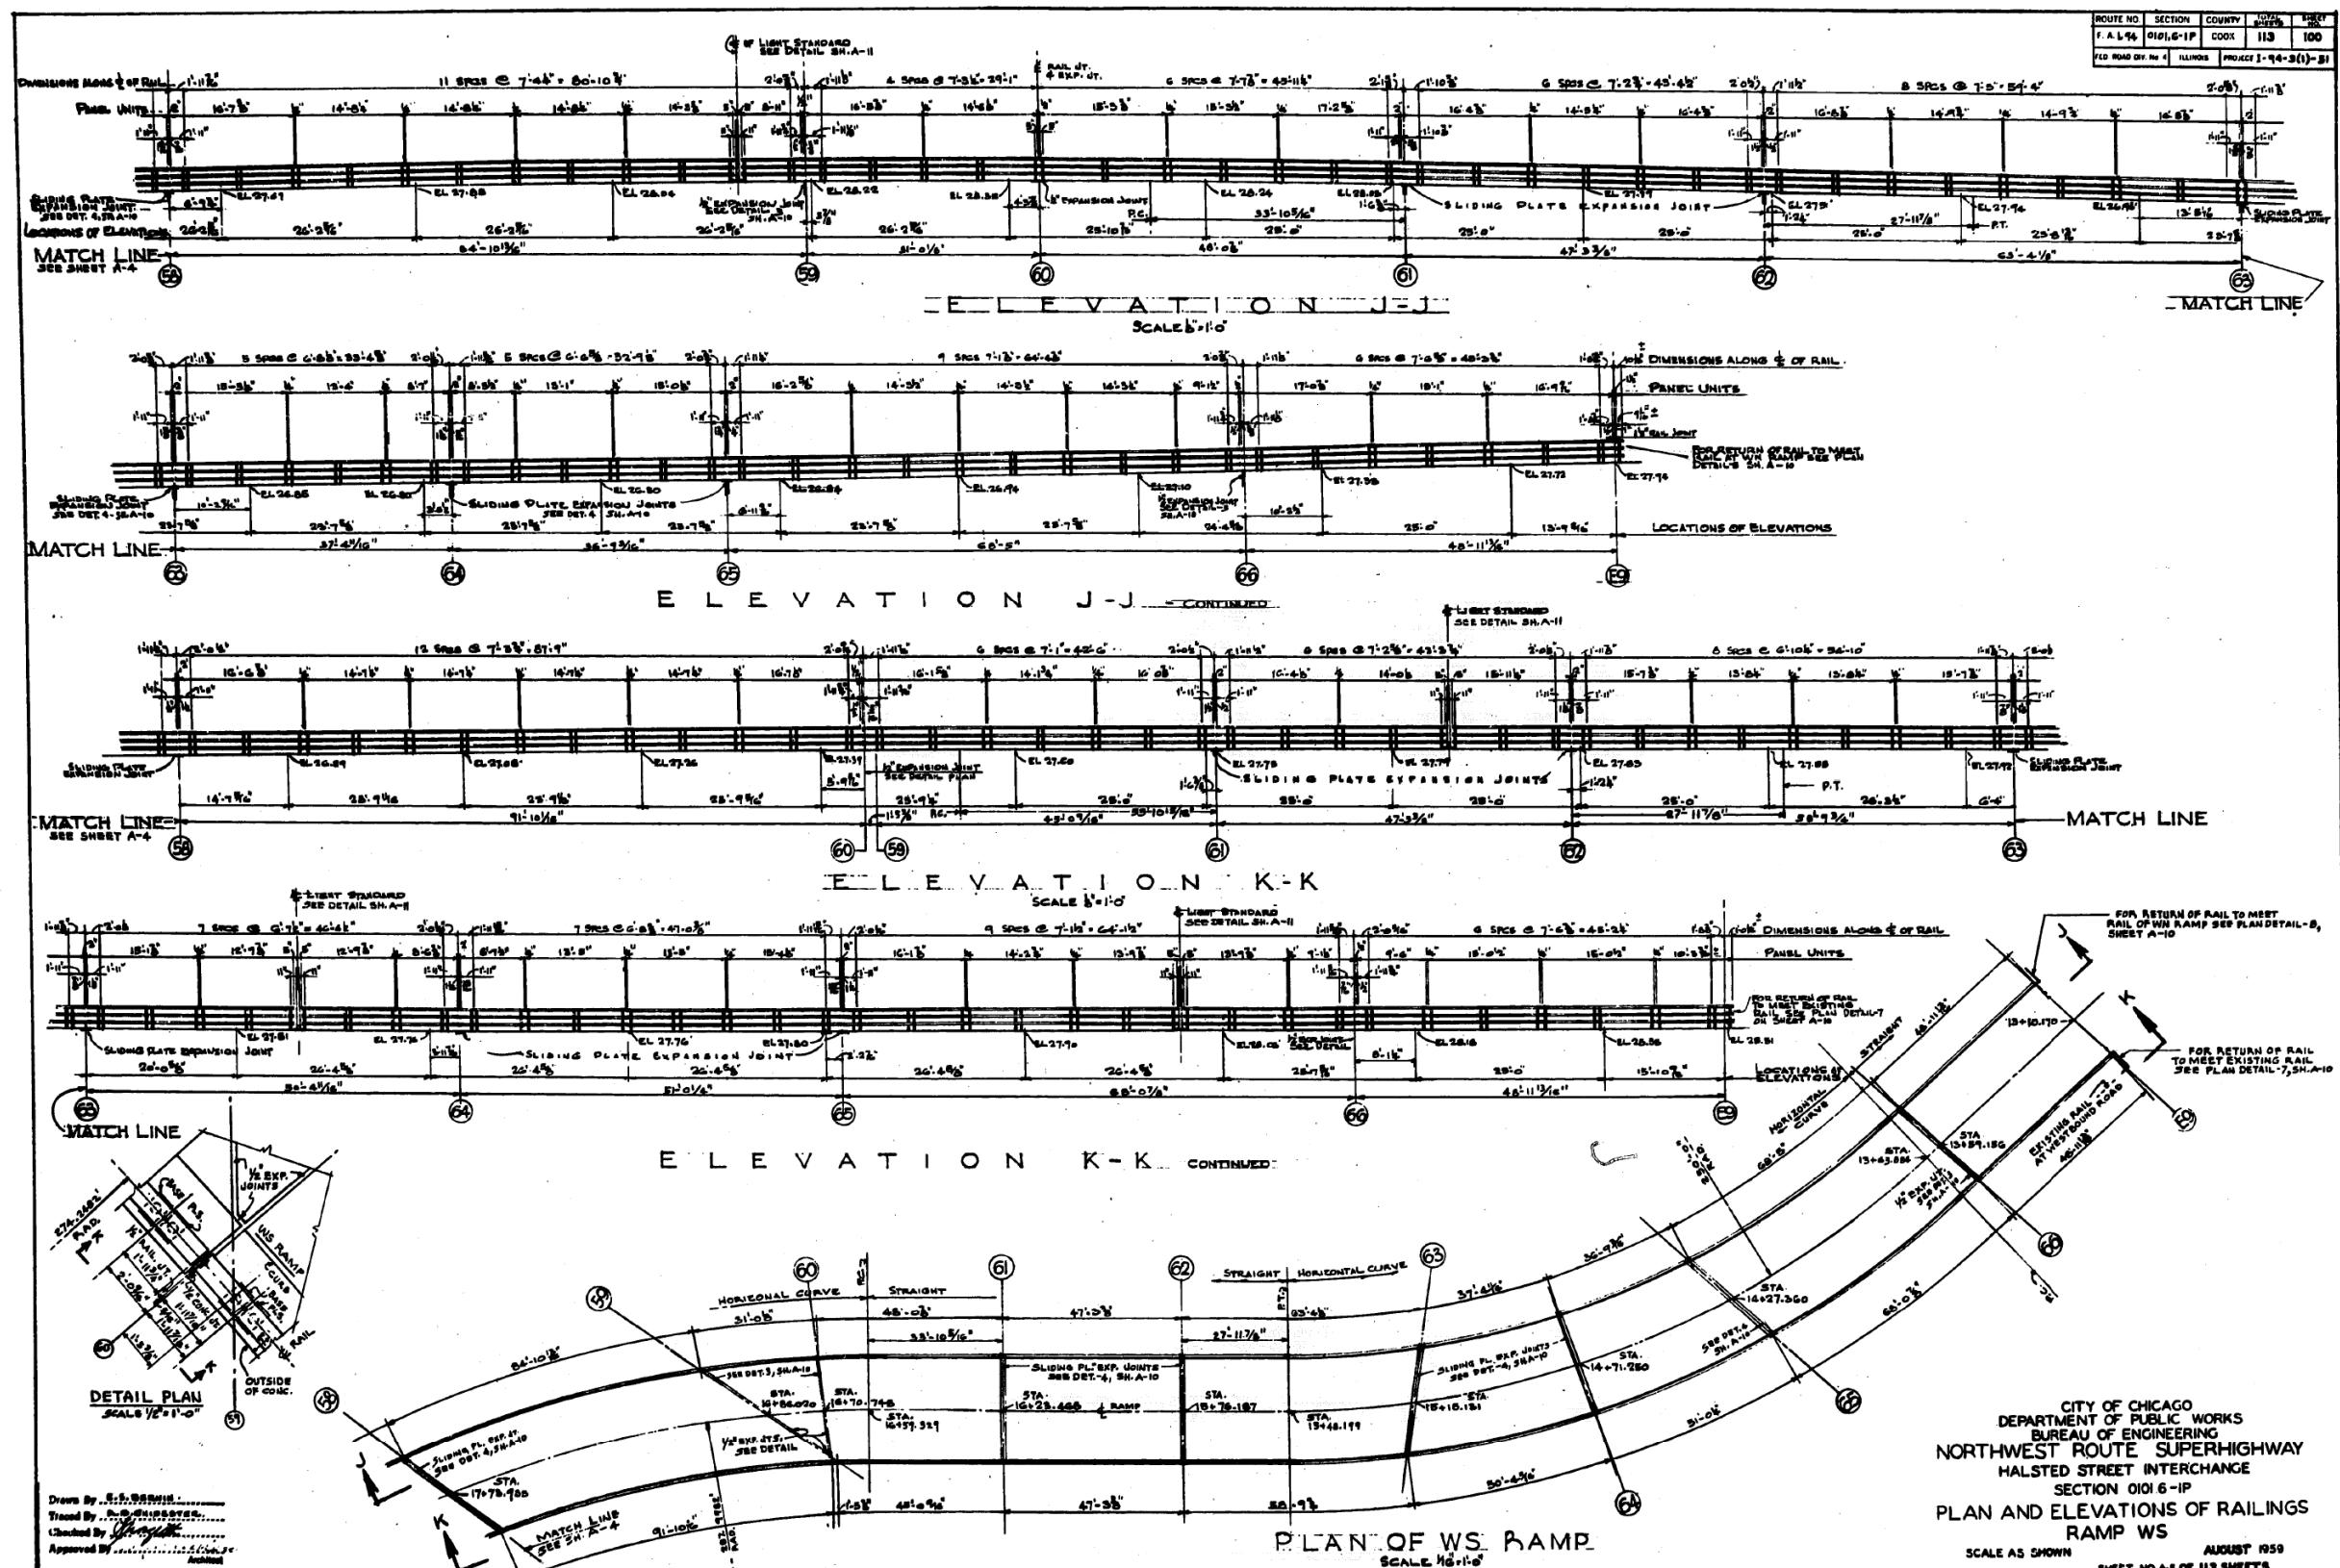
STATE OF ILLINOIS
DEPARTMENT OF TRANSPORTATION

EXISTING RECORD DRAWINGS

F.A.I. RTE.	SECTION	COUNTY	TOTAL SHEETS	SHEET NO.
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		ILLINOIS	FED. AID PROJECT	

FOR INFORMATION ONLY

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STATE OF ILLINOIS
DEPARTMENT OF TRANSPORTATION


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ROUTE NO.	SECTION	COUNTY	TOTAL MILEAGE	BIGEY NO.
F. A. L-44	0101.6-1P	COOK	113	100
FED. ROAD DIV. No 4	ILLINOIS	PROJECT I-94-3(1)-51		

	F.A.I. RTE.	SECTION	COUNTY	TOTAL SHEETS	HEET NO.
	90/94/290	2014-013R&B-R	COOK	1972	1965
				CONTRACT NO. 60X93	
		ILLINOIS	FED. AID PROJECT		

FOR INFORMATION ONLY

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Drawn By ... H. S. BERNIN
Traced By ... J. J. WOLF
Checked By ... *[Signature]*
Approved By ... *[Signature]*


STATE OF ILLINOIS
DEPARTMENT OF TRANSPORTATION

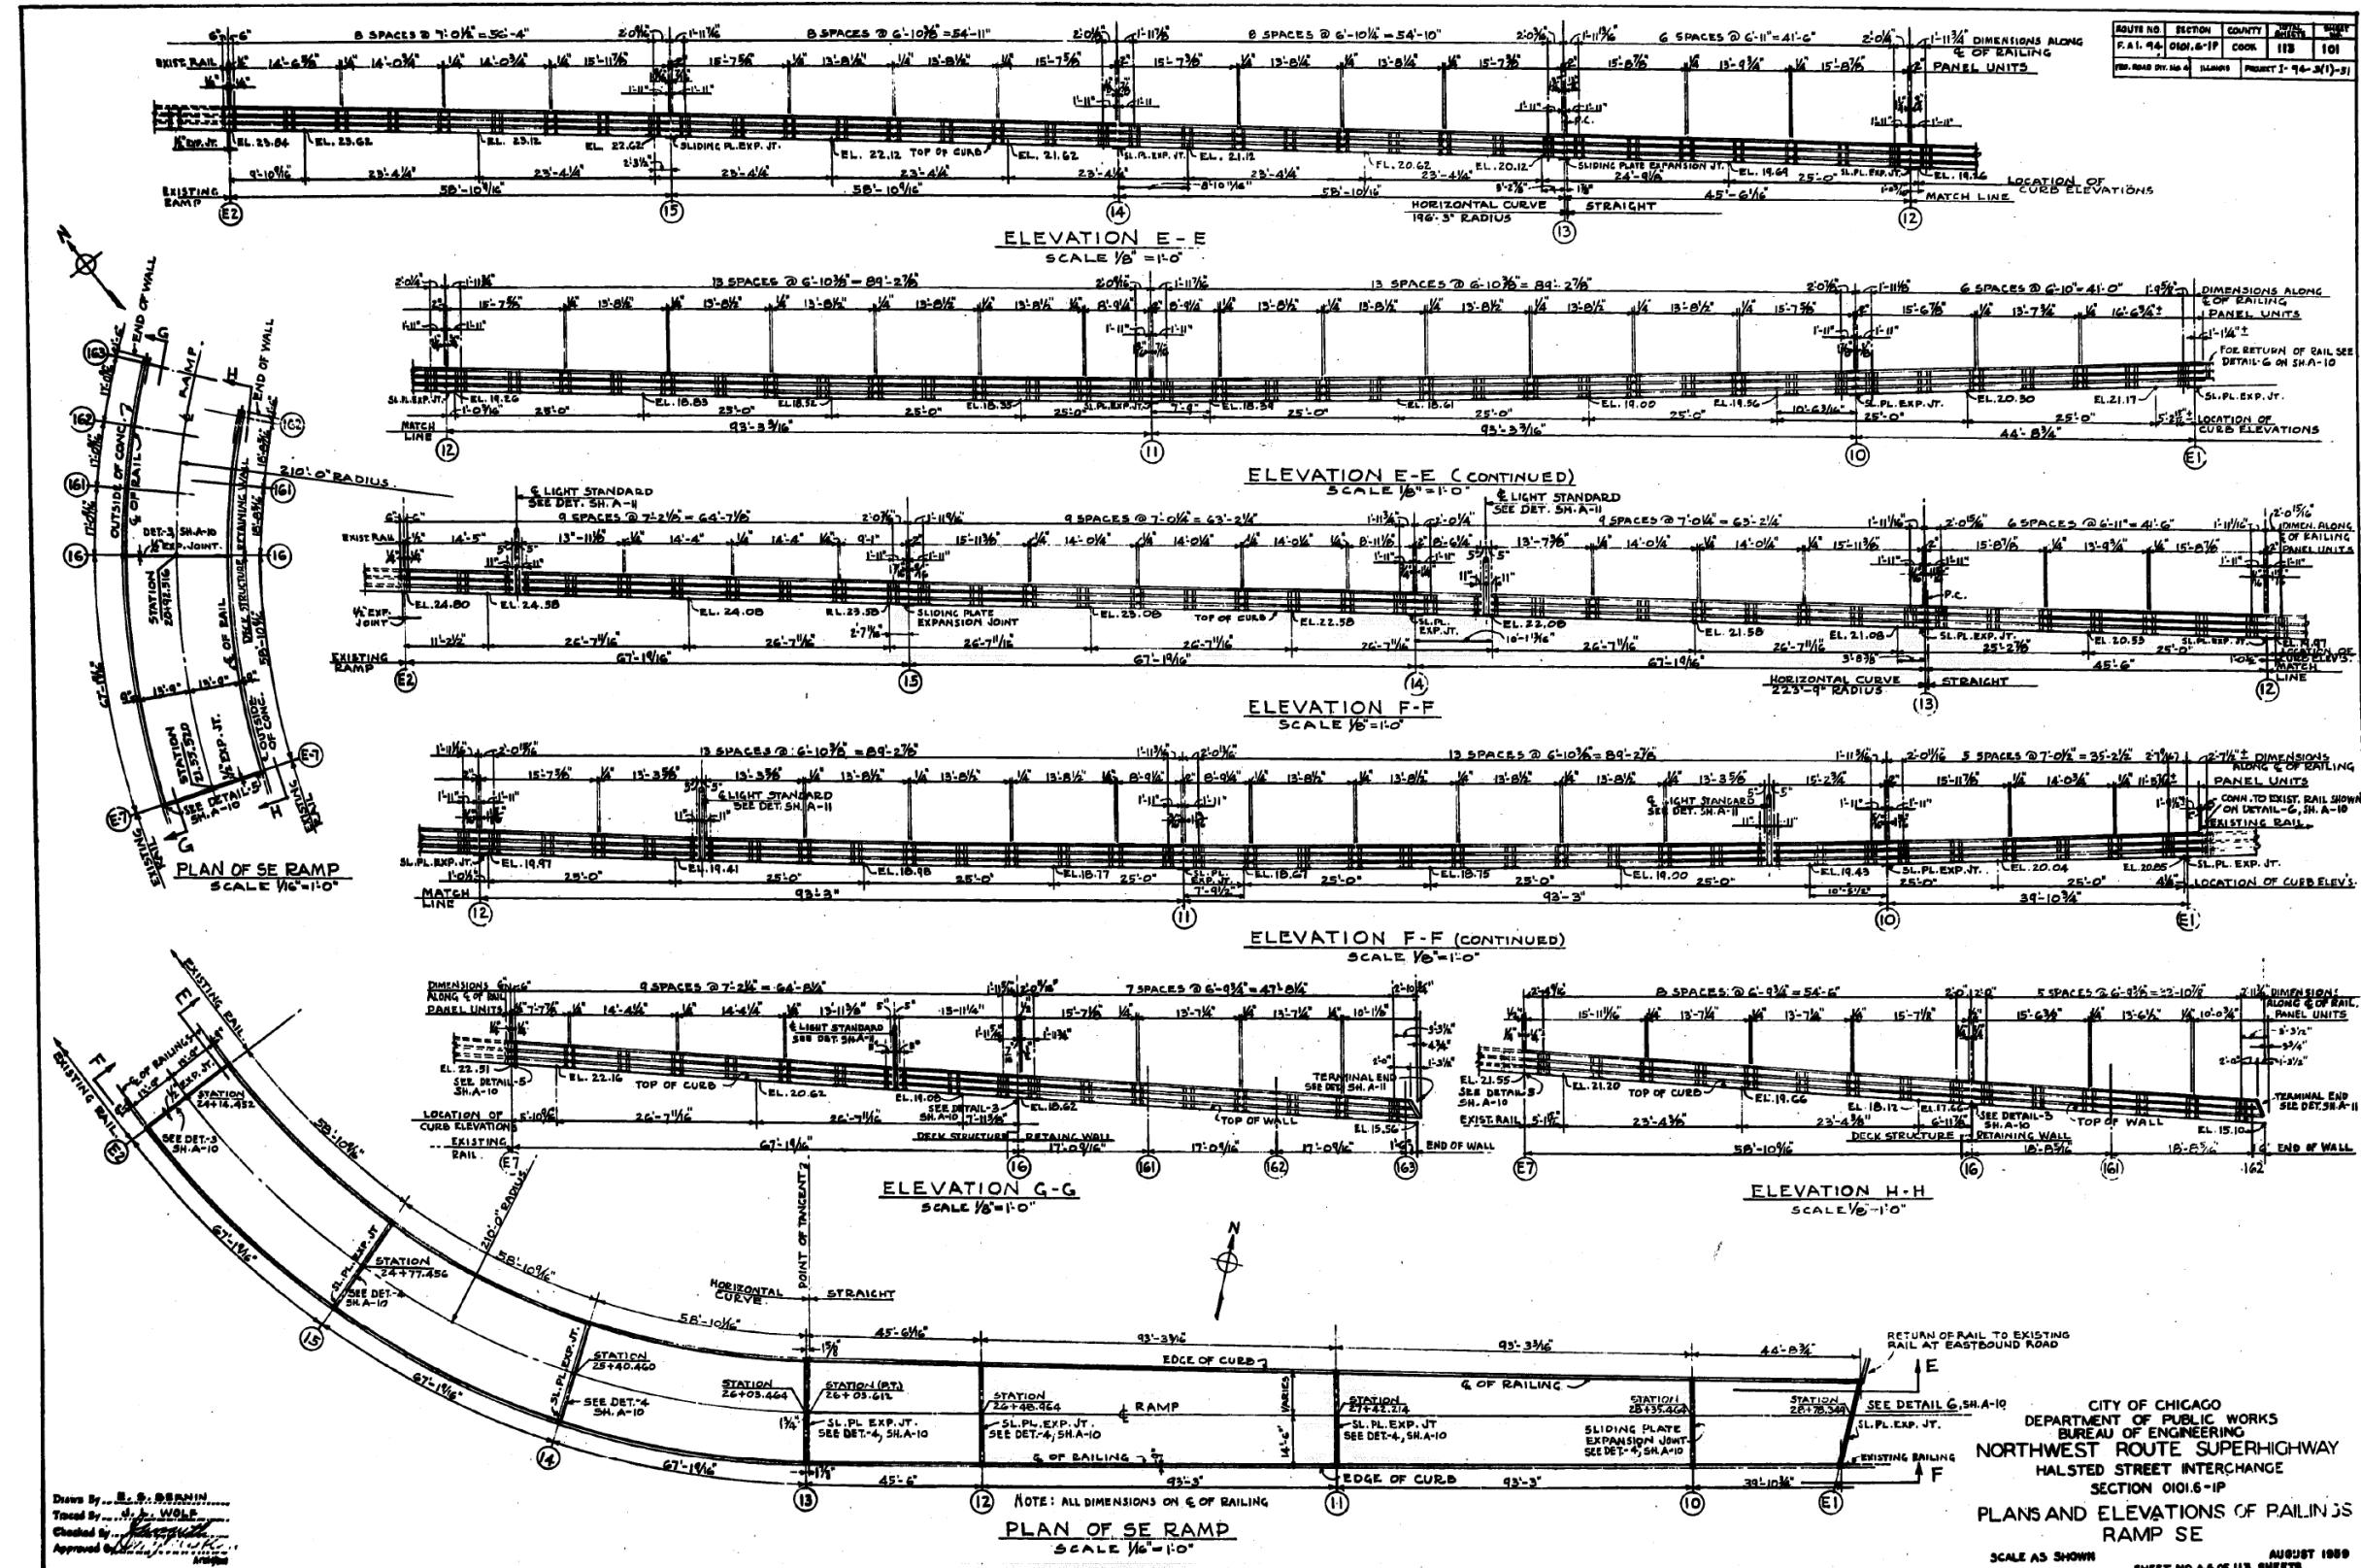EXISTING RECORD DRAWINGS

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1. 94	0101.6-IP	COOK	113	101
ROAD SUR. NO. 4	ILLINOIS	PROJECT I- 94-3(1)-5		

S	F.A.I. RTE.	SECTION	COUNTY	TOTAL SHEETS	SHEET NO.
	90/94/290	2014-013R&B-R	COOK	1972	1966
	CONTRACT NO. 60X93				

FOR INFORMATION ONLY

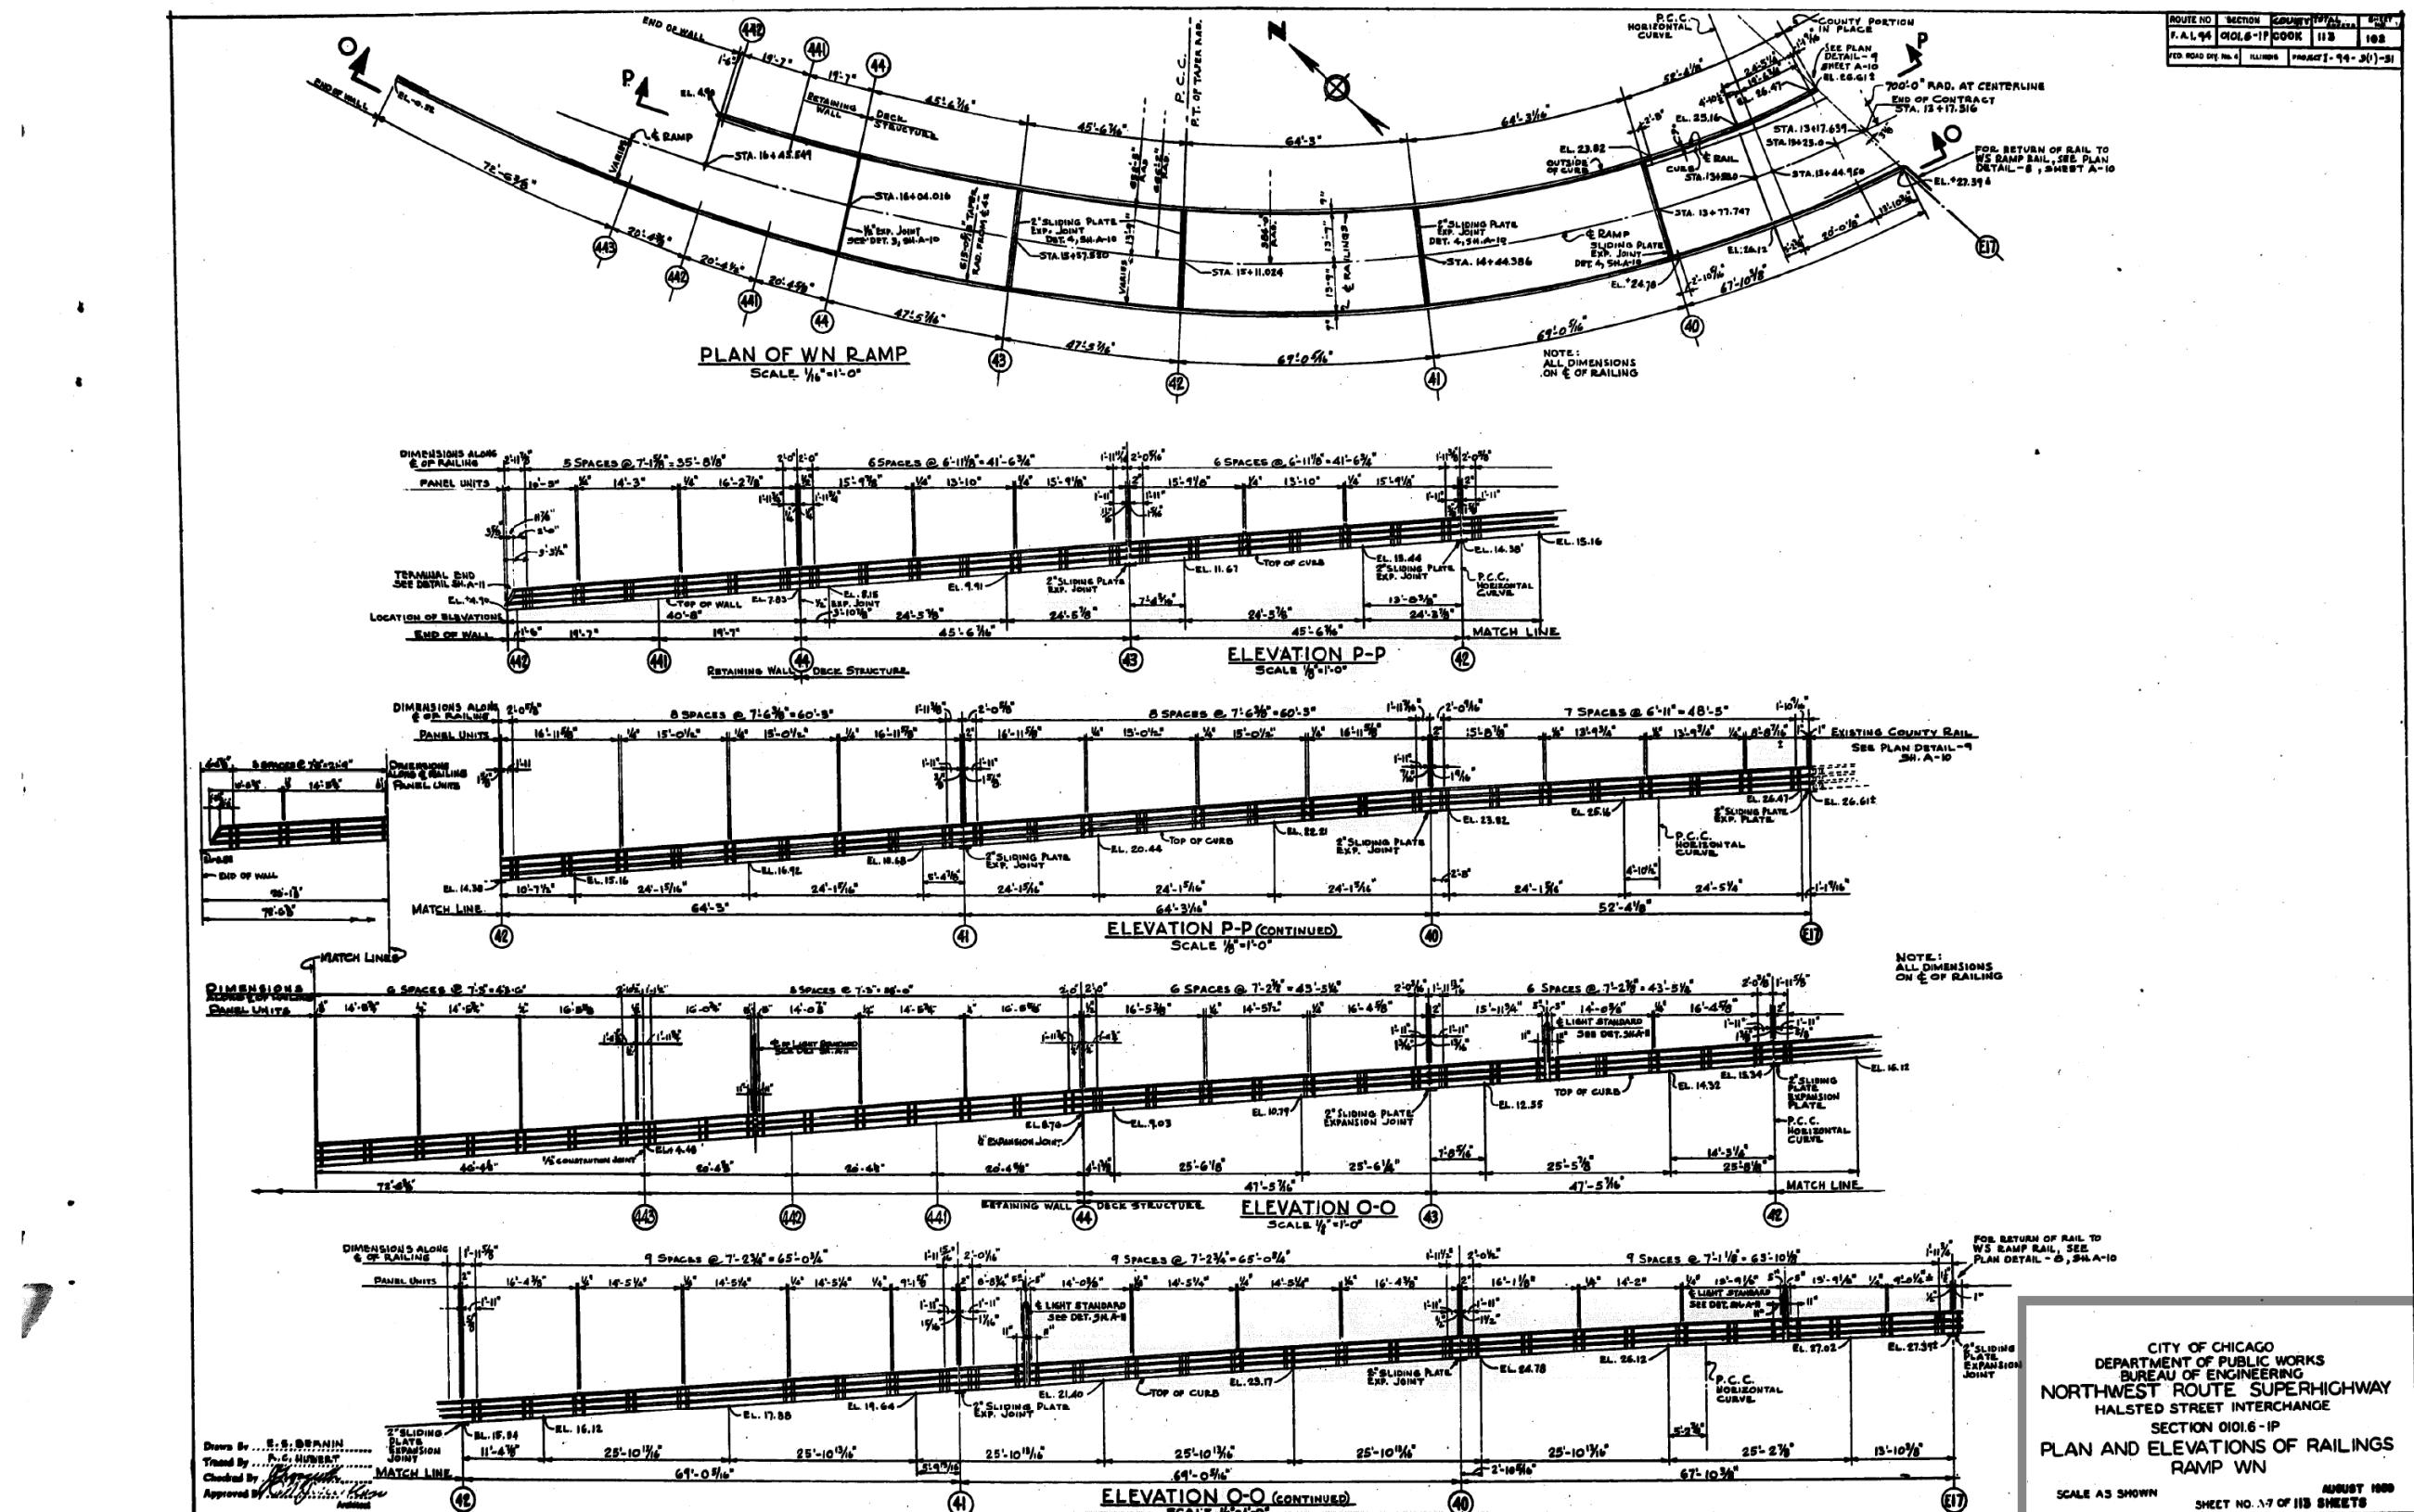

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ENGINEERING GROUP, LLC


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PLOT SCALE	= N.T.S	DRAWN -	REVISED
PLOT DATE	= 7/26/2018	CHECKED - MI, MAI	REVISED

**STATE OF ILLINOIS
DEPARTMENT OF TRANSPORTATION**

EXISTING RECORD DRAWINGS

F.A.I. RTE.	SECTION	COUNTY	TOTAL SHEETS	HEET NO.
90/94/290	2014-013R&B-R	COOK	1972	1967
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	ILLINOIS	FED. AID PROJECT		

FOR INFORMATION ONLY

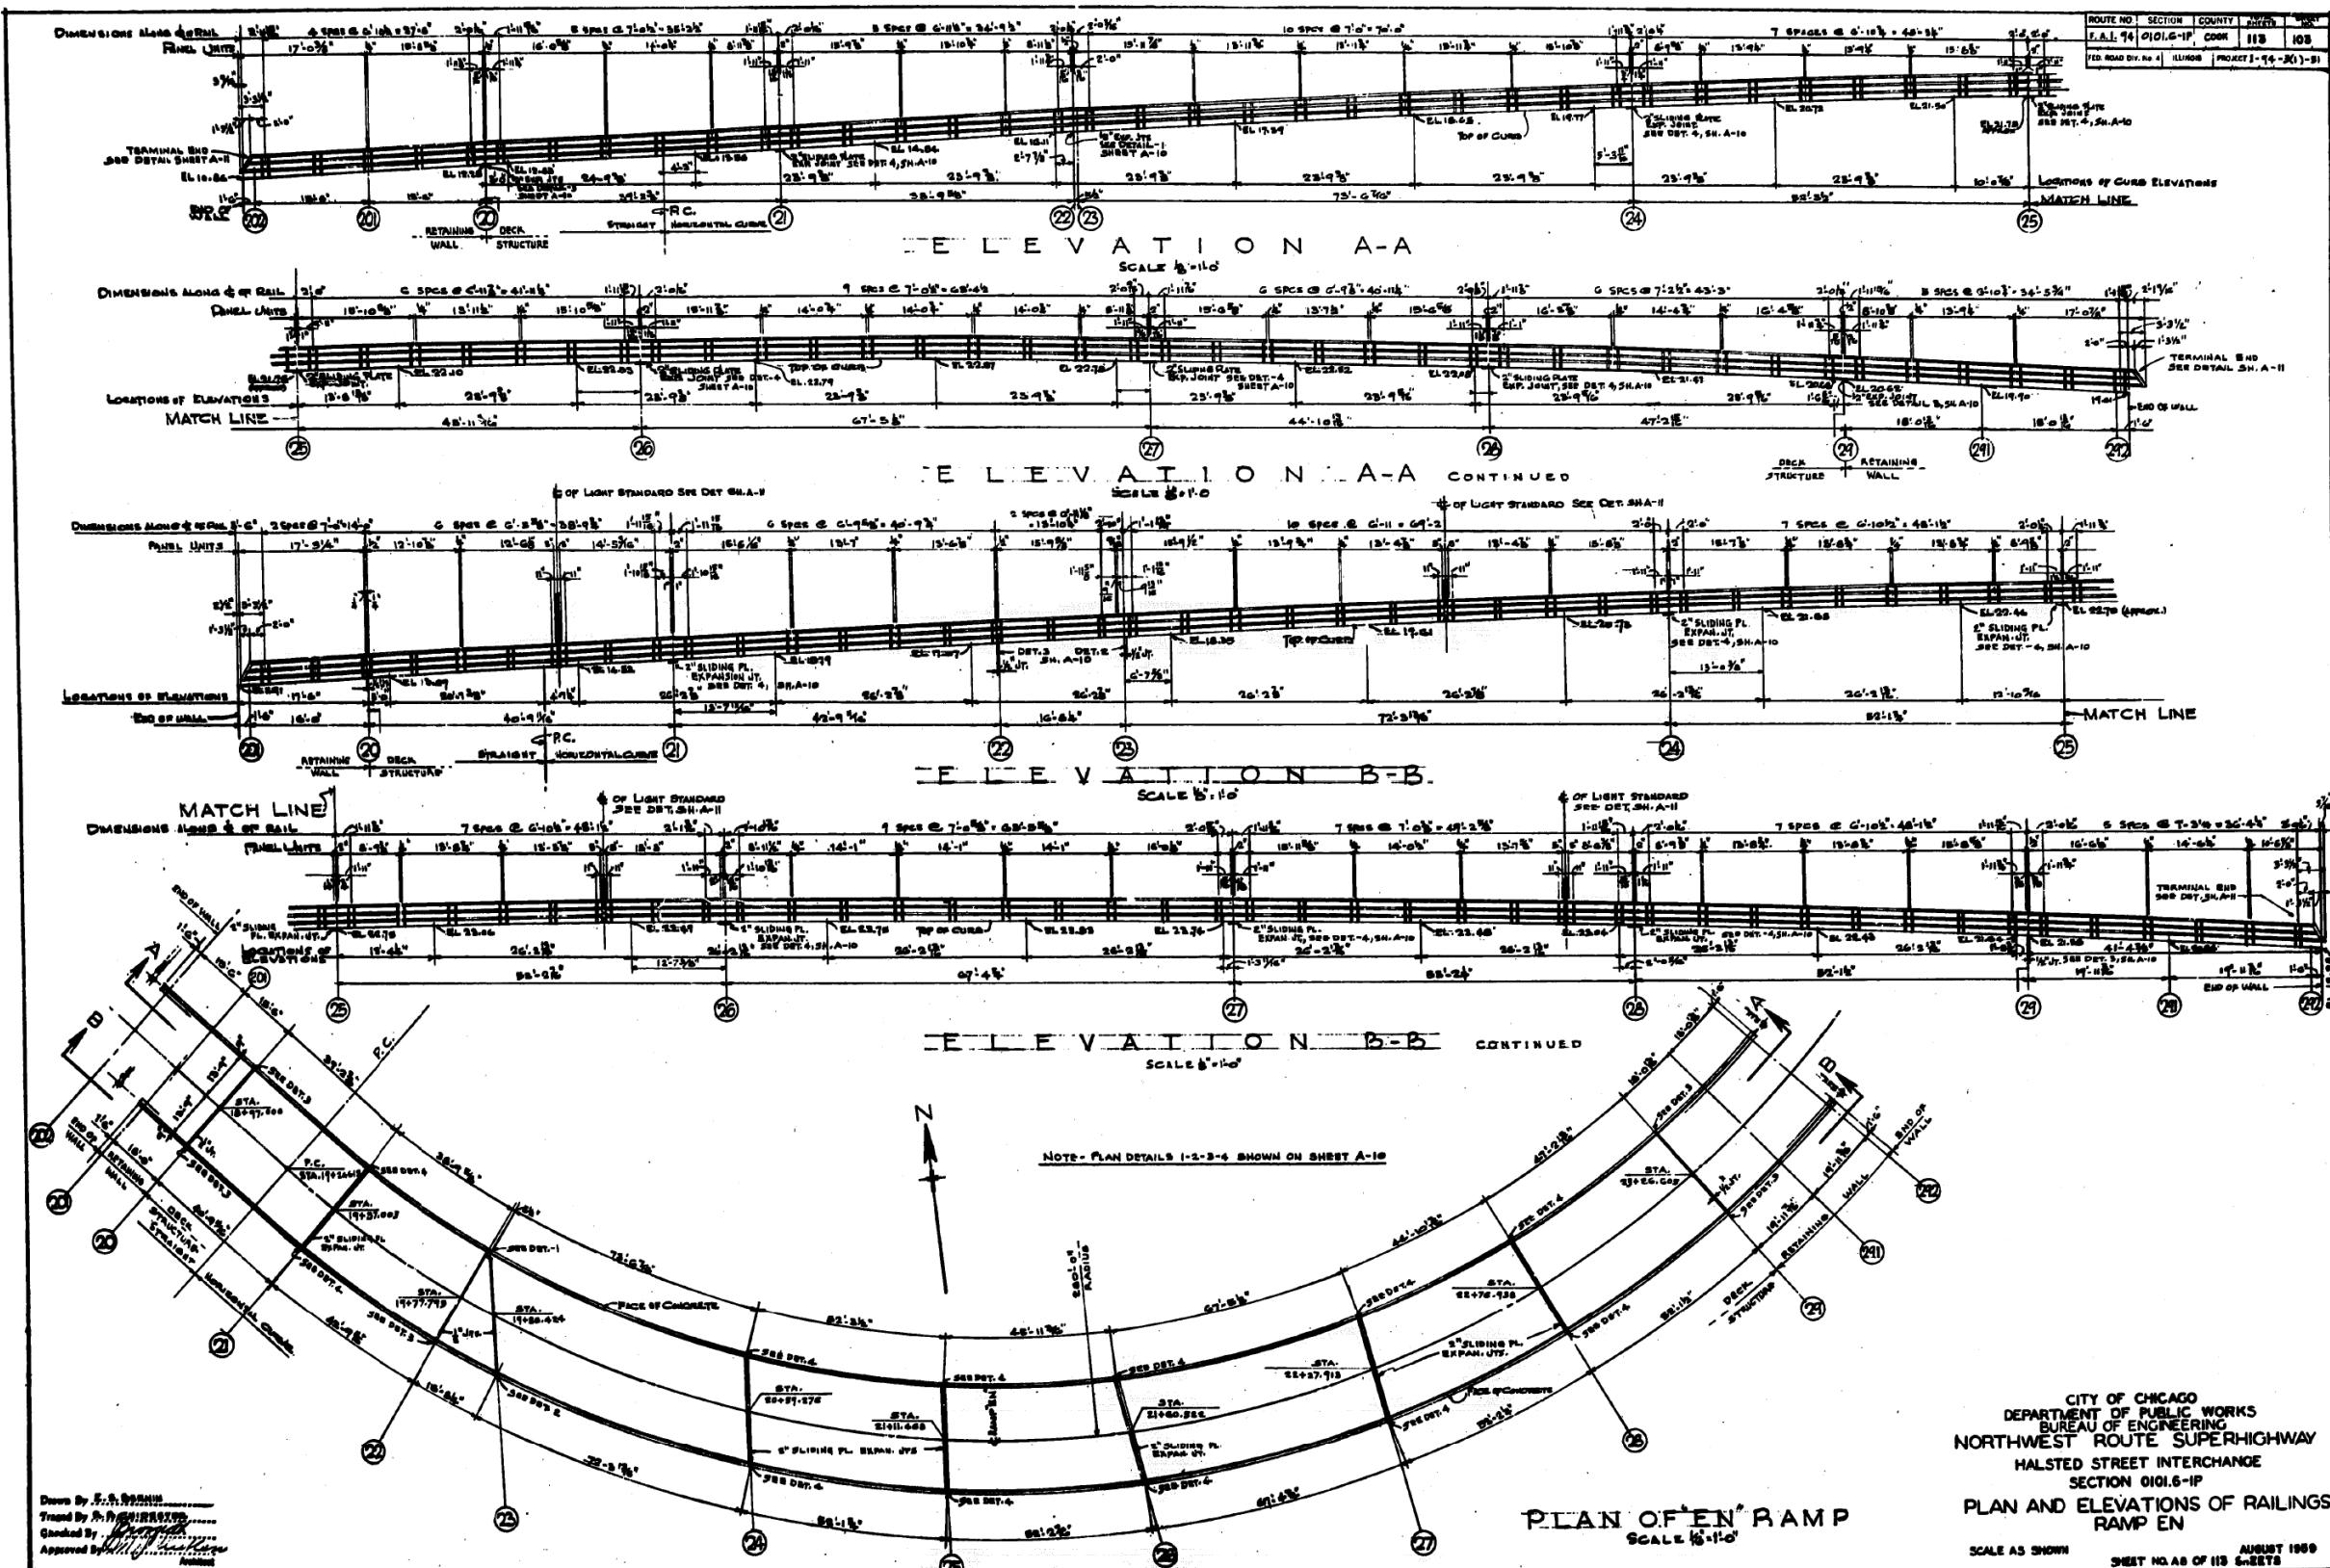


STATE OF ILLINOIS
DEPARTMENT OF TRANSPORTATION

EXISTING RECORD DRAWINGS

ROUTE NO.	SECTION	COUNTY	TYPE MARKERS	NAME
F.A.I. 94	0101.G-IP	COOK	113	103

F.A.I. RTE.	SECTION		COUNTY	TOTAL SHEETS	SHEET NO.
	90/94/290	2014-013R&B-R			
	CONTRACT NO. 60X93				
		ILLINOIS	FED. AID PROJECT		

FOR INFORMATION ONLY

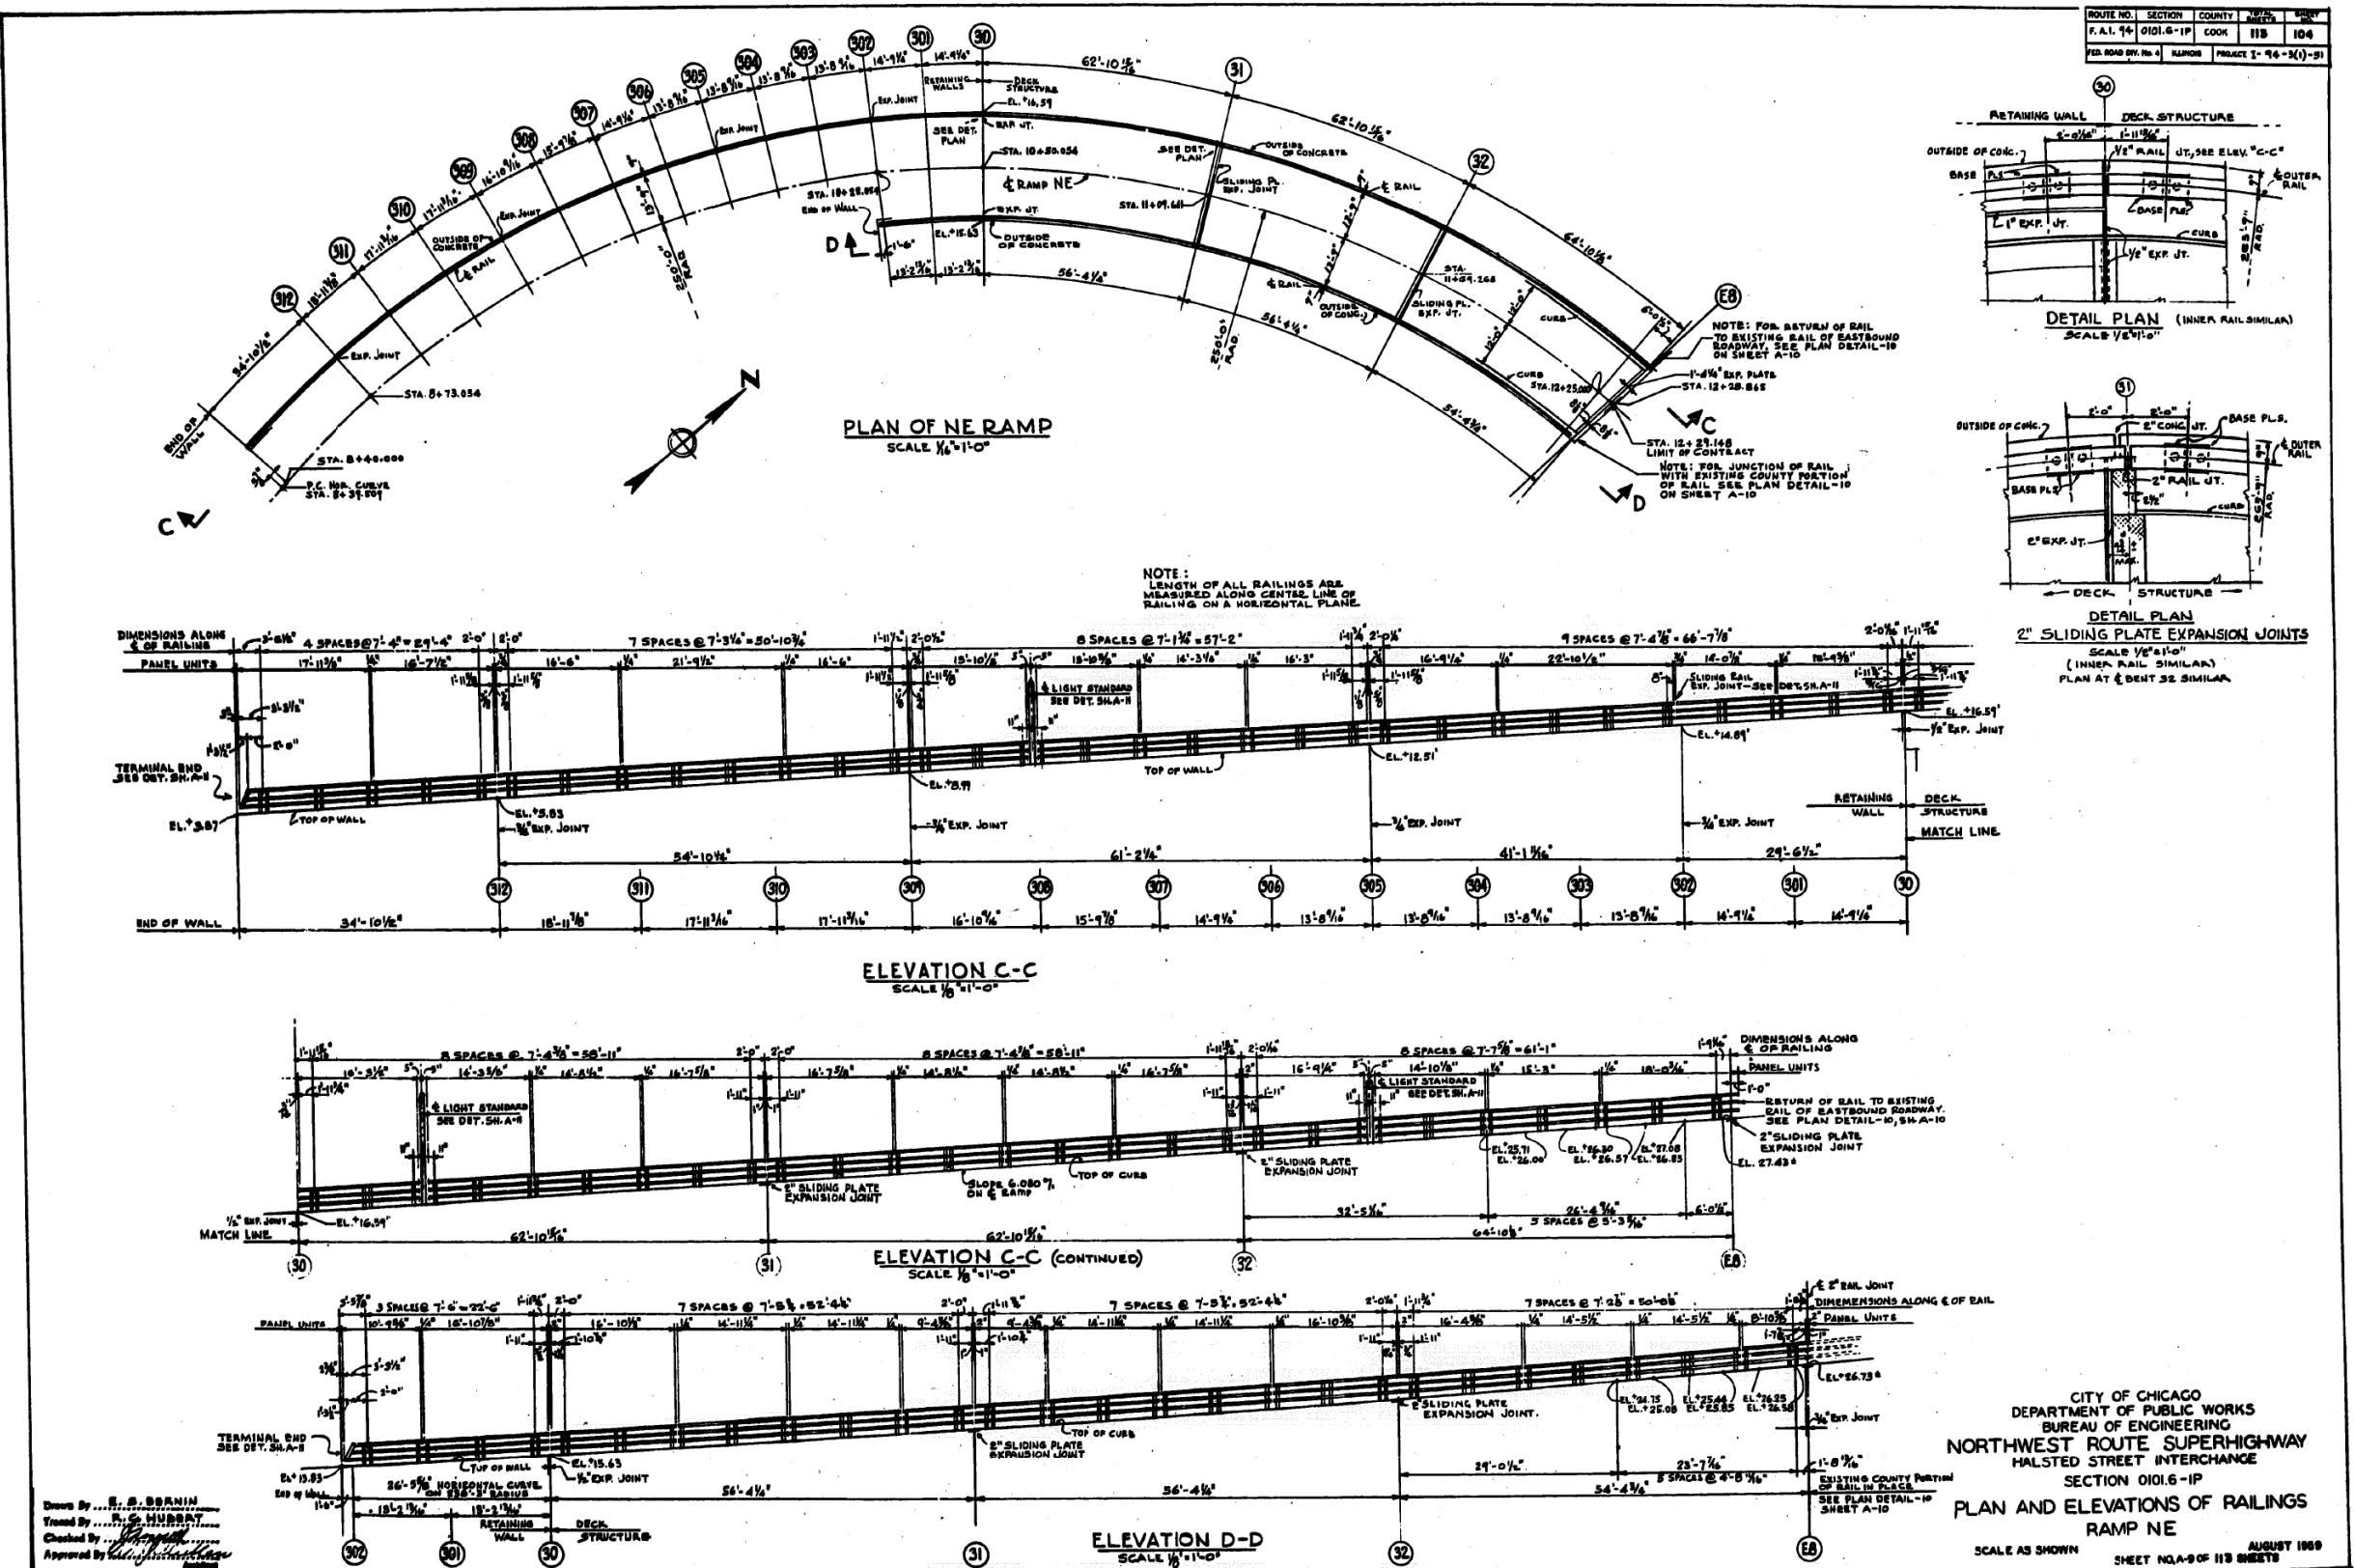

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PLOT SCALE	= N.T.S	DRAWN -	REVISED -
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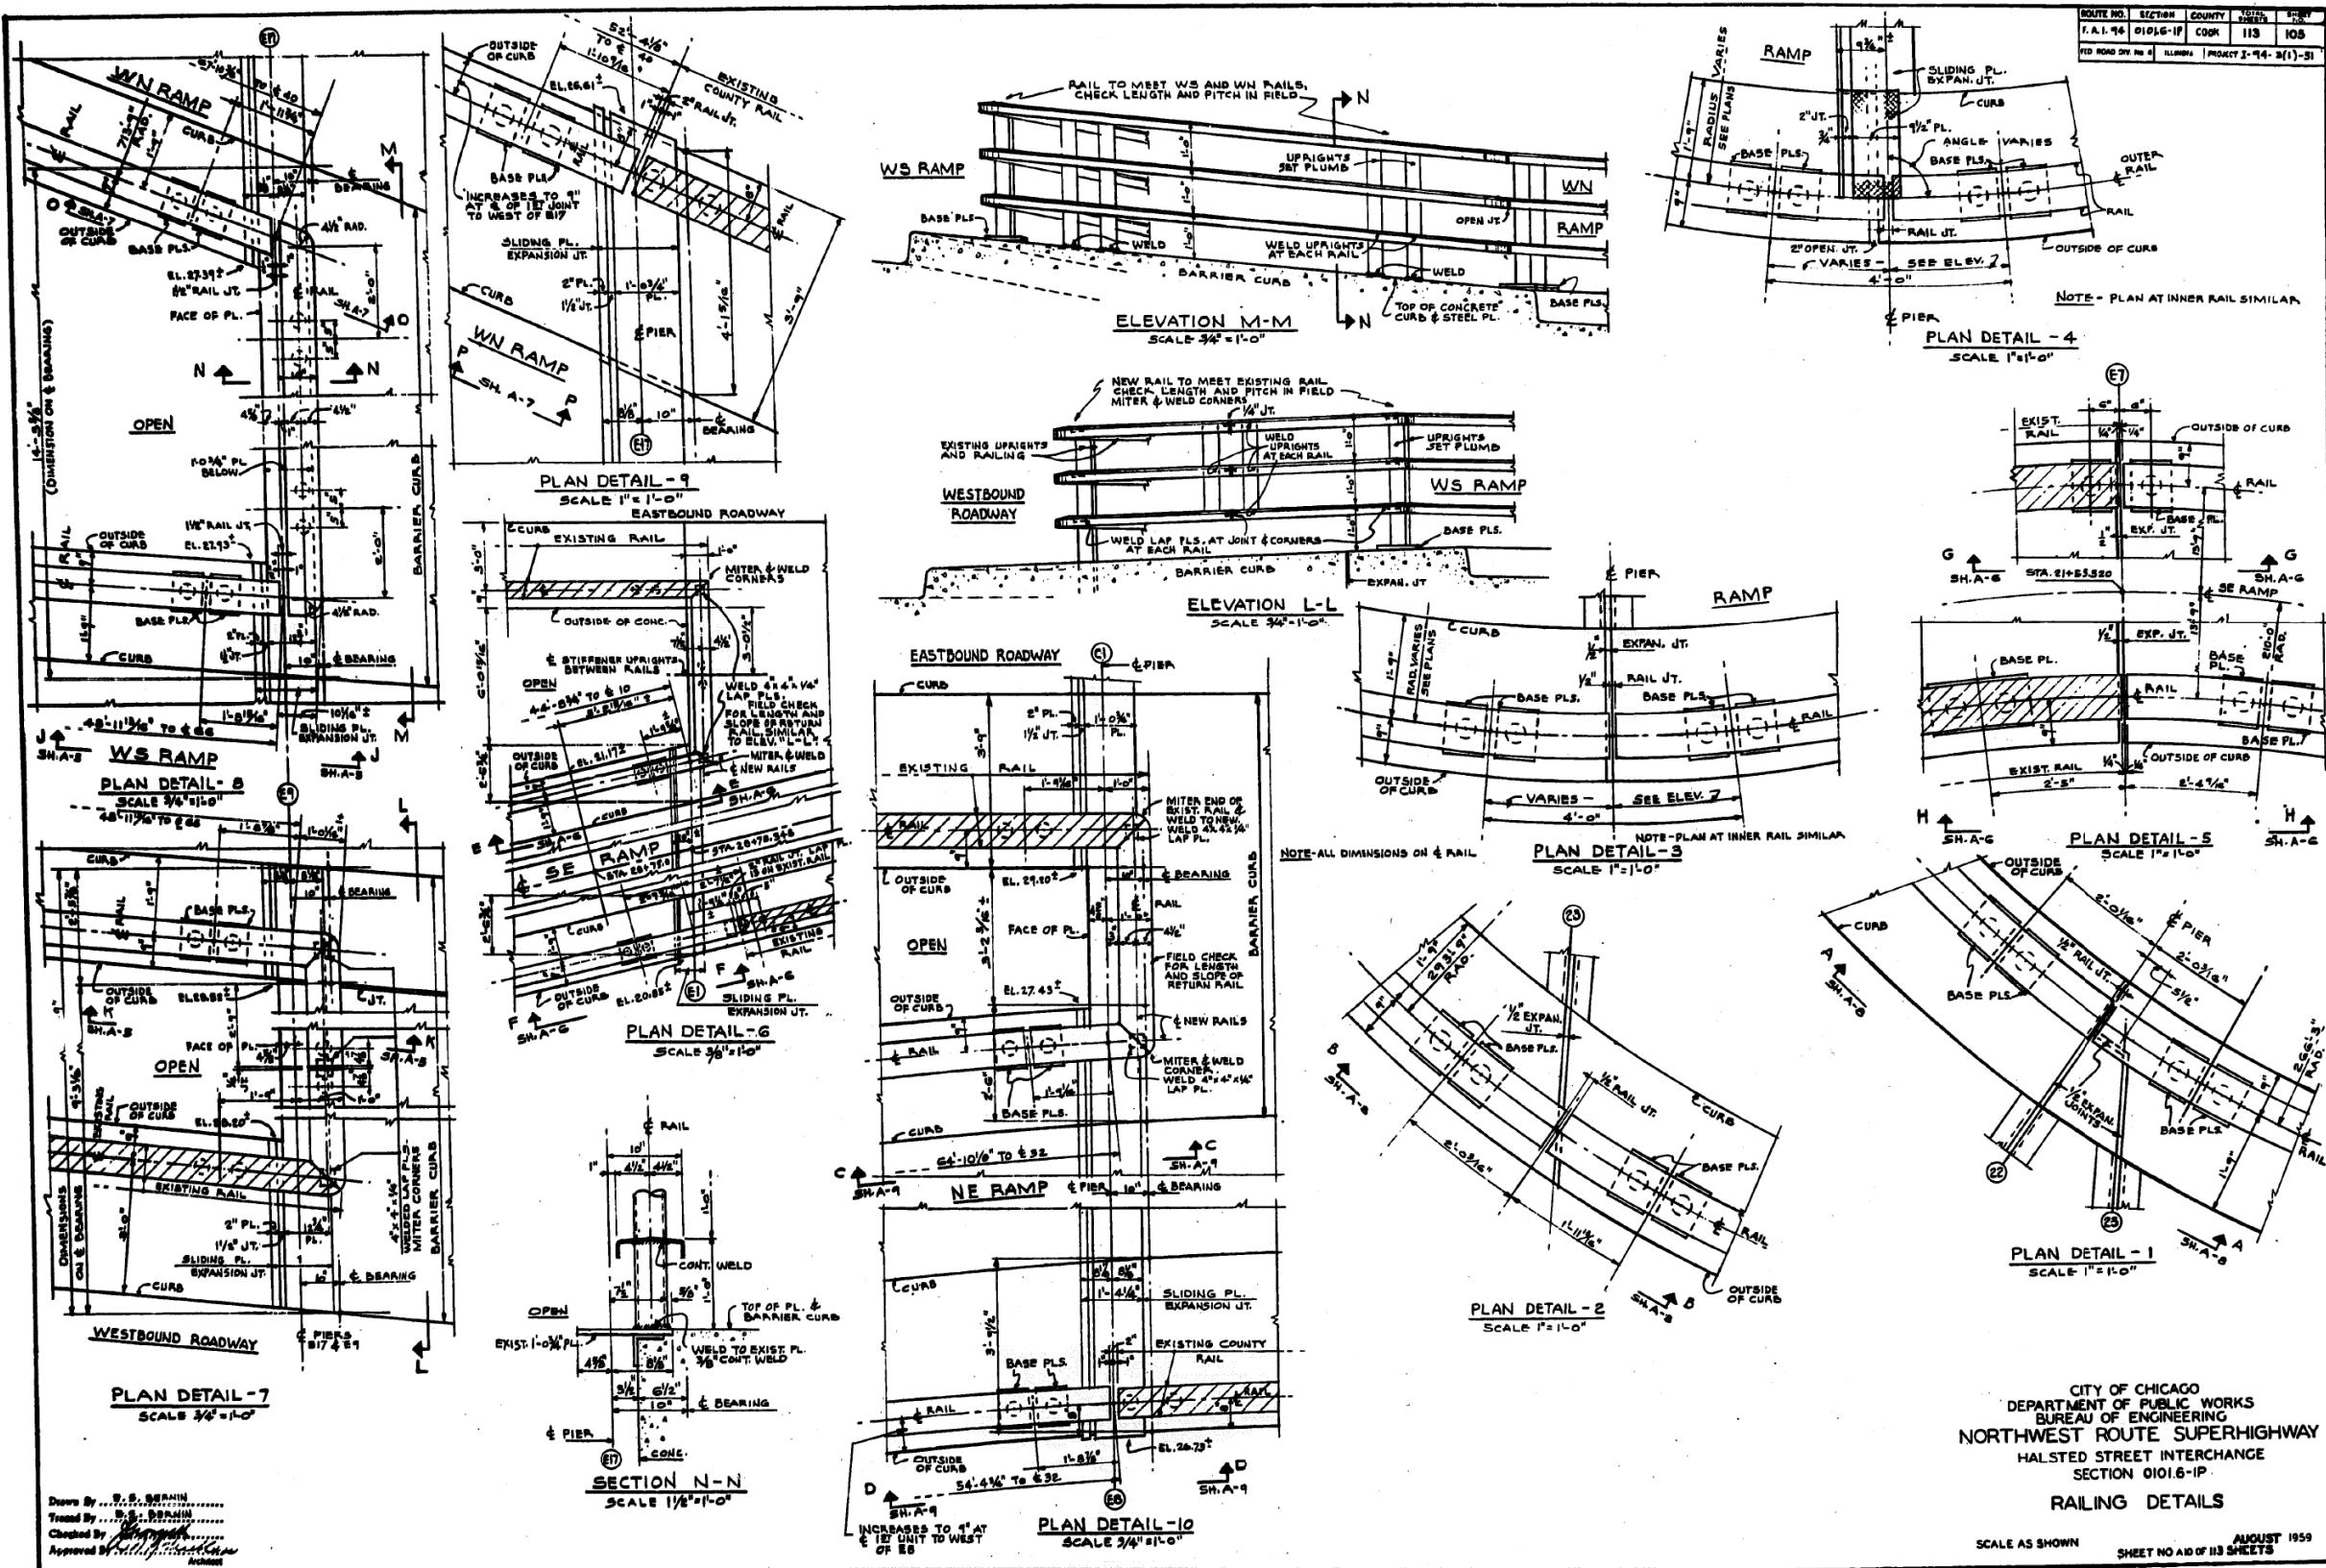
STATE OF ILLINOIS
DEPARTMENT OF TRANSPORTATION

EXISTING RECORD DRAWINGS

F.A.I. RTE.	SECTION	COUNTY	TOTAL SHEETS	HEET NO.
90/94/290	2014-013R&B-R	COOK	1972	1969
			CONTRACT NO. 60X93	
	ILLINOIS	FED. AID PROJECT		

FOR INFORMATION ONLY

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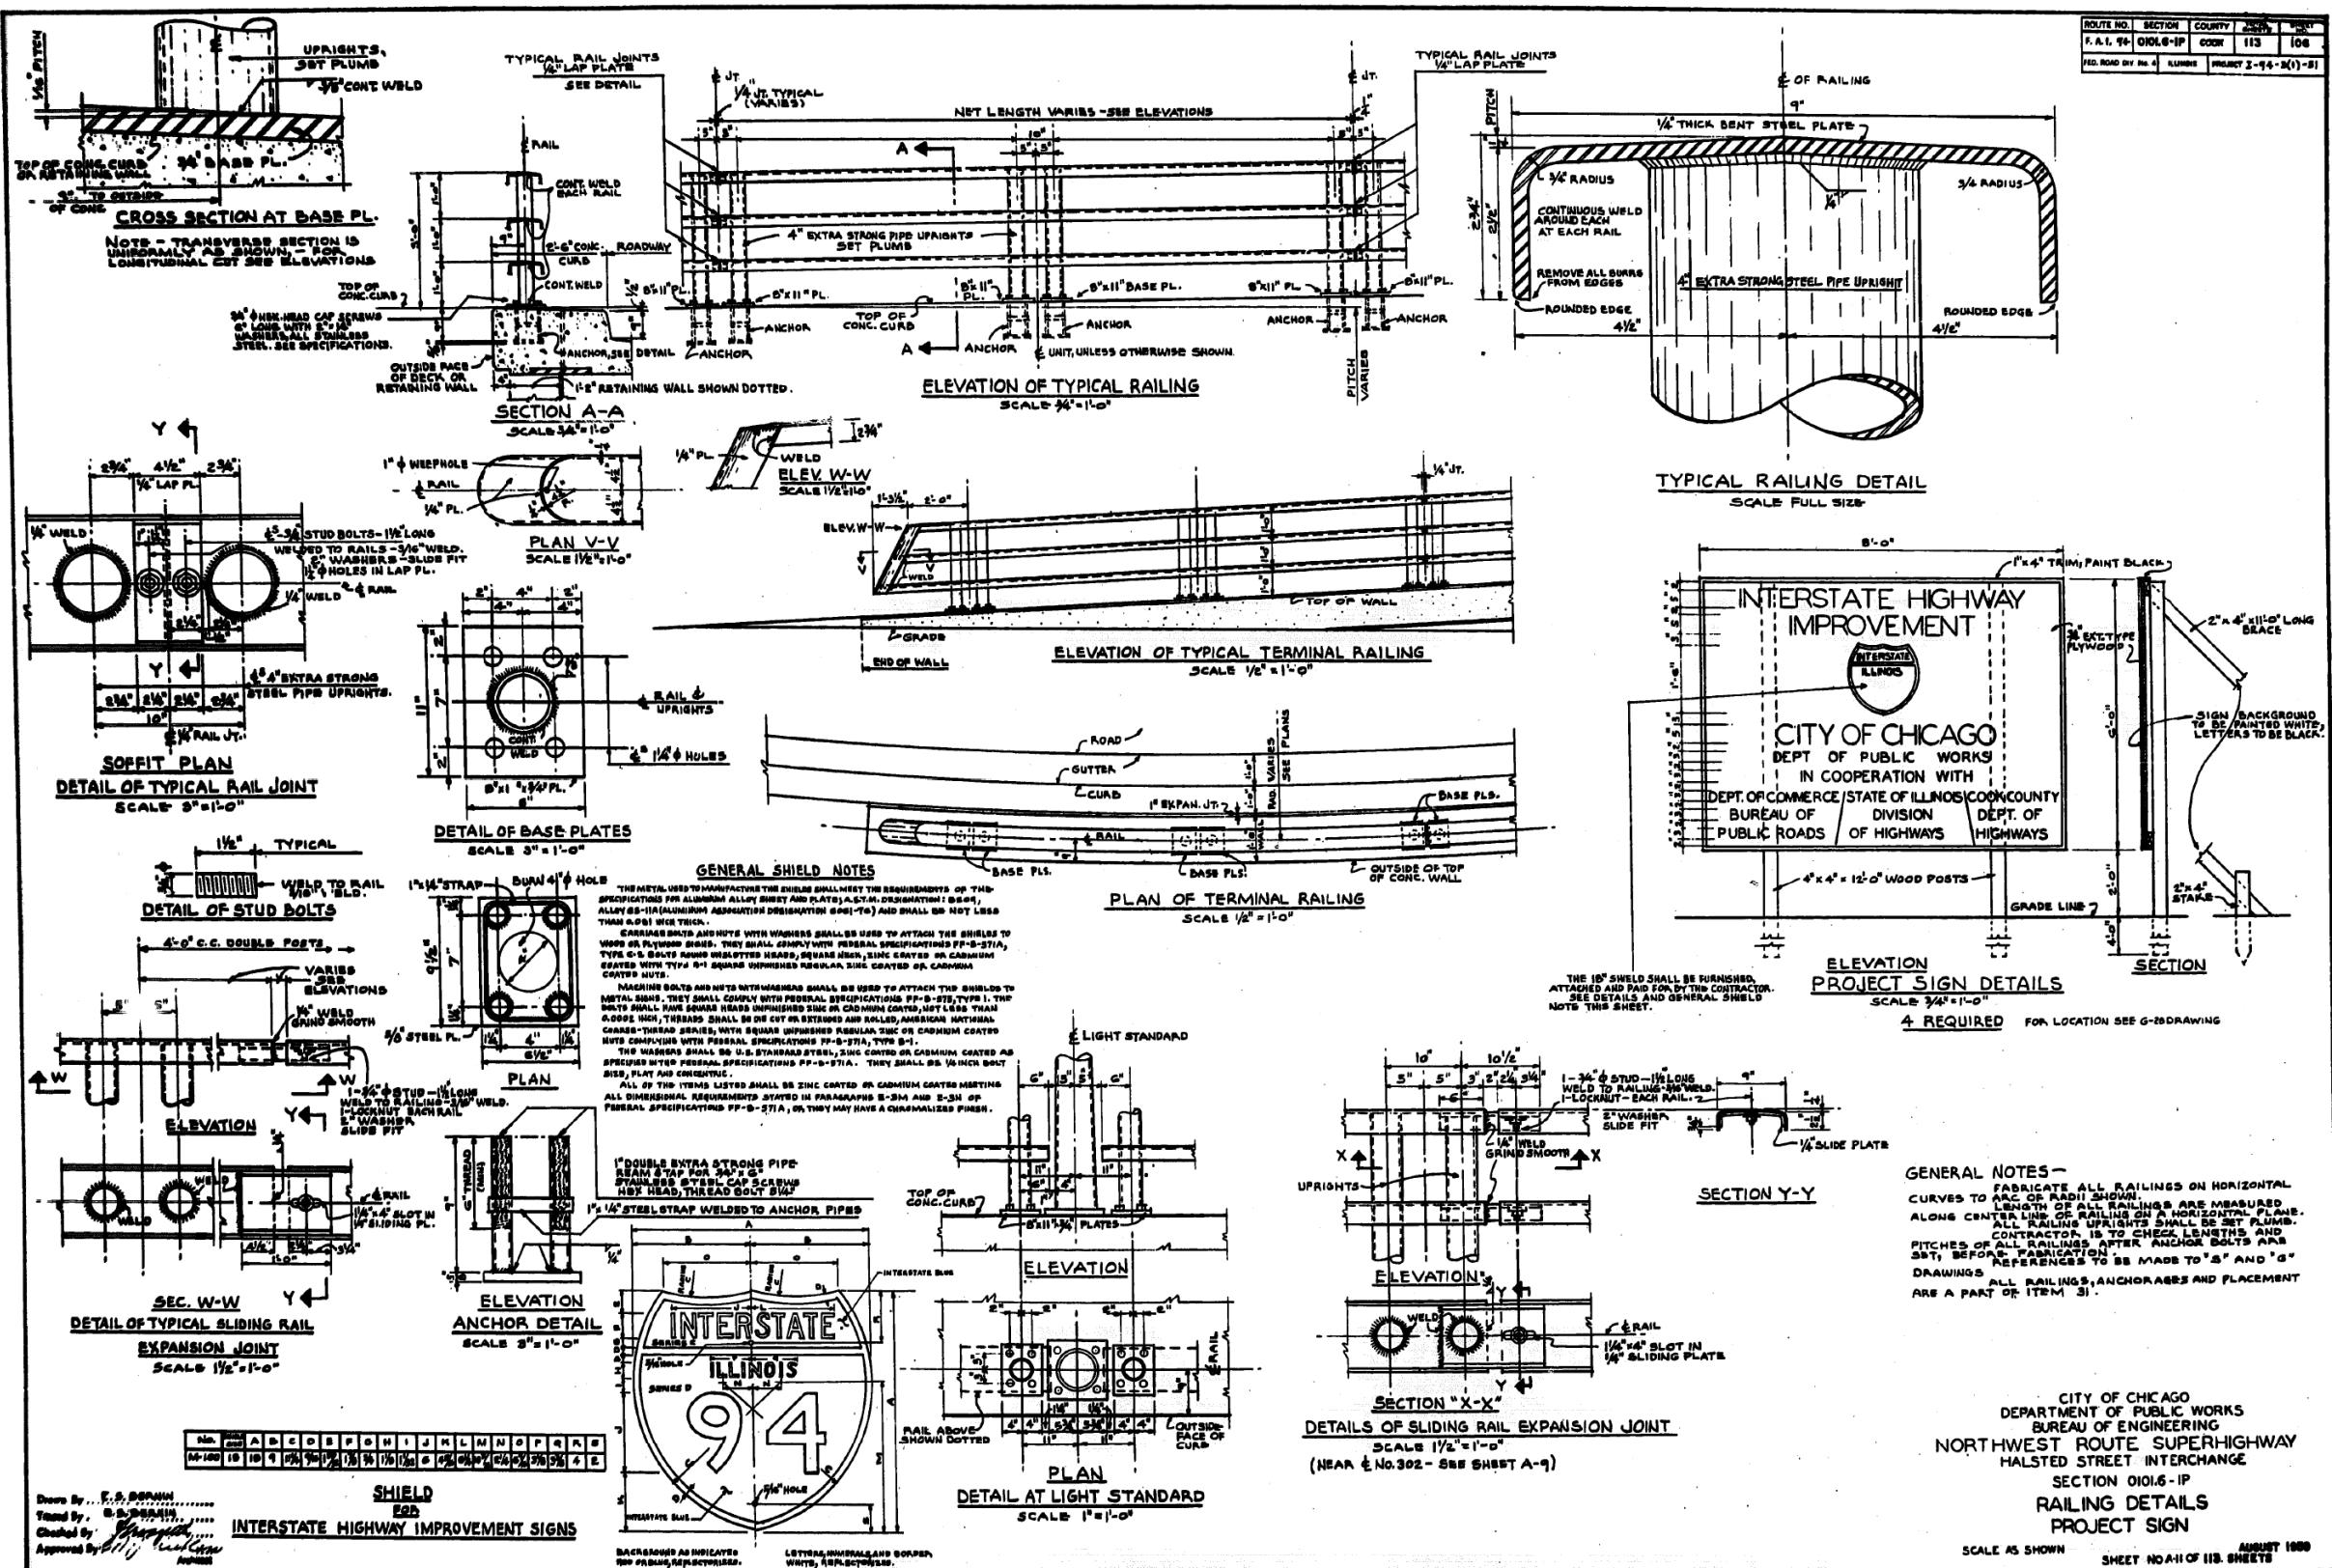
**CITY OF CHICAGO
DEPARTMENT OF PUBLIC WORKS
BUREAU OF ENGINEERING
NORTHWEST ROUTE SUPERHIGHWAY
HALSTED STREET INTERCHANGE
SECTION 0101.6-IP**

RAILING DETAILS

SCALE AS SHOWN AUGUST 1959
SHEET NO A10 OF 113 SHEETS

FILE NAME: pw:	USER NAME = ahmad.issa	DESIGNED -	REVISED -	STATE OF ILLINOIS DEPARTMENT OF TRANSPORTATION	EXISTING RECORD DRAWINGS	F.A.I. RTE.	S
	CHECKED -	REVISED -	90/94/290			2014	
	DRAWN -	REVISED -					
	PLOT DATE = 7/26/2018	CHECKED - MI, MAI	REVISED -				

FOR INFORMATION ONLY



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HBM
ENGINEERING GROUP, LLC

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		CHECKED	-	REVISED	-
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PLOT DATE	= 7/26/2018	CHECKED	- MI, MAI	REVISED	-

STATE OF ILLINOIS
DEPARTMENT OF TRANSPORTATION

EXISTING RECORD DRAWINGS

	F.A.I. RTE.	SECTION	COUNTY	TOTAL SHEETS	SHEET NO.
	90/94/290	2014-013R&B-R	COOK	1972	197
					CONTRACT NO. 60X93
		ILLINOIS	FED. AID PROJECT		

FOR INFORMATION ONLY

NORTHWEST ROUTE
EXPRESSWAY
HALSTED STREET INTERCHANGE
EAST NORTH RAMP

F.A.I. ROUTE 94 SECTION 0101.6-IP

F.A.I. PROJECT I-94-3 (1)-51

STATION 20+59

LOADING H20 - S 16 - 44

1960

INSCRIPTIONS ON THESE TWO LINES DIFFER IN THEIR LOCATIONS. SEE SCHEDULE BELOW FOR VARIATIONS

ROSS ON BACK

MATTED BACKGROUND

NAME PLATE N-1
15"
BOSS ON BACK


BUILT BY
CITY OF CHICAGO
WITH THE CO-OPERATION OF
COUNTY OF COOK
STATE OF ILLINOIS
FEDERAL GOVERNMENT

1960

MATTED BACKGROUND

SCHEDULE OF INSCRIPTION VARIATIONS ON N-1 PLATES.		
LOCATION (STA. OR BENT)	INSCRIPTION	VARIATION TO BE -
STA. 23+16	WEST SOUTH RAMP	W.S.RAMP
STA. 17+76	WEST SOUTH RAMP	W.S.RAMP
STA. 22+24	SOUTH EAST RAMP	S.E.RAMP
STA. 27+32	SOUTH EAST RAMP	S.E.RAMP
STA 17+25	NORTH WEST RAMP	N.W.RAMP

Drew By R.B.CHESTER
Traced By REPRODUCTION
Checked By *J. Young*
Approved By *R. B. Chester*

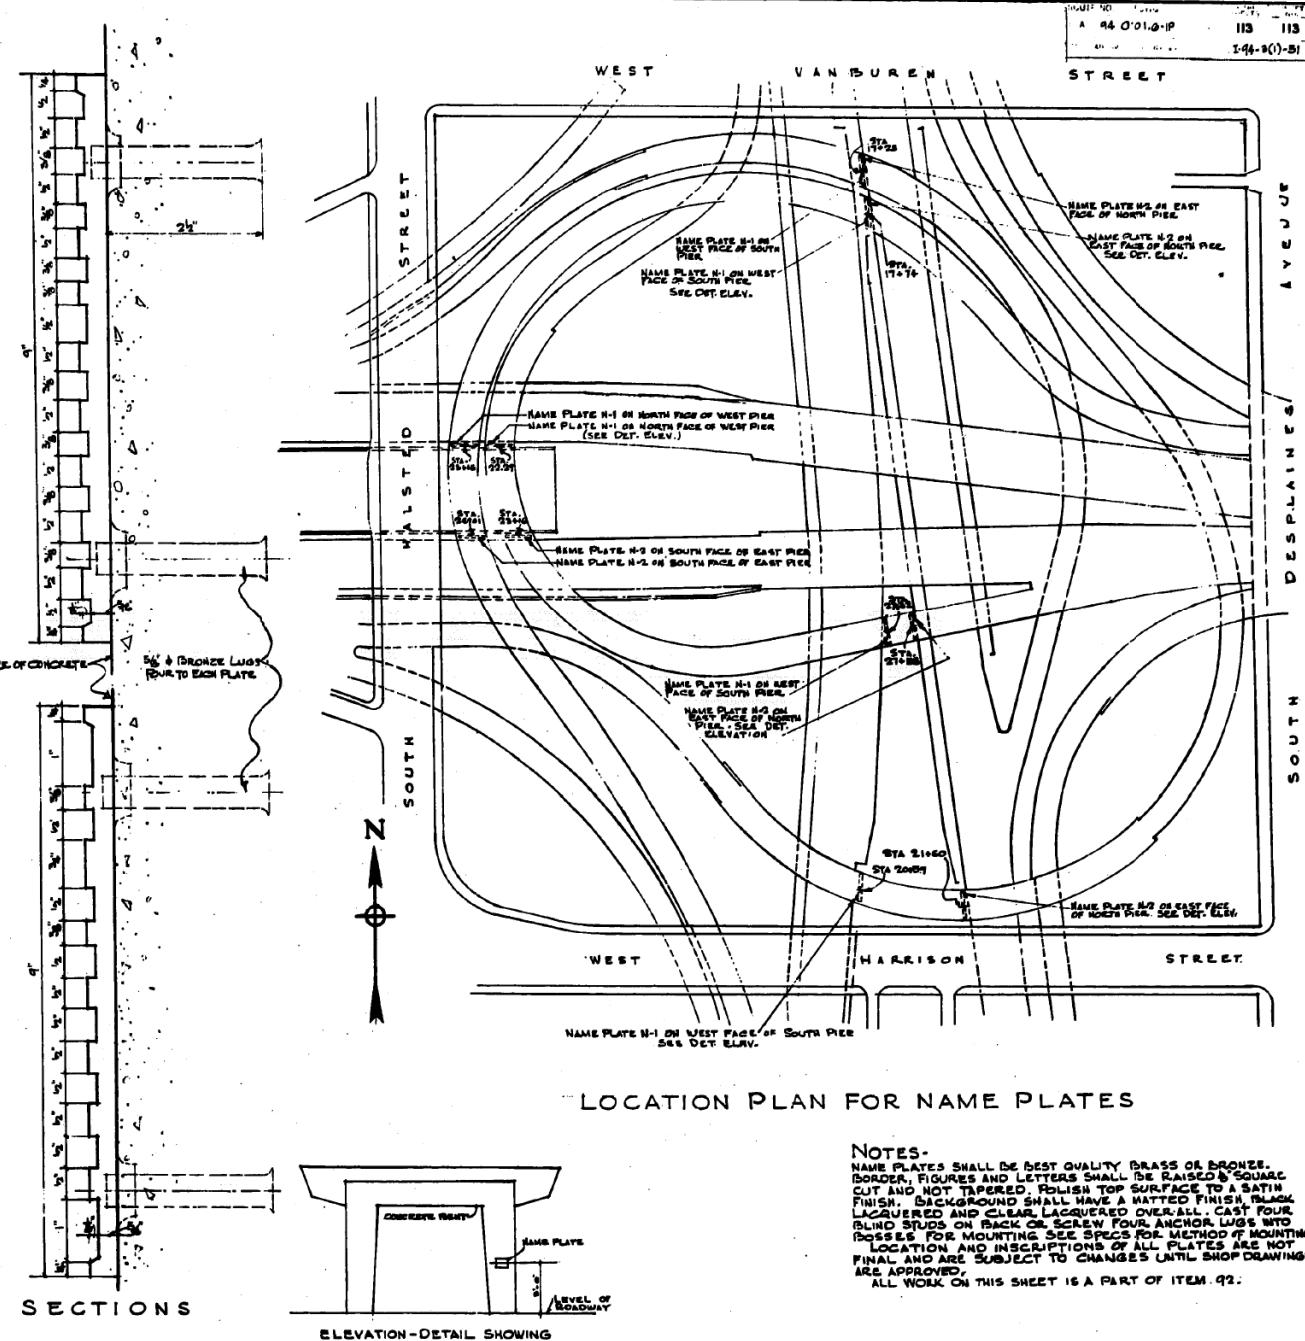

NOTES-
NAME PLATES SHALL BE BEST QUALITY BRASS OR BRONZE.
BORDERS, FIGURES AND LETTERS SHALL BE RAISED & SQUARE
CUT AND NOT TAPERED. POLISH TOP SURFACE TO A SATIN
FINISH. BACKGROUND SHALL HAVE A MATTED FINISH. BLACK
LACQUERED AND CLEAR LACQUERED OVERALL. CAST FOUR
BLIND STUDS ON BACK OR SCREW FOUR ANCHOR LUGS INTO
POSSLES FOR MOUNTING SEE SPECS FOR METHOD OF MOUNTING.
LOCATION AND INSCRIPTIONS OF ALL PLATES ARE NOT
FINAL AND ARE SUBJECT TO CHANGES UNTIL SHOP DRAWINGS
ARE APPROVED.

CITY OF CHICAGO
DEPARTMENT OF PUBLIC WORKS
BUREAU OF ENGINEERING
NORTHWEST ROUTE SUPERHIGHWAY
HALSTED STREET INTERCHANGE
SECTION 0105-1P

NAME PLATE

SCALE AS SHOWN AUGUST 1959
SHEET NO A-8 OF 113 SHEETS

**STATE OF ILLINOIS
DEPARTMENT OF TRANSPORTATION**

EXISTING RECORD DRAWINGS

F.A.I. RTE.	SECTION	COUNTY	TOTAL SHEETS	SHEET NO.
90/94/290	2014-013R&B-R	COOK	1972	1972
			CONTRACT NO. 60X93	
		ILLINOIS	FED. AID PROJECT	