

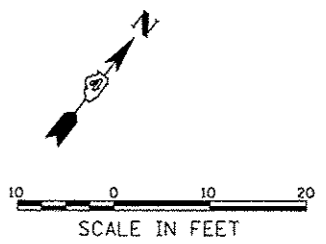
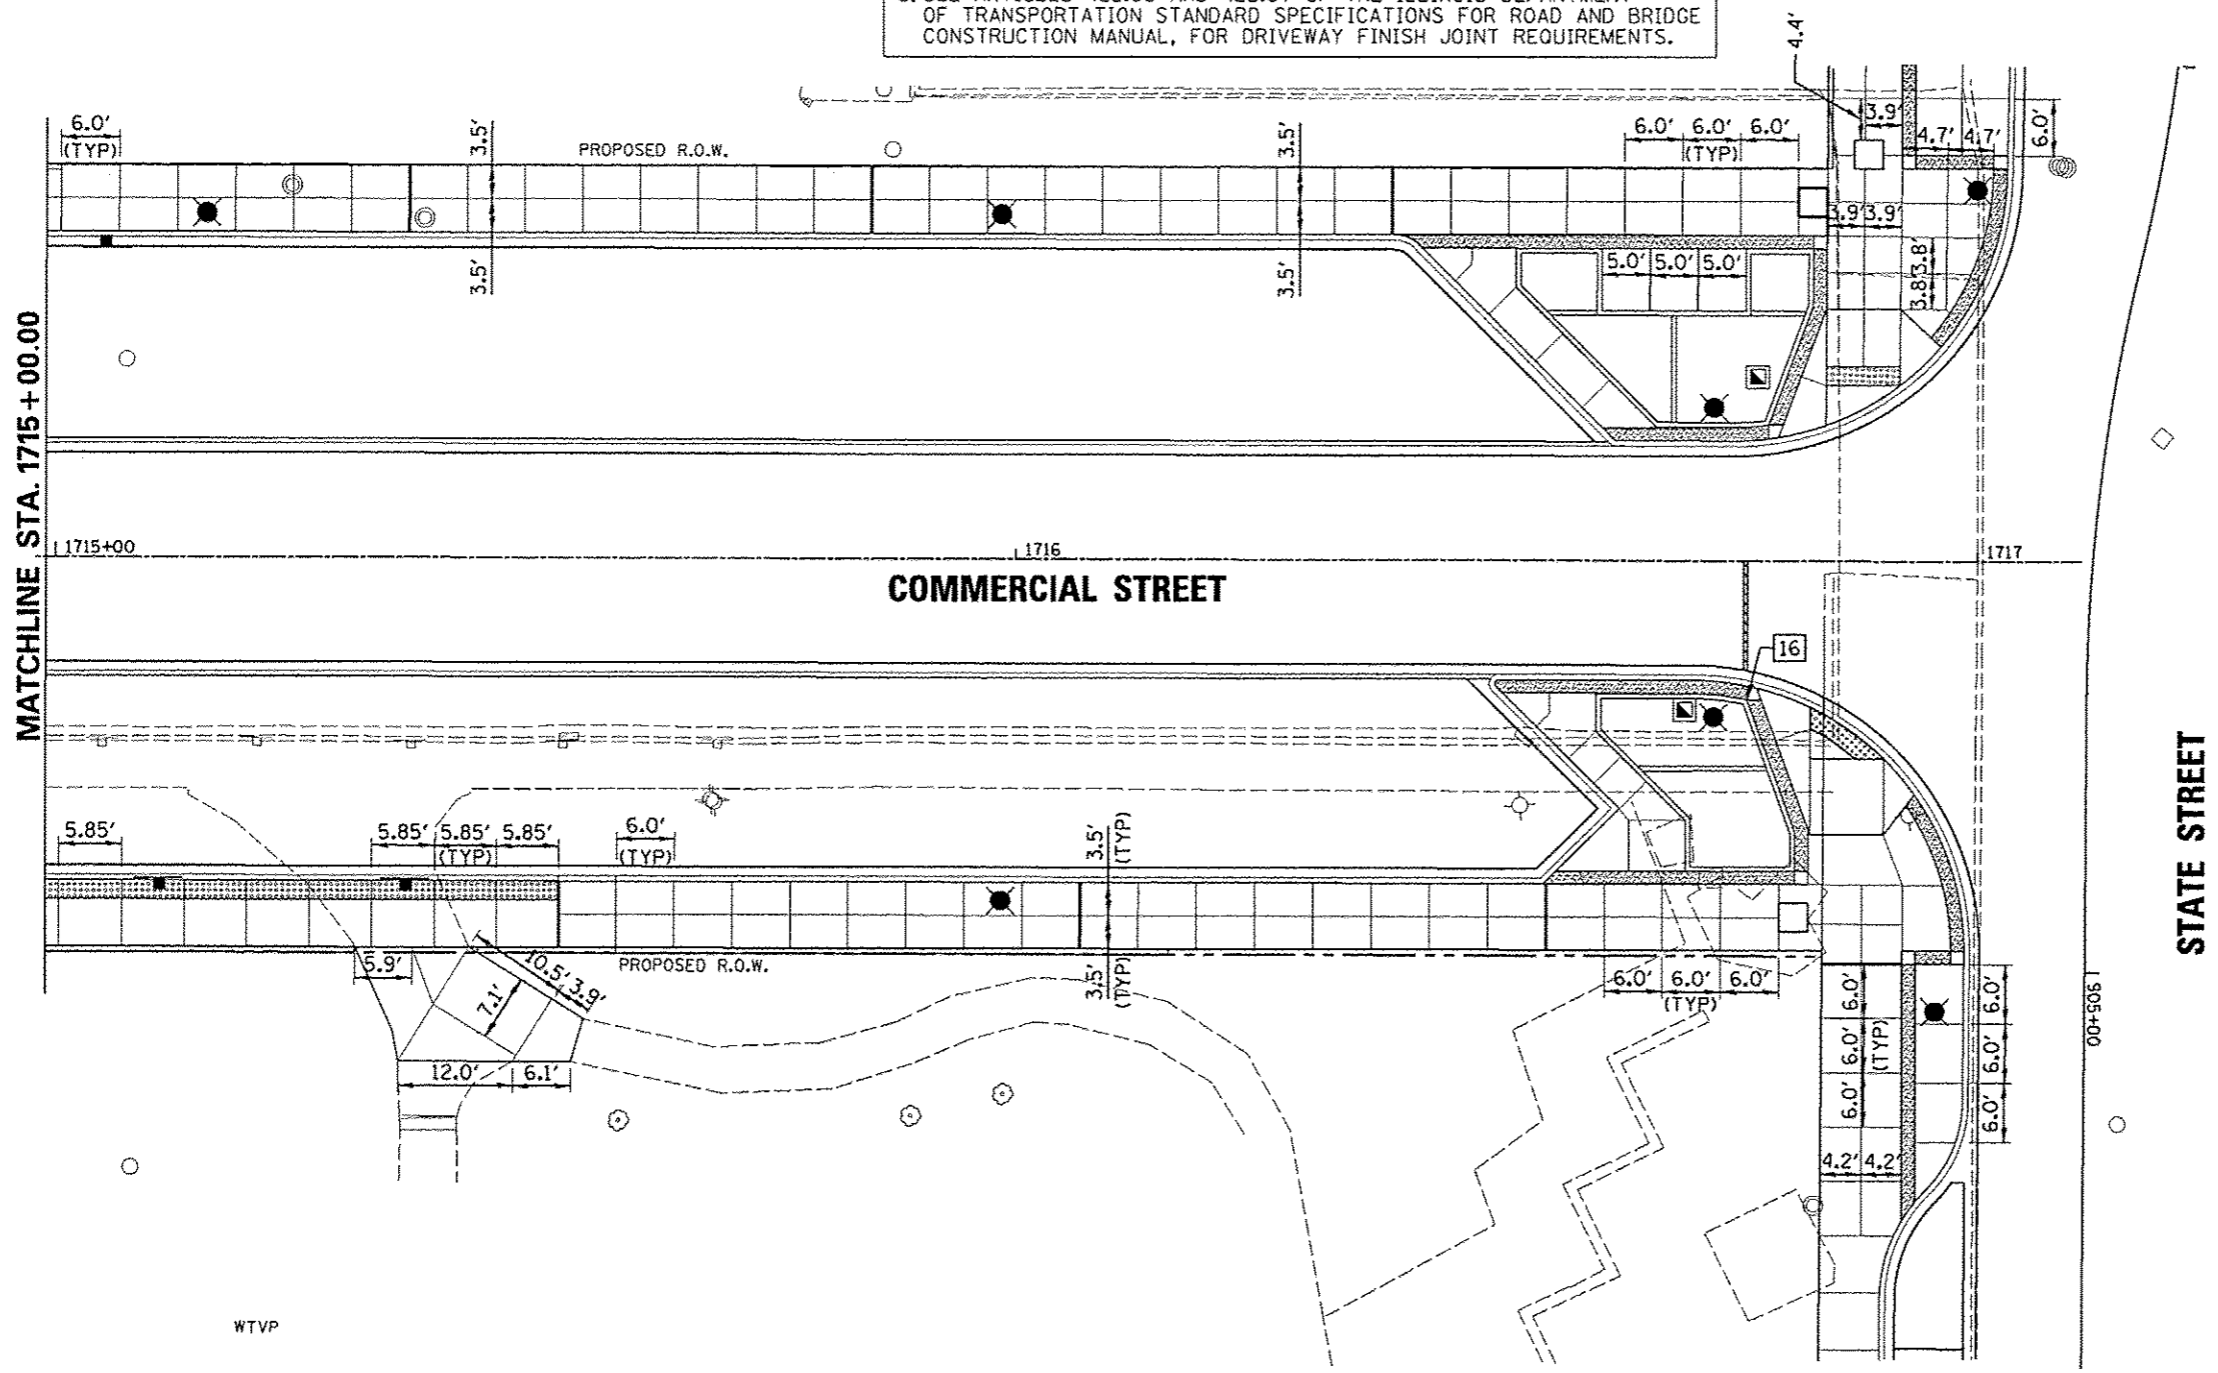


JOINTING LEGEND	
	TOOLED JOINT
	EXPANSION JOINT

- JOINTING NOTES:**
1. EXPANSION AND CONTRACTION JOINTS SHALL BE PROVIDED IN ACCORDANCE WITH THE STANDARD SPECIFICATIONS, SPECIAL PROVISIONS, AND PLAN DETAILS. JOINT LOCATIONS SHOWN ON THIS SHEET ARE SHOWN FOR INFORMATION AND TYPICAL LAYOUT PATTERN. EXACT FIELD CONDITIONS AND CONTRACTOR'S POURING SEQUENCE MAY REQUIRE SOME JOINT LOCATION FIELD ADJUSTMENT.
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  3. SEE SPECIAL PROVISION SECTION, POROUS PORTLAND CEMENT CONCRETE SIDEWALK 4 INCH, (SPECIAL) FOR FINISH AND EXPANSION JOINT REQUIREMENTS.
  4. SEE SPECIAL PROVISION SECTION, PORTLAND CEMENT CONCRETE SIDEWALK 4 INCH, SPECIAL, FOR FINISH AND EXPANSION JOINT REQUIREMENTS.
  5. SEE ARTICLES 423.06 AND 423.07 OF THE ILLINOIS DEPARTMENT OF TRANSPORTATION STANDARD SPECIFICATIONS FOR ROAD AND BRIDGE CONSTRUCTION MANUAL, FOR DRIVEWAY FINISH JOINT REQUIREMENTS.

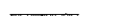

FILE NAME =	USER NAME = monsk01398	DESIGNED - STH	REVISED -
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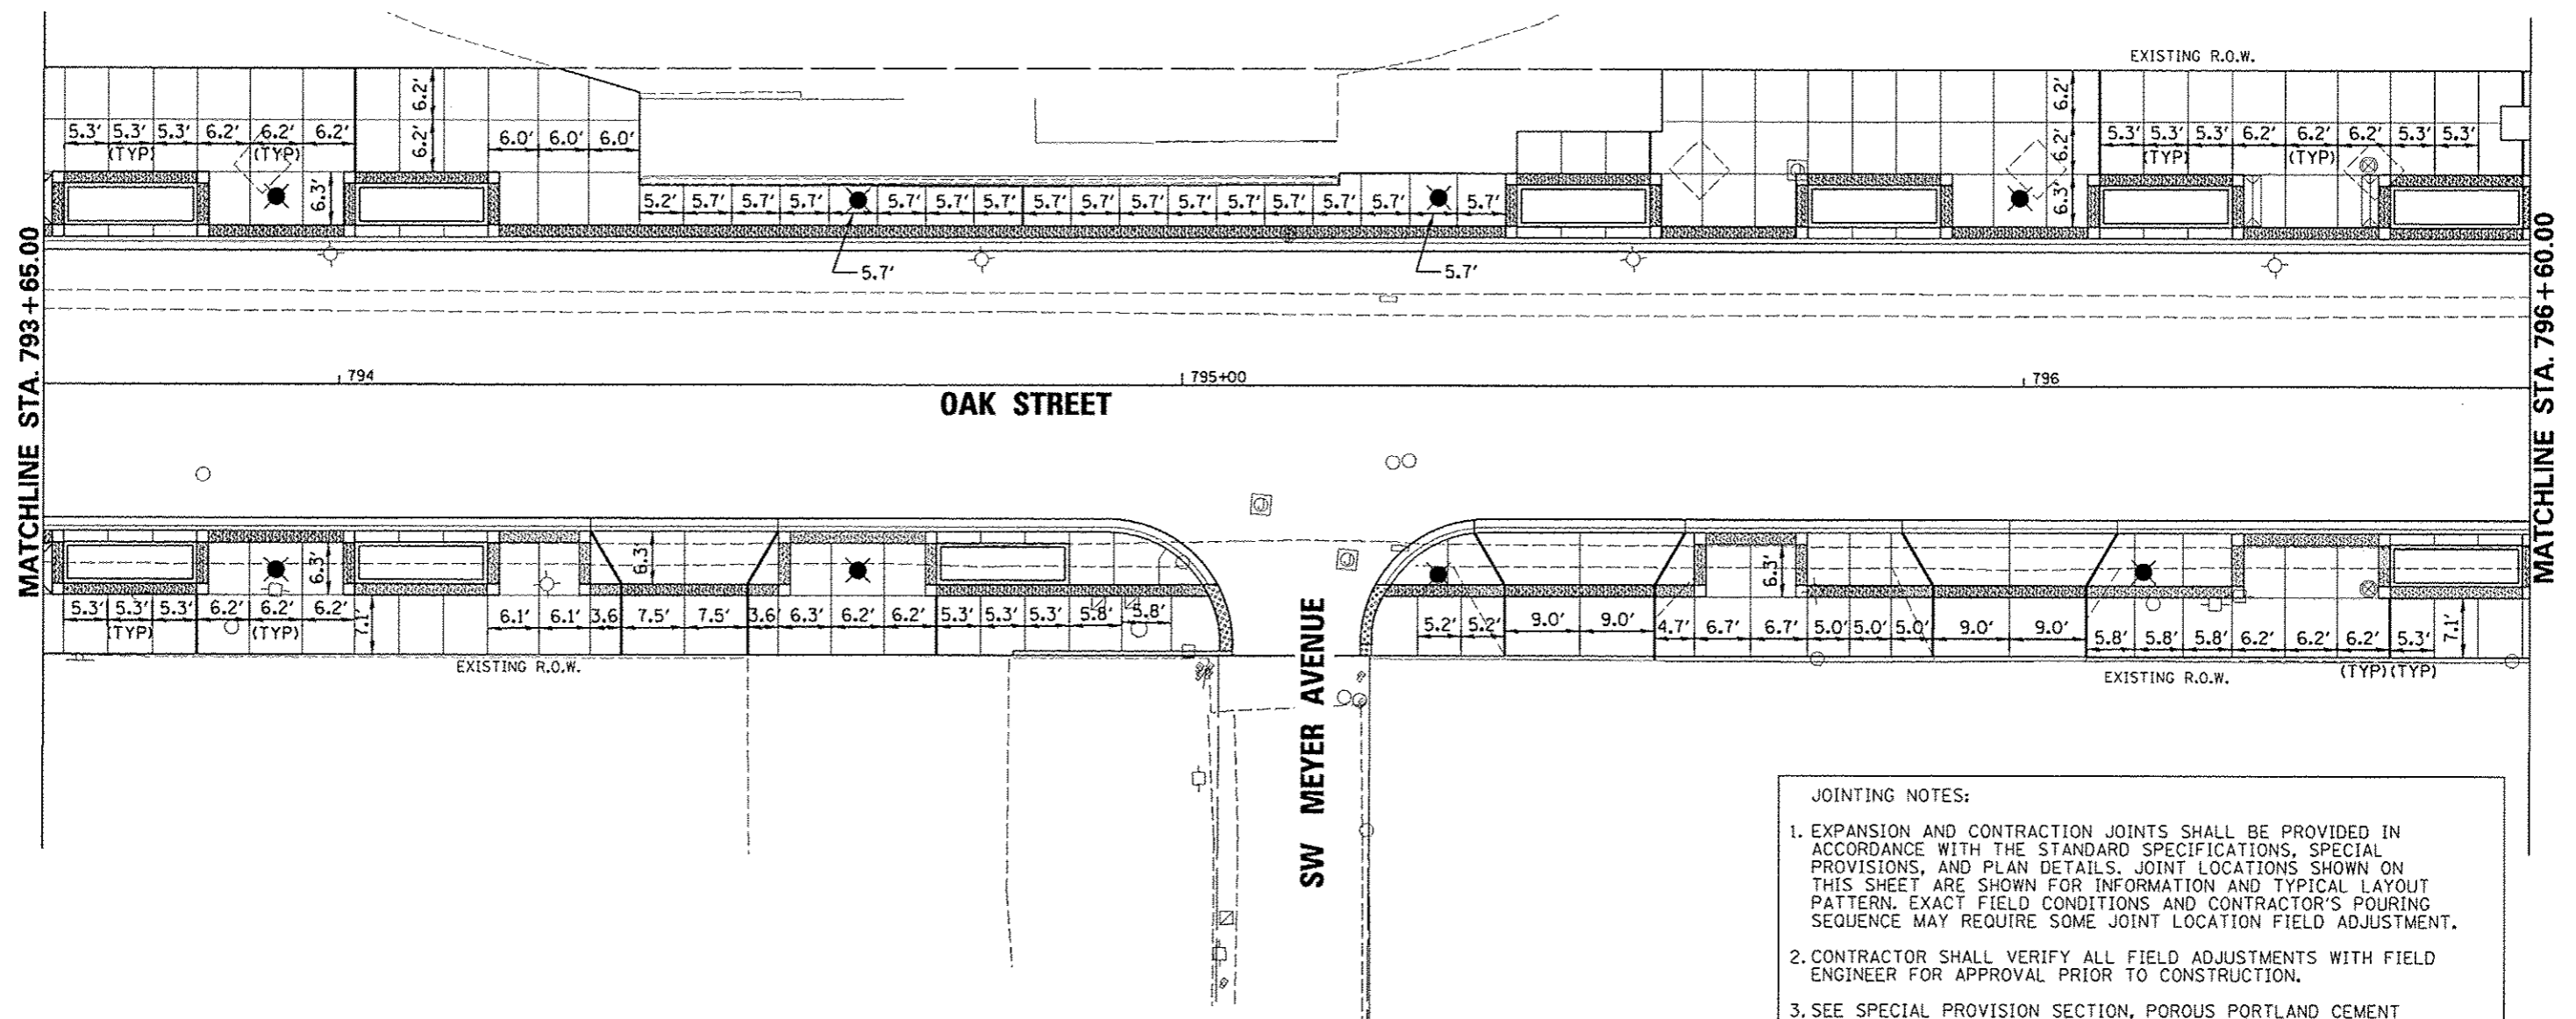
**STATE OF ILLINOIS  
DEPARTMENT OF TRANSPORTATION**

**COMMERCIAL STREET  
STREETSCAPE PAVEMENT JOINTING PLAN**



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F.A.U. RTE.	SECTION	COUNTY	TOTAL SHEETS	SHEET NO.
000	12-00356-01-PV	PEORIA	519	301
CONTRACT NO. 89626				
ILLINOIS FED. AID PROJECT TIC-509315B				

**Farnsworth GROUP**  
7707 N. MONROVILLE AVE., SUITE 100  
PEORIA, ILLINOIS 61614  
(309) 699-0000 / (309) 699-4820 Fax  
www.fsg.com



- JOINTING NOTES:**
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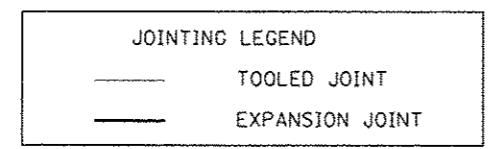
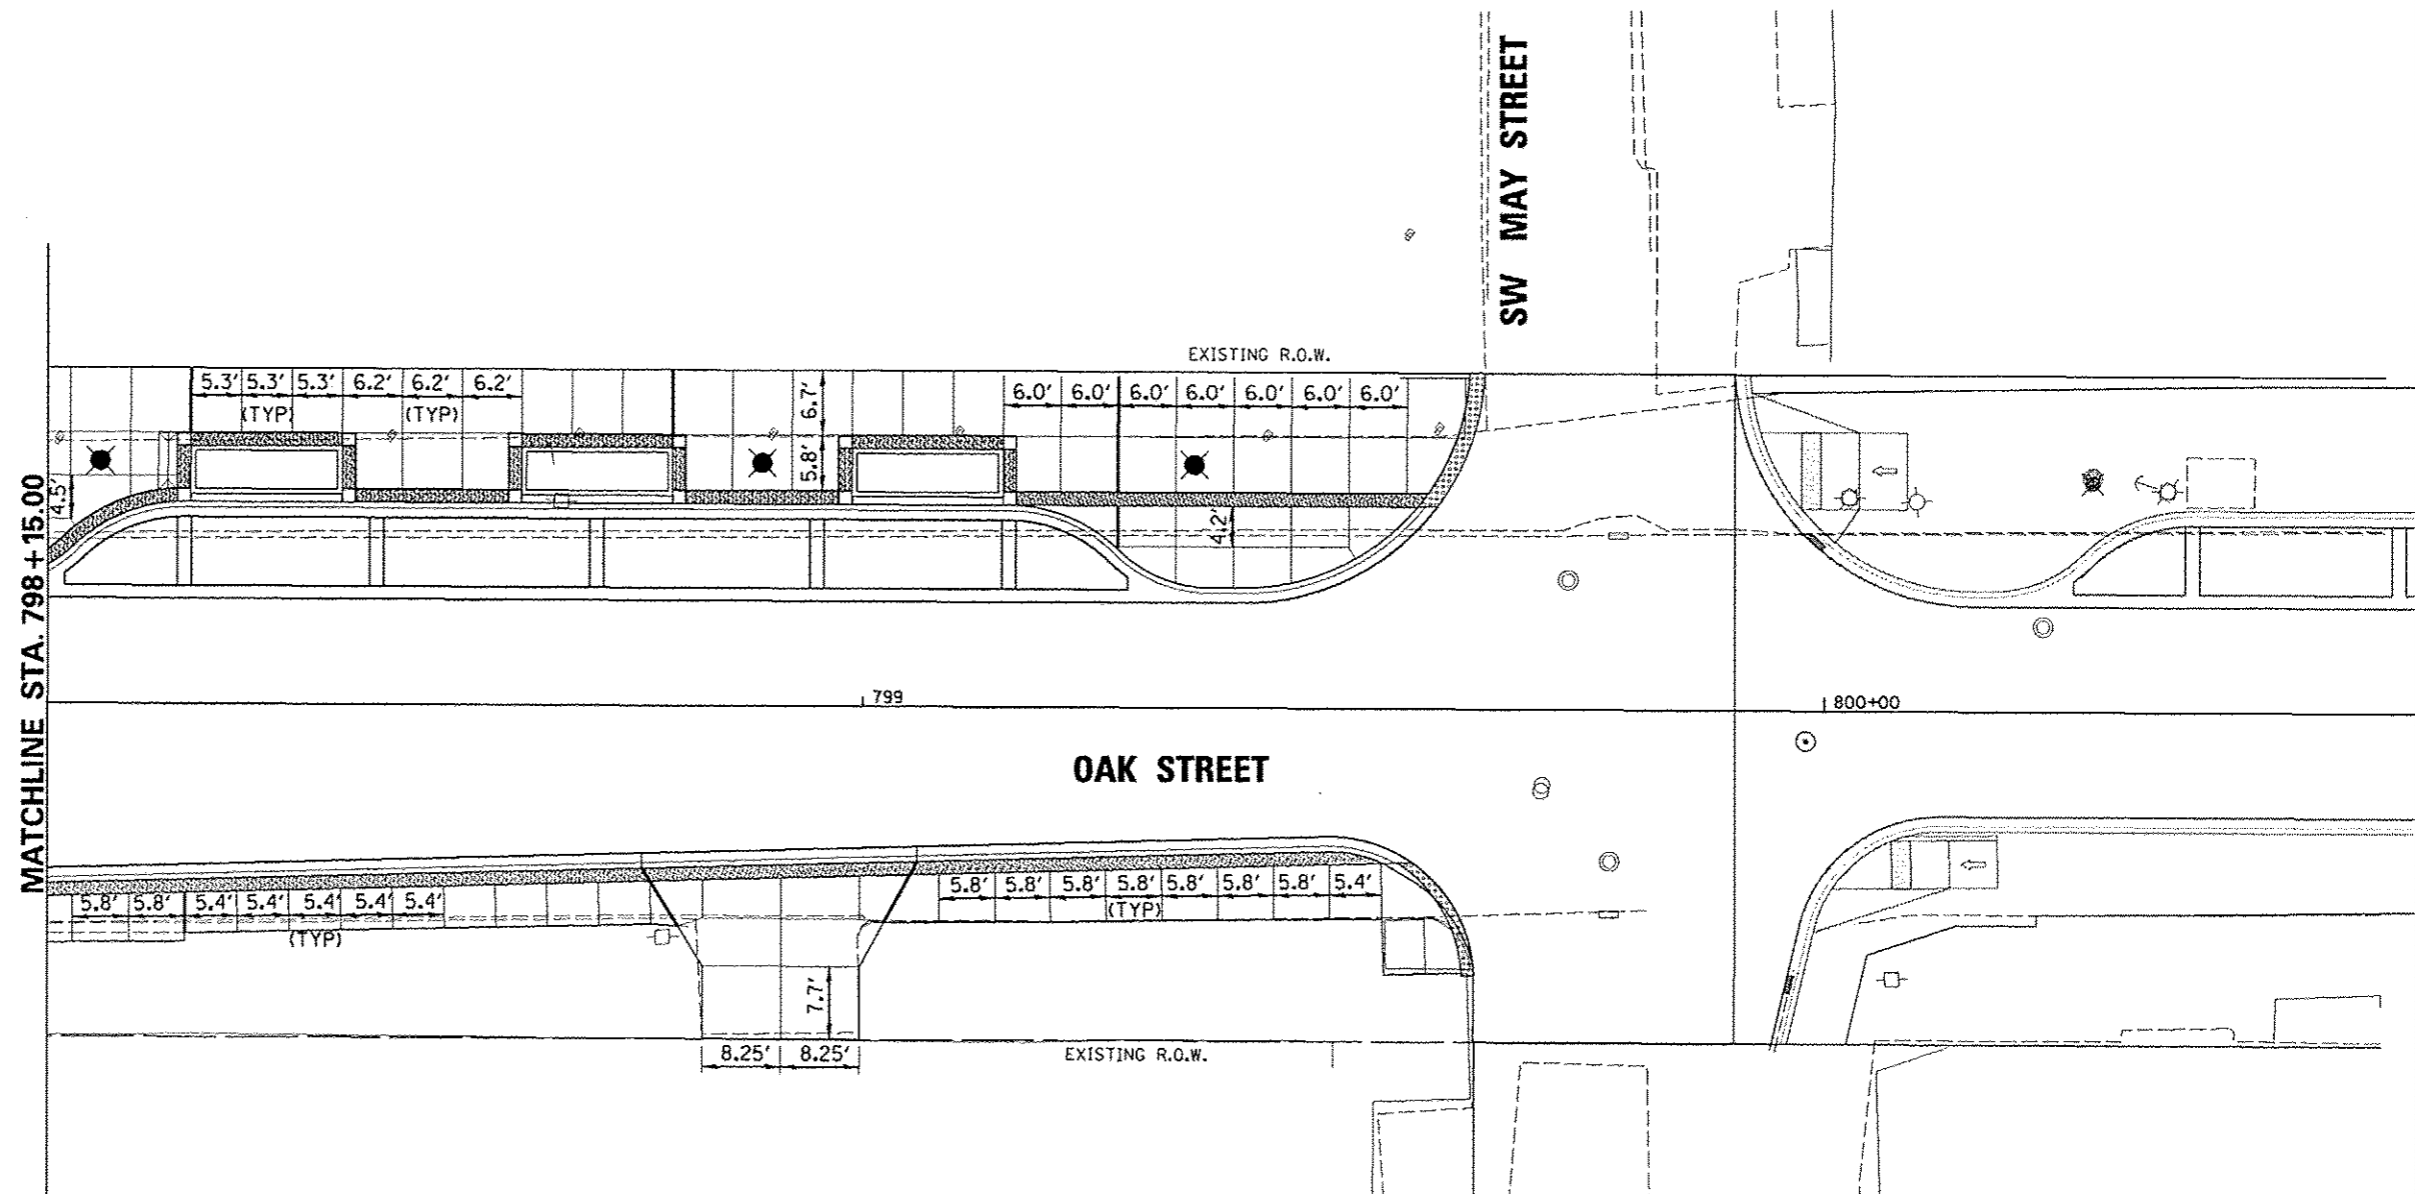
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	PLOT DATE = 07/23/2012	DATE - 7/18/12	REVISED -

**STATE OF ILLINOIS  
DEPARTMENT OF TRANSPORTATION**

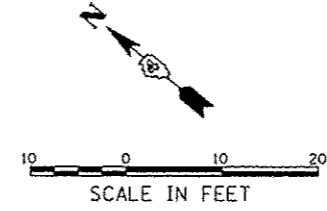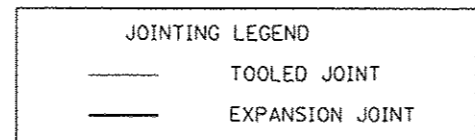
<b>OAK STREET</b>	
<b>STREETSCAPE PAVEMENT JOINTING PLAN</b>	
SCALE: 1"=10'	SHEET NO. OF SHEETS
STA. 793+65.00 TO STA. 796+60.00	

F.A.U. RTE.	SECTION	COUNTY	TOTAL SHEETS	SHEET NO.
003	12-00356-01-PV	PEORIA	519	302
CONTRACT NO. 89626				
ILLINOIS FED. AID PROJECT 710-509311581				

**Farnsworth GROUP**  
7707 N. KNOXVILLE AVE., SUITE 100  
PEORIA, ILLINOIS 61614  
(309) 699-0006 / (309) 699-0820 Fax  
www.fsg.com




- JOINTING NOTES:**
1. EXPANSION AND CONTRACTION JOINTS SHALL BE PROVIDED IN ACCORDANCE WITH THE STANDARD SPECIFICATIONS, SPECIAL PROVISIONS, AND PLAN DETAILS. JOINT LOCATIONS SHOWN ON THIS SHEET ARE SHOWN FOR INFORMATION AND TYPICAL LAYOUT PATTERN. EXACT FIELD CONDITIONS AND CONTRACTOR'S POURING SEQUENCE MAY REQUIRE SOME JOINT LOCATION FIELD ADJUSTMENT.
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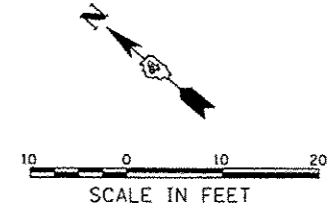
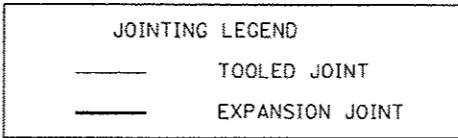
**Farnsworth GROUP**  
 7707 N. KNOXVILLE AVE, SUITE 100  
 PEORIA, ILLINOIS 61614  
 (309) 699-8858 / (309) 699-8820 Fax  
 www.fw.com

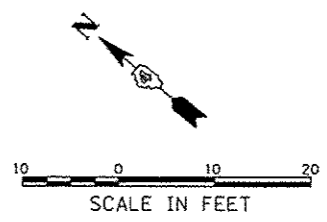FILE NAME *	USER NAME * mansak81398	DESIGNED - STH	REVISED -	<b>STATE OF ILLINOIS DEPARTMENT OF TRANSPORTATION</b>	<b>OAK STREET STREETSCAPE PAVEMENT JOINTING PLAN</b>		F.A.U. RTE.	SECTION	COUNTY	TOTAL SHEETS	SHEET NO.	
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	PLOT SCALE = 20.0000' / in.	CHECKED - BAB	REVISED - in.									CONTRACT NO. 89626
	PLOT DATE = 8/12/2012	DATE - 7/18/12	REVISED -									ILLINOIS FED. AID PROJECT 11C-509315B1




**JOINTING NOTES:**
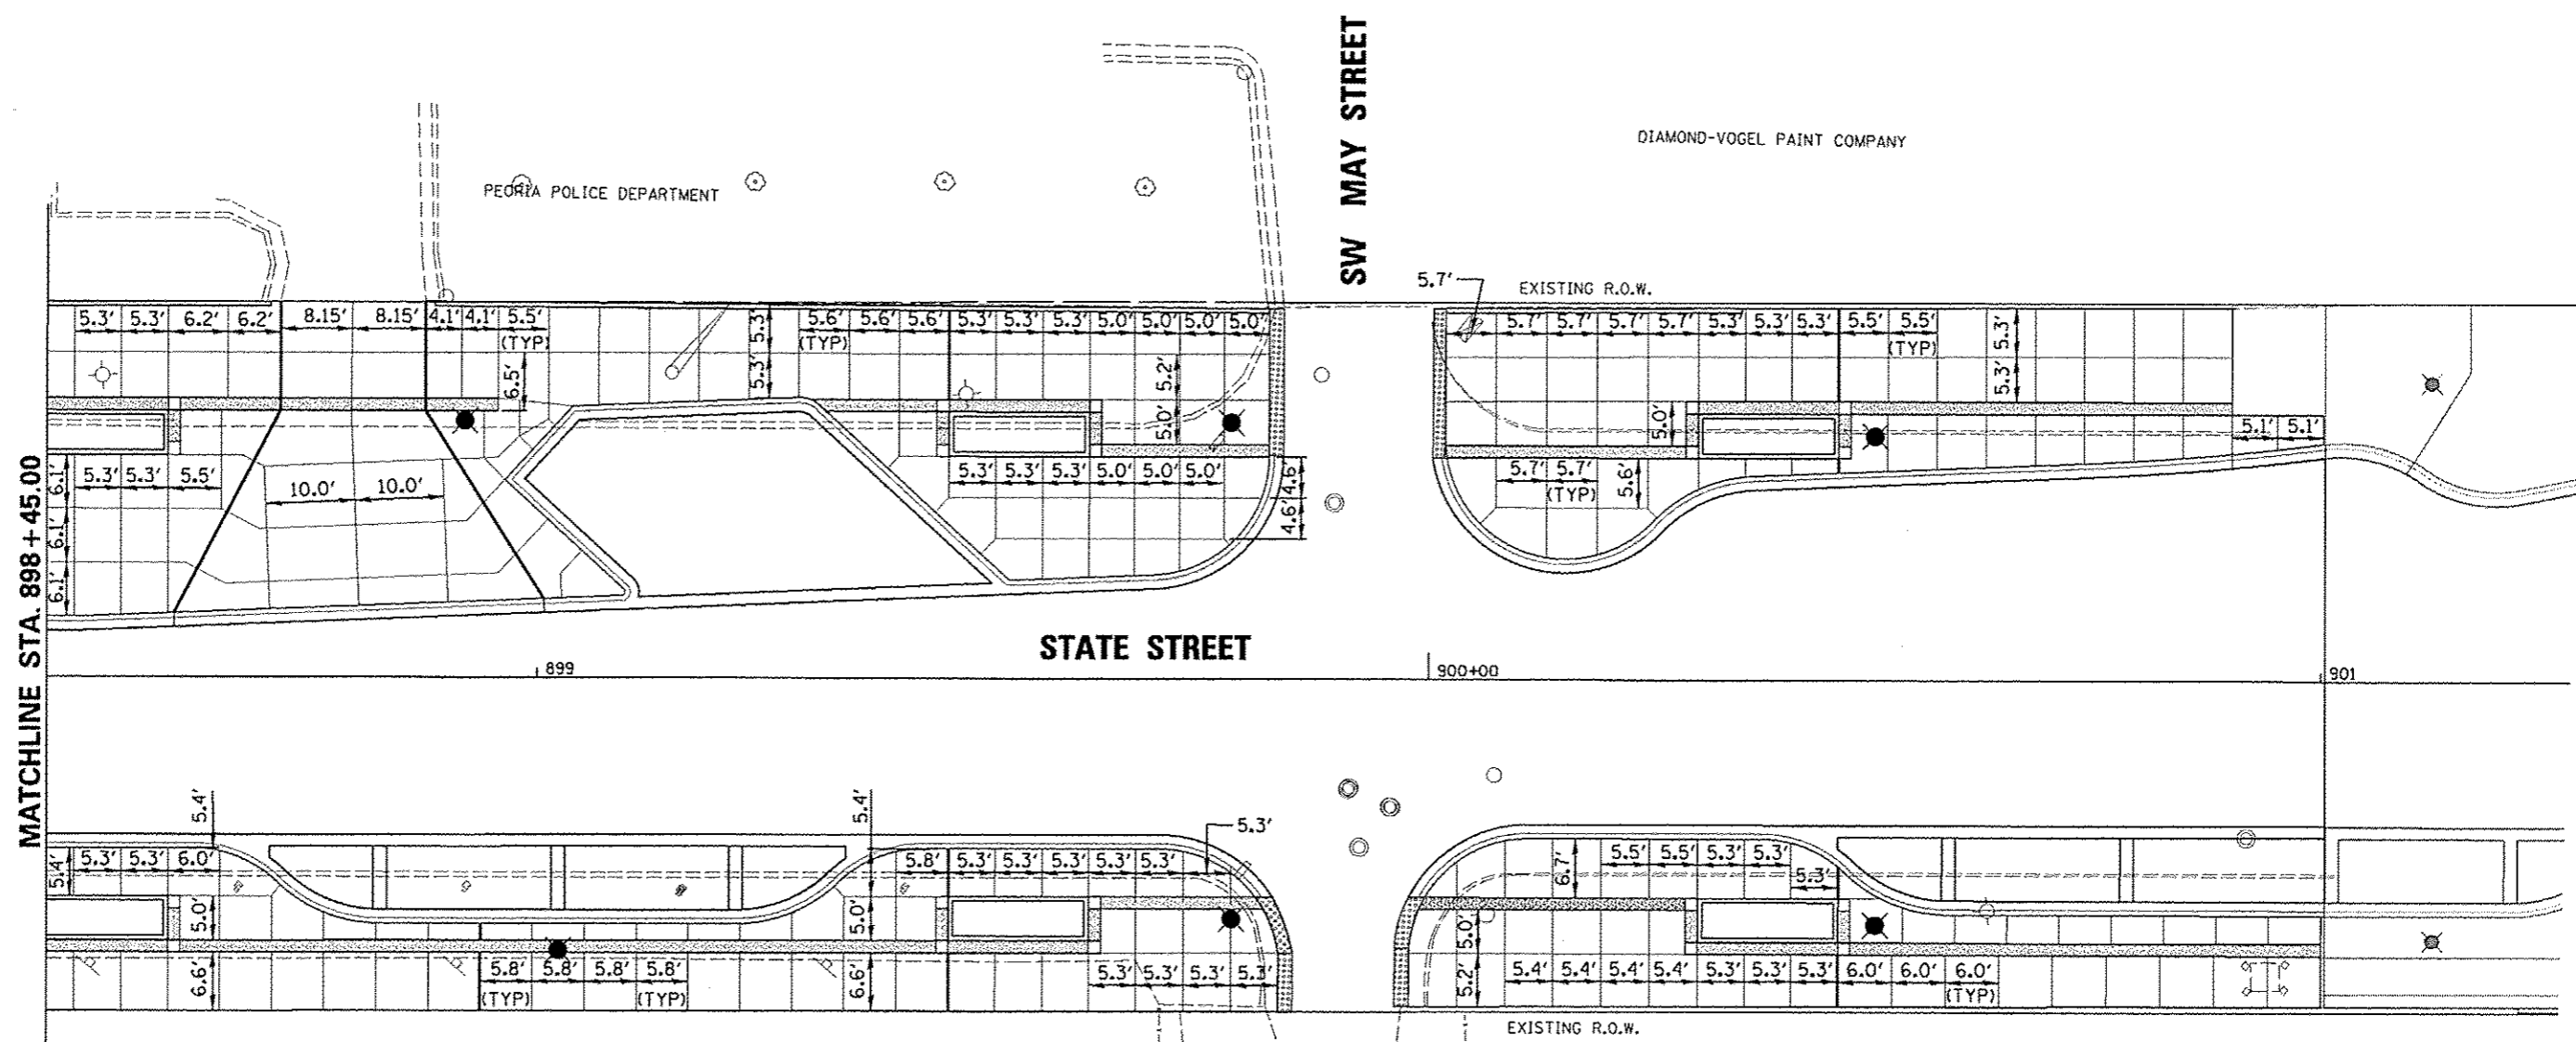
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**Farnsworth GROUP**  
 7707 N. KNOXVILLE AVE., SUITE 100  
 PEORIA, ILLINOIS 61614  
 (309) 690-0500 / (309) 690-0520 Fax  
 www.fg.com

FILE NAME < \\pwise-work\do_not_delete\dms73427\049L0155-rtt-IndscpJoint00.dgn	USER NAME = minak01390	DESIGNED - STH	REVISED -	<b>STATE OF ILLINOIS DEPARTMENT OF TRANSPORTATION</b>	<b>STATE STREET STREETSCAPE PAVEMENT JOINTING PLAN</b>			F.A.U. RTE. 12-00356-01-PV	COUNTY PEORIA	TOTAL SHEETS 519	SHEET NO. 304
PLOT SCALE = 20.0000' / 1" = 10'	CHECKED - BAB	DATE - 7/18/12	REVISED -		SCALE: 1"=10'	SHEET NO. OF SHEETS	STA. 898+45.00 TO STA. 901+00.45	CONTRACT NO. 89626			
PLOT DATE = 07/23/2012	DATE - 7/18/12	REVISED -	REVISED -		ILLINOIS FED. AID PROJECT TIG-50931158						



JOINTING LEGEND	
	TOOLED JOINT
	EXPANSION JOINT

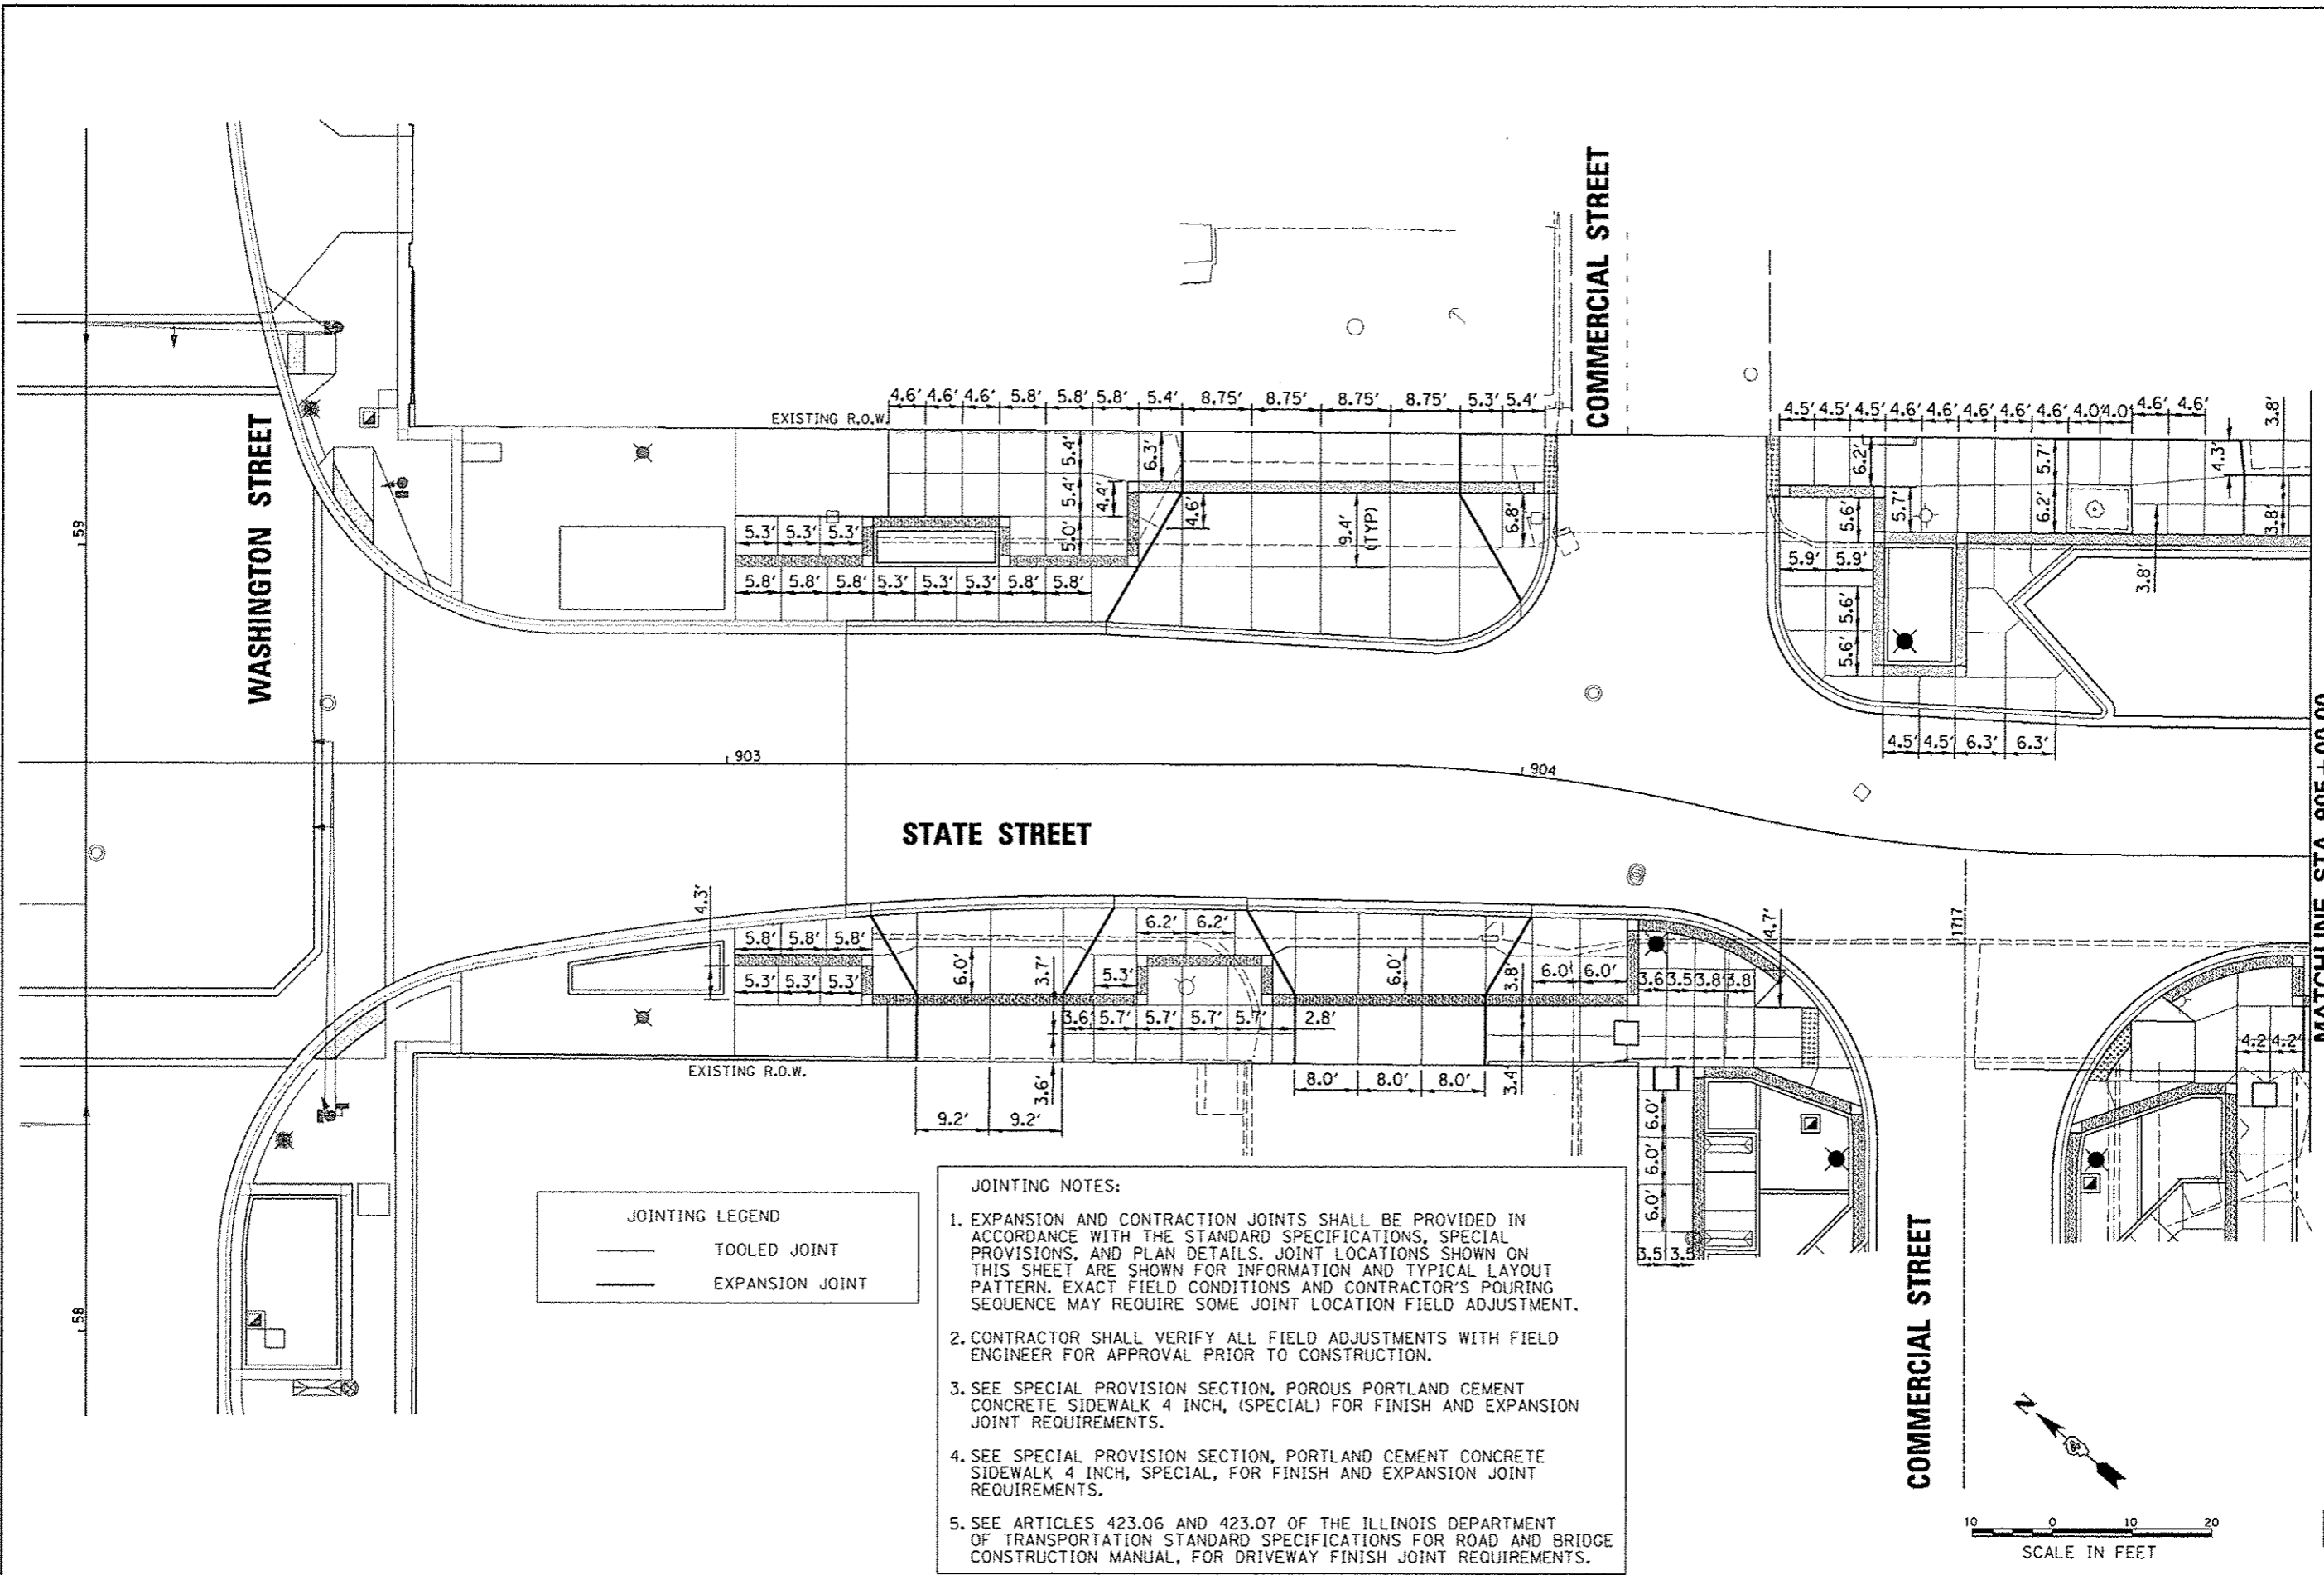- JOINTING NOTES:**
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 DATE - 7/18/12

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**STATE OF ILLINOIS  
 DEPARTMENT OF TRANSPORTATION**

**STATE STREET  
 STREETScape PAVEMENT JOINTING PLAN**

SCALE: 1"=10'  
 SHEET NO. OF SHEETS STA. 903+15.00 TO STA. 905+00.00

F.A.U. RTE.	SECTION	COUNTY	TOTAL SHEETS	SHEET NO.
12	12-00356-01-PV	PEORIA	519	305
CONTRACT NO. 89626			ILLINOIS FED. AID PROJECT TIC-5093050	


**Farnsworth GROUP**  
 7707 N. KNOXVILLE AVE. SUITE 100  
 PEORIA, ILLINOIS 61614  
 (309) 699-8688 / (309) 699-8620 Fax  
 www.Fw.com

RIZZI'S ON STATE

BEIGNETS

WATER STREET


MATCHLINE STA. 905 + 00.00

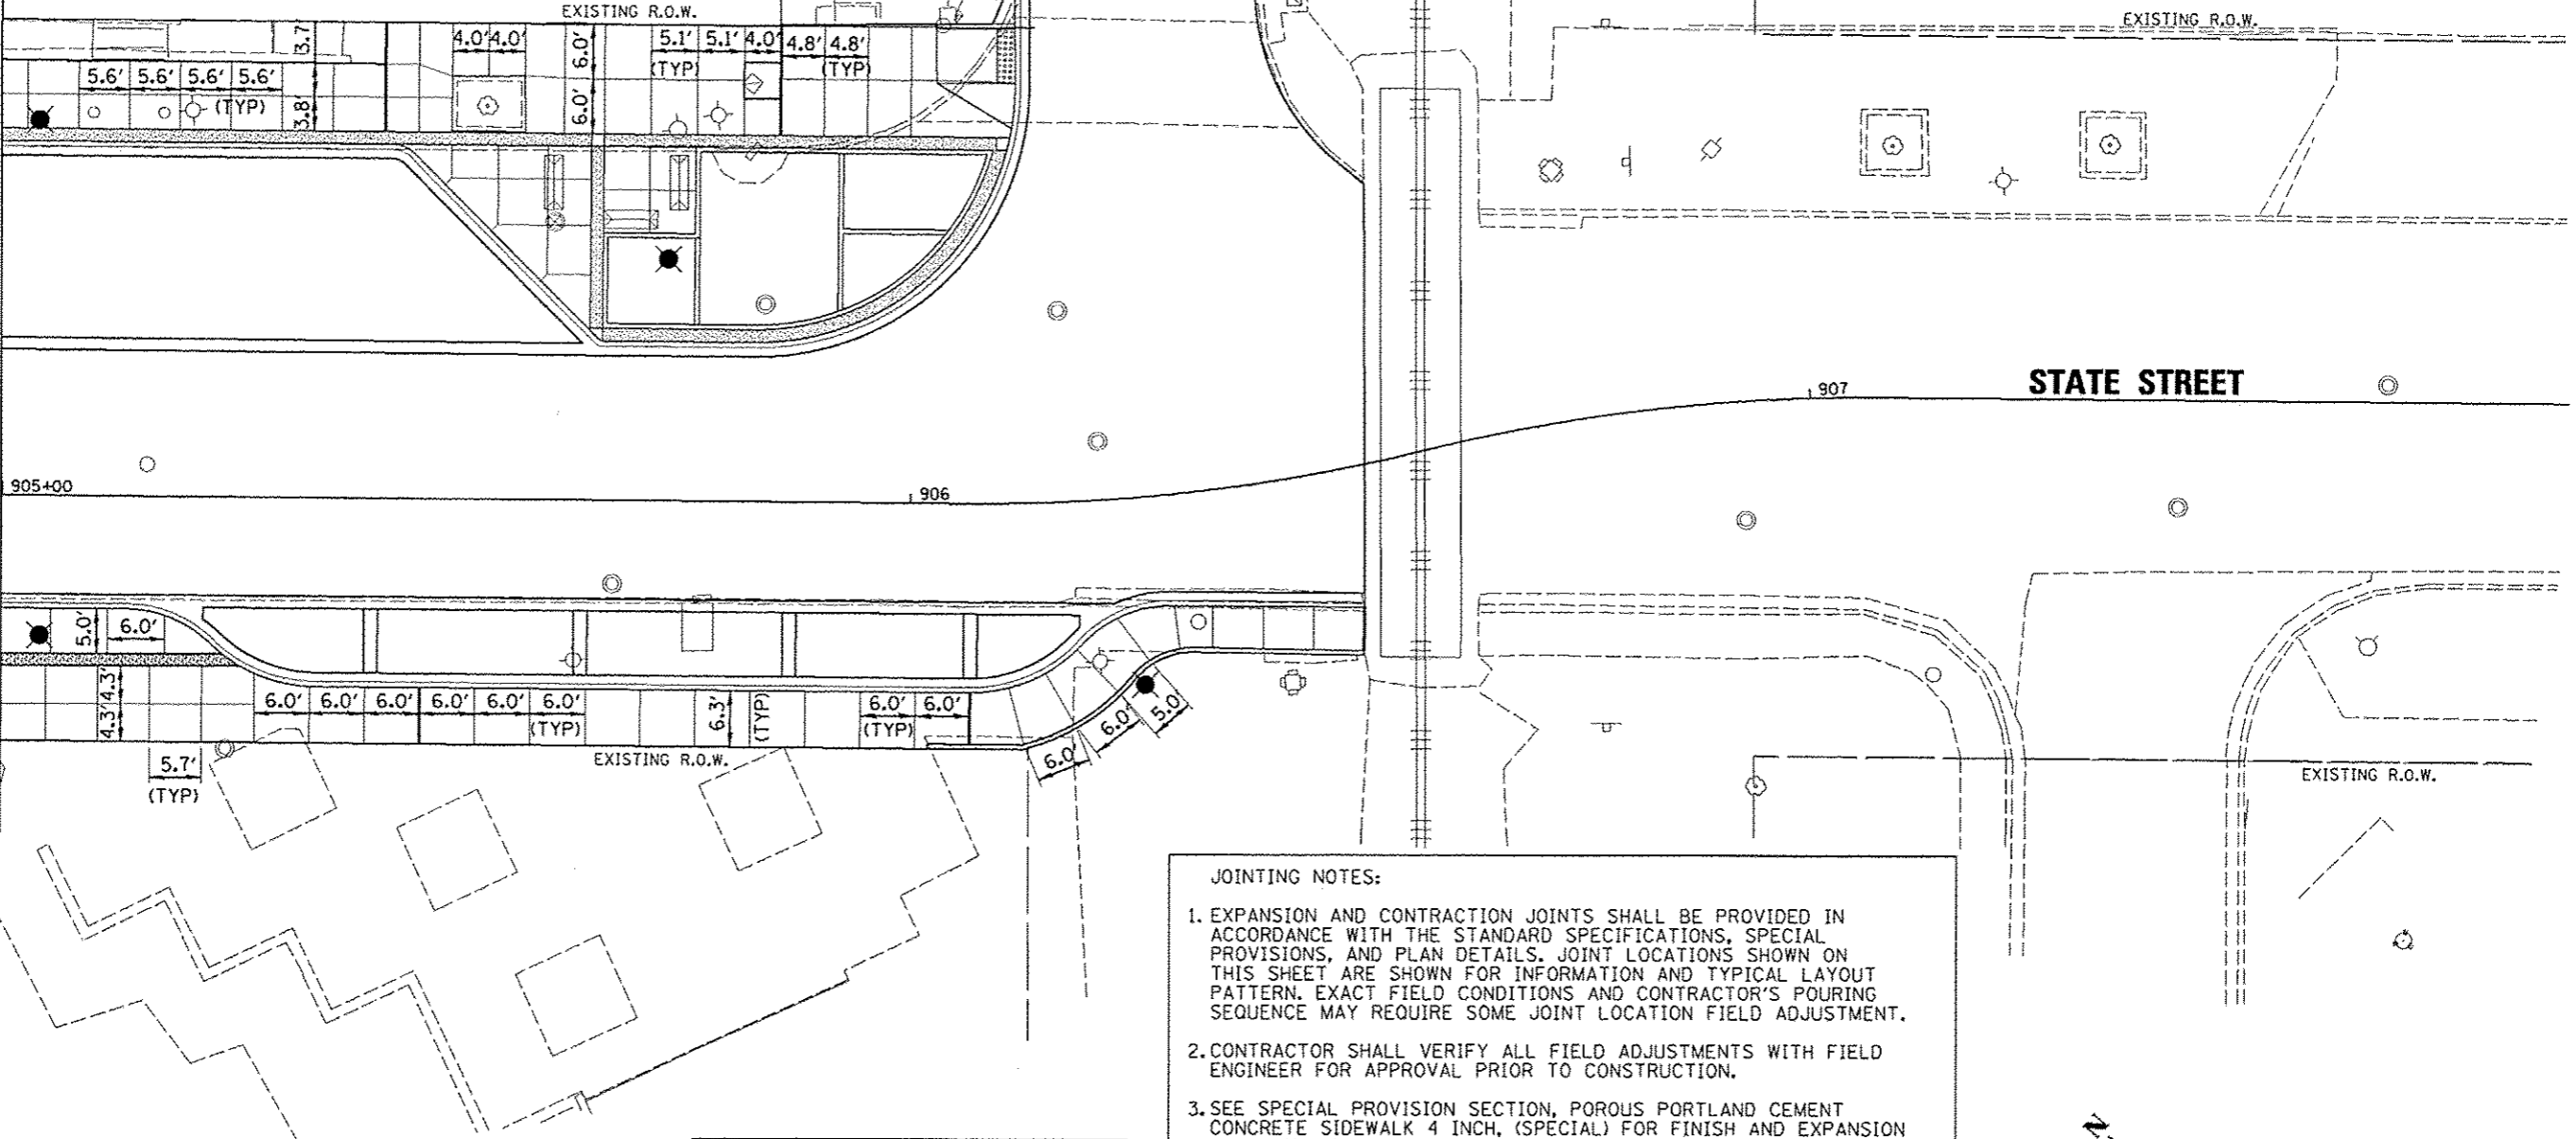

**JOINTING NOTES:**

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JOINTING LEGEND	
	TOOLED JOINT
	EXPANSION JOINT

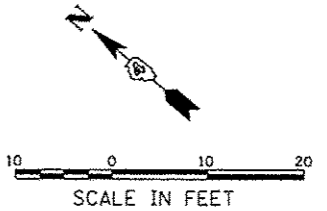

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07/23/2012		7/18/12	-




**STATE OF ILLINOIS  
DEPARTMENT OF TRANSPORTATION**

<b>STATE STREET STREETSCAPE PAVEMENT JOINTING PLAN</b>			
SCALE: 1"=10'	SHEET NO. OF	SHEETS	STA. 905+00.00 TO STA. 908+00.00


F.A.U. RTE.	SECTION	COUNTY	TOTAL SHEETS	SHEET NO.
223	12-00356-01-PV	PEORIA	519	306
CONTRACT NO. 89626				
ILLINOIS FED. AID PROJECT TIC-50931581				

**Farnsworth GROUP**  
7707 N. KNOXVILLE AVE., SUITE 100  
PEORIA, ILLINOIS 61614  
(309) 699-9668 / (309) 699-9620 Fax  
www.far.com

- JOINTING NOTES:**
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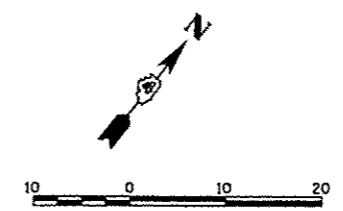

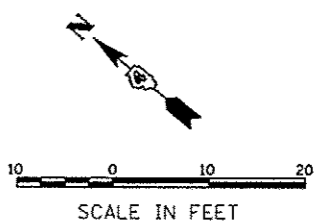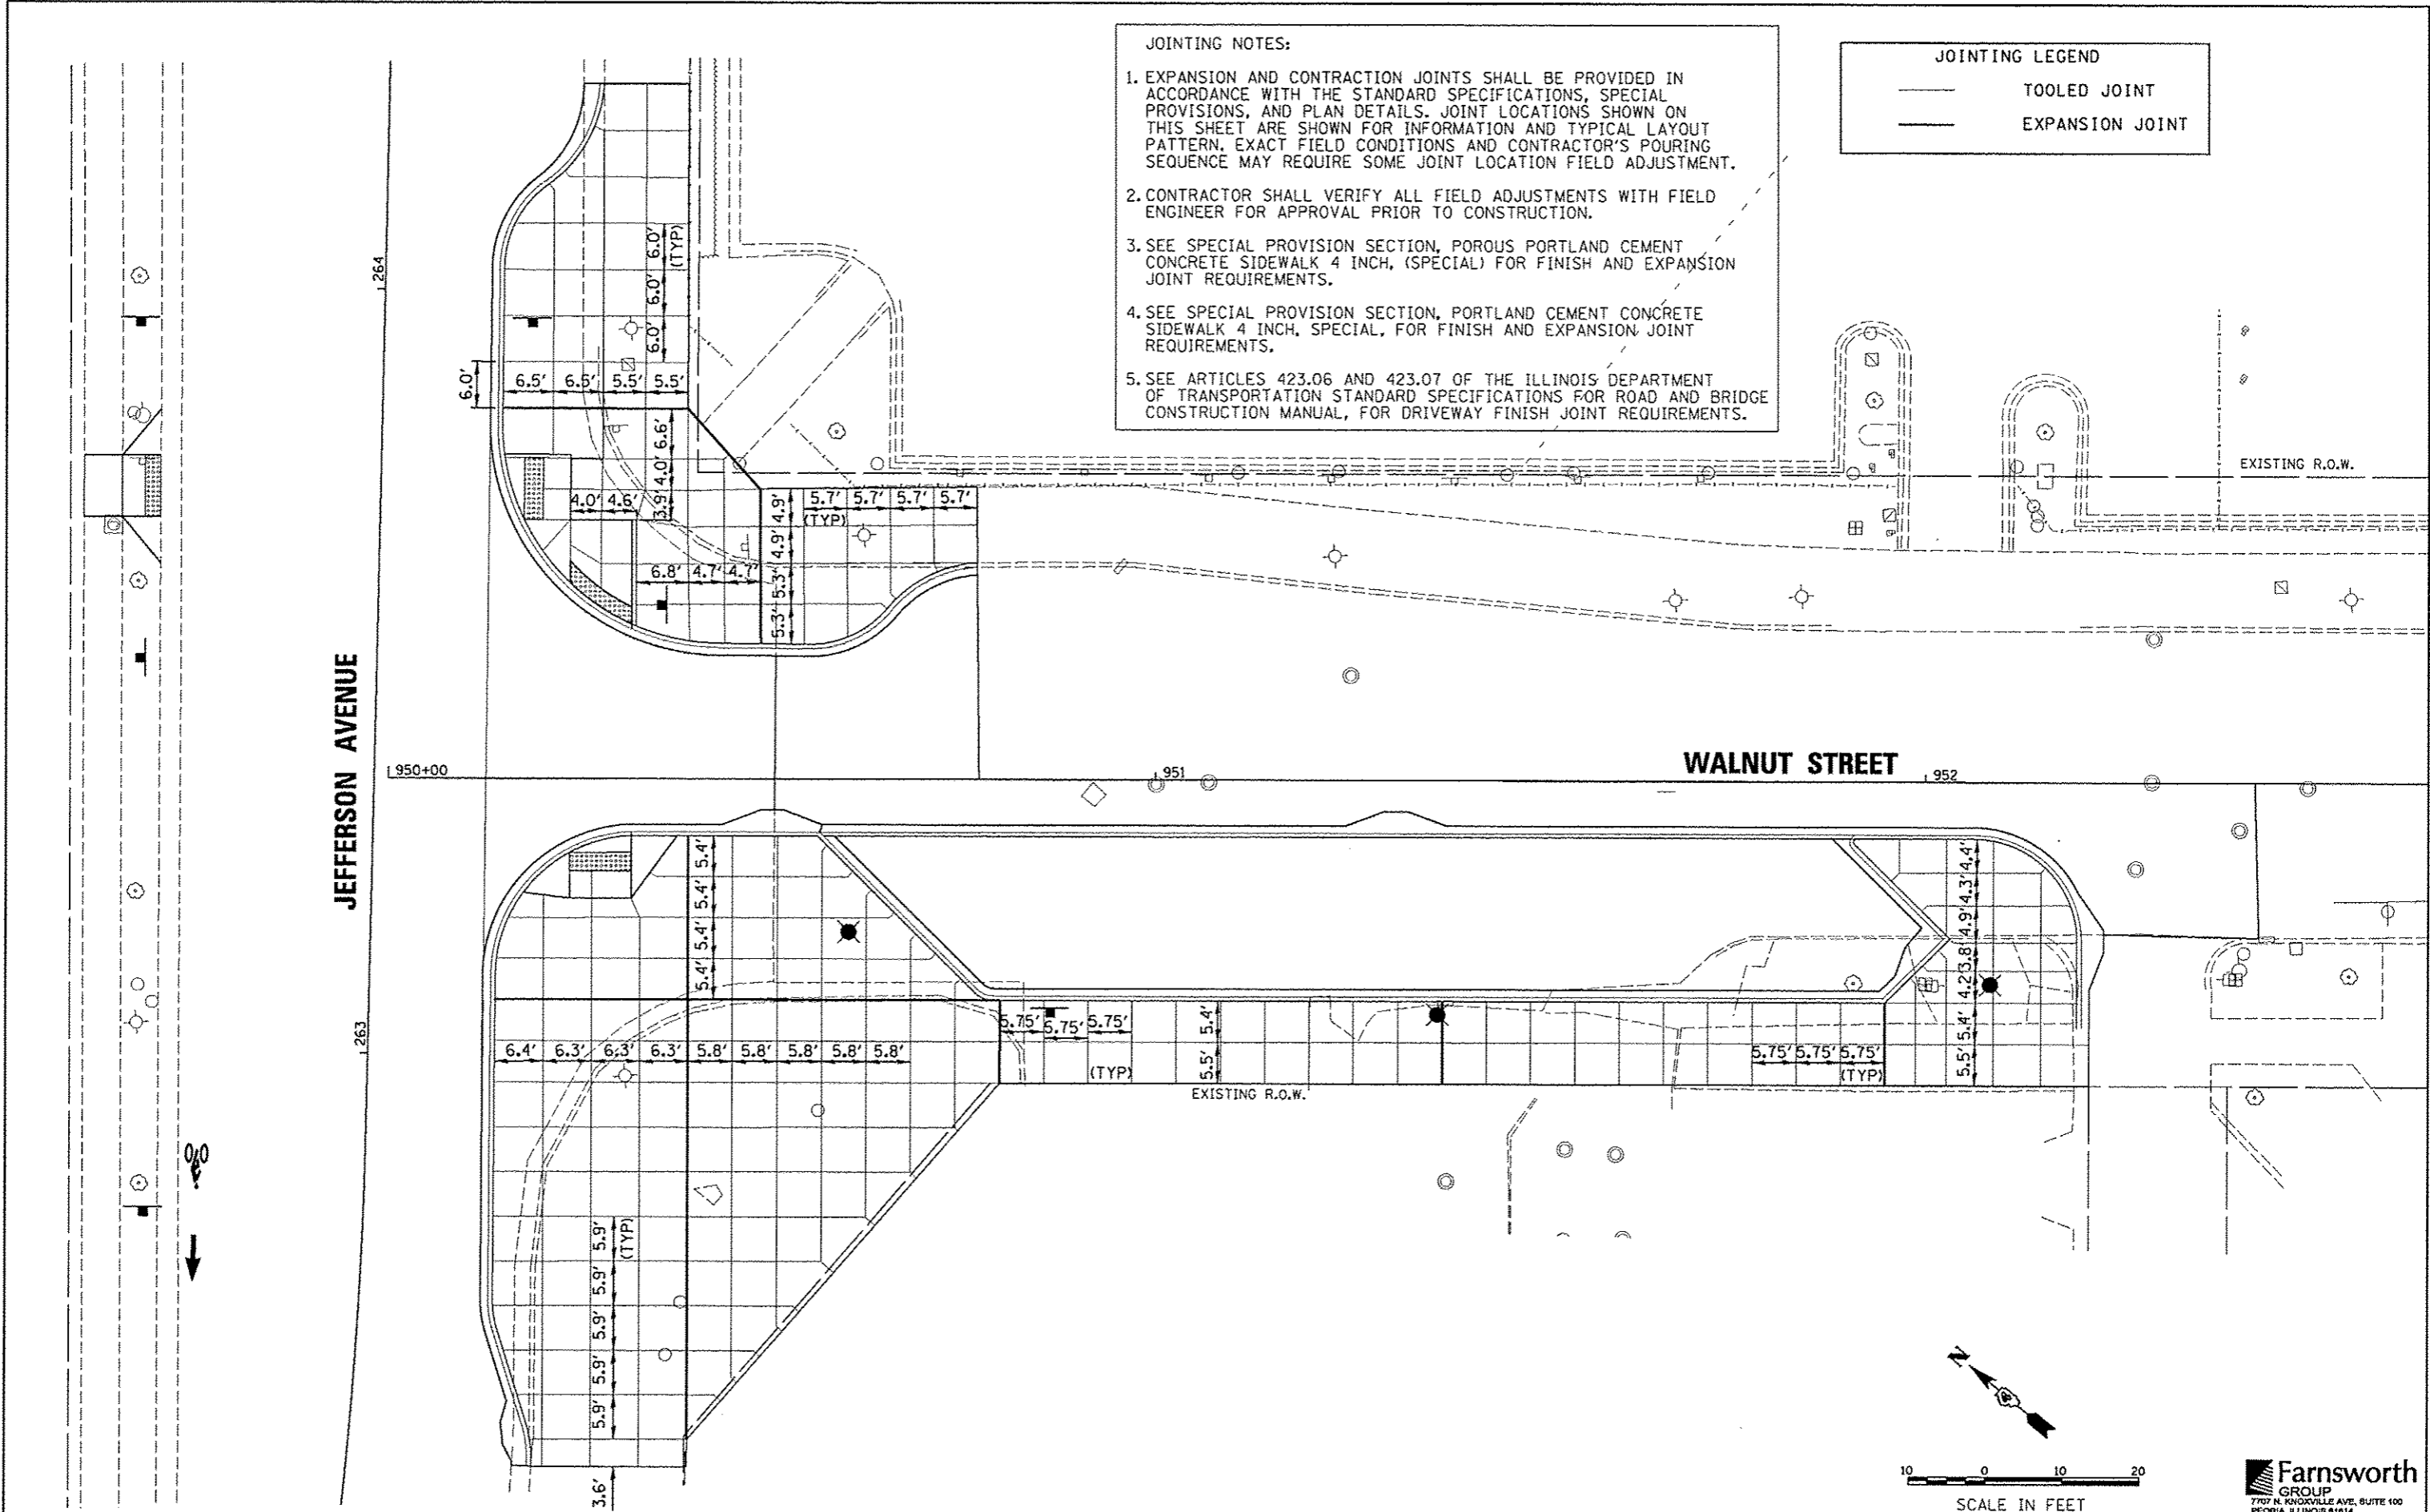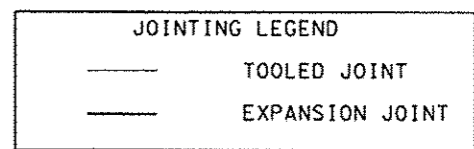
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	PLT DATE = 07/23/2012	DATE - 7/18/12	REVISED -		ILLINOIS FED. AID PROJECT TIC-5093(158)							
<p style="text-align: right;"><b>Farnsworth GROUP</b> 7707 N. KNOXVILLE AVE, SUITE 100 PEORIA, ILLINOIS 61614 (309) 699-8888 / (309) 699-8820 Fax www.fwg.com</p>												

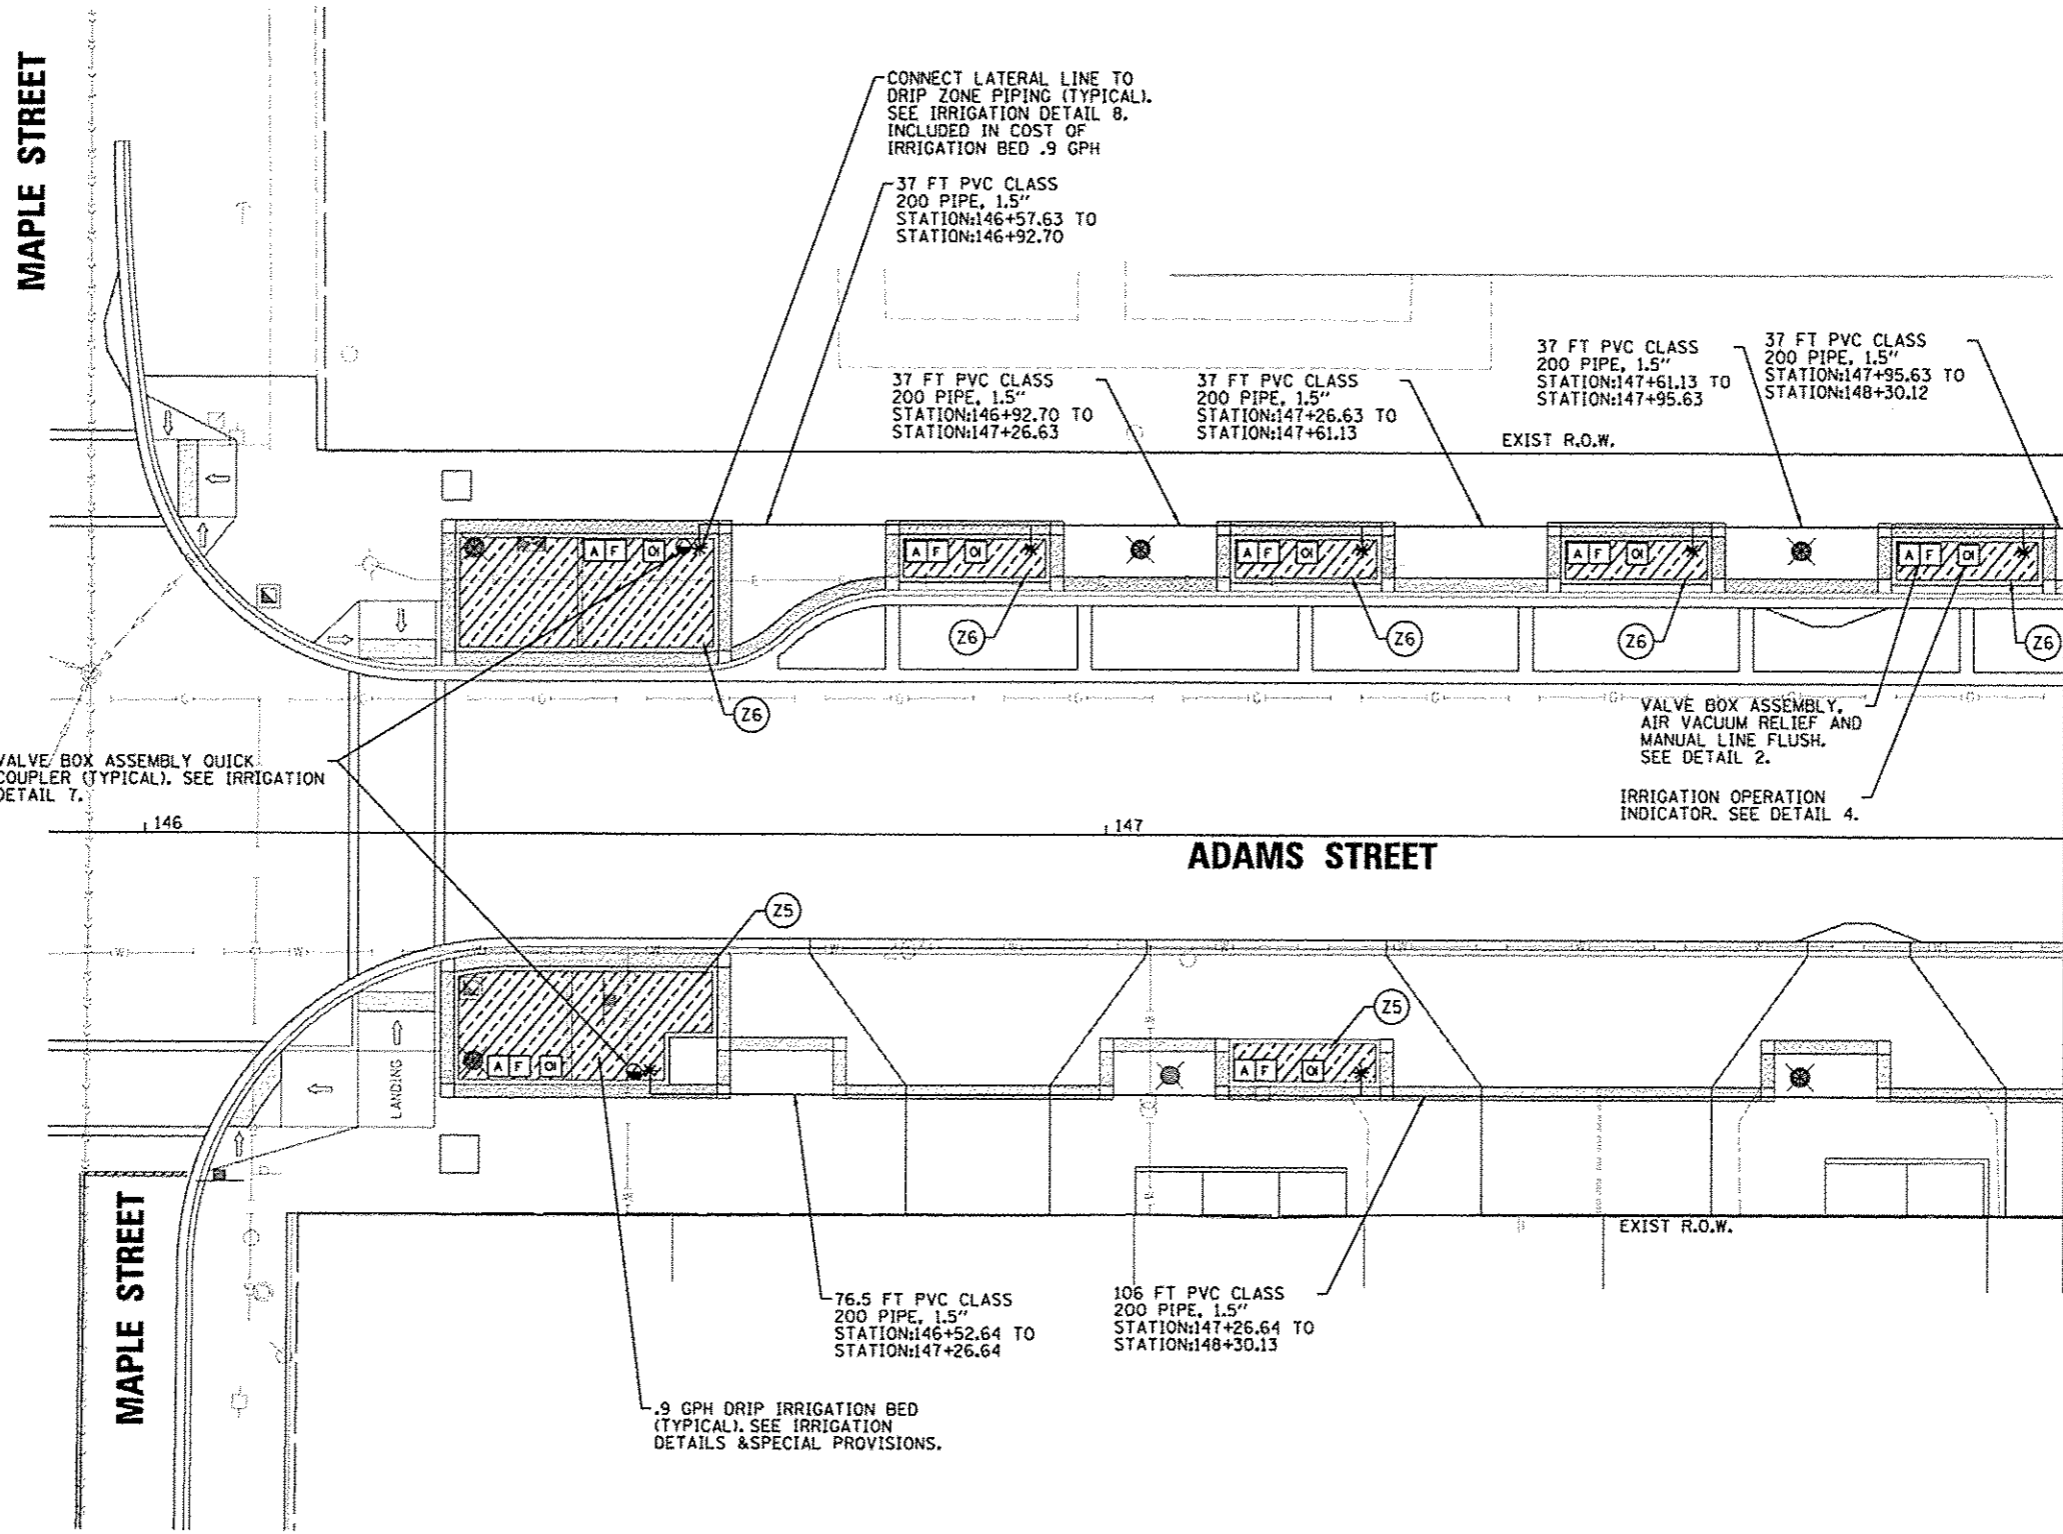


IRRIGATION LEGEND

SYMBOL	DESCRIPTION
F	VALVE BOX ASSEMBLY, MANUAL LINE FLUSH
A	VALVE BOX ASSEMBLY, AIR/VACUUM RELIEF
[Hatched Box]	IRRIGATION BED .9 GPH
OI	IRRIGATION BED, OPERATION INDICATOR
*	PVC PIPE CONNECTION TO DRIP IRRIGATION PIPING
IRR. POB	IRRIGATION SYSTEM TAP AND POINT OF CONNECTION
RPZ	RPZ ASSEMBLY
[Symbol]	VALVE BOX ASSEMBLY, DRIP ZONE
[Symbol]	VALVE BOX ASSEMBLY, QUICK COUPLER
[Symbol]	PVC CLASS 200 PIPE, 1.5"
[Symbol]	PVC CLASS 200 PIPE, 2"
[Symbol]	IRRIGATION CONTROL WIRE IN 2" CONDUIT
C	IRRIGATION SYSTEM, CONTROLLER






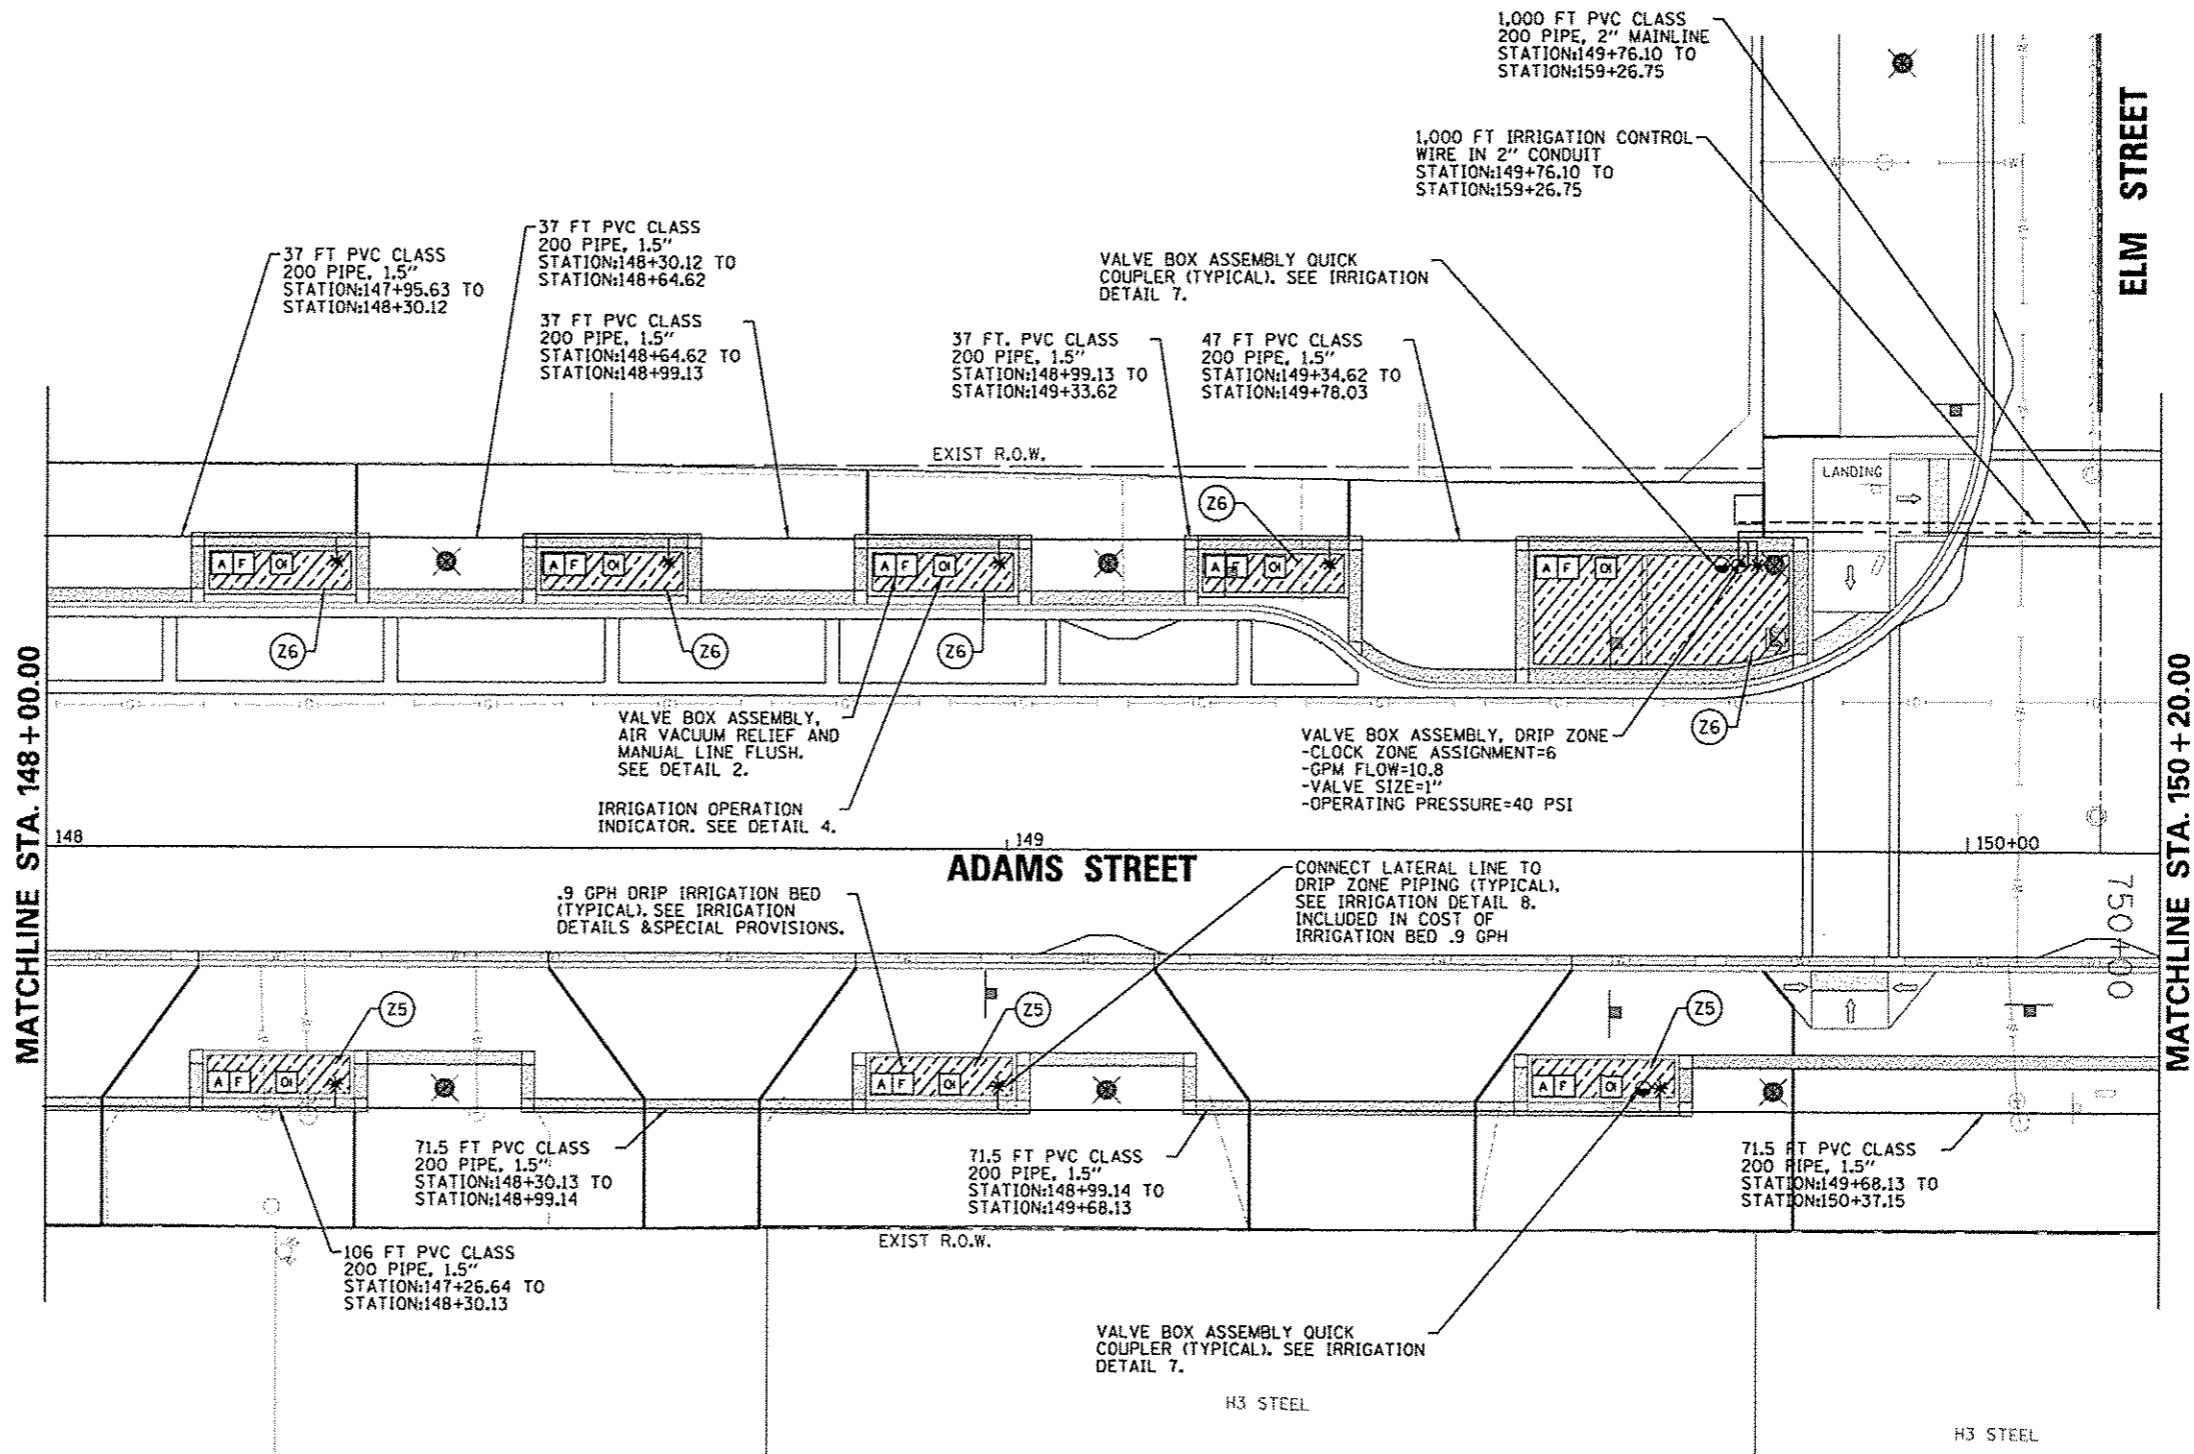

**IRRIGATION LEGEND**



SYMBOL	DESCRIPTION
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A	VALVE BOX ASSEMBLY, AIR VACUUM RELIEF
[Hatched Box]	IRRIGATION BED .9 GPH
OI	IRRIGATION BED, OPERATION INDICATOR
*	PVC PIPE CONNECTION TO DRIP IRRIGATION PIPING
IRR. POB	IRRIGATION SYSTEM TAP AND POINT OF CONNECTION
RPZ	RPZ ASSEMBLY
⊙	VALVE BOX ASSEMBLY, DRIP ZONE
⊙	VALVE BOX ASSEMBLY, QUICK COUPLER
—	PVC CLASS 200 PIPE, 1.5"
- - -	PVC CLASS 200 PIPE, 2"
- - -	IRRIGATION CONTROL WIRE IN 2" CONDUIT
C	IRRIGATION SYSTEM, CONTROLLER

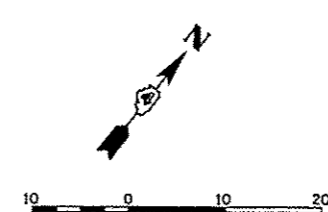

**Farnsworth GROUP**  
 7707 N. KNOXVILLE AVE, SUITE 100  
 PEORIA, ILLINOIS 61614  
 (309) 699-0555 / (309) 699-0620 Fax  
 www.fwg.com


IRRIGATION LEGEND

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[Hatched Box]	IRRIGATION BED .9 GPH
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IRR. POB	IRRIGATION SYSTEM TAP AND POINT OF CONNECTION
RPZ	RPZ ASSEMBLY
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⊕	VALVE BOX ASSEMBLY, QUICK COUPLER
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- - -	IRRIGATION CONTROL WIRE IN 2" CONDUIT
C	IRRIGATION SYSTEM, CONTROLLER

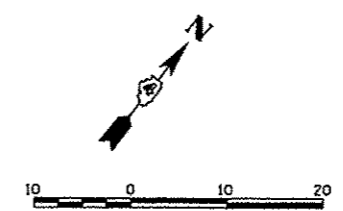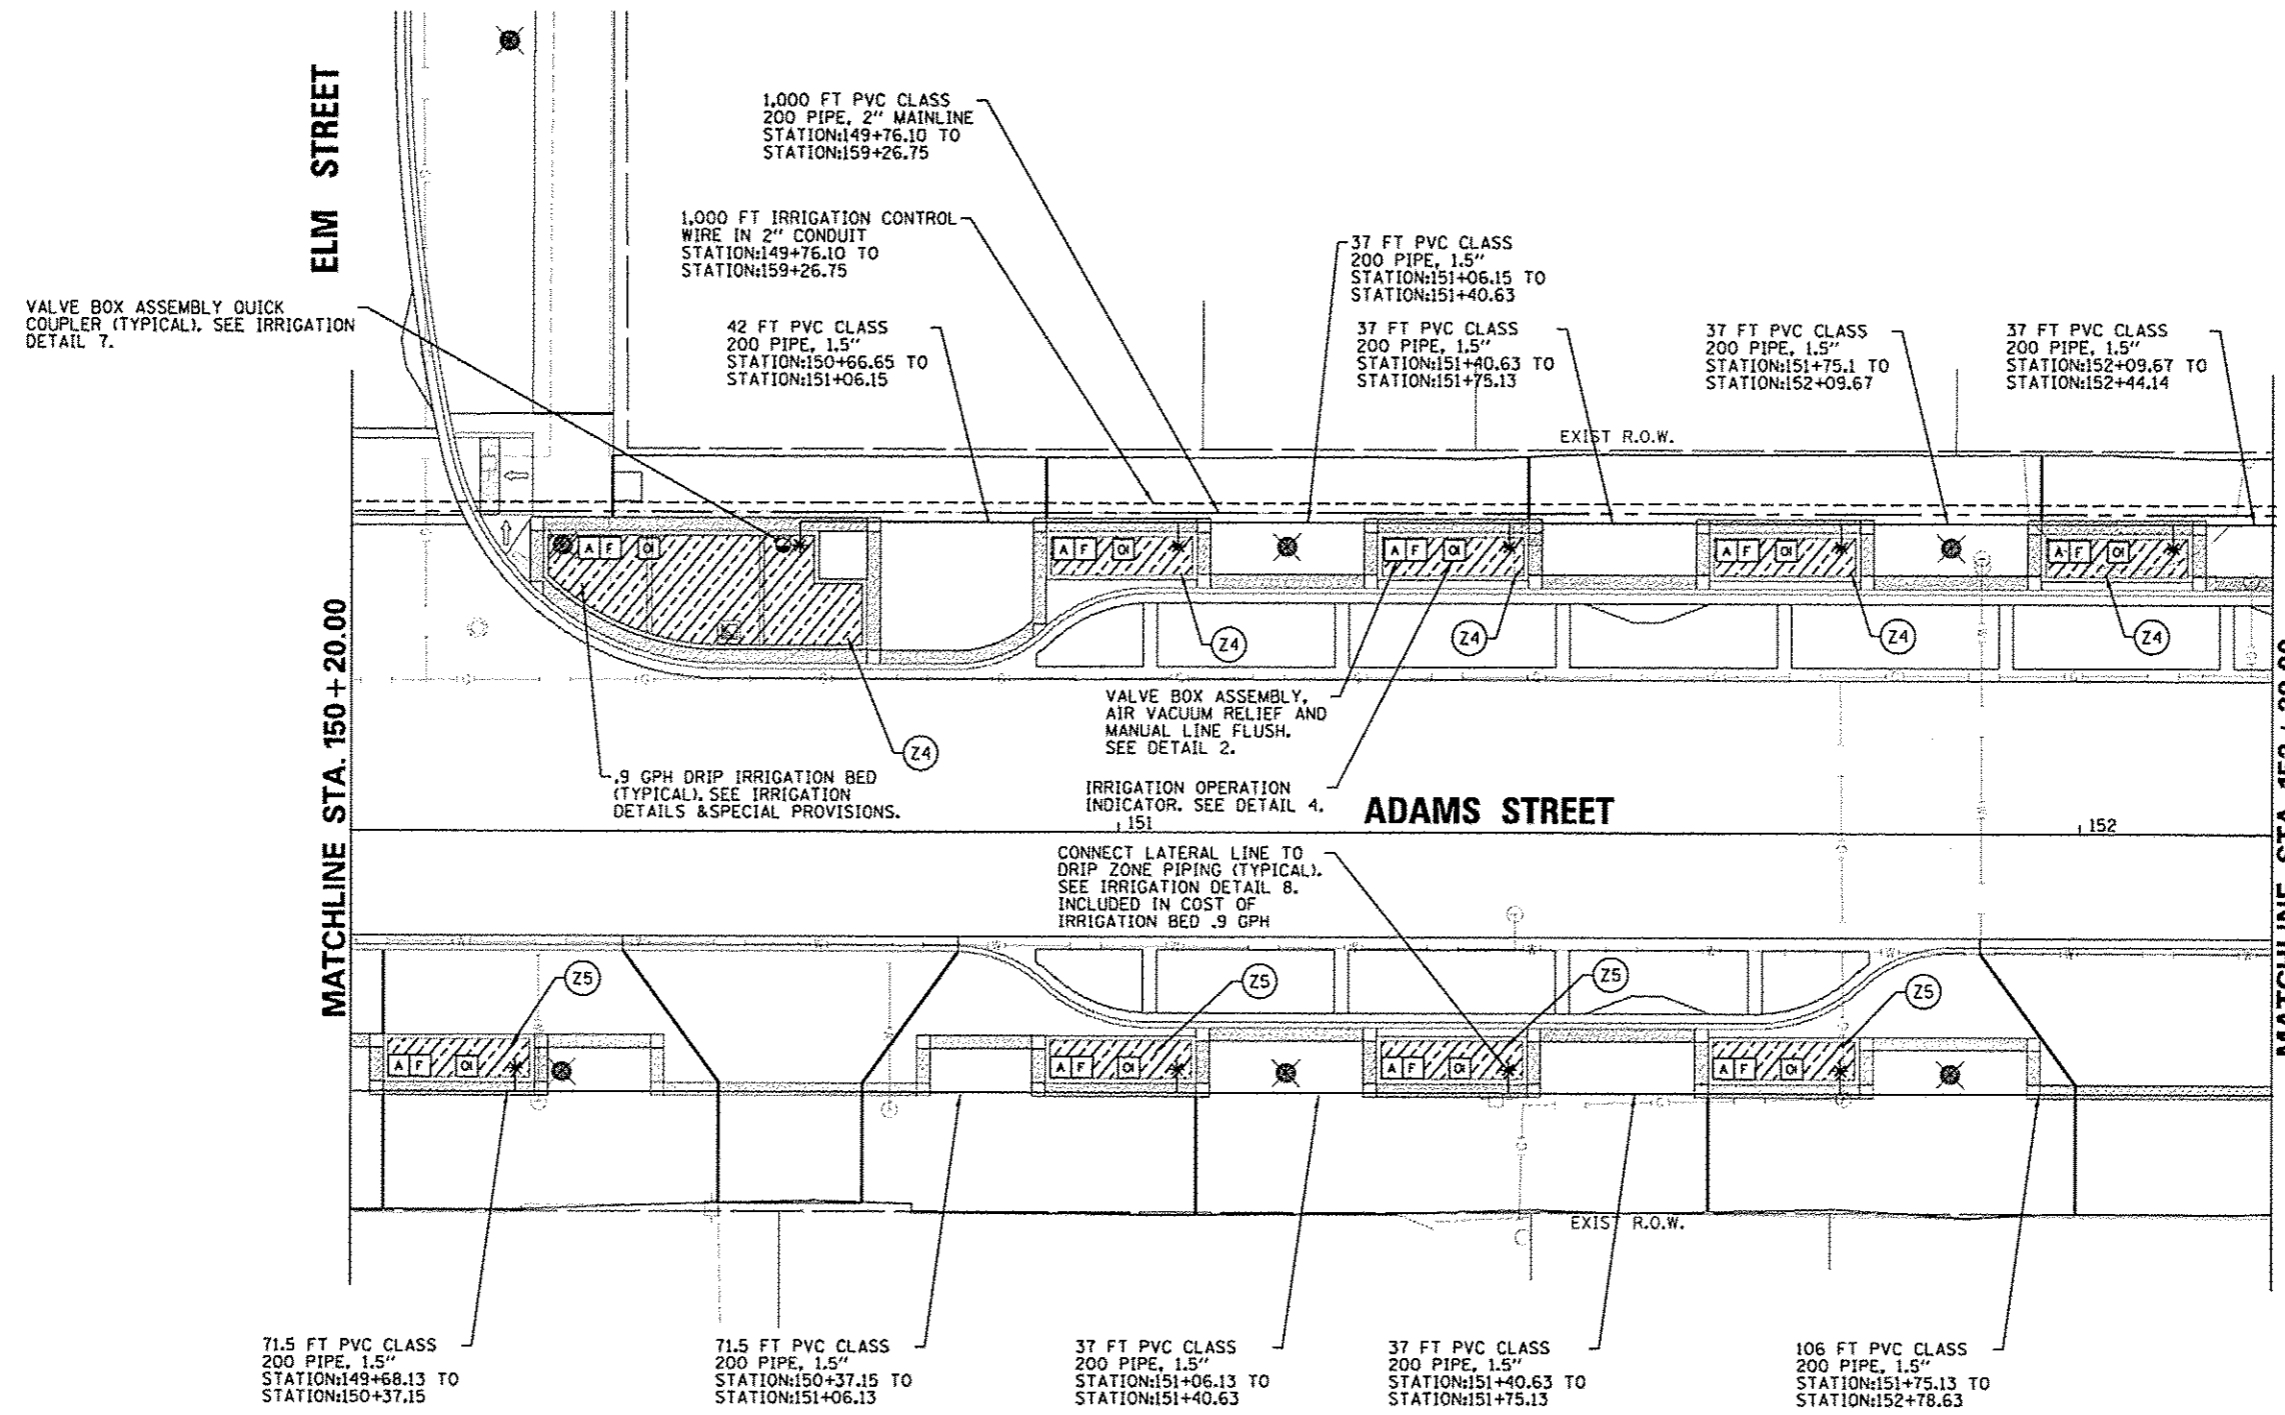


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PLOT SCALE = 20,0000 ' / ' in.	CHECKED - BAB	REVISED - -	REVISED - -							
PLOT DATE = 07/23/2012	DATE - 7/18/12	REVISED - -	REVISED - -							

**Farnsworth GROUP**  
7707 N. KNOXVILLE AVE, SUITE 100  
PEORIA, ILLINOIS 61614  
(309) 699-0500 / (309) 699-0820 Fax  
www.fsg.com

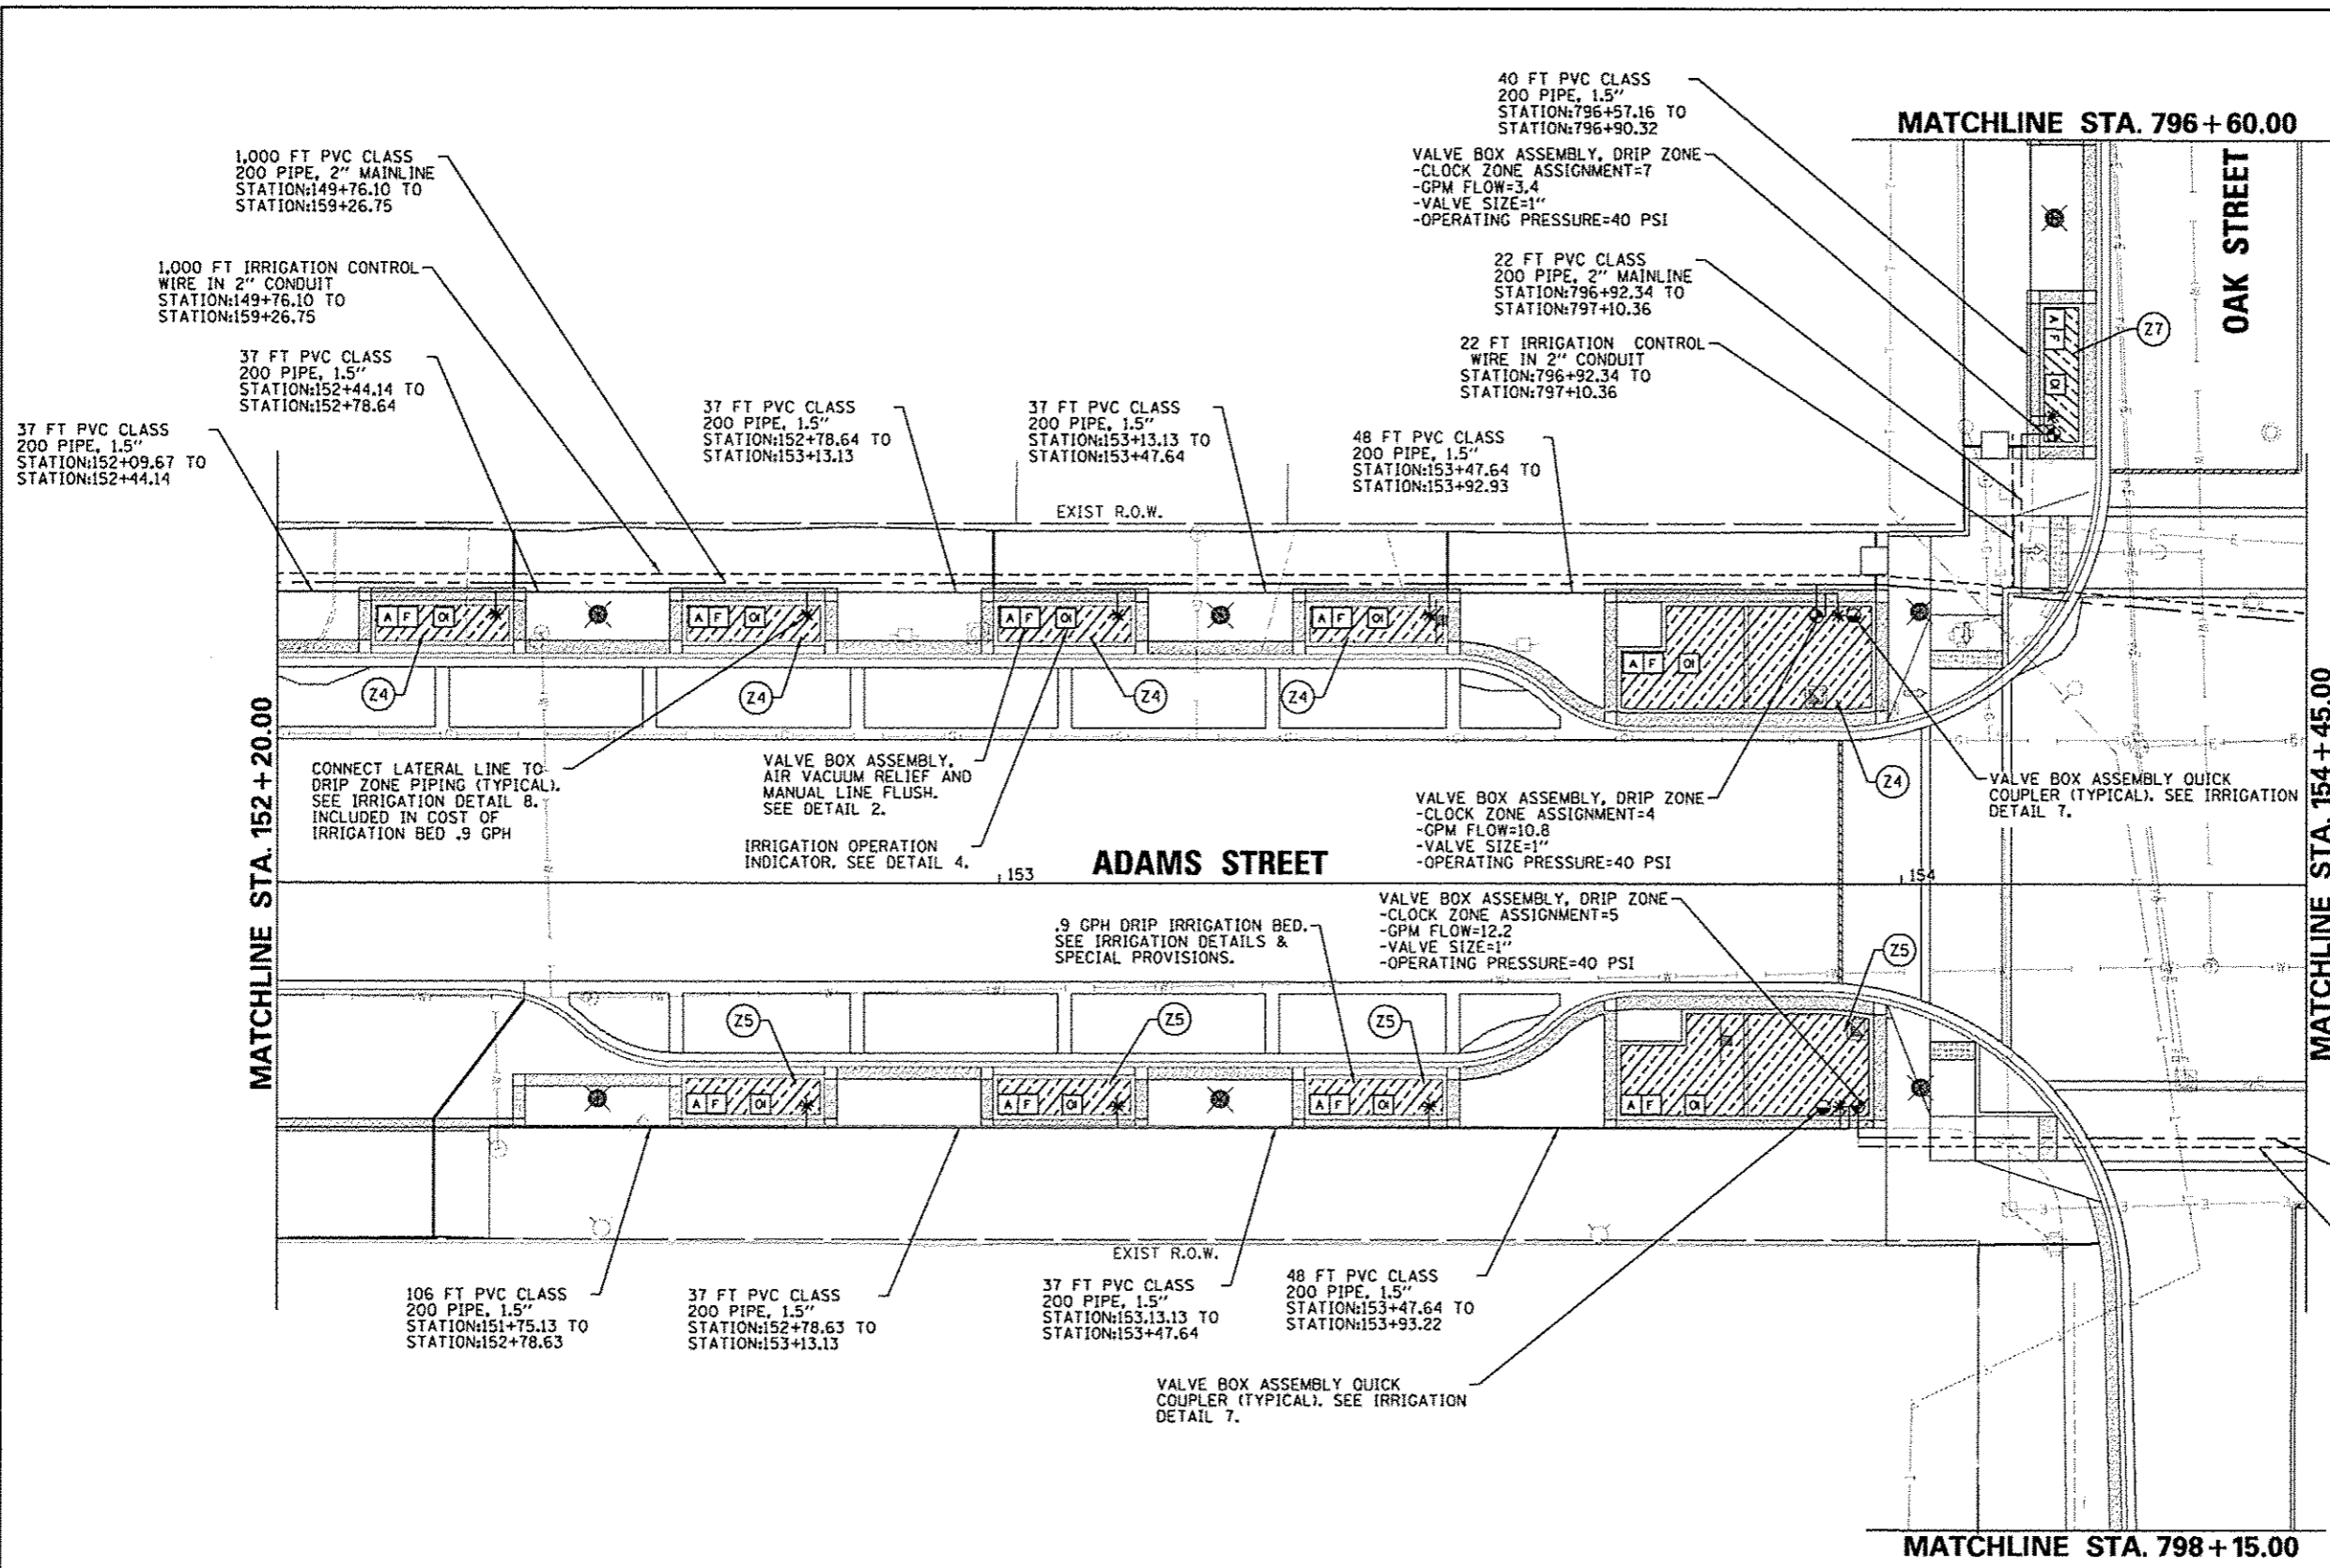

**IRRIGATION LEGEND**

SYMBOL	DESCRIPTION
[F]	VALVE BOX ASSEMBLY, MANUAL LINE FLUSH
[A]	VALVE BOX ASSEMBLY, AIR/VACUUM RELIEF
[Hatched Box]	IRRIGATION BED .9 GPH
[O]	IRRIGATION BED, OPERATION INDICATOR
[*]	PVC PIPE CONNECTION TO DRIP IRRIGATION PIPING
[IRR. POB]	IRRIGATION SYSTEM TAP AND POINT OF CONNECTION
[RPZ]	RPZ ASSEMBLY
[Valve Box]	VALVE BOX ASSEMBLY, DRIP ZONE
[Valve Box]	VALVE BOX ASSEMBLY, QUICK COUPLER
[Solid Line]	PVC CLASS 200 PIPE, 1.5"
[Dashed Line]	PVC CLASS 200 PIPE, 2"
[Dotted Line]	IRRIGATION CONTROL WIRE IN 2" CONDUIT
[C]	IRRIGATION SYSTEM, CONTROLLER

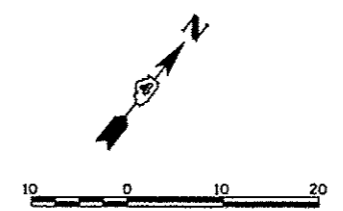

FILE NAME = c:\pwise\work\do_no_c_delete\dms73427\04	USER NAME = mangk01390 BL0155-shc-srr-007.dgn	DESIGNED - JLH	REVISED -	<b>STATE OF ILLINOIS DEPARTMENT OF TRANSPORTATION</b>	<b>ADAMS STREET IRRIGATION PLAN</b>	F.A.U. RTE. 12	SECTION 12-00356-01-PV	COUNTY PEORIA	TOTAL SHEETS 519	SHEET NO. 311	
PLOT SCALE = 20,0000' / in.	CHECKED - BAB	REVISOR -	SCALE: 1"=10'			SHEET NO. OF SHEETS	STA. 152+20 TO STA. 154+45	CONTRACT NO. 89626		ILLINOIS FED. AID PROJECT TIG-50930560	
PLOT DATE = 07/23/2012	DATE - 7/18/12	REVISOR -									

**Farnsworth GROUP**  
 7707 N. KNOXVILLE AVE., SUITE 100  
 PEORIA, ILLINOIS 61614  
 (309) 699-0568 / (309) 699-0620 Fax  
 www.far.com

MATCHLINE STA. 796 + 60.00

OAK STREET

61 FT PVC CLASS 200 PIPE, 2" MAINLINE  
STATION:796+55.34 TO STATION:797+42.36

61 FT IRRIGATION CONTROL WIRE IN 2" CONDUIT  
STATION:796+57.35 TO STATION:797+14.81

1,000 FT PVC CLASS 200 PIPE, 2" MAINLINE  
STATION:149+76.10 TO STATION:159+26.75

1,000 FT IRRIGATION CONTROL WIRE IN 2" CONDUIT  
STATION:149+76.10 TO STATION:159+26.75




148 FT PVC CLASS 200 PIPE, 1.5" STATION:155+11.77 TO STATION:156+57.49

37 FT PVC CLASS 200 PIPE, 1.5" STATION:156+57.49 TO STATION:156+91.98

IRRIGATION LEGEND

SYMBOL	DESCRIPTION
F	VALVE BOX ASSEMBLY, MANUAL LINE FLUSH
A	VALVE BOX ASSEMBLY, AIR/VACUUM RELIEF
[Hatched Box]	IRRIGATION BED .9 GPH
OI	IRRIGATION BED, OPERATION INDICATOR
*	PVC PIPE CONNECTION TO DRIP IRRIGATION PIPING
IRR. POB	IRRIGATION SYSTEM TAP AND POINT OF CONNECTION
RPZ	RPZ ASSEMBLY
[Circle with Z]	VALVE BOX ASSEMBLY, DRIP ZONE
[Circle with C]	VALVE BOX ASSEMBLY, QUICK COUPLER
[Solid Line]	PVC CLASS 200 PIPE, 1.5"
[Dashed Line]	PVC CLASS 200 PIPE, 2"
[Dotted Line]	IRRIGATION CONTROL WIRE IN 2" CONDUIT
C	IRRIGATION SYSTEM, CONTROLLER

MATCHLINE STA. 154 + 45.00

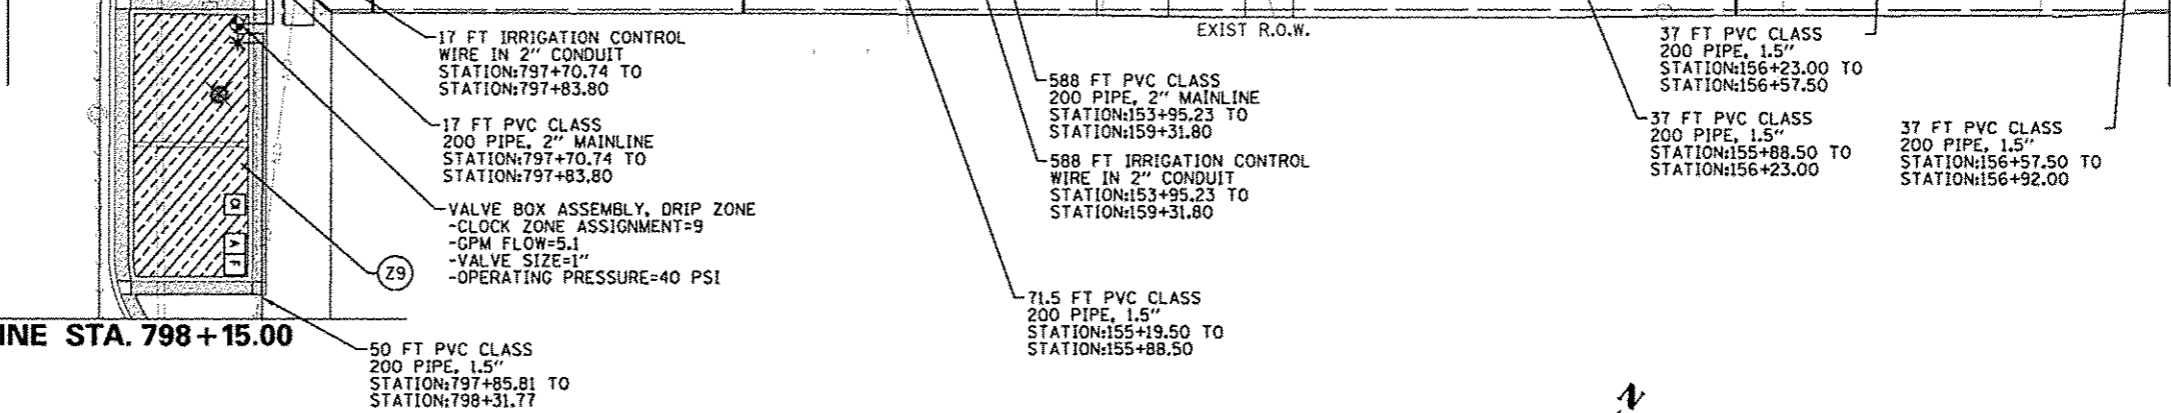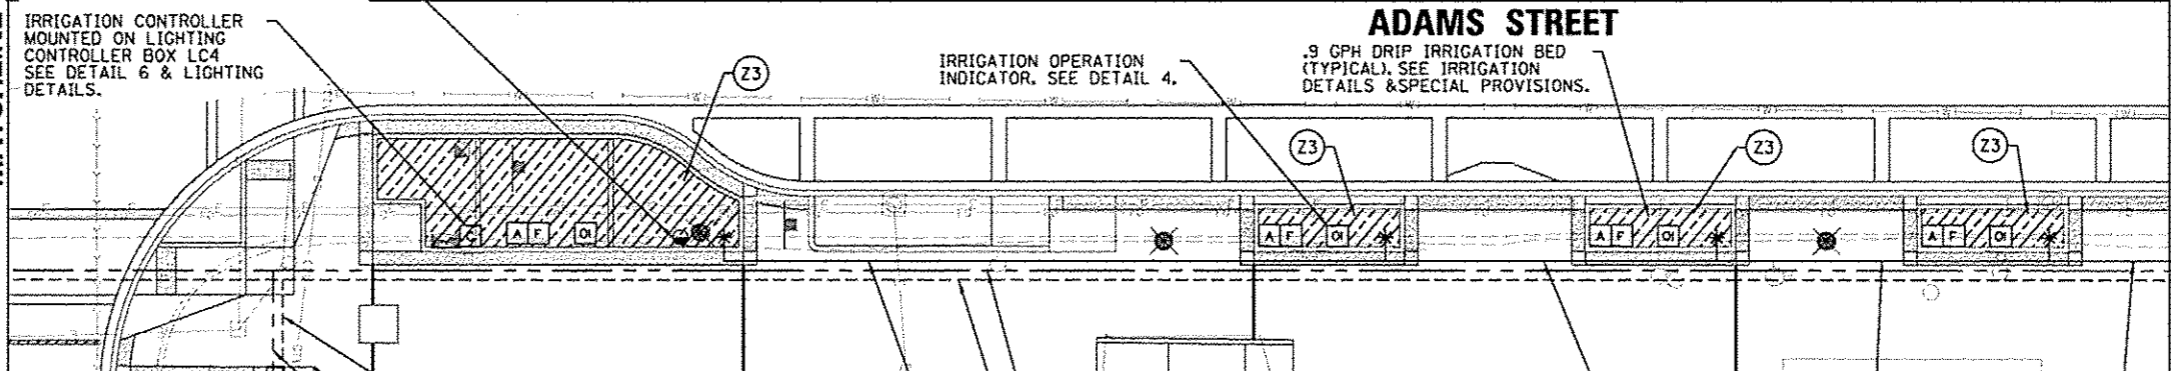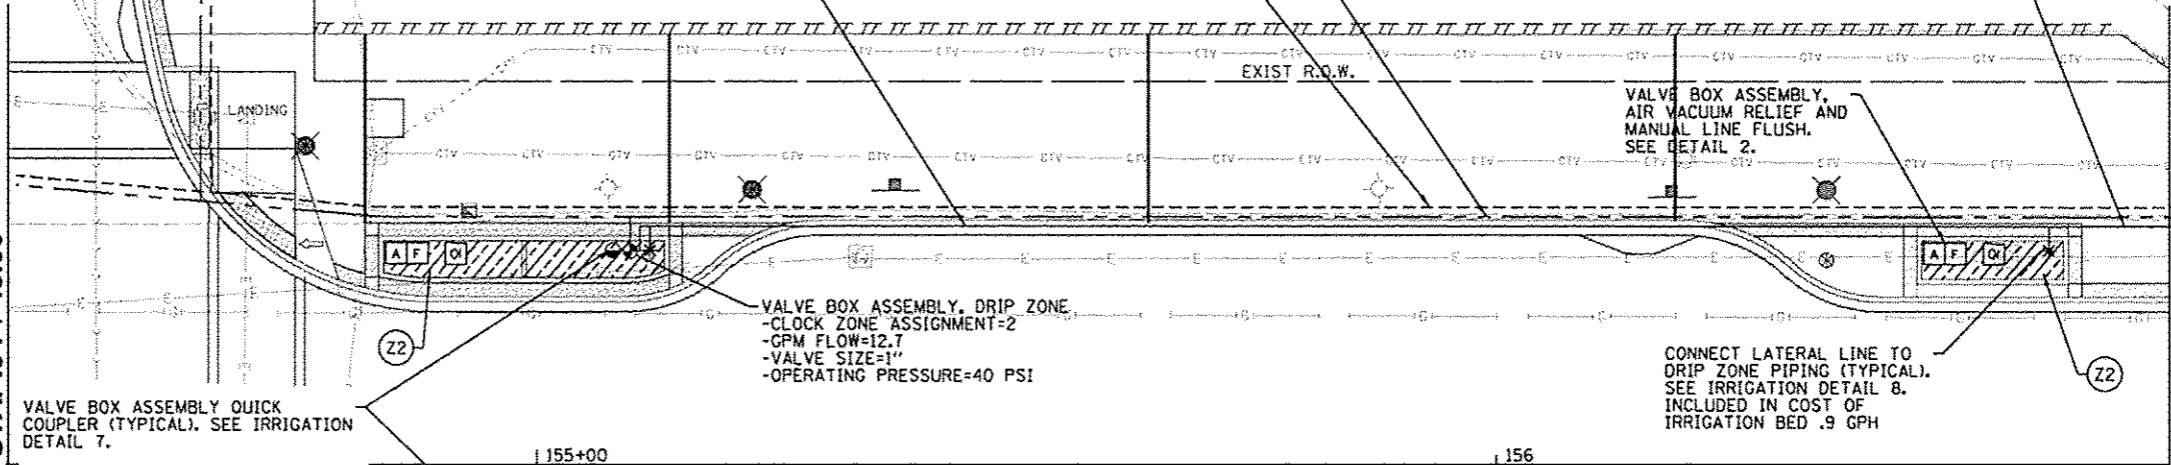

MATCHLINE STA. 798 + 15.00

50 FT PVC CLASS 200 PIPE, 1.5" STATION:797+85.81 TO STATION:798+31.77

17 FT IRRIGATION CONTROL WIRE IN 2" CONDUIT STATION:797+70.74 TO STATION:797+83.80

17 FT PVC CLASS 200 PIPE, 2" MAINLINE STATION:797+70.74 TO STATION:797+83.80

VALVE BOX ASSEMBLY, DRIP ZONE -CLOCK ZONE ASSIGNMENT=9 -GPM FLOW=5.1 -VALVE SIZE=1" -OPERATING PRESSURE=40 PSI

588 FT PVC CLASS 200 PIPE, 2" MAINLINE STATION:153+95.23 TO STATION:159+31.80


588 FT IRRIGATION CONTROL WIRE IN 2" CONDUIT STATION:153+95.23 TO STATION:159+31.80

71.5 FT PVC CLASS 200 PIPE, 1.5" STATION:155+19.50 TO STATION:155+88.50

37 FT PVC CLASS 200 PIPE, 1.5" STATION:156+23.00 TO STATION:156+57.50

37 FT PVC CLASS 200 PIPE, 1.5" STATION:155+88.50 TO STATION:156+23.00

37 FT PVC CLASS 200 PIPE, 1.5" STATION:156+57.50 TO STATION:156+92.00


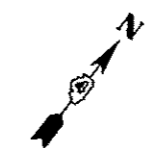


FILE NAME: \\p\pisa\work\do_not_delete\dms\73427\04	USER NAME: mprsk01398	DESIGNED: JLH	REVISED: -	<b>STATE OF ILLINOIS DEPARTMENT OF TRANSPORTATION</b>	<b>ADAMS STREET IRRIGATION PLAN</b>			F.A.U. RTE. 12-00356-01-PV	COUNTY: PEORIA	TOTAL SHEETS: 519	SHEET NO.: 312
PL0155-shr-irr-888.dgn	PL0155-shr-irr-888.dgn	DRAWN: JLH	REVISED: -		SCALE: 1"=10'	SHEET NO. OF SHEETS: 12	STA. 154+45 TO STA. 156+70	CONTRACT NO. B9626			
		CHECKED: BAB	REVISED: -					ILLINOIS FED. AID PROJECT TIG-5693158			
		DATE: 7/18/12	REVISED: -								

**Farnsworth GROUP**  
7707 N. KNOXVILLE AVE, SUITE 100  
PEORIA, ILLINOIS 61614  
(309) 699-8668 / (309) 699-8620 Fax  
www.farnsworth.com

**IRRIGATION LEGEND**

SYMBOL	DESCRIPTION
[F]	VALVE BOX ASSEMBLY, MANUAL LINE FLUSH
[A]	VALVE BOX ASSEMBLY, AIR VACUUM RELIEF
[Hatched]	IRRIGATION BED .9 GPH
[OI]	IRRIGATION BED, OPERATION INDICATOR
[*]	PVC PIPE CONNECTION TO DRIP IRRIGATION PIPING
[IRR. POB]	IRRIGATION SYSTEM TAP AND POINT OF CONNECTION
[RPZ]	RPZ ASSEMBLY
[V]	VALVE BOX ASSEMBLY, DRIP ZONE
[V]	VALVE BOX ASSEMBLY, QUICK COUPLER
[Solid Line]	PVC CLASS 200 PIPE, 1.5"
[Dashed Line]	PVC CLASS 200 PIPE, 2"
[Dotted Line]	IRRIGATION CONTROL WIRE IN 2" CONDUIT
[C]	IRRIGATION SYSTEM, CONTROLLER

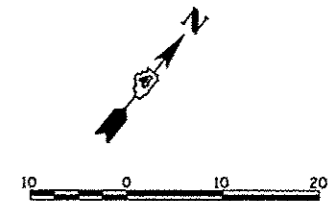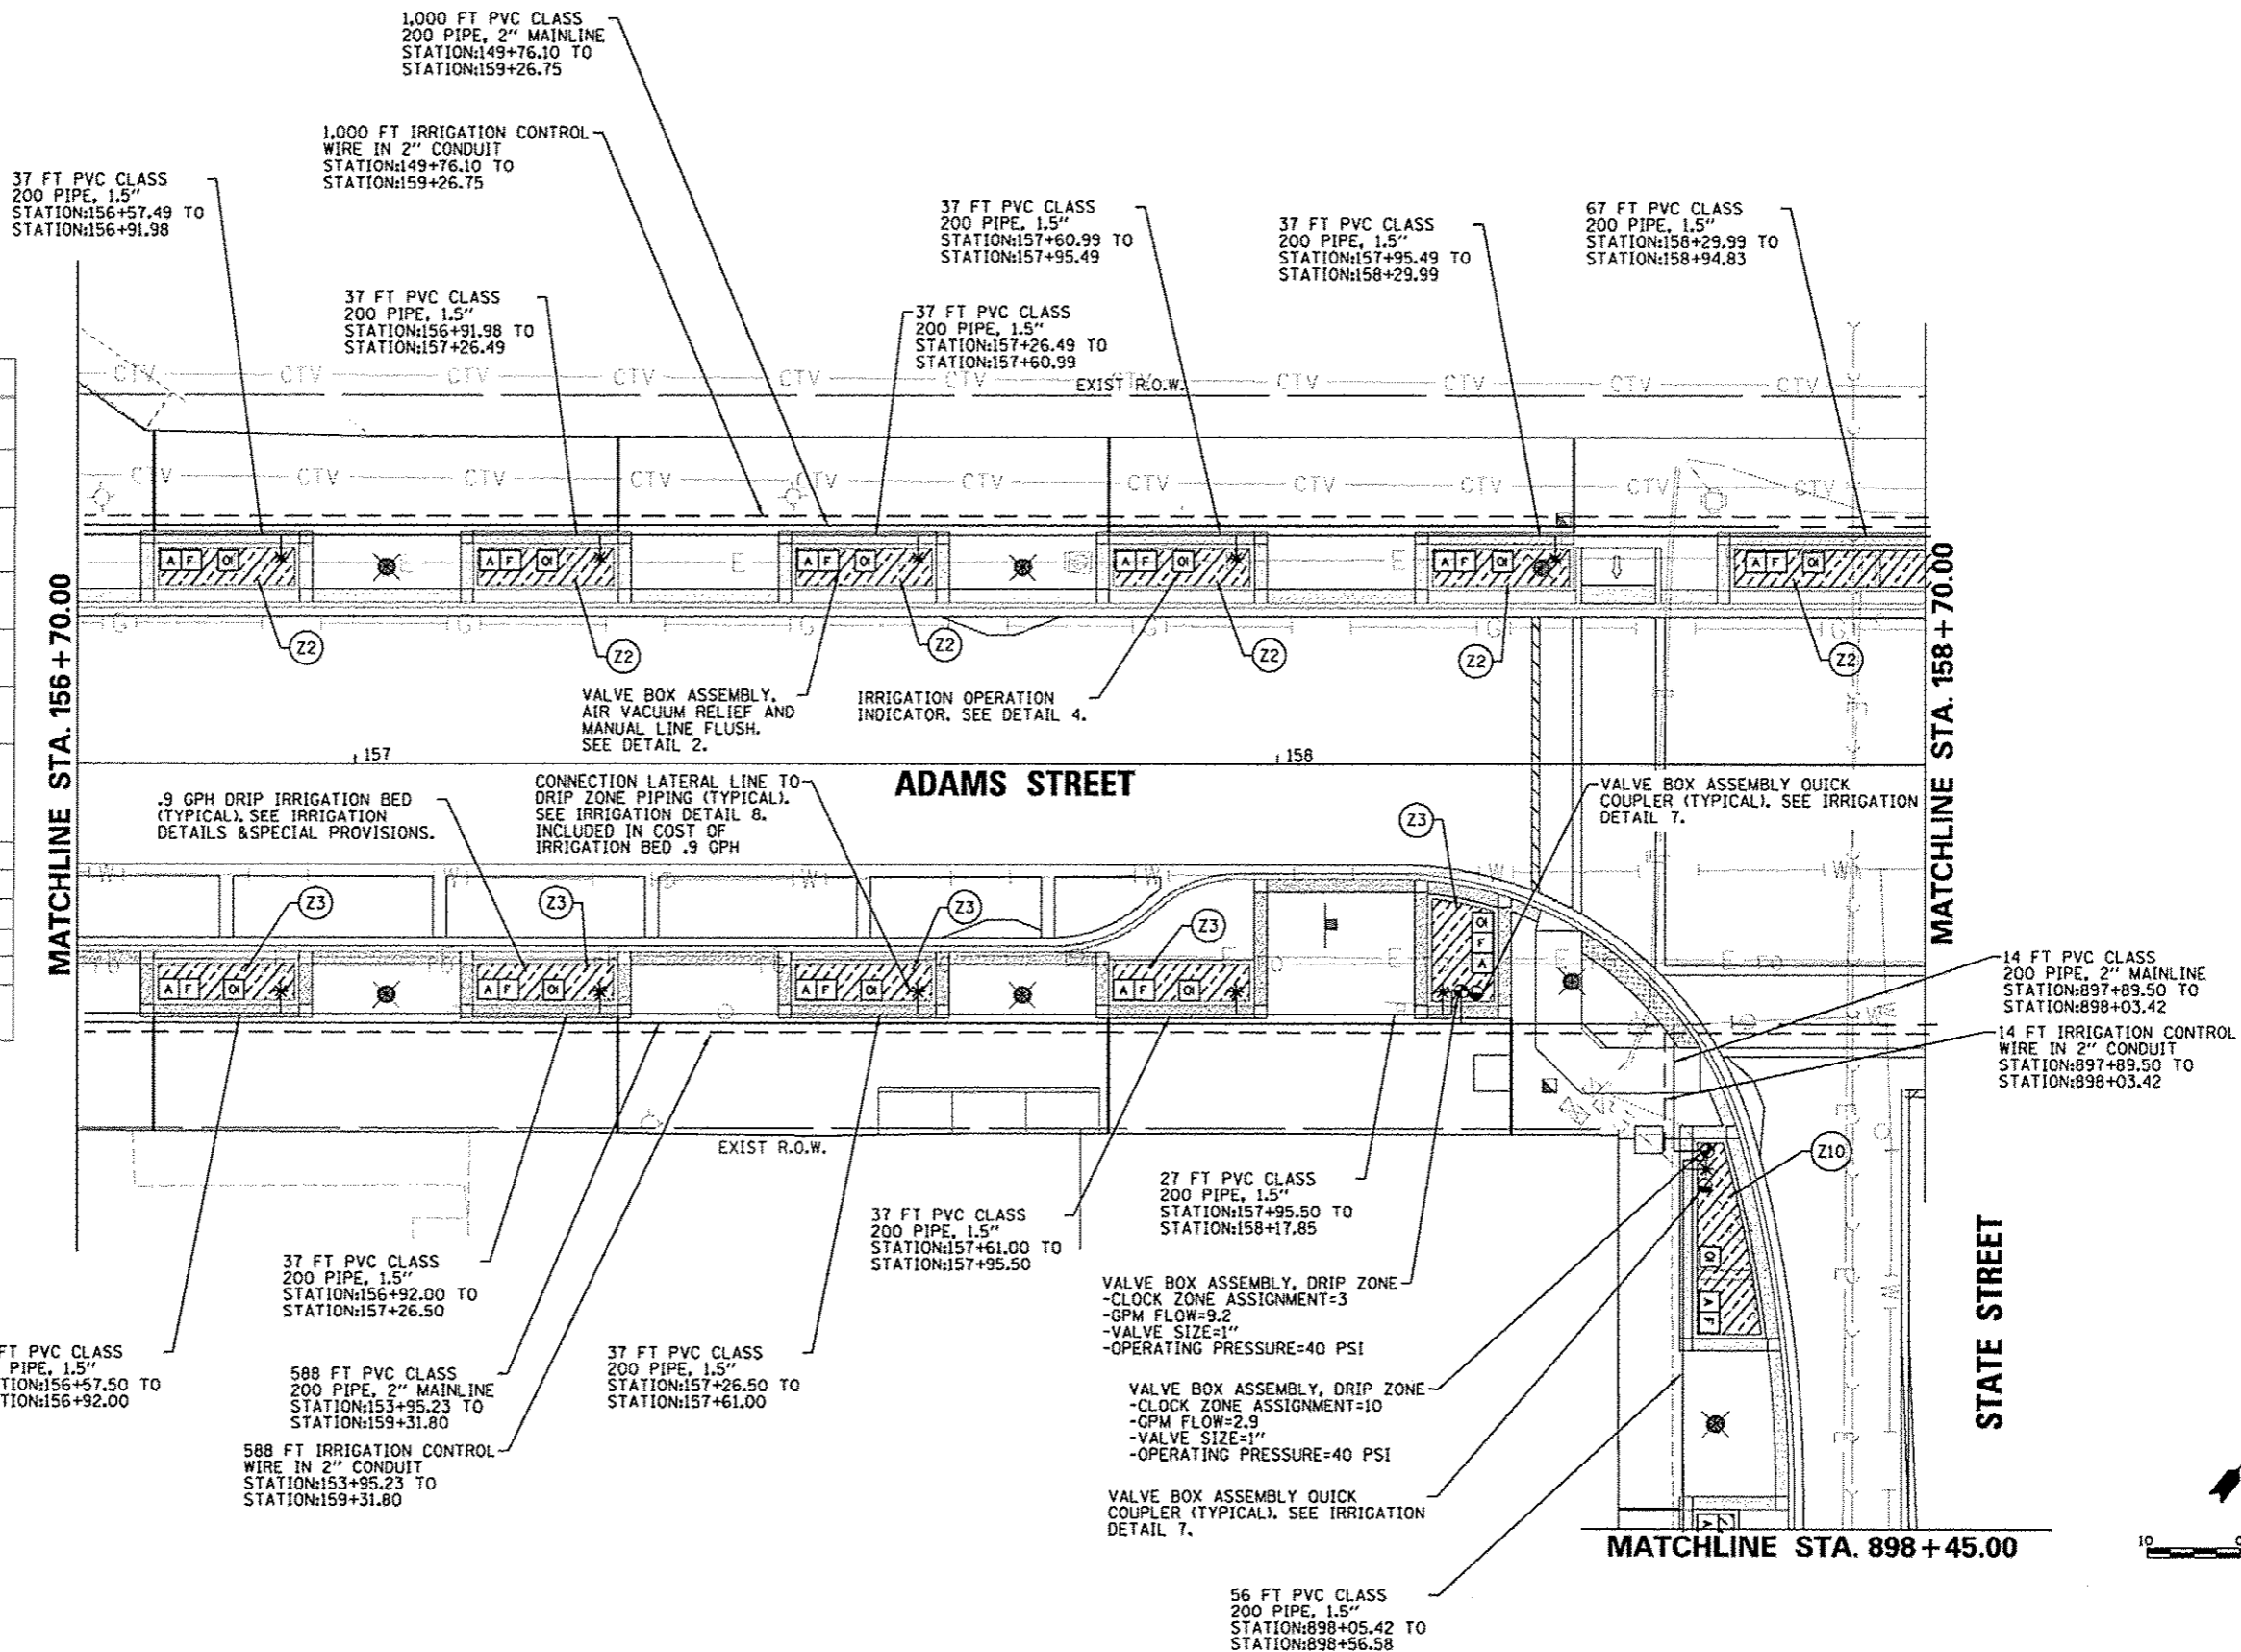

FILE NAME \*  
 c:\pwise\_work\do\_not\_delete\dms73427\04

USER NAME \* mansk01398  
 DLBIS5-sh1-sr-20% dgr  
 PLOT SCALE = 28.0000' / in.  
 PLOT DATE = 07/23/2012

DESIGNED - JLH  
 DRAWN - JLH  
 CHECKED - BAB  
 DATE - 7/18/12

REVISED -  
 REVISED -  
 REVISED -  
 REVISED -

**STATE OF ILLINOIS  
 DEPARTMENT OF TRANSPORTATION**

**ADAMS STREET  
 IRRIGATION PLAN**


SCALE: 1"=10' SHEET NO. OF SHEETS STA. 156+70 TO STA. 158+70

F.A.U. RTE.	SECTION	COUNTY	TOTAL SHEETS	SHEET NO.
55	12-00356-01-PV	PEORIA	519	313
CONTRACT NO. 89626				
ILLINOIS FED. AID PROJECT T16-50931587				


**Farnsworth GROUP**  
 7707 N. KNOXVILLE AVE., SUITE 100  
 PEORIA, ILLINOIS 61614  
 (309) 699-9559 / (309) 699-9820 Fax  
 www.fw.com

IRRIGATION LEGEND

SYMBOL	DESCRIPTION
F	VALVE BOX ASSEMBLY, MANUAL LINE FLUSH
A	VALVE BOX ASSEMBLY, AIR VACUUM RELIEF
[Hatched Box]	IRRIGATION BED .9 GPH
OI	IRRIGATION BED, OPERATION INDICATOR
*	PVC PIPE CONNECTION TO DRIP IRRIGATION PIPING
IRR. POB	IRRIGATION SYSTEM TAP AND POINT OF CONNECTION
RPZ	RPZ ASSEMBLY
⊙	VALVE BOX ASSEMBLY, DRIP ZONE
⊙	VALVE BOX ASSEMBLY, QUICK COUPLER
—	PVC CLASS 200 PIPE, 1.5"
- - -	PVC CLASS 200 PIPE, 2"
- - -	IRRIGATION CONTROL WIRE IN 2" CONDUIT
C	IRRIGATION SYSTEM, CONTROLLER

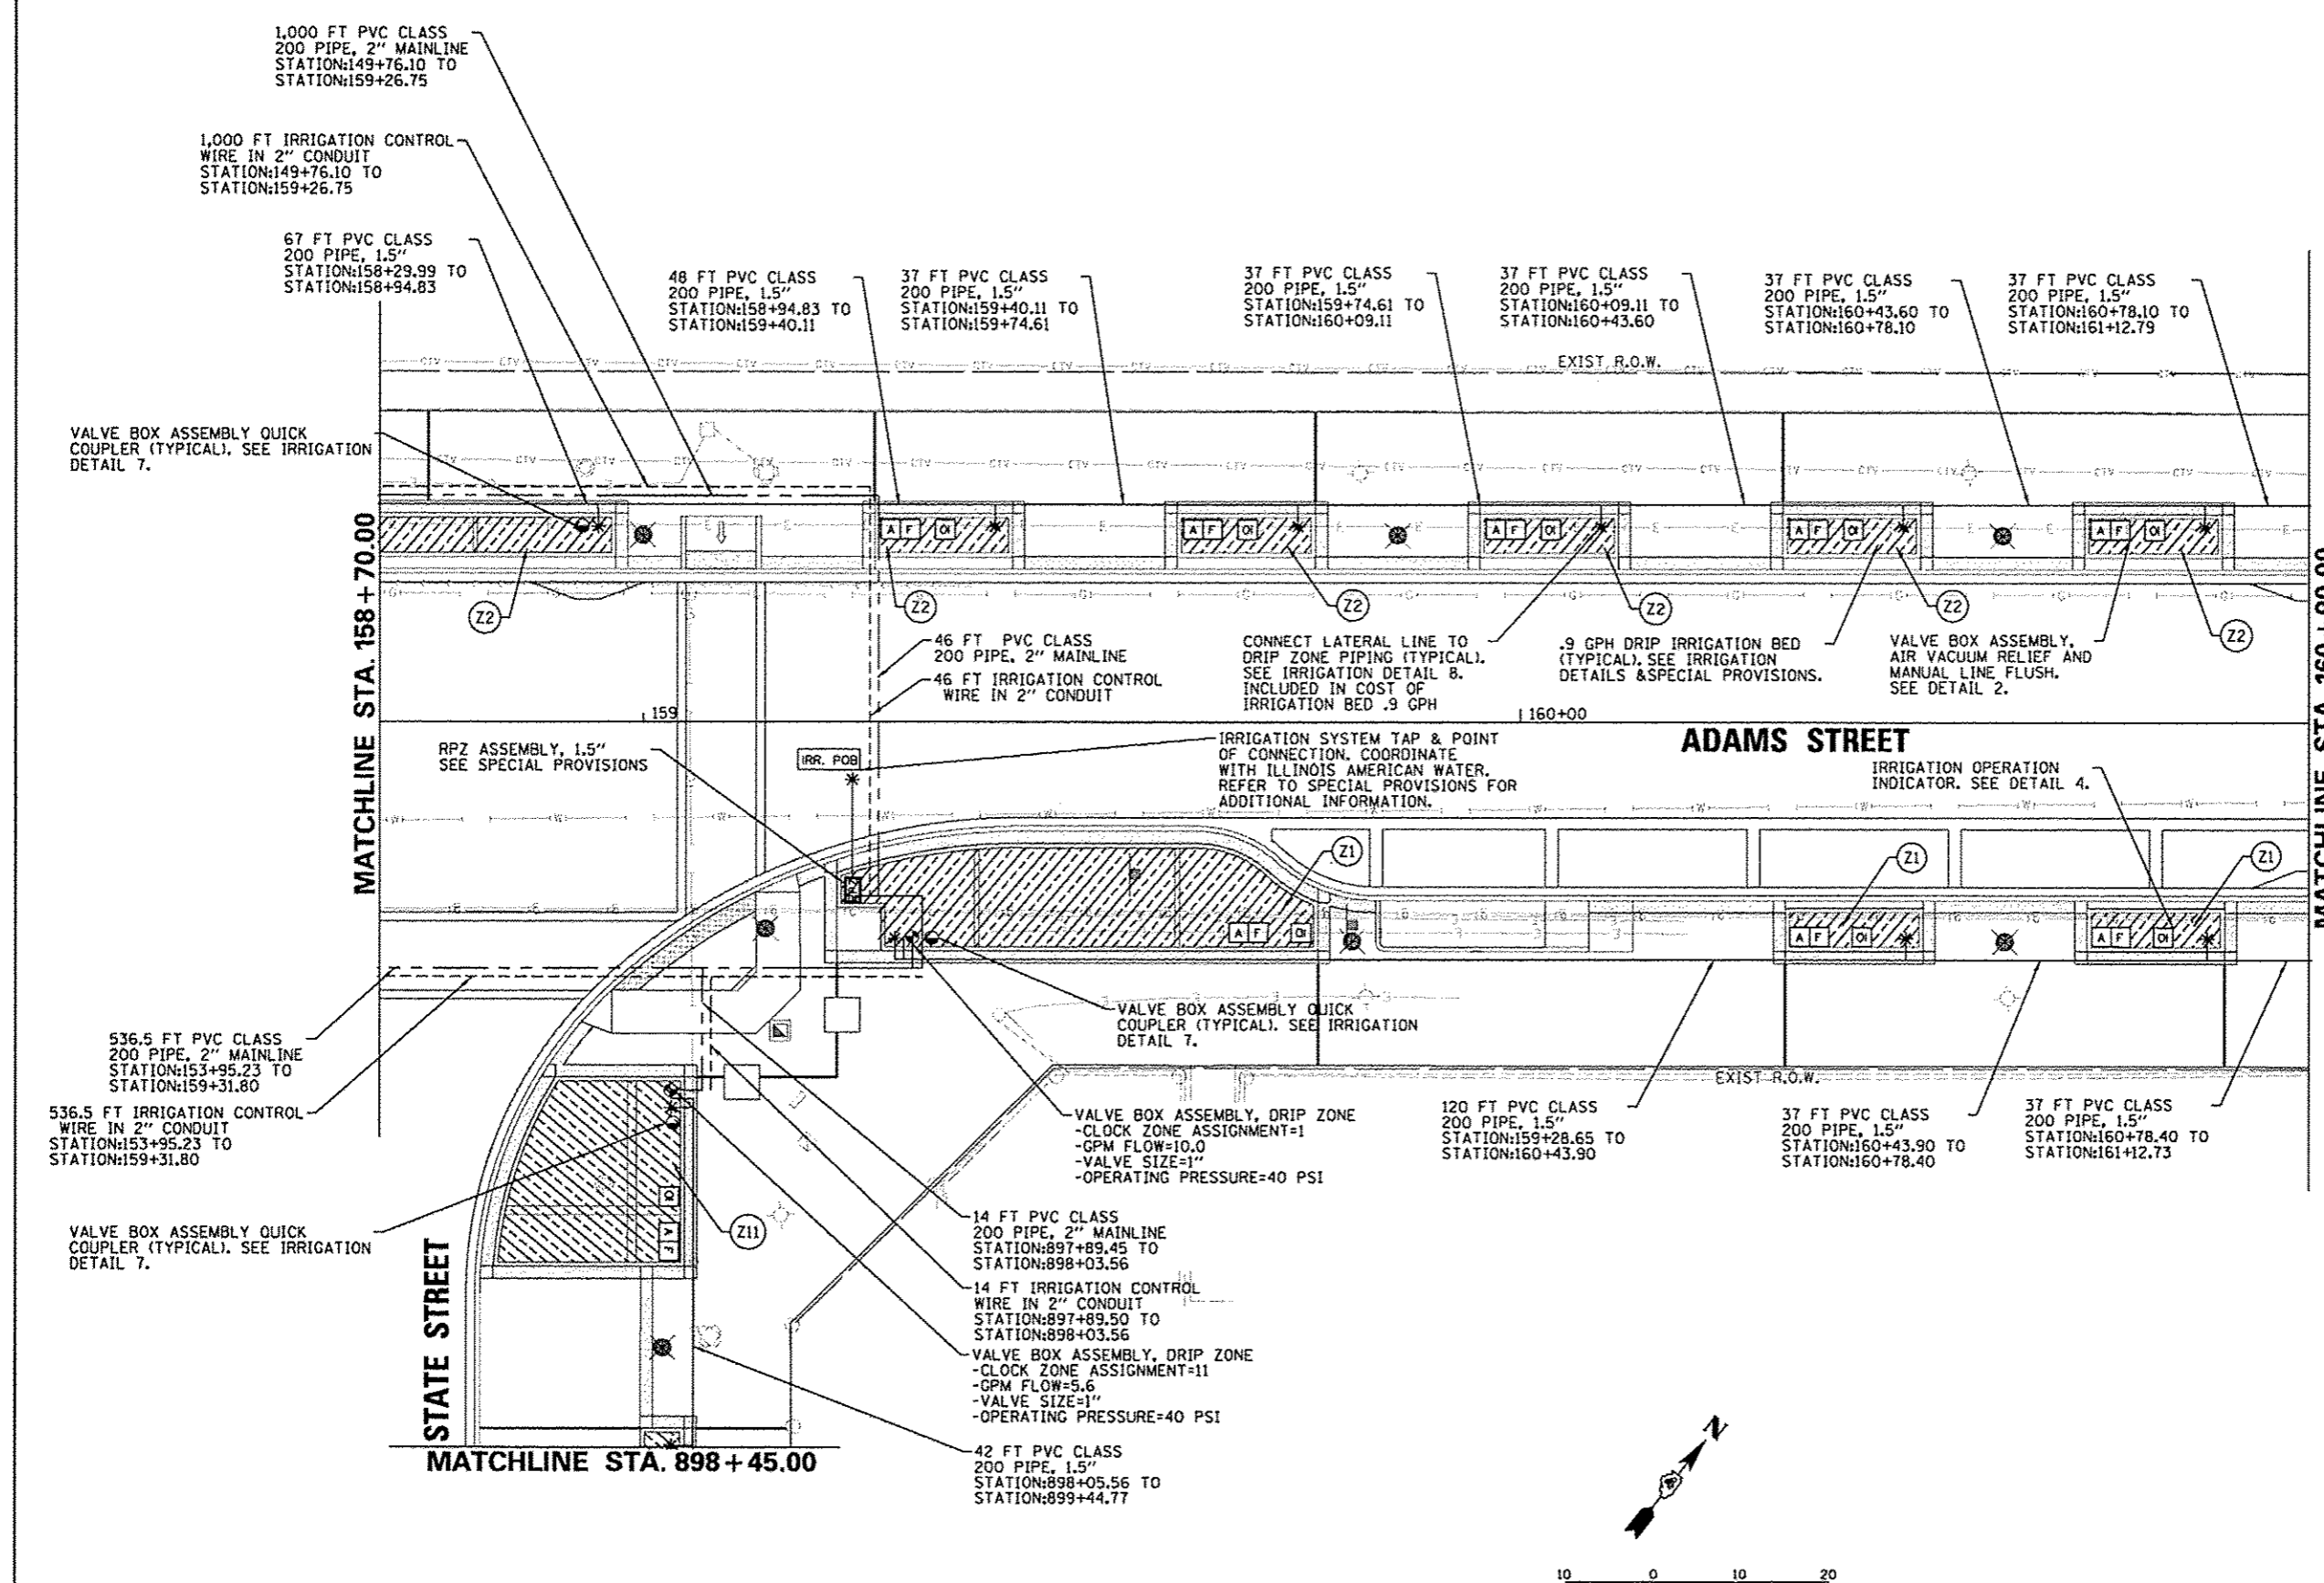


FILE NAME =	USER NAME = mansk01290	DESIGNED - JLH	REVISED -	<b>STATE OF ILLINOIS</b> <b>DEPARTMENT OF TRANSPORTATION</b>	<b>ADAMS STREET</b> <b>IRRIGATION PLAN</b>	F.A.U. R.T.E.	SECTION	COUNTY	TOTAL SHEETS	SHEET NO.
al\pwise_wark\do_no_delete\dwg\73427\01	RL0159-shr-11-818.dgn	DRAWN - JLH	REVISED -			12-00356-01-PV	PEORIA	519	314	
PLOT SCALE = 20.0000' / 1"		CHECKED - BAB	REVISED -			CONTRACT NO. 89626				
PLOT DATE = 07/23/2012		DATE - 7/18/12	REVISED -			ILLINOIS FED. AID PROJECT TIG-5993058				

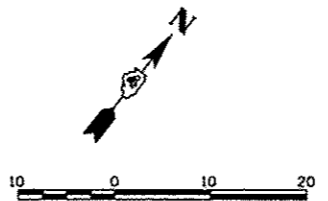

WALNUT STREET

IRRIGATION LEGEND

SYMBOL	DESCRIPTION
F	VALVE BOX ASSEMBLY, MANUAL LINE FLUSH
A	VALVE BOX ASSEMBLY, AIR/VACUUM RELIEF
[Hatched Box]	IRRIGATION BED .9 GPH
OI	IRRIGATION BED, OPERATION INDICATOR
*	PVC PIPE CONNECTION TO DRIP IRRIGATION PIPING
IRR. POB	IRRIGATION SYSTEM TAP AND POINT OF CONNECTION
RPZ	RPZ ASSEMBLY
[Circle with dot]	VALVE BOX ASSEMBLY, DRIP ZONE
[Circle with cross]	VALVE BOX ASSEMBLY, QUICK COUPLER
---	PVC CLASS 200 PIPE, 1.5"
----	PVC CLASS 200 PIPE, 2"
----	IRRIGATION CONTROL WIRE IN 2" CONDUIT
C	IRRIGATION SYSTEM, CONTROLLER

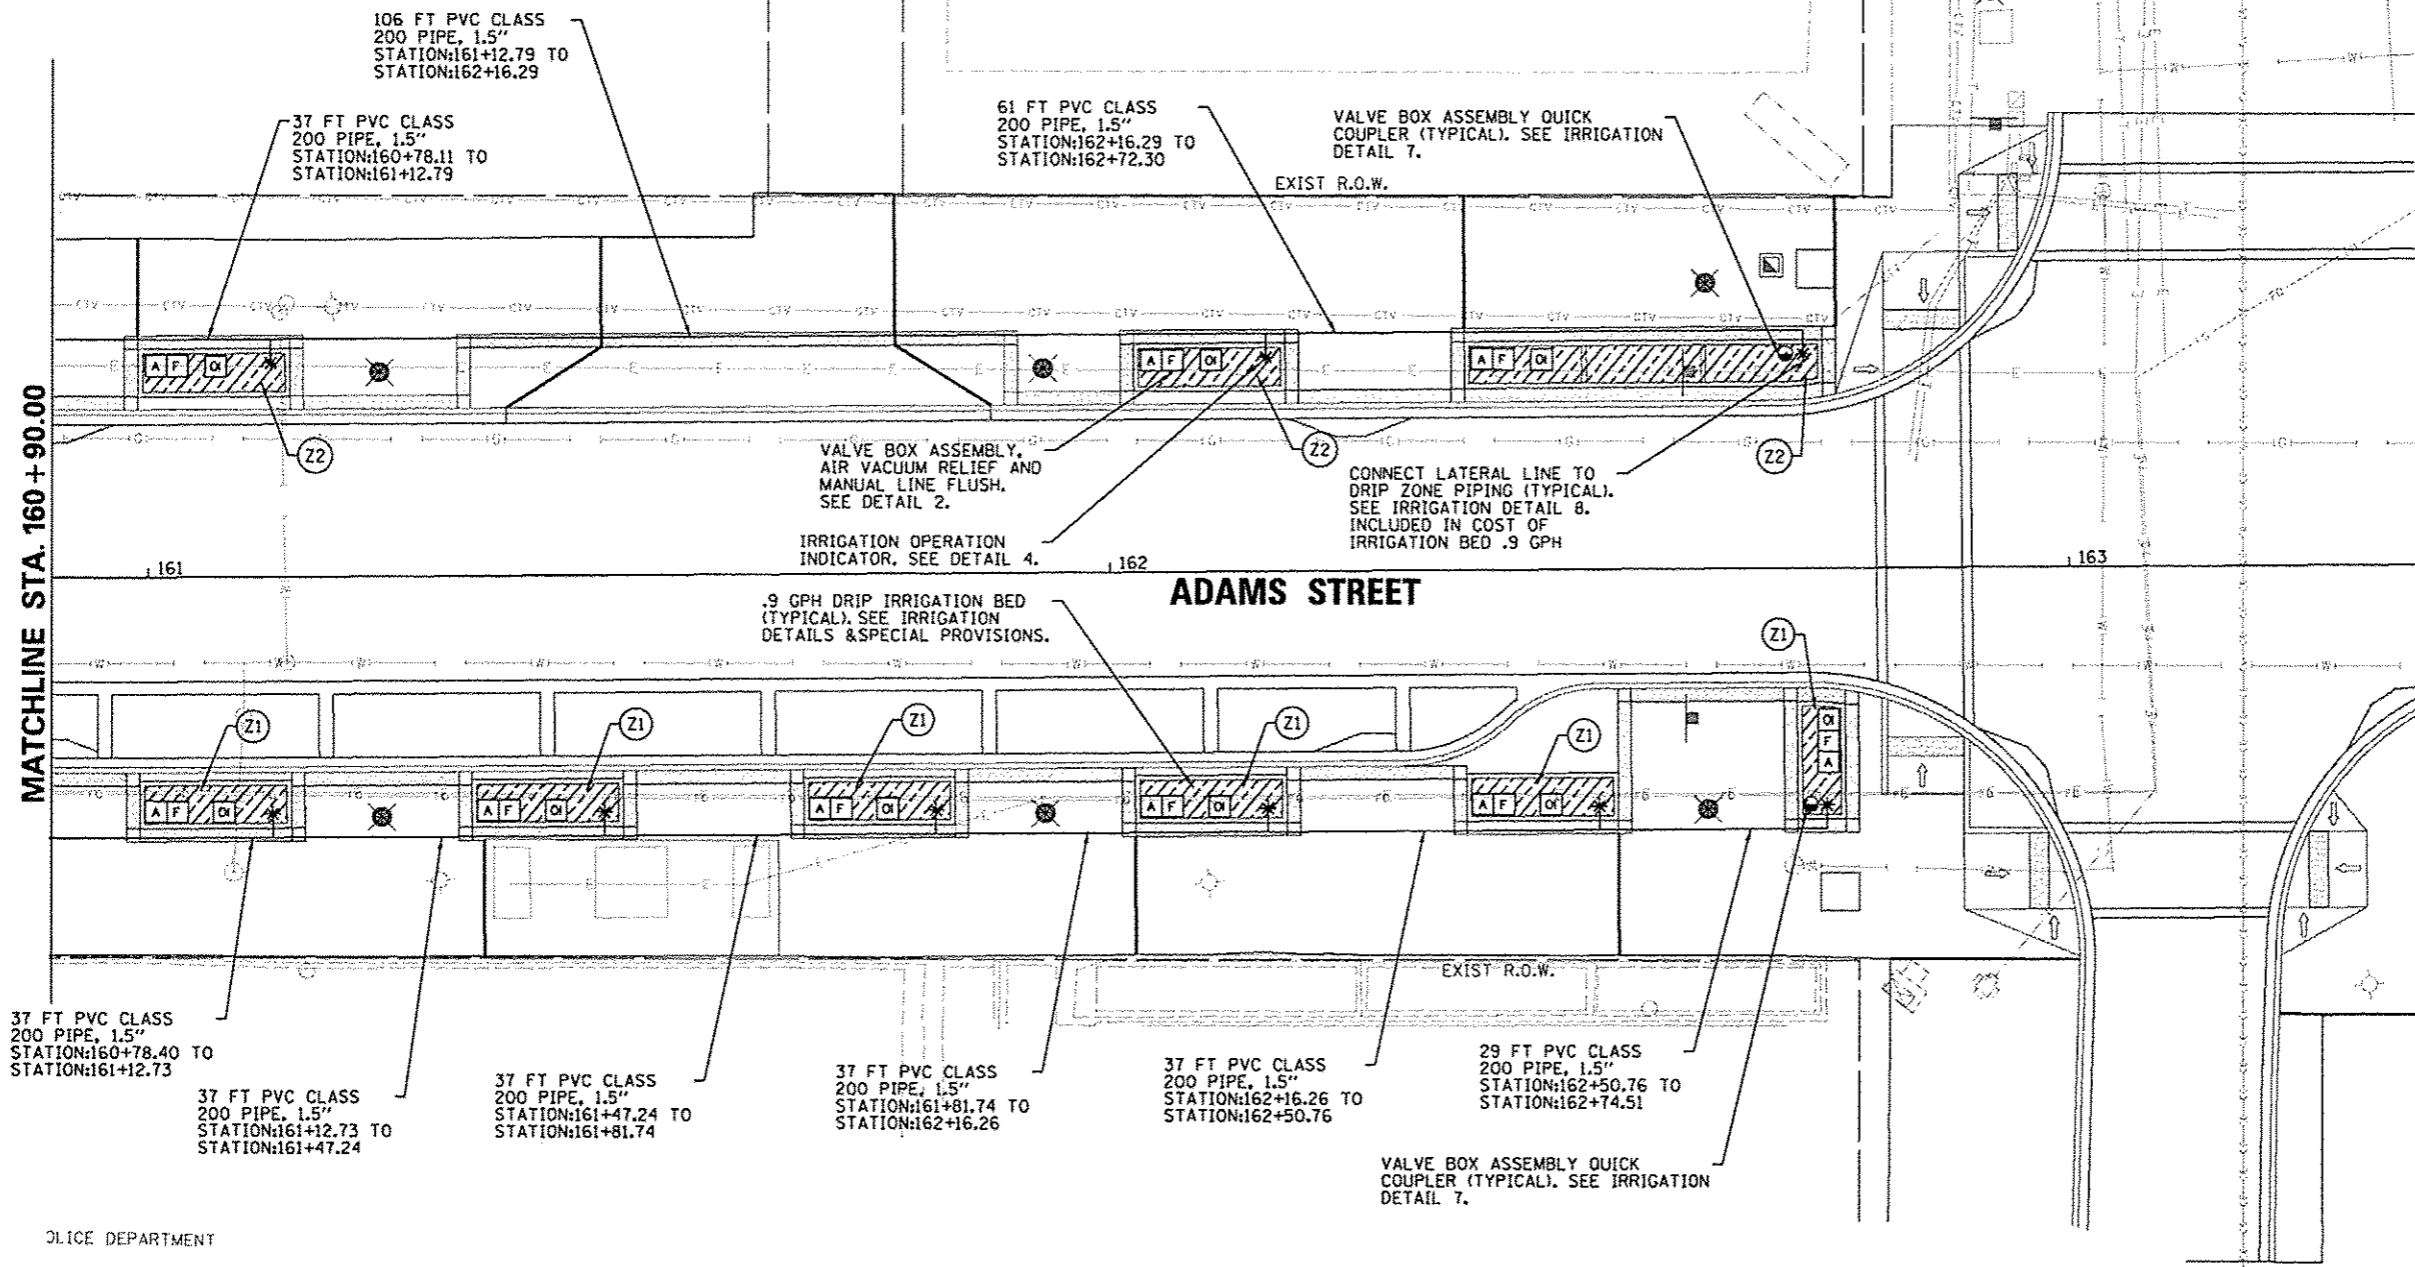

MATCHLINE STA. 160+90.00

ADAMS STREET

37 FT PVC CLASS 200 PIPE, 1.5" STATION:160+78.40 TO STATION:161+12.73

37 FT PVC CLASS 200 PIPE, 1.5" STATION:161+12.73 TO STATION:161+47.24

37 FT PVC CLASS 200 PIPE, 1.5" STATION:161+47.24 TO STATION:161+81.74


37 FT PVC CLASS 200 PIPE, 1.5" STATION:161+81.74 TO STATION:162+16.26

37 FT PVC CLASS 200 PIPE, 1.5" STATION:162+16.26 TO STATION:162+50.76

29 FT PVC CLASS 200 PIPE, 1.5" STATION:162+50.76 TO STATION:162+74.51

VALVE BOX ASSEMBLY QUICK COUPLER (TYPICAL). SEE IRRIGATION DETAIL 7.

OLICE DEPARTMENT

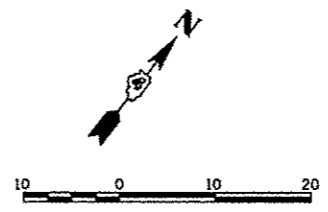

FILE NAME =	USER NAME = mansk81310	DESIGNED - JLH	REVISED -
o:\pwise\work\do_no_L\delata\des73427\04	3L8155-ahc\m=011.dgn	DRAWN - JLH	REVISED -
	PLOT SCALE = 20.0000' / in.	CHECKED - BAB	REVISED -
	PLOT DATE = 07/23/2012	DATE - 7/18/12	REVISED -

STATE OF ILLINOIS  
DEPARTMENT OF TRANSPORTATION

SCALE: 1"=10'	SHEET NO. OF SHEETS	STA. 160+90 TO STA. 163+00
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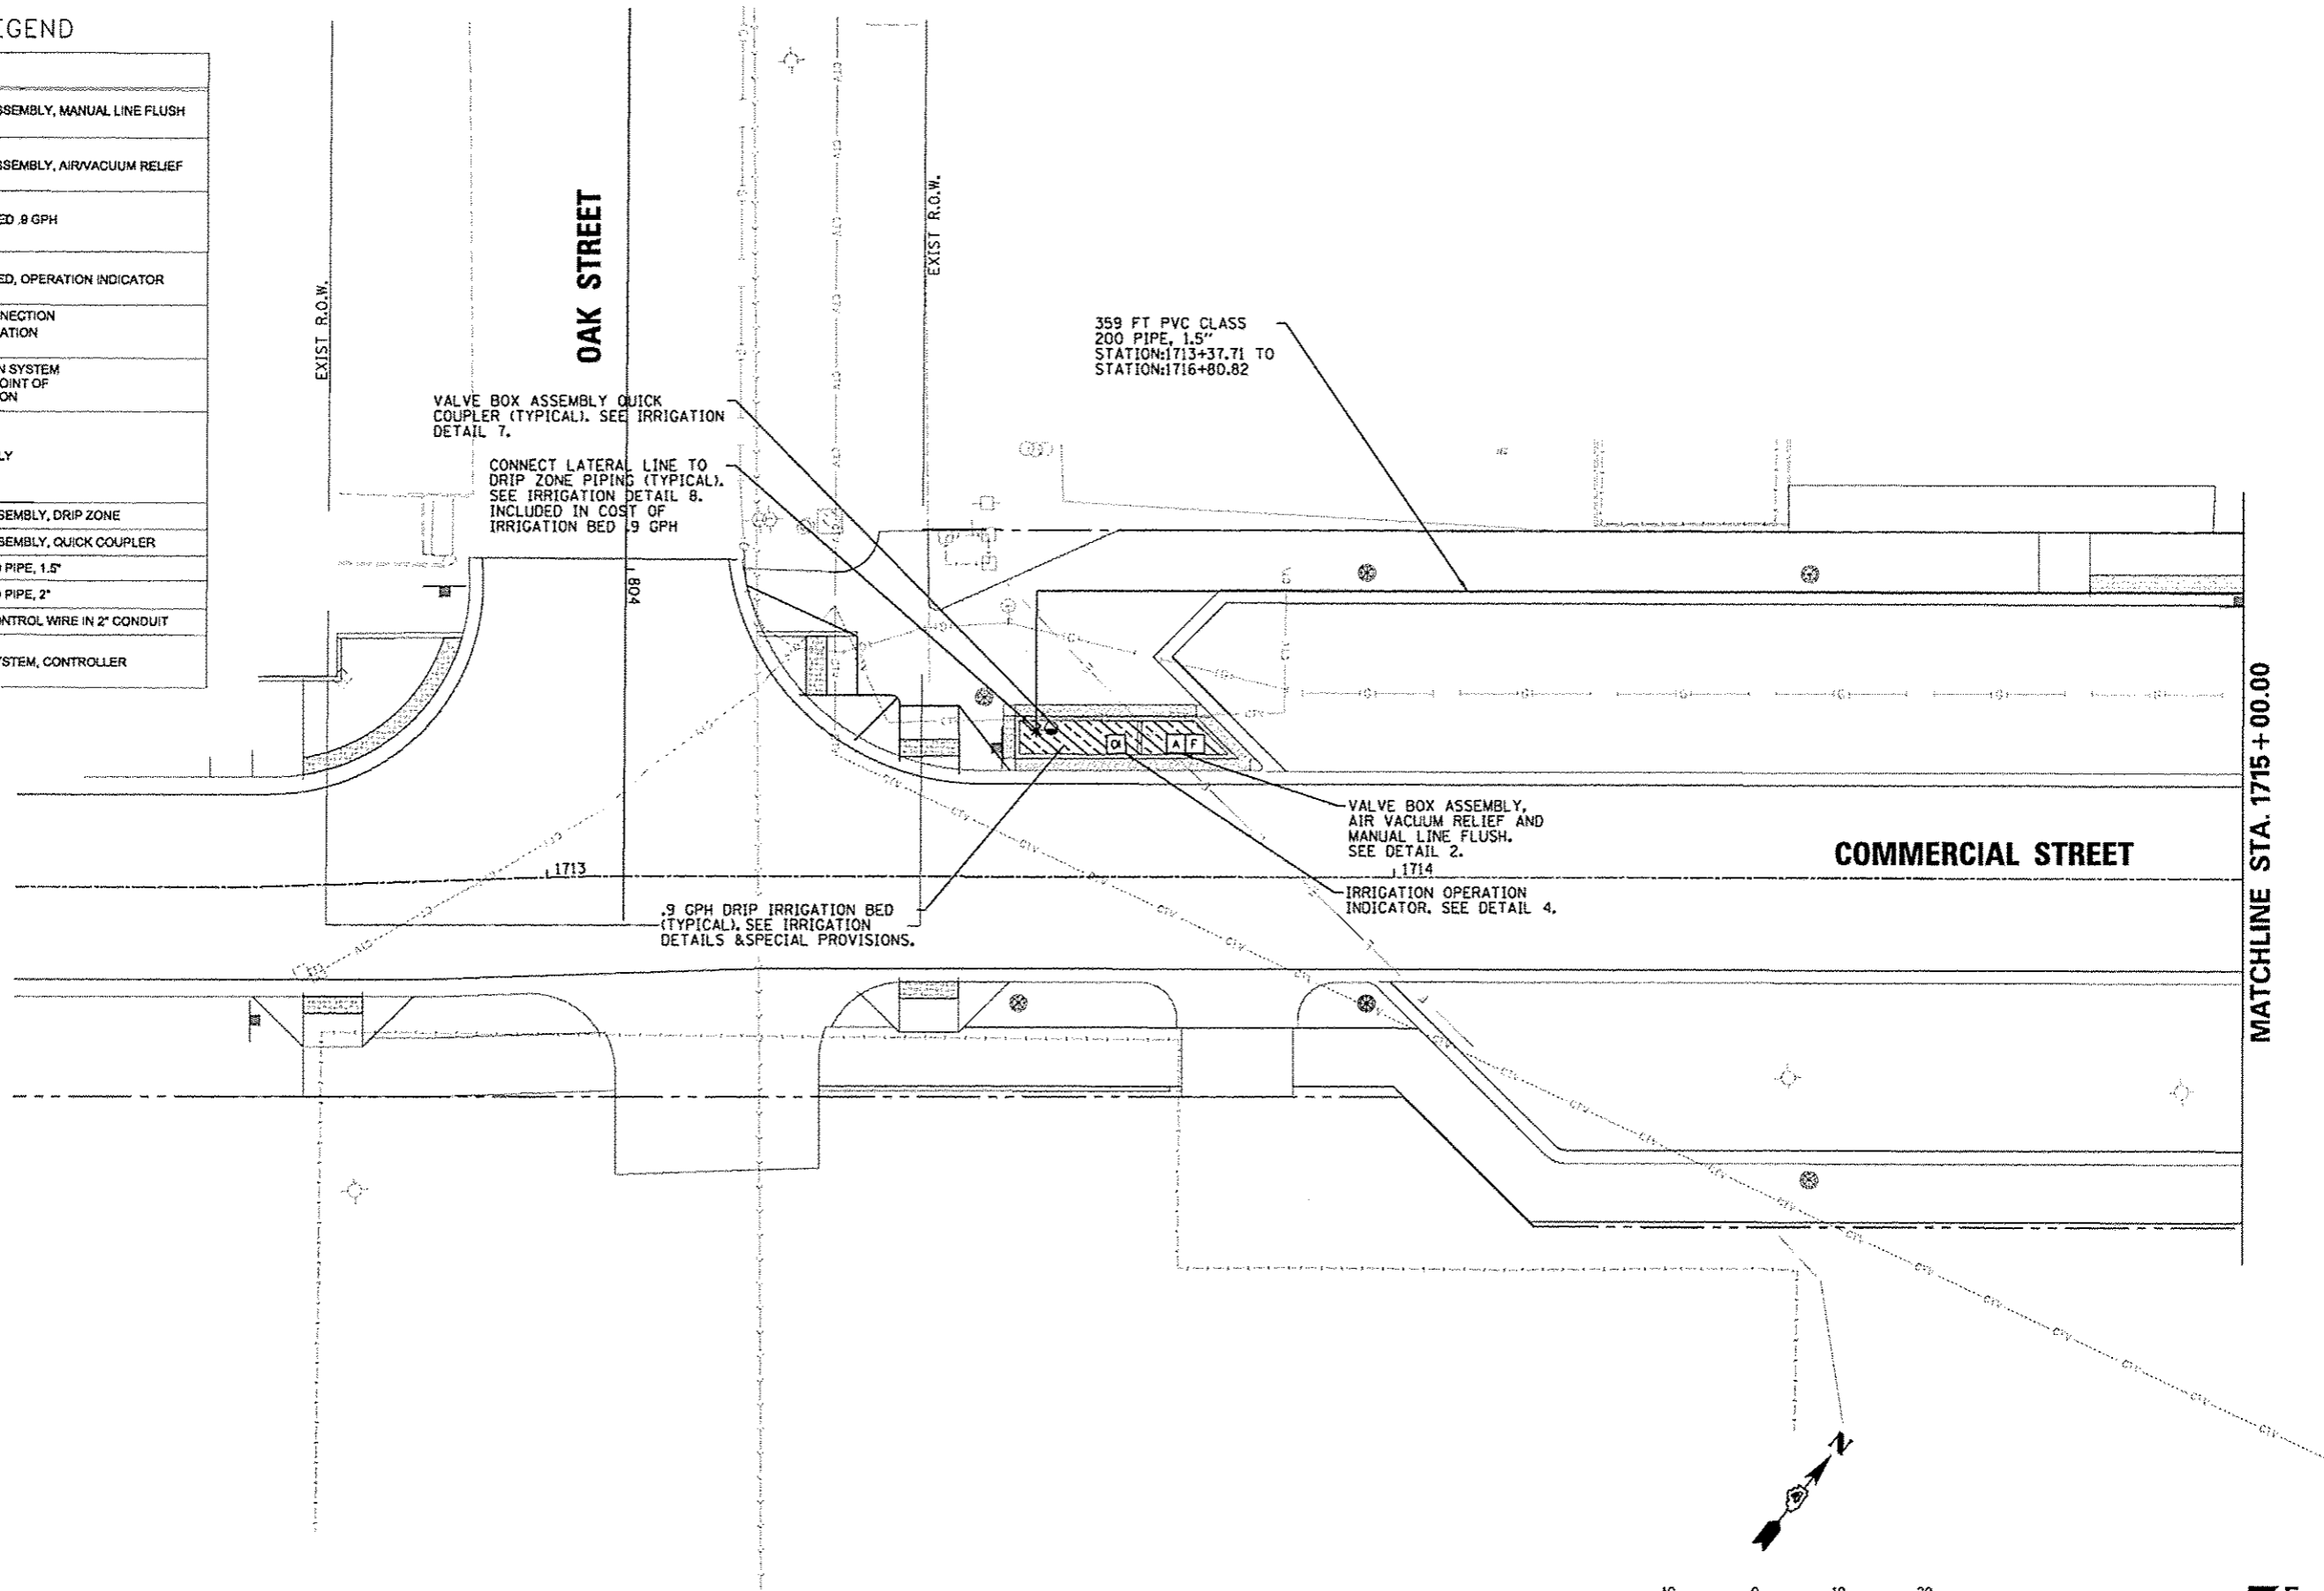
ADAMS STREET  
IRRIGATION PLAN

F.A.U. RTE.	SECTION	COUNTY	TOTAL SHEETS	SHEET NO.
	12-00356-01-PV	PEORIA	519	315
CONTRACT NO. 89626				
ILLINOIS FED. AID PROJECT TIG-5093(158)				

**Farnsworth GROUP**  
7707 N. KNOXVILLE AVE, SUITE 100  
PEORIA, ILLINOIS 61614  
(309) 698-9888 / (309) 698-9820 Fax  
www.fwg.com

IRRIGATION LEGEND

SYMBOL	DESCRIPTION
F	VALVE BOX ASSEMBLY, MANUAL LINE FLUSH
A	VALVE BOX ASSEMBLY, AIR/VACUUM RELIEF
[Hatched Box]	IRRIGATION BED .8 GPH
OI	IRRIGATION BED, OPERATION INDICATOR
*	PVC PIPE CONNECTION TO DRIP IRRIGATION PIPING
IRR. POB	IRRIGATION SYSTEM TAP AND POINT OF CONNECTION
RPZ	RPZ ASSEMBLY
[Circle with dot]	VALVE BOX ASSEMBLY, DRIP ZONE
[Circle with cross]	VALVE BOX ASSEMBLY, QUICK COUPLER
[Solid Line]	PVC CLASS 200 PIPE, 1.5"
[Dashed Line]	PVC CLASS 200 PIPE, 2"
[Dotted Line]	IRRIGATION CONTROL WIRE IN 2" CONDUIT
C	IRRIGATION SYSTEM, CONTROLLER




MATCHLINE STA. 1715 + 00.00



**Farnsworth GROUP**  
 7707 N. KNOXVILLE AVE, SUITE 100  
 PEORIA, ILLINOIS 61614  
 (309) 669-8888 / (309) 669-8820 Fax  
 www.far.com

FILE NAME * c:\pwise_work\do_not_delete\des73427\04	USER NAME * monsk01310	DESIGNED - STH	REVISED -	<b>STATE OF ILLINOIS DEPARTMENT OF TRANSPORTATION</b>	<b>COMMERCIAL STREET IRRIGATION PLAN</b>				F.A.U. RTE. 12-00356-01-PV	SECTION 12-00356-01-PV	COUNTY PEORIA	TOTAL SHEETS 519	SHEET NO. 316
	PLOT SCALE * 20,0000 ' / 1"	DRAWN - STH	REVISED -		SCALE: 1"=10'	SHEET NO. OF SHEETS	STA. 1713+00 TO STA. 1715+00	CONTRACT NO. 89626		ILLINOIS FED. AID PROJECT YIG-509305B1			
	PLOT DATE * 07/23/2012	CHECKED - BAB	REVISED -										
		DATE - 7/18/12	REVISED -										



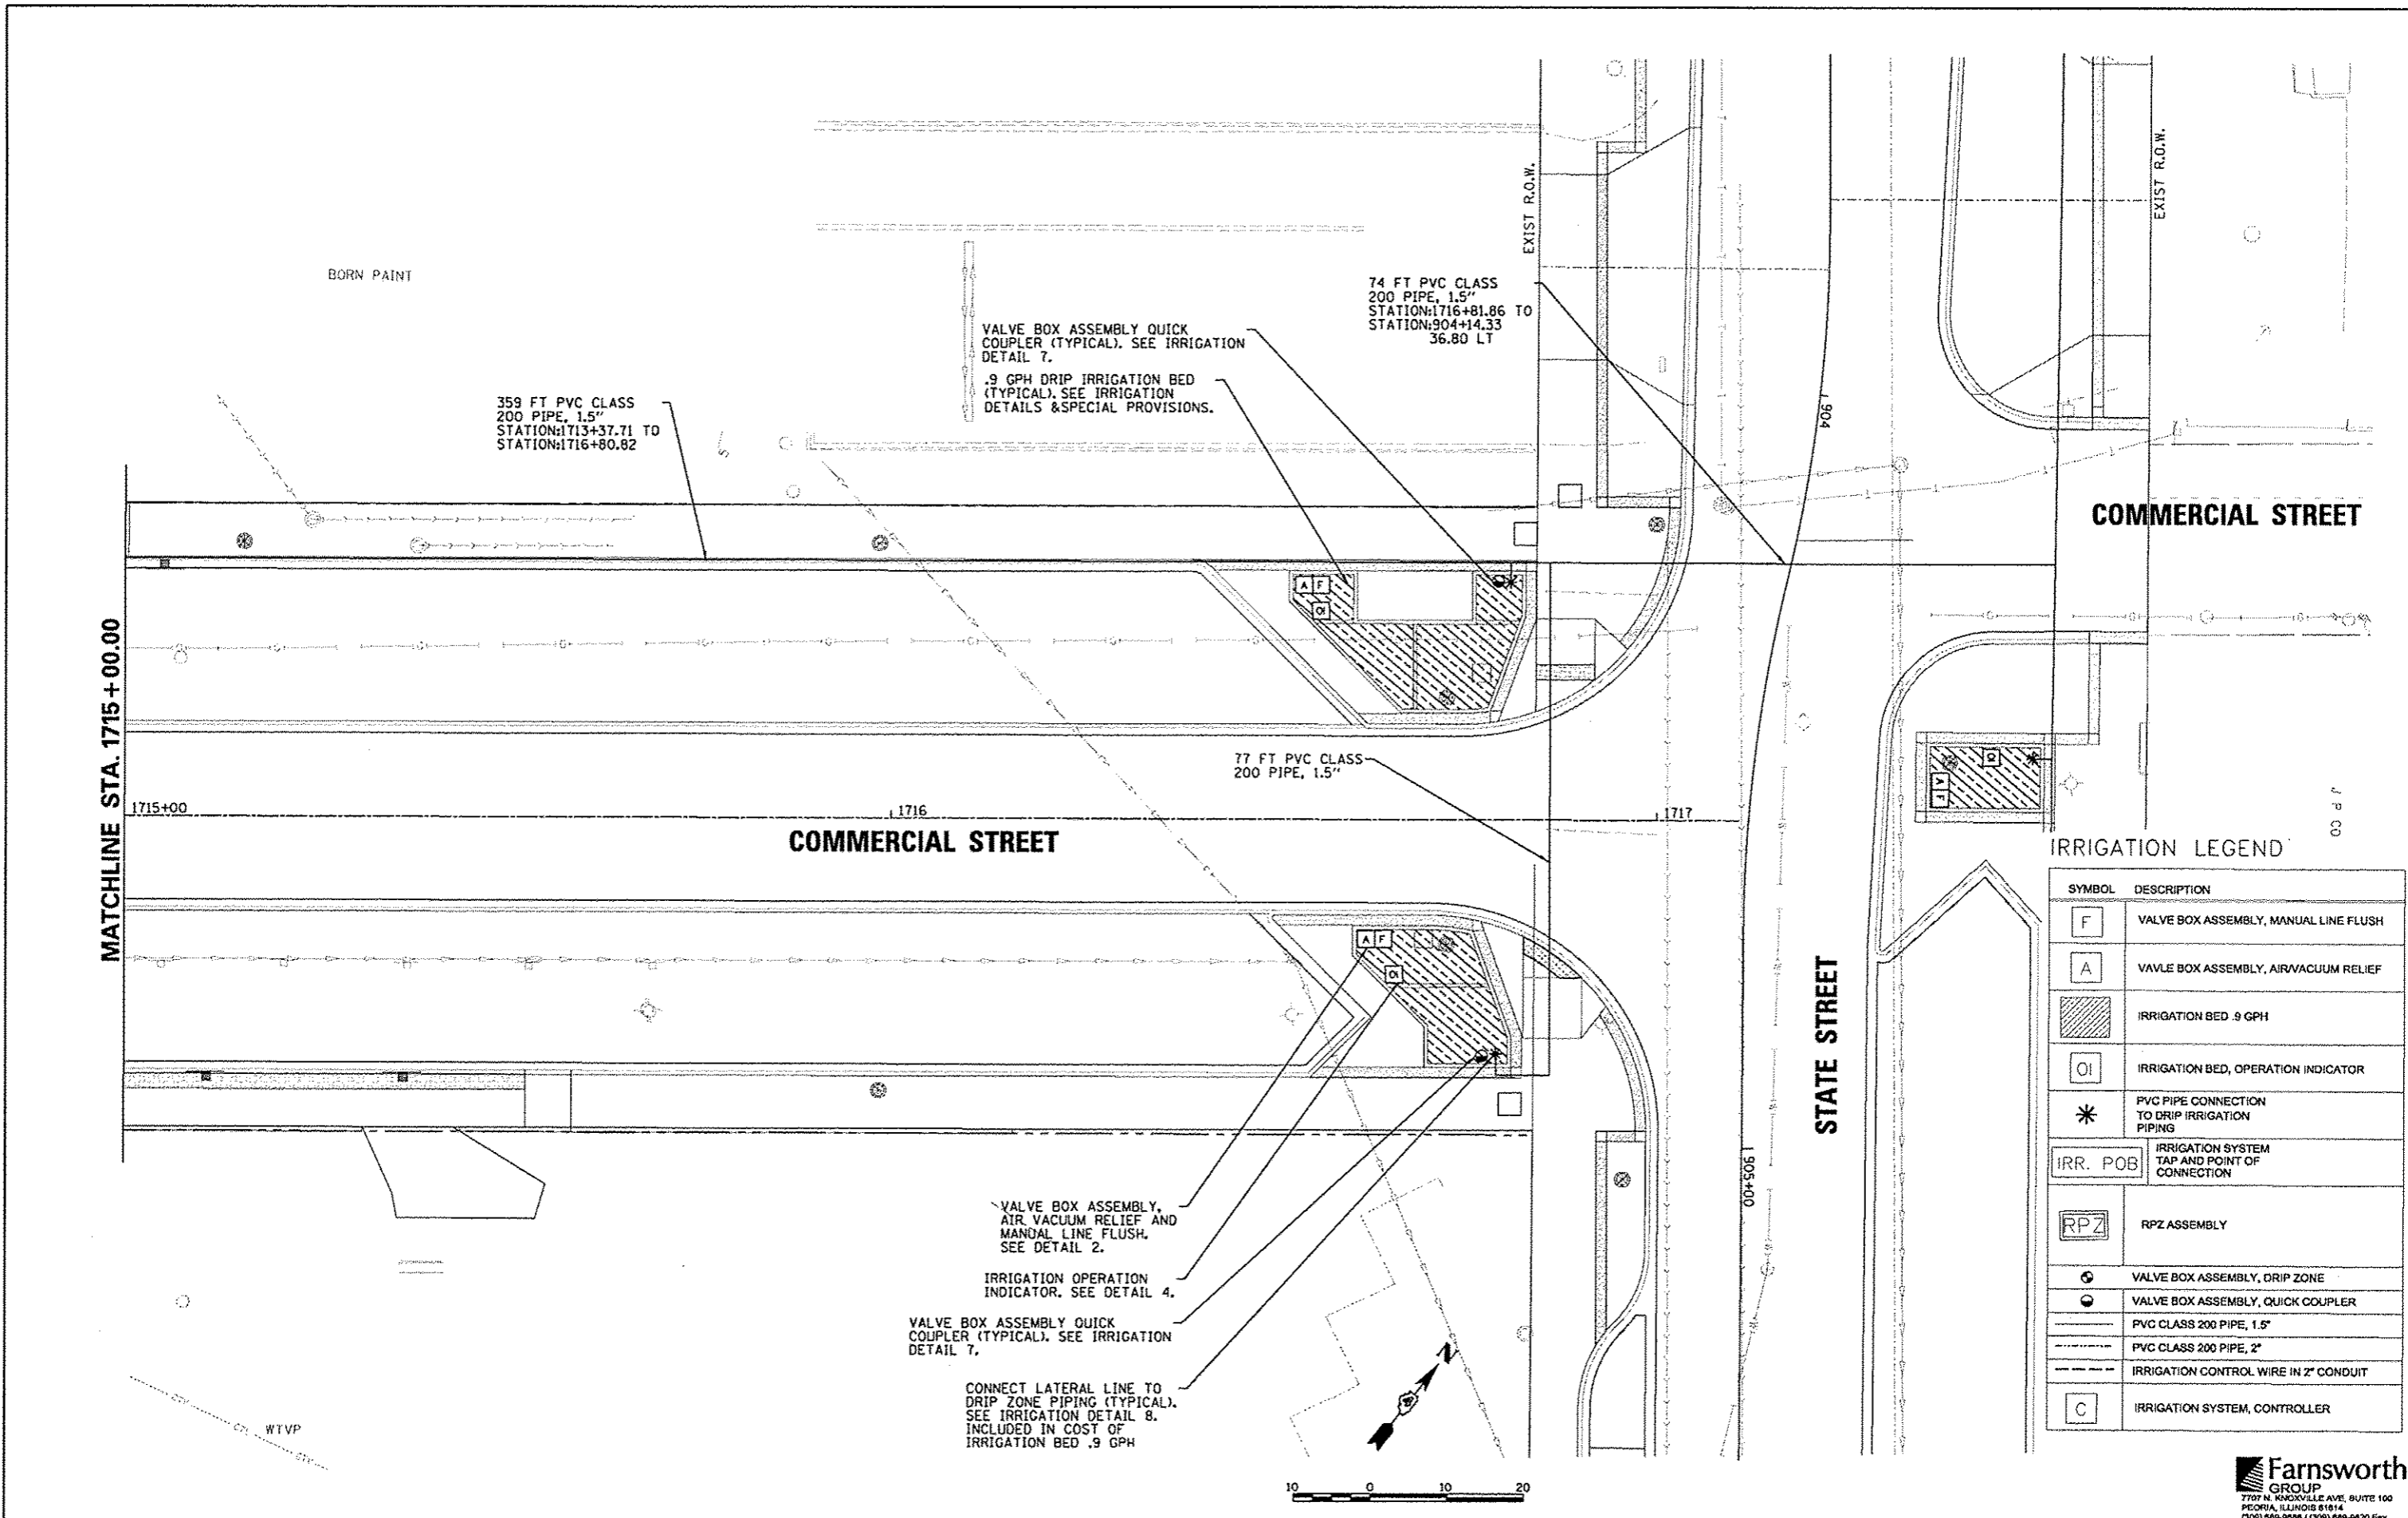


FILE NAME *	USER NAME * manak01390	DESIGNED - STH	REVISED -	<b>STATE OF ILLINOIS DEPARTMENT OF TRANSPORTATION</b>	<b>COMMERCIAL STREET IRRIGATION PLAN</b>			F.A.U. RTE.	SECTION	COUNTY	TOTAL SHEETS	SHEET NO.
0:\p100_work\do_not_delete\dm073427\04	BLD105-ohc\117831.dgn	DRAWN - STH	REVISED -		SCALE: 1"=10'	SHEET NO. OF SHEETS	STA. 1715+00 TO STA. 1717+00	12-00356-01-PV	PEORIA	519	317	
	PLOT SCALE = 20,0000' / in.	CHECKED - BAB	REVISED -									
	PLOT DATE = 07/23/2012	DATE - 7/18/12	REVISED -									
<b>Farnsworth GROUP</b> 7707 N. KNOXVILLE AVE, SUITE 100 PEORIA, ILLINOIS 61614 (309) 690-8008 / (309) 690-0620 Fax www.fg.com												
ILLINOIS FED. AID PROJECT TIG-S093058P												

IRRIGATION LEGEND

SYMBOL	DESCRIPTION
F	VALVE BOX ASSEMBLY, MANUAL LINE FLUSH
A	VALVE BOX ASSEMBLY, AIR/VACUUM RELIEF
[Hatched Box]	IRRIGATION BED .9 GPH
OI	IRRIGATION BED, OPERATION INDICATOR
*	PVC PIPE CONNECTION TO DRIP IRRIGATION PIPING
IRR. POB	IRRIGATION SYSTEM TAP AND POINT OF CONNECTION
RPZ	RPZ ASSEMBLY
[Circle with dot]	VALVE BOX ASSEMBLY, DRIP ZONE
[Circle with cross]	VALVE BOX ASSEMBLY, QUICK COUPLER
[Solid Line]	PVC CLASS 200 PIPE, 1.5"
[Dashed Line]	PVC CLASS 200 PIPE, 2"
[Dotted Line]	IRRIGATION CONTROL WIRE IN 2" CONDUIT
C	IRRIGATION SYSTEM, CONTROLLER

MATCHLINE STA. 252 + 75.00

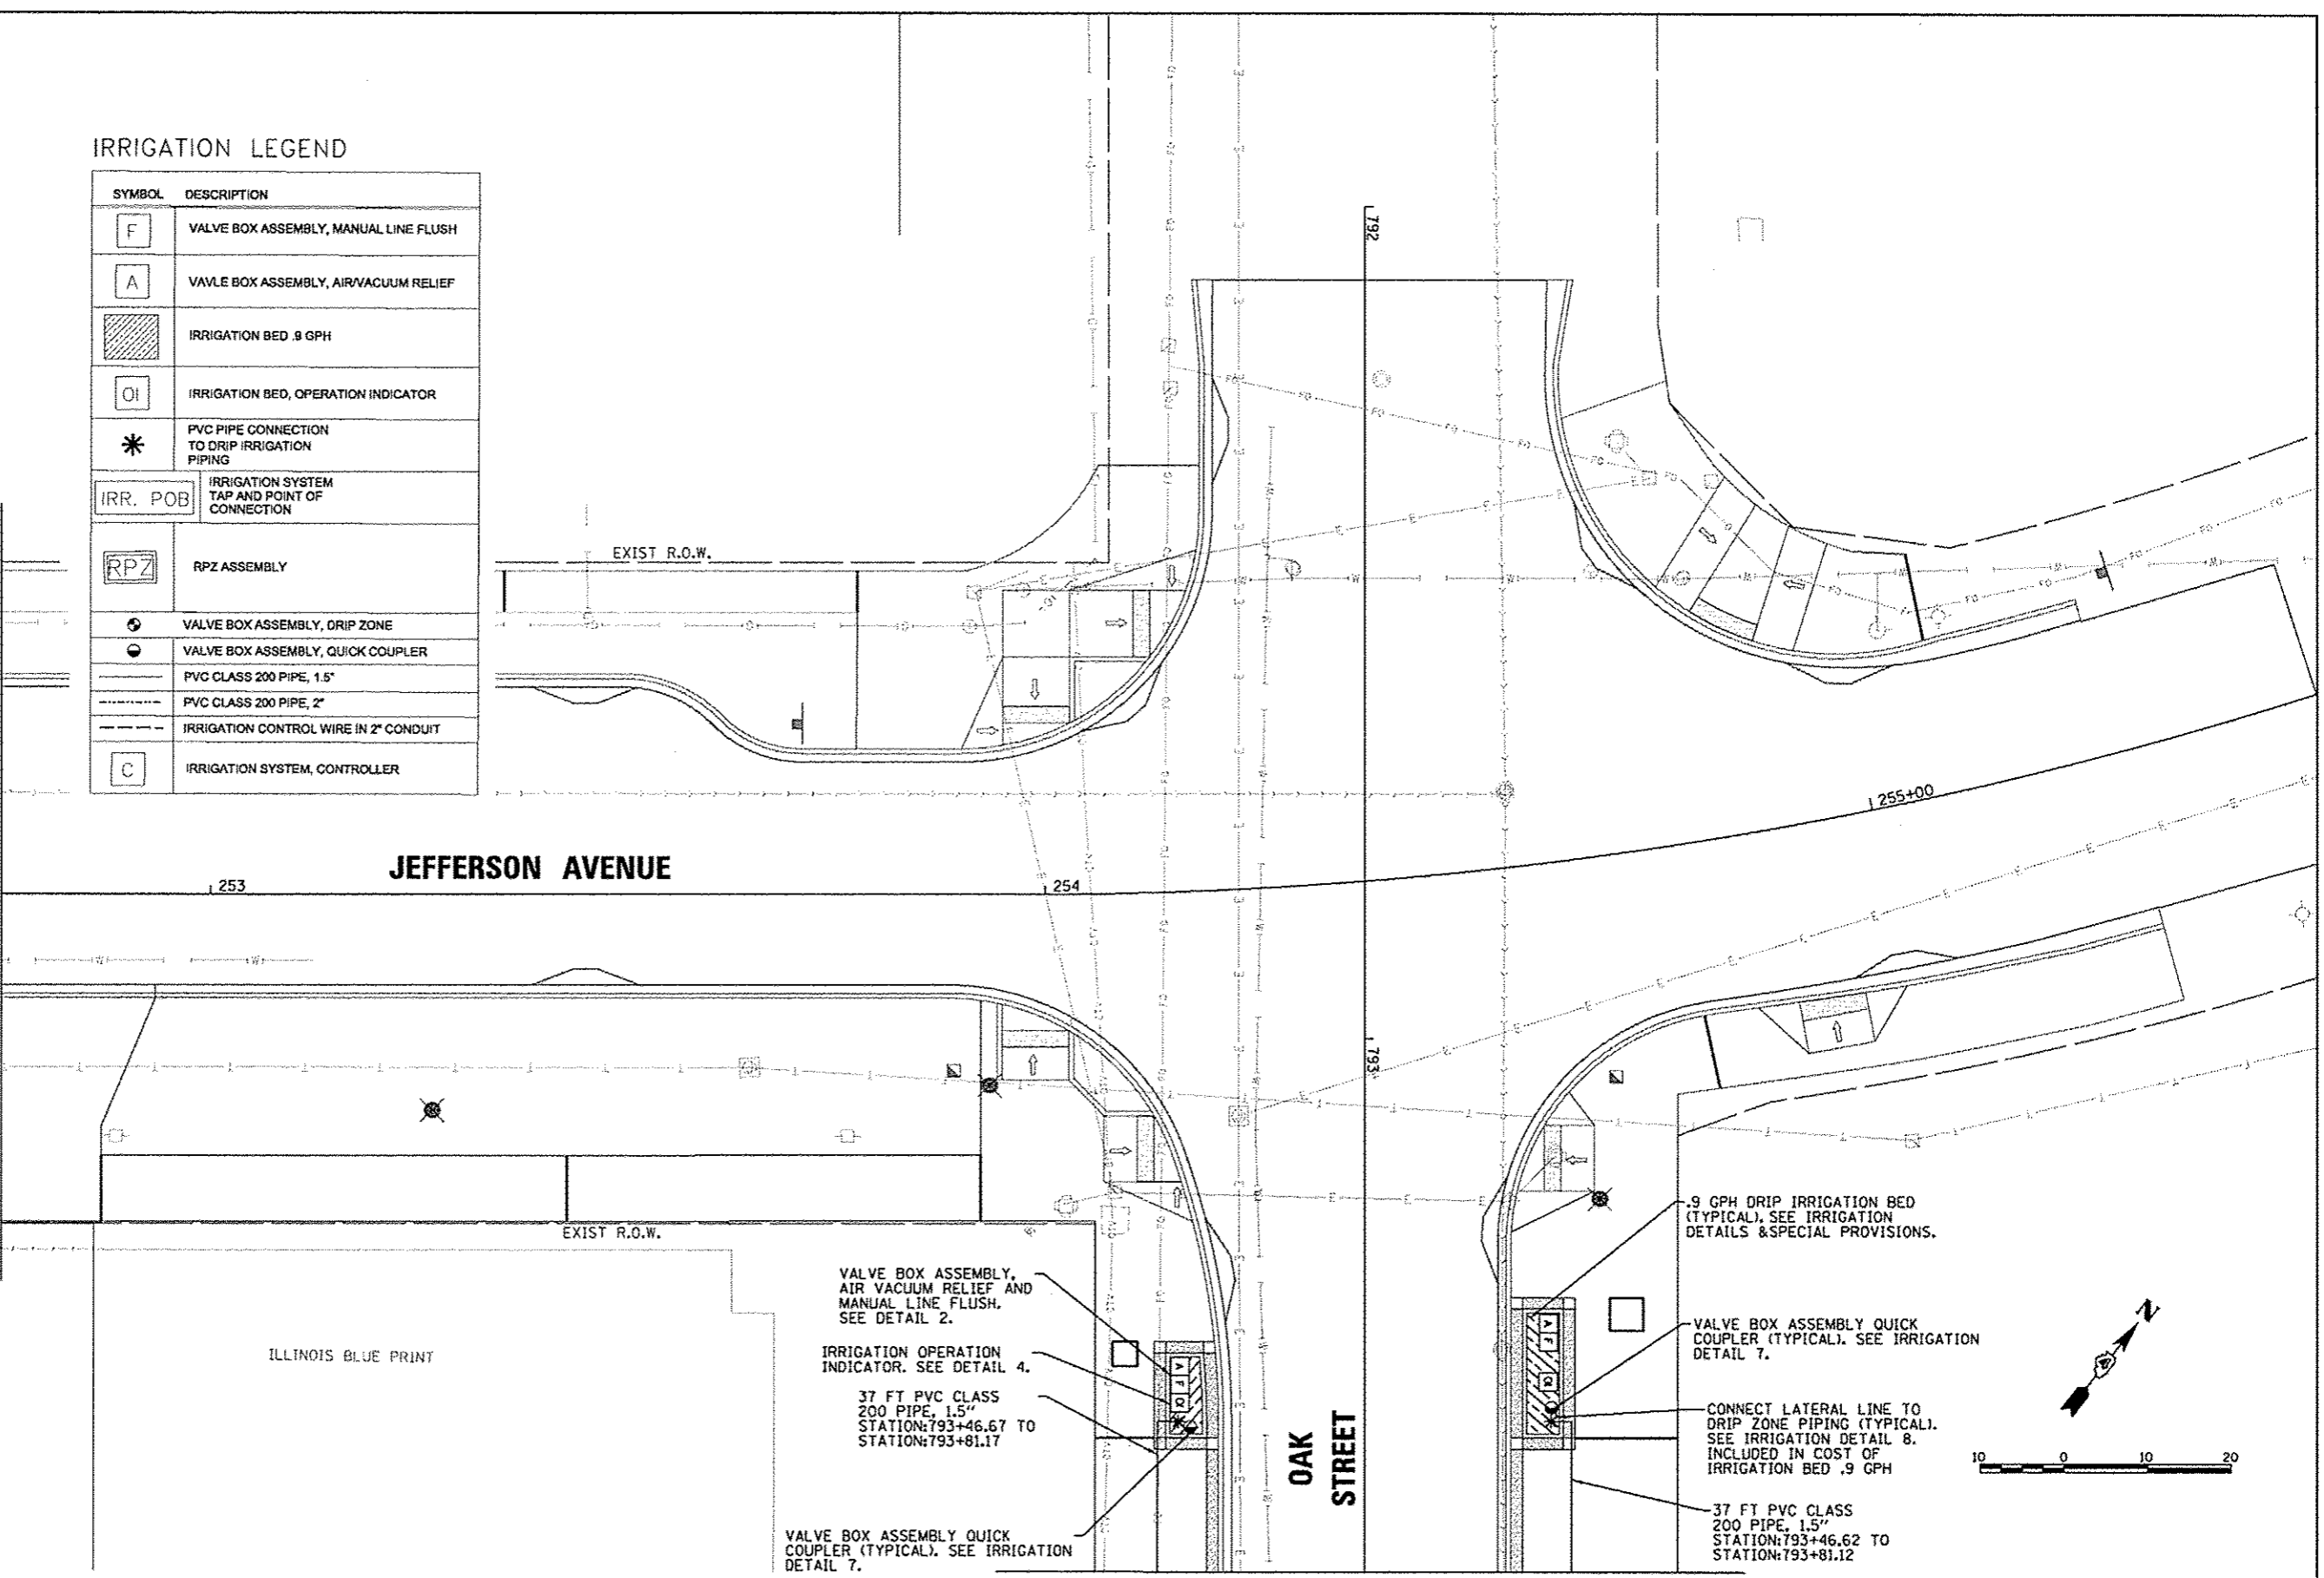

JEFFERSON AVENUE

OAK STREET

ILLINOIS BLUE PRINT

VALVE BOX ASSEMBLY, AIR VACUUM RELIEF AND MANUAL LINE FLUSH. SEE DETAIL 2.

IRRIGATION OPERATION INDICATOR. SEE DETAIL 4.

37 FT PVC CLASS 200 PIPE, 1.5"  
STATION: 793+46.67 TO STATION: 793+81.17


VALVE BOX ASSEMBLY QUICK COUPLER (TYPICAL). SEE IRRIGATION DETAIL 7.

.9 GPH DRIP IRRIGATION BED (TYPICAL). SEE IRRIGATION DETAILS & SPECIAL PROVISIONS.

VALVE BOX ASSEMBLY QUICK COUPLER (TYPICAL). SEE IRRIGATION DETAIL 7.

CONNECT LATERAL LINE TO DRIP ZONE PIPING (TYPICAL). SEE IRRIGATION DETAIL 8. INCLUDED IN COST OF IRRIGATION BED .9 GPH


37 FT PVC CLASS 200 PIPE, 1.5"  
STATION: 793+46.62 TO STATION: 793+81.12

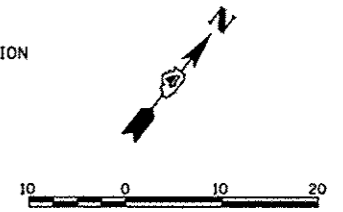

MATCHLINE STA. 793 + 65.00

FILE NAME * a:\pwise_work\do_no_delete\dms73427\104	USER NAME * mansk01310 BL0155-shc-11-825.dgn	DESIGNED - JLH	REVISED -	<b>STATE OF ILLINOIS DEPARTMENT OF TRANSPORTATION</b>	<b>OAK STREET IRRIGATION PLAN</b>			F.A.U. RTE. 12	SECTION 12-00356-01-PV	COUNTY PEORIA	TOTAL SHEETS 519	SHEET NO. 318
					SCALE: 1"=10'	SHEET NO. OF SHEETS	STA. 252+75 TO STA. 255+00	CONTRACT NO. 89626				
					ILLINOIS FED. AID PROJECT YIC-50930158							

**Farnsworth GROUP**  
7707 N. KNOXVILLE AVE. SUITE 100  
PEORIA, ILLINOIS 61614  
(309) 694-0808 / (309) 699-0820 Fax  
www.far.com

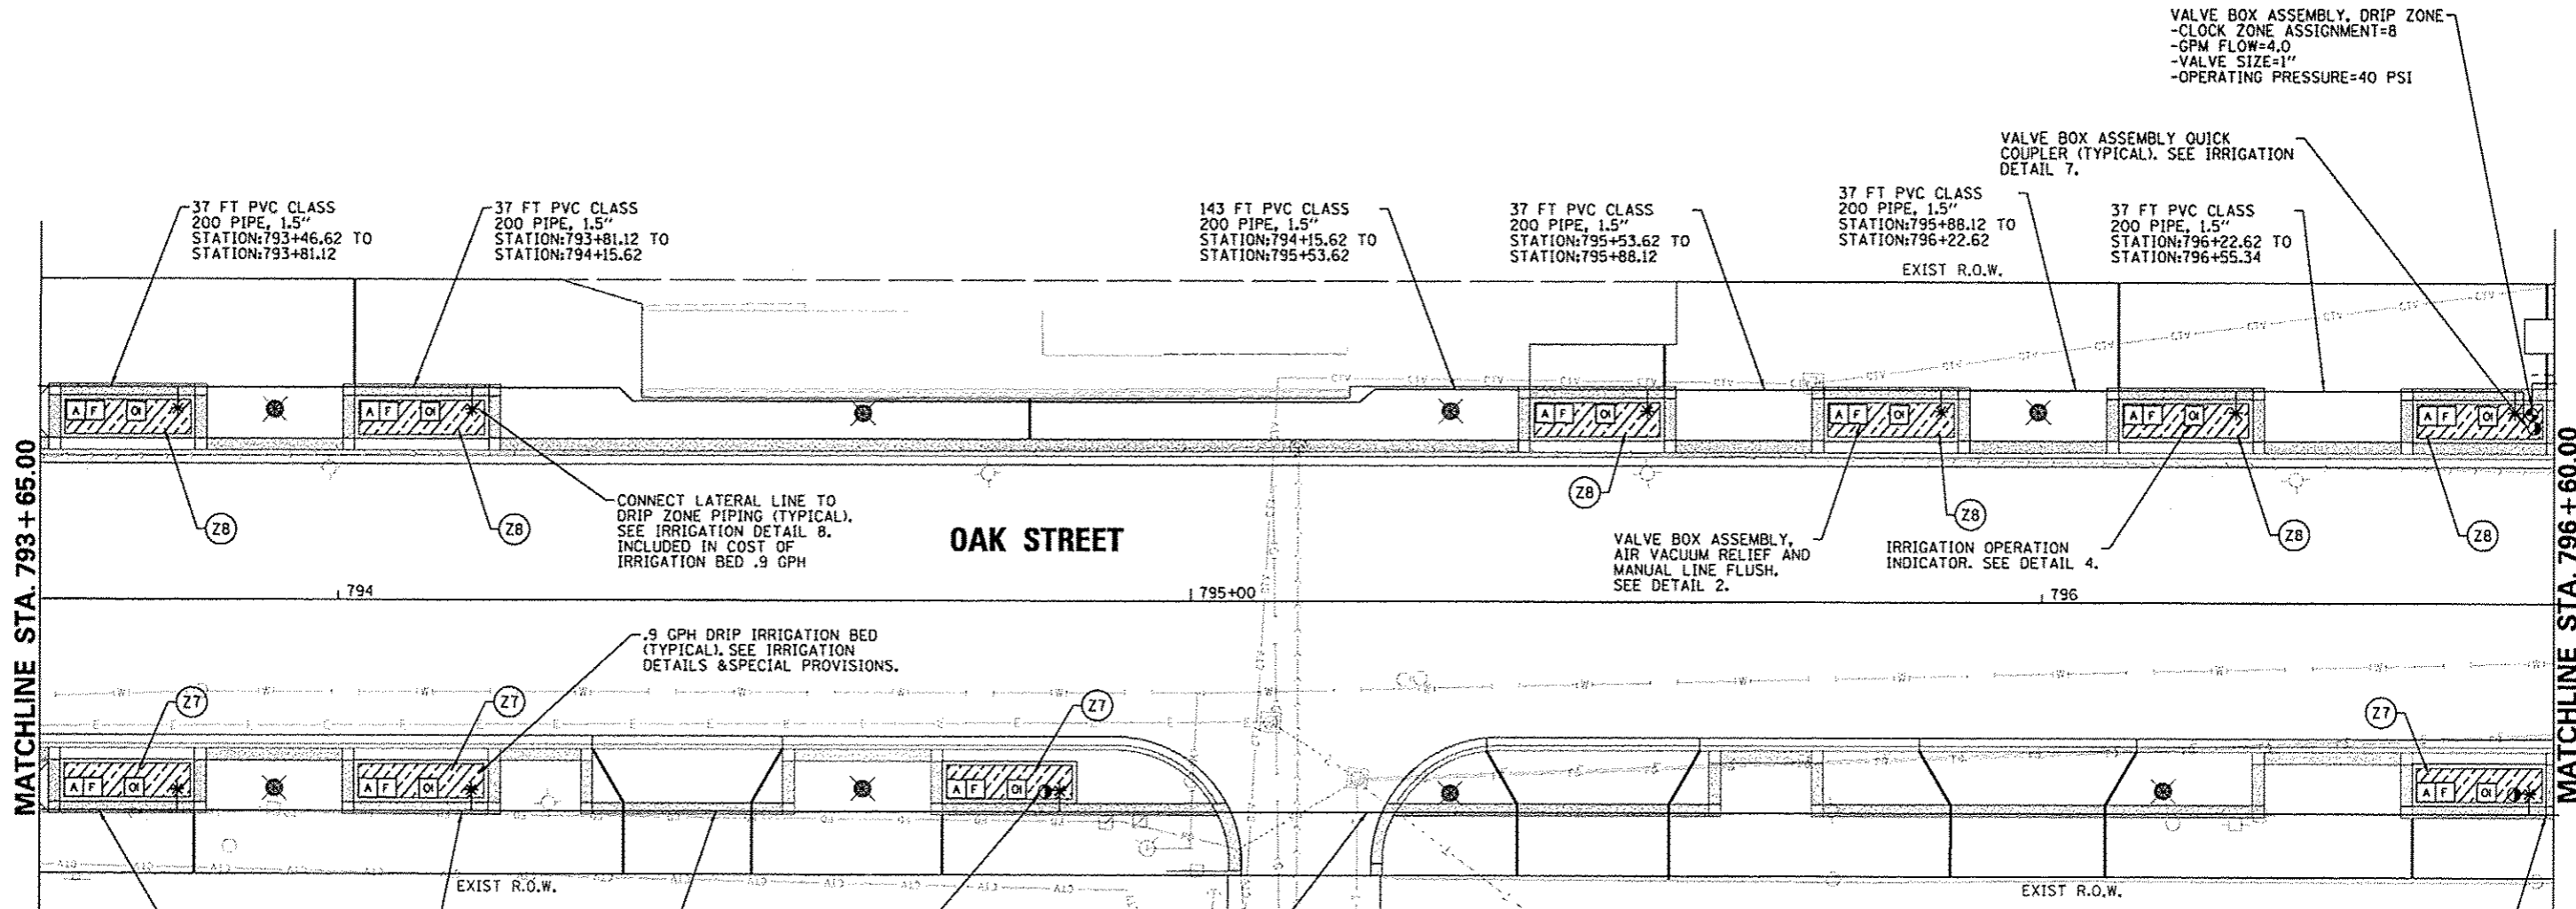

MATCHLINE STA. 793 + 65.00

MATCHLINE STA. 796 + 60.00

**OAK STREET**

**SW MEYER AVE.**

VALVE BOX ASSEMBLY, DRIP ZONE  
 -CLOCK ZONE ASSIGNMENT=8  
 -GPM FLOW=4.0  
 -VALVE SIZE=1"  
 -OPERATING PRESSURE=40 PSI

VALVE BOX ASSEMBLY QUICK COUPLER (TYPICAL). SEE IRRIGATION DETAIL 7.

CONNECT LATERAL LINE TO DRIP ZONE PIPING (TYPICAL). SEE IRRIGATION DETAIL 8. INCLUDED IN COST OF IRRIGATION BED .9 GPH

VALVE BOX ASSEMBLY, AIR VACUUM RELIEF AND MANUAL LINE FLUSH. SEE DETAIL 2.

IRRIGATION OPERATION INDICATOR. SEE DETAIL 4.

.9 GPH DRIP IRRIGATION BED (TYPICAL). SEE IRRIGATION DETAILS & SPECIAL PROVISIONS.

37 FT. PVC CLASS 200 PIPE, 1.5" STATION:793+46.67 TO STATION:793+81.17

71.5 FT PVC CLASS 200 PIPE, 1.5" STATION:794+15.67 TO STATION:794+84.67

37 FT PVC CLASS 200 PIPE, 1.5" STATION:793+81.17 TO STATION:794+15.67


VALVE BOX ASSEMBLY QUICK COUPLER (TYPICAL). SEE IRRIGATION DETAIL 7.

175 FT PVC CLASS 200 PIPE, 1.5" STATION:794+84.67 TO STATION:796+57.16

40 FT PVC CLASS 200 PIPE, 1.5" STATION:796+57.16 TO STATION:796+90.32

**IRRIGATION LEGEND**

SYMBOL	DESCRIPTION
[F]	VALVE BOX ASSEMBLY, MANUAL LINE FLUSH
[A]	VALVE BOX ASSEMBLY, AIR VACUUM RELIEF
[Hatched Box]	IRRIGATION BED .9 GPH
[OI]	IRRIGATION BED, OPERATION INDICATOR
[*]	PVC PIPE CONNECTION TO DRIP IRRIGATION PIPING
[IRR. POB]	IRRIGATION SYSTEM TAP AND POINT OF CONNECTION
[RPZ]	RPZ ASSEMBLY
[ZB]	VALVE BOX ASSEMBLY, DRIP ZONE
[ZC]	VALVE BOX ASSEMBLY, QUICK COUPLER
[Solid Line]	PVC CLASS 200 PIPE, 1.5"
[Dashed Line]	PVC CLASS 200 PIPE, 2"
[Dotted Line]	IRRIGATION CONTROL WIRE IN 2" CONDUIT
[C]	IRRIGATION SYSTEM, CONTROLLER

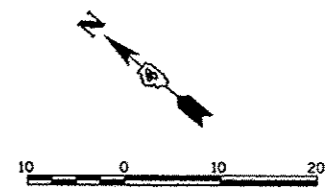

**Farnsworth GROUP**  
 7707 N. KNOXVILLE AVE, SUITE 100  
 PEORIA, ILLINOIS 61614  
 (309) 699-0606 / (309) 699-0620 Fax  
 www.fw.com

FILE NAME *	USER NAME * marak01390	DESIGNED - JLH	REVISED -	<b>STATE OF ILLINOIS DEPARTMENT OF TRANSPORTATION</b>	<b>OAK STREET IRRIGATION PLAN</b>	F.A.U. RTE.	SECTION	COUNTY	TOTAL SHEETS	SHEET NO.
al\pwise\work\do_not_delete\dms73427\04	3L0155-aht-irr-070.dgn	DRAWN - JLH	REVISED -			12-00356-01-PV	PEORIA	519	319	
PLOT SCALE = 20,0000' / in.	CHECKED - BAB	REVISED -	REVISED -			CONTRACT NO. 89626				
PLOT DATE = 07/23/2012	DATE - 7/18/12	REVISED -	REVISED -			ILLINOIS FED. AID PROJECT TIG-5093158				
				SCALE: 1"=10'	SHEET NO. OF SHEETS	STA. 793+65 TO STA. 796+15				

50 FT PVC CLASS  
200 PIPE, 1.5"  
STATION: 797+85.81 TO  
STATION: 798+31.77

37 FT PVC CLASS  
200 PIPE, 1.5"  
STATION: 798+31.77 TO  
STATION: 799+66.26

37 FT PVC CLASS  
200 PIPE, 1.5"  
STATION: 798+66.26 TO  
STATION: 798+00.81

IRRIGATION OPERATION  
INDICATOR. SEE DETAIL 4.

EXIST R.O.W.

MATCHLINE STA. 798 + 15.00

CONNECT LATERAL LINE TO  
DRIP ZONE PIPING (TYPICAL).  
SEE IRRIGATION DETAIL 8.  
INCLUDED IN COST OF  
IRRIGATION BED .9 GPH

VALVE BOX ASSEMBLY,  
AIR VACUUM RELIEF AND  
MANUAL LINE FLUSH.  
SEE DETAIL 2.

.9 GPH DRIP IRRIGATION BED  
(TYPICAL). SEE IRRIGATION  
DETAILS & SPECIAL PROVISIONS.

799

800+00


OAK STREET

EXIST R.O.W.

SW MAY STREET

IRRIGATION LEGEND

SYMBOL	DESCRIPTION
F	VALVE BOX ASSEMBLY, MANUAL LINE FLUSH
A	VALVE BOX ASSEMBLY, AIR/VACUUM RELIEF
[Hatched Box]	IRRIGATION BED .9 GPH
OI	IRRIGATION BED, OPERATION INDICATOR
*	PVC PIPE CONNECTION TO DRIP IRRIGATION PIPING
IRR. POB	IRRIGATION SYSTEM TAP AND POINT OF CONNECTION
RPZ	RPZ ASSEMBLY
[Circle with dot]	VALVE BOX ASSEMBLY, DRIP ZONE
[Circle with dot]	VALVE BOX ASSEMBLY, QUICK COUPLER
[Solid Line]	PVC CLASS 200 PIPE, 1.5"
[Dashed Line]	PVC CLASS 200 PIPE, 2"
[Dotted Line]	IRRIGATION CONTROL WIRE IN 2" CONDUIT
C	IRRIGATION SYSTEM, CONTROLLER

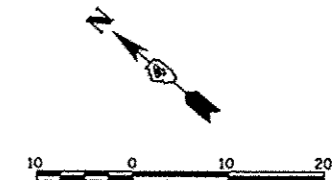


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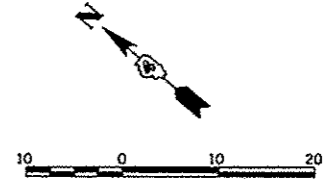
FILE NAME *	USER NAME * mansk01318	DESIGNED - JLH	REVISED -	<b>STATE OF ILLINOIS DEPARTMENT OF TRANSPORTATION</b>	<b>OAK STREET IRRIGATION PLAN</b>			F.A.U. RTE. 123	SECTION 12-00356-01-PV	COUNTY PEORIA	TOTAL SHEETS 519	SHEET NO. 320
or\pwise\work\do_not_delete\dmx73427\04	PL.0155-sh1-r-071.dgn	DRAWN - JLH	REVISED -		SCALE: 1"=10'	SHEET NO. OF SHEETS	STA. 798+15 TO STA. 800+00	CONTRACT NO. 89626				
	PLOT SCALE = 20.0000' / 10.	CHECKED - BAB	REVISED -					ILLINOIS FED. AID PROJECT TIC-5093158				
	PLOT DATE = 07/23/2012	DATE - 7/18/12	REVISED -									

IRRIGATION LEGEND

SYMBOL	DESCRIPTION
[F]	VALVE BOX ASSEMBLY, MANUAL LINE FLUSH
[A]	VALVE BOX ASSEMBLY, AIR/VACUUM RELIEF
[Hatched Box]	IRRIGATION BED .9 GPH
[OI]	IRRIGATION BED, OPERATION INDICATOR
[*]	PVC PIPE CONNECTION TO DRIP IRRIGATION PIPING
[IRR. POB]	IRRIGATION SYSTEM TAP AND POINT OF CONNECTION
[RPZ]	RPZ ASSEMBLY
[Circle with dot]	VALVE BOX ASSEMBLY, DRIP ZONE
[Circle with cross]	VALVE BOX ASSEMBLY, QUICK COUPLER
[Solid Line]	PVC CLASS 200 PIPE, 1.5"
[Dashed Line]	PVC CLASS 200 PIPE, 2"
[Dotted Line]	IRRIGATION CONTROL WIRE IN 2" CONDUIT
[C]	IRRIGATION SYSTEM, CONTROLLER

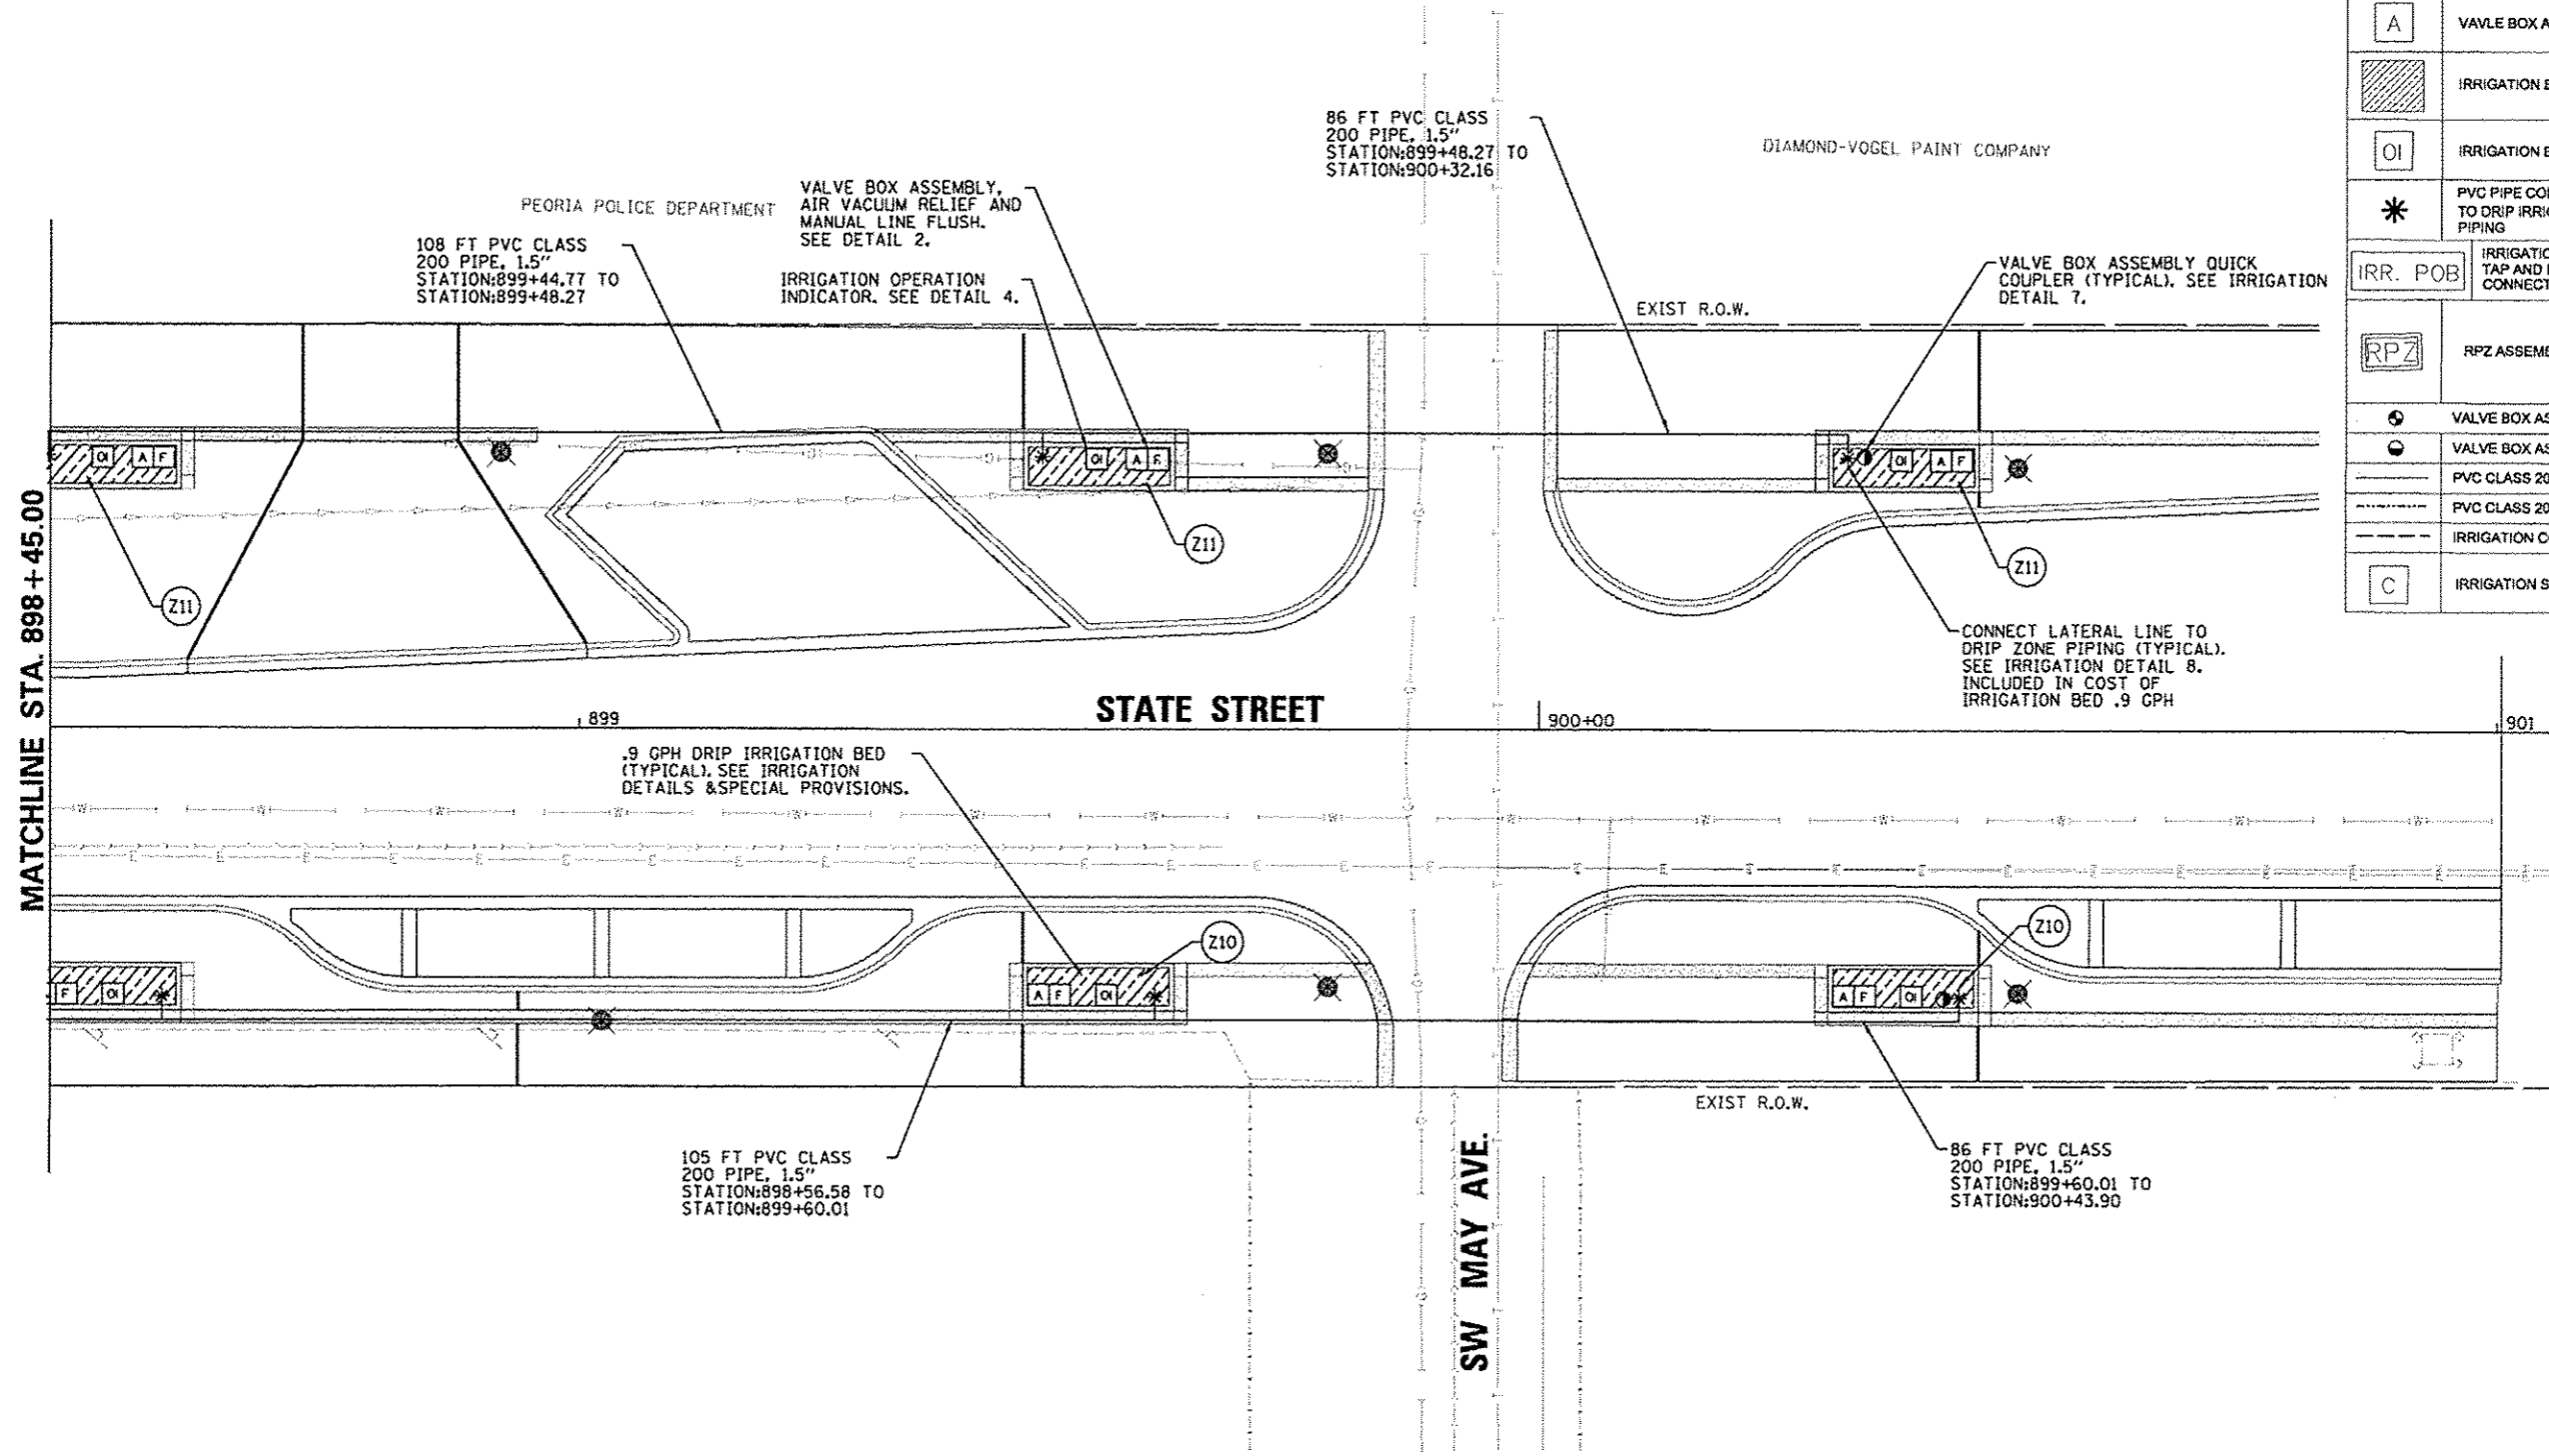

MATCHLINE STA. 898 + 45.00



FILE NAME *	USER NAME * monsk01398	DESIGNED - JLH	REVISED -
c:\pwise_work\do_not_delete\dms73427\04	KL0150-ghl-11-888.dgn	DRAWN - JLH	REVISED -
	PLOT SCALE = 20,0000' / in.	CHECKED - BAB	REVISED -
	PLOT DATE = 07/23/2012	DATE - 7/18/12	REVISED -


**STATE OF ILLINOIS  
DEPARTMENT OF TRANSPORTATION**

**STATE STREET  
IRRIGATION PLAN**

SCALE: 1"=10'    SHEET NO. OF SHEETS    STA. 898+45 TO STA. 901+00

F.A.U. RTE.	SECTION	COUNTY	TOTAL SHEETS	SHEET NO.
12	12-00356-01-PV	PEORIA	519	321
CONTRACT NO. 89626				
ILLINOIS FED. AID PROJECT TIG-5093(158)				

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PEORIA, ILLINOIS 61614  
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www.fw.com

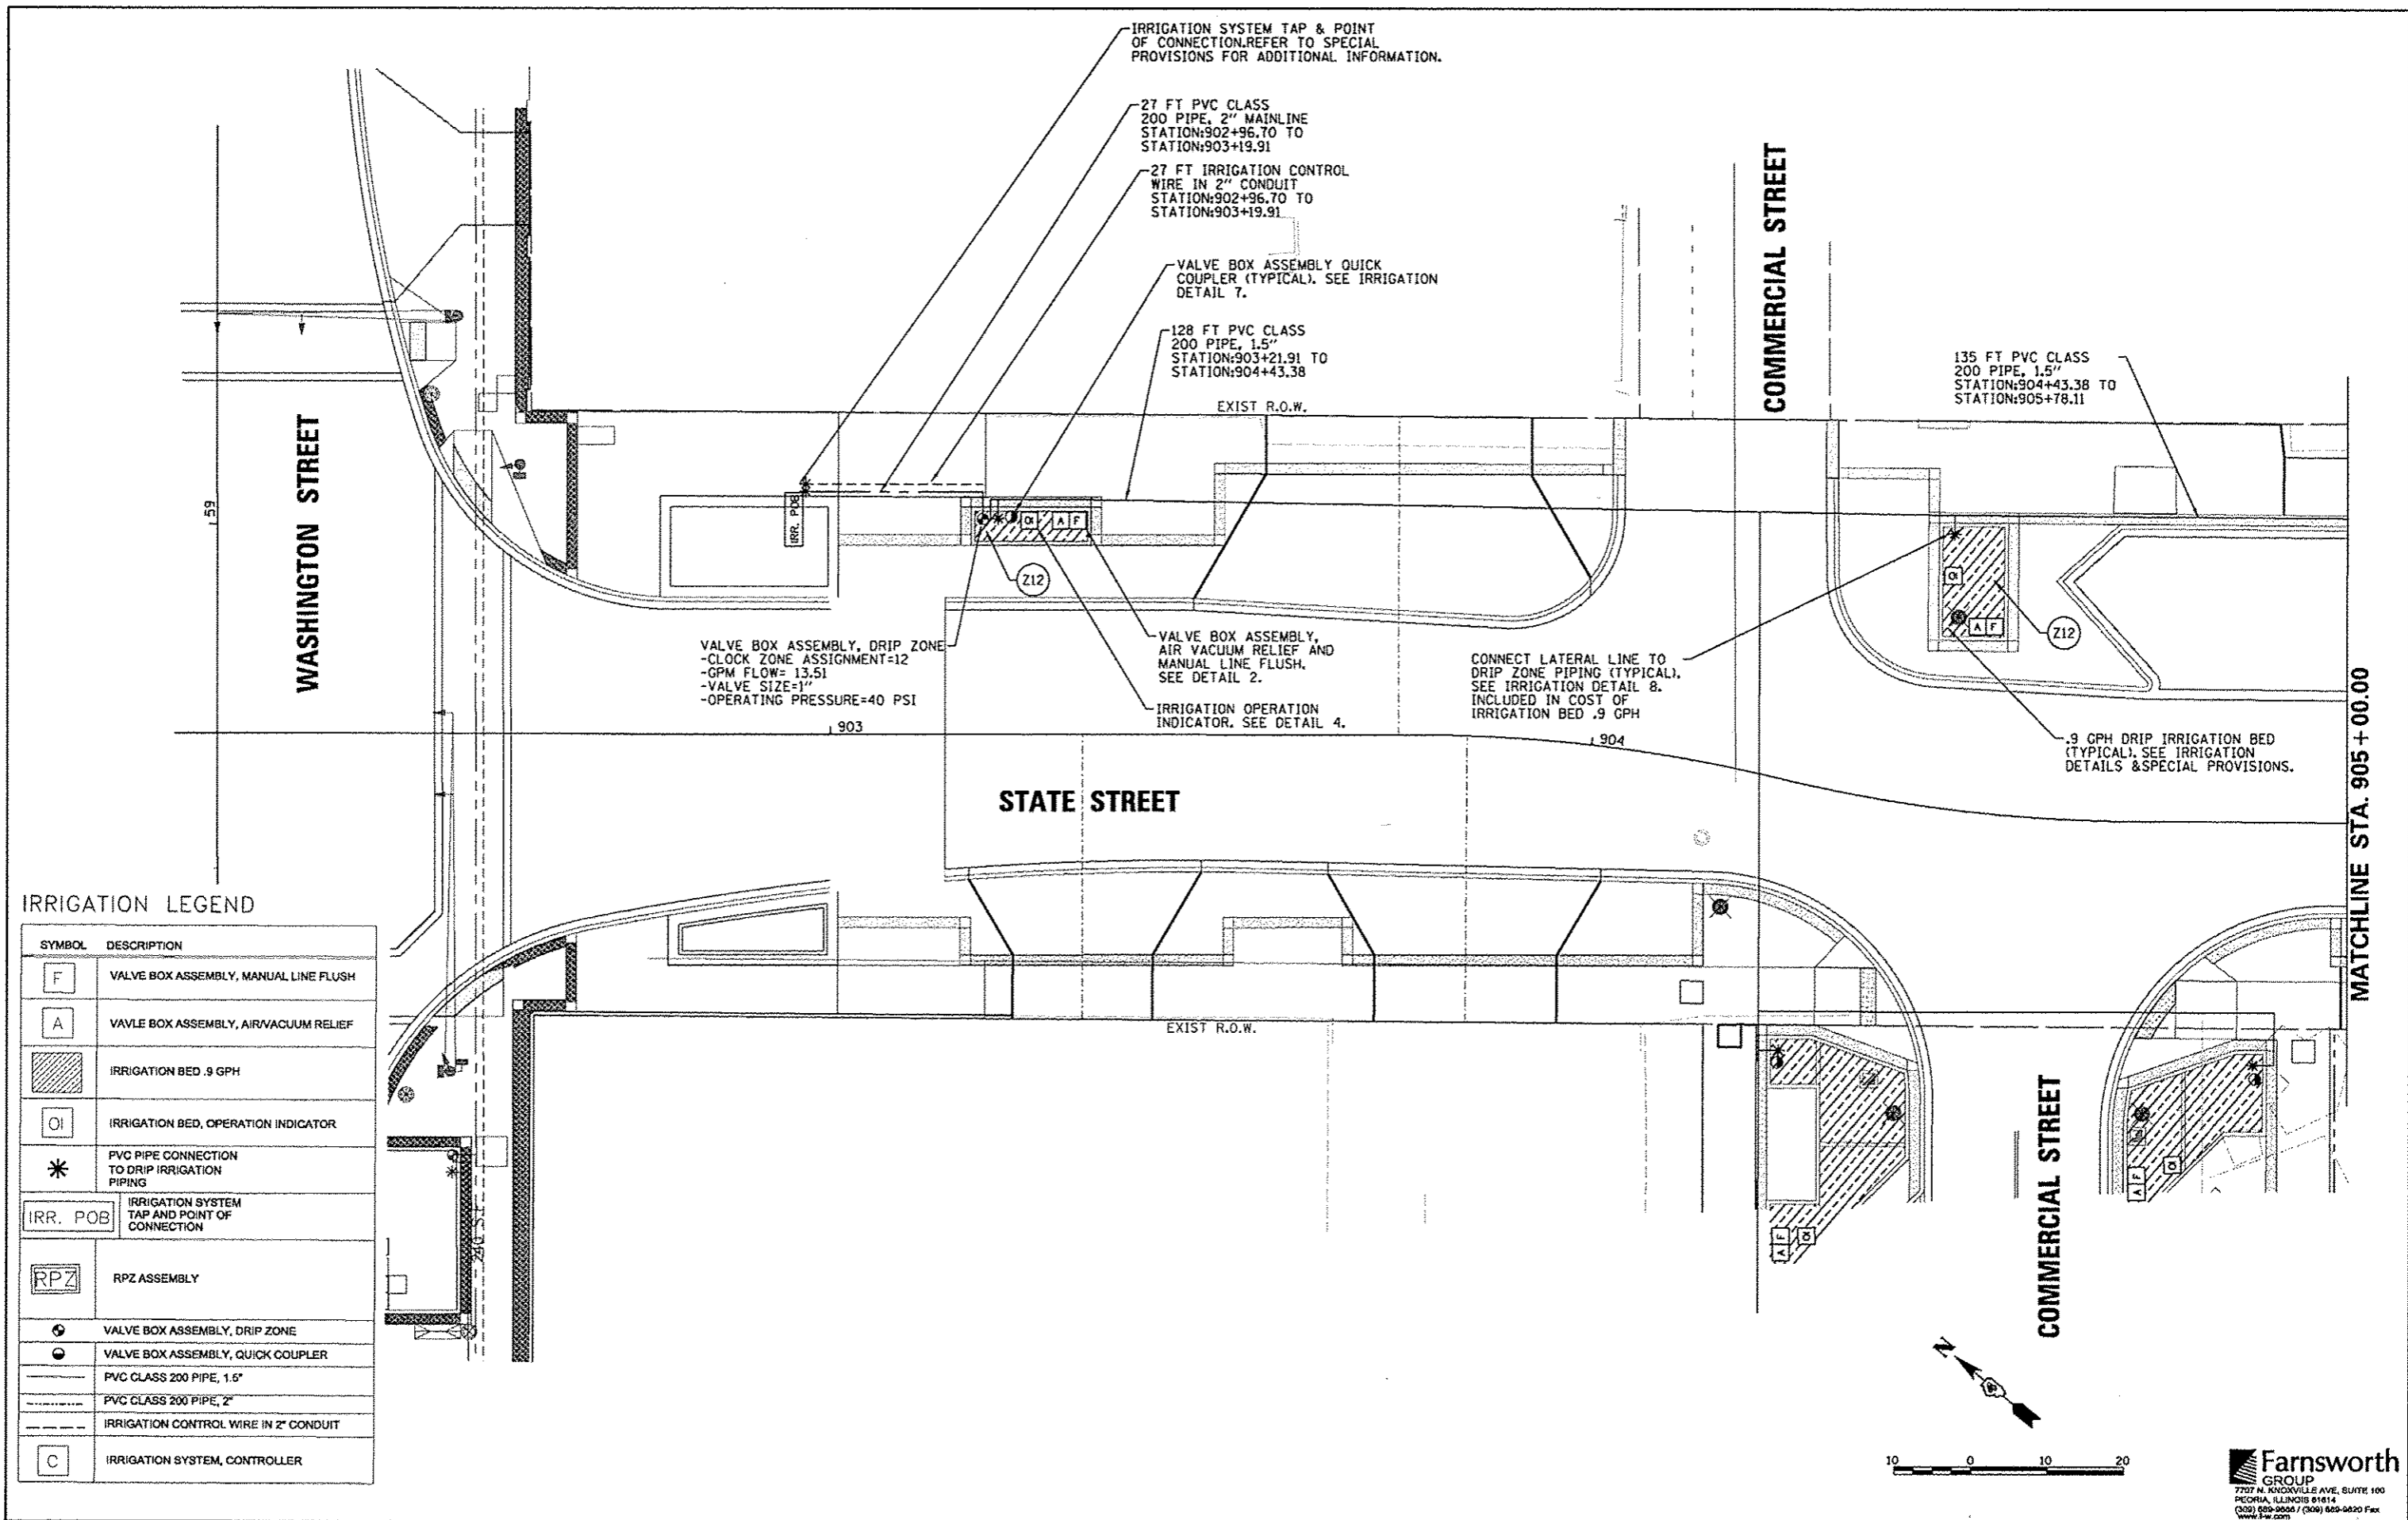

**IRRIGATION LEGEND**

SYMBOL	DESCRIPTION
F	VALVE BOX ASSEMBLY, MANUAL LINE FLUSH
A	VALVE BOX ASSEMBLY, AIR/VACUUM RELIEF
[Hatched Box]	IRRIGATION BED, .9 GPH
OI	IRRIGATION BED, OPERATION INDICATOR
*	PVC PIPE CONNECTION TO DRIP IRRIGATION PIPING
IRR. POB	IRRIGATION SYSTEM TAP AND POINT OF CONNECTION
RPZ	RPZ ASSEMBLY
[Circle with 'Z']	VALVE BOX ASSEMBLY, DRIP ZONE
[Circle with 'Q']	VALVE BOX ASSEMBLY, QUICK COUPLER
[Solid Line]	PVC CLASS 200 PIPE, 1.5"
[Dashed Line]	PVC CLASS 200 PIPE, 2"
[Dotted Line]	IRRIGATION CONTROL WIRE IN 2" CONDUIT
C	IRRIGATION SYSTEM, CONTROLLER

FILE NAME =	USER NAME = monak01390	DESIGNED - JLH	REVISED -
pl\pwise_work\do_not_delete\dms73427\04	01.0155-shl-srv-091.dgn	DRAWN - JLH	REVISED -
	PLOT SCALE = 20.0000' / in.	CHECKED - BAB	REVISED -
	PLOT DATE = 07/23/2012	DATE - 7/18/12	REVISED -

**STATE OF ILLINOIS  
DEPARTMENT OF TRANSPORTATION**

**STATE STREET  
IRRIGATION PLAN**

SCALE: 1"=10'      SHEET NO. OF SHEETS      STA. 902+00 TO STA. 905+00



F.A.U. RTE.	SECTION	COUNTY	TOTAL SHEETS	SHEET NO.
663	12-00356-01-PV	PEORIA	519	322
CONTRACT NO. 89626			ILLINOIS FED. AID PROJECT 110-50931587	

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MATCHLINE STA. 905 + 00.00


IRRIGATION LEGEND

SYMBOL	DESCRIPTION
[F]	VALVE BOX ASSEMBLY, MANUAL LINE FLUSH
[A]	VALVE BOX ASSEMBLY, AIR/VACUUM RELIEF
[Hatched Box]	IRRIGATION BED .9 GPH
[OI]	IRRIGATION BED, OPERATION INDICATOR
[*]	PVC PIPE CONNECTION TO DRIP IRRIGATION PIPING
[IRR. POB]	IRRIGATION SYSTEM TAP AND POINT OF CONNECTION
[RPZ]	RPZ ASSEMBLY
[Circle with dot]	VALVE BOX ASSEMBLY, DRIP ZONE
[Circle with cross]	VALVE BOX ASSEMBLY, QUICK COUPLER
[Solid Line]	PVC CLASS 200 PIPE, 1.5"
[Dashed Line]	PVC CLASS 200 PIPE, 2"
[Dotted Line]	IRRIGATION CONTROL WIRE IN 2" CONDUIT
[C]	IRRIGATION SYSTEM, CONTROLLER

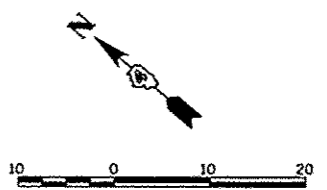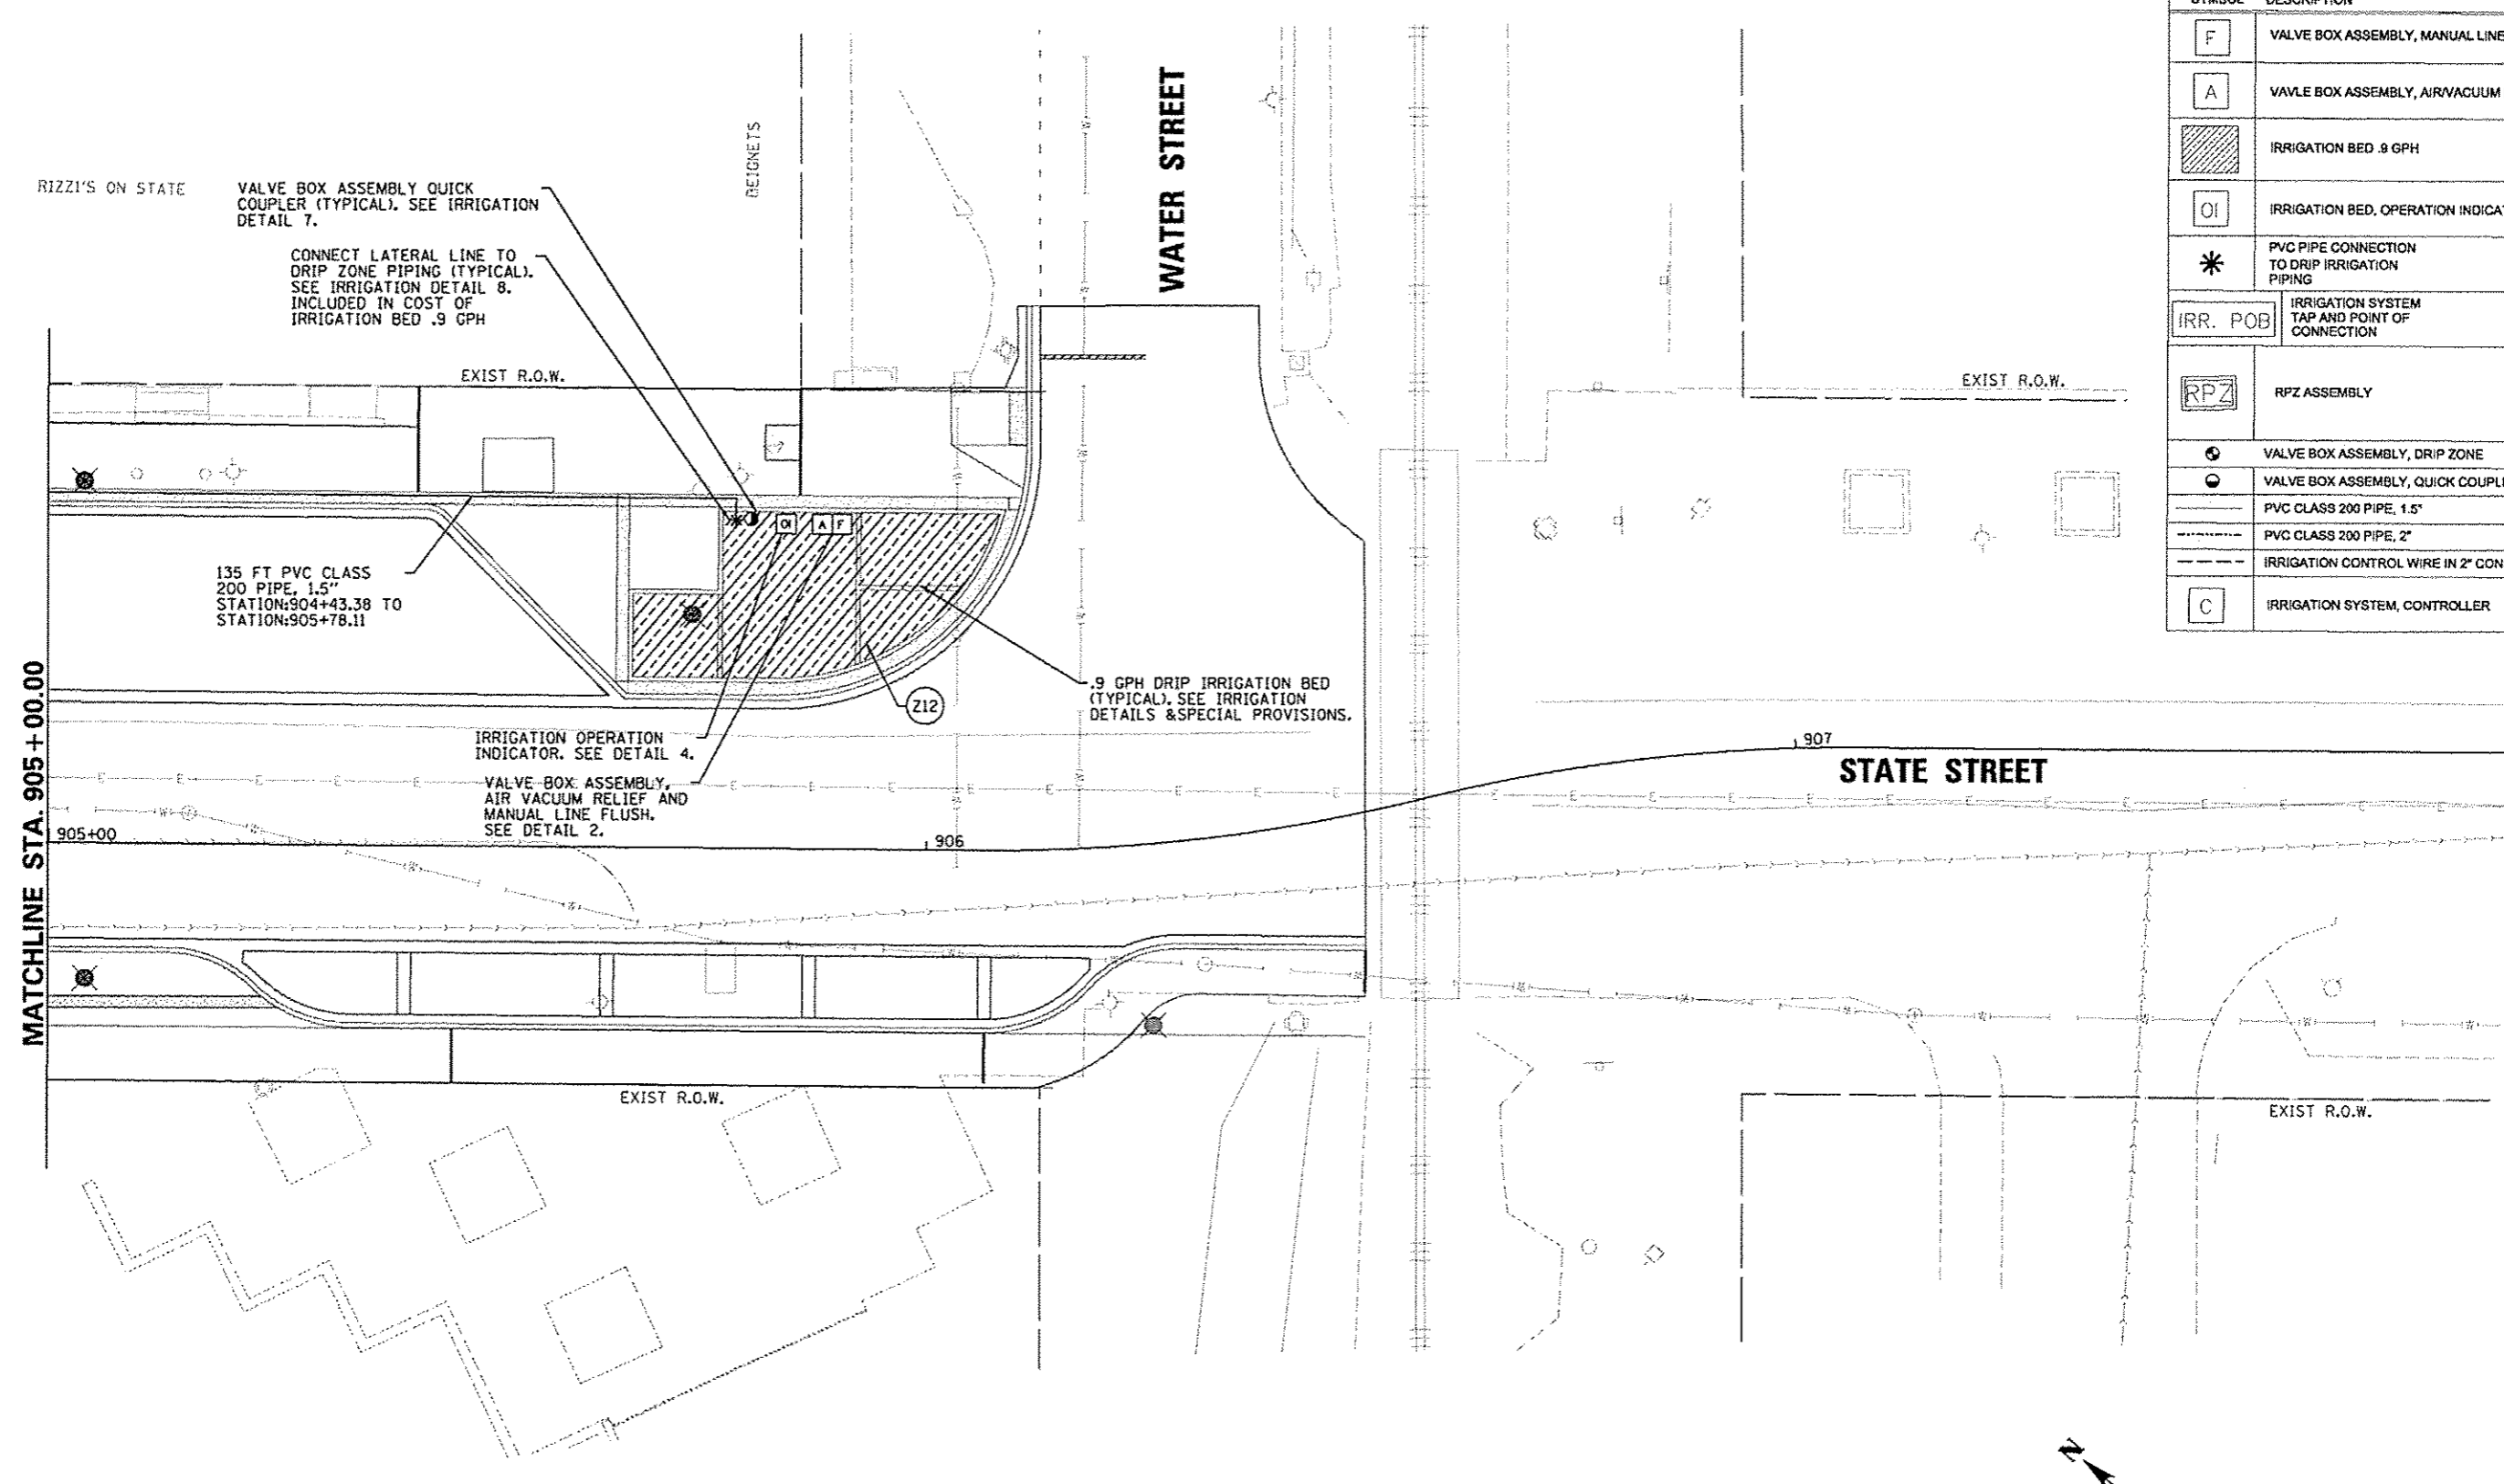


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	PLOT SCALE = 28.8000' / 1"	PLOT DATE = 07\23\2012	SCALE: 1"=10' SHEET NO. OF SHEETS STA. 905+00 TO STA. 908+00			CONTRACT NO. B9626 [ILLINOIS] FED. AID PROJECT TIC-50931581			


**Farnsworth GROUP**  
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 PEORIA, ILLINOIS 61614  
 (309) 699-6666 / (309) 699-0620 Fax  
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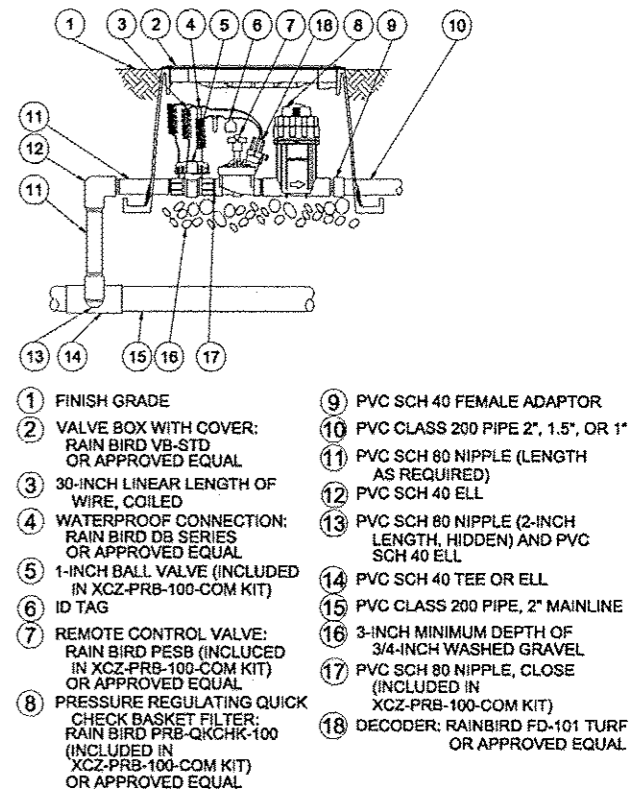
**7 Valve Box Assembly, Quick Coupler**  
Scale: Not to Scale

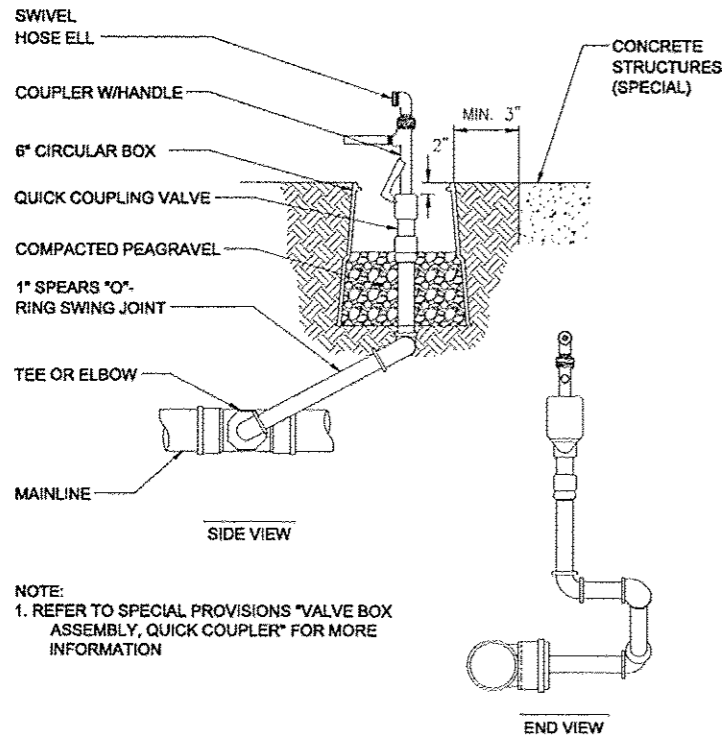


**6 Irrigation Controller Detail**  
Scale: Not to Scale

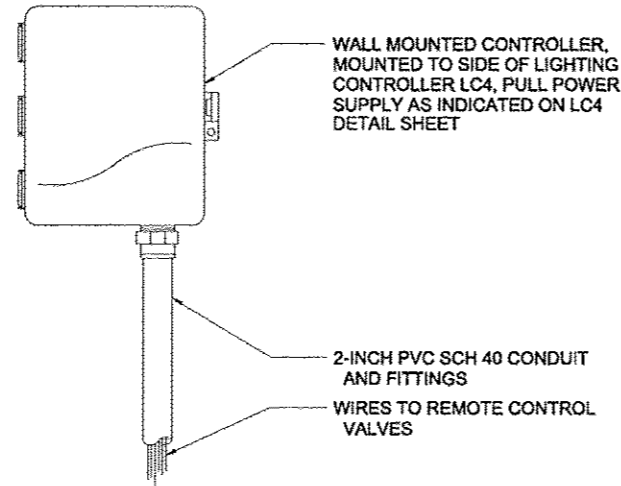


**5 Irrigation Trench Detail**  
Scale: Not to Scale

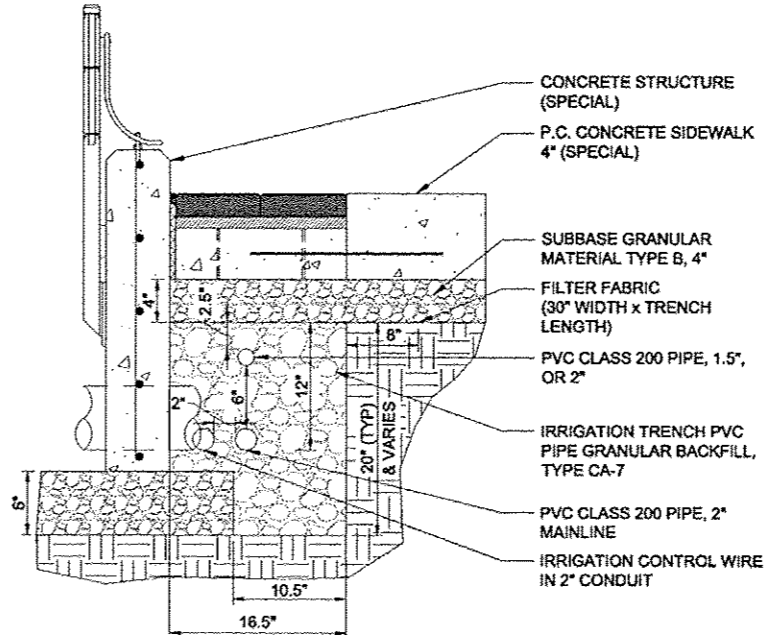


**3 Valve Box Assembly, Drip Zone**  
Scale: Not to Scale

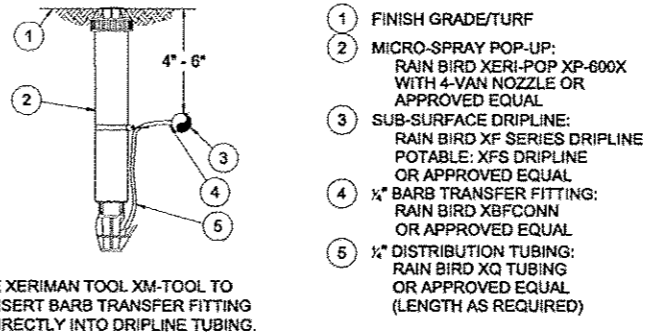

**4 Irrigation Operation Indicator**  
Scale: Not to Scale

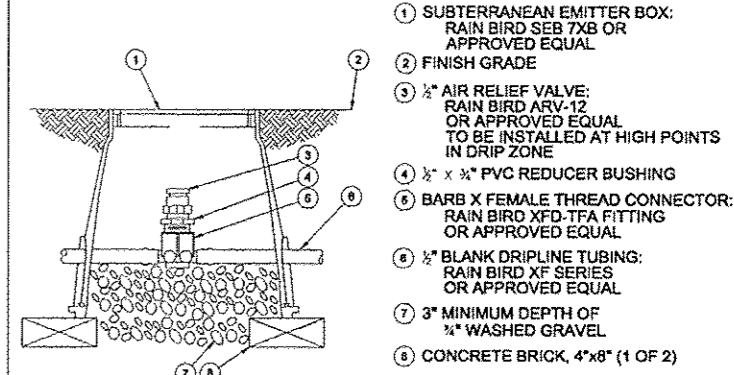

**2 Valve Box Assembly, Air/Vacuum Relief and Manual Line Flush**  
Scale: Not to Scale

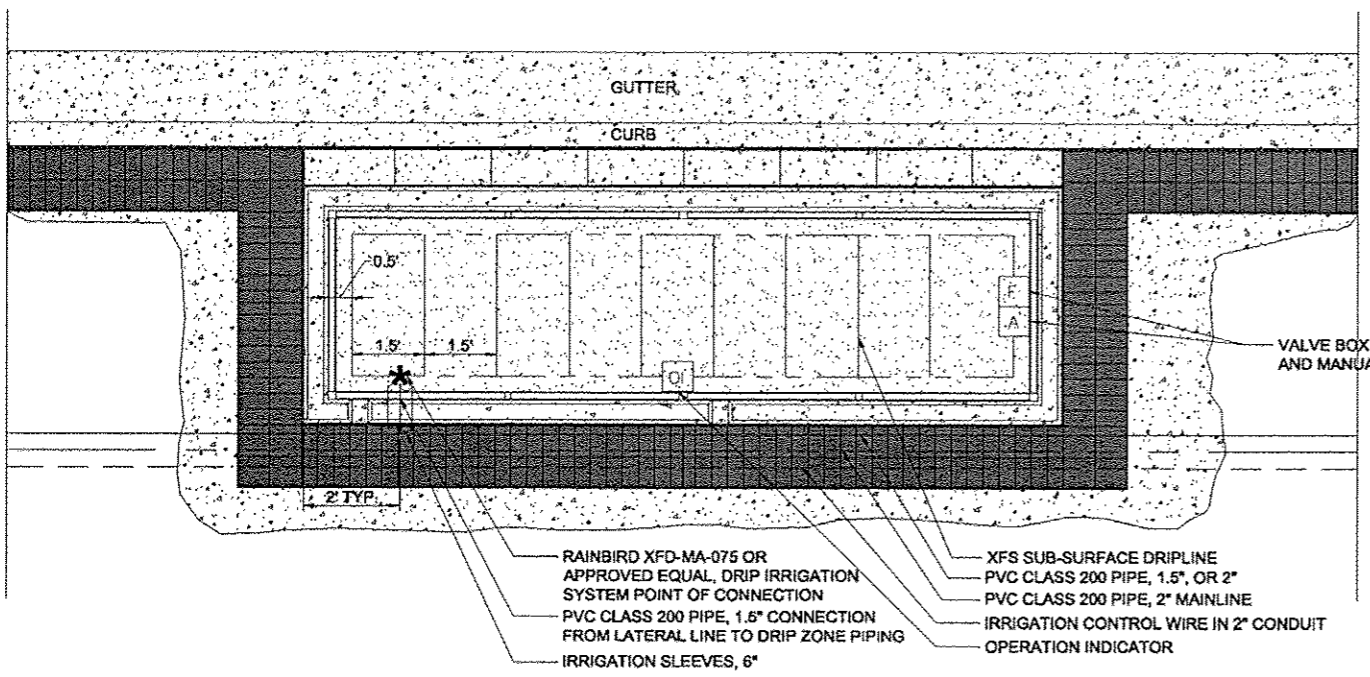

**8 Irrigation Bed .9 GPH**  
Scale: 1/2" = 1'-0"

**1 XFS Sub-Surface Dripline Burial**  
Scale: Not to Scale

FILE NAME *	USER NAME * d0vao0070	DESIGNED - ALW	REVISED -
o:\pwise\work\do_not_delete\dm73427\04\RL0155-shr-details-Indsept11.dgn		DRAWN - ALW	REVISED -
	PLOT SCALE = 2.0000 / in.	CHECKED - BAB	REVISED -
	PLOT DATE = 08/21/2012	DATE - 7/18/12	REVISED -

STATE OF ILLINOIS  
DEPARTMENT OF TRANSPORTATION

TIGER II - WAREHOUSE DISTRICT  
IRRIGATION DETAILS

SCALE: N.T.S. SHEET NO. OF SHEETS STA. TO STA.

F.A.U. RTE.	SECTION	COUNTY	TOTAL SHEETS	SHEET NO.
	12-00356-01-PV	PEORIA	519	324
CONTRACT NO. 89626			ILLINOIS FED. AID PROJECT TIG-59931(58)	

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MATCHLINE STA. 596+70.00

DELTA INDUSTRIES

DRUMHELLER BAG CORP.

(1,283 sf) TUR SOD

EXIST R.O.W.

ADAMS STREET

140+00

141


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Not Available

EXIST R.O.W.


MATCHLINE STA. 141+50.00


PERSIMMON STREET

PLANT SCHEDULE PERSIMMON - JEFFERSON TO ADAMS

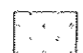TREES	QTY	BOTANICAL NAME	COMMON NAME	SIZE	REMARKS	
GIN AUT	1	Ginkgo biloba 'Autumn Gold' TM	Autumn Gold Ginkgo	2" Cal	PAY ITEM # A2004512	
GYM KEN	1	Gymnocladus dioica	Kentucky Coffeetree	2" Cal	PAY ITEM # A2005016	
GROUND COVERS	CODE	QTY	BOTANICAL NAME	COMMON NAME	SIZE	REMARKS
	TUR SOD	6,852 sf	Turf Sod	Sodding	sod	Topsoil Furnish and Place, 4"

DRUMHELLER BAG CORP.

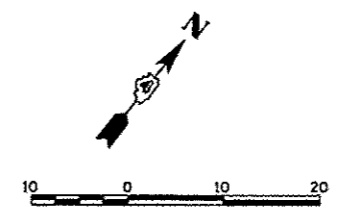


FILE NAME * c:\pwise\work\do-not-delete\dms73427\04	USER NAME * manak81398	DESIGNED - JLH	REVISED -	<b>STATE OF ILLINOIS DEPARTMENT OF TRANSPORTATION</b>	<b>ADAMS STREET PLANTING PLAN</b>			F.A.U. RTE. 	SECTION 12-00356-01-PV	COUNTY PEORIA	TOTAL SHEETS 519	SHEET NO. 325
	PLOT SCALE = 20,000' / 1" =	CHECKED - BAB	REVISED -		SCALE: 1"=10'	SHEET NO. OF	SHEETS	STA. 140+00	TO STA. 141+50	CONTRACT NO. 89626		
	PLOT DATE = 07/23/2012	DATE - 7/18/12	REVISED -		ILLINOIS FED. AID PROJECT FIG-5093158F							
<b>Farnsworth GROUP</b> 7707 N. KNOXVILLE AVE, SUITE 100 PEORIA, ILLINOIS 61614 (309) 693-9055 / (309) 693-9020 Fax www.fsw.com												



# PLANT SCHEDULE PERSIMMON - JEFFERSON TO ADAMS

MATCHLINE STA. 596 + 70.00

TREES	QTY	BOTANICAL NAME	COMMON NAME	SIZE	REMARKS
GIN AUT	1	Ginkgo biloba 'Autumn Gold'™	Autumn Gold Ginkgo	2" Cal	PAY ITEM # A2004512
GYM KEN	1	Gymnocladus dioica	Kentucky Coffeetree	2" Cal	PAY ITEM # A2005016


  

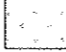GROUND COVERS	CODE	QTY	BOTANICAL NAME	COMMON NAME	SIZE	REMARKS
	TUR SOD	6,852 sf	Turf Sod	Sodding	sod	Topsell Furnish and Place, 4"

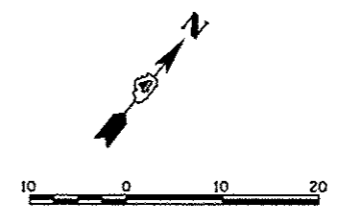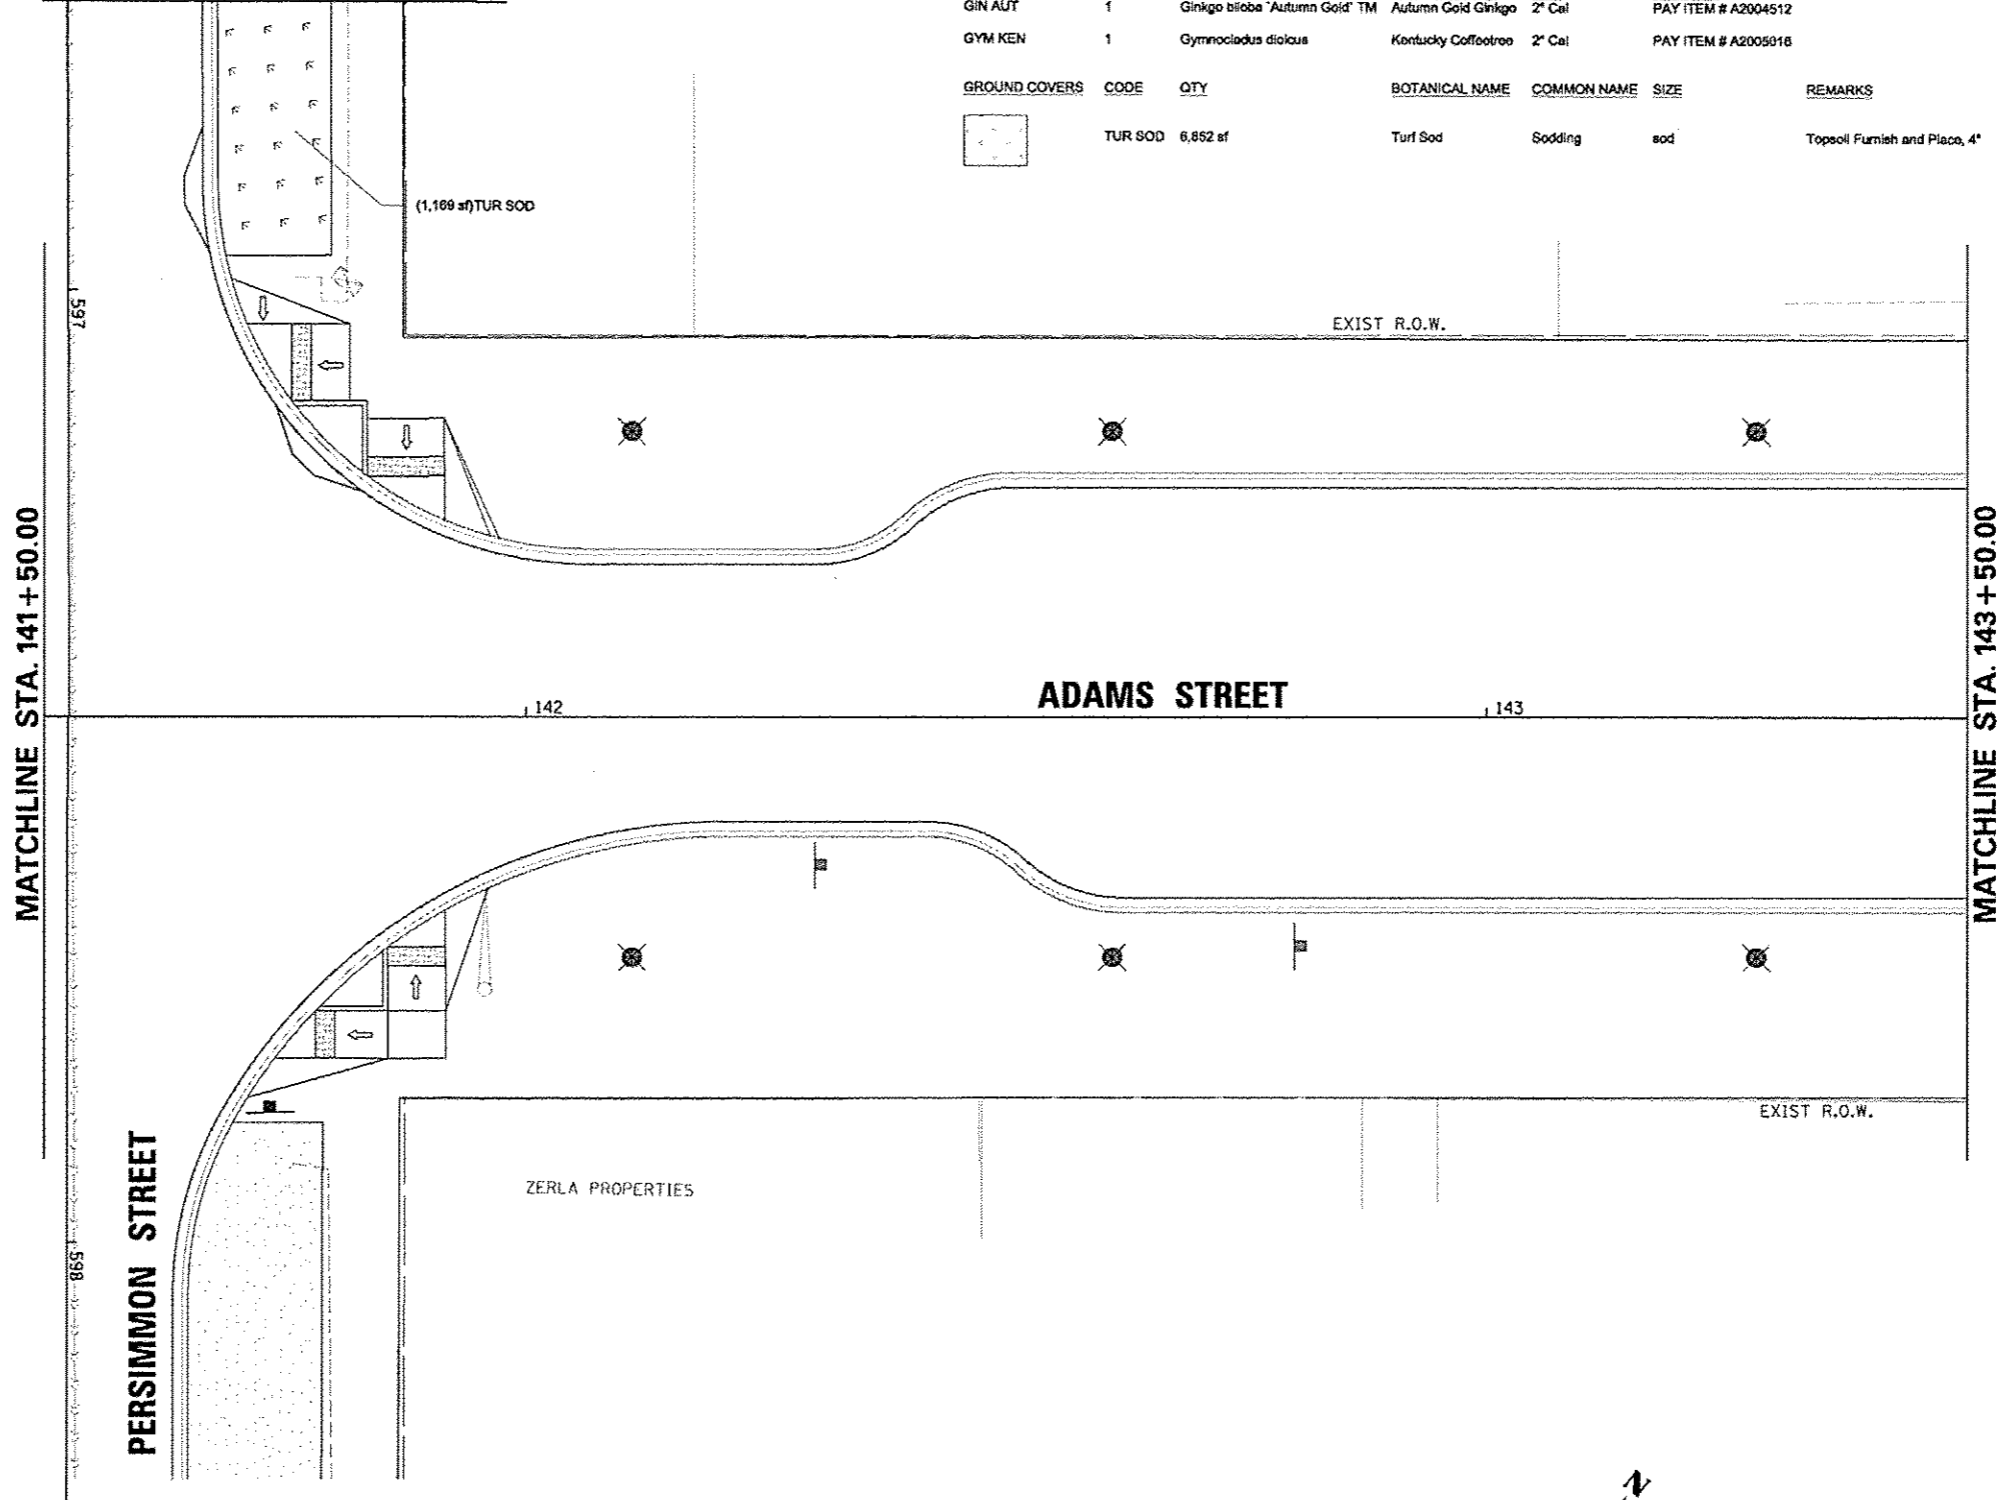


FILE NAME *	USER NAME * mansk01398	DESIGNED - JLH	REVISED -	<b>STATE OF ILLINOIS DEPARTMENT OF TRANSPORTATION</b>	<b>ADAMS STREET PLANTING PLAN</b>	F.A.U. RTE.	SECTION	COUNTY	TOTAL SHEETS	SHEET NO.
or\pwise_work\do_not_delete\dms73427\04	RL0155-akt-plan\02.dgn	DRAWN - JLH	REVISED -			12-00356-01-PV	PEORIA	519	326	
PLOT SCALE * 20,0000' / 1"	CHECKED - BAB	REVISOR -	REVISED -			CONTRACT NO. 89626				
PLOT DATE * 07/23/2012	DATE - 7/18/12	REVISOR -	REVISED -			ILLINOIS FED. AID PROJECT TIG-509311581				

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**PLANT SCHEDULE MAPLE - JEFFERSON TO ADAMS**

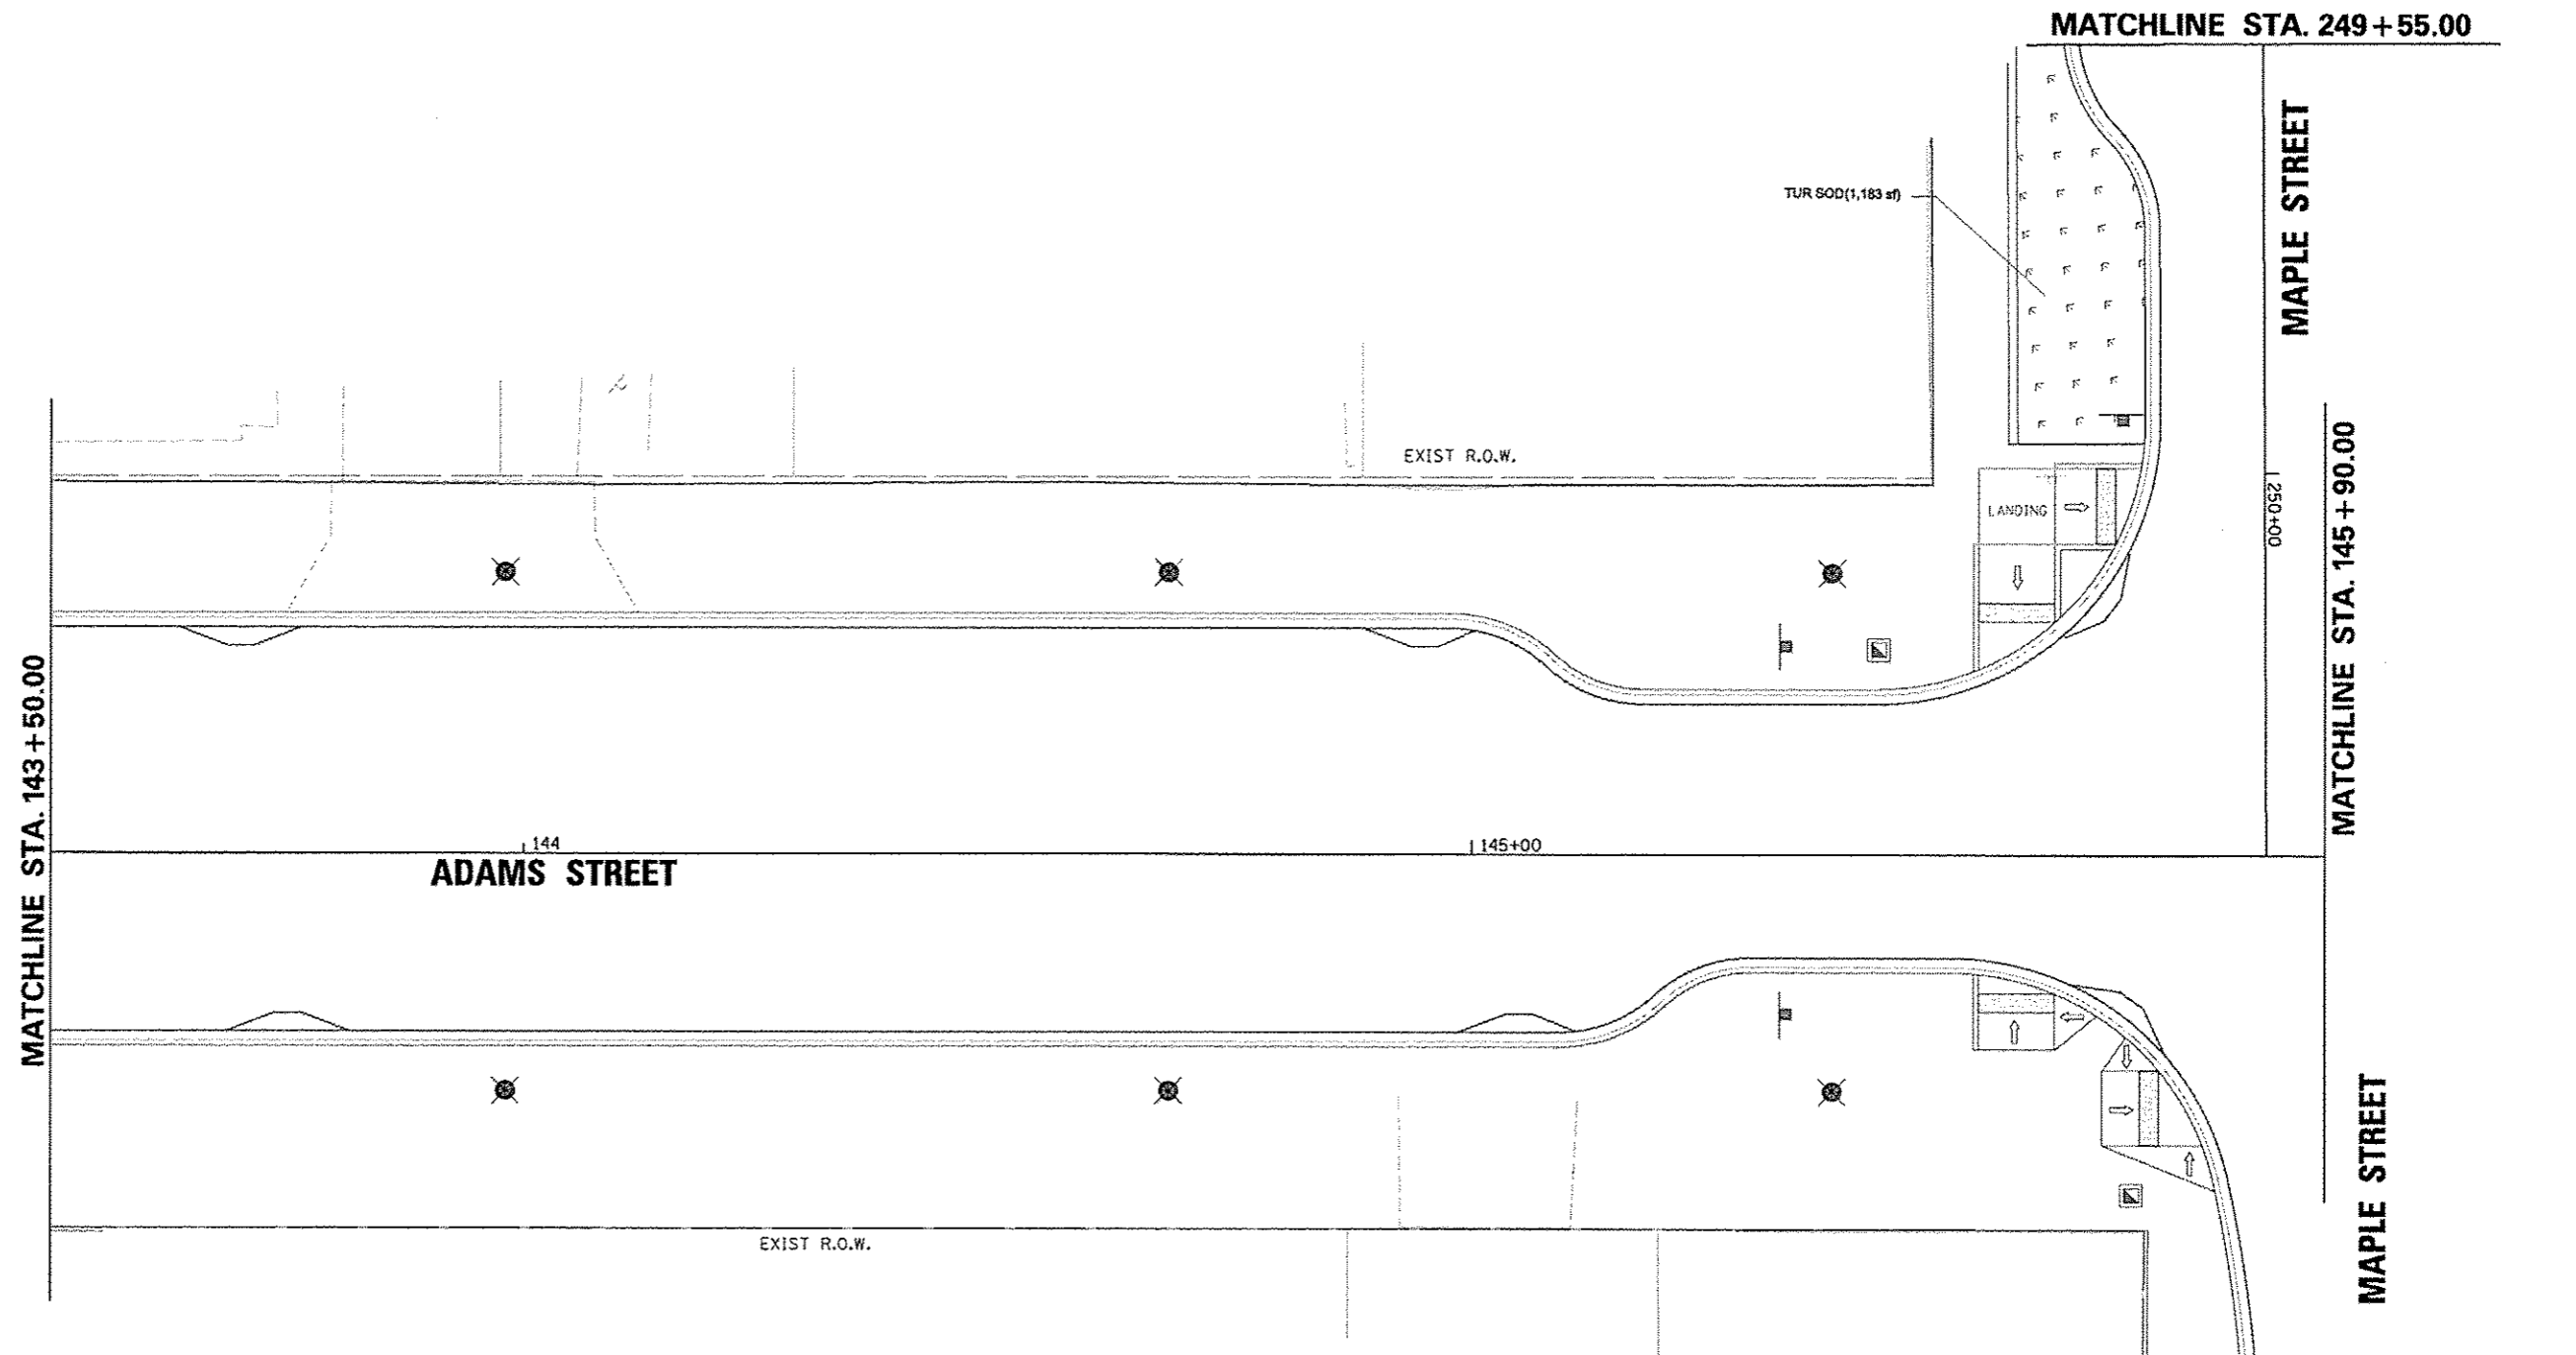TREES	QTY	BOTANICAL NAME	COMMON NAME	SIZE	REMARKS	
ACE LEG	4	<i>Acer saccharum</i> 'Legacy'	Legacy Sugar Maple	2" Cal	PAY ITEM # A2001016	
ACE AUT	5	<i>Acer x freemanii</i> 'Autumn Blaze'	Autumn Blaze Freeman Maple	2" Cal	PAY ITEM # A2000116	
GROUND COVERS	CODE	QTY	BOTANICAL NAME	COMMON NAME	SIZE	REMARKS
	TUR SOD	6,777 sf	Turf Sod	Sodding	sod	Topefit Furnish and Place, 4"




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MATCHLINE STA. 249 + 55.00

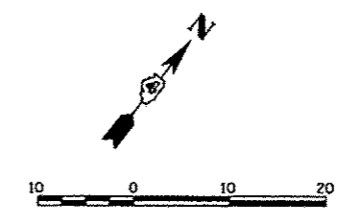MAPLE STREET

MATCHLINE STA. 145 + 90.00

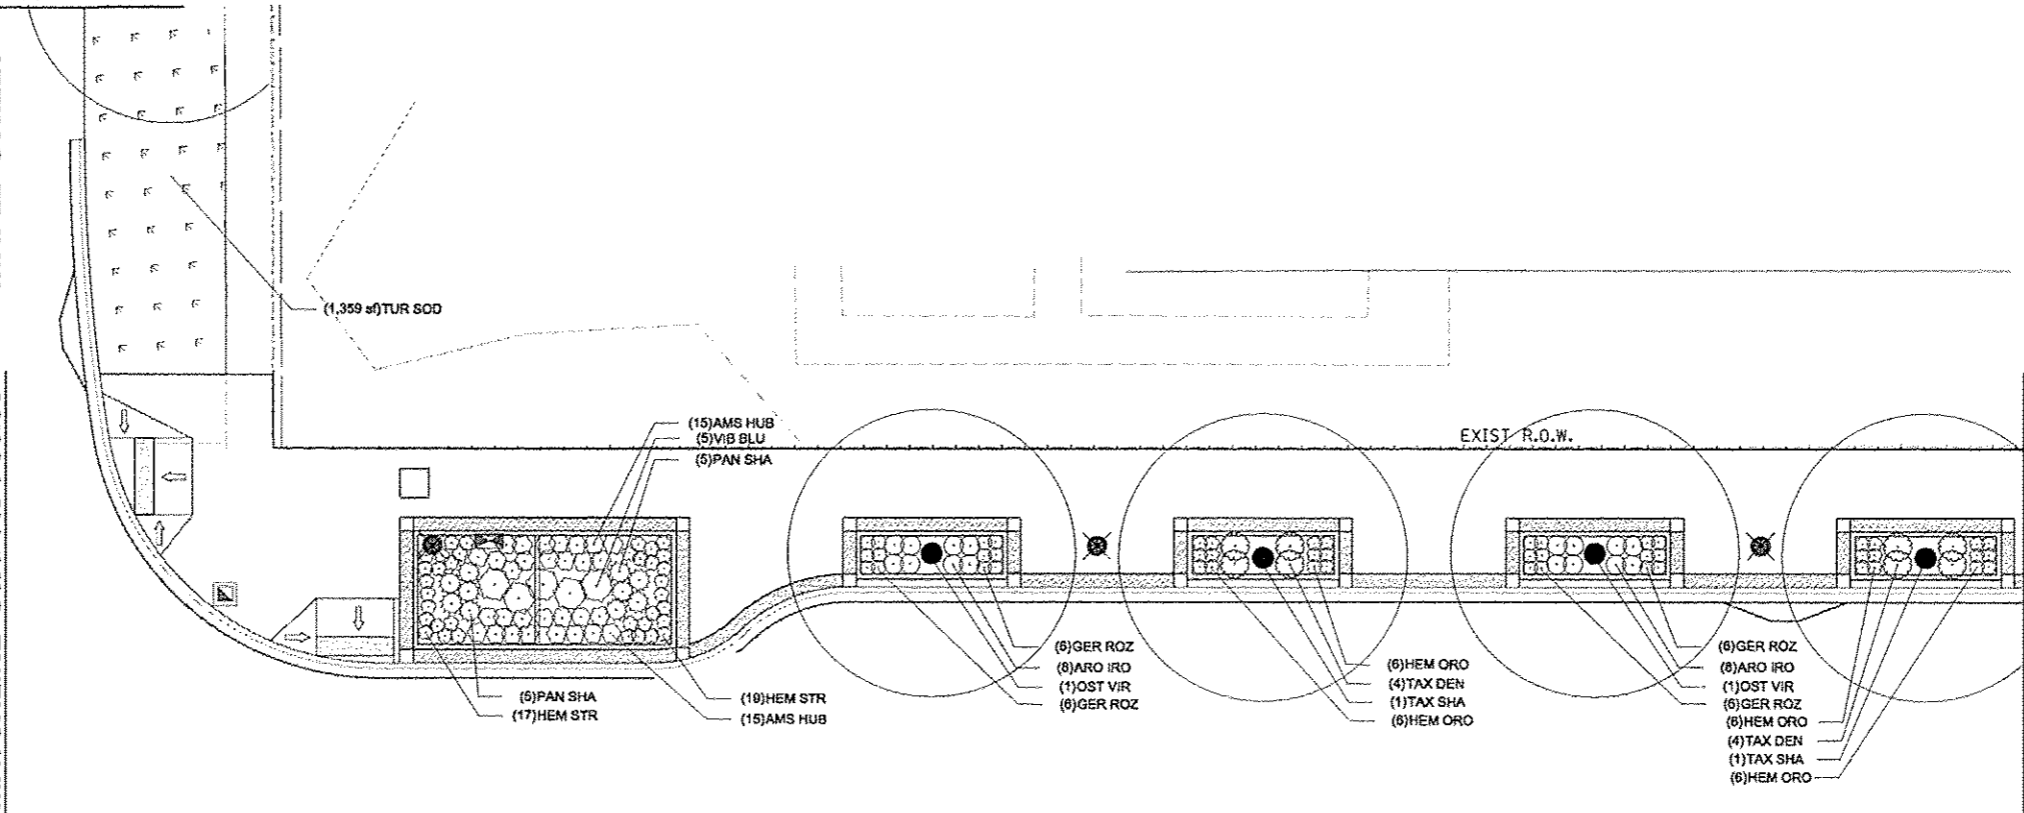


MATCHLINE STA. 148 + 00.00

146

147


ADAMS STREET

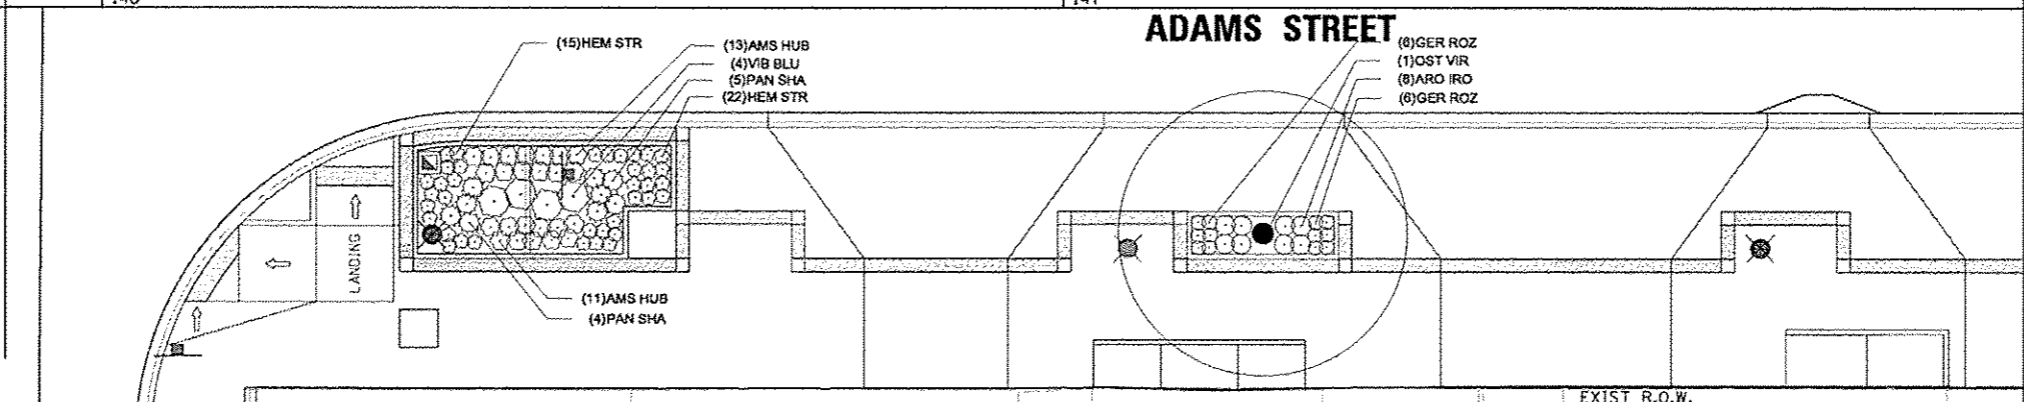

PLANT SCHEDULE ADAMS - MAPLE TO ELM

TREES	QTY	BOTANICAL NAME	COMMON NAME	SIZE	REMARKS
OST VIR	6	Ostrya virginiana	American Hophornbeam	2" Cal	PAY ITEM # A2005818
TAX SHA	6	Taxodium distichum 'Shawnee Brave' TM	Shawnee Brave Bald Cypress	2" Cal	PAY ITEM # A2007710
SHRUBS	QTY	BOTANICAL NAME	COMMON NAME	SIZE	REMARKS
ARO IRO	48	Aronia melanocarpa 'Iroquois Beauty' TM	Iroquois Beauty Black Chokeberry	24" Tall	PAY ITEM # C2C00324
EVO ALA	6	Euonymus alata 'Compacta'	Dwarf Winged Euonymus	3' Tall	PAY ITEM # C2002838
TAX DEN	24	Taxus x media 'Deniformis'	Dense Yew	2" Wide	PAY ITEM # D2003524
VIB BLU	9	Viburnum dentatum 'Christina' TM	Blue Muffin Viburnum	24" Tall	PAY ITEM # C2C11752
ANNUALS/PERENNIALS	QTY	BOTANICAL NAME	COMMON NAME	SIZE	REMARKS
AMS HUB	54	Amsoria hybridis	Arkansas Blue-star	1 gal	PAY ITEM # K0012890
GER ROZ	72	Geranium x 'Rozanne' TM	Rozanne Cranebill	1 gal	PAY ITEM # K0012890
HEM ORO	72	Heemerocallis x 'Stella de Oro'	Stella de Oro Daylily	1 gal	PAY ITEM # K0012890
HEM STR	73	Heemerocallis x 'Strawberry Candy' TM	Strawberry Candy Daylily	1 gal	PAY ITEM # K0012890
NEP WAL	27	Nepeta x faasanii 'Walkers Low'	Walkers Low Catmint	1 gal	PAY ITEM # K0012890
GRASSES	QTY	BOTANICAL NAME	COMMON NAME	SIZE	REMARKS
PAN SHA	19	Panicum virgatum 'Shenandoah'	Burgundy Switch Grass	3 gal	PAY ITEM # K0012893
SPO HET	30	Sporobolus heterolepis	Prairie Dropseed	1 gal	PAY ITEM # K0012890

MATCHLINE STA. 698 + 10.00

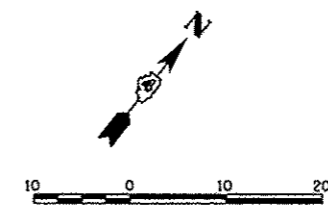

FILE NAME =	USER NAME = monah.01390	DESIGNED = JLH	REVISED =
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	PLOT SCALE = 20.0000' / 1"	CHECKED = BAB	REVISED =
	PLOT DATE = 07/23/2012	DATE = 7/18/12	REVISED =

DESIGNED = JLH	REVISED =
DRAWN = JLH	REVISED =
CHECKED = BAB	REVISED =
DATE = 7/18/12	REVISED =

STATE OF ILLINOIS  
DEPARTMENT OF TRANSPORTATION

ADAMS STREET  
PLANTING PLAN

SCALE: 1"=10'

SHEET NO. OF SHEETS STA. 145+90 TO STA. 148+00


F.A.U. RTE.	SECTION	COUNTY	TOTAL SHEETS	SHEET NO.
6618	12-00356-01-PV	PEORIA	519	328
CONTRACT NO. 89626			ILLINOIS FED. AID PROJECT FIG-50930150	

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MATCHLINE STA. 749 + 15.00

ELM STREET

MATCHLINE STA. 150 + 20.00

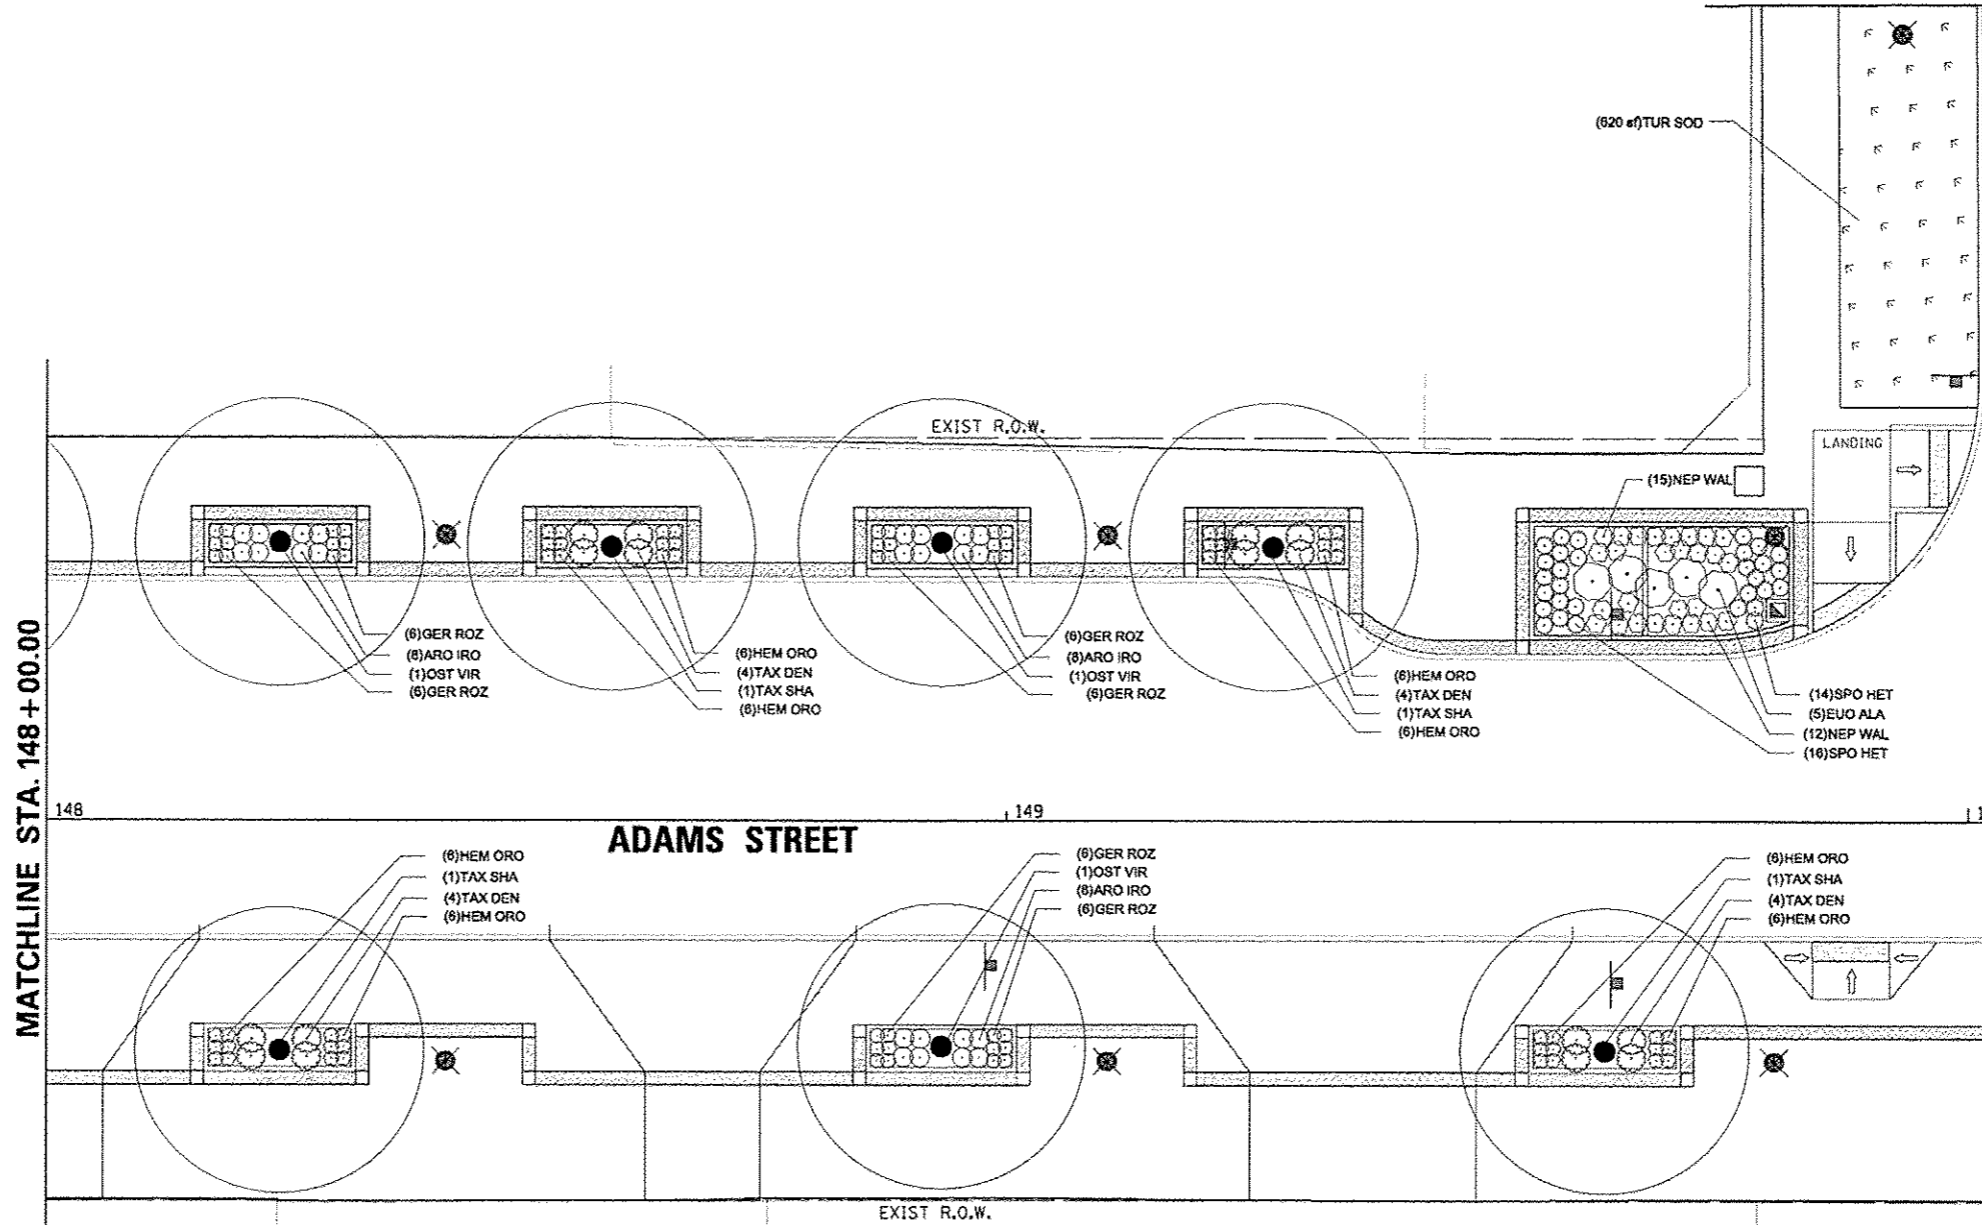

MATCHLINE STA. 148 + 00.00

148

149

150+00


ADAMS STREET

PLANT SCHEDULE ADAMS - MAPLE TO ELM

TREES	QTY	BOTANICAL NAME	COMMON NAME	SIZE	REMARKS
OST VIR	6	<i>Ostrya virginiana</i>	American Hopbroom	2" Cal	PAY ITEM # A2005616
TAX SHA	6	<i>Taxodium distichum</i> 'Shawnee Brave' TM	Shawnee Brave Bald Cypress	2" Cal	PAY ITEM # A2007716
SHRUBS	QTY	BOTANICAL NAME	COMMON NAME	SIZE	REMARKS
ARO IRO	48	<i>Aronia melanocarpa</i> 'Iroquois Beauty' TM	Iroquois Beauty Black Chokeberry	24" Tall	PAY ITEM # C2C00324
EUO ALA	6	<i>Euonymus alata</i> 'Compacta'	Dwarf Winged Euonymus	3" Tall	PAY ITEM # C2002838
TAX DEN	24	<i>Taxus x media</i> 'Densiflora'	Donso Yew	2" Wide	PAY ITEM # D2003524
VIB BLU	8	<i>Viburnum dentatum</i> 'Christina' TM	Blue Muffin Viburnum	24" Tall	PAY ITEM # C2C11752
ANNUALS/PERENNIALS	QTY	BOTANICAL NAME	COMMON NAME	SIZE	REMARKS
AMS HUB	54	<i>Amsinlia hubrichtii</i>	Arkansas Blue-star	1 gal	PAY ITEM # K0012890
GER ROZ	72	<i>Geranium x 'Rozanne'</i> TM	Rozanne Cranesbill	1 gal	PAY ITEM # K0012890
HEM ORO	72	<i>Hemerocallis x 'Stella de Oro'</i>	Stella de Oro Daylily	1 gal	PAY ITEM # K0012890
HEM STR	73	<i>Hemerocallis x 'Strawberry Candy'</i> TM	Strawberry Candy Daylily	1 gal	PAY ITEM # K0012890
NEP WAL	27	<i>Nepeta x faassenii</i> 'Walkers Low'	Walkers Low Catmint	1 gal	PAY ITEM # K0012890
GRASSES	QTY	BOTANICAL NAME	COMMON NAME	SIZE	REMARKS
PAN SHA	19	<i>Panicum virgatum</i> 'Shenandoah'	Burgundy Switch Grass	3 gal	PAY ITEM # K0012893
SPO HET	30	<i>Sporobolus heterolepis</i>	Prairie Dropseed	1 gal	PAY ITEM # K0012890

H3 STEEL

H3 STEEL

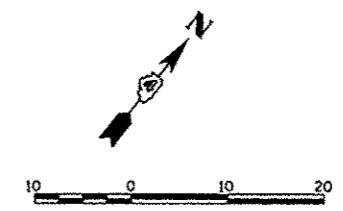

FILE NAME *	USER NAME * mansk.01390
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PLOT SCALE * 20.0000 / / in.	
PLOT DATE * 07/23/2012	

DESIGNED - JLH	REVISED -
DRAWN - JLH	REVISED -
CHECKED - BAB	REVISED -
DATE - 7/18/12	REVISED -

STATE OF ILLINOIS  
DEPARTMENT OF TRANSPORTATION

SCALE: 1"=10'	SHEET NO. OF SHEETS	STA. 148+00 TO STA. 150+20
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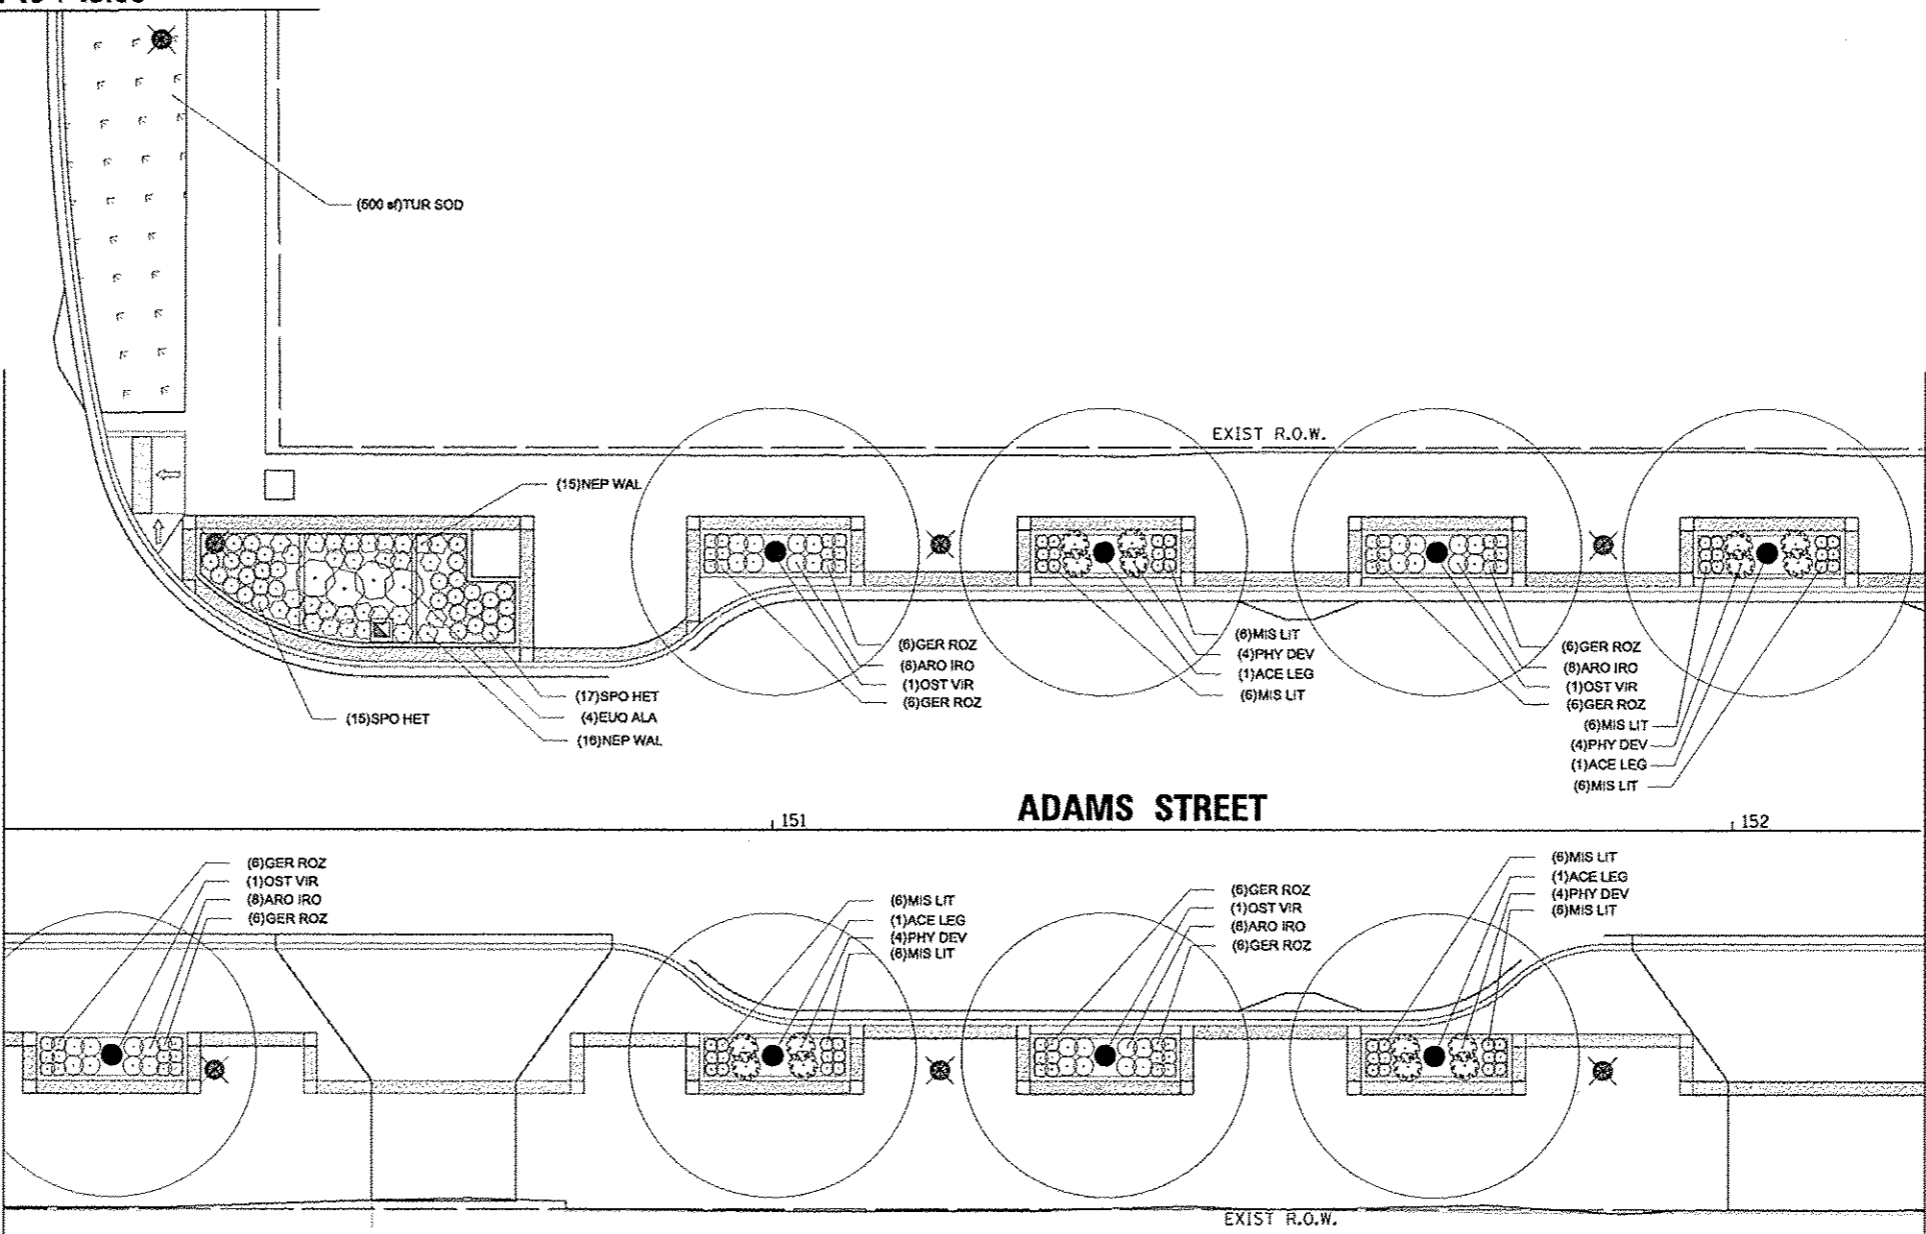
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001	12-00356-01-PV	PEORIA	519	329
CONTRACT NO. 089626			ILLINOIS FED. AID PROJECT T16-909315B	

Farnsworth GROUP  
7707 N. KNOXVILLE AVE, SUITE 100  
PEORIA, ILLINOIS 61614  
(309) 699-9888 / (309) 699-9820 Fax  
www.fw.com

MATCHLINE STA. 749 + 15.00

ELM STREET


MATCHLINE STA. 150 + 20.00



MATCHLINE STA. 152 + 20.00

PLANT SCHEDULE ADAMS - ELM TO OAK

TREES	QTY	BOTANICAL NAME	COMMON NAME	SIZE	REMARKS
ACE LEG	7	Acer saccharum 'Legacy'	Legacy Sugar Maple	2" Cal	PAY ITEM # A2001910
OST VIR	8	Ostrya virginiana	American Hophornbeam	2" Cal	PAY ITEM # A2005616
SHRUBS	QTY	BOTANICAL NAME	COMMON NAME	SIZE	REMARKS
ARO IRO	64	Aronia melanocarpa 'Iroquois Beauty' TM	Iroquois Beauty Black Chokeberry	24" Tall	PAY ITEM # C2C00324
EUO ALA	4	Euonymus alata 'Compacta'	Dwarf Winged Euonymus	3" Tall	PAY ITEM # C2002636
PHY DEV	28	Physocarpus opulifolius 'Donna May'	Little Devil Ninebark	18" Tall	PAY ITEM # C2C04875
RHU GRO	14	Rhus aromatica 'Gro-Low'	Gro-Low Fragrant Sumac	3 gal	PAY ITEM # C2C058G3
ANNUALS/PERENNIALS	QTY	BOTANICAL NAME	COMMON NAME	SIZE	REMARKS
COR ZAG	75	Coreopsis verticillata 'Zagreb'	Zagreb Threadleaf Coreopsis	4" pot	PAY ITEM # K0012875
GER ROZ	96	Geranium x 'Rozanne' TM	Rozanne Cranesbill	1 gal	PAY ITEM # K0012890
NEP WAL	31	Nepeta x faassenii 'Walkers Low'	Walkers Low Catmint	1 gal	PAY ITEM # K0012890
PER LIT	67	Perovskia atriplicifolia 'Little Spire' TM	Little Spire Russian Sage	1 gal	PAY ITEM # K0012890
GRASSES	QTY	BOTANICAL NAME	COMMON NAME	SIZE	REMARKS
MIS GRA	20	Miscanthus sinensis 'Gracillimus'	Gracillimus Maiden Grass	3 gal	PAY ITEM # K0012893
MIS LIT	84	Miscanthus sinensis 'Little Kitten'	Little Kitten Maiden Grass	1 gal	PAY ITEM # K0012890
SPO HET	32	Sporobolus heterolepis	Prairie Dropseed	1 gal	PAY ITEM # K0012890

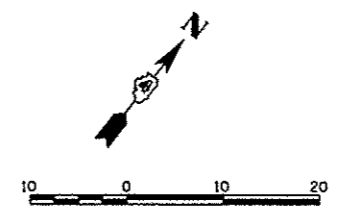

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STATE OF ILLINOIS  
DEPARTMENT OF TRANSPORTATION


ADAMS STREET  
PLANTING PLAN

SCALE: 1"=10'

SHEET NO. OF SHEETS STA. 150+20 TO STA. 154+45


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CONTRACT NO. 09626			ILLINOIS FED. AID PROJECT TIG-50931581	

Farnsworth GROUP  
7707 N. KNOXVILLE AVE, SUITE 100  
PEORIA, ILLINOIS 61614  
(309) 699-9008 / (309) 699-9020 Fax  
www.fwg.com

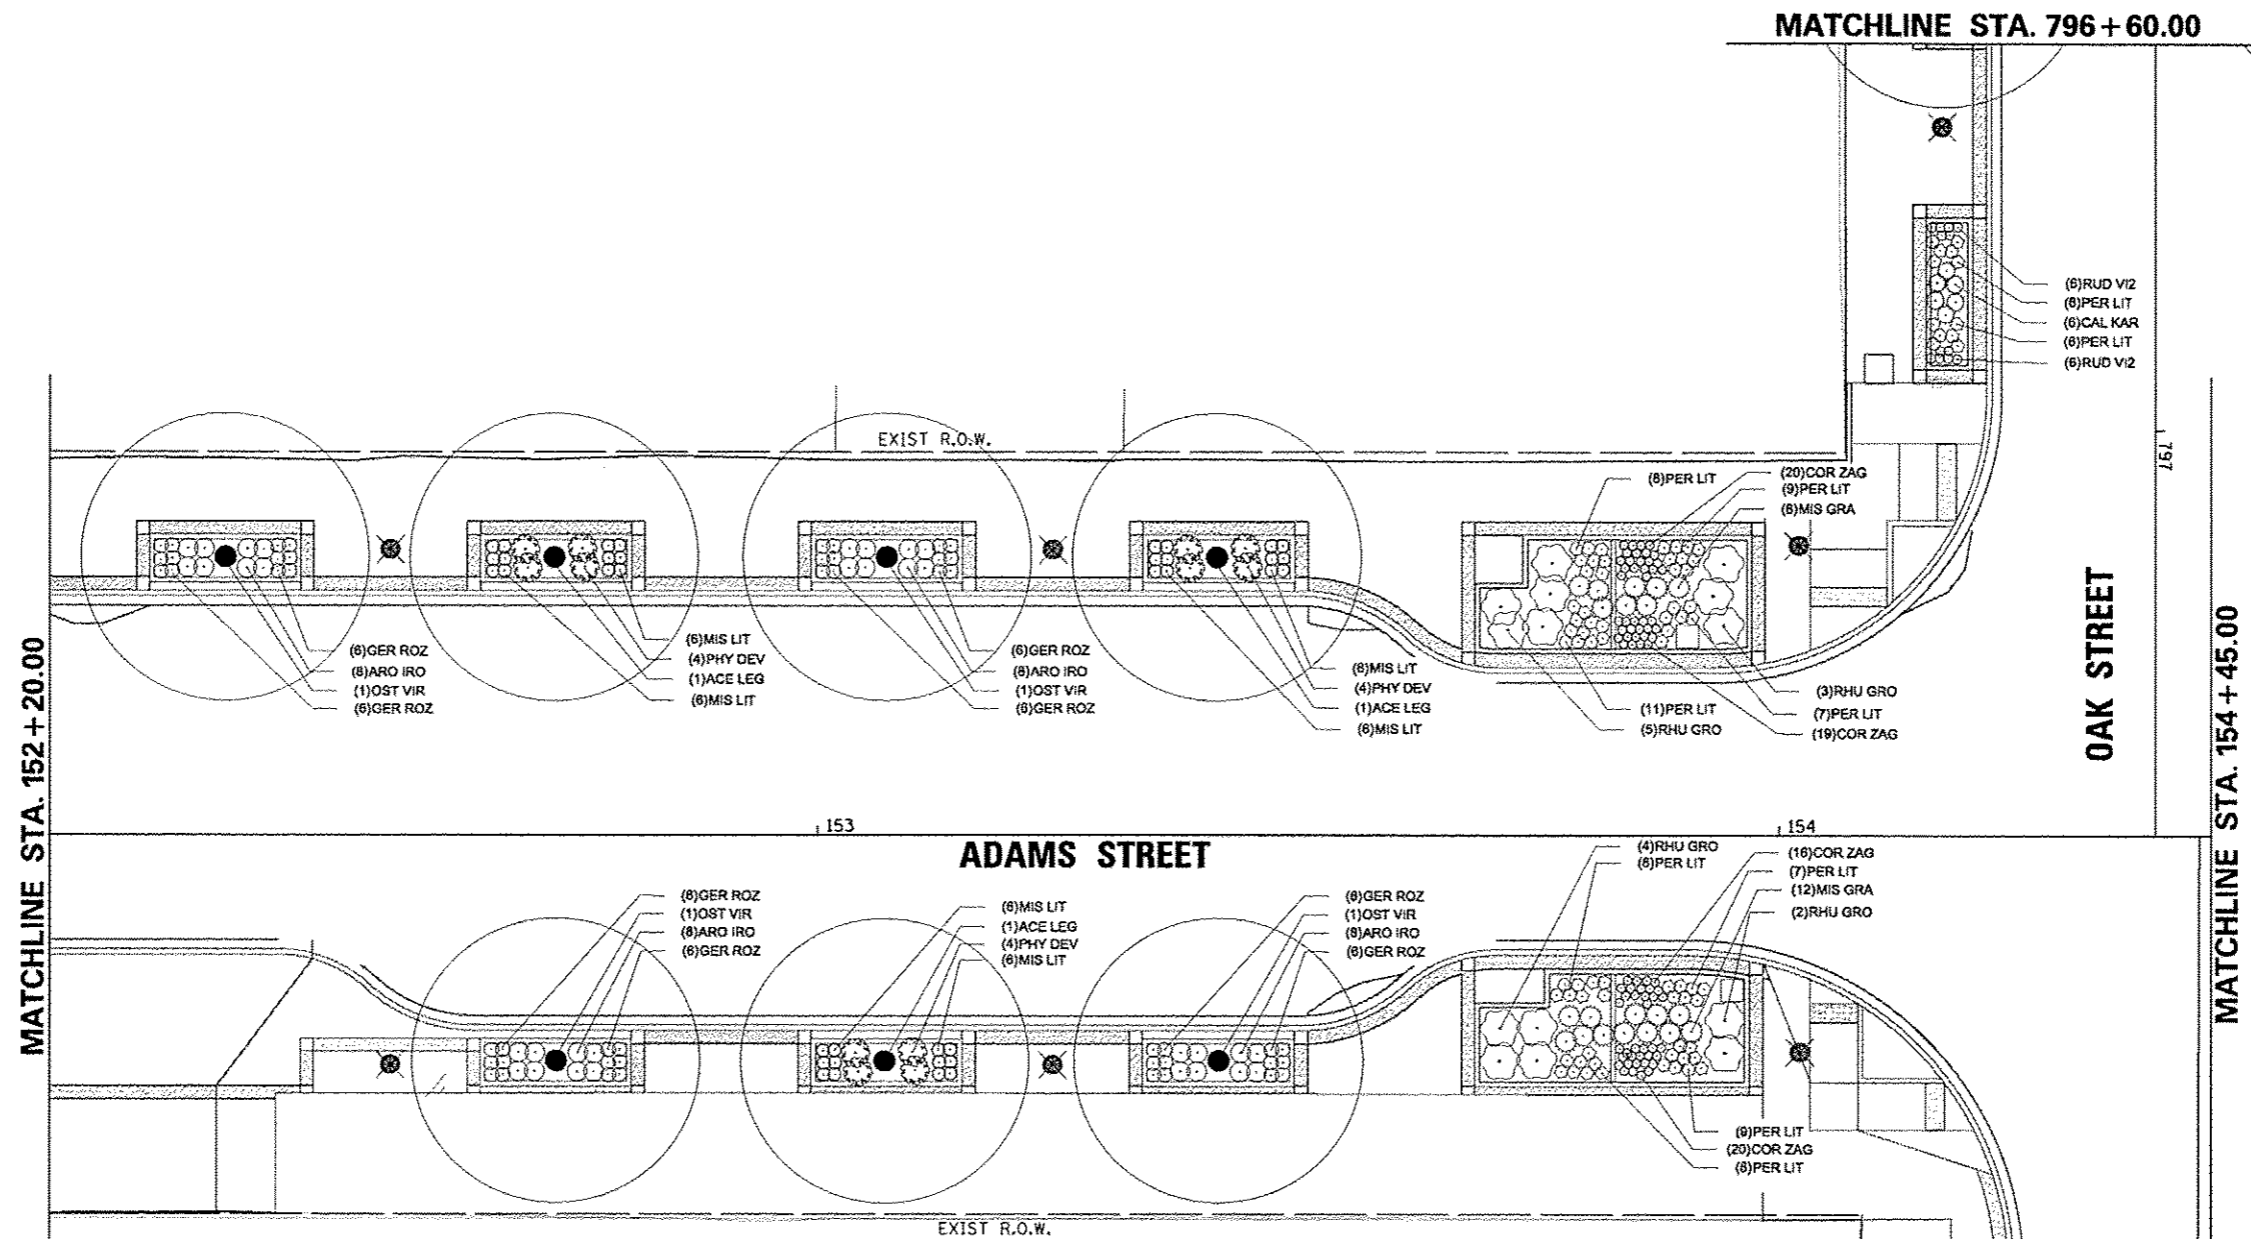


**PLANT SCHEDULE ADAMS - ELM TO OAK**

TREES	QTY	BOTANICAL NAME	COMMON NAME	SIZE	REMARKS
ACE LEG	7	Acer saccharum 'Legacy'	Legacy Sugar Maple	2" Cal	PAY ITEM # A2001916
OST VIR	8	Ostrya virginiana	American Hophornbeam	2" Cal	PAY ITEM # A2005618
SHRUBS	QTY	BOTANICAL NAME	COMMON NAME	SIZE	REMARKS
ARO IRO	84	Aronia melanocarpa 'Iroquois Beauty' TM	Iroquois Beauty Black Chokeberry	24" Tall	PAY ITEM # C2C00324
EJO ALA	4	Euonymus alata 'Compacta'	Dwarf Winged Euonymus	3" Tall	PAY ITEM # C2002636
PHY DEV	28	Physocarpus opulifolius 'Dorina May'	Little Devil Ninebark	18" Tall	PAY ITEM # C2C04675
RHU GRO	14	Rhus aromatica 'Gro-Low'	Gro-Low Fragrant Sumac	3 gal	PAY ITEM # C2C05803
ANNUALS/PERENNIALS	QTY	BOTANICAL NAME	COMMON NAME	SIZE	REMARKS
COR ZAG	75	Coreopsis verticillata 'Zagreb'	Zagreb Threadloaf Comopsis	4" pot	PAY ITEM # K0012976
GER ROZ	96	Geranium x 'Rozanne' TM	Rozanne Cranesbill	1 gal	PAY ITEM # K0012990
NEP WAL	31	Nepeta x faassenii 'Walkers Low'	Walkers Low Catmint	1 gal	PAY ITEM # K0012990
PER LIT	67	Perovskia atriplicifolia 'Little Spire' TM	Little Spire Russian Sage	1 gal	PAY ITEM # K0012990
GRASSES	QTY	BOTANICAL NAME	COMMON NAME	SIZE	REMARKS
MIS GRA	20	Miscanthus sinensis 'Gracillimus'	Gracillimus Maiden Grass	3 gal	PAY ITEM # K0012993
MIS LIT	84	Miscanthus sinensis 'Little Kitten'	Little Kitten Maiden Grass	1 gal	PAY ITEM # K0012990
SPO HET	32	Sporobolus heterolepis	Prairie Dropseed	1 gal	PAY ITEM # K0012990

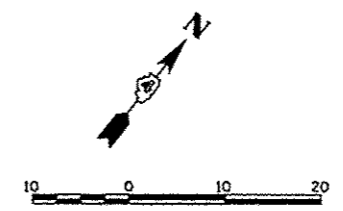

# PLANT SCHEDULE ADAMS - OAK TO STATE

TREES	QTY	BOTANICAL NAME	COMMON NAME	SIZE	REMARKS
ACE LEG	6	<i>Acer saccharum</i> 'Legacy'	Legacy Sugar Maple	2" Cal	PAY ITEM # A2001916
ACE AUT	6	<i>Acer x freemanii</i> 'Autumn Blaze'	Autumn Blaze Freeman Maple	2" Cal	PAY ITEM # A2000116
SHRUBS	QTY	BOTANICAL NAME	COMMON NAME	SIZE	REMARKS
COR ARC	28	<i>Cornus sanguinea</i> 'Arctic Sun'	Arctic Sun Dogwood	2" Tall	PAY ITEM # C2C01612
EUO ALA	1	<i>Euonymus alata</i> 'Compacta'	Dwarf Winged Euonymus	3" Tall	PAY ITEM # C2002836
PHY DEV	24	<i>Physocarpus opulifolius</i> 'Donna May'	Little Devil Ninebark	18" Tall	PAY ITEM # C2C04875
SPI SPI	13	<i>Spiraea japonica</i> 'Little Princess'	Little Princess Japanese Spiraea	18" Tall	PAY ITEM # C2C10218
VIB BLU	6	<i>Viburnum dentatum</i> 'Chistone' TM	Blue Muffin Viburnum	24" Tall	PAY ITEM # C2C11752
ANNUALS/PERENNIALS	QTY	BOTANICAL NAME	COMMON NAME	SIZE	REMARKS
AMS HUB	25	<i>Amsonia hubrichtii</i>	Arkansas Blue-star	1 gal	PAY ITEM # K0012990
ECH KIM	88	<i>Echinacea purpurea</i> 'Kim's Knee High' TM	Kim's Knee High Purple Coneflower	1 gal	PAY ITEM # K0012990
PHL EM2	128	<i>Phlox subulata</i> 'Emerald Pink'	Emerald Pink Crooping Phlox	4" pot	PAY ITEM # K0012975
RUD FUL	26	<i>Rudbeckia fulgida</i> 'Goldsturm'	Goldsturm Black-Eyed Susan	1 gal	PAY ITEM # K0012990
GRASSES	QTY	BOTANICAL NAME	COMMON NAME	SIZE	REMARKS
MIS GRA	2	<i>Miscanthus sinensis</i> 'Gracillimus'	Gracillimus Maiden Grass	3 gal	PAY ITEM # K0012993
MIS LIT	72	<i>Miscanthus sinensis</i> 'Little Kitten'	Little Kitten Maiden Grass	1 gal	PAY ITEM # K0012990
PAN SHA	16	<i>Panicum virgatum</i> 'Shonendoah'	Burgundy Switch Grass	3 gal	PAY ITEM # K0012993
SPO HET	14	<i>Sporobolus heterolepis</i>	Prairie Dropseed	1 gal	PAY ITEM # K0012990

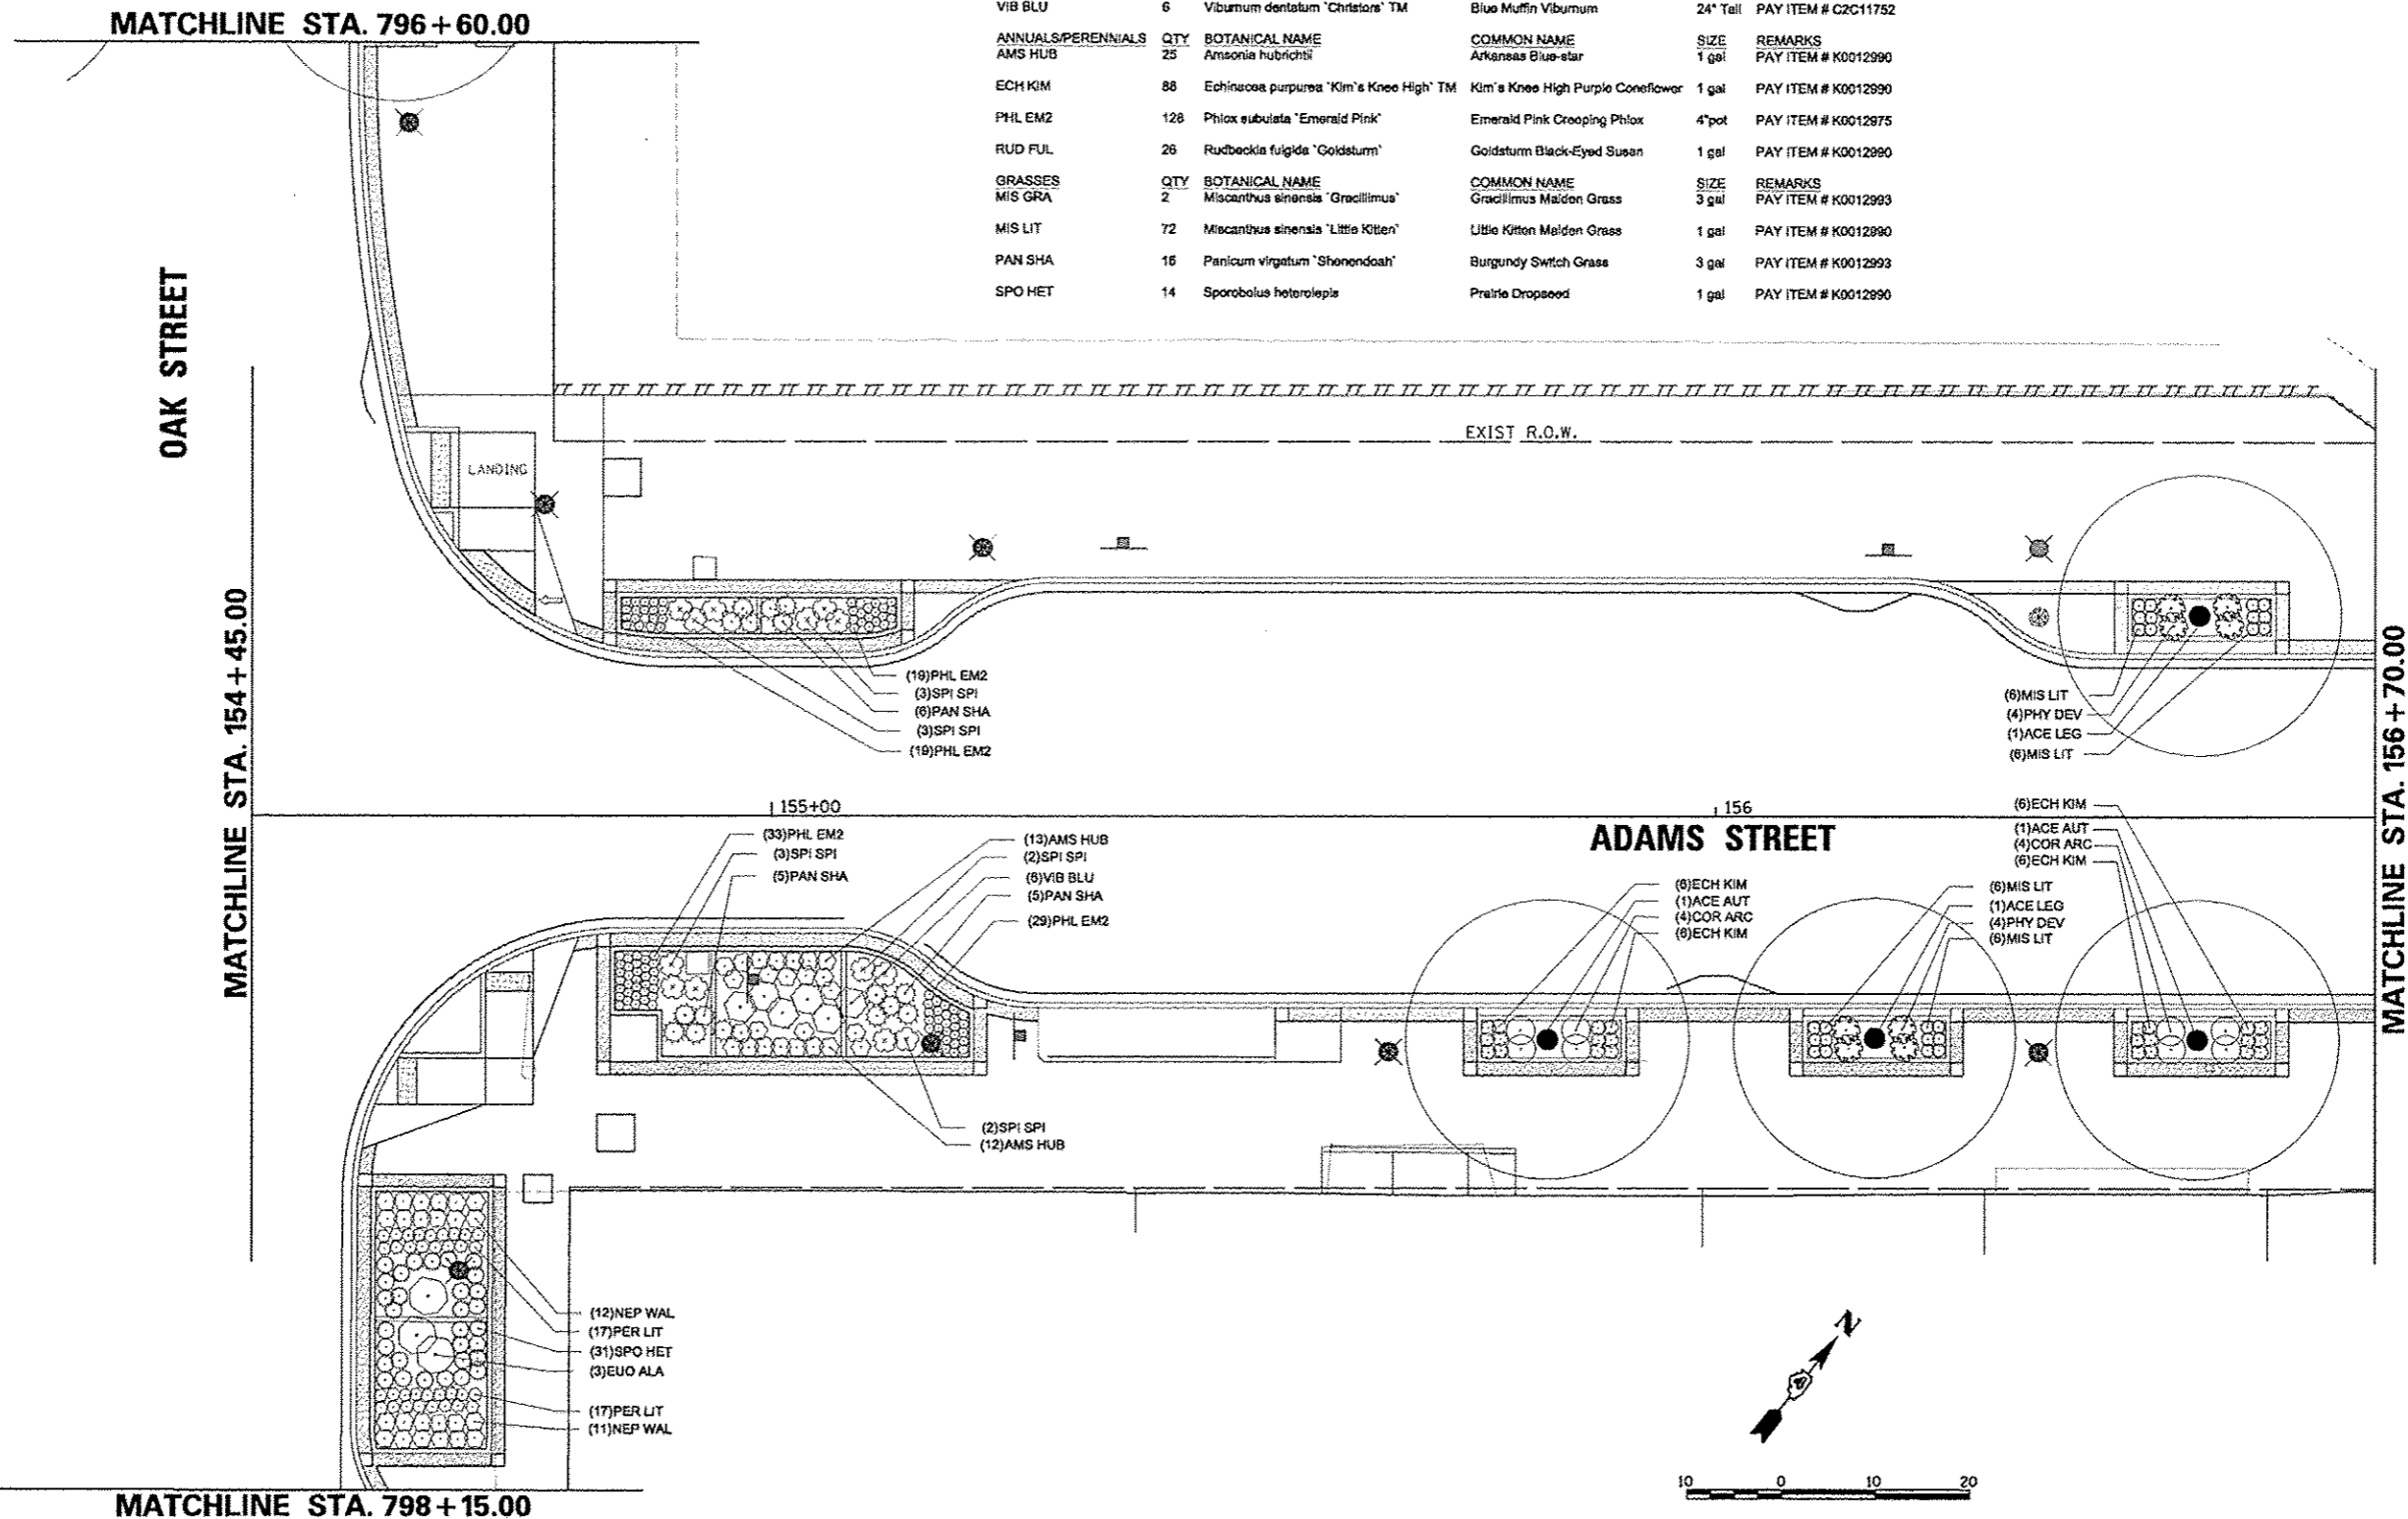

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STATE OF ILLINOIS  
DEPARTMENT OF TRANSPORTATION


ADAMS STREET  
PLANTING PLAN

SCALE: 1"=10' SHEET NO. OF SHEETS STA. 154+45 TO STA. 156+70

F.A.U. RTE.	SECTION	COUNTY	TOTAL SHEETS	SHEET NO.
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CONTRACT NO. 89626			ILLINOIS FED. AID PROJECT TIC-5093058	



Farnsworth GROUP  
7707 N. KNOXVILLE AVE, SUITE 100  
PEORIA, ILLINOIS 61614  
(309) 696-8058 / (309) 699-8820 Fax  
www.fw.com



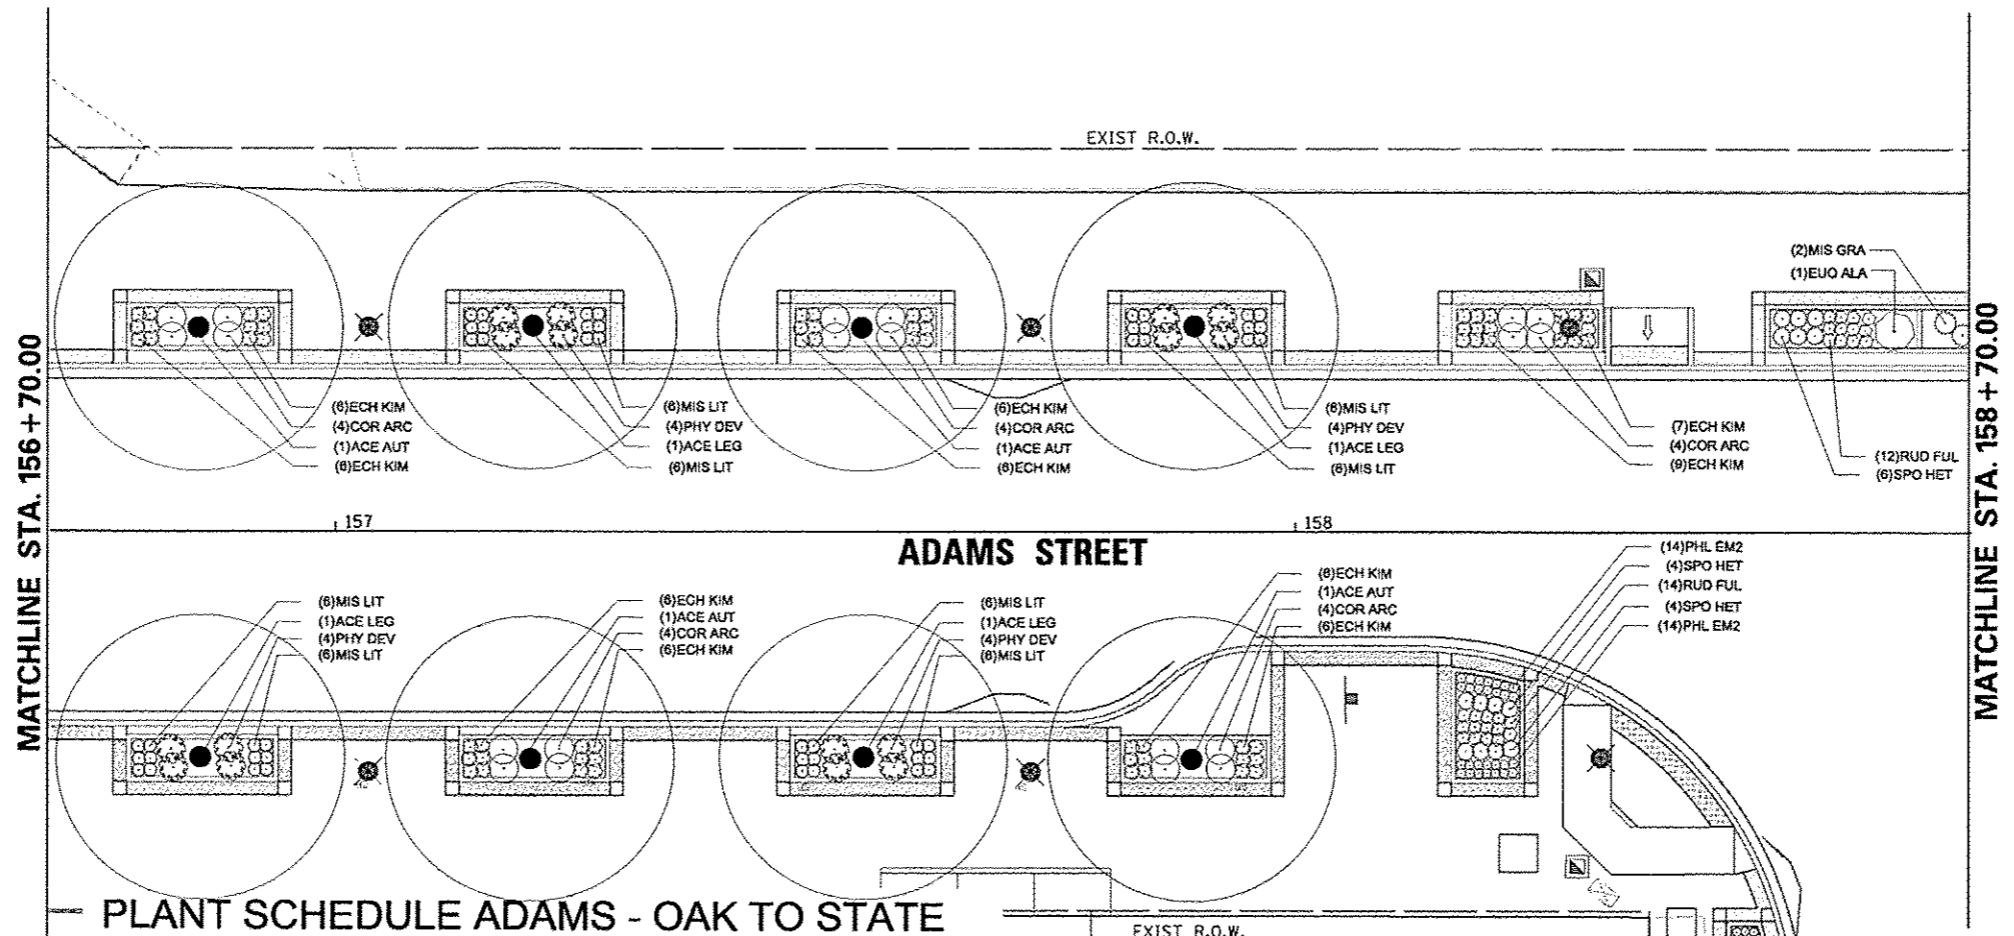


**PLANT SCHEDULE ADAMS - OAK TO STATE**

TREES	QTY	BOTANICAL NAME	COMMON NAME	SIZE	REMARKS
ACE LEG	6	<i>Acer saccharum</i> 'Legacy'	Legacy Sugar Maple	2" Cal	PAY ITEM # A2001918
ACE AUT	6	<i>Acer x freemanii</i> 'Autumn Blaze'	Autumn Blaze Freeman Maple	2" Cal	PAY ITEM # A2000116
SHRUBS	QTY	BOTANICAL NAME	COMMON NAME	SIZE	REMARKS
COR ARC	28	<i>Cornus sanguinea</i> 'Arctic Sun'	Arctic Sun Dogwood	2" Tall	PAY ITEM # C2C01612
EUO ALA	1	<i>Euonymus alata</i> 'Compacta'	Dwarf Winged Euonymus	3" Tall	PAY ITEM # C2002638
PHY DEV	24	<i>Physocarpus opulifolius</i> 'Donna May'	Little Devil Ninebark	18" Tall	PAY ITEM # C2C04675
SPI SPI	13	<i>Spiraea japonica</i> 'Little Princess'	Little Princess Japanese Spiraea	18" Tall	PAY ITEM # C2C10218
VIB BLU	6	<i>Viburnum dentatum</i> 'Chrestone' TM	Blue Muffin Viburnum	24" Tall	PAY ITEM # C2C11762
ANNUALS/PERENNIALS	QTY	BOTANICAL NAME	COMMON NAME	SIZE	REMARKS
AMS HUB	25	<i>Ameionia hubrichtii</i>	Arkansas Blue-star	1 gal	PAY ITEM # K0012990
ECH KIM	68	<i>Echinacea purpurea</i> 'Kim's Knee High' TM	Kim's Knee High Purple Coneflower	1 gal	PAY ITEM # K0012990
PHL EM2	128	<i>Phlox subulata</i> 'Emerald Pink'	Emerald Pink Creeping Phlox	4" pot	PAY ITEM # K0012975
RUD FUL	26	<i>Rudbeckia fulgida</i> 'Goldsturm'	Goldsturm Black-Eyed Susan	1 gal	PAY ITEM # K0012890
GRASSES	QTY	BOTANICAL NAME	COMMON NAME	SIZE	REMARKS
MIS GRA	2	<i>Miscanthus sinensis</i> 'Gracilimus'	Gracilimus Maiden Grass	3 gal	PAY ITEM # K0012963
MIS LIT	72	<i>Miscanthus sinensis</i> 'Little Kitten'	Little Kitten Maiden Grass	1 gal	PAY ITEM # K0012990
PAN SHA	16	<i>Panicum virgatum</i> 'Shenandoah'	Burgundy Switch Grass	3 gal	PAY ITEM # K0012993
SPO HET	14	<i>Sporobolus heterolepis</i>	Prairie Dropseed	1 gal	PAY ITEM # K0012990

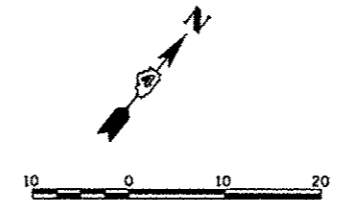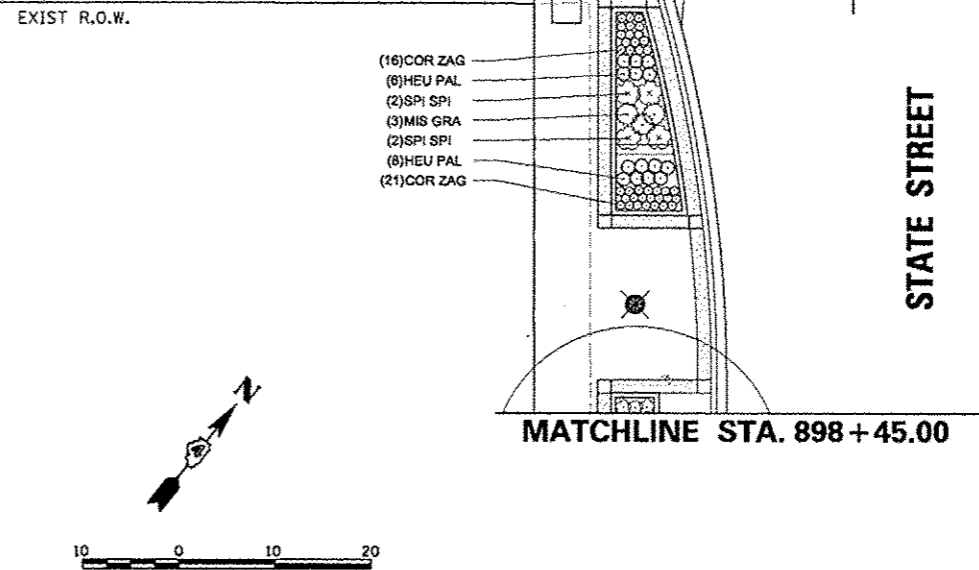

# PLANT SCHEDULE ADAMS - STATE TO WALNUT

TREES	QTY	BOTANICAL NAME	COMMON NAME	SIZE	REMARKS
ACE AUT	6	Acer x freemanii 'Autumn Blaze'	Autumn Blaze Freeman Maple	2" Cal	PAY ITEM # A2000116
GIN AUT	7	Ginkgo biloba 'Autumn Gold' TM	Autumn Gold Ginkgo	2" Cal	PAY ITEM # A2004512
SHRUBS	QTY	BOTANICAL NAME	COMMON NAME	SIZE	REMARKS
COR ARC	24	Cornus sanguinea 'Arctic Sun'	Arctic Sun Dogwood	2" Tall	PAY ITEM # C2C01612
EYO ALA	1	Euonymus alata 'Compacta'	Dwarf Winged Euonymus	3" Tall	PAY ITEM # C2002636
RHU GRO	11	Rhus aromatica 'Gro-Low'	Gro-Low Fragrant Sumac	3 gal	PAY ITEM # C2C05803
ROS PAV	70	Rosa pavement 'Dwarf'	Dwarf Pavement Rose	18" Tall	PAY ITEM # C2C06724
SPI SPI	16	Spiraea japonica 'Little Princess'	Little Princess Japanese Spirea	18" Tall	PAY ITEM # C2C10218
ANNUALS/PERENNIALS	QTY	BOTANICAL NAME	COMMON NAME	SIZE	REMARKS
AMS HUB	12	Amsonia hubrichtii	Arkansas Blue-star	1 gal	PAY ITEM # K0012990
COR ZAG	22	Coreopsis verticillata 'Zagreb'	Zagreb Threadleaf Coreopsis	4" pot	PAY ITEM # K0012975
ECH KIM	72	Echinacea purpurea 'Kim's Knee High' TM	Kim's Knee High Purple Coneflower	1 gal	PAY ITEM # K0012990
EYO COL	117	Euonymus fortunei 'Colorata'	Purpleleaf Wintercreeper	4" pot	PAY ITEM # K0012975
HEM STR	30	Hemerocallis x 'Strawberry Candy' TM	Strawberry Candy Daylily	1 gal	PAY ITEM # K0012990
HEU PAL	19	Heuchera sanguinea 'Palace Purple'	Palace Purple Coralbells	1 gal	PAY ITEM # K0012990
RUD FUL	12	Rudbeckia fulgida 'Goldsturm'	Goldsturm Black-Eyed Susan	1 gal	PAY ITEM # K0012990
GRASSES	QTY	BOTANICAL NAME	COMMON NAME	SIZE	REMARKS
MIS GRA	13	Miscanthus sinensis 'Gracillimus'	Gracillimus Maiden Grass	3 gal	PAY ITEM # K0012993
PAN SHA	6	Panicum virgatum 'Shonondoah'	Burgundy Switch Grass	3 gal	PAY ITEM # K0012993
SPO HET	24	Sporobolus heterolepis	Prairie Dropseed	1 gal	PAY ITEM # K0012990

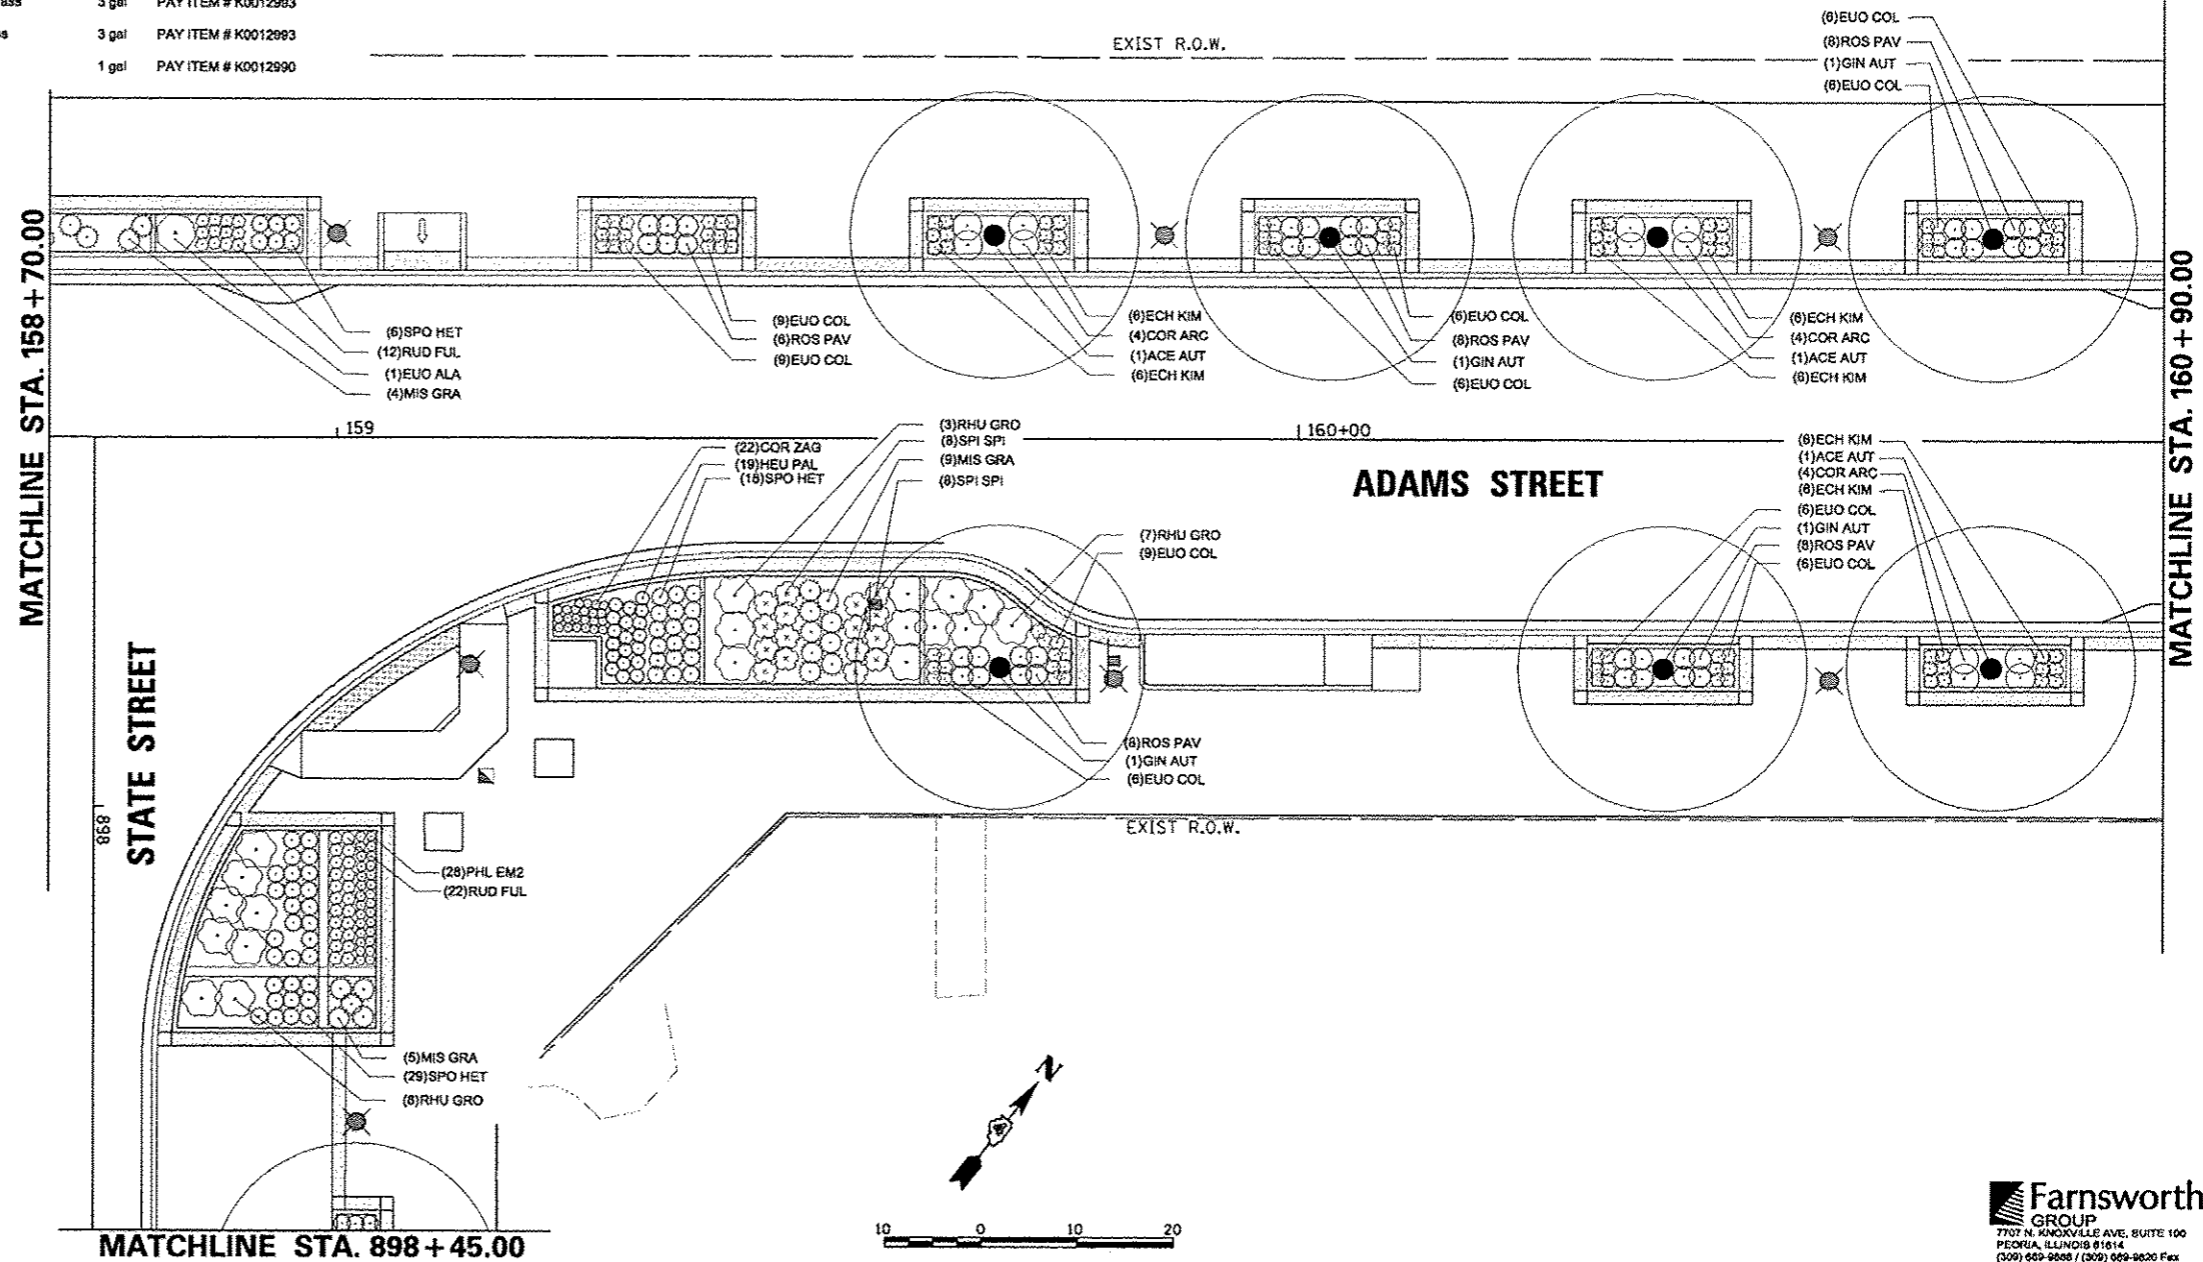


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PLOT DATE: 07/23/2012	DATE: 7/18/12	REVISED: -	CONTRACT NO. 89626							
SCALE: 1" = 10'						SHEET NO. OF SHEETS		STA. 158+70 TO STA. 160+90		ILLINOIS FED. AID PROJECT FIG-50931158



# PLANT SCHEDULE ADAMS - STATE TO WALNUT

TREES	QTY	BOTANICAL NAME	COMMON NAME	SIZE	REMARKS
ACE AUT	6	Acer x freemanii 'Autumn Blaze'	Autumn Blaze Freeman Maple	2" Cal	PAY ITEM # A2000116
GIN AUT	7	Ginkgo biloba 'Autumn Gold' TM	Autumn Gold Ginkgo	2" Cal	PAY ITEM # A2004512
SHRUBS					
COR ARC	24	Cornus sanguinea 'Arctic Sun'	Arctic Sun Dogwood	2" Tall	PAY ITEM # C2C01612
EUO ALA	1	Euonymus alata 'Compacta'	Dwarf Winged Euonymus	3" Tall	PAY ITEM # C2002636
RHU GRO	11	Rhus aromatica 'Gro-Low'	Gro-Low Fragrant Sumac	3 gal	PAY ITEM # C2C056G3
ROS PAV	70	Rosa pavement 'Dwarf'	Dwarf Pavement Rose	18" Tall	PAY ITEM # C2C06724
SPI SPI	18	Spiraea japonica 'Little Princess'	Little Princess Japanese Spiraea	18" Tall	PAY ITEM # C2C10218
ANNUALS/PERENNIALS					
AMS HUB	12	Artemisia ludoviciana	Arkansas Blue-star	1 gal	PAY ITEM # K0012990
COR ZAG	22	Coreopsis verticillata 'Zagreb'	Zagreb Threadleaf Coreopsis	4" pot	PAY ITEM # K0012975
ECH KIM	72	Echinacea purpurea 'Kim's Knee High' TM	Kim's Knee High Purple Coneflower	1 gal	PAY ITEM # K0012990
EUO COL	117	Euonymus fortunei 'Colorata'	Purpleleaf Wintercreeper	4" pot	PAY ITEM # K0012975
HEM STR	30	Hemerocallis x 'Strawberry Candy' TM	Strawberry Candy Daylily	1 gal	PAY ITEM # K0012990
HEU PAL	19	Heuchera sanguinea 'Palace Purple'	Palace Purple Coralbells	1 gal	PAY ITEM # K0012990
RUD FUL	12	Rudbeckia fulgida 'Goldsturm'	Goldsturm Black-Eyed Susan	1 gal	PAY ITEM # K0012990
GRASSES					
MIS GRA	13	Miscanthus sinensis 'Gracillimus'	Gracillimus Maiden Grass	3 gal	PAY ITEM # K0012993
PAN SHA	8	Panicum virgatum 'Shenandoah'	Burgundy Switch Grass	3 gal	PAY ITEM # K0012993
SPO HET	24	Sporobolus heterolepis	Prairie Dropseed	1 gal	PAY ITEM # K0012990

MATCHLINE STA. 160 + 90.00

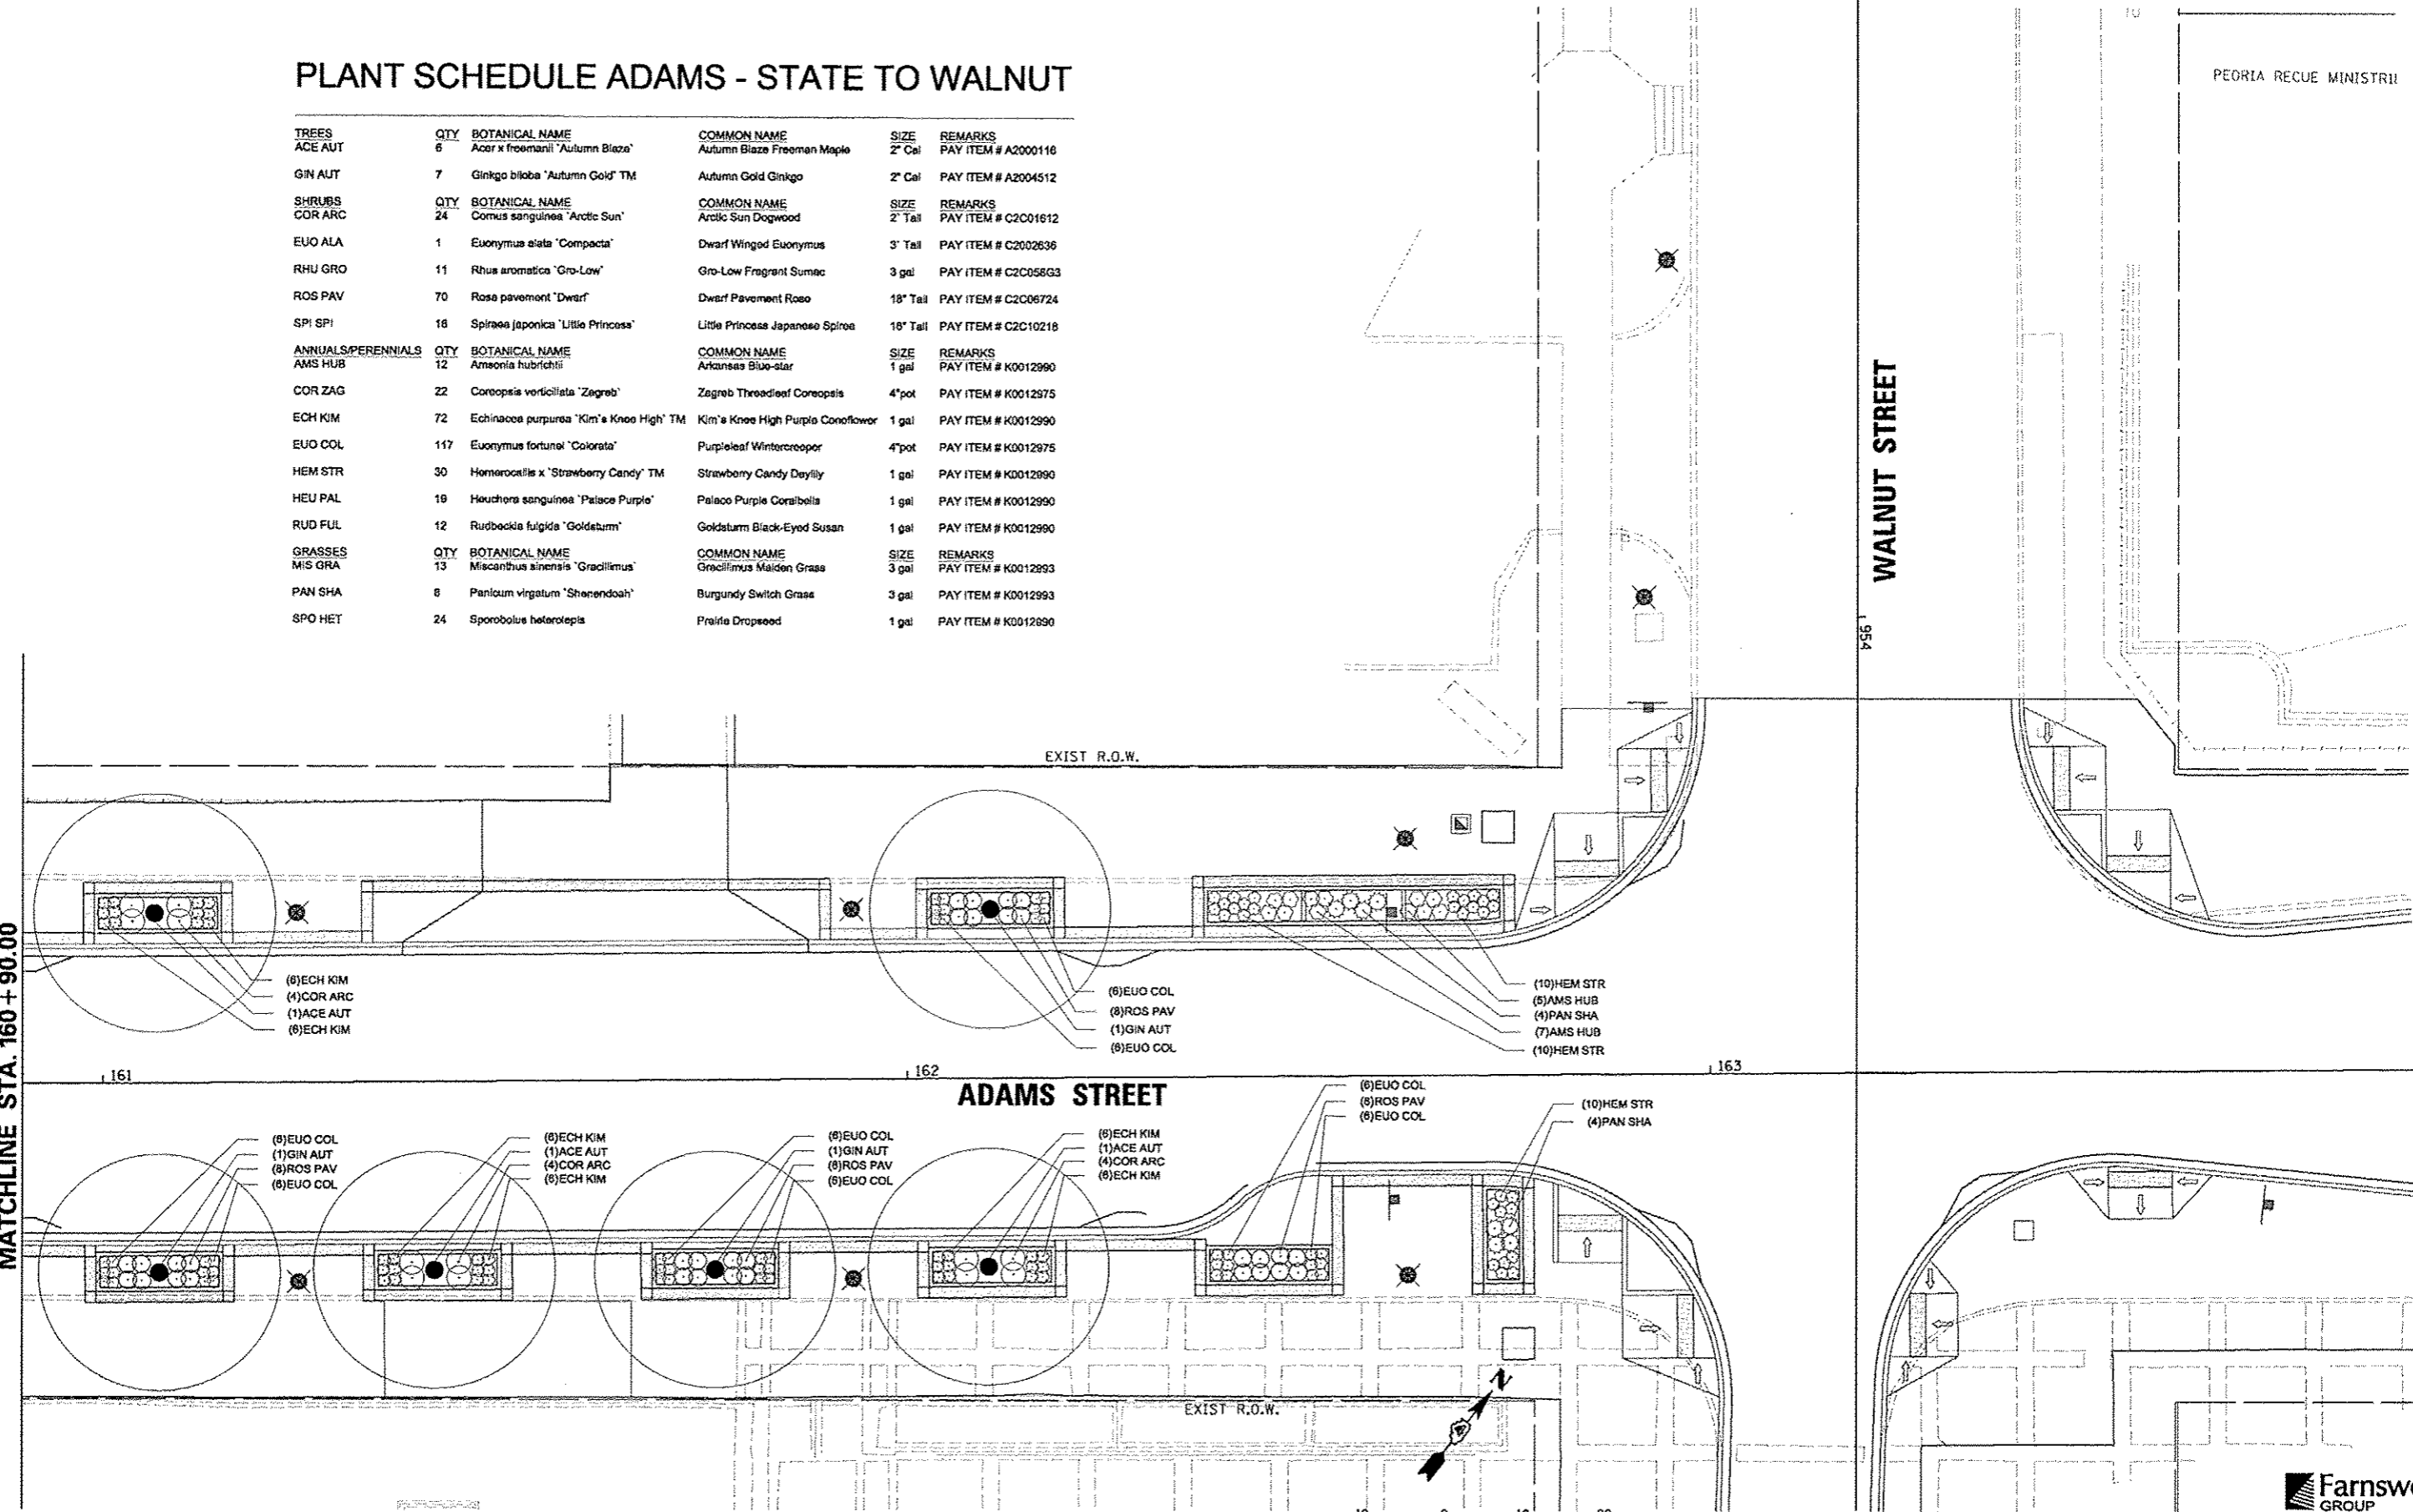

PEORIA RECUE MINISTERII


WALNUT STREET  
1554

## ADAMS STREET

EXIST. R.O.W.




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SCALE: 1"=10'		SHEET NO. OF SHEETS		STA. 160+90 TO STA. 163+00		[ILLINOIS] FED. AID PROJECT		TIC-509305B		

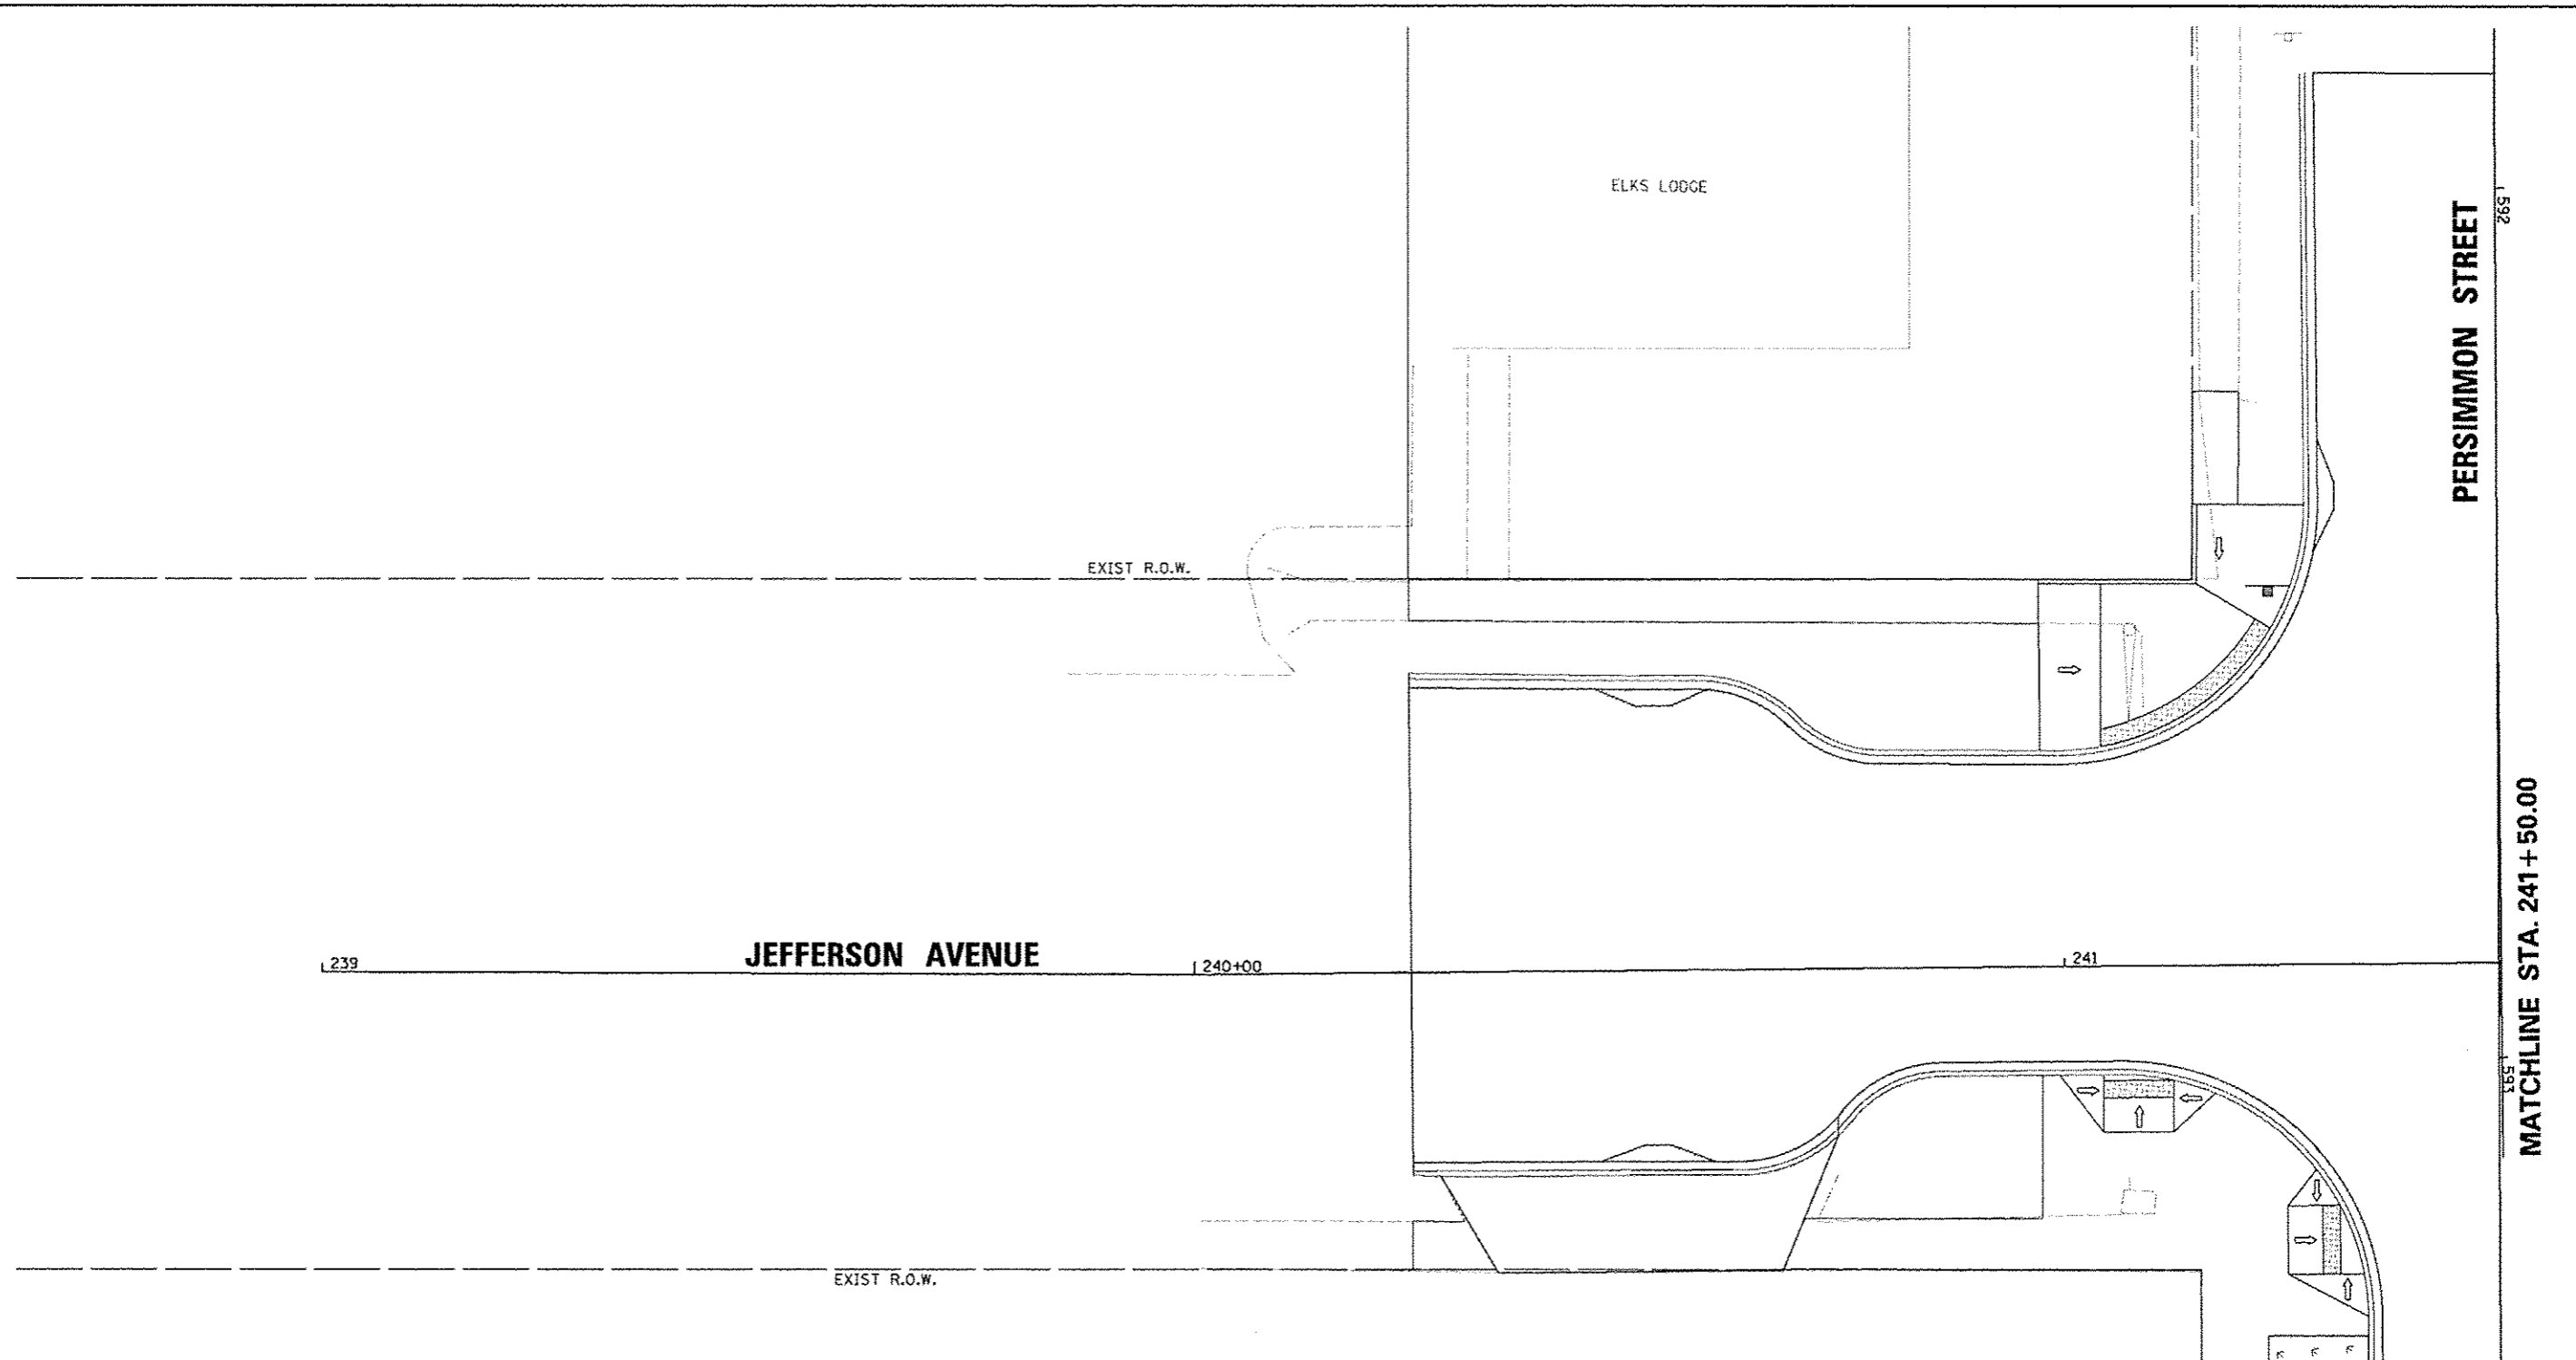

**PLANT SCHEDULE PERSIMMON - JEFFERSON TO ADAMS**

TREES	QTY	BOTANICAL NAME	COMMON NAME	SIZE	REMARKS
GIN AUT	1	Ginkgo biloba 'Autumn Gold' TM	Autumn Gold Ginkgo	2" Cal	PAY ITEM # A2004512
GYM KEN	1	Gymnocladus dioica	Kentucky Coffeetree	2" Cal	PAY ITEM # A2005010


  

GROUND COVERS	CODE	QTY	BOTANICAL NAME	COMMON NAME	SIZE	REMARKS
	TUR SOD	6,852 sf	Turf Sod	Sodding	sod	Topsoil Fumish and Place, 4"

PEORIA RESCUE MINISTRIES

(1,513 sf) TUR SOD

**MATCHLINE STA. 593 + 60.00**

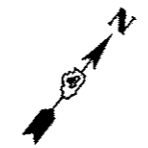

FILE NAME =	USER NAME = mnan01398	DESIGNED - JLH	REVISED -
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	PLOT DATE = 07\23\2012	DATE - 7/18/12	REVISED -

**STATE OF ILLINOIS  
DEPARTMENT OF TRANSPORTATION**

**JEFFERSON AVENUE  
PLANTING PLAN**

SCALE: 1"=10' SHEET NO. OF SHEETS STA. 240+00 TO STA. 241+50

F.A.U. RTE.	SECTION	COUNTY	TOTAL SHEETS	SHEET NO.
	12-00356-01-PV	PEORIA	519	336
CONTRACT NO. 89626			ILLINOIS FED. AID PROJECT TIG-50931501	


**Farnsworth GROUP**  
7707 N. KNOXVILLE AVE, SUITE 100  
PEORIA, ILLINOIS 61614  
(309) 699-9000 / (309) 699-9020 Fax  
www.f-w.com

## PLANT SCHEDULE JEFFERSON - PERSIMMON TO MAPLE

TREES	QTY	BOTANICAL NAME	COMMON NAME	SIZE	REMARKS
GYM KEN	7	Gymnocladus dioica	Kentucky Coffeetree	2" Cal	PAY ITEM # A2005016
TAX SHA	7	Taxodium distichum 'Shawnee Brave' TM	Shawnee Brave Bald Cypress	2" Cal	PAY ITEM # A2007716

GROUND COVERS	CODE	QTY	BOTANICAL NAME	COMMON NAME	SIZE	REMARKS
	TUR SOD	8,279 sf	Turf Sod	Sodding	sod	Topsoli Furnish and Place, 4"

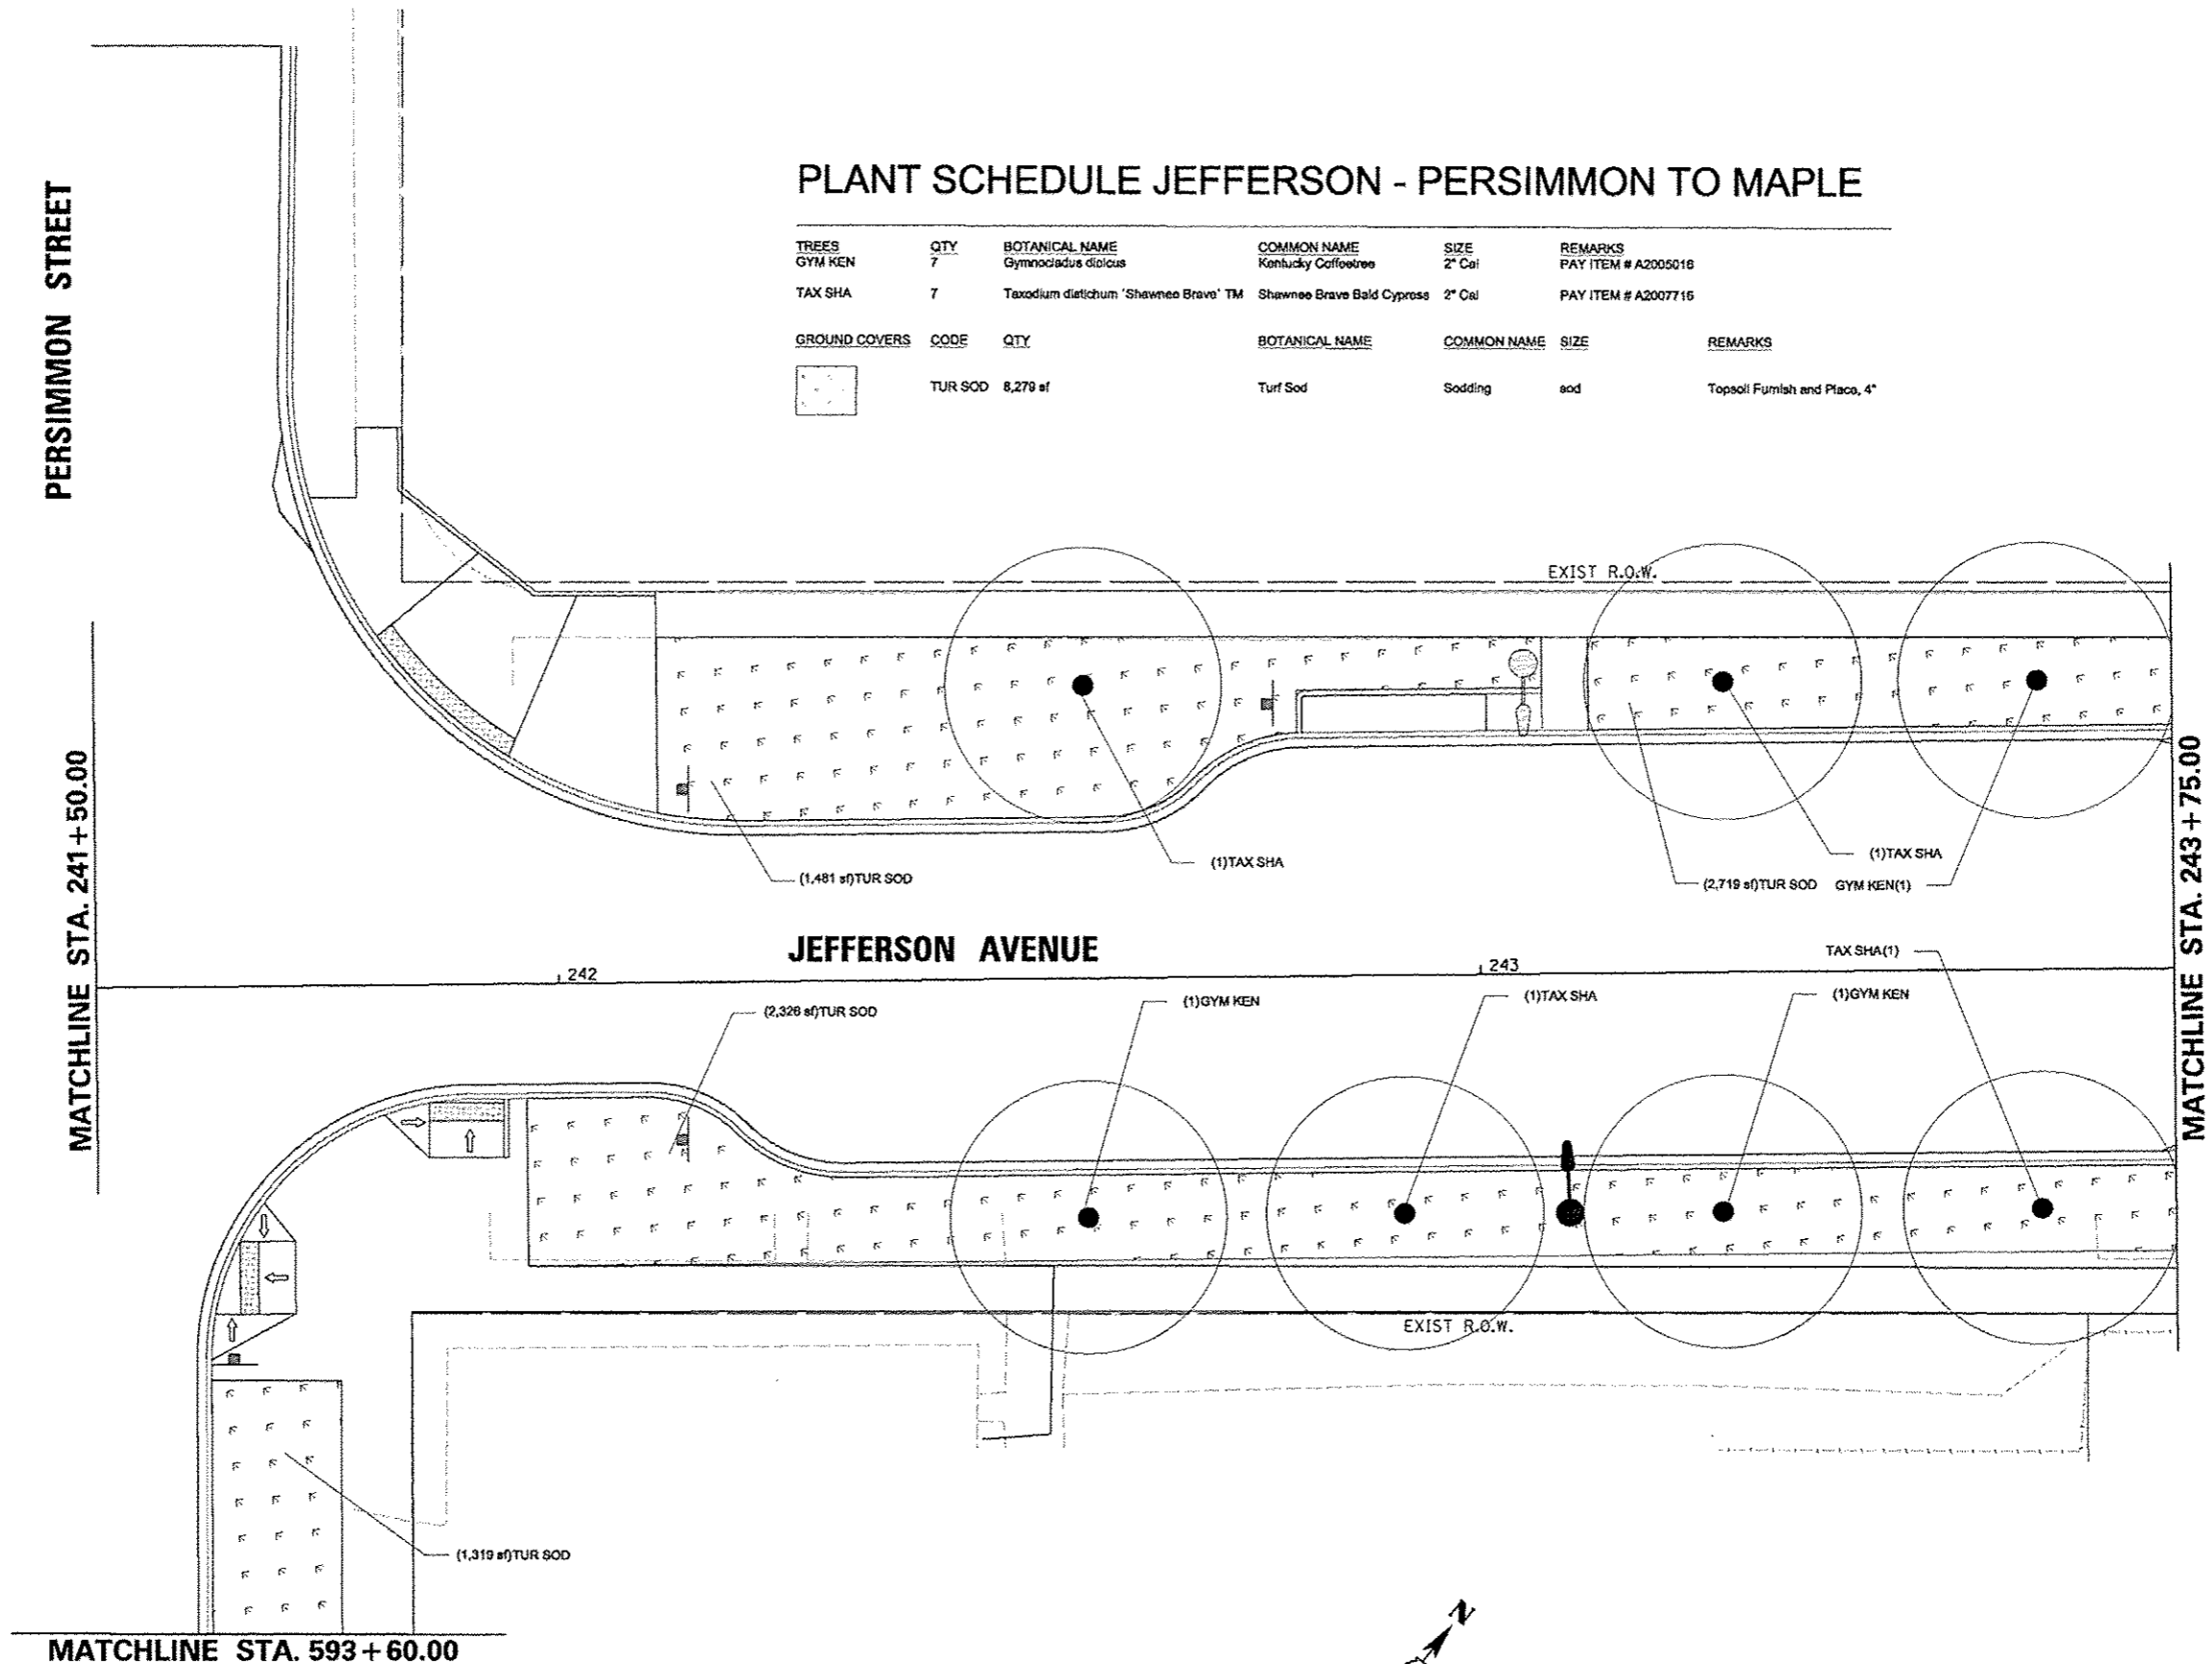

FILE NAME =	USER NAME = monak01398	DESIGNED -	REVISED -
o:\pwise_work\do_not_delete\dm73427\04	BLB155-ah-plant021.dgn	DRAWN -	REVISED -
	PLOT SCALE = 20.0000' / 1" =	CHECKED -	REVISED -
	PLOT DATE = 07/23/2012	DATE = 7/18/12	REVISED -

**STATE OF ILLINOIS  
DEPARTMENT OF TRANSPORTATION**

<b>JEFFERSON AVENUE PLANTING PLAN</b>	
SCALE: 1"=10'	SHEET NO. OF SHEETS
STA. 241+50	TO STA. 243+75


F.A.U. RTE.	SECTION	COUNTY	TOTAL SHEETS	SHEET NO.
243	12-00356-01-PV	PEORIA	519	337
CONTRACT NO. 89626				
ILLINOIS FED. AID PROJECT TIG-509305B				



**Farnsworth GROUP**  
7707 N. KNOXVILLE AVE, SUITE 100  
PEORIA, ILLINOIS 61614  
(309) 693-0000 / (309) 699-0020 Fax  
www.fw.com

# PLANT SCHEDULE JEFFERSON - PERSIMMON TO MAPLE

TREES	QTY	BOTANICAL NAME	COMMON NAME	SIZE	REMARKS
GYM KEN	7	Gymnocladus dioica	Kentucky Coffeetree	2" Cal	PAY ITEM # A2005018
TAX SHA	7	Taxodium distichum 'Shawnee Brave' TM	Shawnee Brave Bald Cypress	2" Cal	PAY ITEM # A2007718

GROUND COVERS	CODE	QTY	BOTANICAL NAME	COMMON NAME	SIZE	REMARKS
	TUR SOD	8,279 sf	Turf Sod	Sodding	sod	Topsoli Furnish and Place, 4"

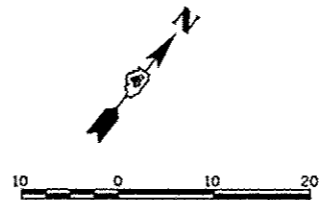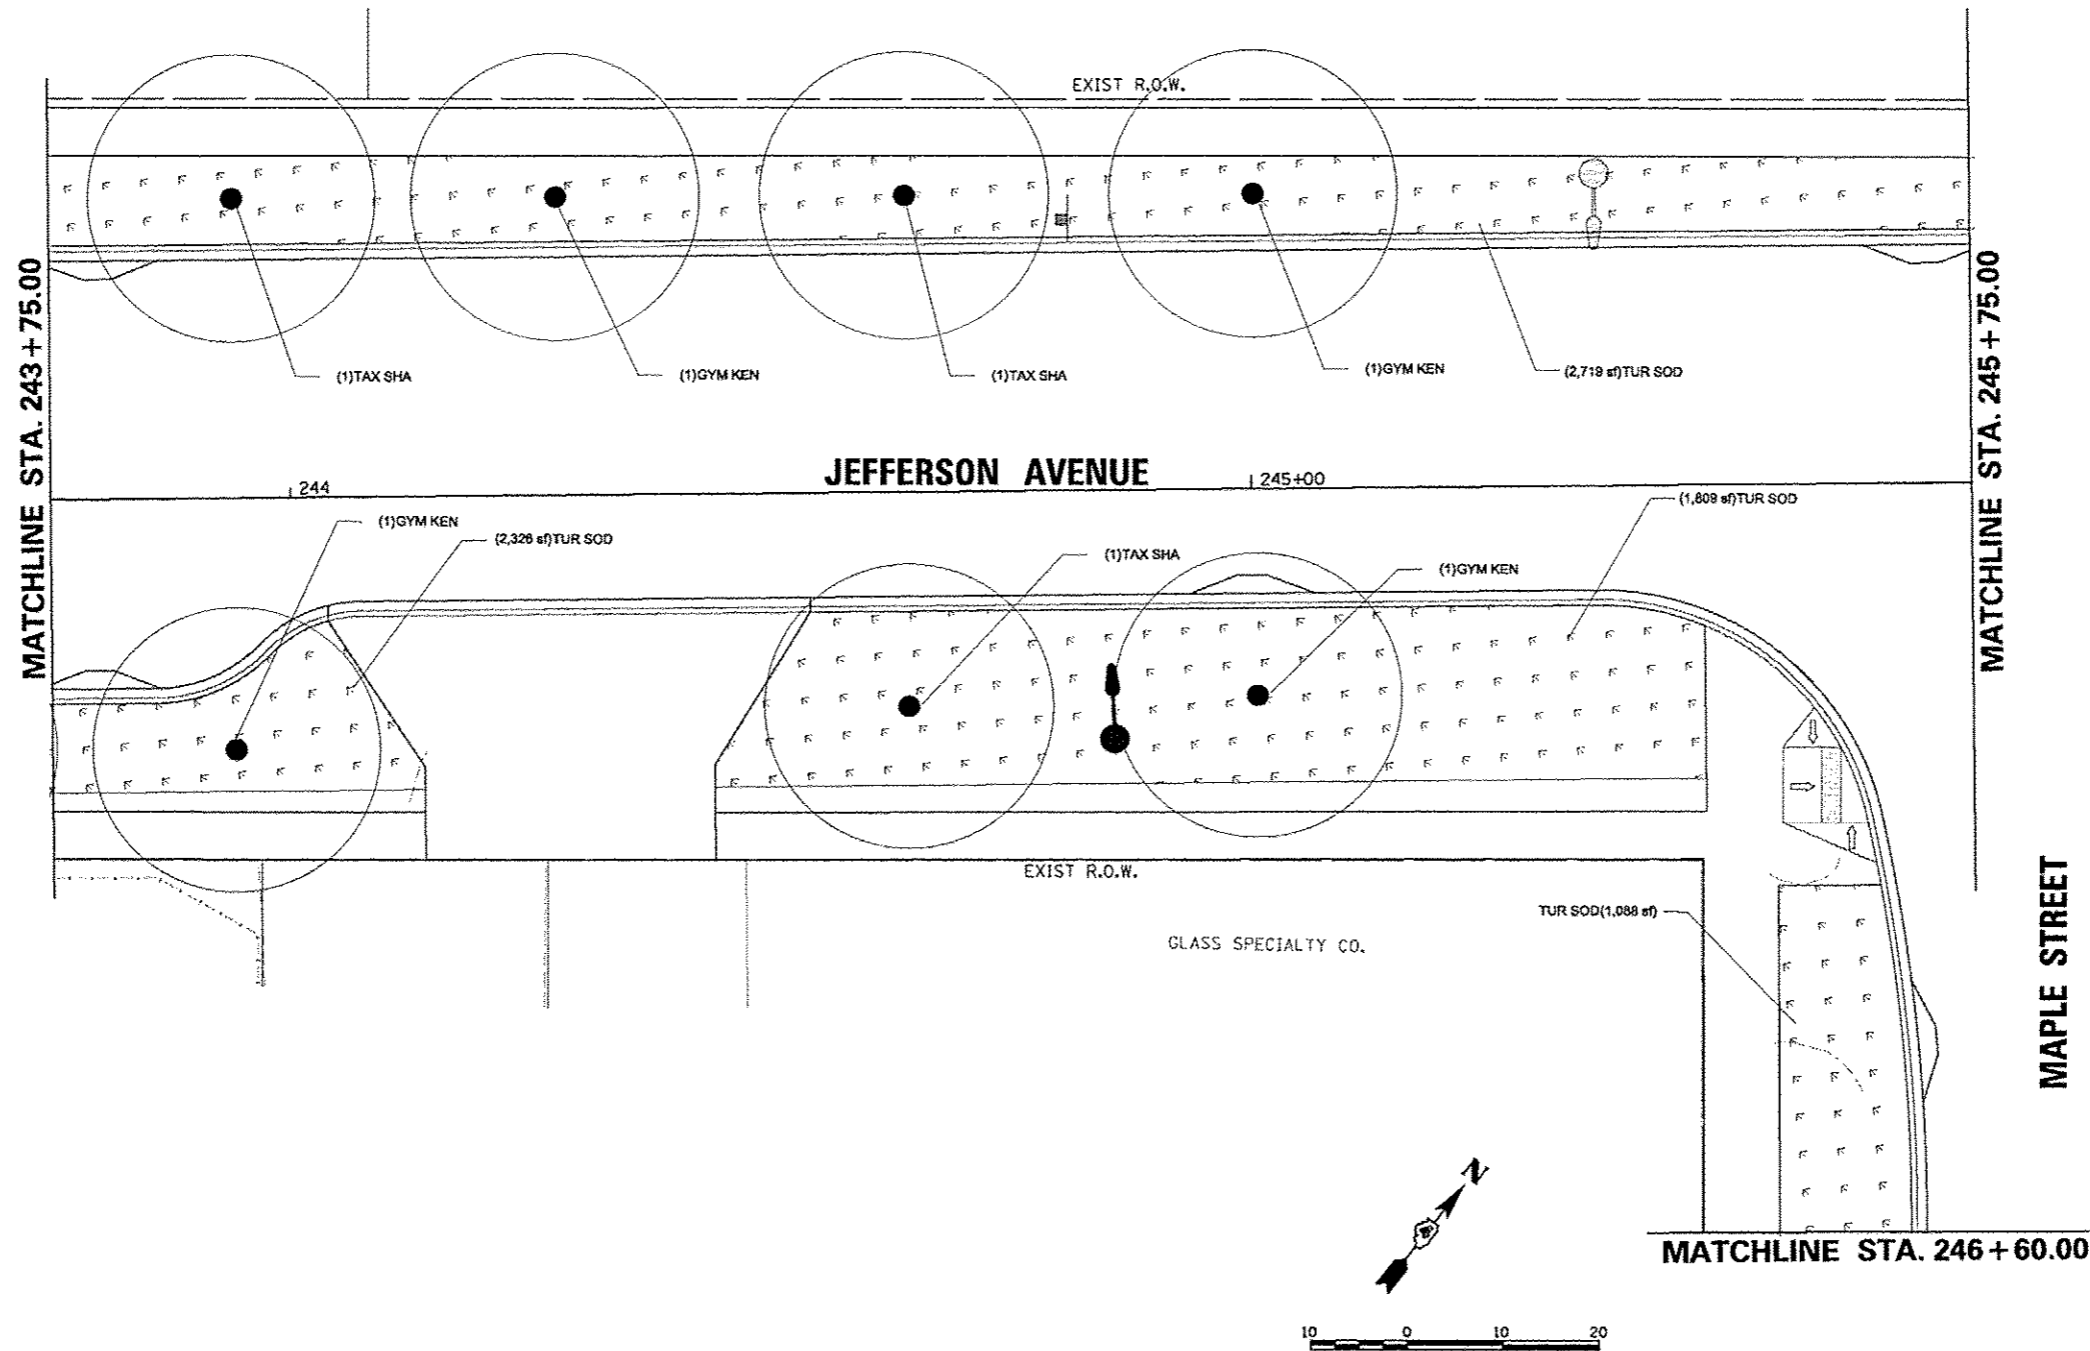

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	PL0155-ehc-plant022.dgn	DRAWN -	REVISED -		SCALE: 1"=10'	SHEET NO. OF SHEETS	STA. 243+75 TO STA. 245+75	CONTRACT NO. 89626		ILLINOIS FED. AID PROJECT TIC-509303B	
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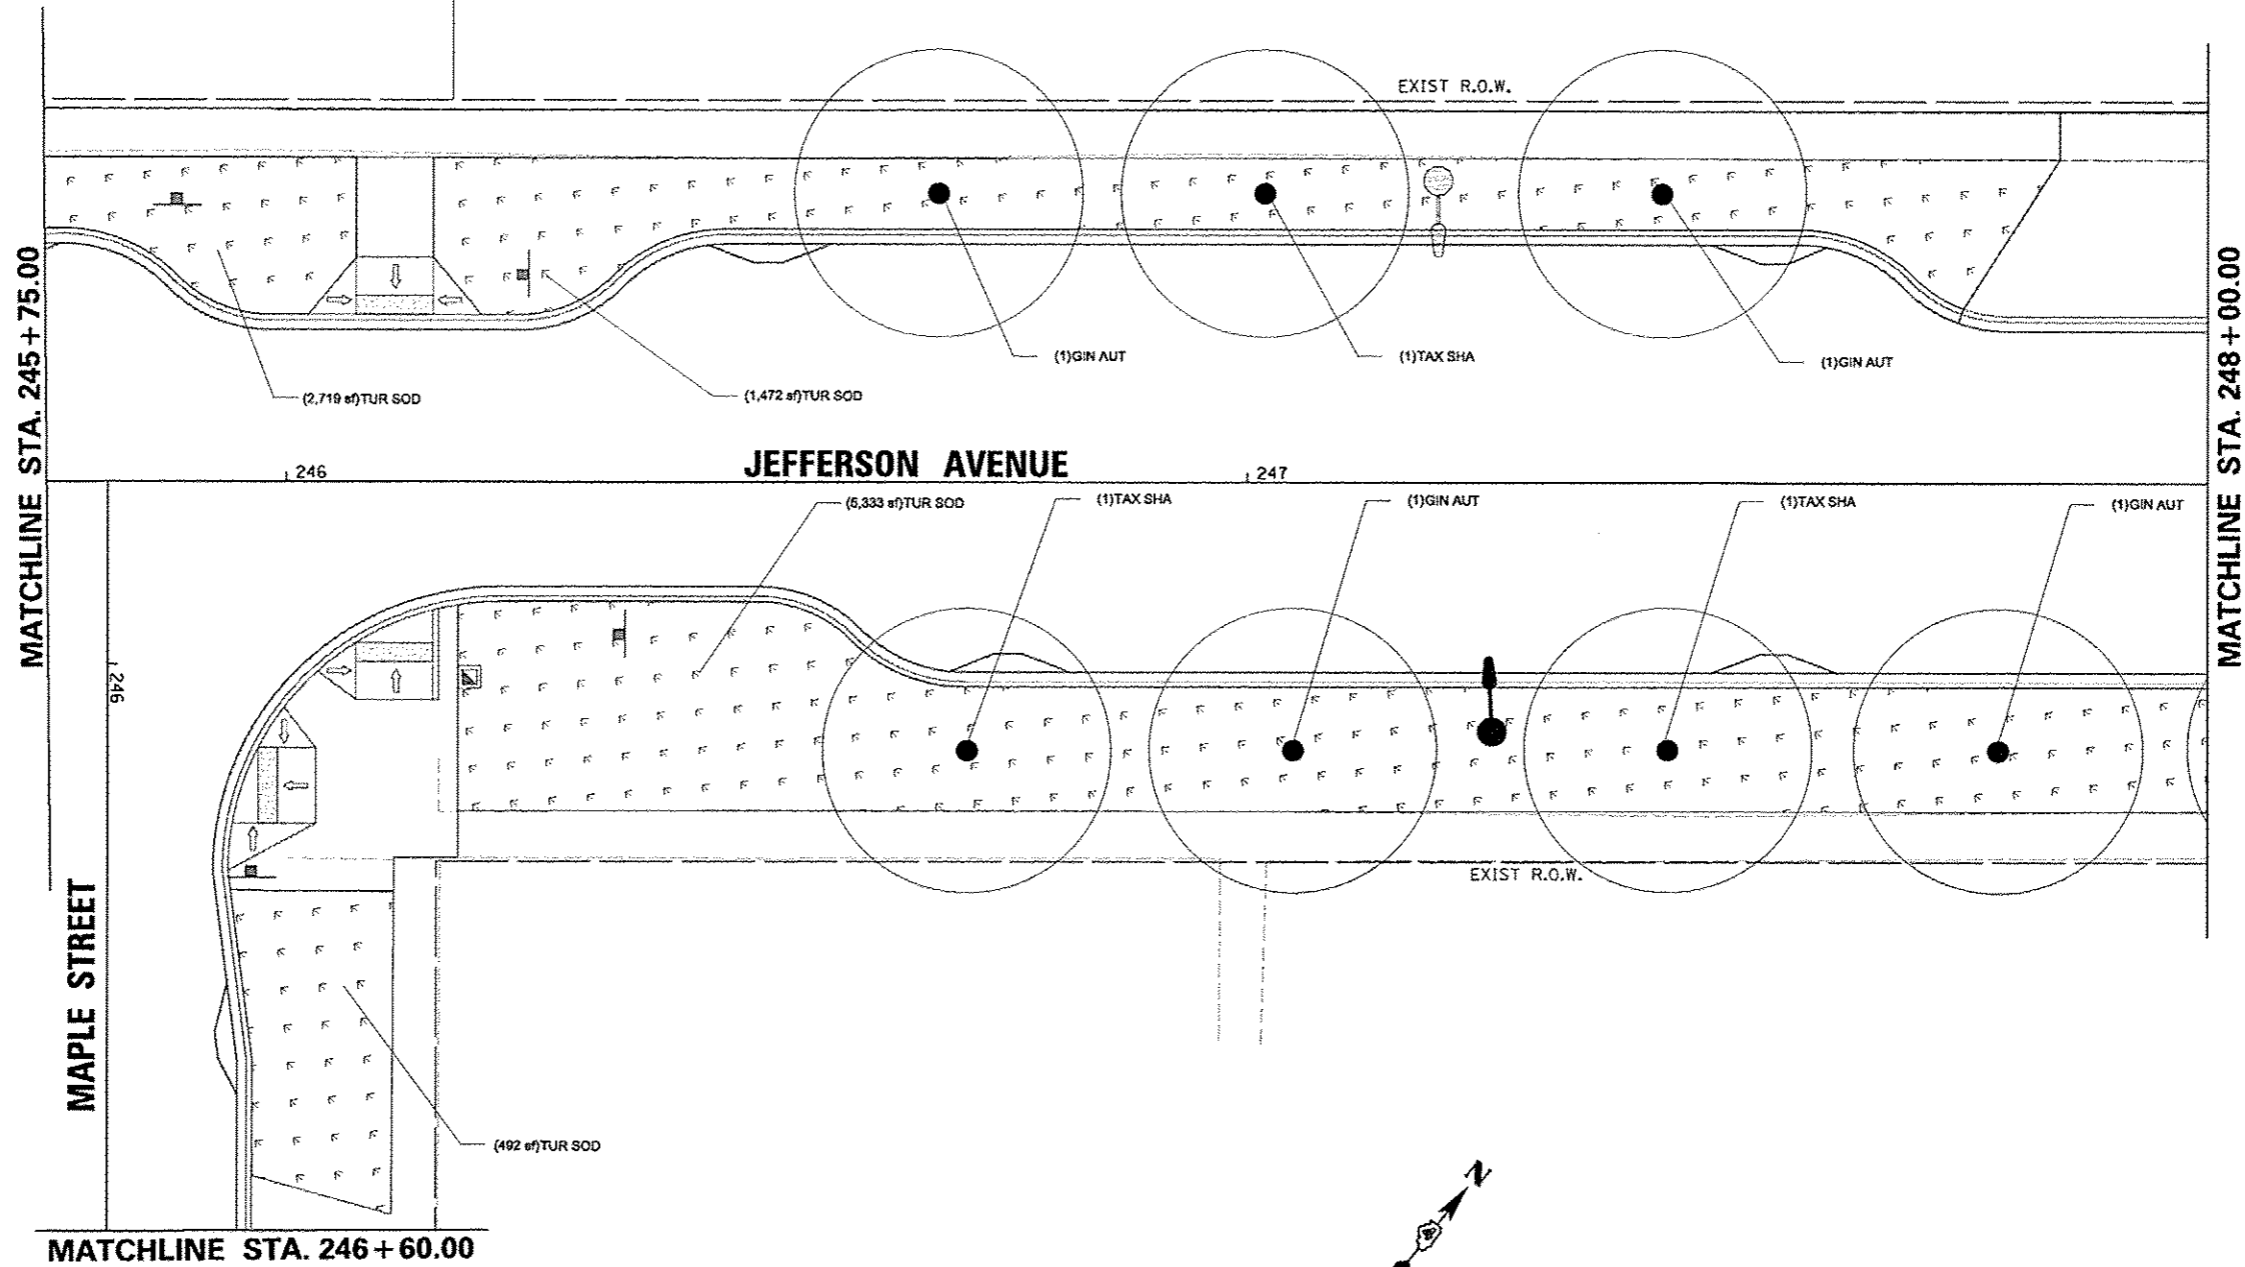
**Farnsworth GROUP**  
 7707 N. KNOXVILLE AVE, SUITE 100  
 PEORIA, ILLINOIS 61614  
 (309) 699-0500 / (309) 699-0020 Fax  
 www.far.com

# PLANT SCHEDULE JEFFERSON - MAPLE TO ELM

TREES	QTY	BOTANICAL NAME	COMMON NAME	SIZE	REMARKS
GIN AUT	7	Ginkgo biloba 'Autumn Gold' TM	Autumn Gold Ginkgo	2" Cal	PAY ITEM # A2004512
TAX SHA	7	Taxodium distichum 'Shawnee Brave' TM	Shawnee Brave Bald Cypress	2" Cal	PAY ITEM # A2007716

GROUND COVERS	CODE	QTY	BOTANICAL NAME	COMMON NAME	SIZE	REMARKS
TUR SOD		8,378 sf	Turf Sod	Sodding	sod	Topsoli Furnish and Place, 4"



FILE NAME *	USER NAME * monak81398	DESIGNED - JLH	REVISED -
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		CHECKED - BAB	REVISED -
		DATE - 7/18/12	REVISED -

**STATE OF ILLINOIS  
DEPARTMENT OF TRANSPORTATION**

**JEFFERSON AVENUE  
PLANTING PLAN**

SCALE: 1"=10'    SHEET NO. OF SHEETS    STA. 245+75 TO STA. 248+00


F.A.U. RTE.	SECTION	COUNTY	TOTAL SHEETS	SHEET NO.
12	12-00356-01-PV	PEORIA	519	339
CONTRACT NO. 89626			ILLINOIS FED. AID PROJECT TIG-50931158	


**Farnsworth GROUP**  
7707 N. KNOXVILLE AVE, SUITE 100  
PEORIA, ILLINOIS 61614  
(309) 699-9099 / (309) 699-9820 Fax  
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# PLANT SCHEDULE JEFFERSON - MAPLE TO ELM

TREES	QTY	BOTANICAL NAME	COMMON NAME	SIZE	REMARKS
GIN AUT	7	Ginkgo biloba "Autumn Gold" TM	Autumn Gold Ginkgo	2" Cal	PAY ITEM # A2004512
TAX SHA	7	Taxodium distichum "Shawnee Brave" TM	Shawnee Brave Bald Cypress	2" Cal	PAY ITEM # A2007716

GROUND COVERS	CODE	QTY	BOTANICAL NAME	COMMON NAME	SIZE	REMARKS
	TUR SOD	8,376 sf	Turf Sod	Sodding	sod	Topsoli Furnish and Place, 4"



FILE NAME *	USER NAME * monek01398	DESIGNED - JLH	REVISED -	<b>STATE OF ILLINOIS DEPARTMENT OF TRANSPORTATION</b>	<b>JEFFERSON AVENUE PLANTING PLAN</b>		F.A.U. RTE.	SECTION	COUNTY	TOTAL SHEETS	SHEET NO.
a:\piso_work\do_not_delete\dm73427\04	PL0155-ah-plant024.dgn	DRAWN - JLH	REVISED -		SCALE: 1"=10'	SHEET NO. OF SHEETS	STA. 248+00 TO STA. 250+05	12-00356-01-PV	PEORIA	519	340
	PLOT SCALE = 20.0000' / in.	CHECKED - BAB	REVISED -								
	PLOT DATE = 07/23/2012	DATE - 7/18/12	REVISED -								
ILLINOIS FED. AID PROJECT 11G-509315B1 CONTRACT NO. 89626											

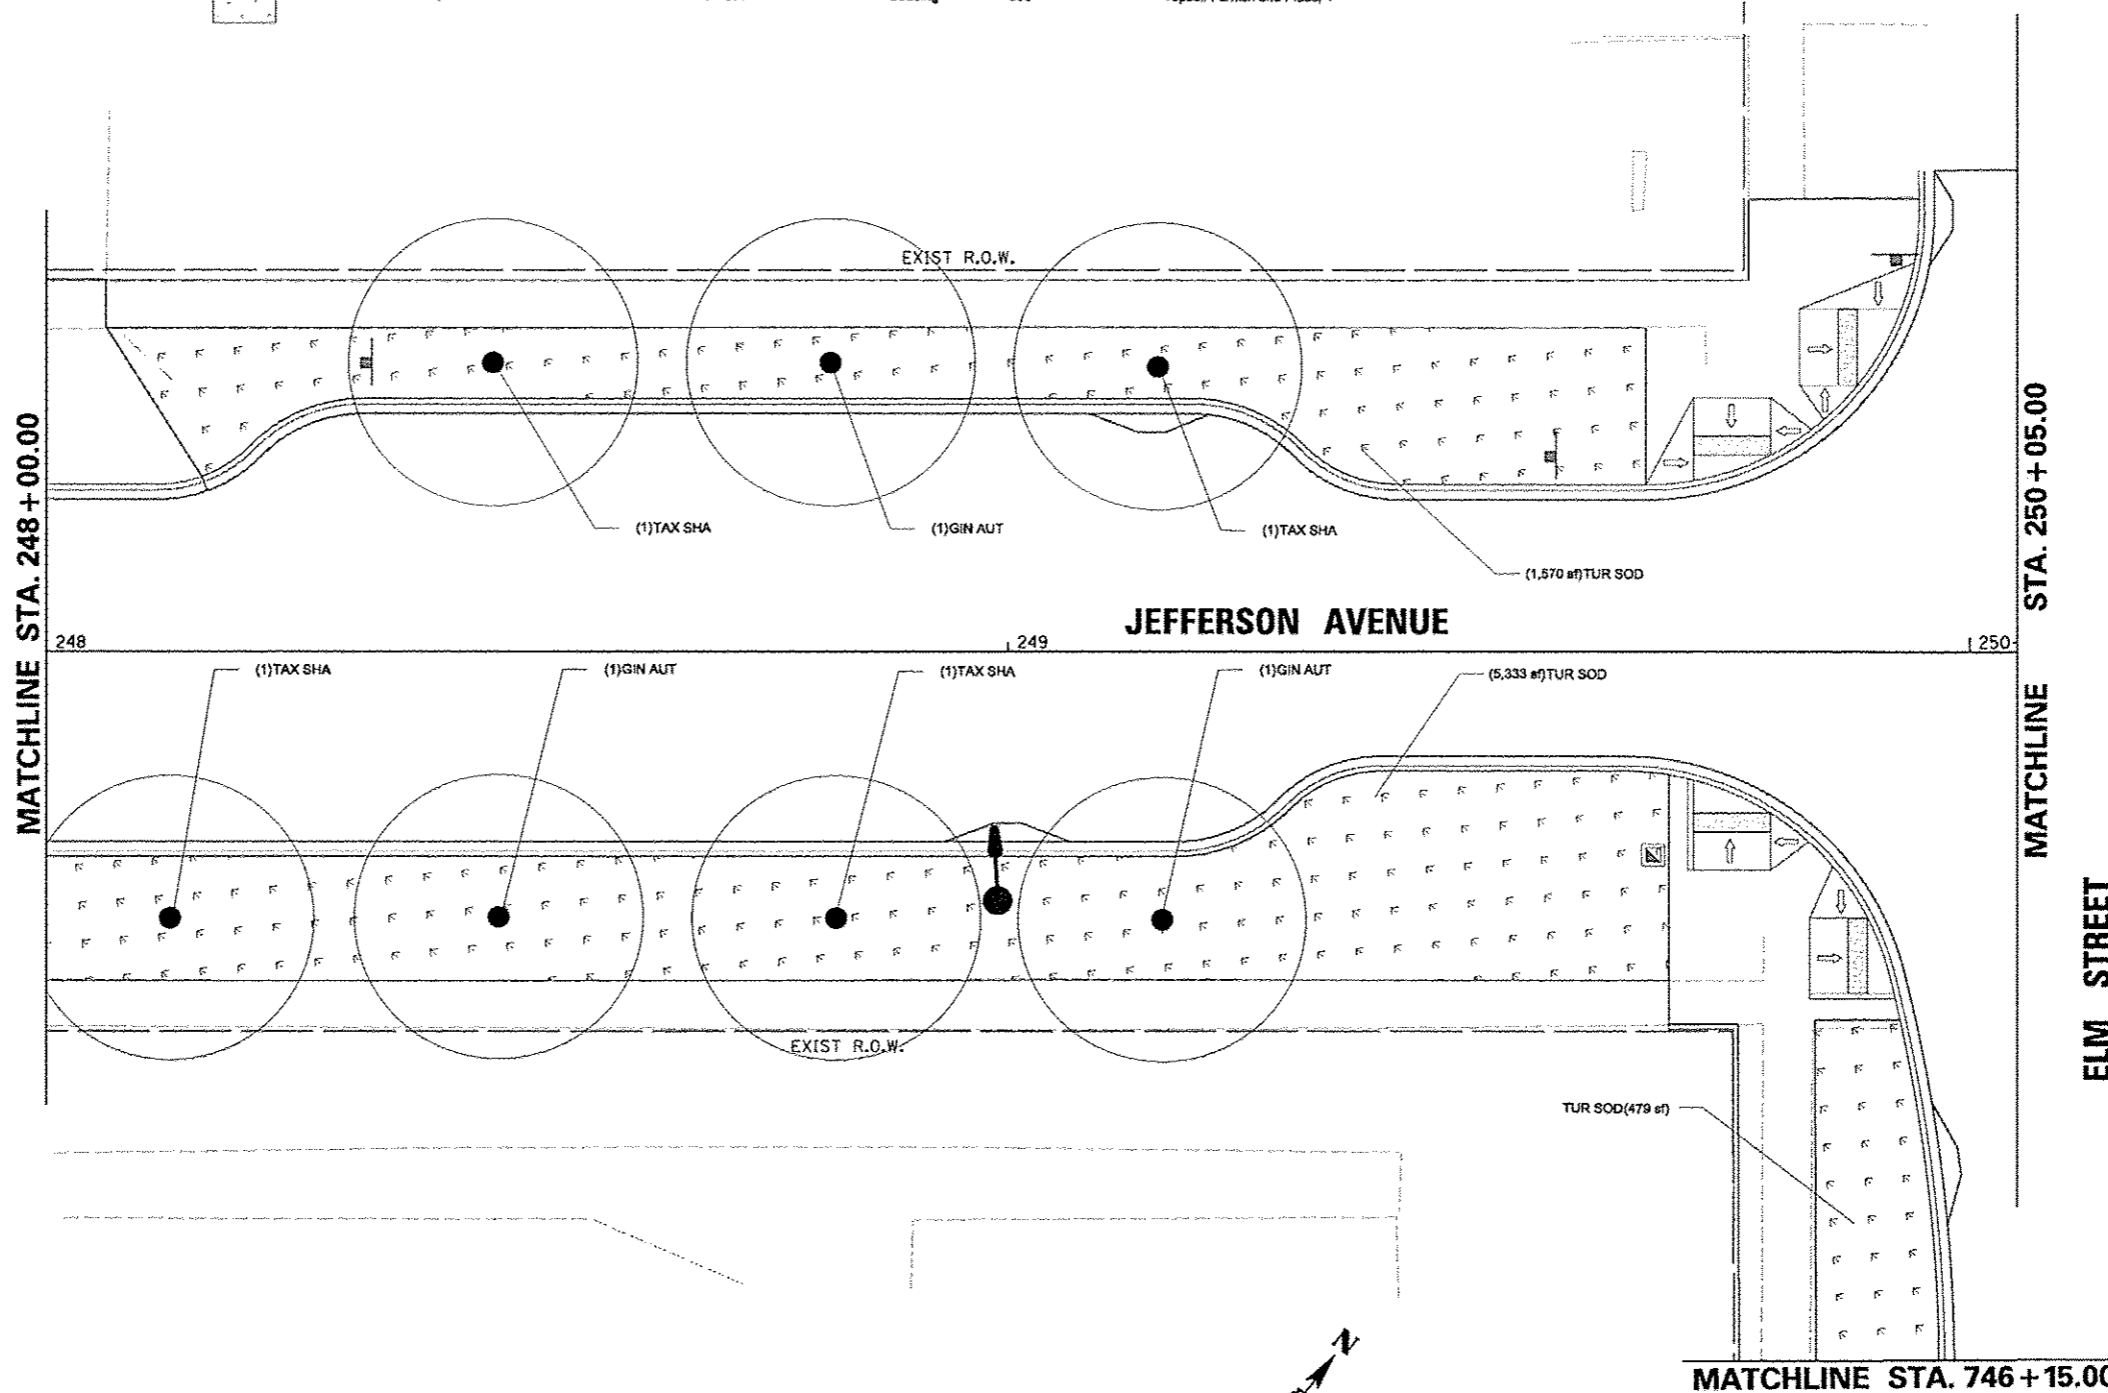


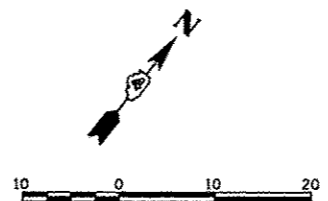
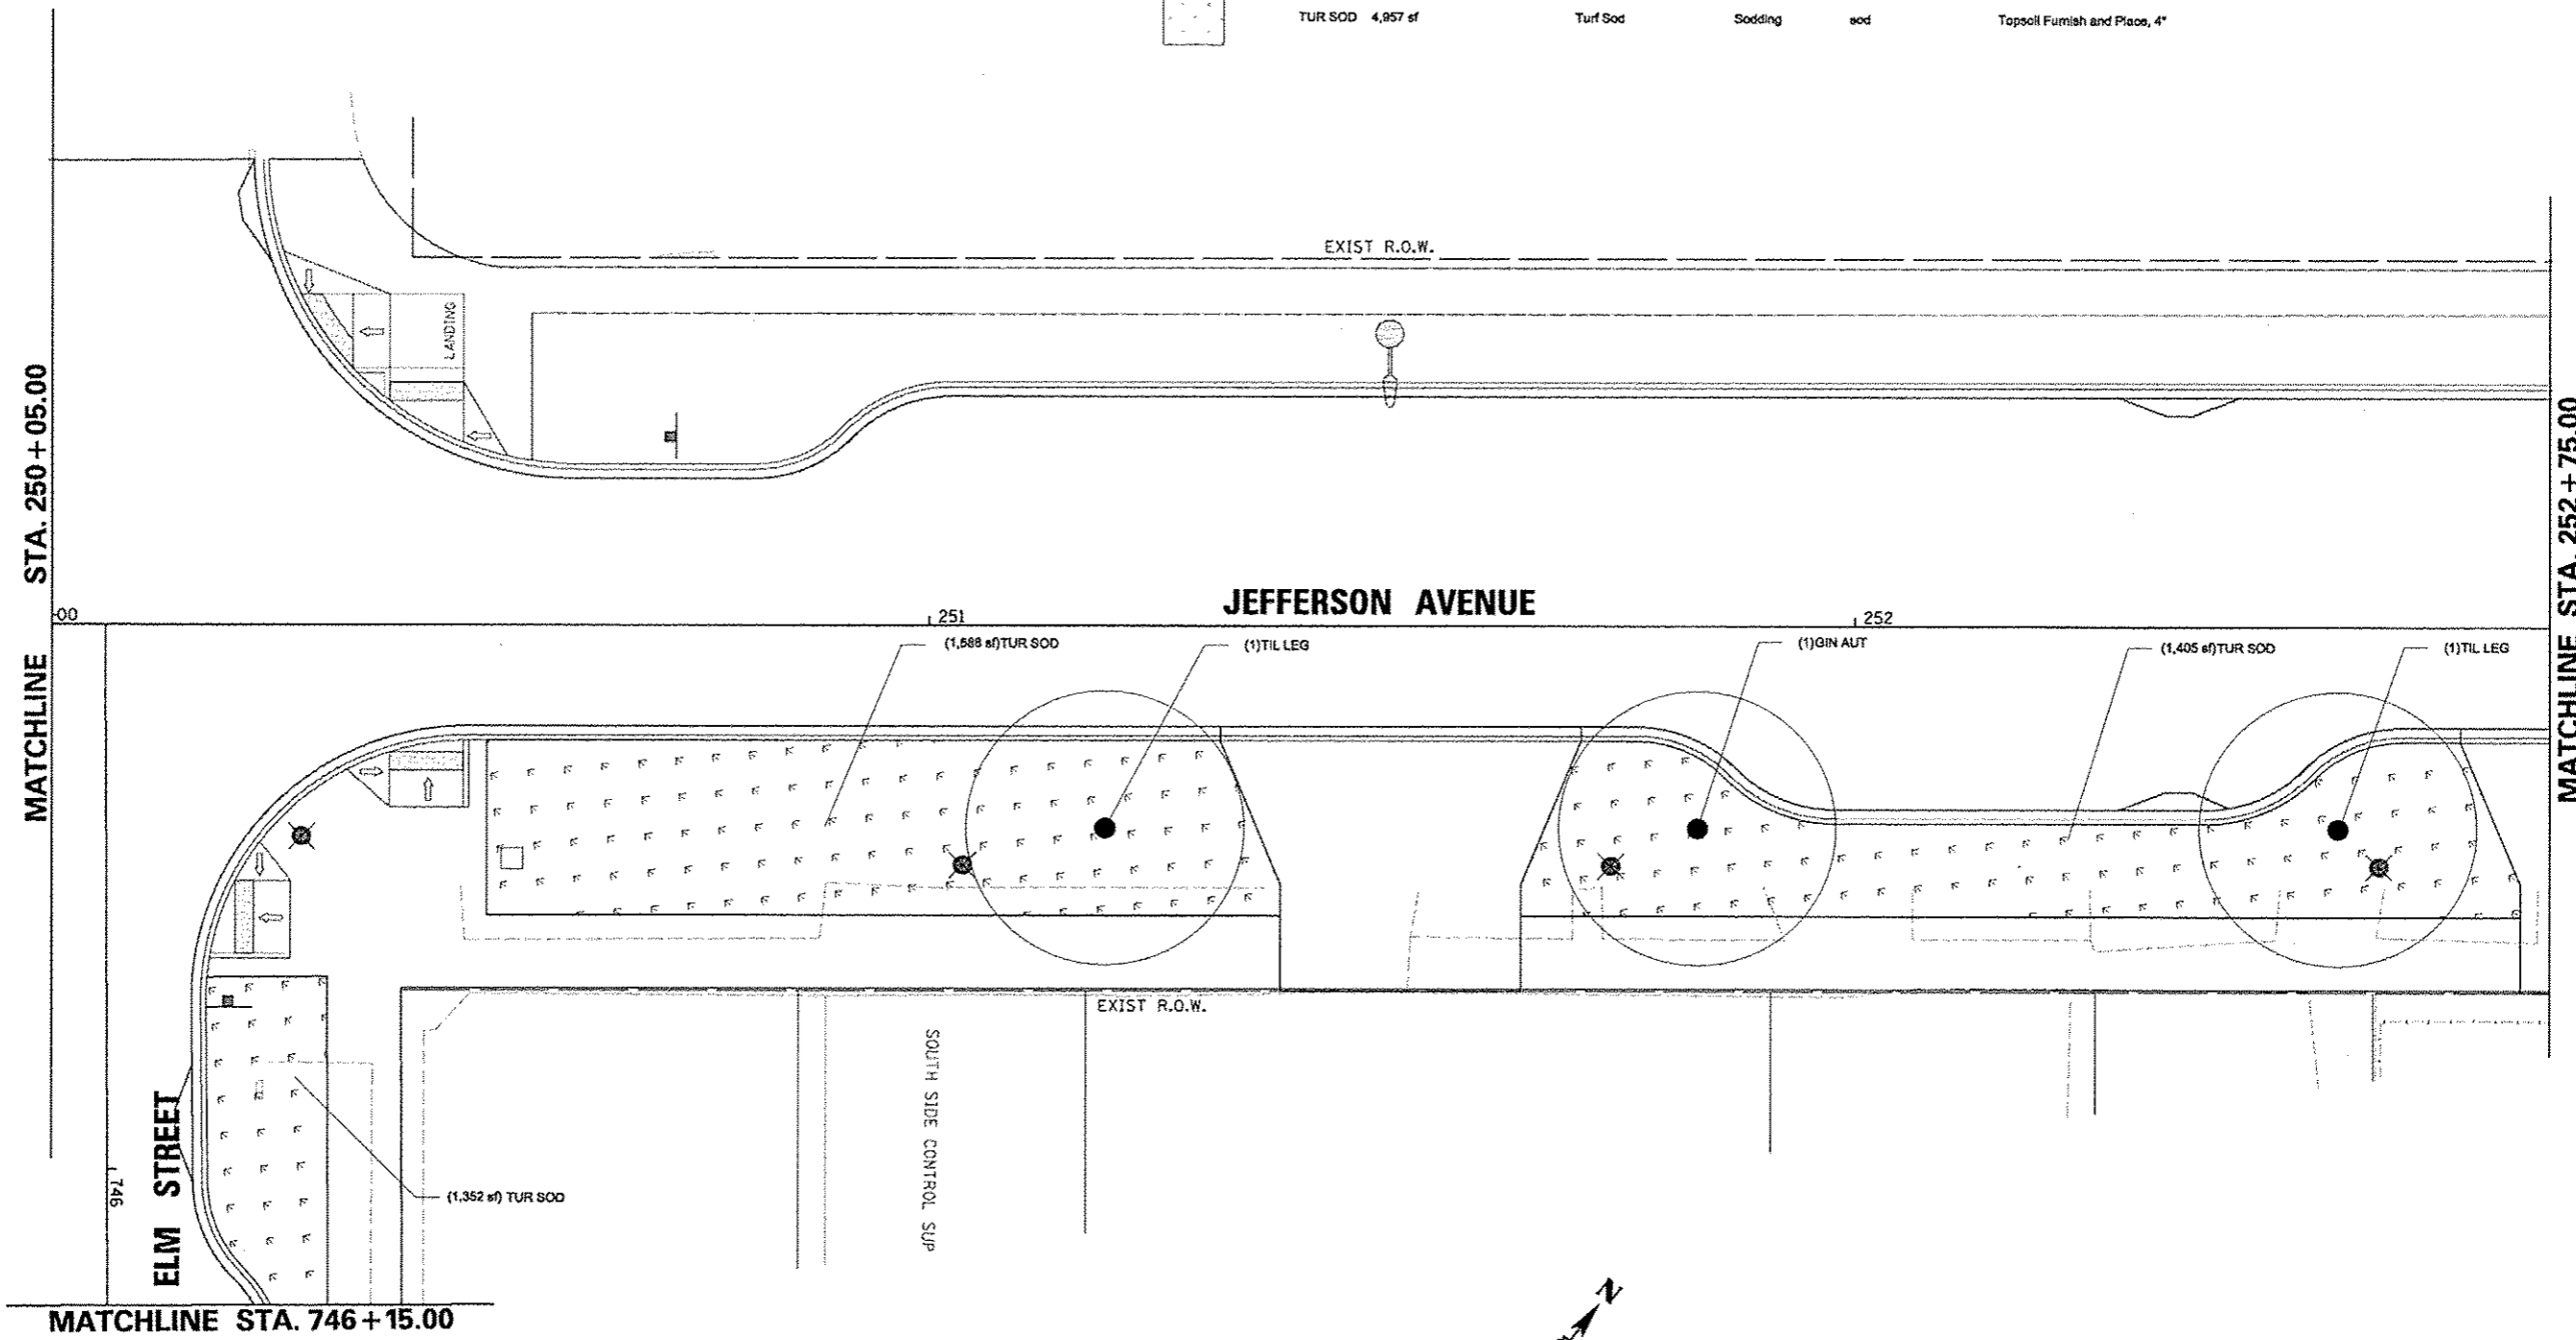


# PLANT SCHEDULE JEFFERSON - ELM TO OAK

TREES	QTY	BOTANICAL NAME	COMMON NAME	SIZE	REMARKS
GIN AUT	2	Ginkgo biloba "Autumn Gold"™	Autumn Gold Ginkgo	2" Cal	PAY ITEM # A2004512
TIL LEG	3	Tilia americana "Legend"	American Legend Linden	2" Cal	PAY ITEM # A2007848

GROUND COVERS	CODE	QTY	BOTANICAL NAME	COMMON NAME	SIZE	REMARKS
	TUR SOD	4,857 sf	Turf Sod	Sodding	sod	Topsoll Furnish and Place, 4"




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cd\pairo_work\do_not_delete\dms73427\04	BL0155-ehf.plant025.dgn	DRAWN - JLH	REVISED -			12-00356-01-PV	PEORIA	519	341	
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	PLOT DATE = 07-23-2012	DATE - 7/18/12	REVISED -			ILLINOIS FED. AID PROJECT TIC-50930501				
					SCALE: 1"=10'	SHEET NO. OF SHEETS		STA. 250+05 TO STA. 252+75		


**Farnsworth GROUP**  
 7707 N. KNOXVILLE AVE., SUITE 100  
 PEORIA, ILLINOIS 61614  
 (309) 699-9626 / (309) 699-0820 Fax  
 www.far.com

# PLANT SCHEDULE JEFFERSON - ELM TO OAK

TREES	QTY	BOTANICAL NAME	COMMON NAME	SIZE	REMARKS
GIN AUT	2	Ginkgo biloba 'Autumn Gold' TM	Autumn Gold Ginkgo	2" Cal	PAY ITEM # A2004512
TIL LEG	3	Tilia americana 'Legend'	American Legend Linden	2" Cal	PAY ITEM # A2007848

GROUND COVERS	CODE	QTY	BOTANICAL NAME	COMMON NAME	SIZE	REMARKS
	TUR SOD	4,957 sf	Turf Sod	Sodding	sod	Topsoil Furnish and Place, 4"

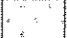


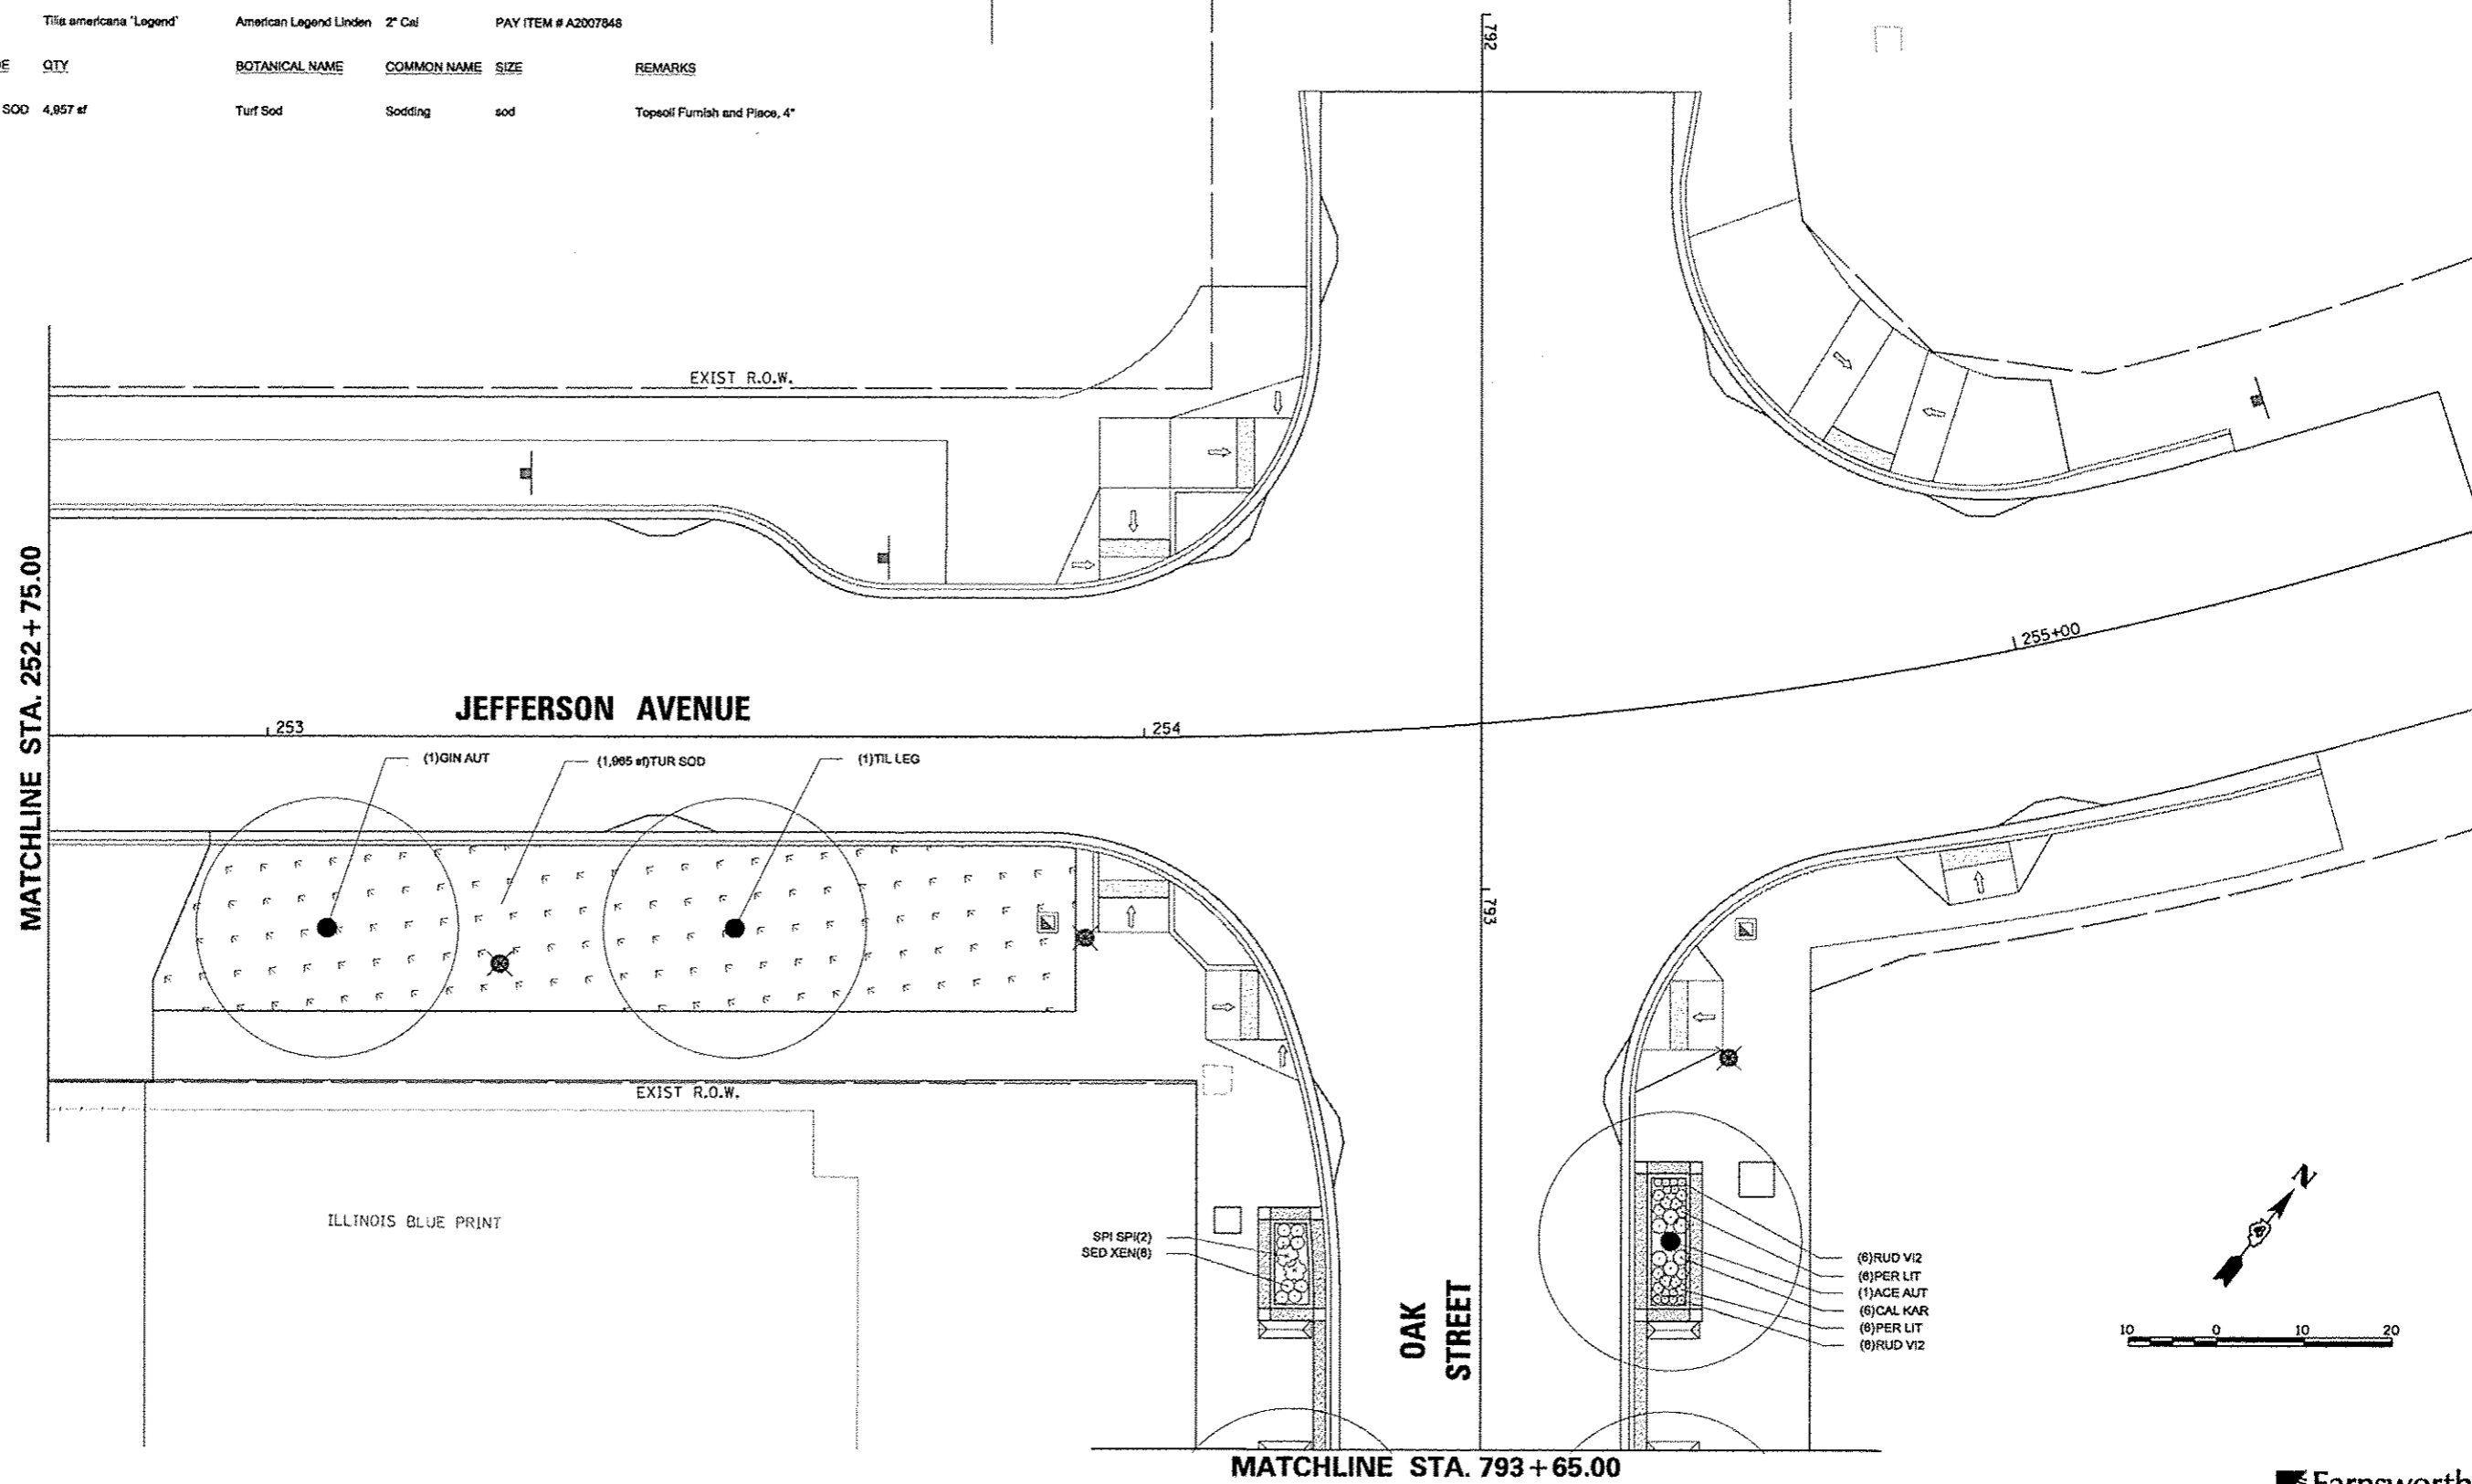FILE NAME *	USER NAME * manak81398	DESIGNED - JLH	REVISED -	<b>STATE OF ILLINOIS DEPARTMENT OF TRANSPORTATION</b>	<b>JEFFERSON AVENUE PLANTING PLAN</b>	F.A.U. RTE.	SECTION	COUNTY	TOTAL SHEETS	SHEET NO.
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	PLOT DATE = 07/23/2012	DATE - 7/18/12	REVISED -			ILLINOIS FED. AID PROJECT TIC-50931580				


**Farnsworth GROUP**  
 7707 N. KNOXVILLE AVE, SUITE 100  
 PEORIA, ILLINOIS 61614  
 (309) 699-9666 / (309) 699-0820 Fax  
 www.far.com

**PLANT SCHEDULE COMMERCIAL OAK TO STATE**

SHRUBS	QTY	BOTANICAL NAME	COMMON NAME	SIZE	REMARKS	
VIB CO2	23	Viburnum cerasifolium 'Compactum'	Compact Koreanopio Viburnum	24" Tall	PAY ITEM # C2C11624	
ANNUALS/PERENNIALS	QTY	BOTANICAL NAME	COMMON NAME	SIZE	REMARKS	
ECH KIM	73	Echinacea purpurea 'Kim's Knee High' TM	Kim's Knee High Purple Coneflower	1 gal	PAY ITEM # K0012990	
RUD VI2	130	Rudbeckia frigidula speciosa 'Vierle's Little Suzy'	Little Suzy Black-Eyed Susan	4" pot	PAY ITEM # K0012975	
GRASSES	QTY	BOTANICAL NAME	COMMON NAME	SIZE	REMARKS	
MIS LIT	12	Miscanthus sinensis 'Little Kitten'	Little Kitten Maiden Grass	1 gal	PAY ITEM # K0012990	
PAN SHA	18	Panicum virgatum 'Shenandoah'	Burgundy Switch Grass	3 gal	PAY ITEM # K0012993	
GROUND COVERS	CODE	QTY	BOTANICAL NAME	COMMON NAME	SIZE	REMARKS
	TUR SOD	298 sf	Turf Sod	Sodding	sod	Topsoil Furnish and Place, 4"

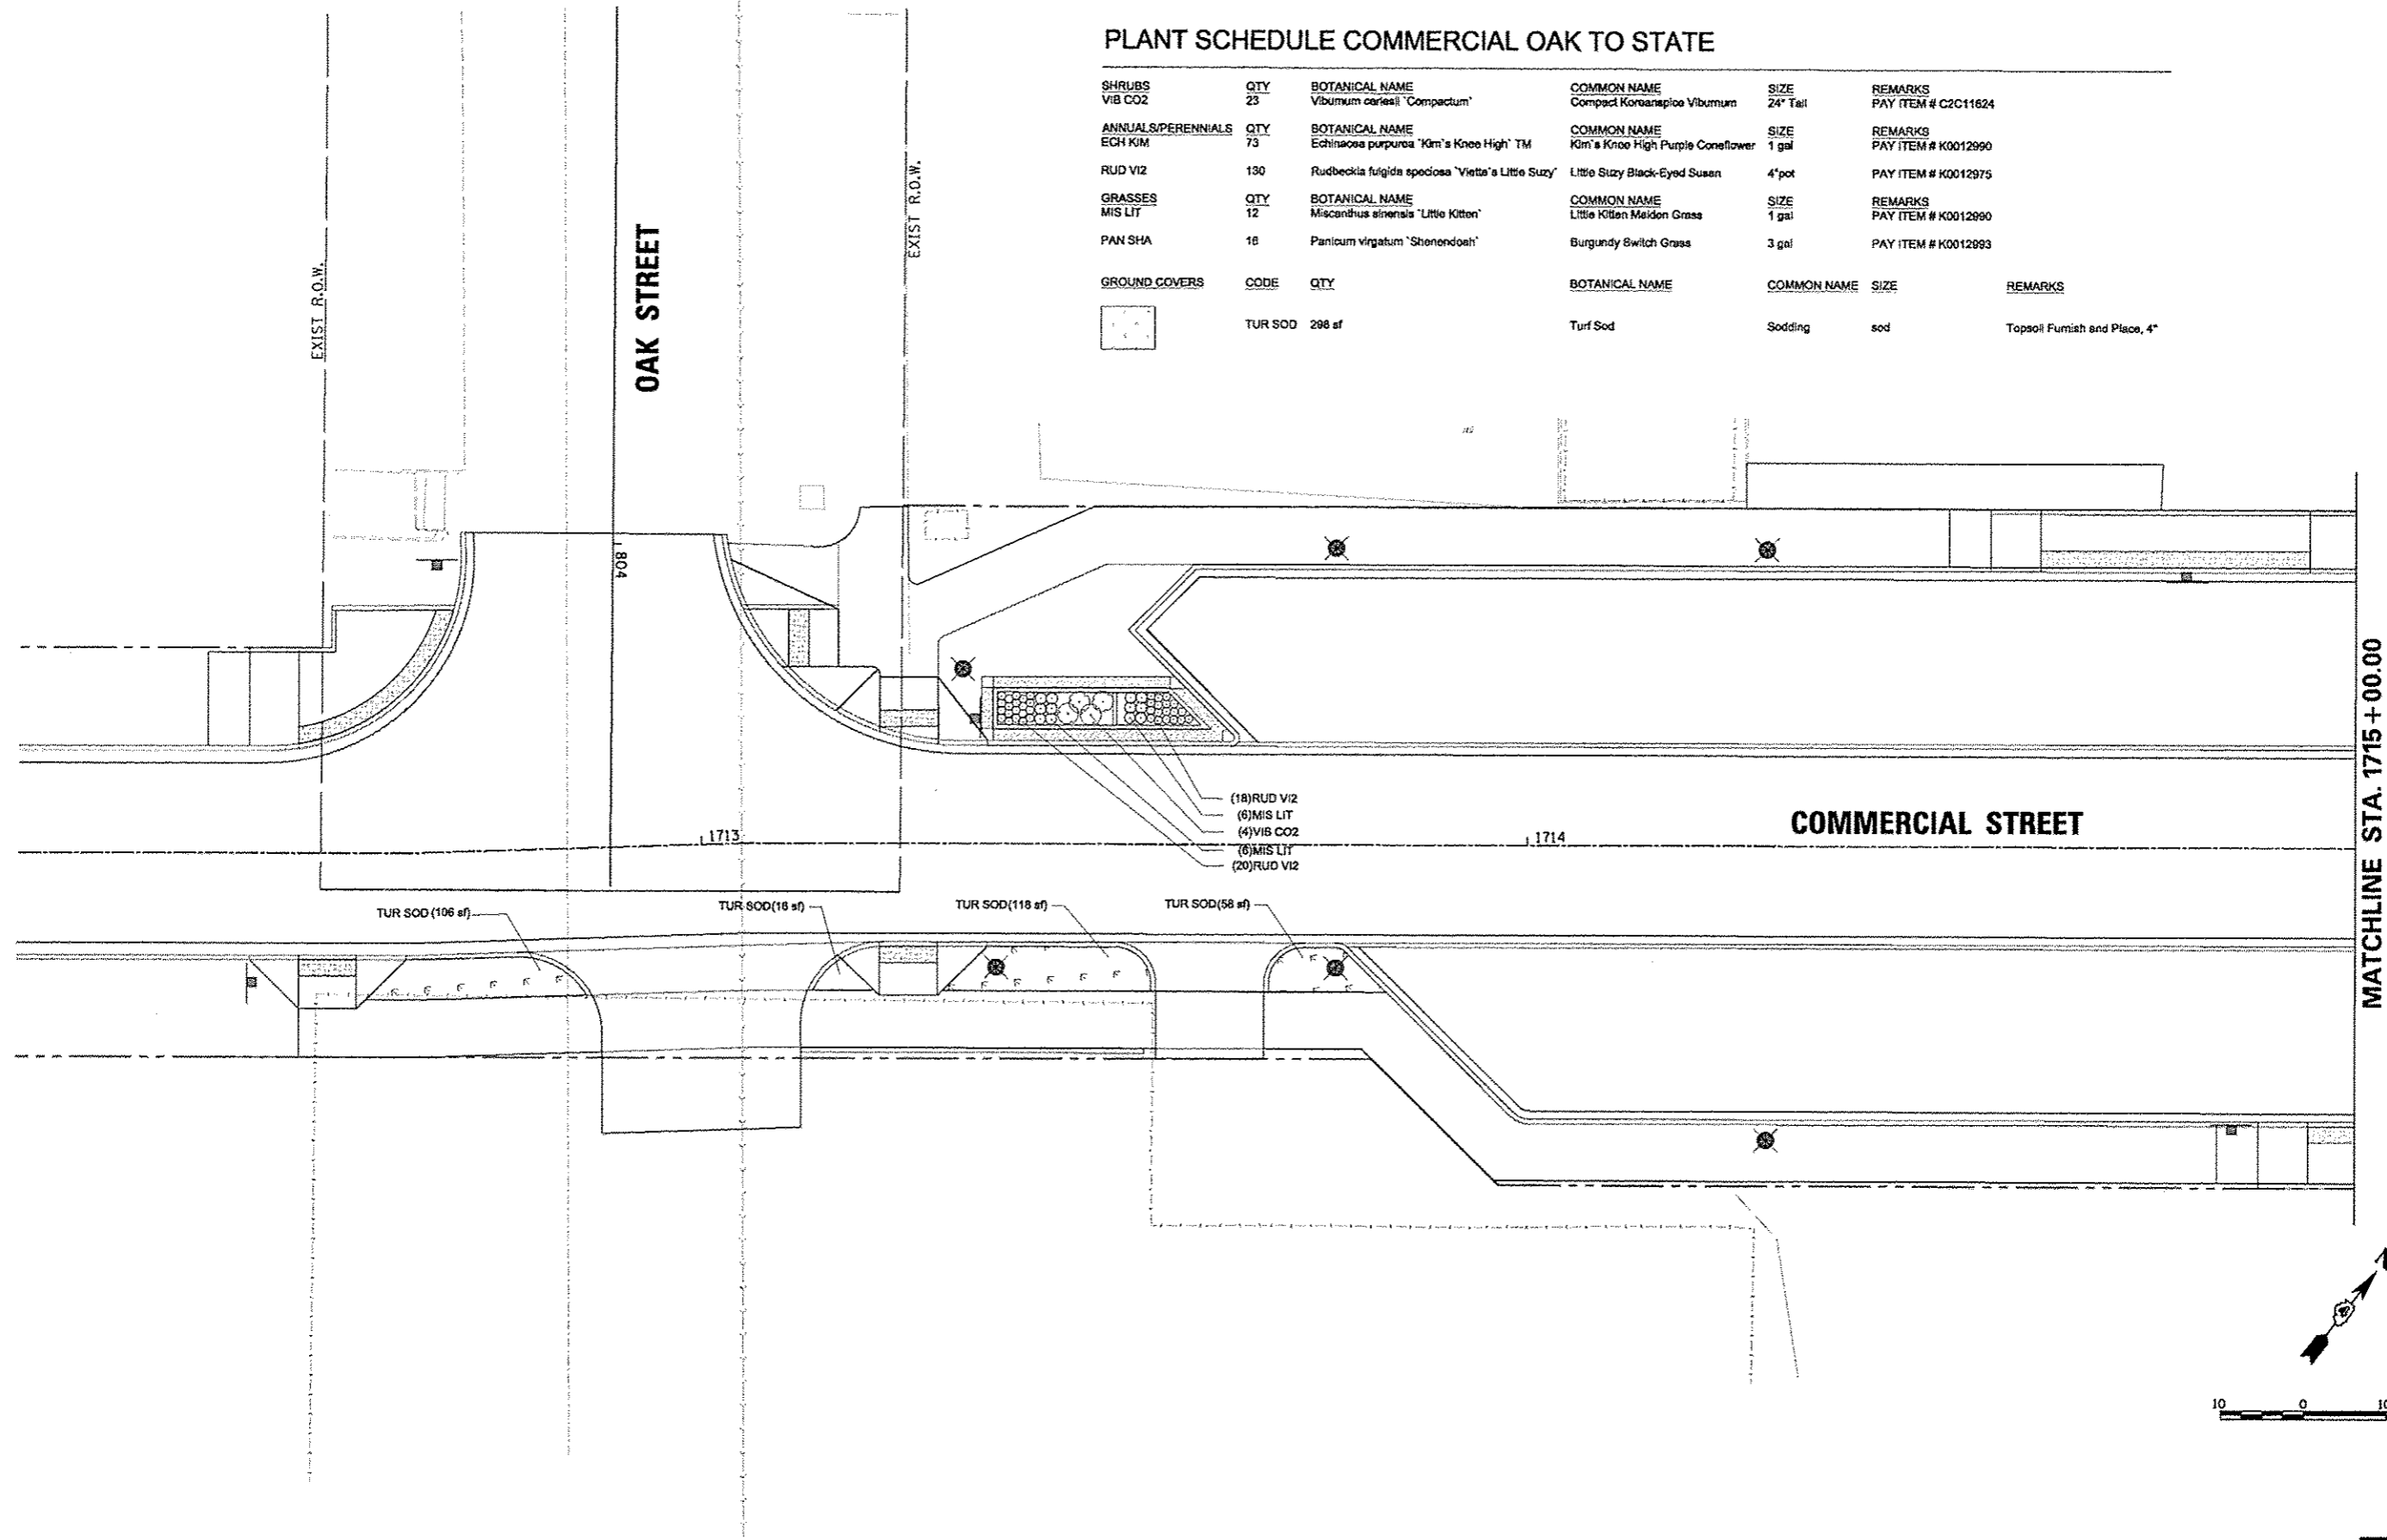

MATCHLINE STA. 1715 + 00.00

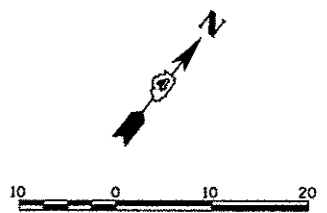



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	PL0T SCALE = 20.0000' / 1"	CHECKED - BAB	REVISED -							
	PL0T DATE = 07/18/2012	DATE - 7/18/12	REVISED -							

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**PLANT SCHEDULE COMMERCIAL OAK TO STATE**


SHRUBS	QTY	BOTANICAL NAME	COMMON NAME	SIZE	REMARKS	
VIB CO2	23	Viburnum cerasifolium 'Compactum'	Compact Koreanspice Viburnum	24" Tall	PAY ITEM # C2C11024	
ANNUALS/PERENNIALS	QTY	BOTANICAL NAME	COMMON NAME	SIZE	REMARKS	
ECH KIM	73	Echinacea purpurea 'Kim's Knee High' TM	Kim's Knee High Purple Coneflower	1 gal	PAY ITEM # K0012990	
RUD V12	130	Rudbeckia fulgida speciosa 'Vitto's Little Suzy'	Little Suzy Black-Eyed Susan	4" pot	PAY ITEM # K0012975	
GRASSES	QTY	BOTANICAL NAME	COMMON NAME	SIZE	REMARKS	
MIS LIT	12	Macanthus aiensis 'Little Kitten'	Little Kitten Maiden Grass	1 gal	PAY ITEM # K0012990	
PAN SHA	16	Panicum virgatum 'Shenendoah'	Burgundy Switch Grass	3 gal	PAY ITEM # K0012993	
GROUND COVERS	CODE	QTY	BOTANICAL NAME	COMMON NAME	SIZE	REMARKS
	TUR SOD	298 sf	Turf Sod	Sodding sod		Topsoll Furnish and Place, 4"

MATCHLINE STA. 1715 + 00.00

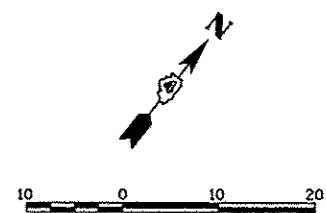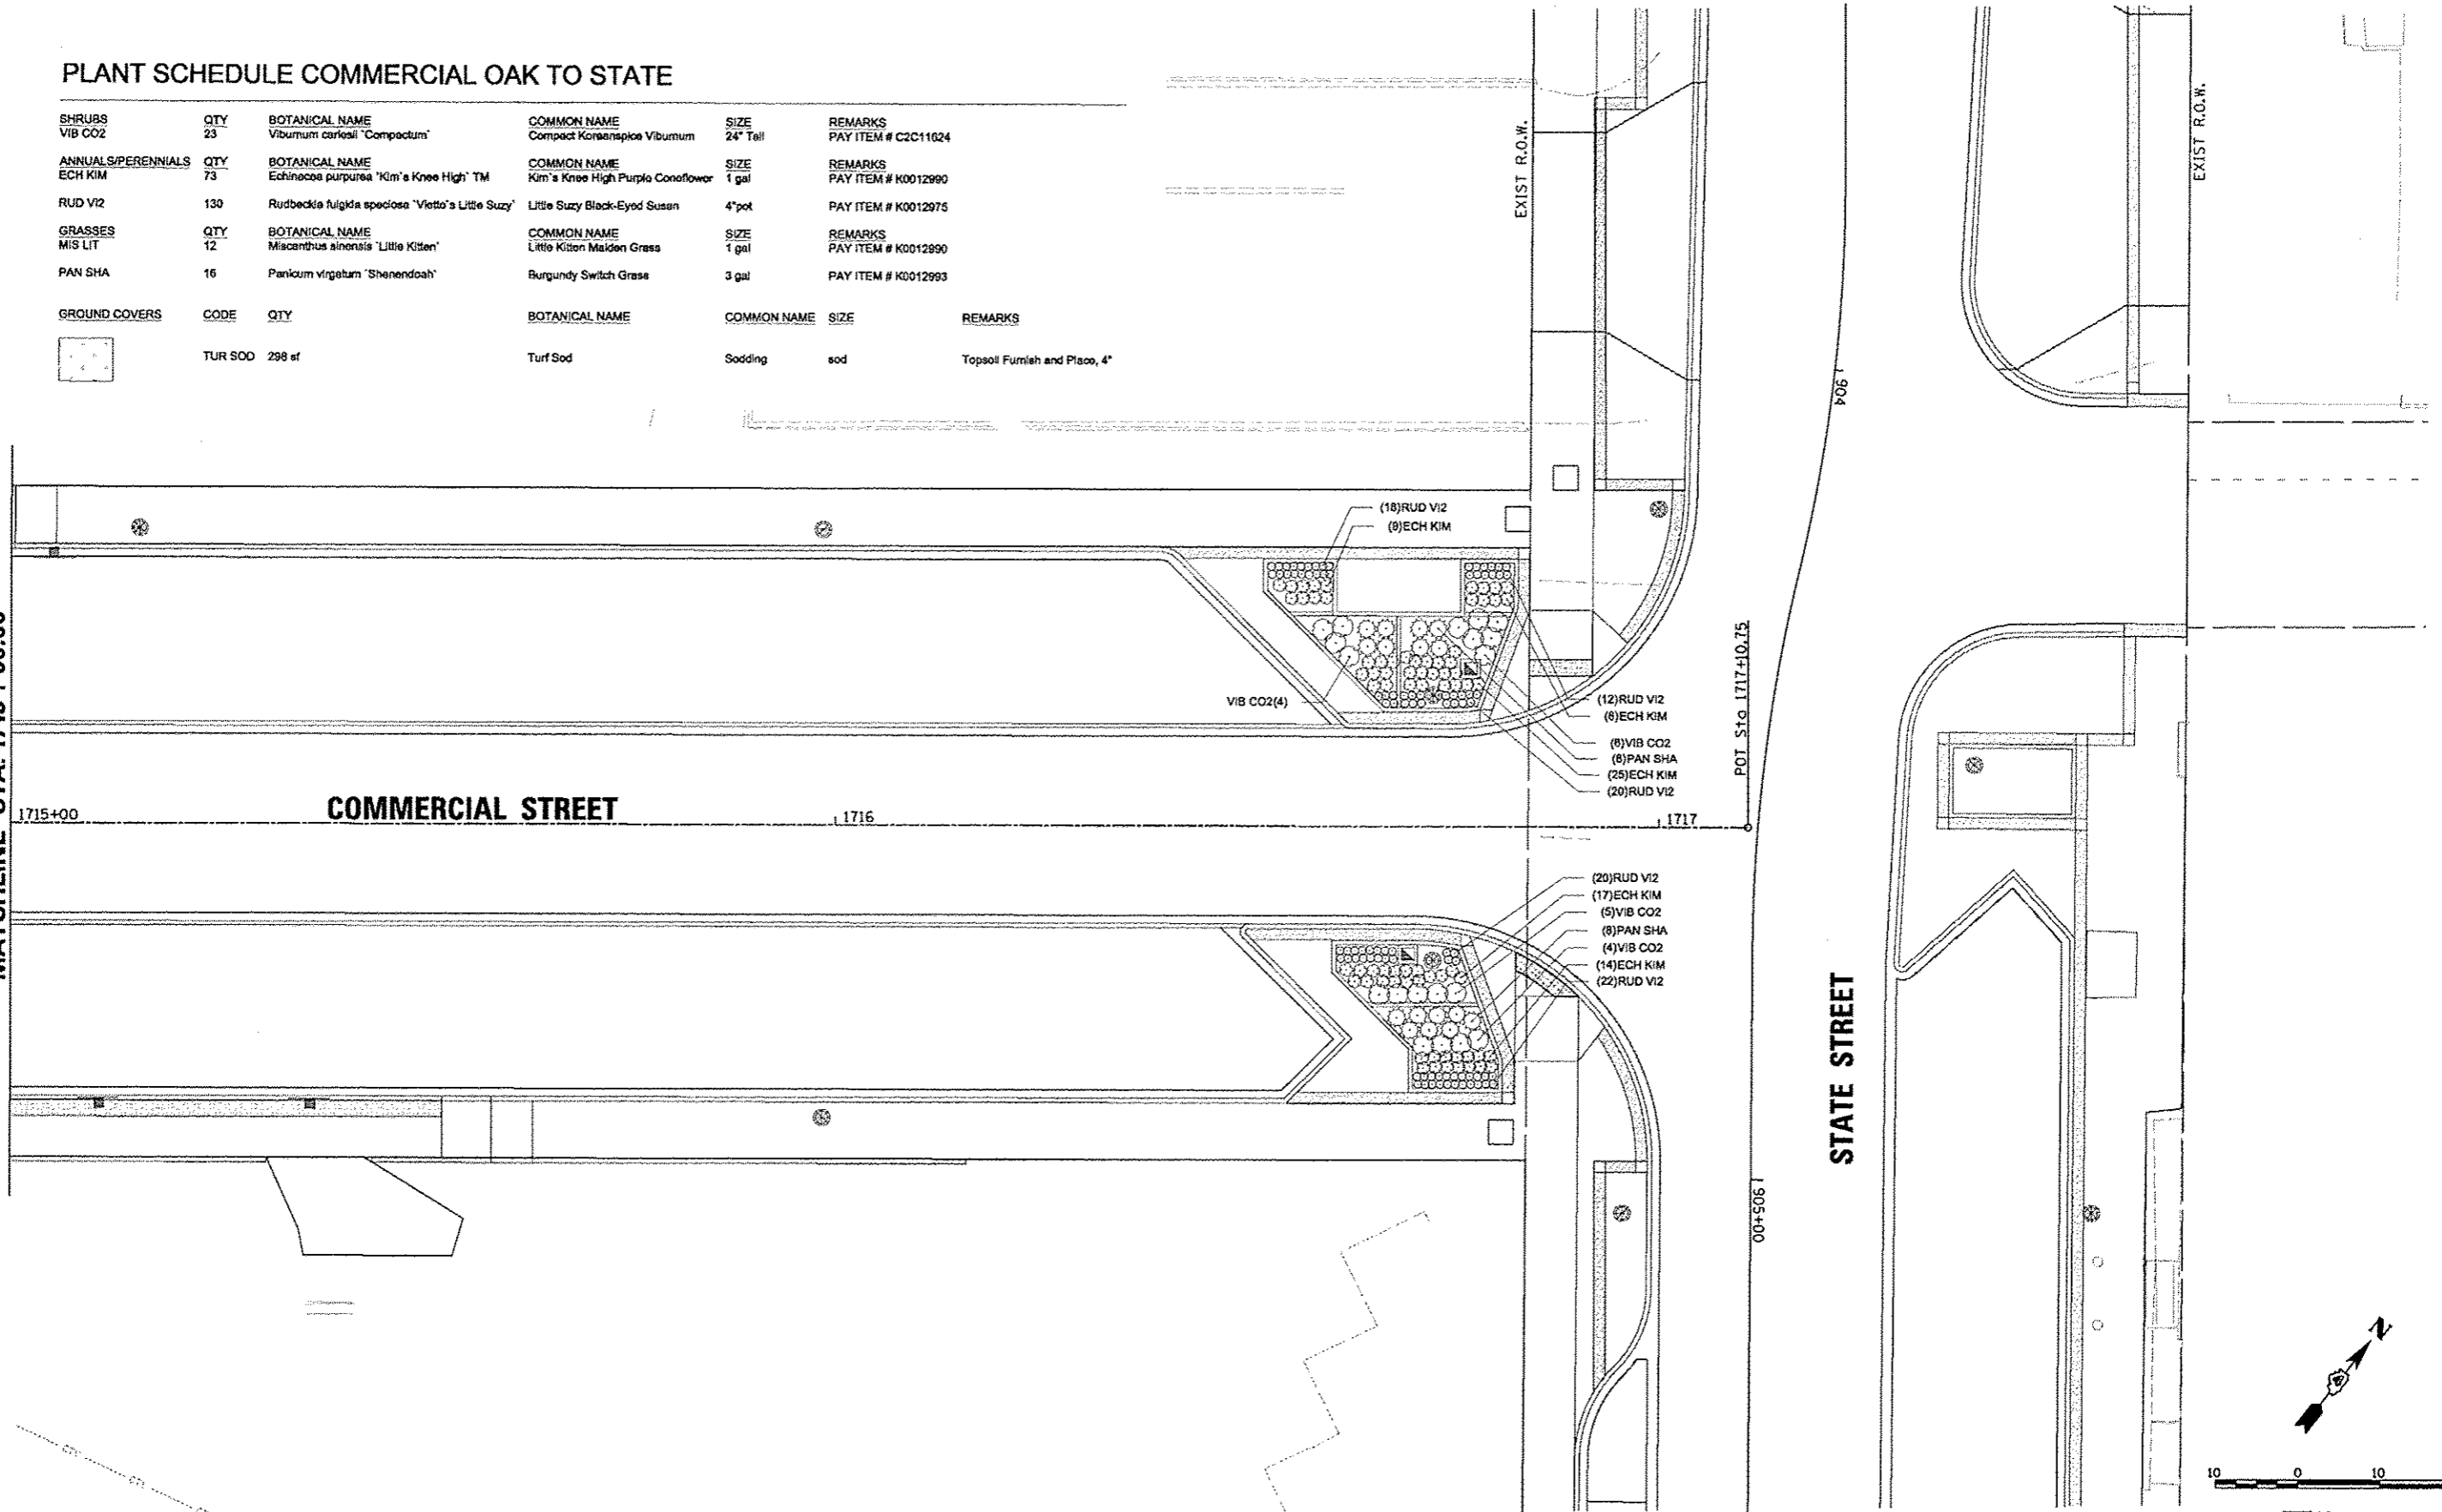

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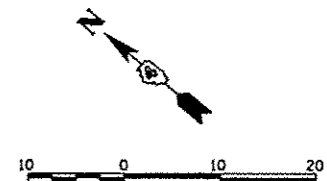
FILE NAME * o:\p\150_wor-k\do_net_doloto\dms73427\04	USER NAME * manah.B1398	DESIGNED - JLH	REVISED -	<b>STATE OF ILLINOIS DEPARTMENT OF TRANSPORTATION</b>	<b>COMMERCIAL STREET PLANTING PLAN</b>		F.A.U. RTE.	SECTION 12-00356-01-PV	COUNTY PEORIA	TOTAL SHEETS 519	SHEET NO. 344	
PLOT SCALE * 20,0000 / in.	DRAWN - JLH	CHECKED - BAB	REVISED -		SCALE: 1"=10'	SHEET NO. OF SHEETS	STA. 1715+00 TO STA. 1717+00	CONTRACT NO. 89626		ILLINOIS FED. AID PROJECT T10-5035(158)		
PLOT DATE * 07/23/2012	DATE - 7/18/12	REVISED -	REVISED -									

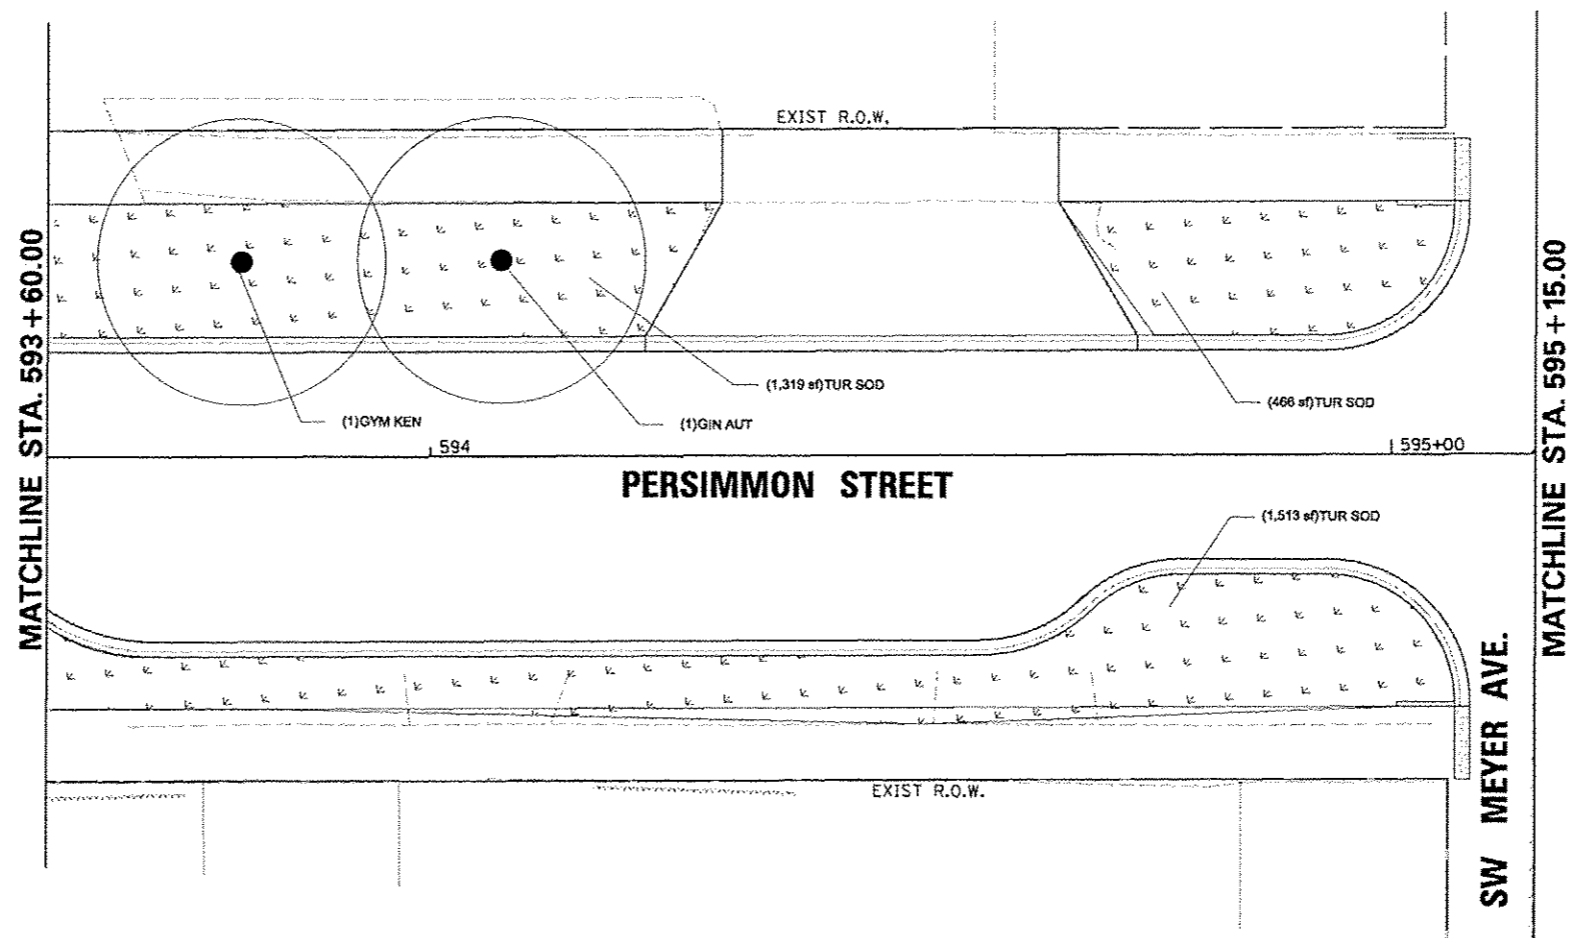

**PLANT SCHEDULE PERSIMMON - JEFFERSON TO ADAMS**

TREES	QTY	BOTANICAL NAME	COMMON NAME	SIZE	REMARKS
GIN AUT	1	Ginkgo biloba 'Autumn Gold' TM	Autumn Gold Ginkgo	2" Cal	PAY ITEM # A2004512
GYM KEN	1	Gymnocladus dioica	Kentucky Coffeetree	2" Cal	PAY ITEM # A2005016

GROUND COVERS	CODE	QTY	BOTANICAL NAME	COMMON NAME	SIZE	REMARKS
	TUR SOD	6,852 sf	Turf Sod	Sodding	sod	Topsoli Furnish and Place, 4"






**Farnsworth GROUP**  
 7707 N. KNOXVILLE AVE., SUITE 100  
 PEORIA, ILLINOIS 61614  
 (309) 693-6666 / (309) 693-9820 Fax  
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FILE NAME *	USER NAME * manak.B1378	DESIGNED - JLH	REVISED -	<b>STATE OF ILLINOIS DEPARTMENT OF TRANSPORTATION</b>	<b>PERSIMMON STREET PLANTING PLAN</b>			F.A.U. RTE.	SECTION	COUNTY	TOTAL SHEETS	SHEET NO.	
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	PLOT DATE * 07/23/2012	DATE - 7/18/12	REVISED -		ILLINOIS FED. AID PROJECT TIC-50931581								

# PLANT SCHEDULE PERSIMMON - JEFFERSON TO ADAMS

TREES	QTY	BOTANICAL NAME	COMMON NAME	SIZE	REMARKS
GIN AUT	1	Ginkgo biloba 'Autumn Gold' TM	Autumn Gold Ginkgo	2" Cal	PAY ITEM # A2004512
GYM KEN	1	Gymnocladus dioica	Kentucky Coffeetree	2" Cal	PAY ITEM # A2005016

GROUND COVERS	CODE	QTY	BOTANICAL NAME	COMMON NAME	SIZE	REMARKS
	TUR SOD	6,852 sf	Turf Sod	Sodding	sod	Topsoil Furnish and Place, 4"

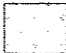

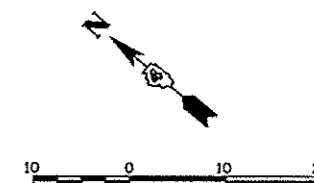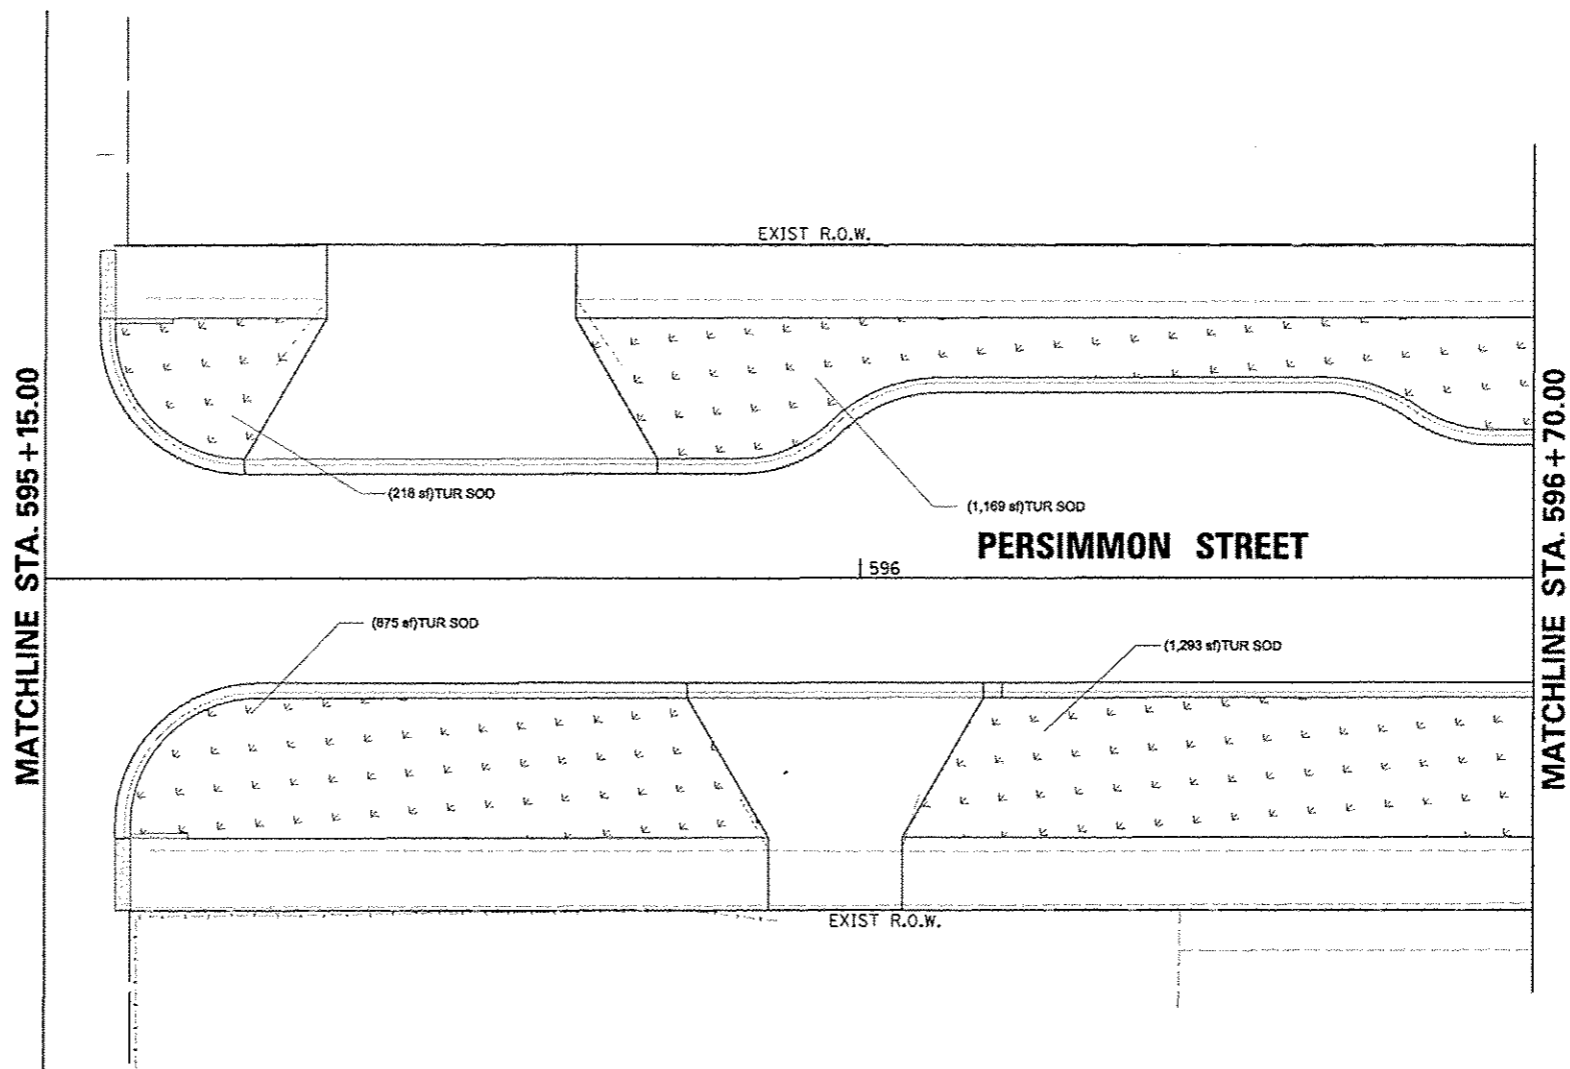
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PLOT SCALE = 20.0000' / 1" =	CHECKED - BAB	REVISED -	SCALE: 1"=10'			SHEET NO. OF SHEETS	STA. 595+15 TO STA. 596+70	CONTRACT NO. 89626		ILLINOIS FED. AID PROJECT	TIC-50931581
PLOT DATE = 07/23/2012	DATE - 7/18/12	REVISED -									



**Farnsworth GROUP**  
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 PEORIA, ILLINOIS 61614  
 (309) 669-9666 / (309) 669-9620 Fax  
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# PLANT SCHEDULE MAPLE - JEFFERSON TO ADAMS

TREES	QTY	BOTANICAL NAME	COMMON NAME	SIZE	REMARKS
ACE LEG	4	Acer saccharum 'Legacy'	Legacy Sugar Maple	2" Cal	PAY ITEM # A2001916
ACE AUT	5	Acer x freemanii 'Autumn Blaze'	Autumn Blaze Freeman Maple	2" Cal	PAY ITEM # A2000116

GROUND COVERS	CODE	QTY	BOTANICAL NAME	COMMON NAME	SIZE	REMARKS
	TUR SOD	6,777 sf	Turf Sod	Sodding	sod	Topsoil Furnish and Place, 4"

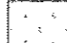

FILE NAME *	USER NAME = monek81390	DESIGNED - JLH	REVISED -
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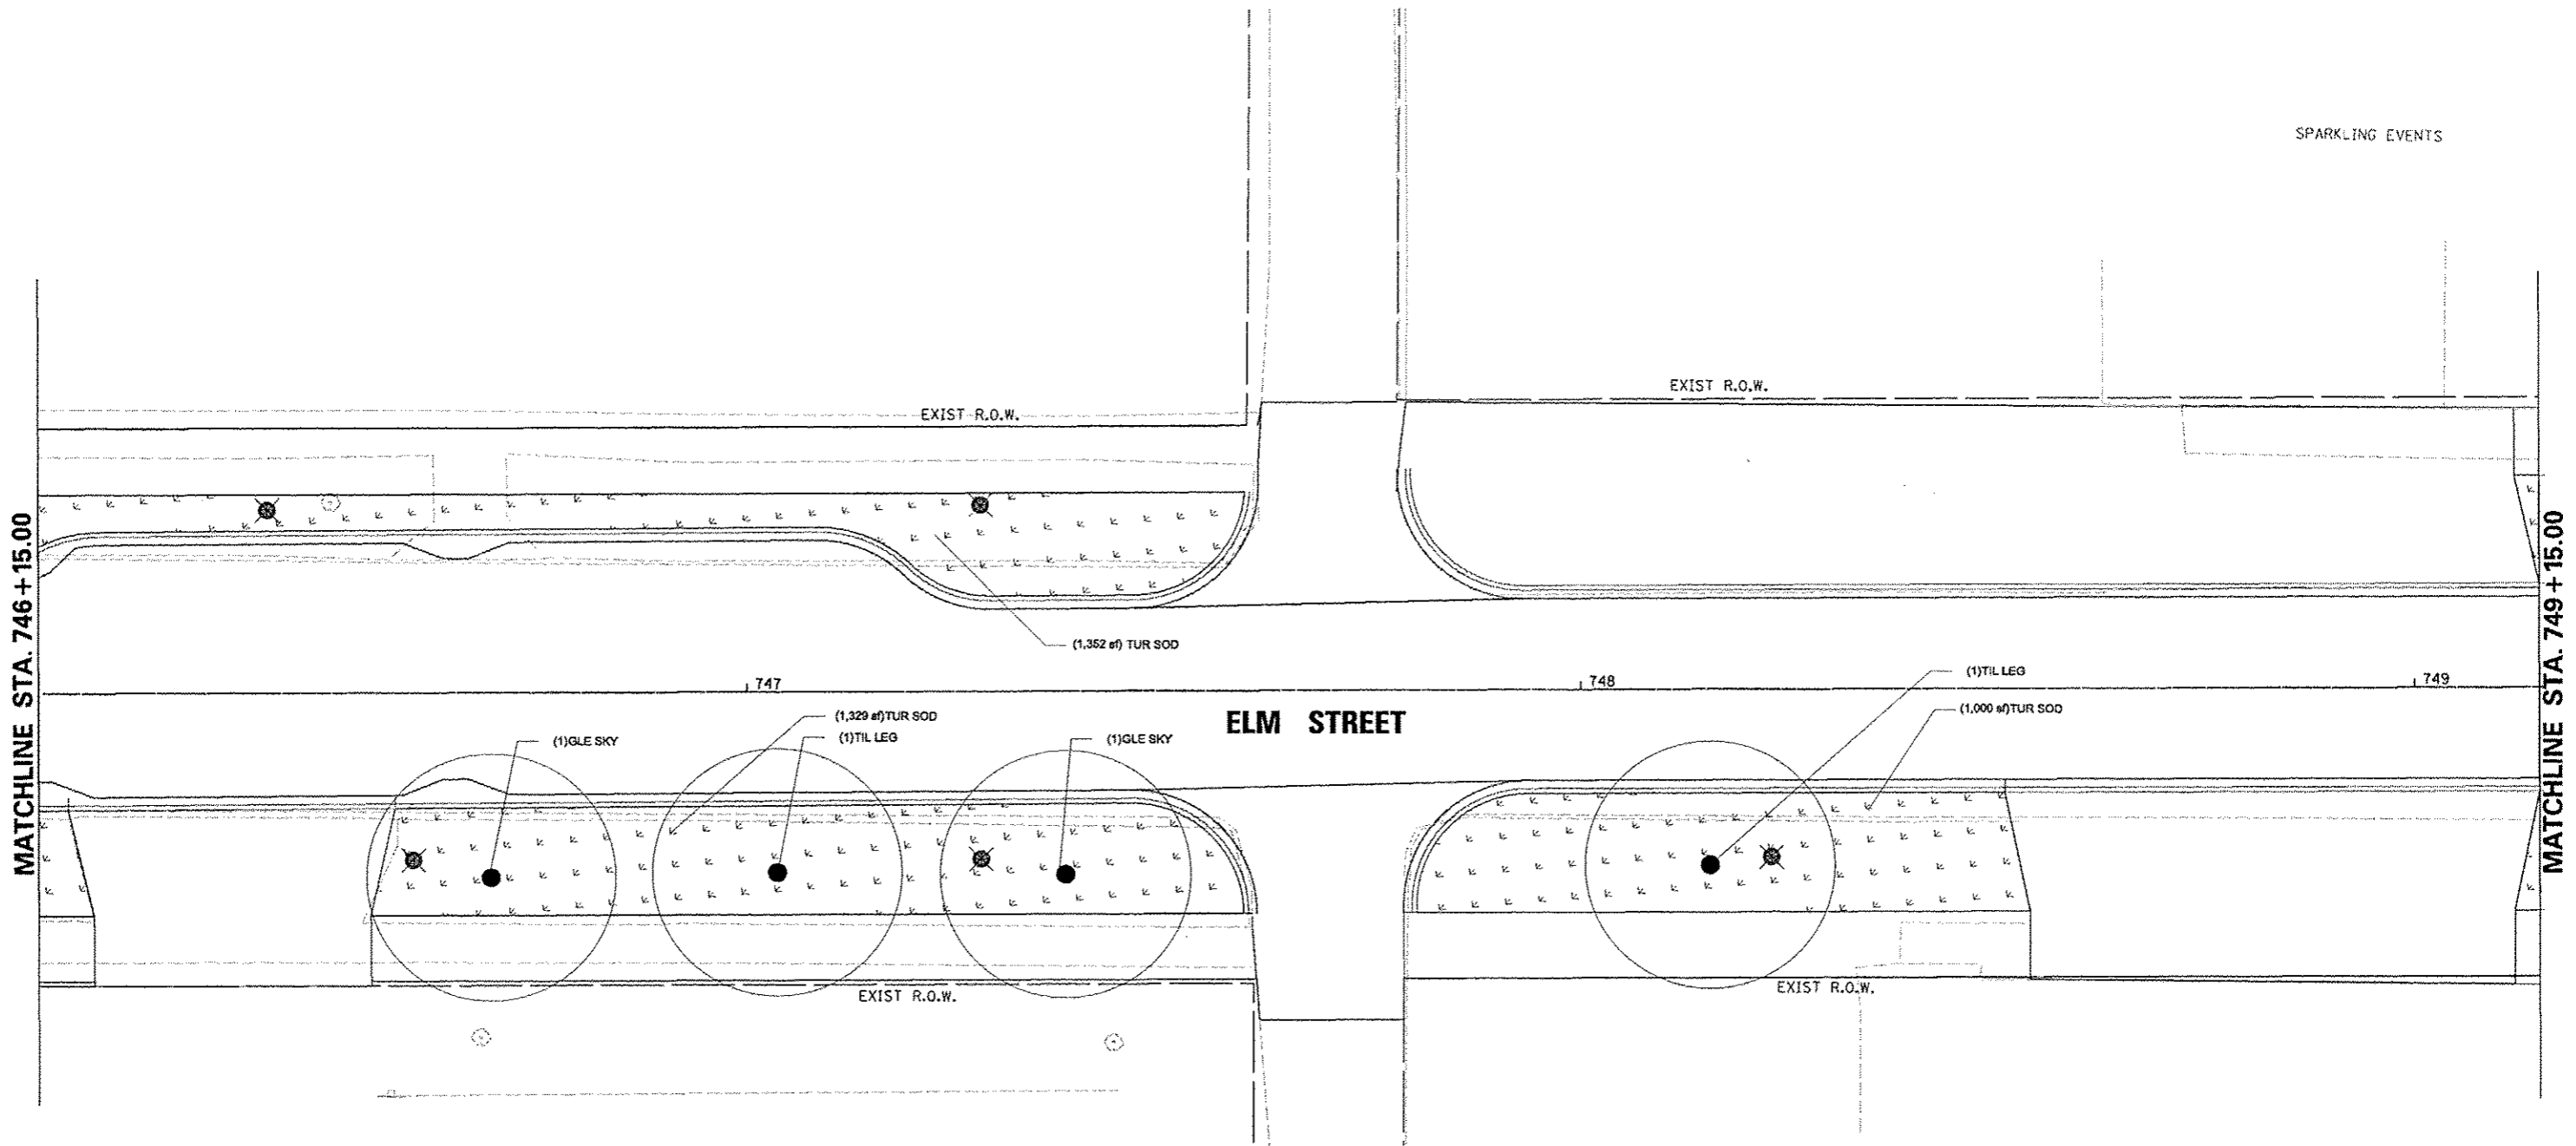
**STATE OF ILLINOIS  
DEPARTMENT OF TRANSPORTATION**
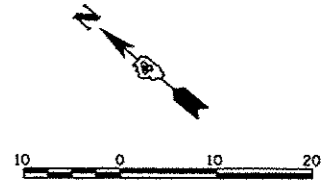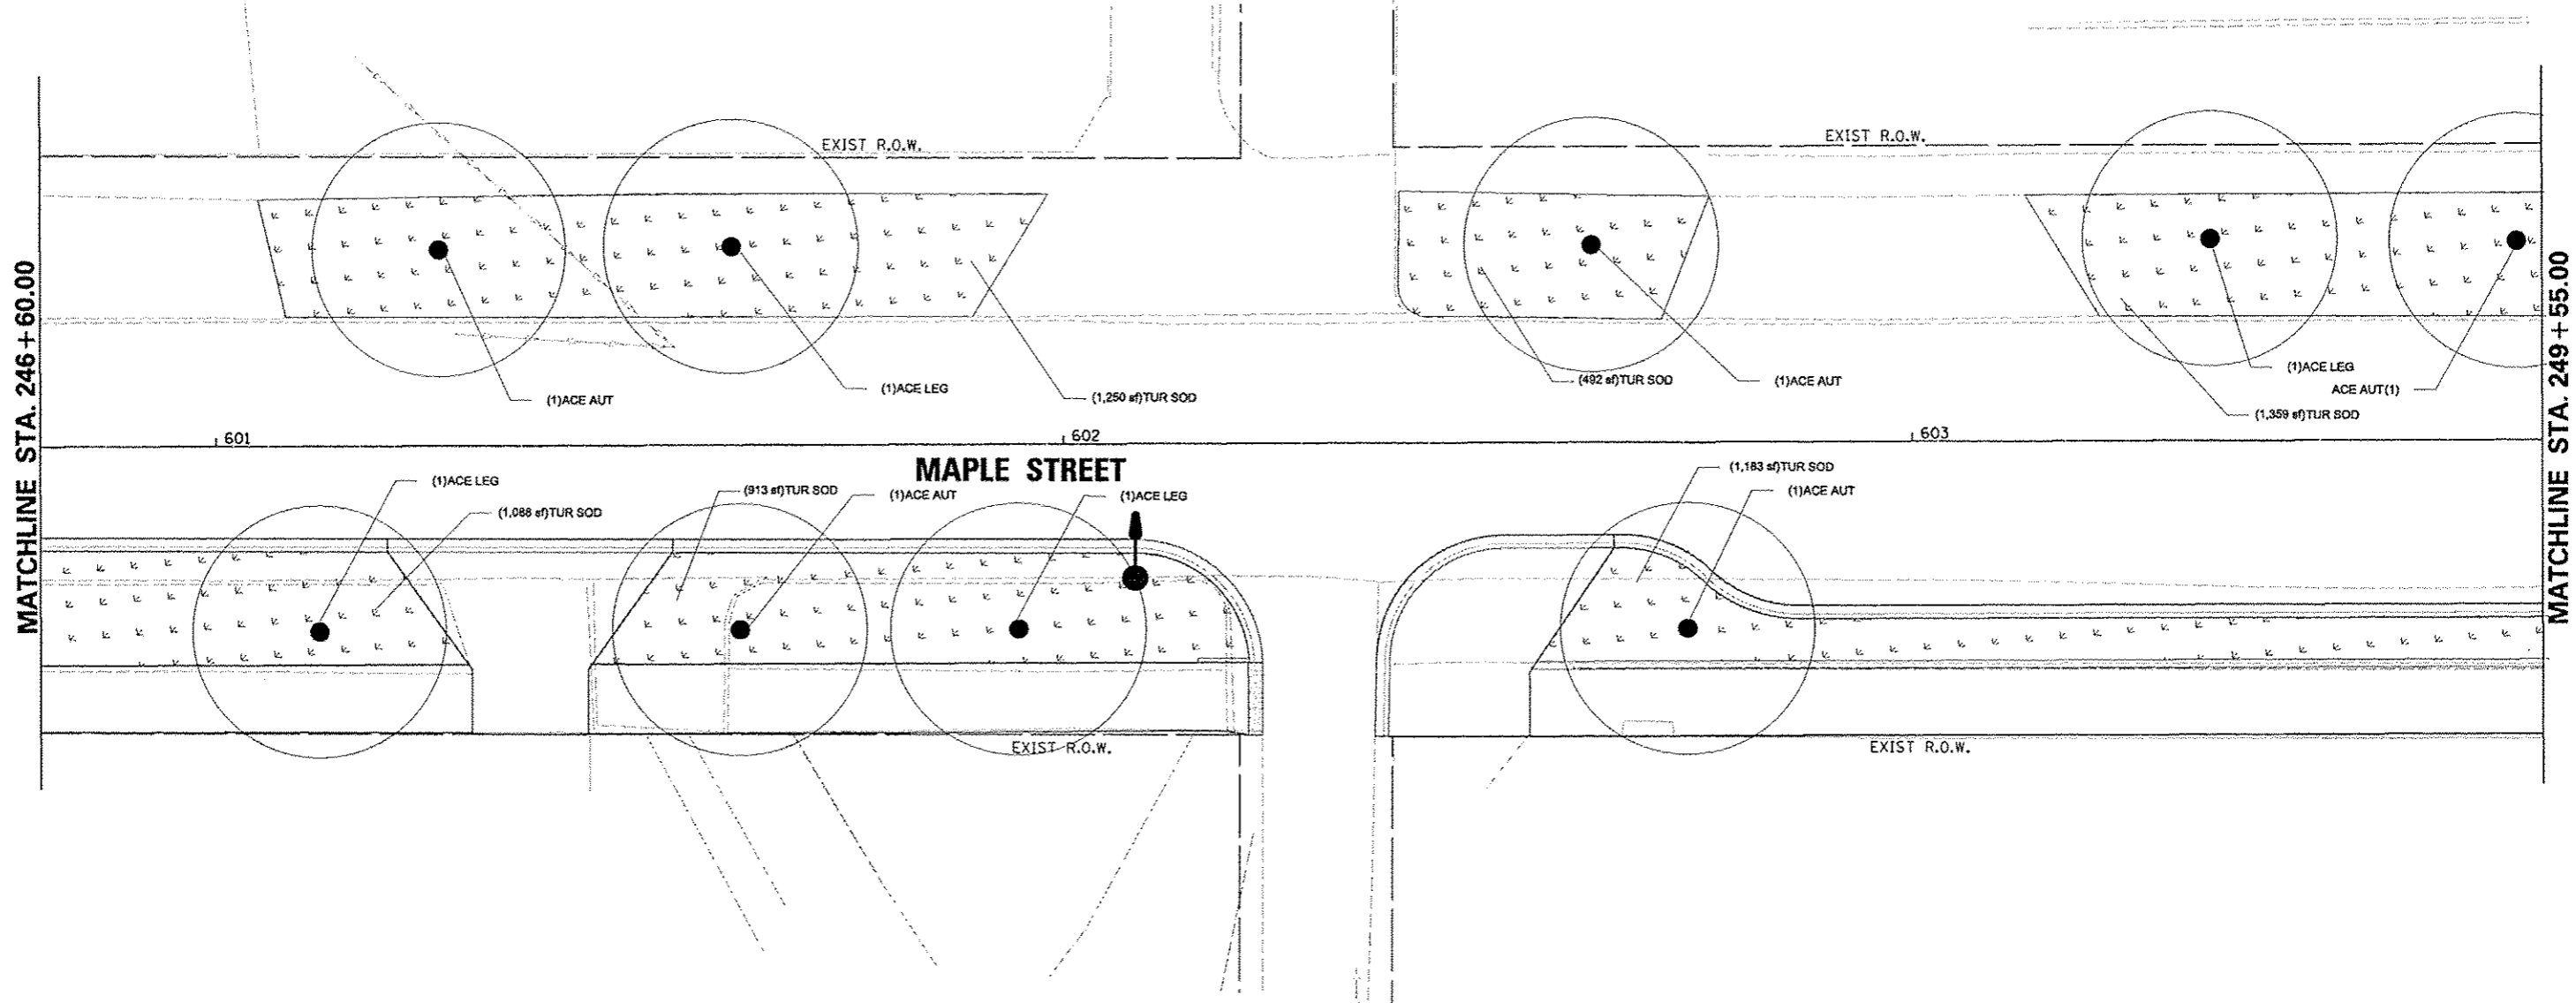
<b>MAPLE STREET PLANTING PLAN</b>		F.A.U. RTE.	SECTION	COUNTY	TOTAL SHEETS	SHEET NO.
SCALE: 1"=10'	SHEET NO. OF SHEETS	STA. 246+60	TO STA. 249+55	12-00356-01-PV	519	347

CONTRACT NO. 89626		ILLINOIS (FEB. 10) PROJECT TIC-509315B1	
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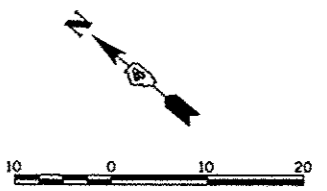
**Farnsworth GROUP**  
7707 N. KNOXVILLE AVE., SUITE 100  
PEORIA, ILLINOIS 61614  
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SPARKLING EVENTS



**PLANT SCHEDULE ELM - JEFFERSON TO ADAMS**


TREES	QTY	BOTANICAL NAME	COMMON NAME	SIZE	REMARKS	
GLE SKY	2	Gleditsia triacanthos inermis 'Skyline'	Skyline Thornless Common Honeylocust	2" Cal	PAY ITEM # A2004816	
TIL LEG	2	Tilia americana 'Legend'	American Legend Linden	2" Cal	PAY ITEM # A2007848	
GROUND COVERS	CODE	QTY	BOTANICAL NAME	COMMON NAME	SIZE	REMARKS
		TUR SOD	5,280 sf	Turf Sod	Sodding sod	Topeco! Furnish and Place, 4"



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FILE NAME = c:\p1510_work\do_not_delete\dms73427\04	USER NAME = monak01310	DESIGNED = JLH	REVISED =	<b>STATE OF ILLINOIS DEPARTMENT OF TRANSPORTATION</b>	<b>ELM STREET PLANTING PLAN</b>		F.A.U. RTE. 12	SECTION 12-00356-01-PV	COUNTY PEORIA	TOTAL SHEETS 519	SHEET NO. 348
	PLOT SCHLE = 20.0000' / 1"	CHECKED = BAB	REVISED =		SCALE: 1"=10'	SHEET NO. OF SHEETS	STA. 746+15 TO STA. 749+15	CONTRACT NO. 89626		[ILLINOIS] FED. AID PROJECT TIC-509311581	
	PLOT DATE = 07/23/2012	DATE = 7/18/12	REVISED =								



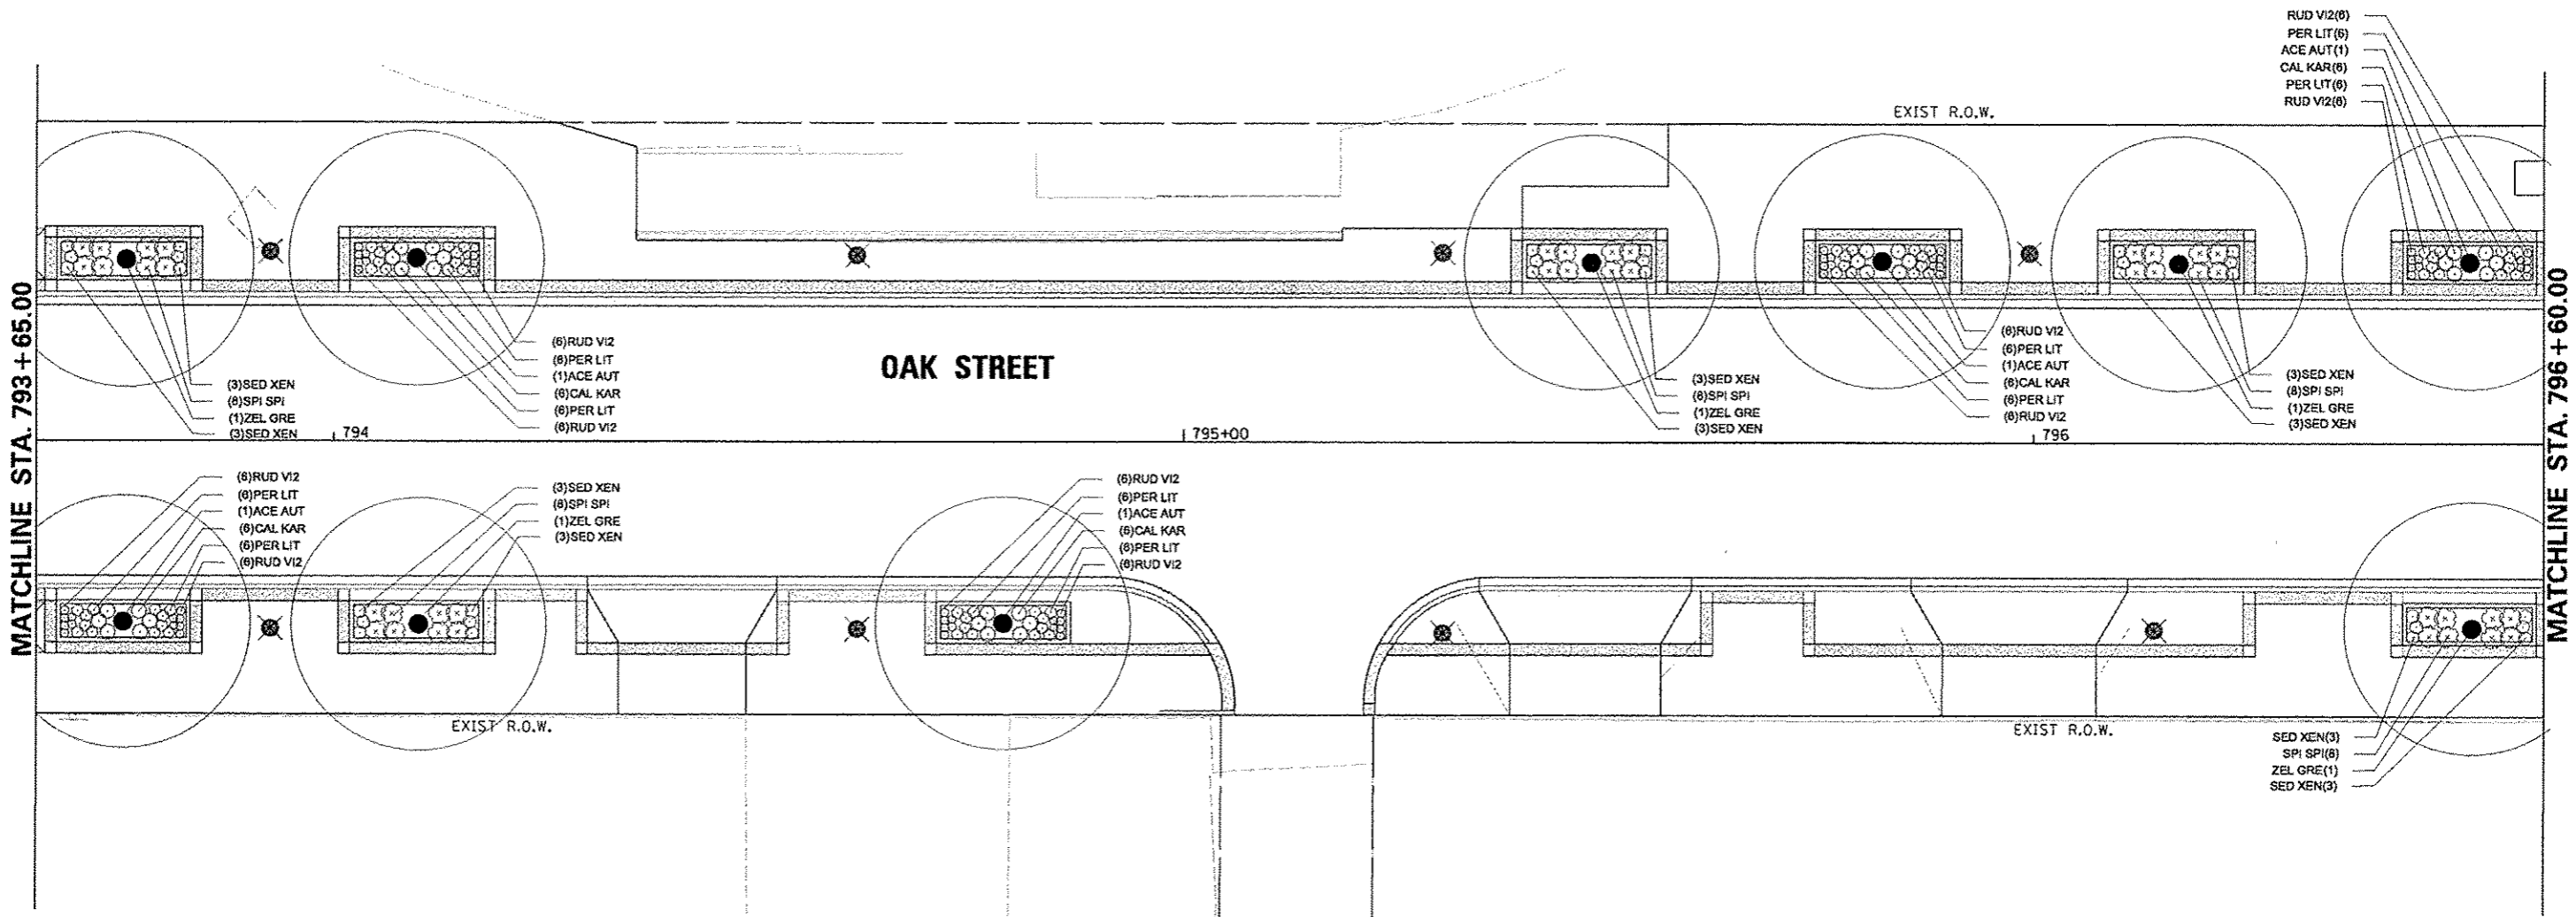


### PLANT SCHEDULE OAK - JEFFERSON TO ADAMS

TREES	QTY	BOTANICAL NAME	COMMON NAME	SIZE	REMARKS
ACE AUT	6	Acor x 'freemanii' 'Autumn Blaze'	Autumn Blaze Freeman Maple	2" Cal	PAY ITEM # A2000116
ZEL GRE	5	Zelkova serrata 'Green Vase'	Green Vase Zelkova	2" Cal	PAY ITEM # A3005238
SHRUBS	QTY	BOTANICAL NAME	COMMON NAME	SIZE	REMARKS
SPI SPI	42	Spiraea japonica 'Little Princess'	Little Princess Japanese Spirea	18" Tall	PAY ITEM # C2C10218
ANNUALS/PERENNIALS	QTY	BOTANICAL NAME	COMMON NAME	SIZE	REMARKS
PER LIT	84	Perovskia atriplicifolia 'Little Spiro' TM	Little Spiro Russian Sage	1 gal	PAY ITEM # K0012990
RUD VI2	84	Rudbeckia fulgida speciosa 'Vitto's Little Suzy'	Little Suzy Black-Eyed Susan	4" pot	PAY ITEM # K0012975
SED XEN	38	Sedum telephium 'Xenox'	Xenox Sedum	1 gal	PAY ITEM # K0012990
GRASSES	QTY	BOTANICAL NAME	COMMON NAME	SIZE	REMARKS
CAL KAR	42	Calamagrostis x scutiflora 'Karl Foerster'	Karl Foerster Feather Reed Grass	3 gal	PAY ITEM # K0012993




**Farnsworth GROUP**  
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FILE NAME c:\pwise_work\do_not_delete\dms73427\04818155-shrtp\plan\078.dgn	USER NAME marak.B1398	DESIGNED - JLH	REVISED -	STATE OF ILLINOIS DEPARTMENT OF TRANSPORTATION	OAK STREET PLANTING PLAN				F.A.U. RTE. 121	SECTION 12-00356-01-PV	COUNTY PEORIA	TOTAL SHEETS 519	SHEET NO. 349
PLOT SCALE = 20.0000' / 1" =	CHECKED - BAB	REVISED -	REVISED -		SCALE 1"=10'	SHEET NO.	OF	SHEETS	STA. 793+65	TO STA. 796+60	CONTRACT NO. B9626		
PLOT DATE = 07/23/2012	DATE - 7/18/12	REVISED -	REVISED -		ILLINOIS FED. AID PROJECT TIG-509315B1								

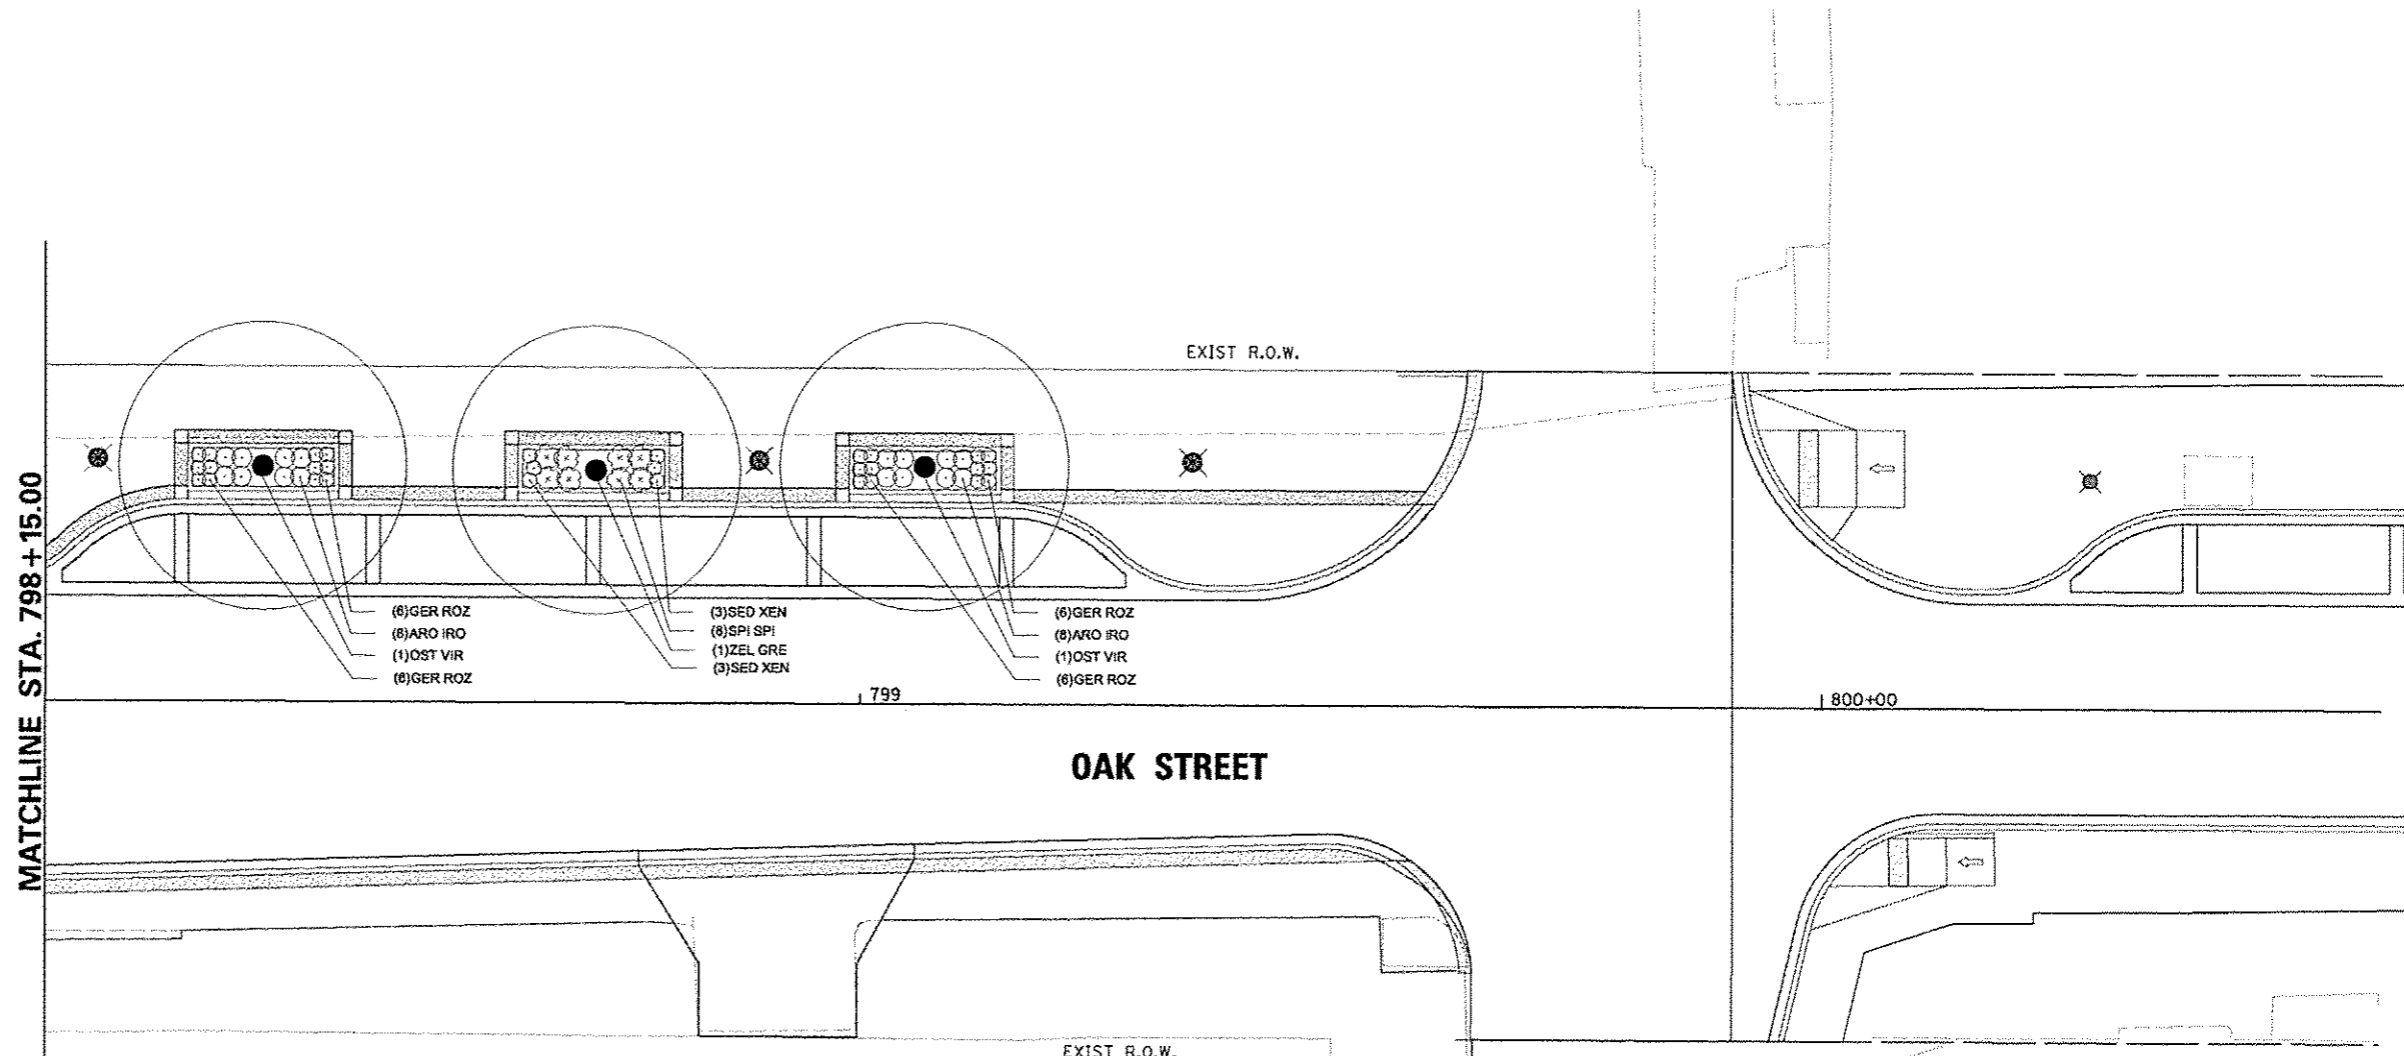


### PLANT SCHEDULE OAK - ADAMS TO WASHINGTON

TREES	QTY	BOTANICAL NAME	COMMON NAME	SIZE	REMARKS
OST VIR	2	Ostrya virginiana	American Hophornbeam	2" Cal	PAY ITEM # A2005816
ZEL GRE	1	Zelkova serrata 'Green Vase'	Green Vase Zelkova	2" Cal	PAY ITEM # A3005238
SHRUBS	QTY	BOTANICAL NAME	COMMON NAME	SIZE	REMARKS
ARO IRO	18	Aronia melanocarpa 'Iroquois Beauty' TM	Iroquois Beauty Black Chokeberry	24" Tall	PAY ITEM # C2000324
EUO ALA	3	Euonymus alata 'Compacta'	Dwarf Winged Euonymus	3' Tall	PAY ITEM # C2002636
SPI SPI	8	Spiraea japonica 'Little Princess'	Little Princess Japanese Spiraea	18" Tall	PAY ITEM # C2C10218
ANNUALS/PERENNIALS	QTY	BOTANICAL NAME	COMMON NAME	SIZE	REMARKS
GER ROZ	24	Geranium x 'Rozanne' TM	Rozanne Cranesbill	1 gal	PAY ITEM # K0012990
NEP WAL	24	Nepeta x faassenii 'Walkers Low'	Walkers Low Catmint	1 gal	PAY ITEM # K0012990
PER LIT	34	Perovskia atriplicifolia 'Little Spire' TM	Little Spire Russian Sage	1 gal	PAY ITEM # K0012990
SED XEN	8	Sedum telephium 'Xenox'	Xenox Sedum	1 gal	PAY ITEM # K0012990
GRASSES	QTY	BOTANICAL NAME	COMMON NAME	SIZE	REMARKS
SPO HET	31	Sporobolus heterolepis	Prairie Dropseed	1 gal	PAY ITEM # K0012990

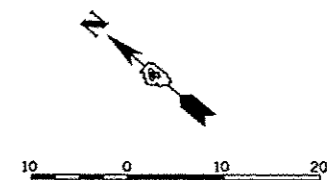


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 PEORIA, ILLINOIS 61614  
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FILE NAME * c:\pwise_work\do_not_delete\dm\73427\04	USER NAME * monak01370	DESIGNED * JLH	REVISED * -	<b>STATE OF ILLINOIS DEPARTMENT OF TRANSPORTATION</b>	<b>OAK STREET PLANTING PLAN</b>			F.A.U. RTE. 12	SECTION 12-00356-01-PV	COUNTY PEORIA	TOTAL SHEETS 519	SHEET NO. 350
PLT SCALE * 20.0000' / 1"	CHECKED * BAB	DATE * 7/18/12	REVISED * -		SCALE: 1"=10'	SHEET NO. OF SHEETS	STA. 798+15 TO STA. 800+00	CONTRACT NO. 89626		ILLINOIS FED. AID PROJ. ECT TIC-50931159		
PLDT DATE * 8/23/2012	DATE * 7/18/12	REVISED * -	REVISED * -									

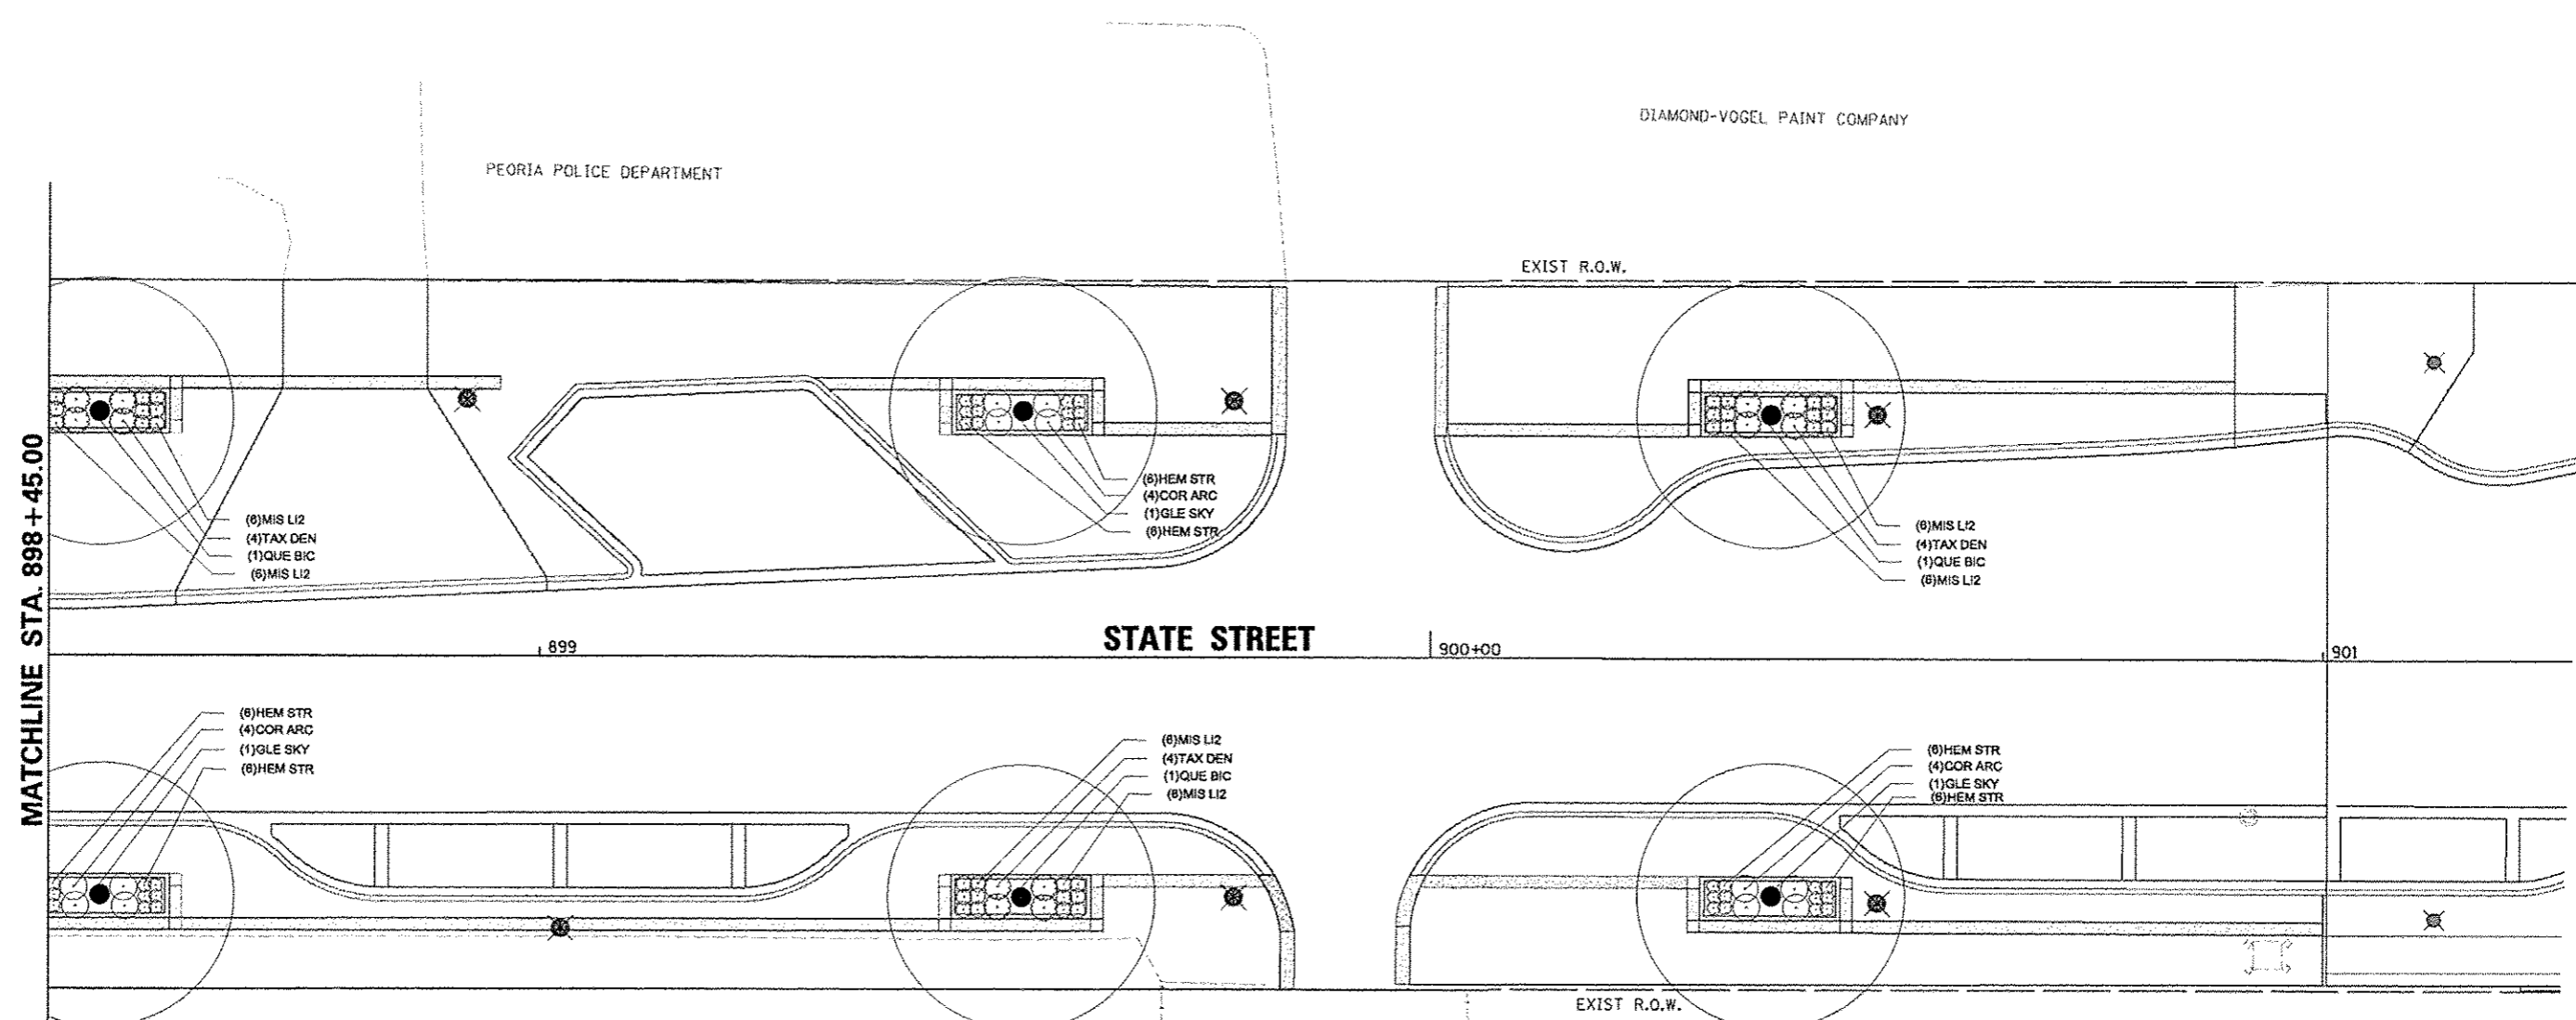


**PLANT SCHEDULE STATE - ADAMS TO WASHINGTON**

TREES	QTY	BOTANICAL NAME	COMMON NAME	SIZE	REMARKS
GLE SKY	3	Gleditsia triacanthos 'Inermis' 'Skyline'	Skyline Thornless Common Honeylocust	2" Cal	PAY ITEM # A2004816
QUE BIC	3	Quercus bicolor	Swamp White Oak	1.5" Cal	PAY ITEM # A2006516
SHRUBS	QTY	BOTANICAL NAME	COMMON NAME	SIZE	REMARKS
COR ARC	12	Cornus sanguinea 'Arctic Sun'	Arctic Sun Dogwood	2" Tall	PAY ITEM # C2C01612
RHU GRO	8	Rhus aromatica 'Gro-Low'	Gro-Low Fragrant Sumac	3 gal	PAY ITEM # C2C05803
SPI SPI	4	Spiraea japonica 'Little Princess'	Little Princess Japanese Spirea	18" Tall	PAY ITEM # C2C10218
TAX DEN	12	Taxus x media 'Danaiformis'	Danao Yew	2" Wide	PAY ITEM # D2003624
ANNUALS/PERENNIALS	QTY	BOTANICAL NAME	COMMON NAME	SIZE	REMARKS
COR ZAG	37	Coreopsis verticillata 'Zagreb'	Zagreb Threadleaf Coreopsis	4" pot	PAY ITEM # K0012975
HEM STR	38	Hemerocallis x 'Strawberry Candy' TM	Strawberry Candy Daylily	1 gal	PAY ITEM # K0012990
HEU PAL	14	Heuchera sanguinea 'Palace Purple'	Palace Purple Coralbells	1 gal	PAY ITEM # K0012990
PHL EM2	28	Phlox subulata 'Emerald Pink'	Emerald Pink Creeping Phlox	4" pot	PAY ITEM # K0012975
RUD FUL	22	Rudbeckia fulgida 'Goldsturm'	Goldsturm Black-Eyed Susan	1 gal	PAY ITEM # K0012990
GRASSES	QTY	BOTANICAL NAME	COMMON NAME	SIZE	REMARKS
MIS GRA	8	Miscanthus sinensis 'Gracillimus'	Gracillimus Maiden Grass	3 gal	PAY ITEM # K0012993
MIS LI2	38	Miscanthus sinensis 'Little Zebra'	Little Zebra Maiden Grass	3 gal	PAY ITEM # K0012993
SPO HET	20	Sporobolus heterolepis	Prairie Dropseed	1 gal	PAY ITEM # K0012990

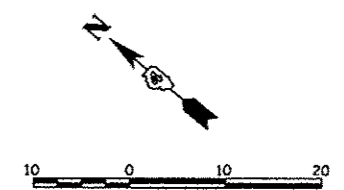


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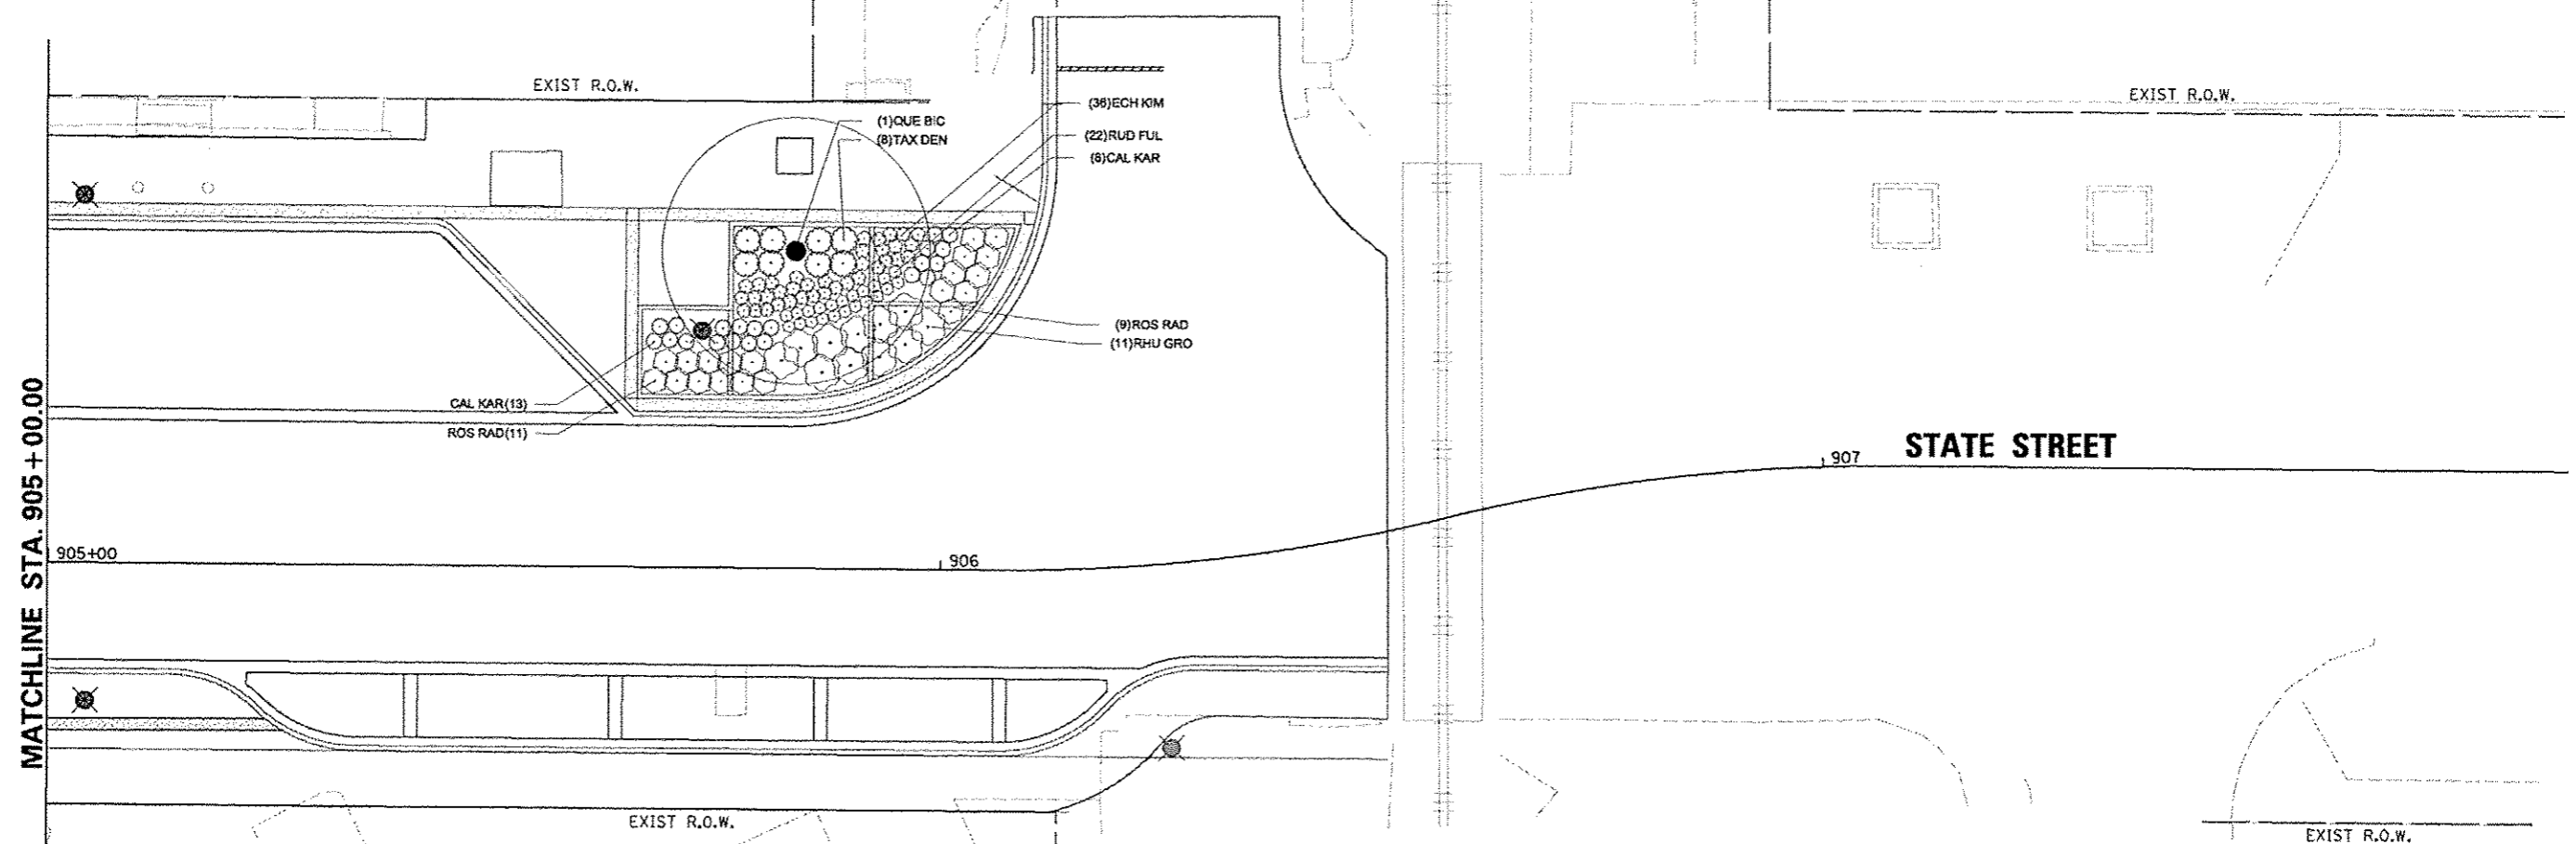
**PLANT SCHEDULE STATE - WASHINGTON TO COMMERCIAL**

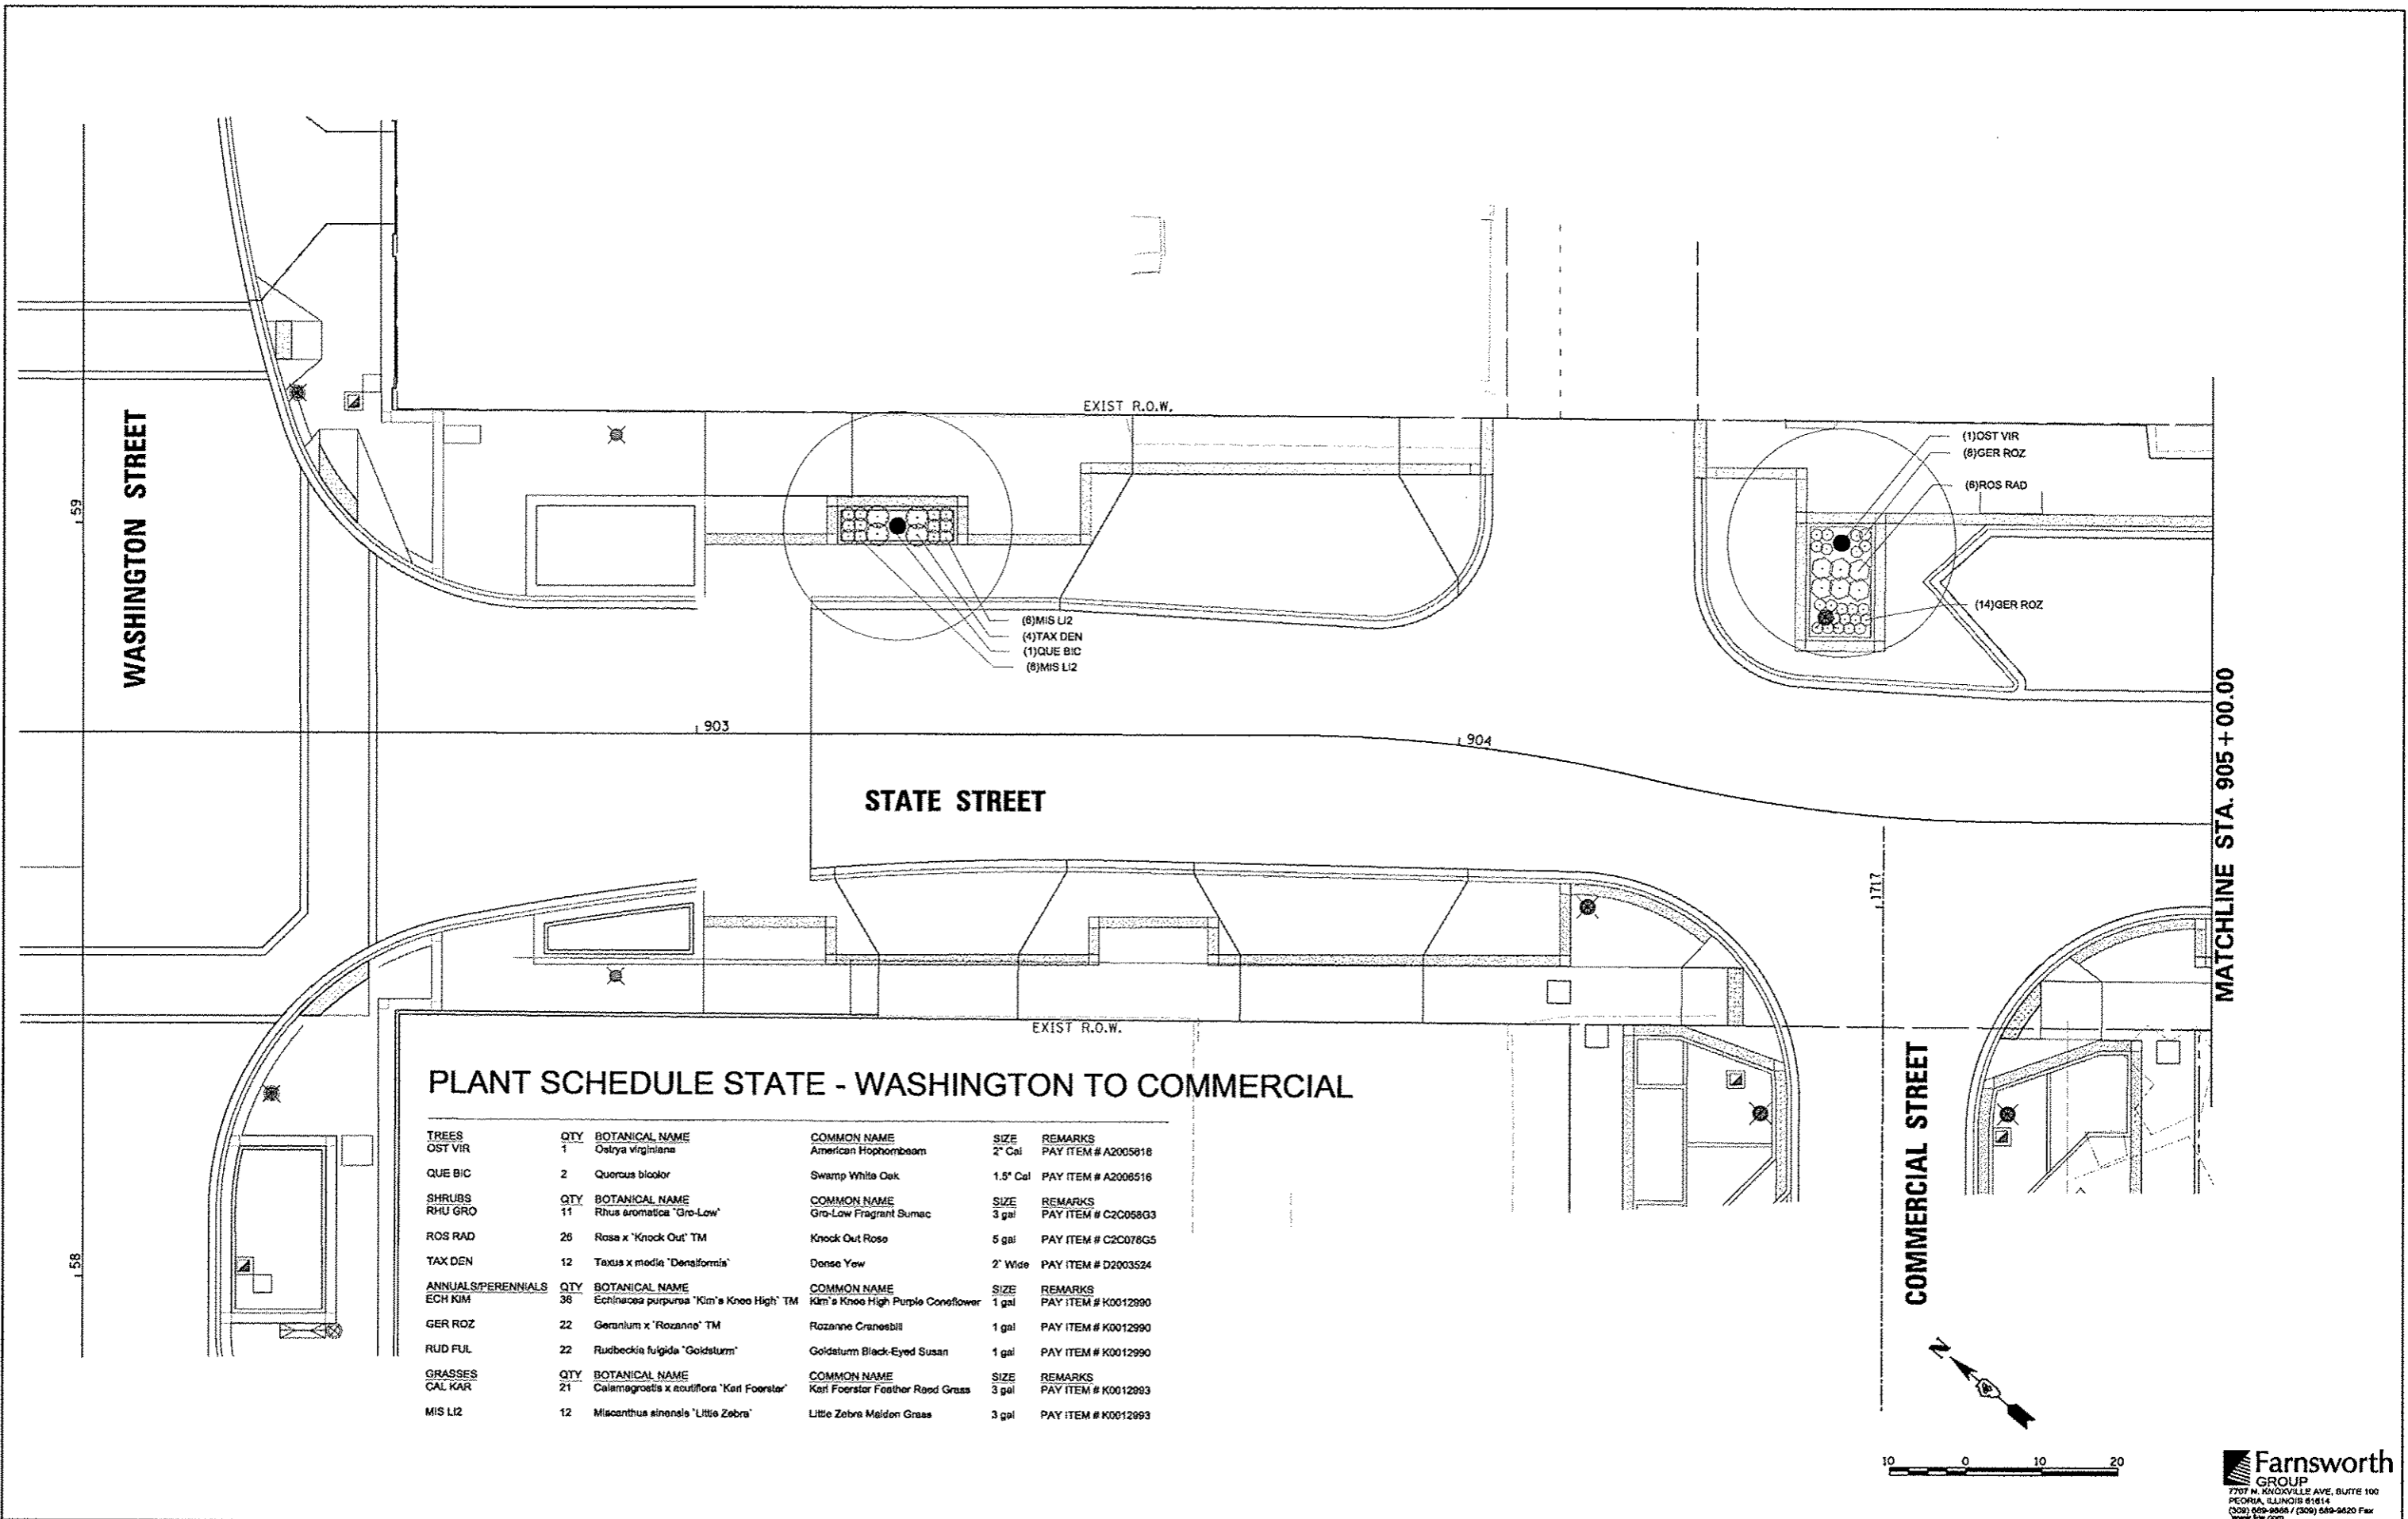TREES	QTY	BOTANICAL NAME	COMMON NAME	SIZE	REMARKS
OST VIR	1	<i>Ostrya virginiana</i>	American Hopbeam	2" Cal	PAY ITEM # A2005018
QUE BIC	2	<i>Quercus bicolor</i>	Swamp White Oak	1.5" Cal	PAY ITEM # A2008516
SHRUBS	QTY	BOTANICAL NAME	COMMON NAME	SIZE	REMARKS
RHU GRO	11	<i>Rhus aromatica</i> 'Gro-Low'	Gro-Low Fragrant Sumac	3 gal	PAY ITEM # C2C058G3
ROS RAD	26	<i>Rosa</i> x 'Knock Out' TM	Knock Out Rose	5 gal	PAY ITEM # C2C078G5
TAX DEN	12	<i>Taxus x media</i> 'Deniformis'	Dense Yew	2' Wide	PAY ITEM # D2003524
ANNUALS/PERENNIALS	QTY	BOTANICAL NAME	COMMON NAME	SIZE	REMARKS
ECH KIM	38	<i>Echinacea purpurea</i> 'Kim's Knee High' TM	Kim's Knee High Purple Coneflower	1 gal	PAY ITEM # K0012990
GER ROZ	22	<i>Geranium</i> x 'Rozanne' TM	Rozanne Cranesbill	1 gal	PAY ITEM # K0012990
RUD FUL	22	<i>Rudbeckia fulgida</i> 'Goldsturm'	Goldsturm Black-Eyed Susan	1 gal	PAY ITEM # K0012990
GRASSES	QTY	BOTANICAL NAME	COMMON NAME	SIZE	REMARKS
CAL KAR	21	<i>Calamagrostis x scutiflora</i> 'Karl Foerster'	Karl Foerster Feather Reed Grass	3 gal	PAY ITEM # K0012993
MIS LI2	12	<i>Miscanthus sinensis</i> 'Little Zebra'	Little Zebra Maiden Grass	3 gal	PAY ITEM # K0012993




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RIZZI'S ON STATE

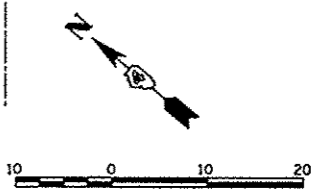

### PLANT SCHEDULE STATE - WASHINGTON TO COMMERCIAL

TREES	QTY	BOTANICAL NAME	COMMON NAME	SIZE	REMARKS
OST VIR	1	Ostrya virginiana	American Hopbeam	2" Cal	PAY ITEM # A2005616
QUE BIC	2	Quercus bicolor	Swamp White Oak	1.5" Cal	PAY ITEM # A2006516
SHRUBS	QTY	BOTANICAL NAME	COMMON NAME	SIZE	REMARKS
RHU GRO	11	Rhus aromatica 'Gro-Low'	Gro-Low Fragrant Sumac	3 gal	PAY ITEM # C2C058G3
ROS RAD	26	Rosa x 'Knock Out' TM	Knock Out Rose	5 gal	PAY ITEM # C2C078G5
TAX DEN	12	Taxus x media 'Densaformis'	Dense Yew	2' Wide	PAY ITEM # D2003524
ANNUALS/PERENNIALS	QTY	BOTANICAL NAME	COMMON NAME	SIZE	REMARKS
ECH KIM	36	Echinacea purpurea 'Kim's Knee High' TM	Kim's Knee High Purple Coneflower	1 gal	PAY ITEM # K0012980
GER ROZ	22	Geranium x 'Rozanne' TM	Rozanne Cranesbill	1 gal	PAY ITEM # K0012980
RUD FUL	22	Rudbeckia fulgida 'Goldsturm'	Goldsturm Black-Eyed Susan	1 gal	PAY ITEM # K0012980
GRASSES	QTY	BOTANICAL NAME	COMMON NAME	SIZE	REMARKS
CAL KAR	21	Calamagrostis x scutiflora 'Karl Foerster'	Karl Foerster Feather Reed Grass	3 gal	PAY ITEM # K0012983
MIS LI2	12	Miscanthus sinensis 'Little Zebra'	Little Zebra Maiden Grass	3 gal	PAY ITEM # K0012983

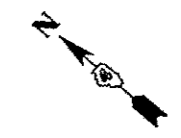



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FILE NAME =	USER NAME = mansk01398	DESIGNED - JLH	REVISED -	<b>STATE OF ILLINOIS DEPARTMENT OF TRANSPORTATION</b>	<b>STATE STREET PLANTING PLAN</b>			F.A.U. RTE.	SECTION	COUNTY	TOTAL SHEETS	SHEET NO.
0:\p1510\work\do_no_delete\ds73427\04	PL0159-sh-trp\12-00356.dwg	DRAWN - JLH	REVISED -		12-00356-01-PV	PEORIA	519	353				
	PLOT SCALE = 20.0000' / 1" =	CHECKED - BAB	REVISED -		SCALE: 1"=10'				SHEET NO. OF SHEETS STA. 905+00 TO STA. 908+00			
	PLOT DATE = 07/23/2012	DATE - 7/18/12	REVISED -		CONTRACT NO. 89626				ILLINOIS FED. AID PROJECT TIC-50931581			

- NOTES:
1. STATIONS AND OFFSETS SHOWN ON THIS SHEET ARE TO THE CENTER OF HANDHOLE AND LIGHT POLE FOUNDATIONS.
  2. COORDINATE INSTALLATION OF UNDERGROUND CONDUIT AND LIGHT FIXTURES WITH ALL EXISTING UNDERGROUND SYSTEMS AND PROPOSED LANDSCAPE FEATURES AND PLANTINGS.
  3. SEE IRRIGATION PLANS FOR UNDERGROUND CONDUIT AND PIPING. COORDINATE INSTALLATION OF UNDERGROUND FACILITIES.
  4. 'F' DESIGNATIONS OF LIGHT FIXTURES SHOWN ON LIGHTING DETAILS SHEET.

ALL KEYED NOTES APPLY TO THIS SHEET ONLY.

- KEYED NOTES:
1. 2" CONDUIT, 2#6 AND 1#6 GND FOR CIRCUIT LC5-2.
  2. 2" CONDUIT, 2#6 AND 1#6 GND FOR CIRCUIT LC5-1.

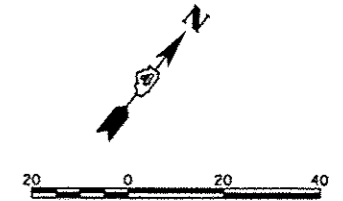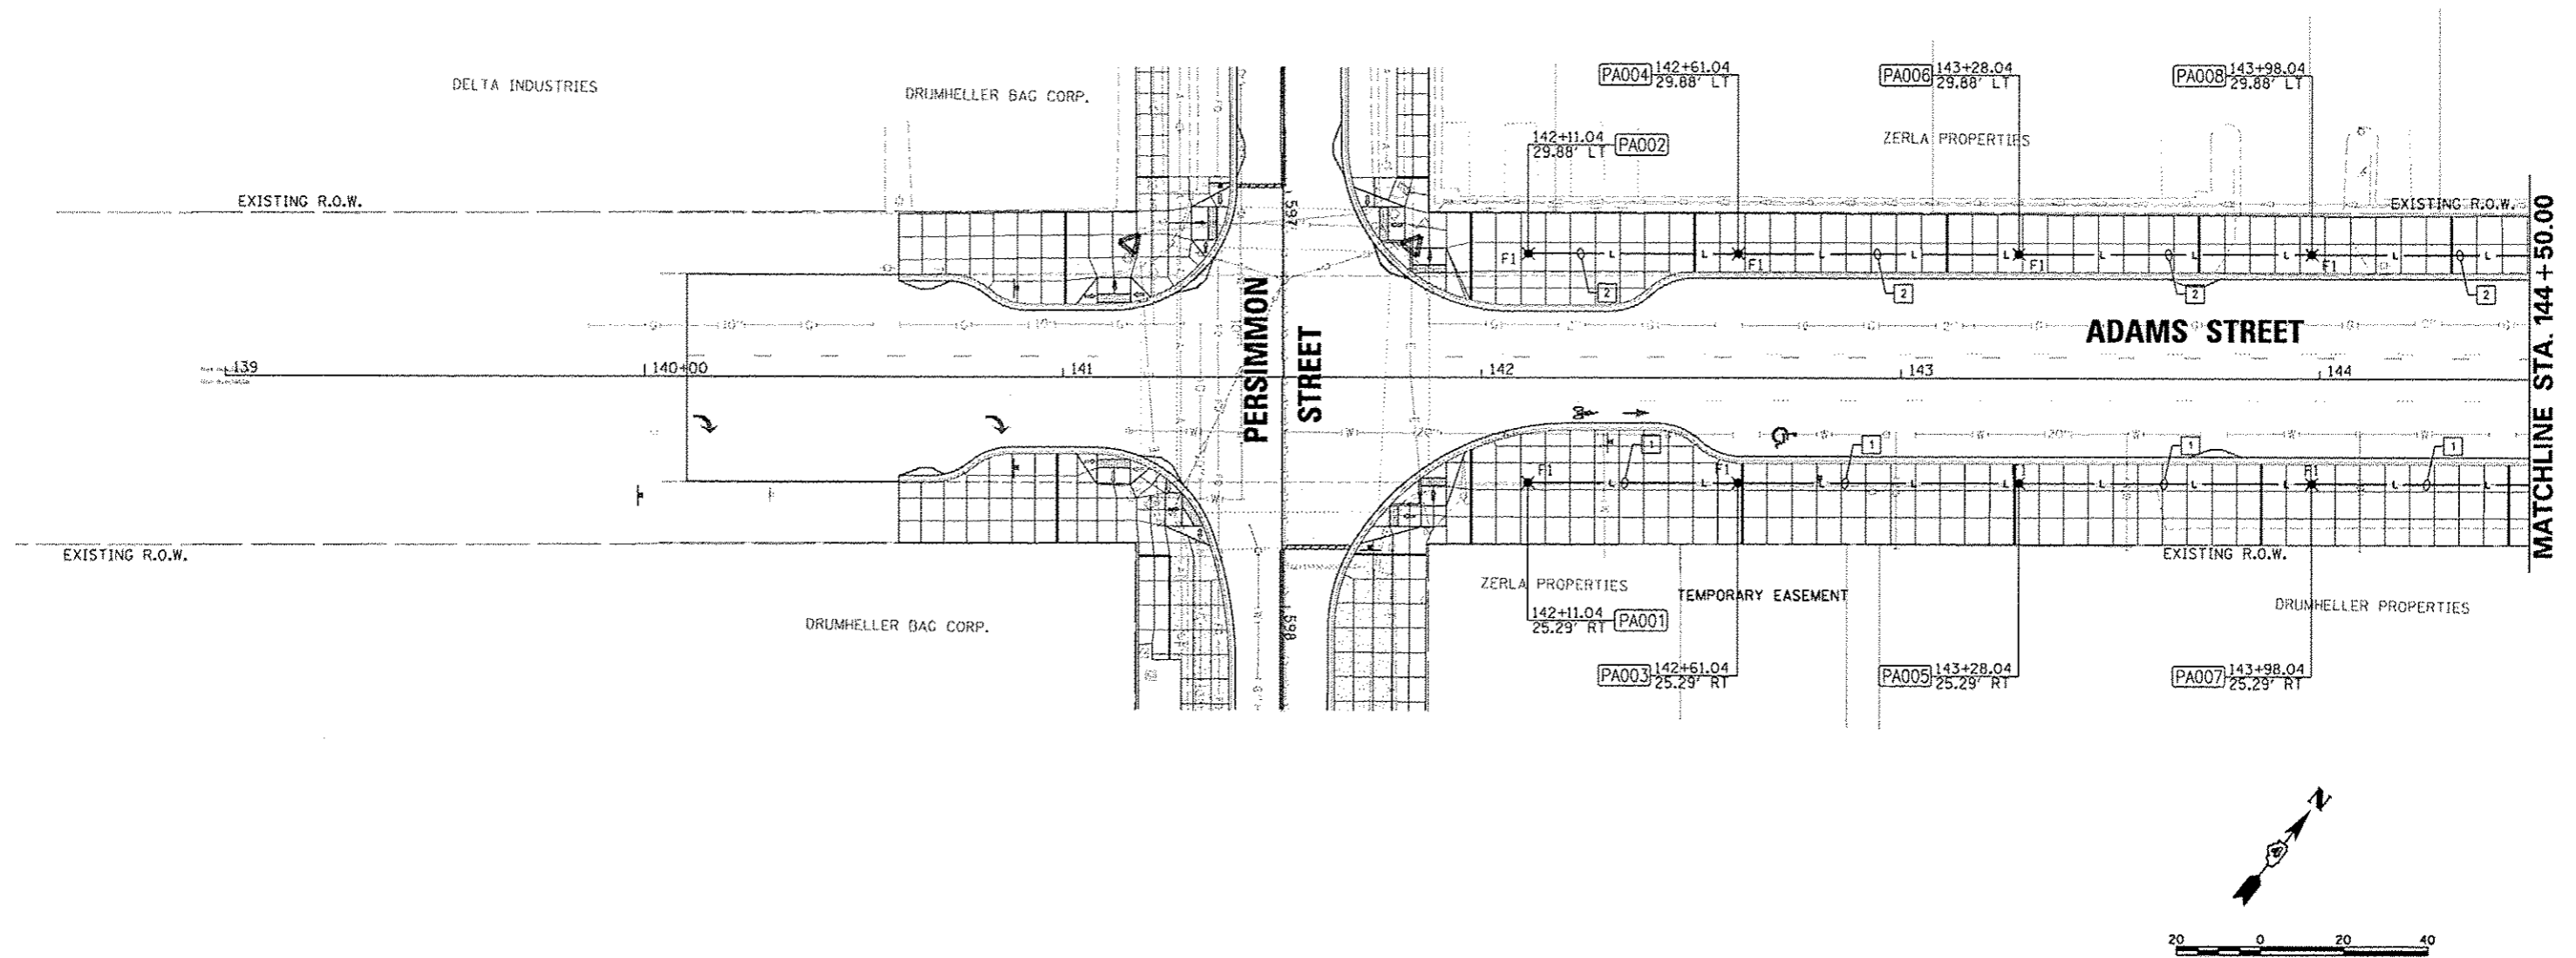

FILE NAME =	USER NAME = mansk01398	DESIGNED -	REVISED -	<b>STATE OF ILLINOIS DEPARTMENT OF TRANSPORTATION</b>	<b>ADAMS STREET LIGHTING PLAN</b>	F.A.U. RTE.	SECTION	COUNTY	TOTAL SHEETS	SHEET NO.
o:\pwise\work\do_not_delete\dms73318\041	LB0155-ehs-light1828.dgn	DRAWN -	REVISED -			12-00356-01-PV	PEORIA	519	354	
	PLOT SCALE = 3/16" = 1' / in.	CHECKED -	REVISED -			CONTRACT NO. 89626				
	PLOT DATE = 07/23/2012	DATE = 7/18/12	REVISED -			ILLINOIS FED. AID PROJECT TIG-50931581				
					SCALE: 1"=20'	SHEET NO. OF SHEETS		STA. 140+65.00 TO STA. 144+50.00		

ALL KEYED NOTES APPLY TO THIS SHEET ONLY.

KEYED NOTES:



1. PORTLAND CEMENT CONCRETE 81400100 - HANDHOLE IDOT STANDARD 814001-02. GROUND HANDHOLE PER IDOT STANDARD 873001-02.
2. 2" CONDUIT, 2\*6 AND 1\*6 GND FOR CIRCUIT LC5-2 AND 2\*6 AND 1\*6 GND FOR CIRCUIT LC5-4.
3. 2" CONDUIT, 2\*6 AND 1\*6 GND FOR CIRCUIT LC5-4.
4. 2" CONDUIT, 2\*6 AND 1\*6 GND FOR CIRCUIT LC5-5.
5. LIGHTING CONTROLLER, BASE MOUNTED, 240V, 200 AMP, \*LC5.
6. 2" CONDUIT, 2\*6 AND 1\*6 GND FOR CIRCUIT LC5-1.
7. 2" CONDUIT, 2\*6 AND 1\*6 GND FOR CIRCUIT LC5-2.
8. 2" CONDUIT, 2\*6 AND 1\*6 GND FOR CIRCUIT LC5-6.
9. 2" CONDUIT, 2\*6 AND 1\*6 GND FOR CIRCUIT LC5-3.

KEYED NOTES (CONTINUED):

10. 2" CONDUIT, 2\*6 AND 1\*6 GND FOR CIRCUIT LC4-1.
11. 2" CONDUIT, 2\*6 AND 1\*6 GND FOR CIRCUIT LC4-2.
12. 2" CONDUIT, 2\*6 AND 1\*6 GND FOR CIRCUIT LC5-1 AND 2\*6 AND 1\*6 GND FOR CIRCUIT LC5-2 AND 2\*6 AND 1\*6 GND FOR CIRCUIT LC5-4 AND 2\*6 AND 1\*6 GND FOR CIRCUIT LC5-6.
13. 2" CONDUIT, 2\*6 AND 1\*6 GND FOR CIRCUIT LC5-2 AND 2\*6 AND 1\*6 GND FOR CIRCUIT LC5-4 AND 2\*6 AND 1\*6 GND FOR CIRCUIT LC5-6.

NOTES:

1. STATIONS AND OFFSETS SHOWN ON THIS SHEET ARE TO THE CENTER OF HANDHOLE AND LIGHT POLE FOUNDATIONS.
2. COORDINATE INSTALLATION OF UNDERGROUND CONDUIT AND LIGHT FIXTURES WITH ALL EXISTING UNDERGROUND SYSTEMS AND PROPOSED LANDSCAPE FEATURES AND PLANTINGS.
3. SEE IRRIGATION PLANS FOR UNDERGROUND CONDUIT AND PIPING. COORDINATE INSTALLATION OF UNDERGROUND FACILITIES.
4. UTILITY SERVICE FROM AMEREN TO LC5 IS CURRENTLY BEING REVIEWED BY AMEREN AND WILL BE COORDINATED WITH SUCCESSFUL CONTRACTOR.
5. 'F' DESIGNATIONS OF LIGHT FIXTURES SHOWN ON LIGHTING DETAILS SHEET.

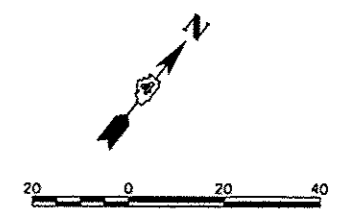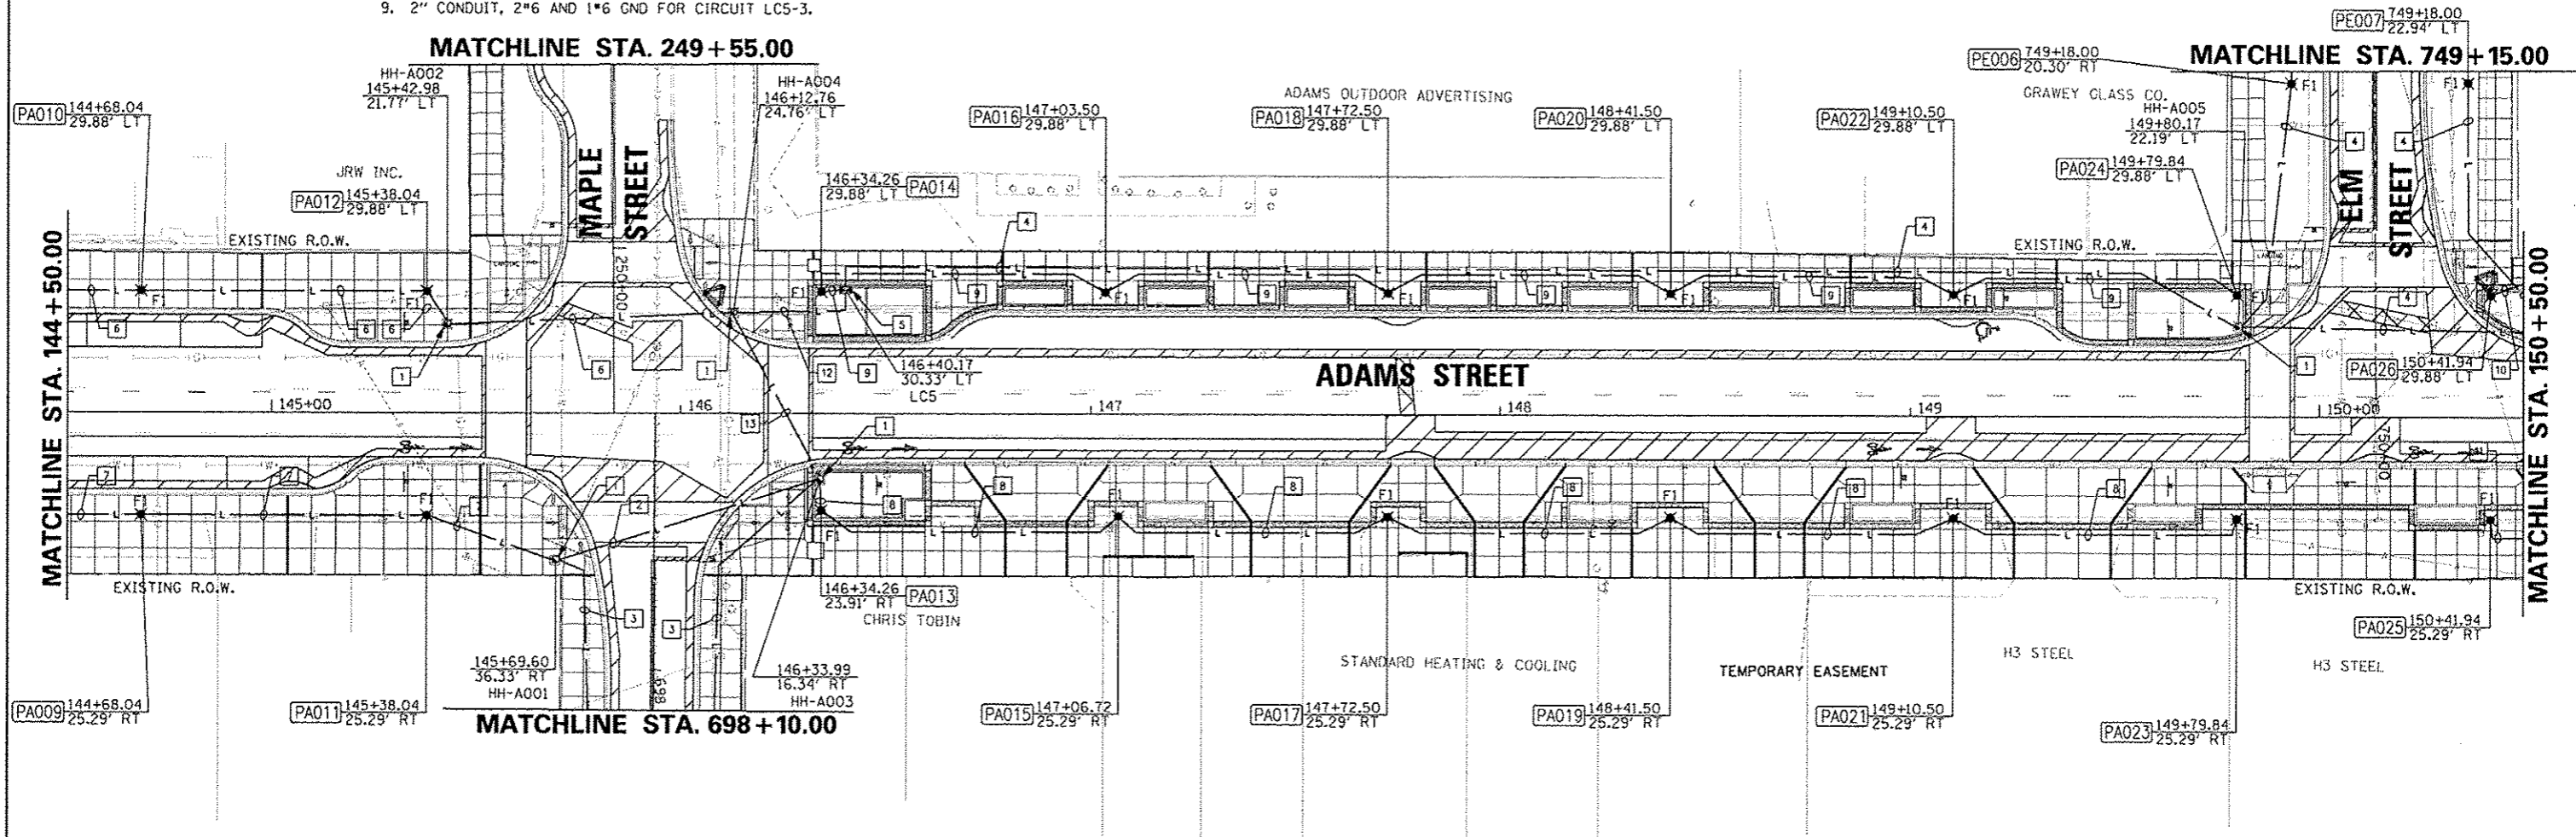

FILE NAME = c:\pwise\work\do_not_delete\adms73318\041	USER NAME = msnak01398	DESIGNED - JDE	REVISED -	<b>STATE OF ILLINOIS DEPARTMENT OF TRANSPORTATION</b>	<b>ADAMS STREET LIGHTING PLAN</b>	F.A.U. RTE. 12	SECTION 12-00356-01-PV	COUNTY PEORIA	TOTAL SHEETS 519	SHEET NO. 355
PLDT SCALE = 3/4" = 1' / in.	CHECKED - BMS	DATE - 7/18/12	REVISED -			SCALE: 1"=20'	SHEET NO. OF SHEETS STA. 144+50.00 TO STA. 150+50.00	CONTRACT NO. 89626		ILLINOIS FED. AID PROJECT TIC-5093158
PLDT DATE = 07/23/2012	DATE - 7/18/12	REVISED -	REVISED -							

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ALL KEYED NOTES APPLY TO THIS SHEET ONLY.

KEYED NOTES:

1. PORTLAND CEMENT CONCRETE 81400100 - HANDHOLE IDOT STANDARD 814001-02. GROUND HANDHOLE PER IDOT STANDARD 873001-02.
2. 2" CONDUIT, 2\*6 AND 1\*6 GND FOR CIRCUIT LC4-8 AND 2\*6 AND 1\*6 GND FOR CIRCUIT LC4-10.
3. 2" CONDUIT, 2\*6 AND 1\*6 GND FOR CIRCUIT LC4-3.
4. 2" CONDUIT, 2\*6 AND 1\*6 GND FOR CIRCUIT LC4-4.
5. LIGHTING CONTROLLER, BASE MOUNTED, 240V, 200 AMP, \*LC4.
6. 2" CONDUIT, 2\*6 AND 1\*6 GND FOR CIRCUIT LC4-2.
7. 2" CONDUIT, 2\*6 AND 1\*6 GND FOR CIRCUIT LC4-1.
8. 2" CONDUIT, 2\*6 AND 1\*6 GND FOR CIRCUIT LC4-1 AND 2\*6 AND 1\*6 GND FOR CIRCUIT LC4-3.

KEYED NOTES (CONTINUED):


9. 2" CONDUIT, 2\*6 AND 1\*6 GND FOR CIRCUIT LC4-2 AND 2\*6 AND 1\*6 GND FOR CIRCUIT LC4-4.
10. 2" CONDUIT, 2\*6 AND 1\*6 GND FOR CIRCUIT LC4-5.
11. 2" CONDUIT, 2\*6 AND 1\*6 GND FOR CIRCUIT LC4-6.
12. 2" CONDUIT, 2\*6 AND 1\*6 GND FOR CIRCUIT LC4-7 AND 2\*4 AND 1\*4 GND FOR CIRCUIT LC4-9.
13. 3" CONDUIT, 2\*6 AND 1\*6 GND FOR CIRCUIT LC4-1 AND 2\*6 AND 1\*6 GND FOR CIRCUIT LC4-3 AND 2\*6 AND 1\*6 GND FOR CIRCUIT LC4-5 AND 2\*6 AND 1\*6 GND FOR CIRCUIT LC4-7 AND 2\*4 AND 1\*4 GND FOR CIRCUIT LC4-9.
14. 3" CONDUIT, 2\*6 AND 1\*6 GND FOR CIRCUIT LC4-1 AND 2\*6 AND 1\*6 GND FOR CIRCUIT LC4-2 AND 2\*6 AND 1\*6 GND FOR CIRCUIT LC4-3 AND 2\*6 AND 1\*6 GND FOR CIRCUIT LC4-4 AND 2\*6 AND 1\*6 GND FOR CIRCUIT LC4-5 AND 2\*6 AND 1\*6 GND FOR CIRCUIT LC4-7 AND 2\*4 AND 1\*4 GND FOR CIRCUIT LC4-9.

KEYED NOTES (CONTINUED):

15. SEE MAST ARM LOADING DIAGRAMS FOR TRAFFIC CONTROL DEVICES MOUNTED TO THIS POLE.
16. COIL 6' WIRE FOR CIRCUIT LC4-4 IN HANDHOLE. TAPE ENDS AND LABEL FOR FUTURE EXTENSION.

NOTES:

1. STATIONS AND OFFSETS SHOWN ON THIS SHEET ARE TO THE CENTER OF HANDHOLE AND LIGHT POLE FOUNDATIONS.
2. COORDINATE INSTALLATION OF UNDERGROUND CONDUIT AND LIGHT FIXTURES WITH ALL EXISTING UNDERGROUND SYSTEMS AND PROPOSED LANDSCAPE FEATURES AND PLANTINGS.
3. SEE IRRIGATION PLANS FOR UNDERGROUND CONDUIT AND PIPING. COORDINATE INSTALLATION OF UNDERGROUND FACILITIES.
4. UTILITY SERVICE FROM AMEREN TO LC4 IS CURRENTLY BEING REVIEWED BY AMEREN AND WILL BE COORDINATED WITH SUCCESSFUL CONTRACTOR.
5. 'F' DESIGNATIONS OF LIGHT FIXTURES SHOWN ON LIGHTING DETAILS SHEET.

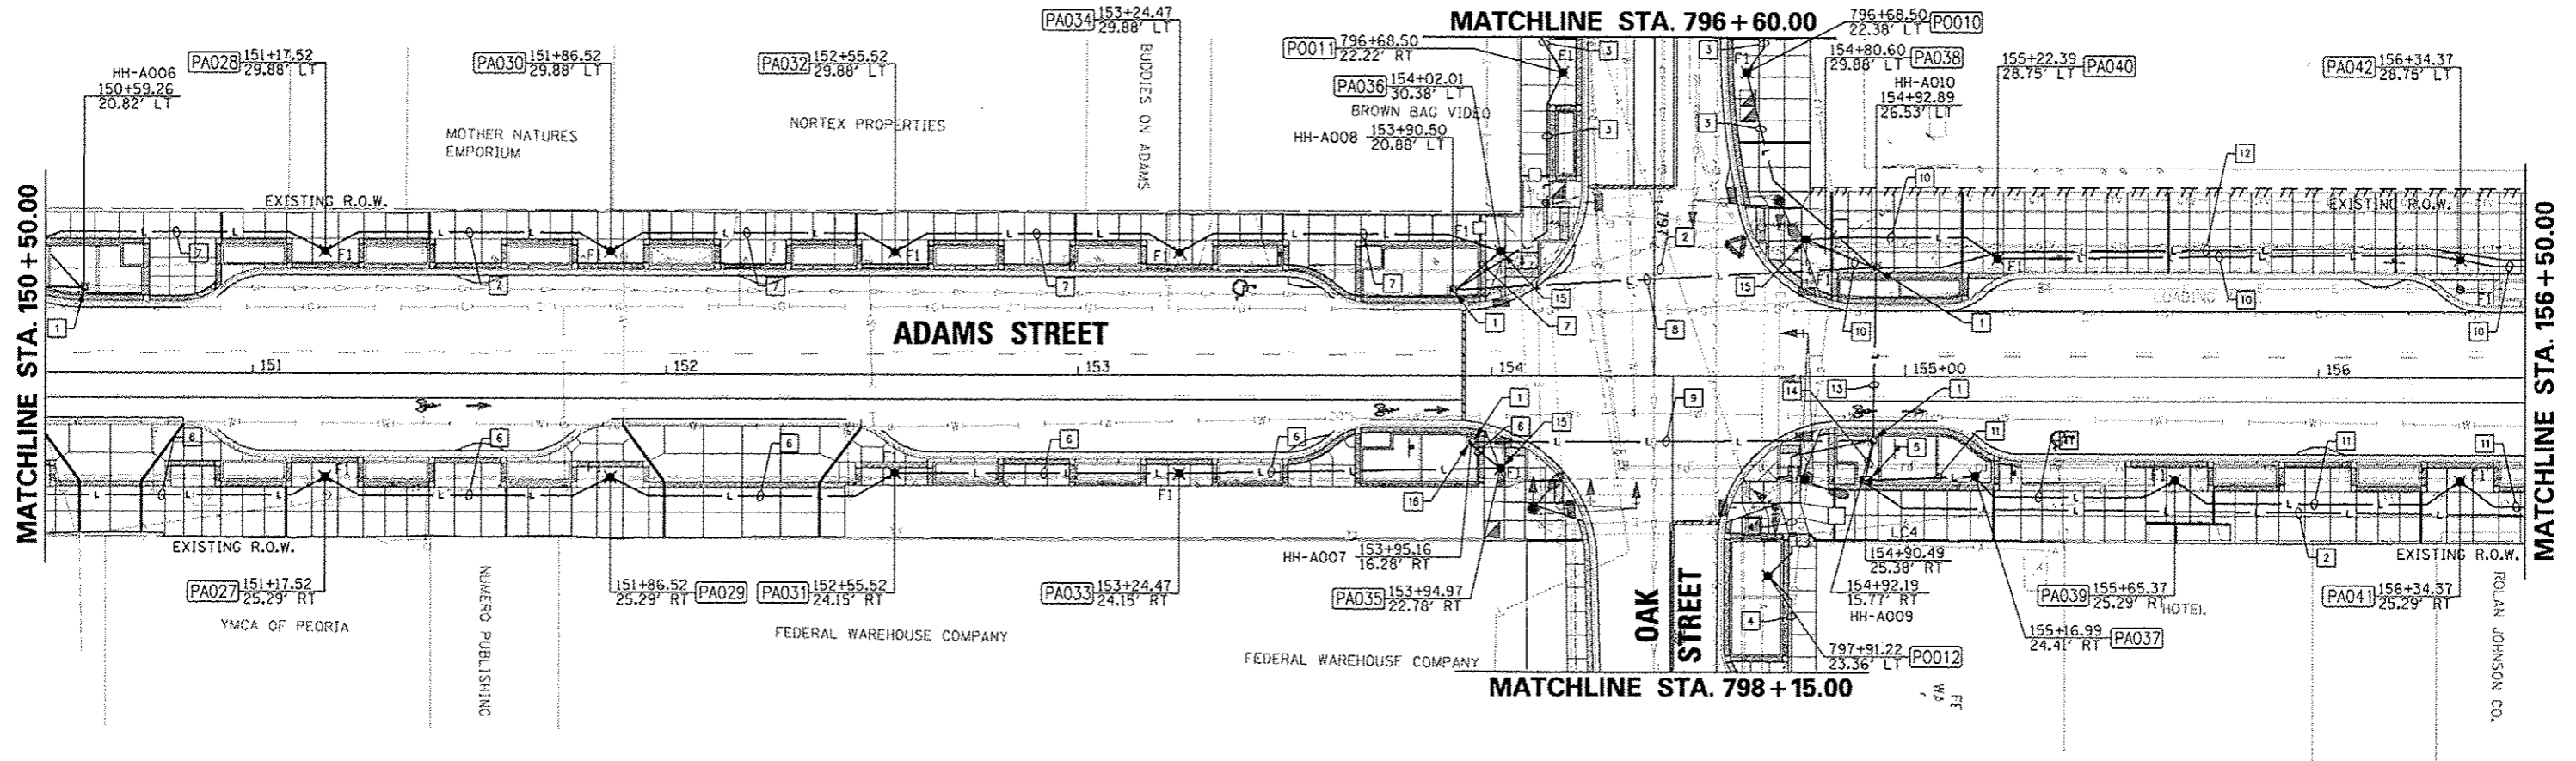

FILE NAME v	USER NAME = mansk01390	DESIGNED - JDE	REVISED -
c:\pwise_work\do_not_delete\des73310\041	BL0155-shr-11ghv022.dgn	DRAWN - TMT	REVISED -
	PLOT SCALE = 3/8"=1' @ in.	CHECKED - BMS	REVISED -
	PLOT DATE = 07/23/2012	DATE - 7/18/12	REVISED -

STATE OF ILLINOIS  
DEPARTMENT OF TRANSPORTATION

SCALE: 1"=20'	SHEET NO. OF SHEETS	STA. 150+50.00 TO STA. 156+50.00
<b>ADAMS STREET LIGHTING PLAN</b>		

F.A.U. RTE.	SECTION	COUNTY	TOTAL SHEETS	SHEET NO.
66	12-00356-01-PV	PEORIA	519	356
CONTRACT NO. 89626				
ILLINOIS FED. AID PROJECT T16-5093150				







ALL KEYED NOTES APPLY TO THIS SHEET ONLY.

KEYED NOTES:

1. PORTLAND CEMENT CONCRETE 81400100 - HANDHOLE IDOT STANDARD 814001-02. GROUND HANDHOLE PER IDOT STANDARD 873001-02.
2. 2" CONDUIT, 2\*6 AND 1\*6 GND FOR CIRCUIT LC4-5.
3. 2" CONDUIT, 2\*6 AND 1\*6 GND FOR CIRCUIT LC4-8.
4. 2" CONDUIT, 2\*6 AND 1\*6 GND FOR CIRCUIT LC4-10.
5. 2" CONDUIT, 2\*6 AND 1\*6 GND FOR CIRCUIT LC4-8 AND 2\*6 AND 1\*6 GND FOR CIRCUIT LC4-10.
6. 2" CONDUIT, 2\*6 AND 1\*6 GND FOR CIRCUIT LC4-7.
7. 2" CONDUIT, 2\*4 AND 1\*4 GND FOR CIRCUIT LC4-9.
8. 2" CONDUIT, 2\*6 AND 1\*6 GND FOR CIRCUIT LC4-7 AND 2\*4 AND 1\*4 GND FOR CIRCUIT LC4-9.
9. 2" CONDUIT, 2\*6 AND 1\*6 GND FOR CIRCUIT LC4-6.
10. SEE MAST ARM LOADING DIAGRAMS FOR TRAFFIC CONTROL DEVICES MOUNTED TO THIS POLE.

NOTES:

1. STATIONS AND OFFSETS SHOWN ON THIS SHEET ARE TO THE CENTER OF HANDHOLE AND LIGHT POLE FOUNDATIONS.
2. COORDINATE INSTALLATION OF UNDERGROUND CONDUIT AND LIGHT FIXTURES WITH ALL EXISTING UNDERGROUND SYSTEMS AND PROPOSED LANDSCAPE FEATURES AND PLANTINGS.
3. SEE IRRIGATION PLANS FOR UNDERGROUND CONDUIT AND PIPING. COORDINATE INSTALLATION OF UNDERGROUND FACILITIES.
4. 'F' DESIGNATIONS OF LIGHT FIXTURES SHOWN ON LIGHTING DETAILS SHEET.

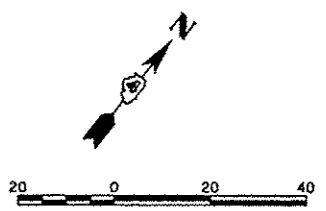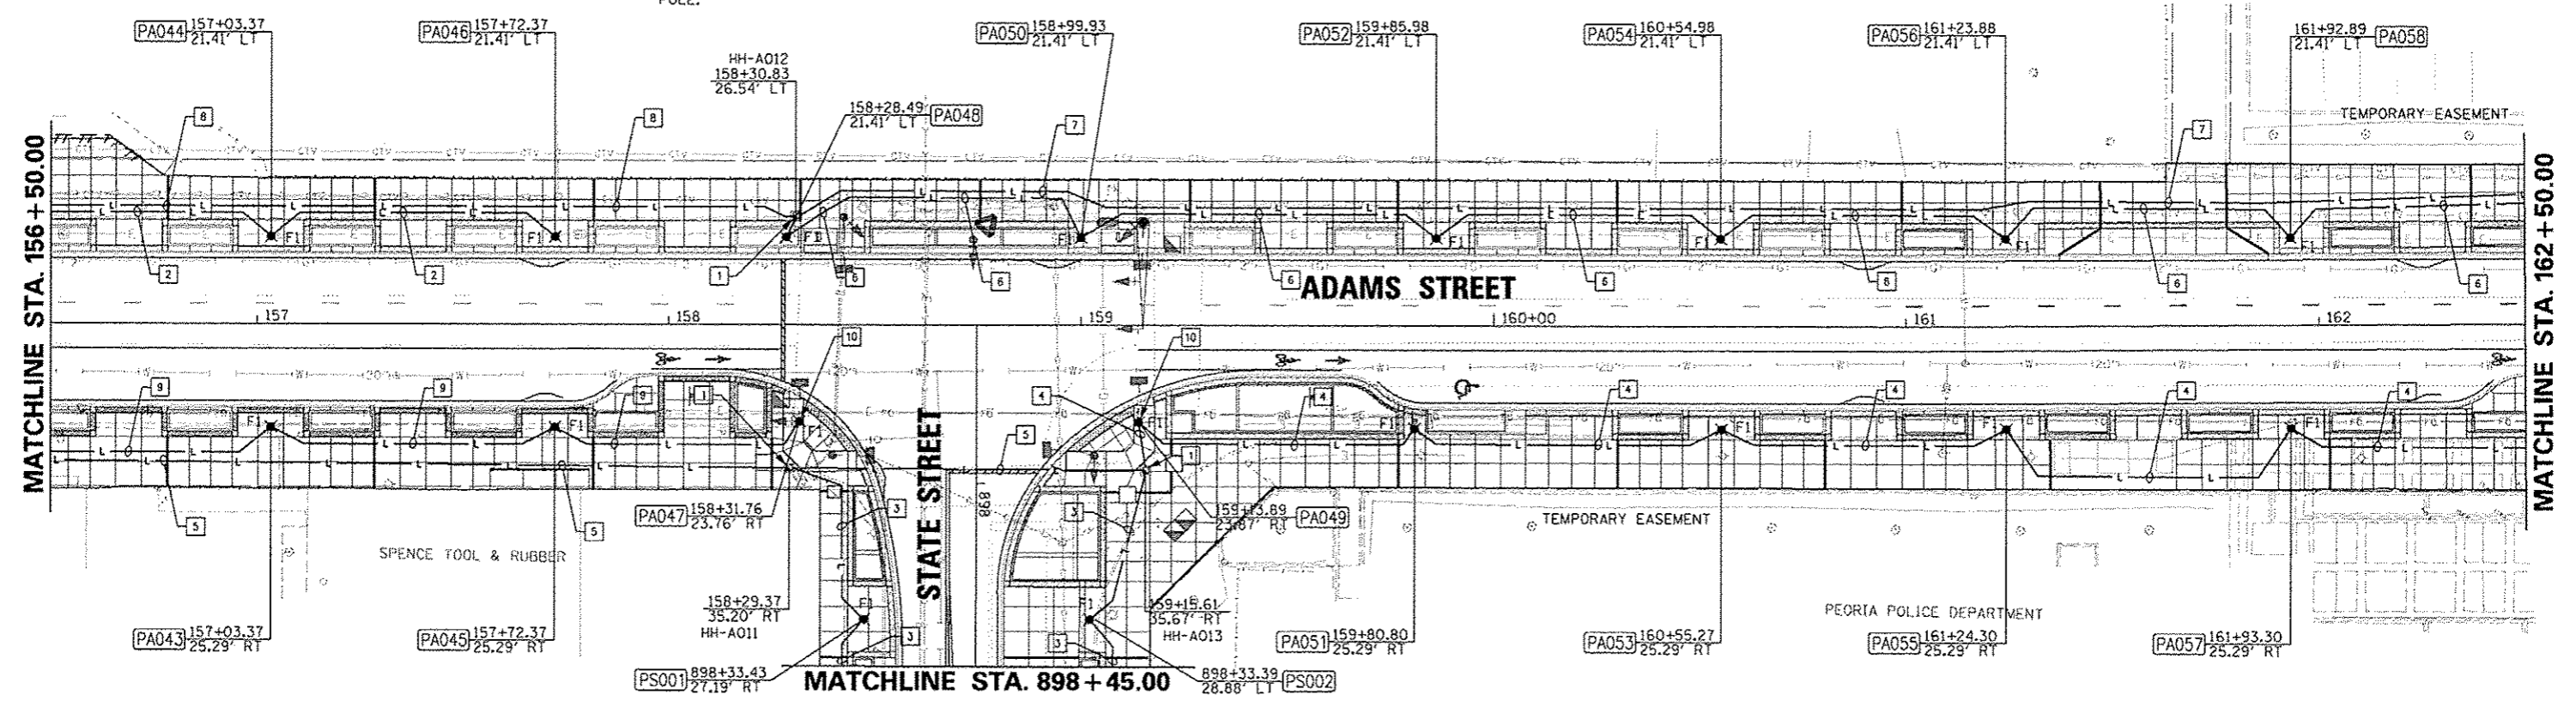


FILE NAME = c:\pwise_work\do_not_delete\dms73318\041	USER NAME = manski01390	DESIGNED - JDE	REVISED -	<b>STATE OF ILLINOIS DEPARTMENT OF TRANSPORTATION</b>	<b>ADAMS STREET LIGHTING PLAN</b>	F.A.U. RTE.	SECTION	COUNTY	TOTAL SHEETS	SHEET NO.
	PLT SCALE = 3/8" = 1' / in.	DRAWN - TMT	REVISED -			12-00356-01-PV	PEORIA	519	357	
	PLT DATE = 07/23/2012	CHECKED - BMS	REVISED -			CONTRACT NO. 89626				
		DATE - 7/18/12	REVISED -			ILLINOIS FED. AID PROJECT TIG-50931581				
					SCALE: 1"=20'	SHEET NO. OF SHEETS		STA. 156+50.00 TO STA. 162+50.00		

- NOTES:
1. STATIONS AND OFFSETS SHOWN ON THIS SHEET ARE TO THE CENTER OF HANDHOLE AND LIGHT POLE FOUNDATIONS.
  2. COORDINATE INSTALLATION OF UNDERGROUND CONDUIT AND LIGHT FIXTURES WITH ALL EXISTING UNDERGROUND SYSTEMS AND PROPOSED LANDSCAPE FEATURES AND PLANTINGS.
  3. SEE IRRIGATION PLANS FOR UNDERGROUND CONDUIT AND PIPING. COORDINATE INSTALLATION OF UNDERGROUND FACILITIES.
  4. 'F' DESIGNATIONS OF LIGHT FIXTURES SHOWN ON LIGHTING DETAILS SHEET.

ALL KEYED NOTES APPLY TO THIS SHEET ONLY.

- KEYED NOTES:
1. PORTLAND CEMENT CONCRETE 81400100 - HANDHOLE IDOT STANDARD 814001-02. GROUND HANDHOLE PER IDOT STANDARD 873001-02.
  2. 2" CONDUIT, 2\*4 AND 1\*4 GND FOR CIRCUIT LC4-9.
  3. 2" CONDUIT, 2\*6 AND 1\*6 GND FOR CIRCUIT LC4-7.
  4. 2" CONDUIT, 2\*6 AND 1\*6 GND FOR CIRCUIT LC4-10.

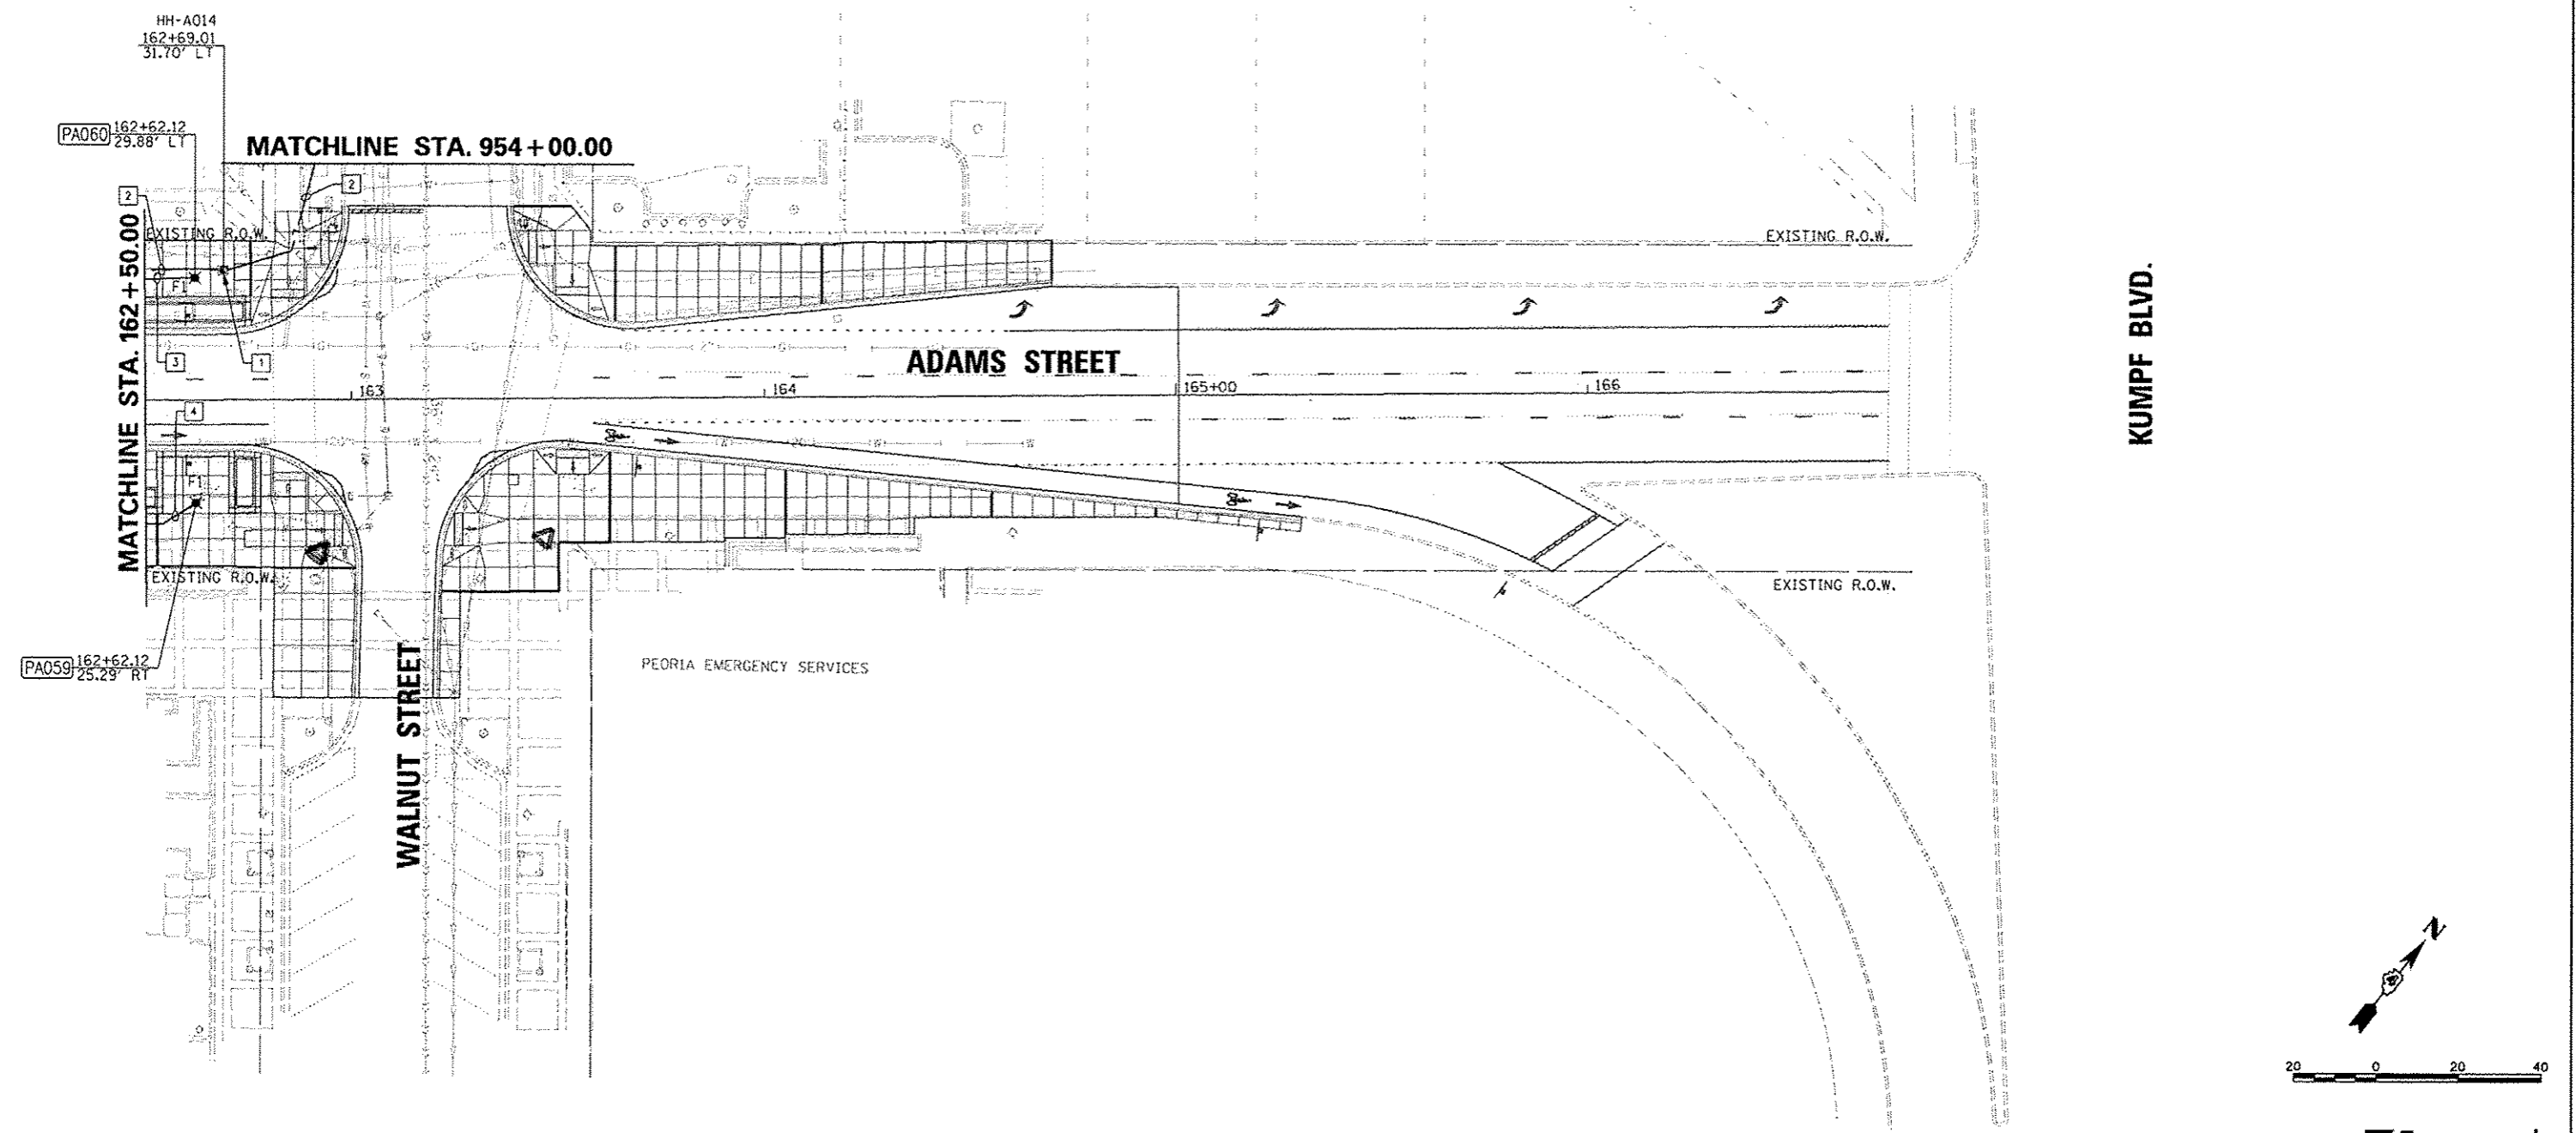

FILE NAME = c:\pwise\work\do_not_delete\dms73318\041	USER NAME = manak01390 RL0155-shr-light024.dgn	DESIGNED - JDE	REVISED -	<b>STATE OF ILLINOIS DEPARTMENT OF TRANSPORTATION</b>	<b>ADAMS STREET LIGHTING PLAN</b>	F.A.U. RTE. 12	SECTION 12-00356-01-PV	COUNTY PEORIA	TOTAL SHEETS 519	SHEET NO. 358	
PLT SCALE = 39.9999 1 / in.	CHECKED - BMS	REVISED -	SCALE: 1"=20'			SHEET NO. OF SHEETS	STA. 162+50 TO STA. 166+50	CONTRACT NO. 89626		ILLINOIS FED. AID PROJECT	TIG-5093H581
PLT DATE = 07/23/2012	DATE - 7/18/12	REVISED -									

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 7707 N. KNOXVILLE AVE, SUITE 100  
 PEORIA, ILLINOIS 61614  
 (309) 699-9655 / (309) 699-9620 Fax  
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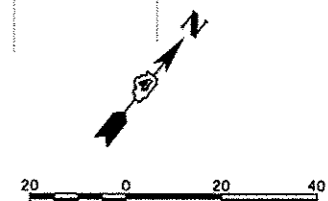
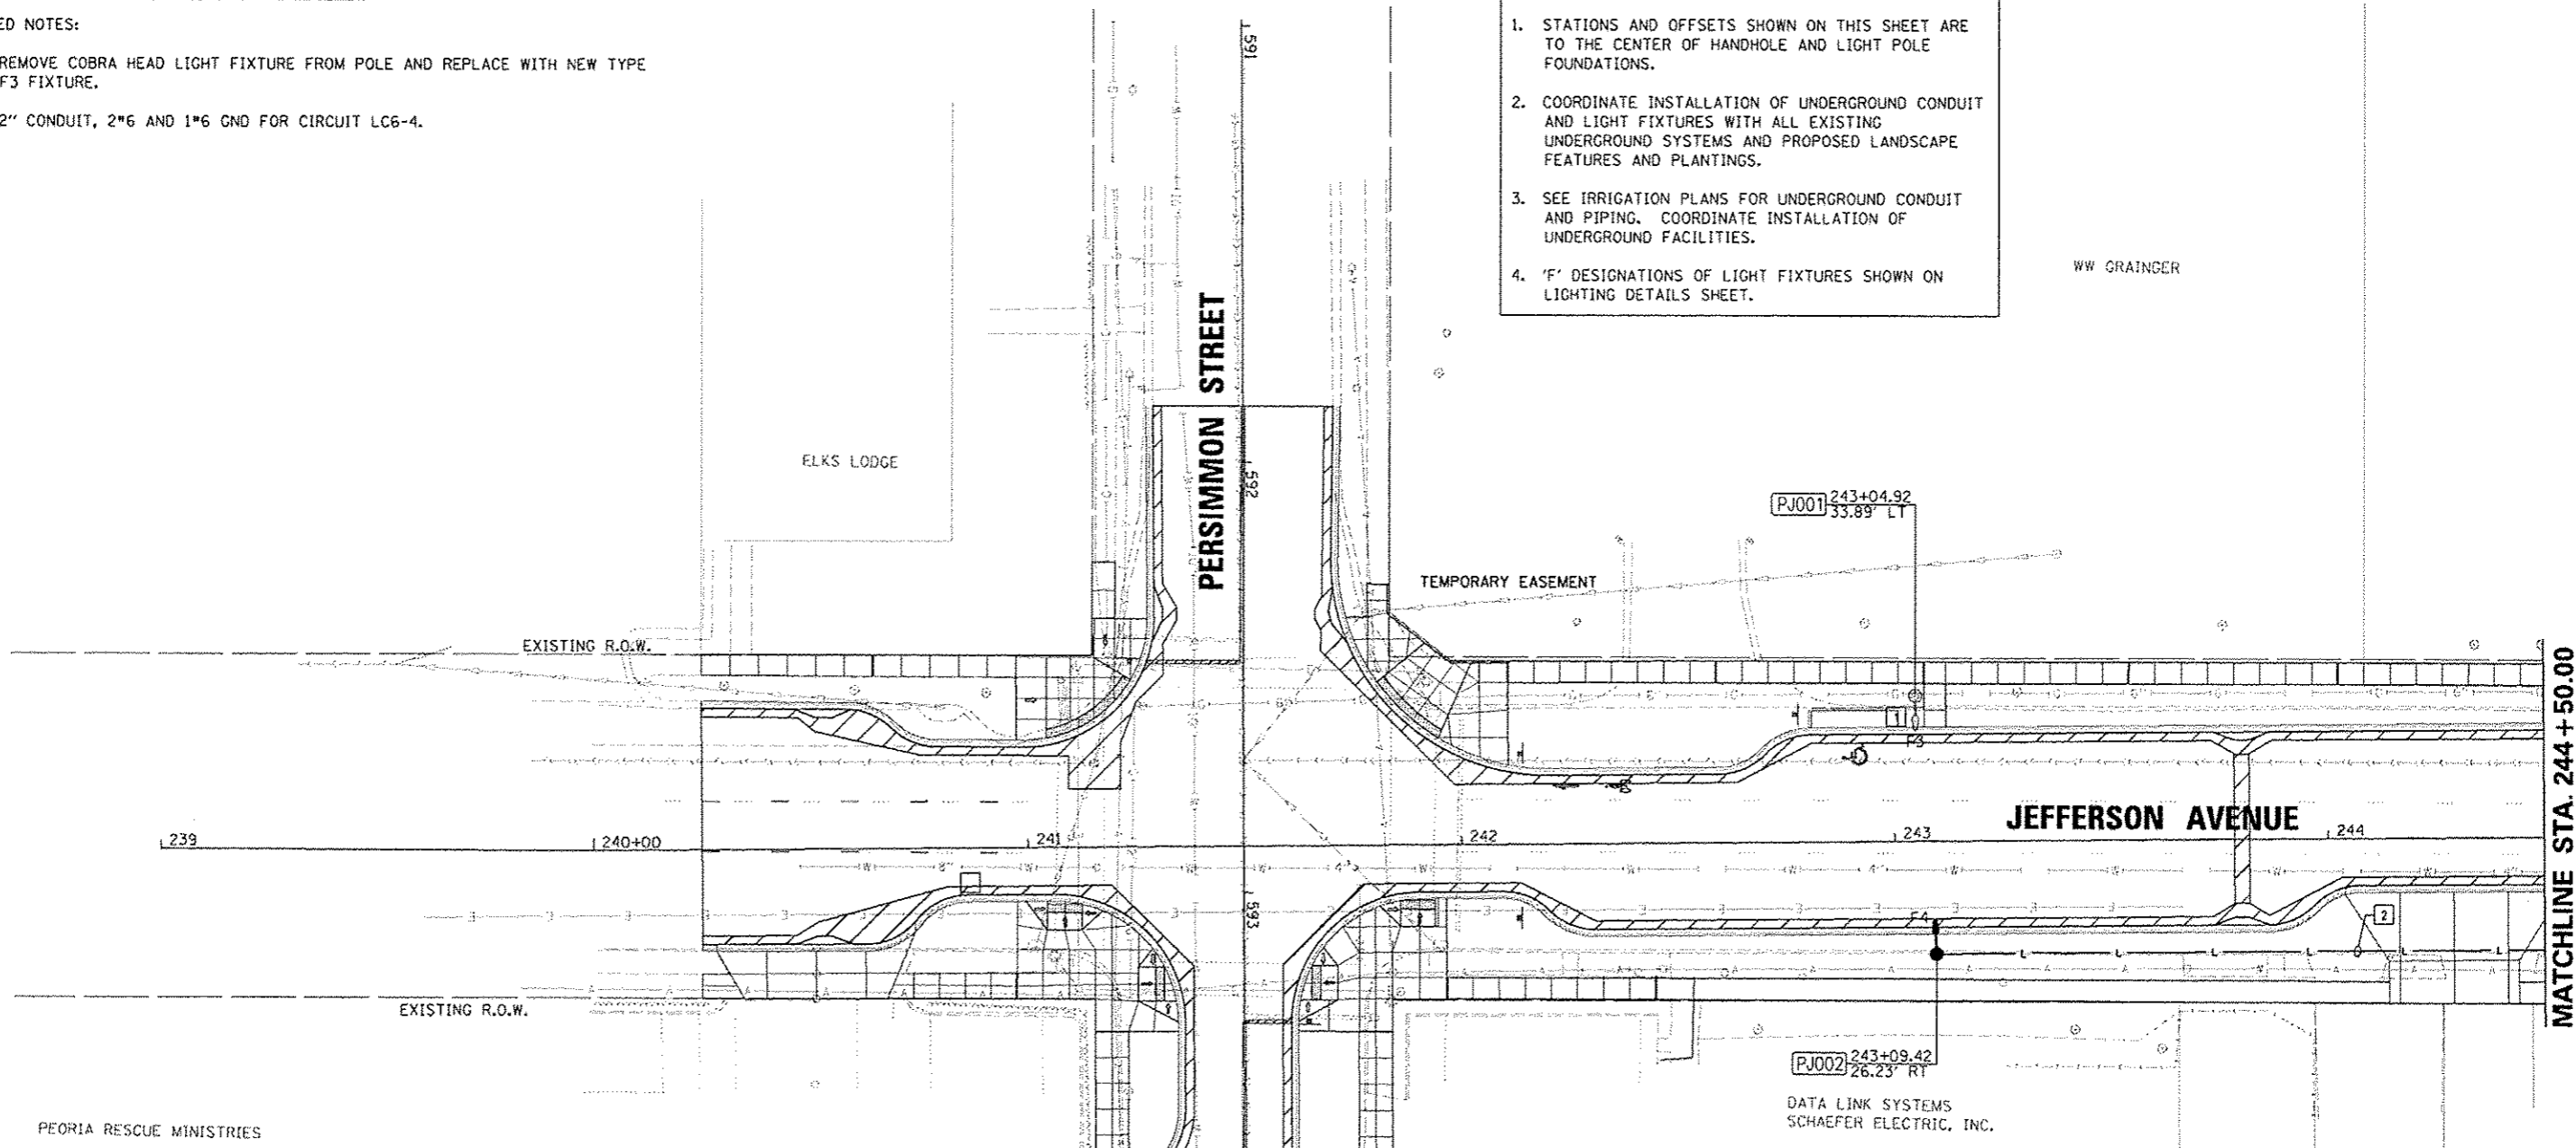
ALL KEYED NOTES APPLY TO THIS SHEET ONLY.

KEYED NOTES:

1. REMOVE COBRA HEAD LIGHT FIXTURE FROM POLE AND REPLACE WITH NEW TYPE F3 FIXTURE.
2. 2" CONDUIT, 2\*6 AND 1\*6 GND FOR CIRCUIT LC6-4.

- NOTES:
1. STATIONS AND OFFSETS SHOWN ON THIS SHEET ARE TO THE CENTER OF HANDHOLE AND LIGHT POLE FOUNDATIONS.
  2. COORDINATE INSTALLATION OF UNDERGROUND CONDUIT AND LIGHT FIXTURES WITH ALL EXISTING UNDERGROUND SYSTEMS AND PROPOSED LANDSCAPE FEATURES AND PLANTINGS.
  3. SEE IRRIGATION PLANS FOR UNDERGROUND CONDUIT AND PIPING. COORDINATE INSTALLATION OF UNDERGROUND FACILITIES.
  4. 'F' DESIGNATIONS OF LIGHT FIXTURES SHOWN ON LIGHTING DETAILS SHEET.

WW CRAINGER



FILE NAME * o:\p\cei\work\do_not_delete\dms73318\041	USER NAME * monsk81399	DESIGNED - JDE	REVISED -	STATE OF ILLINOIS DEPARTMENT OF TRANSPORTATION	JEFFERSON AVENUE LIGHTING PLAN	SCALE: 1"=20'	SHEET NO. OF SHEETS	STA. 240+25.00 TO STA. 244+50.00	F.A.U. RTE.	SECTION	COUNTY	TOTAL SHEETS	SHEET NO.
	PLOT SCALE * 39.9999' / 1" IN.	DRAWN - TMT	REVISED -						12-00356-01-PV	PEORIA	519	359	
	PLOT DATE * 07/23/2012	CHECKED - BMS	REVISED -						CONTRACT NO. 89626		ILLINOIS FED. AID PROJECT TIG-60931(58)		
		DATE - 7/18/12	REVISED -										

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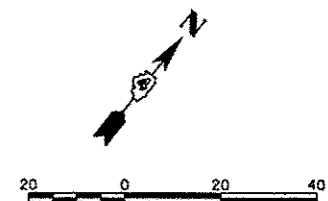
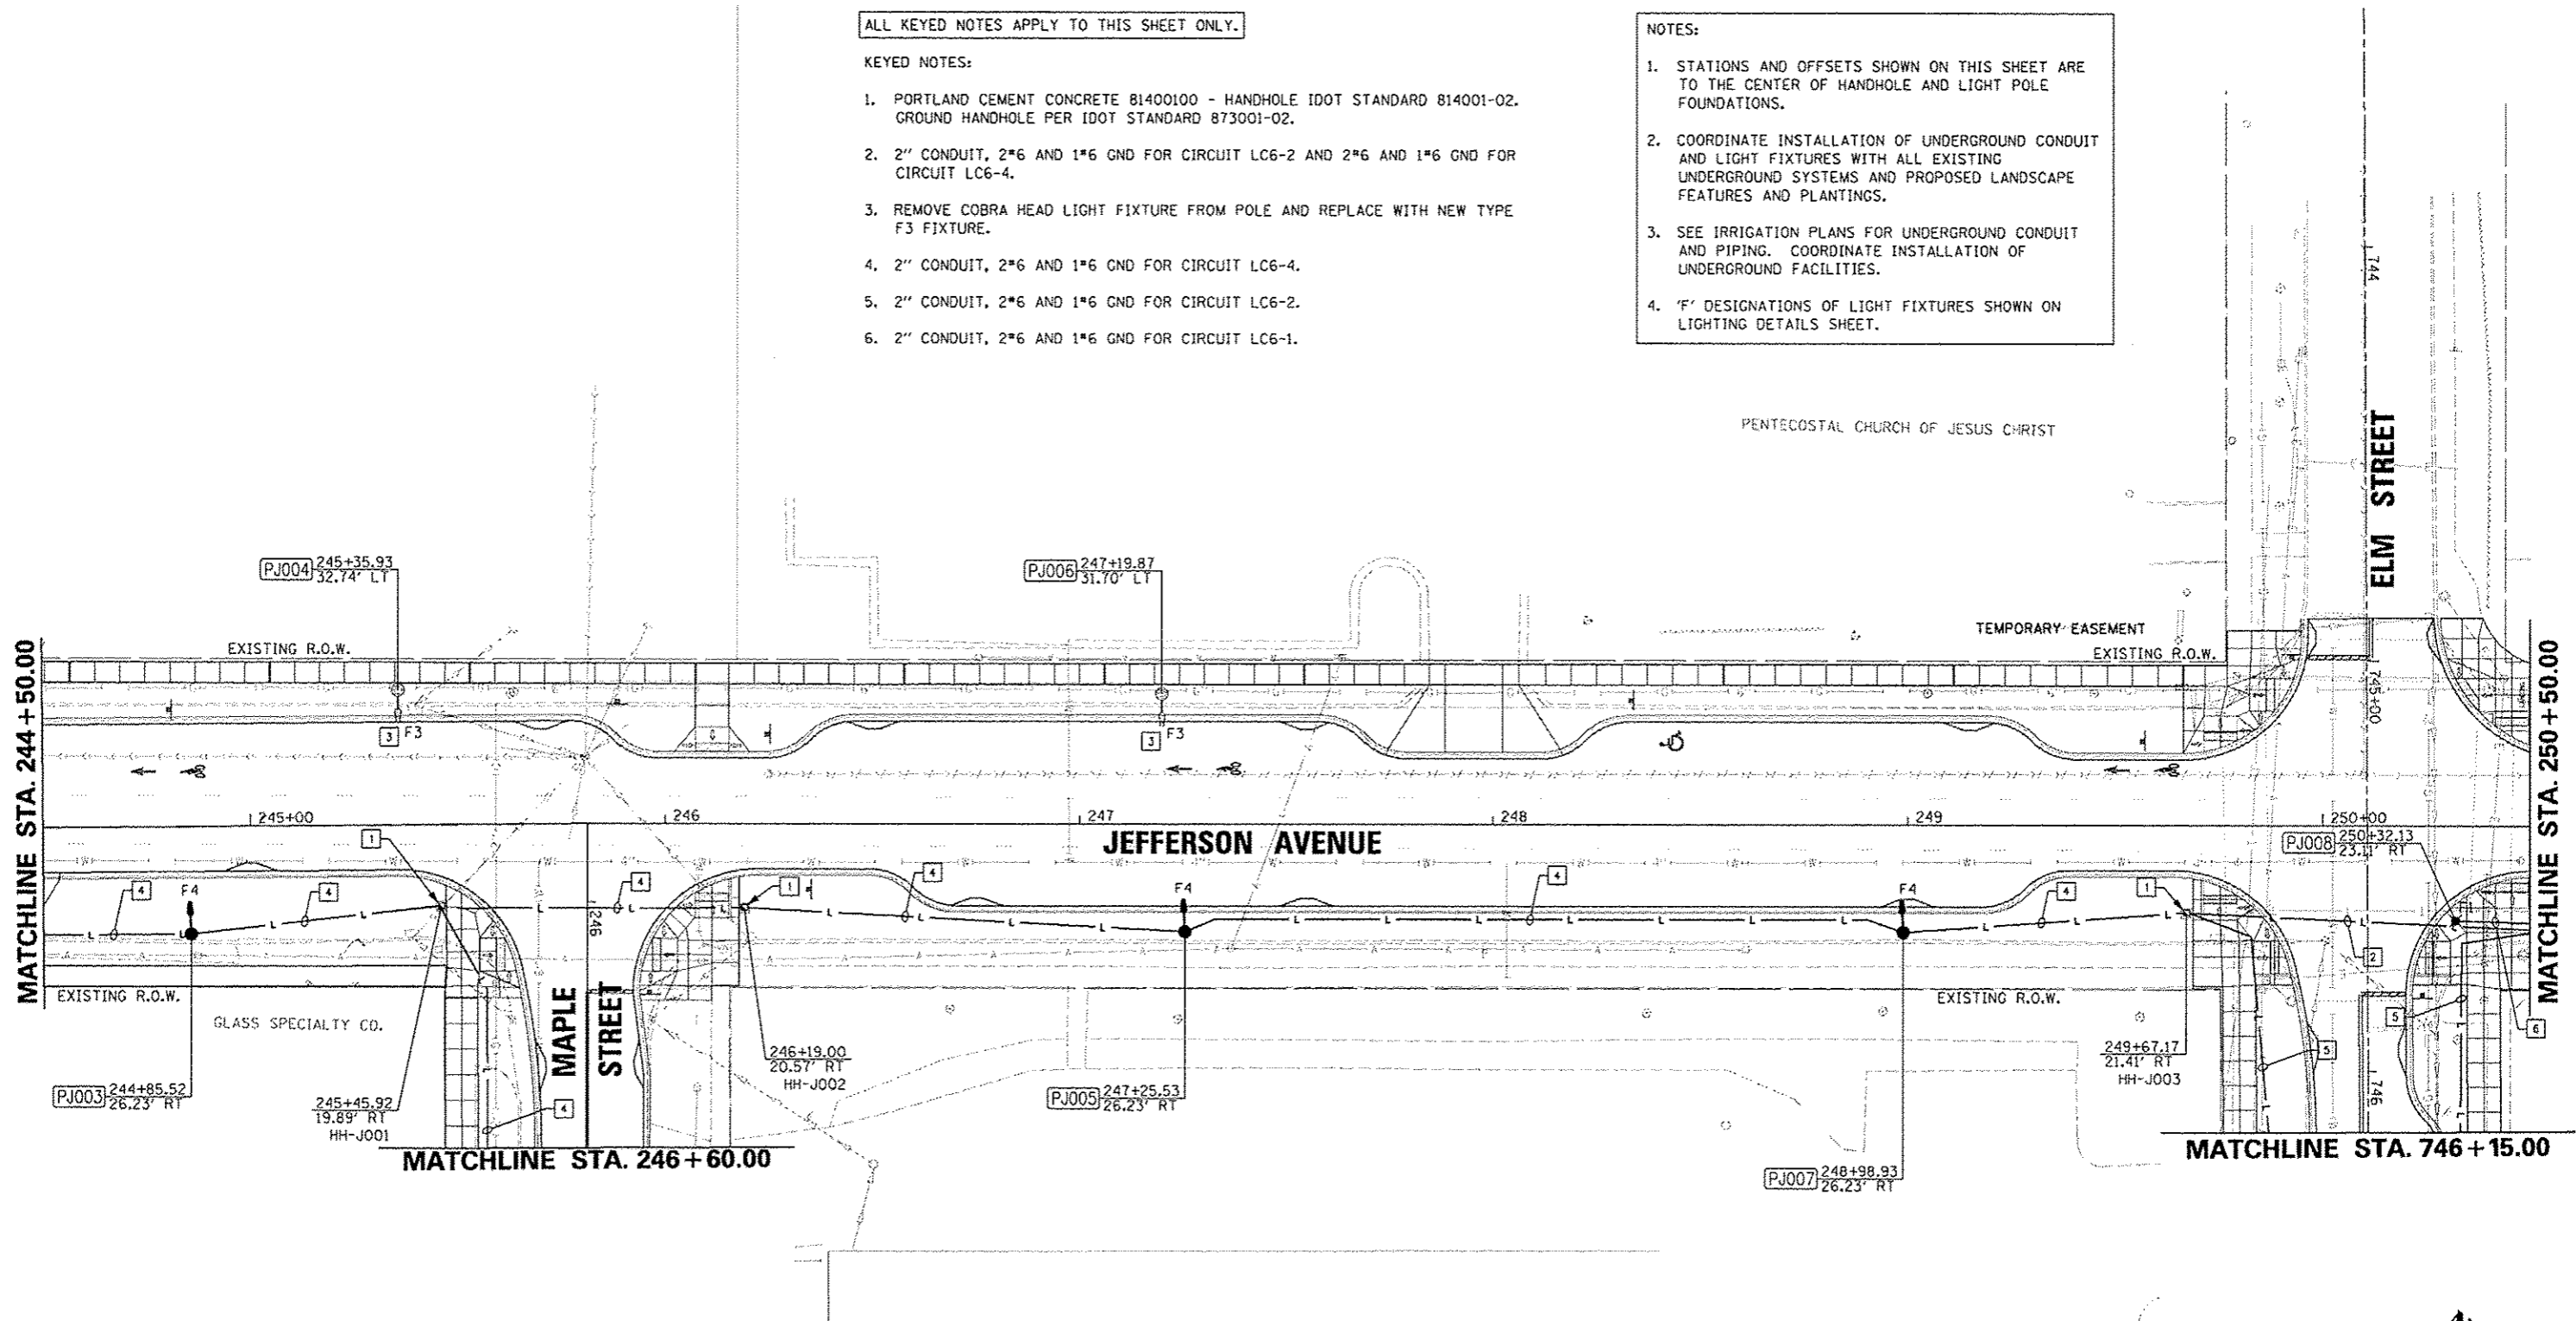
ALL KEYED NOTES APPLY TO THIS SHEET ONLY.

KEYED NOTES:

1. PORTLAND CEMENT CONCRETE 81400100 - HANDHOLE IDOT STANDARD 814001-02. GROUND HANDHOLE PER IDOT STANDARD 873001-02.
2. 2" CONDUIT, 2\*6 AND 1\*6 GND FOR CIRCUIT LC6-2 AND 2\*6 AND 1\*6 GND FOR CIRCUIT LC6-4.
3. REMOVE COBRA HEAD LIGHT FIXTURE FROM POLE AND REPLACE WITH NEW TYPE F3 FIXTURE.
4. 2" CONDUIT, 2\*6 AND 1\*6 GND FOR CIRCUIT LC6-4.
5. 2" CONDUIT, 2\*6 AND 1\*6 GND FOR CIRCUIT LC6-2.
6. 2" CONDUIT, 2\*6 AND 1\*6 GND FOR CIRCUIT LC6-1.

NOTES:

1. STATIONS AND OFFSETS SHOWN ON THIS SHEET ARE TO THE CENTER OF HANDHOLE AND LIGHT POLE FOUNDATIONS.
2. COORDINATE INSTALLATION OF UNDERGROUND CONDUIT AND LIGHT FIXTURES WITH ALL EXISTING UNDERGROUND SYSTEMS AND PROPOSED LANDSCAPE FEATURES AND PLANTINGS.
3. SEE IRRIGATION PLANS FOR UNDERGROUND CONDUIT AND PIPING. COORDINATE INSTALLATION OF UNDERGROUND FACILITIES.
4. 'F' DESIGNATIONS OF LIGHT FIXTURES SHOWN ON LIGHTING DETAILS SHEET.



FILE NAME =	USER NAME = manak01398	DESIGNED - JOE	REVISED -	<b>STATE OF ILLINOIS DEPARTMENT OF TRANSPORTATION</b>	<b>JEFFERSON AVENUE LIGHTING PLAN</b>	F.A.U. RTE.	SECTION	COUNTY	TOTAL SHEETS	SHEET NO.
ca:\pwise_work\do_not_delete\dms73318\041	LB0155-ehs-light826.dgn	DRAWN - TMT	REVISED -			12-00356-01-PV	PEORIA	519	360	
	PLOT SCALE = 3/8" = 1' / in.	CHECKED - BMS	REVISED -			CONTRACT NO. 89626				
	PLOT DATE = 07/25/2012	DATE - 7/18/12	REVISED -			ILLINOIS FED. AID PROJECT TIG-50931581				
				SCALE: 1"=20'		SHEET NO. OF SHEETS		STA. 244+50.00 TO STA. 250+50.00		

**NOTES:**



1. STATIONS AND OFFSETS SHOWN ON THIS SHEET ARE TO THE CENTER OF HANDHOLE AND LIGHT POLE FOUNDATIONS.
2. COORDINATE INSTALLATION OF UNDERGROUND CONDUIT AND LIGHT FIXTURES WITH ALL EXISTING UNDERGROUND SYSTEMS AND PROPOSED LANDSCAPE FEATURES AND PLANTINGS.
3. SEE IRRIGATION PLANS FOR UNDERGROUND CONDUIT AND PIPING. COORDINATE INSTALLATION OF UNDERGROUND FACILITIES.
4. UTILITY SERVICE FROM AMEREN TO LC6 IS CURRENTLY BEING REVIEWED BY AMEREN AND WILL BE COORDINATED WITH SUCCESSFUL CONTRACTOR.
5. 'F' DESIGNATIONS OF LIGHT FIXTURES SHOWN ON LIGHTING DETAILS SHEET.

**ALL KEYED NOTES APPLY TO THIS SHEET ONLY.**

**KEYED NOTES:**

1. PORTLAND CEMENT CONCRETE 81400100 - HANDHOLE IDOT STANDARD 814001-02. GROUND HANDHOLE PER IDOT STANDARD 873001-02.
2. 2" CONDUIT, 2\*6 AND 1\*6 GND FOR CIRCUIT LC6-1 AND 2\*6 AND 1\*6 GND FOR CIRCUIT LC6-2 AND 2\*6 AND 1\*6 GND FOR CIRCUIT LC6-3 AND 2\*6 AND 1\*6 GND FOR CIRCUIT LC6-4.
3. 2" CONDUIT, 2\*6 AND 1\*6 GND FOR CIRCUIT LC6-1.
4. 2" CONDUIT, 2\*6 AND 1\*6 GND FOR CIRCUIT LC6-3.
5. LIGHTING CONTROLLER, BASE MOUNTED, 240V, 200 AMP, "LC6.
6. REMOVE COBRA HEAD LIGHT FIXTURE FROM POLE AND REPLACE WITH NEW TYPE F3 FIXTURE.
7. 2" CONDUIT, 2\*6 AND 1\*6 GND FOR CIRCUIT LC6-4.
8. 2" CONDUIT, 2\*6 AND 1\*6 GND FOR CIRCUIT LC6-4 AND 2\*6 AND 1\*6 GND FOR CIRCUIT LC6-2.
9. SEE MAST ARM LOADING DIAGRAMS FOR TRAFFIC CONTROL DEVICES MOUNTED TO POLE. ONE SET OF BANNER ARMS SHALL REMAIN ON OPPOSITE SIDE OF POLE FROM TRAFFIC CONTROL DEVICE.
10. POLE SHALL BE MOUNTED SO THAT FIXTURES ARE PERPENDICULAR TO OAK STREET.

USA TECHNOLOGIES

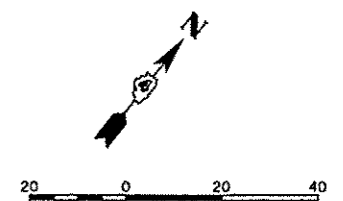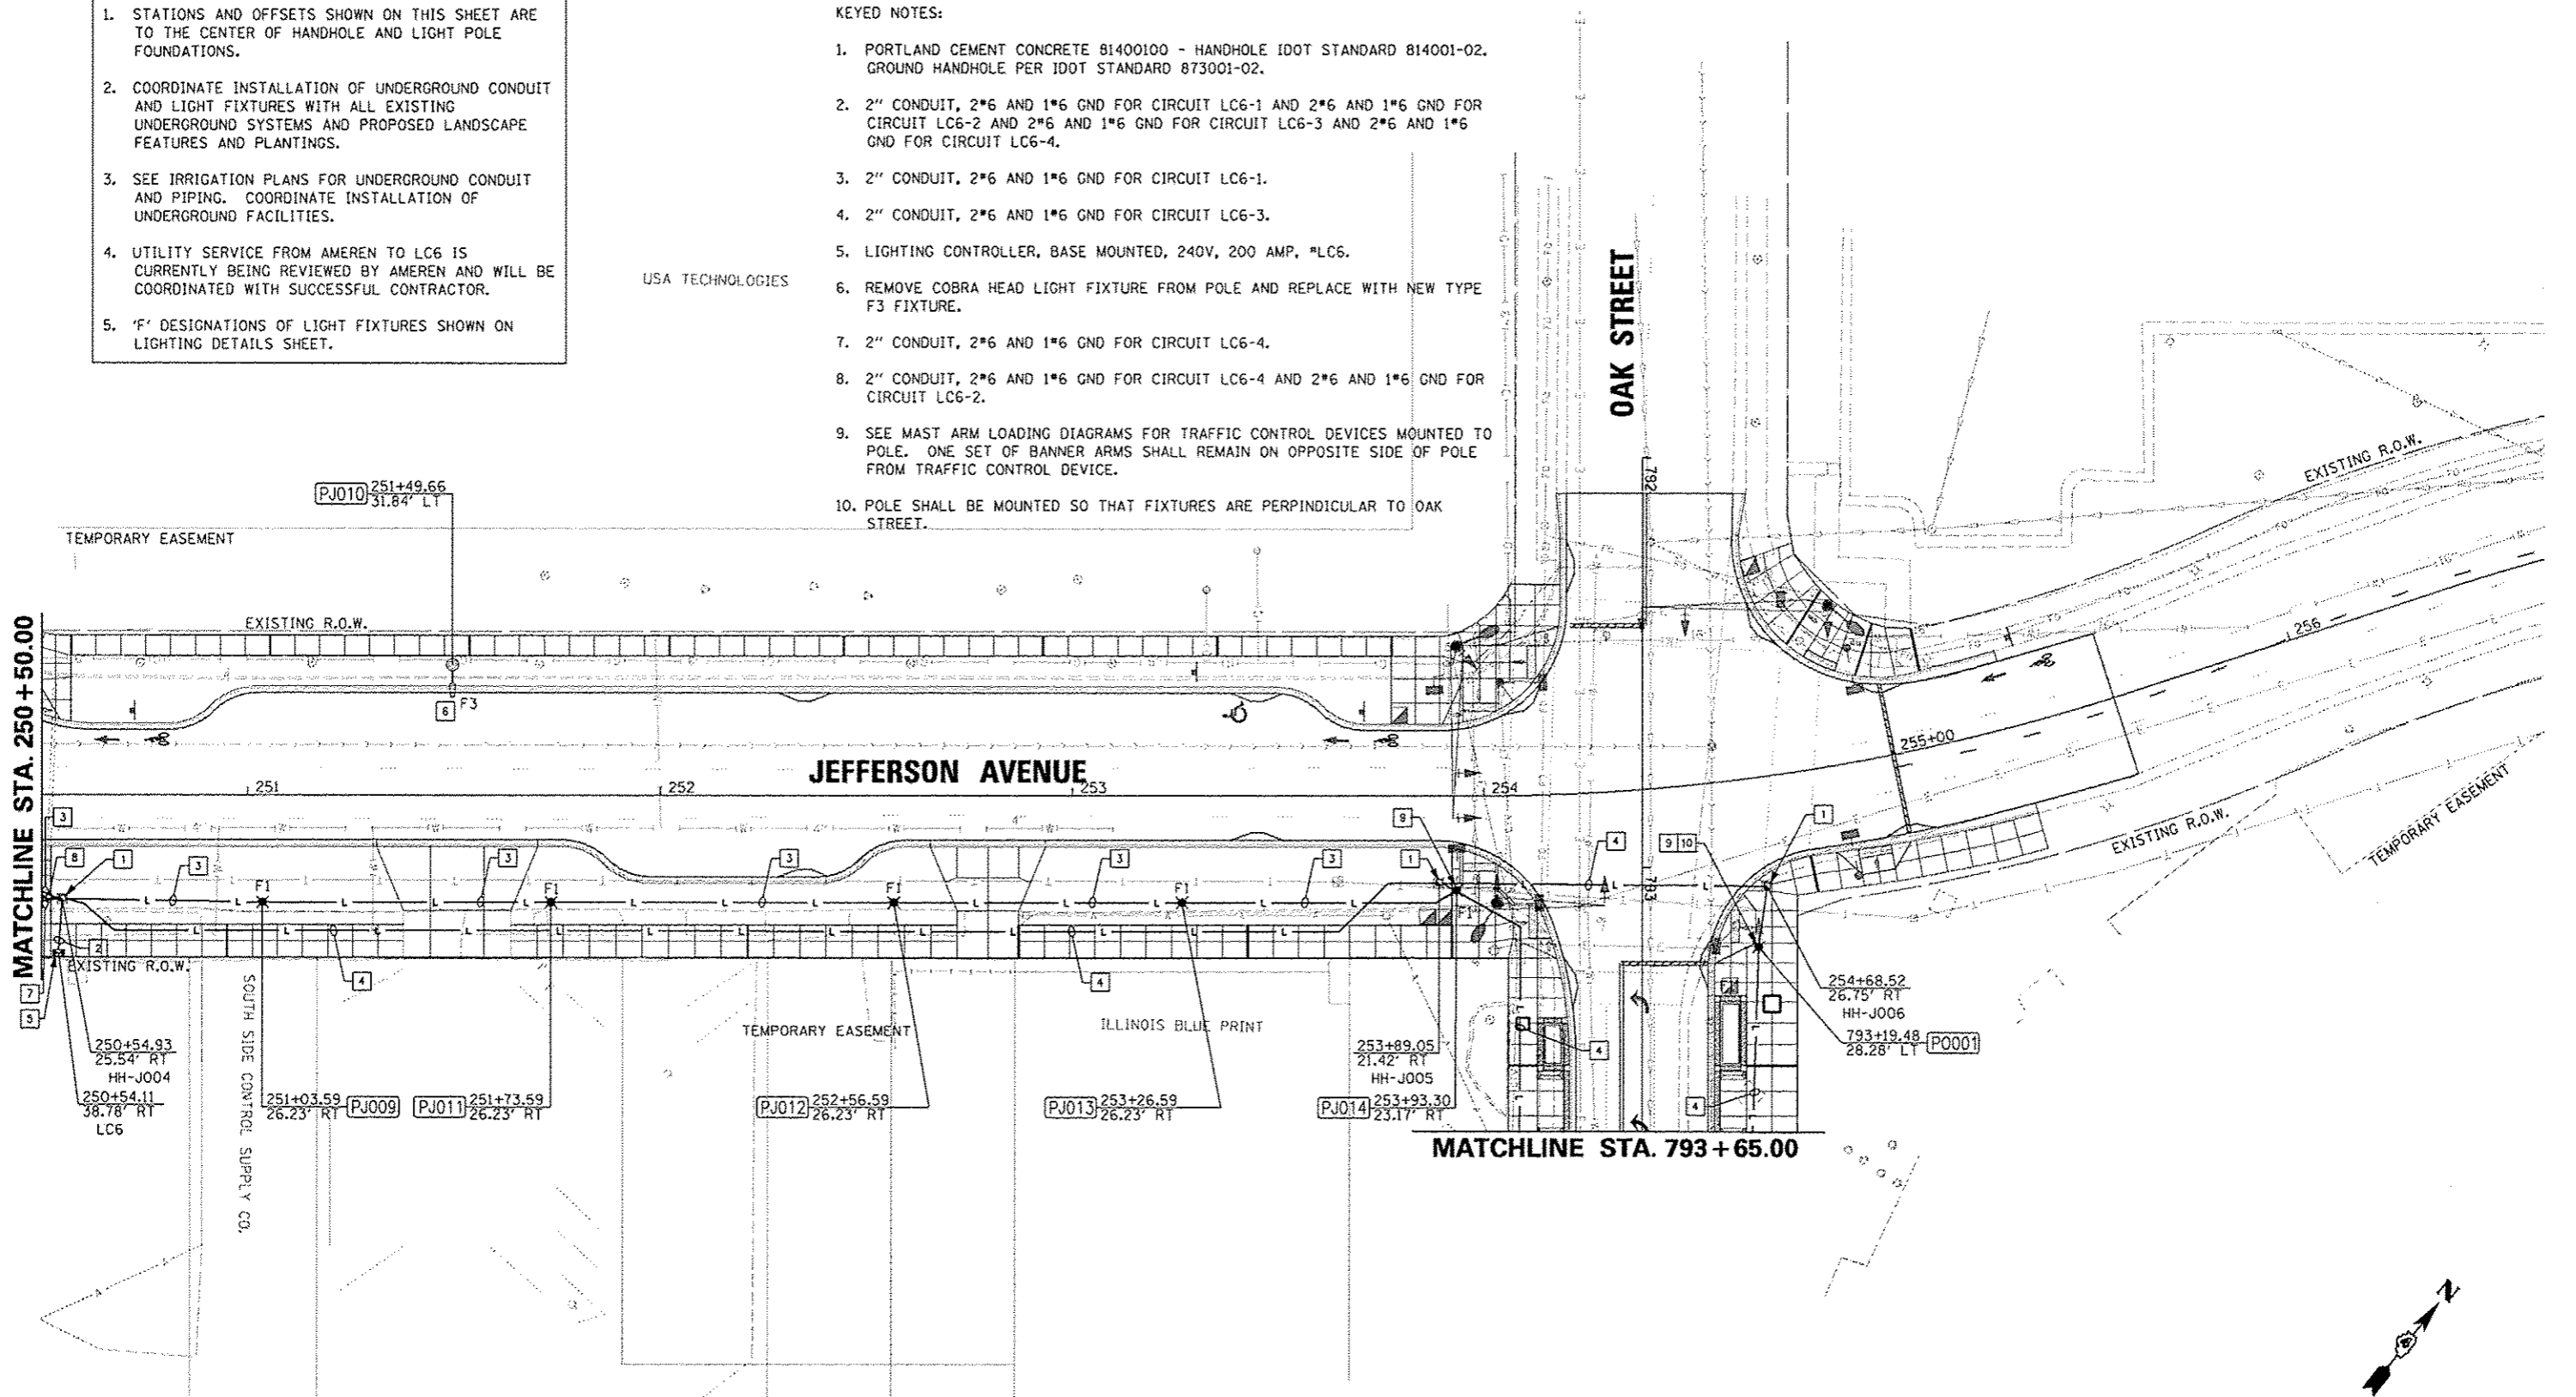

FILE NAME *	USER NAME * mersak01390	DESIGNED - JDE	REVISED -	<b>STATE OF ILLINOIS DEPARTMENT OF TRANSPORTATION</b>	<b>JEFFERSON AVENUE LIGHTING PLAN</b>	F.A.U. RTE.	SECTION	COUNTY	TOTAL SHEETS	SHEET NO.
or\pwise_work\do_no_t_delete\ids*73318\041	AL0155-eh-t-light027.dgn	DRAWN - TMT	REVISED -			12-00356-01-PV	PEORIA	519	361	
	PLOT SCALE = 39.9999' / in.	CHECKED - BMS	REVISED -			CONTRACT NO.89626				
	PLOT DATE = 07/20/2012	DATE - 7/18/12	REVISED -			ILLINOIS FED. AID PROJECT TIC-599301581				
		SCALE: 1"=20'		SHEET NO. OF SHEETS STA. 250+50.00 TO STA. 255+00.00						



ALL KEYED NOTES APPLY TO THIS SHEET ONLY.

KEYED NOTES:

1. 2" CONDUIT, 2\*4 AND 1\*4 GND FOR CIRCUIT LC2-14.
2. 2" CONDUIT, 2\*6 AND 1\*6 GND FOR CIRCUIT LC2-16.

NOTES:

1. STATIONS AND OFFSETS SHOWN ON THIS SHEET ARE TO THE CENTER OF HANDHOLE AND LIGHT POLE FOUNDATIONS.
2. COORDINATE INSTALLATION OF UNDERGROUND CONDUIT AND LIGHT FIXTURES WITH ALL EXISTING UNDERGROUND SYSTEMS AND PROPOSED LANDSCAPE FEATURES AND PLANTINGS.
3. SEE IRRIGATION PLANS FOR UNDERGROUND CONDUIT AND PIPING. COORDINATE INSTALLATION OF UNDERGROUND FACILITIES.
4. 'F' DESIGNATIONS OF LIGHT FIXTURES SHOWN ON LIGHTING DETAILS SHEET.

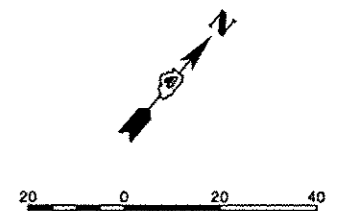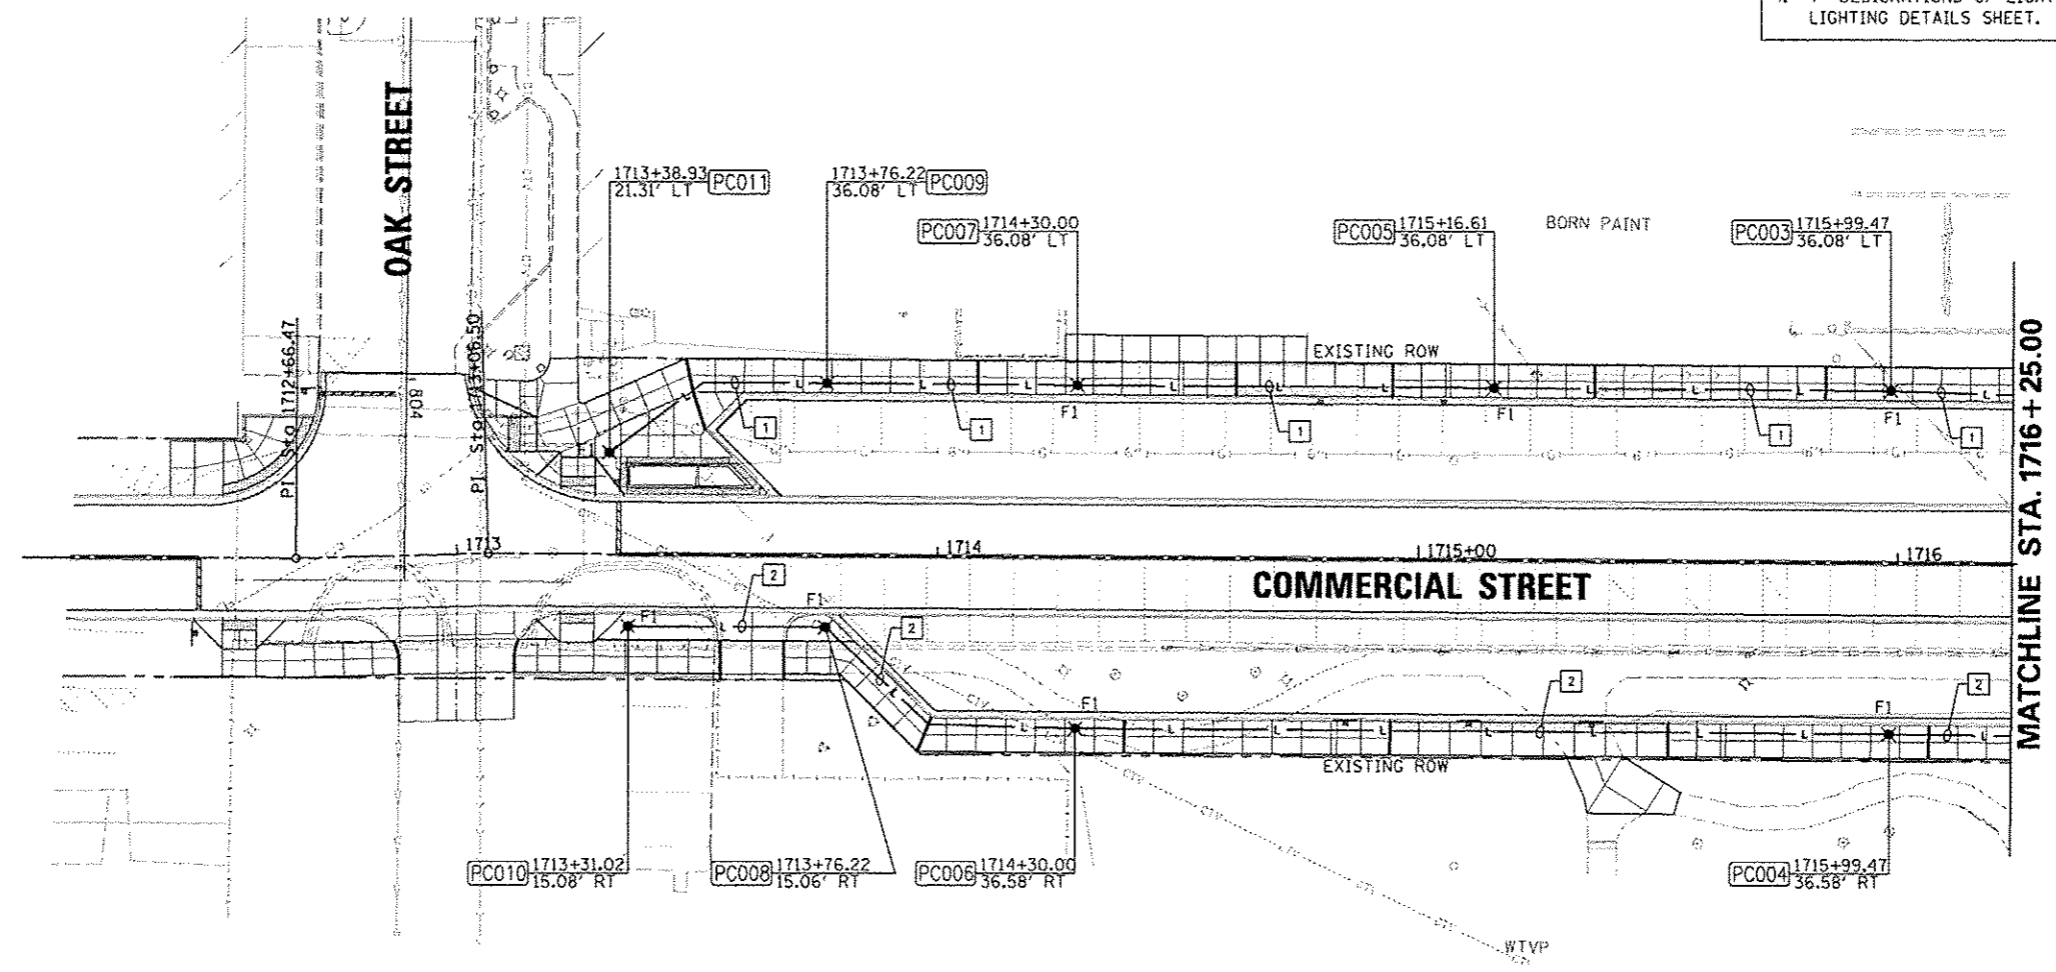



FILE NAME *	USER NAME * mansk01310	DESIGNED - JOE	REVISED -	<b>STATE OF ILLINOIS DEPARTMENT OF TRANSPORTATION</b>	<b>COMMERCIAL STREET LIGHTING PLAN</b>			F.A.U. R.T.E.	SECTION	COUNTY	TOTAL SHEETS	SHEET NO.
c:\pwise\work\do_not_delete\des73318\041	PL0155-shr-light030.dgn	DRAWN - TMT	REVISED -		SCALE: 1"=20'	SHEET NO. OF SHEETS	STA. 1713+00.00 TO STA. 1716+25.00	12-00356-01-PV	PEORIA	519	362	
	PLOT SCALE = 3/4"=1'-0"	CHECKED - BMS	REVISED -					CONTRACT NO. 89626				
	PLOT DATE = 07/23/2012	DATE - 7/18/12	REVISED -					ILLINOIS FED. AID PROJECT				110-50931(58)

**Farnsworth GROUP**  
 7707 N. KNOXVILLE AVE, SUITE 100  
 PEORIA, ILLINOIS 61614  
 (309) 699-3838 / (309) 699-9820 Fax  
 www.f-w.com



- NOTES:
1. STATIONS AND OFFSETS SHOWN ON THIS SHEET ARE TO THE CENTER OF HANDHOLE AND LIGHT POLE FOUNDATIONS.
  2. COORDINATE INSTALLATION OF UNDERGROUND CONDUIT AND LIGHT FIXTURES WITH ALL EXISTING UNDERGROUND SYSTEMS AND PROPOSED LANDSCAPE FEATURES AND PLANTINGS.
  3. SEE IRRIGATION PLANS FOR UNDERGROUND CONDUIT AND PIPING. COORDINATE INSTALLATION OF UNDERGROUND FACILITIES.
  4. 'F' DESIGNATIONS OF LIGHT FIXTURES SHOWN ON LIGHTING DETAILS SHEET.

- ALL KEYED NOTES APPLY TO THIS SHEET ONLY.
- KEYED NOTES:
1. 2" CONDUIT, 2\*4 AND 1\*4 GND FOR CIRCUIT LC2-5.
  2. 2" CONDUIT, 2\*6 AND 1\*6 GND FOR CIRCUIT LC5-4.
  3. SPLICE 2\*4, 1\*4 GND INTO COILED WIRE IN HANDHOLE. EXTEND INTO EXISTING CONDUIT STUB AND NEW CONDUIT.
  4. INTERCEPT EXISTING 2" CONDUIT AND EXTEND 2\*4, 1\*4 GND FOR EXISTING CIRCUIT LC2-5 TO NEW FIXTURES.

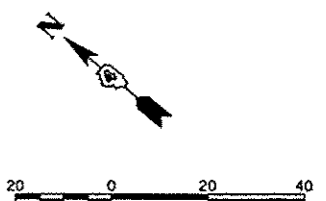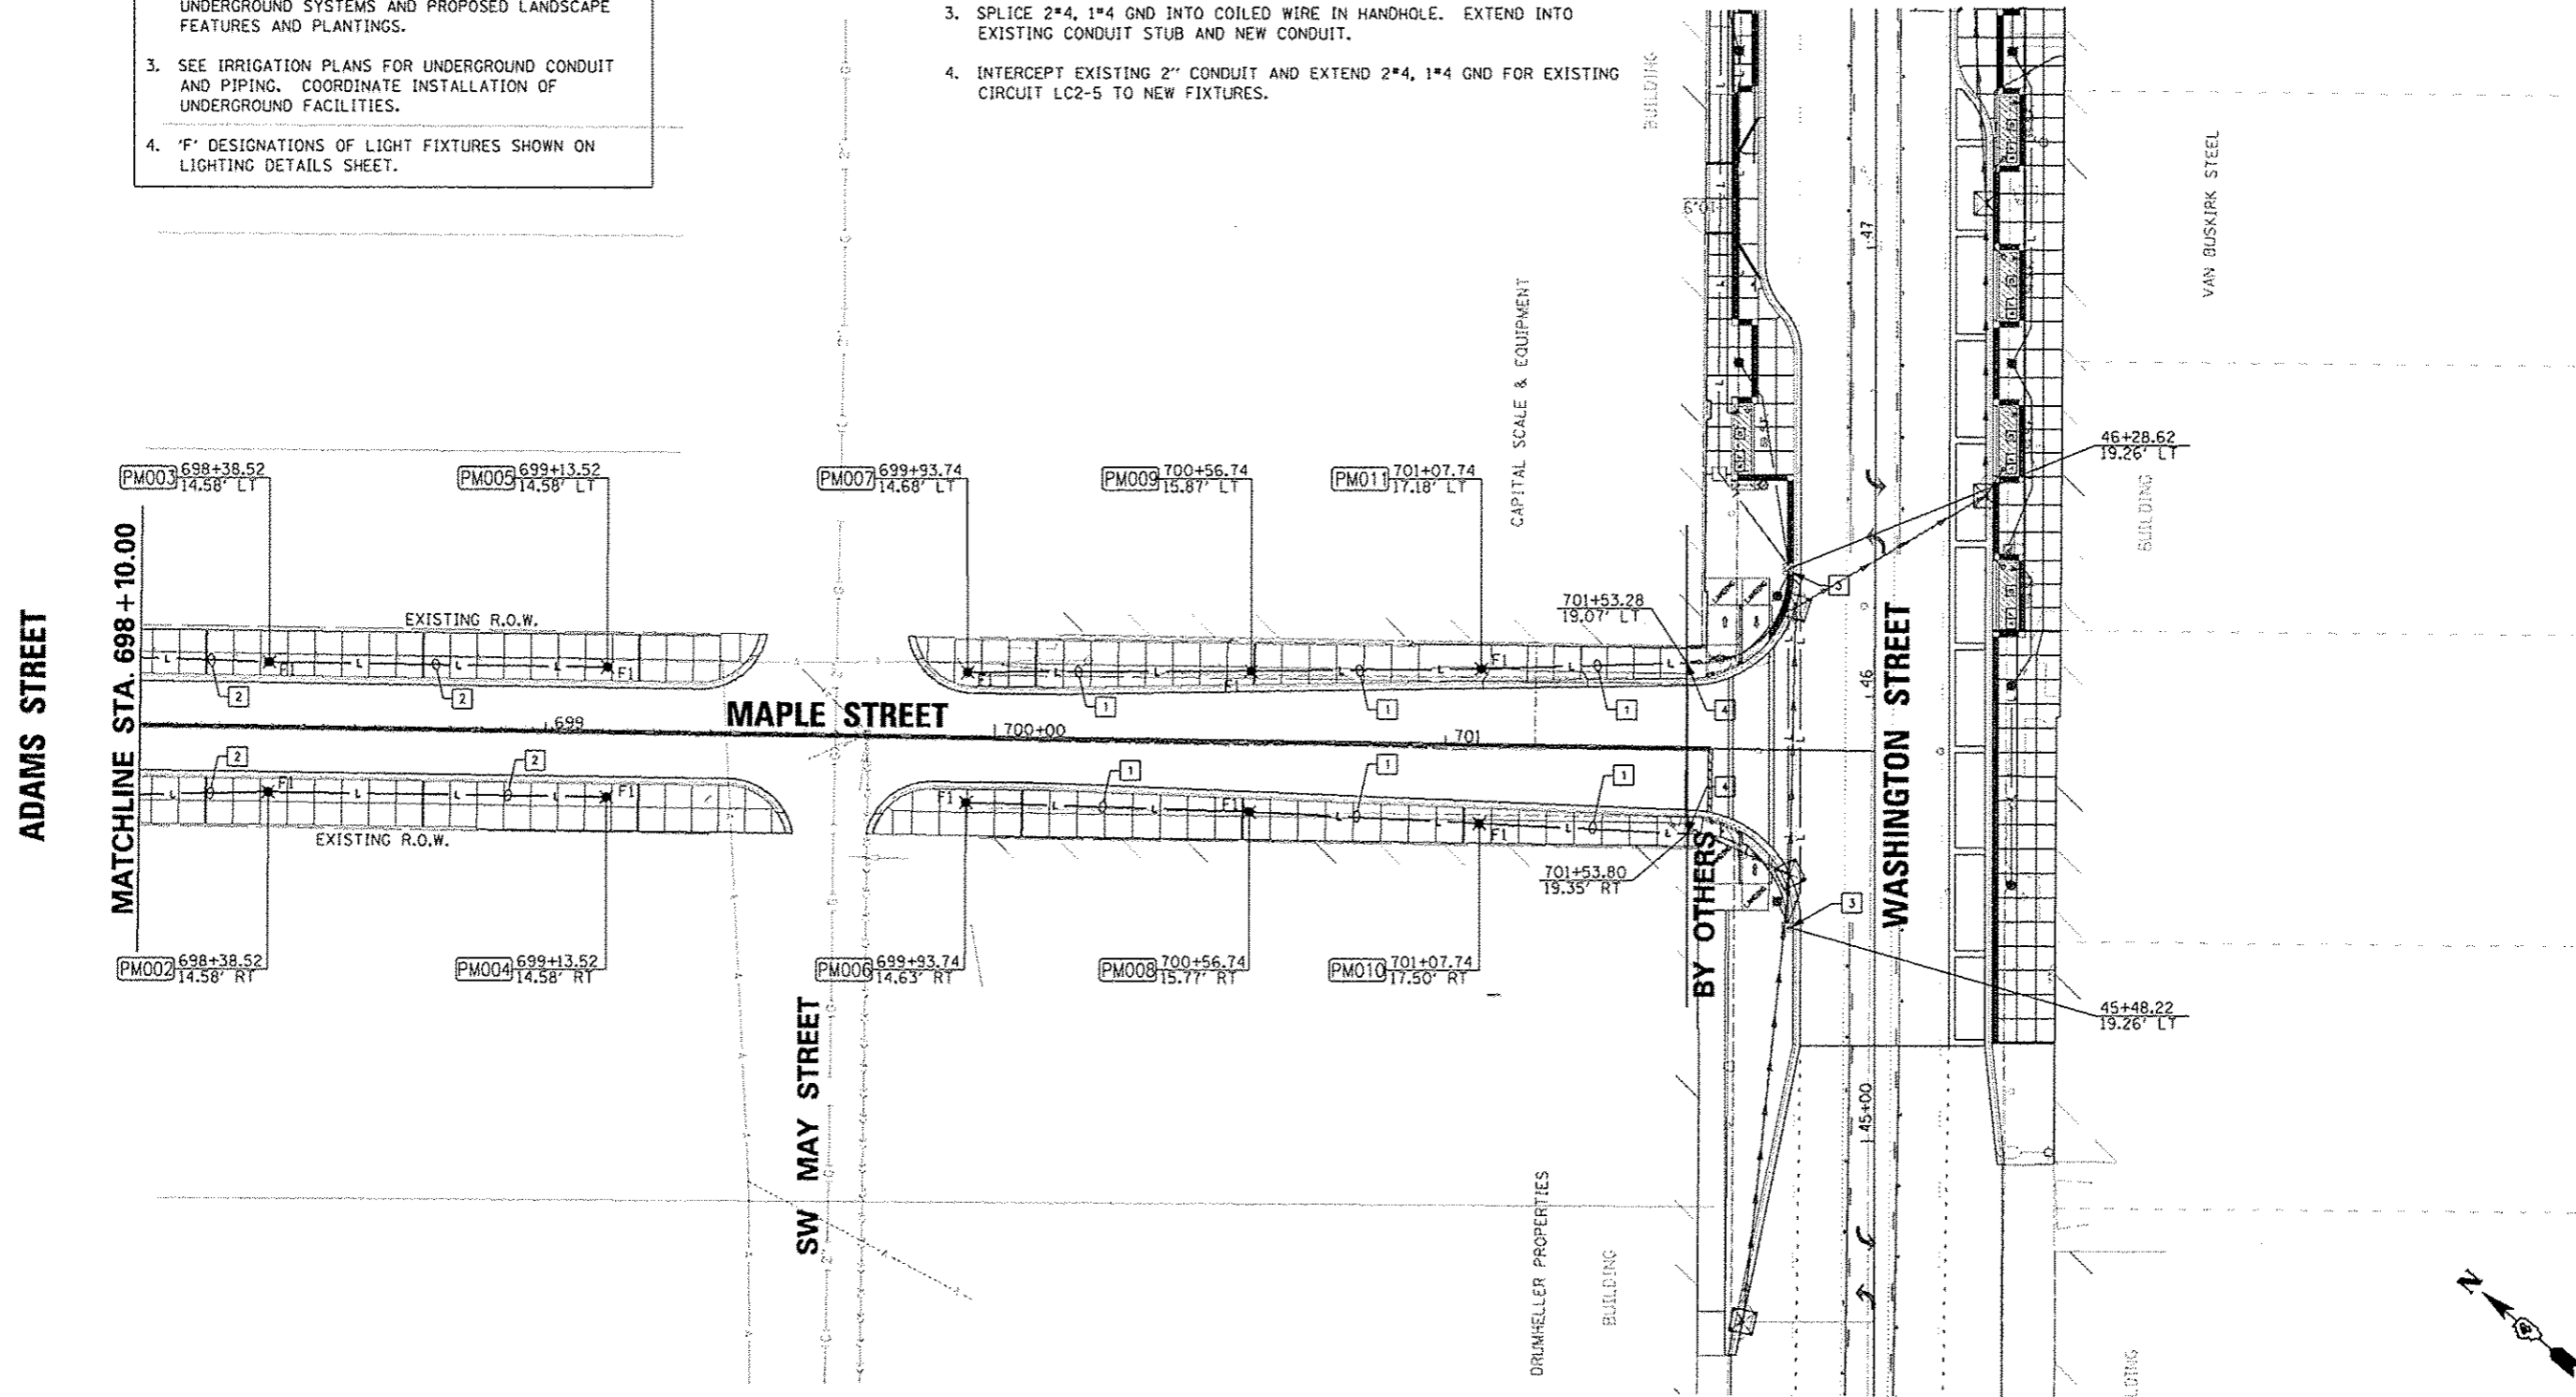

FILE NAME *	USER NAME = dcvsc00870	DESIGNED - JOE	REVISED -	<b>STATE OF ILLINOIS DEPARTMENT OF TRANSPORTATION</b>	<b>MAPLE STREET LIGHTING PLAN</b>	F.A.U. RTE.	SECTION	COUNTY	TOTAL SHEETS	SHEET NO.
or\pwise_work\do_not_delete\dm73318\041	PL0195-shr-light029.dgn	DRAWN - TMT	REVISED -			12-00356-01-PV	PEORIA	519	364	
	PLOT SCALE = 3/4"=1'-0"	CHECKED - BMS	REVISED -			CONTRACT NO. 89626		ILLINOIS FED. AID PROJECT TIG-5093(159)		
	PLOT DATE = 08/23/2012	DATE - 7/18/12	REVISED -			SCALE: 1"=20'	SHEET NO. OF SHEETS	STA. 698+10.00 TO STA. 701+95.00		

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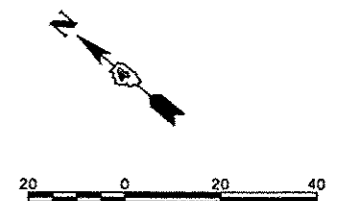
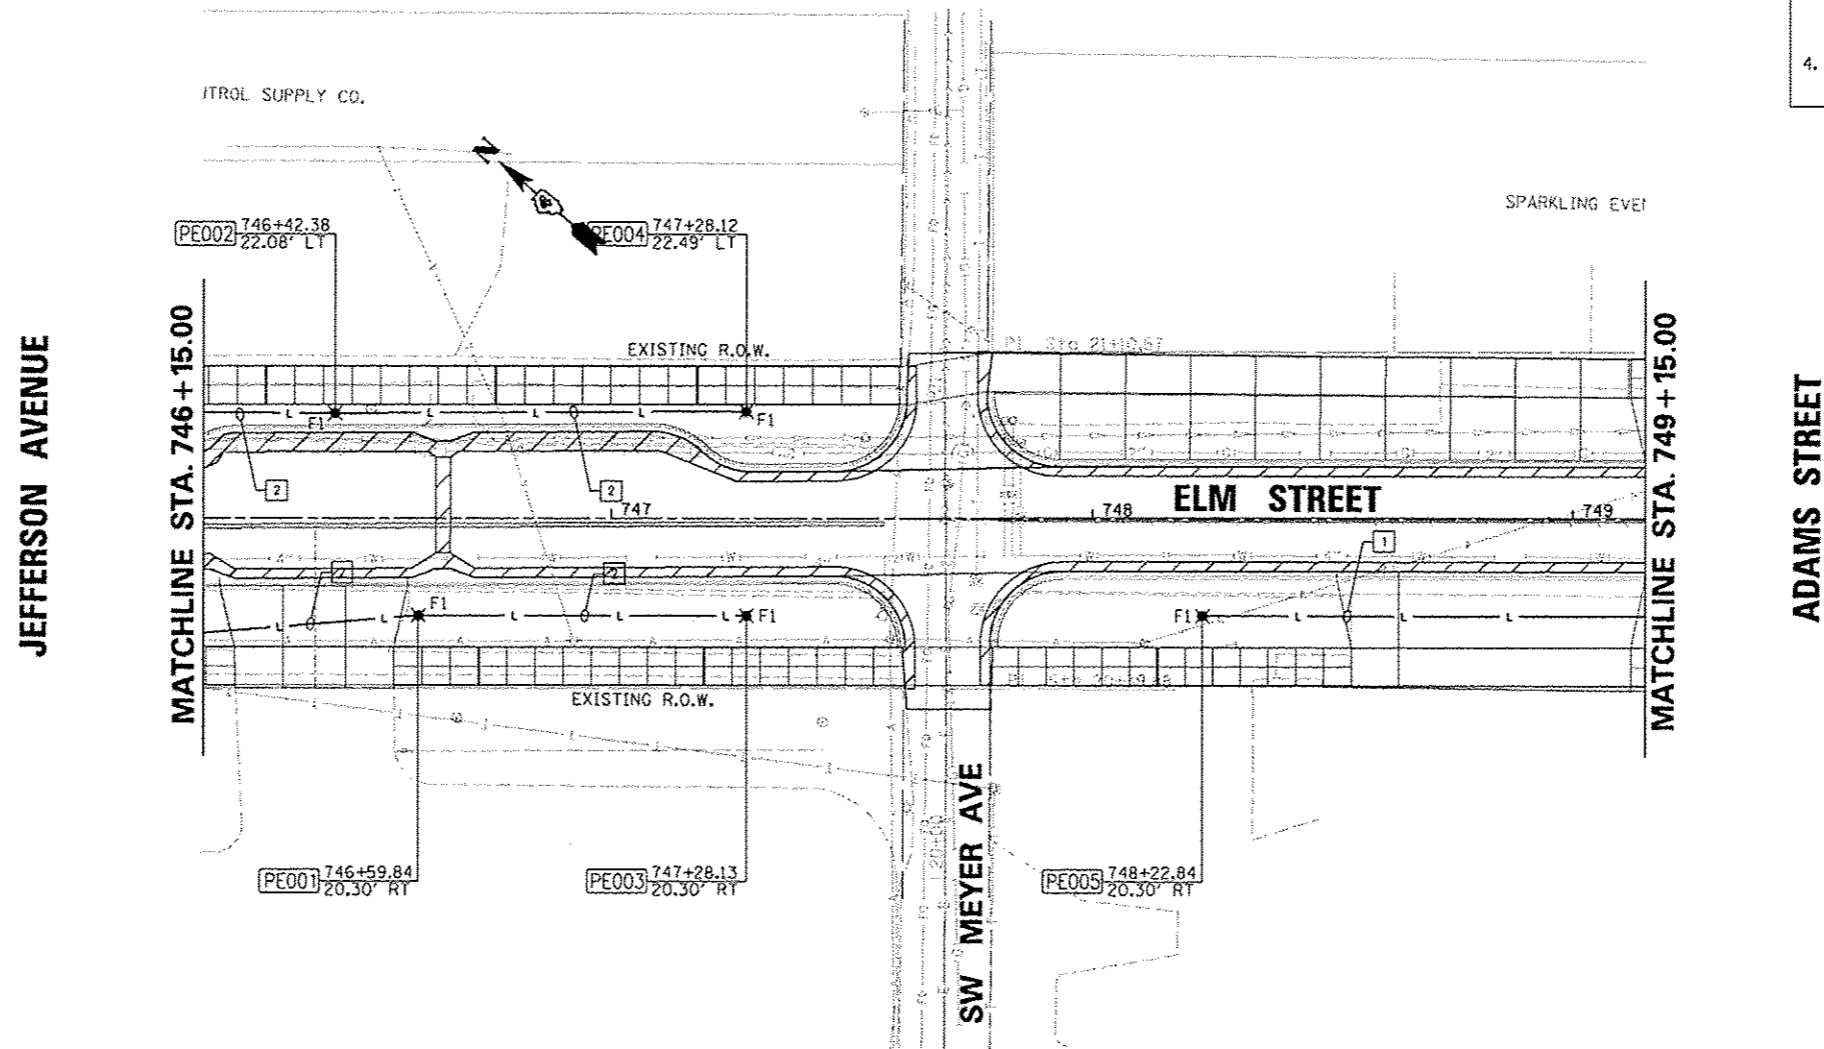
ALL KEYED NOTES APPLY TO THIS SHEET ONLY.

KEYED NOTES:

- 2" CONDUIT, 2\*6 AND 1\*6 GND FOR CIRCUIT LC5-5.
- 2" CONDUIT, 2\*6 AND 1\*6 GND FOR CIRCUIT LC6-2.

NOTES:

- STATIONS AND OFFSETS SHOWN ON THIS SHEET ARE TO THE CENTER OF HANDHOLE AND LIGHT POLE FOUNDATIONS.
- COORDINATE INSTALLATION OF UNDERGROUND CONDUIT AND LIGHT FIXTURES WITH ALL EXISTING UNDERGROUND SYSTEMS AND PROPOSED LANDSCAPE FEATURES AND PLANTINGS.
- SEE IRRIGATION PLANS FOR UNDERGROUND CONDUIT AND PIPING. COORDINATE INSTALLATION OF UNDERGROUND FACILITIES.
- 'F' DESIGNATIONS OF LIGHT FIXTURES SHOWN ON LIGHTING DETAILS SHEET.





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	LO159-eh-11gh-1038.dgn	DRAWN = TMT	REVISED =			12-00356-01-PV	PEORIA	519	365	
	PLOT SCALE = 3/4"=20' / in.	CHECKED = BMS	REVISED =			CONTRACT NO. 89626				
	PLOT DATE = 07/20/2012	DATE = 7/18/12	REVISED =			ILLINOIS FED. AID PROJECT TIG-5093158				
SCALE: 1"=20'						SHEET NO. OF SHEETS	STA. 746+15.00 TO STA. 749+15.00			

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 www.fw.com

- NOTES:
1. STATIONS AND OFFSETS SHOWN ON THIS SHEET ARE TO THE CENTER OF HANDHOLE AND LIGHT POLE FOUNDATIONS.
  2. COORDINATE INSTALLATION OF UNDERGROUND CONDUIT AND LIGHT FIXTURES WITH ALL EXISTING UNDERGROUND SYSTEMS AND PROPOSED LANDSCAPE FEATURES AND PLANTINGS.
  3. SEE IRRIGATION PLANS FOR UNDERGROUND CONDUIT AND PIPING. COORDINATE INSTALLATION OF UNDERGROUND FACILITIES.
  4. 'F' DESIGNATIONS OF LIGHT FIXTURES SHOWN ON LIGHTING DETAILS SHEET.

ALL KEYED NOTES APPLY TO THIS SHEET ONLY.

- KEYED NOTES:
1. 2" CONDUIT, 2#6 AND 1#6 GND FOR CIRCUIT LC6-3.
  2. 2" CONDUIT, 2#6 AND 1#6 GND FOR CIRCUIT LC4-3.

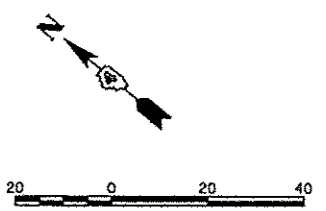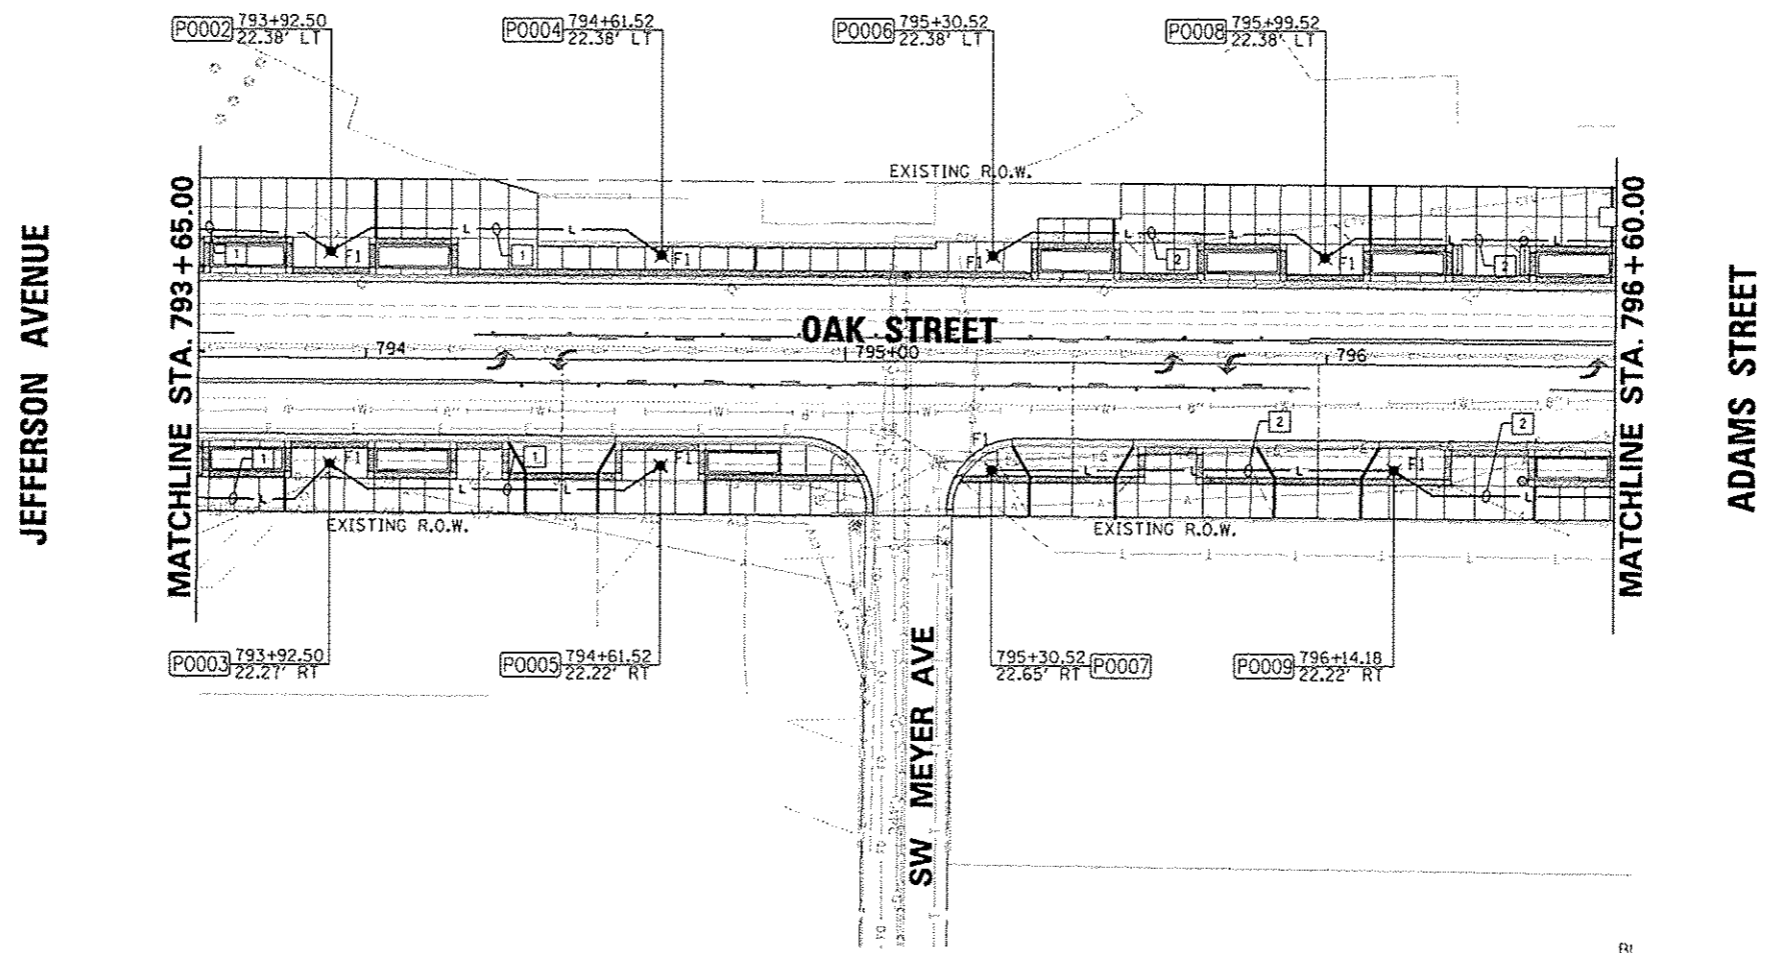



FILE NAME = o:\pwise_work\do_not_delete\dms7338\041	USER NAME = monak81390	DESIGNED = JDE	REVISED = -	<b>STATE OF ILLINOIS DEPARTMENT OF TRANSPORTATION</b>	<b>OAK STREET LIGHTING PLAN</b>			F.A.U. RTE. 663	SECTION 12-00356-01-PV	COUNTY PEORIA	TOTAL SHEETS 519	SHEET NO. 366
	PL0T SCALE = 3/8" = 1' in.	CHECKED = BMS	REVISED = -		SCALE: 1"=20'	SHEET NO. OF SHEETS	STA. 793+65.00 TO STA. 796+60.00	CONTRACT NO. 89626				
	PL0T DATE = 07/23/2012	DATE = 7/18/12	REVISED = -		ILLINOIS FED. AID PROJECT TIC-50931591							

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 www.fwg.com

- NOTES:
1. STATIONS AND OFFSETS SHOWN ON THIS SHEET ARE TO THE CENTER OF HANDHOLE AND LIGHT POLE FOUNDATIONS.
  2. COORDINATE INSTALLATION OF UNDERGROUND CONDUIT AND LIGHT FIXTURES WITH ALL EXISTING UNDERGROUND SYSTEMS AND PROPOSED LANDSCAPE FEATURES AND PLANTINGS.
  3. SEE IRRIGATION PLANS FOR UNDERGROUND CONDUIT AND PIPING. COORDINATE INSTALLATION OF UNDERGROUND FACILITIES.
  4. 'F' DESIGNATIONS OF LIGHT FIXTURES SHOWN ON LIGHTING DETAILS SHEET.

ALL KEYED NOTES APPLY TO THIS SHEET ONLY.

- KEYED NOTES:
1. 2" CONDUIT, 2\*6 AND 1\*6 GND FOR CIRCUIT LC4-4.

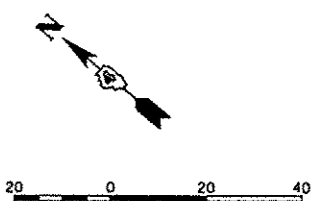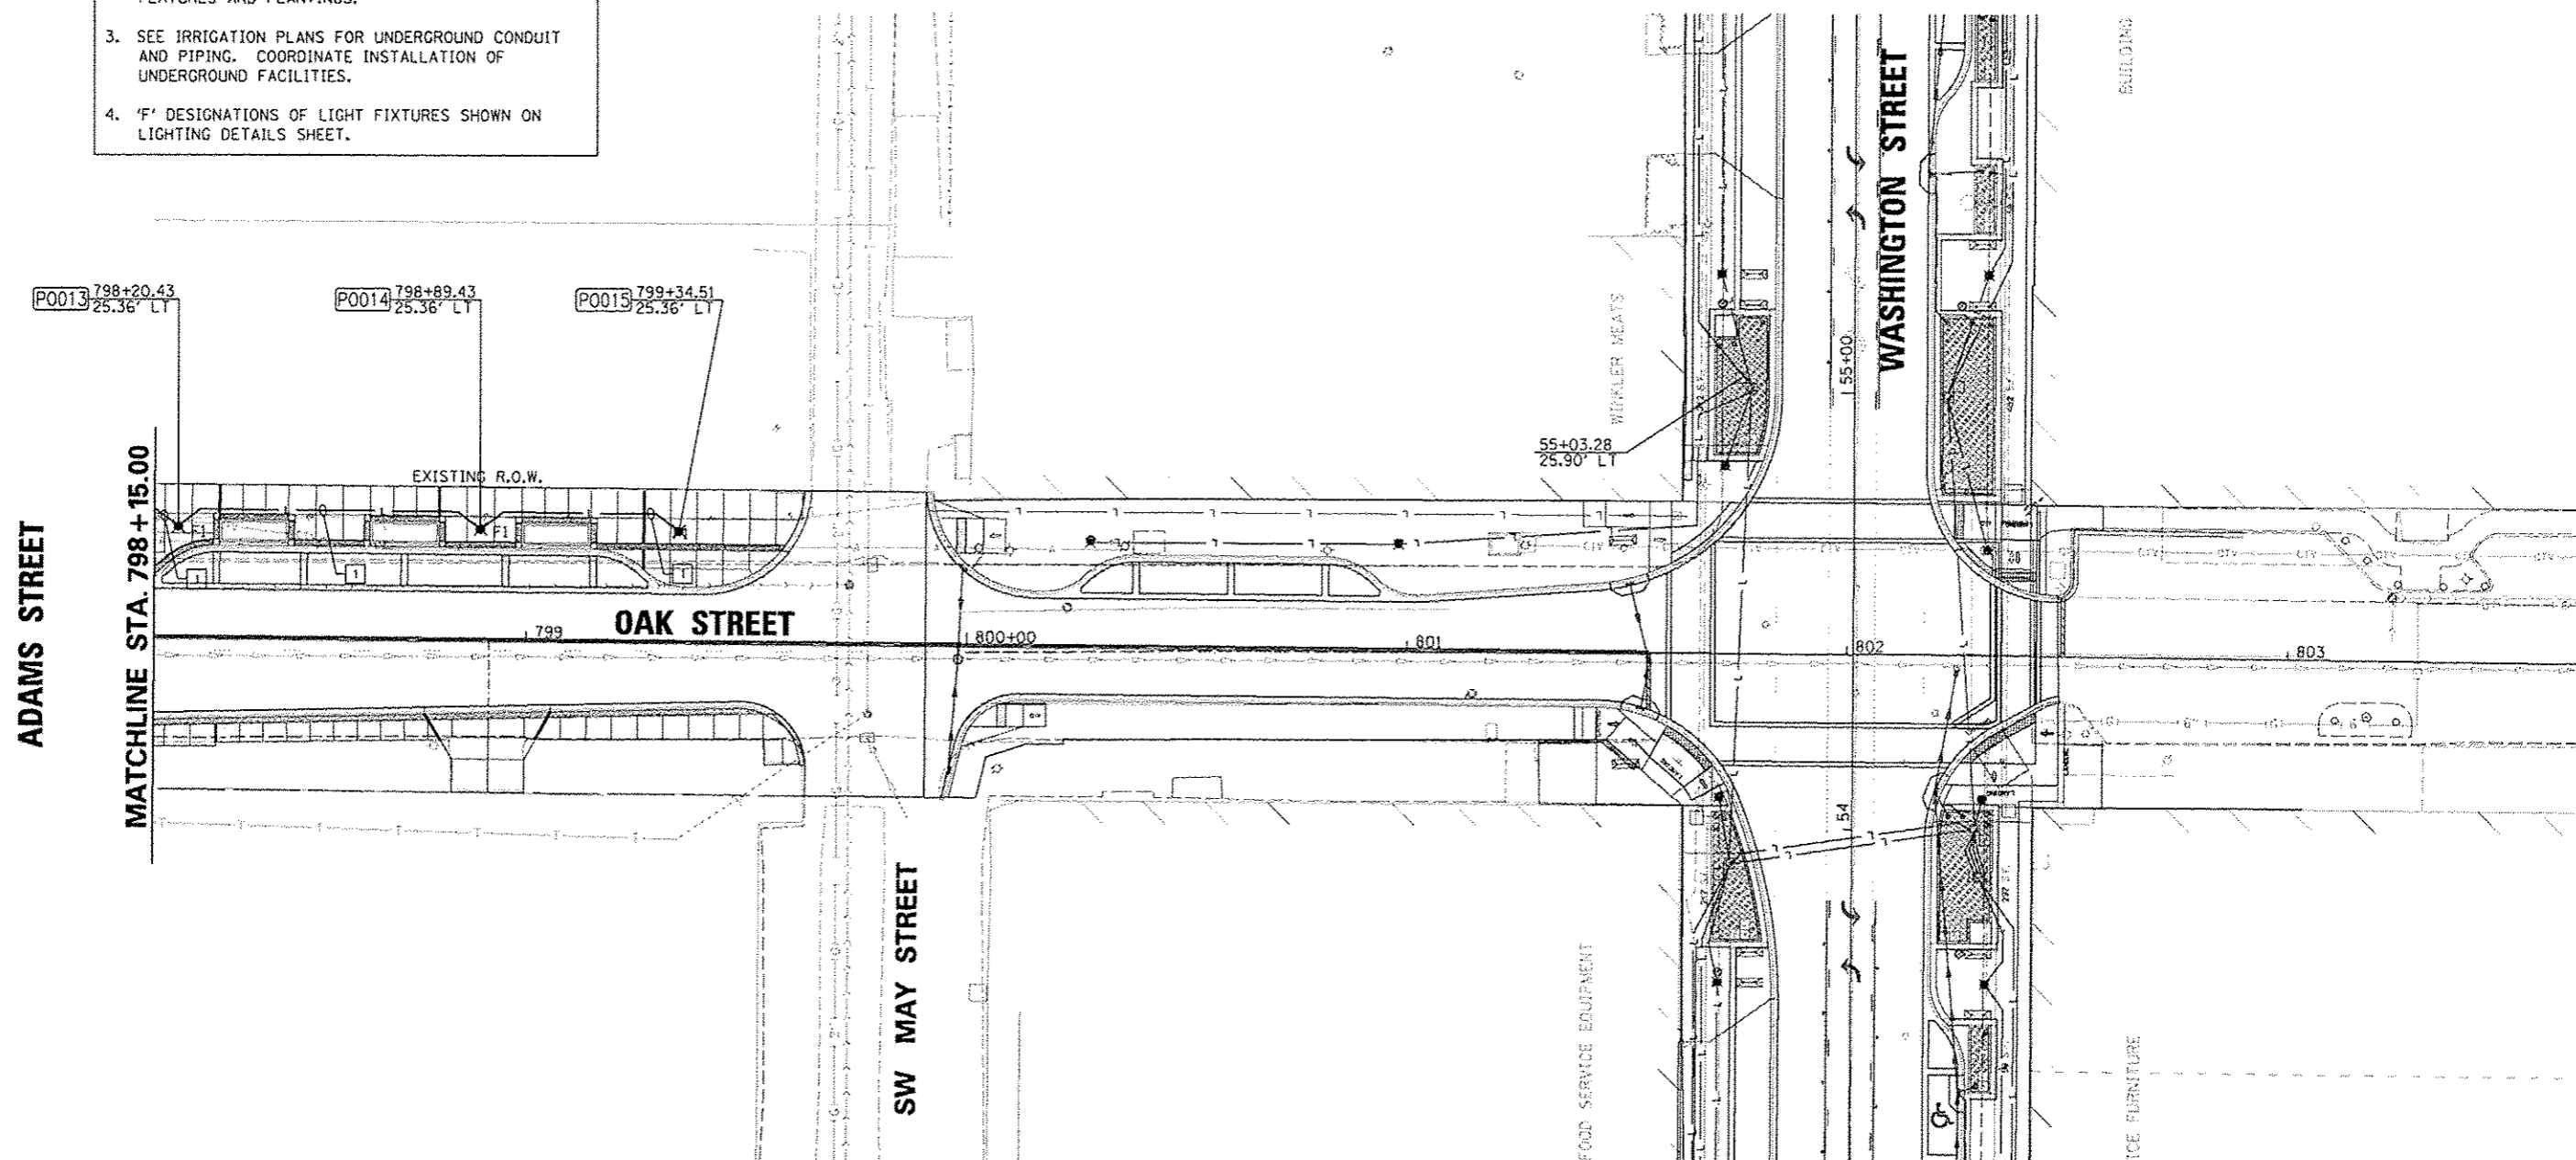

FILE NAME * c:\pwise_work\do_not_delete\dms73316\04	USER NAME * mgnek01390	DESIGNED - JDE	REVISED - -	<b>STATE OF ILLINOIS DEPARTMENT OF TRANSPORTATION</b>	<b>OAK STREET LIGHTING PLAN</b>		F.A.J. RTE. 663	SECTION 12-00356-01-PV	COUNTY PEORIA	TOTAL SHEETS 519	SHEET NO. 367
	PLOT SCALE * 3/4" = 1' (1/8" = 1')	DRAWN - TMT	REVISED - -		SCALE: 1"=20'	SHEET NO. OF SHEETS	STA. 798+15.00 TO STA. 803+65.00	CONTRACT NO. 89626		ILLINOIS FED. AID PROJECT TIG-509315B1	
	PLOT DATE * 07/18/2012	CHECKED - BMS	REVISED - -								
		DATE - 7/18/12	REVISED - -								

**Farnsworth GROUP**  
 7707 N. KNOXVILLE AVE, SUITE 100  
 PEORIA, ILLINOIS 61614  
 (309) 699-8888 / (309) 699-9820 Fax  
 www.fsg.com

ALL KEYED NOTES APPLY TO THIS SHEET ONLY.

KEYED NOTES:


1. INTERCEPT EXISTING 2" CONDUIT FOR CIRCUIT EXTENSION.
2. 2" CONDUIT, 2\*6 AND 1\*6 GND FOR CIRCUIT LC2-14 AND 2\*6 AND 1\*6 GND FOR CIRCUIT LC2-16. EXTEND WIRE IN EXISTING CONDUIT BACK TO HANDHOLE.
3. 2" CONDUIT, 2\*6 AND 1\*6 GND FOR CIRCUIT LC2-8. EXTEND WIRE BACK TO EXISTING POLE AND SPLICE WIRE IN POLE HANDHOLE.
4. 2" CONDUIT, 2\*6 AND 1\*6 GND FOR CIRCUIT LC2-11, EXTEND WIRE BACK TO EXISTING POLE AND SPLICE.
5. EXISTING POLE, SPLICE CIRCUIT CONDUCTORS IN POLE HANDHOLE.
6. 2" CONDUIT, 2\*6 AND 1\*6 GND FOR CIRCUIT LC4-8.
7. EXISTING HANDHOLE - SPLICE AND EXTEND 2\*6 AND 1\*6 GND FOR CIRCUIT LC2-14 AND 2\*6 AND 1\*6 GND FOR CIRCUIT LC2-16.
8. 2" CONDUIT, 2\*6 AND 1\*6 GND FOR CIRCUIT LC2-12. EXTEND WIRE BACK TO EXISTING POLE AND SPLICE WIRE IN POLE HANDHOLE.

NOTES:

1. STATIONS AND OFFSETS SHOWN ON THIS SHEET ARE TO THE CENTER OF HANDHOLE AND LIGHT POLE FOUNDATIONS.
2. COORDINATE INSTALLATION OF UNDERGROUND CONDUIT AND LIGHT FIXTURES WITH ALL EXISTING UNDERGROUND SYSTEMS AND PROPOSED LANDSCAPE FEATURES AND PLANTINGS.
3. SEE IRRIGATION PLANS FOR UNDERGROUND CONDUIT AND PIPING. COORDINATE INSTALLATION OF UNDERGROUND FACILITIES.
4. 'F' DESIGNATIONS OF LIGHT FIXTURES SHOWN ON LIGHTING DETAILS SHEET.

ADAMS STREET

MATCHLINE STA. 898 + 45.00

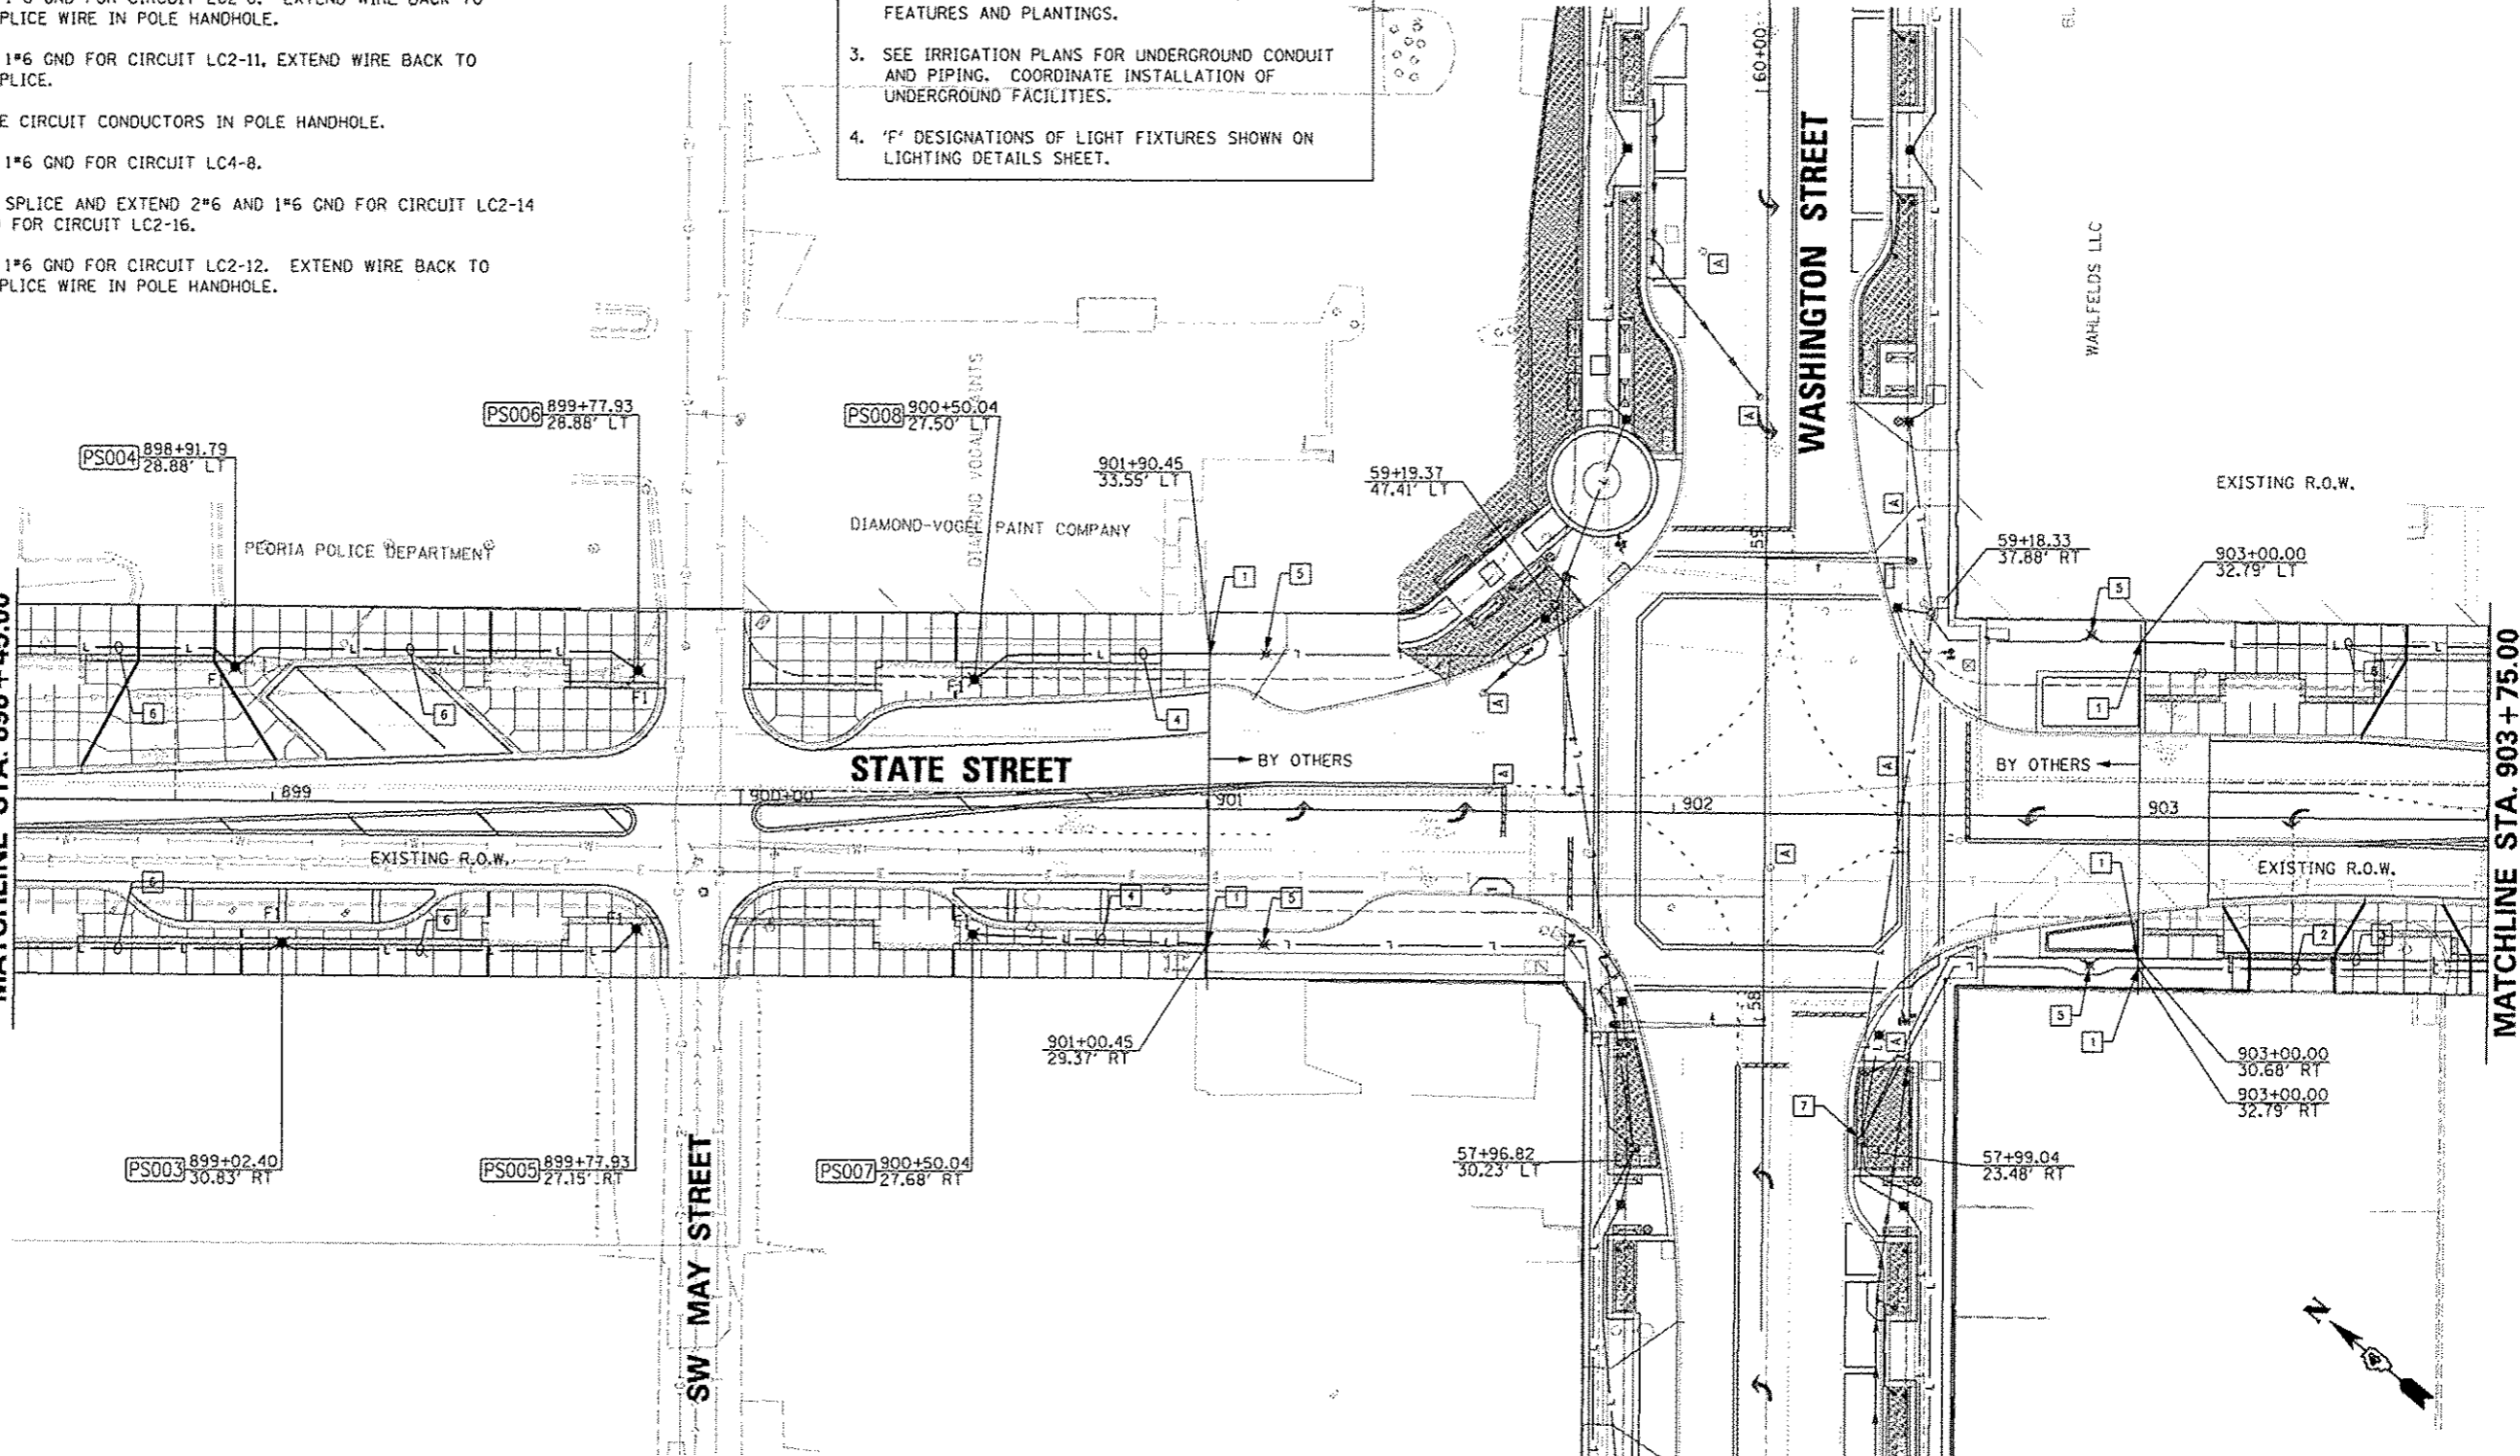

MATCHLINE STA. 903 + 75.00

FILE NAME *	USER NAME = monsk01398	DESIGNED - JDE	REVISED -
c:\pwise_work\do_not_delete\dms73318\041	KL0155-eh1-light833.dgn	DRAWN - TMT	REVISED -
	PLOT SCALE = 3/8" = 1' in.	CHECKED - BMS	REVISED -
	PLOT DATE = 07/23/2012	DATE - 7/18/12	REVISED -

STATE OF ILLINOIS  
DEPARTMENT OF TRANSPORTATION

STATE STREET  
LIGHTING PLAN

SCALE: 1"=20' SHEET NO. OF SHEETS STA. 898+45.00 TO STA. 903+75.00

F.A.U. RTE.	SECTION	COUNTY	TOTAL SHEETS	SHEET NO.
12	12-00356-01-PV	PEORIA	519	368
CONTRACT NO. 89626			ILLINOIS FED. AID PROJECT T16-50931581	

**Farnsworth GROUP**  
7707 N. KNOXVILLE AVE, SUITE 100  
PEORIA, ILLINOIS 61614  
(309) 689-4626 / (309) 689-4620 Fax  
www.fw.com





ALL KEYED NOTES APPLY TO THIS SHEET ONLY.

KEYED NOTES:

1. EXISTING CITY GRANVILLE FIXTURE. REMOVE 2 FIXTURE HEADS, REPLACE WITH 2 TYPE F2 FIXTURE HEADS.
2. EXISTING CITY GRANVILLE FIXTURE. REMOVE 3 FIXTURE HEADS, REPLACE WITH 3 TYPE F2 FIXTURE HEADS.
3. 2" CONDUIT FOR FUTURE.
4. 2" CONDUIT, 2\*4 AND 1\*4 GND FOR CIRCUIT LC4-9.


NOTES:

1. STATIONS AND OFFSETS SHOWN ON THIS SHEET ARE TO THE CENTER OF HANDHOLE AND LIGHT POLE FOUNDATIONS.
2. COORDINATE INSTALLATION OF UNDERGROUND CONDUIT AND LIGHT FIXTURES WITH ALL EXISTING UNDERGROUND SYSTEMS AND PROPOSED LANDSCAPE FEATURES AND PLANTINGS.
3. SEE IRRIGATION PLANS FOR UNDERGROUND CONDUIT AND PIPING. COORDINATE INSTALLATION OF UNDERGROUND FACILITIES.
4. 'F' DESIGNATIONS OF LIGHT FIXTURES SHOWN ON LIGHTING DETAILS SHEET.

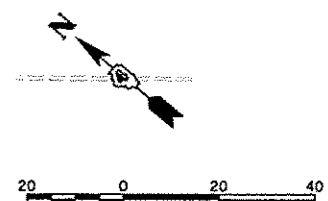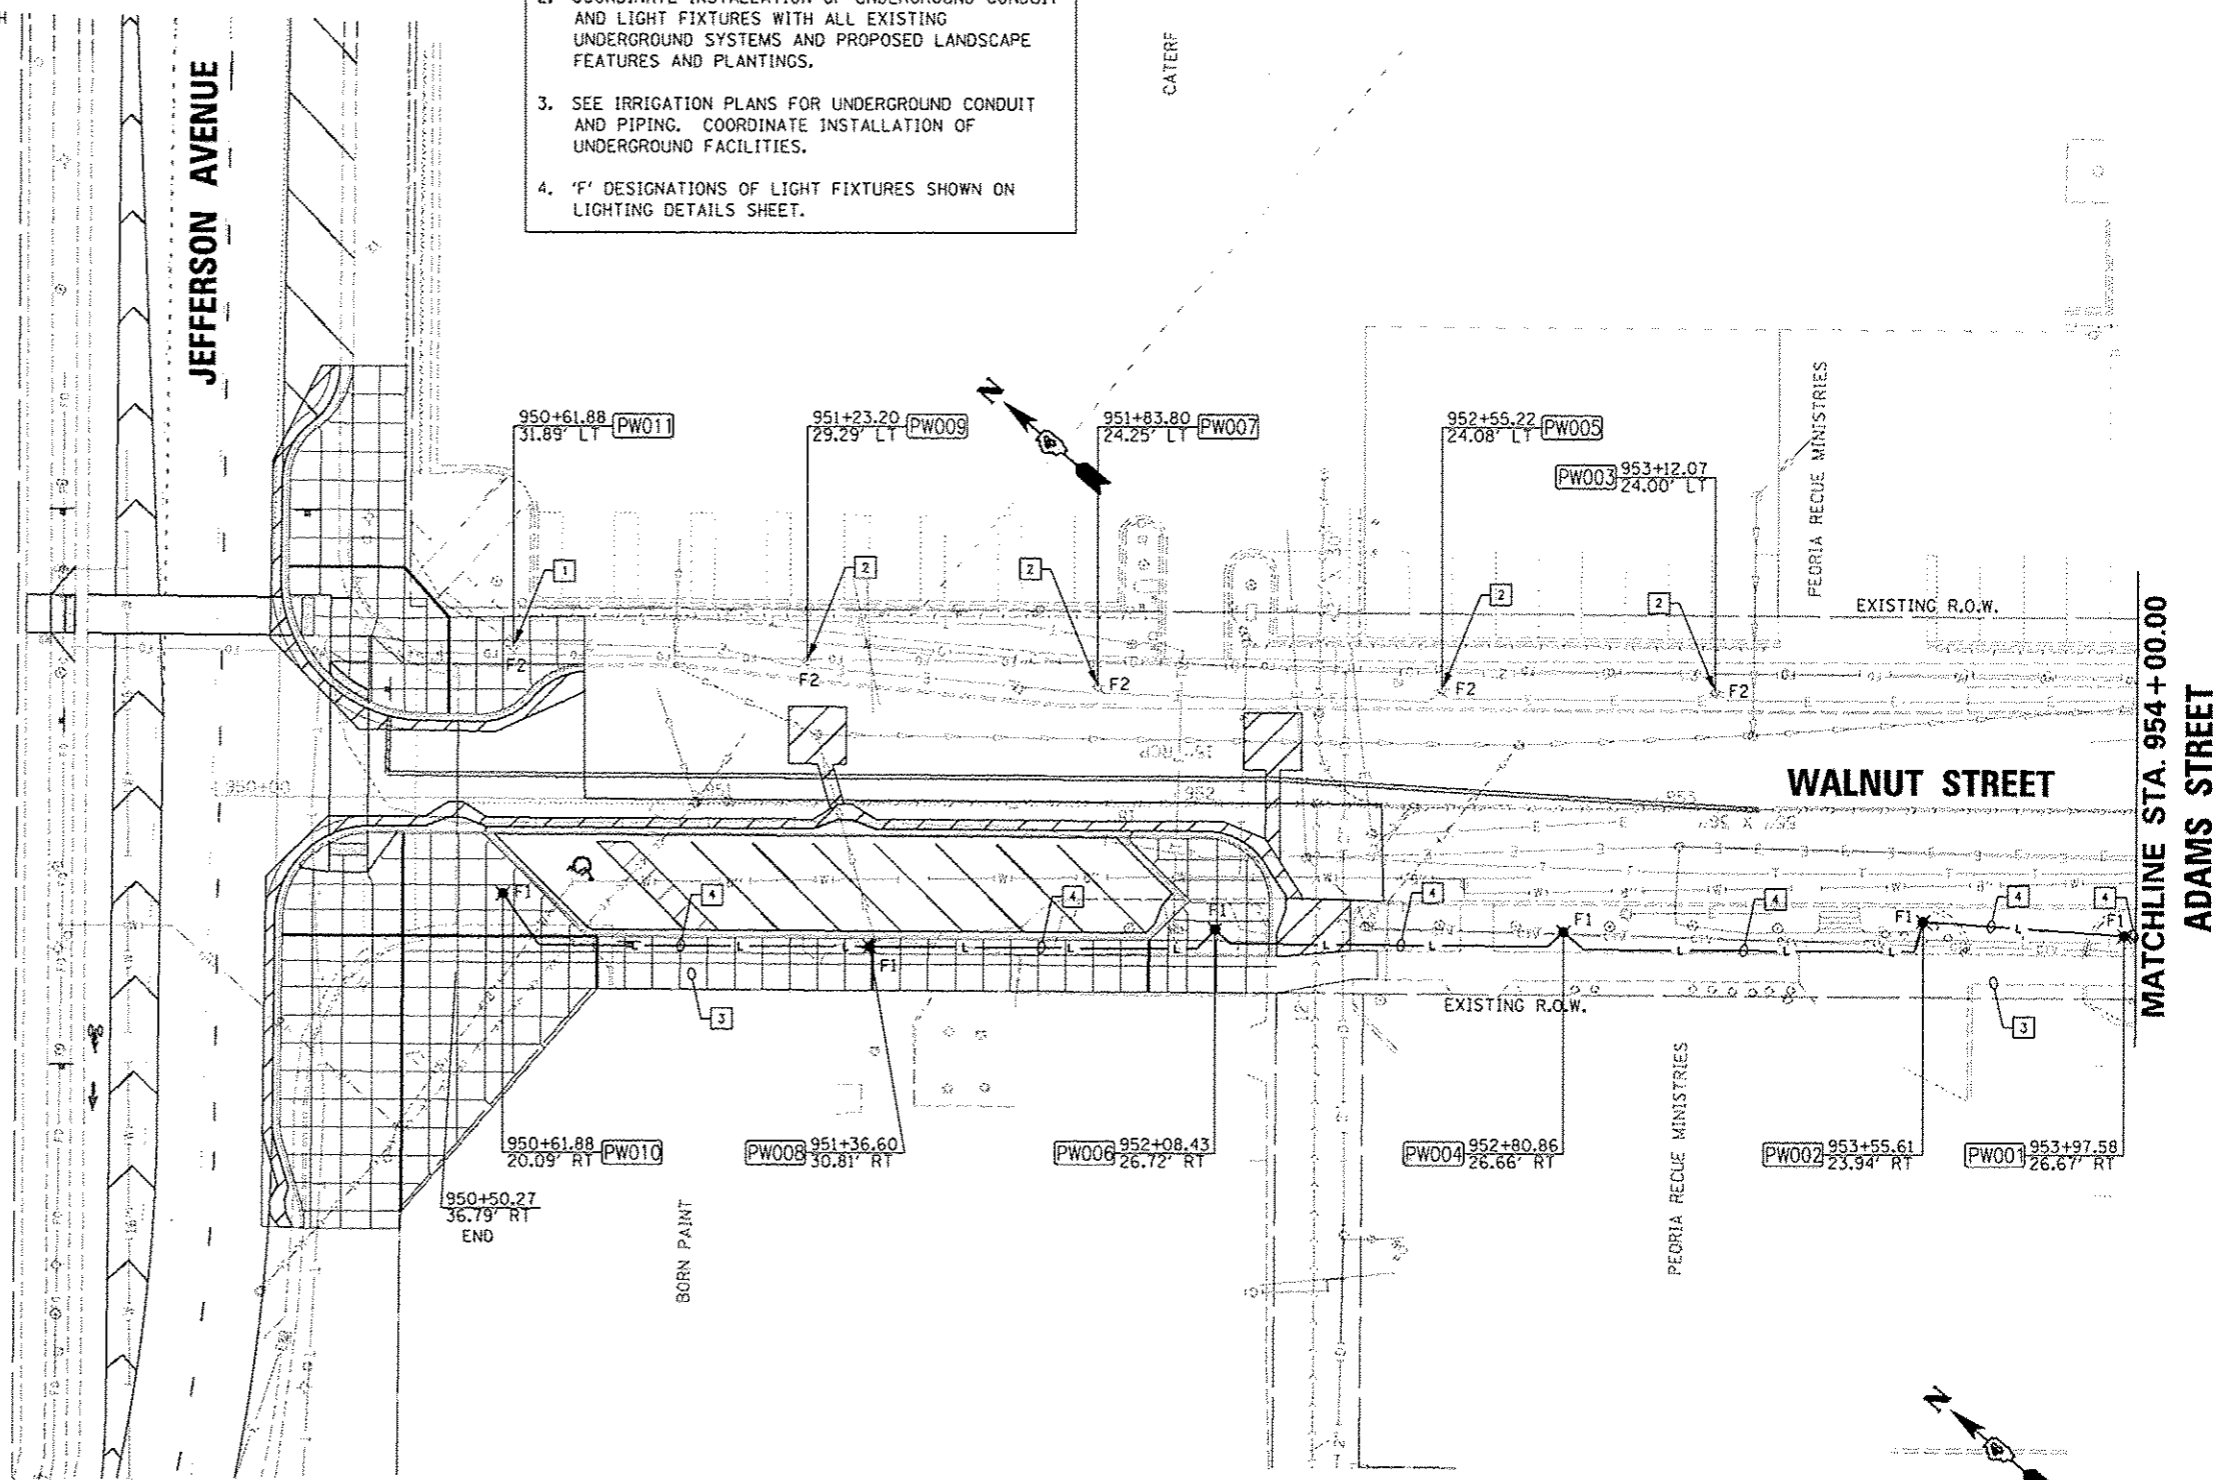


FILE NAME = c:\pview\work\do_not_delete\dms73318\041	USER NAME = manak81398	DESIGNED - JOE	REVISED -	<b>STATE OF ILLINOIS DEPARTMENT OF TRANSPORTATION</b>	<b>WALNUT STREET LIGHTING PLAN</b>	F.A.U. RTE. 12	SECTION 12-00356-01-PV	COUNTY PEORIA	TOTAL SHEETS 519	SHEET NO. 370
	PL01 SCALE = 3/16" = 1' / in.	CHECKED - BMS	REVISED -			SCALE: 1"=20'	SHEET NO. OF SHEETS STA. 950+00.00 TO STA. 954+00.00	CONTRACT NO. 89626	ILLINOIS FED. AID PROJECT TIG-30931581	
PL01 DATE = 07/23/2012	DATE = 7/18/12	REVISED -	REVISED -							


**Farnsworth GROUP**  
 7707 N. KNOXVILLE AVE, SUITE 100  
 PEORIA, ILLINOIS 61614  
 (309) 699-9626 / (309) 699-9620 Fax  
 www.fw.com

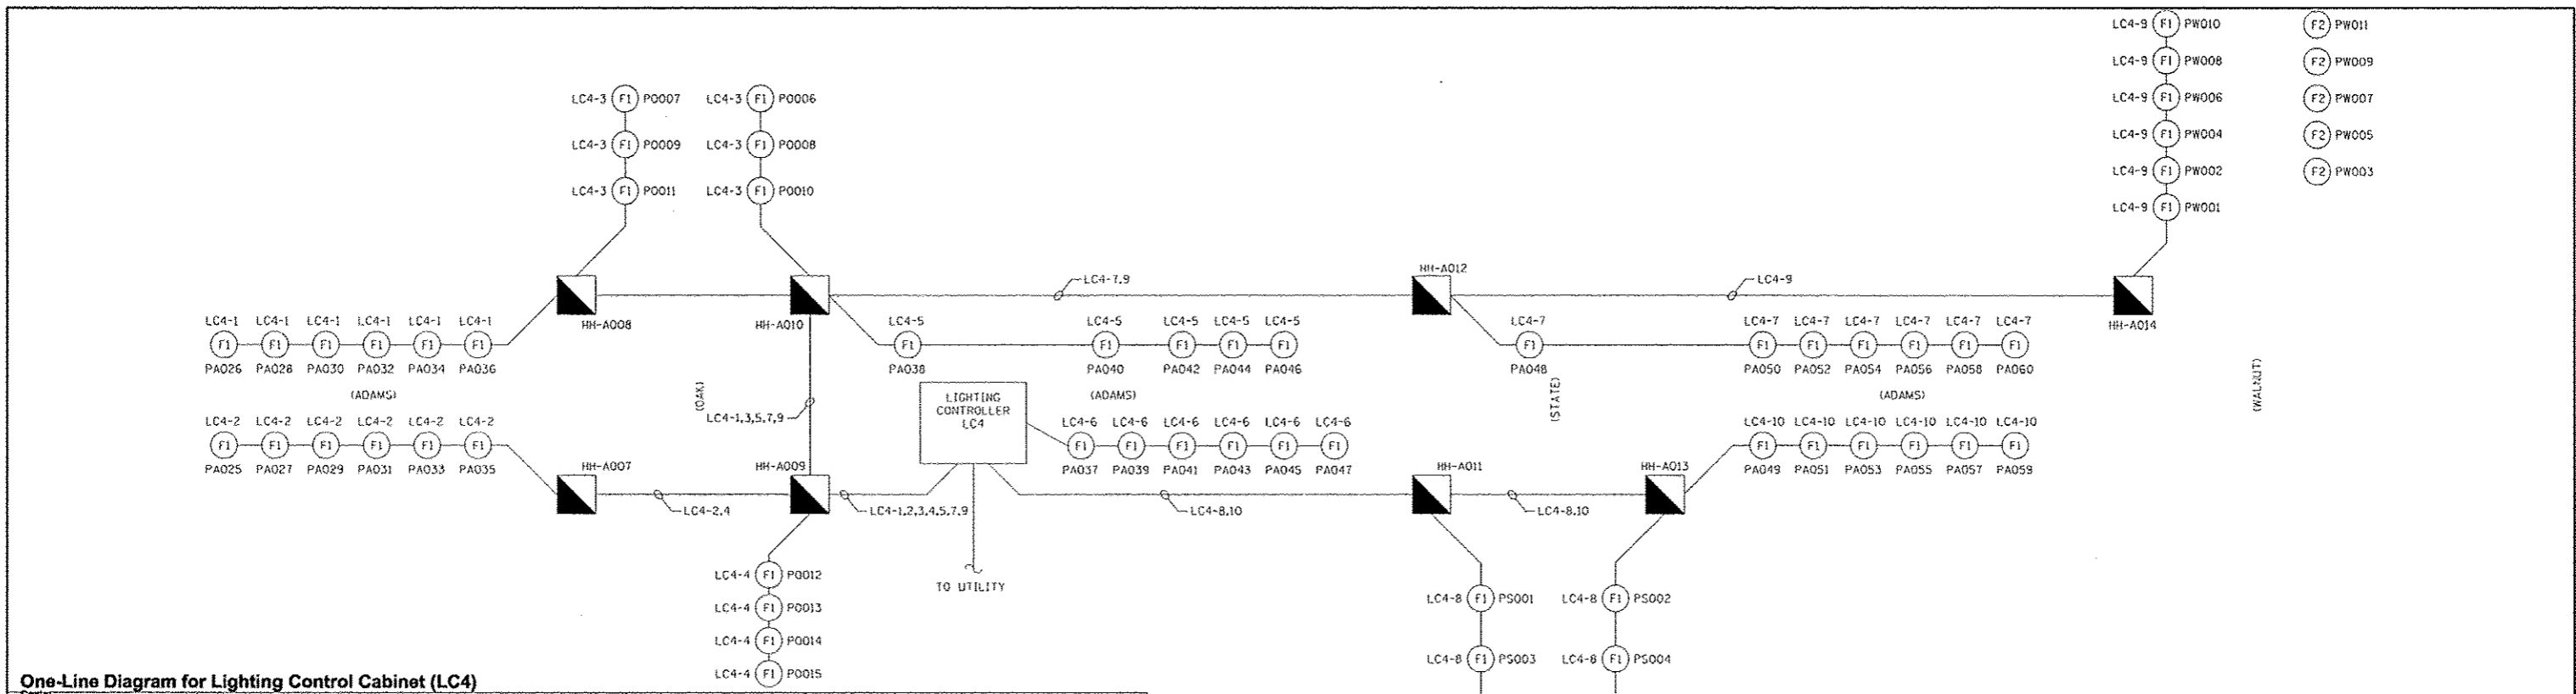


**One-Line Diagram for Lighting Control Cabinet (LC4)**  
Scale: Not To Scale

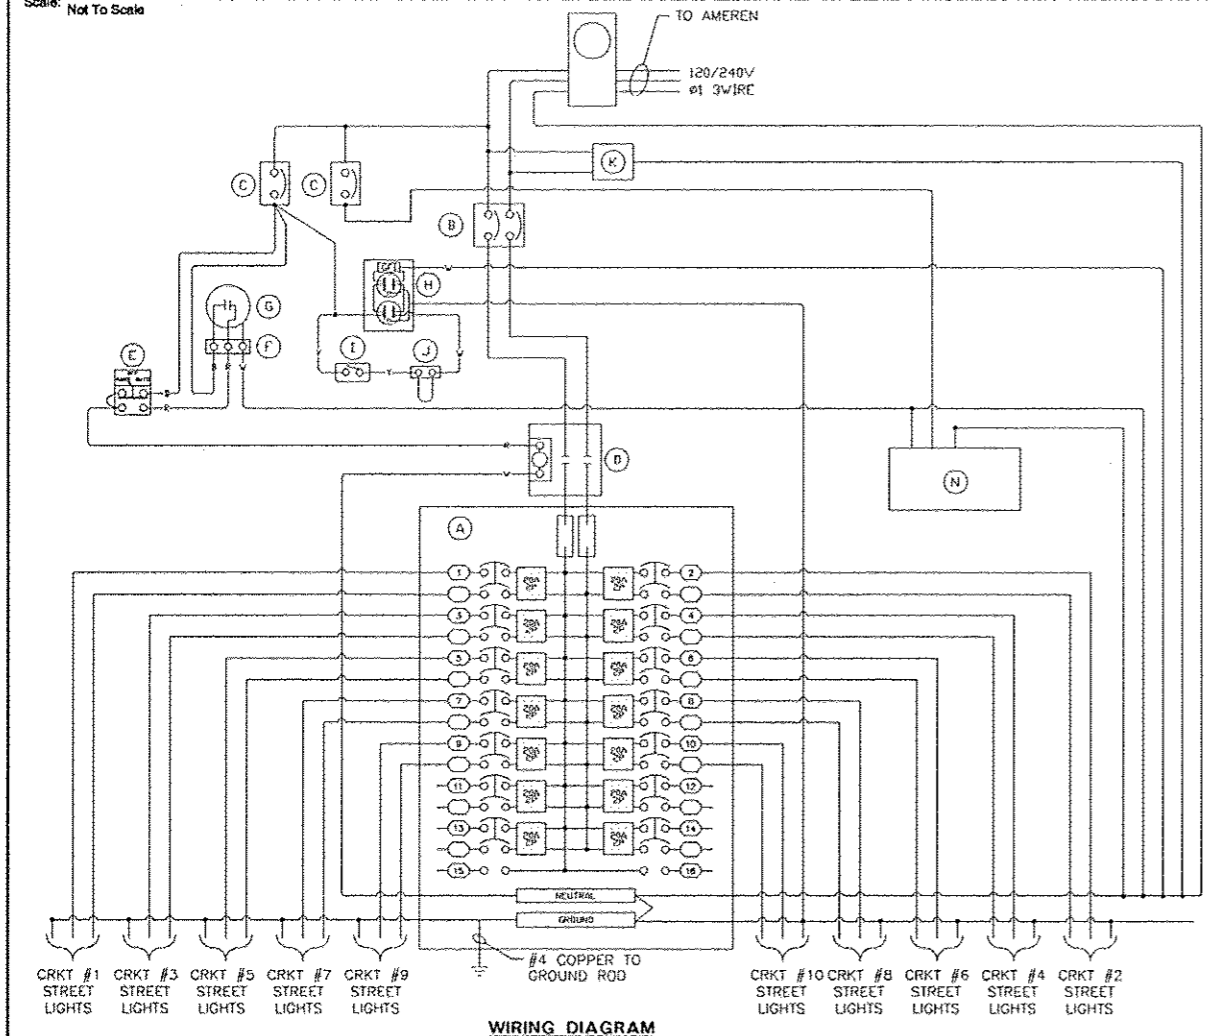

**WIRING DIAGRAM**

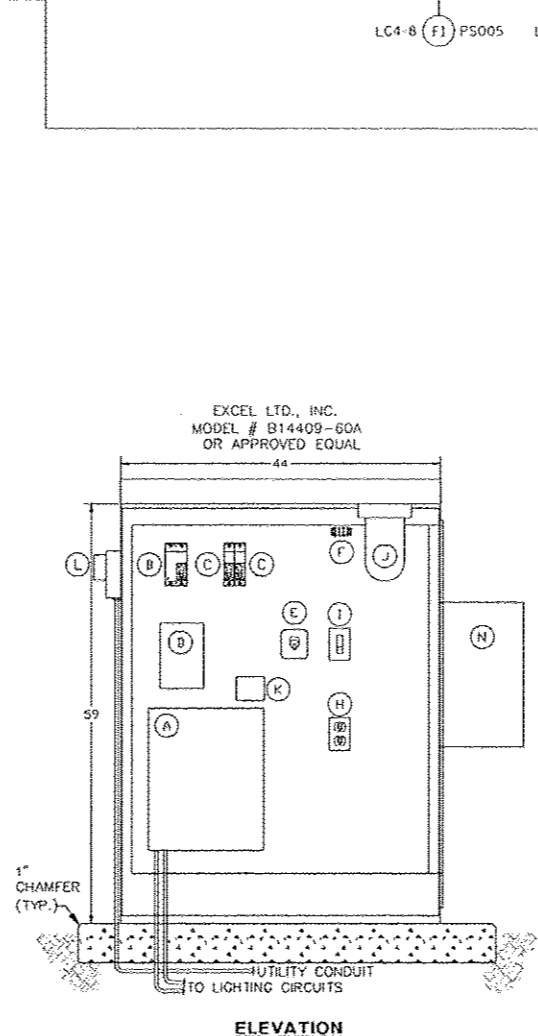

**ELEVATION**

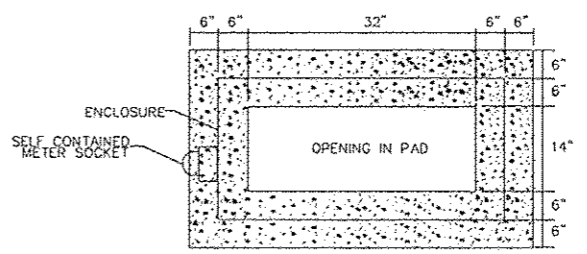

**PLAN**

BILL OF MATERIALS	
ITEM	DESCRIPTION
A	200A MLO (14) 2P/20A BRANCH
B	2P 200A MAIN CIRCUIT BREAKER
C	1P 15A MAIN CIRCUIT BREAKER
D	120V COIL 2 POLE 100 AMP CONTACTOR
E	H.O.A. SWITCH
F	3PT TERMINAL BLOCK
G	PHOTOCELL
H	20A GFI RECPT
I	TOGGLE SWITCH
J	RAB VX100DC LIGHT FIXTURE
K	SURGE SUPPRESSION DEVICE
L	AMEREN METER-SELF CONTAINED CT'S 200A 120/240V
M	44" TYPE V TRAFFIC CONTROL CABINET TYPE 3R POWDER COATED BLACK TO MATCH POLE
N	IRRIGATION CONTROLLER MOUNTED BY IRRIGATION CONTRACTOR. ELECTRICAL CONTRACTOR TO WIRE IN POWER TO UNIT.

- NOTES:**
- ALL POWER WIRING WILL BE RHH/RHW.
  - ALL CONTROL WIRING WILL BE #14 MIN.
  - NOT USED.
  - Ⓚ CKT NUMBER
  - Ⓜ ITEM #. SEE BILL OF MATERIALS

**Lighting Controller Base Mounted 240V, 200Amp #LC4**  
Scale: Not To Scale


FILE NAME =	USER NAME = manah01390	DESIGNED - JDE	REVISED -
o:\pwise_work\do_not_delete\des73318\041\010155-shr-dot-w\1-Light01.dgn	DRAWN - TMT	CHECKED - BMS	REVISED -
	PLOT SCALE = 2.0000 "/td> <td>DATE - 7/18/12</td> <td>REVISED -</td>	DATE - 7/18/12	REVISED -
	PLOT DATE = 07/23/2012		

**STATE OF ILLINOIS  
DEPARTMENT OF TRANSPORTATION**




**LIGHTING DETAILS**

SCALE: N.T.S. SHEET NO. OF SHEETS STA. TO STA.

F.A.U. RTE.	SECTION	COUNTY	TOTAL SHEETS	SHEET NO.
	12-00356-01-PV	PEORIA	519	371
ILLINOIS FED. AID PROJECT			CONTRACT NO. 89626	
TIG-50931(58)				

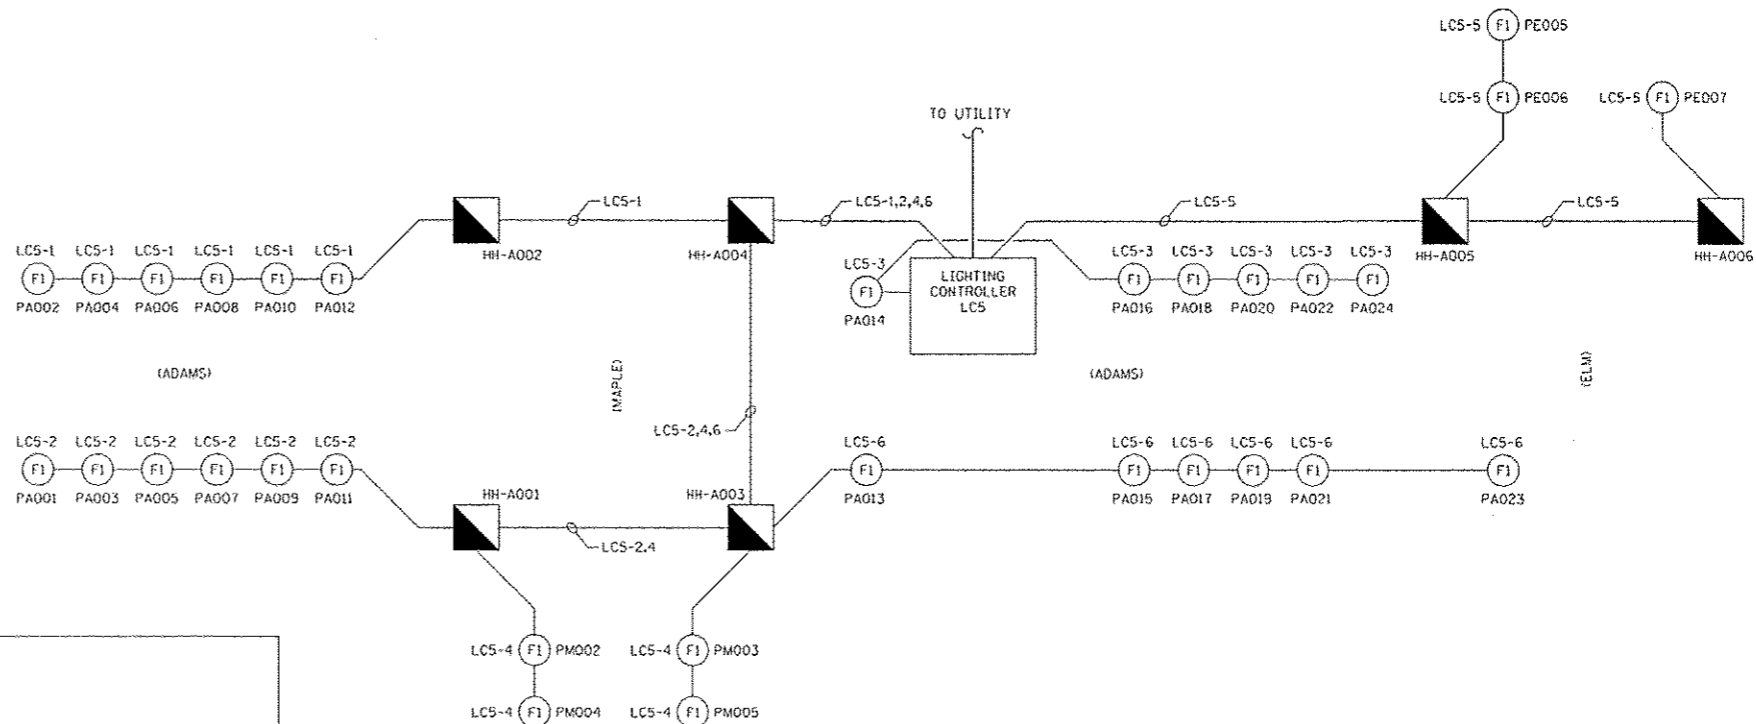

**One-Line Diagram for Lighting Control Cabinet (LC5)**  
Scale: Not To Scale

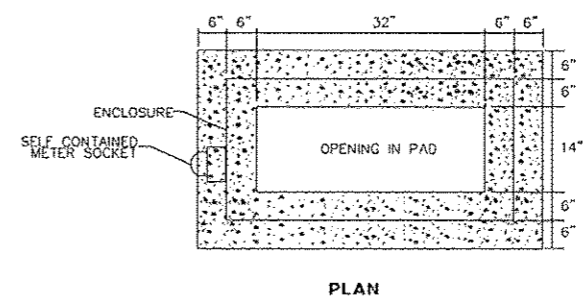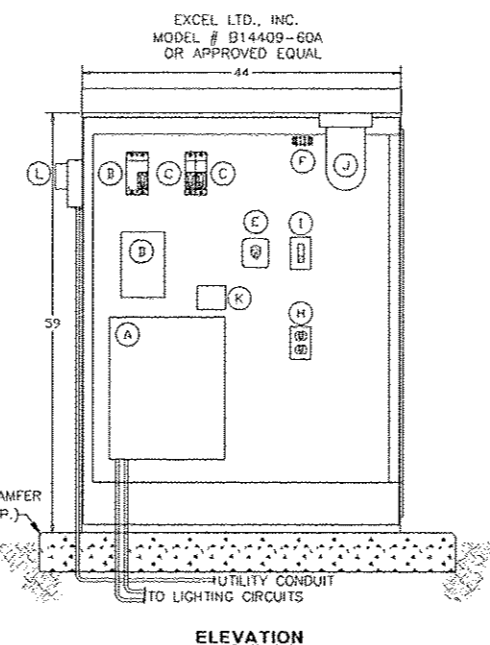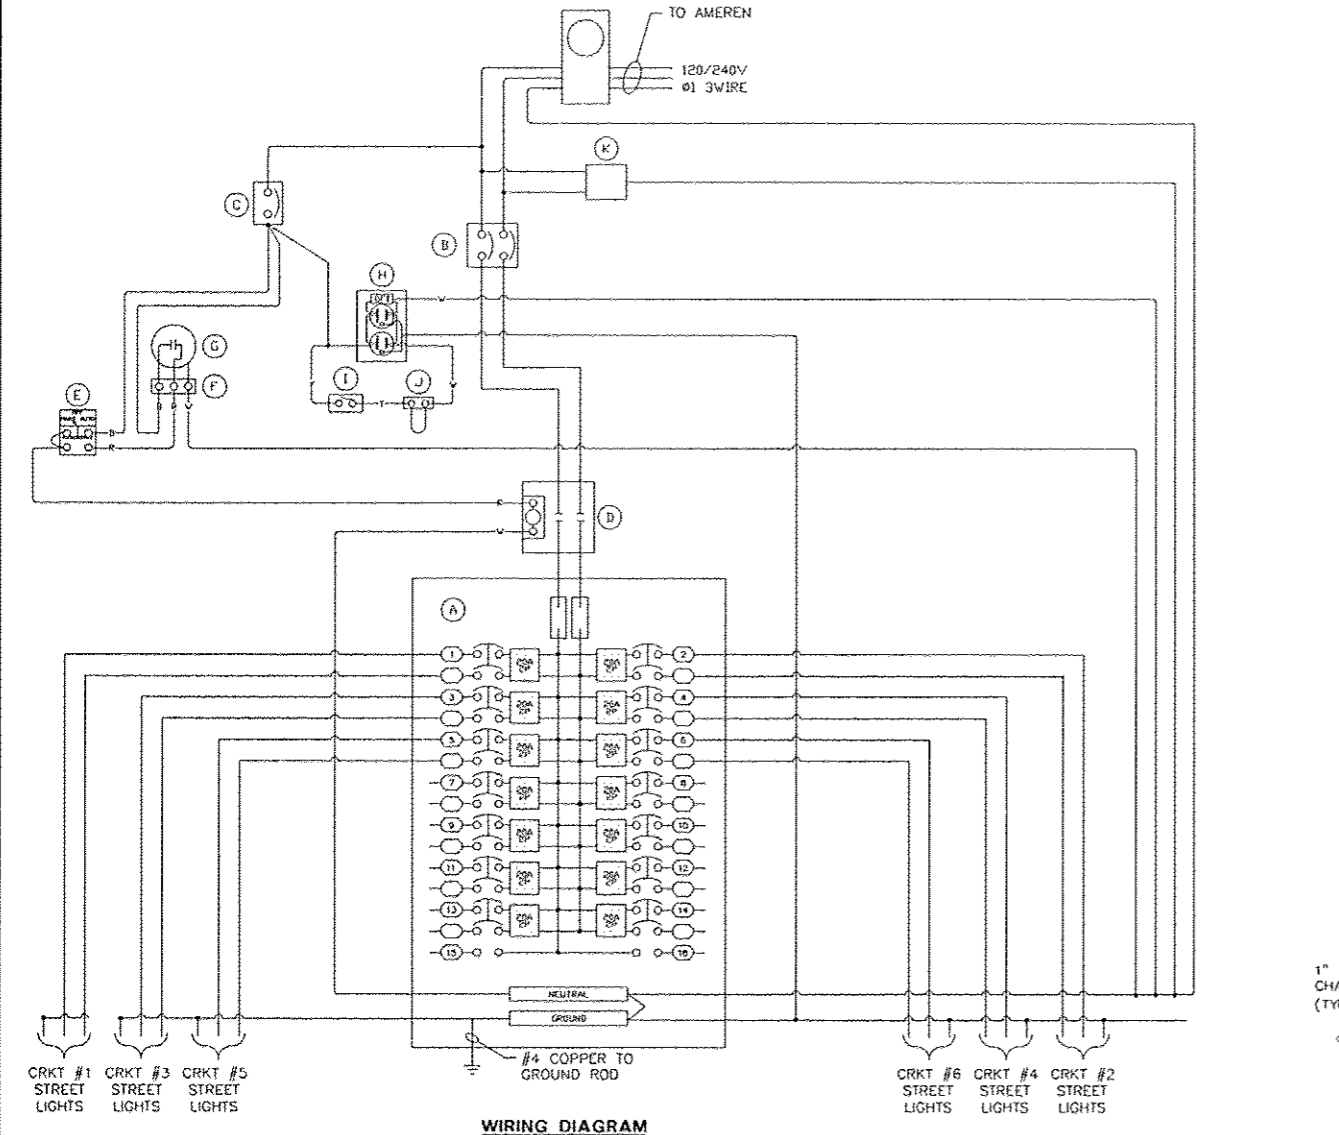

BILL OF MATERIALS	
ITEM	DESCRIPTION
A	200A MLD (14) 2P/20A BRANCH
B	2P 200A MAIN CIRCUIT BREAKER
C	1P 15A MAIN CIRCUIT BREAKER
D	120V COIL 2 POLE 100 AMP CONTACTOR
E	H.O.A. SWITCH
F	3PT TERMINAL BLOCK
G	PHOTOCELL
H	20A GFI RECPT
I	TOGGLE SWITCH
J	RAB VX100DG LIGHT FIXTURE
K	SURGE SUPPRESSION DEVICE
L	AMEREN METER-SELF CONTAINED CT'S 200A 120/240V
M	44" TYPE V TRAFFIC CONTROL CABINET TYPE 3R POWDER COATED BLACK TO MATCH POLE

- NOTES:**
- ALL POWER WIRING WILL BE RHH/RHW.
  - ALL CONTROL WIRING WILL BE #14 MIN.
  - NOT USED.
  - ⊙ CKT NUMBER
  - ⊙ ITEM #. SEE BILL OF MATERIALS

**Lighting Controller Base Mounted 240V, 200Amp #LC5**  
Scale: Not To Scale

FILE NAME *	USER NAME * mansk01390	DESIGNED - JDE	REVISED -
PL0155-ehd-detaile-LightB2.dgn		DRAWN - TMT	REVISED -
PLOT SCALE = 2.0000 "/in.		CHECKED - JBD	REVISED -
PLOT DATE = 07/23/2012		DATE - 7/18/12	REVISED -


**STATE OF ILLINOIS  
DEPARTMENT OF TRANSPORTATION**

**LIGHTING DETAILS**

SCALE: N.T.S. SHEET NO. OF SHEETS STA. TO STA.


F.A.U. RTE.	SECTION	COUNTY	TOTAL SHEETS	SHEET NO.
	12-00356-01-PV	PEORIA	519	372
CONTRACT NO. 89626			ILLINOIS FED. AID PROJECT YIG-50931(58)	



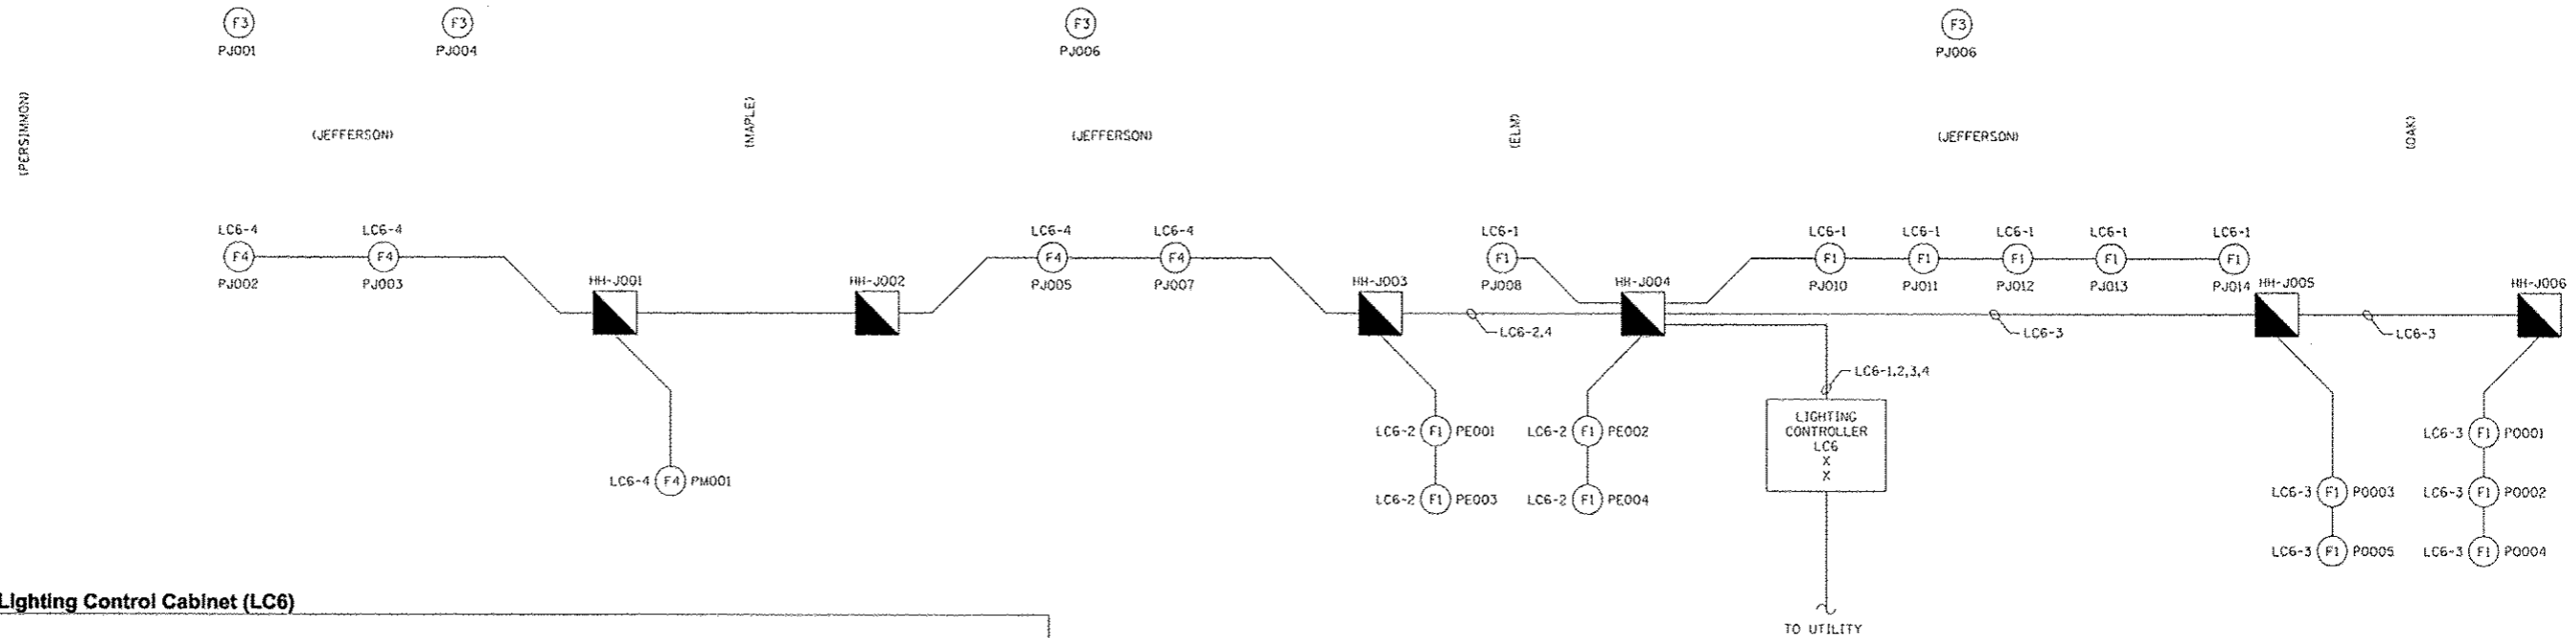


**One-Line Diagram for Lighting Control Cabinet (LC6)**


Scale: Not To Scale

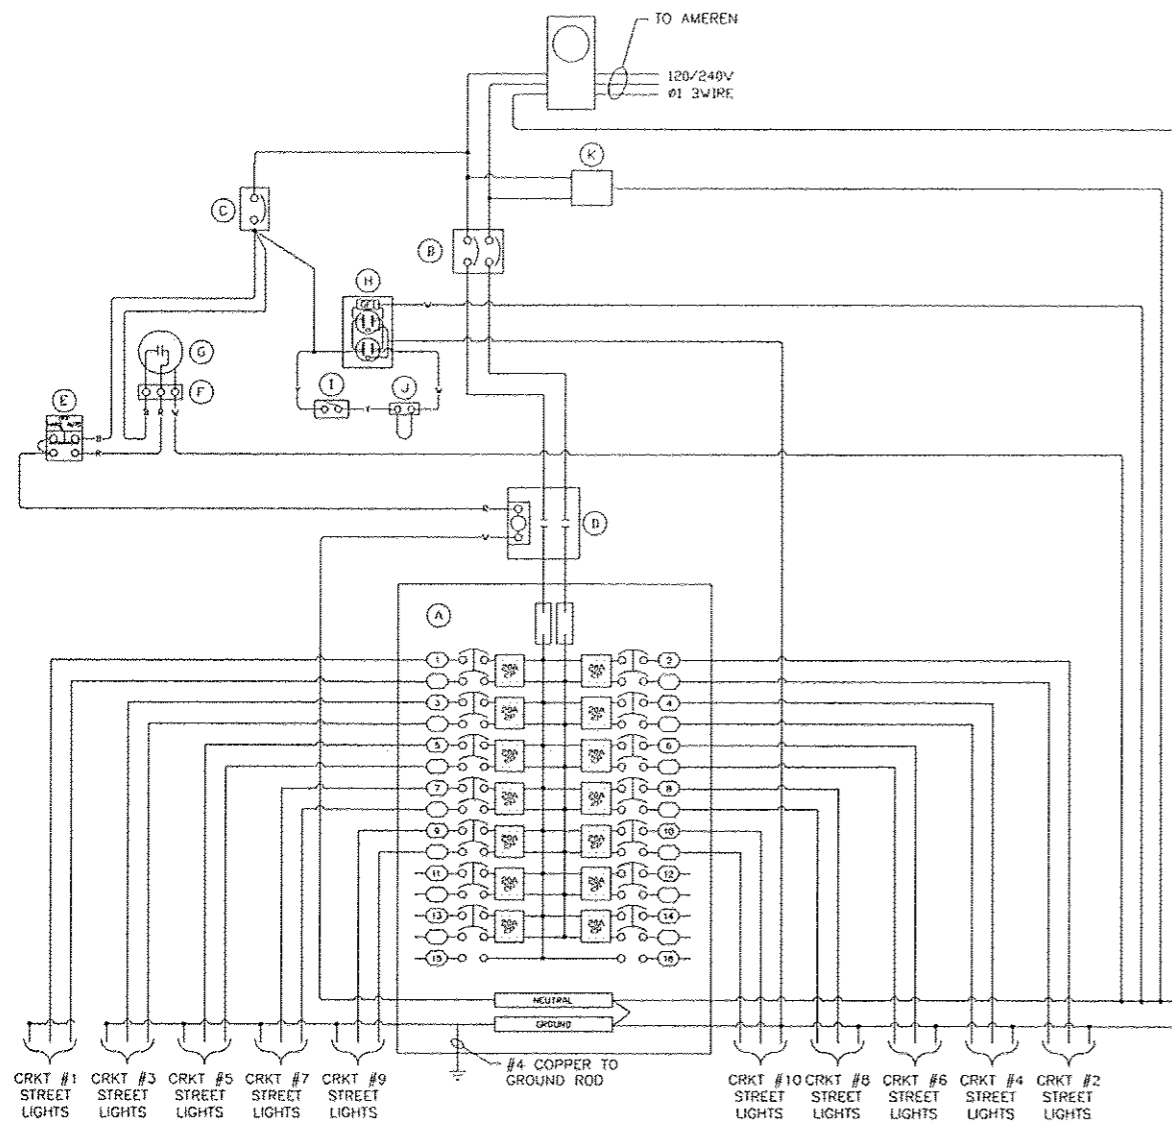

**WIRING DIAGRAM**

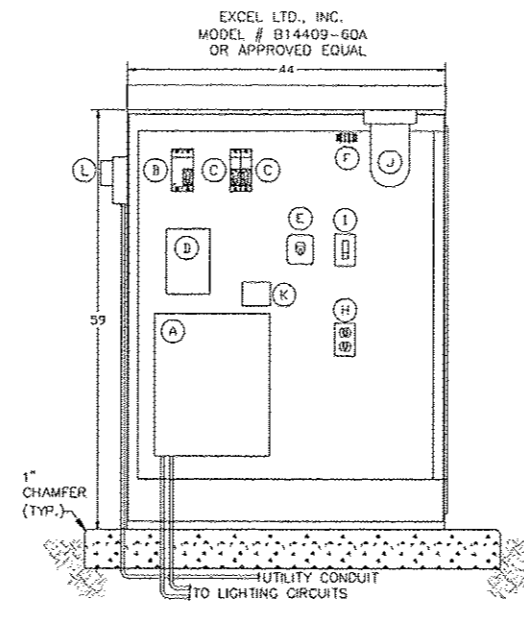

**ELEVATION**

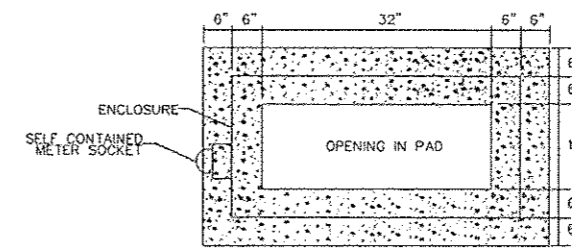

**PLAN**

BILL OF MATERIALS	
ITEM	DESCRIPTION
A	200A MLO (14) 2P/20A BRANCH
B	2P 200A MAIN CIRCUIT BREAKER
C	1P 15A MAIN CIRCUIT BREAKER
D	120V COIL 2 POLE 100 AMP CONTACTOR
E	H.O.A. SWITCH
F	3PT TERMINAL BLOCK
G	PHOTOCELL
H	20A GFI RECPT
I	TOGGLE SWITCH
J	RAB VX100DC LIGHT FIXTURE
K	SURGE SUPPRESSION DEVICE
L	AMERON METER-SELF CONTAINED CT'S 200A 120/240V
M	44" TYPE V TRAFFIC CONTROL CABINET TYPE 3R POWDER COATED BLACK TO MATCH POLE

**NOTES:**

1. ALL POWER WIRING WILL BE RHH/RHW.
2. ALL CONTROL WIRING WILL BE #14 MIN.
3. NOT USED.
4. (C) CKT NUMBER
5. (I) ITEM #, SEE BILL OF MATERIALS

**Lighting Controller Base Mounted 240V, 200Amp #LC6**

Scale: Not To Scale


FILE NAME *	USER NAME = mansk81390	DESIGNED - JDE	REVISED -
o:\pwise\work\do_not_delete\dms73318\041	PLB155-rhs-details-Light03.dgn	DRAWN - TMT	REVISED -
	PLOT SCALE = 2.0000 / in.	CHECKED - BMS	REVISED -
	PLOT DATE = 07/23/2012	DATE - 7/18/12	REVISED -

**STATE OF ILLINOIS  
DEPARTMENT OF TRANSPORTATION**

**LIGHTING DETAILS**

SCALE: N.T.S. SHEET NO. OF SHEETS STA. TO STA.

F.A.U. RTE.	SECTION	COUNTY	TOTAL SHEETS	SHEET NO.
12-00356-01-PV	PEORIA	519	373	
CONTRACT NO. 089626			[ILLINOIS] FED. AID PROJECT TIC-5093150	

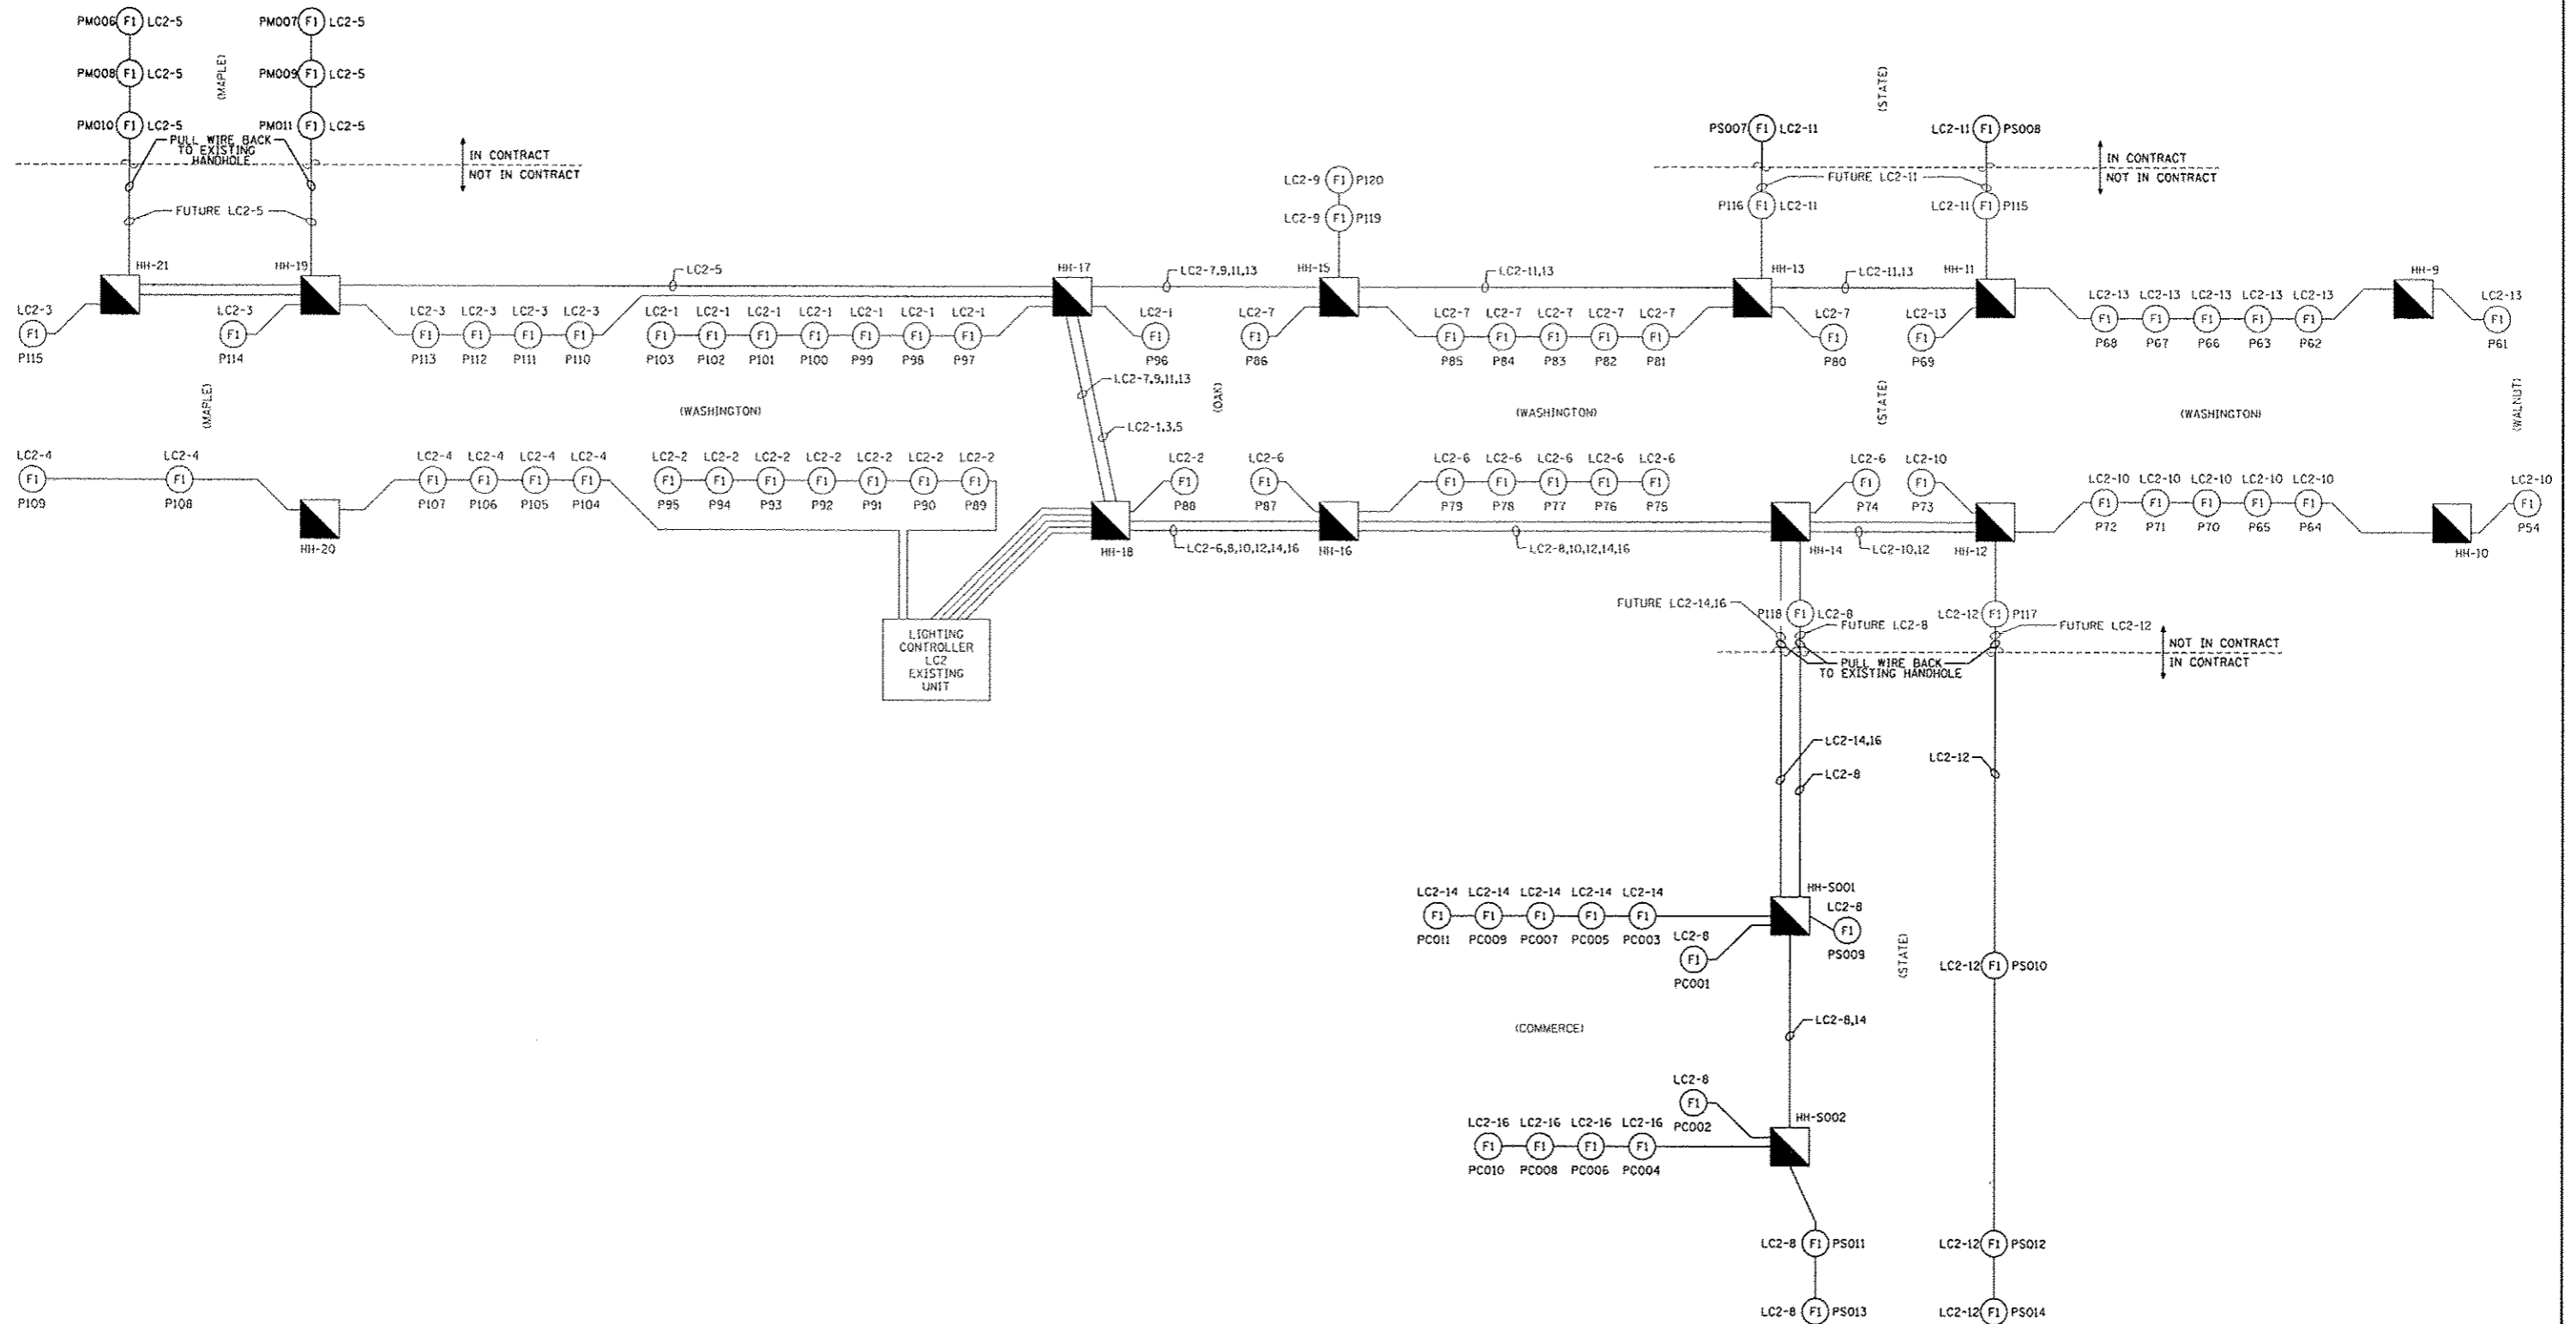


**One-Line Diagram for Lighting Control Cabinet (LC2) - Existing Unit**

Scale: Not To Scale		USER NAME = menak01390		DESIGNED - JDE	REVISED -	<b>STATE OF ILLINOIS DEPARTMENT OF TRANSPORTATION</b>	<b>LIGHTING DETAILS</b>		F.A.U. RTE.	SECTION	COUNTY	TOTAL SHEETS	SHEET NO.
FILE NAME *	0:\p\ee\work\do_not_delete\ds73318\0412\0155-ehs\details-Light84.dgn	DRAWN - TMT	REVISED -	12-00356-01-PV	PEORIA				519	374			
PLOT SCALE = 2.0000' / in.		CHECKED - JBD	REVISED -	CONTRACT NO. 89626									
PLOT DATE = 07/23/2012		DATE - 7/18/12	REVISED -	ILLINOIS FED. AID PROJECT TIG-50931581									
				SCALE: N.T.S.	SHEET NO. OF SHEETS	STA. TO STA.							


## LIGHTING FIXTURE SCHEDULE

PAY ITEM DESCRIPTION	DRAWING TAG	MANUFACTURER	CATALOG NUMBER	NO. OF LAMPS	LAMP TYPE	VOLTAGE	DESCRIPTION
STREET LIGHTING ASSEMBLY COMPLETE TYPE F1	F1	STERNBERG	2-1480CA/T878U/7718TS/BCC/GF1150MHP240LOS-SMHP150/MED/BK	2	150 W MH	240	TWIN CONTEMPORARY HUNG DOWNWARD FROM DECORATIVE CROSSARMS ON 18' SMOOTH TAPERED POLE ON DECORATIVE BASE. METAL HALIDE LAMP SOURCE TYPE 6 DISTRIBUTION WITH GFI RECEPTACLE AT TOP OF POLE NEAR ARMS.
		BEACON PRODUCTS	PIE31/PCAMH15-240-D/GR5/UQS/BZ/2X AA-25SCB/BZ SH05/8/18/5M/BO-BA/OT/BZ				
		SUN VALLEY LIGHTING	CS-6161				
STREET LIGHTING ASSEMBLY COMPLETE TYPE F2	F2	HOLOPHANE	GV100MHMTLB5NN	1	100 W MH	240	CITY OF PEORIA STANDARD BUSINESS DISTRICT GRANVILLE FIXTURE, TYPE V, METAL HALIDE.
STREET LIGHTING ASSEMBLY COMPLETE TYPE F3	F3	AMERICAN ELECTRIC	32525MRH240R3DG	1	250 W MH	240	ROADWAY FIXTURE, 250 W METAL HALIDE, DROP GLASS TYPE 3 RETROFITTED ON EXISTING POLE AND MAST ARM
STREET LIGHTING ASSEMBLY COMPLETE TYPE F4	F4	AMERICAN ELECTRIC/VALMONT	32540MRH240R3DG/DS96-R801A-420-10S-GV-VIBRATION DAMPNER	1	400 W MH	240	ROADWAY FIXTURE, 400 W METAL HALIDE, DROP GLASS TYPE 3 MOUNTED ON 35' GALVANIZED POLE WITH 10' ARM AND VIBRATION DAMPNER


NOTE: MANUFACTURER AND CATALOG NUMBERS ARE PRESENTED HERE TO ESTABLISH MINIMUM DESIRED CONSTRUCTION AND PERFORMANCE. SPECIFICATION ALLOWS FOR "APPROVED EQUALS" FOR EACH TYPE.

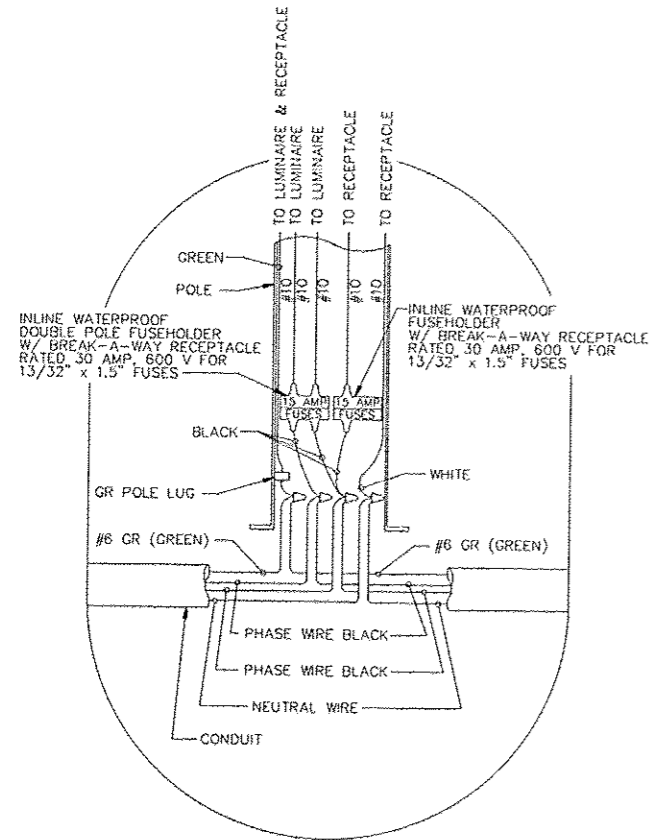

POLE BASE HANDHOLE WIRING DIAGRAM  
NO SCALE

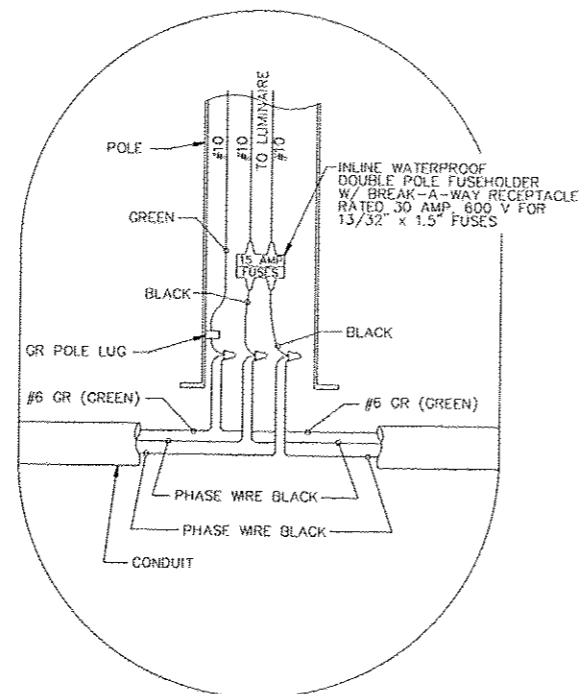

POLE BASE HANDHOLE WIRING DIAGRAM  
NO SCALE

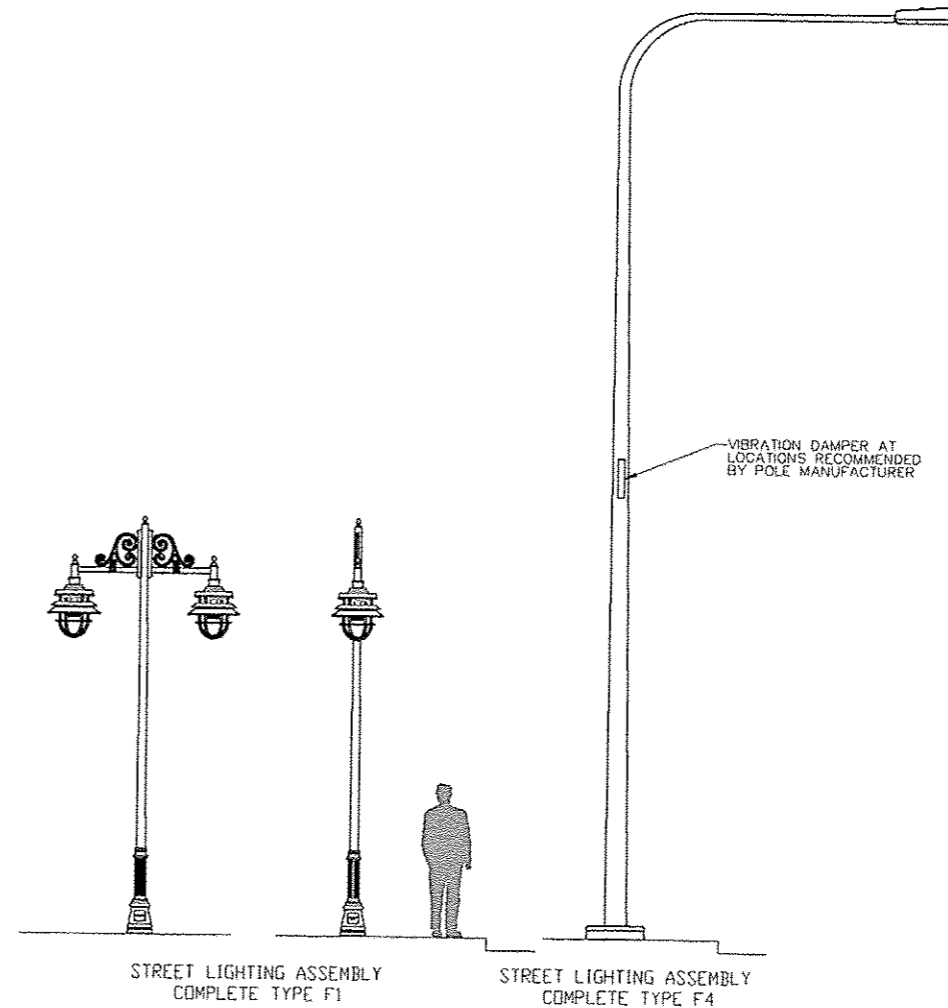



**STATE OF ILLINOIS  
DEPARTMENT OF TRANSPORTATION**

**LIGHTING DETAILS**

FILE NAME * c:\pwise\work\do_not_delete\dms73318\04	USER NAME * monk01398 L0155-ehd-detailed-lighting.dgn	DESIGNED - JDE	REVISED -
		DRAWN - TMT	REVISED -
		CHECKED - JBO	REVISED -
		DATE - 7/18/12	REVISED -

SCALE: N.T.S.      SHEET NO.      OF      SHEETS      STA.      TO      STA.

F.A.U. RTE.	SECTION	COUNTY	TOTAL SHEETS	SHEET NO.
12-00356-01-PV	12-00356-01-PV	PEORIA	519	375
CONTRACT NO. 89626				
ILLINOIS FED. AID PROJECT TIG-5093H501				

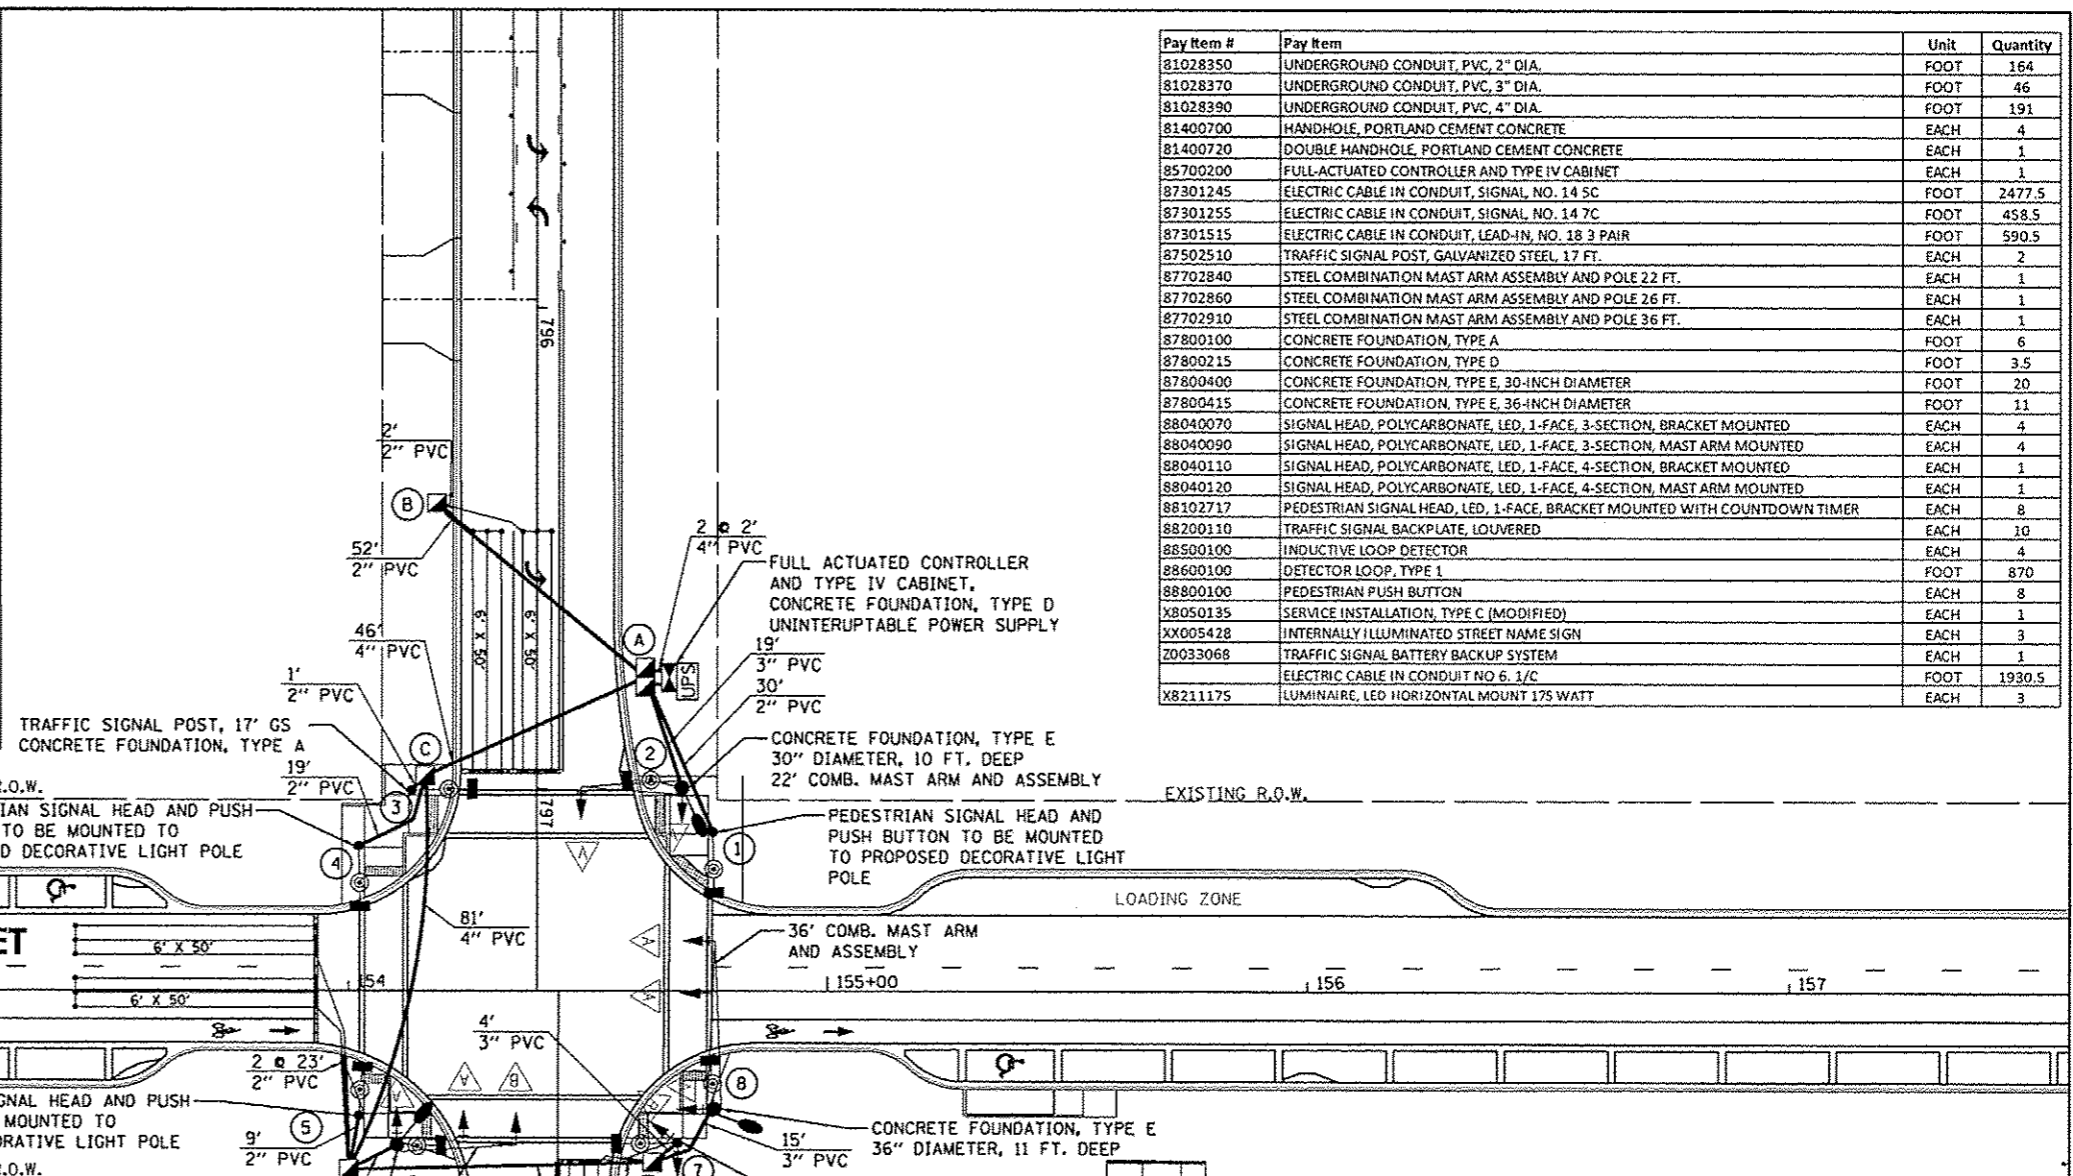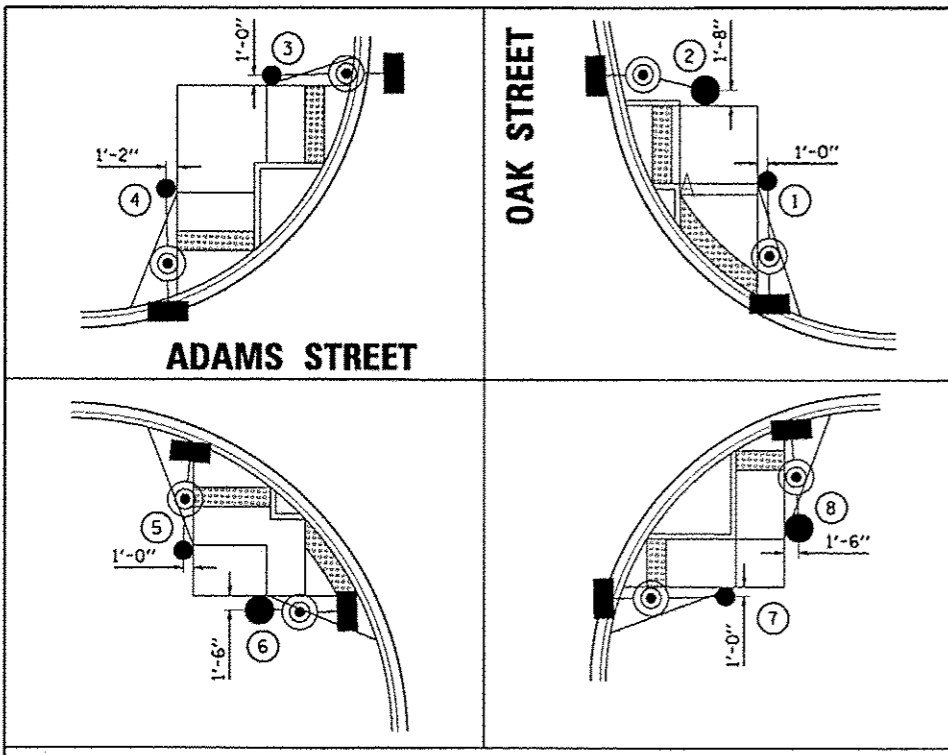


Pay Item #	Pay Item	Unit	Quantity
81028350	UNDERGROUND CONDUIT, PVC, 2" DIA.	FOOT	164
81028370	UNDERGROUND CONDUIT, PVC, 3" DIA.	FOOT	46
81028390	UNDERGROUND CONDUIT, PVC, 4" DIA.	FOOT	191
81400700	HANDHOLE, PORTLAND CEMENT CONCRETE	EACH	4
81400720	DOUBLE HANDHOLE, PORTLAND CEMENT CONCRETE	EACH	1
85700200	FULL-ACTUATED CONTROLLER AND TYPE IV CABINET	EACH	1
87301245	ELECTRIC CABLE IN CONDUIT, SIGNAL, NO. 14 SC	FOOT	2477.5
87301255	ELECTRIC CABLE IN CONDUIT, SIGNAL, NO. 14 7C	FOOT	458.5
87301515	ELECTRIC CABLE IN CONDUIT, LEAD-IN, NO. 18 3 PAIR	FOOT	590.5
87502510	TRAFFIC SIGNAL POST, GALVANIZED STEEL, 17 FT.	EACH	2
87702840	STEEL COMBINATION MAST ARM ASSEMBLY AND POLE 22 FT.	EACH	1
87702860	STEEL COMBINATION MAST ARM ASSEMBLY AND POLE 26 FT.	EACH	1
87702910	STEEL COMBINATION MAST ARM ASSEMBLY AND POLE 36 FT.	EACH	1
87800100	CONCRETE FOUNDATION, TYPE A	FOOT	6
87800215	CONCRETE FOUNDATION, TYPE D	FOOT	3.5
87800400	CONCRETE FOUNDATION, TYPE E, 30-INCH DIAMETER	FOOT	20
87800415	CONCRETE FOUNDATION, TYPE E, 36-INCH DIAMETER	FOOT	11
88040070	SIGNAL HEAD, POLYCARBONATE, LED, 1-FACE, 3-SECTION, BRACKET MOUNTED	EACH	4
88040090	SIGNAL HEAD, POLYCARBONATE, LED, 1-FACE, 3-SECTION, MAST ARM MOUNTED	EACH	4
88040110	SIGNAL HEAD, POLYCARBONATE, LED, 1-FACE, 4-SECTION, BRACKET MOUNTED	EACH	1
88040120	SIGNAL HEAD, POLYCARBONATE, LED, 1-FACE, 4-SECTION, MAST ARM MOUNTED	EACH	1
88102717	PEDESTRIAN SIGNAL HEAD, LED, 1-FACE, BRACKET MOUNTED WITH COUNTDOWN TIMER	EACH	8
88200110	TRAFFIC SIGNAL BACKPLATE, LOUVERED	EACH	10
88500100	INDUCTIVE LOOP DETECTOR	EACH	4
88600100	DETECTOR LOOP, TYPE 1	FOOT	870
88800100	PEDESTRIAN PUSH BUTTON	EACH	8
X8050135	SERVICE INSTALLATION, TYPE C (MODIFIED)	EACH	1
XX005428	INTERNALLY ILLUMINATED STREET NAME SIGN	EACH	3
20033068	TRAFFIC SIGNAL BATTERY BACKUP SYSTEM	EACH	1
	ELECTRIC CABLE IN CONDUIT NO. 6, 1/C	FOOT	1930.5
X8211175	LUMINAIRE, LED HORIZONTAL MOUNT 175 WATT	EACH	3

NOTES:  
1. ALL DISTURBED AREAS SHALL BE RESTORED AND LANDSCAPED TO PRIOR CONDITION.


NOTES:  
1. ALL DISTURBED AREAS SHALL BE RESTORED AND LANDSCAPED TO PRIOR CONDITION.  
2. SERVICE INSTALLATION, TYPE C (MODIFIED) TO INCLUDE COST OF WIRE, CONDUIT AND INSTALLING METER FROM EXISTING SERVICE.



MAST ARM POLES & POSTS			
POLE I.D.	CONTROL LINE	STATION	OFFSET
①	ADAM_PAL	154+76	33' LT
②	ADAM_PAL	154+70	43' LT
③	ADAM_PAL	154+13	42' LT
④	ADAM_PAL	154+02	30' LT
⑤	ADAM_PAL	154+02	26' RT
⑥	ADAM_PAL	154+10	33' RT
⑦	ADAM_PAL	154+69	32' RT
⑧	ADAM_PAL	154+76	25' RT

EXISTING	PROPOSED	DESCRIPTION
		SIGNAL POST FOUNDATION
		CONTROLLER FOUNDATION
		HANDHOLE
		DOUBLE HANDHOLE
		CONDUIT
		CONDUIT LENGTH SIZE - TYPE (S=STEEL P=PVC F=FIBER DUCT)
		STEEL COMBINATION MAST ARM ASSEMBLY AND POLE
		LUMINAIRE
		UNINTERRUPTIBLE POWER SUPPLY

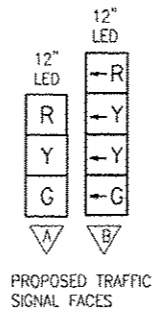


HANDHOLES			
HANDHOLE I.D.	CONTROL LINE	STATION	OFFSET
Ⓐ	ADAM_PAL	154+62	66' LT
Ⓑ	ADAM_PAL	154+18	102' LT
Ⓒ	ADAM_PAL	154+16	45' LT
Ⓓ	ADAM_PAL	154+00	38' RT
Ⓔ	ADAM_PAL	154+63	36' RT

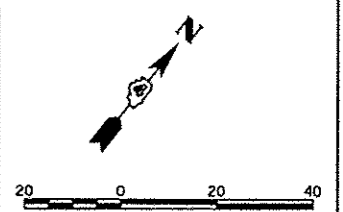

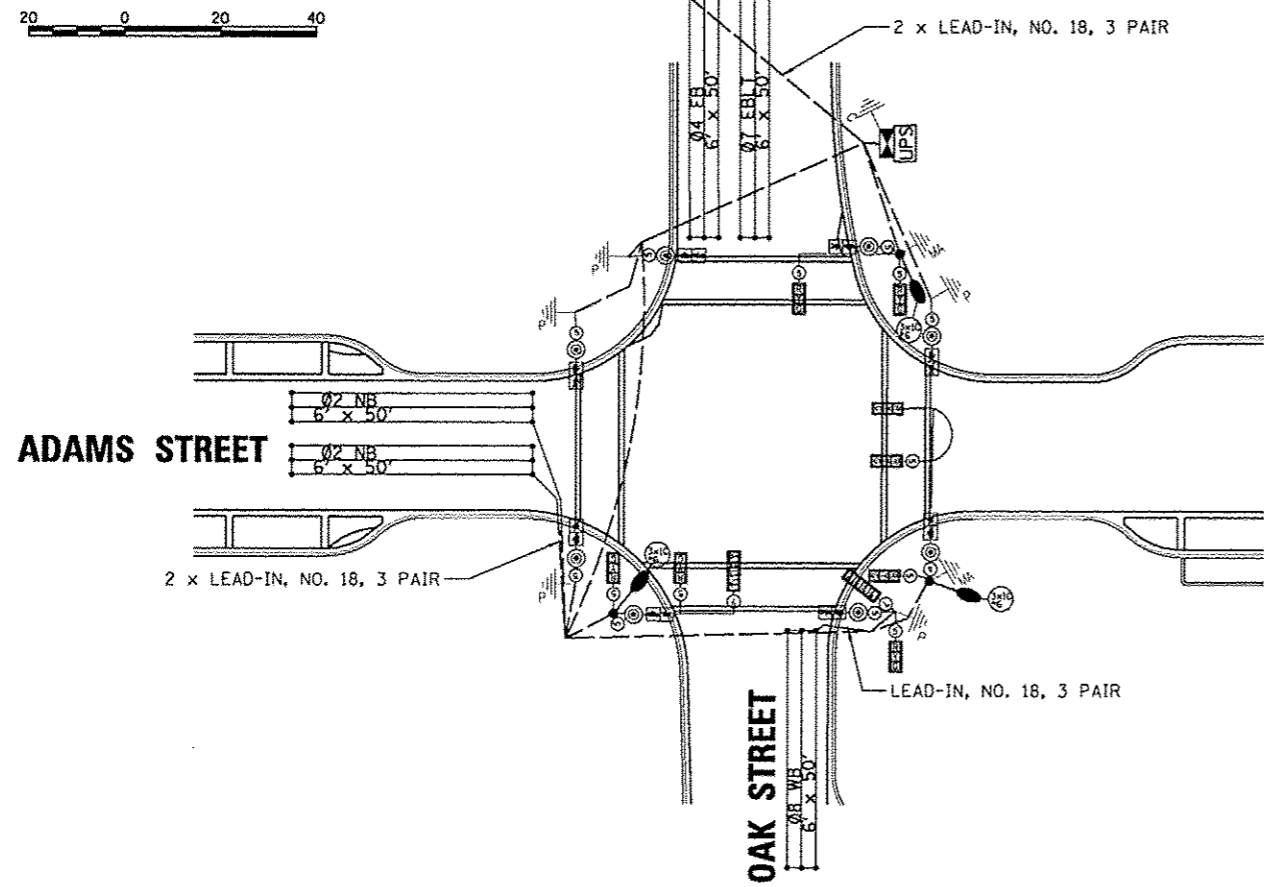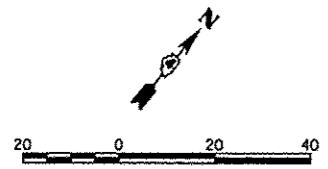

NOTES:  
 1. CABINET TO BE SET-UP PER MANUFACTURER SPECIFICATIONS FOR FLASHING YELLOW ARROW OPERATIONS.

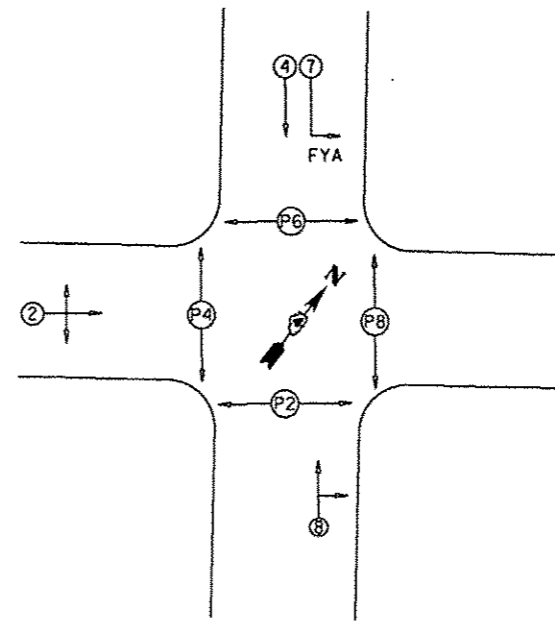

PHASE DESIGNATION DIAGRAM

TRAFFIC SIGNAL WIRING DIAGRAM LEGEND

PROPOSED	DESCRIPTION
⑤	ELECTRIC CABLE DENOTING NUMBER OF CONDUCTORS
⊠	SIGNAL FACE WITH BACKPLATE
→	DIRECTIONAL SIGNAL SECTION
⊠	12" SIGNAL SECTION
⊠	WALK/DON'T WALK SECTION + COUNT DOWN
⊠	GROUND WIRE (POLE)
⊠	GROUND WIRE (MAST ARM)
⊠	PEDESTRIAN PUSHBUTTON
---	CONDUIT
FYA	FLASHING YELLOW ARROW
●	LUMINAIRE
UPS	UNINTERRUPTIBLE POWER SUPPLY


TRAFFIC SIGNAL GENERAL NOTES

- ALL TRAFFIC SIGNAL SECTIONS SHALL HAVE 12" SINGLE LED LENSES.
- ALL PEDESTRIAN SECTIONS SHALL HAVE 16" LENSES WITH A MAN/HAND OVERLAY AND COUNTDOWN TIMER.
- THE RED SECTIONS OF THE SIGNAL HEADS SHARING THE SAME MAST ARM SHALL BE LEVEL WITH ONE ANOTHER AND MAINTAIN A 16" MINIMUM CLEARANCE FROM THE HIGHEST POINT OF THE ROADWAY.
- THE PROPOSED MAST ARM MOUNTED TRAFFIC SIGNAL HEADS SHALL BE MOUNTED DIRECTLY OVER THE CENTER OF THEIR RESPECTIVE LANES.
- ALL TRAFFIC SIGNAL HEAD BRACKETS ARE TO BE ALUMINUM WITH A BLACK FINISH.
- ALL TRAFFIC SIGNAL POSTS ARE TO BE GALVANIZED STEEL.
- EXISTING CONDUIT, IF USED, SHALL BE COUPLED TO THE PROPOSED CONDUIT. THIS WORK SHALL BE INCLUDED IN THE PRICE FOR THE CONDUIT OF THE TYPE SPECIFIED.
- PROPOSED HANDHOLES SHALL BE CAST IN PLACE CONCRETE HANDHOLES.
- THE HANDHOLE SHALL BE CONSTRUCTED SO THAT THE TOP OF THE FRAME WILL BE FLUSH WITH THE SURFACE OF THE MEDIAN, SIDEWALK, OR GROUND LINE.
- THE LOCATION OF ALL UTILITIES SHALL BE FIELD VERIFIED BY THE CONTRACTOR BEFORE THE INSTALLATION OF ANY TRAFFIC SIGNAL COMPONENTS.
- COILABLE POLYETHYLENE DUCT MAY BE SUBSTITUTED FOR PVC CONDUIT PUSHED.
- THE LOCATIONS FOR HANDHOLES, TRAFFIC SIGNAL POST FOUNDATIONS, AND MAST ARM FOUNDATIONS ARE PROVIDED FOR REFERENCE ONLY. THE ENGINEER OF TRAFFIC SHALL BE NOTIFIED FOR LOCATION VERIFICATION BEFORE INSTALLATION.
- ALL SURPLUS MATERIALS SHALL BE DISPOSED OF IN ACCORDANCE WITH ARTICLE 202.03 OF THE STANDARD SPECIFICATIONS.
- NO ADDITIONAL COMPENSATION SHALL BE ALLOWED FOR PLACING CONDUIT AT GREATER THAN 2 FT. MINIMUM DEPTH TO AVOID OBSTACLES SUCH AS UNDERGROUND UTILITIES.
- THE CONTRACTOR IS RESPONSIBLE FOR THE COST OF UNCOVERING, HAND DIGGING, OR ANY SPECIAL EXCAVATION AROUND UTILITIES AS NECESSARY. THIS COST OF THIS WORK SHALL BE INCLUDED IN THE UNIT PRICES FOR THE CONDUITS AND FOUNDATIONS.
- ALL TRAFFIC SIGNAL MAST ARMS, POSTS, HANDHOLE LIDS AND RINGS, HANDHOLE FRAMES, CONTROLLER CABINETS, SERVICE RISERS, EXPOSED METALLIC CONDUITS, AND PHOTOCCELL RELAYS SHALL BE GROUNDED IN ACCORDANCE WITH NEC REQUIREMENTS.
- DRILLING HOLES THROUGH CURB AND GUTTER WILL NOT BE ALLOWED.
- THE LENGTH OF DETECTOR LOOP CABLE FROM CURB TO THE HANDHOLE SHALL BE INCLUDED IN THE DETECTOR LOOP QUANTITY.
- LOOPS IN THE SAME LANE SHALL BE WOUND ALTERNATELY CLOCKWISE AND COUNTER CLOCKWISE.
- THE CONDUITS SHOWN CONNECTING THE BACK OF CURB TO THE ROADSIDE HANDHOLE SHALL CONTAIN ONLY DETECTOR LOOP CABLE.
- A 1/4" DIAMETER CONTINUOUS NYLON ROPE SHALL BE FURNISHED AND LEFT IN PLACE IN ALL CONDUITS BETWEEN HANDHOLES AND FOUNDATIONS OR CONTROLLER.




FILE NAME *	USER NAME * menck01390	DESIGNED - KNB	REVISED -	<b>STATE OF ILLINOIS DEPARTMENT OF TRANSPORTATION</b>	<b>ADAMS STREET AND OAK STREET CABLE PLAN</b>				F.A.U. RTE.	SECTION	COUNTY	TOTAL SHEETS	SHEET NO.
0:\pwise\work\do_not_delete\dms73300\04	DL0155-shy-ta002.dgn	DRAWN - RLA	REVISED -		12-00356-01-PV	PEORIA	519	377					
	PLOT SCALE * 39.9999' / 1"	CHECKED - TMA	REVISED -		SCALE: 1"=20'				SHEET NO. OF SHEETS STA. TO STA.		CONTRACT NO. 89626		
	PLOT DATE * 07/23/2012	DATE - 7/18/12	REVISED -		ILLINOIS DEPT. OF TRANSPORTATION PROJECT TIG-5093(158)								

NOTE:  
 • DENOTES SIGN TO BE PROVIDED AND INSTALLED BY CITY.  
 NOTE:  
 •• DENOTES ILLUMINATED SIGN HUNG FROM MAST ARM. SIGNS WILL MEET MUTCD, CITY OF PEORIA, AND IDOT STANDARDS. DETAILS ARE NOT PROVIDED. INFORMATION PROVIDED IS FOR VISUAL REPRESENTATION ONLY.

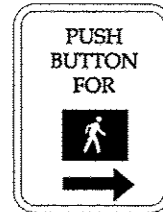

• 4 EACH REQUIRED

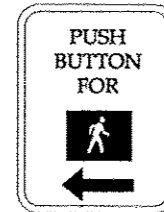

• 4 EACH REQUIRED

PEDESTRIAN PUSH BUTTON SIGN  
 TYPE R10-4B (L OR R)


9" X 12"

• PEDESTRIAN CROSSING  
 SIGN DETAIL  
 (NOT TO SCALE)

TYPE B SHEETING REQUIRED


LEGEND-BLACK  
 BACKGROUND-WHITE

STANDARD PEDESTRIAN PUSH  
 BUTTONS SHALL BE SUPPLIED AND  
 INSTALLED BY THE CONTRACTOR

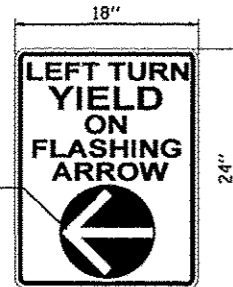


YELLOW ARROW  
 ON BLACK  
 BACKGROUND


• SIGN PANEL-TYPE 1 (SPECIAL)  
 SIGN BACKGROUND: WHITE  
 SIGN LETTERING: BLACK

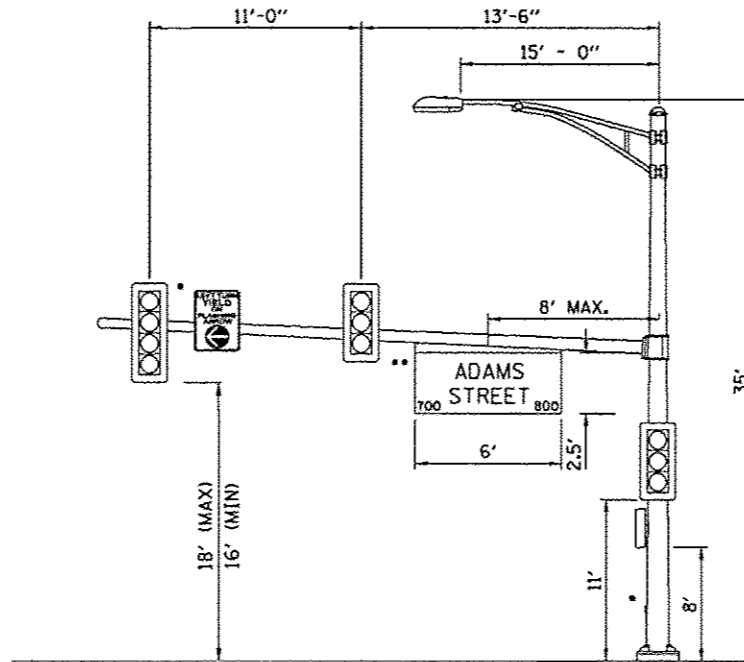


ADAMS ST. AND OAK ST.  
 EASTBOUND OAK ST.  
 POST 6  
 NTS

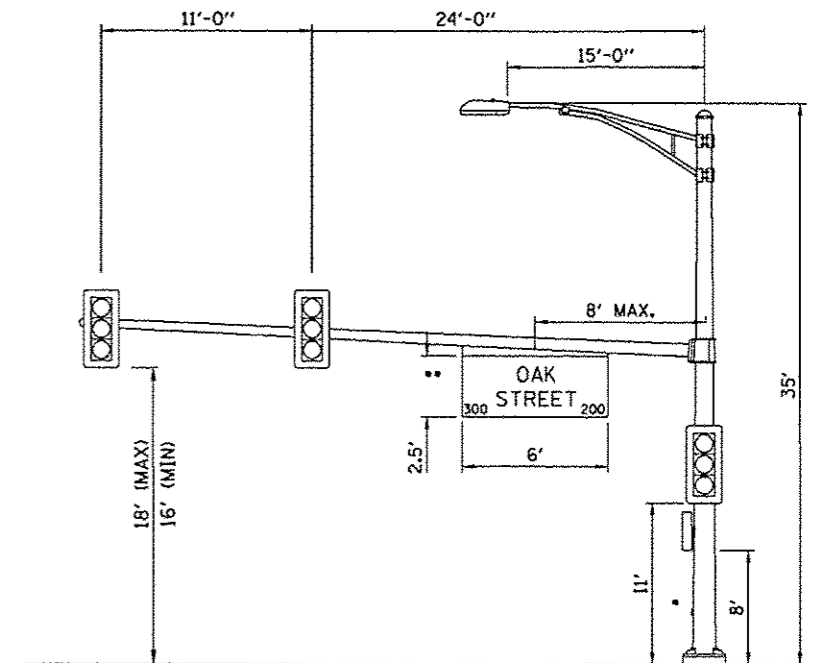


ADAMS ST. AND OAK ST.  
 NORTHBOUND ADAMS ST.  
 POST 8  
 NTS

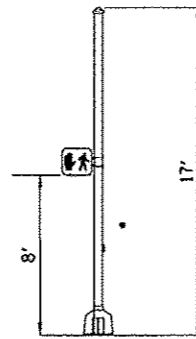


ADAMS ST. AND OAK ST.  
 TRAFFIC SIGNAL POST 1  
 NTS

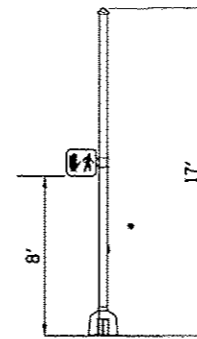


ADAMS ST. AND OAK ST.  
 TRAFFIC SIGNAL POST 3  
 NTS

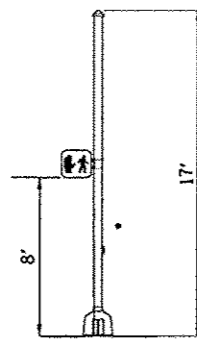


ADAMS ST. AND OAK ST.  
 TRAFFIC SIGNAL POST 4  
 NTS

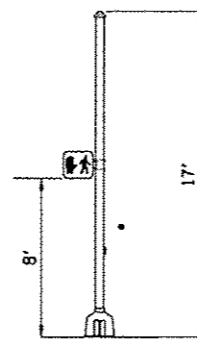

ADAMS ST. AND OAK ST.  
 TRAFFIC SIGNAL POST 5  
 NTS

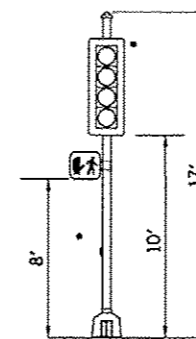

ADAMS ST. AND OAK ST.  
 TRAFFIC SIGNAL POST 7  
 NTS


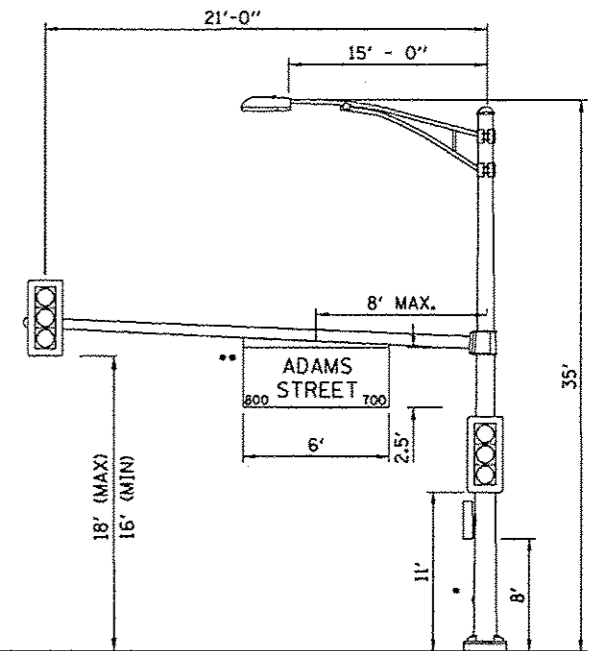


ADAMS ST. AND OAK ST.  
 WESTBOUND OAK ST.  
 POST 2  
 NTS





FILE NAME =	USER NAME = manak81390	DESIGNED - KNB	REVISED -	STATE OF ILLINOIS DEPARTMENT OF TRANSPORTATION	ADAMS STREET AND OAK STREET MAST ARM LOADING DIAGRAM	F.A.U. RTE.	SECTION	COUNTY	TOTAL SHEETS	SHEET NO.
o:\pwise_work\do_not_delete\dms73380\04	PL0195-shc-ta003.dgn	DRAWN - RLA	REVISED -			12-00356-01-PV	PEORIA	519	378	
	PLOT SCALE = 1/8" = 1'-0"	CHECKED - TMA	REVISED -			CONTRACT NO. 89626				
	PLOT DATE = 07/23/2012	DATE - 7/18/12	REVISED -			[ILLINOIS] FED. AID PROJECT 716-50931581				
				SCALE: N.T.S.	SHEET NO. OF SHEETS	STA.	TO STA.			


ADAMS STREET

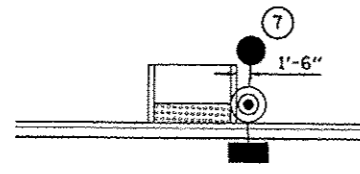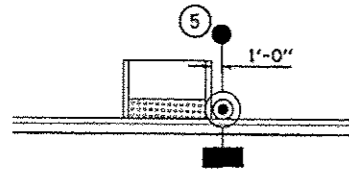

STATE STREET

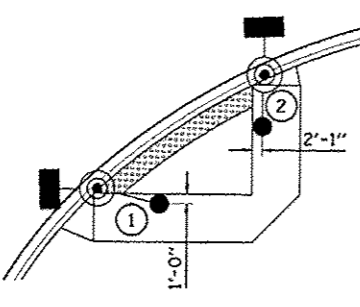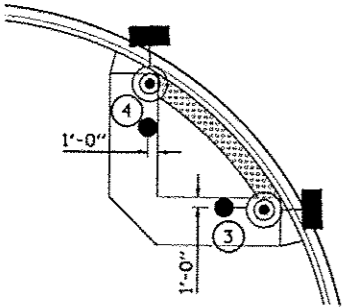

Pay Item #	Pay Item	Unit	Quantity
81028350	UNDERGROUND CONDUIT, PVC, 2" DIA.	FOOT	196
81028370	UNDERGROUND CONDUIT, PVC, 3" DIA.	FOOT	5
81028390	UNDERGROUND CONDUIT, PVC, 4" DIA.	FOOT	167
81400700	HANDHOLE, PORTLAND CEMENT CONCRETE	EACH	3
81400720	DOUBLE HANDHOLE, PORTLAND CEMENT CONCRETE	EACH	1
85700200	FULL-ACTUATED CONTROLLER AND TYPE IV CABINET	EACH	1
87301245	ELECTRIC CABLE IN CONDUIT, SIGNAL, NO. 14 SC	FOOT	1497.5
87301515	ELECTRIC CABLE IN CONDUIT, LEAD-IN, NO. 18 3 PAIR	FOOT	176.5
87502510	TRAFFIC SIGNAL POST, GALVANIZED STEEL, 17 FT.	EACH	4
87702860	STEEL COMBINATION MAST ARM ASSEMBLY AND POLE 26 FT.	EACH	1
87800100	CONCRETE FOUNDATION, TYPE A	FOOT	12
87800215	CONCRETE FOUNDATION, TYPE D	FOOT	3.5
87800400	CONCRETE FOUNDATION, TYPE E, 30-INCH DIAMETER	FOOT	10
88040070	SIGNAL HEAD, POLYCARBONATE, LED, 1-FACE, 3-SECTION, BRACKET MOUNTED	EACH	5
88040090	SIGNAL HEAD, POLYCARBONATE, LED, 1-FACE, 3-SECTION, MAST ARM MOUNTED	EACH	2
88102717	PEDESTRIAN SIGNAL HEAD, LED, 1-FACE, BRACKET MOUNTED WITH COUNTDOWN TIMER	EACH	6
88200110	TRAFFIC SIGNAL BACKPLATE, LOUVERED	EACH	7
88500100	INDUCTIVE LOOP DETECTOR	EACH	2
88600100	DETECTOR LOOP, TYPE 1	FOOT	536.5
88800100	PEDESTRIAN PUSH BUTTON	EACH	6
X8050135	SERVICE INSTALLATION, TYPE C (MODIFIED)	EACH	1
XX005428	INTERNALLY ILLUMINATED STREET NAME SIGN	EACH	1
Z0033068	TRAFFIC SIGNAL BATTERY BACKUP SYSTEM	EACH	1
	ELECTRIC CABLE IN CONDUIT NO. 6, 1/C	FOOT	711
X8211175	LUMINAIRE, LED HORIZONTAL MOUNT 175 WATT	EACH	1

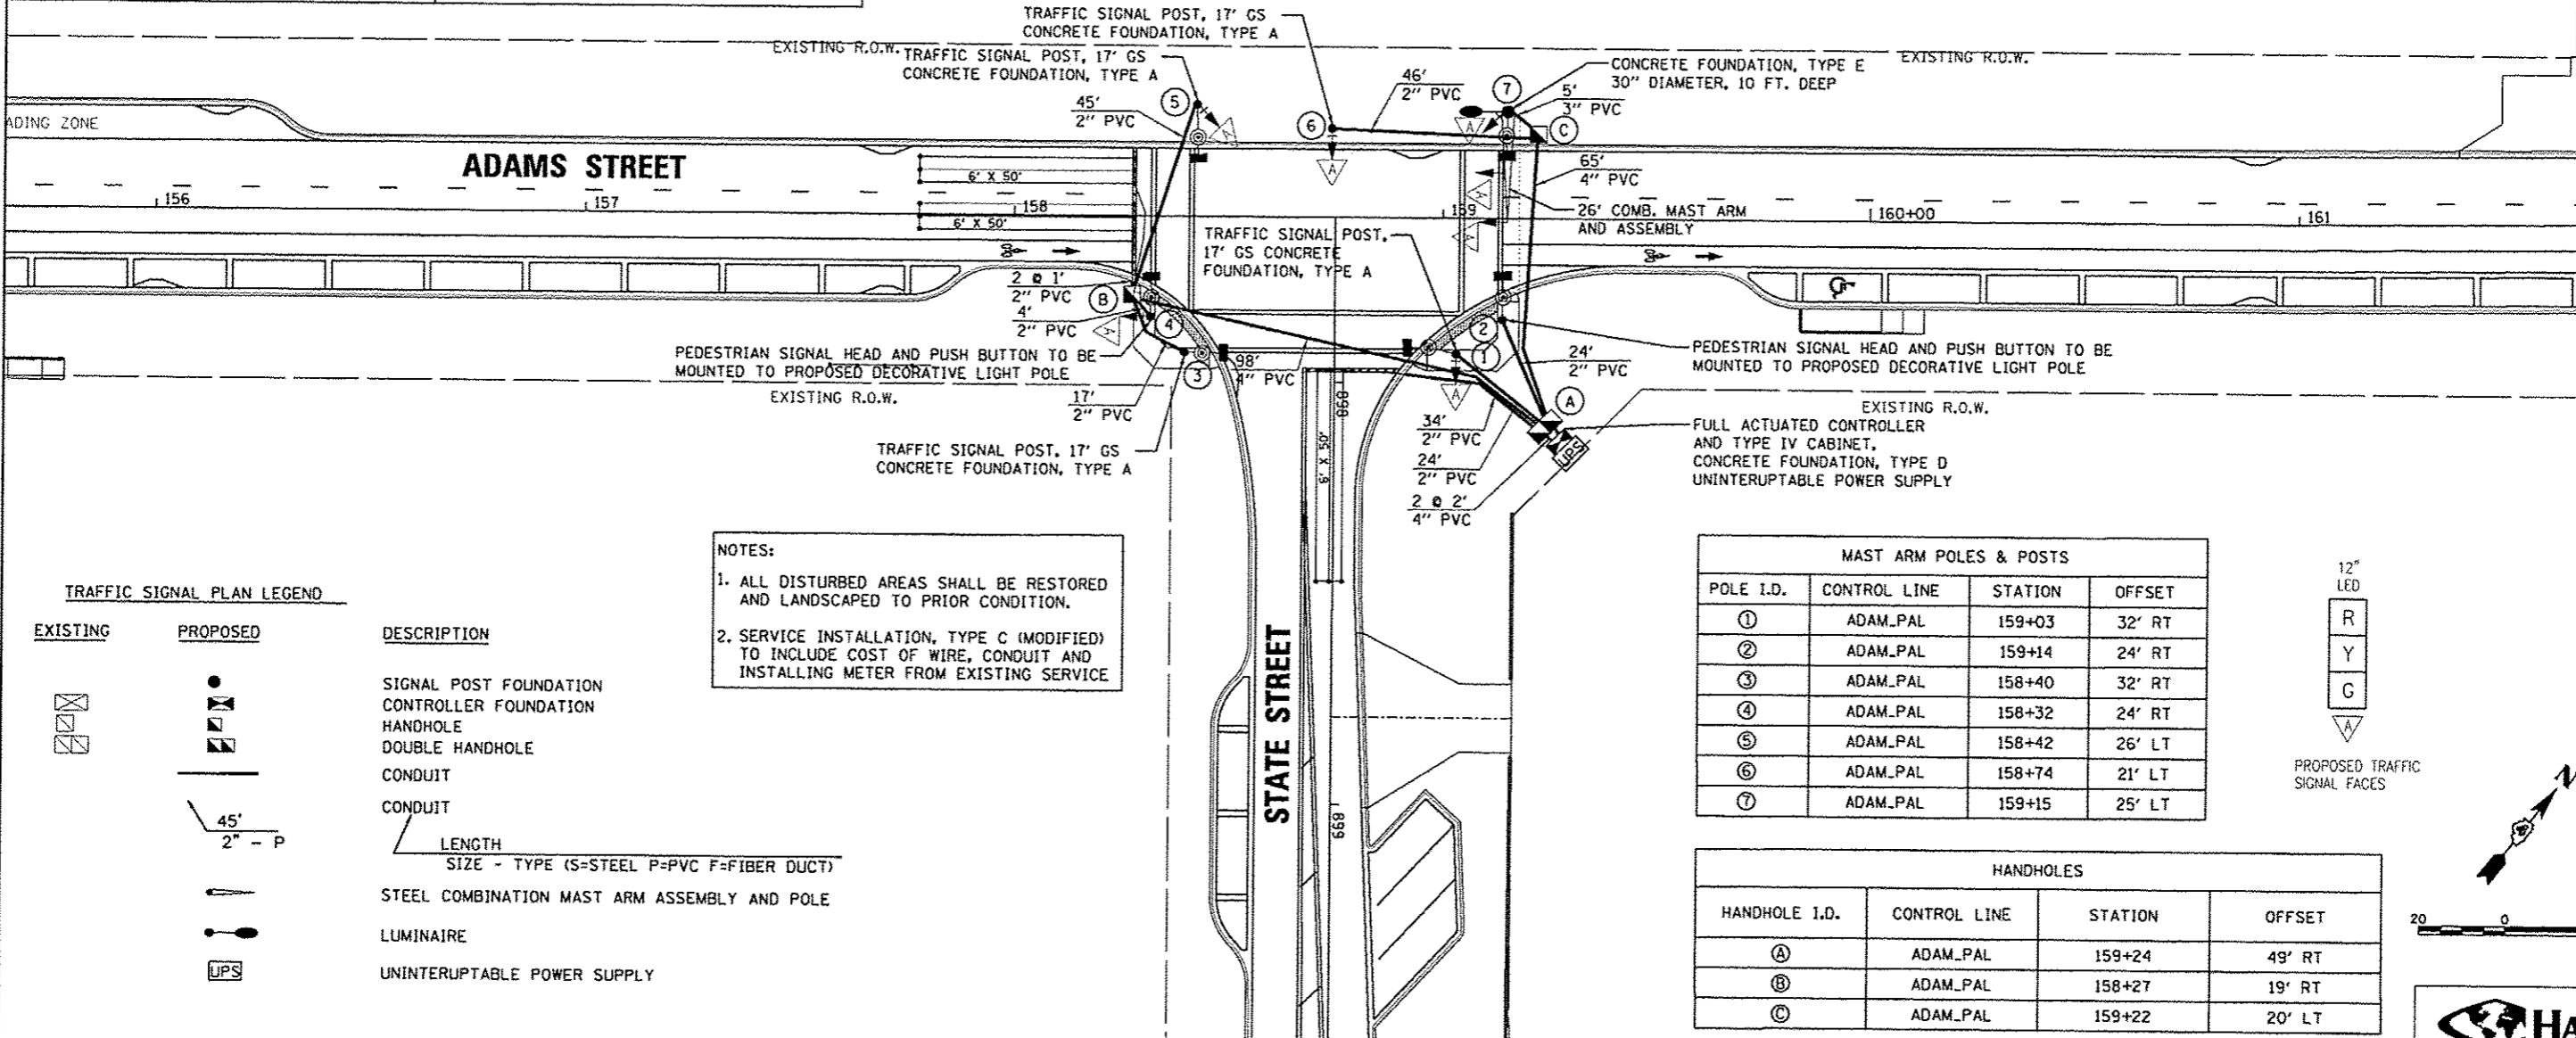



NOTES:  
 1. ALL DISTURBED AREAS SHALL BE RESTORED AND LANDSCAPED TO PRIOR CONDITION.  
 2. SERVICE INSTALLATION, TYPE C (MODIFIED) TO INCLUDE COST OF WIRE, CONDUIT AND INSTALLING METER FROM EXISTING SERVICE



TRAFFIC SIGNAL PLAN LEGEND

EXISTING	PROPOSED	DESCRIPTION
		SIGNAL POST FOUNDATION
		CONTROLLER FOUNDATION
		HANDHOLE
		DOUBLE HANDHOLE
		CONDUIT
		CONDUIT LENGTH
		SIZE - TYPE (S=STEEL P=PVC F=FIBER DUCT)
		STEEL COMBINATION MAST ARM ASSEMBLY AND POLE
		LUMINAIRE
		UNINTERRUPTABLE POWER SUPPLY


MAST ARM POLES & POSTS			
POLE I.D.	CONTROL LINE	STATION	OFFSET
①	ADAM.PAL	159+03	32' RT
②	ADAM.PAL	159+14	24' RT
③	ADAM.PAL	158+40	32' RT
④	ADAM.PAL	158+32	24' RT
⑤	ADAM.PAL	158+42	26' LT
⑥	ADAM.PAL	158+74	21' LT
⑦	ADAM.PAL	159+15	25' LT

HANDHOLES			
HANDHOLE I.D.	CONTROL LINE	STATION	OFFSET
Ⓐ	ADAM.PAL	159+24	49' RT
Ⓑ	ADAM.PAL	158+27	19' RT
Ⓒ	ADAM.PAL	159+22	20' LT

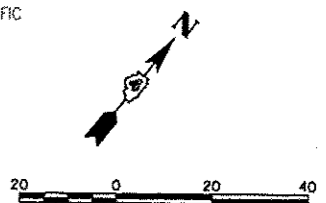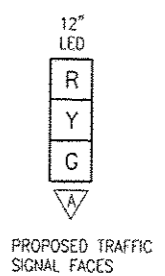

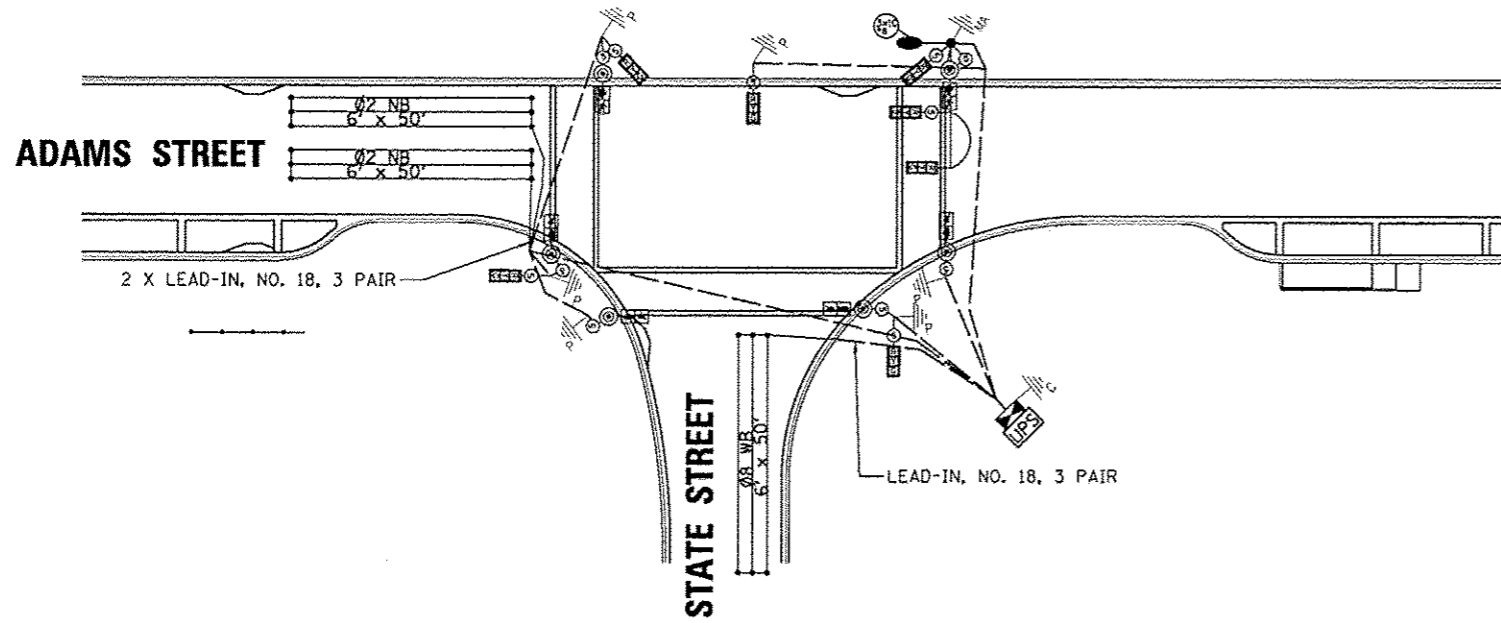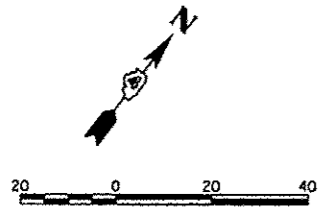

**NOTES:**  
 1. CABINET TO BE SET-UP PER MANUFACTURER SPECIFICATIONS FOR FLASHING YELLOW ARROW OPERATIONS  
 2. WIRING FOR GPS CONFIRMATION BEACON AND ANTENNA TO BE COMPLETED PER SPECIAL PROVISION AND MANUFACTURER SPECIFICATIONS.

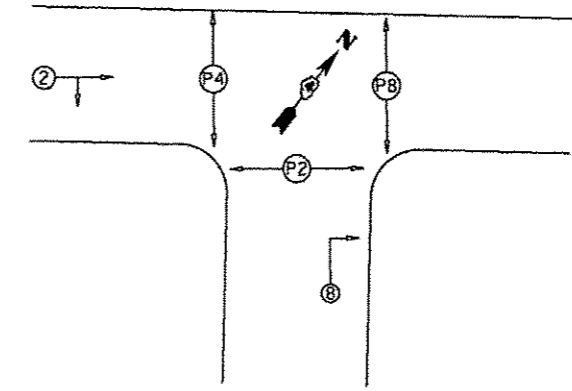

PHASE DESIGNATION DIAGRAM

**TRAFFIC SIGNAL WIRING DIAGRAM LEGEND**

- | PROPOSED | DESCRIPTION                                  |
|----------|--|
|          | ELECTRIC CABLE DENOTING NUMBER OF CONDUCTORS |
|          | SIGNAL FACE WITH BACKPLATE                   |
|          | DIRECTIONAL SIGNAL SECTION                   |
|          | 12" SIGNAL SECTION                           |
|          | WALK/DON'T WALK SECTION + COUNT DOWN         |
|          | GROUND WIRE (POLE)                           |
|          | GROUND WIRE (MAST ARM)                       |
|          | PEDESTRIAN PUSHBUTTON                        |
|          | CONDUIT                                      |
|          | FLASHING YELLOW ARROW                        |
|          | LUMINAIRE                                    |
|          | UNINTERRUPTIBLE POWER SUPPLY                 |

**TRAFFIC SIGNAL GENERAL NOTES**


- ALL TRAFFIC SIGNAL SECTIONS SHALL HAVE 12" SINGLE LED LENSES.
- ALL PEDESTRIAN SECTIONS SHALL HAVE 16" LENSES WITH A MAN/HAND OVERLAY AND COUNTDOWN TIMER.
- THE RED SECTIONS OF THE SIGNAL HEADS SHARING THE SAME MAST ARM SHALL BE LEVEL WITH ONE ANOTHER AND MAINTAIN A 16' MINIMUM CLEARANCE FROM THE HIGHEST POINT OF THE ROADWAY.
- THE PROPOSED MAST ARM MOUNTED TRAFFIC SIGNAL HEADS SHALL BE MOUNTED DIRECTLY OVER THE CENTER OF THEIR RESPECTIVE LANES.
- ALL TRAFFIC SIGNAL HEAD BRACKETS ARE TO BE ALUMINUM WITH A BLACK FINISH.
- ALL TRAFFIC SIGNAL POSTS ARE TO BE GALVANIZED STEEL.
- EXISTING CONDUIT, IF USED, SHALL BE COUPLED TO THE PROPOSED CONDUIT. THIS WORK SHALL BE INCLUDED IN THE PRICE FOR THE CONDUIT OF THE TYPE SPECIFIED.
- PROPOSED HANDHOLES SHALL BE CAST IN PLACE CONCRETE HANDHOLES.
- THE HANDHOLE SHALL BE CONSTRUCTED SO THAT THE TOP OF THE FRAME WILL BE FLUSH WITH THE SURFACE OF THE MEDIAN, SIDEWALK, OR GROUND LINE.
- THE LOCATION OF ALL UTILITIES SHALL BE FIELD VERIFIED BY THE CONTRACTOR BEFORE THE INSTALLATION OF ANY TRAFFIC SIGNAL COMPONENTS.
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- ALL SURPLUS MATERIALS SHALL BE DISPOSED OF IN ACCORDANCE WITH ARTICLE 202.03 OF THE STANDARD SPECIFICATIONS.
- NO ADDITIONAL COMPENSATION SHALL BE ALLOWED FOR PLACING CONDUIT AT GREATER THAN 2 FT. MINIMUM DEPTH TO AVOID OBSTACLES SUCH AS UNDERGROUND UTILITIES.
- THE CONTRACTOR IS RESPONSIBLE FOR THE COST OF UNCOVERING, HAND DIGGING, OR ANY SPECIAL EXCAVATION AROUND UTILITIES AS NECESSARY. THIS COST OF THIS WORK SHALL BE INCLUDED IN THE UNIT PRICES FOR THE CONDUITS AND FOUNDATIONS.
- ALL TRAFFIC SIGNAL MAST ARMS, POSTS, HANDHOLE LIDS AND RINGS, HANDHOLE FRAMES, CONTROLLER CABINETS, SERVICE RISERS, EXPOSED METALLIC CONDUITS, AND PHOTOCCELL RELAYS SHALL BE GROUNDED IN ACCORDANCE WITH NEC REQUIREMENTS.
- DRILLING HOLES THROUGH CURB AND GUTTER WILL NOT BE ALLOWED.
- THE LENGTH OF DETECTOR LOOP CABLE FROM CURB TO THE HANDHOLE SHALL BE INCLUDED IN THE DETECTOR LOOP QUANTITY.
- LOOPS IN THE SAME LANE SHALL BE WOUND ALTERNATELY CLOCKWISE AND COUNTER CLOCKWISE.
- THE CONDUITS SHOWN CONNECTING THE BACK OF CURB TO THE ROADSIDE HANDHOLE SHALL CONTAIN ONLY DETECTOR LOOP CABLE.
- A 1/4" DIAMETER CONTINUOUS NYLON ROPE SHALL BE FURNISHED AND LEFT IN PLACE IN ALL CONDUITS BETWEEN HANDHOLES AND FOUNDATIONS OR CONTROLLER.




FILE NAME *	USER NAME * mansk01398	DESIGNED - KNB	REVISED -	<b>STATE OF ILLINOIS DEPARTMENT OF TRANSPORTATION</b>	<b>ADAMS STREET AND STATE STREET CABLE PLAN</b>				F.A.U. RTE.	SECTION	COUNTY	TOTAL SHEETS	SHEET NO.
c:\pwise\work\do_not_delete\dms73388\04	04.0155-shr-ta005.dgn	DRAWN - RLA	REVISED -		12-00356-01-PV	PEORIA	519	380					
	PLOT SCALE = 39.9999' / in.	CHECKED - TMA	REVISED -		CONTRACT NO. 89626				ILLINOIS FED. AID PROJECT TIG-6093(58)				
	PLOT DATE = 07/23/2012	DATE - 7/18/12	REVISED -		SCALE: 1"=20'	SHEET NO. OF	SHEETS	STA. TO STA.					



NOTE:  
 • DENOTES SIGN TO BE PROVIDED AND INSTALLED BY CITY.  
 NOTE:  
 •• DENOTES ILLUMINATED SIGN HUNG FROM MAST ARM. SIGNS WILL MEET MUTCD, CITY OF PEORIA, AND IDOT STANDARDS. DETAILS ARE NOT PROVIDED. INFORMATION PROVIDED IS FOR VISUAL REPRESENTATION ONLY.

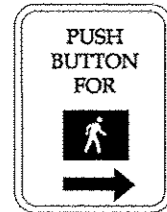

• 3 EACH REQUIRED

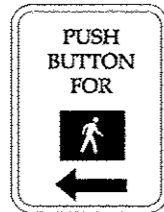

• 3 EACH REQUIRED

PEDESTRIAN PUSH BUTTON SIGN  
 TYPE R10-4B (L OR R)


9" X 12"

• PEDESTRIAN CROSSING  
 SIGN DETAIL  
 (NOT TO SCALE)


TYPE B SHEETING REQUIRED

LEGEND-BLACK  
 BACKGROUND-WHITE


STANDARD PEDESTRIAN PUSH  
 BUTTONS SHALL BE SUPPLIED AND  
 INSTALLED BY THE CONTRACTOR

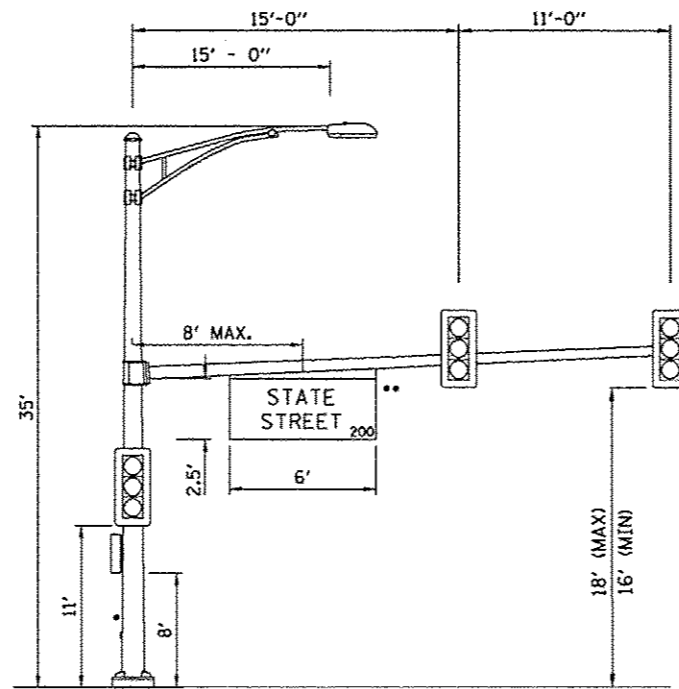


ADAMS ST. AND STATE ST.  
 NORTHBOUND ADAMS ST.  
 POST 7  
 NTS

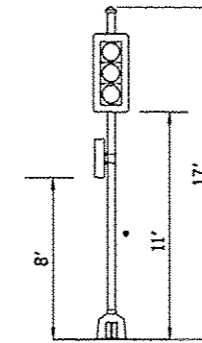


ADAMS ST. AND STATE ST.  
 TRAFFIC SIGNAL POST 1  
 NTS

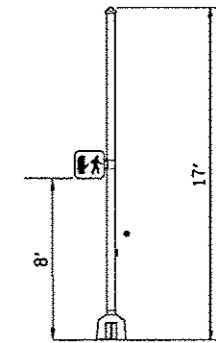


ADAMS ST. AND STATE ST.  
 TRAFFIC SIGNAL POST 2  
 NTS

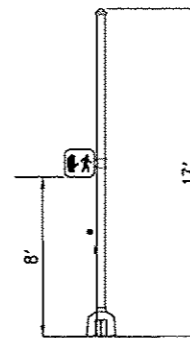


ADAMS ST. AND STATE ST.  
 TRAFFIC SIGNAL POST 3  
 NTS

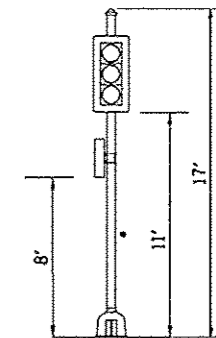

ADAMS ST. AND STATE ST.  
 TRAFFIC SIGNAL POST 4  
 NTS

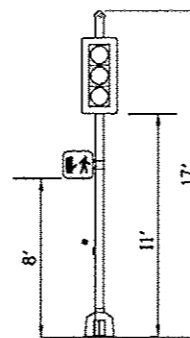




ADAMS ST. AND STATE ST.  
 TRAFFIC SIGNAL POST 5  
 NTS

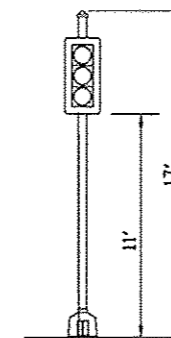

ADAMS ST. AND STATE ST.  
 TRAFFIC SIGNAL POST 6  
 NTS



FILE NAME *	USER NAME * mansk01398	DESIGNED - KND	REVISED -	<b>STATE OF ILLINOIS DEPARTMENT OF TRANSPORTATION</b>	<b>ADAMS STREET AND STATE STREET MAST ARM LOADING DIAGRAM</b>			F.A.U. RTE.	SECTION	COUNTY	TOTAL SHEETS	SHEET NO.
or\pwise\work\do_not_delete\des73389\04	2L0155-eh-t-0885.dgn	DRAWN - RLA	REVISED -					12-00356-01-PV	PEORIA	519	381	
	PLOT SCALE = 1/8" = 1' / 3/16"	CHECKED - TMA	REVISED -					CONTRACT NO. 89626				
	PLOT DATE = 07/23/2012	DATE - 7/18/12	REVISED -					ILLINOIS FED. AID PROJECT TIG-503J1581				
				SCALE: N.T.S.	SHEET NO.	OF	SHEETS	STA.	TO STA.			

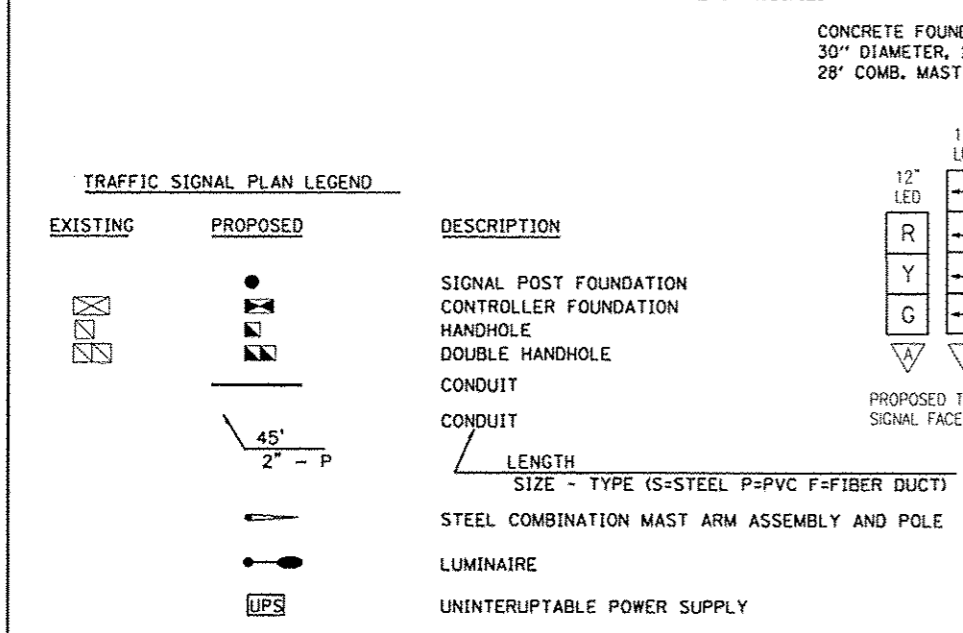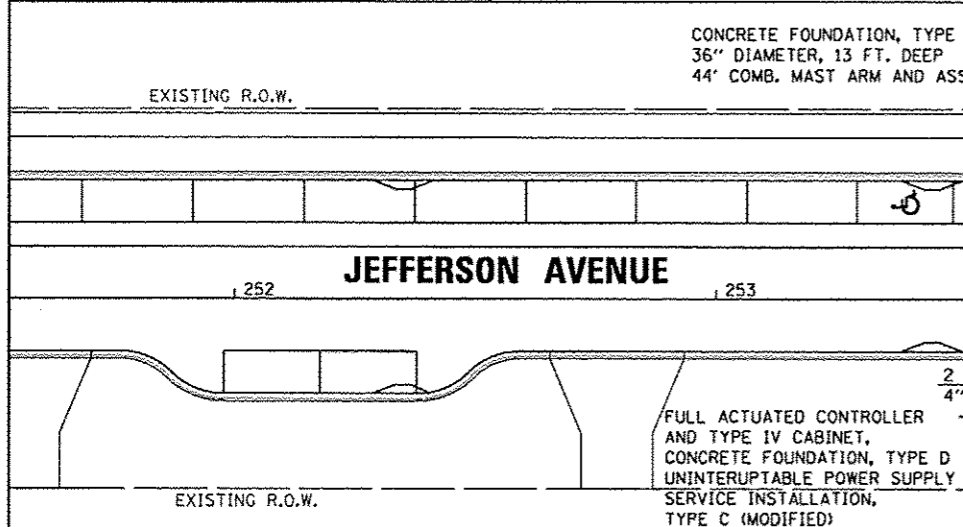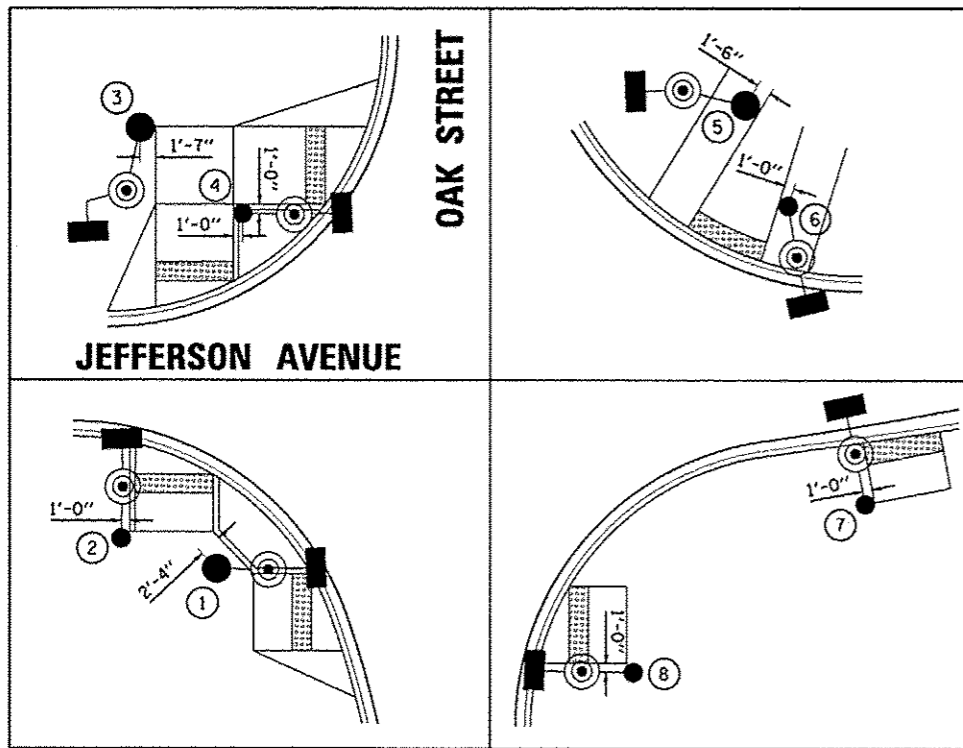

FILE NAME *	USER NAME * mansk01390	DESIGNED - KNB	REVISED -
al\pwise\work\do_not_delete\dm73388\04\0150-ah-tr-1007.dgn		DRAWN - RLA	REVISED -
		CHECKED - TMA	REVISED -
		DATE - 7/18/12	REVISED -

**NOTES:**

- ALL DISTURBED AREAS SHALL BE RESTORED AND LANDSCAPED TO PRIOR CONDITION.
- SERVICE INSTALLATION, TYPE C (MODIFIED) TO INCLUDE COST OF WIRE, CONDUIT AND INSTALLING METER FROM EXISTING SERVICE

HANDHOLE I.D.	CONTROL LINE	STATION	OFFSET
A	JEFF_PAL	253+88	30' RT
B	JEFF_PAL	253+80	20' RT
C	JEFF_PAL	254+72	51' LT
D	JEFF_PAL	254+54	50' RT

POLE I.D.	CONTROL LINE	STATION	OFFSET
①	JEFF_PAL	254+03	26' RT
②	JEFF_PAL	253+93	23' RT
③	JEFF_PAL	253+93	37' LT
④	JEFF_PAL	254+04	28' LT
⑤	JEFF_PAL	254+91	39' LT
⑥	JEFF_PAL	254+94	28' LT
⑦	JEFF_PAL	254+86	28' RT
⑧	JEFF_PAL	254+62	41' RT



Pay Item #	Pay Item	Unit	Quantity
81028350	UNDERGROUND CONDUIT, PVC, 2" DIA.	FOOT	219
81028370	UNDERGROUND CONDUIT, PVC, 3" DIA.	FOOT	85
81028390	UNDERGROUND CONDUIT, PVC, 4" DIA.	FOOT	175
81400700	HANDHOLE, PORTLAND CEMENT CONCRETE	EACH	3
81400720	DOUBLE HANDHOLE, PORTLAND CEMENT CONCRETE	EACH	1
85700200	FULL-ACTUATED CONTROLLER AND TYPE IV CABINET	EACH	1
87301245	ELECTRIC CABLE IN CONDUIT, SIGNAL, NO. 14 5C	FOOT	2070.5
87301255	ELECTRIC CABLE IN CONDUIT, SIGNAL, NO. 14 7C	FOOT	398
87301515	ELECTRIC CABLE IN CONDUIT, LEAD-IN, NO. 18 3 PAIR	FOOT	532
87502510	TRAFFIC SIGNAL POST, GALVANIZED STEEL, 17 FT.	EACH	3
87702870	STEEL COMBINATION MAST ARM ASSEMBLY AND POLE 28 FT.	EACH	1
87702950	STEEL COMBINATION MAST ARM ASSEMBLY AND POLE 44 FT.	EACH	1
87702960	STEEL COMBINATION MAST ARM ASSEMBLY AND POLE 46 FT.	EACH	1
87800100	CONCRETE FOUNDATION, TYPE A	FOOT	9
87800215	CONCRETE FOUNDATION, TYPE D	FOOT	3.5
87800400	CONCRETE FOUNDATION, TYPE E, 30-INCH DIAMETER	FOOT	10
87800415	CONCRETE FOUNDATION, TYPE E, 36-INCH DIAMETER	FOOT	26
88040070	SIGNAL HEAD, POLYCARBONATE, LED, 1-FACE, 3-SECTION, BRACKET MOUNTED	EACH	3
88040090	SIGNAL HEAD, POLYCARBONATE, LED, 1-FACE, 3-SECTION, MAST ARM MOUNTED	EACH	4
88040120	SIGNAL HEAD, POLYCARBONATE, LED, 1-FACE, 4-SECTION, MAST ARM MOUNTED	EACH	1
88040110	SIGNAL HEAD, POLYCARBONATE, LED, 1-FACE, 4-SECTION, BRACKET MOUNTED	EACH	1
88102717	PEDESTRIAN SIGNAL HEAD, LED, 1-FACE, BRACKET MOUNTED WITH COUNTDOWN TIMER	EACH	8
88200110	TRAFFIC SIGNAL BACKPLATE, LOUVERED	EACH	9
88500100	INDUCTIVE LOOP DETECTOR	EACH	4
88600100	DETECTOR LOOP, TYPE 1	FOOT	915.5
88800100	PEDESTRIAN PUSH BUTTON	EACH	8
X8050135	SERVICE INSTALLATION, TYPE C (MODIFIED)	EACH	1
XX005428	INTERNALLY ILLUMINATED STREET NAME SIGN	EACH	3
Z0033068	TRAFFIC SIGNAL BATTERY BACKUP SYSTEM	EACH	1
	ELECTRIC CABLE IN CONDUIT NO 6. 1/C	FOOT	1790
X8211175	LUMINAIRE, LED HORIZONTAL MOUNT 175 WATT	EACH	3

STATE OF ILLINOIS  
DEPARTMENT OF TRANSPORTATION

JEFFERSON AVENUE AND OAK STREET  
TRAFFIC SIGNAL PLAN



SCALE: 1"=20'	SHEET NO. OF SHEETS STA. TO STA.	F.A.U. RTE.	SECTION 12-00356-01-PV	COUNTY PEORIA	TOTAL SHEETS 519	SHEET NO. 382
			CONTRACT NO. 089626		ILLINOIS FED. AID PROJECT TIC-5993(150)	

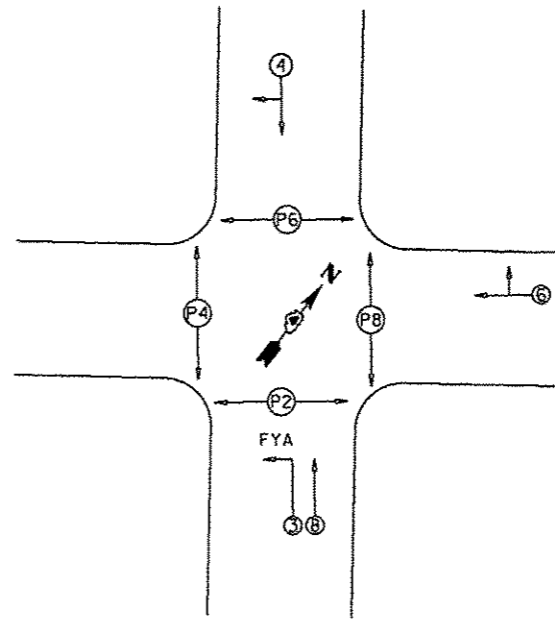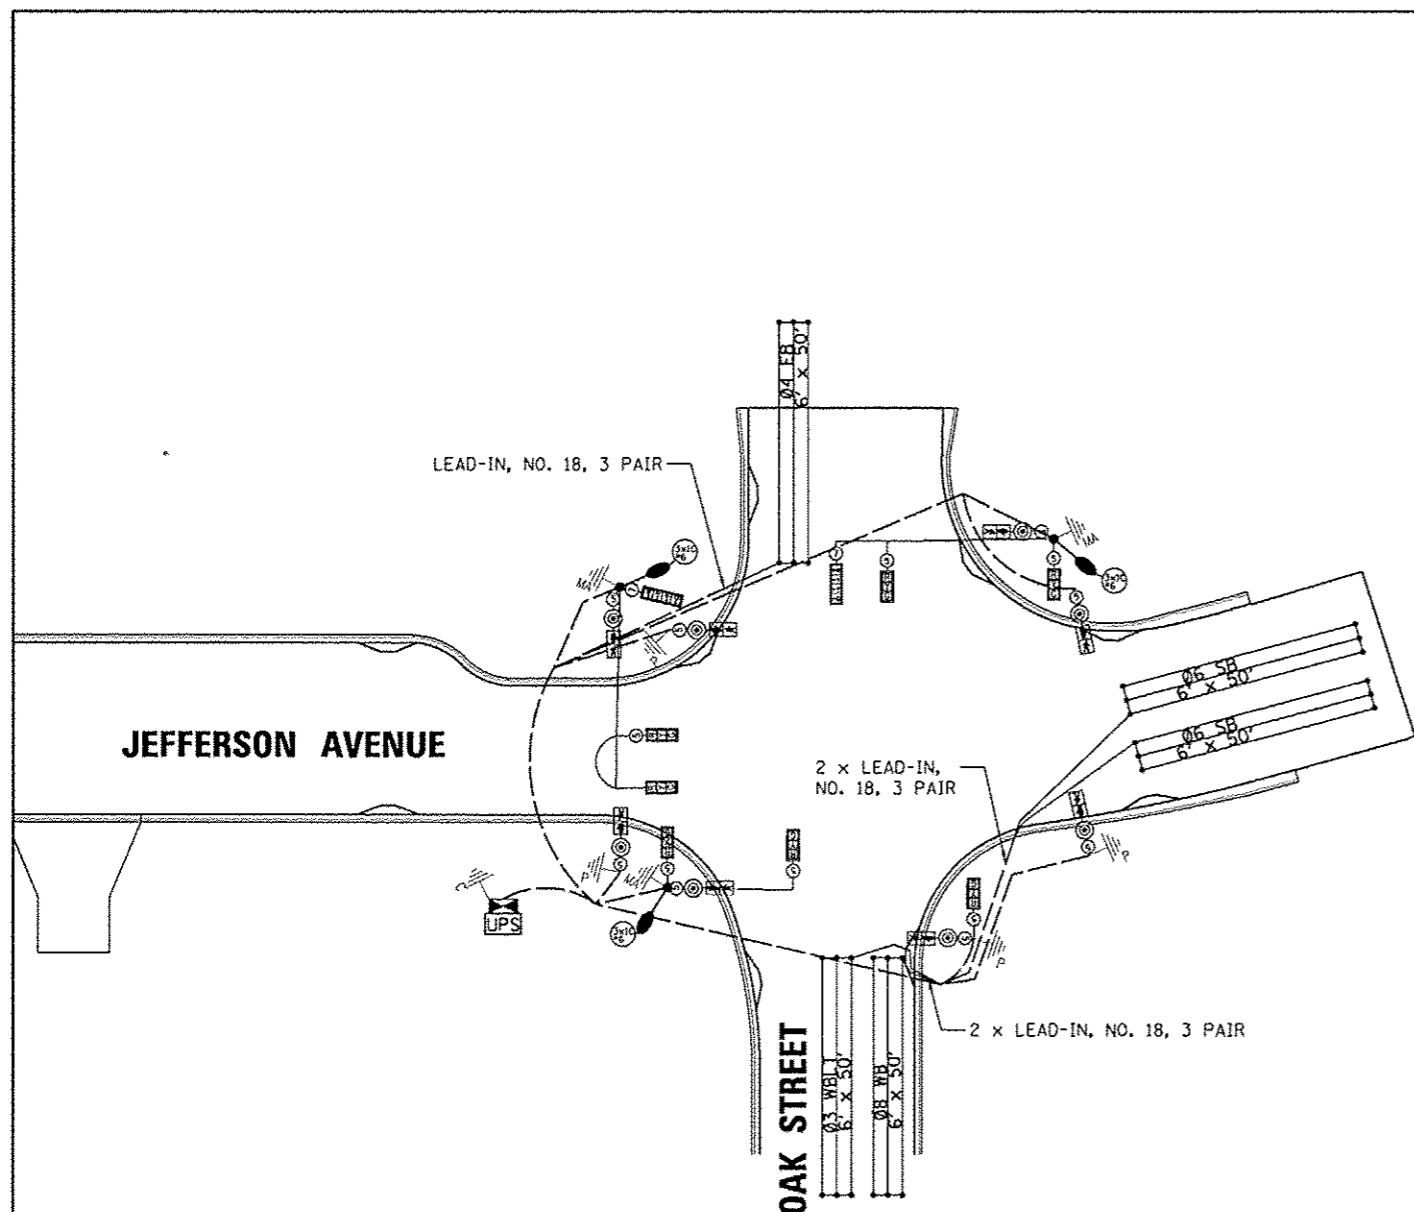

PHASE DESIGNATION DIAGRAM


TRAFFIC SIGNAL WIRING DIAGRAM LEGEND

PROPOSED	DESCRIPTION
⑤	ELECTRIC CABLE DENOTING NUMBER OF CONDUCTORS
☐	SIGNAL FACE WITH BACKPLATE
☐	DIRECTIONAL SIGNAL SECTION
☐	12" SIGNAL SECTION
☐	WALK/DON'T WALK SECTION + COUNT DOWN
⚡	GROUND WIRE (POLE)
⚡	GROUND WIRE (MAST ARM)
⊙	PEDESTRIAN PUSHBUTTON
---	CONDUIT
FYA	FLASHING YELLOW ARROW
☉	LUMINAIRE
UPS	UNINTERRUPTABLE POWER SUPPLY

TRAFFIC SIGNAL GENERAL NOTES

- ALL TRAFFIC SIGNAL SECTIONS SHALL HAVE 12" SINGLE LED LENSES.
- ALL PEDESTRIAN SECTIONS SHALL HAVE 16" LENSES WITH A MAN/HAND OVERLAY AND COUNTDOWN TIMER.
- THE RED SECTIONS OF THE SIGNAL HEADS SHARING THE SAME MAST ARM SHALL BE LEVEL WITH ONE ANOTHER AND MAINTAIN A 16' MINIMUM CLEARANCE FROM THE HIGHEST POINT OF THE ROADWAY.
- THE PROPOSED MAST ARM MOUNTED TRAFFIC SIGNAL HEADS SHALL BE MOUNTED DIRECTLY OVER THE CENTER OF THEIR RESPECTIVE LANES.
- ALL TRAFFIC SIGNAL HEAD BRACKETS ARE TO BE ALUMINUM WITH A BLACK FINISH.
- ALL TRAFFIC SIGNAL POSTS ARE TO BE GALVANIZED STEEL.
- EXISTING CONDUIT, IF USED, SHALL BE COUPLED TO THE PROPOSED CONDUIT. THIS WORK SHALL BE INCLUDED IN THE PRICE FOR THE CONDUIT OF THE TYPE SPECIFIED.
- PROPOSED HANDHOLES SHALL BE CAST IN PLACE CONCRETE HANDHOLES.
- THE HANDHOLE SHALL BE CONSTRUCTED SO THAT THE TOP OF THE FRAME WILL BE FLUSH WITH THE SURFACE OF THE MEDIAN, SIDEWALK, OR GROUND LINE.
- THE LOCATION OF ALL UTILITIES SHALL BE FIELD VERIFIED BY THE CONTRACTOR BEFORE THE INSTALLATION OF ANY TRAFFIC SIGNAL COMPONENTS.
- COILABLE POLYETHYLENE DUCT MAY BE SUBSTITUTED FOR PVC CONDUIT PUSHED.
- THE LOCATIONS FOR HANDHOLES, TRAFFIC SIGNAL POST FOUNDATIONS, AND MAST ARM FOUNDATIONS ARE PROVIDED FOR REFERENCE ONLY. THE ENGINEER OF TRAFFIC SHALL BE NOTIFIED FOR LOCATION VERIFICATION BEFORE INSTALLATION.
- ALL SURPLUS MATERIALS SHALL BE DISPOSED OF IN ACCORDANCE WITH ARTICLE 202.03 OF THE STANDARD SPECIFICATIONS.
- NO ADDITIONAL COMPENSATION SHALL BE ALLOWED FOR PLACING CONDUIT AT GREATER THAN 2 FT. MINIMUM DEPTH TO AVOID OBSTACLES SUCH AS UNDERGROUND UTILITIES.
- THE CONTRACTOR IS RESPONSIBLE FOR THE COST OF UNCOVERING, HAND DIGGING, OR ANY SPECIAL EXCAVATION AROUND UTILITIES AS NECESSARY. THIS COST OF THIS WORK SHALL BE INCLUDED IN THE UNIT PRICES FOR THE CONDUITS AND FOUNDATIONS.
- ALL TRAFFIC SIGNAL MAST ARMS, POSTS, HANDHOLE LIDS AND RINGS, HANDHOLE FRAMES, CONTROLLER CABINETS, SERVICE RISERS, EXPOSED METALLIC CONDUITS, AND PHOTOCCELL RELAYS SHALL BE GROUNDED IN ACCORDANCE WITH NEC REQUIREMENTS.
- DRILLING HOLES THROUGH CURB AND GUTTER WILL NOT BE ALLOWED.
- THE LENGTH OF DETECTOR LOOP CABLE FROM CURB TO THE HANDHOLE SHALL BE INCLUDED IN THE DETECTOR LOOP QUANTITY.
- LOOPS IN THE SAME LANE SHALL BE WOUND ALTERNATELY CLOCKWISE AND COUNTER CLOCKWISE.
- THE CONDUITS SHOWN CONNECTING THE BACK OF CURB TO THE ROADSIDE HANDHOLE SHALL CONTAIN ONLY DETECTOR LOOP CABLE.
- A 1/4" DIAMETER CONTINUOUS NYLON ROPE SHALL BE FURNISHED AND LEFT IN PLACE IN ALL CONDUITS BETWEEN HANDHOLES AND FOUNDATIONS OR CONTROLLER.

NOTES:  
1. CABINET TO BE SET-UP PER MANUFACTURER SPECIFICATIONS FOR FLASHING YELLOW ARROW OPERATIONS.

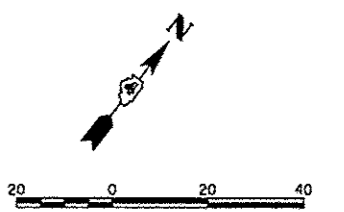

FILE NAME *	USER NAME = manak01390	DESIGNED - KNB	REVISED -
or\pwise_work\do_not_delete\dms73308\04	RL0150-shr-ts000.dgn	DRAWN - RLA	REVISED -
	PLOT SCALE = 3/4" = 1' / in.	CHECKED - TMA	REVISED -
	PLOT DATE = 07/23/2012	DATE = 7/18/12	REVISED -


STATE OF ILLINOIS  
DEPARTMENT OF TRANSPORTATION

JEFFERSON AVENUE AND OAK STREET CABLE PLAN			
SCALE: 1"=20'	SHEET NO.	OF SHEETS	STA. TO STA.


F.A.U. RTE.	SECTION	COUNTY	TOTAL SHEETS	SHEET NO.
12	12-00356-01-PV	PEORIA	519	383
CONTRACT NO. 89626			ILLINOIS FED. AID PROJECT TIG-5093058	



NOTE:  
 • DENOTES SIGN TO BE PROVIDED AND INSTALLED BY CITY.  
 •• DENOTES ILLUMINATED SIGN HUNG FROM MAST ARM. SIGNS WILL MEET MUTCD, CITY OF PEORIA, AND IDOT STANDARDS. DETAILS ARE NOT PROVIDED. INFORMATION PROVIDED IS FOR VISUAL REPRESENTATION ONLY.

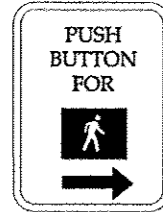

• 4 EACH REQUIRED

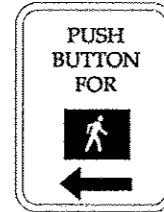

• 4 EACH REQUIRED

PEDESTRIAN PUSH BUTTON SIGN  
 TYPE R10-4B (L OR R)


9" X 12"

• PEDESTRIAN CROSSING  
 SIGN DETAIL  
 (NOT TO SCALE)

TYPE B SHEETING REQUIRED


LEGEND-BLACK  
 BACKGROUND-WHITE

STANDARD PEDESTRIAN PUSH  
 BUTTONS SHALL BE SUPPLIED AND  
 INSTALLED BY THE CONTRACTOR

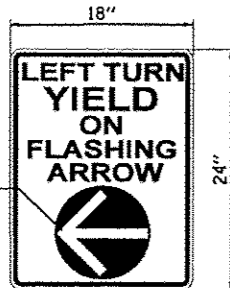


YELLOW ARROW  
 ON BLACK  
 BACKGROUND


• SIGN PANEL-TYPE 1 (SPECIAL)  
 SIGN BACKGROUND: WHITE  
 SIGN LETTERING: BLACK

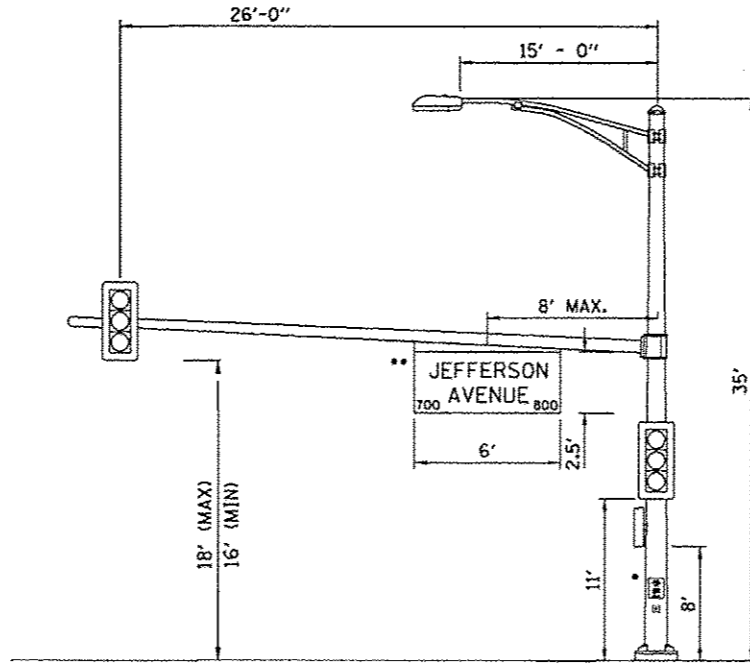


JEFFERSON AVE. AND OAK ST,  
 EASTBOUND OAK ST,  
 POST 1  
 NTS

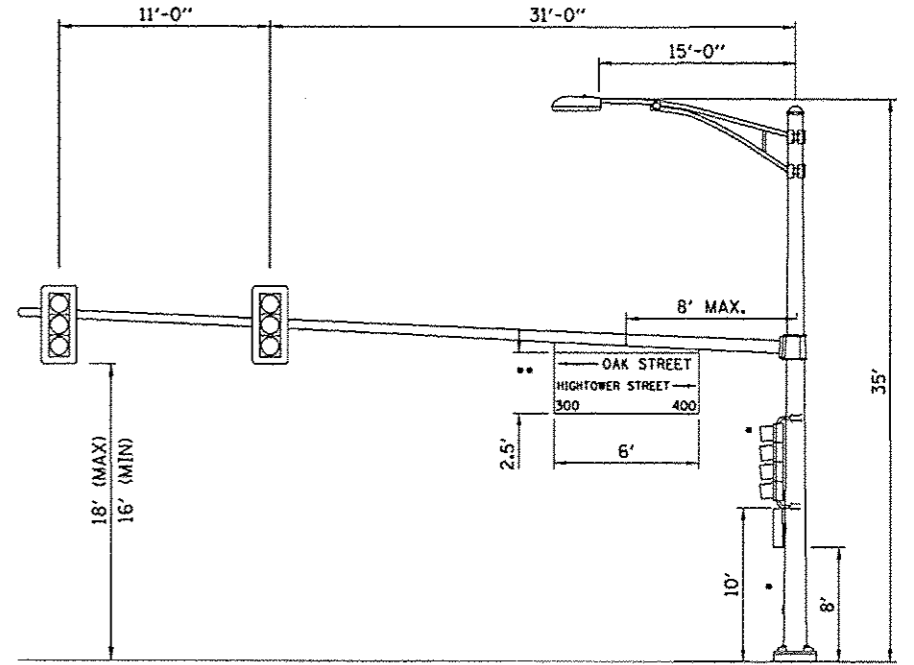


JEFFERSON AVE. AND OAK ST,  
 SOUTHBOUND JEFFERSON AVE,  
 POST 3  
 NTS

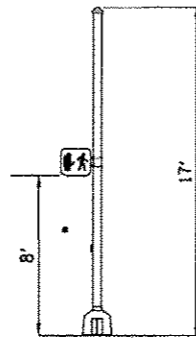


JEFFERSON AVE. AND OAK ST,  
 TRAFFIC SIGNAL POST 2  
 NTS

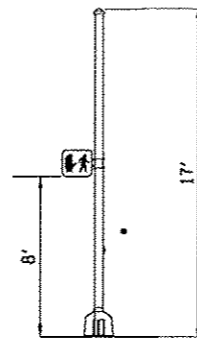


JEFFERSON AVE. AND OAK ST,  
 TRAFFIC SIGNAL POST 4  
 NTS

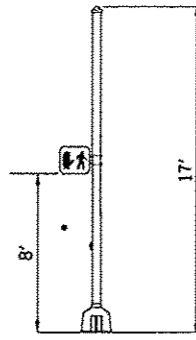


JEFFERSON AVE. AND OAK ST,  
 TRAFFIC SIGNAL POST 6  
 NTS

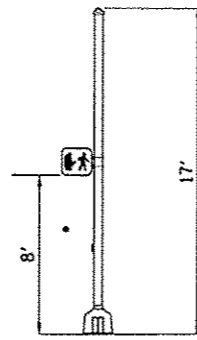

JEFFERSON AVE. AND OAK ST,  
 TRAFFIC SIGNAL POST 7  
 NTS

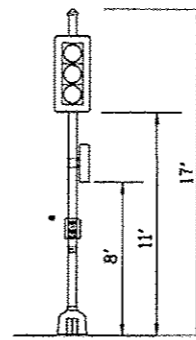


JEFFERSON AVE. AND OAK ST,  
 TRAFFIC SIGNAL POST 8  
 NTS

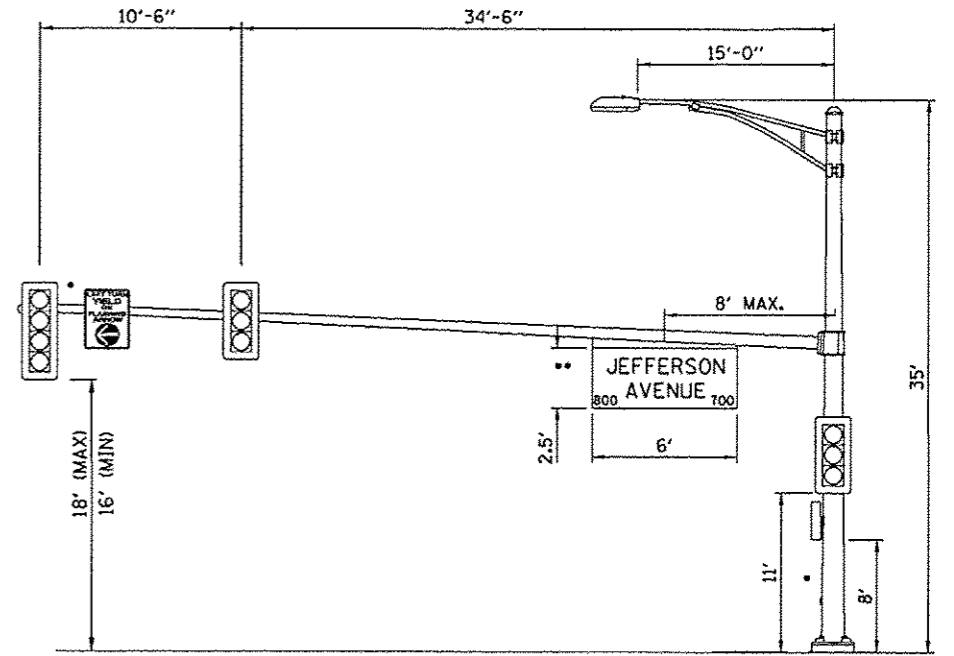

JEFFERSON AVE. AND OAK ST,  
 WESTBOUND OAK ST,  
 POST 5  
 NTS




FILE NAME *	USER NAME * manak01370	DESIGNED - KNB	REVISED -	STATE OF ILLINOIS DEPARTMENT OF TRANSPORTATION	JEFFERSON AVENUE AND OAK STREET MAST ARM LOADING DIAGRAM			F.A.U. RTE.	SECTION	COUNTY	TOTAL SHEETS	SHEET NO.
or\pwise_work\do_not_delete\dms73388\04	04.0155-shr-tu809.dgn	DRAWN - RLA	REVISED -		SCALE: N.T.S.	SHEET NO. OF SHEETS	STA. TO STA.	12-00356-01-PV	PEORIA	519	364	
	PLOT SCALE = 10.0000 / 1 in.	CHECKED - TMA	REVISED -									CONTRACT NO.89626
	PLOT DATE = 07/23/2012	DATE - 7/18/12	REVISED -									ILLINOIS FED. AID PROJECT TIG-50931150

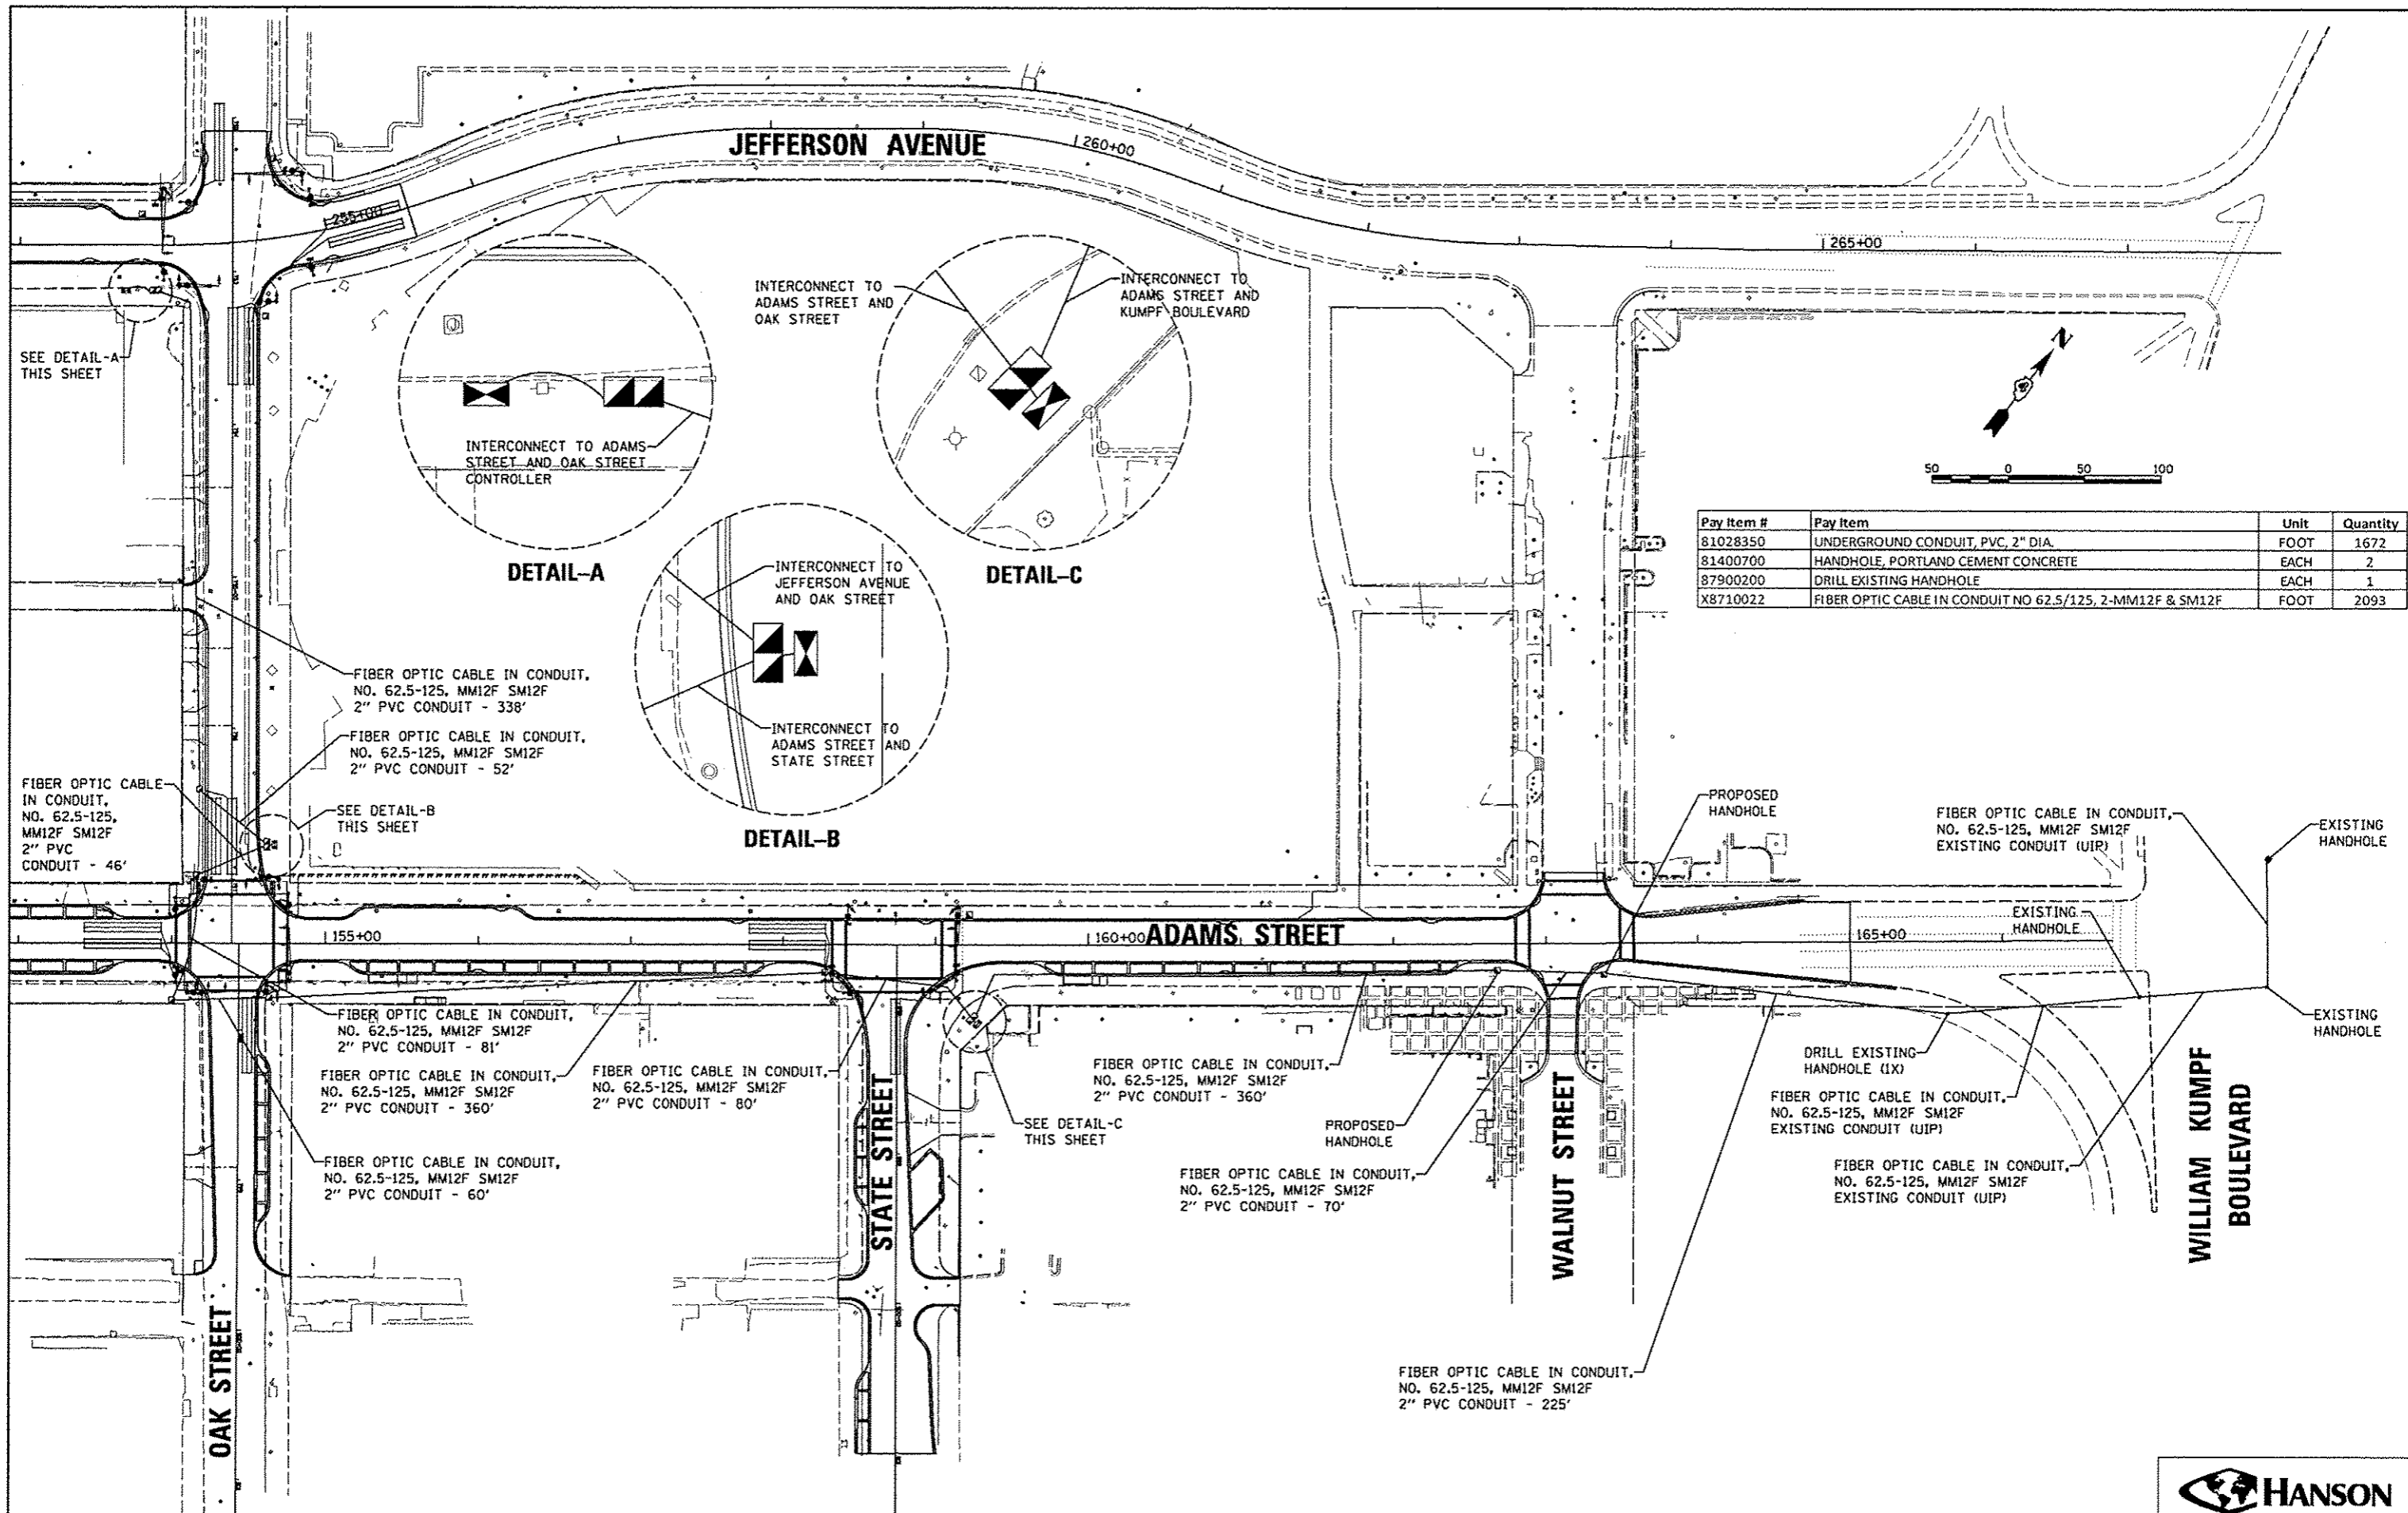


Pay Item #	Pay Item	Unit	Quantity
81028350	UNDERGROUND CONDUIT, PVC, 2" DIA.	FOOT	1672
81400700	HANDHOLE, PORTLAND CEMENT CONCRETE	EACH	2
87900200	DRILL EXISTING HANDHOLE	EACH	1
X8710022	FIBER OPTIC CABLE IN CONDUIT NO 62.5/125, 2-MM12F & SM12F	FOOT	2093




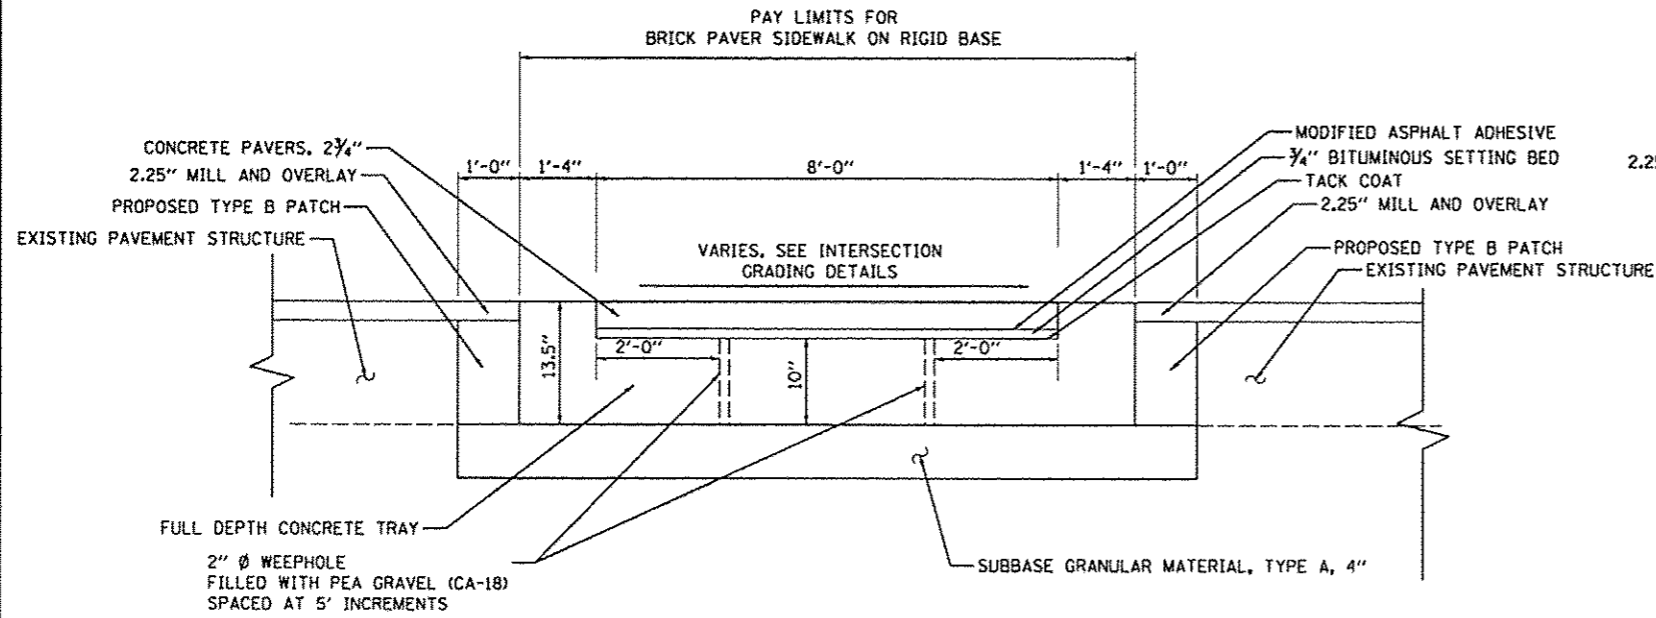

**CROSSWALK PAVER DETAIL**  
(NOT TO SCALE)

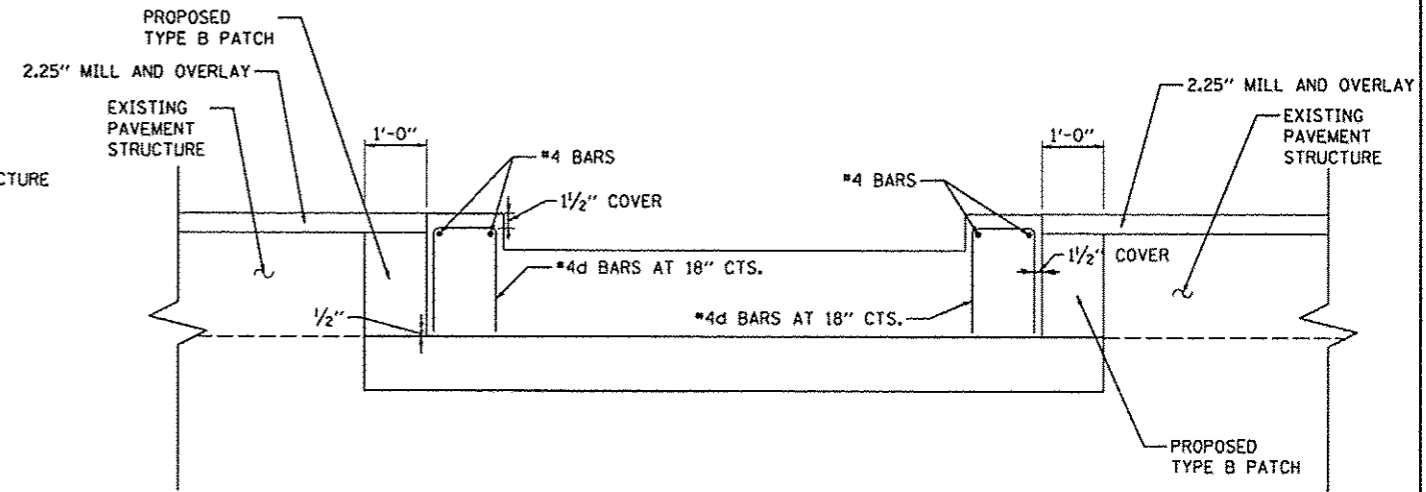


**CROSSWALK REINFORCEMENT DETAIL**  
(NOT TO SCALE)

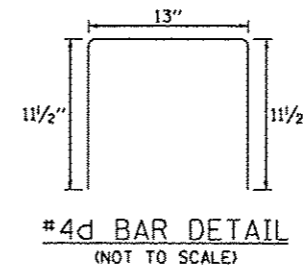

**NOTES:**





1. ALL BARS SHALL BE EPOXY COATED
2. SEE SPECIFICATIONS FOR INFORMATION ON SIZE, COLOR, STYLE, AND FINISH OF PAVERS ALONG WITH CONSTRUCTION PROCEDURES.

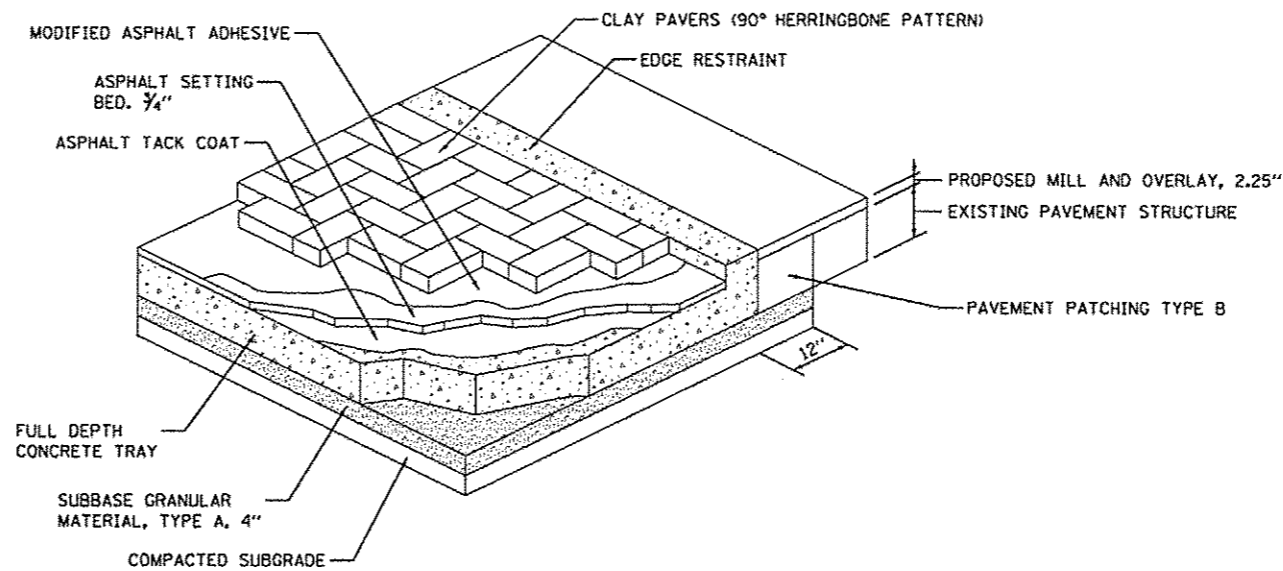

**CROSSWALK SECTION DETAIL**  
(NOT TO SCALE)




FILE NAME =	USER NAME = mansk01390	DESIGNED - DLC	REVISED -	<b>STATE OF ILLINOIS DEPARTMENT OF TRANSPORTATION</b>	<b>PAVER CROSSWALK DETAILS</b>	F.A.U. RTE.	SECTION	COUNTY	TOTAL SHEETS	SHEET NO.
or\pwise_work\do_not_delete\dm573308\04	XL0155-ah-t-detail.dgn	DRAWN - RLA	REVISED -			12-00356-01-PV	PEORIA	519	386	
PLOT SCALE = 10.0000		CHECKED - MGD	REVISED -			CONTRACT NO. 89626		ILLINOIS FED. AID PROJECT TIG-5033(150)		
PLOT DATE = 07/23/2012		DATE - 7/18/12	REVISED -			SCALE: N.T.S.	SHEET NO. OF SHEETS	STA.	TO STA.	

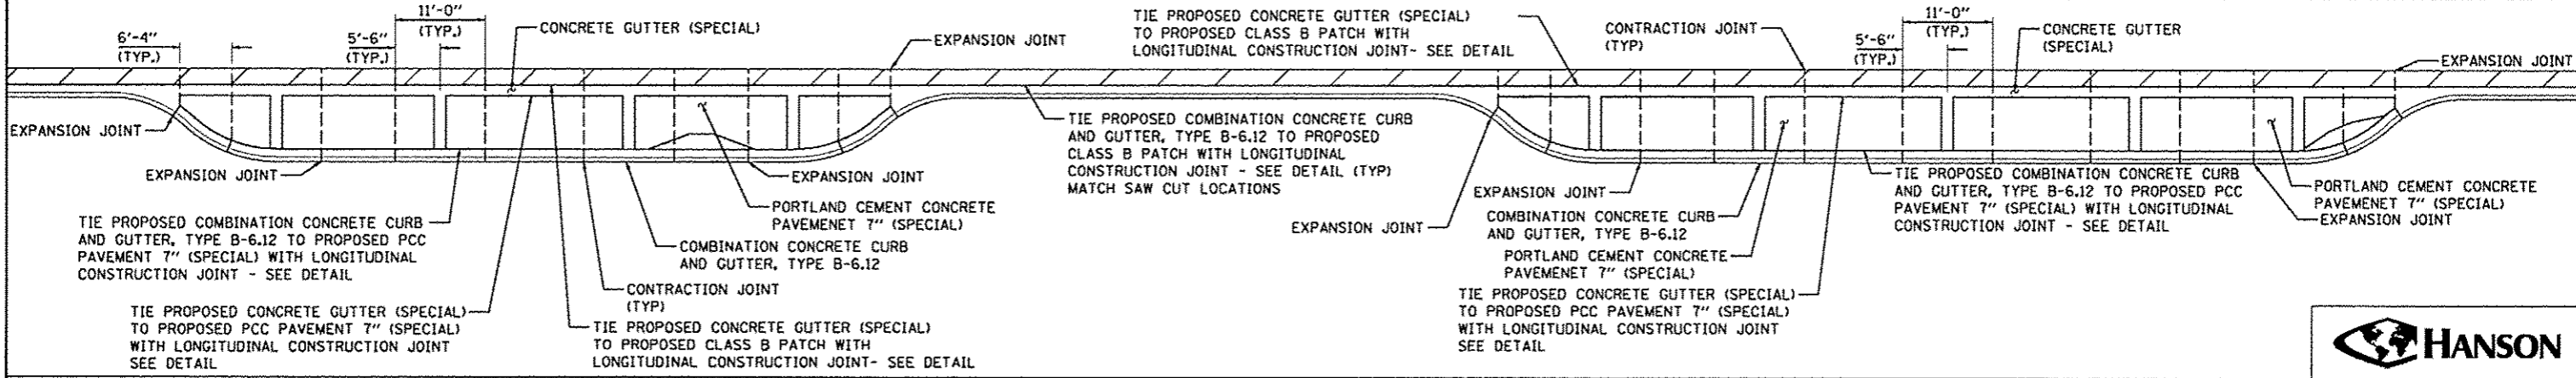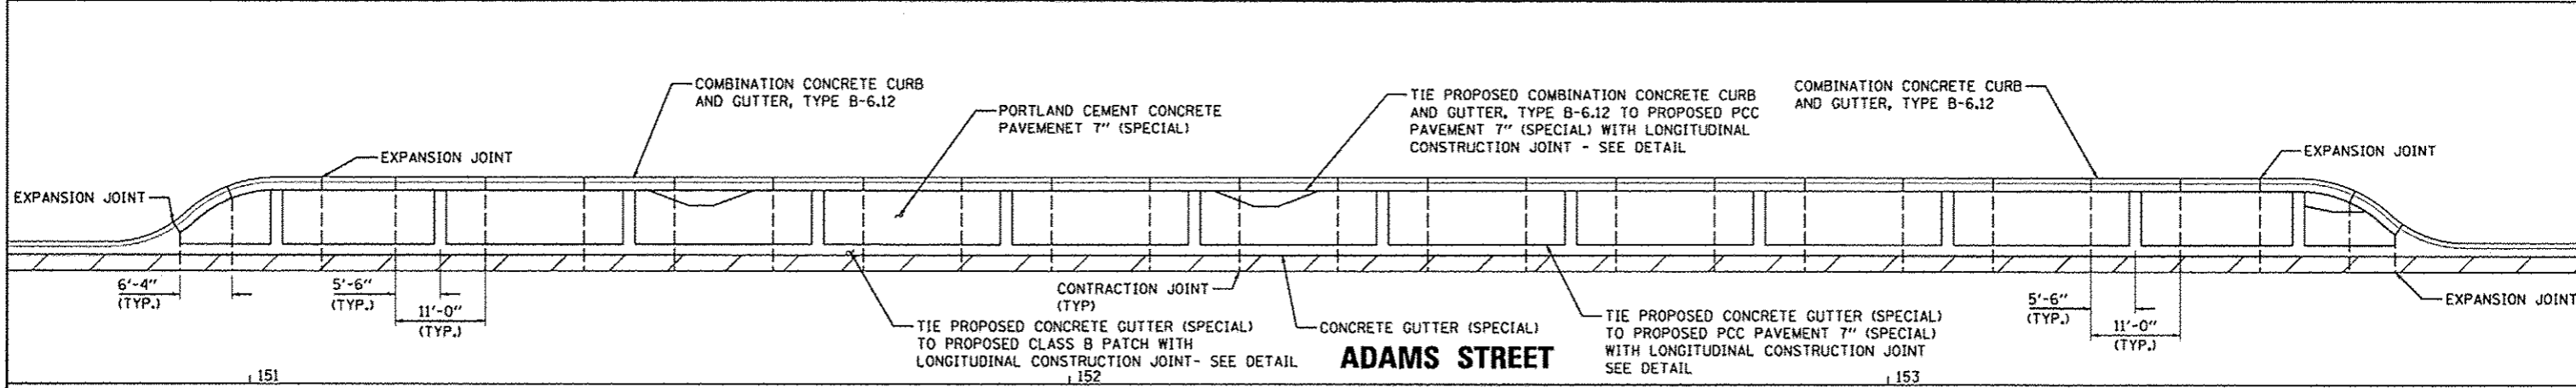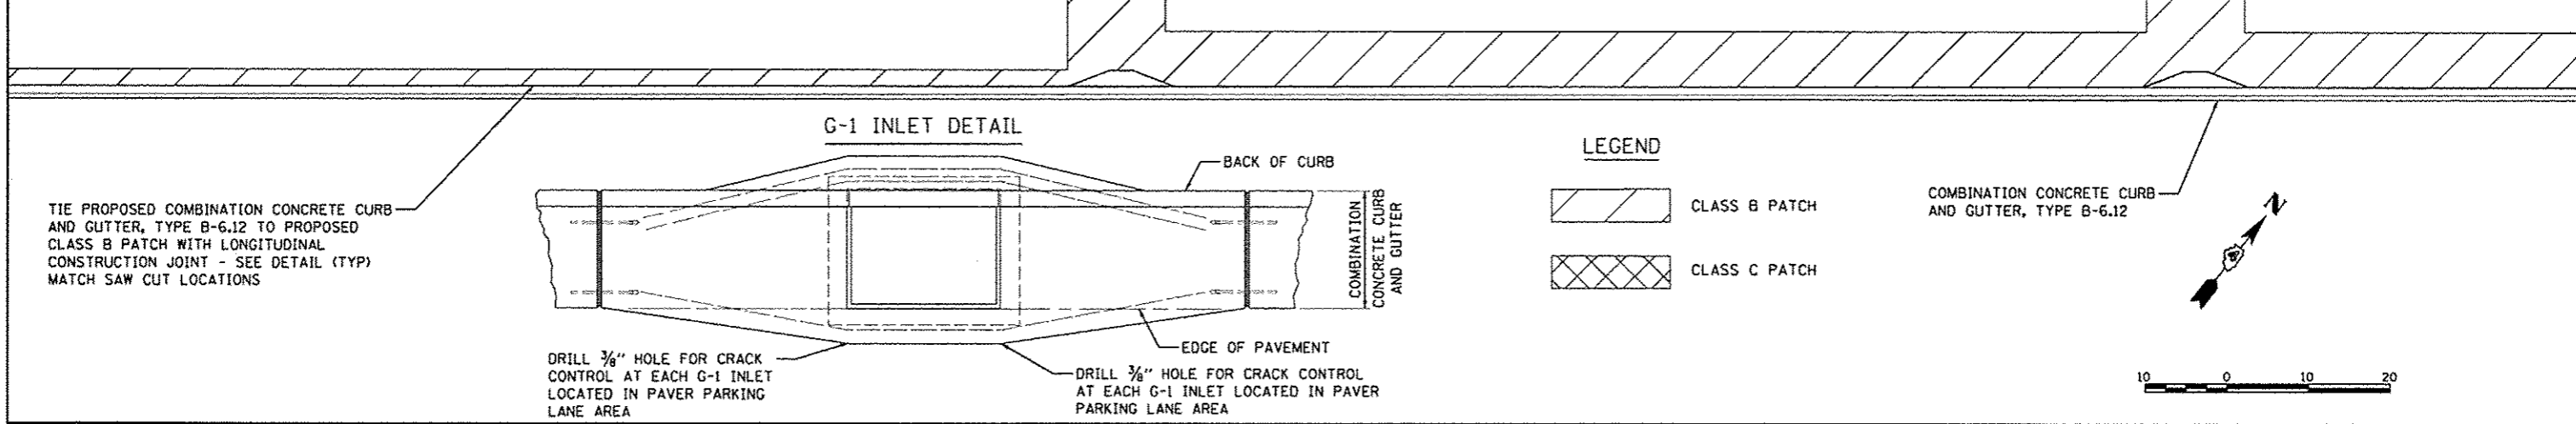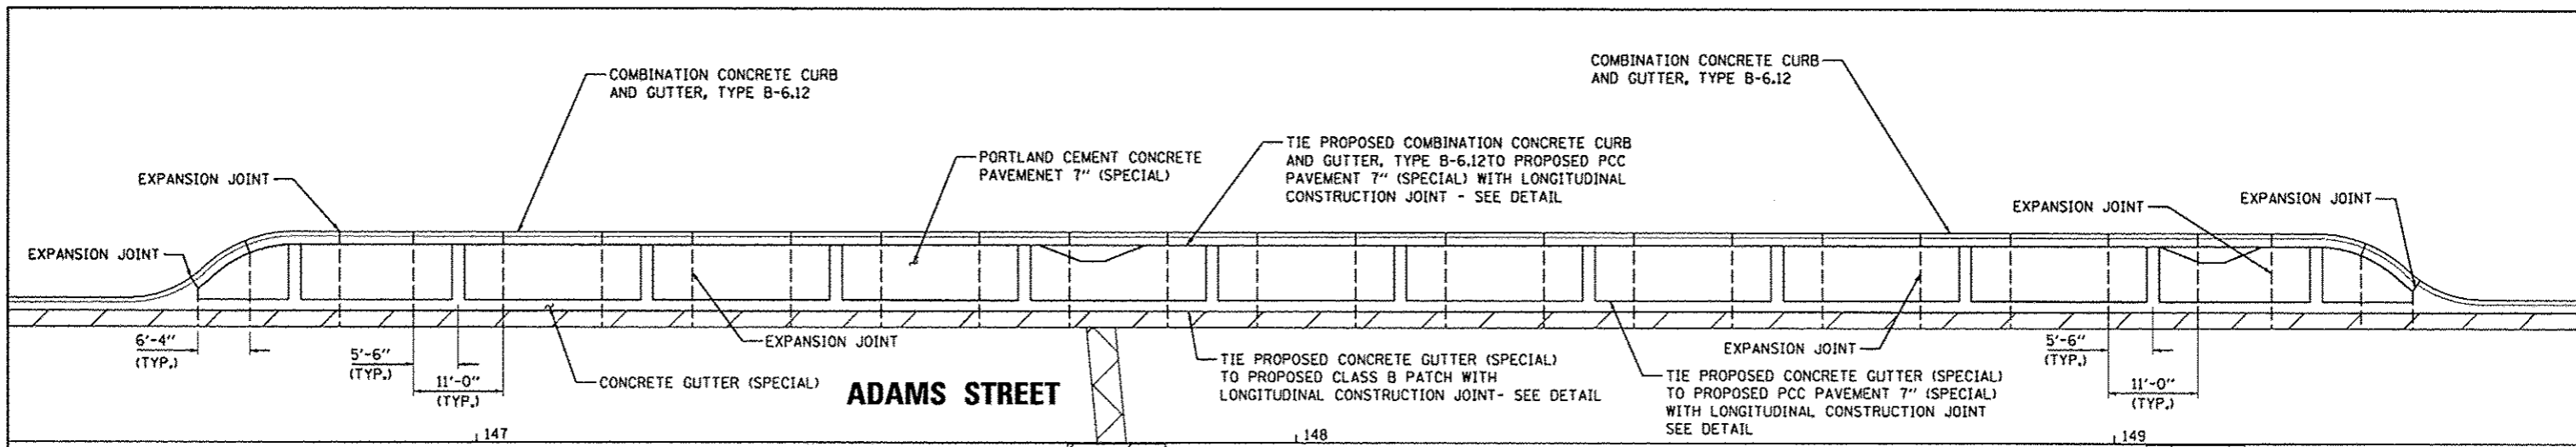


FILE NAME =	USER NAME = manak01390	DESIGNED = KNB	REVISED =	STATE OF ILLINOIS DEPARTMENT OF TRANSPORTATION	ADAMS STREET PARKING LANE JOINTING PLAN	SCALE: 1"=10'	SHEET NO. OF SHEETS	STA. 146+50 TO STA. 154+00	F.A.U. RTE.	SECTION	COUNTY	TOTAL SHEETS	SHEET NO.
pr\pwise_work\do_not_delete\dm\73308\04	3.0155-shr-joint081.dgn	DRAWN = RLA	REVISED =						12-00356-01-PV	PEORIA	519	387	
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	PLOT DATE = 07/23/2012	DATE = 7/18/12	REVISED =						[ILLINOIS] FED. AID PROJECT TIG-5093(158)				



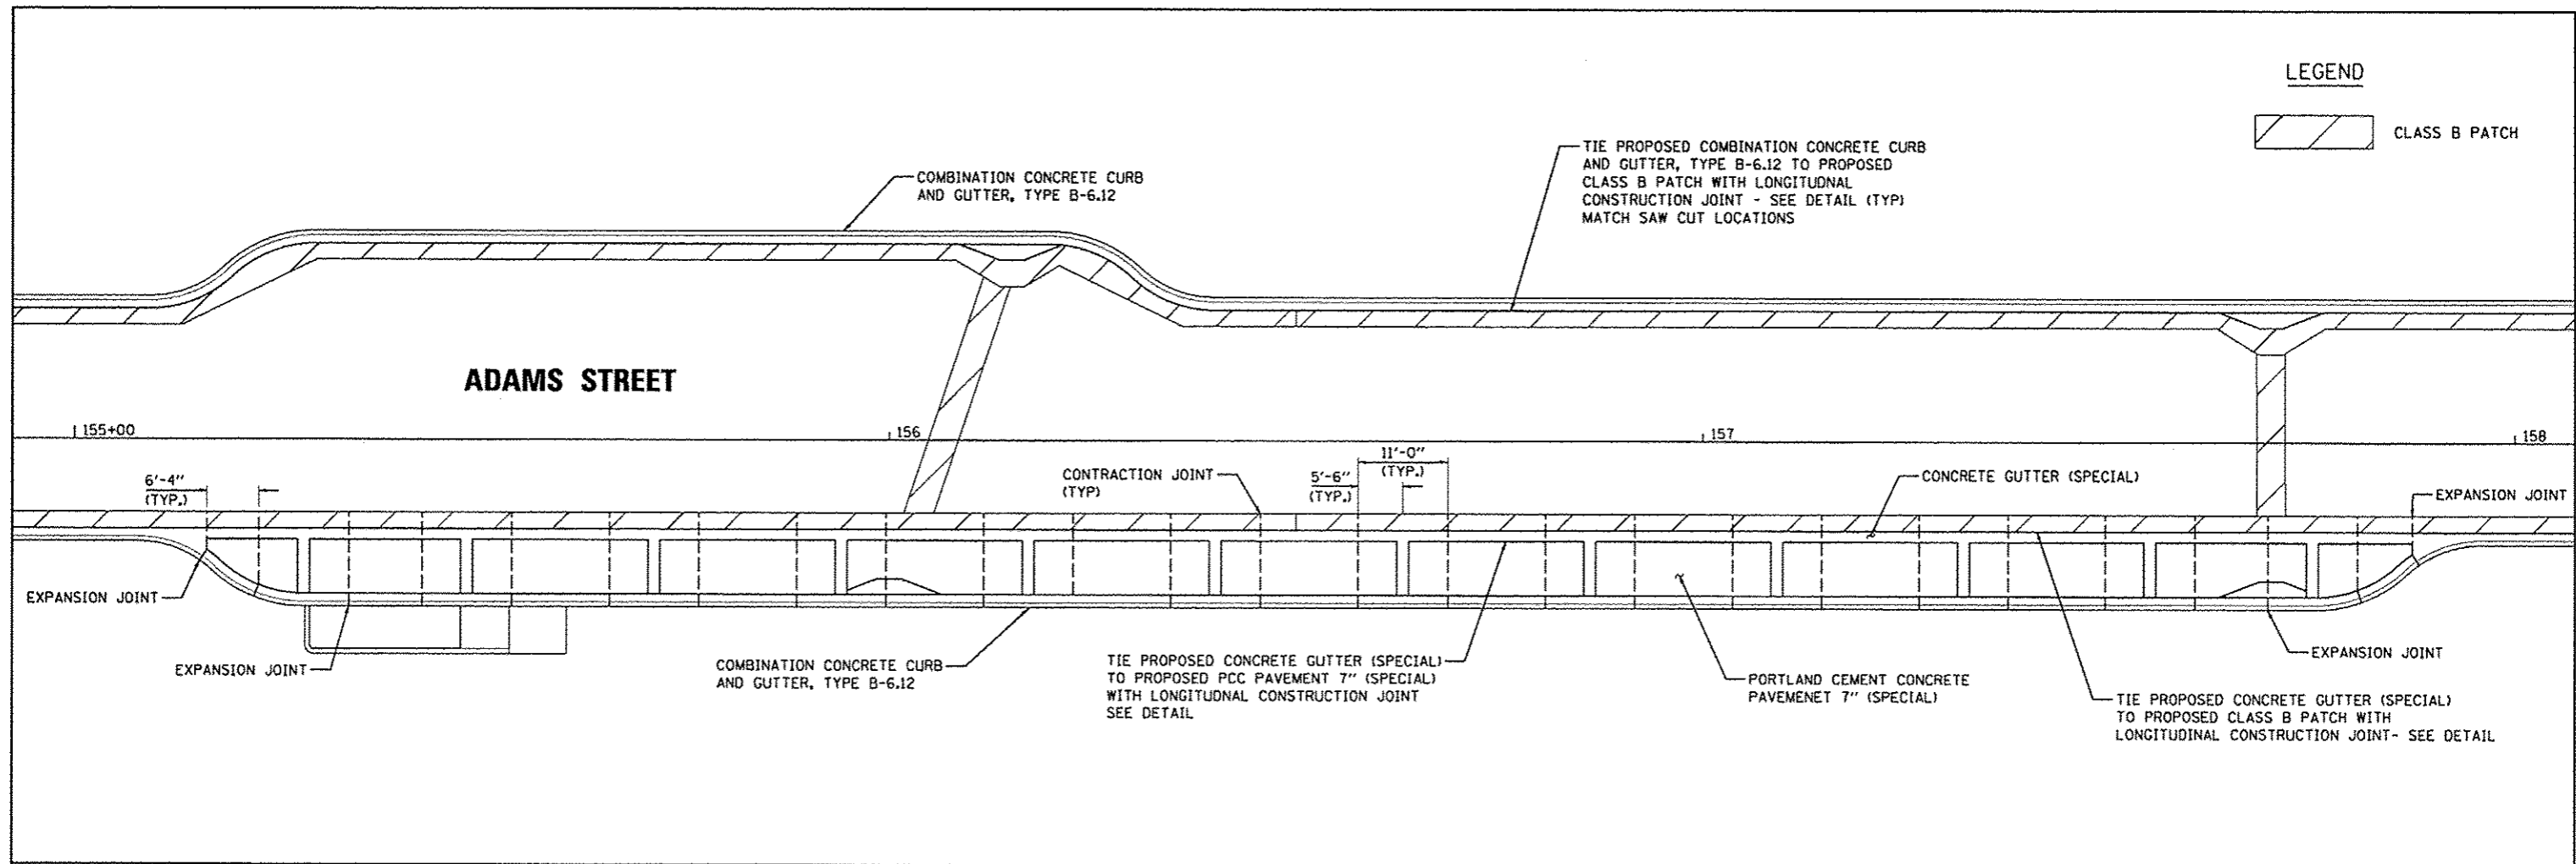




**LEGEND**

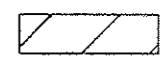 CLASS B PATCH

TIE PROPOSED COMBINATION CONCRETE CURB AND GUTTER, TYPE B-6.12 TO PROPOSED CLASS B PATCH WITH LONGITUDINAL CONSTRUCTION JOINT - SEE DETAIL (TYP) MATCH SAW CUT LOCATIONS

**LEGEND**

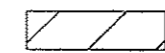
 CLASS B PATCH

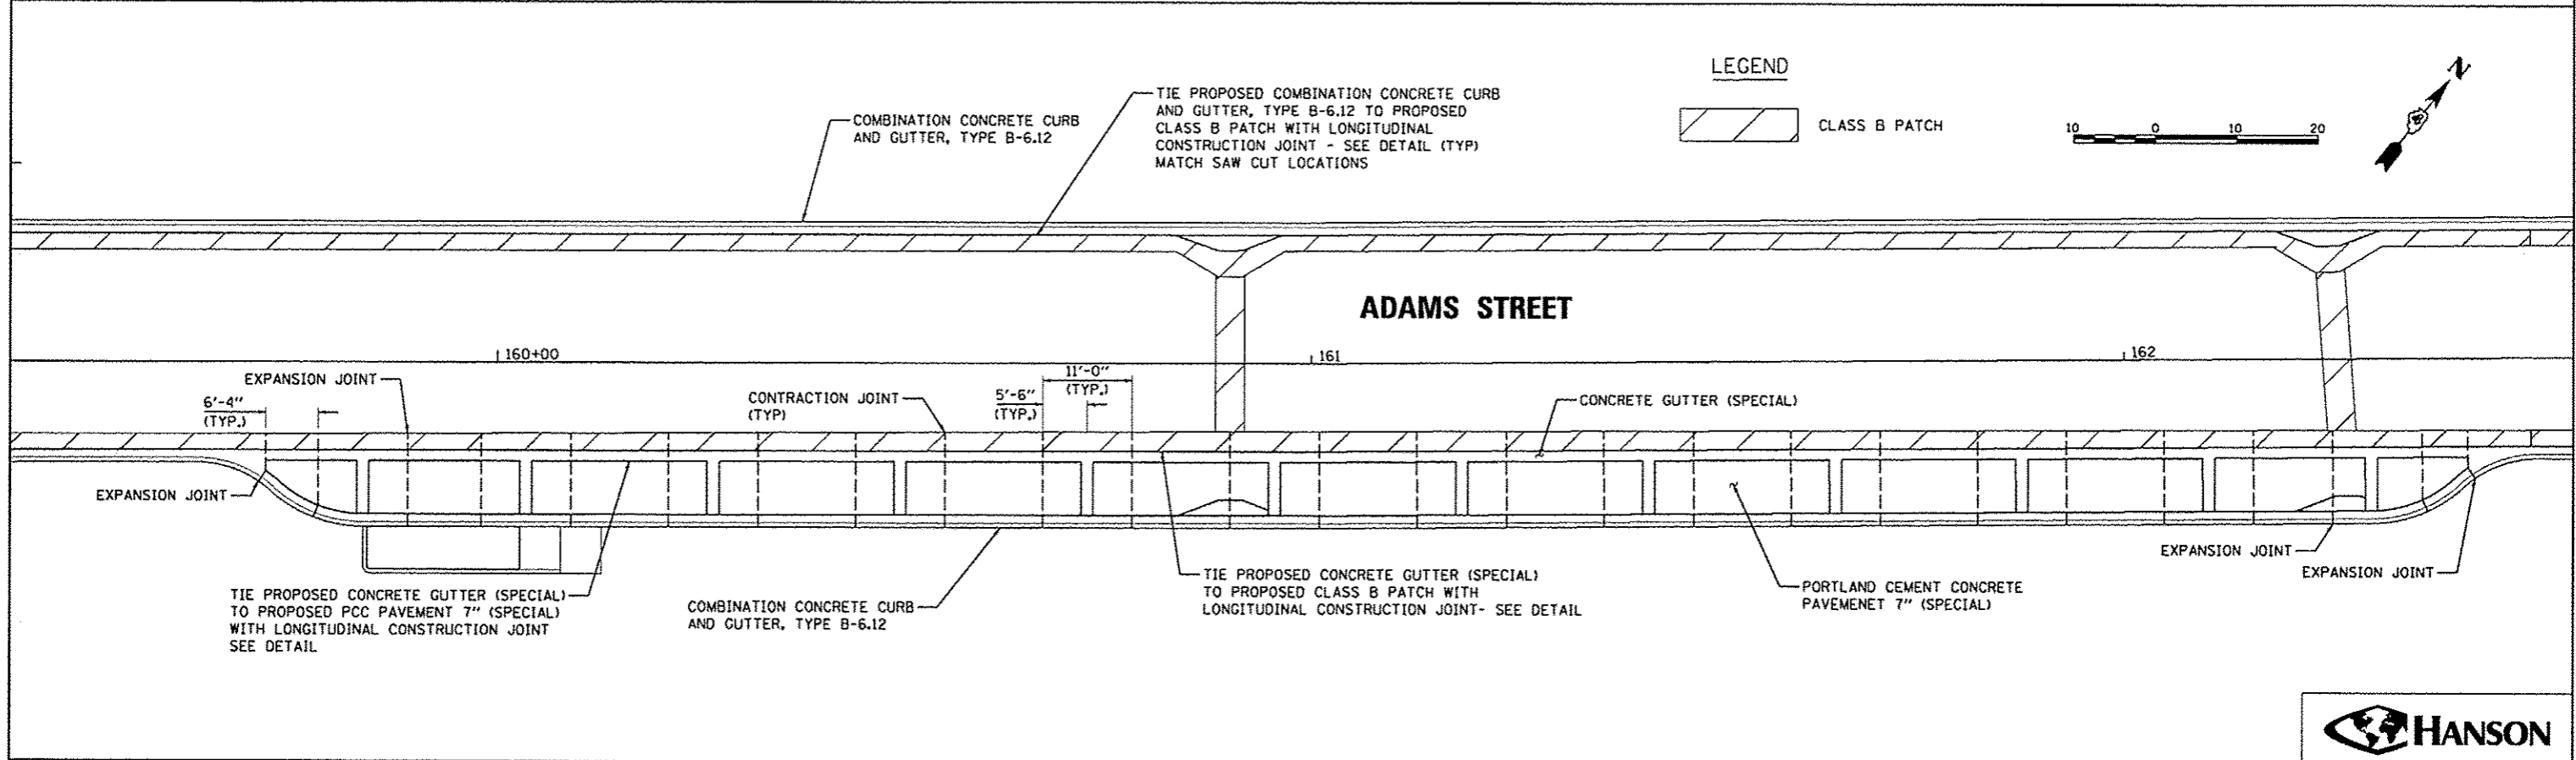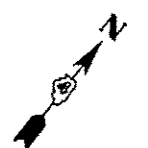


FILE NAME =	USER NAME = manak01398	DESIGNED - KNB	REVISED -	<b>STATE OF ILLINOIS DEPARTMENT OF TRANSPORTATION</b>	<b>ADAMS STREET PARKING LANE JOINTING PLAN</b>			F.A.U. RTE.	SECTION	COUNTY	TOTAL SHEETS	SHEET NO.	
cr:\pwise\work\do_not_delete\dms73388\04	RA.0195-akt-joint082.dgn	DRAWN - RLA	REVISED -		SCALE: 1"=10'	SHEET NO.	OF	SHEETS	STA. 155+00	TO STA. 163+00	PEORIA	519	388
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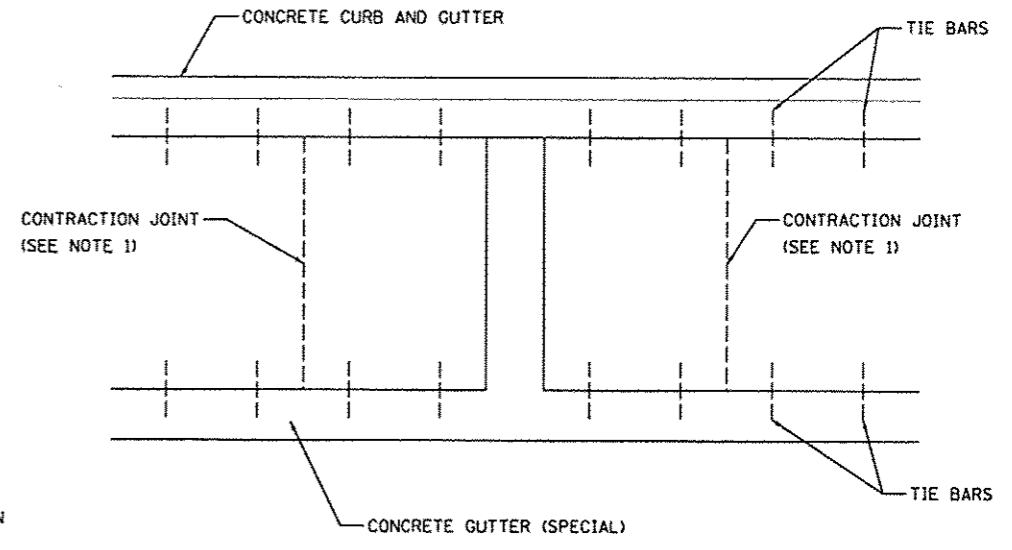




**EDGE OF CROWNED PAVEMENT**  
(NOT TO SCALE)

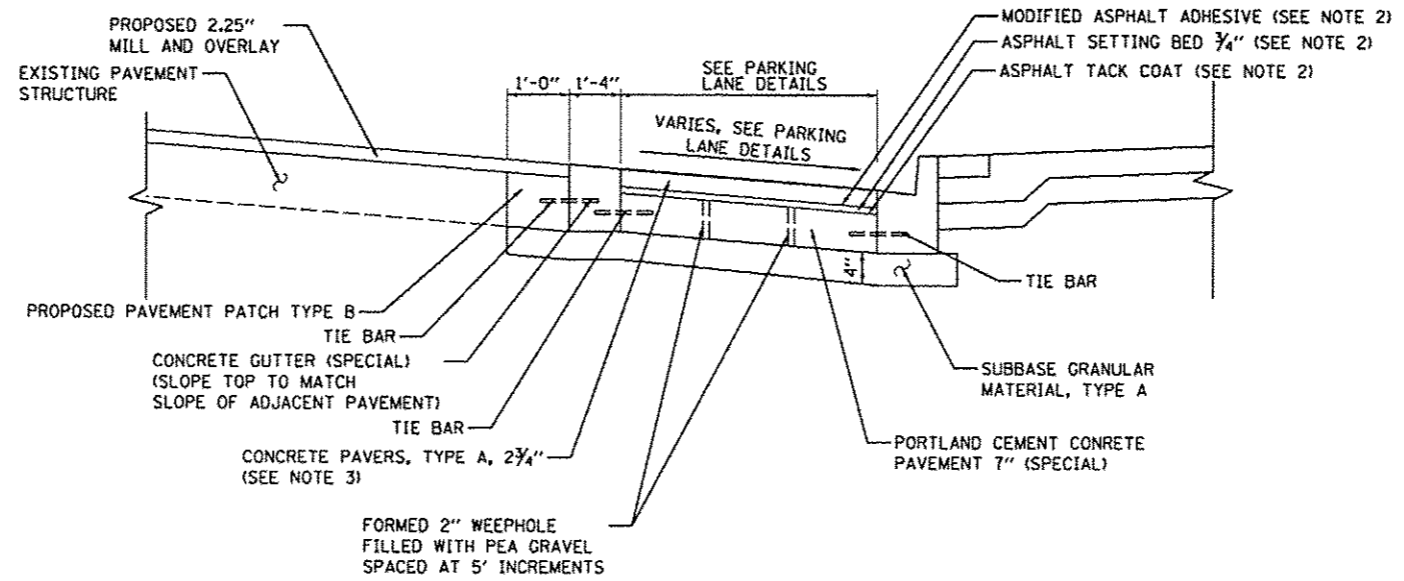


**PARKING LANE SECTION DETAIL**  
(NOT TO SCALE)

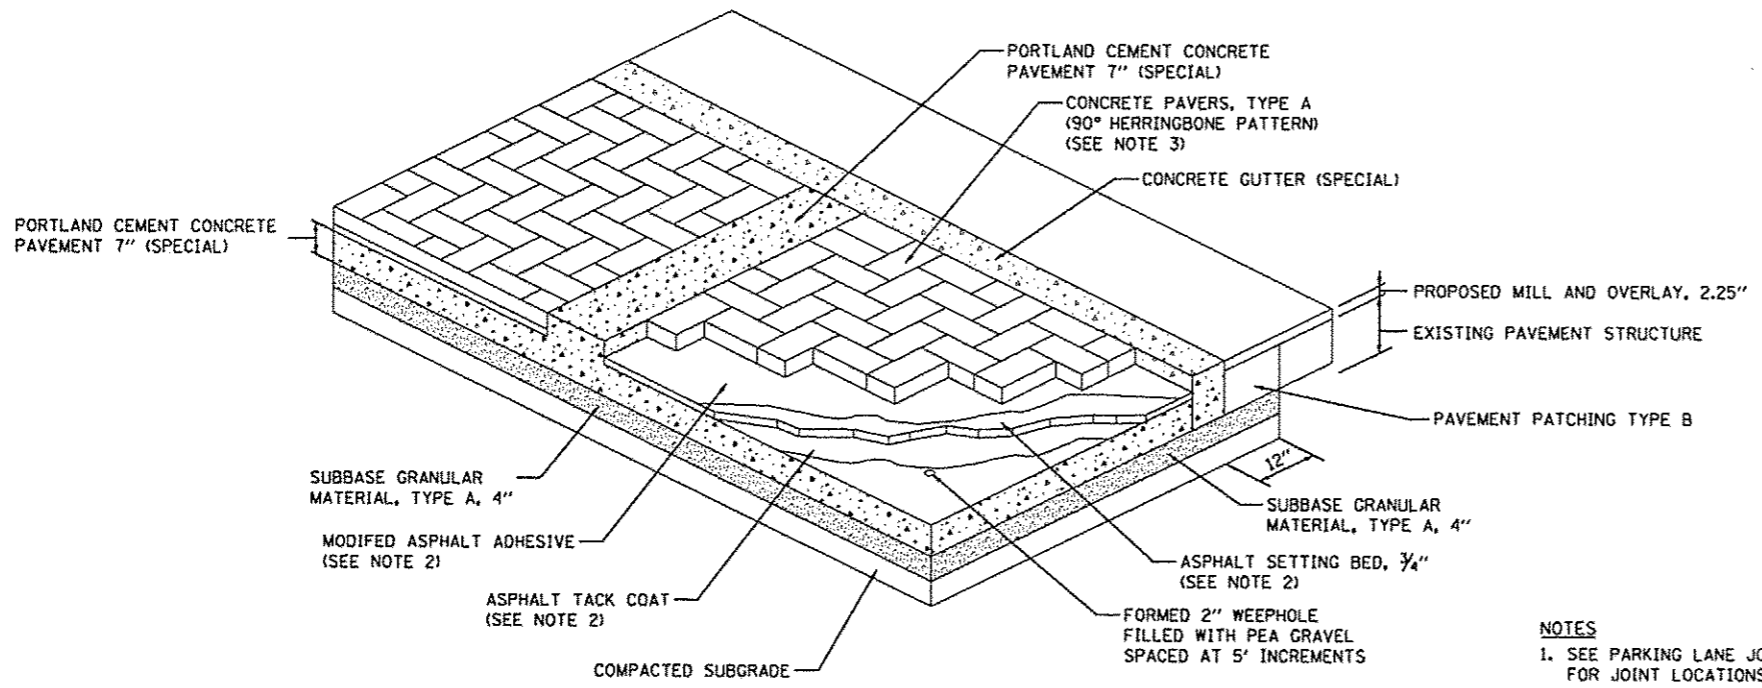

**PARKING LANE JOINTING DETAIL**  
(ALSO SEE PARKING LANE JOINTING DETAIL)  
(NOT TO SCALE)

- NOTES**
1. SEE PARKING LANE JOINTING PLAN FOR JOINT LOCATIONS.
  2. PAVERS AND BEDDING WILL BE PAID FOR TOGETHER AS CONCRETE PAVERS, TYPE A.
  3. SEE SPECIFICATIONS FOR INFORMATION ON SIZE, COLOR, STYLE, AND FINISH OF PAVERS ALONG WITH CONSTRUCTION PROCEDURES.




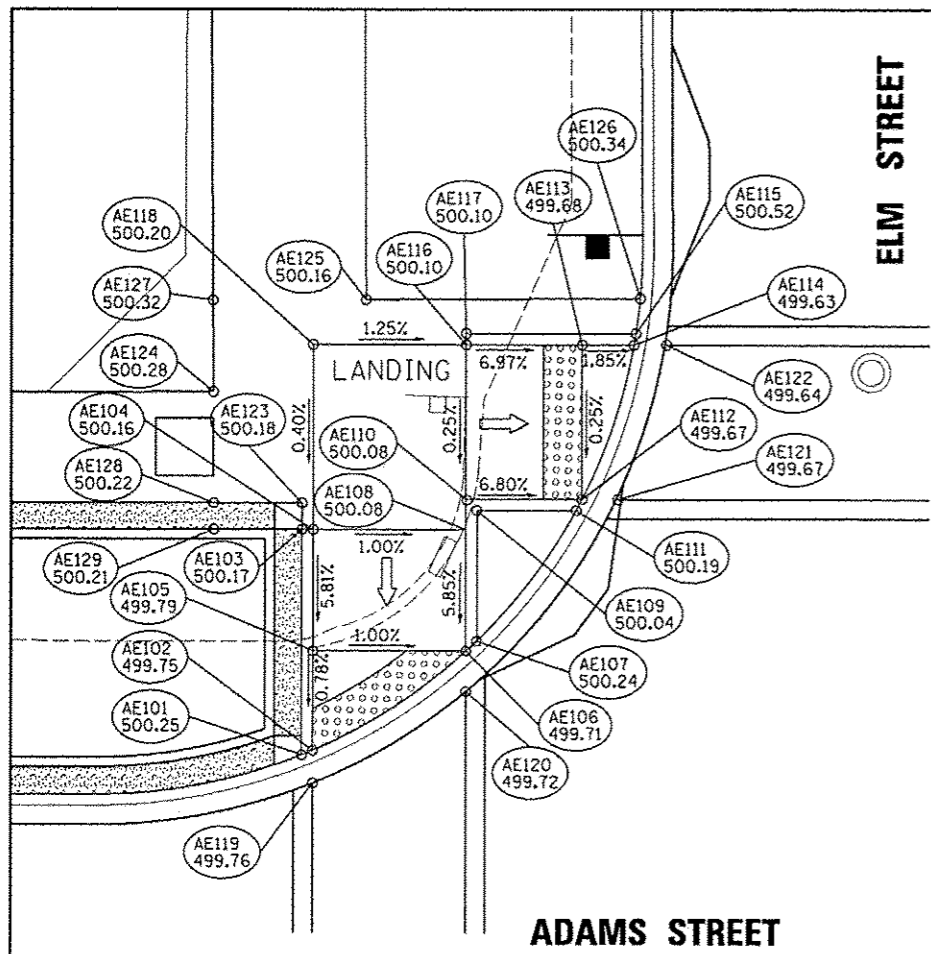

ADAMS STREET AND ELM STREET INTERSECTION SOUTHWEST SIDEWALK RAMP GRADES					
POINT NO.	STATION	OFFSET	SIDE	ELEVATION	LOCATION
AE101	149+83.30	19.66	LT	500.25	TOC
AE102	149+83.87	19.90	LT	499.75	EOP
AE103	149+83.30	31.41	LT	500.17	TOC
AE104	149+83.88	31.41	LT	500.16	TOC
AE105	149+83.88	25.09	LT	499.79	SW
AE106	149+91.87	25.09	LT	499.71	EOP
AE107	149+92.42	25.61	LT	500.24	TOC
AE108	149+91.87	31.41	LT	500.08	SW
AE109	149+92.42	32.42	LT	500.04	TOC
AE110	149+91.92	32.95	LT	500.08	TOC
AE111	149+97.59	32.42	LT	500.19	TOC
AE112	149+97.90	33.00	LT	499.67	EOP
AE113	149+97.90	41.00	LT	499.69	SW
AE114	150+00.60	41.00	LT	499.63	EOP
AE115	150+00.70	41.58	LT	500.52	TOC
AE116	149+91.87	41.00	LT	500.10	TOC
AE117	149+91.87	41.58	LT	500.10	TOC
AE118	149+83.88	41.00	LT	500.20	SW
AE119	149+83.87	18.18	LT	499.76	CW
AE120	149+91.87	22.98	LT	499.72	CW
AE121	149+99.76	33.00	LT	499.68	CW
AE122	150+02.31	41.00	LT	499.64	CW
AE123	149+83.30	32.79	LT	500.18	SW
AE124	149+78.67	38.55	LT	500.28	SW
AE125	149+86.64	43.33	LT	500.16	SW
AE126	150+00.93	43.40	LT	500.34	SW
AE127	149+78.64	43.29	LT	500.32	SW
AE128	149+78.70	32.79	LT	500.22	SW
AE129	149+78.70	31.41	LT	500.21	SW

ADAMS STREET AND ELM STREET INTERSECTION NORTHWEST SIDEWALK RAMP GRADES					
POINT NO.	STATION	OFFSET	SIDE	ELEVATION	LOCATION
AE200	150+30.51	41.58	LT	499.95	TOC
AE201	150+30.62	41.06	LT	499.51	SW
AE202	150+33.36	41.00	LT	499.56	SW
AE203	150+38.82	41.00	LT	499.86	TOC
AE204	150+38.83	41.58	LT	499.86	TOC
AE205	150+38.82	33.00	LT	499.82	SW
AE206	150+33.37	32.99	LT	499.52	SW
AE207	150+36.03	28.78	LT	499.98	BOC
AE208	150+29.01	41.00	LT	499.51	CW
AE209	150+31.60	33.00	LT	499.53	CW
AE210	150+30.09	43.54	LT	499.95	SW
AE211	150+38.83	43.58	LT	499.87	SW
AE212	150+47.14	39.29	LT	499.83	SW
AE213	150+38.57	25.88	LT	499.99	SW
AE214	150+47.15	43.62	LT	499.85	SW
AE215	150+47.15	41.58	LT	499.84	SW
AE216	150+47.14	32.79	LT	499.80	SW


EOP	= EDGE OF PAVEMENT
BOC	=BACK OF CURB
SW	=SIDEWALK
TOC	=TOP OF CURB
CW	=CROSSWALK

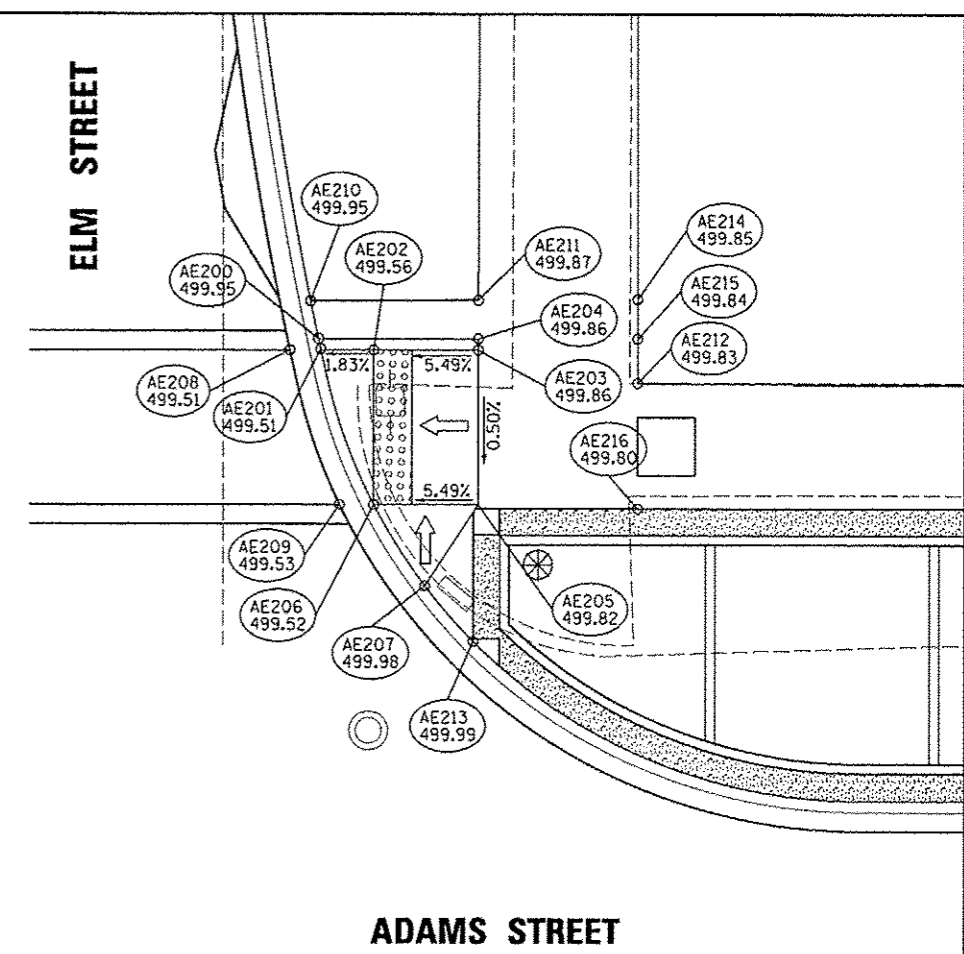



ADAMS STREET


ADAMS STREET

ADAMS STREET AND ELM STREET INTERSECTION EAST SIDEWALK RAMP GRADES					
POINT NO.	STATION	OFFSET	SIDE	ELEVATION	LOCATION
AE300	149+83.81	12.58	RT	499.74	SW
AE301	149+91.81	12.58	RT	499.72	SW
AE302	149+83.87	18.58	RT	500.18	SW
AE303	149+91.87	18.58	RT	500.18	SW
AE304	149+96.81	12.58	RT	500.15	BOC
AE305	149+78.81	12.58	RT	500.20	BOC
AE306	149+91.87	11.00	RT	499.72	CW
AE307	149+83.87	11.00	RT	499.75	CW
AE308	149+70.13	21.41	RT	500.09	SW
AE309	149+70.13	26.41	RT	500.20	SW
AE310	149+83.87	21.41	RT	500.21	SW
AE311	149+83.87	26.41	RT	500.26	SW
AE312	149+91.87	21.41	RT	500.21	SW
AE313	149+91.87	26.41	RT	500.26	SW
AE314	150+23.38	21.41	RT	500.22	SW
AE315	150+23.38	26.41	RT	500.25	SW
AE316	149+70.13	12.58	RT	500.23	SW
AE317	150+23.38	12.58	RT	500.15	SW
AE318	149+70.13	39.80	RT	500.33	SW
AE319	149+83.87	39.81	RT	500.39	SW
AE320	149+91.87	39.81	RT	500.39	SW
AE321	150+23.38	39.82	RT	500.38	SW

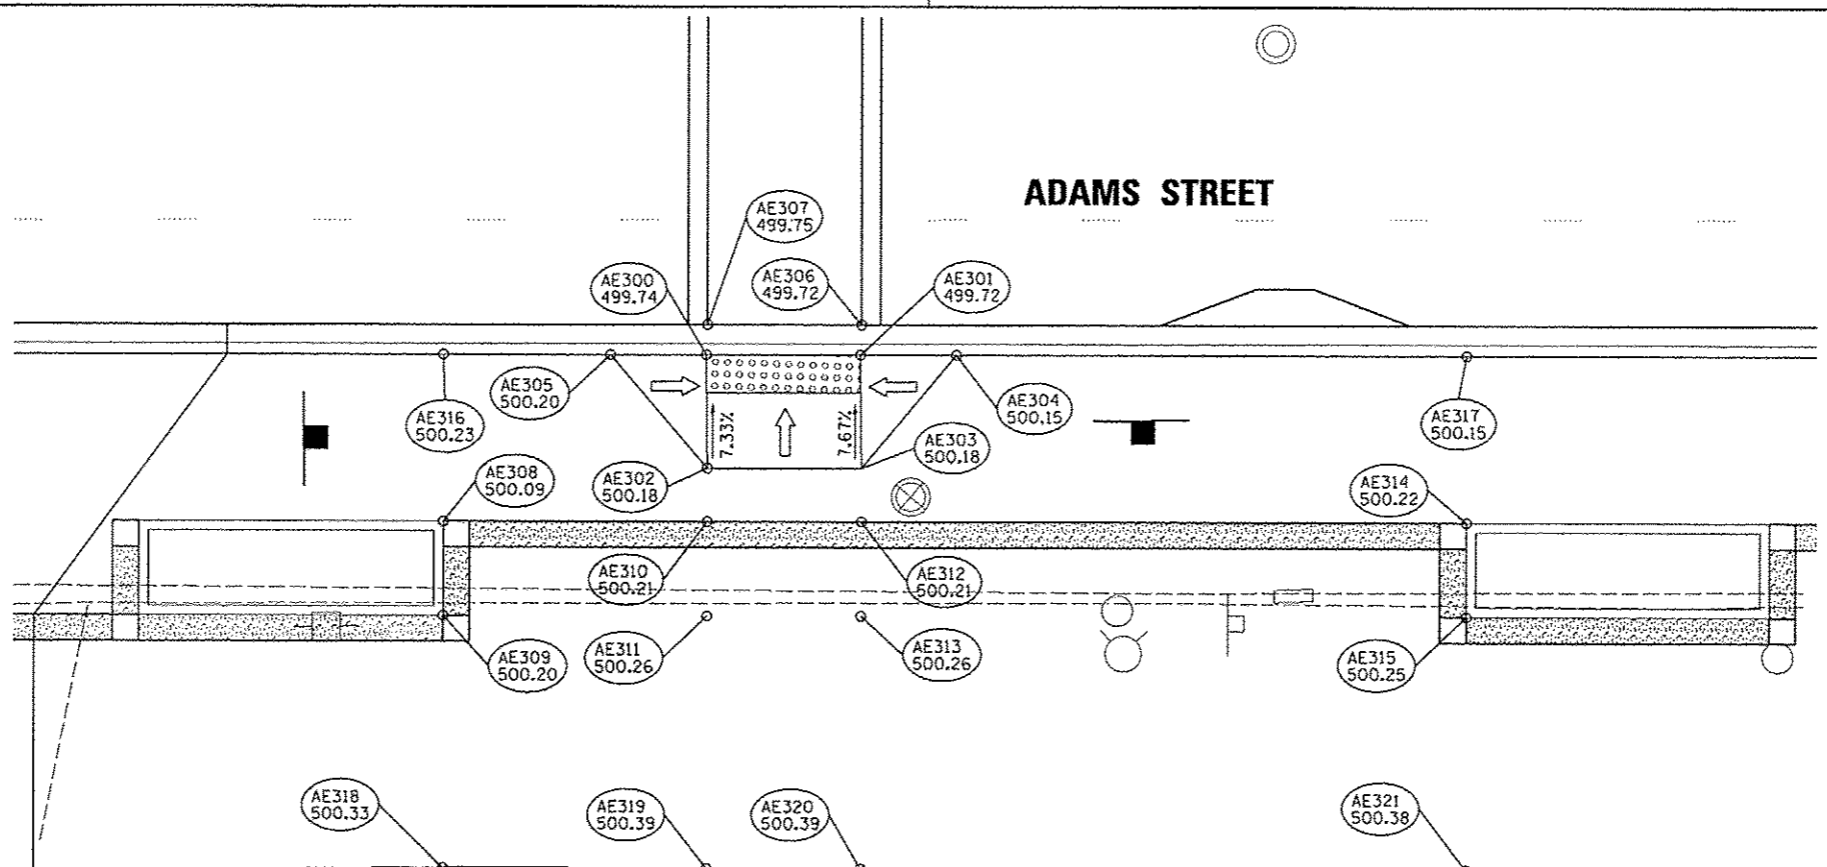

ADAMS STREET

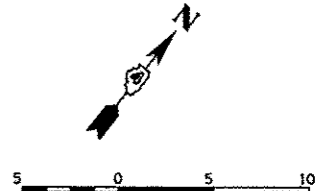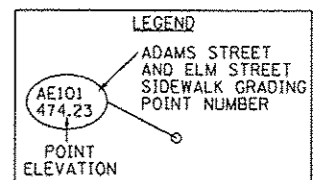

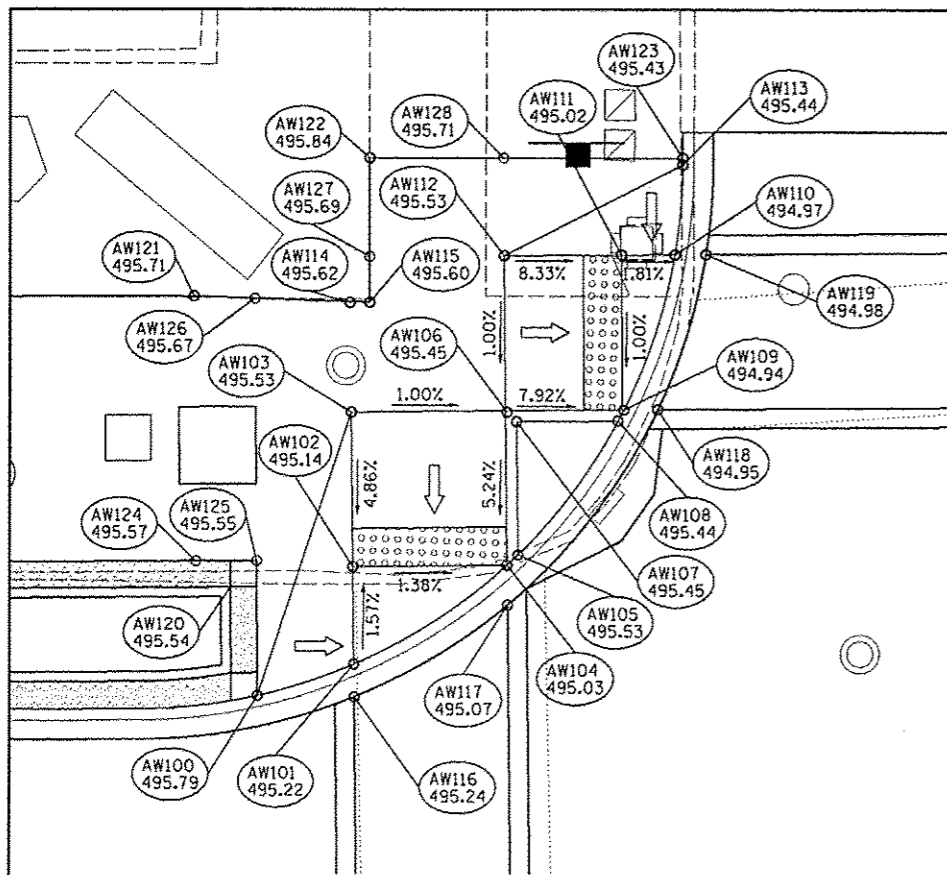


ADAMS STREET AND WALNUT STREET INTERSECTION SOUTHWEST SIDEWALK RAMP GRADES					
POINT NO.	STATION	OFFSET	SIDE	ELEVATION	LOCATION
AW100	162+75.68	18.25	LT	495.79	BOC
AW101	162+80.73	19.86	LT	495.22	SW
AW102	162+80.70	24.94	LT	495.14	SW
AW103	162+80.66	32.96	LT	495.53	SW
AW104	162+88.70	24.98	LT	495.03	SW
AW105	162+89.28	25.52	LT	495.53	TOC
AW106	162+88.75	32.92	LT	495.45	TOC
AW107	162+89.25	32.42	LT	495.45	TOC
AW108	162+94.54	32.42	LT	495.44	TOC
AW109	162+94.85	33.00	LT	494.94	SW
AW110	162+97.56	41.00	LT	494.97	SW
AW111	162+94.78	41.00	LT	495.02	SW
AW112	162+88.66	41.00	LT	495.53	SW
AW113	162+98.00	45.64	LT	495.44	BOC
AW114	162+80.64	38.63	LT	495.62	SW
AW115	162+81.67	38.64	LT	495.60	SW
AW116	162+80.73	18.15	LT	495.24	CW
AW117	162+88.71	22.89	LT	495.07	CW
AW118	162+96.62	33.00	LT	494.95	CW
AW119	162+99.16	41.00	LT	494.98	CW
AW120	162+74.30	23.92	LT	495.54	SW
AW121	162+72.51	39.02	LT	495.71	SW
AW122	162+81.72	46.09	LT	495.84	SW
AW123	162+98.00	45.97	LT	495.43	SW
AW124	162+72.51	25.29	LT	495.57	SW
AW125	162+75.68	25.29	LT	495.55	SW
AW126	162+75.68	38.89	LT	495.67	SW
AW127	162+81.69	41.00	LT	495.69	SW
AW128	162+88.66	46.04	LT	495.71	SW

WALNUT STREET


ADAMS STREET AND WALNUT STREET INTERSECTION NORTHWEST SIDEWALK RAMP GRADES					
POINT NO.	STATION	OFFSET	SIDE	ELEVATION	LOCATION
AW200	163+39.45	45.96	LT	495.51	BOC
AW201	163+40.11	41.00	LT	494.99	SW
AW202	163+43.11	41.00	LT	495.01	SW
AW203	163+49.59	41.00	LT	495.52	SW
AW204	163+43.44	32.42	LT	495.36	TOC
AW205	163+43.14	33.01	LT	494.87	SW
AW206	163+49.00	32.42	LT	495.40	TOC
AW207	163+49.59	33.00	LT	495.40	SW
AW208	163+49.00	25.70	LT	495.59	TOC
AW209	163+49.60	25.22	LT	495.11	SW
AW210	163+57.60	20.47	LT	495.29	SW
AW211	163+57.59	25.20	LT	495.23	SW
AW212	163+57.59	33.00	LT	495.52	SW
AW213	163+62.38	19.08	LT	495.79	BOC
AW214	163+58.22	41.04	LT	495.54	SW
AW215	163+58.16	37.34	LT	495.58	SW
AW216	163+57.59	18.79	LT	495.31	CW
AW217	163+49.59	23.19	LT	495.14	CW
AW218	163+41.34	33.00	LT	494.89	CW
AW219	163+38.49	41.00	LT	495.01	CW
AW220	163+39.43	47.00	LT	495.43	SW
AW221	163+53.61	46.88	LT	495.66	SW
AW222	163+65.81	37.26	LT	496.04	SW
AW223	163+49.59	46.91	LT	495.74	SW
AW224	163+65.81	33.00	LT	495.96	SW

EOP = EDGE OF PAVEMENT  
 BOC = BACK OF CURB  
 SW = SIDEWALK  
 TOC = TOP OF CURB  
 CW = CROSSWALK

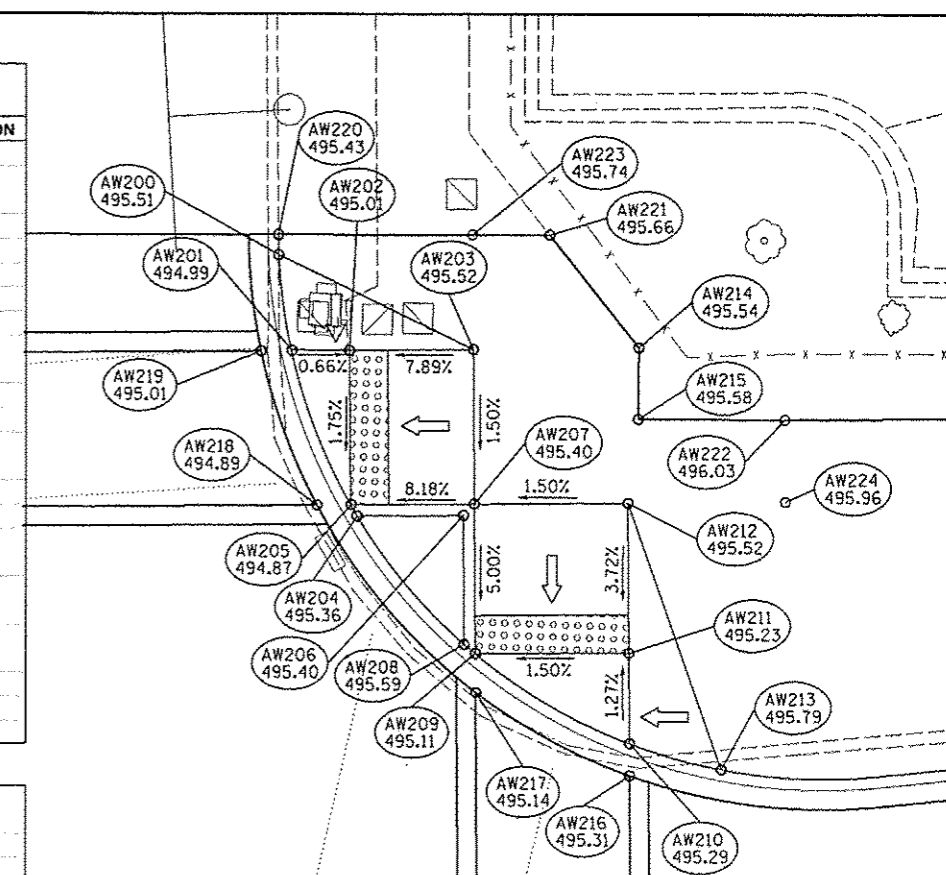

ADAMS STREET


ADAMS STREET

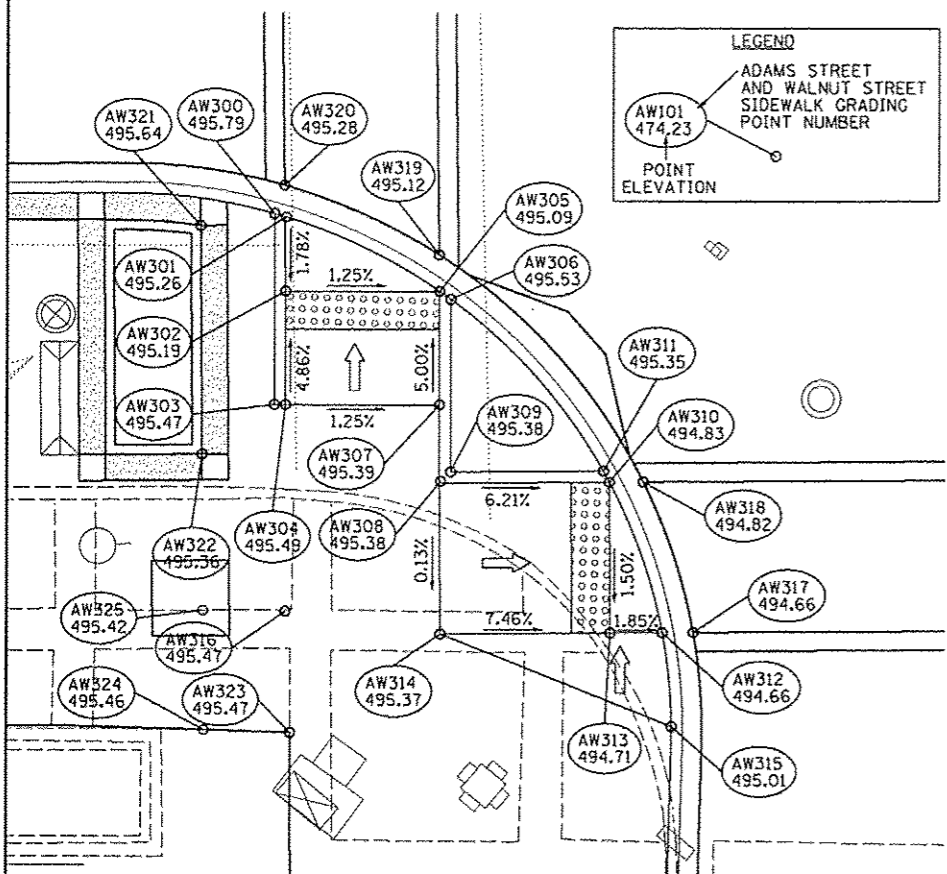

LEGEND  
 ADAMS STREET AND WALNUT STREET SIDEWALK GRADING POINT NUMBER  
 POINT ELEVATION

ADAMS STREET AND WALNUT STREET INTERSECTION SOUTHEAST SIDEWALK RAMP GRADES					
POINT NO.	STATION	OFFSET	SIDE	ELEVATION	LOCATION
AW300	162+80.35	13.72	RT	495.79	TOC
AW301	162+80.97	13.90	RT	495.26	SW
AW302	162+80.90	17.80	RT	495.19	SW
AW303	162+80.28	23.80	RT	495.47	TOC
AW304	162+80.86	23.80	RT	495.49	SW
AW305	162+88.91	17.87	RT	495.09	SW
AW306	162+89.48	18.28	RT	495.53	TOC
AW307	162+88.86	23.86	RT	495.39	SW
AW308	162+88.91	27.92	RT	495.38	TOC
AW309	162+89.42	27.42	RT	495.38	TOC
AW310	162+97.68	28.00	RT	494.83	SW
AW311	162+97.37	27.42	RT	495.35	TOC
AW312	163+00.38	36.00	RT	494.66	SW
AW313	162+97.68	36.00	RT	494.71	SW
AW314	162+88.83	36.00	RT	495.37	SW
AW315	163+00.83	40.97	RT	495.01	BOC
AW316	162+80.78	34.76	RT	495.47	SW
AW317	163+01.99	36.00	RT	494.66	CW
AW318	162+99.45	28.00	RT	494.82	CW
AW319	162+88.90	15.93	RT	495.12	CW
AW320	162+80.88	12.22	RT	495.28	CW
AW321	162+76.49	14.33	RT	495.64	SW
AW322	162+76.49	26.41	RT	495.36	SW
AW323	162+81.00	41.19	RT	495.47	SW
AW324	162+76.49	42.02	RT	495.46	SW
AW325	162+76.49	34.69	RT	495.42	SW

ADAMS STREET AND WALNUT STREET INTERSECTION NORTHEAST SIDEWALK RAMP GRADES					
POINT NO.	STATION	OFFSET	SIDE	ELEVATION	LOCATION
AW400	163+21.81	41.01	RT	494.88	BOC
AW401	163+22.18	36.00	RT	494.64	SW
AW402	163+24.72	28.00	RT	494.77	SW
AW403	163+27.30	23.72	RT	495.29	BOC
AW404	163+24.72	36.00	RT	494.69	SW
AW405	163+30.72	28.00	RT	494.95	SW
AW406	163+30.72	36.00	RT	494.87	SW
AW407	163+20.60	36.00	RT	494.65	CW
AW408	163+22.97	28.00	RT	494.77	CW
AW409	163+44.63	12.59	RT	495.61	BOC
AW410	163+49.59	12.03	RT	495.20	SW
AW411	163+57.59	12.66	RT	495.18	SW
AW412	163+62.56	13.20	RT	495.60	BOC
AW413	163+49.59	12.66	RT	495.20	SW
AW414	163+49.59	18.66	RT	495.14	SW
AW415	163+57.59	18.66	RT	495.13	SW
AW416	163+49.59	10.45	RT	495.21	CW
AW417	163+57.59	11.06	RT	495.19	CW
AW418	163+26.05	47.29	RT	494.27	SW
AW419	163+50.05	47.35	RT	494.71	SW
AW420	163+49.98	35.40	RT	494.91	SW
AW421	163+62.35	35.40	RT	494.97	SW
AW422	163+40.21	36.00	RT	494.90	SW
AW423	163+40.15	28.00	RT	494.98	SW
AW424	163+49.59	28.00	RT	495.01	SW
AW425	163+57.59	28.00	RT	494.86	SW
AW426	163+57.59	35.42	RT	494.98	SW
AW427	163+21.56	47.11	RT	494.51	SW

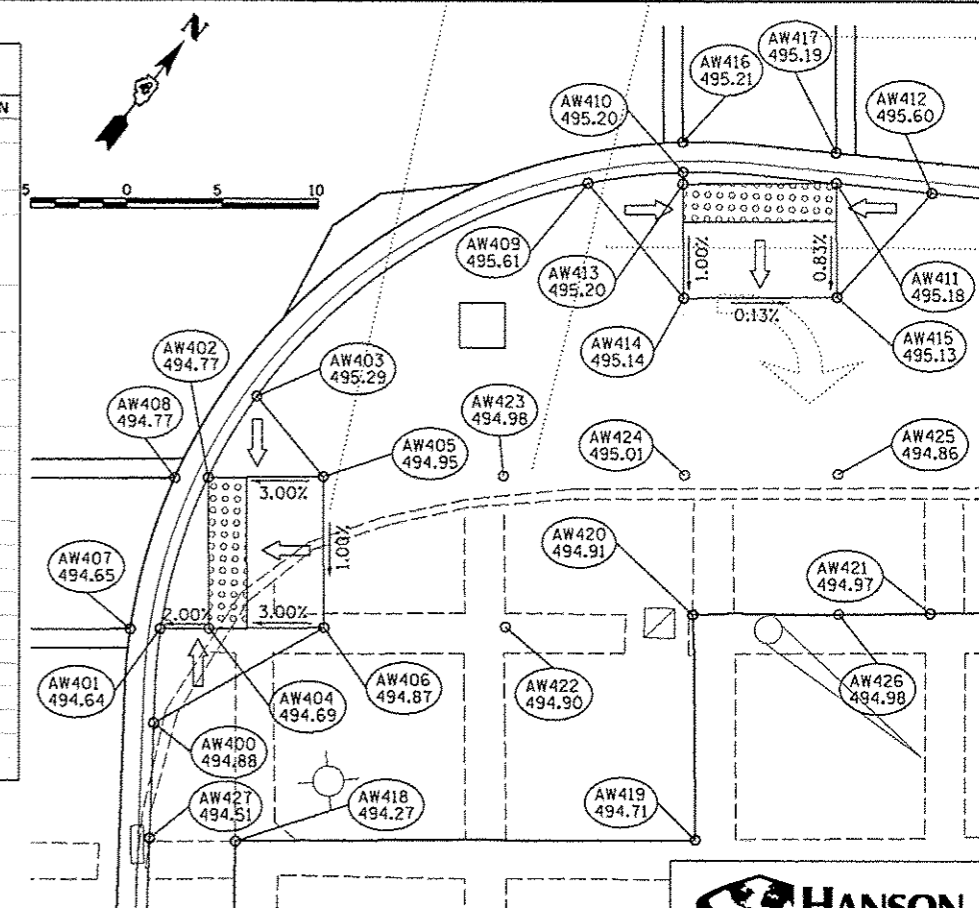

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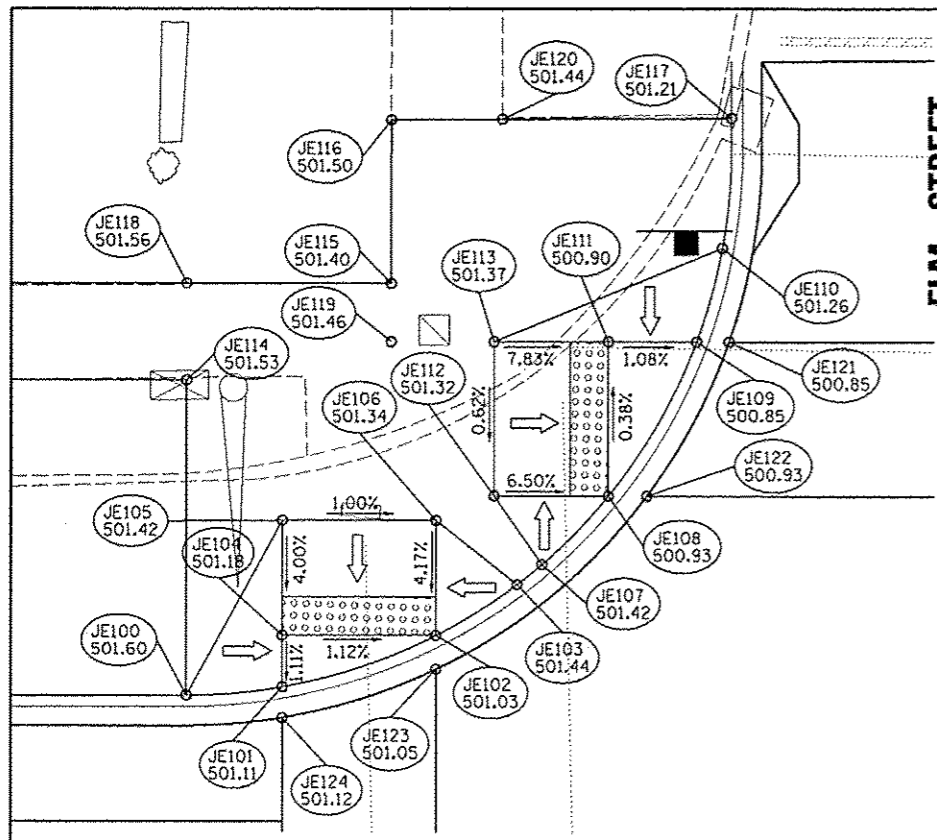
STATE OF ILLINOIS  
 DEPARTMENT OF TRANSPORTATION

ADAMS STREET AND WALNUT STREET  
 SIDEWALK RAMP DETAIL


SCALE: 1"=5'  
 SHEET NO. OF SHEETS STA. 162+00 TO STA. 164+00

F.A.U. RTE.	SECTION	COUNTY	TOTAL SHEETS	SHEET NO.
12-00356-01-PV	PEORIA	519	391	
CONTRACT NO. 89626				
ILLINOIS FED. AID PROJECT T10-50931(58)				









JEFFERSON AVENUE AND ELM STREET INTERSECTION SOUTHWEST SIDEWALK RAMP GRADES					
POINT NO.	STATION	OFFSET	SIDE	ELEVATION	LOCATION
JE100	249+66.41	17.58	LT	501.60	BOC
JE101	249+71.38	18.02	LT	501.11	SW
JE102	249+79.38	20.72	LT	501.03	SW
JE103	249+83.60	23.38	LT	501.44	BOC
JE104	249+71.38	20.72	LT	501.14	SW
JE105	249+71.38	26.72	LT	501.42	SW
JE106	249+79.38	26.72	LT	501.34	SW
JE107	249+84.90	24.43	LT	501.42	BOC
JE108	249+88.39	28.00	LT	500.93	SW
JE109	249+93.00	36.00	LT	500.85	SW
JE110	249+94.34	40.81	LT	501.26	BOC
JE111	249+88.39	36.00	LT	500.90	SW
JE112	249+82.39	28.00	LT	501.32	SW
JE113	249+82.39	36.00	LT	501.37	SW
JE114	249+66.40	34.00	LT	501.53	SW
JE115	249+77.04	39.00	LT	501.40	SW
JE116	249+77.04	47.42	LT	501.50	SW
JE117	249+94.80	47.51	LT	501.21	SW
JE118	249+66.40	39.00	LT	501.56	SW
JE119	249+77.03	36.00	LT	501.46	SW
JE120	249+82.82	47.45	LT	501.44	SW
JE121	249+94.69	36.00	LT	500.85	CW
JE122	249+90.40	28.00	LT	500.93	CW
JE123	249+79.38	18.95	LT	501.05	CW
JE124	249+71.38	16.42	LT	501.12	CW

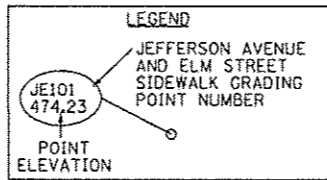

JEFFERSON AVENUE AND ELM STREET INTERSECTION NORTHWEST SIDEWALK RAMP GRADES					
POINT NO.	STATION	OFFSET	SIDE	ELEVATION	LOCATION
JE200	250+30.12	40.62	LT	501.14	BOC
JE201	250+32.02	36.00	LT	500.71	SW
JE202	250+37.64	28.00	LT	500.73	SW
JE203	250+38.21	27.42	LT	501.23	TOC
JE204	250+41.06	27.42	LT	501.03	TOC
JE205	250+41.64	28.00	LT	501.03	SW
JE206	250+41.06	24.87	LT	501.24	TOC
JE207	250+41.64	24.41	LT	500.74	SW
JE208	250+49.64	19.91	LT	500.76	SW
JE209	250+54.41	18.43	LT	501.22	SW
JE210	250+49.64	24.41	LT	500.84	SW
JE211	250+49.64	28.00	LT	501.13	SW
JE212	250+49.64	36.00	LT	501.26	SW
JE213	250+41.64	36.00	LT	501.12	SW
JE214	250+37.64	36.00	LT	500.81	SW
JE215	250+28.47	50.60	LT	501.12	SW
JE216	250+38.69	50.59	LT	501.67	SW
JE217	250+53.21	39.00	LT	501.36	SW
JE218	250+57.05	34.00	LT	501.32	SW
JE219	250+57.05	17.94	LT	501.23	SW
JE220	250+57.05	39.00	LT	501.39	SW
JE221	250+57.05	28.00	LT	501.27	SW
JE222	250+45.56	41.92	LT	501.25	SW
JE223	250+30.26	36.00	LT	500.71	CW
JE224	250+35.50	28.00	LT	500.73	CW
JE225	250+41.64	22.45	LT	500.75	CW
JE226	250+49.64	18.21	LT	500.77	CW

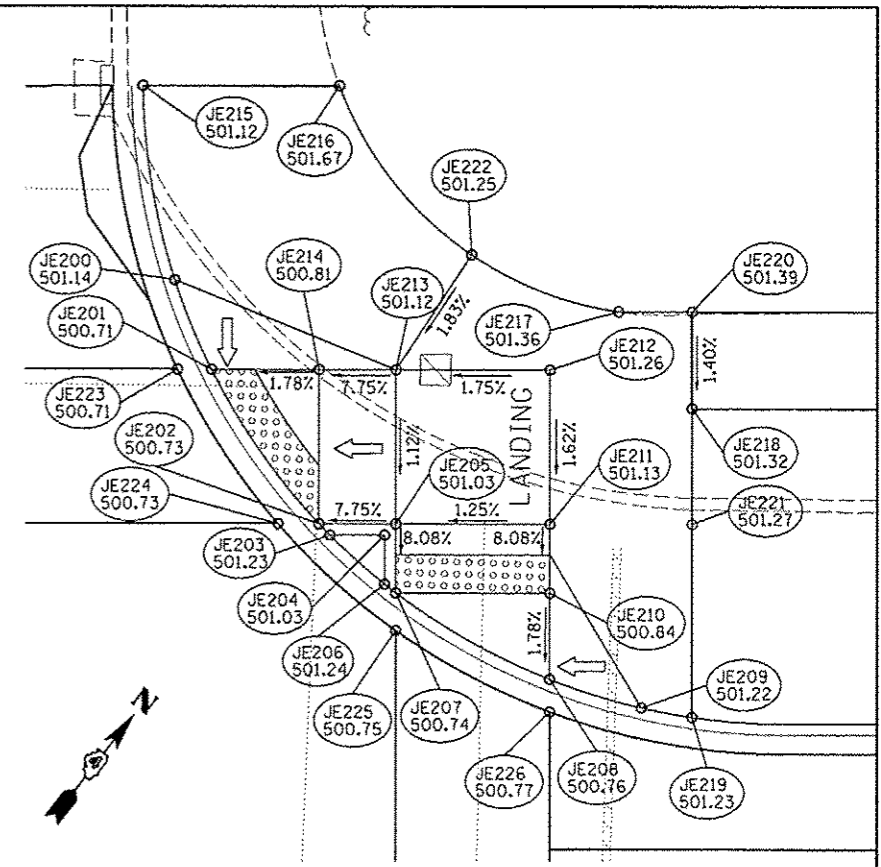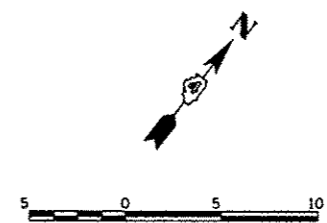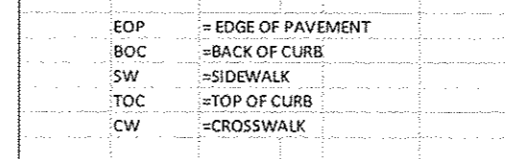


**JEFFERSON AVENUE**

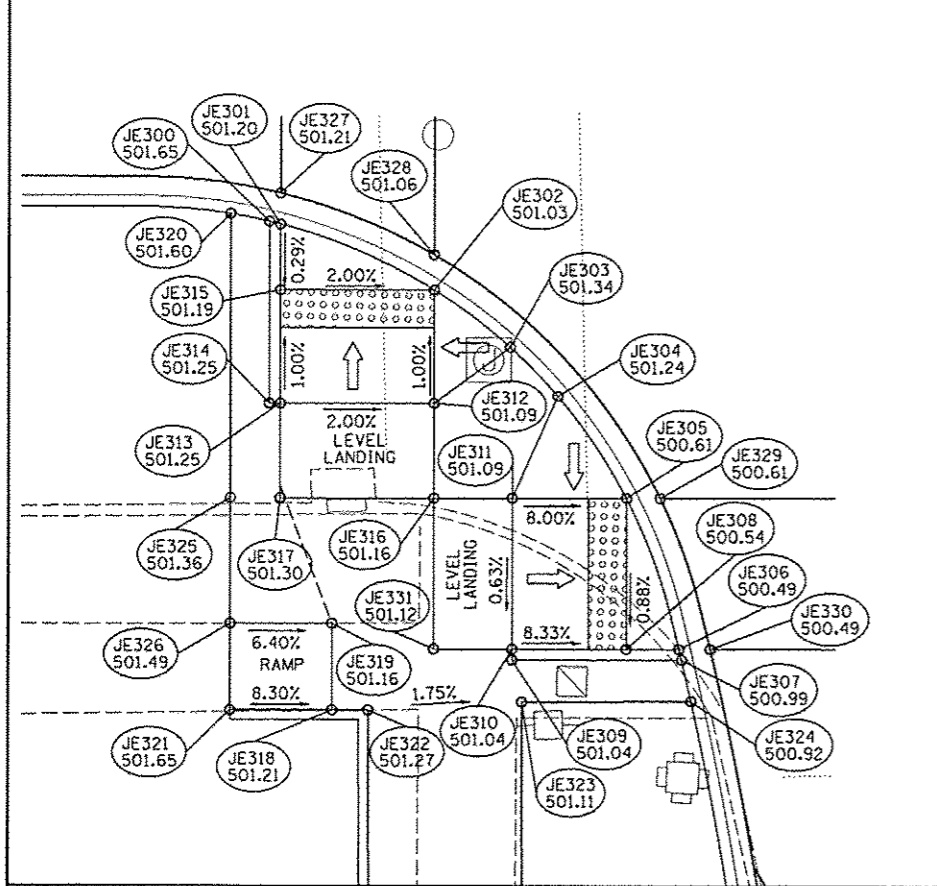

JEFFERSON AVENUE AND ELM STREET INTERSECTION SOUTHEAST SIDEWALK RAMP GRADES					
POINT NO.	STATION	OFFSET	SIDE	ELEVATION	LOCATION
JE300	249+70.80	13.36	RT	501.65	TOC
JE301	249+71.38	13.51	RT	501.20	SW
JE302	249+79.38	16.99	RT	501.03	SW
JE303	249+83.35	20.02	RT	501.34	BOC
JE304	249+85.84	22.60	RT	501.24	BOC
JE305	249+89.46	28.00	RT	500.61	SW
JE306	249+92.22	36.00	RT	500.49	SW
JE307	249+92.36	36.58	RT	500.99	TOC
JE308	249+89.46	36.00	RT	500.54	SW
JE309	249+83.46	36.58	RT	501.04	TOC
JE310	249+83.46	36.00	RT	501.04	SW
JE311	249+83.46	28.00	RT	501.09	SW
JE312	249+79.38	22.99	RT	501.09	SW
JE313	249+71.38	22.99	RT	501.25	SW
JE314	249+70.80	22.99	RT	501.25	TOC
JE315	249+71.38	16.99	RT	501.19	SW
JE316	249+79.38	28.00	RT	501.16	SW
JE317	249+71.38	28.00	RT	501.30	SW
JE318	249+74.10	39.24	RT	501.21	SW
JE319	249+74.10	34.65	RT	501.16	SW
JE320	249+68.80	12.96	RT	501.60	SW
JE321	249+68.80	39.24	RT	501.65	SW
JE322	249+75.97	39.24	RT	501.18	SW
JE323	249+83.97	38.81	RT	501.04	SW
JE324	249+92.85	38.77	RT	500.92	SW
JE325	249+68.80	28.00	RT	501.36	SW
JE326	249+68.80	34.65	RT	501.49	SW
JE327	249+71.38	11.87	RT	501.21	CW
JE328	249+79.38	15.13	RT	501.06	CW
JE329	249+91.22	28.00	RT	500.61	CW
JE330	249+93.84	36.00	RT	500.49	CW
JE331	249+79.38	36.00	RT	501.12	CW

JEFFERSON AVENUE AND ELM STREET INTERSECTION NORTHEAST SIDEWALK RAMP GRADES					
POINT NO.	STATION	OFFSET	SIDE	ELEVATION	LOCATION
JE400	250+22.12	36.58	RT	501.17	TOC
JE401	250+22.22	36.00	RT	500.67	SW
JE402	250+24.92	28.00	RT	500.72	SW
JE403	250+27.59	23.78	RT	501.21	BOC
JE404	250+37.03	15.81	RT	501.29	BOC
JE405	250+41.64	13.90	RT	500.87	SW
JE406	250+49.64	12.59	RT	500.94	SW
JE407	250+50.23	12.58	RT	501.44	TOC
JE408	250+49.64	13.90	RT	500.94	SW
JE409	250+49.64	19.90	RT	501.27	SW
JE410	250+50.23	19.90	RT	501.27	TOC
JE411	250+41.64	19.90	RT	501.19	SW
JE412	250+30.92	28.00	RT	501.02	SW
JE413	250+30.92	36.00	RT	501.02	SW
JE414	250+30.92	36.58	RT	501.03	TOC
JE415	250+24.92	36.00	RT	500.72	SW
JE416	250+41.64	31.72	RT	501.11	SW
JE417	250+21.87	38.63	RT	501.10	SW
JE418	250+34.93	38.56	RT	501.08	SW
JE419	250+42.93	39.72	RT	501.23	SW
JE420	250+52.23	31.72	RT	501.14	SW
JE421	250+52.23	12.58	RT	501.37	SW
JE422	250+41.64	28.00	RT	501.16	SW
JE423	250+52.23	28.00	RT	501.15	SW
JE424	250+34.92	36.00	RT	501.06	SW
JE425	250+52.23	39.72	RT	501.22	SW
JE426	250+52.23	19.90	RT	501.37	SW
JE427	250+49.64	11.01	RT	500.94	CW
JE428	250+41.64	12.24	RT	500.89	CW
JE429	250+23.15	28.00	RT	500.73	CW
JE430	250+20.61	36.00	RT	500.67	CW

**JEFFERSON AVENUE**

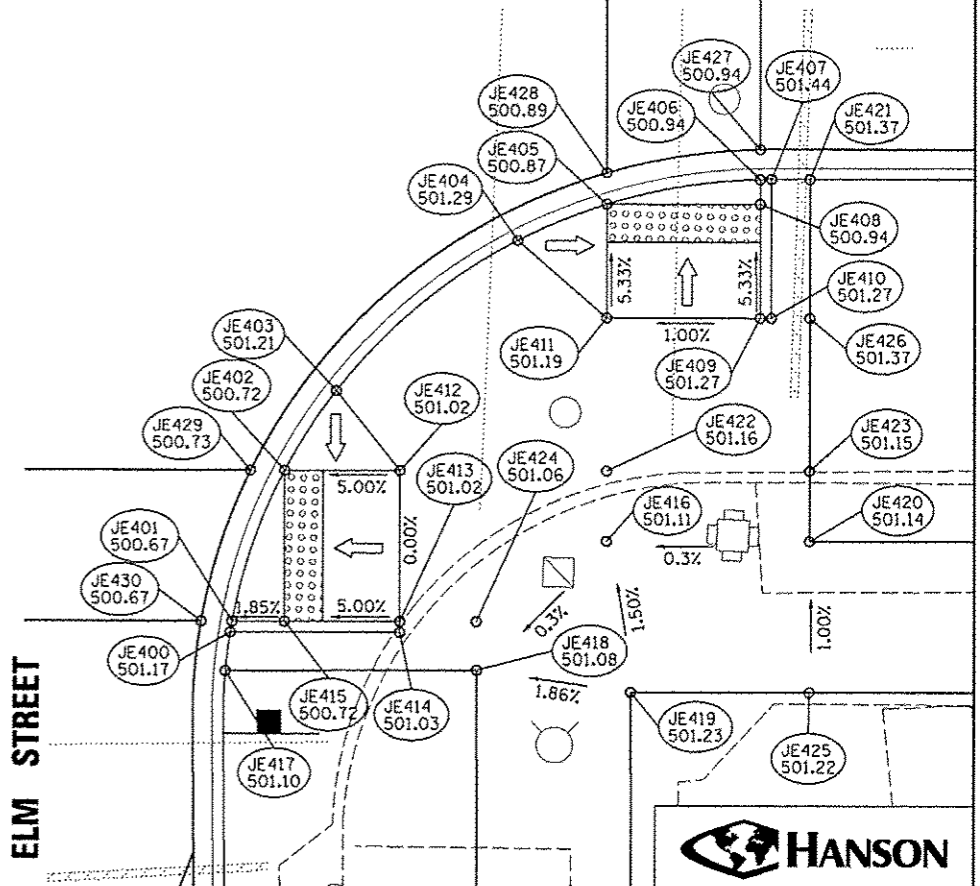

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 DRAWN: RLA  
 CHECKED: KMB  
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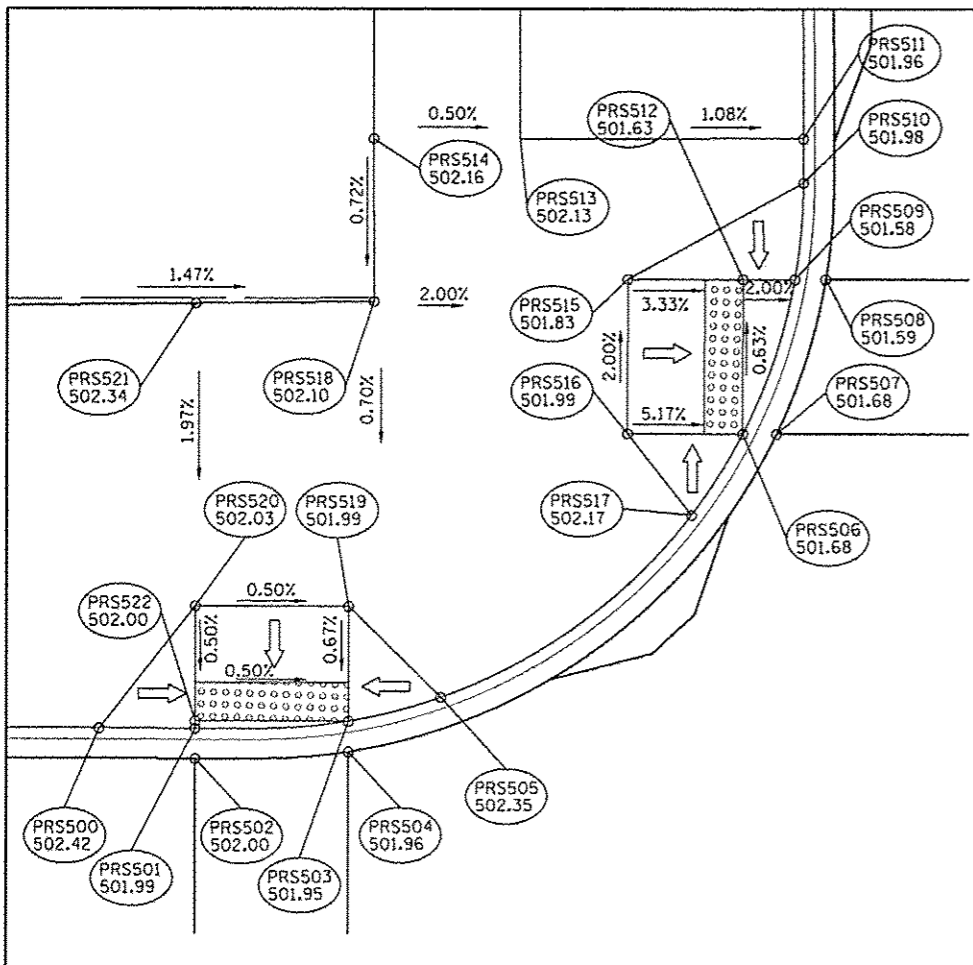
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 REVISED: -

STATE OF ILLINOIS  
 DEPARTMENT OF TRANSPORTATION

JEFFERSON AVENUE AND ELM STREET  
 SIDEWALK RAMP DETAIL  
 SCALE: 1"=5'  
 SHEET NO. OF SHEETS: STA. 249+00 TO STA. 251+00

F.A.U. R.E. SECTION: 12-00356-01-PV COUNTY: PEORIA TOTAL SHEETS: 519 SHEET NO.: 392 CONTRACT NO.: 89626 ILLINOIS FED. AID PROJECT: 110-80931(5)B







ADAMS & PERSIMMON STREET INTERSECTION NORTHWEST SIDEWALK RAMP GRADES					
POINT NO	STATION	OFFSET	SIDE	ELEVATION	LOCATION
PRS500	141+03.20	17.58	LT	502.42	TOC
PRS501	141+08.20	17.58	LT	501.99	TOC
PRS502	141+08.20	16.00	LT	501.00	EOP
PRS503	141+16.20	17.98	LT	501.95	TOC
PRS504	141+16.20	16.37	LT	501.96	EOP
PRS505	141+21.03	19.24	LT	502.35	TOC
PRS506	141+36.74	33.00	LT	501.68	TOC
PRS507	141+38.51	33.00	LT	501.68	EOP
PRS508	141+41.05	41.00	LT	501.59	EOP
PRS509	141+39.45	41.00	LT	501.58	TOC
PRS510	141+39.89	45.97	LT	501.98	TOC
PRS511	141+39.89	48.25	LT	501.96	TOC
PRS512	141+36.74	41.00	LT	501.63	SW
PRS513	141+25.14	48.20	LT	502.12	SW
PRS514	141+17.47	48.20	LT	502.16	SW
PRS515	141+30.74	41.00	LT	501.83	SW
PRS516	141+30.74	32.98	LT	501.99	SW
PRS517	141+34.08	28.78	LT	502.17	TOC
PRS518	141+17.49	39.81	LT	502.10	SW
PRS519	141+16.20	23.98	LT	501.99	SW
PRS520	141+08.20	23.98	LT	502.03	SW
PRS521	141+08.20	39.70	LT	502.34	SW
PRS522	141+08.20	17.98	LT	502.00	SW
PRS523	141+01.20	25.01	LT	501.66	SW

PERSIMMON STREET

ADAMS & PERSIMMON STREET INTERSECTION NORTHEAST SIDEWALK RAMP GRADES					
POINT NO	STATION	OFFSET	SIDE	ELEVATION	LOCATION
PRS600	141+03.20	17.58	LT	501.96	TOC
PRS601	141+69.43	45.72	LT	501.98	TOC
PRS602	141+69.37	41.00	LT	501.56	EOP
PRS603	141+71.08	41.00	LT	501.55	TOC
PRS604	141+73.72	33.00	LT	501.61	EOP
PRS605	141+78.92	29.20	LT	502.06	TOC
PRS606	141+79.72	28.41	LT	502.11	TOC
PRS607	141+83.53	25.17	LT	501.66	TOC
PRS608	141+83.53	23.22	LT	501.68	EOP
PRS609	141+91.54	20.60	LT	501.70	TOC
PRS610	141+91.54	18.88	LT	501.72	EOP
PRS611	141+97.19	18.72	LT	502.18	TOC
PRS612	141+98.51	25.21	LT	502.22	SW
PRS613	141+91.53	25.19	LT	501.79	SW
PRS614	141+91.52	27.19	LT	501.93	SW
PRS615	141+91.51	31.19	LT	502.07	SW
PRS616	141+98.51	39.73	LT	502.28	SW
PRS617	141+83.51	31.17	LT	502.03	SW
PRS618	141+81.68	33.00	LT	502.03	SW
PRS619	141+75.68	32.98	LT	501.60	TOC
PRS620	141+87.26	39.73	LT	502.22	SW
PRS621	141+81.68	41.00	LT	502.11	SW
PRS622	141+75.68	41.00	LT	501.64	SW
PRS623	141+87.26	48.12	LT	501.71	SW
PRS624	141+79.80	48.12	LT	501.64	SW
PRS625	141+91.49	39.57	LT	502.24	SW
PRS626	141+87.26	41.00	LT	502.22	SW
PRS627	141+83.51	33.00	LT	502.07	SW

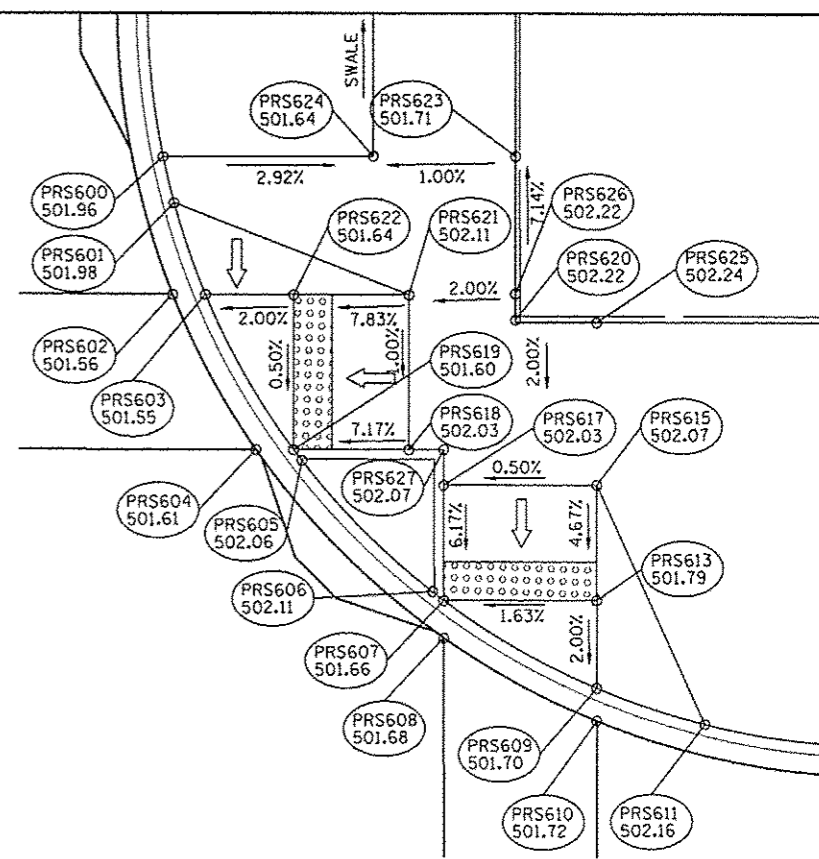


ADAMS STREET

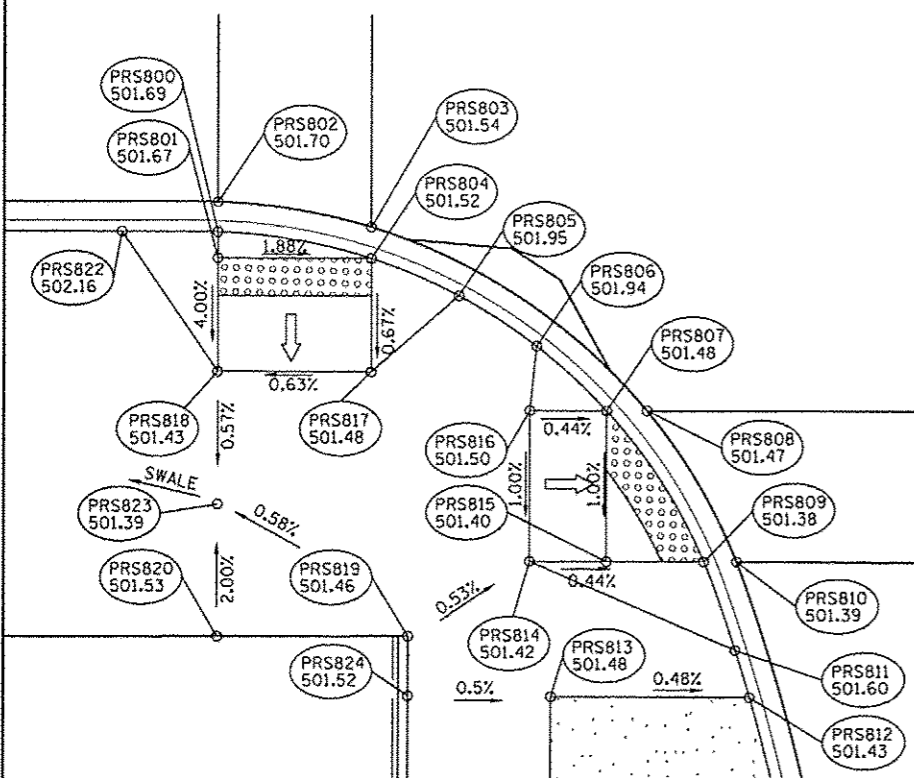


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POINT NO	STATION	OFFSET	SIDE	ELEVATION	LOCATION
PRS800	141+08.20	18.58	RT	501.69	TOC
PRS801	141+08.20	19.98	RT	501.67	SW
PRS802	141+08.20	17.01	RT	501.70	EOP
PRS803	141+16.20	18.32	RT	501.54	EOP
PRS804	141+16.20	19.98	RT	501.52	TOC
PRS805	141+20.79	21.94	RT	501.95	TOC
PRS806	141+24.87	24.59	RT	501.94	TOC
PRS807	141+28.52	28.00	RT	501.48	TOC
PRS808	141+30.61	28.00	RT	501.47	EOP
PRS809	141+33.59	36.00	RT	501.38	TOC
PRS810	141+35.30	36.00	RT	501.38	EOP
PRS811	141+35.24	40.70	RT	501.60	TOC
PRS812	141+36.00	43.21	RT	501.43	TOC
PRS813	141+25.66	43.19	RT	501.48	SW
PRS814	141+24.52	36.00	RT	501.42	SW
PRS815	141+28.52	36.00	RT	501.40	SW
PRS816	141+24.52	28.00	RT	501.50	SW
PRS817	141+16.20	25.98	RT	501.48	SW
PRS818	141+08.20	25.98	RT	501.43	SW
PRS819	141+17.66	40.00	RT	501.46	SW
PRS820	141+07.70	40.06	RT	501.53	SW
PRS822	141+03.20	18.58	RT	502.16	TOC
PRS823	141+08.20	33.01	RT	501.39	SW
PRS824	141+18.17	43.18	RT	501.52	SW

PERSIMMON STREET

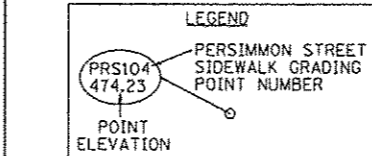

ADAMS & PERSIMMON STREET INTERSECTION SOUTHEAST SIDEWALK RAMP GRADES					
POINT NO	STATION	OFFSET	SIDE	ELEVATION	LOCATION
PRS700	141+96.08	18.03	RT	502.06	TOC
PRS701	141+91.64	20.33	RT	501.57	TOC
PRS702	141+91.63	18.51	RT	501.59	EOP
PRS703	141+85.65	24.26	RT	501.52	SW
PRS704	141+85.15	24.65	RT	501.97	TOC
PRS705	141+83.65	23.81	RT	501.52	EOP
PRS706	141+78.86	28.00	RT	501.48	EOP
PRS707	141+78.61	30.50	RT	501.90	TOC
PRS708	141+78.13	31.00	RT	501.45	SW
PRS709	141+73.94	36.00	RT	501.40	TOC
PRS710	141+71.97	36.00	RT	501.40	EOP
PRS711	141+71.11	40.13	RT	501.81	TOC
PRS712	141+69.59	42.73	RT	501.73	TOC
PRS713	141+78.89	42.75	RT	501.60	SW
PRS714	141+78.15	36.00	RT	501.48	SW
PRS715	141+86.89	42.75	RT	501.68	SW
PRS716	141+86.90	40.07	RT	501.77	SW
PRS717	141+85.68	36.01	RT	501.69	SW
PRS718	141+91.69	40.07	RT	501.73	SW
PRS719	141+91.68	36.00	RT	501.65	SW
PRS720	141+91.68	31.00	RT	501.63	SW
PRS721	141+85.66	31.00	RT	501.67	SW
PRS722	141+91.65	24.24	RT	501.59	SW

ADAMS STREET

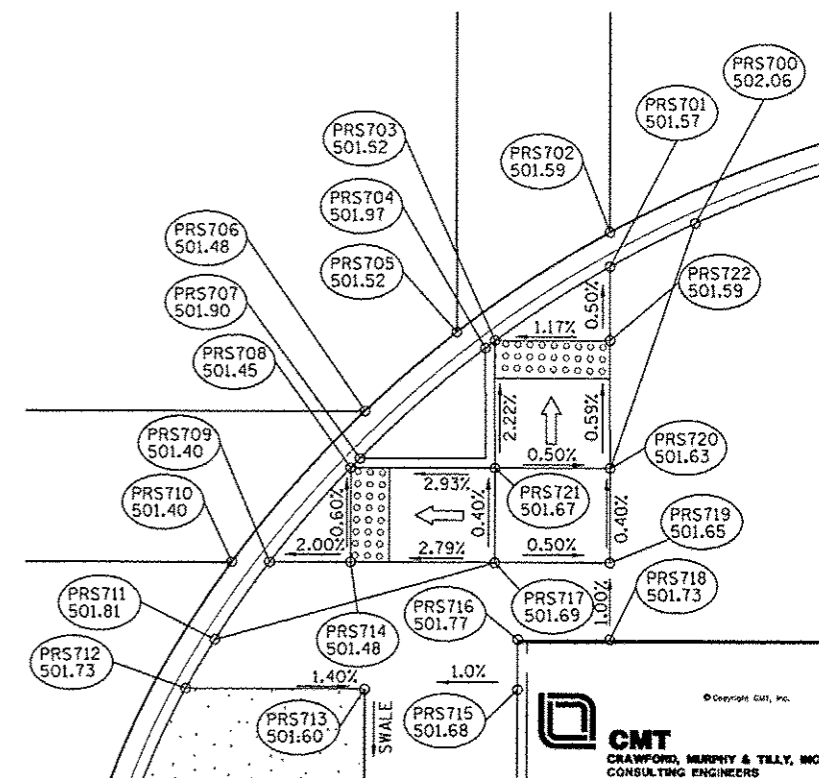

FILE NAME = ... USER NAME = manak81398  
 DESIGNER - RMM/ENM  
 DRAWN - RJE  
 CHECKED - EJM  
 DATE - 7/18/12

REVISED -  
 REVISED -  
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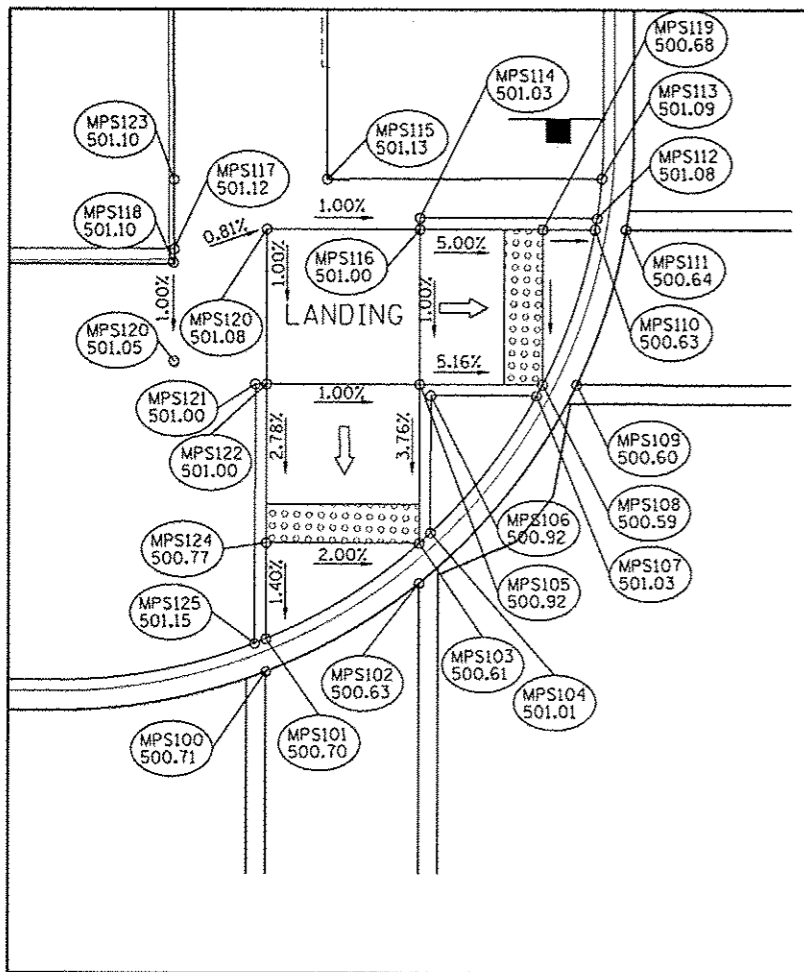
STATE OF ILLINOIS  
 DEPARTMENT OF TRANSPORTATION

ADAMS STREET AND PERSIMMON STREET  
 SIDEWALK RAMP DETAIL

SCALE: 1"=5' SHEET NO. OF SHEETS STA. TO STA.

F.A.U. SECTION COUNTY TOTAL SHEETS SHEET NO.  
 12-00356-01-PV PEORIA 519 393  
 CONTRACT NO. 89626  
 ILLINOIS FED. AID PROJECT 116-50931581







**ADAMS & MAPLE STREET INTERSECTION  
NORTHWEST SIDEWALK RAMP GRADES**

POINT NO	STATION	OFFSET	SIDE	ELEVATION	LOCATION
MPS100	145+53.50	18.04	LT	500.71	EOP
MPS101	145+53.50	19.75	LT	500.70	TOC
MPS102	145+61.50	22.68	LT	500.63	EOP
MPS103	145+61.50	24.76	LT	500.61	TOC
MPS104	145+62.09	25.29	LT	501.01	TOC
MPS105	145+61.50	33.00	LT	500.92	SW
MPS106	145+62.09	32.42	LT	500.92	SW
MPS107	145+67.59	32.42	LT	501.03	TOC
MPS108	145+67.90	33.00	LT	500.59	TOC
MPS109	145+69.67	33.00	LT	500.60	EOP
MPS110	145+70.61	41.00	LT	500.63	TOC
MPS111	145+72.21	41.00	LT	500.64	EOP
MPS112	145+70.70	41.58	LT	501.08	TOC
MPS113	145+70.95	43.63	LT	501.09	TOC
MPS114	145+61.50	41.58	LT	501.03	SW
MPS115	145+56.64	43.56	LT	501.13	SW
MPS116	145+61.50	41.00	LT	501.00	SW
MPS117	145+48.66	39.96	LT	501.12	SW
MPS118	145+48.62	39.27	LT	501.10	SW
MPS119	145+67.90	41.00	LT	500.68	SW
MPS120	145+53.50	41.00	LT	501.08	SW
MPS121	145+52.92	33.00	LT	501.00	SW
MPS122	145+53.50	33.00	LT	501.00	SW
MPS123	145+48.64	43.52	LT	501.16	SW
MPS124	145+53.50	24.75	LT	500.77	SW
MPS125	145+52.92	19.51	LT	501.15	TOC
MPS126	145+48.67	34.15	LT	501.05	SW


**MAPLE STREET**

**ADAMS & MAPLE STREET INTERSECTION  
NORTHEAST SIDEWALK RAMP GRADES**

POINT NO	STATION	OFFSET	SIDE	ELEVATION	LOCATION
MPS200	145+99.74	47.69	LT	500.65	TOC
MPS201	146+00.00	45.69	LT	500.64	TOC
MPS202	146+00.70	41.00	LT	500.31	TOC
MPS203	145+99.10	41.00	LT	500.25	EOP
MPS204	146+03.36	41.00	LT	500.36	SW
MPS205	146+01.64	33.00	LT	500.35	EOP
MPS206	146+03.36	33.00	LT	500.35	TOC
MPS207	146+06.05	28.81	LT	500.84	TOC
MPS208	146+17.50	19.87	LT	501.04	TOC
MPS209	146+22.23	18.31	LT	500.65	TOC
MPS210	146+22.23	16.70	LT	500.66	EOP
MPS211	146+30.23	17.58	LT	500.70	TOC
MPS212	146+30.23	16.00	LT	500.71	EOP
MPS213	146+30.82	17.58	LT	501.14	TOC
MPS214	146+30.23	18.31	LT	500.71	SW
MPS215	146+30.23	24.31	LT	500.91	SW
MPS216	146+22.23	24.31	LT	501.07	SW
MPS217	146+30.88	24.31	LT	500.91	SW
MPS218	146+30.88	32.79	LT	500.95	SW
MPS219	146+09.36	33.00	LT	500.81	SW
MPS220	146+17.78	39.99	LT	501.03	SW
MPS221	146+09.36	41.00	LT	500.86	SW
MPS222	146+17.71	47.69	LT	501.23	SW
MPS223	146+30.88	39.95	LT	501.03	SW
MPS224	146+12.88	47.68	LT	501.13	SW

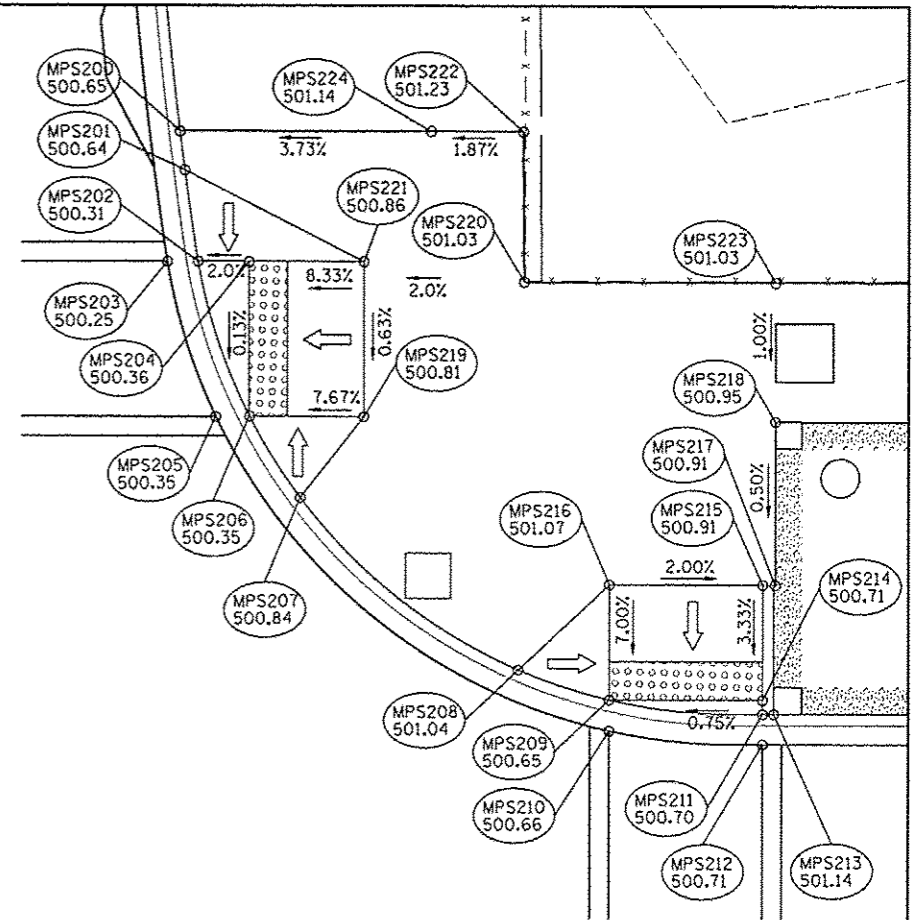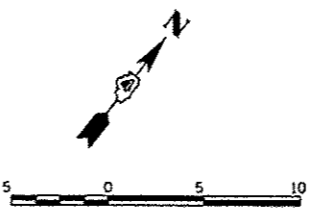


**ADAMS STREET**

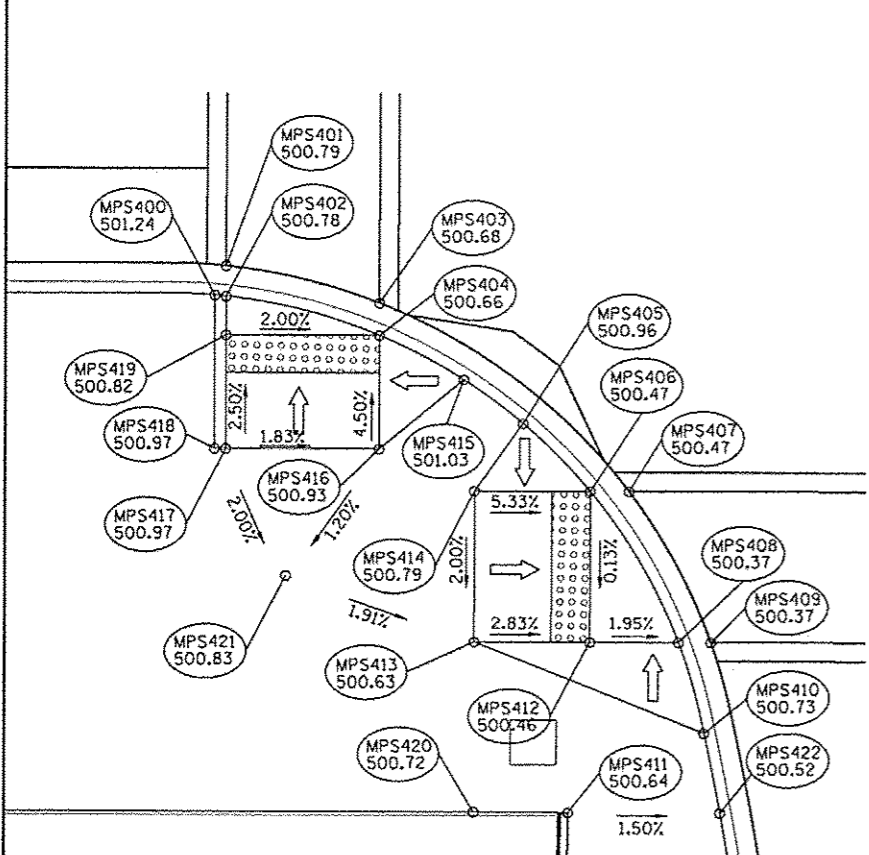

**ADAMS & MAPLE STREET INTERSECTION  
SOUTHWEST SIDEWALK RAMP GRADES**


POINT NO	STATION	OFFSET	SIDE	ELEVATION	LOCATION
MPS400	145+52.92	12.69	RT	501.24	TOC
MPS401	145+53.50	11.15	RT	500.79	EOP
MPS402	145+53.50	12.74	RT	500.78	TOC
MPS403	145+61.50	13.09	RT	500.68	TOC
MPS404	145+61.50	14.79	RT	500.66	TOC
MPS405	145+69.01	19.43	RT	500.96	TOC
MPS406	145+72.50	23.00	RT	500.47	TOC
MPS407	145+74.52	23.00	RT	500.47	EOP
MPS408	145+77.11	31.00	RT	500.37	TOC
MPS409	145+78.80	31.00	RT	500.37	EOP
MPS410	145+78.47	35.82	RT	500.73	EOP
MPS411	145+70.91	40.04	RT	500.64	SW
MPS412	145+72.50	31.00	RT	500.46	SW
MPS413	145+66.50	31.00	RT	500.63	SW
MPS414	145+66.50	23.00	RT	500.79	SW
MPS415	145+65.32	17.12	RT	501.03	SW
MPS416	145+61.51	20.79	RT	500.93	SW
MPS417	145+53.51	20.79	RT	501.08	SW
MPS418	145+52.62	20.79	RT	501.08	SW
MPS419	145+53.50	14.79	RT	500.82	SW
MPS420	145+66.50	40.06	RT	500.72	SW
MPS421	145+56.64	27.53	RT	500.83	SW
MPS422	145+79.30	40.08	RT	500.52	TOC


**MAPLE STREET**

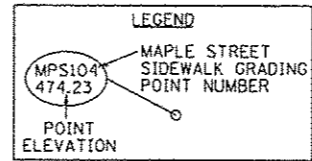

**ADAMS & MAPLE STREET INTERSECTION  
SOUTHEAST SIDEWALK RAMP GRADES**

POINT NO	STATION	OFFSET	SIDE	ELEVATION	LOCATION
MPS300	146+30.88	13.46	RT	501.12	TOC
MPS301	146+30.23	11.98	RT	500.67	EOP
MPS302	146+30.23	13.62	RT	500.66	TOC
MPS303	146+22.23	15.00	RT	500.60	EOP
MPS304	146+22.23	16.80	RT	500.58	TOC
MPS305	146+21.65	17.12	RT	501.02	TOC
MPS306	146+14.80	22.42	RT	500.94	TOC
MPS307	146+14.23	23.00	RT	500.48	TOC
MPS308	146+12.09	23.00	RT	500.48	EOP
MPS309	146+08.61	31.00	RT	500.39	TOC
MPS310	146+06.85	31.00	RT	500.44	EOP
MPS311	146+06.71	35.62	RT	500.79	TOC
MPS312	146+14.23	31.00	RT	500.55	SW
MPS313	146+21.65	22.42	RT	500.93	SW
MPS314	146+22.23	30.99	RT	500.77	SW
MPS315	146+30.23	31.00	RT	500.81	SW
MPS316	146+30.88	27.79	RT	500.87	SW
MPS317	146+30.23	23.00	RT	500.95	SW
MPS318	146+30.82	23.00	RT	500.95	SW
MPS319	146+30.23	16.80	RT	500.72	SW
MPS320	146+22.23	23.00	RT	500.89	SW
MPS321	146+14.88	40.04	RT	500.82	SW
MPS322	146+22.23	40.04	RT	500.85	SW
MPS323	146+30.23	40.11	RT	500.86	SW
MPS324	146+05.59	40.04	RT	500.78	TOC

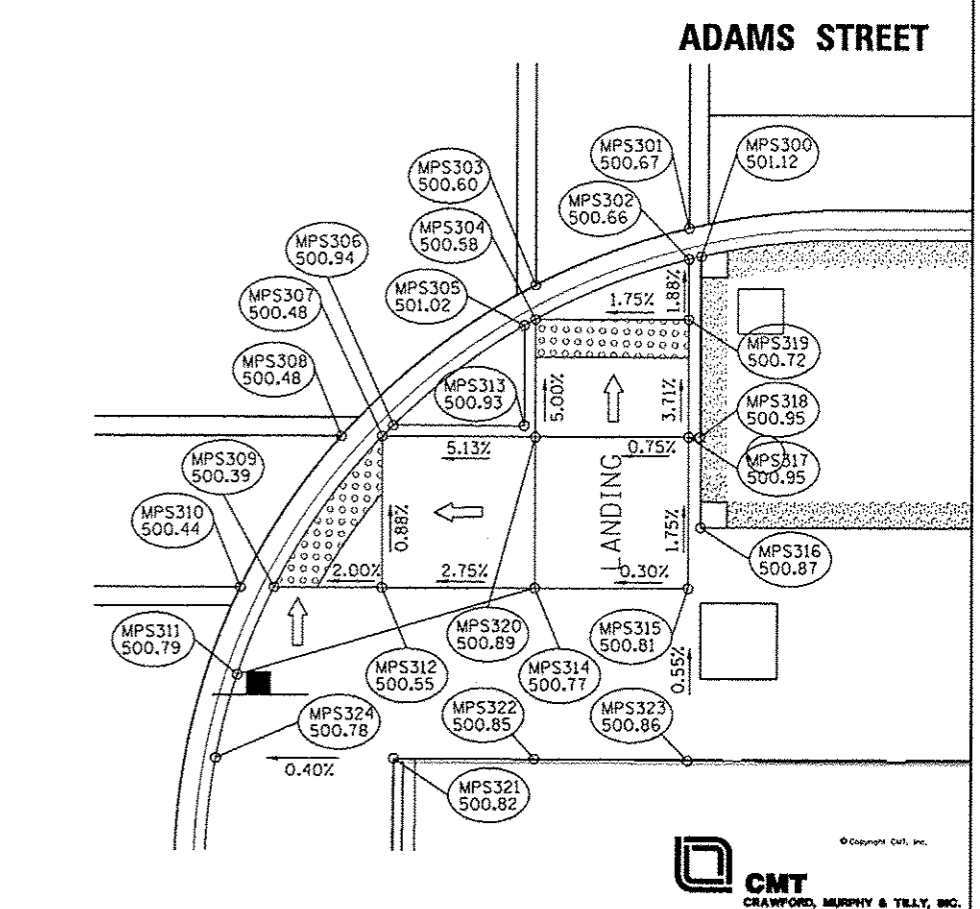


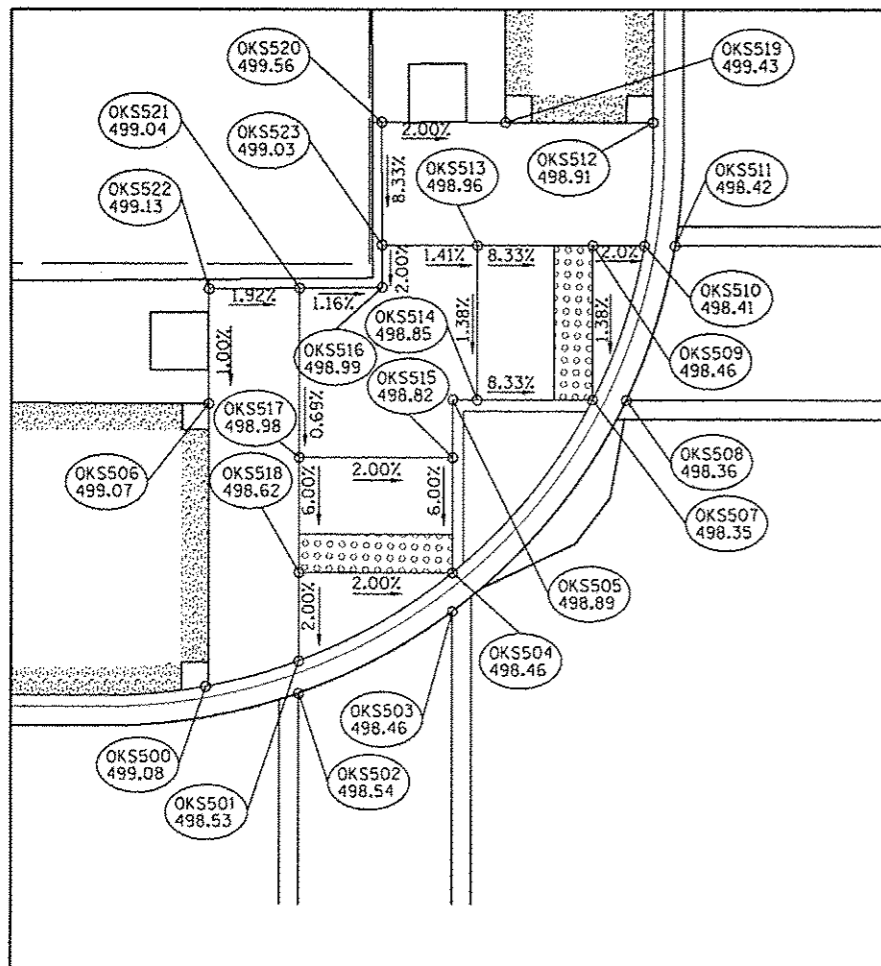


**ADAMS & OAK STREET INTERSECTION  
SOUTHWEST SIDEWALK RAMP GRADES**


POINT NO	STATION	OFFSET	SIDE	ELEVATION	LOCATION
OKS500	153+98.44	18.06	LT	499.08	TOC
OKS501	154+03.25	19.40	LT	498.53	TOC
OKS502	154+03.25	17.72	LT	498.54	EOP
OKS503	154+11.25	22.00	LT	498.46	EOP
OKS504	154+11.25	24.01	LT	498.46	TOC
OKS505	154+14.82	27.50	LT	498.89	SW
OKS506	153+98.55	32.79	LT	499.11	SW
OKS507	154+18.51	33.00	LT	498.35	TOC
OKS508	154+20.28	33.00	LT	498.36	EOP
OKS509	154+18.51	41.00	LT	498.46	SW
OKS510	154+21.22	41.00	LT	498.41	TOC
OKS511	154+22.83	41.00	LT	498.42	EOP
OKS512	154+12.51	41.58	LT	498.91	SW
OKS513	154+12.51	41.00	LT	498.96	SW
OKS514	154+12.51	33.00	LT	498.85	SW
OKS515	154+11.25	30.01	LT	498.82	SW
OKS516	154+07.04	39.30	LT	498.99	SW
OKS517	154+03.25	30.01	LT	498.98	SW
OKS518	154+03.25	24.01	LT	498.62	SW
OKS519	154+13.96	47.34	LT	499.43	SW
OKS520	154+07.51	47.34	LT	499.56	SW
OKS521	154+03.25	38.77	LT	499.04	SW
OKS522	153+98.56	38.72	LT	499.13	SW
OKS523	154+07.54	41.00	LT	499.03	SW

**ADAMS & OAK STREET INTERSECTION  
NORTHWEST SIDEWALK RAMP GRADES**

POINT NO	STATION	OFFSET	SIDE	ELEVATION	LOCATION
OKS600	154+59.61	41.00	LT	498.22	EOP
OKS601	154+61.23	41.00	LT	498.21	TOC
OKS602	154+62.21	33.00	LT	498.25	EOP
OKS603	154+63.98	33.00	LT	498.25	TOC
OKS604	154+66.32	29.21	LT	498.71	TOC
OKS605	154+64.29	32.42	LT	498.69	TOC
OKS606	154+66.93	28.40	LT	498.26	TOC
OKS607	154+66.92	25+96	LT	498.27	EOP
OKS608	154+74.91	21.47	LT	498.31	TOC
OKS609	154+74.90	19.65	LT	498.32	EOP
OKS610	154+79.42	19.34	LT	498.81	TOC
OKS611	154+74.91	31.90	LT	498.42	SW
OKS612	154+74.91	32.99	LT	498.65	SW
OKS613	154+76.87	40.04	LT	498.98	SW
OKS614	154+66.91	33.00	LT	498.49	SW
OKS615	154+74.91	41.00	LT	498.66	SW
OKS616	154+66.91	41.00	LT	498.50	SW
OKS617	154+66.91	41.58	LT	499.03	SW
OKS618	154+63.98	41.00	LT	498.26	SW
OKS619	154+61.10	41.58	LT	498.70	TOC

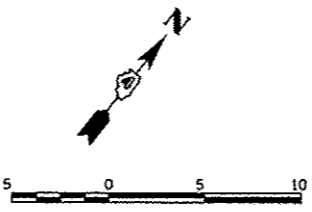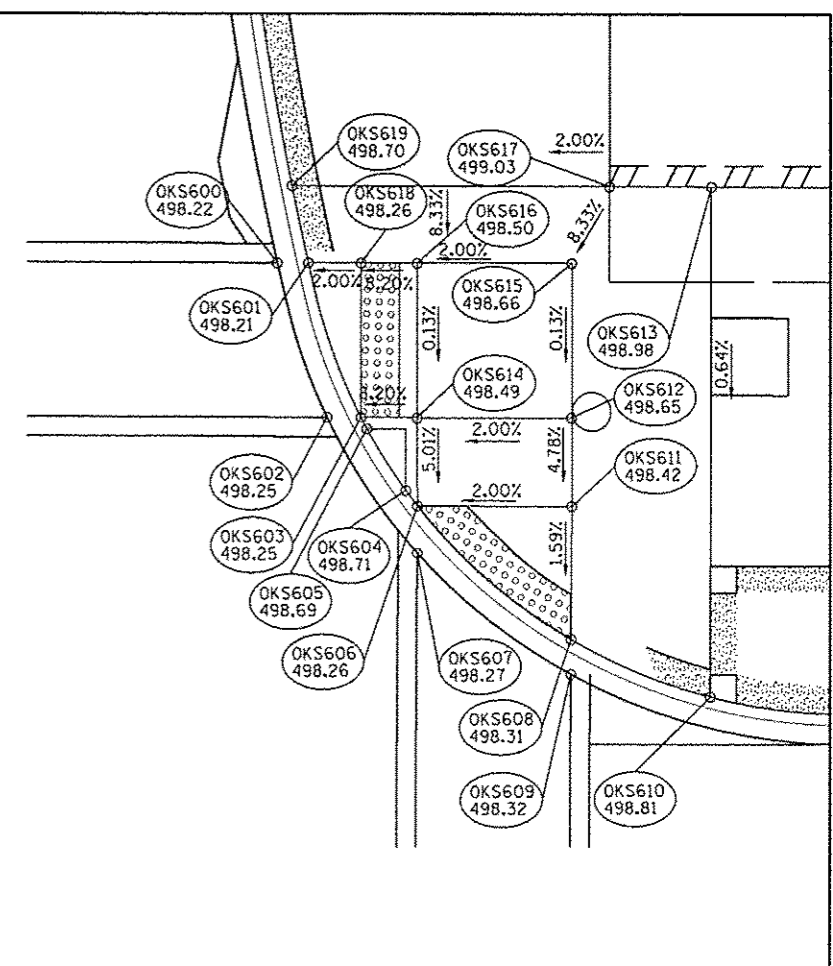


**ADAMS STREET**

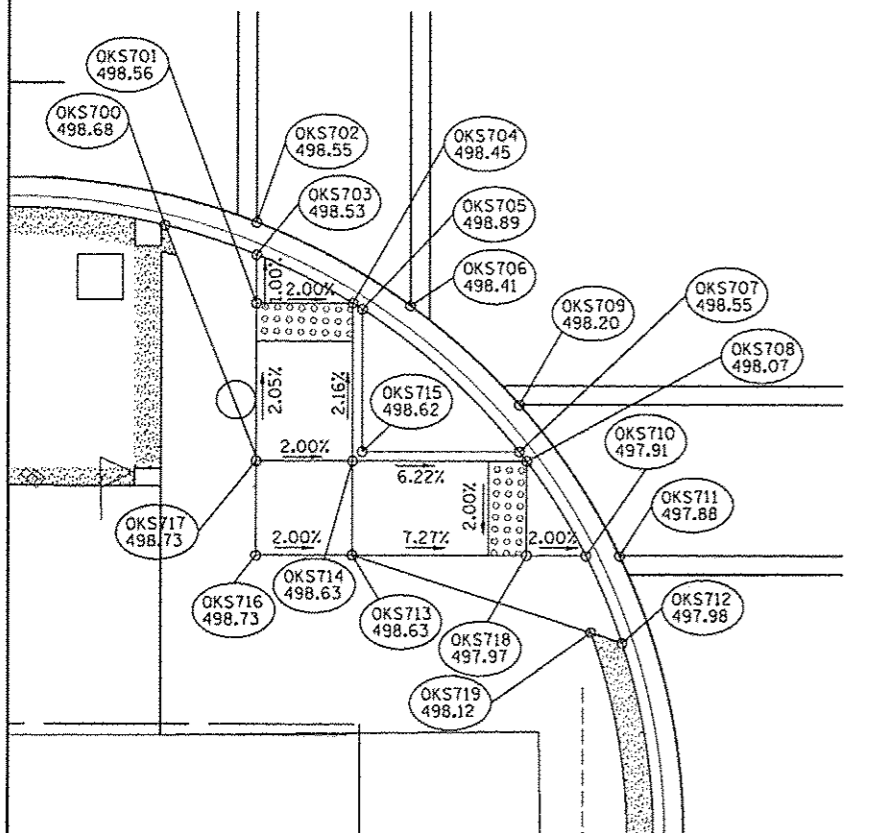


**ADAMS & OAK STREET INTERSECTION  
SOUTHEAST SIDEWALK RAMP GRADES**


POINT NO	STATION	OFFSET	SIDE	ELEVATION	LOCATION
OKS700	153+98.50	13.54	RT	498.68	SW
OKS701	154+03.25	17.65	RT	498.56	SW
OKS702	154+03.25	13.38	RT	498.55	EOP
OKS703	154+03.25	15.09	RT	498.53	TOC
OKS704	154+08.25	17.65	RT	498.45	SW
OKS705	154+08.75	17.97	RT	498.89	TOC
OKS706	154+11.25	17.77	RT	498.41	EOP
OKS707	154+16.95	25.50	RT	498.55	TOC
OKS708	154+17.33	26.00	RT	498.07	SW
OKS709	154+16.94	23.00	RT	498.20	EOP
OKS710	154+20.42	31.00	RT	497.91	TOC
OKS711	154+22.18	31.00	RT	497.88	EOP
OKS712	154+22.32	35.61	RT	497.98	TOC
OKS713	154+08.25	31.00	RT	498.63	SW
OKS714	154+08.25	26.00	RT	498.63	SW
OKS715	154+08.75	25.50	RT	498.62	TOC
OKS716	154+03.25	31.00	RT	498.73	SW
OKS717	154+03.25	26.00	RT	498.73	SW
OKS718	154+17.33	31.00	RT	497.97	SW
OKS719	154+20.68	35.08	RT	498.12	SW

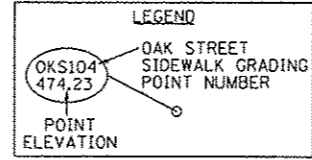

**ADAMS & OAK STREET INTERSECTION  
NORTHEAST SIDEWALK RAMP GRADES**


POINT NO	STATION	OFFSET	SIDE	ELEVATION	LOCATION
OKS800	154+79.59	13.04	RT	498.84	TOC
OKS801	154+74.77	14.36	RT	498.32	TOC
OKS802	154+74.78	12.68	RT	498.33	EOP
OKS803	154+69.78	16.84	RT	498.23	SW
OKS804	154+69.27	17.11	RT	498.67	TOC
OKS805	154+66.76	16.93	RT	498.20	EOP
OKS806	154+60.67	23.00	RT	498.00	EOP
OKS807	154+60.85	25.50	RT	498.38	TOC
OKS808	154+60.53	26.00	RT	497.91	SW
OKS809	154+58.07	31.00	RT	497.76	TOC
OKS810	154+56.39	31.00	RT	497.76	EOP
OKS811	154+56.73	35.81	RT	498.00	TOC
OKS812	154+62.68	31.00	RT	497.81	SW
OKS813	154+69.77	31.00	RT	498.54	SW
OKS814	154+69.27	25.50	RT	498.63	TOC
OKS815	154+74.77	31.00	RT	498.64	SW
OKS816	154+69.77	26.02	RT	498.64	SW
OKS817	154+74.77	26.00	RT	498.68	SW
OKS818	154+74.77	16.84	RT	498.33	SW
OKS819	154+71.97	38.60	RT	498.89	SW
OKS820	154+81.54	27.79	RT	498.86	SW
OKS821	154+78.68	40.25	RT	498.99	SW
OKS822	154+78.68	35.25	RT	498.89	SW

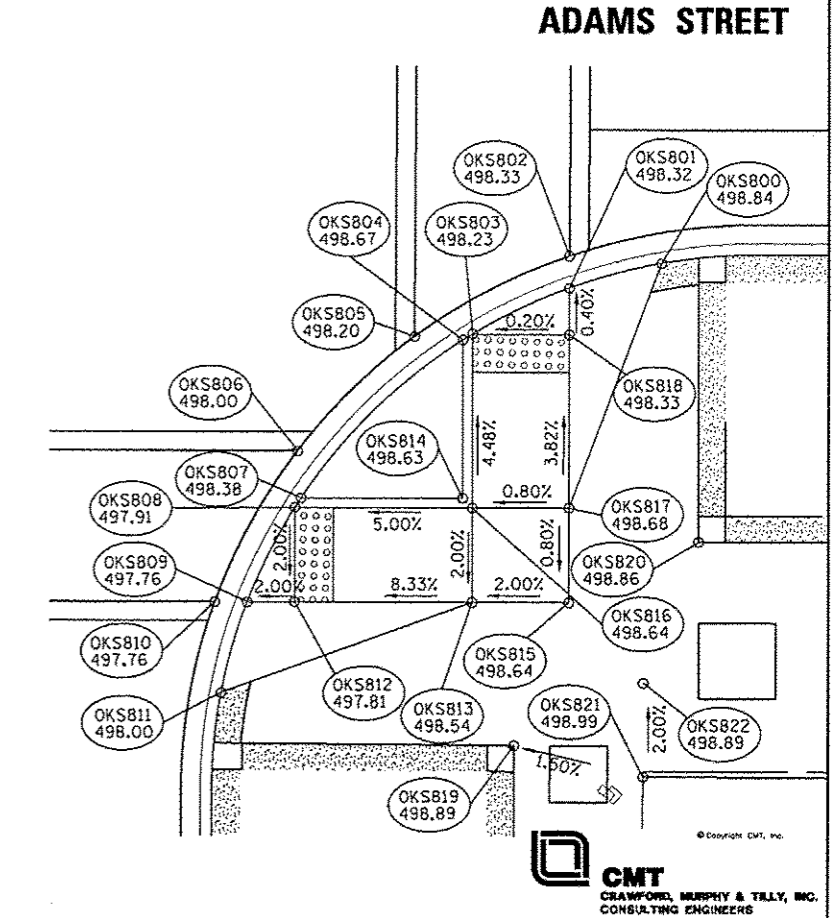

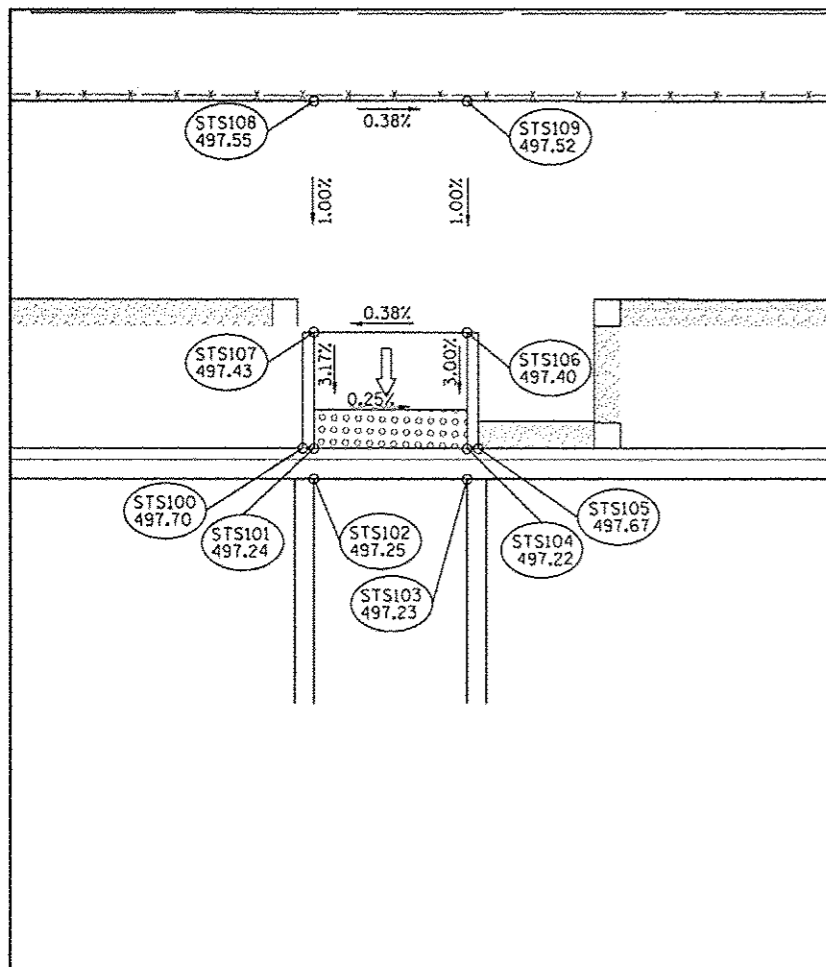




**ADAMS & STATE STREET INTERSECTION  
SOUTHWEST SIDEWALK RAMP GRADES**

POINT NO	STATION	OFFSET	SIDE	ELEVATION	LOCATION
STS100	158+32.26	17.58	LT	497.70	TOC
STS101	158+32.84	17.58	LT	497.24	TOC
STS102	158+32.84	16.00	LT	497.25	EOP
STS103	158+40.84	16.00	LT	497.23	EOP
STS104	158+40.84	17.58	LT	497.22	TOC
STS105	158+41.42	17.58	LT	497.67	TOC
STS106	158+41.42	23.58	LT	497.40	SW
STS107	158+32.26	23.58	LT	497.43	SW
STS108	158+32.83	35.51	LT	497.55	SW
STS109	158+40.84	35.51	LT	497.52	SW

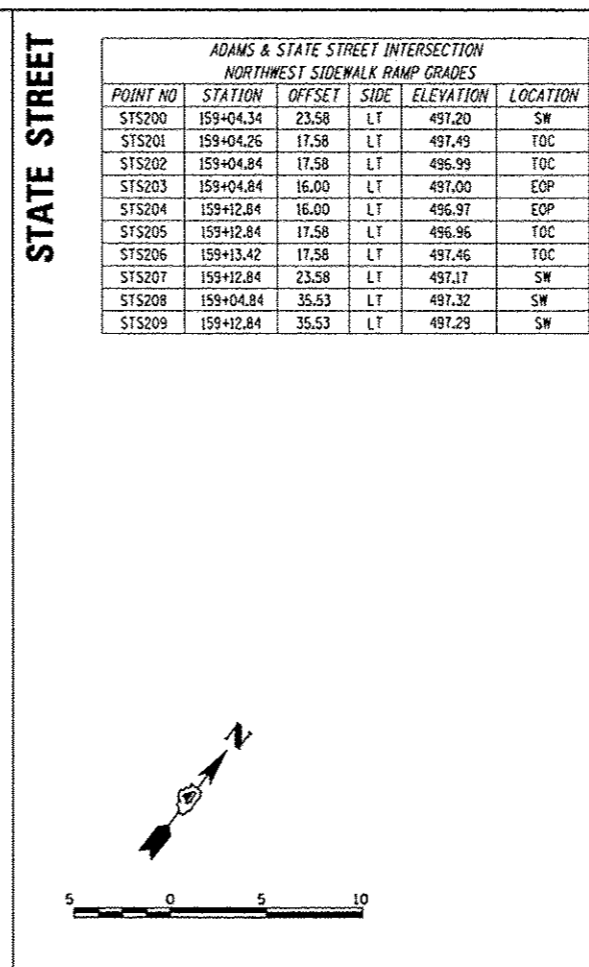


**ADAMS & STATE STREET INTERSECTION  
NORTHWEST SIDEWALK RAMP GRADES**

POINT NO	STATION	OFFSET	SIDE	ELEVATION	LOCATION
STS200	159+04.34	23.58	LT	497.20	SW
STS201	159+04.26	17.58	LT	497.49	TOC
STS202	159+04.84	17.58	LT	496.99	TOC
STS203	159+04.84	16.00	LT	497.00	EOP
STS204	159+12.84	16.00	LT	496.97	EOP
STS205	159+12.84	17.58	LT	496.96	TOC
STS206	159+13.42	17.58	LT	497.46	TOC
STS207	159+12.84	23.58	LT	497.17	SW
STS208	159+04.84	35.53	LT	497.32	SW
STS209	159+12.84	35.53	LT	497.29	SW

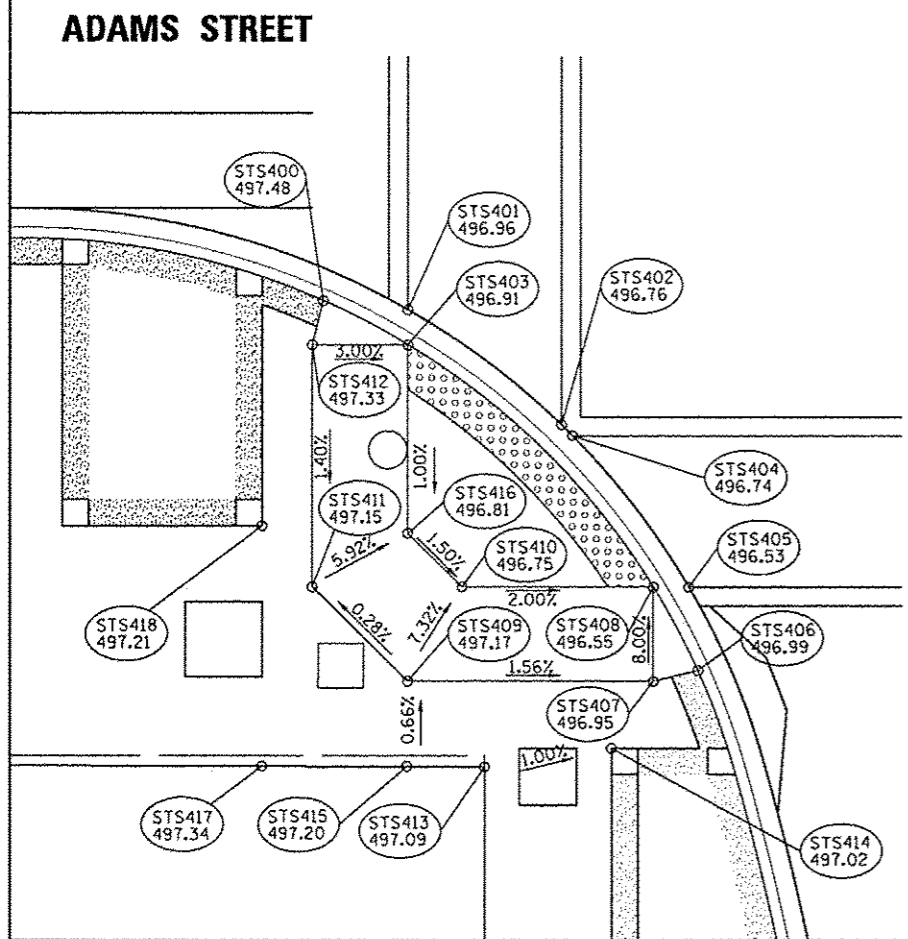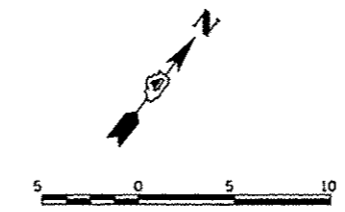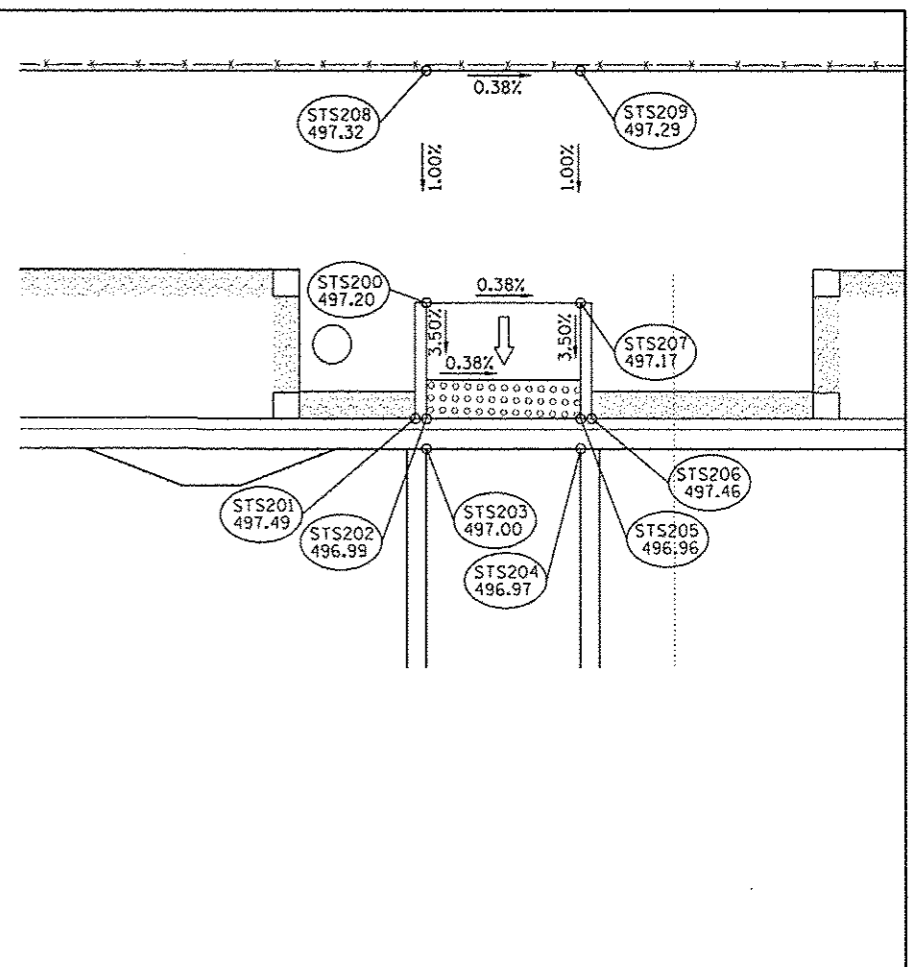


**ADAMS & STATE STREET INTERSECTION  
SOUTHEAST SIDEWALK RAMP GRADES**

POINT NO	STATION	OFFSET	SIDE	ELEVATION	LOCATION
STS400	158+28.43	15.88	RT	497.48	TOC
STS401	158+32.86	16.35	RT	496.96	EOP
STS402	158+40.86	22.42	RT	496.76	EOP
STS403	158+32.86	18.19	RT	496.91	EOP
STS404	158+41.44	23.00	RT	496.74	EOP
STS405	158+47.51	31.00	RT	496.53	EOP
STS406	158+47.59	35.43	RT	496.99	TOC
STS407	158+45.68	36.00	RT	496.95	SW
STS408	158+45.67	31.00	RT	496.55	TOC
STS409	158+32.86	36.01	RT	497.17	SW
STS410	158+35.69	31.01	RT	496.75	SW
STS411	158+27.86	31.01	RT	497.15	SW
STS412	158+27.86	18.19	RT	497.33	SW
STS413	158+36.87	40.57	RT	497.08	SW
STS414	158+43.49	39.58	RT	497.02	SW
STS415	158+32.86	40.56	RT	497.20	SW
STS416	158+32.86	28.18	RT	496.81	SW
STS417	158+25.23	40.54	RT	497.34	SW
STS418	158+25.23	27.79	RT	497.21	SW

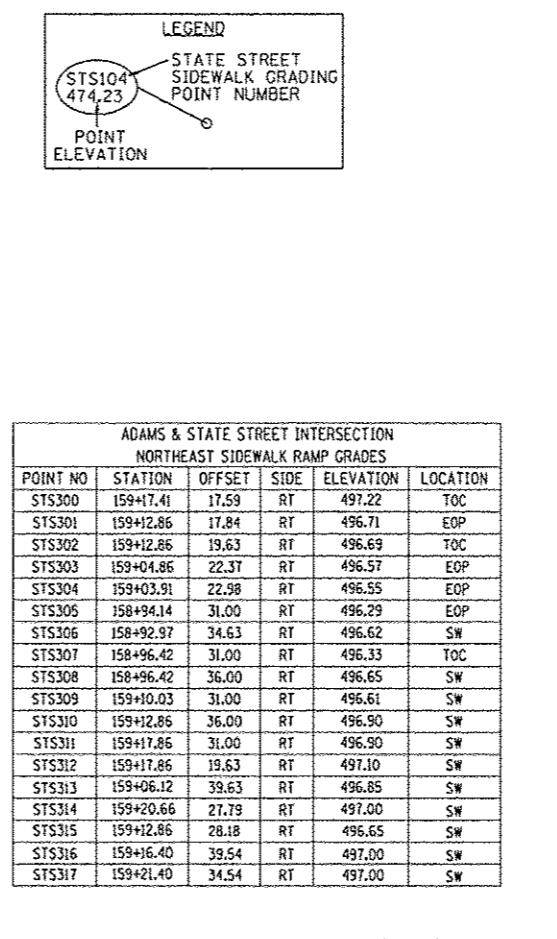

**ADAMS & STATE STREET INTERSECTION  
NORTHEAST SIDEWALK RAMP GRADES**

POINT NO	STATION	OFFSET	SIDE	ELEVATION	LOCATION
STS300	159+17.41	17.59	RT	497.22	TOC
STS301	159+12.86	17.84	RT	496.71	EOP
STS302	159+12.86	19.63	RT	496.69	TOC
STS303	159+04.86	22.37	RT	496.57	EOP
STS304	159+03.91	22.98	RT	496.55	EOP
STS305	158+94.14	31.00	RT	496.29	EOP
STS306	158+92.97	34.63	RT	496.62	SW
STS307	158+96.42	31.00	RT	496.33	TOC
STS308	158+96.42	36.00	RT	496.65	SW
STS309	159+10.03	31.00	RT	496.61	SW
STS310	159+12.86	36.00	RT	496.90	SW
STS311	159+17.86	31.00	RT	496.50	SW
STS312	159+17.86	19.63	RT	497.10	SW
STS313	159+06.12	39.63	RT	496.85	SW
STS314	159+20.66	27.79	RT	497.00	SW
STS315	159+12.86	28.18	RT	496.65	SW
STS316	159+16.40	39.54	RT	497.00	SW
STS317	159+21.40	34.54	RT	497.00	SW

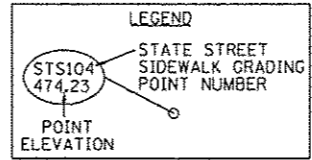


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	PLT SCALE = 1/8"=1'-0"	CHECKED = EJH	REVISED =
	PLT DATE = 07/23/2012	DATE = 7/18/12	REVISED =

**STATE OF ILLINOIS  
DEPARTMENT OF TRANSPORTATION**


**ADAMS STREET AND STATE STREET  
SIDEWALK RAMP DETAIL**

SCALE: 1"=5'      SHEET NO. OF SHEETS      STA. TO STA.

F.A.U. RTE.	SECTION	COUNTY	TOTAL SHEETS	SHEET NO.
	12-00356-01-PV	PEORIA	519	396
CONTRACT NO. 89626				
[ILLINOIS] FED. AID PROJECT YIG-50931581				

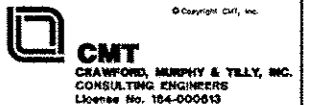



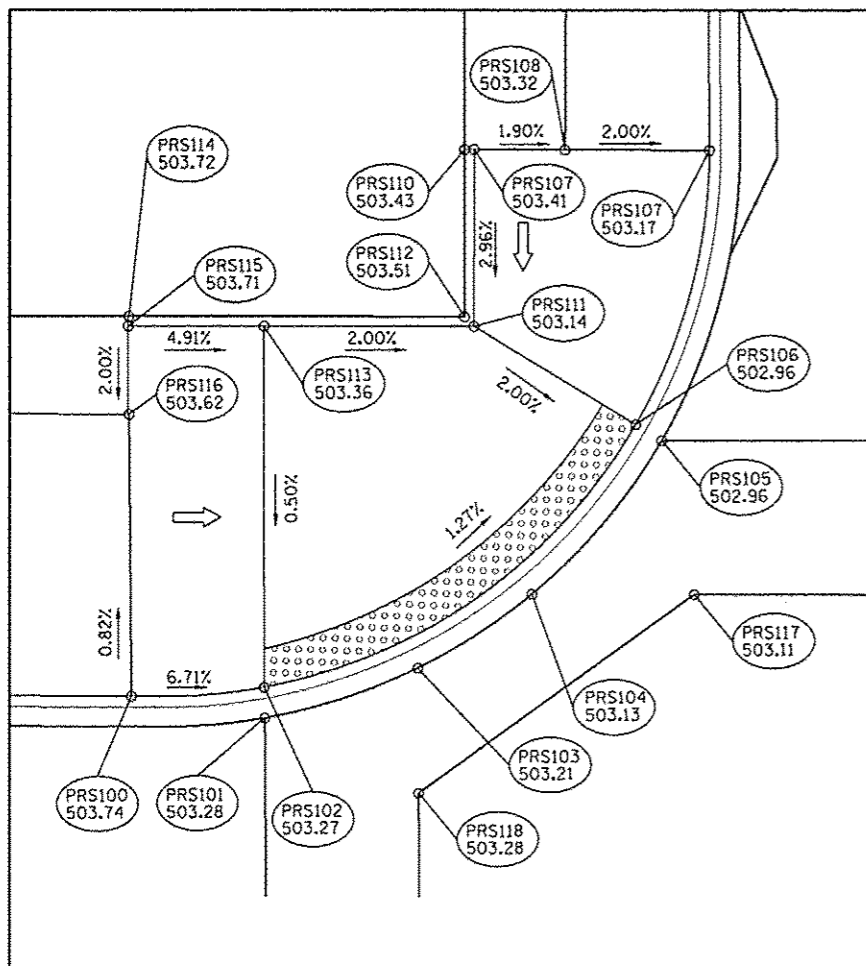




**JEFFERSON & PERSIMMON STREET INTERSECTION**  
SOUTHWEST SIDEWALK RAMP GRADES

POINT NO	STATION	OFFSET	SIDE	ELEVATION	LOCATION
PRS100	240+97.43	25.02	LT	503.74	TOC
PRS101	241+04.42	23.82	LT	503.28	EOP
PRS102	241+04.41	25.43	LT	503.27	TOC
PRS103	241+12.43	26.36	LT	503.21	EOP
PRS104	241+18.43	30.17	LT	503.13	EOP
PRS105	241+25.29	38.09	LT	502.96	EOP
PRS106	241+23.90	38.92	LT	502.96	TOC
PRS107	241+27.87	53.06	LT	503.17	TOC
PRS108	241+20.37	53.13	LT	503.32	SW
PRS109	241+15.63	53.20	LT	503.41	SW
PRS110	241+15.13	53.21	LT	503.43	TOC
PRS111	241+15.53	44.07	LT	503.14	SW
PRS112	241+15.04	44.57	LT	503.51	TOC
PRS113	241+04.57	44.18	LT	503.64	SW
PRS114	240+97.44	44.75	LT	503.72	TOC
PRS115	240+97.43	44.25	LT	503.71	SW
PRS116	240+97.43	39.68	LT	503.62	SW
PRS117	241+26.86	30.06	LT	503.11	PVMT
PRS118	241+12.42	19.82	LT	503.28	PVMT

**PERSIMMON STREET**

**JEFFERSON & PERSIMMON STREET INTERSECTION**  
NORTHWEST SIDEWALK RAMP GRADES

POINT NO	STATION	OFFSET	SIDE	ELEVATION	LOCATION
PRS300	241+73.61	53.13	LT	503.11	TOC
PRS301	241+79.26	37.41	LT	502.82	EOP
PRS302	241+80.75	38.05	LT	502.81	TOC
PRS303	241+86.30	29.32	LT	502.89	EOP
PRS304	241+94.24	23.31	LT	502.98	EOP
PRS305	241+94.77	24.85	LT	502.97	TOC
PRS306	242+10.87	18.51	LT	503.50	TOC
PRS307	242+10.87	37.63	LT	503.62	SW
PRS308	242+10.87	42.15	LT	503.64	SW
PRS309	242+10.87	42.65	LT	503.65	TOC
PRS310	242+02.36	42.22	LT	503.33	SW
PRS311	241+97.89	42.76	LT	503.75	TOC
PRS312	241+97.71	42.26	LT	503.24	SW
PRS313	241+91.80	46.87	LT	503.09	SW
PRS314	241+83.68	54.09	LT	503.70	TOC
PRS315	241+83.18	53.85	LT	503.30	SW
PRS316	241+38.65	53.07	LT	503.21	SW

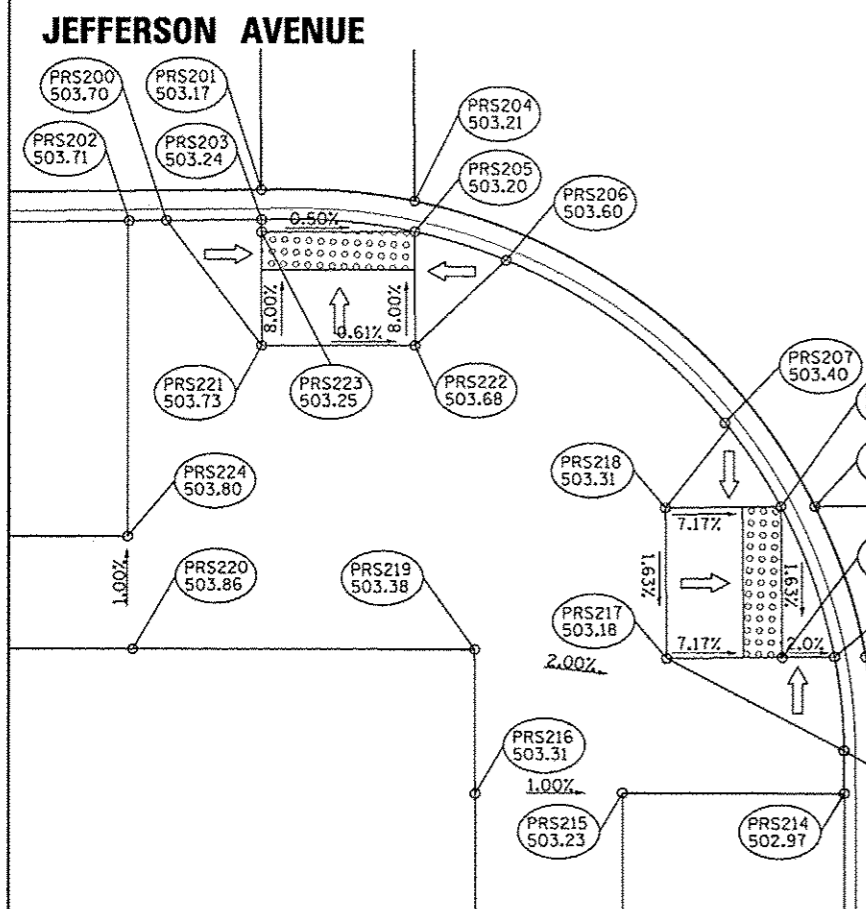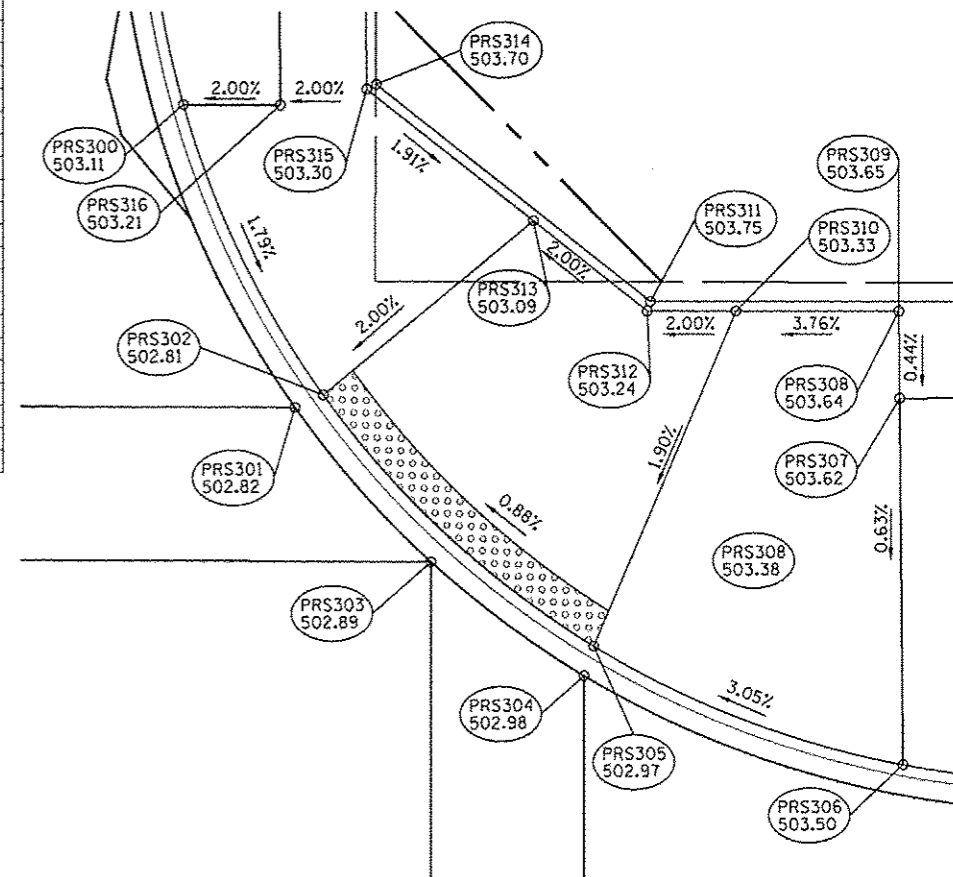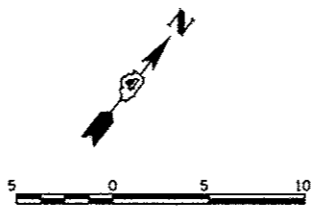



**JEFFERSON & PERSIMMON STREET INTERSECTION**  
SOUTHEAST SIDEWALK RAMP GRADES

POINT NO	STATION	OFFSET	SIDE	ELEVATION	LOCATION
PRS200	240+99.39	12.58	RT	503.70	TOC
PRS201	241+04.38	11.00	RT	503.17	EOP
PRS202	240+97.43	12.58	RT	503.71	TOC
PRS203	241+04.38	12.58	RT	503.24	TOC
PRS204	241+12.38	11.68	RT	503.21	EOP
PRS205	241+12.38	13.30	RT	503.20	TOC
PRS206	241+17.13	14.84	RT	503.60	TOC
PRS207	241+28.44	23.52	RT	503.40	TOC
PRS208	241+31.30	28.00	RT	502.88	TOC
PRS209	241+33.07	28.00	RT	502.87	EOP
PRS210	241+31.30	36.00	RT	502.75	SW
PRS211	241+34.01	36.00	RT	502.70	TOC
PRS212	241+35.61	36.00	RT	502.70	EOP
PRS213	241+34.45	40.97	RT	503.01	TOC
PRS214	241+34.44	43.24	RT	502.97	TOC/SW
PRS215	241+22.94	43.11	RT	503.23	SW
PRS216	241+15.27	43.07	RT	503.31	SW
PRS217	241+25.30	36.00	RT	503.18	SW
PRS218	241+25.30	28.00	RT	503.31	SW
PRS219	241+15.31	35.43	RT	503.38	SW
PRS220	240+97.43	35.26	RT	503.86	SW
PRS221	241+04.33	19.23	RT	503.73	SW
PRS222	241+12.33	19.30	RT	503.68	SW
PRS223	241+04.38	13.23	RT	503.25	SW
PRS224	240+97.22	29.25	RT	503.80	SW

**PERSIMMON STREET**

**JEFFERSON & PERSIMMON STREET INTERSECTION**  
NORTHEAST SIDEWALK RAMP GRADES

POINT NO	STATION	OFFSET	SIDE	ELEVATION	LOCATION
PRS400	241+94.47	12.58	RT	503.61	TOC
PRS401	241+93.89	12.58	RT	503.16	TOC
PRS402	241+93.91	11.00	RT	503.17	EOP
PRS403	241+85.90	11.36	RT	503.17	EOP
PRS404	241+81.05	14.21	RT	503.56	TOC
PRS405	241+65.27	28.00	RT	502.83	TOC
PRS406	241+63.50	28.00	RT	502.83	EOP
PRS407	241+65.27	36.00	RT	502.74	SW
PRS408	241+60.95	36.00	RT	502.69	EOP
PRS409	241+62.56	36.00	RT	502.69	TOC
PRS410	241+62.12	40.97	RT	503.09	TOC
PRS411	241+62.11	43.26	RT	503.12	TOC
PRS412	241+76.10	43.42	RT	503.19	SW
PRS413	241+83.77	43.46	RT	503.23	SW
PRS414	241+71.27	36.00	RT	502.90	SW
PRS415	241+83.85	35.88	RT	503.03	SW
PRS416	241+71.27	28.00	RT	503.06	SW
PRS417	241+67.93	23.78	RT	503.33	TOC
PRS418	241+85.84	18.97	RT	503.28	SW
PRS419	241+93.84	19.03	RT	503.36	SW
PRS420	241+96.42	30.99	RT	503.05	SW
PRS421	241+94.42	19.04	RT	503.36	SW
PRS422	241+96.42	12.58	RT	503.60	TOC
PRS423	241+93.89	13.03	RT	503.17	SW
PRS424	241+85.89	12.97	RT	503.16	TOC
PRS425	241+96.37	35.99	RT	503.10	SW

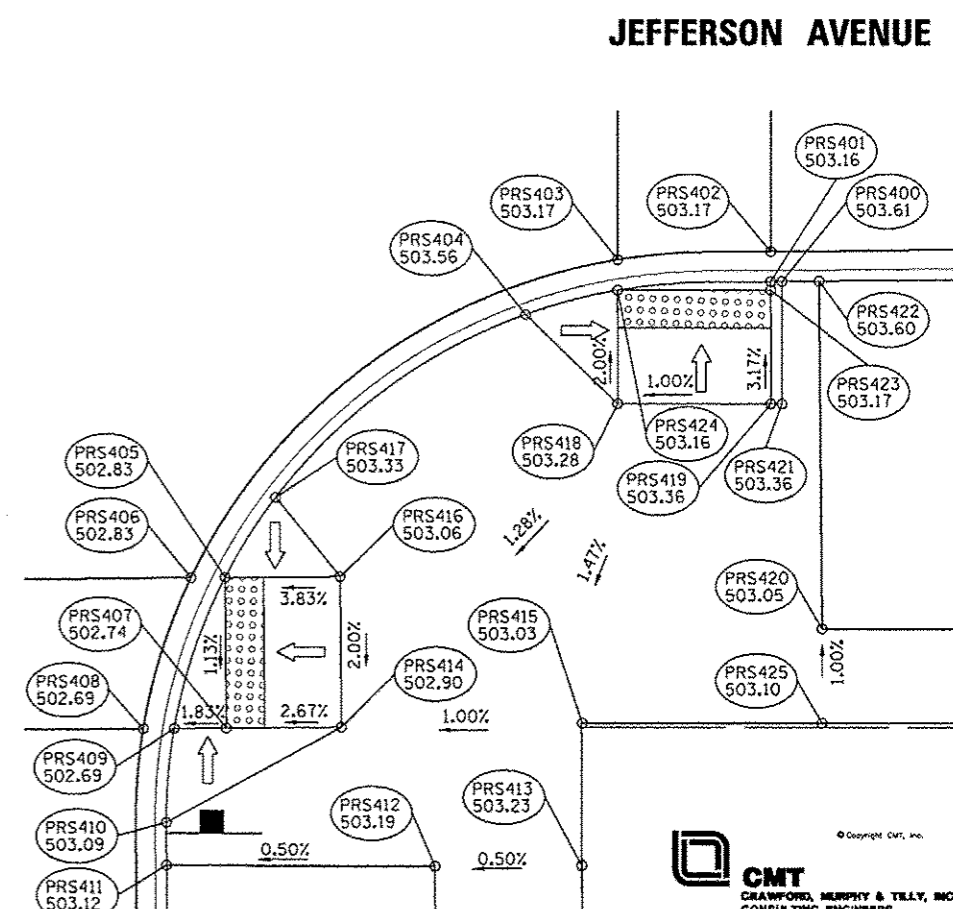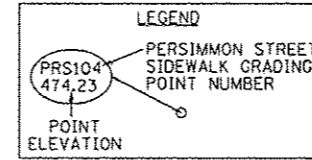

FILE NAME: ... USER NAME: davso80878  
DESIGNED: RMM/EMM  
DRAWN: RJE  
CHECKED: EJM  
DATE: 7/18/12

REVISED: -  
REVISED: -  
REVISED: -  
REVISED: -

**STATE OF ILLINOIS**  
**DEPARTMENT OF TRANSPORTATION**

**JEFFERSON STREET AND PERSIMMON STREET**  
**SIDEWALK RAMP DETAIL**

SCALE: 1"=5'      SHEET NO.      OF SHEETS      STA.      TO STA.



F.A.U. RTE.      SECTION      COUNTY      TOTAL SHEETS      SHEET NO.  
12-00356-01-PV      PEORIA      519      397  
CONTRACT NO. 89626  
ILLINOIS FED. AID PROJECT TIG-5093158




MAPLE STREET

JEFFERSON AND MAPLE STREET INTERSECTION  
SOUTHWEST SIDEWALK RAMP GRADES

POINT NO	STATION	OFFSET	SIDE	ELEVATION	LOCATION
MPS100	246+07.23	16.00	LT	502.16	EOP
MPS101	246+15.23	16.00	LT	502.16	EOP
MPS102	246+02.23	17.58	LT	502.60	TOC
MPS103	246+07.23	17.58	LT	502.15	TOC
MPS104	246+07.23	23.58	LT	502.46	SW
MPS105	246+07.23	34.00	LT	502.51	SW
MPS106	246+07.23	39.00	LT	502.53	SW
MPS107	246+15.23	39.00	LT	502.51	SW
MPS108	246+15.23	34.00	LT	502.49	SW
MPS109	246+15.23	23.58	LT	502.40	SW
MPS110	246+20.23	17.58	LT	502.60	TOC
MPS111	246+15.23	17.58	LT	502.15	TOC

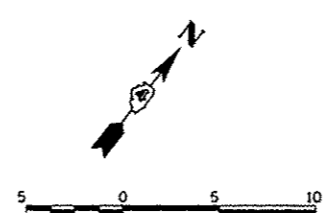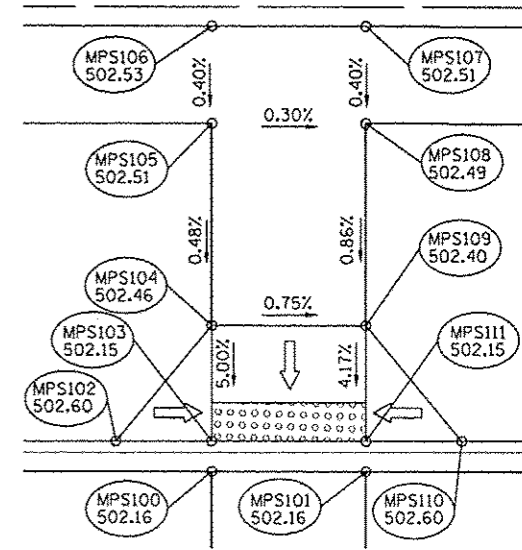


JEFFERSON STREET

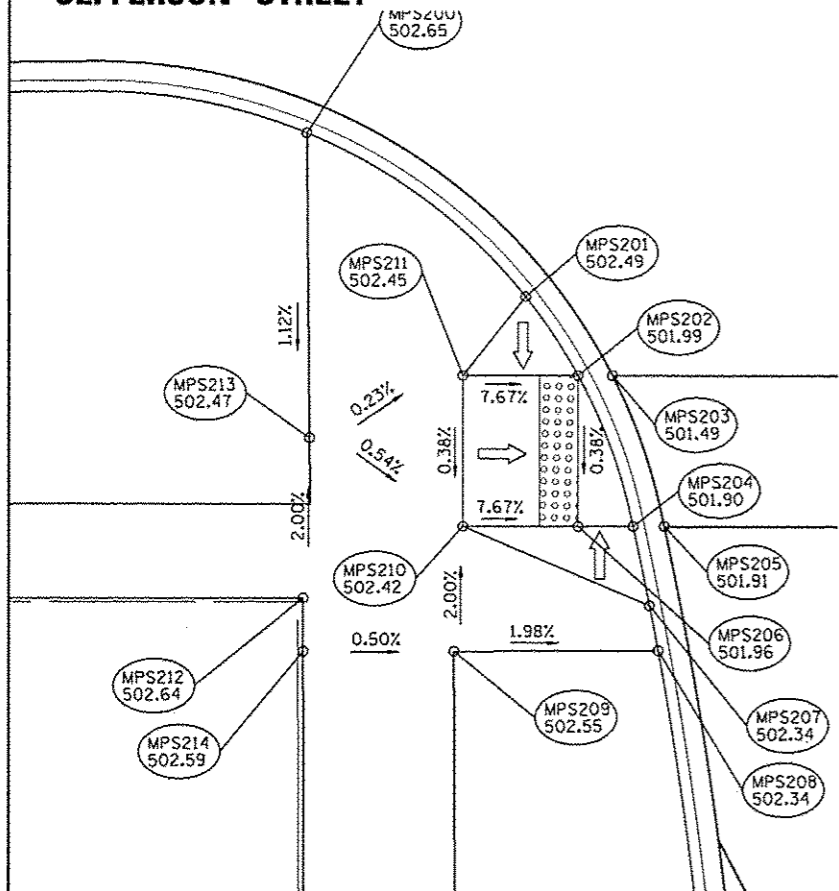

JEFFERSON AND MAPLE STREET INTERSECTION  
NORTHWEST SIDEWALK RAMP GRADES

POINT NO	STATION	OFFSET	SIDE	ELEVATION	LOCATION
MPS200	245+47.12	14.87	RT	502.65	TOC
MPS201	245+58.42	23.61	RT	502.49	TOC
MPS202	245+61.12	27.81	RT	501.99	TOC
MPS203	245+62.91	27.83	RT	501.99	EOP
MPS204	245+63.90	35.84	RT	501.90	TOC
MPS205	245+65.52	35.85	RT	501.91	EOP
MPS206	245+61.04	35.81	RT	501.96	SW
MPS207	245+64.72	40.65	RT	502.34	TOC
MPS208	245+65.15	42.43	RT	502.34	TOC
MPS209	245+54.53	42.38	RT	502.55	SW
MPS210	245+55.04	35.75	RT	502.42	SW
MPS211	245+55.12	27.75	RT	502.45	SW
MPS212	245+46.72	34.48	RT	502.64	SW
MPS213	245+47.12	30.99	RT	502.47	SW
MPS214	245+46.70	42.34	RT	502.59	SW



MAPLE STREET

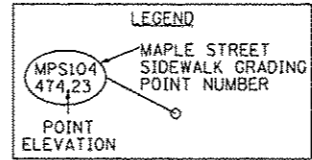

JEFFERSON AND MAPLE STREET INTERSECTION  
NORTHWEST SIDEWALK RAMP GRADES

POINT NO	STATION	OFFSET	SIDE	ELEVATION	LOCATION
MPS300	245+94.21	43.10	RT	502.32	TOC
MPS301	245+93.94	40.97	RT	502.34	TOC
MPS302	245+94.38	36.00	RT	501.94	TOC
MPS303	245+92.78	36.00	RT	501.94	EOP
MPS304	245+95.32	28.00	RT	502.02	EOP
MPS305	245+87.09	28.00	RT	502.01	TOC
MPS306	245+99.75	23.78	RT	502.51	TOC
MPS307	246+03.25	19.96	RT	502.56	TOC
MPS308	246+07.23	16.94	RT	502.15	TOC
MPS309	246+07.23	15.09	RT	502.17	EOP
MPS310	246+15.23	11.86	RT	502.25	EOP
MPS311	246+17.82	12.95	RT	502.71	TOC
MPS312	246+15.23	13.49	RT	502.24	SW
MPS313	246+15.23	16.94	RT	502.31	SW
MPS314	246+15.23	22.94	RT	502.56	SW
MPS315	246+07.23	22.94	RT	502.40	SW
MPS316	246+03.09	28.00	RT	502.31	SW
MPS317	246+03.09	36.00	RT	502.26	SW
MPS318	246+17.82	39.57	RT	502.56	SW
MPS319	246+11.22	39.57	RT	502.35	SW
MPS320	246+11.20	43.20	RT	502.39	SW
MPS321	246+17.82	34.72	RT	502.50	SW
MPS322	246+17.82	22.94	RT	502.61	SW
MPS323	245+97.09	36.00	RT	501.97	SW
MPS324	246+17.82	28.00	RT	502.56	SW

JEFFERSON STREET

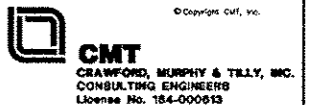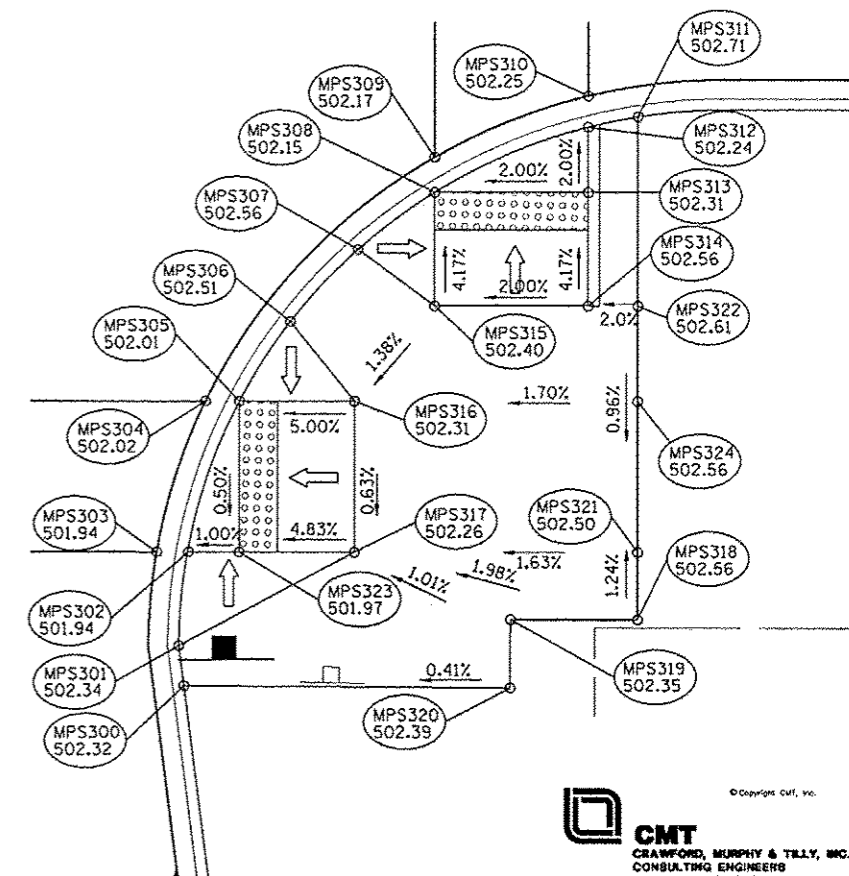


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	PLOT SCALE = 18.0000' / 1"	CHECKED - E.J.H.	REVISED -
	PLOT DATE = 07/23/2012	DATE - 7/18/12	REVISED -

STATE OF ILLINOIS  
DEPARTMENT OF TRANSPORTATION

JEFFERSON STREET AND MAPLE STREET  
SIDEWALK RAMP DETAIL

SCALE: 1"=5' SHEET NO. OF SHEETS STA. TO STA.

F.A.U. RTE.	SECTION	COUNTY	TOTAL SHEETS	SHEET NO.
121	12-00356-01-PV	PEORIA	519	398
CONTRACT NO. 89626			ILLINOIS FED. AID PROJECT T16-509315(B)	

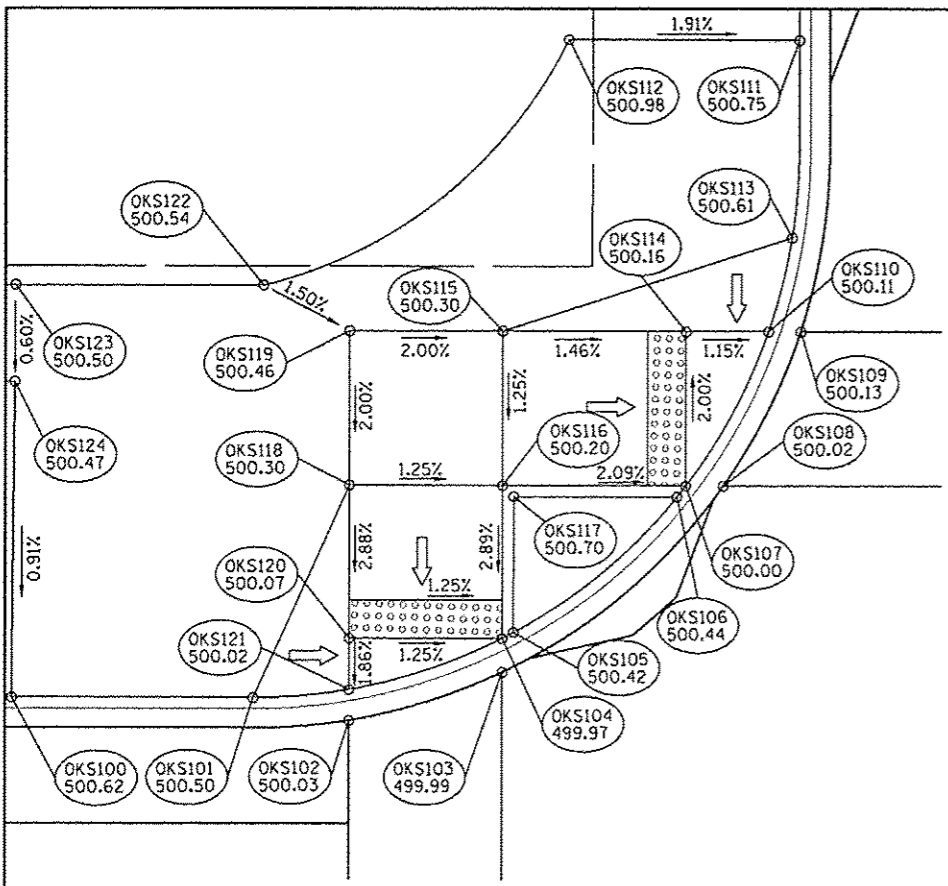



**JEFFERSON & OAK STREET INTERSECTION  
SOUTHWEST SIDEWALK RAMP GRADES**

POINT NO	STATION	OFFSET	SIDE	ELEVATION	LOCATION
OKS100	253+71.40	17.58	LT	500.62	TOC
OKS101	253+89.94	17.58	LT	500.50	TOC
OKS102	253+94.91	16.41	LT	500.03	PVMT
OKS103	254+03.09	18.91	LT	499.99	PVMT
OKS104	245+03.11	20.68	LT	499.97	SW
OKS105	254+07.57	23.28	LT	500.42	TOC
OKS106	254+09.66	24.87	LT	500.44	TOC
OKS107	254+13.33	28.46	LT	500.00	SW
OKS108	254+15.42	28.39	LT	500.02	EOP
OKS109	254+20.05	36.23	LT	500.13	EOP
OKS110	254+18.25	36.30	LT	500.11	TOC
OKS111	254+20.68	51.20	LT	500.75	TOC
OKS112	254+07.24	51.59	LT	500.98	SW
OKS113	254+19.78	41.09	LT	500.61	TOC
OKS114	254+13.59	36.45	LT	500.16	SW
OKS115	254+07.12	36.59	LT	500.30	SW
OKS116	254+06.97	28.59	LT	500.20	SW
OKS117	254+03.17	26.68	LT	500.70	SW
OKS118	253+94.92	26.70	LT	500.30	SW
OKS119	253+77.57	38.47	LT	500.46	SW
OKS120	253+94.92	20.70	LT	500.07	SW
OKS121	253+94.92	18.02	LT	500.02	TOC
OKS122	253+77.57	38.47	LT	500.54	SW
OKS123	253+94.92	20.70	LT	500.50	SW
OKS124	253+94.92	18.02	LT	500.47	SW


**OAK STREET**

**JEFFERSON & OAK STREET INTERSECTION  
NORTHWEST SIDEWALK RAMP GRADES**

POINT NO	STATION	OFFSET	SIDE	ELEVATION	LOCATION
OKS200	254+70.39	47.00	LT	500.78	TOC
OKS201	254+76.55	30.97	LT	499.78	EOP
OKS202	254+94.59	20.65	LT	499.94	PVMT
OKS203	254+94.61	18.97	LT	499.97	PVMT
OKS204	254+99.60	19.31	LT	499.82	EOP
OKS205	255+10.46	18.73	LT	500.21	TOC
OKS206	254+99.81	20.68	LT	499.80	TOC
OKS207	255+10.70	29.32	LT	499.84	TOC
OKS208	254+99.81	28.03	LT	500.26	TOC
OKS209	255+04.27	30.96	LT	500.37	TOC
OKS210	254+94.51	28.00	LT	500.52	SW
OKS211	254+79.09	30.59	LT	500.10	SW
OKS212	254+95.53	32.91	LT	500.12	SW
OKS213	254+79.96	35.52	LT	500.43	SW
OKS214	254+75.85	34.56	LT	500.48	SW
OKS215	254+88.85	44.26	LT	500.50	SW
OKS216	254+72.81	39.79	LT	500.29	TOC
OKS217	254+87.82	46.07	LT	500.59	SW

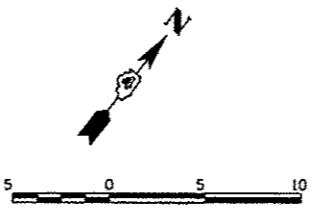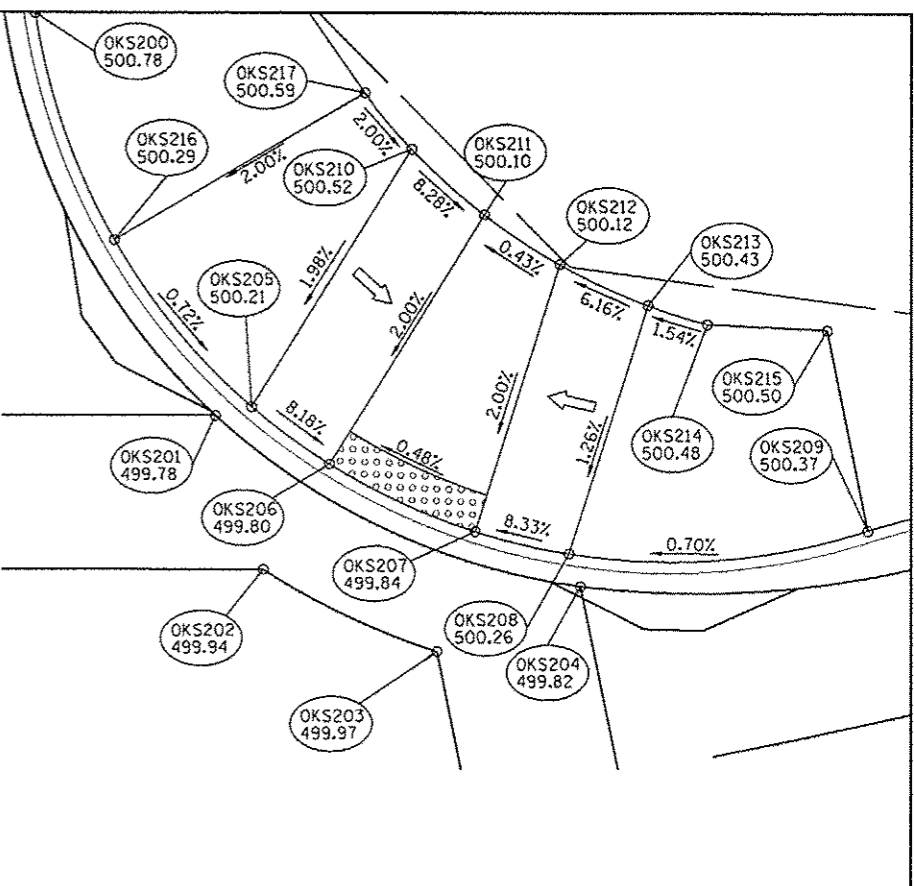

**JEFFERSON AVENUE**

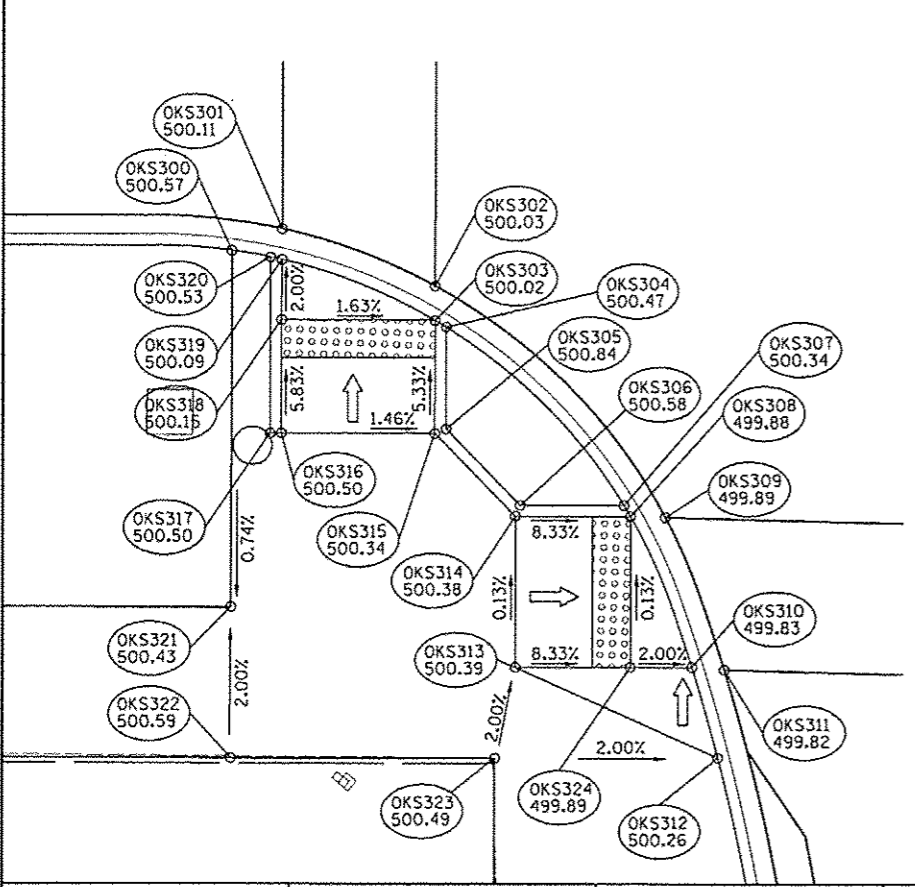


**JEFFERSON & OAK STREET INTERSECTION  
SOUTHEAST SIDEWALK RAMP GRADES**

POINT NO	STATION	OFFSET	SIDE	ELEVATION	LOCATION
OKS300	253+92.25	12.85	RT	500.57	TOC
OKS301	253+94.85	11.71	RT	500.11	EOP
OKS302	254+02.72	14.74	RT	500.03	EOP
OKS303	254+02.70	16.56	RT	500.02	TOC
OKS304	254+06.58	19.52	RT	500.47	TOC
OKS305	254+10.41	23.92	RT	500.84	TOC
OKS306	254+12.84	28.21	RT	500.58	TOC
OKS307	254+14.51	28.27	RT	500.34	EOP
OKS308	254+15.41	36.30	RT	499.88	SW
OKS309	254+16.95	36.36	RT	499.89	EOP
OKS310	254+15.55	36.89	RT	499.83	TOC
OKS311	254+12.63	36.21	RT	499.82	EOP
OKS312	254+07.02	36.66	RT	500.26	TOC
OKS313	254+07.03	36.08	RT	500.39	SW
OKS314	254+07.16	28.08	RT	500.38	SW
OKS315	254+02.66	22.52	RT	500.34	SW
OKS316	253+94.83	22.50	RT	500.50	SW
OKS317	253+94.25	22.50	RT	500.50	TOC
OKS318	253+94.83	16.50	RT	500.15	SW
OKS319	253+94.85	13.33	RT	500.09	SW
OKS320	253+94.25	13.20	RT	500.53	TOC
OKS321	253+94.25	22.50	RT	500.43	SW
OKS322	253+94.83	16.50	RT	500.59	SW
OKS323	253+94.85	13.33	RT	500.49	SW
OKS324	253+94.25	13.20	RT	499.89	SW


**OAK STREET**

**JEFFERSON & OAK STREET INTERSECTION  
NORTHEAST SIDEWALK RAMP GRADES**

POINT NO	STATION	OFFSET	SIDE	ELEVATION	LOCATION
OKS400	254+95.01	21.50	RT	499.94	TOC
OKS401	254+99.80	21.65	RT	500.40	TOC
OKS402	254+94.99	19.55	RT	499.95	EOP
OKS403	254+87.29	19.47	RT	499.92	EOP
OKS404	254+82.54	21.02	RT	500.35	TOC
OKS405	254+54.71	31.42	RT	499.78	EOP
OKS406	254+56.47	31.56	RT	499.78	TOC
OKS407	254+52.61	39.14	RT	499.72	TOC
OKS408	254+51.11	38.97	RT	499.73	EOP
OKS409	254+51.46	43.99	RT	500.15	TOC
OKS410	254+55.61	39.50	RT	499.75	SW
OKS411	254+61.13	40.22	RT	499.98	SW
OKS412	254+62.06	32.28	RT	500.01	SW
OKS413	254+71.90	29.87	RT	500.14	SW
OKS414	254+87.33	21.19	RT	499.91	SW
OKS415	254+87.37	27.50	RT	500.42	SW
OKS416	254+94.48	27.50	RT	500.43	SW
OKS417	254+67.65	33.08	RT	500.25	SW
OKS418	254+66.63	41.00	RT	500.40	SW
OKS419	254+59.67	27.88	RT	500.25	TOC

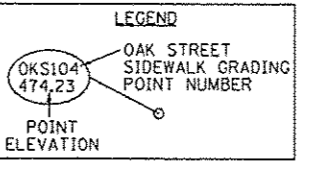

**JEFFERSON AVENUE**

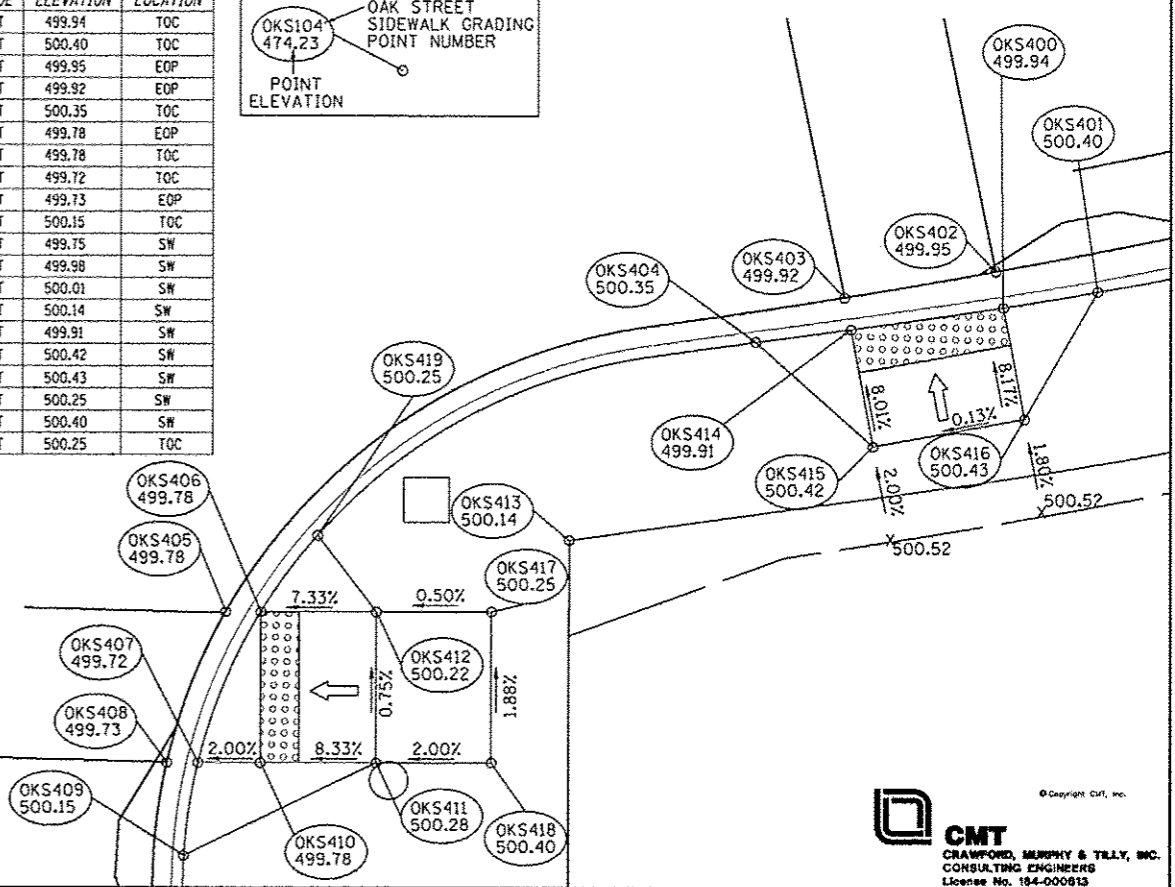



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		CHECKED - EJM	REVISED -
		DATE - 7/18/12	REVISED -

**STATE OF ILLINOIS  
DEPARTMENT OF TRANSPORTATION**

<b>JEFFERSON STREET AND OAK STREET SIDEWALK RAMP DETAIL</b>			
SCALE: 1"=5'	SHEET NO.	OF SHEETS	STA. TO STA.

F.A.U. RTE.	SECTION	COUNTY	TOTAL SHEETS	SHEET NO.
	12-00356-01-PV	PEORIA	519	399
CONTRACT NO. 89626				
[ILLINOIS] FEB. 410 PROJECT 115-5093(38)				


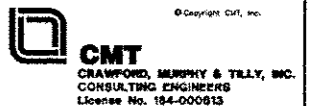


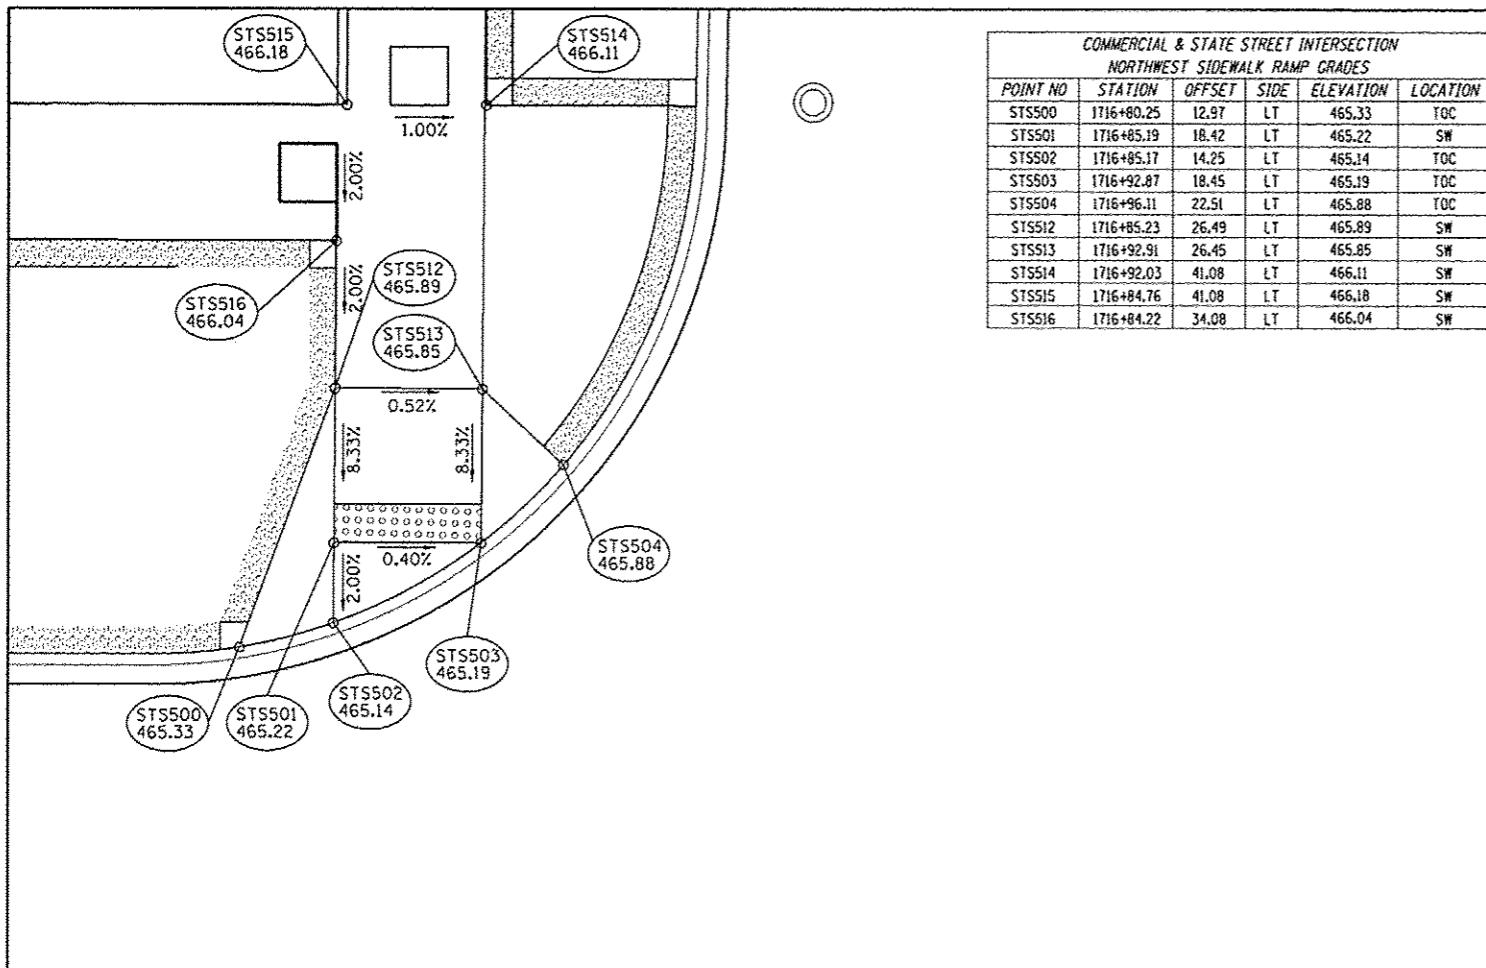

COMMERCIAL & STATE STREET INTERSECTION  
NORTHWEST SIDEWALK RAMP GRADES

POINT NO	STATION	OFFSET	SIDE	ELEVATION	LOCATION
STS500	1716+80.25	12.97	LT	465.33	TOC
STS501	1716+85.19	18.42	LT	465.22	SW
STS502	1716+85.17	14.25	LT	465.14	TOC
STS503	1716+92.87	18.45	LT	465.19	TOC
STS504	1716+96.11	22.51	LT	465.88	TOC
STS512	1716+85.23	26.49	LT	465.89	SW
STS513	1716+92.91	26.45	LT	465.85	SW
STS514	1716+92.03	41.08	LT	466.11	SW
STS515	1716+84.76	41.08	LT	466.18	SW
STS516	1716+84.22	34.08	LT	466.04	SW


STATE STREET

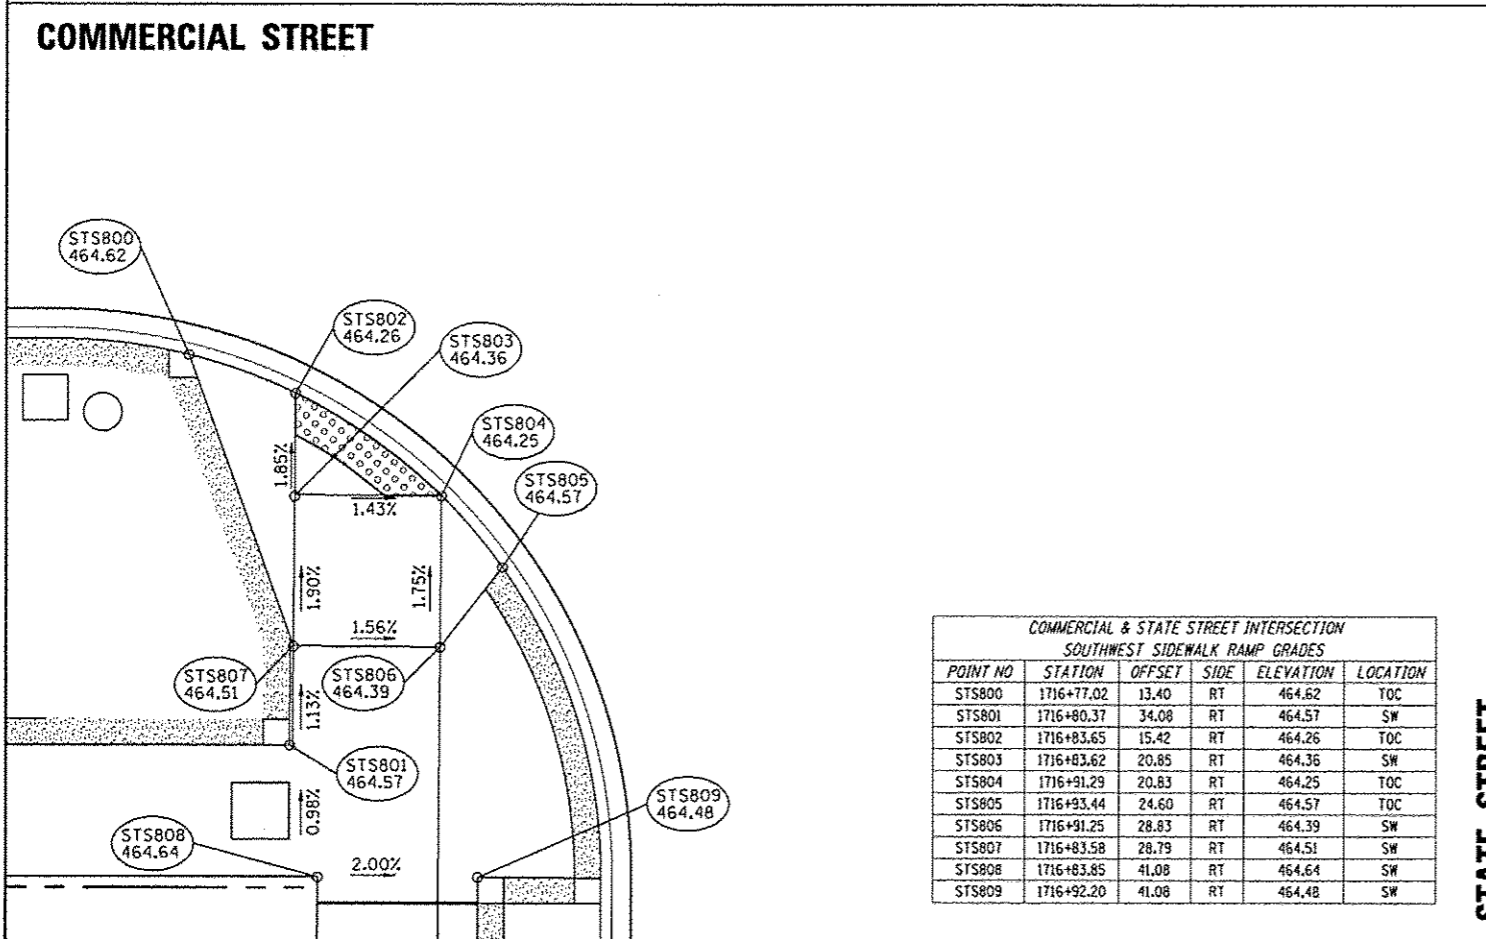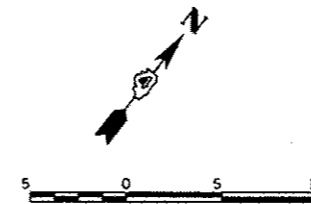

COMMERCIAL & STATE STREET INTERSECTION  
SOUTHWEST SIDEWALK RAMP GRADES

POINT NO	STATION	OFFSET	SIDE	ELEVATION	LOCATION
STS800	1716+77.02	13.40	RT	464.62	TOC
STS801	1716+80.37	34.08	RT	464.57	SW
STS802	1716+83.65	15.42	RT	464.26	TOC
STS803	1716+83.62	20.85	RT	464.36	SW
STS804	1716+91.29	20.83	RT	464.25	TOC
STS805	1716+93.44	24.60	RT	464.57	TOC
STS806	1716+91.25	28.83	RT	464.39	SW
STS807	1716+83.58	28.79	RT	464.51	SW
STS808	1716+83.85	41.08	RT	464.64	SW
STS809	1716+92.20	41.08	RT	464.48	SW

STATE STREET

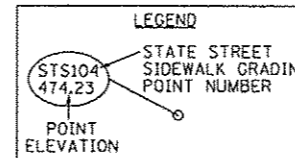

COMMERCIAL STREET

FILE NAME *	USER NAME = mansk01390	DESIGNED - RMM/EMM	REVISED -
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	PLOT DATE = 07/23/2012	DATE - 7/18/12	REVISED -

STATE OF ILLINOIS  
DEPARTMENT OF TRANSPORTATION

COMMERCIAL STREET AND STATE STREET  
SIDEWALK RAMP DETAIL

SCALE: 1"=5'	SHEET NO. OF SHEETS	STA. TO STA.
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F.A.U. RTE.	SECTION	COUNTY	TOTAL SHEETS	SHEET NO.
223	12-00356-01-PV	PEORIA	519	400
ILLINOIS FED. AID PROJECT			CONTRACT NO. 89626	
			TIG-5993(158)	

