


NOTES:

- 1. CONDUIT DEPTH SHALL BE A MINIMUM OF 30" (760mm) BELOW THE BOTTOM OF THE DRAINAGE DITCH OR ANY SLOPING GROUND
- 2. THE MINIMUM CONDUIT DEPTH APPLIES TO ALL CONDUIT PLACED UNDER ROADWAY PAVEMENT, MULTI-USE PATHS, SIDEWALKS AND SOIL SURFACES.
- 3. THE MINIMUM CONDUIT DEPTH APPLIES TO ALL HANDHOLES, HEAVY DUTY HANDHOLES AND DOUBLE HANDHOLES.

USER NAME = footem

PLOT SCALE = 50.0000 ' / in.

HANDHOLE WITH MINIMUM CONDUIT DEPTH (NOT TO SCALE)

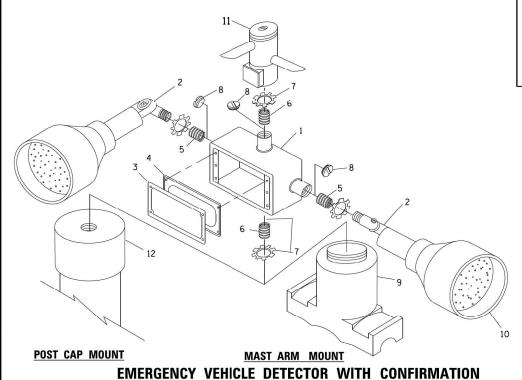

BEACON MOUNTING DETAIL

DRAWN

DATE


CHECKED

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REVISED


REVISED

REVISED

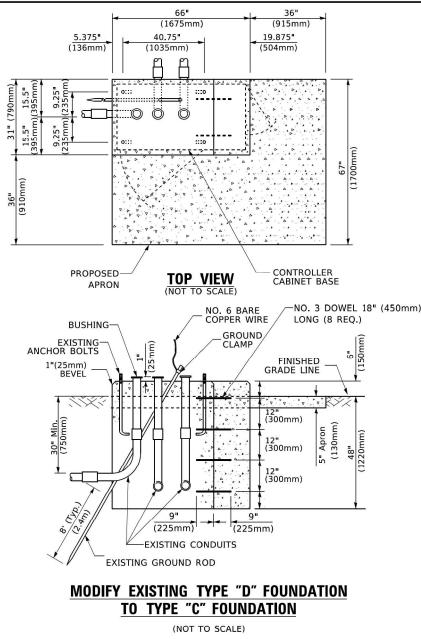

| ITEM | NO. IDENTIFICATION |
|------|---|
| 1 | OUTLET BOX- GALV. 21 CU.IN. (0.000344 CU-M) |
| 2 | LAMP HOLDER AND COVER |
| 3 | OUTLET BOX COVER |
| 4 | RUBBER COVER GASKET |
| 5 | REDUCING BUSHING |
| 6 | ¾"(19 mm) CLOSE NIPPLE |
| 7 | ¾"(19 mm) LOCKNUT |
| 8 | ¾"(19 mm) HOLE PLUG |
| 9 | SADDLE BRACKET - GALV. |
| 10 | 6 WATT PAR 38 LED FLOOD LAMP |
| 11 | DETECTOR UNIT |
| 12 | POST CAP [18 FT. (5.4 m) POST MIN.] |


- 1. ALL ELECTRICAL ITEMS, EXCEPT ITEMS #2 AND #11 SHALL BE ALUMINUM OR
- 2. ITEM #1- OZ/GEDNEY FSX-1-50 OR EQUIVALENT ITEM #2- MULBERRY CON-O-SHADE LAMP SHIELD OR EQUIVALENT ITEM #9- "BAND-IT" SADDLE BRACKET OR EQUIVALENT
- 3. WHEN POST MOUNTING IS SPECIFIED, ITEM #9 SHALL NOT BE REQUIRED. THE DETECTION UNIT SHALL BE MOUNTED DIRECTLY ON TOP OF THE CAP BY DRILLING AND TAPPING A 3/4 "(19 mm) HOLE WITH PIPE THREADS. THE POST CAP SHALL EITHER BE SCREWED TO THE TOP OF THE POST OR A MINIMUM OF 3 TIGHTENING SCREWS SHALL BE REQUIRED ON EACH CAP.

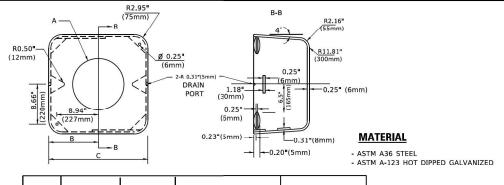

| Α | В | С | HEIGHT | WEIGHT |
|--------|---------------|--------------|--------------------------|-----------------|
| VARIES | 9.5"(241mm) | 19"(483mm) | 7" (178mm) - 12" (300mm) | 53 lbs (24kg) |
| VARIES | 10.75"(273mm) | 21.5"(546mm) | 7" (178mm) - 12" (300mm) | 68 lbs (31 kg) |
| VARIES | 13,0"(330mm) | 26"(660mm) | 7" (178mm) - 12" (300mm) | 81 lbs (37 kg) |
| VARIES | 18.5"(470mm) | 37"(940mm) | 7" (178mm) - 12" (300mm) | 126 lbs (57 kg) |

SHROUD

- . DIMENSION "A" IS EQUAL TO THE DIAMETER OF THE MAST ARM POLE AT THE TOP OF THE SHROUD. THE SHROUD SHALL BE TIGHT TO THE MAST ARM POLE.
- 2. THE SUPPLIER SHALL VERIFIED THE ABOVE DIMENSIONS BASED ON MAST ARM REQUIREMENTS.
- 3. THE HEIGHT OF THE SHROUD SHALL COVER THE ANCHOR BOLTS, NUTS AND MAST ARM POLE BASE.

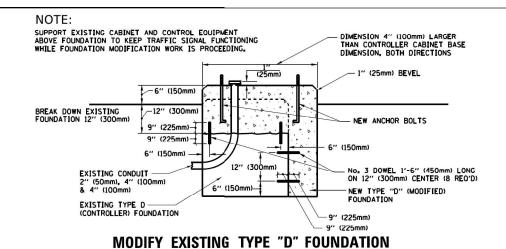


EXISTING CONDUIT PLAN **ELEVATION**

- 1. HANDHOLE CONSTRUCTED PER STATE STANDARD 814001.
- 2. REMOVAL OF THE EXISTING CONDUIT FROM THE HANDHOLE AND THE INSTALLATION OF THE CONDUIT BUSHINGS SHALL BE INCLUDED WITH THE COST OF THE HANDHOLE.

HANDHOLE TO INTERCEPT EXISTING CONDUIT

DISTRICT ONE 2018-100-BR COOK STANDARD TRAFFIC SIGNAL DESIGN DETAILS CONTRACT NO. 62W38 TS-05 SHEET 6 OF 7 SHEETS STA.

STATE OF ILLINOIS **DEPARTMENT OF TRANSPORTATION**

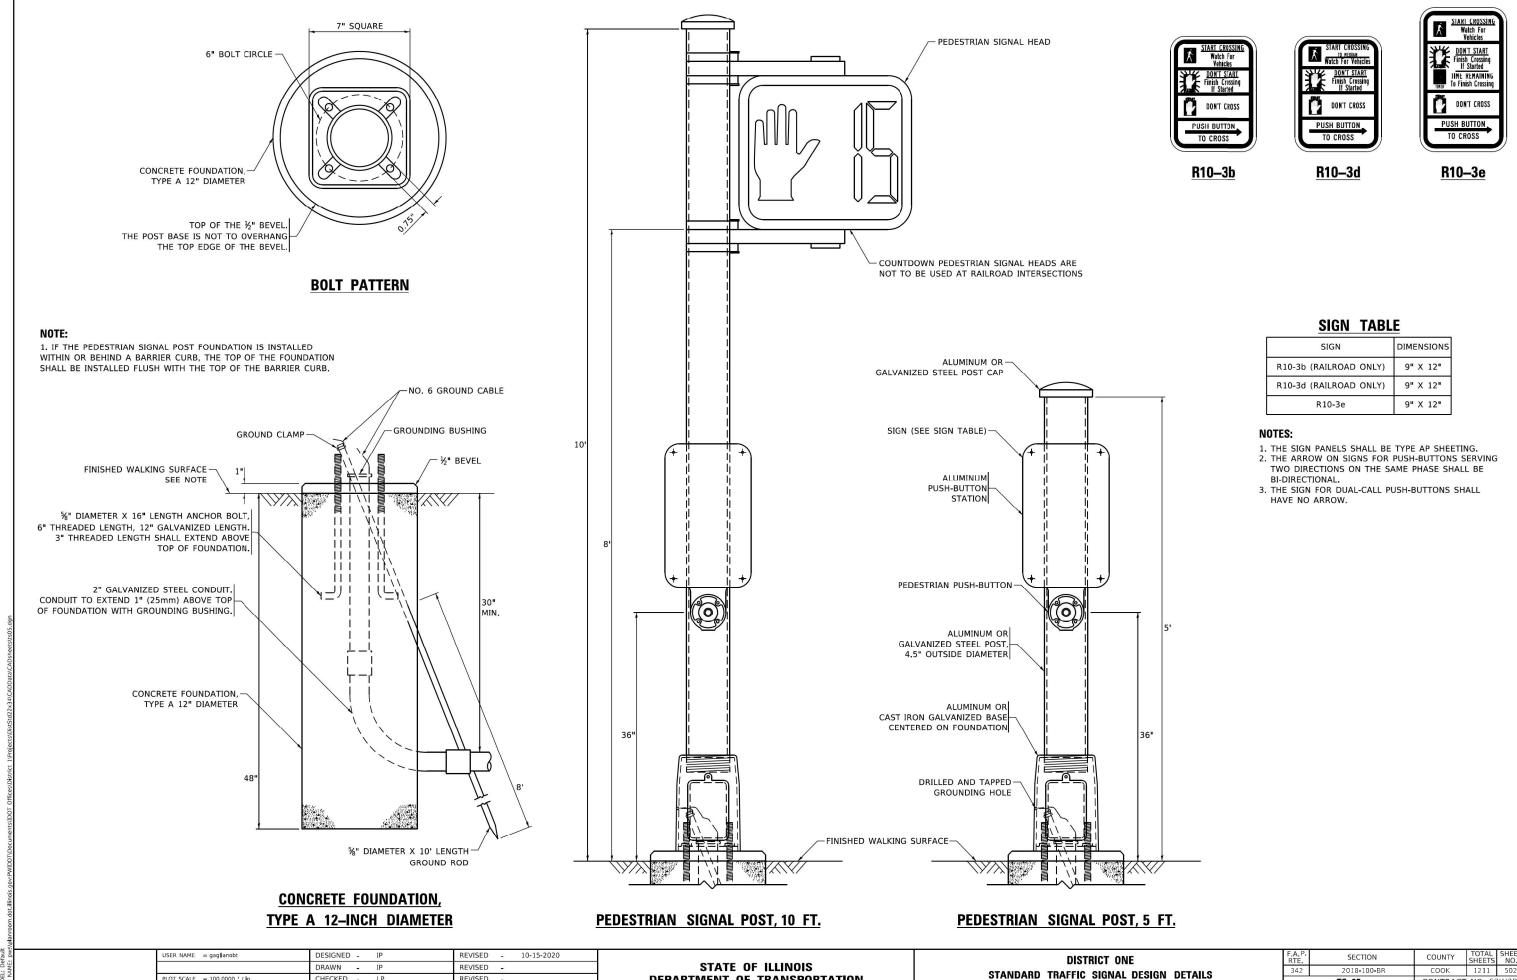

DEPARTMENT OF TRANSPORTATION

TS-05

SHEET 7 OF 7 SHEETS STA.

CONTRACT NO. 62W38

PLOT SCALE = 100.0000 ' / in.

PLOT DATE = 11/23/2020

CHECKED -

- 10-15-2018

REVISED

REVISED -

SUMMARY OF TRAFFIC SIGNAL QUANTITES


| ITEM | UNIT | TOTAL QUANTITY | US 14 & IL SB 53 WEST RAMPS | US 14 & IL NB 53 EAST RAMPS | IL 53 NB EXIT RAMP & KIRCHOFF | KIRCHOFF & FRONTAGE | INDUSTRIAL AVE & WINNETKA | INDUSTRIAL AVE & ROHLWING | US 14 & IL 53 INTERCONNECT |
|---|-------|-------------------|--------------------------------|--------------------------------|----------------------------------|---------------------|------------------------------|--|-------------------------------|
| SIGN PANEL - TYPE 1 | SQ FT | 7.5 | | | 7.5 | | | | |
| SIGN PANEL - TYPE 2 | SQ FT | 35.0 | 17.5 | 17.5 | | | | | |
| UNDERGROUND CONDUIT, GALVANIZED STEEL, 2" DIA. | FOOT | 1,237 | 568 | 121 | 493 | | 55 | | |
| UNDERGROUND CONDUIT, GALVANIZED STEEL, 3" DIA. | FOOT | 500 | 106 | 184 | 172 | | 38 | | |
| UNDERGROUND CONDUIT, GALVANIZED STEEL, 4" DIA. | FOOT | 432 | 186 | 121 | 109 | | 16 | | |
| HANDHOLE | EACH | 6 | 2 | 2 | 2 | | | | |
| HEAVY-DUTY HANDHOLE | EACH | 2 | 1 | 1 | | | | | |
| MAINTENANCE OF EXISTING TRAFFIC SIGNAL INSTALLATION | EACH | 6 | 1 | 1 | 1 | 1 | 1 | 1 | |
| TRANSCEIVER - FIBER OPTIC | EACH | 1 | | 1 | | | | | |
| ELECTRIC CABLE IN CONDUIT, SIGNAL NO. 14 2C | FOOT | 1,839 | 961 | 836 | | | 42 | | |
| ELECTRIC CABLE IN CONDUIT, SIGNAL NO. 14 3C | FOOT | 2,307 | 1,388 | 878 | | | 41 | | |
| ELECTRIC CABLE IN CONDUIT, SIGNAL NO. 14 5C | FOOT | 8,479 | 2,471 | 1,939 | 3,879 | | 190 | | |
| ELECTRIC CABLE IN CONDUIT, SIGNAL NO. 14 7C | FOOT | 1,061 | 353 | 514 | 194 | | | | |
| ELECTRIC CABLE IN CONDUIT, LEAD-IN, NO. 14 1 PAIR | FOOT | 4,040 | 1,856 | 608 | 1,576 | | | | |
| ELECTRIC CABLE IN CONDUIT, SERVICE, NO. 6 2 C | FOOT | 386 | , | 165 | 221 | | | | |
| ELECTRIC CABLE IN CONDUIT, EQUIPMENT GROUNDING CONDUCTOR, NO. 6 1C | FOOT | 1,597 | 554 | 592 | 430 | | 21 | | |
| ELECTRIC CABLE IN CONDUIT, TRACER, NO. 14 1C | FOOT | 1,562 | | | | | | | 1,562 |
| TRAFFIC SIGNAL POST, GALVANIZED STEEL 16 FT. | EACH | 8 | 3 | 3 | 2 | | | | -/ |
| STEEL MAST ARM ASSEMBLY AND POLE, 30 FT. | EACH | 2 | | 1 | 1 | | | | |
| STEEL MAST ARM ASSEMBLY AND POLE, 38 FT. | EACH | 1 | 1 | - | - | | | | |
| STEEL MAST ARM ASSEMBLY AND POLE, 42 FT. | EACH | 2 | 1 | 1 | | | | | |
| STEEL MAST ARM ASSEMBLY AND POLE, 42 FT. | EACH | 1 | 1 | 1 | 1 | | | | |
| CONCRETE FOUNDATION, TYPE A | FOOT | 36 | 12 | 12 | 12 | | | | |
| | FOOT | 84 | 24 | 24 | 36 | | | | |
| CONCRETE FOUNDATION, TYPE E 36-INCH DIAMETER | + | | | 9 | | | 1 | | |
| DRILL EXISTING HANDHOLE | EACH | 37 | 13 | _ | 14 | | 1 | | |
| SIGNAL HEAD, LED, 1-FACE, 3-SECTION, MAST-ARM MOUNTED | EACH | 26 | 9 | 8 | 9 | | | | |
| SIGNAL HEAD, LED, 1-FACE, 3-SECTION, BRACKET MOUNTED | EACH | 14 | 5 | 5 | 4 | | | | |
| SIGNAL HEAD, LED, 1-FACE, 4-SECTION, BRACKET MOUNTED | EACH | 3 | 1 | 1 | 1 | | | | |
| SIGNAL HEAD, LED, 1-FACE, 5-SECTION, BRACKET MOUNTED | EACH | 2 | 1 | 1 | | | | | |
| SIGNAL HEAD, LED, 1-FACE, 5-SECTION, MAST-ARM MOUNTED | EACH | 1 | | 1 | | | | | |
| PEDESTRIAN SIGNAL HEAD, LED, 1-FACE, BRACKET MOUNTED WITH COUNTDOWN TIMER | EACH | 12 | 6 | 6 | | | | | |
| TRAFFIC SIGNAL BACKPLATE, LOUVERED, FORMED PLASTIC | EACH | 27 | 9 | 9 | 9 | | | | |
| INDUCTIVE LOOP DETECTOR | EACH | 11 | 2 | 7 | 2 | | | | |
| DETECTOR LOOP, TYPE I | FOOT | 1,145 | 271 | 326 | 360 | | 188 | | |
| RELOCATE EXISTING PEDESTRIAN SIGNAL HEAD | EACH | 1 | | | | | 1 | | |
| * RELOCATE EXISTING EMERGENCY VEHICLE PRIORITY SYSTEM, DETECTOR UNIT | EACH | 6 | 2 | 2 | 2 | | | | |
| * RELOCATE EXISTING EMERGENCY VEHICLE PRIORITY SYSTEM, PHASING UNIT | EACH | 1 | | 1 | | | | | |
| REMOVE ELECTRIC CABLE FROM CONDUIT | FOOT | 3,287 | | 253 | 144 | | | | 2,890 |
| REMOVE AND REINSTALL ELECTRIC CABLE FROM CONDUIT | FOOT | 25 | | | | | 25 | | |
| REMOVE EXISTING HANDHOLE | EACH | 7 | 1 | 3 | 2 | | 1 | | |
| REMOVE EXISTING TRAFFIC SIGNAL EQUIPMENT | EACH | 4 | 1 | 1 | 1 | | 1 | | |
| REBUILD EXISTING HANDHOLE | EACH | 3 | 2 | 1 | | | | | |
| REMOVE EXISTING CONCRETE FOUNDATION | EACH | 16 | 6 | 5 | 5 | | | | |
| ROD AND CLEAN EXISTING CONDUIT | FOOT | 736 | | | | | | | 736 |
| * EMERGENCY VEHICLE PRIORITY SYSTEM LINE SENSOR CABLE, NO. 20 3/C | FOOT | 1,347 | 458 | 209 | 585 | | 95 | | |
| OUTDOOR RATED NETWORK CABLE | FOOT | 371 | 146 | 225 | | | | | |
| SERVICE INSTALLATION, GROUND MOUNTED, METERED | EACH | 2 | | 1 | 1 | | | | |
| REMOTE CONTROLLED VIDEO SYSTEM | EACH | 2 | 1 | 1 | | | | | |
| LAYER II (DATALINK) SWITCH | EACH | 1 | 1 | | | | | | |
| PEDESTRIAN SIGNAL POST, 10 FT. | EACH | 8 | 3 | 4 | | | 1 | | |
| PEDESTRIAN SIGNAL POST, 5 FT. | EACH | 3 | 2 | | | | 1 | | |
| INTERCEPT EXISTING CONDUIT | EACH | 2 | | | | | 2 | | |
| FULL-ACTUATED CONTROLLER AND TYPE IV CABINET (SPECIAL) | EACH | 1 | | 1 | | | | | |
| UNINTERRUPTABLE POWER SUPPLY AND CABINET (SPECIAL) | EACH | 1 | | 1 | | | | | |
| FIBER OPTIC CABLE IN CONDUIT, NO. 62.5/125, MM12F SM24F | FOOT | 1,562 | | | | | | | 1,562 |
| FIBER OPTIC INTERCONNECT CENTER, 24 PORT | EACH | 1 | | 1 | | | | | |
| FIBER OPTIC INTERCONNECT CENTER, 48 PORT | EACH | 3 | 2 | 1 | | | | | |
| ACCESSIBLE PEDESTRIAN SIGNALS | EACH | 14 | 6 | 6 | | | 2 | | |
| CONCRETE FOUNDATION, TYPE A 12-INCH DIAMETER | FOOT | 40 | 20 | 16 | | | 4 | | |
| LED SIGNAL FACE, LENS COVER | EACH | 46 | 16 | 16 | 14 | | | | |
| CAMERA MOUNTING ASSEMBLY | EACH | 2 | 1 | 1 | | | | | |
| RE-OPTIMIZE TRAFFIC SIGNAL SYSTEM LEVEL 1 | EACH | 2 | 1 | 1 | | | | | |
| TEMPORARY TRAFFIC SIGNAL TIMING | EACH | 6 | 1 | 1 | 1 | 1 | 1 | 1 | |
| STEEL MAST ARM ASSEMBLY AND POLE WITH DUAL MAST ARMS, 24 FT AND 30 FT | EACH | 1 | - | * | 1 | * | - | <u> </u> | |
| *100% COST TO LOCAL AGENCY | | | 1 | | | | 1 | 1 | |


^{*100%} COST TO LOCAL AGENCY




| USER NAME = alexam | DESIGNED | - | MAG | REVISED - |
|----------------------------|----------|---|-----------|-----------|
| | DRAWN | - | DJW | REVISED - |
| PLOT SCALE = 40.0000 / in. | CHECKED | - | DWG | REVISED - |
| PLOT DATE = 8/23/2024 | DATE | - | 8/23/2024 | REVISED - |

| OURANA DV. OF OURANTITIES | F.A.P. RTE | SECTION | | COUNTY | TOTAL SHEETS | SHEE' |
|--|---------------|-------------|---------|-------------|-----------------|-------|
| SUMMARY OF QUANTITIES | 342 | (531) BR 2: | 3 | соок | 1211 | 503 |
| | | | | CONTRACT | NO. 62 | 2W38 |
| SCALE: N.T.S. SHEET 1 OF 1 SHEETS STA. TO STA. | | ILLING | OIS FED | AID PROJECT | | |

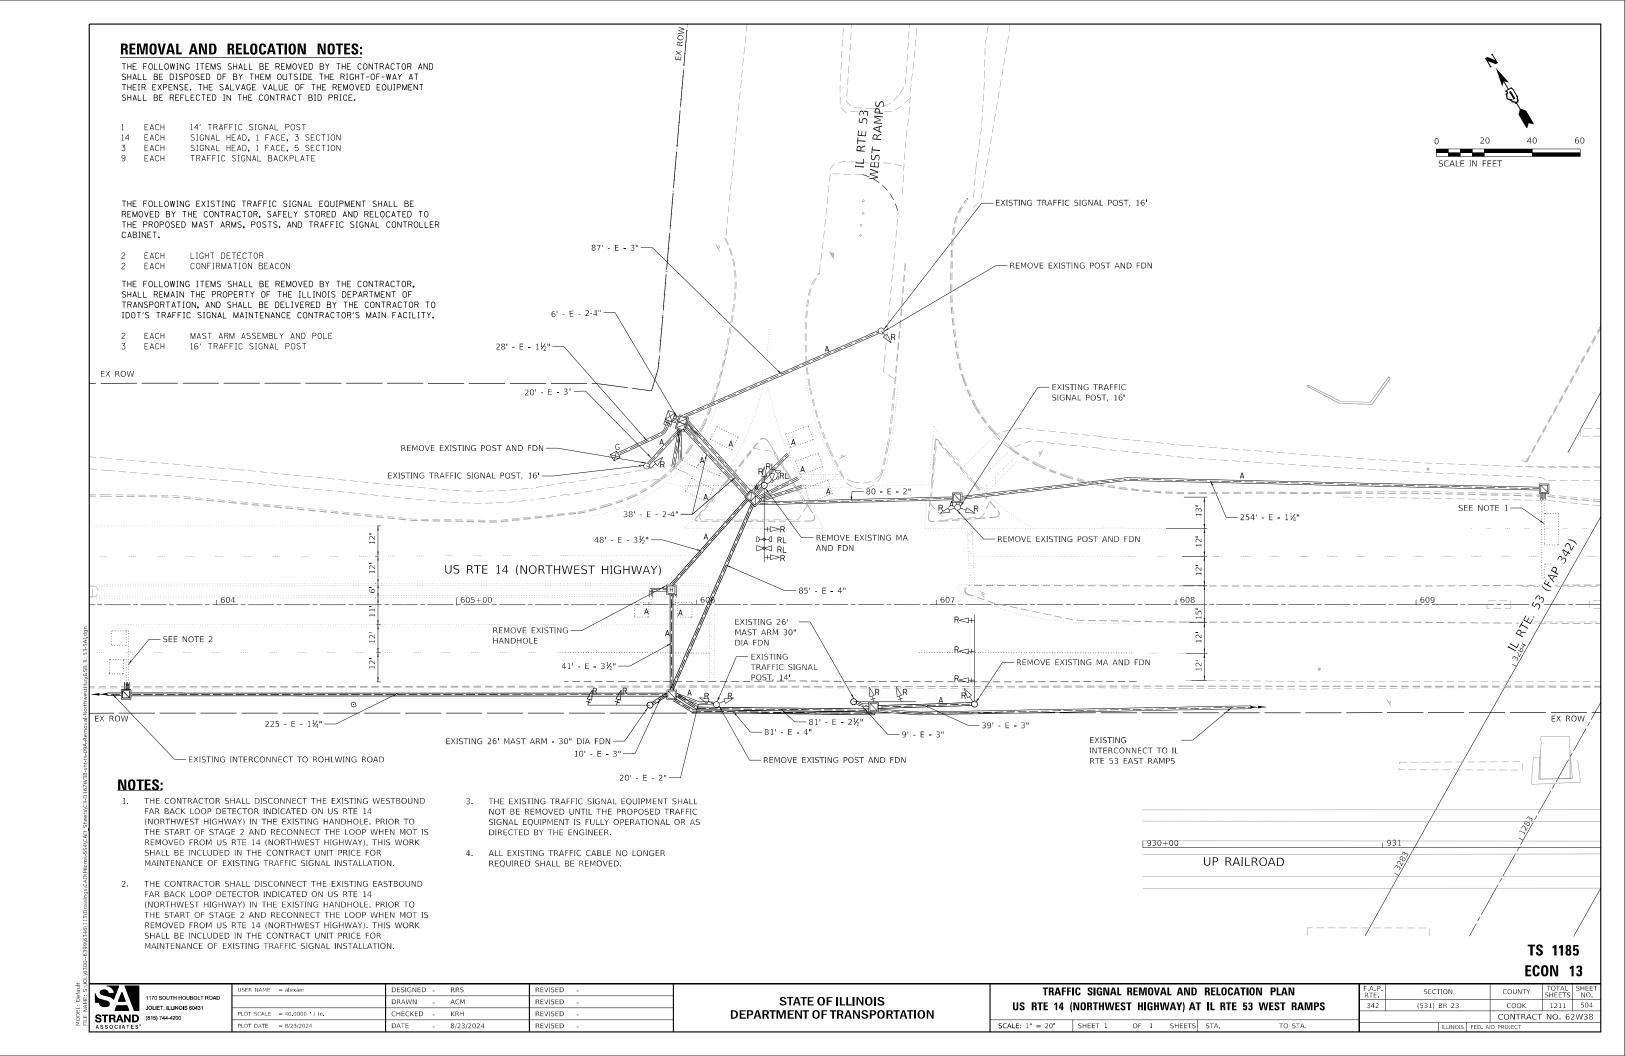

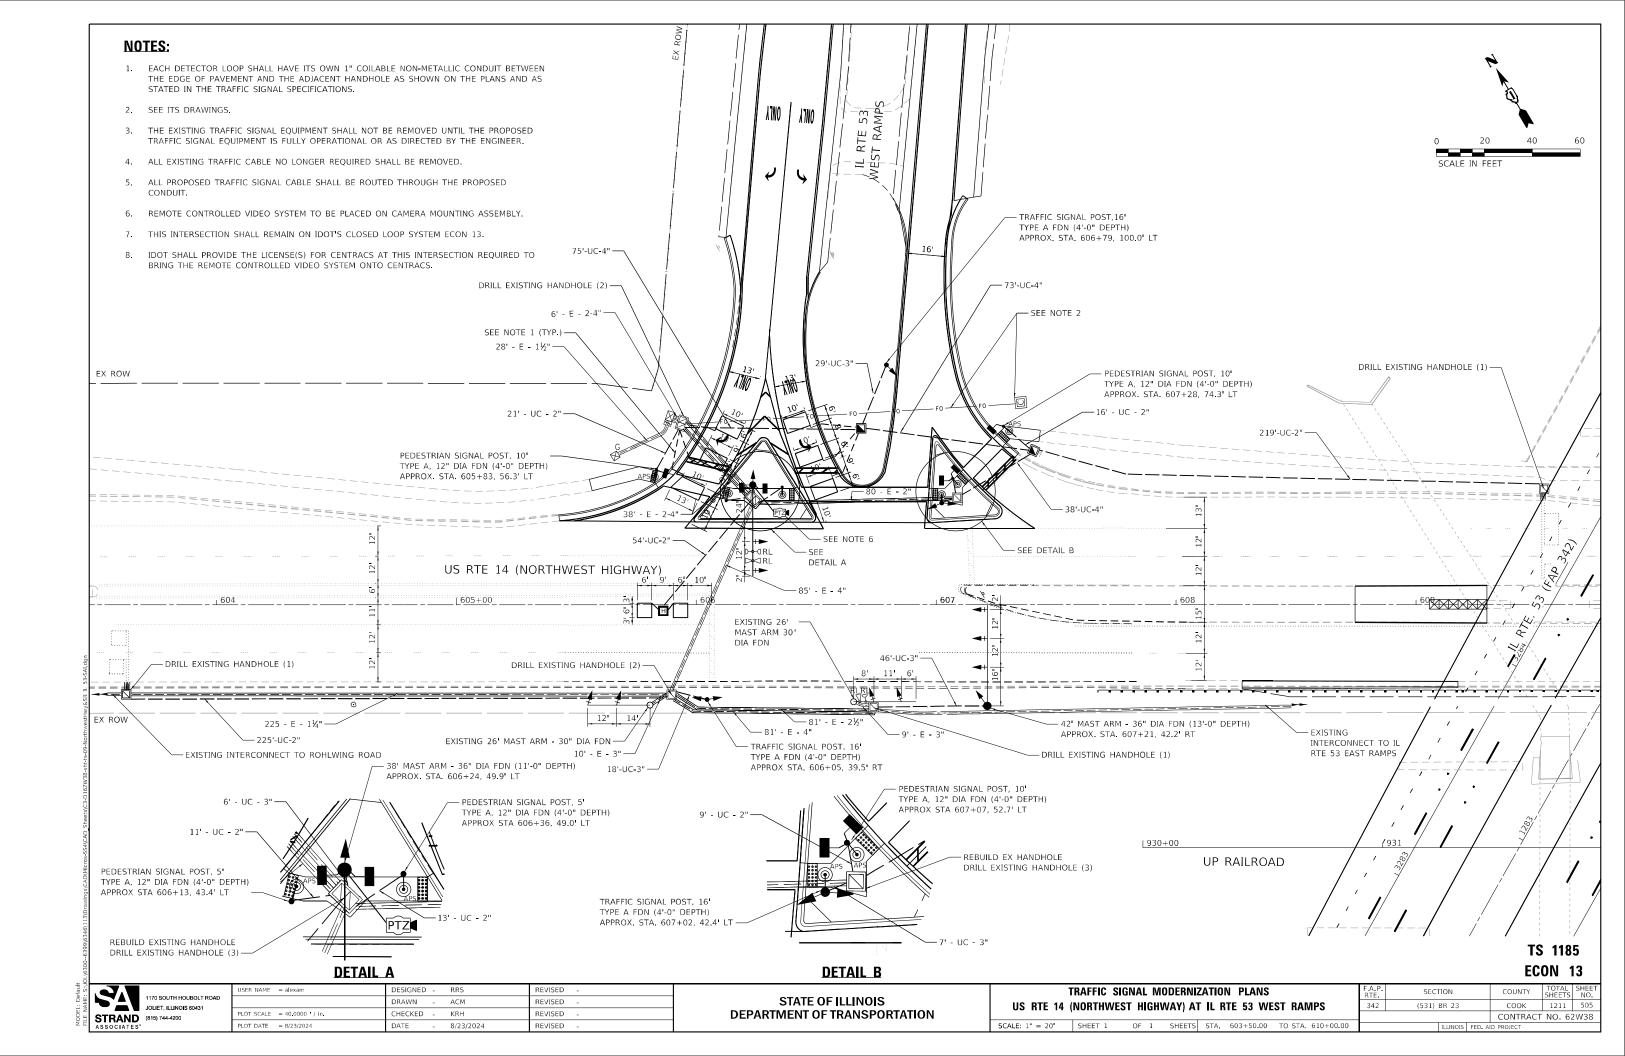

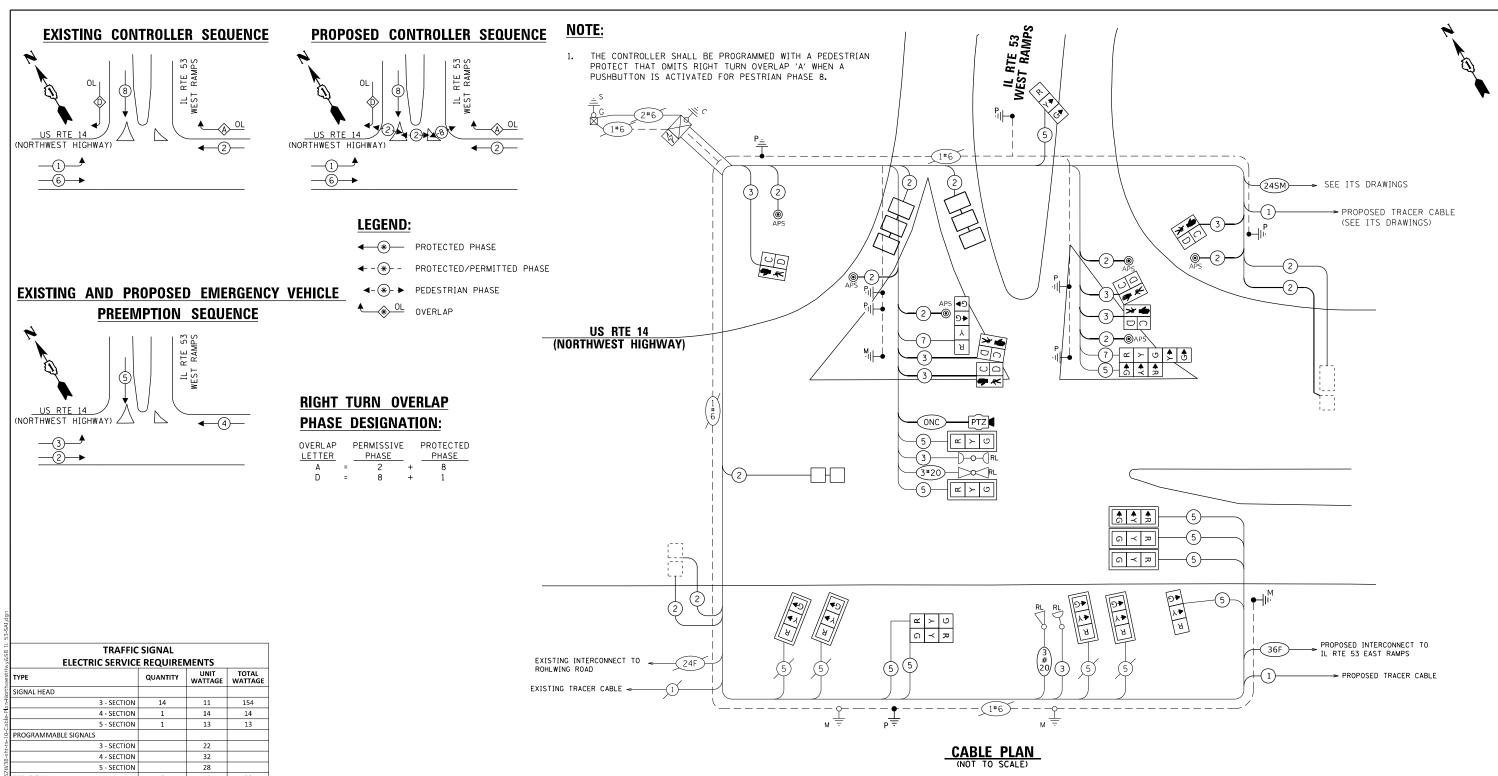

CONTROLLER 150 150 MASTER CONTROLLER 100 25 DETECTION RADAR 20 DETECTION VIDEO 20 BLANK-OUT SIGN NETWORK SWITCH II OR III 35 CELLULAR MODEM 15 PTZ CAMERA UPS CHARGING 225 BATTERY HEATER MAT 180 180 CABINET HEATER 200 200 FLASHER 15 120 LED STREET NAME SIGN

240

ENERGY COSTS TO:

ILLINOIS DEPARTMENT OF TRANSPORATION

DIVISION OF HIGHWAY/DISTRICT 1

201 WEST CENTER COURT/SCHAUMBURG, ILLINOIS 60196-1096

ENERGY SUPPLY: CONTACT: JAMES CAMPBELL

PHONE: (630) 940-6805

COMPANY: COMMONWEALTH EDISON

THIS INTERSECTION SHALL REMAIN ON IDOTS CLOSED LOOP SYSTEM ECON 13.

TS 1185 ECON 13

TOTAL SERVICE WIRE SIZING

1170 SOUTH HOUBOLT ROAD
JOLIET, ILLINOIS 60431

STRAN
815 OLIATES"
815 744-4200

IIMINΔIRE

| VER NAME | SALE | SA


STATE OF ILLINOIS
DEPARTMENT OF TRANSPORTATION

CABLE PLAN, PHASE DESIGNATION DIAGRAM, AND EMERGENCY
VEHICLE PREEMPTION SEQUENCE
US RTE 14 (NORTHWEST HWY) AT IL RTE 53 WEST RAMPS

T.S. SHEET 1 OF 1 SHEETS STA. TO STA.

SIGN PANEL – TYPE 2

ALL DIMENSIONS ARE IN INCHES UNLESS OTHERWISE NOTED.

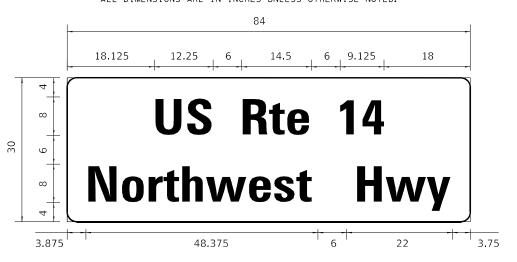

| DESIGN | AREA | SIGN PANEL | SHEETING | QTY. |
|--------|---------|------------|----------|----------|
| SERIES | (SQ FT) | TYPE | TYPE | REQUIRED |
| D | 17.5 | 2 | ZZ | 1 |


NOTE: FOR ADDITIONAL DESIGN AND INSTALLATION INFORMATION SEE DISTRICT ONE MAST ARM MOUNTED STREET NAME SIGNS DETAIL.

SCHEDULE OF QUANTITIES

| ITEM | UNIT | QUANTITY |
|---|-------|----------|
| SIGN PANEL - TYPE 2 | SQ FT | 17.5 |
| UNDERGROUND CONDUIT, GALVANIZED STEEL, 2" DIA. | FOOT | 568 |
| UNDERGROUND CONDUIT, GALVANIZED STEEL, 3" DIA. | FOOT | 106 |
| UNDERGROUND CONDUIT, GALVANIZED STEEL, 4" DIA. | FOOT | 186 |
| HANDHOLE | EACH | 2 |
| HEAVY-DUTY HANDHOLE | EACH | 1 |
| MAINTENANCE OF EXISTING TRAFFIC SIGNAL INSTALLATION | EACH | 1 |
| ELECTRIC CABLE IN CONDUIT, SIGNAL NO. 14 2C | FOOT | 961 |
| ELECTRIC CABLE IN CONDUIT, SIGNAL NO. 14 3C | FOOT | 1,388 |
| ELECTRIC CABLE IN CONDUIT, SIGNAL NO. 14 5C | FOOT | 2,471 |
| ELECTRIC CABLE IN CONDUIT, SIGNAL NO. 14 7C | FOOT | 353 |
| ELECTRIC CABLE IN CONDUIT, LEAD-IN, NO. 14 1 PAIR | FOOT | 1,856 |
| ELECTRIC CABLE IN CONDUIT, EQUIPMENT GROUNDING CONDUCTOR, NO. 6 1C | FOOT | 554 |
| TRAFFIC SIGNAL POST, GALVANIZED STEEL 16 FT. | EACH | 3 |
| STEEL MAST ARM ASSEMBLY AND POLE, 38 FT. | EACH | 1 |
| STEEL MAST ARM ASSEMBLY AND POLE, 42 FT. | EACH | 1 |
| CONCRETE FOUNDATION, TYPE A | FOOT | 12 |
| CONCRETE FOUNDATION, TYPE E 36-INCH DIAMETER | FOOT | 24 |
| DRILL EXISTING HANDHOLE | EACH | 13 |
| SIGNAL HEAD, LED, 1-FACE, 3-SECTION, MAST-ARM MOUNTED | EACH | 9 |
| SIGNAL HEAD, LED, 1-FACE, 3-SECTION, BRACKET MOUNTED | EACH | 5 |
| SIGNAL HEAD, LED, 1-FACE, 4-SECTION, BRACKET MOUNTED | EACH | 1 |
| SIGNAL HEAD, LED, 1-FACE, 5-SECTION, BRACKET MOUNTED | EACH | 1 |
| PEDESTRIAN SIGNAL HEAD, LED, 1-FACE, BRACKET MOUNTED WITH COUNTDOWN TIMER | EACH | 6 |
| TRAFFIC SIGNAL BACKPLATE, LOUVERED, FORMED PLASTIC | EACH | 9 |
| INDUCTIVE LOOP DETECTOR | EACH | 2 |
| DETECTOR LOOP, TYPE I | FOOT | 271 |
| RELOCATE EXISTING EMERGENCY VEHICLE PRIORITY SYSTEM, DETECTOR UNIT | EACH | 2 |
| REMOVE EXISTING HANDHOLE | EACH | 1 |
| REMOVE EXISTING TRAFFIC SIGNAL EQUIPMENT | EACH | 1 |
| REBUILD EXISTING HANDHOLE | EACH | 2 |
| REMOVE EXISTING CONCRETE FOUNDATION | EACH | 6 |
| EMERGENCY VEHICLE PRIORITY SYSTEM LINE SENSOR CABLE, NO. 20 3/C | FOOT | 458 |
| OUTDOOR RATED NETWORK CABLE | FOOT | 146 |
| REMOTE CONTROLLED VIDEO SYSTEM | EACH | 1 |
| LAYER II (DATALINK) SWITCH | EACH | 1 |
| PEDESTRIAN SIGNAL POST, 10 FT. | EACH | 3 |
| PEDESTRIAN SIGNAL POST, 5 FT. | EACH | 2 |
| FIBER OPTIC INTERCONNECT CENTER, 48 PORT | EACH | 2 |
| ACCESSIBLE PEDESTRIAN SIGNALS | EACH | 6 |
| CONCRETE FOUNDATION, TYPE A 12-INCH DIAMETER | FOOT | 20 |
| LED SIGNAL FACE, LENS COVER | EACH | 16 |
| · | EACH | 1 1 |
| CAMERA MOUNTING ASSEMBLY RE-OPTIMIZE TRAFFIC SIGNAL SYSTEM LEVEL 1 | | 1 |
| RE-UPTIIVIIZE TRAFFIC SIGNAL SYSTEM LEVEL I | EACH | 1 1 |
| TEMPORARY TRAFFIC SIGNAL TIMING | EACH | 1 |

| USER NAME = alexam | DESIGNED | - | RRS | REVISED - |
|----------------------------|----------|---|-----------|-----------|
| | DRAWN | - | ACM | REVISED - |
| PLOT SCALE = 20.0000 / in. | CHECKED | - | KRH | REVISED - |
| PLOT DATE = 8/23/2024 | DATE | - | 8/23/2024 | REVISED - |

| MAST ARM | MOUNTED | STREET N | IAME SIG | NS AND | SCHEDULE OF QUANTITIES | F.A.P. RTE | SECT | ПОИ | |
|---------------|-----------|----------|----------|----------|------------------------|---------------|-------|----------|------|
| IIS | RTF 14 (N | ORTHWEST | HWY) A | T II RTE | 53 WEST RAMPS | 342 | (531) | BR 23 | |
| | , | | | | 00 11201 11711111 0 | | | | |
| SCALE: N.T.S. | SHEET 1 | OF 1 | SHEETS | STA. | TO STA. | | | ILLINOIS | FED. |

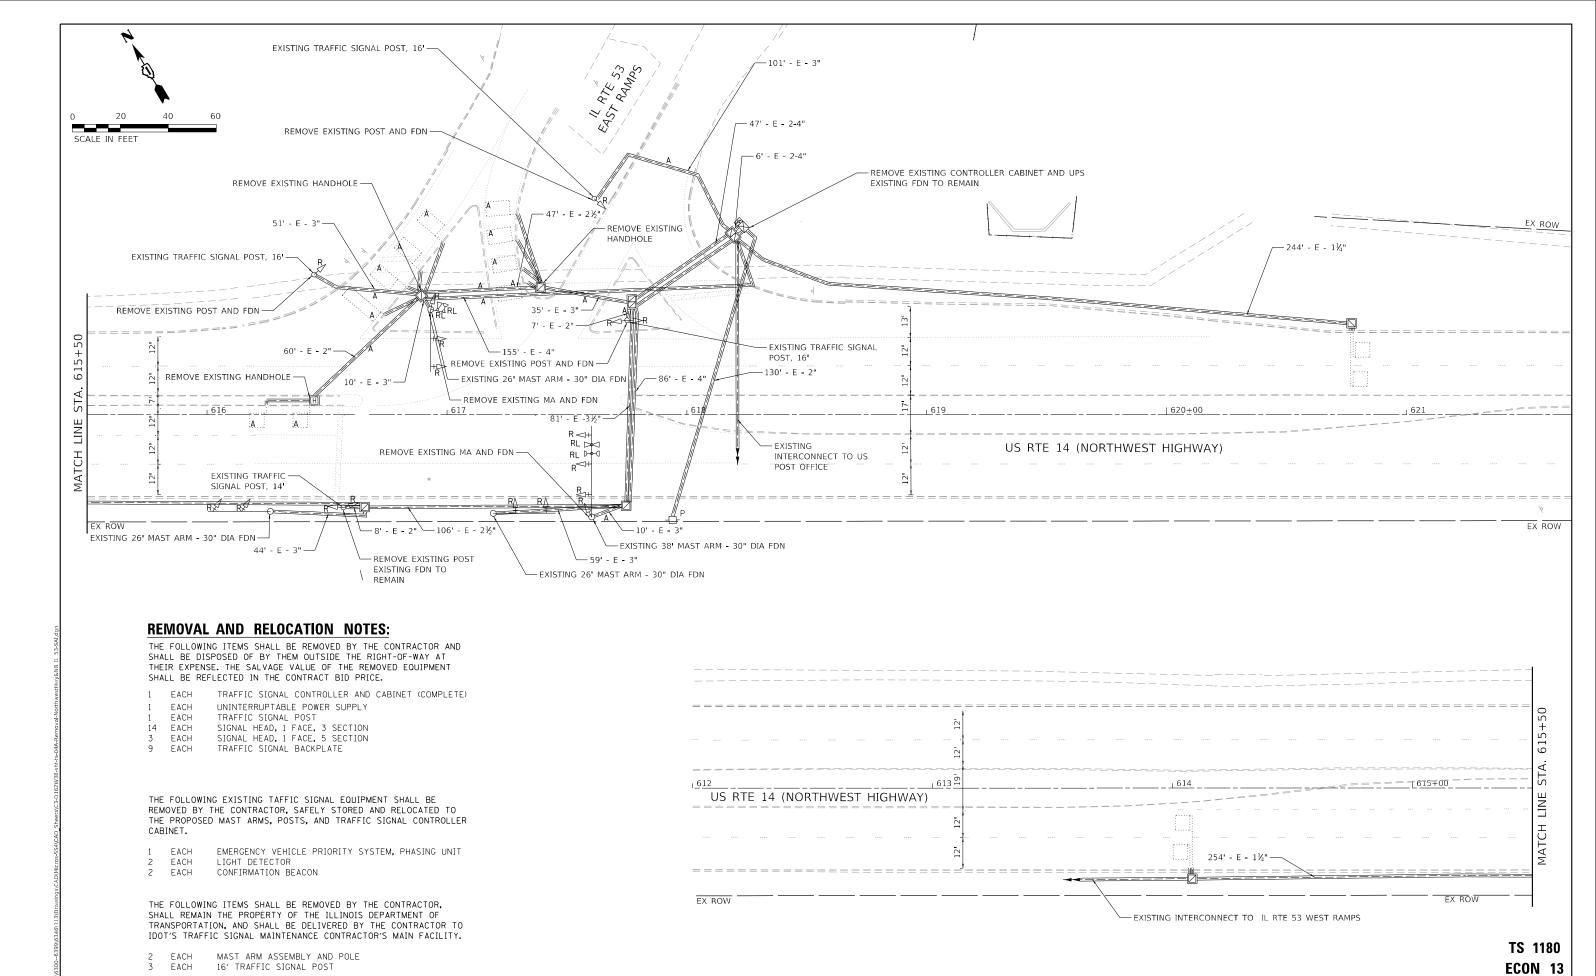

1170 SOUTH HOUBOLT I JOLIET, ILLINOIS 60431 STRAND (815) 744-4200

RRS DESIGNED -REVISED DRAWN ACM REVISED HECKED KRH REVISED 8/23/2024


STATE OF ILLINOIS


TRAFFIC SIGNAL REMOVAL AND RELOCATION PLAN US RTE 14 (NORTHWEST HIGHWAY) AT IL RTE 53 EAST RAMPS SCALE: 1" = 20' SHEET 1

SECTION (531) BR 23 COOK 1211 508 CONTRACT NO. 62W38

1170 SOUTH HOUBOLT ROAD

DEPARTMENT OF TRANSPORTATION

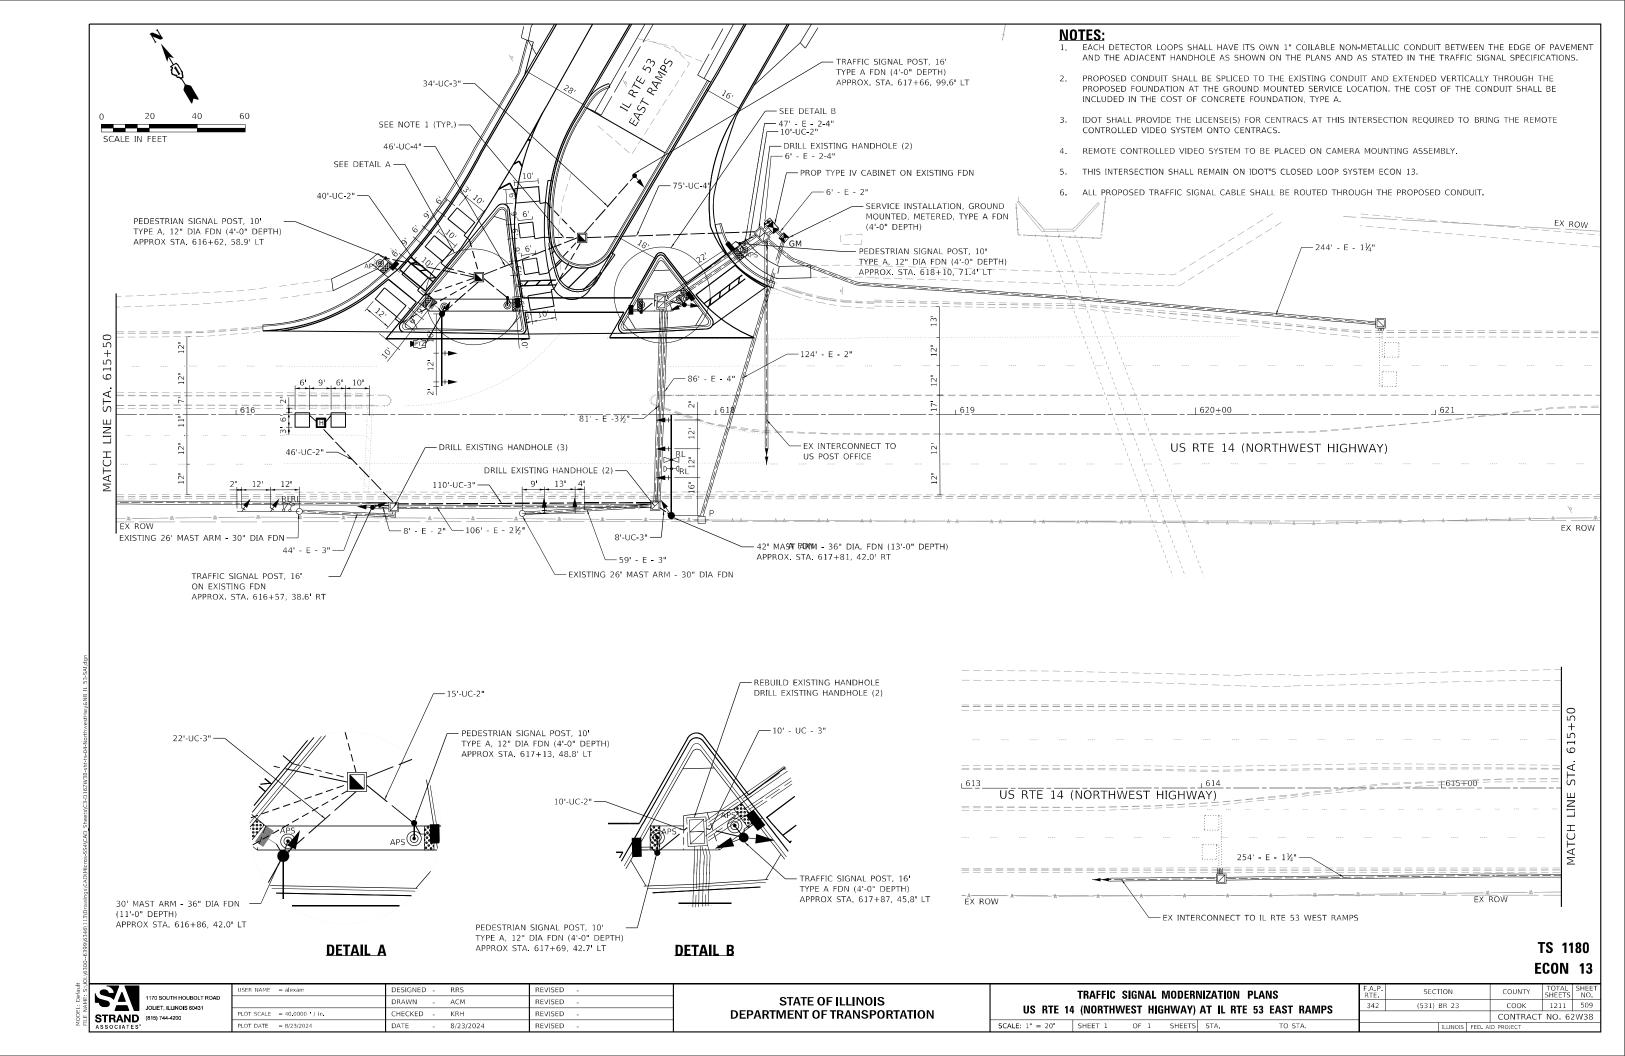

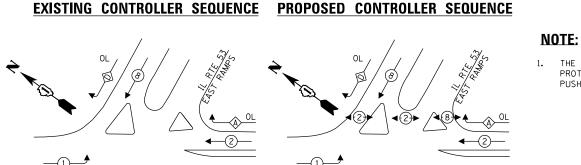

LEGEND:

←(*)— PROTECTED PHASE

(NORTHWEST HIGHWAY)


IL RTE 53 WEST RAMPS

√-(*)- ► PEDESTRIAN PHASE

♦ OL OVERLAP

PREEMPTION SEQUENCE

(NORTHWEST HIGHWAY)

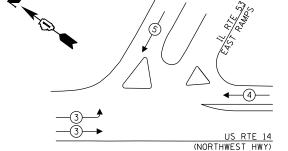

RIGHT TURN OVERLAP PHASE DESIGNATION:

| OVERLAP | | PERMISSIVE | | PROTECTED |
|---------|---|------------|---|-----------|
| LETTER | | PHASE | | PHASE |
| A | = | 2 | + | 8 |
| n | _ | 0 | | 1 |

TRAFFIC SIGNAL **ELECTRIC SERVICE REQUIREMENTS** UNIT TOTAL WATTAGE QUANTITY SIGNAL HEAD 3 - SECTION 4 - SECTION 14 14 5 - SECTION 26 PROGRAMMABLE SIGNALS 4 - SECTION 32 PED. SIGNAL CONTROLLER 150 150 MASTER CONTROLLER 100 DETECTION RADAR DETECTION VIDEO 20 BLANK-OUT SIGN NETWORK SWITCH II OR III 35 ENERGY COSTS TO: CELLULAR MODEM 15 PTZ CAMERA 523 UPS CHARGING 225 DIVISION OF HIGHWAY/DISTRICT 1 BATTERY HEATER MAT 180 180 CABINET HEATER 200 200 FLASHER 15 ENERGY SUPPLY: LED STREET NAME SIGN 120 HIMINΔIRE 240

ILLINOIS DEPARTMENT OF TRANSPORATION 201 WEST CENTER COURT/SCHAUMBURG, ILLINOIS 60196-1096 CONTACT: JAMES CAMPBELL PHONE: (630) 940-6805

THIS INTERSECTION SHALL REMAIN ON IDOT'S CLOSED LOOP

TS 1180 ECON 13

EXISTING INTERCONNECT -TO US POST OFFICE

EXISTING TRACER CABLE -

TOTAL SERVICE WIRE SIZING 1170 SOUTH HOUBOLT ROAD JOLIET, ILLINOIS 60431 STRAND (815) 744-4200

DESIGNED - RRS DRAWN ACM REVISED OT SCALE = 20.0000 / in. HECKED KRH REVISED PLOT DATE = 8/23/2024 REVISED DATE 8/23/2024

STATE OF ILLINOIS **DEPARTMENT OF TRANSPORTATION**

THE CONTROLLER SHALL BE PROGRAMMED WITH A PEDESTRIAN PROTECT THAT OMITS RIGHT TURN OVERLAP 'A' WHEN A PUSHBUTTON IS ACTIVATED FOR PEDESTRIAN PHASE 8.

> CABLE PLAN, PHASE DESIGNATION DIAGRAM, AND EMERGENCY SECTION VEHICLE PREEMPTION SEQUENCE (531) BR 23 COOK 1211 510 US RTE 14 (NORTHWEST HWY) AT IL RTE 53 EAST RAMPS CONTRACT NO. 62W38 SCALE: N.T.S. SHEET 1 OF 1 SHEETS STA.


US RTE 14 (NORTHWEST HIGHWAY) PROPOSED INTERCONNECT TO PROPOSED TRACER CABLE --(1#6)CABLE PLAN SYSTEM ECON 13.

-7- a > 0 **\$ \$**

COMPANY: COMMONWEALTH EDISON ACCOUNT NUMBER: 7184835000

SIGN PANEL - TYPE 2

ALL DIMENSIONS ARE IN INCHES UNLESS OTHERWISE NOTED.

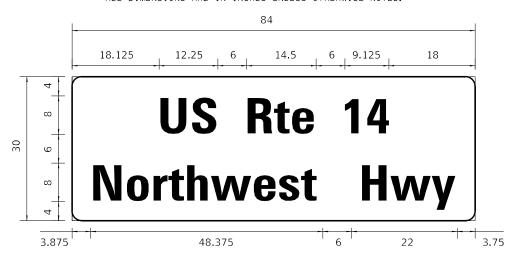

| DESIGN | AREA | SIGN PANEL | SHEETING | QTY. |
|--------|---------|------------|----------|----------|
| SERIES | (SQ FT) | TYPE | TYPE | REQUIRED |
| D | 17.5 | 2 | ZZ | |

NOTE: FOR ADDITIONAL DESIGN AND INSTALLATION INFORMATION SEE DISTRICT ONE MAST ARM MOUNTED STREET NAME SIGNS DETAIL.


SCHEDULE OF QUANTITIES

| ITEM | UNIT | QUANTIT |
|---|-------|---------|
| SIGN PANEL - TYPE 2 | SQ FT | 17.5 |
| UNDERGROUND CONDUIT, GALVANIZED STEEL, 2" DIA. | FOOT | 121 |
| UNDERGROUND CONDUIT, GALVANIZED STEEL, 3" DIA. | FOOT | 184 |
| UNDERGROUND CONDUIT, GALVANIZED STEEL, 4" DIA. | FOOT | 121 |
| HANDHOLE | EACH | 2 |
| HEAVY-DUTY HANDHOLE | EACH | 1 |
| MAINTENANCE OF EXISTING TRAFFIC SIGNAL INSTALLATION | EACH | 1 |
| TRANSCEIVER - FIBER OPTIC | EACH | 1 |
| ELECTRIC CABLE IN CONDUIT, SIGNAL NO. 14 2C | FOOT | 836 |
| ELECTRIC CABLE IN CONDUIT, SIGNAL NO. 14 3C | FOOT | 878 |
| ELECTRIC CABLE IN CONDUIT, SIGNAL NO. 14 5C | FOOT | 1,939 |
| ELECTRIC CABLE IN CONDUIT, SIGNAL NO. 14 7C | FOOT | 514 |
| ELECTRIC CABLE IN CONDUIT, LEAD-IN, NO. 14 1 PAIR | FOOT | 608 |
| ELECTRIC CABLE IN CONDUIT, SERVICE, NO. 6 2 C | FOOT | 165 |
| ELECTRIC CABLE IN CONDUIT, EQUIPMENT GROUNDING CONDUCTOR, NO. 6 1C | FOOT | 592 |
| TRAFFIC SIGNAL POST, GALVANIZED STEEL 16 FT. | EACH | 3 |
| STEEL MAST ARM ASSEMBLY AND POLE, 30 FT. | EACH | 1 |
| STEEL MAST ARM ASSEMBLY AND POLE, 42 FT. | EACH | 111 |
| CONCRETE FOUNDATION, TYPE A | FOOT | 12 |
| CONCRETE FOUNDATION, TYPE E 36-INCH DIAMETER | FOOT | 24 |
| DRILL EXISTING HANDHOLE | EACH | 9 |
| SIGNAL HEAD, LED, 1-FACE, 3-SECTION, MAST-ARM MOUNTED | EACH | 8 |
| SIGNAL HEAD, LED, 1-FACE, 3-SECTION, BRACKET MOUNTED | EACH | 5 |
| SIGNAL HEAD, LED, 1-FACE, 4-SECTION, BRACKET MOUNTED | EACH | 1 |
| SIGNAL HEAD, LED, 1-FACE, 5-SECTION, BRACKET MOUNTED | EACH | 1 |
| SIGNAL HEAD, LED, 1-FACE, 5-SECTION, MAST-ARM MOUNTED | EACH | 1 |
| PEDESTRIAN SIGNAL HEAD, LED, 1-FACE, BRACKET MOUNTED WITH COUNTDOWN TIMER | EACH | 6 |
| TRAFFIC SIGNAL BACKPLATE, LOUVERED, FORMED PLASTIC | EACH | 9 |
| INDUCTIVE LOOP DETECTOR | EACH | 7 |
| DETECTOR LOOP, TYPE I | FOOT | 326 |
| RELOCATE EXISTING EMERGENCY VEHICLE PRIORITY SYSTEM, DETECTOR UNIT | EACH | 2 |
| RELOCATE EXISTING EMERGENCY VEHICLE PRIORITY SYSTEM, PHASING UNIT | EACH | 1 |
| REMOVE ELECTRIC CABLE FROM CONDUIT | FOOT | 10 |
| REMOVE EXISTING HANDHOLE | EACH | 3 |
| REMOVE EXISTING TRAFFIC SIGNAL EQUIPMENT | EACH | 1 |
| REBUILD EXISTING HANDHOLE | EACH | 1 |
| REMOVE EXISTING CONCRETE FOUNDATION | EACH | 5 |
| EMERGENCY VEHICLE PRIORITY SYSTEM LINE SENSOR CABLE, NO. 20 3/C | FOOT | 209 |
| OUTDOOR RATED NETWORK CABLE | FOOT | 225 |
| SERVICE INSTALLATION, GROUND MOUNTED, METERED | EACH | 1 |
| REMOTE CONTROLLED VIDEO SYSTEM | EACH | 1 |
| PEDESTRIAN SIGNAL POST, 10 FT. | EACH | 4 |
| FULL-ACTUATED CONTROLLER AND TYPE IV CABINET (SPECIAL) | EACH | 1 |
| UNINTERRUPTABLE POWER SUPPLY AND CABINET (SPECIAL) | EACH | 1 |
| FIBER OPTIC INTERCONNECT CENTER, 24 PORT | EACH | 1 |
| FIBER OPTIC INTERCONNECT CENTER, 48 PORT | EACH | 1 |
| ACCESSIBLE PEDESTRIAN SIGNALS | EACH | 6 |
| CONCRETE FOUNDATION, TYPE A 12-INCH DIAMETER | FOOT | 16 |
| LED SIGNAL FACE, LENS COVER | EACH | 16 |
| CAMERA MOUNTING ASSEMBLY | EACH | 1 |
| RE-OPTIMIZE TRAFFIC SIGNAL SYSTEM LEVEL 1 | EACH | 1 |

^{*100%} COST TO THE VILLAGE OF PALATINE

| USER NAME = alexam | DESIGNED - RRS | REVISED - |
|----------------------------|------------------|-----------|
| | DRAWN - ACM | REVISED - |
| PLOT SCALE = 20.0000 / in. | CHECKED - KRH | REVISED - |
| PLOT DATE = 8/23/2024 | DATE - 8/23/2024 | REVISED - |


| MAST ARM MOUNTED STREET NAME SIGI | GNS AND SCHEDULE OF QUANTITIES | F.A.P. RTE | SECTION | COUNTY | TOTAL SHEETS | |
|-------------------------------------|--------------------------------|---------------|-----------------|------------|-----------------|------|
| US RTE 14 (NORTHWEST HWY) AT | AT IL RTE 53 EAST RAMPS | 342 | (531) BR 23 | соок | 1211 | 511 |
| | | | | CONTRACT | NO. 62 | 2W38 |
| SCALE: N.T.S. SHEET 1 OF 1 SHEETS | S STA. TO STA. | | ILLINOIS FED. A | ID PROJECT | | |

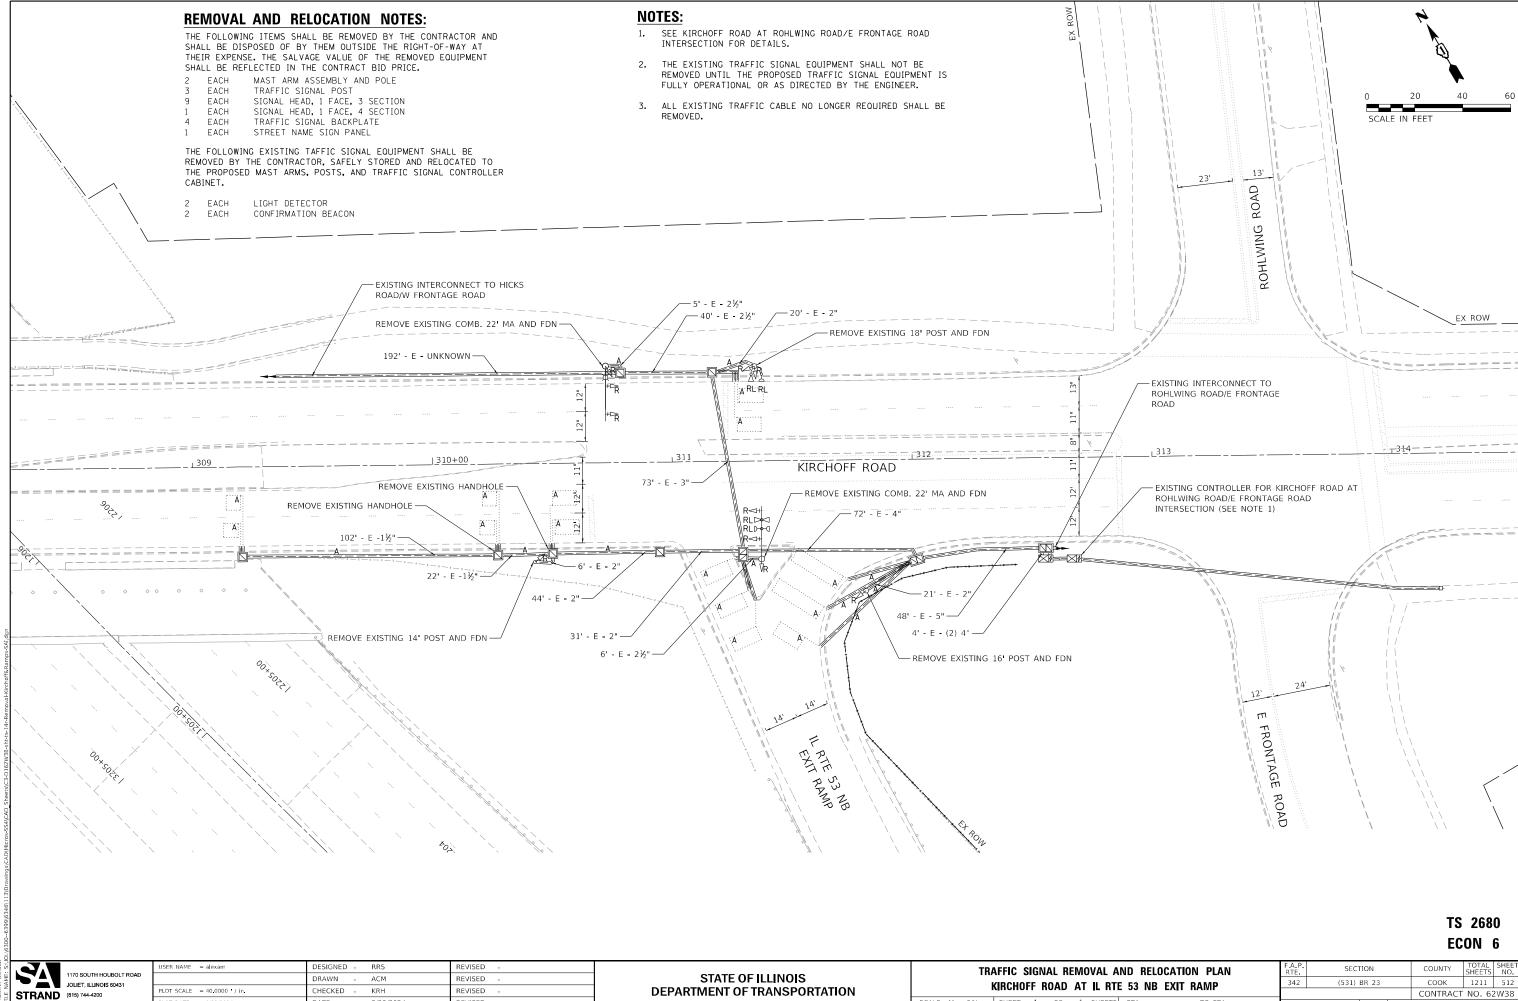


PLOT DATE = 8/23/2024 8/23/2024

SCALE: 1" = 20' SHEET 1 OF 1 SHEETS STA.

CONTRACT NO. 62W38

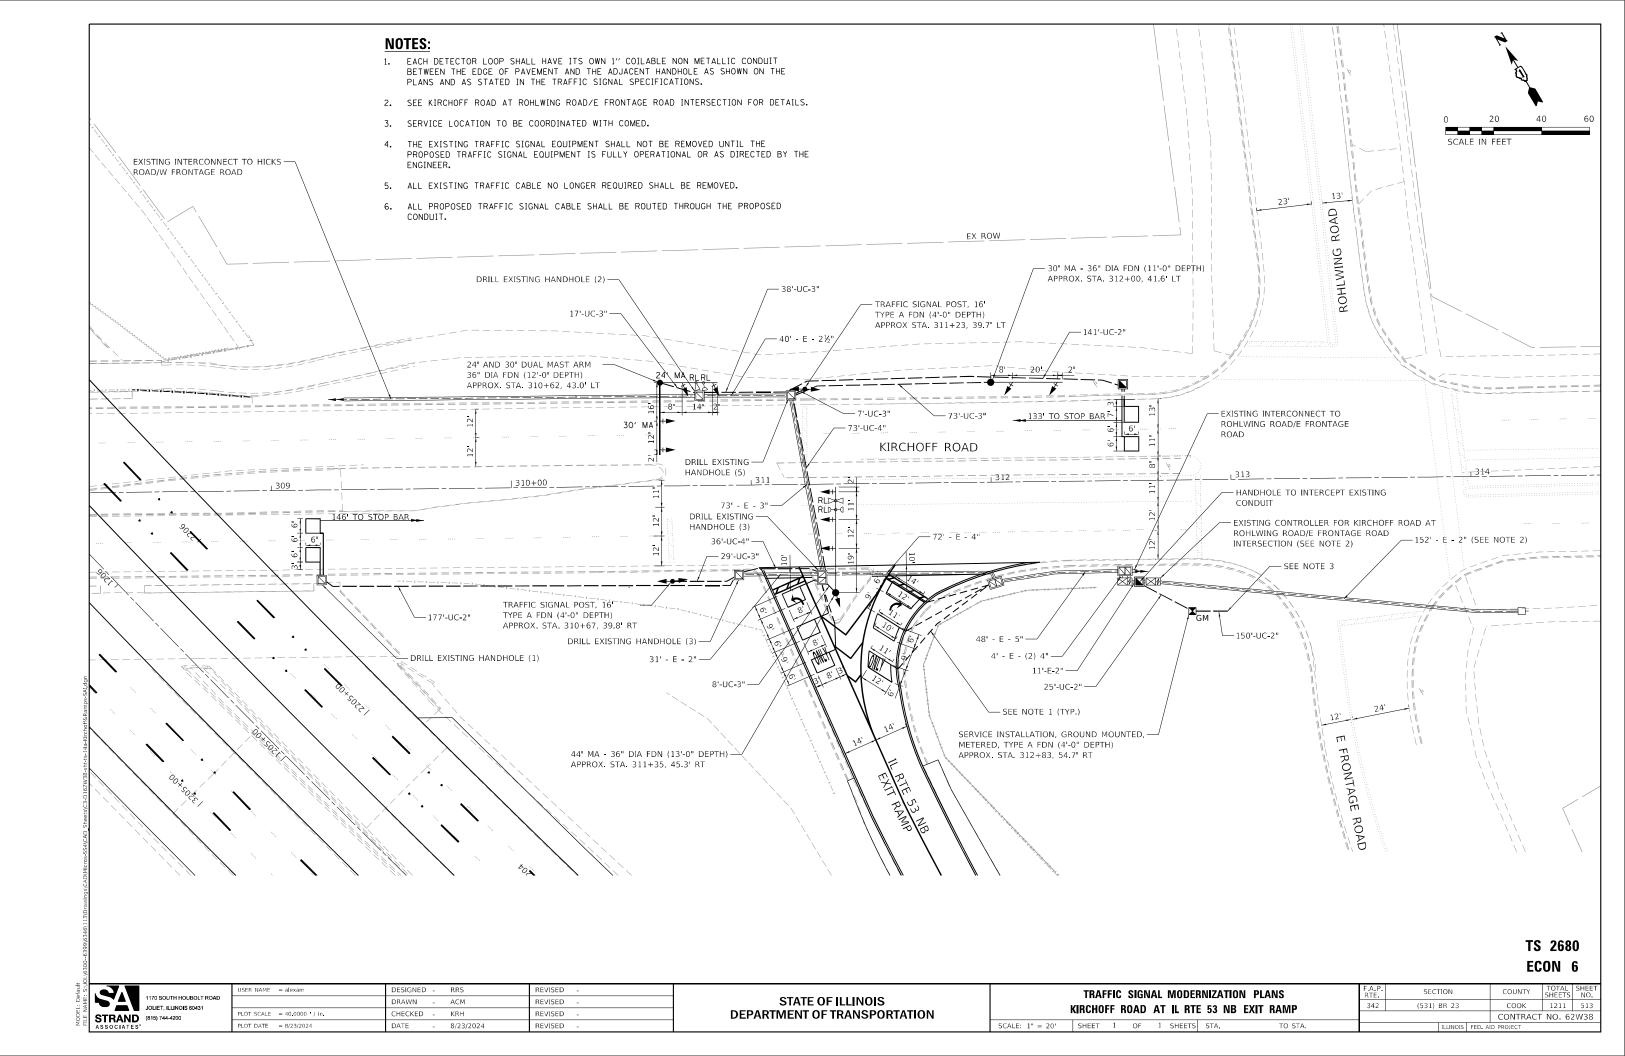


EXISTING & PROPOSED PHASE DESIGNATION DIAGRAM

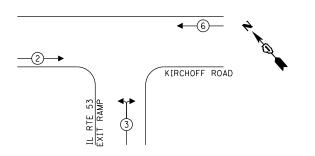

LEGEND:


- **◆** PROTECTED PHASE
- ← -(*)- PROTECTED/PERMITTED PHASE
- √
 →
 →
 PEDESTRIAN PHASE
- OL OVERLAP

EXISTING & PROPOSED EMERGENCY VEHICLE PREEMPTION SEQUENCE

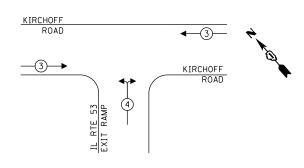

STRAND (815) 744-4200

| TRAFFIC | SIGNAL | | | | |
|--|-----------|-----------------|------------------|-------------------------------------|-------------|
| ELECTRIC SERVICE | REQUIREN | MENTS | | | |
| TYPE | QUANTITY | UNIT WATTAGE | TOTAL WATTAGE | | |
| SIGNAL HEAD | | | | | |
| 3 - SECTION | 12 | 11 | 132 | | |
| 4 - SECTION | 1 | 14 | 14 | | |
| 5 - SECTION | | 13 | | | |
| PROGRAMMABLE SIGNALS | | | | | |
| 3 - SECTION | | 22 | | | |
| 4 - SECTION | | 32 | | | |
| 5 - SECTION | | 28 | | | |
| PED. SIGNAL | | 15 | | | |
| CONTROLLER | 1 | 150 | 150 | | |
| MASTER CONTROLLER | | 100 | | | |
| UPS | 1 | 25 | 25 | | |
| DETECTION RADAR | | 20 | | | |
| DETECTION VIDEO | | 20 | | | |
| BLANK-OUT SIGN | | 25 | | ENERGY COSTS TO: | |
| NETWORK SWITCH II OR III | | 35 | | ENERGY COSTS TO: | |
| CELLULAR MODEM | | 15 | | | |
| TOTAL UPS SIZIN | G | | 321 | CITY OF ROLLING MEADOWS | |
| UPS CHARGING | 1 | 225 | 225 | | |
| BATTERY HEATER MAT | 1 | 180 | 180 | | |
| CABINET HEATER | 1 | 200 | 200 | | |
| FLASHER | | 15 | | ENERGY SUPPLY: CONTACT: JAMES CAMPB | ELL |
| LED STREET NAME SIGN | | 120 | | PHONE: (630) 940-680 | 5 |
| LUMINAIRE | | 240 | | COMPANY: COMMONWE | ALTH EDISON |
| 1170 SOUTH HOUBOLT ROAD 1170 SOUTH HOUBO | | | 926 | ACCOUNT NUMBER: 8469284122 | 22 |
| , 3 , 1 | USER NAMI | E = alexam | | DESIGNED - RRS | REVISED - |
| 1170 SOUTH HOUBOLT ROAD | | | | DRAWN - ACM | REVISED - |
| JOLIET, ILLINOIS 60431 | PLOT SCAL | E = 20,0000 | / in. | CHECKED - KRH | REVISED - |

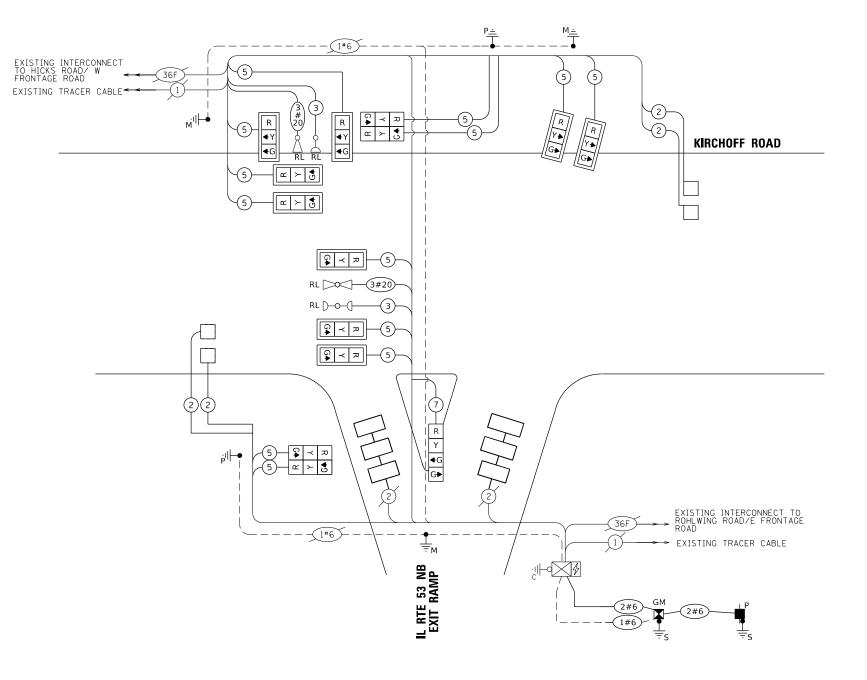

CABLE PLAN
(NOT TO SCALE)

TS 2680 ECON 6

REVISED DRAWN -ACM REVISED LOT SCALE = 20.0000 / in. CHECKED KRH REVISED PLOT DATE = 8/23/2024 REVISED DATE 8/23/2024


STATE OF ILLINOIS
DEPARTMENT OF TRANSPORTATION

CABLE PLAN, PHASE DESIGNATION DIAGRAM, AND EMERGENCY VEHICLE PREEMPTION SEQUENCE KIRCHOFF ROAD AT IL RTE 53 NB EXIT RAMP OF 1 SHEETS STA.

SECTION COUNTY 342 (531) BR 23 COOK 1211 514 CONTRACT NO. 62W38

SIGN PANEL - TYPE 1

ALL DIMENSIONS ARE IN INCHES UNLESS OTHERWISE NOTED

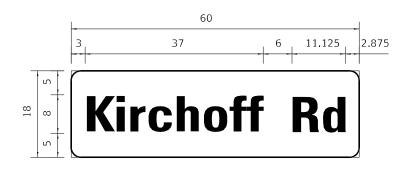

| DESIGN | AREA | SIGN PANEL | SHEETING | QTY. |
|--------|---------|------------|----------|----------|
| SERIES | (SQ FT) | TYPE | TYPE | REQUIRED |
| D | 7.5 | 1 | ZZ | |

NOTE: FOR ADDITIONAL DESIGN AND INSTALLATION INFORMATION DETAIL.


SCHEDULE OF QUANTITIES

| ITEM | UNIT | QUANTIT |
|---|-------|---------|
| SIGN PANEL - TYPE 1 | SQ FT | 7.5 |
| UNDERGROUND CONDUIT, GALVANIZED STEEL, 2" DIA. | FOOT | 493 |
| UNDERGROUND CONDUIT, GALVANIZED STEEL, 3" DIA. | FOOT | 172 |
| UNDERGROUND CONDUIT, GALVANIZED STEEL, 4" DIA. | FOOT | 109 |
| HANDHOLE | EACH | 2 |
| MAINTENANCE OF EXISTING TRAFFIC SIGNAL INSTALLATION | EACH | 1 |
| ELECTRIC CABLE IN CONDUIT, SIGNAL NO. 14 5C | FOOT | 3,879 |
| ELECTRIC CABLE IN CONDUIT, SIGNAL NO. 14 7C | FOOT | 194 |
| ELECTRIC CABLE IN CONDUIT, LEAD-IN, NO. 14 1 PAIR | FOOT | 1,576 |
| ELECTRIC CABLE IN CONDUIT, SERVICE, NO. 6 2 C | FOOT | 221 |
| ELECTRIC CABLE IN CONDUIT, EQUIPMENT GROUNDING CONDUCTOR, NO. 6 1C | FOOT | 430 |
| TRAFFIC SIGNAL POST, GALVANIZED STEEL 16 FT. | EACH | 2 |
| STEEL MAST ARM ASSEMBLY AND POLE, 30 FT. | EACH | 1 |
| STEEL MAST ARM ASSEMBLY AND POLE, 44 FT. | EACH | 1 |
| CONCRETE FOUNDATION, TYPE A | FOOT | 12 |
| CONCRETE FOUNDATION, TYPE E 36-INCH DIAMETER | FOOT | 36 |
| DRILL EXISTING HANDHOLE | EACH | 14 |
| SIGNAL HEAD, LED, 1-FACE, 3-SECTION, MAST-ARM MOUNTED | EACH | 9 |
| SIGNAL HEAD, LED, 1-FACE, 3-SECTION, BRACKET MOUNTED | EACH | 4 |
| SIGNAL HEAD, LED, 1-FACE, 4-SECTION, BRACKET MOUNTED | EACH | 1 |
| TRAFFIC SIGNAL BACKPLATE, LOUVERED, FORMED PLASTIC | EACH | 9 |
| INDUCTIVE LOOP DETECTOR | EACH | 2 |
| DETECTOR LOOP, TYPE I | FOOT | 360 |
| RELOCATE EXISTING EMERGENCY VEHICLE PRIORITY SYSTEM, DETECTOR UNIT | EACH | 2 |
| REMOVE ELECTRIC CABLE FROM CONDUIT | FOOT | 144 |
| REMOVE EXISTING HANDHOLE | EACH | 2 |
| REMOVE EXISTING TRAFFIC SIGNAL EQUIPMENT | EACH | 1 |
| REMOVE EXISTING CONCRETE FOUNDATION | EACH | 5 |
| EMERGENCY VEHICLE PRIORITY SYSTEM LINE SENSOR CABLE, NO. 20 3/C | FOOT | 585 |
| SERVICE INSTALLATION, GROUND MOUNTED, METERED | EACH | 1 |
| LED SIGNAL FACE, LENS COVER | EACH | 14 |
| TEMPORARY TRAFFIC SIGNAL TIMING | EACH | 1 |
| STEEL MAST ARM ASSEMBLY AND POLE WITH DUAL MAST ARMS, 24 FT AND 30 FT | EACH | 1 |


^{*100%} COST TO THE CITY OF ROLLING MEADOWS

| USER NAME = alexam | DESIGNED - RRS | REVISED - | |
|----------------------------|------------------|-----------|--|
| | DRAWN - ACM | REVISED - | |
| PLOT SCALE = 20.0000 / in. | CHECKED - KRH | REVISED - | |
| PLOT DATE = 8/23/2024 | DATE - 8/23/2024 | REVISED - | |


| MAST ARM | MOUNTED STREET NAME SIGN | S AND SCHEDULE OF QUANTITIES | F.A.P. RTE | SECTION | COUNTY | TOTAL SHEETS | SHEET NO. |
|---------------|------------------------------|------------------------------|---------------|--------------|---------------|-----------------|--------------|
| | KIRCHOFF ROAD AT IL RTE | 53 NR FXIT RAMP | 342 | (531) BR 23 | соок | 1211 | 515 |
| | Killonori Horiz /II Iz III z | | | CONTRAC | T NO. 62 | 2W38 | |
| SCALE: N.T.S. | SHEET 1 OF 1 SHEETS | STA. TO STA. | | ILLINOIS FED | . AID PROJECT | | |

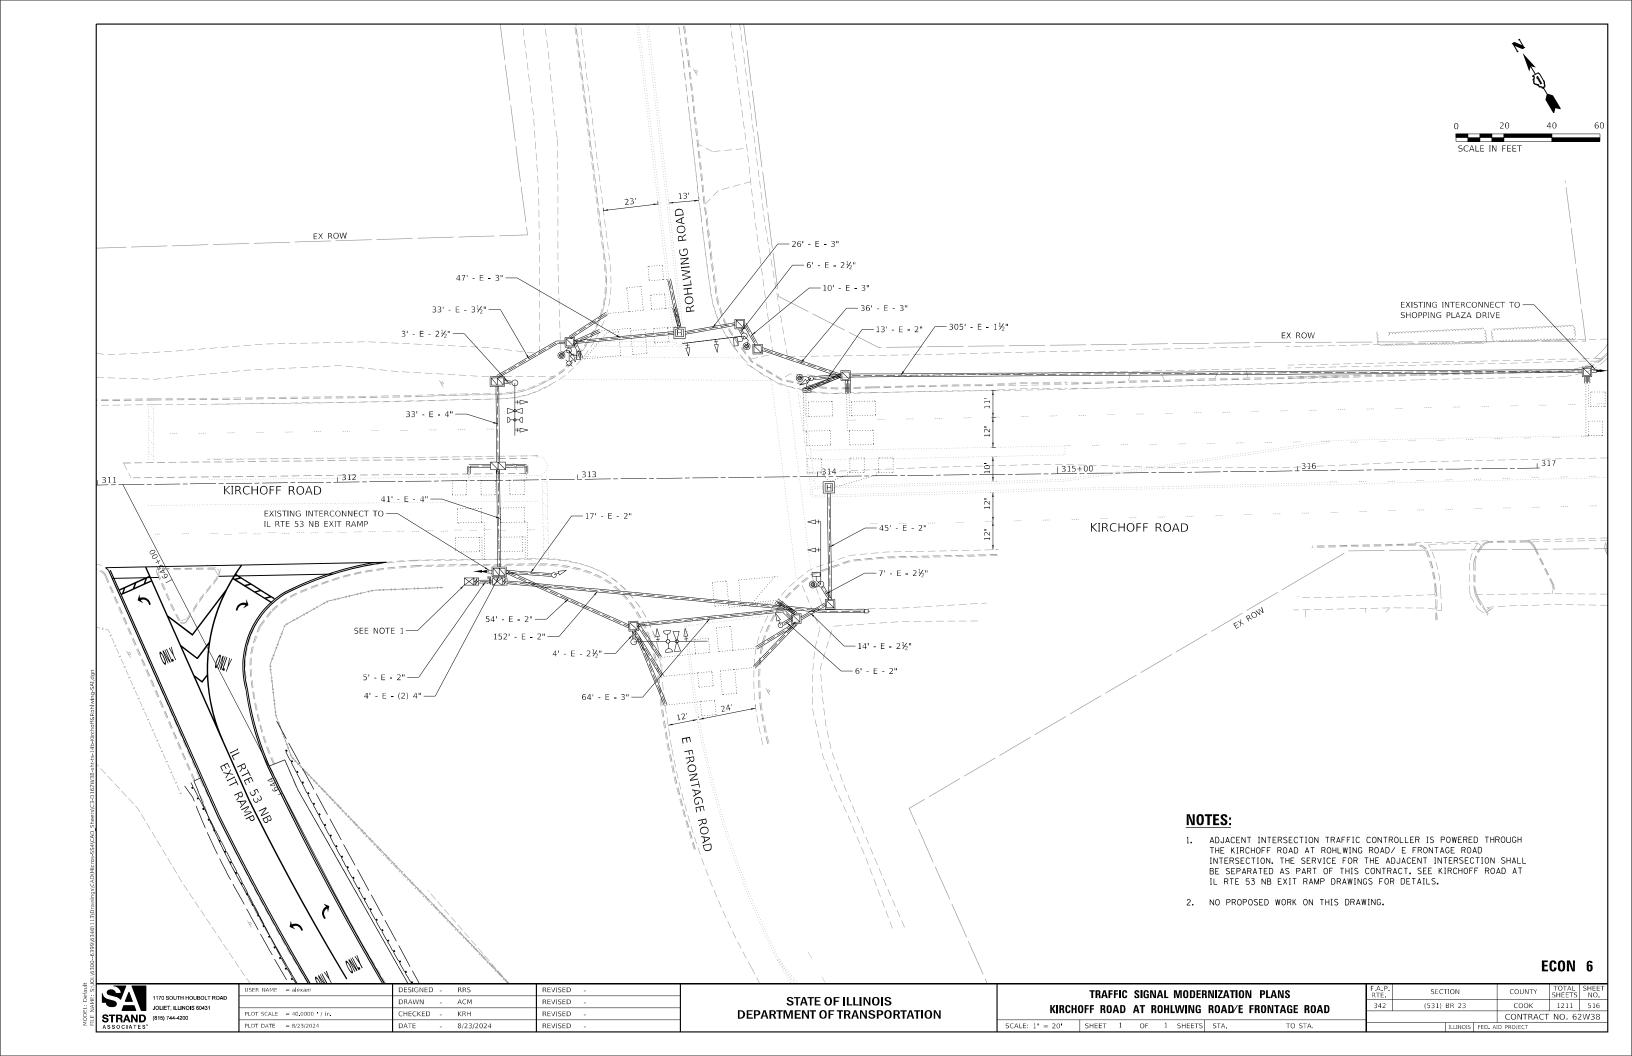


EXISTING & PROPOSED PHASE DESIGNATION DIAGRAM

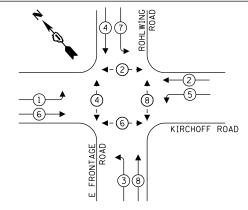


EXISTING & PROPOSED EMERGENCY VEHICLE PREEMPTION SEQUENCE

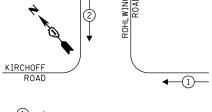

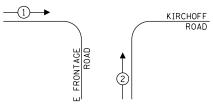

| | TRAFFIC ELECTRIC SERVICE | | MENTS | |
|---|-----------------------------|-----------|-----------------|------------------|
| | TYPE | QUANTITY | UNIT WATTAGE | TOTAL WATTAGE |
| | SIGNAL HEAD | | | |
| | 3 - SECTION | 4 | 11 | 44 |
| | 4 - SECTION | | 14 | |
| lgn | 5 - SECTION | 8 | 13 | 104 |
| SAI.c | PROGRAMMABLE SIGNALS | | | |
| ing- | 3 - SECTION | | 22 | |
| 3 | 4 - SECTION | | 32 | |
| &Ro | 5 - SECTION | | 28 | |
| hoff | PED. SIGNAL | 4 | 15 | 60 |
| Ϋ́ | CONTROLLER | 1 | 150 | 150 |
| Jan | MASTER CONTROLLER | | 100 | |
| o e | UPS | 1 | 25 | 25 |
| -Cal | DETECTION RADAR | | 20 | |
| -15b | DETECTION VIDEO | | 20 | |
| t-ts | BLANK-OUT SIGN | | 25 | |
| -Sh | NETWORK SWITCH II OR III | | 35 | |
| W38 | CELLULAR MODEM | | 15 | |
| Sheets\C3-D162W38sht-ts-15b-Cable Plan-Kirchoff&Rohlwing-SALdgn | TOTAL UPS SIZ | ING | | 383 |
| 3-5 | UPS CHARGING | 1 | 225 | 225 |
| ets\ | BATTERY HEATER MAT | 1 | 180 | 180 |
| She | CABINET HEATER | 1 | 200 | 200 |
| PΒ | FLASHER | | 15 | |
| S4/C | LED STREET NAME SIGN | | 120 | |
| S-S0 | LUMINAIRE | | 240 | |
| AD\Micros-SS4\CAD | TOTAL SERVICE WIF | RE SIZING | | 988 |
| ġ | ENERGY COSTS TO: | | | |

LEGEND:

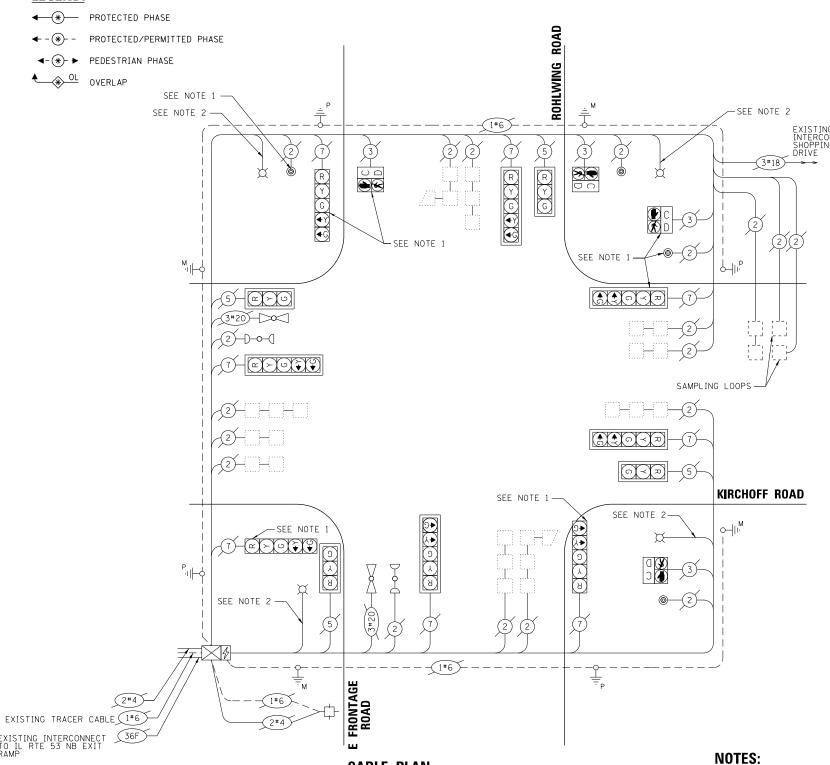

CABLE PLAN

SCHEDULE OF QUANTITIES

| ITEM | UNIT | QUANTIT |
|---|------|---------|
| MAINTENANCE OF EXISTING TRAFFIC SIGNAL INSTALLATION | EACH | 1 |
| TEMPORARY TRAFFIC SIGNAL TIMING | EACH | 1 |
| | | |

ECON 6

STRAND (815) 744-4200

ENERGY SUPPLY:

CONTACT: JAMES CAMPBELL

PHONE: (630) 940-6805 COMPANY: COMMONWEALTH EDISON

CITY OF ROLLING MEADOWS

DRAWN ACM REVISED OT SCALE = 20.0000 / in. HECKED KRH REVISED PLOT DATE = 8/23/2024 8/23/2024 REVISED DATE

STATE OF ILLINOIS

CABLE PLAN, PHASE DESIGNATION DIAGRAM, AND EMERGENCY VEHICLE PREEMPTION SEQUENCE KIRCHOFF ROAD AT ROHLWING ROAD/E FRONTAGE ROAD SHEET 1 OF 1 SHEETS STA.


SECTION COUNTY (531) BR 23 COOK 1211 517 CONTRACT NO. 62W38


1. EXISTING TRAFFIC SIGNAL EQUIPMENT IS LOCATED ON EXISTING STREET LIGHTING POLE

2. EXISTING STREET LIGHTING WIRE SIZE AND CONTROLLER LOCATION IS UNKNOWN.

DESIGNED -RRS REVISED


DEPARTMENT OF TRANSPORTATION

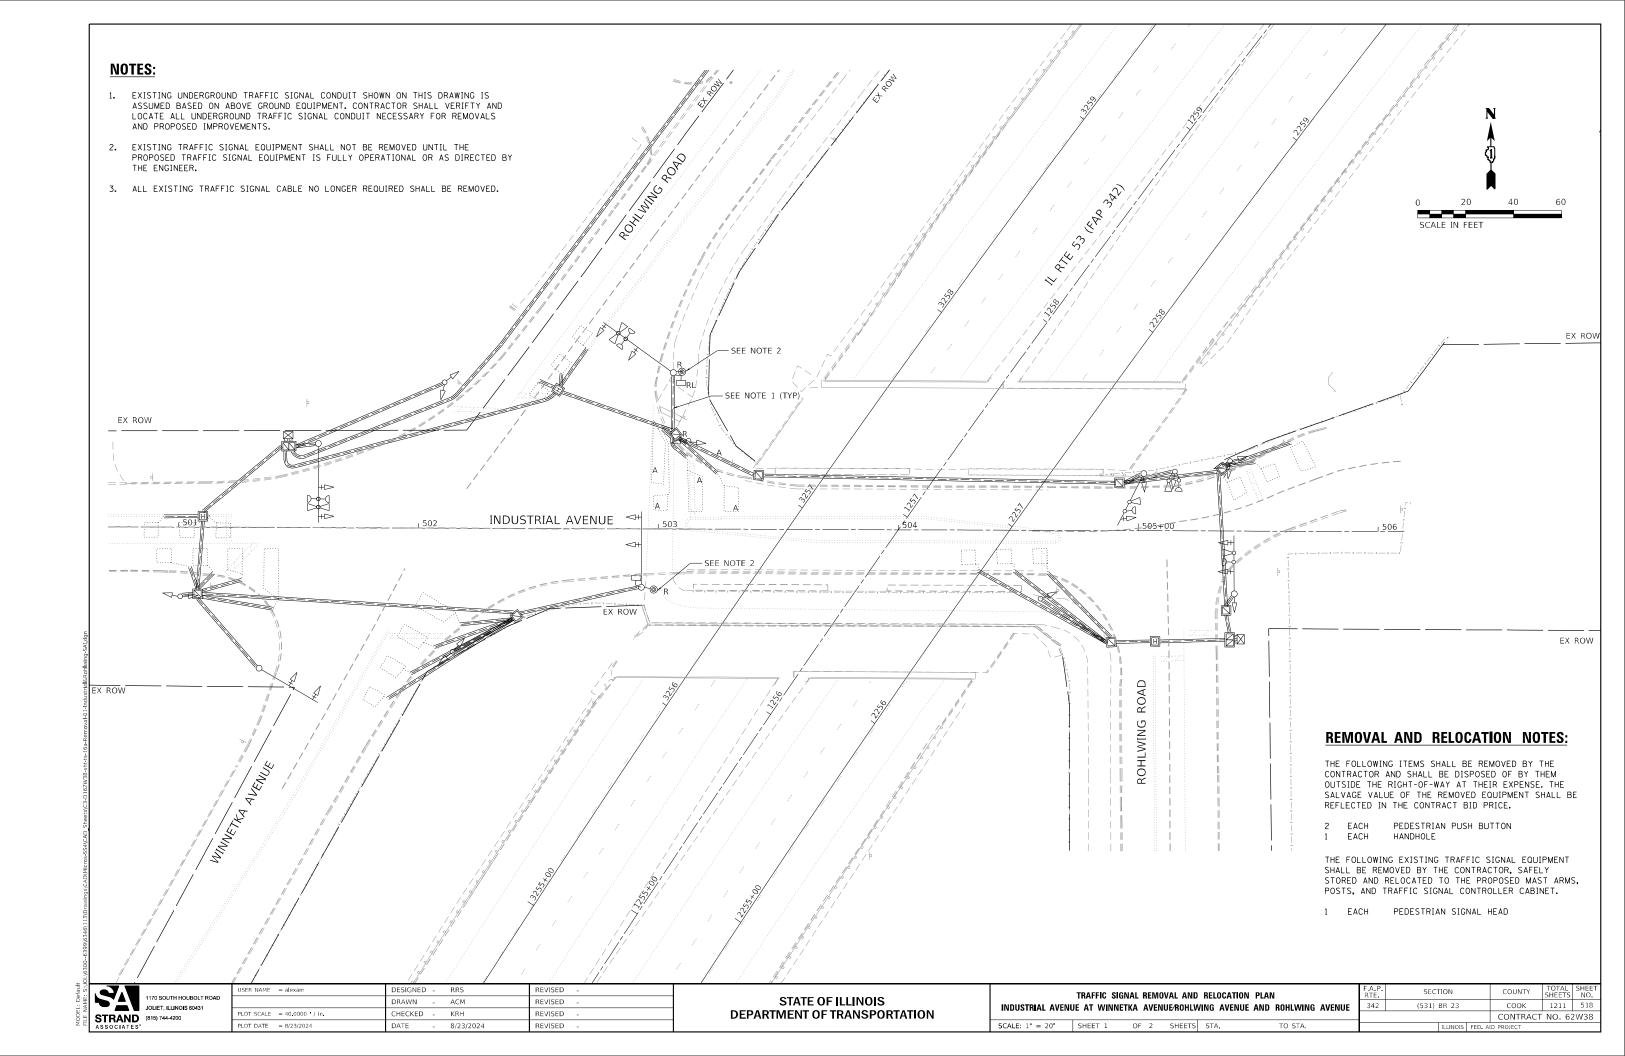


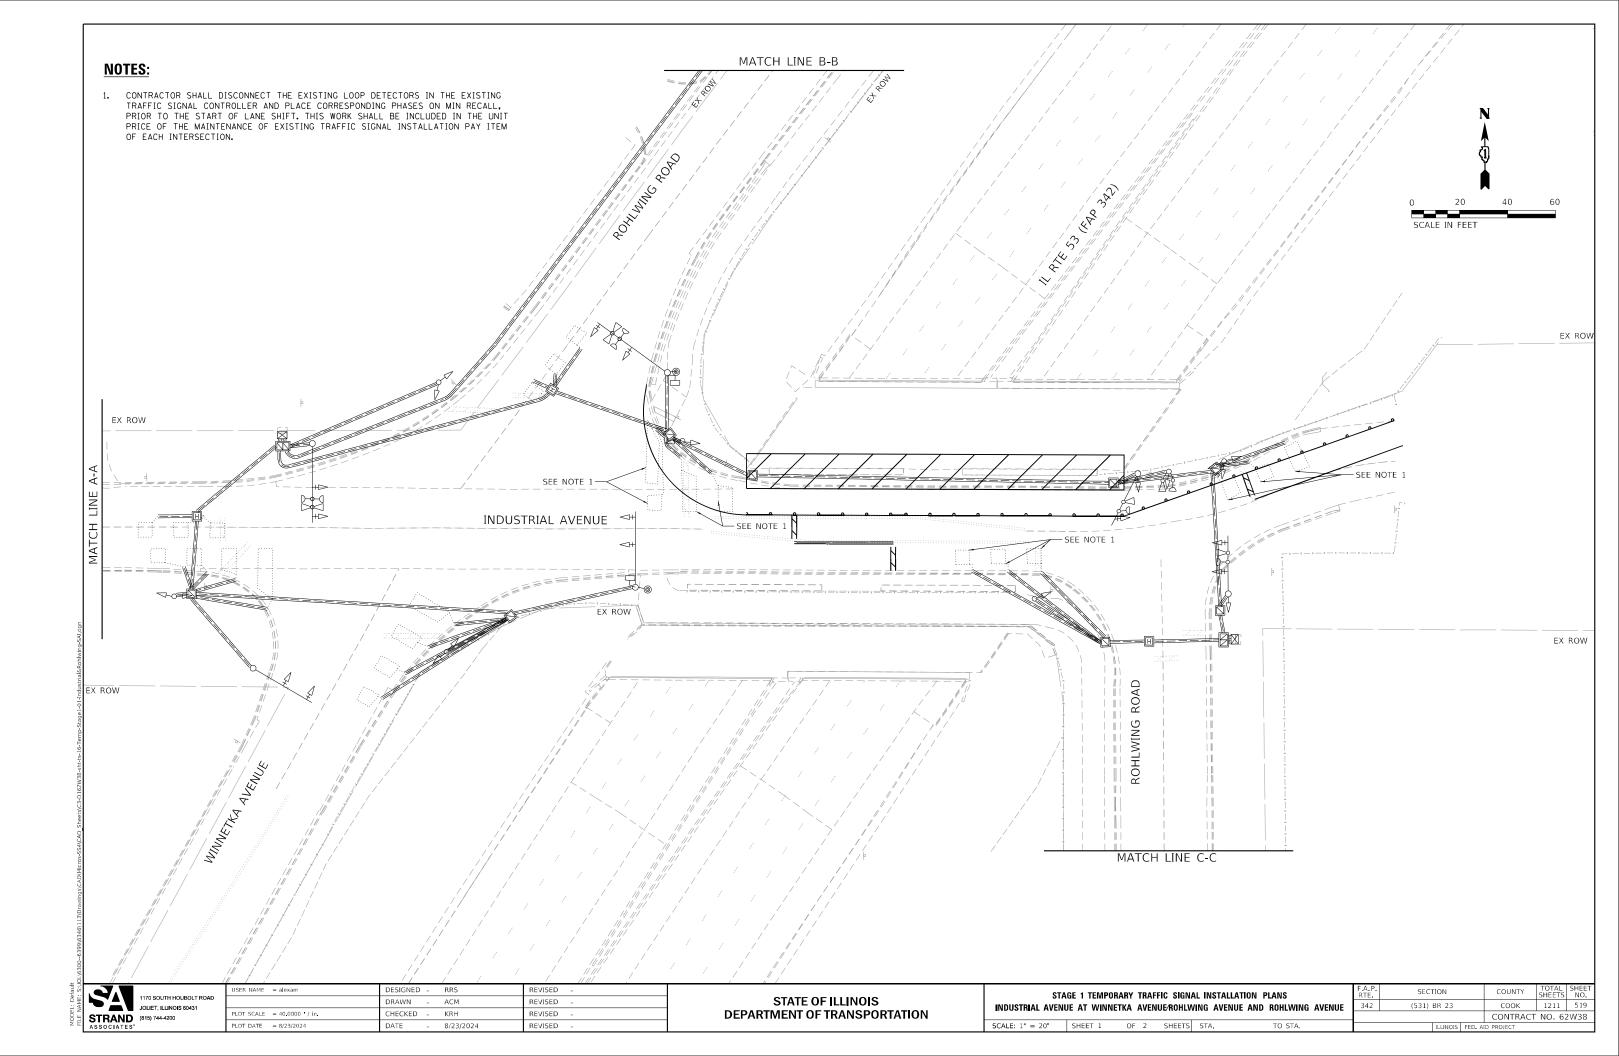


NOTE: 1. EXISTING UNDERGY ASSUMED BASED C LOCATE ALL UNDE ACCESSIBLE PEDES

1. EXISTING UNDERGROUND TRAFFIC SIGNAL CONDUIT SHOWN ON THIS DRAWING IS ASSUMED BASED ON ABOVE GROUND EQUIPMENT. CONTRACTOR SHALL VERIFTY AND LOCATE ALL UNDERGROUND TRAFFIC SIGNAL CONDUIT NECESSARY TO INSTALL THE ACCESSIBLE PEDESTRIAN SIGNAL IMPROVEMENTS

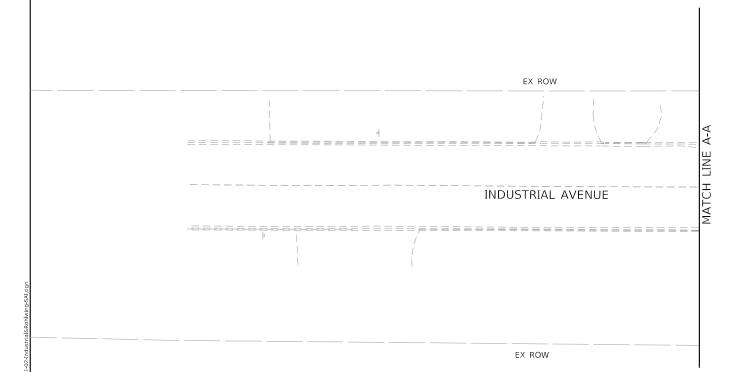

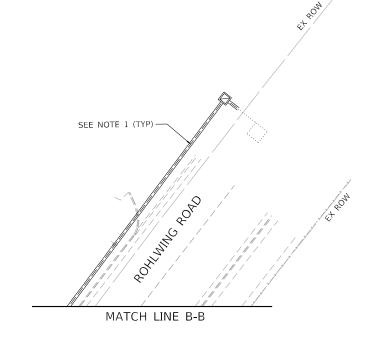

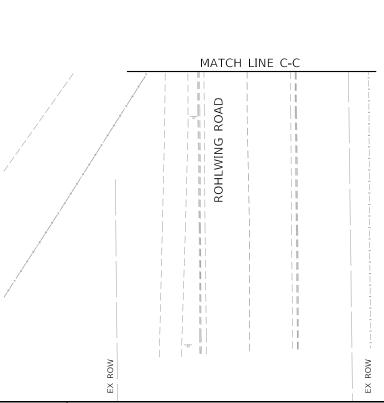


1170 SOUTH HOUBOLT ROA
JOLIET, ILLINOIS 60431
STRAND
(815) 744-4200
ASSOCIATES"

| USER NAME = alexam | DESIGNED | - | RRS | REVISED - |
|----------------------------|----------|---|-----------|-----------|
| | DRAWN | - | ACM | REVISED - |
| PLOT SCALE = 40.0000 / in. | CHECKED | - | KRH | REVISED - |
| PLOT DATE = 8/23/2024 | DATE | - | 8/23/2024 | REVISED - |


STATE OF ILLINOIS
DEPARTMENT OF TRANSPORTATION


| | STAGE 1 TRAFFIC S | IGNAL REMO | VAL AND 1 | TEMPORARY | TRAFFIC | SIGNAL | INSTALLATIO | N PLANS | F.A.P. RTE |
|--|-------------------|------------|-----------|-----------|---------|--------|-------------|---------|---------------|
| INDUSTRIAL AVENUE AT WINNETKA AVENUE/ROHLWING AVENUE AND ROHLWING AVENUE | | | | | | | | | 342 |
| | SCALE: 1" = 20' | SHEET 2 | OF 2 | SHEETS | STA. | | TO STA. | | |

| F.A.P. RTE | SECTION | | COUNTY | TOTAL SHEETS | SHEET NO. |
|---------------------------|-------------|--|----------|-----------------|--------------|
| 342 | (531) BR 23 | | соок | 1211 | 520 |
| | | | CONTRACT | NO. 62 | 2W38 |
| ILLINOIS FED. AID PROJECT | | | | | |

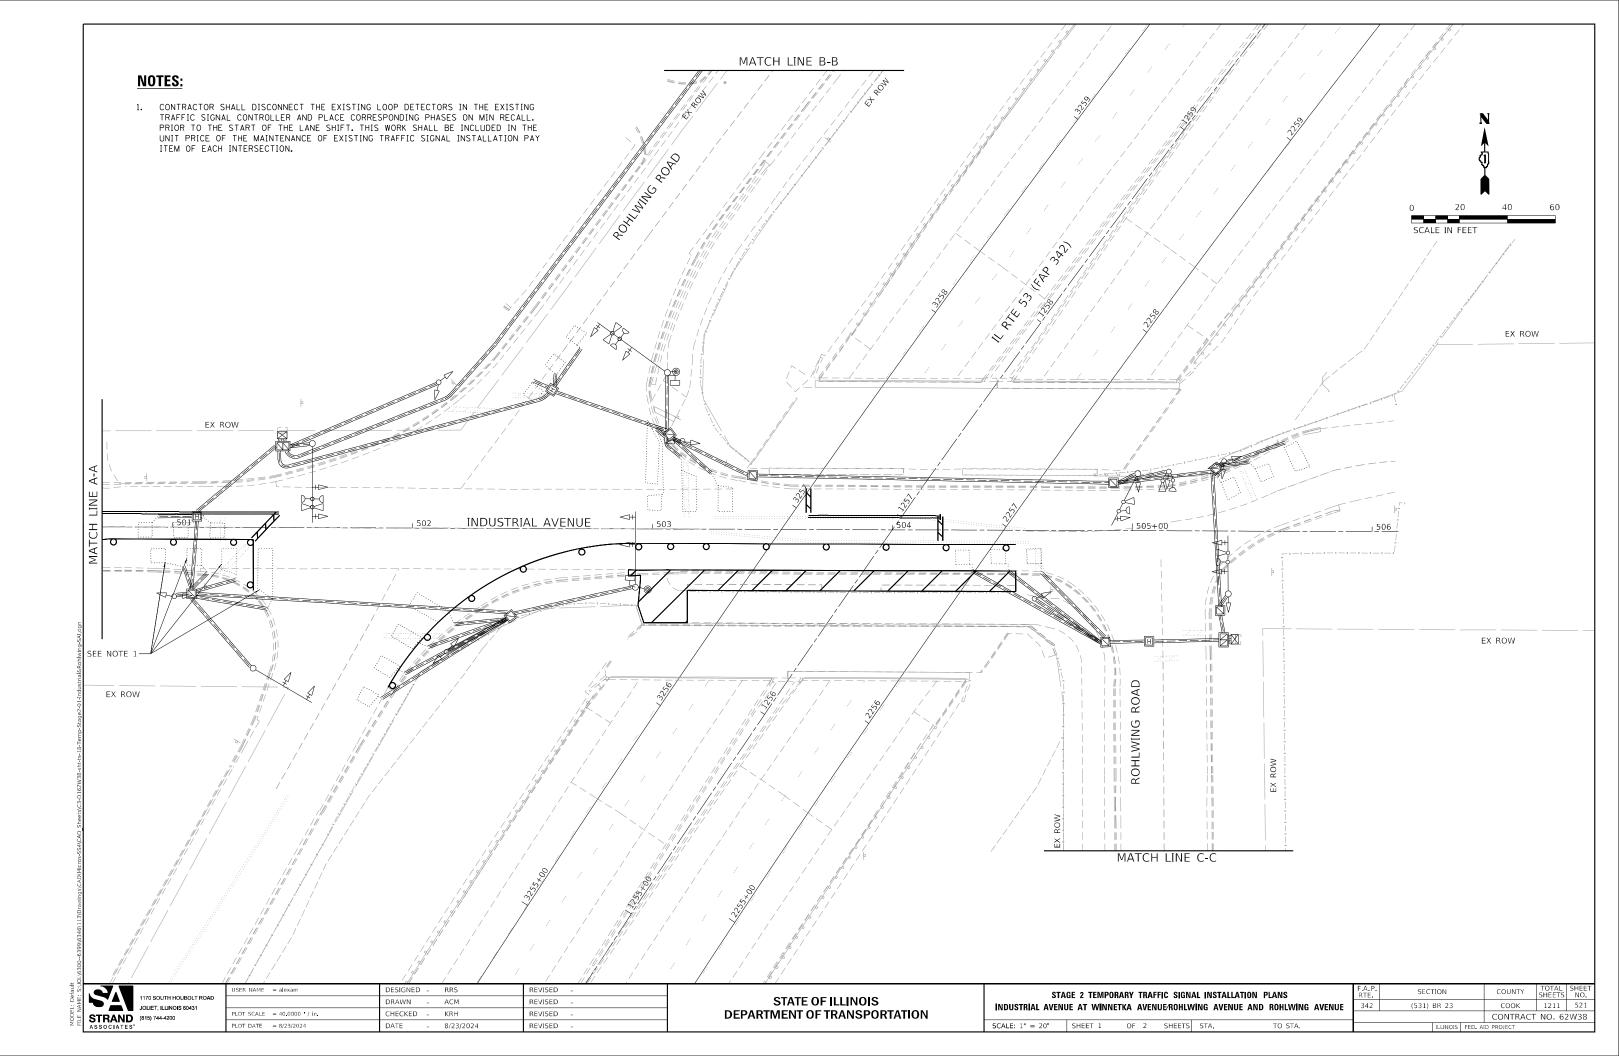

NOTES: 1. EXISTING UNDERGROUND TRAFFIC SIGNAL CONDUIT SHOWN ON THIS DRAWING IS ASSUMED BASED ON ABOVE GROUND EQUIPMENT. CONTRACTOR SHALL VERIFTY AND LOCATE ALL UNDERGROUND TRAFFIC SIGNAL CONDUIT NECESSARY TO INSTALL THE ACCESSIBLE PEDESTRIAN SIGNAL IMPROVEMENTS. EX ROW [500+00 INDUSTRIAL AVENUE EX ROW

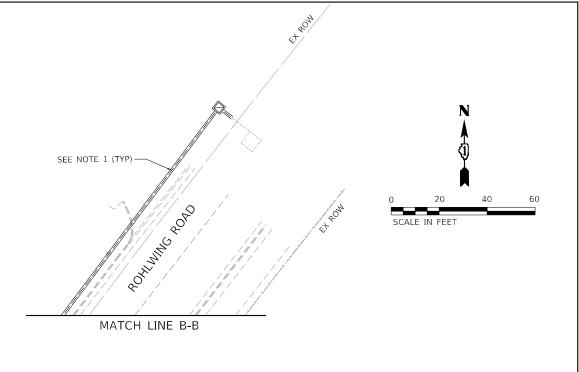

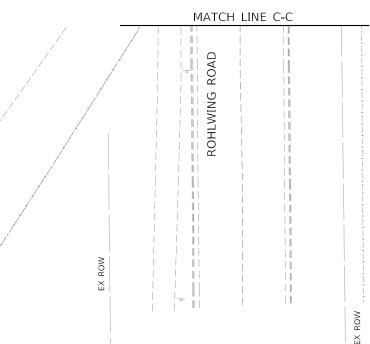

1170 SOUTH HOUBOLT ROA JOLIET, ILLINOIS 60431 STRAND ASSOCIATES"


| USER NAME = alexam | DESIGNED | - | RRS | REVISED - | |
|----------------------------|----------|---|-----------|-----------|--|
| | DRAWN | - | ACM | REVISED - | |
| PLOT SCALE = 40.0000 / in. | CHECKED | - | KRH | REVISED - | |
| PLOT DATE = 8/23/2024 | DATE | - | 8/23/2024 | REVISED - | |

STATE OF ILLINOIS DEPARTMENT OF TRANSPORTATION

| I | STA | GE 2 TEMPO | RARY TRAFF | IC SIGNA | L INSTALL | ATION PLANS | F.A |
|---|------------------|-------------|------------|----------|-----------|------------------------|-----|
| I | INDUSTRIAL AVENU | IE AT WINNI | ETKA AVENI | JE⁄ROHLW | ING AVEN | UE AND ROHLWING AVENUE | 3 |
| I | SCALE: 1" = 20' | SHEET 2 | OF 2 | SHEETS | STA. | TO STA. | 1 |

| F.A.P. RTE | SECTION | | COUNTY | TOTAL SHEETS | SHEET NO. |
|---------------|-------------|----------|-----------|-----------------|--------------|
| 342 | (531) BR 23 | соок | 1211 | 522 | |
| | | CONTRACT | NO. 62 | 2W38 | |
| | ILLINOIS | FED. A | D PROJECT | | |

TEMPORARY PHASE DESIGNATION DIAGRAM

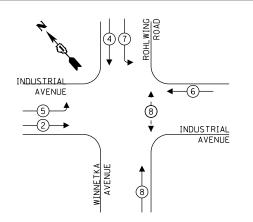

LEGEND:


★PROTECTED PHASE

← -(*)- - PROTECTED/PERMITTED PHASE

√- *- PEDESTRIAN PHASE

OVERLAP OVERLAP

TEMPORARY EMERGENCY VEHICLE PREEMPTION SEQUENCE

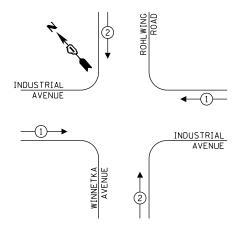

| CNIAI | | |
|--------------|--------------------------------|--|
| GNAL | | |
| EQUIREN | MENTS | |
| QUANTIT Y | UNIT WATTAGE | TOTAL |
| | | |
| 1 12 | 11 | 132 |
| ı | 14 | |
| 1 4 | 13 | 52 |
| | | |
| ı | 22 | |
| I | 32 | |
| ı | 28 | |
| 2 | 15 | 30 |
| 1 | 150 | 150 |
| | 100 | |
| | 25 | |
| | 20 | |
| | 20 | |
| | 25 | |
| | 35 | |
| | 15 | |
| | | 364 |
| | 225 | |
| | 180 | |
| | 200 | |
| | 15 | |
| | 120 | |
| | 240 | |
| IZING | | 364 |
| | | |
| | QUANTITY 1 12 1 4 1 4 1 4 1 2 | EQUIREMENTS QUANTIT VINIT WATTAGE 4 12 11 4 14 4 13 4 22 4 28 28 7 2 15 7 1 150 7 100 7 25 7 20 7 20 7 20 7 20 7 20 7 20 7 20 7 20 |

CITY OF ROLLING MEADOWS


ENERGY SUPPLY:

CONTACT: JAMES CAMPBELL

PHONE: (630) 940-6805 COMPANY: COMMONWEALTH EDISON

NOTES

- 1. CABLE ROUTING SHOWN ON THIS DRAWING ARE ASSUMED BASED ON INDUSTRY STANDARDS. CONTRACTOR SHALL VERIFY ALL TRAFFIC SIGNAL CABLES NECCESSARY FOR REMOVALS AND PROPOSED IMPROVEMENTS.
- 2. CONTRACTOR SHALL DISCONNECT THE EXISTING LOOP DETECTOR IN THE EXISTING TRAFFIC SIGNAL CONTROLLER, PRIOR TO THE LANE SHIFT IN STAGE 1, AND PLACE PHASE 6 ON MIN RECALL. THIS WORK SHALL BE INCLUDED IN THE UNIT PRICE OF THE MAINTENANCE OF EXISTING TRAFFIC SIGNAL INSTALLATION PAY
- 3. AT THE COMPLETION OF STAGE 2, THE CONTRACTOR SHALL RECONNECT THE EXISTING LOOP DECTECTORS IN THE EXISTING CABINET. THIS WORK SHALL BE INCLUDED IN THE UNIT PRICE OF THE MAINTENANCE OF EXISTING TRAFFIC SIGNAL INSTALLATION PAY ITEM.
- CONTRACTOR SHALL DISCONNECT THE EXISTING LOOP DETECTOR IN THE EXISTING TRAFFIC SIGNAL CONTROLLER, PRIOR TO THE START OF STAGE 2, AND PLACE PHASE 2 ON MIN RECALL. THIS WORK SHALL BE INCLUDED IN THE UNIT PRICE OF THE MAINTENANCE OF EXISTING TRAFFIC SIGNAL INSTALLATION PAY

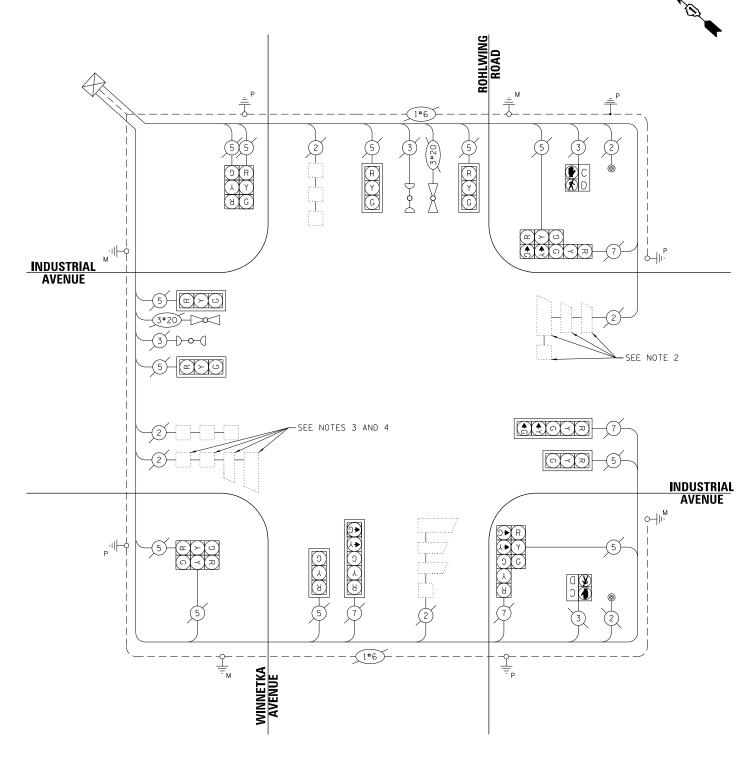

CABLE PLAN


| STATE OF ILLINOIS | |
|------------------------------|--|
| DEPARTMENT OF TRANSPORTATION | |

| | | | | | , | F.A.P. RTE | SECTION | COUNTY | TOTAL SHEETS | |
|---------------|------------|----------|----------|----------|-----------------|---------------|--------------|-------------|-----------------|------|
| | | | | | IPTION SEQUENCE | 342 | (531) BR 23 | соок | 1211 | 523 |
| INDUST | RIAL AVENU | je at wi | NNETKA A | AVENUE/R | OHLWING ROAD | | | CONTRACT | F NO. 6 | 2W38 |
| SCALE: N.T.S. | SHEET 1 | OF 2 | SHEETS | STA. | TO STA. | | ILLINOIS FEE | AID PROJECT | | |

1170 SOUTH HOUBOLT ROAD JOLIET, ILLINOIS 60431

DESIGNED - RRS REVISED DRAWN -ACM REVISED LOT SCALE = 20.0000 / in. HECKED KRH REVISED PLOT DATE = 8/23/2024 DATE 8/23/2024 REVISED

TEMPORARY PHASE DESIGNATION DIAGRAM

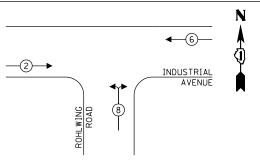


LEGEND:

OL OVERLAP

←PROTECTED PHASE ← -(*)- - PROTECTED/PERMITTED PHASE √-(*)- ► PEDESTRIAN PHASE

TEMPORARY EMERGENCY VEHICLE PREEMPTION SEQUENCE

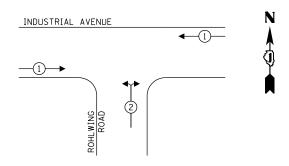

| | TRAFFIC S | SIGNAL |
|-----------------|-----------|--------------|
| ELECTRIC | SERVICE | REQUIREMENTS |

| | TYPE | QUANTITY | UNIT WATTAGE | TOTAL WATTAG |
|---|--------------------------|----------|-----------------|-----------------|
| Sheets\C3-D162W38-sht-ts-20-01-Temp-Cable-Plan-Industrial&Rohlwing-East-SAI.dgn | SIGNAL HEAD | | | |
| -SA | 3 - SECTION | 10 | 11 | 110 |
| Eas | 4 - SECTION | | 14 | |
| /ing | 5 - SECTION | | 13 | |
| - N | PROGRAMMABLE SIGNALS | | | |
| S.R | 3 - SECTION | | 22 | |
| Strig | 4 - SECTION | | 32 | |
| ngri | 5 - SECTION | | 28 | |
| au- | PED. SIGNAL | | 15 | |
| e-P | CONTROLLER | 1 | 150 | 150 |
| Cab | MASTER CONTROLLER | | 100 | |
| due | UPS | | 25 | |
| Ĭ-Ĭ | DETECTION RADAR | | 20 | |
| 20-0 | DETECTION VIDEO | | 20 | |
| -ts | BLANK-OUT SIGN | | 25 | |
| 3-sht | NETWORK SWITCH II OR III | | 35 | |
| W38 | CELLULAR MODEM | | 15 | |
| 162 | TOTAL UPS SIZIN | G | • | 260 |
| 33-0 | UPS CHARGING | | 225 | |
| ets/ | BATTERY HEATER MAT | | 180 | |
| She | CABINET HEATER | | 200 | |
| ΑD | FLASHER | | 15 | |
| S4/C | LED STREET NAME SIGN | | 120 | |
| (Micros SS4\CAD | LUMINAIRE | | 240 | |
| ٩ic | TOTAL SERVICE WIRE | SIZING | | 260 |
| = | | | | |

ENERGY COSTS TO:

CITY OF ROLLING MEADOWS


ENERGY SUPPLY:

CONTACT: JAMES CAMPBELL PHONE: (630) 940-6805 COMPANY: COMMONWEALTH EDISON

NOTES

- 1. CABLE ROUTING SHOWN ON THIS DRAWING ARE ASSUMED BASED ON INDUSTRY STANDARDS. CONTRACTOR SHALL VERIFY ALL TRAFFIC SIGNAL CABLES NECCESSARY FOR REMOVALS AND PROPOSED IMPROVEMENTS.
- 2. CONTRACTOR SHALL DISCONNECT THE EXISTING LOOP DETECTOR IN THE EXISTING TRAFFIC SIGNAL CONTROLLER, PRIOR TO THE LANE SHIFT IN STAGE 1, AND PLACE PHASE 2 ON MIN RECALL. THIS WORK SHALL BE INCLUDED IN THE UNIT PRICE OF THE MAINTENANCE OF EXISTING TRAFFIC SIGNAL INSTALLATION PAY
- 3. AT THE COMPLETION OF STAGE 2, THE CONTRACTOR SHALL RECONNECT THE EXISTING LOOP DECTECTORS IN THE EXISTING CABINET. THIS WORK SHALL BE INCLUDED IN THE UNIT PRICE OF THE MAINTENANCE OF EXISTING TRAFFIC SIGNAL INSTALLATION PAY ITEM.
- 4. CONTROLLER SHALL DISCONNECT THE EXISTING LOOP DETECTOR IN THE EXISTING TRAFFIC SIGNAL CONTROLLER, PRIOR TO LANE SHIFT IN STAGE 1, AND PLACE PHASE 6 ON MIN RECALL. THIS WORK SHALL BE INCLUDED IN THE UNIT PRICE OF THE
 MAINTENANCE OF EXISTING TRAFFIC SIGNAL INSTALLATION PAY



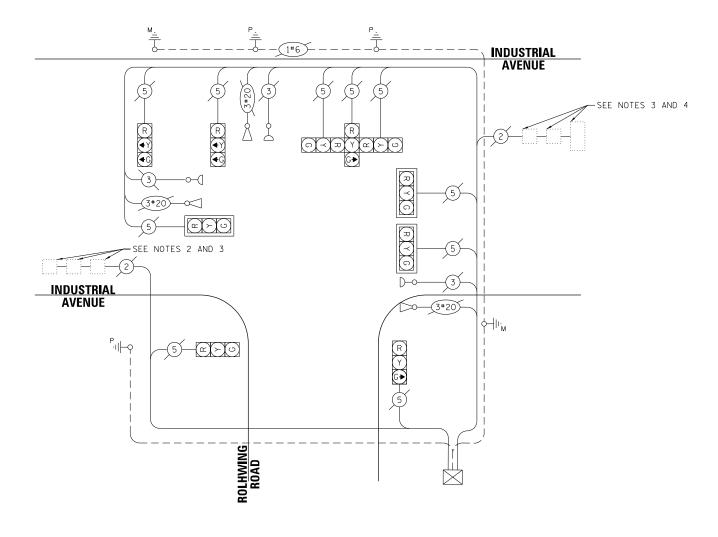


CABLE PLAN (NOT TO SCALE)

| STATE OF ILLINOIS |
|------------------------------|
| STATE OF ILLINOIS |
| DEPARTMENT OF TRANSPORTATION |

| ALL STAGES TEM | PORARY CA | BLE PLAN | , TEMPOR | ARY PHAS | SE DESIGNATION DIAGRAM, | F.A.P. RTE | SEC. | TION | | COUNTY | TOTAL SHEETS | |
|----------------|-----------|-----------|----------|----------|-------------------------|---------------|-------|----------|--------|-----------|-----------------|------|
| AND T | EMPORARY | EMERGEN | CY VEHIC | LE PREEN | MPTION SEQUENCE | 342 | (531) | BR 23 | | соок | 1211 | 524 |
| | INDUST | RIAL AVEN | UE AT R | OHLWING | ROAD | | | | | CONTRACT | NO. 6 | 2W38 |
| SCALE: N.T.S. | SHEET 2 | OF 2 | SHEETS | STA. | TO STA. | | | ILLINOIS | FED. A | D PROJECT | | |


1170 SOUTH HOUSE JOLIET, ILLINOIS 60431 /815) 744-4200 1170 SOUTH HOUBOLT ROAD


DESIGNED - RRS REVISED DRAWN -ACM REVISED HECKED KRH REVISED PLOT DATE = 8/23/2024 REVISED DATE 8/23/2024

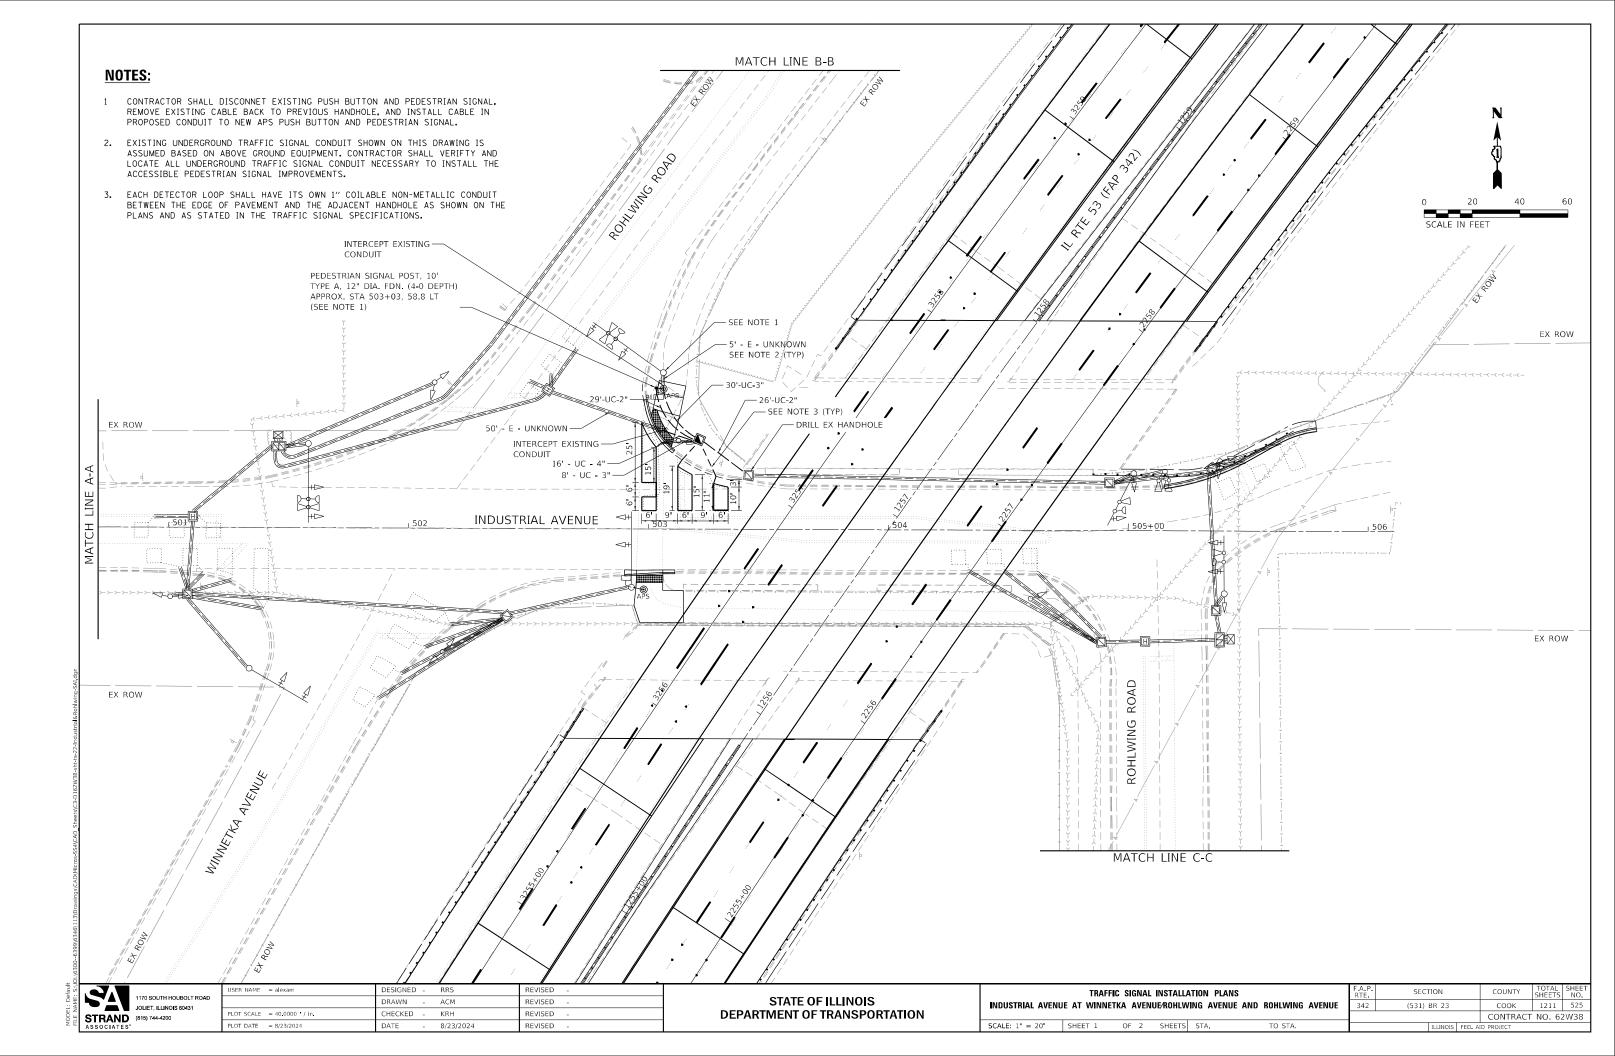

NOTES:

- 1. EXISTING UNDERGROUND TRAFFIC SIGNAL CONDUIT SHOWN ON THIS DRAWING IS ASSUMED BASED ON ABOVE GROUND EQUIPMENT. CONTRACTOR SHALL VERIFTY AND LOCATE ALL UNDERGROUND TRAFFIC SIGNAL CONDUIT NECESSARY TO INSTALL THE ACCESSIBLE PEDESTRIAN SIGNAL IMPROVEMENTS.
- 2. NO WORK SHOWN ON THIS DRAWING.

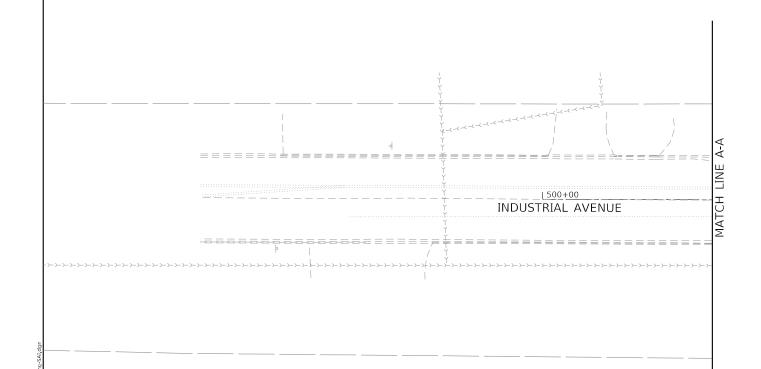

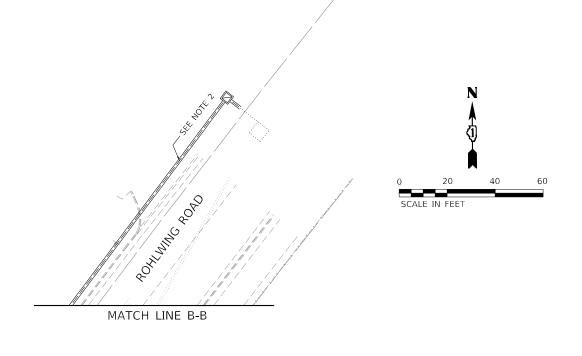

| Λ. | AATCH LINE C.C. |
|----|--|
| | ROHLWING ROAD A CONTRACTOR OF THE CONTRACTOR OF |

1170 SOUTH HOUBOLT ROA JOLIET, ILLINOIS 60431 STRAND ASSOCIATES*


| USER NAME = alexam | DESIGNED | - | RRS | REVISED - |
|----------------------------|----------|---|-----------|-----------|
| | DRAWN | - | ACM | REVISED - |
| PLOT SCALE = 40.0000 / in. | CHECKED | - | KRH | REVISED - |
| PLOT DATE = 8/23/2024 | DATE | - | 8/23/2024 | REVISED - |

STATE OF ILLINOIS DEPARTMENT OF TRANSPORTATION

| | TRAFFIC | SIGNAL I | NSTALLA | TION PLANS | | F.A. RTE |
|-------------------|--------------|----------|----------|---------------|-----------------|-------------|
| INDUSTRIAL AVENUE | E AT WINNETK | A AVENU | E⁄ROHLWI | NG AVENUE AND | ROHLWING AVENUE | 34 |
| SCALE: 1" = 20' | SHEET 2 | OF 2 | SHEETS | STA. | TO STA. | \vdash |

| F.A.P. RTE | SECTION | | COUNTY | TOTAL SHEETS | SHEE NO. |
|---------------|-------------|--------|-----------|-----------------|-------------|
| 342 | (531) BR 23 | соок | 1211 | 526 | |
| | | | CONTRACT | NO. 62 | 2W38 |
| | ILLINOIS | FED. A | D PROJECT | | |


EXISTING & PROPOSED PHASE DESIGNATION DIAGRAM

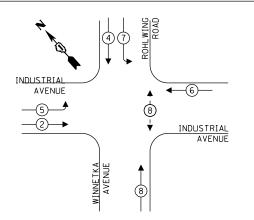

LEGEND:

- **◆ * PROTECTED PHASE**
- PROTECTED/PERMITTED PHASE
- √- *- PEDESTRIAN PHASE
- ♦ OL OVERLAP

EXISTING & PROPOSED EMERGENCY VEHICLE PREEMPTION SEQUENCE

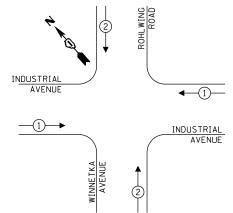


NOTES

CABLE ROUTING SHOWN ON THIS DRAWING ARE ASSUMED BASED ON INDUSTRY STANDARDS. CONTRACTOR SHALL VERIFY ALL TRAFFIC SIGNAL CABLES NECCESSARY TO INSTALL ACCESSIBLE SIGNAL IMPROVEMENTS AT INDUSTRIAL AND WINNETKA/ROHLWING.

SCHEDULE OF QUANTITIES

| UNIT | QUANTITY |
|------|---|
| FOOT | 55 |
| FOOT | 38 |
| FOOT | 16 |
| EACH | 1 |
| FOOT | 42 |
| FOOT | 41 |
| FOOT | 190 |
| FOOT | 21 |
| EACH | 1 |
| FOOT | 188 |
| EACH | 1 |
| FOOT | 25 |
| EACH | 1 |
| EACH | 1 |
| FOOT | 95 |
| EACH | 1 |
| EACH | 1 |
| EACH | 2 |
| EACH | 2 |
| FOOT | 4 |
| EACH | 1 |
| | |
| | FOOT FOOT FOOT FOOT FOOT FOOT FOOT FOOT |

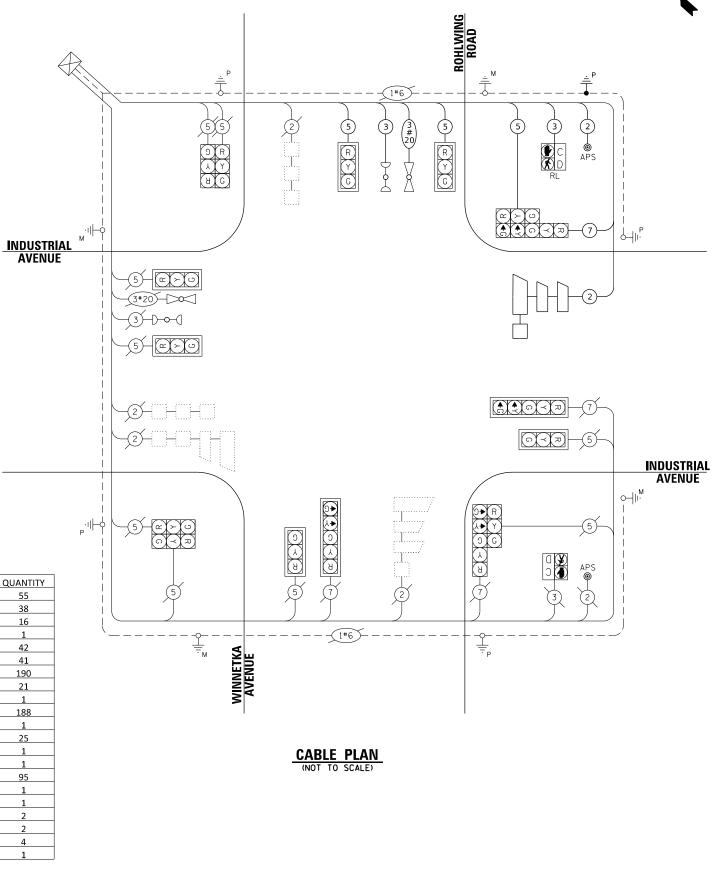

ELECTRIC SERVICE REQUIREMENTS UNIT TOTAL WATTAGE SIGNAL HEAD 3 - SECTION 132 4 - SECTION 14 52 5 - SECTION 13 PROGRAMMABI E SIGNAI S 3 - SECTION 22 4 - SECTION 32 5 - SECTION 28 PED. SIGNAL CONTROLLER 150 150 MASTER CONTROLLER 25 DETECTION RADAR DETECTION VIDEO 20 BLANK-OUT SIGN 25 NETWORK SWITCH II OR III 35 CELLULAR MODEM 15 364 UPS CHARGING 225 BATTERY HEATER MAT 180 200 CABINET HEATER FLASHER 15 120 LED STREET NAME SIGN 240 LUMINAIRE TOTAL SERVICE WIRE SIZING ENERGY COSTS TO:

TRAFFIC SIGNAL

ILLINOIS DEPARTMENT OF TRANSPORATION

1170 SOUTH HOUBOLT ROAD

DIVISION OF HIGHWAY/DISTRICT 1

1170 SOUTH HOUDGE... JOLIET, ILLINOIS 60431 /815) 744-4200

201 WEST CENTER COURT/SCHAUMBURG, ILLINOIS 60196-1096

ENERGY SUPPLY:

CONTACT: JAMES CAMPBELL


PHONE: (630) 940-6805 COMPANY: COMMONWEALTH EDISON

> DESIGNED - RRS REVISED DRAWN ACM REVISED OT SCALE = 20.0000 / in. HECKED KRH REVISED PLOT DATE = 8/23/2024 REVISED DATE 8/23/2024

STATE OF ILLINOIS **DEPARTMENT OF TRANSPORTATION**


SECTION CABLE PLAN, PROPOSED PHASE DESIGNATION DIAGRAM, AND EMERGENCY VEHICLE PREEMPTION INDUSTRIAL AVENUE AT WINNETKA AVENUE/ROHLWING ROAD (531) BR 23 COOK 1211 527 CONTRACT NO. 62W38 SCALE: N.T.S. SHEET 1 OF 2 SHEETS STA.

EXISTING & PROPOSED PHASE DESIGNATION DIAGRAM

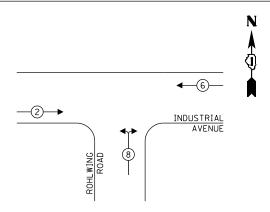

LEGEND:

DREEMBTION SECTIONCE

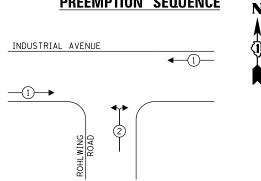

110

150

260

11

13

22

32

28

150

100 25

20

25

35

15

225

180

200

15

120

240

14

EXISTING & PROPOSED EMERGENCY VEHICLE


★PROTECTED PHASE ← -(*)- - PROTECTED/PERMITTED PHASE ◆- *- PEDESTRIAN PHASE ◆ OL OVERLAP

1. CABLE ROUTING SHOWN ON THIS DRAWING ARE ASSUMED BASED ON INDUSTRY STANDARDS. CONTRACTOR SHALL VERIFY ALL TRAFFIC SIGNAL CABLES NECCESSARY TO INSTALL ACCESSIBLE SIGNAL IMPROVEMENTS AT INDUSTRIAL AND WINNETKA/ROHLWING.

NOTES

SCHEDULE OF QUANTITIES

| ITEM | UNIT | QUANTITY |
|---|------|----------|
| MAINTENANCE OF EXISTING TRAFFIC SIGNAL INSTALLATION | EACH | 1 |
| TEMPORARY TRAFFIC SIGNAL TIMING | EACH | 1 |

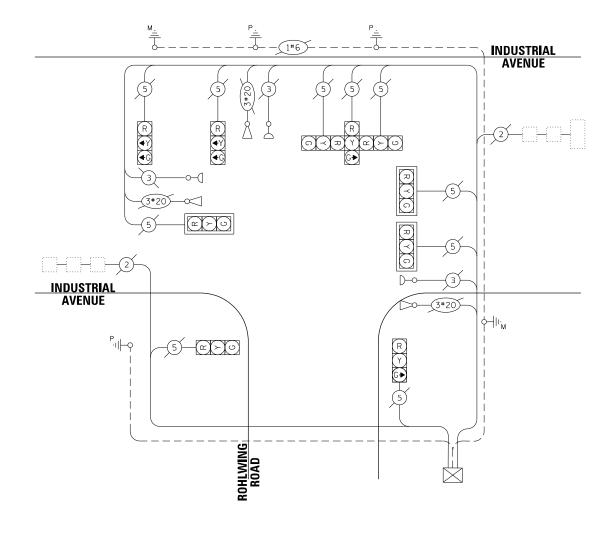

CABLE PLAN (NOT TO SCALE)

CONTACT: JAMES CAMPBELL PHONE: (630) 940-6805 COMPANY: COMMONWEALTH EDISON 1170 SOUTH HUUL-JOLIET, ILLINOIS 60431 (815) 744-4200 1170 SOUTH HOUBOLT ROAD

| USER NAME = alexam | DESIGNED - RRS | REVISED - |
|----------------------------|------------------|-----------|
| | DRAWN - ACM | REVISED - |
| PLOT SCALE = 20.0000 / in. | CHECKED - KRH | REVISED - |
| PLOT DATE = 8/23/2024 | DATE - 8/23/2024 | REVISED - |

STATE OF ILLINOIS **DEPARTMENT OF TRANSPORTATION**

| | | | | | AND EMERGENCY LWING ROAD | VEHICLE |
|--------------|---------|------|--------|-----|-----------------------------|---------|
| CCALE: N.T.C | CHEET 2 | OF 2 | СПЕЕТС | CTA | TO STA | |

| F.A.P. RTE | | | | COUNTY | TOTAL SHEETS | SHEET NO. |
|---------------|-------------|----------|--------|-----------|-----------------|--------------|
| 342 | (531) BR 23 | | | соок | 1211 | 528 |
| · | | | | CONTRACT | NO. 62 | 2W38 |
| | | ILLINOIS | FED. A | D PROJECT | | |

ENERGY SUPPLY:

SIGNAL HEAD

PED. SIGNAL CONTROLLER

MASTER CONTROLLER

DETECTION RADAR DETECTION VIDEO

BLANK-OUT SIGN

CELLULAR MODEM

BATTERY HEATER MAT

LED STREET NAME SIGN

CITY OF ROLLING MEADOWS

UPS CHARGING

FLASHER

LUMINAIRE

CABINET HEATER

ENERGY COSTS TO:

NETWORK SWITCH II OR III

PROGRAMMABLE SIGNALS

STRAND (815) 744-4200

TRAFFIC SIGNAL **ELECTRIC SERVICE REQUIREMENTS**

3 - SECTION

4 - SECTION

5 - SECTION

3 - SECTION

4 - SECTION

5 - SECTION

TOTAL UPS SIZING

TOTAL SERVICE WIRE SIZING







NOTE:

1. CONTRACTOR SHALL DISCONNECT EXISTING FIBER OPTIC CABLE AT IL RTE 53 WEST RAMPS AND IL RTE 53 EAST RAMPS. CONTRACTOR SHALL REMOVE EXISTING FIBER OPTIC CABLE AND TRACER CABLE FROM HH01 TO HH02 TO HH03 TO HH04 TO HH05 TO HH06 TO HH07 TO HH08 TO HH09 TO HH10 TO HH11 AND INSTALL NEW FIBER OPTIC CABLE AND TRACER WIRE FROM H11 TO HH10 TO HH09 TO HH08 TO HH06 TO HH06 TO HH06 TO HH06 TO HH06 TO HH06 TO HH07 TO HH07 TO HH07 TO HH07 TO HH08 T

ECON 13


1211 529

| S | 7. | |
|-------|-------------|------------------------|
| ij | | 1170 SOUTH HOUBOLT RO |
| NAME: | | JOLIET, ILLINOIS 60431 |
| H.E | STRAND | (815) 744-4200 |
| ıΰ | ASSOCIATES" | |

| USER NAME = alexam | DESIGNED | - | RRS | REVISED - | |
|-----------------------------|----------|---|-----------|-----------|--|
| | DRAWN | - | ACM | REVISED - | |
| PLOT SCALE = 100.0000 / in. | CHECKED | - | KRH | REVISED - | |
| PLOT DATE = 8/23/2024 | DATE | - | 8/23/2024 | REVISED - | |

| STATE OF ILLINOIS | |
|------------------------------|--|
| DEPARTMENT OF TRANSPORTATION | |

| INTERCONNECT PLAN | F.A.P. RTE | SECTION | | COUNTY |
|---|---------------|-------------|--------|------------|
| US RTE 14 (NORTHWEST HIGHWAY) | 342 | (531) BR 23 | | соок |
| , | | | | CONTRAC |
| SCALE: 1"=50 SHEET 1 OF 1 SHEETS STA. 603+50.00 TO STA. 618+50.00 | | ILLINOIS | FED. A | ID PROJECT |

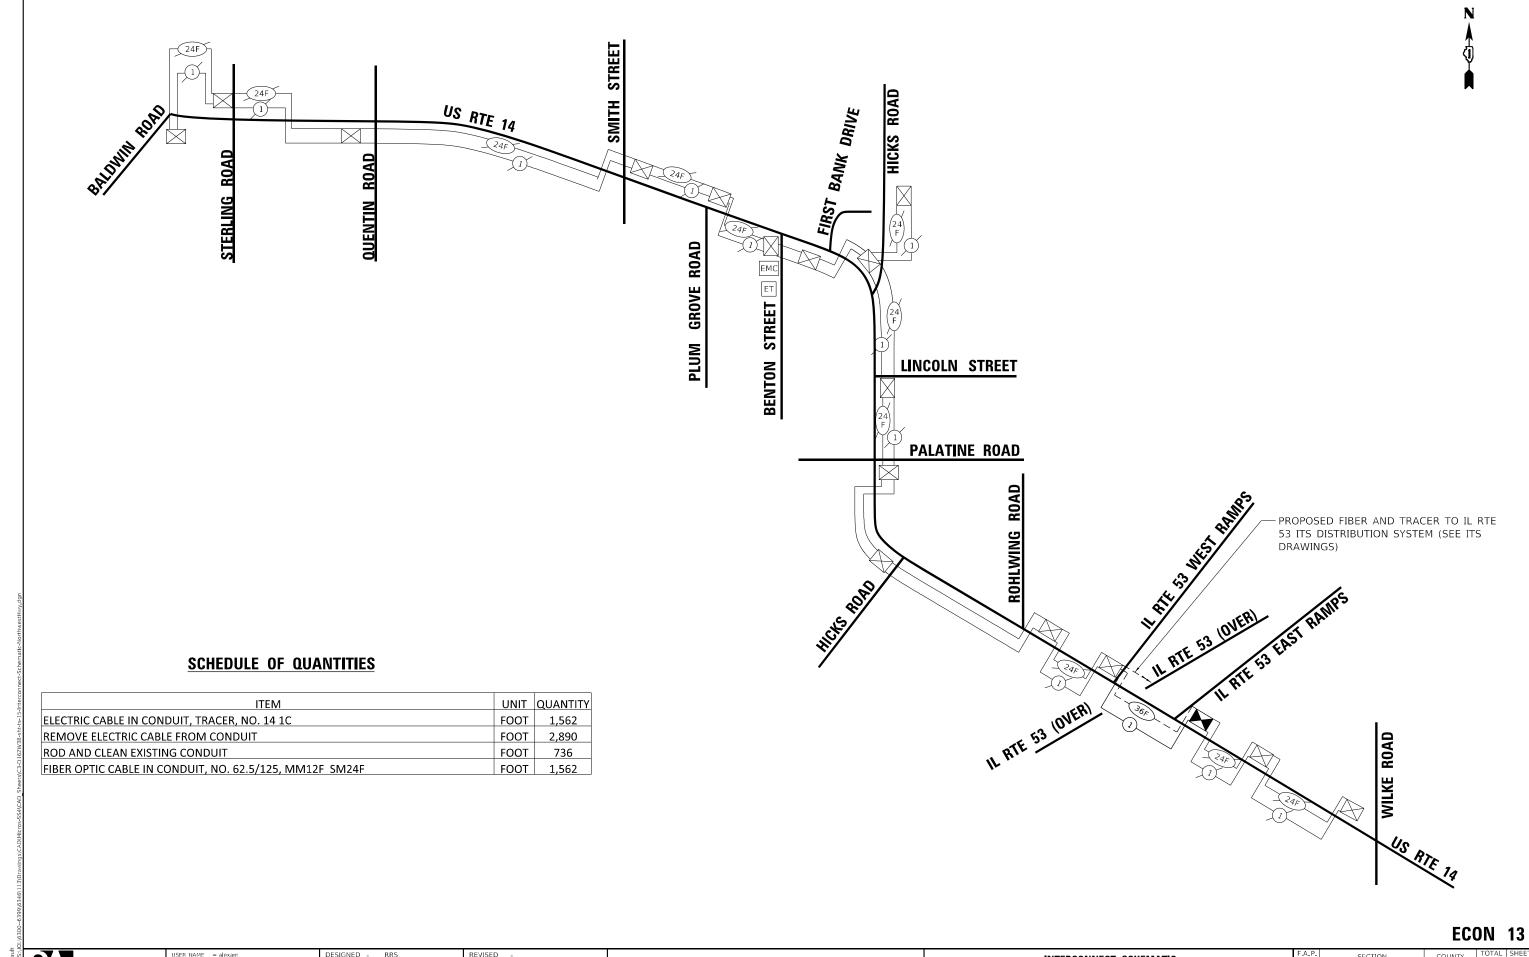

1170 SOUTH HO
JOLIET, ILLINOIS
STRAND
ASSOCIATES*
(815) 744-4200 1170 SOUTH HOUBOLT ROAD

ACM DRAWN REVISED LOT SCALE = 20.0000 / in. CHECKED KRH REVISED PLOT DATE = 8/23/2024 8/23/2024

STATE OF ILLINOIS
DEPARTMENT OF TRANSPORTATION

INTERCONNECT SCHEMATIC US RTE 14 (NORTHWEST HIGHWAY) OF 1 SHEETS STA.

SECTION 342 (531) BR 23 COOK 1211 530 CONTRACT NO. 62W38

| LIG | SHTING AND ELECTRICAL LEGEND |
|---|---|
| SYMBOL | DESCRIPTION |
| O—E EXISTING LIGHT POLE W/ MAST ARM TO REMAIN | |
| E,—E | EXISTING MEDIAN MOUNTED LIGHT POLE W/ DUAL MAST ARM TO REMAIN |
| ○—(R) | EXISTING LIGHTING UNIT TO BE REMOVED. EXISTING LUMINAIRE AND LIGHTING ARM TO BE SALVAGED. |
| RR | EXISTING MEDIAN MOUNTED LIGHTING UNIT TO BE REMOVED. EXISTING LUMINAIRE & LIGHTING ARMS TO BE SALVAGED. |
| o — ∭ | TEMPORARY LIGHTING UNIT, 60 FT WOOD POLE (UNLESS OTHERWISE NOTED), 47.5 FT MOUNTING HEIGHT (UNLESS OTHERWISE NOTED) 15-FT MAST ARM, TEMPORARY LUMINAIRE, LED, ROADWAY OUTPUT DESIGNATION H, TYPE III DISTRIBUTION, MINIMUM 25,200 LUMENS (240VAC) |
| • | TEMPORARY WOOD POLE, CLASS 4, 60 FT |
| ○ | REMOVE EXISTING LUMINAIRE, SALVAGE. INSTALL LUMINAIRE SAFETY CABLE AND LUMINAIRE, LED, ROADWAY, REPLACEMENT (HORIZONTAL MOUNT, OUTPUT DESIGNATION H) ON EXISTING GROUND MOUNTED LIGHT POLE AND MAST ARM. |
| G G | REMOVE EXISTING MEDIAN LUMINAIRES AND DUAL MAST ARMS, SALVAGE. INSTALL 6-FT DUAL MAST ARMS (UNLESS OTHERWISE NOTED), LUMINAIRE SAFETY CABLES, AND 2 LUMINAIRES, LED, ROADWAY, REPLACEMENT (HORIZONTAL MOUNT, OUTPUT DESIGNATION H) ON LIGHT POLE. |
| ○ -P | PROPOSED LIGHTING UNIT MOUNTED ON BRIDGE PARAPET WALL (UNLESS OTHERWISE NOTED), 47.5 FT MOUNTING HEIGHT, 6 FT. MAST ARM (UNLESS OTHERWISE NOTED), LUMINAIRE TO BE LED, HORIZONTAL MOUNT, OUTPUT DESIGNATION H (240VAC). |
| <u>D</u> U | PROPOSED LIGHTING UNIT MOUNTED INTEGRAL WITH BARRIER WALL, 24" DIAMETER, (UNLESS OTHERWISE NOTED) 47.5 FT MOUNTING HEIGHT, 2-6 FT MAST ARMS, 2 LUMINAIRES TO BE LED, HORIZONTAL MOUNT, OUTPUT DESIGNATION H (240VAC). |
| Ŭ E R | EXISTING LPS UNDERPASS LUMINAIRE TO BE REMOVED, NO SALVAGE |
| J _E | EXISTING JUNCTION BOX TO REMAIN |
| J _R | EXISTING JUNCTION BOX TO BE REMOVED |
| • | PROPOSED UNDERPASS LED LUMINAIRE, SUSPENDED MOUNT, OUTPUT DESIGNATION D |

OUTPUT DESIGNATION E

PROPOSED UNDERPASS LED LUMINAIRE, SUSPENDED MOUNT,

PROPOSED UNDERPASS LED LUMINAIRE, WALLMOUNT,

PROPOSED JUNCTION BOX, TYPE AND SIZE AS NOTED

EXISTING UNDERGROUND UNIT DUCT TO BE REMOVED OR

TEMPORARY AERIAL LIGHTING CABLE WITH MESSENGER WIRE,

PROPOSED UNIT DUCT/CABLE IN EMBEDDED CONDUIT, TYPE AND

PROPOSED UNIT DUCT IN CONCEALED CONDUIT, TYPE AND SIZE

PROPOSED UNIT DUCT, TYPE AND SIZE AS NOTED

EXISTING EMBEDDED CONDUIT TO REMAIN

EXISTING UNIT DUCT TO REMAIN

EXISTING CONDUIT TO BE REMOVED

TYPE AND SIZE AS NOTED

SIZE AS NOTED

AS NOTED

EXISTING UNDERGROUND CONDUIT TO REMAIN

| CALL-OUT SAMPLE |
|--|
| DEFINITION AND EXAMPLE |
| CONTROLLER DESIGNATION CIRCUIT DESIGNATION |
| CIRCUIT DESIGNATION CIRCUIT NUMBER |
| STA. 205+10 SET BACK 18' FROM F.O.C. OR E.O.P. |
| TEMPORARY & PROPOSED LIGHTING UNIT |
| SET BACK SET BACK SET BACK SET BACK SET BACK SET BACK |
| POLE SET BACK DETAIL |

| LIGHTING | AND ELECTRICAL LEGEND (CONTINUED) |
|----------------|---|
| SYMBOL | DESCRIPTION |
| H _E | EXISTING HANDHOLE TO REMAIN |
| \bowtie | EXISTING IDOT LIGHTING CONTROLLER TO REMAIN |
| A | EXISTING ELECTRICAL UTILITY SERVICE TO REMAIN |

B.O.C. BACK OF CURB СВ CIRCUIT BREAKER CKT CIRCUIT СМ CENTIMETER COMED COMMONWEALTH EDISON COMPANY CONTROL PANEL CP CT CURRENT TRANSFORMER DA DAVIT ARM DC DIRECT CURRENT DIA DIAMETER DP DISTRIBUTION PANEL EXISTING UNIT TO REMAIN EX. EXISTING ECA ELECTRIC CABLE ASSEMBLY EIS EMBEDDED IN STRUCTURE EDGE OF PAVEMENT E.O.P. F.O.C. FACE OF CURB FT FEET OR FOOT FU FUSE GND GROUND HID HIGH INTENSITY DISCHARGE JUNCTION BOX KILOVOLT-AMPERE KVA ΚW KILOWATTS LED LIGHT EMITTING DIODE LP LIGHT POLE METER MA MAST ARM MC MULTI-CONDUCTOR MM MILLIMETER M.H. MOUNTING HEIGHT MW MESSENGER WIRE NESC NATIONAL ELECTRIC SAFETY CODE NO. # NUMBER N.T.S. NOT TO SCALE PROPOSED PUSH BUTTON PNL PVC POLYVINYL CHLORIDE PVC COATED RIGID GALVANIZED CONDUIT PVCC RGC POTENTIAL TRANSFORMER EXISTING UNIT TO BE REMOVED (OWNER SALVAGED U.N.O.) RR EXISTING UNIT TO BE REMOVED AND REINSTALLED RECP RECEPTACLE RIGID GALVANIZED CONDUIT RGC SEL SW SELECTOR SWITCH STAINLESS STEEL STA STATION T/F TOP OF FOUNDATION UD UNIT DUCT UNLESS NOTED OTHERWISE U.N.O. UNDERGROUND CONDUCT, UGC, GS GALVANIZED STEEL VAC VOLTS, ALTERNATING CURRENT W WATTS WP WOOD POLE XFMR TRANSFORMER HIGH PRESSURE SODIUM LPS LOW PRESSURE SODIUM LIQUID TIGHT FLEXIBLE METALLIC LTEM

SCALE:

ABBREVIATIONS

ALTERNATING CURRENT

ATTACHED TO STRUCTURE

DESCRIPTION

AFRIAL CARLE

ABBREVIATION

A/C

ATS

GENERAL NOTES

- THE ELECTRICAL WORK SHALL BE PERFORMED IN ACCORDANCE WITH THE LATEST CODES, STANDARDS AND THE IDOT STANDARD SPECIFICATIONS FOR ROAD AND BRIDGE CONSTRUCTION ADOPTED JANUARY 1, 2022, AND SUPPLEMENTAL SPECIFICATIONS AND RECURRING SPECIAL PROVISIONS.
- PRIOR TO ANY WORK IN THE FIELD, THE CONTRACTOR SHALL CONTACT MEADE ELECTRIC CO. DISTRICT ONE ELECTRICAL MAINTENANCE CONTRACTOR TO LOCATE IDOT ELECTRICAL EQUIPMENT AND UNDERGROUND CABLES 773-287-7672.
- ALL EXISTING HPS LUMINAIRES AND LIGHTING ARMS ON POLES BEING REMOVED SHALL BE SALVAGED TO IDOT. CONTACT THE ELECTRICAL MAINTENANCE SECTION (708) 524-2145 TO COORDINATE THE DELIVERY OF THE HPS LUMINAIRES TO STATE STOCK.
- AT LOCATIONS OF LUMINAIRE REPLACEMENT ONLY, THE CONTRACTOR SHALL TAKE PROPER MEASURES NOT TO DAMAGE THE EXISTING CABLES COMING OUT OF THE EXISTING MEDIAN BARRIER WALL FOUNDATIONS.
- AERIAL CABLES SHALL MAINTAIN A MINIMUM CLEARANCE OF 18 FT OVER ROADWAYS PER NEC 225.18.
- WHEN THERE ARE MULTIPLE TEMPORARY CIRCUITS ON THE SAME POLE, MAINTAIN A MINIMUM OF A 4 FT VERTICAL GAP BETWEEN CIRCUITS.

IDOT-D1 STANDARDS:

| STANDARD NO. | TITLE |
|-----------------|---|
| BE-301 | LIGHT POLE FOUNDATION, 40' TO 47 1/2' M.H. 15" BOLT CIRCLE |
| BE-305 | LIGHT POLE FOUNDATION, METAL |
| BE-322 | $24\ensuremath{^{"}}$ DIA. LIGHT POLE FOUNDATION INTEGRAL WITH DOUBLE FACE BARRIER WALL |
| BE-400 | ALUMINUM LIGHT POLE 47'-6" (14.478 m) MOUNTING HEIGHT |
| BE-701 | LUMINAIRE SAFETY CABLE ASSEMBLY |
| BE-702 | MISC. ELECTRICAL DETAILS SHEET A |
| BE-703 | MISC. ELECTRICAL DETAILS SHEET B |
| BE-800 | TEMPORARY LIGHT POLE DETAILS |
| BE-801 | TEMPORARY AERIAL CABLE INSTALLATION |
| BE-901 | SUSPENDED MOUNT LED UNDERPASS LUMINAIRE INSTALLATION DETAILS |
| | |

INDEX OF LIGHTING SHEETS

| HADEN OF | LIGITING SHELTS |
|-------------|-------------------------------------|
| DRAWING NO. | TITLE |
| 531 | LIGHTING LEGEND AND GENERAL NOTES |
| 532 | IDOT LIGHTING BILL OF MATERIAL |
| 533 - 552 | REMOVAL AND TEMPORARY LIGHTING PLAN |
| 553 - 557 | TEMPORARY LIGHTING PLANS |
| 558 - 577 | PROPOSED LIGHTING PLAN |
| 578 - 579 | UNDERPASS REMOVAL LIGHTING PLANS |
| 580 - 581 | UNDERPASS LIGHTING PLAN |
| 582 - 585 | SINGLE LINE DIAGRAMS |
| 586 - 587 | LIGHTING DETAILS |
| 588 - 598 | IDOT DISTRICT 1 STANDARDS |
| 599 - 601 | ROLLING MEADOWS LIGHTING PLANS |
| | |

LT-01



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DESIGNED - AJR REVISED DRAWN JED REVISED OT SCALE = 2 0000 / in HECKED RGT REVISED PLOT DATE = 9/20/2024 REVISED DATE 8/23/2024

STATE OF ILLINOIS **DEPARTMENT OF TRANSPORTATION**

IL ROUTE 53 LIGHTING LEGEND AND GENERAL NOTES SHEETS STA.

SECTION COUNTY 342 (531) BR 23 COOK 1211 531 CONTRACT NO. 62W38

IDOT LIGHTING BILL OF MATERIAL

| ITEM | UNIT | TOTAL QUANTITY |
|---|------|-------------------|
| UNDERGROUND CONDUIT, GALVANIZED STEEL, 2" DIA. | FOOT | 40 |
| UNDERGROUND CONDUIT, GALVANIZED STEEL, 4" DIA. | FOOT | 297 |
| CONDUIT ATTACHED TO STRUCTURE, 1" DIA., PVC COATED GALVANIZED STEEL | FOOT | 690 |
| CONDUIT ATTACHED TO STRUCTURE, 2" DIA., PVC COATED GALVANIZED STEEL | FOOT | 160 |
| CONDUIT EMBEDDED IN STRUCTURE, 2" DIA., PVC | FOOT | 3399 |
| CONDUIT EMBEDDED IN STRUCTURE, 4" DIA., PVC | FOOT | 4029 |
| JUNCTION BOX, STAINLESS STEEL, ATTACHED TO STRUCTURE, 6" X 6" X 4" | EACH | 20 |
| JUNCTION BOX, STAINLESS STEEL, ATTACHED TO STRUCTURE, 12" X 10" X 6" | EACH | 4 |
| JUNCTION BOX, STAINLESS STEEL, ATTACHED TO STRUCTURE, 18" X 12" X 6" | EACH | 4 |
| JUNCTION BOX, STAINLESS STEEL, ATTACHED TO STRUCTURE, 18" X 18" X 8" | EACH | 2 |
| UNIT DUCT, 600V, 3-1C NO.2, 1/C NO.4 GROUND, (XLP-TYPE USE), 1 1/2" DIA. POLYETHYLENE | FOOT | 6268 |
| ELECTRIC CABLE IN CONDUIT, 600V (XLP-TYPE USE) 1/C NO. 10 | FOOT | 3310 |
| ELECTRIC CABLE IN CONDUIT, 600V (XLP-TYPE USE) 1/C NO. 4 | FOOT | 9393 |
| ELECTRIC CABLE IN CONDUIT, 600V (XLP-TYPE USE) 1/C NO. 2 | FOOT | 43454 |
| AERIAL CABLE, 2-1/C NO. 2 WITH MESSENGER WIRE | FOOT | 343 |
| AERIAL CABLE, 3-1/C NO. 2 WITH MESSENGER WIRE | FOOT | 18616 |
| LUMINAIRE, LED, ROADWAY, OUTPUT DESIGNATION H | EACH | 55 |
| LUMINAIRE, LED, UNDERPASS, SUSPENDED, OUTPUT DESIGNATION D | EACH | 4 |
| LUMINAIRE, LED, UNDERPASS, SUSPENDED, OUTPUT DESIGNATION E | EACH | 16 |
| LIGHT POLE, ALUMINUM, 47.5 FT. M.H., 15 FT. MAST ARM | EACH | 1 |
| LIGHT POLE, ALUMINUM, 47.5 FT. M.H., 2-6 FT. MAST ARMS | EACH | 27 |
| LIGHT POLE, WOOD, 60 FOOT, CLASS 4, WITH 15FT MAST ARM | EACH | 46 |
| LIGHT POLE, WOOD, 70 FOOT, CLASS 3, WITH 15FT MAST ARM | EACH | 10 |
| LIGHT POLE, WOOD, 90 FOOT, CLASS 3, WITH 15FT MAST ARM | EACH | 2 |
| LIGHT POLE FOUNDATION, 24" DIAMETER | FOOT | 90 |

| * | INDICATES | SPECIAL | PROVISION |
|---|-----------|---------|-----------|

| ITEM | UNIT | TOTAL QUANTITY |
|--|--------|-------------------|
| LIGHT POLE FOUNDATION, METAL, 15" BOLT CIRCLE, 10" X 8' | EACH | 1 |
| BREAKAWAY DEVICE, TRANSFORMER BASE, 15 INCH BOLT CIRCLE | EACH | 1 |
| REMOVAL OF TEMPORARY LIGHTING UNIT | EACH | 58 |
| REMOVAL OF LIGHTING UNIT, NO SALVAGE | EACH | 30 |
| REMOVAL OF POLE FOUNDATION | EACH | 30 |
| ROD AND CLEAN EXISTING CONDUIT | FOOT | 2366 |
| REPLACE EXISTING DECAL WITH NEW LUMINAIRE NUMBERING DECAL | EACH | 11 |
| REMOVAL OF CABLE IN CONDUIT | FOOT | 26624 |
| REMOVAL OF LUMINAIRE, SALVAGE | EACH | 335 |
| 6 FT DUAL MAST ARMS, ALUMINUM, 180 DEGREES APART | EACH | 56 |
| INTERCEPT EXISTING CONDUIT | EACH | 11 |
| JUNCTION BOX, NON-METALLIC, EMBEDDED IN STRUCTURE, 20" X 13" X 12" | EACH | 8 |
| TEMPORARY LUMINAIRE, LED, ROADWAY, OUTPUT DESIGNATION H | EACH | 61 |
| REMOVE TEMPORARY WOOD POLE | EACH | 35 |
| TEMPORARY WOOD POLE, 60 FT., CLASS 4 | EACH | 35 |
| LIGHT POLE FOUNDATION, INTEGRAL WITH BARRIER WALL, 24" DIAMETER | FOOT | 189 |
| REMOVAL OF UNDERPASS LIGHTING UNIT, NO SALVAGE | EACH | 16 |
| LUMINAIRE SAFETY CABLE ASSEMBLY | EACH | 335 |
| MAINTENANCE OF LIGHTING SYSTEM | CAL MO | 21 |
| REMOVAL OF LIGHTING ARM, SALVAGE | EACH | 167 |
| LUMINAIRE, LED, ROADWAY, REPLACEMENT, OUTPUT DESIGNATION H | EACH | 280 |
| LUMINAIRE, LED, ROADWAY, OUTPUT DESIGNATION H (MATERIAL ONLY) | EACH | 12 |
| LIGHT POLE, ALUMINUM, 47.5 FT. M.H., 6 FT. MAST ARM (MATERIAL ONLY) | EACH | 6 |
| LIGHT POLE, ALUMINUM, 47.5 FT. M.H., 2-6 FT. MAST ARMS (MATERIAL ONLY) | EACH | 3 |

INDICATES SPECIAL PROVISION

1170 SOUTH HOUBOLT ROAD
JOLIET, ILLINOIS 80431
STRAND
(815) 744-4200
ASSOCIATES*


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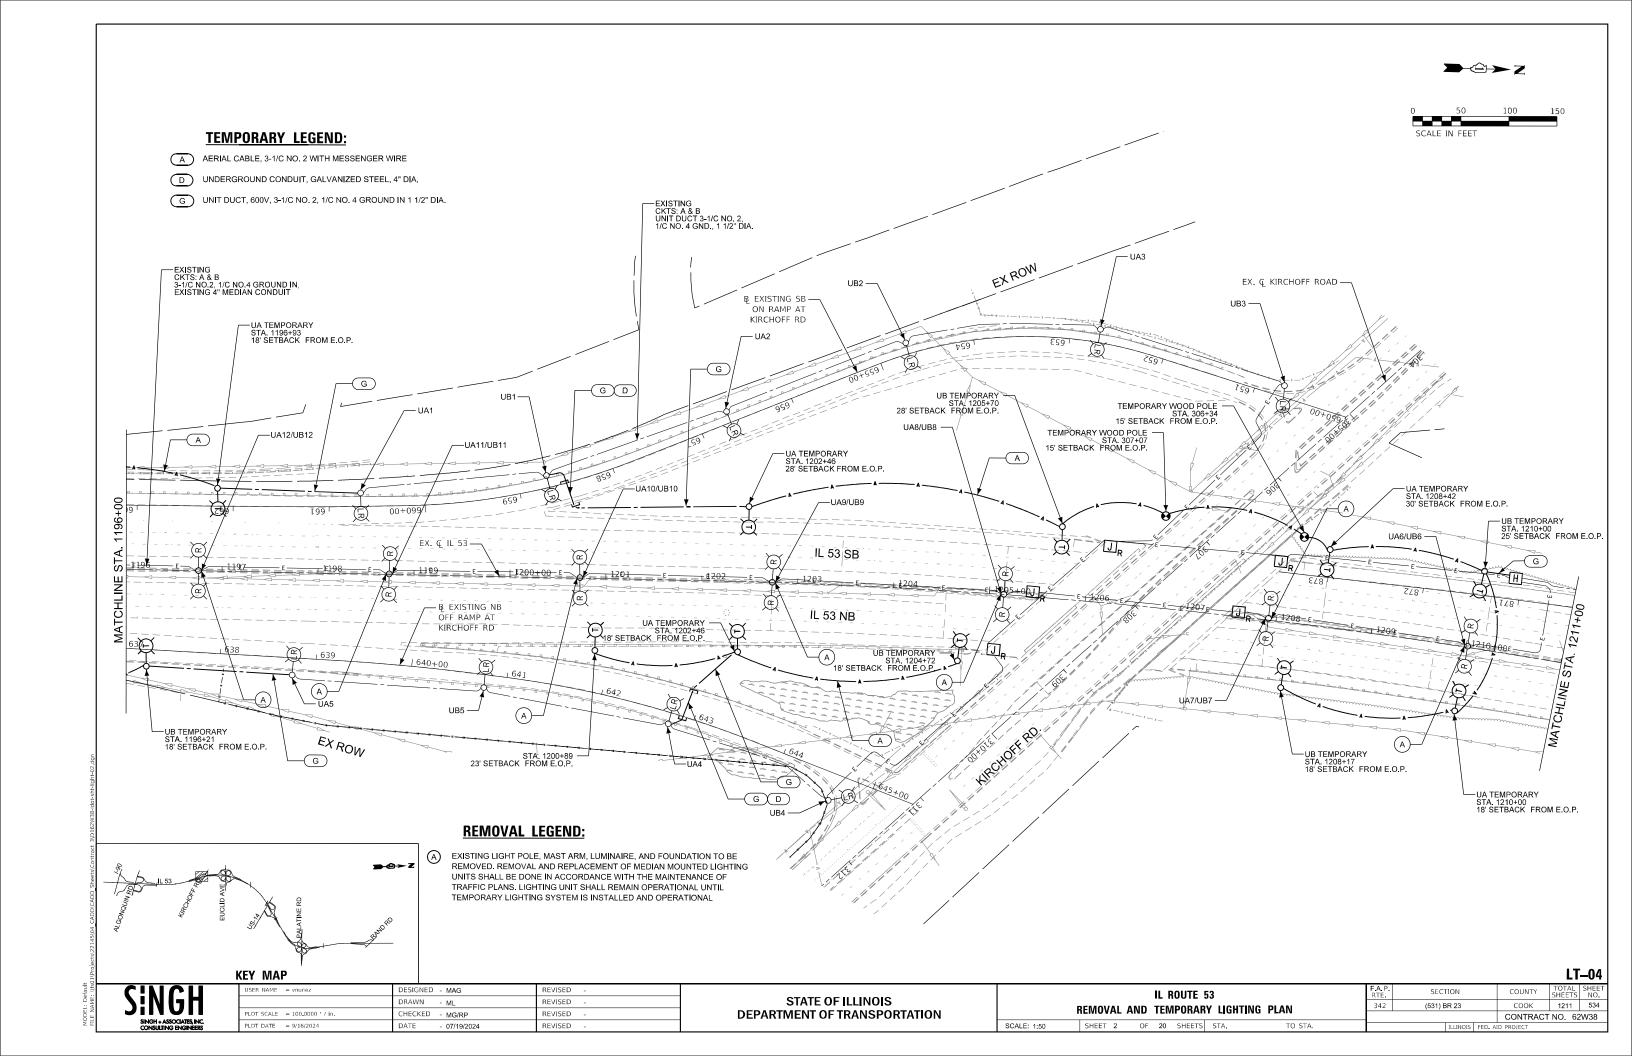
STATE OF ILLINOIS DEPARTMENT OF TRANSPORTATION


IL ROUTE 53 IDOT LIGHTING BILL OF MATERIAL SHEET 1 OF 1 SHEETS STA.


SECTION COUNTY COOK 1211 532 CONTRACT NO. 62W38 (531) BR 23


F.A.P. RTE. 342



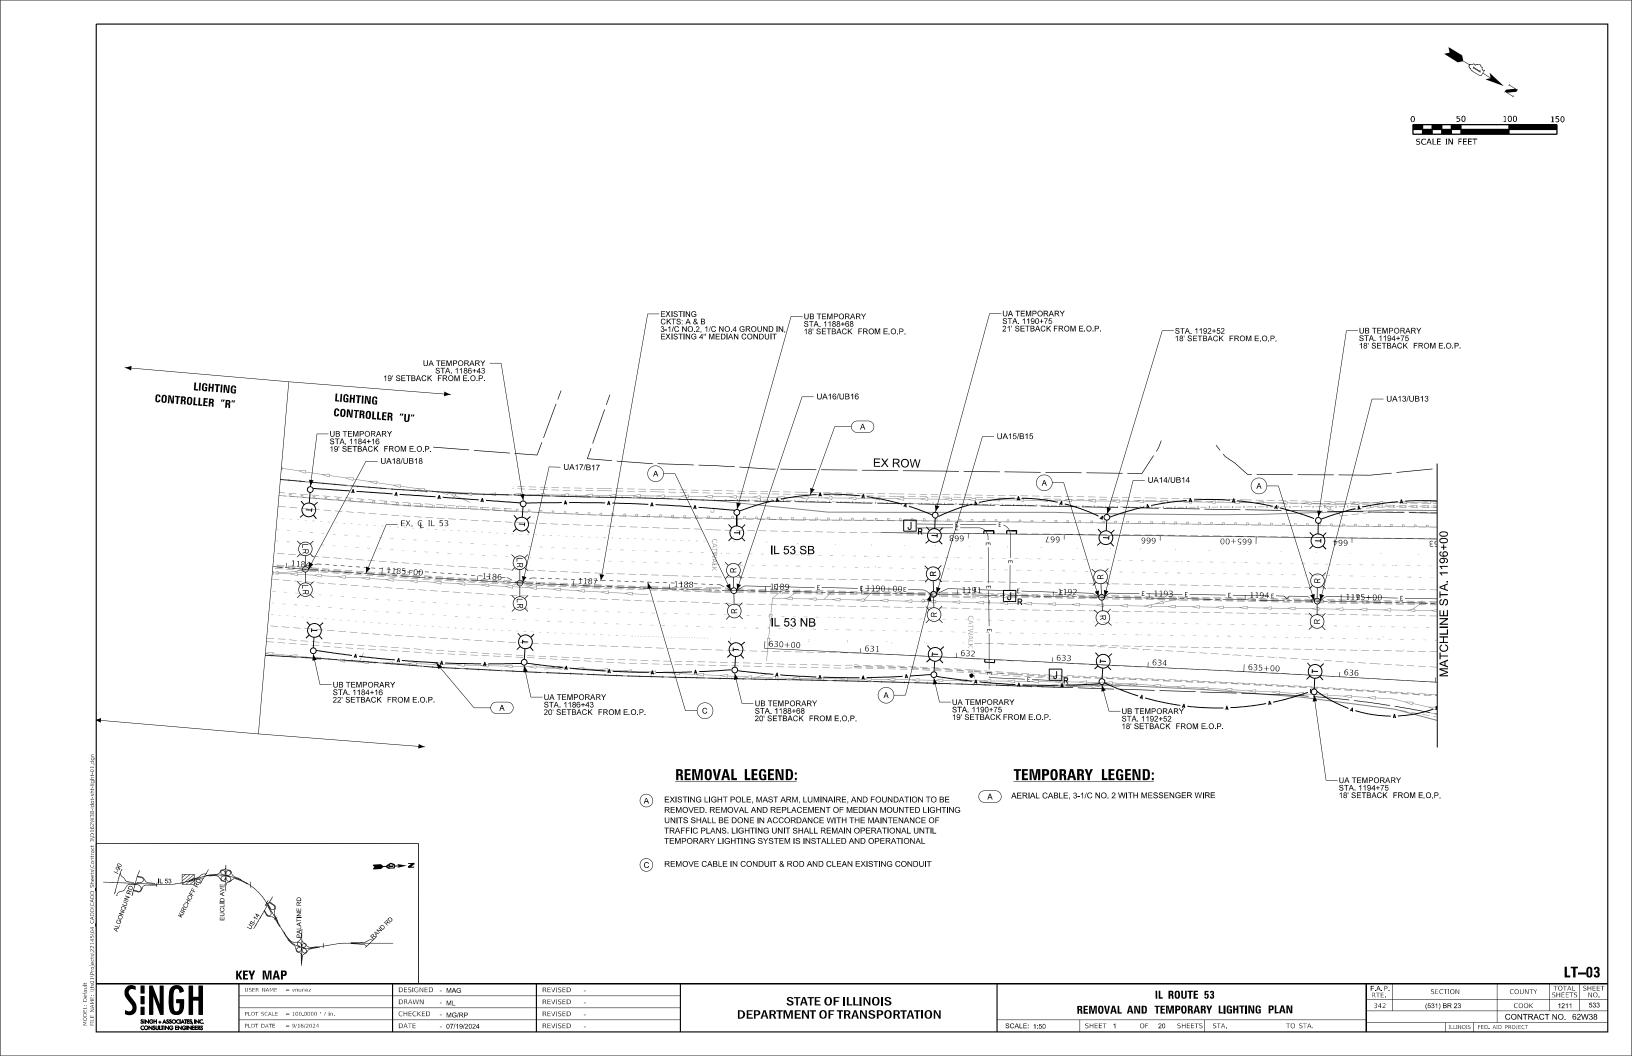

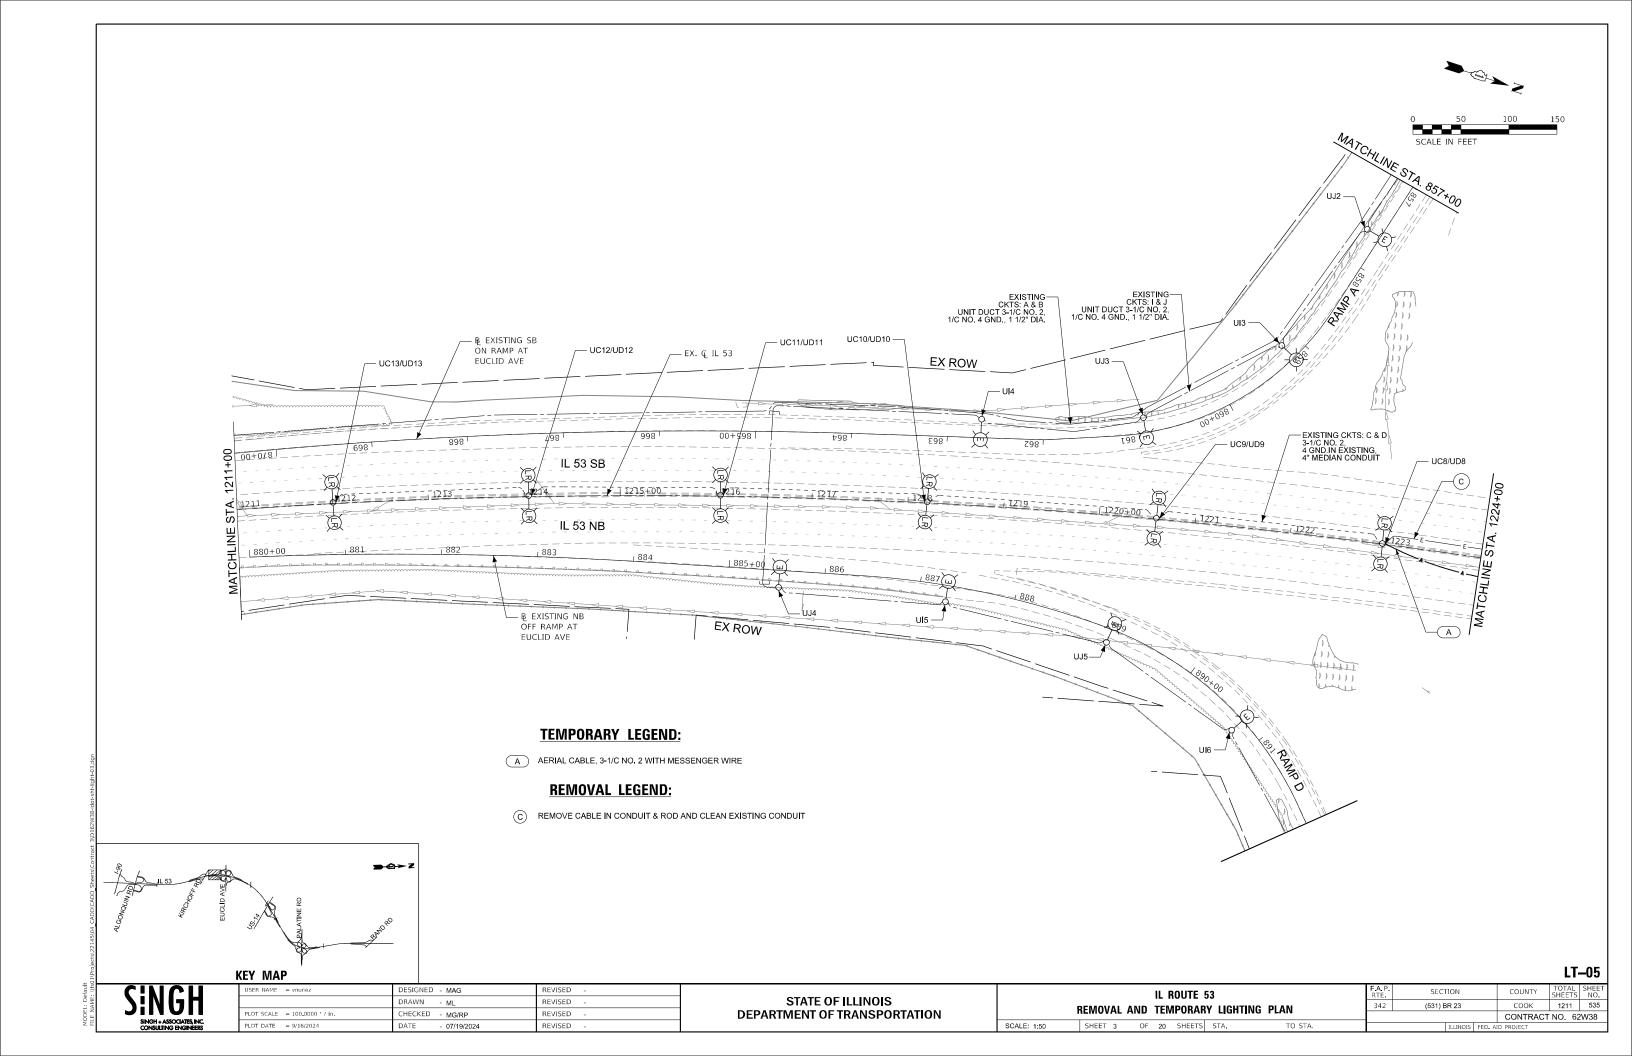

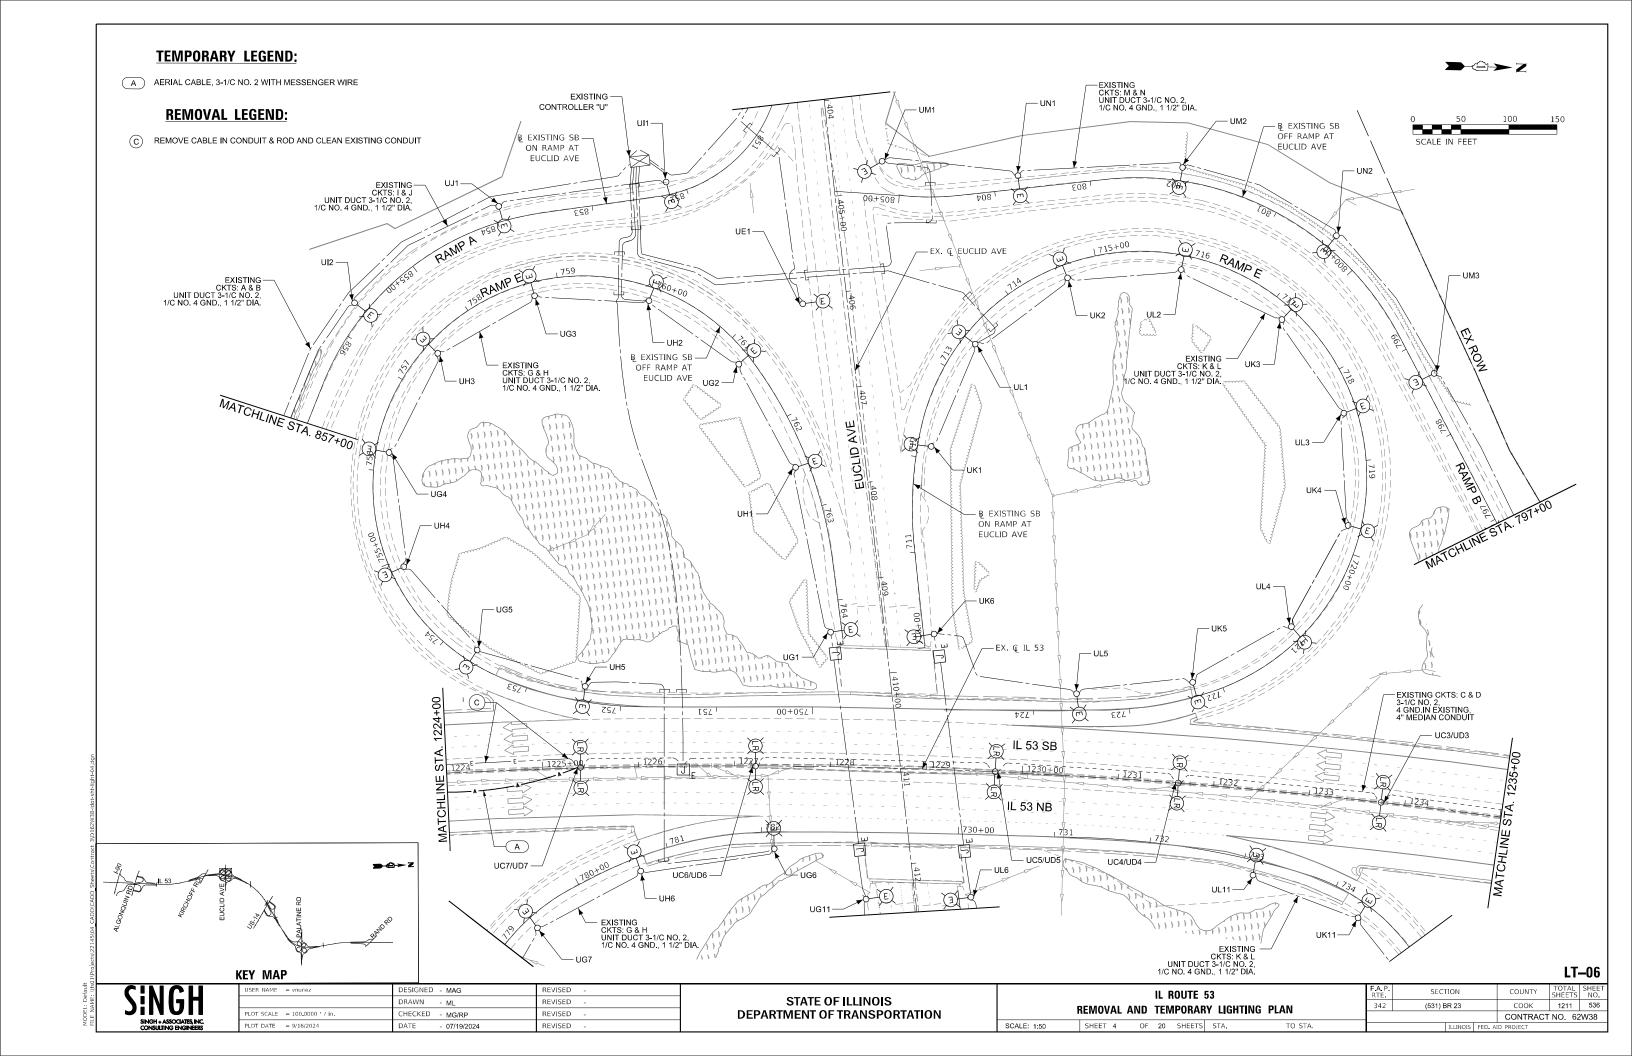

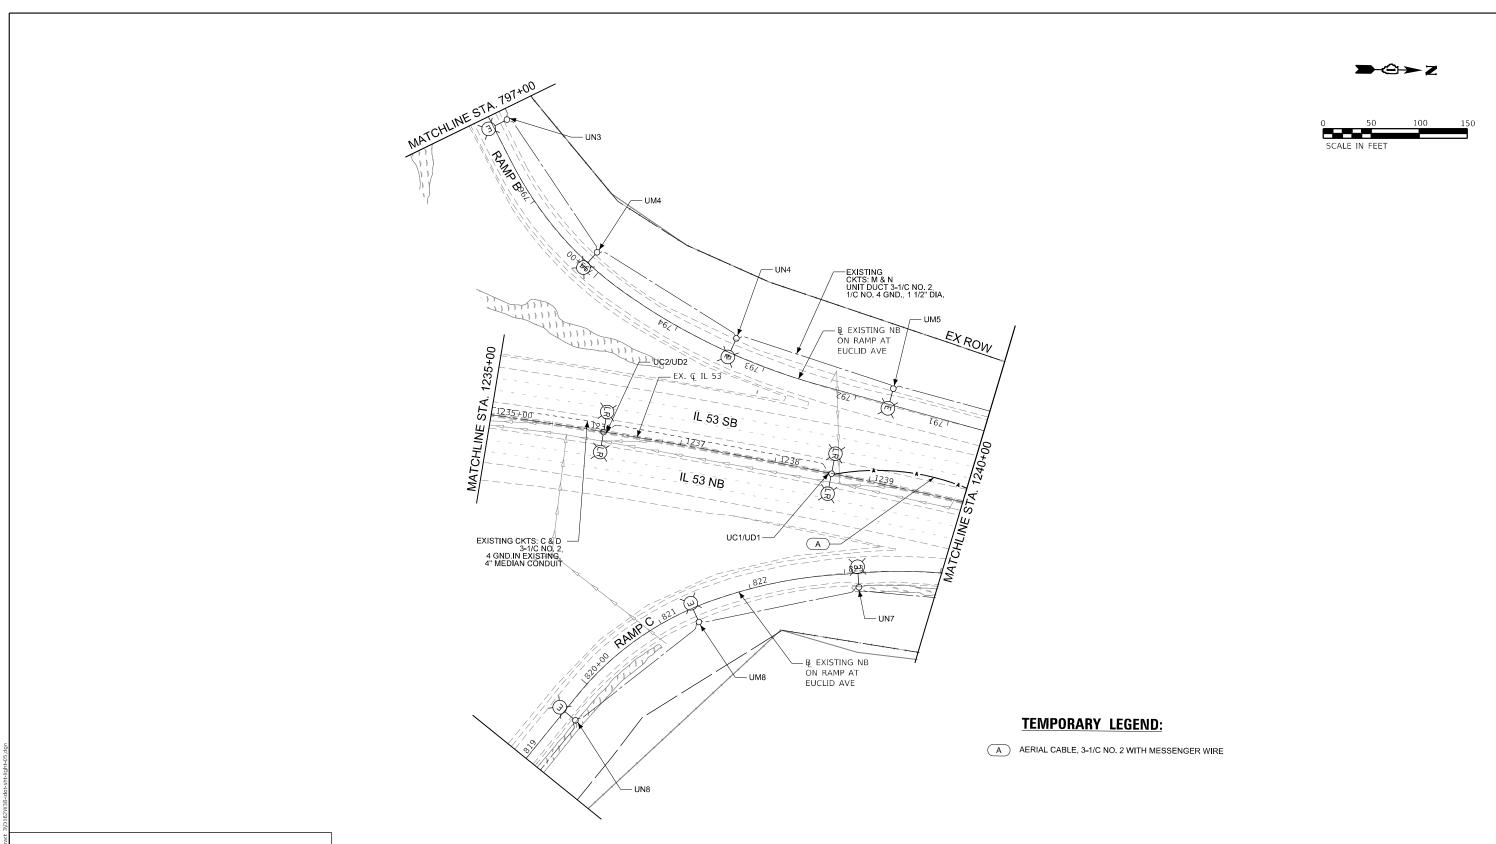

KEY MAP

 LT-07

 DUNTY
 TOTAL SHEET NO.

 COOK
 1211
 537


SINGH ASSOCIATES INC.


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|----------------------------|-------------------|-----------|
| | DRAWN - ML | REVISED - |
| PLOT SCALE = 100.0000 / in | CHECKED - MG/RP | REVISED - |
| PLOT DATE = 9/16/2024 | DATE - 07/19/2024 | REVISED - |


| STATE OF ILLINOIS |
|------------------------------|
| DEPARTMENT OF TRANSPORTATION |

SCALE: 1:50

| | IL ROUTE 53 | | | | RTE | SECTION | | COUNTY SHE | | NO. | | | |
|-------------------------------------|--------------------------------------|---|----|----|--------|-----------------|---------|------------|----------|----------|-----------|------|--|
| REMOVAL AND TEMPORARY LIGHTING PLAN | | | | | 342 | 342 (531) BR 23 | | COOK | 1211 | 537 | | | |
| • | NEWOVAL AND TEMPONANT LIGHTING PLAIN | | | | | | | | | CONTRACT | NO. 62 | 2W38 | |
| | SHEET | 5 | OF | 20 | SHEETS | STA. | TO STA. | | ILLINOIS | FED. AI | D PROJECT | | |

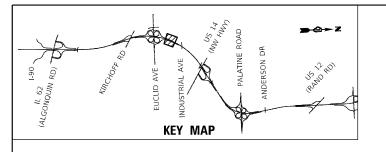

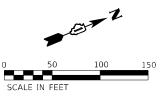

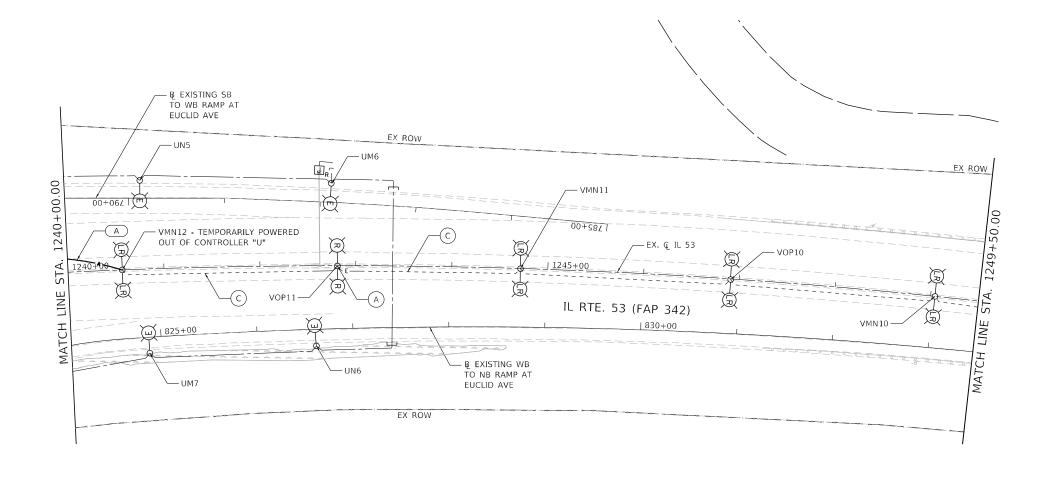

- (A) EXISTING LIGHT POLE, MAST ARM, LUMINAIRE, AND FOUNDATION TO BE REMOVED. REMOVAL AND REPLACEMENT OF MEDIAN MOUNTED LIGHTING UNITS SHALL BE DONE IN ACCORDANCE WITH THE MAINTENANCE OF TRAFFIC DRAWINGS. LIGHTING UNIT SHALL REMAIN OPERATIONAL UNTIL TEMPORARY LIGHTING SYSTEM IS INSTALLED AND OPERATIONAL.
- (C) REMOVE CABLE IN CONDUIT AND ROD & CLEAN EXISTING CONDUIT

TEMPORARY LEGEND:

A AERIAL CABLE, 3-1/C NO. 2 WITH MESSENGER WIRE

1170 SOUTH HOUBOLT R
JOLIET, ILLINOIS 60431

STRAND
ASSOCIATES"


1170 SOUTH HOUBOLT R
JOLIET, 1110 NO 1170 SOUTH HOUBOLT ROAD


| USER NAME = jackd | DESIGNED | - | AJR | REVISED | - |
|----------------------------|----------|---|-----------|---------|---|
| | DRAWN | - | JED | REVISED | - |
| PLOT SCALE = 100.0000 / in | CHECKED | - | RGT | REVISED | - |
| PLOT DATE = 9/20/2024 | DATE | - | 8/23/2024 | REVISED | - |
| | | | | | |


STATE OF ILLINOIS DEPARTMENT OF TRANSPORTATION

| | F.A.P. SECTION | | cou | NTY TOTAL SHEETS | |
|---|----------------|-----------------|-----------------|---------------------|------|
| REMOVAL AND TEMPORARY LIGHTING PLAN | 342 | 342 (531) BR 23 | | OK 1211 | 538 |
| INCINIOVAL AND ILINII ONANI LIGITIINGI LAN | | | CON. | TRACT NO. 6 | 2W38 |
| SCALE: 1" = 50' SHEET 6 OF 20 SHEETS STA. 1240+00.00 TO STA. 1249+50.00 | | ILLINOIS | FED. AID PROJEC | T | |

LT-08 COOK 1211 538

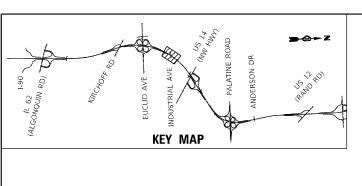

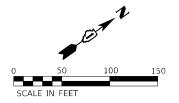

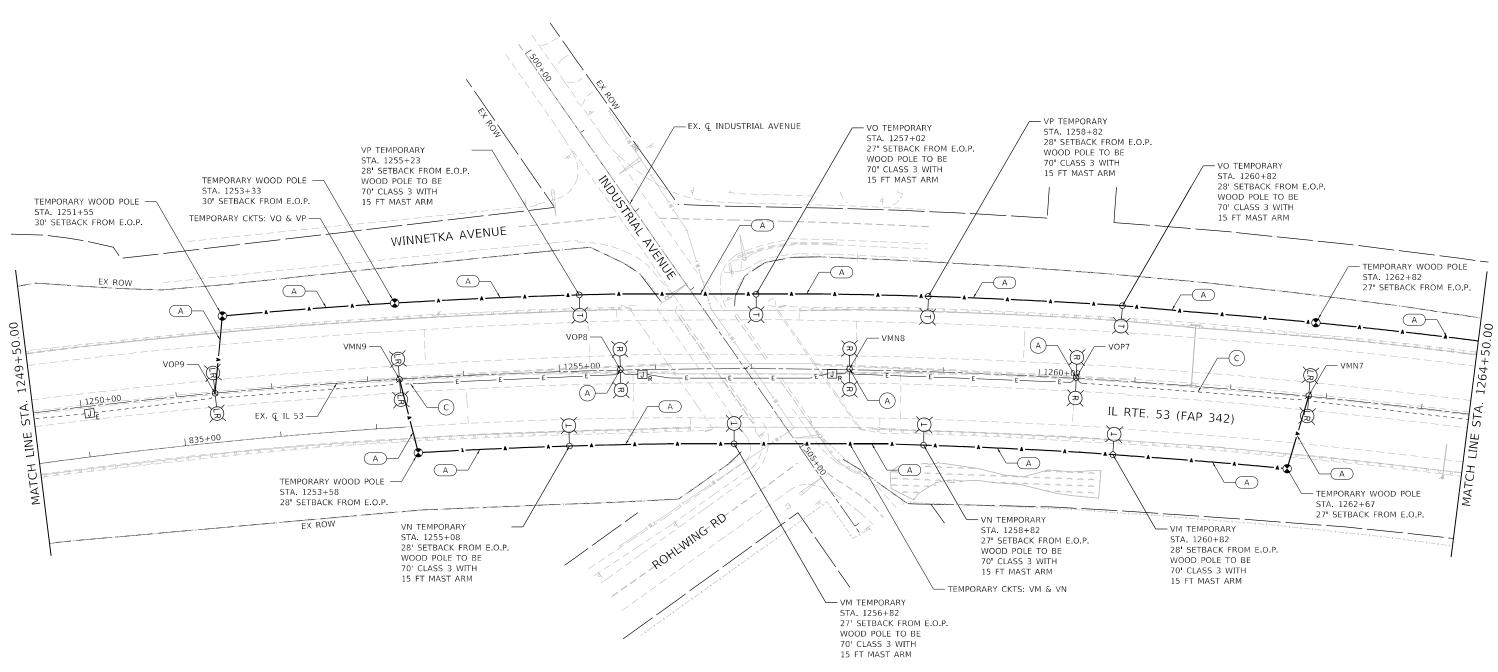

- (A) EXISTING LIGHT POLE, MAST ARM, LUMINAIRE, AND FOUNDATION TO BE REMOVED. REMOVAL AND REPLACEMENT OF MEDIAN MOUNTED LIGHTING UNITS SHALL BE DONE IN ACCORDANCE WITH THE MAINTENANCE OF TRAFFIC DRAWINGS. LIGHTING UNIT SHALL REMAIN OPERATIONAL UNTIL TEMPORARY LIGHTING SYSTEM IS INSTALLED AND OPERATIONAL.
- (C) REMOVE CABLE IN CONDUIT AND ROD & CLEAN EXISTING CONDUIT

TEMPORARY LEGEND:

A AERIAL CABLE, 3-1/C NO. 2 WITH MESSENGER WIRE


LT-09 TOTAL SHEET NO. 1211 539





| USER NAME = jackd | DESIGNED | - | AJR | REVISED | - |
|-----------------------------|----------|---|-----------|---------|---|
| | DRAWN | - | JED | REVISED | - |
| PLOT SCALE = 100.0000 / in. | CHECKED | - | RGT | REVISED | - |
| PLOT DATE = 9/20/2024 | DATE | - | 8/23/2024 | REVISED | - |
| | | | | | |

| STATE OF ILLINOIS |
|------------------------------|
| DEPARTMENT OF TRANSPORTATION |

| IL ROUTE 53 | F.A.P. RTE | SECTION | COUNTY | TOTAL SHEETS | SHEET NO. |
|---|---------------------------|---------|----------|-----------------|--------------|
| REMOVAL AND TEMPORARY LIGHTING PLAN | 342 (531) BR 23 | | соок | 1211 | 539 |
| INCINIOVAL AND TEINII ONAINT EIGITIINGT LAIN | | | CONTRACT | NO. 62 | 2W38 |
| SCALE: 1" = 50' SHEET 7 OF 20 SHEETS STA. 1249+50.00 TO STA. 1264+50.00 | ILLINOIS FED. AID PROJECT | | | | |

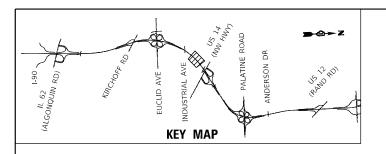

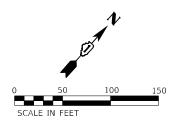

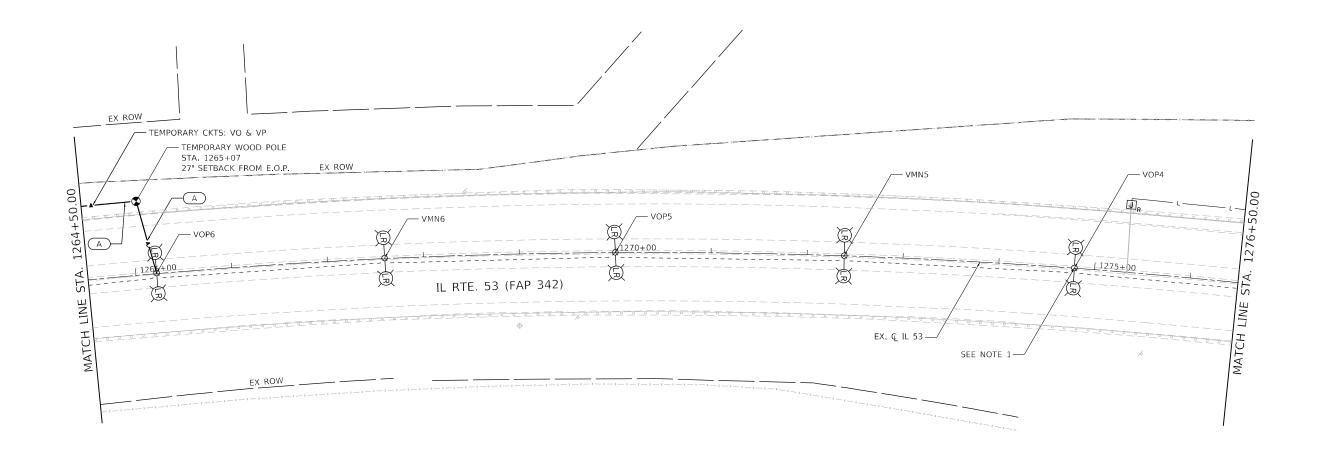

TEMPORARY LEGEND:

A AERIAL CABLE, 3-1/C NO. 2 WITH MESSENGER WIRE

NOTES:

 SEE SEPARATE TEMPORARY LIGHTING PLANS FOR STAGED TEMPORARY LIGHTING PLAN AT US 14 (NORTHWEST HIGHWAY) BRIDGE.

LT-10

1170 SOUTH HOUBOLT ROAD
JOLIET, ILLINOIS 60431
STRAND (815) 744-4200
ASSOCIATES*

 USER NAME
 = jackd
 DESIGNED
 AJR
 REVISED


 DRAWN
 JED
 REVISED


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 = 100,0000 '/ in.
 CHECKED
 RGT
 REVISED


 PLOT DATE
 = 9/20/2024
 DATE
 8/23/2024
 REVISED


STATE OF ILLINOIS
DEPARTMENT OF TRANSPORTATION


| IL ROUTE 53 | REMOVAL AND TEMPORARY LIGHTING PLAN | SCALE: | 1" = 50' | SHEET | 8 | OF | 20 | SHEETS | STA. | 1264+50.00 | TO STA. | 1276+50.00

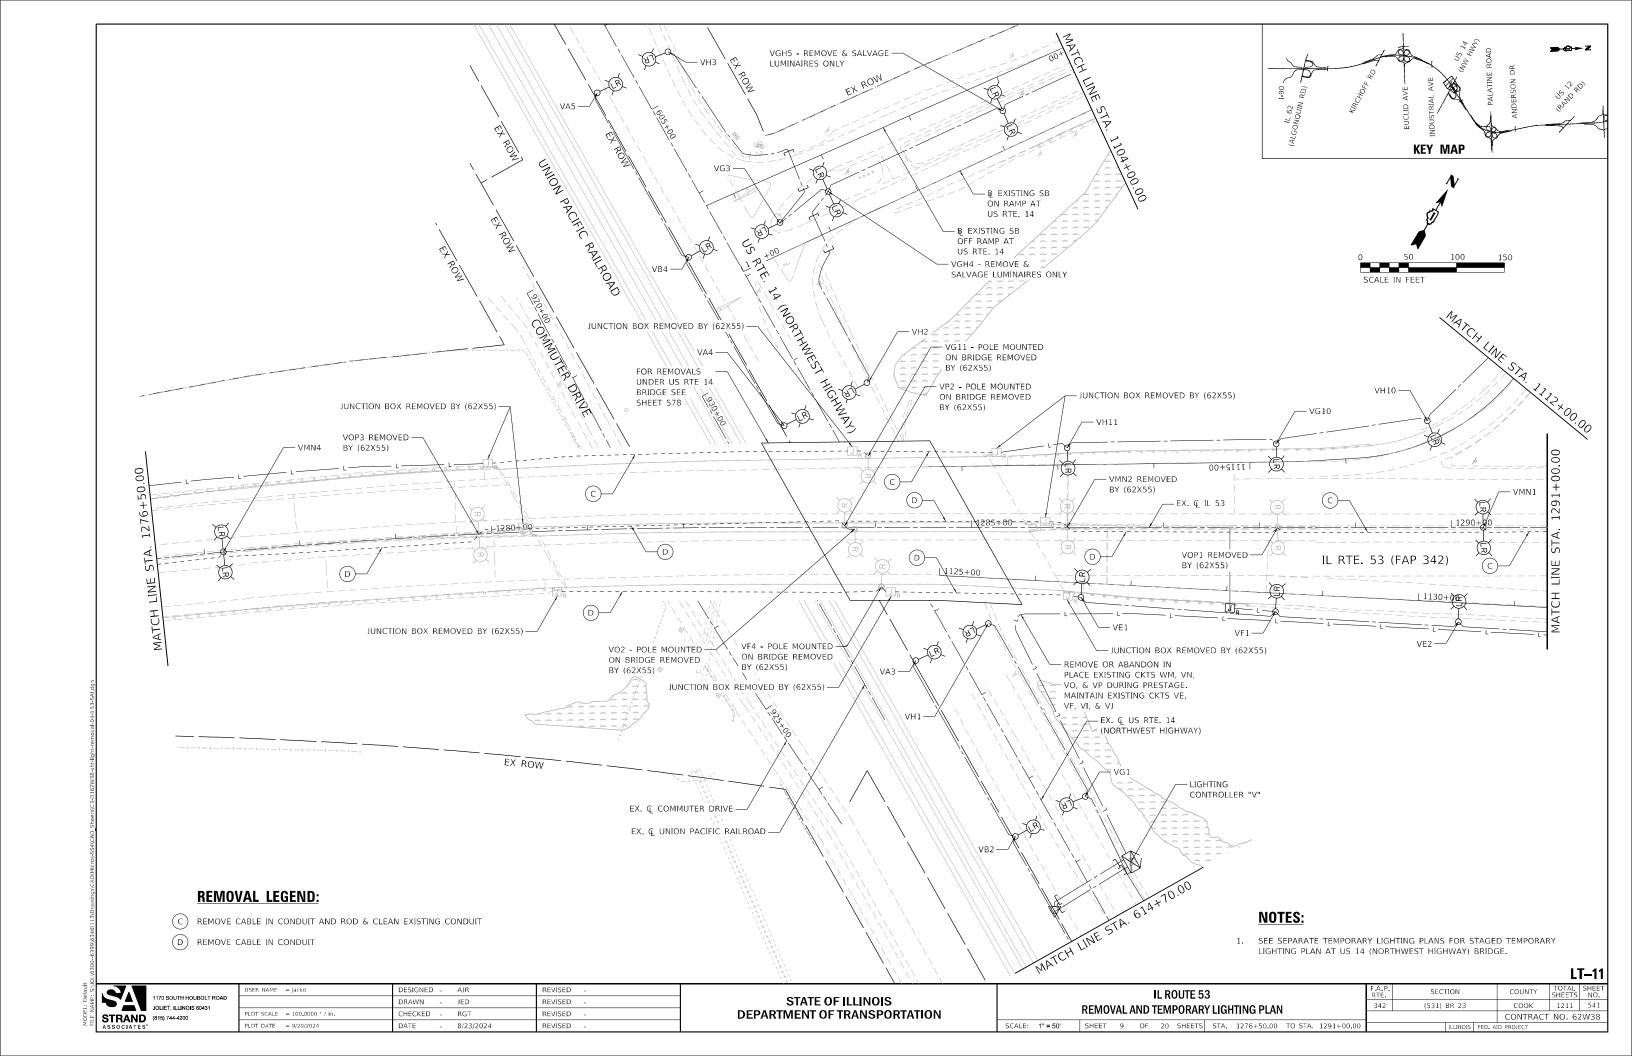

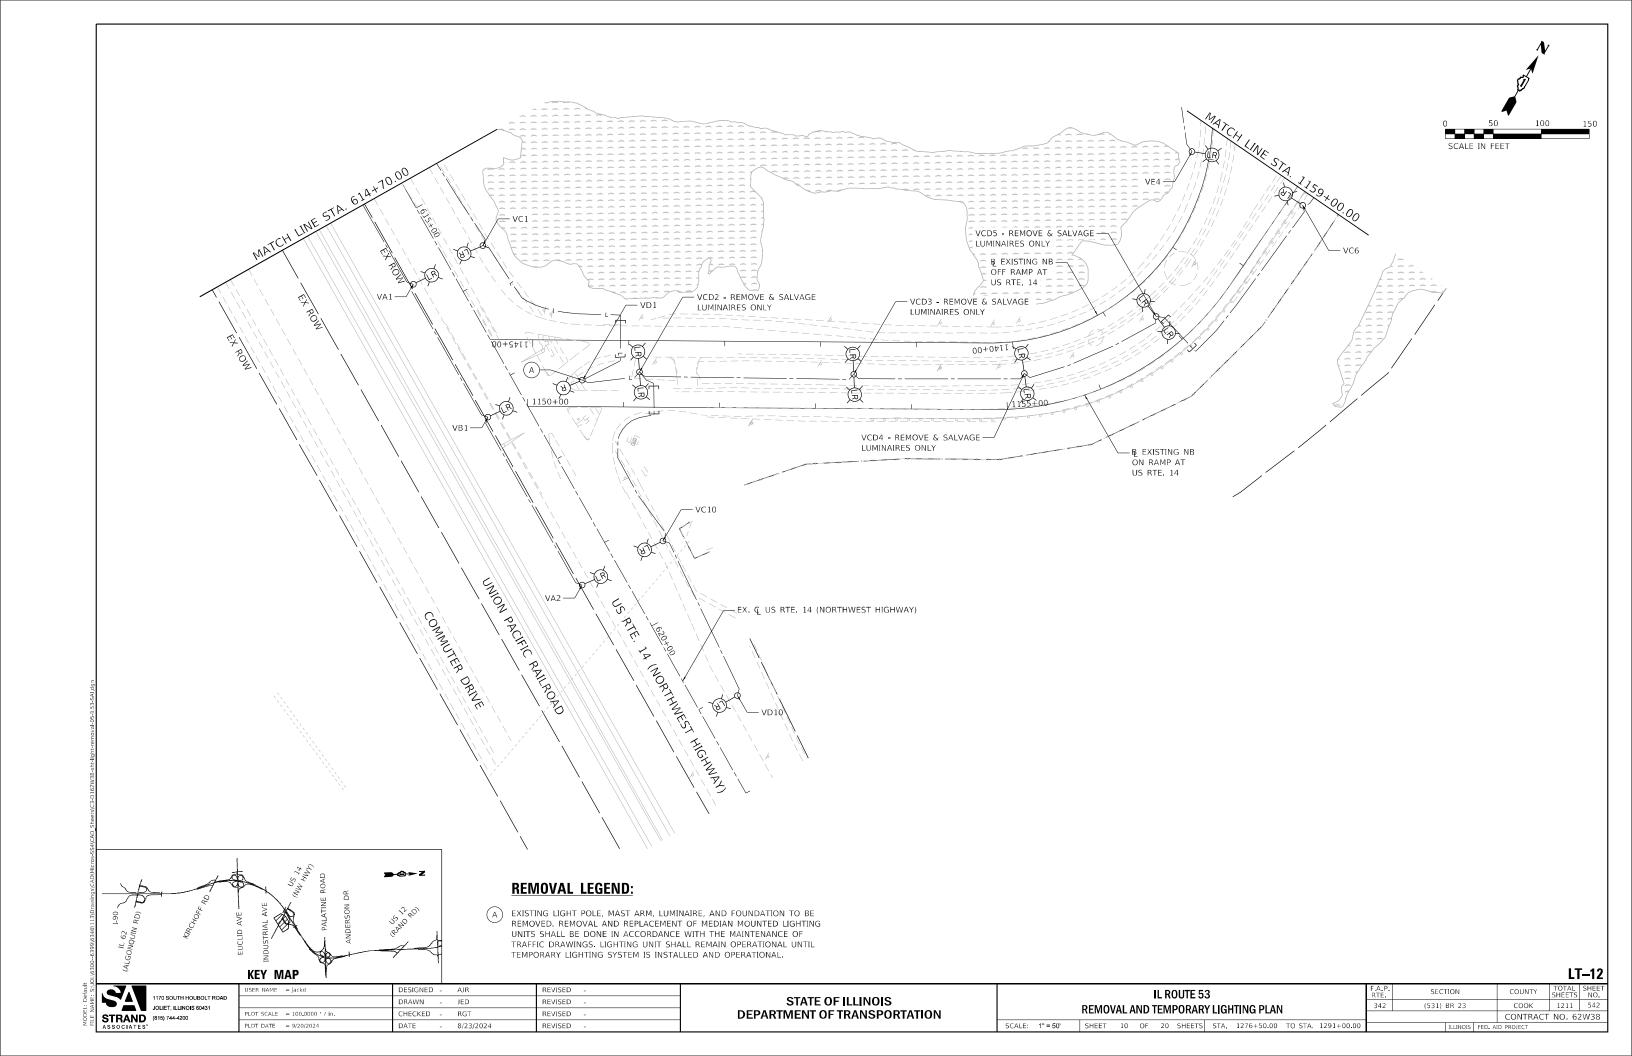

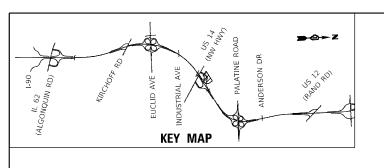

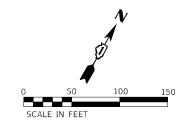

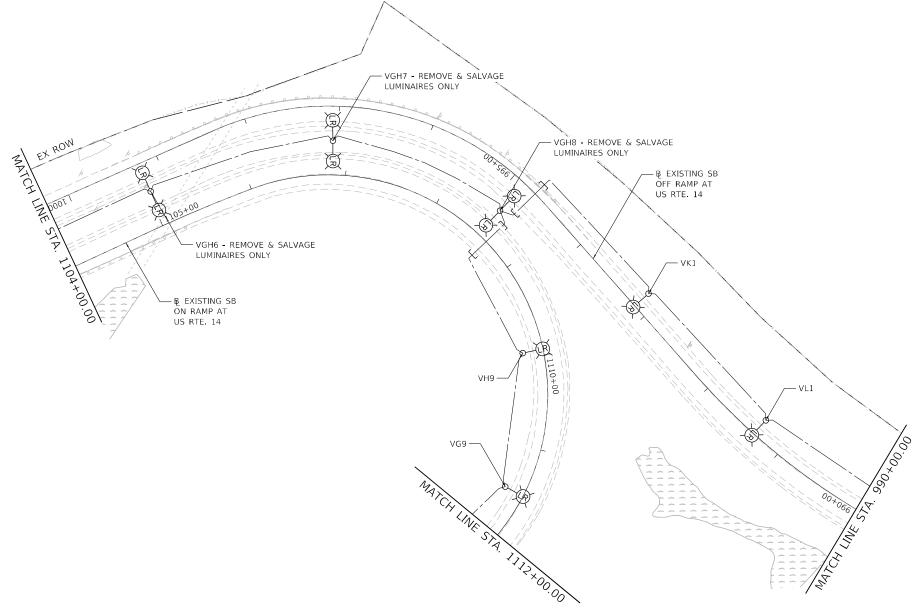

| | LT | -13 |
|--------|-------|--------------|
| COUNTY | TOTAL | SHEET NO. |


| NAME: S:\ | SA | 1170 SOUTH HOUBOLT RO JOLIET, ILLINOIS 60431 |
|-----------|--------|---|
| FILE | STRAND | (815) 744-4200 |
| | | |


| USER NAME = jackd | DESIGNED - | AJR | REVISED - | |
|-----------------------------|------------|-----------|-----------|--|
| | DRAWN - | JED | REVISED - | |
| PLOT SCALE = 100.0000 / in. | CHECKED - | RG⊤ | REVISED - | |
| PLOT DATE = 9/20/2024 | DATE - | 8/23/2024 | REVISED - | |
| | | | | |


STATE OF ILLINOIS DEPARTMENT OF TRANSPORTATION


| | IL ROUTE 53 REMOVAL AND TEMPORARY LIGHTING PLAN | | | | | | | | | F | | |
|--|---|-----------------------------------|-------|----|----|----|--------|------|------------|---------|------------|--|
| | | | | | | | | | | | | |
| | | REMOVALAND TEMPORARY EIGHTING LAN | | | | | | | | | | |
| | SCALE: | 1" = 50" | SHEET | 11 | OF | 20 | SHEETS | STA. | 1276+50.00 | TO STA. | 1291+00.00 | |

| | F.A.P. RTE | SEC ⁻ | LION | | COUNTY | TOTAL SHEETS | SHEE NO. |
|---|---------------|------------------|----------|--------|------------|-----------------|----------|
| | 342 | (531) | BR 23 | | соок | 1211 | 543 |
| | | | | | CONTRACT | NO. 62 | 2W38 |
|) | | | ILLINOIS | FED. A | ID PROJECT | | |
| | | | | | | | |

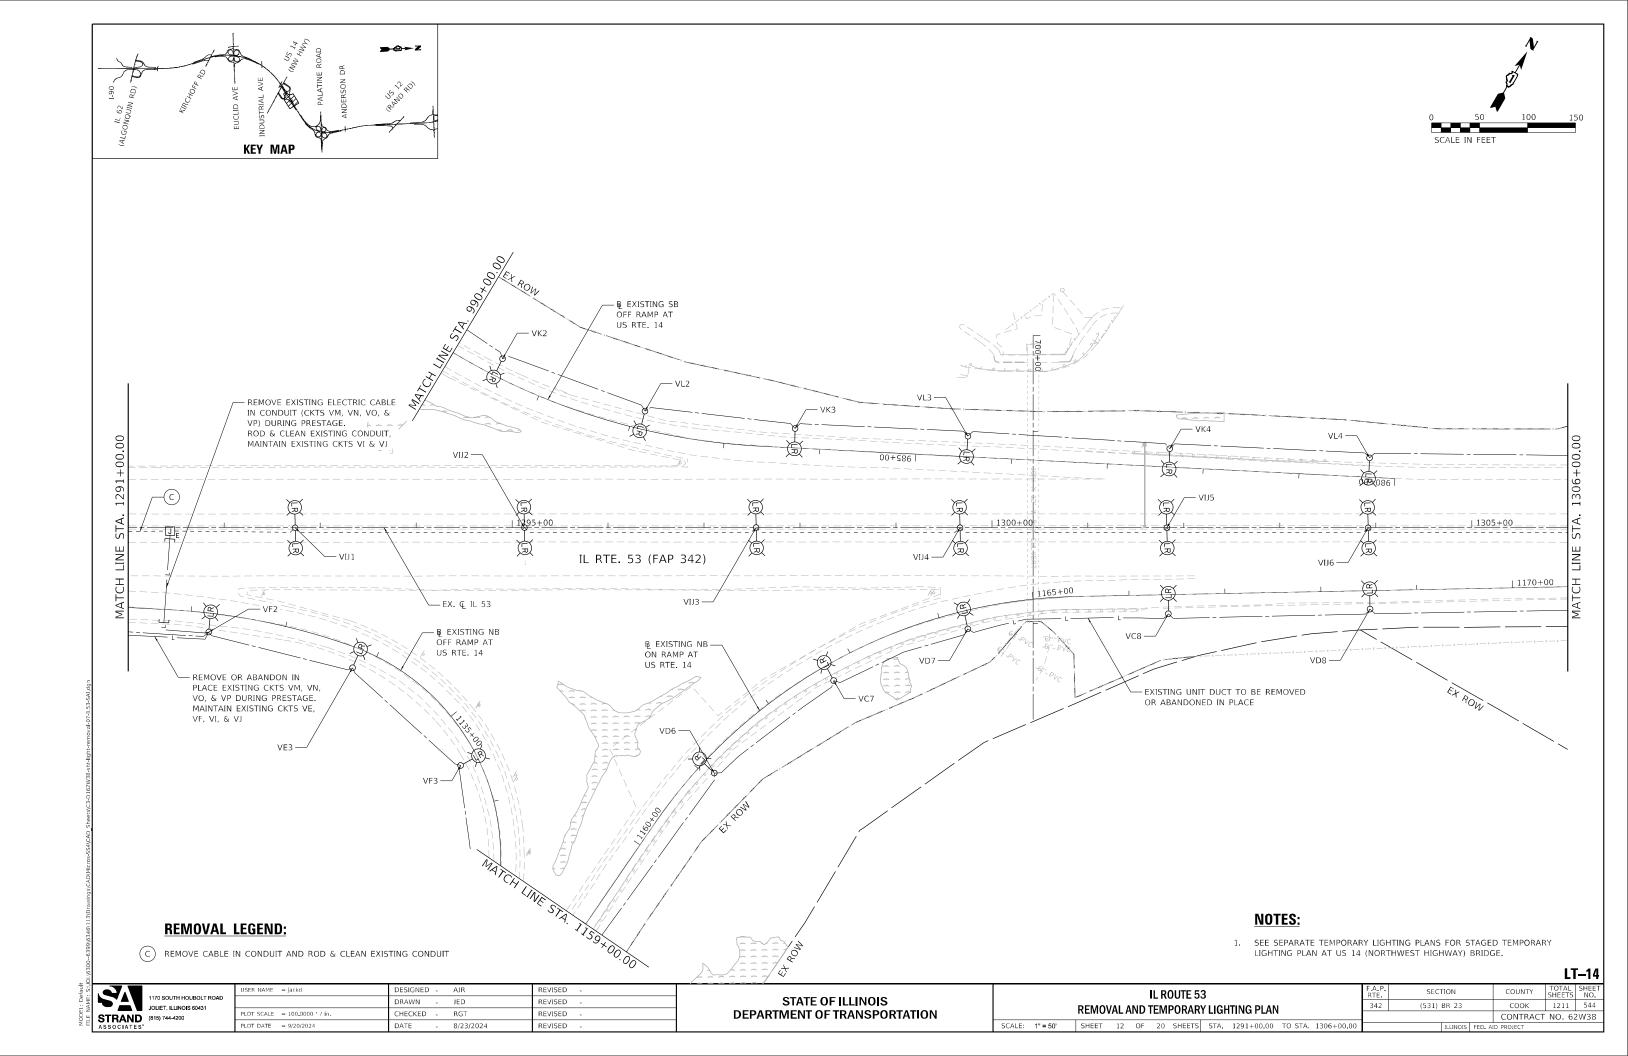

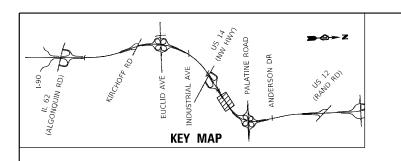

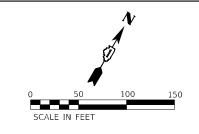

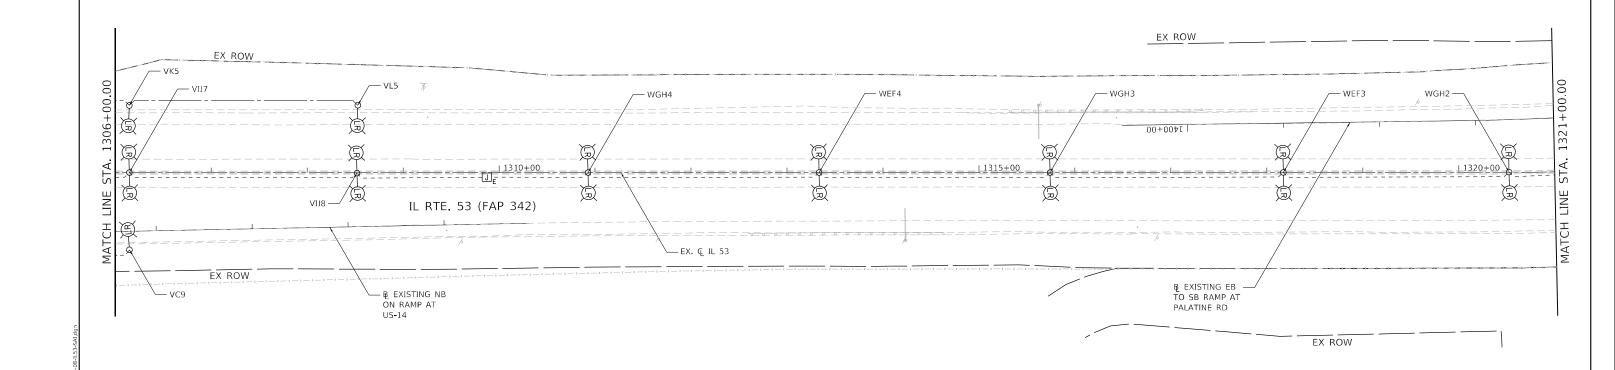

1170 SOUTH HOUBOLT R
JOLIET, ILLINOIS 60431


STRAND
ASSOCIATES*


(815) 744-4200


| USER NAME = JackD | DESIGNED - | AJR | REVISED - |
|-----------------------------|------------|-----------|-----------|
| | DRAWN - | JED | REVISED - |
| PLOT SCALE = 100.0000 / in. | CHECKED - | RG⊤ | REVISED - |
| PLOT DATE = 8/23/2024 | DATE - | 8/23/2024 | REVISED - |


STATE OF ILLINOIS DEPARTMENT OF TRANSPORTATION


| IL ROUTE 53 REMOVAL AND TEMPORARY LIGHTING PLAN | | | | | | | | | |
|--|--|--|--|--|--|--|--|--|--------------------------------------|
| | | | | | | | | | TENIOVALAND IEMI ONANI EIGIIING FEAN |
| SCALE: 1" = 50' SHEET 13 OF 20 SHEETS STA. 1306+00.00 TO STA. 1321+00.00 | | | | | | | | | |

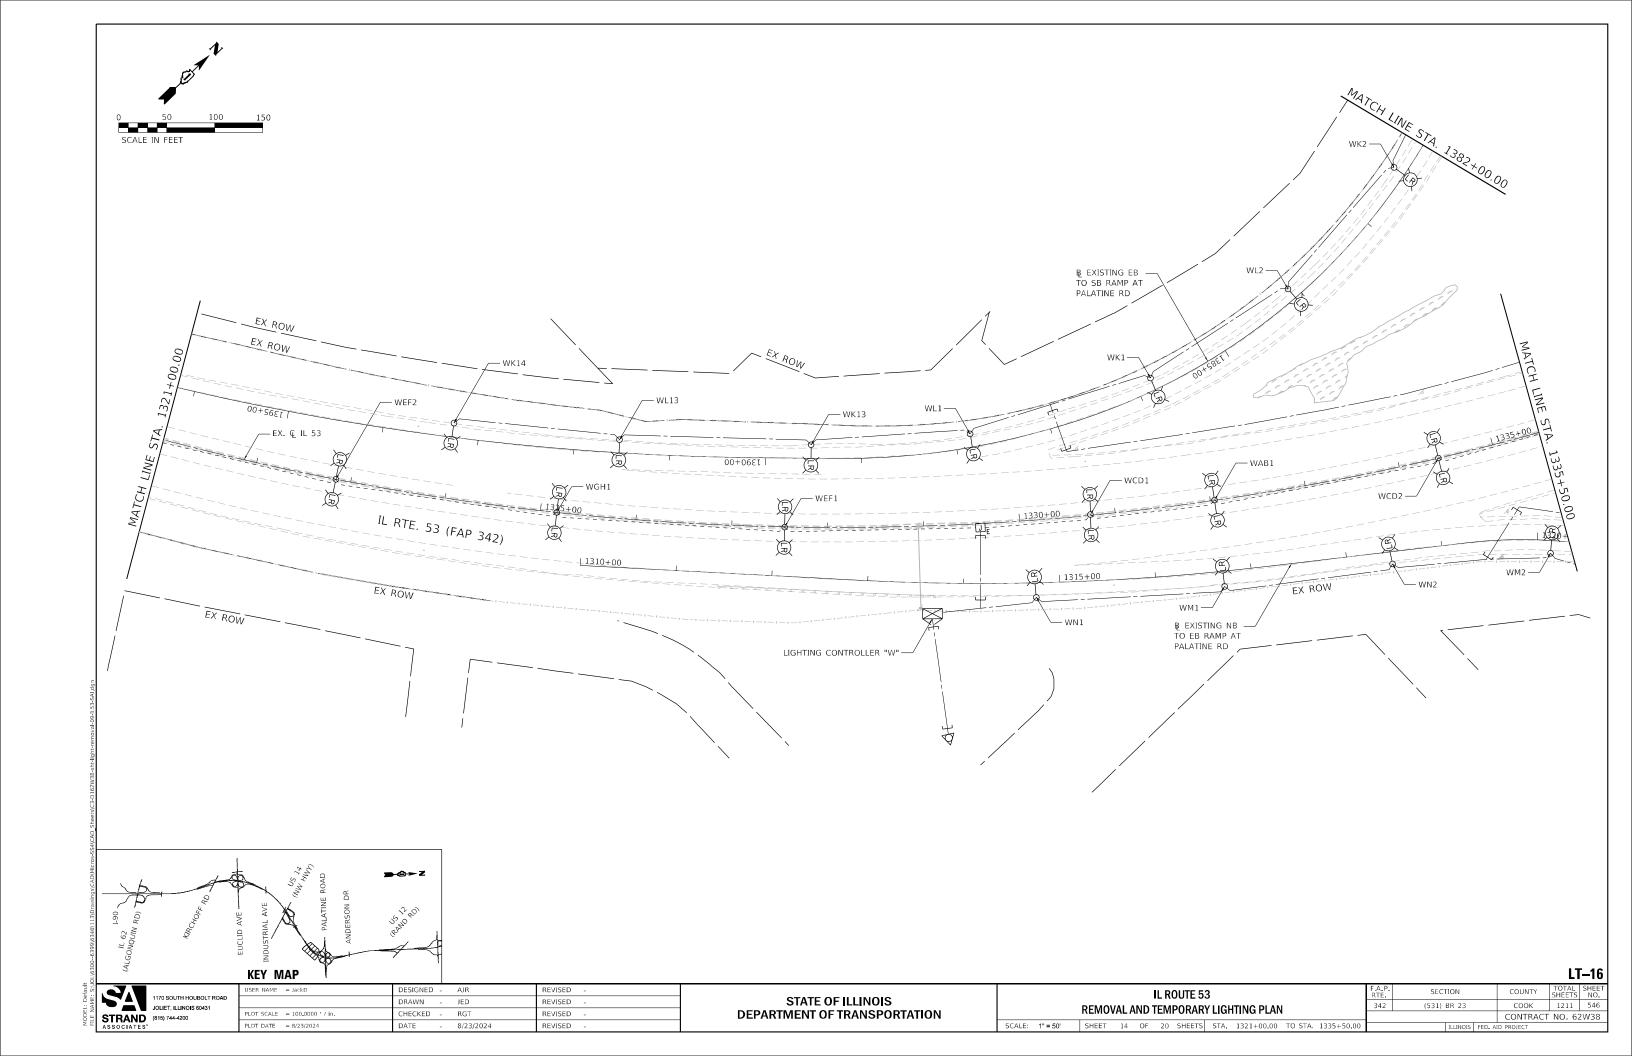


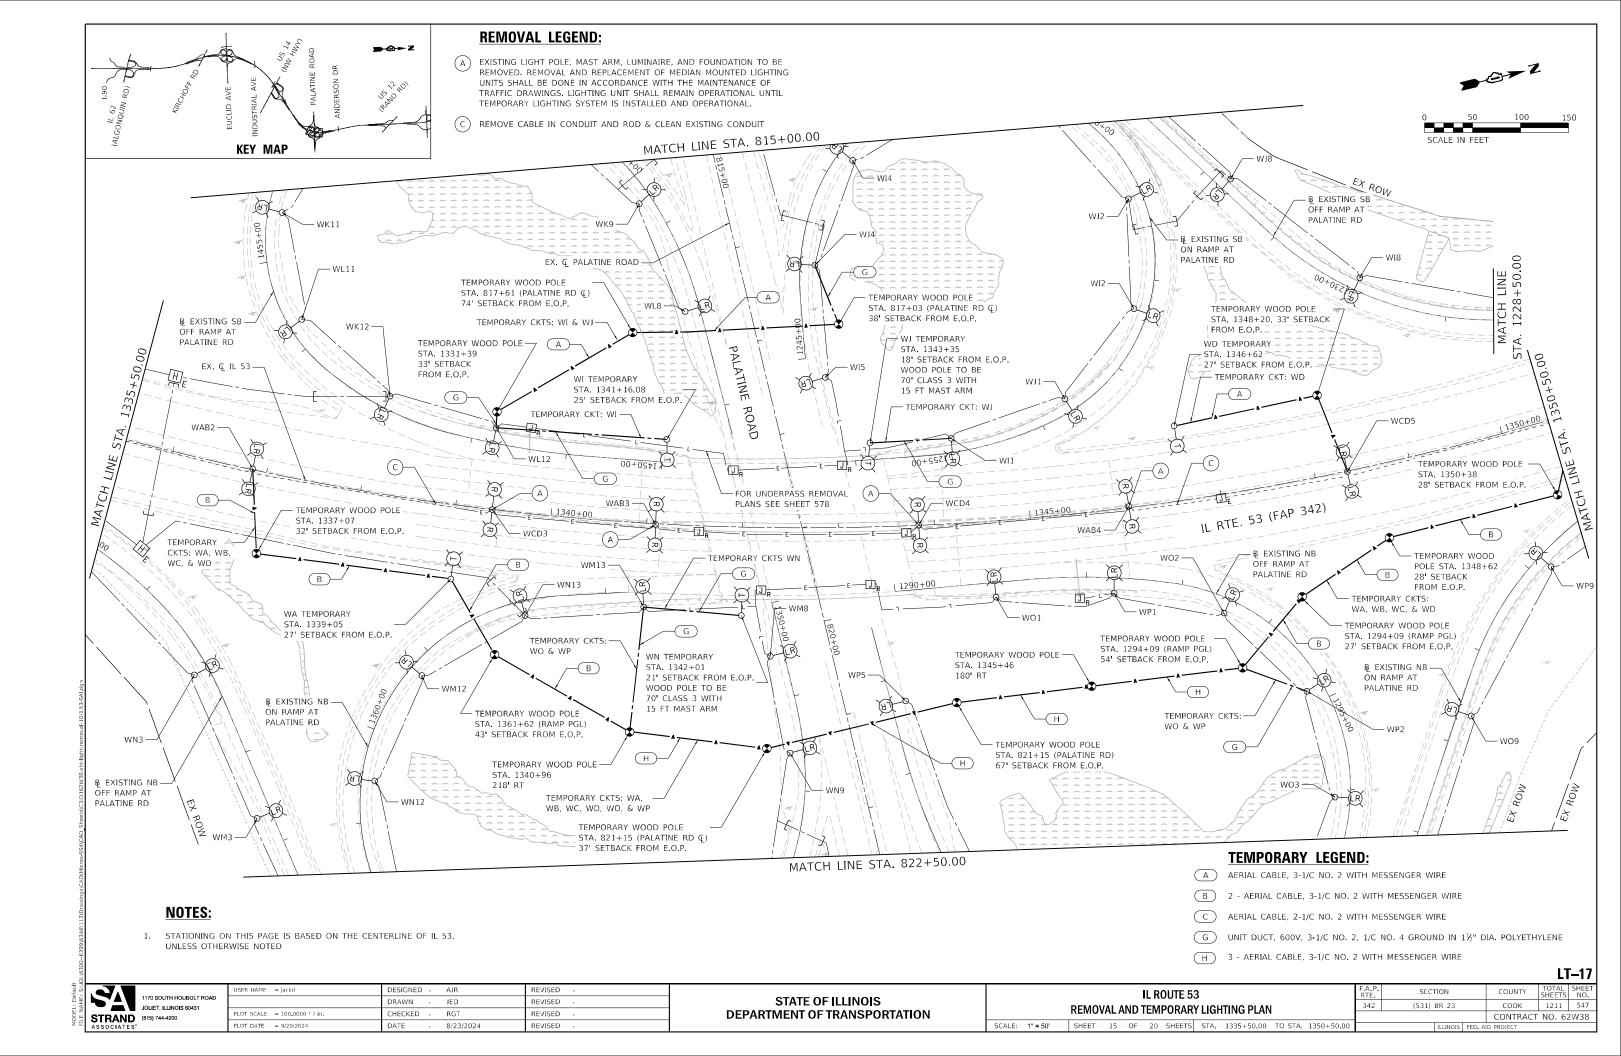


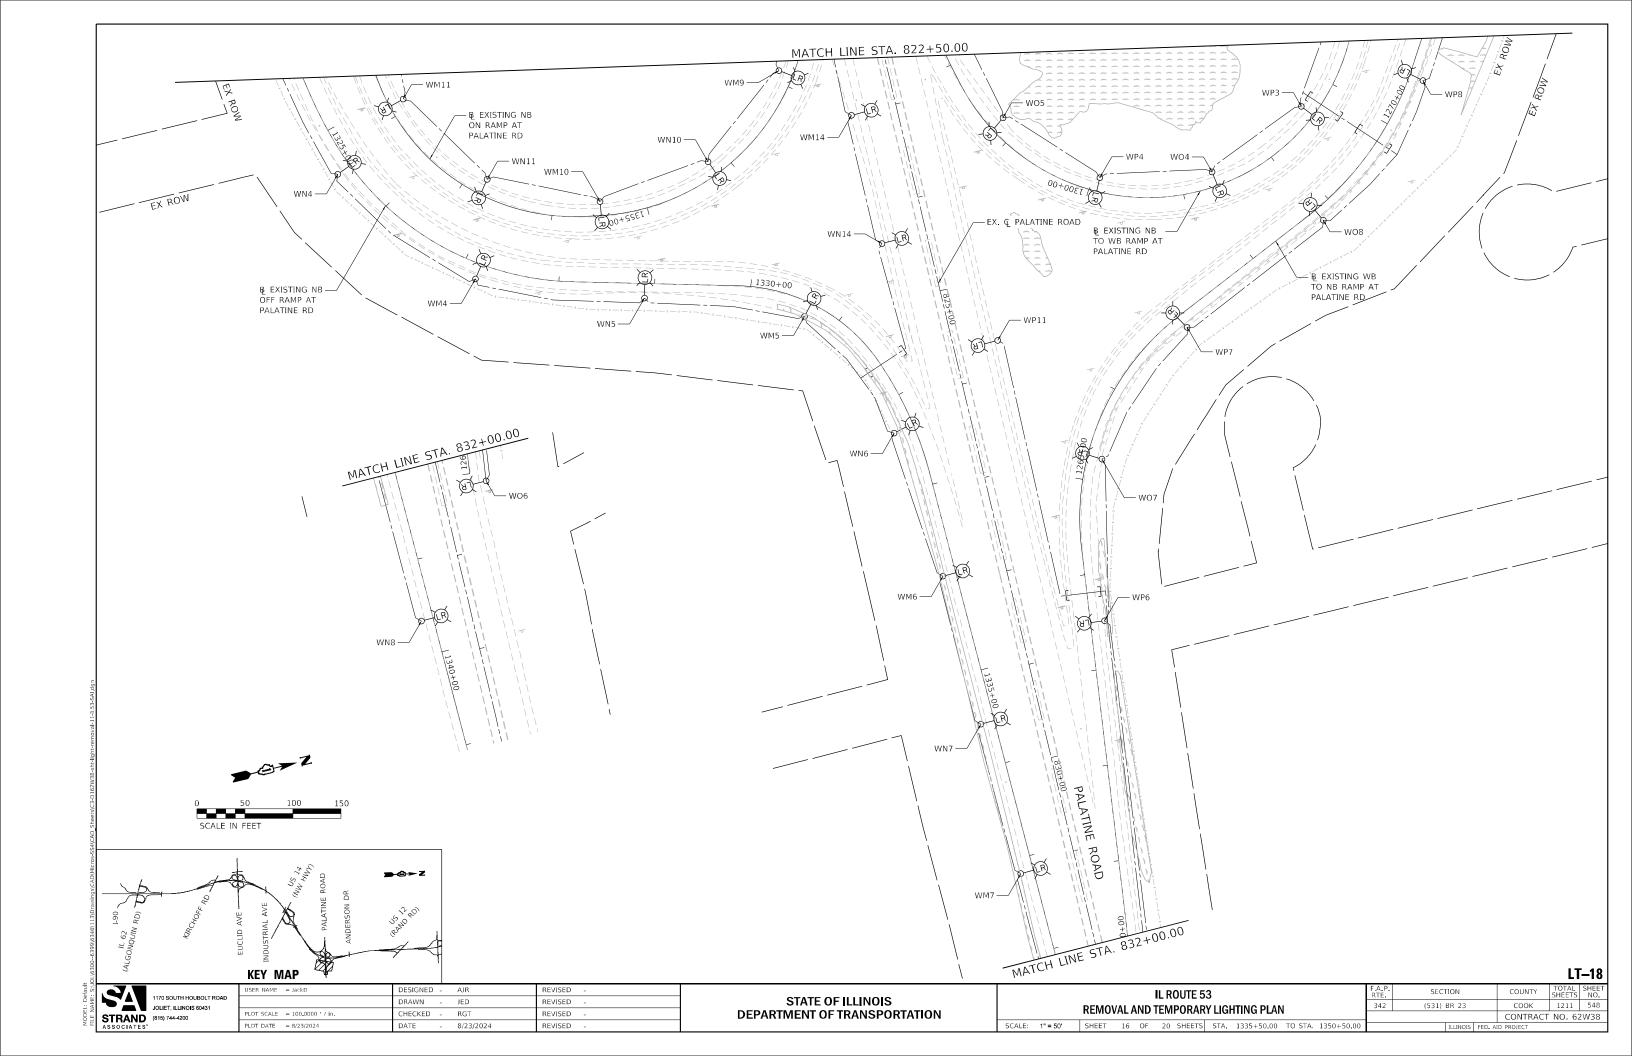

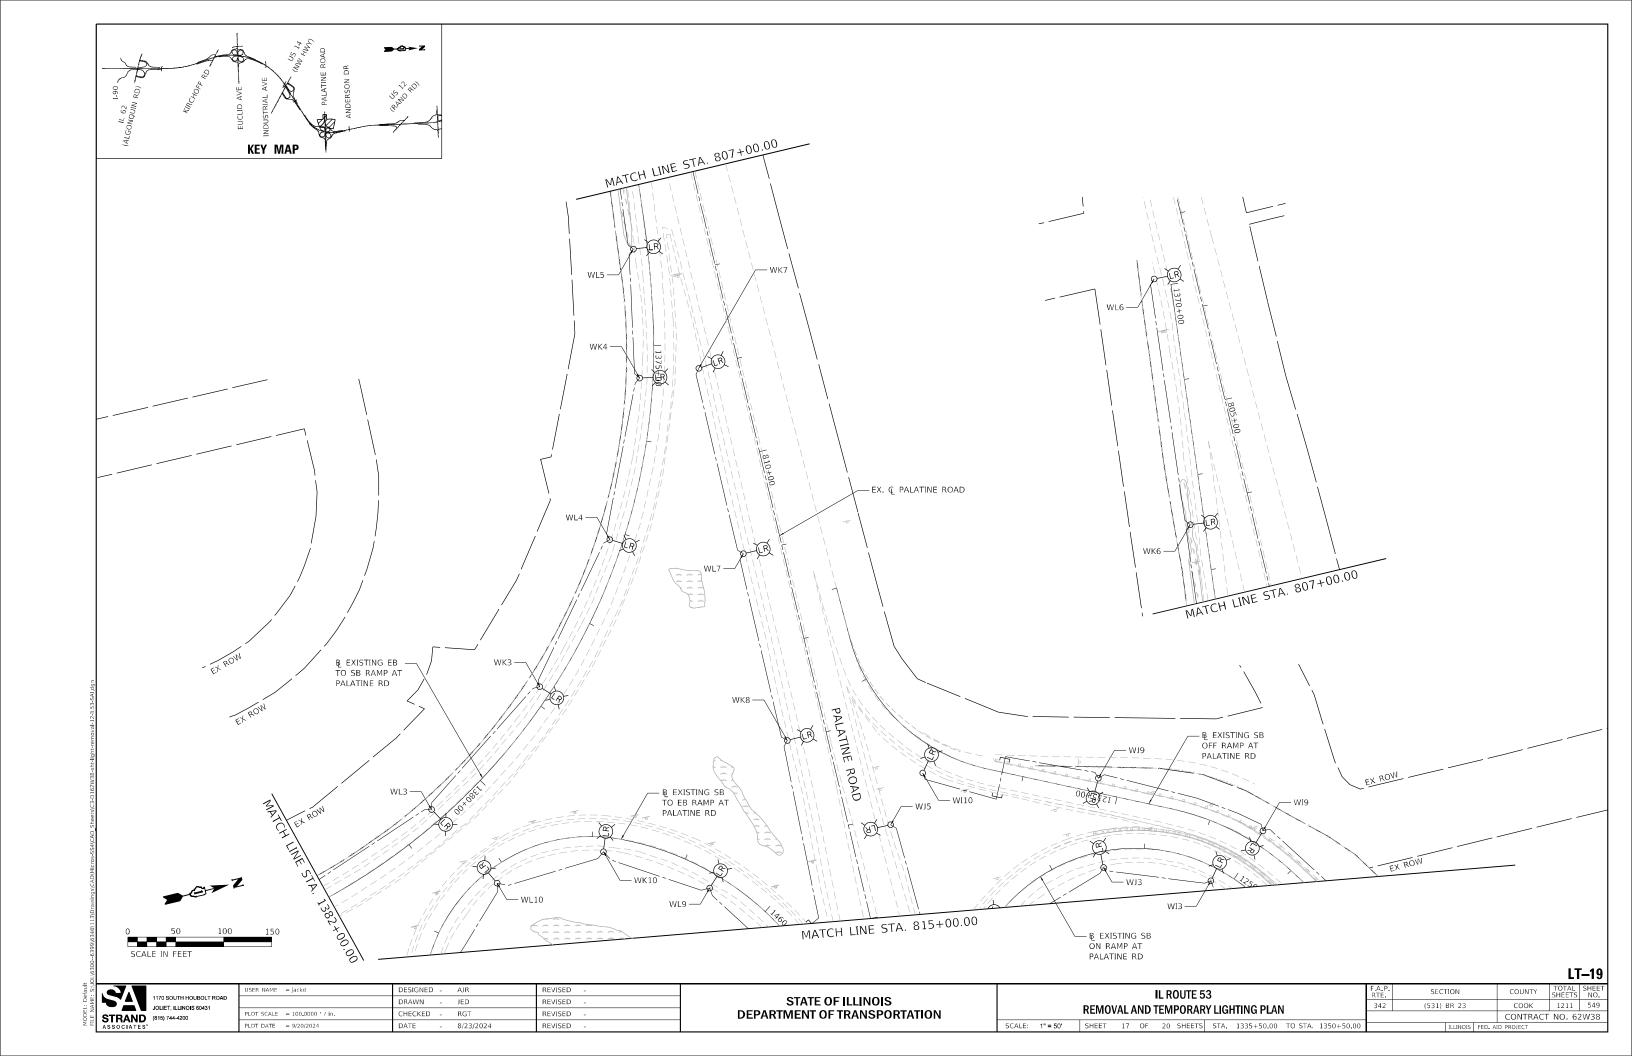

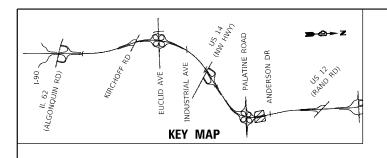

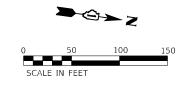

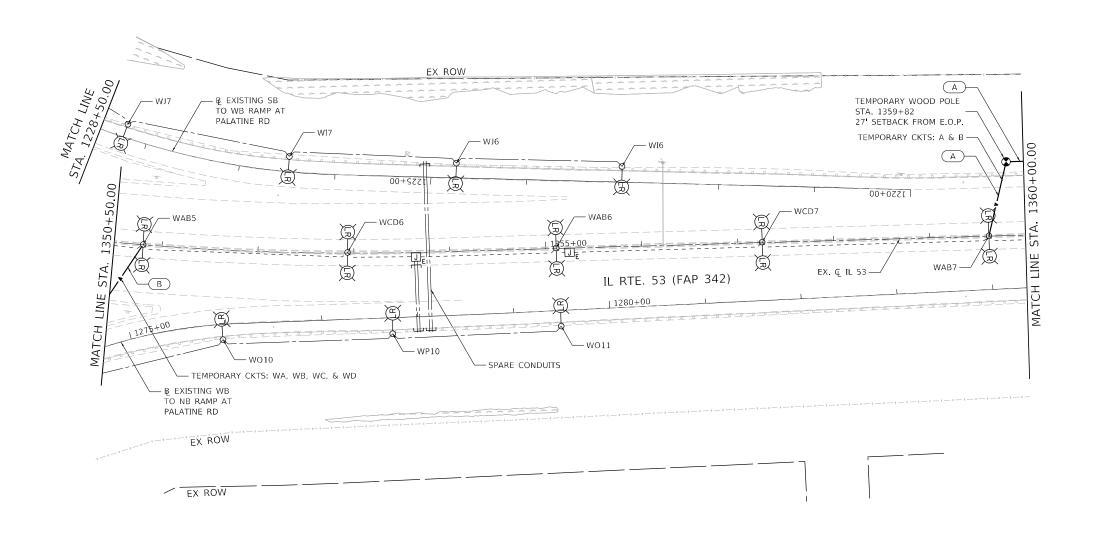

TEMPORARY LEGEND:

- A AERIAL CABLE, 3-1/C NO. 2 WITH MESSENGER WIRE
- B 2 AERIAL CABLE, 3-1/C NO. 2 WITH MESSENGER WIRE

COUNTY TOTAL SHEET NO.

COOK 1211 550

CONTRACT NO. 62W38

SECTION

(531) BR 23

LT-20


1170 SOUTH HOUBOLT ROAD
JOLIET, ILLINOIS 80431


STRAND
ASSOCIATES*


| DRAWN - JED REVISED - PLOT SCALE = 100,0000 ' / in. CHECKED - RGT REVISED - PLOT DATE = 8/(3/0024 REVISED REVI | USER NAME = JackD | DESIGNED - AJR | REVISED - |
|--|-----------------------------|------------------|-----------|
| | | DRAWN - JED | REVISED - |
| PLOT DATE = 8/23/2024 DATE 8/23/2024 REVISED | PLOT SCALE = 100.0000 / in. | CHECKED - RGT | REVISED - |
| TEOT BATE = 0/23/2024 REVISED = | PLOT DATE = 8/23/2024 | DATE - 8/23/2024 | REVISED - |

| STATE OF ILLINOIS | |
|------------------------------|--|
| DEPARTMENT OF TRANSPORTATION | |

IL ROUTE 53

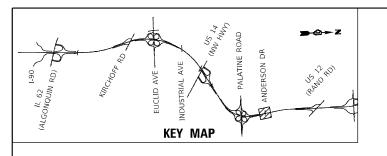

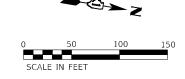

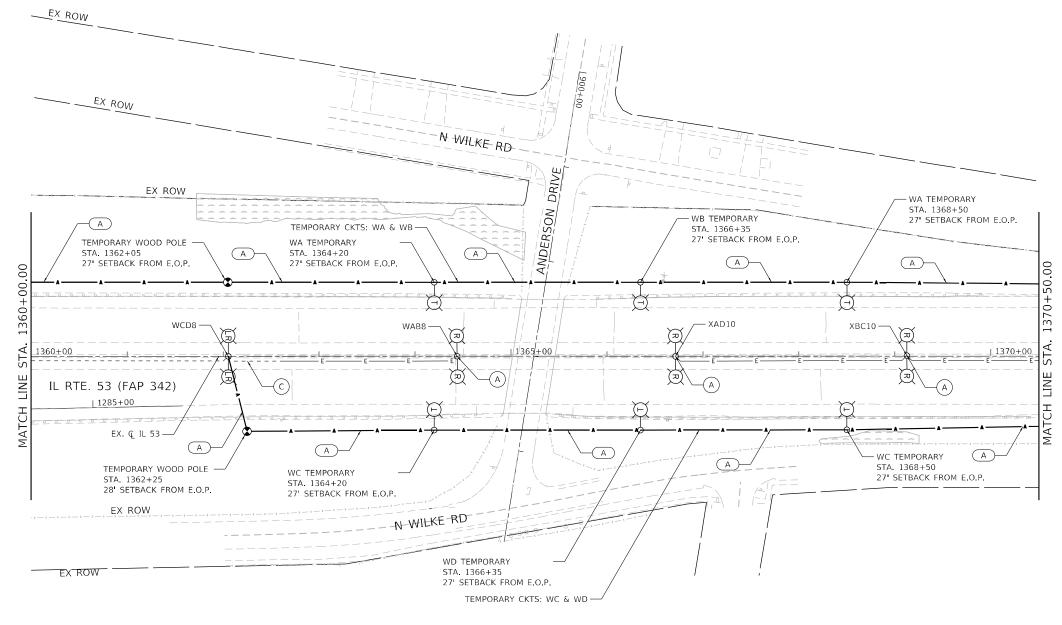

A EXISTING LIGHT POLE, MAST ARM, LUMINAIRE, AND FOUNDATION TO BE REMOVED. REMOVAL AND REPLACEMENT OF MEDIAN MOUNTED LIGHTING UNITS SHALL BE DONE IN ACCORDANCE WITH THE MAINTENANCE OF TRAFFIC DRAWINGS. LIGHTING UNIT SHALL REMAIN OPERATIONAL UNTIL TEMPORARY LIGHTING SYSTEM IS INSTALLED AND OPERATIONAL.

TEMPORARY LEGEND:

C) REMOVE CABLE IN CONDUIT AND ROD & CLEAN EXISTING CONDUIT

A AERIAL CABLE, 3-1/C NO. 2 WITH MESSENGER WIRE





| USER NAME = jackd | DESIGNED | - | AJR | REVISED | - |
|-----------------------------|----------|---|-----------|---------|---|
| | DRAWN | - | JED | REVISED | - |
| PLOT SCALE = 100.0000 / in. | CHECKED | - | RG⊤ | REVISED | - |
| PLOT DATE = 9/20/2024 | DATE | - | 8/23/2024 | REVISED | - |


| STATE OF ILLINOIS |
|------------------------------|
| DEPARTMENT OF TRANSPORTATION |

SCALE: 1" = 50'

| IL ROUTE 53 | F.A.P. RTE | SECTION | | COUNTY | TOTAL SHEETS | SHEET NO. |
|--|---------------|-------------|---------|----------|-----------------|--------------|
| REMOVAL AND TEMPORARY LIGHTING PLAN | 342 | (531) BR 23 | | соок | 1211 | 551 |
| NEWOVALAND IEMI ONANI EIGITIINGI EAN | | | | CONTRACT | NO. 62 | 2W38 |
| SHEET 19 OF 20 SHEETS STA. 1360+00.00 TO STA. 1370+50.00 | | ILLINOIS F | ED. AID | PROJECT | | |

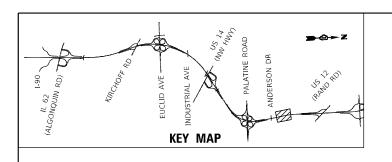

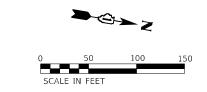

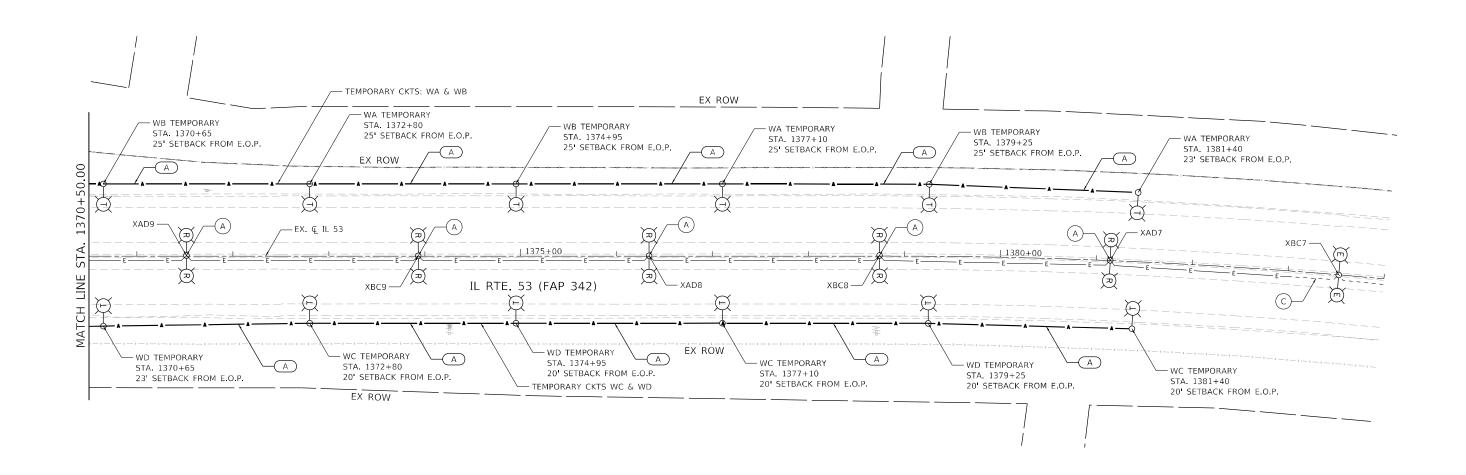

A EXISTING LIGHT POLE, MAST ARM, LUMINAIRE, AND FOUNDATION TO BE REMOVED. REMOVAL AND REPLACEMENT OF MEDIAN MOUNTED LIGHTING UNITS SHALL BE DONE IN ACCORDANCE WITH THE MAINTENANCE OF TRAFFIC DRAWINGS. LIGHTING UNIT SHALL REMAIN OPERATIONAL UNTIL TEMPORARY LIGHTING SYSTEM IS INSTALLED AND OPERATIONAL.

TEMPORARY LEGEND:

(C) REMOVE CABLE IN CONDUIT AND ROD & CLEAN EXISTING CONDUIT

(A) AERIAL CABLE, 3-1/C NO. 2 WITH MESSENGER WIRE

LT-22





| USER NAME = jackd | DESIGNED | - | AJR | REVISED | - |
|-----------------------------|----------|---|-----------|---------|---|
| | DRAWN | - | JED | REVISED | - |
| PLOT SCALE = 100.0000 / in. | CHECKED | - | RG⊤ | REVISED | - |
| PLOT DATE = 9/20/2024 | DATE | - | 8/23/2024 | REVISED | - |


| STATE OF ILLINOIS |
|------------------------------|
| DEPARTMENT OF TRANSPORTATION |


SCALE: 1" = 50'


| | | | IL R | OUTE 53 | 3 | | | | RTE | SEC* | TION | | COUNTY | SHEETS | NO |
|---------|-------|------|------|---------|---------|------------|---------|------------|-----|-------|----------|---------|------------|--------|-----|
| REMOV | /ΔΙ Δ | ND 1 | ГEМ | PUBVB | V L ICH | TING PLAN | ı | | 342 | (531) | BR 23 | | соок | 1211 | 55 |
| ILLIVIO | /AL / | IIID | LIVI | UNAIN | LIGIT | TING I LA | | | | | | | CONTRACT | NO. 62 | 2W3 |
| SHEET | 20 | OF | 20 | SHEETS | STA. | 1370+50.00 | TO STA. | 1384+00.00 | | | ILLINOIS | FED. AI | ID PROJECT | | |

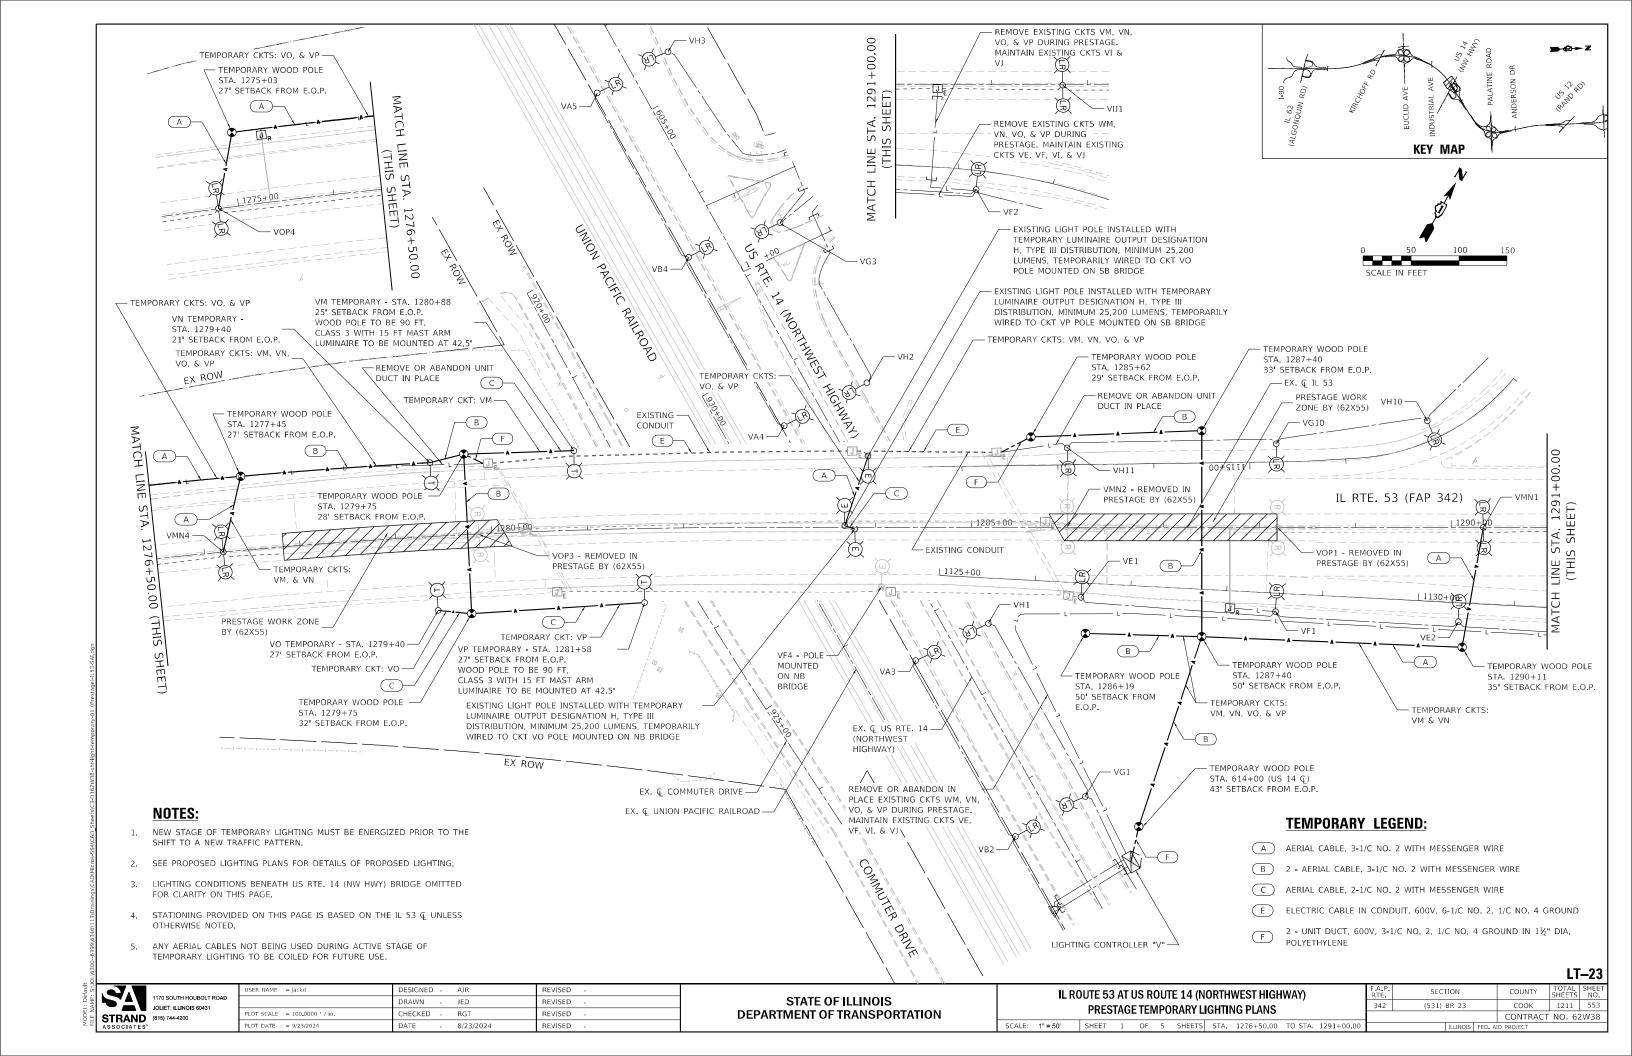


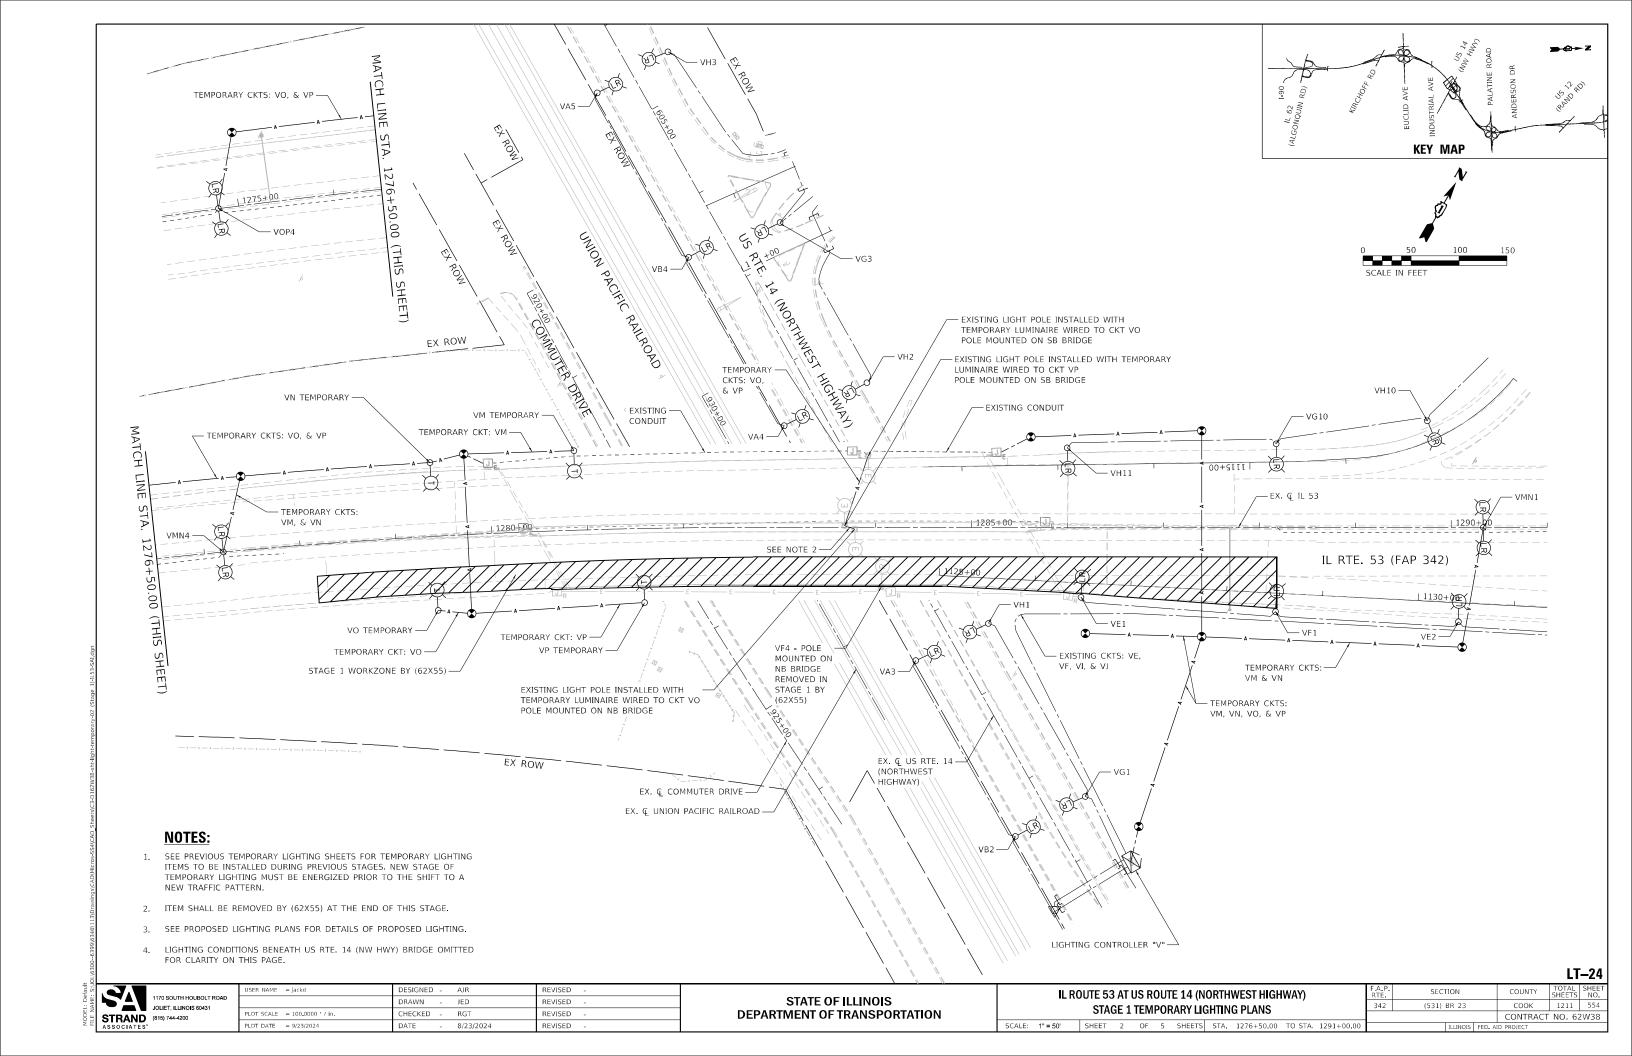

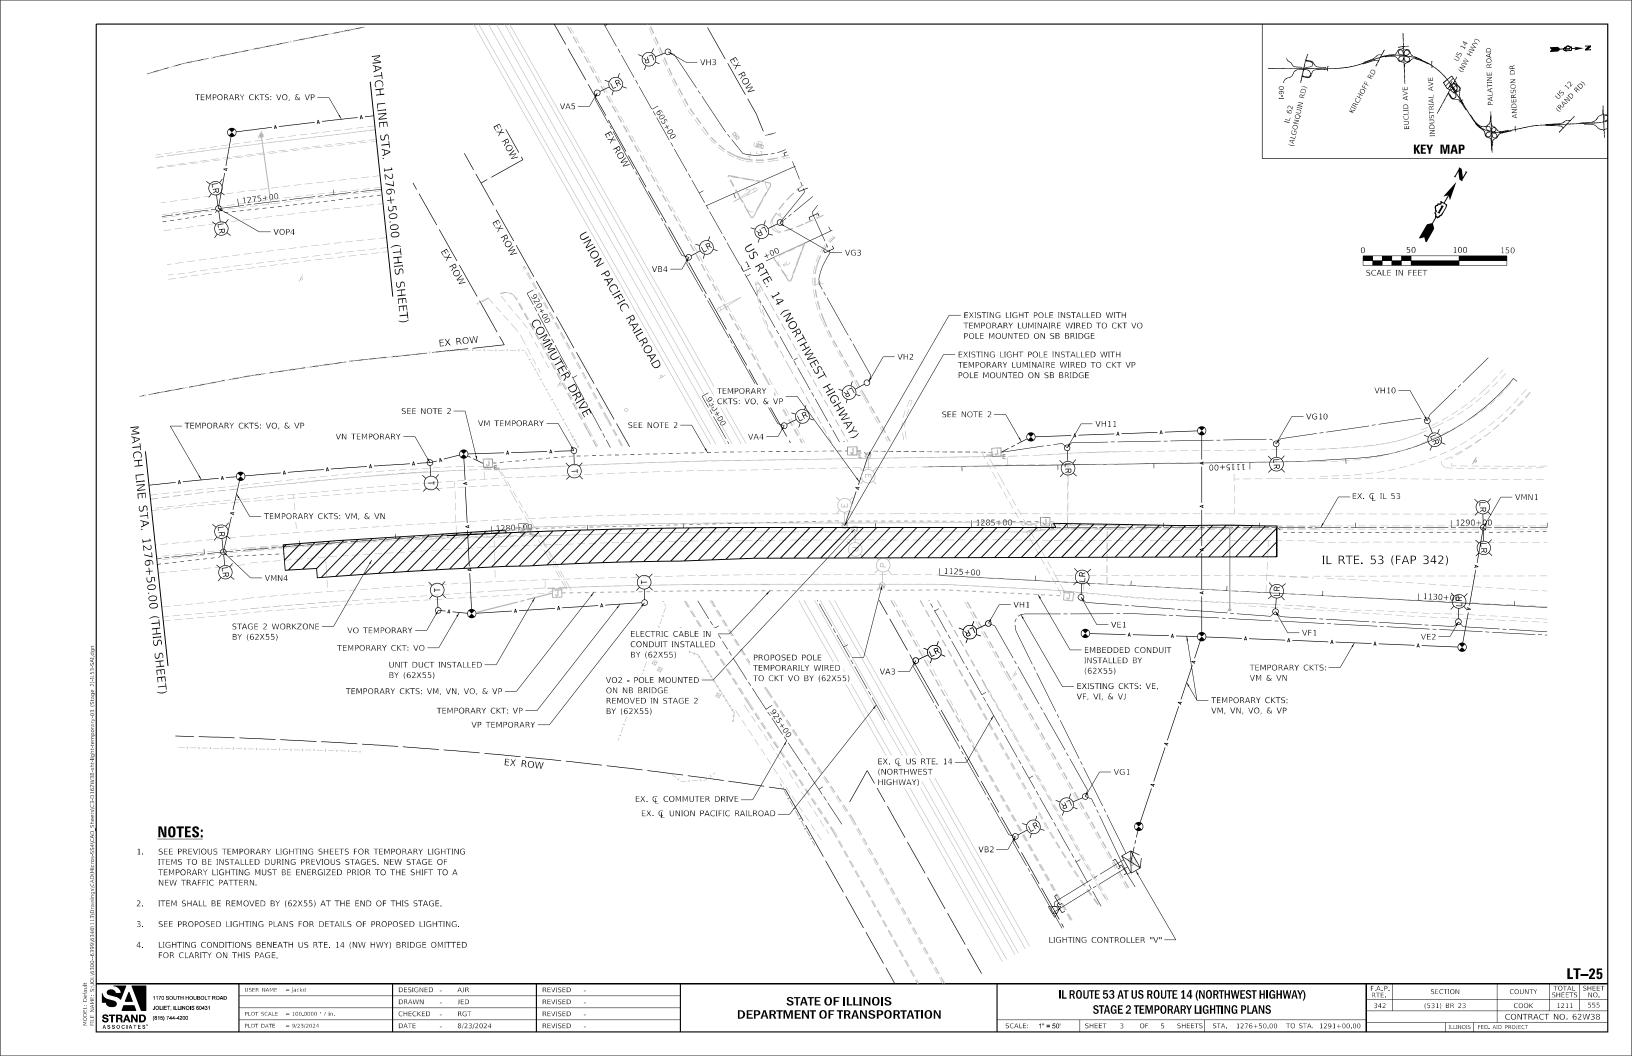

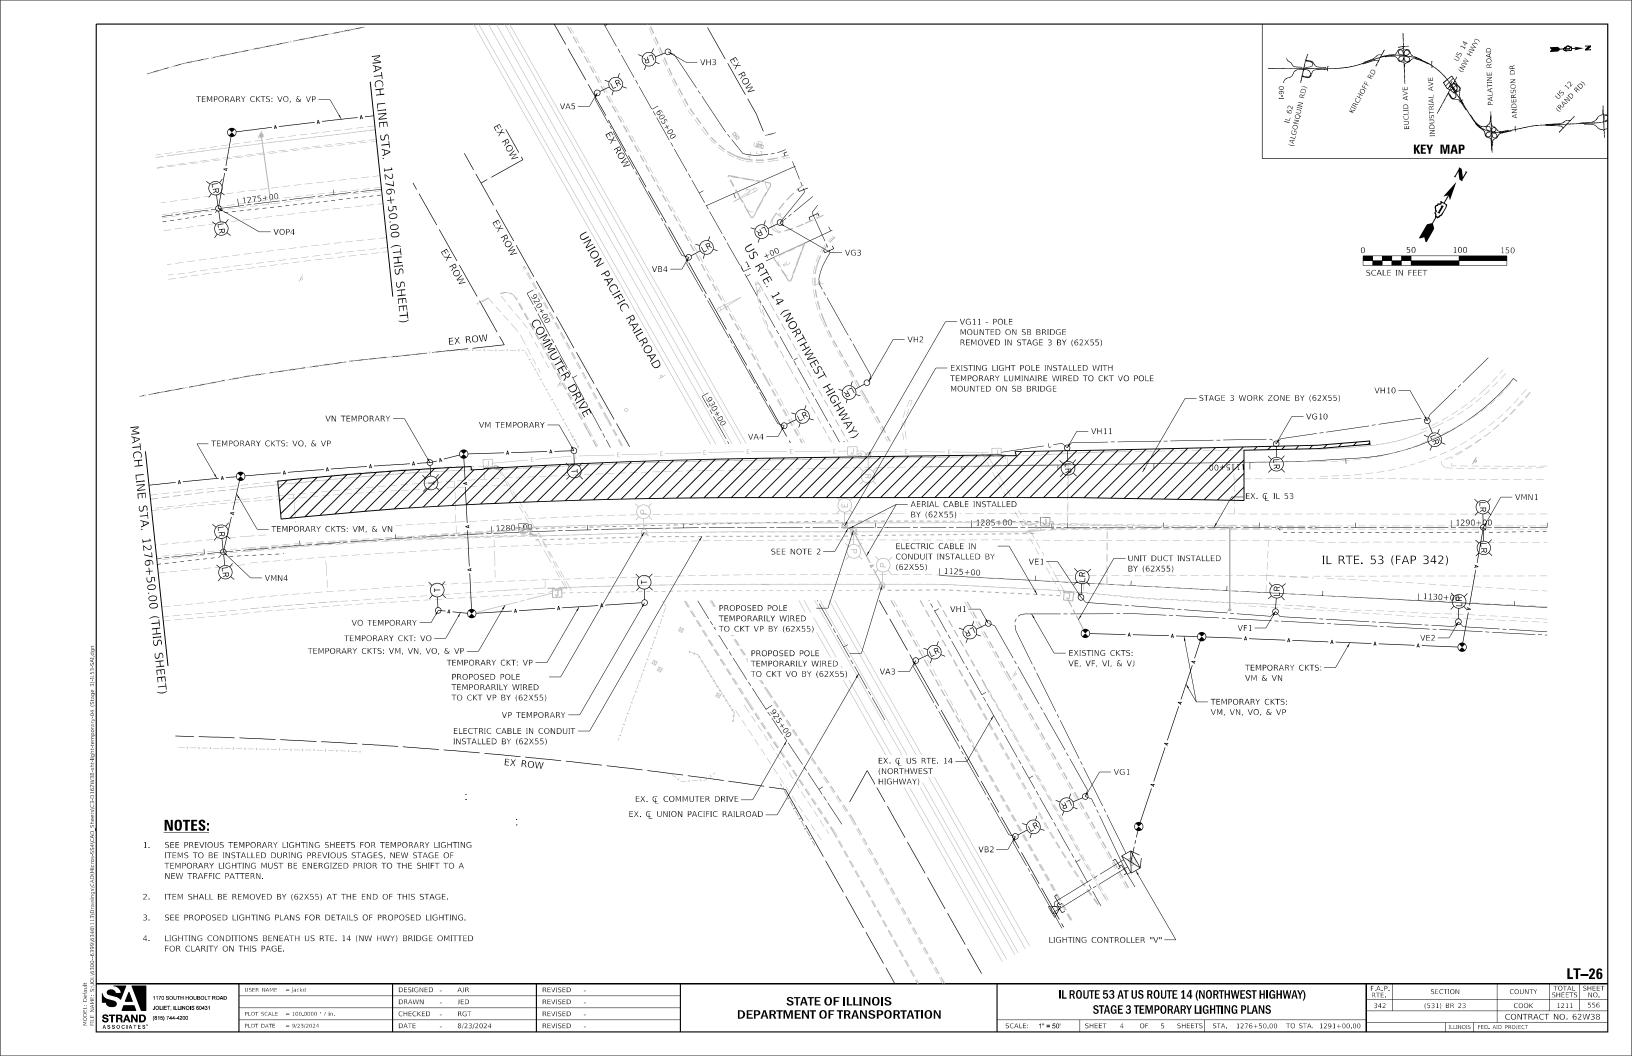

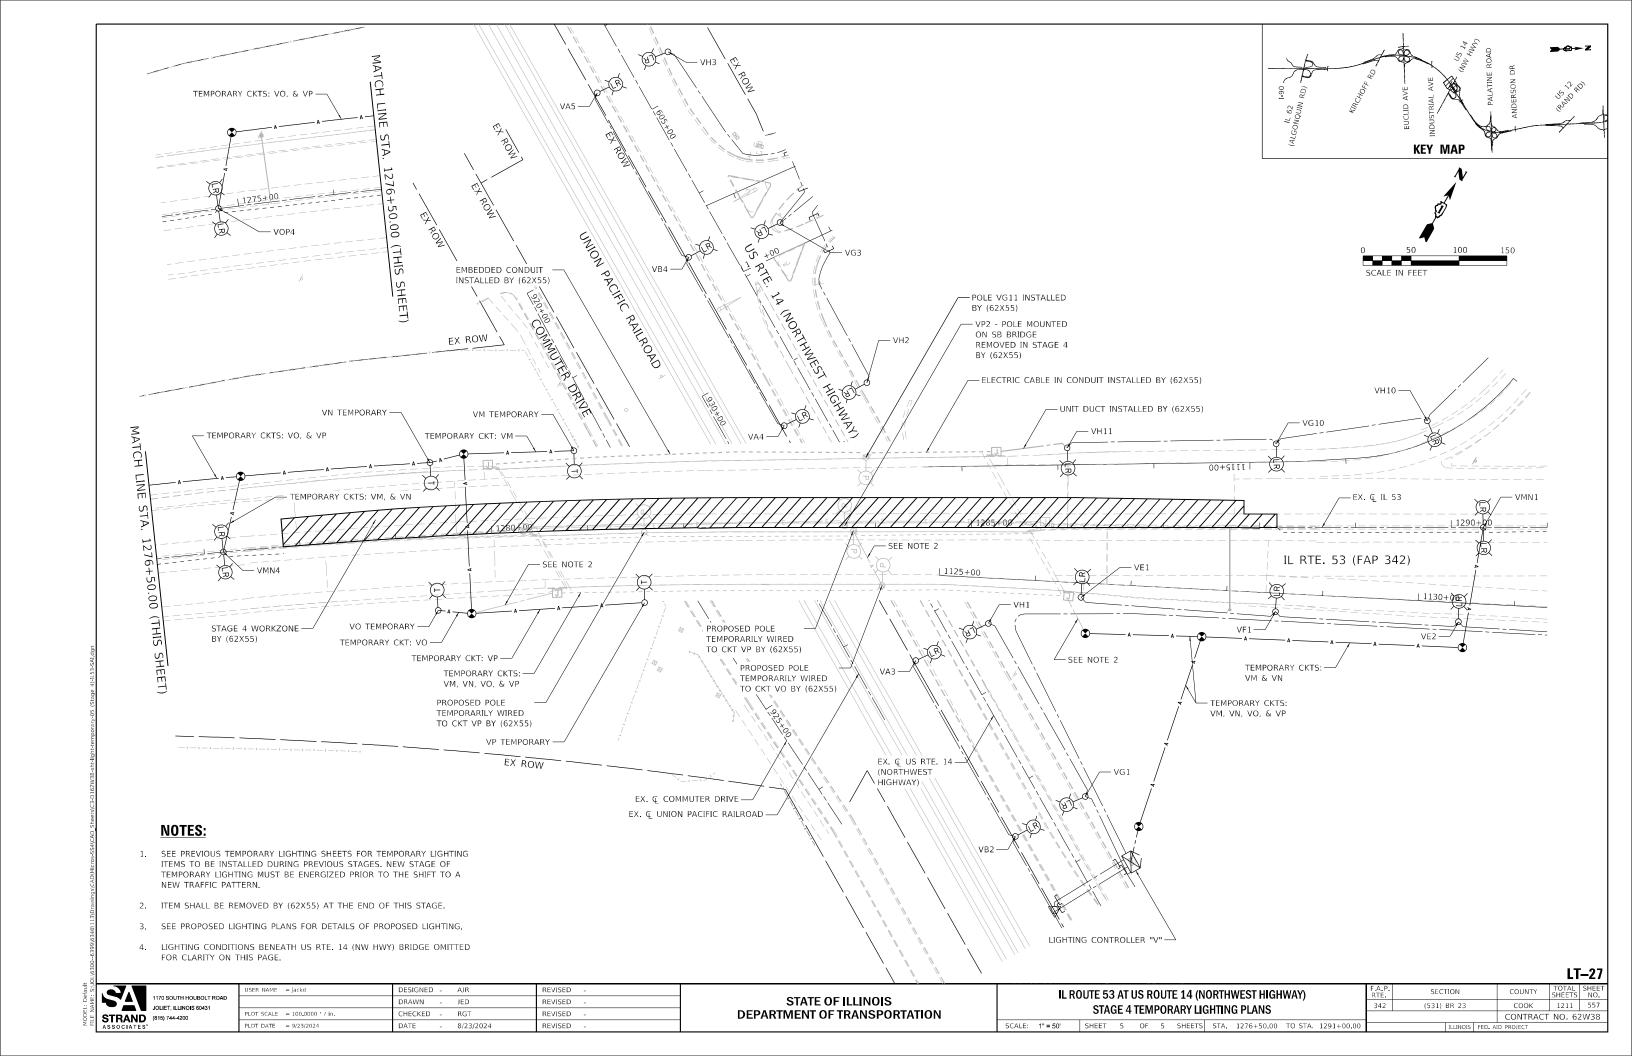

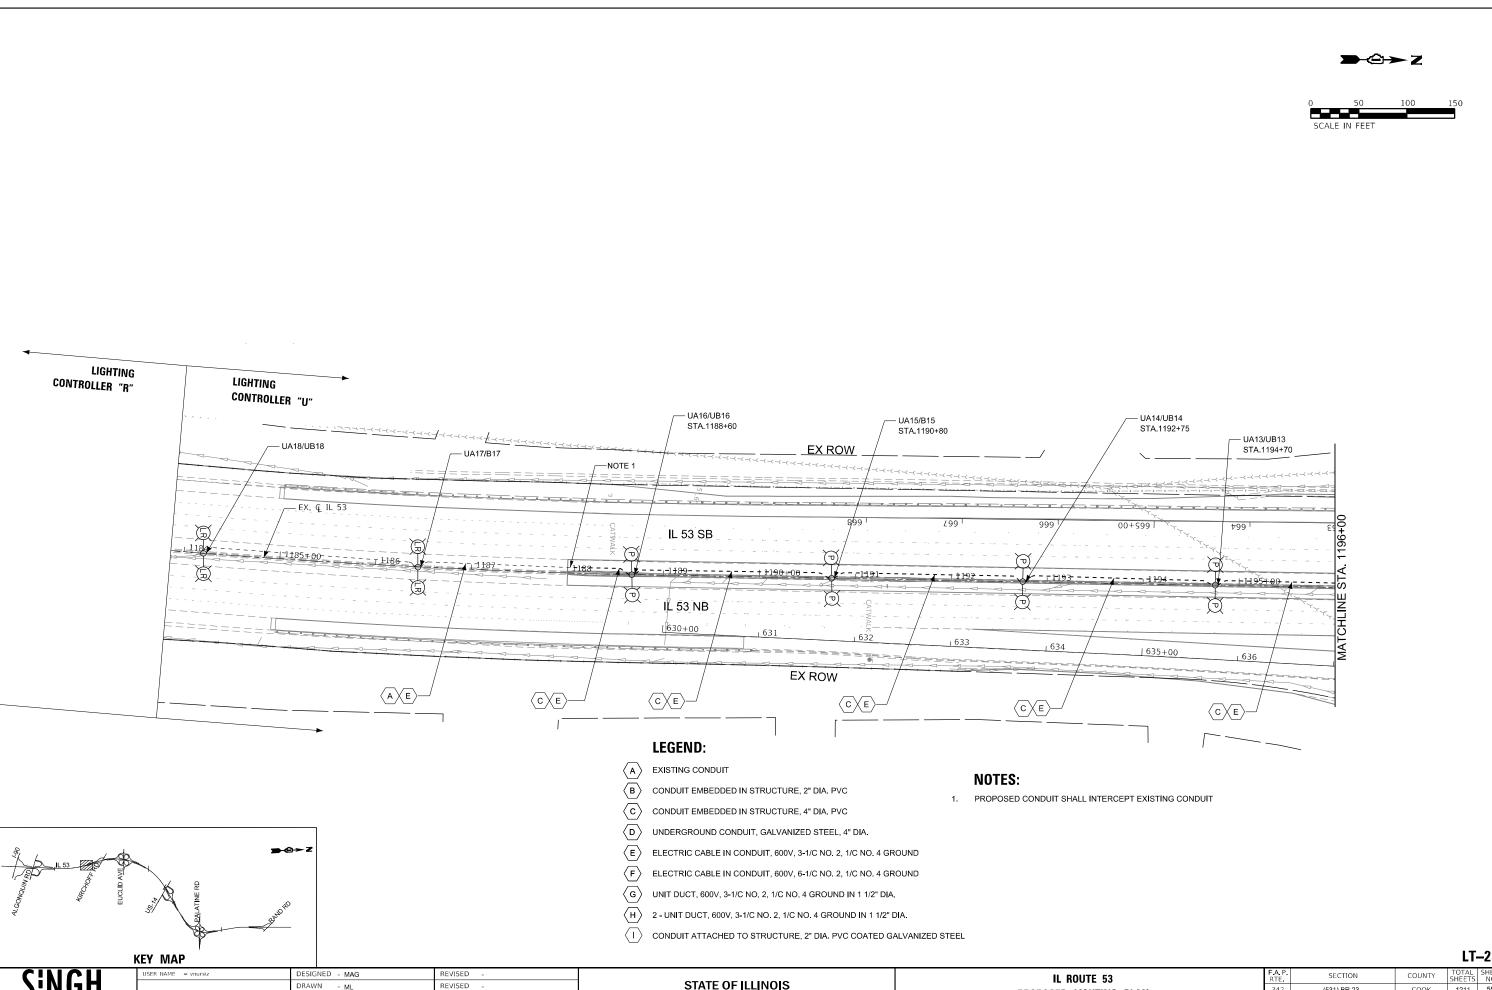


LT-28


DRAWN - ML LOT SCALE = 100.0000 / in. CHECKED - MG/RP REVISED PLOT DATE = 9/20/2024


STATE OF ILLINOIS DEPARTMENT OF TRANSPORTATION


PROPOSED LIGHTING PLAN SHEET 1 OF 20 SHEETS STA.


1211 558 (531) BR 23 COOK CONTRACT NO. 62W38

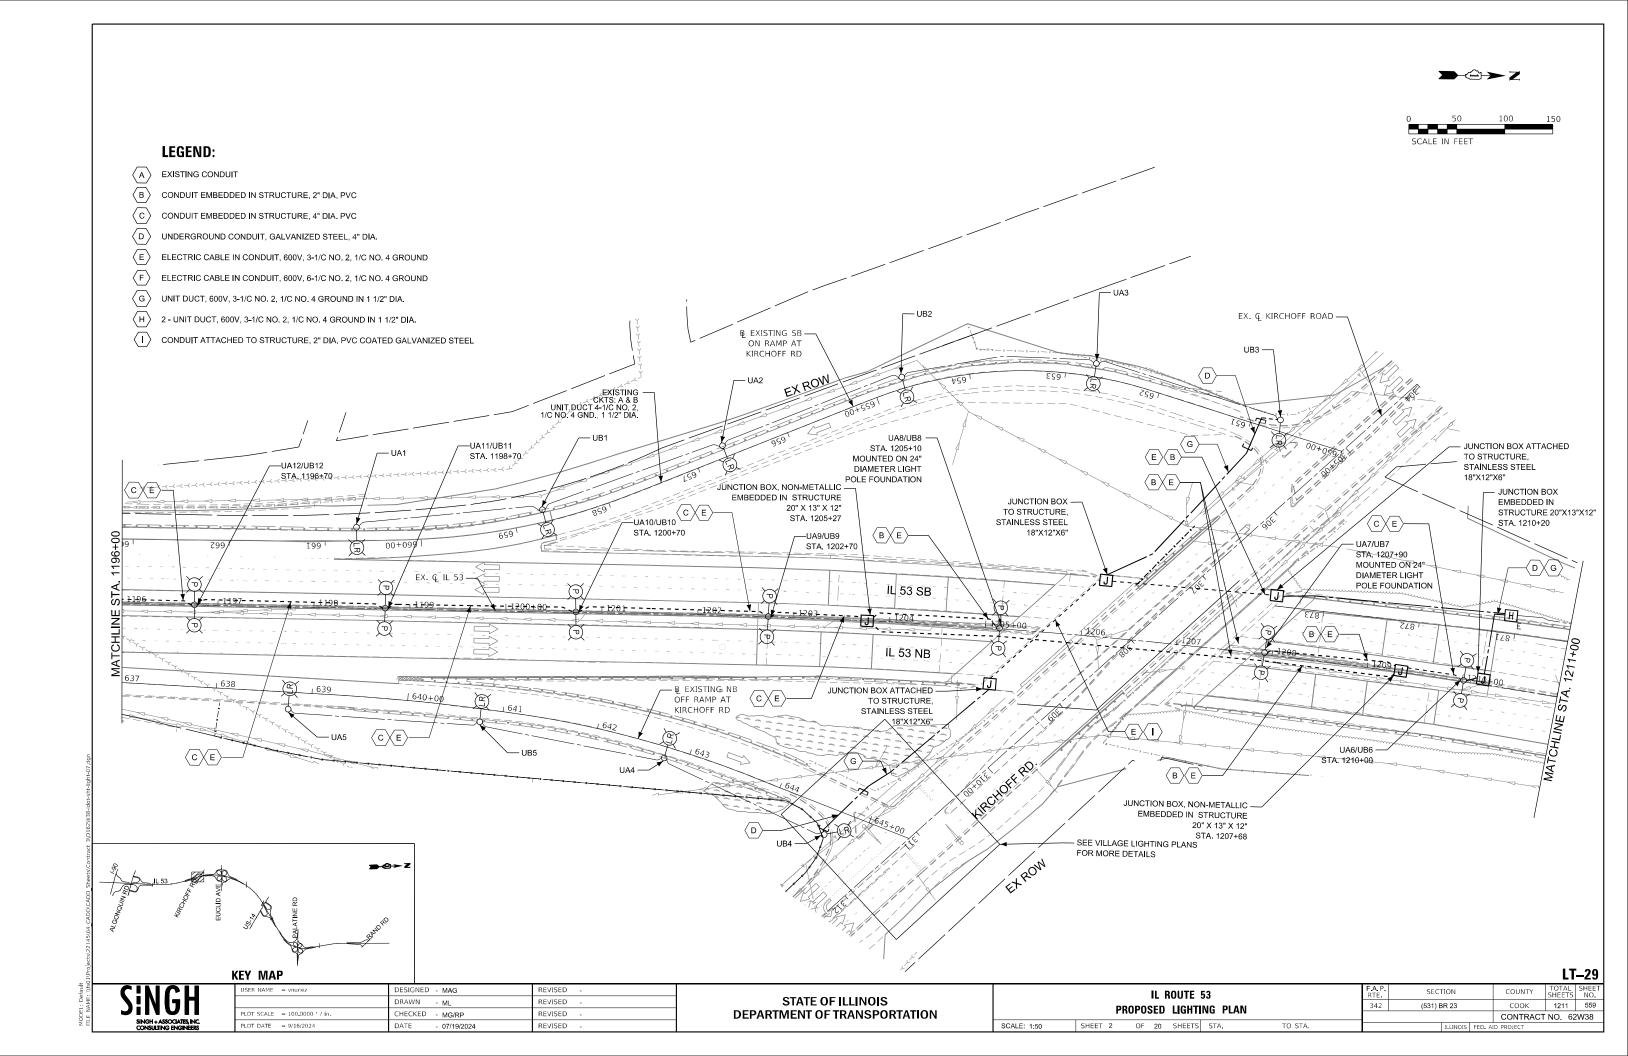

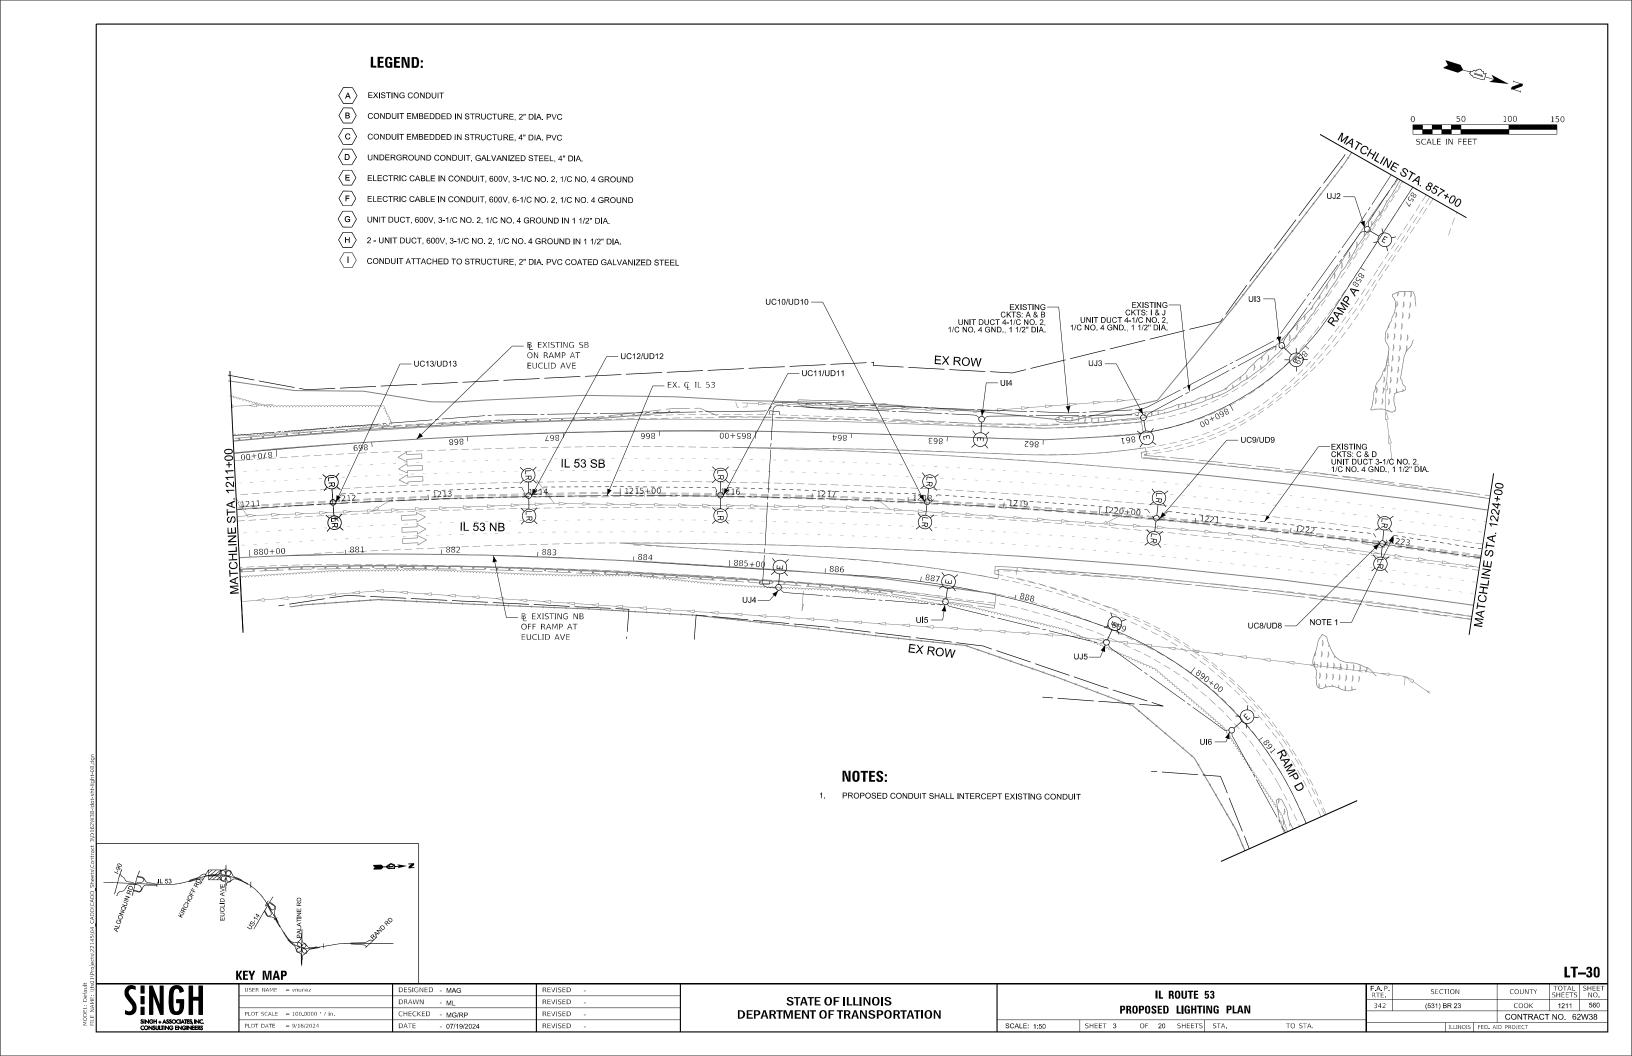

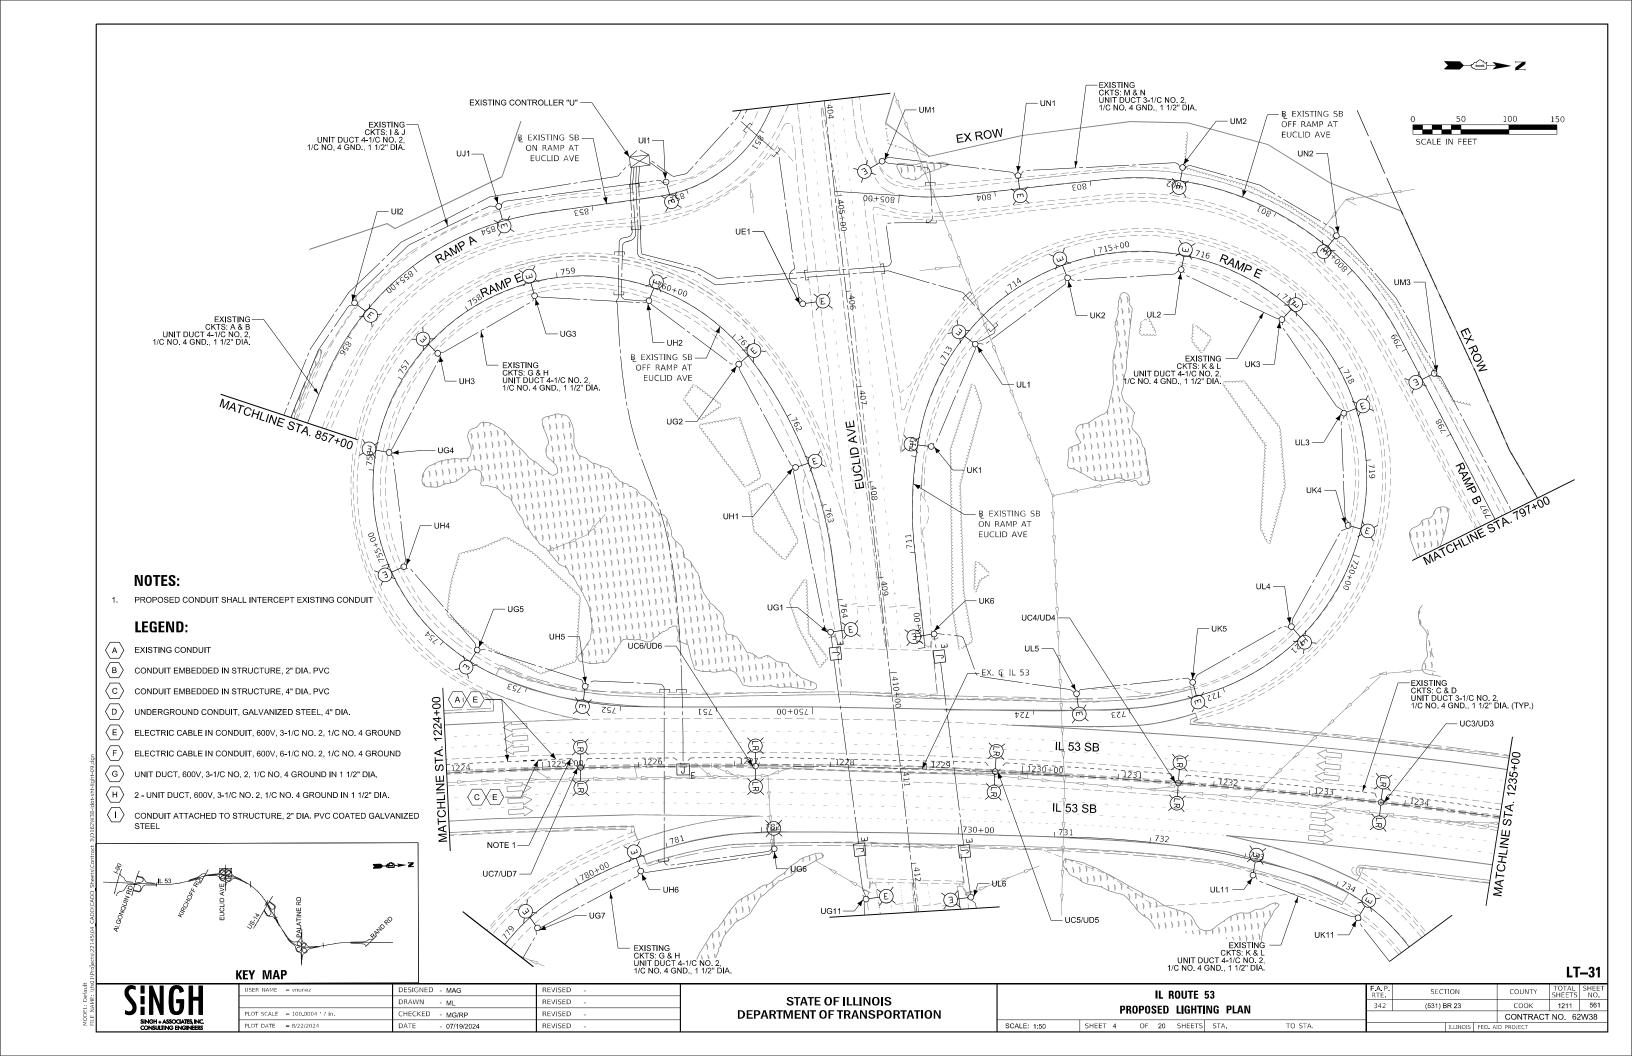

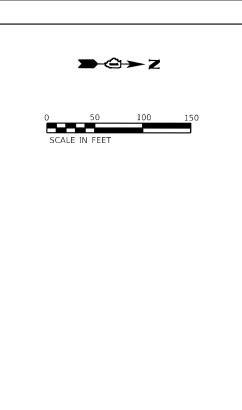

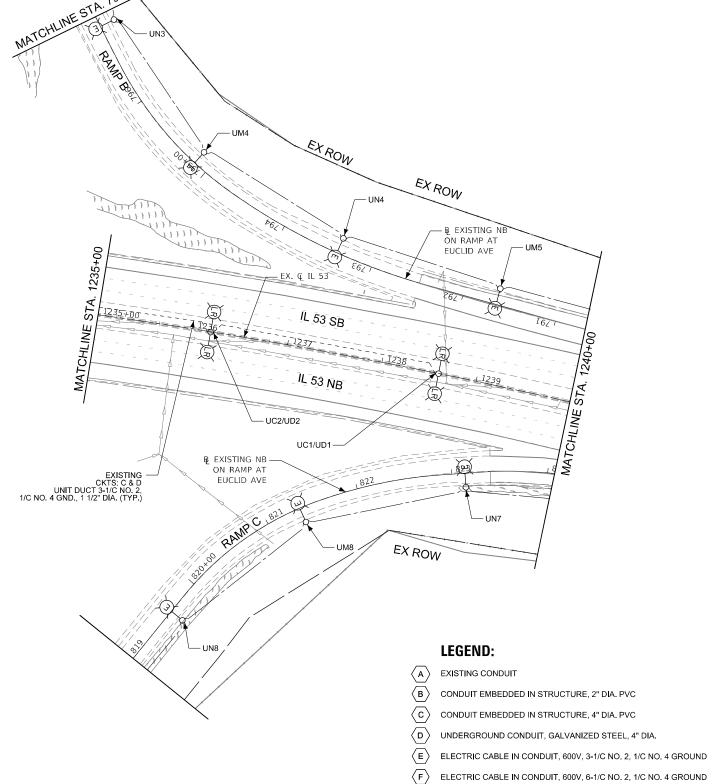

KEY MAP

UNDERGROUND CONDUIT, GALVANIZED STEEL, 4" DIA.

ELECTRIC CABLE IN CONDUIT, 600V, 6-1/C NO. 2, 1/C NO. 4 GROUND

UNIT DUCT, 600V, 3-1/C NO. 2, 1/C NO. 4 GROUND IN 1 1/2" DIA.


(I) CONDUIT ATTACHED TO STRUCTURE, 2" DIA. PVC COATED GALVANIZED STEEL


LT-32


| USER NAME = vnunez | DESIGNED - MAG | REVISED - |
|-----------------------------|-------------------|-----------|
| | DRAWN - ML | REVISED - |
| PLOT SCALE = 100.0000 / in. | CHECKED - MG/RP | REVISED - |
| PLOT DATE = 8/22/2024 | DATE - 07/19/2024 | REVISED - |

| STATE OF ILLINOIS |
|------------------------------|
| DEPARTMENT OF TRANSPORTATION |

| | IL ROUTE 53 | | RTE | SECTION | COUNTY | SHEETS | |
|-------------|---------------------------|---------|-----|-------------|-----------------|----------|------|
| | PROPOSED LIGHTING PLA | u [| 342 | (531) BR 23 | соок | 1211 | 562 |
| | THOIOSED ENGINEER TEA | | | | CONTRAC | T NO. 62 | 2W38 |
| SCALE: 1:50 | SHEET 5 OF 20 SHEETS STA. | TO STA. | | ILLINOIS F | ED. AID PROJECT | | |

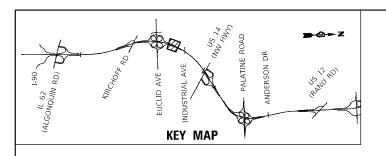

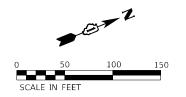

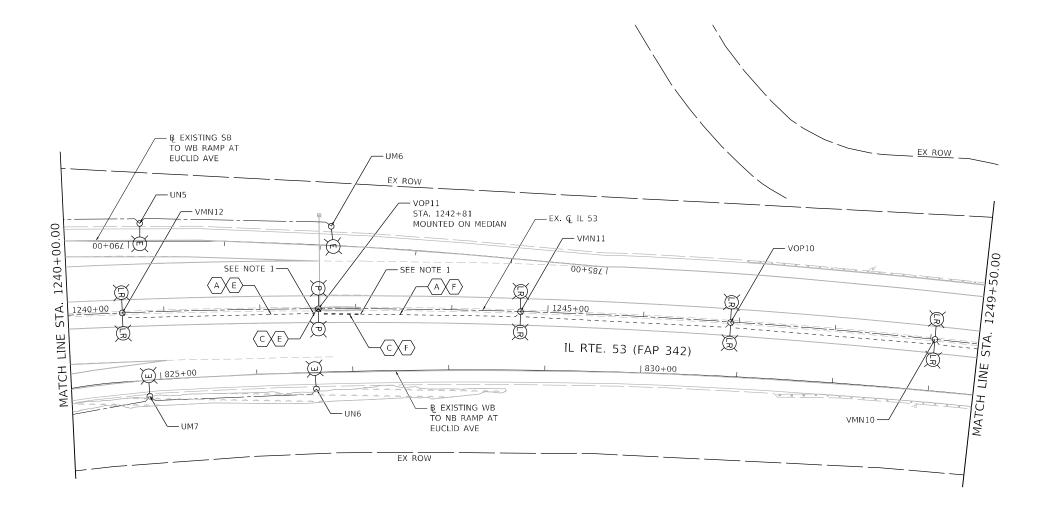

PROPOSED LEGEND:

- A EXISTING CONDUIT
- B CONDUIT EMBEDDED IN STRUCTURE, 2" DIA. PVC
- C CONDUIT EMBEDDED IN STRUCTURE, 4" DIA. PVC
- $\langle D \rangle$ UNDERGROUND CONDUIT, GALVANIZED STEEL, 4" DIA.
- $\langle E \rangle$ ELECTRIC CABLE IN CONDUIT, 600V, 3-1/C NO. 2, 1/C NO. 4 GROUND
- (F)
 ELECTRIC CABLE IN CONDUIT, 600V, 6-1/C NO. 2, 1/C NO. 4 GROUND
- $\langle \mathsf{G}
 angle$ UNIT DUCT, 600V, 3-1/C NO. 2, 1/C NO. 4 GROUND IN 1½" DIA. POLYETHYLENE
- $\langle H \rangle$ 2 UNIT DUCT, 600V, 3-1/C NO. 2, 1/C NO. 4 GROUND IN 1½" DIA. POLYETHYLENE
- (I) CONDUIT ATTACHED TO STRUCTURE, 2" PVC COATED GALVANIZED STEEL

NOTES:

- 1. PROPOSED CONDUIT SHALL INTERCEPT EXISTING CONDUIT.
- 2. FOR CONDUIT TO BE EMBEDDED IN THE OVERHEAD SIGN STRUCTURE FOUNDATION AT MEDIAN BARRIER WALL SEE BE-322

LT-33

1170 SOUTH HOUBOLT ROAD
JOLIET, ILLINOIS 60431

STRAND (815) 744-4200
ASSIGNATES"


| USER NAME = jackd | DESIGNED - AJR | REVISED - |
|-----------------------------|------------------|-----------|
| | DRAWN - JED | REVISED - |
| PLOT SCALE = 100.0000 / in. | CHECKED - RGT | REVISED - |
| PLOT DATE = 9/20/2024 | DATE - 8/23/2024 | REVISED - |

STATE OF ILLINOIS
DEPARTMENT OF TRANSPORTATION

| | | | PR | | | OUTE 53 LIGHTII | - | AN | | |
|--------|----------|-------|----|----|----|--------------------|------|------------|---------|------------|
| SCALE: | 1" = 50' | SHEET | 6 | OF | 20 | SHEETS | STA. | 1240+00.00 | TO STA. | 1249+50.00 |

P. SECTION COUNTY TOTAL SHEETS NO.
2 (531) BR 23 COOK 1211 563

CONTRACT NO. 62W38

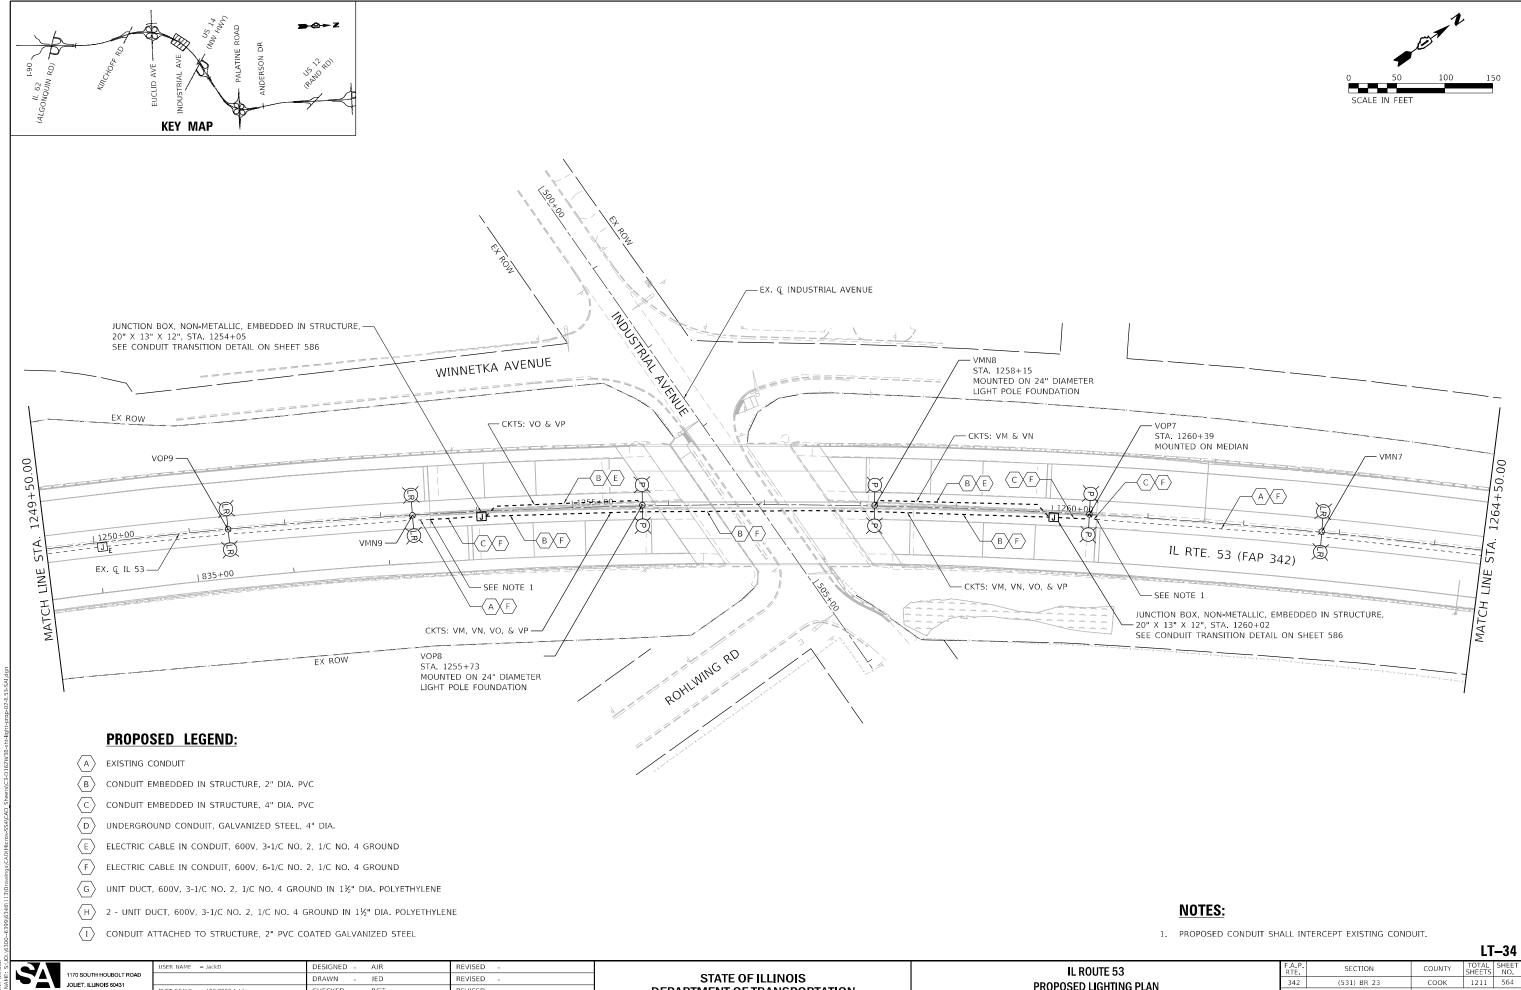

1211 564


STRAND (815) 744-4200


LOT SCALE = 100.0000 / in. RGT REVISED 8/23/2024


DEPARTMENT OF TRANSPORTATION

PROPOSED LIGHTING PLAN SCALE: 1"=50' SHEET 7 OF 20 SHEETS STA. 1249+50.00 TO STA. 1264+50.00

CONTRACT NO. 62W38

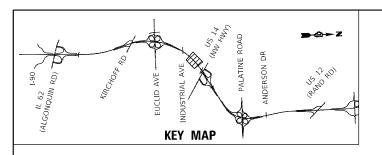

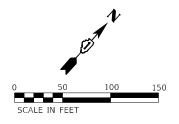

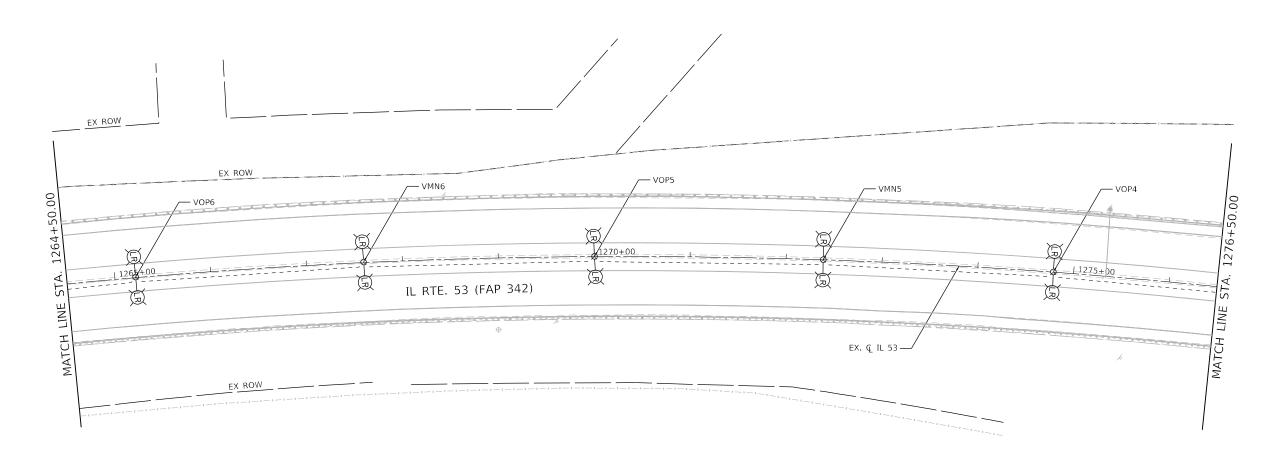

PROPOSED LEGEND:

- A EXISTING CONDUIT
- B CONDUIT EMBEDDED IN STRUCTURE, 2" DIA. PVC
- C CONDUIT EMBEDDED IN STRUCTURE, 4" DIA. PVC
- (D) UNDERGROUND CONDUIT, GALVANIZED STEEL, 4" DIA.
- E ELECTRIC CABLE IN CONDUIT, 600V, 3-1/C NO. 2, 1/C NO. 4 GROUND
- F ELECTRIC CABLE IN CONDUIT, 600V, 6-1/C NO. 2, 1/C NO. 4 GROUND
- $\langle G \rangle$ UNIT DUCT, 600V, 3-1/C NO. 2, 1/C NO. 4 GROUND IN 1½" DIA. POLYETHYLENE
- $\langle H \rangle$ 2 UNIT DUCT, 600V, 3-1/C NO. 2, 1/C NO. 4 GROUND IN $1\frac{1}{2}$ " DIA. POLYETHYLENE
- (I) CONDUIT ATTACHED TO STRUCTURE, 2" PVC COATED GALVANIZED STEEL

LT-35


1170 SOUTH HOUBOLT ROAD
JOLIET, ILLINOIS 60431


STRAND (815) 744-4200
ASSOCIATES*


| ER NAME = JackD DESIGNED - AJR | REVISED - |
|---|-----------|
| DRAWN - JED | REVISED - |
| OT SCALE = 100,0000 / in. CHECKED - RGT | REVISED - |
| OT DATE = 8/23/2024 DATE - 8/23/2024 | REVISED - |

| STATE OF ILLINOIS | |
|------------------------------|--|
| DEPARTMENT OF TRANSPORTATION | |

| IL ROUTE 53 PROPOSED LIGHTING PLAN | | | | | | | | | | F.A.P. RTE | SEC | TION | | COUNTY | TOTAL SHEETS | SHEE NO. |
|------------------------------------|-------|----|-----|-------|----------|-------|------------|---------|------------|---------------|-------|----------|---------|-----------|-----------------|----------|
| | | DE | ngn | SED I | ICHTII | NG DI | ΛN | | | 342 | (531) | BR 23 | | соок | 1211 | 565 |
| | | | 010 | JLD I | LIGITIII | NOIL | -711 | | | | | | | CONTRACT | NO. 62 | 2W38 |
| SCALE: 1" = 50' | SHEET | 8 | OF | 20 | SHEETS | STA. | 1264+50.00 | TO STA. | 1276+50.00 | | | ILLINOIS | FED. AI | D PROJECT | | |

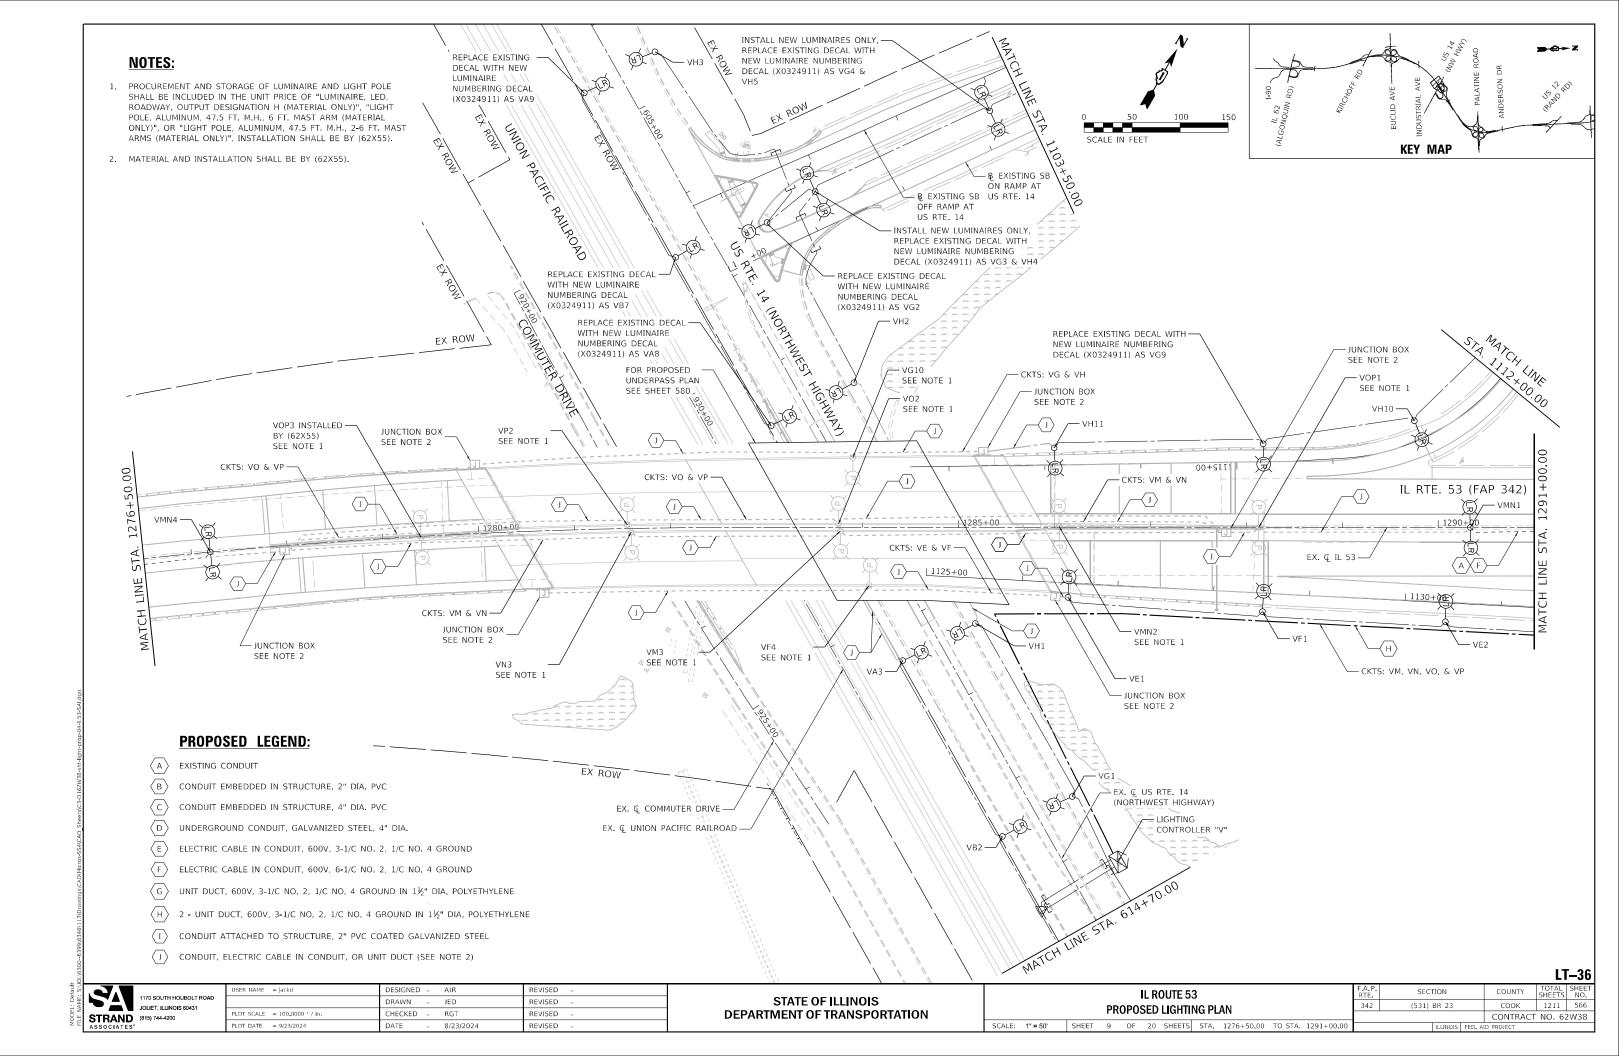

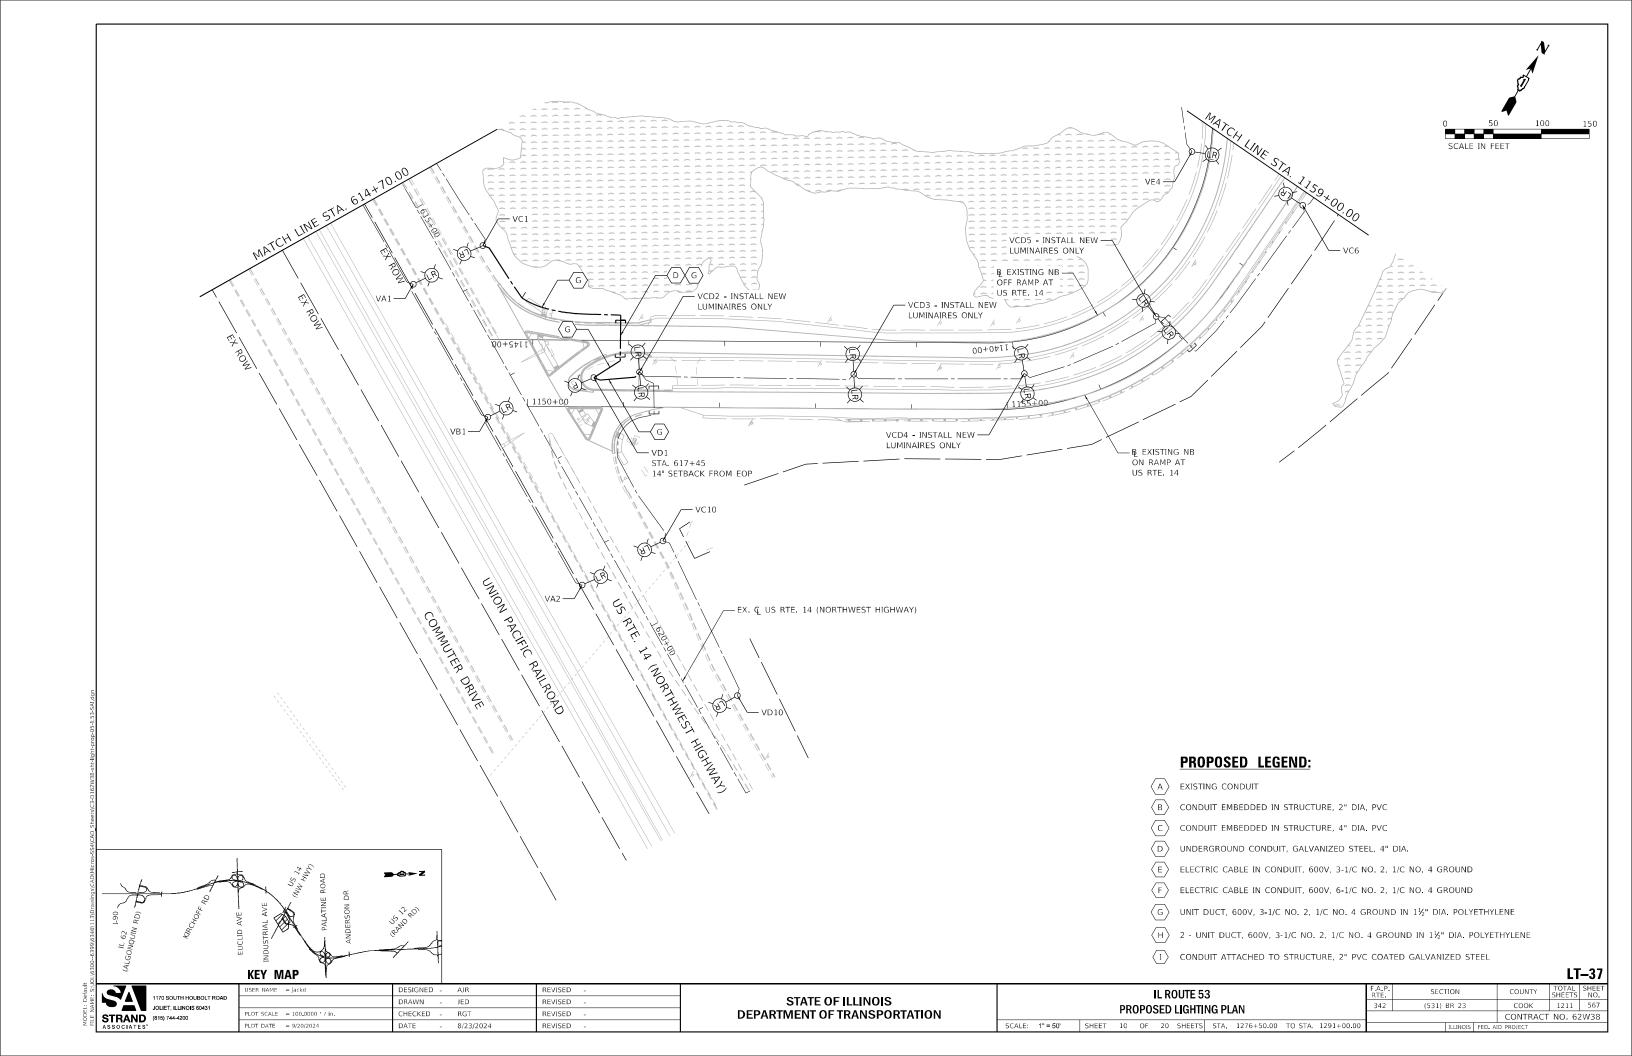


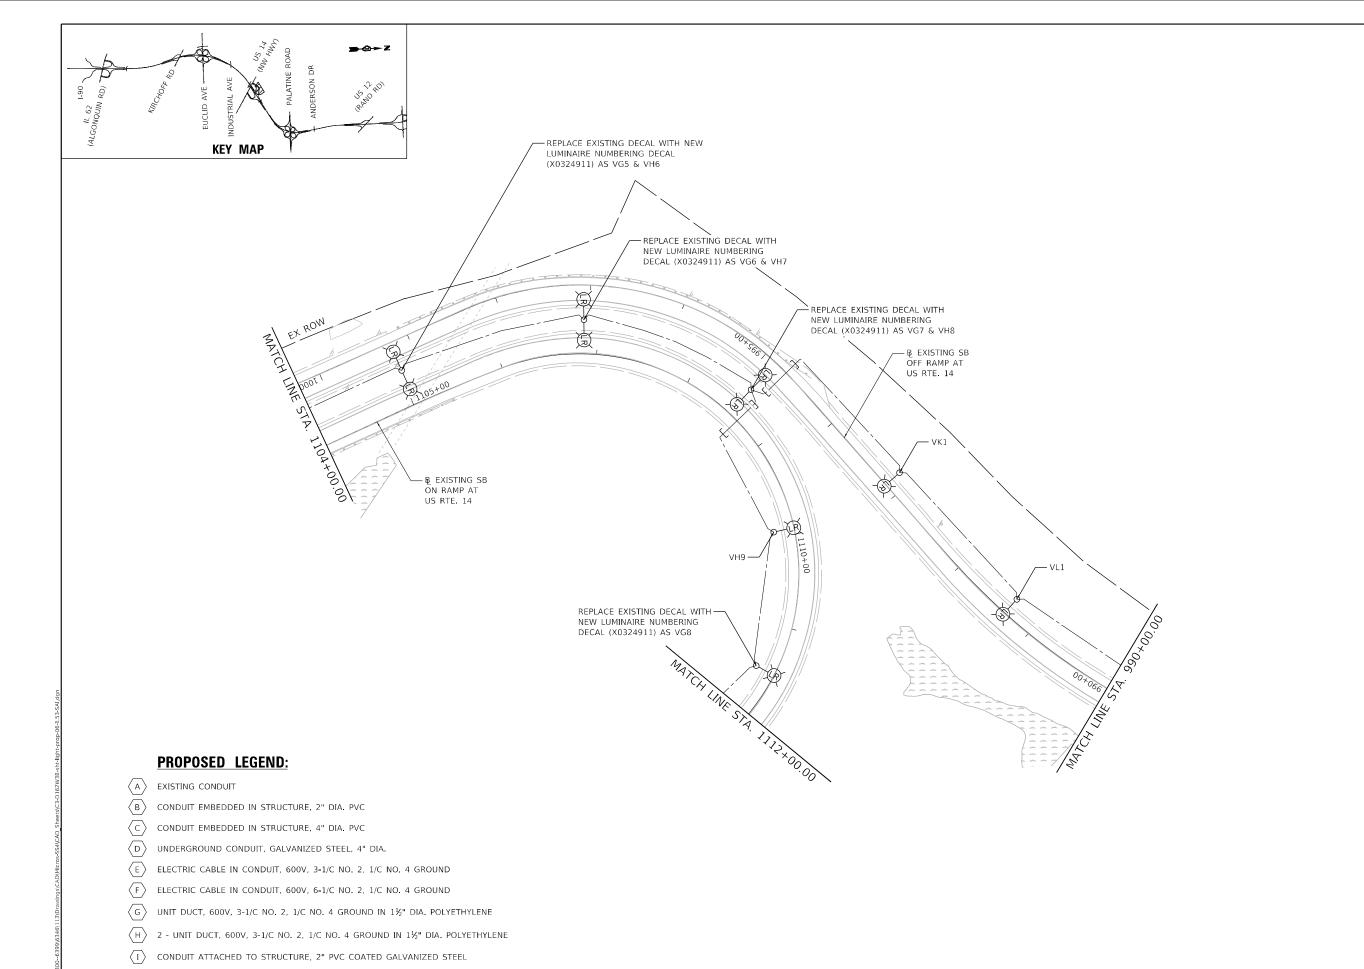



TOTAL SHEET NO.




| USER NAME = jackd | DESIGNED - | AJR | REVISED - |
|-----------------------------|------------|-----------|-----------|
| | DRAWN - | JED | REVISED - |
| PLOT SCALE = 100.0000 / in. | CHECKED - | RG⊤ | REVISED - |
| PLOT DATE = 9/20/2024 | DATE - | 8/23/2024 | REVISED - |
| PLOT DATE = 9/20/2024 | DATE - | 8/23/2024 | REVISED - |

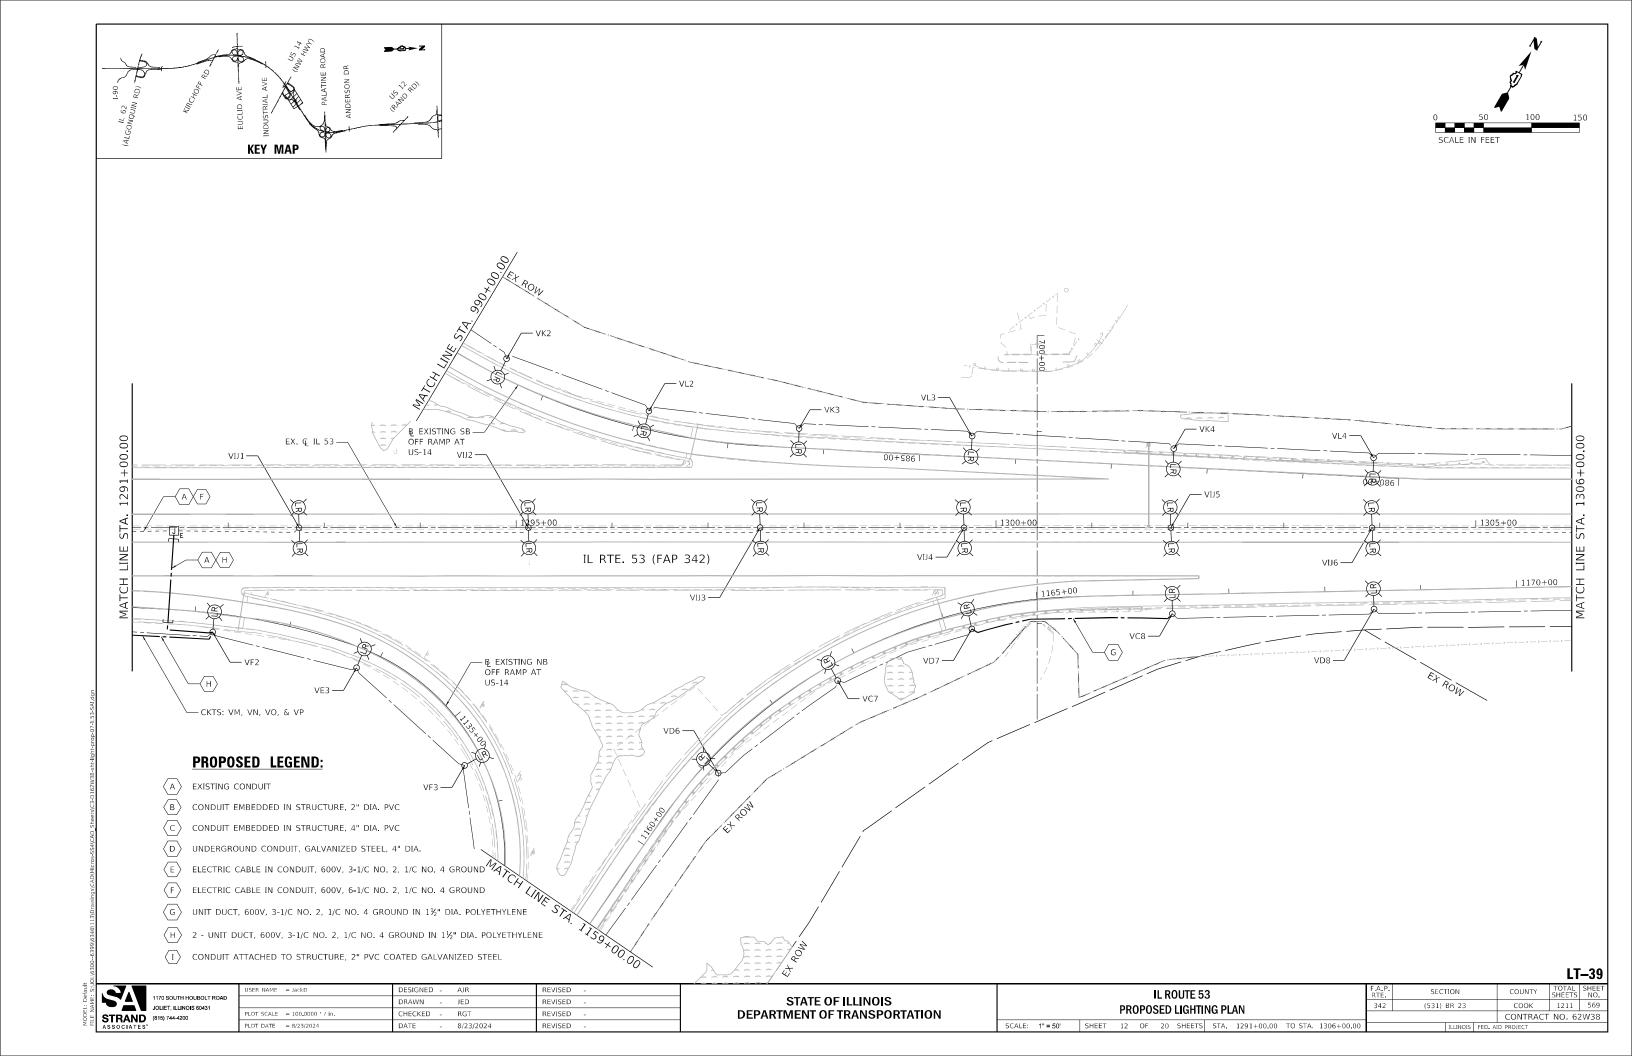

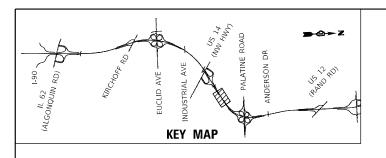

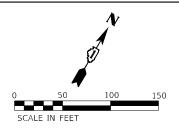

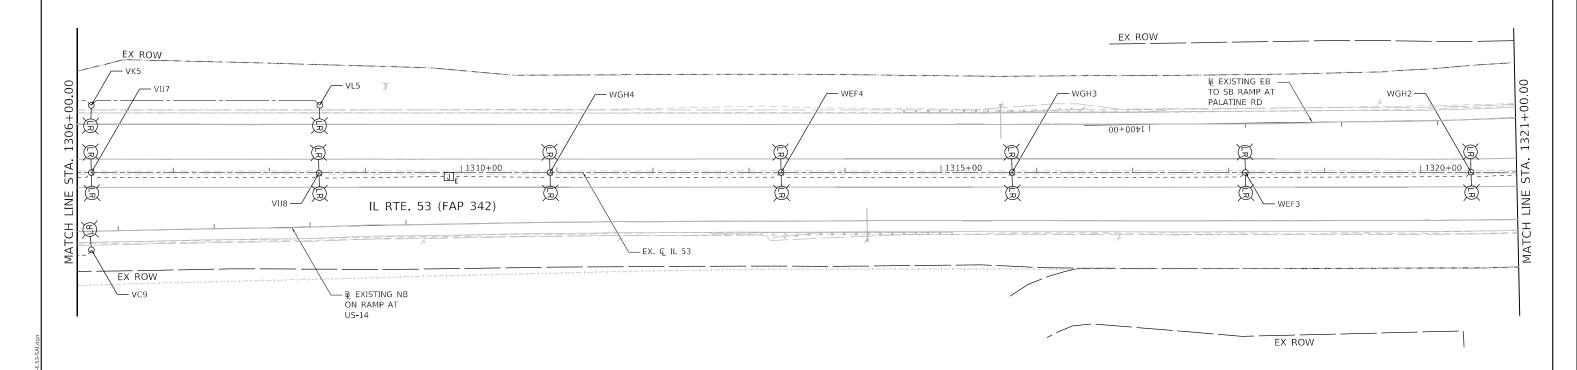

PROPOSED LEGEND:

- A EXISTING CONDUIT
- CONDUIT EMBEDDED IN STRUCTURE, 2" DIA. PVC
- CONDUIT EMBEDDED IN STRUCTURE, 4" DIA. PVC
- UNDERGROUND CONDUIT, GALVANIZED STEEL, 4" DIA.
- ELECTRIC CABLE IN CONDUIT, 600V, 3-1/C NO. 2, 1/C NO. 4 GROUND
- ELECTRIC CABLE IN CONDUIT, 600V, 6-1/C NO. 2, 1/C NO. 4 GROUND
- UNIT DUCT, 600V, 3-1/C NO. 2, 1/C NO. 4 GROUND IN 1½" DIA. POLYETHYLENE
- $\langle H \rangle$ 2 UNIT DUCT, 600V, 3-1/C NO. 2, 1/C NO. 4 GROUND IN 1½" DIA. POLYETHYLENE
- (I) CONDUIT ATTACHED TO STRUCTURE, 2" PVC COATED GALVANIZED STEEL

1170 SOUTH HOUBOLT R
JOLIET, ILLINOIS 60431


STRAND
ASSOCIATES"


1170 SOUTH HOUBOLT R
JOLIET, 1110 NO 1170 SOUTH HOUBOLT ROAD


| USER NAME = JackD | DESIGNED - | AJR | REVISED | - |
|-----------------------------|------------|-----------|---------|---|
| | DRAWN - | JED | REVISED | - |
| PLOT SCALE = 100.0000 / in. | CHECKED - | RG⊤ | REVISED | - |
| PLOT DATE = 8/23/2024 | DATE - | 8/23/2024 | REVISED | - |


| STATE OF ILLINOIS | |
|------------------------------|--|
| DEPARTMENT OF TRANSPORTATION | |


| | | | | LT-40 |
|--|---------------|-----------------|------------|------------------------|
| IL ROUTE 53 | F.A.P. RTE | SECTION | COUNTY | TOTAL SHEET SHEETS NO. |
| PROPOSED LIGHTING PLAN | 342 | (531) BR 23 | соок | 1211 570 |
| TROI OOLD LIGHTING I LAN | | | CONTRACT | Г NO. 62W38 |
| SCALE: 1" = 50' SHEET 13 OF 20 SHEETS STA. 1306+00.00 TO STA. 1321+00.00 | | ILLINOIS FED. A | ID PROJECT | |

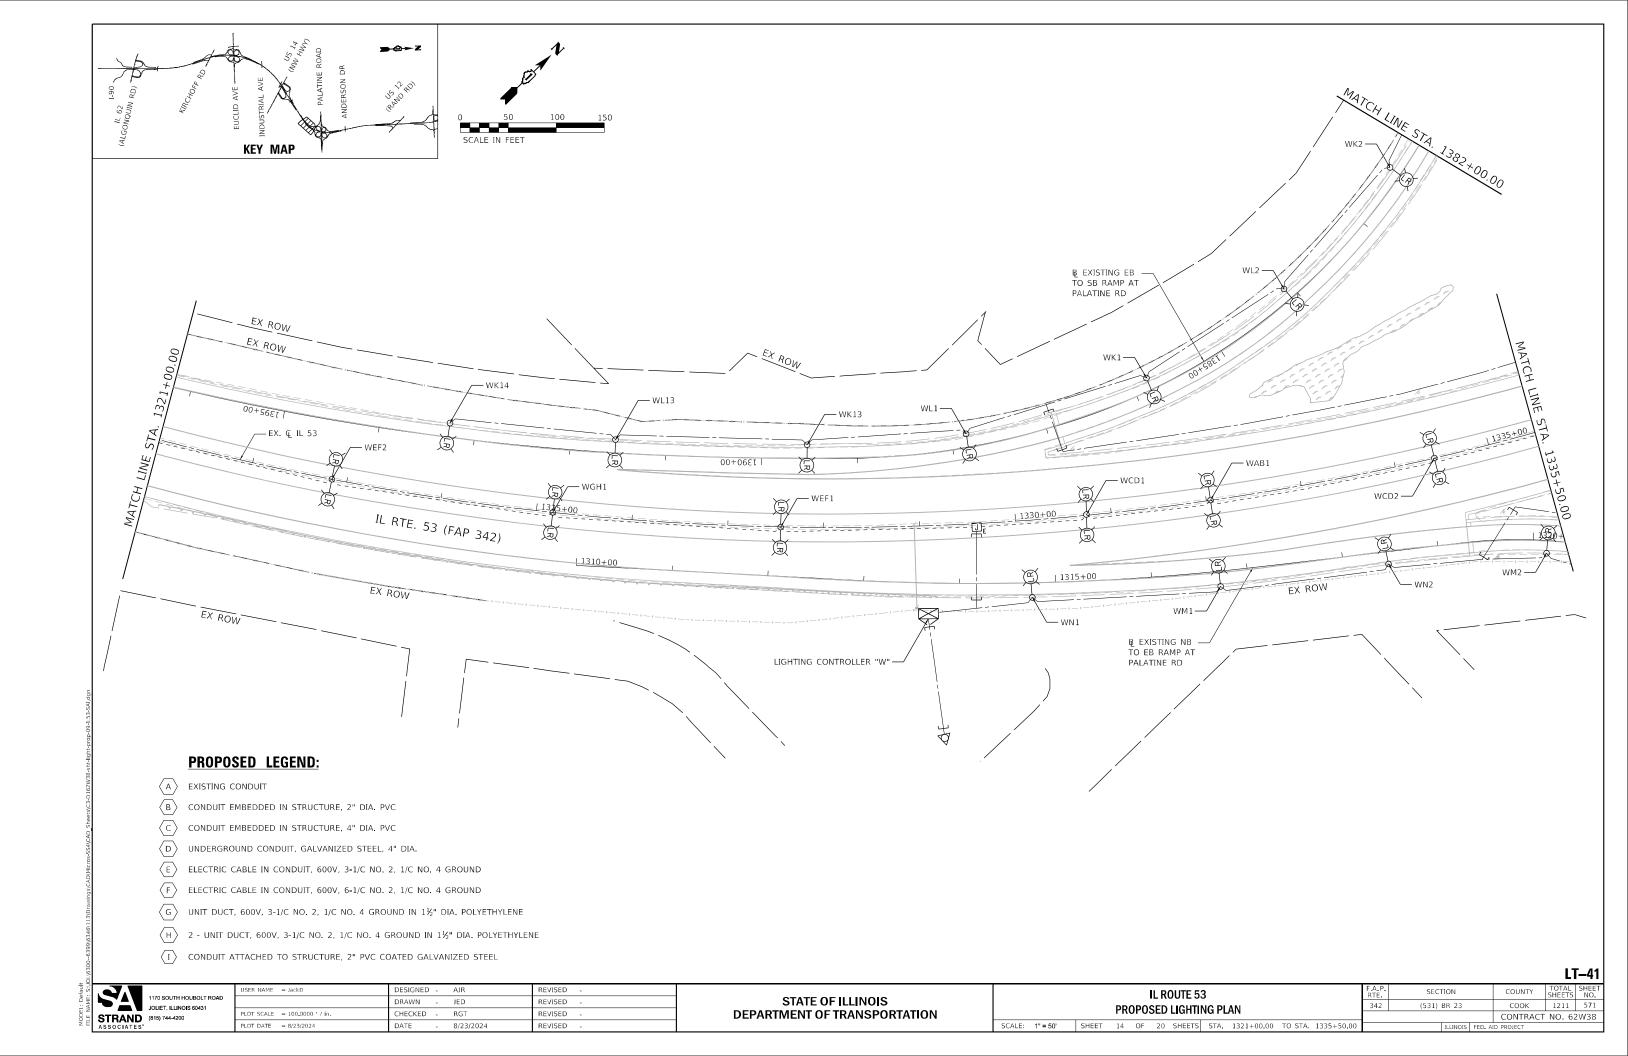


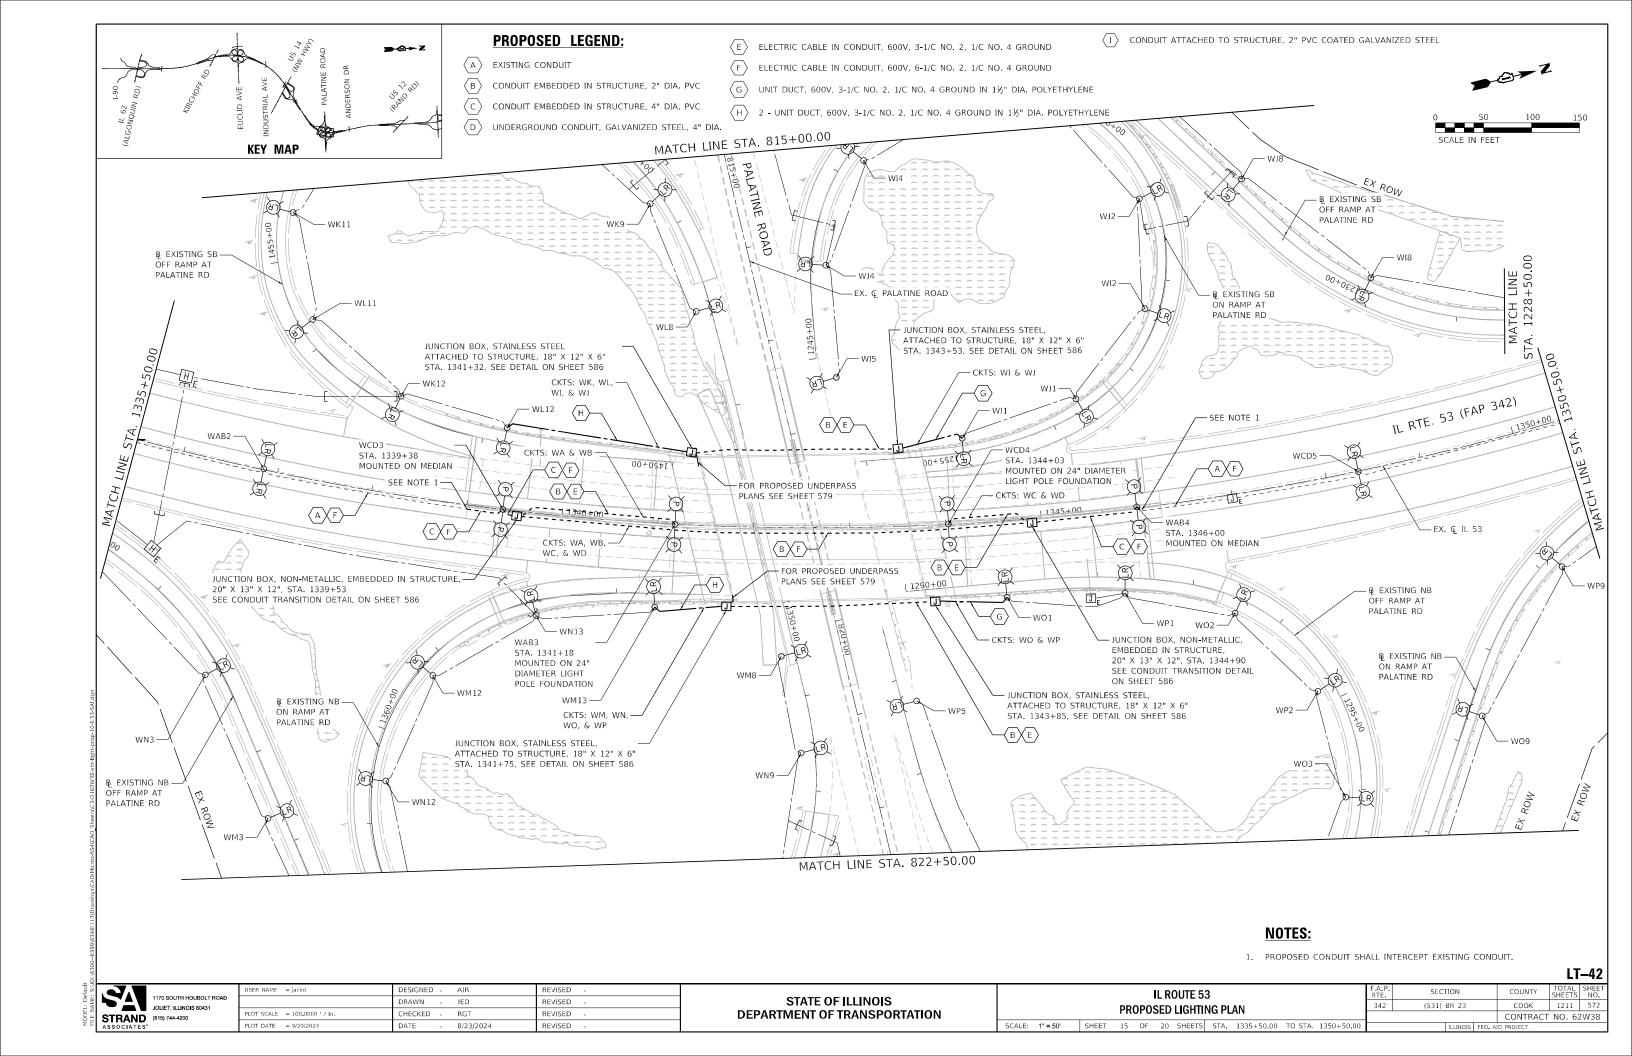


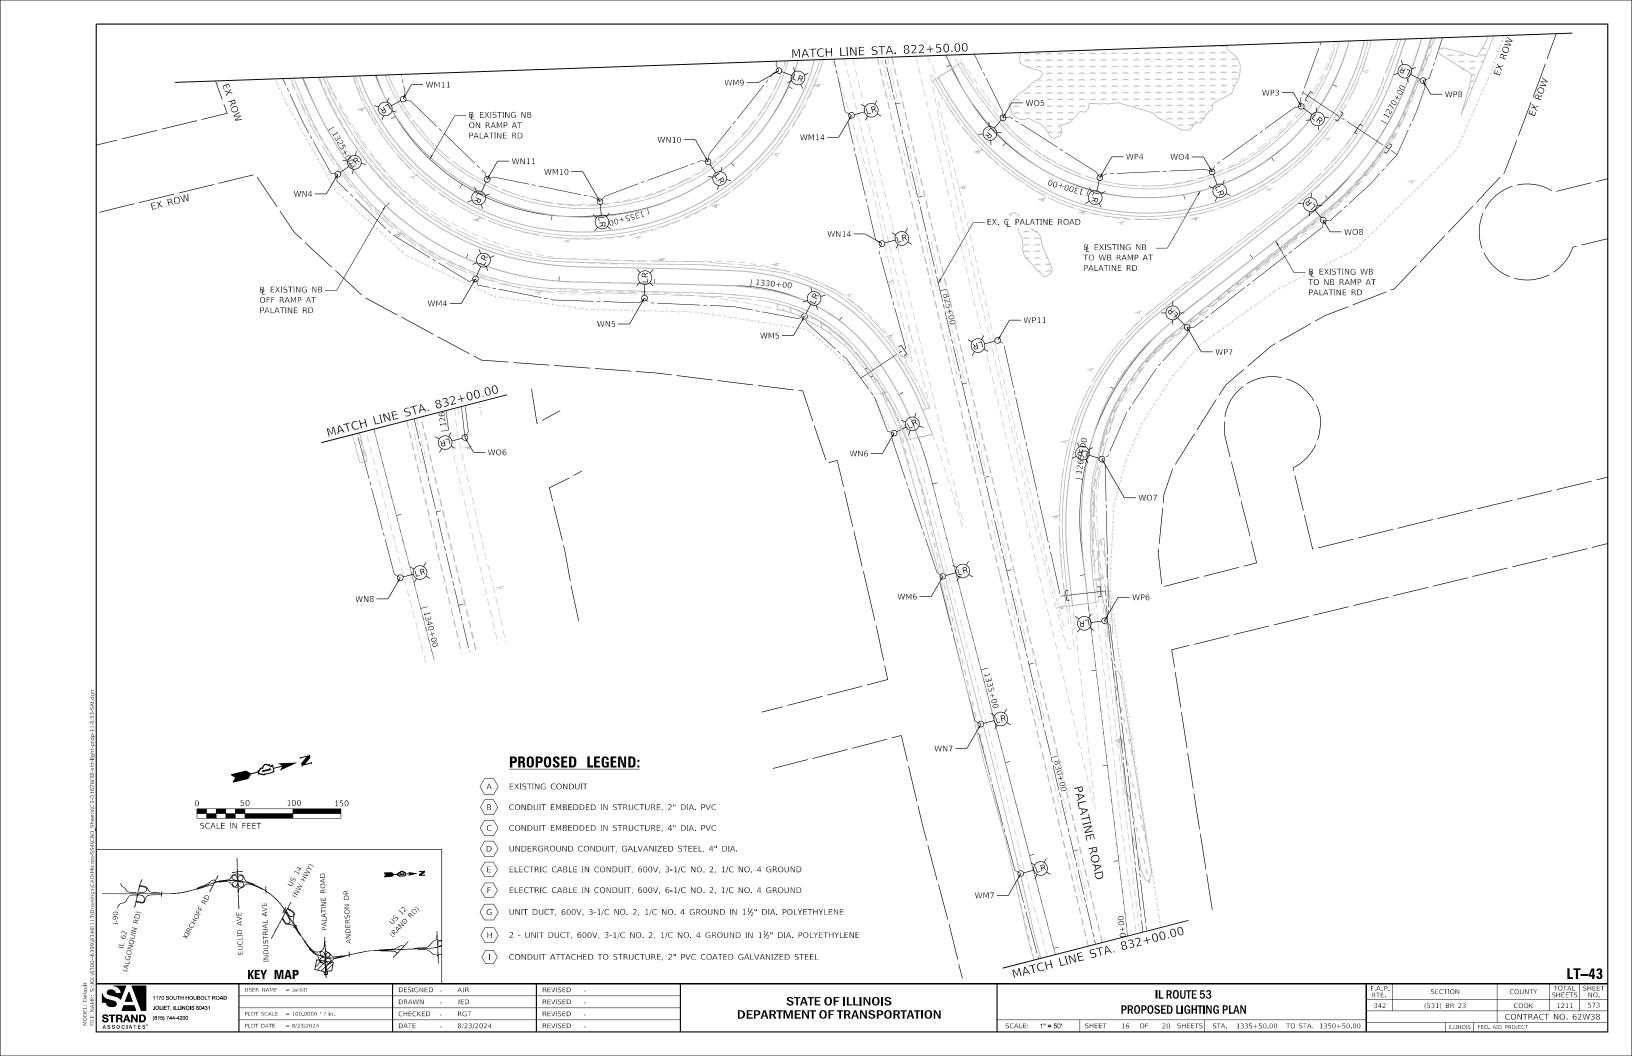

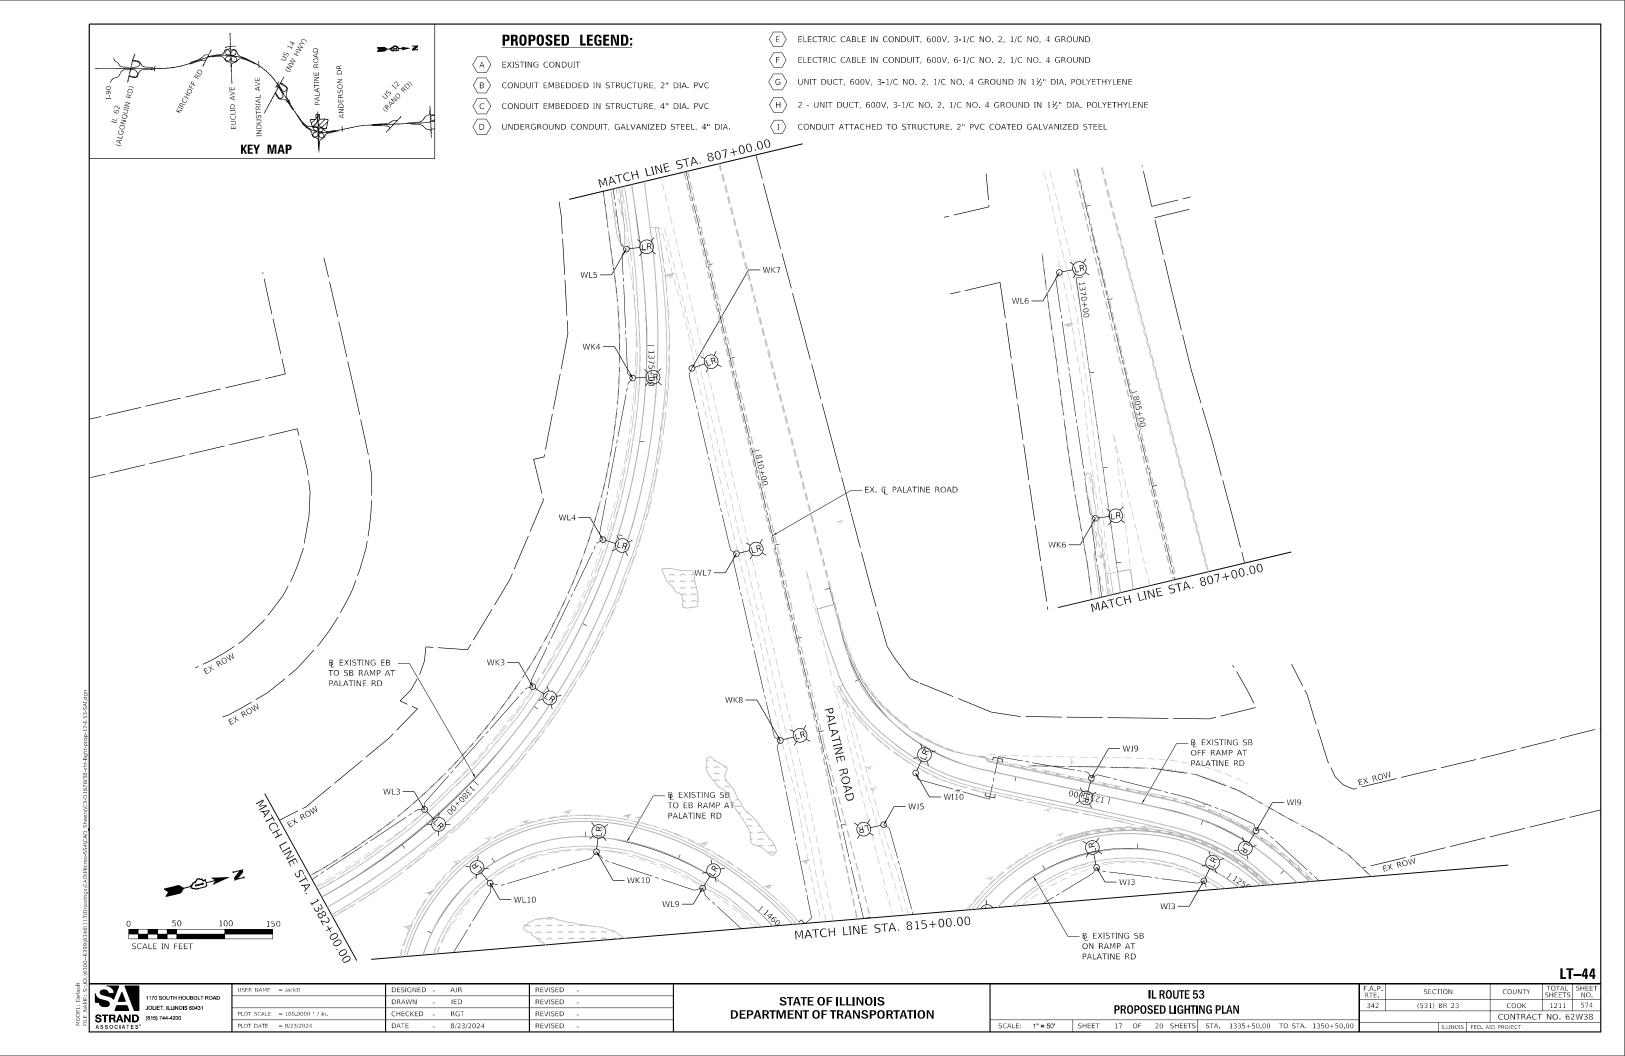

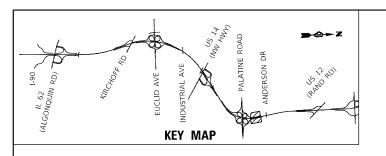

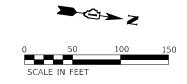

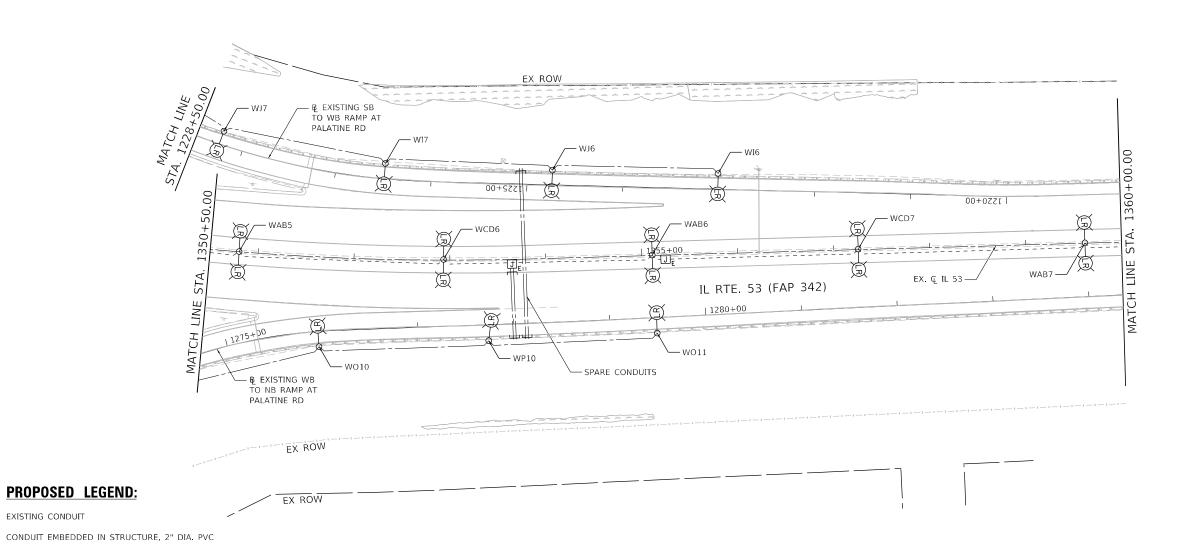

1170 SOUTH HOUBOLT R
JOLIET, ILLINOIS 60431
STRAND
(815) 744-4200
ASSOCIATES* 1170 SOUTH HOUBOLT ROAD

EXISTING CONDUIT

CONDUIT EMBEDDED IN STRUCTURE, 4" DIA. PVC UNDERGROUND CONDUIT, GALVANIZED STEEL, 4" DIA.

ELECTRIC CABLE IN CONDUIT, 600V, 3-1/C NO. 2, 1/C NO. 4 GROUND ELECTRIC CABLE IN CONDUIT, 600V, 6-1/C NO. 2, 1/C NO. 4 GROUND

(I) CONDUIT ATTACHED TO STRUCTURE, 2" PVC COATED GALVANIZED STEEL


UNIT DUCT, 600V, 3-1/C NO. 2, 1/C NO. 4 GROUND IN 1½" DIA. POLYETHYLENE H 2 - UNIT DUCT, 600V, 3-1/C NO. 2, 1/C NO. 4 GROUND IN 1½" DIA. POLYETHYLENE


> REVISED DRAWN JED REVISED LOT SCALE = 100.0000 / in. CHECKED -RG⊤ REVISED 8/23/2024


STATE OF ILLINOIS DEPARTMENT OF TRANSPORTATION

SECTION IL ROUTE 53 (531) BR 23 PROPOSED LIGHTING PLAN SCALE: 1" = 50' SHEET 18 OF 20 SHEETS STA. 1350+50.00 TO STA. 1360+00.00

LT-45 COOK 1211 575 CONTRACT NO. 62W38

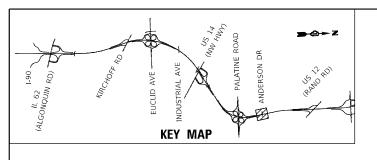

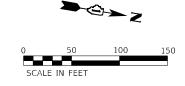

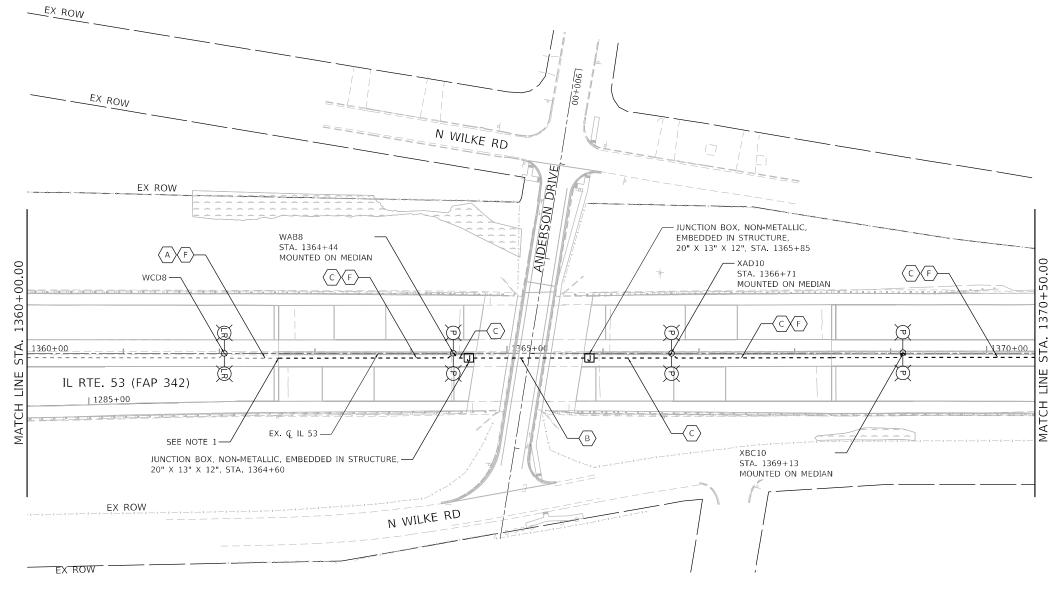

PROPOSED LEGEND:

- A EXISTING CONDUIT
- B CONDUIT EMBEDDED IN STRUCTURE, 2" DIA. PVC
- C CONDUIT EMBEDDED IN STRUCTURE, 4" DIA. PVC
- D UNDERGROUND CONDUIT, GALVANIZED STEEL, 4" DIA.
- (E) ELECTRIC CABLE IN CONDUIT, 600V, 3-1/C NO. 2, 1/C NO. 4 GROUND
- F ELECTRIC CABLE IN CONDUIT, 600V, 6-1/C NO. 2, 1/C NO. 4 GROUND
- G UNIT DUCT, 600V, 3-1/C NO. 2, 1/C NO. 4 GROUND IN 1½" DIA. POLYETHYLENE
- $\langle H \rangle$ 2 UNIT DUCT, 600V, 3-1/C NO. 2, 1/C NO. 4 GROUND IN $1\frac{1}{2}$ " DIA. POLYETHYLENE
- (1) CONDUIT ATTACHED TO STRUCTURE, 2" PVC COATED GALVANIZED STEEL

NOTES:

1. PROPOSED CONDUIT SHALL INTERCEPT EXISTING CONDUIT.


LT-46





| USER NAME = JackD | DESIGNED | - | AJR | REVISED | - |
|-----------------------------|----------|---|-----------|---------|---|
| | DRAWN | - | JED | REVISED | - |
| PLOT SCALE = 100.0000 / in. | CHECKED | - | RG⊤ | REVISED | - |
| PLOT DATE = 8/23/2024 | DATE | - | 8/23/2024 | REVISED | - |

STATE OF ILLINOIS DEPARTMENT OF TRANSPORTATION

| SECTION | COUNTY | TOTAL SHEET | NO. |
| (531) BR 23 | COOK | 1211 | 576 |
| CONTRACT NO. 62W38

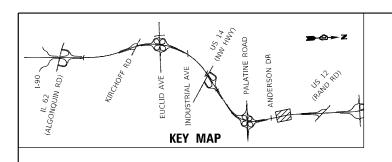

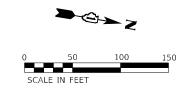

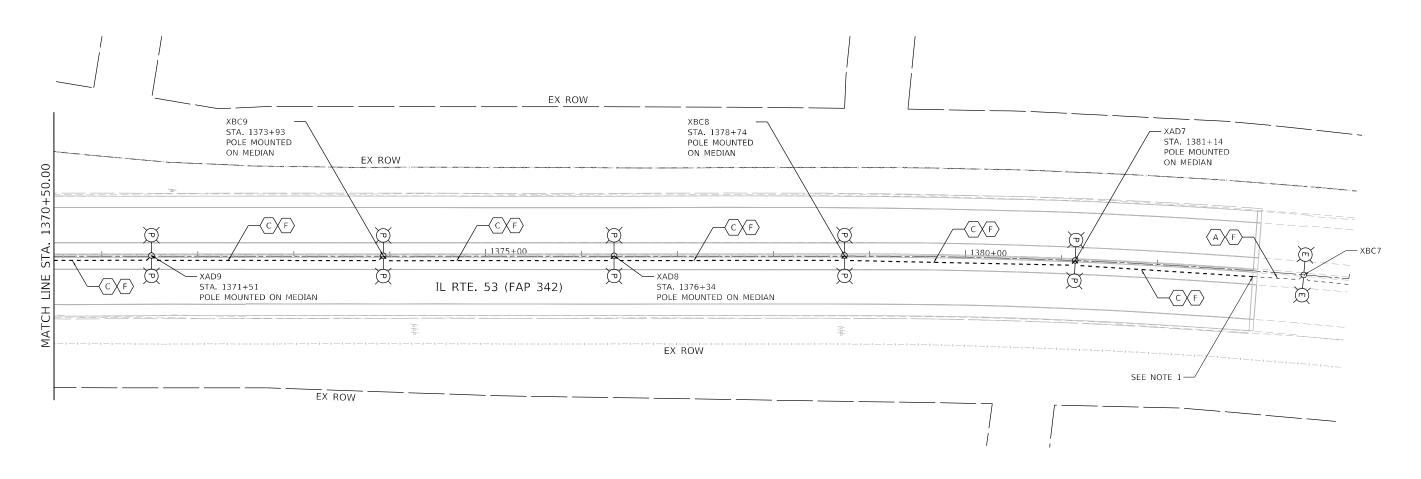

PROPOSED LEGEND:

- A EXISTING CONDUIT
- B CONDUIT EMBEDDED IN STRUCTURE, 2" DIA. PVC
- C CONDUIT EMBEDDED IN STRUCTURE, 4" DIA. PVC
- D UNDERGROUND CONDUIT, GALVANIZED STEEL, 4" DIA.
- $\langle E \rangle$ ELECTRIC CABLE IN CONDUIT, 600V, 3-1/C NO. 2, 1/C NO. 4 GROUND
- $\langle F \rangle$ ELECTRIC CABLE IN CONDUIT, 600V, 6-1/C NO. 2, 1/C NO. 4 GROUND
- G UNIT DUCT, 600V, 3-1/C NO. 2, 1/C NO. 4 GROUND IN 1½" DIA. POLYETHYLENE
- $\langle H \rangle$ 2 UNIT DUCT, 600V, 3-1/C NO. 2, 1/C NO. 4 GROUND IN 1½" DIA. POLYETHYLENE
- $\left\langle 1 \right\rangle$ Conduit attached to structure, 2" PVC coated galvanized steel

NOTES:

1. PROPOSED CONDUIT SHALL INTERCEPT EXISTING CONDUIT.


LT-47



| USER NAME = JackD | DESIGNED - AJR | REVISED - |
|-----------------------------|------------------|-----------|
| | DRAWN - JED | REVISED - |
| PLOT SCALE = 100.0000 / in. | CHECKED - RGT | REVISED - |
| PLOT DATE = 8/23/2024 | DATE - 8/23/2024 | REVISED - |


STATE OF ILLINOIS DEPARTMENT OF TRANSPORTATION

| | IL ROUTE 53 Proposed lighting plan | | | | | | | | | |
|--------|---------------------------------------|-------|----|----|----|--------|------|------------|---------|------------|
| SCALE: | 1" = 50' | SHEET | 20 | OF | 20 | SHEETS | STA. | 1370+50.00 | TO STA. | 1384+00.00 |

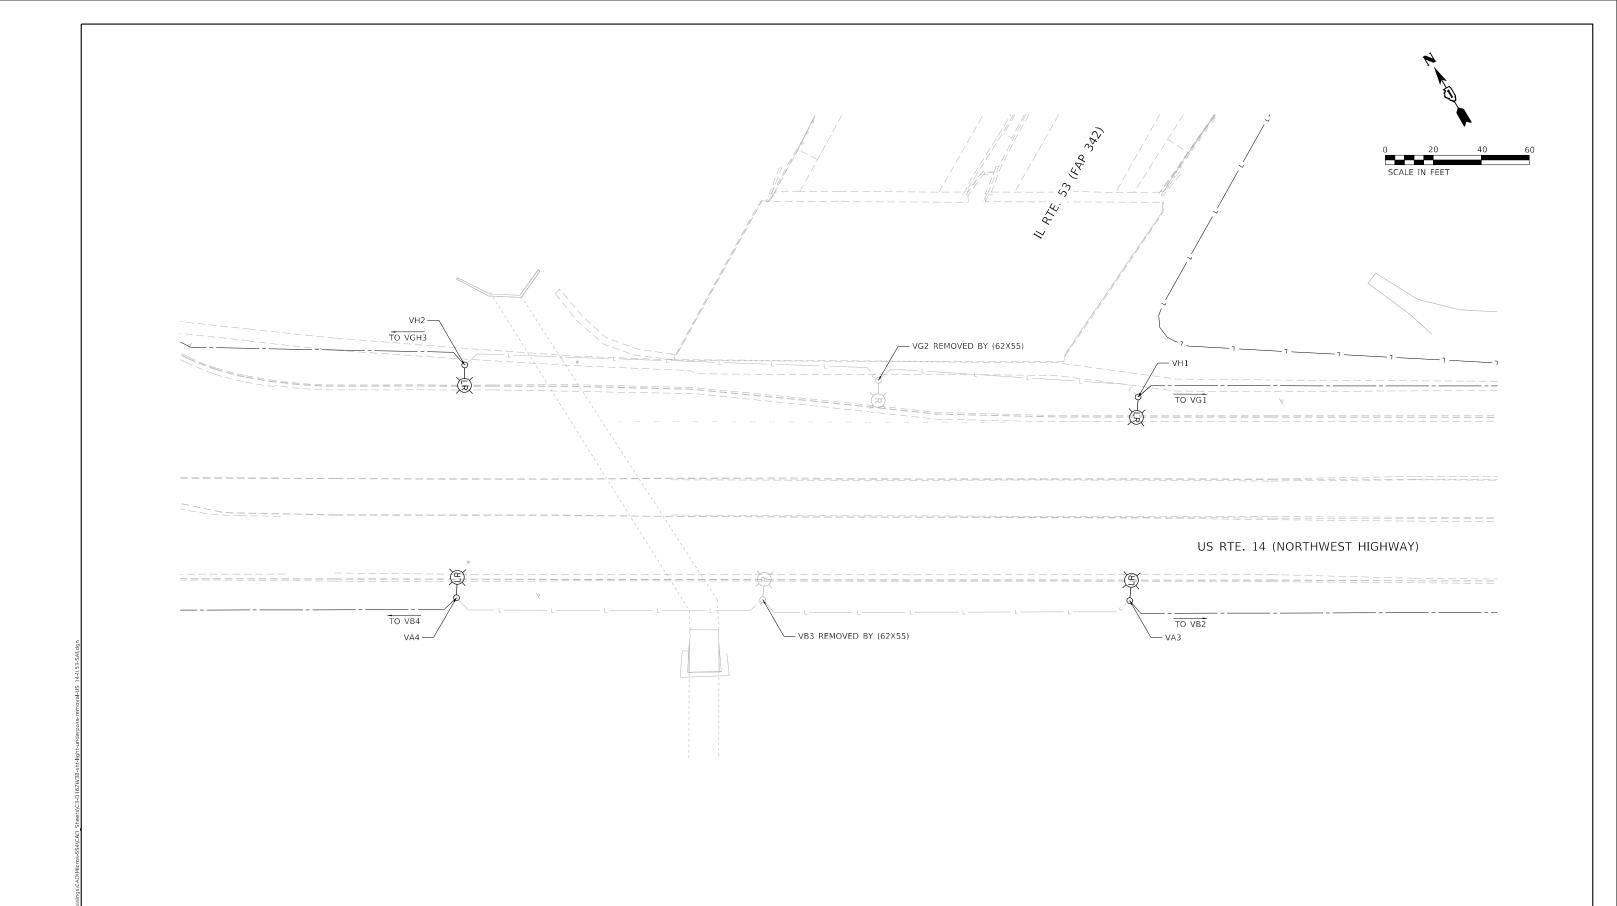

LT-48

| USER NAME = jackd | DESIGNED - | AJR | REVISED - | |
|----------------------------|------------|-----------|-----------|--|
| | DRAWN - | JED | REVISED - | |
| PLOT SCALE = 40.0000 / in. | CHECKED - | RG⊤ | REVISED - | |
| PLOT DATE = 9/20/2024 | DATE - | 8/23/2024 | REVISED - | |

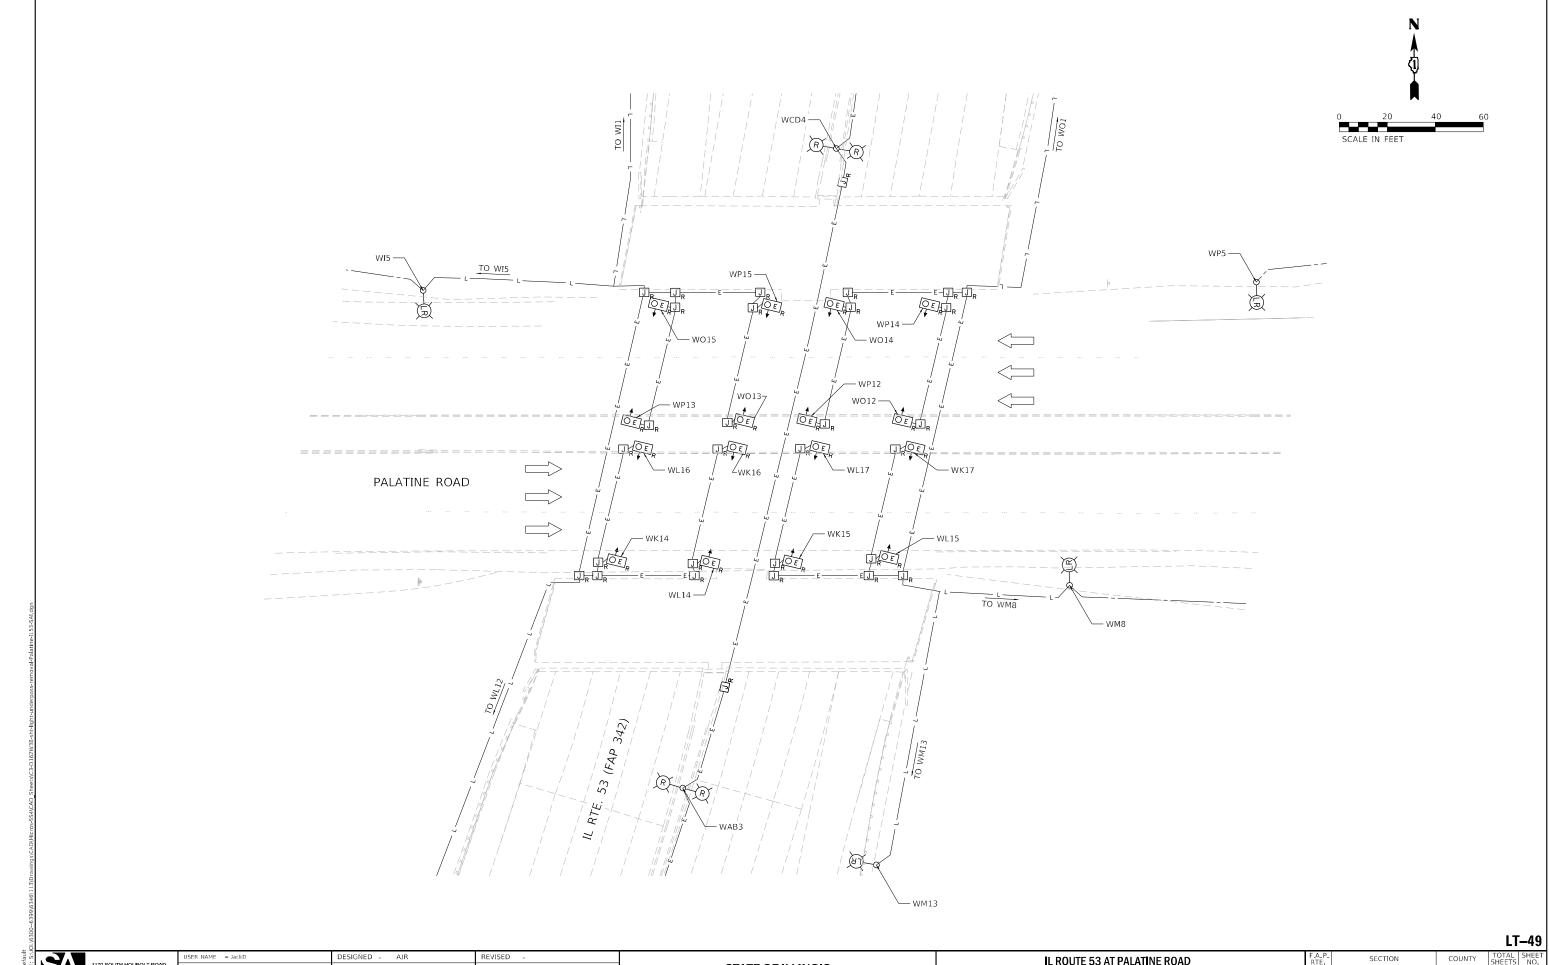

1170 SOUTH HOUBOLT ROAD
JOILET, ILLINOIS 80431
STRAND
ASSOCIATES"


1170 SOUTH HOUBOLT ROAD
JOILET, ILLINOIS 80431

DRAWN -JED REVISED LOT SCALE = 40.0000 '/ in. REVISED CHECKED -RGT PLOT DATE = 8/23/2024 8/23/2024

STATE OF ILLINOIS DEPARTMENT OF TRANSPORTATION

IL ROUTE 53 AT PALATINE ROAD UNDERPASS REMOVAL LIGHTING PLANS SCALE: 1" = 20' SHEET 2 OF 2 SHEETS STA.

COUNTY TOTAL SHEET NO.
COOK 1211 579
CONTRACT NO. 62W38 (531) BR 23

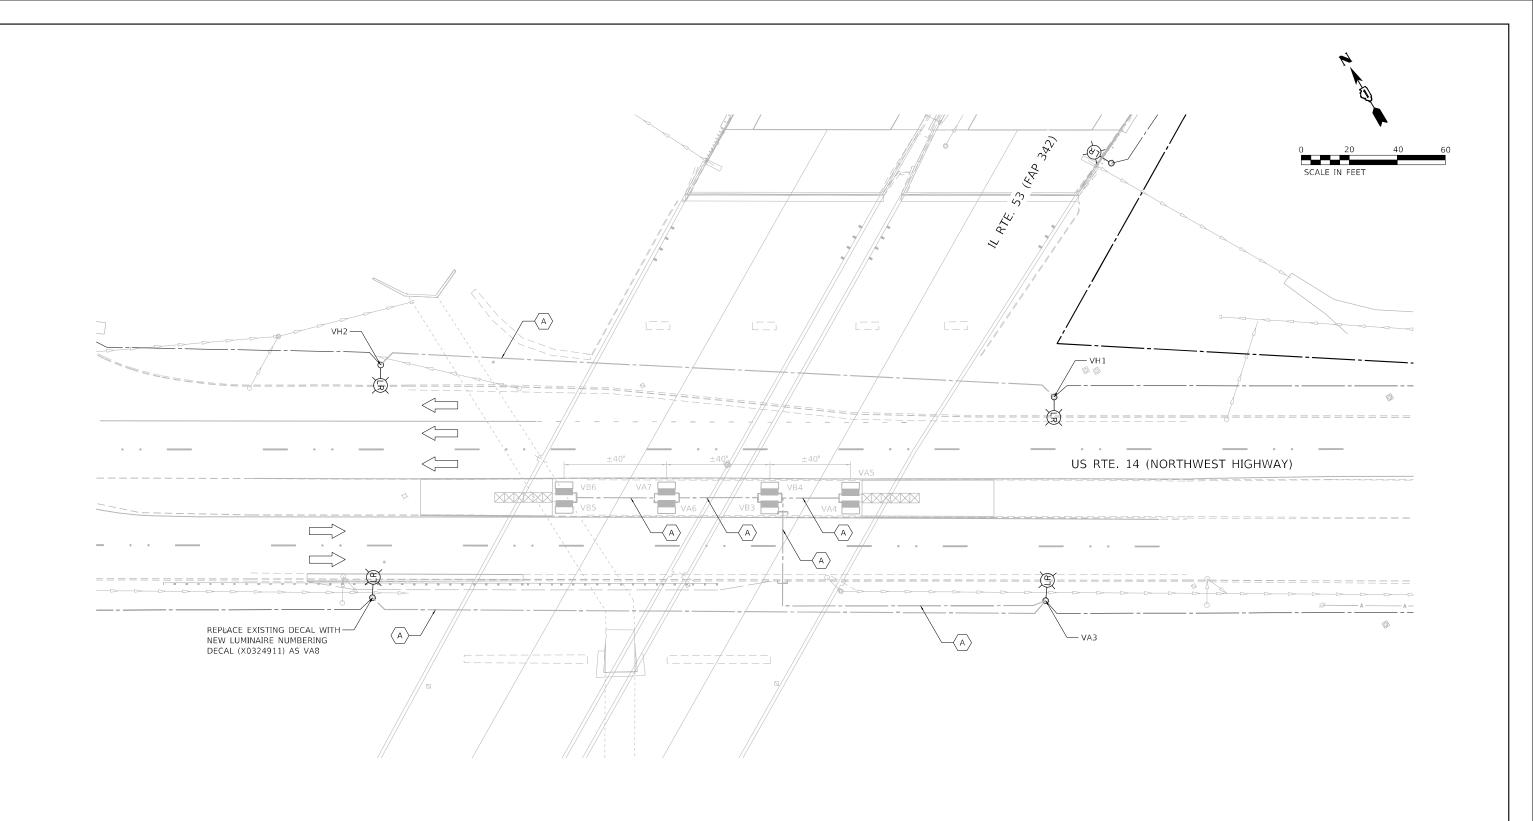

NOTES

- 1. PROPOSED LIGHTING CONDITIONS ON US 14 BRIDGE OMITTED ON THIS PAGE FOR CLARITY
- 2. US 14 UNDERPASS LIGHTING SYSTEM SHOWN FOR INFORMATION ONLY AND TO BE INSTALLED BY (62X55)

PROPOSED UNDERPASS LEGEND


CONDUIT, CABLE IN CONDUIT, OR UNIT DUCT MATERIAL AND INSTALLATION BY (62X55)

LUMINAIRE, LED, UNDERPASS, WALLMOUNT, OUTPUT DESIGNATION E MATERIAL AND INSTALLATION BY (62X55)

LT-50



| DRAWN - JED REVISED - | USER NAME = jackd | DESIGNED - AJR | REVISED - |
|--|----------------------------|------------------|-----------|
| | | DRAWN - JED | REVISED - |
| PLOT DATE = 9/20/2024 DATE - 8/23/2024 REVISED - | PLOT SCALE = 40.0000 / in. | CHECKED - RGT | REVISED - |
| | PLOT DATE = 9/20/2024 | DATE - 8/23/2024 | REVISED - |

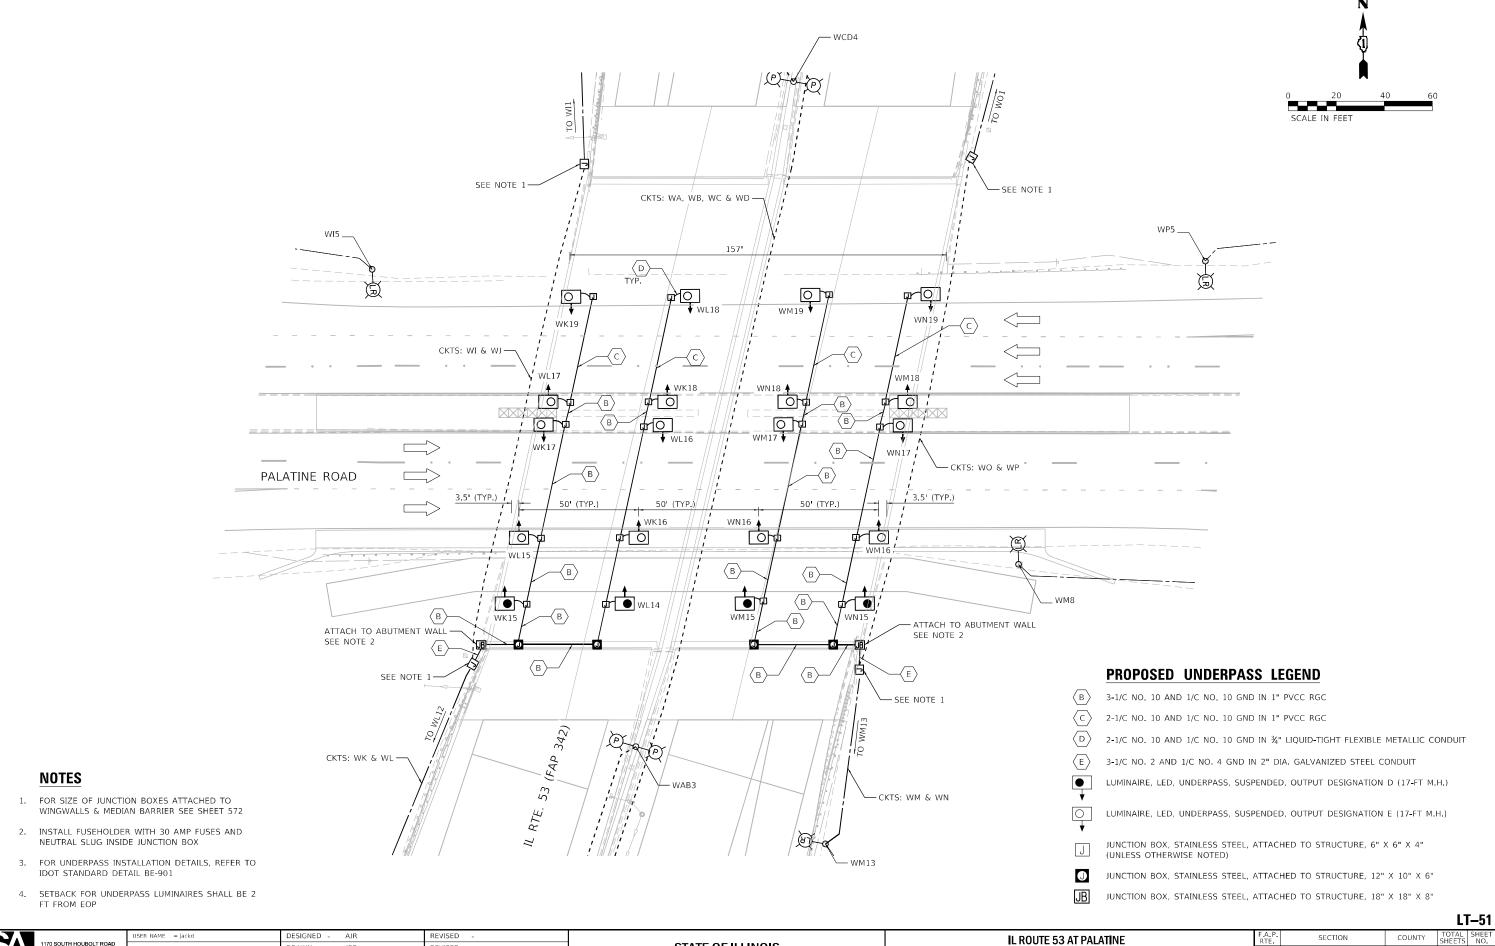

1170 SOUTH HOUSE JOLIET, ILLINOIS 60431 (815) 744-4200 STRAND (815) 744-4200

DRAWN JED OT SCALE = 40.0000 / in. HECKED RGT


REVISED REVISED 8/23/2024


STATE OF ILLINOIS **DEPARTMENT OF TRANSPORTATION**


IL ROUTE 53 AT PALATINE UNDERPASS LIGHTING PLAN SCALE: 1" = 20' SHEET 2 OF 2 SHEETS STA.


TO STA. XXX


SECTION (531) BR 23 COOK 1211 581 CONTRACT NO. 62W38

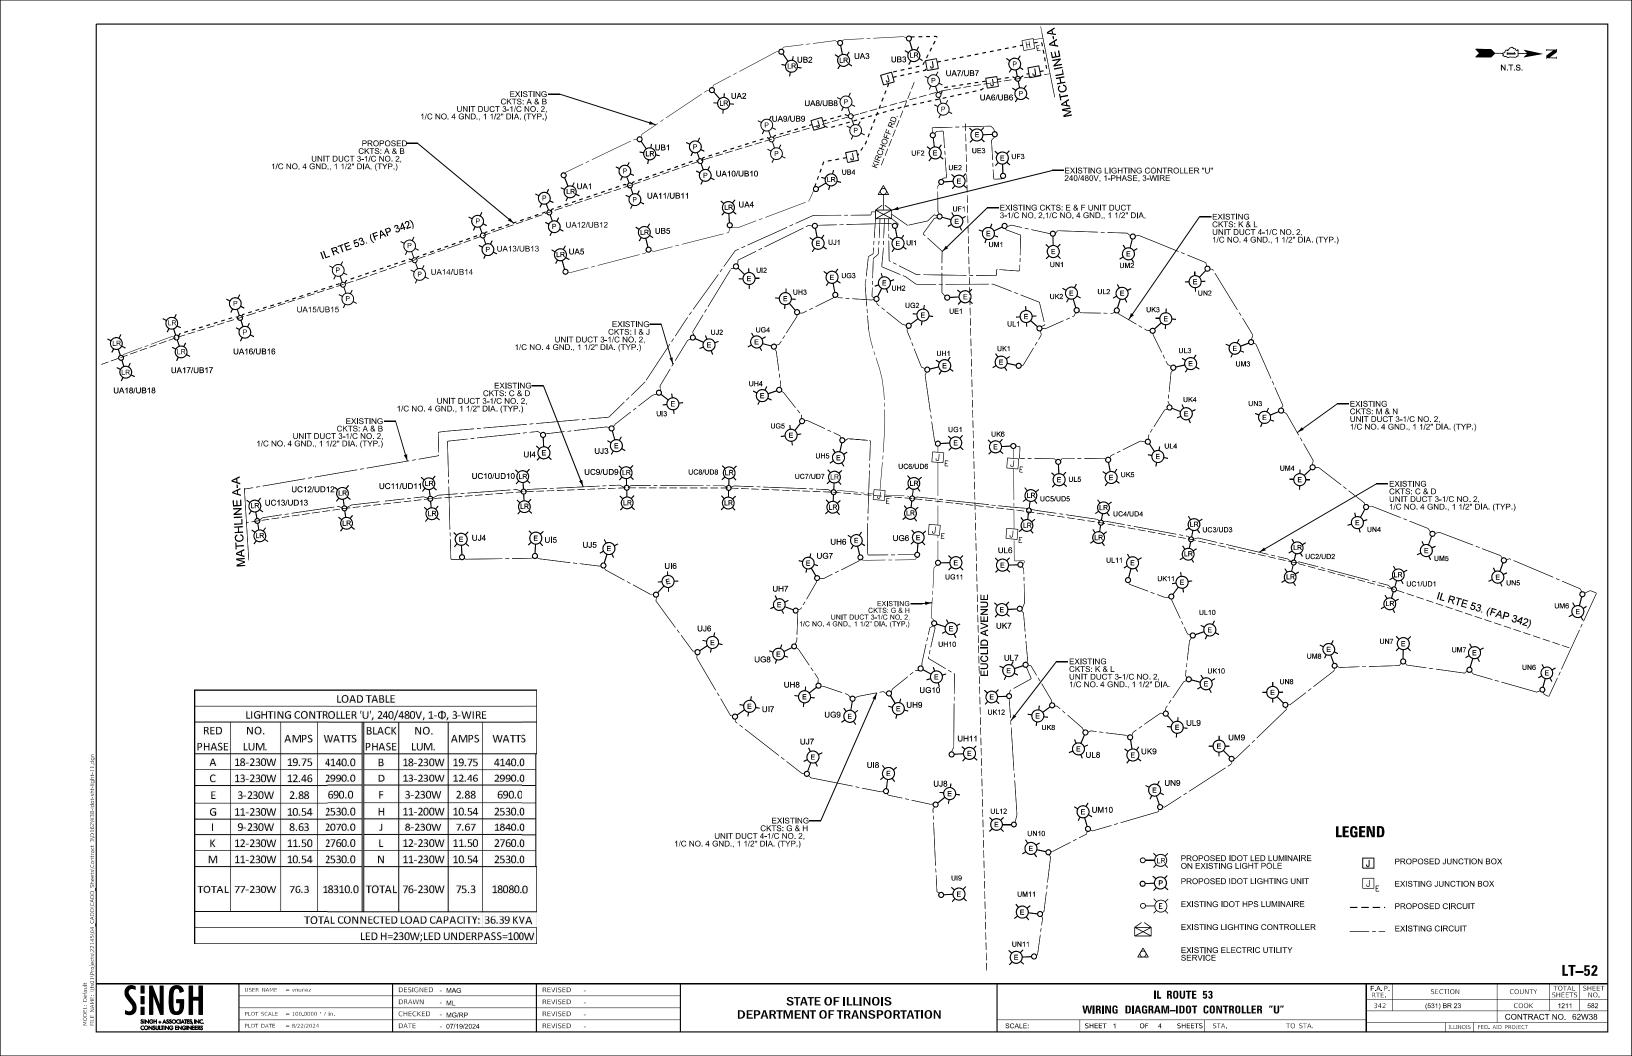

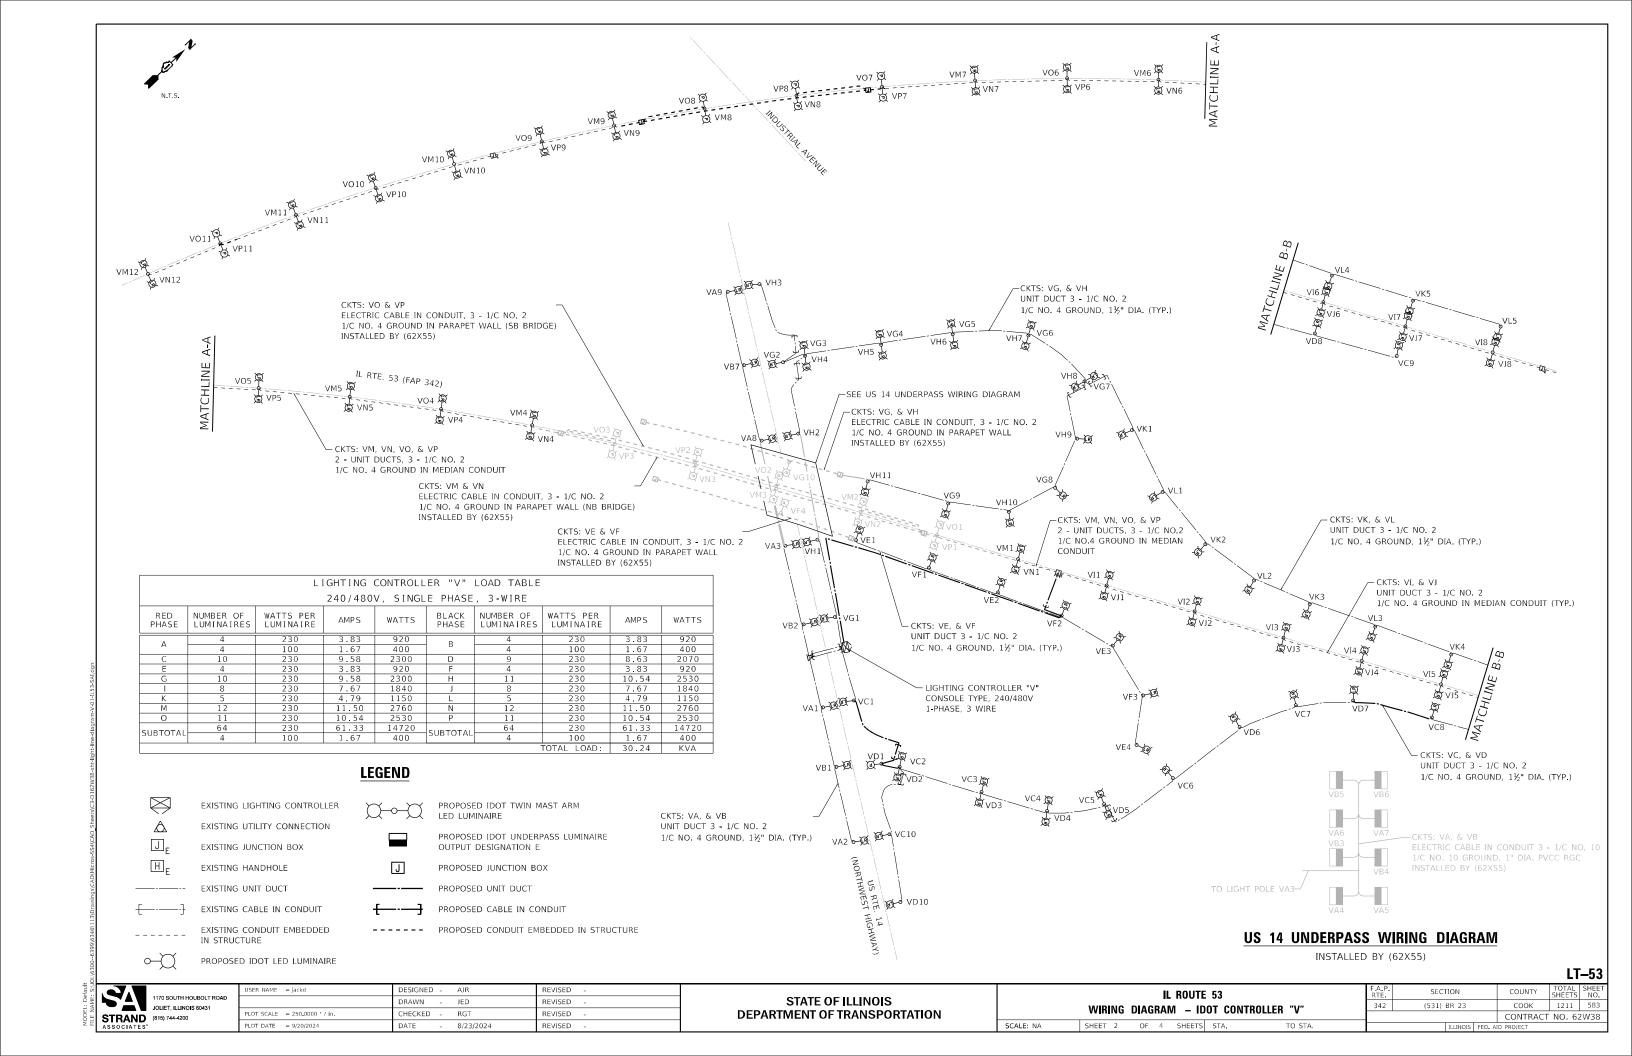


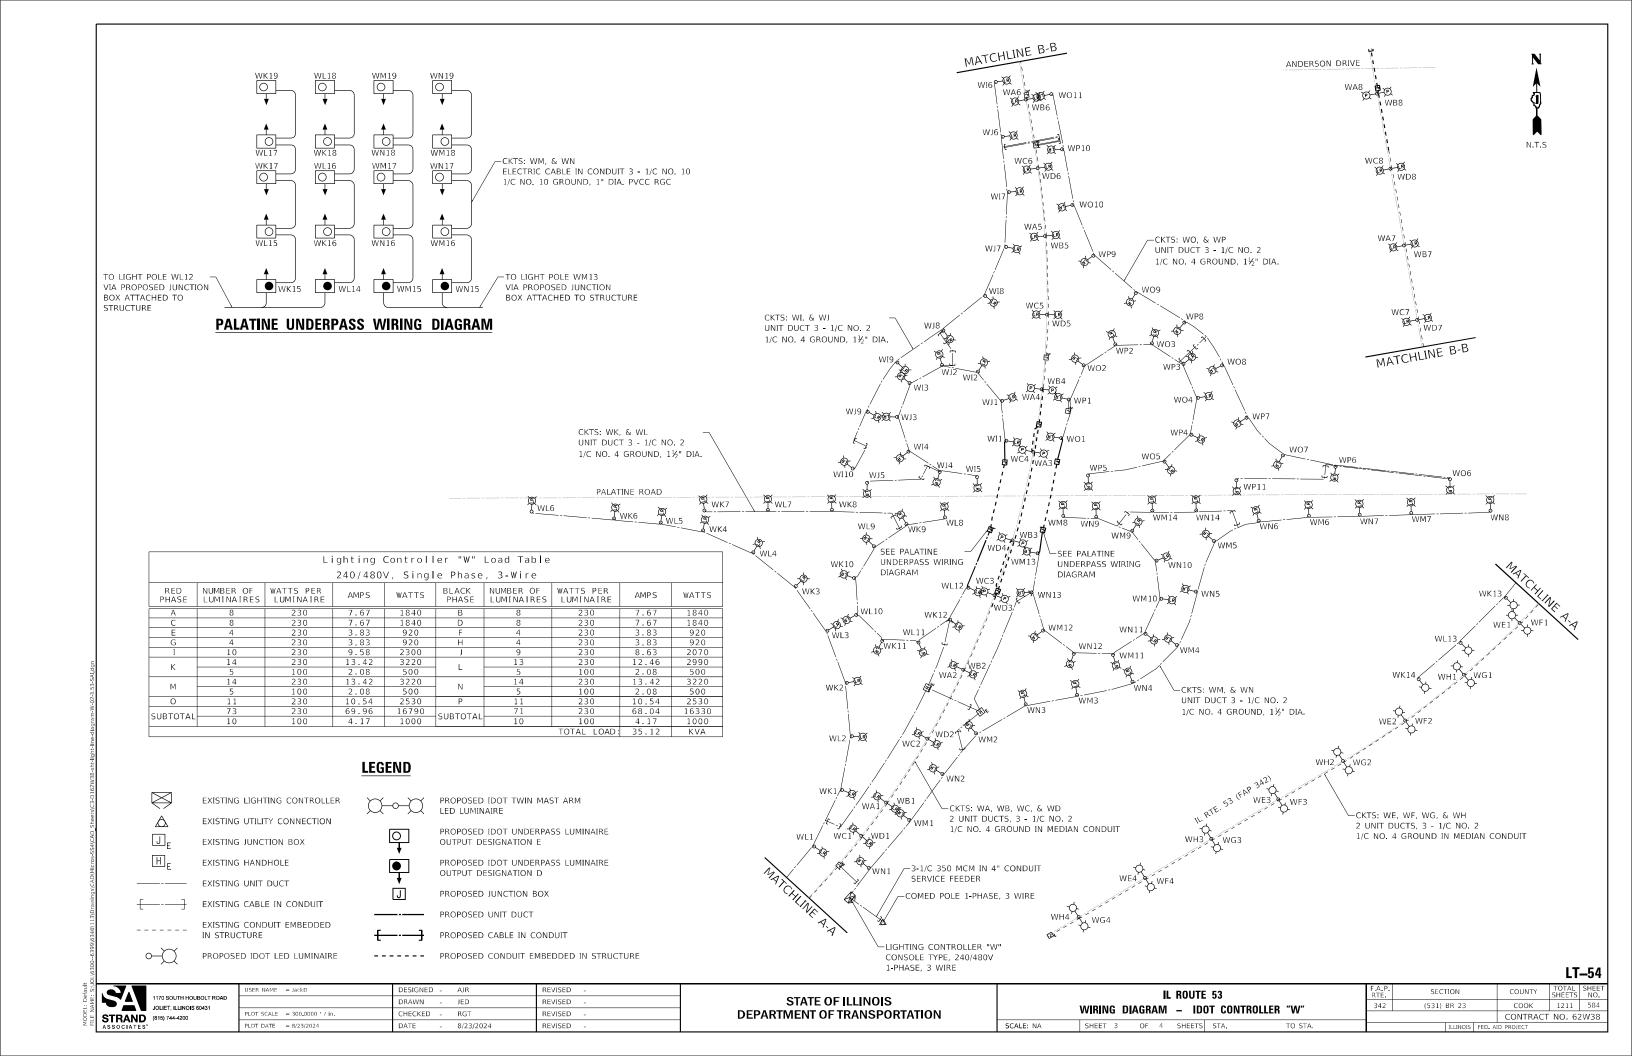

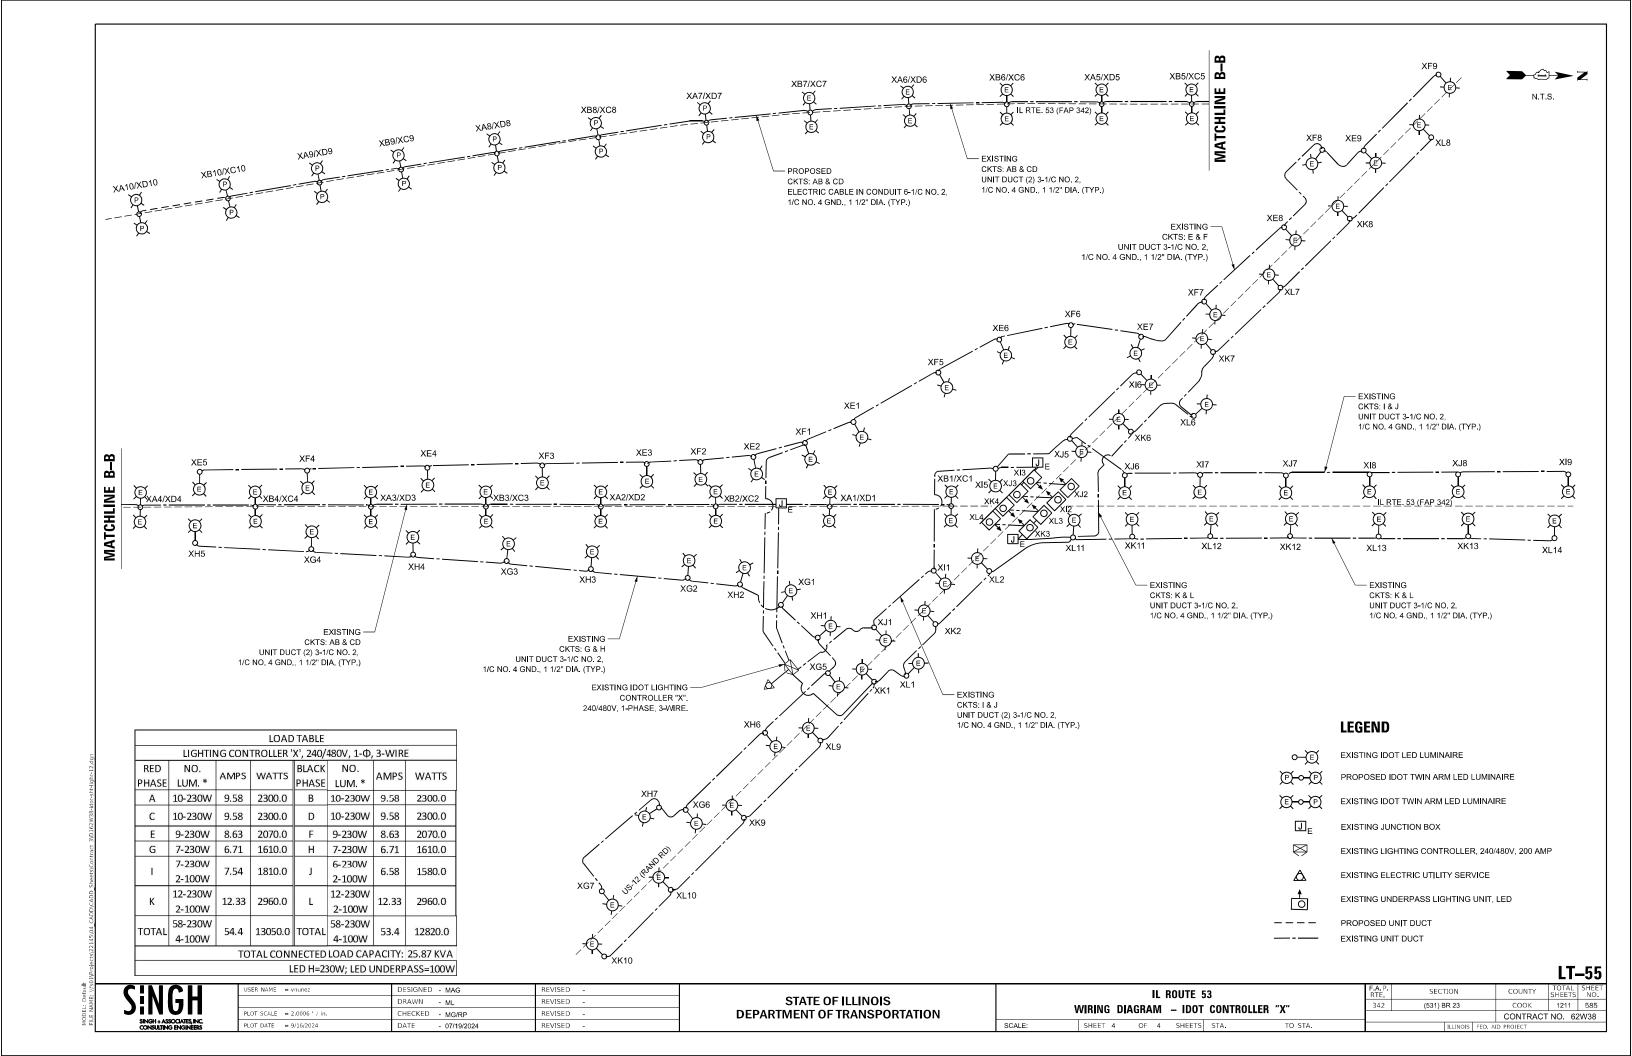

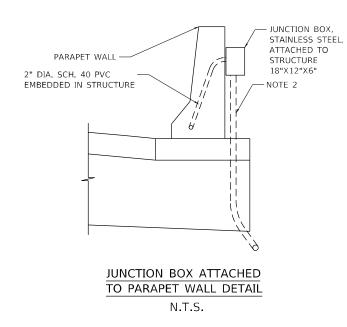

- (SEE PROPOSED LIGHTING SPLICE CKTS IN JUNCTION BOX AS NECESSARY — DRAWINGS FOR CKT DESIGNATION) - JUNCTION BOX, NON-METALLIC, EMBEDDED TOE OF SINGLE FACE WALL IN STRUCTURE, 20" X 13" X 12" TOE OF BARRIER WALL -FRONT TOP OF BARRIER WALL TOP OF BARRIER WALL -BACK TOP OF BARRIER WALL 4" EMBEDDED PVC CONDUIT -CONCRETE MEDIAN SURFACE 6" OVER SAND BACKFILL TOP OF BARRIER WALL -BACK TOP OF BARRIER WALL TOE OF BARRIER WALL -FRONT TOP OF BARRIER WALL 2" EMBEDDED PVC CONDUITS (SEE PROPOSED LIGHTING DRAWINGS FOR NUMBER OF CONDUITS) TOE OF SINGLE FACE WALL CONCRETE BARRIER, DOUBLE FACE, 44 INCH HEIGHT OR CONCRETE BARRIER, SINGLE FACE, 44 INCH HEIGHT CONCRETE BARRIER, VARIABLE CROSS SECTION, 44 INCH HEIGHT
 - CONCRETE BARRIER, DOUBLE FACE TO CONCRETE BARRIER, SINGLE FACE CONDUIT TRANSITION (PLAN VIEW DETAIL) N.T.S.

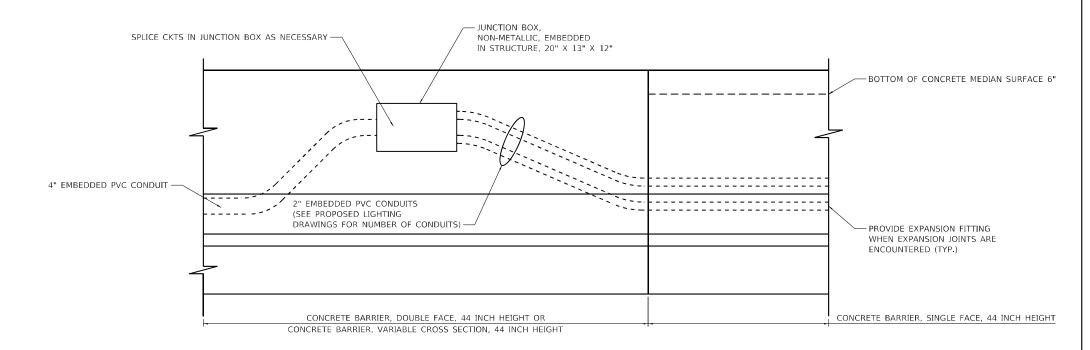

LIMITS OF CONCRETE BARRIERS.

SEE BRIDGE APPROACH DETAIL DRAWINGS FOR

2. REFER TO IDOT STANDARD 812001 FOR MORE DETAILS. USE 3" CONDUIT TRANSITIONING FROM JUNCTION BOX ATTACHED TO STRUCTURE GOING UNDERGROUND TO ACCOMMODATE 1½" UNIT DUCT. USE IDOT STANDARD 812001 WITH EXCEPTION NOTED ON DETAILS HERE ON PLANS.

CONCRETE BARRIER, DOUBLE FACE TO CONCRETE BARRIER, SINGLE FACE CONDUIT TRANSITION (ELEVATION VIEW DETAIL) N.T.S.

TOTAL SHEET NO.


CONDUIT TO MEDIAN LIGHT POLE

1170 SOUTH HOUBOLT ROAD
JOLIET, ILLINOIS 60431
STRAND
ASSOCIATES"

1170 SOUTH HOUBOLT ROAD
JOLIET, ILLINOIS 60431
ASSOCIATES"


| | USER NAME = jackd | DESIGNED | - | AJR | REVISED - |
|---|--------------------------|----------|---|-----------|-----------|
| | | DRAWN | - | JED | REVISED - |
| | PLOT SCALE = 2 0000 / in | CHECKED | - | RGT | REVISED - |
| | PLOT DATE = 9/20/2024 | DATE | - | 8/23/2024 | REVISED - |
| - | | | | | |


THIS PAGE IS FOR INFORMATION ONLY WORK TO BE PERFORMED BY (62X55)

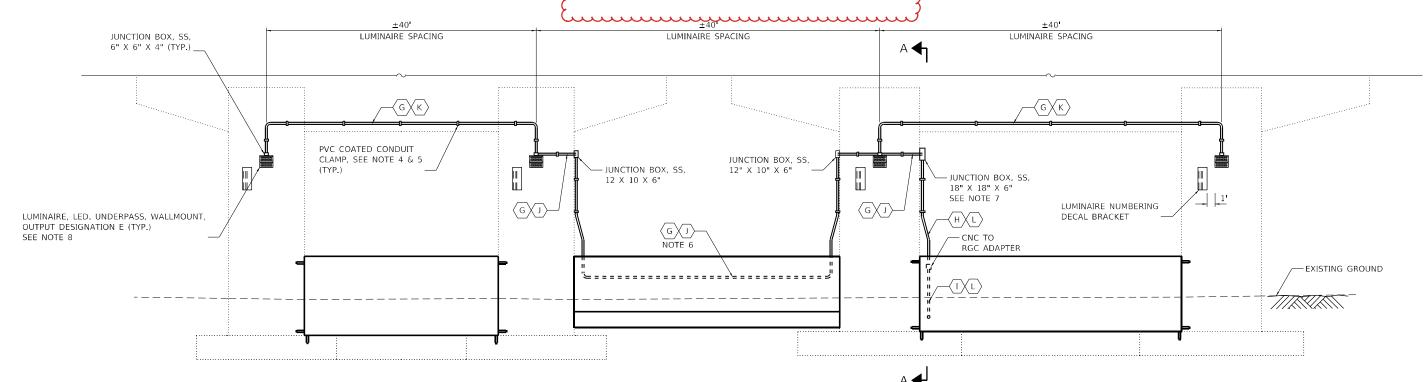

PIER 5 - US RTE. 14 (NORTHWEST HIGHWAY) UNDERPASS LIGHTING DETAILS

(LOOKING NORTH)

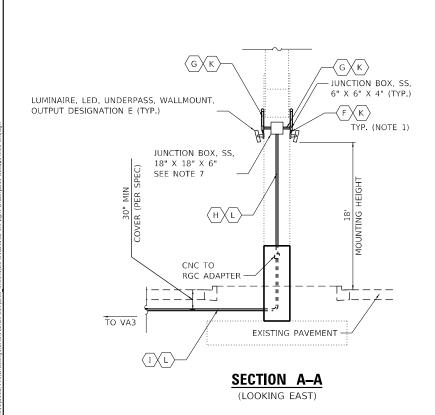

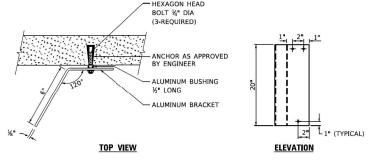



NOT TO SCALE



CONDUIT CLAMI NOT TO SCALE

LUMINAIRE NUMBERING DECAL BRACKET

NOT TO SCALE

PROPOSED UNDERPASS LEGEND

- 3/4" LIQUID-TIGHT FLEXIBLE METALLIC CONDUIT
- $\langle G \rangle$ CONDUIT ATTACHED TO STRUCTURE, 1" DIA., PVC COATED GALVANIZED STEEL
- $\langle H \rangle$ CONDUIT ATTACHED TO STRUCTURE, 3" DIA., PVC COATED GALVANIZED STEEL
- $\langle 1 \rangle$ UNDERGROUND CONDUIT, GALVANIZED STEEL, 3" DIA.
- $\langle 1 \rangle$ ELECTRIC CABLE IN CONDUIT 3-1/C NO. 10 AND 1/C NO. 10 GND
- $\langle K \rangle$ ELECTRIC CABLE IN CONDUIT 2-1/C NO. 10 AND 1/C NO. 10 GND
- UNIT DUCT, 600V, 3-1/C NO. 2, 1/C NO. 4 GND, (XLP-TYPE USE), 1½" DIA. POLYETHELENE

NOTES:

- PROVIDE LIQUID TIGHT FLEXIBLE METAL CONDUIT AT ALL LOCATIONS BETWEEN UNDERPASS LUMINAIRES & JUNCTION BOX, SS, 6" X 6" X 4". MAXIMUM LENGTH 6' - 0", TYPICAL FOR EACH INSTANCE AS SHOWN. PROVIDE PVC COATED RIGID GALVANIZED STEEL CONDUIT AS REQUIRED NOT TO EXCEED 6' - 0" OF FLEXIBLE LIQUID TIGHT FLEXIBLE METAL CONDUIT. LIQUID TIGHT FLEXIBLE METAL CONDUIT WILL BE INCLUDED IN THE COST OF THE CONDUIT ATTACHED TO STRUCTURE, OF THE CORRESPONDING DIA., GALVANIZED STEEL, PVC COATED PAY ITEM EXCEPT THAT THE COST OF THE " DIA. RIGID STEEL CONDUIT AND " DIA. FLEXIBLE CONDUIT SHALL BE INCLUDED IN THE LUMINAIRE INSTALLATION.
- SEE UNDERPASS LIGHTING PLANS FOR INSTALLATION LOCATION OF UNDERPASS LIGHTING LUMINAIRES
- EXPANSION ANCHOR, POWDER ACTUATED FASTENERS WILL NOT BE ALLOWED, EXPANSION ANCHOR MUST BE SIZED IN ACCORDANCE WITH MANUFACTURERS REQUIREMENTS.
- SECURE THE CONDUIT WITH PVC COATED CONDUIT CLAMPS OR CONDUIT BEAM CLAMPS AS SHOWN AT 5' - 0" INTERVALS FOR LATERALS AND WITHIN 2' - 0" MAXIMUM FROM ANY JUNCTION BOX, FLEXIBLE CONDUIT, OR CHANGE IN DIRECTION. ALL PVC COATED CONDUIT CLAMPS OR BEAM CLAMPS SHALL BE INCLUDED WITH THE COST OF THE "CONDUIT ATTACHED TO STRUCTURE, OF THE CORRESPONDING DIA., GALVANIZED STEEL, PVC COATED" PAY ITEM.
- ALL CONDUIT ATTACHED TO STRUCTURE SHALL BE PVC COATED RIGID STEEL CONDUIT (PVCC RGC) TYPICAL.
- FOR CONDUIT EMBEDDED IN PIER INFILLS, COORDINATE PLACEMENT WITH "SB AND NB PIER 5 INFILL WALLS" DRAWINGS.
- INSTALL FUSEHOLDER WITH 30 AMP FUSES AND NEUTRAL SLUG INSIDE JUNCTION BOX.
- PLACE WALLMOUNT LUMINAIRES IN THE CENTER OF THE FACE OF THE US 14 BRIDGE PIERS.

LT-57

1170 SOUTH HOUSE JOLIET, ILLINOIS 60431 (815) 744-4200 1170 SOUTH HOUBOLT ROAD

DESIGNED - AJR REVISED DRAWN JED REVISED HECKED RGT REVISED PLOT DATE = 9/20/2024 8/23/2024 REVISED

STATE OF ILLINOIS **DEPARTMENT OF TRANSPORTATION**


US 14 (NORTHWEST HIGHWAY) UNDERPASS LIGHTING SYSTEM DETAILS IL ROUTE 53 LIGHTING DETAILS SCALE: NA SHEET 1 OF 1 SHEETS STA. TO STA.

(531) BR 23 COOK 1211 587 CONTRACT NO. 62W38

SECTION


LIGHT POLE FOUNDATION DEPTH TABLE 40 FT. (12.192 m) TO 47.5 FT. (14.478 m) MOUNTING HEIGHT

| SOIL CONDITIONS | DESIGN DEPTH "D" OF FOUNDATION | | | | | |
|-------------------------|--------------------------------|---------------|--|--|--|--|
| SOIL CONDITIONS | SINGLE ARM POLE | TWIN ARM POLE | | | | |
| SOFT CLAY | 13'-0" | 15'-0" | | | | |
| Qu = 0.375 TON/SQ. FT. | (3.96 m) | (4.57 m) | | | | |
| MEDIUM CLAY | 9'-6" | 10'-9" | | | | |
| Qu = 0.75 TON/SQ.FT | (2.09 m) | (3.23 m) | | | | |
| STIFF CLAY | 7'-0" | 8'-0" | | | | |
| Qu = 1.50 TON/SQ. FT. | (2,13 m) | (2.44 m) | | | | |
| LOOSE SAND | 9'-0" | 10'-0" | | | | |
| Ø = 34° | (2.74 m) | (3.05 m) | | | | |
| MEDIUM SAND | 8'-3" | 9'-0" | | | | |
| ∅ = 37.5° | (2.52 m) | (2.74 m) | | | | |
| DENSE SAND | 7'-9" | 9'-0 " | | | | |
| Ø = 40° | (2,36 m) | (2.74 m) | | | | |
| | | | | | | |

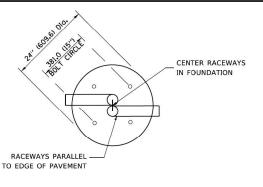

ANCHOR ROD 4-1" Dia. X 5'-0" (4-25.4 Dia. X 1.524 m)


TOP VIEW

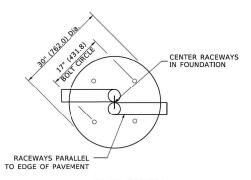

TOP VIEW


¾" (19) CHAMFER #2/0 BARE COPPER-EXOTHERMIC WELD CONNECTION TO GND ROD EXOTHERMIC WELD CONNECTION 3½" X 36" RADIUS #2/0 BARE COPPER (88.9 Dia, X 914.4) PVC RACEWAY (2 MIN.) GROUND CLAMP UL LISTED 8-#6 VERTICAL BARS GROUND ROD (WHEN SPECIFIED) %" Dia. X 10' (15.875 Dia. X 3.048 m) - 3 LOOPS MIN. AT TOP & BOTTOM - 2" (50.8) 3" (76.2) 24" (609.6) Dia.


FOUNDATION DETAIL

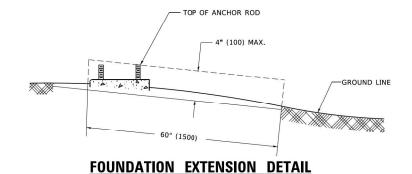

RADIUS NOT LESS THAN

4 TIMES NOMINAL ROD DIA

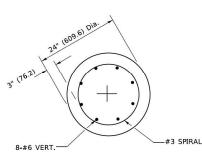

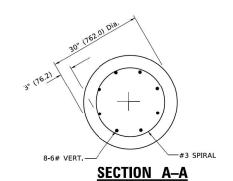

SECTION A-A

NOTES

- 1. ALL DIMENSIONS ARE IN INCHES (MILLIMETERS) UNLESS OTHERWISE SHOWN.
- 2. THE ANCHOR RODS AND RACEWAYS SHALL BE PROPERLY SECURED IN PLACE BEFORE THE CONCRETE IN PLACED.
- 3. THE FOUNDATION SHALL NOT PROTRUDE MORE THAN 100MM (4 IN.) ABOVE THE FINISHED GRADE WITHIN A 60 IN. (1.5 m) CHORD ACROSS THE FOUNDATION, WITH ANCHOR RODS INCLUDED, IN ACCORDANCE WITH AASHTO GUIDELINES. IF THE FOUNDATION HEIGHT, INCLUDING ANCHOR RODS, EXTENDS BEYOND THESE SPECIFIED LIMITS, THE FOUNDATION SHALL BE REPLACED AT THE CONTRACTOR'S EXPENSE. SEE FOUNDATION EXTENSION DETAIL.
- THE HOLE FOR THE FOUNDATION SHALL BE MADE BY DRILLING WITH AN AUGER, OF THE SAME DIAMETER AS THE FOUNDATION. IF SOIL CONDITIONS REQUIRE THE USE OF A LINER TO FORM THE HOLE, THE LINER SHALL BE WITHDRAWN AS THE CONCRETE IS DEPOSITED.
- THE TOP OF THE FOUNDATION SHALL BE CONSTRUCTED LEVEL. A LINER OR FORM SHALL BE USED TO PRODUCE A UNIFORM SMOOTH SIDE TO THE TOP OF THE FOUNDATION. FOUNDATION TOP SHALL BE CHAMFERED 3#4-IN. (20 mm).
- 6. THE CONCRETE SHALL BE CLASS SI. CONCRETE SHALL CURE ACCORDING TO ARTICLE 1020.13 BEFORE LIGHT POLES ARE INSTALLED.
- 7. THE ANCHOR ROD SHALL BE A HOOK ROD TYPE, COLD BENDING OF THE ANCHOR ROD WILL NOT BE ALLOWED. THE RADIUS OF THE HCOK BEND SHALL NOT BE LESS THAN 4 TIMES THE NOMINAL DIAMETER OF THE ANCHOR ROD. A TACK WELDED ANCHOR ROD MAY BE SUBSTITUTED WITH THE APPROVAL OF THE ENGINEER.
- THE ANCHOR RODS SHALL BE ACCORDING TO ASTM F1554 GRADE 725 (GRADE 105). NUTS SHALL BE HEXAGON NUTS ACCORDING TO ASTM A 194 2H OR ASTM A 563 DH, AND WASHERS SHALL BE ACCORDING TO ASTM F 436.
- 9 ANCHOR RODS, NUTS AND WASHERS SHALL BE COMPLETELY GALVANIZED BY EITHER THE HOT-DIPPED PROCESS CONFORMING WITH AASHTO M 232, THE MECHANICAL PLATING METHOD CONFORMING TO AASHTO M 298, CLASS 50 WITH A MAXIMUM COATING THICKNESS OF 150 UM(6 MILS) OR THE ELECTROLYTIC PROCESS ACCORDING TO ASTM F 1135.
- 10. THE ANCHOR RODS SHALL BE THREADED A MINIMUM OF 6 INCHES (150 mm) WITH A MINIMUM OF 3 INCHES (75 mm) OF THREADED ANCHOR ROD EMBEDDED IN THE FOUNDATION.
- 11. ANCHOR RODS SHALL PROJECT 23#4" (69.9 mm) ABOVE THE TOP OF THE FOUNDATION. IF BREAKAWAY COUPLINGS ARE SPECIFIED, THE CONTRACTOR SHALL CAREFULLY COORDINATE THE ANCHOR ROD PROJECTION WITH THE INSTALLATION REQUIREMENTS OF THE BREAKAWAY COUPLINGS.
- 12. THE CONTRACTOR SHALL USE A #3 SPIRAL AT 6" (152.4 mm) PITCH OR MAY SUBSTITUTE #3 TIES AT 12" (304.8 mm) O.C. WITH THE APPROVAL OF THE ENGINEER.
- 13. THE CABLE TRENCHES AND FOUNDATION SHALL BE BACK FILLED AND COMPACTED AS SPECIFIED BEFORE THE LIGHT POLE IS ERECTED.
- 14 THE RACEWAYS SHALL PROJECT 1" (25.4 mm) ABOVE THE TOP OF THE FOUNDATION.

LT-58

1170 SOUTH HOUBOLT ROAD
JOUET, ILLINOIS 60431

STRAND
ASSOCIATES*

6" (152.4)

%" T. X 4" Dia.

Dia. Dia.

5" (127.0)

ANCHOR ROD DETAIL

 USER NAME
 Footenij
 DESIGNED
 REVISED
 04-22-02

 DRAWN
 REVISED

 PLOT SCALE
 = 50.0000 ' / h.
 CHECKED
 REVISED


 PLOT DATE
 = 4/19/2019
 DATE
 REVISED


STATE OF ILLINOIS
DEPARTMENT OF TRANSPORTATION

LIGHT POLE FOUNDATION

40' (12.192 m) TO 47 1/2' (14.478 m) M.H. 15" (381 mm) BOLT CIRCLE

LE: NONE SHEET 1 OF 1 SHEETS STA. TO STA.

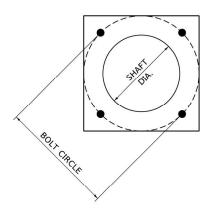

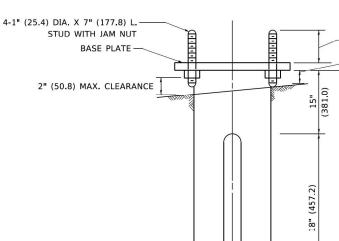


HELIX FOUNDATION SIZE

| POLE MOUNTING HEIGHT | BOLT CIRCLE | SHAFT DIAMETER | SHAFT LENGTH | BASEPLATE |
|-------------------------|----------------|-------------------|-----------------|-------------|
| 30 FT. | 11½" | 8%" | 6 FT. | 12"x12"x1" |
| 31 FT35 FT. | 11½" | 8%" | 6 FT. | 12"x12"x1" |
| 36 FT40FT. | 15" | 8%" | 6 FT. | 15"x15"x1¾" |
| 41 FT45 FT. | 15" | 8%" | 6 FT. | 15"x15"x1¼" |
| 46 FT50 FT. | 15" | 10" | 8 FT. | 15"x15"x1¾" |

METAL HELIX FOUNDATION MATERIALS

| ITEM | MATERIAL REQUIREMENT |
|-------------------|---|
| BASEPLATE | AASHTO M 270M, GRADE 36 (M270M, GRADE 250) |
| SHAFT | ASTM A 252, GRADE 2 (PHOSPHOROUS 0.04% MAXIMUM, SULFUR 0.05% MAXIMUM) |
| HELIX SCREW | AASHTO M 183 (ASTM A 635) |
| PILOT POINT | AASHTO M 270 (ASTM A 575) |
| ANCHOR RODS/STUDS | AASHTO M 314 (ASTM F 1554) |
| HEXAGON NUTS | AASHTO M 291M (ASTM A 563) GRADE DH, OR AASHTO M 292 (ASTM A 194) GRADE 2H |
| WASHERS | AASHTO M 293 (ASTM F 436) |

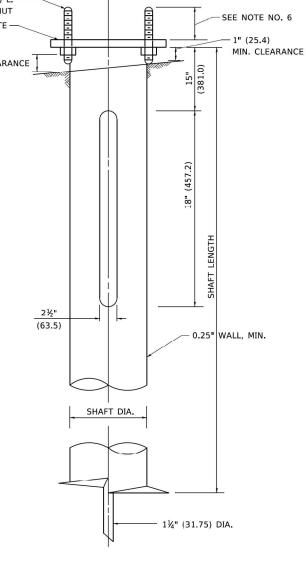

NOTES

- 1. ALL DIMENSION IN INCHES (MILLIMETERS) UNLESS OTHERWISE SHOWN.
- 2. ALL MATERIAL SHALL BE GALVINIZED ACCORDING TO AASHTO M111, UNLESS OTHERWISE SPECIFIED.
- 3. ALL WELDS SHALL BE CONTINUOUS AND NOT LESS THAN 1#4" (6.35 mm) FILLET WELDS. THE WELDED FOUNDATION SHALL BE CAPABLE OF WITHSTANDING 10,000 FT/LBS (13558.18 n.m) OF INSTALLATION TORQUE APPLIED ABOUT THE AXIS OF THE FOUNDATION.
- 4. THE HELIX FOUNDATION SHAFT SHALL BE INSTALLED VERTICAL AND THE BASE PLATE SHALL BE IN LEVEL. THE BREAKAWAY COUPLINGS AND HARDWARE SHALL NOT BE USED TO ALIGN THE POLE INSTALLATION.
- 5. THE CABLE TRENCH SHALL BE BACKFILLED AND FIRMLY COMPACTED BEFORE THE INSTALLATION OF THE LIGHT POLE.
- 6. THE CONTRACTOR SHALL COORDINATE EXTENSION OF ANCHOR BOLTS ABOVE TOP OF THE BASE PLATE WITH THE BREAKAWAY DEVICE MANUFACTURER'S REQUIREMENTS.
- 7. ANY VOIDS WITHIN THE METAL FOUNDATION SHALL BE FILLED WITH FINE AGGREGATE.
- 8. METAL FOUNDATIONS SHALL BE INSTALLED IN UNDISTURBED SOIL, PREDRILLING A PILOT HOLE AND/OR BACKFILLING AROUND THE FOUNDTION IS NOT ALLOWED.
- 9. THE METAL FOUNDATION SHALL NOT BE INSTALLED TO A TORQUE WHICH EXCEEDS THE MANUFACTURER'S MAXIMUM TORQUE RATING NOR SHALL IT BE INSTALLED TO AN INSTALLATION TORQUE VALUE OF LESS THAN 3,500 FT LB (4,750 KNM). METAL FOUNDATIONS THAT ARE NOT INSTALLED TO FULL INSTALLATION DEPTH OR DO NOT ACHIEVE THE MINIMUM INSTALLATION TORQUE SHALL BE REMOVED AND REPLACED WITH A CONCRETE FOUNDATION AT NO ADDITIONAL COST.
- 10. THE BASEPLATE SHALL BE PERPENDICULAR TO THE SHAFT AXIS (\pm 1 $^{\circ}$) AND THE HOLE CENTERLINE SHALL BE CONCENTRIC (± 0.188) TO THE SHAFT AXIS.
- 11. THE PILOT POINT AND SHAFT AXIS SHALL BE CONCENTRIC (± 0.125) AND IN LINE $(\pm 2^{\circ})$.
- 12. THE BASEPLATE SHALL BE STAMPED WITH THE MANUFACTURERS NAME AND DATE OF MANUFACTURE.

1170 SOUTH HUGGE.
JOUET, ILLINOIS 60431
(#15) 744-4200

1170 SOUTH HOUROLT ROAD

| JSER NAME = footemj | DESIGNED - | REVISED - |
|------------------------------|-----------------|-----------|
| | DRAWN - DLB | REVISED - |
| PLOT SCALE = 50.0000 ' / in. | CHECKED - | REVISED - |
| PLOT DATE = 4/19/2019 | DATE - 02-27-07 | REVISED - |
| | | |

STATE OF ILLINOIS **DEPARTMENT OF TRANSPORTATION**

| Ц | GHT | POL | E | FOUNDA [*] | NDATION, METAL | | | |
|-------|-----|-----|---|---------------------|----------------|---------|--|--|
| SHEET | 1 | OF | 1 | SHEETS | STA. | TO STA. | | |

SCALE: NONE


| | | | | | 33 |
|--------|-------------|-------|------------|-----------------|--------------|
| | SECTION | | COUNTY | TOTAL SHEETS | SHEET NO. |
| | (531) BR 23 | | соок | 1211 | 589 |
| BE-305 | | | CONTRACT | NO. 62 | 2W38 |
| Ī | ILLINOIS E | FD. A | ID PROJECT | | |

342

I T_59

NOTES:

- 1. ALL DIMENSIONS ARE IN INCHES (MILLIMETERS) UNLESS OTHERWISE SHOWN.
- 2. THE ANCHOR BOLTS AND RACEWAYS SHALL BE PROPERLY SECURED IN PLACE BEFORE THE CONCRETE IS PLACED IN THE FORMS.
- THE CONTRACTOR AT HIS OPTION MAY SUBSTITUTE #4 (15 m) TIES AT 12" (304.8 m) CTRS. FOR THE #3 (3 m) SPIRAL. TACKWELDED TYPE BOLT MAY BE SUBSTITUTED FOR THE HOOK TYPE BOLT.
- 4. COLD BENDING OF THE HOOK BOLT SHALL NOT BE ALLOWED.
- 5. EXCAVATION FOR THE POLE FOUNDATION SHALL BE MADE WITH
- 6. THE ENGINEER SHALL DETERMINE THE TYPE OF SOIL DURING EXCAVATION AND SELECT THE DESIGN DEPTH OF FOUNDATION FROM THE DESIGN TABLE USING THE DOMINANT CHARACTERISTIC OF THE SOIL ENCOUNTERED.
- BARRIER WALL EXPANSION AND CONSTRUCTION JOINTS SHALL BE IN ACCORDANCE WITH STANDARD DETAIL 637001-02 AND 637006 AS APPLICABLE.

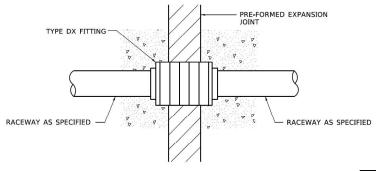


CONDUIT DEFLECTION FITTING DETAIL

FOUNDATION DEPTH

| TOOLS ALL THE | | | |
|----------------------------|---------------------------|-----------------------------|-----------------|
| TYPE OF SOIL | FOUND FEPTH D | REINFORCEMENT IN FOUNDATION | |
| | | VERTICAL BARS | SPIRAL |
| ROCK OR SOLIDIFIED SLAG | 5'-0 " (1.52 m) | NONE | NONE |
| DENSE SAND | 7'-9 " | 8-#6 x 9'-0" | #3 x 90' |
| | (2.36 m) | (8-20 m x 2.74 m) | (3 m x 27.43 m) |
| MEDIUM SAND | 8'-3" | 8-#6 x 9'-5" | #3 x 94' |
| | (2.51 m) | (8-20 m x 2.87 m) | (3 m x 28.65 m) |
| LOOSE SAND | 9'-0 " | 8-#6 x 10'-2" | #3 x 100' |
| | (2.74 m) | (8-20 m x 3.09 m) | (3 m x 30.48 m) |
| STIFF CLAY | 7'-0 " | 8-#6 x 10'-8" | #3 x 80' |
| | (2.13 m) | (8-20 m x 2.48 m) | (3 m x 24.38 m) |
| MEDIUM CLAY | 9'-6 " | 8-#6 x 10'-8" | #3 x 104' |
| | (2.89 m) | (8-20 m x 3.25 m) | (3 m x 31.69 m) |
| SOFT CLAY | 13'-0" | 8-#6 x 14'-2" | #3 x 144' |
| | (3.96 m) | (8-20 m x 4.32 m) | (3 m x 43.89 m) |

DESIGN: 80 MPH AASHTO

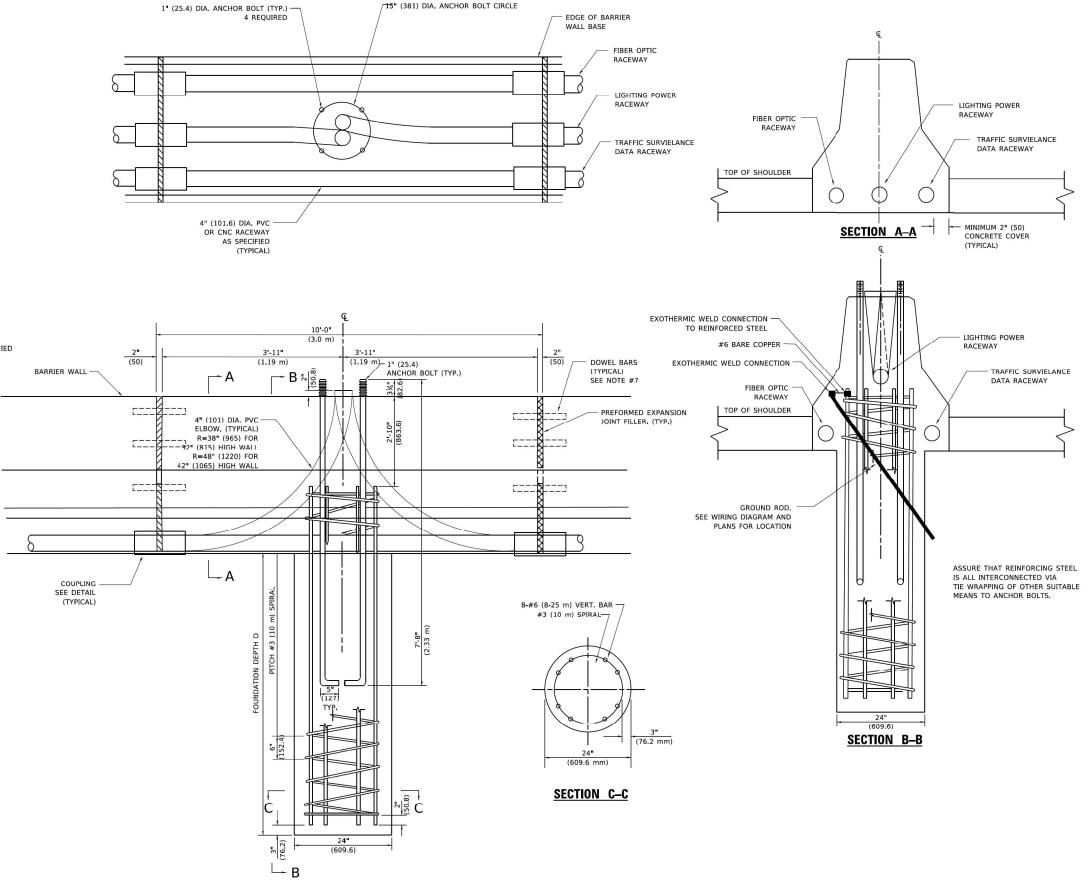

SCALE: NONE

1170 SOUTH HOUSE. JOLIET, ILLINOIS 60431 (815) 744-4200

1170 SOUTH HOUROLT ROA

REVISED - 04-07-04 JSER NAME = footemi DESIGNED -DRAWN REVISED -PLOT SCALE = 50.0000 ' / in. CHECKED -REVISED PLOT DATE = 4/19/2019 DATE REVISED -

STATE OF ILLINOIS **DEPARTMENT OF TRANSPORTATION**

24" (609.6 mm) DIA. LIGHT POLE FOUNDATION INTEGRAL WITH DOUBLE FACE BARRIER WALL SHEET 1 OF 1 SHEETS STA.

SECTION 342 (531) BR 23 COOK 1211 590 BE-322 CONTRACT NO. 62W38

LT-60

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1170 SOUTH HOUBOLT RC
JOLIET, ILLINOIS 60431
(815) 744-4200
ASSOCIATES"


 USER NAME
 = fackd
 DESIGNED
 MAG
 REVISED

 DRAWN
 DJW
 REVISED

 PLOT SCALE
 = 1.0000 ' / in.
 CHECKED
 DWG
 REVISED

 PLOT DATE
 = 9/20/2024
 DATE
 8/23/2024
 REVISED

STATE OF ILLINOIS DEPARTMENT OF TRANSPORTATION

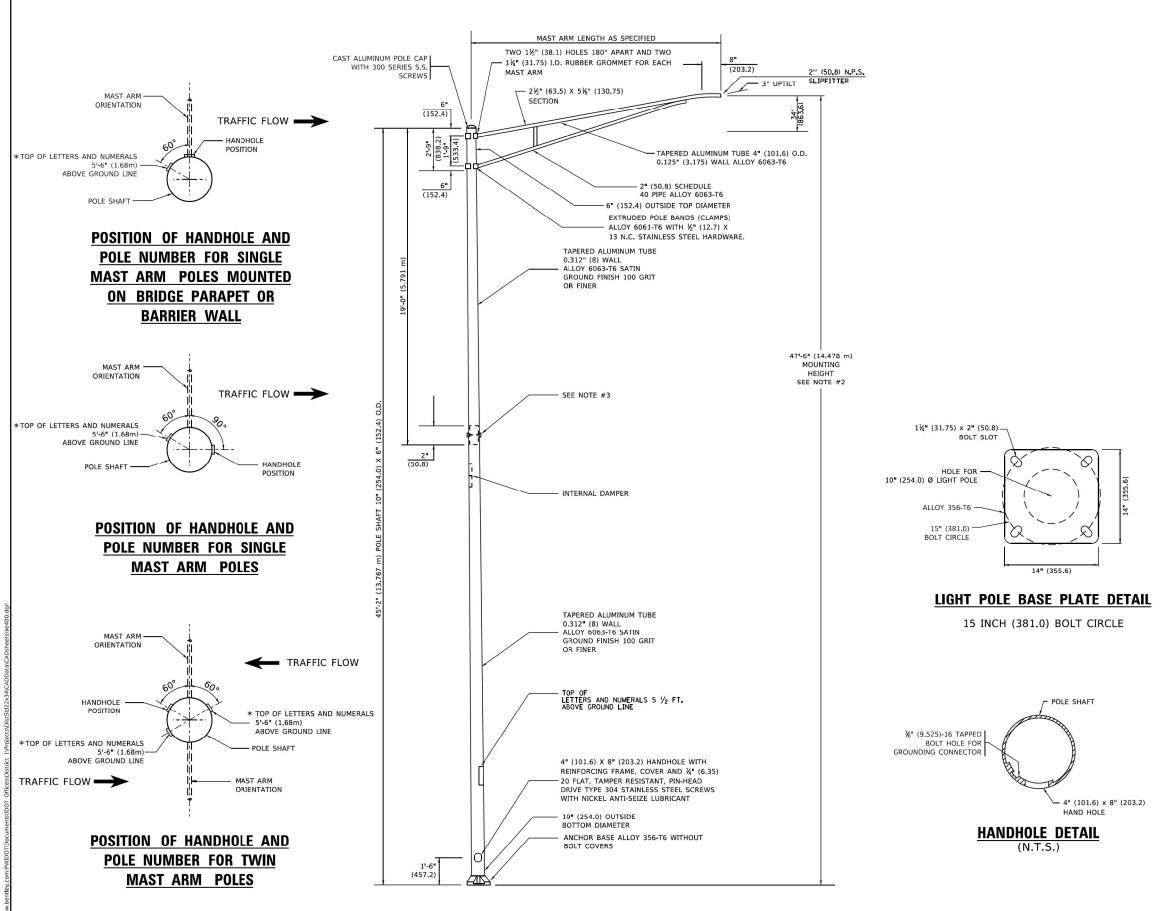

NOTES

- 1. ALL DIMENSIONS ARE IN INCHES (MILLIMETERS) UNLESS OTHERWISE SHOWN.
- . MOUNTING HEIGHT IS DEFINED AS THE DISTANCE FROM THE CENTERLINE OF THE TENON TO THE BOTTOM OF THE ANCHOR BASE.
- 3. TWO PIECE SHAFT WILL BE MATCHED MARKED AND INTERCHANGEABLE BETWEEN DIFFERENT UNITS. FIELD DRILLING OF THE HOLES WILL NOT BE ALLOWED.
- 4. THE LIGHT POLE WILL MEET AASHTO DESIGN CRITERIA AS SPECIFIED.
- THE INSTALLING CONTRACTOR WILL PROVIDE A
 UL LISTED GROUNDING CONNECTOR. BURNDY
 K2C23. T&B SP4DL OR APPROVED EQUAL.
- LIGHT POLES WILL NOT BE INSTALLED WITHOUT MAST ARMS AND LUMINAIRES.
- . LIGHT POLES WILL BE SET PLUMB ON THE FOUNDATION WITHOUT THE USE OF LEVELING NUTS, WASHERS OR SHIMS.
- 8. LIGHTING UNIT IDENTIFICATION NUMBERS
 SHALL BE INSTALLED BEFORE THE LIGHTING
 UNIT IS ENERGIZED.

LT-62

1170 SOUTH HOUBOLT ROAI JOUET, ILLINOIS 60431 STRAND (815) 744-4200 ASSOCIATES*

 USER NAME
 = Lawrence.DeManche
 DESIGNED REVISED - R. TOMSONS 01-18-13

 DRAWN REVISED - R. TOMSONS 03-18-15

 PLOT SCALE = 100,0000 '/ in.
 CHECKED REVISED - TG 06-13-22


 PLOT DATE = 12/19/2023
 DATE REVISED - R. TOMSONS 12-19-23

STATE OF ILLINOIS
DEPARTMENT OF TRANSPORTATION


ALUMINUM LIGHT POLE
47'-6" (14.478 m) MOUNTING HEIGHT

SHEET 1 OF 1 SHEETS STA. TO


SCALE: NONE

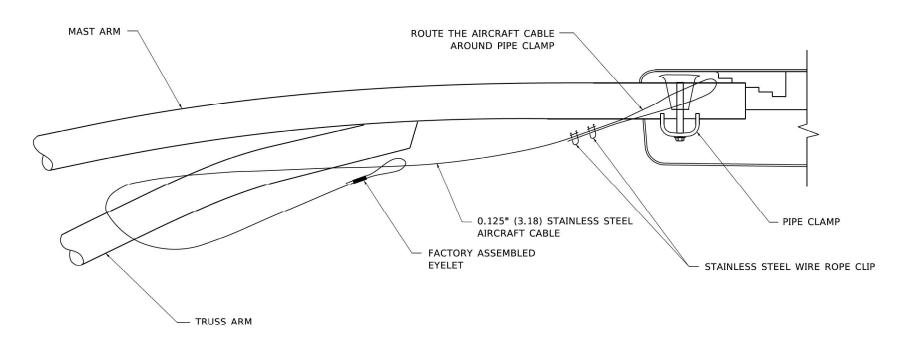

SIDE VIEW (TRUSS ARM) N.T.S.

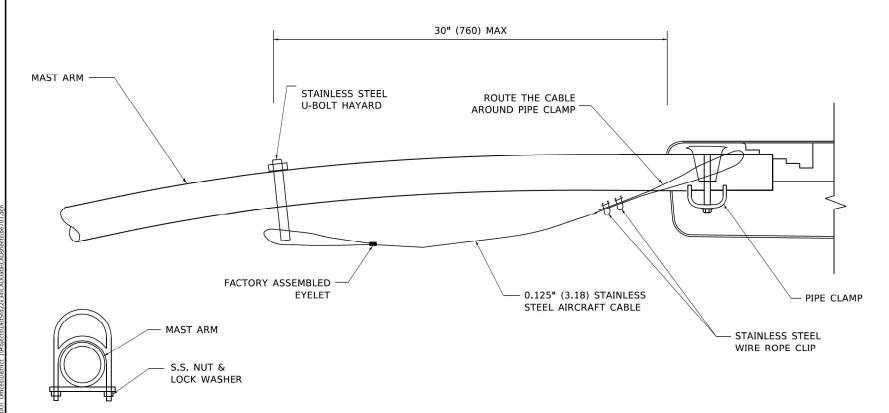

SIDE VIEW (SINGLE MEMBER OR DAVIT ARM) N.T.S.

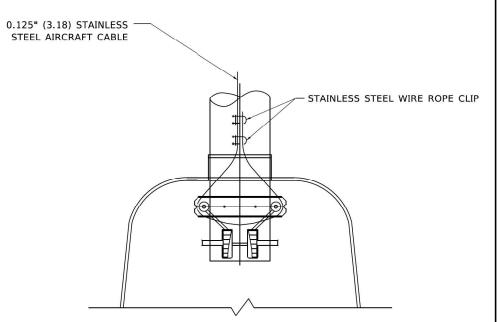

BOTTOM VIEW N.T.S.

NOTES:

- 1. ALL DIMENSIONS ARE IN MILLIMETERS (INCHES) UNLESS OTHERWISE SHOWN.
- 2. CONTRACTOR SHALL ADJUST THE WIRE CLIP TO ELIMINATE ANY SLACK FROM THE WIRE ROPE.
- 3. THE 0.125" (3.18) STAINLESS STEEL AIRCRAFT CABLE SHALL REMAIN VISIBLE FROM THE GROUND LEVEL.
- 4. THE BREAKING STRENGTH OF THE CABLE SHALL BE 1700 LBS. MIN.

LT-63

1170 SOUTH HOUBOLT ROAD
JOUET, ILLING'S 60431

STRAND
ASSOCIATES*

STAINLESS STEEL

U-BOLT HAYARD

STATE OF ILLINOIS
DEPARTMENT OF TRANSPORTATION

LUMINAIRE SAFETY CABLE ASSEMBLY


SHEET 1 OF 1 SHEETS STA. TO

SCALE: NONE

F.A. P. SECTION COUNTY TOTAL SHEET'S NO.

342 (531) BR 23 COOK 1211 593

BE-701 CONTRACT NO. 62W38

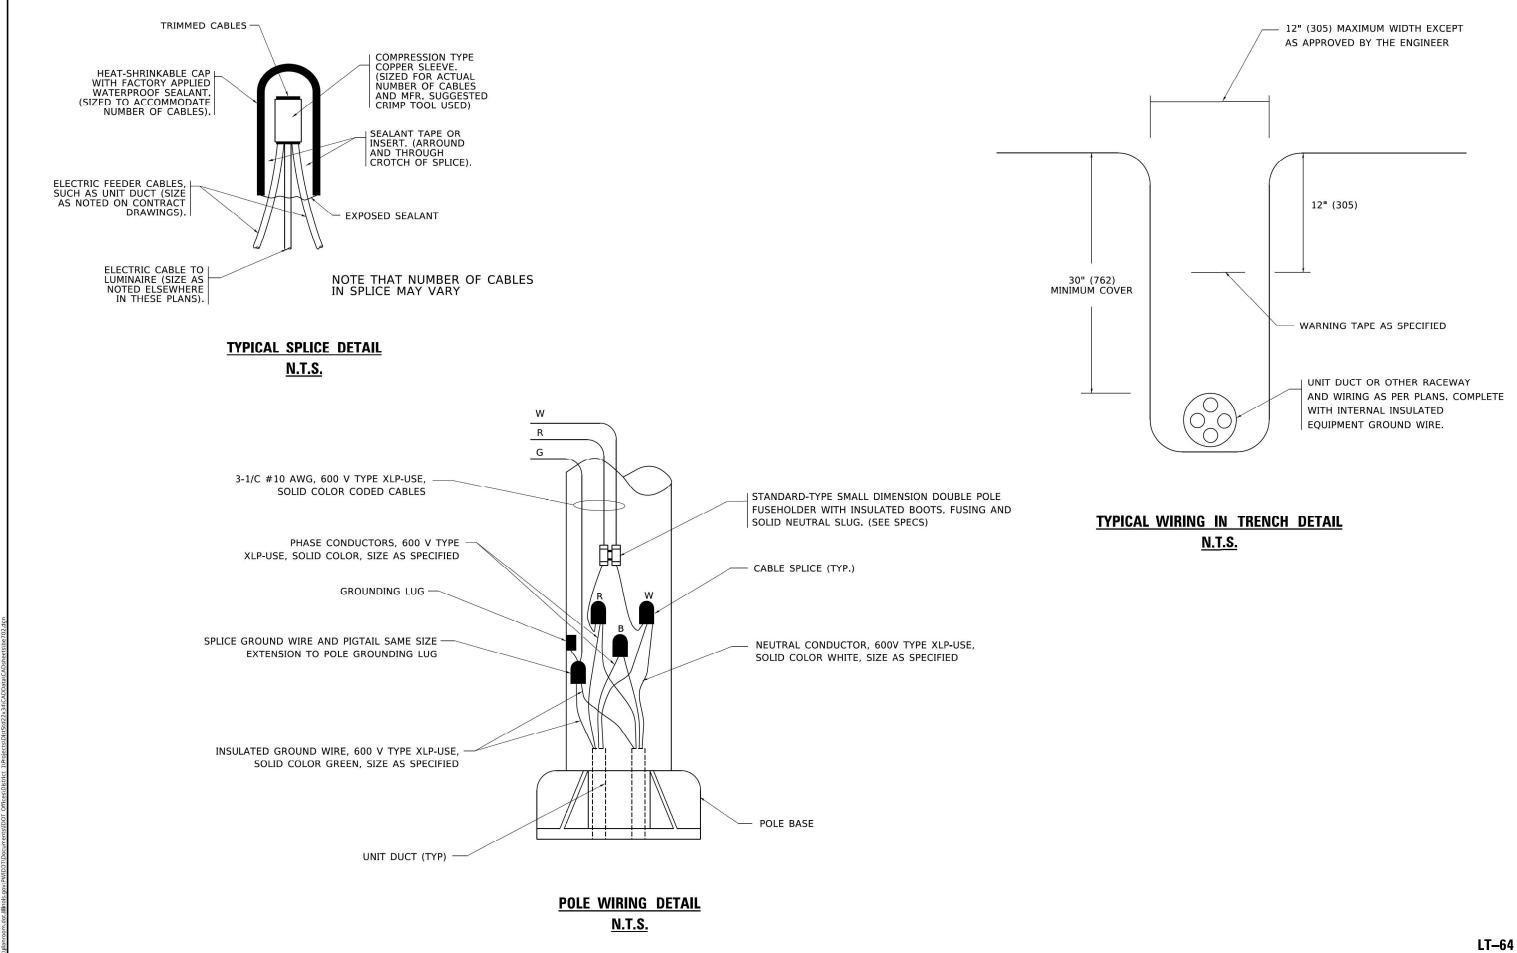

1170 SOUTH HOUBOLT ROAD
JOUET, ILLINOIS 60431
STRAND
(815) 744-4200
ASSOCIATES*

DE

REVISED - 02/04/2020

REVISED -

REVISED -

REVISED -

STATE OF ILLINOIS
DEPARTMENT OF TRANSPORTATION

MISC. ELECTRICAL DETAILS
SHEET A

SHEET 1 OF 1 SHEETS STA.


TO STA

SCALE: NONE

F.A.P. SECTION COUNTY TOTAL SHEETS NO.


342 (531) BR 23 COOK 1211 594

BE-702 CONTRACT NO. 62W38

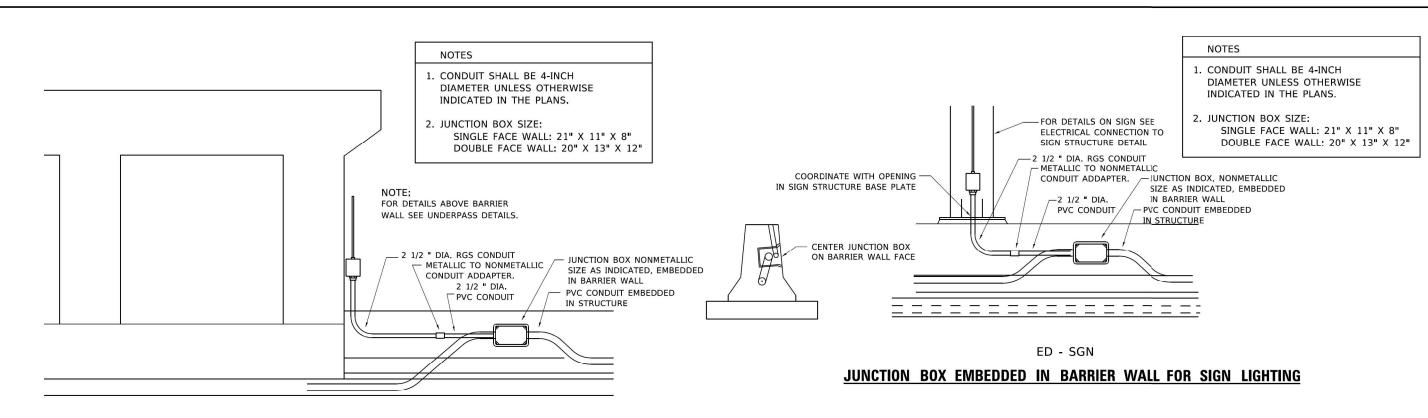


ED - BWD

ELECTRIC CONNECTION TO UNDERPASS LIGHTING

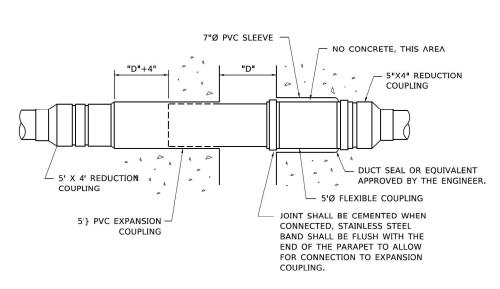

INSTALLATION OF CONDUIT IN BRIDGE PARAPET EXPANSION JOINT

(N.T.S.)

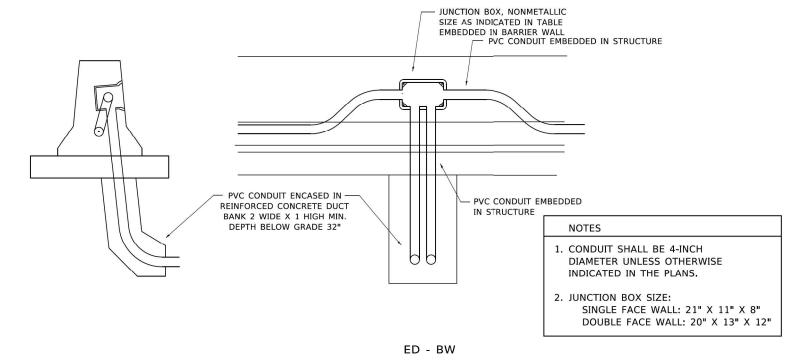

JUNCTION BOX EMBEDDED IN BARRIER WALL

LT-65

1170 SOUTH HOUBOLT ROAD JOUET, ILLINOIS 60431 STRAND (815) 744-4200

 USER NAME
 = footemj
 DESIGNED
 REVISED

 DRAWN
 REVISED

 PLOT SCALE
 = 50.0000 ' / h.
 CHECKED
 REVISED

 PLOT DATE
 = 4/19/2019
 DATE
 01-20-2009
 REVISED

STATE OF ILLINOIS
DEPARTMENT OF TRANSPORTATION


MISCELLANEOUS ELECTRICAL DETAILS, SHEET B


J BOX EMBEDDED IN BARRIER WALL – INSTALLATION OF CONDUIT IN BRIDGE
PARAPET EXPANSION JOINT – ELECTRIC CONNECTION TO UNDERPASS LIGHTING

CALE: NONE SHEET 1 OF 1 SHEETS STA. TO STA.

P. SECTION COUNTY TOTAL SHEE'S NO. 2 (531) BR 23 COOK 1211 595

| BE-703 | CONTRACT NO. 62W38 | CONTRACT NO. 62W38

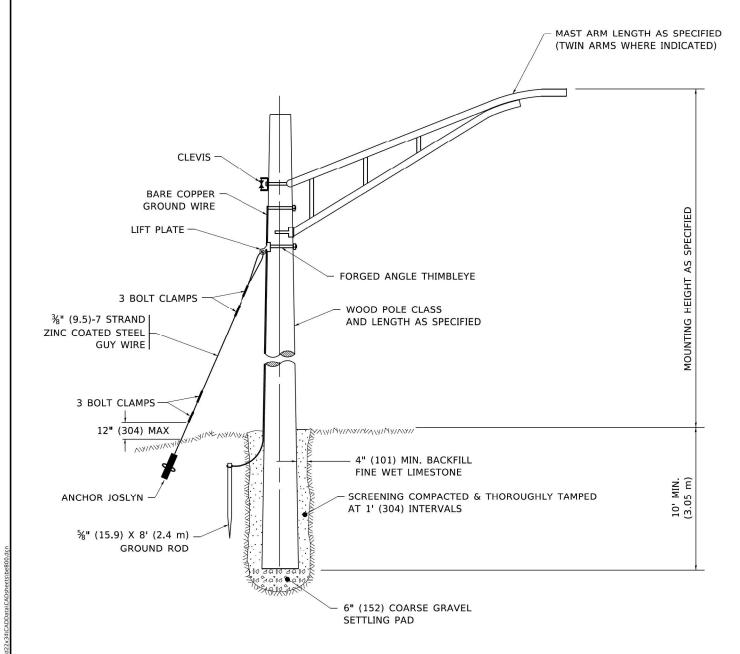

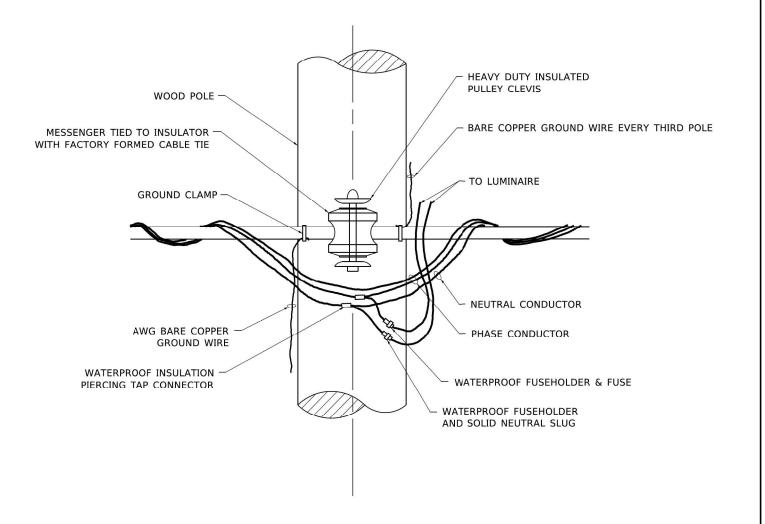

TEMPORARY LIGHT POLE DETAIL

TEMPORARY LIGHT POLE ATTACHMENT DETAIL

NOTE:

- 1. ALL DIMENSIONS IN INCHES (MILLIMETERS) UNLESS OTHERWISE INDICATED.
- 2. MAST ARM SHALL BE RATED FOR THE SPECIFIED MOUNTING HEIGHT.

1170 SOUTH HOUBOLT ROAD JOLIET, ILLINOIS 60431

| DESIGNED | REVISED | 08-08-03 | | DRAWN | REVISED | R.T. 07-26-16 | REVISED | R.T. 07-26-16 | REVISED | REVISED | R.T. 07-26-16 | REVISED | REVI

STATE OF ILLINOIS
DEPARTMENT OF TRANSPORTATION

SCALE: NONE

TEMPORARY LIGHT POLE DETAILS

SHEET 1 OF 1 SHEETS STA. TO STA.


| LT-66 | COUNTY | TOTAL SHEETS | NO. | COOK | 1211 | 596 | CONTRACT | NO. 62W38 | CONTRACT | CONTRACT | NO. 62W38 | CONTRACT | CONTR


342

(531) BR 23

BE-800


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AERIAL CABLE ATTACHED TO STRUCTURE

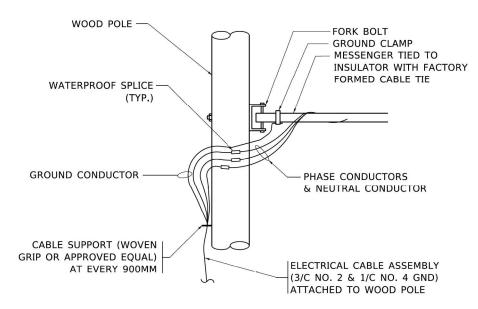NOT TO SCALE

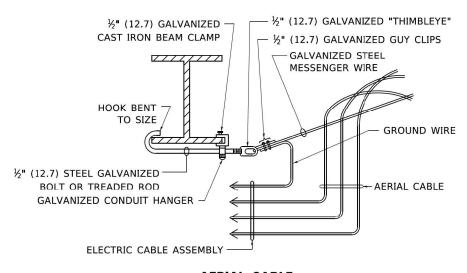

NOTES:

- 1. ALL DIMENSIONS IN INCHES (MILLIMETERS) UNLESS OTHERWISE INDICATED.
- 2. SEE PROPOSED LIGHTING PLAN FOR CONDUIT, CABLE AND ROUTING.
- 3. THE CONTRACTOR SHALL PROVIDE INTERMEDIATE SUPPORTS TO MAINTAIN MINIMUM CLEARANCES. REFER TO AERIAL AERIAL CABLE ATTACHED TO STRUCTURE DETAIL.
- 4. COST OF SPLICES AND MOUNTING HARDWARE SHALL BE INCLUDED IN THE UNIT PRICE FOR AERIAL CABLE.

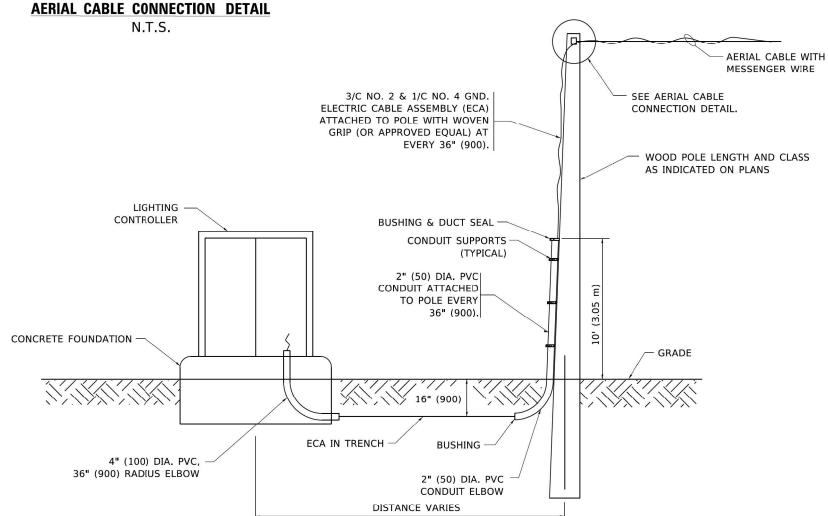WOOD POLE TO LIGHTING CONTROLLER WIRING CONNECTION DETAIL

N.T.S.

1170 SOUTH NO... JOUET, ILLINOIS 60431 (815) 744-4200 1170 SOUTH HOUROLT ROA


REVISED - 08-08-03 DESIGNED -JSER NAME = footemi REVISED -DRAWN -PLOT SCALE = 50.0000 ' / in. CHECKED -REVISED -PLOT DATE = 4/19/2019 DATE REVISED -

STATE OF ILLINOIS **DEPARTMENT OF TRANSPORTATION**

TEMPORARY AERIAL CABLE INSTALLATION SHEET 1 OF 1 SHEETS STA.

SCALE: NONE

LT-67 SECTION COUNTY 1211 597 (531) BR 23 COOK BE-801 CONTRACT NO. 62W38

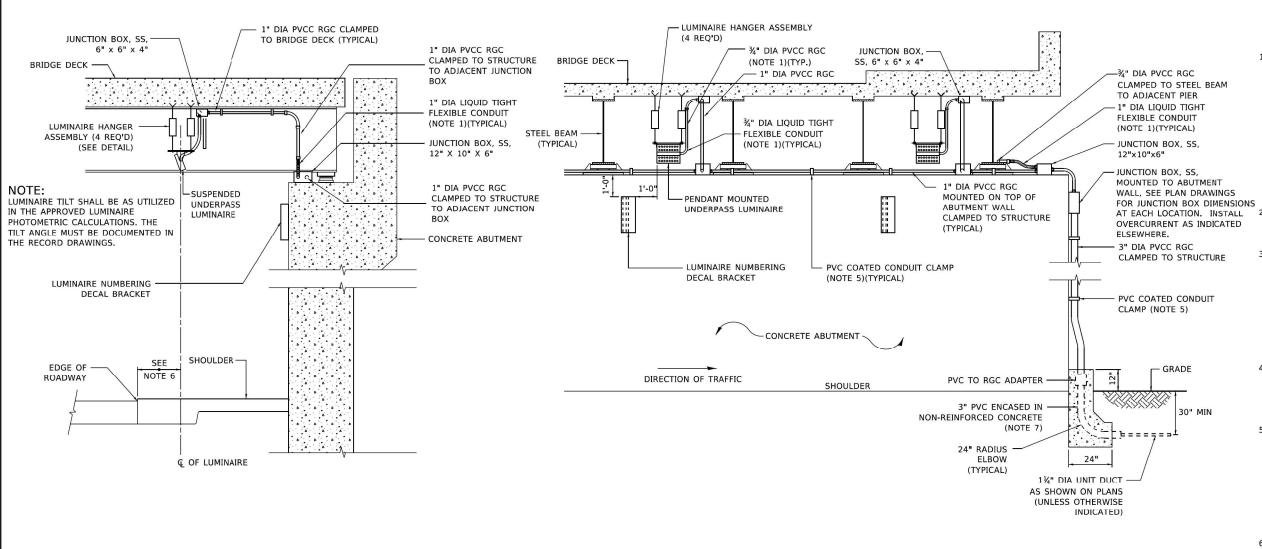

NEW BRIDGE DECK

NEW BRIDGE DECK INSTALLATION

STAINLESS STEEL STUD BOLT

½" DIA THREADED BOTH ENDS

FLAT WASHER (SS)

- LUMINAIRE MOUNTING PLATE

-STEEL SPRING

LENGTH AS REQUIRED (TYPICAL)

NUT. LOCK WASHER &

FLAT WASHER & LOCKNUT (SS)

VIBRATION DAMPER ASSEMBLY

SINGLE COIL, FLARED

LOOP INSERTS CAST

STUD BOLTS (NOTE 4)

NEOPRENE CUSHION-

NUT. LOCK WASHER

& FLAT WASHER (SS)

LOCKNUT, FLAT WASHER.

NEOPRENE WASHER &

CUPPED WASHER (SS)

IN DECK FOR 1/8"

NOTES:

- 1. LIQUID TIGHT FLEXIBLE METAL CONDUIT. MAXIMUM LENGTH 6'-0". TYPICAL FOR EACH INSTANCE AS SHOWN, PROVIDE PVC COATED RIGID GALVANIZED STEEL CONDUIT AS REQUIRED NOT TO EXCEED 6'-0" OF FLEXIBLE LIQUID TIGHT METAL CONDUIT. LIQUID TIGHT FLEXIBLE METAL CONDUIT WILL BE INCLUDED IN THE COST OF THE CONDUIT ATTACHED TO STRUCTURE, OF THE CORRESPONDING DIA., GALVANIZED STEEL, PVC COATED PAY ITEM EXCEPT THAT " DIA. CONDUIT AND " DIA. FLEXIBLE CONDUIT SHALL BE INCLUDED IN THE COST OF UNDERPASS LUMINAIRE INSTALLATION.
- 2. SEE UNDERPASS LIGHTING PLANS FOR INSTALLATION LOCATION OF UNDERPASS LIGHTING LUMINAIRES.
- 3. THE CONTRACTOR SHALL USE APPROVED SINGLE COIL FLARED LOOP INSERTS WHEN SUSPENDED MOUNTING AN UNDERPASS LUMINAIRE TO A NEW BRIDGE DECK. THE FLARED LOOP INSERTS MUST BE CAST INTO THE CONCRETE DECK. THE CONTRACTOR IS RESPONSIBLE FOR LOCATING AND COORDINATING THE INSERT LOCATIONS FOR MOUNTING THE UNDERPASS LIGHTING SYSTEM AS SHOWN ON THE PLANS WITH THE BRIDGE DECK CONTRACTOR. SEE DETAIL.
- 4. THE UNDERPASS LUMINAIRE HANGER ASSEMBLY COMPLETE WITH HEAVY DUTY ANCHORS/INSERTS AND ALL APPLICABLE HARDWARE SHALL BE INCLUDED IN THE COST OF THE UNDERPASS LUMINAIRE PAY ITEM.
- 5. SECURE THE CONDUIT WITH PVC COATED CONDUIT CLAMPS OR CONDUIT BEAM CLAMPS AS SHOWN AT 5'-0" INTERVALS FOR LATERALS AND WITHIN 2'-0" MAXIMUM FROM ANY JUNCTION BOX, FLEXIBLE CONDUIT, OR CHANGE IN DIRECTION. ALL PVC COATED CONDUIT CLAMPS OR BEAM CLAMPS SHALL BE INCLUDED WITH THE COST OF THE "CONDUIT ATTACHED TO STRUCTURE, OF THE CORRESPONDING DIA., GALVANIZED STEEL, PVC COATED" PAY ITEM.
- 6. ALL UNDERPASS LUMINAIRES MUST BE CENTERED IN THE BEAM SPACE AS INDICATED ON THE PLANS UNLESS OTHERWISE DIRECTED BY THE ENGR. LUMINAIRE SETBACK SHALL BE AS INDICATED IN PLANS FOR EACH SPECIFIC UNDERPASS
- 7. THE CONCRETE ENCASED CONDUIT TRANSITION SHALL BE INCLUDED IN THE COST OF THE GALVANIZED RIGID STEEL CONDUIT PAY ITEMS.
- 8. ALL CONDUIT ATTACHED TO STRUCTURE SHALL BE PVC COATED RIGID STEEL CONDUIT (PVCC RGC) TYPICAL.
- 9. IN NO INSTANCE SHALL ANY UNDERPASS LUMINAIRE OR ANY OTHER ELECTRICAL EQUIPMENT BE INSTALLED BELOW THE ELEVATION OF THE BOTTOM OF THE BRIDGE BEAM WHEN OVER ANY PAVEMENT (ROADWAY OR SHOULDER).

LUMINAIRE NUMBERING DECAL BRACKET

HEXAGON HEAD

ANCHOR AS APPROVED

ALUMINUM BUSHING

ALUMINUM BRACKET

BOLT 1/4" DIA

(3-REOUIRED)

BY ENGINEER

½" LONG

TOP VIEW

SCALE: NONE

NOT TO SCALE



2" L_{1" (TYP!CAL)}

ELEVATION

PVC COATED **CONDUIT CLAMP** NOT TO SCALE

PVC COATED CONDUIT BEAM CLAMP NOT TO SCALE

1170 SOUTH HUGGE.
JOLIET, ILLINOIS 60431
(915) 744-4200 1170 SOUTH HOUROLT ROA

EXPANSION ANCHOR, -HEAVY DUTY AS APPROVED BY THE ENGINEER

NEOPRENE CUSHION

NUT, LOCK WASHER — & FLAT WASHER (SS)

LOCKNUT, FLAT WASHER, NEOPRENE WASHER & CUPPED WASHER (SS)

-EXISTING BRIDGE DECK

EXISTING BRIDGE DECK INSTALLATION

STAINLESS STEEL STUD BOLT 1/2" DIA THREADED BOTH ENDS LENGTH AS REQUIRED (TYPICAL

-NUT, LOCK WASHER & FLAT WASHER (SS)

- LUMINAIRE MOUNTING PLATE

-STEEL SPRING

FLAT WASHER & LOCKNUT (SS)

VIBRATION DAMPER ASSEMBLY

REVISED - 12-12-05 JSER NAME = gaglianobt DESIGNED -DRAWN REVISED -OT SCALE = 100.0000 ' / in. HECKED REVISED PLOT DATE = 1/15/2020 DATE REVISED -


TYPICAL LUMINAIRE HANGER ASSEMBLY DETAILS

STATE OF ILLINOIS

SUSPENDED MOUNT LED UNDERPASS **LUMINAIRE INSTALLATION DETAILS** SHEET 1 OF 1 SHEETS STA.

LT-68 SECTION COUNTY 1211 598 BE-901 CONTRACT NO. 62W38


DEPARTMENT OF TRANSPORTATION

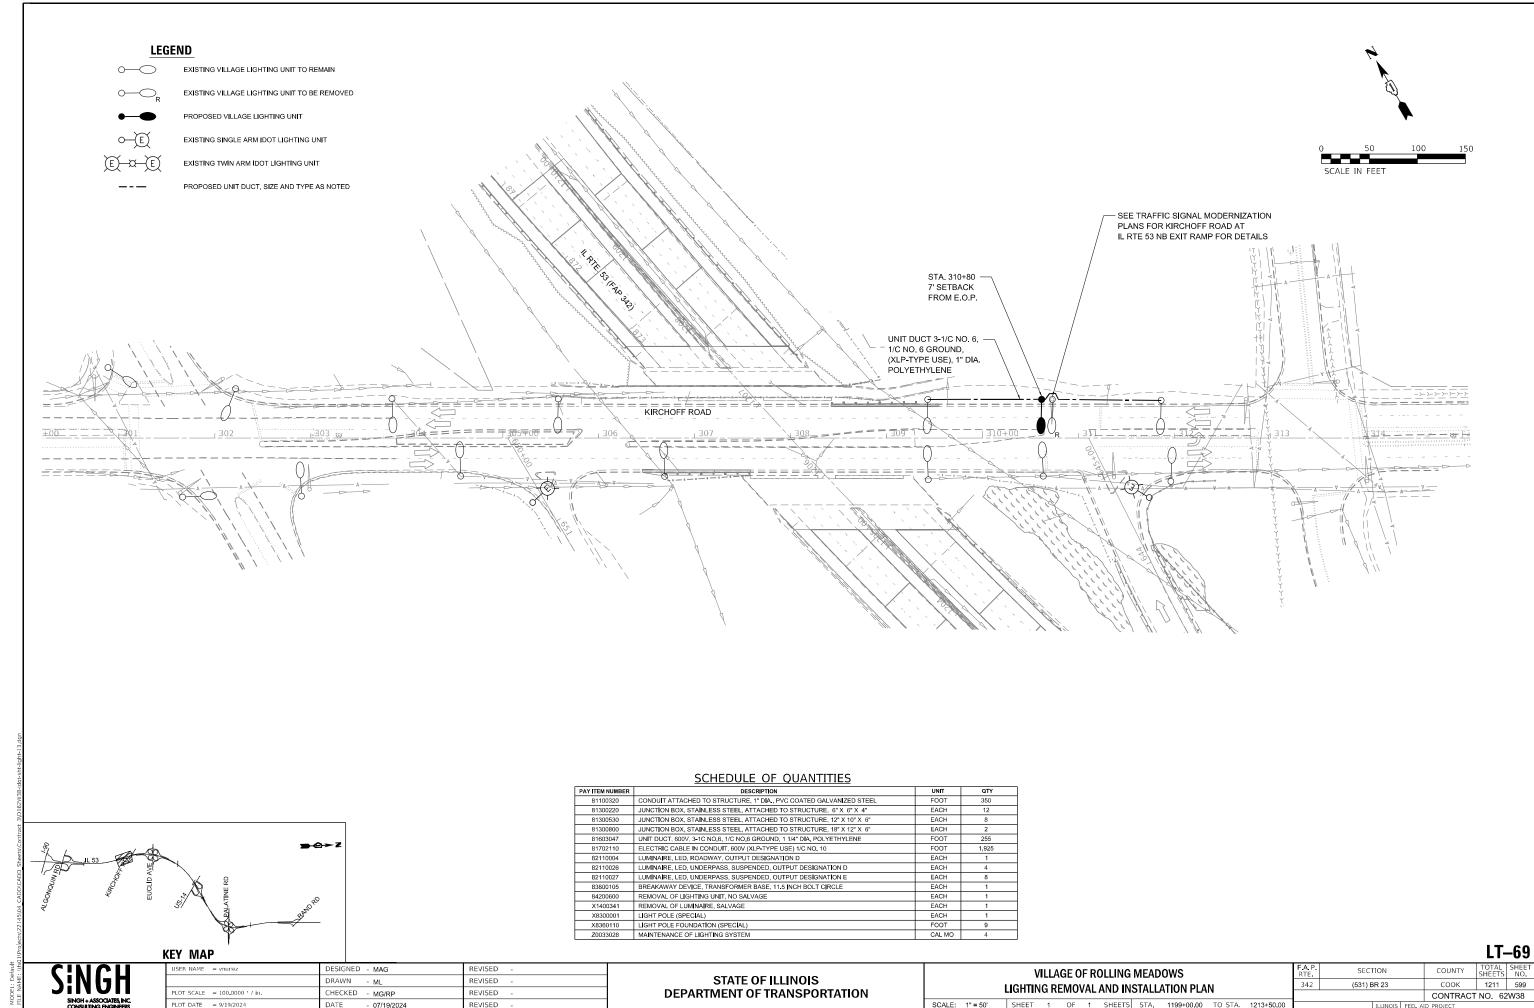

REVISED

DATE

- 07/19/2024

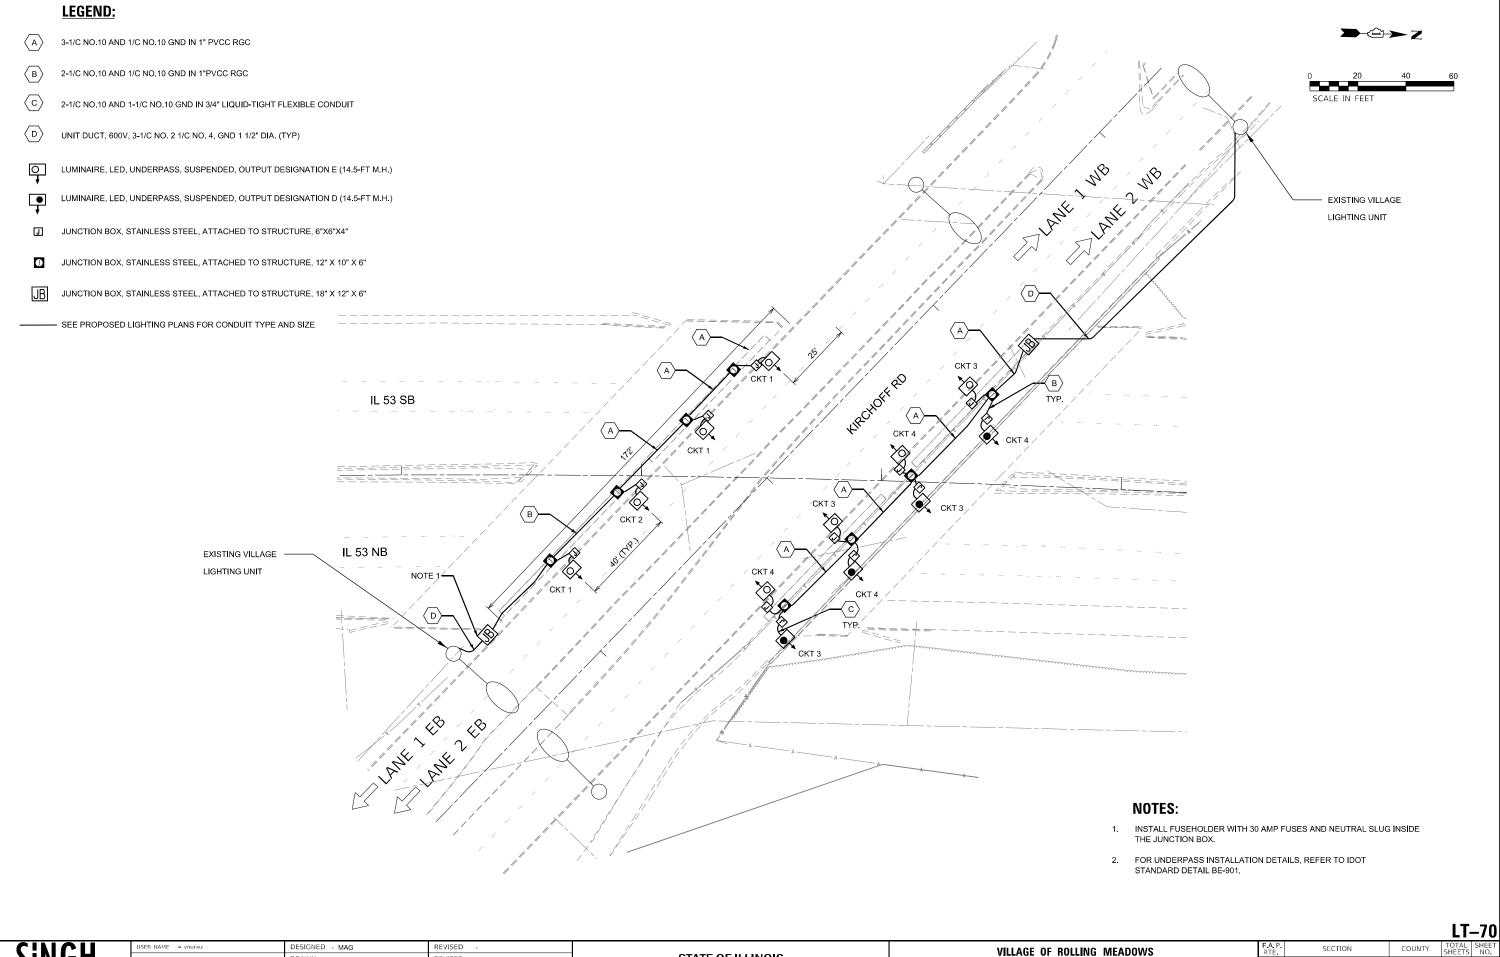

SINGH ASSOCIATES, IN CONSULTING ENGINEER

DRAWN - ML REVISED PLOT SCALE = 40,0000 / in. CHECKED - MG/RP REVISED PLOT DATE = 9/16/2024 DATE - 07/19/2024 REVISED -

STATE OF ILLINOIS
DEPARTMENT OF TRANSPORTATION

VILLAGE OF ROLLING MEADOWS

IL ROUTE 53 AT KIRCHOFF UNDERPASS LIGHTING PLAN

SHEET 1 OF 2 SHEETS STA. TO STA.