STATE OF ILLINOIS DEPARTMENT OF TRANSPORTATION

PROPOSED

HIGHWAY PLANS

FAU ROUTE 2503: IL 25 / 5th AVENUE NORTH OF IL 64 (at 404 N. 5th AVE.)

SECTION: 2024-988-I RETAINING WALL REPAIRS AND SIDEWALK RECONSTRUCTION KANE COUNTY

C-91-296-24

FOR INDEX OF SHEETS, SEE SHEET NO. 2

THIS PROJECT IS LOCATED IN THE CITY

SECTION 27 TOWNSHIP ST. CHARLES

OF ST. CHARLES

0

DESIGN DESIGNATION:

IL RTE 25

ADT (2021) = 8,150 vpd

POSTED SPEED LIMIT = 30 MPH

RAMP POSTED SPEED LIMIT = 30 MPH

FUNCTIONAL CLASSIFICATION: MINOR ARTERIAL

EXISTING IL 25 OVER
ABANDONED UPRR
SN 045-0061

SN 045-0061

SN 045-0061

FULL SIZE PLANS HAVE BEEN PREPARED USING STANDARD
ENGINEERING SCALES. REDUCED SIZED PLANS WILL NOT
CONFORM TO STANDARD SCALES. IN MAKING MEASUREMENTS
ON REDUCED PLANS, THE ABOVE SCALES MAY BE USED.

JULLIE.
JOINT UTILITY LOCATION INFORMATION FOR EXCAVATORS
1-800-892-0123
OR 811

R 8E, 3RD P.M.

DELNOR
WOODS PARK

PUTTOR AVE

PARE AVE

LOCATION MAP

NOT TO SCALE

TOTAL LENGTH = 214 FT. = 0.04 MILE

MUHAMMAD MUHAMMAD MUHAMMAD ARIF MUHAMMAD ARIF No. 062-056451 Expires: 11/30/2025 Date: 8/8/2024 For Sheets:

END IMPROVEMENT

BEGIN IMPROVEMENT

STA 11+22

STA 9+08



Nadir Shah, S.E. No. 081-005469 Expires: 11/30/2024 Date: 8/8/2024


DELT. 111 W JA CHICAG T 312.377 F 312.427

DELTA ENGINEERING GROUP, LLC 111 W JACKSON BLVD., SUITE 910 CHICAGO, IL 60604 T 312.377.7700

* 48 + 1 = 49 TOTAL SHEETS

D-91-234-24



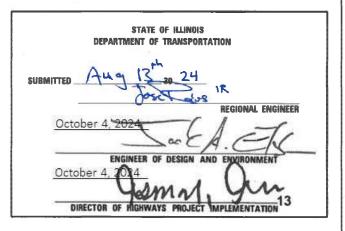

PRINTED BY THE AUTHORITY OF THE STATE OF ILLINOIS

PROJECT MANAGER: VESELIN VELICHKOV, P.E.

INDEX OF SHEETS:

SHEET NO.

1	COVER SHEET
2	INDEX OF SHEETS/INDEX OF STATE STANDARDS
3	GENERAL NOTES
4- 5	SUMMARY OF QUANTITIES
6- 7 8	ALIGNMENTS, TIES, AND BENCHMARKS ROADWAY TYPICAL SECTIONS
9	MAINTENANCE OF TRAFFIC - GENERAL NOTES
10	MAINTENANCE OF TRAFFIC - PLAN
11	REMOVAL AND PROPOSED ROADWAY PLAN
12	EROSION CONTROL AND LANDSCAPING PLAN
12 24	STRUCTURAL PLANS
13- 34	ST CHARLES IL-25 - RETAINING WALL REPAIRS
35- 44	EXISTING RETAINING WALL PLANS (FOR INFORMATION ONLY)
4.5	IDOT DISTRICT 1 STANDARDS
45	TC-10: TRAFFIC CONTROL AND PROTECTION FOR SIDE ROADS , INTERSECTIONS, AND DRIVEWAYS
46	TC-11: TYPICAL APPLICATIONS RAISED REFLECTIVE PAVEMENT MARKERS
70	(SNOW-PLOW RESISTANT)
47	TC-13: DISTRICT ONE TYPICAL PAVEMENT MARKINGS
48	TC-22: ARTERIAL ROAD INFORMATION SIGN
48A	TC-26: DRIVEWAY ENTRANCE SIGNING

SHEET TITLE

IDOT HIGHWAY STANDARDS:

STD. NO.	STANDARD TITLE
000001-08	STANDARD SYMBOLS, ABBREVIATIONS AND PATTERNS
280001-07	TEMPORARY EROSION CONTROL SYSTEMS
601001-05	PIPE UNDERDRAINS
606001-08	CONCRETE CURB TYPE B AND COMBINATION CONCRETE CURB AND GUTTER
664001-02	CHAIN LINK FENCE
701001-02	OFF-RD OPERATIONS, 2L, 2W, MORE THAN 15' (4.5 M) AWAY
701006-05	OFF-RD OPERATIONS, 2L, 2W, 15' (4.5 M) TO 24" (600 MM) FROM PAVEMENT EDGE
701011-04	OFF-RD MOVING OPERATIONS, 2L, 2W, DAY ONLY
701301-04	LANE CLOSURE, 2L, 2W, SHORT TIME OPERATIONS
701311-03	LANE CLOSURE, 2L, 2W, MOVING OPERATIONS - DAY ONLY
701501-06	URBAN LANE CLOSURE, 2L, 2W, UNDIVIDED
701502-09	URBAN LANE CLOSURE, 2L, 2W, BI-DIRECTIONAL LEFT TURN LANE
701801-06	SIDEWALK, CORNER OR CROSSWALK CLOSURE
701901-09	TRAFFIC CONTROL DEVICES
704001-08	TEMPORARY CONCRETE BARRIER
725001-01	OBJECT AND TERMINAL MARKERS
780001-05	TYPICAL PAVEMENT MARKINGS
782006-01	GUARDRAIL AND BARRIER WALL REFELCTOR MOUNTING DETAILS

SCALE: N/A

	F.A.S. RTE	SECTION	COUNTY	TOTAL SHEETS		
DISTRICT 1 STANDARDS	106	2024-988-I	KANE	48	2	
			CONTRACT	NO. 62	2X13	
SHEET 01 OF 01 SHEETS STA. N/A TO STA. N/A		ILLINOIS FED.	AID PROJECT			

GENERAL NOTES:

- I. ALL CONSTRUCTION SHALL BE DONE IN ACCORDANCE WITH THE "STANDARD SPECIFICATIONS FOR ROAD AND BRIDGE CONSTRUCTION", ADOPTED JANUARY 1, 2022; THE "SUPPLEMENTAL SPECIFICATIONS AND RECURRING SPECIAL PROVISIONS", ADOPTED JANUARY 1, 2025; THE LATEST EDITION OF THE "ILLINOIS MANUAL ON UNIFORM TRAFFIC CONTROL DEVICES FOR STREETS AND HIGHWAYS" (IMUTCD); THE "STANDARD SPECIFICATIONS FOR TRAFFIC CONTROL ITEMS" (SSTCI); THE DETAILS IN THE PLANS AND THE "SPECIAL PROVISIONS" INCLUDED IN THE CONTRACT DOCUMENTS.
- 2. THE CONTRACTOR SHALL BE MADE AWARE THAT ALL CONSTRUCTION VEHICLES SHALL BE LIMITED TO 15 FEET ABOVE EXISTING GRADE WHILE CROSSING UNDER COMMONWEALTH EDISON'S TRANSMISSION LINES.
- THE CONTRACTOR SHALL MAINTAIN ALL ROADWAYS OPEN TO TRAFFIC AS SHOWN ON THE MAINTENANCE OF TRAFFIC PLANS.
- 4. PRIOR TO STARTING ANY EXCAVATION OR ANY OTHER CONSTRUCTION ACTIVITIES, THE CONTRACTOR SHALL CALL J.U.L.I.E. AT (800) 892-0123 FOR FIELD LOCATIONS OF BURIED ELECTRIC, TELEPHONE, CABLE, AND GAS FACILITIES (48 HOURS NOTIFICATION IS REQUIRED). CONTACT THE APPLICABLE MUNICIPALITY FOR SEWER AND WATER LOCATIONS.

IT SHALL BE THE CONTRACTOR'S RESPONSIBILITY TO NOTIFY IDOT AND/OR APPLICABLE MUNICIPALITY AT LEAST 10 DAYS IN ADVANCE OF ANY CONSTRUCTION NEAR IDOT OR MUNICIPALITY OWNED ELECTRICAL, COMMUNICATIONS, OR TRAFFIC CONTROL CABLES. IDOT AND/OR APPLICABLE MUNICIPALITY ELECTRICIANS WILL LOCATE ANY POSSIBLE INTERFERING CABLES.

NOTE: IDOT FACILITIES ARE NOT LOCATED BY JULIE OR DIGGER. IDOT ELECTRICAL FACILITIES INCLUDING ROADWAY LIGHTING, FIBER OPTIC, ITS EQUIPMENT, TRAFFIC SIGNAL AND PUMP STATION FACILITIES ARE LOCATED BY THE DEPARTMENT'S ELECTRICAL MAINTENANCE CONTRACTOR. AS OF THE LETTING DATE, CONTACT THE MEADE ELECTRIC COMPANY AT 773-287-7672

IF THE CONTRACTOR CUTS OR DAMAGES ANY CABLES, EITHER THROUGH CARELESSNESS OR FAILURE TO FOLLOW THE ABOVE PROCEDURE, HE SHALL THEN BE HELD RESPONSIBLE FOR THE REPAIRING OF ALL DAMAGES AT HIS EXPENSE, TO THE SATISFACTION OF THE AGENCY.

- ANY ITEM NOT CALLED FOR REMOVAL AND DAMAGED BY THE CONTRACTOR DURING CONSTRUCTION
 WILL BE REPLACED BY THE CONTRACTOR AT HIS EXPENSE WITH NO ADDITIONAL COST TO THE
 DEPARTMENT.
- 6. THE LOCATIONS OF EXISTING DRAINAGE STRUCTURES AND STORM LINES ARE APPROXIMATE, AND THE PLANS DO NOT GUARANTEE THEIR ACCURACY. THEIR EXACT HORIZONTAL AND VERTICAL LOCATIONS ARE TO BE DETERMINED IN THE FIELD BY THE CONTRACTOR AT HIS OWN EXPENSE.
- 7. ANY EXISTING OR PROPOSED STORM SEWER DAMAGED BY THE CONTRACTOR DURING CONSTRUCTION SHALL BE REPLACED TO THE SATISFACTION OF THE ENGINEER AT THE CONTRACTOR'S EXPENSE.
- 8. THE CONTRACTOR SHALL NOT OPEN OR SHUT ANY WATER VALVES OR FIRE HYDRANTS WITHOUT PRIOR WRITTEN AUTHORIZATION FROM THE OWNING MUNICIPALITY. UNAUTHORIZED USE IS SUBJECT TO ARREST AND PROSECUTION.
- THE CONTRACTOR TO CONTACT THE ROADSIDE DEVELOPMENT UNIT AT (847) 705-4171 AT LEAST 2
 WEEKS PRIOR TO FORESTRY WORK TO IDENTIFY AND MARK TREES TO SAVE WITHIN TREE REMOVAL
 AREAS.
- THE ENGINEER SHALL CONTACT THE IDOT TRAFFIC CONTROL SUPERVISOR AT 847-705-4155 AND THE MUNICIPALITIES A MINIMUM OF 72 HOURS PRIOR TO THE PLACEMENT OF ANY TEMPORARY TRAFFIC CONTROL DEVICES WITHIN IDOT JURISDICTION.
- 11. THE CONTRACTOR SHALL USE CARE IN GRADING OR EXCAVATING NEAR ANY AND ALL EXISTING ITEMS THAT WILL NOT BE REMOVED. ANY DAMAGE DONE TO EXISTING ITEMS BY THE CONTRACTOR SHALL BE REPAIRED OR REPLACED TO THE SATISFICATION OF THE ENGINEER AT THE CONTRACTORS OWN EXPENSE.

- 12. ANY ABANDONED UTILITY OR SEWER ENCOUNTERED DURING CONSTRUCTION OR ANY EXISTING UTILITY OR SEWER ABANDONED AS PART OF THE CONSTRUCTION THAT IS NOT BEING FILLED WITH C.L.S.M., AS PER PLAN, SHALL BE PLUGGED AS DIRECTED BY THE ENGINEER AND ABANDONED IN PLACE. THIS WORK SHALL BE INCLUDED IN THE COST OF THE CONTRACT.
- 13. THE CONTRACTOR SHALL TAKE ALL NECESSARY SAFETY PRECAUTIONS TO PROTECT AND PROVIDE ACCESS TO ABUTTING PROPERTY, UTILITIES, PEDESTRIANS, AND VEHICULAR TRAFFIC.
- 14. NO PAYMENT WILL BE MADE FOR RESTORATION BEYOND THE LIMITS SHOWN ON THE PLANS.
- ANY EXISTING UTILITY ADJUSTMENT AGREEMENTS AND SCHEDULES FOR THE ADJUSTMENT OF UTILITIES, WHICH MAY AFFECT THE WORK, WILL BE MADE AVAILABLE TO THE BIDDERS UPON REQUEST.
- 16. AT THE TIME OF THE PRECONSTRUCTION CONFERENCE, THE CONTRACTOR SHALL SUBMIT FOR APPROVAL, THE PROPOSED CONCRETE TRUCK WASH OUT LOCATIONS, RUNOFF FROM WASH AREAS SHALL BE CONTAINED IN THE DESIGNATED AREAS SO THAT RUNOFF DOES NOT REACH THE STORM SEWER OR DITCH SYSTEMS.
- 17. DURING CONSTRUCTION OPERATIONS THE CONTRACTOR SHALL TAKE NECESSARY PRECAUTIONS TO PROTECT ADJACENT TRAVEL LANES FROM DEBRIS BLOWN OR OTHERWISE REMOVED FROM THE CONSTRUCTION AREAS. THE CONTRACTOR SHALL ALSO BE RESPONSIBLE FOR KEEPING DEBRIS OFF THE TRAVELED LANE SURFACES. THIS WORK SHALL BE INCIDENTAL TO THE CONTRACT.
- 18. THE CONTRACTOR'S OPERATIONS AND TEMPORARY STORAGE ACTIVITIES SHALL BE LIMITED TO THE WORK AREA AND/OR CONSTRUCTION LIMITS. ANY ADDITIONAL STAGING AREAS ADJACENT TO THE PROJECT ARE SUBJECT TO THE APPROVAL BY THE APPROPRIATE AGENCY.
- 19. THE CONTRACTOR IS REQUIRED TO OBTAIN ALL NECESSARY PERMITS AND WRITTEN AUTHORIZATION FROM ALL GOVERNING AGENCIES FOR CONSTRUCTION ABOVE, ADJACENT TO AND ON ROADWAYS UNDER THEIR JURISDICTION.
- 20. FULL DEPTH SAW CUTS WILL BE REQUIRED FOR ALL REMOVAL ITEMS. SAW CUTTING WILL NOT BE MEASURED FOR PAYMENT SEPERATELY, BUT SHALL BE INCLUDED IN THE COST OF THE WORK PERFORMED.
- 21. AT ANY TIME WHEN, IN THE JUDGEMENT OF THE ENGINEER, THE CONTRACTOR HAS OBSTRUCTED OR CLOSED A ROAD OR IS CARRYING ON OPERATIONS CAUSING GREATER INTERFERENCE OR INCONVENIENCE THAN NECESSARY FOR THE PROPER PROSECUTION OF THE WORK, THE ENGINEER MAY REQUIRE THE CONTRACTOR TO FINISH THE SECTION OF THE WORK WHICH IS IN PROGRESS BEFORE WORK IS STARTED ON ANY ADDITIONAL SECTION AND, IN ADDITION THERETO, MAY REQUIRE THE CONTRACTOR TO TAKE ANY OTHER ACTIONS WHICH WILL MINIMIZE INCONVENIENCE TO VEHICULAR AND PEDESTRIAN TRAFFIC.
- 22. PLEASE CONTACT THE ROADSIDE DEVELOPMENT UNIT AT (847) 705-4171 AT LEAST 72 HOURS IN ADVANCE OF BOTH TREE CLEARING WORK AND WEED CONTROL WORK.
- 23. THE DEPARTMENT HAS NOT OBTAINED ANY PERMITS FOR OFFSITE BORROW, WASTE, USE (BWU) AREAS, PRIOR TO WORKING IN BWU AREAS, IF THE CONTRACTOR CHOOSES TO USE ACTIVITIES REQUIRING PERMITS IT IS THE CONTRACTOR'S RESPONSIBILITY TO SECURE THE PROPER PERMITS. IN ADDITION TO THE BORROW REVIEW (BDE 2289) and USE/WASTE REVIEW (BDE 2290) SUBMITTALS, THE CONTRACTOR SHALL SUBMIT AN EROSION AND SEDIMENT CONTROL (ESC) PLAN FOR EVERY BWU SITE TO THE DEPARTMENT FOR ACCEPTANCE, GUIDELINES FOR ACCEPTABLE BWU PRACTICES CAN BE FOUND IN SECTION I.G.1 AND 2 of the SWPPP.
- 24. THE COST OF ALL MATERIALS AND LABOR NECESSARY TO COMPLY WITH THE ABOVE PROVISIONS TO PREPARE AND IMPLEMENT ESC PLANS WILL NOT BE MEASURED FOR PAYMENT SEPARATELY BUT SHALL BE CONSIDERED AS INCLUDED IN THE UNIT BID PRICES OF THE CONTRACT.

SCALE:

IL 25 (404 N 5TH AVENUE) - RETAINING WALL REPAIRS					F.A.S. RTE	SECTION	COUNTY	TOTAL SHEETS	SHEET NO.	
	GENERAL NOTES					106	2024-988-I	KANE	48	3
								CONTRACT	T NO. 62	2X13
	SHEET	OF	SHEETS	STA	TO STA.		TILLIMOIS FED A	ID DROIECT		

				CONSTRUCTION CODE
CODE				URBAN
CODE NO.	ITEM	UNIT	TOTAL	100% STATE
				0044
20100110	TREE REMOVAL (6 TO 15 UNITS DIA)	EACH	7	7
20101200	TREE ROOT PRUNING	EACH	8	8
20100210	TREE REMOVAL (OVER 15 UNITS DIA)	EACH	1	1
21101600	TOPSOIL FURNISH AND PLACE, VARIABLE DEPTH	CU YD	18	18
25000400	NITROGEN FERTILIZER NUTRIENT	POUND	7	7
25000500	PHOSPHOROUS FERTILIZER NUTRIENT	POUND	7	7
25000600	POTASSIUM FERTILIZER NUTRIENT	POUND	7	7
25200110	SODDING, SALT TOLERANT	SQ YD	340	340
28000400	PERIMETER EROSION BARRIER	FOOT	280	280
28000500	INLET AND PIPE PROTECTION	EACH	4	4
28001100	TEMPORARY EROSION CONTROL BLANKET	SQ YD	330	330
31101400	SUBBASE GRANULAR MATERIAL, TYPE B 6"	SQ YD	68	68
42001300	PROTECTIVE COAT	SQ YD	287	287
42400200	PORTLAND CEMENT CONCRETE SIDEWALK 5 INCH	SQ FT	1050	1050
44000500	COMBINATION CURB AND GUTTER REMOVAL	FOOT	214	214

* =	SPECIALTY	ITEM
-----	-----------	------

		1		CONSTRUCTION CO
CODE	ITEM		TOT4 1	URBAN
NO.	I I EIM	UNIT	TOTAL	100% STATE
				0044
44000600	SIDEWALK REMOVAL	SQ FT	1050	1050
50102400	CONCRETE REMOVAL	CU YD	44	44
50200100	STRUCTURE EXCAVATION	CU YD	439	439
50800205	REINFORCEMENT BARS EPOXY COATED	POUND	4921	4921
50901760	PIPE HANDRAIL	FOOT	186	186
52200900	CONCRETE STRUCTURES (RETAINING WALL)	CU YD	46.7	46.7
58600101	GRANULAR BACKFILL FOR STRUCTURES	CU YD	260	260
59100100	GEOCOMPOSITE WALL DRAIN	SQ YD	150	150
33100100	GEOCOM OSTIE WALL DIATIN	30 10		130
60250200	CATCH BASINS TO BE ADJUSTED	EACH	1	1
60605000	COMBINATION CONCRETE CURB AND GUTTER, TYPE B-6.24	FOOT	214	214
67100100	MOBILIZATION	L SUM	1	1
70107025	CHANGEABLE MESSAGE SIGN	CAL DA	360	360
70300150	SHORT TERM PAVEMENT MARK I NG REMOVAL	SQ FT	634	634
70307120	TEMPORARY PAVEMENT MARKING - LINE 4"- TYPE IV TAPE	FOOT	1900	1900
70400100	TEMPORARY CONCRETE BARRIER	FOOT	335	335
70400125	PINNING TEMPORARY CONCRETE BARRIER	EACH	81	81

^{* =} SPECIALTY ITEM

SCALE:

	USER NAME = \$USER\$	DESIGNED -	NS .	REVISED -
١		DRAWN -	NS	REVISED -
İ	PLOT SCALE = \$SCALE\$	CHECKED -	MA	REVISED -
	PLOT DATE = \$DATE\$	DATE -	8/8/2024	REVISED -

IL 25 (4	IL 25 (404 N 5TH AVENUE) - RETAINING WALL REPAIRS						F.A.S. RTE.	SECTION	COUNTY	TOTAL SHEETS	SHEET NO.
,	SUMMARY OF QUANTITIES						106	2024-988-I	KANE	48	4
	COMMANT OF QUANTITIES								CONTRACT	NO. 62	X13
	SHEET OF SHEETS STA. TO STA.							ILLINOIS FED. A	ID PROJECT		

					CONSTRUCTION CODE
	605 F				URBAN
	CODE NO.	ITEM	UNIT	TOTAL	100% STATE
-					0044
	70600260	IMPACT ATTENUATORS, TEMPORARY (FULLY REDIRECTIVE, NARROW), TEST LEVEL 3	EACH	4	4
*	78000200	THERMOPLASTIC PAVEMENT MARKING - LINE 4"	FOOT	160	160
	78300202	PAVEMENT MARKING REMOVAL - WATER BLASTING	SQ FT	53	53
Ī					
Ī	X5220010	TEMPORARY SOIL RETENTION SYSTEM (TO REMAIN IN PLACE)	SQ FT	1570	1570
Ī					
Ì	X0322906	WEEP HOLES CORED	EACH	12	12
İ					
Ì	X2020410	EARTH EXCAVATION (SPECIAL)	CU YD	18	18
İ					
İ	X6700407	ENGINEER'S FIELD OFFICE, TYPE A (D1)	CAL MO	9	9
Ì					
Ì	X7010216	TRAFFIC CONTROL AND PROTECTION (SPECIAL)	L SUM	1	1
Ì		` '	L GOIN		
*	X7830052	RAISED REFLECTIVE PAVEMENT MARKER, REFLECTOR REPLACEMENT	EACH	13	13
İ					
ł	Z0013798	CONSTRUCTION LAYOUT	L SUM	1	1
ł	70030850	TEMPORARY INFORMATION SIGNING	SQ FT	158	158
ł	_555555		54		
ł	2010516	SELECTIVE CLEARING	UNIT	2	2
}	2010310	SEECOTIVE GEE/MING	0111		-
}					
}					
}					
}					

^{* =} SPECIALTY ITEM


)	USER NAME = \$USER\$	DESIGNED -	NS	REVISED -	
Ě		DRAWN -	NS	REVISED -	
	PLOT SCALE = \$SCALE\$	CHECKED -	MA	REVISED -	
	PLOT DATE = \$DATE\$	DATE -	8/8/2024	REVISED -	


SCALE:

IL 25 (404 N 5TH AVENUE) - RETAINING WALL REPAIRS							SECTION
SUMMARY OF QUANTITIES							2024-988-I
	SHEET	OF	SHEETS	STA.	TO STA.		ILLINOIS

COUNTY TOTAL SHEET NO.

KANE 48 5

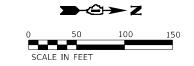

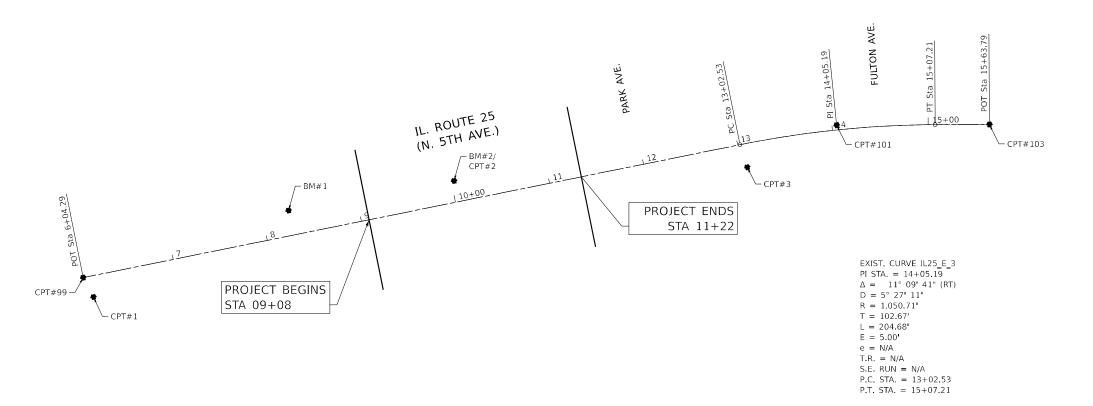


		CONTROL POINTS		
CONTROL POINT#	NORTHING	EASTING	ELEVATION	DESCRIPTION
CPT#99	1912091.959	990808.721	754.47	MAG NAIL CL (SOUTH)
CPT#101	1912876.949	990649.854	748.754	MAG NAIL PI
CPT#103	1913036.190	990649.077	751.17	MAG NAIL CL (NORTH)
CPT#1	1912102.664	990828.858	754.50	"X" IN SIDEWALK
CPT#2	1912478.373	990707.820	747.95	"X" IN SIDEWALK
CPT#3	1912783.873	990693.632	747.83	"X" IN SIDEWALK


ALIGNMENT CO	ORDINATES - IL-25	
STATION	NORTHING	EASTING
06+04.29	1912091.959	990808.721
13+02.53	1912776.324	990670.219
14+05.19	1912876.949	990649.854
15+07.21	1912979.614	990649.353
15+63.79	1913036.190	990649.077
	STATION 06+04.29 13+02.53 14+05.19 15+07.21	06+04.29 1912091.959 13+02.53 1912776.324 14+05.19 1912876.949 15+07.21 1912979.614

BENCHMARK LIST				
BM#	NORTHING	EASTING	ELEV	DESCRIPTION
BM#1	1912305.92	990738.75	755.16	SQUARE CUT IN N END OF BRIDGE WALL NW QUADRANT OF BRIDGE +- 200' S OF BROKEN RETAINING WALL
BM#2	1912478.37	990707.82	747.95	"X" IN SIDEWALK W SIDE IL-25 +- 300' S OF PARK AVE, OPPOSITE OF BROKEN RETAINING WALL.


IL 25 (4	404 N 5TH	AVENU	E) - RET/	AINING W	ALL REPAIRS	F.A.S. RTE	F.A.S. SECTION			COUNTY	TOTAL SHEETS	SHEET NO.
(ALIGNMENT. TIES AND BENCHMARKS							2024-988-I			48	6
	, 12101111	,								CONTRACT	NO. 62	2X13
	SHEET	OF	SHEETS	STA.	TO STA.		ILLINOIS FED. AID PROJECT					

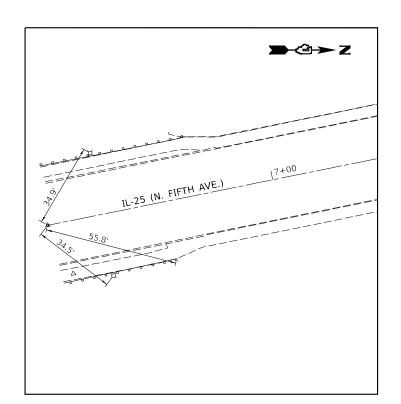


CP T#99 (MAG NAIL CL (SOUTH))
NTS

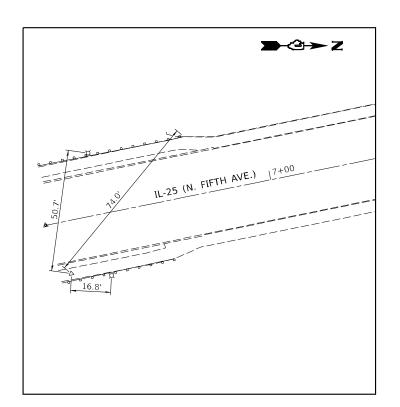


CP T#1 ("X" IN SIDEWALK)
NTS

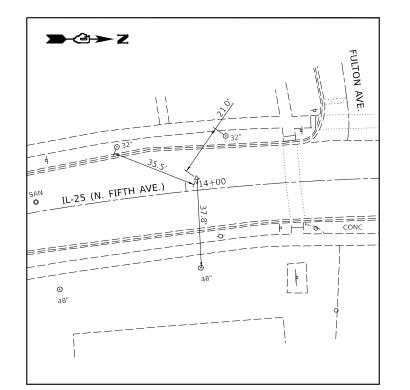


CP T#101 (MAG NAIL PI IL-25) NTS

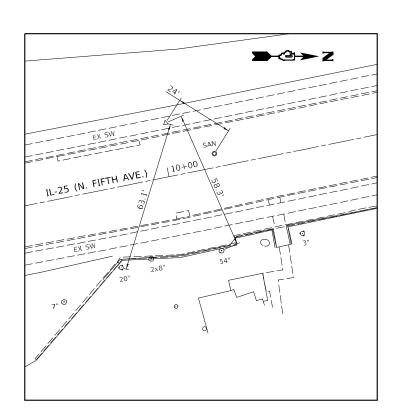

CP T#2 ("X" IN SIDEWALK)
NTS

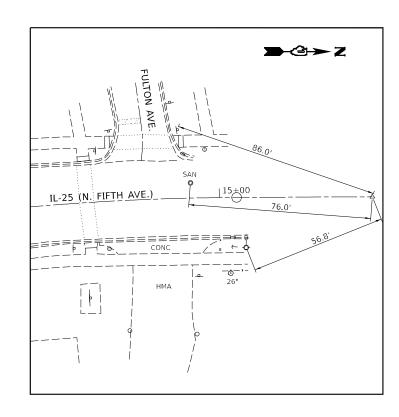

CP T#103 (MAG NAIL CL (NORTH))
NTS

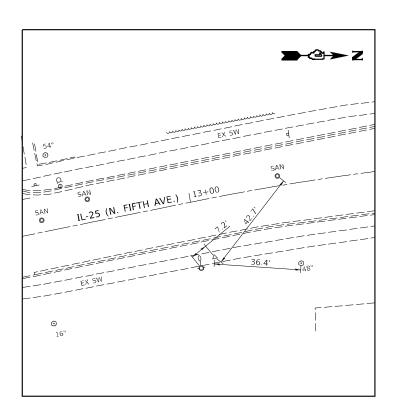


CP T#3 ("X" IN SIDEWALK)
NTS

	DELTA ENGINEERING GROUP, LLC	USER
Δ	CONSULTING ENGINEERS, CONSTRUCTION VANAGERS, SURVEYORS 111 W JACKSON BLVD. SUITE 910	
ρĒG	CHICAGO, IL 60604 T 312.377.7700, F 312.427 6145	PLOT
	1 512.577.7700,1 512.427 0145	PLOT

OUP, LLC	USER NAME = \$USER\$	DESIGNED -	NS	REVISED
FRS, SUÉVEYORS		DRAWN -	NS	REVISED
	PLOT SCALE = \$SCALE\$	CHECKED -	MA	REVISED
	PLOT DATE = \$DATES	DATE -	8/8/2024	REVISED

STATE OF ILLINOIS DEPARTMENT OF TRANSPORTATION

IL 25 (4	404 N 5TH	AVENU	E) - RETA	AINING '	WALL REPAIRS	F.A.S. SECTION			COUNTY	TOTAL SHEETS	
(25 (404 N 5TH AVENUE) - RETAINING WALL REPAIRS ALIGNMENT, TIES AND BENCHMARKS		106	2024-98	KANE	48	7				
	, (210) (111)	,							CONTRAC	T NO. 62	2X13
	SHEET	OF	SHEETS	STA	TO STA		- 1	INOIC FED A	D DROIECT		

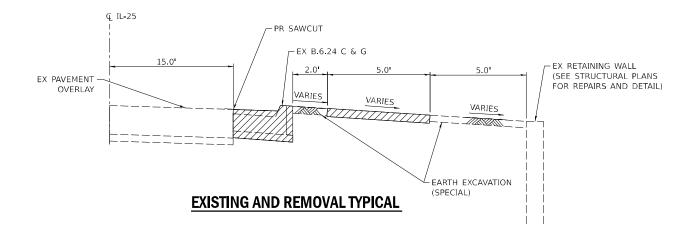


LEGEND



OVERLAY, CURB AND GUTTER AND SIDEWALK REMOVAL

NOTE:

RECONSTRUCTION OF THE SIDE OF THE ROADWAY SEGMENT ALONG THE RETAINING WALL INVOLVES REGRADING THE CROSS SLOPE BETWEEN THE CURB AND THE RETAINING WALL TO PITCH/SLOPE TRANSVERSELY TOWARDS THE ROADWAY TO ELIMINATE THE RUNOFF PONDING ISSUES ALONG THE WALL.

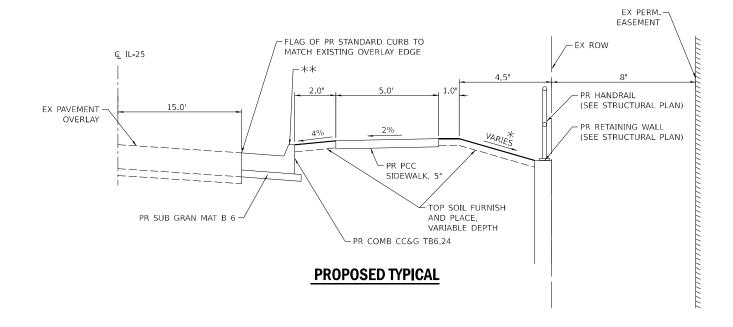

- structure HEIGHT OF EMBANKMENT AND PR SLOPE TO VARY TO PROVIDE 2% AND 4% CROSS SLOPES FOR PROPOSED SIDEWALK AND PARKWAY, RESPECTIVELY TO ACCOMODATE AND MATCH TOP OF STANDARD CURB.
- ** 5' LOGITUDINAL TRANSITION SEGMENT AT BOTH ENDS OF THE PROJECT TO PROVIDE TRANSITION IN STANDARD CURB HEIGHT REDUCED TO MATCH EXISTING TOP OF CURB.

A	
AEA.	

L 25 (404 N 5TH	H AVENU	E) - RET/	AINING	WALL REPAIRS	F.A.S. RTE	SECT	ΠΟN		COUNTY	TOTAL SHEETS	SHEET NO.
(ΓΥΡΙCAL			106	6 2024-988-1			KANE	48	8
		, , , , , , , , , , , , , , , , , , , ,								CONTRACT	NO. 62	2X13
	SHEET	OF	SHEETS	STA.	TO STA.	TILLINOIS LEED, AID PROJECT						

MAINTENANCE OF TRAFFIC CONTROL GENERAL NOTES:

- 1. TRAFFIC CONTROL AND PROTECTION SHALL BE PERFORMED IN ACCORDANCE WITH THE MAINTENANCE OF TRAFFIC NOTES AND PROTECTION SECTION 701 OF THE STANDARD SPECIFICATIONS.
- 2. THE CONTRACTOR SHALL BE RESPONSIBLE FOR THE INSTALLATION AND MAINTENANCE OF ADEQUATE SIGNS, TRAFFIC CONTROL DEVICES AND WARNING DEVICES TO INFORM AND PROTECT THE PUBLIC DURING ALL PHASES OF CONSTRUCTION. BARRICADES AND WARNING SIGNS SHALL BE PROVIDED IN ACCORDANCE WITH ARTICLE 107.14 OF THE IDOT STANDARD SPECIFICATIONS.
- 3. ALL SIGNS SHALL BE IN ACCORDANCE WITH IDOT STANDARD SPECIFICATIONS, LATEST EDITION, AND THE MANUAL ON UNIFORM TRAFFIC CONTROL DEVICES, LATEST EDITION.
- 4. PORTABLE/CHANGEABLE ELECTRONIC MESSAGE BOARDS SHALL BE USED IN ADVANCE OF THE PROJECT ACCORDING TO IDOT STANDARDS AND SHALL BE IN PLACE A MINIMUM OF 72 HOURS PRIOR TO COMMENCING THE WORK AND SHALL REMAIN THROUGHOUT THE ROADWAY CONSTRUCTION WORK. CHANGES IN TRAFFIC STAGING SHALL BE NOTED 2 WEEKS IN ADVANCED WITH MESSAGES AS DIRECTED BY THE ENGINEER.
- 5. THE CONTRACTOR SHALL CONTACT THE DISTRICT ONE ARTERIAL TRAFFIC CONTROL SUPERVISOR, KALPANA-HANNA-HOSADURGA AT KALPANA.KANNAN-HOSADURGA@ILLINOIS.GOV A MINIMUM OF 72 HOURS IN ADVANCE OF BEGINNING WORK.
- ALL "ROAD CONSTRUCTION AHEAD" WARNING SIGNS SHALL BE EQUIPPED WITH HIGH INTENSITY MONO-DIRECTIONAL FLASHING LIGHTS.
- 7. TRAFFIC CONDITIONS, ACCIDENTS AND OTHER UNFORESEEN EMERGENCY CONDITIONS MAY REQUIRE THE ENGINEER TO RESTRICT, MODIFY, OR REMOVE LANE CLOSURES OR CHANNELIZATION SHOWN ON THE PLANS. THE CONTRACTOR SHALL MAKE THE NECESSARY ADJUSTMENTS AS DIRECTED BY THE ENGINEER TO ANY REQUEST MADE BY THE ENGINEER FOR CORRECTION, IMPROVEMENT OR MODIFICATION OF THE MAINTENANCE OF TRAFFIC CONTROL DEVICES.
- 8. ALL TEMPORARY PAVEMENT MARKINGS SHOWN DETERIORATION SHALL BE REPLACED BY THE CONTRACTOR WITHIN 7 DAYS AS DIRECTED BY THE ENGINEER.
- A MINIMUM (ONE) 1 FOOT SHY DISTANCE BETWEEN THE TEMPORARY CONCRETE BARRIER WALL AND THE OUTSIDE EDGE OF THE ADJACENT TEMPORARY PAVEMENT MARKING SHALL BE PROVIDED AT ALL LOCATIONS.
- 10. CONTRACTOR SHALL NOT STORE ANY EXCAVATION MATERIAL OR EQUIPMENT ON EXISTING BRIDGE.
- 11. THE CONTRACTOR SHALL BE REQUIRED TO REMOVE ALL EXISTING PAVEMENT MARKINGS WHICH CONFLICT WITH THE DESIGNATED TRAFFIC CONTROL PLAN. THIS WORK SHALL BE PAID FOR AS PAVEMENT MARKING REMOVAL. WATER BLASTING
- 12. THE ENGINEER SHALL BE INFORMED 48 HOURS IN ADVANCE OF ANY CHANGE TO THE MOT PLANS.
- 13. ALL VEHICLES, EQUIPMENT, WORKERS, AND THEIR ACTIVITIES ARE RESTRICTED AT ALL TIMES TO ONE SIDE OF THE PAVEMENT UNLESS OTHERWISE AUTHORIZED BY THE ENGINEER.

SEQUENCE OF CONSTRUCTION:

CONSTRUCTION IMPROVEMENTS:

CONSTRUCTION TO BE CARRIED OUT FOR THE REPAIR OF COLLAPSED EXISTING WALL AND THE EXISTING ITEMS ALONG THE ROADSIDE OF NORTHBOUND IL 25.

ROOT PRUNING OF EXISTING TREES IN VICINITY OF THE COLLAPSED WALL (AS MARKED ON PLANS).

EXISTING CURB AND GUTTER AND 5' SIDEWALK TO BE REPLACED. PROPOSED FILL/ EMBANKMENT

TO BE CREATED ALONG THE RETAINING WALL WHICH WILL HELP IN CREATING GREEN AREA AND PROPOSED SIDEWALK CROSS SLOPES TO BE PITCHED TOWARDS THE ROADWAY. NOTE UNDER EXISTING CONDITIONS


THE ROADSIDE BETWEEN BACK OF THE CURB AND RETAINING WALL IS PITCHED TOWARDS THE RETAINING WALL.

CONSTRUCTION TRAFFIC CONTROL:

IL 25 IS A TWO LANE ROADWAY ALONG THE PROJECT. UTILIZING IDOT STANDARD 701502, EXISTING NB IL 25 LANE WILL BE SHIFTED TO THE WEST TO CREATE WORK ZONE FOR THE AFOREMENTIONED CONSTRUCTION. BOTH EXISTING LANES WILL BE REDUCED TO 11' IN EACH DIRECTION.

DELTA ENGINEERING GRC CINSULTING PRODUCES CONSTRUCTION MANAGER 111 W JACKSON BLVD, SUTTE 910 CHICAGO, IL 60604 T 312.377.7700, F 312.427 6145

_	USER NAME = \$USER\$	DESIGNED	-	NS	REVISED -
es.		DRAWN	-	NS	REVISED -
	PLOT SCALE = \$SCALE\$	CHECKED	-	MA	REVISED -
	PLOT DATE = \$DATES	DATE	-	9/27/2024	REVISED -

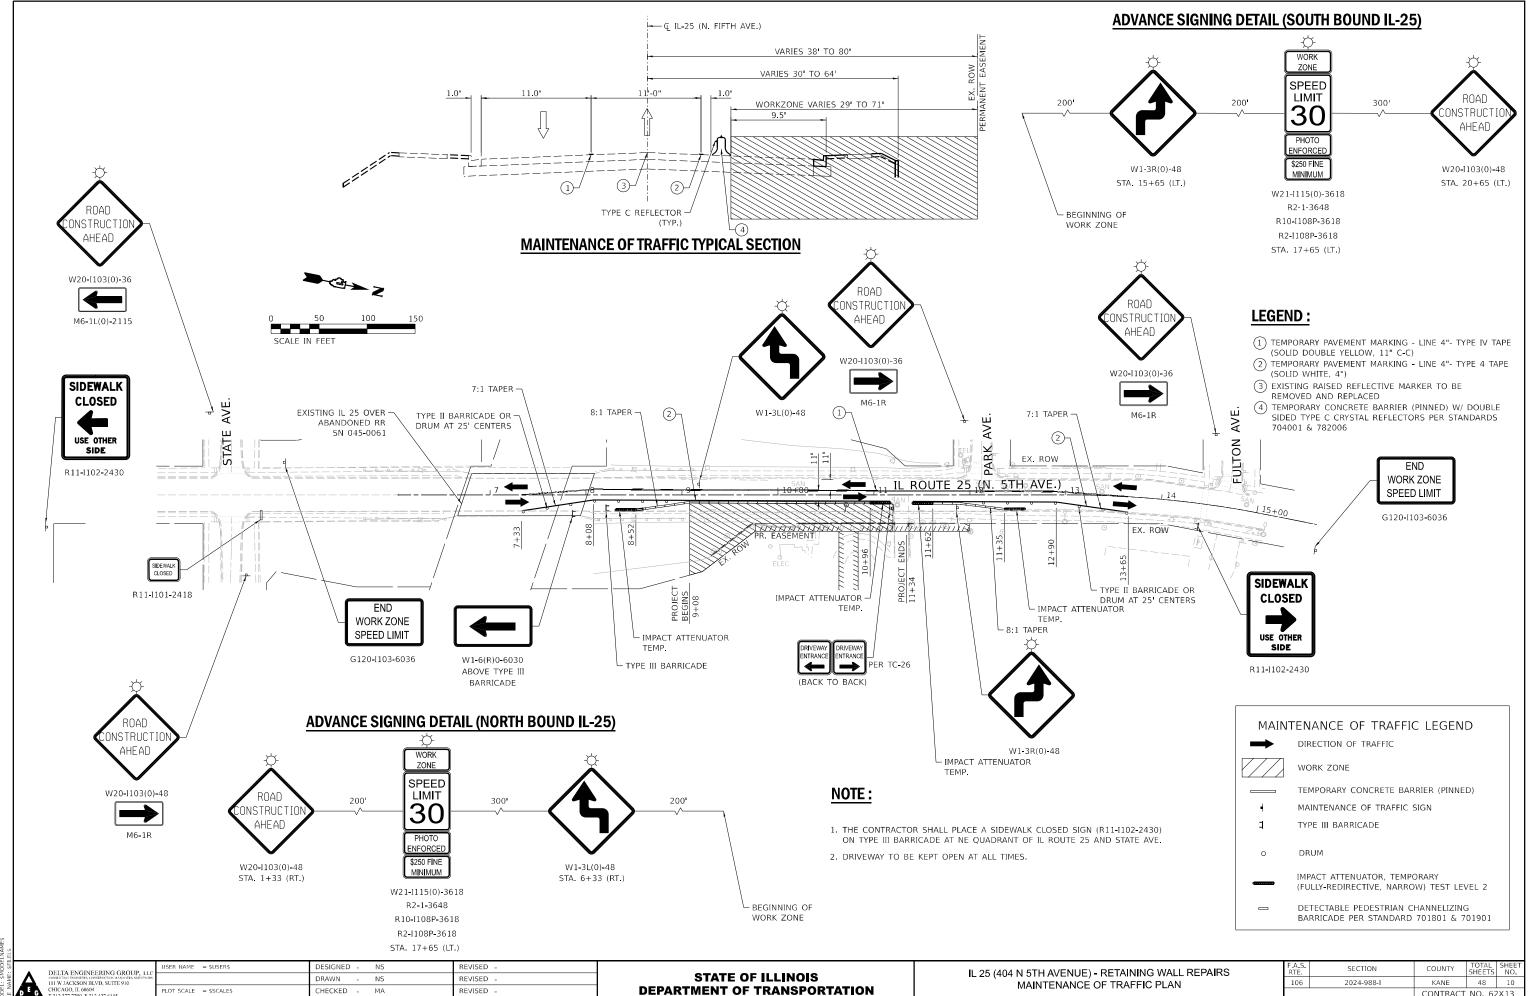


LOT DATE = \$DATES

9/27/2024

REVISED


DEPARTMENT OF TRANSPORTATION

SHEETS STA. TO STA. CONTRACT NO. 62X13

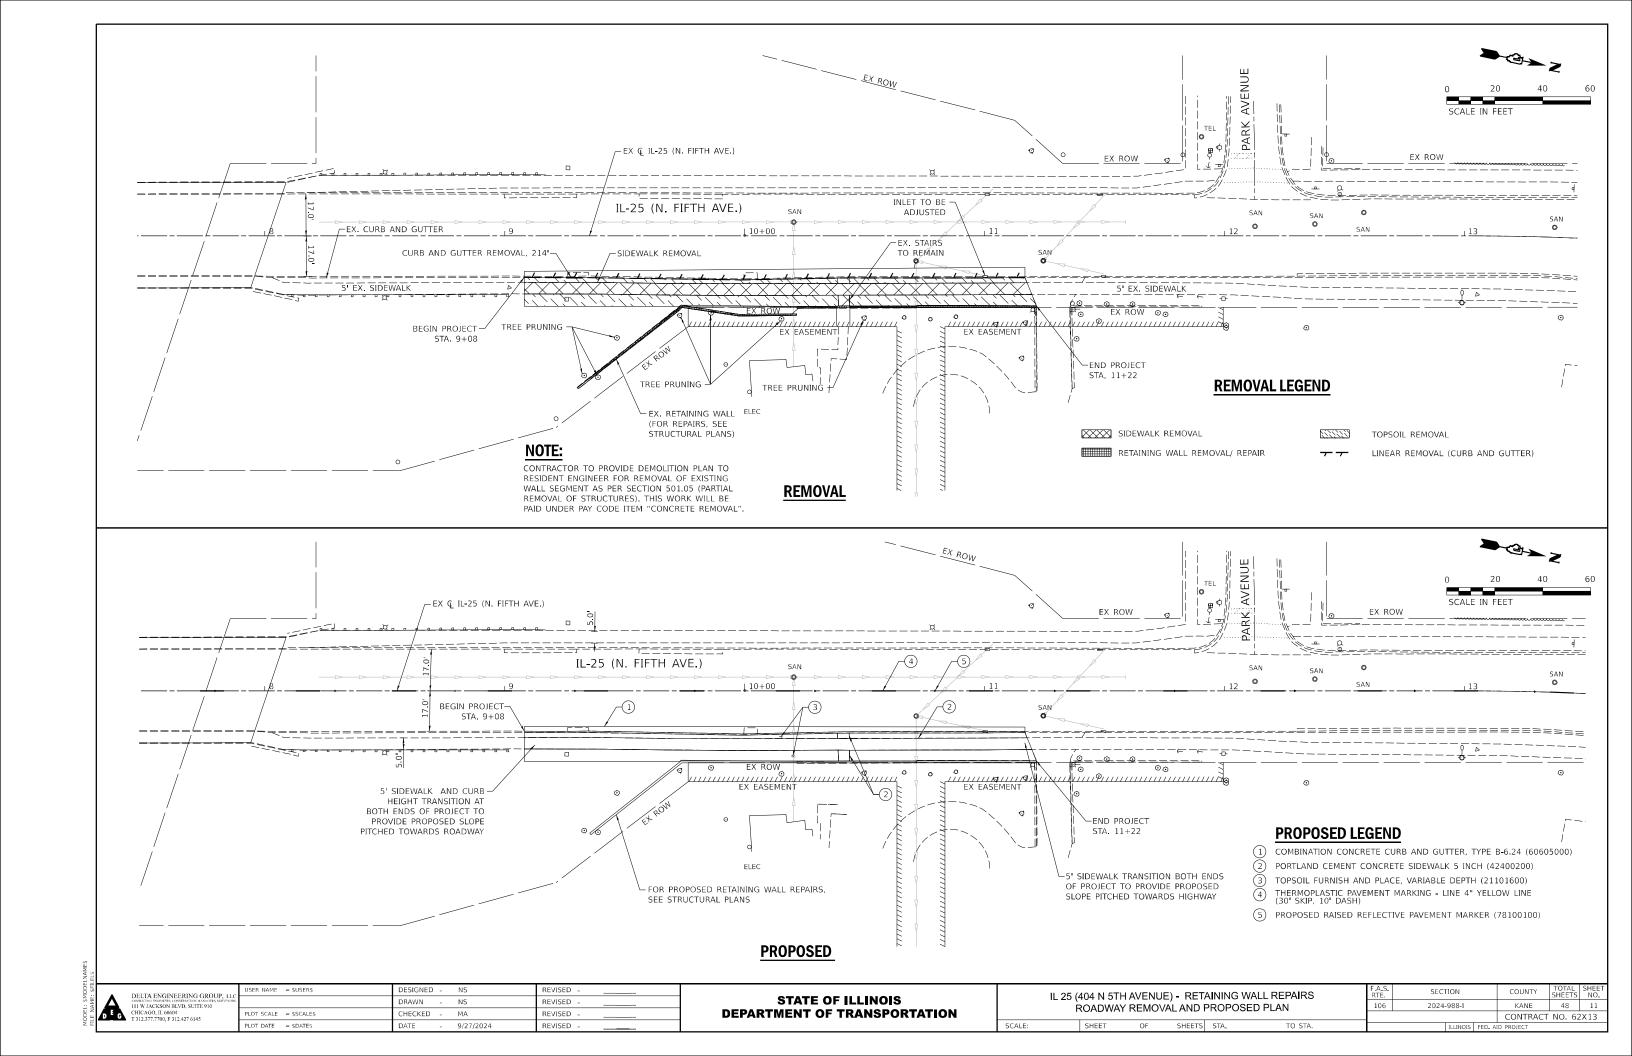

EROSION CONTROL GENERAL NOTES:

- 1. ALL EROSION CONTROL MEASURES WILL BE MAINTAINED IN ACCORDANCE WITH THE IDOT EROSION AND SEDIMENT CONTROL FIELD GUIDE FOR CONSTRUCTION INSPECTION FOUND ON THE CONSTRUCTION TAB AT: HTTP://WWW.IDOT.ILLINOIS.GOV/TRANSPORTATION-SYSTEM/ENVIRONMENT/EROSION-AND-SEDIMENT-CONTROL
- 2. THE CONTRACTOR WILL ASSUME RESPONSIBILITY FOR MAINTENANCE OF ALL SOIL EROSION CONTROL DURING CONSTRUCTION.
- 3. THE CONTRACTOR SHALL CHECK ALL EROSION CONTROL MEASURES WEEKLY AND AFTER EACH RAINFALL, 0.5 INCHES OR GREATER IN A 24-HOUR PERIOD, OR EQUIVALENT SNOWFALL, ADDITIONALLY, DURING WINTER MONTHS, ALL MEASURE SHOULD BE CHECKED BY THE CONTRACTOR AFTER EACH SIGNIFICANT SNOWMELTS.
- 4. ANY LOOSE MATERIAL DEPOSITED IN THE FLOW LINE OF DRAINAGE STRUCTURES, WHICH OBSTRUCTS THE NATURAL FLOW OF WATER, SHALL BE REMOVED AT THE CLOSE OF EACH WORKING DAY, PRIOR TO ACCEPTANCE OF THE IMPROVEMENT ALL DRAINAGE STRUCTURES SHALL BE FREE OF DIRT AND DEBRIS, THIS WORK WILL NOT BE PAID FOR SEPARATELY BUT SHALL BE CONSIDERED INCIDENTAL.
- 5. TEMPORARY OR PERMANENT STABILIZATION SHALL BE INITIATED IMMEDIATELY UPON COMPLETION OF DISTURBANCE OR IF THE WORK AREA IS TO BE LEFT UNDISTURBED FOR 14 DAYS OR MORE.
- 6. UNDER NO CIRCUMSTANCES SHALL THE CONTRACTOR PROLONG FINAL GRADING AND SHAPING SO THAT THE ENTIRE PROJECT CAN BE PERMANENTLY SEEDED AT ONE TIME.
- 7. THE CONTRACTOR IS RESPONSIBLE FOR INSTALLATION OF ANY ADDITIONAL EROSION CONTROL MEASURES NECESSARY TO PREVENT EROSION AND SEDIMENTATION AS DETERMINED BY THE RESIDENT ENGINEER.

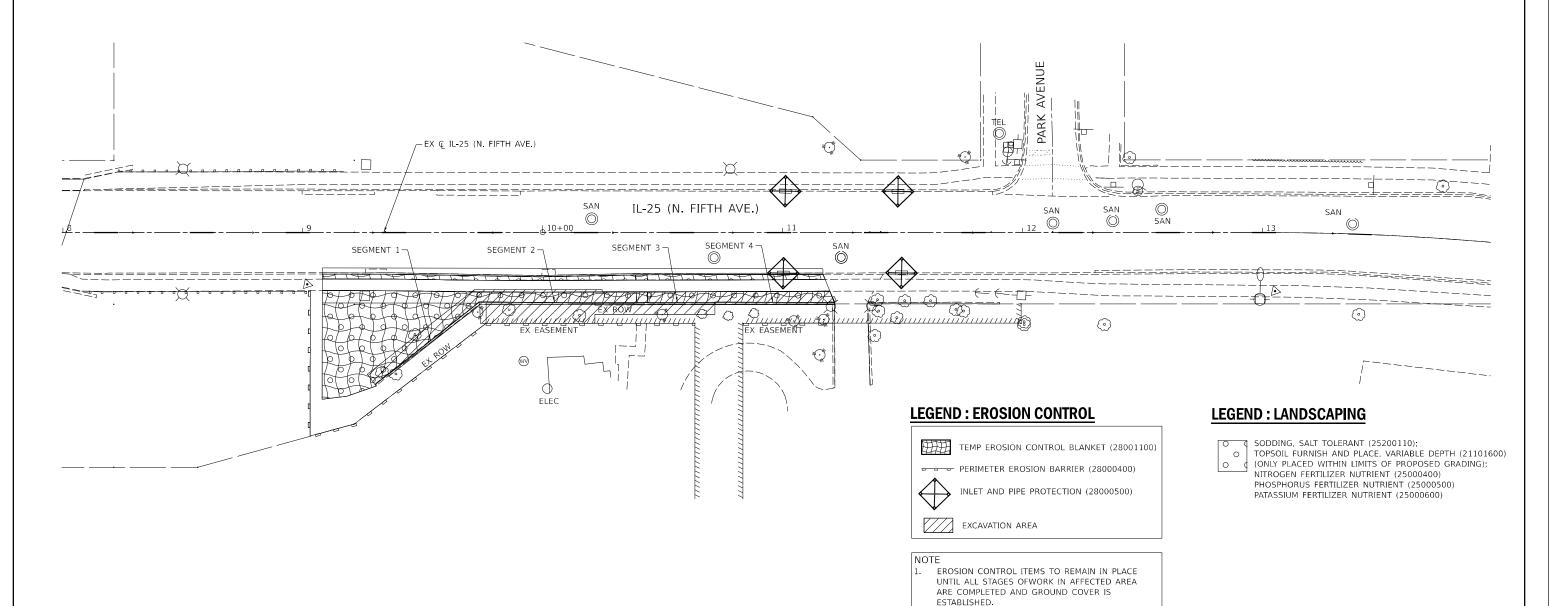

IL 25 (4	404 N 5TH	AVENU	E) - RET	AINING V	VALL REPAIRS	F.A.S. RTE	SEC.	TION	COUNTY	TOTAL SHEETS	SHEET NO.	
	ROSION C		,			106	2024	-988-I	KANE	48	12	
_							CONTR				ACT NO. 62X13	
	SHEET	OF	SHEETS	STA.	TO STA.		TILLINOIS FED. AID PROJECT					

BENCH MARK:

Square cut in N. end of Bridge wall ±200' S. of broken Retaining Wall El. 755.16. "X" in Southwest W. side IL 25 ±300' S. of Park Ave. opposite of broken Retaining Wall El. 747.05,

EXISTING STRUCTURE

DELTA ENGINEERING GROUP, I

OT SCALE = 21.333 ' / in.

I OT DATE = 9/26/2024

11 W JACKSON BLVD, SUITE 910

The retaining wall was constructed in 1968 under F.A.S. Route 106, 39 Ext. R-VB, Section 32-CS and is a cast-in-place concrete T-wall and approximately 272 feet long which is parallel with the IL Route 25 alignment, compromised of 4 segments which are separated by expansion joints. The wall retains the IL Route 25 embankment and the side adjacent to a residential property located at 404 North 5th Avenue, St. Charles, IL 60174. A permanent construction easement of eight (8) feet wide into residential property is noted in the Agreement recorded with Kane County.

DESIGNED -

DRAWN

DATE

HECKED

NS

RM


SMK

9/27/2024

REVISED

REVISED

REVISED

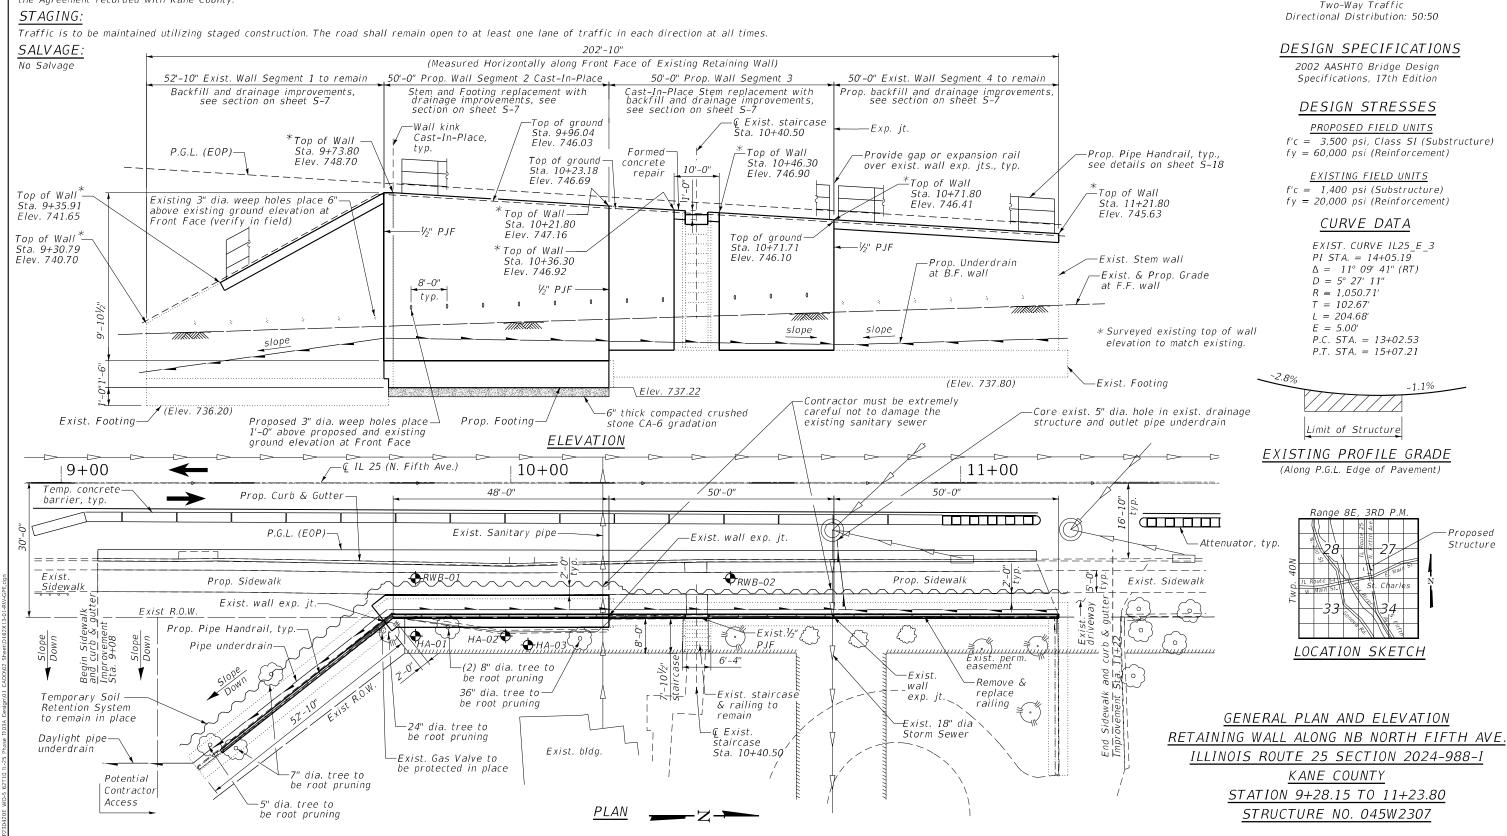

STATE OF ILLINOIS

DEPARTMENT OF TRANSPORTATION

HIGHWAY CLASSIFICATION

North Fifth Avenue Functional Class: Minor Arterial ADT: 8150 (2021); 10,000 (2041)

ADTT: 410 (2021); 503 (2041)

DHV: 815 (2021)

Posted Speed: 30 m.p.h.

Design Speed: 30 m.p.h.

SECTION

2024-988-I

106

IL 25 (NB NORTH 5TH AVE.) - RETAINING WALL REPAIRS

GENERAL PLAN AND ELEVATION

SHEET S-1 OF S-22 SHEETS STA.

COUNTY

KANE

48 13

CONTRACT NO. 62X13

GENERAL NOTES:

- 1. Plan dimension and details relative to existing plans are subject to nominal construction variations. The contractor shall field verify existing dimensions and details affecting new construction and make necessary approved adjustments prior to construction or ordering of materials, such variations shall not be cause for additional Compensation for a change in scope of the work. However, the contractor will be paid for the quantity actually furnished at the unit price bid for the work.
- 2. Drilling and grouting of dowel bars will be in accordance with the Article 584 of Standard Specifications. The cost of this work will not be paid separately but shall be included in the contract unit price per cu. yd. for Concrete Structures (Retaining Wall).
- 3. The contractor shall take care as to not damage footing when erecting the temporary soil retention system.
- 4. The ½" preformed joint filler and sealing compound shall not be paid for separately but shall be included in the contract unit price per cubic yard for Concrete Structures (Retaining Wall).
- 5. Reinforcement bars designated (E) shall be epoxy coated.
- 6. For Structure Excavation details, see sheets S-17.
- 7. The contractor shall exercise extreme caution during construction to make certain that construction activities, live load surcharge, structure excavation, installation of Temporary Soil Retention System and other loads applied will not have detrimental affects on the adjacent Retaining Wall and Roadway. Any damage to the adjacent Retaining Wall and Roadway during construction shall be repaired by the contractor at no additional cost to the Department.
- 8. The removal of the existing portions of the retaining wall shown in the plans shall be included in Concrete Removal.
- 9. For Cored weep hole filter system details, see sheet S-20.
- 10. The Contractor shall exercise extreme caution during construction to avoid any damage to the existing utilities. Any damage to the existing utilities shall be repaired by the Contractor, to the satisfaction of the Engineer, at no additional cost to the Department. The Contractor shall be responsible for maintaining the normal level of sanitary and sewer service to all affected properties and shall be solely liable for any damages that occur as a result of sewer back-ups.
- 11. The Contractor must be extremely careful not to damage the existing sanitary sewer while installing and driving the temporary soil retention system.

 Any damage done to the sanitary sewer lines will be repaired at no additional cost to the Department.

SCOPE OF WORK:

- 1. Install erosion control fence along 8'-0" easement line to prevent construction debris and sediment from entering the private property.
- 2. Install Temporary Soil Retention System on the roadway side for segments 1, 2, 3 and 4 to retain the soil due to traffic live load surcharge.
- 3. Excavate the soil up to the depth shown on the sections for segments 1, 2, 3 and 4 as shown in the cross sections details.
- 4. Demolish the stem wall of segment 2 that has failed. Suggested procedure is to secure the wall segment with a small crane during demolition.
- 5. The stem wall of segment 3 must be removed carefully leaving 10'-0" around the existing staircase as shown in the elevation on sheet S-1.
- 6. The portions of the segment 2 and segment 3 must be removed by saw cutting (where needed) while incorporating the horizontal and vertical reinforcement bars for lap length. Existing reinforcement shall be straightened, cleaned and incorporated into the new portions of the stem and footing.
- 7. Remove 1'-0" concrete from the top of stem wall which will remain in place such as for segment 1, portion of the segment 3 and segment 4. Existing vertical reinforcement shall be straightened, cleaned and incorporated into the new construction as detailed on sheets S-3, S-6, S-7 and S-8.
- 8. Drill and Epoxy Grout vertical and horizontal reinforcement in stem and footing as shown in details on plans and according to Section 584 of the Standard Specifications for segments 2 and 3.
- 9. Reconstruct the removed portions of the Retaining Wall segment 2 and segment 3.
- 10. Cut the Temporary Soil Retention System to 2'-0" below the top finished surface of the backfill and leave it in place.
- 11. Protective Coat shall be applied to all the exposed surfaces of the new stem wall and install Geocomposite Wall Drains prior to backfilling.
- 12. Place and compact the backfill.
- 13. Core and install new weep holes in the existing retaining wall segments 1 and 4.


INDEX OF SHEETS:

S-1	General Plan and Elevation
S-2	General Notes, Index of Sheets and Bill of Materials
S-3	Reinforcement Details (Segment 1)
5-4	Reinforcement Details (Segment 2)
S-5	Reinforcement Details (Segment 3)
5-6	Reinforcement Details (Segment 4)
S-7 to S-8	Sections and Details
S-9	Temporary Soil Retention System Details (Segment 1)
S-10	Temporary Soil Retention System Details (Segment 2)
S-11	Temporary Soil Retention System Details (Segment 3)
S-12	Temporary Soil Retention System Details (Segment 4)
S-13	Concrete Removal (Segment 1)
S-14	Concrete Removal (Segment 2)
S-15	Concrete Removal (Segment 3)
S-16	Concrete Removal (Segment 4)
S-17	Excavation Sections
S-18	Pipe Handrail Details
S-19	Temporary Soil Retention System and Backfill
S-20	Weep Hole Filter System Details
S-21 & S-22	Soil Borings


TOTAL BILL OF MATERIAL


ITEM	UNIT	QUANTITY
Concrete Removal	Cu Yd	44
Concrete Structures (Retaining Wall)	Cu Yd	46.7
Geocomposite Wall Drain	Sq Yd	150
Granular Backfill for Structures	Cu Yd	260
Pipe Handrail	Foot	186
Protective Coat	Sq Yd	103
Reinforcement Bars, Epoxy Coated	Pound	4921
Structure Excavation	Cu Yd	439
Temporary Soil Retention System (To Remain in Place)	Sq Ft	1570
Weep Holes Cored	Each	12

	USER NAME = rmamucod	DESIGNED -	NS	REVISED -
is.		DRAWN -	RM	REVISED -
	PLOT SCALE = 2.000 / in.	CHECKED -	SMK	REVISED -
	PLOT DATE = 9/26/2024	DATE -	9/27/2024	REVISED -

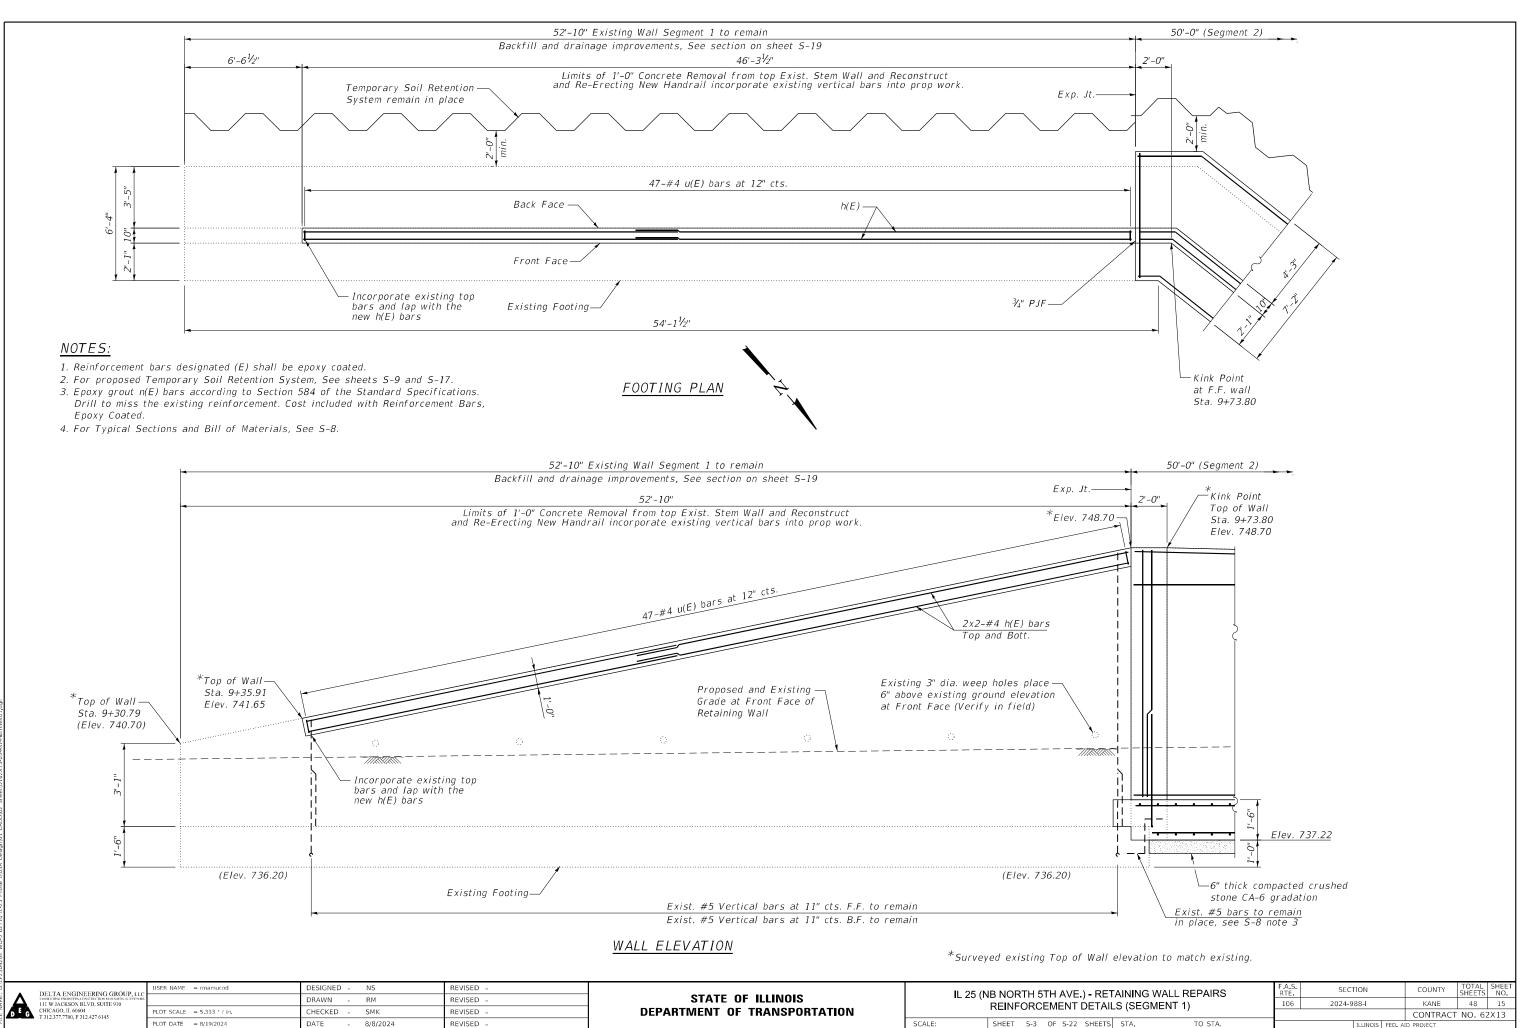

MODEL: \$MODELNAMES

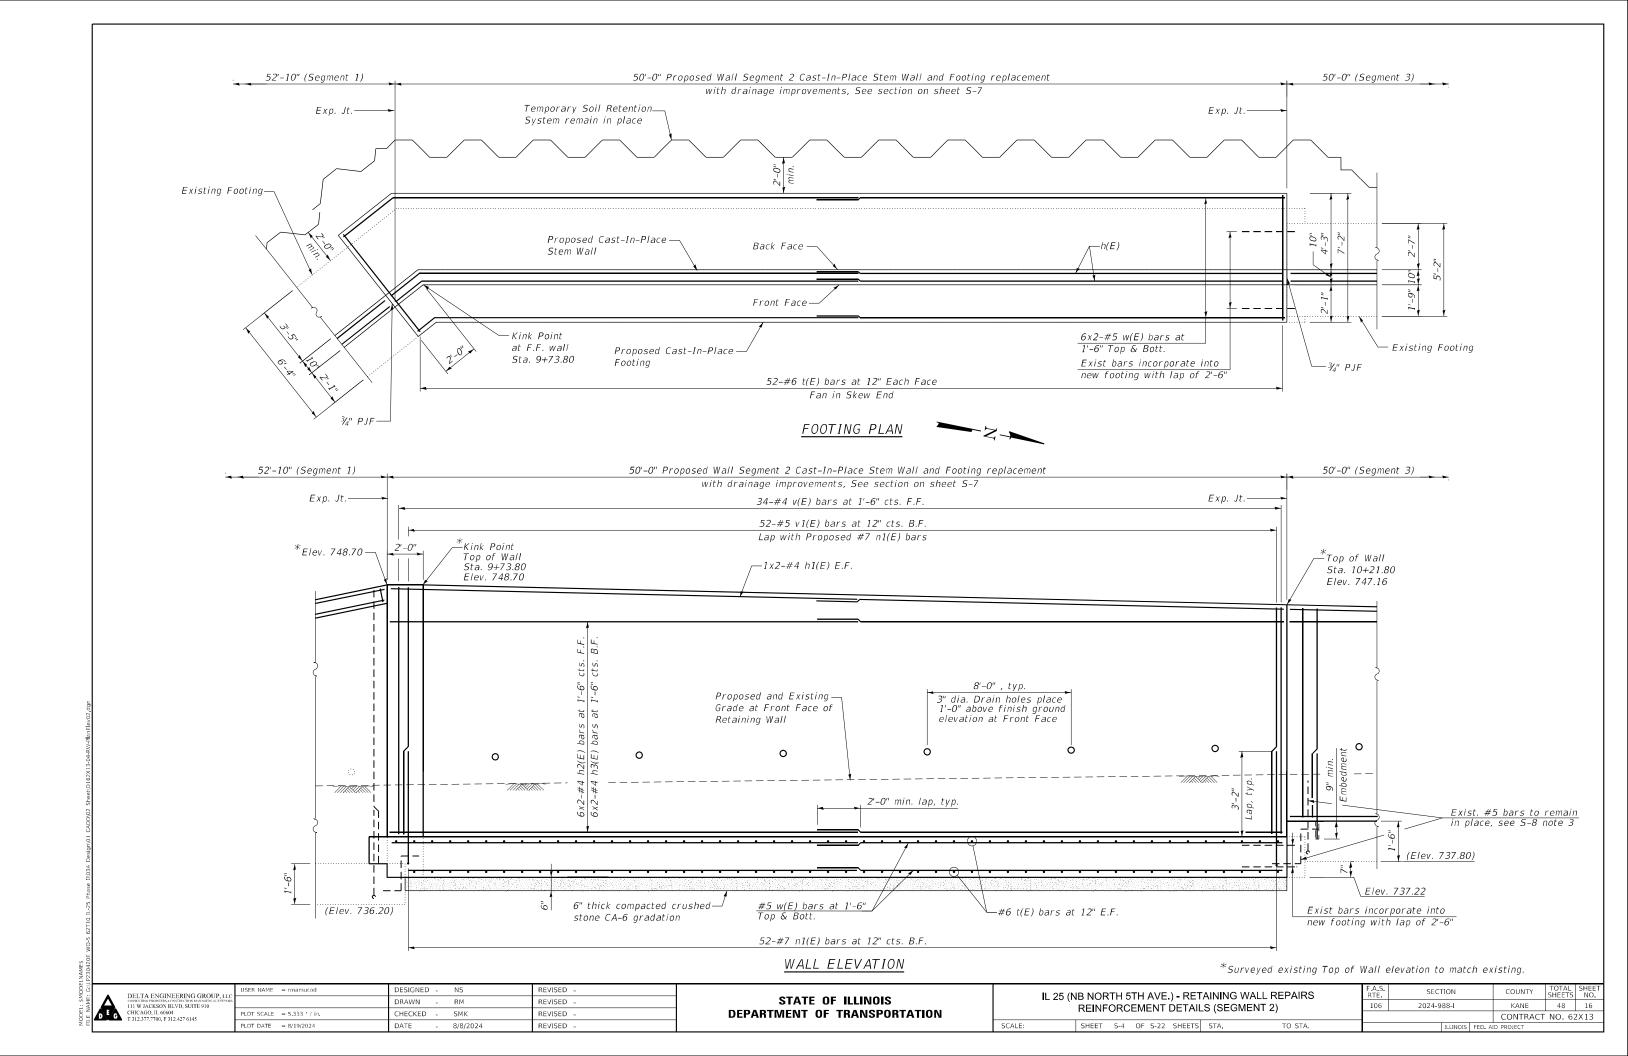


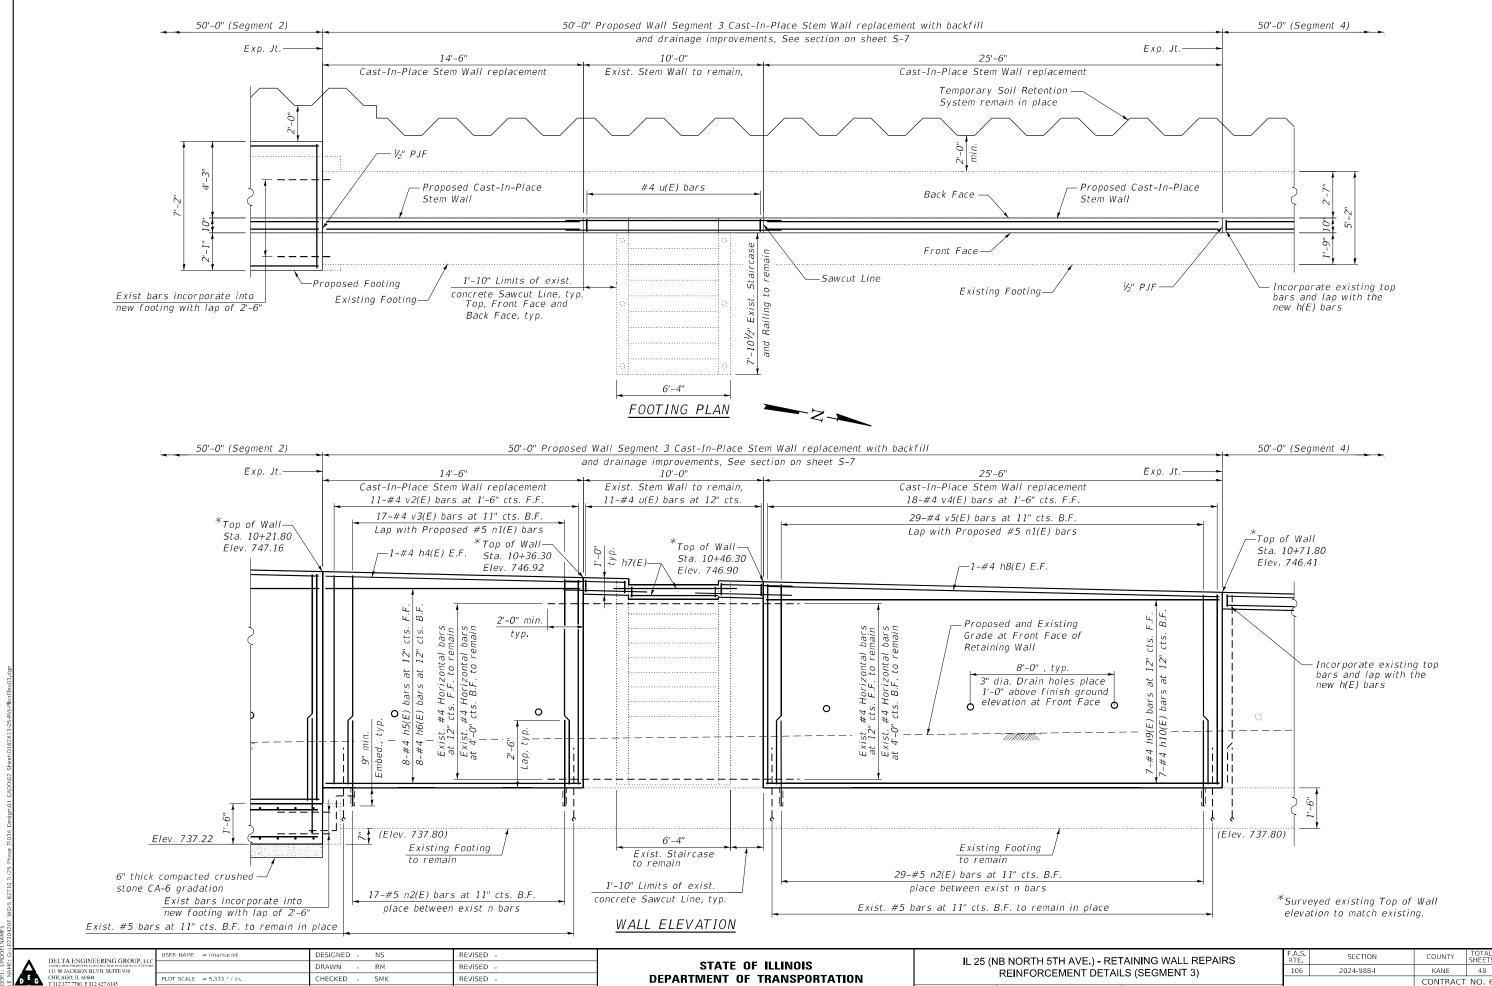

9/27/2024

SHEET S-5 OF S-22 SHEETS STA.

48 17 CONTRACT NO. 62X13

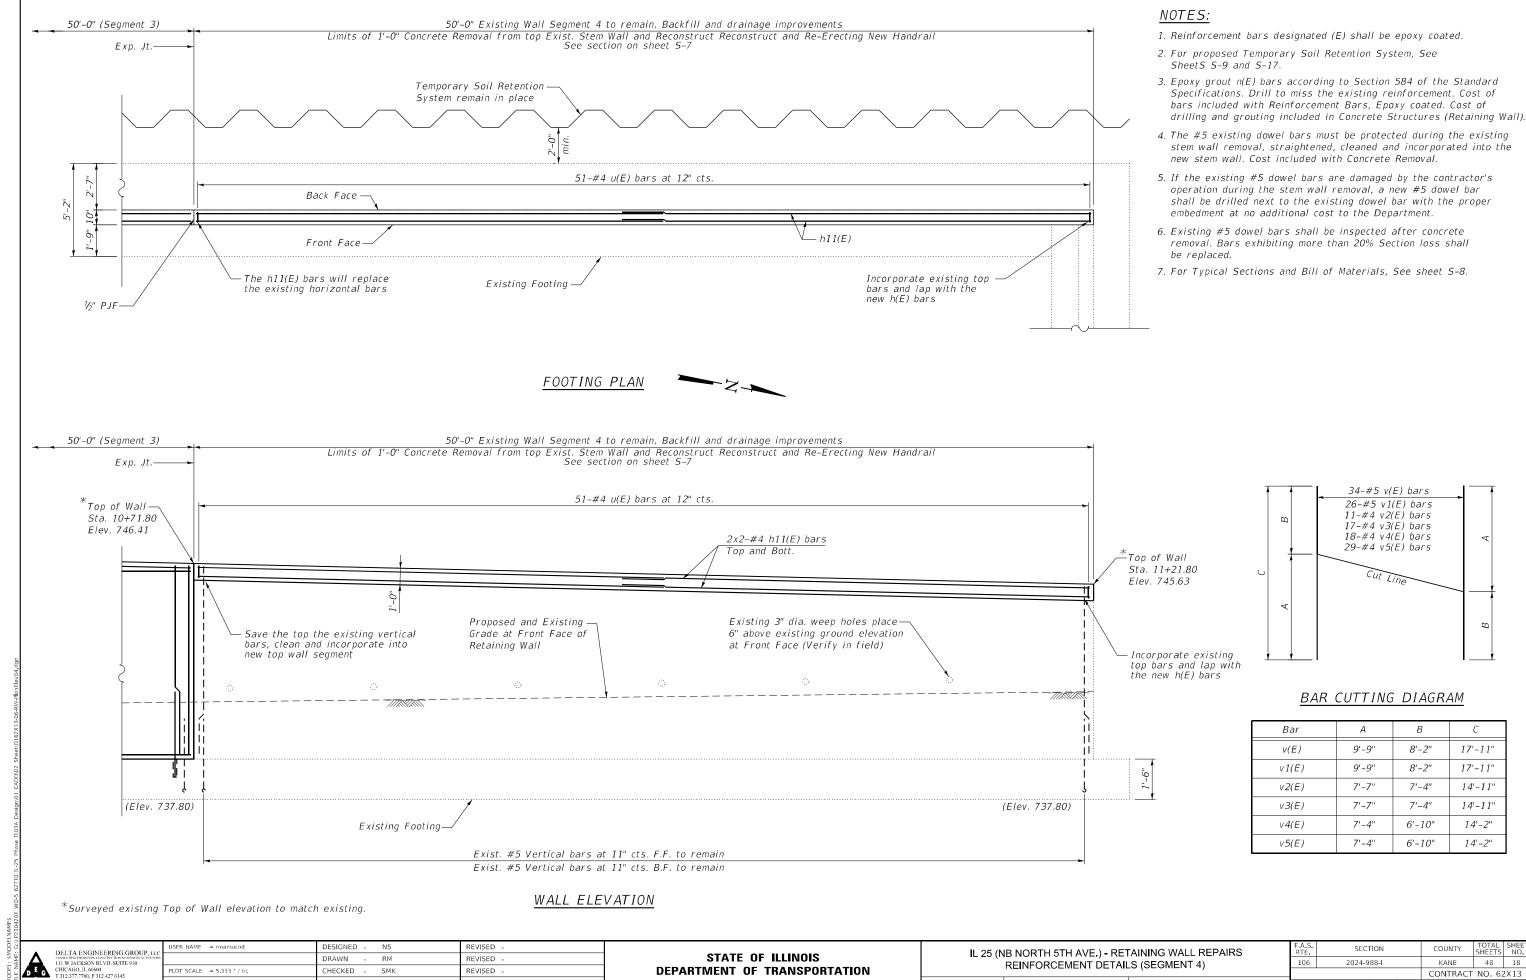


SHEET S-6 OF S-22 SHEETS STA.

LOT DATE = 9/26/2024

9/27/2024

DATE

REVISED -

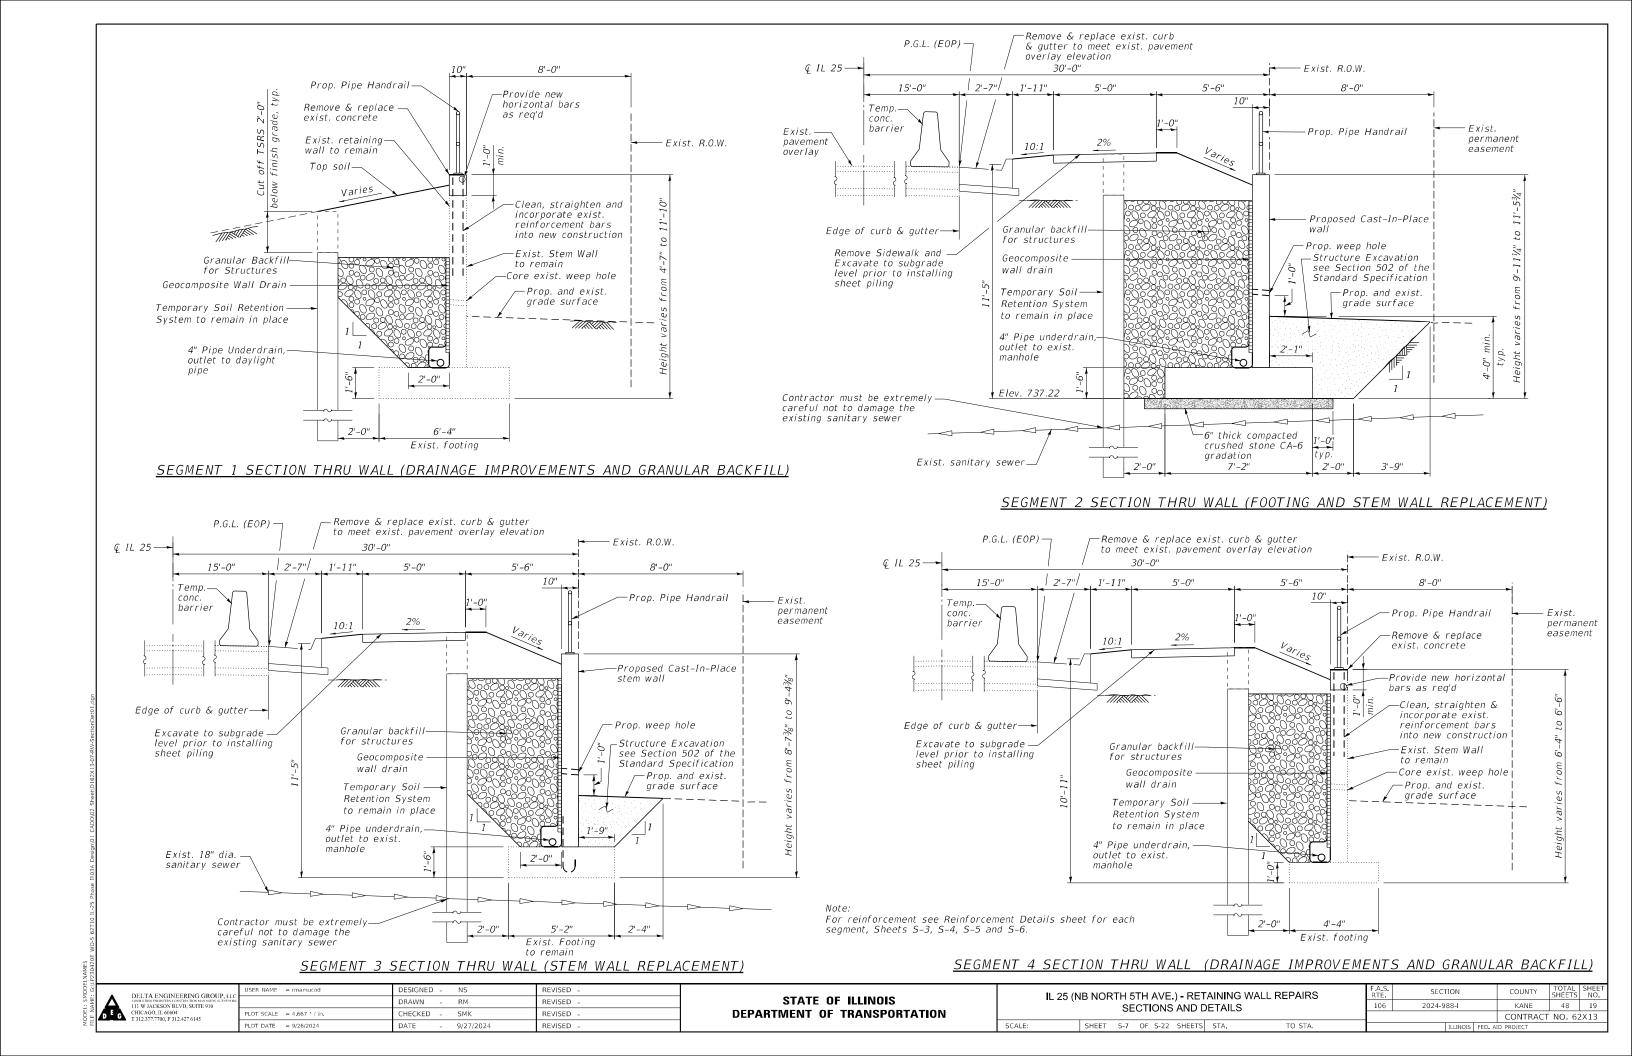

SECTION DETAILS (SEGMENT 1 AND 4)


BILL OF MATERIAL (SEGMENT 1 AND 4)

Mark	No.	Size	Length	Shape
h(E)	8	#4	24'-10"	
h11(E)	8	#4	26'-8"	
u(E)	98	#4	1'-10"	

Total weight of reinforcement bars for Segment 1 and 4 = 396 lbs.

NOTES:


- 1. Reinforcement bars designated (E) shall be epoxy coated.
- 2. Epoxy grout all n2(E) bars according to Section 584 of the Standard Specifications. Drill to miss existing reinforcement. Cost included with reinforcement bars, Epoxy coated.
- 3. Existing reinforcement shall be cleaned, straightened and incorporated into the new construction. Cost included with Concrete Removal
- 4. Refer the details on sheet S-20 for Weep Holes Cored with filter system.
- 5. See Sheet S-6 for Bar Cutting Diagram.

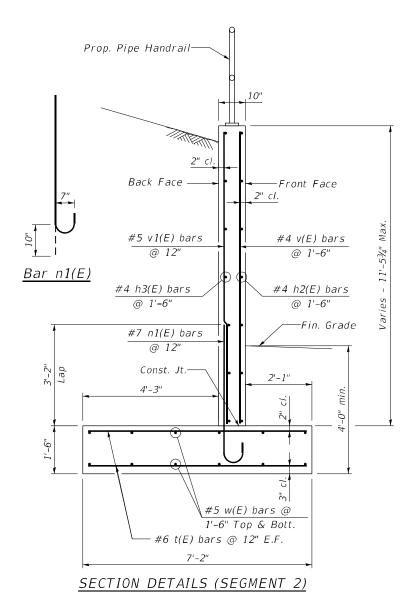

BILL OF MATERIAL (SEGMENT 2)

Mark	No.	Size	Length	Shape
h1(E)	4	#4	26'-9"	
h2(E)	12	#4	26'-8"	
h3(E)	12	#4	26'-8"	
n1(E)	52	#7	5'-3"	
v(E)	34	#4	17'-11"	
v 1(E)	26	#5	17'-11"	
t(E)	52	#6	6'-8"	
w(E)	24	#5	26'-9"	

Total weight of reinforcement bars for Segment 2 is 3143 lbs.

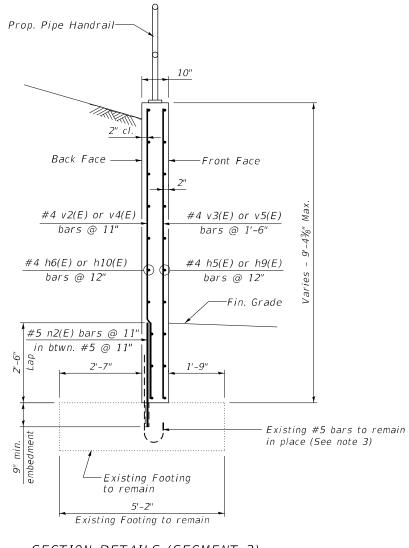

SECTION DETAILS (SEGMENT 3)

BILL OF MATERIAL (SEGMENT 3)

Mark	No.	Size	Length	Shape
h4(E)	2	#4	14'-3"	
h5(E)	8	#4	14'-2"	
h6(E)	8	#4	14'-2"	
h7(E)	4	#4	14'-0"	
h8(E)	2	#4	25'-3"	
h9(E)	7	#4	25'-2"	
h10(E)	7	#4	25'-2"	
n2(E)	46	#5	3'-3"	
v2(E)	11	#4	14'-11"	
v 3(E)	17	#4	14'-11"	
v4(E)	18	#4	14'-2"	
v5(E)	29	#4	14'-2"	
u(E)	11	#5	1'-10"	

Total weight of reinforcement bars for Segment 3 is 1382 lbs.

DELTA ENGINEERING GROUP, LLC
CROSSE PROJECTION MAN LOOKE, N. 24 VEVINS
111 W JACKSON BLVD, SUITE 910
CHICAGO, IL 60604
T 312.377.7700, F 312.427 6145

STATE OF ILLINOIS
DEPARTMENT OF TRANSPORTATION


IL 25 (NB NORTH 5TH AVE.) - RETAINING WALL REPAIRS
SECTIONS AND DETAILS

SHEET S-8 OF S-22 SHEETS STA. TO STA.

 F.A.S. RTE.
 SECTION
 COUNTY
 TOTAL SHEETS
 SHEET NO.

 106
 2024-988-I
 KANE
 48
 20

 CONTRACT NO. 62X13

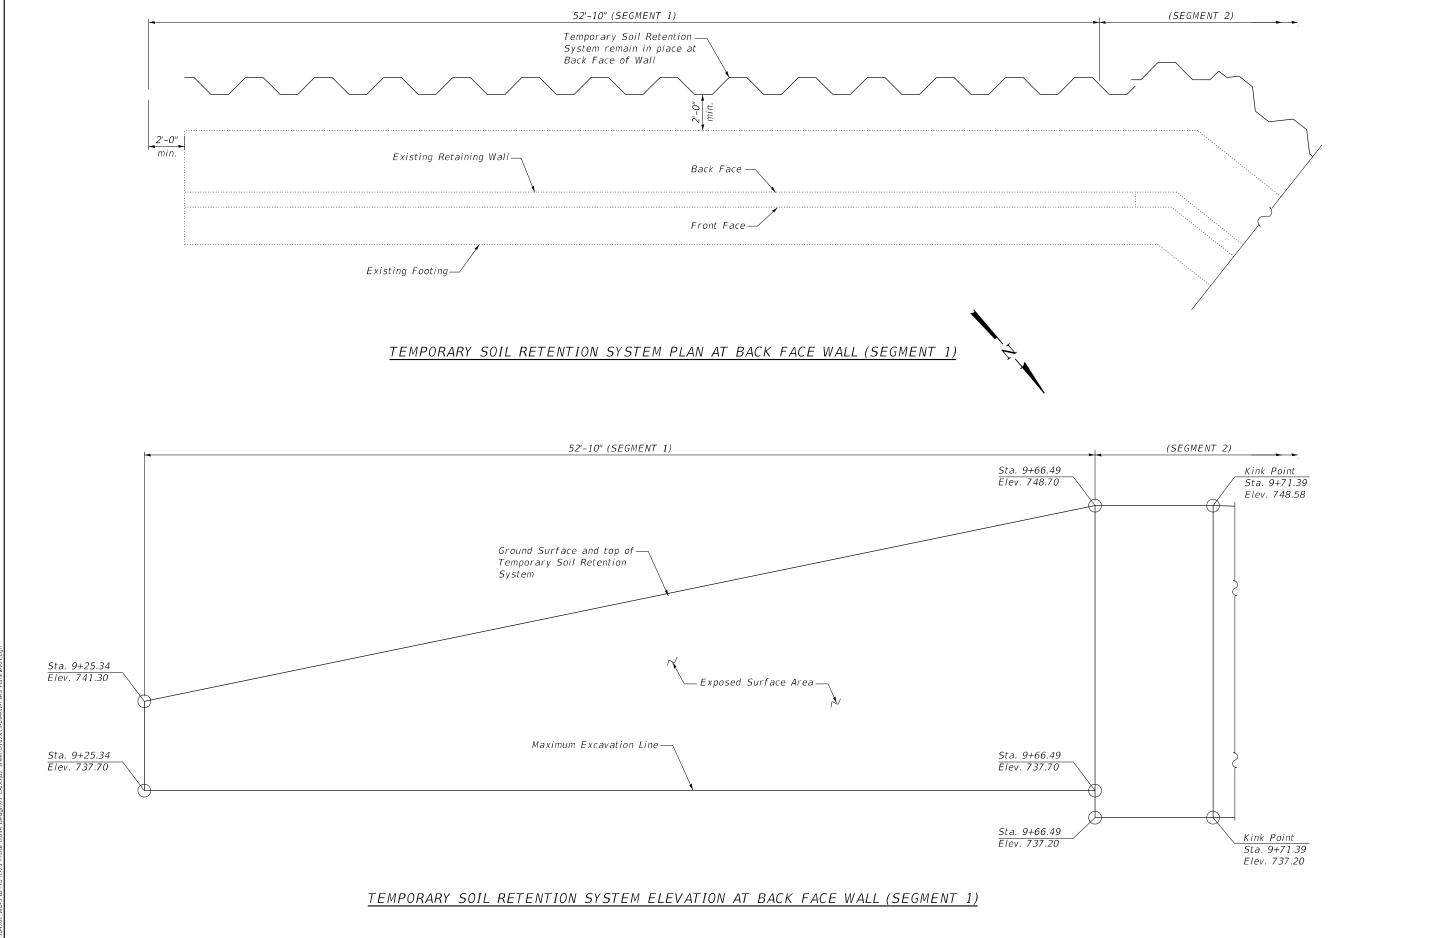

MODEL: \$MODELNAME\$

DELTA ENGINEERING GROUP, LLC
CONSULTING PROMPSES, CONSTITUCTION MANAGES, SLEVEYORS
111 W JACKSON BLVD, SUITE 910
CHICAGO, IL. 60604
T312.377.7700, F312.427 6145
PLOT DA

STATE OF ILLINOIS
DEPARTMENT OF TRANSPORTATION


IL 25 (NB NORTH 5TH AVE.) - RETAINING WALL REPAIRS
TEMPORARY SOIL RETENTION SYSTEM DETAILS (SEGMENT 1)

SHEET S-9 OF S-22 SHEETS STA. TO STA.

 F.A.S. RTE.
 SECTION
 COUNTY SHEETS
 TOTAL NO.
 SHEETS NO.

 106
 2024-988-I
 KANE
 48
 21

 CONTRACT NO. 62X 13

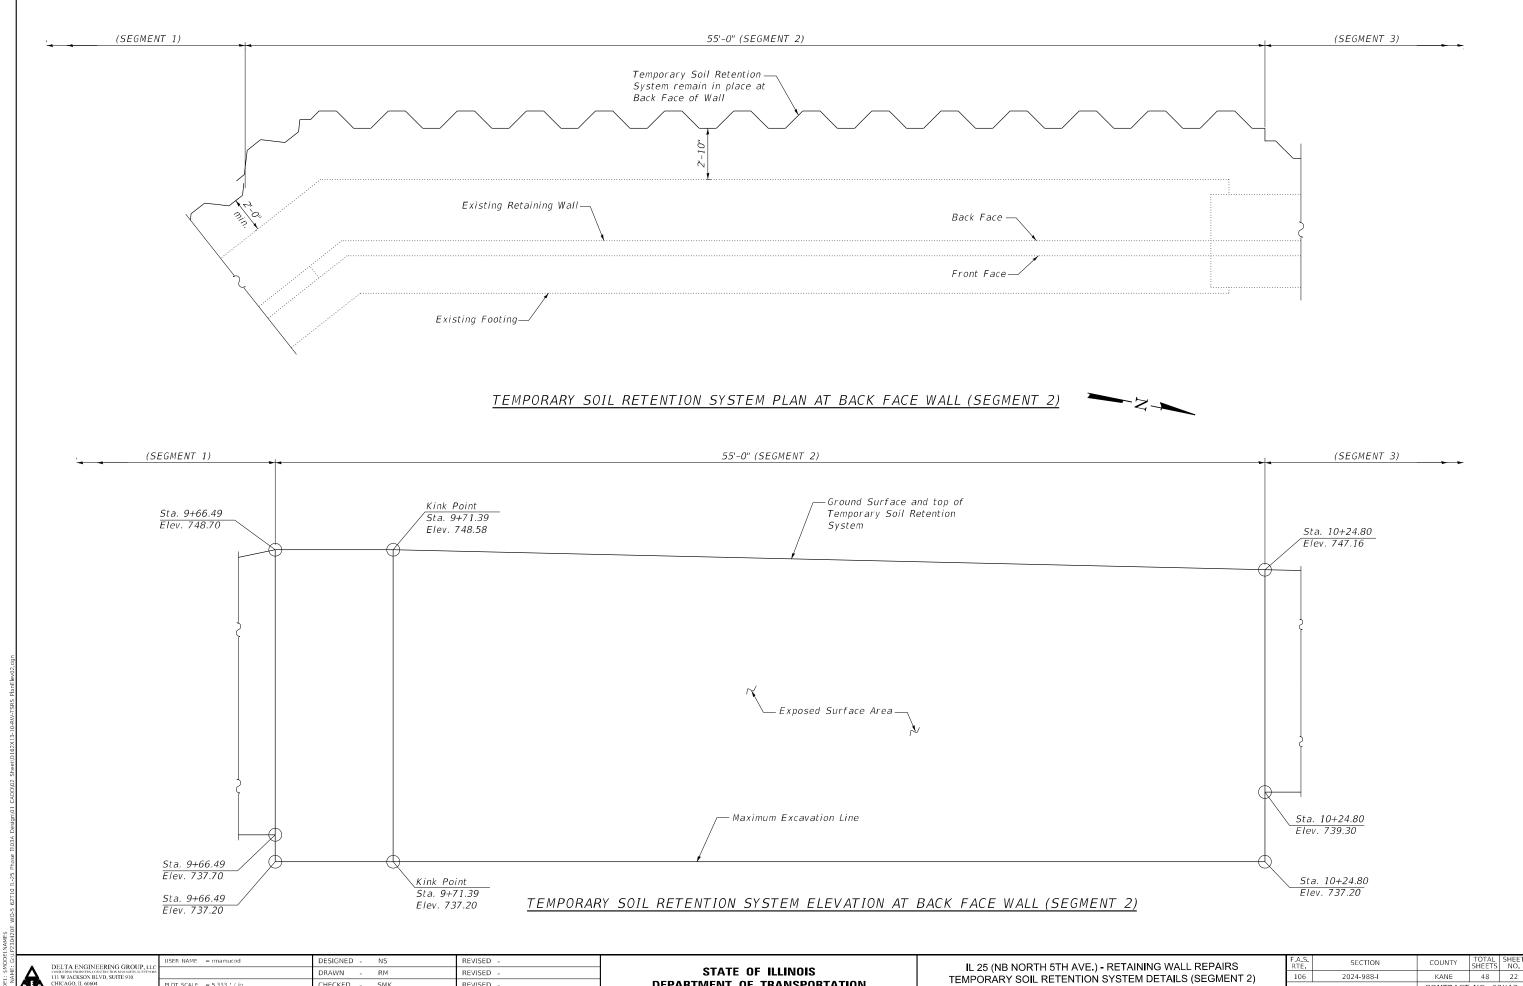

DELTA ENGINEERING GROUP, LI CONSULTING PRODUCTION OF THE STATE OF THE

LOT SCALE = 5.333 / in. CHECKED -SMK REVISED PLOT DATE = 8/19/2024 REVISED -DATE 8/8/2024

DEPARTMENT OF TRANSPORTATION

SHEET S-10 OF S-22 SHEETS STA.

CONTRACT NO. 62X13

MODEL: \$MODELNAMES FILE NAME: G:\LP230420E WO-5 62T1

DELTA ENGINEERING GROUP, LLC
crossel from sendorfer, constitution on values, statewords
111 W JACKSON BLVD, SUITE 910
CHICAGO, IL 60604
T 312.377.7700, F 312.427 6145

 USER NAME
 = rmamucod
 DESIGNED
 NS
 REVISED

 PLOT SCALE
 = 5.333 ' / in.
 CHECKED
 SMK
 REVISED

 PLOT DATE
 = 8/19/2024
 DATE
 8/8/2024
 REVISED

STATE OF ILLINOIS
DEPARTMENT OF TRANSPORTATION


IL 25 (NB NORTH 5TH AVE.) - RETAINING WALL REPAIRS
TEMPORARY SOIL RETENTION SYSTEM DETAILS (SEGMENT 3)

SHEET 5-11 OF S-22 SHEETS STA. TO STA.

 F.A.S. RTE.
 SECTION
 COUNTY
 TOTAL SHEETS
 SHEETS NO.

 106
 2024-988-I
 KANE
 48
 23

 CONTRACT NO. 62×13

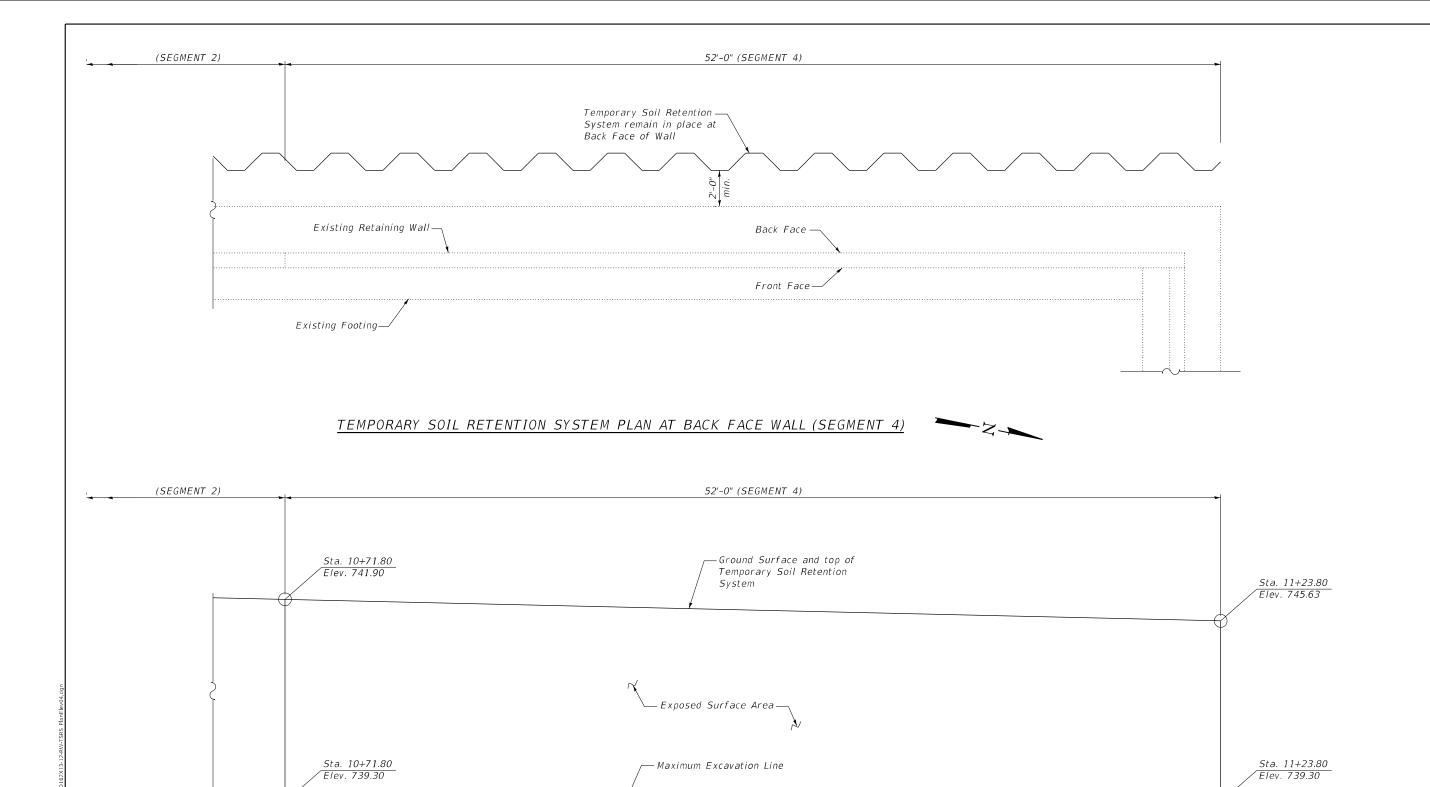

BILL OF MATERIAL


ITEM	UNIT	QUANTITY
Temporary Soil Retention System (To Remain in Place)	Sq Ft	1570

TEMPORARY SOIL RETENTION SYSTEM ELEVATION AT BACK FACE WALL (SEGMENT 4)

DELTA ENGINEERING GROUP, LLC ONSULTEN REMISSES, CONSTRUCTION MANAGES, SLEVEVORS 111 W JACKSON BLVD, SUITE 910 CHICAGO, IL 66060 T 312.377.7700, F 312.427 6145	PLOT SCALE = 5.333 ' / in.	DRAWN - RM CHECKED - SMK	REVISED -	STATE OF ILLINOIS DEPARTMENT OF TRANSPORTATION
	PLOT DATE = 8/19/2024	DATE - 8/8/2024	REVISED -	

F.A.S. RTE	SECT	ION	COUNTY	TOTAL SHEETS	SHEET NO.	
106	2024-9	88-I	KANE	48	24	
				CONTRACT	NO. 62	2X13
		ILLINOIS	D PROJECT			

MODEL: \$MODELNAME\$

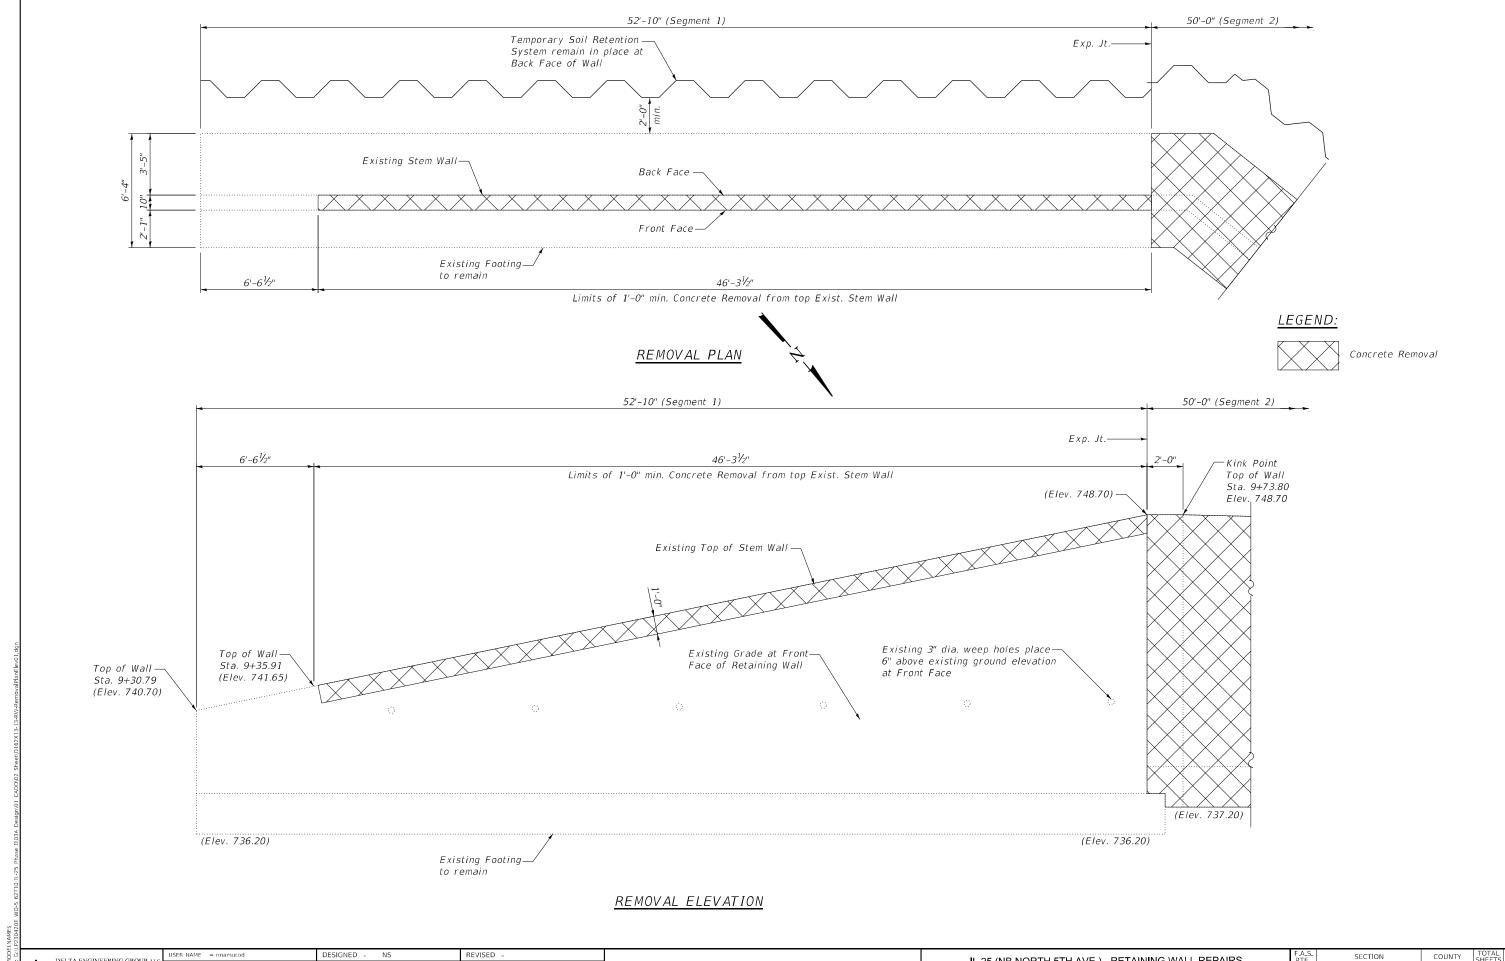


DELTA ENGINEERING GROUP, LI CONSULTING ENGINEERS, CONSTRUCTION MONAGERS 111 W JACKSON BLVD, SUITE 910 CHICAGO, IL 60604 T 312.377.7700, F 312.427 6145

DRAWN -RM REVISED -OT SCALE = 5.333 / in. CHECKED -SMK REVISED -PLOT DATE = 8/19/2024 REVISED -DATE 8/8/2024

STATE OF ILLINOIS **DEPARTMENT OF TRANSPORTATION** IL 25 (NB NORTH 5TH AVE.) - RETAINING WALL REPAIRS CONCRETE REMOVAL (SEGMENT 1) SHEET S-13 OF S-22 SHEETS STA. TO STA.

SECTION 2024-988-I KANE 48 25 106 CONTRACT NO. 62X13

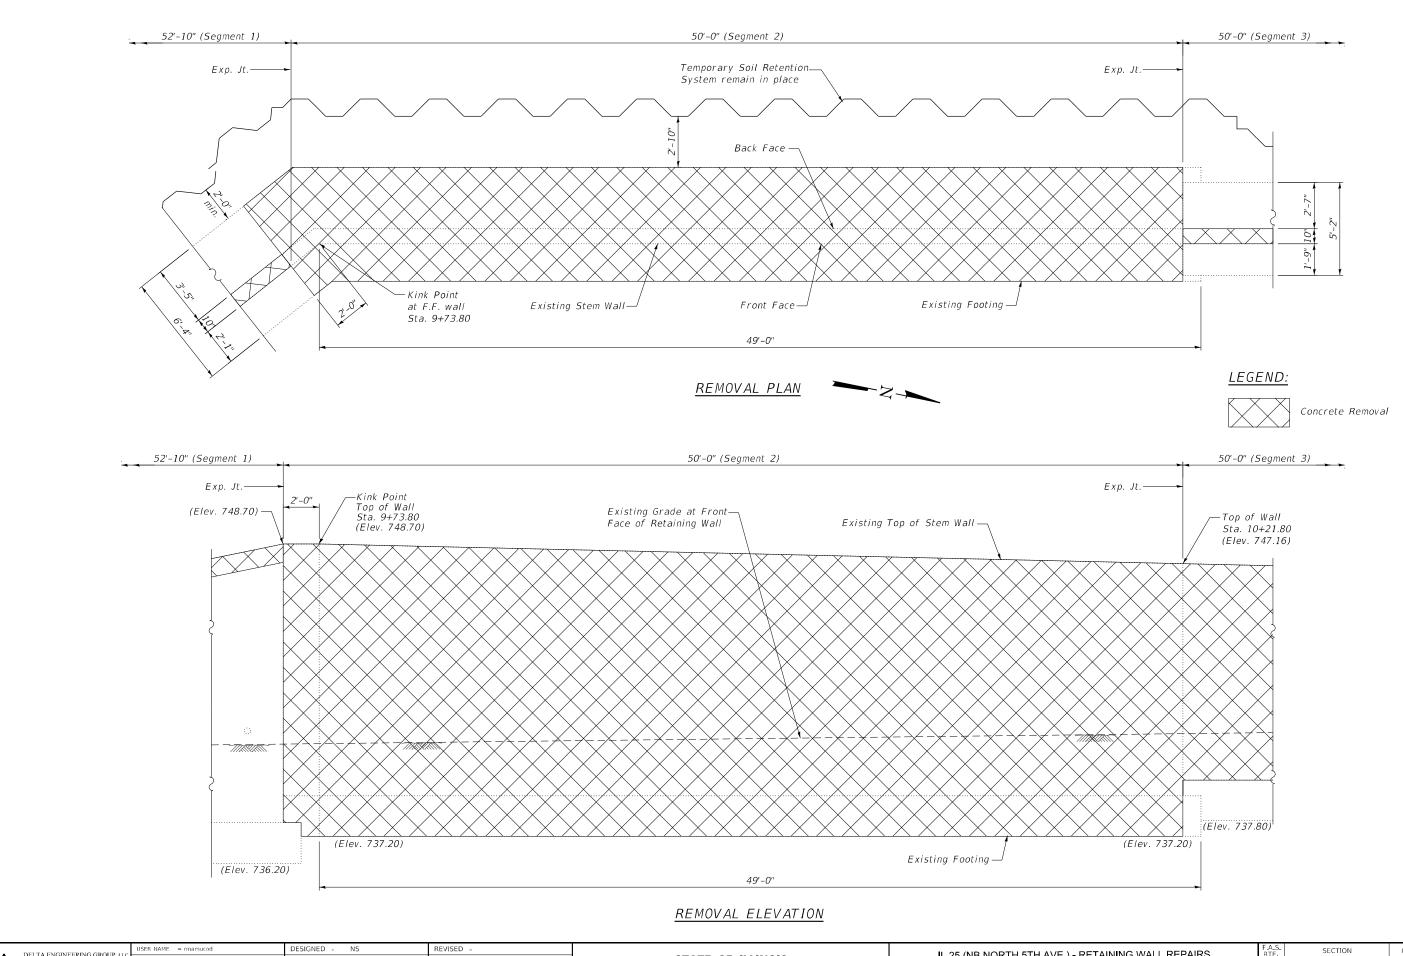


MODEL: \$MODELNAMES FILE NAME: G:\LP230420E WO-5 62T

DELTA ENGINEERING GROUP, ILL
CONSULTING PROMPPIES, CONSTRUCTION MONAGERS, SLAVE-VOX
111 W JACKSON BLVD, SUITE 910
CHICAGO, IL 60604
T 312.377.7700, F 312.427 6145

STATE OF ILLINOIS
DEPARTMENT OF TRANSPORTATION

IL 25 (NB NORTH 5TH AVE.) - RETAINING WALL REPAIRS CONCRETE REMOVAL (SEGMENT 2)

SHEET S-14 OF S-22 SHEETS STA. TO STA.

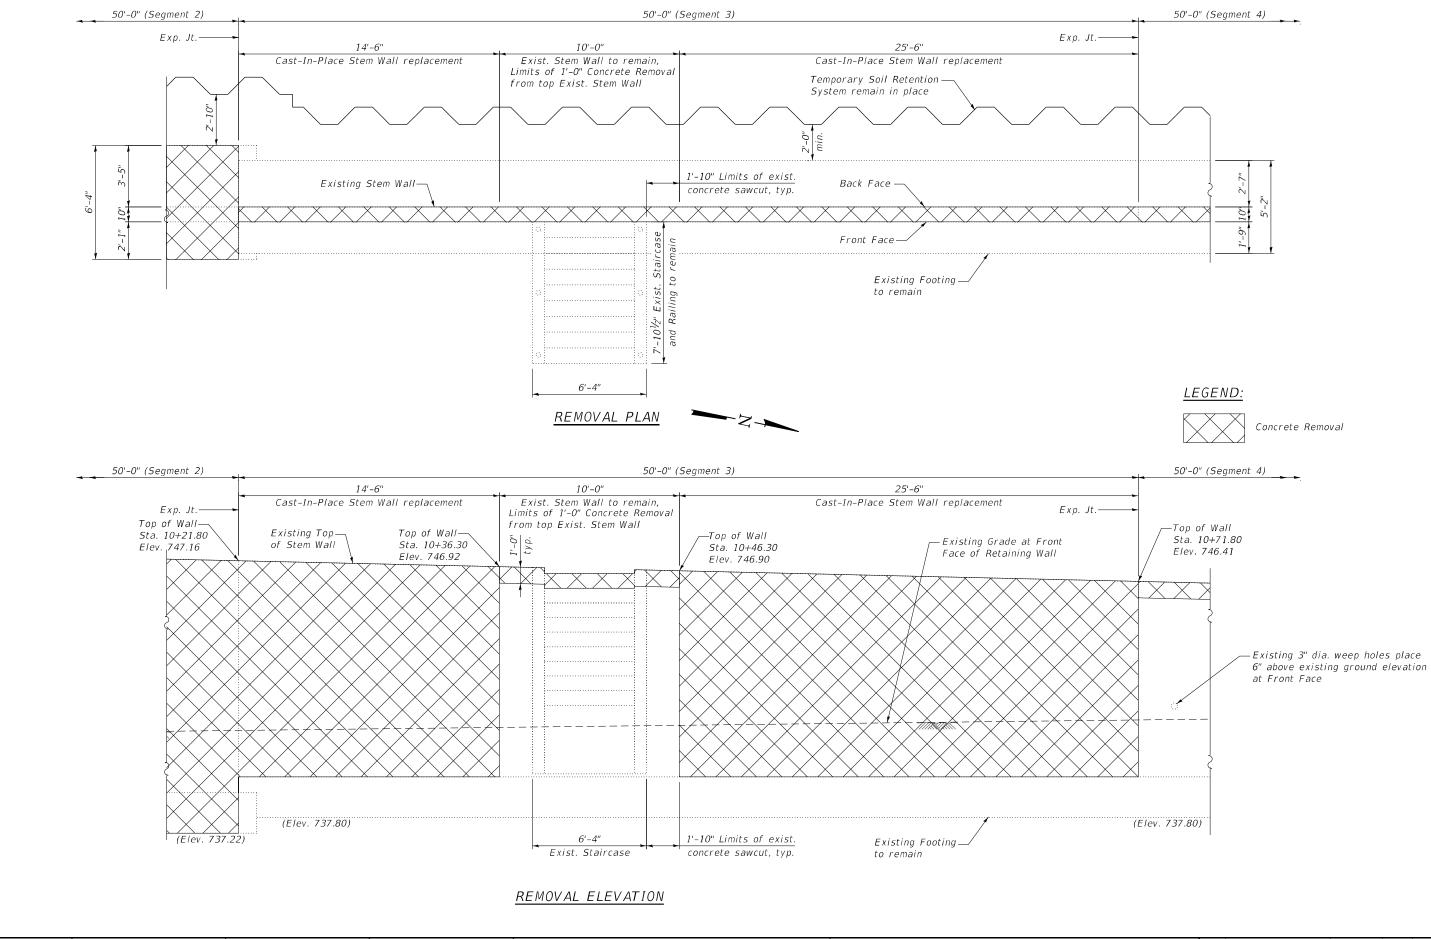

MODEL: \$MODELNAME\$


DELTA ENGINEERING GROUP, L CONSULTING PRIGHTERS CONSTITUCTION MAN MORES, NLRWES 111 W JACKSON BLVD, SUITE 910 CHICAGO, IL 60604 T 312.377.7700, F 312.427 6145

USER NAME = rmanucod DESIGNED - NS REVISED
DRAWN - RM REVISED
PLOT SCALE = 5.333 ' / in. CHECKED - SMK REVISED
PLOT DATE = 8/19/2024 DATE - 8/8/2024 REVISED -

STATE OF ILLINOIS
DEPARTMENT OF TRANSPORTATION

IL 25 (NB NORTH 5TH AVE.) - RETAINING WALL REPAIRS
CONCRETE REMOVAL (SEGMENT 3)

| SHEET | S-15 | OF | S-22 | SHEETS | STA. | TO STA.

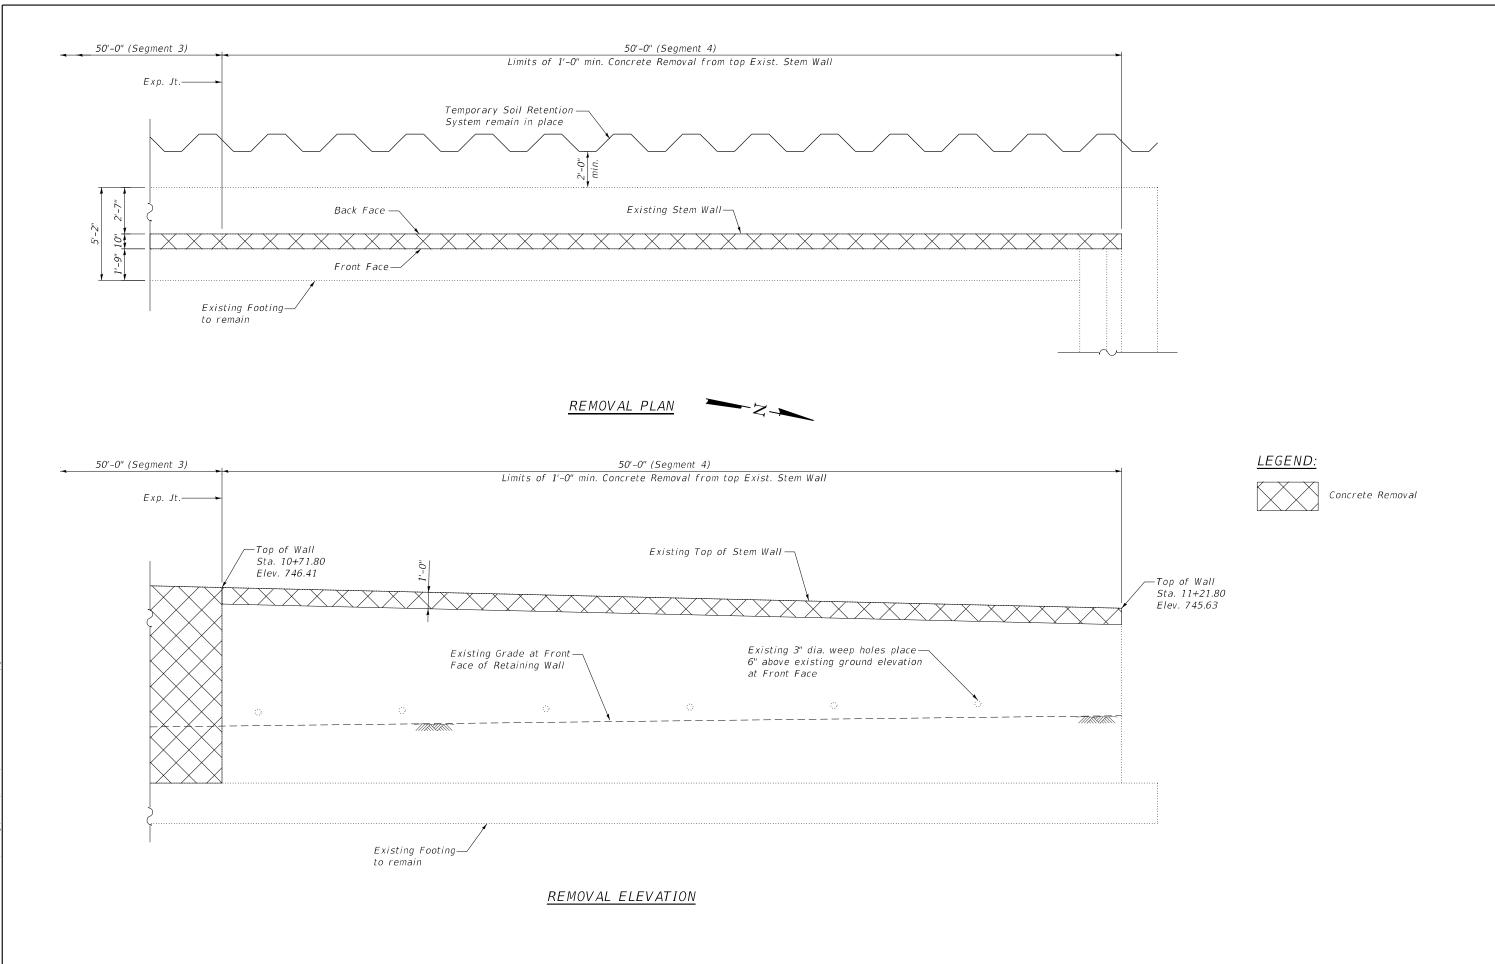



DELTA ENGINEERING GROUP, LI CONSULTING PRODUCTION OF THE STATE OF THE

DESIGNED - NS REVISED -DRAWN -RM REVISED -LOT SCALE = 5.333 / in. SMK REVISED -PLOT DATE = 8/19/2024 8/8/2024 REVISED -

STATE OF ILLINOIS **DEPARTMENT OF TRANSPORTATION** IL 25 (NB NORTH 5TH AVE.) - RETAINING WALL REPAIRS CONCRETE REMOVAL (SEGMENT 4) SHEET S-16 OF S-22 SHEETS STA. TO STA.

SECTION 2024-988-I KANE 48 28 106 CONTRACT NO. 62X13

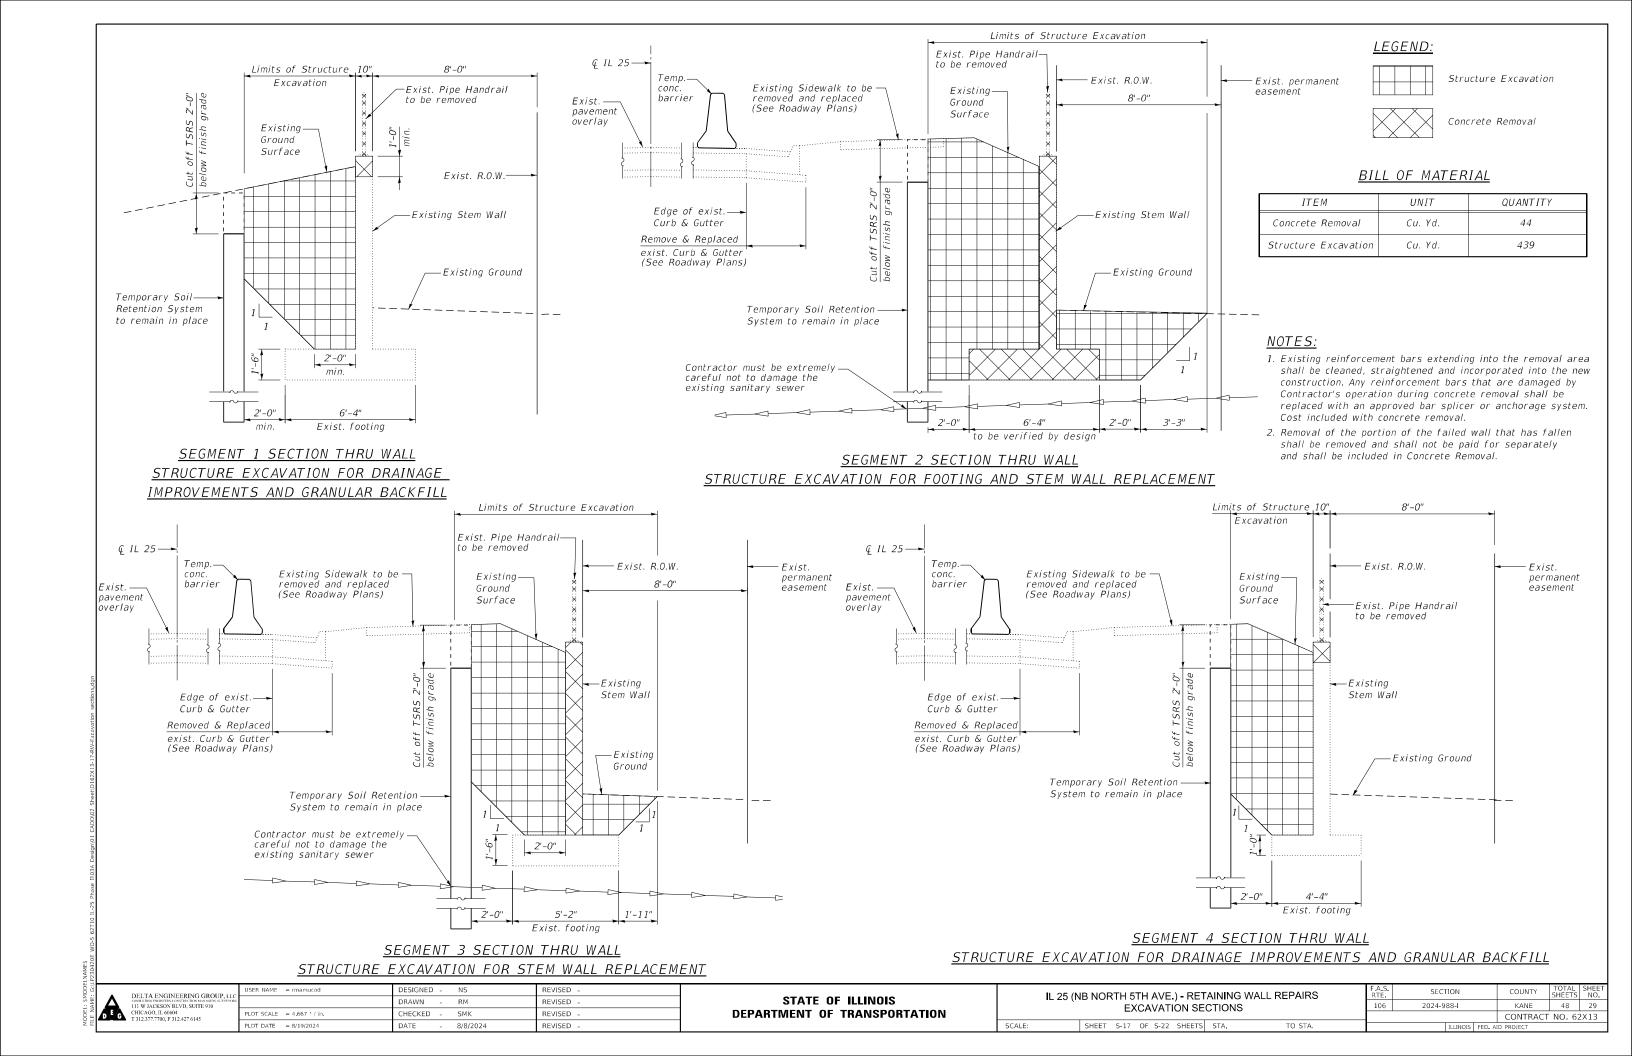

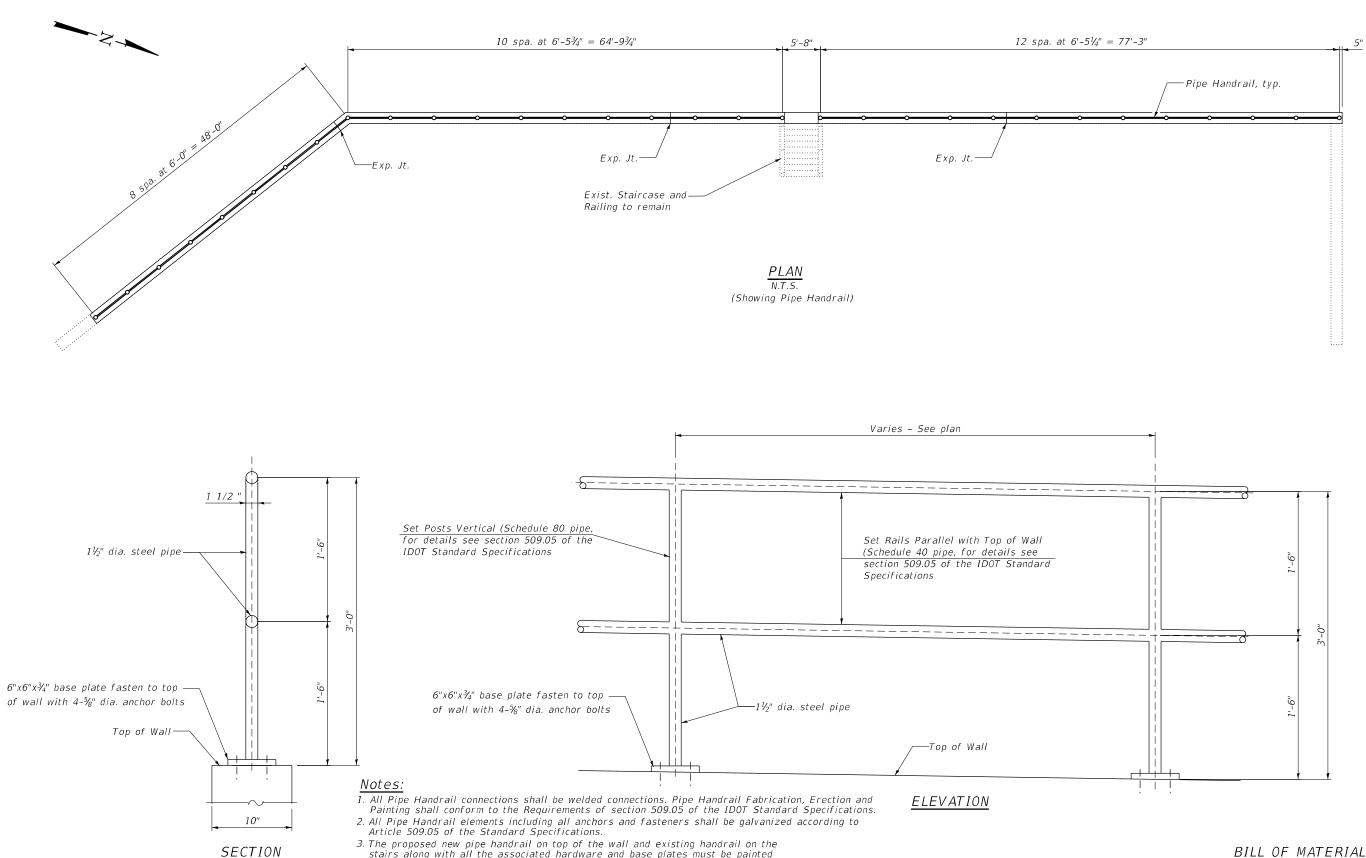

DELTA ENGINEERING GROUP, LI CONSULTING ENGINEERS, CONSTRUCTION MANAGER 111 W JACKSON BLVD, SUITE 910 CHICAGO, IL 60604 T 312.377.7700, F 312.427 6145

DESIGNED - NS REVISED -DRAWN -RM REVISED -OT SCALE = 1 000 / in. CHECKED SMK REVISED PLOT DATE = 9/26/2024 9/27/2024 REVISED -DATE

STATE OF ILLINOIS **DEPARTMENT OF TRANSPORTATION**

stairs along with all the associated hardware and base plates must be painted black. The cost of the painting for the proposed pipe handrail on top of the wall and existing pipe handrail on the stairs will not be paid for separately but it will be included in the pay item for Pipe Handrail.


4. Add rail splice or expansion joint in the pipe handrail as needed to accommodate the expansion joint in the wall.


IL 25 (NB NORTH 5TH AVE.) - RETAINING WALL REPAIRS PIPE HANDRAIL DETAILS SHEET S-18 OF S-22 SHEETS STA. TO STA.

SECTION COUNTY 106 2024-988-I KANE 48 30 CONTRACT NO. 62X13

BILL OF MATERIAL

QUANTITY UNIT Pipe Handrail 186 Foot

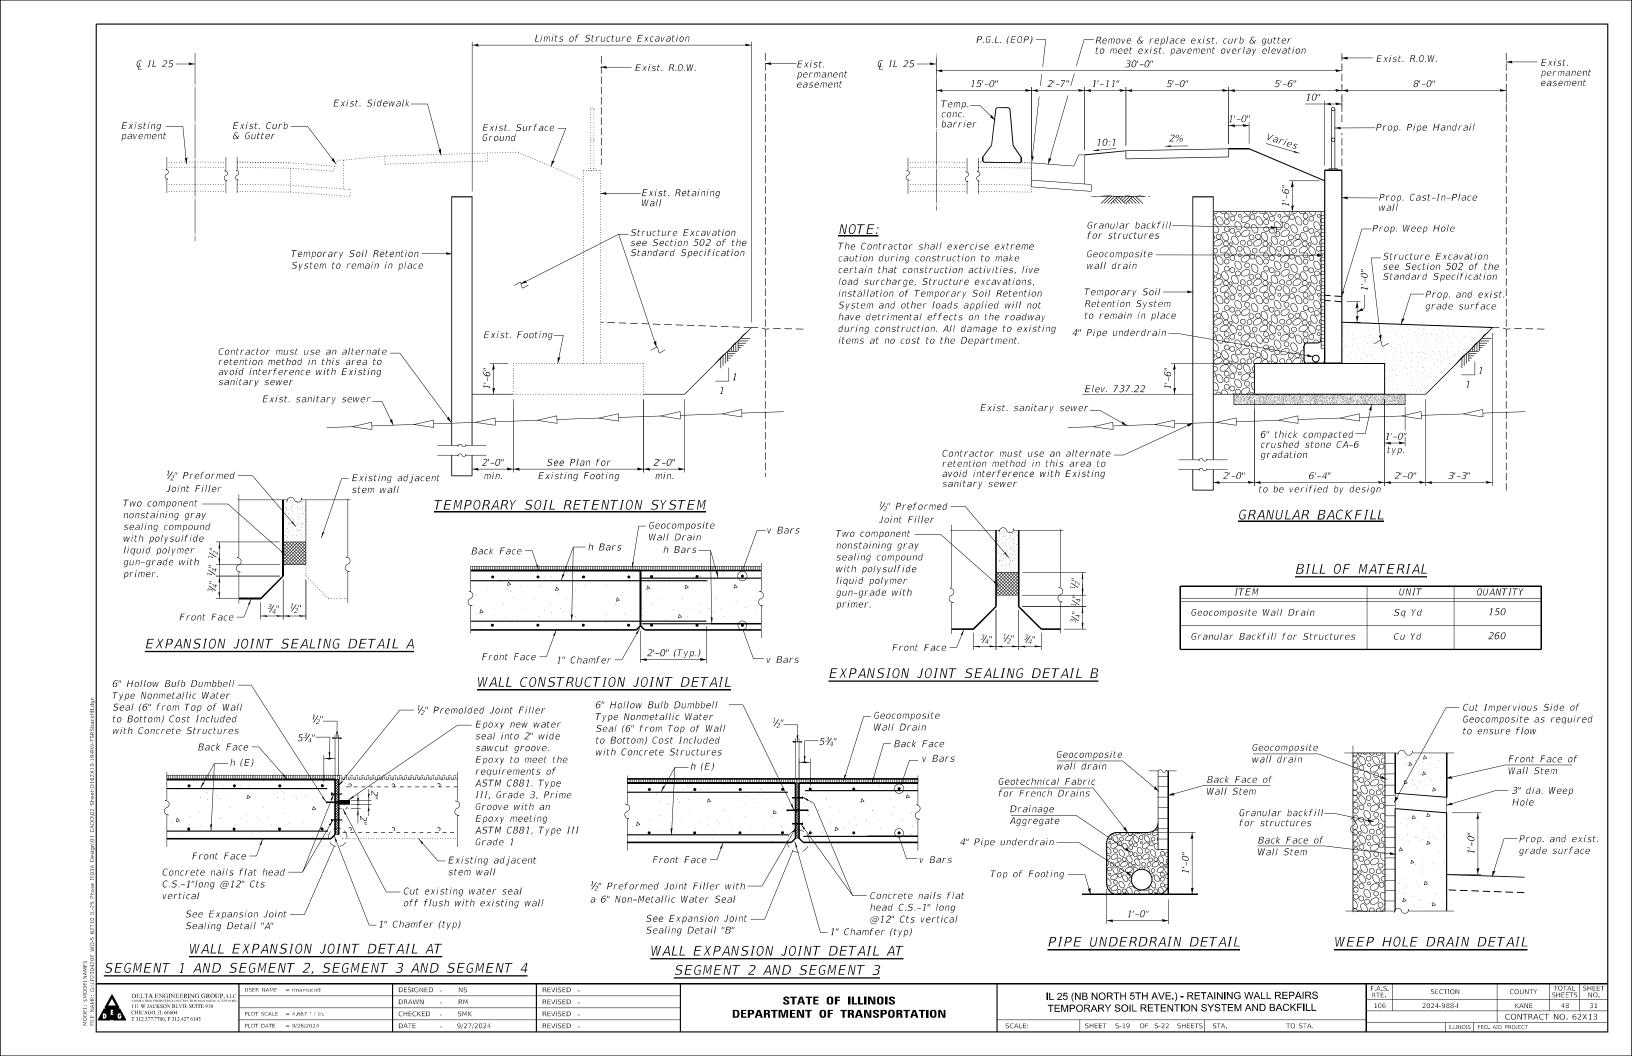

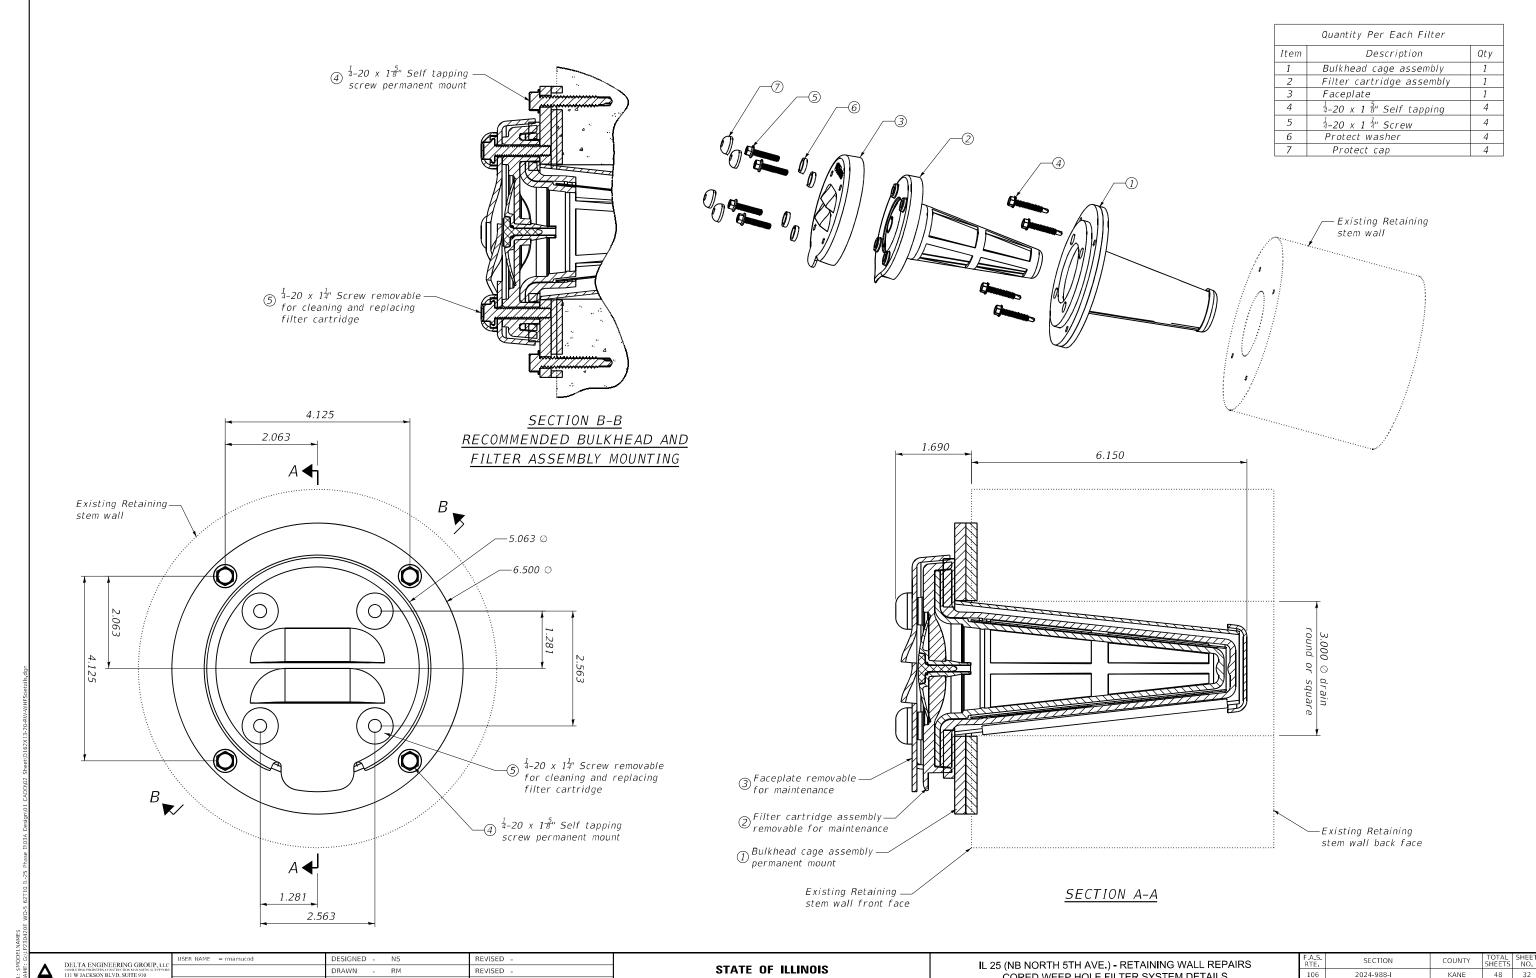


OT SCALE = 2 000 / in. CHECKED -SMK REVISED PLOT DATE = 8/19/2024 REVISED -DATE 8/8/2024

DEPARTMENT OF TRANSPORTATION

CORED WEEP HOLE FILTER SYSTEM DETAILS SHEET S-20 OF S-22 SHEETS STA.

2024-988-I KANE 48 32 106 CONTRACT NO. 62X13

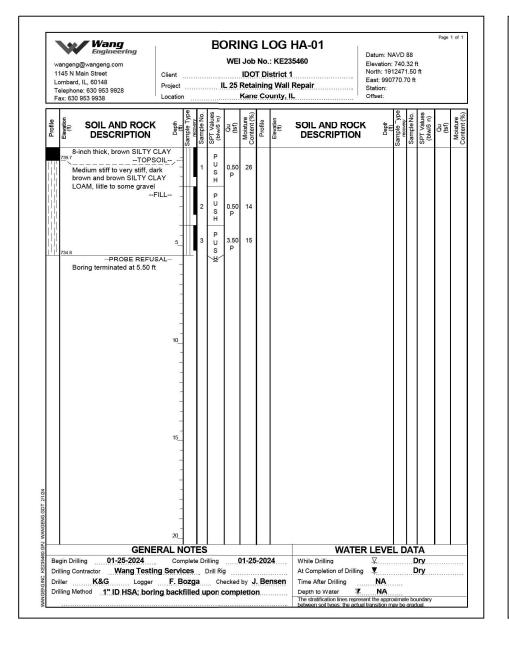

1 Li	145 N N ombard elephor	@wanger flain Stree , IL, 6014 e: 630 95 953 9938	t 8 3 9928		Project				WE L 25	I Job IDO Reta	No T Di	: KE2 strict g Wal	HA-02 35460 1 I Repair	Datur Eleva North East: Statio	tion: : 191 9907 n:	741. 2481	28 ft .84			
Profile	Elevation (ft)	DES	. AND R	ION	Deptr	Sample Type	Sample No.	SPT Values (blw/6 n)	Qu (tsf)	Moisture Content (%)	Profile	Elevation (ft)	SOIL AND ROO DESCRIPTION		Depti (ft)	Sample Type recovery	Sample No.	SPT Values (blw/6 n)	Qu (tsf)	Moisture
REDSBULGHT WANGEN'S GDT Z1/24	737.8 St litt	oft, dark ace grave	brown SIL	-TOPSC TY CLA* FII LAY LOA	AM, _		3	TOCA TOCA TOCA	0.25 P 0.25 P	19										
					20_	1														
				ENEF	RALN	İOT	ËS	;	_		Pi .		WATI	R LE						
Dri	illing Co	ntractor K&	01-25-20 Wang G (Testing ogger	Servi F. E	ces	ja	Drill Ri	g ecked	by •	J. Be	nsen	At Completion of Drilli Time After Drilling	ng ¥ N Z N	A IA	ximate	D	iry Iry Indary		


wangeng@wangeng.com 1145 N Main Street Lombard, IL, 60148 Telephone: 630 953 9928 Fax: 630 953 9938	Page 1 of 1 Datum: NAVD 88 Elevation: 741.31 ft North: 1912488.22 ft Fast: 990763 84 ft Station: Offset:													
SOIL AND ROCK DESCRIPTION	Depti (ft) Sample _vpe	sample No.	SPT Values (blw/6 n)	Qu (tsf)	Moisture Content (%)	Profile	Elevation (ft)	SOIL AND ROCI		Sample Type	Sample No.	SPT Values (blw/6 in)	Qu (tsf)	Moisture
12-inch thick, dark brown SI CLAYTOPS0 Medium stiff, dark brown to	DIL-,	1	поп	0.50 P	25									
grvaelF	- LL 	2	P U N H	0.75 P	19									
Very stiff, brown SILTY CLA LOAM, trace gravel	Y 5_	3	T O C T	2.50 P	14									
	Al	4	P ⊃ ω ±	2.00 P	14									
	10													
Begin Drilling 01-26-2024	RAL NC	lete Di	rilling	(01-26	-202	24	WATE While Drilling	R LEVE ▽		D	ry		
Drilling Contractor Wang Testin Driller K&G Logger Drilling Method 1" ID HSA; borin	F. Bo	zga	Che	ecked	by J	. Be	nsen	At Completion of Drilling Time After Drilling Depth to Water The stratification lines represelveen soil types: the acture	NA NA			undary	******	


DELTA ENGINEERING GR
CINNAL BROOFFISC CONSTRICTION MINMO
111 W JACKSON BLVD, SUITE 91
CHCAGO, II. GOOD
T 312.377.7700, F 312.427 6145

ROUP, LLC	USER NAME = rmamucod	DESIGNED	-	NS	REVISED -
NAGERS, SURVEYORS		DRAWN	-	RM	REVISED -
	PLOT SCALE = 2.000 / in.	CHECKED	-	SMK	REVISED -
	PLOT DATE = 8/19/2024	DATE	-	8/8/2024	REVISED -

SCALE:

<u>RWB-01</u>

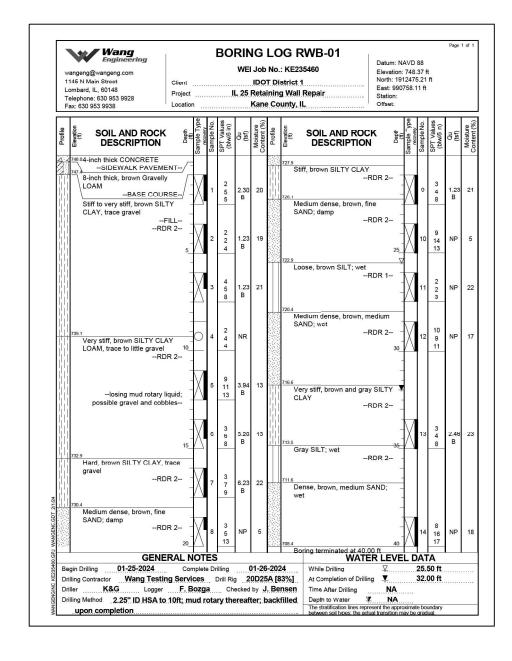


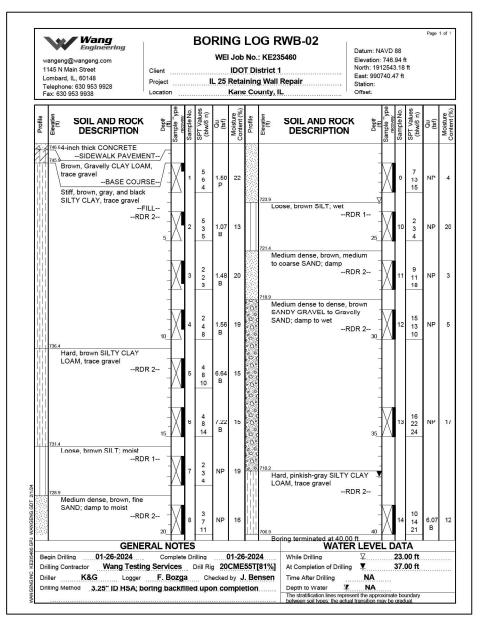

DELTA ENGINEERING GROO total bandwards decision and will be 111 W JACKSON BLVD, SUITE 910 CHICAGO, IL 6000 T 312.377.7700, F 312.427 6145

LLC	USER NAME = rmamucod	DESIGNED	-	NS	REVISED -	
EYORS		DRAWN	-	RM	REVISED -	
	PLOT SCALE = 2.000 / in.	CHECKED	-	SMK	REVISED -	
	PLOT DATE = 8/19/2024	DATE	-	8/8/2024	REVISED -	

IL 25 (NB NORTH 5TH AVE.) - RETAINING WALL REPAIRS SOIL BORING LOGS						F.A.S. SECTION				COUNTY	TOTAL SHEETS	SHEET NO.				
						106	2024-988-I			KANE	48	34				
											CONTRACT	NO. 62	2X13			
	SHEET S-2	22	OF S	5-22	SHEETS	STA.	TO STA.				ILLINOI	FED.	AID	PROJECT		

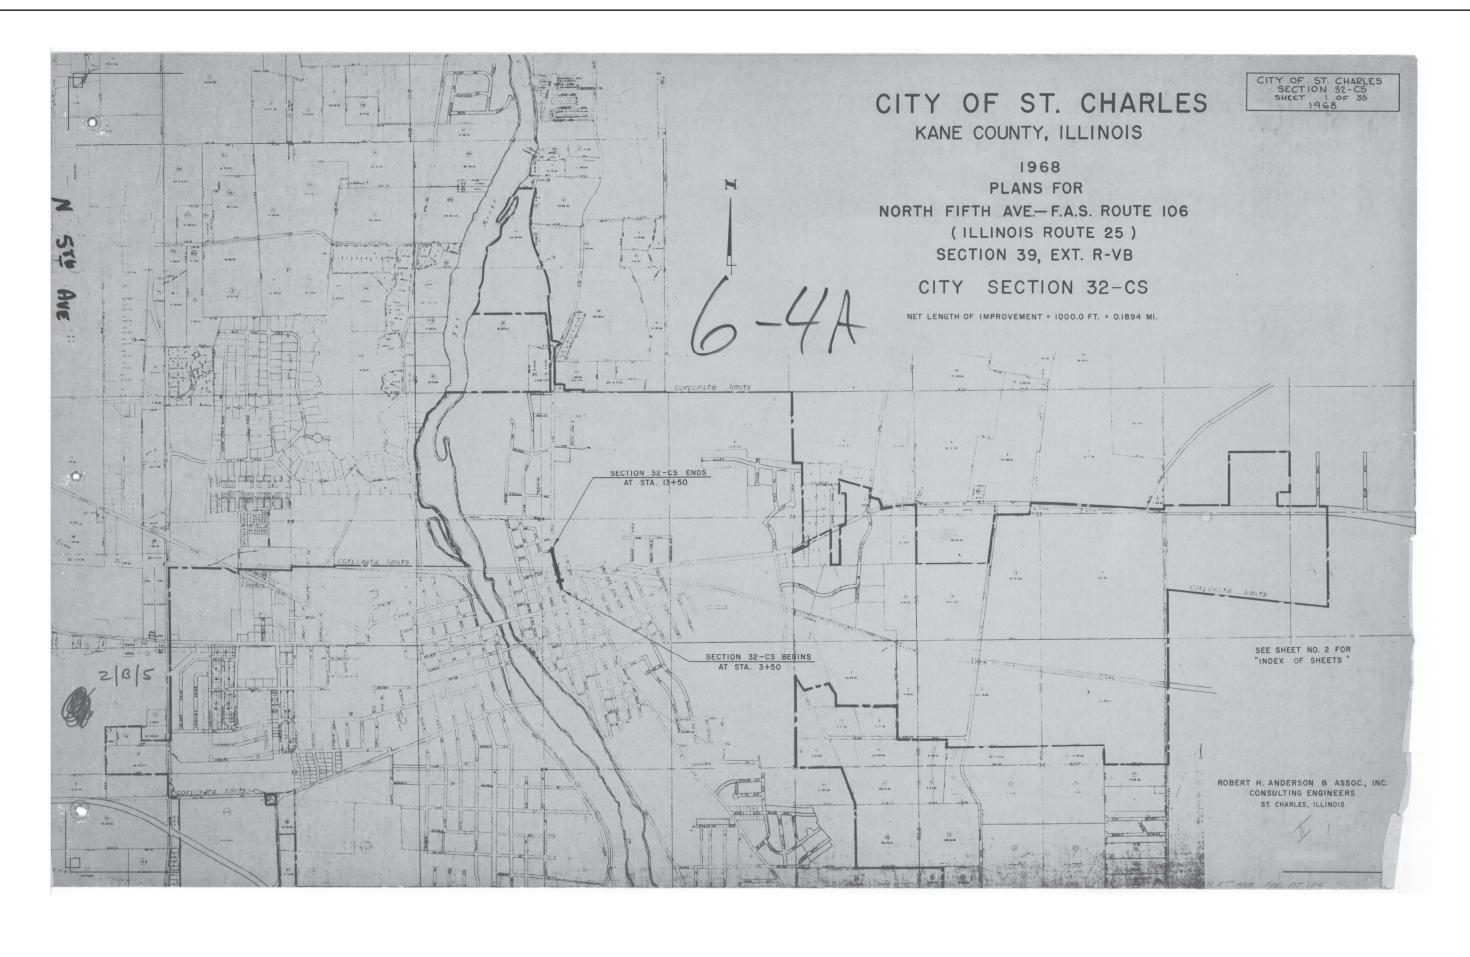

DELTA ENGINEERING GROUP, LLC
CONNUTS INCOMPANY CONSUMER CONSUMER CONSUMER CONSUMER CONSUMER CONSUMER CONSUMER CONSUMER CONSUMER CONSUMER CONSUMER CONSUMER CONSUMER CONSUMER CONSUMER CONSUMER CONSUMER CONSUMER CONSUMER CONS

LC	USER NAME = \$USER\$	DESIGNED	-	NS	REVISED
(00S		DRAWN	-	NS	REVISED
	PLOT SCALE = \$SCALE\$	CHECKED	-	MA	REVISED
	PLOT DATE = \$DATES	DATE	-	8/8/2024	REVISED

STATE OF ILLINOIS
DEPARTMENT OF TRANSPORTATION

EXISTING	RETA	ININ	G WALI	PLANS	(FOR	REFE	RENCE ONLY)
1:10	SHEET	12	OF 13	SHEETS	STA.	N/A	TO STA. N/A

F.A.S. RTE	SECTION		COUNTY	TOTAL SHEETS	SHEET NO.
106	2024-988-I		KANE	48	35
		CONTRACT	NO. 62	2X13	
	ILLINOIS	D PROJECT			


	SUMMARY OF QUANTITIES					SECTION 32-C
	ITEM	QUANTITY	UNIT			SHEET 2 OF 3
	BORROW EXCAVATION	18,950	CU. YDS.			1766
	SPECIAL EXCAVATION	1,348	CU. YDS.			
	TRENCH BACKFILL	300	CU. YDS.		INDEX OF SHEETS	
	STABILIZED SUB-BASE (BITUMINOUS AGGREGATE MIXTURE)	3,818	SQ. YDS.	SHEET NO.		
	SUB-BASE GRANULAR MATERIAL, TYPE A (ALTERNATE)	900	TONS	1	COVER SHEET	
	GRAVEL OR CRUSHED STONE BASE COURSE, TYPE A	371	TONS	2	SUMMARY OF QUANTITIES & INDEX OF SHEETS	
	BITUMINOUS MATERIALS (PRIME COAT)	190	GALS.	3	TYPICAL SECTION, GENERAL NOTES & SCHEDULES	
	BITUMINOUS MATERIALS (COVER & SEAL COATS)	350	GALS.	4	SCHEDULES	
	COVER COAT AGGREGATE	10	TONS	5 & 6	PLAN & PROFILE	
	SEAL COAT AGGREGATE	5	TONS	7	INTERSECTION DETAILS	
	P. C. CONCRETE PAVEMENT - 10"	3,174	SQ. YDS.	8 - 18	CROSS - SECTIONS	
	P. C. CONCRETE PAVEMENT - 16 1/2" - 10 1/2" - 16 1/2"	266	SQ. YDS.	19	RETAINING WALL DETAILS	
	REMOVING & REPLACING CURING COVERING	10	UNITS	20 - 27	BRIDGE DETAILS	
	PAVEMENT FABRIC	3,174	SQ. YDS.	28	STANDARD NO. 1766-4 LONG. METAL JOINT	
	PROTECTIVE COAT	5,936	SQ. YDS.		STANDARD NO. 2179-1 24' CONC. PAVEMENT	
	CLASS X CONCRETE	916.5	CU. YDS.		STANDARD NO. 2115-1 PAVEMENT FABRIC	
	REINFORCEMENT BARS	165,790	LBS.	29	STANDARD NO. 1909-8 CONC. BRIDGE APPROACH PAVEMENT	
	FURNISHING STEEL PILES (8 BP 36)	3,208	LIN. FT.	30	STANDARD NO. 21320 CONCRETE CHIRR & CHITTER	
	DRIVING STEEL PILES	3,208	LIN. FT.		STANDARD NO. 2130 CONCRETE CURB & GUTTER	
	TEST PILES (STEEL)	2	EACH	31	STANDARD NO. 1683–2 INLET, TYPE A STANDARD NO. 2217–1 TYPE 8 GRATE	
	PREFORMED JOINT SEALER	100	LIN. FT.		STANDARD NO. 1527-3 MANHOLE, TYPE A	
	ALUMINUM HAND RAIL	287	LIN. FT.		STANDARD NO. 2213-1 FRAME & LID, TYPE 1	
	CLASS A EXCAVATION FOR STRUCTURES	522	CU. YDS.	32	INLET, TYPE B, SPECIAL – STANDARD NO. 55 STANDARD NO. 52-B CONTRACTION JOINT	
	NAME PLATES	1	EACH		STANDARD NO. 70 CONCRETE STEPS	
	SLOPE WALL	626	SQ. YDS.	33	STANDARD NO. 26.2 ENTRANCE APPROACHES	
	STRUCTURAL STEEL	1,980	LBS.		STANDARD NO. 2208-2 BARRICADES	
	RAILROAD PROTECTIVE SERVICES	1	LUMP SUM	34	STANDARD NO. 2168-1 CHAIN-LINK FENCE	
	FURNISHING CREOSOTED PILES (20.1 – 38)	480	LIN. FT.	35	STANDARD NO. 2209-1 TRAFFIC CONTROL DEVICES	
	DRIVING TIMBER PILES	480	LIN. FT.			
	PIPE HANDRAIL	197	LIN. FT.			
	PIPE CULVERTS, T-1, (CSCP) - 18"	34	LIN. FT.			
	PIPE CULVERTS, T-1, (CSCP) - 24"	26	LIN. FT.			
	STORM SEWERS, TYPE 1 - 12"	274	LIN. FT.			
	STORM SEWERS, TYPE 1, 15"	180	LIN. FT.			
	STORM SEWERS, TYPE 1, 18"	546	LIN. FT.			
	MANHOLES, TYPE A, 4' DIA. WITH TYPE 1 FRAME & CLOSED LID	10	EACH			
TO THE REAL PROPERTY.	MANHOLE, TYPE A, 5' DIA . WITH TYPE 1 FRAME & CLOSED LID	1	EACH			
The state of the s	INLETS, TYPE A, WITH TYPE 8 GRATE	2	EACH			
	INLETS, TYPE B SPECIAL WITH FRAME AND GRATE	8	EACH			
	MANHOLES TO BE ADJUSTED	5	EACH			
	FILLING EXISTING MANHOLES	2	EACH			
	FILLING EXISTING INLETS	6	EACH			
	COMBINATION CONCRETE CURB & GUTTER, TYPE M-6.24	1,933	LIN. FT.			
	DRIVEWAY PAVEMENT REMOVAL	44	SQ. YDS.			
	PAVEMENT REMOVAL - SPECIAL	1,157	SQ. YDS.			
	PAVEMENT REPLACEMENT, ENTIRE	153	SQ. YDS.			
	P. C. CONC. DRIVEWAY PAVEMENT - 7"	137	SQ. YDS.			
	P. C. CONCRETE SIDEWALK - 5"	9,626	SQ. FT.			
	GROUND PREPARATION FOR SODDING	6,177	SQ. YDS.			
A TESTINETE STATE	CHAIN-LINK FENCE TO BE REMOVED	224	LIN. FT.			
	CHAIN-LINK FENCE TO BE RE-ERECTED	66	LIN. FT.			

DELTA ENGINEERING GROUP, 11 countries commercine conservation and with the minimal commercine conservation and with the countries and with the countries of the

STATE OF ILLINOIS DEPARTMENT OF TRANSPORTATION

EXISTING RETAINING WALL PLANS (FOR REFERENCE ONLY)

SCALE: 1:10 SHEET 12 OF 13 SHEETS STA. N/A TO STA. N/A

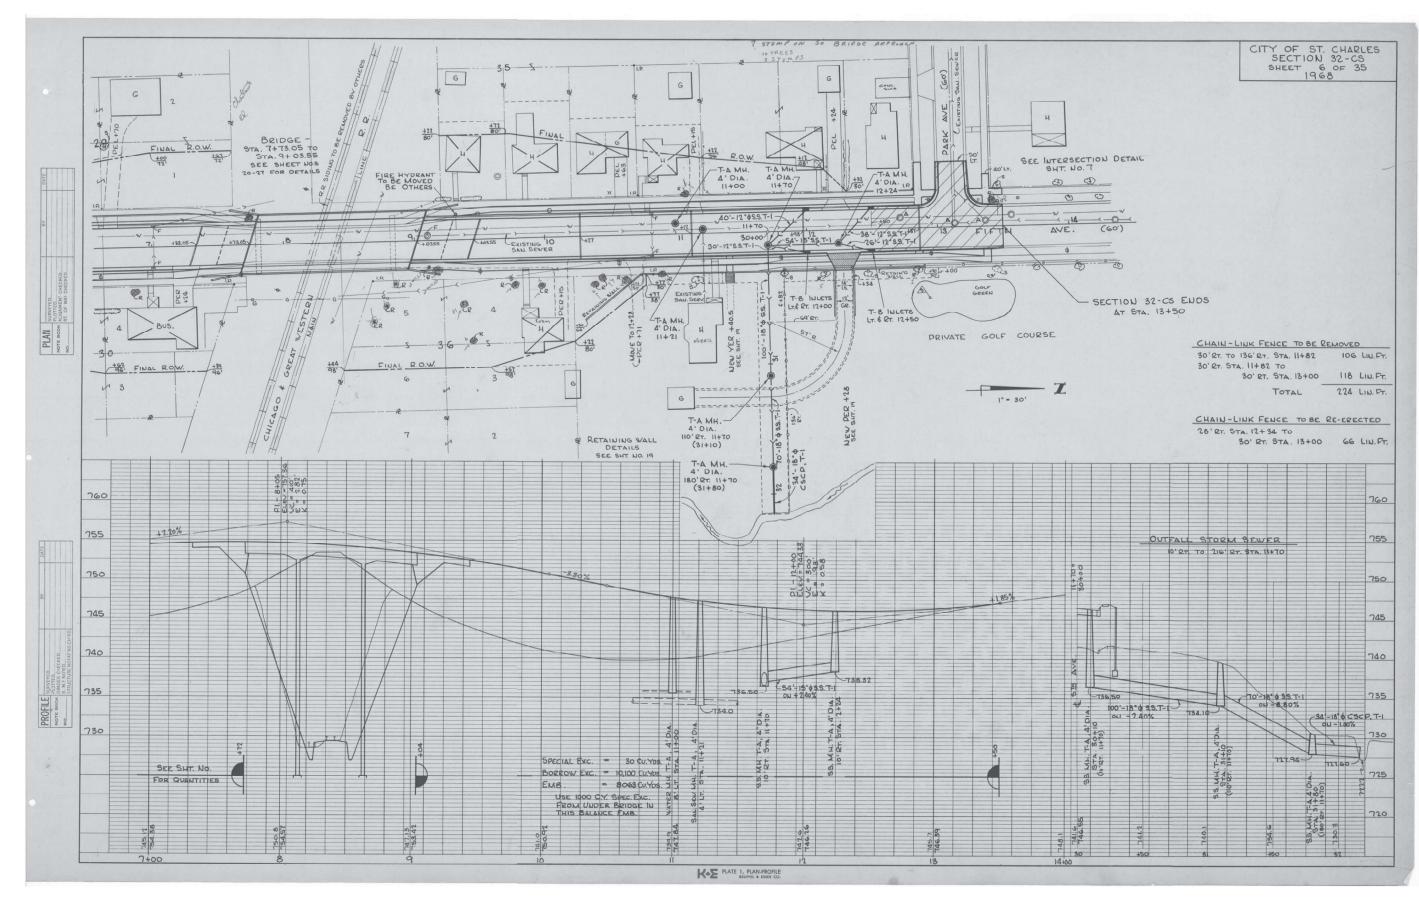


DELTA ENGINEERING GROUP, LLC
LISSELT IND INSURPRISE CONSTITUTION ACCESSOR BLDVD, SUTTE 910
CHICAGO, IL 00604
T 312.377.7700, F 312.427 6145

)	USER NAME = \$USER\$	DESIGNED - NS	REVISED
ß		DRAWN - NS	REVISED
	PLOT SCALE = \$SCALE\$	CHECKED - MA	REVISED
	PLOT DATE = \$DATES	DATE - 8/8/2024	REVISED

STATE OF ILLINOIS DEPARTMENT OF TRANSPORTATION

			5.		/E0D	DEFEE	SENIOE ON III		F.A.S. RTE	SEC.	TION		COUNTY	TOTAL SHEETS	SHEET NO.
EXISTING	3 RETAININ	IG W	ALL PL	_ANS	(FOR	KEFEF	RENCE ONL'	Υ)	106	2024	-988-I		KANE	48	37
													CONTRACT	NO. 62	2X13
SCALE: 1:10	SHEET 12	OF	13 S	HEETS	STA.	N/A	TO STA.	N/A			ILLINOIS	FED. AI	D PROJECT		

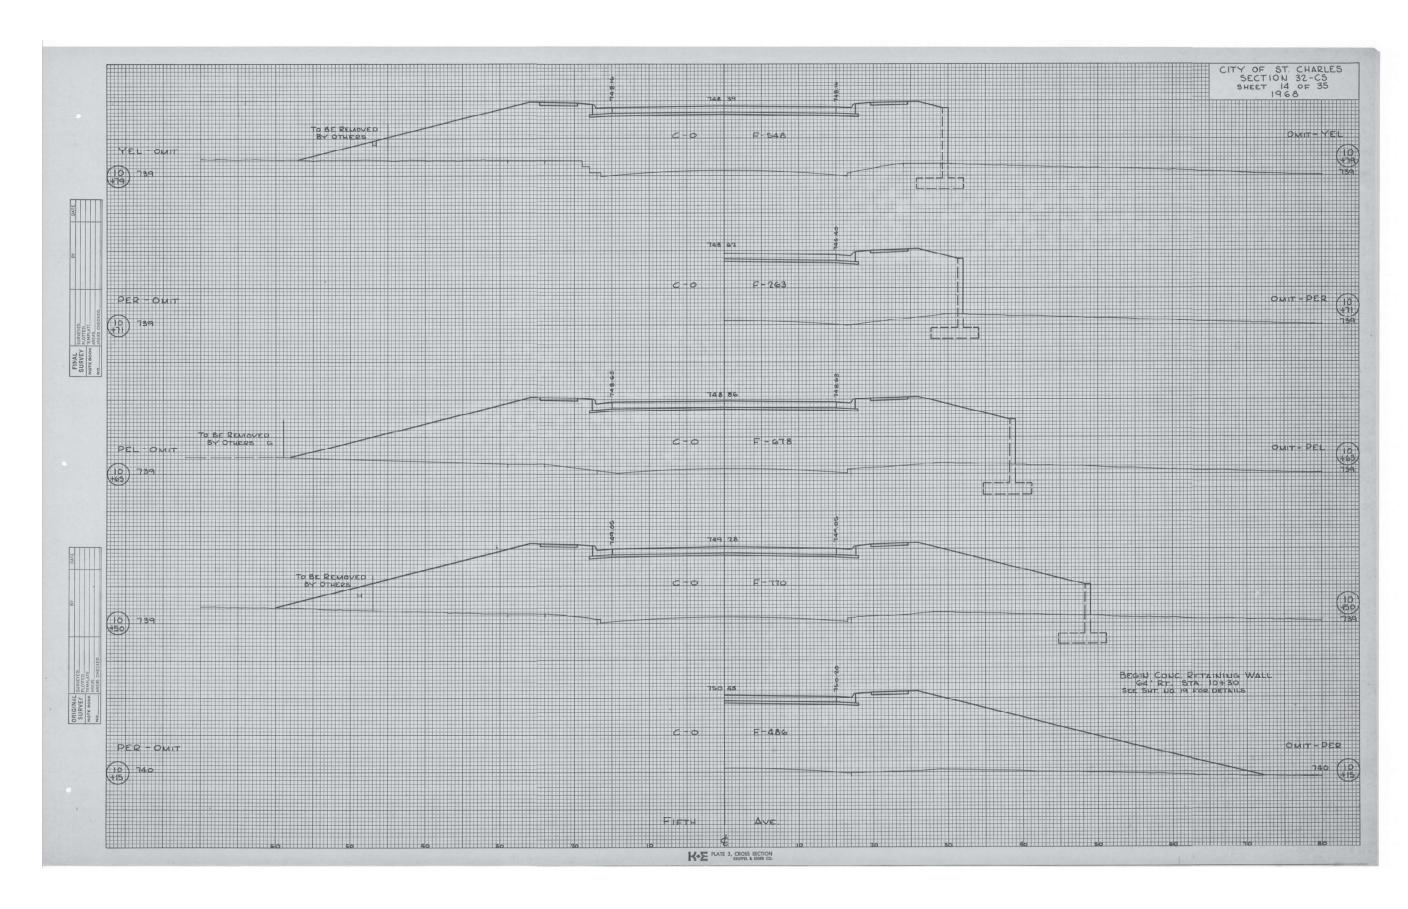


A I

DELTA ENGINEERING GROUP, LLC
CTOMALING TRANSPORT OF STREET OF STREET OF STREET OF STREET OF STREET OF STREET OF STREET OF STREET OF STREET OF STREET OF STREET OF STREET OF STREET OF STREET OF STREET OF STREET OF STREET

STATE OF ILLINOIS DEPARTMENT OF TRANSPORTATION EXISTING RETAINING WALL PLANS (FOR REFERENCE ONLY)

E: 1:10 | SHEET 12 OF 13 SHEETS STA. N/A TO STA. N/A

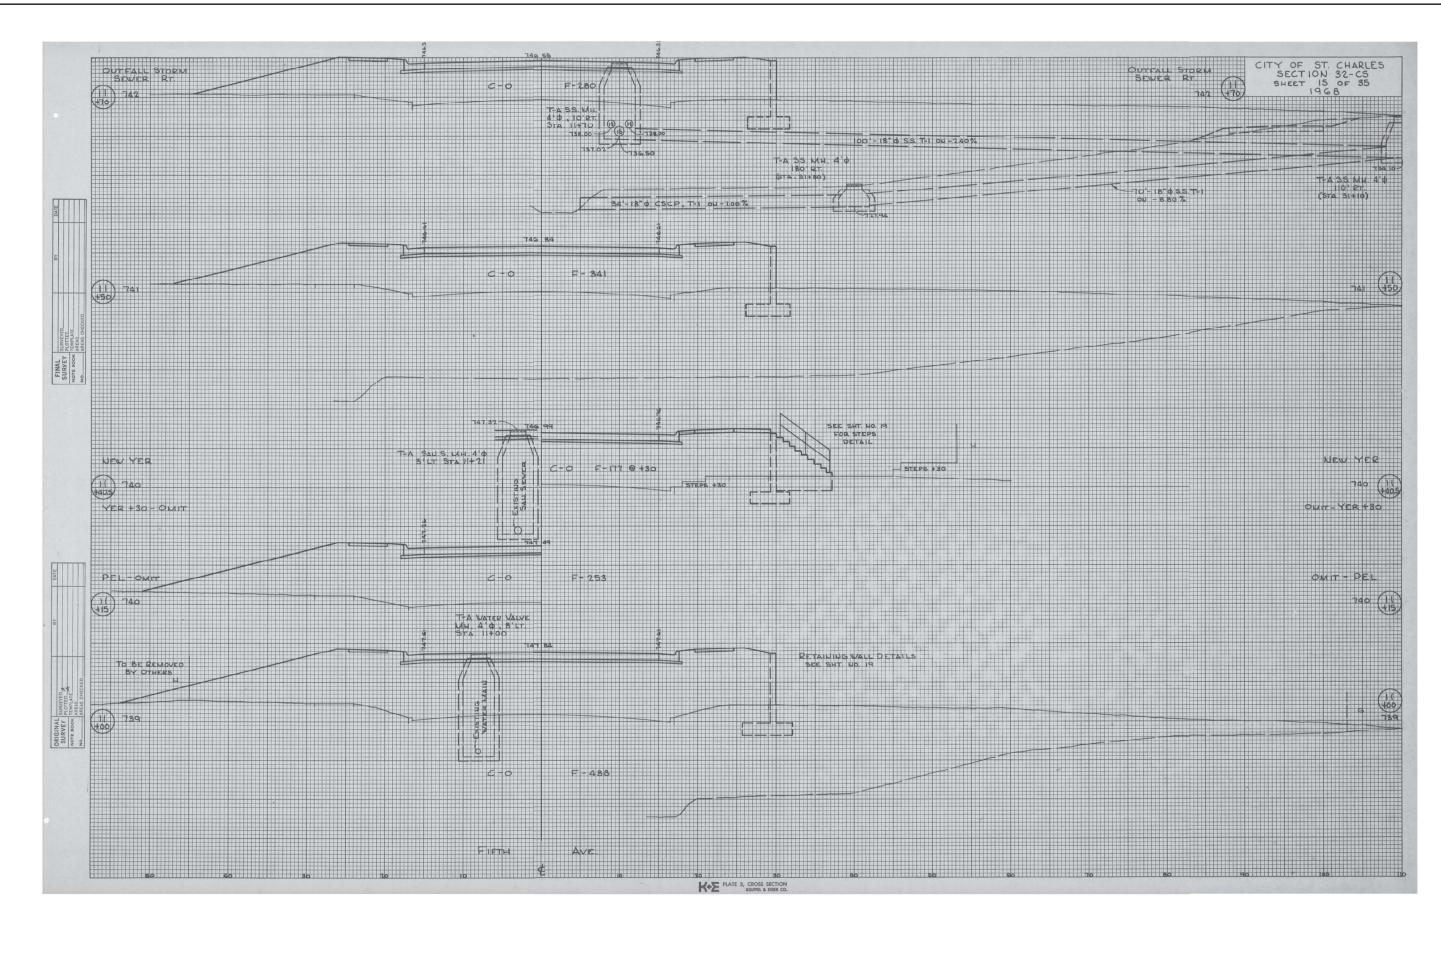


D CH

| USER | USER |

STATE OF ILLINOIS DEPARTMENT OF TRANSPORTATION EXISTING RETAINING WALL PLANS (FOR REFERENCE ONLY)

1:10 SHEET 12 OF 13 SHEETS STA. N/A TO STA. N/A

| F.A.S. | SECTION | COUNTY | TOTAL SHEET | RTE. | 106 | 2024-988-I | KANE | 48 | 39 | | CONTRACT | NO. 62X13

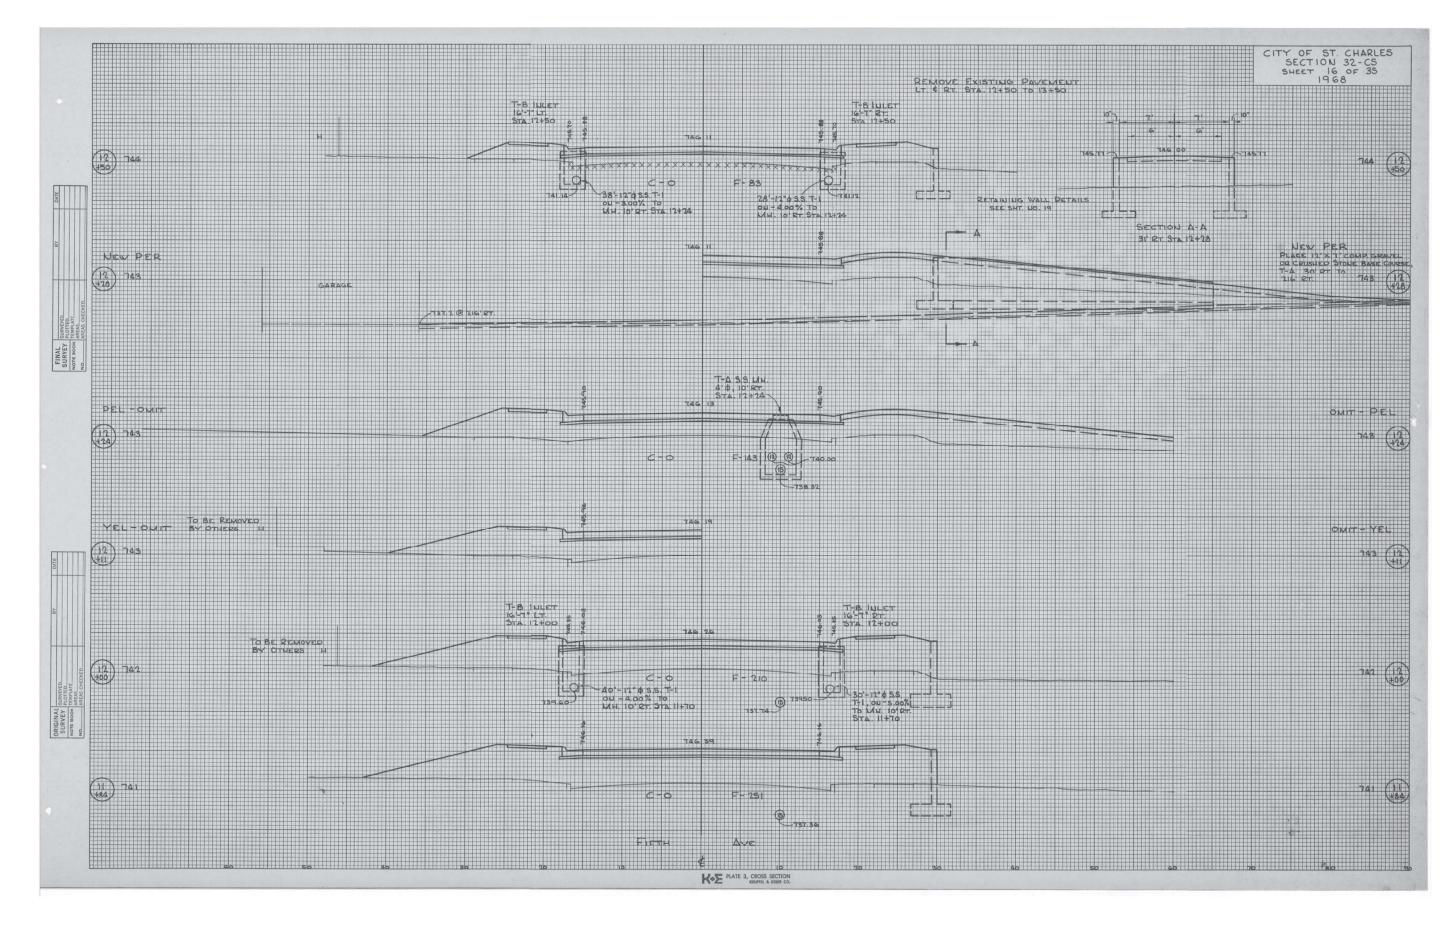


DELTA ENGINEERING GROUP. It consults to humbras consults suchers in WACKSON BLUD, SUITE 910 CHICAGO, IL 09604 T 312.377.7700, F 312.427 6145

STATE OF ILLINOIS DEPARTMENT OF TRANSPORTATION

EXISTING RETAINING WALL PLANS (FOR REFERENCE ONLY)

1:10 SHEET 12 OF 13 SHEETS STA. N/A TO STA. N/A

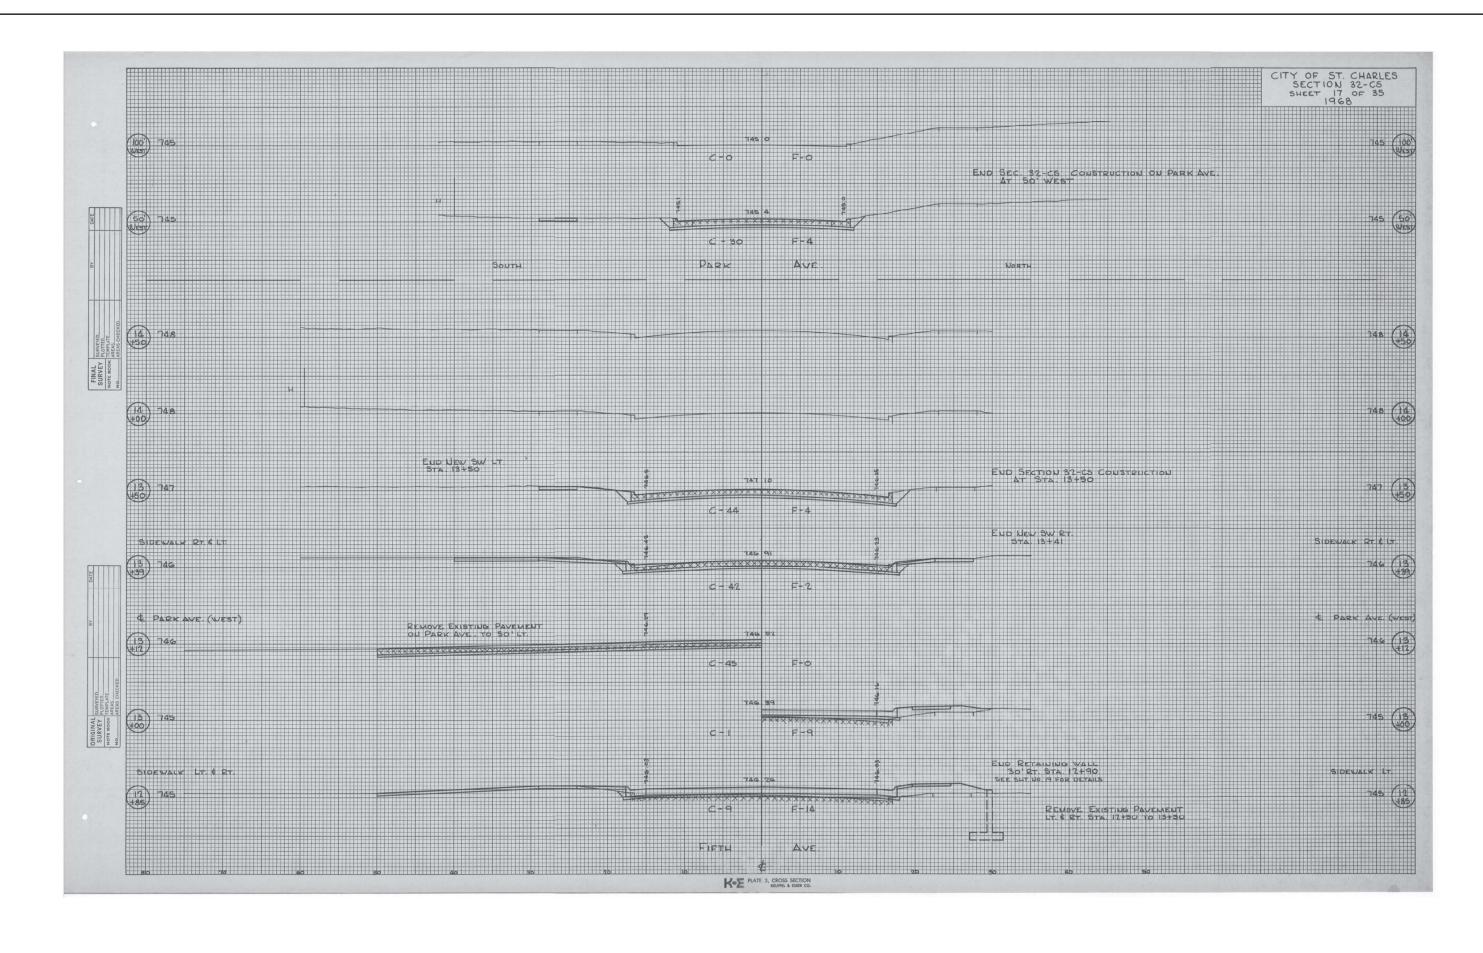

 USER NAME
 = SUSERS
 DESIGNED
 NS
 REVISED


 PLOT SCALE
 = SSCALES
 CHECKED
 MA
 REVISED

 PLOT DATE
 = SDATES
 DATE
 8/8/2024
 REVISED

STATE OF ILLINOIS DEPARTMENT OF TRANSPORTATION

EXISTING RETAINING WALL PLANS (FOR REFERENCE ONLY)

1:10 SHEET 12 OF 13 SHEETS STA. N/A TO STA. N/A

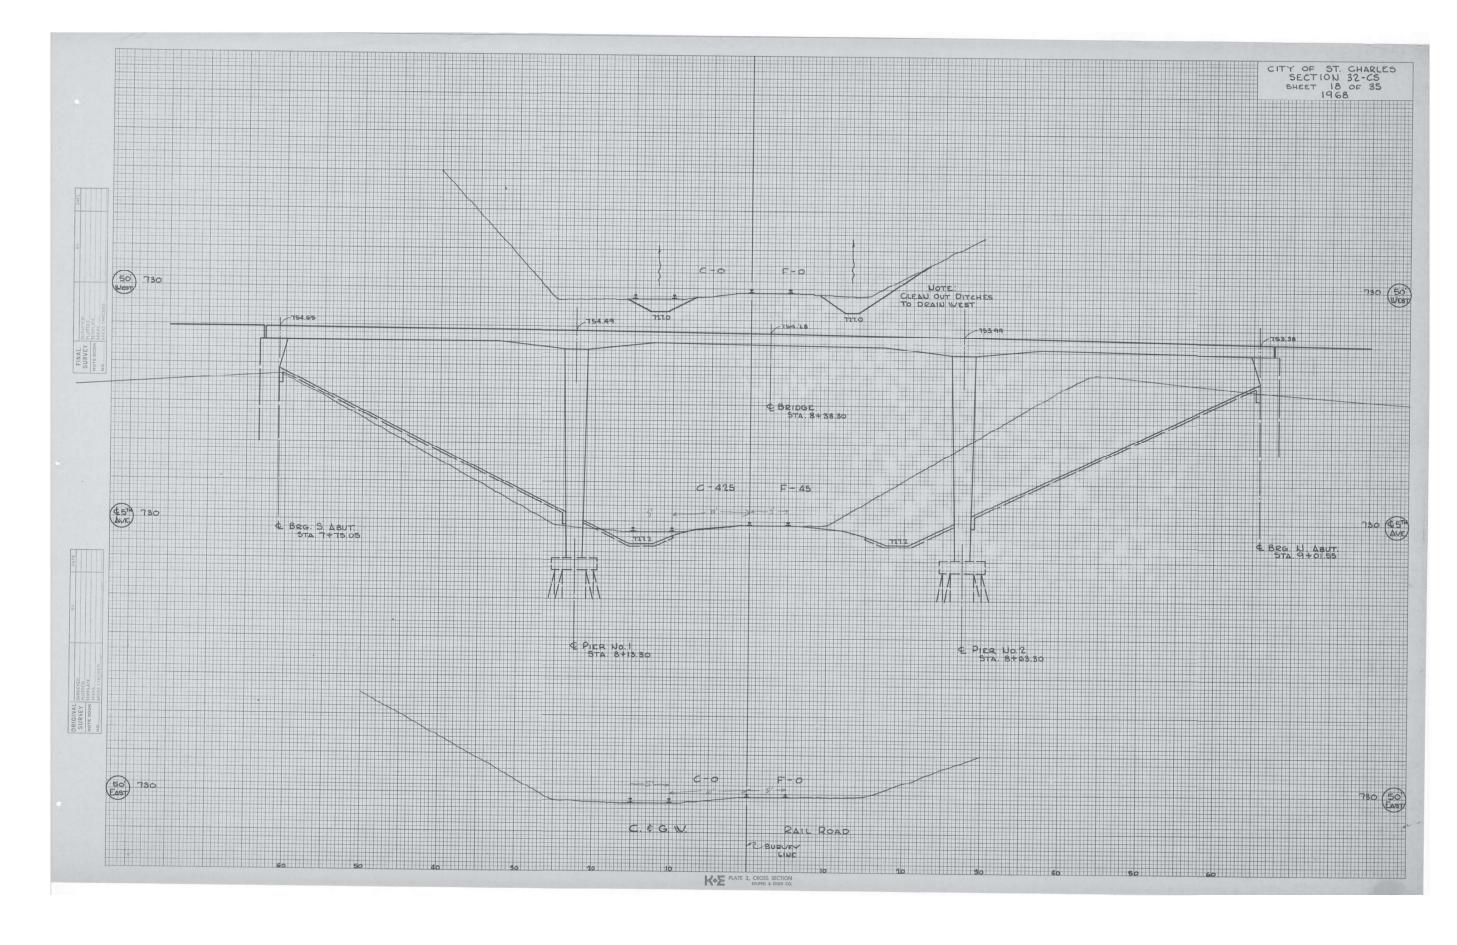


A C

DELTA ENGINEERING GROUP, LLC
CONSULTAND PROMPTISC CONSULTAND TO THE PROPERTY OF THE PROPERTY O


STATE OF ILLINOIS DEPARTMENT OF TRANSPORTATION EXISTING RETAINING WALL PLANS (FOR REFERENCE ONLY)

1:10 SHEET 12 OF 13 SHEETS STA. N/A TO STA. N/A

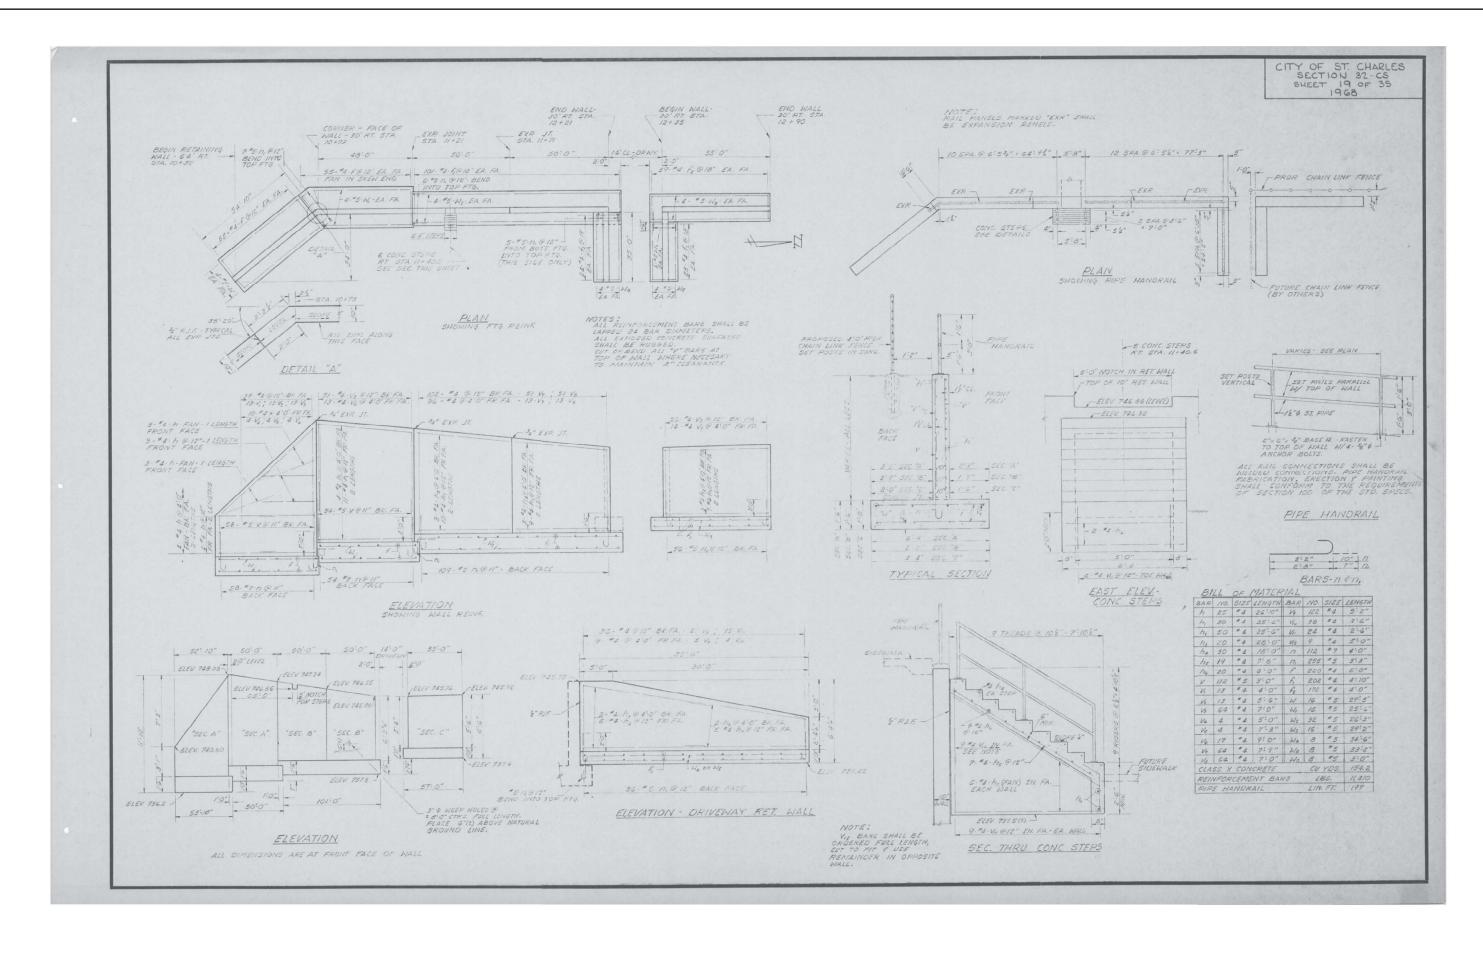

DELTA ENGINEERING GROUP,
INSELENCIA SOURCES CONSTRUCTION MANAGER CONTROLLED TO MANAGER CONTROLLED TO THE MANAGER CONTROLLE

STATE OF ILLINOIS
DEPARTMENT OF TRANSPORTATION

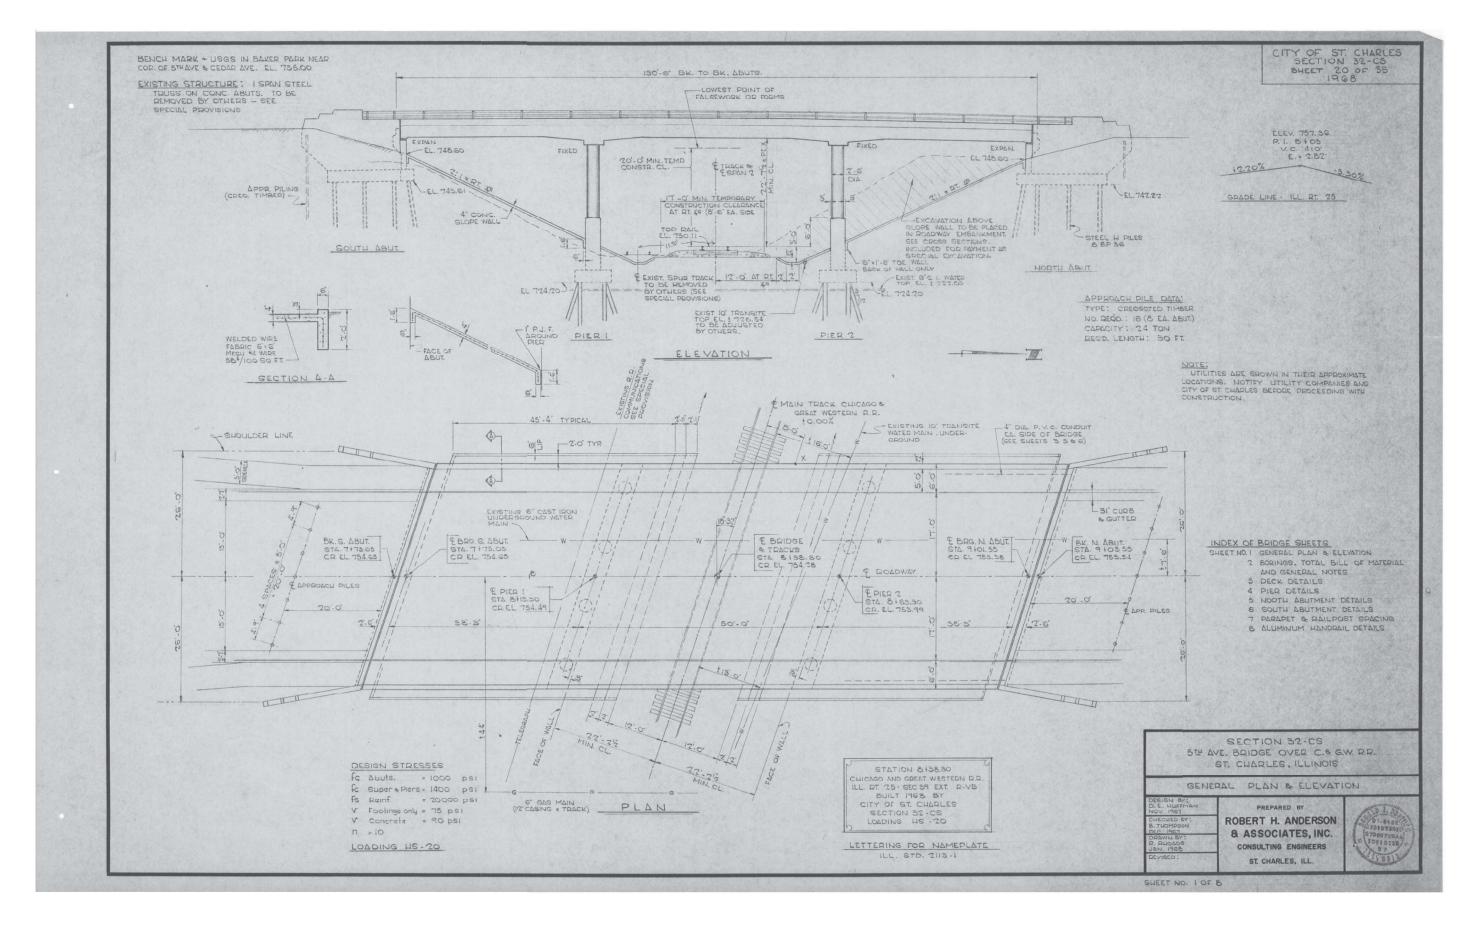


DELTA ENGINEERING GROUP, LL CONSULTAN INCOMPRESS CONTROLLES AUGUSTES AUGUSTES III W JACKSON BLVD, SUITE 910 CHCAGO, II. 600-604, SUITE 910 T 312,377,7700, F 312-427 6145

LC	USER NAME = \$USER\$	DESIGNED	-	NS	REVISED	J
rous		DRAWN	-	NS	REVISED	1
	PLOT SCALE = \$SCALE\$	CHECKED	-	MA	REVISED	1
	PLOT DATE = \$DATES	DATE	-	8/8/2024	REVISED	1

STATE OF ILLINOIS
DEPARTMENT OF TRANSPORTATION

				<u> </u>		DI 4410	/E O D	DEEE	DENIOE ON!!	. ^	F	RTE	SECT	1
	EXISTING	REIA	ININ	G W	ALL	PLANS	(FOR	KEFE	RENCE ONLY	Υ)		106	2024-	g
SCALE:	1:10	SHEET	12	OF	13	SHEETS	STA.	N/A	TO STA.	N/A				ī

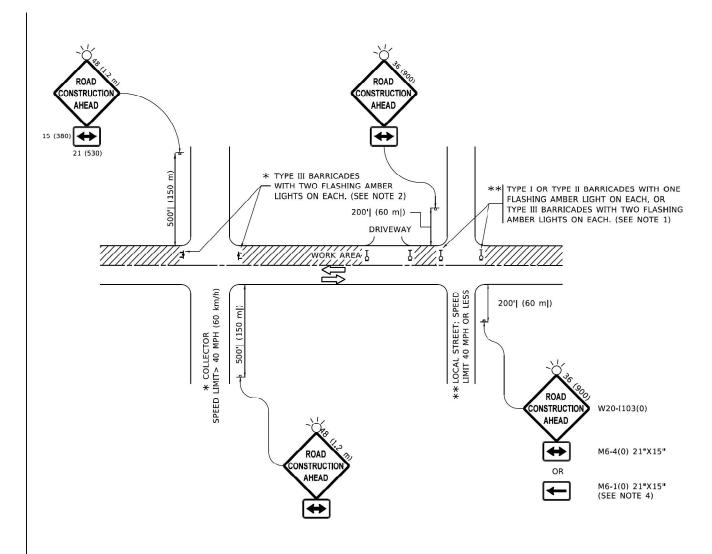

NOTES:

- SIDE ROAD WITH A SPEED LIMIT OF 40 MPH (60 km/h) OR LESS AS SHOWN ON THE DRAWING AND AS DIRECTED BY THE ENGINEER:
- a) ONE "ROAD CONSTRUCTION AHEAD" SIGN 36 x 36 (900x900) WITH A FLASHER MOUNTED ON IT APPROXIMATELY 200' (60 m) IN ADVANCE OF THE MAIN ROUTE.
- b) THE CLOSED PORTION OF THE MAIN ROUTE SHALL BE PROTECTED BY BLOCKING WITH TYPE I. TYPE II OR TYPE III BARRICADES, 1/3 OF THE CROSS SECTION OF THE CLOSED PORTION.
- 2. SIDE ROAD WITH A SPEED LIMIT GREATER THAN 40 MPH (60 km/h) AS SHOWN ON THE DRAWING AND AS DIRECTED BY THE ENGINEER:
- a) ONE "ROAD CONSTRUCTION AHEAD" SIGN 48 x 48 (1.2 m x 1.2 m) WITH A FLASHER MOUNTED ON IT APPROXIMATELY 500' (150 m) IN ADVANCE OF THE MAIN ROUTE.
- THE CLOSED PORTION OF THE MAIN ROUTE SHALL BE PROTECTED BY b) BLOCKING WITH TYPE III BARRICADES, 1/2 OF THE CROSS SECTION OF THE CLOSED PORTION.
- CONES MAY BE SUBSTITUTED FOR BARRICADES OR DRUMS AT HALF THE SPACING DURING DAY OPERATIONS. CONES SHALL BE A MINIMUM OF 28 (710) IN HEIGHT.
- WHEN THE SIDE ROAD LIES BETWEEN THE BEGINNING OF THE MAINLINE
 4. SIGNING AND THE WORK ZONE, A SINGLE HEADED ARROW (M6-1) SHALL
 BE USED IN LIEU OF THE DOUBLE HEADED ARROW (M6-4).

- WHEN WORK IS BEING PERFORMED ON A SIDE ROAD OR DRIVEWAY, FOLLOW THE APPLICABLE STANDARD(S). THE DIRECTIONAL ARROW (M6-1 OR M6-4) SHALL BE COVERED OR REMOVED WHEN NO LONGER CONSISTENT WITH THE TRAFFIC CONTROL SET-UP.
- ADVANCE WARNING SIGNS ARE TO BE OMITTED ON DRIVEWAYS UNLESS OTHERWISE SPECIFIED IN THE PLANS OR BY THE ENGINEER.
- 7. THE TRAFFIC CONTROL AND PROTECTION FOR SIDE ROADS, INTERSECTIONS, AND DRIVEWAYS SHALL BE INCLUDED IN THE COST OF SPECIFIED TRAFFIC CONTROL STANDARDS OR ITEMS.


All dimensions are in inches (millimeters) unless otherwise shown.

DELTA ENGINEERING GROUP, LI CINNULTING PRIGNEERS, CONSTRUCTION MANAGERS, SHEWEY HI W JACKSON BLVD, SUITE 910 CHICAGO, IL 60604 T 312.377.7700, F 312.427 6145

LLC	USER NAME = \$USER\$	DESIGNED	-	NS	REVISED	
EYORS		DRAWN	-	NS	REVISED	
	PLOT SCALE = \$SCALE\$	CHECKED	-	MA	REVISED	
	PLOT DATE = \$DATES	DATE	-	9/27/2024	REVISED	

		T	/PIC	AL A	APPLICA	NOITA	s		
RAISED REFLE	CTIVE	PAV	EME	NT	MARKE	RS (S	NOW-	PLOW RESISTANT)	F
SCALE: 1:10	SHEET	03	OF	13	SHEETS	STA.	N/A	TO STA. N/A	1


	F.A.S. RTE	SEC ⁻	ΓΙΟΝ		COUNTY	TOTAL SHEETS	SHEET NO.
I	106	2024	-988-I	KANE	48	45	
l		TC-	10	CONTRACT	NO. 62	2X13	
ı	ILLINOIS FED. A				D PROJECT		

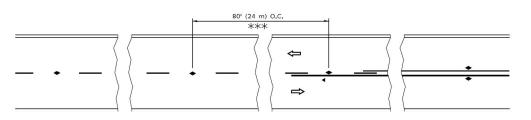

*** REDUCE TO 40' (12 m) O.C. ON CURVES WITH POSTED OR ADVISORY SPEED 45 M.P.H. (70 km/h) OR LESS.


LANE REDUCTION TRANSITION


SEE FIGURE 3B-14 MUTCD

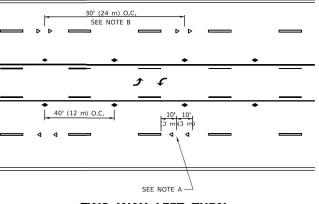

TWO-WAY LEFT TURN


TW0-LANE/TW0-WAY

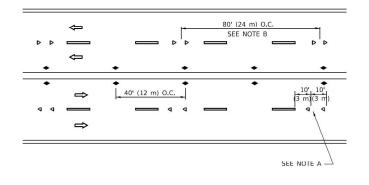


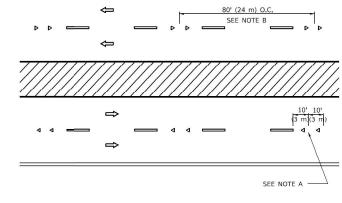

MULTI-LANE/UNDIVIDED



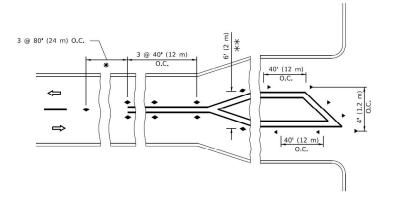

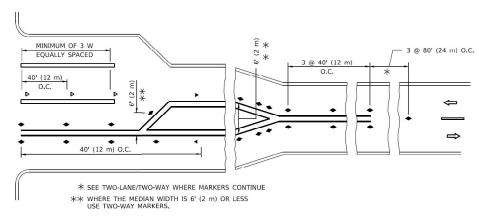

TURN LANES

GENERAL NOTES

- MARKERS USED WITH DASHED LINES SHALL BE CENTERED IN THE GAP BETWEEN SEGMENTS.
- MARKERS USED ADJACENT TO SOLID LINES SHALL BE OFFSET
 TO 3 (50 TO 75) TOWARD TRAFFIC AS SHOWN.
- MARKERS THROUGH TANGENTS LESS THAN 500' (150 m) IN LENGTH BETWEEN CURVES SHALL BE INSTALLED AT THE LESSER OF THE TWO CURVE SPACINGS.
- 4. MARKERS ARE TO BE USED ADJACENT TO BOTH SOLID WHITE LINES IN DUAL LEFT TURN LANES

LANE MARKER NOTES

A. USE DOUBLE LANE LINE MARKERS SPACED AS SHOWN.

10 M.P.H (20 km/h) LOWER THAN POSTED SPEEDS.

B. REDUCE TO 40' (12 m) O.C. ON CURVES WHERE ADVISORY SPEEDS ARE

SYMBOLS

YELLOW STRIPE

WHITE STRIPE

- ONE-WAY AMBER MARKER
- ONE-WAY CRYSTAL MARKER (W/O)
- ◆ TWO-WAY AMBER MARKER

DESIGN NOTES

- 1. DOUBLE LANE LINE MARKERS SHALL BE USED UNLESS SPECIFIED OTHERWISE.
- 2. EXCEPT AS SHOWN ON THE LANE REDUCTION TRANSITION AND FREEWAY EXIT RAMP DETAIL, MARKERS ARE NOT TO BE SPECIFIED ON RIGHT EDGE LINES.
- 3. THE EXACT MARKER LIMITS, SPACING, AND COLOR SHALL BE INCLUDED IN THE PLANS WHEN STANDARD SPECIFICATIONS ARE NOT BEING USED.
- 4. MARKERS SHOULD NOT BE USED ALONGSIDE CURBS EXCEPT FOR EXTREMELY SHORT SECTIONS OF CURBS WHERE NOT MORE THAN TWO MARKERS WOULD BE INVOLVED.

All dimensions are in inches (millimeters) unless otherwise shown.


DI CH T3

DELTA ENGINEERING GROUP, LLC	USER NAME = \$USER\$	DESIGNED - NS	REVISED
DELIA ENGINEERS CONSTRUCTION MANAGERS SUFFEYORS 11 W JACKSON BLVD, SUITE 910		DRAWN - NS	REVISED
CHICAGO, IL 60604 312,377,7700, F 312,427 6145	PLOT SCALE = \$SCALE\$	CHECKED - MA	REVISED
312.377.7700,1 312.427 0143	PLOT DATE = \$DATES	DATE - 9/27/2024	REVISED


STATE OF ILLINOIS
DEPARTMENT OF TRANSPORTATION

		T	/PIC	AL	APPLIC/	NOITA	S		F./ RT
RAISED REFLE	CTIVE	PAV	EME	ENT	MARKE	RS (S	NOW-	PLOW RESISTANT)	1
TO GOLD THE LE									
SCALE: 1:10	SHEET	03	OF	13	SHEETS	STA.	N/A	TO STA. N/A	

A.S. RTE	SECT	ПОИ	COUNTY	TOTAL SHEETS	SHEET NO.	
106	2024-	-988-I		KANE	48	46
	TC-	11	CONTRACT	NO. 62	2X13	
		ILLINOIS	D PROJECT			

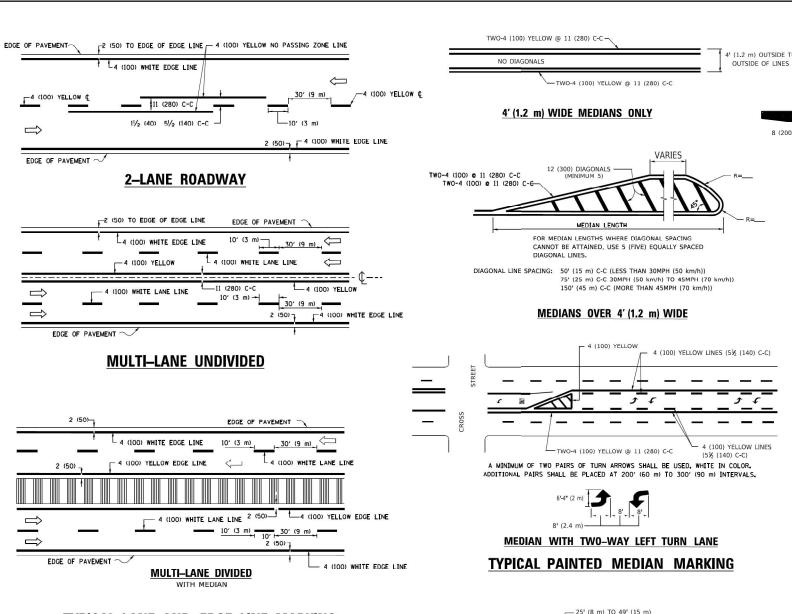

TYPICAL LANE AND EDGE LINE MARKING

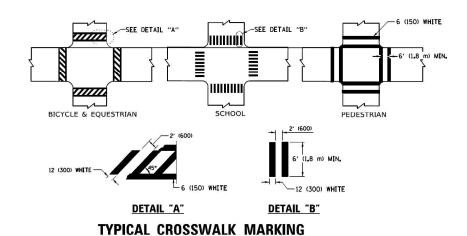


* MARKINGS SHALL BE INSTALLED PARALLEL TO THE CENTERLINE OF THE ROAD WHICH IT CROSSES

- 25' (8 m) TO 49' (15 m) OVER 200' (60 m) - 6 (150) WHITE


* TURN LANES IN EXCESS OF 400' (120 m) IN LENGTH MAY HAVE AN ADDITIONAL SET OF ARROW - "ONLY" INSTALLED MIDWAY BETWEEN THE OTHER TWO SETS OF ARROW - "ONLY".

TYPICAL LEFT (OR RIGHT) TURN LANE


TYPICAL TURN LANE MARKING

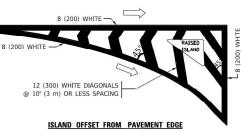


8 (200) WHITE -ISLAND AT PAVEMENT EDGE TYPICAL ISLAND MARKING

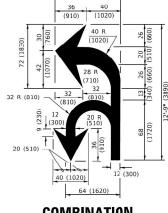

COMBINATION LEFT AND U-TURN

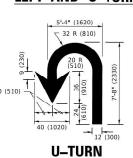

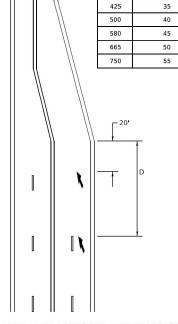

D(FT)

345

SPEED LIMIT

30

LANE REDUCTION TRANSITION

 $m{\star}$ LANE REDUCTION ARROWS REQUIRED AT SPEEDS OF 45 MPH OR GREATER OR WHEN SPECIFIED IN PLANS.

			<u> </u>	
TYPE OF MARKING	WIDTH OF LINE	PATTERN	COLOR	SPACING / REMARKS
CENTERLINE ON 2 LANE PAVEMENT	4 (100)	SKIP-DASH	YELLOW	10' (3 m) LINE WITH 30' (9 m) SPACE
CENTERLINE ON MULTI-LANE UNDIVIDED PAVEMENT	2 @ 4 (100)	SOLID	YELLOW	11 (280) C-C
NO PASSING ZONE LINES: FOR ONE DIRECTION FOR BOTH DIRECTIONS	4 (100) 2 @ 4 (100)	SOLID SOLID	YELLOW YELLOW	5½ (140) C-C FROM SKIP-DASH CENTERLINE 11 (280) C-C OMIT SKIP-DASH CENTERLINE BETWEEN
LANE LINES	4 (100) 5 (125) ON FREEWAYS	SKIP-DASH	WHITE WHITE	10' (3 m) LINE WITH 30' (9 m) SPACE
DOTTED LINES (EXTENSIONS OF CENTER, LANE OR TURN LANE MARKINGS)	SAME AS LINE BEING EXTENDED	SKIP-DASH	SAME AS LINE BEING EXTENDED	2' (600) LINE WITH 6' (1.8 m) SPACE
EDGE LINES	4 (100)	SOLID	YELLOW-LEFT WHITE-RIGHT	OUTLINE MEDIANS IN YELLOW
TURN LANE MARKINGS	6 (150) LINE; FULL SIZE LETTERS & SYMBOLS (8' (2.4m))	SOLID	WHITE	SEE TYPICAL TURN LANE MARKING DETAIL
TWO WAY LEFT TURN MARKING	2 @ 4 (100) EACH DIRECTION B' (2.4m) LEFT ARROW	SKIP-DASH AND SOLID IN PAIRS	YELLOW	10' (3 m) LINE WITH 30' (9 m) SPACE FOR SKIP-DASH; 5½ (140) C-C BETWEEN SOLID LINE AND SKIP-DASH LINE SEE TYPICAL TWO-WAY LEFT TURN MARKING DETAIL
CROSSWALK LINES (PEDESTRIAN) A. DIAGONALS (BIKE & EQUESTRIAN) B. LONGITUDINAL BARS (SCHOOL)	2 @ 6 (150) 12 (300) @ 45° 12 (300) @ 90°	SOLID SOLID SOLID	WHITE WHITE WHITE	NOT LESS THAN 6' (1.8 m) APART 2' (600) APART 2' (600) APART 5EE TYPICAL CROSSWALK MARKING DETAILS.
STOP LINES	24 (600)	SOLID	WHITE	PLACE 4' (1.2 m) IN ADVANCE OF AND PARALLEL TO CROSSWALK, IF RESENT. OTHERWISE, PLACE AT DESIRED STOPPING PARALLEL TO CROSSROAD CENTERLINE, WHERE POSSIBLE
PAINTED MEDIANS	2 @ 4 (100) WITH 12 (300) DIAGONALS @ 45° NO DIAGONALS USED FOR 4' (1.2 m) WIDE MEDIANS	SOLID	YELLOW: TWO WAY TRAFFIC WHITE: ONE WAY TRAFFIC	11 (280) C-C FOR THE DOUBLE LINE SEE TYPICAL PAINTED MEDIAN MARKING.
GORE MARKING AND CHANNELIZING LINES	8 (200) WITH 12 (300) DIAGONALS @ 45°	SOLID	WHITE	DIAGONALS: 15' (4,5 m) C-C (LESS THAN 30MPH (50 km/h)) 20' (6 m) C-C 30MPH (50 km/h) TO 45MPH (70 km/h)) 30' (9 m) C-C (OVER 45MPH (70 km/h))
RAILROAD CROSSING	24 (600) TRANSVERSE LINES; "RR" IS 6' (1.8 m) LETTERS; 16 (400) LINE FOR "X"	SOLID	WHITE	SEE STATE STANDARD 780001 AREA OF: *R"-3.6 SQ. FT. (0.33 m PEACH *X"=54.0 SQ. FT. (5.0 m PE
SHOULDER DIAGONALS (REQUIRED FOR SHOULDERS > 8')	12 (300) @ 45°	SOLID	WHITE - RIGHT YELLOW - LEFT	50' (15 m) C-C (LESS THAN 30MPH (50 km/h)) 75' (25 m) C-C (30 MPH (50 km/h) TO 45MPH (70 km/h)) 150' (45 m) C-C (OVER 45MPH (70 km/h))
U TURN ARROW	SEE DETAIL	SOLID	WHITE	16.3 SF
2 ARROW COMBINATION LEFT AND U TURN	SEE DETAIL	SOLID	WHITE	30.4 SF

FOR FURTHER DETAILS ON PAVEMENT MARKING REFER TO STANDARD SPECIFICATIONS FOR ROAD AND BRIDGE CONSTRUCTION AND STATE STANDARD 780001.


SCALE: N/A

All dimensions are in inches (millimeters)

SER NAME = \$USER\$ DESIGNED -REVISED DRAWN NS REVISED CONSULTING ENGINEERS, CONSTRUCTION WANAGE 111 W JACKSON BLVD, SUITE 910 CHICAGO, IL 60604 T 312.377.7700, F 312.427 6145 HECKED МА REVISED LOT DATE = \$DATES 9/27/2024

STATE OF ILLINOIS DEPARTMENT OF TRANSPORTATION

DISTICT ONE										F.A.S. RTE					SHEET NO.		
TYPICAL PAVEMENT MARKINGS									106 2024-988-I			KANE	48	47			
														TC-13	CONTRACT	NO. 62	2X13
	SHEET	06	OF	13	SHEETS	STA.	N/A	TO S	TA.	N/A				ILLINOIS FED	AID PROJECT		

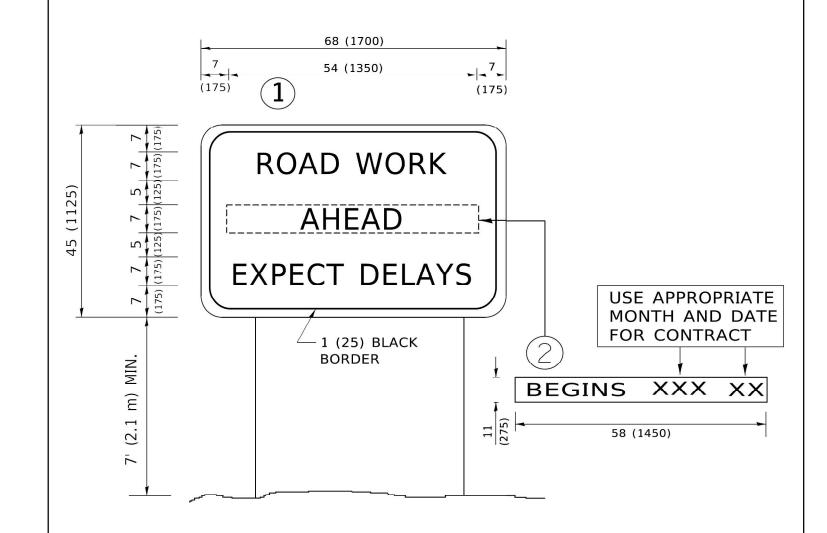

NOTES:

- 1. USE BLACK LETTERING ON ORANGE BACKGROUND.
- 2. ERECT SIGNS IN ADVANCE OF THE LOCATION FOR THE "ROAD CONSTRUCTION AHEAD" SIGN AT LOCATIONS AS DIRECTED BY THE ENGINEER.
- 3. ERECT SIGN 1) WITH INSTALLED PANEL 2) ONE WEEK PRIOR TO THE START OF CONSTRUCTION.
- 4. REMOVE PANEL(2)SOON AFTER THE START OF CONSTRUCTION.
- 5. SEE SPECIAL PROVISION FOR "TEMPORARY INFORMATION SIGNING" FOR ADDITIONAL INFORMATION.
- 6. ONE SIGN ASSEMBLY EQUALS 25.70 SQ. FT. (2.3 SQ. M.)

SCALE: N/A

7. SHALL BE PAID FOR AS TEMPORARY INFORMATION SIGNING.


ALL DIMENSIONS ARE IN INCHES (MILLIMETERS) UNLESS OTHERWISE SHOWN.

	Di con 11 CH
/WX/WX	Τ3

NULTING ENGINEERS, CONSTRUCTION MANAGER W JACKSON BLVD, SUITE 910 ICAGO, IL 60604 12.377.7700, F 312.427 6145

P. LLC	USER NAME = \$USER\$	DESIGNED	-	NS	REVISED	
SURVEYORS		DRAWN	-	NS	REVISED	1
	PLOT SCALE = \$SCALE\$	CHECKED	-	MA	REVISED	1
	PLOT DATE = \$DATES	DATE	-	8/8/2024	REVISED	1

			ART	ΓEF	RIAL RO	AD						F.A.S. RTE	SE	CTION		COUNTY	TOTAL SHEETS	SHEET NO.
INFORMATION SIGN										106	106 2024-988-I			KANE	48	48		
													Т	C - 22		CONTRACT	NO. 62	2X13
	SHEET	10	OF 1	13	SHEETS	STA.	N/A	TO ST	Α.	N/A				ILLINOI	S FED. A	D PROJECT	-	

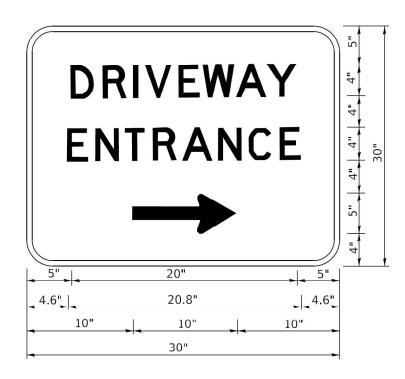

3.0" RADIUS, 0.5" BORDER, WHITE ON GREEN; REFLECTORIZED "DRIVEWAY" D; "ENTRANCE" D; STANDARD ARROW CUSTOM 12.0" x 5.0"

NOTES:

- 1. HALF OF THE SIGNS WILL REQUIRE A LEFT HAND FACING ARROW.
- 2. TWO SIGNS SHALL BE USED AT EACH COMMERCIAL ENTRANCE PLACED BACK-TO-BACK: ONE WITH A RIGHT HAND ARROW (SHOWN) SHALL BE PLACED ON THE NEAR RIGHT SIDE THE DRIVEWAY AND ONE WITH A LEFT HAND ARROW SHALL BE PLACED ON THE FAR LEFT SIDE OF THE DRIVEWAY.
- 3. SIGNS TO BE PAID FOR AS ITEM "TEMPORARY INFORMATION SIGNING".

FILE NAME: SFILELS	DELTA ENGINEERING GROUP, 1. CONSULTING PROBLEMS GROUPS AND PROBLEMS GROUPS AND PROBLEMS GROUPS AND ACKSON BLUE SUPPORT OF THE STATE OF
-	

	USER NAME = \$USER\$	DESIGNED	-	NS	REVISED
LLC VEYORS		DRAWN	-	NS	REVISED -
	PLOT SCALE = \$SCALE\$	CHECKED	-	MA	REVISED -
	PLOT DATE = \$DATES	DATE	-	9/27/2024	REVISED

STATE OF ILLINOIS
DEPARTMENT OF TRANSPORTATION

SCALE: N/A

ARTERIAL ROAD										F.A.S. SECTION			COUNTY	TOTAL SHEETS	SHEET NO.
INFORMATION SIGN									106 2024-988-I			KANE	48	48A	
										TC-	-26		CONTRACT	NO. 62	2X13
Г 1	0	OF	13	SHEETS	STA.	N/A	TO STA.	N/A			ILLINOIS	FED. AI	D PROJECT		