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11-08-2019 LETTING ITEM 024

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HIGHWAY STANDARDS

SEE SHEET 2 OF 329, FOR HIGHWAY STANDARDS.

DISTRICT 4 STANDARDS


SEE SHEET 2 OF 329, FOR DISTRICT STANDARDS.

STATE OF ILLINOIS DEPARTMENT OF TRANSPORTATION

PROPOSED HIGHWAY PLANS

FAI ROUTE 74 (I-74 /IL 29)
SECTION 90(10D-1)BRR
PROJECT NHPP-Y4TH(575)
BRIDGE REPAIR
TAZEWELL COUNTY

C-94-111-15

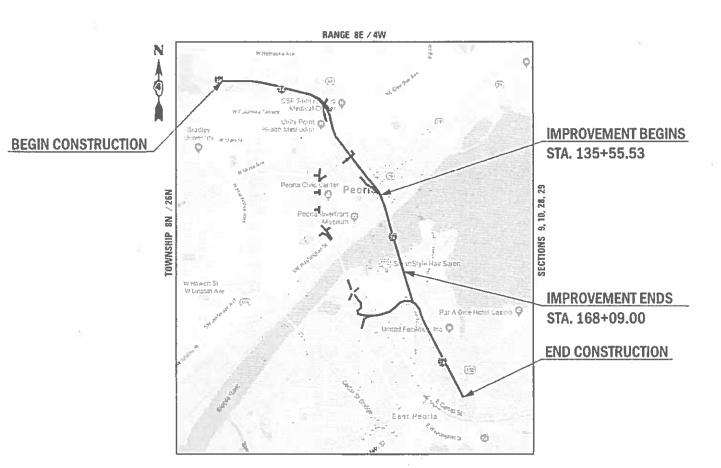

GROSS LENGTH = 3,254 FT. = 0.616 MILES

NET LENGTH = 3,254 FT. = 0.616 MILES

ALL SECTION COUNTY TOTAL SHEET NO.
73 90(100-1)BRR 1 1000-1 1300-1 1000-

* 329 + 3 = 332 TOTAL SHEETS

D-94-072-15



FUNCTIONAL CLASSIFICATION INTERSTATE AADT (2020) = 67,600 SU=1.85%, MU=4.75%

STATE OF ILLINOIS
DEPARTMENT OF TRANSPORTATION


Kensil A Marnether Market ENGINEE

ENGINEER OF DESIGN AND ENVIRONMENT

DIRECTOR OF HIGHWAYS PROJECT IMPLEMENTA ON

PRINTED BY THE AUTHORITY OF THE STATE OF ILLINOIS

REV. 9/19/19 REV. 9/12/19

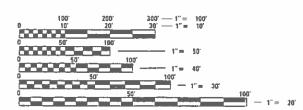

FULL SIZE PLANS HAVE BEEN PREPARED USING STANDARD ENGINEERING SCALES. REDUCED SIZED PLANS WILL NOT CONFORM TO STANDARD SCALES. IN MAKING MEASUREMENTS ON REDUCED PLANS, THE ABOVE SCALES MAY BE USED.


J.U.L.I.

JOINT UTILITY LOCATION INFORMATION FOR EXCAVATION 1-800-892-0123

OR 811

PROJECT ENGINEER: RICHARD DOTSON (309)671–3455 PROJECT MANAGER: KEVIN HORST (309)671–3472 CATALOG NO. 035323–00D

CONTRACT NO. 68C89

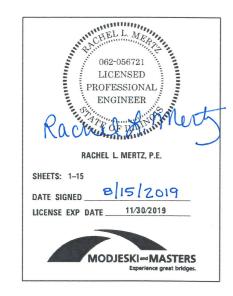






ILLINOIS DEPARTMENT OF TRANSPORTATION RESPONSIBLE FOR THE DESIGN AND SHEET DEVELOPMENT OF THE WASTE SITE DETAILS.

SHEETS: 82




ILLINOIS DEPARTMENT OF TRANSPORTATION
RESPONSIBLE FOR THE DESIGN
AND SHEET DEVELOPMENT OF THE
NAVIGATION AND ROADWAY LIGHTING
AND THE MISCELLANEOUS ELECTRICAL DETAILS.

SHEETS: 83-99 AND 159-182

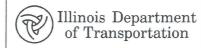

SHEETS: 100-158 SEE SHEET 100 FOR SIGNATURE



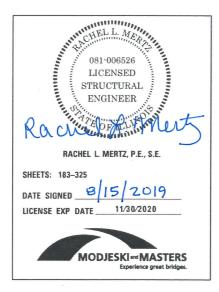

ILLINOIS DEPARTMENT OF TRANSPORTATION RESPONSIBLE FOR THE DESIGN AND SHEET DEVELOPMENT OF THE SCOUR COUNTERMEASURES.

SHEETS: 326-327



HIGHWAY STANDARDS

000001-07	STANDARD SYMBOLS, ABBREVIATIONS AND PATTERNS
001001-02	AREAS OF REINFORCEMENT BARS
001006	DECIMAL OF AN INCH AND OF A FOOT
280001-07	TEMPORARY EROSION CONTROL SYSTEMS
515001-03	NAME PLATE FOR BRIDGES
701006-05	OFF-ROAD OPERATIONS, 2L, 2W, 15' (4.5 M) TO 24" (600 MM) FROM PAVEMENT EDGE
701101-05	OFF-ROAD OPERATIONS, MULTILANE, 15' (4.5 M) TO 24" (600 MM) FROM PAVEMENT EDGE
701106-02	OFF-ROAD OPERATIONS, MULTILANE, MORE THAN 15' (4.5M) AWAY
701400-09	APPROACH TO LANE CLOSURE, FREEWAY/EXPRESSWAY
701401-12	LANE CLOSURE, FREEWAY/EXPRESSWAY
701411-09	LANE CLOSURE, MULTILANE, AT ENTRANCE OR EXIT RAMP, FOR SPEEDS ≥ 45 MPH
701426-09	LANE CLOSURE, MULTILANE, INTERMITTENT OR MOVING OPERATION, FOR SPEEDS ≥ 45 MPH
701427-05	LANE CLOSURE, MULTILANE, INTERMITTENT OR MOVING OPERATION, FOR SPEEDS ≤ 40 MPH
701428-01	TRAFFIC CONTROL, SETUP AND REMOVAL, FREEWAY/EXPRESSWAY
701451-05	RAMP CLOSURE FREEWAY/EXPRESSWAY
701501-06	URBAN LANE CLOSURE, 2L, 2W, UNDIVIDED
701601-09	URBAN LANE CLOSURE, MULTILANE, 1W OR 2W WITH NONTRAVERSABLE MEDIAN
701701-10	URBAN LANE CLOSURE, MULTILANE INTERSECTION
701901-08	TRAFFIC CONTROL DEVICES
720001-01	SIGN PANEL MOUNTING DETAILS
720006-04	SIGN PANEL ERECTION DETAILS
	SIGN PANELS, EXTRUDED ALUMINUM TYPE
728001-01	TELESCOPING STEEL SIGN SUPPORT
780001-05	TYPICAL PAVEMENT MARKINGS
	CURB REFLECTORS
	RACEWAY EMBEDDED IN STRUCTURE
	HANDHOLES
	LUMINAIRE WIRING IN POLE
826001-02	NAVIGATION OBSTRUCTION LIGHTING CONTROLLER, 240V
830006-05	LIGHT POLE ALUMINUM DAVIT ARM
830021-03	LIGHT POLE STEEL TENON TOP
838001-01	BREAKWAY DEVICES
	TRAFFIC SIGNAL GROUNDING & BONDING
	CONCRETE FOUNDATION DETAILS
	SPAN WIRE MOUNTED SIGNALS AND FLASHING BEACON INSTALLATION
880006-01	TRAFFIC SIGNAL MOUNTING DETAILS

DISTRICT 4 STANDARDS

780001-D4 TYPICAL PAVEMENT MARKINGS

MODJESKI-MASTERS
Experience great bridges.

USER NAME = aecook	DESIGNED - CSG	REVISED -
	DRAWN - AEC	REVISED -
PLOT SCALE = 2.0000 ' / in.	CHECKED - RLM	REVISED -
PLOT DATE = 8/15/2019	DATE - 8/9/2019	REVISED -

STATE OF ILLINOIS **DEPARTMENT OF TRANSPORTATION**

							F.A.I. RTE.	SECT	ION		COUNTY	TOTAL	
PROJECT SEAL	S, HIGHWAY	STAND	ARDS	AND	DISTRICT	4 STANDARDS	74	90(10D	-1)BRR		3.	329	2
											CONTRACT	NO.	68C89
SCALE: N.T.S.	SHEET	OF	SHEETS	STA.		TO STA.			ILLINOIS	FED. Al	D PROJECT		

PROPERTY OWNER ACCESS REQUIREMENTS

ACCESS MUST BE MAINTAINED TO ALL EXISTING PROPERTIES DURING CONSTRUCTION PER ARTICLE 107.09 UNLESS ARRANGEMENTS ARE MADE IN WRITING BY THE CONTRACTOR WITH THE PROPERTY OWNERS WITH A COPY TO THE ENGINEER FOR SHORT-TERM CLOSURES.

CRITICAL PATH WORK SCHEDULE REQUIREMENT

THE CONTRACTOR WILL SUBMIT TO THE ENGINEER A SATISFACTORY PROGRESS SCHEDULE AND CRITICAL PATH SCHEDULE WHICH SHALL SHOW THE PROPOSED SEQUENCE OF WORK AT THE TIME OF THE PRE-CONSTRUCTION CONFERENCE

ENVIRONMENTAL REVIEWS

PRIOR TO THE USE OF ANY PROPOSED BORROW AREAS, USE AREAS (TEMPORARY ACCESS ROADS, DETOURS, RUN-AROUNDS, ETC.) AND/OR WASTE AREAS, THE CONTRACTOR SHALL FILE THE REQUIRED ENVIRONMENTAL RESOURCE REQUEST SURVEYS ACCORDING TO SECTION 107.22 OF THE STANDARD SPECIFICATIONS. THESE SURVEYS ARE REQUIRED IN ORDER FOR THE DEPARTMENT TO CONDUCT CULTURAL AND BIOLOGICAL RESOURCE SURVEYS FOR THE PROPOSED SITE.

THE REQUIRED ENVIRONMENTAL RESOURCE DOCUMENTATION SHALL INCLUDE THE FOLLOWING:

- * BDE FORM 2289 (CULTURAL AND NATURAL RESOURCES REVIEW OF BORROW AREAS)
- * BDE FORM 2290 (WASTE/USE AREA REVIEW)
- * A LOCATION MAP SHOWING THE SIZE LIMITS AND LOCATION OF THE USE AREA

SHALL INCLUDE APPROPRIATE LANGUAGE BINDING THEM TO SIMILAR RESPONSIBILITIES.

- COLOR PHOTOGRAPHS DEPICTING THE USE AREA
- * BORROW AREA ENTRY AGREEMENT FORM D4 PI0101

PRIOR TO ANY WASTE MATERIALS BEING REMOVED FROM THE CONSTRUCTION SITE THE REQUIRED ENVIRONMENTAL RESOURCE SURVEYS SHALL BE OBTAINED AND FILED BY THE CONTRACTOR. EXCESS WASTE PRODUCTS REMOVED FROM THE CONSTRUCTION SITE SHALL BE DISPOSED OF AS REQUIRED IN SECTION 202.03 OF THE STANDARD SPECIFICATIONS.

ANY PROTRUDING METAL BARS SHALL BE REMOVED PRIOR TO THE DISPOSAL OF BROKEN CONCRETE AT APPROVED DISPOSAL SITES.

PLEASE NOTE THAT A MINIMUM OF FOUR WEEKS SHALL BE ALLOWED FOR THE DISTRICT TO OBTAIN THE REQUIRED ENVIRONMENTAL CLEARANCES AND SIX WEEKS FOR THE REQUIRED BORROW SITE ENVIRONMENTAL CLEARANCES.

SECURING DRAINAGE STRUCTURE GRATES

PRIOR TO ROUTING TRAFFIC ONTO THE SHOULDERS AS SHOWN IN THE STAGING PLANS, THE CONSTRACTOR SHALL SECURE GRATINGS ON SHOULDER INLETS AS DIRECTED BY THE ENGINEER. THIS WORK WILL NOT BE PAID FOR SEPARATELY, BUT SHALL BE INCLUDED IN THE COST OF THE TRAFFIC CONTROL PAY ITEM.

ADDITIONAL SUPPLEMENTAL TRAFFIC CONTROL

THE DEPARTMENT RESERVES THE RIGHT AT ANY TIME TO ADD ADDITIONAL TRAFFIC CONTROL SYSTEMS OR DEVICES WITHIN THE ACTIVE CONTRACT LIMITS, BY MEANS OF AN ADDITIONAL CONTRACT. ALL TERMS OF ARTICLE 105.08 OF THE STANDARD SPECIFICATIONS SHALL BE FOLLOWED BY EACH CONTRACTOR.

SIGNIN

SIGN LOCATIONS MAY VARY FROM THE STATIONS SHOWN ON THE PLANS IN ACCORDANCE WITH DIRECTIONS FROM THE ENGINEER AT THE TIME OF CONSTRUCTION. SIGN LOCATIONS MAY BE ADJUSTED IN THE FIELD TO AVOID ANY FOUND UTILITIES.

ALL WOOD POST LOCATIONS SHALL BE VERIFIED WITH THE BUREAU OF OPERATIONS, TRAFFIC SECTION, BEFORE INSTALLATION.

PROJECT SPECIFIC NOTES

AN EXISTING STRUCTURE INFORMATION PACKAGE IS AVAILABLE UPON REQUEST. CONTACT KEVIN HORST AT (309) 671-3472

ILLINOIS STATE LAW REQUIRES A 48-HOUR NOTICE TO BE GIVEN TO ALL UTILITIES WITHIN THE PROJECT AREA BEFORE DIGGING BY CALLING J.U.L.I.E. AND BY NOTIFYING NON-J.U.L.I.E. MEMBERS INDIVIDUALLY.

THE MAJORITY OF THE PAVEMENT MARKINGS AND TRAFFIC CONTROL DETAILS ARE DRAWN BASED ON AERIAL PHOTOGRAPHS, NOT SURVEY. USE OF THE AVAILABLE ELECTRONIC FILES MAY AID IN THE LAYOUT OF PAVEMENT MARKINGS AND TRAFFIC CONTROL, BUT THE ELECTRONIC FILES WILL NOT PROVIDE THE EXACT LOCATIONS OF PROPOSED ITEMS.

COORDINATION

SEE SPECIAL PROVISIONS FOR UNITED STATES COAST GUARD (U.S.C.G.) REQUIREMENTS.

U.S.C.G. CONTACT:

MR. PETER J. SAMBOR, M.P.A U.S.C.G. BRIDGE MANAGEMENT SPECIALIST COAST GUARD 8TH DISTRICT 1222 SPRUCE STREET. SUITE 2107F ST. LOUIS, MISSOURI 63103 PHONE: (314) 269-2380 U.S.C.G. 24-HOUR WATCH CENTER: (314) 269-2332

SEE SPECIAL PROVISIONS FOR TAZEWELL AND PEORIA RAILROAD (T.Z.P.R) REQUIREMENTS.

COMMITMENTS

COMMITMENTS ARE NOT TO BE ALTERED WITHOUT THE WRITTEN APPROVAL OF ALL PARTIES TO WHICH THE COMMITMENT WAS MADE.

PEORIA PARK DISTRICT

THE CONTRACTOR SHALL CONTACT THE PEORIA PARK DISTRICT TWO WEEKS PRIOR TO INSTALLING FENCING BENEATH THE MURRAY BAKER BRIDGE ON THE PEORIA RIVERFRONT. THE CONTRACTOR SHALL ALLOW THE PARK DISTRICT TO ACCESS THEIR UTILITIES BENEATH THE BRIDGE, AS NEEDED, DURING CONSTRUCTION. BELOW IS THE CONTACT FOR THE PEORIA PARK DISTRICT:

NICK CONRAD SUPERVISOR OF RIVERFRONT EVENTS PEORIA PARK DISTRICT 309-681-2951 (OFFICE) 309-370-1734 (CELL)

THE CONTRACTOR SHALL MAINTAIN ACCESS FOR PEDESTRIAN AND BICYCLE TRAFFIC ON THE PATH BETWEEN THE RAILROAD AND MURRAY BAKER BRIDGE PIER 3.

THE CONTRACTOR SHALL MAINTAIN ACCESS ALONG THE PATH BETWEEN MURRAY BAKER BRIDGE PIER 4 AND THE ILLINOIS RIVER FOR PEDESTRIAN, BICYCLE, AND OCCASIONAL MAINTENANCE PICKUP TRUCK TRAFFIC. THE PATH MUST BE ABLE TO ACCOMMODATE A LARGE VOLUME OF PEDESTRIANS DURING RIVERFRONT EVENTS.

<u>UNITY POINT HEALTH</u>

THE CONTRACTOR SHALL NOTIFY UNITY POINT HEALTH BEFORE CLOSING ENTRANCES TO THE PARKING LOT ON FAYETTE ST. AND GLENDALE AVE. THE ENTRANCES TO THE LOT SHALL BE CLOSED ONE WEEK PRIOR TO THE CLOSURE OF THE MURRAY BAKER BRIDGE. BELOW IS THE CONTACT FOR UNITY POINT HEALTH:

MIKE MCINTYRE MANAGER, SECURITY 309-672-4764 (OFFICE) 309-251-8703 (CELL)

UTILITY NOTE

THE LOCATIONS OF THOSE BURIED AND ABOVEGROUND UTILITIES SHOWN ARE APPROXIMATE, ARE SHOWN FOR CONTRACTOR INFORMATIONAL USE ONLY, AND ARE NOT TO BE REFERENCED FOR CONSTRUCTION PURPOSES. THE IMPLIED PRESENCE OR ABSENCE OF UTILITIES IS NOT TO BE CONSTRUED BY THE OWNER, ENGINEER, CONTRACTOR. OR SUBCONTRACTORS TO BE AN ACCURATE AND COMPLETE REPRESENTATION OF UTILITIES THAT MAY OR MAY NOT EXIST ON THE CONSTRUCTION SITE. BURIED AND ABOVEGROUND UTILITY LOCATION, IDENTIFICATION, AND MARKING ARE THE SOLE RESPONSIBILITY OF THE CONTRACTOR. REROUTING, DISCONNECTION, PROTECTION, ETC. OF ANY UTILITIES MUST BE COORDINATED AMONG THE CONTRACTOR, UTILITY COMPANY, AND OWNER. SITE SAFETY, INCLUDING THE AVOIDANCE OF HAZARDS, ASSOCIATED WITH THE BURIED AND ABOVEGROUND UTILITIES REMAIN THE SOLE RESPONSIBILITY OF THE CONTRACTOR.

*PEORIA/TAZEWELL

MODJESKI and MASTERS
Experience great bridges.

 USER NAME
 = aecook
 DESIGNED
 CSG
 REVISED

 DRAWN
 AEC
 REVISED

 PLOT SCALE
 = 2.0000 ' / in.
 CHECKED
 RLM
 REVISED

 PLOT DATE
 = 8/8/2019
 DATE
 8/9/2019
 REVISED

STATE OF ILLINOIS
DEPARTMENT OF TRANSPORTATION

GENERAL NOTES, COMMITMENTS AND PROJECT SPECIFIC NOTES

SCALE: N.T.S. | SHEET OF SHEETS STA. TO STA.

ALI. SECTION COUNTY TOTAL SHEETS NO. 74 90(10D-1)BRR * 329 3 CONTRACT NO. 68C89

				TAZEWELL COUNTY	TAZEWELL COUNTY
				90% FEDERAL 10% STATE	100% STATE
				10% STATE	
CODE	ITEM	UNIT	TOTAL	BR I DGE	DECORATIVE LIGHTING
NO.		UNII	QUANTITY	0013	0021
				S.N.090-0001	
20300100	CHANNEL EXCAVATION	CU YD	1418	1418	
25000200	SEEDING, CLASS 2	ACRE	0.6	0.6	
25000400	NITROGEN FERTILIZER NUTRIENT	POUND	54	54	
25000500	PHOSPHORUS FERTILIZER NUTRIENT	POUND	54	54	
25000600	POTASSIUM FERTILIZER NUTRIENT	POUND	54	54	
2300000		7 00112	3,		
25100115	MULCH, METHOD 2	ACRE	0.6	0.6	
28000250	TEMPORARY EROSION CONTROL SEEDING	POUND	60	60	
28000400	PERIMETER EROSION BARRIER	FOOT	460	460	
28100107	STONE RIPRAP, CLASS A4	SQ YD	139	139	
28100801	STONE DUMPED RIPRAP, CLASS A1	TON	174.6	174.6	
28100811	STONE DUMPED RIPRAP, CLASS A6	TON	2053	2053	
28200200	FILTER FABRIC	SQ YD	134	134	
44000600	SIDEWALK REMOVAL	SQ FT	10.5	10.5	
50104720	REMOVAL OF EXISTING CONCRETE DECK	EACH	1	1	

MODJESKI and MASTERS
Experience great bridges.

USER NAME = aecook DESIGNED - CSG REVISED -DRAWN - AEC REVISED -PLOT SCALE = 2.0000 ' / in. CHECKED - RLM REVISED -PLOT DATE = 8/9/2019 DATE - 8/9/2019 REVISED

STATE OF ILLINOIS **DEPARTMENT OF TRANSPORTATION**

SUMMARY OF QUANTITIES SCALE: N.T.S. SHEET 1 OF 12 SHEETS STA.

TO STA.

CONSTRUCTION CODE

*PEORIA/TAZEWELL
ITY TOTAL SHEET NO.
329 4 F.A.I. RTE. SECTION COUNTY 90(10D-1)BRR CONTRACT NO. 68C89

				TAZEWELL COUNTY	TAZEWELL COUNTY
				90% FEDERAL	100% STATE
				10% STATE BRIDGE	DECORATIVE LIGHTING
CODE	ITEM	UNIT	TOTAL		
NO.	1	ONII	QUANTITY	0013	0021
				S.N.090-0001	
50157300	PROTECTIVE SHIELD	SQ YD	5401	5401	
50300100	FLOOR DRAINS	EACH	4	4	
50300225	CONCRETE STRUCTURES	CU YD	4.3	4.3	
30300223	CONCRETE STRUCTURES	CO 115	4.3	7.3	
50300255	CONCRETE SUPERSTRUCTURE	CU YD	5384.3	5384.3	
50300300	PROTECTIVE COAT	SQ YD	22115	22115	
50301350	CONCRETE SUPERSTRUCTURE (APPROACH SLAB)	CU YD	32.4	32.4	
50500405	FURNISHING AND ERECTING STRUCTURAL STEEL	POUND	11360	11360	
50500505	STUD SHEAR CONNECTORS	EACH	113459	113459	
50800205	REINFORCEMENT BARS, EPOXY COATED	POUND	1435770	1435770	
51500100	NAME PLATES	EACH	1	1	
52000110	PREFORMED JOINT STRIP SEAL	FOOT	1249	1249	
F2000216	FINCED DUATE EVRANCION JOINT EN	5007	50		
52000216	FINGER PLATE EXPANSION JOINT, 5"	FOOT	58	58	
52000365	NEOPRENE EXPANSION JOINT 6 1/2"	FOOT	119	119	
2200000	27171101011 00111 0 1/2	7.001	110	115	
52000600	FABRIC REINFORCED ELASTOMERIC TROUGH	FOOT	60	60	

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STATE OF ILLINOIS **DEPARTMENT OF TRANSPORTATION**

SUMMARY OF QUANTITIES SCALE: N.T.S. SHEET 2 OF 12 SHEETS STA.

TO STA.

CONSTRUCTION CODE

*PEONIA/TAZEWELL
COUNTY TOTAL SHEET NO.
* 329 5 F.A.I. RTE. SECTION 90(10D-1)BRR CONTRACT NO. 68C89

					TAZEWELL COUNTY	TAZEWELL COUNTY
					90% FEDERAL	100% STATE
Г	1			1	10% STATE BRIDGE	DECORATIVE LIGHTING
	CODE	ITEM	UNIT	TOTAL	0013	
	NO.	1	ONTT	QUANTITY		0021
F					S.N.090-0001	
	52100560	ANCHOR BOLTS, 2"	EACH	8	8	
[58700300	CONCRETE SEALER	SQ FT	5841	5841	
	59000200	EPOXY CRACK INJECTION	FOOT	29	29	
(56900200	NON-SPECIAL WASTE DISPOSAL	CU YD	1328	1328	
	56900530	SOIL DISPOSAL ANALYSIS	EACH	3	3	
'	00900330	SOIL DISPOSAL ANALISIS	EACH	3	3	
,	56900540	VOCS SOIL ANALYSIS	EACH	3	3	
-	56900545	SVOCS SOIL ANALYSIS	EACH	3	3	
	56900550	PCBS SOIL ANALYSIS	EACH	3	3	
	,0,000,000	TCBS SOIL AVALUSTS	LACII	3		
(56900620	RCRA METALS AND PH SOIL ANALYSIS	EACH	3	3	
-						
[56900645	PESTICIDE SOIL ANALYSIS	EACH	3	3	
	56901001	REGULATED SUBSTANCES PRE-CONSTRUCTION PLAN	LSUM	1	1	
	56901002	ON-SITE MONITORING OF REGULATED SUBSTANCES	CAL DA	8	8	
	56901003	REGULATED SUBSTANCES FINAL CONSTRUCTION REPORT	LSUM	1	1	
ľ			23377			
(57000400	ENGINEER'S FIELD OFFICE, TYPE A	CAL MO	16	16	

MODJESKI and MASTERS
Experience great bridges.

Pl

USER NAME = aecook	DESIGNED - CSG	REVISED -
	DRAWN - AEC	REVISED -
PLOT SCALE = 2.0000 ' / in.	CHECKED - RLM	REVISED -
PLOT DATE = 8/15/2019	DATE - 8/9/2019	REVISED -

STATE OF ILLINOIS
DEPARTMENT OF TRANSPORTATION

				TAZEWELL COUNTY	TAZEWELL COUNTY
				90% FEDERAL	100% STATE
1				10% STATE BRIDGE	DECORATIVE LIGHTING
CODE	ITEM	UNIT	TOTAL		
NO.	ITEM	UNII	QUANTITY	0013	0021
				S.N.090-0001	
67000600	ENGINEER'S FIELD LABORATORY	CAL MO	16	16	
67100100	MOBILIZATION	L SUM	1	1	
70107025	CHANCEARLE MECCACE CLON	CAL DA	003	202	
70107025	CHANGEABLE MESSAGE SIGN	CAL DA	903	903	
70300100	SHORT TERM PAVEMENT MARKING	FOOT	13652	13652	
70300150	SHORT TERM PAVEMENT MARKING REMOVAL	SQ FT	3415	3415	
70300210	TEMPORARY PAVEMENT MARKING LETTERS AND SYMBOLS	SQ FT	2424	2424	
70300220	TEMPORARY PAVEMENT MARKING - LINE 4"	FOOT	45701	45701	
70300250	TEMPORARY PAVEMENT MARKING - LINE 8"	FOOT	3627	3627	
70300260	TEMPORARY PAVEMENT MARKING - LINE 12"	FOOT	1429	1429	
70300280	TEMPORARY PAVEMENT MARKING - LINE 24"	FOOT	36	36	
72000100	SIGN PANEL - TYPE 1	SQ FT	17.6	17.6	
72000200	SIGN PANEL - TYPE 2	SQ FT	16	16	
72000200	SION FAWEL - HIFE Z	SQ FI	10	10	
72000300	SIGN PANEL - TYPE 3	SQ FT	175	175	
72700100	STRUCTURAL STEEL SIGN SUPPORT - BREAKAWAY	POUND	1475	1475	

MODJESKI and MASTERS
Experience great bridges.

USER NAME = aecook DESIGNED - CSG REVISED -REVISED -DRAWN - AEC PLOT SCALE = 2.0000 ' / in.

PLOT DATE = 8/15/2019 CHECKED - RLM REVISED -DATE - 8/9/2019 REVISED -

STATE OF ILLINOIS
DEPARTMENT OF TRANSPORTATION

SUMMARY OF QUANTITIES SCALE: N.T.S. | SHEET 4 OF 12 SHEETS STA. TO STA.

CONSTRUCTION CODE

*PEORIA/TAZEWELL

COUNTY TOTAL SHEET NO.

* 329 7 F.A.I. RTE. SECTION 90(10D-1)BRR CONTRACT NO. 68C89

				TAZEWELL COUNTY	TAZEWELL COUNTY
				90% FEDERAL	100% STATE
		<u> </u>	<u> </u>	10% STATE BRIDGE	DECORATIVE LIGHTING
CODE	ITEM	UNIT	TOTAL		
NO.	I I CIVI	ONTI	QUANTITY	0013	0021
				S.N.090-0001	
73400200	DRILLED SHAFT CONCRETE FOUNDATIONS	CU YD	3.8	3.8	
73700200	REMOVE CONCRETE FOUNDATION - GROUND MOUNT	EACH	2	2	
73700200	NEMOVE CONCILETE FORMER FOR				
78003100	PREFORMED PLASTIC PAVEMENT MARKING, TYPE B - LETTERS AND SYMBOLS	SQ FT	568	568	
78003140	PREFORMED PLASTIC PAVEMENT MARKING, TYPE B - LINE 8"	FOOT	6941	6941	
78009004	MODIFIED URETHANE PAVEMENT MARKING - LINE 4"	FOOT	13977	13977	
78009006	MODIFIED URETHANE PAVEMENT MARKING - LINE 6"	FOOT	1066	1066	
78009008	 MODIFIED URETHANE PAVEMENT MARKING - LINE 8"	FOOT	6464	6464	
		1 2 2 1			
7000013		5007	505	505	
78009012	MODIFIED URETHANE PAVEMENT MARKING - LINE 12"	FOOT	505	505	
78200020	CURB REFLECTORS	EACH	3	3	
80400100	ELECTRIC SERVICE INSTALLATION	EACH	1	1	
81028340	UNDERGROUND CONDUIT, PVC, 1 1/2" DIA.	FOOT	96	96	
81028350	UNDERGROUND CONDUIT, PVC, 2" DIA.	FOOT	400	400	
81100200	CONDUIT ATTACHED TO STRUCTURE, 3/4" DIA., GALVANIZED STEEL	FOOT	7944		7944
81104580	CONDUIT ATTACHED TO STRUCTURE, 2" DIA., STAINLESS STEEL	FOOT	30	30	40000
81100600	CONDUIT ATTACHED TO STRUCTURE, 2" DIA., GALVANIZED STEEL	FOOT	12330		12330
81200230	CONDUIT EMBEDDED IN STRUCTURE, 2" DIA., PVC	FOOT	8650	8650	
					•

MODJESKI and MASTERS
Experiences great bridges.

USER NAME = aecook	DESIGNED	-	CSG	REVISED -	
	DRAWN	-	AEC	REVISED -	
PLOT SCALE = 2,0000 ' / in,	CHECKED	-	RLM	REVISED -	
PLOT DATE = 8/16/2019	DATE	-	8/9/2019	REVISED -	

STATE OF ILLINOIS DEPARTMENT OF TRANSPORTATION

SUMMARY OF QUANTITIES SCALE: N.T.S. SHEET 5 OF 12 SHEETS STA. TO STA.

				TAZEWELL COUNTY	TAZEWELL COUNTY
				90% FEDERAL	100% STATE
	<u> </u>			10% STATE	
CODE	ITEM	UNIT	TOTAL	BR I DGE	DECORATIVE LIGHTING
NO.	ITEM	UNII	QUANTITY	0013	0021
				S.N.090-0001	
81300400	JUNCTION BOX, STAINLESS STEEL, ATTACHED TO STRUCTURE, 10" X 6" X 4"	EACH	28	28	
81300550	JUNCTION BOX, STAINLESS STEEL, ATTACHED TO STRUCTURE, 12" X 12" X 6"	EACH	1	1	
81300710	JUNCTION BOX, STAINLESS STEEL, ATTACHED TO STRUCTURE, 16" X 12" X 6"	EACH	56		56
81300600	JUNCTION BOX, STAINLESS STEEL, ATTACHED TO STRUCTURE, 14" X 8" X 6"	EACH	42	42	
81300810	JUNCTION BOX, STAINLESS STEEL, ATTACHED TO STRUCTURE, 18" X 12" X 8"	EACH	2	2	
81400700	HANDHOLE, PORTLAND CEMENT CONCRETE	EACH	1	1	
81400710	HEAVY-DUTY HANDHOLE, PORTLAND CEMENT CONCRETE	EACH	1	1	
81500120	GULFBOX JUNCTION, COMPOSITE CONCRETE	EACH	1	1	
81702101	ELECTRIC CABLE IN CONDUIT, 600V (XLP-TYPE USE) 1/C NO. 14	FOOT	14400		14400
81702120	ELECTRIC CABLE IN CONDUIT, 600V (XLP-TYPE USE) 1/C NO. 8	FOOT	34320		34320
81702420	ELECTRIC CABLE IN CONDUIT, 600V (XLP-TYPE USE) 3-1/C NO. 8	FOOT	10000	10000	
01702420	ZZZENNE CJEZZ IN CONSCIP, COOK (XZN 1777 Z USZ) S 17C NO. U	7007	10000	10000	
82110005	LUMINAIRE, LED, ROADWAY, OUTPUT DESIGNATION E	EACH	28	28	
82110006	LUMINAIRE, LED, ROADWAY, OUTPUT DESIGNATION F	EACH	5	5	
82200606	WATERWAY OBSTRUCTION WARNING LUMINAIRE, LED, 180 DEGREE RED, PARAPET MOUNTED	EACH	6	6	

MODJESKI and MASTERS
Experiences great bridges.

	USER NAME = aecook	DESIGNED	-	CSG	REVISED -
		DRAWN	-	AEC	REVISED -
	PLOT SCALE = 2.0000 ' / in.	CHECKED	-	RLM	REVISED -
ĺ	PLOT DATE = 8/16/2019	DATE	-	8/9/2019	REVISED -

STATE OF ILLINOIS DEPARTMENT OF TRANSPORTATION

F.A.I. RTE. SECTION SUMMARY OF QUANTITIES SCALE: N.T.S. SHEET 6 OF 12 SHEETS STA. TO STA.

					TAZEWELL COUNTY	TAZEWELL COUNTY
					90% FEDERAL	100% STATE
			1		10% STATE BRIDGE	DECORATIVE LIGHTING
	CODE	ITEM	UNIT	TOTAL	0013	0021
	NO.			QUANTITY	S.N.090-0001	0021
					3.10.030-0001	
k	82200607	WATERWAY OBSTRUCTION WARNING LUMINAIRE, LED, 360 DEGREE GREEN, PARAPET MOUNTED	EACH	2	2	
	82600105	NAVIGATION OBSTRUCTION LIGHTING CONTROLLER	EACH	1	1	
	83060220	LIGHT POLE, GALVANIZED STEEL, 35 FT. M.H., 8 FT. MAST ARM	EACH	5	5	
	83060830	LIGHT POLE, GALVANIZED STEEL, 45 FT. M.H., TENON MOUNT	EACH	1	1	
	83060840	LIGHT POLE, GALVANIZED STEEL, 50 FT. M.H., TENON MOUNT	EACH	1	1	
*	83600355	LIGHT POLE FOUNDATION, METAL, 15" BOLT CIRCLE, 8" X 6'	EACH	2	2	
	83800205	BREAKAWAY DEVICE, TRANSFORMER BASE, 15 INCH BOLT CIRCLE	EACH	1	1	
	84200600	REMOVAL OF LIGHTING UNIT, NO SALVAGE	EACH	5	5	
	84500110	REMOVAL OF LIGHTING CONTROLLER	EACH	2	1	1
	84500120	REMOVAL OF ELECTRIC SERVICE INSTALLATION	EACH	1	1	
k	85820400	FLASHER CONTROLLER, SPECIAL, WITHOUT CABINET	EACH	2	2	
	87301245	ELECTRIC CABLE IN CONDUIT, SIGNAL NO. 14 5C	FOOT	988.5	988.5	
	87301900	ELECTRIC CABLE IN CONDUIT, EQUIPMENT GROUNDING CONDUCTOR, NO. 6 1C	FOOT	803	803	

MODJESKI and MASTERS
Experiences great bridges.

USER NAME = aecook	DESIGNED	-	CSG	REVISED -
	DRAWN	-	AEC	REVISED -
PLOT SCALE = 2.0000 ' / in.	CHECKED	-	RLM	REVISED -
PLOT DATE = 8/15/2019	DATE	-	8/9/2019	REVISED -

STATE OF ILLINOIS DEPARTMENT OF TRANSPORTATION

F.A.I. RTE. SUMMARY OF QUANTITIES SCALE: N.T.S. SHEET 7 OF 12 SHEETS STA. TO STA.

CONSTRUCTION CODE

*PEORIATAZEWELL

COUNTY TOTAL SHEET NO.

* 329 10

CONTRACT NO. 68C89 SECTION 90(10D-1)BRR

					CONSTRUCTION CODE		
					TAZEWELL COUNTY	TAZEWELL COUNTY	
					90% FEDERAL 10% STATE	100% STATE	
					10% STATE		
	CODE			TOTAL	BR I DGE	DECORATIVE LIGHTING	
	NO.	ITEM	UNIT	QUANTITY	0013	0021	
	110.			QUANTITI	S.N.090-0001		
*	87502520	TRAFFIC SIGNAL POST, GALVANIZED STEEL 18 FT.	EACH	2	2		
	87800100	CONCRETE FOUNDATION, TYPE A	FOOT	6	6		
*	87800100	CONCRETE TOUNDATION, TITE A	7 007	· ·			
*	87900100	DRILL EXISTING FOUNDATION	EACH	2	2		
	87900200	DRILL EXISTING HANDHOLE	EACH	1	1		
*	07300200	DATEL EXISTING HANDIOLE	EACH	1			
*	87900205	DRILL EXISTING HEAVY DUTY HANDHOLE	EACH	2	2		
*	88040020	SIGNAL HEAD, POLYCARBONATE, LED, 1-FACE, 1-SECTION, BRACKET MOUNTED	EACH	6	6		
*	88200510	TRAFFIC SIGNAL BACKPLATE, RETROREFLECTIVE	EACH	6	6		
*	89502300	REMOVE ELECTRIC CABLE FROM CONDUIT	FOOT	1674	1674		
*	X0320023	CLOSED CIRCUIT TELEVISION DOME CAMERA, HD	EACH	11	11		
*	X0320024	ETHERNET MANAGE SWITCH	EACH	2	2		
*	X0320586	FLEXIBLE DELINEATORS	EACH	48	48		
	V0.33.15.55	CONCORTE DAD	0				
*	X0321309	CONCRETE PAD	SQ YD	8.4	8.4		
*	X0322559	BOLT REPLACEMENT	EACH	211	211		
*	X0323388	TRAFFIC COUNTER	EACH	2	2		
			27.677	_			

*PEORIA/TAZEWELL
COUNTY TOTAL SHEET NO.
* 329 11

USER NAME = aecook DESIGNED - CSG REVISED -DRAWN - AEC REVISED -PLOT SCALE = 2.0000 ' / in.
PLOT DATE = 8/15/2019 CHECKED -RLM REVISED -DATE - 8/9/2019 REVISED -

STATE OF ILLINOIS **DEPARTMENT OF TRANSPORTATION**

F.A.I. RTE. SECTION SUMMARY OF QUANTITIES 90(10D-1)BRR CONTRACT NO. 68C89 SCALE: N.T.S. SHEET 8 OF 12 SHEETS STA. TO STA.

					TAZEWELL COUNTY	TAZEWELL COUNTY
					90% FEDERAL 10% STATE	100% STATE
	CODE			TOTAL	BRIDGE	DECORATIVE LIGHTING
	CODE	ITEM	UNIT	TOTAL	0013	0021
	NO.			QUANTITY	S.N.090-0001	
					31111030 0001	
*	X0324603	CIRCUIT BREAKER, 1-POLE, 20 AMP, 120V IN EXISTING TSC CABINET	EACH	2	2	
*	X0325541	REMOVE EXISTING LIGHTING SYSTEM	L SUM	1		1
*	X0325654	HIGH LOAD MULTI-ROTATIONAL BEARINGS, GUIDED EXPANSION, 1500K	EACH	2	2	
*	X0325924	CLEAN, RELAMP AND MAINTENANCE OF EXISTING LUMINAIRE	EACH	67	67	
*	X0325941	ACCESS LADDER	EACH	8	8	
*	X0326784	MAINTAIN EXISTING LIGHTING CONTROLLER	EACH	1	1	
*	X0326796	CLEAN TROUGH	EACH	7	7	
~	XU326796	CLEAN I ROUGH	EACH	1	1	
*	X0326812	CAT 5 ETHERNET CABLE	FOOT	940	940	
*	X0327206	DATA SERVER	L SUM	1	1	
	X0327980	PAVEMENT MARKING REMOVAL - WATER BLASTING	SQ FT	30723	30723	
*	X1200231	FILTER MATTRESS	SQ YD	1699	1699	
*	X1400103	ROAD WEATHER INFORMATION SYSTEM, COMPLETE	L SUM	1	1	
*	X1400222	BLUETOOTH DETECTOR	EACH	7	7	
*	X1400267	REMOVAL OF LIGHTING LUMINAIRE, NO SALVAGE	EACH	22	22	
*	X1400368	RELOCATE EXISTING PTZ CAMERA	EACH	2	2	

MODJESKI === MASTERS Experience great bridges.

	USER NAME = aecook	DESIGNED -	CSG	REVISED -
		DRAWN -	AEC	REVISED -
i	PLOT SCALE = 2.0000 ' / in.	CHECKED -	RLM	REVISED -
	PLOT DATE = 8/15/2019	DATE -	8/9/2019	REVISED -

					TAZEWELL COUNTY	TAZEWELL COUNTY
					90% FEDERAL 10% STATE	100% STATE
	0055				BRIDGE	DECORATIVE LIGHTING
	CODE	ITEM	UNIT	TOTAL	0013	0021
	NO.			QUANTITY	S.N.090-0001	0021
					31111030 0001	
*	X1400371	MAST ARM, STREET LIGHTING, 4'	EACH	28	28	
*	X1400375	DMX CONTROL CABLE IN CONDUIT	FOOT	32944		32944
*	X1400376	CONTROL CABINET, BASE MOUNT (SPECIAL)	EACH	2		2
*	X1400377	CBX SPLITTER BOX	EACH	38		38
	X5030250	BRIDGE DECK GROOVING (LONGITUDINAL)	SQ YD	14454	14454	
	X5870015	BRIDGE DECK CONCRETE SEALER	SQ FT	54276	54276	
	X6350120	DELINEATOR REMOVAL	EACH	45	45	
	X7010216	TRAFFIC CONTROL AND PROTECTION, (SPECIAL)	L SUM	1	1	
	X7010240	TRAFFIC CONTROL SURVEILLANCE (SPECIAL)	CAL DA	217	217	
*	X7240207	REMOVE EXISTING SIGN COMPLETE	EACH	1	1	
*	X7830060	GROOVING FOR RECESSED PAVEMENT MARKING, LETTERS AND SYMBOLS	SQ FT	568	568	
*	X7830070	GROOVING FOR RECESSED PAVEMENT MARKING 5"	FOOT	13009	13009	
*	X7830076	GROOVING FOR RECESSED PAVEMENT MARKING 9"	FOOT	7664	7664	
*	X7830078	GROOVING FOR RECESSED PAVEMENT MARKING 13"	FOOT	164	164	
					104	
*	X8040102	ELECTRIC SERVICE INSTALLATION, SPECIAL	EACH	2		2

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STATE OF ILLINOIS DEPARTMENT OF TRANSPORTATION SUMMARY OF QUANTITIES

SCALE: N.T.S. SHEET 10 OF 12 SHEETS STA. TO STA.

CONSTRUCTION CODE

					UCTION CODE
				TAZEWELL COUNTY	TAZEWELL COUNTY
				90% FEDERAL	100% STATE
				10% STATE	
CODE			TOTAL	BR I DGE	DECORATIVE LIGHTIN
NO.	ITEM	UNIT	QUANTITY	0013	0021
NO.			QUANTITY	S.N.090-0001	
X8110453	CONDUIT ATTACHED TO STRUCTURE, 3/4" DIA. STAINLESS STEEL	FOOT	968	968	
X8130110	JUNCTION BOX (SPECIAL)	EACH	177		177
X8130125	REMOVE EXISTING JUNCTION BOX	EACH	35	35	
X8140102	GROUND EXISTING HANDHOLE	EACH	2	2	
V0210402	LUMINALDE MOUNTING DRACKET CRECIAL	EACH.	20	20	
X8210402	LUMINAIRE MOUNTING BRACKET - SPECIAL	EACH	28	28	
X8212031	LUMINAIRE, TYPE A (SPECIAL)	EACH	144		144
X8212032	LUMINAIRE, TYPE B (SPECIAL)	EACH	286		286
X8212033	LUMINAIRE, TYPE C (SPECIAL)	EACH	72		72
X8260105	REMOVAL OF EXISTING NAVIGATION LIGHTING	EACH	8	8	
X8260112	MAINTENANCE OF NAVIGATION LIGHTING SYSTEM	CAL MO	12	12	
X8360103	LIGHT POLE FOUNDATION, INTEGRAL WITH BARRIER WALL	EACH	5	5	
X8430100	REMOVE EXISTING CONDUIT ATTACHED TO STRUCTURE	FOOT	880	880	
				555	
X8570015	CONTROLLER (SPECIAL)	EACH	3	3	
X8710024	FIBER OPTIC CABLE IN CONDUIT, NO. 62.5/125, MM12F SM24F	FOOT	445.5	445.5	
X8710035	FIBER OPTIC CABLE 96 FIBERS, SINGLE MODE	FOOT	2572		2572
X8710050	FIBER OPTIC ETHERNET DROP AND REPEAT SWITCH	EACH	5	5	
X8900100	TEMPORARY TRAFFIC SIGNAL INSTALLATION (SPECIAL)	EACH	1	1	

USER NAME = aecook	DESIGNED -	CSG	REVISED -
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PLOT DATE = 8/15/2019	DATE -	8/9/2019	REVISED -

				TAZEWELL COUNTY	TAZEWELL COUNTY
				90% FEDERAL 10% STATE	100% STATE
CODE			TOTAL	BRIDGE	DECORATIVE LIGHTING
CODE	ITEM	UNIT	TOTAL	0013	0021
NO.			QUANTITY	S.N.090-0001	3321
Z0001899	JACK AND REMOVE EXISTING BEARINGS	EACH	2	2	
Z0001903	STRUCTURAL STEEL REMOVAL	POUND	22050	22050	
Z0001905	STRUCTURAL STEEL REPAIR	POUND	56040	56040	
Z0006710	BRIDGE DRAINAGE SYSTEM REPAIR	EACH	5	5	
20000710	DIVIDUE DIVATIVACE STOTEM RETAIN	LACIT	3	<u> </u>	
Z0007101	CONTAINMENT AND DISPOSAL OF LEAD PAINT CLEANING RESIDUES NO. 1	L SUM	1	1	
Z0010501	CLEANING AND PAINTING STEEL BRIDGE NO. 1	L SUM	1	1	
Z0010605	CLEANING DRAINAGE SYSTEM	L SUM	1	1	
Z0012754	STRUCTURAL REPAIR OF CONCRETE (DEPTH EQUAL TO OR LESS THAN 5 INCHES)	SQ FT	60	60	
70012700	CONCERNACE ION A MONEY		1		
Z0013798	CONSTRUCTION LAYOUT	L SUM	1	1	
Z0018002	DRAINAGE SCUPPERS, DS-11	EACH	162	162	
Z0018800	DRAINAGE SYSTEM	L SUM	1	1	
Z0029090	DIAMOND GRINDING (BRIDGE SECTION)	SQ YD	14893	14893	
Z0076600	TRAINEES	HOUR	2000	2000	
Z0033022	CLEAN AND RELAMP EXISTING LUMINAIRE	EACH	268	268	
Z0076604	TRAINEES TRAINING PROGRAM GRADUATE	HOUR	2000	2000	
Z0033072	VIDEO VEHICLE DETECTION SYSTEM	EACH	5	5	
Z0073300	TEMPORARY SHORING AND CRIBBING	L SUM	1	1	

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Experience great bridges.


STATE OF ILLINOIS
DEPARTMENT OF TRANSPORTATION

SCALE: N.T.S. SHEET 12 OF 12 SHEETS STA.

TO STA.

CONSTRUCTION CODE

| **PEORIA/TAZEWELL | F.A.I. | SECTION | COUNTY | SHEETS | NO. |
| 74 | 90(10D-1)BRR | * 329 | 15 |
| CONTRACT NO. 68C89

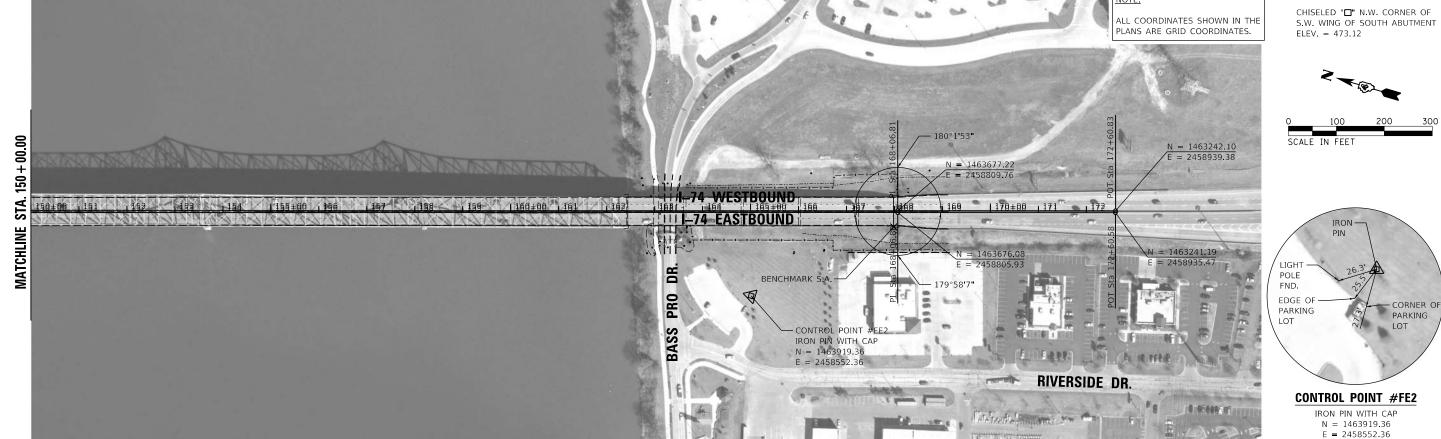

 DESIGNED
 BAB
 1/16/2019

 DRAWN
 RLA
 1/16/2019

 REVIEWED
 KNB
 8/8/2019

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Hanson Professional Services Inc.

 USER NAME
 = Ander00846
 DESIGNED
 BAB
 REVISED

 DRAWN
 RLA
 REVISED

 PLOT SCALE
 = 200,00 °/ In.
 CHECKED
 KNB
 REVISED

 PLOT DATE
 = 8/8/2019
 DATE
 8/8/19
 REVISED

STATE OF ILLINOIS
DEPARTMENT OF TRANSPORTATION

I-74 MURRAY BAKER BRIDGE
ALIGNMENT, BENCHMARKS AND CONTROL POINTS

SCALE: 1"=100' SHEET OF SHEETS STA. TO STA.



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GNED	BAB	1/16/2019
	RLA	1/16/2019
EWED	KNB	8/8/2019

PAVEME	ENT MARKING REMO	VAL SCHEDULE				
1.004.7	1011		,	327980		
LOCATI	ION	PAVEMENT MA			WATER B	LASTING
			SC	Q FT		
BEGIN STATION	END STATION	SYMBOLS	4"	6"	8"	12"
PEORIA CO	OUNTY					
BEGIN I-74 PEORIA	MATCHLINE A					
MATCHLINE A	MATCHLINE B			28		
MATCHLINE B	MATCHLINE C			627	291	85
MATCHLINE C	MATCHLINE D		391	547	1488	136
MATCHLINE D	MATCHLINE E			374		
MATCHLINE E	MATCHLINE F			342	156	
MATCHLINE F	133+00.00			5	677	
IL RTE 40 / AI	DAMS ST					
IL RTE 40 / W JOHN H	. GWYNN JR AVE					
IL RTE 40 / ROMEO E	B GARRETT AVE					
IL RTE 40 / PE	RRY AVE					
IL RTE 40 / FA	YETTE ST					
IL RTE 40 / SPA	LDING AVE			42	144	
JEFFERSON AVE	/ FAYETTE ST				232	
IL RTE 40 / GLE	N OAK AVE				172	
TAZEWELL (COUNTY					
BEGIN I-74 TAZEWELL	MATCHLINE G			29	478	121
MATCHLINE G	MATCHLINE H			163	245	
MATCHLINE H	33+00.00			298	25	
33+00.00	46+50.00		169	423	346	214
46+50.00	61+00.00		389	68	866	489
61+00.00	67+00.00		285	32	912	235
BEGIN WASHINGTON ST	21+00.00		9	5		
67+00.00	MATCHLINE J		617	69	58	107
MATCHLINE J	END IL RTE 40	332	550	92	413	169
135+60.00	144+00.00		696	130	482	164
FROM TEMP PVMT MA	RKING SCHEDULE		11,931		2,065	1,310
SUBTO	TAL	332	3,106	3,274	6,985	1,720
TOTA	L		30	0,723		

	TE	EMPORARY PAVEM	ENT MARKING SC	HEDULE		
		70300210	70300220	70300250	70300260	70300280
LOCATION		TEMPORARY PAVEMENT MARKING LETTERS AND SYMBOLS	TEMPORARY PAVEMENT MARKING - LINE 4"	TEMPORARY PAVEMENT MARKING - LINE 8"	TEMPORARY PAVEMENT MARKING - LINE 12"	TEMPORARY PAVEMENT MARKING - LINE 24'
BEGIN STATION	END STATION	SQ FT	FOOT	FOOT	FOOT	FOOT
PEORIA (
BEGIN I-74 PEORIA	MATCHLINE A					
MATCHLINE A	MATCHLINE B		1,381			
MATCHLINE B	MATCHLINE C	144	4,803	1,649	171	
MATCHLINE C	MATCHLINE D		8,550	459	172	
MATCHLINE D	MATCHLINE E		3,049			
MATCHLINE E	MATCHLINE F		3,726			
MATCHLINE F	133+00.00		1,212			
IL RTE 40 / /	ADAMS ST	288				
IL RTE 40 / W JOHN	H. GWYNN JR AVE	288				
IL RTE 40 / ROMEO	B GARRETT AVE	144				
IL RTE 40 / P	PERRY AVE	144				
IL RTE 40 / F.	AYETTE ST	144				
IL RTE 40 / SP	ALDING AVE	144	239	72		
JEFFERSON AVE	E / FAYETTE ST		583			
IL RTE 40 / GL	EN OAK AVE	432	356			
IL RTE 40 (OVER I-74					
TAZEWELL	COUNTY					
BEGIN I-74 TAZEWELL	MATCHLINE G		1.020	956	348	
MATCHLINE G	MATCHLINE H		2,245	19	0.10	
MATCHLINE H	33+00.00		3.102	18		
33+00.00	46+50.00		5.009		619	
46+50.00	61+00.00		3,639			
61+00.00	67+00.00		1.710			
BEGIN WASHINGTON ST	21+00.00		88			
67+00.00	MATCHLINE K		2,334		20	
MATCHLINE K	END IL RTE 40	696	2,655	454	99	36
ТОТ	AL	2,424	45,701	3,627	1,429	36

	REMOVAL AND DISPOSAL OF REGULATED SUBSTANCES									
	66900200	66901001	66901002	66901003	66900620	66900540	66900545	66900550	66900645	66900530
LOCATION	NON-SPECIAL WASTE DISPOSAL	REGULATED SUBSTANCES PRE-CONSTRUCTION PLAN	ON-SITE MONITORING OF REGULATED SUBSTANCES	REGULATED SUBSTANCES FINAL CONSTRUCTION REPORT	RCRA METALS & pH SOIL ANALYSIS	VOCS SOIL ANALYSIS	SVOCS SOIL ANALYSIS	PCBS SOIL ANALYSIS	PESTICIDE SOILS ANALYSIS	SOIL DISPOSAL ANALYSIS
	CU YD	LUMP	CAL DA	LUMP	EACH	EACH	EACH	EACH	EACH	EACH
MBB PIERS 5 & 6	1,328	1	8	1	3	3	3	3	3	3
TOTAL:	1,328	1	8	1	3	3	3	3	3	3

LANDSCAPING AND EROSION CONTROL							
	25000200	25000400	25000500	25000600	25100115	28000250	28000400
	CEEDING	NITROGEN	PHOSPHORUS	POTASSIUM	NALII CI I	TEMPORARY	PERIMETER
LOCATION	SEEDING,	FERTILIZER	FERTILIZER	FERTILIZER	MULCH, METHOD 2	EROSION	EROSION
	CLASS 2	NUTRIENT	NUTRIENT	NUTRIENT	IVIETHOD 2	CONTROL SEEDING	BARRIER
	ACRE	POUND	POUND	POUND	ACRE	POUND	FOOT
CHANNEL EXCAVATION	0.6	54	54	54	0.6	60	460
WASTE SITE ON I-474	0.0	34	34	J4	0.0	00	400
TOTAL:	0.6	54	54	54	0.6	60	460

CHANNEL EXCAV	'ATION
	20300100
LOCATION	CHANNEL
LOCATION	EXCAVATION
	CU YD
TAZEWELL COUNTY	
SOUTH ABUTMENT	90
PIER 5	749
PIER 6	579
TOTAL	1,418

SHEET

SCALE:

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Ž	CST HANSON
1	
1	Hanson Professional Services Inc.

	USER NAME = Ander00846	DESIGNED -	BAB	REVISED -
		DRAWN -	RLA	REVISED -
	PLOT SCALE = 2.00 ' / In.	CHECKED -	KNB	REVISED -
	PLOT DATE = 8/15/2019	DATE -	8/8/19	REVISED -
_				

STATE	OF ILLINOIS
DEPARTMENT (OF TRANSPORTATION

I–74 MURRAY BAKER BRIDGE		F.A.I. RTE	SECTION		COUNTY	TOTAL SHEETS	SHEET NO.			
SCHEDULE OF QUANTITIES			74	90(10D-1)BRR			PEORIA TAZEWELL	329	17	
JUILDUL	L 01 Q0	- INTITLE	.					CONTRACT	NO.	68C89
OF	SHEETS	STA.	TO STA.			ILLINOIS	FED. A	ID PROJECT		



SHOF	RT TERM PAVEMENT	MARKING SCHEDU	JLE
		70300100	70300150
LOCA	TION	SHORT TERM PAVEMENT MARKING	SHORT TERM PAVEMENT MARKING REMOVAL
BEGIN STATION	END STATION	FOOT	SQ FT
PEORIA			
BEGIN I-74 PEORIA	MATCHLINE A		
MATCHLINE A	MATCHLINE B	287	72
MATCHLINE B	MATCHLINE C	1,680	420
MATCHLINE C	MATCHLINE D	2,763	691
MATCHLINE D	MATCHLINE E	759	190
MATCHLINE E	MATCHLINE F	929	232
MATCHLINE F	133+00.00	447	112
IL RTE 40 /	ADAMS ST		
IL RTE 40 / W JOHN	H. GWYNN JR AVE		
IL RTE 40 / ROMEC	B GARRETT AVE		
IL RTE 40 / F	PERRY AVE		
IL RTE 40 / F	AYETTE ST		
IL RTE 40 / SP	ALDING AVE	60	15
JEFFERSON AVI	E / FAYETTE ST	186	47
IL RTE 40 / GL	EN OAK AVE	123	31
TAZEWELL			
BEGIN I-74 TAZEWELL	MATCHLINE G	644	161
MATCHLINE G	MATCHLINE H	592	148
MATCHLINE H	33+00.00	751	188
33+00.00	46+50.00	1,475	369
46+50.00	61+00.00	837	209
61+00.00	67+00.00	504	126
BEGIN WASHINGTON ST	21+00.00	7	2
67+00.00	MATCHLINE J	437	109
MATCHLINE J	END IL RTE 40	524	131
135+60.00	144+00.00	647	162
TO 1	-A I	42.052	2.445
TOT	AL	13,652	3,415

IEMPORA	RY PAVEMENT MARK	ING REMOVALS			
			X032798		
LOCA	TION	PAVEMENT MA			WATER
			BLASTIN	G	
			SQ FT		
BEGIN STATION	END STATION	LETTERS AND SYMBOLS	4"	8"	12"
PEORIA (COUNTY				
BEGIN I-74 PEORIA	MATCHLINE A				
MATCHLINE A	MATCHLINE B		460		
MATCHLINE B	MATCHLINE C		1601	1099	171
MATCHLINE C	MATCHLINE D		2850	306	172
MATCHLINE D	MATCHLINE E		1016		
MATCHLINE E	MATCHLINE F		1242		
MATCHLINE F	133+00.00		404		
IL RTE 40 /	ADAMS ST				
IL RTE 40 / W JOHN	H. GWYNN JR AVE				
IL RTE 40 / ROMEO	B GARRETT AVE				
IL RTE 40 / P	ERRY AVE				
IL RTE 40 / F	AYETTE ST				
IL RTE 40 / SP	ALDING AVE				
JEFFERSON AV	E / FAYETTE ST		194		
IL RTE 40 / GL	EN OAK AVE		119		
TAZEWELL	. COUNTY				
BEGIN I-74 TAZEWELL	MATCHLINE G		341	635	348
MATCHLINE G	MATCHLINE H		748	13	
MATCHLINE H	33+00.00		1034	12	
33+00.00	46+50.00		1558		619
46+50.00	61+00.00		364		
SUBTO		11,931	2,065	1,310	
ТОТ	TAIL		15.306		

REFLECTOR AND DELINEATOR SCHEDULE					
		78200020	X0320586	X6350120	
LO	CATION	CURB	FLEXIBLE	DELINEATOR	
		REFLECTORS	DELINEATORS	REMOVAL	
STATION	OFFSET	EACH	EACH	EACH	
PEORI	IA COUNTY				
ML B	ML C		14	14	
ML C	ML D		8	8	
IL RTE 40	/ FAYETTE ST	3	3		
TAZEW	ELL COUNTY				
33+00.00	46+50.00		12	12	
61+00.00	67+00.00		11	11	
Т	OTAL	3	48	45	

CHANGEABLE MESSAGE SIGN SCHEDULE						
			70107025			
	LOCATION		CHANGEABLE			
			MESSAGE SIGN			
STATION	OFFSET	NO. OF SIGNS	CAL DA			
PEORIA	COUNTY					
FAYETTE E.	OF MONROE	1	42			
FAYETTE &	GLENDALE	1	217			
IL 40 O\	/ER I-74	2	84			
EB I-74 AT	NORTH ST.	1	217			
TAZEWEL	L COUNTY					
IL 116	AT I-74	2	84			
CAMP S	T. AT I-74	1	42			
WASH ST. S. OF	CLOCKTOWER	1	217			
			·			
TO'	TAL		903			

				PAVEM	ENT MARKING SC	HEDULE					
		78003100	78003140	78009004	78009006	78009008	78009012	X7830060	X7830070	X7830076	X7830078
LOCA	TION	PREFORMED PLASTIC PAVEMENT MARKING, TYPE B - LETTERS AND SYMBOLS	PREFORMED PLASTIC PAVEMENT MARKING, TYPE B - LINE 8"	MODIFIED URETHANE PAVEMENT MARKING - LINE 4"	MODIFIED URETHANE PAVEMENT MARKING - LINE 6"	MODIFIED URETHANE PAVEMENT MARKING - LINE 8"	MODIFIED URETHANE PAVEMENT MARKING - LINE 12"	GROOVING FOR RECESSED PAVEMENT MARKING, LETTERS AND SYMBOLS	GROOVING FOR RECESSED PAVEMENT MARKING 5"	GROOVING FOR RECESSED PAVEMENT MARKING 9"	GROOVING FOR RECESSED PAVEMENT MARKING 13"
			CONTRAST (1.5" BLACK - 5" WHITE - 1.5" BLACK)								
BEGIN STATION	END STATION	SQ FT	FOOT	FOOT	FOOT	FOOT	FOOT	SQ FT	FOOT	FOOT	FOOT
PEORIA	COUNTY										
BEGIN I-74 PEORIA	MATCHLINE A										
MATCHLINE A	MATCHLINE B		55							55	
MATCHLINE B	MATCHLINE C		1,254		30	462	85			1,254	
MATCHLINE C	MATCHLINE D		1,038	887	174	2,115	135			1,038	
MATCHLINE D	MATCHLINE E		747							747	
MATCHLINE E	MATCHLINE F		684		195	40				684	
MATCHLINE F	133+00.00		9		53	1,309				9	
IL RTE 40 / SF	ALDING AVE	189						189			
IL RTE 40 / GL	EN OAK AVE	379				258		379			
TAZEWELI	COUNTY										
BEGIN I-74 TAZEWELL	MATCHLINE G		57		223	495	121			57	
MATCHLINE G	MATCHLINE H		334			367				334	
MATCHLINE H	33+00.00		599			38				599	
33+00.00	46+50.00		538	81	308	519				538	
46+50.00	61+00.00				83	137					
135+60.00	144+00.00		421	3,373		724	164		3,373	1,144	164
144+00.00	159+00.00		750	6,000					6,000	750	
159+00.00	168+09.00		455	3,636					3,636	455	
TO	ΓΑΙ	568	6,941	13,977	1,066	6.464	505	568	13,009	7,664	164


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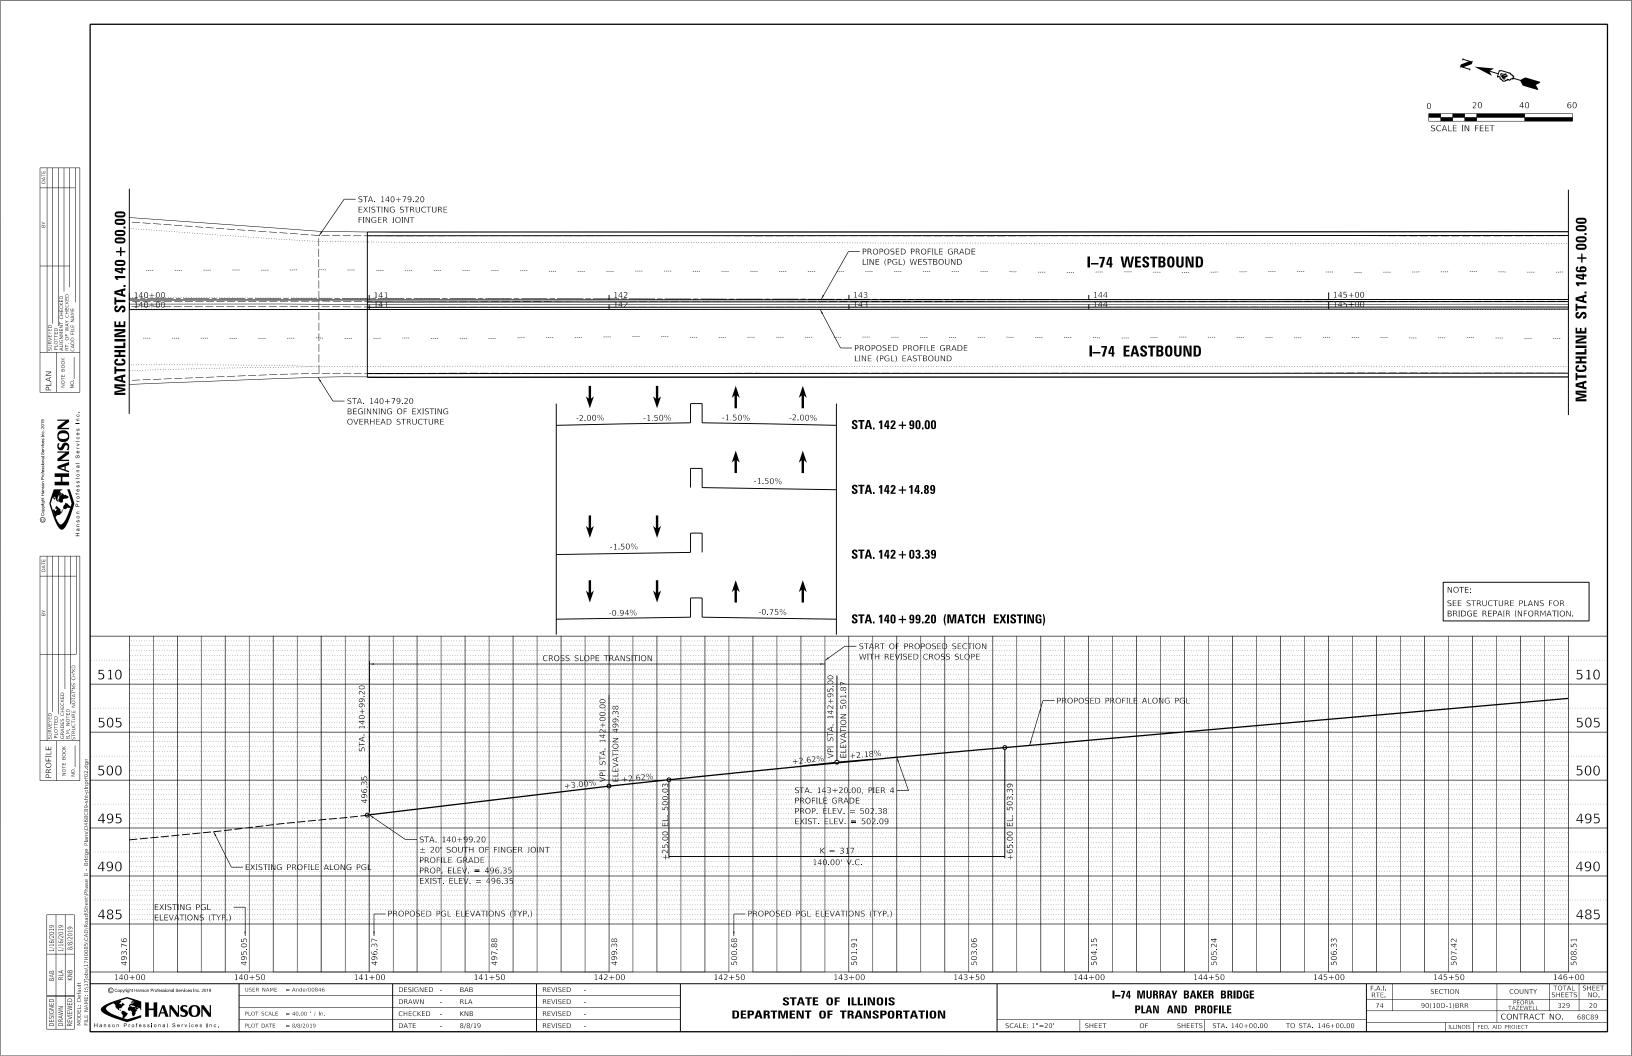
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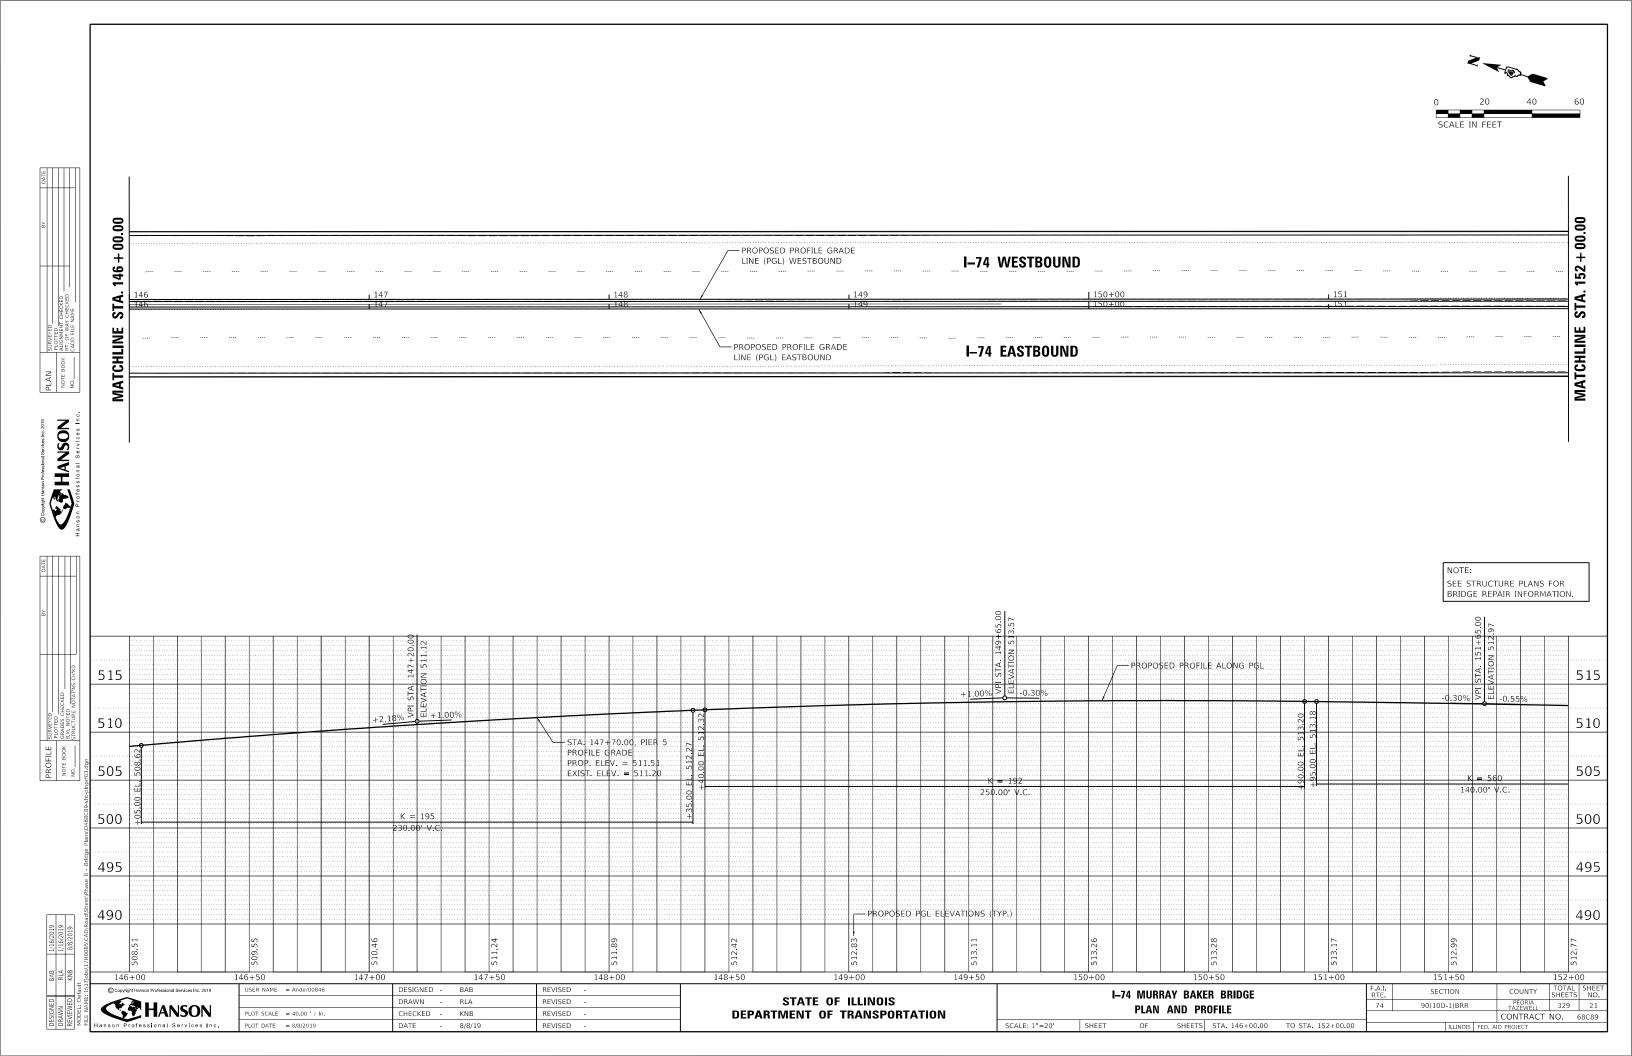
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DEPARTMENT	OF TRANSPORTA	ATION


SHEET


	I–74 MURR	AY BAKE	R BRI	DGE	F.A.I. RTE	SEC ⁻	ΓΙΟΝ	COUNTY	TOTAL SHEETS	
	SCHEDULE	OF OU	MITITIA	= 0	74	90(10D-	1)BRR	PEORIA TAZEWELL	329	18
		01 407	~!!					CONTRACT	NO.	68C89
CT	OF	CHEETC	CTA	TO CTA				 		






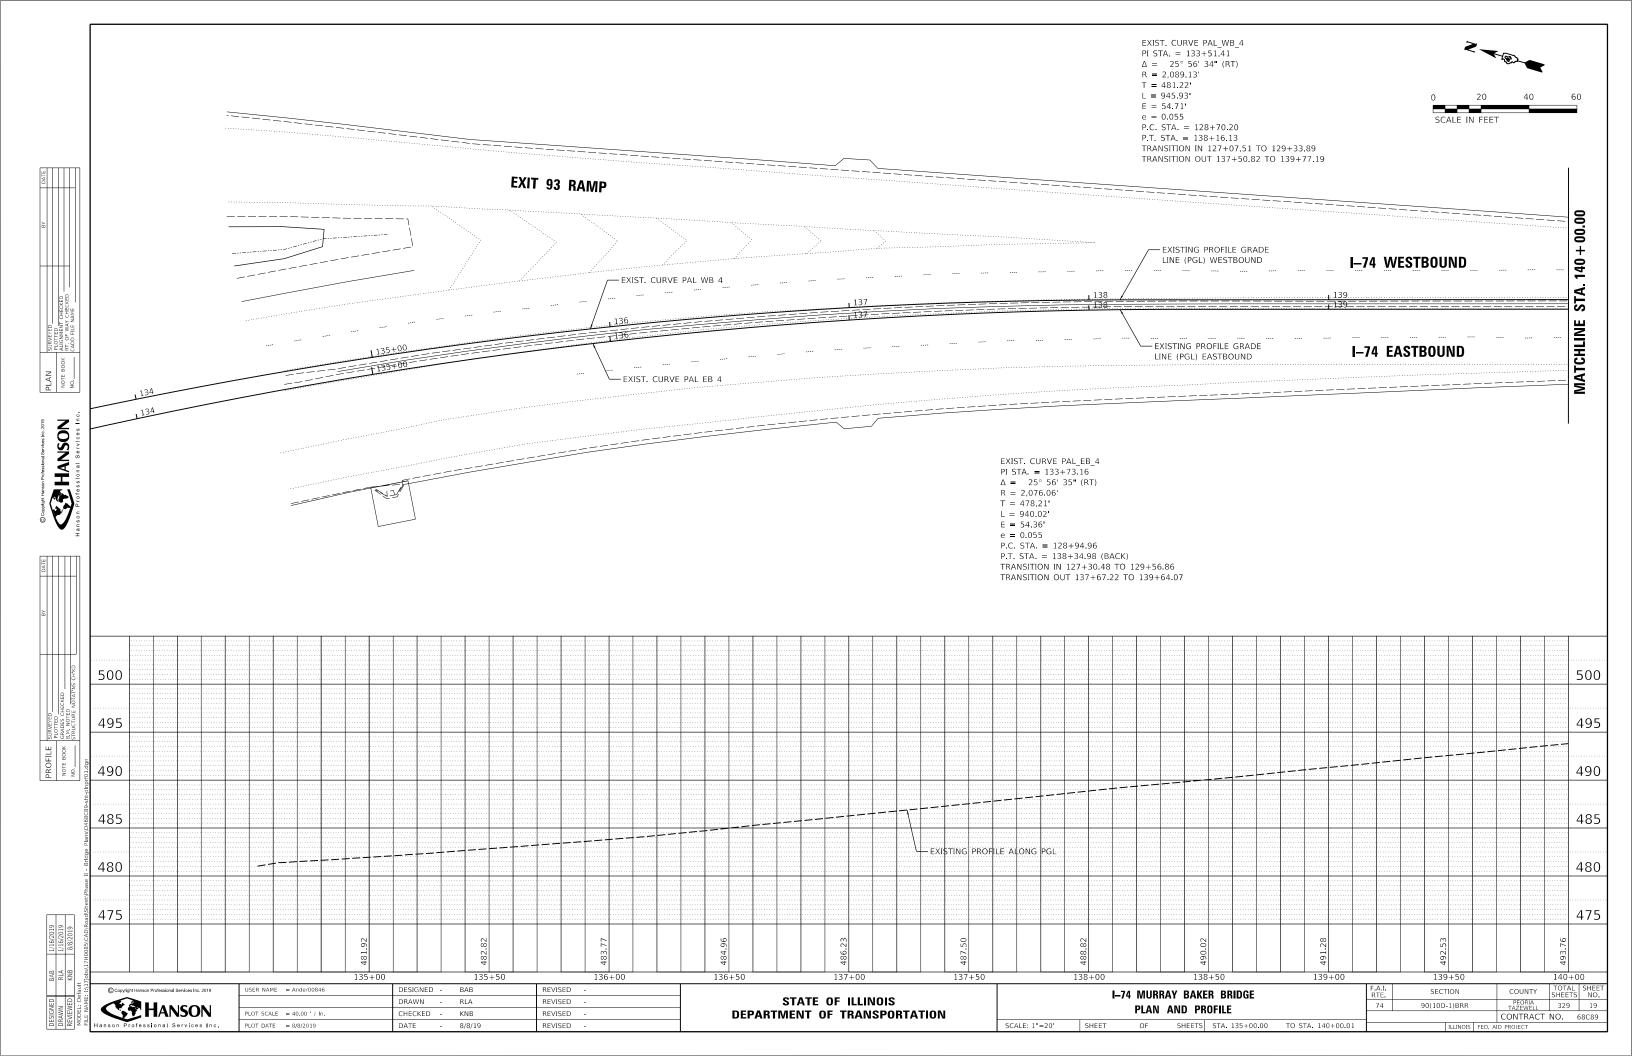

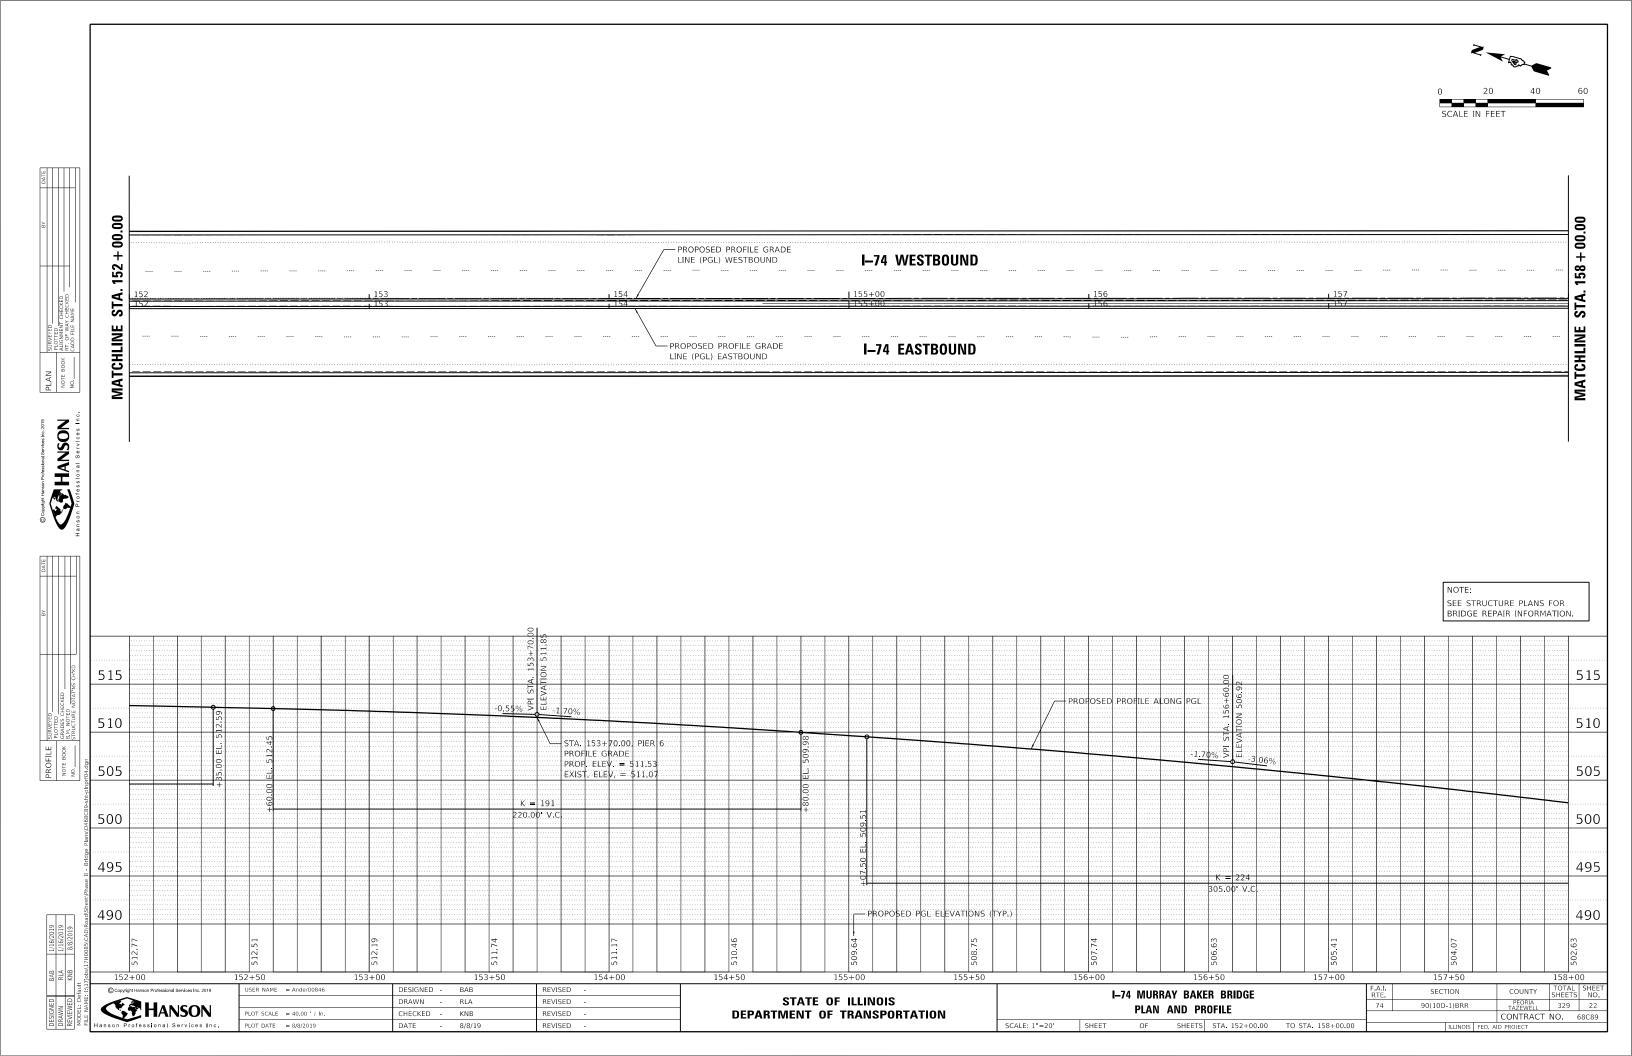

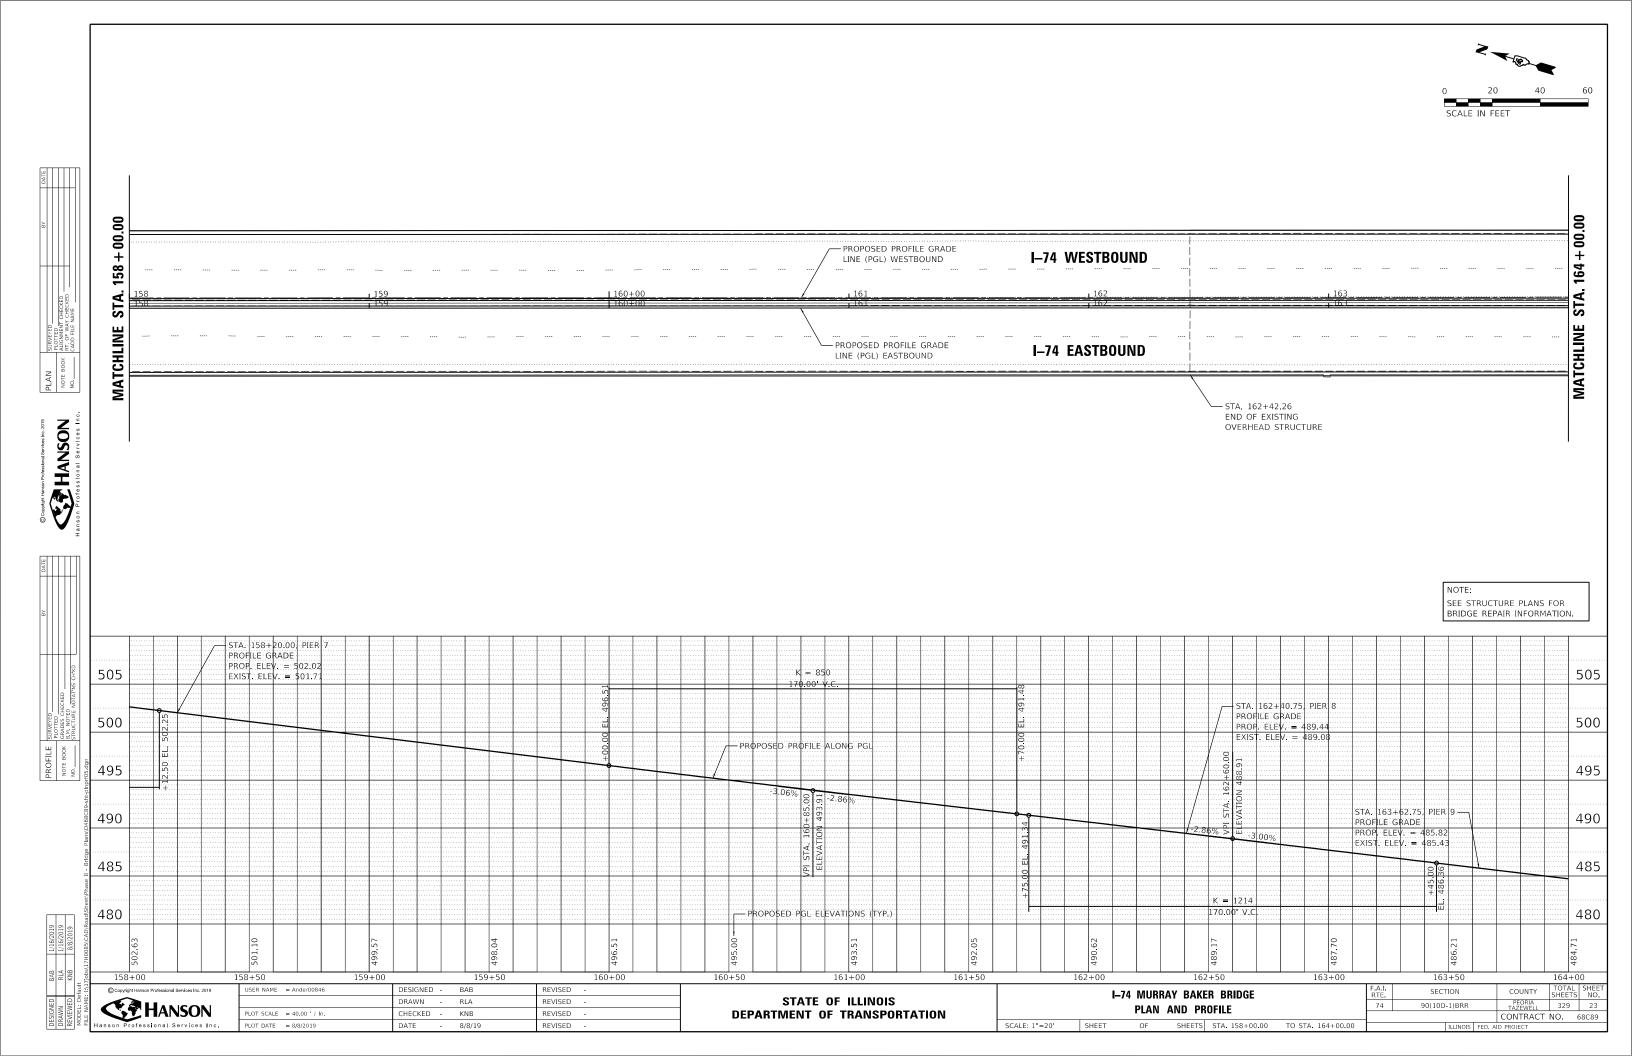

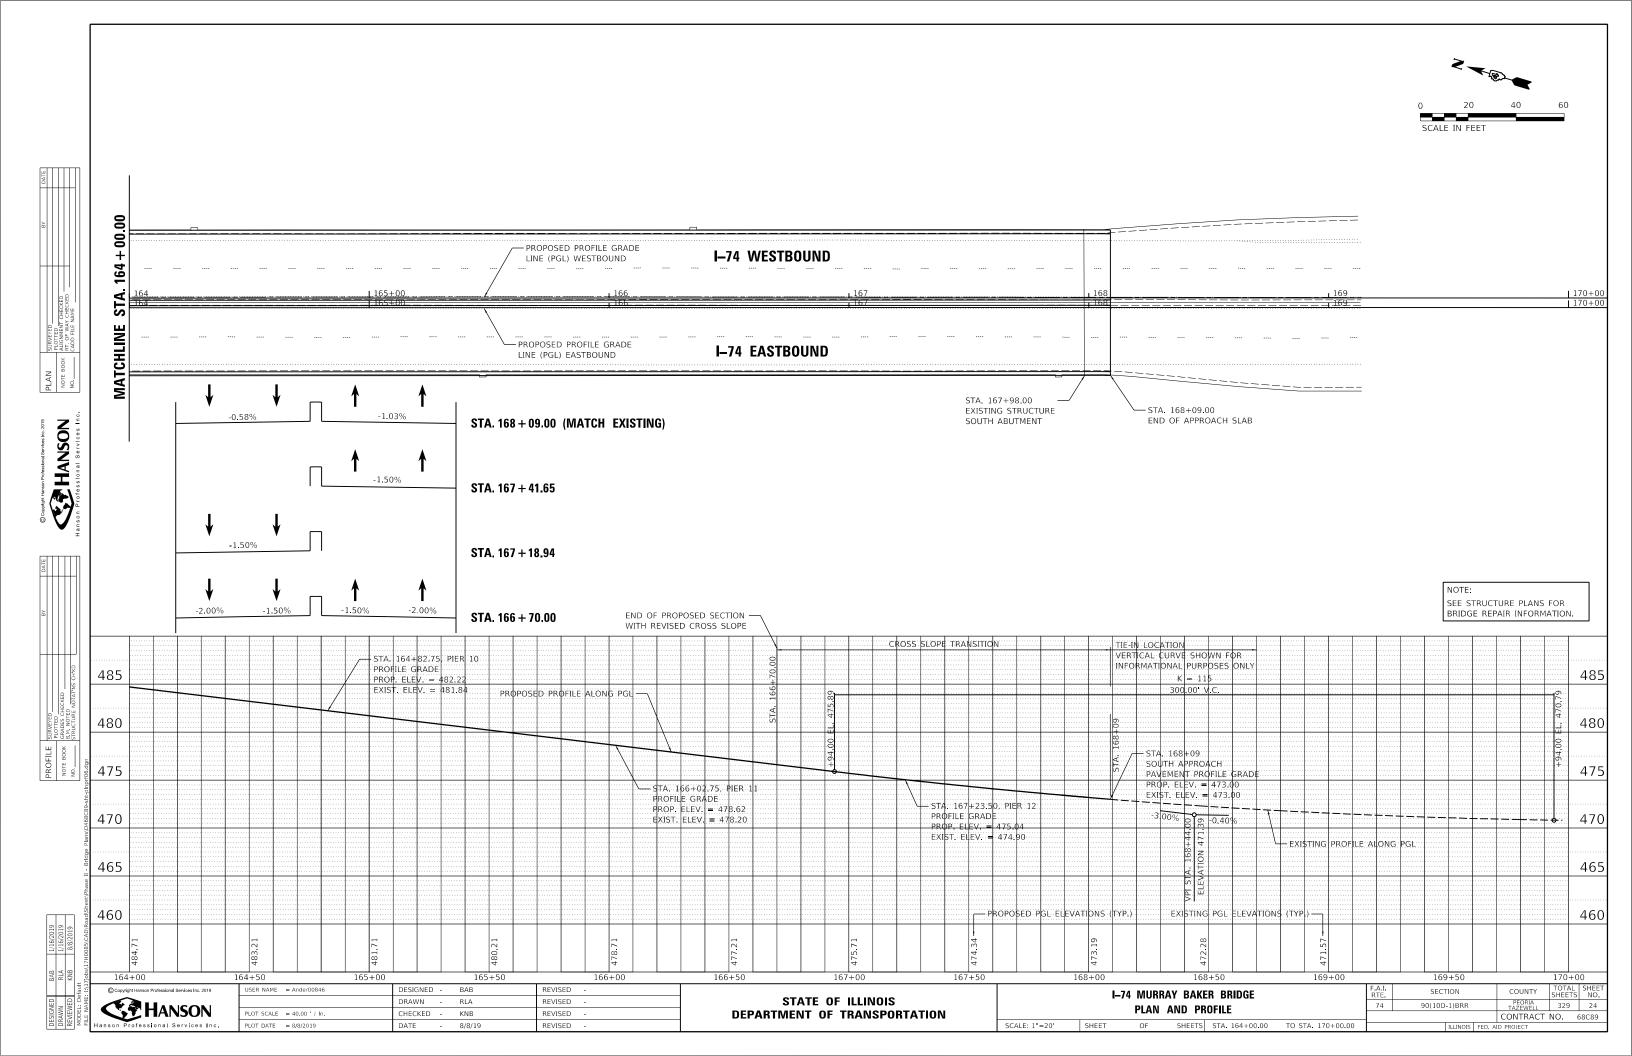



STATE OF ILLINOIS
DEPARTMENT OF TRANSPORTATION

I–74 MURRAY BAKER BRIDGE
PAVEMENT MARKING REMOVAL PLANS – STAGING

SHEET OF SHEETS STA. TO STA.

MATCHLINE



I–74 WESTBOUND


I-74 EASTBOUND

N UNIVERSITY ST

LEGEND

PAVEMENT MARKING REMOVAL -WATER BLASTING LETTERS AND SYMBOLS



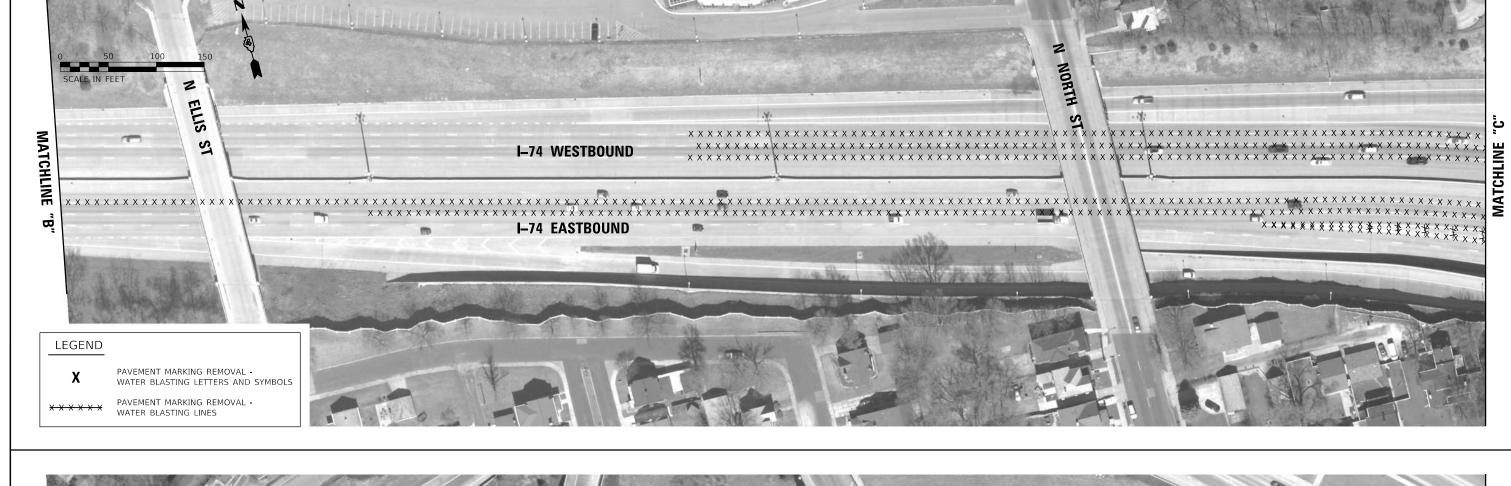



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 PLOT DATE
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 DATE
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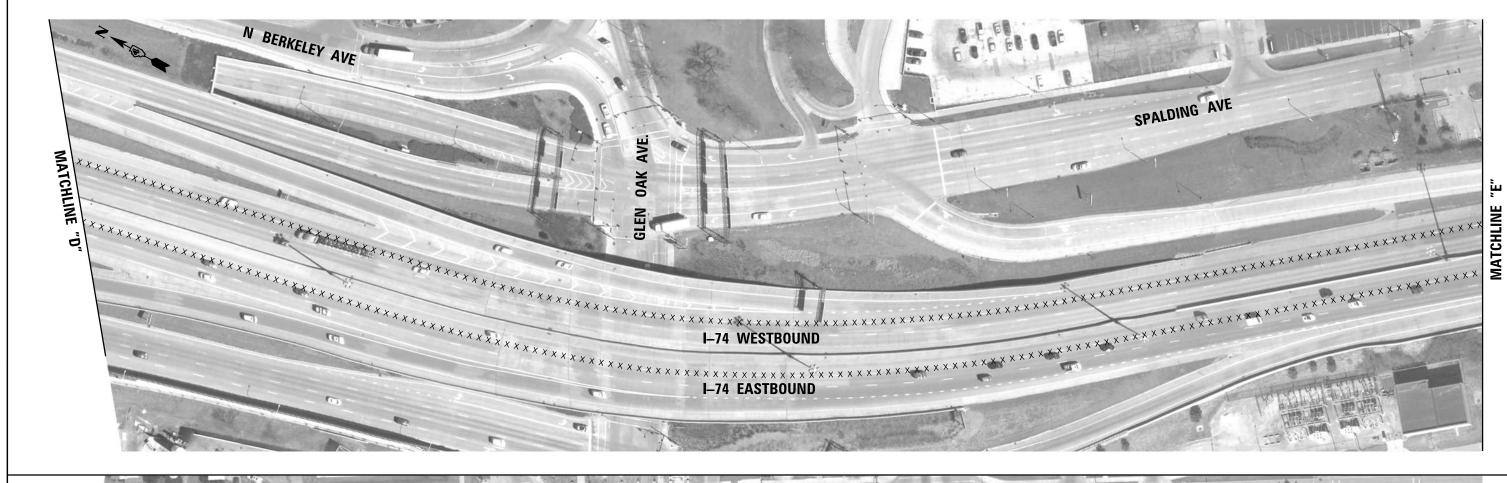
STATE OF ILLINOIS
DEPARTMENT OF TRANSPORTATION


I-74 MURRAY BAKER BRIDGE
PAVEMENT MARKING REMOVAL PLANS - STAGING

SHEET OF SHEETS STA. TO STA.

A.I. SECTION COUNTY TOTAL SHEET NO.
44 90(10D-1)BRR PEORIA TAZEWELL 329 26
CONTRACT NO. 68C89





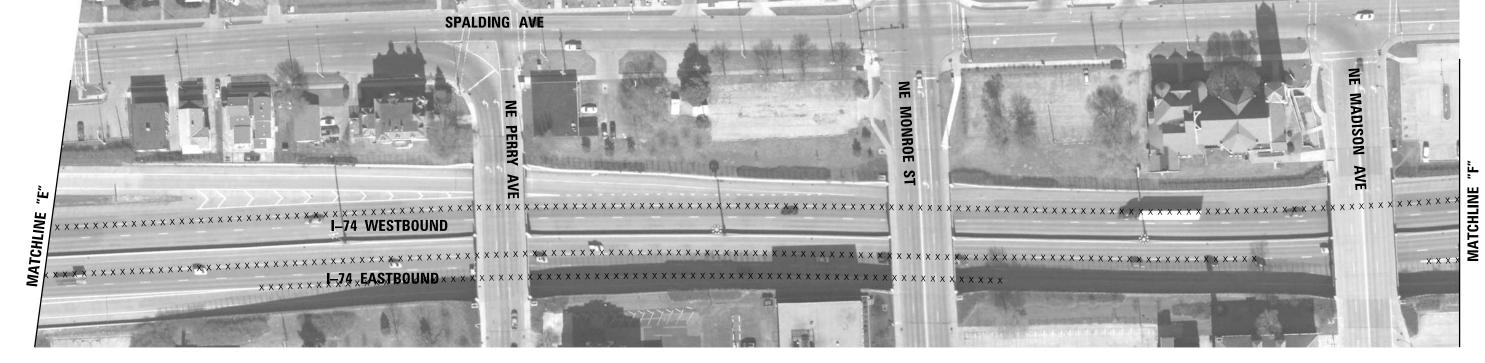

LEGEND

PAVEMENT MARKING REMOVAL -WATER BLASTING LETTERS AND SYMBOLS

X X X X PAVEMENT MARKING REMOVAL - WATER BLASTING LINES

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STATE OF ILLINOIS DEPARTMENT OF TRANSPORTATION

I–74 MURRAY BAKER BRIDGE						
P	PAVEMENT	MARKING	REMOVA	L PLAI	IS – STAGING	
SCALE: 1"=50"	SHEET	OF	SHEETS	STA.	TO STA.	


	F.A.I. SECTION			COUNTY	TOTAL SHEETS	SHEET NO.	
	74 90(10D-1)BRR		PEORIA TAZEWELL	329	27		
					CONTRACT	NO.	8C89
ILLINOIS FED. AID PROJECT				ID PROJECT			



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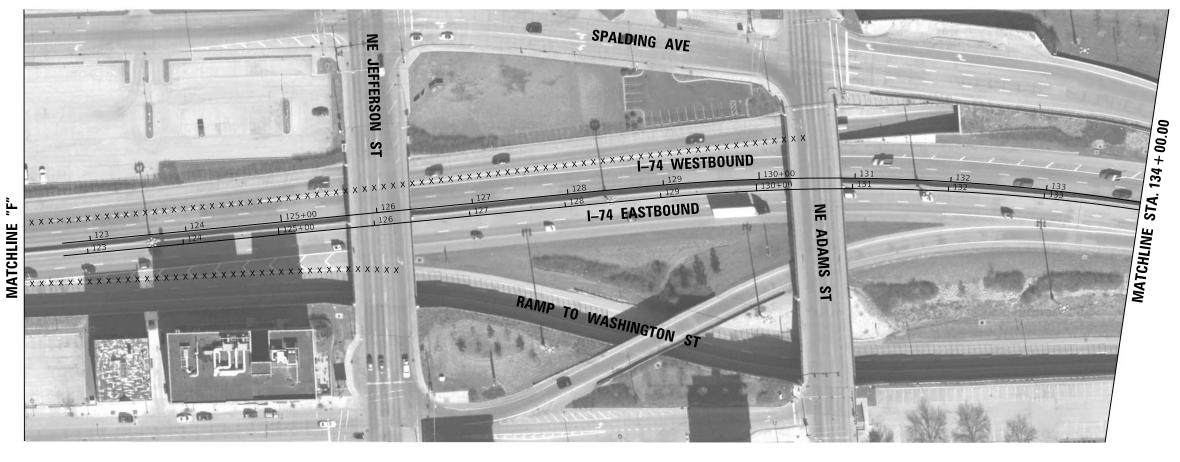


STATE OF ILLINOIS **DEPARTMENT OF TRANSPORTATION**

I-74 MURRAY BAKER BRIDGE PAVEMENT MARKING REMOVAL PLANS - STAGING SCALE: 1"=50' SHEETS STA.

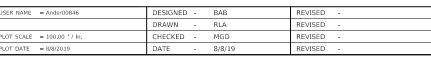SECTION PEORIA TAZEWELL 329 28 90(10D-1)BRR CONTRACT NO. 68C89

LEGEND PAVEMENT MARKING REMOVAL -WATER BLASTING LETTERS AND SYMBOLS PAVEMENT MARKING REMOVAL -WATER BLASTING LINES



134 + 00.00		
L-74 EASTBOUND XXXXXXXXXXXXXXXXXXXXXXXXXXXXXXXXXXXX		
MATCHLINE TO THE TOTAL TOT		
IGTON ST		
WASHINGTON		



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DESIGNED - BAB REVISED DRAWN - RLA REVISED -PLOT SCALE = 100.00 '/ In. CHECKED -MGD REVISED -PLOT DATE = 8/8/2019

STATE OF ILLINOIS **DEPARTMENT OF TRANSPORTATION**

I-74 MURRAY BAKER BRIDGE PAVEMENT MARKING REMOVAL PLANS - STAGING SCALE: 1"=50' SHEETS STA.

SECTION PEORIA TAZEWELL 329 29 CONTRACT NO. 68C89 90(10D-1)BRR

FONDULAC DR. ֖֖֖֖֖֟ MATCHLINE I-74 EASTBOUND I-74 WESTBOUND

LEGEND


PAVEMENT MARKING REMOVAL -WATER BLASTING LETTERS AND SYMBOLS

PAVEMENT MARKING REMOVAL -

WATER BLASTING LINES





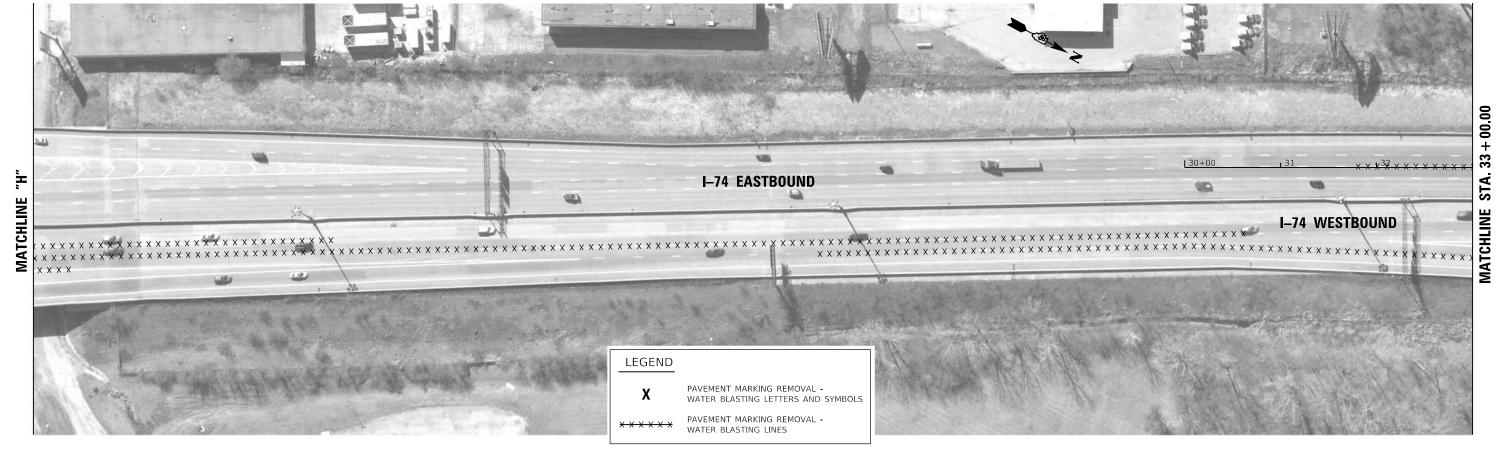

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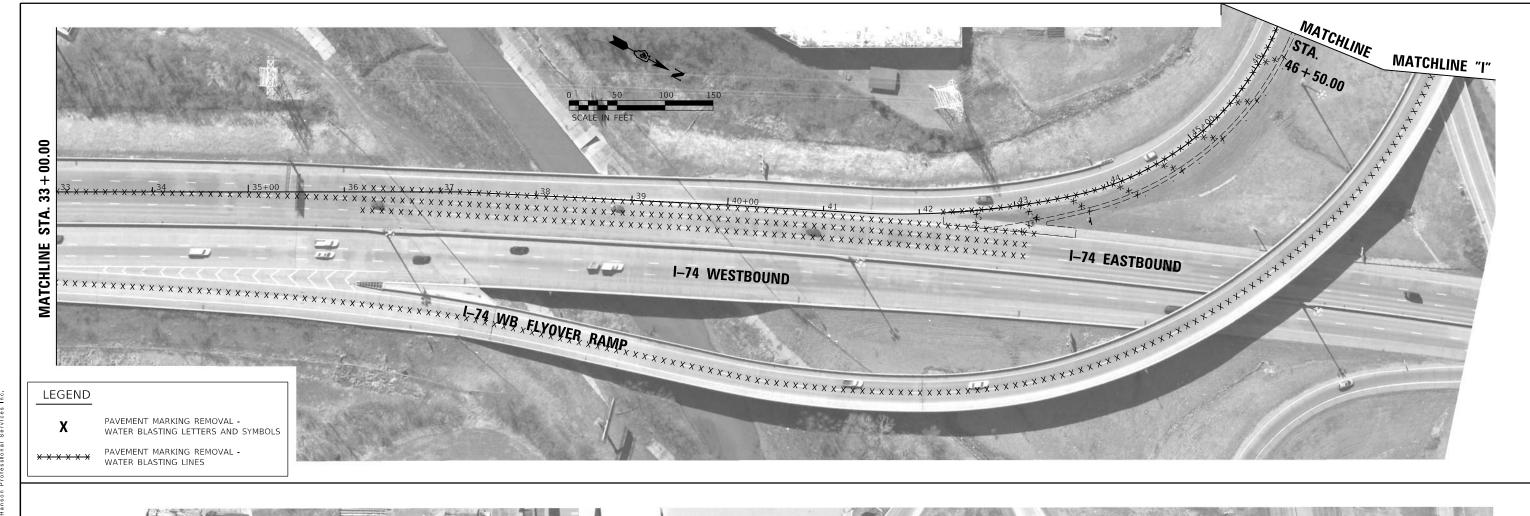
STATE OF ILLINOIS DEPARTMENT OF TRANSPORTATION


I-74 MURRAY BAKER BRIDGE
PAVEMENT MARKING REMOVAL PLANS - STAGING

50' SHEET OF SHEETS STA. TO STA.

F.A.I. RTE. SECTION COUNTY TOTAL SHEETS NO. 74 90(10D-1)BRR PEORIAL 329 30 CONTRACT NO. 68C89





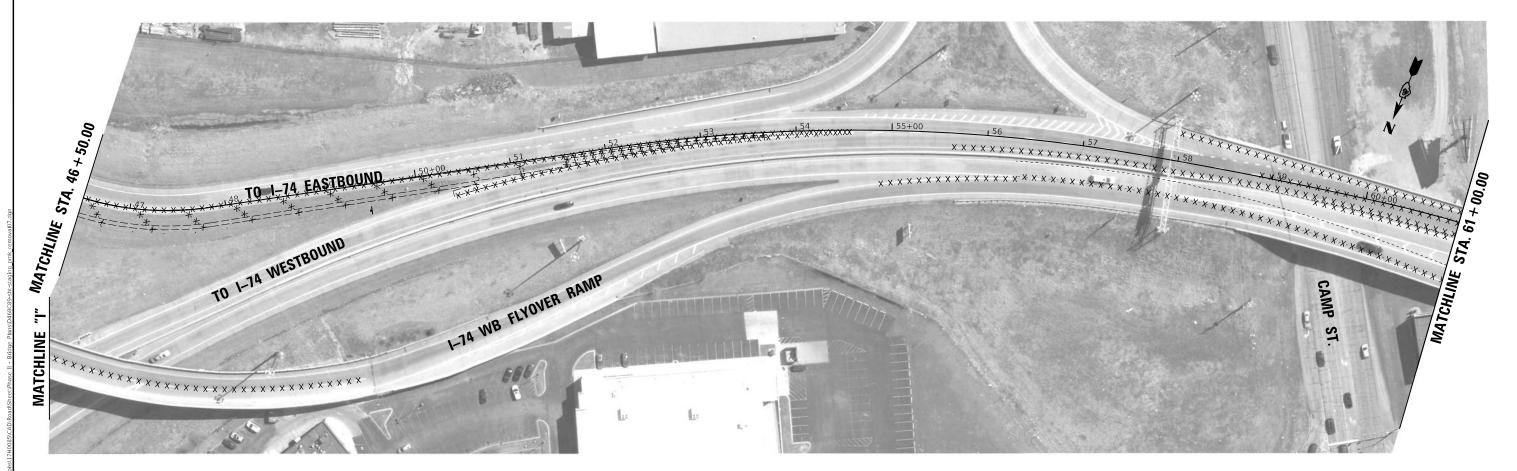

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 PLOT DATE
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 DATE
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STATE OF ILLINOIS
DEPARTMENT OF TRANSPORTATION

I-74 MURRAY BAKER BRIDGE
PAVEMENT MARKING REMOVAL PLANS - STAGING

SCALE: 1"=50' SHEET OF SHEETS STA. TO STA.

F.A.I. SECTION COUNTY TOTAL SHEE SHEETS NO. 74 90(10D-1)BRR PEORIA 329 31 CONTRACT NO. 68C89





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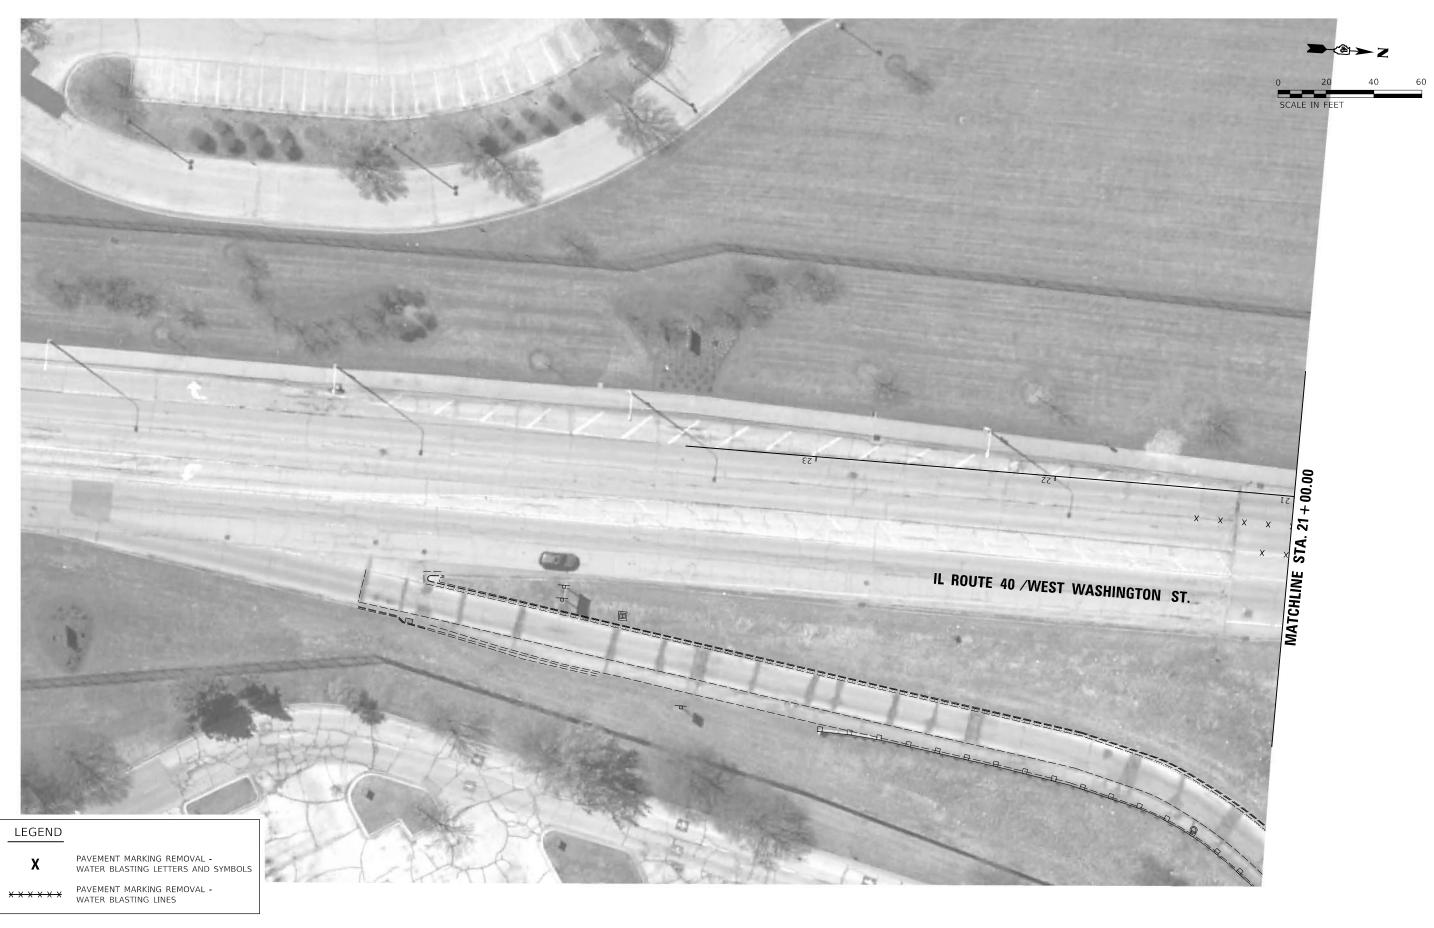
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STATE OF ILLINOIS DEPARTMENT OF TRANSPORTATION I-74 MURRAY BAKER BRIDGE
PAVEMENT MARKING REMOVAL PLANS - STAGING

SCALE: 1"=20' SHEET OF SHEETS STA. TO STA.





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STATE OF ILLINOIS DEPARTMENT OF TRANSPORTATION


I-74 MURRAY BAKER BRIDGE
PAVEMENT MARKING REMOVAL PLANS - STAGING

SCALE: 1"=20' SHEET OF SHEETS STA. TO STA.

A.I. SECTION COUNTY TOTAL SHEETS NO. 74 90(10D-1)BRR PEORIA TAZEWELL 329 33 CONTRACT NO. 68C89

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PEORIA TAZEWELL 329 34 CONTRACT NO. 68C89

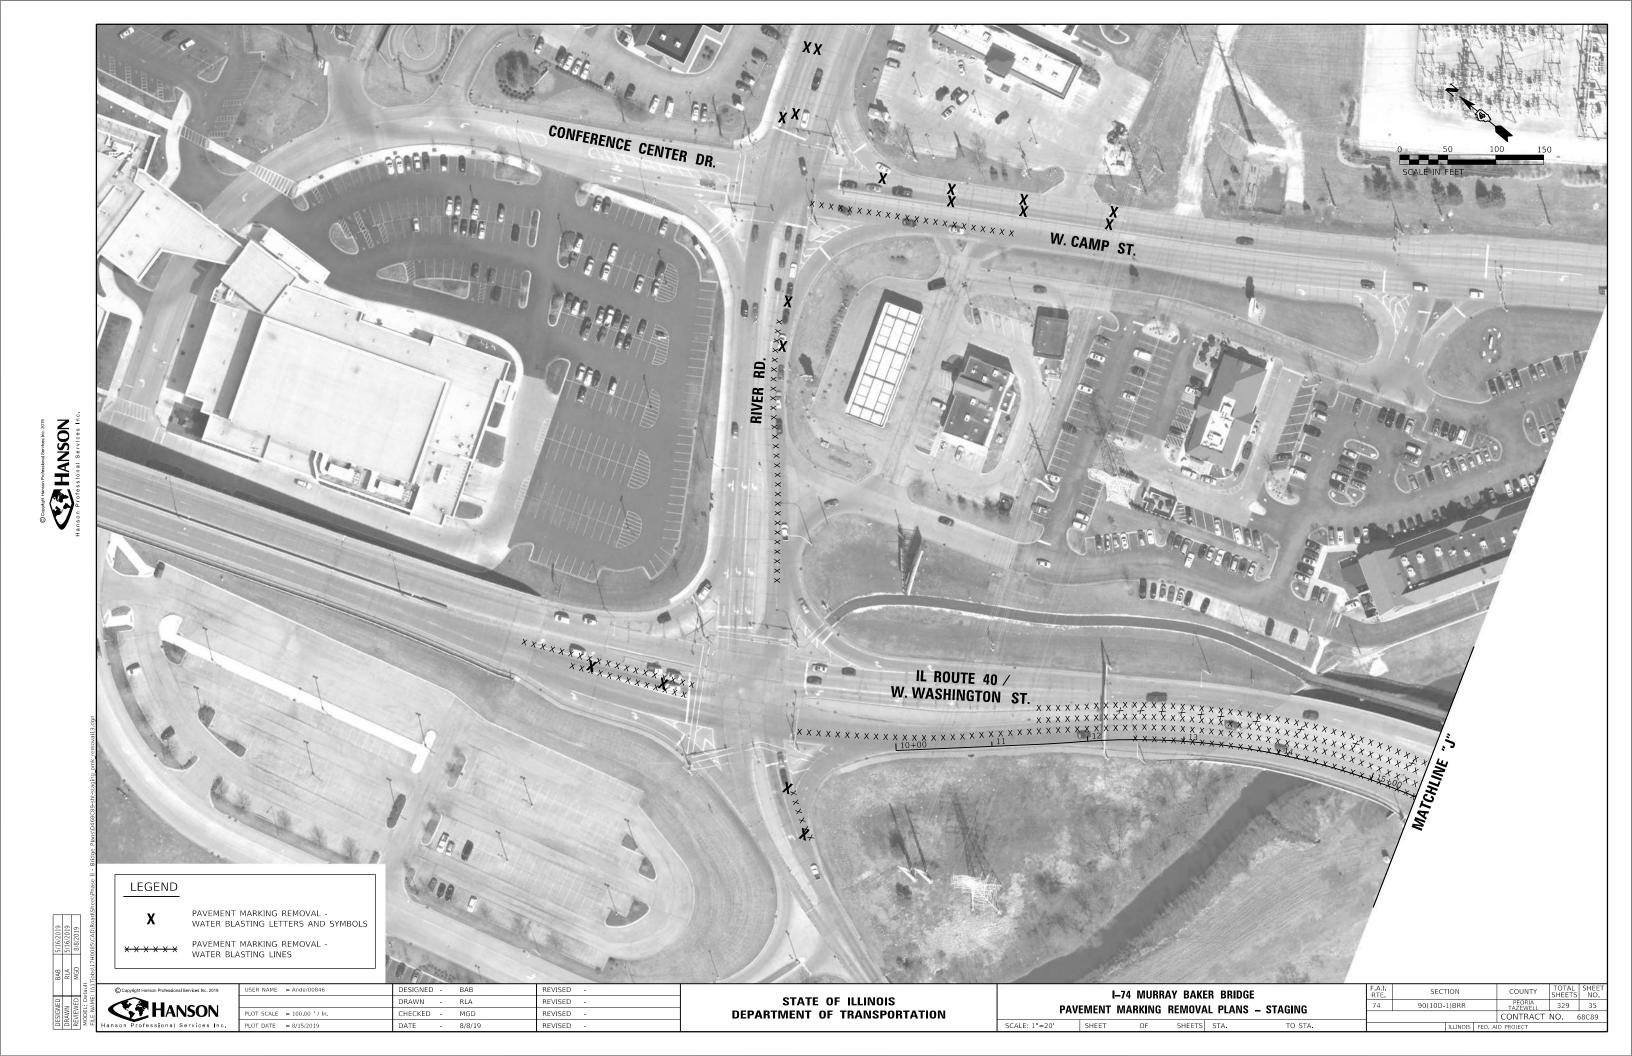


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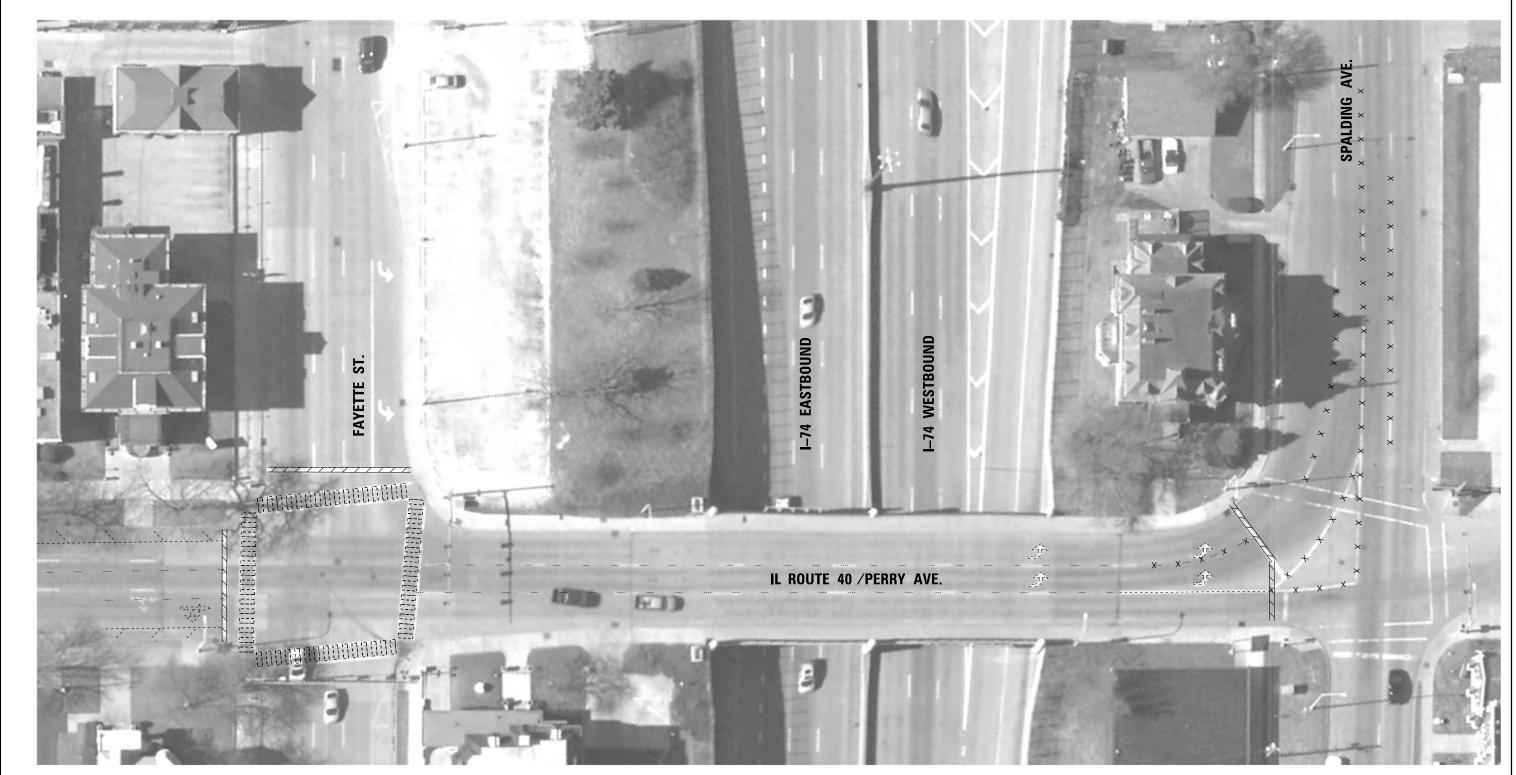
Hanson Professional Services Inc.

LEGEND

PAVEMENT MARKING REMOVAL -WATER BLASTING LETTERS AND SYMBOLS

PAVEMENT MARKING REMOVAL -WATER BLASTING LINES



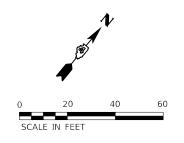



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STATE OF ILLINOIS						
DEPARTMENT OF TRANSPORTATIO	N					

I–74 MURRAY BAKER BRIDGE									
PAVEMENT MARKING REMOVAL PLANS - STAGING									
SCALE: 1"=20"	SHEET	OF	SHEETS	STA.	TO STA.				

I. E.	SECTION		COUNTY	TOTAL SHEETS	SHEET NO.
	90(10D-1)BRR		PEORIA TAZEWELL	329	36
			CONTRACT	NO.	8C89
ILLINOIS FED. AID PROJECT					




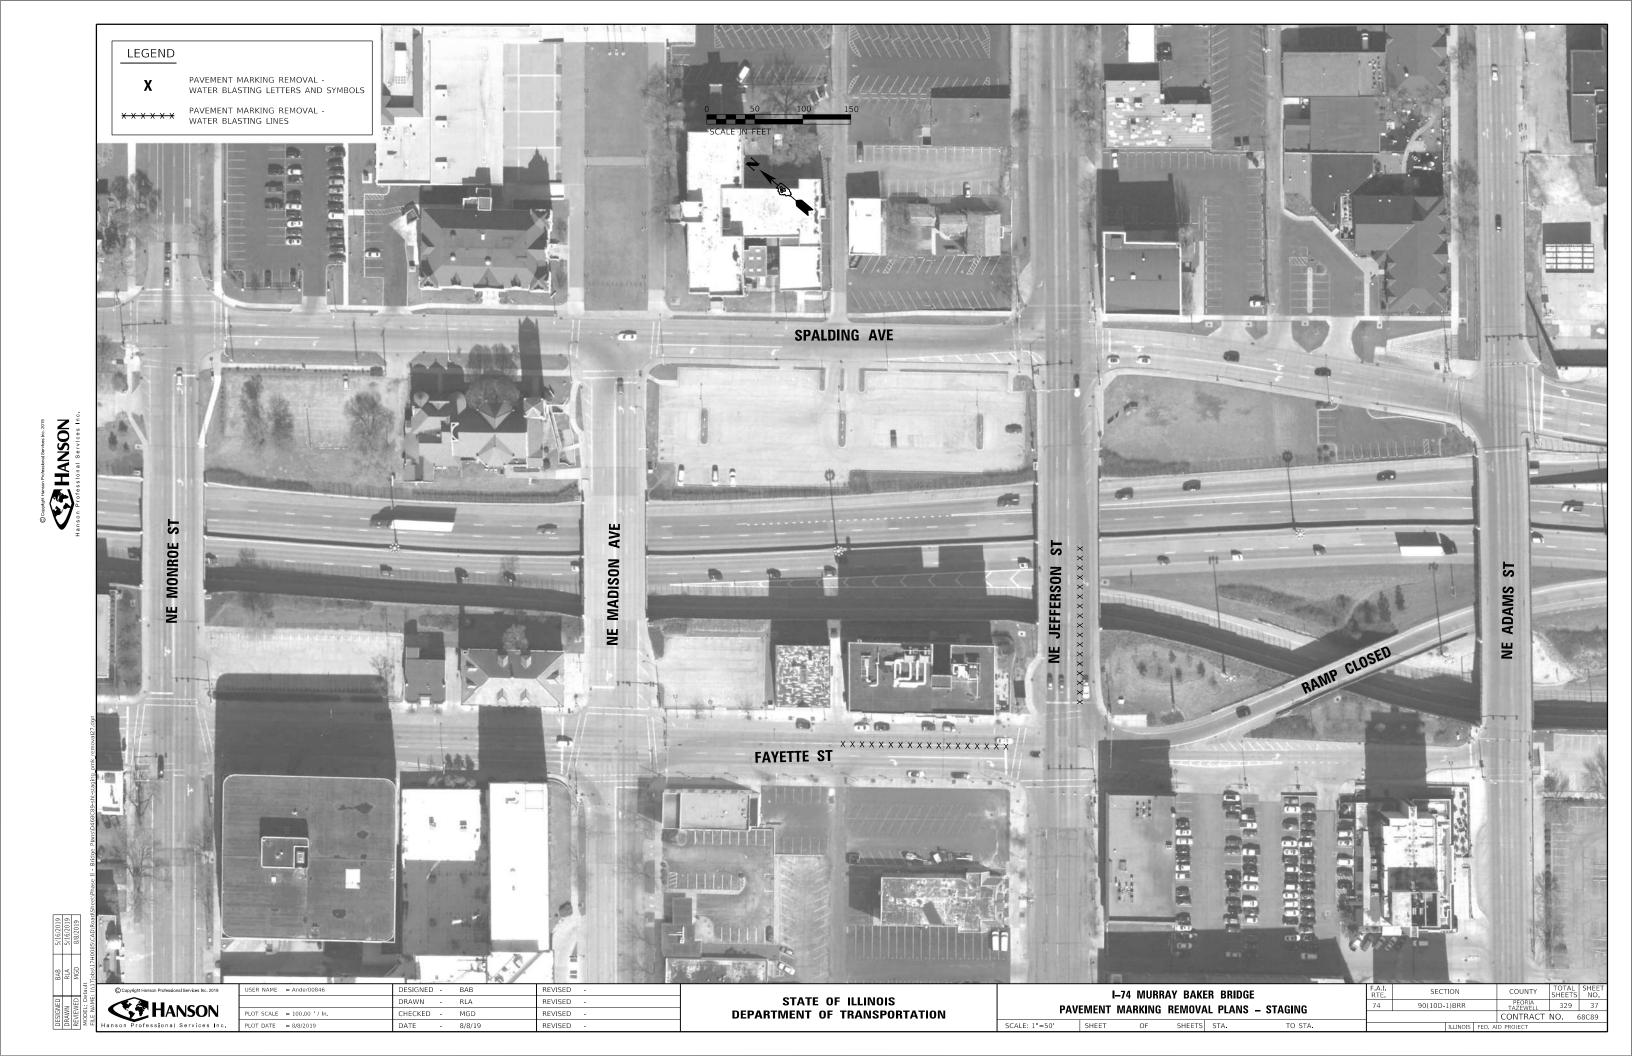

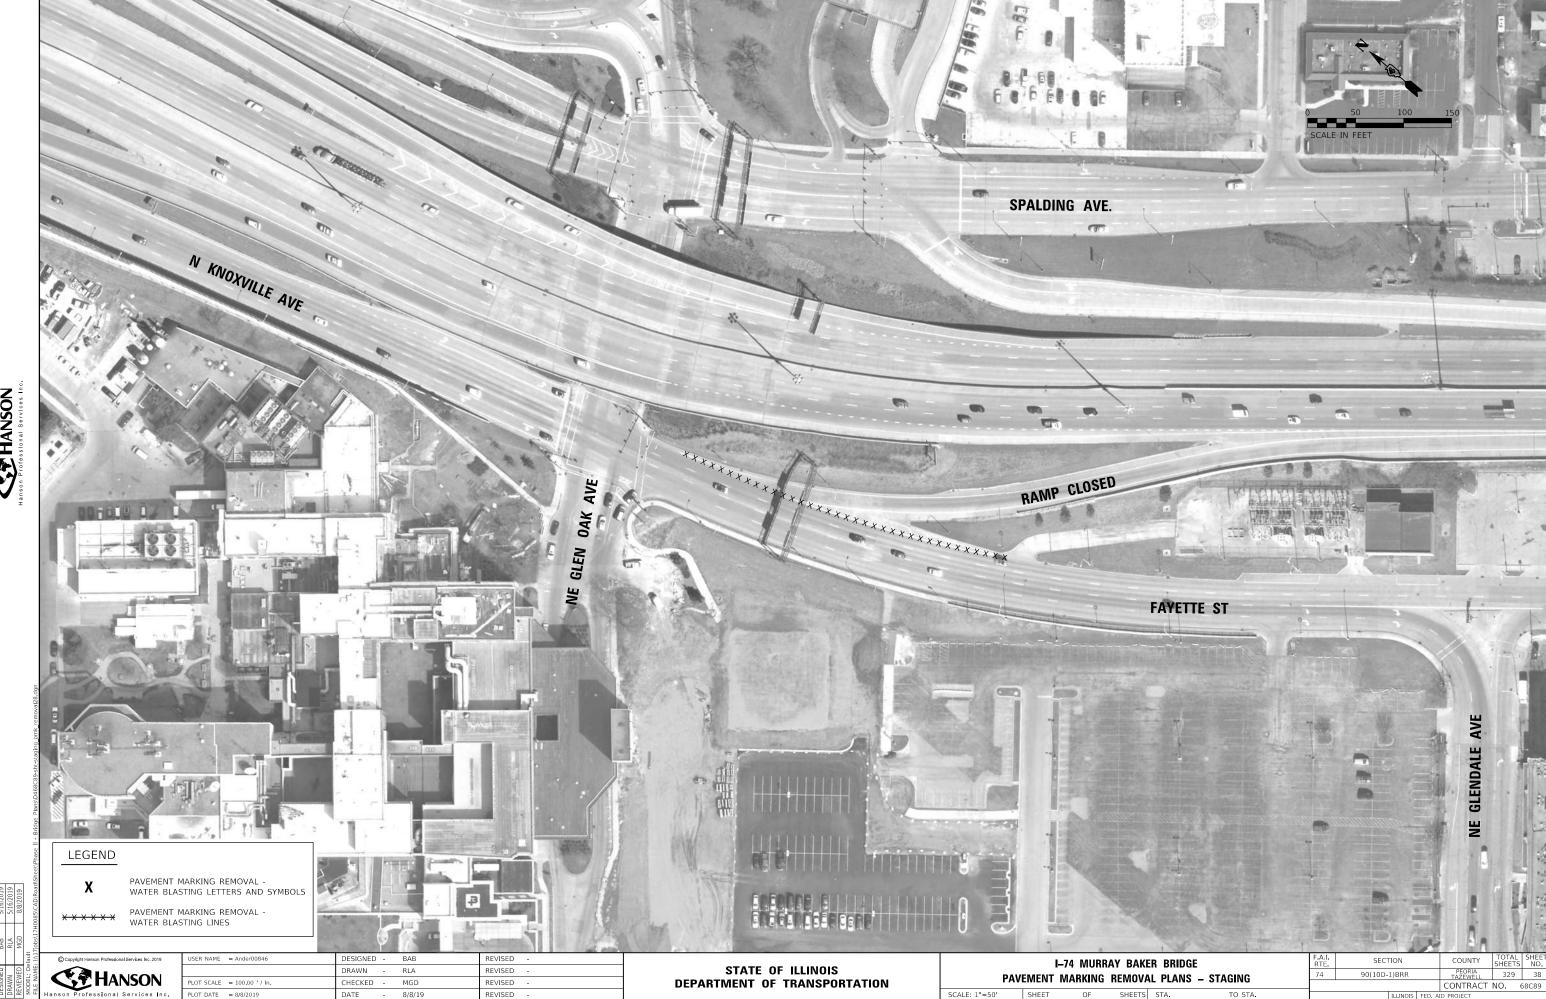
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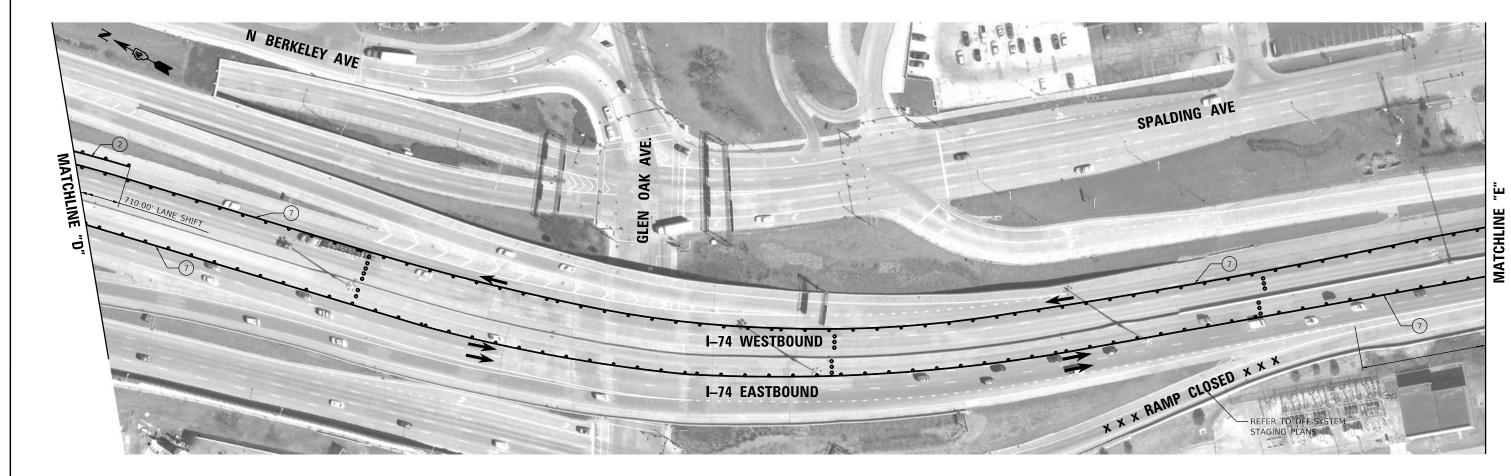
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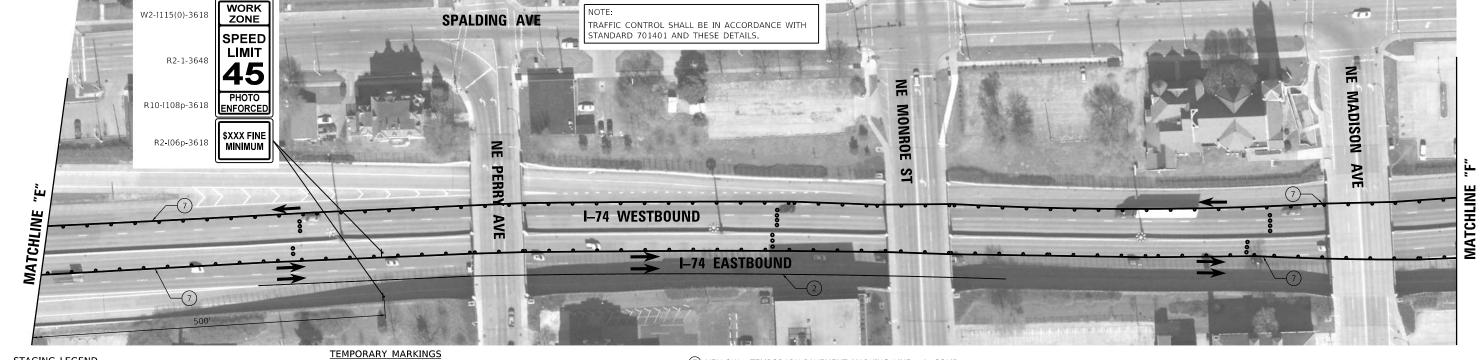


SCALE: 1"=50' SHEET



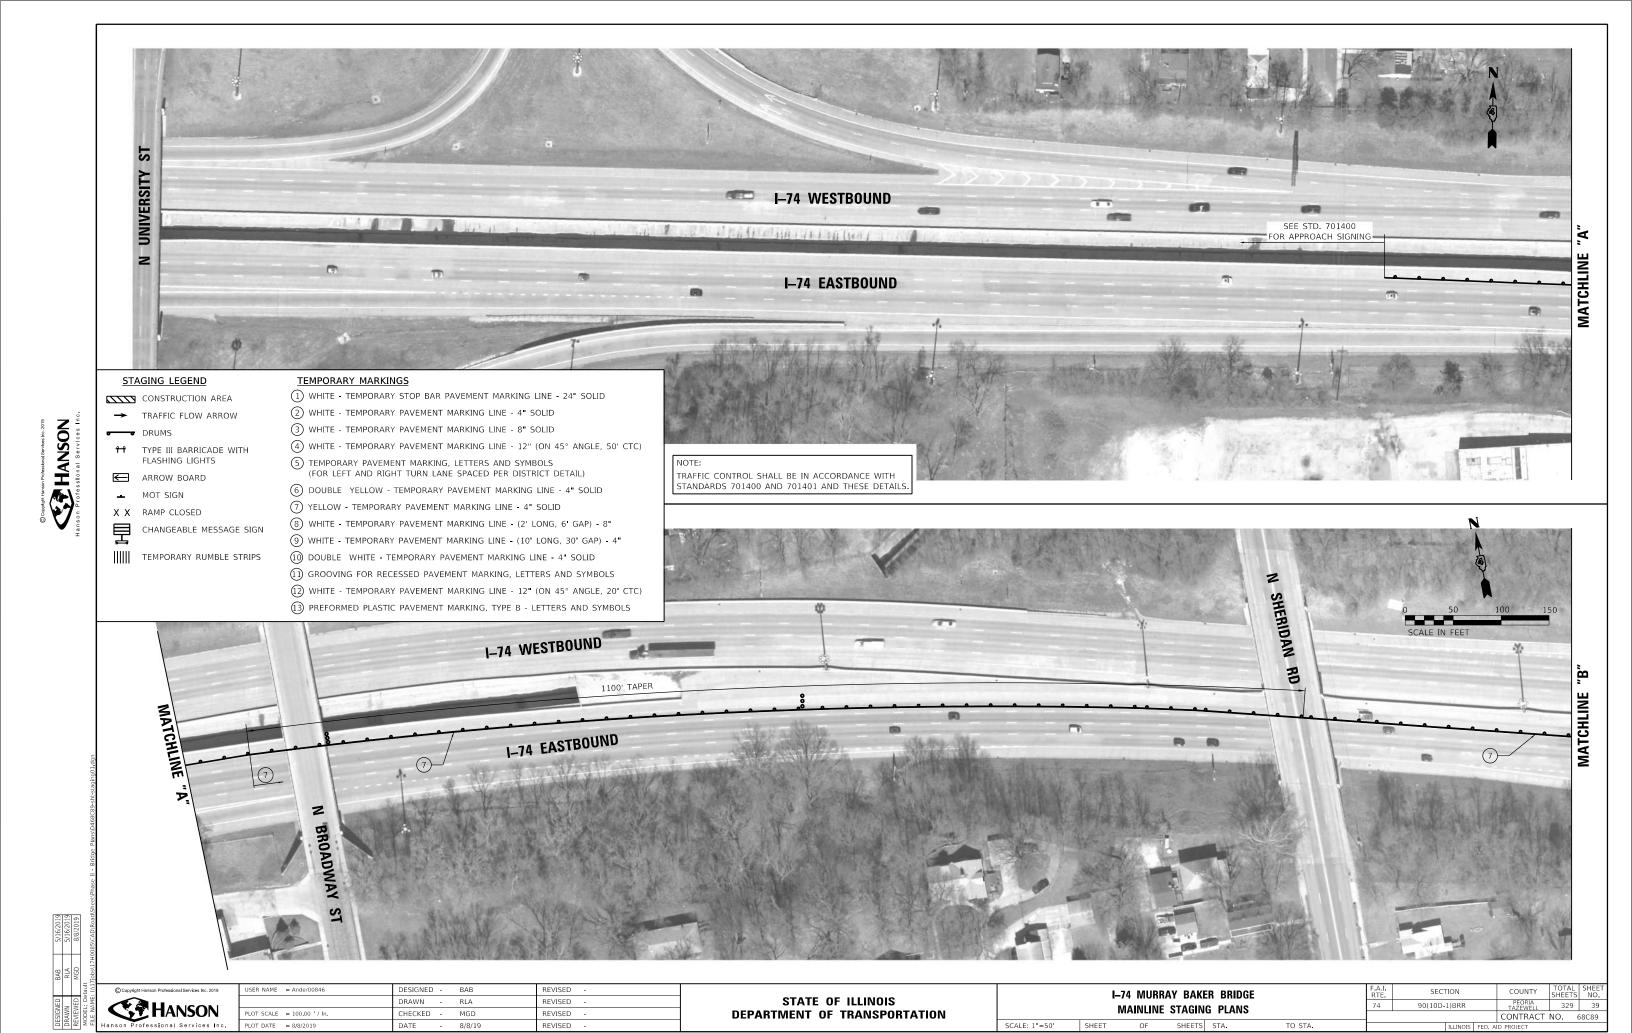



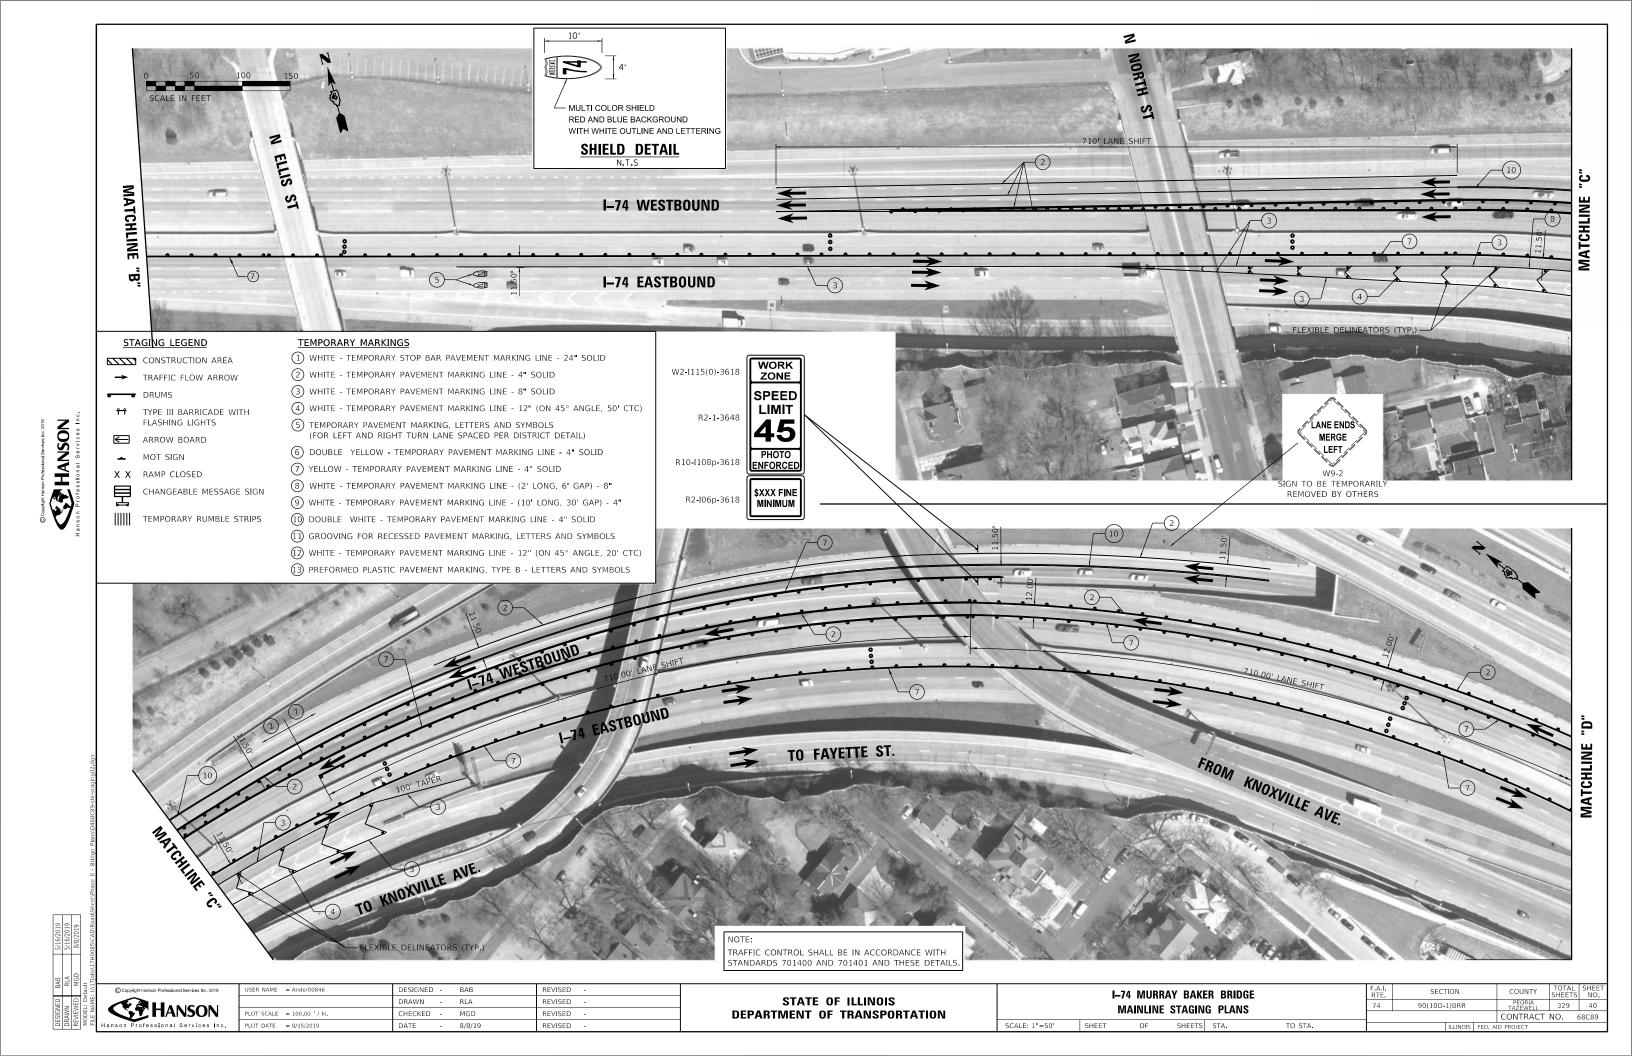

STAGING LEGEND

CONSTRUCTION AREA

TRAFFIC FLOW ARROW

TYPE III BARRICADE WITH FLASHING LIGHTS FLASHING LIGHTS

X X RAMP CLOSED

ARROW BOARD

CHANGEABLE MESSAGE SIGN TEMPORARY RUMBLE STRIPS

- ① WHITE TEMPORARY STOP BAR PAVEMENT MARKING LINE 24" SOLID
- 2 WHITE TEMPORARY PAVEMENT MARKING LINE 4" SOLID
- 3 WHITE TEMPORARY PAVEMENT MARKING LINE 8" SOLID
- (5) TEMPORARY PAVEMENT MARKING, LETTERS AND SYMBOLS (FOR LEFT AND RIGHT TURN LANE SPACED PER DISTRICT DETAIL)
- 6 DOUBLE YELLOW TEMPORARY PAVEMENT MARKING LINE 4" SOLID
- 7 YELLOW TEMPORARY PAVEMENT MARKING LINE 4" SOLID
- (8) WHITE TEMPORARY PAVEMENT MARKING LINE (2' LONG, 6' GAP) 8"
- 9 WHITE TEMPORARY PAVEMENT MARKING LINE (10' LONG, 30' GAP) 4"
- 10 DOUBLE WHITE TEMPORARY PAVEMENT MARKING LINE 4" SOLID
- (1) GROOVING FOR RECESSED PAVEMENT MARKING, LETTERS AND SYMBOLS
- (12) WHITE TEMPORARY PAVEMENT MARKING LINE 12" (ON 45° ANGLE, 20' CTC)
- (13) PREFORMED PLASTIC PAVEMENT MARKING, TYPE B LETTERS AND SYMBOLS

				7
0	50	100	150	(2)
SCALE	IN FEET			

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PLOT DATE = 8/8/2019	DATE -	8/8/19	REVISED -

STATE OF ILLINOIS **DEPARTMENT OF TRANSPORTATION**

		I–74 MURRA MAINLINE		
SCALE: 1"=50'	SHEET	OF	SHEETS	STA.

F.A.I. RTE	SECT	ION		COUNTY	TOTAL SHEETS	SHEET NO.
74	90(10D-	1)BRR		PEORIA TAZEWELL	329	41
				CONTRACT	NO. 6	8C89
		ILLINOIS	FED. Al	ID PROJECT		





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ROAD

CONSTRUCTION

AHEAD

W20-I103(0)-48


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WASHINGTON

STATE OF ILLINOIS **DEPARTMENT OF TRANSPORTATION**

I-74 MURRAY BAKER BRIDGE MAINLINE STAGING PLANS SCALE: 1"=50' SHEET

CONTRACT NO. 68C89

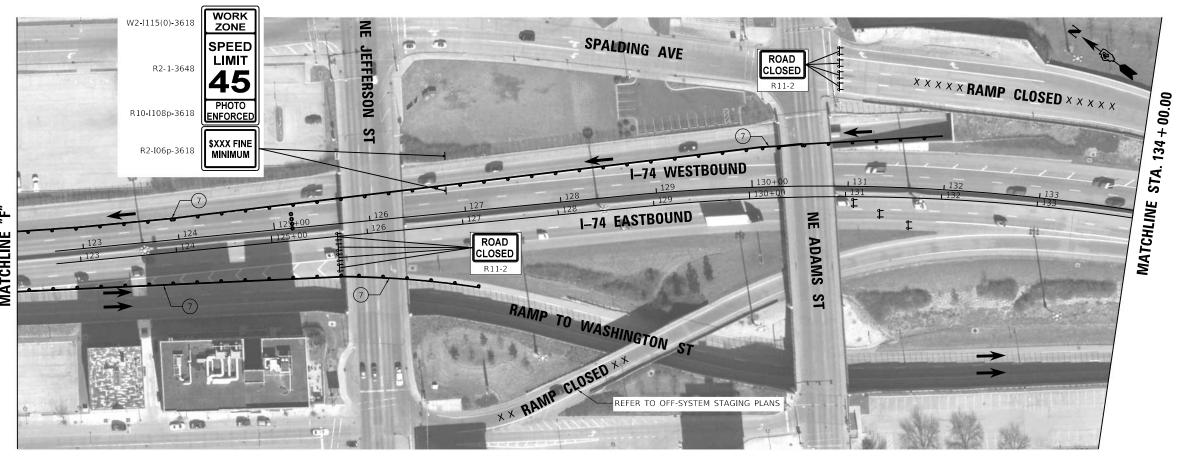

TRAFFIC CONTROL SHALL BE IN ACCORDANCE WITH STANDARD 701401 AND THESE DETAILS.

STAGING LEGEND

CONSTRUCTION AREA

→ TRAFFIC FLOW ARROW

TYPE III BARRICADE WITH FLASHING LIGHTS

■ ARROW BOARD

MOT SIGN


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CHANGEABLE MESSAGE SIGN

TEMPORARY RUMBLE STRIPS

TEMPORARY MARKINGS

- 1) WHITE TEMPORARY STOP BAR PAVEMENT MARKING LINE 24" SOLID
- 2 WHITE TEMPORARY PAVEMENT MARKING LINE 4" SOLID
- 3 WHITE TEMPORARY PAVEMENT MARKING LINE 8" SOLID
- (4) WHITE TEMPORARY PAVEMENT MARKING LINE 12" (ON 45° ANGLE, 50' CTC)
- (5) TEMPORARY PAVEMENT MARKING, LETTERS AND SYMBOLS (FOR LEFT AND RIGHT TURN LANE SPACED PER DISTRICT DETAIL)
- (6) DOUBLE YELLOW TEMPORARY PAVEMENT MARKING LINE 4" SOLID
- 7 YELLOW TEMPORARY PAVEMENT MARKING LINE 4" SOLID 8 WHITE - TEMPORARY PAVEMENT MARKING LINE - (2' LONG, 6' GAP) - 8"
- (9) WHITE TEMPORARY PAVEMENT MARKING LINE (10' LONG, 30' GAP) 4"
- 10 DOUBLE WHITE TEMPORARY PAVEMENT MARKING LINE 4" SOLID
- (1) GROOVING FOR RECESSED PAVEMENT MARKING, LETTERS AND SYMBOLS
- (12) WHITE TEMPORARY PAVEMENT MARKING LINE 12" (ON 45° ANGLE, 20' CTC)
- (13) PREFORMED PLASTIC PAVEMENT MARKING, TYPE B LETTERS AND SYMBOLS

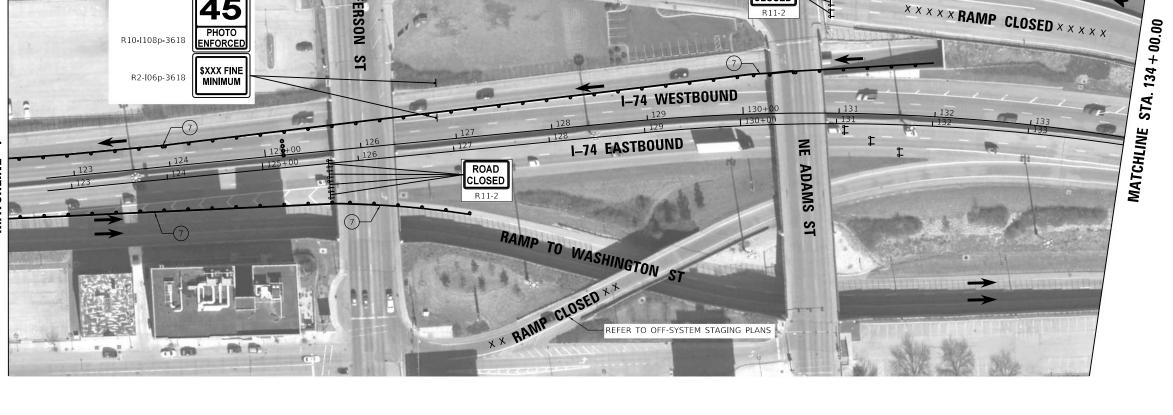

ROAD CONSTRUCTION AHEAD

M6-3(0)-2115



ROAD ONSTRUCTION AHEAD


W20-I103(0<u>)-48</u>

MATCHLINE

STA. 134 + 00.00





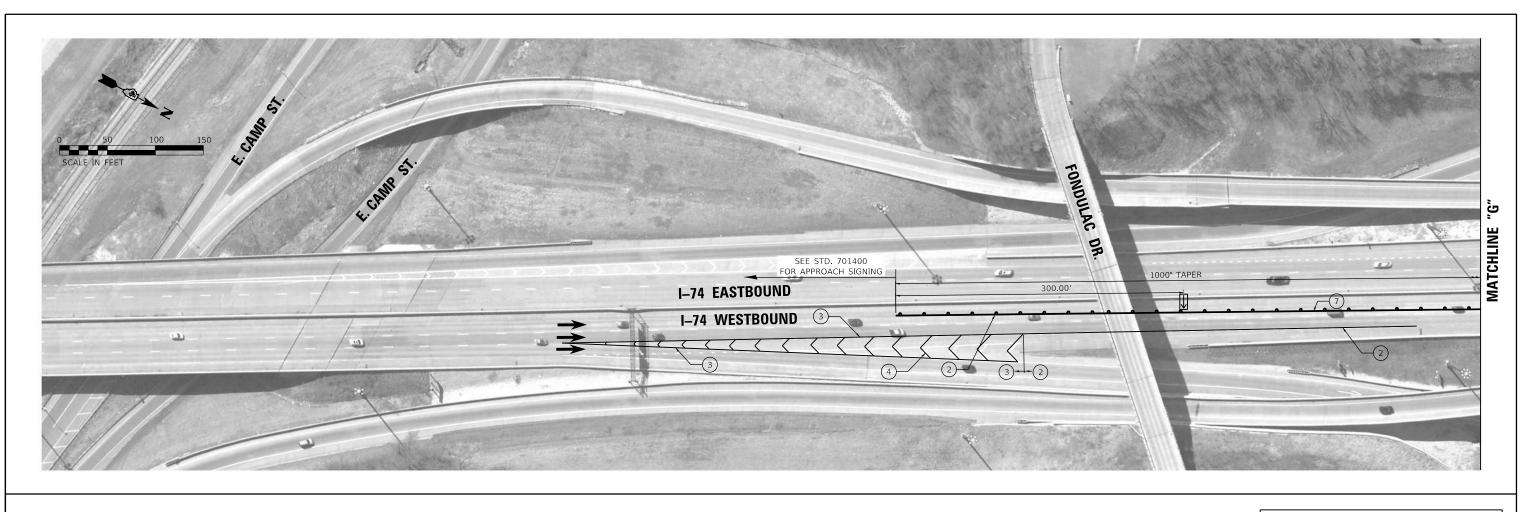

STAGING LEGEND

CONSTRUCTION AREA

→ TRAFFIC FLOW ARROW

TYPE III BARRICADE WITH FLASHING LIGHTS

■ ARROW BOARD

MOT SIGN

X X RAMP CLOSED 胃

CHANGEABLE MESSAGE SIGN

TEMPORARY RUMBLE STRIPS

TEMPORARY MARKINGS

- ① WHITE TEMPORARY STOP BAR PAVEMENT MARKING LINE 24" SOLID
- 2 WHITE TEMPORARY PAVEMENT MARKING LINE 4" SOLID
- 3 WHITE TEMPORARY PAVEMENT MARKING LINE 8" SOLID
- 4 WHITE TEMPORARY PAVEMENT MARKING LINE 12" (ON 45° ANGLE, 50' CTC)
- (5) TEMPORARY PAVEMENT MARKING, LETTERS AND SYMBOLS (FOR LEFT AND RIGHT TURN LANE SPACED PER DISTRICT DETAIL)
- 6 DOUBLE YELLOW TEMPORARY PAVEMENT MARKING LINE 4" SOLID
- 7 YELLOW TEMPORARY PAVEMENT MARKING LINE 4" SOLID
- (8) WHITE TEMPORARY PAVEMENT MARKING LINE (2' LONG, 6' GAP) 8"
- 9 WHITE TEMPORARY PAVEMENT MARKING LINE (10' LONG, 30' GAP) 4"
- 10 DOUBLE WHITE TEMPORARY PAVEMENT MARKING LINE 4" SOLID
- (1) GROOVING FOR RECESSED PAVEMENT MARKING, LETTERS AND SYMBOLS
- 12) WHITE TEMPORARY PAVEMENT MARKING LINE 12" (ON 45° ANGLE, 20' CTC)
- (13) PREFORMED PLASTIC PAVEMENT MARKING, TYPE B LETTERS AND SYMBOLS

TRAFFIC CONTROL SHALL BE IN ACCORDANCE WITH STANDARDS 701400 AND 701401 AND THESE DETAILS.

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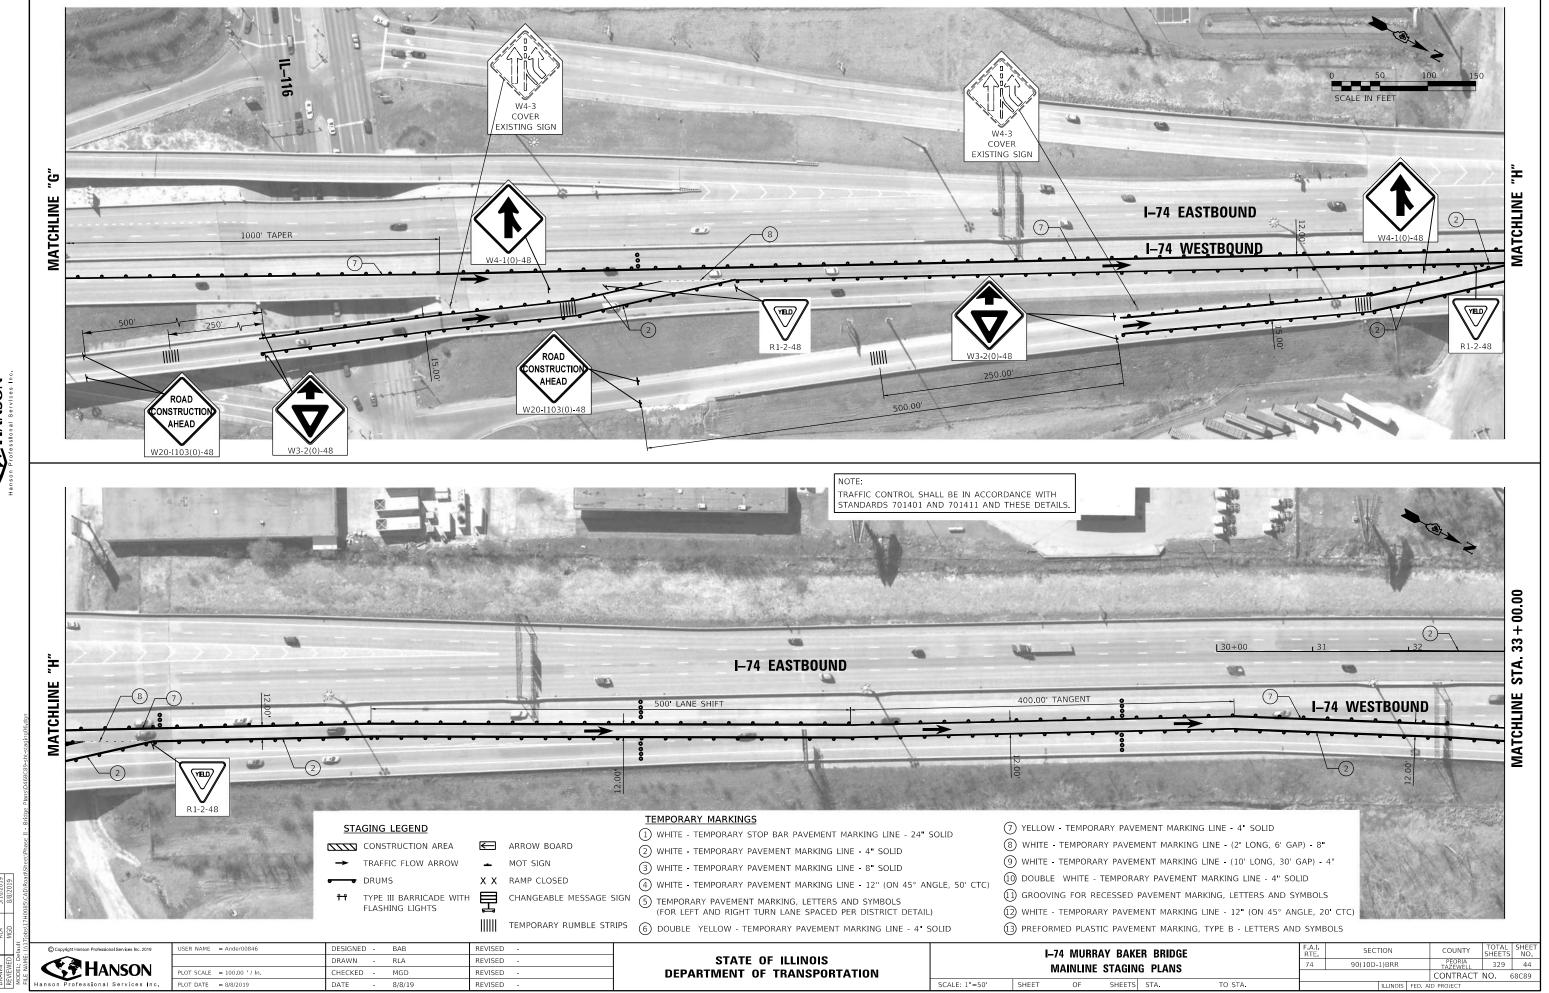
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	DRAWN -	RLA	REVISED -	
PLOT SCALE = 100.00 ' / In.	CHECKED -	MGD	REVISED -	
PLOT DATE = 8/8/2019	DATE -	8/8/19	REVISED -	

STATE OF ILLINOIS **DEPARTMENT OF TRANSPORTATION**

SCALE: 1"=50'

I–74 MURRAY BAKER BRIDGE MAINLINE STAGING PLANS			F.A.I. RTE	SEC.	TION		COUNTY	TOTAL SHEETS			
			74	90(10D-1)BRR		PEORIA TAZEWELL	329	43			
	IVIAIIVEIIVE	STAUING	ILAN			·				NO.	68C89
Т	OF	SHEETS	STA	TO STA			ILLINIOIC.	EED A	D DDOJECT		






SCALE: 1"=50' SHEET


SHEETS STA.

TO STA.

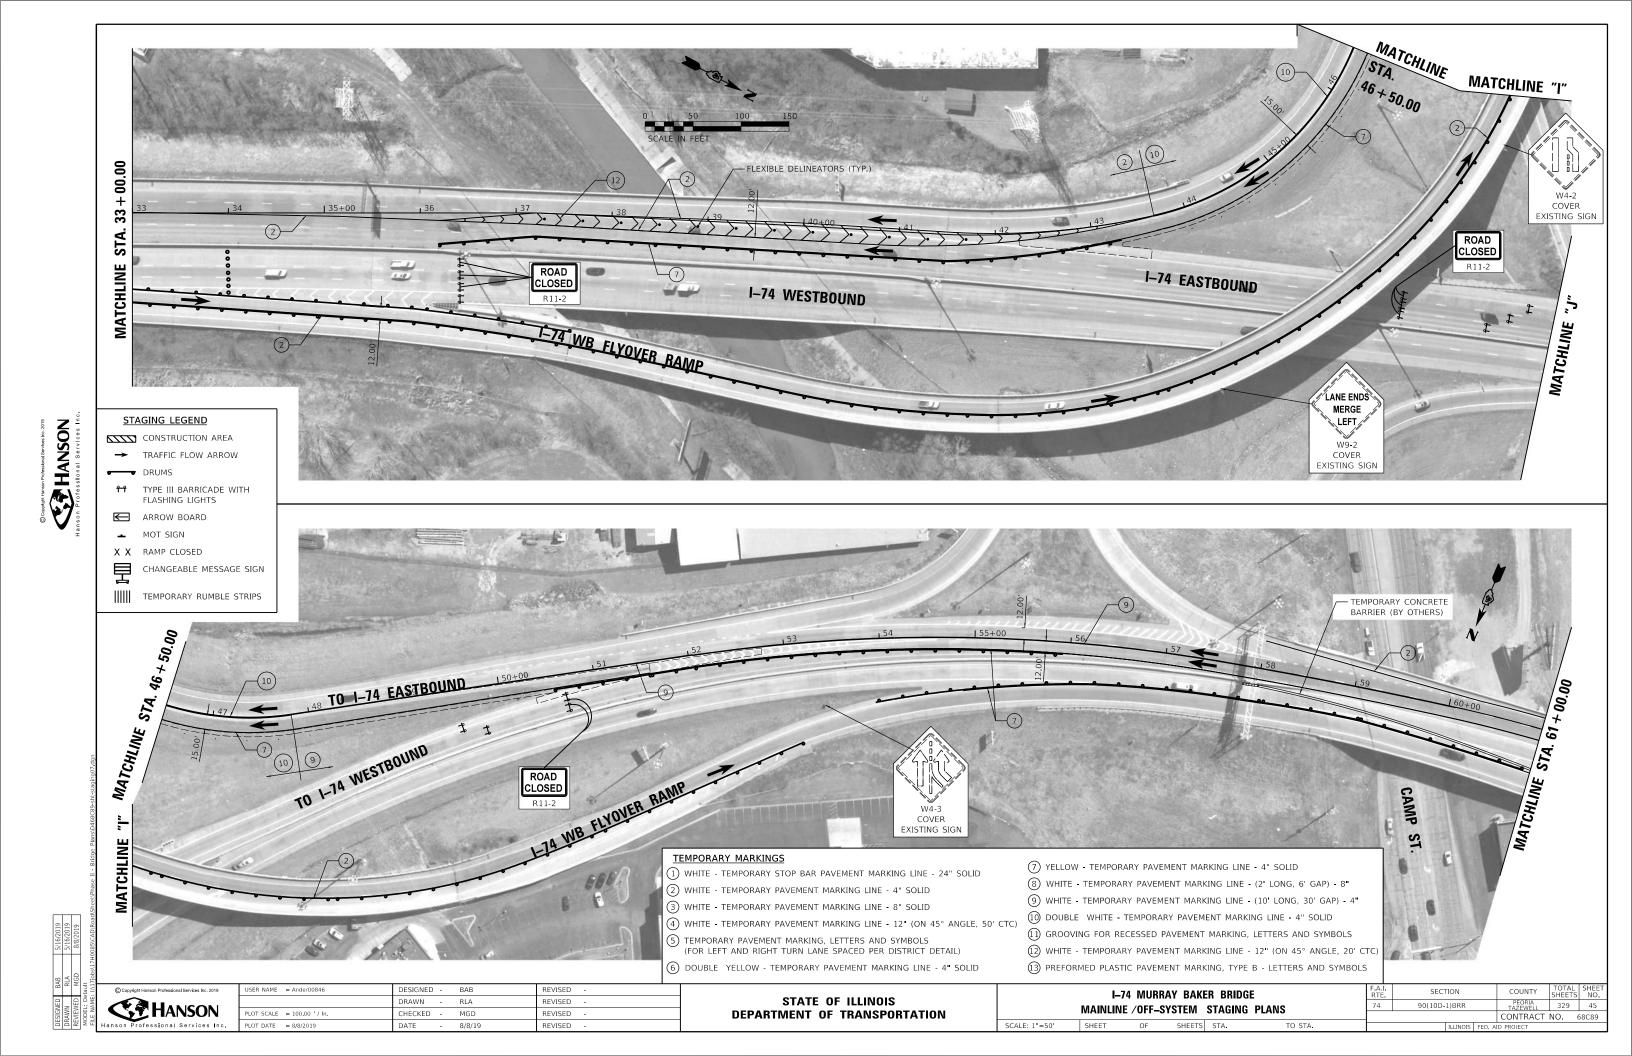





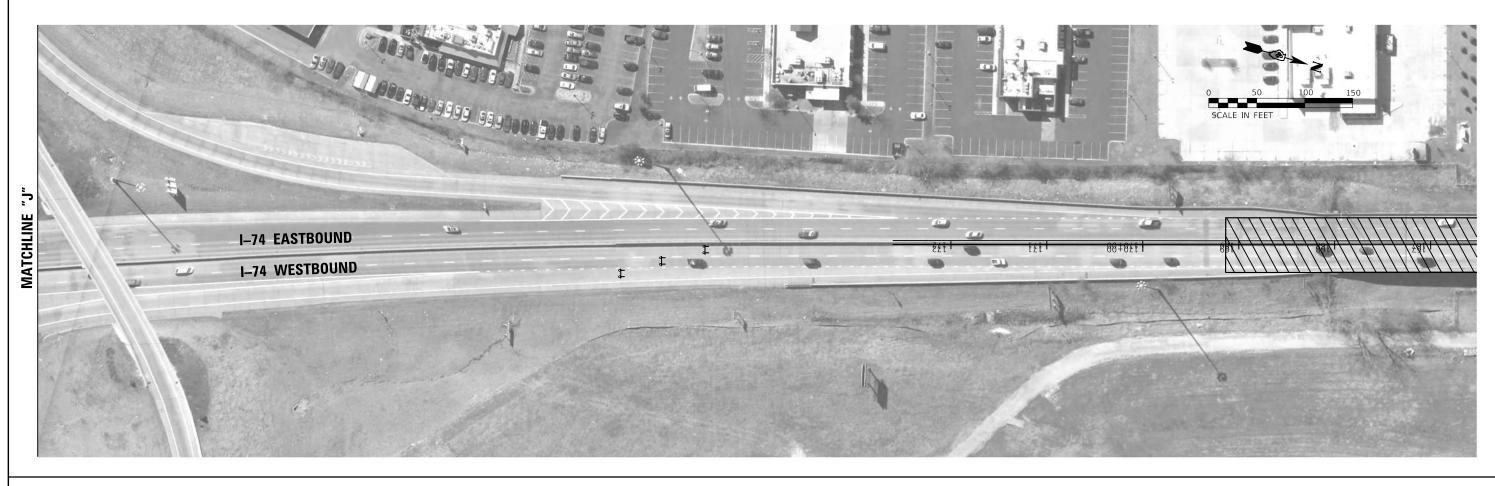

STAGING LEGEND

CONSTRUCTION AREA

→ TRAFFIC FLOW ARROW

TYPE III BARRICADE WITH FLASHING LIGHTS

ARROW BOARD

MOT SIGN

X X RAMP CLOSED CHANGEABLE MESSAGE SIGN

TEMPORARY RUMBLE STRIPS

TEMPORARY MARKINGS


- ① WHITE TEMPORARY STOP BAR PAVEMENT MARKING LINE 24" SOLID
- 2 WHITE TEMPORARY PAVEMENT MARKING LINE 4" SOLID
- 3 WHITE TEMPORARY PAVEMENT MARKING LINE 8" SOLID
- 4 WHITE TEMPORARY PAVEMENT MARKING LINE 12" (ON 45° ANGLE, 50' CTC)
- (5) TEMPORARY PAVEMENT MARKING, LETTERS AND SYMBOLS (FOR LEFT AND RIGHT TURN LANE SPACED PER DISTRICT DETAIL)
- 6 DOUBLE YELLOW TEMPORARY PAVEMENT MARKING LINE 4" SOLID
- (7) YELLOW TEMPORARY PAVEMENT MARKING LINE 4" SOLID
- (8) WHITE TEMPORARY PAVEMENT MARKING LINE (2' LONG, 6' GAP) 8"
- $\begin{tabular}{ll} \end{tabular}$ White Temporary pavement marking line (10' long, 30' GAP) 4"
- 10 DOUBLE WHITE TEMPORARY PAVEMENT MARKING LINE 4" SOLID
- (11) GROOVING FOR RECESSED PAVEMENT MARKING, LETTERS AND SYMBOLS
- (12) WHITE TEMPORARY PAVEMENT MARKING LINE 12" (ON 45° ANGLE, 20' CTC)
- (13) PREFORMED PLASTIC PAVEMENT MARKING, TYPE B LETTERS AND SYMBOLS

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PLOT DATE = 8/8/2019	DATE -	8/8/19	REVISED -	

STATE OF ILLINOIS DEPARTMENT OF TRANSPORTATION		Į.
	SCALE: 1"=50'	SHEET

-74 MURRAY BAKER BRIDGE					F.A.I. RTE.	SECTIO	ON	COUNTY	TOTAL SHEETS	SHEET NO.
MAINLINE STAGING PLANS				74	90(10D-1)BRR		PEORIA TAZEWELL	329	46	
							CONTRACT	NO. 6	58C89	
OF	SHEETS	STA.	TO S	TA.		11	LINOIS FED	. AID PROJECT		

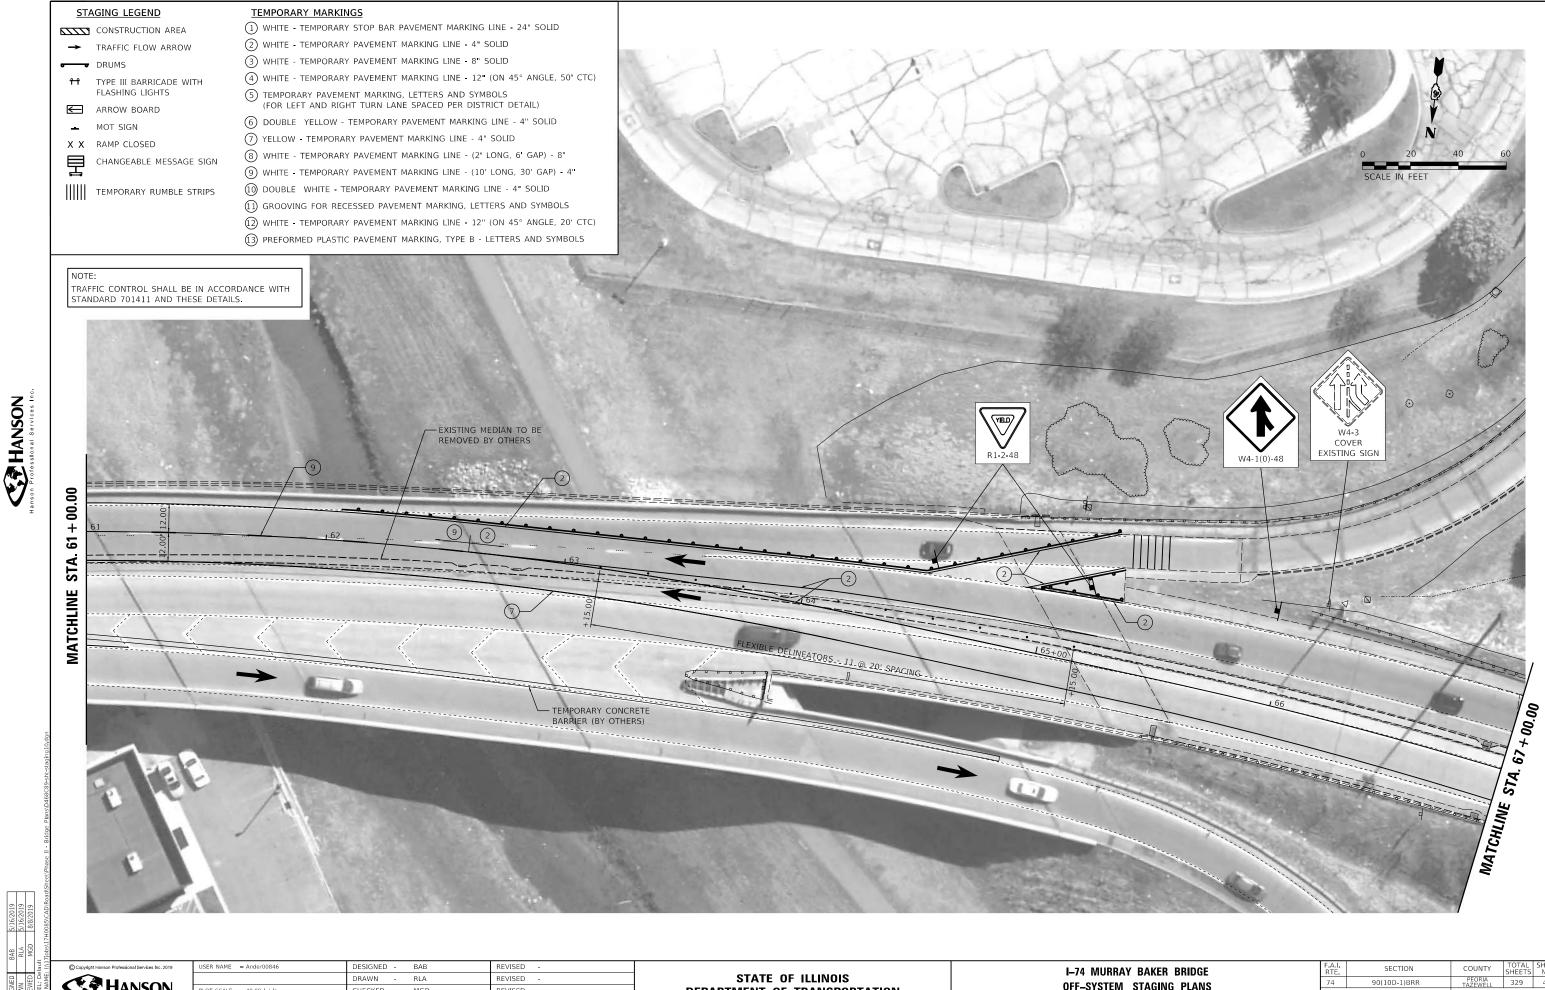

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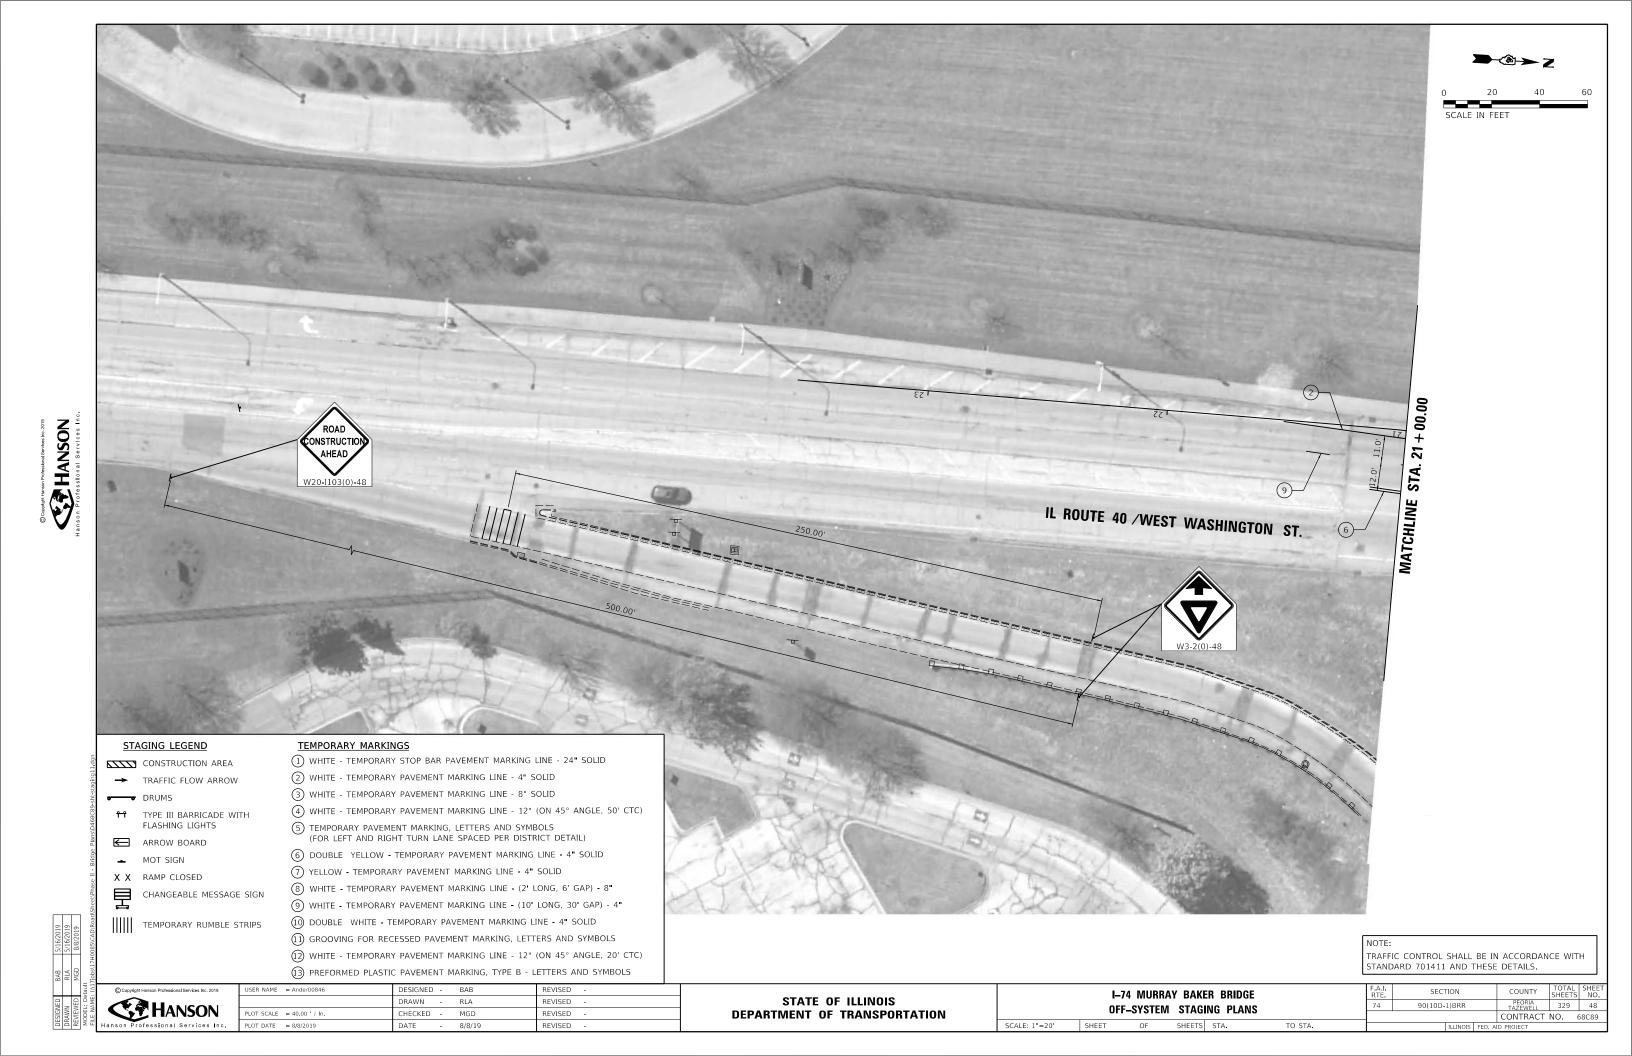
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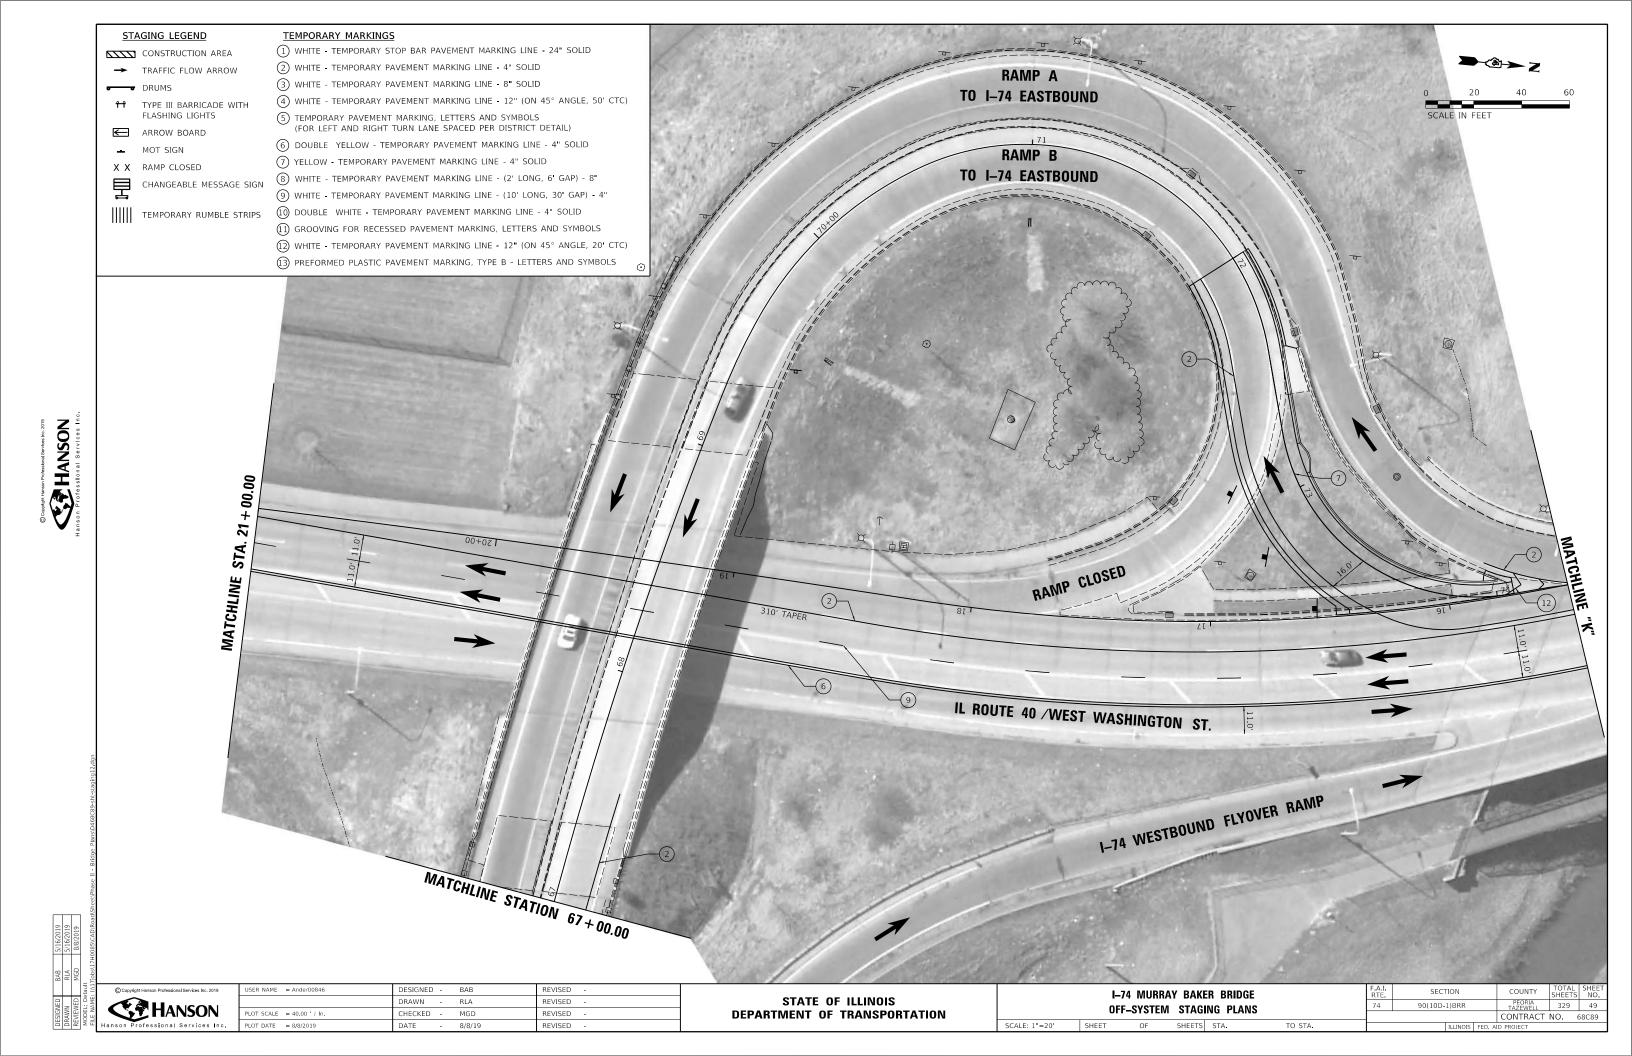
DEPARTMENT OF TRANSPORTATION

SCALE: 1"=20' SHEET

OFF-SYSTEM STAGING PLANS

329 47 CONTRACT NO. 68C89





DEPARTMENT OF TRANSPORTATION

REVISED

OFF-SYSTEM STAGING PLANS

SCALE: 1"=50' SHEET

CONTRACT NO. 68C89




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DESIGNED -REVISED DRAWN -RLA REVISED PLOT SCALE = 40.00 ' / In. CHECKED -REVISED REVISED

STATE OF ILLINOIS **DEPARTMENT OF TRANSPORTATION**

I-74 MURRAY BAKER BRIDGE **OFF-SYSTEM STAGING PLANS** SCALE: 1"=20' SHEET SHEETS STA. TO STA. 90(10D-1)BRR CONTRACT NO. 68C89

CONTRACTOR SHALL MAINTAIN A MINIMUM OF 12' TRAVEL LANES ALONG BASS PRO DRIVE.

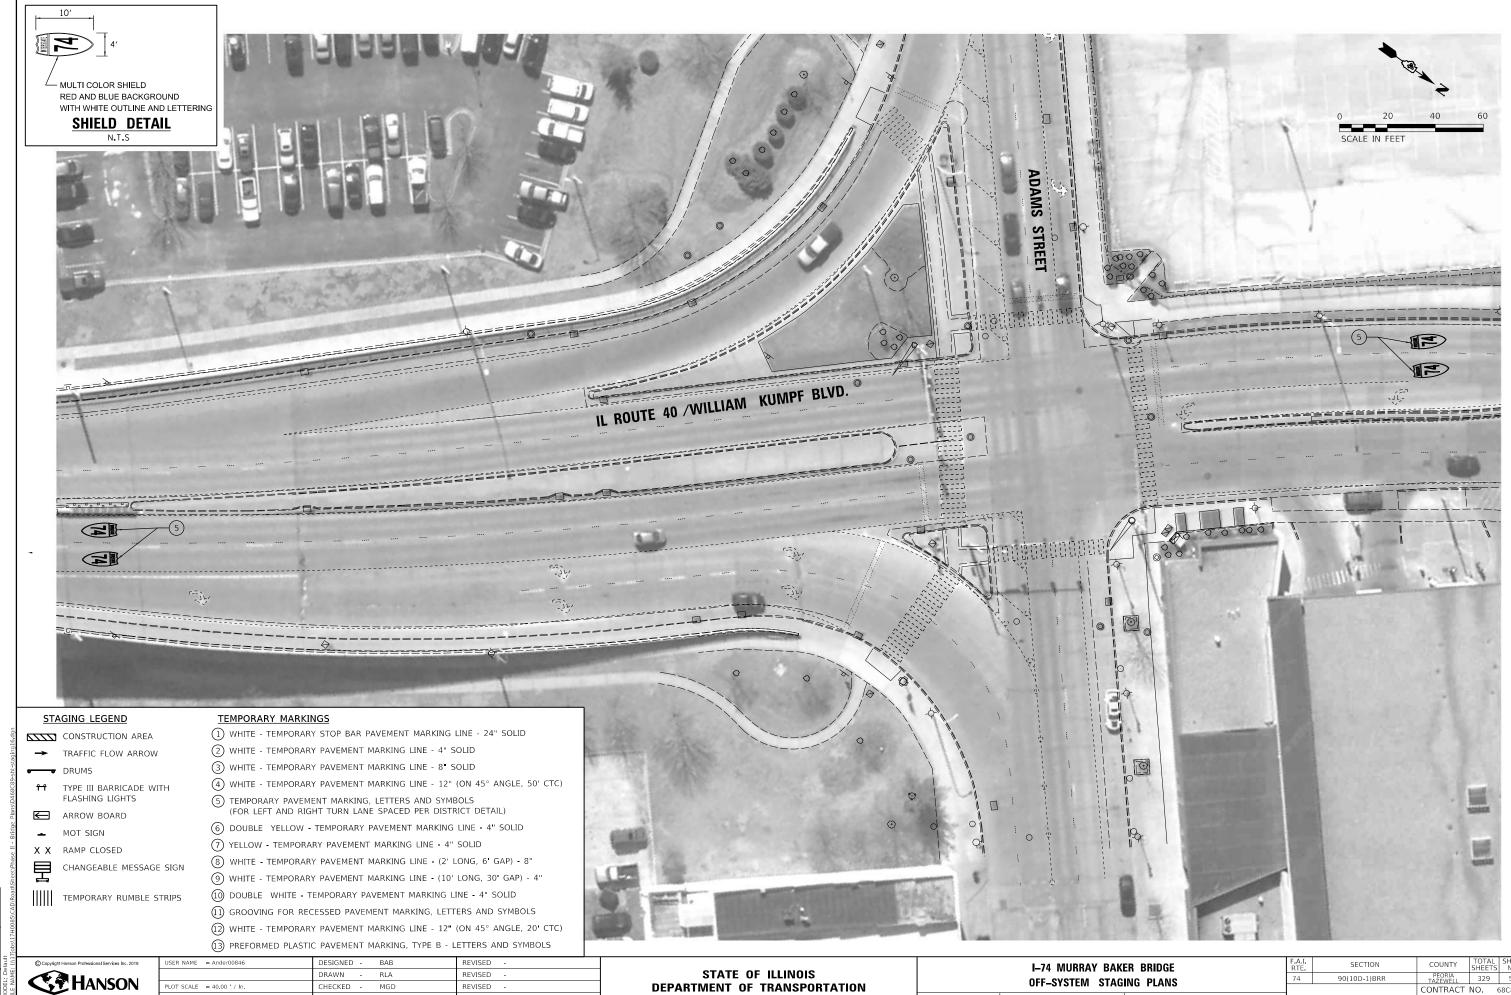



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DEPARTMENT OF TRANSPORTATION

OFF-SYSTEM STAGING PLANS SCALE: 1"=20' SHEET

329 52 CONTRACT NO. 68C89



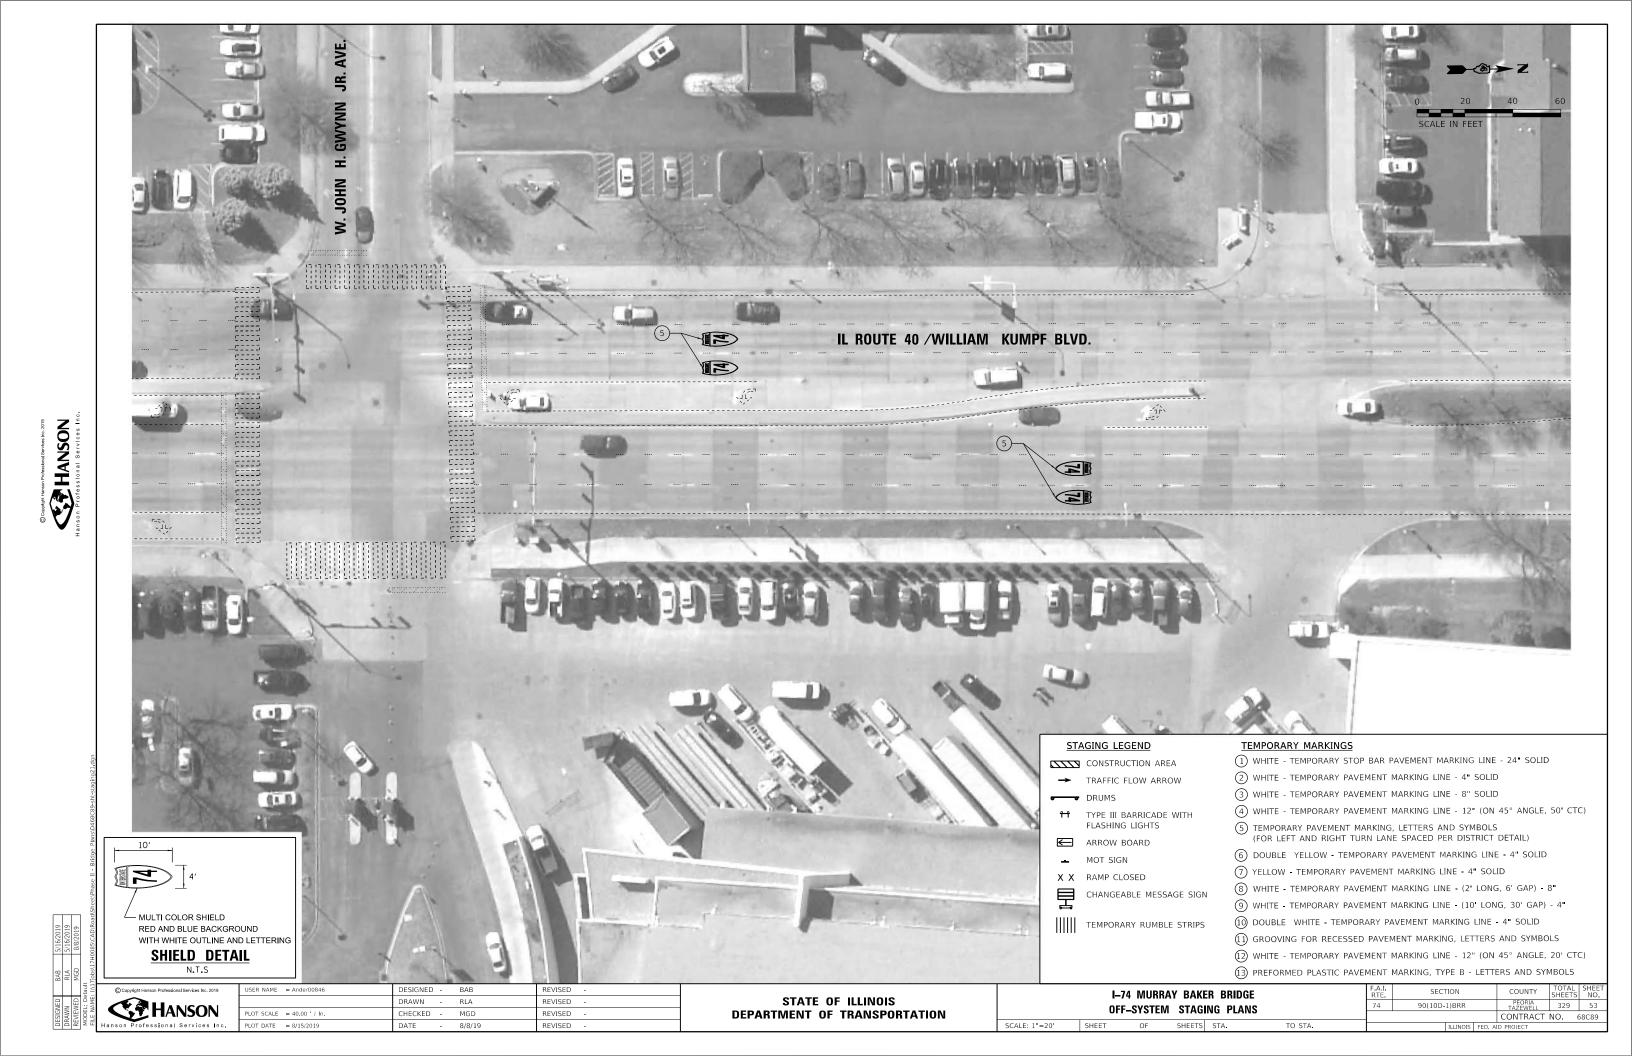

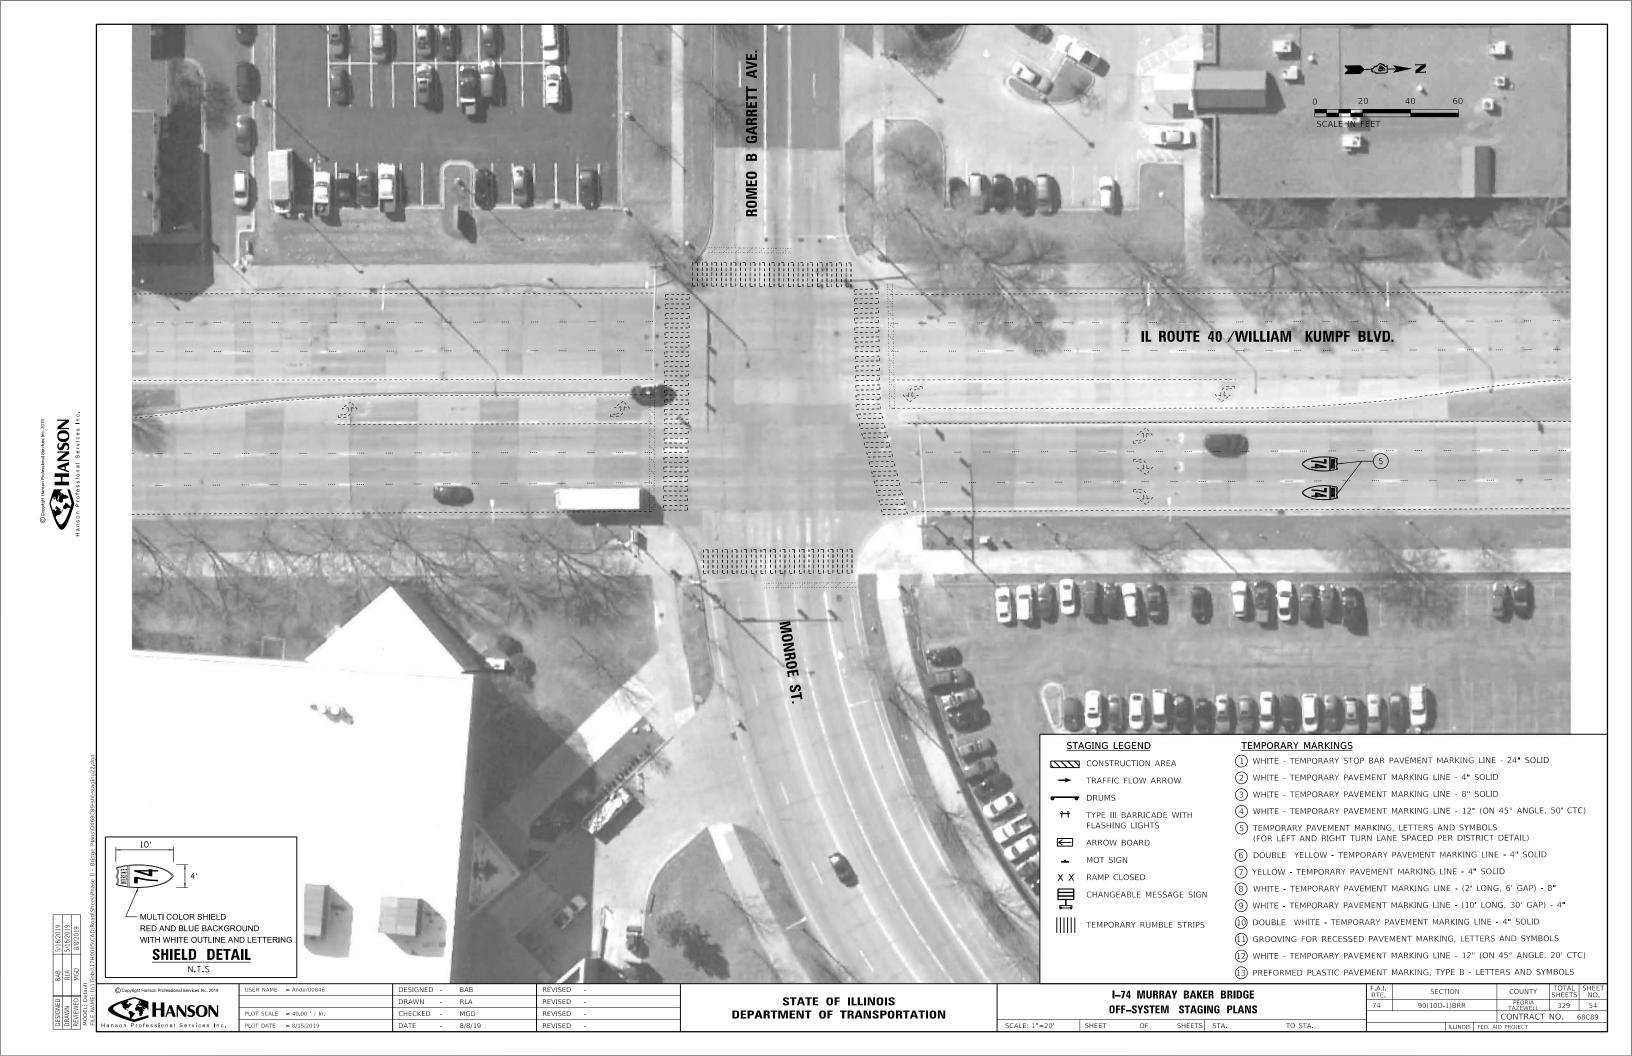STAGING LEGEND TEMPORARY MARKINGS

CONSTRUCTION AREA

→ TRAFFIC FLOW ARROW

2 WHITE - TEMPORARY PAVEMENT MARKING LINE - 4" SOLID

3 WHITE - TEMPORARY PAVEMENT MARKING LINE - 8" SOLID

4 WHITE - TEMPORARY PAVEMENT MARKING LINE - 12" (ON 45° ANGLE, 50' CTC)

(5) TEMPORARY PAVEMENT MARKING, LETTERS AND SYMBOLS (FOR LEFT AND RIGHT TURN LANE SPACED PER DISTRICT DETAIL)

6 DOUBLE YELLOW - TEMPORARY PAVEMENT MARKING LINE - 4" SOLID

1) WHITE - TEMPORARY STOP BAR PAVEMENT MARKING LINE - 24" SOLID

7 YELLOW - TEMPORARY PAVEMENT MARKING LINE - 4" SOLID

8 WHITE - TEMPORARY PAVEMENT MARKING LINE - (2' LONG, 6' GAP) - 8"


9 WHITE - TEMPORARY PAVEMENT MARKING LINE - (10' LONG, 30' GAP) - 4"


10 DOUBLE WHITE - TEMPORARY PAVEMENT MARKING LINE - 4" SOLID


(1) GROOVING FOR RECESSED PAVEMENT MARKING, LETTERS AND SYMBOLS

(12) WHITE - TEMPORARY PAVEMENT MARKING LINE - 12" (ON 45° ANGLE, 20' CTC)

(13) PREFORMED PLASTIC PAVEMENT MARKING, TYPE B - LETTERS AND SYMBOLS

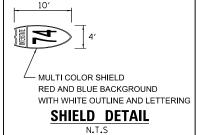

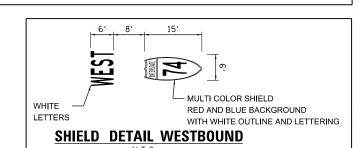

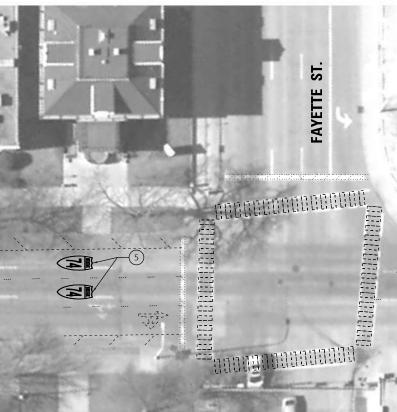



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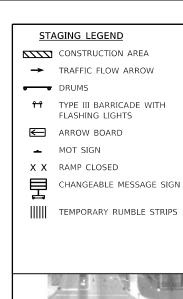
STATE OF ILLINOIS **DEPARTMENT OF TRANSPORTATION** I-74 MURRAY BAKER BRIDGE **OFF-SYSTEM STAGING PLANS**

SECTION COUNTY 90(10D-1)BRR 329 56 CONTRACT NO. 68C89

SPALDING

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SCALE: 1"=20' SHEET TO STA.



TEMPORARY MARKINGS

① WHITE - TEMPORARY STOP BAR PAVEMENT MARKING LINE - 24" SOLID

2 WHITE - TEMPORARY PAVEMENT MARKING LINE - 4" SOLID

(3) WHITE - TEMPORARY PAVEMENT MARKING LINE - 8" SOLID

4 WHITE - TEMPORARY PAVEMENT MARKING LINE - 12" (ON 45° ANGLE, 50' CTC)

(5) TEMPORARY PAVEMENT MARKING, LETTERS AND SYMBOLS (FOR LEFT AND RIGHT TURN LANE SPACED PER DISTRICT DETAIL)

6 DOUBLE YELLOW - TEMPORARY PAVEMENT MARKING LINE - 4" SOLID

7 YELLOW - TEMPORARY PAVEMENT MARKING LINE - 4" SOLID

8 WHITE - TEMPORARY PAVEMENT MARKING LINE - (2' LONG, 6' GAP) - 8"

9 WHITE - TEMPORARY PAVEMENT MARKING LINE - (10' LONG, 30' GAP) - 4"

10 DOUBLE WHITE - TEMPORARY PAVEMENT MARKING LINE - 4" SOLID

(1) GROOVING FOR RECESSED PAVEMENT MARKING, LETTERS AND SYMBOLS

ROAD


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CONSTRUCTIO

TRAFFIC CONTROL SHALL BE IN ACCORDANCE WITH STANDARDS 701451, 701601, AND 701701 AND THESE DETAILS.



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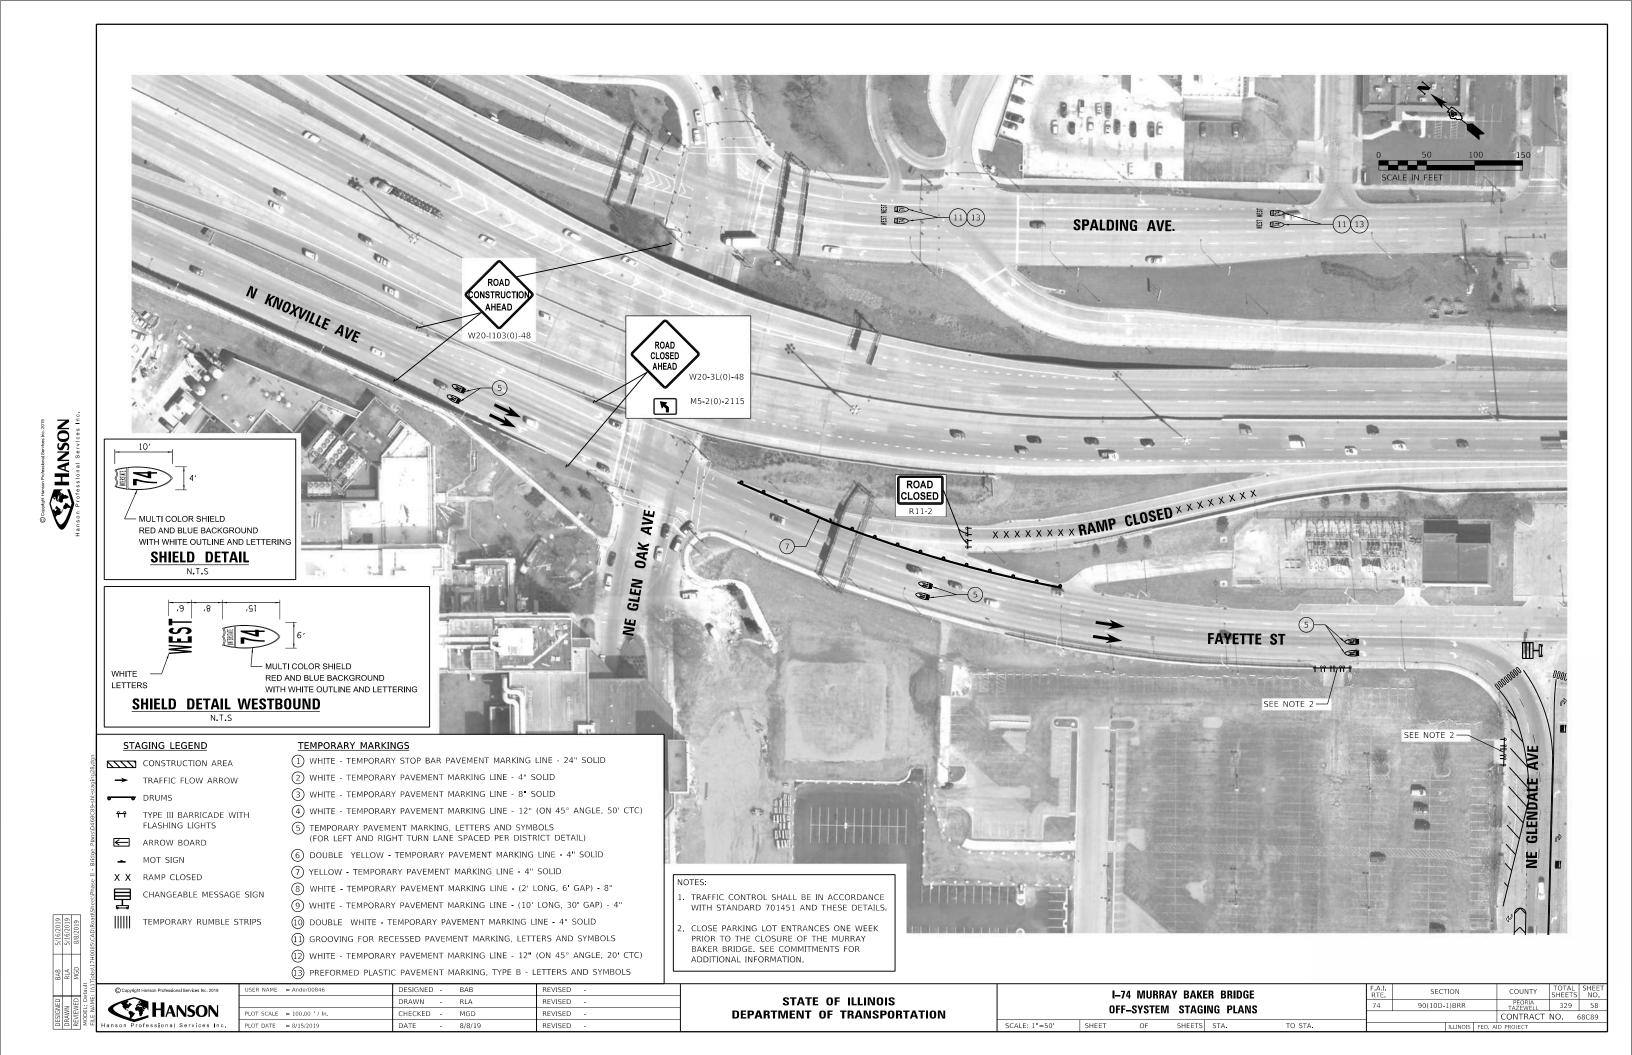
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	DRAWN -	RLA	REVISED -
PLOT SCALE = 100.00 / In	CHECKED -	MGD	REVISED -
PLOT DATE = 8/8/2019	DATE -	8/8/19	REVISED -

STATE OF ILLINOIS **DEPARTMENT OF TRANSPORTATION**

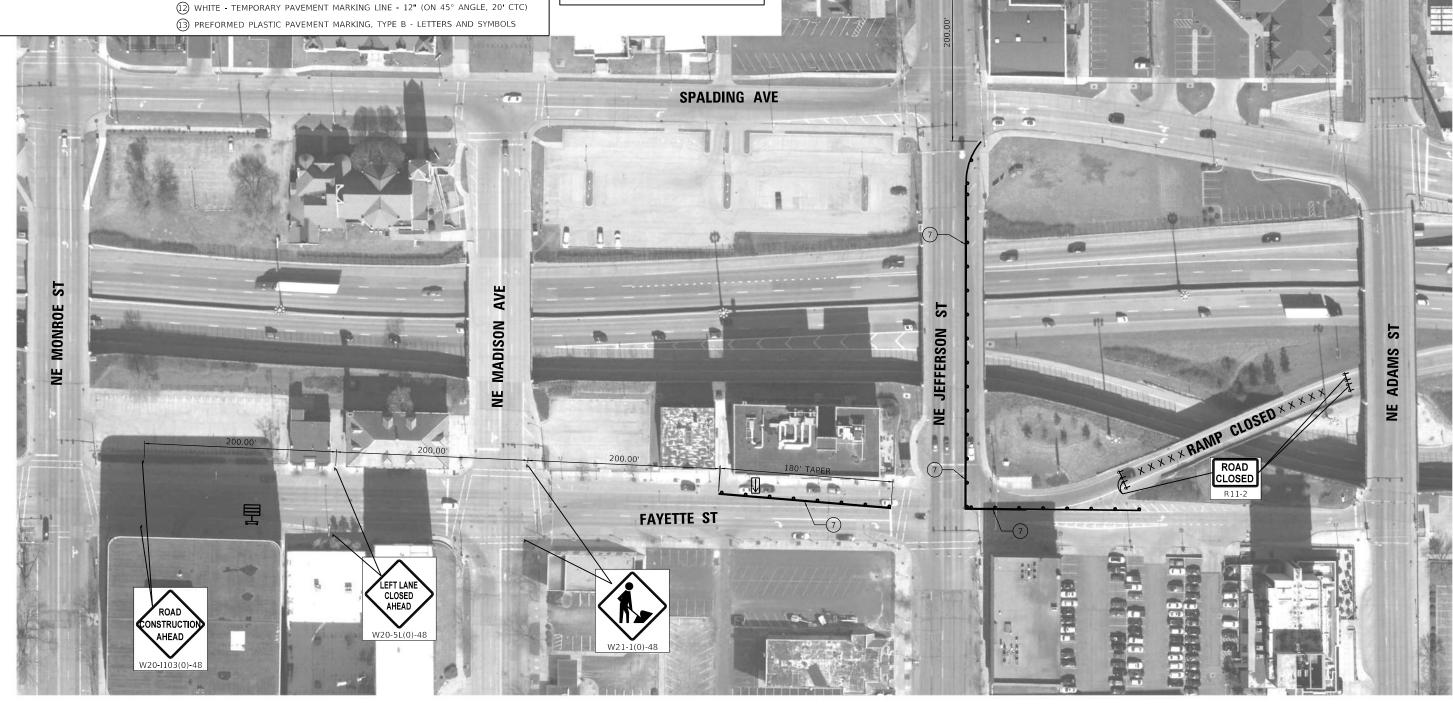		I–74 MURRAY OFF–SYSTEM		
SCALE: 1"=50'	SHEET	OF	SHEETS	STA.

TO STA.

F.A.I. RTE.	SECT	ΓΙΟΝ		COUNTY	TOTAL SHEETS	SHEE NO.
74	90(10D-1)BRR			PEORIA TAZEWELL	329	57
				CONTRACT	NO.	68C89
		H I INIOIC	ren.	ND BROIECE		



 DESIGNED
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 5/16/2019

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 RLA
 5/16/2019

 REVIEWED
 MGD
 8/8/2019

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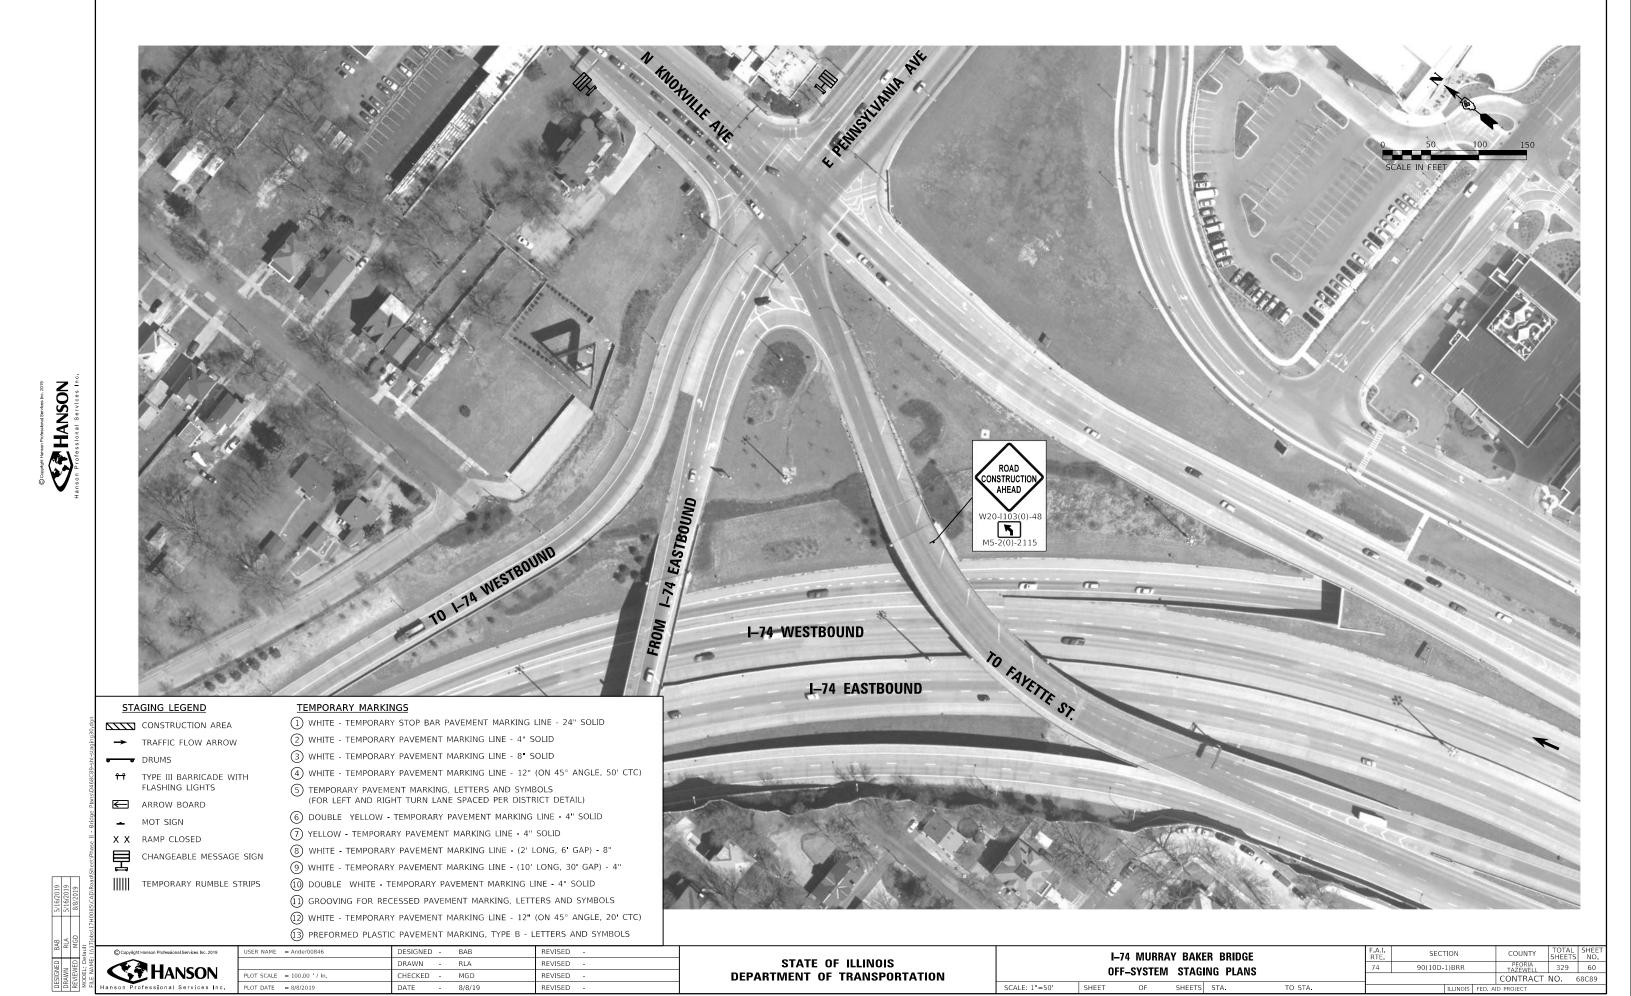
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STATE OF ILLINOIS
DEPARTMENT OF TRANSPORTATION

I–74 MURRAY BAKER BRIDGE
OFF-SYSTEM STAGING PLANS

SCALE: 1"=50' SHEET OF SHEETS STA.



SCALE: 1"=50' SHEET

SHEETS STA.

CONTRACT NO. 68C89

THIS SHEET **INTENTIONALLY** LEFT BLANK.


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STATE OF ILLINOIS **DEPARTMENT OF TRANSPORTATION**


I-74 MURRAY BAKER BRIDGE OFF-SYSTEM STAGING PLANS OF SHEETS STA. TO STA.

*PEORIA/TAZEWELL
TOTAL
SHEETS NO.
329 61 SECTION 90(10D-1)BRR CONTRACT NO. 68C89



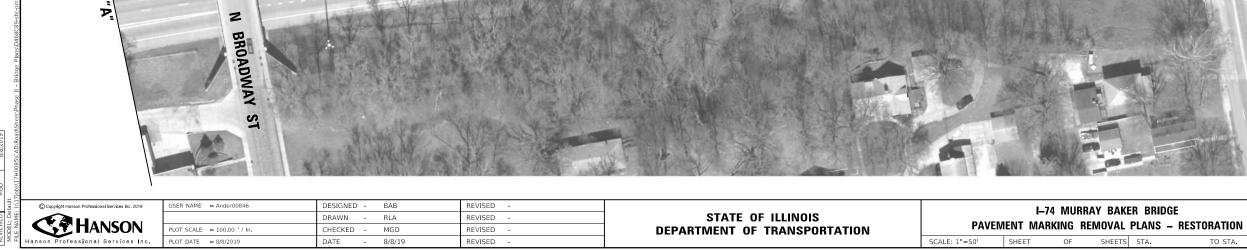

REVISED -

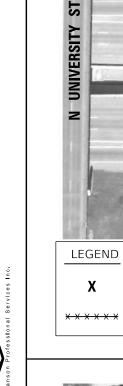

LOT SCALE = 100.00 / In.

PAVEMENT MARKING REMOVAL - WATER BLASTING LETTERS AND SYMBOLS PAVEMENT MARKING REMOVAL -WATER BLASTING LINES N SHERIDAN RD I-74 WESTBOUND MATCHLINE MATCHLINE "A" 1-74 EASTBOUND

I—74 WESTBOUND


I-74 EASTBOUND


MATCHLINE

SECTION

PEORIA 329 62
CONTRACT NO. 68C89



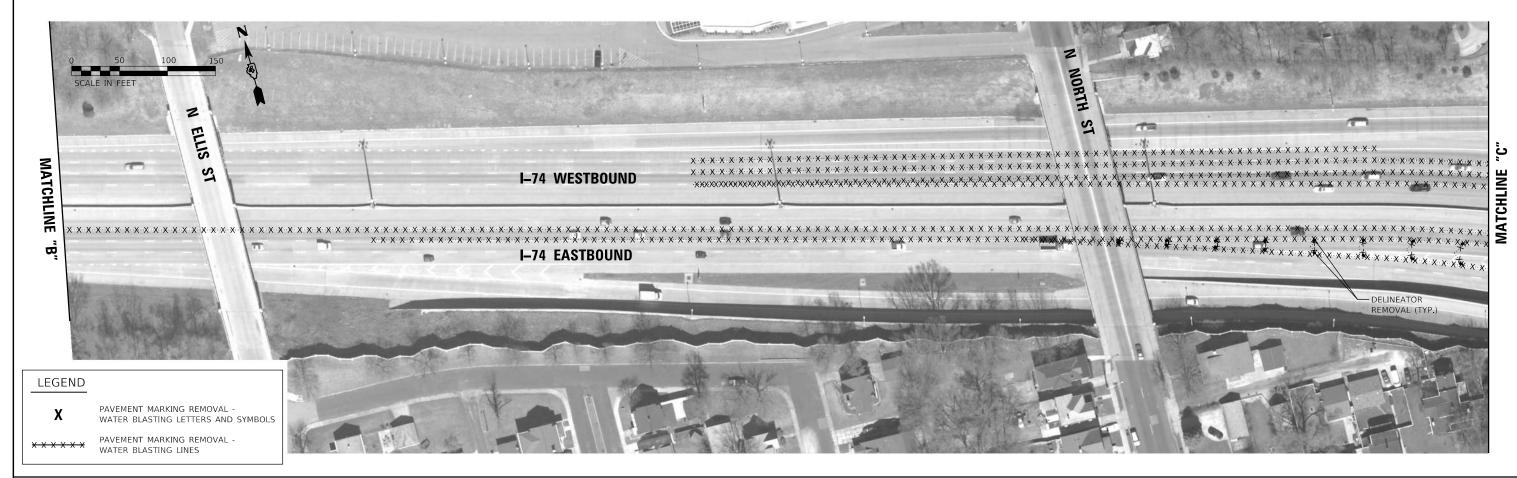

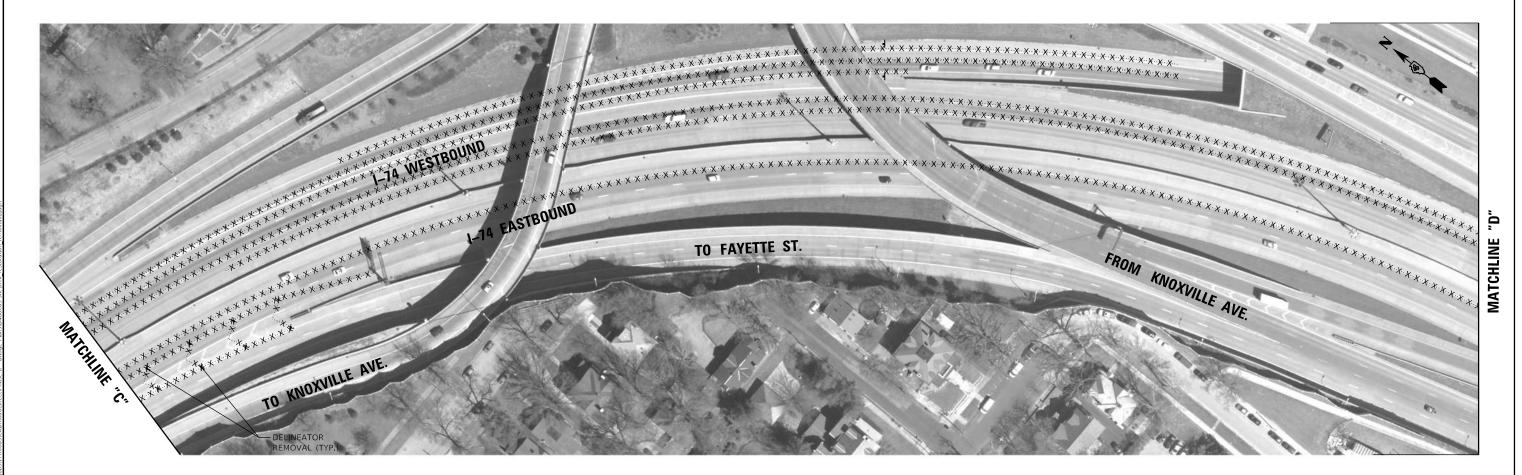

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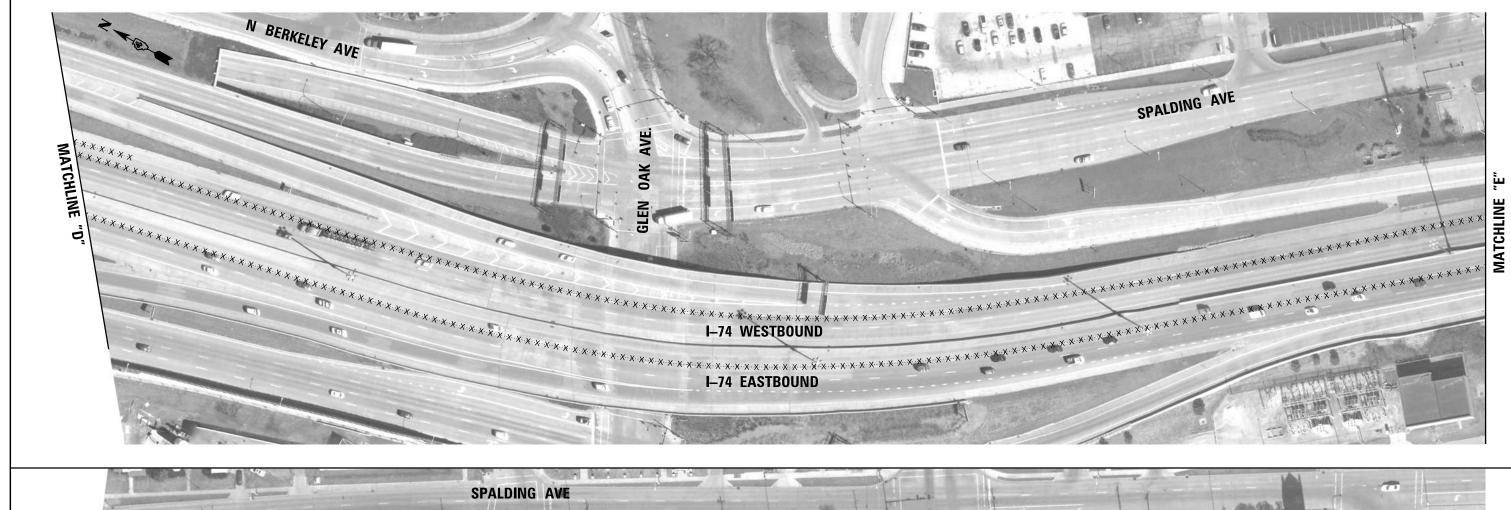
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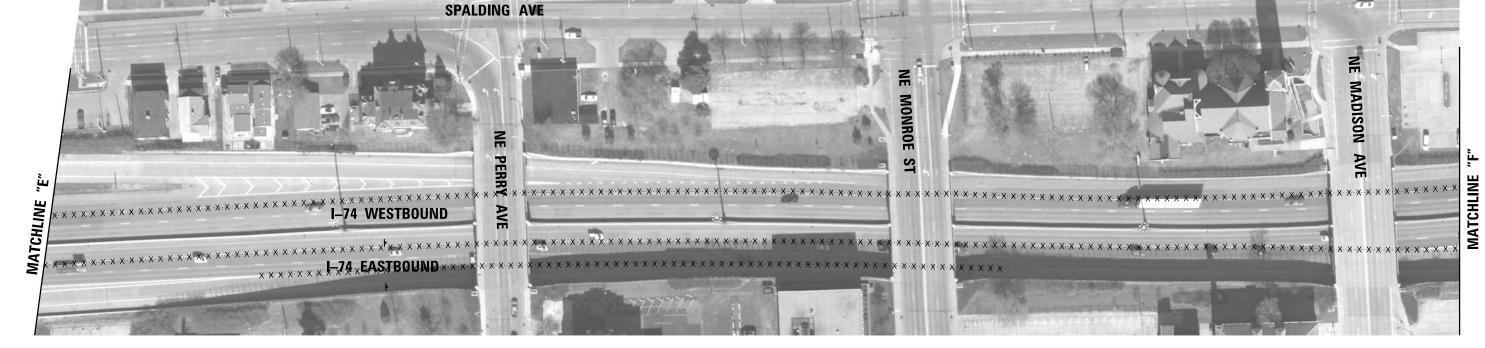
STATE OF ILLINOIS
DEPARTMENT OF TRANSPORTATION

I-74 MURRAY BAKER BRIDGE
PAVEMENT MARKING REMOVAL PLANS - RESTORATION

50' SHEET OF SHEETS STA. TO STA.







LEGEND

PAVEMENT MARKING REMOVAL -WATER BLASTING LETTERS AND SYMBOLS

PAVEMENT MARKING REMOVAL WATER BLASTING LINES

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PLOT DATE = 8/8/2019	DATE -	8/8/19	REVISED -

STATE	OF	: ILLINOIS	
DEPARTMENT	0F	TRANSPORTATION	

I–74 MURRAY BAKER BRIDGE					
PAVEM	ENT MAR	RKING F	REMOVAL	PLANS	- RESTORATION
SCALE: 1"=50'	SHEET	OF	SHEETS	STA.	TO STA.

F.A.I. RTE.	SECTION		COUNTY	TOTAL SHEETS	SHEE NO.	
74	90(10D-1)BRR			PEORIA TAZEWELL	329	64
				CONTRACT	NO.	58C89
		ILLINOIS	FED. AI	D PROJECT		




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STATE OF ILLINOIS
DEPARTMENT OF TRANSPORTATION

I-74 MURRAY BAKER BRIDGE PAVEMENT MARKING REMOVAL PLANS - RESTORATION SCALE: 1"=50' SHEET OF SHEETS STA.


SECTION 90(10D-1)BRR

LEGEND PAVEMENT MARKING REMOVAL -WATER BLASTING LETTERS AND SYMBOLS X PAVEMENT MARKING REMOVAL -WATER BLASTING LINES

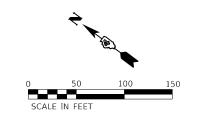

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RAMP TO WASHINGTON ST		
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LEGEND

PAVEMENT MARKING REMOVAL -WATER BLASTING LETTERS AND SYMBOLS

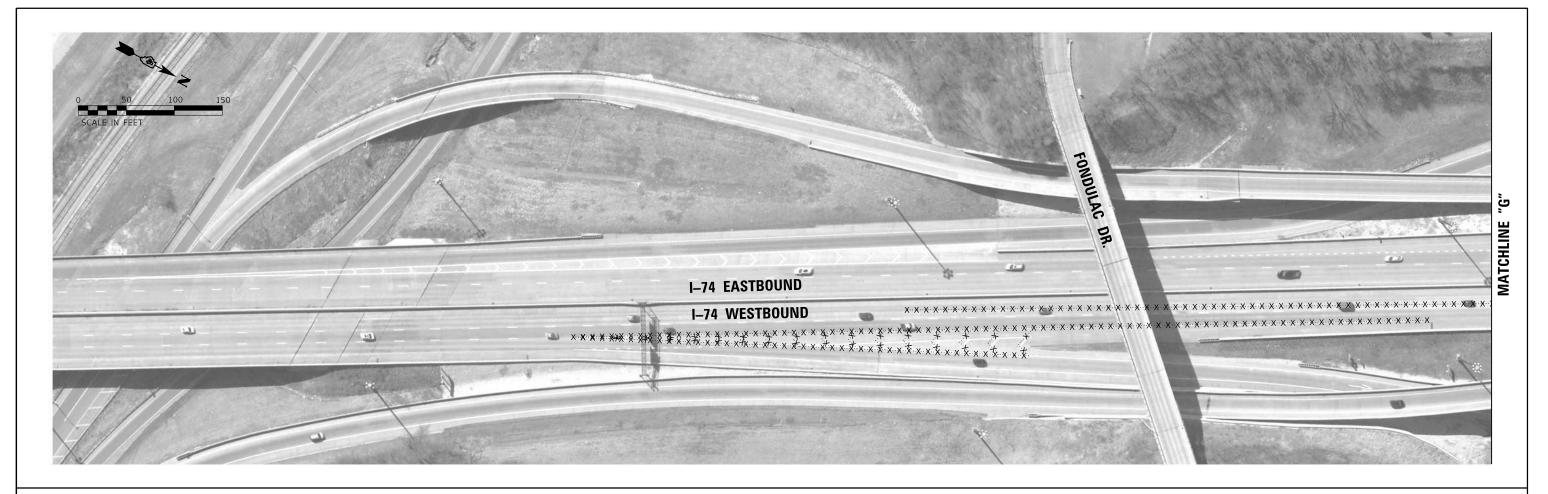PAVEMENT MARKING REMOVAL -WATER BLASTING LINES

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PLOT DATE = 8/8/2019	DATE -	8/8/19	REVISED -	

STATE OF ILLINOIS
DEPARTMENT OF TRANSPORTATION

I–74 MURRAY BAKER BRIDGE								
PAVEMENT MARKING REMOVAL PLANS - RESTORATION								
SCALE: 1"=50'	SHEET	OF	SHEETS	STA.	TO STA.			

F.A.I. RTE	SECTION			COUNTY	TOTAL SHEETS	SHEET NO.
74	90(10D-1)BRR			PEORIA TAZEWELL	329	66
			CONTRACT	NO.	58C89	
		ILLINOIS	ID PROJECT			





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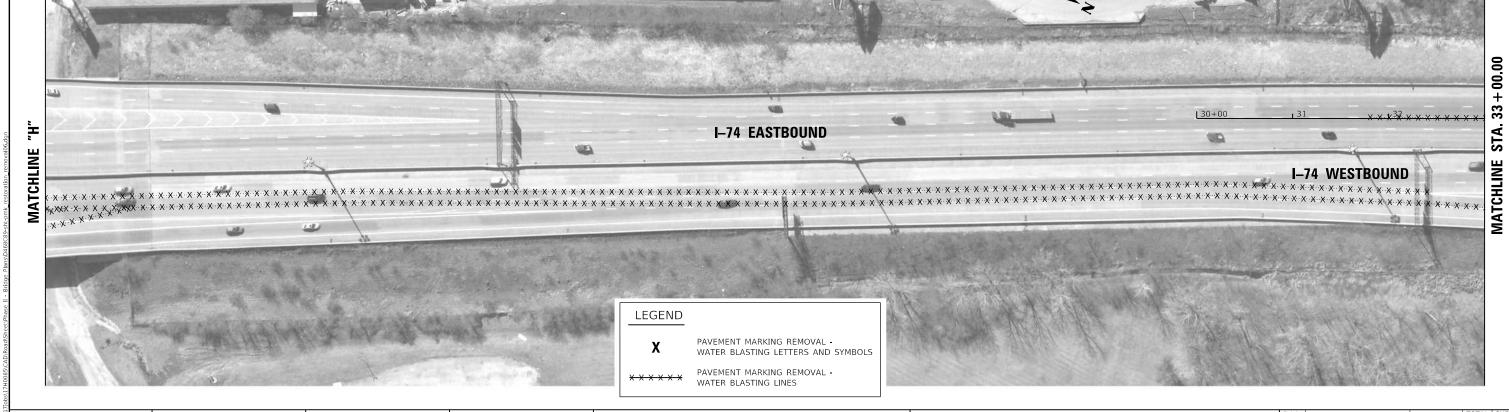
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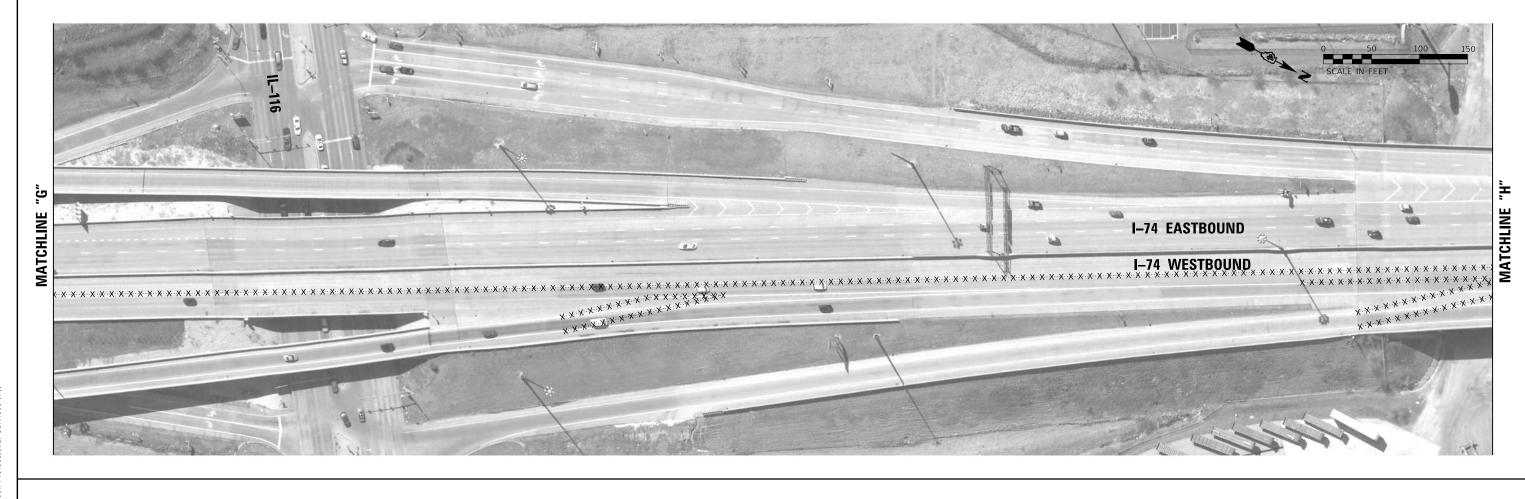


STATE OF ILLINOIS DEPARTMENT OF TRANSPORTATION


I-74 MURRAY BAKER BRIDGE

PAVEMENT MARKING REMOVAL PLANS - RESTORATION

PEORIA TAZEWELL 329 67 CONTRACT NO. 68C89





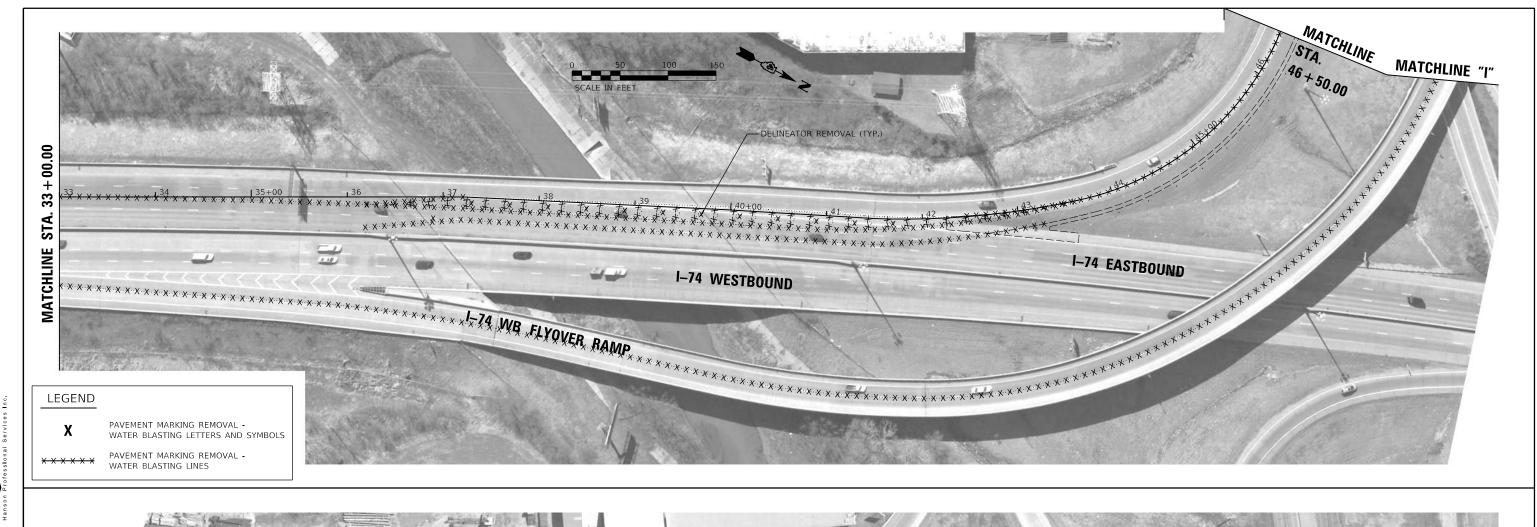



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 PLOT DATE
 = 8/8/2019
 DATE
 8/8/19
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STATE OF ILLINOIS
DEPARTMENT OF TRANSPORTATION

I–74 MURRAY BAKER BRIDGE									
PAVE	PAVEMENT MARKING REMOVAL PLANS - RESTORATION								
SCALE: 1"=50'	SHEET	OF	SHEETS	STA.	TO STA.				


 F.A.I. RTE.
 SECTION
 COUNTY PEORIA AZEWELL
 TOTAL SHEETS NO.
 SHEETS NO.

 74
 90(10D-1)BRR
 TEORIA TAZEWELL
 32.9
 68.089

 CONTRACT
 NO.
 68.089

 ILLINOIS
 FED. AID PROJECT
 NO.
 68.089



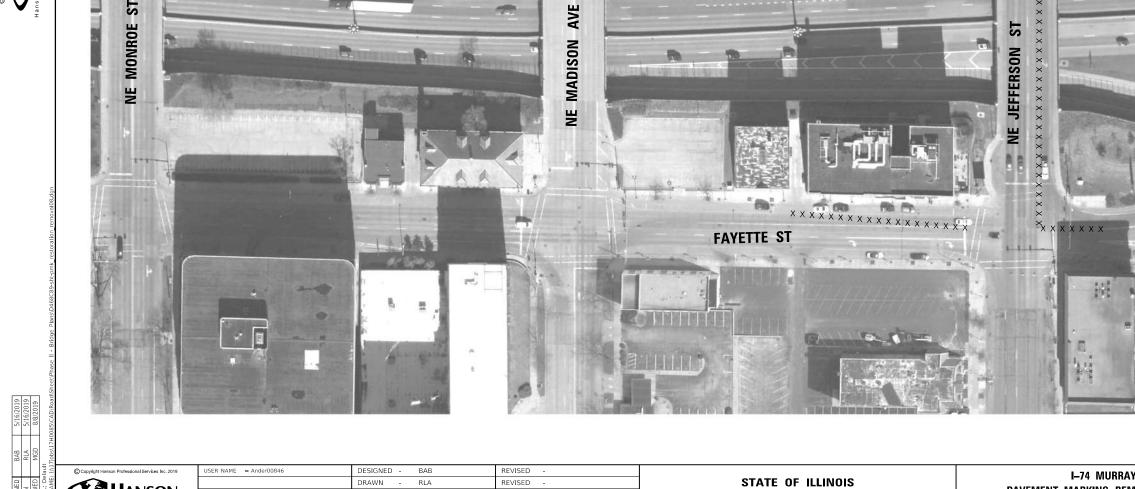

LEGEND PAVEMENT MARKING REMOVAL -X WATER BLASTING LETTERS AND SYMBOLS PAVEMENT MARKING REMOVAL -WATER BLASTING LINES ST NE ADAMS

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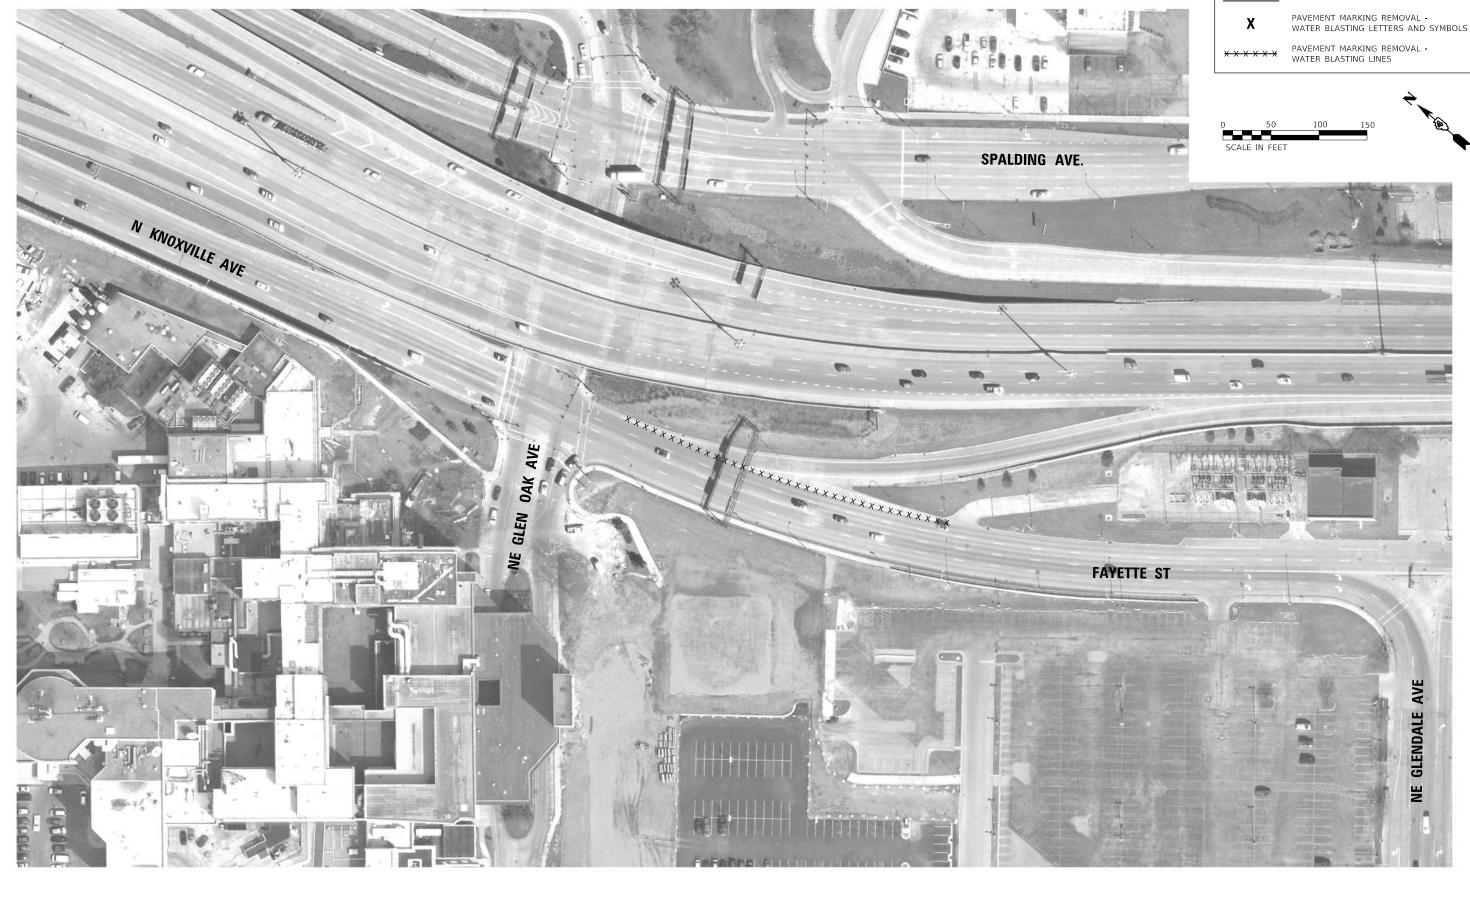
STATE OF ILLINOIS
DEPARTMENT OF TRANSPORTATION

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I-74 MURRAY BAKER BRIDGE PAVEMENT MARKING REMOVAL PLANS - RESTORATION SHEETS STA.

SECTION 90(10D-1)BRR





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 RLA
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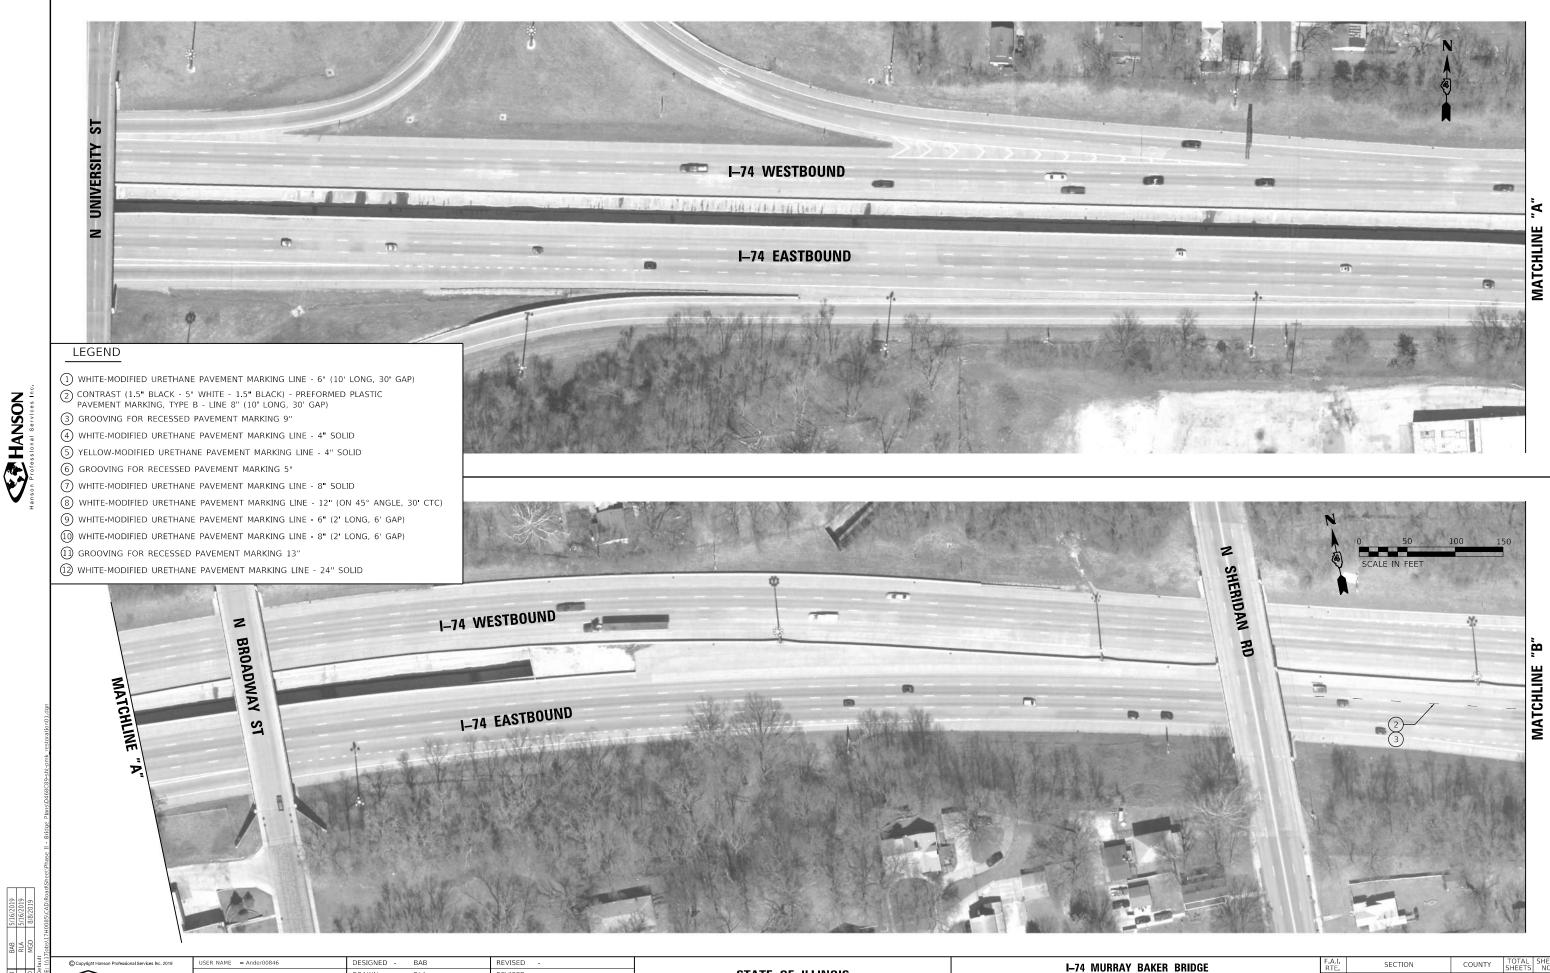
 PLOT DATE
 = 8/8/2019
 DATE
 8/8/19
 REVISED

STATE OF ILLINOIS DEPARTMENT OF TRANSPORTATION

I-74 MURRAY BAKER BRIDGE
PAVEMENT MARKING REMOVAL PLANS - RESTORATION

50' SHEET OF SHEETS STA. TO STA.

LEGEND




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DRAWN -RLA REVISED

STATE OF ILLINOIS **DEPARTMENT OF TRANSPORTATION**

I–74 MURRAY BAKER BRIDGE PAVEMENT MARKING PLANS – RESTORATION SCALE: 1"=50'

CONTRACT NO. 68C89

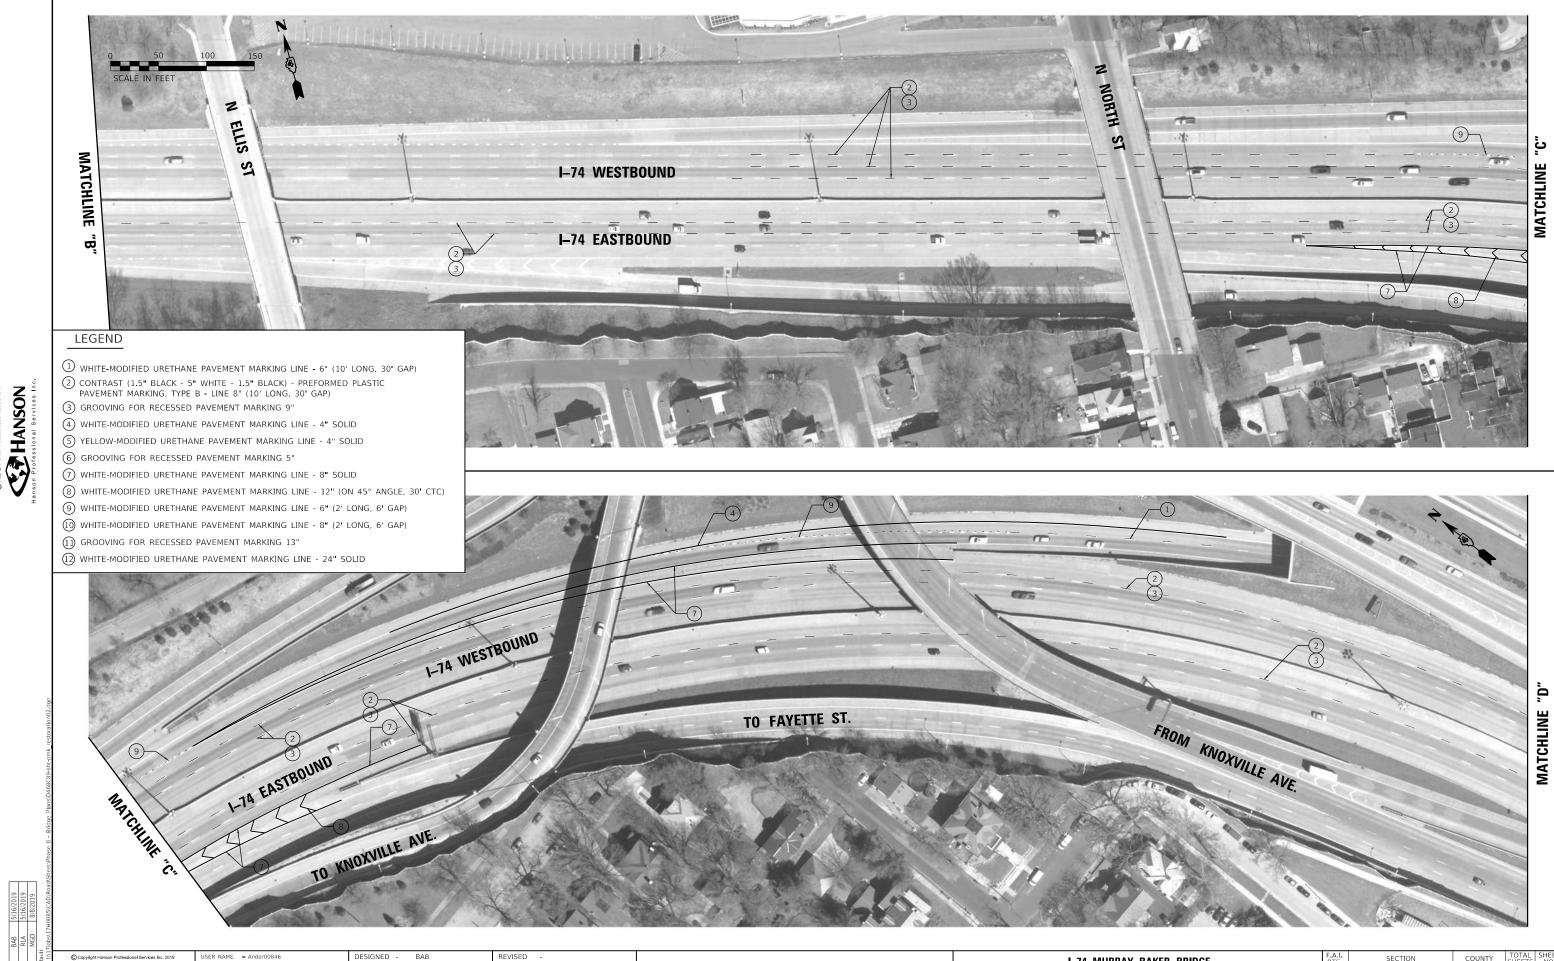

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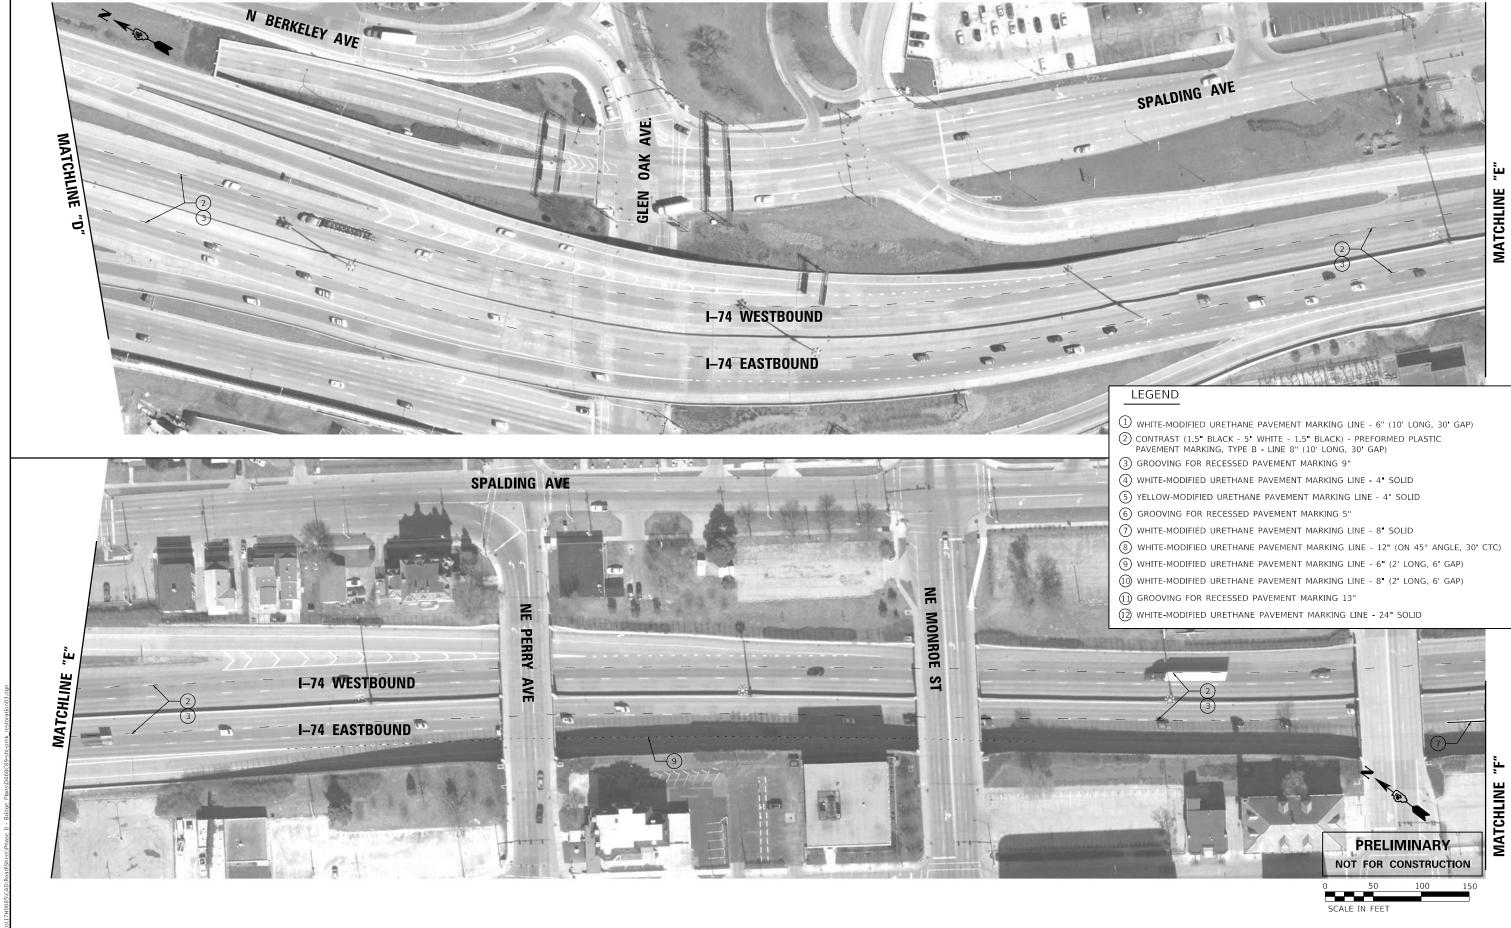
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STATE OF ILLINOIS DEPARTMENT OF TRANSPORTATION

I–74 MURRAY BAKER BRIDGE								
PAVEMENT MARKING PLANS - RESTORATION								
SCALE: 1"=50'	SHEET	OF	SHEETS	STA.	TO STA.			

SECTION 90(10D-1)BRF 329 72 CONTRACT NO. 68C89





STATE OF ILLINOIS

DEPARTMENT OF TRANSPORTATION

SECTION

CONTRACT NO. 68C89

90(10D-1)BRR

I-74 MURRAY BAKER BRIDGE

PAVEMENT MARKING PLANS - RESTORATION

SHEETS STA.

SCALE: 1"=50'

 DESIGNED
 BAB
 5/16/2019

 DRAWN
 RLA
 5/16/2019

 REVIEWED
 MGD
 8/8/2019

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OT SCALE = 100.00 / In.

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DATE

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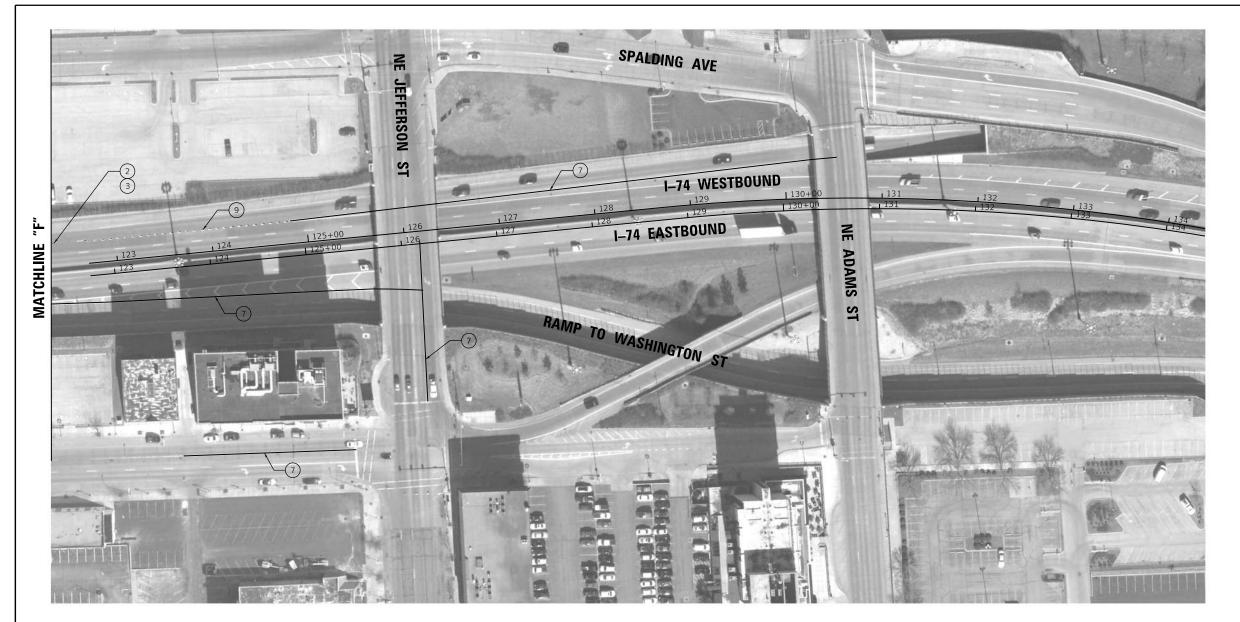
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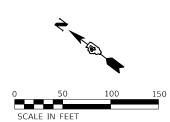
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REVISED

REVISED







LEGEND

- 1) WHITE-MODIFIED URETHANE PAVEMENT MARKING LINE 6" (10' LONG, 30' GAP)
- (2) CONTRAST (1.5" BLACK 5" WHITE 1.5" BLACK) PREFORMED PLASTIC PAVEMENT MARKING, TYPE B LINE 8" (10' LONG, 30' GAP)
- (3) GROOVING FOR RECESSED PAVEMENT MARKING 9"
- (4) WHITE-MODIFIED URETHANE PAVEMENT MARKING LINE 4" SOLID
- (5) YELLOW-MODIFIED URETHANE PAVEMENT MARKING LINE 4" SOLID
- 6 GROOVING FOR RECESSED PAVEMENT MARKING 5"
- 7 WHITE-MODIFIED URETHANE PAVEMENT MARKING LINE 8" SOLID
- (8) WHITE-MODIFIED URETHANE PAVEMENT MARKING LINE 12" (ON 45° ANGLE, 30' CTC)
- 9) WHITE-MODIFIED URETHANE PAVEMENT MARKING LINE 6" (2' LONG, 6' GAP)
- (1) WHITE-MODIFIED URETHANE PAVEMENT MARKING LINE 8" (2' LONG, 6' GAP)
- (1) GROOVING FOR RECESSED PAVEMENT MARKING 13"
- (12) WHITE-MODIFIED URETHANE PAVEMENT MARKING LINE 24" SOLID

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PLOT DATE = 8/8/2019	DATE -	8/8/19	REVISED -

STATE OF ILLINOIS	
DEPARTMENT OF TRANSPORTATION	

SCALE: 1"=50'

	I-7-	4 MURRA	Y BAKE	R BRI	DGE	F.A.I. RTE	SECT	ION		COUNTY	TOTAL SHEETS	SHEET NO.
PAVEMENT MARKING PLANS – RESTORATION						74	90(10D-1	l)BRR		PEORIA TAZEWELL	329	74
	AVEIVIEIVI	IVIAIIIVIIV	U I LAN	J – II	LUTUIATION					CONTRACT	NO.	68C89
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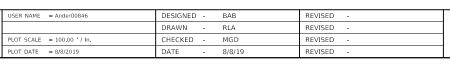


NED 8AB 5/16/2019
N RLA 5/16/2019
MGD 8/8/2019
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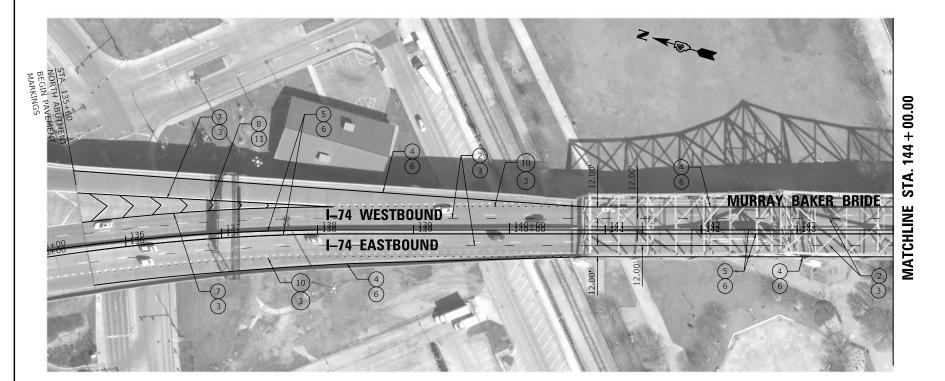
STATE OF ILLINOIS
DEPARTMENT OF TRANSPORTATION


I-74 MURRAY BAKER BRIDGE
PAVEMENT MARKING PLANS – RESTORATION

SCALE IN FEET


LEGEND

- (1) WHITE-MODIFIED URETHANE PAVEMENT MARKING LINE 6" (10' LONG, 30' GAP)
- (2) CONTRAST (1.5" BLACK 5" WHITE 1.5" BLACK) PREFORMED PLASTIC PAVEMENT MARKING, TYPE B LINE 8" (10' LONG, 30' GAP)
- 3 GROOVING FOR RECESSED PAVEMENT MARKING 9"
- 4 WHITE-MODIFIED URETHANE PAVEMENT MARKING LINE 4" SOLID
- (5) YELLOW-MODIFIED URETHANE PAVEMENT MARKING LINE 4" SOLID
- 6 GROOVING FOR RECESSED PAVEMENT MARKING 5"
- 7 WHITE-MODIFIED URETHANE PAVEMENT MARKING LINE 8" SOLID
- (8) WHITE-MODIFIED URETHANE PAVEMENT MARKING LINE 12" (ON 45° ANGLE, 30' CTC)
- 9 WHITE-MODIFIED URETHANE PAVEMENT MARKING LINE 6" (2' LONG, 6' GAP)
- 10 WHITE-MODIFIED URETHANE PAVEMENT MARKING LINE 8" (2' LONG, 6' GAP)
- (1) GROOVING FOR RECESSED PAVEMENT MARKING 13"
- (12) WHITE-MODIFIED URETHANE PAVEMENT MARKING LINE 24" SOLID



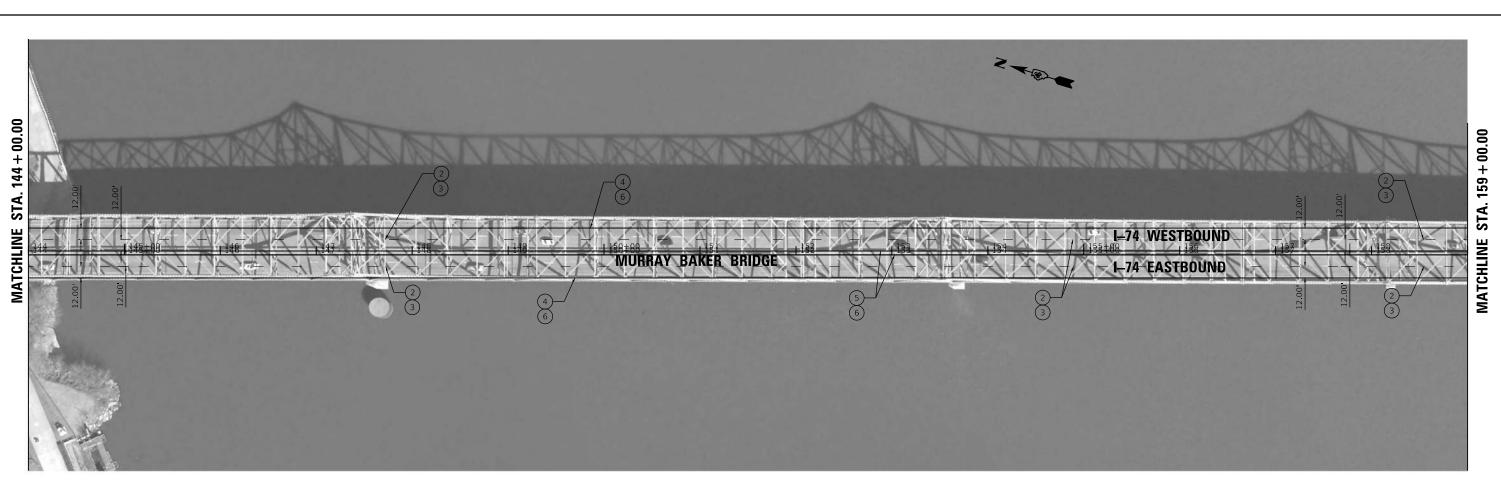



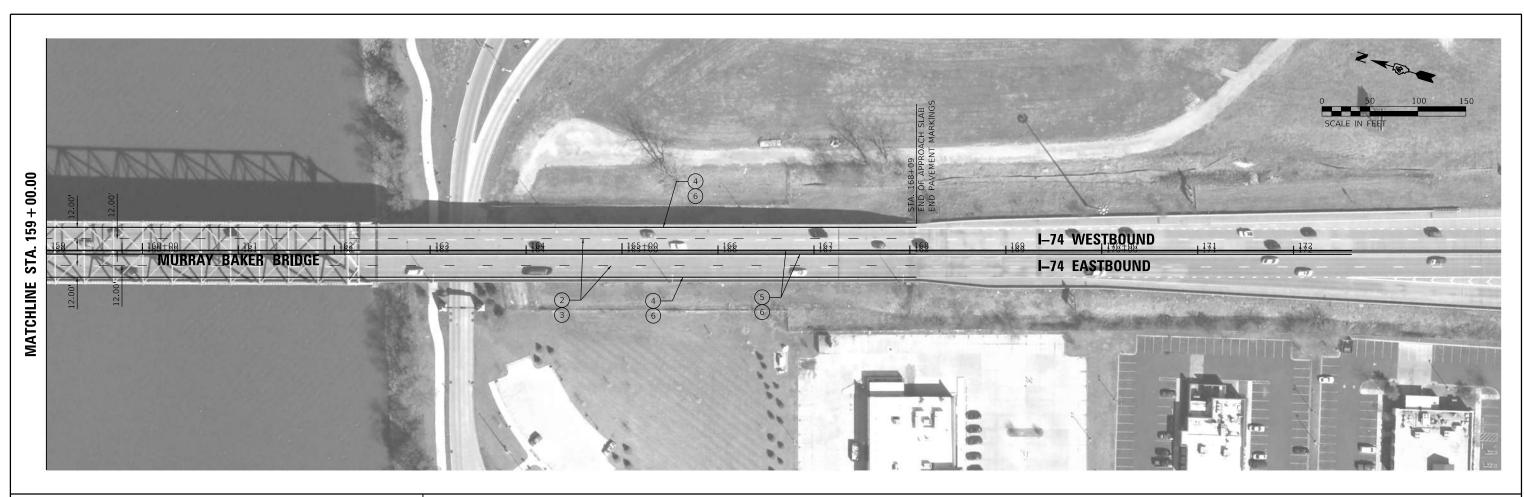

LEGEND

- 1 WHITE-MODIFIED URETHANE PAVEMENT MARKING LINE 6" (10' LONG, 30' GAP)
- CONTRAST (1.5" BLACK 5" WHITE 1.5" BLACK) PREFORMED PLASTIC PAVEMENT MARKING, TYPE B LINE 8" (10' LONG, 30' GAP)
- 3 GROOVING FOR RECESSED PAVEMENT MARKING 9"
- 4 WHITE-MODIFIED URETHANE PAVEMENT MARKING LINE 4" SOLID
- 5 YELLOW-MODIFIED URETHANE PAVEMENT MARKING LINE 4" SOLID
- 6 GROOVING FOR RECESSED PAVEMENT MARKING 5"
- 7) WHITE-MODIFIED URETHANE PAVEMENT MARKING LINE 8" SOLID
- 8 WHITE-MODIFIED URETHANE PAVEMENT MARKING LINE 12" (ON 45° ANGLE, 30' CTC)
- 9 WHITE-MODIFIED URETHANE PAVEMENT MARKING LINE 6" (2' LONG, 6' GAP)
- (1) WHITE-MODIFIED URETHANE PAVEMENT MARKING LINE 8" (2' LONG, 6' GAP)
- (1) GROOVING FOR RECESSED PAVEMENT MARKING 13"
- 12 WHITE-MODIFIED URETHANE PAVEMENT MARKING LINE 24" SOLID


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STATE OF ILLINOIS	
DEPARTMENT OF TRANSPORTATION	

SCALE: 1"=50'

	I–74 MURRAY BAKER BRIDGE						SECTION	COUNTY	TOTAL SHEETS	SHEET NO.
PAVEMENT MARKING PLANS - RESTORATION						74	90(10D-1)BRR	PEORIA TAZEWELL	329	76
•	AVEIVICIAI	IVIAIIINII	NO I LAN	J - IILJ	TOTATION			CONTRACT	NO.	58C89
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CONSTRUCTION AREA → TRAFFIC FLOW ARROW **●** DRUMS

TYPE III BARRICADE

← ARROW BOARD

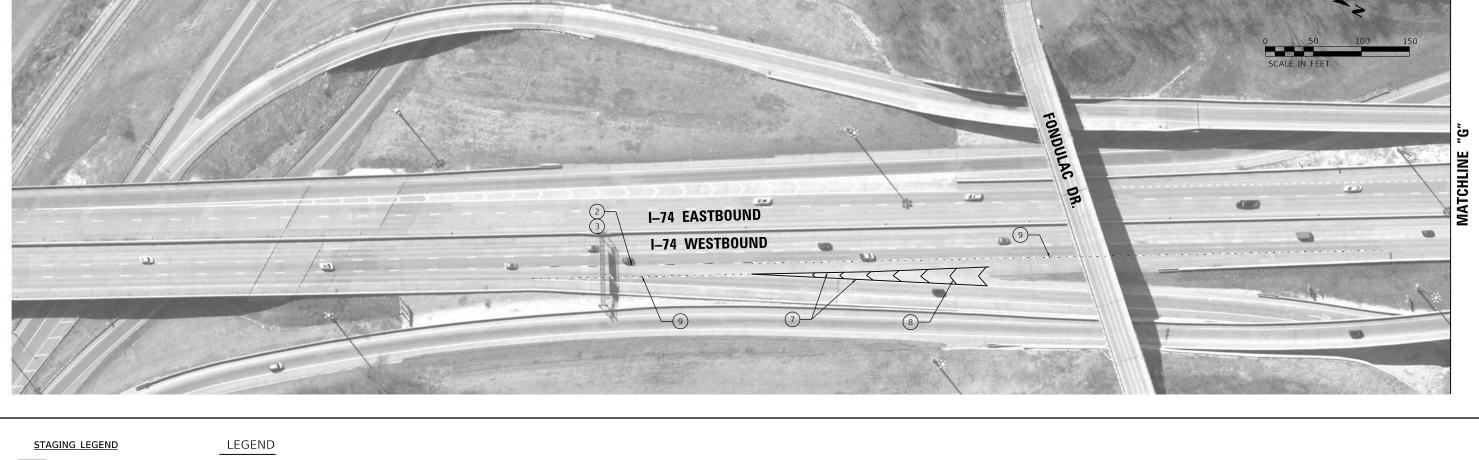MOT SIGN

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- ① WHITE-MODIFIED URETHANE PAVEMENT MARKING LINE 6" (10' LONG, 30' GAP)
- (2) CONTRAST (1.5" BLACK 5" WHITE 1.5" BLACK) PREFORMED PLASTIC PAVEMENT MARKING, TYPE B LINE 8" (10' LONG, 30' GAP)
- 3 GROOVING FOR RECESSED PAVEMENT MARKING 9"
- 4 WHITE-MODIFIED URETHANE PAVEMENT MARKING LINE 4" SOLID
- 5 YELLOW-MODIFIED URETHANE PAVEMENT MARKING LINE 4" SOLID
- 6 GROOVING FOR RECESSED PAVEMENT MARKING 5"
- 7 WHITE-MODIFIED URETHANE PAVEMENT MARKING LINE 8" SOLID
- (8) WHITE-MODIFIED URETHANE PAVEMENT MARKING LINE 12" (ON 45° ANGLE, 30' CTC)
- 9 WHITE-MODIFIED URETHANE PAVEMENT MARKING LINE 6" (2' LONG, 6' GAP)
- (10) WHITE-MODIFIED URETHANE PAVEMENT MARKING LINE 8" (2' LONG, 6' GAP)
- ① GROOVING FOR RECESSED PAVEMENT MARKING 13"
- 12) WHITE-MODIFIED URETHANE PAVEMENT MARKING LINE 24" SOLID

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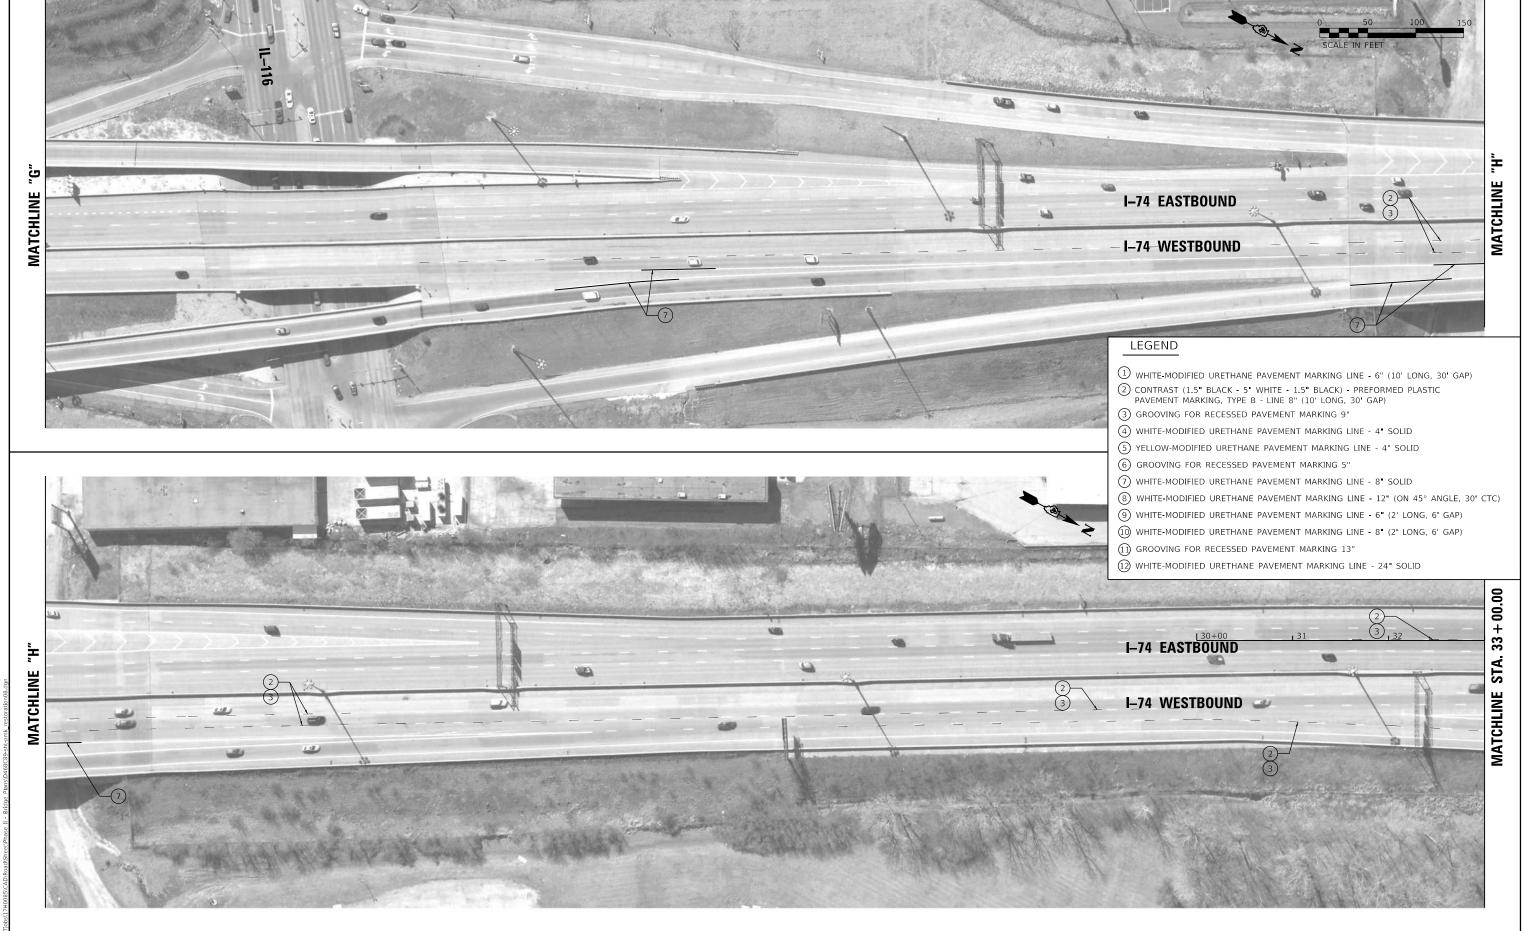
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STATE OF ILLINOIS **DEPARTMENT OF TRANSPORTATION**

SCALE: 1"=50'

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PAVEMENT MARKING PLANS – RESTORATION					74	90(10D-1)BRR	PEORIA TAZEWELL	329	Ī	
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STATE OF ILLINOIS

DEPARTMENT OF TRANSPORTATION

I-74 MURRAY BAKER BRIDGE

PAVEMENT MARKING PLANS - RESTORATION

SCALE: 1"=50'

CONTRACT NO. 68C89


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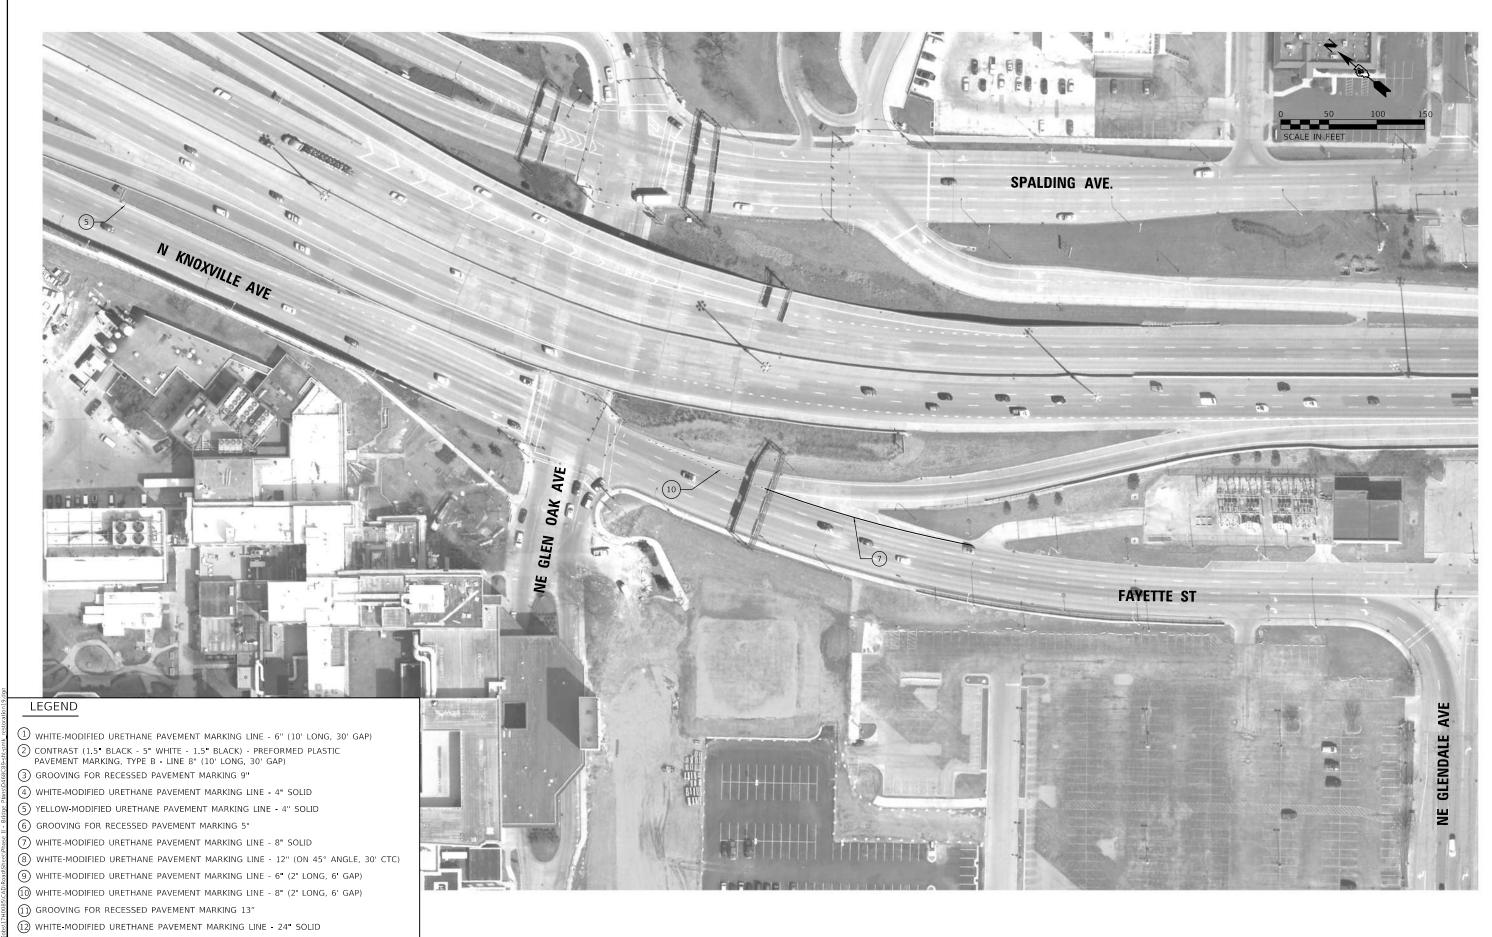
STATE OF ILLINOIS **DEPARTMENT OF TRANSPORTATION**

I-74 MURRAY BAKER BRIDGE PAVEMENT MARKING PLANS - RESTORATION

SCALE: 1"=50'

SECTION CONTRACT NO. 68C89



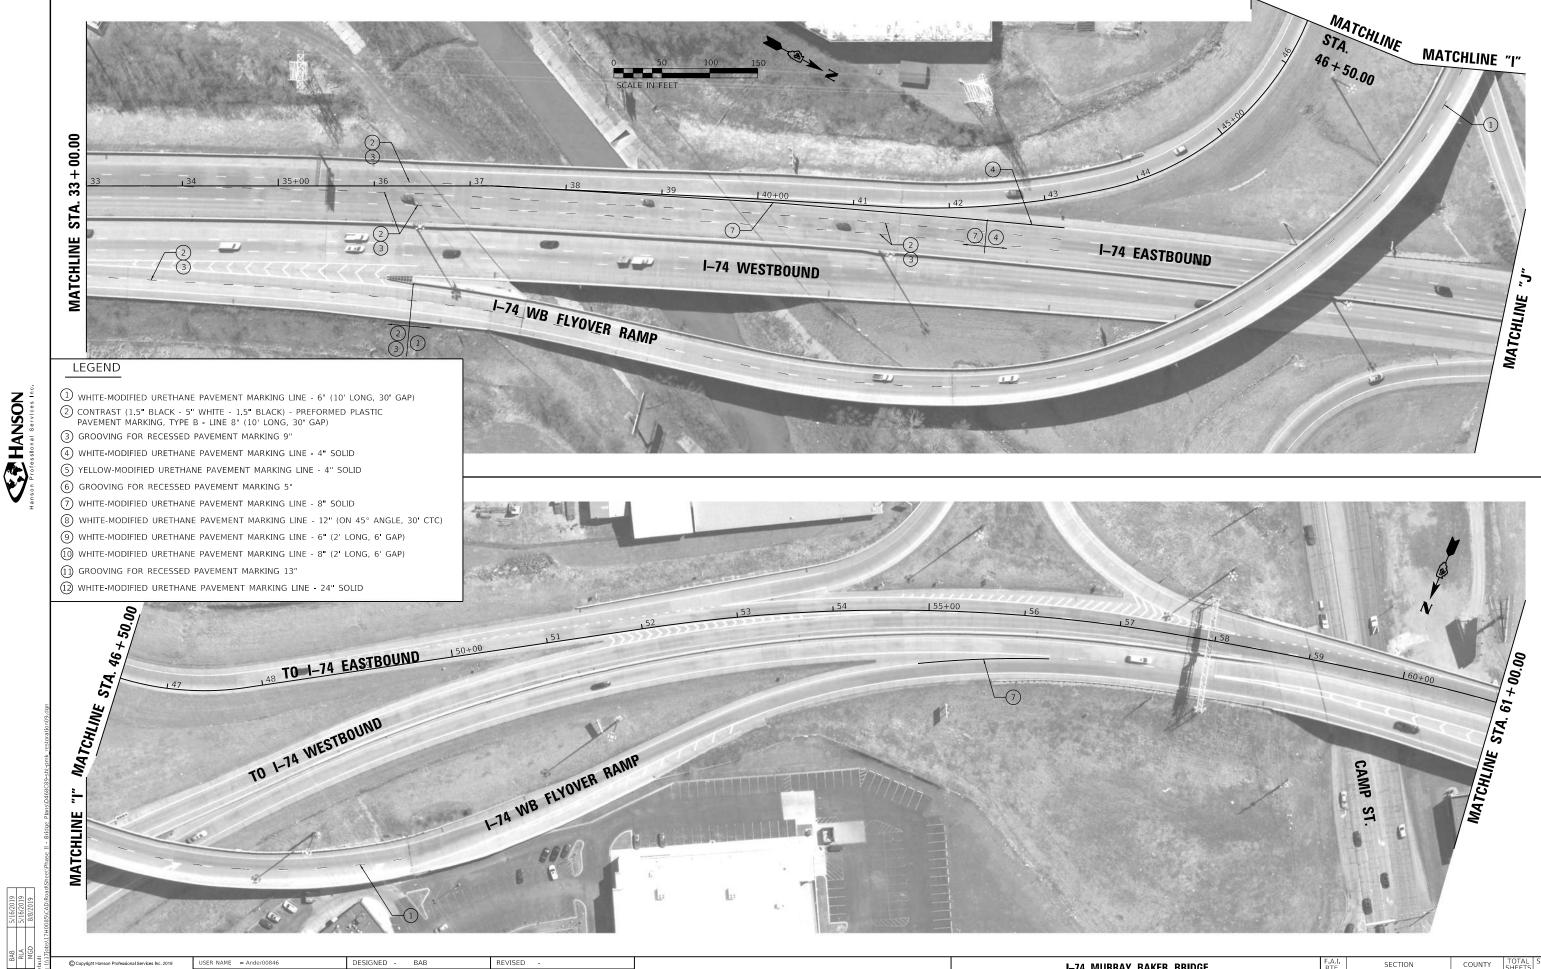

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STATE OF ILLINOIS
DEPARTMENT OF TRANSPORTATION

I-74 MURRAY BAKER BRIDGE
PAVEMENT MARKING PLANS - RESTORATION

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SCALE: 1"=50'

F.A.I. SECTION COUNTY TOTAL SHEETS NO.

74 90(10D-1)BRR TAZEWELL 329 80

CONTRACT NO. 68C89

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*PEORIA/TAZEWELL


329 81

CONTRACT NO. 68C89

STATE OF ILLINOIS
DEPARTMENT OF TRANSPORTATION


I–74 MURRAY BAKER BRIDGE
PAVEMENT MARKING PLANS – RESTORATION

F.A.I. RTE. SECTION
74 90(10D-1)BRR

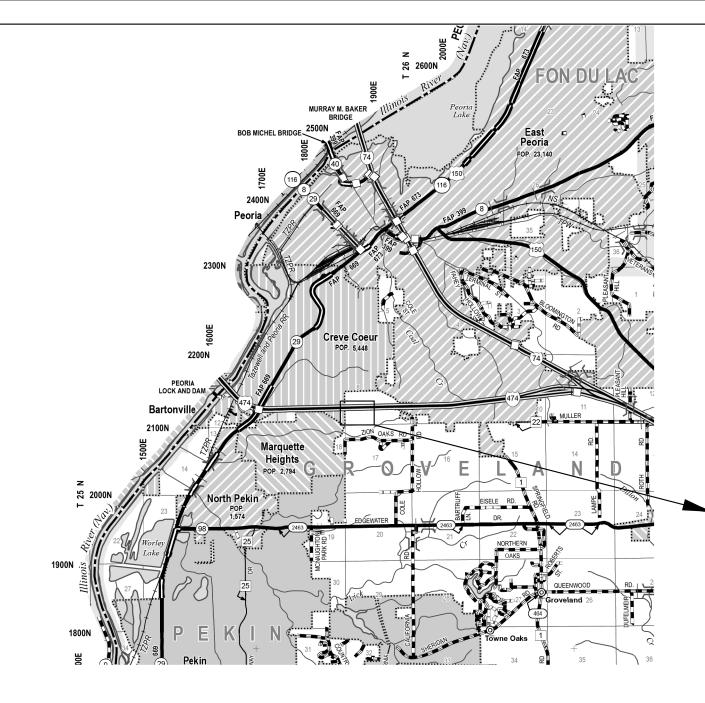



IF SOIL TESTING RESULTS ALLOW (SEE SPECIAL PROVISION TITLED, REMOVAL AND DISPOSAL OF REGULATED SUBSTANCES), THE CONTRACTOR SHALL DISPOSE OF THE SOIL FROM CHANNEL EXCAVATION AT THIS SITE. IF THE MATERIAL IS DISPOSED AT THIS SITE, THE PAY ITEM FOR NON-SPECIAL WASTE DISPOSAL WILL BE DELETED.

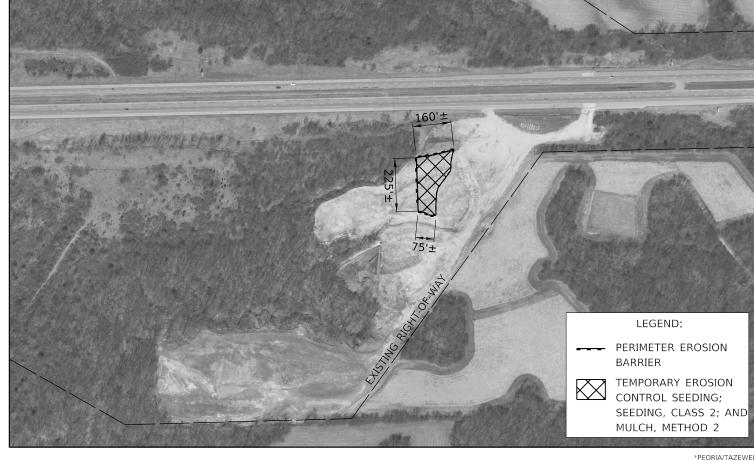

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STATE OF ILLINOIS
DEPARTMENT OF TRANSPORTATION

SCALE:

SHEET

LIGHTING LEGEND:

⊠R	EVICTING NAVIGATION OPOTPHOTION HOUTING CONTROLLED TO BE DEMOVED
1×1 K	EXISTING NAVIGATION OBSTRUCTION LIGHTING CONTROLLER TO BE REMOVED.

EXISTING JUNCTION BOX TO BE REMOVED.

EXISTING CABLE AND CONDUIT TO BE REMOVED.

— x — x — EXISTING CABLE IN EXISTING CONDUIT TO BE REMOVED.

PROPOSED ELECTRIC CABLE IN EXISTING EMBEDDED CONDUIT. SIZE AS NOTED ON PLAN.

Ø R EXISTING NAVIGATIONAL LIGHT TO BE REMOVED.

O—O R EXISTING LUMINAIRE AND MAST ARM TO BE REMOVED.

R EXISTING PARAPET MOUNTED LIGHT POLE TO BE REMOVED, NO SALVAGE.

PROPOSED NAVIGATION OBSTRUCTION LIGHTING CONTROLLER.

0 PROPOSED JUNCTION BOX, SIZE AS NOTED ON PLAN.

PROPOSED CABLE AND CONDUIT, SIZE AS NOTED ON PLAN.

PROPOSED RED NAVIGATIONAL LIGHT, LED, 180°.

PROPOSED GREEN NAVIGATIONAL LIGHT, LED, 360°

PROPOSED LUMINAIRE, LED, ROADWAY, OUTPUT DESIGNATION E, 240V,

4' MAST ARM AND 22' M H

PROPOSED LIGHT POLE, GALVANIZED STEEL, 35' M.H., 8' MAST ARM, LUMINAIRE, LED, ROADWAY, OUTPUT DESIGNATION F, 240V. ON NEW PARAPET WALL FOUNDATION. SEE STRUCTURAL PLANS FOR FOUNDATION DETAIL.

CABLE/CONDUIT SCHEDULE:

ELECTRIC CABLE IN CONDUIT, 600V (XLP-TYPE USE) 2-1C NO.8, 1/C NO.8 GROUND IN 2" DIA., PVC CONDUIT EMBEDDED IN STRUCTURE.

ELECTRIC CABLE IN CONDUIT, 600V (XLP-TYPE USE) $\langle \mathbb{B} \rangle$ 2-1C NO.8, 1/C NO.8 GROUND IN 3/4" DIA., STAINLESS STEEL CONDUIT ATTACHED TO STRUCTURE

2" DIA., PVC CONDUIT EMBEDDED IN STRUCTURE.

HIGHWAY STANDARDS

000001-07 STANDARD SYMBOLS, ABBREVIATIONS, AND PATTERNS DECIMAL OF AN INCH AND OF A FOOT

701001-02 OFF-ROAD OPERATIONS, 2L, 2W, MORE THAN 15' AWAY

701006-05 OFF-ROAD OPERATIONS, 2L, 2W, 15' TO 24" FROM PAVEMENT EDGE

701101-05 OFF-ROAD OPERATIONS, MULTILANE, 15' TO 24" FROM PAVEMENT EDGE

701106-02 OFF-ROAD OPERATIONS, MULTILANE, MORE THAN 15' AWAY 701456-05 PARTIAL EXIT RAMP CLOSURE FREEWAY / EXPRESSWAY

701901-08 TRAFFIC CONTROL DEVICES

812001 RACEWAY EMBEDDED IN STRUCTURE

821101-02 LUMINAIRE WIRING IN POLE

** 826001-02 NAVIGATION OBSTRUCTION LIGHTING CONTROLLER, 240V

830001-03 LIGHT POLE, STEEL MAST ARM

PROPOSED RWIS CONTROL CABINET.

USER NAME =

PLOT DATE =

830021-03 LIGHT POLE STEEL TENON TOP 836001-04 LIGHT POLE FOUNDATION

838001-01 BREAKAWAY DEVICES

BOTH SPARE 20A CIRCUIT BREAKERS LABELED AS "REQUIRED BUT NOT SHOWN" SHALL BE USED FOR **FUTURE ROADWAY LIGHTING CIRCUITS** CONTROLLER SHALL BE EQUIPPED WITH AN ADDITIONAL 20AMP SINGLE POLE CIRCUIT BREAKER TO POWER

BILL OF MATERIALS:

PAY ITEM	UNIT	QUANTITY
ELECTRIC SERVICE INSTALLATION	EACH	1
CONDUIT EMBEDDED IN STRUCTURE, 2" DIA., PVC	FOOT	8,650
JUNCTION BOX, STAINLESS STEEL, ATTACHED TO STRUCTURE, 10" X 6" X 4"	EACH	28
JUNCTION BOX, STAINLESS STEEL, ATTACHED TO STRUCTURE, 14" X 8" X 6"	EACH	42
JUNCTION BOX, STAINLESS STEEL, ATTACHED TO STRUCTURE, 18" X 12" X 8"	EACH	2
ELECTRIC CABLE IN CONDUIT, 600V (XLP-TYPE USE) 3-1/C NO. 8	FOOT	10,000
LUMINAIRE, LED, ROADWAY, OUTPUT DESIGNATION E	EACH	28
LUMINAIRE, LED, ROADWAY, OUTPUT DESIGNATION F	EACH	5
WATERWAY OBSTRUCTION WARNING LUMINAIRE, LED, 180 DEGREE RED, PARAPET MOUNTED	EACH	6
WATERWAY OBSTRUCTION WARNING LUMINAIRE, LED, 360 DEGREE GREEN, PARAPET MOUNTED	EACH	2
NAVIGATION OBSTRUCTION LIGHTING CONTROLLER	EACH	1
LIGHT POLE, GALVANIZED STEEL, 35 FT. M.H., 8 FT. MAST ARM	EACH	5
REMOVAL OF LIGHTING UNIT, NO SALVAGE	EACH	5
REMOVAL OF LIGHTING CONTROLLER	EACH	1
REMOVAL OF ELECTRIC SERVICE INSTALLATION	EACH	1
REMOVE ELECTRIC CABLE FROM CONDUIT	FOOT	1,674
REMOVAL OF LIGHTING LUMINAIRE, NO SALVAGE	EACH	22
MAST ARM, STREET LIGHTING, 4'	EACH	28
CONDUIT ATTACHED TO STRUCTURE, 3/4" DIA. STAINLESS STEEL	FOOT	728
CONDUIT ATTACHED TO STRUCTURE, 2" DIA., STAINLESS STEEL	FOOT	30
REMOVE EXISTING JUNCTION BOX	EACH	35
LUMINAIRE MOUNTING BRACKET - SPECIAL	EACH	28
REMOVAL OF EXISTING NAVIGATION LIGHTING	EACH	8
MAINTENANCE OF NAVIGATION LIGHTING SYSTEM	CAL MO	12
LIGHT POLE FOUNDATION, INTEGRAL WITH BARRIER WALL	EACH	5
REMOVE EXISTING CONDUIT ATTACHED TO STRUCTURE	FOOT	880

INDEX OF SHEETS

- CABLE/CONDUIT SCHEDULE, GENERAL NOTES, HIGHWAY STANDARDS, INDEX OF SHEETS, LIGHTING LEGEND, AND BILL OF MATERIALS.
- L-2 NAVIGATION LIGHTING REMOVAL PLAN.
- NAVIGATION LIGHTING REMOVAL PLAN.
- L-4 LIGHTING REMOVAL PLAN.
- L-5 LIGHTING REMOVAL PLAN.
- PROPOSED NAVIGATION LIGHTING PLAN.
- PROPOSED NAVIGATION LIGHTING PLAN.
- PROPOSED LIGHTING PLAN.
- PROPOSED LIGHTING PLAN
- L-10 PROPOSED LIGHTING PLAN.
- L-11 PROPOSED LIGHTING PLAN
- L-12 LIGHTING DETAILS.
- L-13 LIGHTING DETAILS.
- L-14 LIGHTING DETAILS.
- L-15 WIRING DIAGRAM.
- L-16 LUMINAIRE PERFORMANCE TABLES.
- L-17 ELECTRICAL SERVICE DETAILS.


GENERAL NOTES:

- THE CONTRACTOR SHALL STAGE THE REMOVAL OF EXISTING LIGHT POLES AND INSTALLATION OF NEW POLES SO THAT THE ROADWAY IS ADEQUATELY LIT
- THE CONTRACTOR SHALL STAGE THE REMOVAL OF THE EXISTING NAVIGATION LIGHTING AND THE INSTALLATION OF NEW NAVIGATION LIGHTING SO AS TO MAINTAIN CONTINUOUS OPERATION OF THE NAVIGATION LIGHTING SYSTEM
- THE LOCATION OF ALL UTILITIES AND PRIVATELY OWNED FACILITIES SHALL BE FIELD VERIFIED BY THE CONTRACTOR PRIOR TO THE INSTALLATION OF ANY COMPONENTS.
- THE CONTRACTOR SHALL VERIFY FIELD CONDITIONS PRIOR TO BIDDING. THERE WILL BE NO ADDITIONAL COMPENSATION PAID FOR CLAIMS THAT ARISE FROM A FAILURE TO FULLY INVESTIGATE EXISTING FIELD CONDITIONS.
- IT IS THE CONTRACTOR'S RESPONSIBLITY TO ADEQUATELY IDENTIFY AND LOCATE ALL EXISTING UNDERGROUND FACILITIES WITHIN THE LIMITS OF THE PROJECT. THE CONTRACTOR SHALL BE LIABLE FOR ANY DAMAGE TO IDOT FACILITIES RESULTING FROM INACCURATE LOCATING.
- ELECTRICAL WORK SHALL CONFORM WITH NATIONAL, STATE, AND LOCAL CODES.
- THE CONTRACTOR SHALL PROVIDE ELECTRICAL CABLE SLACK IN ACCORDANCE WITH
- ELECTRICAL CABLE WILL BE MEASURED FOR PAYMENT IN ACCORDANCE WITH ARTICLE 817.04.
- ALL SURPLUS MATERIALS SHALL BE DISPOSED OF IN ACCORDANCE WITH ARTICLE 202.03 OF THE STANDARD SPECIFICATIONS
- THE COST OF REMOVING THE EXISTING WIRING WILL NOT BE PAID SEPARATELY, BUT SHALL BE INCLUDED IN THE COST OF THE LIGHTING REMOVAL ITEMS.
- 11. THE CONTRACTOR SHALL DISPOSE OF THE EXISTING LIGHTING EQUIPMENT (LIGHT POLES, LUMINAIRE ARMS, LUMINAIRES, WIRING, CONDUIT, LIGHTING CONTROLLER, ETC). OFF THE JOB SITE. THE SALVAGE COST OF THESE ITEMS SHALL BE INCLUDED IN THE BID PRICES FOR THE LIGHTING REMOVAL PAY ITEMS
- 12. THE CONTRACTOR SHALL FURNISH AND INSTALL FLEXIBLE LIQUID TIGHT CONDUIT AS REQUIRED FOR THE PROPOSED LIGHTING INSTALLATION. THE COST OF THE FLEXIBLE LIQUID TIGHT CONDUIT SHALL BE INCLUDED IN THE COST OF THE PROPOSED CONDUIT.
- THE CONTRACTOR SHALL FURNISH AND INSTALL ALL ITEMS REQUIRED TO ATTACH THE CONDUITS AND JUNCTION BOXES TO THE STRUCTURE, INCLUDING, BUT NOT LIMITED TO UNI-STRUT, BRACKETS, FLEXIBLE LIQUID TIGHT CONDUIT, LB CONDUIT, FITTINGS, HARDWARE, AND OTHER MISCELLANEOUS ITEMS. THESE ITEMS SHALL BE STAINLESS STEEL OR HOT-DIPPED GALVANIZED STEEL AND WILL NOT BE PAID FOR SEPARATELY, BUT SHALL BE INCLUDED IN THE BID PRICE FOR THE CONDUIT ATTACHED TO STRUCTURE AND JUNCTION BOX PAY ITEMS.
- CONDUIT ATTACHMENT BRACKETS SHALL BE INSTALLED AT 8 FT. SPACINGS (MAXIMUM) ON STRUCTURES
- THE CONTRACTOR SHALL FURNISH AND INSTALL EXPANSION/DEFLECTION COUPLINGS (OR OTHER EQUIPMENT AND METHODS AS APPROVED BY THE ENGINEER) FOR ALL BRIDGE JOINTS AS SHOWN ON THE PLAN SHEETS AND DIRECTED BY THE ENGINEER. THE COST OF THIS WORK SHALL BE INCLUDED IN THE COST OF THE PROPOSED CONDUIT.
- ALL FLEXIBLE LIQUID TIGHT CONDUIT SHALL BE NON-METALLIC AND SHALL INCLUDE CONNECTORS WITH INTEGRAL STAINLESS STEEL KELLUM GRIPS AT THE ENDS FOR INCREASED STRENGTH AND DURABILITY
- 17. ALL CONDUIT ATTACHMENT BRACKETS AND HARDWARE SHALL BE STAINLESS STEEL.
- THE CONTRACTOR SHALL INSTALL THREAD LOCKER ON ALL ATTACHED GALVANIZED CONDUIT THREADED CONNECTIONS TO PREVENT LOOSENING THROUGH VIBRATION.

L-1

*PEORIA/TAZEWEL

DESIGNED - MKR REVISED -TOTAL SHEET NO. SECTION COUNTY CABLE/CONDUIT SCHEDULE, GENERAL NOTES, HIGHWAY STANDARDS, INDEX OF SHEETS, REPORT OF STATE OF ILLINOIS CHECKED - MKR REVISED -90(10D-1)BRR 329 83 LIGHTING LEGEND, AND BILL OF MATERIALS. DRAWN - MRT REVISED **DEPARTMENT OF TRANSPORTATION** CONTRACT NO. 68C89 SHEET SHEETS CHECKED -REVISED -ILLINOIS FED. AID PROJECT

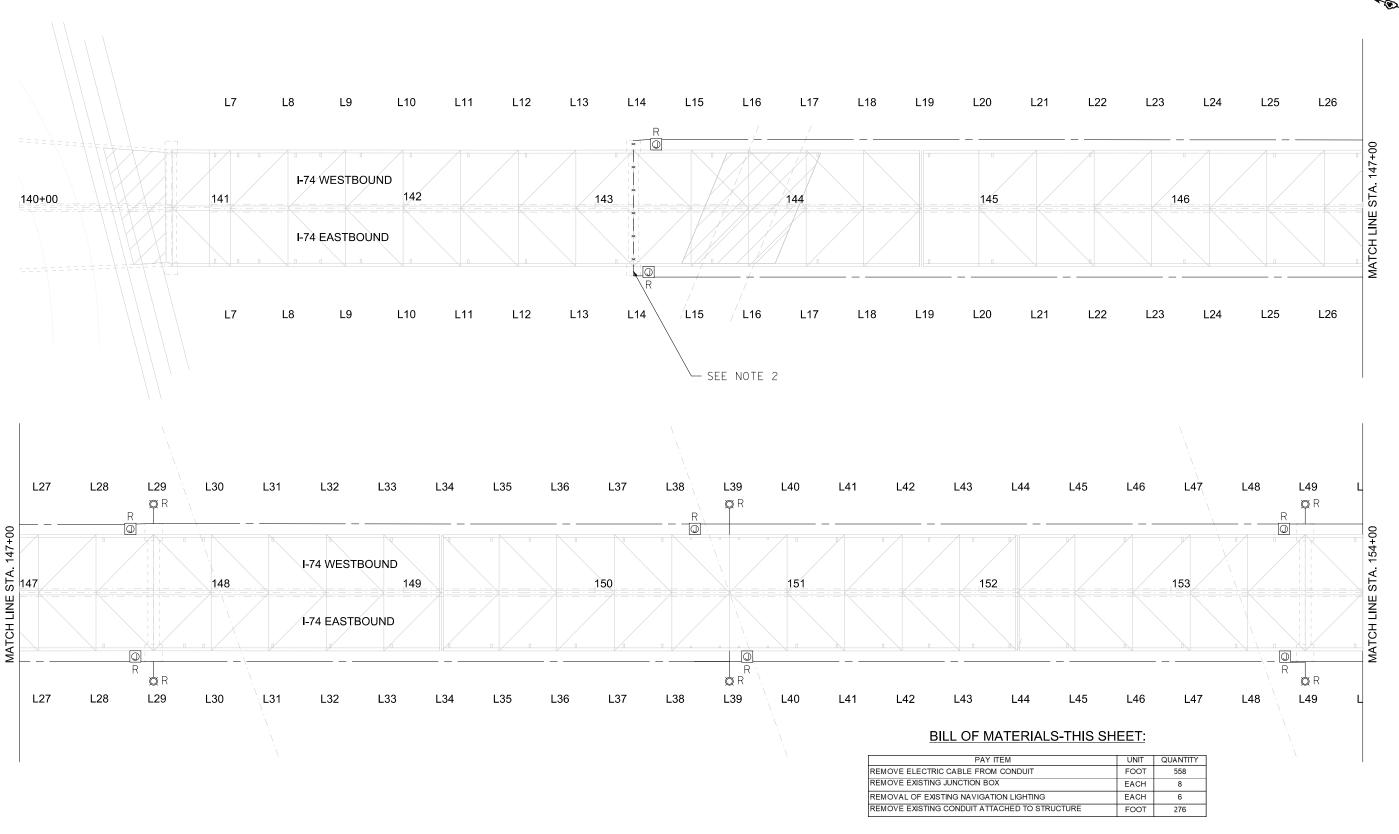

STATE OF ILLINOIS

DEPARTMENT OF TRANSPORTATION

NOTES:

FOR LEGEND SEE SHEET L-1

USER NAME =

PLOT DATE =

PLOT SCALE = 1"=50"

FOR PAY ITEM "REMOVE ELECTRIC CABLE FROM CONDUIT" DETAIL, SEE SHEET L-14.

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CHECKED - MKR

DRAWN - MRT

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NAVIGATION LIGHTING REMOVAL PLAN	F.A.I. RTE	SECTION	co
MURRAY BAKER BRIDGE OVER ILLINOIS RIVER	74	90(10D-1)BRR	
MONNAI BANEN BRIDGE OVER IEEHOOS RIVER			_

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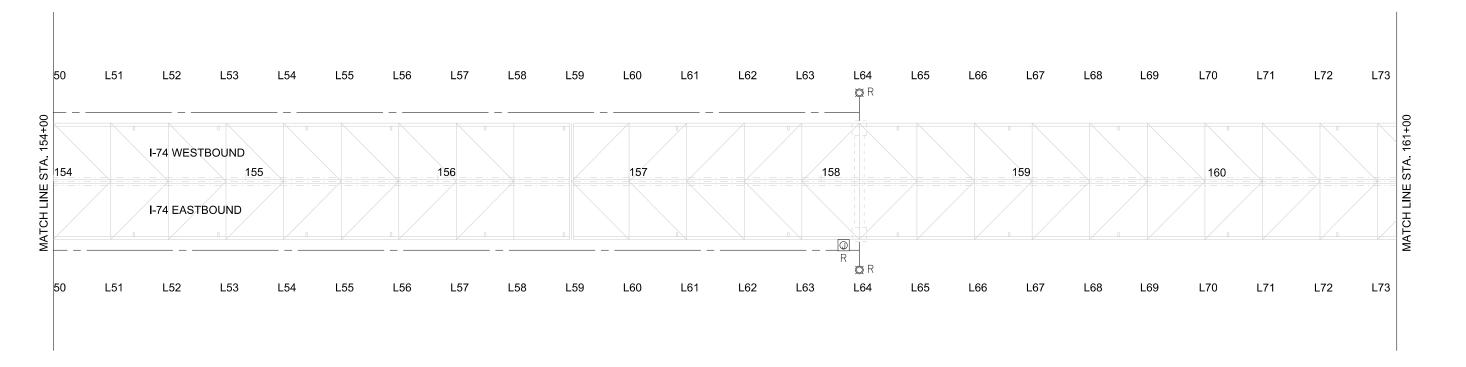
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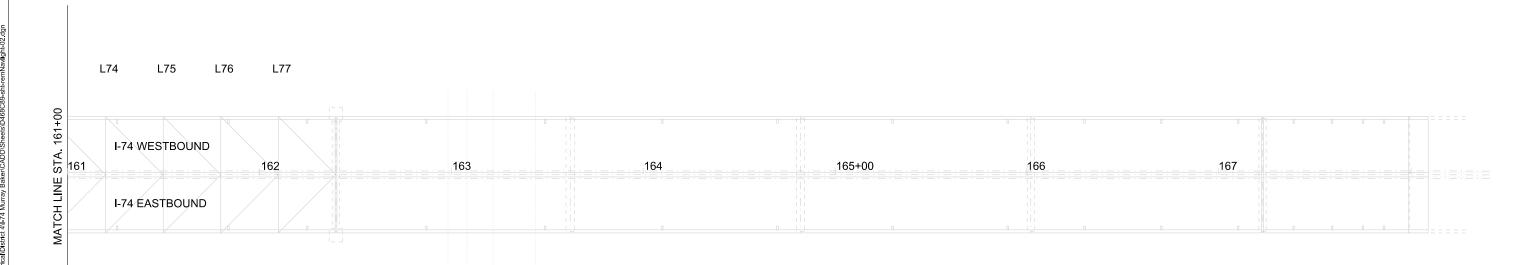
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COUNTY TOTAL SHEET NO.
* 329 84 CONTRACT NO. 68C89

ILLINOIS FED. AID PROJECT

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STATE OF ILLINOIS

DEPARTMENT OF TRANSPORTATION

BILL OF MATERIALS-THIS SHEET:

PAY ITEM	UNIT	QUANTITY
REMOVE EXISTING JUNCTION BOX	EACH	1
REMOVAL OF EXISTING NAVIGATION LIGHTING	EACH	2
REMOVE EXISTING CONDUIT ATTACHED TO STRUCTURE	FOOT	90

NOTES:

1. FOR LEGEND SEE SHEET L-1

USER NAME =

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PLOT SCALE = 1"=50"

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L74

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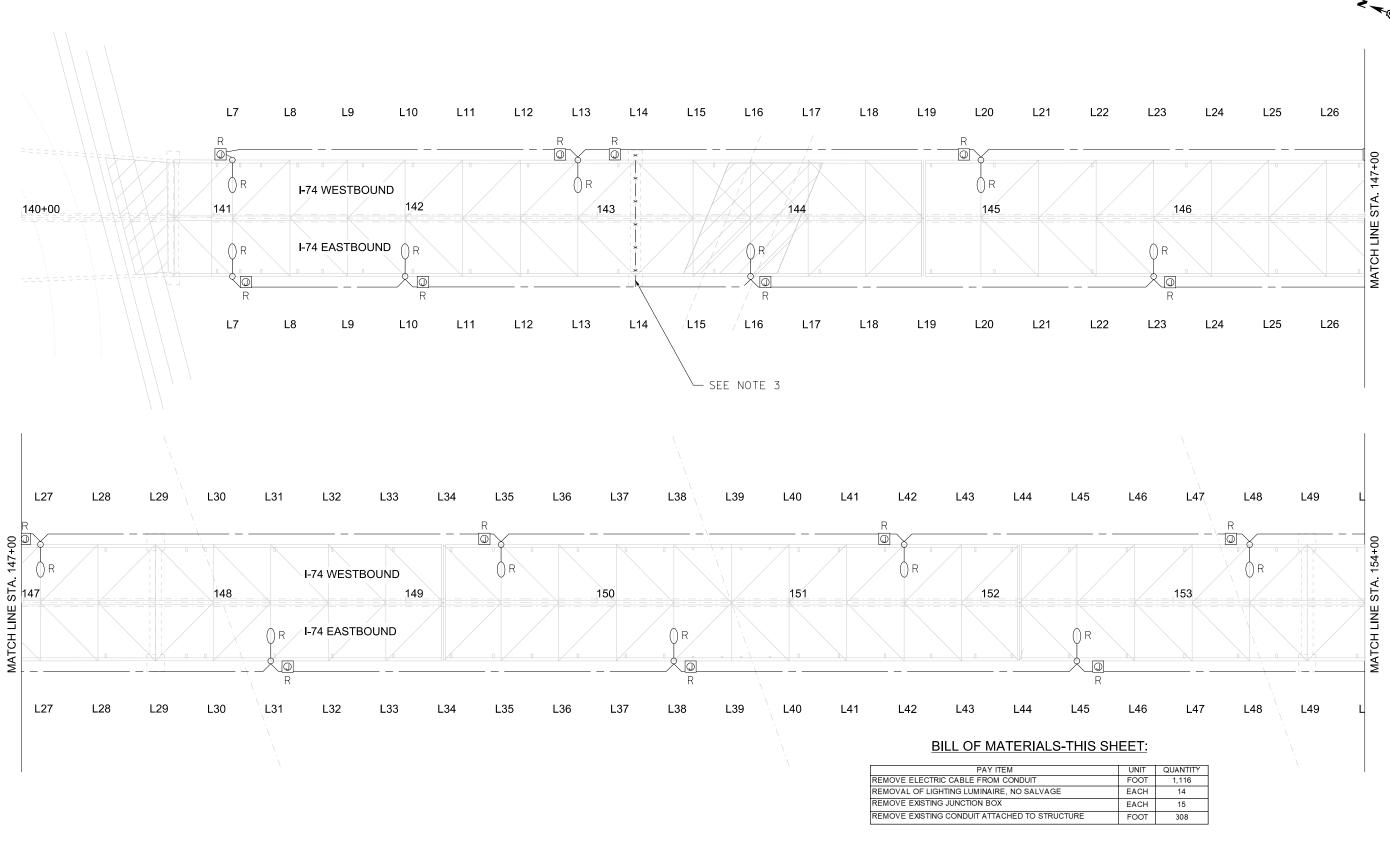
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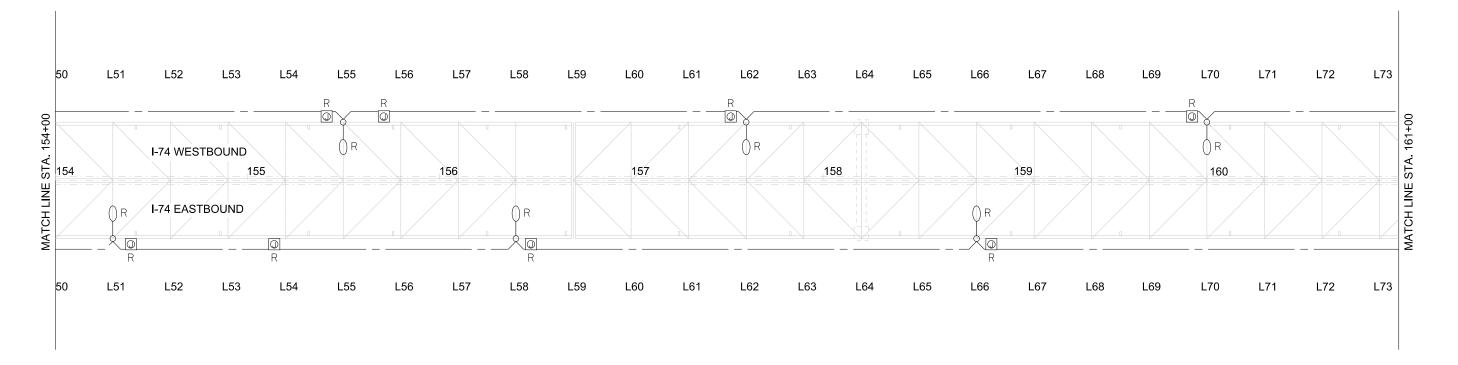
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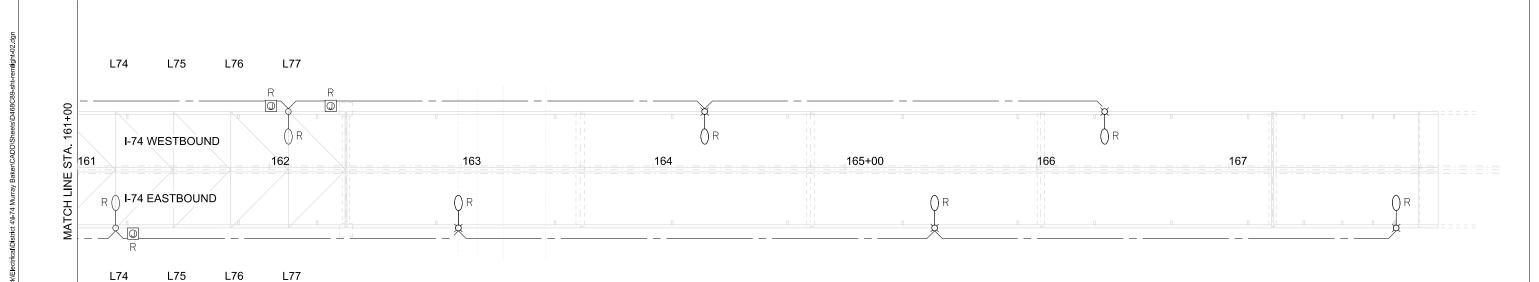
- 1. FOR LEGEND SEE SHEET L-1
- PAY ITEM FOR "REMOVE EXISTING CONDUIT ATTACHED TO STRUCTURE" INCLUDES VERTICAL CONDUIT FROM EXISTING PARAPET WALL JUNCTION BOX TO ROADWAY LUMINAIRE.
- 3. FOR PAY ITEM "REMOVE ELECTRIC CABLE FROM CONDUIT" DETAIL, SEE SHEET L-14.

*PEORIA/TAZEWELL

TOTAL SHEET NO. USER NAME = REVISED -DESIGNED - MKR LIGHTING REMOVAL PLAN SECTION COUNTY **STATE OF ILLINOIS** CHECKED - MKR REVISED -90(10D-1)BRR 329 86 MURRAY BAKER BRIDGE OVER ILLINOIS RIVER DRAWN - MRT REVISED -**DEPARTMENT OF TRANSPORTATION** CONTRACT NO. 68C89 OF SHEETS PLOT DATE = CHECKED -REVISED -








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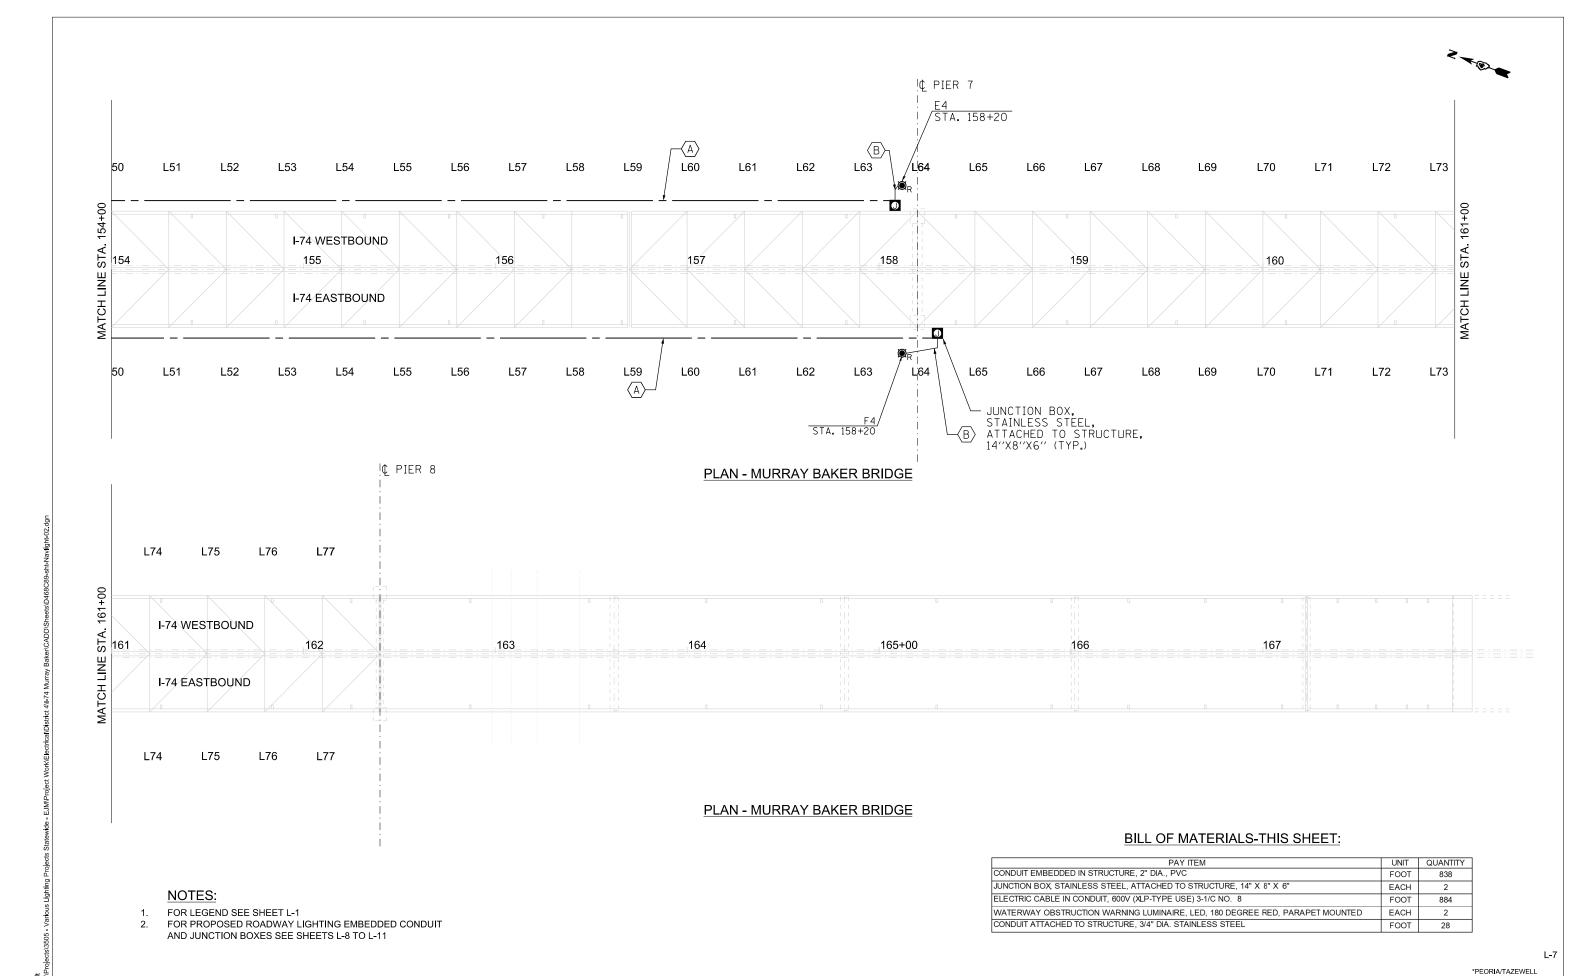
PAY ITEM	UNIT	QUANTITY
REMOVAL OF LIGHTING UNIT, NO SALVAGE	EACH	5
REMOVAL OF LIGHTING LUMINAIRE, NO SALVAGE	EACH	8
REMOVE EXISTING JUNCTION BOX	EACH	11
REMOVE EXISTING CONDUIT ATTACHED TO STRUCTURE	FOOT	176

NOTES:

- FOR LEGEND SEE SHEET L-1
- PAY ITEM FOR "REMOVE EXISTING CONDUIT ATTACHED TO STRUCTURE" INCLUDES VERTICAL CONDUIT FROM EXISTING PARAPET WALL JUNCTION BOX TO ROADWAY LUMINAIRE.

							*PEORIA/TAZEV	:WELL
USER NAME =	DESIGNED - MKR	REVISED -		LIGHTING REMOVAL PLAN	F.A.I.	SECTION	COUNTY TOT	TAL SHEET
	CHECKED - MKR	REVISED -	STATE OF ILLINOIS		74	90(10D-1)BRR	* 3.	329 87
PLOT SCALE = 1"=50"	DRAWN - MRT	REVISED -	DEPARTMENT OF TRANSPORTATION	MURRAY BAKER BRIDGE OVER ILLINOIS RIVER		(CONTRACT	NO. 68C89
PLOT DATE =	CHECKED -	REVISED -		SHEET OF SHEETS		ILLINOIS FED. AII	D PROJECT	



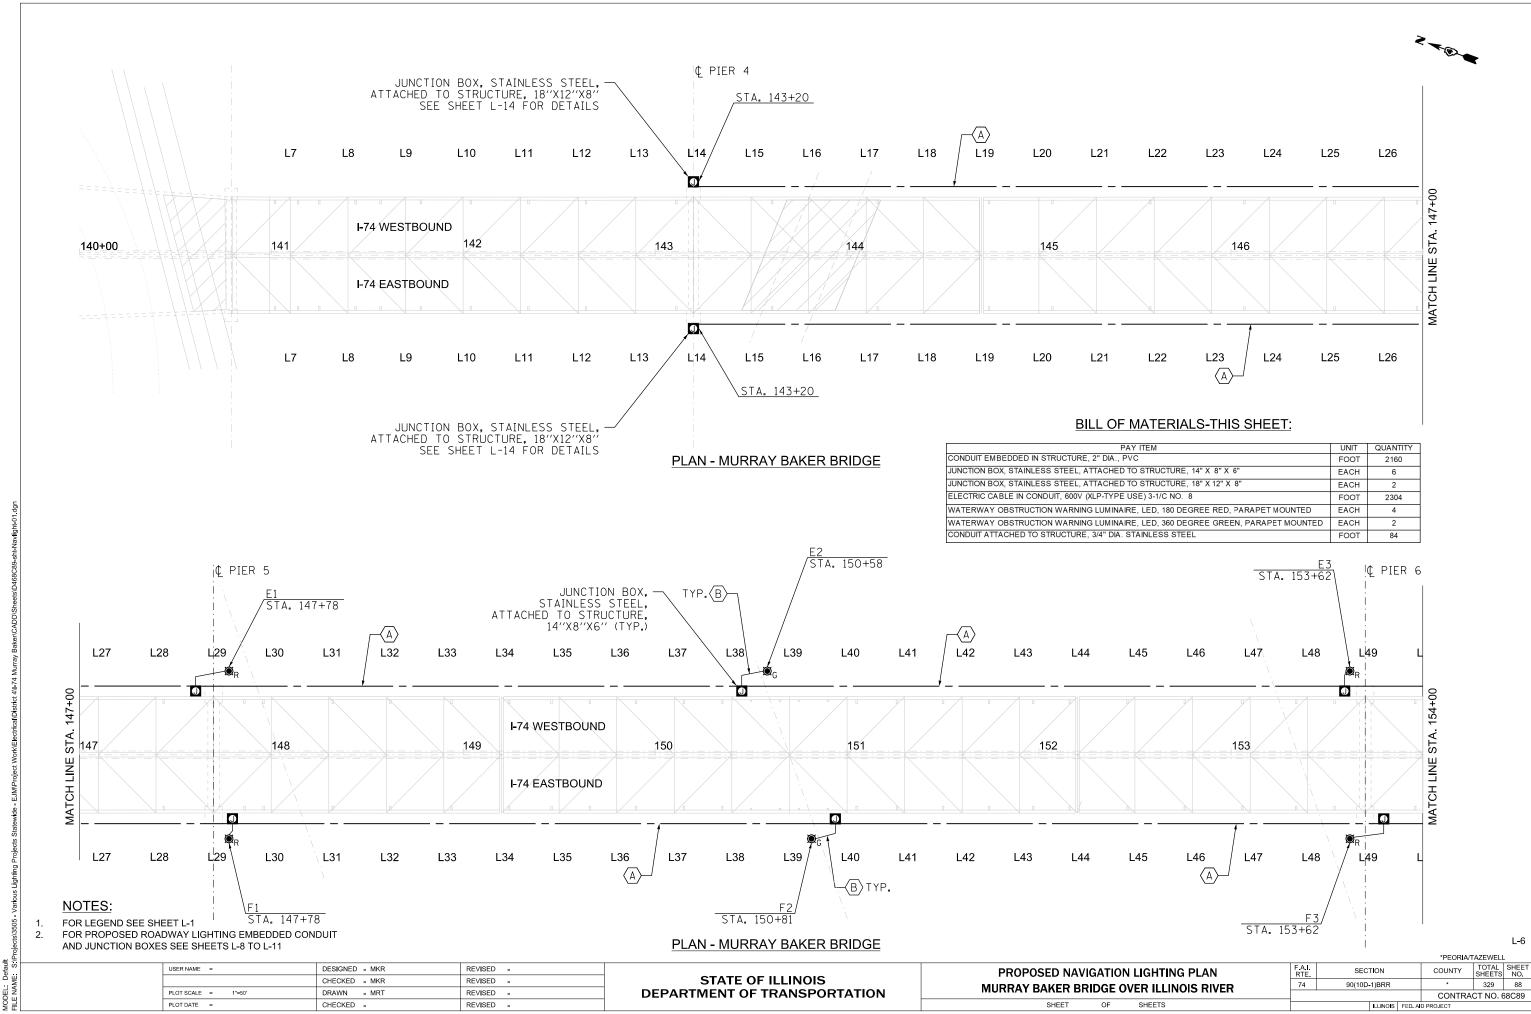

TOTAL SHEET NO. COUNTY

STATE OF ILLINOIS CHECKED - MKR REVISED -REVISED -**DEPARTMENT OF TRANSPORTATION** PLOT DATE = CHECKED -REVISED -


REVISED -

PROPOSED NAVIGATION LIGHTING PLAN MURRAY BAKER BRIDGE OVER ILLINOIS RIVER


SECTION 90(10D-1)BRR 329 89 CONTRACT NO. 68C89

USER NAME =


DESIGNED - MKR

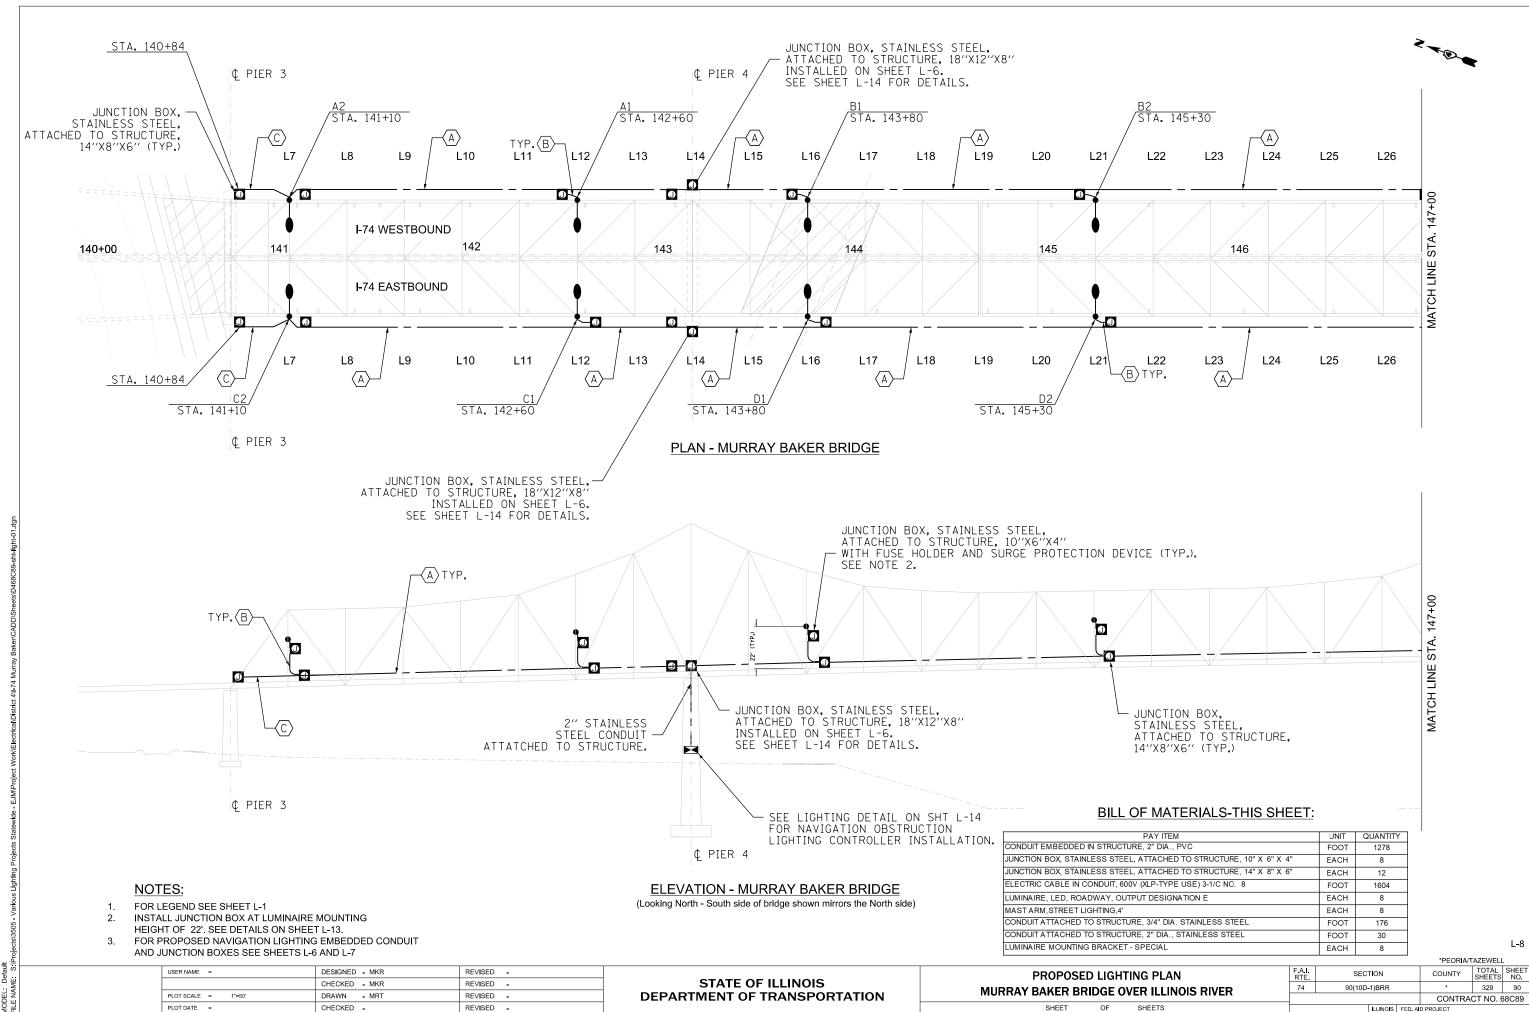


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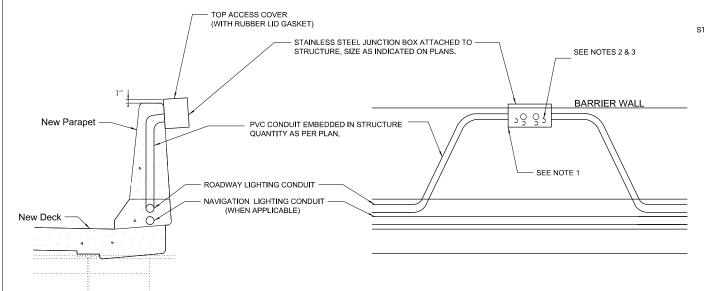
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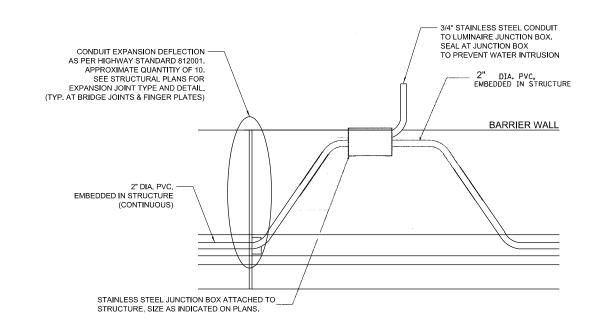

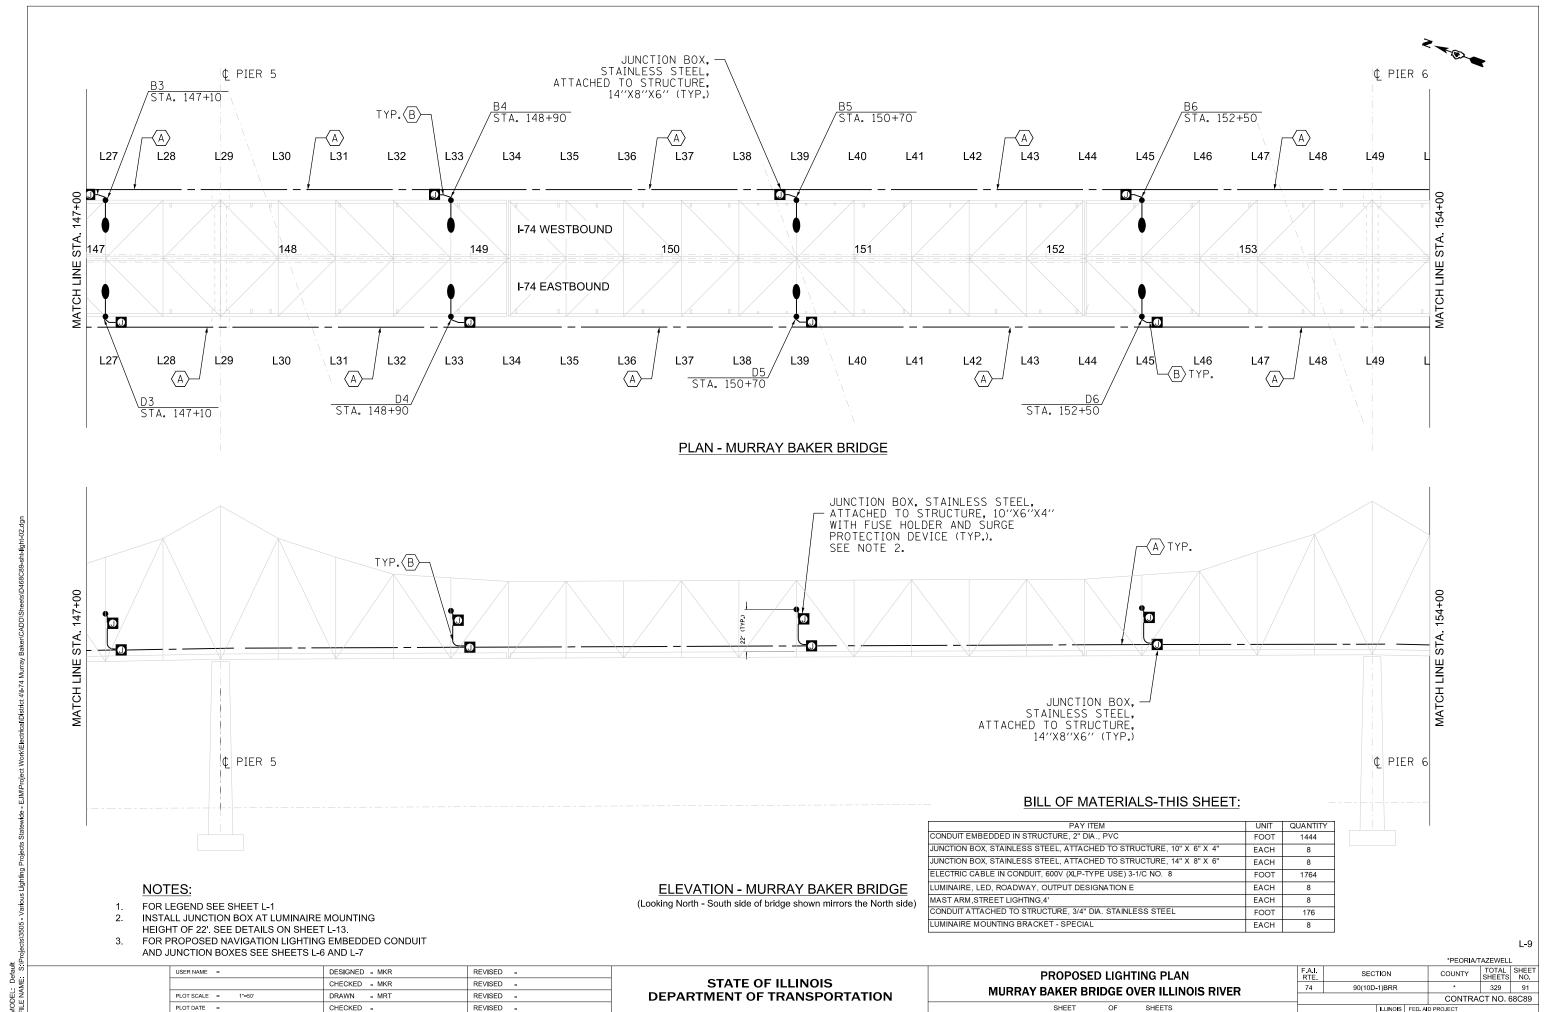
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BARRIER WALL JUNCTION BOX - DETAIL 1

N.T.S.

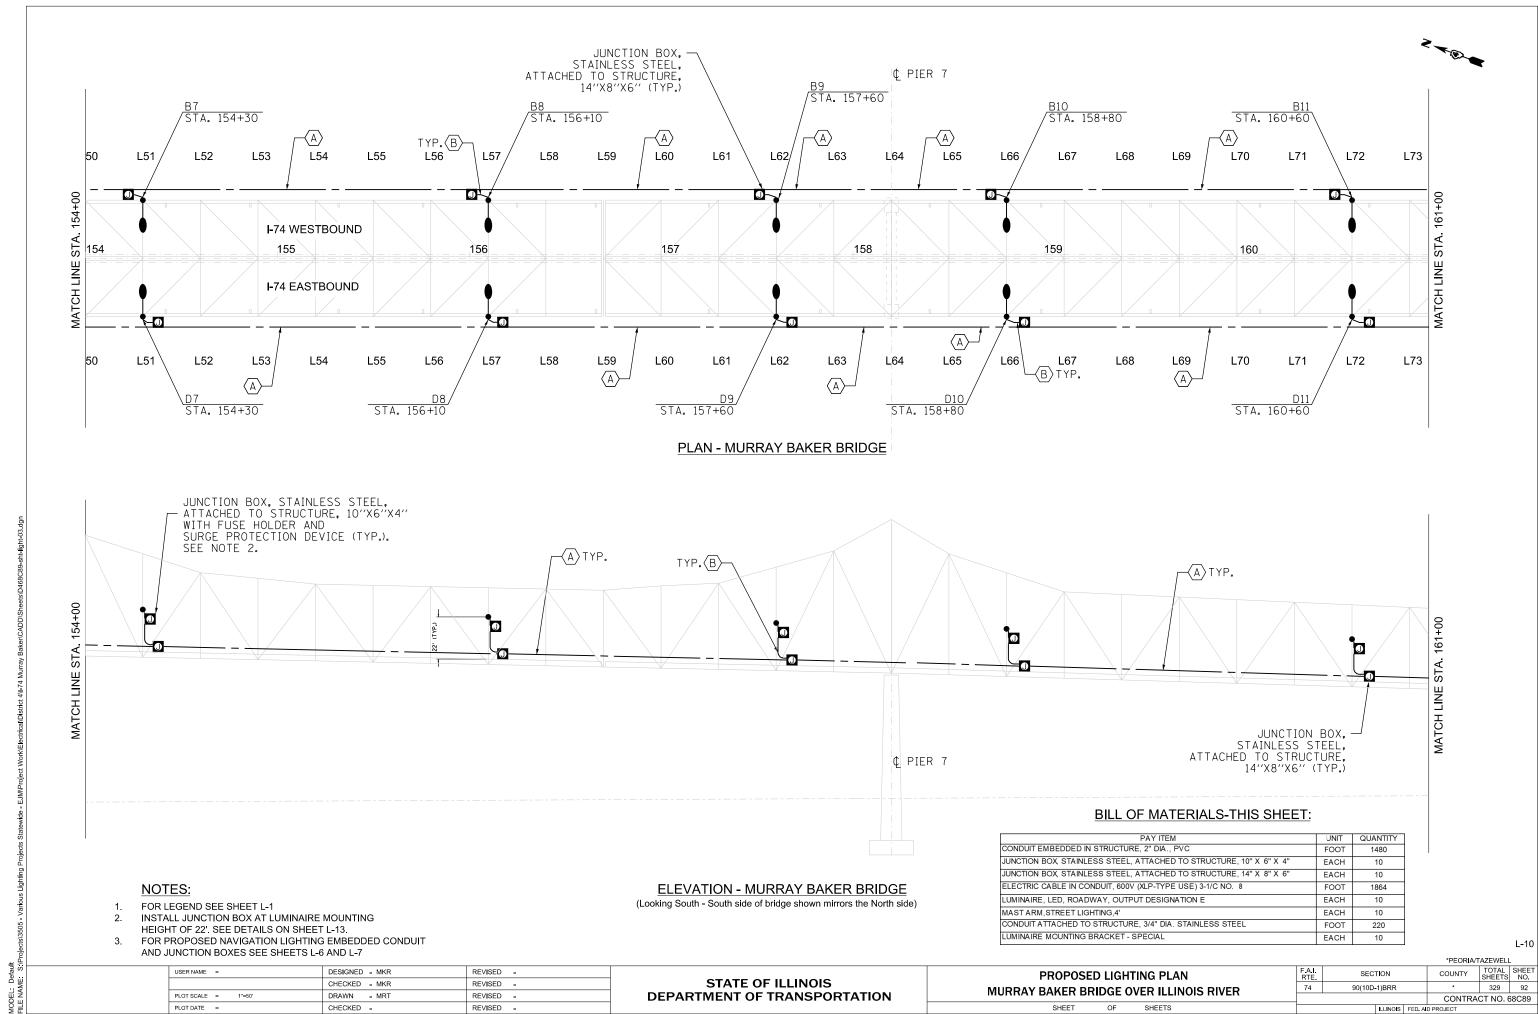

BARRIER WALL JUNCTION BOX -DETAIL 2

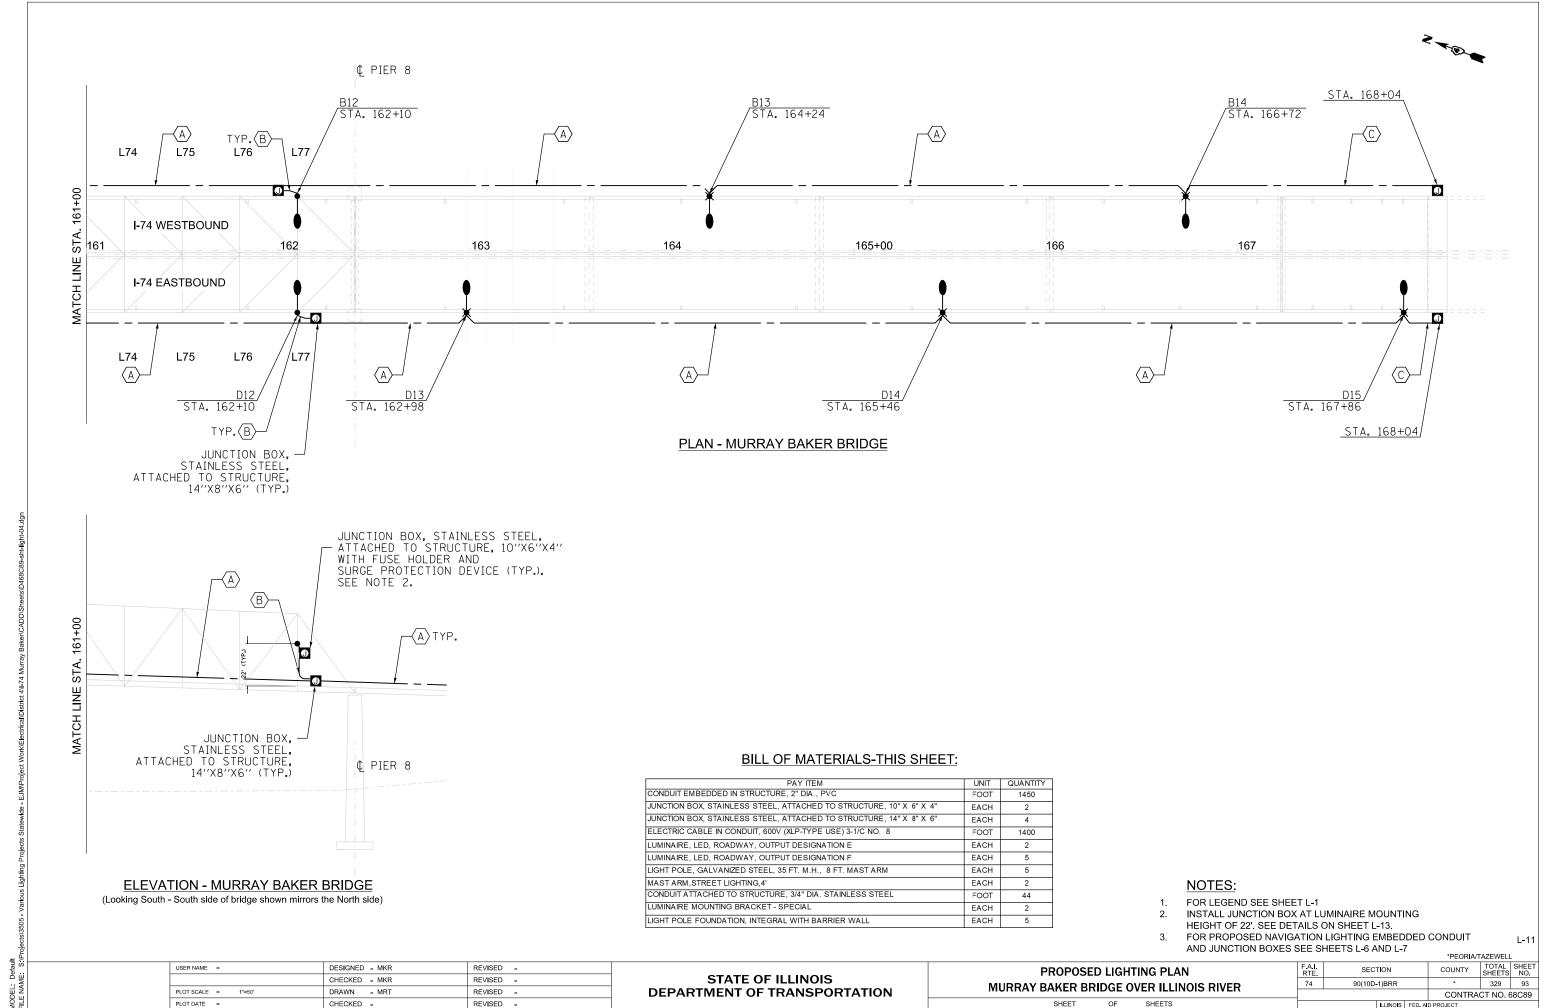
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STAINLESS STEEL JUNCTION BOX ATTACHED TO STRUCTURE, SIZE AS INDICATED ON PLANS. SEE NOTE 1 SEE NOTES 2 & 3 BARRIER WALL PVC CONDUIT EMBEDDED IN STRUCTURE QUANTITY AS PER PLAN.

BARRIER WALL JUNCTION BOX - DETAIL 3

NOTES

- PVC CONDUIT ENTERING/TERMINATING AT JUNCTION BOX SHALL BE CLEAR OF ANY SHARP EDGES.
- JUNCTION BOX TOP ANCHOR BOLTS SHALL BE INSTALLED A MINIMUM OF 3" FROM THE TOP OF THE JUNCTION BOX.
- JUNCTION BOX SHALL BE STAINLESS STEEL WITH A HINGED DOOR ON TOP. THE JUNCTION BOX SHALL BE MOUNTED AT THE TOP OF WALL FOR EASY ACCESS. THE JUNCTION BOX SHALL BE GASKETED TO PREVENT MOISTURE INGRESS.

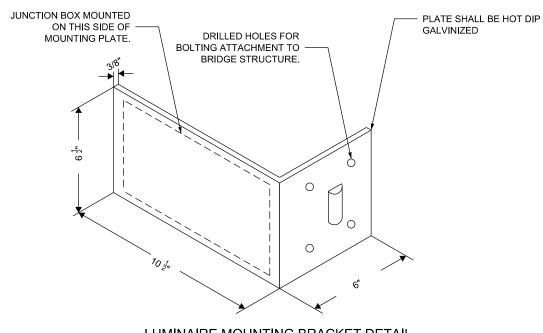

LUMINAIRE MOUNTING BRACKET DETAIL (SIDE VIEW)

DESIGNED - MKR REVISED -USER NAME = CHECKED - MKR REVISED -PLOT SCALE = REVISED

CHECKED -

STATE OF ILLINOIS DEPARTMENT OF TRANSPORTATION


LIGHTING DETAILS MURRAY BAKER BRIDGE OVER ILLINOIS RIVER SHEETS

*PEORIA/TAZEWELL SECTION COUNTY 90(10D-1)BRR 329 94 CONTRACT NO. 68C89 ILLINOIS FED. AID PROJECT

L-12

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PLOT DATE =

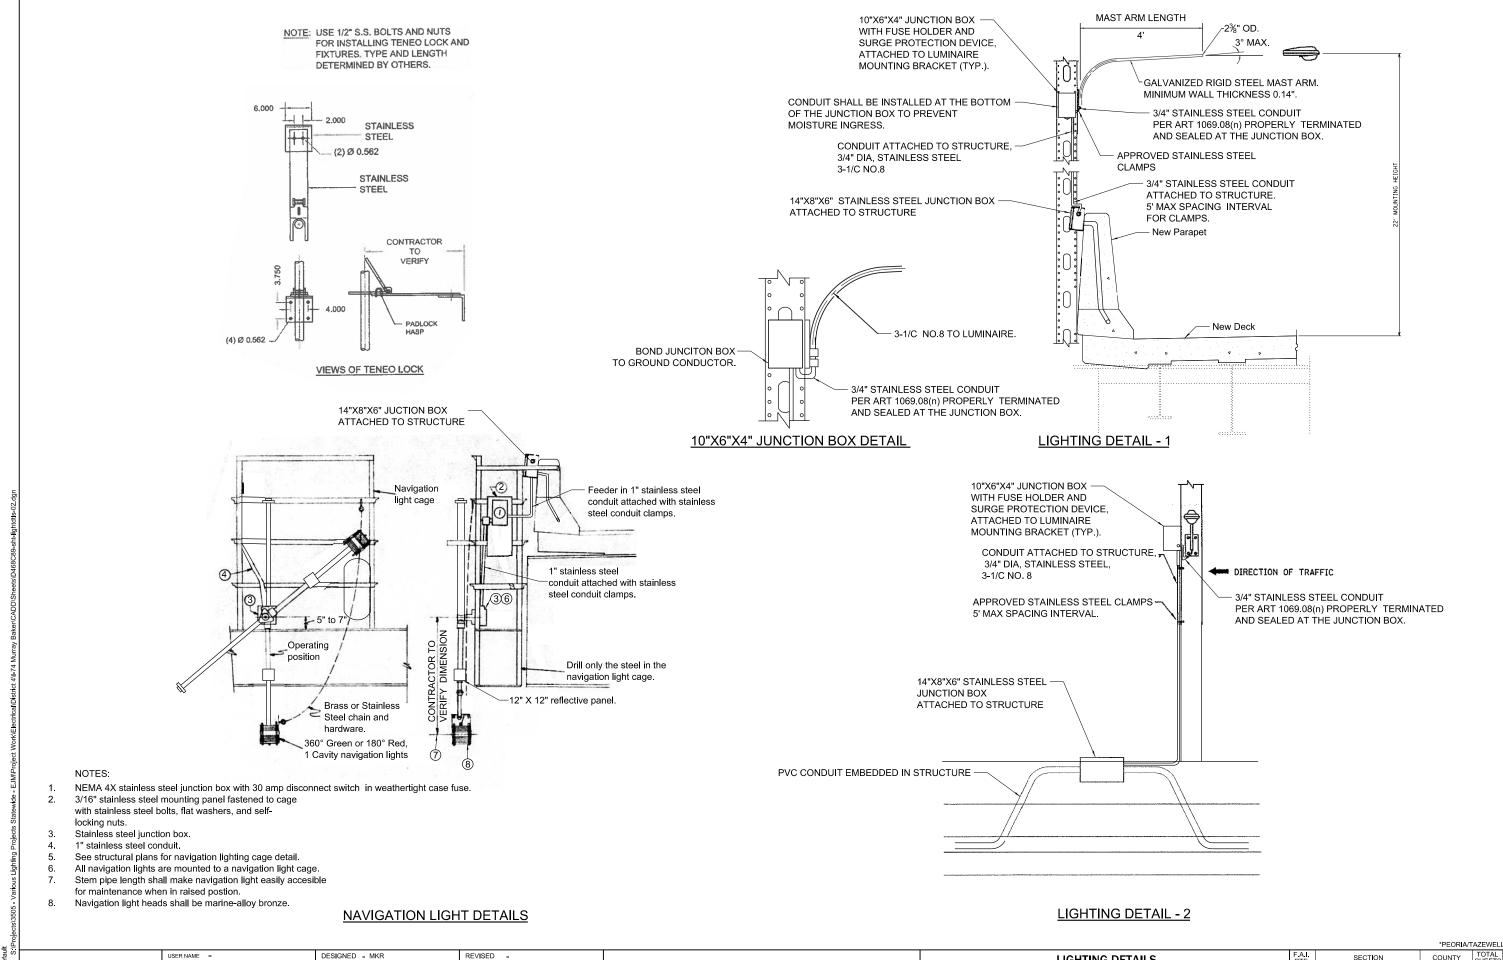

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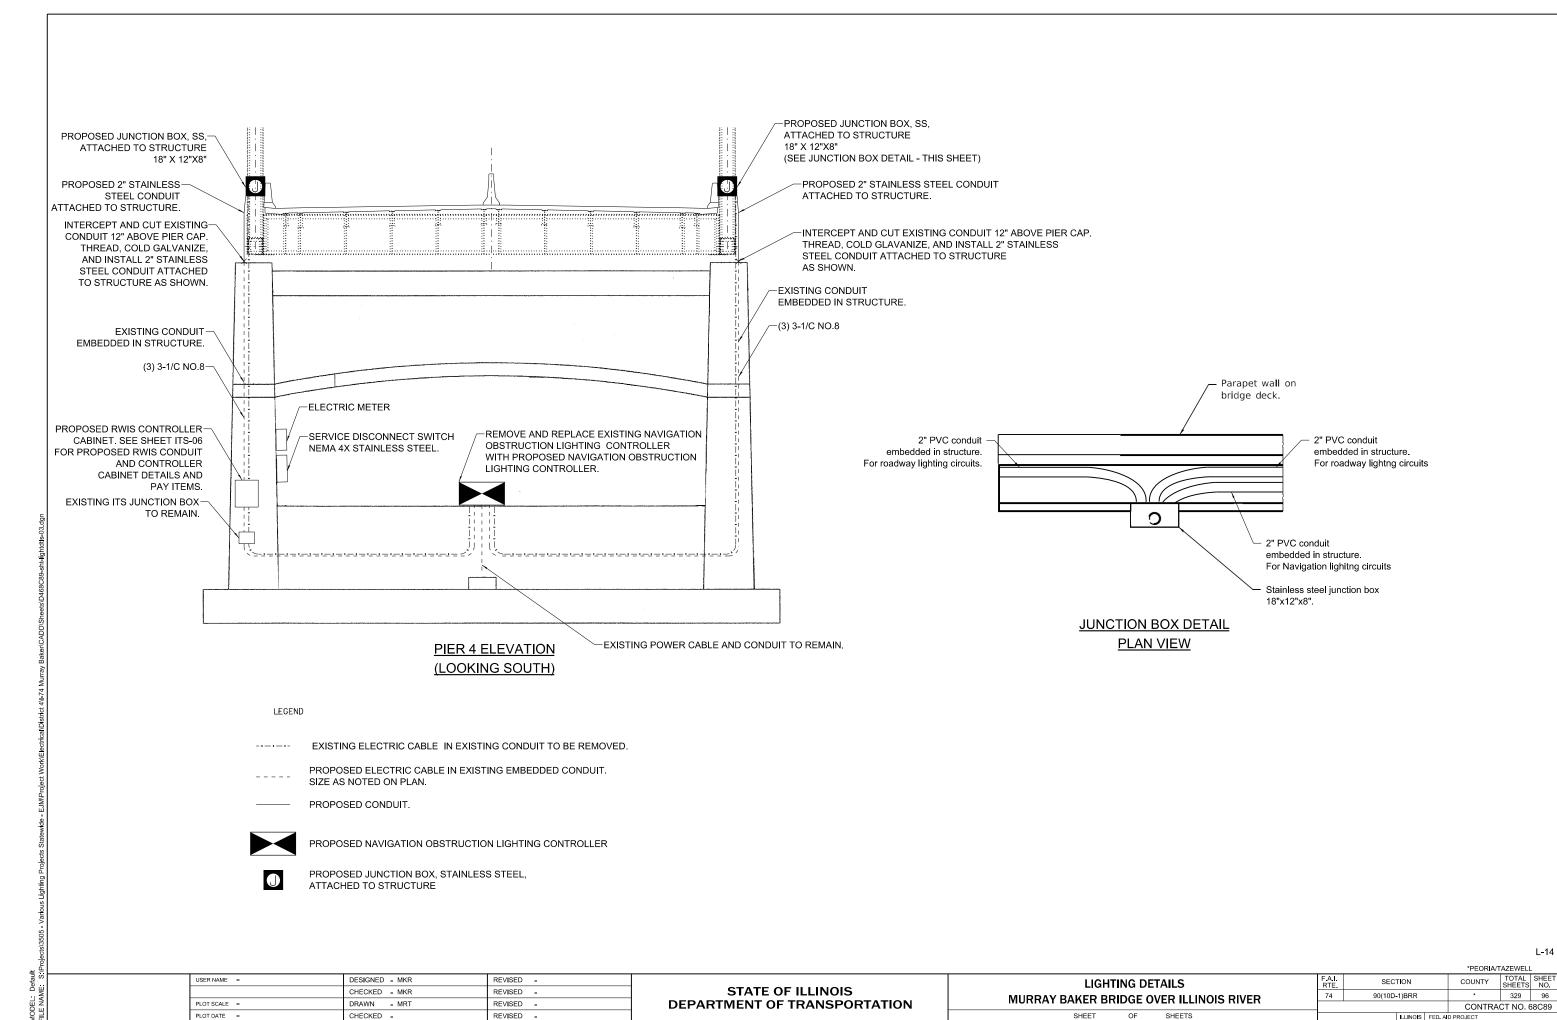
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REVISED -


STATE OF ILLINOIS DEPARTMENT OF TRANSPORTATION

LIGHTING DETAILS MURRAY BAKER BRIDGE OVER ILLINOIS RIVER SHEET

TOTAL SHEET NO. SECTION COUNTY 90(10D-1)BRR 329 CONTRACT NO. 68C89



8/16/2019 4:20:46 PM

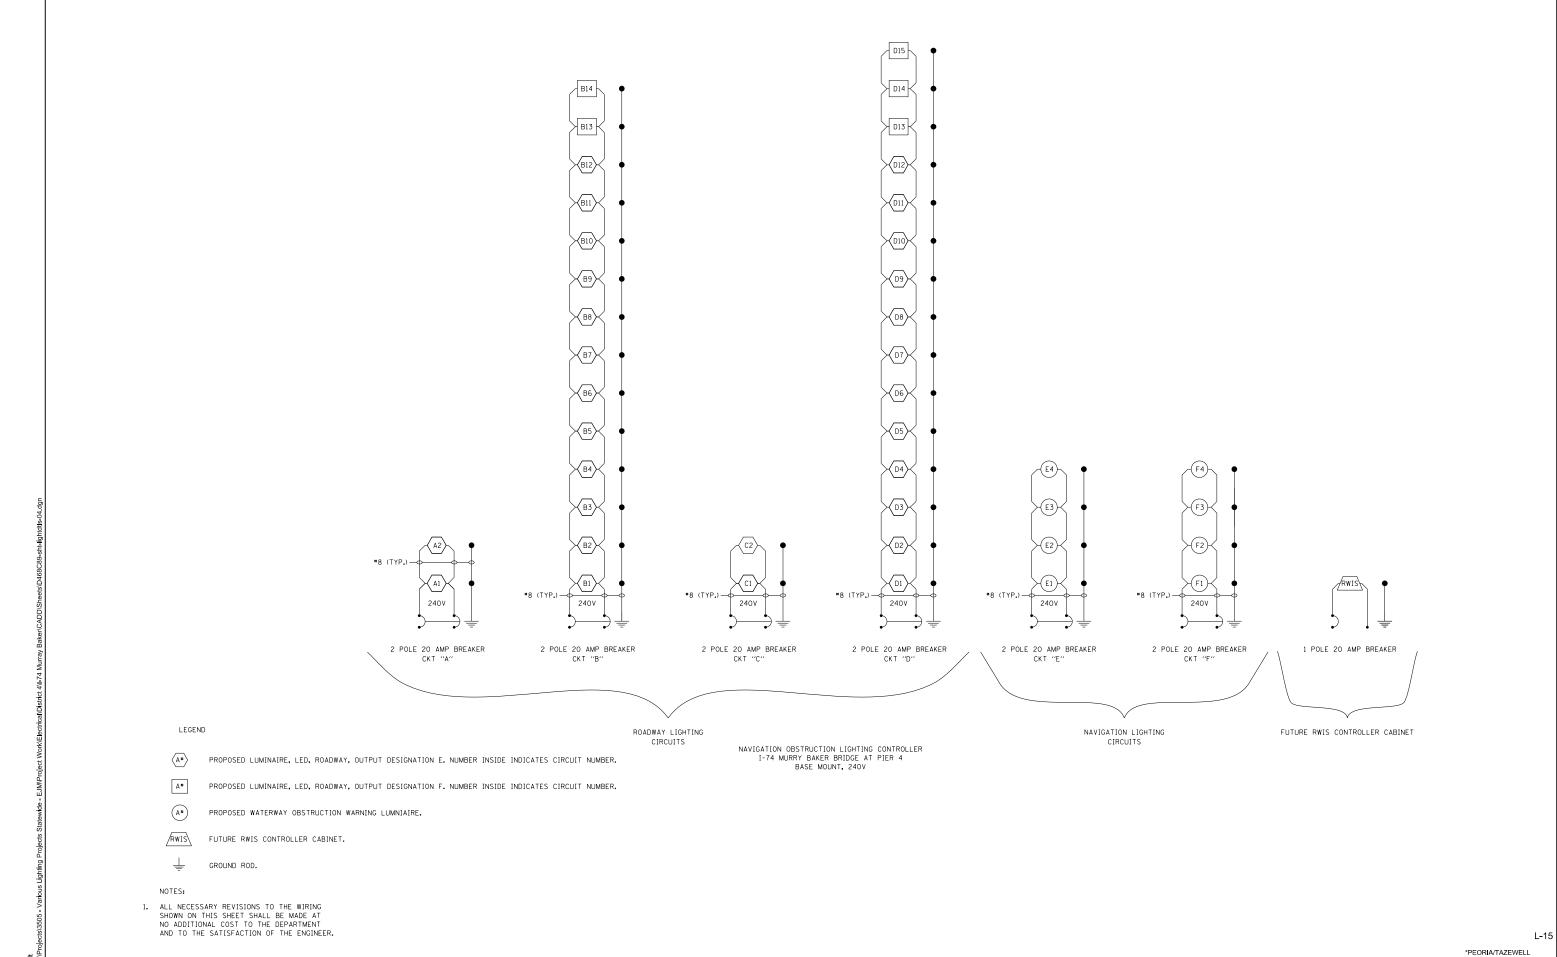

STATE OF ILLINOIS

DEPARTMENT OF TRANSPORTATION

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USER NAME =

PLOT SCALE =

PLOT DATE =

DESIGNED - MKR

CHECKED - MKR

- MRT

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REVISED -

REVISED -

REVISED -

REVISED -

SHEET

OF SHEETS

Project

06/18/19

Contract Number

68C89

Date

I-74		Peoria/ East Peoria								
Roadway										
Lane Width	# of Lanes	Median V	Vidth	I.E.S. Sur	face Classifi	cation Q	-Zero Value			
12 Ft.	2	4 Ft.		R3		0	.07			
Structure			N	umber of L	uminaires					
Mounting Heig	ht Arm Lengt	\neg	\neg r	Highmast &	Sign Lightin	g Only)				
22 Ft.	4 Ft.	3 FT.	[\	I/A						
Luminaire										
Description					I.E.S. Later	al Distrib	ution	I.E.S	. Vertical Distribution	
LED, OUTF	PUT DESIG	NATION	1 E		Type III			Med	lium	
Total Light Lo	ss Factor (LLF) B-U-	-G Rati	ng		Shields			Dimming Protocol	
0.684		U =	:0			N/A			0-10V	
Performanco Average Illum	e inance, E _{AVE} (fo	c)	Unif	ormity Rati	o, Eave/Emin					
Average Lumi	nance, Lave (cd	l/m²) Unif	l∟ ormity	Ratio, Lave/	/Lmin Uniformity Ratio, Lmax/Lmin			Veiling Luminance Ratio, Lv/Lave		
0.6		3.5			6.0			0.30		
Light Tressp	oass									
Distance to Re	OW (behind po	ole) Max. I	Horizor	ital Illumina	ince at ROW	′, Ен	Max. Vertical	Illumina	ance at ROW, E _V	
N/A N/A			N/A							
										ne sign

Section Number

90(10D-18)B-R

County

Peoria / Tazewell

LUMINAIRE PERFORMANCE TABLE LUMINAIRE, LED, ROADWAY, OUTPUT DESIGNATION E

REVISED -

REVISED -

REVISED -

REVISED -

DESIGNED - MKR

CHECKED - MKR

CHECKED -

Project

Date	Contract Number	Section Nun	nber	County	
06/18/19	68C89	90(10D-18	3)B-R	Peoria / Tazewell	
Marked Route N	umber		Municipality		
I-74			Peoria/East Peo	oria	

Roadway

Lane Width	# of Lanes	Median Width	I.E.S. Surface Classification	Q-Zero Value
12 Ft.	2	4 Ft.	R3	0.07

Structure Number of Luminaires

Mounting Height	Arm Length	Set-Back	(Highmast & Sign Lighting Only)
35 Ft.	8 Ft.	3 Ft.	N/A

Luminaire

Description		I.E.S. Lateral Distribution	n I.E.S. Vertical Distribution
LED, OUTPUT DESIGNAT	ΓΙΟΝ F	Type III	Medium
Total Light Loss Factor (LLF)	B-U-G Rating	Shields	Dimming Protocol
0.684	U =0	N/A	0-10V

Layout

Spacing (to Nearest 5 ft)	Configuration (Opposite, Staggered, 1 Sided, or Median)
240 Ft.	Staggered

Performance

Average Illuminance, EAVE (fc)	Uniformity Ratio, EAVE/EMIN		
Average Luminance, Lave (cd/m²)	Uniformity Ratio, Lave/Lmin	Uniformity Ratio, L _{MAX} /L _{MIN}	Veiling Luminance Ratio, L _V /L _{AVE}
0.6	3.5	6.0	0.30

Light Tresspass

Distance to ROW (behind pole)	Max. Horizontal Illuminance at ROW, E _H	Max. Vertical Illuminance at ROW, E _V
N/A	N/A	N/A

- 1. Set-Back is from Edge of Pavement (white line) except for sign luminaires when it is vertical and horizontal distance from the sign
- 2. Lighting calculations shall be performed with all luminaires oriented toward and perpendicular to the roadway.
- 3. Total Light Loss Factor (LLF) = the product of "Lumen Maintenance" (LLD) = 0.9, "Dirt Depreciation" (LDD) = 0.8, and "Equipment
- 4. Performance requirements shall be the minimum acceptable standards of photometric performance for the luminaire, based on the given conditions listed above.


LUMINAIRE PERFORMANCE TABLE LUMINAIRE, LED, ROADWAY, OUTPUT DESIGNATION F

*PEORIA/TAZEWELL TOTAL SHEET NO.

LUMINAIRE PERFORMANCE TABLES SECTION COUNTY STATE OF ILLINOIS 90(10D-1)BRR 329 98 MURRAY BAKER BRIDGE OVER ILLINOIS RIVER **DEPARTMENT OF TRANSPORTATION** CONTRACT NO. 68C89

USER NAME =

PLOT DATE =

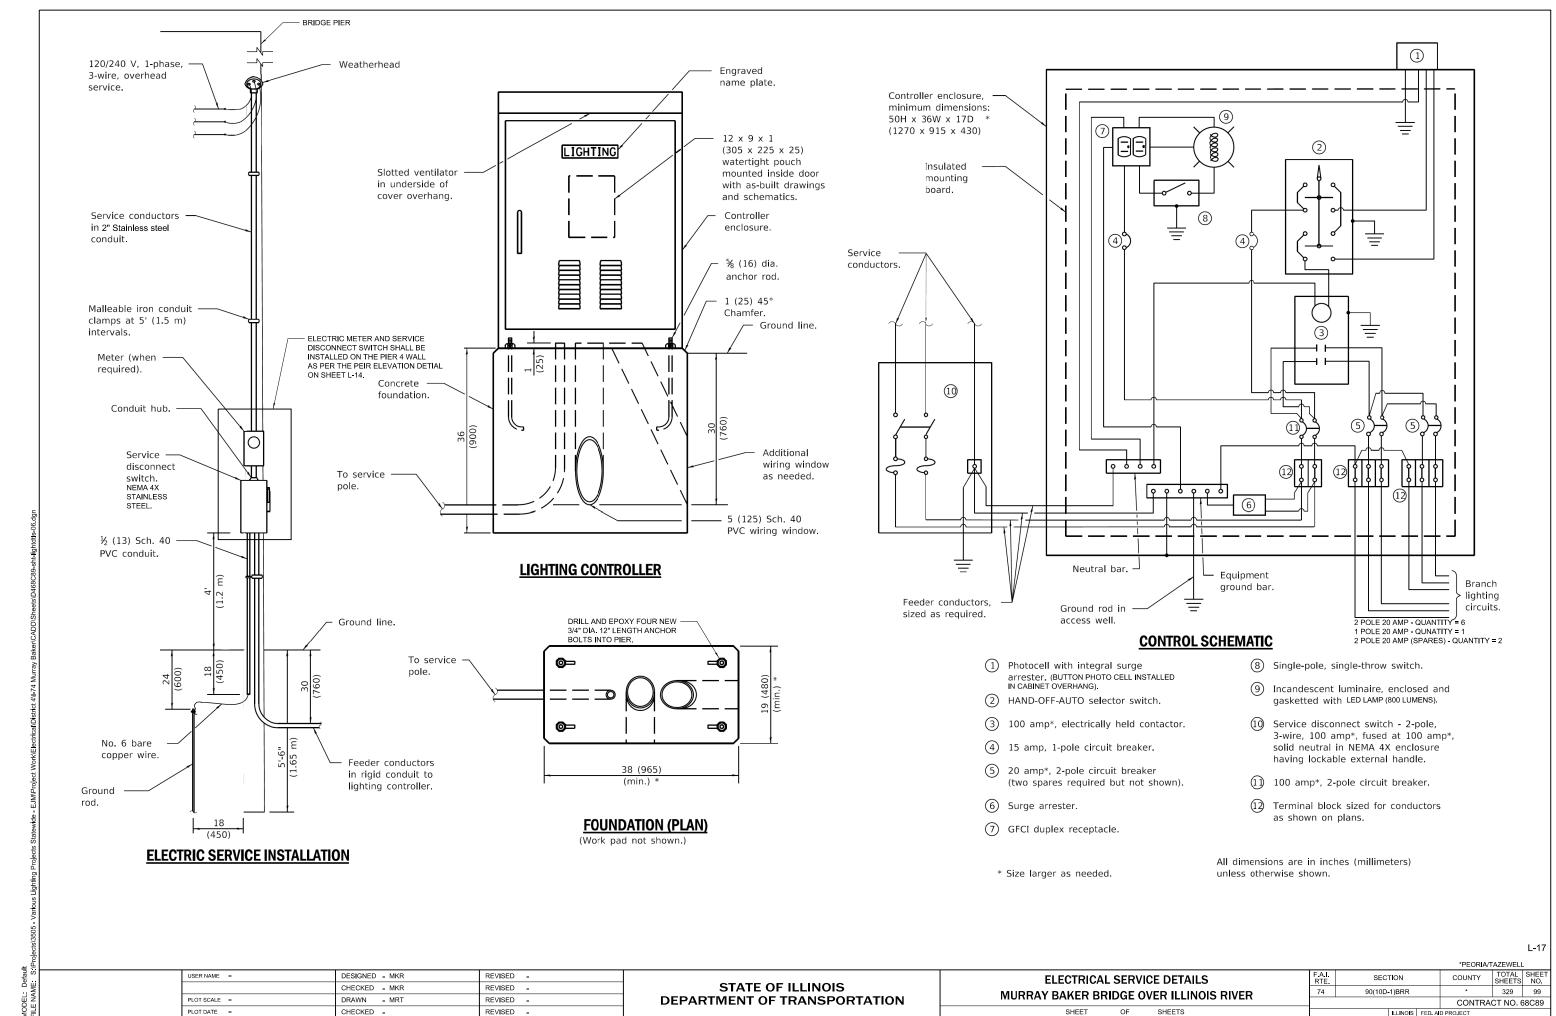

8/16/2019 4:21:05 PM

INDEX OF SHEETS

SHEET NUMBER	SHEET TITLE			
100	DECORATIVE LIGHTING SHEET INDEX AND GENERAL NOTES			
101	SCHEDULE OF QUANTITIES - CONDUIT AND CONDUCTORS			
102	SCHEDULE OF QUANTITIES - CONDUIT AND CONDUCTORS			
103	SCHEDULE OF QUANTITIES - CONDUIT AND CONDUCTORS			
104	SCHEDULE OF QUANTITIES - ELECTRICAL ITEMS			
105	LIGHTING CRITERIA AND CONSTRUCTION NOTES			
106	EXISTING LIGHTING SYSTEM REMOVALS			
107	REMOVAL DETAILS			
108	KEY PLAN			
109	ELEVATION VIEW - POSITION 06 - 10			
110	ELEVATION VIEW - POSITION 11 - 17			
111	ELEVATION VIEW - POSITION 18 - 24			
112	ELEVATION VIEW - POSITION 25 - 31			
113	ELEVATION VIEW - POSITION 32 - 38			
114	ELEVATION VIEW - POSITION 39 - 45			
115	ELEVATION VIEW - POSITION 46 - 52			
116	ELEVATION VIEW - POSITION 53 - 59			
117	ELEVATION VIEW - POSITION 60 - 66			
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119	ELEVATION VIEW - POSITION 74 - 78			
120	PLAN - POSITION 06 - 10			
121	PLAN - POSITION 11 - 17			
122	PLAN - POSITION 18 - 24			
123	PLAN - POSITION 25 - 31			
124	PLAN - POSITION 32 - 38			
125	PLAN - POSITION 39 - 45			
126	PLAN - POSITION 46 - 52			
127	PLAN - POSITION 53 - 59 PLAN - POSITION 60 - 66			
129	PLAN - POSITION 67 - 73 PLAN - POSITION 74 - 78			
131				
132	SCHEDULES - WIRE AND CABLE SCHEDULES - WIRE, CABLE AND CONDUIT			
133	SCHEDULES - WIRE, CABLE AND CONDUIT			
134	SCHEDULES - WIRE, CABLE AND CONDUIT			
135	SCHEDULES - WIRE, CABLE AND CONDUIT			
136	SCHEDULES - WIRE, CABLE AND CONDUIT			
137	SCHEDULES - WIRE, CABLE AND CONDUIT			
138	SCHEDULES - WIRE, CABLE AND CONDUIT			
139	SCHEDULES - WIRE, CABLE AND CONDUIT			
140	SCHEMATIC DIAGRAM - POSITION 06 -17 (WEST)			
141	SCHEMATIC DIAGRAM - POSITION 18 - 31 (WEST)			
142	SCHEMATIC DIAGRAM - POSITION 32 - 45 (WEST)			
143	SCHEMATIC DIAGRAM - POSITION 46 - 59 (WEST)			
144	SCHEMATIC DIAGRAM - POSITION 60 - 73 (WEST)			
145	SCHEMATIC DIAGRAM - POSITION 74 - 78 (WEST)			
146	SCHEMATIC DIAGRAM - POSITION 06 -17 (EAST)			
147	SCHEMATIC DIAGRAM - POSITION 18 - 31 (EAST)			
148	SCHEMATIC DIAGRAM - POSITION 32 - 45 (EAST)			
149	SCHEMATIC DIAGRAM - POSITION 46 - 59 (EAST)			
150	SCHEMATIC DIAGRAM - POSITION 60 - 73 (EAST)			
151	SCHEMATIC DIAGRAM - POSITION 74 - 78 (EAST)			
152A	CONTROL CABINET DETAILS			
152B	CONTROL CABINET POWER DETAILS			
152C	LUMINAIRE WIRING DETAILS			
153	LUMINAIRE MOUNTING DETAILS			
154	LUMINAIRE MOUNTING DETAILS			
155	LUMINAIRE MOUNTING DETAILS - PIERS			
156	CONDUIT MOUNTING DETAILS			
	NORTH CONTROL CARINET SITE DI ANI			
157	NORTH CONTROL CABINET SITE PLAN			

GENERAL NOTES

- 1. PROVIDE ALL LABOR, MATERIALS, AND EQUIPMENT TO FURNISH AND INSTALL THE ELECTRICAL WORK AS SHOWN ON THE PLANS, AS DETAILED IN THE SPECIFICATIONS, AS REQUIRED BY THE NATIONAL ELECTRICAL CODE (NEC), AND AS REQUIRED FOR SPECIFIED OPERATION. CONTRACTOR SHALL EMPLOY ONLY EXPERIENCED ELECTRICIANS. A DULY LICENSED ELECTRICIAN SHALL SUPERVISE ALL WORK. CONTRACTOR SHALL ENSURE THAT ALL EMPLOYEES ARE FAMILIAR WITH THE TYPE OF WORK ENCOUNTERED ON THE PROJECT. ALL MATERIALS AND EQUIPMENT PROVIDED, WHERE APPLICABLE, SHALL HAVE A UL OR FM "LISTING MARK" AFFIXED TO THEM OR THEIR PACKING CONTAINERS AND THEY SHALL MEET ALL UL OR FM AND NEC STANDARDS FOR THEIR INDICATED USE.
- 2. WHEREVER THE TERM "STANDARD SPECIFICATIONS" IS USED, IT SHALL MEAN "STANDARD SPECIFICATIONS FOR ROAD AND BRIDGE CONSTRUCTION, 2016 EDITION BY THE ILLINOIS DEPARTMENT OF TRANSPORTATION."
- 3. CONTRACTOR SHALL VERIFY THE LOCATION OF ALL EXISTING UTILITIES BEFORE BEGINNING CONSTRUCTION AND SHALL PROTECT ALL EXISTING UNDERGROUND FACILITIES FROM DAMAGE AND DISRUPTION. CONTRACTOR SHALL PHYSICALLY LOCATE ALL UTILITIES IN THE AFFECTED AREA. REGARDLESS OF THE OWNERSHIP OF THE UTILITY. JULIE LOCATING ALONE IS NOT SUFFICIENT. METHODS THE CONTRACTOR SHALL USE INCLUDE HAND DIGGING, VACUUM POTHOLING, PROBING, ELECTRONIC LOCATING USING CONTRACTOR'S OWN EQUIPMENT, VISUAL SURVEY OF NEARBY FACILITIES (MANHOLES, INLETS, STREET BOXES, HYDRANTS AND THE LIKE), CITY SEWER MAPS, IN SHORT: ANY METHOD DEEMED BY THE CONTRACTOR TO BE SUFFICIENT TO PREVENT ANY DAMAGE OR DISRUPTION TO EXISTING UTILITIES. FIELD LOCATING OF UTILITIES SHALL BE INCLUDED WITH THE ASSOCIATED PAY ITEM. CONTRACTOR SHALL REPAIR AND RESTORE ANY UNDERGROUND UTILITIES DAMAGED OR DISRUPTED DURING CONSTRUCTION OPERATIONS TO THE SATISFACTION OF THE UTILITY OWNER AT CONTRACTOR'S OWN EXPENSE
- 4. PLANS AND SPECIAL PROVISIONS DETAIL ONE METHOD OF WIRING FOR THE DMX CONTROL SYSTEM THAT IS BASED ON THE DMX-512 OPEN PROTOCOL WIRING METHODS. SOME EQUIPMENT REFERENCED ON THE PLANS AND IN THE SPECIAL PROVISIONS INCLUDES EQUIPMENT AVAILABLE FROM A SINGLE MANUFACTURER. OTHER EQUIPMENT AND WIRING METHODS BY OTHER MANUFACTURERS FOR APPLYING A DMX-512 COMPLIANT SYSTEM IS ACCEPTABLE. THE MANUFACTURER OF THE LIGHTING EQUIPMENT AND ASSOCIATED POWER AND CONTROL SYSTEM SHALL BE RESPONSIBLE TO PROVIDE ALL DETAILS OF INSTALLATION FOR THE SYSTEM PROVIDED. THE MANUFACTURER SHALL UTILIZE WIRING METHODS AND EQUIPMENT THAT PROVIDE RELIABLE, ROBUST, AND REPEATABLE OPERATION WHEN INSTALLED FOR THIS SPECIFIC APPLICATION. SUBMIT SHOP DRAWINGS THAT INCLUDE SPECIFIC DETAILS OF THE CIRCUITRY REQUIRED FOR THE MANUFACTURER'S SPECIFIC FOULPMENT FOR THIS SPECIFIC APPLICATION AND CONSIDERATION SHALL BE GIVEN TO CIRCUIT WIRING LENGTHS. DMX WIRING RESTRICTIONS, VOLTAGE DROP, CIRCUIT LOADING, SURGE PROTECTION OF LUMINAIRES (POWER AND SIGNAL CONNECTIONS), AND SURGE PROTECTION FOR THE LIGHTING CONTROLLER MOUNTED EQUIPMENT (FIELD AND POWER WIRING).
- 5. CONTRACTOR SHALL EVALUATE REMOVED MATERIALS AND EQUIPMENT BEFORE DISPOSAL. HANDLING AND DISPOSAL OF HAZARDOUS MATERIALS SHALL BE ACCOMPLISHED AS REQUIRED FOR THE MATERIALS AND EQUIPMENT REMOVED. RECYCLE THE LED AND DRIVER ELECTRONICS COMPONENTS WITH A LICENSED RECYCLER. DISPOSE OTHER REMOVED MATERIAL AS REQUIRED BY THE GOVERNING LAWS. SPECIAL HANDLING AND DISPOSAL SHALL NOT BE MEASURED SEPARATELY AND IS INCLUDED IN THE ASSOCIATED PAY ITEM.
- 6. THE DETAILS SHOWN IN THE PLANS FOR THE FABRICATION OF THE LUMINAIRE SUPPORTS INDICATE MATERIALS OF CONSTRUCTION AND GENERAL FABRICATION REQUIREMENTS. DIMENSIONS SHOWN ARE PROVIDED FOR GENERAL GUIDANCE. EVERY MOUNTING LOCATION IS UNIQUE, AND THE SUPPORT STRUCTURE PROVIDED FOR EACH LOCATION SHALL BE FABRICATED FOR THAT SPECIFIC UNIQUE SITUATION. PROVIDE THE LUMINAIRE SUPPORT STRUCTURE REQUIRED FOR EACH SITUATION AT THE BID PRICE AND NO ADDITIONAL PAYMENT WILL BE MADE. SUBMIT SHOP DRAWINGS TO THE ENGINEER FOR REVIEW FOR THE PROPOSED LUMINAIRE SUPPORTS BEFORE FABRICATION BEGINS.

- 7. THE DECORATIVE LIGHTING SYSTEM DESCRIBED IN THE PLANS AND SPECIAL PROVISIONS IS BASED ON THE EQUIPMENT OF A SPECIFIC MANUFACTURER. OTHER MANUFACTURER'S EQUIPMENT IS ACCEPTABLE, HOWEVER IT MUST MEET THE DESIGN INTENT DESCRIBED IN THESE DOCUMENTS, WHETHER SPECIFICALLY STATED OR IMPLIED BY THE DESIGN DETAILS. AN OPEN PLATFORM CONTROL SYSTEM HAS BEEN DESCRIBED THAT UTILIZES USITT DMX 512 PROTOCOL WITH RDM (REMOTE DEVICE MANAGEMENT, ANSI E1.20) ENHANCEMENT TO ALLOW BI-DIRECTIONAL COMMUNICATION BETWEEN THE LIGHTING SYSTEM CONTROLLER AND EACH LUMINAIRE. PROPOSED SYSTEMS BY OTHER MANUFACTURERS SHALL UTILIZE THE SAME DMX/RDM PROTOCOL. THE MANUFACTURER SHALL PROVIDE A SYSTEM OF THEIR OWN DESIGN THAT MEETS THE DESIGN INTENT OF THESE DOCUMENTS AND CONFORMS TO THE METHODS OF THE MANUFACTURER TO PROVIDE A ROBUST AND RELIABLE CONTROL SYSTEM THAT IS SPECIFICALLY DESIGNED FOR THIS APPLICATION. THE MANUFACTURER'S PROPOSED SYSTEM SHALL TAKE INTO CONSIDERATION THE RESTRICTIONS IMPOSED FOR LOCATING AND MOUNTING EQUIPMENT TO THE BRIDGE STRUCTURE. BRIDGE MOUNTED EQUIPMENT SHALL BE LIMITED TO CONDUIT, JUNCTION BOXES, SIGNAL SPLITTERS, BOOSTERS, AND LUMINAIRES. PROPOSALS FOR MOUNTING ADDITIONAL EQUIPMENT SHALL BE REVIEWED AND ACCEPTED BY THE ENGINEER AND OWNER BEFORE PROCEEDING WITH THESE MODIFICATIONS. THE MANUFACTURER SHALL SUBMIT TO THE ENGINEER FOR REVIEW SHOP DRAWINGS FOR THE COMPLETE CONTROL SYSTEM. SUBMITTAL SHALL INCLUDE LIGHTING CONTROLLER PANEL DRAWINGS (INTERIOR, EXTERIOR LAYOUT DRAWINGS, PANEL WIRING DRAWINGS, CONTROL AND POWER ONE-LINES, FIELD WIRING DRAWINGS AND SPEC SHEETS FOR ALL CONTROL FOUI PMENT).
- 8. THE EQUIPMENT MOUNTED ON THE BRIDGE WILL BE EXPOSED TO HARSH OUTDOOR CONDITIONS SUCH AS EXTREME HIGH AND LOW TEMPERATURES, SUN EXPOSURE, HUMIDITY, RAIN, SNOW, ICE THAT IS TYPICAL FOR THIS GEOGRAPHIC AREA. PROXIMITY TO THE ROADWAY WILL ALSO EXPOSE THE INSTALLATION TO ROAD DE-ICING SALT SPRAY. THE BRIDGE STRUCTURE EXPERIENCES VIBRATION FROM VARIOUS SOURCES WITH VARIOUS FREQUENCIES AND INTENSITIES. STEEL COMPONENTS AND FABRICATED ASSEMBLIES SHALL BE HOT-DIPPED GALVANIZED AFTER FABRICATION AND CUTTING TO SIZE (I.E. CHANNEL STRUT USED FOR CONDUIT AND JUNCTION BOX SUPPORTS). SEAL ALL FIELD CUT THREADS AND SUPPORTS (I.E. CHANNEL STRUT USED FOR CONDUIT AND JUNCTION BOX SUPPORTS) WITH APPROPRIATE COLD GALVANIZING TREATMENT. FASTENERS AND WASHERS SHALL BE HOT-DIPPED GALVANIZED. THE CONTRACTOR SHALL TAKE EXTREME CARE WITH THIS INSTALLATION TO MAKE JOINTS TIGHT, FASTENERS SECURE TO MANUFACTURER'S SPECIFICATION, USE THREAD SEAL AND LOCK COMPOUND ON FASTENERS AND LOINT SEALANT ON THREADED JOINTS TO SEAL AND LOCK THE JOINT FROM LOOSENING FROM VIBRATION.



FULL SIZE PLANS HAVE BEEN PREPARED USING STANDARD ENGINEERING SCALES. REDUCED SIZED PLANS WILL NOT CONFORM TO STANDARD SCALES. IN MAKING MEASUREMENTS ON REDUCED PLANS, THE ABOVE SCALES MAY BE USED.

J.U.L.I.E.
JOINT UTILITY LOCATING INFORMATION FOR EXCAVATORS
1-800-892-0123
OR 811



100 WALNUT ST., SUITE 200 PEORIA, ILLINOIS 61602 (309) 689-9888 / info@f-w.com

PROJECT # 0181069.00

TOTAL BILL OF MATERIALS						
PAY CODE	DESCRIPTION	UNIT	TOTAL QUANTITY			
81100200	CONDUIT ATTACHED TO STRUCTURE, 3/4" DIA., GALVANIZED STEEL	FOOT	7,944			
81100600	CONDUIT ATTACHED TO STRUCTURE, 2" DIA., GALVANIZED STEEL	FOOT	12,330			
81300710	JUNCTION BOX, STAINLESS STEEL, ATTACHED TO STRUCTURE, 16" X 12" X 6"	EACH	56			
81702101	ELECTRIC CABLE IN CONDUIT, 600V (XLP-TYPE USE) 1/C NO. 14	FOOT	14,400			
81702120	ELECTRIC CABLE IN CONDUIT, 600V (XLP-TYPE USE) 1/C NO. 8	FOOT	34,320			
84500110	REMOVAL OF LIGHTING CONTROLLER	EACH	1			
X0325541	REMOVE EXISTING LIGHTING SYSTEM	L SUM	1			
X1400375	DMX CONTROL CABLE IN CONDUIT	FOOT	32,944			
X1400376	CONTROL CABINET, BASE MOUNT (SPECIAL)	EACH	2			
X1400377	CBX SPLITTER BOX	EACH	38			
X8040102	ELECTRIC SERVICE INSTALLATION, SPECIAL	EACH	2			
X8130110	JUNCTION BOX (SPECIAL)	EACH	177			
X8212031	LUMINAIRE, TYPE A (SPECIAL)	EACH	144			
X8212032	LUMINAIRE, TYPE B (SPECIAL)	EACH	286			
X8212033	LUMINAIRE, TYPE C (SPECIAL)	EACH	72			
X8710035	FIBER OPTIC CABLE 96 FIBERS, SINGLE MODE	FOOT	2,572			

DIRK RANNEBARGER, P.E.

LICENSED PROFESSIONAL ENGINEER

ILLINOIS NO. 062 058019 EXPIRES 11–30–19

F.A.I. 74 - SECTION 90(10D-1)BRR

PEORIA / TAZEWELL COUNTY

STATION 151+85

STRUCTURE NO. 090-0001

This seal applies to Decorative Lighting Sheets #100 to #158.

Farnsworth

GROUP
100 WALNUT ST., SUITE 200
PEORIA. ILLINOIS 61602
(300) 1880-1888 I Julipubly uron

USER NAME = rtarntlino	DESIGNED -	DAR	REVISED
	CHECKED -	JDA	REVISED
PLOT SCALE = 24:0 ':" / ft.	DRAWN -	RJT	REVISED
PLOT DATE = 09/06/19	CHECKED -	JJO	REVISED

STATE OF ILLINOIS
DEPARTMENT OF TRANSPORTATION

DECORATIVE LIGHTING SHEET INDEX AND GENERAL NOTES
MURRAY BAKER BRIDGE OVER ILLINOIS RIVER

SHEET 1 OF 1 SHEETS

F.A. I. RTE.	SECTION		COUNTY	TOTAL SHEETS	SHEE NO.
74	90(10D-1)BRR		**	329	100
			CONTRACT	NO. 6	8C89
ILLINOIS FED AID PROJECT					