

**CONTROLLER CABINETS** 

65" (SEE NOTE 4) (1651mm) 49" (SEE NOTE 3) (1245mm) SEE NOTE 5-44" 16" (406mm) 2" x 6" (51mm x 152mm) WOOD FRAMING (TYP.) TRAFFIC SIGNAL -CONTROLLER CABINET CABINET ¾" (19mm) TREATED PHYWOOD DECK 2<u>" x 6" (51mm x 152mm)</u> TREATED WOOD NOTES: TREATED WOOD POSTS

- BASED ON CONTROLLER CABINET TYPE IV WITH BASE DIMENSIONS OF 26" x 44" (660mm x 1118mm).
   ADJUST PLATFORM SIZE TO FIT CABINET BASE DIMENSIONS BEING SUPPLIED
- BASED ON UNINTERRUPTIBLE POWER SUPPLY CABINET WITH BASE DIMENSIONS OF 16" x 25" (406mm x 635mm).
   ADJUST PLATFORM SIZE TO FIT CABINET BASE DIMENSIONS BEING SUPPLIED.
- $\ensuremath{\mathfrak{I}}_\bullet$  PLATFORM SIZE FOR CONTROLLER CABINET TYPE IV.
- 4. PLATFORM SIZE FOR CONTROLLER CABINET TYPE IV AND UNINTERRUPTIBLE POWER SUPPLY CABINET.
- 5. DRILLED HOLES THROUGH THE PLATFORM BASE TO MATCH THE CONTROLLER CABINET BOLT TEMPLATE. FASTEN THE CONTROLLER CABINET TO THE PLATFORM WITH CARRIAGE BOLTS, WASHERS AND NUTS.
- 6. FASTEN ALL SUPPORT WOOD FRAMING TO THE WOOD POSTS WITH 2 LAG SCREWS FOR EACH CONNECTION.

## TEMPORARY SIGNAL CONTROLLER **WOOD SUPPORT PLATFORM**

CABLE SLACK LENGTH	FEET	METER
HANDHOLE	6.5	2.0
DOUBLE HANDHOLE	13.0	4.0
SIGNAL POST	2.0	0.6
MAST ARM	2.0	0.6
CONTROLLER CABINET	1.5	0.5
FIBER OPTIC AT CABINET	13.0	4.0
ELECTRIC SERVICE AT (CABINET OR SERVICE LOCATION)	1.5	0.5
GROUND CABLE (SIGNAL POST, MAST ARM, CABINET)	1.5	0.5
GROUND CABLE (BETWEEN FRAME AND COVER)	5.0	1.6

VERTICAL CABLE LENGTH	FEET	METER
MAST ARM POLE ( MAST ARM MOUNTED SIGNAL HEAD)		
(L = MAST ARM LENGTH - DISTANCE TO SIGNAL HEAD FROM END OF ARM)	20.0+L	6.0+L
BRACKET MOUNTED (MAST ARM POLE OR SIGNAL POLE)	13.0	4.0
PEDESTRIAN PUSH BUTTON	6.0	2.0
SERVICE INSTALLATION POLE MOUNT TO SERVICE DROP	13.5	4.1
SERVICE INSTALLATION POLE MOUNT TO GROUND	13.5	4.1
SERVICE INSTALLATION GROUND MOUNT	6.0	2.0
FOUNDATION (SIGNAL POST, MAST ARM POLE, CONTROLLER CABINET, SERVICE-GROUND MOUNT)	3.0	1.0

### **VERTICAL CABLE LENGTH**

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FOUNDATION	DEPTH
TYPE A - Signal Post	4'-0" (1.2m)
TYPE C - CONTROLLER W/ UPS	4'-0" (1.2m)
TYPE D - CONTROLLER	4'-0" (1.2m)
SERVICE INSTALLATION, GROUND MOUNT, TYPE A - SQUARE	4'-0" (1.2m)

## **DEPTH OF FOUNDATION**

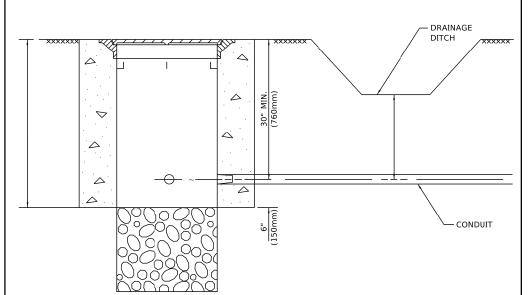
Mast Arm Length	① Foundation Depth	Foundation Diameter	Spiral Diameter	Quantity of Rebars	Size of Rebars
Less than 30′ (9.1 m)	10'-0" (3.0 m)	30" (750mm)	24" (600mm)	8	6(19)
Greater than or equal to	13'-6" (4.1 m)	30" (750mm)	24" (600mm)	8	6(19)
30' (9.1 m) and less than 40' (12.2 m)	11'-0'' (3.4 m)	36'' (900mm)	30" (750mm)	12	7(22)
Greater than or equal to 40' (12.2 m) and less than 50' (15.2 m)	13'-0'' (4.0 m)	36'' (900mm)	30'' (750mm)	12	7(22)
Greater than or equal to 50' (15.2 m) and up to 55' (16.8 m)	15'-0'' (4.6 m)	36'' (900mm)	30'' (750mm)	12	7(22)
Greater than or equal to 56' (16.8 m) and less than 65' (19.8 m)	21'-0'' (6.4 m)	42'' (1060mm)	36" (900mm)	16	8(25)
Greater than or equal to 65' (19.8 m) and up to 75' (22.9 m)	25'-0" (7.6 m)	42'' (1060mm)	36'' (900mm)	16	8(25)

### NOTES:

- 1. These foundation depths are for sites which have cohesive soils (clayey silt, sandy clay, etc.) along the length of the shaft, with an average Unconfined Compressive Strength (0u) > 1.0 tsf (100 kpa). This strength shall be verified by boring data prior to construction or with testing by the Engineer during foundation drilling. The Bureau of Bridges & structures should be contacted for a revised design if other conditions are encountered.
- 2. Combination mast arm assemblies under 55 feet (16.8 m) shall use 36" (900 mm) diameter foundations.
- 3. Combination mast arm assemblies under 56 feet (16.8 m) through 75 feet (22.9 m) shall use 42" (1060 mm) diameter foundations
- 4. For most arm assemblies with dual arms refer to state standard 878001..


## DEPTH OF MAST ARM FOUNDATIONS, TYPE E

USER NAME = footemj	DESIGNED -	REVISED -				DIS.	TRICT O	NF		F.A.U.	SECTION	COUNTY	TOTAL S	HEET
	DRAWN -	REVISED -	STATE OF ILLINOIS		OT 4 NID 4 D.D.				DETAILO	1349	16-00061-00-LS	соок	167	102
PLOT SCALE = 50.0000 ' / in.	CHECKED -	REVISED -	DEPARTMENT OF TRANSPORTATION	STANDARD TRAFFIC SIGNAL DESIGN DETAILS				TS-05	CONTRACT	NO. 61L	92			
PLOT DATE = 3/4/2019	DATE -	REVISED -		SCALE: NONE	SHEET 5	OF 7	SHEETS	STA.	TO STA.		ILLINOIS FED.	AID PROJECT		-




- 1. CONDUIT DEPTH SHALL BE A MINIMUM OF 30" (760mm) BELOW THE BOTTOM OF THE DRAINAGE DITCH OR ANY SLOPING GROUND
- 2. THE MINIMUM CONDUIT DEPTH APPLIES TO ALL CONDUIT PLACED UNDER ROADWAY PAVEMENT, MULTI-USE PATHS, SIDEWALKS AND SOIL SURFACES.
- 3. THE MINIMUM CONDUIT DEPTH APPLIES TO ALL HANDHOLES, HEAVY DUTY HANDHOLES AND DOUBLE HANDHOLES.

## HANDHOLE WITH MINIMUM CONDUIT DEPTH

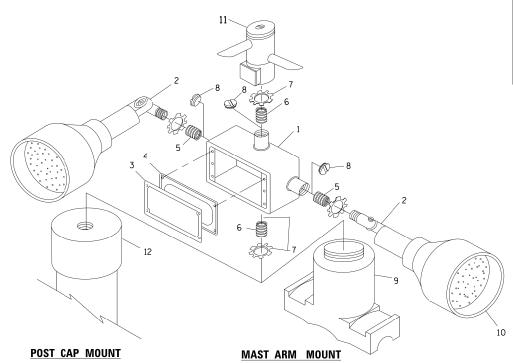

**EMERGENCY VEHICLE DETECTOR WITH CONFIRMATION BEACON MOUNTING DETAIL** 

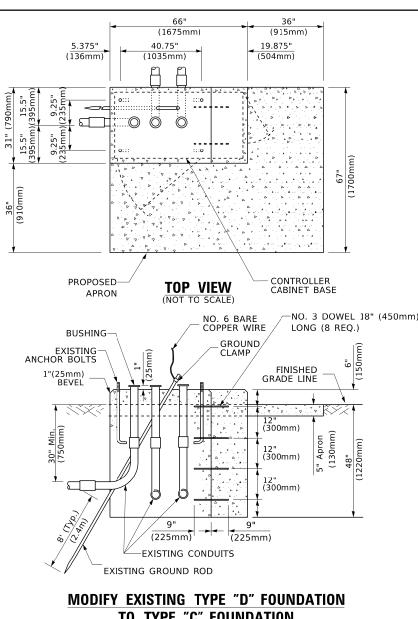DESIGNED JSER NAME = footem REVISED DRAWN REVISED CHECKED REVISED




# TO TYPE "C" FOUNDATION

(NOT TO SCALE)

## IDENTIFICATION 1 OUTLET BOX- GALV. 21 CU.IN. (0.000344 CU-M) 2 LAMP HOLDER AND COVER 3 OUTLET BOX COVER 4 RUBBER COVER GASKET ¾"(19 mm) CLOSE NIPPLE ¾"(19 mm) LOCKNUT 8 ¾"(19 mm) HOLE PLUG 9 SADDLE BRACKET - GALV. 10 6 WATT PAR 38 LED FLOOD LAMP DETECTOR UNIT 12 POST CAP [18 FT. (5.4 m) POST MIN.]

### NOTES:

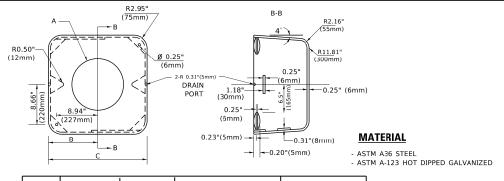
- 1. ALL ELECTRICAL ITEMS, EXCEPT ITEMS #2 AND #11 SHALL BE ALUMINUM OR
- 2. ITEM #1- OZ/GEDNEY FSX-1-50 OR EQUIVALENT ITEM #2- MULBERRY CON-O-SHADE LAMP SHIELD OR EQUIVALENT ITEM #9- "BAND-IT" SADDLE BRACKET OR EQUIVALENT
- 3. WHEN POST MOUNTING IS SPECIFIED, ITEM #9 SHALL NOT BE REQUIRED. THE DETECTION UNIT SHALL BE MOUNTED DIRECTLY ON TOP OF THE CAP BY DRILLING AND TAPPING A 3/4 "(19 mm) HOLE WITH PIPE THREADS. THE POST CAP SHALL EITHER BE SCREWED TO THE TOP OF THE POST OR A MINIMUM OF 3 TIGHTENING SCREWS SHALL BE REQUIRED ON EACH CAP.




А	АВ		HEIGHT	WEIGHT
VARIES 9.5"(241mm) 19'		19"(483mm)	7" (178mm) - 12" (300mm)	53 lbs (24kg)
VARIES	10.75"(273mm)	21.5"(546mm)	7" (178mm) - 12" (300mm)	68 lbs (31 kg)
VARIES	13.0"(330mm)	26"(660mm)	7" (178mm) - 12" (300mm)	81 lbs (37 kg)
VARIES	18.5"(470mm)	37"(940mm)	7" (178mm) - 12" (300mm)	126 lbs (57 kg)

### **SHROUD**

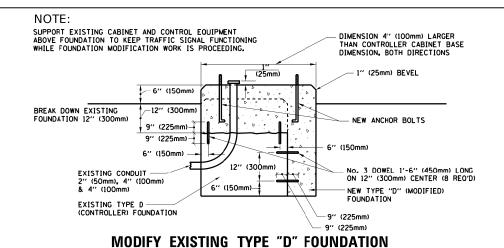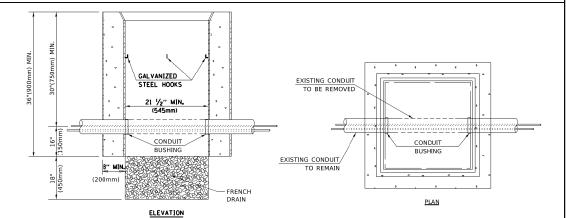- 1. DIMENSION "A" IS EQUAL TO THE DIAMETER OF THE MAST ARM POLE AT THE TOP OF THE SHROUD. THE SHROUD SHALL BE TIGHT TO THE MAST ARM POLE.
- 2. THE SUPPLIER SHALL VERIFIED THE ABOVE DIMENSIONS BASED ON MAST ARM REQUIREMENTS.
- 3. THE HEIGHT OF THE SHROUD SHALL COVER THE ANCHOR BOLTS, NUTS AND MAST ARM POLE BASE.






#### NOTES:

- 1. HANDHOLE CONSTRUCTED PER STATE STANDARD 814001.
- 2. REMOVAL OF THE EXISTING CONDUIT FROM THE HANDHOLE AND THE INSTALLATION OF THE CONDUIT BUSHINGS SHALL BE INCLUDED WITH THE COST OF THE HANDHOLE.

## HANDHOLE TO INTERCEPT EXISTING CONDUIT

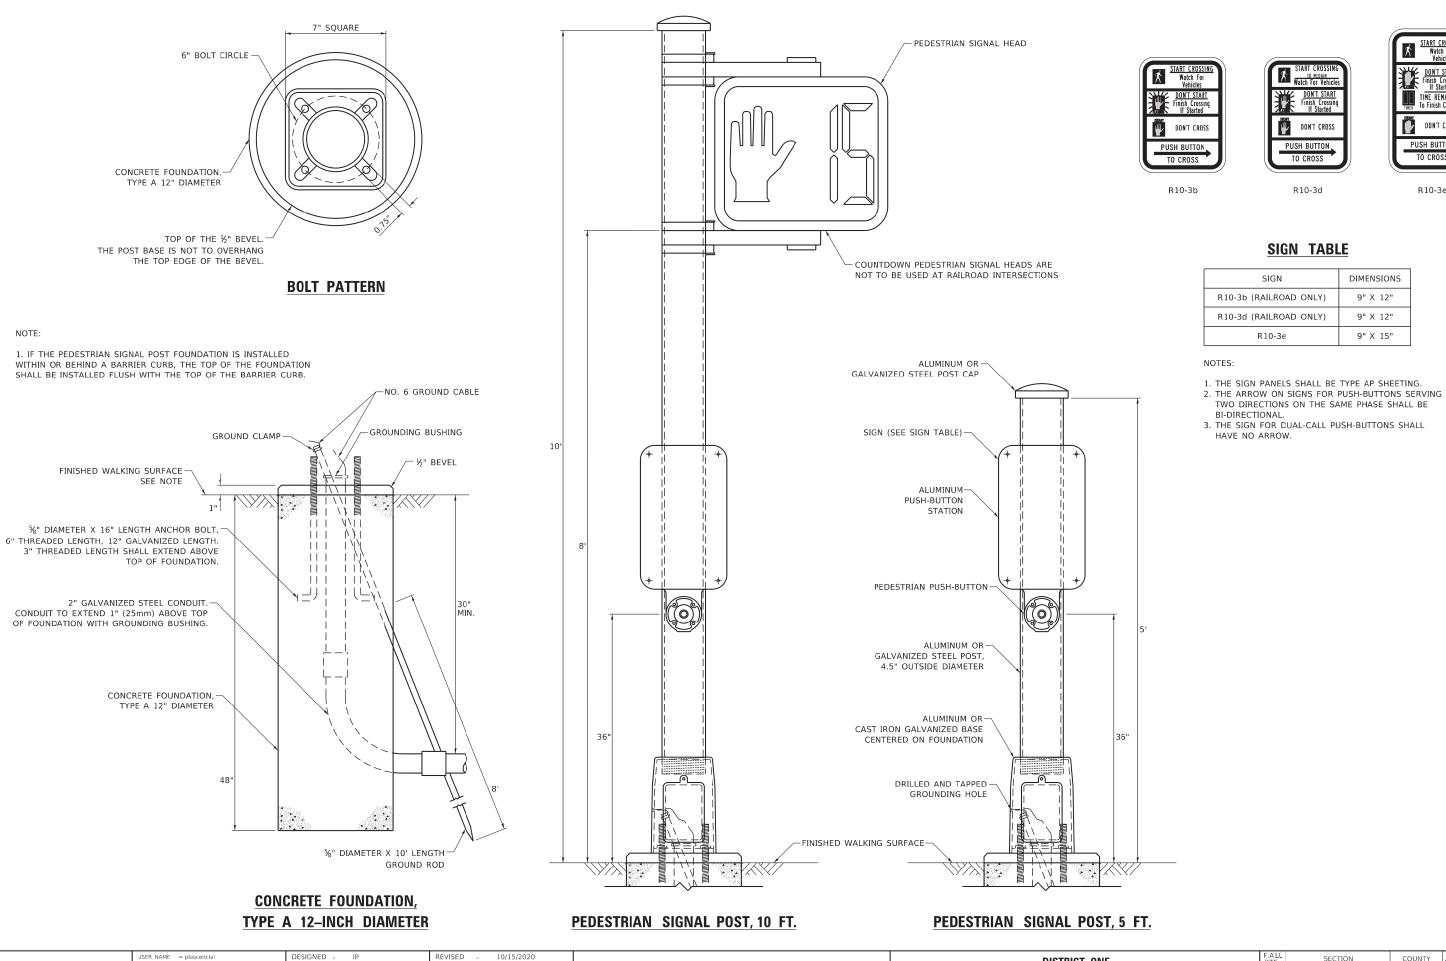	DISTRICT ONE						F.A.U. RTE.	SECTION	COUNTY	TOTAL SHEETS	SHEET NO.
STANDARD TRAFFIC SIGNAL D		I DECIGN	DETAILS	1349	16-00061-00-LS	COOK	167	103			
STANDARD TRAFFIC SIGNAL DESIGN DETAILS						TS-05	CONTRAC	Г NO. 61	L92		
SCALE: NO	NF	SHEET 6	OF 7	SHEETS	STA.	TO STA.		ILLINOIS FED	VID PROJECT		



JSER NAME = plascenciai	DESIGNED - IP	REVISED - 10/15/2020			DISTRICT ONE		F.A.U.	SECTION	COUNTY	TOTAL	SHEET		
	DRAWN - IP REVISED -		DRAWN - IP REVISED - STATE OF ILI		STATE OF ILLINOIS			ETAU O	1349	16-00061-00-LS	соок	167	104
PLOT SCALE = 100.0000 ' / in.	CHECKED - LP	REVISED -	DEPARTMENT OF TRANSPORTATION STANDARD TRAFFIC SIGNAL DESIGN DETAILS				TS-05	CONTRACT	T NO. 61	92			
PLOT DATE = 11/17/2020	DATE - 10/15/2018	REVISED -		SCALE: NTS	SHEET NO. 7 OF 7 SHEETS STA.	TO STA.		ILLINOIS FE	D. AID PROJECT				

TIME REMAINING To Finish Crossing

DON'T CROSS

PUSH BUTTON,

R10-3e

DON'T CROSS

PUSH BUTTON TO CROSS

R10-3d

SIGN TABLE

SIGN

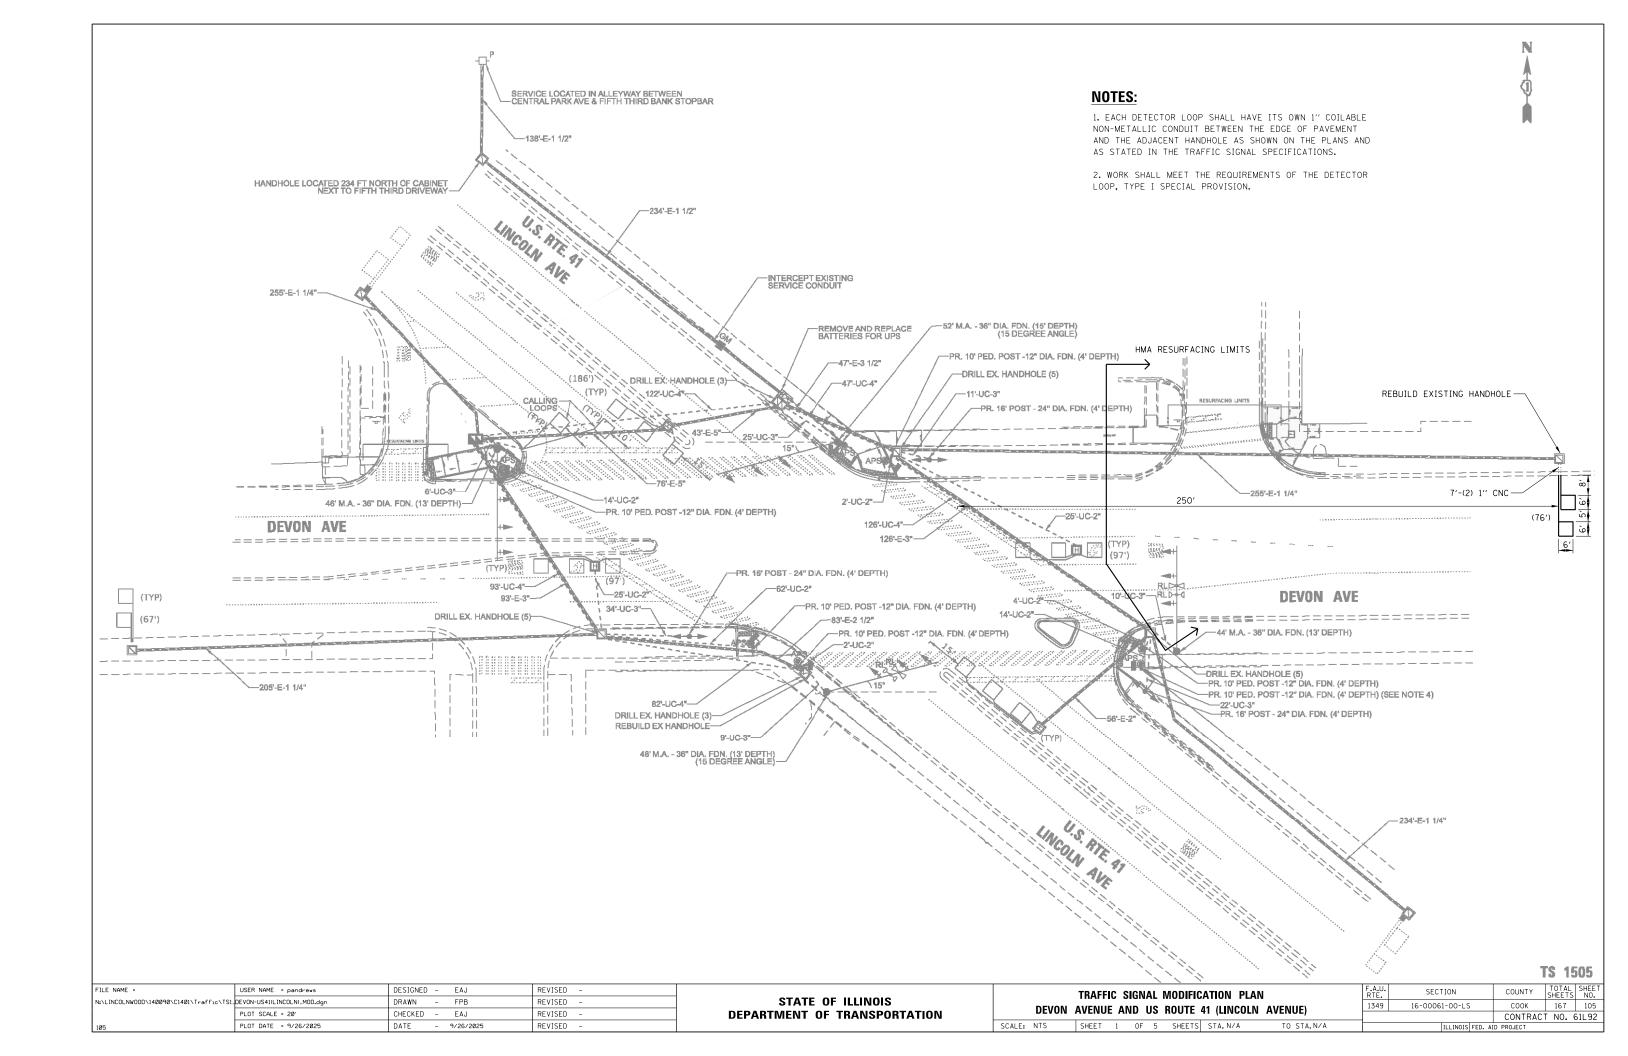
R10-3e

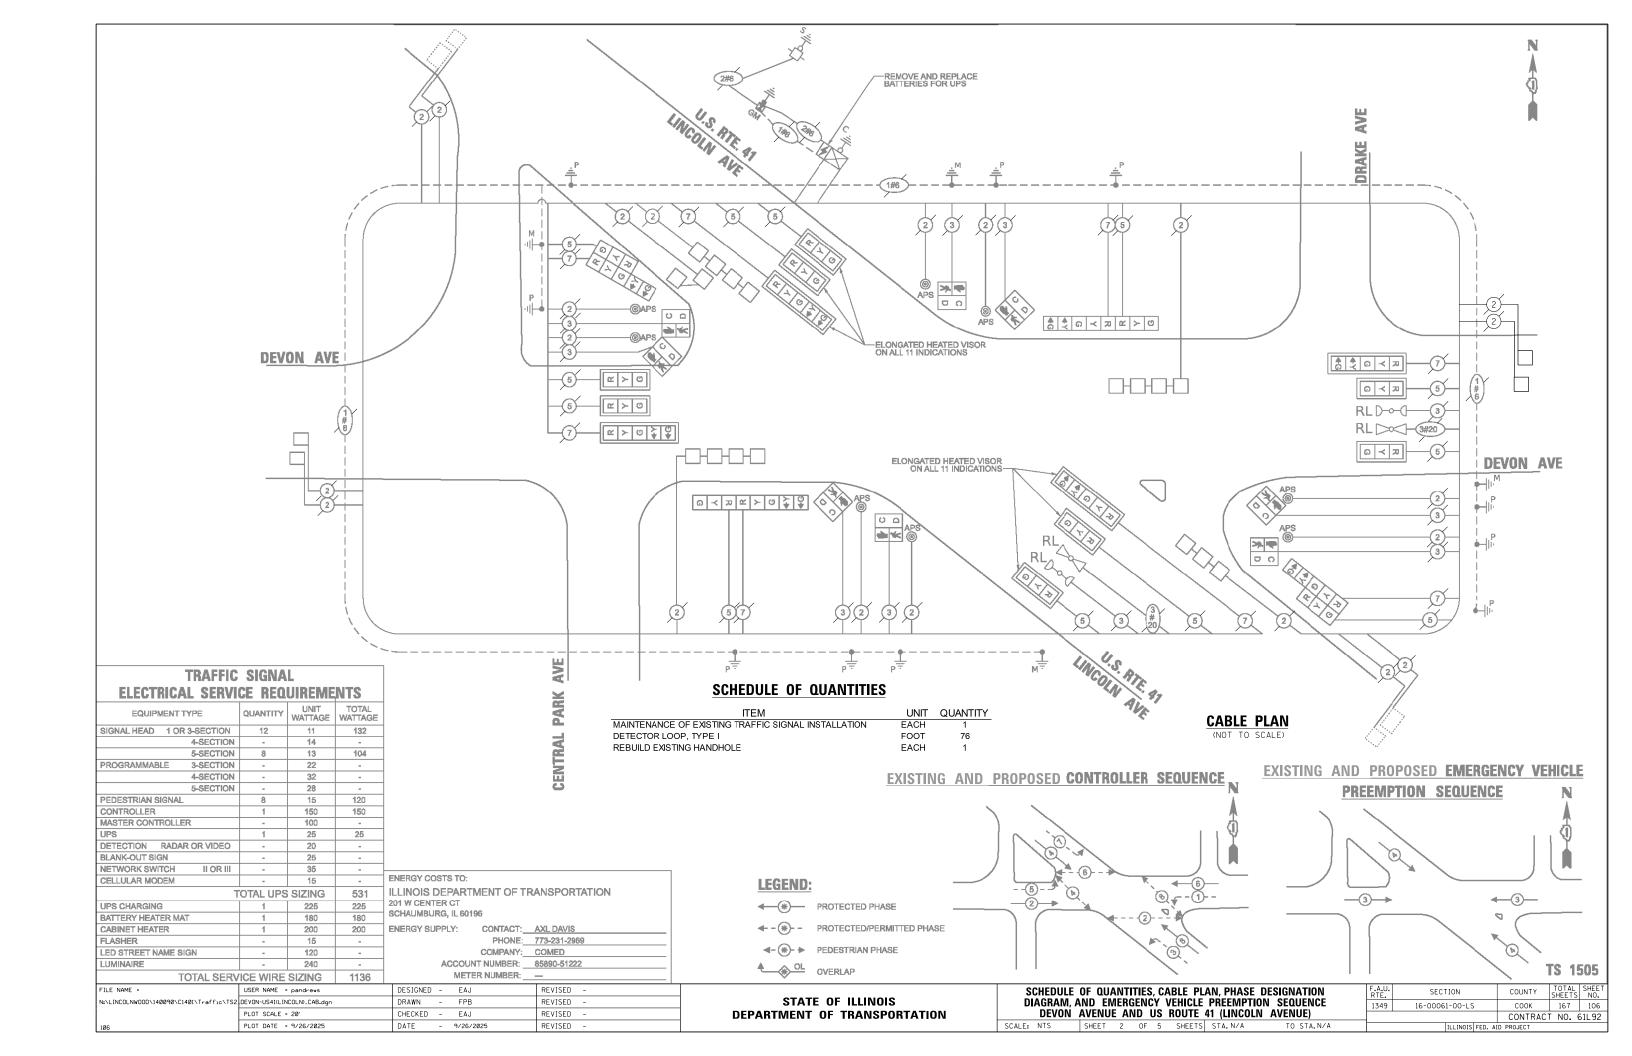
DIMENSIONS

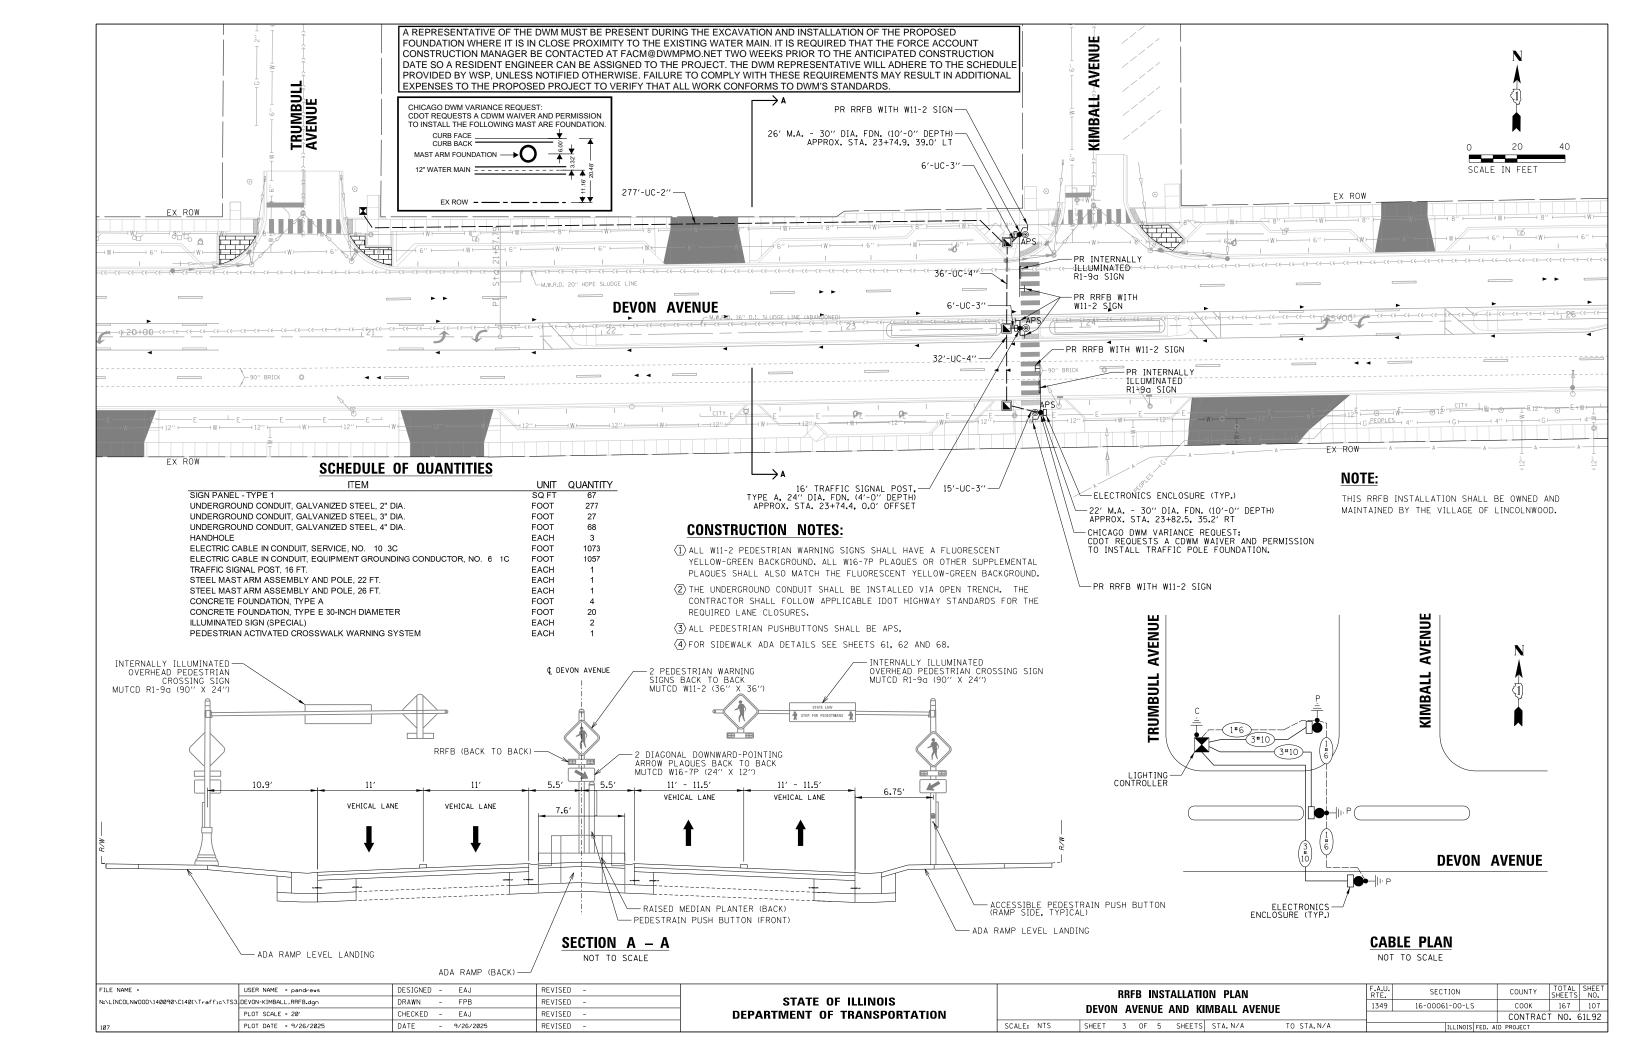
9" X 12"

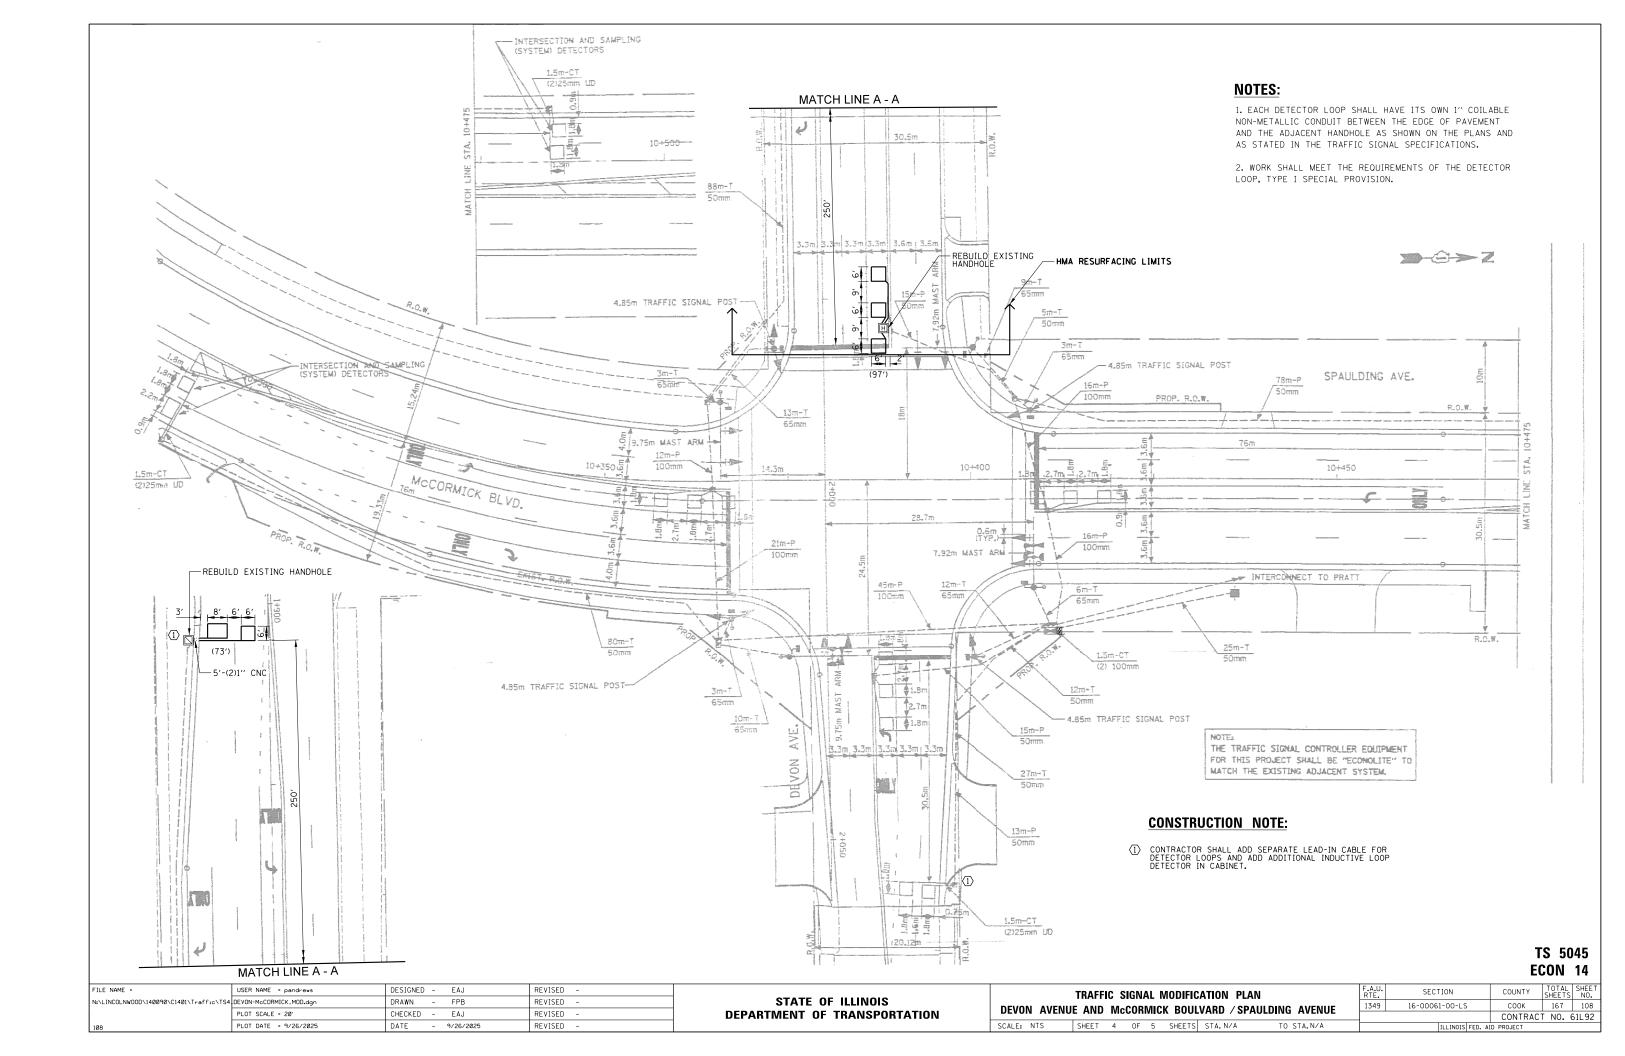
9" X 12"

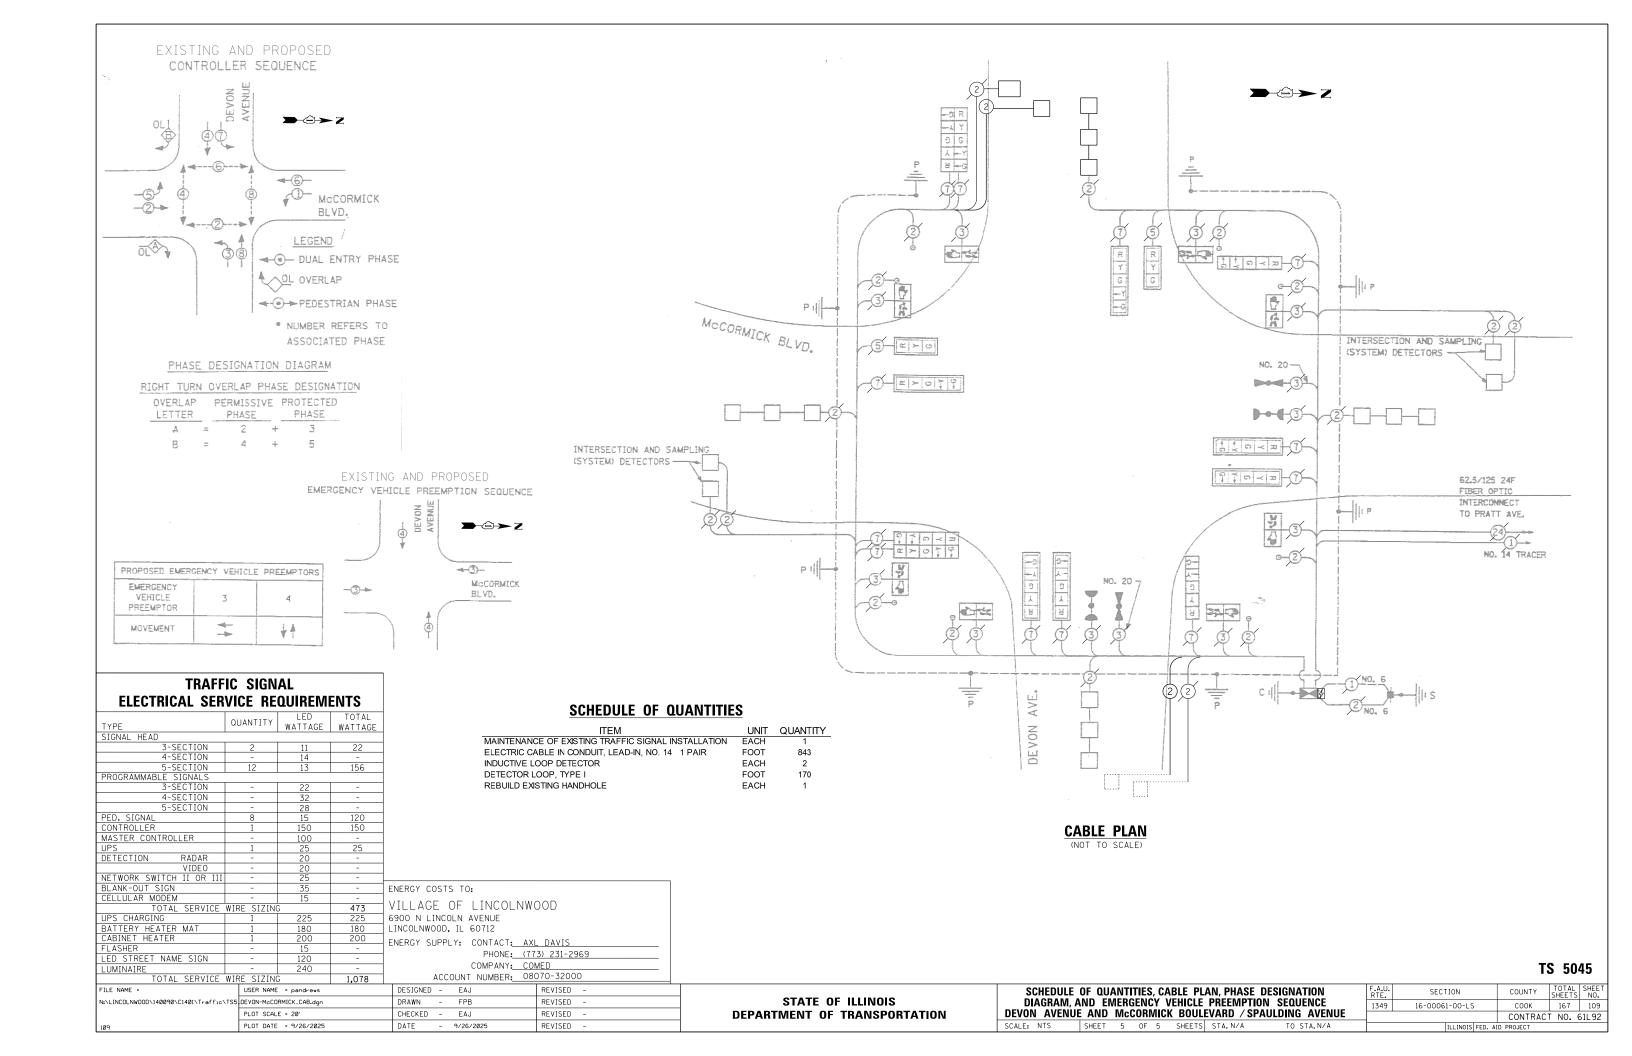
9" X 15"











# VILLAGE OF LINCOLNWOOD LIGHTING GENERAL NOTES

- 1. THE EXACT LOCATIONS OF ALL UTILITIES SHALL BE VERIFIED BY THE CONTRACTOR BEFORE THE INSTALLATION OF ANY EQUIPMENT. FOR THE LOCATIONS OF THE UTILITIES, CALL JULIE AT (800) 892-0123.
- BEFORE INSTALLING LIGHT STANDARDS NEAR OVERHEAD AND UNDERGROUND ELECTRIC UTILITIES, CONTRACTOR SHALL CALL COM ED FOR LOCATION APPROVAL AND MINIMUM CLEARANCE REQUIREMENTS.
- THE CONTRACTOR SHALL BE SOLELY RESPONSIBLE FOR JOB SITE SAFETY AS WELL AS SUPERVISION/ DIRECTION AND MEANS/METHODS OF CONSTRUCTION.
- 4. ALL WORK SHALL BE IN ACCORDANCE WITH THE LATEST EDITION OF THE FOLLOWING SPECIFICATIONS, WHICH ARE HEREBY MADE A PART HEREOF:
  - A. "STANDARD SPECIFICATIONS FOR ROAD AND BRIDGE CONSTRUCTION", AS PREPARED BY IDOT.
  - B. "THE NATIONAL ELECTRICAL CODE".
  - C. MUNICIPAL CODES & STANDARDS.
- 5. NO MATERIALS SHALL BE DELIVERED TO THE JOB SITE UNTIL ALL PERTINENT EQUIPMENT SUBMITTALS HAVE BEEN REVIEWED BY THE ENGINEER.
- 6. ALL UNDERGROUND CONDUITS SHALL BE INSTALLED BY DIRECTIONAL BORING METHOD. SOME LOCATIONS MAY REQUIRE TRENCHING AND/OR HAND DIGGING. CONTRACTOR SHALL PROVIDE PRIOR NOTICE TO ENGINEER BEFORE TRENCHING
- ALL UNDERGROUND WIRING SHALL BE XLP TYPE-USE, 600 VOLTS, BURIED A MINIMUM 30 INCHES BELOW FINISHED GRADE, FOLLOWING THE ROADWAY OR SIDEWALK FOGE.
- 8. NO POLES SHALL BE ERECTED UNTIL THE RESPECTIVE FOUNDATIONS HAVE CURED, (IF APPLICABLE) AND HAVE BEEN REVIEWED BY THE ENGINEER.
- TO MAINTAIN THE STRUCTURAL INTEGRITY OF LIGHT POLES WITH MAST ARMS, THEY SHALL NOT BE ERECTED AND LEFT TO STAND WITHOUT LUMINAIRES.
- 10. ALL POLE HANDHOLES SHALL FACE AWAY FROM TRAFFIC.
- 11. THE CONTRACTOR SHALL BE RESPONSIBLE FOR THE ESTABLISHMENT OF THE TOP OF FOUNDATION ELEVATION WITH THE FINISHED GRADE.
- 12. THE CONTRACTOR SHALL STAKE ALL POLE LOCATIONS PRIOR TO REQUESTING A JULIE UTILITY LOCATE. ONCE ALL LOCATIONS ARE STAKED CONTRACTOR SHALL SET UP A MEETING WITH THE VILLAGE AND ENGINEER FOR POLE LOCATION APPROVAL.
- 13. THE ELECTRICAL CONTRACTOR SHALL FURNISH TWO SETS OF FULL SIZE RECORD DRAWINGS TO THE ENGINEER UPON COMPLETION OF THE LIGHTING AND ELECTRICAL IMPROVEMENTS. THE DRAWINGS SHALL SHOW THE INSTALLED LOCATIONS OF ALL LIGHT POLES, UNDERGROUND CONDUITS/WIRING, HANDHOLES, JUNCTION BOXES & CONTROLLER CABINETS. THE DRAWINGS WILL BE REVIEWED BY THE ENGINEER.
- 14. UPON COMPLETION OF THE PROPOSED LIGHTING IMPROVEMENTS, THE CONTRACTOR SHALL PERFORM ELECTRICAL TESTING AND VERIFY THAT THE INSTALLATION COMPLIES WITH THE LATEST EDITION OF THE STANDARD SPECIFICATIONS FOR ROAD AND BRIDGE CONSTRUCTION IN ILLINOIS.
- 15. THE CONTRACTOR SHALL BE RESPONSIBLE FOR TIMELY NOTIFICATION AND ALL COORDINATION WITH COM ED FOR NEW ELECTRIC SERVICE TO THE PROPOSED LIGHTING CONTROLLER.
- 16. THE CONTRACTOR SHALL LABEL ALL WIRES WITH WIRE MARKERS INDICATING THE CIRCUIT ID IN EVERY CONTROLLER, POLE BASE, HAND HOLE AND SPLICE/CONNECTION POINT. WIRE MARKERS SHALL BE WHITE NYLON WITH INTEGRAL MECHANICAL FASTENER WITH MINIMUM 34" X 1" WRITEABLE AREA.
- 17. THE LIGHT POLE LOCATIONS SHALL COMPLY WITH THE MINIMUM CLEAR WIDTH FOR ADA REQUIREMENTS FOR CLEAR WIDTH OF SIDEWALK, AND SHALL COMPLY WITH BDE CHAPTER 17-4.04 AND PROWAG R301.3.1.
- 18. THE CONTRACTOR SHALL USE A STANDARD FOUNDATION WHENEVER POSSIBLE. WHEN UTILITY CONFLICT PROHIBITS USE OF STANDARD FOUNDATION THE CONTRACTOR MAY USE AN OFFSET FOUNDATION AT THE DIRECTION OF THE ENGINEER.

## **ABBREVIATIONS**

Α	AMPS	HH	HAND HOLE
BOC	BACK OF CURB	HPS	HIGH PRESSURE SODIUM
CKT	CIRCUIT	PVC	POLYVINYL CHLORIDE
DIA	DIAMETER	RGS	RIGID GALVANIZED STEEL
FT	FOOT	ROW	RIGHT OF WAY
FOC	FACE OF CURB	STA	STATION
GND	GROUND	٧	VOLTS
HD	HEAVY DUTY	W	WATTS
HDPE	HIGH DENSITY POLYETHYLENE		

## CITY OF CHICAGO LIGHTING GENERAL NOTES

- CONTRACTOR SHALL BE RESPONSIBLE FOR OBTAINING A PERMIT FROM THE CITY OF CHICAGO BEFORE THE START OF WORK, ANY COST FOR THE PERMIT SHALL BE INCLUDED IN THE COST OF THE OVERALL CONTRACT.
- 2. PRIOR TO PERFORMING ANY ELECTRICAL WORK THE CONTRACTOR SHALL REQUEST AN INSPECTION AND MAINTENANCE TRANSFER OF THE EXISTING LIGHTING SYSTEM, A MINIMUM OF 5 DAYS, FROM THE CITY OF CHICAGO INSPECTION SERVICES. CONTACT MR. HENRY YAU AT (312) 744-3600.
- . THE EXACT LOCATIONS OF ALL UTILITIES SHALL BE VERIFIED BY THE CONTRACTOR BEFORE THE INSTALLATION OF ANY EQUIPMENT. FOR THE LOCATIONS OF THE UTILITIES, CALL CHICAGO UTILITY ALERT NETWORK (CUAN) AT (312) 744-7000 AND CITY OF CHICAGO OFFICE OF UNDERGROUND COORDINATION.
- 4. BEFORE INSTALLING LIGHT STANDARDS NEAR OVERHEAD UTILITIES CALL COM ED FOR LOCATION APPROVAL.
- 5. THE WORK PERFORMED UNDER THIS CONTRACT SHALL IN NO WAY INTERFERE WITH THE NORMAL OPERATION OF ANY EXISTING UTILITY SERVICE. THE CONTRACTOR SHALL FURNISH ALL NECESSARY ITEMS OF EQUIPMENT REQUIRED TO MAINTAIN SUCH NORMAL OPERATION AT NO ADDITIONAL COST TO THE OWNER. THE COST ASSOCIATED FOR THIS WORK SHALL BE INCLUDED IN THE COST OF THE CONTRACT, AND NO ADDITIONAL COMPENSATION SHALL BE AWARDED.
- 6. ALL DISTURBED AREAS WHERE RESTORATION IS NOT COVERED BY THE CONTRACT DRAWINGS AND/OR APPLICABLE SECTIONS OF THE SPECIAL PROVISIONS MUST BE RESTORED TO THE SATISFACTION OF THE INSPECTOR AND/OR ENGINEER. THIS WORK SHALL BE INCLUDED IN THE COST OF THE CONTRACT. SEPARATE PAYMENT WILL NOT BE MADE.
- 7. THE CONTRACTOR SHALL BE SOLELY RESPONSIBLE FOR JOB SITE SAFETY AS WELL AS SUPERVISION/DIRECTION AND MEANS/METHODS OF CONSTRUCTION.
- 8. ALL WORK SHALL BE IN ACCORDANCE WITH THE LATEST EDITION OF THE FOLLOWING SPECIFICATIONS, WHICH ARE HEREBY MADE A PART HEREOF:
  - A. STANDARD SPECIFICATIONS FOR ROAD AND BRIDGE CONSTRUCTION IN ILLINOIS, AS PREPARED BY IDOT (HEREWITH REFERRED TO AS THE STANDARD SPECIFICATIONS)
  - B. THE NATIONAL ELECTRIC CODE
  - C. MUNICIPAL CODE AND STANDARDS
  - D. THE CHICAGO ELECTRICAL CODE
  - E. COM ED STANDARDS AND REQUIREMENTS
  - F. CHICAGO DEPARTMENT OF TRANSPORTATION DIVISION OF ELECTRICAL OPERATIONS (DEO) STANDARD DRAWINGS AND SPECIFICATIONS.
- 9. THE CONTRACT DRAWINGS AND SPECIFICATIONS ARE NOT INTENDED TO SHOW ALL DETAILS OF WORK TO BE PERFORMED OR EQUIPMENT TO BE SUPPLIED. THE INTENT OF THE CONTRACT DRAWINGS AND SPECIFICATIONS IS TO ILLUSTRATE THE CONCEPTUAL DESIGN AND LAYOUT. THE CONTRACTOR SHALL BE KNOWLEDGEABLE AND REGULARLY ENGAGED IN THE TYPE OF WORK DESCRIBED BY THESE CONTRACT DRAWINGS AND SPECIFICATIONS AND SHALL BE RESPONSIBLE FOR UNDERSTANDING THEIR INTENT. ANY WORK TO BE PERFORMED OR ITEM OF EQUIPMENT TO BE SUPPLIED WHICH IS NOT SPECIFICALLY CALLED FOR BY THESE CONTRACT DRAWINGS AND SPECIFICATIONS, BUT WHICH IS NECESSARY TO PROVIDE A COMPLETE AND SUCCESSFUL WORKING SYSTEM SHALL BE INCLUDED IN THE CONTRACTOR'S SCOPE OF WORK AT NO ADDITIONAL COST TO THE OWNER.
- 10. NO MATERIALS SHALL BE DELIVERED TO THE JOB SITE UNTIL ALL PERTINENT EQUIPMENT SUBMITTALS HAVE BEEN REVIEWED AND APPROVED BY THE ENGINEER AND CHICAGO DEPARTMENT, DIVISION OF ENGINEERING, ELECTRICAL SECTION.
- 11. IT IS THE CONTRACTOR'S RESPONSIBILITY FOR TIMELY NOTIFICATION AND COORDINATION WITH COM ED, OFFICE OF PUBLIC SAFETY AND ADMINISTRATION, CDOT AND IDOT (AS REQUIRED).
- 12. THE CONTRACTOR SHALL LABEL ALL WIRES WITH WIRE MARKERS INDICATING THE CIRCUIT ID IN EVERY CONTROLLER, POLE BASE, HAND HOLE AND SPLICE/CONNECTION POINT. WIRE MARKERS SHALL BE MECHANICALLY FASTENED, WHITE PLASTIC OR NYLON, WITH A WRITE-ON AREA TO INDICATE CIRCUIT IDS.
- 13. CONDUITS INSTALLED IN TRENCH SHALL AVOID CONFLICTS WITH EXISTING AND PROPOSED UTILITIES. IF THE CONTRACTOR MUST INCREASE THE TRENCH DEPTH TO AVOID CONFLICTS, THIS WORK SHALL BE INCLUDED IN THE COST OF THE CONDUIT. IN THE EVENT A TRENCH CANNOT BE EXCAVATED TO A MINIMUM DEPTH OF 30 INCHES THE CONTRACTOR MUST NOTIFY THE OWNER'S REPRESENTATIVE AND AWAIT WRITTEN DIRECTION ON HOW TO PROCEED.
- 14. THE QUANTITIES OF CONDUIT AND WIRING INDICATED ON THE DRAWINGS ARE APPROXIMATIONS. THE CONTRACTOR SHALL FIELD VERIFY ALL LENGTHS OF PROPOSED CONDUIT AND WIRING.
- 15. THE CONTRACTOR SHALL BE RESPONSIBLE FOR THE ESTABLISHMENT OF THE TOP OF FOUNDATION ELEVATION WITH THE FINISHED GRADE.
- 16. THE LIGHT POLE LOCATIONS SHALL COMPLY WITH THE MINIMUM CLEAR WIDTH FOR AN ACCESSIBLE ROUTE FOR SIDEWALKS PER CURRENT AMERICAN WITH DISABILITIES ACT (ADA) REQUIREMENTS.
- 17. CONTRACTOR SHALL USE A STANDARD METAL HELIX FOUNDATION WHEREVER POSSIBLE. IF UTILITY CONFLICTS PROHIBIT THE USE OF A METAL HELIX FOUNDATION, THE CONTRACTOR SHALL CONSULT WITH INSPECTOR AND ENGINEER PRIOR TO THE USE OF AN OFFSET FOUNDATION.
- 18. CONTRACTOR SHALL REMOVE ANY DEBRIS AND WATER LOCATED WITHIN EXISTING HAND HOLES AND MANHOLES PRIOR TO DRILLING/CORING STRUCTURE. EXISTING CABLES SHALL BE GROUPED, LABELED AND COILED ON EXISTING CABLE HOOKS. CONTRACTOR SHALL FURNISH AND INSTALL NEW CABLE RACKS AND HOOKS AS REQUIRED TO FACILITATE NEW CABLE INSTALLATION, WHICH SHALL BE INCLUDED IN THE COST OF THE CABLE.
- 19. THE CONTRACTOR SHALL REFER TO THE TRAFFIC SIGNAL DRAWINGS FOR TRAFFIC SIGNAL AND CONTROL WORK AFFECTED BY PROPOSED STREET LIGHTING IMPROVEMENTS.
- 20. TO MAINTAIN THE STRUCTURAL INTEGRITY OF LIGHT POLES, THEY SHALL NOT BE ERECTED AND LEFT TO STAND WITHOUT LUMINAIRES.
- 21. IT SHALL BE THE CONTRACTOR'S RESPONSIBILITY TO MARK THE PROPOSED LOCATIONS OF ALL LIGHT POLES, CONTROLLERS AND HANDHOLES/MANHOLES FOR EXAMINATION BY THE INSPECTOR AND ENGINEER. THE CONTRACTOR SHALL VERIFY ALL UTILITIES SHALL BE LOCATED PRIOR TO MARKING PROPOSED LIGHTING EQUIPMENT LOCATIONS.
- 22. THE ELECTRICAL CONTRACTOR SHALL FURNISH TWO FULL SIZE SETS OF RECORD DRAWINGS TO THE ENGINEER UPON COMPLETION OF THE LIGHTING AND ELECTRICAL IMPROVEMENTS. ONE COPY SHALL BE PRINTED ON VELLUM AND SUBMITTED TO DEO. THE DRAWINGS SHALL SHOW THE INSTALLED LOCATION OF ALL LIGHT POLES, UNDERGROUND CONDUIT/WIRING, HANDHOLES AND CONTROL CABINETS. HAND DRAWINGS SHALL NOT BE ALLOWED. REVISIONS TO CONSTRUCTION DRAWINGS SHALL BE MADE IN CAD, OR SIMILAR PROGRAM, AND PLOTTED ON BOND/VELLUM PAPER. RECORD DRAWINGS SHALL BE REVIEWED BY THE ENGINEER.
- 23. UPON COMPLETION OF THE PROPOSED LIGHTING IMPROVEMENTS, THE CONTRACTOR SHALL PERFORM ELECTRICAL TESTING AND VERIFY THAT THE INSTALLATION COMPLIES WITH THE STANDARD SPECIFICATIONS AND CDOT REQUIREMENTS. ALL ELECTRICAL TESTING SHALL BE PERFORMED IN THE PRESENCE OF THE INSPECTOR, ENGINEER AND DEO.

## VILLAGE OF LINCOLNWOOD LIGHTING BILL OF MATERIALS

<b>V</b> I	LLAGE OF LINCOLINAAOOD LIGHTING DILL	UF IVIA	<b>LUIAL</b> 3
	DESCRIPTION	UNIT	QUANTITY
	ELECTRIC SERVICE INSTALLATION	EACH	1
	ELECTRIC UTILITY SERVICE CONNECTION	L SUM	1
	UNDERGROUND CONDUIT, GALVANIZED STEEL, 2" DIA.	FOOT	120
	UNDERGROUND CONDUIT, GALVANIZED STEEL, 2 1/2" DIA.	FOOT	195
	UNDERGROUND CONDUIT, COILABLE NONMETALLIC CONDUIT, 1 1/4" DIA.	FOOT	1785
	HANDHOLE, COMPOSITE CONCRETE	EACH	1
	ELECTRIC CABLE IN CONDUIT, 600V (XLP-TYPE USE) 1/C NO. 8	FOOT	13105
	ELECTRIC CABLE IN CONDUIT, 600V (XLP-TYPE USE) 1/C NO. 2	FOOT	400
	LIGHTING CONTROLLER, BASE MOUNTED, 240VOLT, 100AMP	EACH	1
	LIGHTING UNIT COMPLETE (SPECIAL)	EACH	10
	LIGHT POLE FOUNDATION, 24" DIAMETER, SPECIAL	FOOT	50
	LIGHT POLE FOUNDATION, 24" DIAMETER, OFFSET	FOOT	70

## CITY OF CHICAGO LIGHTING BILL OF MATERIALS

DESCRIPTION	UNIT	QUANTITY
UNDERGROUND CONDUIT, GALVANIZED STEEL, 3" DIA.	FOOT	30
UNDERGROUND CONDUIT, PVC, 2" DIA.	FOOT	1375
ELECTRIC CABLE IN CONDUIT, 600V (XLP-TYPE USE) 1/C NO. 2/0	FOOT	190
LIGHT POLE, ALUMINUM, 35 FT. M.H., 15 FT. DAVIT ARM	EACH	10
LIGHT POLE FOUNDATION METAL, 15" BOLT CIRCLE, 8 5/8" X 7'	EACH	7
REMOVAL OF POLE FOUNDATION	EACH	15
PVC CONDUIT IN TRENCH, 3" (SCHEDULE #40)	FOOT	35
PVC CONDUIT IN TRENCH, 2" (SCHEDULE 40)	FOOT	290
CABLE IN CONDUIT, TRIPLEX, 2-1/C NO. 6 AND 1-1/C NO. 8 GROUND	FOOT	1825
LUMINAIRE (SPECIAL)	EACH	10
LUMINAIRE, LED, SPECIAL	EACH	10
TRENCH AND BACKFILL WITH SCREENINGS	FOOT	1760
ELECTRIC SERVICE INSTALLATION (SPECIAL)	EACH	1
ELECTRICAL SERVICE CONNECTION	L SUM	1
HEAVY-DUTY HANDHOLE (SPECIAL)	EACH	1
LIGHTING CONTROLLER (SPECIAL)	EACH	1
LIGHTING CONTROLLER FOUNDATION	EACH	1
LIGHT POLE FOUNDATION (SPECIAL)	FOOT	48
MAINTENANCE OF STREET LIGHTING SYSTEM (CITY OF CHICAGO)	L SUM	1
REMOVE EXISTING LIGHTING SYSTEM	L SUM	1

#### CAUTION NOTICE TO CONTRACTOR

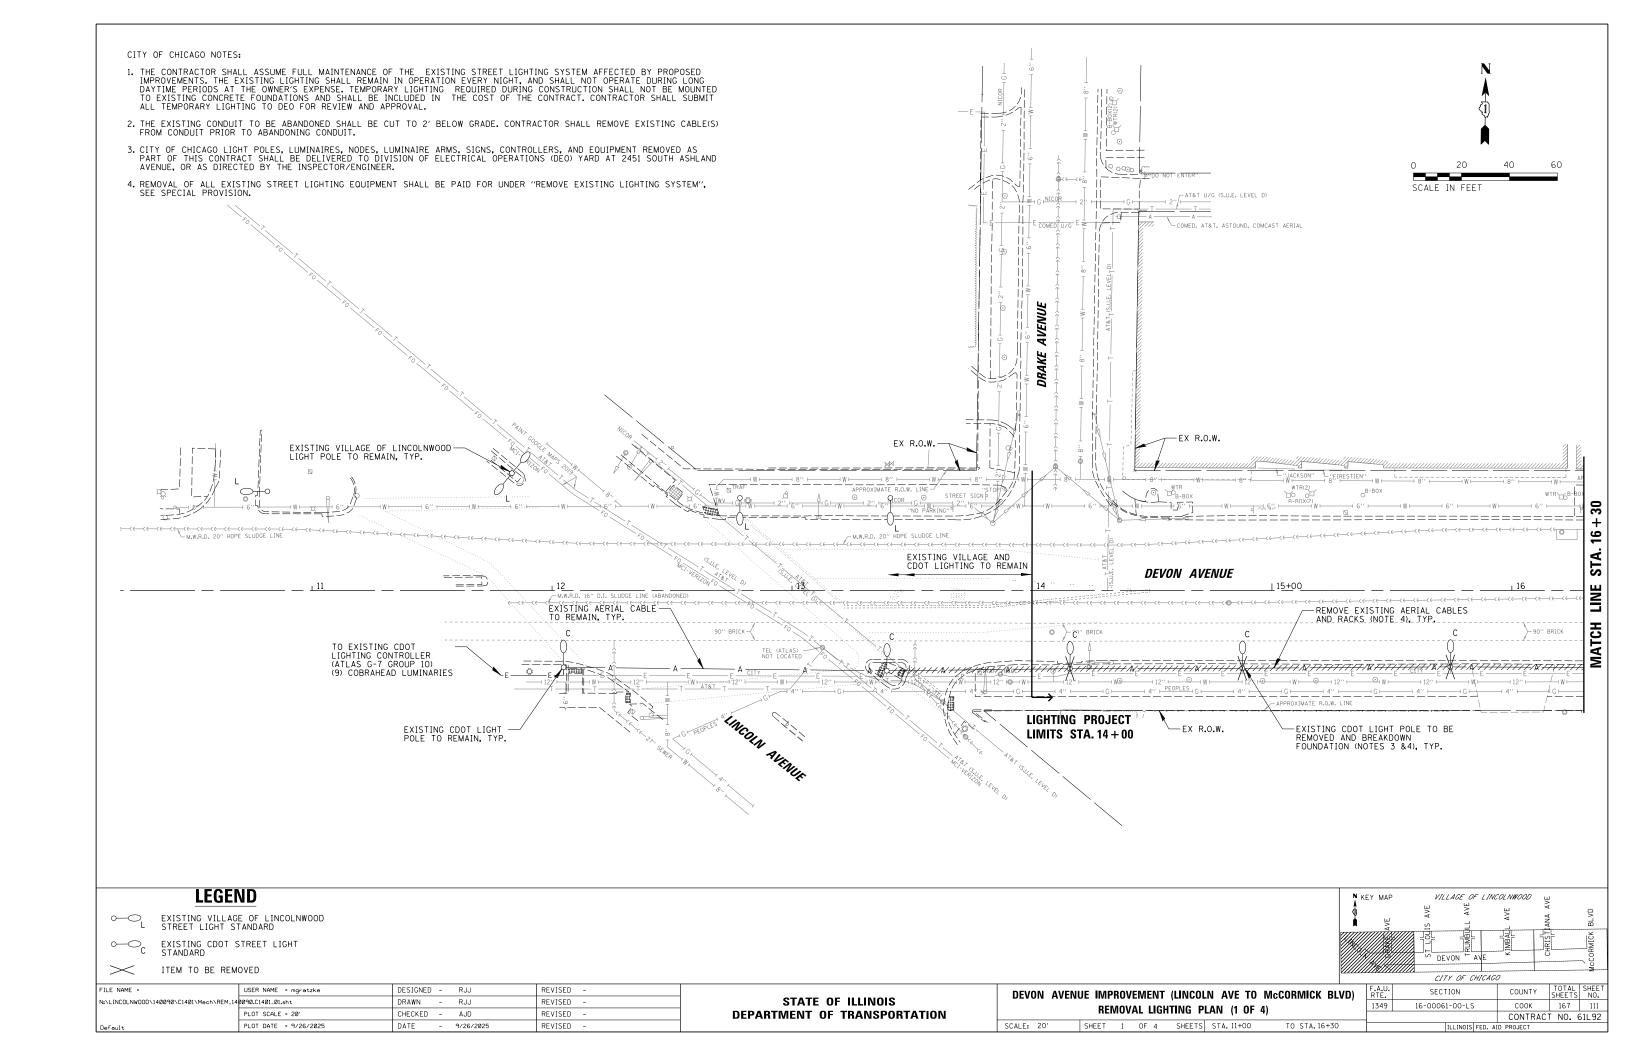
THE CONTRACTOR IS SPECIFICALLY CAUTIONED THE LOCATION

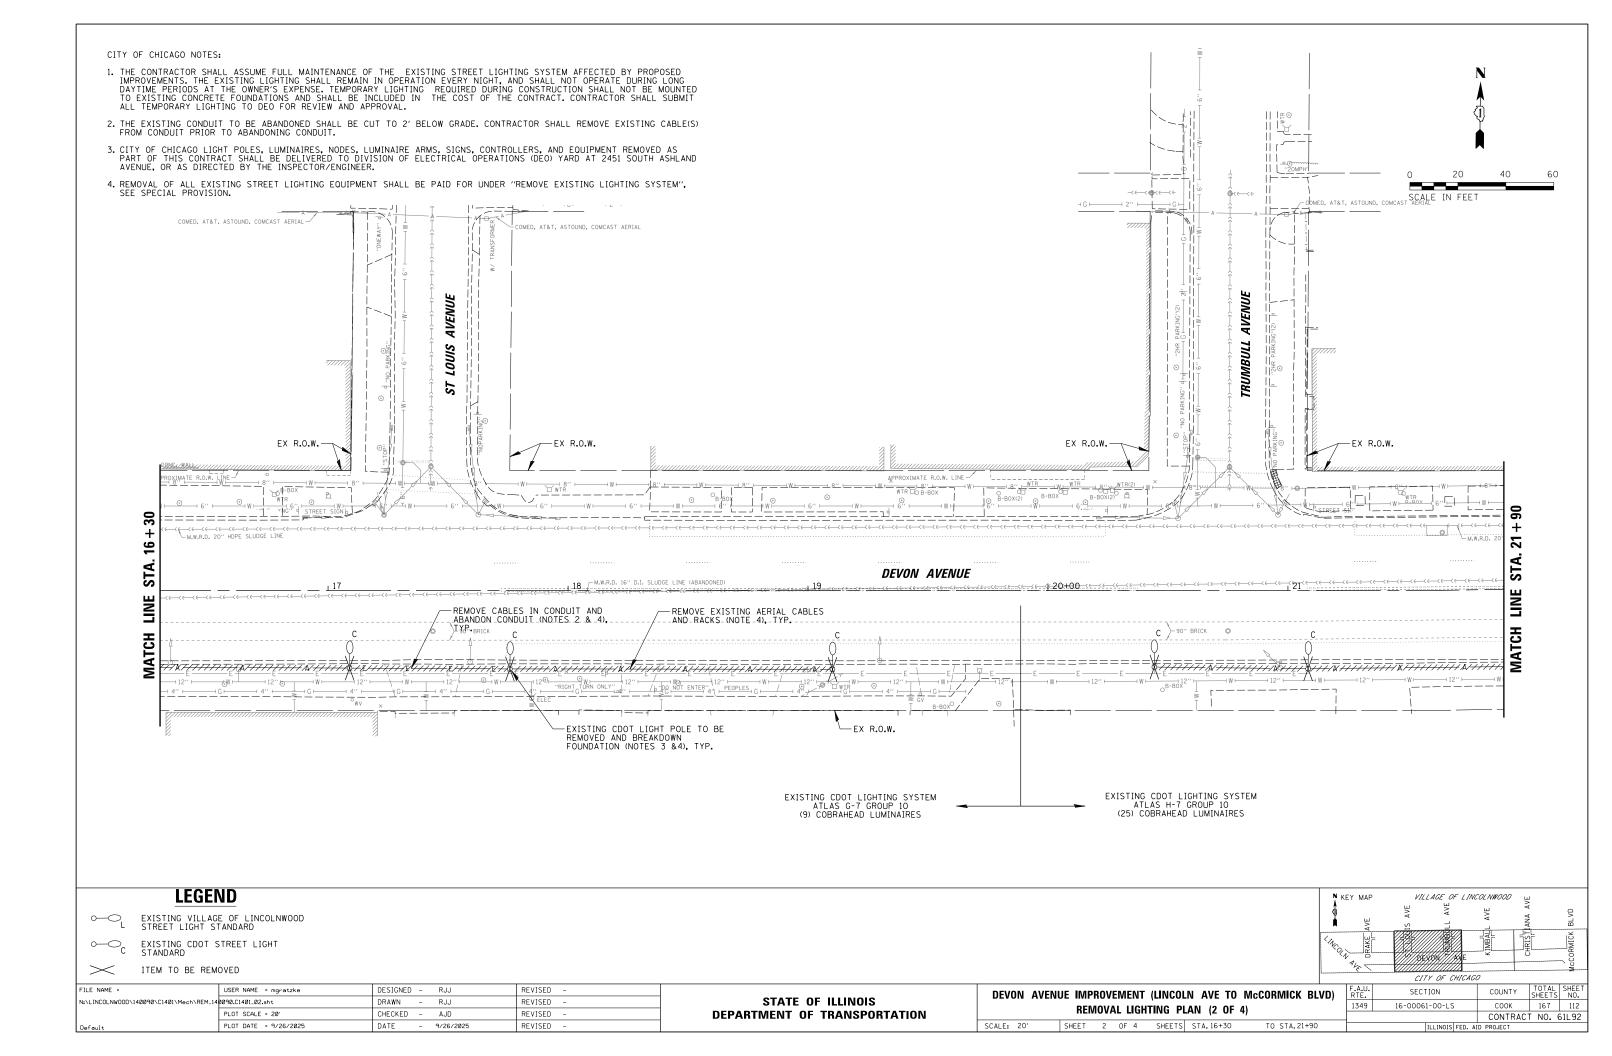
AND/OR ELEVATION OF EXISTING AND PROPOSED UTILITIES AS SHOWN ON
THESE PLANS. THE INFORMATION IS NOT TO BE RELIED ON AS
BEING EXACT OR COMPLETE. THE CONTRACTOR MUST CALL THE
LOCAL UTILITY LOCATION CENTER AT LEAST 72 HOURS BEFORE
ANY EXCAVATION TO REQUEST EXACT FIELD LOCATIONS OF
THE UTILITIES. IT SHALL BE THE RESPONSIBILITY OF THE
CONTRACTOR TO INFORM ENGINEER OF ANY EXISTING UTILITIES
WHICH CONFLICT WITH THE PROPOSED IMPROVEMENTS.

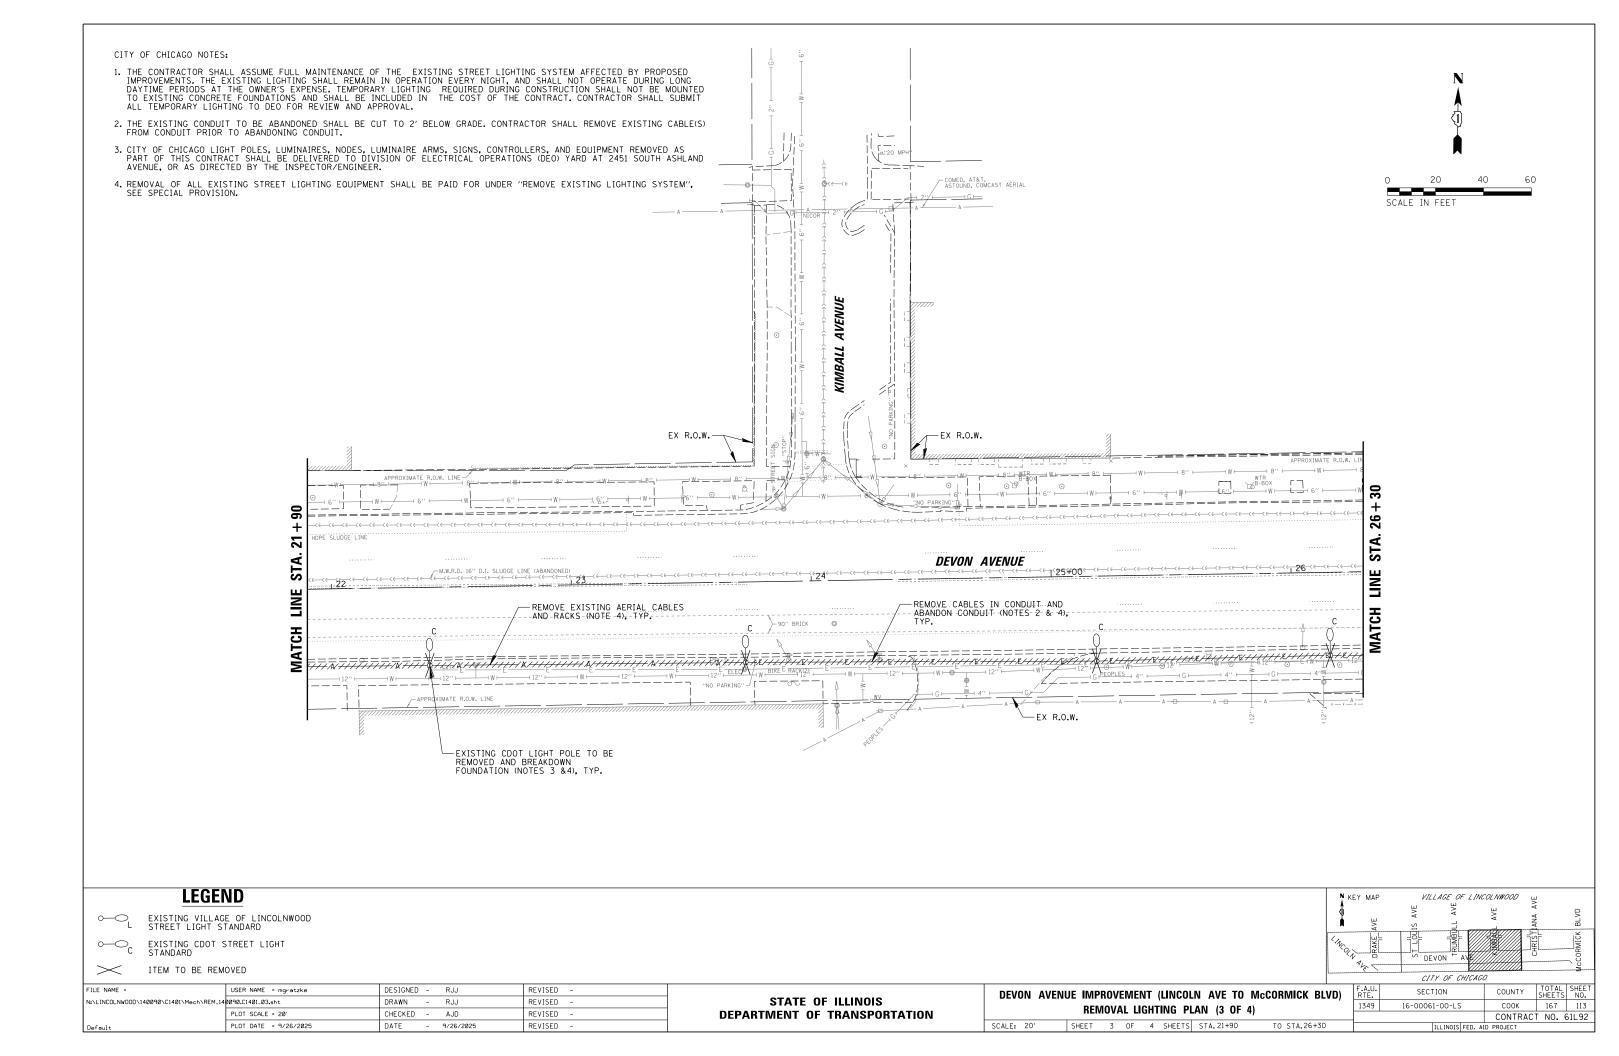
THE VILLAGE OF LINCOLNWOOD WILL OWN AND MAINTAIN THE PROPOSED LIGHTING ON THE NORTH SIDE OF DEVON AVENUE.

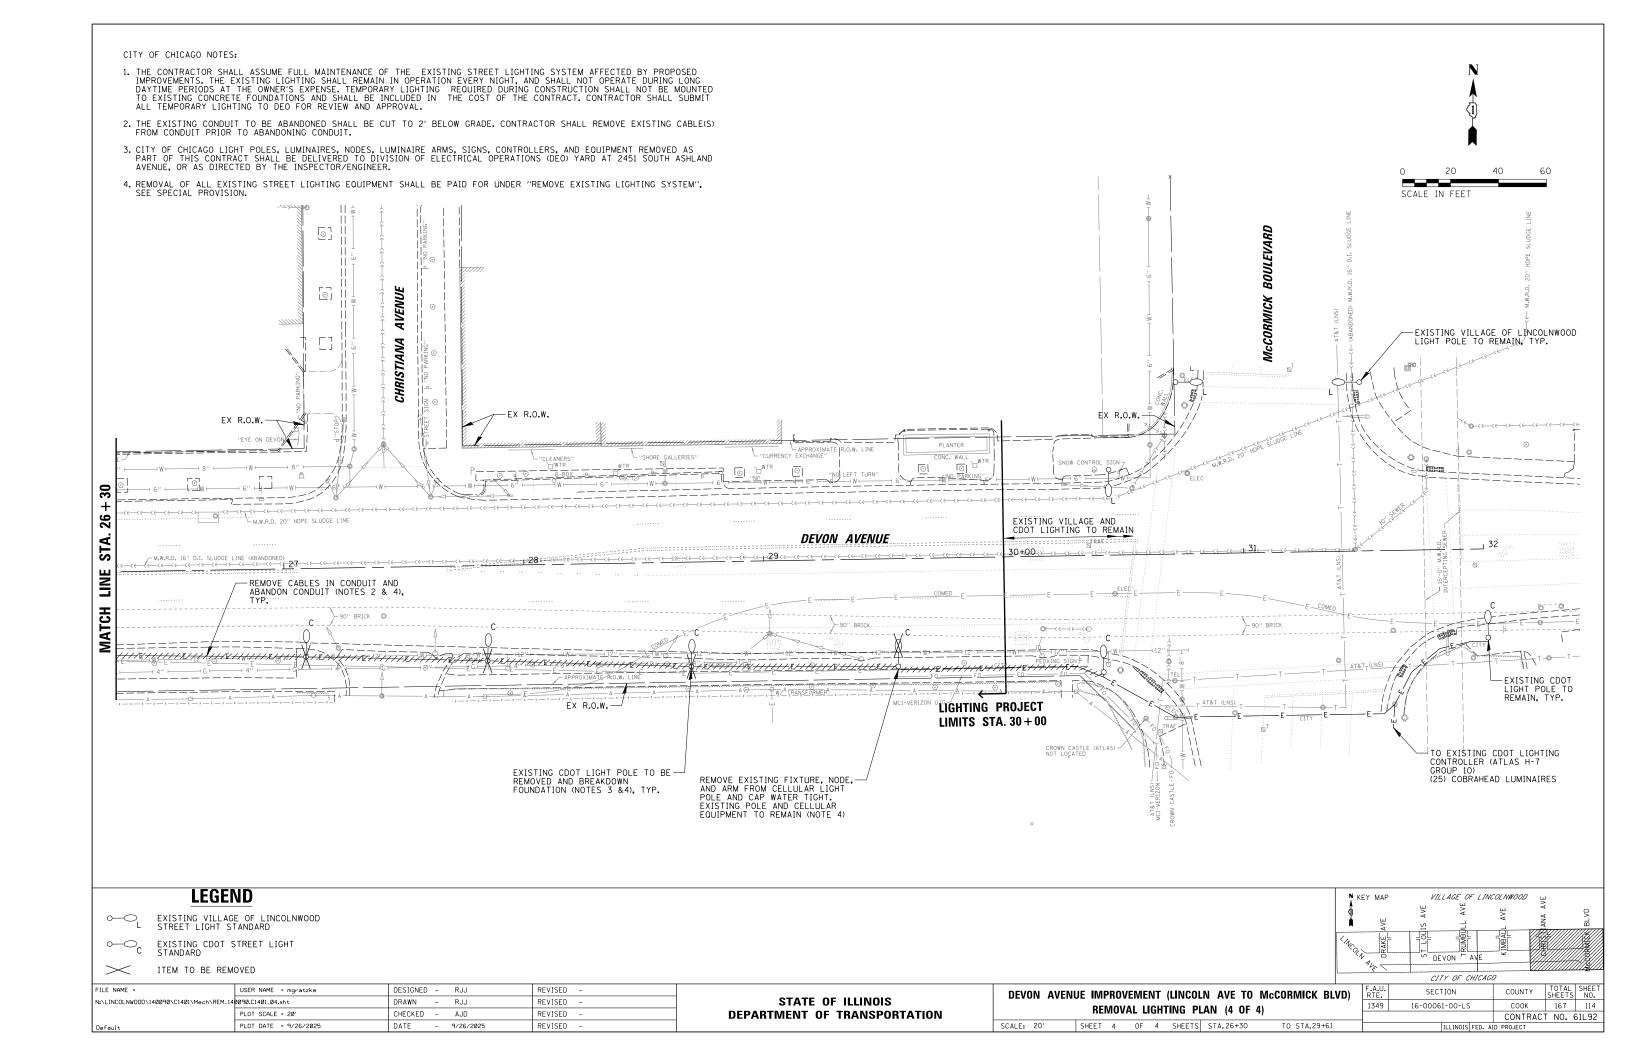
THE CITY OF CHICAGO WILL OWN AND MAINTAIN THE PROPOSED LIGHTING ON THE SOUTH SIDE OF DEVON AVENUE.

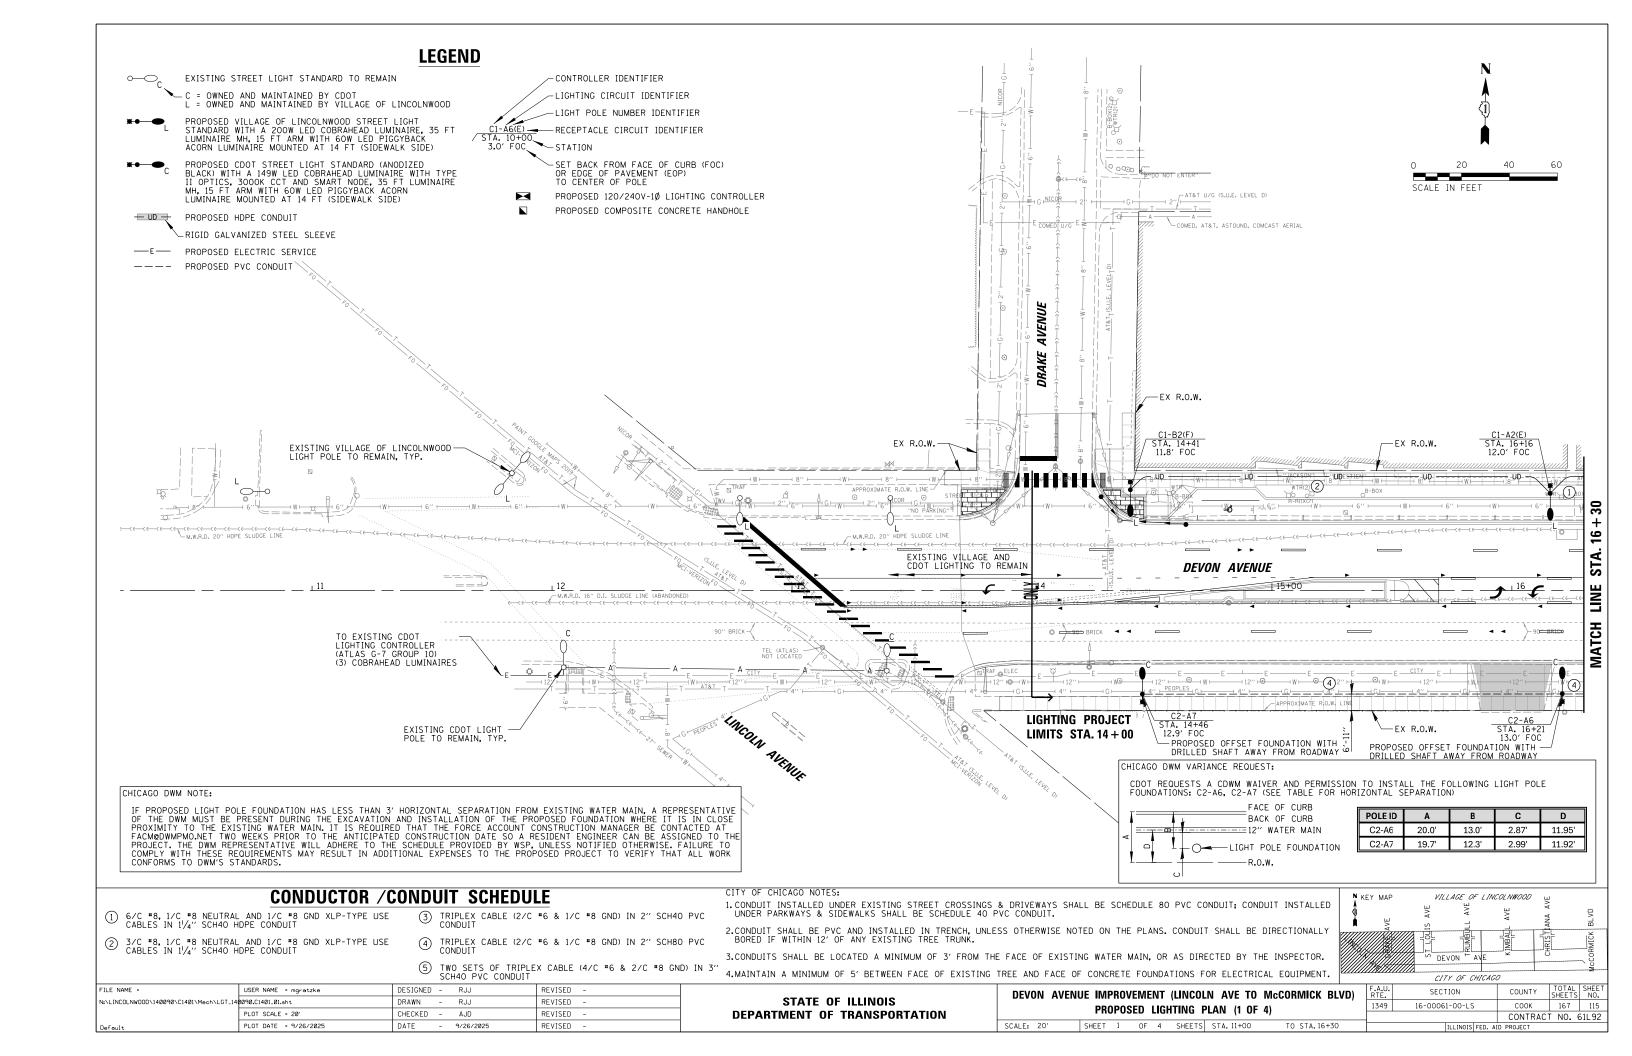
FILE NAME =	USER NAME = mgratzke	DESIGNED	-	RJJ	REVISED	-	
N:\LINCOLNWOOD\140090\C1401\Mech\GN_1400	990.C1401_01.sht	DRAWN	-	RJJ	REVISED	-	
	PLOT SCALE = 20'	CHECKED	-	AJD	REVISED	-	DEPART
Default	PLOT DATE = 9/26/2025	DATE	-	9/26/2025	REVISED	_	

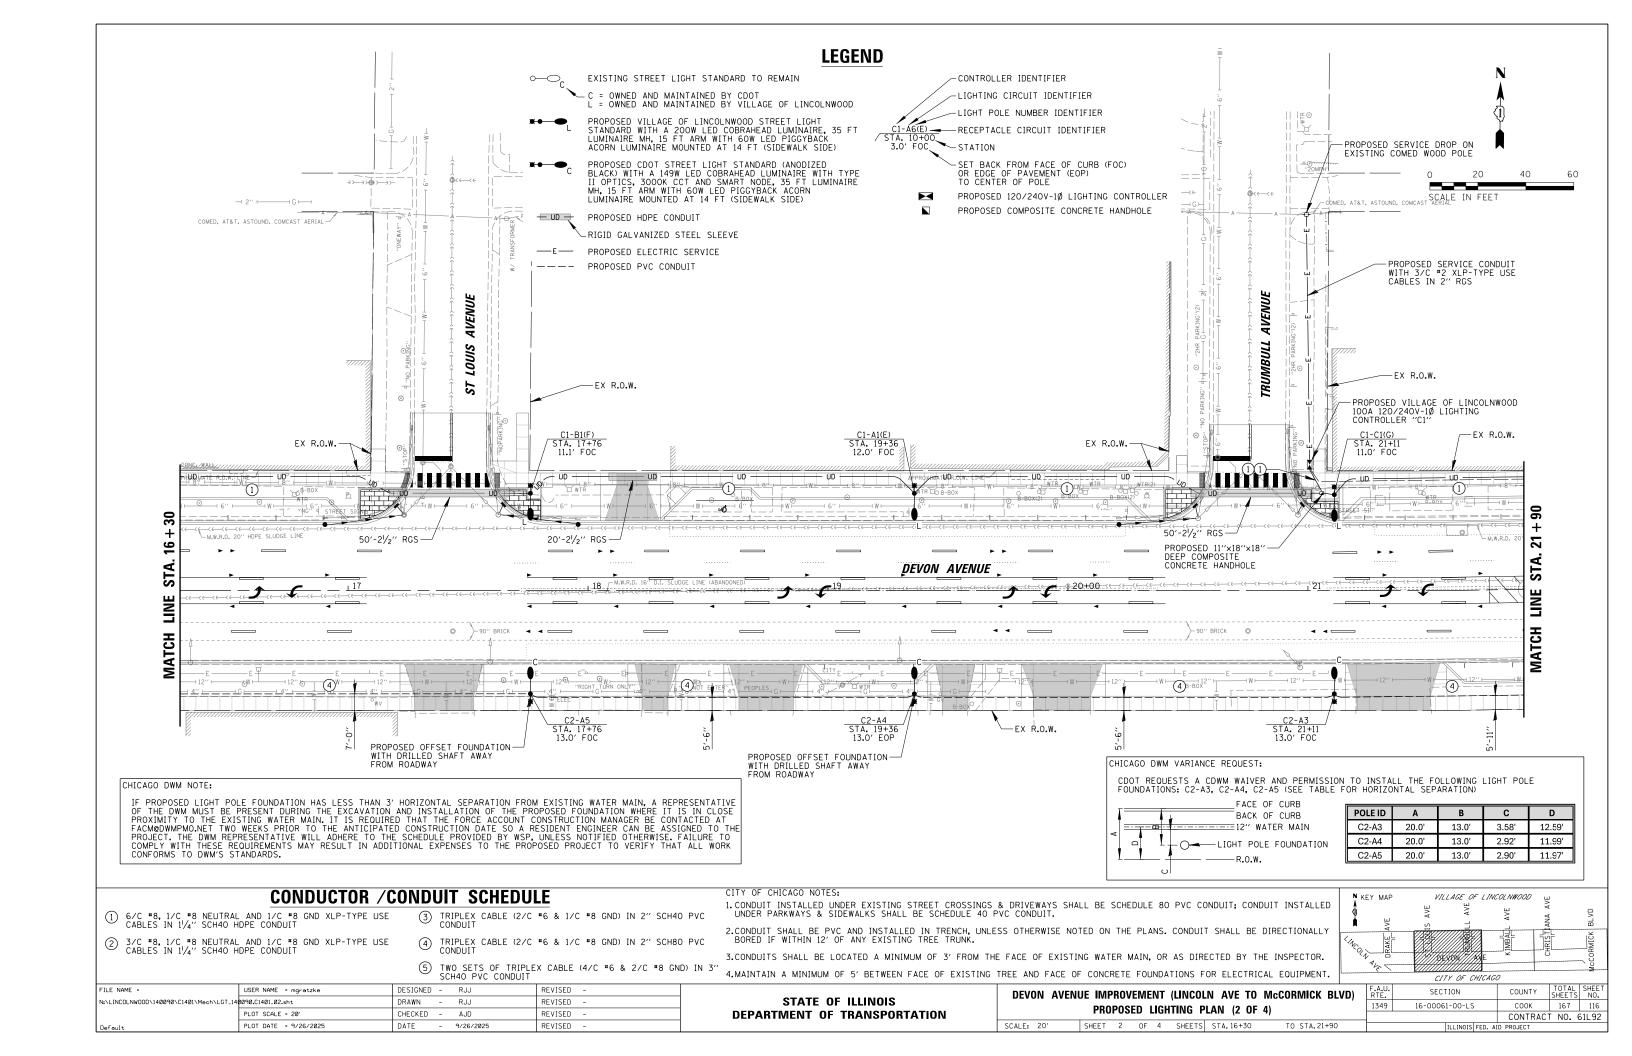


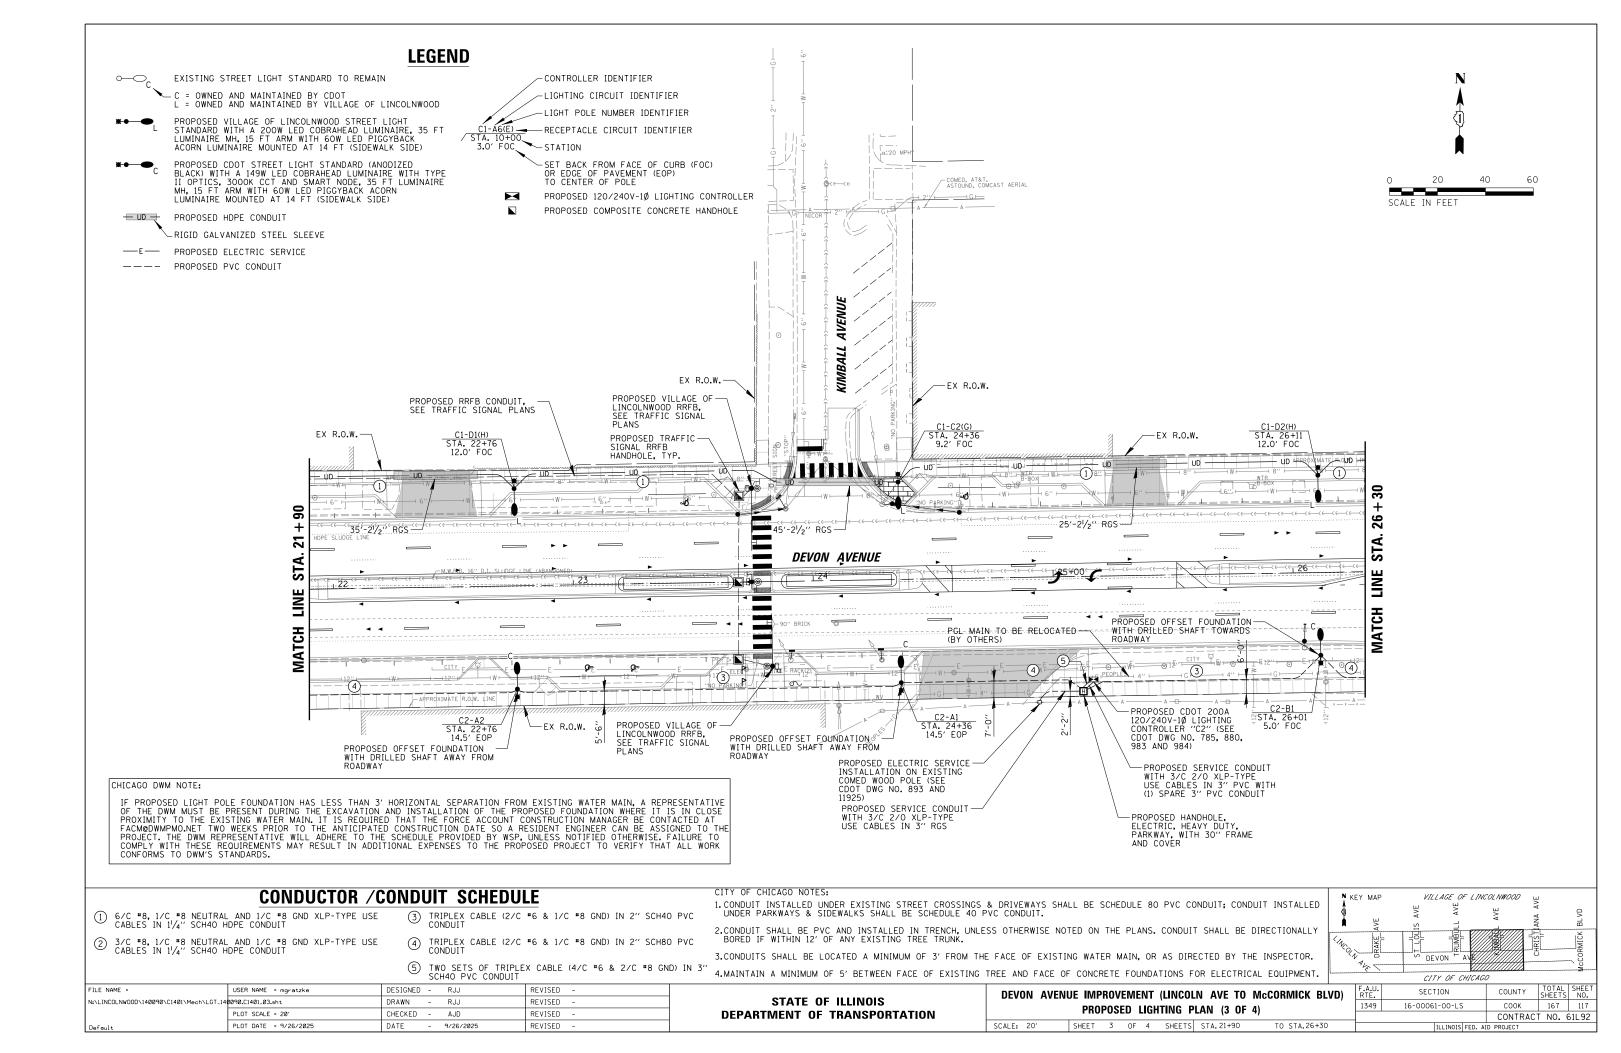


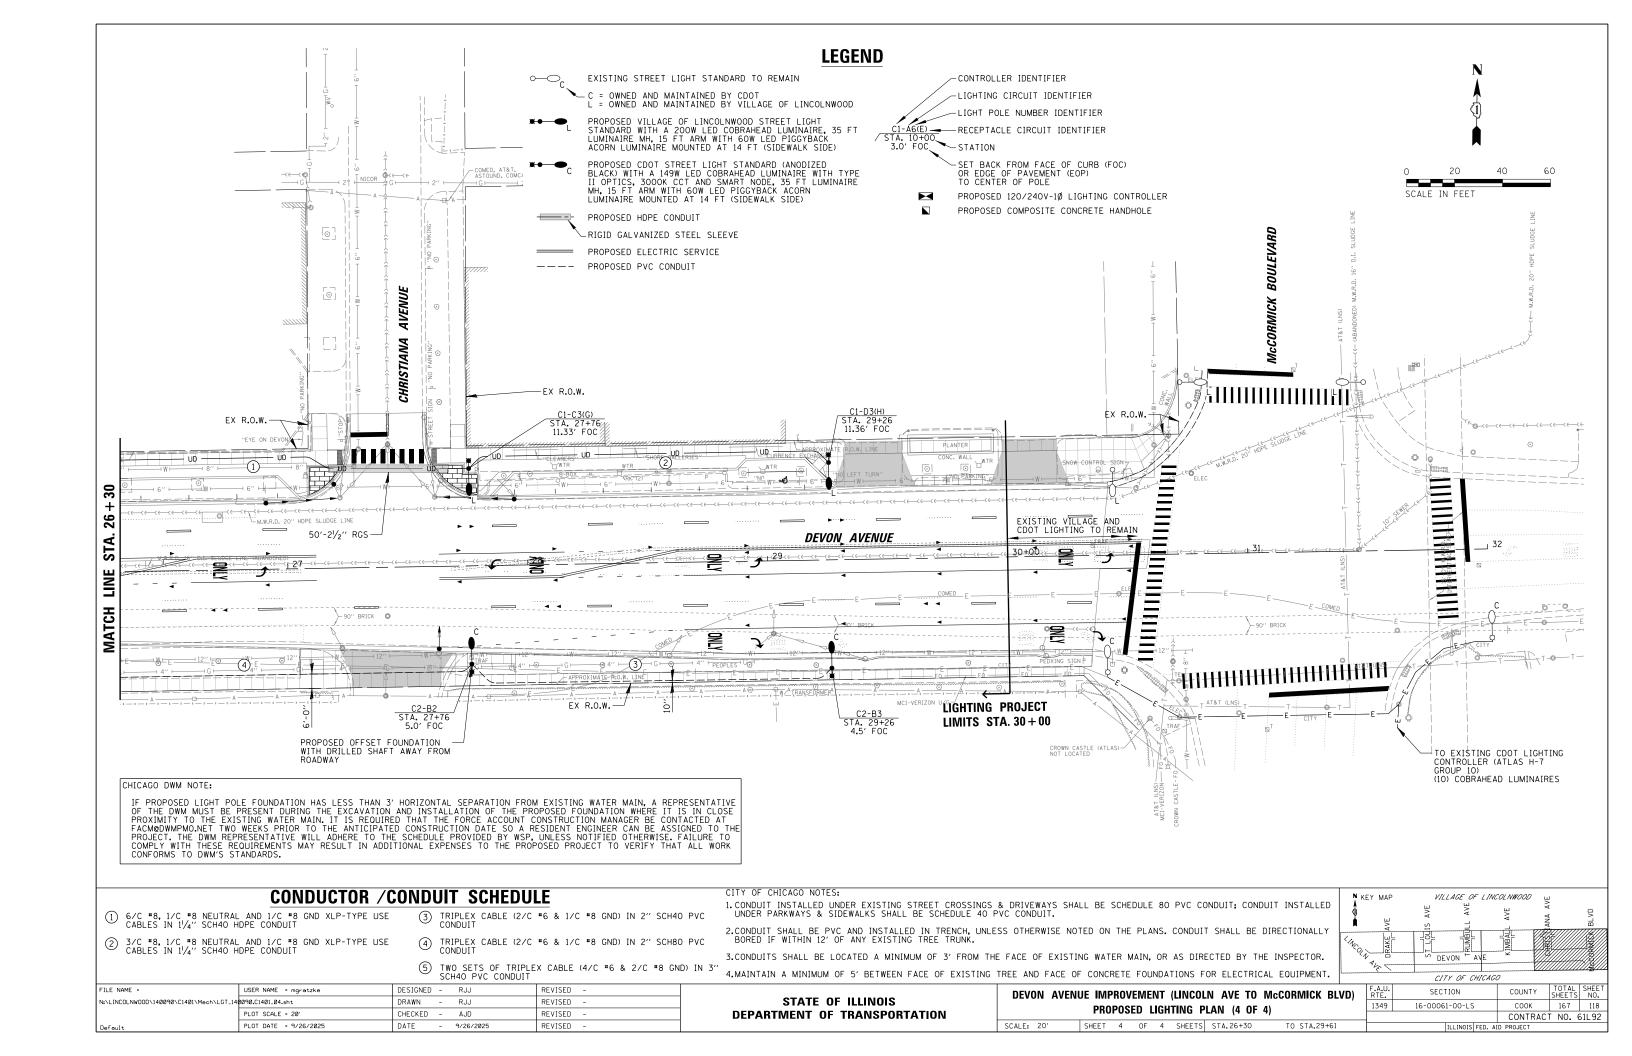













ITEM	SPECIFICATION
1) MAIN CIRCUIT BREAKER	100 AMPERE, 2P, 240V SERVICE RATING, 10KAIC
2 LAMPHOLDER CIRCUIT BREAKER	20 AMPERE, 1P, 120V RATING, 10KAIC
3 PHOTOELECTRIC CONTROL CIRCUIT BREAKER	15 AMPERE, 1P, 120V RATING, 10KAIC
4 AUXILIARY RELAY	120 V OPERATED DPDT 60 HZ COIL 2 NO & 2 NC CONTACTS
5) CABINET RECEPTACLE AND BOX	COMMERCIAL GRADE GFCI 20A/120V, MOUNTED IN A WEATHERPROOF CAST ALUMINUM SINGLE GANG BOX WITH WEATHERPROOF COVER
6 CABINET LIGHT	5 WATT LED STRIP LIGHT, 60K HOUR RATING, 65K COLOR TEMPERATURE, DOOR SWITCH CONTROLLED, FASTENED TO TOP OF CABINET
7 CONTACTOR	100 AMPERE, 2P, 120V COIL, MECHANICALLY HELD
8 BRANCH LINE CIRCUIT BREAKERS	(7) 20A, 2P, 240V RATING, 10KAIC
9 POWER DISTRIBUTION BLOCK	600 VOLT, INSULATED, SIZE AS REQ'D, 10KAIC
10 SERVICE CABLES	3-600V (XLP-TYPE USE) NO. #2
11) LAMPHOLDER WIRE	2-600V XLP NO. 12
12 CONTROL WIRE	2-600V XLP NO. 12
13 SURGE ARRESTOR	10 K AMPERE RATING
14 PHOTOELECTRIC CONTROL WIRE	3-600V XLP NO. 12
15 DOOR SWITCH	20A/120V, DOOR MOUNTED SNAP ACTION TYPE PLUNGER SWITCH
(16) HAND-AUTO-OFF CONTROL SWITCH	20A, 3 POS. MTD IN CAST ALUM. ENCLOSURE
(17) PHOTOCELL	120V, MTD. ON CABINET, DELAY TYPE, SPST-NC
18) TERMINAL BLOCK	3 TERMINAL, SCREW TYPE, MAX. #10 WIRE SIZE
(19) CIRCUIT BREAKER DIST. BLOCKS	30A, 600V, 10 KAIC - WIRE RANGE: LINE SIDE LUG (1) #2/0-#14 AWG, LOAD SIDE LUGS (2) #4-#14 AWG
20 RRFB CIRCUIT BREAKER	20 AMPERE, 1P, 120V RATING, 10KAIC

- 1. ALL ITEMS LISTED IN LIGHTING CONTROLLER COMPONENT SCHEDULE SHALL BE CONSIDERED INCLUDED IN THE PRICE BID FOR "LIGHTING CONTROLLER, BASE MOUNTED, 240 VOLT, 100 AMP" INCLUDING CABINET AND FOUNDATION.
- 2. THE LIGHTING CONTROLLER TOGETHER WITH ALL OF ITS COMPONENTS SHALL BE UL LISTED AS AN "ENCLOSED INDUSTRIAL CONTROL PANEL" UNDER UL508A.
- 3. CONNECTION OF SURGE ARRESTOR TO LINE SIDE OF MAIN CIRCUIT BREAKER SHALL NOT BE "DOUBLE LUGGED."
- 4. THE MAIN CIRCUIT BREAKER ,LAMPHOLDER, AND RRFB CIRCUIT BREAKER SHALL BE LABELED "SERVICE DISCONNECT".
- 5. ALL SWITCHES AND CONTROLS SHALL BE IDENTIFIED USING TWO COLOR ENGRAVED NAMEPLATES.
- 6. THE PANEL MANUFACTURER SHALL LABEL THE CABINET WITH THE APPROPRIATE ARC FLASH WARNING AND PERSONNEL PROTECTION EQUIPMENT REQUIRED FOR SERVICING.
- 7. ALL EXPOSED BUS BARS SHALL BE INSULATED.
- 8. ALL WIRING SHALL BE COPPER.

## PROPOSED LIGHTING CONTROLLER "C1" COMPONENT SCHEDULE

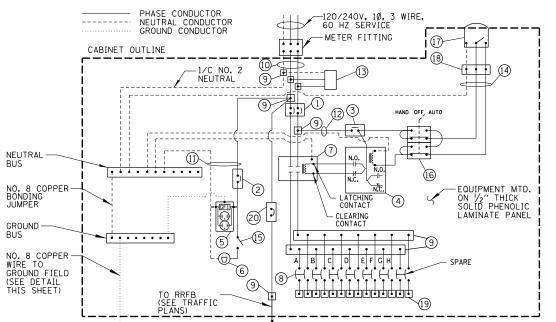
LIGHTING CONTROLLER 1 CIRCUIT LOADS											
CIRCUIT	WIRE	200W PROPOSED ROADWAY LUMINAIRE		60W PROPOSED PEDESTRIAN LUMINAIRE		RRFB			ESTOON EPTACLE	TOTAL CIRCUIT LOAD	
ID	COLOR	QTY.	LOAD/FIXT. (WATTS)	QTY.	LOAD/FIXT. (WATTS)	QTY.	LOAD/FIXT. (WATTS)	QTY.	LOAD/FIXT. (WATTS)	(WATTS) AMPS (VOLTS)	
Α	R	2	200 W	2	60 W	-	80 W	-	180 W	520 W 2.2 A (240V)	
В	В	2	200 W	2	60 W	-	80 W	-	180 W	520 W 2.2 A (240V)	
С	R	3	200 W	3	60 W	-	80 W	-	180 W	780 W 3.3 A (240V)	
D	В	3	200 W	3	60 W	-	80 W	-	180 W	780 W 3.3 A (240V)	
E	BL	-	200 W	-	60 W	-	80 W	2	180 W	360 W 3.0 A (120V)	
F	0	-	200 W	-	60 W	-	80 W	2	180 W	360 W 3.0 A (120V)	
G	BL	-	200 W	-	60 W	-	80 W	3	180 W	540 W 4.5 A (120V)	
Н	0	-	200 W	-	60 W	-	80 W	3	180 W	540 W 4.5 A (120V)	
I	В	-	200 W	-	N/A	3	80 W	-	180 W	240 W 2.0 A (120V)	
TOTAL	-	10	N/A	10	N/A	3	N/A	10	N/A	4,640 W 19.3 A (240V)	

## PROPOSED LIGHTING /ELECTRICAL CIRCUIT LOADS - C1



- 1. ALL GROUND CONDUCTORS SHALL BE GREEN AND NEUTRAL CONDUCTORS SHALL BE WHITE. PHASE CONDUCTORS SHALL BE COLOR CODED IN ACCORDANCE WITH SECTION 1066.02 OF THE STANDARD SPECIFICATIONS. CONTRACTOR SHALL ONLY USE SOLID COLOR CODED INSULATIONS. COLOR STRIPPING OF PHASE CONDUCTORS SHALL NOT BE
- 2. IN ADDITION TO THE TERMINATIONS SHOWN, THE NEUTRAL AND GROUND BUS BARS SHALL EACH ACCOMMODATE A MINIMUM OF 8 ADDITIONAL TERMINATIONS (#2-#14).

## PROPOSED LIGHTING CONTROLLER "C1" WIRING DETAIL

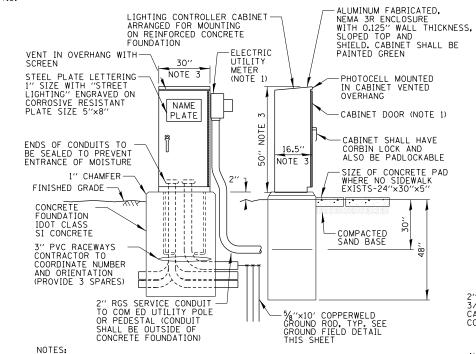


WIRE COLORS

R=RED B=BLACK


BL=BLUE O=ORANGE

- 1. SEE DETAIL THIS SHEET FOR CABINET METER FITTING & DOOR ORIENTATION. METER AND DISCONNECT SHALL BE CECHA APPROVED. METER FITTING AND SERVICE CONDUIT SHALL BE PAINTED BLACK.
- 2. ALL ITEMS SHOWN ABOVE (INCLUDING FOUNDATION, ELECTRIC METER & GROUND FIELD) SHALL BE INCLUDED IN THE PRICE BID FOR "LIGHTING CONTROLLER, BASE MOUNTED, 240 VOLT, 100 AMP", EXCEPT FOR THE SERVICE CONDUIT/WIRE WHICH WILL BE PAID FOR SEPARATELY.
- 3. CABINET DIMENSIONS SHOWN ARE APPROXIMATE, CABINET SHALL BE AS COMPACT AS POSSIBLE, CONTRACTOR TO COORDINATE.


## PROPOSED LIGHTING CONTROLLER "C1" **CABINET AND FOUNDATION**N.T.S.

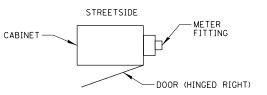

## PROPOSED CABINET METER FITTING & DOOR ORIENTATION

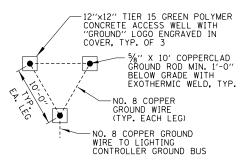

## **GROUND FIELD DETAIL (TYP.)**

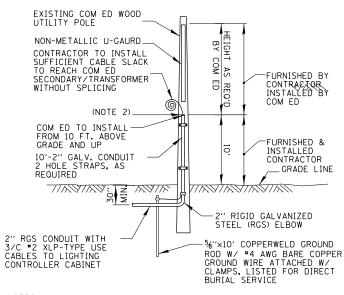

- ALL WORK SHALL CONFORM TO COM ED'S BOOK OF "INFORMATION AND REQUIREMENTS FOR THE SUPPLY OF ELECTRIC SERVICE."
- 2. CONTRACTOR SHALL PROVIDE CONDUIT BUSHING AND SEALING COMPOUND AT TOP OF RISER.
- 3. ALL MATERIAL ABOVE (EXCEPT FOR POLE) SHALL BE INCLUDED IN THE PRICE BID FOR "ELECTRIC SERVICE INSTALLATION". THE HORIZONTAL SERVICE CONDUIT AND WIRING FROM POLE TO CONTROLLER SHALL BE


## COM ED OVERHEAD CONNECTION POLE

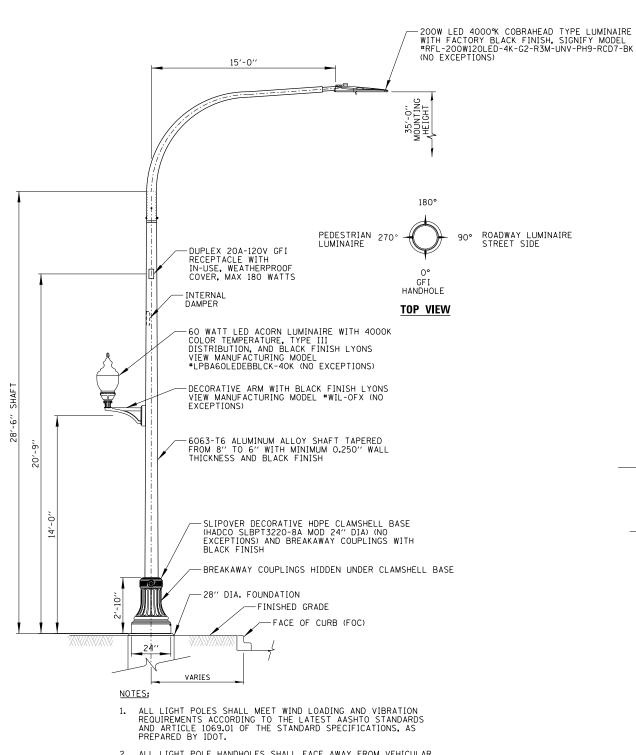FILE NAME =	USER NAME = mgratzke	DESIGNED	-	RJJ	REVISED	-
N:\LINCOLNW00D\140090\C1401\Mech\LDT_14	0090.C1401_01.sht	DRAWN	-	RJJ	REVISED	-
	PLOT SCALE = 20'	CHECKED	-	AJD	REVISED	-
Default	PLOT DATE = 9/26/2025	DATE	-	9/26/2025	REVISED	_

STATE OF ILLINOIS **DEPARTMENT OF TRANSPORTATION** 

DEVON AVENUE IMPROVEMENT (LINCOLN AVE TO McCORMICK BLVD) VILLAGE OF LINCOLNWOOD LIGHTING DETAILS (1 OF 6) SCALE: NO SCALE SHEET 1 OF 6 SHEETS STA.


F.A.U. RTE.	SECTION	COUNTY	TOTAL SHEETS	SHEET NO.
1349	16-00061-00-LS	COOK	167	119
		CONTRAC	NO. (	61L92
	ILLINOIS FED. A	D PROJECT		



# POLE HANDHOLE WIRING DIAGRAM

- 2. ALL LIGHT POLE HANDHOLES SHALL FACE AWAY FROM VEHICULAR TRAFFIC.
- 3. PAID FOR UNDER, "LIGHTING UNIT COMPLETE (SPECIAL)" (SEE
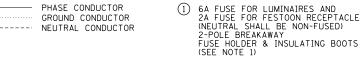
## **DAVIT LIGHTING UNIT**



TO 240V

LUMINAIRES

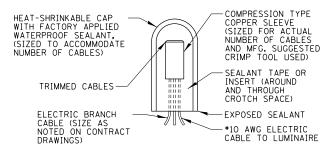
BL-

1)-


(9)

- XLP-TYPE USE POLE WIRES (#10 TO LUMINAIRE & #12 TO RECEPTACLE) COLOR TO MATCH BRANCH WIRING
- MULTIPLE COMPRESSION FITTINGS (SPLICE), TYP.
- 4 CONCRETE FOUNDATION
- (5) WIRES AS SHOWN ON PLANS
- 6 PROPOSED LIGHTING DUCT PULLED THROUGH PVC RACEWAY
- 7 POLE GROUND LUG
- 8 NO. 6 GROUND WIRE MECHANICALLY CLAMPED TO GROUND ROD
- 9 GROUND ROD
- 10 20A-120V GFCI-WR RECEPTACLE
- (11) WIRE COLOR R=RED \ LIGHTING B=BLACK BI =BI UF O=ORANGE W=WHITE RECEPTACLES G=GREEN


-(4)



## SPLICING ELECTRIC CABLE

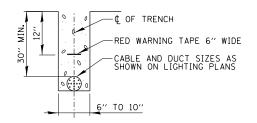


### TRENCH CROSS SECTION

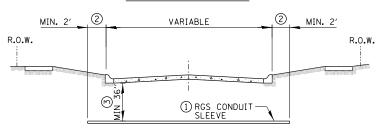

#### **ROADWAY CROSSING**

- ① SLEEVE SHALL BE HEAVY WALL RIGID GALVANIZED STEEL (RGS) CONDUIT.
- 2 SLEEVE SHALL EXTEND A MINIMUM OF 2 FT. BEYOND BACK OF CURB.
- 3 SLEEVE SHALL BE A MINIMUM OF 36" BELOW ROADWAY OR CURB BOTTOM.

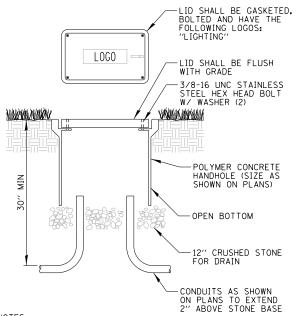
## **ELECTRIC CONDUIT INSTALLATION**



- 1. NO SPLICING ALLOWED IN HANDHOLE.
- 2. POLYMER CONCRETE HANDHOLE AND LID SHALL BE GREY.
- 3. BOX & LID SHALL MEET/EXCEED ANSI TIER 15 LOADING REQUIREMENTS, AND BE TESTED IN ACCORDANCE WITH THE LATEST EDITION OF THE ANSI/SCTE 77 "SPECIFICATION FOR UNDERGROUND ENCLOSURE INTEGRITY", AND THE PROVISIONS OF PARAGRAPHS 5.2.3 AND 5.2.4 OF WESTERN UNDERGROUND COMMITTEE GUIDE 3.6.

## **POLYMER CONCRETE HANDHOLE**

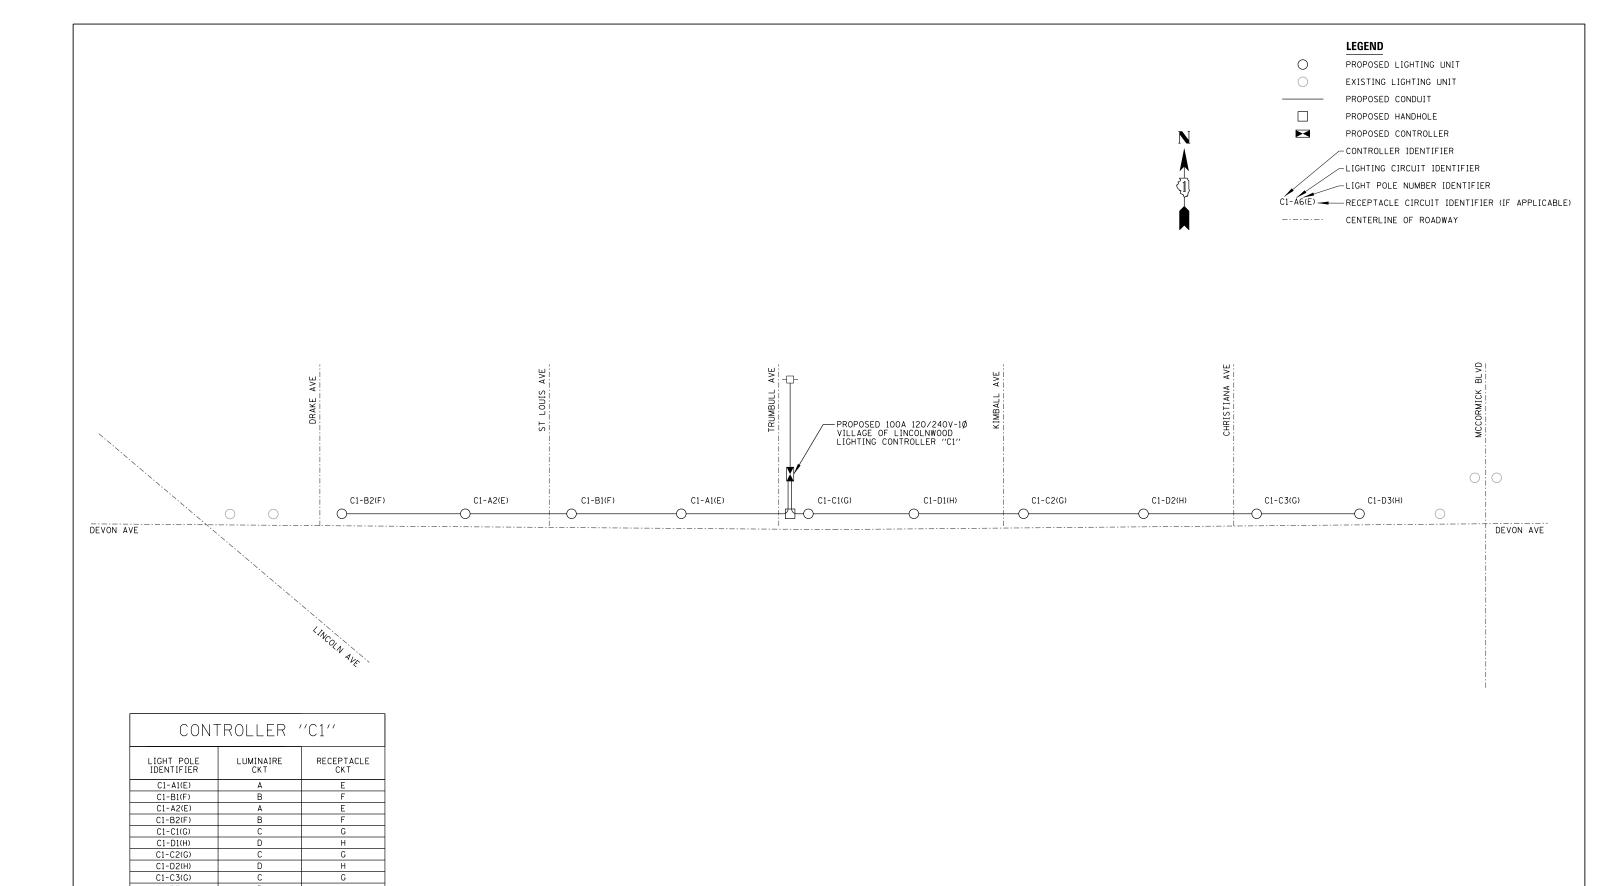FILE NAME =	USER NAME = mgratzke	DESIGNED - RJJ	REVISED -		DEVON AVENUE IMPROVEMENT (LINCOLN AVE TO McCORMICK BLVD)	F.A.U.	SECTION	COUNTY	TOTAL SH	ĒΤ
N:\LINCOLNWOOD\140090\C1401\Mech\LDT_14	0090.C1401_02.sht	DRAWN - RJJ	REVISED -	STATE OF ILLINOIS	VILLAGE OF LINCOLNWOOD LIGHTING DETAILS (2 OF 6)	1349	16-00061-00-LS	соок	167 1	0
	PLOT SCALE = 20'	CHECKED - AJD	REVISED -	DEPARTMENT OF TRANSPORTATION	VILLAGE OF LINCOLNWOOD LIGHTING DETAILS (2 OF 6)			CONTRACT	NO. 61L	<del>.</del> 2
Default	PLOT DATE = 9/26/2025	DATE - 9/26/2025	REVISED -		SCALE: NO SCALE SHEET 2 OF 6 SHEETS STA. TO STA.		ILLINOIS FED.	ID PROJECT		



VILLAGE	OF LINCO	LNWOOD	LIGHTI	NG
ONE-LINE	DIAGRAM	- CONT	ROLLER	"C1"
N.T.S.				

C1-D3(H)

FILE NAME =	USER NAME = mgratzke	DESIGNED - RJJ	REVISED -		DEVON AVENUE IMPROVEMENT (LINCOLN AVE TO McCORMICK BLVD)	RTF.	SECTION	COUNTY	SHEETS NO.
N:\LINCOLNWOOD\140090\C1401\Mech\LDT_14	0090.C1401_03.sht	DRAWN - RJJ	REVISED -	STATE OF ILLINOIS	,	1349	16-00061-00-LS	СООК	167 121
	PLOT SCALE = 20'	CHECKED - AJD	REVISED -	DEPARTMENT OF TRANSPORTATION	VILLAGE OF LINCOLNWOOD LIGHTING DETAILS (3 OF 6)				T NO. 61L92
Default	PLOT DATE = 9/26/2025	DATE - 9/26/2025	REVISED -		SCALE: NO SCALE SHEET 3 OF 6 SHEETS STA. TO STA.		ILLINOIS FED. AI	D PROJECT	

#### LIGHT POLE FOUNDATION DEPTH TABLE 30 FT. (9.144 m) TO 35 FT. (10.668 m) MOUNTING HEIGHT

SOIL CONDITIONS	DESIGN DEPTH "D	" OF FOUNDATION					
SOIL CONDITIONS	SINGLE ARM POLE	TWIN ARM POLE					
SOFT CLAY	11'-0"	12'-8"					
Qu = 0.375 TON/SQ. FT.	(3.35 m)	(3.85 m)					
MEDIUM CLAY	9'-0"	14'-10"					
Qu = 0.75 TON/SQ.FT	(2.74 m)	(4.52 m)					
STIFF CLAY	7'-6"	8'-7"					
Qu = 1.50  TON/SQ. FT.	(2.29 m)	(2.61 m)					
LOOSE SAND	9'-6"	10'-7"					
∅ = 34°	(2.90 m)	(3.22 m)					
MEDIUM SAND	9'-0"	9'-10"					
∅ = 37.5°	(2.74 m)	(2.99 m)					
DENSE SAND	8'-3"	9'-7"					
∅ = 40°	(2.51 m)	(2.91 m)					

6" (152.4)

THREADED

%" T. X 4" DIA. WASHER, TACK WELDED

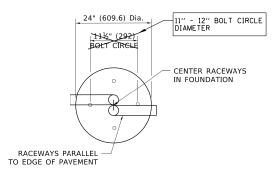
1" DIA. X 5'-0" .4 DIA. X 1.524

5" (127.0)


TOP OF ANCHOR ROD

**ANCHOR BOLT DETAIL** 


60" (1500)



### **TOP VIEW**

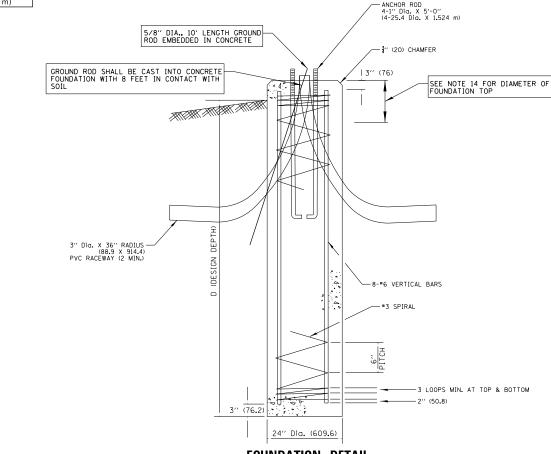



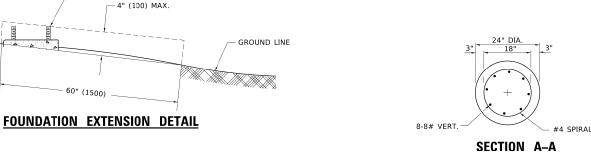

## LIGHT POLE FOUNDATION

#### **NOTES**

- 1. ALL DIMENSIONS ARE IN INCHES (MILLIMETERS) UNLESS OTHERWISE SHOWN.
- 2. THE ANCHOR RODS AND RACEWAYS SHALL BE PROPERLY SECURED IN PLACE BEFORE THE CONCRETE IN PLACED.
- 3 THE FOUNDATION SHALL NOT PROTRUDE MORE THAN 4 IN (100 mm) ABOVE THE FINISHED GRADE WITHIN A 60 IN. (1.5 m) CHORD ACROSS THE FOUNDATION, WITH ANCHOR RODS INCLUDED, IN ACCORDANCE WITH AASHTO GUIDELINES. IF THE FOUNDATION HEIGHT, INCLUDING ANCHOR RODS, EXTENDS BEYOND THESE SPECIFIED LIMITS, THE FOUNDATION SHALL BE REPLACED AT THE CONTRACTOR'S EXPENSE. SEE FOUNDATION EXTENSION DETAIL.
- 4. THE HOLE FOR THE FOUNDATION SHALL BE MADE BY DRILLING WITH AN AUGER, OF THE SAME DIAMETER AS THE FOUNDATION. IF SOIL CONDITIONS REQUIRE THE USE OF A LINER TO FORM THE HOLE, THE LINER SHALL BE WITHDRAWN AS THE CONCRETE IS DEPOSITED.
- 5. THE TOP OF THE FOUNDATION SHALL BE CONSTRUCTED LEVEL. A LINER OR FORM SHALL BE USED TO PRODUCE A UNIFORM SMOOTH SIDE TO THE TOP OF THE FOUNDATION. FOUNDATION TOP SHALL BE CHAMFERED 3#4-IN. (20 mm).
- 6. THE CONCRETE SHALL BE CLASS SI. CONCRETE SHALL CURE ACCORDING TO ARTICLE 1020.13 BEFORE LIGHT POLES ARE INSTALLED.
- 7. THE ANCHOR ROD SHALL BE A HOOK ROD TYPE, COLD BENDING OF THE ANCHOR ROD WILL NOT BE ALLOWED. THE RADIUS OF THE HOOK BEND SHALL NOT BE LESS THAN 4 TIMES THE NOMINAL DIAMETER OF THE ANCHOR ROD. A TACK WELDED ANCHOR ROD MAY BE SUBSTITUTED WITH THE APPROVAL OF THE ENGINEER.
- 8. ANCHOR RODS, NUTS AND WASHERS SHALL BE COMPLETELY GALVANIZED BY EITHER THE HOT-DIPPED PROCESS CONFORMING WITH AASHTO M 232, THE MECHANICAL PLATING METHOD CONFORMING TO AASHTO M 298, CLASS 50 WITH A MAXIMUM COATING THICKNESS OF 150 UM(6 MILS) OR THE ELECTROLYTIC PROCESS ACCORDING TO ASTM F 1136.
- 9. THE ANCHOR RODS SHALL BE THREADED A MINIMUM OF 6 INCHES (150 mm) WITH A MINIMUM OF 3 INCHES (75 mm) OF THREADED ANCHOR ROD EMBEDDED IN THE FOUNDATION.
- 10. ANCHOR RODS SHALL PROJECT 23#4" (69.9 mm) ABOVE THE TOP OF THE FOUNDATION. IF BREAKAWAY COUPLINGS ARE SPECIFIED, THE CONTRACTOR SHALL CAREFULLY COORDINATE THE ANCHOR ROD PROJECTION WITH THE INSTALLATION REQUIREMENTS OF THE BREAKAWAY COUPLINGS.
- 11. THE CONTRACTOR SHALL USE A #3 SPIRAL AT 6" (152.4 mm) PITCH OR MAY SUBSTITUTE #3 TIES AT 12" (304.8 mm) O.C. WITH THE APPROVAL OF THE ENGINEER.
- 12. THE CABLE TRENCHES AND FOUNDATION SHALL BE BACK FILLED AND COMPACTED AS SPECIFIED BEFORE THE LIGHT POLE IS ERECTED.
- 13 THE RACEWAYS SHALL PROJECT 1" (25.4 mm) ABOVE THE TOP OF THE FOUNDATION.
- 14. TOP 12" OF FOUNDATIONS SHALL BE 28" DIAMETER.

PAID FOR UNDER "LIGHT POLE FOUNDATION, 24" DIAMETER, SPECIAL" (SEE SPECIAL PROVISION).

## **IDOT STANDARD BE-300 MODIFIED FOR THIS PROJECT**

FILE NAME =	USER NAME = mgratzke	DESIGNED - RJJ	REVISED -		DEVON AVENUE IMPROVEMENT (LINCOLN AVE TO McCORMICK BLVD)	F.A.U.	SECTION	COUNTY	TOTAL SHEET
N:\LINCOLNWOOD\140090\C1401\Mech\LDT_14	10090.C1401_04.sht	DRAWN - RJJ	REVISED -	STATE OF ILLINOIS	,	1349	16-00061-00-LS	соок	167 122
	PLOT SCALE = 20'	CHECKED - AJD	REVISED -	DEPARTMENT OF TRANSPORTATION	VILLAGE OF LINCOLNWOOD LIGHTING DETAILS (4 OF 6)			CONTRAC	T NO. 61L92
Default	PLOT DATE = 9/26/2025	DATE - 9/26/2025	REVISED -		SCALE: NO SCALE SHEET 4 OF 6 SHEETS STA. TO STA.		ILLINOIS FED. A	D PROJECT	

#### FOUNDATION DESIGN TABLE

	DESIGN DEPTH	OF FOUNDATION	R	EINFORCEMENT	T IN FOUNDATION	)N
TYPE OF SOIL	SINGLE ARM	TWIN ARM	SINGLE	ARM	TWIN	ARM
	D	D	VERT BARS	SPIRAL	VERT BARS	SPIRAL
SOFT CLAY	13'-0"	15'-0"	8-#6X12'-6"	#3X122'	8-#6X14'-3"	#3X141'
	(3.962 m)	(4.572 m)	(3.810 m)	(37.186 m)	(4.343 m)	(42.977 m)
MEDIUM CLAY	9'-6"	10'-9"	8-#6X9'-0"	#3X90'	8-#6X10'-0"	#3X100'
	(2.896 m)	(3.277 ml)	(2.743 m)	(27.432 m)	(3.048 m)	(30.480 m)
STIFF CLAY	7'-0"	8'-0"	8-#6X6'-6"	#3X66'	8-#6X7 6"	#3X76'
	(2.134 m)	(2.438 m)	(1.981 m)	(20.112 m)	(2.286 m)	(23.165 m)
LOOSE SAND	9'-0"	10V0"	8-#6X8'-6"	#3X85'	8-#6X9'-6"	#3X94'
	(2.743 m)	(3/048 m)	(2.591 m)	(25.908 m)	(2.896 m)	(28.651 m)
MEDIUM SAND	8'-3"	9'-0"	8-#6X8'-0"	#3X78'	8-#6X8'-6'	#3X85'
	(2.515 m)	(2.743\m)	(2.438 m)	(23.774 m)	(2.591 m)	(25.908 m)
DENSE SAND	7'-9"	9'-0"	8-#6X7'-6"	#3X73'	8-#6X8'-6"	#3X85'
	(2.362 m)	(2.743 m)	(2.286 m)	(22.250 m)	(2,591 m)	(25.908 m)
ROCK OR SOLIDIFIED SLAG	5'-0" (1.524 m)	5'-0" (1.524 m)	NONE	NONE	NONE	NONE

## OFFSET SCHEDULE

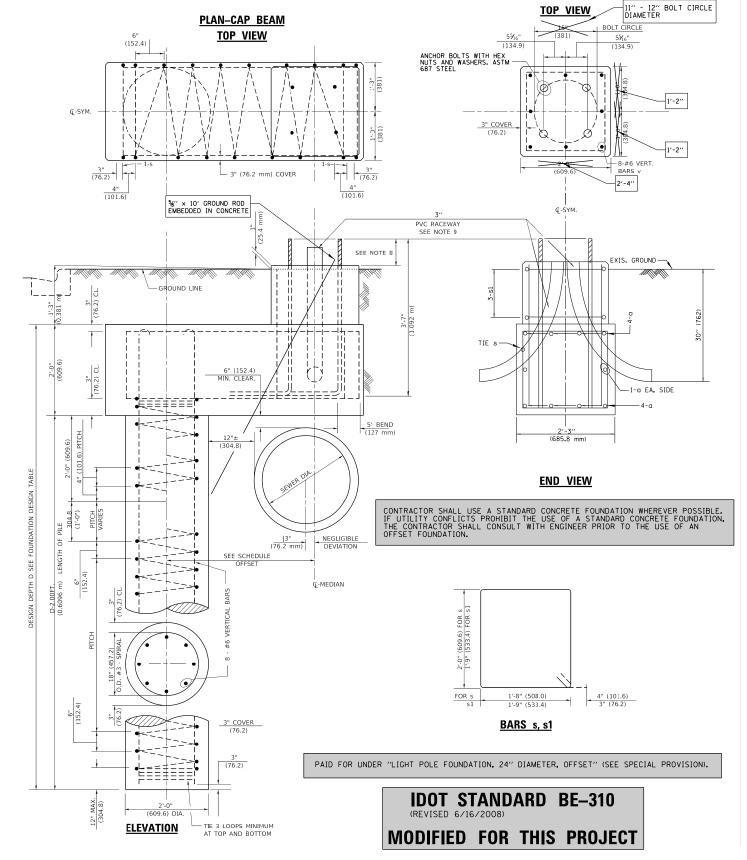
#### BILL OF MATERIAL

MARK	ARK NO.		LENGTH	SHAPE
a	10	6	SEE BELOW	_
S	12	4	8'-0" (2.438 m)	
s <sub>1</sub>	3	3	7'-6" (2.286 m)	
v <sub>1</sub>	8	6	2'-9" (0.838 m)	_
v <sub>2</sub>				

SEWER	PILE OFFSET	LENGTH of
DIAM. d	from Q-MED'N	BAR a
IN.	FT.	FT.
UP TO 24"	3'-3"	#6 x 5'-3"
(609.6 mm)	(0.991 m)	(1.600 m)
27" (685.8 m)TO	3'-9"	5'-9"
36" (914.4 mm)	(1.143 m)	(1.753 m)
42" (1066.8 mm) TO	4'-6"	6'-6"
48" (1219.2 mm)	(1.372 m)	(1.981 m)
54" (1371.6 mm) TO	5'-0"	7'-0"
60" (1524.0 mm)	(1.524 m)	(2.134 m)
66" (1676.4 mm) TO	5'-6"	7'-6"
72" (1828.8 mm)	(1.676 m)	(2.286 m)

## <u>Notes</u>

- 1. ALL DIMENSIONS ARE IN INCHES (MILLIMETERS) UNLESS OTHERWISE SHOWN.
- 2. THE ENGINEER SHALL DETERMINE THE CLASS OF SOIL DURING EXCAVATION AND SELECT THE DESIGN DEPTH OF FOUNDATION FROM THE DESIGN TABLE.
- 3. EXCAVATION OF THE POLE FOUNDATION SHALL BE MADE WITH AN AUGER, 24" (609.6 mm)  $\overline{OR}$  30" (762.0 mm) IN DIAMETER.
- 4. THE ANCHOR ROD SHALL BE A HOOK ROD TYPE. COLD BENDING OF THE ANCHOR ROD WILL NOT BE ALLOWED. THE RADIUS OF THE HOOK BEND SHALL NOT BE LESS THAN 4 TIMES THE NOMINAL DIAMETER OF THE ANCHOR ROD. A TACK WELDED ANCHOR ROD MAY BE SUBSTITUTED WITH THE APPROVAL OF THE ENGINEER.
- 5. THE ANCHOR BOLTS AND RACEWAYS SHALL BE PROPERLY SECURED IN PLACE BEFORE THE CONCRETE IS PLACED IN THE FORM.
- 6. THE ANCHOR RODS SHALL BE ACCORDING TO ASTM F1554 GRADE 725 (GRADE 105). NUTS SHALL BE HEXAGON NUTS ACCORDING TO ASTM A 194 2H OR ASTM A 563 DH, AND WASHERS SHALL BE ACCORDING TO ASTM F 436.
- 7. THE CONTRACTOR SHALL COORDINATE EXTENSION OF ANCHOR BOLTS ABOVE TOP OF FOUNDATION WITH THE BREAKAWAY DEVICE MANUFACTURER'S REQUIREMENTS. IF LIGHT POLE IS MOUNTED WITHOUT BREAKAWAY DEVICE, ANCHOR BOLTS SHALL PROJECT 23#4" (69.9 mm) ABOVE TOP OF THE FOUNDATION. THE CONTRACTOR SHALL CONFIRM ANCHOR BOLT EXTENTION WITH ENGINEER.
- 8. RACEWAYS SHALL PROJECT 1" (25.4 mm) ABOVE THE TOP OF THE FOUNDATION.
- 9. THE CABLE TRENCH SHALL BE BACKFILLED AND FIRMLY COMPACTED BEFORE THE LIGHT IS ERECTED.



## LIGHT POLE FOUNDATION OFFSET

FILE NAME =	USER NAME = mgratzke	DESIGNED - RJJ	REVISED -		DEVON AVENUE IMPROVEMENT (LINCOLN AVE TO McCORM	ICK BLVD)	F.A.U.	SECTION	COUNTY	TOTAL	SHEET
N:\LINCOLNWOOD\140090\C1401\Mech\LDT_14	40090.C1401_05.sht	DRAWN - RJJ	REVISED -	STATE OF ILLINOIS	VILLAGE OF LINCOLNWOOD LIGHTING DETAILS (5 OF	, ,	1349	16-00061-00-LS	соок	167	123
	PLOT SCALE = 20'	CHECKED - AJD	REVISED -	DEPARTMENT OF TRANSPORTATION		- 1			CONTRAC	T NO. 6	IL92
Default	PLOT DATE = 9/26/2025	DATE - 9/26/2025	REVISED -		SCALE: NO SCALE SHEET 5 OF 6 SHEETS STA. TO ST	ΓA.		ILLINOIS FED.	AID PROJECT		





# Service and Meter Application Switch and Load Information Sheet

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Switch Name a Service Volt 120/240V 1 120/240V 3	age (d -phase,	check one 3-wire	):   277/	480V 3-phase	, 4-wire	of Devon Ave & Tr e phase Grounded)	rumbull Ave.	
120/240V 3 120/208V 3 Other:						grounded – require	es ground dete	ction equip.)
☐ 4kV ☐ 12k ☐ 4kV ☐ 12k								
<b>Other Items</b> ☑ New Constr ☐ Building Add	uction	<b>ck all that</b> Sq. F Sg. Ft	t. 🗵 Unde	erground Serv head Service	ice			
Relocating E Hi-Rise/ Va	Existing	Service Ent	rance 🔲 Com	mercial – No. dential – No. (		-	q. Ft. q. Ft.	
Date of Ground Date to Energiz		ng (est.):				al Grade (est.): peration Per Day:	□ 8 ⊠ 12 □	] 16 [] 24
Secondary Con	ductors	: 1 S (Number)	ets of 3 /C (No. of co	#2 nductors) (Size)	$\boxtimes$ (	CU or		
Total Connecte	d Load	Information	· 1:	, (,				
Total Connecte ( KW or HP )	d Load	Information	Description	, , ,			nnected Load:	
( KW or HP )	d Load			, , ,		1-phase		-phase
( KW or HP ) Lighting: VAC:	d Load	Information		, , ,				
( KW or HP ) Lighting: VAC: Receptacle:	d Load			, , ,		1-phase		
( KW or HP ) Lighting: VAC: Receptacle: Process Heat:	d Load			, , ,		1-phase		
Lighting: VAC: Receptacle: Process Heat: Water Heat:	d Load			, , ,		1-phase		
Lighting: VAC: Receptacle: Process Heat: Water Heat: Space Heat: Motors*:	d Load			, , ,		1-phase		
( KW or HP ) Lighting: VAC: Receptacle: Process Heat: Water Heat: Space Heat: Motors*: Welders**:	d Load			, , ,		<b>1-phase</b> 4.64 Kw		
Lighting: VAC: Receptacle: Process Heat: Water Heat: Space Heat: Motors*:	d Load			, , ,		1-phase		
Lighting: VAC: Receptacle: Process Heat: Water Heat: Space Heat: Motors*: Welders**: TOTAL LOAD:	tail incl	Lighting  Lighting	Description	on:		1-phase 4.64 Kw 4.64 Kw	3	-phase
( KW or HP ) Lighting: VAC: Receptacle: Process Heat: Water Heat: Space Heat: Motors*: Welders**: TOTAL LOAD:		Lighting  Lighting	Description   Efficiency	on:	Nem	4.64 KW  4.64 KW		
Lighting: VAC: Receptacle: Process Heat: Water Heat: Space Heat: Motors*: Welders**: TOTAL LOAD:	tail incl	Lighting  Lighting	Description   Efficiency	Phase /		4.64 KW  4.64 KW	Starting	-phase
Lighting: VAC: Receptacle: Process Heat: Water Heat: Space Heat: Motors*: Welders**: TOTAL LOAD:	tail incl	Lighting  Lighting	Description   Efficiency	Phase /		4.64 KW  4.64 KW	Starting	-phase
Lighting: VAC: Receptacle: Process Heat: Water Heat: Space Heat: Motors*: Welders**: TOTAL LOAD:	tail incl	Lighting  Lighting	Description   Efficiency	Phase /		4.64 KW  4.64 KW	Starting	-phase
Lighting: VAC: Receptacle: Process Heat: Water Heat: Space Heat: Motors*: Welders**: TOTAL LOAD:	tail incl	Lighting  Lighting	Description   Efficiency	Phase /		4.64 KW  4.64 KW	Starting	-phase
Lighting: VAC: Receptacle: Process Heat: Water Heat: Space Heat: Motors*: Welders**: TOTAL LOAD:	tail incl	Lighting  Lighting	Description   Efficiency	Phase /		4.64 KW  4.64 KW	Starting	-phase
Lighting: VAC: Receptacle: Process Heat: Water Heat: Space Heat: Motors*: Welders**: TOTAL LOAD: *Motor Load De Description	tail incl Quar	Lighting  Lided above:  Lided above:	e Efficiency ) Rating	Phase /	Code	4.64 Kw  4.64 Kw  4.64 Kw	Starting	-phase
Lighting: VAC: Receptacle: Process Heat: Water Heat: Space Heat: Motors*: Welders**: TOTAL LOAD: Motor Load Department	tail incl Quar	Lighting  Lighti	Efficiency Rating Type	Phase / Voltage	P.F.	4.64 Kw  4.64 Kw  Starts Per Hr. or Day	Starting Amps	Use Hours Per
Lighting: VAC: Receptacle: Process Heat: Water Heat: Space Heat: Motors*: Welders**: TOTAL LOAD: *Motor Load De Description	tail incl Quar	Lighting  Lided above:  Lided above:	Efficiency Rating Type	Phase / Voltage	Code	4.64 Kw  4.64 Kw  Starts Per Hr. or Day	Starting Amps	Use
Lighting: VAC: Receptacle: Process Heat: Water Heat: Space Heat: Motors*: Welders**: TOTAL LOAD: *Motor Load De Description	tail incl Quar	Lighting  Lighti	Efficiency Rating Type	Phase / Voltage	P.F.	4.64 Kw  4.64 Kw  Starts Per Hr. or Day	Starting Amps	Use Hours Per



# Service and Meter Application Project Information Sheet

Project Name: Devon Avenue Street Lighting Site Address: 3448 W. Devon Avenue	City: Lincolnwood	Zip: 60712	
Fotal Number of Service Entrance Locations (	meters/switches) Request	ed: 1	
_egal Name of Entity (Electric Consumer): Vill ☐ Corporation ☐ Partnership ☐ Sole Propri Tax I.D.:		•	51
Principle(s) to Sign Contracts For Set Property Owner: Building Owner: Building Manager: John Welch	Phone: Phone: Phone: Phone: Phone: (847)		
Mailing Address For Contracts: Company: Village of Lincolnwood Address:	Phone: (847) City: Lincoln		Fax: Zip: 60018
Mailing Address For Electric Bills: Company: Village of Lincolnwood Address: 6900 N. Lincoln Avenue	Phone: (847) City: Lincoln		Fax: Zip: 60018
Project Contacts: Consulting Engineer: Rich Jezierny Firm Name: Christopher Burke Engineering, L Address: 9575 W. Higgins Road, Suite 600	•		Fax: (847) 823-0520 Zip: 60018
Electrical Contractor: Consulting Engineer: Firm Name: Address:	E-mail: Phone: City:		Fax: Zip:
Other: Consulting Engineer: Firm Name: Address:	E-mail: Phone: City:		Fax: Zip:
The Following Documents May Be Re 1. Plat of Survey with legal description o 2. Site Plan showing building relative to 3. Civil drawings (showing water, sewer, 4. Complete electrical drawings and/or leadings.)	f property (for easement, property lines – mark serv gas, phone, electric, pav	vice entrance loc	

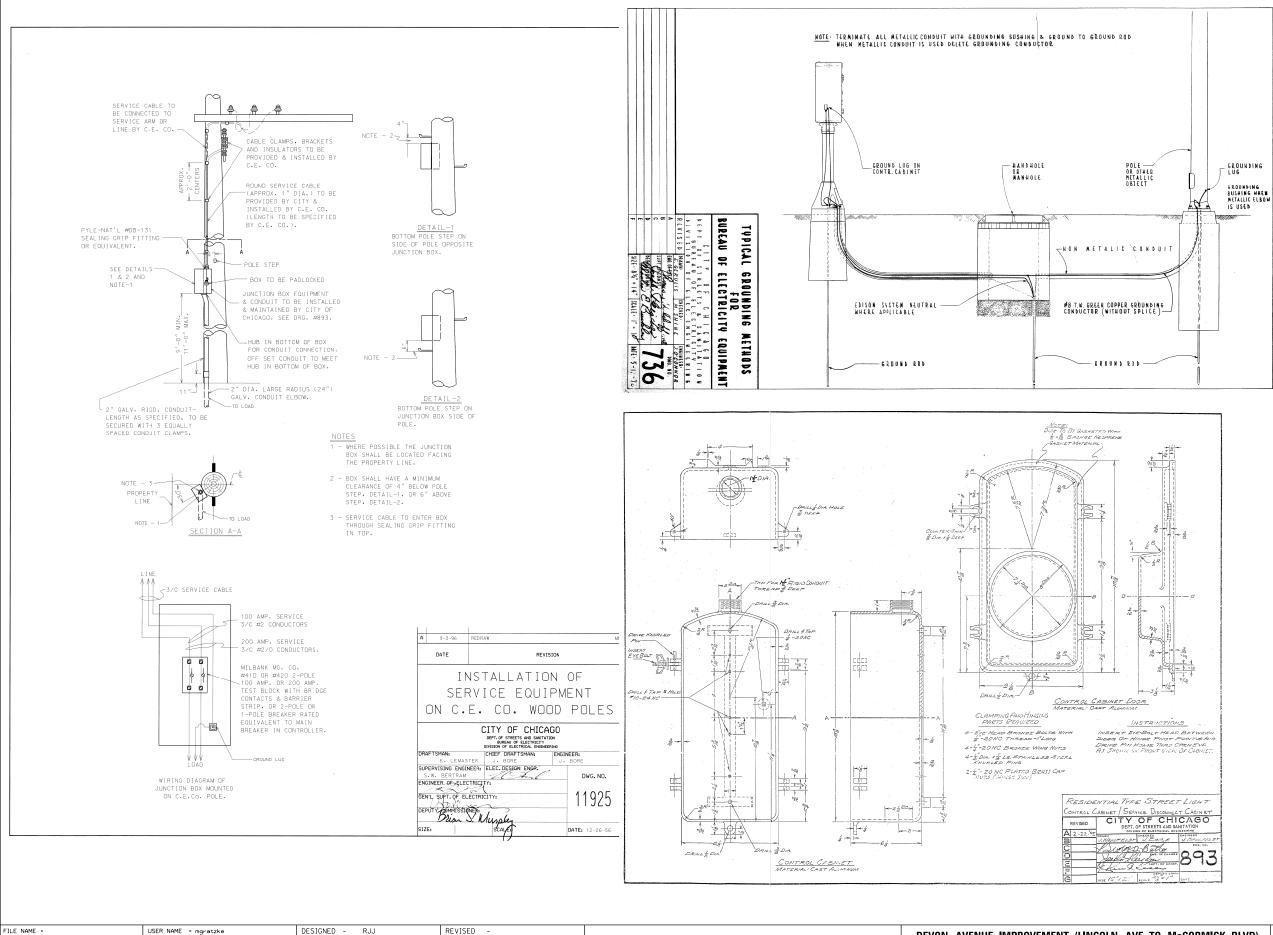
# **Information Provided By:** Print Name: Rich Jezierny

Signature:

Date: July 21, 2025

# ELECTRICAL SERVICE APPLICATION FOR INFORMATIONAL PURPOSES ONLY

FILE NAME =	USER NAME = mgratzke	DESIGNED - RJJ	REVISED -		DEVON AVENUE IMPROVEMENT (LINCOLN AVE TO McCORMICK BLVD)	F.A.U. RTF.	SECTION	COUNTY	TOTAL SHEET
N:\LINCOLNWOOD\140090\C1401\Mech\LDT_14	0090.C1401_06.sht	DRAWN - RJJ	REVISED -	STATE OF ILLINOIS	VILLAGE OF LINCOLNWOOD LIGHTING DETAILS (6 OF 6)	1349	16-00061-00-LS	соок	167 124
	PLOT SCALE = 20'	CHECKED - AJD	REVISED -	DEPARTMENT OF TRANSPORTATION	VILLAGE OF LINCOLNWOOD LIGHTING DETAILS (6 OF 6)			CONTRACT	NO. 61L92
Default	PLOT DATE = 9/26/2025	DATE - 9/26/2025	REVISED -		SCALE: NO SCALE SHEET 6 OF 6 SHEETS STA. TO STA.		ILLINOIS FED. A	VID PROJECT	



- 1. SERVICE DISCONNECT CABINET SHALL BE FACTORY DRILLED AND TAPPED FOR A 3" DIA. SERVICE CONDUIT.
- 2. PROPOSED ELECTRIC SERVICE IS 200A.
- 3. CONTRACTOR SHALL **COORDINATE ALL WORK WITH** COMED. PROPOSED ELECTRIC **SERVICE PAID FOR UNDER** "ELECTRIC SERVICE INSTALLATION (SPECIAL)" AND "ELECTRIC SERVICE CONNECTION", SEE SPECIAL PROVISIONS.

N:\LINCOLNWOOD\140090\C1401\Mech\LDT\_140090.C1401\_07.sht

PLOT DATE = 9/26/2025

DRAWN

DATE

CHECKED -

RJJ

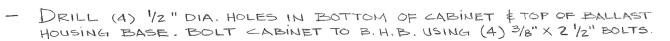
AJD

- 9/26/2025

REVISED

REVISED


REVISED



- OPENINGS IN BOTTOM OF CABINET & TOP OF B. H. B. MAY BE ENLARGED TO A MAX. OF 5" X 10" TO FACILITATE ADDITIONAL CABLE.
- NUMBER & SIZE OF CONDUITS TO BE SHOWN ON CONSTRUCTION DRAWINGS.
- SEE DRAWING # 984 FOR ELECTRICAL PANEL DETAILS.
- SEE DRAWINGS # 983 FOR WIRING DIAGRAM.


CODE	DRWG.	MATERIAL	SIZE	QUANT.
05 -5082 - 5324		FIBER FORM	20" ø	4'
05-3267-2940	-	CONCRETE	CU. YD.	0.7
37-8180-0236	830	ANCHOR ROD	1" × 60"	4
09-7796-9200		GROUND ROD	3/4" × 10'	1
09-2636-3240	Name and American Control of Cont	CLAMP, GROUND ROD	3/4"	1.
09-3392-7850		CABINET ALUMINUM		1
37 - 2130 - 4280	785	BALLAST HOUSING BS	1'-4" ×1' - 8"	

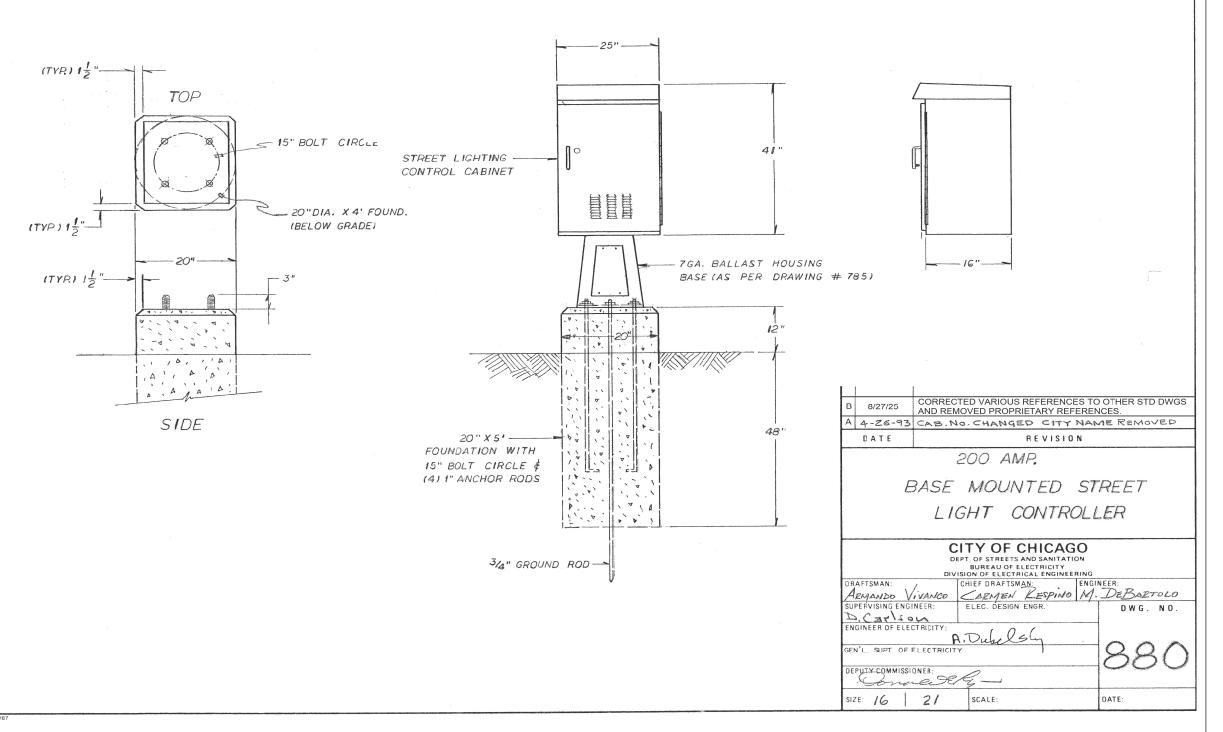
1. PROPOSED LIGHTING
CONTROLLER SHALL BE PAID
FOR UNDER "LIGHTING
CONTROLLER (SPECIAL)",
AND PROPOSED LIGHTING
CONTROLLER FOUNDATION PAID
FOR UNDER "LIGHTING
CONTROLLER FOUNDATION",
SEE SPECIAL PROVISIONS.





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Default	PLOT DATE = 9/26/2025	DATE -	_	9/26/2025	REVISED	_	


F.A.U. RTE.	SECTION	COUNTY	TOTAL SHEETS	SHEET NO.
1349	16-00061-00-LS	соок	167	126
		CONTRAC	T NO. (	51L92
	ILLINOIS FED.	AID PROJECT		

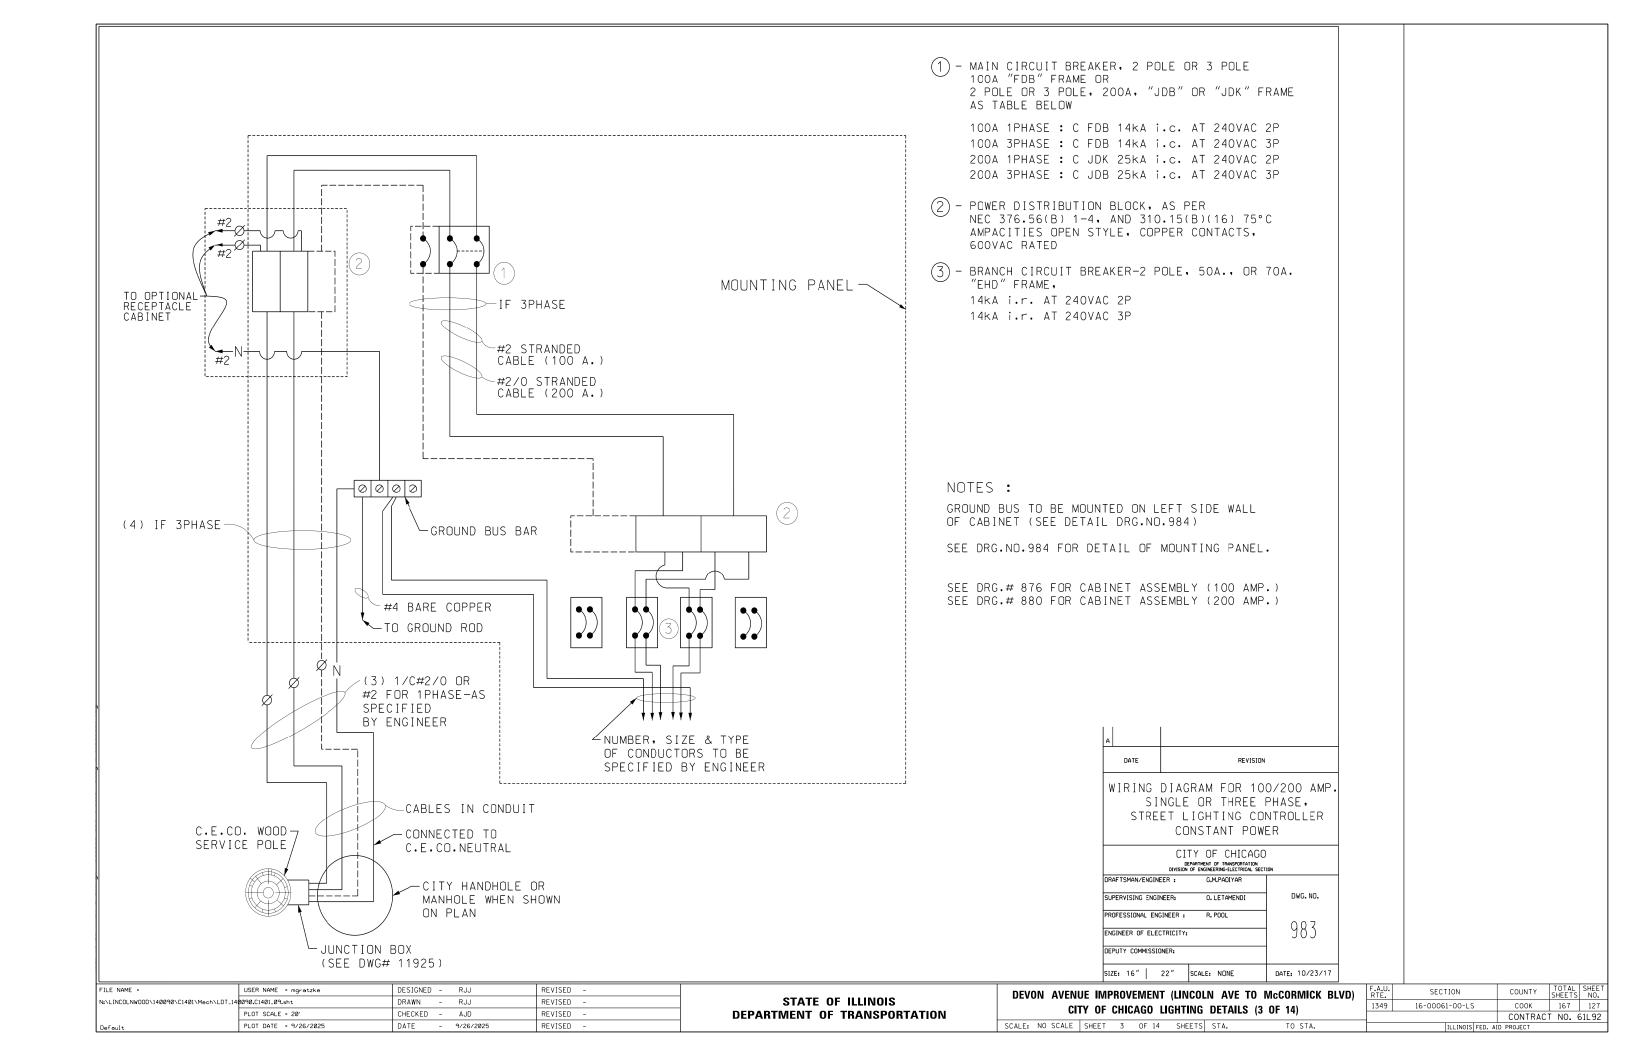

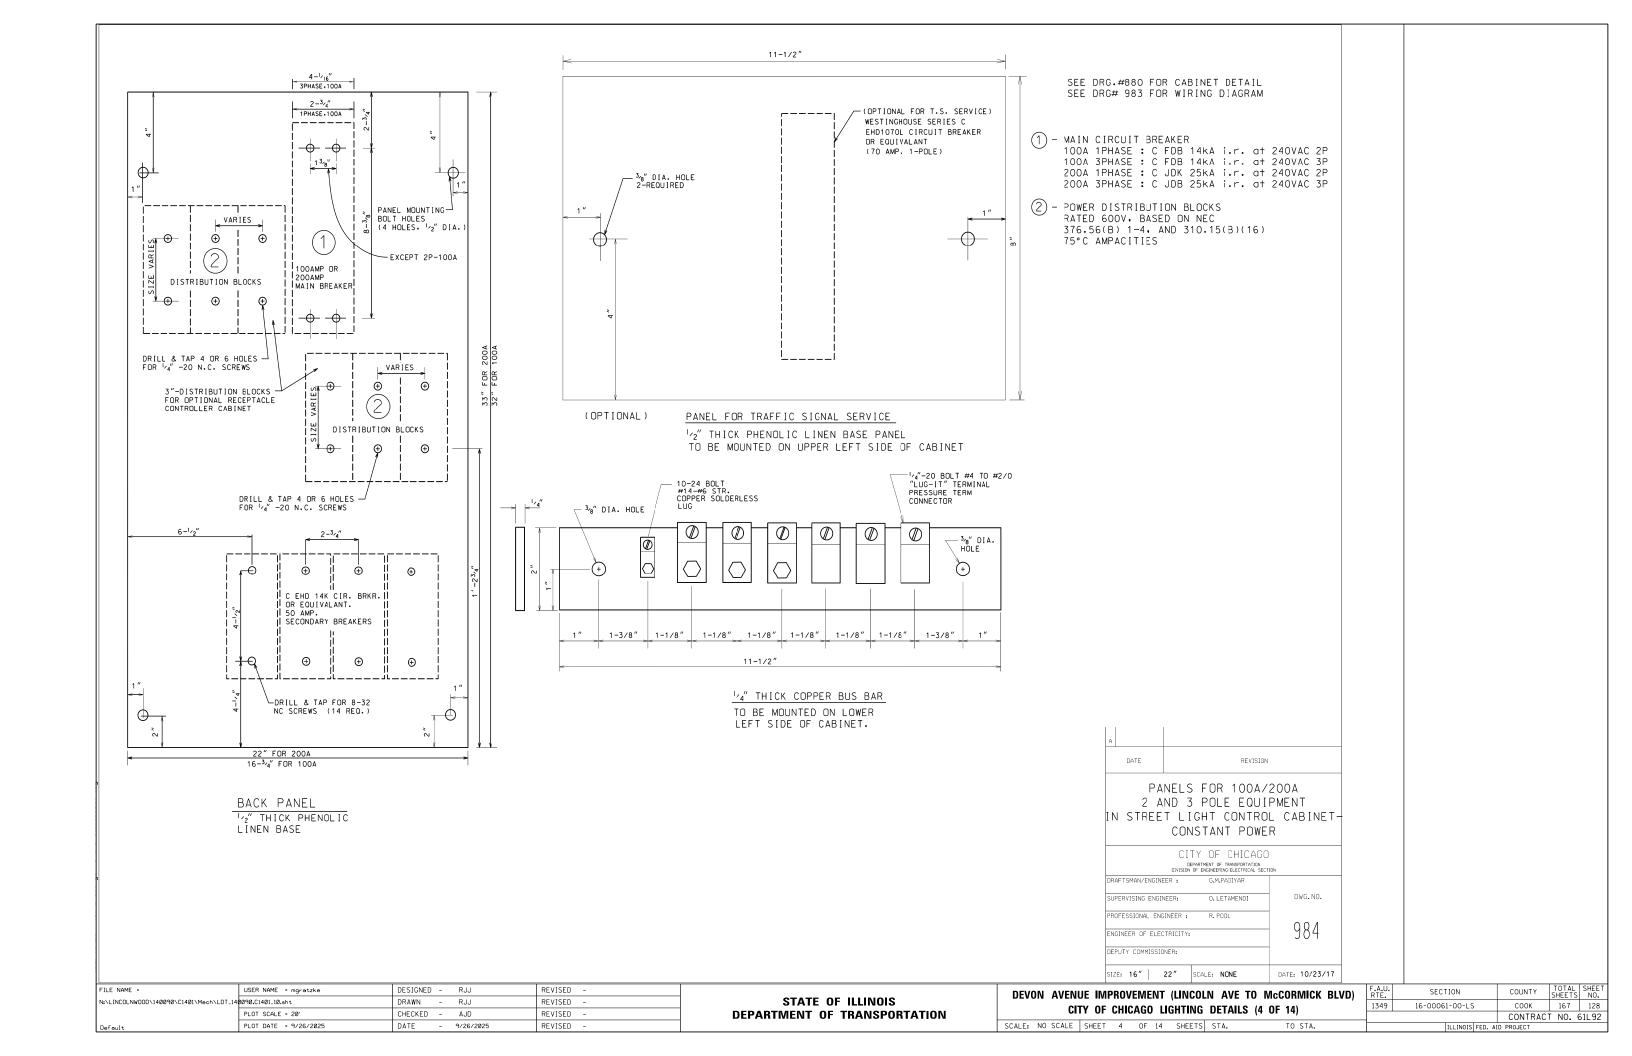

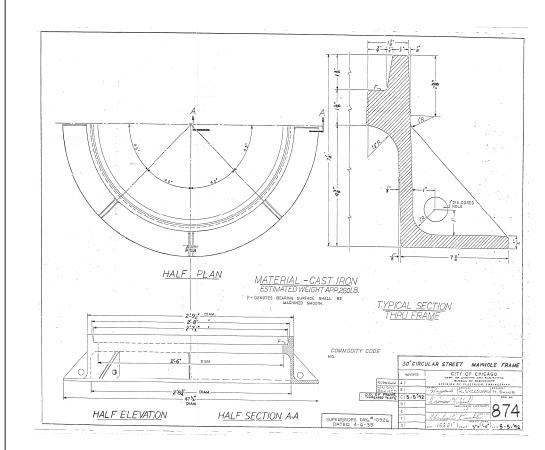

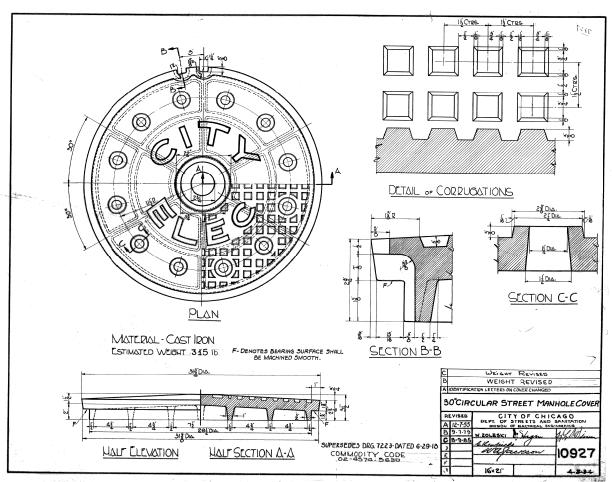


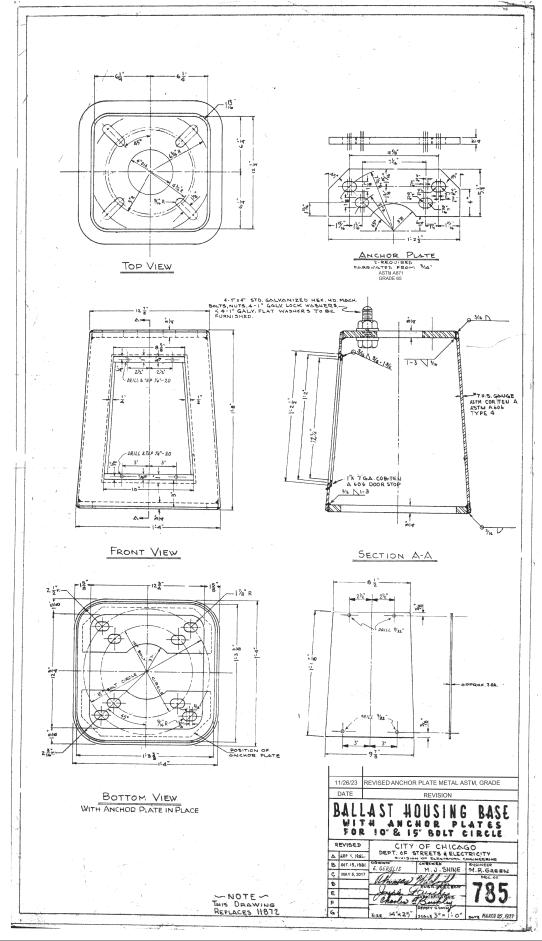


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	PLOT SCALE = 20'	CHECKED	-	AJD	REVISED	-
Default	PLOT DATE = 9/26/2025	DATE	-	9/26/2025	REVISED	-
	•					

<b>DEVO</b>	N	AVENU	JE IM	PROV	EME	NT	(LINCOL	N AVE	T0	McC	ORMICK	BLVD)
		CIT	Y OF	CHIC	AGC	L	IGHTING	DETAIL	S (!	OF	14)	
CALE.	NΙΟ	SCALE	CHEET	6	ΩE	1./	CHEETS	STA			TO STA	

A.U. RTE.	SECT	ION		COUNTY	TOTAL SHEETS	SHEET NO.
1349	16-0006	1-00-LS		COOK	129	
				CONTRAC	T NO. 6	51L92
		ILLINOIS	FED. A	D PROJECT		

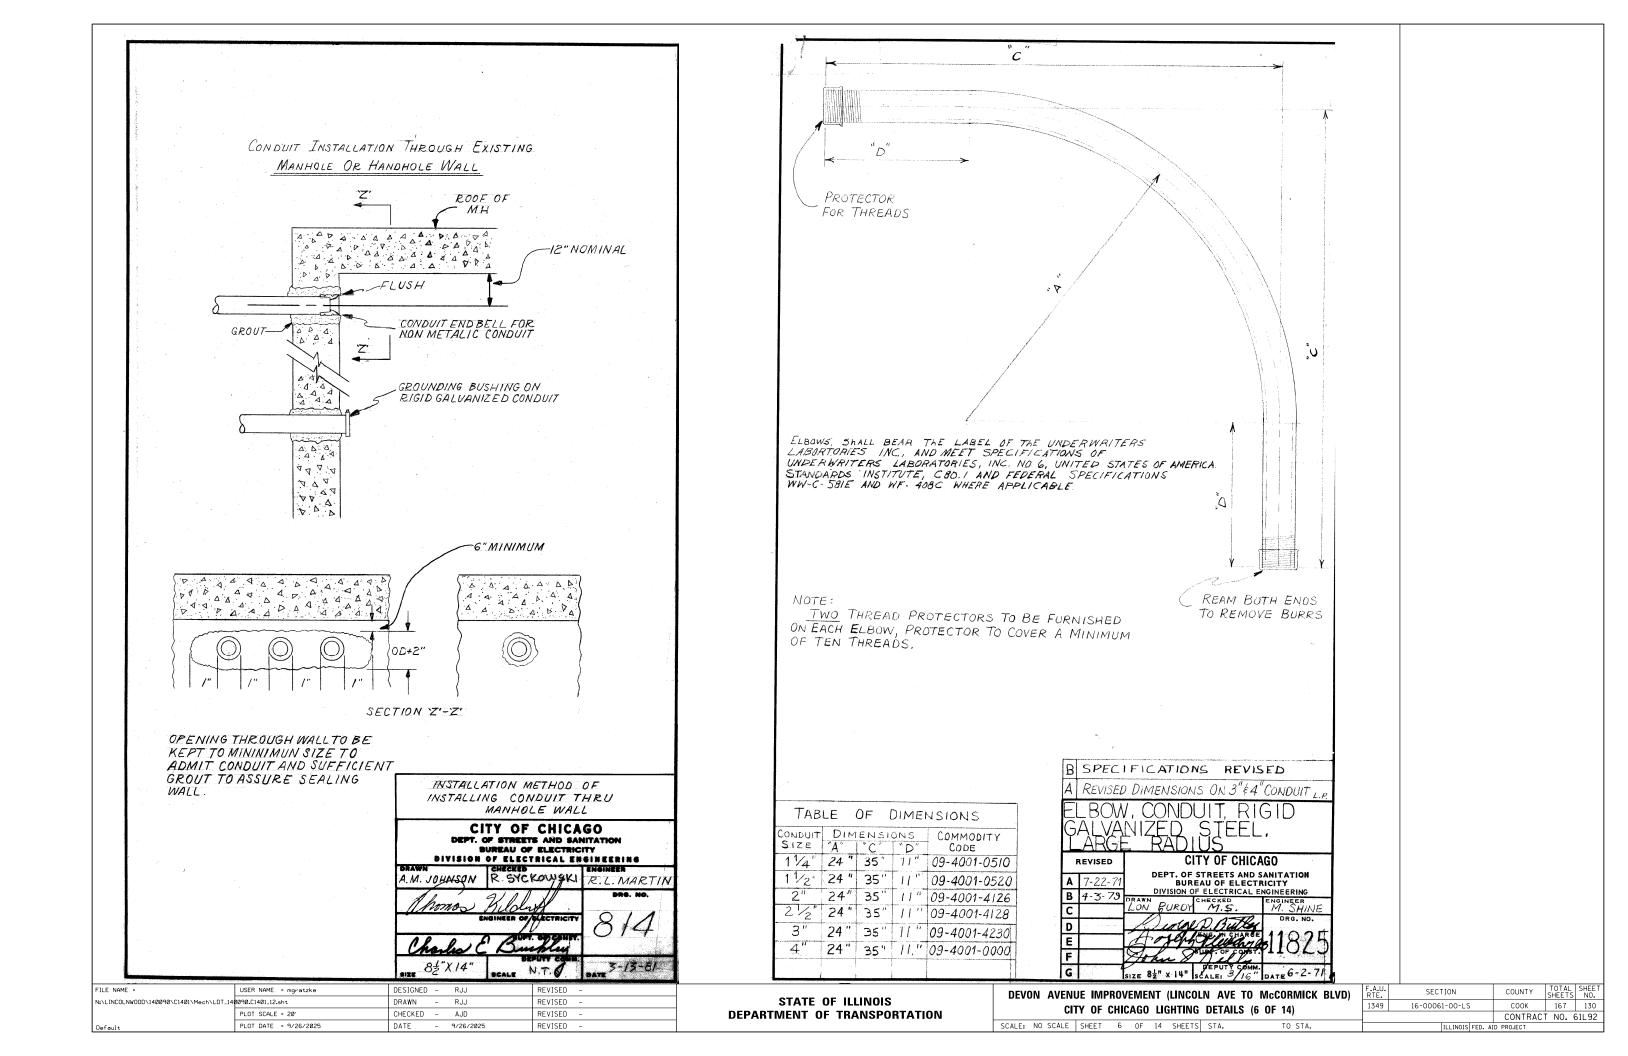

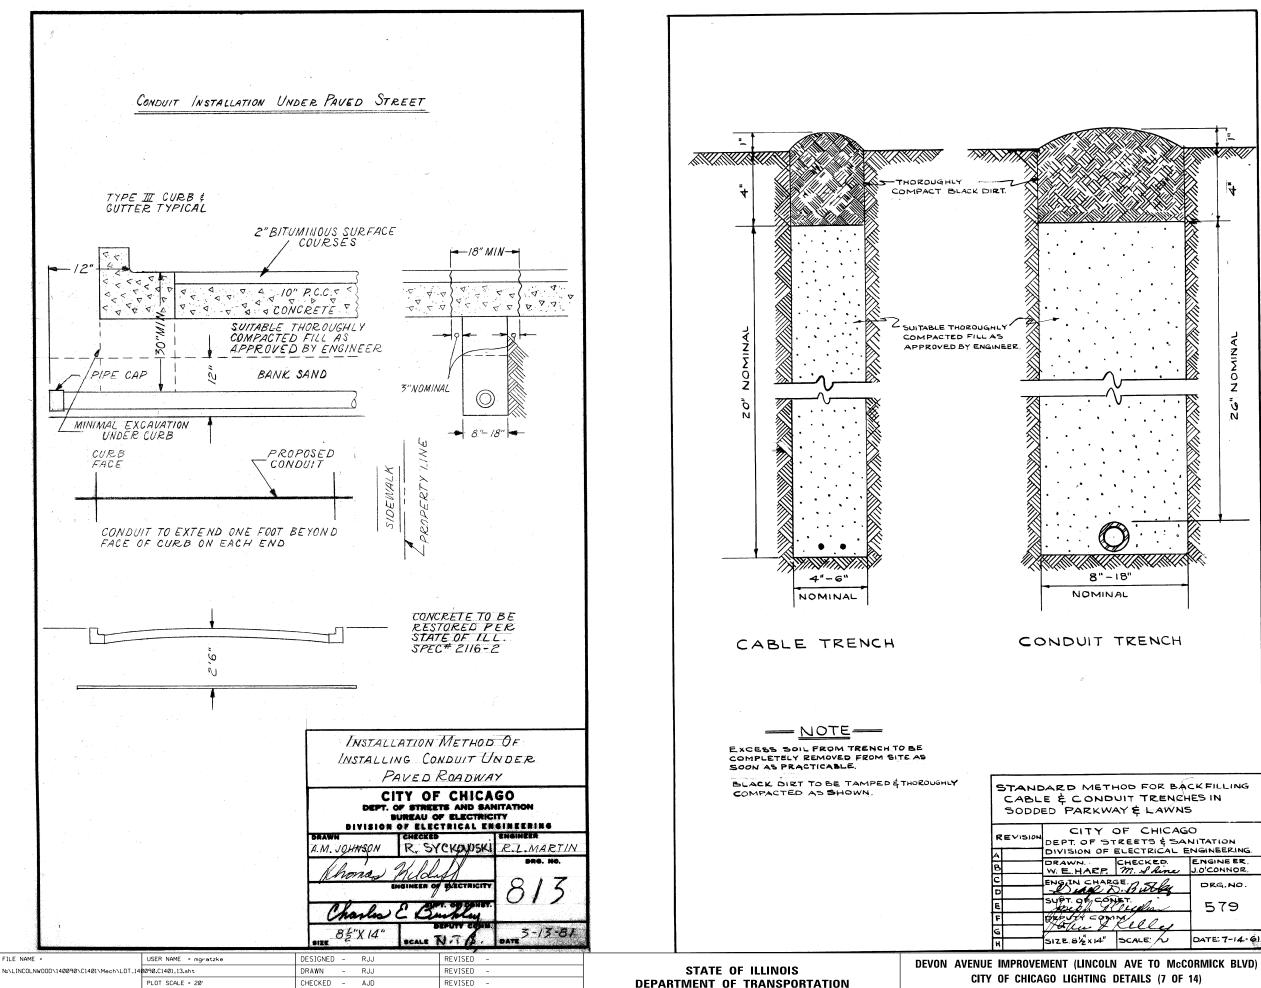

REVISED

DATE - 9/26/2025


PLOT DATE = 9/26/2025

### **LIGHTING DETAIL NOTES:**

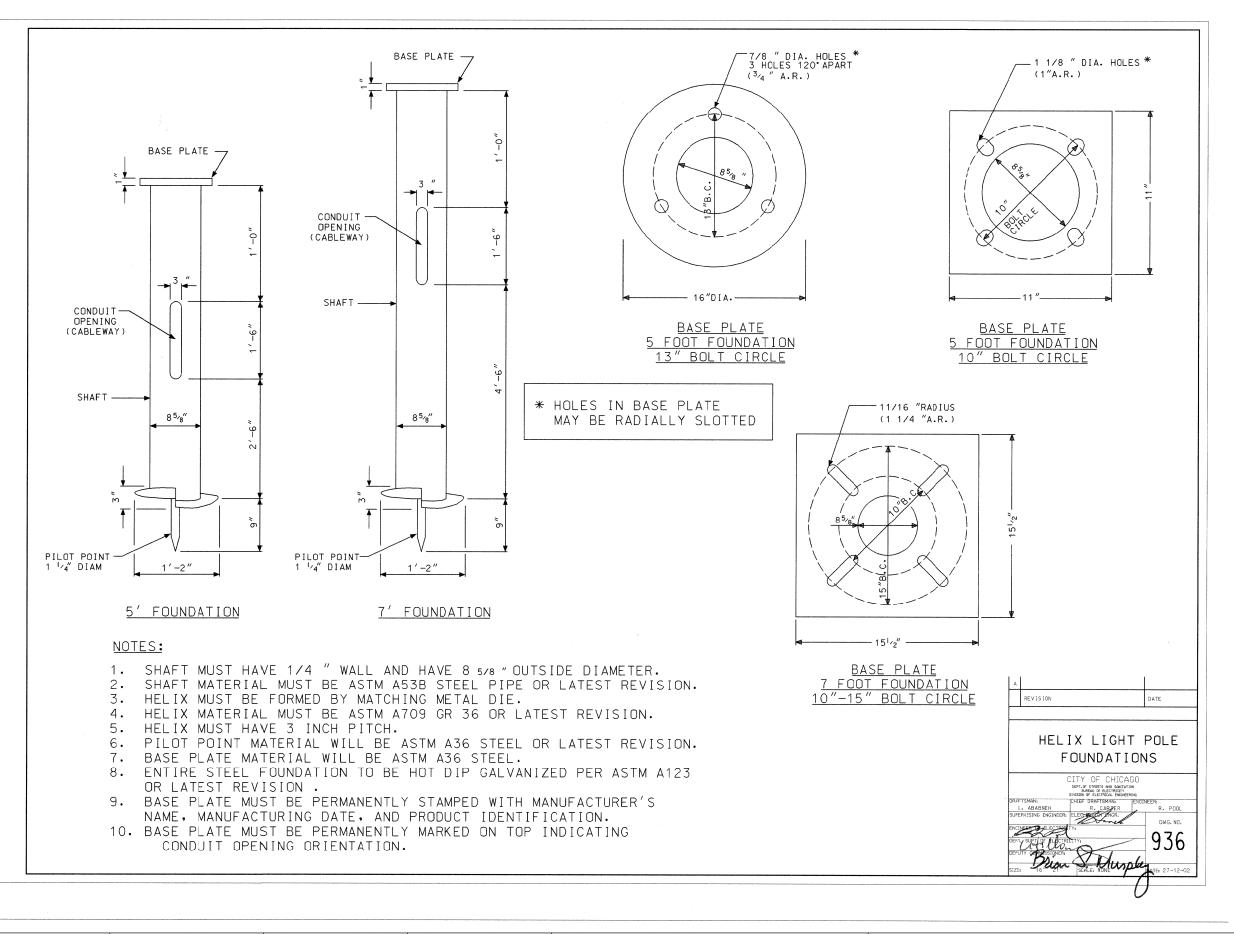- 1. CONTRACTOR SHALL INSTALL LIMESTONE SCREENINGS TO FILL BOTTOM OF TRENCHES TO A DEPTH OF 1' ABOVE TOP OF CONDUIT, OR AS DIRECTED BY INSPECTED OR DIRECTED BY INSPECTOR OR ENGINEER.
- 2. UNDERGROUND CABLE MARKING TAPE SHALL BE INSTALLED A MINIMUM OF 12" BELOW GRADE.

DEVON AVENUE IMPROVEMENT (LINCOLN AVE TO McCORMICK BLVD) SCALE: NO SCALE SHEET 7 OF 14 SHEETS STA.


F.A.U. RTE.	SECT	TION			COUNTY	TOTAL SHEETS	SHEET NO.
1349	16-0006	1-00-LS	;		COOK	167	131
					CONTRAC	T NO.	61L92
		ILLINOIS	FED.	AII	PROJECT		



1. PROPOSED METAL HELIX
FOUNDATION PAID FOR UNDER
"LIGHT POLE FOUNDATION
METAL, 15" BOLT CIRCLE,
8 5/8" X 7"", SEE SPECIAL
PROVISION.

DEV	ON AVEN	IUE IMI	PROV	ЕМЕ	NT	(LINCOL	N AVE	TO McCORMICK BLVD)
	C	ITY OF	CHIC	AG0	LI	GHTING	DETAILS	(8 OF 14)
SCALE:	NO SCALE	SHEET	8	OF	14	SHEETS	STA.	TO STA.

RTE.	SEC.	LION			COUNTY	SHEETS	NO.
1349	16-0006	1-00-LS			COOK	167	132
					CONTRAC	NO. 6	51L92
		ILLINOIS	FED.	ΑI	D PROJECT		

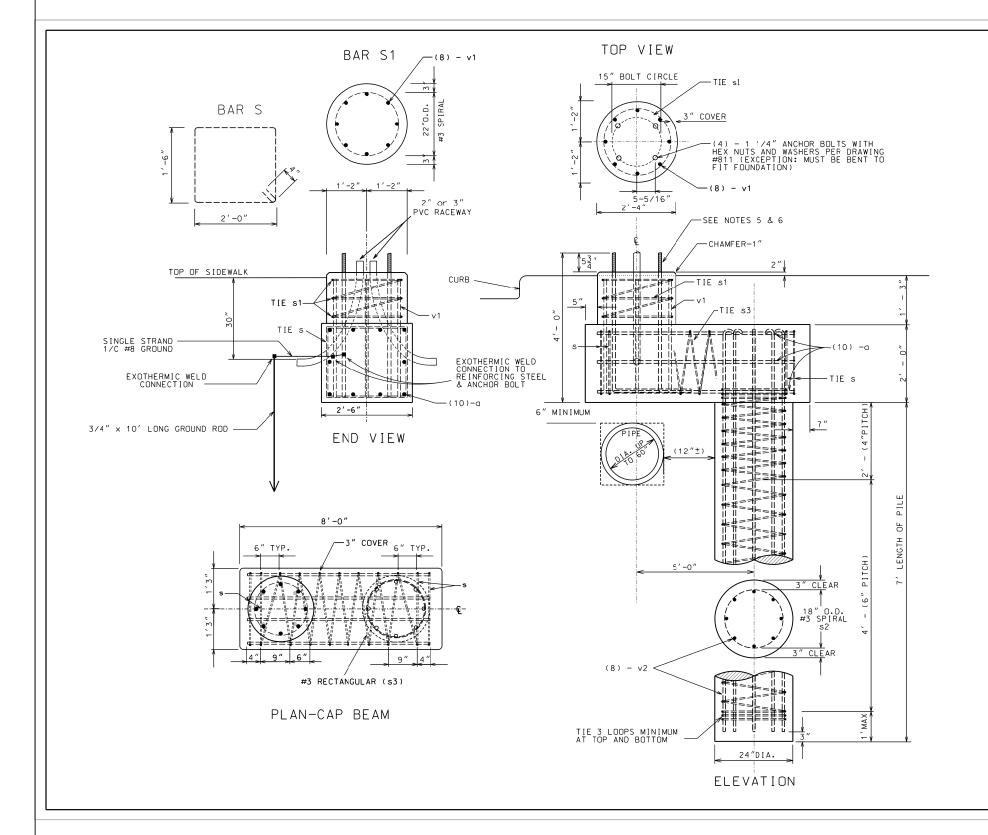

## NOTES

- 1. EXCAVATION OF THE POLE FOUNDATION MUST BE MADE WITH AN AUGER, 30" IN DIAMETER
- 2. THE ANCHOR WILL BE A TACK WELDED TYPE BOLT OR HOOK TYPE BOLT. COLD BENDING OF THE HOOK BOLT WILL NOT BE ALLOWED.
- 3. THE ANCHOR BOLTS AND CONDUITS MUST BE PROPERLY SECURED IN PLACE BEFORE THE CONCRETE IS PLACED IN THE FORM
- 4. THE ENTIRE LENGTH OF THE ANCHOR BOLTS AS WELL AS THE NUTS AND WASHERS MUST BE HOT DIP GALVANIZED IN ACCORDANCE WITH THE REQUIREMENTS OF ASTM DESIGNATION A153
- 5. ANCHOR BOLTS AND CONDUITS MUST PROJECT 5-3/4" ABOVE TOP OF THE FOUNDATION. THE CONTRACTOR MUST CONFIRM ANCHOR BOLT AND CONDUIT EXTENSIONS WITH ENGINEER.
- 6. POLES MUST BE INSTALLED PER DRAWING 837
- 7. THE CONDUIT TRENCH MUST BE BACKFILLED AND FIRMLY COMPACTED BEFORE THE LIGHT POLE IS ERECTED
- 8. CONCRETE MUST MEET IDOT REQUIREMENTS FOR PORTLAND CEMENT CLASS SI CONCRETE
- 9. ALL REINFORCEMENT SHALL HAVE A MINIMUM 3" COVER OF CONCRETE

#### RE-BAR SCHEDULE

MARK	NO.	SIZE	SHAPE	LENGTH
a 10		6		7′-0″
S	4	4		7′-8″
s1	1	3	0	14'-0"
s2	1	3	0	93′-0″
s3	1	3		112'-0"
v1	8	6		2'-11"
v2	8	6		9′-0″

A 2-27-12 ROUND CAP

DATE

	OFFSET FOUNDATION FOR LIGHT POLE									
CITY OF CHICAGO DEPARTMENT OF TRANSPORTATION DIVISON OF ENGINEERING-ELECTRICAL SECTION										
DRAFTSMAN: B. GARNSEY   ENGINEER: GARNSEY. L	.ETAMENDI									
SUPERVISING ENGINEER: ELEC. DESIGN ENGR.										
ENGINEER OF ELECTRICITY:	DWG. NO.									
GEN'L SUPT. OF ELECTRICITY:	937									
DEPUTY COMMISSIONER:	Α									
SIZE: 36"   22"   SCALE: N.T.S.	DATE: 1/28/03									

REVISION

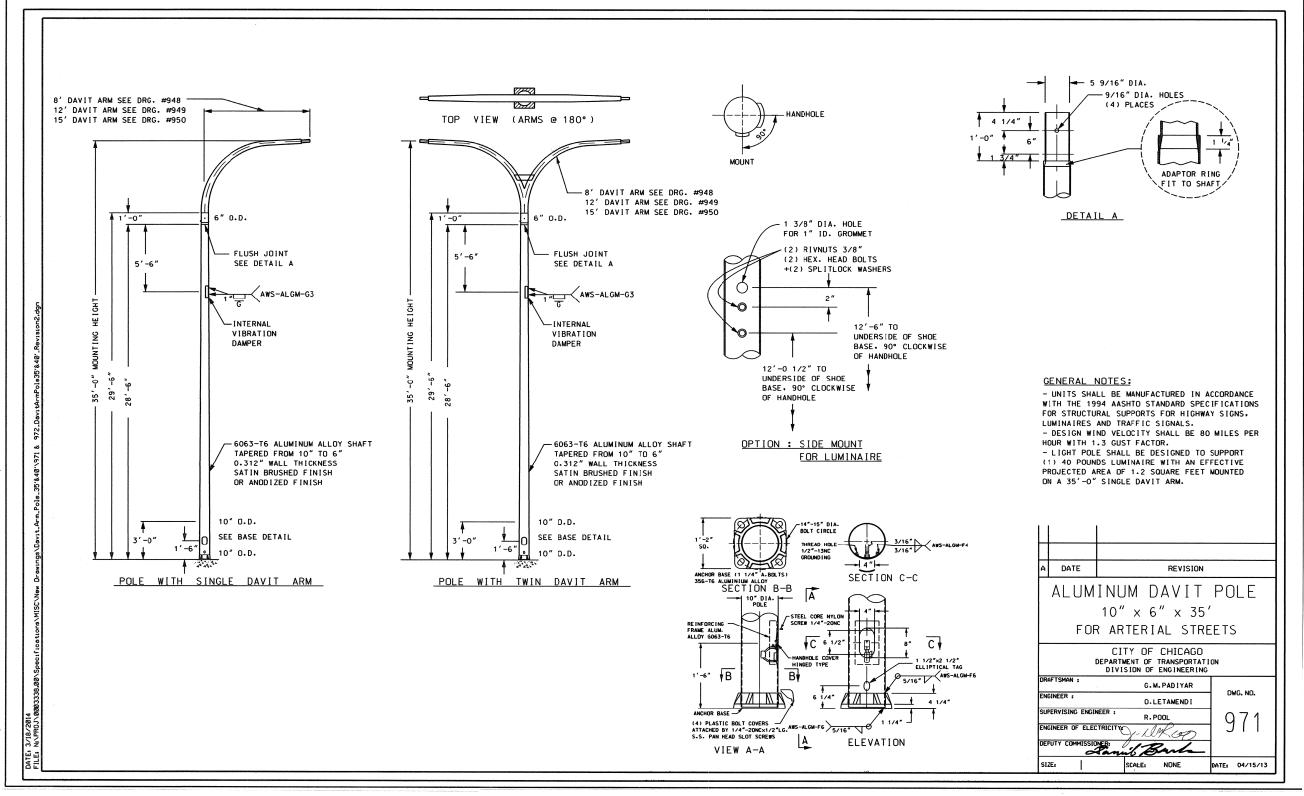
## LIGHTING DETAIL NOTES:

- THE CONTRACTOR SHALL LOCATE THE PROPOSED OFFSET FOUNDATIONS AS REQUIRED TO MAINTAIN THE FOLLOWING MIN. CLEARANCES FROM EXISTING WATERMAIN, IN ACCORDANCE WITH DEPARTMENT OF WATER MANAGEMENT (DWM) STANDARDS:

  —HORIZONTAL CLEARANCE: 3'—4"
- -HORIZONTAL CLEARANCE: 3'--VERTICAL CLEARANCE: 1'-6"
- 2. PROPOSED OFFSET FOUNDATION SHALL BE PAID FOR UNDER "LIGHT POLE FOUNDATION (SPECIAL)", SEE SPECIAL PROVISION.

LE NAME =	USER NAME = mgratzke	DESIGNED	-	RJJ	REVISED	-
\LINCOLNW00D\140090\C1401\Mech\LDT_1400	090.C1401_15.sht	DRAWN	-	RJJ	REVISED	-
	PLOT SCALE = 20'	CHECKED	-	AJD	REVISED	-
efault	PLOT DATE = 9/26/2025	DATE	-	9/26/2025	REVISED	-


F.A.U. RTE.	SECTION	COUNTY	TOTAL SHEETS	SHEE'
1349	16-00061-00-LS	СООК	167	133
		CONTRAC	Γ NO. (	51L92
	ILLINOIS FED.	AID PROJECT		




- 1. THE LIGHT POLE SHALL HAVE A BLACK ANODIZED FINISH.
- 2. PROPOSED LIGHT POLE SHALL BE PAID FOR UNDER "LIGHT POLE, ALUMINUM, 35 FT. M.H., 15 FT. DAVIT ARM", SEE SPECIAL PROVISIONS.
- 3. PROPOSED LED ROADWAY COBRAHEAD LUMINAIRE WITH SMART NODE PAID FOR UNDER "LUMINAIRE, LED, SPECIAL", SEE SPECIAL PROVISIONS.


FILE NAME =	USER NAME = mgratzke	DESIGNED	-	RJJ	REVISED -
N:\LINCOLNWOOD\140090\C1401\Mech\LDT_140	090.C1401_16.sht	DRAWN	-	RJJ	REVISED -
	PLOT SCALE = 20'	CHECKED	-	AJD	REVISED -
Default	PLOT DATE = 9/26/2025	DATE	-	9/26/2025	REVISED -


F.A.U. RTE.		SECT	ION		COUNTY	TOTAL SHEETS	SHEET NO.			
1349		16-0006	1-00-LS		COOK	167	134			
				CONTRAC	T NO. 6	51L92				
	ILLINOIS FED. AID PROJECT									

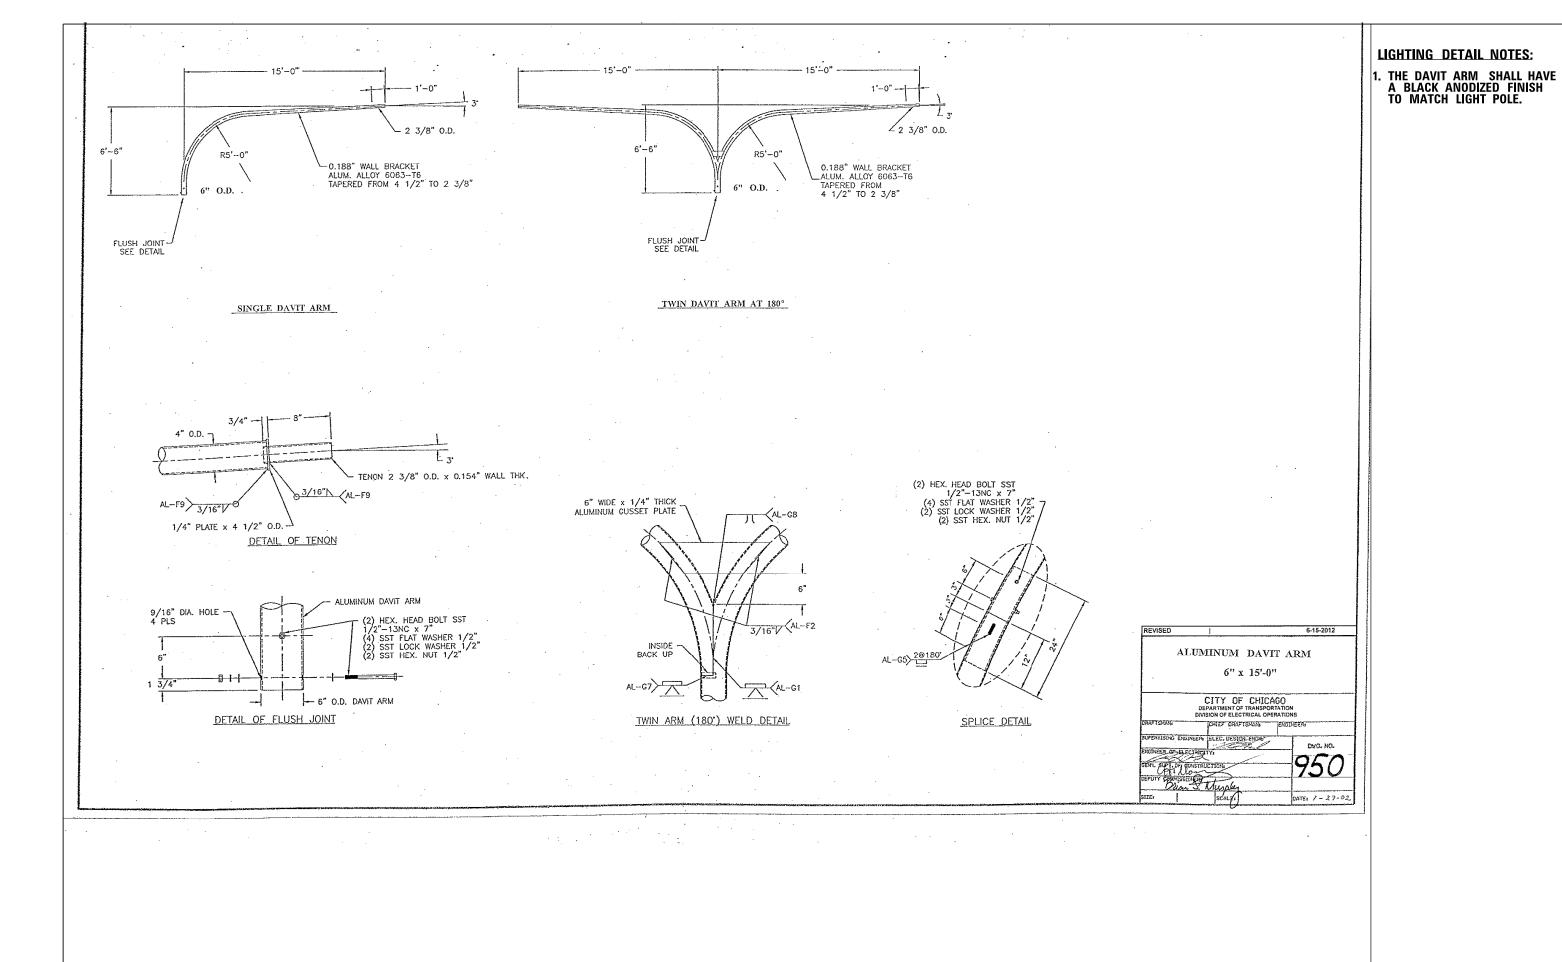

	FILE NAME =	USER NAME = mgratzke	DESIGNED - RJJ	REVISED -		DEVON AVENUE IMPROVEMENT (LINCOLN AVE TO McCORMICK BLVD)	F.A.U.	SECTION	COUNTY	TOTAL	SHEET
- 1	N:\LINCOLNWOOD\140090\C1401\Mech\LDT_14	0090.C1401_17.sht	DRAWN - RJJ	REVISED -	STATE OF ILLINOIS	,	1349	16-00061-00-LS	COOK	167	135
		PLOT SCALE = 20'	CHECKED - AJD	REVISED -	DEPARTMENT OF TRANSPORTATION	CITY OF CHICAGO LIGHTING DETAILS (11 OF 14)			CONTRACT	T NO.	61L92
	Default	PLOT DATE = 9/26/2025	DATE - 9/26/2025	REVISED -		SCALE: NO SCALE SHEET 11 OF 14 SHEETS STA. TO STA.	1	ILLINOIS FED. AII	PROJECT		

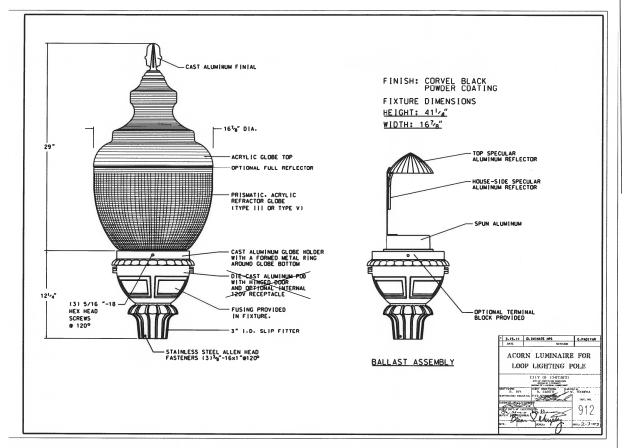

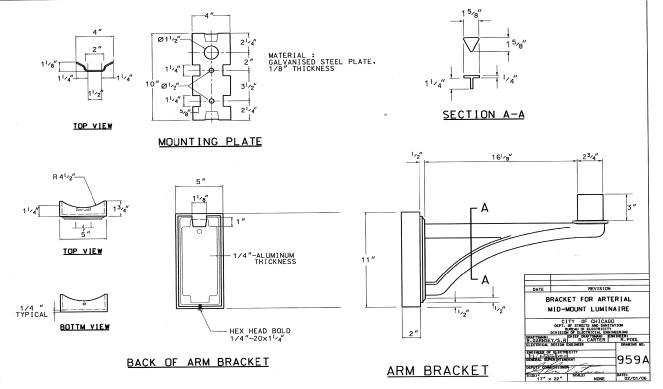

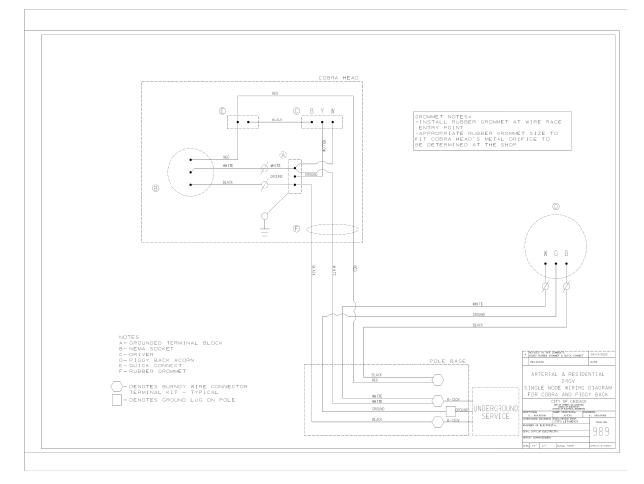


- 1. FIXTURE AND ARM SHALL HAVE BLACK FINISH TO MATCH LIGHT POLE.
- 2. PROPOSED LED ACORN LUMINAIRE, ARM, AND SMART NODE SHALL BE PAID FOR UNDER "LUMINAIRE (SPECIAL)", SEE SPECIAL PROVISION.



l	DEVO	N	AVENI	JE IM	PROVI	EME	NT	(LINCOL	N AVE T	O McCORMICK BLVD)
			CIT	Y OF	CHICA	4G0	LIC	GHTING	DETAILS	(12 OF 14)
	SCALE:	N0	SCALE	SHEET	12	OF	14	SHEETS	STA.	TO STA.

F.A.U. RTE.		SECT	TION		COUNTY	TOTAL SHEETS	SHEET NO.			
1349		16-0006	1-00-LS		COOK	167	136			
				CONTRAC	T NO. 6	51L92				
	ILLINOIS FED. AID PROJECT									



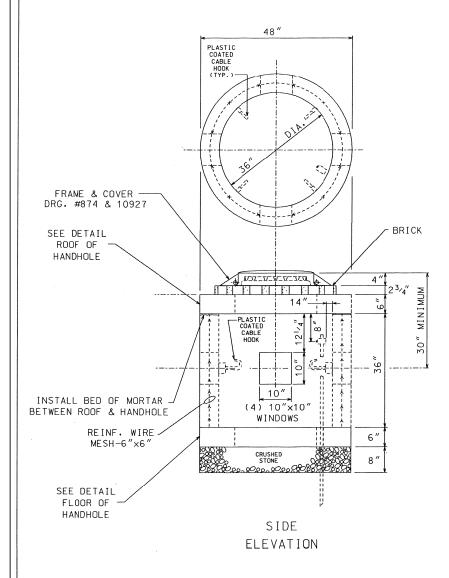


COMPLETE COM	MMODITY CODE NO	05-661	0-5310M
CODE NO.	MATERIALS	SIZE	QUAN.
(1) 05-6610-5312	PRE-CAST HANDHOLE	36" X 36"	1
(2) 05-6610-5312	PRE-CAST ROOF & FLOOR	SEE DETAIL	2
05-9075-5470	STONE3/4" CRUSHED	BAG	5
05-1452-9720	BRICK		24
02-4299-5524	FRAME, MANHOLE	30"	1
02-4574-5624	COVER, MANHOLE	30"	1
09-7796-9312	GROUND ROD	3/4" ×12′	1
09-2636-3240	GROUND CLAMP		1
(3)05-5082-5330	SONO TUBE	36"	1
(3) 05-5082-5342	SONO TUBE	. 48″	1
(3) 05-3267-2940	CONC. REDI-MIX	CU. YD.	1
(3) 20-5472-9630	REINFORCING BAR	#3 ( <sup>3</sup> / <sub>8</sub> ")	40′
(3) 20-5472-9630	REINFORCING BAR	#3 ( <sup>3</sup> / <sub>8</sub> ")	16′
(3) 20-5472-9640	REINFORCING BAR	#4 (1/2")	8′
(3) 57-0770-0000	(MESH (6" X6")	36" X 11'	1

- (1) PRE-CAST HANDHOLE SHALL INCLUDE CABLE HOOKS AND CONDUIT KNOCK-OUTS.
- (2) PRE-CAST ROOF & FLOOR SHALL INCLUDE LIFTING EYES.
- (3) THESE ITEMS ARE FOR POURED-IN-PLACE HANDHOLES ONLY.

#### CONSTRUCTION NOTES:

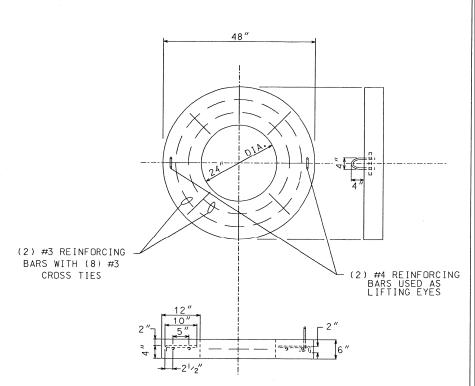- 1 8" BED OF STONE FOR DRAINAGE.
- 2 ALL METALLIC CONDUIT(S) ENTERING HANDHOLE SHALL EXTEND MIN. 1" & MAX. OF 3" INSIDE INNER WALL & BE EQUIPPED WITH AN APPROVED TYPE THREADED GROUNDING BUSHING.



DETAIL-ROOF & FLOOR OF HANDHOLE

	DATE	REVISION	
		400C0 040LE 10040 050 000440050050	#IPD W
В	01-23-00	ADDED CABLE HOOKS PER CONMISSIONER N	
Α		REDRAW (CAD.)	MP.
	3	6" DIA. HEAVY DUT	Y
		CONCRETE HANDHOLE	
		WITH 30" FRAME &	
		COVER FOR	
	5	TREET INSTALLATIO	N
		CITY OF CHICAGO  DEPT. OF STREETS AND SANITATION BUREAU OF ELECTRICITY DIVISION OF ELECTRICAL ENGINEERING	
	AFTSMAN: M. PATTO	N B. CARTER	NEER: W. TROMPKA M. DEBARTOLO
l	DINEER OF ELE	V The Hal	DWG. NO.
GÉ		ECTRICITY:	871
DE	B.M.V	NERO S	
SIZ	E: 17"	22" SCALE: NONE	DATE: 1-12-96

#### **LIGHTING DETAIL NOTES:**

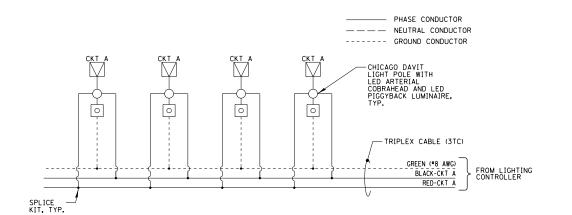
- 1. NO SPLICES SHALL BE ALLOWED IN PROPOSED MANHOLES OR HANDHOLES.
- 2. SEE CHICAGO DWG. NO. 736 FOR HANDHOLE GROUNDING DETAILS.
- 3. PROPOSED CONCRETE
  HANDHOLE SHALL BE PAID
  FOR UNDER "HEAVY-DUTY
  HANDHOLE (SPECIAL)", SEE
  SPECIAL PROVISION.

		L NEVISION						
D 01 00 00 A0550 04515 10000 055 00111001150 11100115								
В	01-23-00	-23-00 ADDED CABLE HOOKS PER CONMISSIONER					(RC/R	
Α				MP.				
	36" DIA. HEAVY DUTY							
		CONC	RETE	HANDHO	DLE			
		WITH	1 30 <i>"</i>	FRAME	&			
			COVE	RFOR				
	S	TREE	T INS	STALLAT	ΓΙΟΙ	N		
		CI	TY OF	CHICA	30			
			BUREAU O	TS AND SANITATION				
	AFTSMAN:		SION OF ELE	CTRICAL ENGINEER		NEER: W.		
				ARTER			TROMPKA	
DR	M. PATTO	ו אוו	D. (	ANILN			ARTOLO	
	M. PATTO		EC. DESIG			l	ARTOLO 3. NO.	
SU		NEER: EL				l		
SU	PERVISING ENGI	NEER: EL	EC. DESIG			l		
SU EN	PERVISING ENGI GINEER OF ELEC N'L SUPT. OF EL	TRICITY	EC. DESIG			l		
SU EN	PERVISING ENGI	TRICITY	EC. DESIG			l		

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	PLOT SCALE = 20'	CHECKED	-	AJD	REVISED -
Default	PLOT DATE = 9/26/2025	DATE	-	9/26/2025	REVISED -

1	DEV	ON A	AVENU	JE IMI	PROVI	ЕМЕ	NT	(LINCOL	N AVE	TO McCORMICK BLVD)	F
								-		.S (13 OF 14)	
ı										-5 (15 01 14)	┰
ı	SCALE:	NO S	CALE	SHEET	13	OF	14	SHEETS	STA.	TO STA.	Г

F.A.U. RTE.	SEC <sup>-</sup>	TION			COUNTY	TOTAL SHEETS	SHEET NO.
1349	16-0006	1-00-LS	;		COOK	167	137
					CONTRACT	T NO. 6	51L92
		ILLINOIS	FED.	A)	ID PROJECT		




#### **LIGHTING DETAIL NOTES:**

1. NO FUSES ARE ALLOWED ON LUMINAIRE BRANCH CIRCUIT CABLES IN ACCORDANCE WITH CDOT STANDARDS.

#### NOTES:

- 1. ABOVE WIRING DIAGRAM REPRESENTS LIGHTING CIRCUITS FOR A TYPCIAL CITY BLOCK.
- 2. SEE CDOT STANDARD DETAIL 989 FOR WIRING DIAGRAM. CABLE AND CONDUIT SIZE AS SHOWN ON PLANS.
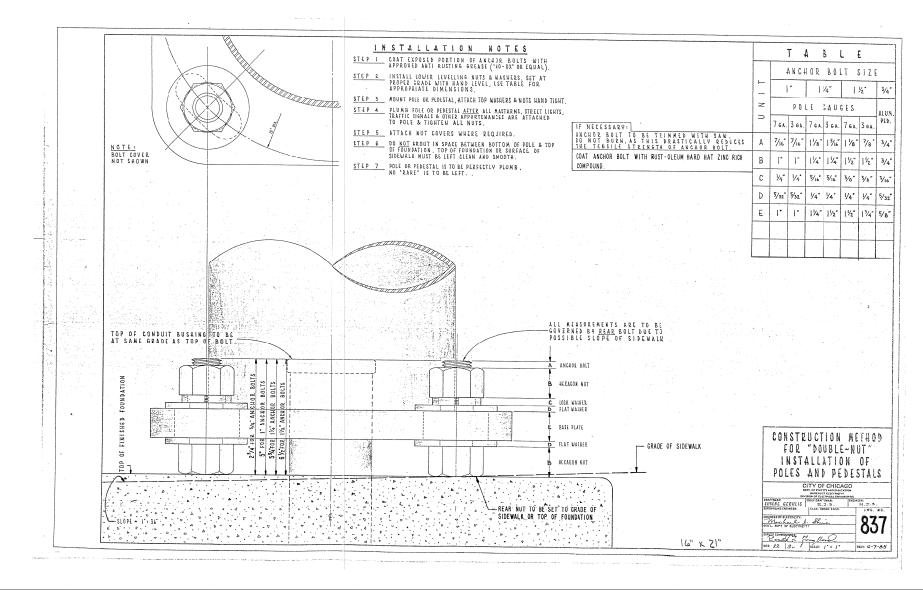
### TYPICAL LIGHTING CIRCUIT WIRING DIAGRAM



FILE NAME =	USER NAME = mgratzke	DESIGNED	-	RJJ	REVISED -
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	PLOT SCALE = 20'	CHECKED	-	AJD	REVISED -
Default.	PLOT DATE = 9/26/2025	DATE	-	9/26/2025	REVISED -

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DESCRIPTION

REVISIONS

### **DEVON AVENUE IMPROVEMENTS**

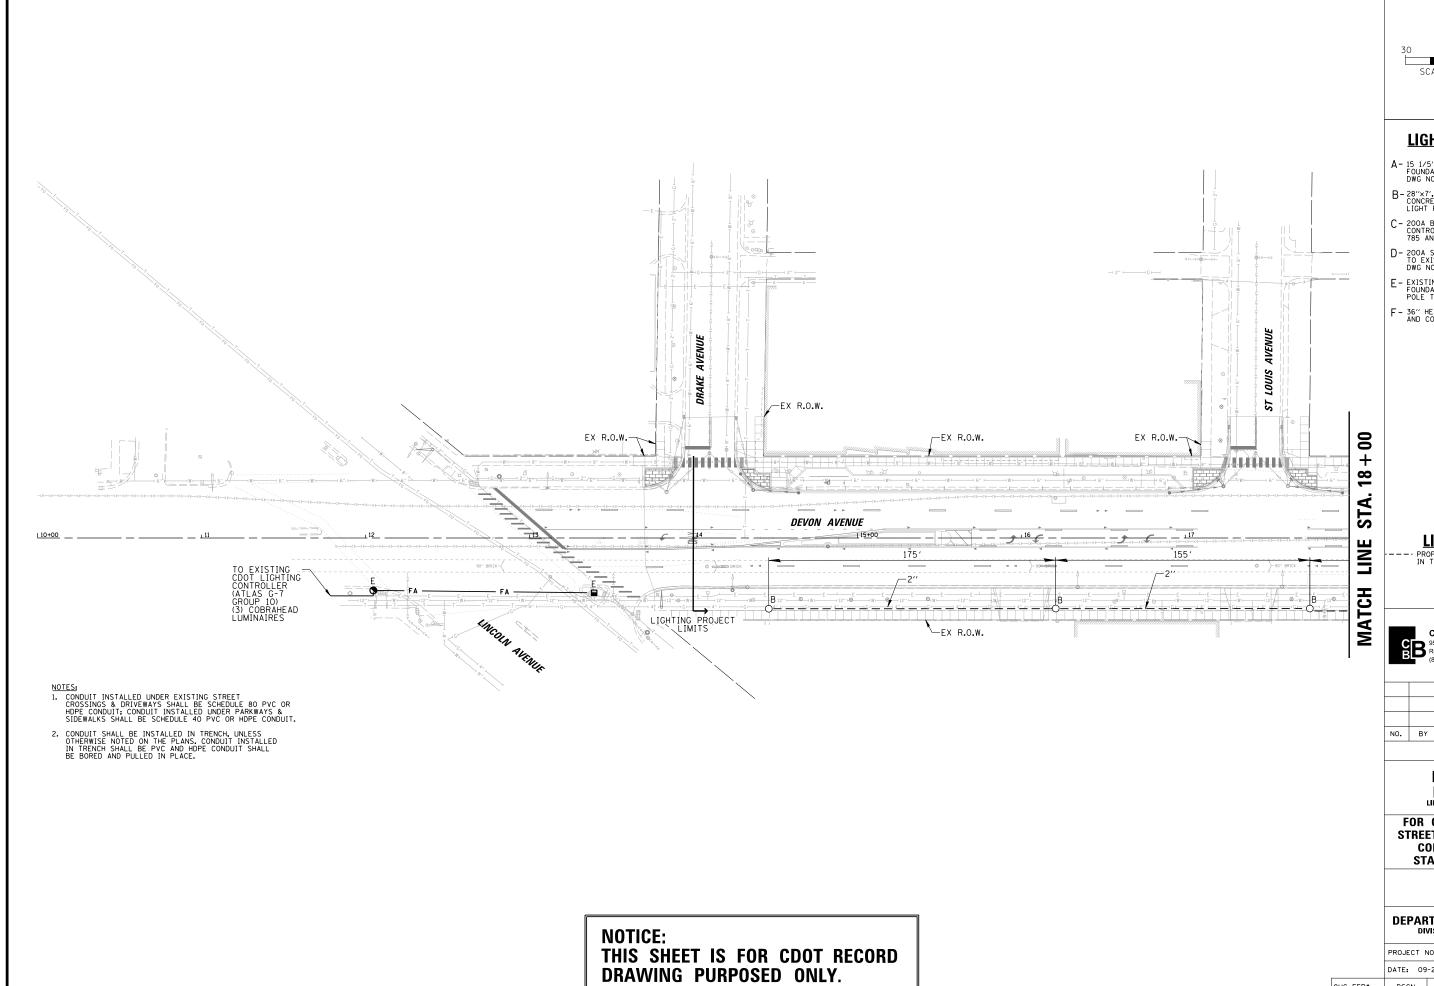
FOR CDOT INFORMATION ONLY STREET LIGHTING AND TRAFFIC SIGNAL STANDARD LEGEND

**CITY OF CHICAGO** 

## **DEPARTMENT OF TRANSPORTATION**

PROJECT NO.: 140090-C1401 DEO SHEET NUMBER

DATE: 09-25-25 SHEET NUMBER CHECK SHEET 139 OF 167 AJD



SCALE IN FEET

### **LIGHTING IDENTIFIERS**

- A- 15 1/5" SQUIARE x 7' DEEP METAL HELIX FOUNDATION FOR DAVIT LIGHT POLE (CHICAGO DWG NO. 936)
- B-28"x7', 11/4" AR, 15" BC OFFSET CONCRETE FOUNDATION FOR DAVIT LIGHT POLE (CHICAGO DWG NO. 937A)
- C 200A BASE MOUNTED STREET LIGHTING CONTROLLER FOUNDATION (SEE CHICAGO DWG NO. 785 AND 880)
- D- 200A SERVICE DISCONNECT BOX MOUNTED TO EXISTING WOOD POLE (CHICAGO DWG NO. 893 AND 11925)
- E EXISTING CONCRETE OR HELIX FOUNDATION/LIGHT POLE TO REMAIN
- F 36" HEAVY DUTY HANDHOLE WITH 30" FRAME AND COVER (CHICAGO DWG NO. 871 AND 872)

### **LIGHTING LEGEND**

PROPOSED UNDERGROUND CONDUIT INSTALLED IN TRENCH (NOTE 2)



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NO.	BY	DATE	DESCRIPTION

REVISIONS

# DEVON AVENUE IMPROVEMENTS LINCOLN AVE TO MCCORMICK BLVD

FOR CDOT INFORMATION ONLY STREET LIGHTING UNDERGROUND **CONDUIT FACILITIES PLAN** STA. 10 + 00 TO STA. 18 + 00

CITY OF CHICAGO

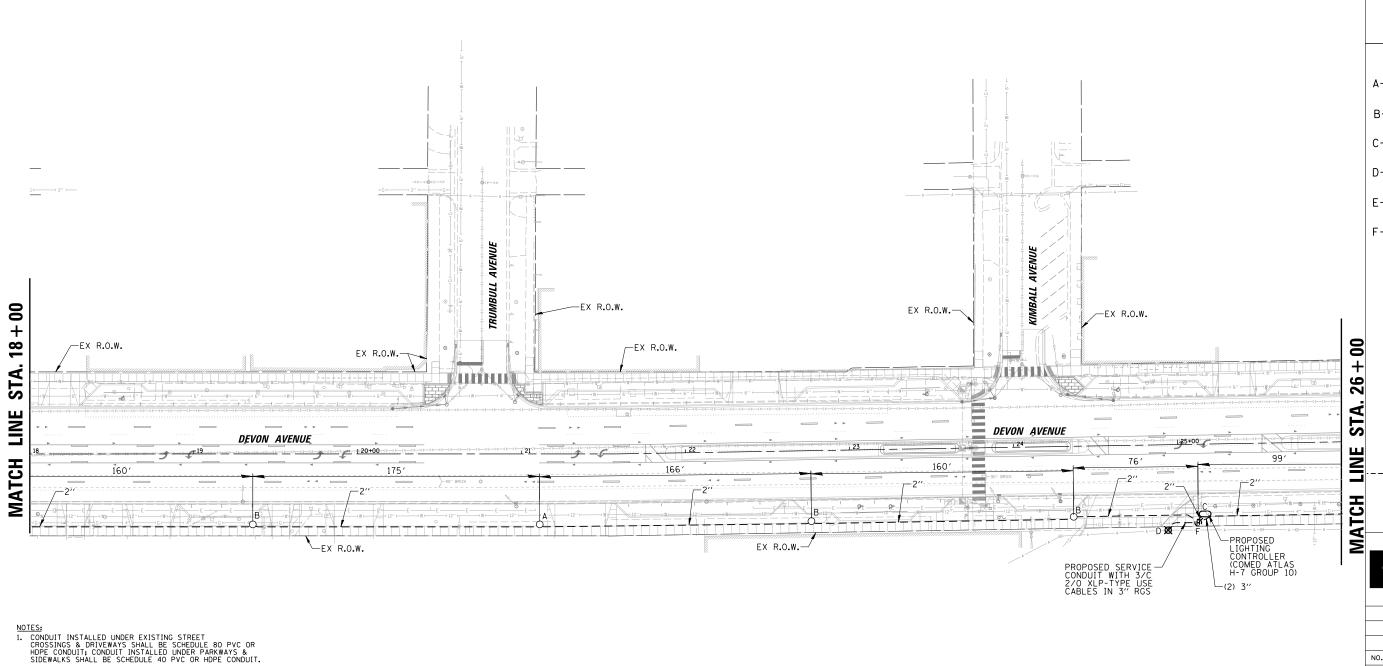
# DEPARTMENT OF TRANSPORTATION DIVISION OF PROJECT DEVELOPMENT

PROJECT N	NO.: 140	DEO SHEE	T NUMBER	
DATE: 09-25-25		25–3	343	
DSGN	DRAWN	CHECK	SHEET	NUMBER

AJD

ATLAS:

SHEET 140 OF 167



. CONDUIT SHALL BE INSTALLED IN TRENCH, UNLESS OTHERWISE NOTED ON THE PLANS. CONDUIT INSTALLED IN TRENCH SHALL BE PVC AND HOPE CONDUIT SHALL BE BORED AND PULLED IN PLACE.

### **LIGHTING IDENTIFIERS**

- A- 15 1/5" SQUIARE x 7' DEEP METAL HELIX FOUNDATION FOR DAVIT LIGHT POLE (CHICAGO DWG NO. 936)
- B-28"x7', 11/4" AR, 15" BC OFFSET CONCRETE FOUNDATION FOR DAVIT LIGHT POLE (CHICAGO DWG NO. 937A)
- C 200A BASE MOUNTED STREET LIGHTING CONTROLLER FOUNDATION (SEE CHICAGO DWG NO. 785 AND 880)
- D- 200A SERVICE DISCONNECT BOX MOUNTED TO EXISTING WOOD POLE (CHICAGO DWG NO. 893 AND 11925)
- E EXISTING CONCRETE OR HELIX FOUNDATION/LIGHT POLE TO REMAIN

SCALE IN FEET

F - 36" HEAVY DUTY HANDHOLE WITH 30" FRAME AND COVER (CHICAGO DWG NO. 871 AND 872)

### **LIGHTING LEGEND**

PROPOSED UNDERGROUND CONDUIT INSTALLED IN TRENCH (NOTE 2)

CHRISTOPHER B. BURKE ENGINEERING, LTD. 9575 W. Higgins Road, Sulte 600 Rosemont, Minois 60018 (847) 823-0500

REVISIONS

### **DEVON AVENUE** IMPROVEMENTS LINCOLN AVE TO MCCORMICK BLVD

FOR CDOT INFORMATION ONLY STREET LIGHTING UNDERGROUND **CONDUIT FACILITIES PLAN** STA.18+00 TO STA.26+00

CITY OF CHICAGO

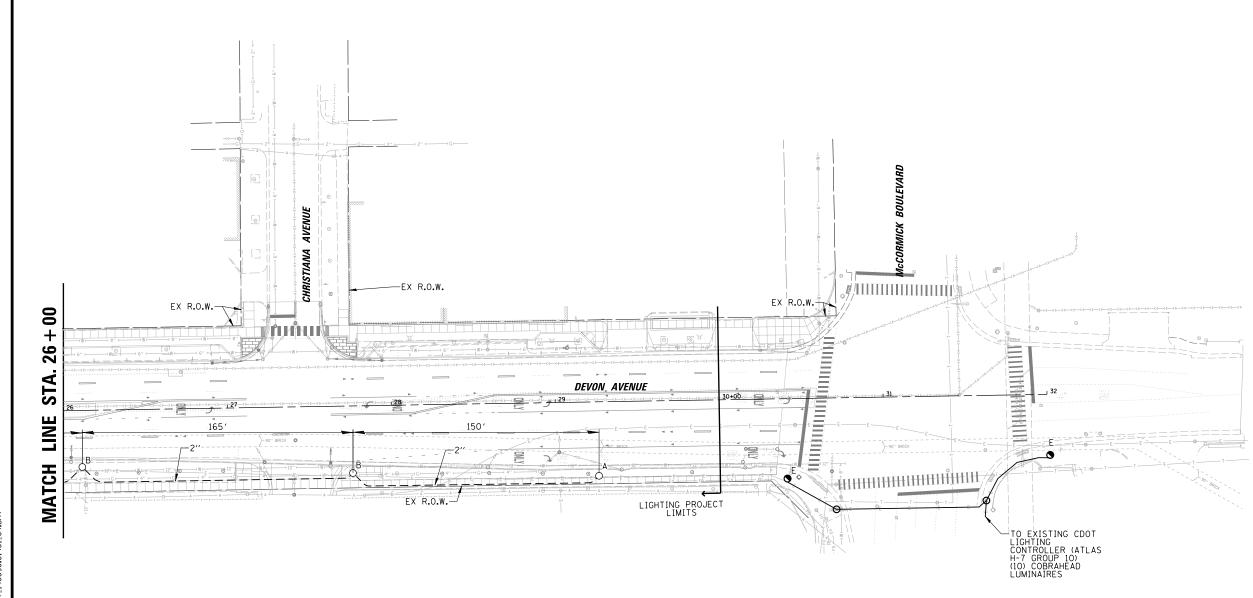
# DEPARTMENT OF TRANSPORTATION DIVISION OF PROJECT DEVELOPMENT

PROJECT N	NO.: 140	090-C1401	DEO SHEE	T NUMBE
DATE: 09	-25-25		25–	344
DSGN	DRAWN	CHECK	SHEET	NUMBER

AJD

SHEET 141 OF 167


NOTICE: THIS SHEET IS FOR CDOT RECORD DRAWING PURPOSED ONLY.



1. CONDUIT INSTALLED UNDER EXISTING STREET
CROSSINGS & DRIVEWAYS SHALL BE SCHEDULE 80 PVC OR
HDPE CONDUIT. INSTALLED UNDER PARKWAYS &
SIDEWALKS SHALL BE SCHEDULE 40 PVC OR HDPE CONDUIT.

2. CONDUIT SHALL BE INSTALLED IN TRENCH, UNLESS OTHERWISE NOTED ON THE PLANS. CONDUIT INSTALLED IN TRENCH SHALL BE PVC AND HDPE CONDUIT SHALL BE BORED AND PULLED IN PLACE.

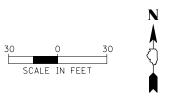NOTICE: THIS SHEET IS FOR CDOT RECORD DRAWING PURPOSED ONLY.



### **LIGHTING IDENTIFIERS**

- A-151/5" SOUIARE x 7' DEEP METAL HELIX FOUNDATION FOR DAVIT LIGHT POLE (CHICAGO DWG NO. 936)
- B-28"x7", 11/4" AR, 15" BC OFFSET CONCRETE FOUNDATION FOR DAVIT LIGHT POLE (CHICAGO DWG NO. 937A)
- C 200A BASE MOUNTED STREET LIGHTING CONTROLLER FOUNDATION (SEE CHICAGO DWG NO. 785 AND 880)
- D- 200A SERVICE DISCONNECT BOX MOUNTED TO EXISTING WOOD POLE (CHICAGO DWG NO. 893 AND 11925)
- E EXISTING CONCRETE OR HELIX FOUNDATION/LIGHT POLE TO REMAIN
- F 36" HEAVY DUTY HANDHOLE WITH 30" FRAME AND COVER (CHICAGO DWG NO. 871 AND 872)

### **LIGHTING LEGEND**

PROPOSED UNDERGROUND CONDUIT INSTALLED IN TRENCH (NOTE 2)



ATLAS:

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NO.	BY	DATE	DESCRIPTION

REVISIONS

### **DEVON AVENUE** IMPROVEMENTS LINCOLN AVE TO MCCORMICK BLVD

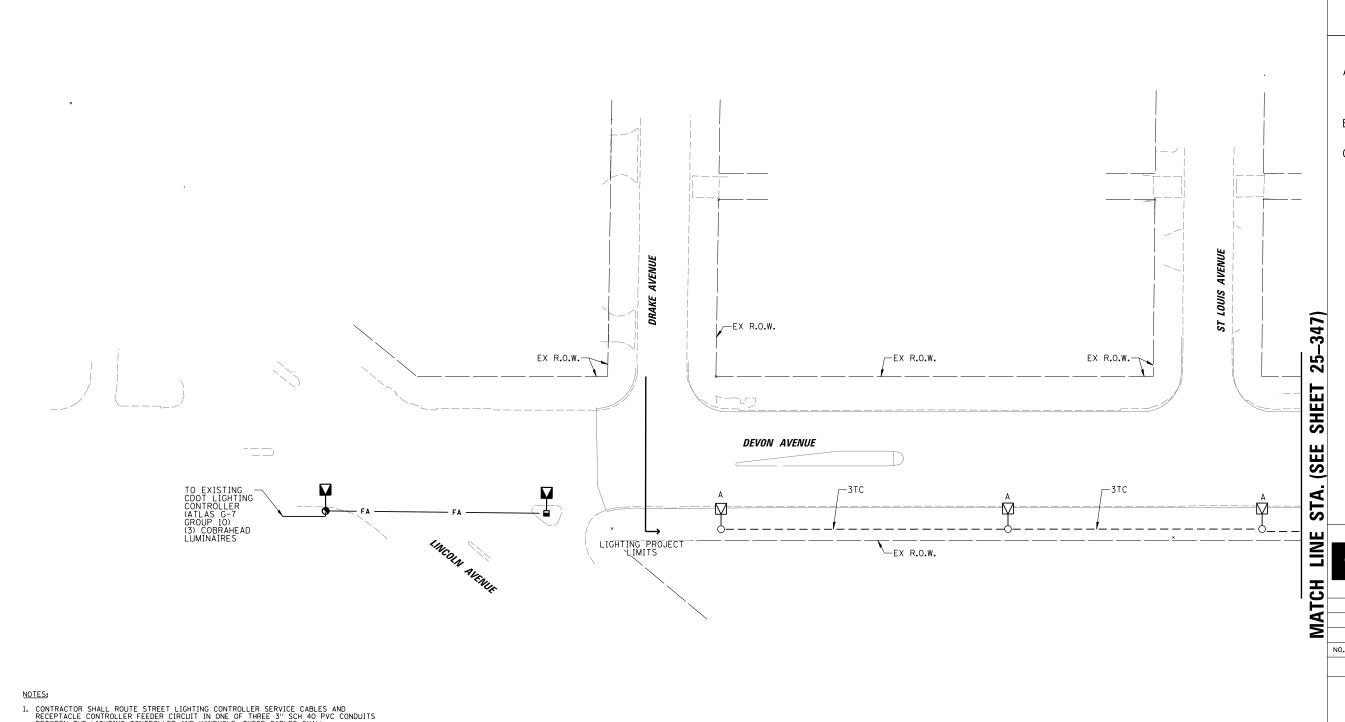
FOR CDOT INFORMATION ONLY STREET LIGHTING UNDERGROUND **CONDUIT FACILITIES PLAN** STA. 26 + 00 TO STA. 32 + 00

CITY OF CHICAGO

# DEPARTMENT OF TRANSPORTATION DIVISION OF PROJECT DEVELOPMENT

PROJECT NO.:		NO.: 140	140090-C1401		T NUMBER
	DATE: 09	-25-25	25–	345	
	DSGN	DRAWN	SHEET	NUMBER	

SHEET 142 OF 167 AJD




- 1. CONTRACTOR SHALL ROUTE STREET LIGHTING CONTROLLER SERVICE CABLES AND RECEPTACLE CONTROLLER FEEDER CIRCUIT IN ONE OF THREE 3" SCH 40 PVC CONDUITS BETWEEN THE LIGHTING CONTROLLER AND HANDHOLE. THESE CABLES SHALL NOT BE COMBINED WITH ANY LIGHTING BRANCH CIRCUITS.
- 2. ALL CDOT SERVICE AND BRANCH CIRCUITS CABLES SHALL BE EPR-TYPE RHW CABLES.
- 3. ALL PROPOSED LUMINAIRES SHALL BE PROVIDED WITH A SMART LIGHT CONTROL NODE, IN ACCORDANCE WITH THE CITY'S LATEST STANDARDS. CONTRACTOR SHALL VERIFY THE LUMINAIRE AND LIGHT CONTROL NODE MODEL INFORMATION WITH THE CITY PRIOR TO ORDERING ANY EQUIPMENT.

NOTICE: THIS SHEET IS FOR CDOT RECORD DRAWING PURPOSED ONLY.



### **LIGHTING IDENTIFIERS**

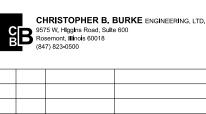- A 35' ALUMINUM DAVIT LIGHT POLE PAINTED
  BLACK ANDDIZED WITH A 149W LED COBRAHEAD
  LUMINAIRE WITH TYPE II OPTICS, 3000K CCT
  AND SMART NODE, 35' LUMINAIRE MH, 15' ARM
  WITH GOW LED PIGGYBACK ACORN LUMINAIRE
  MOUNTED AT 14' (SIDEWALK SIDE)
- B- 200A, 120/240V, 10 BASE MOUNTED STREET LIGHTING CONTROLLER (SEE CHICAGO DWG NO. 785, 880, 983 AND 984)
- C PROPOSED 200A ELECTRIC SERVICE INSTALLATION ON AN EXISTING COM ED WOOD POLE (SEE CHICAGO DWG NO. 893 AND 11925)



REVISIONS

## **DEVON AVENUE** IMPROVEMENTS LINCOLN AVE TO MCCORMICK BLVD

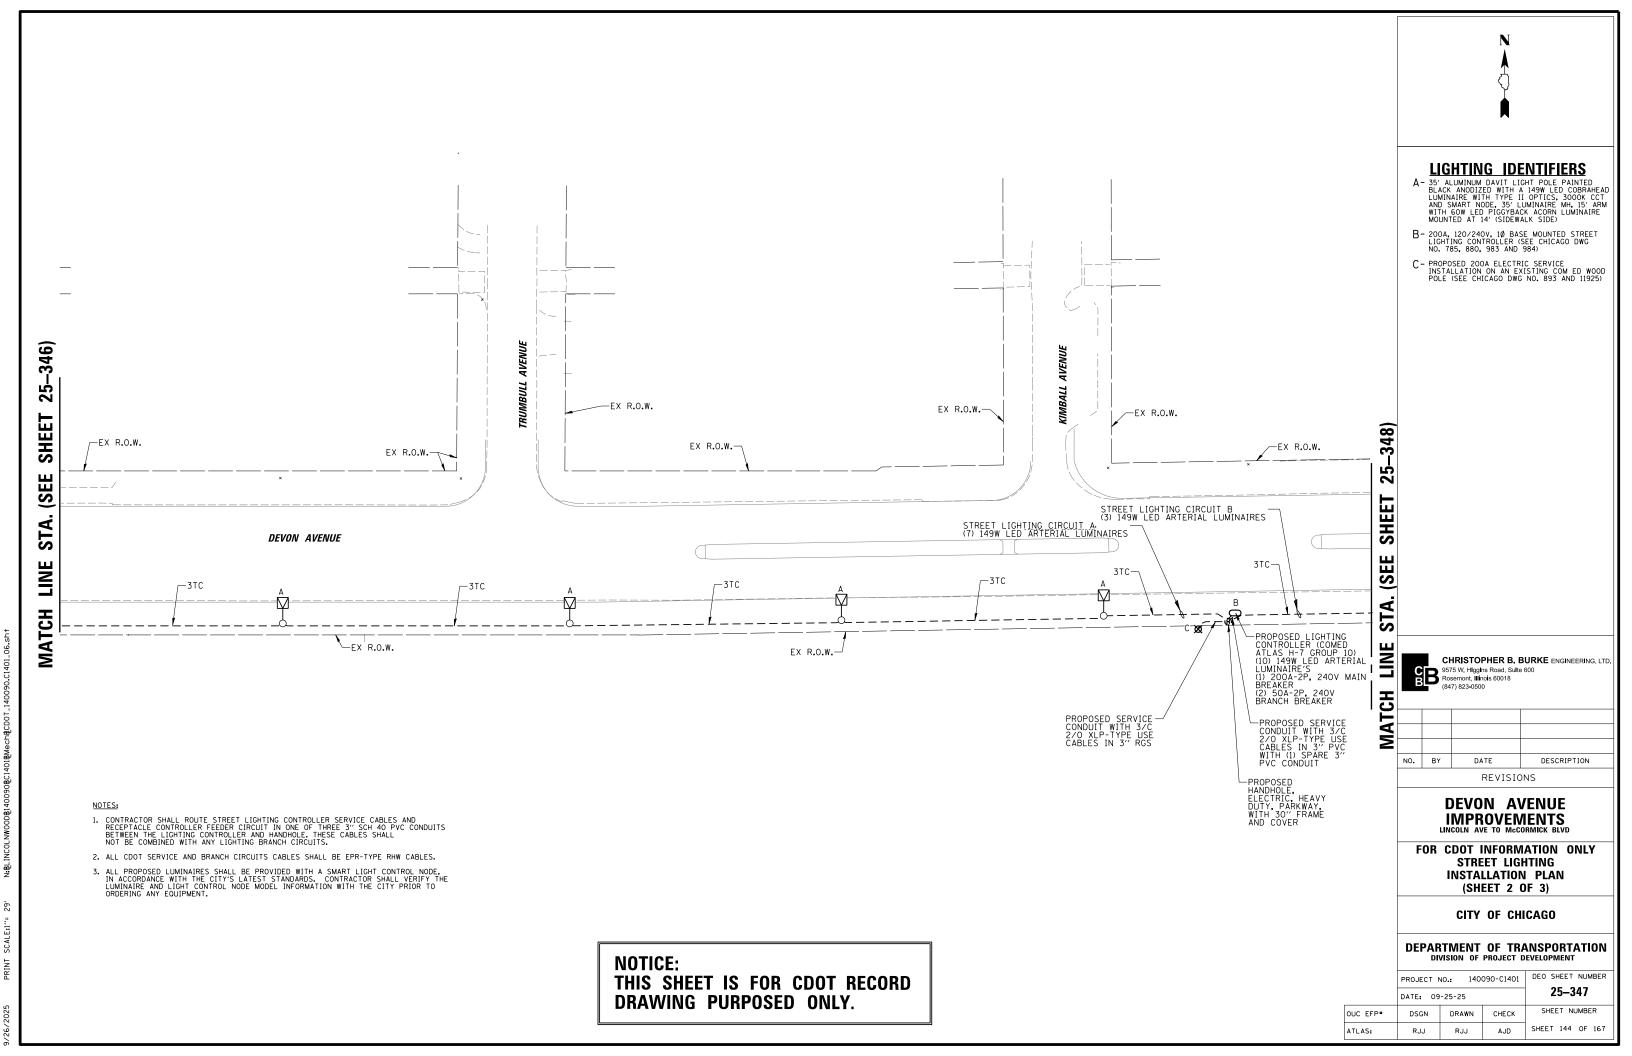
FOR CDOT INFORMATION ONLY STREET LIGHTING **INSTALLATION PLAN** (SHEET 1 OF 3)

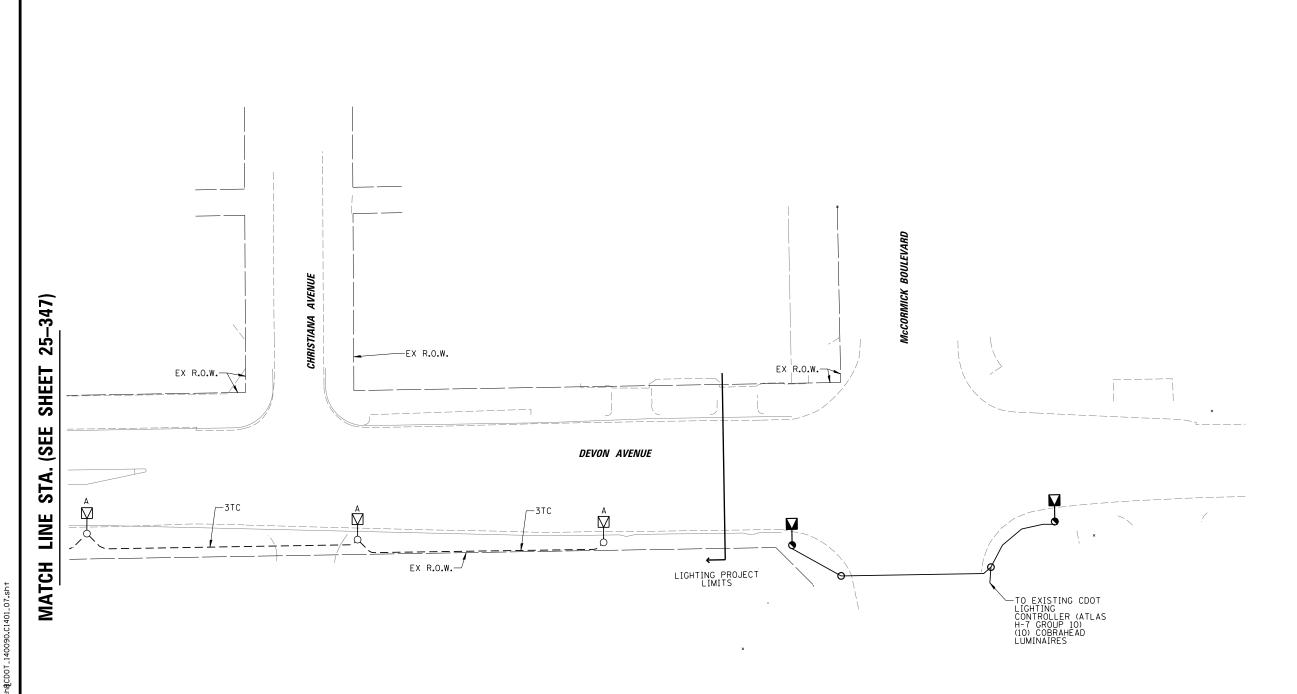
CITY OF CHICAGO

# DEPARTMENT OF TRANSPORTATION DIVISION OF PROJECT DEVELOPMENT

PROJECT N	NO.: 1400	090-C1401	DEO S	HEET	NUMBER
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DATE: 09	-25-25	Z	5-34	10	
DSGN	DRAWN	CHECK	SHE	ET NL	JMBER

SHEET 143 OF 167 ATLAS: RJJ AJD





#### NOTES:

- 1. CONTRACTOR SHALL ROUTE STREET LIGHTING CONTROLLER SERVICE CABLES AND RECEPTACLE CONTROLLER FEEDER CIRCUIT IN ONE OF THREE 3" SCH 40 PVC CONDUITS BETWEEN THE LIGHTING CONTROLLER AND HANDHOLE. THESE CABLES SHALL NOT BE COMBINED WITH ANY LIGHTING BRANCH CIRCUITS.
- 2. ALL CDOT SERVICE AND BRANCH CIRCUITS CABLES SHALL BE EPR-TYPE RHW CABLES.
- 3. ALL PROPOSED LUMINAIRES SHALL BE PROVIDED WITH A SMART LIGHT CONTROL NODE, IN ACCORDANCE WITH THE CITY'S LATEST STANDARDS. CONTRACTOR SHALL VERIFY THE LUMINAIRE AND LIGHT CONTROL NODE MODEL INFORMATION WITH THE CITY PRIOR TO ORDERING ANY EQUIPMENT.

NOTICE: THIS SHEET IS FOR CDOT RECORD DRAWING PURPOSED ONLY.



### **LIGHTING IDENTIFIERS**

- A 35' ALUMINUM DAVIT LIGHT POLE PAINTED
  BLACK ANDDIZED WITH A 149W LED COBRAHEAD
  LUMINAIRE WITH TYPE II OPTICS, 3000K CCT
  AND SMART NODE, 35' LUMINAIRE MH, 15' ARM
  WITH GOW LED PIGGYBACK ACORN LUMINAIRE
  MOUNTED AT 14' (SIDEWALK SIDE)
- B- 200A, 120/240V, 10 BASE MOUNTED STREET LIGHTING CONTROLLER (SEE CHICAGO DWG NO. 785, 880, 983 AND 984)
- C PROPOSED 200A ELECTRIC SERVICE INSTALLATION ON AN EXISTING COM ED WOOD POLE (SEE CHICAGO DWG NO. 893 AND 11925)



NO.	BY	DATE	DESCRIPTION

REVISIONS

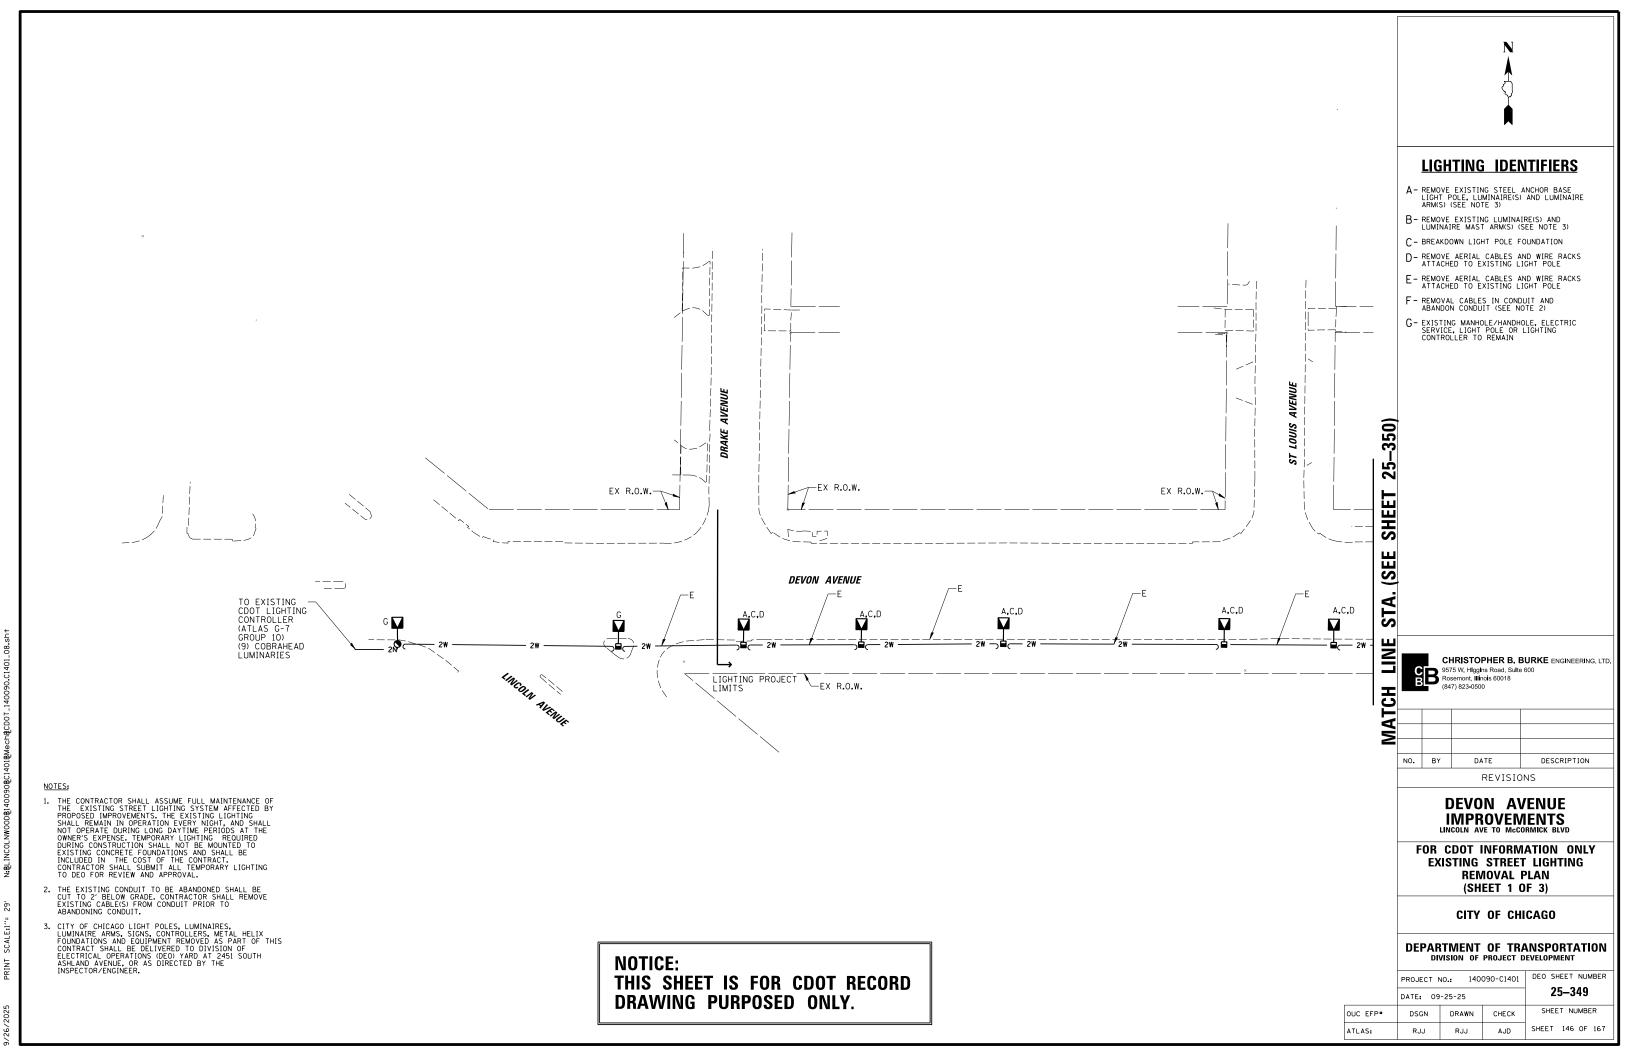
# DEVON AVENUE IMPROVEMENTS LINCOLN AVE TO MCCORMICK BLVD

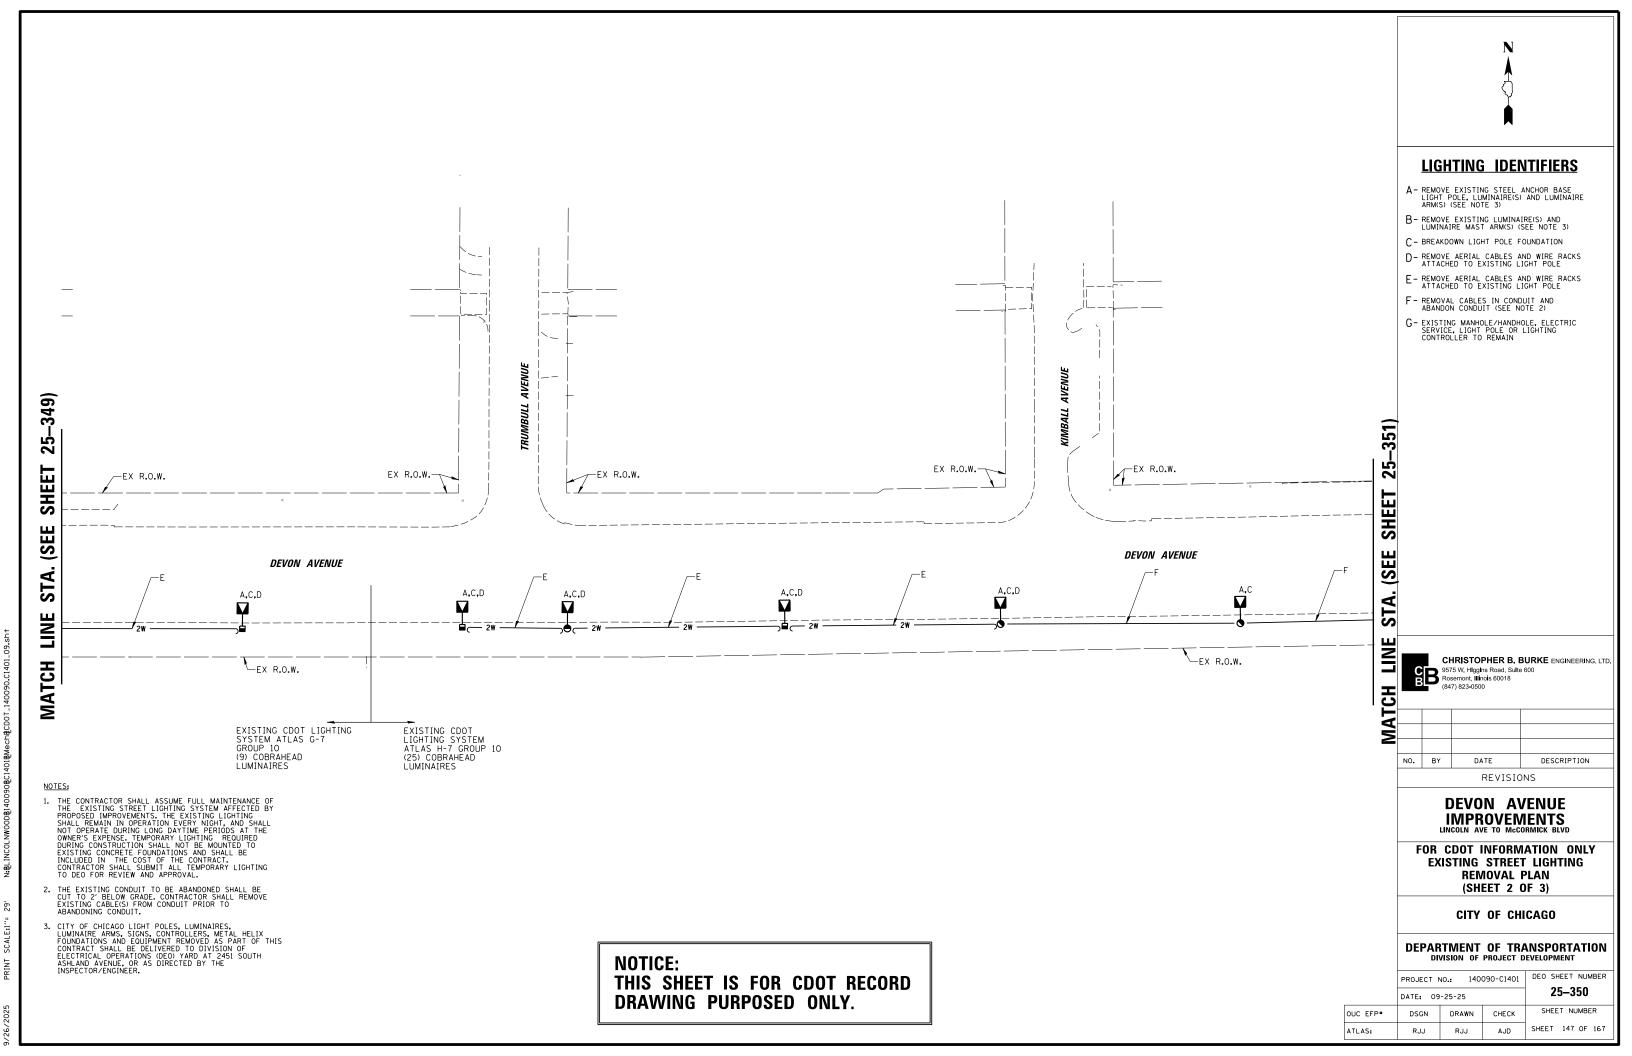
FOR CDOT INFORMATION ONLY STREET LIGHTING INSTALLATION PLAN (SHEET 3 OF 3)

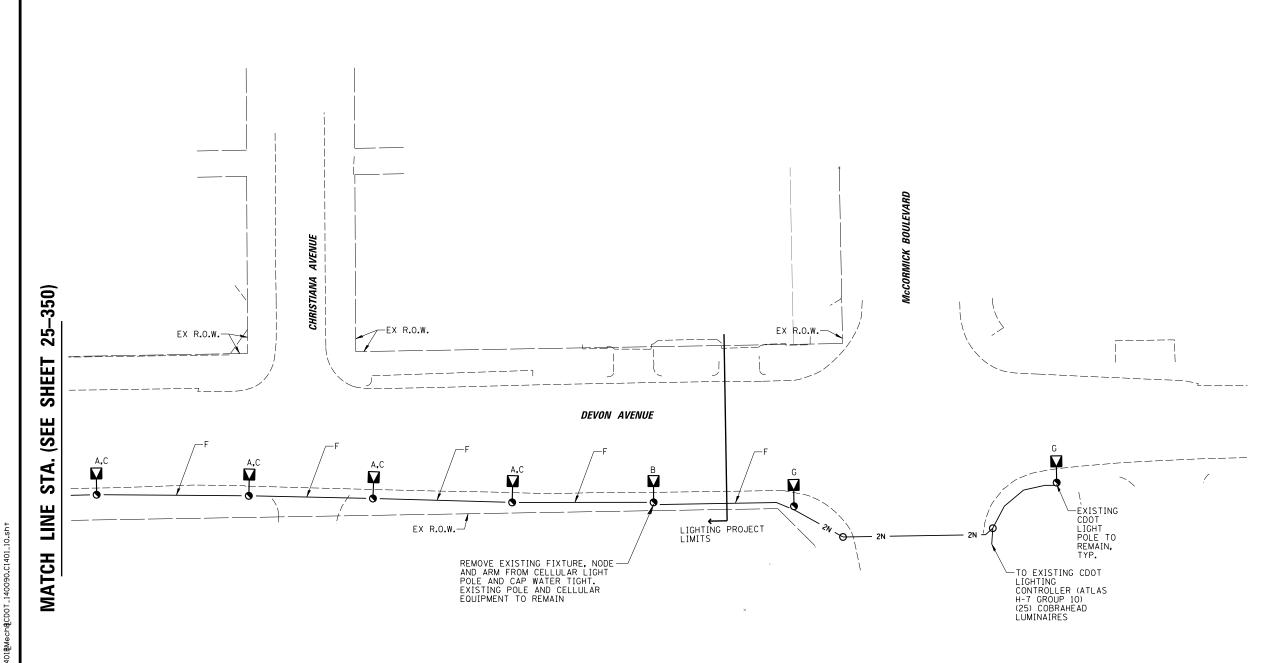
CITY OF CHICAGO

# DEPARTMENT OF TRANSPORTATION DIVISION OF PROJECT DEVELOPMENT

	PROJECT N	NO.: 1400	DEO SHEET NUMBER	
	DATE: 09	-25-25	25-348	
OUC EFP#	DSGN	DRAWN	CHECK	SHEET NUMBER
ATLAS:	RJJ	RJJ	AJD	SHEET 145 OF 167







- 1. THE CONTRACTOR SHALL ASSUME FULL MAINTENANCE OF THE EXISTING STREET LIGHTING SYSTEM AFFECTED BY PROPOSED IMPROVEMENTS. THE EXISTING LIGHTING SHALL REMAIN IN OPERATION EVERY NIGHT, AND SHALL NOT OPERATE DURING LONG DAYTIME PERIODS AT THE OWNER'S EXPENSE. TEMPORARY LIGHTING REQUIRED DURING CONSTRUCTION SHALL NOT BE MOUNTED TO EXISTING CONCRETE FOUNDATIONS AND SHALL BE INCLUDED IN THE COST OF THE CONTRACT. CONTRACTOR SHALL SUBMIT ALL TEMPORARY LIGHTING TO DEO FOR REVIEW AND APPROVAL.
- 2. THE EXISTING CONDUIT TO BE ABANDONED SHALL BE CUT TO 2' BELOW GRADE. CONTRACTOR SHALL REMOVE EXISTING CABLE(S) FROM CONDUIT PRIOR TO ABANDONING CONDUIT.
- 3. CITY OF CHICAGO LIGHT POLES, LUMINAIRES, LUMINAIRE ARMS, SIGNS, CONTROLLERS, METAL HELIX FOUNDATIONS AND EQUIPMENT REMOVED AS PART OF THIS CONTRACT SHALL BE DELIVERED TO DIVISION OF ELECTRICAL OPERATIONS (DEO) YARD AT 2451 SOUTH ASHLAND AVENUE, OR AS DIRECTED BY THE INSPECTOR/ENGINEER.

NOTICE: THIS SHEET IS FOR CDOT RECORD DRAWING PURPOSED ONLY.



### **LIGHTING IDENTIFIERS**

- A- REMOVE EXISTING STEEL ANCHOR BASE LIGHT POLE, LUMINAIRE(S) AND LUMINAIRE ARM(S) (SEE NOTE 3)
- B- REMOVE EXISTING LUMINAIRE(S) AND LUMINAIRE MAST ARM(S) (SEE NOTE 3)
- C BREAKDOWN LIGHT POLE FOUNDATION
- D- REMOVE AERIAL CABLES AND WIRE RACKS ATTACHED TO EXISTING LIGHT POLE
- E REMOVE AERIAL CABLES AND WIRE RACKS ATTACHED TO EXISTING LIGHT POLE
- F REMOVAL CABLES IN CONDUIT AND ABANDON CONDUIT (SEE NOTE 2)
- G- EXISTING MANHOLE/HANDHOLE, ELECTRIC SERVICE, LIGHT POLE OR LIGHTING CONTROLLER TO REMAIN



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NO.	BY	DATE	DESCRIPTION

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### **DEVON AVENUE** IMPROVEMENTS

FOR CDOT INFORMATION ONLY **EXISTING STREET LIGHTING REMOVAL PLAN** (SHEET 3 OF 3)

CITY OF CHICAGO

# DEPARTMENT OF TRANSPORTATION DIVISION OF PROJECT DEVELOPMENT

	PROJECT N	NO.: 1400	090-C1401	DEO SHEET NUMBER
				25 251
	DATE: 09	-25-25	25–351	
OUC EFP#	DSGN	DRAWN	CHECK	SHEET NUMBER
ATLAS:	RJJ	RJJ	AJD	SHEET 148 OF 167

#### APPROVED LIST OF DETECTABLE WARNING PRODUCTS

EJ AMERICAS (EAST JORDAN CORPORATE)
301 SPRING STREET

PO BOX 439 EAST JORDAN, MI 49727 (800) 874-4100

EJCO.COM

NEENAH FOUNDRY 2121 BROOKS AVENUE NEENAH, WI 54956 GROUPNEI.COM (920) 725-7000

PIONEER DETECTABLE, LLC

N8060 MAPLE STREET IXONIA, WI 53036 (262) 370-5355 CASTDWD.COM

ADVANTAGE CAST IRON 241 MAIN STREET, SUITE 100

BUFFALO, NY 14203 (800) 679-4022 ADVANTAGETACTILE.COM

DETECTTILE CORPORATION

13491 SUMTER LANE NAPLES, FL 34109 (630) 400-2956 DETECTILE.COM TUFTILE 905 TELSER ROAD LAKE ZURICH, IL 60047 (888) 960-8897 TUFTILE.COM

ADA SOLUTIONS, INC

323 ANDOVER STREET - SUITE 3 WILMINGTON, MA 01887 (844) 339-5967 ADATILE.COM

EQUALTILE 1025 BLANTON STREET

TITUSVILLE, FL 32796 (800) 996-4510 EQUALTILE.COM

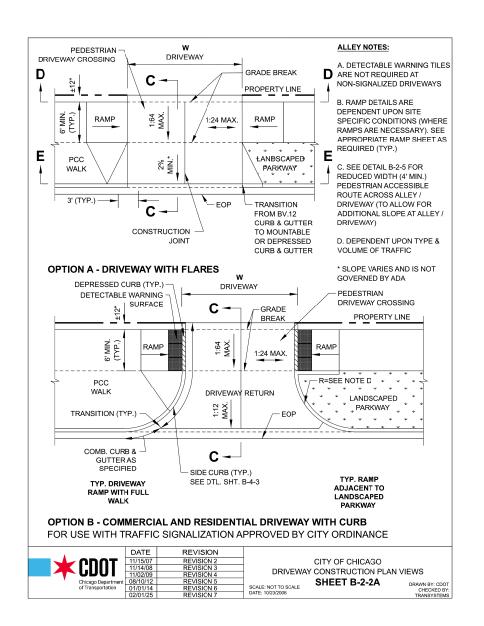
#### NOTE:

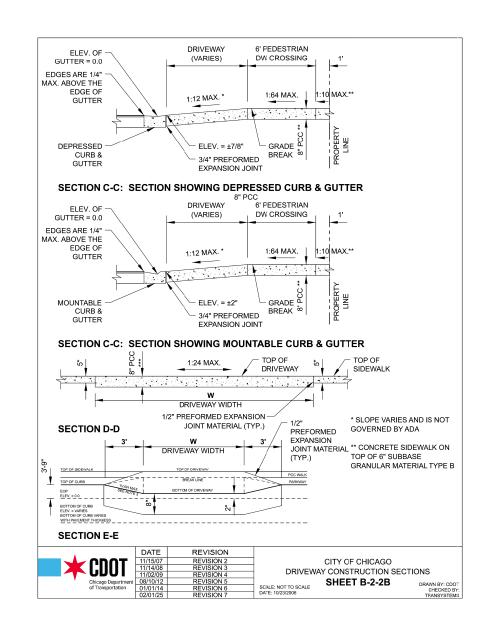
- ALL DETECTABLE WARNING UNITS MUST BE CAST IRON WITH A NATURAL FINISH, AND PROVIDE SUFFICIENT CONTRAST WITH THE SURROUNDING WALKWAY
- 2. IT IS NOT ACCEPTABLE TO INSTALL TWO DIFFERENT DETECTABLE WARNING PRODUCTS ADJACENT TO ONE ANOTHER AT ANY LOCATION





CITY OF CHICAGO
APPROVED LIST OF
DECTECTABLE WARNING PRODUCTS
December 21, 2022





TO BE USED PROJECT WIDE

FILE NAME =	USER NAME = mgratzke	DESIGNED - M.	IAG	REVISED -		DEVON AVEN	UE IMPROVEMENT (LINCOLN AVE TO McCORMICK BLVD)	F.A.U.	SECTION	COUNTY	TOTAL SHEET
N:\LINCOLNWOOD\140090\C1401\C1v1\CONST_	DET_C1401_03.sht	DRAWN - HS	SM	REVISED -	STATE OF ILLINOIS	` .		1349	16-00061-00-LS	COOK	167 149
	PLOT SCALE = 5'	CHECKED - BL	LL	REVISED -	DEPARTMENT OF TRANSPORTATION		CDOT CONSTRUCTION DETAILS			CONTRACT	T NO. 61L92
Default	PLOT DATE = 9/26/2025	DATE - 9/2	26/2025	REVISED -		SCALE: NTS	SHEET 1 OF 4 SHEETS STA. N/A TO STA. N/A		ILLINOIS FED. AI	ID PROJECT	

#### GENERAL NOTES

- . THE DETECTABLE WARNING TILES INSTALLED SHALL BE CHOSEN FROM THE CHICAGO DEPARTMENT OF TRANSPORTATION LIST OF APPROVED DETECTABLE WARNING PRODUCTS (SEE THE CITY OF CHICAGO APPROVED DETECTABLE WARNING PRODUCT LIST). IT IS NOT ACCEPTABLE TO INSTALL TWO DIFFERENT DETECTABLE WARNING PRODUCTS ADJACENT TO ONE ANOTHER AT ANY LOCATION. IN THE CENTRAL BUSINESS DISTRICT, GRANITE OR OTHER SPECIALTY PAVING MATERIALS MAY BE SUBMITTED TO THE COMMISSIONER FOR APPROVA
- B-4-2) THE DETECTABLE TILE WARING SHALL BE INSTALLED PER CURRENT PROWAG STANDARDS
- 3. THE DETECTABLE WARNING MUST COVER FULL WIDTH OF RAMP EXCLUDING SIDE FLARES FOR A MINIMUM UNOBSTRUCTED DEPTH OF 24". THE DETECTABLE WARNING LOCATED ON THE SURFACES OF RAMPS ARE TYPICALLY ORIENTED PERPENDICULAR TO THE RUN OF THE RAMP UNLESS SPECIAL CIRCUMSTANCES OCCUR (SEE DETAIL SHEET B-1-5). THE DETECTABLE WARNING MUST BE PROVIDED FOR A MINIMUM DEPTH OF 24" FOR THE ENTIRE LENGTH OF THE SIDEWALK WHERE THE SIDEWALK IS FLUSH WITH THE STREET (DEPRESSED CURB OR FLUSH TRANSITION). IF IT IS NECESSARY TO CUT UNIT(S) IN THE PROVISION OF A COMPLIANT RAMP OR SIDEWALK WITH 24" MINIMUM DEPTH OF DETECTABLE WARNING, THE UNITS SHALL BE CUT IN A NEAT AND WORKMANLIKE MANNER PER MANUFACTURER'S REQUIREMENTS WITH A MINIMUM OF THREE PINS OR ANCHOR POINTS (AS APPLICABLE). THE UNITS SHALL BE ARRANGED SO THAT THE CUT TILES ARE LARGE ENOUGH TO BE PROPERLY AND ADEQUATELY SECURED. CUT UNITS SHALL NOT BE USED UNLESS ALL OTHER DESIGN OPTIONS HAVE BEEN EXHAUSTED. THE USE OF SALVAGE PIECES FROM UNITS THAT ARE CUT WILL NOT BE PERMITTED WITHOUT WRITTEN APPROVAL OF THE COMMISSIONER. CUT UNIT SALVAGE PIECES NOT APPROVED FOR USE MUST BE REMOVED FROM THE SITE AND DISPOSED PROPERLY
- 4 WHERE APPLICABLE. A COMBINATION OF STRAIGHT AND RADIAL DETECTABLE WARNING UNITS MAY BE USED ON
- 5. PRIOR TO PLACING CONCRETE FOR DEPRESSED CURBS, RAMPS, OR SIDEWALKS THE CONTRACTOR SHALL VERIFY THAT LAYOUT OR DESIGN COMPLIES WITH THE REQUIREMENTS OF THE CDOT ADA STANDARDS
- 6. RAMP WIDTH MUST BE A MINIMUM OF 6'-0" AND IN INCREMENTS OF 1'-0", EXCEPT WHEN USING THE PERPENDICULAR RAMP AT CORNER (OR OTHER SPECIAL CDOT APPROVED CONDITIONS), WHICH HAS A MINIMUM
- 7. THE MAXIMUM ALLOWABLE RAMP RUNNING SLOPE IS 1:14, MEASURED AT ANY PORTION OF THE RAMP. IF POSSIBLE, A MORE GRADUAL SLOPE SHALL BE USED. GRADE BREAKS AT THE TOP AND BOTTOM OF RAMPS SHALL BE PERPENDICULAR TO THE DIRECTION OF RAMP RUN
- 8. THE MAXIMUM ALLOWABLE RAMP CROSS SLOPE IS 1:64, MEASURED AT ANY PORTION OF THE RAMP
- 9. THE MAXIMUM ALLOWABLE RAMP LANDING SLOPE IS 1:64, MEASURED AT ANY LOCATION AND IN ANY DIRECTION ON THE LANDING. THE RAMP LANDING WIDTH SHALL MATCH THE FULL WIDTH OF THE RAMP FOR A MINIMUM UNOBSTRUCTED DEPTH OF 4"-0". RAMP LANDINGS SHALL BE PROVIDED AT THE TOP AND/OR BOTTOM OF RAMPS WHERE TURNING IS REQUIRED
- 10. RAMP SIDE FLARES SHALL BE INSTALLED AT ANY LOCATION WHERE THE SURFACE ADJACENT TO THE RAMP SURFACE IS INTENDED FOR PEDESTRIAN USE. TRIPPING HAZARDS, INCLUDING STEPS, DROP-OFFS, OR CURBS SHALL NOT BE LOCATED WITHIN THE LIMITS OF THE SIDEWALK. RAMPS SIDE FLARES ARE NOT REQUIRED WHERE THE SURFACE ADJACENT TO THE RAMP SURFACE IS LANDSCAPE OR IS OCCUPIED BY A BARRIER THAT BLOCKS PEDESTRIAN ACCESS. EXCEPTION TO THIS RULE MAY BE SUBMITTED TO THE COMMISSIONER FOR APPROVAL
- 11. UTILITIES, SUCH AS LIGHT POLES, TRAFFIC POLES AND HYDRANTS, MAY BE LOCATED IN THE FLARE OF THE RAMP BUT ARE NOT ALLOWED ON THE RAMP SURFACE OR LANDING AREAS. EXISTING UTILITY STRUCTURE LIDS MAY REMAIN WITHIN THE FLARE OR ON THE SURFACE OF THE RAMP IF THE EQUIPMENT OF GENERAL NOTE #19
- 12. ALL LOCATIONS WITH TYPE B CURB (EXCEPT ALLEY APRONS) SHALL BE CONSTRUCTED AS CURB AND GUTTER TYPE BV.12 THROUGH THE LIMITS OF THE CORNER AND THE CURB RAMPS

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GENERAL NOTES SHEET B-3-2

CITY OF CHICAGO

#### GENERAL NOTES (CONTINUED):

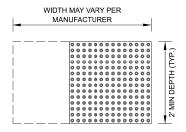
13. ALTERATIONS SHALL NOT DECREASE THE ACCESSIBILITY TO EXISTING FACILITIES, SIDEWALKS LEADING TO EXISTING FACILITIES OR DOOR OR GATE ACCESS POINTS TO FACILITIES. THE ELEVATION AT THE EXISTING PROPERTY LINE OR FACILITY ACCESS POINT SHALL BE MAINTAINED, ANY ALTERATIONS ADJACENT TO OR AFFECTING A FACILITY ACCESS POINT SHALL RESULT IN IMPROVED ACCESS OR AT A MINIMUM A REPLICATION OF EXISTING CONDITIONS, INCLUDING SIDEWALK SLOPES AND SURFACE CONDITIONS, FACILITIES INCLUDE, BUT ARE NOT LIMITED TO PRIVATE BUSINESSES, PUBLIC BUILDINGS, RESIDENCES, BUS STOPS, PUBLIC BENCHES, AND

- 14. IF RUNNING SLOPE OF SIDEWALK AND ALLEY ARE LESS THAN 1:50, A RAMP IS NOT REQUIRED. IF SIDEWALK AND DRIVEWAY ARE AT THE SAME GRADE, A RAMP IS NOT REQUIRED BUT DETECTABLE WARNING TILES ARE STILL REQUIRED IF THE DRIVEWAY HAS TRAFFIC CONTROL DEVICES (I.E. TRAFFIC SIGNALS)
- 15. MAINLINE SIDEWALK RUNNING SLOPES SHALL NOT EXCEED 1:24 OR THE GENERAL GRADE ESTABLISHED FOR
- 16. THERE SHALL BE NO VERTICAL LEVEL DIFFERENCES BETWEEN SURFACES GREATER THAN 1/4" ON THE MAINLINE SIDEWALK. THERE SHALL BE NO HORIZONTAL GAPS OR OPENINGS GREATER THAN 1/2" ON THE MAINLINE
- 17. THE CLEAR WIDTH OF USEABLE SIDEWALK SHALL NOT BE LESS THAN 4'-0", OBSTRUCTIONS INCLUDE, BUT ARE NOT LIMITED TO SIDEWALK BENCHES, FIRE HYDRANTS, SIGNAL OR LIGHT POLES, PARKING PAY STATION NEWSPAPER DISPENSERS, TRASH RECEPTACLES, AND UTILITY PEDESTALS
- 18. CURB RAMPS AND LANDING (KEYSTONE) TO BE CONSTRUCTED WITH 8" THICK CONCRETE AT ALL TRAFFIC SIGNALIZED INTERSECTIONS AND INDUSTRIAL STREET INTERSECTIONS. AT ALL OTHER LOCATIONS, 5" THICK
- 19. DEPRESSED CURB, RAMP, OR SIDEWALK DESIGNS OR LAYOUTS SHALL MAINTAIN OR IMPROVE EXISTING DRAINAGE AND THE EXISTING INTERSECTION GEOMETRY SHALL NOT BE MODIFIED WITHOUT CDOT APPROVAL
- 20. ALL CONSTRUCTION DOCUMENTS MUST BE STAMPED BY A LICENSED ARCHITECT/LANDSCAPE ARCHITECT/ENGINEER TO CERTIFY THAT THEY ARE IN ACCORDANCE WITH THE AMERICANS WITH DISABILITIES ACT (ADA) AND ALL CODES AND BUILDING ORDINANCES OF THE CITY OF CHICAGO AND STATE OF ILLINOIS
- 21. NO DEVIATIONS FROM THESE STANDARDS ARE ALLOWED WITHOUT WRITTREN APPROVAL FROM THE COMMISSIONER


REVISION

CITY OF CHICAGO GENERAL NOTES (CONTINUED) SHEET B-3-3

#### STRAIGHT DETECTABLE WARNING UNITS



#### **RADIAL DETECTABLE WARNING UNITS**

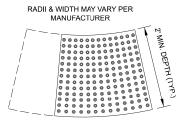

#### **DETECTABLE WARNING UNIT SIZES**

- VERIFY ALL DIMENSIONS WITH THE PRODUCT MANUFACTURES
- IF USING RADIAL UNITS, VERIFY THAT THE CURB RADIUS MATCHES AVAILABLE TILE RADII WITH THE PRODUCT MANUFACTURER

4	DATE	REVISION
	02/20/07	REVISION 1
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Chicago Department	11/02/09	REVISION 4
of Transportation	08/10/12	REVISION 5
	02/01/25	REVISION 6

CITY OF CHICAGO DETECTABLE WARNING TILE SIZES SHEET B-4-1

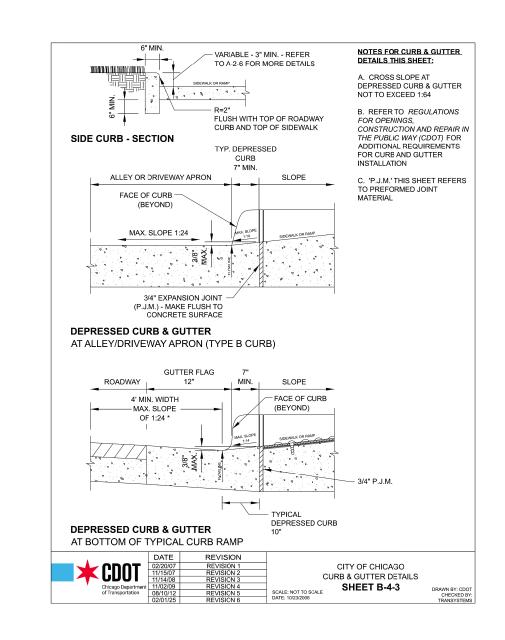
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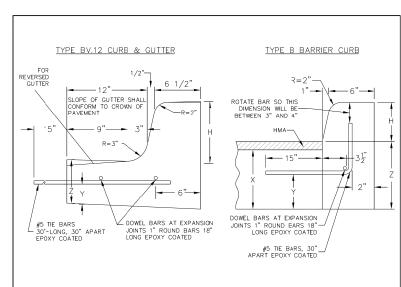
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STATE OF ILLINOIS **DEPARTMENT OF TRANSPORTATION** 

DEVON AVENUE IMPROVEMENT (LINCOLN AVE TO McCORMICK BLVD) **CDOT CONSTRUCTION DETAILS** SCALE: NTS SHEET 2 OF 4 SHEETS STA. N/A TO STA.N/A

COUNTY SECTION 1349 16-00061-00-LS COOK 167 | 150 CONTRACT NO. 61L92





#### JOINTS IN CONCRETE CURB, COMBINATION CONCRETE CURB & GUTTER

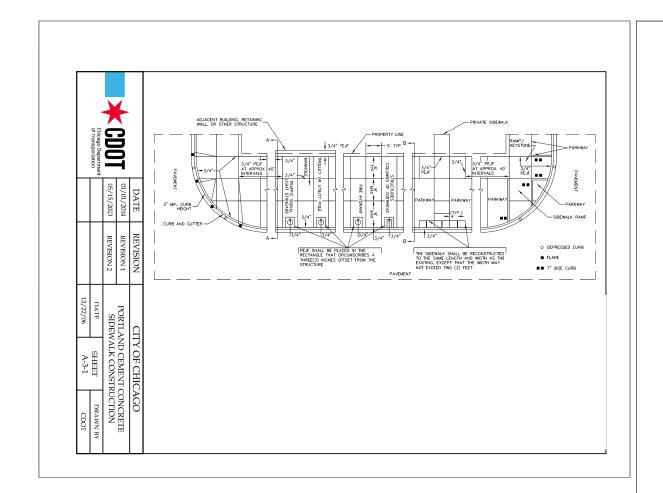
TRANSVERSE JOINTS OF A TYPE SIMILAR TO THAT USED IN THE ADJACENT PAVEMENT SHALL BE INSTALLED IN THE CURB, GUTTER AND COMBINED CURB & GUTTER IN PROLONGATION WITH THE JOINTS IN THE PAVEMENT. THE DETAILS OF THE TRANSVERSE JOINTS IN THE CURB, GUTTER AND COMBINED CURB & GUTTER SHALL BE APPROVED BY THE COMMISSIONER. WHEN CURB, GUTTER OR COMBINED CURB & GUTTER IS CONSTRUCTED ADJACENT TO A FLEMBLE BASE PAVEMENT. 1" THICK EXPANSION JOINTS COMPOSED OF BITUMINOUS PREFORD JOINT FILLER SHALL BE INSTALLED IN THE CLEB AND/OR GUTTER AT POINTS OF CURVATURE AND AT CONSTRUCTION JOINTS PER A-2-3B CONTRACTION JOINTS ALL ALSO BE PLACED BETWEEN THESE EXPANSION JUSTS AT DISTANCES NOT EXCEEDING 20 FEET. ALL THE BARS SHALL BE DEFORMED. ALL DOWEL BARS SHALL BE SMOOTH.

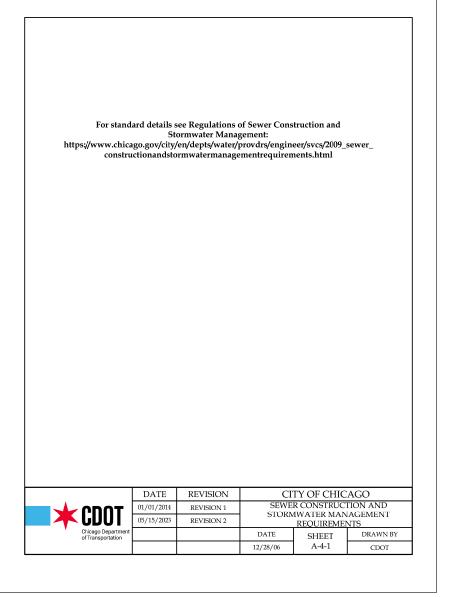
- 1. AT LOCATIONS REQUIRING DEPRESSED CURBS SEE THE ADA STANDARDS FOR CONSTRUCTION DETAILS.
- 2. H = VARIABLE 3" TO 9"
  X = THICKNESS OF PAVEMENT
  Y = ONE HALF THE THICKNESS OF CONCRETE PAVEMENT OR CONCRETE BASE
  Z = 10" OR THICKNESS OF PAVEMENT WHICHEVER IS GREATER

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■ ❖ ቦከበΤ	01/01/2014	REVISION 1	CONCRETE CURB & GUTTER DETAIL				
<b>── </b>	05/15/2023	REVISION 2					
Chicago Department of Transportation			DATE	SHEET	DRAWN BY		
			12/12/06	A-2-6	CDOT		

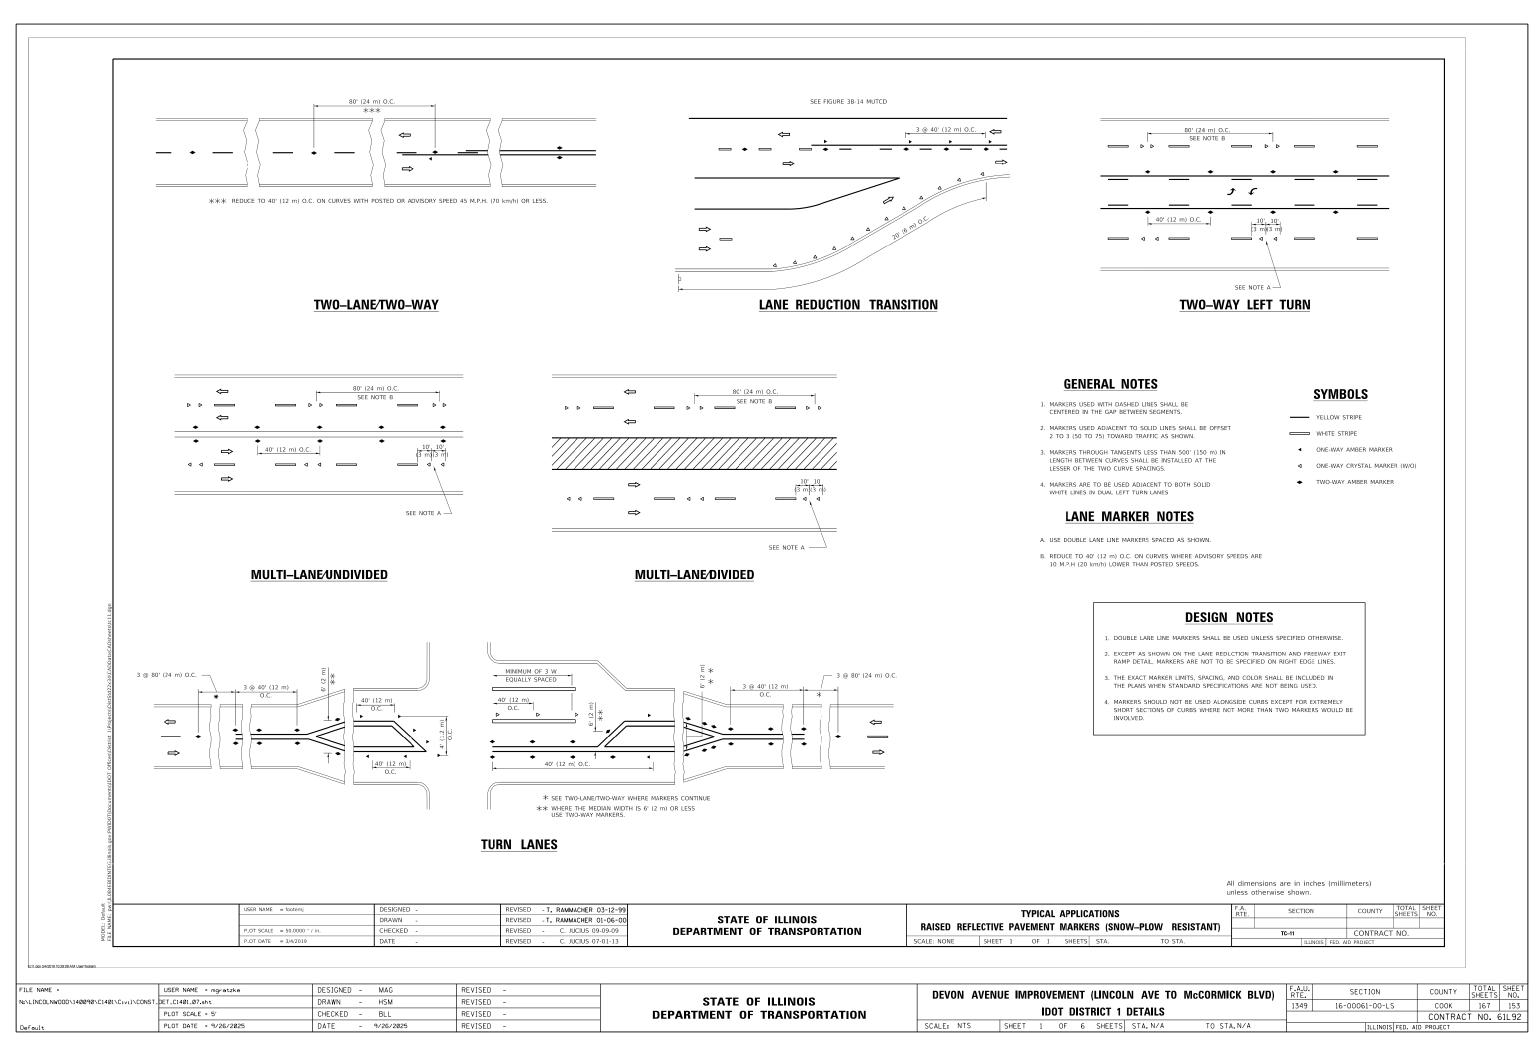
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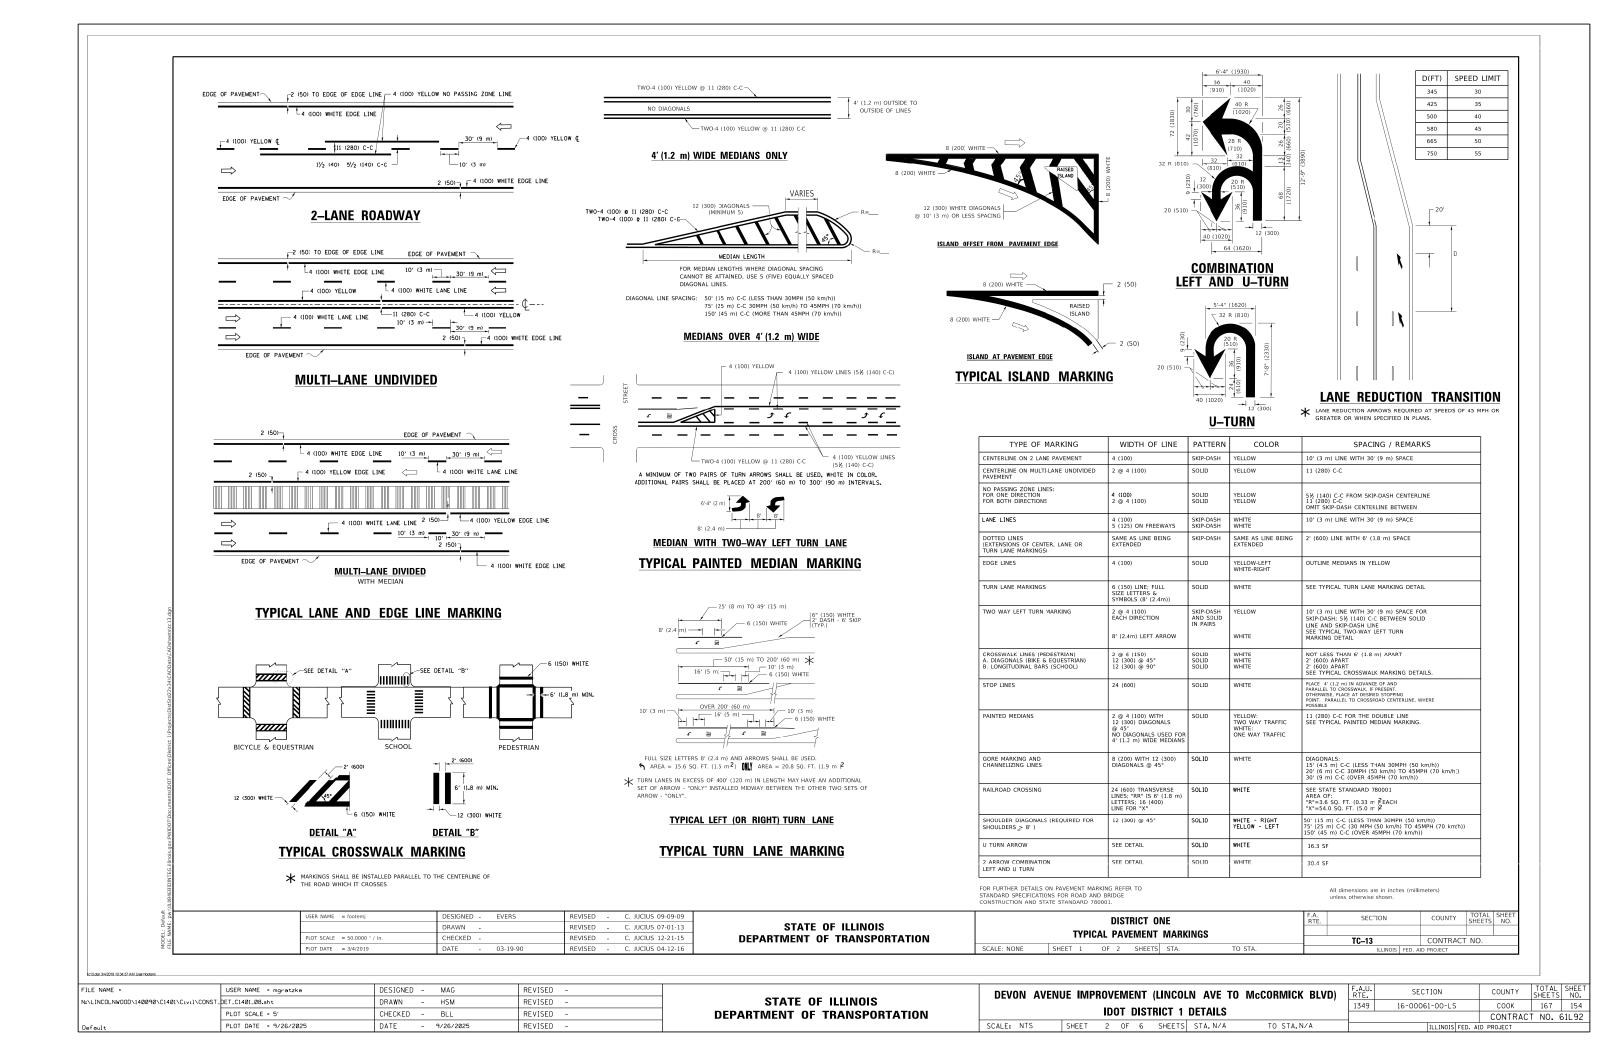
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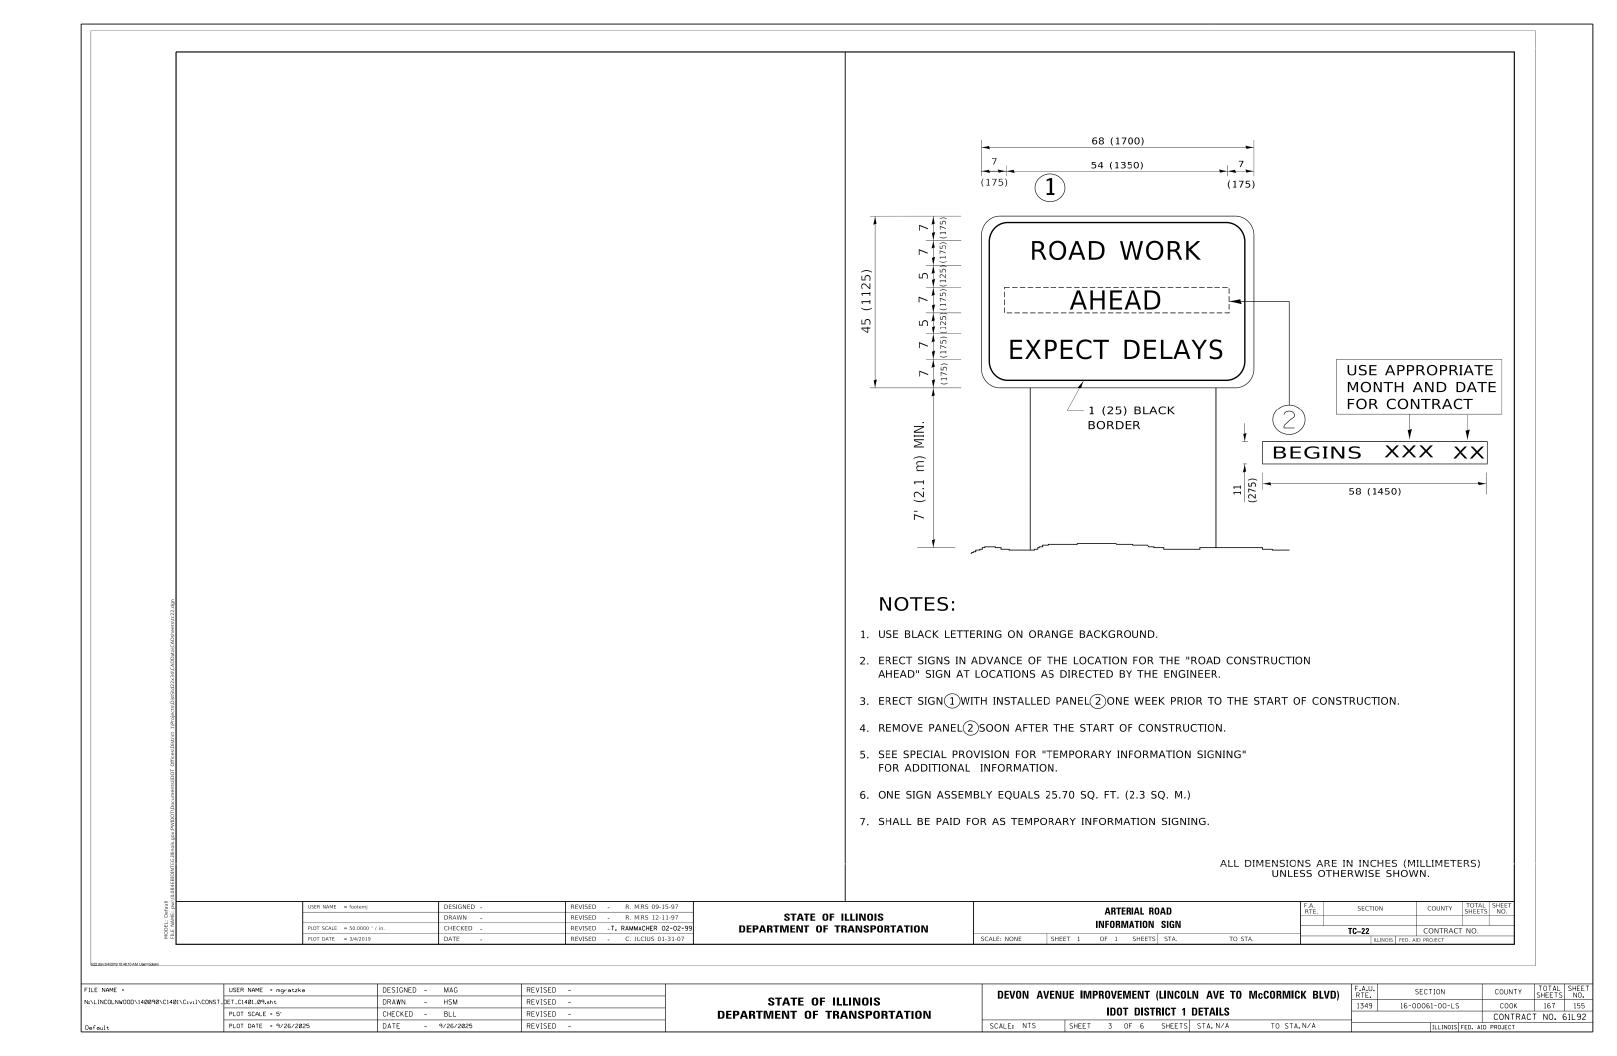




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3.0" RADIUS, 0.5" BORDER, WHITE ON GREEN; REFLECTORIZED "DRIVEWAY" D; "ENTRANCE" D; STANDARD ARROW CUSTOM 12.0" x 5.0"

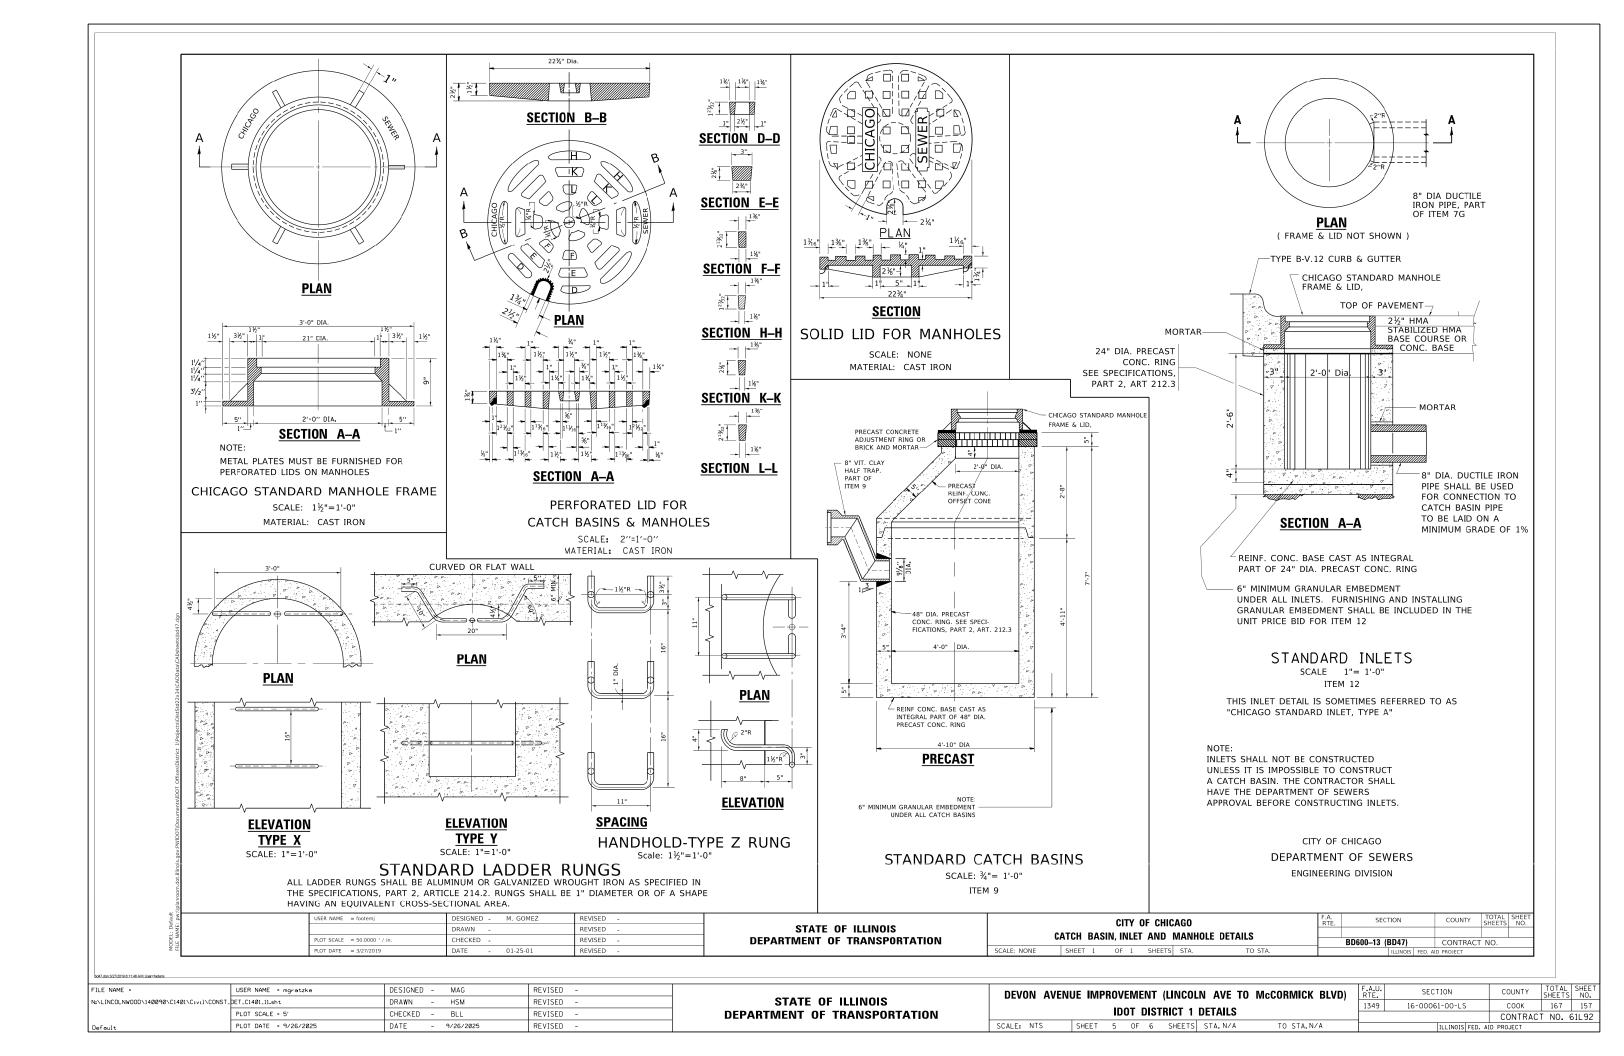
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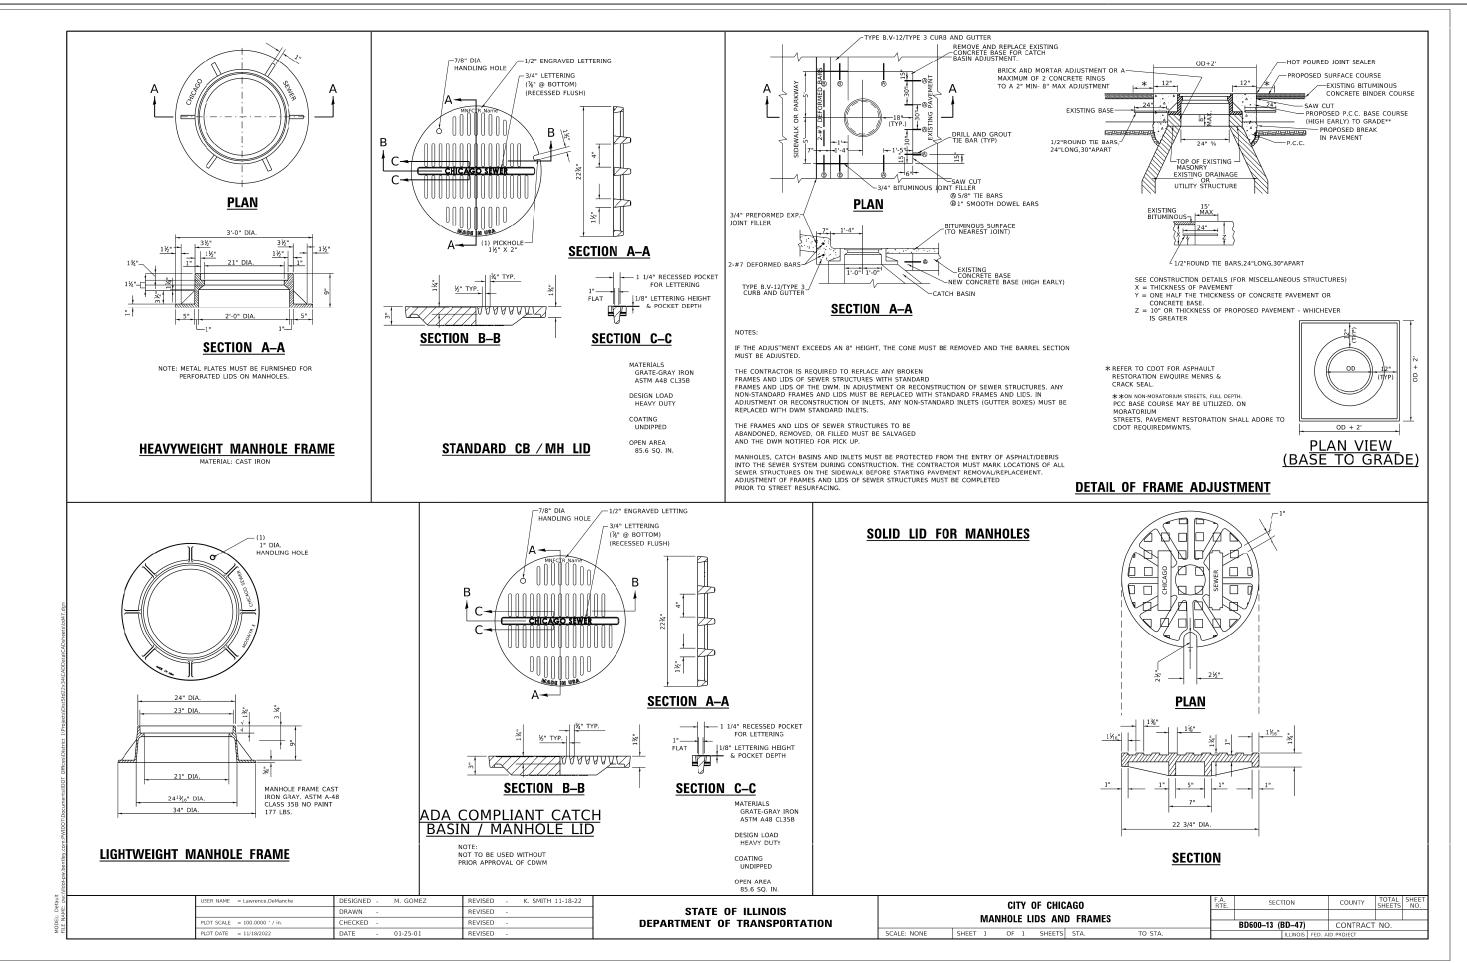
- 1. HALF OF THE SIGNS WILL REQUIRE A LEFT HAND FACING ARROW.
- 2. TWO SIGNS SHALL BE USED AT EACH COMMERCIAL ENTRANCE PLACED BACK-TO-BACK: ONE WITH A RIGHT HAND ARROW (SHOWN) SHALL BE PLACED ON THE NEAR RIGHT SIDE THE DRIVEWAY AND ONE WITH A LEFT HAND ARROW SHALL BE PLACED ON THE FAR LEFT SIDE OF THE DRIVEWAY.
- 3. SIGNS TO BE PAID FOR AS ITEM "TEMPORARY INFORMATION SIGNING".

USER NAME = leysa	DESIGNED -	REVISED - C. JUCIUS 02-15-07		DRIVEWAY ENTRANCE SIGNING				F.A.	SECTION	COUNTY	TOTAL
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Default	PLOT DATE = 9/26/2025	DATE	-	9/26/2025	REVISED -

STATE OF ILLINOIS **DEPARTMENT OF TRANSPORTATION** 

DEVON AVENUE IMPROVEMENT (LINCOLN AVE TO McCORMICK BLVD)	F.A.U. RTE.	SECTION	COUNTY	TOTAL SHEETS	SHEET NO.
IDOT DISTRICT 1 DETAILS	1349	16-00061-00-LS	COOK	167	158
IDOI DISTRICT I DETAILS			CONTRAC	T NO. 6	51L92
SCALE: NTS   SHEET 6 OF 6 SHEETS   STA.N/A TO STA.N/A		ILLINOIS FED. AI	D PROJECT		

