STATE OF ILLINOIS
DEPARTMENT OF TRANSPORTATION
DIVISION OF HIGHWAYS

# PROPOSED HIGHWAY PLANS

FAP ROUTE 330: U.S. 45 (LA GRANGE RD.)

AT EJ & E RAILROAD


AND 1/2 MILE SOUTH OF NEBRASKA ST.

SECTION NO.: 104 T-3

DRAINAGE IMPROVEMENT

WILL COUNTY

C-91-266-06

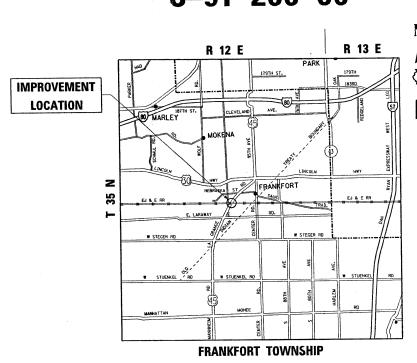

TRAFFIC DATA

2005 ADT = 13300 POSTED SPEED LIMIT = 45 MPH

D-91-266-09



STATE OF ILLINOIS
DEPARTMENT OF TRANSPORTATION
DIVISION OF HIGHWAYS

SUBMITTED

JULY 27 20 08

DEPUTY DIRECTOR OF HIGHWAYS, REGION ENGINEER

August 15, 20 08

Ontron Engineer of Design and Environment

August 15, 20 08

Christia M. Reud B

DIRECTOR OF HIGHWAYS, CHIEF ENGINEER

PRINTED BY THE AUTHORITY OF THE STATE OF ILLINOIS

IMPROVEMENT IS LOCATED IN

THE VILLAGE OF FRANKFORT IN WILL COUNTY

FOR INDEX OF SHEETS, SEE SHEET NO. 2

 $\circ$ 

0 100' 200' 300' — 1" = 100' 0 50' 100' — 1" = 50' 0 50' 100' — 1" = 40' 0 50' 100' — 1" = 30' 0 50' 100' — 1" = 20'

FULL SIZE PLANS HAVE BEEN PREPARED USING STANDARD ENGINEERING SCALES. REDUCED SIZED PLANS WILL NOT CONFORM TO STANDARD SCALES. IN MAKING MEASUREMENTS ON REDUCED PLANS, THE ABOVE SCALES MAY BE USED.

J.U.L.I.E.
JOINT UTILITY LOCATION INFORMATION FOR EXCAVATION
1-800-892-0123
OR 811

PROJECT ENGINEER: JENPAI P. CHANG (847) 705 - 4432 PROJECT MANAGER: KEN ENG (847) 705 - 4247

CONTRACT NO. 60B09

#### INDEX OF SHEETS:

SHEET NO.	DESCRIPTION:
1	COVER SHEET
2	INDEX OF SHEETS, HIGHWAY STANDARDS, AND GENERAL NOTES
3	SUMMARY OF QUANTITIES
4	EXISTING TYPICAL SECTIONS
5	SCHEDULE OF QUANTITIES
6	EASEMENTS, WETLAND LOCATIONS AND BENCHMARKS
7	EXISTING ROADWAY AND PAVEMENT MARKING PLAN
8	EROSION AND SEDIMENT CONTROL PLAN
9-10	EXISTING AND PROPOSED DRAINAGE AND UTILITY PLAN
11	PROPOSED STORM SEWER UNDER E J & E TRACKS (EXHIBIT)
12-16	RIGHT OF WAY PLATS
17-19	HEADWALL DETAIL
20	DETAIL OF STORM SEWER CONNECTION TO EXISTING SEWER
21	PAVEMENT PATCHING FOR HOT-MIX ASPHALT SURFACED PAVEMENT
22	CURB OR CURB AND GUTTER REMOVAL AND REPLACEMENT
23-26	REMOVE AND RE-ERECT STEEL PLATE BEAM GUARDRAIL
27	TRAFFIC CONTROL AND PROTECTION FOR SIDE ROADS, INTERSECTIONS, AND DRIVEWAYS
28	DISTRICT ONE TYPICAL PAVEMENT MARKINGS
29	TRAFFIC CONTROL PROTECTION AT TURN BAYS (TO REMAIN OPEN TO TRAFFIC)
30	ARTERIAL ROAD INFORMATION SIGN
31-32	DITCH CROSS SECTIONS

#### STATE STANDARDS:

SHEET NO.	DESCRIPTION:
000001 <i>-05</i>	STANDARD SYMBOLS, ABBREVIATIONS, AND PATTERNS
280001-04	TEMPORARY EROSION CONTROL SYSTEM
442201- <i>03</i>	CLASS C AND D PATCHES
482001- <i>02</i>	HMA SHOULDER ADJACENT TO FLEXIBLE PAVEMENT
602001	CATCH BASIN TYPE A
602401- <i>0</i> /	MANHOLE TYPE A
604001 <i>-02</i>	FRAME AND LIDS, TYPE1
604036 <i>-01</i>	GRATE, TYPE 8
604086-01	FRAME AND GRATE, TYPE 23
606001 <i>-03</i>	CONCRETE CURB AND COMBINATION CONCRETE CURB AND GUTTER
701001-0/	OFF-RD OPERATIONS, 2L, 2W, MORE THAN 15 FEET (4.5 m) AWAY.
701006 <i>-02</i>	OFF-RD OPERATIONS, 2L, 2W, 15 FEET (4.5 m) TO 24 INCH (600 mm) FROM PAVEMENT EDGE
701011-0/	OFF-RD MOVING OPERATIONS 2L, 2W, DAY ONLY
701301 <i>-0</i> 2	LANE CLOSURE, 2L, 2W SHORT TIME OPERATIONS
701901	TRAFFIC CONTROL DEVICES

#### **GENERAL NOTES:**

BEFORE STARTING ANY EXCAVATION, THE CONTRACTOR SHALL CALL "JULIE" AT (800) 892-0123 OR 811 FOR FIELD LOCATIONS OF BURIED ELECTRIC, TELEPHONE AND GAS FACILITIES. 48 HOUR NOTIFICATION IS REQUIRED.

THE CONTRACTOR SHALL COORDINATE CONSTRUCTION ACTIVITIES WITH UTILITY COMPANIES, AND THE CITY OF FRANKFORT.

THE CONTRACTOR WILL NOT BE ALLOWED TO SET UP A YARD OR FIELD OFFICE ON STATE PROPERTY WITHOUT WRITTEN PERMISSION FROM THE DEPARTMENT.

TRANSITIONS SHALL BE USED TO MATCH PROPOSED CURB AND GUTTER AND MEDIAN ITEMS OF WORK TO EXISTING CURBS AND GUTTER AND MEDIANS IN THE FIELD, UNLESS OTHERWISE SHOWN. THE TRANSITIONS SHALL BE PAID FOR AT THE CONTRACT UNIT PRICE FOR THE PROPOSED ITEMS OF WORK SPECIFIED.

ALE DAMAGE TO EXISTING PAVEMENT MARKINGS OR RAISED REFLECTIVE PAVEMENT MARKERS OUTSIDE THE REMOVAL LINE SHOWN ON THE PLANS SHALL BE REPLACED AT THE CONTRACTOR'S EXPENSE.

BEFORE BEGINNING ANY WORK, THE CONTRACTOR SHALL RETAIN AND RECORD FOR FUTURE REFERENCE ALL EXISTING PAVEMENT MARKING LINES AND RAISED REFLECTIVE PAVEMENT MARKERS IN ORDER THAT THESE LOCATIONS CA BE RE-ESTABLISHED FOR STRIPING. EXACT LOCATIONS OF ALL PAVEMENT MARKINGS SHALL BE AS DIRECTED BY THE ENGINEER.

LOCATION OF COMBINATION CONCRETE CURB AND GUTTER REMOVAL AND COMBINATION CONCRETE CURB ABD GUTTER WITH THE TYPE SPECIFIED ON THE PLANS, WILL BE DETERMINED IN THE FIELD BY THE ENGINEER.

THE CONTRACTOR SHALL CONTACT THE DISTRICT ONE TRAFFIC CONTROL SUPERVISOR AT (847) 705-4470 A MINIMUM OF 72 HOURS ON ADVANCE OF BEGINNING WORK.

THE RESIDENT ENGINEER SHALL CONTACT Ms. CORA MATHIS, AREA FIELD ENGINEER AT (815) 485-6475 A MINIMUM OF TWO WEEKS PRIOR TO PLACEMENT OF ANY PERMANENT PAVEMENT MARKINGS.

THE CONTRACTOR SHALL BE REQUIRED TO PROVIDE ACCESS TO ABUTTING PROPERTY AT ALL TIMES DURING THE ENTIRE CONSTRUCTION PERIOD.

DO NOT SCALE PLANS FOR CONSTRUCTION DIMENSIONS.

ANY DAMAGE TO EXISTING GUARDRAIL AND CONCRETE CURB AND GUTTER DURING EXCAVATION AND PLACEMENT OF STONE RIPRAP BEHIND THE CURB AND GUTTER FROM STA. 59+44 TO STA. 60+71 AND FROM STA. 59+76 TO STA. 61+09 AS SHOWN ON THE PLANS SHALL BE REPLACED AT THE CONTRACTOR'S EXPENSE.

ABANDONED SEWERS SHALL BE PLUGGED WITH CLASS SI MORTAR, OR BRICK AND SUITABLE MATERIAL, TO THE SATISFACTION OF THE ENGINEER AS SPECIFIED IN ART. 550.05 OF THE STANDARD SPECIFICATIONS FOR ROAD AND BRIDGE CONSTRUCTION AND SHALL NOT BE PAID FOR SEPARATELY, BUT WILL BE CONSIDERED AS INCLUDED IN THE CONTRACT UNIT PRICE PER LINEAR FOOT OF THE STORM SEWER REMOVAL WITH THE SIZE SPECIFIED.

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c:\projects\pi18604\design_ea.dgn		DRAWN -	REVISED -
1	PLOT SCALE = 50.0000 '/ IN.	CHECKED -	REVISED -
	PLOT DATE = 5/1/2008	DATE -	REVISED -

STATE 0	F ILLINOI	S
DEPARTMENT OF	TRANSP	ORTATION

SCALE:

US 45 (LA GRANGE ROAD) UNDER EJ & E RAILROAD	F.A.P. RTE.	SECTION	COUNTY	TOTAL SHEETS	SHEET NO.
	330	104 T-3	WILL	32	2
INDEX OF SHEETS, HIGHWAY STANDARDS, & GENERAL NOTES			CONTRACT	NO. 6	OB09
E. SHEET NO DE SHEETS STA. TO STA.	FED. R	DAD DIST. NO. 1 THE INDIS FED. AT	ID PROJECT		

F.A.P. RTE.	SECTION	CTION COUNTY		Υ	TOTAL SHEETS	SHEET NO.	
330			WILL		32	3	
FED.	ROAD DIST. NO. 1	ILL	INOIS	HIG	HWAY PRO	JECT	

CONTRACT NO. 60B09


	CONTRACTOR OF CHANTITIES				(	CONSTRUCT	ION TYPE (	ODE	
CODE NO	SUMMARY OF QUANTITIES  ITEM	UNIT	URBAN TOTAL QUANTITIES	100% STATE Y009	50% STATE 50% VILLAGE Y009				
20100110	TREE REMOVAL (6 TO 15 UNITS DIAMETER)	UNIT	177.6	76.6	101				
20100210	TREE REMOVAL (OVER 15 UNITS DIAMETER)	UNIT	97. 1	50.7	46.4				
20101000	TEMPORARY FENCE	FOOT	65	65					
20101100	TREE TRUNK PROTECTION	EACH	2	2					
20101200	TREE ROOT PRUNING	EACH	20	7	13				
20200100	EARTH EXCAVATION	CU YD	1107	1070	37				
20400800	FURNISHED EXCAVATION	CU YD	56		56				
20800150	TRENCH BACKFILL	CU YD	16	16					
21101815	COMPOST FURNISH AND PLACE, 4"	SQ YD	3812	3431	381				
25000310	SEEDING, CLASS 4	ACRE	0.8	0.6	0.2				
25100630	EROSION CONTROL BLANKET	SQ YD	3812	3249	563				
28000400	PERIMETER EROSION BARRIER	FOOT	2655	2311	344				
28000500	INLET AND PIPE PROTECTION	EACH	8	6	2				
28100101	STONE RIPRAP, CLASS A1	SO YD	59		59				
28100107	STONE RIPRAP, CLASS A4	SQ YD	524	465	59				
28200200	FILTER FABRIC	SQ YD	524	465	59				
40601005	HOT-MIX ASPHALT REPLACEMENT OVER PATCHES	TON	5	5					
44001700	COMBINATION CONCRETE CURB AND GUTTER REMOVAL AND REPLACEMENT	FOOT	20	20					
44002224	HOT-MIX ASPHALT REMOVAL OVER PATCHES, 6"	SQ YD	14	14					
44201749	CLASS D PATCHES. TYPE I, 9 INCH	SQ YD	14	14			ļ		
50800105	REINFORCEMENT BARS	POUND	380		380				
54248500	CONCRETE HEADWALLS	CU YD	5		5				
55039700	STORM SEWERS TO BE CLEANED	FOOT	455	156	299				
550A0120	STORM SEWERS, CLASS A, TYPE 1 24"	FOOT	12	12					
550A0160	STORM SEWERS, CLASS A, TYPE 1 36"	FOOT	175	175					
550A0410	STORM SEWERS, CLASS A. TYPE 2 24"	FOOT	85	41	44				
550A0450	STORM SEWERS, CLASS A, TYPE 2 36"	FOOT	891	816	75				
550A0750	STORM SEWERS, CLASS A, TYPE 3 36"	F00T	33	33					
55101200	STORM SEWER REMOVAL 24"	FOOT	400	382	18				

	SUMMARY OF QUANTITIES		URBAN			CONSTRUCTI	ON TYPE CO	ODE	
			11K FS 64A1				1		
CODE NO	ITEM	UNIT	TOTAL QUANTITIES	100% STATE Y009	50% STATE 50% VILLAGE Y009				
552A1300 STG	ORM SEWERS JACKED IN PLACE, CLASS A	FOOT	102		102				
60205040 CA	TCH BASINS, TYPE A, 5' - DIAMETER, PE 24 FRAME AND GRATE	EACH	1	1					
60221100 MAI	NHOLES, TYPE A, 5'-DIAMETER, TYPE 1	EACH	3	2	1				
	ANHOLES, TYPE A, 5'-DIAMETER, TYPE 8 RATE	EACH	2	2					
	ANHOLES, TYPE A, 6'-DIAMETER, TYPE 8 RATE	EACH	1		1	·		. !	
60500050 RE	MOVING CATCH BASINS	EACH	1	1			-		
	EMOVE AND RE-ERECT STEEL PLATE BEAM UARD RAIL, TYPE A	FOOT	25	25	`				٠
	EMOVE AND RE-ERECT TRAFFIC BARRIER ERMINAL, TYPE 2	EACH	1	1					
67000400 EN	NGINEER'S FIELD OFFICE, TYPE A	CAL MO	5	4	1				
67100100 M0	OBILIZATION	L SUM	1	0.5	0.5			٠	
X0322256 TE	EMPORARY INFORMATION SIGNING	SO FT	51.4	51.4	-				
	TEEL CASING PIPE, AUGURED AND JACKED, 2"	FOOT	100		100				
X0329862 RE	EMOVE EXISTING MANHOLE	EACH	1		1				
Z0013798 C0	ONSTRUCTION LAYOUT	L SUM	1	1				,	
Z0018500 DF	RAINAGE STRUCTURES TO BE CLEANED	EACH	6	6					
Z0048665 RA	AILROAD PROTECTIVE LIABILITY INSURANCE	L SUM	1	1					

REVISIONS					
NAME	DATE				

ILLINOIS DEPARTMENT OF TRANSPORTATION
US 45 (LA GRANGE RD)
UNDER EJ & E RAILROAD VIADUCT
SUMMARY OF QUANTITIES

PLOT DATE: 6/25/2008

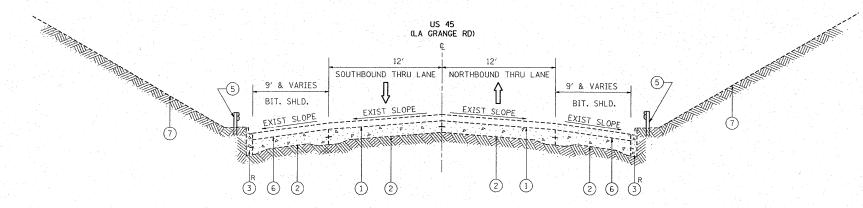

EXISTING TYPICAL SECTION
US 45 (NORTH & SOUTH OF E J & E RR VIADUCT)


#### LEGEND

- 1 EXISTING HMA SURFACING, 6" (±)
- 2 EXISTING PCCPAVEMENT (9-7-9)
- 3 EXISTING COMBINATION CONCRETE CURB AND GUTTER, TYPE B-6.12
- 4 EXISTING COMBINATION CONCRETE CURB AND GUTTER, TYPE B.6-24
- (5) EXISTING STEEL PLATE BEAM GUARDRAIL, TYPE A
- 6 EXISTING HMA SHOULDER
- 7 EXISTING GROUND LINE
- R CURB AND GUTTER REMOVAL AND REPLACEMENT (LOCATION AS DIRECTED BY THE ENGINEER)

#### ree.

ADDITIONAL SUB-BASE GRANULAR MATERIAL UNDER PROPOSED CUB AND GUTTER SHALL NOT BE PAID FOR SEPARATELY BUT WILL BE CONSIDERED AS INCLUDED IN THE COST PER SQUARE YARD OF "SUB-BASE GRANULAR MATERIAL, TYPE B 4 INCHES

ANY SAW CUTTING REQUIRED TO REMOVE ANY ITEM ADJACENT TO AN ITEM TO BE SAVED WILL BE CONSIDERED AS PART OF THE REMOVAL ITEM AND WILL NOT BE PAID FOR SEPARATELY.

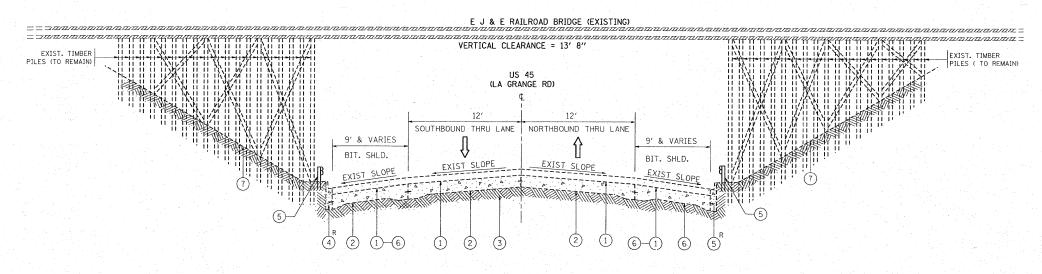

## EXISTING TYPICAL SECTION US 45 UNDER E J & E RR VIADUCT

	FILE NAME =	USER NAME = galbannb	DESIGNED -	REVISED -		HO AR HA CRANCE DE HEIDER EL O E DANDOLD MADIOT	F.A.P. SECTION COUNTY TOTAL SHEET
- 1	c:\projects\p118604\design_aa.dgn		DRAWN -	REVISED -	STATE OF ILLINOIS	US 45 (LA GRANGE RD) UNDER EJ & E RAILROAD VIADUCT	MIE. SHEETS NO.
		PLOT SCALE = 52.9396 '/ IN.	CHECKED -	REVISED -	DEPARTMENT OF TRANSPORTATION	EXISTING TYPICAL SECTION	330 104 1-3 WILL 4
. [		PLOT DATE = 12/27/2007	DATE -	REVISED -		SCALE: NTS SHEET NO. OF SHEETS STA. TO STA.	FEO. ROAD DIST. NO. 1 ILLINOIS FED. AID PROJECT

#### TREE REMOVAL SCHEDULE US 45 (LA GRANGE RD) - ALONG THE DITCH LINE ON THE NORTH

OFFSETS		DESCRIPTION		REASON FOR
(FEET)	CIRCUM. (INCH)	6 TO 15 UNITS	OVER 15 UNITS	REMOVAL
2.2	27.96	8.90		DITCH
2.2	33.12	10.54		DITCH
2.2	18.96	6.04		DITCH
2.2	39.96	12.72		DITCH
7.3	24.84	7.91		DITCH
37.4	27.00	8.59		DITCH
50	47.40		15.09	DITCH
61	22.92	7.30		DITCH
64	45.72	14 <b>.</b> 55		EMBANKMENT
64	50.40		16.04	EMBANKMENT
	TOTAL	76.55	31.13	
	(FEET) 2.2 2.2 2.2 2.2 7.3 37.4 50 61 64	(FEET) CIRCUM. (INCH) 2.2 27.96 2.2 33.12 2.2 18.96 2.2 39.96 7.3 24.84 37.4 27.00 50 47.40 61 22.92 64 45.72 64 50.40	OFFSETS         CIRCUM. (INCH)         6 TO 15 UNITS           2.2         27.96         8.90           2.2         33.12         10.54           2.2         18.96         6.04           2.2         39.96         12.72           7.3         24.84         7.91           37.4         27.00         8.59           50         47.40           61         22.92         7.30           64         45.72         14.55           64         50.40         14.55	CIRCUM. (INCH)         6 TO 15 UNITS         OVER 15 UNITS           2.2         27.96         8.90           2.2         33.12         10.54           2.2         18.96         6.04           2.2         35.96         12.72           7.3         24.84         7.91           37.4         27.00         8.59           50         47.40         15.09           61         22.92         7.30           64         45.72         14.55           64         50.40         16.04

#### TREE REMOVAL SCHEDULE US 45 (LA GRANGE RD) - LEFT SIDE (NORTH)

LOCATION OFFSETS (FEET)			DESCRIPTION	REASON FOR	
		CIRCUM. (INCH)	6 TO 15 UNITS	OVER 15 UNITS	REMOVAL
60 + 23.16	80.38	55.20		17.57	EASEMENT
60 + 12.05	72.25	21.60	6.88		EASEMENT
60 + 0.20	65.74	39.00	12.41	·	EASEMENT
59 + 89.52	69.26	45.60	14.51		DEAD
59 + 88.61	77.38	33.20	10.89		EASEMENT
59 + 80.70	60.30	22.80	7.26	·	EASEMENT
59 + 78.96	63.54	19.80	6.30		EASEMENT
59 + 70.94	55.21	55.20		17.57	EASEMENT
59 + 63.20	54.06	37.80	12.08	-	EASEMENT
59 + 49.37	49.11	19.80	6.30		EASEMENT
59+ 37.80	39.12	21.12	6.72		EASEMENT
59 + 37.80	39.12	48.84		15.55	EASEMENT
59 + 39 <b>.</b> 81	35.32	25.80	8.21		EASEMENT
59 + 39.81	35.32	29.64	9.43		EASEMENT
		TOTAL	100.99	50.69	

#### TREE REMOVAL SCHEDULE US 45 (LA GRANGE RD) - RIGHT SIDE (SOUTH)

LOCATION	OFFSETS		DESCRIPTION	REASON FOR	
STATION	(FEET)	CIRCUM. (INCH)	6 TO 15 UNITS	OVER 15 UNITS	REMOVAL
60 + 05	37.70	48		15.28	EMBAKMENT
		TOTAL		15.28	

#### EARTHWORK (DITCH) SCHEDULE

US 45 UNDER EJ & E VIADUCT IN FRANKFURT, IL IN WILL COUNTY

		IN FRANKFORT, IL	IN WILL COUNTY		
1	2	3	4	(5)	
LOCATION	EARTH EXCAVATION	EARTH EXCAVATION ADJUSTED FOR SHRINKAGE	EMBANKMENT	EARTHWORK BALANCE WASTE (+) OR SHORTAGE (-)	
STATIONS	CUBIC YARD	CUBIC YARD	CUBIC YARD	CUBIC YARD	
STA. 00+00 - STA. 00+50	128.24	109.00	00.00	+109.00	
STA. 00+50 - STA. 01+00	223.61	190.07	00.00	+190.07	
STA. 01+00 - STA. 01+50	165.74	140.88	00.00	+140.88	
STA. 01+50 - STA. 01+75.71	63.08	53.62	00.00	+53.62	
STA. 01+75.71 - STA. 02+00	43.41	36.90	00.00	+36.90	
STA. 02+00 - STA. 02+50	66.20	56.27	00.00	+56.27	
STA. 02+50 - STA. 03+00	44.91	38.17	00.00	+38.17	
STA. 03+00 - STA. 03+50	19.91	16.92	00.00	+16.92	
STA. 03+50 - STA. 04+00	4.17	3.54	00.00	+3.54	
TOTAL	759.27	645.37	00.00	+645.37	

COLUMN 1: LOCATION FROM PLANS
COLUMN 2: QUANTITY OF EARTH EXCAVATION (CUT) FROM CROSS SECTIONS
COLUMN 3: QUANTITY OF EARTH EXCAVATION (CUT) ADJUSTED FOR A
SHRINKAGE FACTOR OF 15%

SHRINKAGE FACTOR OF 15X

COLUMN 4: QUANTITY OF EMBANKMENT (FILL) FROM CROSS SECTIONS

COLUMN 5: (COLUMN 3-COLUMN 4)

(-) = QUANTITY OF FURNISHED EXCAVATION NEEDED

(+) = QUANTITY TO BE WASTED

ADDITIONAL EARTH EXCAVATION QUANTITY (310 CU YD.) WILL BE NECESSARY FOR SLOPE STABILIZATION ON US 45 AS SHOWN ON THE PLAN.

ADDITIONAL EARTH EXCAVATION QUANTITY (37 CU YD.) AND FURNISHED EXCAVATION (56 CU YD) WILL BE NECESSARY FOR THE CONSTRUCTION OF THE CONCRETE HEADWALL.

#### HOT-MIX ASPHALT MIXTURE REQUIREMENTS THE FOLLOWING MIXTURE REQUIREMENTS ARE APPLICABLE FOR THIS PROJECT.

MIXTURE TYPE	AC/PG	AIR VOIDS	THICKNESS
IN AL DATOURIO			

#### HMA PATCHING

	CLASS D PATCH			0,4	
•	(HMA BINDER IL-19 mm)	PG 64-22*	4%@70 GYR	9″	
	HMA REPLACEMENT OVER PATCHES	PG 64-22*	4%070 CVD	N/A	
	(HMA BINDER IL-19 mm)	FG 64-22	4%@70 GYR	N/A	

THE UNIT WEIGHT USED TO CALCULATE ALL HMA SURFACE MIXTURE QUANTITIES IS 112 POUNDS PER SQUARE YARD PER INCH.


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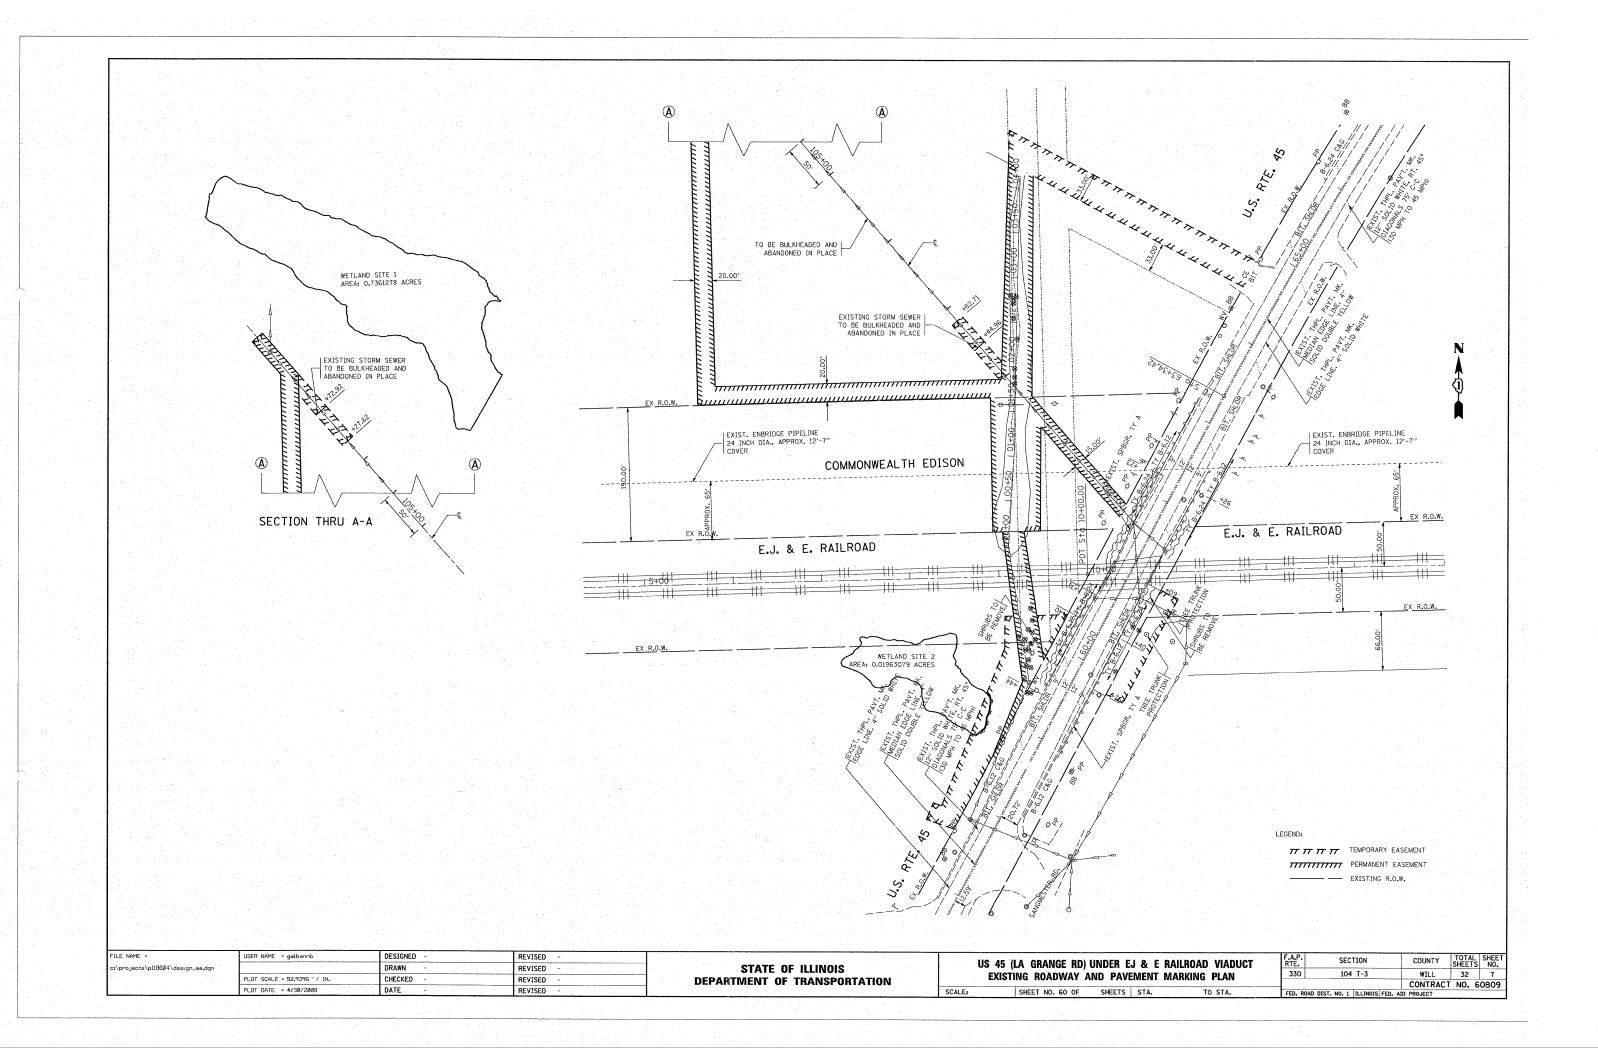
\* WHEN RAP EXCEEDS 20%, THE NEW ASPHALT BINDER IN THE MIX SHALL BE PG 58-22


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	PLOT DATE = 4/23/2008	DATE	REVISED -	


STATE OF ILLINOIS **DEPARTMENT OF TRANSPORTATION** 


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US 45	(LA	GRANGE ROA	AD) UNDE	R EJ & E	RR VIADUCT	F.A.P RTE.	SECTION	COUNTY	TOTAL	SHE
•			CHEDULE OF QUANTITIES			330	104 T-3	WILL	32	5
	1			DANTITIES				CONTRAC	T NO. 6	50B0
	SHEE	T NO. OF	SHEETS	STA.	TO STA	EEO 2010 E	TET NO 1 THE THOTE FED A	ID DOG CAT		




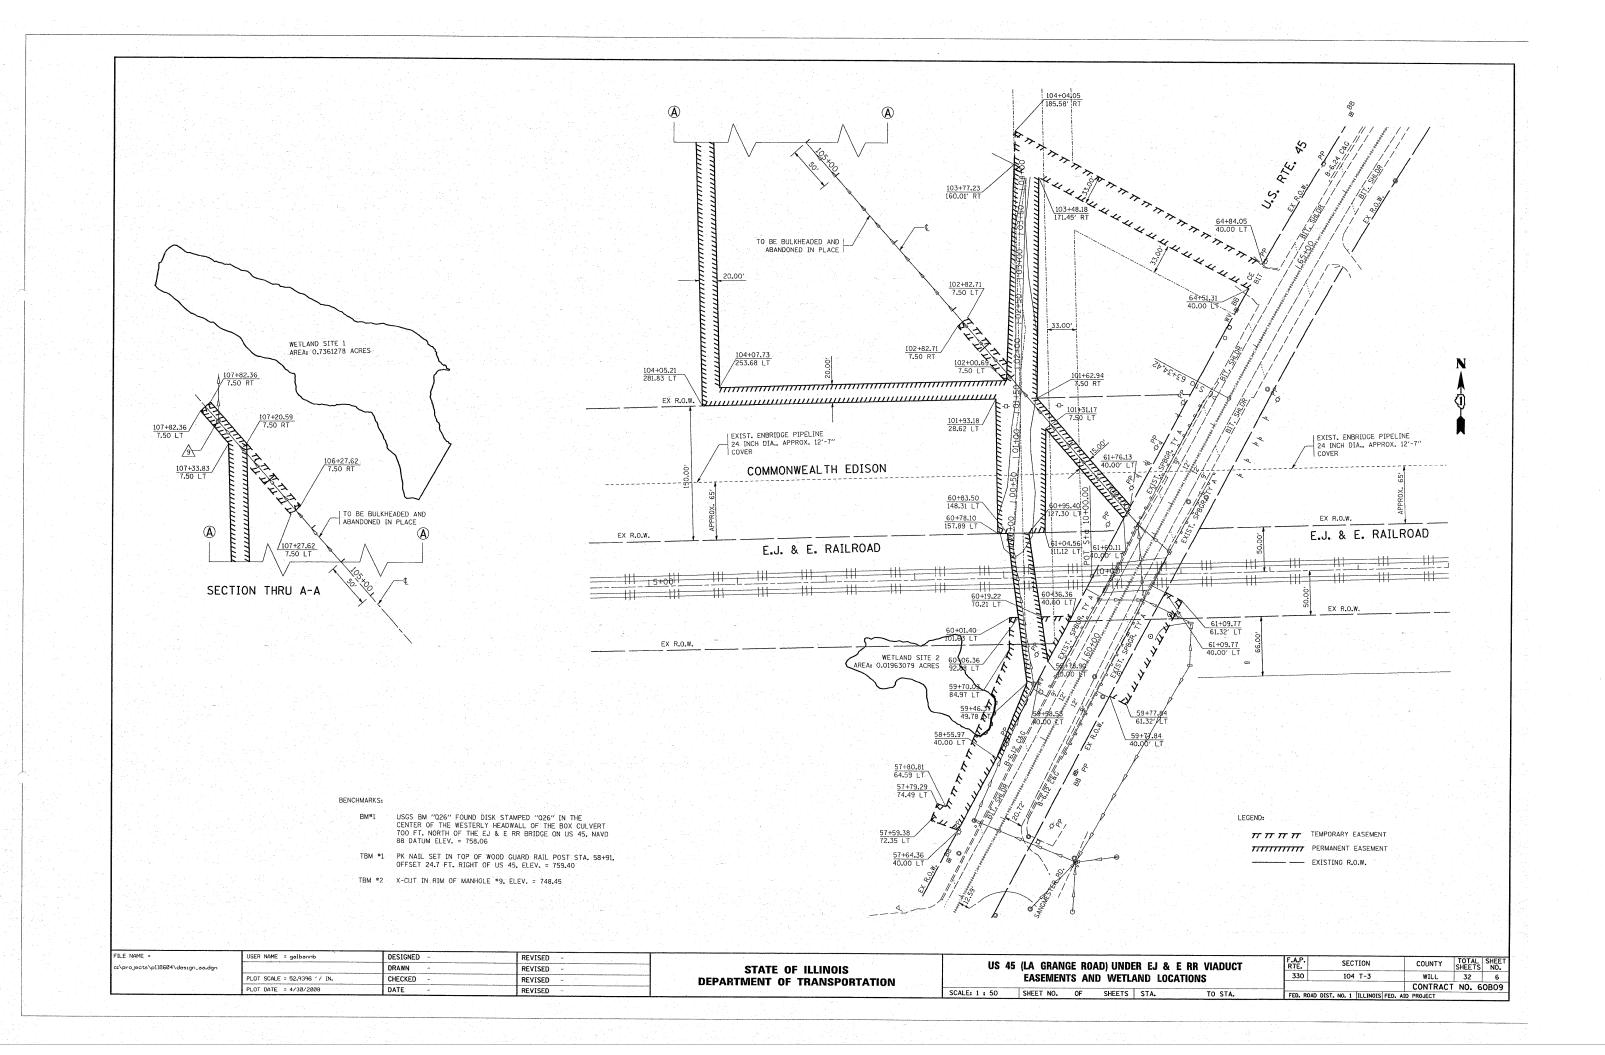

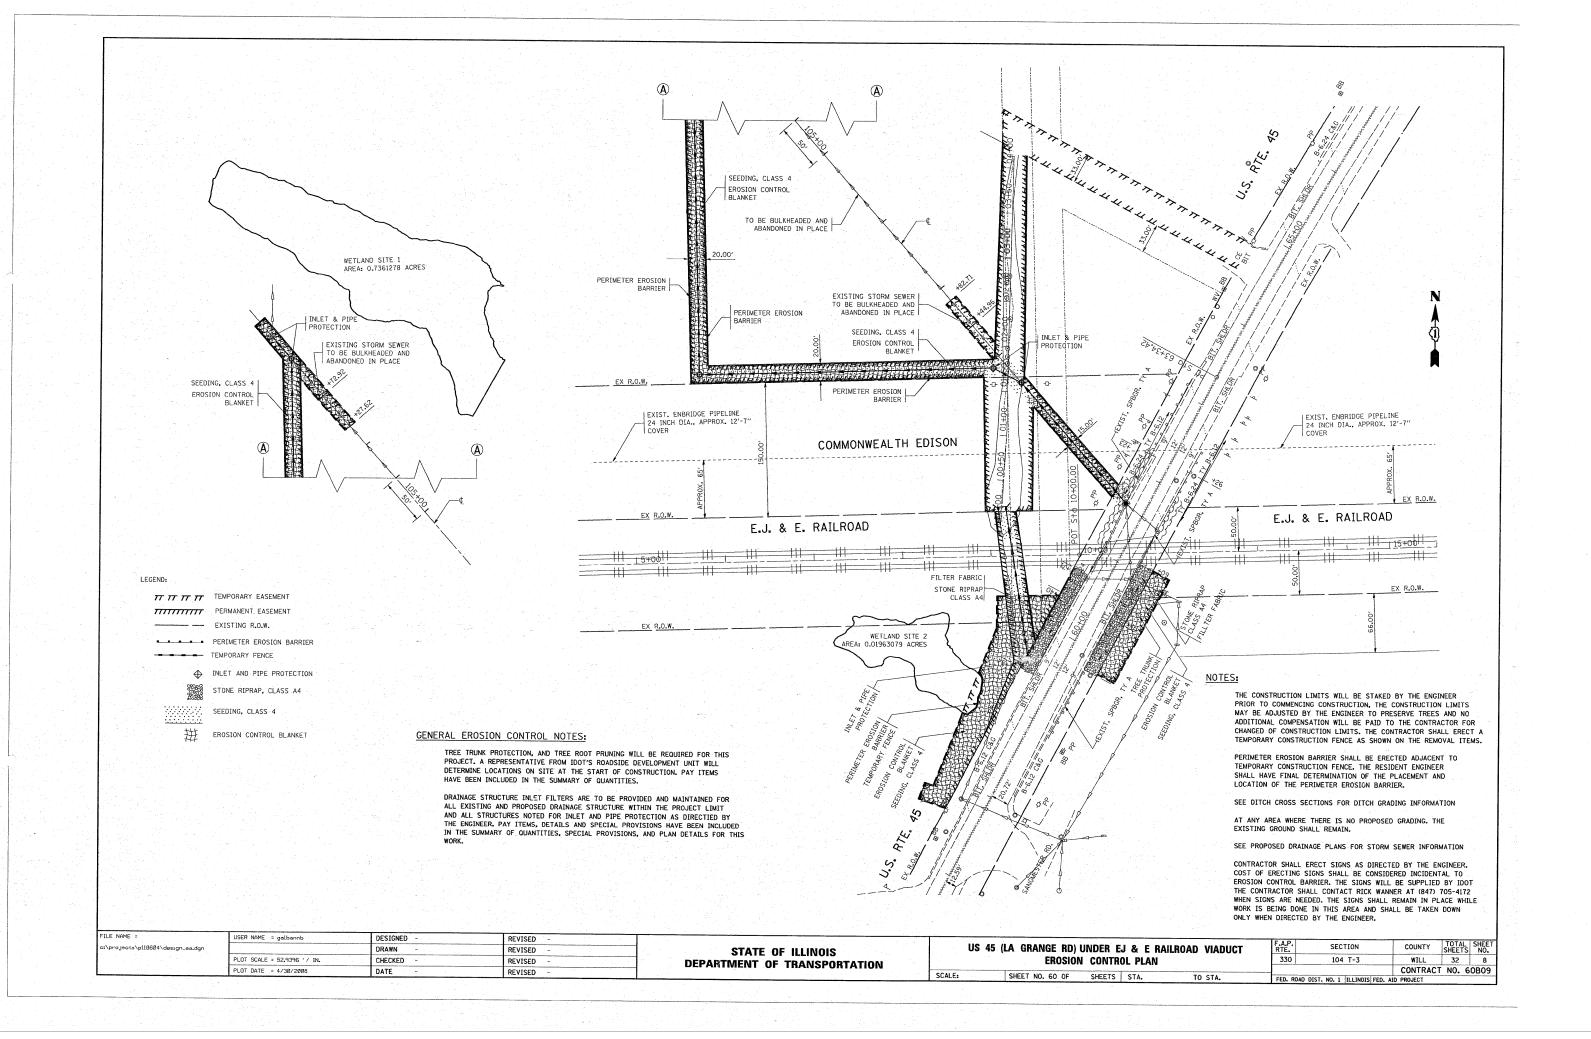

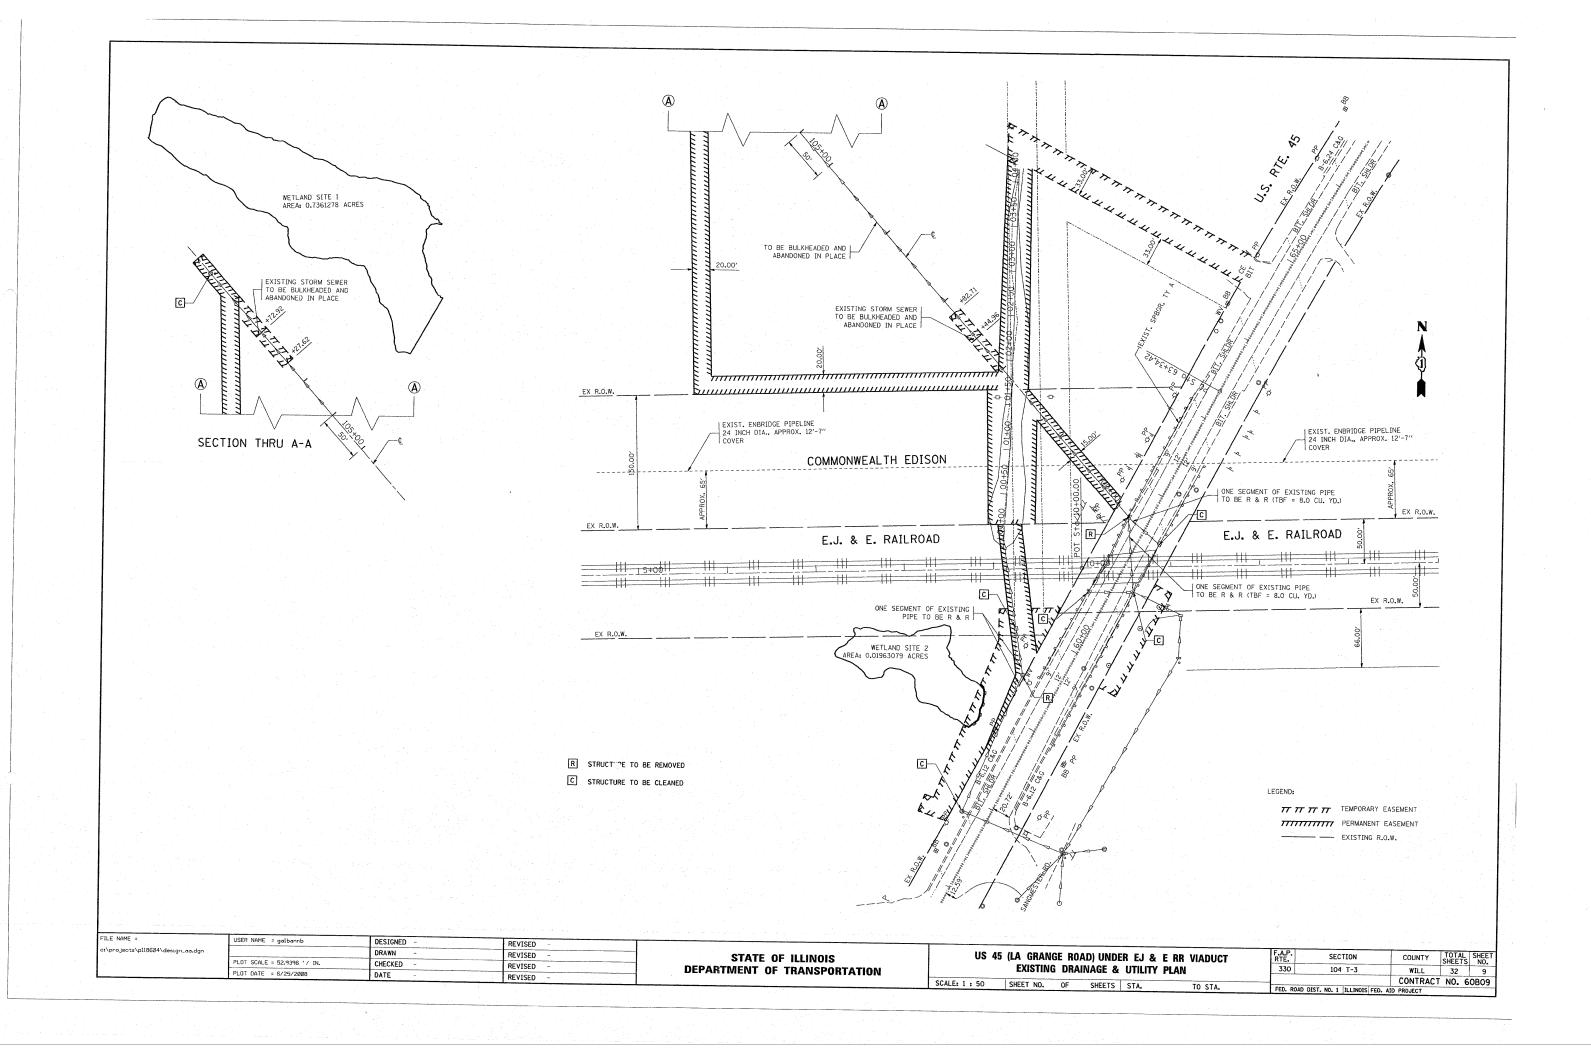

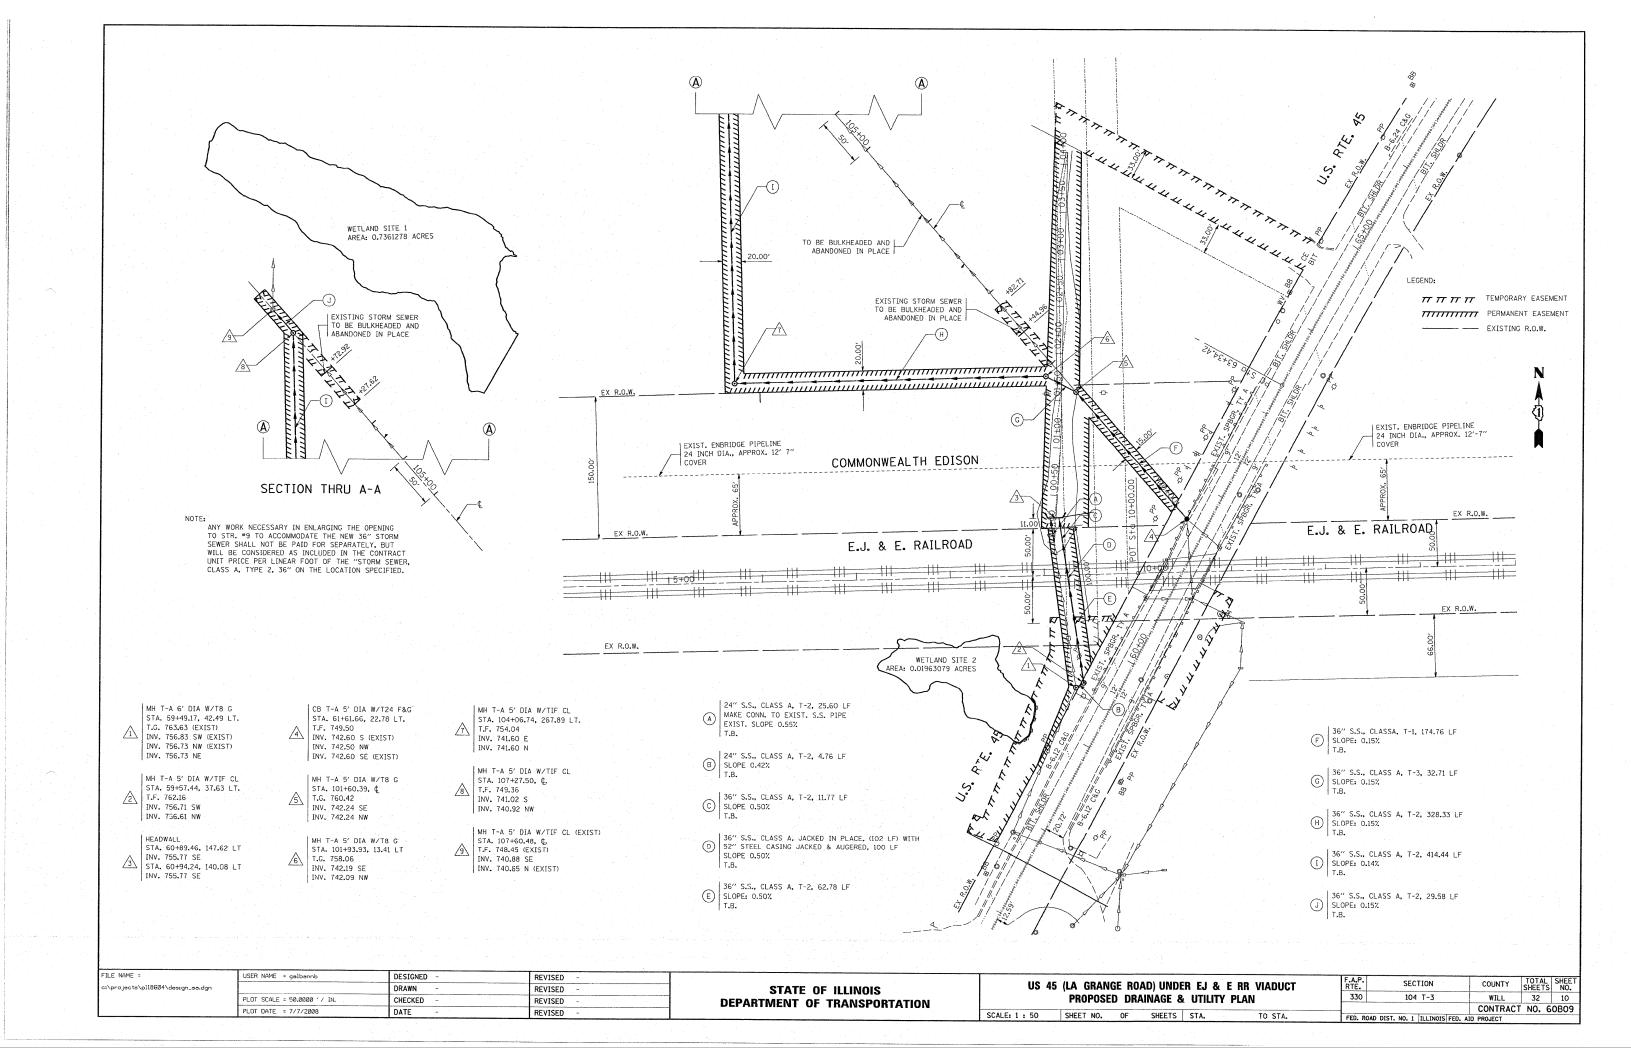


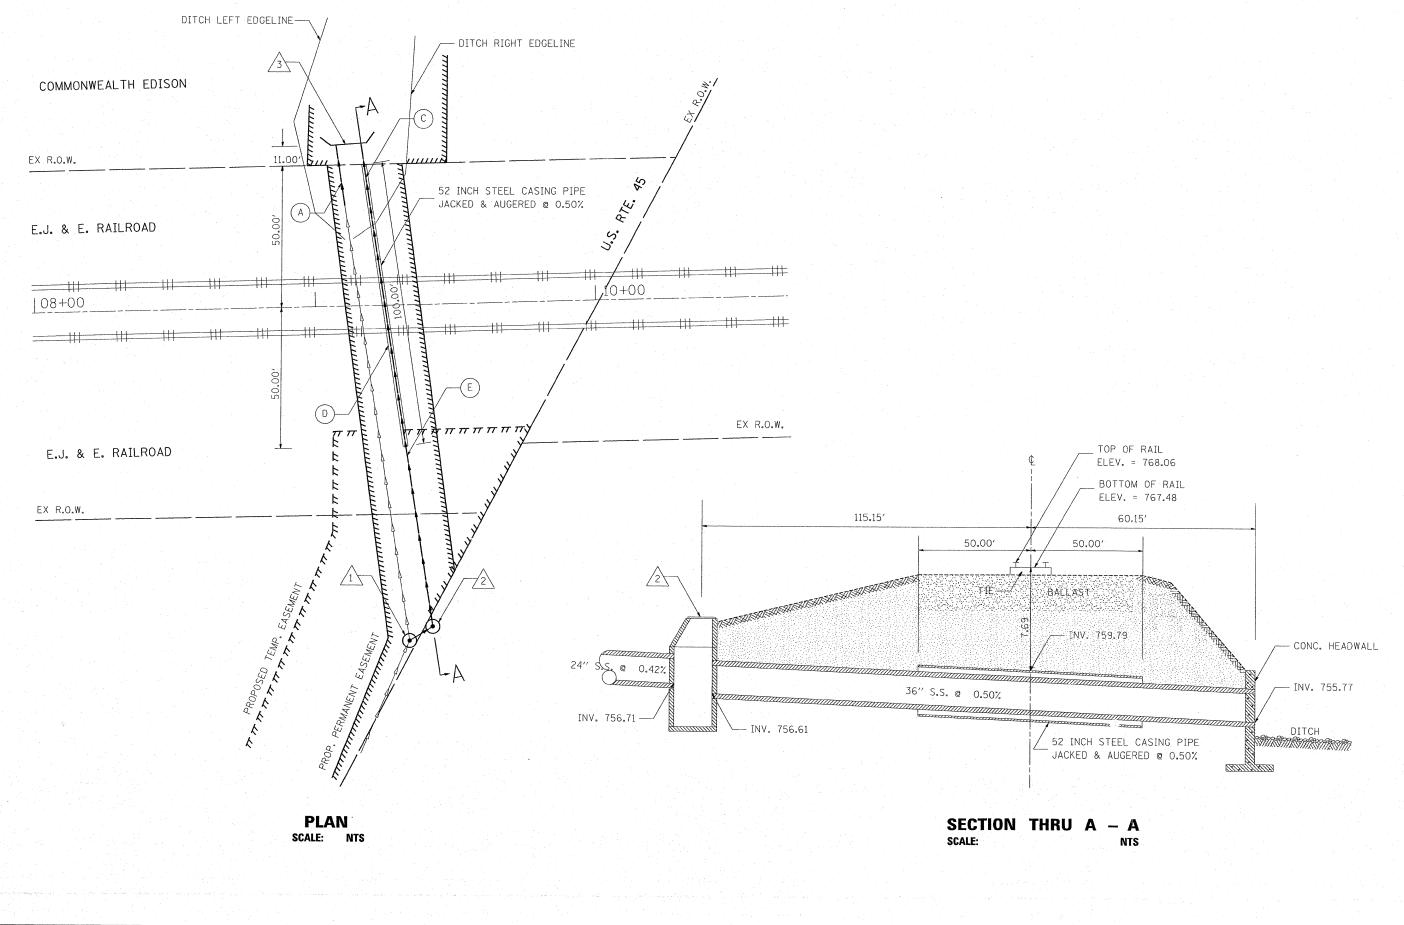



STATE OF ILLINOIS
DEPARTMENT OF TRANSPORTATION


US 45 (LA GRANGE RD) UNDER E J & E RAILROAD
PROPOSED STORM SEWER UNDER E J & E TRACKS (EXHIBIT)


SCALE: SHEET NO. OF SHEETS STA. TO STA.

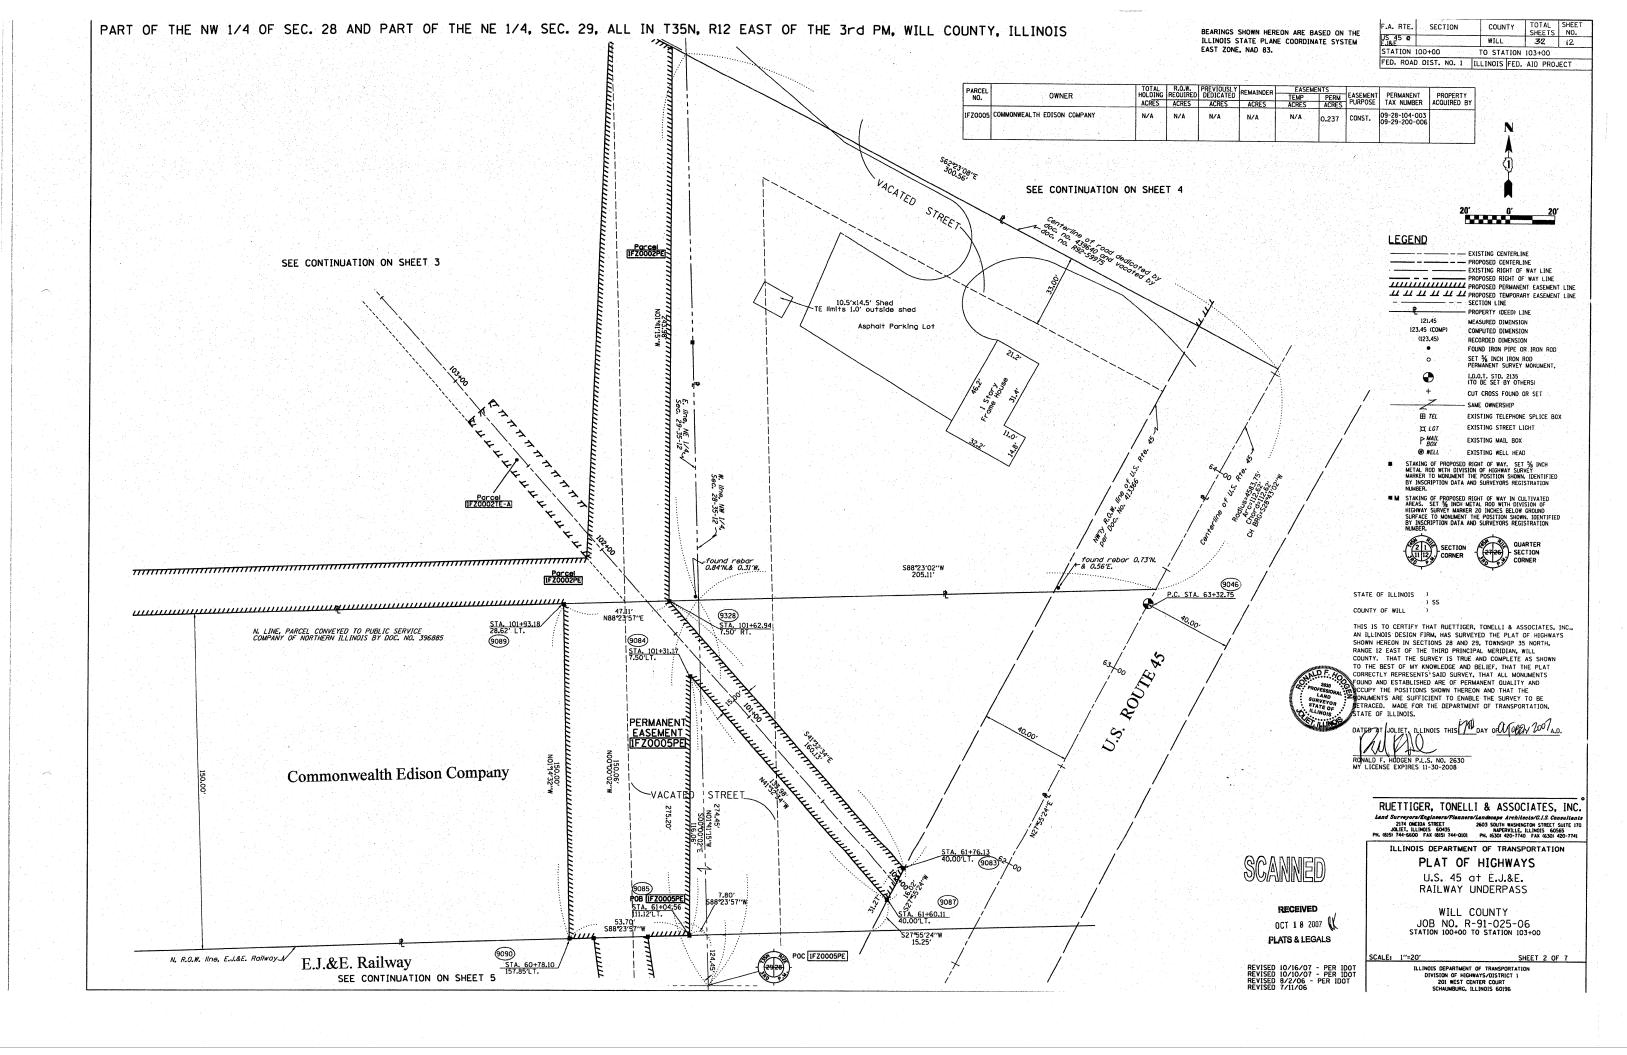


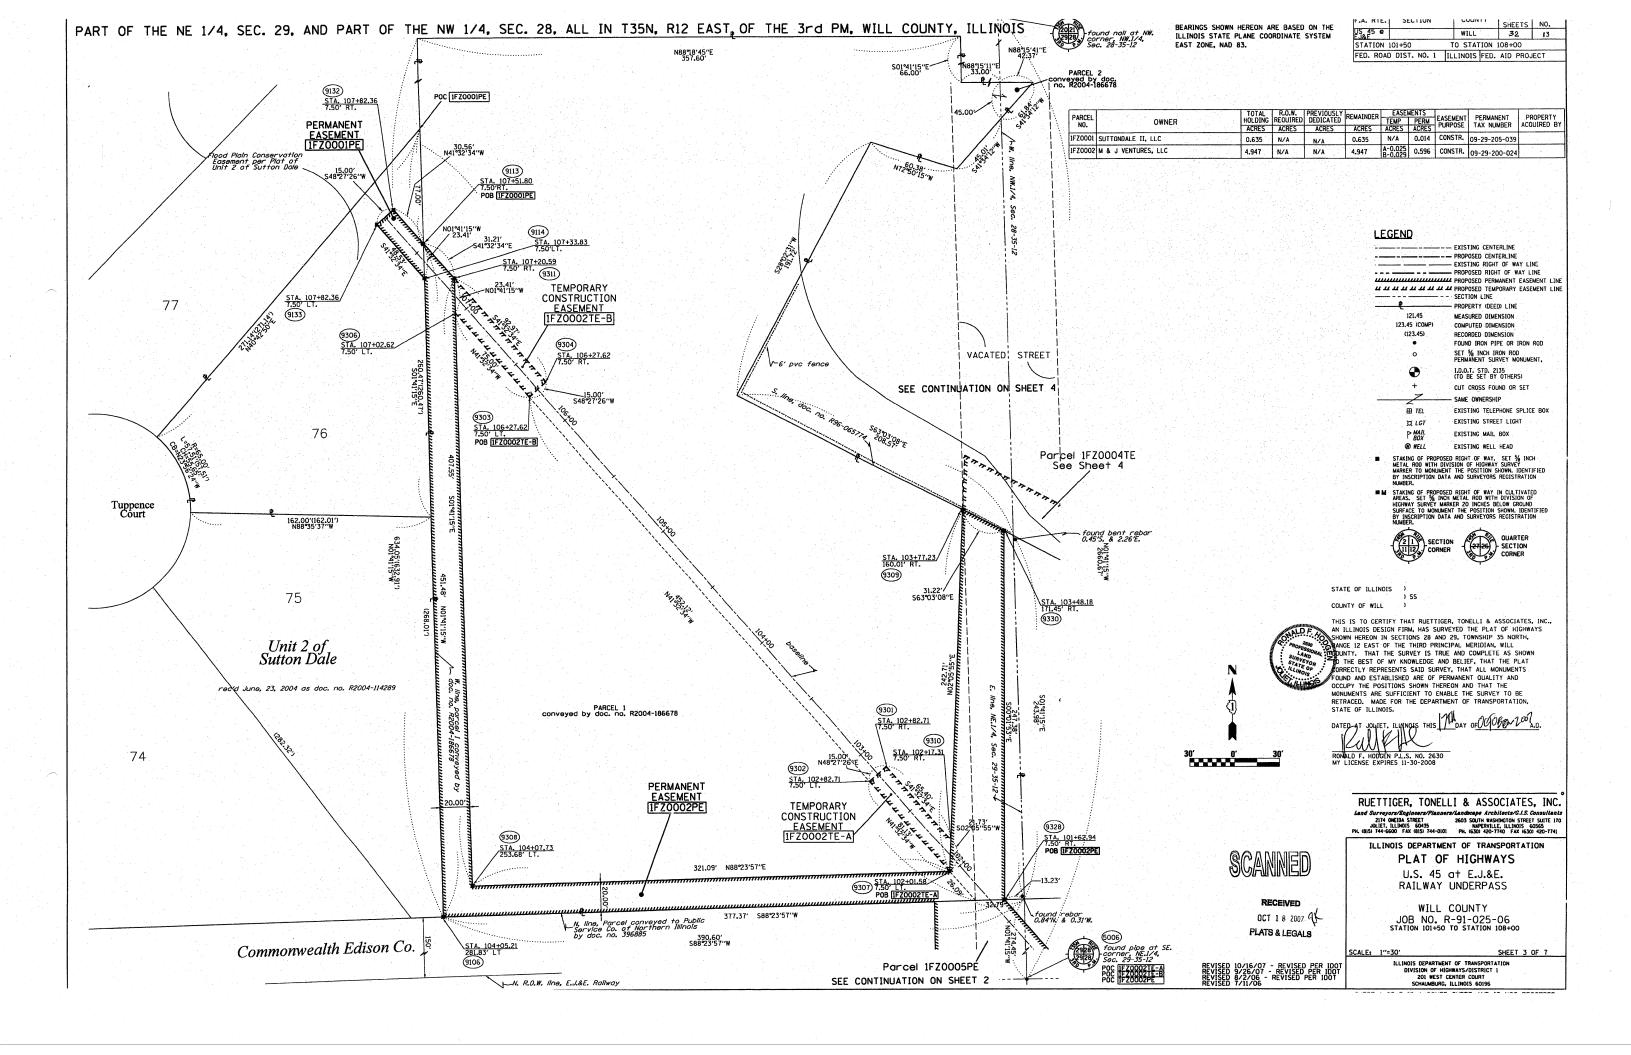


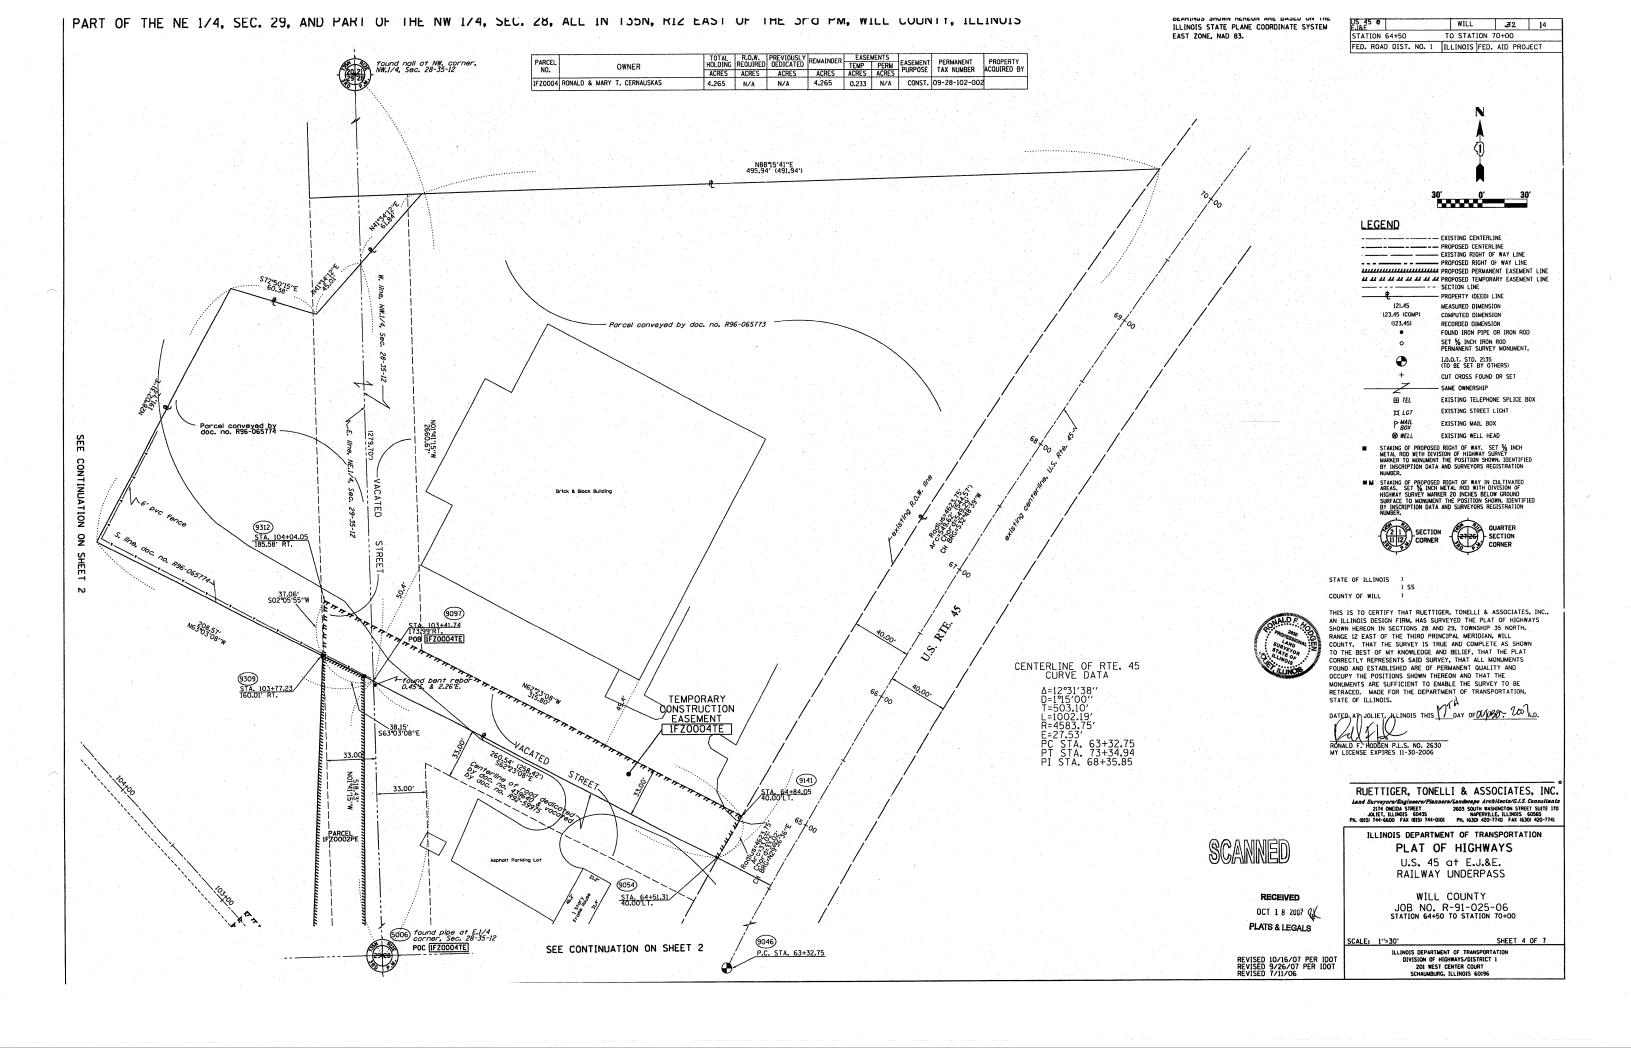

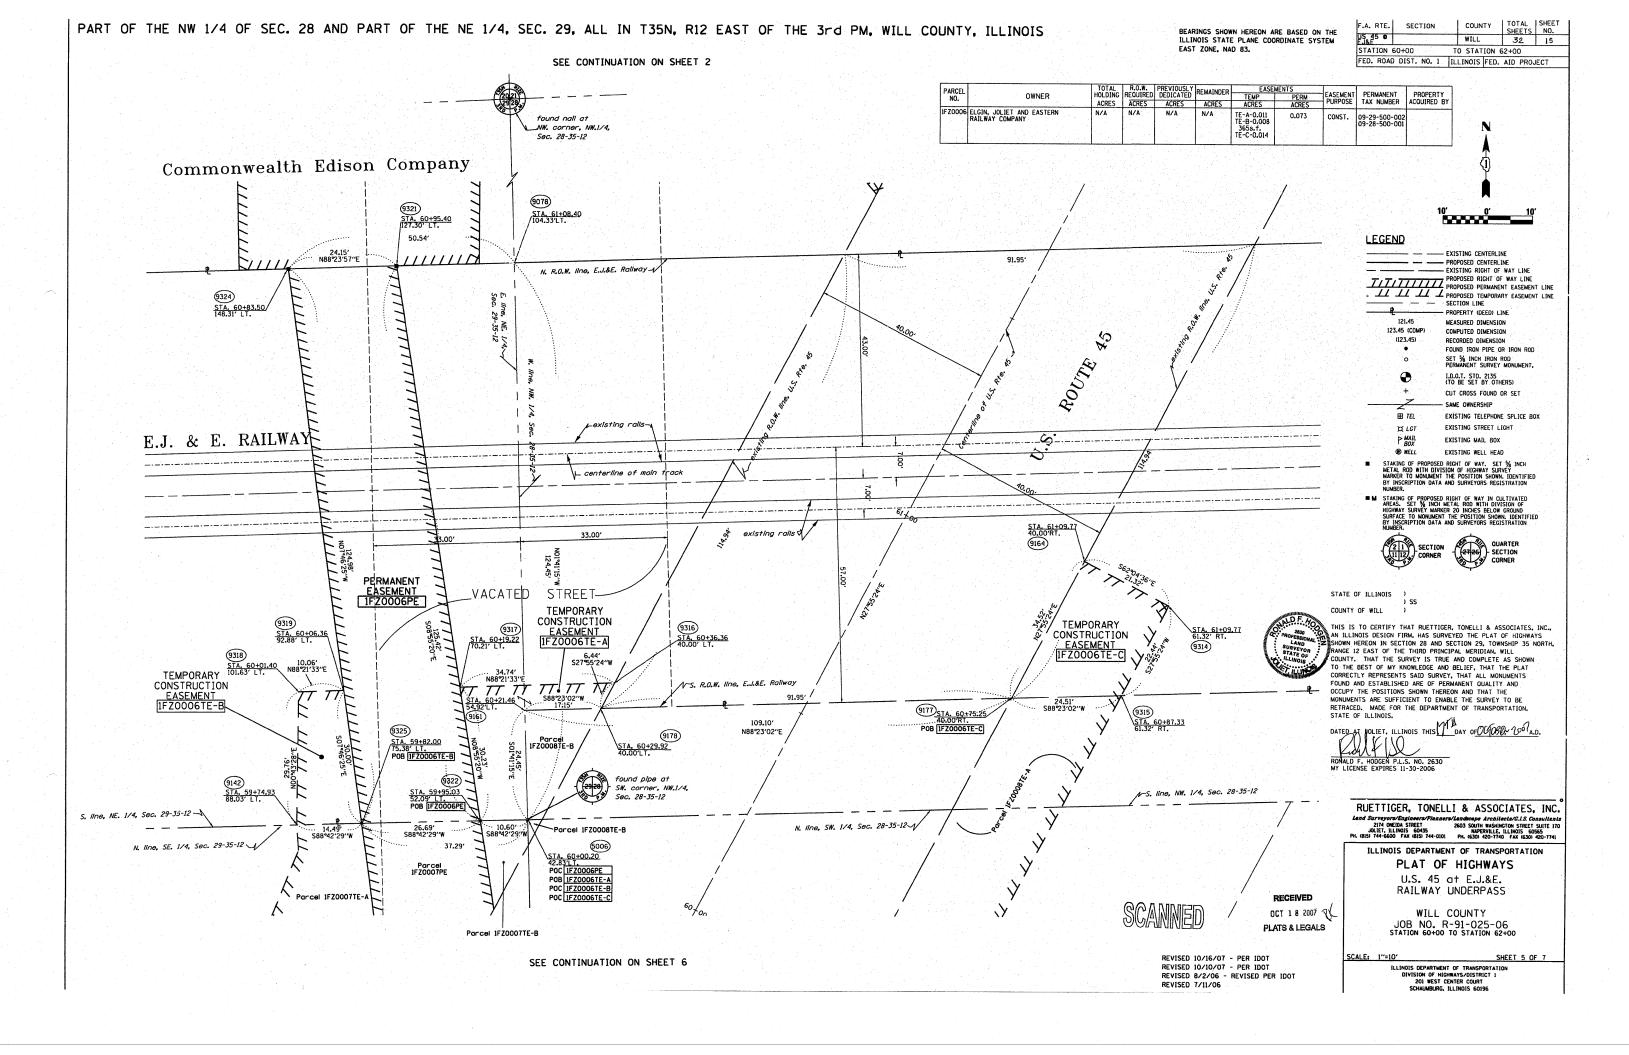

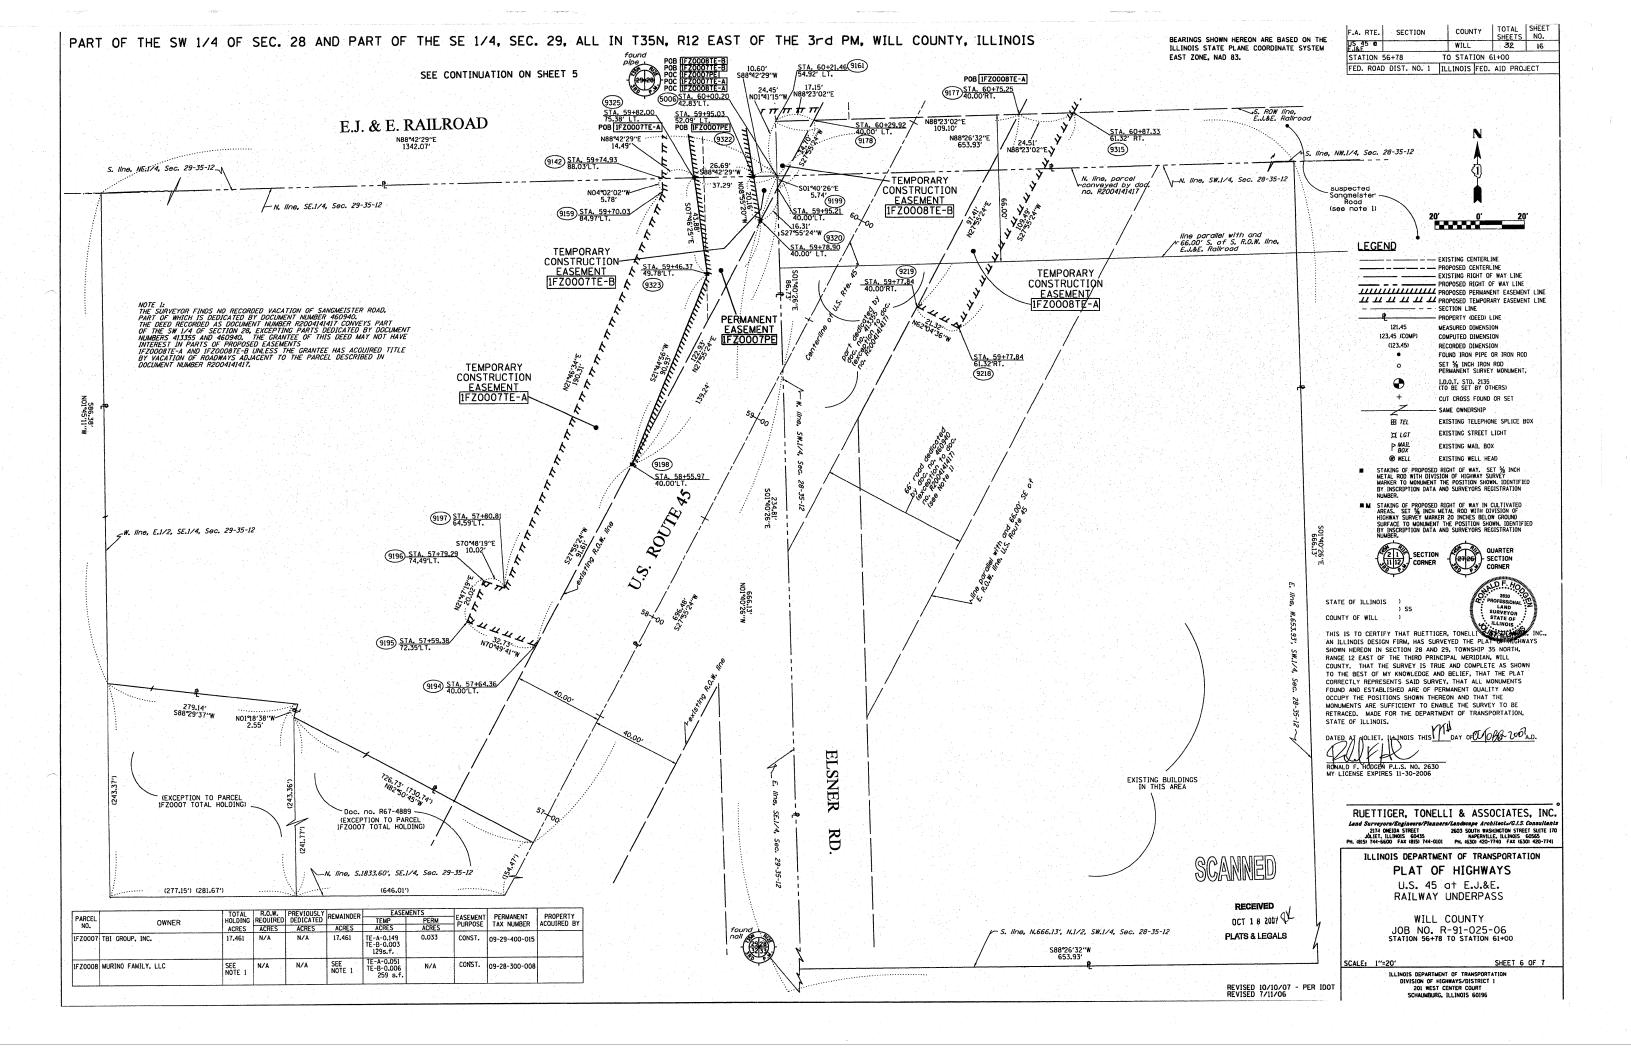

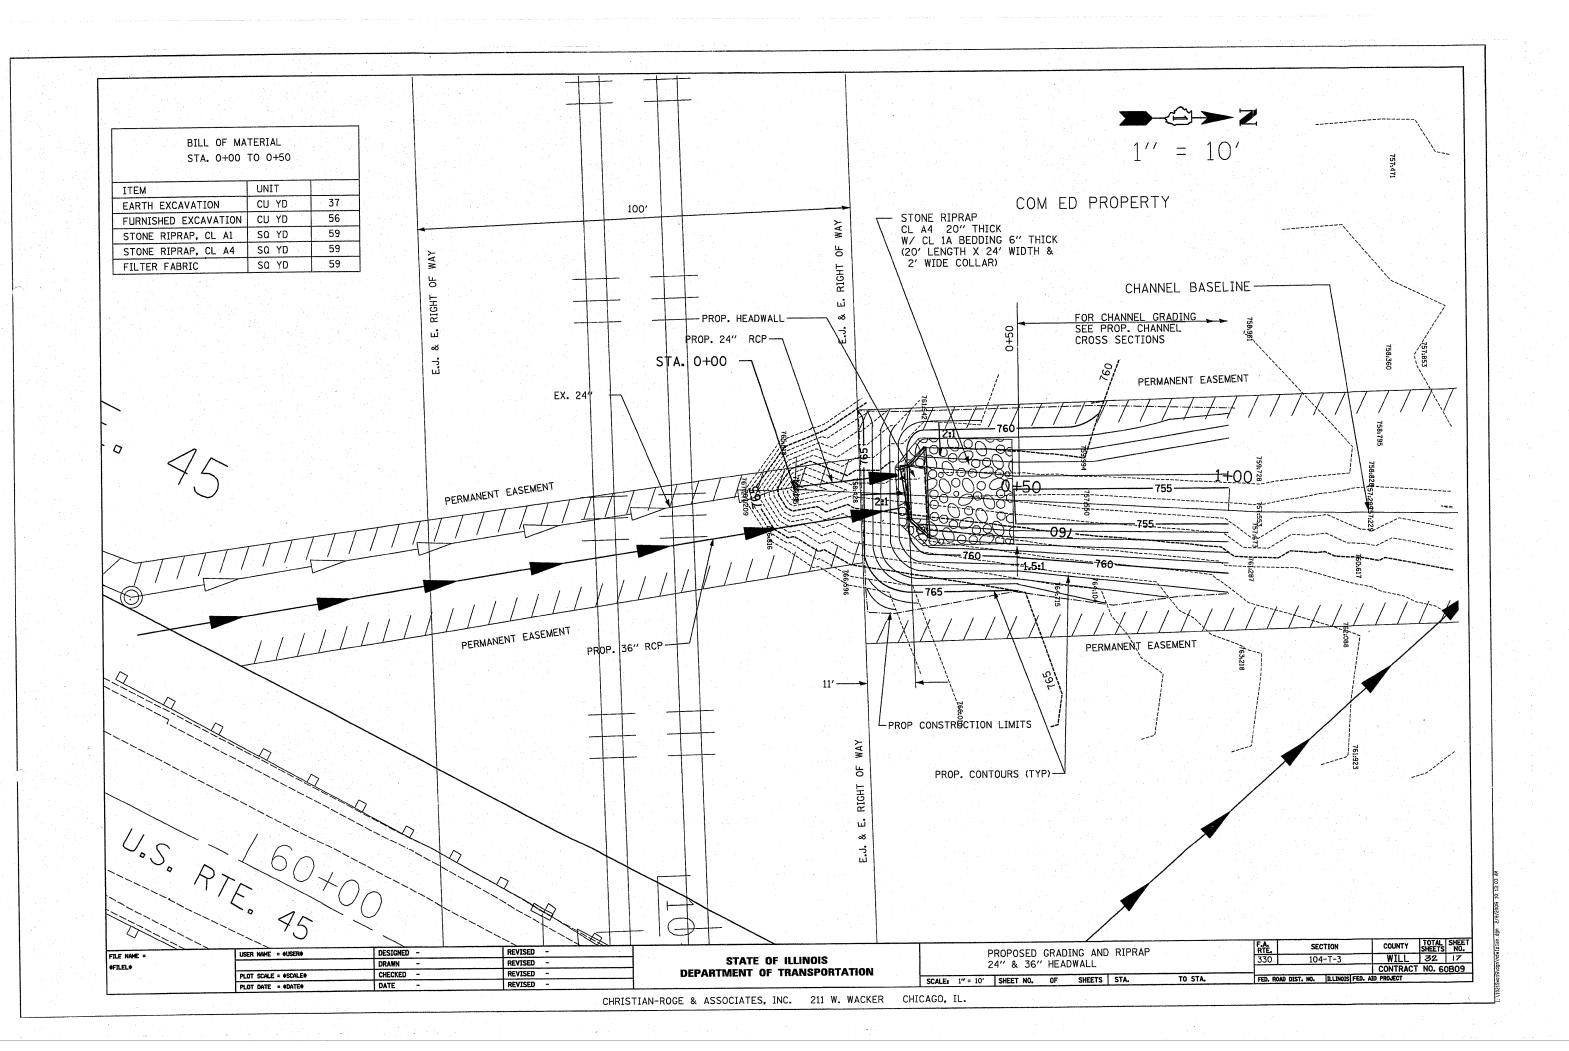

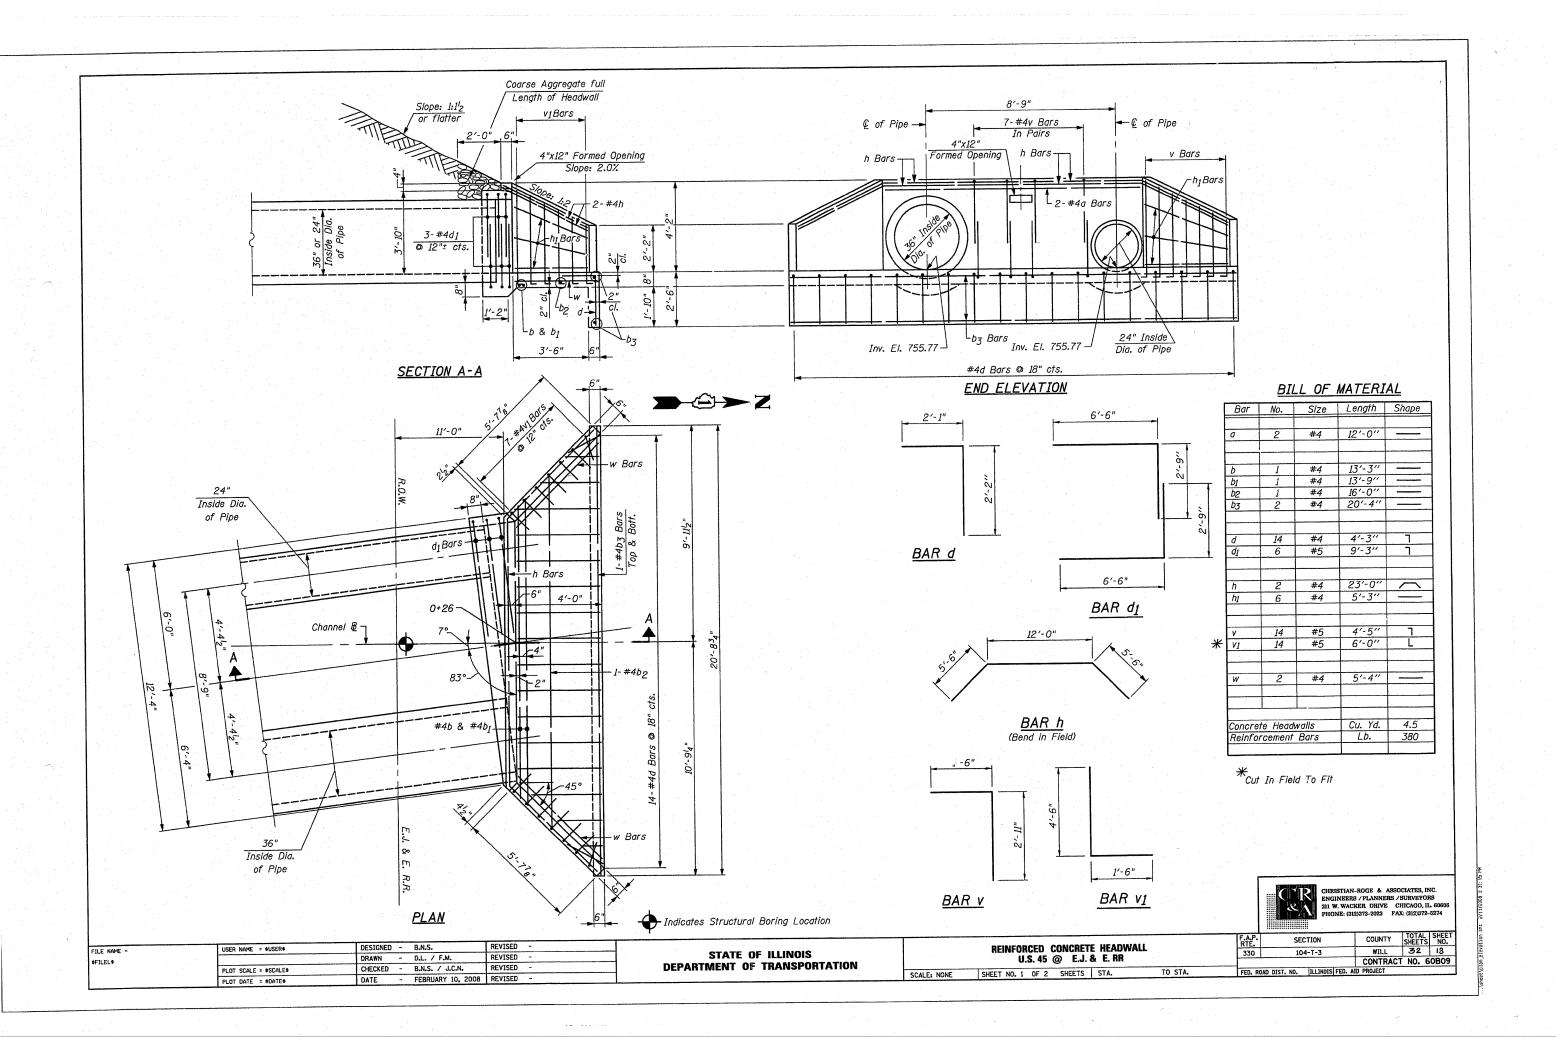

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### **SOIL BORING LOG**

Page <u>1</u> of <u>1</u>

Date 8/2/07

						RNG. 12E, 3 <sup>rd</sup> PM
COUNTY Will DE	RILLING M	ETHOD		· 	Hand Auger	HAMMER TYPE
STRUCT. NO	_ D	L	UCS	M O I	Surface Water Elev Stream Bed Elev	ft ft
BORING NO.         B-1           Station         9+25           Offset         48.00ft Lt CL	_   H	S	Qu	S T	Groundwater Elev.: First Encounter Upon Completion	ft
Ground Surface Elev. 758.74	ft (fi	(/6")	(tsf)	(%)	After Hrs.	ft
Very Soft Brown SANDY LOAM			0.5	28		
		_	0.0			
S CONTROL O CONTROL ON TY	757.24		0.0	39		
Soft to Stiff Black Organic SILTY	-	-	1.3	33		
V-104 \$1		-	2.0	26		
Grades to Gray		7	0.8			
•	754.74		1.5	25		
Note: Unconfined compressive						
strength values based on measurements with a pocket	-	-5	1			
penetrometer.		4				
Note: Railroad stationing was						
used for distance measurement, Benchmark used was TBM #1 a	•	-				
PK nail set in ton of wood quard		$\dashv$	1			
rail post sta. 58+91 / 24.7 ft. Rt Cl of US 45. Elevation is 759.40 ft.	<del>-</del> *	_				
End of Boring	٠.					
Lite of Bonning						
		4	ļ			
	_	-10				
		-				
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)				1	11	

The Unconfined Compressive Strength (UCS) Failure Mode is indicated by (B-Bulge, S-Shear, P-Penetrometer)
The SPT (N value) is the sum of the last two blow values in each sampling zone (AASHTO T206)

BBS, from 137 (Rev. 8-99)




CHRISTIAN-ROGE & ASSOCIATES, INC.
ENGINEERS / PLANNERS / SURVEYORS
211 W. WACKER DRIVE CHICAGO, IL. 60606
PHONE: (312)372-2023 FAX: (312)372-5274

					_
FILE NAME =	USER NAME = \$USER\$	DESIGNED -	B.N.S.	REVISED -	
\$FILEL\$		DRAWN -	D.L. / F.M.	REVISED -	
	PLOT SCALE = \$SCALE\$	CHECKED -	B.N.S. / J.C.N.	REVISED ~	
	PLOT DATE = \$DATE\$	DATE -	FEBRUARY 10, 2008	REVISED -	

STATE	OF	ILLINOIS		
DEPARTMENT	OF	TRANSPOR	TATION	
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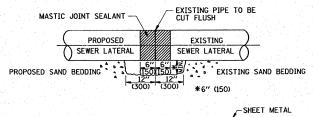
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SCALE: NONE	SHEET	NO.	2	OF	2	SHEETS	STA.	


P. E.	Π	DAD DIST. N	SE	CTION		COUNTY	TOTAL SHEETS	SHE
50	T	104-T-3			WILL	32	19	
	-					CONTRACT	NO. 6	080
). R	DAO	DIST.	NO.	ILLINOIS FED.	AID	PROJECT		

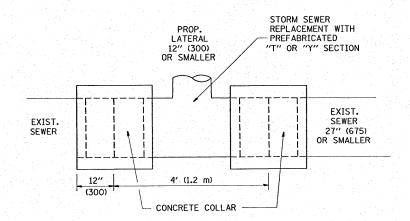


#### DETAIL "A"

LATERAL CONNECTION TO EXISTING SEWER
OF 27" (675) OR SMALLER



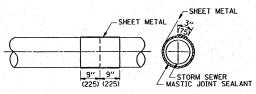

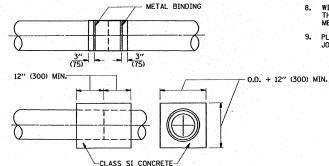


DETAIL "B"

CLASS SI CONCRETE COLLAR

#### CONSTRUCTION SEQUENCE

- CUT THE EXISTING END OF THE PIPE SO AS TO PRESENT A FLUSH BUTT JOINT. BRUSH AND CLEAN ALL PIPES.
- 2. APPLY THE MASTIC JOINT SEALANT TO THE FIRST 6" (150) OF EACH PIPE.
- 3. BUTT THE PIPES TOGETHER LEAVING A MINIMUM OF 12' × 6' (300 × 150) DEEP EXCAVATION UNDER AND AROUND EACH PIPE END.
- . CUT A PIECE OF SHEET METAL GAGE NO. 19 1.1 (0.0418) 18" (450) WIDE BY THE OUTSIDE CIRCUMFERANCE OF THE PIPE PLUS 3" (75) LONG.
- 5. WRAP THE SHEET METAL AROUND THE PIPES, 9" (225) ON EACH SIDE OF THE JOINT, STARTING AT THE TOP OF THE PIPE.
- LAP THE SHEET METAL AT LEAST 3" (75) AT THE TOP OF THE PIPE AND PLACE THE MASTIC JOINT SEALANT BETWEEN THE LAP.
- PLACE TWO METAL BANDS AROUND THE SHEET METAL AND TIGHTEN.
- 8. WIPE OFF ANY EXCESS MASTIC JOINT SEALANT THAT OOZES OUT FROM BETWEEN THE SHEET METAL AND THE PIPES.
- 9. PLACE CLASS SI CONCRETE AROUND THE JOINT.

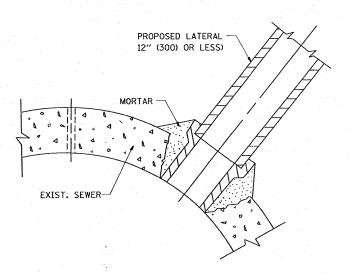

DETAIL "C"

PROPOSED LATERAL

CONNECTION TO EXISTING SEWER

OF 30" (750) OR LARGER

#### NOTES

#### MATERIAL

MATERIAL USED FOR THE TEE OR WYE SECTION SHALL BE COMPATIBLE WITH THE EXISTING STORM SEWER OR THE PROPOSED STORM SEWER.

#### CONSTRUCTION METHODS

- I. THIS WORK SHALL BE CONSTRUCTED IN CONFORMANCE WITH THE APPLICABLE PORTIONS OF SECTION 550 OF THE STANDARD SPECIFICATIONS.
- II. CONNECTION TO AN EXISTING STORM SEWER SHALL BE BY EITHER OF THE FOLLOWING METHODS: A) PROPOSED STORM SEWER CONNECTION TO EXISTING SEWER OF 27" (675) OR SMALLER SEE DETAIL "A" AND "B".
  - B) PROPOSED STORM SEWER CONNECTION TO EXISTING SEWER OF 30" (750) OR LARGER SEE DETAIL "C".

IF THE EXISTING SEWER PIPE IS CRACKED, BROKEN OR OTHERWISE DAMAGED BY THE CONTRACTOR IN MAKING THE CIRCULAR OPENING, THE CONTRACTOR SHALL REPLACE THAT SECTION OF PIPE WITH PIPE EQUAL AND SIMILAR IN ALL RESPECTS TO THE PIPE IN THE EXISTING SEWER, IN A CAREFUL WORKMANLIKE MANNER, WITHOUT EXTRA COMPENSATION.

#### GENERAL

CARE MUST BE TAKEN TO PREVENT DEBRIS FROM ENTERING THE SEWER. ALL DEBRIS WHICH ENTERS THE SEWER MUST BE REMOVED. THE SEWER MUST BE LEFT CLEAN AND UNOBSTRUCTED UPON COMPLETION OF THE CONTRACT.

CARE MUST BE TAKEN TO PREVENT ANY PART OF THE NEW PIPE CONNECTION FROM PROJECTING INTO THE EXISTING SEWER.

#### BASIS OF PAYMENT


TEE OR WYE CONNECTIONS SHALL BE PAID FOR AT THE CONTRACT UNIT PRICE EACH FOR STORM SEWER TEE OR WYE OF THE TYPE AND SIZE SPECIFIED IN THE PLANS, THIS PRICE SHALL INCLUDE ALL EXCAVATION OF THE TRENCH, REMOVAL OF THE EXISTING STORM SEWER, FURNISHING AND INSTALLING THE SPECIFIED TEE OR WYE SECTION, FURNISHING AND INSTALLING THE REQUIRED CONCRETE COLLAR, AND ALL OTHER MATERIAL NECESSARY TO COMPLETE THIS WORK AS SHOWN AND SPECIFIED.

REMOVAL AND REINSTALLATION OF EXISTING STORM SEWER ADJACENT TO THE PROPOSED TEE OR WYE SECTION, FOR THE PURPOSE OF FACILITATING THE INSTALLATION OF THE TEE OR WYE SECTION, WILL NOT BE PAID FOR SEPARATELY BUT SHALL BE INCLUDED IN THE UNIT PRICE BID FOR THE WORK.

TRENCH BACKFILL, EXCAVATION IN ROCK AND REMOVAL AND REPLACEMENT OF UNSUITABLE MATERIAL BELOW PLAN BEDDING GRADE WILL BE PAID FOR SEPARATELY.

CONCRETE COLLAR FOR CONNECTING A PROPOSED STORM SEWER TO AN EXISTING STORM SEWER WILL NOT BE PAID PAID FOR SEPARATELY BUT SHALL BE INCLUDED IN THE COST OF THE PROPOSED STORM SEWER.

FILE NAME =	USER NAME = galbannb	DESIGNED - M. DE YONG	REVISED - M. DE YONG 05-08-92			DETAIL OF STORM SEWER	F.A.P. SECTION	COUNTY TOTAL SHEET NO.
\\distIntfs2\users\galbannb\Desktop\bd@	7.dgn	DRAWN -	REVISED ~ R. SHAH 09-09-94	STATE OF ILLINOIS		CONNECTION TO EXISTING SEWER	330 104 T-3	WILL 32 20
	PLOT SCALE = 50.000 '/ IN.	CHECKED -	REVISED - R. SHAH 10-25-94	DEPARTMENT OF TRANSPORTATION			BD50001 (BD7)	CONTRACT NO. 60B09
	PLOT DATE = 12/27/2007	DATE - 07-25-90	REVISED - R. SHAH 06-12-96		SCALE: NONE	SHEET NO. 1 OF 1 SHEETS STA. TO STA.	FED. ROAD DIST. NO. 1   ILLINOIS   FED.	AID PROJECT

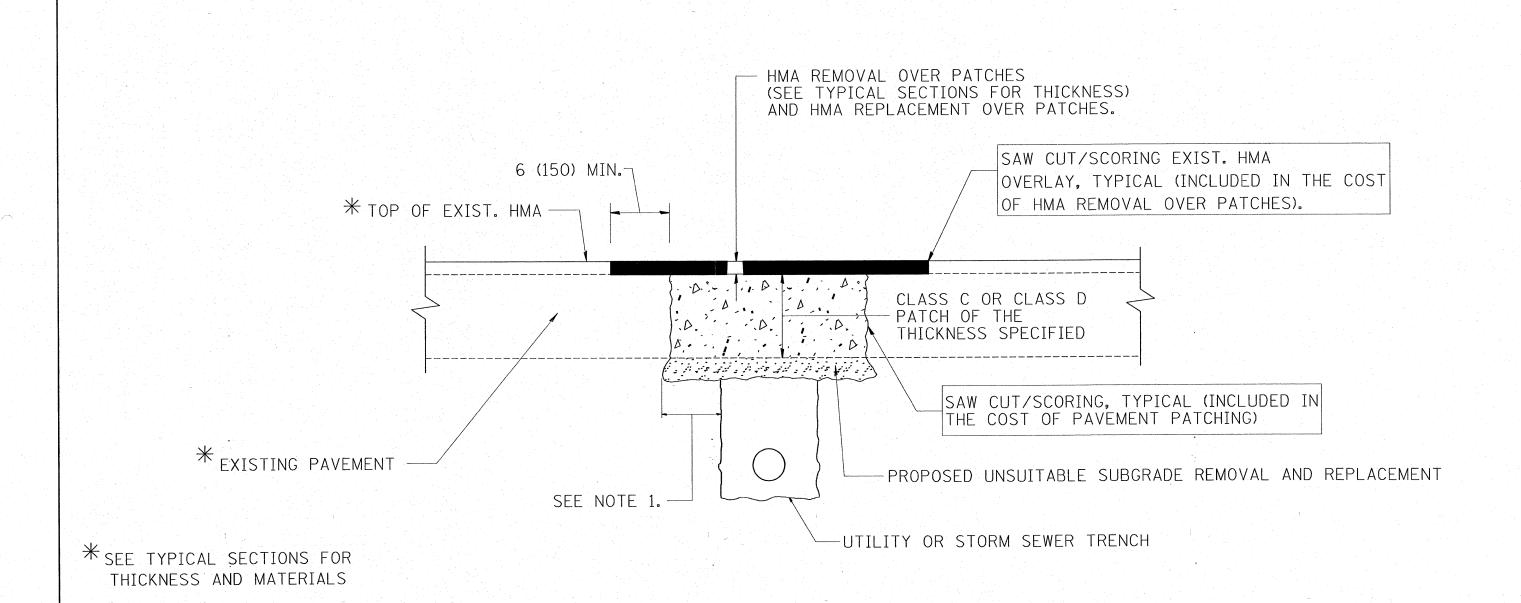


#### NOTES:

- 1. THE WIDTH OF THE FULL DEPTH PATCH OVER A TRENCH SHALL BE 12 (300) WIDER ON EACH SIDE OF THE TRENCH.
- 2. FOR METHOD OF MEASUREMENT AND BASIS OF PAYMENT, SEE RECURRING SPECIAL PROVISION "PATCHING WITH HOT-MIX ASPHALT OVERLAY REMOVAL".

### SEQUENCE OF CONSTRUCTION


- 1. REMOVE THE EXISTING HMA MATERIAL OVER THE AREA TO BE PATCHED.
- 2. REMOVE AND REPLACE FULL DEPTH PATCHES
- 3. REPLACE HMA MATERIAL OVER THE AREA TO BE PATCHED.


FIL	_E NAME =	USER NAME = galbannb	DESIGNED - R. SHAH	REVISED ~	A. ABBAS 01-20-98		PAVEMENT PATCHING FOR	E. SECTION	COUNTY SHEETS NO.
110	distIntfs2\users\galbannb\Desktop\bd2	.dgn	DRAWN -	REVISED -	A. ABBAS 04-27-98	STATE OF ILLINOIS		30 104 T-3	WILL 32 21
		PLOT SCALE = 50.000 '/ IN.	CHECKED -	REVISED -	R. BORO 01-01-07	DEPARTMENT OF TRANSPORTATION		BD400-04 (BD-22)	CONTRACT NO. 60B09
		PLOT DATE = 12/27/2007	DATE - 10-25-94	REVISED -	R. BORO 09-04-07		SCALE: NONE SHEET NO. 1 OF 1 SHEETS STA. TO STA. FE	D. ROAD DIST. NO. 1 ILLINOIS FED. AID	) PROJECT

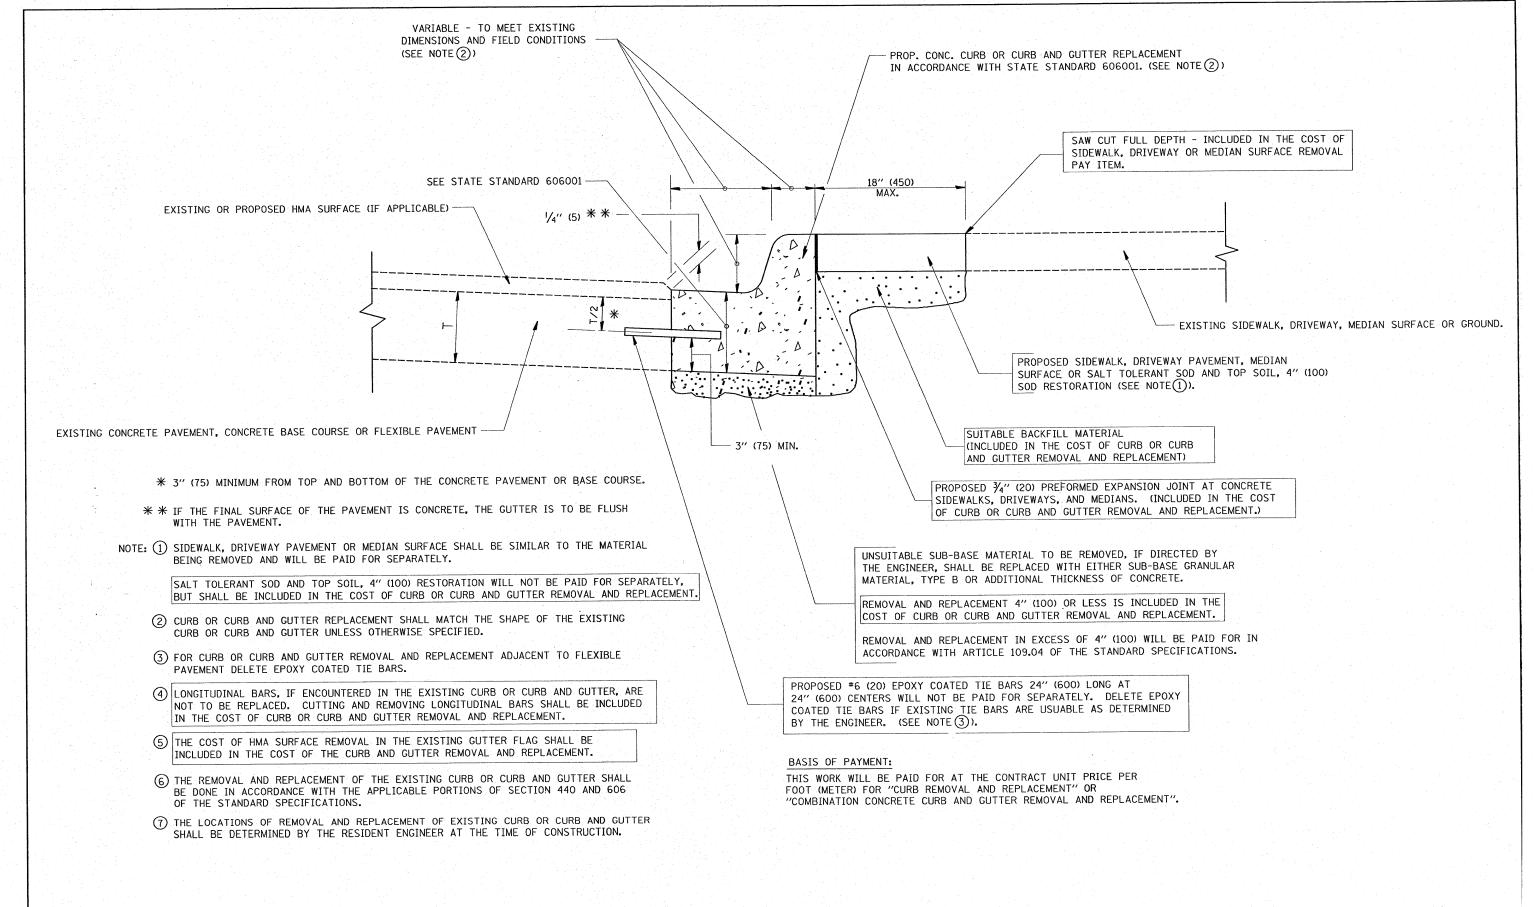

# CURB OR CURB AND GUTTER REMOVAL AND REPLACEMENT


- 1	FILE NAME =	USER NAME = galbannb	DESIGNED - A. HOUSEH	REVISED - R. SHAH 10-03-96		CURB OR CURB AND GUTTER	RTE. SECTION COUNTY SHEETS NO.
ı	\\distIntfs2\users\galbannb\Desktop\bd2	.dgn	DRAWN -	REVISED - A. ABBAS 03-21-97	STATE OF ILLINOIS	REMOVAL AND REPLACEMENT	330 104 T-3 WILL 32 22
		PLOT SCALE = 50.000 '/ IN.	CHECKED -	REVISED - M. GOMEZ 01-22-01	DEPARTMENT OF TRANSPORTATION		BD600-06 (BD-24) CONTRACT NO. 60B09
		PLOT DATE = 12/27/2007	DATE - 03-11-94	REVISED - R. BORO 01-01-07		SCALE: NONE SHEET NO. 1 OF 1 SHEETS STA. TO STA.	FED. ROAD DIST. NO. 1   ILLINOIS   FED. AID PROJECT

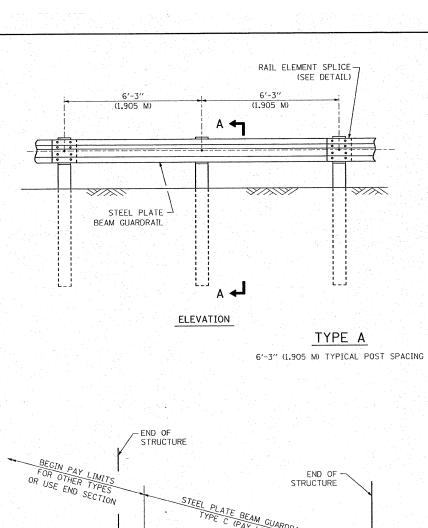


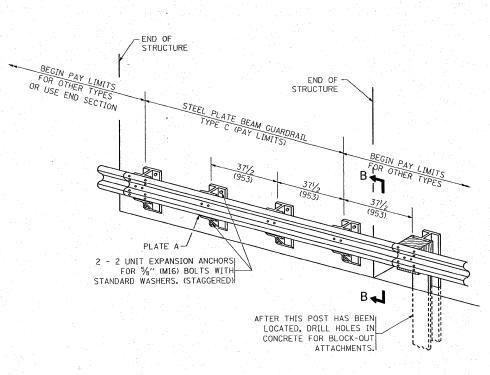



TYPE C

371/2 (953) BLOCK-OUT SPACING

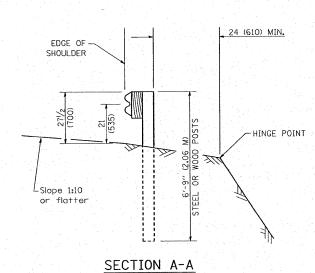


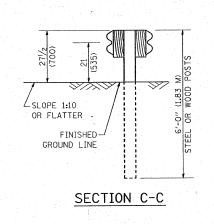

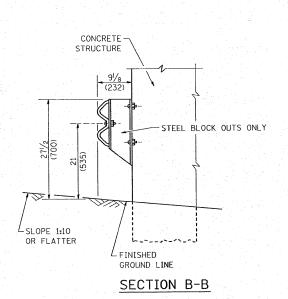

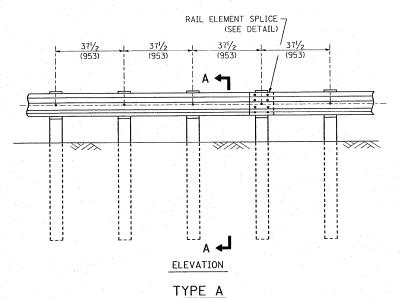

371/2 (953) CLOSED POST SPACING

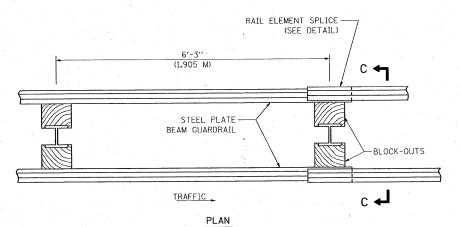

TYPE D

DOUBLE STEEL PLATE BEAM GUARDRAIL 6'-3" (1.905 M) TYPICAL POST SPACING

#### GENERAL NOTES

SCALE: NONE

ALL SLOPE RATIOS ARE EXPRESSED AS UNITS OF VERTICAL DISPLACEMENT TO UNITS OF HORIZONTAL DISPLACEMENT (V:H).

ALL DIMENSIONS ARE IN INCHES (MILLIMETERS) UNLESS OTHERWISE SHOWN.


THE EXISTING STEEL POSTS MAY BE DRILLED TO MATCH THE BOLT PATTERN SHOWN HEREIN FOR THE WOOD BLOCK-OUT, OR A NEW STEEL POST SHALL BE PROVIDED.

THIS DETAIL IS APPLICABLE TO THE GUARDRAIL SYSTEM USED PRIOR TO JANUARY 1, 2007. FOR DETAILS ON THE MIDWEST GUARDRAIL SYSTEM, SEE STANDARD 630001.


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	PLOT DATE = 12/27/2007	DATE -	REVISED -
<u> </u>			

STATE OF ILLINOIS
DEPARTMENT OF TRANSPORTATION

	REMOVE AND	RFFRECT		F.A.P. RTE.	SECTION	COUNTY	TOTAL SHEETS	SHEET NO.
OT.	EL PLATE BEA			330	104 T-3	WILL	32	23
91	EL PLAIE DEA	W GUANDRAIL			BM-21	CONTRACT	NO. 6	50B09
SHEET NO.	1 OF 4 SHEE	rs sta.	TO STA.	FED. RO	DAD DIST. NO. 1   ILLINOIS FED. A	D PROJECT		

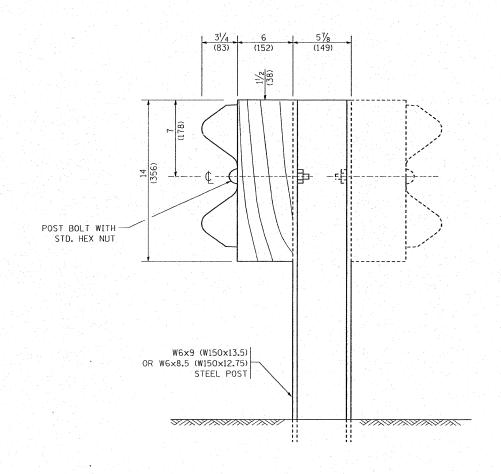


#### STEEL POST CONSTRUCTION

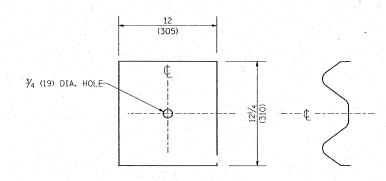


#### NOTE:

PLATE A SHALL BE PLACED BETWEEN RAIL ELEMENT AND BLOCK-OUT AT NON-SPLICE MOUNTING POINTS ONLY WHEN STEEL BLOCK-OUTS ARE USED.


#### PLATE A

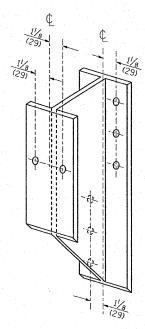

STEEL BLOCK-OUT DETAIL

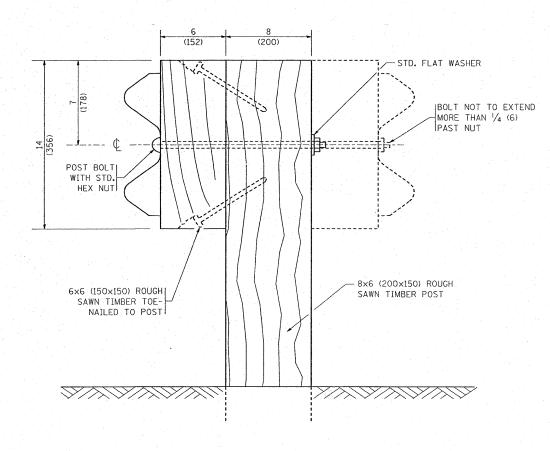



#### WOOD POST CONSTRUCTION

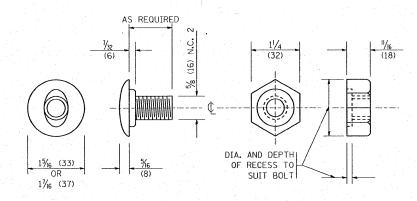


POST OR SPLICE BOLT & NUT

FILE NAME =	USER NAME = galbannb	DESIGNED -	REVISED - 10-31-06			REMOVE AND REERECT		F.A.P. SECTION	COUNTY TOTAL SHEET
\\distIntfs2\users\galbannb\Desktop\bm2	-dgn	DRAWN -	REVISED -	STATE OF ILLINOIS		STEEL PLATE BEAM GUARDRAIL		330 104 T-3	WILL 32 24
	PLOT SCALE = 50.0000 '/ IN.	CHECKED -	REVISED -	DEPARTMENT OF TRANSPORTATION				BM-21	CONTRACT NO. 60B09
	PLOT DATE = 12/27/2007	DATE -	REVISED -		SCALE: NONE	SHEET NO. 2 OF 4 SHEETS STA.	TO STA.	FED. ROAD DIST. NO. 1 ILLINOIS F	ED. AID PROJECT

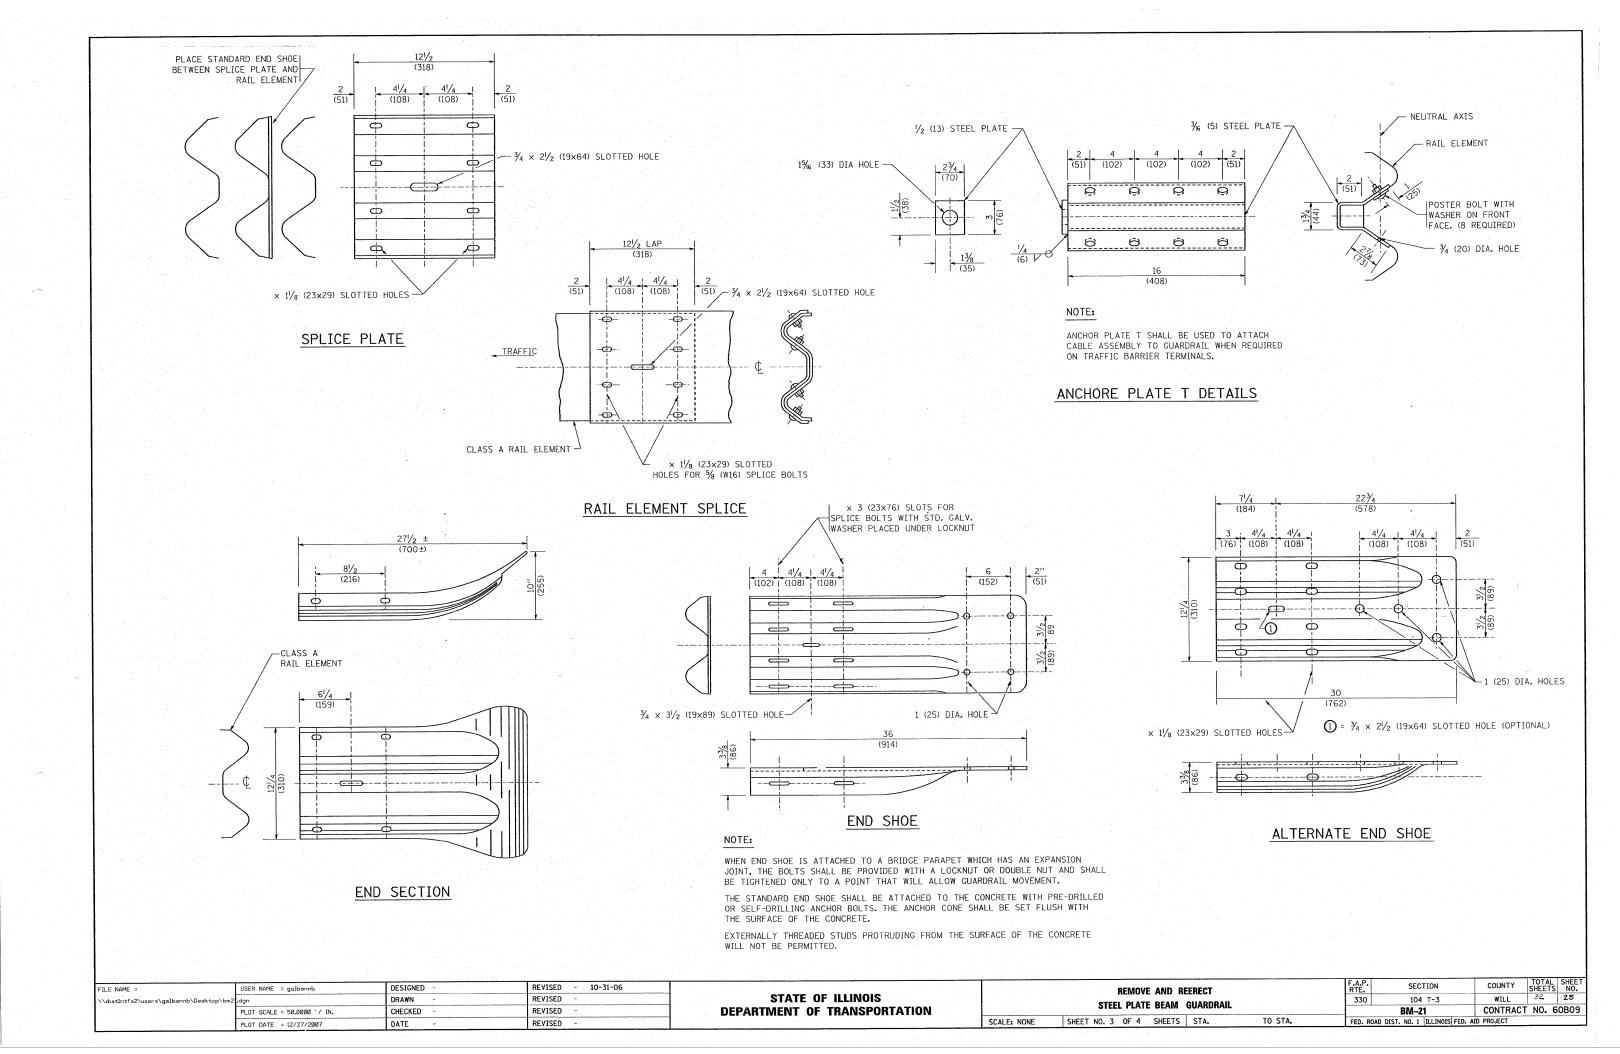

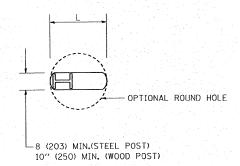

#### PLAN

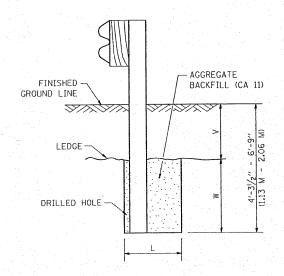


#### NOTE:

LEDGE LINE IS TOP OF ROCK LEDGE OR HARD SLAG FILL.

#### ELEVATION

# FOOTING FOR POST WHEN IMPERVIOUS MATERIAL IS ENCOUNTERED

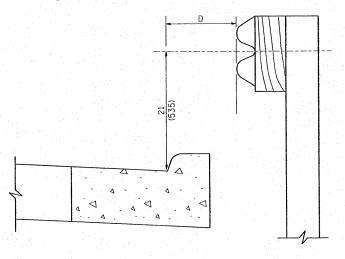


#### NOTE:

IF IT IS NECESSARY FOR D TO BE MORE THAN 12 (300) AND LESS THAN 10'-0" (3.0 M) TYPE M-2 (M-5) CURB AND GUTTER (STD. 606001) SHALL BE USED IN FRONT OF AND IN ADVANCE OF THE GUARDRAIL.


#### GUARDRAIL PLACED BEHIND CURB

(D = 0 DESIRABLE TO 12 (300) MAXIMUM)

		1	the street of the street of the street
	w		
	. <b>W</b>	STEEL POST	WOOD POST
0 - 18	24	21	23
(0 - 460)	(610)	(530)	(580)
>18 - 41.5	12	8	10
(> 460 - 825)	(305)	(203)	(250)
>41.5 - 53.5	12 - 0	8	10
(> 825 - 1.13 M)	(350 - 0)	(203)	(250)

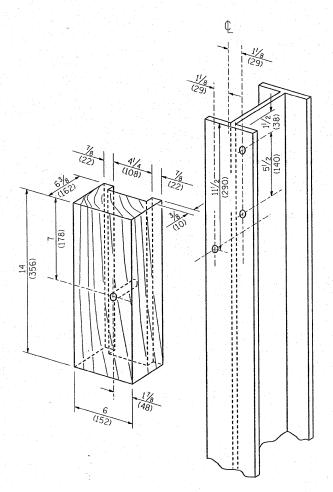

# WOOD BLOCK-OUT AND STEEL POST DETAILS

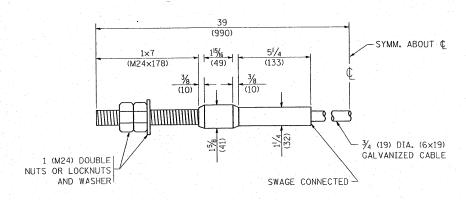


#### CABLE ASSEMBLY

(40,000 LBS (18,100 KG) MIN. BREAKING STRENGTH)
TIGHTEN TO TAUT TENSION

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	PLOT DATE = 12/27/2007	DATE -	REVISED -

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REMOVE AND R	FERECT	F.A.P. RTE.	SECTION	COUNTY	TOTAL SHEETS	SHEET NO.
		330	104 T-3	WILL	32	26
STEEL PLATE BEAM	GUAKUKAIL	1	BM-21	CONTRACT	NO. 6	OB09
NONE SHEET NO. 4 OF 4 SHEETS	STA. TO STA.	FED. RO	AD DIST. NO. 1 ILLINOIS FED. AI	D PROJECT		

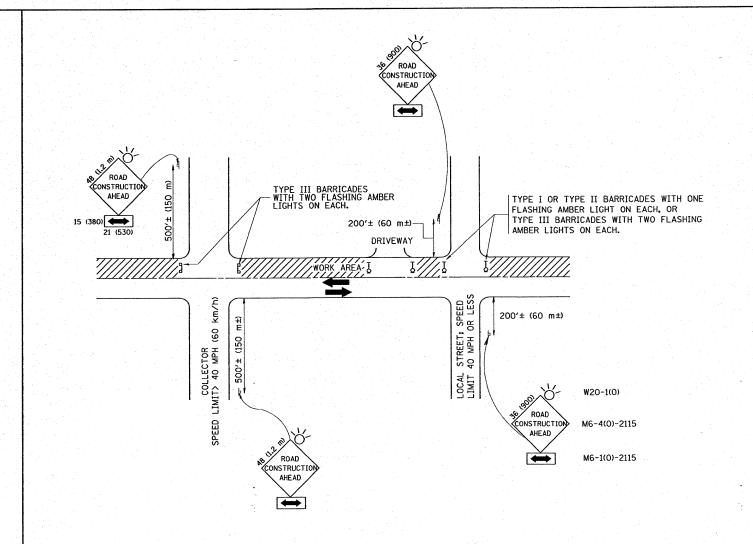

TRAFFIC CONTROL AND PROTECTION FOR SIDE ROADS, INTERSECTIONS, AND DRIVEWAYS

#### NOTES:

- A. FOR NO LANE RESTRICTION ON THE SIDE ROAD OR DRIVEWAYS
- 1. SIDE ROAD WITH A SPEED LIMIT OF 40 MPH (60 km/h) OR LESS AS SHOWN ON THE DRAWING AND AS DIRECTED BY THE ENGINEER:
- O) ONE ROAD CONSTRUCTION AHEAD SIGN 36 x 36 (900x900) WITH A FLASHER AND FLAG MOUNTED ON IT APPROXIMATELY 200' (60 m) IN ADVANCE OF THE MAIN ROUTE.
- b) THE CLOSED PORTION OF THE MAIN ROUTE SHALL BE PROTECTED BY BLOCKING WITH TYPE I, TYPE II OR TYPE III BARRICADES, 1/3 OF THE CROSS SECTION OF THE CLOSED PORTION.
- 2. SIDE ROAD WITH A SPEED LIMIT GREATER THAN 40 MPH (60 km/h)
  AS SHOWN ON THE DRAWING AND AS DIRECTED BY THE ENGINEER:
- O) ONE ROAD CONSTRUCTION AHEAD SIGN 48 x 48 (1.2 m x 1.2 m) WITH A FLASHER MOUNTED ON IT APPROXIMATELY 500' (150 m) IN ADVANCE OF THE MAIN ROUTE.
- b) THE CLOSED PORTION OF THE MAIN ROUTE SHALL BE PROTECTED BY BLOCKING WITH TYPE III BARRICADES, 1/2 OF THE CROSS SECTION OF THE CLOSED PORTION.
- 3. WHEN THE SIDE ROAD LIES BETWEEN THE BEGINNING OF THE MAINLINE SIGNING AND THE WORK ZONE, A SINGLE HEADED ARROW (M6-1) SHALL BE USED IN LIEU OF THE DOUBLE HEADED ARROW (M6-4).

SCALE: NONE


#### B. FOR A LANE CLOSURE ON A SIDE ROAD OR DRIVEWAY:

- USE APPLICABLE PORTIONS OF THE TYPICAL APPLICATION OF TRAFFIC CONTROL DEVICES (STD. 701501, STD. 701606 OR THE APPROPRIATE STANDARD). THE SPACING OF SIGNS AND BARRICADES SHALL BE ADJUSTED FOR FIELD CONDITIONS AS DIRECTED BY THE ENGINEER. THE DIRECTIONAL ARROW SHALL BE COVERED OR REMOVED WHEN NO LONGER CONSISTENT WITH THE SIDE ROAD LANE CLOSURE.
- C. ADVANCE WARNING SIGNS ARE TO BE OMITTED ON DRIVEWAY UNLESS OTHERWISE NOTED.
- D. THE TRAFFIC CONTROL AND PROTECTION FOR SIDE ROADS, INTERSECTIONS, AND DRIVEWAYS SHALL BE INCIDENTAL TO THE COST OF SPECIFIED TRAFFIC CONTROL STANDARDS OR ITEMS.

All dimensions are in millimeters (inches) unless otherwise shown.

STATE OF ILLINOIS
DEPARTMENT OF TRANSPORTATION

TRAFFIC	CONTROL AND	PROTECTION	FOR
SIDE ROAD	S, INTERSECTION	IS, AND DRIV	/EWAYS
SHEET NO. 1	OF 1 SHEETS	STA.	TO S

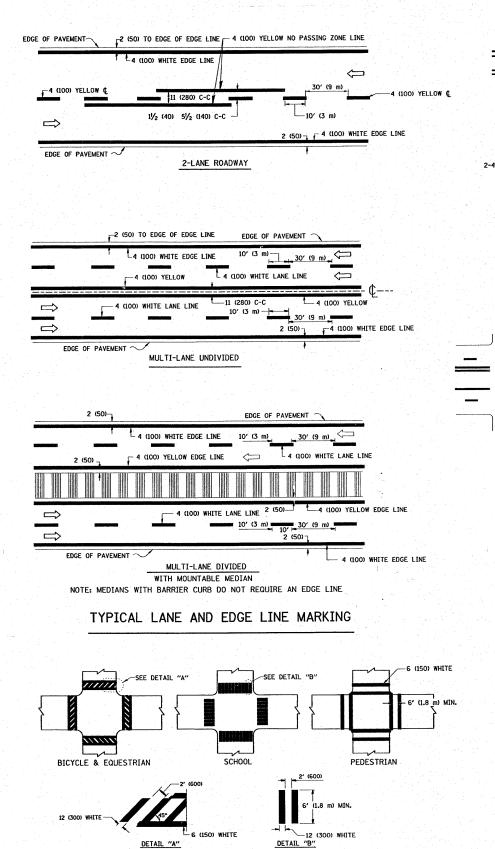

TYPICAL CROSSWALK MARKING


DATE

USER NAME = galbannb


PLOT SCALE = 50.000 '/ IN.

PLOT DATE = 12/27/2007

FILE NAME =

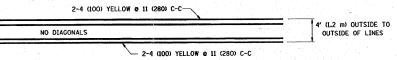


#### 4' (1.2 m) WIDE MEDIANS ONLY

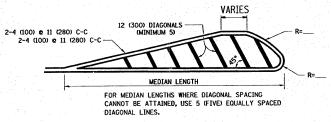


DIAGONAL LINE SPACING: 50' (15 m) C-C (LESS THAN 30MPH (50 km/h))
75' (25 m) C-C 30MPH (50 km/h) TO 45MPH (70 km/h))
150' (45 m) C-C (MORE THAN 45MPH (70 km/h))

#### MEDIANS OVER 4' (1.2 m) WIDE

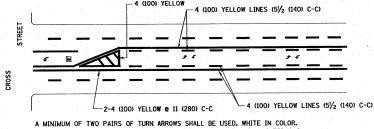


A MINIMUM OF TWO PAIRS OF TURN ARROWS SHALL BE USED, WHITE IN COLOR. ADDITIONAL PAIRS SHALL BE PLACED AT 200' (60 m) TO 300' (90 m) INTERVALS.

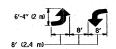

MEDIAN WITH TWO-WAY LEFT TURN LANE

#### TYPICAL PAINTED MEDIAN MARKING

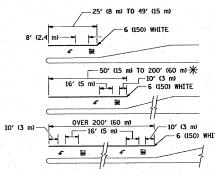



FULL SIZE LETTERS 8' (2.4 m) AND ARROWS SHALL BE USED.  $\P$  AREA = 15.6 SO. FT. (1.5 m²) (III) AREA = 20.8 SQ. FT. (1.9 m²)

\* TURN LANES IN EXCESS OF 400' (120 m) IN LENGTH MAY HAVE AN ADDITIONAL SET OF ARROW - "ONLY" INSTALLED MIDWAY BETWEEN THE OTHER TWO SETS OF ARROW - "ONLY".

TYPICAL LEFT (OR RIGHT) TURN LANE

#### TYPICAL TURN LANE MARKING

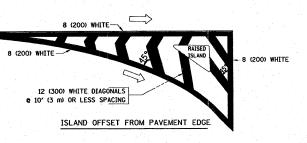

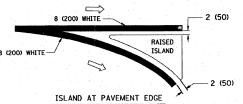

#### TYPICAL ISLAND MARKING

TYPE OF MARKING	WIDTH OF LINE	PATTERN	COLOR	SPACING / REMARKS
CENTERLINE ON 2 LANE PAVEMENT	4 (100)	SKIP-DASH	YELLOW	10' (3 m) LINE WITH 30' (9 m) SPACE
CENTERLINE ON MULTI-LANE UNDIVEDED PAVEMENT	2 & 4 (100)	SOLID	YELLOW	11 (280) C-C
NO PASSING ZONE LINES: FOR ONE DIRECTION FOR BOTH DIRECTIONS	4 (100) 2 @ 4 (100)	SOLID SOLID	YELLOW YELLOW	5½ (140) C-C FROM SKIP-DASH CENTERLINE 11 (280) C-C OMIT SKIP-DASH CENTERLINE BETWEEN
LANE LINES	4 (100) 5 (125) ON FREEWAYS	SKIP-DASH SKIP-DASH	WHITE WHITE	10' (3 m) LINE WITH 30' (9 m) SPACE
DOTTED LINES (EXTENSIONS OF CENTER, LANE OR TURN LANE MARKINGS)	SAME AS LINE BEING EXTENDED	SKIP-DASH	SAME AS LINE BEING EXTENDED	2' (600) LINE WITH 6' (1.8 m) SPACE
EDGE LINES	4 (100)	SOLID	YELLOW-LEFT WHITE-RIGHT	OUTLINE MOUNTABLE MEDIANS IN YELLOW: EDGE LINES ARE NOT USED NEXT TO BARRIER CURB
TURN LANE MARKINGS	6 (150) LINE; FULL SIZE LETTERS & SYMBOLS (8' (2.4m))	SOLID	WHITE	SEE TYPICAL TURN LANE MARKING DETAIL
TWO WAY LEFT TURN MARKING	2 & 4 (100) EACH DIRECTION	SKIP-DASH AND SOLID	YELLOW	10' (3 m) LINE WITH 30' (9 m) SPACE FOR SKIP-DASH; 5½ (140) C-C BETWEEN SOLID LINE AND SKIP-DASH LINE
	8' (2.4m) LEFT ARROW	IN PAIRS	WHITE	SEE TYPICAL TWO-WAY LEFT TURN MARKING DETAIL
CROSSWALK LINES (PEDESTRIAN) A. DIAGONALS (BIKE & EQUESTRIAN) B. LONGITUDINAL BARS (SCHOOL)	2 e 6 (150) 12 (300) e 45° 12 (300) e 90°	SOLID SOLID SOLID	WHITE WHITE WHITE	NOT LESS THAN 6' (1.8 m) APART 2' (500) APART 2' (500) APART SEE TYPICAL CROSSWALK MARKING DETAILS.
STOP LINES	24 (600)	SOLID	WHITE	PLACE 4' (1.2 m) IN ADVANCE OF AND PARALLEL TO CROSSWALK, IF PRESENT. OTHERWISE, PLACE AT DESIRED STOPPING POINT. PARALLEL TO CROSSROAD CENTERLINE, WHERE POSSIBLE
PAINTED MEDIANS	2 @ 4 (100) WITH 12 (300) DIAGONALS @ 45°	SOLID	YELLOW: TWO WAY TRAFFIC WHITE: ONE WAY TRAFFIC	11 (280) C-C FOR THE DOUBLE LINE SEE TYPICAL PAINTED MEDIAN MARKING.
GORE MARKING AND CHANNELIZING LINES	4' (1.2 m) WIDE MEDIANS 8 (200) WITH 12 (300) DIAGONALS @ 45°	SOLID	WHITE	DIAGONALS: 15' (4.5 m) C-C (LESS THAN 30MPH (50 km/h)) 20' (6 m) C-C 30MPH (50 km/h) TO 45MPH (70 km/h)) 30' (9 m) C-C (0VER 45MPH (70 km/h))
RAILROAD CROSSING	24 (600) TRANSVERSE LINES; "RR" IS 6' (1.8 m) LETTERS; 16 (400) LINE FOR "X"	SOLID	WHITE	SEE STATE STANDARD 780001 AREA OF: "R"-3.6 SQ. FT. (0.33 m²) EACH "X"-54.0 SQ. FT. (5.0 m²)
SHOULDER DIAGONALS	12 (300) <b>e</b> 45°	SOLID	WHITE - RIGHT YELLOW - LEFT	50' (15 m) C-C (LESS THAN 30MPH (50 km/h)) 75' (25 m) C-C (30 MPH (50 km/h) TO 45MPH (70 km/h) 150' (45 m) C-C (0VER 45MPH (70 km/h))


FOR FURTHER DETAILS ON PAVEMENT MARKING REFER TO STANDARD SPECIFICATIONS FOR ROAD AND BRIDGE CONSTRUCTION AND STATE STANDARD 780001.


All dimensions are in inches (millimeters) unless otherwise shown.

DISTRICT ONE	F.A.P. SECTION	COUNTY TOTAL SHEET NO.	
	330 104 T-3	WILL 32 28	
TYPICAL PAVEMENT MARKINGS	TC-13	CONTRACT NO. 60B09	
SCALE: NONE SHEET NO. 1 OF 1 SHEETS STA. TO STA.	FED. ROAD DIST, NO. 1 ILLINOIS FED. AI	D PROJECT	

DESIGNED - EVERS	REVISED -T. RAMMACHER 10-27-94
DRAWN -	REVISED -A. HOUSEH 10-09-96
CHECKED -	REVISED -A. HOUSEH 10-17-96
DATE - 03-19-90	REVISED - T. RAMMACHER 01-06-00

STATE OF ILLINOIS **DEPARTMENT OF TRANSPORTATION** 

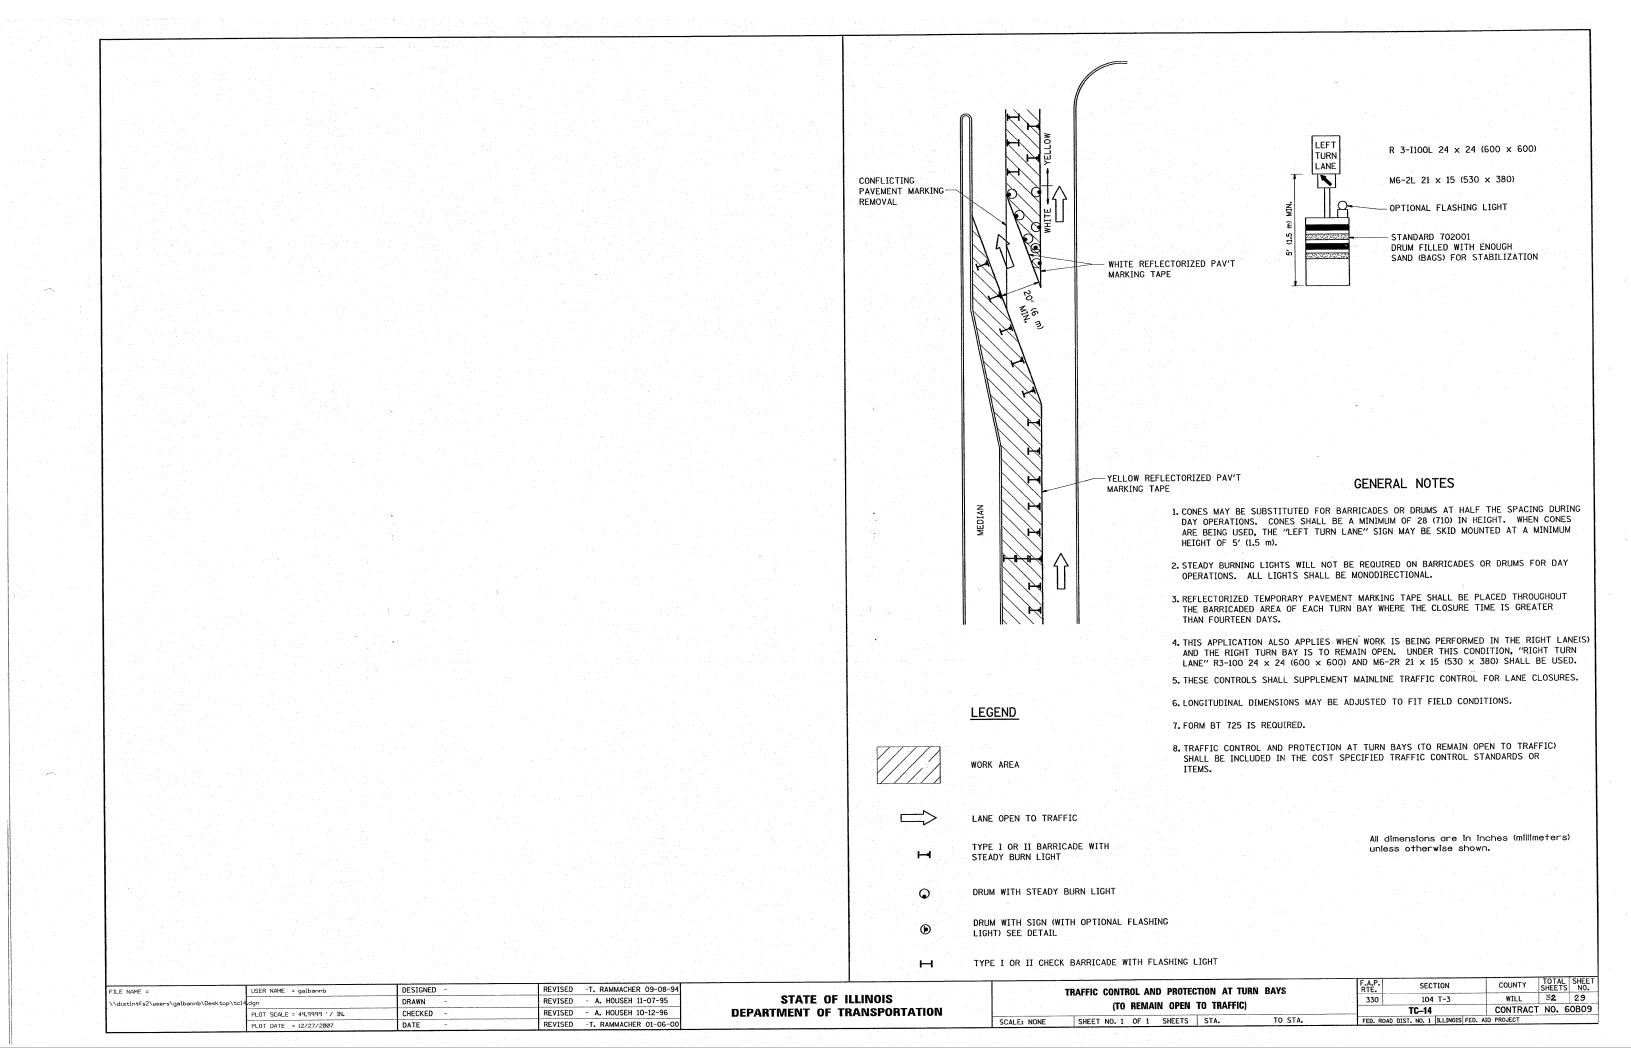

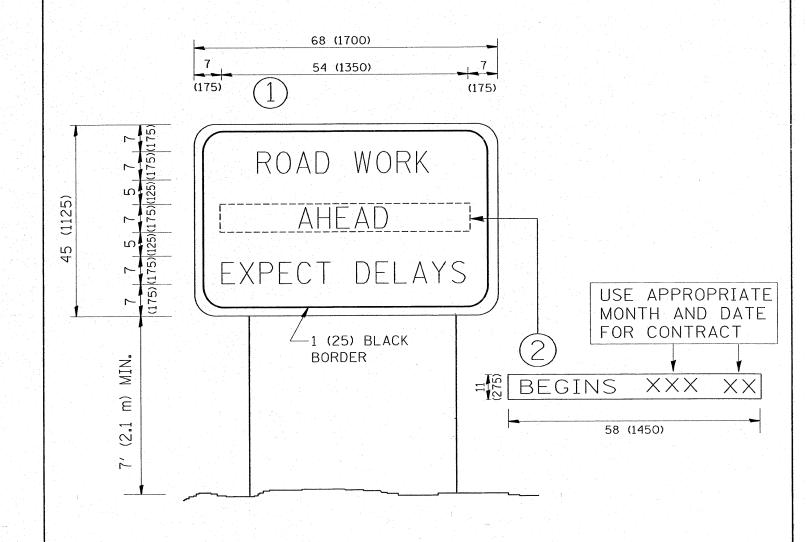

### NOTES:

- 1. USE BLACK LETTERING ON ORANGE BACKGROUND.
- 2. ERECT SIGNS IN ADVANCE OF THE LOCATION FOR THE "ROAD CONSTRUCTION AHEAD" SIGN AT LOCATIONS AS DIRECTED BY THE ENGINEER.
- 3. ERECT SIGN (1) WITH INSTALLED PANEL (2) ONE WEEK PRIOR TO THE START OF CONSTRUCTION.
- 4. REMOVE PANEL 2 SOON AFTER THE START OF CONSTRUCTION.
- 5. SEE SPECIAL PROVISION FOR "TEMPORARY INFORMATION SIGNING" FOR ADDITIONAL INFORMATION.
- 6. ONE SIGN ASSEMBLY EQUALS 25.70 SQ. FT. (2.3 SQ. M.)
- 7. SHALL BE PAID FOR AS TEMPORARY INFORMATION SIGNING.

FILE NAME =	USER NAME = galbannb	DESIGNED -	REVISED - R. MIRS 09-15-97			ARTERIAL ROAD		F.A. SECTION	COUNTY TOTAL SHEET NO.
\\distIntfs2\users\galbannb\Desktop\tc2	.dgn	DRAWN -	REVISED - R. MIRS 12-11-97	STATE OF ILLINOIS		FORMATION SIGN		330 104 T-3	WILL 32 30
	PLOT SCALE = 50.000 '/ IN.	CHECKED -	REVISED -T. RAMMACHER 02-02-99	DEPARTMENT OF TRANSPORTATION			TO CTA	TC-22	CONTRACT NO. 60B09
	PLOT DATE = 12/27/2007	DATE -	REVISED - C. JUCIUS 01-31-07		SCALE: NONE   SHEET NO. 1 OF	1 SHEETS STA.	TO STA.	FED. ROAD DIST. NO. 1 ILLINOIS FED. A	AID PROJECT

