SHEET DESCRIPTION

COVER SHEET, INDEX, HIGHWAY STANDARDS

GENERAL NOTES

SUMMARY OF QUANTITIES

ALIGNMENT PLANS, SURVEY TIES AND CONTROL POINTS

MAINTENANCE OF TRAFFIC

11-14 EXISTING CONDITIONS AND UTILITIES PLAN WATER SERVICE LINE PLAN

₹ 17-20 35TH ST. GATEWAY LANDSCAPE PLAN

21-22 35TH ST. GATEWAY LAYOUT

35TH ST. GATEWAY IRRIGATION PLAN

35TH ST. GATEWAY LANDSCAPE DETAILS 24 35TH ST. GATEWAY OVERALL PLANT LIST

EROSION CONTROL PLAN

¥ 27-30 CIVIL DETAILS

31-38 DISTRICT ONE DETAILS

* PLAN SHEETS 18, 19 AND 30 DELETED

IDOT HIGHWAY STANDARDS

STANDARD DESCRIPTION 000001-05

001006

STANDARD SYMBOLS, ABBREVIATIONS, AND PATTERNS

DECIMAL OF AN INCH AND OF A FOOT

606001-03 CONCRETE CURB TYPE B AND COMBINATION CONCRETE CURB AND GUTTER 701101-*01* 'OFF-RD OPERATIONS, MULTILANE 45M (15') TO 600mm (24") FROM PAVEMENT EDGE' 701601 - 05 URBAN LANE CLOSURE, MULTILANE, 1W OR 2W WITH NONTRAVERSABLE MEDIAN

701701-05 URBAN LANE CLOSURE MULTILANE INTERSECTION

701801-03 LANE CLOSURE MULTILANE 1W OR 2W CROSSWALK OR SIDEWALK CLOSURE

701901 TRAFFIC CONTROL DEVICES

STATE OF ILLINOIS DEPARTMENT OF TRANSPORTATION

DIVISION OF HIGHWAYS

PLANS FOR PROPOSED FEDERAL AID HIGHWAY

F.A.I. ROUTE 90/94 (DAN RYAN EXPRESSWAY) **SECTION 2005-073 LS**

GATEWAY LANDSCAPING & IRRIGATION at 35TH STREET

C-91-109-06

T. 38 N. T. 39 N.

PROJECT LOCATED IN CITY OF CHICAGO

DESIGN DESIGNATION

LA SALLE ST: 8275 (20) URBAN COLLECTOR

FULL SIZE PLANS HAVE BEEN PREPARED USING STANDARD ENGINEERING SCALES, REDUCED SIZED PLANS WILL NOT

ON REDUCED PLANS, THE ABOVE SCALES MAY BE USED.

BEFORE EXCAVATING CALL:

(312) 744-7000

CHICAGO UTILITY ALERT NETWORK

CONFORM TO STANDARD SCALES. IN MAKING MEASUREMENTS

ADT DESIGN POSTED (2020) SPEED SPEED

FRONTAGE ROAD: LA SALLE ST

WENTWORTH AVE

15.000

15.000 30 25

PROJECT BEGINS NB LA SALLE ST STA 420 + 35 SB WENTWORTH AVE STA 122+65

PROJECT ENDS NB LA SALLE ST STA 430+50 SB WENTWORTH AVE STA 132+75

OF THE STATE OF ILLINOIS

LOCATION OF SECTION INDICATED THUS: - -

SUBMITTED MARCH 21, 20 08

STATE OF ILLINOIS DEPARTMENT OF TRANSPORTATION DIVISION OF HIGHWAYS

May 9, 20 08

PRINTED BY THE AUTHORITY

Eru E Har m/D Jaloum ENGINEER OF DESIGN AND ENVIRONMENT

BOWMAN, BARRETT & ASSOCIATES INC. CONSULTING ENGINEERS Chicago, Illinois 312.228.0100 www.bbandainc.com

SECTION ·

90/94 2005-073 LS

COOK

LOCATION MAP

GROSS LENGTH OF PROJECT = 2,025 FT (0.384 MILES) NET LENGTH OF PROJECT = 2,025 FT (0.384 MILES)

CONTRACT NO. 60A79

22H

F.A.I.	SECTION		COUNTY	TOTAL	SHEET NO.
94/90	4/90 •		COOK	38	2
STA.		TO	O STA.		
FED. RO	DAD DIST. NO.	ILLINO	IS FED. AID	PROJECT	

60A79

* 2005-073 LS

GENERAL NOTES:

1. THE CONTRACTOR SHALL COORDINATE ALL ACTIVITIES WITH:

CONTRACT 60A05 - SB FENCE AND GATES FROM 47TH PLACE TO 31ST ST

CONTRACT 60A04 - NB FENCE AND GATES FROM 47TH PLACE TO 31ST ST.

CONTRACT 62992 - NB KNEE WALLS (PERSHING RD TO 35TH ST)

CONTRACT 62993 - NB KNEE WALLS (35TH ST TO 33RD ST)

CONTRACT 62998 - SB KNEE WALLS (PERSHING RD TO 35TH ST)

CONTRACT 62999 - SB KNEE WALLS (35TH ST TO 33RD ST)

CONTRACT 62901 - RECONSTRUCTION OF NORTHBOUND LOCAL LANES AND RAMPS

BETWEEN GARFIELD BOULEVARD AND 31ST ST.

CONTRACT 62303 - RECONSTRUCTION OF SOUTHBOUND LOCAL LANES AND RAMPS
BETWEEN GARFIELD BOULEVARD AND 31ST ST

CONTRACT 62583 - LIGHTING AND SURVEILLANCE 31ST ST TO I-57 INTERCHANGE

- 2. CONTRACTOR SHALL MATCH ALL WORK COMPLETED IN THE ABOVE CONTRACTS.
- 3. THE LOCATIONS OF EXISTING UTILITIES, AS SHOWN ON THE DRAWINGS, REPRESENT DATA RECEIVED FROM VARIOUS SOURCES. IT IS NOT GUARANTEED TO BE CORRECT OR ALL INCLUSIVE. THE CONTRACTOR MUST CONDUCT HIS OWN INVESTIGATIONS INTO THE LOCATION, SIZE, DEPTH, AND NATURE OF ANY AND ALL EXISTING UTILITIES WHICH MAY IMPACT THE WORK UNDER THIS CONTRACT. ANY EXISTING UTILITIES WHICH ARE TO REMAIN IN SERVICE MUST BE FULLY PROTECTED BY THE CONTRACTOR AND ANY DAMAGE CAUSED BY THE CONSTRUCTION MUST BE IMMEDIATELY REPAIRED AT THE CONTRACTOR'S EXPENSE TO THE SATISFACTION OF THE ENGINEER. THE CONTRACTOR WILL BE RESPONSIBLE FOR THE PROTECTION OF ANY AND ALL SURFACE AND UNDERGROUND UTILITIES, EVEN THOUGH THEY MAY NOT BE IDENTIFIED
- 4. THE CONTRACTOR MUST COORDINATE CONSTRUCTION ACTIVITIES WITH THE RESPECTIVE UTILITIES OF THE CITY OF CHICAGO. BEFORE STARTING ANY EXCAVATION, THE CONTRACTOR MUST CALL THE CHICAGO UTILITY ALERT NETWORK (C.U.A.N.) AT (312) 744-7000 OR 811 FOR FIELD LOCATIONS OF BURIED ELECTRICAL, TELEPHONE, CABLE, AND GAS FACILITIES (48 HOURS NETLIFICATION IS REQUIRED). THE CONTRACTOR MUST CONTACT THE CITY OF CHICAGO DEPARTMENT OF WATER MANAGEMENT, PERMIT SECTION AT (312) 747-7893 FOR WATER AND CITY SEWER LOCATIONS.
- 5. THE CONTRACTOR WILL NOT BE ALLOWED TO SET UP A YARD OR FIELD OFFICE ON STATE PROPERTY WITHOUT WRITTEN PERMISSION FROM IDOT.
- 6. WHEN ARTIFICIAL LIGHTING IS USED IN NIGHT OPERATIONS, THE CONTRACTOR MUST EXERCISE THE UTMOST PRECAUTIONS IN PREVENTING ADVERSE VISIBILITY TO THE MOTORING PUBLIC AND ADJOINING COMMERCIAL AND RESIDENTIAL AREAS.
- 7. USE NO. 6 EPOXY-COATED TIE BARS CONFORMING TO ARTICLE 1006.10(B)(2) OF THE STANDARD SPECIFICATIONS FOR TYING THE CURB AND GUTTER SECTIONS TO PAVEMENT AS SHOWN ON THE PLANS. THE TIE BARS WILL NOT BE PAID FOR SEPARATELY. TIE BARS USED WITH CURB AND GUTTER MUST BE INCLUDED IN THE COST OF THE COMBINATION CONCRETE CURB AND GUTTER OF THE TYPE SPECIFIED.
- 8. CHAIN LINK FENCE REMOVAL MUST BE CONSIDERED AS PART OF CLEARING.
- 9. IT MUST BE THE CONTRACTOR'S RESPONSIBILITY TO ENSURE THAT NO GAP REMAINS BETWEEN PROPOSED KNEE WALLS OR WHERE PROPOSED KNEE WALL TERMINATES AND EXISTING FENCE REMAINS IN PLACE.
- 10. THE CONTRACTOR MUST TAKE ALL NECESSARY SAFETY PRECAUTIONS TO PROTECT AND PROVIDE ACCESS TO ABUTTING PROPERTY, UTILITIES, PEDESTRIANS, AND VEHICULAR TRAFFIC.
- 11. WHERE SECTION OR SUBSECTION MONUMENTS ARE ENCOUNTERED, THE ENGINEER MUST BE NOTIFIED BEFORE SUCH MONUMENTS ARE REMOVED. THE CONTRACTOR MUST PROTECT AND CAREFULLY PRESERVE ALL PROPERTY MARKS AND MONUMENTS. THE ENGINEER OR AN AUTHORIZED SURVEYOR AGENT WILL WITNESS OR OTHERWISE REFERENCE AND RESET MONUMENTS AS NECESSARY. ALL PROPERTY CORNERS EXCEPT THOSE WITHIN AREAS WHERE THE SCHEDULE, IF PROVIDED, SHOWS PLACEMENT OF R.O.W. MARKERS MUST REMAIN UNDISTURBED.
- 12. ALL ELEVATIONS IN THIS PLAN SET ARE BASED ON THE CHICAGO CITY DATUM. THE CONVERSION EQUATION FROM CCD TO NAVD 88 IS: NAVD 88 ELEVATION = CCD + 579.19.

- 13 BARRICADES: THE CONTRACTOR MUST PROVIDE AND INSTALL TWO WEIGHTED SANDBAGS ON EACH TYPE I OR TYPE II BARRICADE USED ONE WEIGHTED SANDBAG ACROSS EACH BOTTOM RAIL. ALL TYPE III BARRICADES REQUIRE A MINIMUM OF FOUR SANDBAGS PER BARRICADE.
- 14. SUPERSTRUCTURE RATING COARSE AGGREGATE MUST BE USED IN THE CONCRETE BARRIER WALL CONCRETE MIXTURE.
- 15. LOCATIONS OF ACCESS CONTROL FENCING AS SHOWN ON THE PLANS MAY BE ADJUSTED AS DIRECTED BY THE ENGINEER TO BETTER FIT FIELD CONDITIONS.
- 16. THE LOCATION OF VARIOUS ITEMS SUCH AS PAVEMENT, BARRIER WALLS, ELECTRICAL SYSTEMS AND DRAINAGE STRUCTURES BUILT IN CONTRACTS UNDER CONSTRUCTION DURING THE PREPARATION OF THESE PLANS IS BASED ON THE PUBLISHED CONTRACT PLAN DRAWINGS AVAILABLE DURING DESIGN. THE CONTRACTOR MUST FIELD VERIFY LIMITS, LOCATIONS AND ELEVATIONS OF THESE PREVIOUSLY CONSTRUCTED ITEMS.
- 17. CRUSHING PLANT AND CONCRETE PLANT LOCATIONS REQUIRE CITY OF CHICAGO APPROVAL.
- 18. THE CONTRACTOR IS ALERTED THAT THERE ARE EXISTING CTA UTILITY FACILITIES WITHIN, ADJACENT TO, AND CROSSING UNDER THE EXPRESSWAY FROM THE FRONTAGE ROADS TO THE CTA OPERATING AREA. THE EXACT LOCATION OF THESE FACILITIES IS NOT KNOWN. THE CONTRACTOR MUST CONTACT THE CTA AT 312-681-3860 FOR LOCATIONS OF THESE FACILITIES BEFORE PROCEEDING WITH ANY WORK WITHIN OR ADJACENT TO THE CTA OPERATING AREA. FOR ADDITIONAL INFORMATION REGARDING BURIED CONDUITS, CONTACT MR. RICK STRAUBEL, MANAGER TECH SUPPORT, AT 312-922-0508.
- 19. THE CONTRACTOR MUST USE CARE IN GRADING OR EXCAVATING NEAR ANY AND ALL EXISTING ITEMS THAT WILL NOT BE REMOVED. ANY DAMAGE DONE TO EXISTING ITEMS BY THE CONTRACTOR MUST BE REPAIRED BY THE CONTRACTOR AT THE CONTRACTOR'S OWN EXPENSE.
- 20. THE CONTRACTOR MUST MAINTAIN THE SURFACE DRAINAGE OF ALL ROADWAYS DURING CONSTRUCTION OF THIS PROJECT, WHEN EXISTING DRAINAGE FACILITIES ARE DISTURBED. THE CONTRACTOR MUST PROVIDE AND MAINTAIN TEMPORARY OUTLETS AND CONNECTIONS FOR ALL PRIVATE OR PUBLIC DRAINS, SEWERS, AND CATCH BASINS. THE CONTRACTOR MUST PROVIDE FACILITIES TO TAKE IN ALL STORM WATER WHICH WILL BE RECEIVED BY THESE DRAINS AND SEWERS AND DISCHARGE THE SAME. THE CONTRACTOR MUST PROVIDE AND MAINTAIN A TEMPORARY OUTLET AND BE PREPARED AT ALL TIMES TO DISPOSE OF THE WATER RECEIVED FROM THESE TEMPORARY CONNECTIONS UNTIL INSTALLATION IS COMPLETE INCLUDING PAVEMENT. THIS WORK MUST NOT BE PAID FOR SEPERATELY BUT MUST BE CONSIDERED INCLUDED IN THE COST OF THIS CONTRACT.
- 21. THE CONTRACTOR SHALL TAKE ALL NECESSARY PRECAUTIONS FOR THE PROTECTION OF EXISTING PLANT MATERIAL FOR WHICH THE CONTRACT DOES NOT PROVIDE REMOVAL. THE PROTECTION OF EXISTING PLANT MATERIAL AND THE REPAIR OR REPLACEMENT OF EXISTING PLANT MATERIAL DAMAGED BY THE CONTRACTOR SHALL BE DONE IN ACCORDANCE WITH THE REQUIREMENTS OF SECTION 201 OF THE STANDARD SPECIFICATIONS.
- 22. ALL RELOCATION OF EXISTING SIGNS IN CONFLICT WITH PROPOSED CONSTRUCTION SHALL CONFORM TO ARTICLE 107.25 OF THE STANDARD SPECIFICATIONS. EXISTING SIGNS TO BE RELOCATED IN PROPOSED CONCRETE MEDIAN SURFACE SHALL BE INSTALLED USING A SLEEVE OR BY CORING THE CONCRETE MEDIAN SURFACE. THE SLEEVE AND CORING OPERATIONS SHALL BE AS DIRECTED AND APPROVED BY THE ENGINEER. EXISTING SIGNS TO BE RELOCATED ONTO PROPOSED KNEE WALL FOOTINGS SHALL BE INSTALLED ACCORDING TO SECTIONS 728 AND 731 OF THE STANDARD SPECIFICATIONS. LABOR AND MATERIALS FOR RELOCATION OF EXISTING SIGNS WILL NOT BE MEASURED FOR PAYMENT, BUT SHALL BE INCLUDED IN THE COST OF THE FLUTED KNEE WALL.
- 23. THE INTENT OF THE CONTRACT DOCUMENTS IS TO CONSTRUCT THE FLUTED KNEE WALL BEHIND THE EXISTING CURB AND GUTTER, ANY DAMAGE TO THE EXISTING CURB AND GUTTER SHALL BE REPAIRED TO THE ORIGINAL CONDITION OF THE CURB AND GUTTER BY THE CONTRACTOR AT THE CONTRACTOR'S EXPENSE.
- 24. THE CONTRACTOR SHALL SHOW PROOF OF PROCUREMENT, SOURCES, QUANTITIES AND VARIETIES FOR ALL SHRUBS, TREES, GROUND COVERS, PERENNIAL AND ORNAMENTAL GRASSES WITHIN 21 DAYS FOLLOWING THE AWARD OF CONTRACT. TIMELY PROCUREMENT OF ALL PLANT MATERIAL IS ESSENTIAL TO THE SUCCESSFUL COMPLETION AND SUBSTANTIAL COMPLETION ACCEPTANCE OF THE OVERALL PROJECT.

GENERAL NOTES: CITY OF CHICAGO

- IN CASE OF DAMAGE TO CITY OF CHICAGO SEWERS, PRIVATE AND PUBLIC DRAINS, SEWER STRUCTURES AND/OR BENCH MONUMENTS, THE CONTRACTOR MUST IMMEDIATELY CONTACT THE DEPARTMENT OF WATER MANAGEMENT AT (312) 747-7892 OR (312) 747-7893.
- BENCH MONUMENT LOCATIONS WITHIN THE LIMITS OF THE IMPROVEMENT CAN BE OBTAINED FROM THE DEPARTMENT OF WATER MANAGEMENT AT 333 SOUTH STATE STREET, SUITE 410, CHICAGO, IL 60604. THE CONTRACTOR IS RESPONSIBLE FOR THE COST OF REPLACING ANY BENCH MONUMENT DAMAGED OR DESTROYED DURING CONSTRUCTION.
- 3. IN LOCATIONS WHERE THE MAIN SEWERS, DRAINAGE STRUCTURES, PUBLIC, AND PRIVATE DRAIN CONNECTIONS ARE DISTURBED OR DAMAGED DURING CONSTRUCTION BY THE CONTRACTOR, IT WILL BE THE CONTRACTOR'S RESPONSIBILITY TO RESTORE AND REPLACE THE DAMAGED FACILITIES AT HIS/HER OWN EXPENSE TO THE SATISFACTION OF THE DEPARTMENT OF WATER MANAGEMENT. THE SEWER FLOWS MUST BE MAINTAINED AT ALL TIMES.
- 4. EXTREME CAUTION IS TO BE TAKEN TO ENSURE THAT NO FACILITY OWNED AND MAINTAINED BY THE DEPARTMENT OF WATER MANAGEMENT IS DAMAGED DURING CONSTRUCTION, IF ANY DAMAGE OCCURS TO ANY FACILITIES, THE CONTRACTOR WILL BE HELD RESPONSIBLE FOR THE COST OF REPAIRING OR REPLACING THEM.
- 5. CITY OF CHICAGO WATER VALVE VAULTS AND SEWER STRUCTURES MUST NOT BE CLOSED, COVERED OR OTHERWISE OBSTRUCTED DURING CONSTRUCTION WITHOUT WRITTEN PERMISSION FROM THE CITY OF CHICAGO DEPARTMENT OF WATER MANAGEMENT.
- 6. THE CHICAGO TRANSIT AUTHORITY (CTA) HAS BUS OPERATIONS ALONG WENTWORTH AVENUE/WELLS STREET. THE CONTRACTOR MUST INFORM THE CTA REPRESENTATIVE MS. CHARLENE RIFFER (GENERAL MANAGER CONSTRUCTION) OF THE ON-GOING PROJECT SCHEDULE STARTING 28 DAYS BEFORE THE START OF CONSTRUCTION AT (312) 681-3851.
- 7. PAVEMENT REPLACEMENT AROUND FRAMES AND GRATES OR LIDS WHERE DRAINAGE, WATER MAIN OR ELECTRICAL STRUCTURES ARE ADJUSTED OR RECONSTRUCTED, MUST BE WITH CLASS SI CONCRETE.

SPECIAL COMMITMENTS

- THE CONTRACTOR AND THE ENGINEER SHALL SUBMIT THE IRRIGATION SHOP DRAWINGS FOR REVIEW AND APPROVAL BY THE CITY OF CHICAGO - STREETSCAPE UNIT, 4 WEEKS IN ADVANCE, PRIOR TO THE START OF THE IRRIGATION WORK.
- 2. THE CITY OF CHICAGO STREETSCAPE UNIT REPRESENTATIVES SHALL BE INVITED TO PARTICIPATE IN THE CONSTRUCTION PROGRESS MEETINGS. THE MEETINGS SCHEDULE SHALL BE PROVIDED TO THE CITY IN ADVANCE.
- 3. THE CITY OF CHICAGO STREETSCAPE UNIT REPRESENTATIVES SHALL BE AFFORDED THE OPPPORTUNITY TO OBSERVE ALL LANDSCAPE AND IRRIGATION WORK IN COORDINATION WITH AND CONCURRENCE OF THE ENGINEER
- 4. THE CONTRACTOR AND THE ENGINEER, IN COORDINATION WITH IDOT'S LANDSCAPING REPRESENTATIVE, SHALL PROVIDE A WRITTEN DESCRIPTION OF THE TURN OVER PROCEDURE OF THE IIRIGATION WORK AT THE END OF THE PROJECT TO THE CITY OF CHICAGO STREETSCAPE UNIT.
- 5. THE CITY OF CHICAGO STREETSCAPE UNIT REPRESENTATIVES SHALL BE INVITED BY THE C'ONTRACTOR AND THE ENGINEER TO ATTEND AND PARTICIPATE IN THE FINAL PROJECT INSPECTION.

REVISION		ILLINOIS DEPARTMENT OF TRANSPORTATION				
NAME	DATE	ILLINOIS DE	AITHEN	I OF TRANSFORTA	TION	
		F.A.I. 94/90	(DAN	RYAN EXPRE	(SSWAY)	
		GATEWAY LAN	DSCAPING	& IRRIGATION @	35TH	
		GE	NERAL	NOTES		
		SCALE: NONE		DRAWN BY:	JDC	

CHECKED BY: RS

DATE: 03/13/07

BOWMAN, BARRETT & ASSOCIATES INC.
CONSULTING ENGINEERS
Chicago, Illinois
312,228,0100
www.bbandainc.com

F.A.I. SECTION COUNTY TOTAL SHEETS NO. 94/90 • COOK 38 3

STA. TO STA.

FED. ROAD DIST. NO. | ILLINOIS | FED. AID | PROJECT | 98

60A79

* 2005-073 LS

SUMMARY OF QUANTITIES

CODE NO	VIEW .	T	URBAN	100°L STATE	100% CITY
CODE NO.	ITEM	UNIT	QUANTITY	Y003	Y003
C 2007010	SHRUB, ROSA RADRAZZ (KNOCKOUT ROSE), CONTAINER GROWN, 3-GALLON	EACH	392	392	
C2C03120	SHRUB, FORSYTHIA X INTERMEDIA HAPPY CENTENNIAL (HAPPY CENTENNIAL FORSYTHIA) 18" HEIGHT, CONTAINER	EACH	542	542	
A2005034	TREE, GYMNOCLADUS DIOICUS (KENTUCKY COFFEETREE), 10' HEIGHT, CLUMP FORM, BALLED AND BURLAPPED	EACH	10	10	
C2003353	SHRUB, HEPTACODIUM MICRONOIDES (SEVEN SON FLOWER), 8' HEICHT, BALLED AND BURLAPPED	EACH	12	12	
C2G04738	SHRUB, PHYSOCARPUS OPULIFOLIUS SUMMER WINE (SUMMER WINE COMMON NINEBARK), 2-1/2' HEIGHT, CONTAINER	EACH	222	222	
_A2008L18	TREE, ULMUS MORTON GLOSSY (TRIUMPH ELM), 3" CALIPER, BALLED AND BURLAPPED	EACH	10	10	
C2C06004	SHRUB, RHUS COPALLINA VAR. LATIFOLIA MORTON (PRAIRIE FLAME SHINING SUMAC), 3' HEIGHT, CONTAINER	EACH	is40	640	
X0325962	PERENNIAL PLANTS, ALLIUM BULBS	UNIT	33	<i>33</i>	
25000210	SEEDING, CLASS 2A	ACRE	0.50	0.56	
25000400	NITROGEN FERTILIZER NUTRIENT	POUND	52	52	
25000500	PHOSPHORUS FERTILIZER NUTRIENT	POUNTS	52	52	
25000600	POTASSIUM FERTILIZER NUTRIENT	POUND	52	5Z	
25000750	MOWING	ACRE	2.6	2.6	
25100630	EROSION CONTROL BLANKET	SQ YD	2,711	2,7/1	
28000510	INLET FILTERS	EACH	26	26	
42001300	PROTECTIVE COAT	SQ YD	306		300
42400200	PORTLAND CEMENT CONCRETE SIDEWALK 5 INCH	SQ FT	2556		255
44000500	COMBINATION CURB AND GUTTER REMOVAL	FOOT	99		99
44000600	SIDEWALK REMOVAL	SQ FT	2556		255
56104600	WATER VALVES 2"	EACH	2		2
56200900	WATER SERVICE LINE 2 1/2"	FOOT	380		380
66400550	CHAIN LINK FENCE, 4' (SPECIAL)	FOOT	1,325	1,325	
67100100	MOBILIZATION	L · SUM	1	0.8	0.Z
70101800	TRAFFIC CONTROL AND PROTECTION, (SPECIAL)	L SUM	1	0.8	0.2
78008200	POLYUREA PAVEMENT MARKING TYPE I - LETTERS SYMBOLS	SQ FT	59		59
78008240	POLYUREA PAVEMENT MARKING TYPE I - LINE 8"	FOOT	61		61
78008250	POLYUREA PAVEMENT MARKING TYPE I - LINE 12"	F00T	501		501
78008270	POLYUREA PAVEMENT MARKING TYPE I - LINE 24"	FOOT	70		70
B2006320	TREE, SYRINGA RETICULATA IVORY SILK (IVORY SILK JAPANESE TREE LILAC), 2-1/2" CALIPER, TREE FORM,	EACH	18	18	
	BALLED AND BURLAPPED				
B2006374	TREE, SYRINGA RETICULATA IVORY SILK (IVORY SILK JAPANESE TREE LILAC), 10' HEIGHT, CLUMP FORM,	EACH	jų į	14.	
	BALLED AND BURLAPPED		177		

CODE NO.	ITEM	UNIT	URBAN QUANTITY	STATE -	CITY
	/-VAR.			,,,,	7000
E2009001	VINE,—EUONYMUS FORTUNEI COLORATUS (PURPLE LEAF WINTERCREEPER), 1-QUART POT	EACH	1075	1075	
K0030400	PERENNIAL PLANTS, DAYLILIES	UNIT	14	14	
K0030450	PERENNIAL PLANTS, DAFFODIL BULBS	UNIT	61	61	
K0030470	PERENNIAL PLANT, ORNAMENTAL GRASS TYPE	UNIT	32	32	
X0301407	PERENNIAL PLANTS, GALLON POT	UNIT	48	48	
X0322256	TEMPORARY INFORMATION SIGNING	SQ FT	103	103	
X0325, 9 71	CAST-IN-PLACE DETECTABLE WARNING SURFACE	SQ FT	26		26
X0325103	WATER METER IN VAULT, 2 INCH	EACH	2		2
X0325104	WATER TAP, 2 INCH	EACH	2		2
X0325105	IRRIGATION SYSTEM	sa yo	5210		5210
X0656300	PAVEMENT REMOVAL AND REPLACEMENT	SQ YD	249		249
-X6065740-	-CONCRETE MEDIAN SURFACE, 8" (MODIFIED)	-SQ FI	192	192	$\widetilde{\supset} \Delta$
XX000541	EXPLORATORY EXCAVATION	CU YD	18		18
XX003710	BACKFLOW PREVENTER, 2"	EACH	2		2
X0325970	SOIL CONDITIONER 300	SQ YD	4,360	4,360	
-XX006326	TYPE K COPPER PIPE 2"	-F00T	-425-		-425-
XX104800	COMBINATION CONCRETE CURB AND GUTTER, TYPE B-V.12	FOOT	(99		99
Z0013798	CONSTRUCTION LAYOUT	L SUM	1		
- Z0076600-	-TRAINEES	HOUR-			
X0325106	SYSTEM IRRIGATION FALL SHUT-DOWN	EACH	2		2
X0375107	- SYSTEM IRRIGATION SPRING START-UP	EACH	2		2
K1003460	LANDSCAPE MAINTENANCE	CAL MO	12	12	
-62602950	SHRUB, FORSYTHIA X INTERMEDIA COURTACOUR (COLDILOCKS FORSYTHIA)- 18" HEIGHT, CONTAINER	EACH	284	284	
62607949	SHRUB, FORSYTHIA X INTERMEDIA COURDIJAU (GOLDEN PEEP FORSYTHIA)-18" HEIGHT, CONTAINER-	EACH -	286	286-	
X0325604	WEED CONTROL, PRE-EMERGENT HERBICIDE	GALLON	2	2	
X7011015	TRAFFIC CONTROL AND PROTECTION (EXPRESSWAYS)	LSUM	/	,	
20048665	RAILROAD PROTECTIVE LIABILITY INSURANCE	L SUM	1		······
56104605	WATER VALVES 21/2"	EACH	۵		6
	Annual Control of the				
		.1			

BOWMAN, BARRETT & ASSOCIATES INC.
CONSULTING ENGINEERS
Chicago, Illinois
312.228.0100
www.bbandainc.com

* - Specialty Items

Rev. 7-24-08

Rev. 6-2-08

Rev. 6-2-08

ILLINOIS DEPARTMENT OF TRANSPORTATION


F.A.I. 94/90 (DAN RYAN EXPRESSWAY)


GATEWAY LANDSCAPING & IRRIGATION @ 35TH


SUMMARY OF QUANTITIES


SCALE: NONE DATE: 03/13/07 DRAWN BY: JDC CHECKED BY: DDM


..\22F\22F_SHEET\$\660_22FCSOQ.dgn 3/15/2008 12:00:52 AM

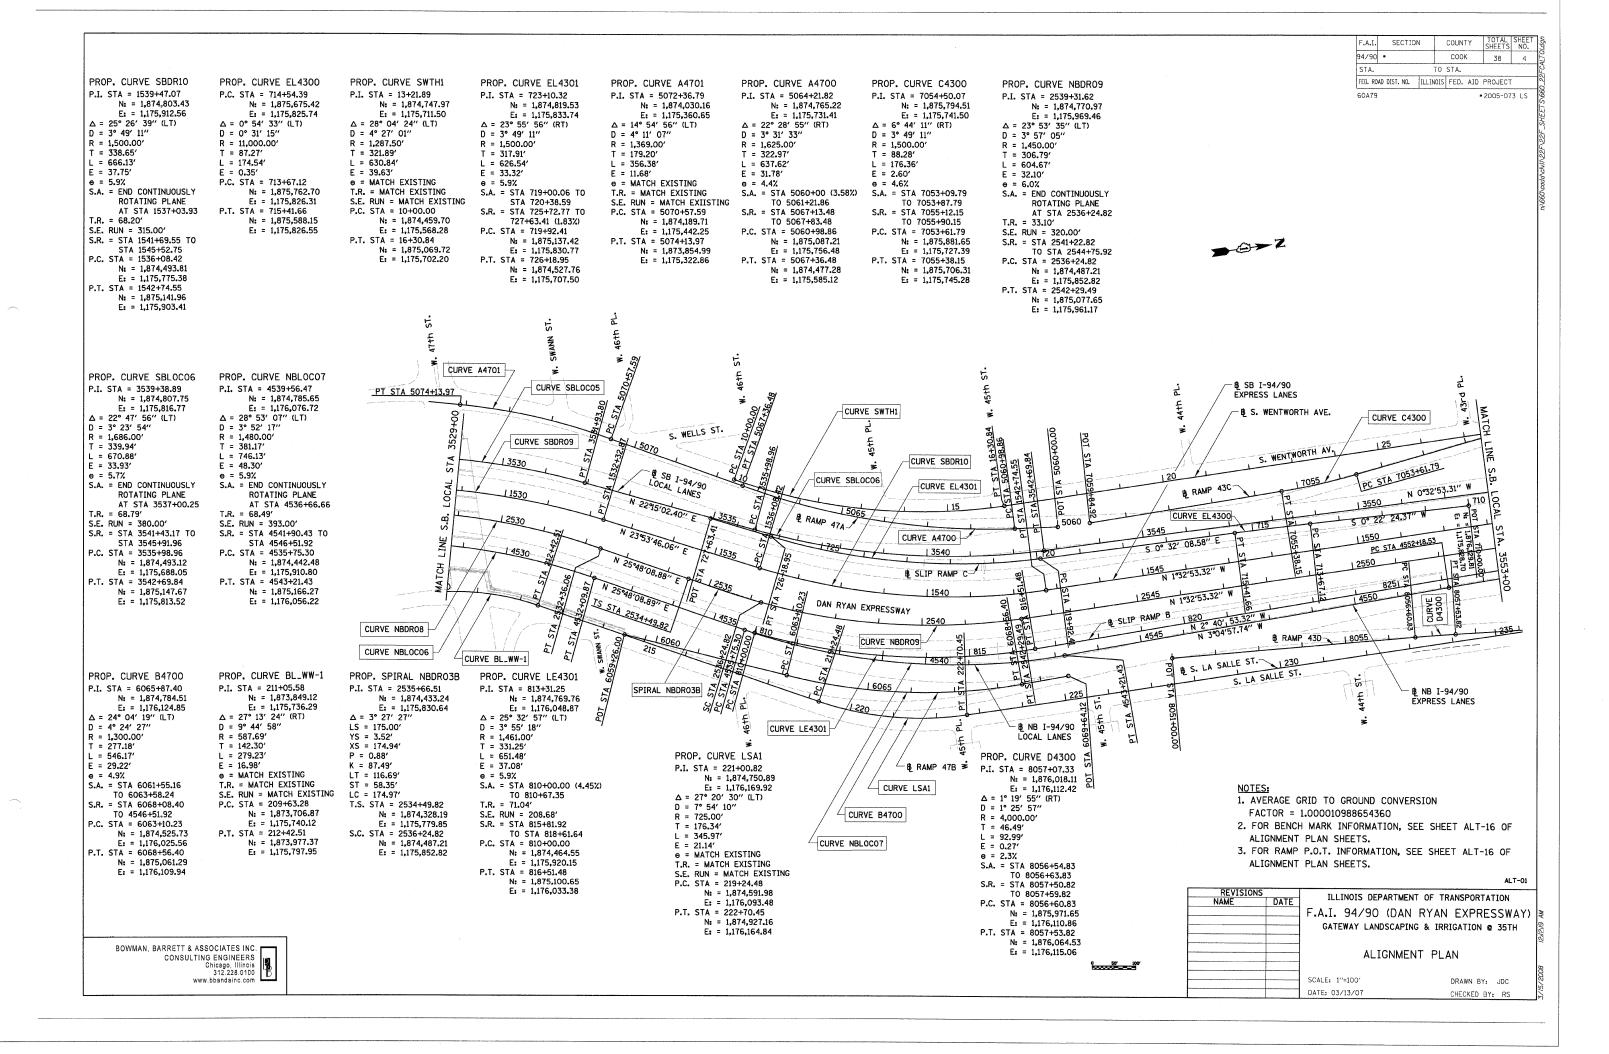


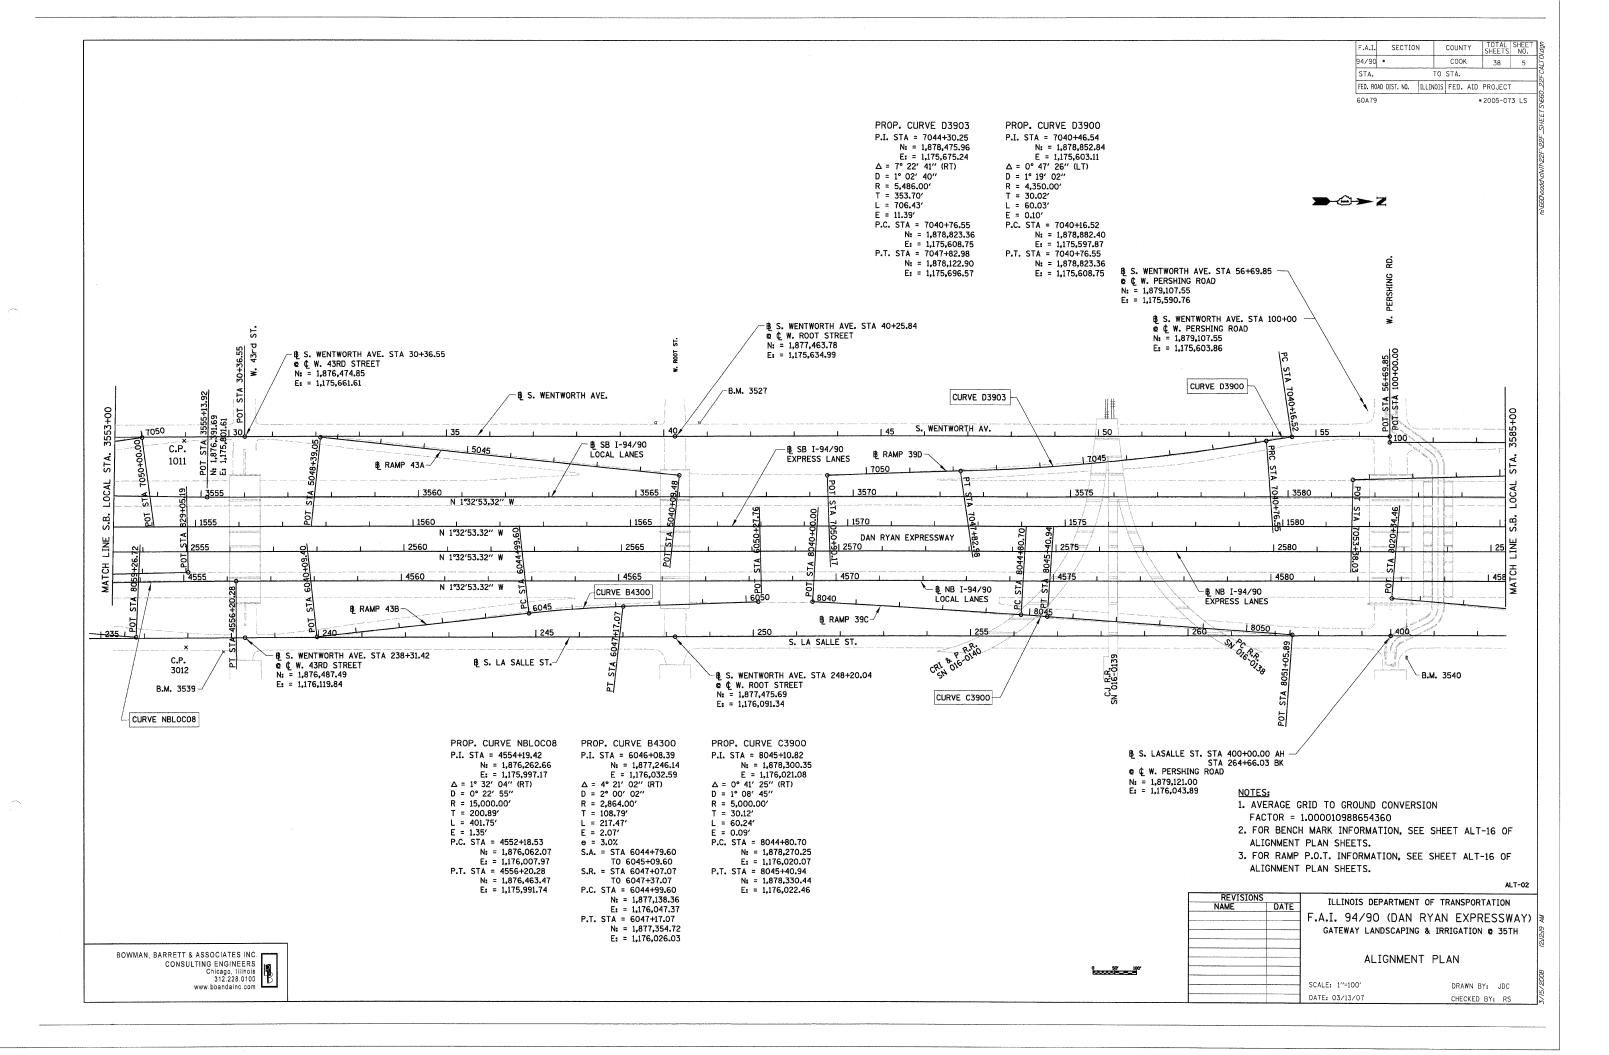


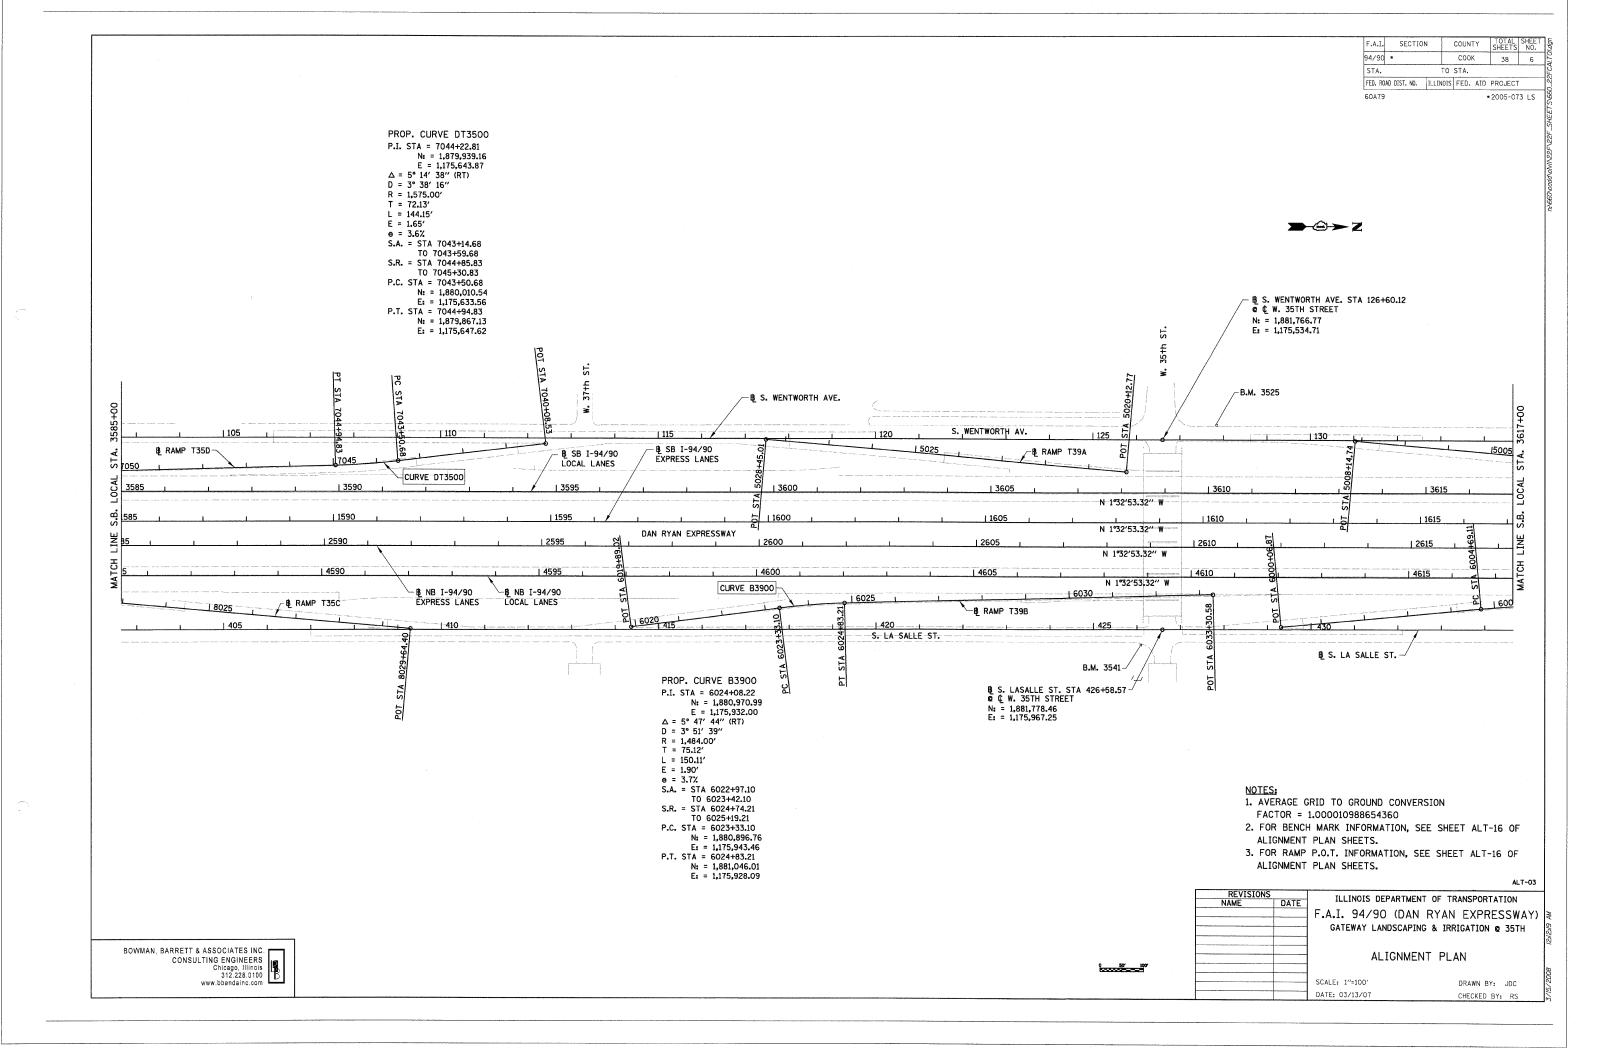


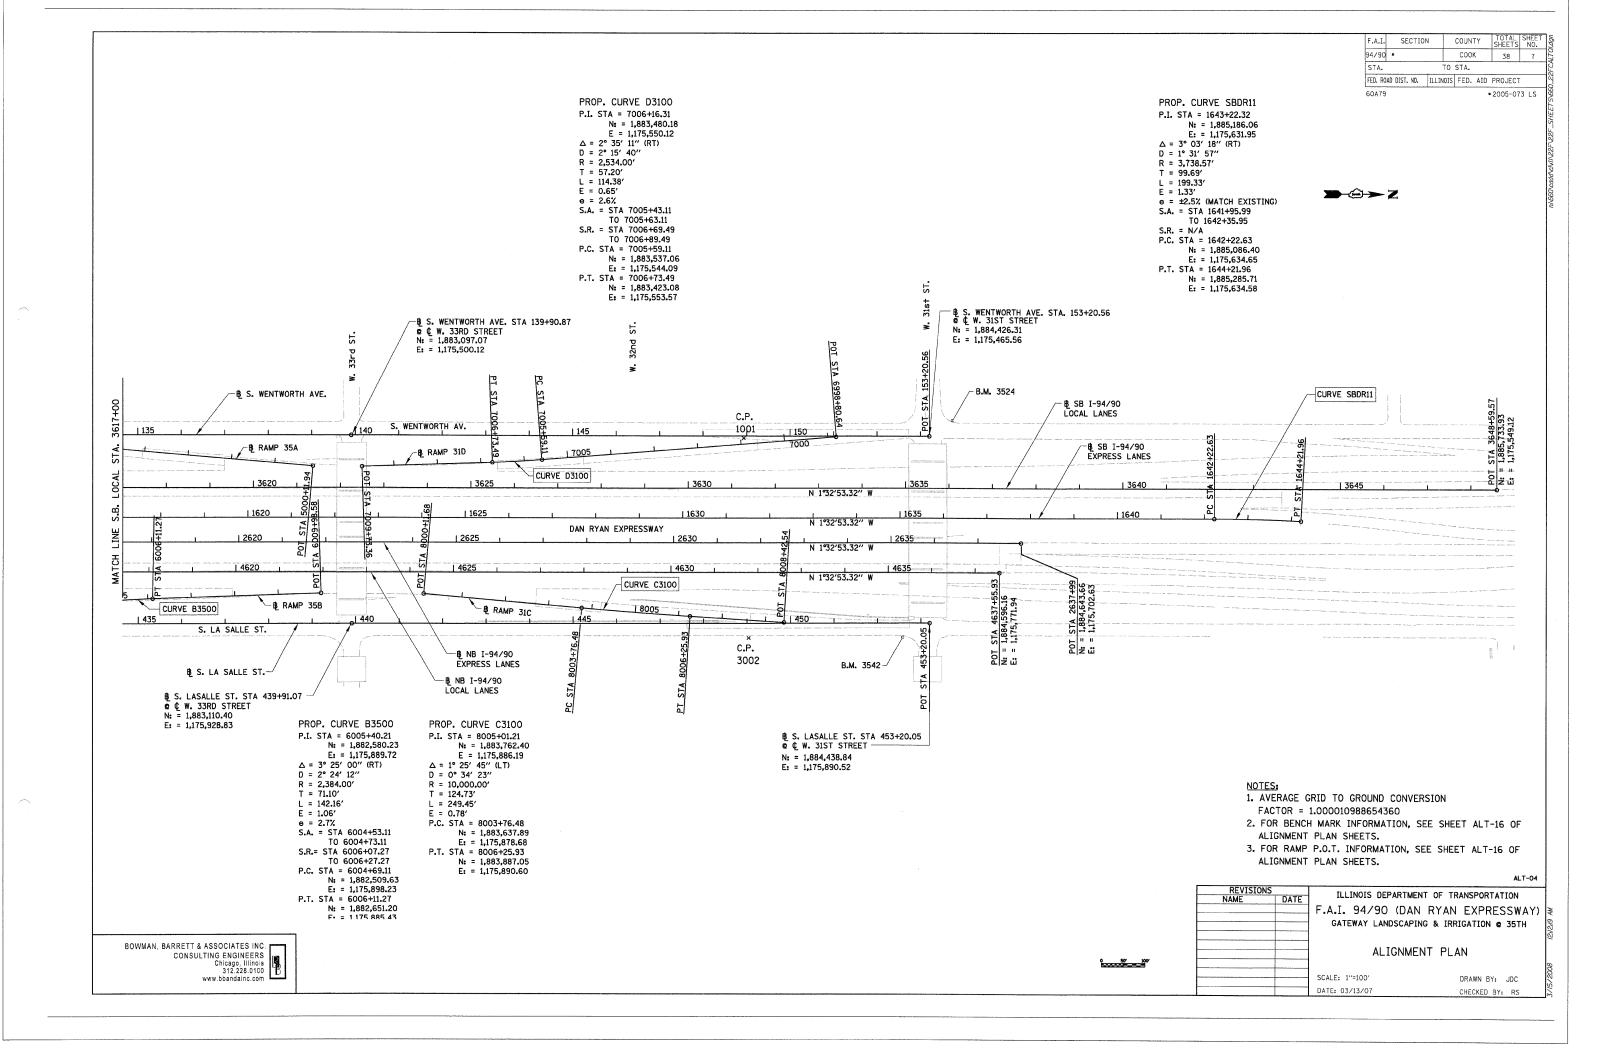


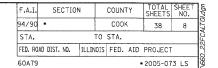

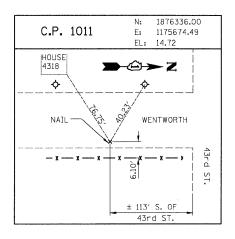

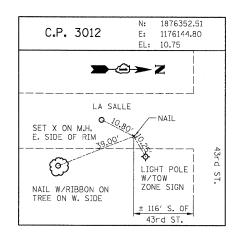

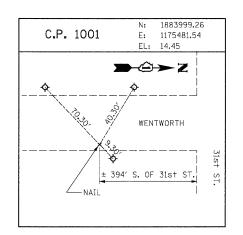

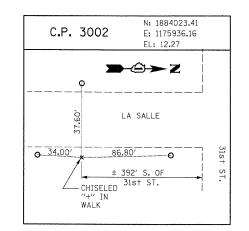

RAMP P.O.T. COORDINATE INFORMATION

POINT	DESCRIPTION	STATION	NORTH	EAST
BEGIN	RAMP 47A	5060+00.00	1.875.185.77	1.175.764.15
END	RAMP 47A	5074+13.97	1,873,854.99	1,175,322.86
BEGIN	RAMP 47B	6059+26.00	1.874.166.99	1.175.887.94
END	RAMP 47B	6069+64.12	1,875,168.85	1,176,104.15
BEGIN	RAMP 43C	7050+00.00	1.876.238.80	1.175.669.59
END	RAMP 43C	7059+84.92	1,875,259.95	1,175,764.44
BEGIN	RAMP 43D	8051+00.00	1.875.411.12	1.176.092.10
END	RAMP 43D	8059+26.72	1,876,237.16	1,176,124.86
BEGIN	RAMP 43A	5040+09.48	1.877.475.98	1,175,723,30
END	RAMP 43A	5048+39.05	1,876,648.91	1,175,658.90
BEGIN	RAMP 43B	6040+09.40	1.876.652.70	1.176.113.96
END	RAMP 43B	6050+27.76	1,877,664.85	1,176,007.29
BEGIN	RAMP 39D	7040+16.52	1.878.882.40	1.175.597.87
END	RAMP 39D	7050+90.17	1,877,816.27	1,175,715.09
BEGIN	RAMP 39C	8040+00.00	1.877.789.82	1,176,003.91
END	RAMP 39C	8051+05.89	1,878,894.81	1,176,048.24

POINT	DESCRIPTION	STATION	NORTH	EAST
BEGIN	RAMP T35D	7040+08.53	1,880,349.18	1,175,584.62
END	RAMP T35D	7053+38.03	1,879,025.07	1,175,691.43
BEGIN	RAMP T35C	8020+34.46	1,879,121.15	1,175,958.93
END	RAMP T35C	8029+64.40	1,880,049.40	1,176,014.92
BEGIN	RAMP T39A	5020+12.77	1,881,685.70	1,175,610.45
END	RAMP T39A	5028+45.01	1,880,854.96	1,175,560.34
BEGIN	RAMP T39B	6019+89.02	1,880,556.70	1,175,995.95
END	RAMP T39B	6033+30.58	1,881,892.23	1,175,884.04
BEGIN	RAMP 35A	5000+11.94	1,883,011.02	1,175,573.65
END	RAMP 35A	5008+14.74	1,882,209.69	1,175,525.14
BEGIN	RAMP 35B	6000+06.87	1,882,050.72	1,175,953.56
END	RAMP 35B	6009+98.58	1,883,037.81	1,175,862.08
BEGIN	RAMP 31D	6998+80.64	1,884,211.76	1,175,472.66
END	RAMP 31D	7009+73.36	1,883,123.75	1,175,571.65
BEGIN	RAMP 31C	8000+11.68	1,883,273.75	1,175,856.72
END	RAMP 31C	8008+42.54	1,884,103.52	1,175,898.24

BENCH MARK NO. 3524 ELEV. 15.17

DESCRIPTION:

CROSS CUT ON NORTH FLANGE BOLT OF FIRE HYDRANT AT THE NORTHWEST CORNER OF 31st ST. AND WENTWORTH AVE.

BENCH MARK NO. 3525 ELEV. 16.93

DESCRIPTION:
CROSS CUT ON NORTHWEST FLANGE BOLT OF FIRE HYDRANT AT THE NORTHWEST CORNER. OF 35+h ST. AND WENTWORTH AVE.

BENCH MARK NO. 3526 ELEV. 17.37

CROSS CUT ON NORTHWEST FLANGE BOLT OF FIRE HYDRANT AT THE WENTWORTH GARDEN OFFICE ALONG THE WEST SIDE OF WENTWORTH AVE.

BENCH MARK NO. 3527 ELEV. 15.63

DESCRIPTION:

CROSS CUT ON NORTHERLY FLANGE BOLT OF FIRE HYDRANT AT THE NORTHWEST CORNER OF ROOT ST. AND WENTWORTH AVE.

BENCH MARK NO. 3539 ELEV. 13.10

DESCRIPTION:

CROSS CUT ON EASTERLY BOLT OF LIGHT POLE BASE AT THE SOUTHEAST CORNER OF 43rd ST. AND LA SALLE ST.

BENCH MARK NO. 3540 ELEV. 12.33

DESCRIPTION:

SOUARE CUT ON THE SOUTHWEST CORNER OF THE TRAFFIC CONTROL BOX AT THE NORTHEAST CORNER OF 39th ST. AND LA SALLE ST.

BENCH MARK NO. 3541 ELEV. 14.78

DESCRIPTION:

CROSS CUT ON THE SOUTHWEST BOLT OF LIGHT POLE BASE AT THE SOUTH EAST CORNER OF 35th ST. AND LA SALLE ST.


BENCH MARK NO. 3542 ELEV. 13.57


DESCRIPTION:


CROSS CUT ON THE EASTERLY FLANGE BOLT OF THE FIRE HYDRANT AT THE INTERSECTION OF 31st ST. AND LA SALLE ST.


		ALT-05
REVISIONS NAME DA	F.A.I. 94/90 (DAN	IT OF TRANSPORTATION RYAN EXPRESSWAY) IG & IRRIGATION @ 35TH
	ALIGNME	NT PLAN
	SCALE: 1"=100' DATE: 03/13/07	DRAWN BY: JDC CHECKED BY: RS


BOWMAN, BARRETT & ASSOCIATES INC.
CONSULTING ENGINEERS
Chicago, Illinois
312 228.0100
www.bbandainc.com

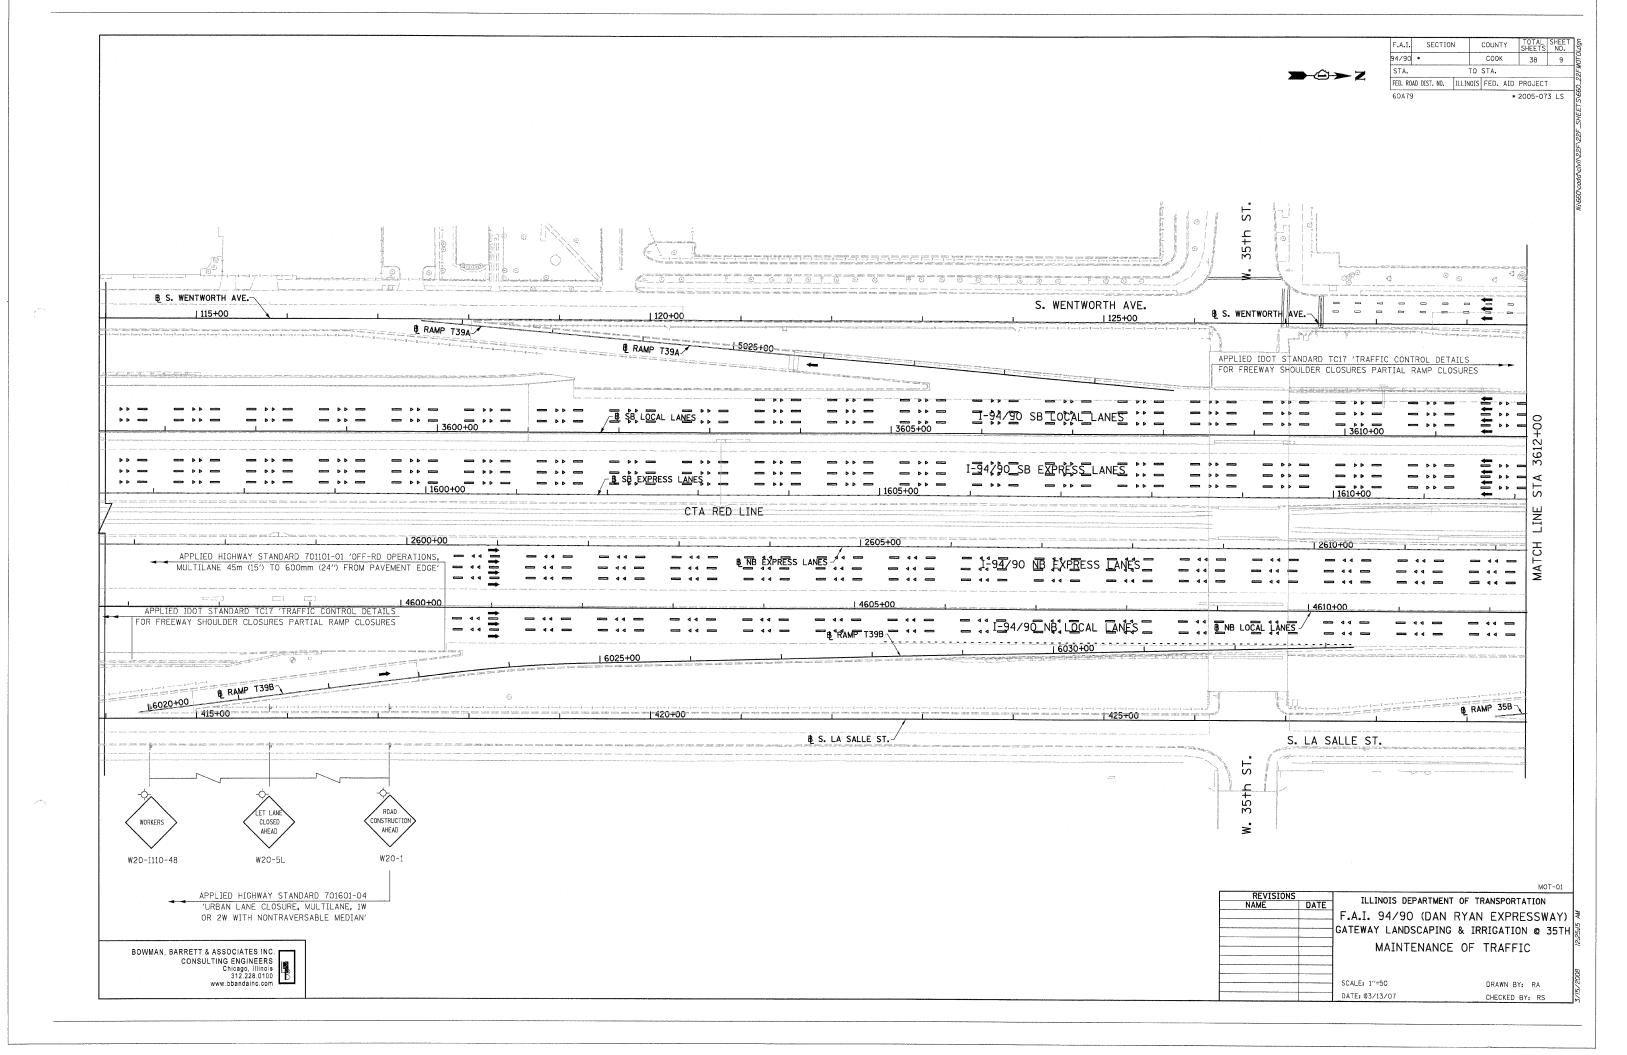


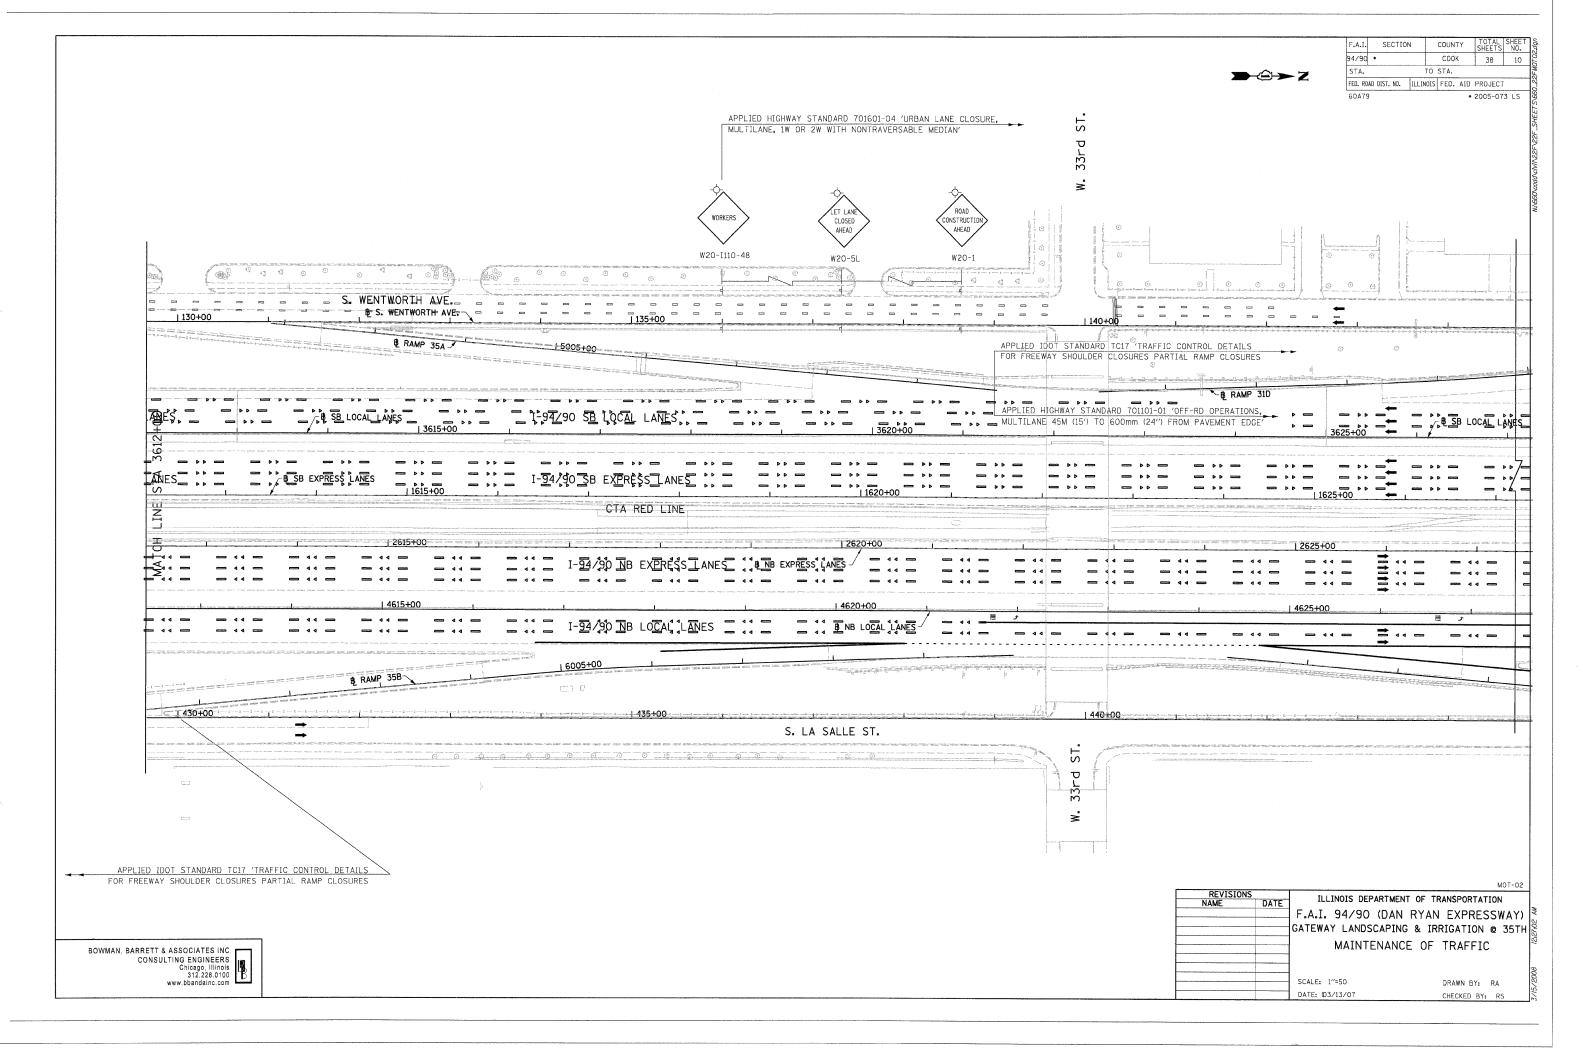


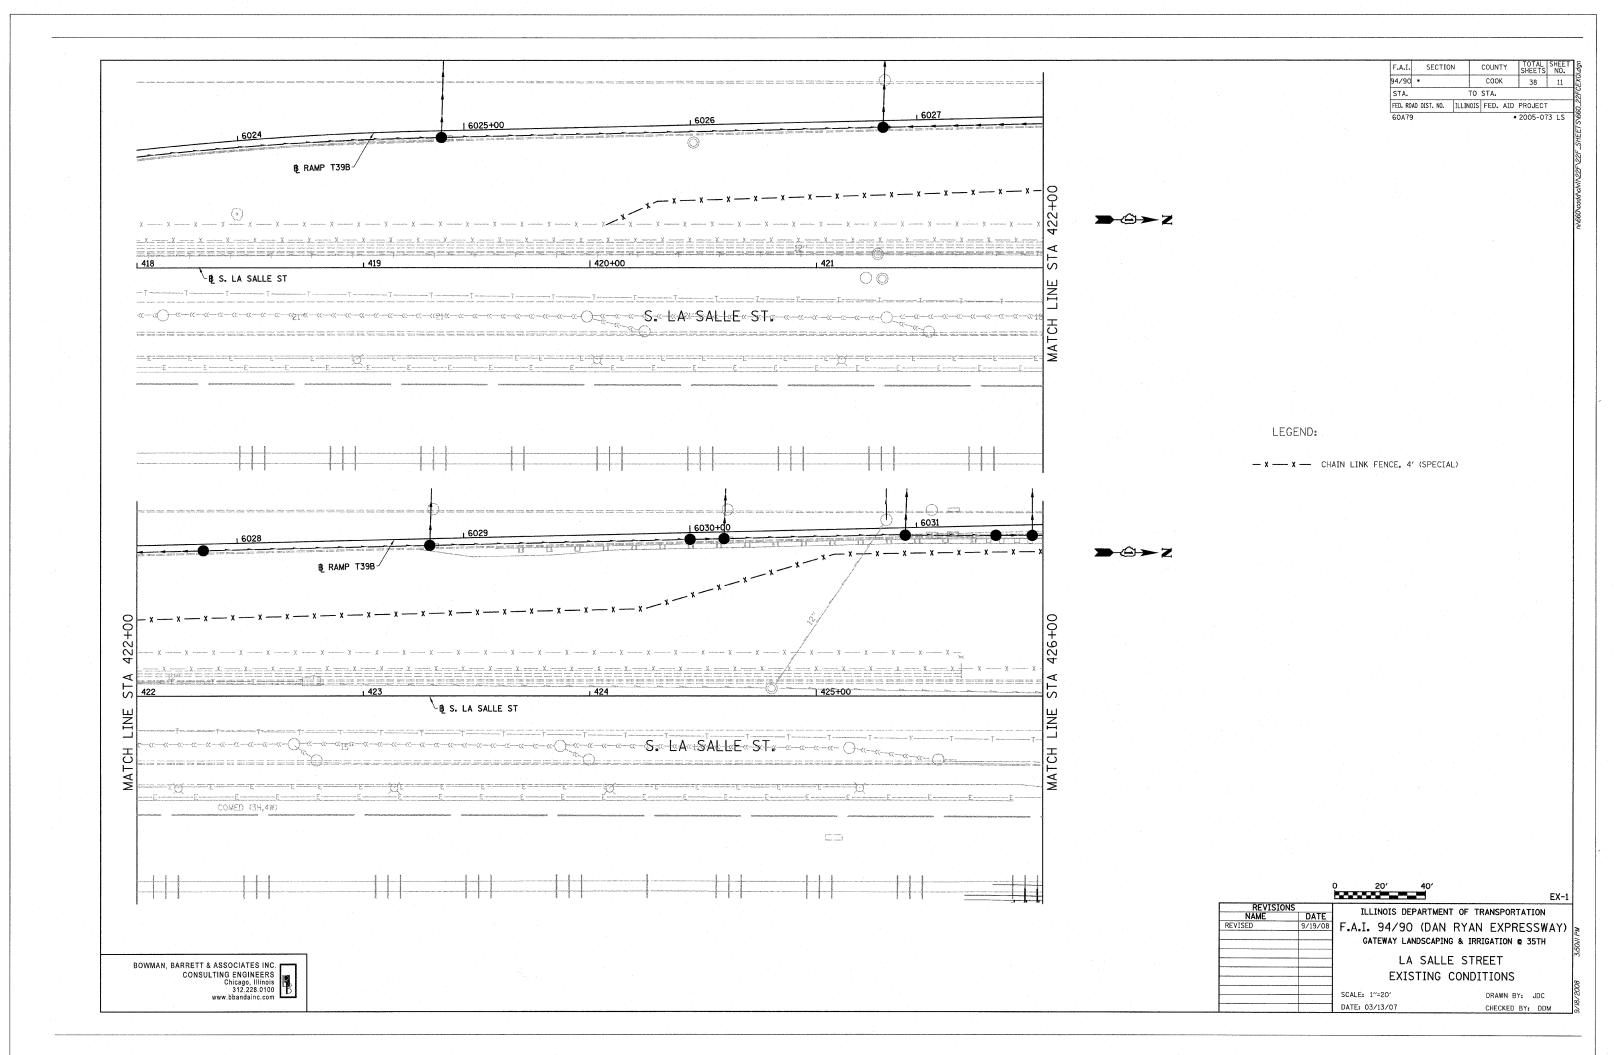


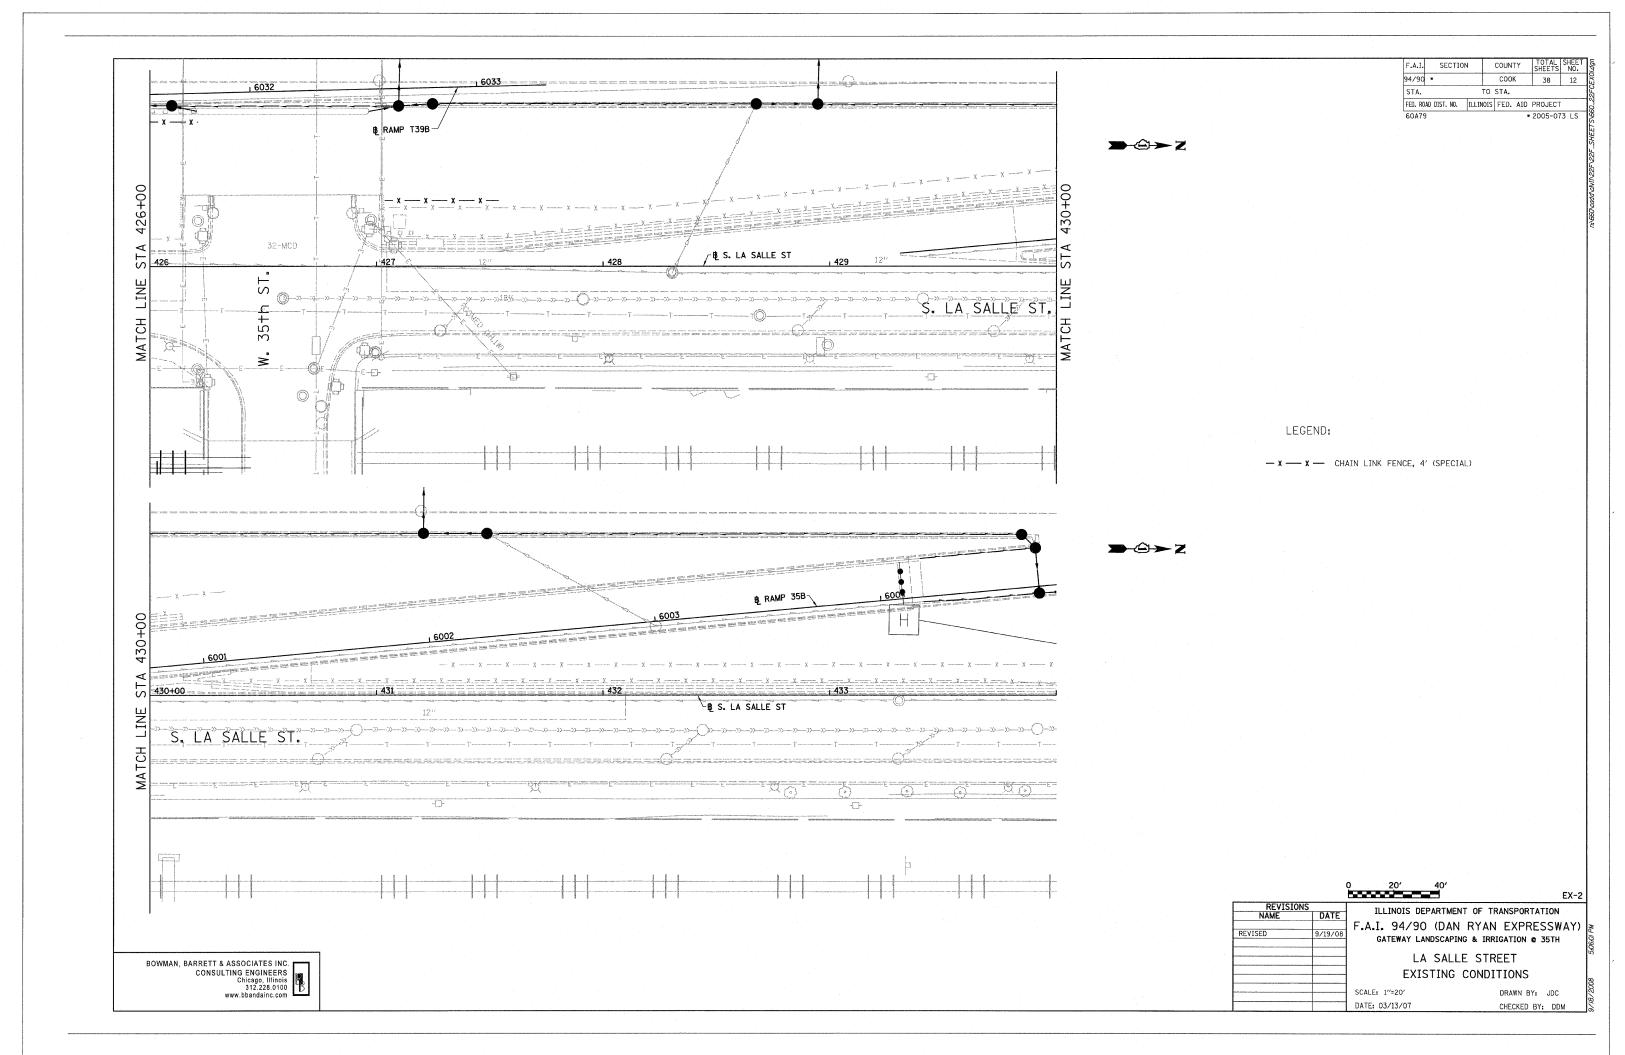


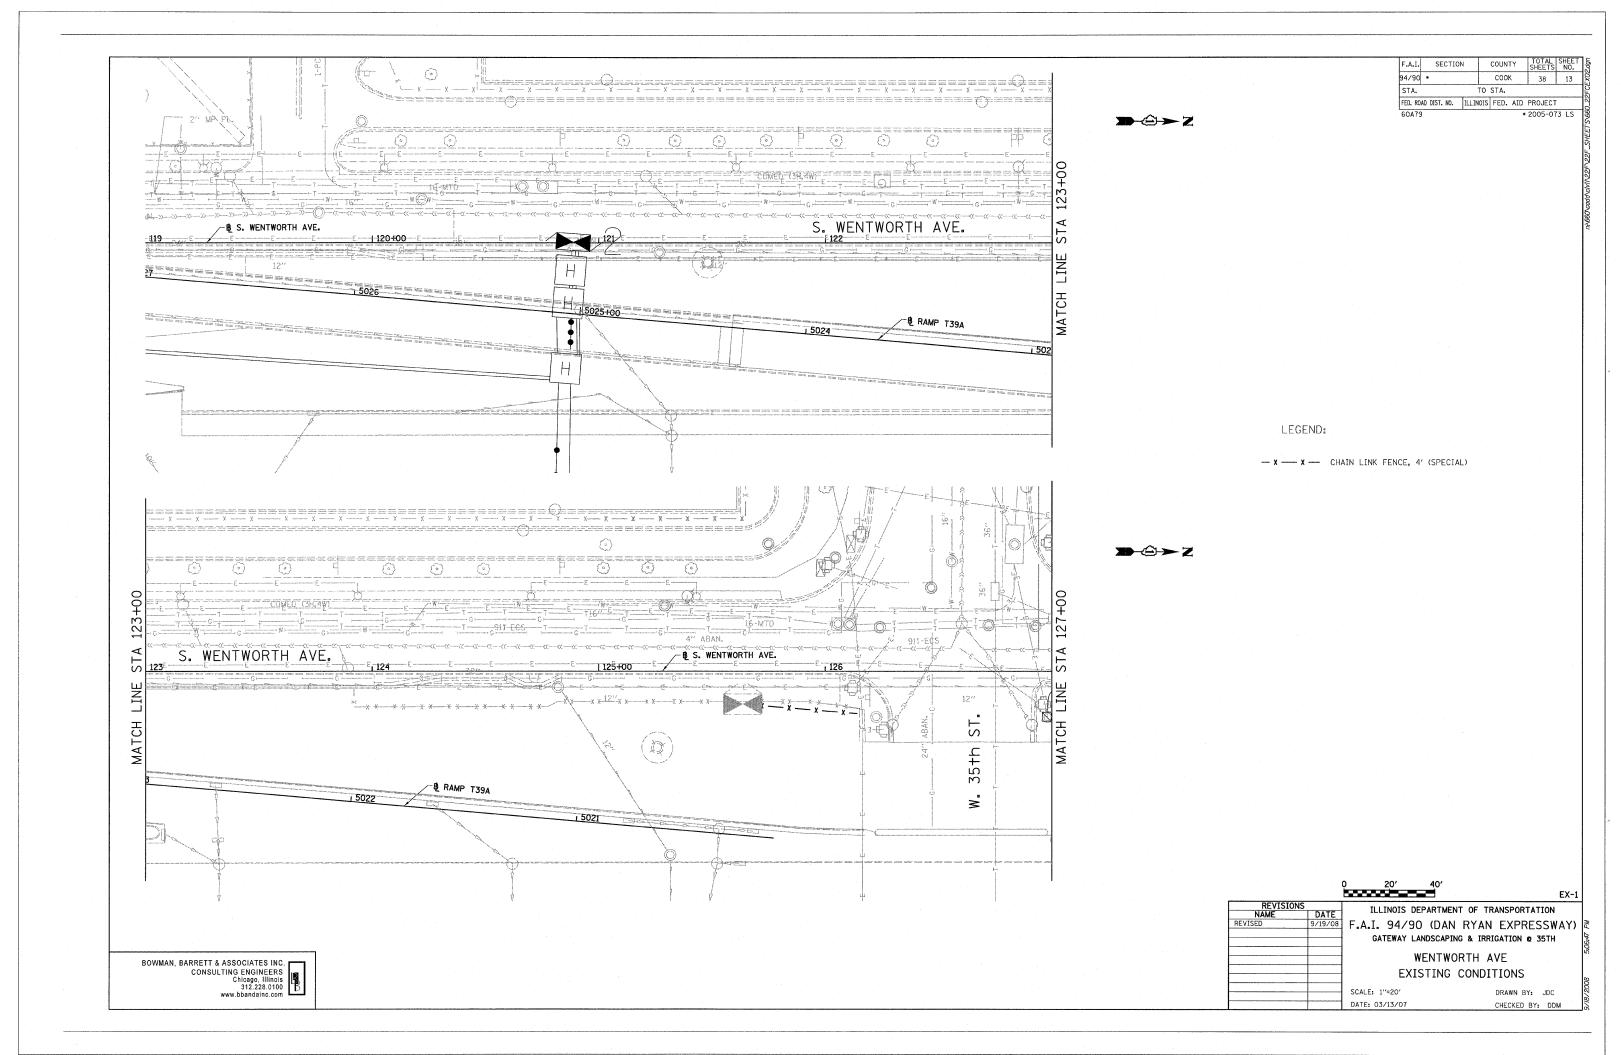

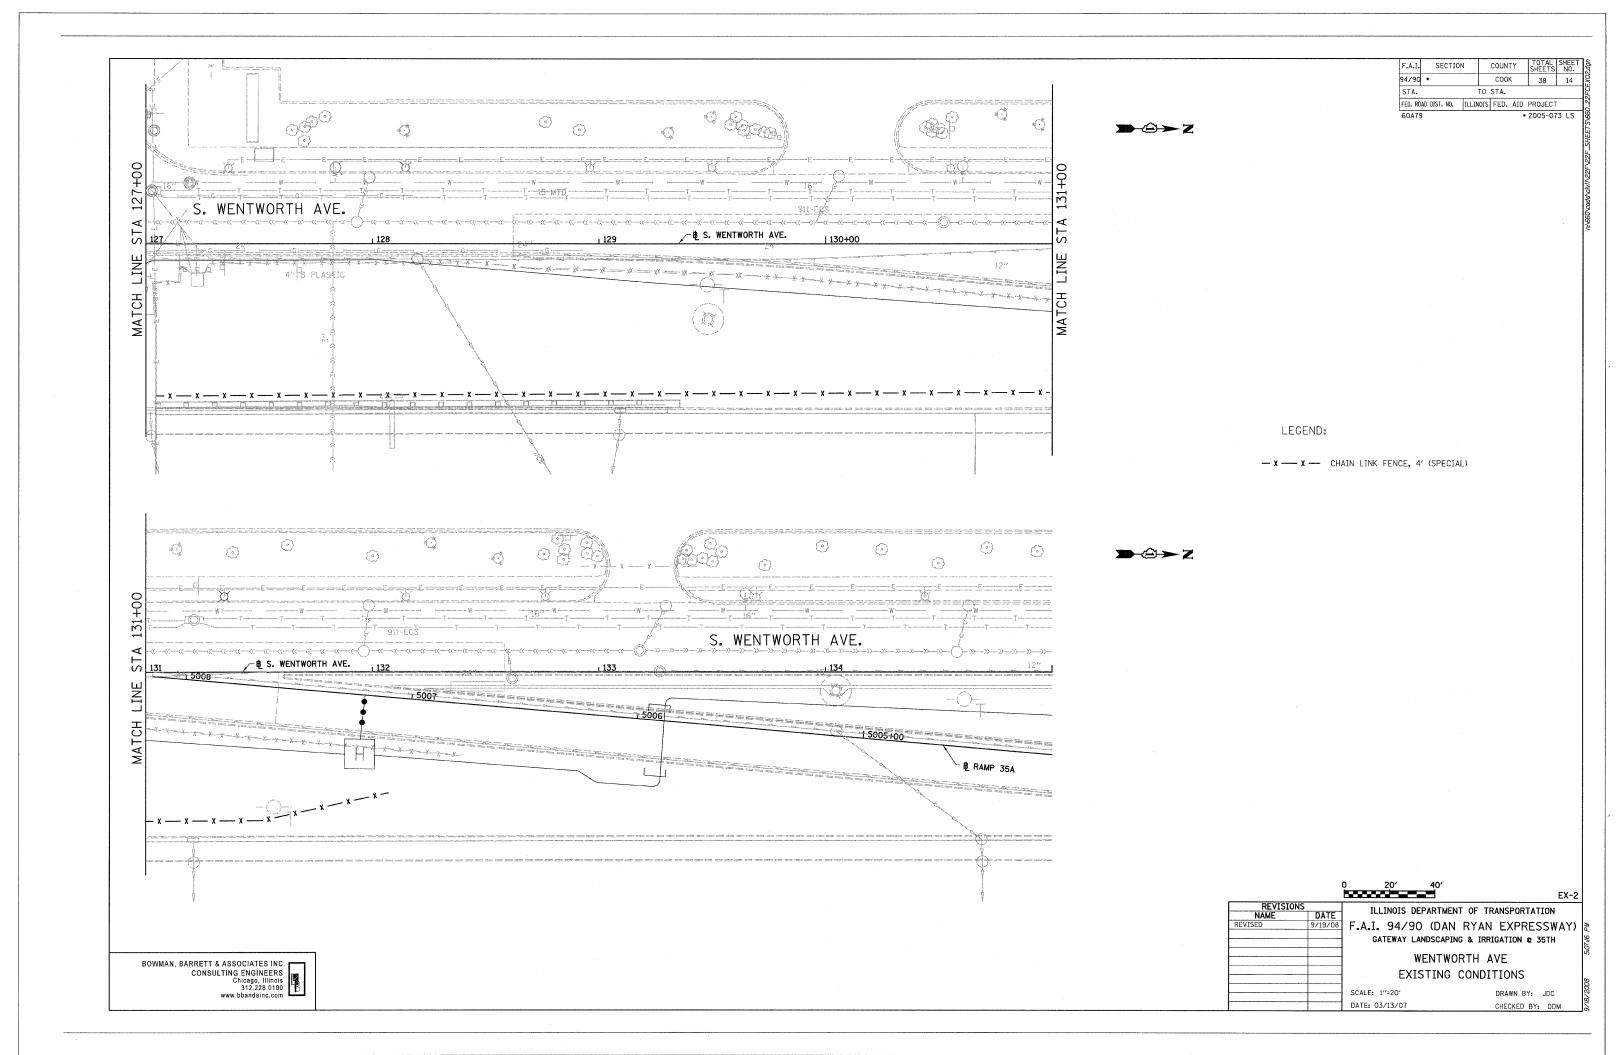

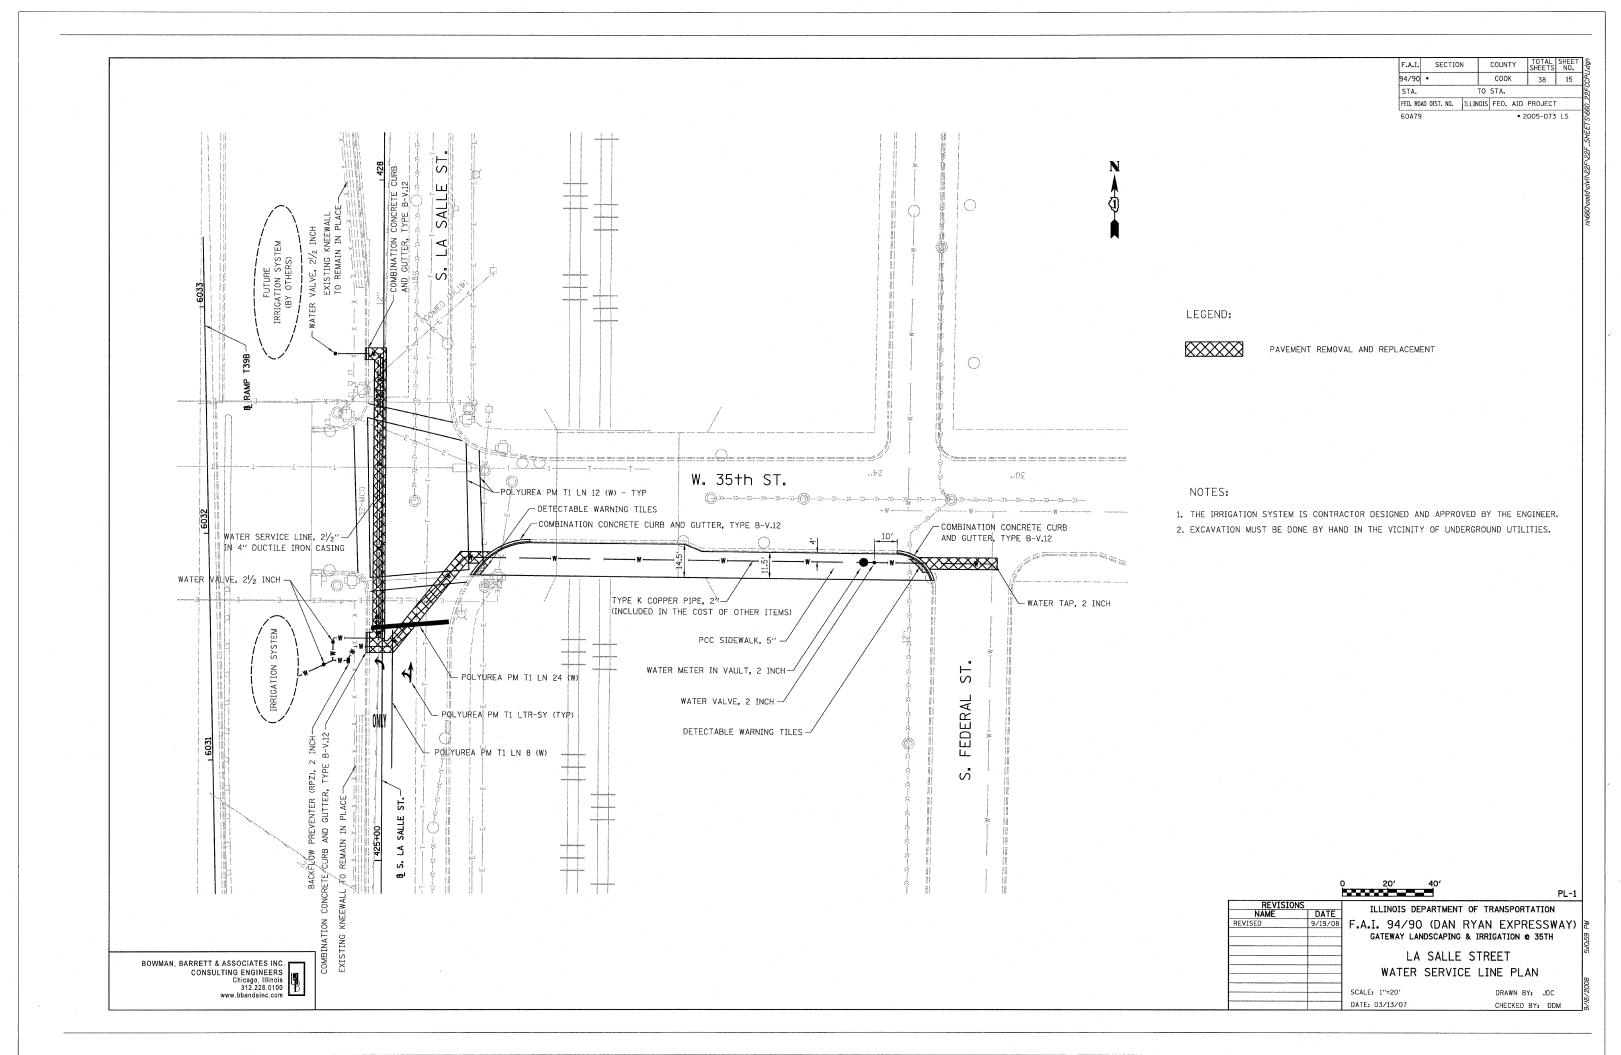

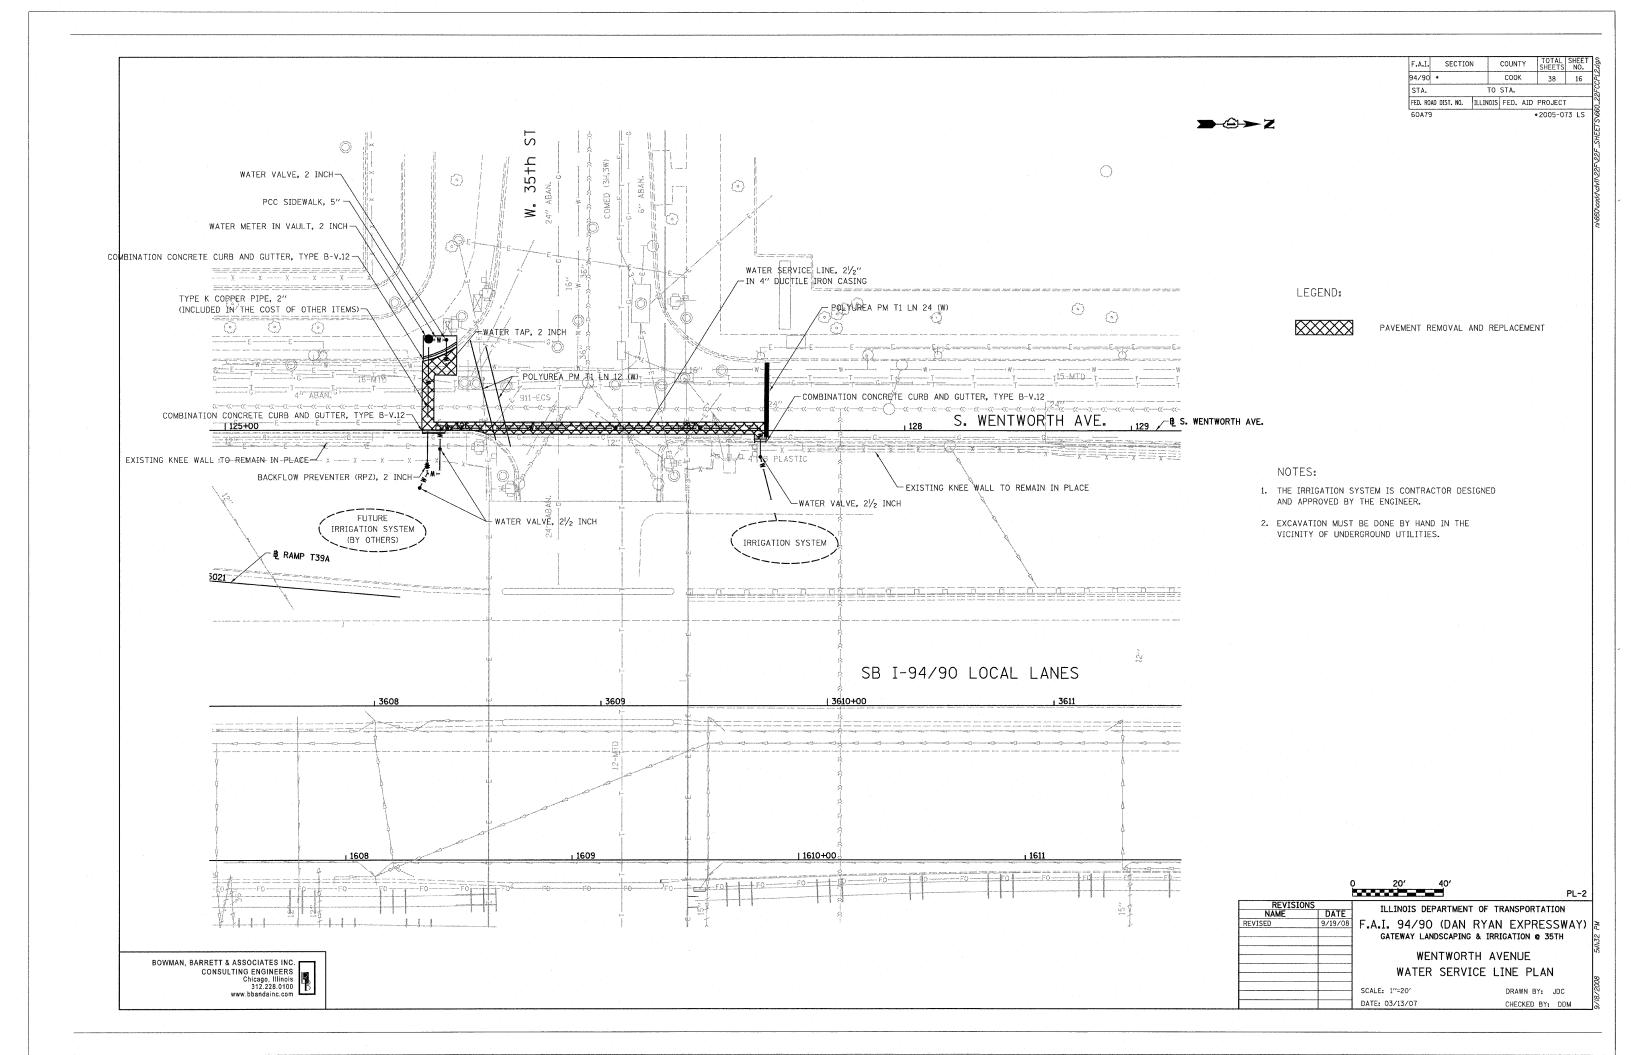

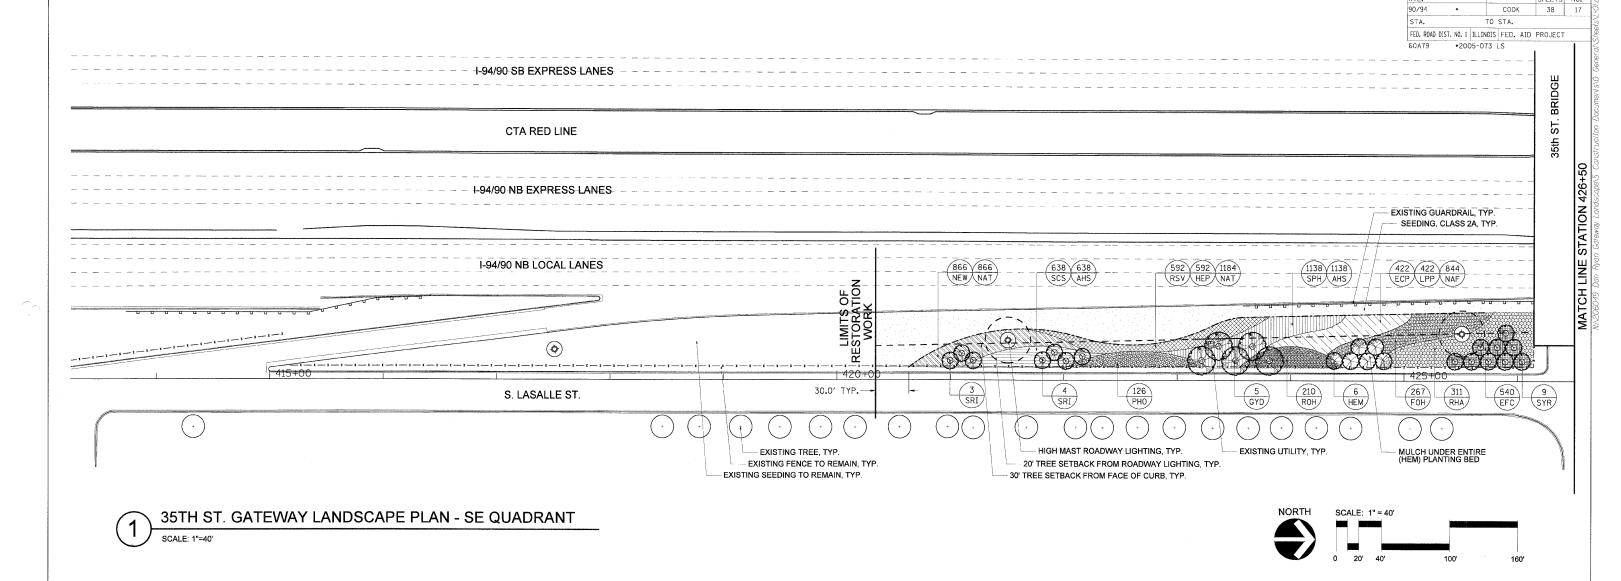

35th ST. GATEWAY LANDSCAPE PLANT LIST - SE QUADRANT

KEY	BOTANICAL NAME	COMMON NAME	SIZE	QUANTITY	SPACING	NOTES
SHADE T	REES					
GYD	GYMNOCLADUS DIOICA	KENTUCKY COFFEE TREE	10' HT.	5	ON PLANS	CLUMP FORM B/B
					A.	
	NTAL TREES					
SRI	SYRINGA RETICULATA 'IVORY SILK'	JAPANESE TREE LILAC	10' HT.	7	ON PLANS	HEAVY CLUMP B/B
SYR	SYRINGA RETICULATA 'IVORY SILK'	JAPANESE TREE LILAC	2.5" CAL.	9	ON PLANS	B/B
SHRUBS						
FOH	FORSYTHIA X INTERMEDIA 'HAPPY CENTENNIAL'	HAPPY CENTENNIAL FORSYTHIA	18" HT. 5 GAL.	267	36" O.C.	
HEM	HEPTACODIUM MICONIOIDES	SEVEN-SON FLOWER	8' HT.	6	ON PLANS	HEAVY CLUMP B/B
PHO	PHYSOCARPUS OPULIFOLIUS 'SUMMER WINE'	SUMMER WINE COMMON NINEBARK	2 1/2' HT. 5 GAL.	126	42" O.C.	
RHA	RHUS COPALLINA LATIFOLIA 'MORTON'	PRAIRIE FLAME SUMAC	3' HT. 5 GAL.	311	36" O.C.	
ROH	ROSA 'KNOCKOUT'	KNOCKOUT SHRUB ROSE	3 GAL.	210	30" O.C.	
	NTAL GRASSES					
SCS	SCHIZACHRIUM SCOPARIUM 'CAROUSEL' SPOROBOLUS HETEROLEPSIS	CAROUSEL LITTLE BLUESTEM PRAIRIE DROPSEED	1 GAL.	638 1138	18" O.C. 18" O.C.	
PERENNI ECP	ALS ECHINACEA PURPUREA 'FATAL ATTRACTION'	FATAL ATTRACTION PURPLE CONEFLOWER	1 GAL.	422	18" O C	
		FATAL ATTRACTION PURPLE CONEFLOWER	1 GAL.	422	18" O.C.	
HEP	HEMEROCALLIS 'PARDON ME'	PARDON ME DAYLILY	1 GAL.	592	15" O.C.	
LPP	LIATRIS PYCNOSTACHYA	PRAIRIE BLAZING STAR	1 GAL.	422	18" O.C.	
NEW	NEPETA X FAASSENNII 'WALKER'S LOW'	WALKER'S LOW CATMINT	1 GAL.	866	18" O.C.	
RSV	RUDBECKIA SPECIOSA 'VIETTE'S LITTLE SUZY'	DWARF BLACK-EYED SUSAN	1 GAL.	592	15" O.C.	
GROUND	COVER					
EFC	EUONYMUS FORTUNEI 'COLORATUS'	PURPLE LEAF WINTERCREEPER	1 QT.	540	18" O.C.	
BULBS			A	· · · · · · · · · · · · · · · · · · ·		
AHS	ALLIUM HOLLANDICUM 'SENSATION'	ORNAMENTAL ONION	TOP SIZE	1776	INTERPLANT W/ GRASSES	
NAF	NARCISSUS 'FORTISSIMO'	FORTISSIMO DAFFODIL	TOP SIZE	844	INTERPLANT W/ PER.	
NAT	NARCISSUS 'TETE A TETE'	TETE A TETE DAFFODIL	TOP SIZE	2050	INTERPLANT W/ PER.	
LANDSCA	APE MATERIALS SOIL CONDITIONER		SY	7 0400		
	SEEDING, CLASS 2A		ACRE	2180 0.27		
	DEEDING, OLAGO ZA					

GENERAL	NOTES:

- 1. SEE SHEET L-05 FOR LAYOUT PLAN.
- 2. SEE SHEET L-07 FOR IRRIGATION PLAN.
- 3. SEE SHEET L-08 FOR LANDSCAPE DETAILS.
- 4. SEE SHEET L-09 FOR OVERALL PLANT LIST.
- 5. THE LOCATION OF ALL PLANT MATERIAL SHALL BE STAKED BY CONTRACTOR FOR APPROVAL BY ENGINEER IN FIELD, PRIOR TO INSTALLATION. INDIVIDUAL TREES SHALL BE STAKED WITH IDENTITIES WRITTEN ON STAKES. SHRUB BEDS SHALL BE OUTLINED WITH STAKES AND PAINTED LINES.
- 6. ALL ROADWAY, SEWER, ELECTRICAL AND OTHER UTILITY WORK (EXCEPT FOR IRRIGATION) SHALL BE CONSTRUCTED BY OTHERS. ADJUSTMENTS TO INSTALLED UTILITIES MAY HAVE BEEN MADE DURING CONSTRUCTION THAT ARE NOT INDICATED ON THESE PLANS. CONTRACTOR SHALL COORDINATE LANDSCAPE AND IRRIGATION WORK WITH WORK BY OTHER CONTRACTORS AND SHALL NOTIFY ENGINEER OF POTENTIAL CONFLICTS. CONTRACTOR SHALL PROTECT ALL UTILITIES AND OTHER FACILITIES, NEW AND EXISTING, DURING THE COURSE OF INSTALLATION OF THE LANDSCAPE AND IRRIGATION SYSTEMS. REPAIRS SHALL BE PERFORMED BY THE CONTRACTOR AT NO ADDITIONAL COST TO IDOT OR CDOT.
- 7. NO STOCK-PILING OR STAGING ALLOWED ON CHICAGO PARKWAYS.


L-01

NAME D	ATE	ILLINOIS DEPARTMENT OF TRANSPORTATION	
		35th ST. GATEWAY	
		LANDSCAPE PLAN	
		STA. 420+00 TO STA. 426+50	

SCALE: 1"=40' DRAWN BY:

TE: MAR 13, 2008

CHECKED BY: JAE

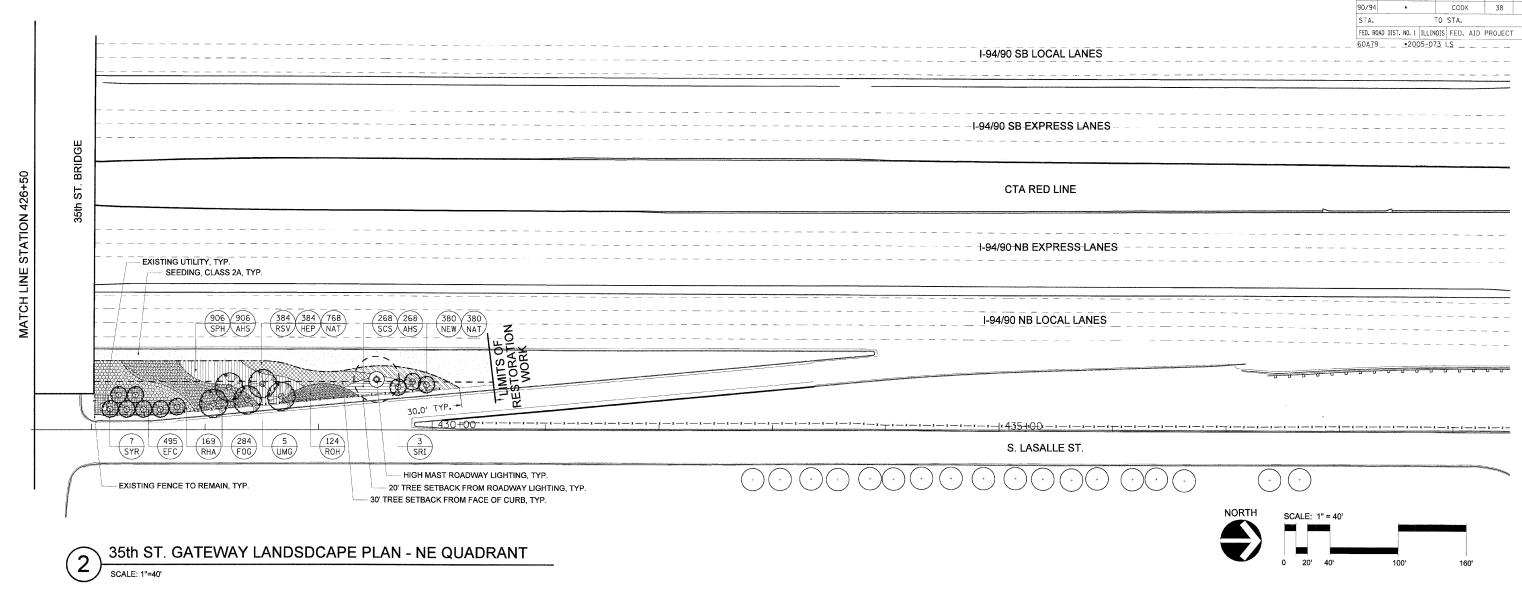

35th ST. GATEWAY LANDSCAPE PLANT LIST - NE QUADRANT

KEY	BOTANICAL NAME	COMMON NAME	SIZE	QUANTITY	SPACING	NOTES
SHADE TREE	S					
UMG	ULMUS J X W 'MORTON GLOSSY'	TRIUMPH ELM	3" CAL.	5	ON PLANS	B/B
RNAMENTA	L TREES					
SRI	SYRINGA RETICULATA 'IVORY SILK'	JAPANESE TREE LILAC	10' HT.	3	ON PLANS	HEAVY CLUMP B/B
SYR	SYRINGA RETICULATA 'IVORY SILK'	JAPANESE TREE LILAC	2.5" CAL.	7	ON PLANS	B/B
SHRUBS		•		· · · · · · · · · · · · · · · · · · ·		
FOG	FORSYTHIA X INTERMEDIA 'COURTACOUR'	GOLDILOCKS FORSYTHIA	18" HT. 5 GAL.	284	36" O.C.	
RHA	RHUS COPALLINA LATIFOLIA 'MORTON'	PRAIRIE FLAME SUMAC	3' HT. 5 GAL.	169	36" O.C.	
ROH	ROSA 'KNOCKOUT'	KNOCKOUT SHRUB ROSE	3 GAL.	124	30" O.C.	
ORNAMENTA						
SCS	SCHIZACHRIUM SCOPARIUM 'CAROUSEL'	CAROUSEL LITTLE BLUESTEM	1 GAL.	268	18" O.C.	
SPH	SPOROBOLUS HETEROLEPSIS	PRAIRIE DROPSEED	1 GAL.	906	18" O.C.	
PERENNIALS						
HEP	HEMEROCALLIS 'PARDON ME'	PARDON ME DAYLILY	1 GAL.	384	15" O.C.	
NEW	NEPETA X FAASSENNII 'WALKER'S LOW'	WALKER'S LOW CATMINT	1 GAL.	380	18" O.C.	
RSV	RUDBECKIA SPECIOSA 'VIETTE'S LITTLE SUSY'	DWARF BLACK-EYED SUSAN	1 GAL.	384	15" O.C.	
GROUNDCOV	/ER					
EFC	EUONYMUS FORTUNEI 'COLORATUS'	PURPLE LEAF WINTERCREEPER	1 QT.	495	18" O.C.	
BULBS						
AHS	ALLIUM HOLLANDICUM 'SENSATION'	ORNAMENTAL ONION	TOP SIZE	1174	INTERPLANT W/ GRASSES	
NAT	NARCISSUS 'TETE A TETE'	TETE A TETE DAFFODIL	TOP SIZE	1148	INTERPLANT W/ PER,	***************************************
ANDSCAPE	MATERIALS					
	SOIL CONDITIONER		SY	1205		
	COLE COLLECT					


GENERAL NOTES:

- 1. SEE SHEET L-05 FOR LAYOUT PLAN.
- 2. SEE SHEET L-07 FOR IRRIGATION PLAN.
- 3. SEE SHEET L-08 FOR LANDSCAPE DETAILS.
- 4. SEE SHEET L-09 FOR OVERALL PLANT LIST.
- 5. THE LOCATION OF ALL PLANT MATERIAL SHALL BE STAKED BY CONTRACTOR FOR APPROVAL BY ENGINEER IN FIELD, PRIOR TO INSTALLATION. INDIVIDUAL TREES SHALL BE STAKED WITH IDENTITIES WRITTEN ON STAKES. SHRUB BEDS SHALL BE OUTLINED WITH STAKES AND PAINTED LINES.
- 6. ALL ROADWAY, SEWER, ELECTRICAL AND OTHER UTILITY WORK (EXCEPT FOR IRRIGATION) SHALL BE CONSTRUCTED BY OTHERS. ADJUSTMENTS TO INSTALLED UTILITIES MAY HAVE BEEN MADE DURING CONSTRUCTION THAT ARE NOT INDICATED ON THESE PLANS. CONTRACTOR SHALL COORDINATE LANDSCAPE AND IRRIGATION WORK WITH WORK BY OTHER CONTRACTORS AND SHALL NOTIFY ENGINEER OF POTENTIAL CONFLICTS. CONTRACTOR SHALL PROTECT ALL UTILITIES AND OTHER FACILITIES, NEW AND EXISTING, DURING THE COURSE OF INSTALLATION OF THE LANDSCAPE AND IRRIGATION SYSTEMS. REPAIRS SHALL BE PERFORMED BY THE CONTRACTOR AT NO ADDITIONAL COST TO IDOT OR CDOT.
- 7. NO STOCK-PILING OR STAGING ALLOWED ON CHICAGO PARKWAYS.

L-02

COUNT

REVISIONS		TI	RANSPORTATIO			
NAME	DATE	11	LINOIS DEL ANTINI	INT OF I	NANSFURTALI	ЛΝ
***************************************			OEth OT	\triangle	T \ \ \ \ \ \ \	
	-		35th ST	. GAT	EVVAY	
			LANDO	~ ^ ¬	DIANI	
			LANDS	JAPE	PLAN	
			STA. 426+	50 TO STA.	430+50	
			411-401			
		SCALE:	1"=40'		DRAWN BY:	RPS
		DATE	MAD 42 2000			

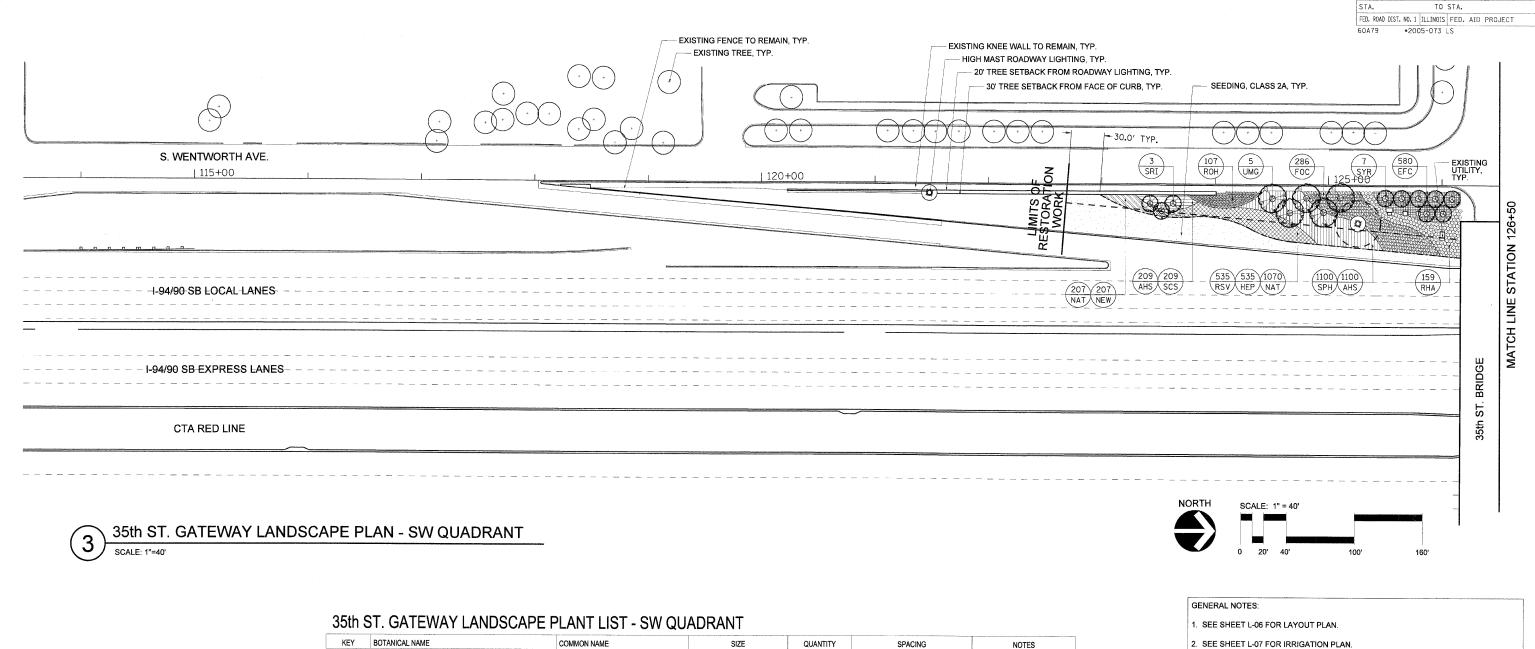

KEY	BOTANICAL NAME	COMMON NAME	SIZE	QUANTITY	SPACING	NOTES
SHADE TRE	ES					
UMG	ULMUS J X W 'MORTON GLOSSY'	TRIUMPH ELM	3" CAL.	5	ON PLANS	CLUMP FORM B/B
ORNAMENT	AL TREES					
SRI	SYRINGA RETICULATA 'IVORY SILK'	JAPANESE TREE LILAC	10' HT.	3	ON PLANS	HEAVY CLUMP B/B
SYR	SYRINGA RETICULATA 'IVORY SILK'	JAPANESE TREE LILAC	2.5" CAL.	7	ON PLANS	B/B
SHRUBS						
FOC	FORSYTHIA X INTERMEDIA 'COURDIJAU'	GOLDEN PEEP FORSYTHIA	18" HT. 5 GAL.	286	36" O.C.	
RHA	RHUS COPALLINA LATIFOLIA 'MORTON'	PRAIRIE FLAME SUMAC	3' HT. 5 GAL.	159	36" O.C.	
ROH	ROSA 'KNOCKOUT'	KNOCKOUT SHRUB ROSE	3 GAL.	107	30" O.C.	
	AL GRASSES	7				
SCS	SCHIZACHRUIM SOCPARIUM 'CAROUSEL'	CAROUSEL LITTLE BLUESTEM	1 GAL.	209	18" O.C.	
SPH	SPORABOLUS HETEROLEPSIS	PRAIRIE DROPSEED	1 GAL.	1100	18" O.C.	
PERENNIAL	S					
HEP	HEMEROCALLIS 'PARDON ME'	PARDON ME DAYLILY	1 GAL.	535	15" O.C.	
NEW	NEPETA X FAASSENNII 'WALKER'S LOW'	WALKER'S LOW CATMINT	1 GAL.	207	18" O.C.	
RSV	RUDBECKIA SPECIOSA 'VIETTE'S LITTLE SUZY'	DWARF BLACK-EYED SUSAN	1 GAL.	535	15™ O.C.	
GROUNDCO	OVER					
EFC	EUONYMUS FORTUNEI 'COLORATUS'	PURPLE LEAF WINTERCREEPER	1 QT.	580	18" O.C.	
BULBS						
AHS	ALLIUM HOLLANDICUM 'SENSATION'	ORNAMENTAL ONION	TOP SIZE	1309	INTERPLANT W/ GRASSES	
NAT	NARCISSUS 'TETE A TETE'	TETE A TETE DAFFODIL	TOP SIZE	1277	INTERPLANT W/ PER.	
	· · · · · · · · · · · · · · · · · · ·					
.ANDSCAPE	MATERIALS					
LANDSCAPE	E MATERIALS SOIL CONDITIONER	i	SY	1260		

- 3. SEE SHEET L-08 FOR LANDSCAPE DETAILS.
- 4. SEE SHEET L-09 FOR OVERALL PLANT LIST.
- 5. THE LOCATION OF ALL PLANT MATERIAL SHALL BE STAKED BY CONTRACTOR FOR APPROVAL BY ENGINEER IN FIELD, PRIOR TO INSTALLATION. INDIVIDUAL TREES SHALL BE STAKED WITH IDENTITIES WRITTEN ON STAKES. SHRUB BEDS SHALL BE OUTLINED WITH STAKES AND PAINTED LINES.

SECTION

90/94

COUNTY

СООК


38 19

- 6. ALL ROADWAY, SEWER, ELECTRICAL AND OTHER UTILITY WORK (EXCEPT FOR IRRIGATION) SHALL BE CONSTRUCTED BY OTHERS. ADJUSTMENTS TO INSTALLED UTILITIES MAY HAVE BEEN MADE DURING CONSTRUCTION THAT ARE NOT INDICATED ON THESE PLANS. CONTRACTOR SHALL COORDINATE LANDSCAPE AND IRRIGATION WORK WITH WORK BY OTHER CONTRACTORS AND SHALL NOTIFY ENGINEER OF POTENTIAL CONFLICTS. CONTRACTOR SHALL PROTECT ALL UTILITIES AND OTHER FACILITIES, NEW AND EXISTING, DURING THE COURSE OF INSTALLATION OF THE LANDSCAPE AND IRRIGATION SYSTEMS. REPAIRS SHALL BE PERFORMED BY THE CONTRACTOR AT NO ADDITIONAL COST TO IDOT OR CDOT.
- 7. NO STOCK-PILING OR STAGING ALLOWED ON CHICAGO PARKWAYS.

L-03

				~~~					
REVISIONS		TII	INOIS	DEPAR	TMENT	OF T	TRANSP	ORTATIO	NI
ME [	ATE		111010	DEI AIT	· MILITA	01	IIIAIIOI	ONTATIO	14
				oth S					
				STA. 12	2+50 T	STA	. 126+50	)	
		SCALE:	1"=40'				DRAWN	N BY:	RPS

DATE: MAR 13, 2008

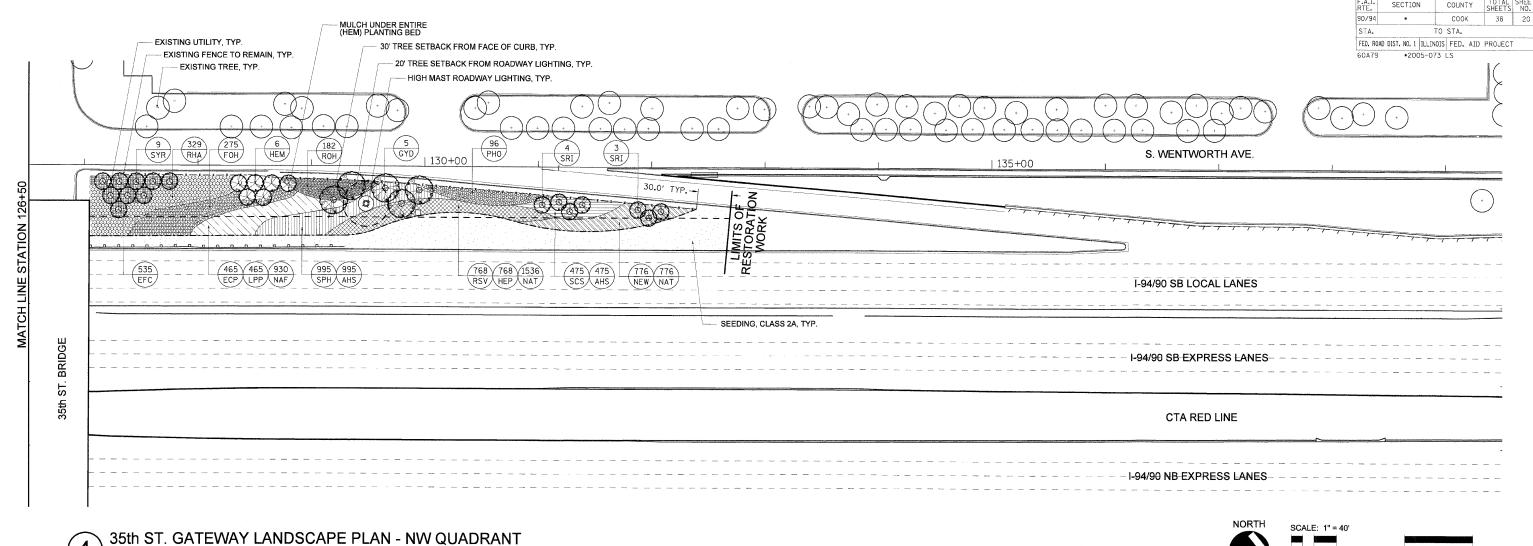

# 35th ST. GATEWAY LANDSCAPE PLANT LIST - NW QUADRANT

KEY	BOTANICAL NAME	COMMON NAME	SIZE	QUANTITY	SPACING	NOTES
SHADE TREES	S					
GYD	GYMNOCLADUS DIOICA	KENTUCKY COFFEE TREE	10' HT.	5	ON PLANS	CLUMP FOR B/B
			<u> </u>			
ORNAMENTAL	LTREES					
	SYRINGA RETICULATA 'IVORY SILK'	JAPANESE TREE LILAC	10' HT.	7	ON PLANS	HEAVY CLUMP B/B
SYR	SYRINGA RETICULATA 'IVORY SILK'	JAPANESE TREE LILAC	2.5" CAL.	9	ON PLANS	B/B
SHRUBS						
FOH	FORSYTHIA X INTERMEDIA 'HAPPY CENTENNIAL'	HAPPY CENTENNIAL FORSYTHIA	18" HT. 5 GAL.	275	36" O.C.	
HEM	HEPTACODIUM MICONIOIDES	SEVEN-SON FLOWER	8' HT.	6	ON PLANS	HEAVY CLUMP B/B
PHO	PHYSOCARPUS OPULIFOLIUS 'SUMMER WINE'	SUMMER WINE COMMON NINEBARK	2 1/2' HT. 5 GAL.	96	42" O.C.	
RHA	RHUS COPALLINA LATIFOLIA 'MORTON'	PRAIRIE FLAME SUMAC	3' HT. 5 GAL.	329	36" O.C.	
ROH	ROSA 'KNOCKOUT'	KNOCKOUT SHRUB ROSE	3 GAL.	182	30" O.C.	
ORNAMENTAL SCS	L GRASSES SCHIZACHRIUM SCOPARIUM 'CAROUSEL'	CAROUSELLITTLE BLUESTEM	1 GAL.	475	18" O.C.	
	SPOROBOLUS HETEROLEPSIS	PRAIRIE DROPSEED	1 GAL.	995	18" O.C.	
PERENNNIALS ECP	S ECHINACEA PURPUREA 'FATAL ATTRACTION'	FATAL ATTRACTION PURPLE CONEFLOWER	1 GAL.	465	18" O.C.	
HEP	HEMEROCALLIS 'PARDON ME'	PARDON ME DAYLILY	1 GAL.	768	15" O.C.	
LPP	LIATRIS PYCNOSTACHYA	PRAIRIE BLAZING STAR	1 GAL.	465	18" O.C.	
NEW	NEPETA X FAASSENII 'WALKER'S LOW'	WALKER'S LOW CATMINT	1 GAL.	776	18" O.C.	
RSV	RUDBECKIA SPECIOSA 'VIETTE'S LITTLE SUZY'	DWARF BLACK-EYED SUSAN	1 GAL.	768	15" O.C.	
GROUNDCOV	ER					
EFC	EUONYMUS FORTUNEI 'COLORATUS'	PURPLE LEAF WINTERCREEPER	1 QT.	535	18" O.C.	
BULBS				mana di sensa sensi s		***************************************
AHS	ALLIUM HOLLANDICUM 'SENSATION'	ORNAMENTAL ONION	TOP SIZE	1470	INTERPLANT W/ GRASSES	
NAF	NARCISSUS 'FORTISSIMO'	FORTISSIMO DAFFODIL	TOP SIZE	930	INTERPLANT W/ PER.	
NAT	NARCISSUS 'TETE A TETE'	TETE A TETE DAFFODIL	TOP SIZE	2312	INTERPLANT W/ PER.	
ANDSCAPE N	WATERIALS					
	SOIL CONDITIONER		SY	2180		×
	SEEDING, CLASS 2A		ACRE	0.25		





### GENERAL NOTES:

- 1. SEE SHEET L-06 FOR LAYOUT PLAN.
- 2. SEE SHEET L-07 FOR IRRIGATION PLAN.
- 3. SEE SHEET L-08 FOR LANDSCAPE DETAILS.
- 4. SEE SHEET L-09 FOR OVERALL PLANT LIST.
- 5. THE LOCATION OF ALL PLANT MATERIAL SHALL BE STAKED BY CONTRACTOR FOR APPROVAL BY ENGINEER IN FIELD, PRIOR TO INSTALLATION. INDIVIDUAL TREES SHALL BE STAKED WITH IDENTITIES WRITTEN ON STAKES. SHRUB BEDS SHALL BE OUTLINED WITH STAKES AND PAINTED LINES.
- 6. ALL ROADWAY, SEWER, ELECTRICAL AND OTHER UTILITY WORK (EXCEPT FOR IRRIGATION) SHALL BE CONSTRUCTED BY OTHERS. ADJUSTMENTS TO INSTALLED UTILITIES MAY HAVE BEEN MADE DURING CONSTRUCTION THAT ARE NOT INDICATED ON THESE PLANS. CONTRACTOR SHALL COORDINATE LANDSCAPE AND IRRIGATION WORK WITH WORK BY OTHER CONTRACTORS AND SHALL NOTIFY ENGINEER OF POTENTIAL CONFLICTS. CONTRACTOR SHALL PROTECT ALL UTILITIES AND OTHER FACILITIES, NEW AND EXISTING, DURING THE COURSE OF INSTALLATION OF THE LANDSCAPE AND IRRIGATION SYSTEMS. REPAIRS SHALL BE PERFORMED BY THE CONTRACTOR AT NO ADDITIONAL COST TO IDOT OR COOT.
- 7. NO STOCK-PILING OR STAGING ALLOWED ON CHICAGO PARKWAYS.

L-04

REVISIONS		ILLINOIS DEPARTMENT OF TRANSPORTAT					
NAME	DATE	16.0	TINOIS DEL AINT	WILLIAI OI II	NANSFOR LATE	'IN	
			35th S	$T \wedge AT$	T\A/A\/		
· · · · · · · · · · · · · · · · · · ·	-		ວວແາ ວ	I. GAI			
	<del></del>		LAND		DIANI		
			LAND	SCAPE	PLAN		
***************************************							
			STA. 126	S+50 TO ŠTA.	132+75		
		SCALE:	1"=40'		DRAWN BY:	RPS	
					DIVERS DIE	IN O	
		DΔTF:	MAR 13 2008		CHECKED BY-	IAT	

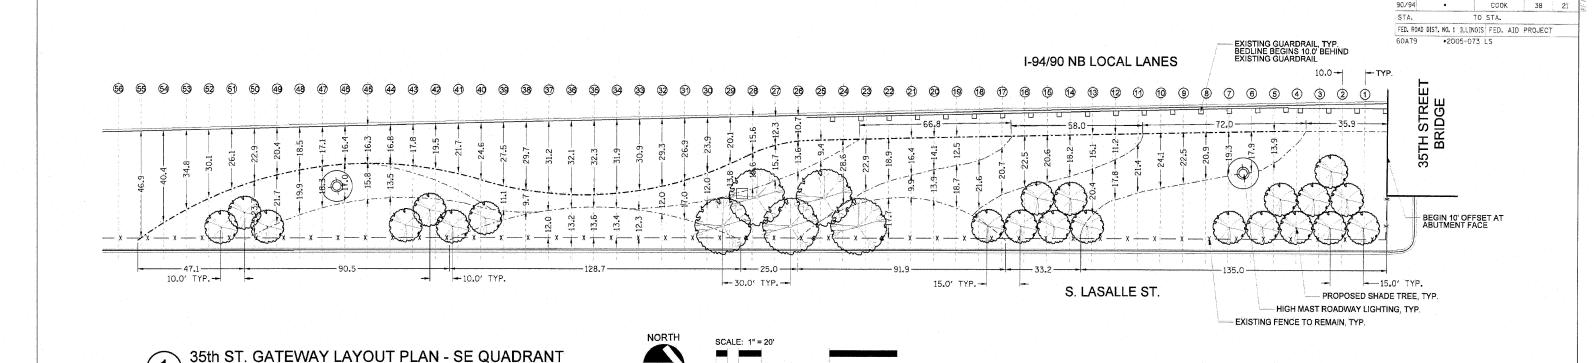

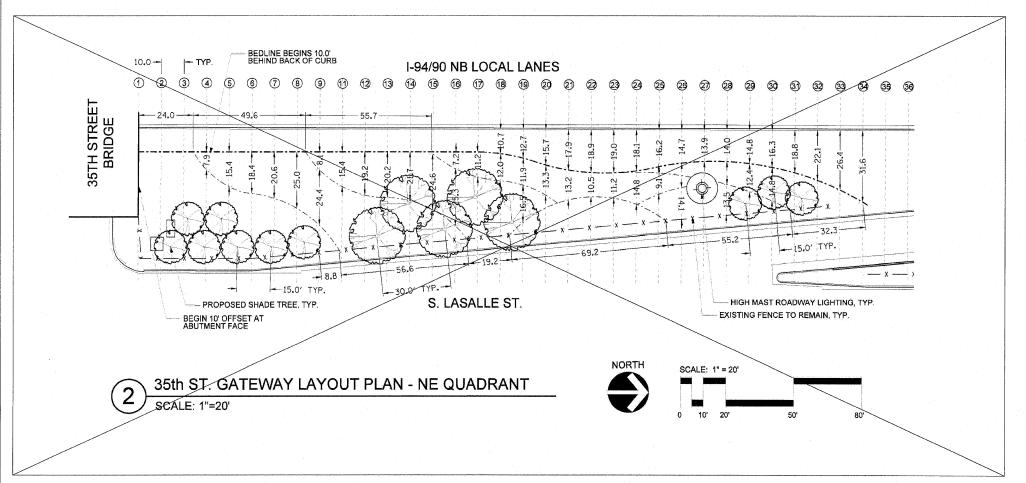

NE QUADRANT REMOVED FROM THIS CONTRACT



SCALE: 1"=20"

GENERAL NOTES:

1. SEE SHEETS L-01 AND L-02 FOR LANDSCAPE PLANS.

2. SEE SHEET L-07 FOR IRRIGATION PLAN.

3. SEE SHEET L-08 FOR LANDSCAPE DETAILS.

4. SEE SHEET L-09 FOR OVERALL PLANT LIST.

5. THE LOCATION OF ALL PLANT MATERIAL SHALL BE STAKED BY CONTRACTOR FOR APPROVAL BY ENGINEER IN FIELD, PRIOR TO INSTALLATION. INDIVIDUAL TREES SHALL BE STAKED WITH IDENTITIES WRITTEN ON STAKES. SHRUB BEDS SHALL BE OUTLINED WITH STAKES AND PAINTED LINES.

SECTION

90/94

COUNTY COOK

6. ALL ROADWAY, SEWER, ELECTRICAL AND OTHER UTILITY WORK (EXCEPT FOR IRRIGATION) SHALL BE CONSTRUCTED BY OTHERS. ADJUSTMENTS TO INSTALLED UTILITIES MAY HAVE BEEN MADE DURING CONSTRUCTION THAT ARE NOT INDICATED ON THESE PLANS. CONTRACTOR SHALL COORDINATE LANDSCAPE AND IRRIGATION WORK WITH WORK BY OTHER CONTRACTORS AND SHALL NOTIFY ENGINEER OF POTENTIAL CONFLICTS. CONTRACTOR SHALL PROTECT ALL UTILITIES AND OTHER FACILITIES, NEW AND EXISTING, DURING THE COURSE OF INSTALLATION OF THE LANDSCAPE AND IRRIGATION SYSTEMS. REPAIRS SHALL BE PERFORMED BY THE CONTRACTOR AT NO ADDITIONAL COST TO IDOT OR COOT.


7. NO STOCK-PILING OR STAGING ALLOWED ON CHICAGO PARKWAYS.


DRAWN BY: RPS

L-05


ILLINOIS DEPARTMENT OF TRANSPORTATION 35th ST. GATEWAY LAYOUT STA. 413+75 TO STA. 426+50

SCALE: 1"=20"

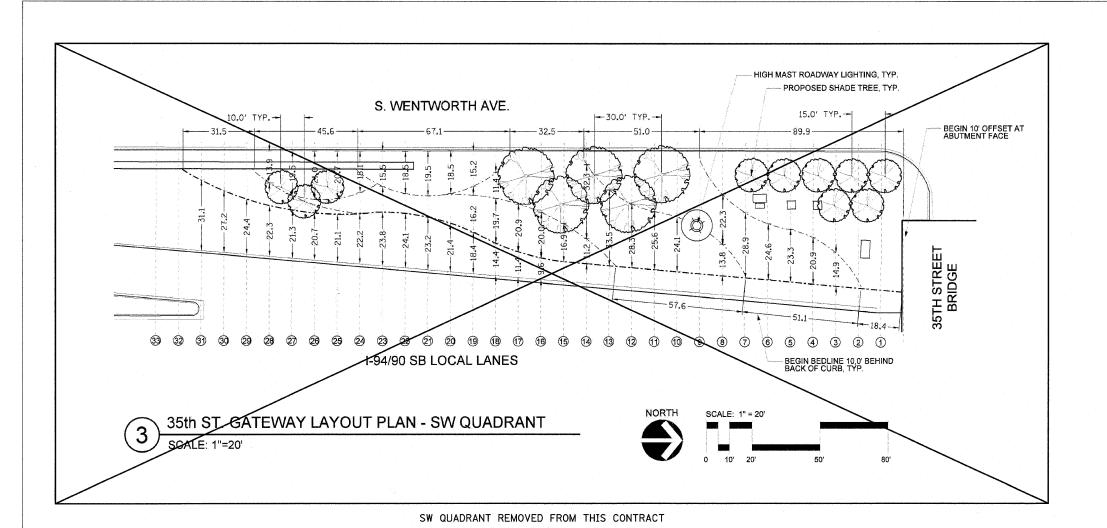

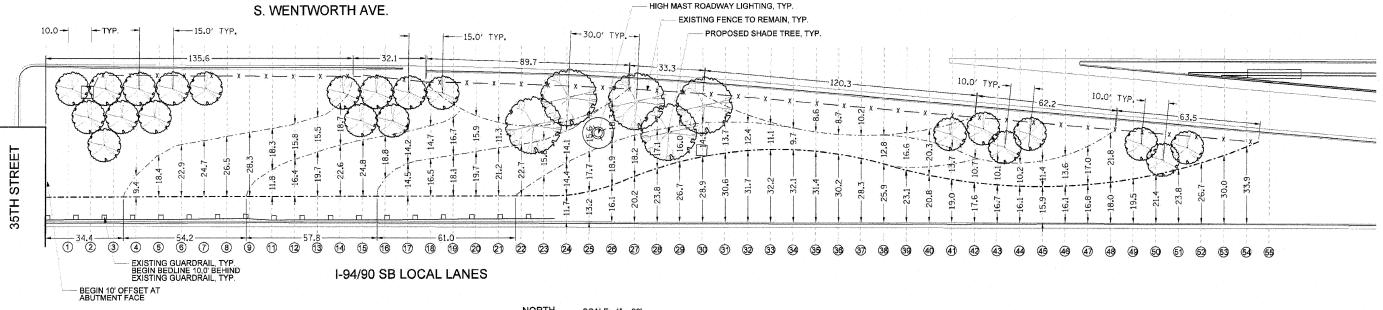

35th ST. GATEWAY LAYOUT PLAN - NW QUADRANT
SCALE: 1"=20"

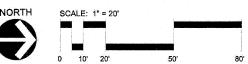

•2005-073 LS

GENERAL NOTES:

1. SEE SHEETS L-03 AND L-04 FOR LANDSCAPE PLANS

2. SEE SHEET L-07 FOR IRRIGATION PLAN.

3. SEE SHEET L-08 FOR LANDSCAPE DETAILS.

4. SEE SHEET L-09 FOR OVERALL PLANT LIST.

5. THE LOCATION OF ALL PLANT MATERIAL SHALL BE STAKED BY CONTRACTOR FOR APPROVAL BY ENGINEER IN FIELD, PRIOR TO INSTALLATION, INDIVIDUAL TREES SHALL BE STAKED WITH IDENTITIES WRITTEN ON STAKES. SHRUB BEDS SHALL BE OUTLINED WITH STAKES AND PAINTED LINES.

60A79

6. ALL ROADWAY, SEWER, ELECTRICAL AND OTHER UTILITY WORK (EXCEPT FOR IRRIGATION) SHALL BE CONSTRUCTED BY OTHERS. ADJUSTMENTS TO INSTALLED UTILITIES MAY HAVE BEEN MADE DURING CONSTRUCTION THAT ARE NOT INDICATED ON THESE PLANS. CONTRACTOR SHALL COORDINATE LANDSCAPE AND IRRIGATION WORK WITH WORK BY OTHER CONTRACTORS AND SHALL NOTIFY ENGINEER OF POTENTIAL CONFLICTS. CONTRACTOR SHALL PROTECT ALL UTILITIES AND OTHER FACILITIES, NEW AND EXISTING, DURING THE COURSE OF INSTALLATION OF THE LANDSCAPE AND IRRIGATION SYSTEMS. REPAIRS SHALL BE PERFORMED BY THE CONTRACTOR AT NO ADDITIONAL COST TO IDDT OR CDOT.

7. NO STOCK-PILING OR STAGING ALLOWED ON CHICAGO PARKWAYS.

L-06

DRAWN BY: RPS

CHECKED BY:

REVISIONS

AME DATE

TISED 4.25.08

D BY BBA 9/19/08

35th ST. GATEWAY


LAYOUT PLAN


WESTERN QUADRANTS

MAR 13, 2008


SCALE: 1"=40"

DATE:

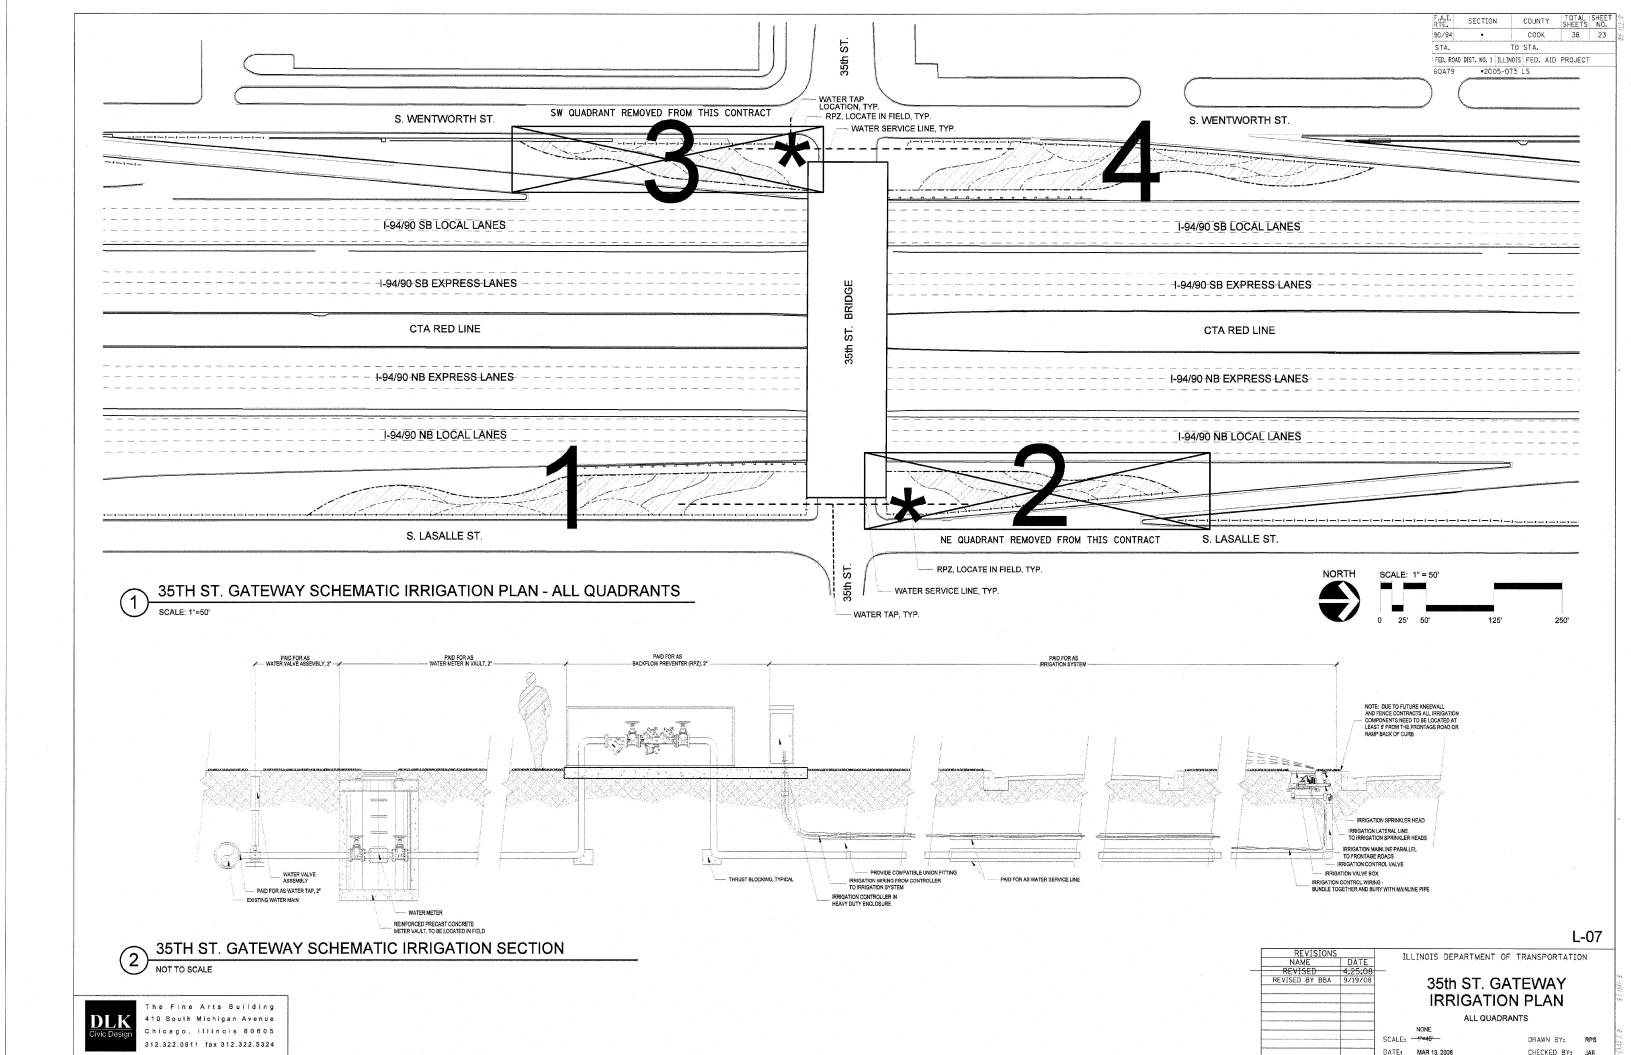


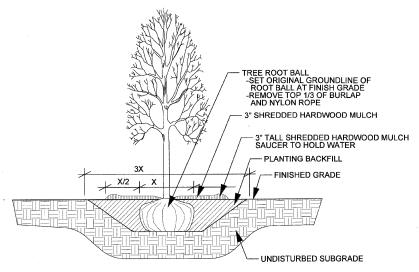

1 SHADE TREE PLANTING DETAIL

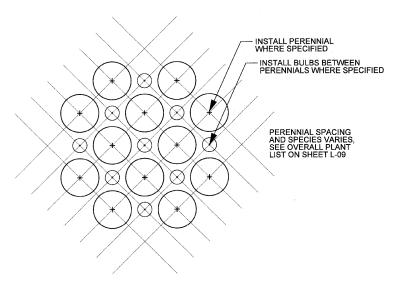


(4) INTERPLANTING DETAIL

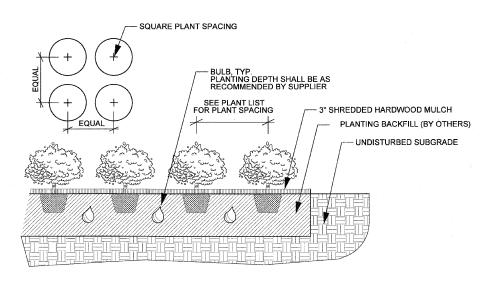


PERENNIAL AND BULB PLANTING DETAIL

No Scale

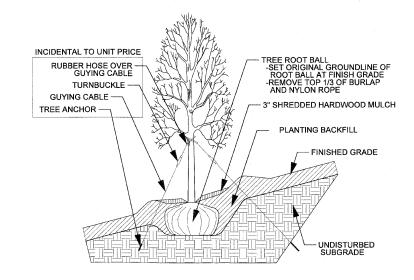

TREE PLANTING ON SLOPE DETAIL

No Scale

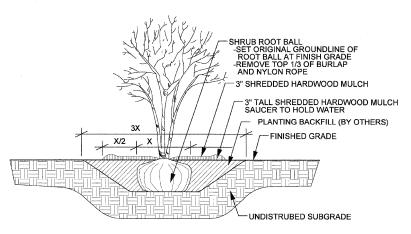

SECTION


STA.

COUNTY

TO STA.

FED. ROAD DIST. NO. 1 | ILLINOIS | FED. AID PROJECT 60A79 *2005-073 LS

3) SHRUB PLANTING DETAIL

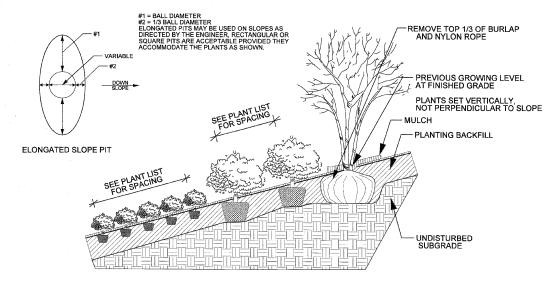

PERENNIAL AND SHRUB PLANTING ON SLOPE DETAIL


No Scale

3" ORGANIC MULCH, SEE SPECS
PLANTING BACKFILL
UNDISTURBED SUBGRADE

INCORPORATE TOGETHER BY ROTO-TILLING TO DEPTH OF 12"

7) SOIL AMENDMENT, ORGANIC


NOTE: ANY CLAY SOIL EXCAVATED FOR TREE OR SHRUB INSTALLATION SHALL BE REMOVED FROM SITE AND HOLE BACKFILLED WITH TOPSOIL FROM UPPER PORTION OF EXCAVATION.

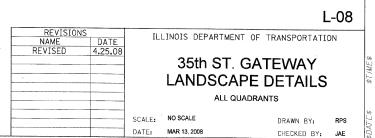

25+h	CT	CATEMAY	LANDSCAPE -	OVERALL	TOT LIMA ID
$30\mathrm{m}$	JI.	UHIEWHI	LHNDOCHEE -	UVENHLL	LTHINI FIDI

KEY	BOTANICAL NAME	COMMON NAME	SIZE	QUANTITY	SPACING	NOTES	L-Ø1	L-Ø2	L-Ø3	
SHADE TR	EES									
GYD	GYMNOCLADUS DIOICA	KENTUCKY COFFEE TREE	10' HT.	10	ON PLANS	CLUMP FORM B/B	5			
UMG	ULMUS J X W 'MORTON GLOSSY'	TRIUMPH-ELM	3ª CAL.	10	ON PLANS	B/B		5	5	
							<u> </u>			
ORNAMENT	AL TREES									
SRI	SYRINGA RETICULATA 'IVORY SILK'	JAPANESE TREE LILAC	10' HT.	<del>-20</del> 14	ON PLANS	HEAVY CLUMP B/B	7.	3-	3-	
SYR	SYRINGA RETICULATA 'IVORY SILK'	JAPANESE TREE LILAC	2.5' CAL.	<del>32</del> 18	ON PLANS	B/B	9	<del>-7-</del>	<del>-7-</del>	
SHRUBS FOC	FORSYTHIA X INTERMEDIA 'COURDIJAU'	GOLDEN PEEP FORSYTHIA	18ª HT. 5 GAL.	286	36' 0.C.			1	286	Г
FOG	FORSYTHIA X INTERMEDIA 'COURTACOUR'	GOLDILOCKS FORSYTHIA	18" HT. 5 GAL.	284	36' 0.C.			284	200	E
FOH	FORSYTHIA X INTERMEDIA 'HAPPY CENTENNIAL'	HAPPY CENTENNIAL FORSYTHIA	18' HT. 5 GAL.	542	36° O.C.		267	204		-
HEM	HEPTACODIUM MICONIOIDES	SEVEN-SON FLOWER	8' HT.	12	ON PLANS	HEAVY CLUMP B/B	6			-
PHO	PHYSOCARPUS OPULIFOLIUS 'SUMMER WINE'	SUMMER WINE COMMON NINEBARK	2 1/2' HT.5 GAL.	222	42' O.C.	TILHVI CLUM D/D	126			-
RHA	RHUS COPALLINA LATIFOLIA 'MORTON'	PRAIRIE FLAME SUMAC	3' HT. 5 GAL.	<del>968</del> 640	36° O.C.		311	169	<del>-159</del> -	-
ROH	ROSA 'KNOCKOUT'	KNOCKOUT SHRUB ROSE	3 GAL.	<del>623</del> 392	30° O.C.		210	124	107	
		· · · · · · · · · · · · · · · · · · ·								<u></u>
ORNAMENT	FAL GRASSES									
SCS	SCHIZACHRIUM SCOPARIUM 'CAROUSEL'	CAROUSEL LITTLE BLUESTEM	1 GAL.	<del>-1590</del> 1113	18° O.C.		638	-268-	-209-	
SPH	SPOROBOLUS HETEROLEPSIS	PRAIRIE DROPSEED	1 GAL.	<del>4139</del> 2133	18 <b>'</b> O.C.		1138	-906-	-1100-	
PERENNIAL				······································		· · · · · · · · · · · · · · · · · · ·	-			<del></del>
ECP	ECHINACEA PURPUREA 'FATAL ATTRACTION'	FATAL ATTRACTION PURPLE CONEFLOWER	1 GAL.	887	18' O.C.		422			<u> </u>
HEP	HEMEROCALLIS 'PARDON ME'	PARDON ME DAYLILY	1 GAL.	<del>-2279-</del> 1360	15 <b>'</b> 0.C.		592	384	-535-	<u> </u>
LPP	LIATRIS PYCNOSTACHYA	PRAIRIE BLAZING STAR	1 GAL.	887	18' O.C.		422			<u> </u>
NEW	NEPETA X FAASSENNII 'WALKER'S LOW'	WALKER'S LOW CATMINT	1 GAL.	<del>-2229-</del> 1642	18 <b>'</b> O.C.		866	380	-207-	
RSV	RUDBECKIA SPECIOSA 'VIETTE'S LITTLE SUZY'	DWARF BLACK-EYED SUSAN	1 GAL.	<del>-2279-</del> 1360	15 <b>'</b> O.C.		592	-384	-535	<u></u>
	OVED									
GROUNDC FFC	EUONYMUS FORTUNEI 'COLORATUS'	PURPLE LEAF WINTERCREEPER	1 QT.	<del>-2150</del> 1075	18 <b>'</b> 0.C.		540	495	-580	
EFU	EDUNTMOS FORTUNEI CULURHTOS	FORTLE LEHF WINTERCREEFER	1 41.	7130 1013	10 U _{*U_*}		340	470	300	<u></u>
2111 220										
BULBS	ALLIUM HOLLANDICUM 'SENSATION'	ORNAMENTAL ONION	TOP SIZE	<del>-5729</del> -3246	INTERPLANT W/ GRASSES		1776	-1174-	-1309-	Γ
BULBS AHS	The state of the s	FORTISSIMO DAFFODIL	TOP SIZE	1774	INTERPLANT W/ PER.	and a street measurement of the street measu	844			
	NARCISSUS 'FORTISSIMO'	LOUI 1991MO DHLLODIF			INTERPLANT W/ PER.		2050	-1148-	<del>-1277-</del>	
AHS		TETE A TETE DAFFODIL	TOP SIZE	<del>-6787-</del> 4362	INTENFLHNI W/ FER.		1 2200	1110	12//	
AHS NAF NAT	NARCISSUS 'FORTISSIMO' NARCISSUS 'TETE A TETE'		TOP SIZE	<del>-6787-</del> 4362	INTERFLHINT W/ FER.		2.500	1 1110	1277	-
AHS NAF NAT	NARCISSUS 'FORTISSIMO' NARCISSUS 'TETE A TETE'  E MATERIALS				INTENTEHNI W/ FER.					
AHS NAF NAT	NARCISSUS 'FORTISSIMO' NARCISSUS 'TETE A TETE'		TOP SIZE  SY  ACRE	<del>-6787-</del> 4362 <del>-6825-</del> 4360 <del>-8.79-</del> 0.56	INTENTENNI W/ FER.		218Ø Ø,27	-1205 -0.130.02	-1260-	

L-09

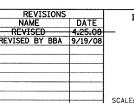


ILLINOIS DEPARTMENT OF TRANSPORTATION


35th ST. GATEWAY **OVERALL PLANT LIST** 


ALL QUADRANTS

SCALE: NO SCALE DATE: MAR 13, 2008


COOK STA. TO STA. **→**©→ Z FED. ROAD DIST. NO. | ILLINOIS | FED. AID PROJECT LEGEND: INLET FILTER EROSION CONTROL BLANKET 35th `. S. WENTWORTH AVE. S. WENTWORTH AVE. B S. WENTWORTH AVE. B RAMP 35A -B SB LOCAL LANES I-94/90 SB LOCAL LANES - B SB LOCAL LANES F B SB EXPRESS LANES I-94/90 SB EXPRESS LANES 11605+00 B NB EXPRESS LANES -I-94/90 NB EXPRESS LANES 1 4610+00 I-94/90 NB LOCAL LANES B NB LOCAL LANES -BE RAMP T39B-S. LA SALLE ST. ST. 35th ILLINOIS DEPARTMENT OF TRANSPORTATION F.A.I. 94/90 (DAN RYAN EXPRESSWAY) GATEWAY LANDSCAPING & IRRIGATION @ 35TH EROSION CONTROL PLAN BOWMAN, BARRETT & ASSOCIATES INC.
CONSULTING ENGINEERS
CHICAGO, ILLINOIS
312.228.0100
WWW.BBANDAINC.COM SCALE: 1"=50 DRAWN BY: JMP DATE: 03/13/07 CHECKED BY: RS

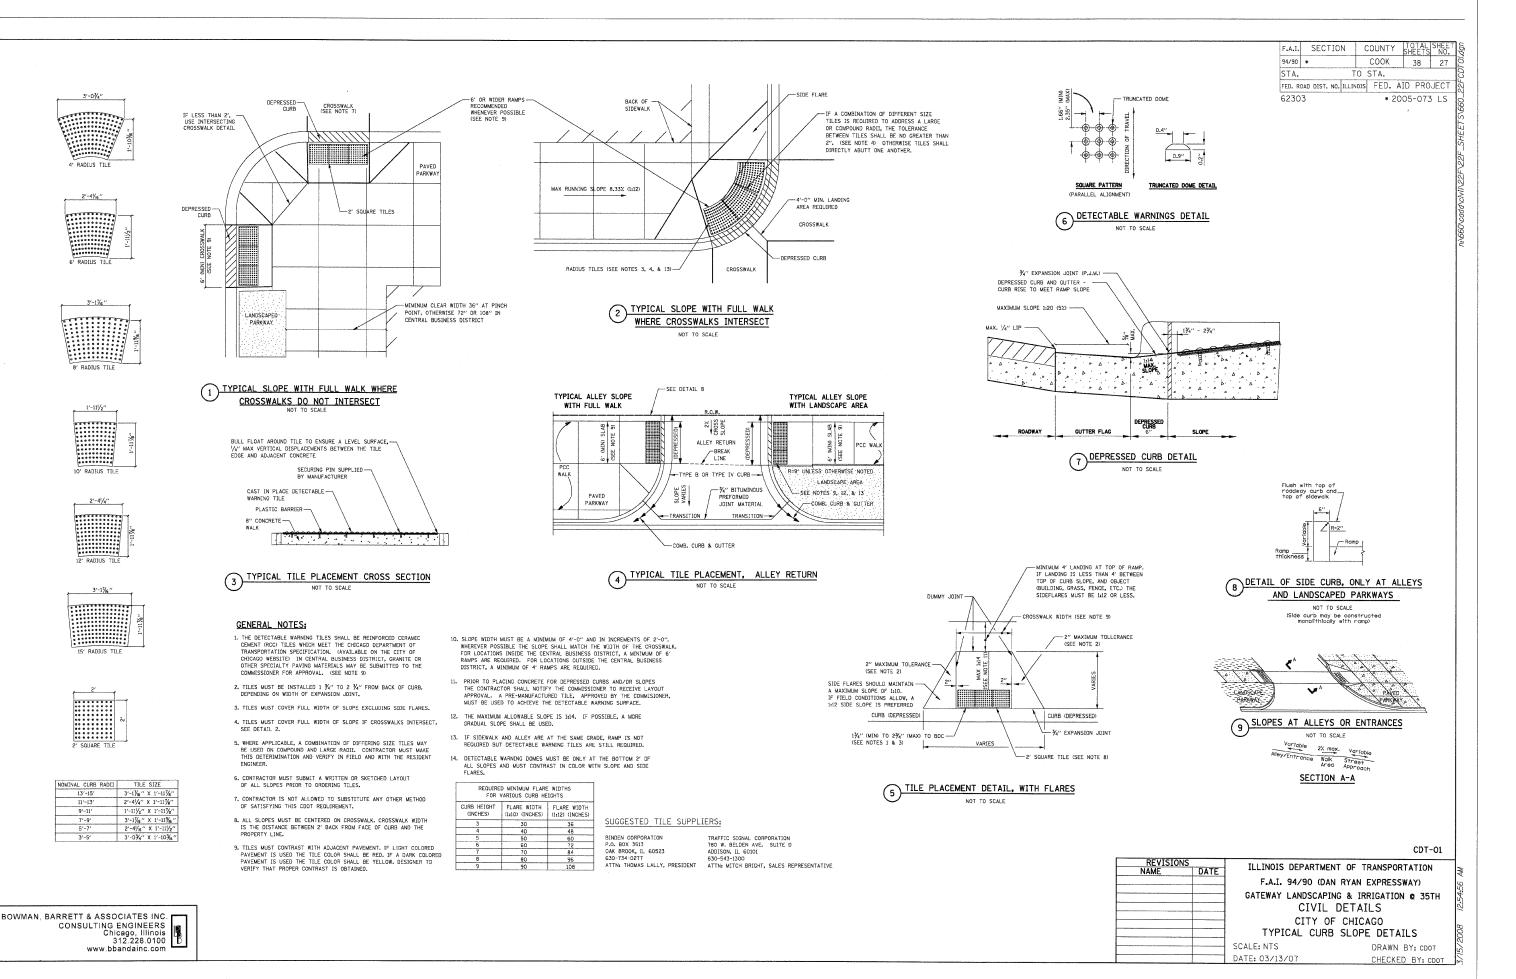

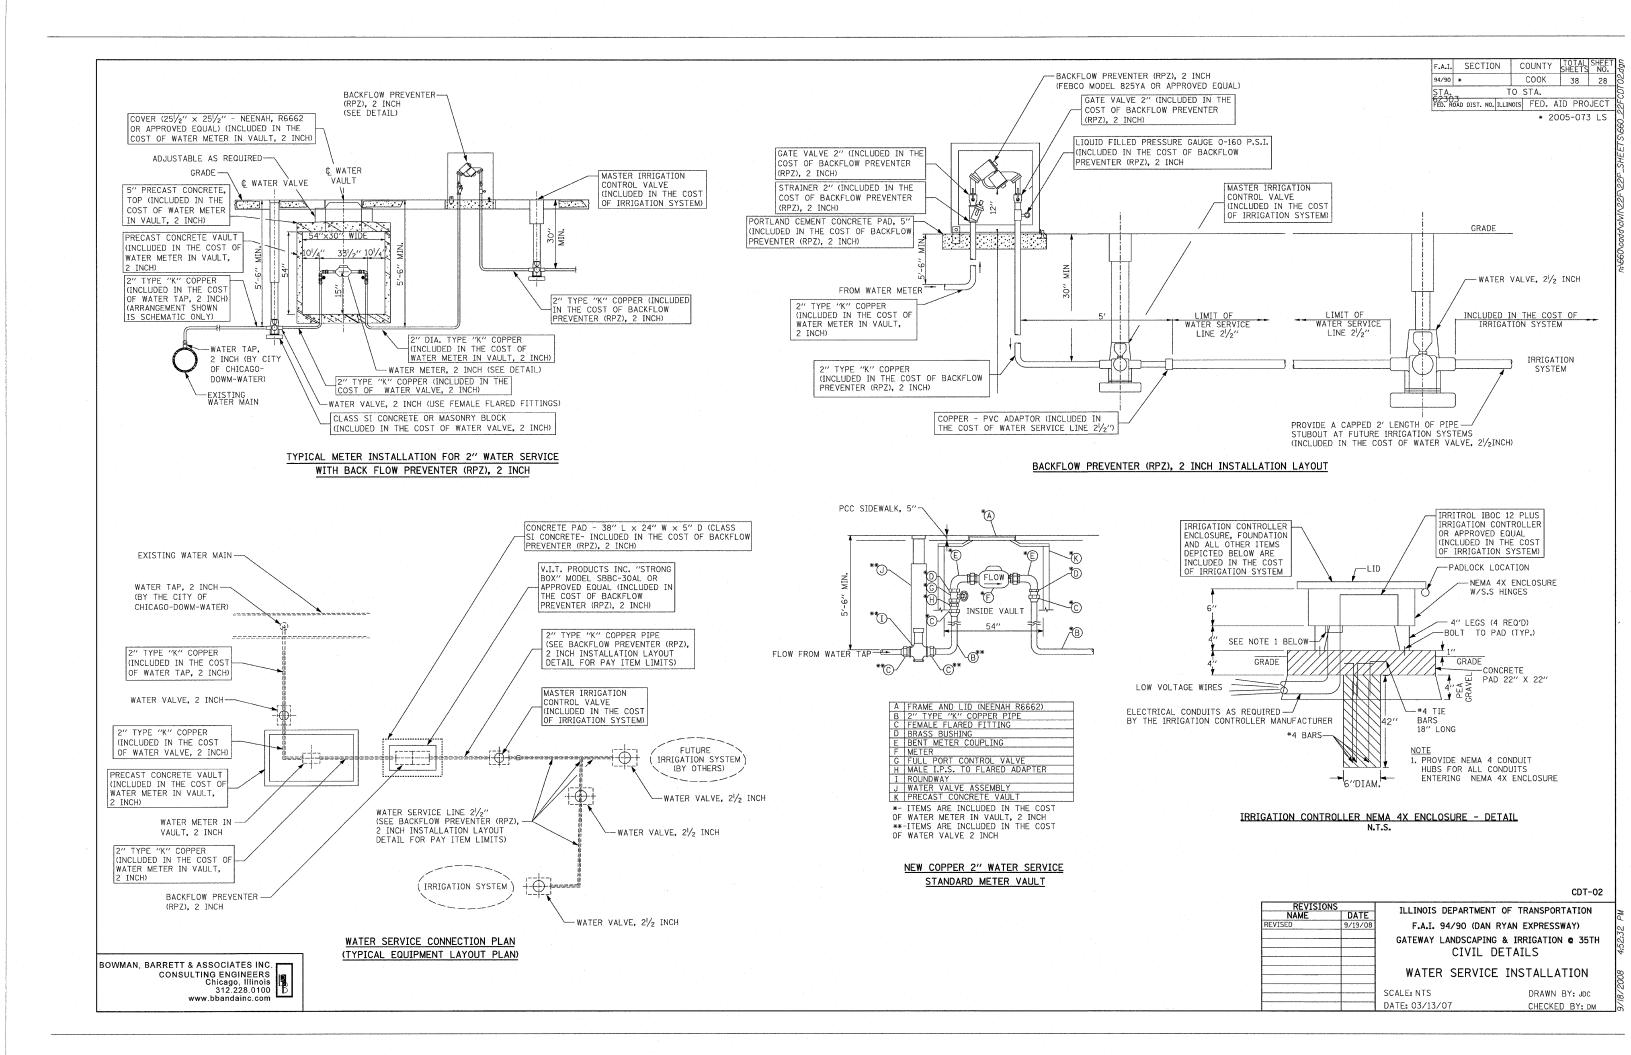

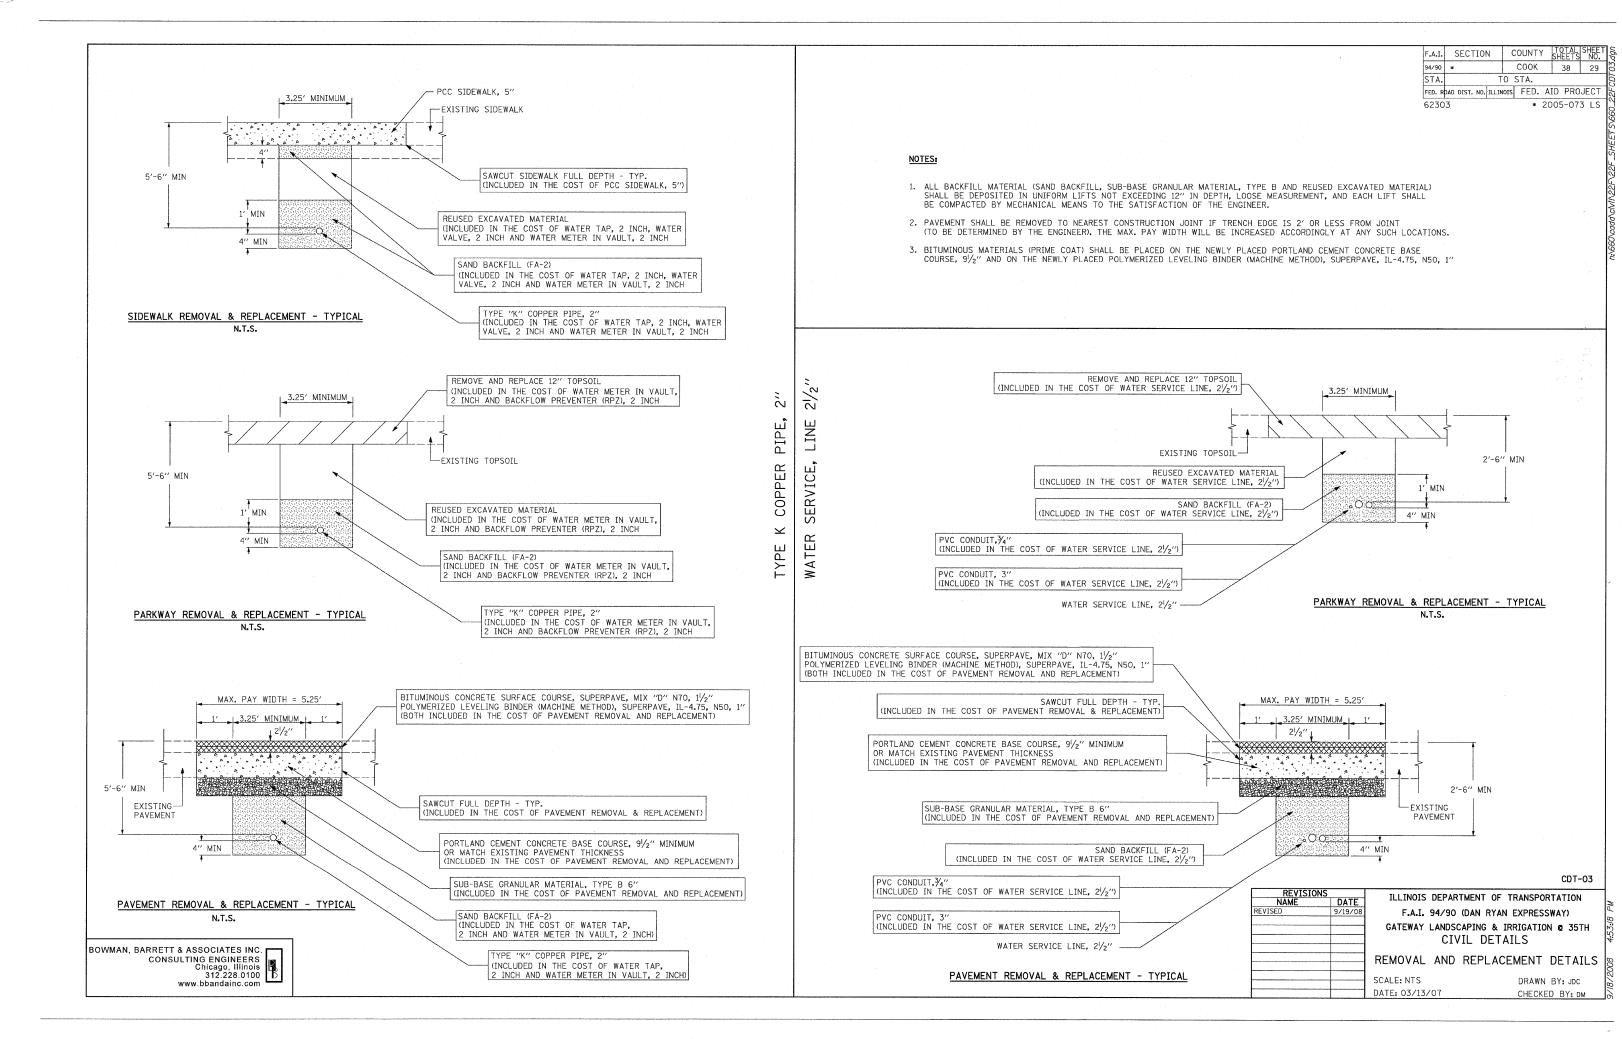

F.A.I. SECTION COUNTY SHEETS NO.
94/90 * COOK 38 30
STA. TO STA. FED. ROAD DIST. NO. ILLINOIS FED. AID PROJECT * 2005-073 LS 62303 PAGE INTENTIONALLY LEFT BLANK CDT-04 ILLINOIS DEPARTMENT OF TRANSPORTATION F.A.I. 94/90 (DAN RYAN EXPRESSWAY) GATEWAY LANDSCAPING & IRRIGATION @ 35TH BOWMAN, BARRETT & ASSOCIATES INC.
CONSULTING ENGINEERS
Chicago, Illinois
312.228.0120
www.bbandainc.com SCALE: NTS DRAWN BY: CDOT DATE: 03/13/07 CHECKED BY: CDOT

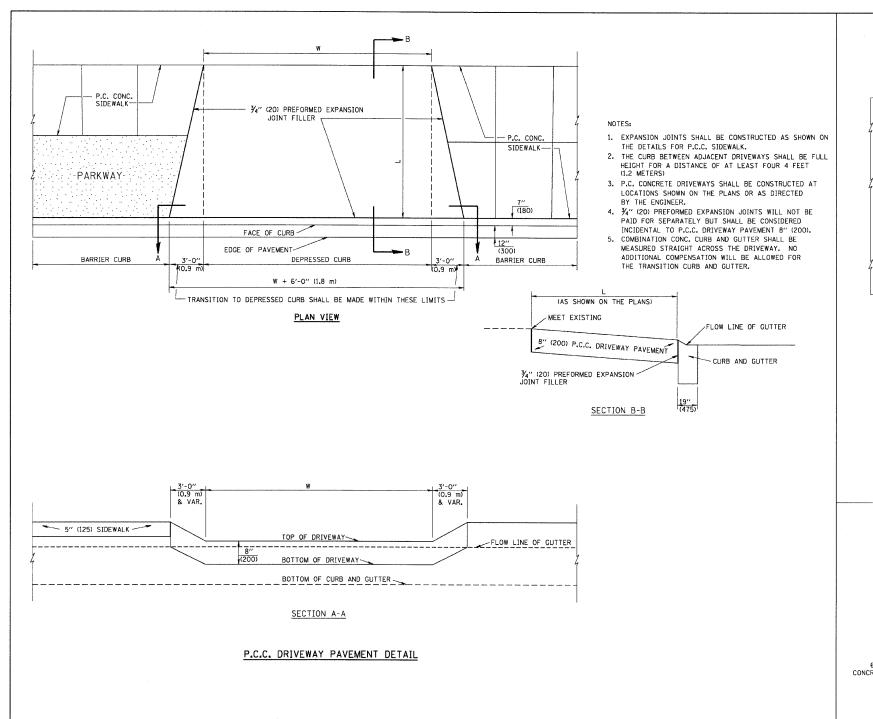

ADJACENT BUILDING, RETAINING PRIVATE WALL OR OTHER STRUCTURE SIDEWALK - R.O.W. (20) KEYSTONE-DRIVEWAY L sop. (13) (20) RAMP SIDEWALK CURB AND GUTTER -DEPRESSED CURB TRAFFIC SIGNAL, TROLLEY POWER THE PROPOSED CARRIAGE WALK SHALL DEPRESSED CURB -POLE, LIGHT STANDARD OR COLUMN TO BE 3'-0" (0.9 m) SQUARE OR AS DIRECTED BY THE ENGINEER. BE CONSTRUCTED THE SAME WIDTH AND LENGTH AS THE EXISTING CARRIAGE WALK AND PAID FOR AS PORTLAND CEMENT CONCRETE SIDEWALK, 5-INCHES (125). PAVEMENT -- PAVEMENT /


# -SIDEWALK -PREFORMED EXPANSION

SLOPE FOR SIDEWALK 1" (25) IN 3'-0" (0.9 m) IN CHICAGO

ALLEY RETURN DETAIL

- 1. ONE-HALF INCH THICK EXPANSION JOINTS SHALL BE PLACED BETWEEN THE SIDEWALK AND ALL STRUCTURES SUCH AS LIGHT STANDARDS, TRAFFIC LIGHT STANDARDS, MANHOLES, WHICH EXTEND THROUGH THE SIDEWALK.
- 2. ¾" (20) THICK EXPANSION JOINTS SHALL BE PLACED AT INTERVALS OF NOT MORE THAN 100 FEET (30 METERS) IN THE SIDEWALK. WHERE THE SIDEWALK IS CONSTRUCTED ADJACENT-TO PAVEMENT OR CURB HAVING EXPANSION JOINTS, THE EXPANSION JOINTS IN THE SIDEWALK SHALL BE PLACED OPPOSITE THE EXISTING EXPANSION JOINTS AS NEARLY AS PRACTICABLE. EXPANSION JOINTS SHALL ALSO BE PLACED WHERE THE SIDEWALK ABUTS EXISTING SIDEWALKS, BETWEEN DRIVEWAY PAVEMENT AND SIDEWALK, AND BETWEEN SIDEWALK AND CURBS WHERE THE-SIDEWALK ABUTS A CURB.

### PORTLAND CEMENT CONCRETE SIDEWALK DETAILS

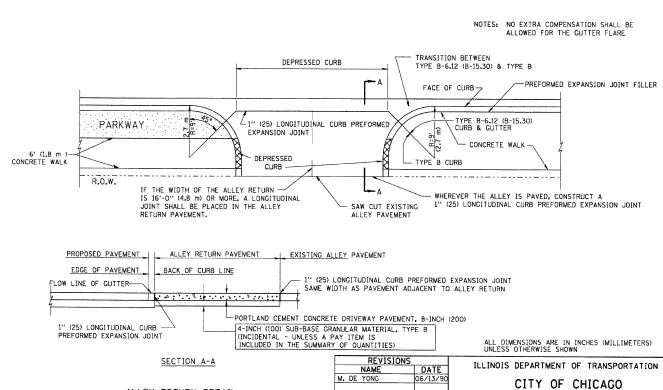

CHECKED BY BD400-03

DETAILS FOR P.C. CONCRETE DRIVEWAY, ALLEY RETURN AND SIDEWALK

SCALE: VERT. NONE

CONTRACT NO.

94/90 2005-073 LS COOK 38 31


TO STA. FED. ROAD DIST. NO. ILLINOIS FED. AID PROJECT

COUNTY TOTAL SHEE SHEETS NO.

RTE. SECTION

STA.

60A79

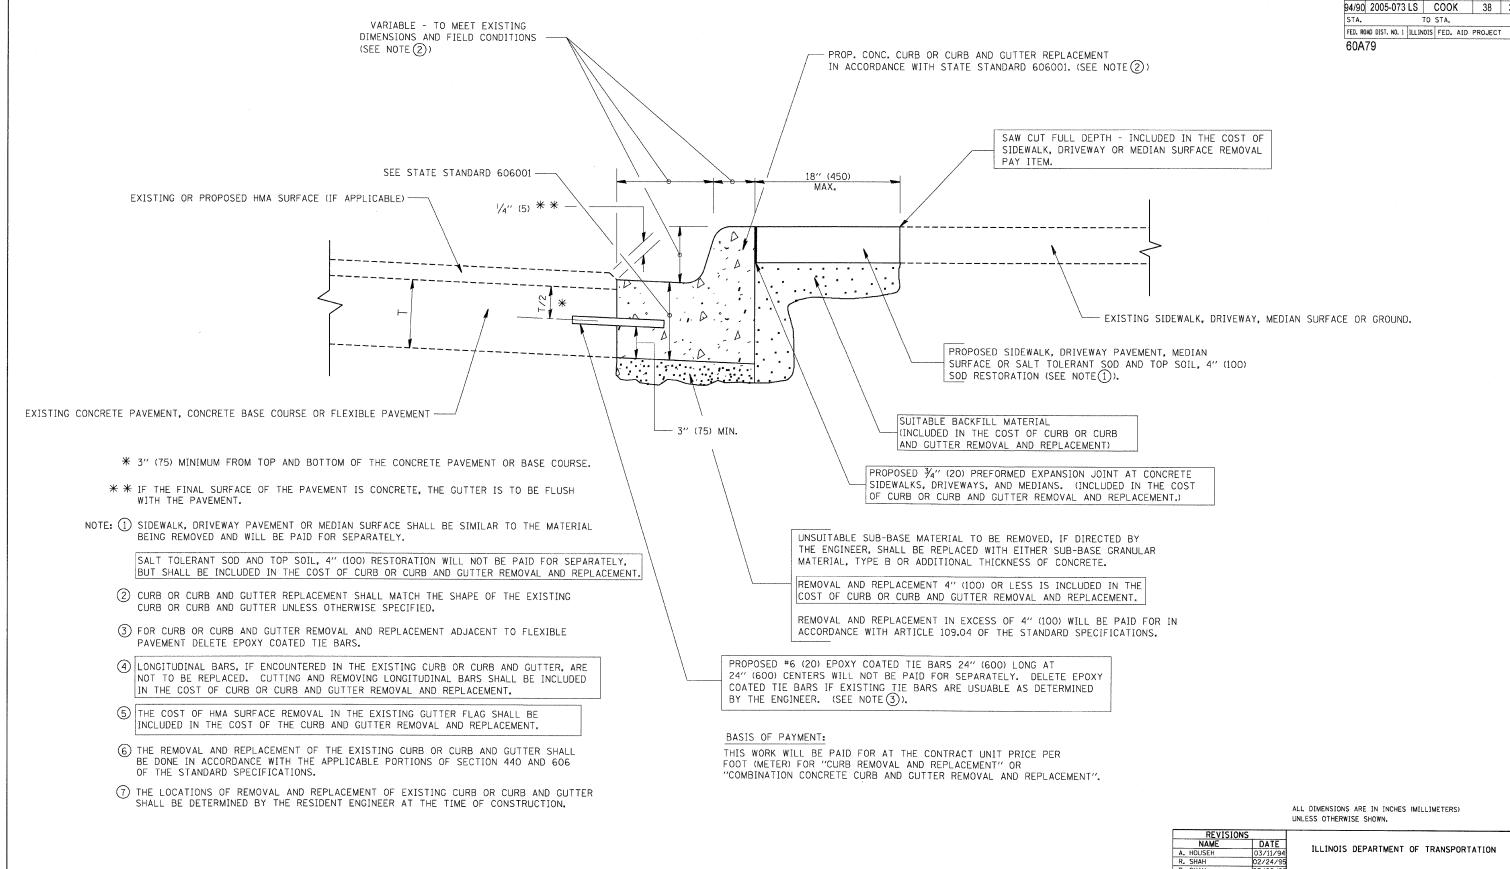

CURB OR CURB AND GUTTER REMOVAL AND REPLACEMENT

	KE VISIONS	
	NAME	DATE
Α.	HOUSEH	03/11/94
R.	SHAH	02/24/95
R.	SHAH	03/02/95
R.	SHAH	08/19/96
R.	SHAH	09/12/96
R.	SHAH	09/19/96
R.	SHAH	10/03/96
Α.	ABBAS	03/21/97
М.	GOMEZ	01/22/01
R.	BORO	01/01/07

CURB OR CURB AND GUTTER REMOVAL AND REPLACEMENT

SCALE: VERT. NONE

DRAWN BY

CONTRACT NO.

COUNTY

SECTION

TOTAL SHEE SHEETS NO.

38 32

BD600-06 (BD-24)

94/90 2005-073 LS COOK 38 33 STA. TO STA. FED. ROAD DIST. NO. ILLINOIS FED. AID PROJECT 60A79 ROAD CONSTRUCTION AHEAD ROAD CONSTRUCTION AHEAD TYPE III BARRICADES WITH TWO FLASHING AMBER LIGHTS ON EACH. TYPE I OR TYPE II BARRICADES WITH ONE FLASHING AMBER LIGHT ON EACH, OR 15 (380) TYPE III BARRICADES WITH TWO FLASHING 200'± (60 m±)-21 (530) AMBER LIGHTS ON EACH. DRIVEWAY WORK AREA ! STREET; SPEED 40 MPH OR LESS 200'± (60 m±) 09) COLLECTOR LIMIT> 40 MPH ( W20-1(0) CONSTRUCTION M6-4(0)-2115 AHEAD ROAD CONSTRUCTION M6-1(0)-2115

TRAFFIC CONTROL AND PROTECTION FOR SIDE ROADS, INTERSECTIONS, AND DRIVEWAYS

# NOTES:

- A. FOR NO LANE RESTRICTION ON THE SIDE ROAD OR DRIVEWAYS
- 1. SIDE ROAD WITH A SPEED LIMIT OF 40 MPH (60 km/h) OR LESS AS SHOWN ON THE DRAWING AND AS DIRECTED BY THE ENGINEER:
- Q) ONE ROAD CONSTRUCTION AHEAD SIGN 36 x 36 (900x900) WITH A FLASHER AND FLAG MOUNTED ON IT APPROXIMATELY 200' (60 m) IN ADVANCE OF THE MAIN ROUTE.
- b) THE CLOSED PORTION OF THE MAIN ROUTE SHALL BE PROTECTED BY BLOCKING WITH TYPE I, TYPE II OR TYPE III BARRICADES, 1/3 OF THE CROSS SECTION OF THE CLOSED PORTION.
- 2. SIDE ROAD WITH A SPEED LIMIT GREATER THAN 40 MPH (60 km/h) AS SHOWN ON THE DRAWING AND AS DIRECTED BY THE ENGINEER:
- o) ONE ROAD CONSTRUCTION AHEAD SIGN 48  $\times$  48 (1.2 m  $\times$  1.2 m) WITH A FLASHER MOUNTED ON IT APPROXIMATELY 500' (150 m) IN ADVANCE OF THE MAIN ROUTE.
- b) THE CLOSED PORTION OF THE MAIN ROUTE SHALL BE PROTECTED BY BLOCKING WITH TYPE III BARRICADES, 1/2 OF THE CROSS SECTION OF THE CLOSED PORTION,
- 3. WHEN THE SIDE ROAD LIES BETWEEN THE BEGINNING OF THE MAINLINE SIGNING AND THE WORK ZONE, A SINGLE HEADED ARROW (MG-1) SHALL BE USED IN LIEU OF THE DOUBLE HEADED ARROW (MG-4).

#### B. FOR A LANE CLOSURE ON A SIDE ROAD OR DRIVEWAY:

USE APPLICABLE PORTIONS OF THE TYPICAL APPLICATION OF TRAFFIC CONTROL DEVICES (STD. 701601, STD. 701606 OR THE APPROPRIATE STANDARD). THE SPACING OF SIGNS AND BARRICADES SHALL BE ADJUSTED FOR FIELD CONDITIONS AS DIRECTED BY THE ENGINEER. THE DIRECTIONAL ARROW SHALL BE COVERED OR REMOVED WHEN NO LONGER CONSISTENT WITH THE SIDE ROAD LANE CLOSURE.

- C. ADVANCE WARNING SIGNS ARE TO BE OMITTED ON DRIVEWAY UNLESS OTHERWISE NOTED.
- D. THE TRAFFIC CONTROL AND PROTECTION FOR SIDE ROADS, INTERSECTIONS, AND DRIVEWAYS SHALL BE INCIDENTAL TO THE COST OF SPECIFIED TRAFFIC CONTROL STANDARDS OR ITEMS.

All dimensions are in millimeters (inches) unless otherwise shown.

	NS	REVISIO
	DATE	NAME
TF	6/89	LHA
1 1	09/08/94	T. RAMMACHER
	10/18/95	J. OBERLE
S	03/06/96	A. HOUSEH
_ >	10/15/96	A. HOUSEH
i	01/06/00	T. RAMMACHER
	4	
SC/		

ILLINOIS DEPARTMENT OF TRANSPORTATION

TRAFFIC CONTROL AND PROTECTION
FOR

SIDE ROADS, INTERSECTIONS, AND
DRIVEWAYS

CALE: NONE

DRAWN BY CHECKED BY

TC-10

CONTRACT NO.


COUNTY

SECTION

TOTAL SHEET SHEETS NO.

FE = 3/6/2007
NE = K:\diststd\tc10.d
NLE = 50.000 ' IN.

PLOT DATE = 3/6, FILE NAME = K:\d PLOT SCALE = 50.0

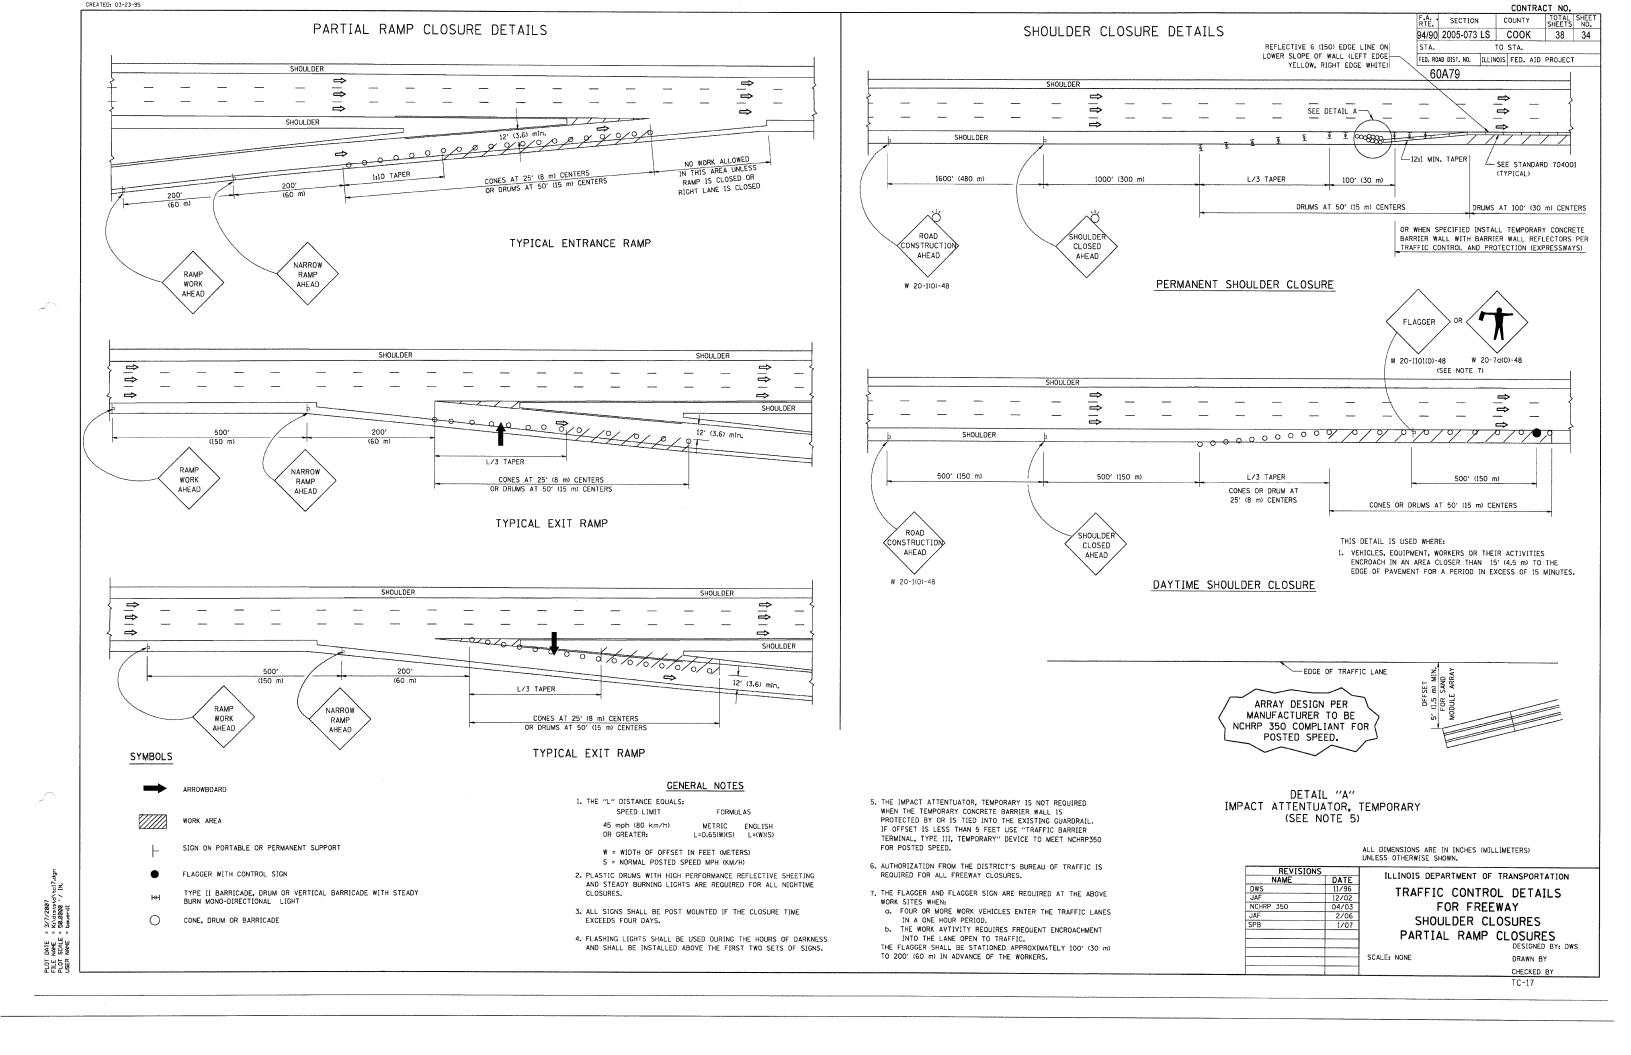


94/90 2005-073 LS COOK 38 35 SIGNING FOR FLAGGING OPERATIONS AT WORK ZONE OPENINGS STA. TO STA. FED. ROAD DIST. NO. ILLINOIS FED. AID PROJECT 60A79 WORK ZONE EXIT OPENING - ARROWBOARD TYPE C (FLASHING A BAR OR 4-CORNER) BE PREPARED W20-1101(0)-48 W20-7a(0)-48 TO STOP 36 × 36 8 CAPS 1000 8' (2.4 m) FEET (900 × 900) 5' (1.5 m ) MIN. CLEAR HEIGHT - BLACK LEGEND ORANGE REFL. BACKGROUND 500' (150 m) 500' (150 m) 100' (30 m) 300' (90 m) MIN. DRUMS @ 50' (15 m) C-C 0 . |û|û| TRAFFIC DIRECTION FLAGGER WITH CONTROL SIGN WORK ZONE ENTRY OPENING TRUCKS LEAVING (W21-I105) HIGHWAY 500' (150 m) [100' (30 m)] 200' (60 m) TRAFFIC DIRECTION - FLAGGER WITH 1. The Arrowboard, the Flagger Ahead trailer mounted sign, and the Trucks Leaving Highway sign shall be removed or turned away from traffic and the exit and entry openings shall be closed when the flagging operation ceases. 2. Work Zone Exit Openings should be a minimum of one half mile apart. 3. Exiting the work zone at any place other than at a Work Zone Exit Opening will be prohibited. ALL DIMENSIONS ARE IN INCHES (MILLIMETERS)
UNLESS OTHERWISE SHOWN 4. All vehicles shall enter the work zone at entry openings, using their turn signals to warn motorists ILLINOIS DEPARTMENT OF TRANSPORTATION SIGNING FOR FLAGGING OPERATIONS AT WORK ZONE OPENINGS SCALE: NONE DRAWN BY CADD

SECTION


COUNTY


CHECKED BY

II DATE = 3/7/2007 E NAME = Kivdiststd'tol8.dgn IT SCALE = 50.000 '/ IN. IR NAME = handed

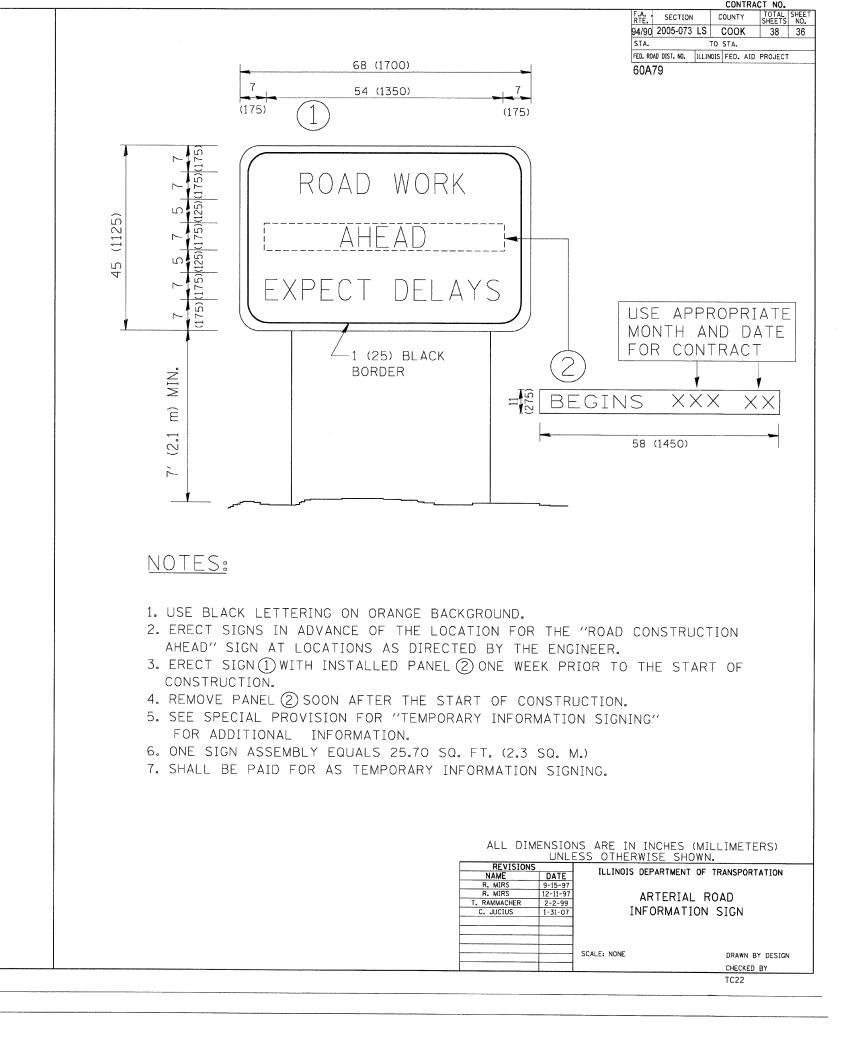

JATE = 3/8/2007 IAME = Kildiststdltc22,dgn SCALE = 50.000 '/ IN.

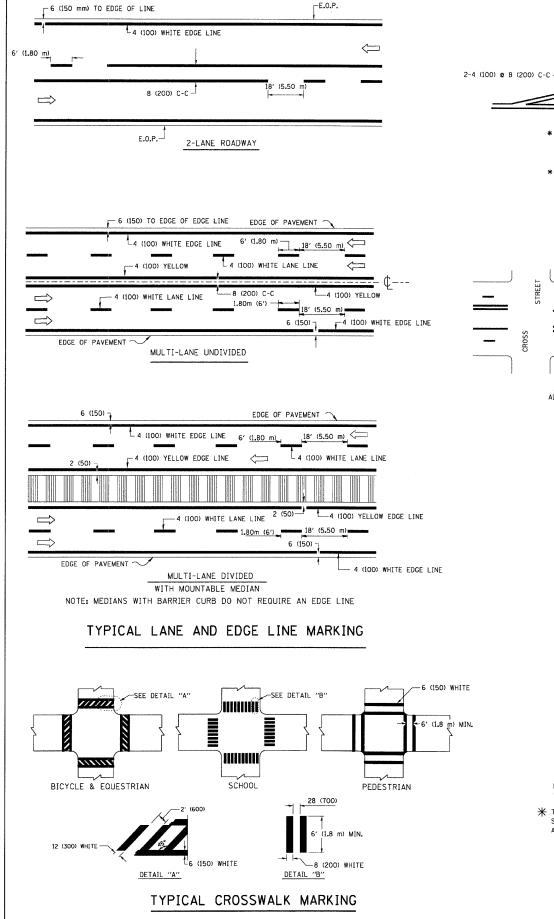


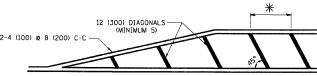


*FOR MEDIAN LENGTHS WHERE DIAGONAL SPACING CANNOT BE ATTAINED, USE 5 (FIVE) EQUALLY SPACED DIAGONAL LINES,

* DIAGONAL LINE SPACING: 20' (6.1 m) C-C

#### PAINTED MEDIANS

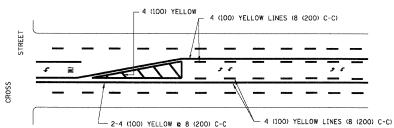


A MINIMUM OF TWO PAIRS OF TURN ARROWS SHALL BE USED, WHITE IN COLOR. ADDITIONAL PAIRS SHALL BE PLACED AT 200' (60 m) TO 300' (90 m) INTERVALS.

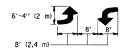

MEDIAN WITH TWO-WAY LEFT TURN LANE

### TYPICAL PAINTED MEDIAN MARKING

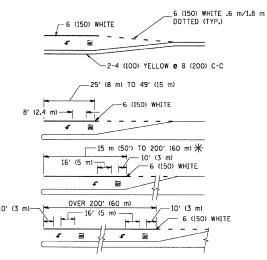

FULL SIZE LETTERS 8' (2.4 m) AND ARROWS SHALL BE USED.

The AREA = 15.8 SO. FT. (1.47 m²) The Area = 22.9 SO. FT. (2.13 m²)

* TURN LANES IN EXCESS OF 400' (120 m) IN LENGTH MAY HAVE AN ADDITIONAL SET OF ARROW - "ONLY" INSTALLED MIDWAY BETWEEN THE OTHER TWO SETS OF ARROW - "ONLY".

TYPICAL LEFT (OR RIGHT) TURN LANE

### TYPICAL TURN LANE MARKING

8 (200) WHITE

12 (300) WHITE DIAGONALS

2 6' (1.8 m) SPACING

ISLAND OFFSET FROM PAVEMENT EDGE

F.A.	SECTION	COUNTY	TOTAL	SHEET	NO.
94/90	2005-073 LS	COOK	38	37	
STA.	TO STA.				
FED. ROAD DIST. NO.	ILLINOIS	FED. AID	PROJECT		
60A79					

CUNTRACT NO.

8 (200) WHITE 2 (50)

RAISED ISLAND AT PAVEMENT EDGE

# TYPICAL ISLAND MARKING

TYPE OF MARKING	WIDTH OF LINE	PATTERN	COLOR	SPACING / REMARKS
CENTERLINE ON 2 LANE PAVEMENT	4 (100)	SKIP-DASH	YELLOW	6' (1.80 m) LINE WITH 18' (5.50 m) SPACE
CENTERLINE ON MULTI-LANE UNDIVIDED PAVEMENT	2 @ 4 (100)	SOLID	YELLOW	8 (200) C-C
NO PASSING ZONE LINES: FOR ONE DIRECTION FOR BOTH DIRECTIONS	4 (100) 2 <b>e</b> 4 (100)	SOLID SOLID	YELLOW YELLOW	8 (200) C-C
LANE LINES	4 (100) 5 (125) ON FREEWAYS	SKIP-DASH SKIP-DASH	WHITE WHITE	6' (1.80 m) LINE WITH 18' (5.50 m) SPACE
DOTTED LINES (EXTENSIONS OF CENTER, LANE OR TURN LANE MARKINGS)	SAME AS LINE BEING EXTENDED	SKIP-DASH	SAME AS LINE BEING EXTENDED	2' (600) LINE WITH 6' (1.8) SPACE
EDGE LINES	4 (100)	SOLID	YELLOW-LEFT WHITE-RIGHT	OUTLINE MOUNTABLE MEDIANS IN YELLOW: EDGE LINES ARE NOT USED NEXT TO BARRIER CURB
TURN LANE MARKINGS	6 (150) LINE; FULL SIZE LETTERS & SYMBOLS (8' (2.4 m))	SOLID	WHITE	SEE TYPICAL TURN LANE MARKING DETAIL
TWO WAY LEFT TURN MARKING	2 @ 4 (100) EACH DIRECTION	SKIP-DASH AND SOLID	YELLOW	6' (1.8 m) LINE WITH 18' (5.50 m) SPACE FOR SKIP-DASH; 8 (200) C-C BETWEEN SOLID LINE AND SKIP-DASH LINE
	8' (2.4 m) LEFT ARROW	IN PAIRS	WHITE	SEE TYPICAL TWO-WAY LEFT TURN MARKING DETAIL
CROSSWALK LINES (PEDESTRIAN) A. DIAGONALS (BIKE & EOUESTRIAN) B. LONGITUDINAL BARS (SCHOOL)	2 & 6 (150) 12 (300) & 45° 8 (200) & 90°	SOLID SOLID SOLID	WHITE WHITE WHITE	NOT LESS THAN 6' (I.8 m) APART 2' (600) APART 2'-4" (700) APART SEE TYPICAL CROSSWALK MARKING DETAILS.
STOP LINES	24 (600)	SOLID	WHITE	PLACE 4' (1.2 m) IN ADVANCE OF AND PARALLEL TO CROSSMALK, IF PRESENT. OTHERWISE, PLACE AT DESIRED STOPPING POINT. PARALLEL TO CROSSROAD CENTERLINE, WHERE POSSIBLE
PAINTED MEDIANS	2 to 4 (100) WITH 12 (300) DIAGONALS to 45°	SOLID	YELLOW: TWO WAY TRAFFIC WHITE: ONE WAY TRAFFIC	8 (200) C-C FOR THE DOUBLE LINE SEE TYPICAL PAINTED MEDIAN MARKING.
GORE MARKING AND CHANNELIZING LINES	8 (200) WITH 12 (300) DIAGONALS & 45°	SOLID	WHITE	DIAGONALS: 20' (6.1 m) (LESS THAN 30 MPH (50 km/h))
RAILROAD CROSSING	24 (600) TRANSVERSE LINES; "RR" IS 6' (1.8 m) LETTERS; 16 (400) LINE FOR "X"	SOLID	WHITE	SEE STATE STANDARD 780001 AREA OF: "R"*-3.6 SO. FT. (0.33m ² ) EACH "X"*-54.0 SO. FT. (5.0 m ² )

DEVICTORE


FOR FURTHER DETAILS ON PAVEMENT MARKING REFER TO STREET MARKING STANDARDS, PRINTED BY CITY OF CHICAGO, DEPARTMENT OF TRANSPORTATION, BURGAL OF TRAFFIC.


ALL DIMENSIONS ARE IN INCHES (MILLIMETERS) UNLESS OTHERWISE SHOWN.

RTMENT OF TRANSPORTATION

112710113		ILLINOIS DEPARTMENT OF TRANSPORTA	TIOL
NAME	DATE	ILLINOIS DEPARTMENT OF TRANSPORTA	IION
T, RAMMACHER	12/07/00		
		CITY OF CHICAGO	
		TYPICAL PAVEMENT	
		I I I I I I I I I I I I I I I I I I I	
		MADUTHOC	
		MARKINGS	
		.,	
		SCALE: NONE DRAWN BY	CARD
		DIVATIN DI	CADD

CHECKED BY

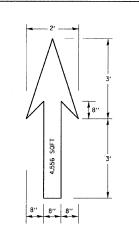


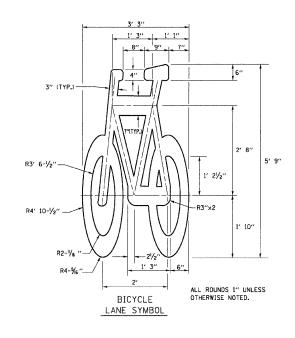



- NOTE:


  1.) FOR BIKE LANE SYMBOLS ONLY,
  USE PRE-FORMED THERMOPLASTIC
  WITH A MINIMUM THICKNESS OF 90 MILS,
  MINIMUM SKID RESISTANCE VALUE OF 60 BPN, & A MINIMUM INDEX OF REFRACTION OF 1.50.
- 2.) THE RESIDENT ENGINEER SHALL CONTACT MR. BEN GOMBERG AT 312-744-8093 AT LEAST ONE CALENDAR WEEK PRIOR TO INSTALLING BIKE LANE SYMBOLS.

TYPICAL BIKE LANE SYMBOLS DRAWING #28

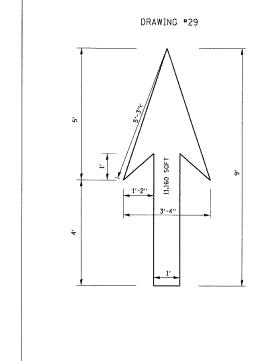

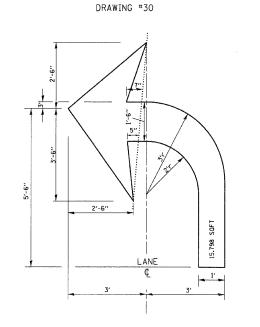

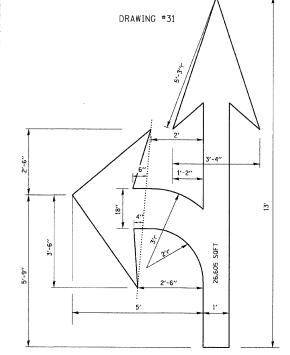

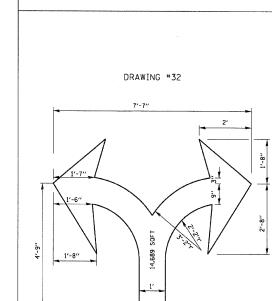


STA.


60A79


CONTRACT NO.

| F.A. | SECTION | COUNTY | TOTAL SHEETS | NO. |
| 94/90 | 2005-073 LS | COOK | 38 | 38 |

TO STA. FED. ROAD DIST. NO. ILLINOIS FED. AID PROJECT

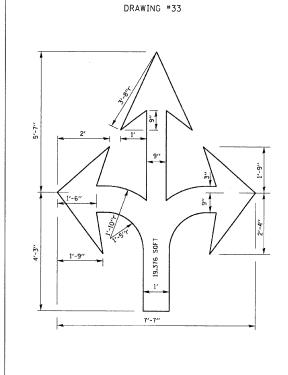

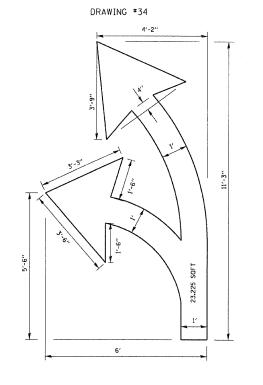

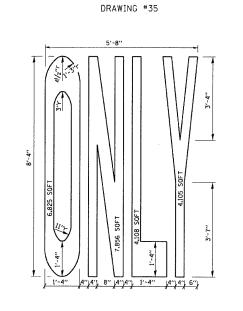

NOTE: ALL MARKINGS SHALL BE SOLID WHITE UNLESS OTHERWISE NOTED IN THE PLANS

ILLINOIS DEPARTMENT OF TRANSPORTATION CITY OF CHICAGO TYPICAL PAVEMENT MARKINGS

DRAWN BY CHECKED BY

2 OF 2

SCALE: NONE

TC-24