### INDEX OF SHEETS

FOR INDEX OF SHEETS, SEE SHEET NO. 2

### PROJECT LOCATED IN THE CITY OF CHICAGO

DAN RYAN EXPRESSWAY:	ABT (2020)	DESIGN SPEED	POSTED SPEE
SB I-94 (DAN RYAN)	140,500	60 MPH	55 MPH
SB 79TH STREET C-D ENTRANCE RAMP	15,300	45 MPH	40 MPH
SB 79TH STREET C-D EXIT RAMP	7,300	45 MPH	40 MPH
NB I-94 (DAN RYAN)	151,800	60 MPH	55 MPH
NB 79TH STREET C-D EXIT RAMP	14,000	45 MPH	40 MPH
NB 79TH STREET C-D ENTRANCE RAMP	9,200	45 MPH	40 MPH

### **DESCRIPTION OF PROJECT**

LANDSCAPING AND IRRIGATION OF **GATEWAYS AND CORNER GARDENS** LOCATED WITHIN THE PROJECT LIMITS, AND FLUTED KNEE WALL CONSTRUCTION IN THE SOUTHWEST QUADRANT.


# STATE OF ILLINOIS **DEPARTMENT OF TRANSPORTATION DIVISION OF HIGHWAYS**

# PROPOSED HIGHWAY PLANS

F.A.I. ROUTE 94 (DAN RYAN EXPRESSWAY) **SECTION 2005-070 LS GATEWAYS AND CORNER GARDENS** NE, SE, NW & SW QUADRANTS AT 79TH STREET

> **COOK COUNTY** C-91-106-06

0 1/2 MILE 1 MILE GROSS LENGTH OF PROJECT = 1,887.21 FT. = 0.36 MI. MAP SCALE: 1 $^{\circ}$  = 1/2 MILE NET LENGTH OF PROJECT = 1,887.21 FT. = 0.36 MI.

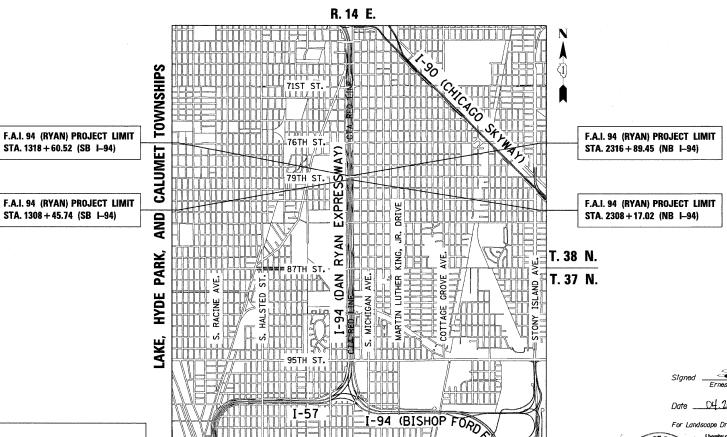

CHICAGO UTILITY ALERT NETWORK (312) 744-7000

CTA CONTACT: DAVID HEARD MANAGER, CONSTRUCTION MANAGEMENT OVERSIGHT (312) 681-3862

STA. 1318 + 60.52 (SB I-94)

STA. 1308 + 45.74 (SB I-94)

CONTRACT NO. 60A76

FULL SIZE PLANS HAVE BEEN PREPARED USING STANDARD ENGINEERING SCALES; REDUCED SIZED PLANS WILL NOT CONFORM TO STANDARD SCALES. IN MAKING MEASUREMENTS

ON REDUCED PLANS. THE ABOVE SCALES MAY BE USED

04-28-08

STATE OF ILLINOIS DEPARTMENT OF TRANSPORTATION

DIVISION OF HIGHWAYS

Que 27, 20 08

Dime M. O'Keefe & DEPUTY DIRECTOR OF HIGHWAYS, REGION ENGINEER

Eric E. Harm/10 tum engineer of design and envir

Christine M. Reed (18)

**CONTRACT 22E** 

SECTION COUNTY

94 2005-070 LS COOK 65

FED. ROAD DIST. NO. ILLINOIS FED. AID PROJECT

60A76

TY:LININTERNATIONAL

PRINTED BY THE AUTHORITY OF THE STATE OF ILLINOIS

### INDEX OF SHEETS

	INDEX OF	- SHEETS
*	SHEET NO.	TITLE
	1	COVER SHEET
	2	INDEX OF SHEETS, INDEX OF STATE STANDARDS, GENERAL NOTES, AND SPECIAL COMMITMENTS
	3	CALENDAR OF CONSTRUCTION WORK, QUADRANT NOMENCLATURE, AND HOT-MIX ASPHALT MIXTURE REQUIREMENTS
	4 - 5	SUMMARY OF QUANTITIES
	6	PLANT SCHEDULE - SUMMARY AND SE + NE QUADRANTS AT 79TH ST NB I-94
	7	PLANT SCHEDULE - SW + NW QUADRANTS AT 79TH ST SB I-94
	8 - 18	ALIGNMENT AND SURVEY TIES FOR CONTROL POINTS
	19 - 20	WATER SERVICE AND EROSION CONTROL PLAN - SE QUADRANTS AT 79TH ST NB I-94
	22	PLANTING BED LAYOUT PLAN - SE QUADRANTS AT 79TH ST NB I-94
	24	IRRIGATION PLAN - SE QUADRANT AT 79TH ST NB I-94
	26	LANDSCAPE PLAN - SE QUADRANT AT 79TH ST NB I-94
	28	SE CORNER GARDEN DETAIL - AT 79TH STREET AND STATE STREET
	29	MAINLINE LANDSCAPING RESTORATION - SE QUADRANT AT 79TH ST NB I-94
	32	FLUTED KNEE WALL, SPECIAL AND CORNER GARDEN PLAN - SW QUADRANT AT 79TH ST SB I-94
	34 - 36	WATER SERVICE AND EROSION CONTROL PLAN - SW AND NW QUADRANTS AT 79TH ST SB I-94
	37	PLANTING BED LAYOUT PLAN - SW + NW QUADRANTS AT 79TH ST SB I-94
	38	IRRIGATION PLAN - SW + NW QUADRANTS AT 79TH ST SB I-94
	39	LANDSCAPE PLAN - SW + NW QUADRANTS AT 79TH ST SB I-94
	40	SW CORNER GARDEN DETAIL - AT 79TH STREET AND LAFAYETTE AVENUE
	41	NW CORNER GARDEN DETAIL - AT 79TH STREET AND LAFAYETTE AVENUE
	43 - 45	MAINLINE LANDSCAPING RESTORATION - SW AND NW QUADRANTS AT 79TH ST SB I-94
	46	LANDSCAPE DETAILS
	47	FLUTED KNEE WALL, SPECIAL ALONG LAFAYETTE AT 79TH ST STANDARD DETAILS (1 OF 2)
	48	FLUTED KNEE WALL, SPECIAL ALONG LAFAYETTE AT 79TH ST TRANSITION DETAILS (2 OF 2)
	49	TYPICAL SECTIONS, ELEVATIONS, AND DETAILS - CORNER GARDEN
	50 - 52	PROPOSED CROSS SECTIONS
	53 - 54	GATEWAY AND CORNER GARDEN - WATER SERVICE EQUIPMENT INSTALLATION, PAVEMENT REMOVAL AND REPLACEMENT DETAILS
	55	GATEWAY AND CORNER GARDEN - UTILITY DROP DOWN DETAILS
	56	CONCRETE MEDIAN SURFACE, 5" (MODIFIED) - WITH CALIFORNIA FINISH DETAIL
	57 - 59	CITY OF CHICAGO STANDARD DETAILS - DETAILS OF CURB RAMPS FOR PEOPLE WITH DISABILITIES
	60	TC-10 DIST 1, TRAFFIC CONTROL AND PROTECTION FOR SIDE ROADS, INTERSECTIONS, AND DRIVEWAYS
	61	TC-14 DIST 1, TRAFFIC CONTROL AND PROTECTION AT TURN BAYS (TO REMAIN OPEN TO TRAFFIC)
	62	TC-17 DIST 1, TRAFFIC CONTROL DETAILS FOR FREEWAY SHOULDER CLOSURES PARTIAL RAMP CLOSURES
	63	TC-22 DIST 1, ARTERIAL ROAD INFORMATION SIGN
	64 - 65	TC-24 DIST 1, CITY OF CHICAGO TYPICAL PAVEMENT MARKINGS
	* DELETE	D SHEETS 21, 23, 25, 27, 31, 33 AND 42

\* DELETED SHEETS 21, 23, 25, 27, 31, 33 AND 42

TYLININTERNATIONAL

### INDEX OF STATE STANDARDS

STANDARD NO.	TITLE					
000001-05	STANDARD SYMBOLS, ABBREVIATIONS, AND PATTERNS					
280001- <i>04</i>	TEMPORARY EROSION CONTROL SYSTEM					
606001 <b>- 03</b>	CONCRETE CURB AND COMBINATION CONCRETE CURB AND GUTTER					
701601 <b>- 05</b>	URBAN LANE CLOSURE, MULTILANE 1W OR 2W WITH NONTRAVERSABLE MEDIAN					
701701- <b>05</b>	URBAN LANE CLOSURE MULTILANE INTERSECTION					
701801- 03	LANE CLOSURE MULTILANE 1W OR 2W CROSSWALK OR SIDEWALK CLOSURE					
701901	TRAFFIC CONTROL DEVICES					
814001- <i>01</i>	HANDHOLES					

### **GENERAL NOTES:**

- THE CONTRACTOR SHALL NOT SET UP A YARD/FIELD OFFICE OR STOCKPILE MATERIALS ON IDOT PROPERTY WITHOUT WRITTEN PERMISSION FROM IDOT.
- 2. THE CONTRACTOR SHALL TAKE ALL NECESSARY SAFETY PRECAUTIONS TO PROTECT AND PROVIDE ACCESS TO ABUTTING PROPERTY, UTILITIES, PEDESTRIANS, AND VEHICULAR TRAFFIC.
- 3. NIGHT OPERATIONS: SHALL NOT BE ALLOWED.
- 4. ALL ELEVATIONS SHOWN ARE BASED ON THE CHICAGO CITY DATUM OF 0.00, WHICH IS 579.19 FEET ABOVE MEAN TIDE NEW YORK. (NAVD 88)
- 5. ANY DAMAGE DONE TO EXISTING ITEMS BY THE CONTRACTOR SHALL BE REPAIRED BY THE CONTRACTOR AT THE CONTRACTOR'S OWN EXPENSE
- 6. THE CONTRACTOR SHALL PROVIDE ALL NECESSARY TRAFFIC CONTROL DEVICES NEEDED TO COMPLETE THE WORK. THIS WORK SHALL BE INCLUDED IN THE COST OF TRAFFIC CONTROL AND PROTECTION (SPECIAL).
- 7. THE CONTRACTOR SHALL NOT MAINTAIN A PERMANENT PARTIAL RAMP OR SHOULDER CLOSURE ALONG THE MAINLINE I-94 (DAN RYAN) FOR THE DURATION OF THIS PROJECT. ONLY TEMPORARY PARTIAL RAMP OR SHOULDER CLOSURES SHALL BE PERMITTED.
- 8. PLANS FOR THE WATER SERVICE CONNECTIONS FOR IRRIGATION SYSTEMS SHALL BE SUBMITTED FOR REVIEW AND APPROVAL TO:

MR. JOHN FLYNN
DEPARTMENT OF CONSTRUCTION AND PERMITS
ROOM 906, CITY HALL
121 NORTH LASALLE STREET

- 9. THE CONTRACTOR SHALL OBTAIN ALL NECESSARY PERMITS FROM THE CITY OF CHICAGO AND THE STATE OF ILLINOIS PRIOR TO COMMENCING CONSTRUCTION. THE COSTS SHALL BE INCLUDED IN THE CONTRACT. THE COST SHALL BE INCLUDED IN THE COST OF MOBILIZATION.
- 10. PAYMENTS FOR ADJUSTMENTS TO WATER VALVE VAULTS SHALL NOT BE MADE TO THE CONTRACTOR UNTIL THIS WORK HAS BEEN INSPECTED AND APPROVED BY THE CITY OF CHICAGO DEPARTMENT OF WATER MANAGEMENT.
- 11. PERMITS FROM THE DEPARTMENT OF WATER MANAGEMENT ARE REQUIRED FOR ALL WORK INVOLVING ADJUSTMENT OF STRUCTURES. THE DEPARTMENT OF WATER MANAGEMENT'S PERMIT SHALL BE OBTAINED BY A LICENSED SEWER DRAIN LAYER PRIOR TO START OF CONSTRUCTION. THE LICENSED SEWER CONTRACTOR SHALL SUBMIT TWO SETS OF PLANS APPROVED BY THE DEPARTMENT OF WATER MANAGEMENT FOR THE ISSUANCE OF THE SEWER PERMIT TO: BUREAU OF ENGINEERING SERVICES-SEWER SECTION, JARDINE PURIFICATION PLANT, EL+51, ROOM 313, 1000 E. OHIO ST., CHICAGO, IL 60611. INSPECTION WILL BE PROVIDED BY THE DEPARTMENT OF WATER MANAGEMENT.
- 12. CITY OF CHICAGO WATER VALVE VAULTS AND SEWER STRUCTURES SHALL NOT BE CLOSED, COVERED, OR OTHERWISE OBSTRUCTED DURING CONSTRUCTION WITHOUT WRITTEN PERMISSION FROM THE CITY OF CHICAGO DEPARTMENT OF WATER MANAGEMENT.
- 13. THE RESIDENT ENGINEER AND THE CONTRACTOR SHALL FIELD VERIFY THE CITY'S EXISTING SEWER FACILITIES IN THE LIMITS OF THE REFERENCED PROJECT FOR ANY CONFLICTS DUE TO THE PROPOSED IMPROVEMENT. ANY CONFLICT SHALL BE RESOLVED WITH THE DEPARTMENT OF WATER MANAGEMENT PRIOR TO START OF CONSTRUCTION.
- 14. THE LOCATION OF THE ELECTRICAL EQUIPMENT AND CONDUIT, INSTALL BY CONTRACT 62583, SHOWN IN THE PLANS IS APPROXIMATE. THE RESIDENT ENGINEER AND THE CONTRACTOR SHALL FIELD VERIFY THE EXACT LOCATION OF ALL ELECTRICAL ITEMS WITHIN THE PROJECT LIMITS WITH THE IDOT ELECTRICAL REPRESENTATIVE PRIOR TO THE START OF CONSTRUCTION.
- 15. IT IS CALLED TO THE CONTRACTOR'S ATTENTION THAT HE/SHE WILL BE REQUIRED TO PAY FOR ANY INSPECTION OR PERMIT FEES TO THE VARIOUS DEPARTMENTS OF THE CITY OF CHICAGO. THE COST FOR THESE FEES WILL NOT BE PAID FOR SEPARATELY BUT SHALL BE CONSIDERED INCLUDED IN THE COST OF MOBILIZATION. PERMIT FEES MUST BE PAID PRIOR TO COMMENCING CONSTRUCTION.
- 16. A "BOXED" NOTE INDICATES AN ITEM OF WORK THAT IS NOT PAID FOR SEPARATELY, BUT IS PAID FOR AS PART OF ANOTHER ITEM LISTED IN THE SUMMARY OF QUANTITIES.
- 17. THE CONTRACTOR SHALL SHOW PROOF OF PROCUREMENT, SOURCES, QUANTITIES AND VARIETIES FOR ALL SHURBS, TREES, GROUND COVERS, PERENNIALS AND ORNAMENTAL GRASSES WITHIN 21 DAYS FOLLOWING THE AWARD OF CONTRACT. TIMELY PROCUREMENT OF ALL PLANT MATERIAL IS ESSENTIAL TO THE SUCCESSFUL COMPLETION AND SUBSTANTIAL COMPLETION ACCEPTANCE OF THE OVERALL PROJECT.

F.A.I. RTE.	SECTION	1	COUN	ΤΥ	TOTAL	SHEET NO.
94	2005-070	LS	COO	K	65	2
STA.	308+17 (NB 308+46 (SB	I-94	} то sт	A. 23	16+90 (N 18+61 (SE	B I-94) I-94)
FED. RO	AD DIST. NO.	ILLIN	IS FED.	AID	PROJECT	Γ

60A76

### SPECIAL COMMITMENTS:

- THE CONTRACTOR AND THE ENGINEER SHALL SUBMIT THE IRRIGATION SHOP DRAWINGS FOR REVIEW AND APPROVAL BY THE CITY OF CHICAGO - STREETSCAPE UNIT, 4 WEEKS IN ADVANCE, PRIOR TO THE START OF THE IRRIGATION WORK.
- 2. THE CITY OF CHICAGO STREETSCAPE UNIT REPRESENTATIVES SHALL BE INVITED TO PARTICIPATE IN THE CONSTRUCTION PROGRESS MEETINGS. THE MEETING'S SCHEDULE SHALL BE PROVIDED TO THE CITY OF CHICAGO IN ADVANCE.
- 3. THE CITY OF CHICAGO STREETSCAPE UNIT REPRESENTATIVES SHALL BE AFFORDED THE OPPORTUNITY TO OBSERVE ALL LANDSCAPING AND IRRIGATION WORK IN COORDINATION WITH AND CONCURRENCE OF THE ENGINEER.
- 4. THE CONTRACTOR AND THE ENGINEER, IN COORDINATION WITH ILLINOIS DEPARTMENT OF TRANSPORTATION'S LANDSCAPING REPRESENTATIVE, SHALL PROVIDE A WRITTEN DESCRIPTION OF THE TURN OVER PROCEDURE OF THE IRRIGATION WORK AT THE END OF THE PROJECT TO THE CITY OF CHICAGO STREETSCAPE UNIT.
- 5. THE CITY OF CHICAGO STREETSCAPE UNIT SHALL BE INVITED BY THE CONTRACTOR AND THE ENGINEER TO ATTEND AND PARTICIPATE IN THE FINAL PROJECT INSPECTION.

REVISIONS
NAME
DATE
F.A.I. 94 (DAN RYAN EXPRESSWAY)
INDEX OF SHEETS, STATE STANDARDS,
GENERAL NOTES, AND SPECIAL COMMITMENTS

SCALE: NONE
DRAWN BY: JDF

CHECKED BY: JPM

DATE: MAY 1, 2008

Rev

### CALENDAR OF CONSTRUCTION WORK


PHASE	YEAR	WORK	DATES	CONSTRUCTION WORK
L	ILAN	FROM	ТО	CONSTRUCTION WORK
PHASE I	2009	MARCH 1	JUNE 1	INSTALLATION OF UTILITY SERVICE DROP DOWNS FOR THE SE QUADRANT AT THE CORNER GARDEN. EXCAVATION AND PLACEMENT OF POROUS GRANULAR MATERIAL, PLANTING MIX, GEOTECHNICAL FABRIC, AND MULCH (ALL CORNER GARDENS). INSTALLATION OF WATER SERVICE, IRRIGATION SYSTEMS AND ALL ASSOCIATED HARDSCAPE ITEMS FOR THE GATEWAYS AND CORNER GARDENS.
		MARCH 1	JUNE 1	INSTALLATION OF ALL WOODY PLANTS. WOODY PLANTS MUST BE CONTAINER OR DUG WHILE DORMANT AND MAINTAINED PROPERLY UNTIL PLANTED. ALL WOODY PLANTS MUST BE INSTALLED PRIOR TO PERENNIALS.
		MARCH 1	JUNE 1	INSTALL PERENNIAL PLANTS AND MULCH AFTER ALL WOODY PLANTS HAVE BEEN INSTALLED.
		JUN	IE 1	INTERIM COMPLETION DATE
PHASE I	2009	JUNE 1		CERTIFICATION TO THE BUREAU OF MAINTENANCE THAT ALL PLANTS HAVE BEEN INSTALLED AND ARE IN A LIVE HEALTHLY CONDITION AND ELIGIBLE FOR A SEPTEMBER PERIOD OF ESTABLISHMENT INSPECTION.
PHASE	YFAR	WORK DATES		CONSTRUCTION WORK
THASE	TLAIN	FROM	ТО	CONSTRUCTION WORK
PHASE II	2009	JUNE 1, 2009	MAY 1, 2010	PROVIDE PLANT CARE REQUIRED FOR ALL PLANTS (WEEDING, WATERING, OR OTHER WORK WHICH IS NECESSARY TO MAINTAIN HEALTH AND SATISFACTORY APPEARANCE OF THE GATEWAY AND CORNER GARDENS) DURING THE PERIOD OF ESTABLISHMENT AND ACCORDING TO THE LANDSCAPE MAINTENANCE SPECIAL PROVISION.
		SEPT. 1	SEPT. 30	PERIOD OF ESTABLISHMENT INSPECTION.
		OCT. 1	OCT. 31	INSTALL BULBS.
		OCT. 1	OCT. 31	FALL SHUT DOWN.
		APRIL 1	MAY 1	SPRING START UP.
PHASE II	2010	MA'	′ 1	COMPLETION DATE
	2010	MAY	17	FINAL INSPECTION DATE

### CONTRACTOR ACCESS ASSUMPTIONS

FOR THE SW QUADRANT ACCESS IS ASSUMED TO BE FROM THE FRONTAGE ROAD. THE EXISTING FENCE IS SHOWN TO BE REMOVED. THE CONTRACTOR SHALL MAINTAIN ACCESS CONTROL BY INSTALLING TEMPORARY CHAIN LINK FENCE (PORTABLE) WHILE EXISTING FENCE IS REMOVED. TEMPORARY FENCE (PORTABLE) IS INCLUDED IN THE COST OF TRAFFIC CONTROL AND PROTECTION (SPECIAL).

FOR THE SE AND NW QUADRANTS ACCESS IS ASSUMED TO BE FROM THE THE EXPRESSWAY RAMP. ACCESS FROM THE FRONTAGE ROAD IS BLOCKED BY EXISTING RETAINING WALLS. TEMPORARY EXPRESSWAY RAMP CLOSURES SHALL BE PERMITTED.

# QUADRANT NOMENCLATURE

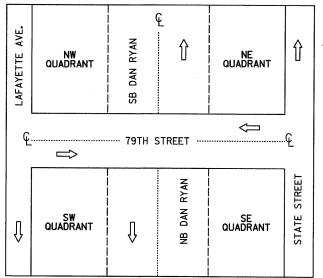

### IDOT HOT-MIX ASPHALT MIXTURE REQUIREMENTS

ITEM	AC TYPE	AIR VOIDS
PAVEMENT REMOVAL AND REPLACEMENT		
HOT-MIX ASPHALT SURFACE COURSE, MIX "D", N 70 11/2"	PG 64-22	4%@70Gyr
LEVELING BINDER (MACHINE METHOD), N 70, $1\frac{1}{2}$ "	PG 64-22/58-22	4% <b>@</b> 70Gyr

THE UNIT WEIGHT USED TO CALCULATE ALL HMA SURFACE MIXTURE QUANTITIES IS 112/SQ YD/IN. USE 135 LB/SQ YD/IN. IF USING A SMA MIX.

WHEN RAP EXCEEDS 20%, THE NEW ASPHALT BINDER IN THE MIX SHALL BE PG 58-22.

REVISIONS	
NAME DATE	ILLINOIS DEPARTMENT OF TRANSPORTATION
	F.A.I. 94 (DAN RYAN EXPRESSWAY)
	CALENDAR OF CONSTRUCTION, QUADRANT
	NOMENCLATURE, AND HOT-MIX ASPHALT
	MIXTURE REQUIREMENTS

SCALE: NONE 09/19/08 DATE: MAY 1, 2008

DRAWN BY: CHECKED BY: TGB

TY:LIN INTERNATIONAL

## PROJECT: GATEWAYS AND CORNER GARDENS AT 79TH STREET COOK COUNTY / CITY OF CHICAGO

SUMMARY OF QUANTITIES

	SUMMARY OF QUANTI1	IES		5EQ 01	3EQ 02
CODE NUMBER	ITEM DESCRIPTION	UNIT	URBAN TOTAL	100% STATE	100% STATE
20101000	TEMPORARY FENCE	FOOT	74	DAN RYAN YOO3 74	DAN RYAN YOUZ
20200100	EARTH EXCAVATION	CU YD	35	35	
20201200	REMOVAL AND DISPOSAL OF UNSUITABLE MATERIAL	CU YD	35	35	
20700220	POROUS GRANULAR EMBANKMENT	CU YD	10		10
21101645	TOPSOIL FURNISH AND PLACE, 12"	SQ YD	79	79	
21101825	COMPOST FURNISH AND PLACE, 6"	SQ YD	79	79	
25000210	SEEDING, CLASS 2A	ACRE	0,5	0.5	
25000400	NITROGEN FERTILIZER NUTRIENT	POUND	65		
25000500	PHOSPHORUS FERTILIZER NUTRIENT	POUND	· · · · · · · · · · · · · · · · · · ·	65 53	
25000600	POTASSIUM FERTILIZER NUTRIENT		53	47	
25100630		POUND	47		
	EROSION CONTROL BLANKET	SQ YD	1831	1831	
28000250	TEMPORARY EROSION CONTROL SEEDING	POUND	37	37	
28000510	INLET FILTERS	EACH	20	20	
40603340	HOT-MIX ASPHALT SURFACE COURSE, MIX "D", N70	TON	9		9
42001300	PROTECTIVE COAT	SQ YD	140		140
42400200	PORTLAND CEMENT CONCRETE SIDEWALK 5 INCH	SQ FT	788		788
44000155	HOT-MIX ASPHALT SURFACE REMOVAL, 1 1/2"	SQ YD	102		102
44000300	CURB REMOVAL	FOOT	30		30
44000500	COMBINATION CURB AND GUTTER REMOVAL	F00T	149		149
44000600	SIDEWALK REMOVAL	SQ FT	786		786
44003100	MEDIAN REMOVAL	SQ FT	16		16
44004250	PAVED SHOULDER REMOVAL	SQ YD	3		3
48300700	PORTLAND CEMENT CONCRETE SHOULDERS 12"	SQ YD	7		7
50200100	STRUCTURAL EXCAVATION	CU YD	46	39	7
50300225	CONCRETE STRUCTURES	CU YD	/7		
50300300	PROTECTIVE COAT	SQ YD	39	39	
50300510	RUSTICATION FINISH	SQ FT	28	28	
50800205	REINFORCEMENT BARS, EPOXY COATED	POUND	3640	3640	
56104600	WATER VALVES 2"	, EACH	2		2
56200700	WATER SERVICE LINE 2 1/2"	FOOT	395		395
60250200	CATCH BASINS TO BE ADJUSTED	EACH	4		4
60255500	MANHOLES TO BE ADJUSTED	EACH	5		5
60600605	CONCRETE CURB, TYPE B	FOOT	50.0		50
66410300	CHAIN LINK FENCE REMOVAL	FOOT	63.0	63.0	
67000400	ENGINEER'S FIELD OFFICE, TYPE A	CAL MO	16	16	
67100100	MOBILIZATION	L SUM	1	1	
70101800	TRAFFIC CONTROL AND PROTECTION (SPECIAL)	L SUM	1	1	
		1 E 50M			·

REVISIONS NAME	DATE	ILLINOIS DEPARTMENT OF TRANSPORTATION F.A.I. 94 (DAN RYAN EXPRESSWAY)
		SUMMARY OF QUANTITIES SHEET 1 OF 2

\* - SPECIALTY ITEM

TYLININTERNATIONAL

DRAWN BY: JDF CHECKED BY: JPM

## PROJECT: GATEWAYS AND CORNER GARDENS AT 79TH STREET COOK COUNTY / CITY OF CHICAGO

COUNTY TOTAL SHEET NO. SECTION 94 2005-070 LS COOK 65 5 STA. 2308+17 (NB 1-94) TO STA. 2316+90 (NB 1-94) FED. ROAD DIST. NO. | ILLINOIS | FED. AID PROJECT

SUMMARY OF QUANTITIES

5EQ 01 58002 100% STATE 100% STATE ITEM DESCRIPTION UNIT DAN RYAN YOO3 DAN RYAM YOUZ • 78000100 THERMOPLASTIC PAVEMENT MARKING - LETTERS AND SYMBOLS SQ FT 66 64 78000200 THERMOPLASTIC PAVEMENT MARKING - LINE 4" FOOT 23 23 233 78000400 | THERMOPLASTIC PAVEMENT MARKING - LINE 6" FOOT 233 78000600 THERMOPLASTIC PAVEMENT MARKING - LINE 12" FOOT 28 28 81400200 HEAVY-DUTY HANDHOLE EACH X0326143 FLUTED KNEE WALL (SPECIAL) FOOT 25 25 KI003460 LANDSCAPE MAINTENANCE CAL MO 11. X0326144 TACTILE/DETECTABLE WARNING SURFACE SQ FT 32 32 A2012003 TREE, AESCULUS X CARNEA 'FORT MCNAIR' (FORT MCNAIR RED HORSECHESTNUT), 3" CALIPER, MATCHING HEADS EACH 10 B2004568 TREE, MALUS RED PEACOCK (RED PEACOCK CRABAPPLE), 2-1/2" CALIPER, MATCHING HEADS

BALLED AND BURLAPPED, EACH X0326145 WATER SERVICE LINE 3" (SPECIAL) FOOT 15 15 C2010930 SHRUB, SYRINGA MEYERI PALIBIN (DWARF KOREAN LILAC), 2-1/2' HEIGHT, BALLED AND BURLAPPED EACH 440 440 K0030400 PERENNIAL PLANTS, DAYLILIES UNIT 13 13 KOO30470 | PERENNIAL PLANT, ORNAMENTAL GRASS TYPE 22 UNIT 22 X0301407 PERENNIAL PLANTS, GALLON POT UNIT \_19 19 X0320870 BRACED EXCAVATION CU YD 10 X0322256 TEMPORARY INFORMATION SIGNING SQ FT 103 103 X0325604 WEED CONTROL, PRE-EMERGENT HERBICIDE GALLON X0323973 SEDIMENT CONTROL, SILT FENCE FOOT 404 404 X0324525 PLANTING MIX FURNISH AND PLACE 36" SQ YD 15 X0325102 INSPECTION PIPE 4 INCH EACH X0325103 WATER METER IN VAULT, 2 INCH EACH X0325104 WATER TAP, 2 INCH EACH 2 X0325105 IRRIGATION SYSTEM SQ YD 858 858 X0325106 IRRIGATION SYSTEMS FALL SHUTDOWN EACH X0325107 | IRRIGATION SYSTEMS SPRING STARTUP EACH X0325108 BACKFLOW PREVENTER (RPZ), 2 INCH EACH X0325109 POROUS GRANULAR MATERIAL CU YD 6 6 X0656300 PAVEMENT REMOVAL AND REPLACEMENT SQ YD 108 108 69 X6065740 CONCRETE MEDIAN SURFACE, 5" (MODIFIED) SQ FT 69 X0325970 SOIL CONDITIONER 3" SQ YD 1588 1588 XX104800 | COMBINATION CONCRETE CURB AND GUTTER, TYPE B-V.12 FOOT Z0013798 CONSTRUCTION LAYOUT SUM Z0027800 GEOTECHNICAL FABRIC SQ YD 28 28

REVISIONS NAME	DATE			 	TRANSPOI EXPRE		
			SU	 OF QU. ET 2 O	ANTITIES F 2	\$	
		SCALE: N	ONE	DI	RAWN BY:	JDF	

CHECKED BY: JPM

DATE: MAY 1, 2008

\* - SPECIALTY ITEM

TY:LIN INTERNATIONAL

F.A.I. RTE.	SECTION	1		COUNTY	TOTAL SHEETS	SHEET NO.		
94	2005-070	LS		COOK	65	6		
STA.	. TO STA.							
FED. RO	AD DIST. NO.	ILLIN	DIS	FED. AID	PROJECT			
					P	50A76		

Code	Item	Common Name	Size	Root	Remarks	Unit	Total
	SHADE TREES	Control State State Control State St				\$158 Pt.533	4
AC	Aesculus x carnea 'Fort McNair'	Fort McNair Red Horsechestnut	3" caliper	B&B	matching heads, 20' o.c.	each	10
	INTERMEDIATE TREES			economic cocaso	Principles of the Control of the Con		1
MA	Malus 'Red Peacock'	Red Peacock Crabapple	2-1/2" caliper	B&B	matching heads, 12' o.c.	each	7
	SHRUBS						100
SM	Syringa meyeri 'Palibin'	Dwarf Korean Lilac	24" height	B&B	24" o.c.	each	440
	PERENNIAL PLANTS, DAYLILIES						
HC	Hemerocallis 'Cherry Cheeks'	Cherry Cheeks Daylily	1 gallon	pot	18" o.c.	UNIT	3.13
HH	Hemerocallis 'Chicago Heirloom'	Chicago Heirloom Daylily	1 gallon	pot	15" o.c.	UNIT	4.29
HP	Hemerocallis 'Preppy Pink'	Preppy Pink Daylily	1 gallon	pot	15" o.c.	UNIT	4.74
						Total units:	12.16
	PERENNIAL PLANTS, GALLON POT				A PERMANENTAL SECTION AND ASSESSMENT		era Keranci (K. Keran
AS	Aster azureus	Sky Blue Aster	1 gallon	pot	15" o.c.	UNIT	4.06
LB	Liatris spicata 'Blazing Star'	Blazing Star Gayfeather	1 gallon	pot	15" o.c.	UNIT	4.74
LS	Liatris spicata 'Kolbold'	Kolbold Spike Gayfeather	1 gallon	pot	18" o.c.	UNIT	3.13
NF	Nepeta faassenii 'Walker's Low'	Walker's Low Faassen's Catmint	1 gallon	pot	18" o.c.	UNIT	2.90
PE	Perovskia atriplicifoia	Russian Sage	1 gallon	pot	15" o.c.	UNIT	4.06
					E41532366.22 (#2411 Ltd.)	Total units:	18.89
	PERENNIAL PLANTS, ORNAMENTAL GRAS	SS TYPE	2200000-09-0-0				u casolina e
BC	Bouteloria curtipendula	Side Oats Grama	1 gallon	pot	15" o.c.	UNIT	4.74
CA	Calamagrostis acutiflora 'Karl Foerster'	Karl Foerster Feather Reed Grass	1 gallon	pot	15" o.c.	UNIT	4.36
-MG-	Miscanthus sinensis 'Graziella'	Maiden Eulalia Grass	1 gallon	<del>pot</del>	15" o.c.	UNIT	0.00
MS	Miscanthus sinensis 'Silberfeder'	Silver Feather Eulalia Grass	1 gallon	pot	18" o.c.	UNIT	2.21
PN	Panicum virgatum 'Northwind'	Northwind Switch Grass	1 gallon	pot	15" o.c.	UNIT	1.83
PR	Panicum virgatum 'Rotstrahlbusch'	Rotstrahlbusch Switch Grass	1 gallon	pot	18" o.c.	UNIT	1.98
PS	Panicum virgatum 'Shenandoah'	Shenandoah Switch Grass	1 gallon	pot	18" o.c.	UNIT	2.54
SH	Sporobolus heterolepis	Prairie Dropseed	1 gallon	pot	18" o.c.	UNIT	3.65
					- 1 to 1 t	Total units:	21.31

Code	Item	Common Name	Size	Root	Remarks	Unit	Total
	SHADE TREES		Control of the control of				
AC	Aesculus x carnea 'Fort McNair'	Fort McNair Red Horsechestnut	3" caliper	B&B	matching heads, 20' o.c.	each	3
	INTERMEDIATE TREES						
MA	Malus 'Red Peacock'	Red Peacock Crabapple	2-1/2" caliper	B&B	matching heads, 12' o.c.	each	. 3
	SHRUBS	READER CONTROL OF THE PROPERTY			012y (595)		
SM	Syringa meyeri 'Palibin'	Dwarf Korean Lilac	24" height	B&B	24" o.c.	each	134
	PERENNIAL PLANTS, DAYLILIES					77.0	
HC	Hemerocallis 'Cherry Cheeks'	Cherry Cheeks Daylily	1 gallon	pot	18" o.c.	UNIT	1.48
	Hemerocallis 'Chicago Heirloom'	Chicago Heirloom Daylily	1 gallon	pot	15" o.c.	UNIT	1.95
HP	Hemerocallis 'Preppy Pink'	Preppy Pink Daylily	1 gallon	pot	15" o.c.	UNIT	2.3
						Total units:	5.73
	PERENNIAL PLANTS, GALLON POT	2. sacradd Medical Carlos (1. profesion 1. p					100
AS	Aster azureus	Sky Blue Aster	1 gallon	pot	15" o.c.	UNIT	1.95
	Liatris spicata 'Blazing Star'	Blazing Star Gayfeather	1 gallon	pot	15" o.c.	UNIT	2.3
	Liatris spicata 'Kolbold'	Kolbold Spike Gayfeather	1 gallon	pot	18" o.c.	UNIT	1.48
NF	Nepeta faassenii 'Walker's Low'	Walker's Low Faassen's Catmint	1 gallon	pot	18" o.c.	UNIT	1.48
PE	Perovskia atriplicifoia	Russian Sage	1 gallon	pot	15" o.c.	UNIT	1.95
					10.00 (in 1970) 11.00 (in 1970)	Total units:	9.16
1467	PERENNIAL PLANTS, ORNAMENTAL GRA	SS TYPE					
вс	Bouteloria curtipendula	Side Oats Grama	1 gallon	pot	15" o.c.	UNIT	2.3
CA	Calamagrostis acutiflora 'Karl Foerster'	Karl Foerster Feather Reed Grass	1 gallon	pot	15" o.c.	UNIT	4.36
MS	Miscanthus sinensis 'Silberfeder'	Silver Feather Eulalia Grass	1 gallon	pot	18" o.c.	UNIT	2.21
PS	Panicum virgatum 'Shenandoah'	Shenandoah Switch Grass	1 gallon	pot	18" o.c.	UNIT	2.54
						Total units:	11.41

Code	Item	Common Name	Size	Root	Remarks	Unit	Total
	SHRUBS			10 a 2 ft - \$ 0 a 2 ft	The second second		
SM	Syringa meyeri 'Palibin'	Dwarf Korean Lilac	24" height	B&B	24" o.c.	each	6
127	PERENNIAL PLANTS, DAYLILIES		Wester Court				
HC	Hemerocallis 'Cherry Cheeks'	Cherry Cheeks Daylily	1 gallon	pot	18" o.c.	UNIT	0.08
НН	Hemerocallis 'Chicago Heirloom'	Chicago Heirloom Daylily	1 gallon	pot	15" o.c.	UNIT	0.08
					1277 PERSON	Total units:	0.16
	PERENNIAL PLANTS, GALLON POT	ALEXANDER OF THE STREET, STREE				Treate of	and various as
LS	Liatris spicata 'Kolbold'	Kolbold Spike Gayfeather	1 gallon	pot	18" o.c.	UNIT	0.08
						Total units:	0.08

SITE DESIGN GROUP

**TYLIN**INTERNATIONAL

PLANT SCHEDULES
SUMMARY AT 79TH ST. - NB I-94
SE + NE QUADRANTS AT 79TH ST. - NB I-94
SCALE: NTS DRAWN BY: EM

09/19/08 DATE: May 1, 2008

CHECKED BY: JO

F.A.I. RTE.	SECTION	ı		COUNTY	TOTAL	SHEET NO.	1
94	2005-070	LS		соок	65	7	i
STA.			TO	STA.		***************************************	1
FED. ROA	AD DIST. NO.	ILLING	DIS	FED. AID	PROJECT		1
					6	50A76	1

Code	Item	Common Name	Size	Root	Remarks	Unit	Tota
4.2	SHRUBS						
SM	Syringa meyeri 'Palibin'	Dwarf Korean Lilac	24" height	B&B	24" o.c.	each	6
	PERENNIAL PLANTS, DAYLILIES						W 10 2 15 15 15 15 15 15 15 15 15 15 15 15 15
HC	Hemerocallis 'Cherry Cheeks'	Cherry Cheeks Daylily	1 gallon	pot	18" o.c.	UNIT	0.07
НН	Hemerocallis 'Chicago Heirloom'	Chicago Heirloom Daylily	1 gallon	pot	15" o.c.	UNIT	0.07
						Total units:	0.14
	PERENNIAL PLANTS, GALLON POT						
LS	Liatris spicata 'Kolbold'	Kolbold Spike Gayfeather	1 gallon	pot	18" o.c.	UNIT	0.07
					HIII COLORED TO BE SHOULD BE	Total units:	0.07

	SCHEDULE OF LANDSCAPE ITEMS - 79TH STREET GATEWAY - NORTHWEST										
Code		Common Name	Size	Root	Remarks	Unit	Tota				
	SHADE TREES	Parameter Control of the Control of			The House of Contract of Contr						
AC	Aesculus x carnea 'Fort McNair'	Fort McNair Red Horsechestnut	3" caliper	B&B	matching heads, 20' o.c.	each	7				
	INTERMEDIATE TREES						19 (6)				
MA	Malus 'Red Peacock'	Red Peacock Crabapple	2-1/2" caliper	B&B	matching heads, 12' o.c.	each	4				
	SHRUBS					17701					
SM	Syringa meyeri 'Palibin'	Dwarf Korean Lilac	24" height	B&B	24" o.c.	each	288				
	PERENNIAL PLANTS, DAYLILIES	Part I was a second of the sec									
HC	Hemerocallis 'Cherry Cheeks'	Cherry Cheeks Daylily	1 gallon	pot	18" o.c.	I UNIT I	1.42				
HH	Hemerocallis 'Chicago Heirloom'	Chicago Heirloom Daylily	1 gallon	pot	15" o.c.	UNIT	2.11				
HP	Hemerocallis 'Preppy Pink'	Preppy Pink Daylily	1 gallon	pot	15" o.c.	UNIT	2.44				
						Total units:	5.97				
	PERENNIAL PLANTS, GALLON POT	Market 1997 - Professor 1997	2574-90032		17 (17 (17 (17 (17 (17 (17 (17 (17 (17 (	Marie and the					
AS	Aster azureus	Sky Blue Aster	1 gallon	pot	15" o.c.	UNIT	2.11				
LB	Liatris spicata 'Blazing Star'	Blazing Star Gayfeather	1 gallon	pot	15" o.c.	UNIT	2.44				
LS	Liatris spicata 'Kolbold'	Kolbold Spike Gayfeather	1 gallon	pot	18" o.c.	UNIT	1.42				
NF	Nepeta faassenii 'Walker's Low'	Walker's Low Faassen's Catmint	1 gallon	pot	18" o.c.	UNIT	1.42				
PE	Perovskia atriplicifoia	Russian Sage	1 gallon	pot	15" o.c.	UNIT	2.11				
					(200 to 100 to 1	Total units:	9.5				
	PERENNIAL PLANTS, ORNAMENTAL GI	RASS TYPE					11.5				
BC	Bouteloria curtipendula	Side Oats Grama	1 gallon	pot	15" o.c.	UNIT	2.44				
PN	Panicum virgatum 'Northwind'	Northwind Switch Grass	1 gallon	pot	15" o.c.	UNIT	1.83				
PR	Panicum virgatum 'Rotstrahlbusch'	Rotstrahlbusch Switch Grass	1 gallon	pot	18" o.c.	UNIT	1.98				
SH	Sporobolus heterolepis	Prairie Dropseed	1 gallon	pot	18" o.c.	UNIT	3.65				
					100	Total units:	9.9				

Code	Item	Common Name	Size	Root	Remarks	Unit	Tota
	SHRUBS	e established for a final control of the control of					17 E I
SM	Syringa meyeri 'Palibin'	Dwarf Korean Lilac	24" height	B&B	24" o.c.	each	6
	PERENNIAL PLANTS, DAYLILIES						
HC	Hemerocallis 'Cherry Cheeks'	Cherry Cheeks Daylily	1 gallon	pot	18" o.c.	UNIT	0.08
НН	Hemerocallis 'Chicago Heirloom'	Chicago Heirloom Daylily	1 gallon	pot	15" o.c.	UNIT	0.08
						Total units:	0.16
	PERENNIAL PLANTS, GALLON POT						
LS	Liatris spicata 'Kolbold'	Kolbold Spike Gayfeather	1 gallon	pot	18" o.c.	UNIT	0.08
					property and the second	Total units:	0.08

SITE DESIGN GROUP

TY:LININTERNATIONAL

REVISIONS

NAME
DATE

ILLINOIS DEPARTMENT OF TRANSPORTATION

F.A.I. 94 (DAN RYAN EXPRESSWAY)

PLANT SCHEDULES

SW + NW QUADRANTS AT 79TH ST. - NB I-94

SCALE: NTS


DRAWN BY: EM


REVISED


09/19/08

DATE: Moy I, 2008

CHECKED BY: JO

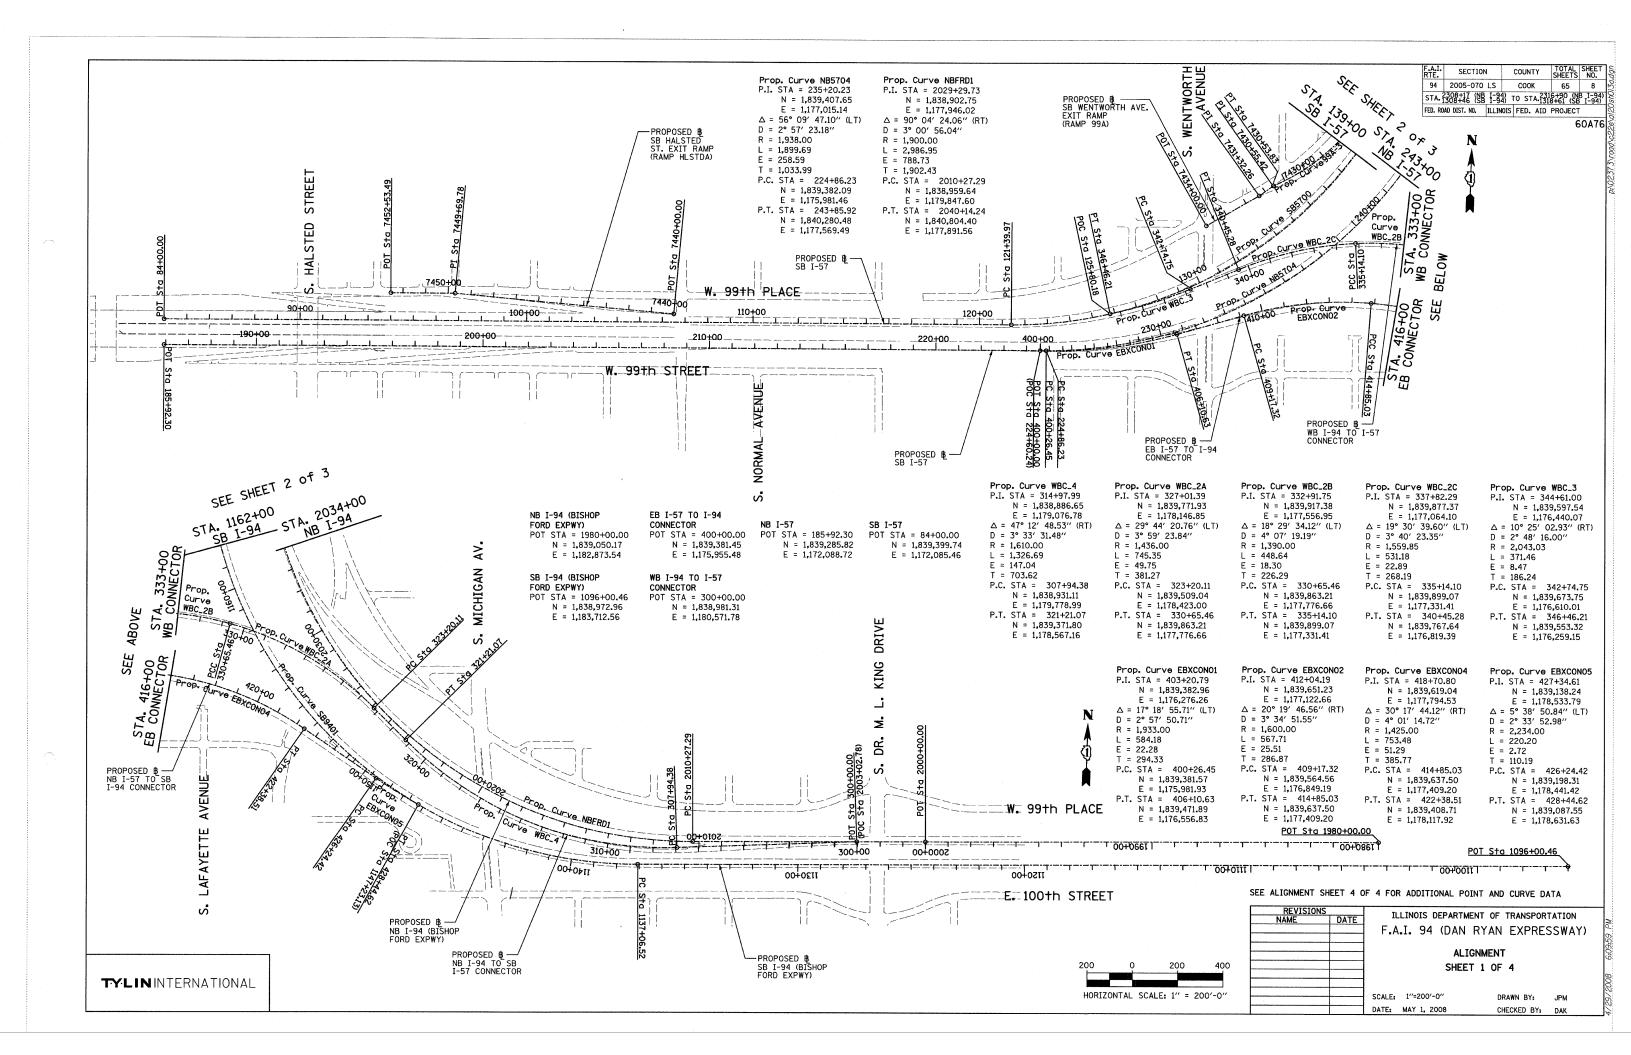

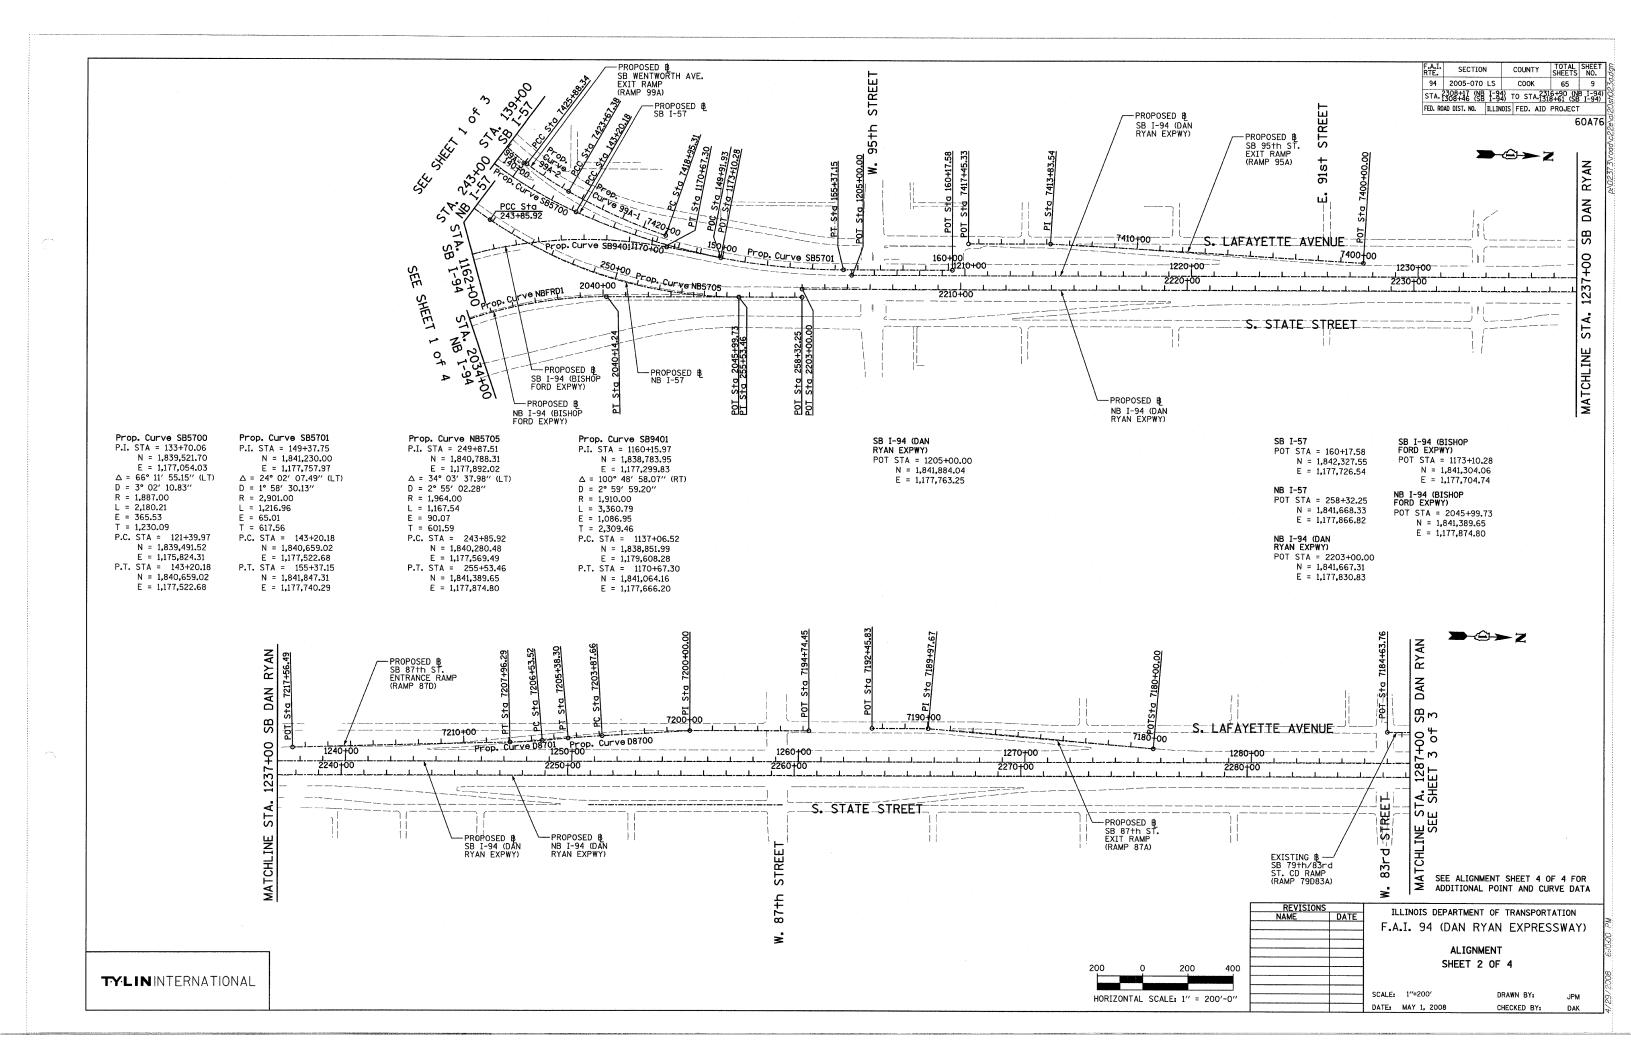

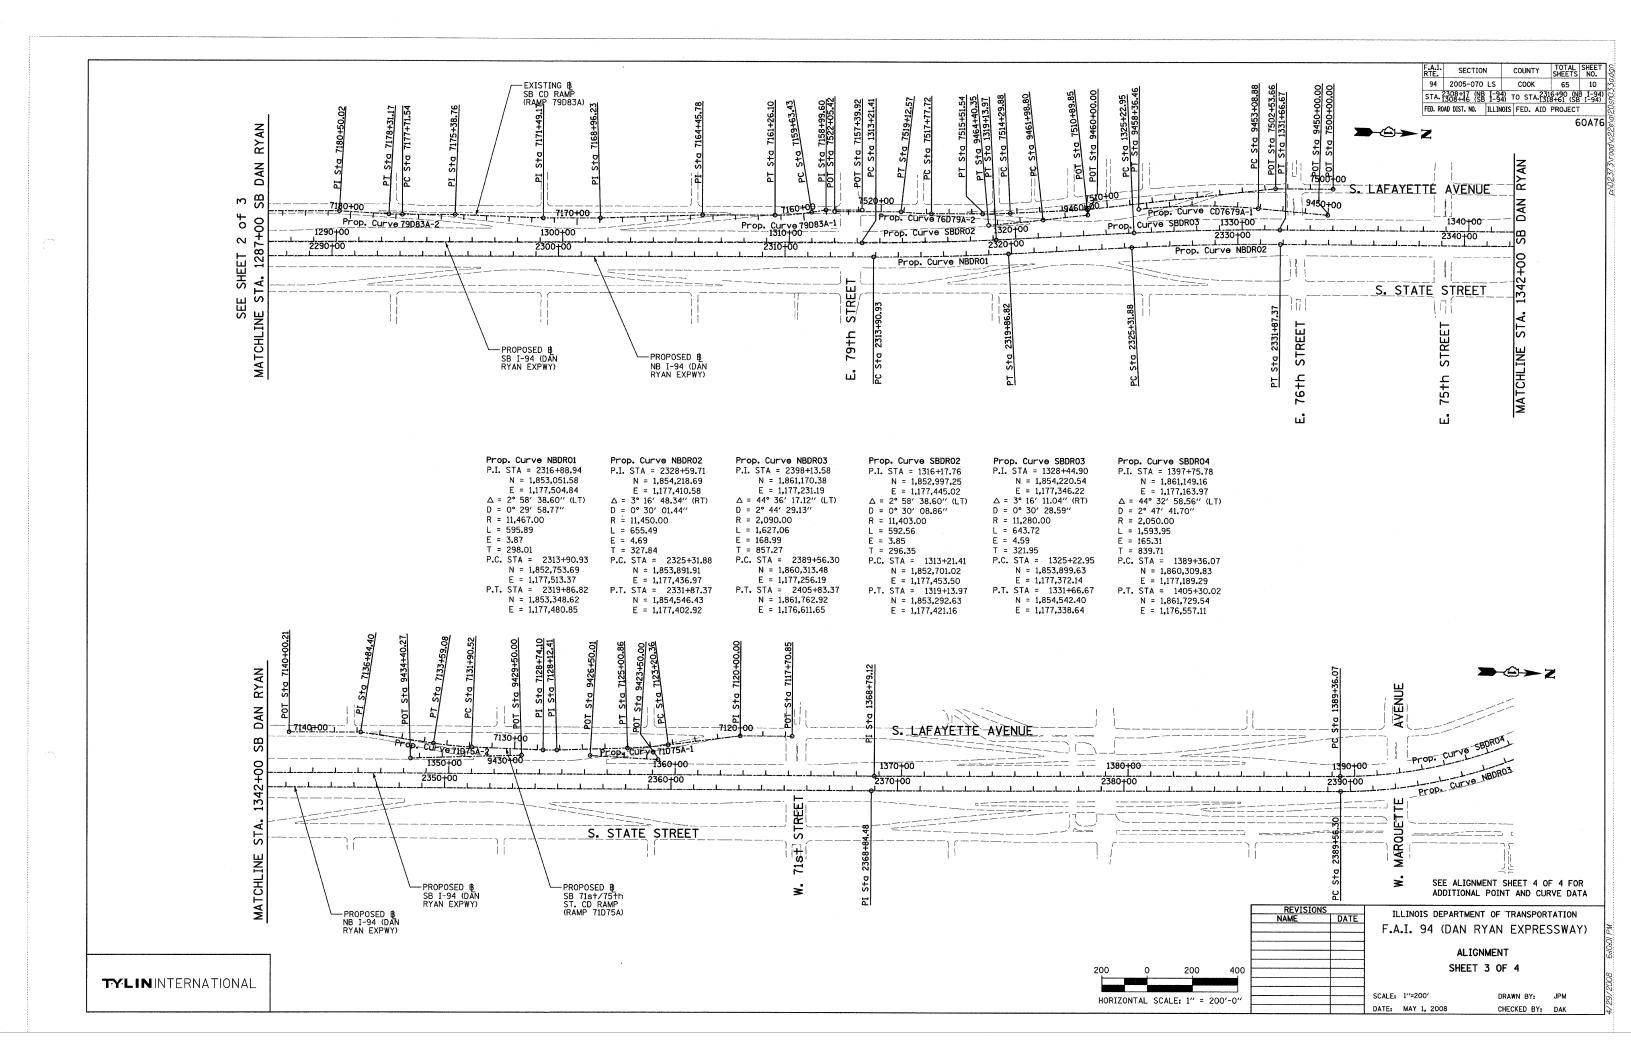

SB HALSTED ST. EXIT RAMP (RAMP HLSTDA) POT STA = 7440+00.00 N = 1.839.490.94E = 1.174.333.70P.I. STA = 7449+69.78 N = 1,839,551.73E = 1,173,365.83POT STA = 7452+53.49 N = 1.839.544.76E = 1.173.082.20SB WENTWORTH AVE. EXIT RAMP (RAMP 99A) Prop. Curve 99A-1 Prop. Curve 99A-2 Prop. Curve 99A-3 P.I. STA = 7428+26.42 P.I. STA = 7421+32.05 P.I. STA = 7424+78.02 N = 1,840,832.05N = 1,840,525.59N = 1.840.241.82 POT STA = 7430+55.42 E = 1,177,544.75E = 1,177,381.20 E = 1,177,178.53N = 1,840,141.17 $\Delta = 10^{\circ} 49' 08.53'' (RT)$  $\Delta = 7^{\circ} 26' 49.68'' (RT)$  $\Delta = 29^{\circ} 38' 02.27'' (RT)$ F = 1.176.961.02 D = 2° 17′ 30.59″ D = 3° 22′ 13.22″ D = 6° 21′ 58.31″ POT STA = 7431+32.26 R = 2.500.00R = 1.700.00R = 900.00N = 1.840.094.48L = 472.07L = 220.96L = 465.49E = 1,176,899.99E = 11.18 E = 3.60E = 30.96POT STA = 7434+00.00 T = 236.74= 110.64 T = 238.08P.C. STA = 7425+88.34 N = 1,839,955.89P.C. STA = 7418+95.31 P.C. STA = 7423+67.38 E = 1,176,670.92N = 1,841,058.12N = 1,840,623.20N = 1,840,435.56E = 1,177,615.03 E = 1.177.433.29E = 1,177,316.90P.T. STA = 7423+67.38 P.T. STA = 7425 + 88.34P.T. STA = 7430+53.83 N = 1,840,623.20N = 1,840,435.56N = 1,840,141.84 E = 1,177,433.29E = 1,177,316.90E = 1,176,962.46SB 95th ST. EXIT RAMP (RAMP 95A) POT STA = 7400+00.00 N = 1,844,139.73E = 1,177,638.63P.I. STA = 7413+83.54 N = 1.842.756.77E = 1,177,598.60POT STA = 7417+45.33 N = 1,842,395.13E = 1,177,608.95 SB 87th ST. ENTRANCE RAMP (RAMP 87D) Prop. Curve D8700 Prop. Curve D8701 P.I. STA = 7204+62.99 P.I. STA = 7207+24.93N = 1.846.437.54N = 1.846.177.29POT STA = 7194+74.45 E = 1,177,524.69E = 1,177,554.49 N = 1,847,424.06 $\Delta = 1^{\circ} 30' \ 03.72'' \ (LT)$  $\Delta = 3^{\circ} 27' 36.43'' (RT)$ E = 1,177,468.58D = 0° 59′ 47.21″ D = 2° 25' 25.25" P.I. STA = 7200+00.00 R = 5.750.00R = 2,364.00N = 1.846.898.74 L = 150.64L = 142.76E = 1,177,484.09F = 0.49F = 1.08POT STA = 7217+56.49 T = 75.32T = 71.40N = 1,845,147.17P.C. STA = 7203+87.66 P.C. STA = 7206+53.52 E = 1,177,609.78N = 1,846,512.58N = 1,846,248.23E = 1,177,518.09E = 1,177,546.37

P.T. STA = 7207+96.29

N = 1.846.105.99

E = 1,177,558,32

SB 87th ST. EXIT RAMP (RAMP 87A) POT STA = 7180+00.00

N = 1,848,946.30 E = 1,177,501.00P.I. STA = 7189+97.67 N = 1.847.950.35E = 1,177,442.53POT STA = 7192+45.83

N = 1,847,702.29E = 1.177.449.63

P.T. STA = 7205+38.30

N = 1.846.362.71

E = 1.177.533.26

P.I. STA = 7120+00.00 P.I. STA = 7128+12.41P.I. STA = 7128+74.10 P.I. STA = 7136+84.40 N = 1,855,981.27E = 1,177,124.75 POT = 7140+00.21 N = 1.855.665.56 E = 1.177.132.18

E = 1,177,159.94E = 1,177,164.79

> ILLINOIS DEPARTMENT OF TRANSPORTATION F.A.I. 94 (DAN RYAN EXPRESSWAY) ALIGNMENT SHEET 4 OF 4

N = 1.853.693.06

E = 1,177,298.94

N = 1,853,376.57

N = 1,853,496.18

E = 1,177,326.52

N = 1,853,256.63

E = 1,177,357.48

E = 1,177,233.1786

**TYLIN**INTERNATIONAL

SCALE: NO SCALE DRAWN BY: .IPA DATE: MAY 1, 2008 CHECKED BY: JPM

SECTION

2005-070 LS


COUNTY


COOK

STA. 2308+17 (NB I-94) TO STA. 2316+90 (NB I-94)

FED. ROAD DIST. NO. ILLINOIS FED. AID PROJECT

65

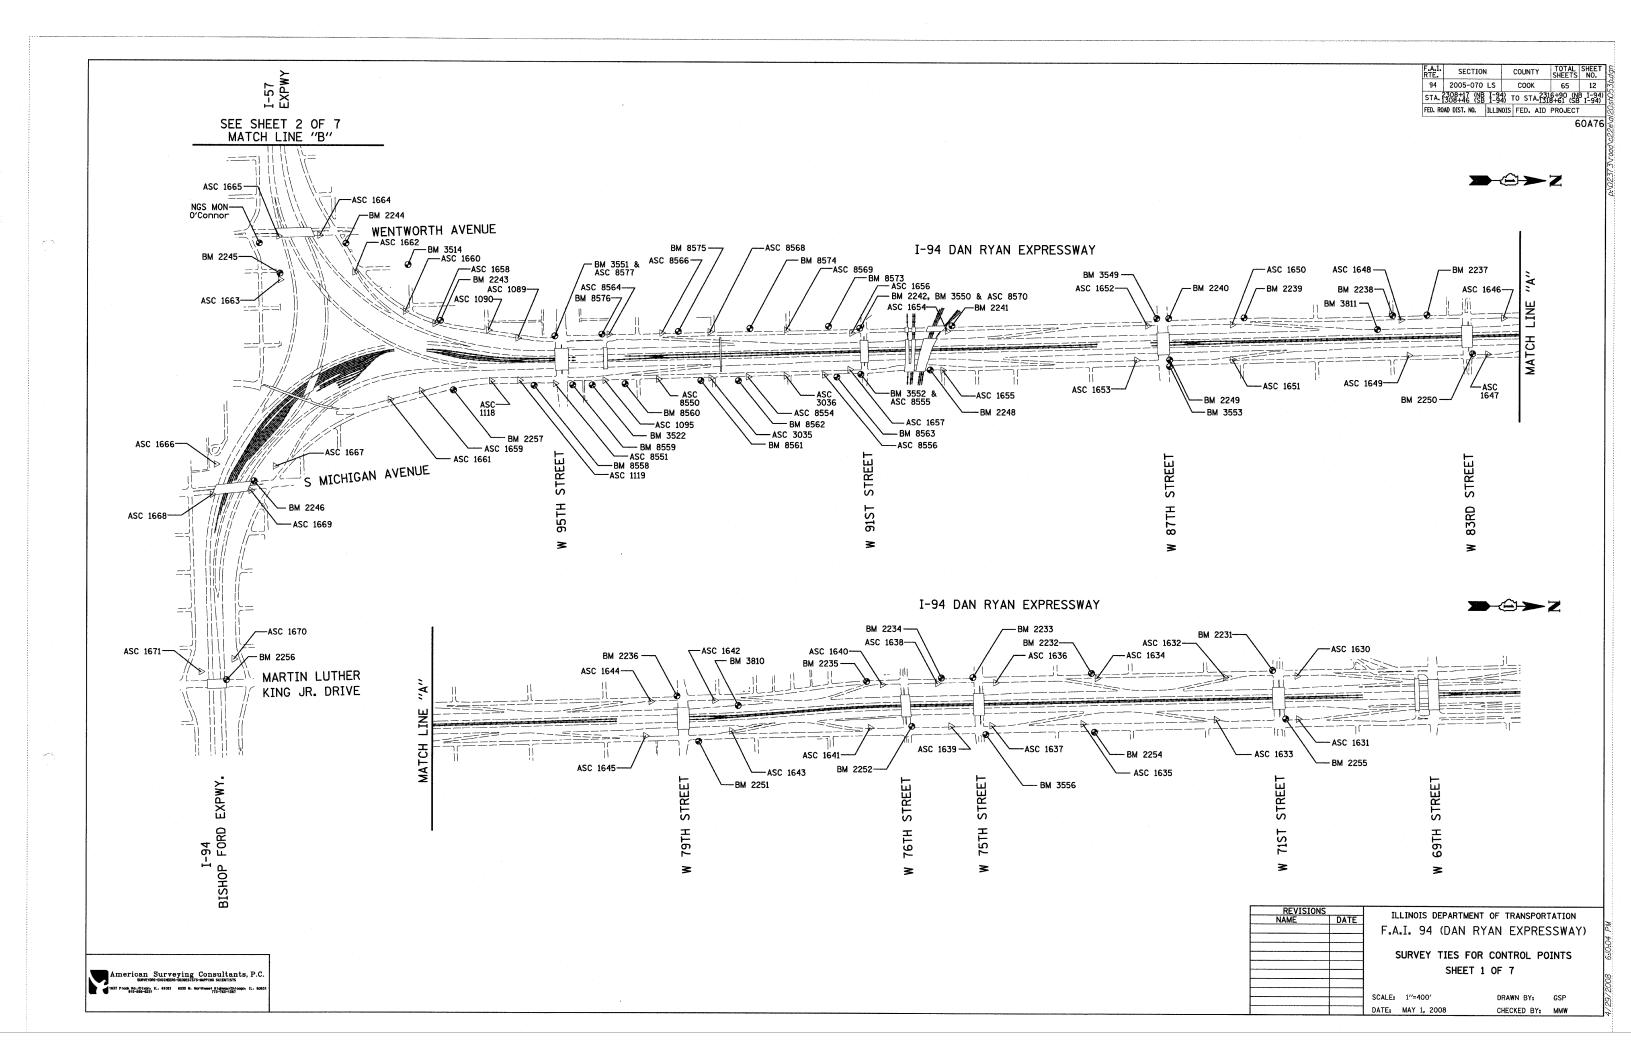

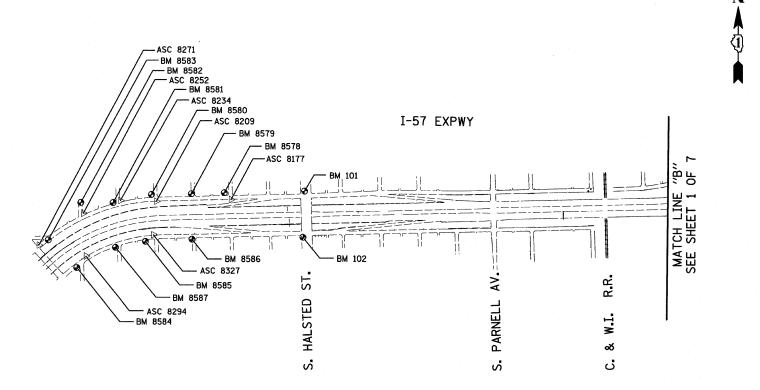

REVISIONS
NAME DATE
F.A.I. 94 (DAN RYAN EXPRESSWAY)


SURVEY TIES FOR CONTROL POINTS
SHEET 2 OF 7


SCALE: 1"=400' DATE: MAY 1, 2008 DRAWN BY: GSP CHECKED BY: MMW


American Surveying Consultants, P.C.


BANKING-Consultants-Accessive-weeping scientists


1637 Picos Ref. 2910cpt. 11. 61021 6005 St. Northweet Riferanticogn. 11. 60031

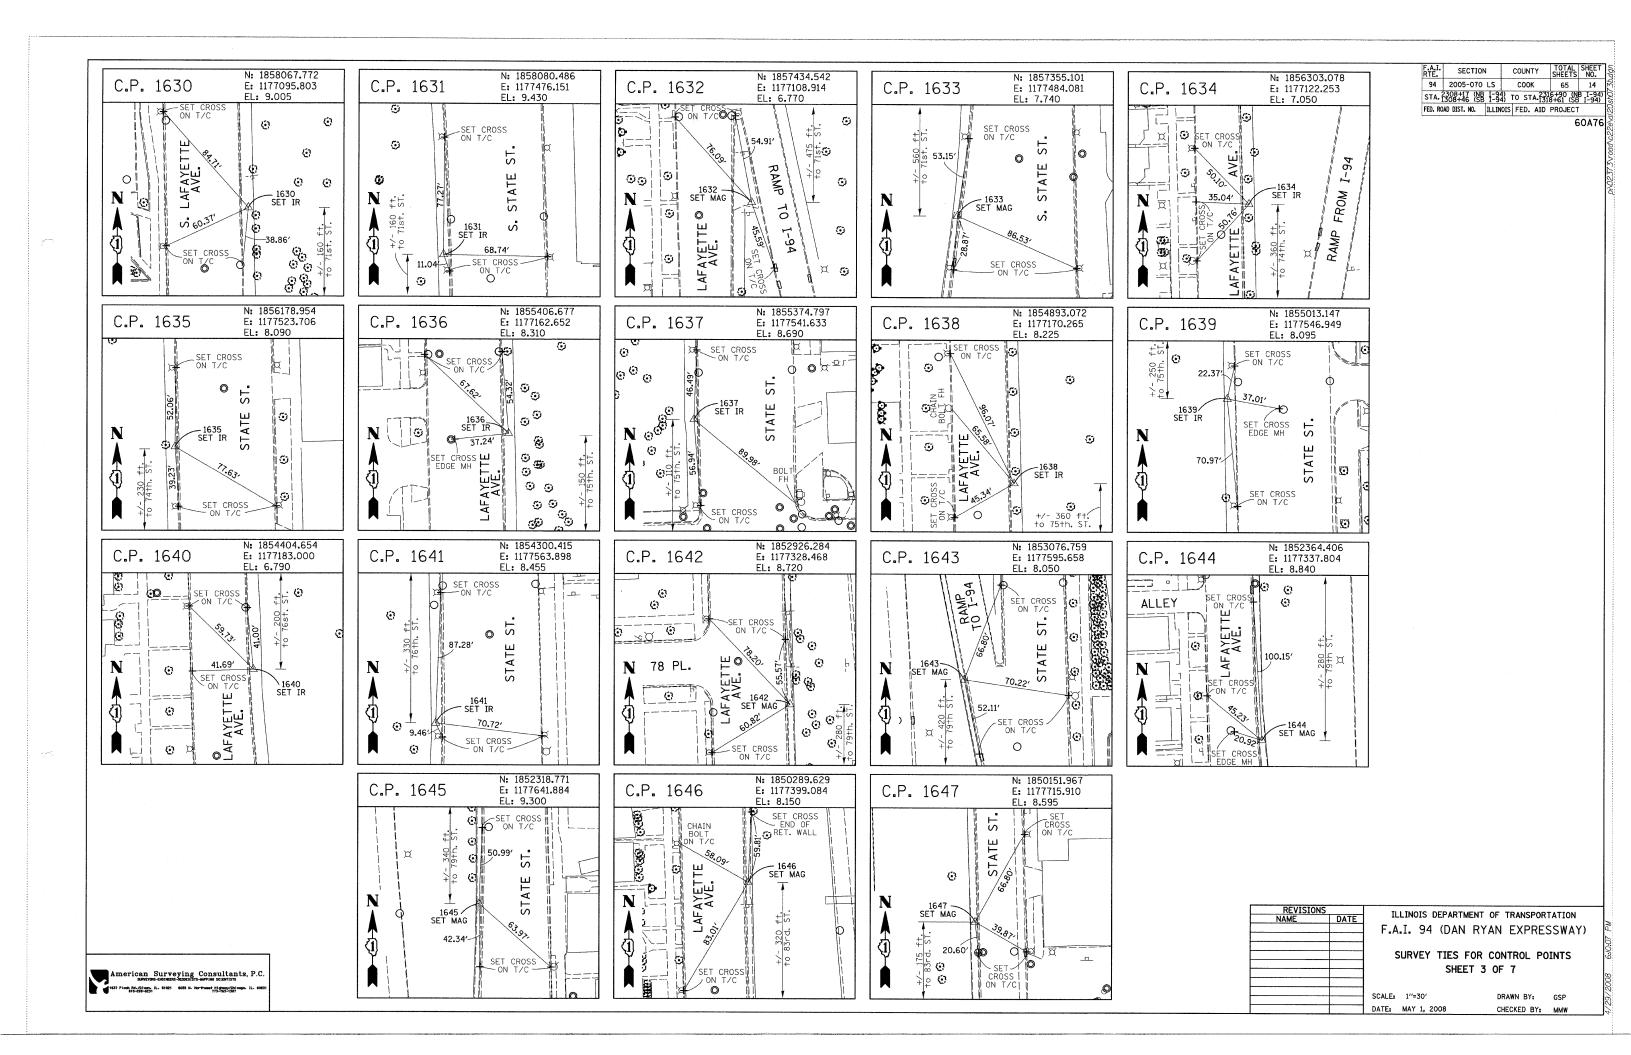


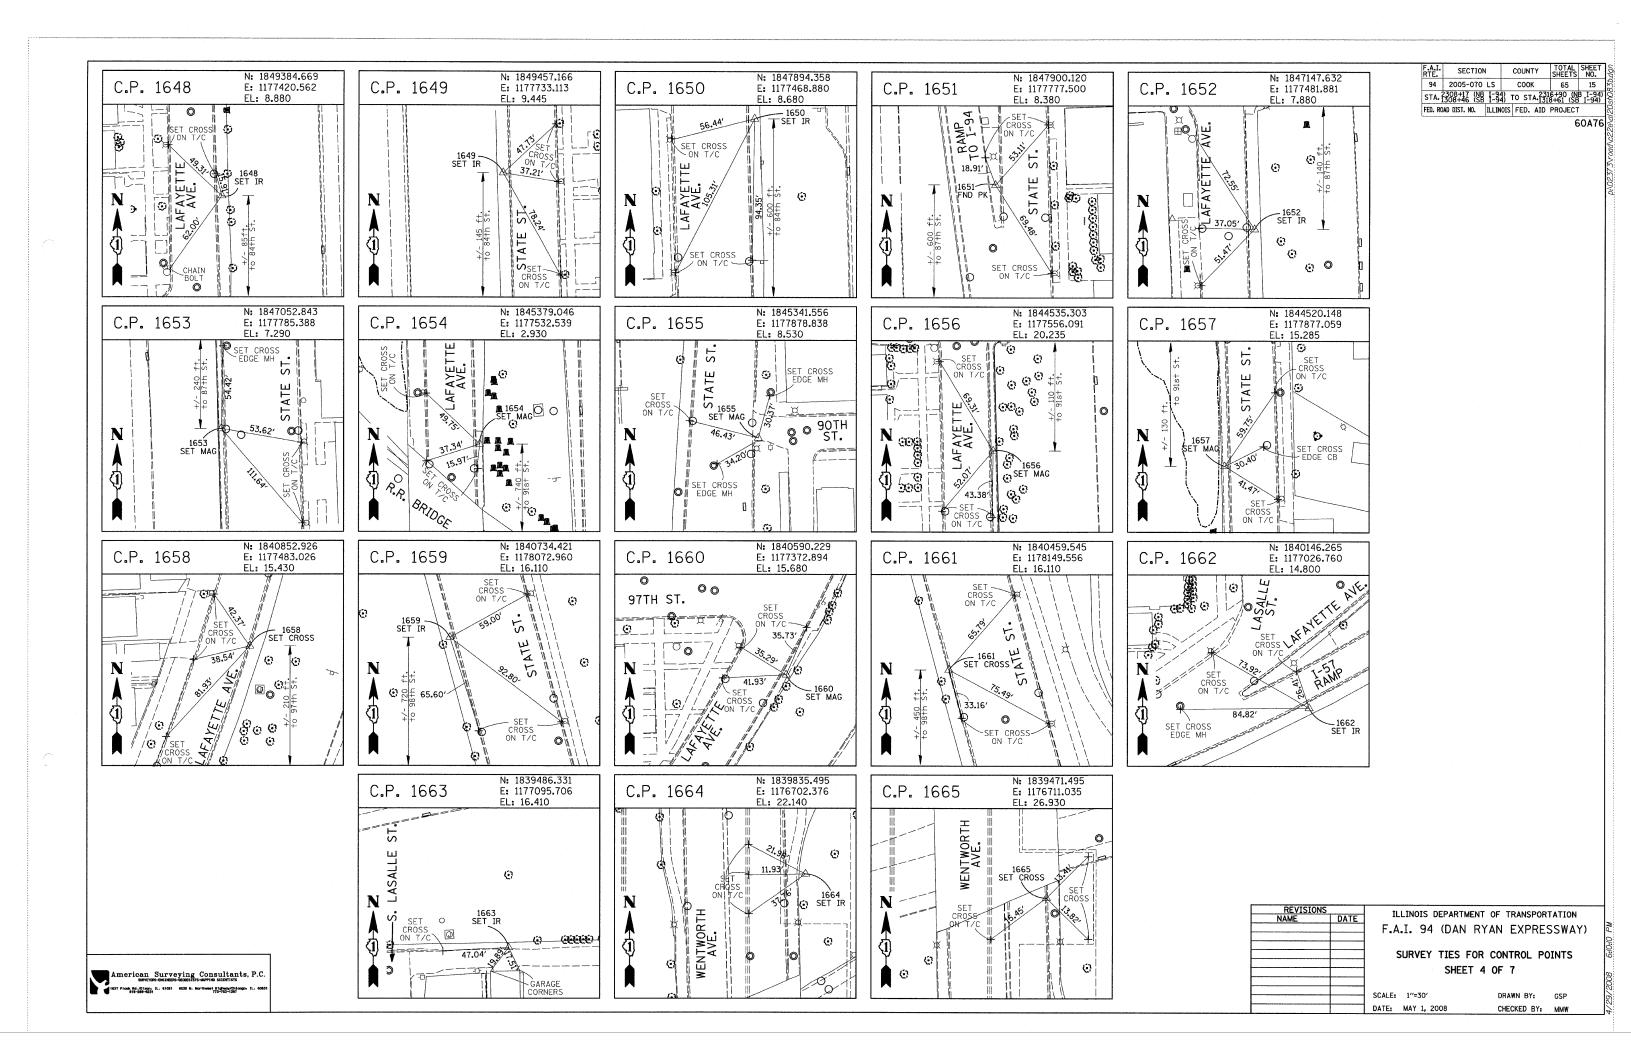


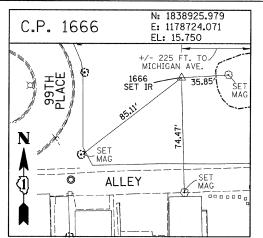

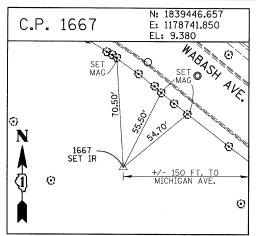


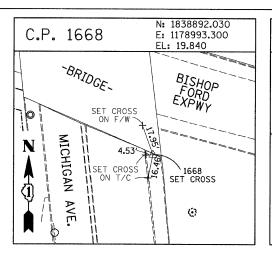

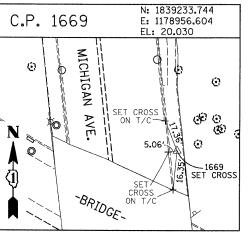

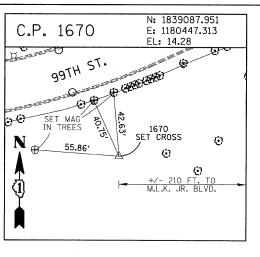

SECTION COUNTY 94 2005-070 LS COOK 65 16 STA. 2308+17 (NB 1-94) TO STA. 2316+90 (NB 1-94) STA. 1308+46 (SB 1-94) TO STA. 1318+61 (SB 1-94) FED. ROAD DIST. NO. | ILLINOIS | FED. AID PROJECT

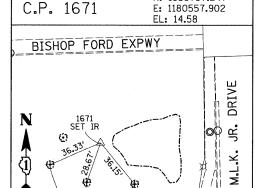

£ 28.67.

N: 1838797.247

### PROJECT BENCHMARKS

BM 2231 ELEVATION= 10.24 FEET SET CROSS ON CHAIN BOLT OF FIRE HYDRANT ON THE SOUTHWEST CORNER OF 71ST STREET AND LAFAYETTE AVENUE.

BM 2232 ELEVATION= 8.46 FEET SET CROSS ON CHAIN BOLT OF FIRST FIRE HYDRANT SOUTH OF 73RD STREET ON THE WEST SIDE OF LAFAYETTE AVENUE. APPROXIMATELY 330 FEET SOUTH OF 73RD STREET.

BM 2233 ELEVATION= 9.90 FEET SET CROSS ON NORTHWEST BOLT OF FIRE HYDRANT ON THE NORTHWEST CORNER OF 75TH STREET AND LAFAYETTE AVENUE.

BM 2234 ELEVATION= 9.56 FEET SET CROSS ON CHAIN BOLT OF FIRST FIRE HYDRANT SOUTH OF 75TH STREET ON THE WEST SIDE OF LAFAYETTE AVENUE, APPROXIMATELY 320 FEET SOUTH OF 75TH STREET.

BM 2235 ELEVATION= 7.50 FEET SET CROSS ON CHAIN BOLT OF FIRST FIRE HYDRANT SOUTH OF 76TH STREET ON THE WEST SIDE OF LAFAYETTE. APPROXIMATELY 330 FEET SOUTH OF 76TH STREET.

BM 2236 ELEVATION= 10.41 FEET SET CROSS ON WEST BOLT OF FIRE HYDRANT ON THE SOUTHWEST CORNER OF 79TH STREET AND LAFAYETTE AVENUE.

BM 2237 ELEVATION= 9.20 FEET SET CROSS ON CHAIN BOLT OF FIRST FIRE HYDRANT NORTH OF 83RD STREET ON THE WEST SIDE OF LAFAYETTE AVENUE, APPROXIMATELY 350 FEET NORTH OF 83RD STREET.

BM 2238 ELEVATION= 10.04 FEET SET CROSS ON CHAIN BOLT OF FIRE HYDRANT OF THE NORTHWEST CORNER OF 4TH STREET AND LAFAYETTE AVENUE.

BM 2239 ELEVATION= 9.59 FEET SET CROSS ON CHAIN BOLT OF SECOND FIRE HYDRANT NORTH OF 87TH STREET ON THE WEST SIDE OF LAFAYETTE AVENUE. APPROXIMATELY 720 FEET OF NORTH OF 87TH STREET.

BM 2240 ELEVATION= 9.49 FEET SET CROSS ON THE NORTHWEST BOLT OF FIRE HYDRANT ON THE SOUTHWEST CORNER OF 78TH STREET AND LAFAYETTE AVENUE.

BM 2241 ELEVATION= 3.63 FEET SUARE CUT ON TOP OF CURB NEXT TO LIGHT POLE ON THE NORTHWEST CORNER OF LAFAYETTE AVENUE AND RAILROAD BRIDGE. APPROXIMATELY 770 FEET NORTH OF 91ST STREET.

BM 2242 ELEVATION= 22.82 FEET SET CROSS ON CHAIN BOLT OF FIRE HYDRANT ON THE SOUTHWEST CORNER OF 91ST STREET AND LAFAYETTE AVENUE.

BM 2243 ELEVATION= 15.68 FEET SQUARE CUT ON THE TOP OF CURB NEXT TO THIRD LIGHT POLE NORTH OF 97TH STREET ON THE WEST SIDE OF LAFAYETTE AVENUE. APPROXIMATELY 260 FEET NORTH OF 97TH STREET.

BM 2244 ELEVATION= 15.94 FEET SQUARE CUT ON TOP OF CURB NEXT TO LIGHT POLE ON THE NORTH SIDE OF 98TH STREET. APPROXIMATELY 120 FEET EAST OF WENTWORTH AVENUE.

BM 2245 ELEVATION= 16.35 FEET
SET SQUARE CUT ON THE EAST END OF CURB AT THE NORTHEAST CORNER OF
FIRST ALLEY NORTH OF 99TH STREET. APPROXIMATELY 35 FEET EAST OF LASALLE
STREET.

BM 2246 ELEVATION= 20.00 FEET SQUARE CUT WITH CROSS ON TOP OF ABUTMENT WALL ON THE NORTHWEST CORNER OF STATE STREET BRIDGE OVER THE BISHOP FORD EXPRESSWAY. APPROXIMATELY 20 FEET NORTH OF THE NORTH EDGE OF THE BRIDGE.

BM 2248 ELEVATION= 9.77 FEET SET CROSS ON CHAIN BOLT OF FIRST FIRE HYDRANT NORTH OF RAILROAD BRIDGE ON THE EAST SIDE OF STATE STREET. APPROXIMATELY 110 FEET SOUTH OF 90TH STREET.

BM 2249 ELEVATION= 9.67 FEET SET CROSS ON CHAIN BOLT OF FIRE HYDRANT ON THE NORTHWEST CORNER OF 87TH AND STATE STREET.

BM 2250 ELEVATION= 10.03 FEET SET CROSS ON CHAIN BOLT OF FIRE HYDRANT ON THE NORTHWEST CORNER OF 83RD ST. AND STATE STREET.

BM 2251 ELEVATION= 10.95 FEET FOUND CROSS ON EAST BOLT OF FIRE HYDRANT ON THE EAST SIDE OF STATE STREET. APPROXIMATELY 135 FEET NORTH OF 79TH STREET.

BM 2252 ELEVATION= 10.02 FEET SET CROSS ON WEST BOLT OF FIRE HYDRANT ON THE NORTHWEST CORNER OF STATE STREET AND 76TH STREET.

BM 2254 ELEVATION= 9.17 FEET SET CROSS ON CHAIN BOLT OF FIRST FIRE HYDRANT SOUTH OF 73RD STREET ON THE EAST SIDE OF STATE STREET. APPROXIMATELY 330 FEET SOUTH OF 73RD STREET.

BM 2255 ELEVATION= 11.25 FEET SET CROSS ON CHAIN BOLT OF FIRE HYDRANT ON THE NORTHWEST CORNER OF 71ST STREET AND STATE STREET.

BM 2256 ELEVATION= 16.36 FEET SUARE CUT ON TOP OF ABUTMENT WALL ON THE NORTHWEST CORNER OF MARTIN LUTHER KING DRIVE BRIDGE OVER THE BISHOP FORD EXPRESSWAY. APPROXIMATELY 1 FOOT NORTH OF THE NORTH END OF THE BRIDGE.

BM 2257 ELEVATION= 18.25 FEET
SET CROSS ON NORTHEAST BOLT OF LIGHT POLE BASE ON THE EAST SIDE OF
STATE STREET. APPROXIMATELY 970 FEET SOUTH OF 95TH STREET.

BM 2258 ELEVATION= 10.53 FEET SET CROSS ON NORTHWEST BOLT OF LIGHT BASE ON NORTHWEST CORNER OF 71ST STREET AND LAFAYETTE AVENUE.


REVISIONS NAME	DATE	ILLINOIS DEPARTMENT OF TRANSPORTATION F.A.I. 94 (DAN RYAN EXPRESSWAY)
		SUBVEY TIES FOR CONTROL POINTS

SCALE: 1"=30" DATE: MAY 1, 2008

DRAWN BY: CHECKED BY:

SHEET 5 OF 7

American Surveying Consultants, P.C. 37 Plook Rd./01xon. IL. 61021 6035 N. Northweet Highway/Chilosgo

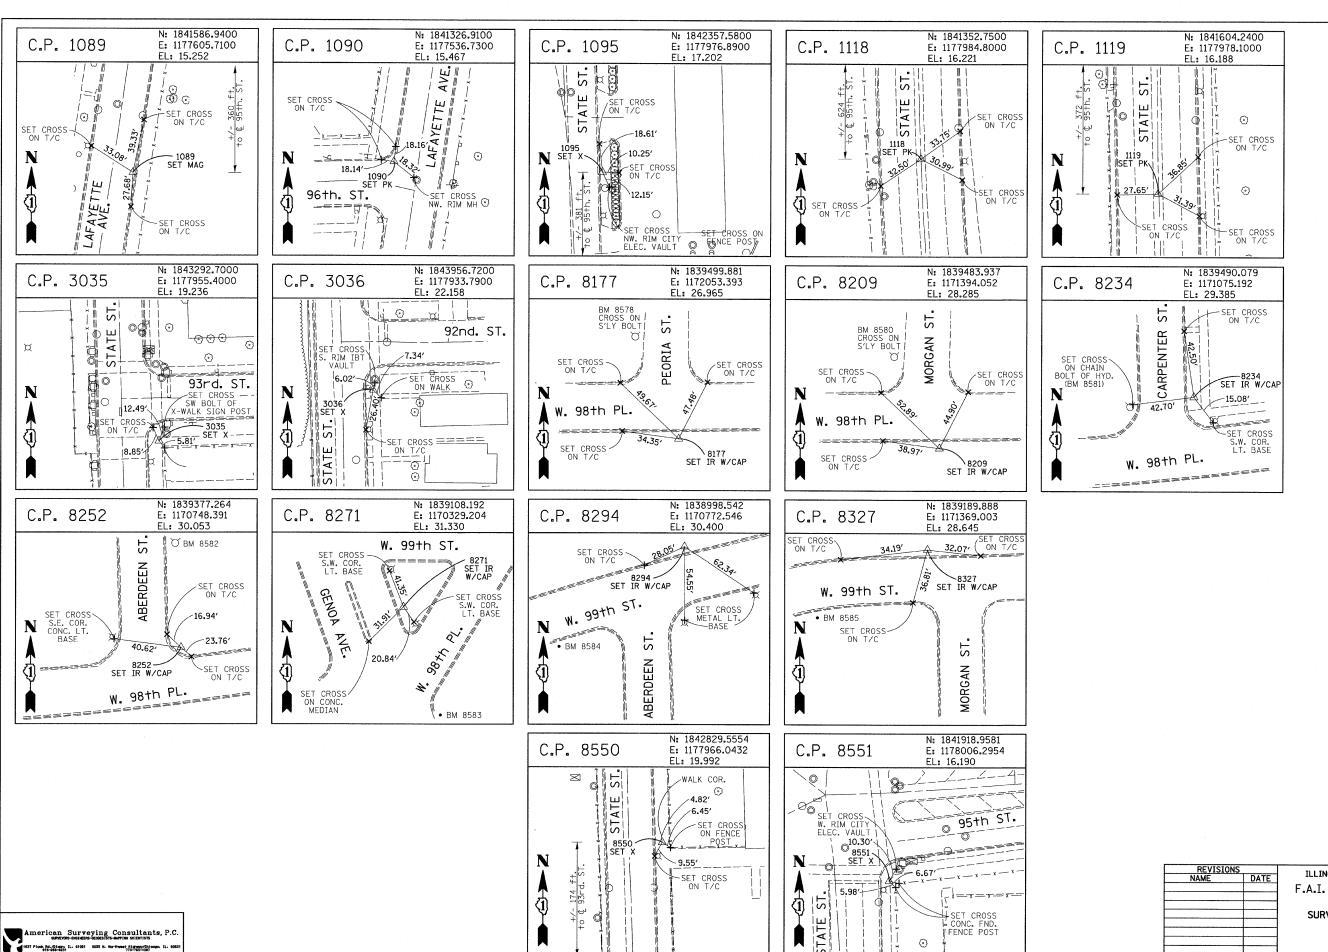

REVISIONS
NAME DATE

F.A.I. 94 (DAN RYAN EXPRESSWAY)

SURVEY TIES FOR CONTROL POINTS
SHEET 6 OF 7

SECTION

2005-070 LS

COUNTY


соок


STA. 2308+46 (SB 1-94) TO STA. 2316+90 (NB 1-94) 5


FED. ROAD DIST. NO. ILLINOIS FED. AID PROJECT


65 17


SCALE: 1"=30' DATE: MAY 1, 2008 DRAWN BY: GSP
CHECKED BY: MMW

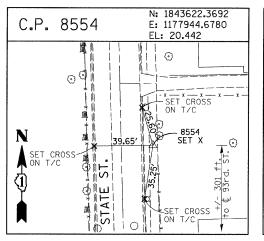


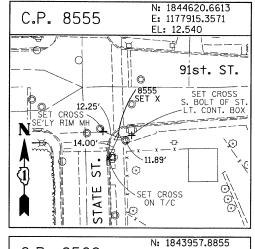


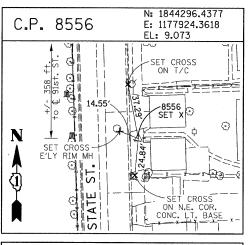


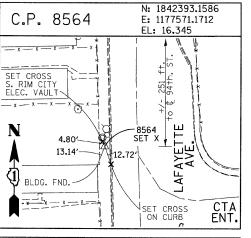


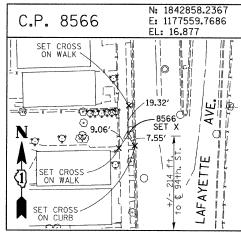


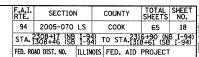

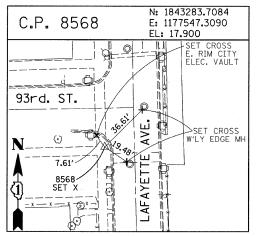

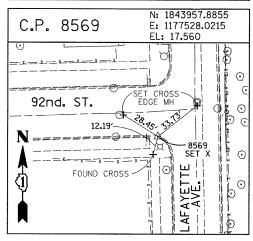

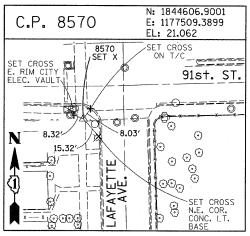

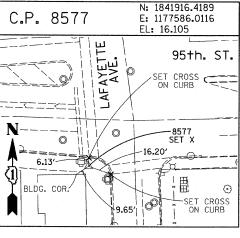

### PROJECT BENCHMARKS

BM 101 ELEVATION= 24.89 FEET
SET SQUARE CUT ON SOUTHERLY CURB OF WEST 98TH PLACE. APPROXIMATELY
70 FEET EAST OF THE CENTERLINE OF GREEN STREET.

BM 102 ELEVATION= 27.36 FEET SET CROSS ON SOUTHERLY FLANGE BOLT OF FIRE HYDRANT AT THE SOUTHWEST CORNER OF WEST 99TH STREET AND GREEN STREET.

BM 8558 ELEVATION= 17.73 FEET SET SQUARE CUT ON SOUTHEAST CORNER OF FOURTH LIGHT BASE SOUTH OF 95TH STREET, ON THE EAST SIDE OF STATE STREET.

BM 8559 ELEVATION= 17.10 FEET
SET SQUARE CUT ON SOUTHWEST CORNER OF CONCRETE SIGN BASE AT THE
NORTHWEST CORNER OF THE MOBIL GAS STATION PROPERTY AT THE NORTHEAST
CORNER OF 95TH STREET AND STATE STREET.

BM 8560 ELEVATION= 17.50 FEET SET SQUARE CUT ON SOUTHEAST CORNER OF CONCRETE BUS SLAB ON THE EAST SIDE OF STATE STREET. APPROXIMATELY 50 FEET SOUTH OF THE CENTERLINE OF 94TH STREET.

BM 8561 ELEVATION= 19.77 FEET
SET CROSS ON SOUTHEASTERLY FLANGE BOLT OF FIRST FIRE HYDRANT SOUTH OF 93RD STREET, ON THE EAST SIDE OF STATE STREET.

BM 8562 ELEVATION= 22.29 FEET SET CROSS ON SOUTHEASTERLY FLANGE BOLT OF FIRST FIRE HYDRANT NORTH OF 93RD STREET, ON THE EAST SIDE OF STATE STREET.

BM 8563 ELEVATION= 20.47 FEET SET CROSS ON SOUTHEASTERLY FLANGE BOLT OF FIRST FIRE HYDRANT SOUTH OF 91ST STREET, ON THE EAST SIDE OF STATE STREET.

BM 8573 ELEVATION= 19.89 FEET
SET SQUARE CUT ON EAST SIDE OF SIDEWALK OPPOSITE TO THE SECOND FIRE
HYDRANT SOUTH OF 91ST STREET, ON THE WEST SIDE OF LAFAYETTE AVENUE.

BM 8574 ELEVATION= 18.90 FEET
SET CROSS ON THE WESTERLY FLANGE BOLT OF FIRE HYDRANT APPROXIMATELY
AT 9224 S. LAFAYETTE AVENUE, ON THE WEST SIDE OF LAFAYETTE AVENUE.

BM 8575 ELEVATION= 17.77 FEET
SET CROSS ON THE WESTERLY FLANGE BOLT OF FIRE HYDRANT APPROXIMATELY
AT 9326 S. LAFAYETTE AVENUE, ON THE WEST SIDE OF LAFAYETTE AVENUE.

BM 8576 ELEVATION= 17.43 FEET
SET CROSS ON THE WESTERLY FLANGE BOLT OF FIRE HYDRANT AT THE VACANT
LOT BETWEEN 9416 AND 9422 S. LAFAYETTE AVENUE, ON THE WEST SIDE OF LAFAYETTE AVENUE.

BM 8578 ELEVATION= 27.92 FEET SET CROSS ON SOUTHERLY FLANGE BOLT OF FIRE HYDRANT AT THE NORTHWEST CORNER OF WEST 98TH PLACE AND PEORIA STREET.

BM 8579 ELEVATION= 28.59 FEET SET CROSS ON SOUTHERLY FLANGE BOLT OF FIRE HYDRANT AT THE NORTHWEST CORNER OF WEST 98TH PLACE AND SANGAMON STREET.

BM 8580 ELEVATION= 29.24 FEET SET CROSS ON SOUTHERLY FLANGE BOLT OF FIRE HYDRANT AT THE NORTHWEST CORNER OF WEST 98TH PLACE AND MORGAN STREET.

BM 8581 ELEVATION= 30.82 FEET SET CROSS ON CHAIN BOLT OF FIRE HYDRANT ON THE NORTHWEST CORNER OF CARPENTER STREET AND WEST 98TH PLACE.

BM 8582 ELEVATION= 30.69 FEET SET CROSS ON CHAIN BOLT OF FIRST FIRE HYDRANT NORTH OF WEST 98TH PLACE, ON THE EAST SIDE OF ABERDEEN STREET.

BM 8583 ELEVATION= 33.14 FEET SET SQUARE CUT ON CONCRETE BRIDGE WALL AT THE SOUTHEASTERLY CORNER OF GENOA AVENUE AND 99TH STREET.

BM 8584 ELEVATION= 32.36 FEET SET CROSS ON CHAIN BOLT OF FIRST FIRE HYDRANT WEST OF ABERDEEN STREET, ON THE SOUTHERLY SIDE OF 99TH STREET.

BM 8585 ELEVATION= 30.28 FEET SET CROSS ON SOUTHERLY FLANGE BOLT OF FIRST FIRE HYDRANT WEST OF MORGAN STREET, ON THE SOUTH SIDE OF 99TH STREET.

BM 8586 ELEVATION= 28.75 FEET SET CROSS ON NORTHERLY FLANGE BOLT OF FIRE HYDRANT AT THE SOUTHWEST CORNER OF 99TH STREET AND SANGAMON STREET.

BM 8587 ELEVATION= 31.19 FEET SET CROSS ON SOUTHERLY FLANGE BOLT OF FIRE HYDRANT AT THE SOUTHWEST CORNER OF 99TH STREET AND CARPENTER STREET.

BM 3514 ELEVATION= 17.56 FEET SET CROSS ON CHAIN BOLT OF HYDRANT AT SOUTHTHWEST INTERSECTION OF LASALLE ST. AND 97TH ST.

BM 3522 ELEVATION= 18.06 FEET SET CROSS ON SOUTH SOUTHEAST FLANGE BOLT OF HYDRANT ± HALFWAY BETWEEN NORTH AND SOUTH ENTRANCE TO CITGO, EAST SIDE OF STATE ST. AND NORTH OF 95TH ST.

BM 3549 ELEVATION= 9.49 FEET SET CROSS WESTERLY FLANGE BOLT OF HYDRANT AT SOUTHWEST INTERSECTION OF 87TH ST. AND LAFAYETTE AVE.

BM 3550 ELEVATION= 22.88 FEET SET CROSS WESTERLY FLANGE BOLT OF HYDRANT AT SOUTHWEST INTERSECTION OF 91ST ST. AND LAFAYETTE AVE.

BM 3551 ELEVATION= 17.50 FEET SET CROSS NORTHERLY FLANGE BOLT OF HYDRANT AT SOUTHWEST INTERSECTION OF 95TH ST. AND LAFAYETTE AVE.

BM 3552 ELEVATION= 14.81 FEET SET CROSS NORTHEAST BOLT OF TRAFFIC SIGNAL/LIGHT BASE AT SOUTHEAST INTERSECTION OF 91ST ST. AND STATE ST.

BM 3553 ELEVATION= 8.47 FEET SET CROSS NORTHWEST BOLT OF TRAFFIC SIGNAL/LIGHT BASE AT NORTHEAST INTERSECTION OF 87TH ST. AND STATE ST.

BM 3556 ELEVATION= 9.06 FEET SET CROSS EASTERLY FLANGE BOLT OF HYDRANT AT NORTHEAST CORNER OF 75TH ST. AND STATE ST.

BM 3558 ELEVATION= 18.15 FEET SET CROSS SOUTHWESTERLY FLANGE BOLT OF HYDRANT AT NORTHWEST INTERSECTION OF NORMAL ST. AND 98TH PLACE.

BM 3810 ELEVATION= 0.29 FEET
CUT SQUARE ON SOUTHERLY CORNER OF METAL BASE FOR OVERHEAD
SIGN, ON THE WESTERLY SIDE OF SOUTHBOUND DAN RYAN, OPPOSITE
OF WEST 77TH PLACE, APPROXIMATELY 1000 FEET NORTH OF 79TH
STREET BRIDGE.


BM 3811 ELEVATION= 1.95 FEET CUT SQUARE ON SOUTHEASTERLY CORNER OF METAL BASE FOR OVERHEAD SIGN, ON THE WESTERLY SIDE OF SOUTHBOUND DAN RYAN APPROXIMATELY 840 FEET SOUTHERLY OF 83RD STREET.


DATE: MAY 1, 2008


REVISIONS		ILLINOIS DEPARTMENT OF TRANSPORTATION					
NAME	DATE	IFFI	4012 F	EPARIM	ENI OF IRA	NSPURI	AIION
			0.4	(DANI	RYAN EX	יחחדכ	CWAVA
		L • A•T	. 34	UDAN	LIAN EV	LLES	SWAII
		l suf	RVEY	TIES F	OR CONTRO	DL P01	INTS
				SHEE	T 7 OF 7		
		SCALE: 1	′′=30′		DRAWN	DV.	GSP
		JOALL. 1	-50		DIVATIN	01:	GSF


CHECKED BY: MMW


American Surveying Consultants, P.C 1637 Plook Rd./Dixon- IL. 61021 6035 M. Northwest Highway/Chicago. 773-763-1387

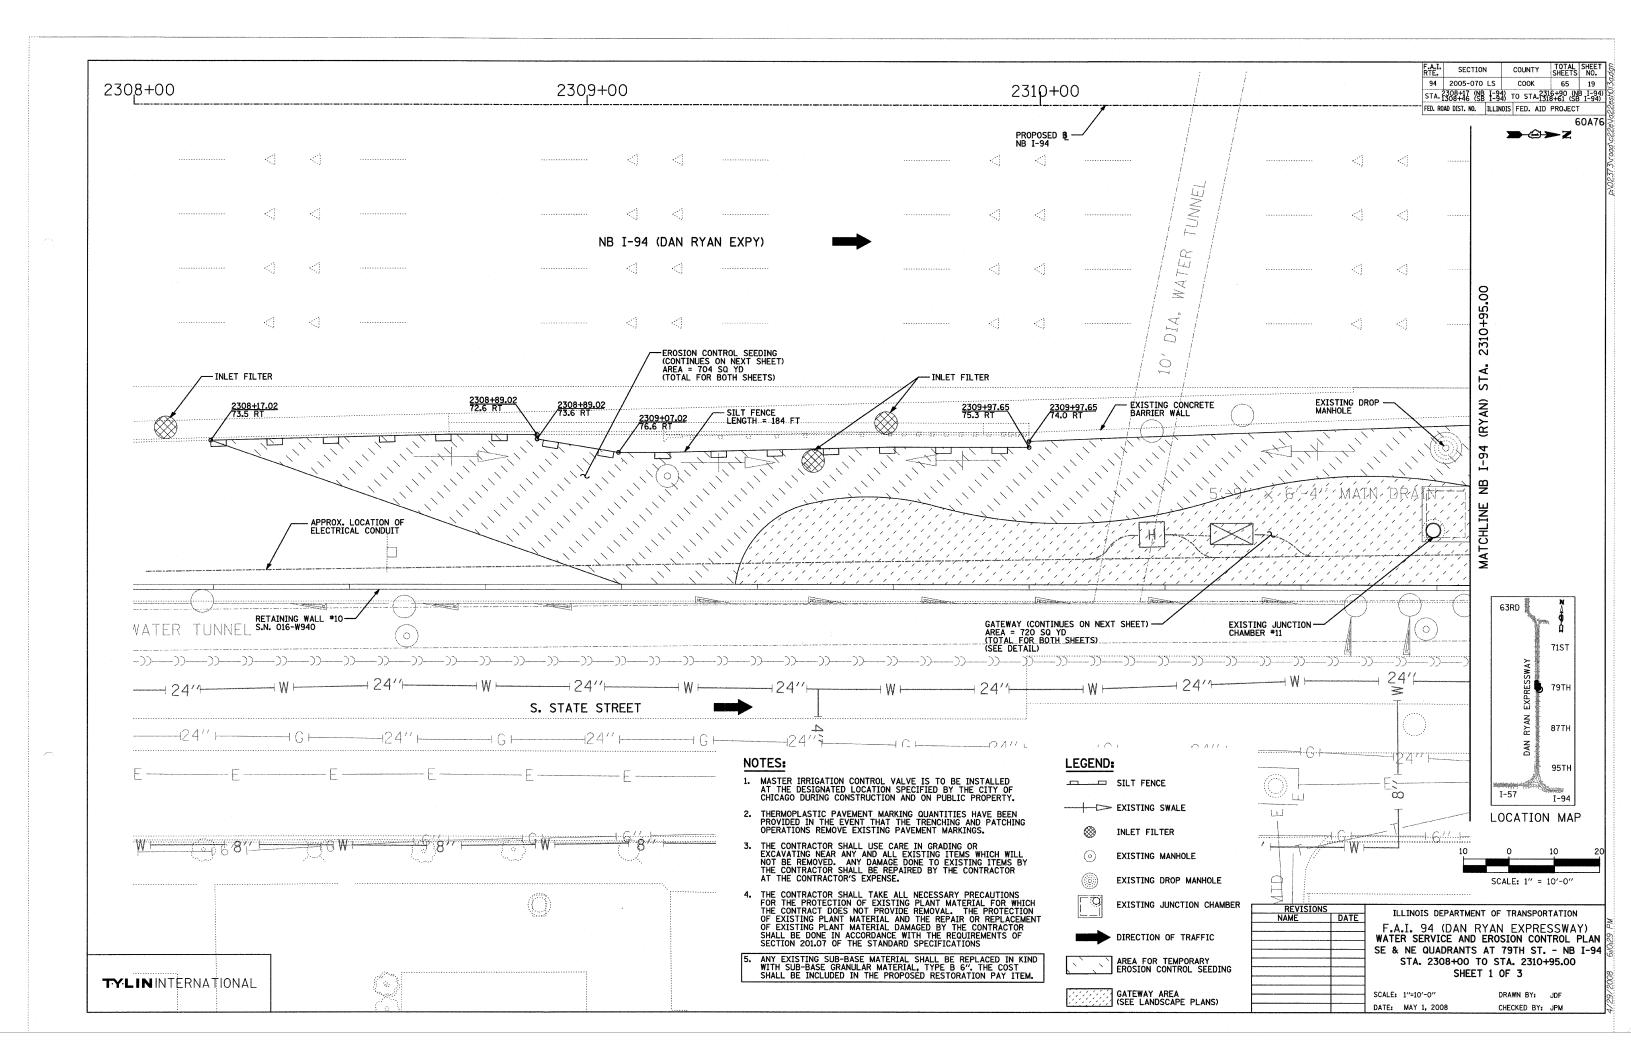


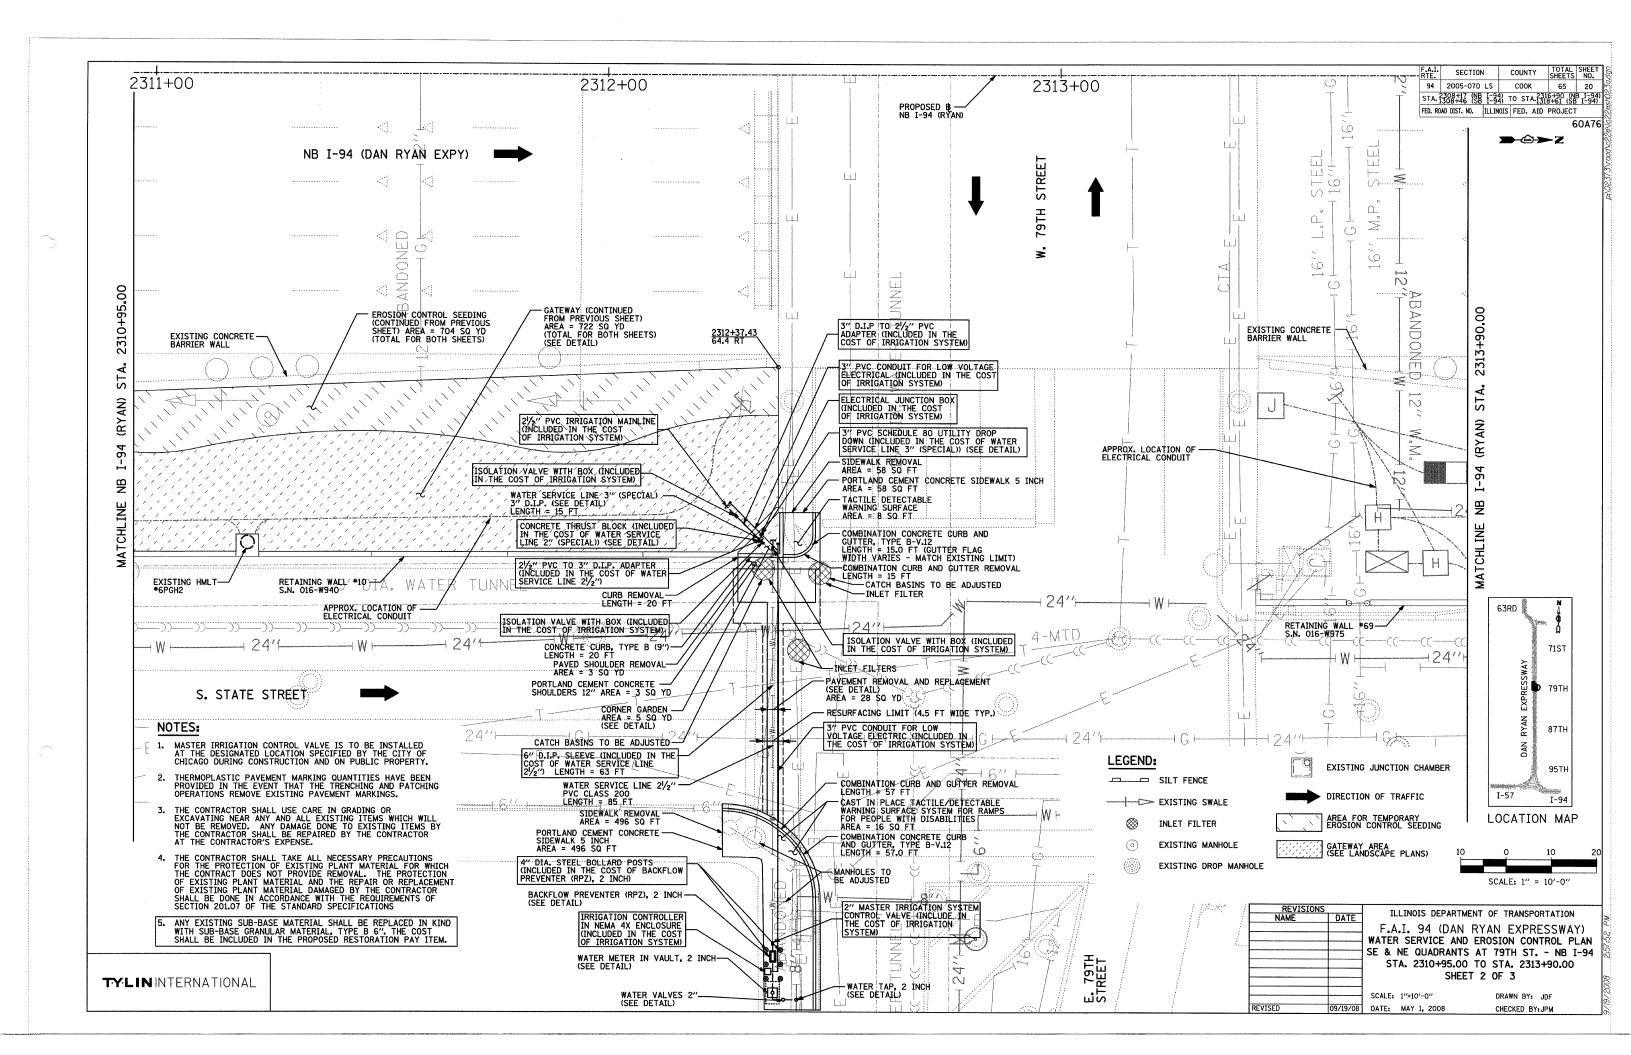


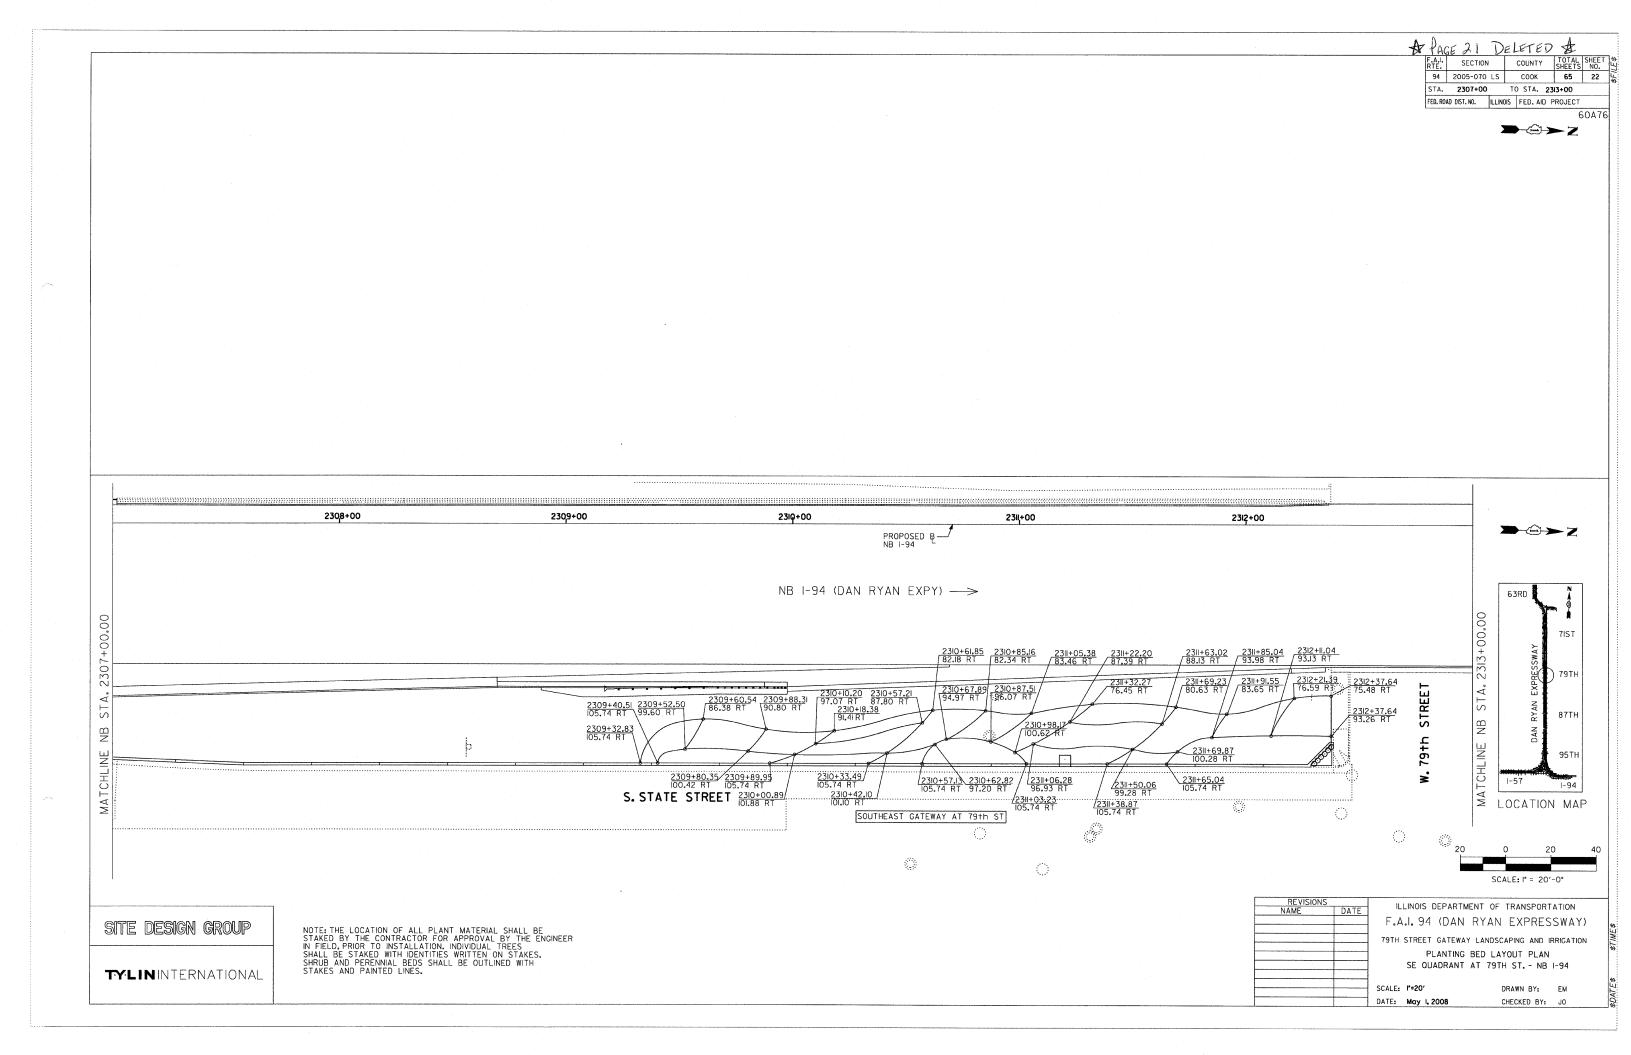

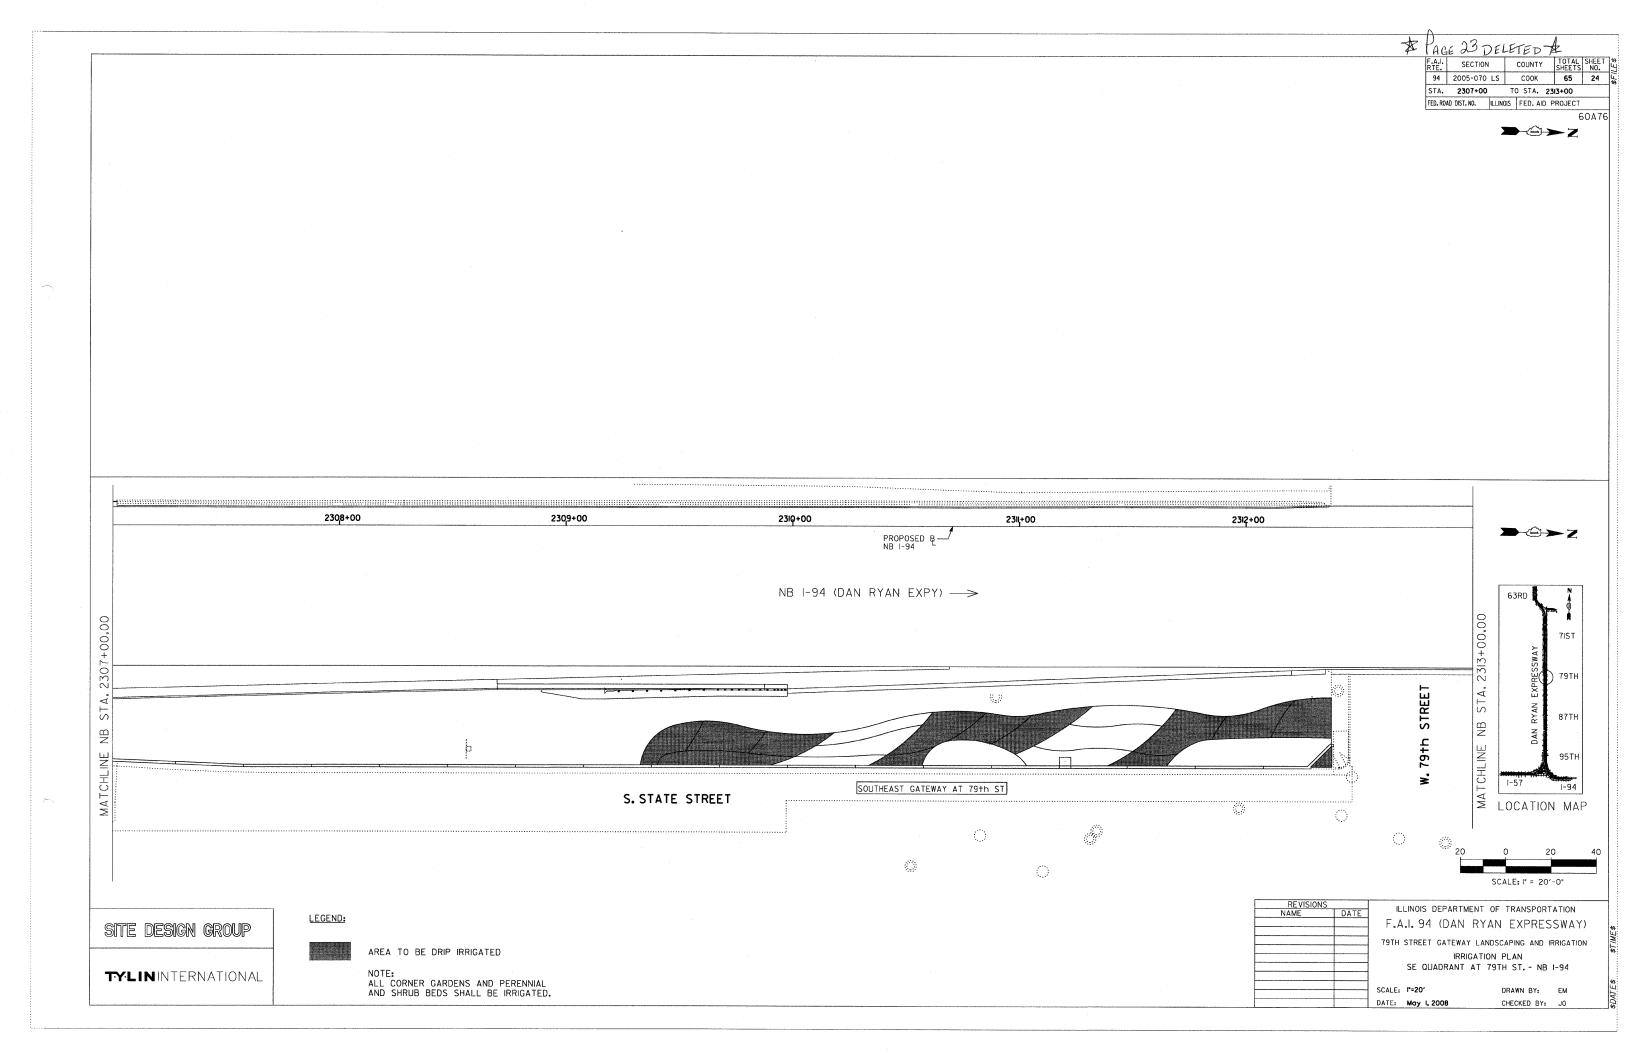

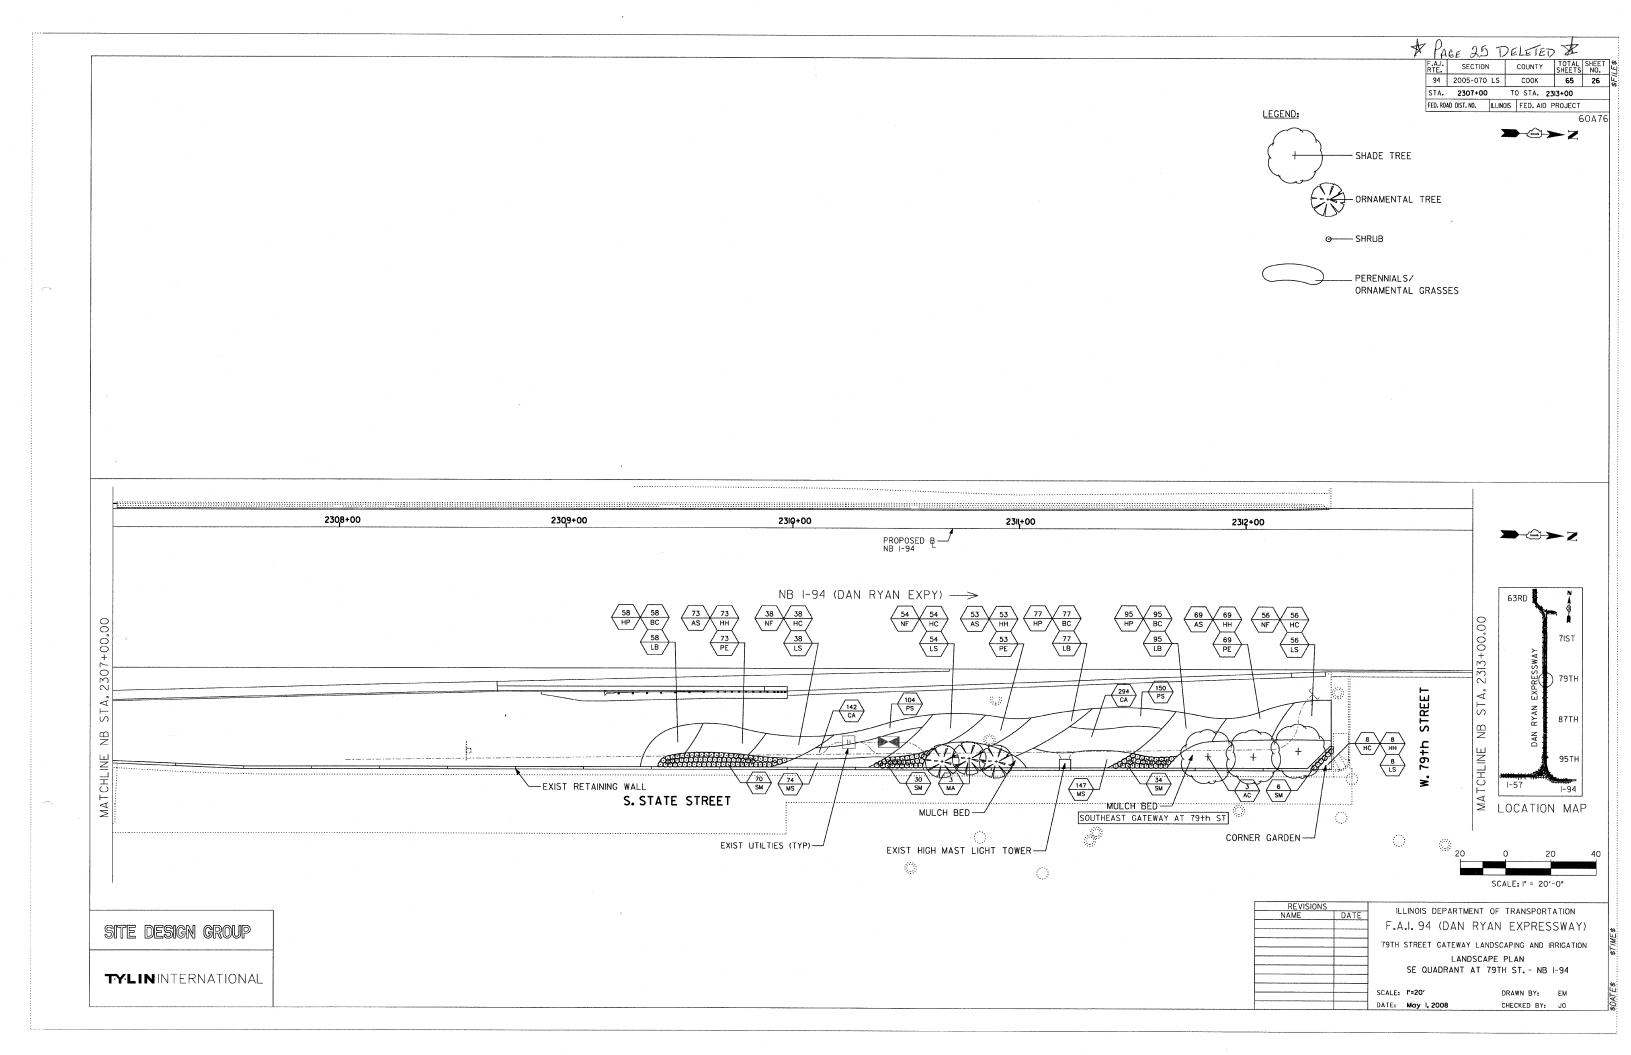

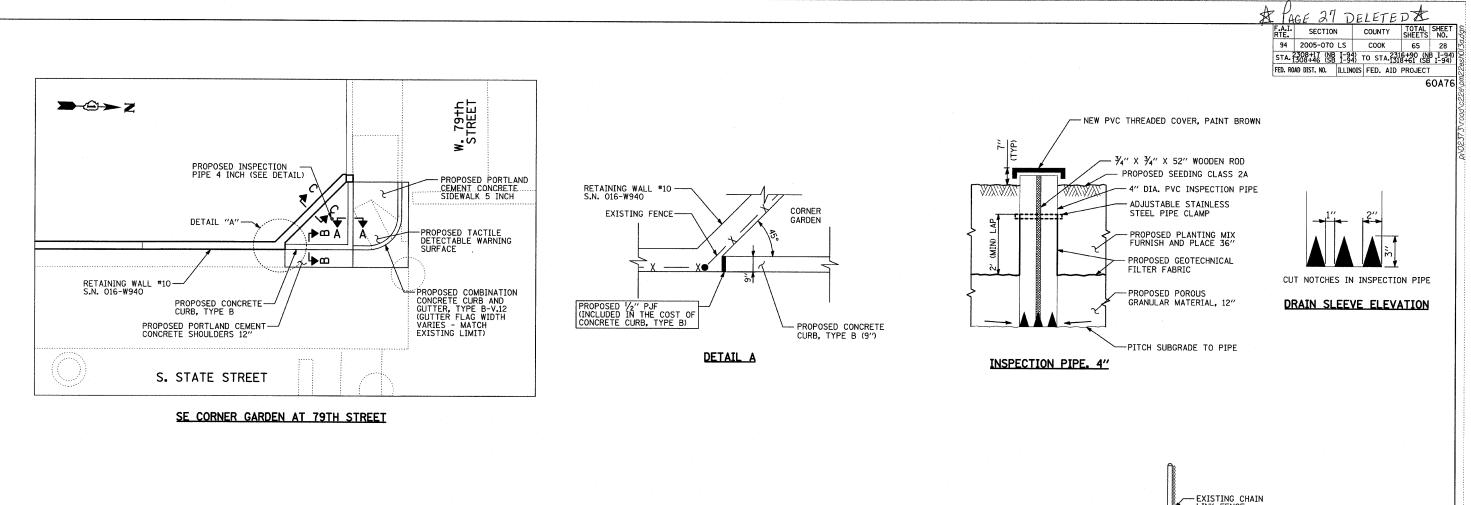

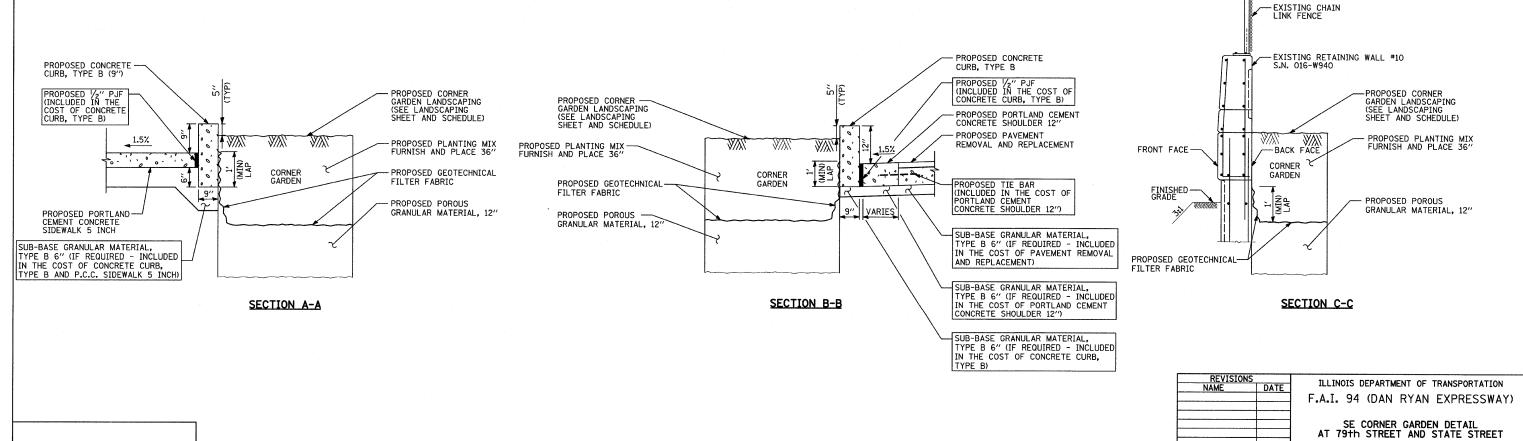

SCALE: NOT TO SCALE

DATE: MAY 1, 2008


DRAWN BY:


CHECKED BY:


JDF


RTM


**TYLIN**INTERNATIONAL

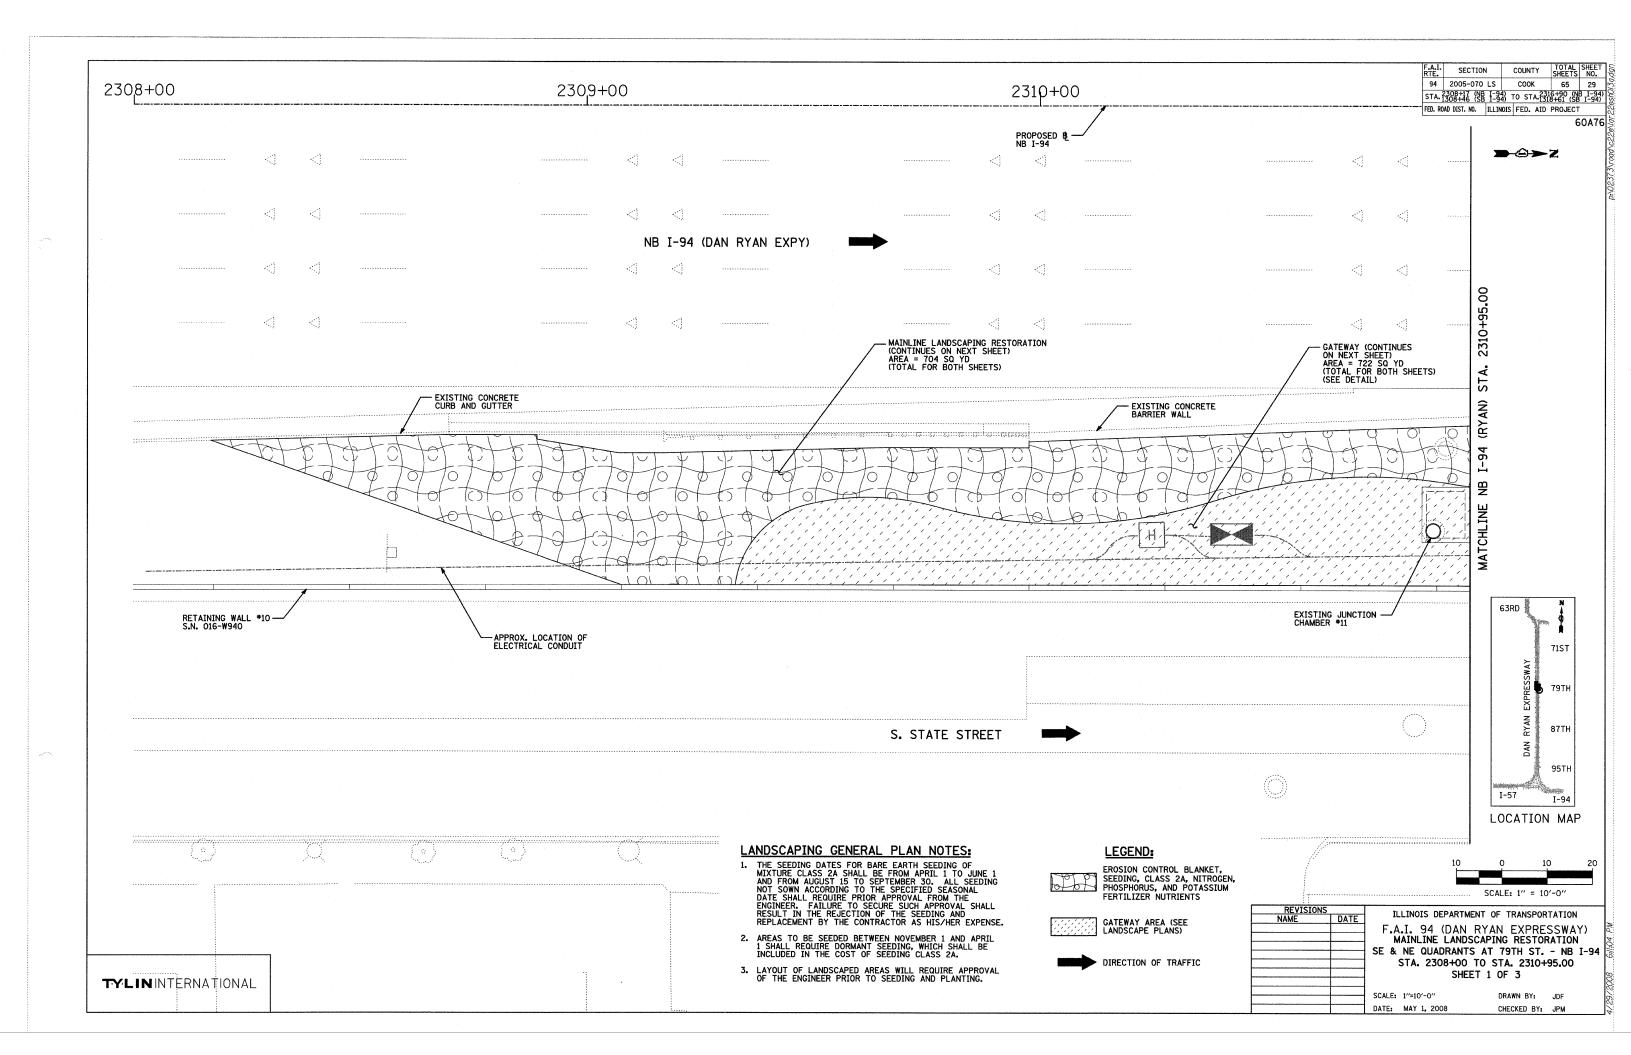


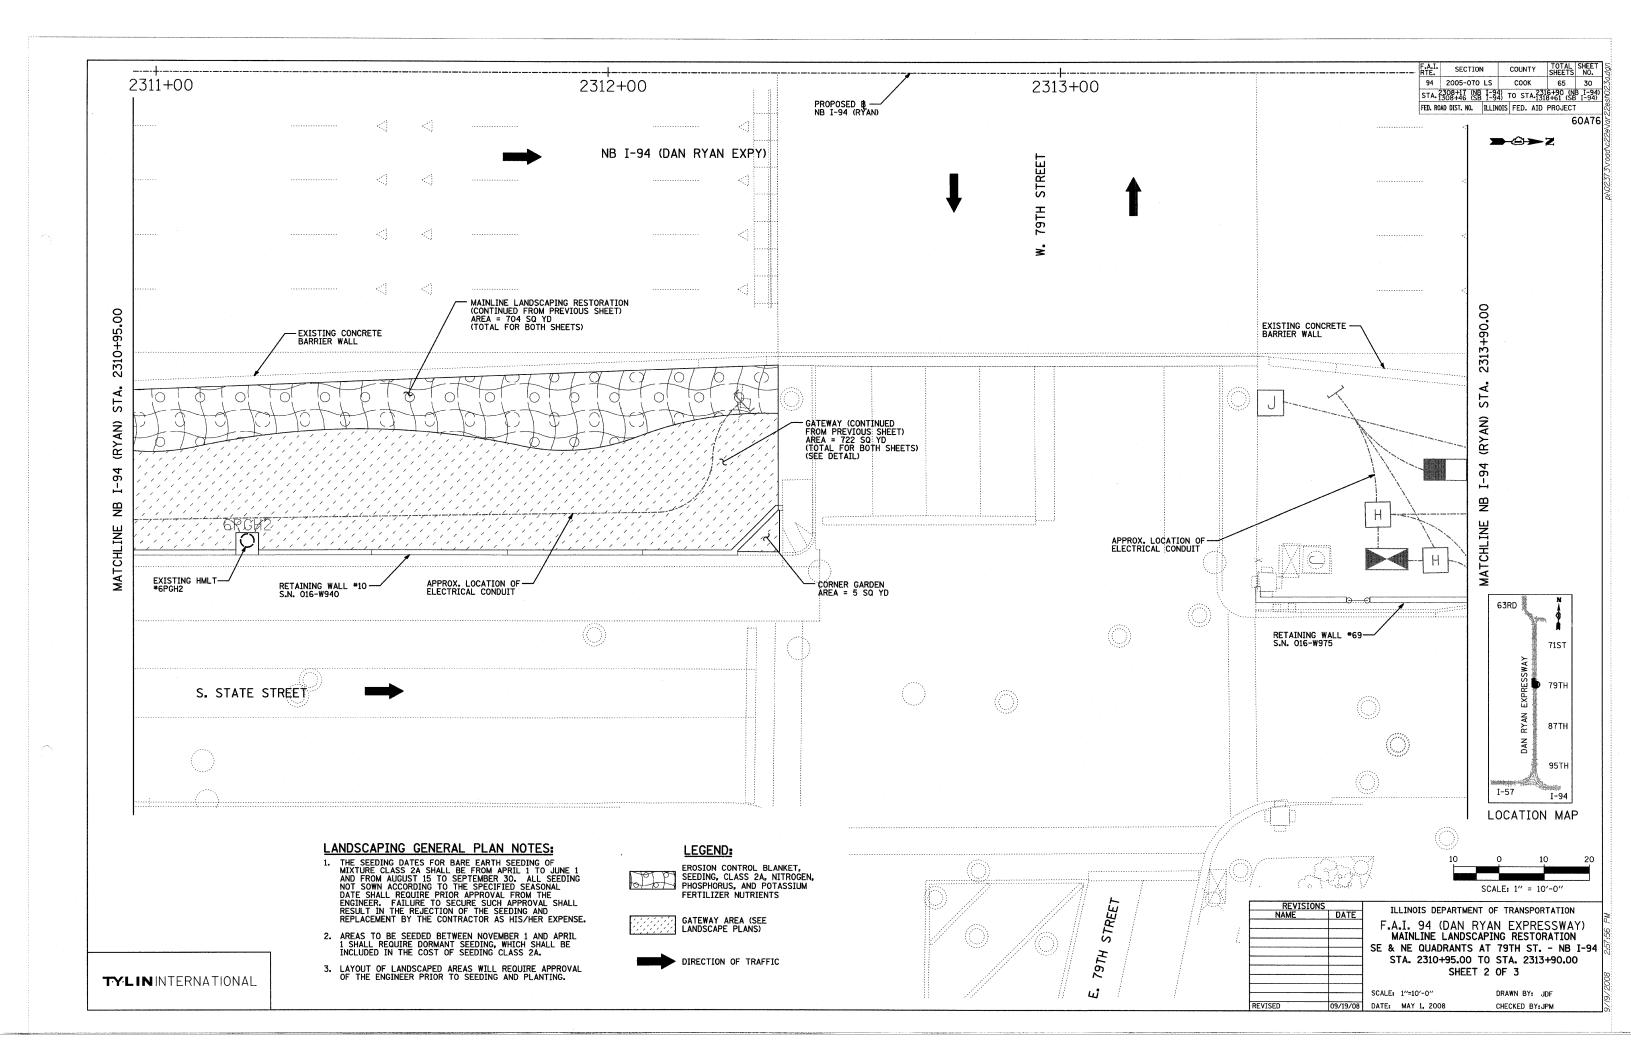


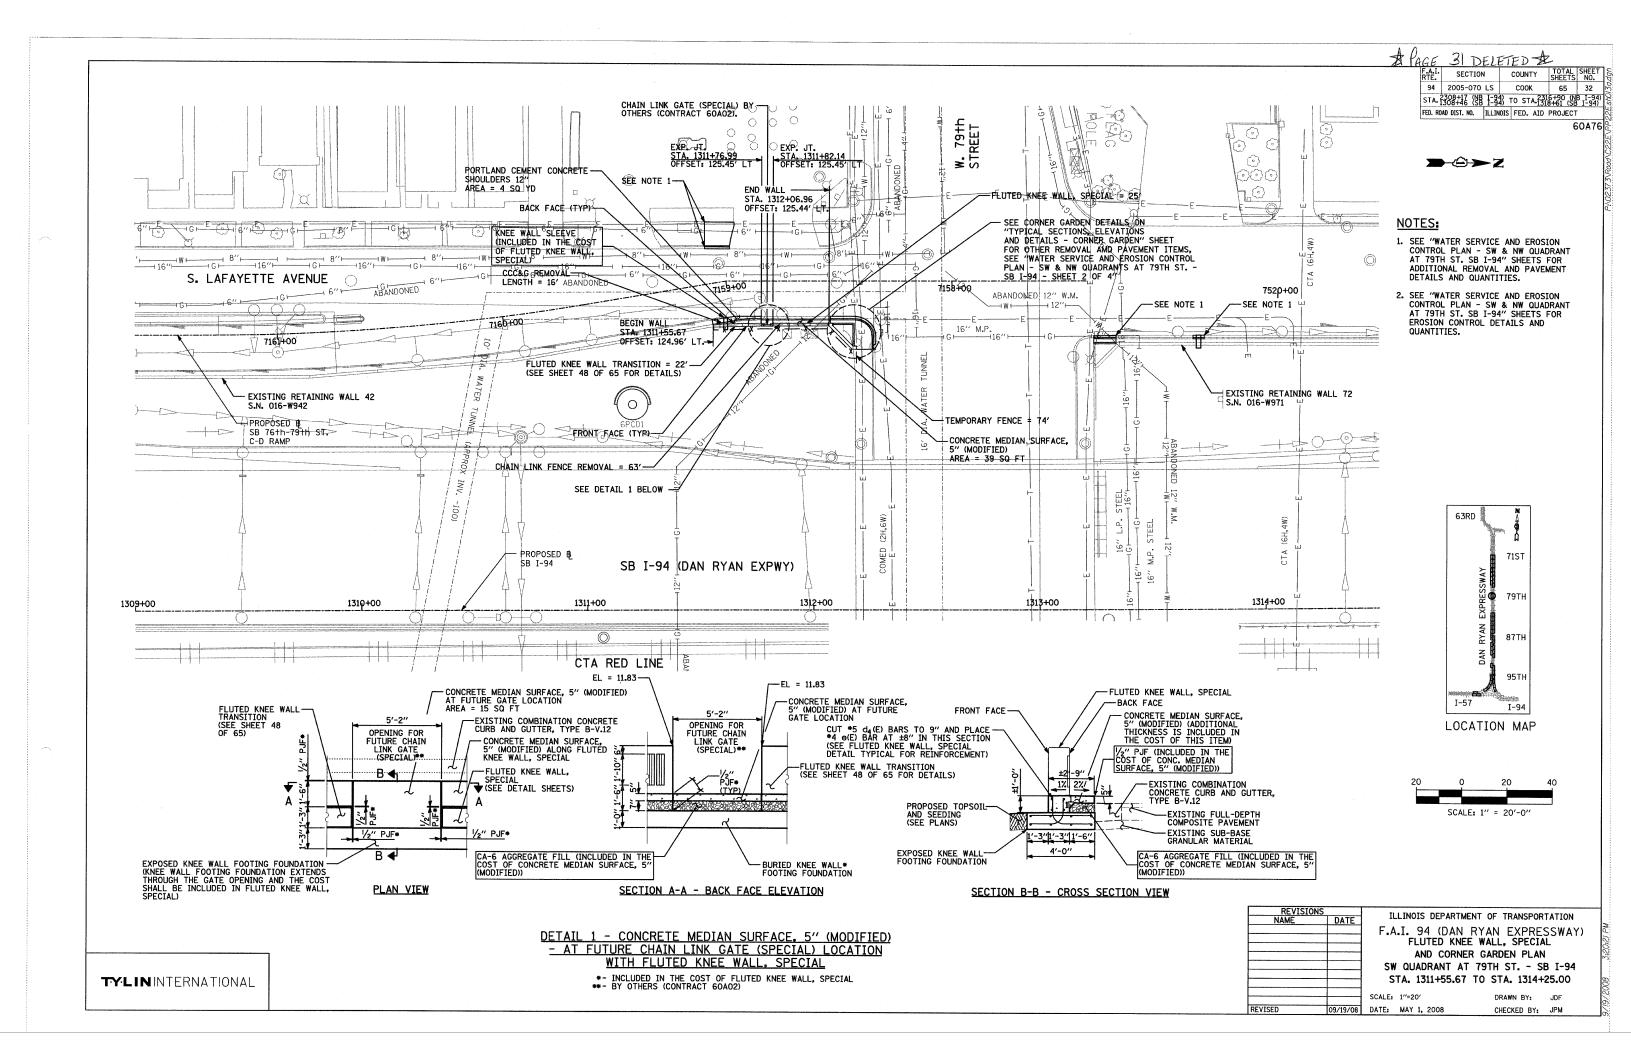


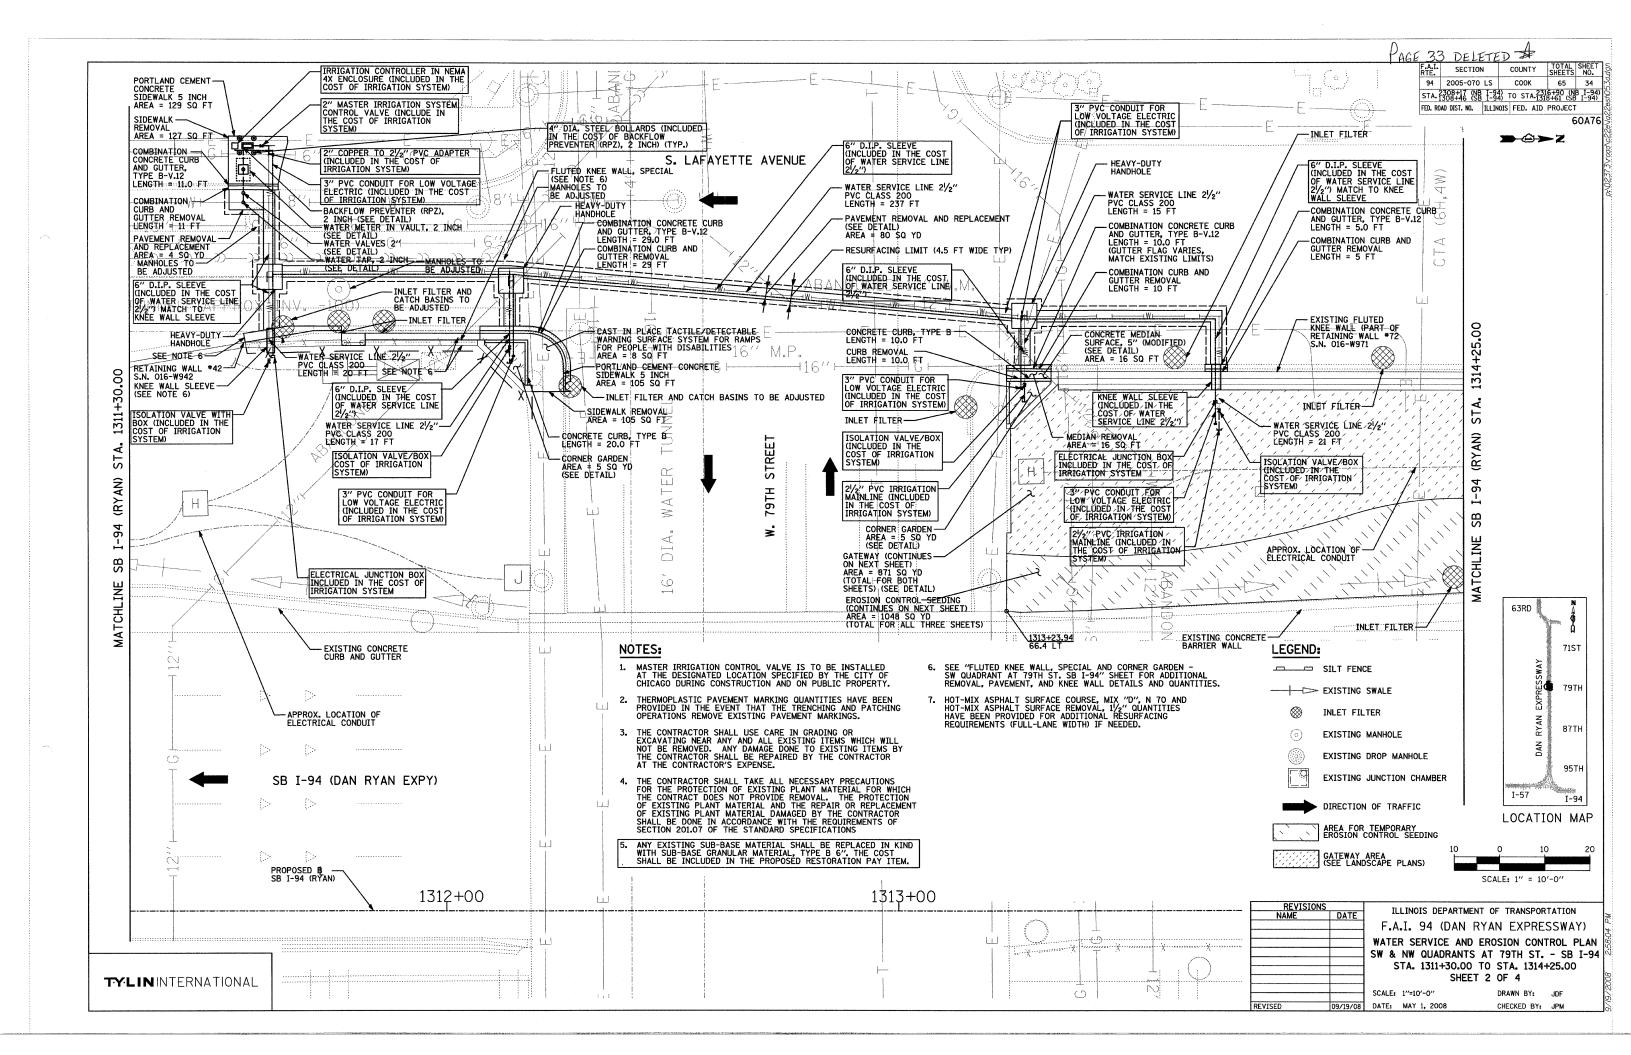


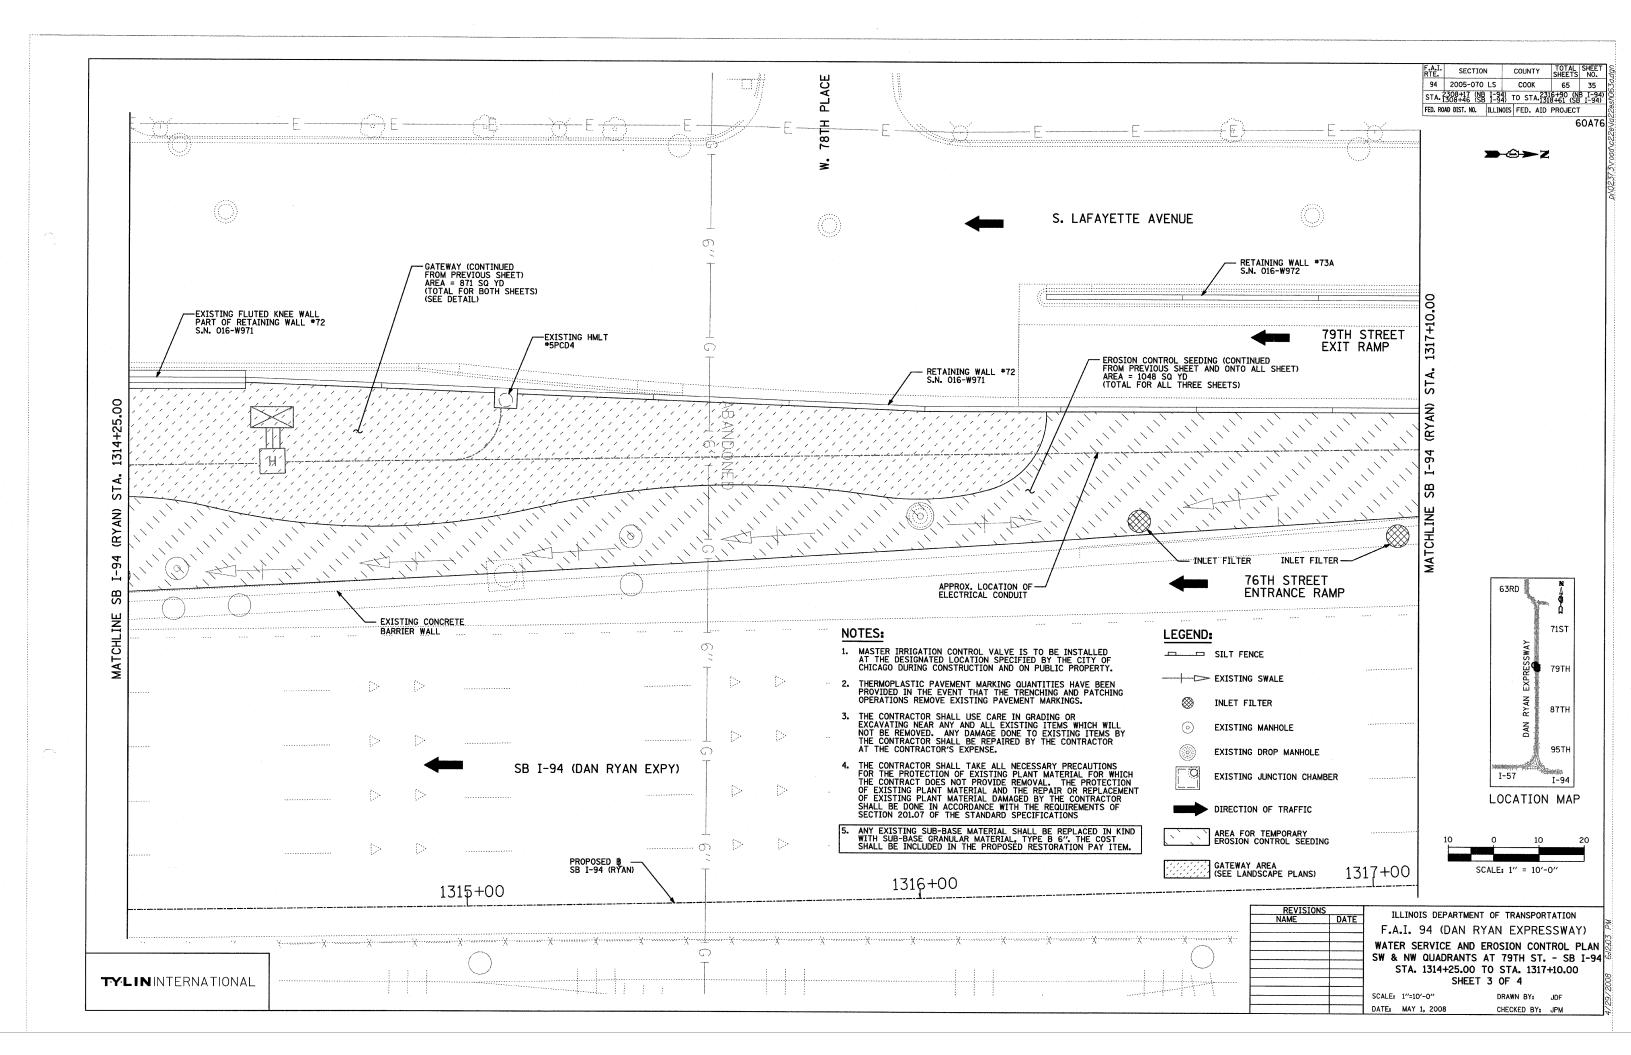


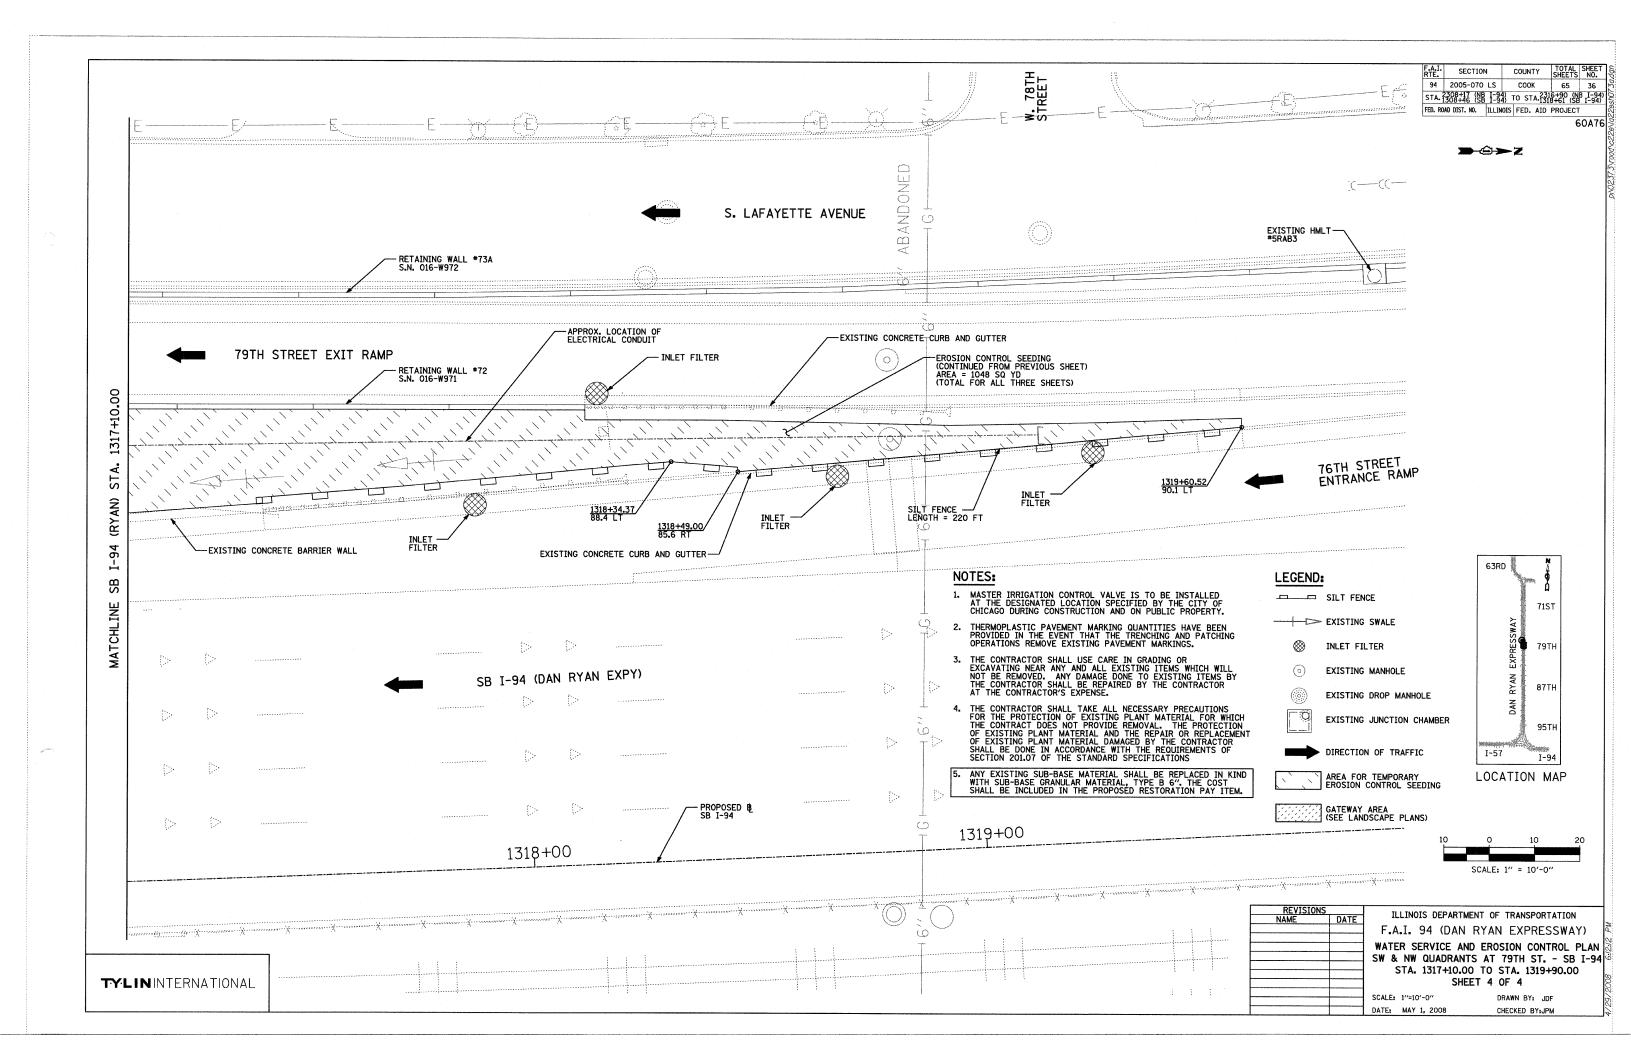


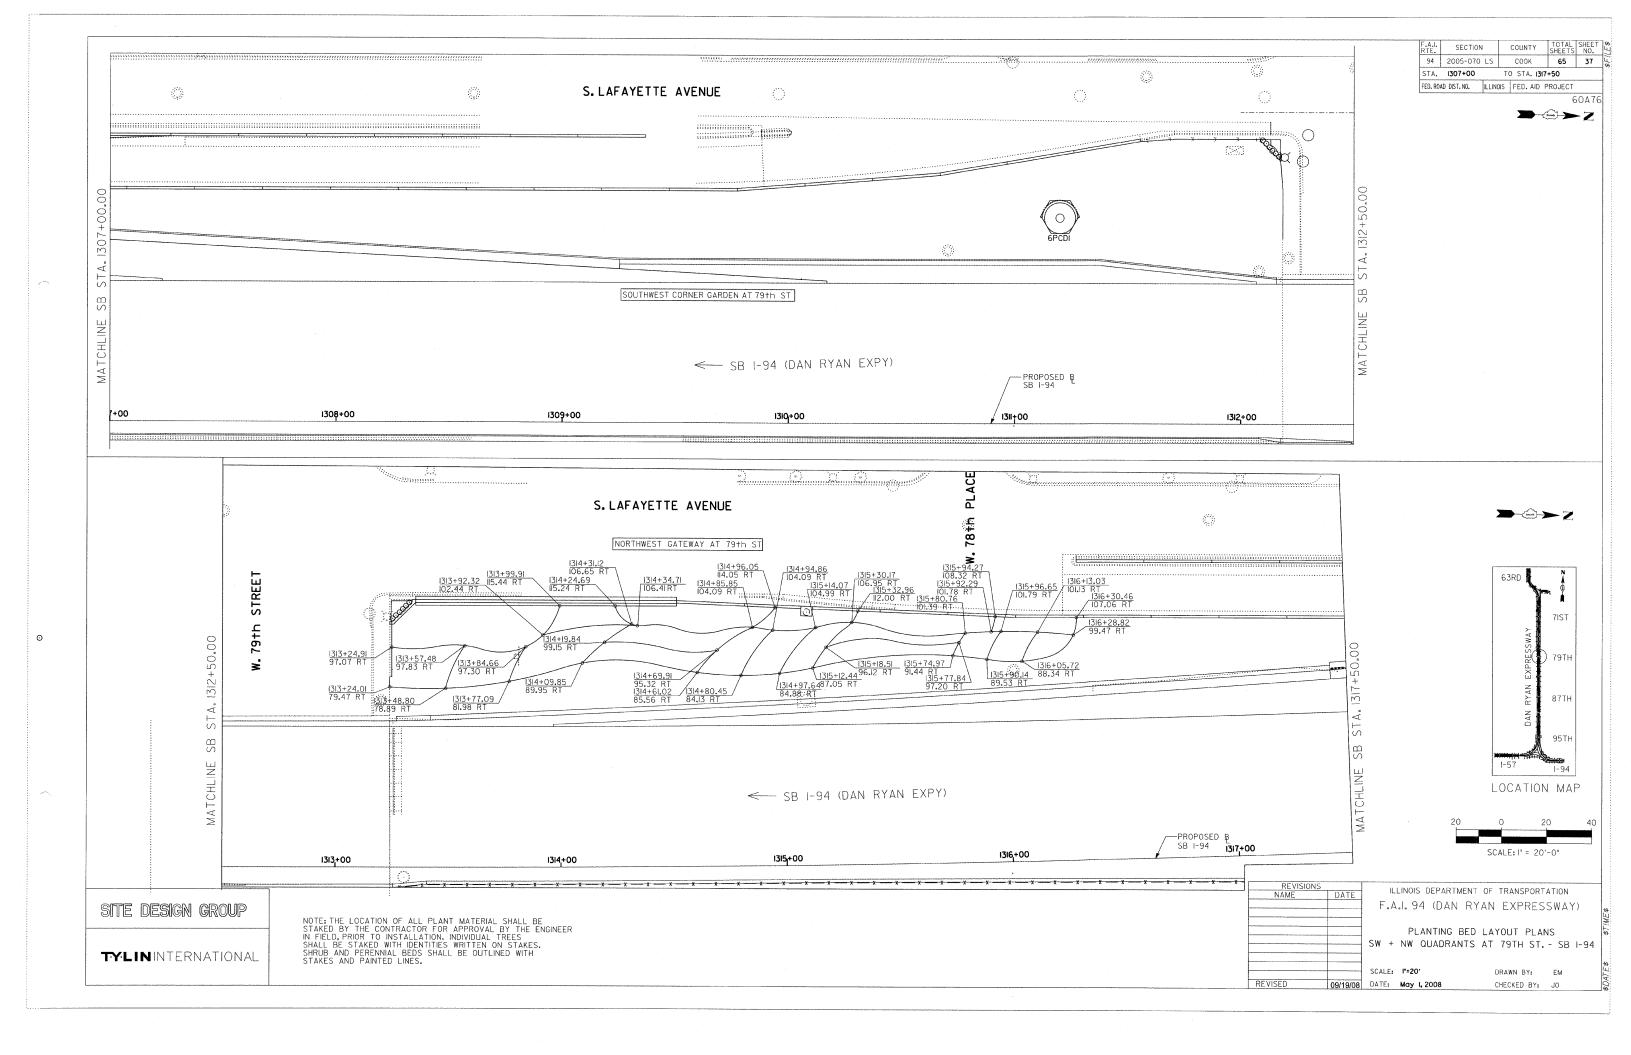


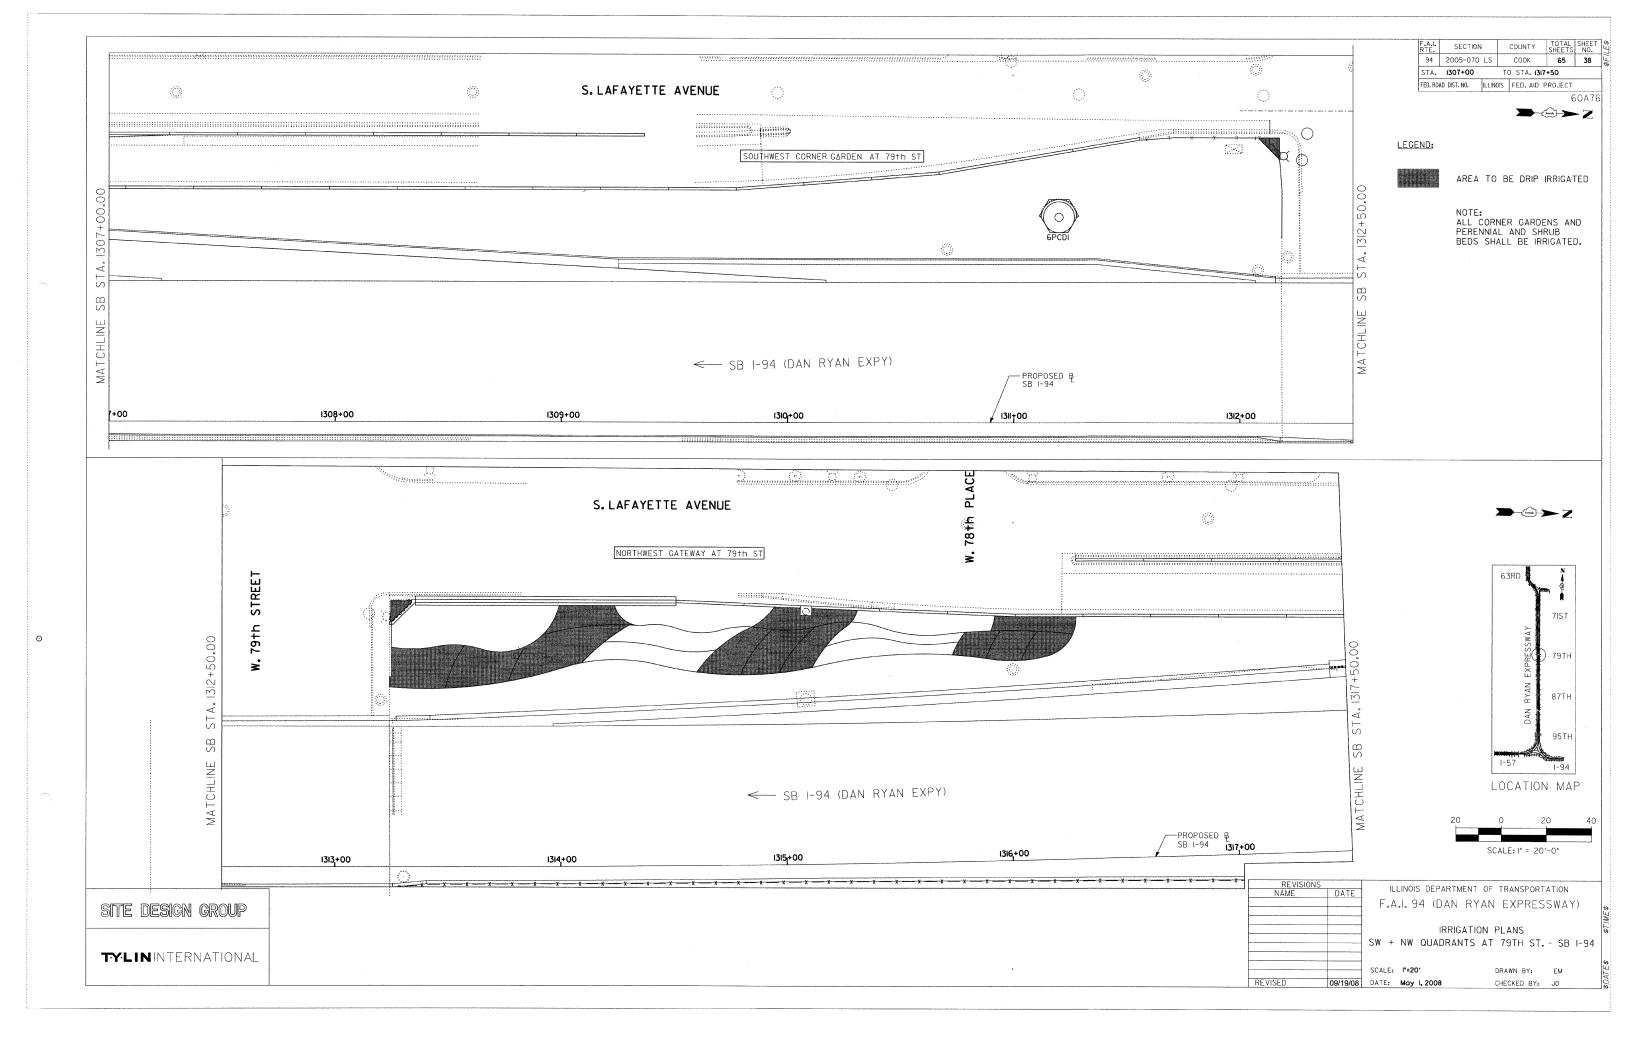


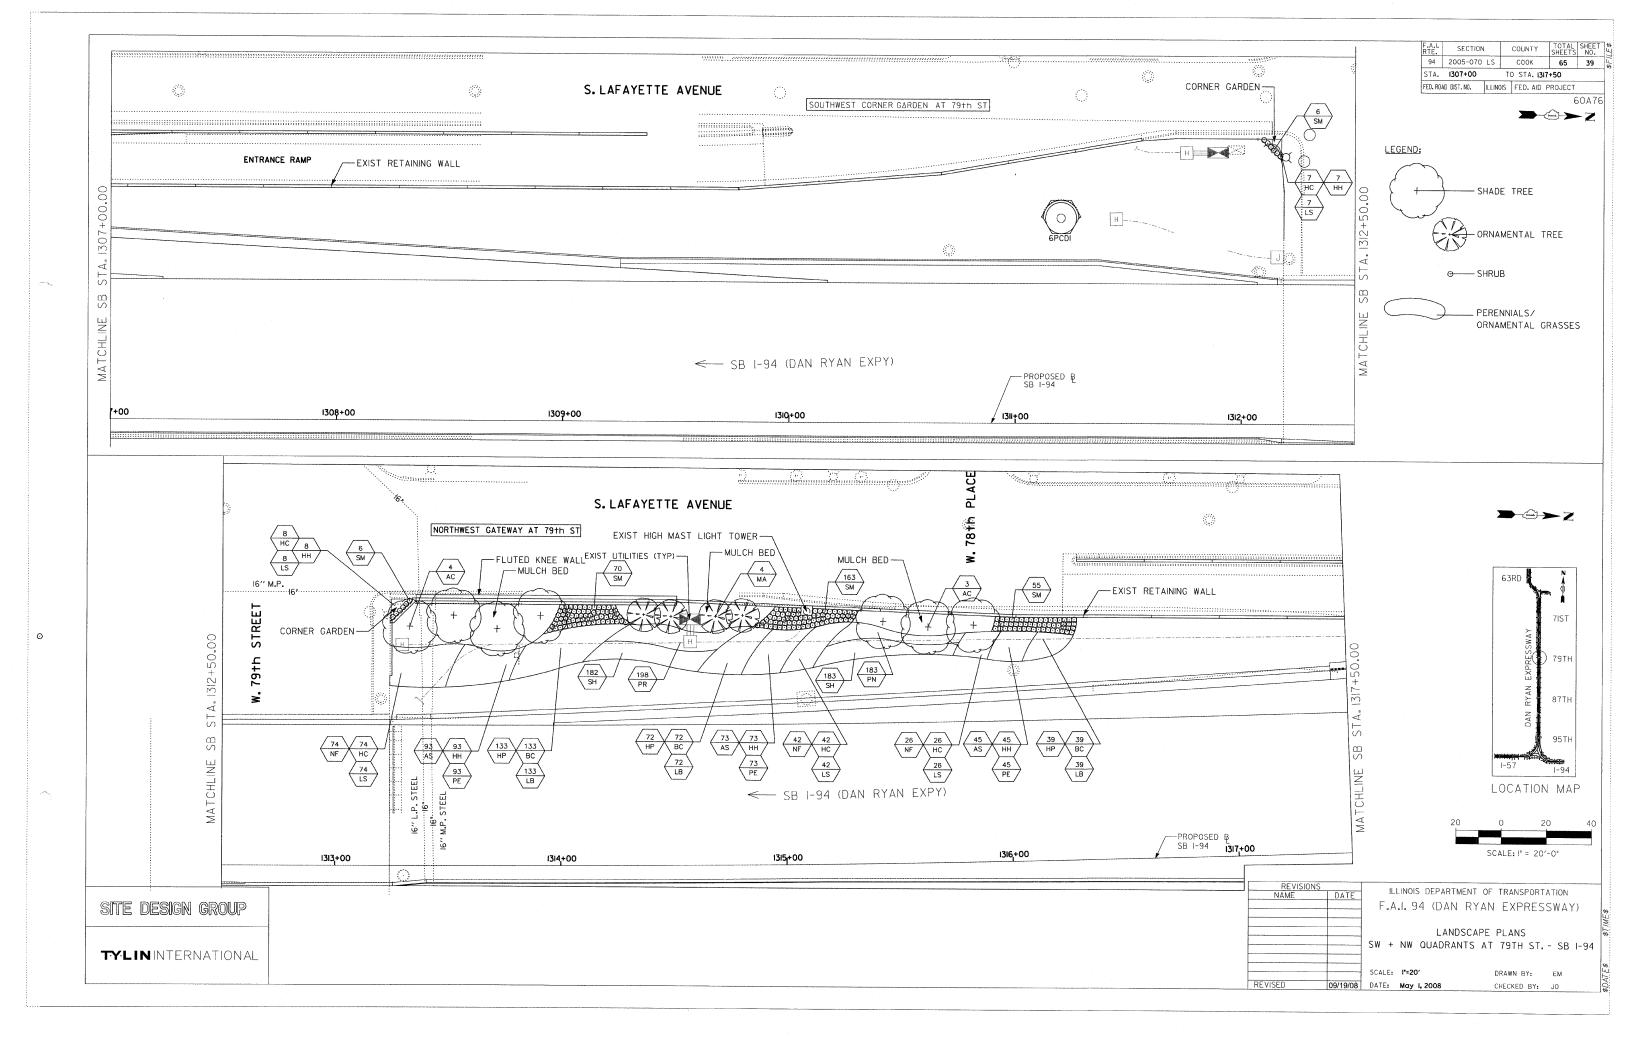


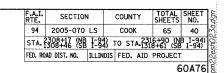

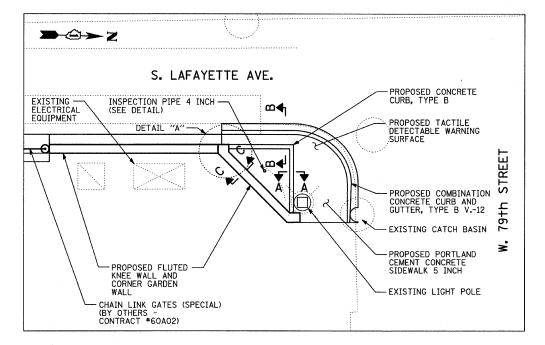


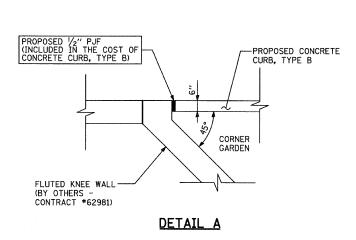


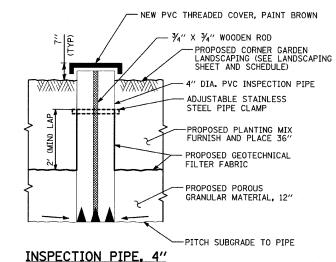


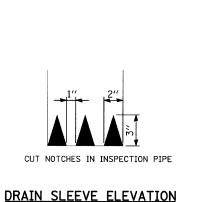



SW CORNER GARDEN AT 79TH STREET

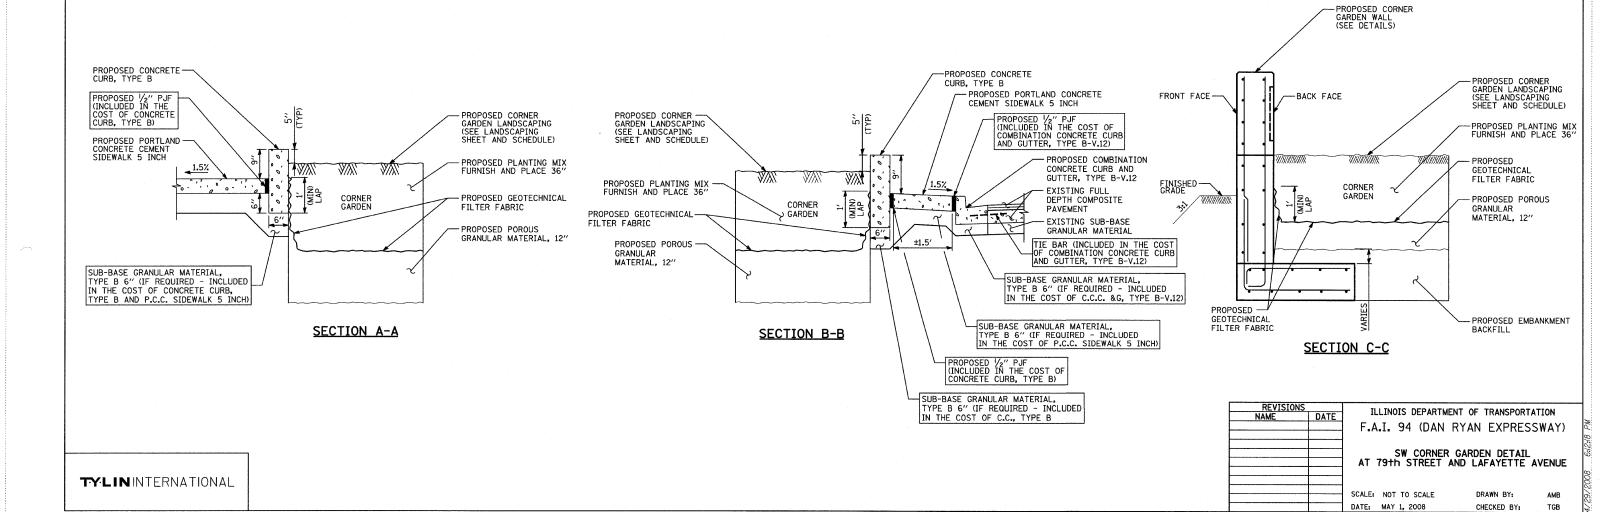


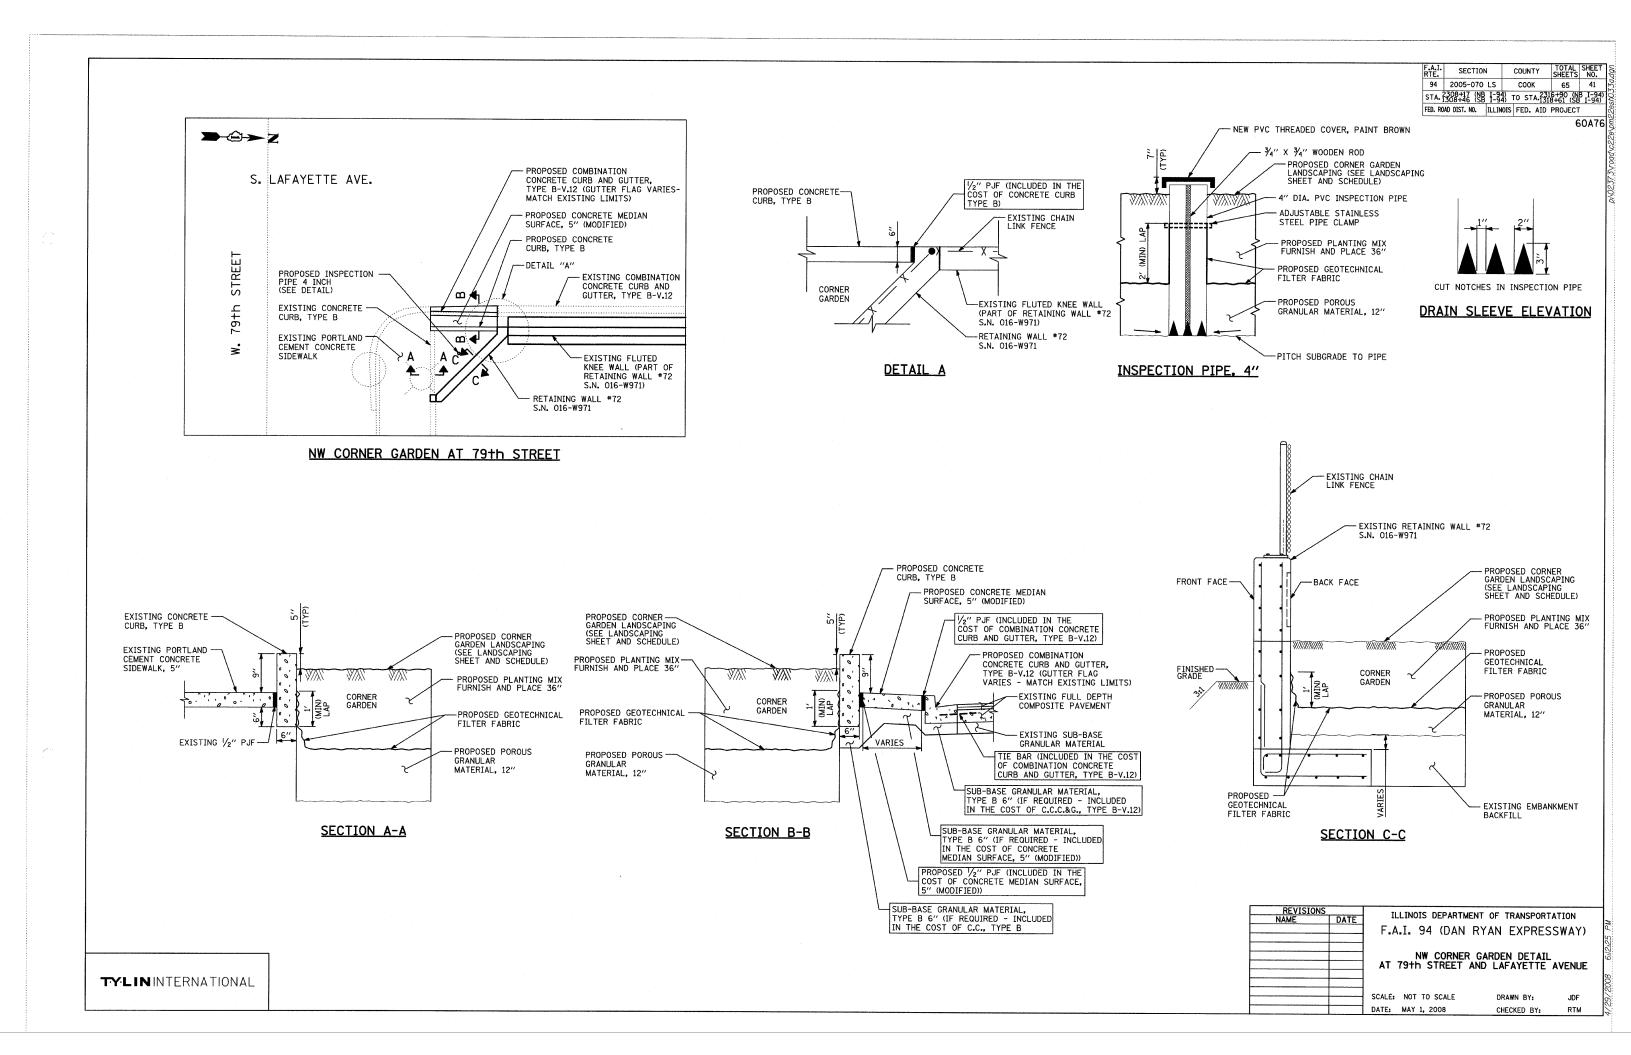


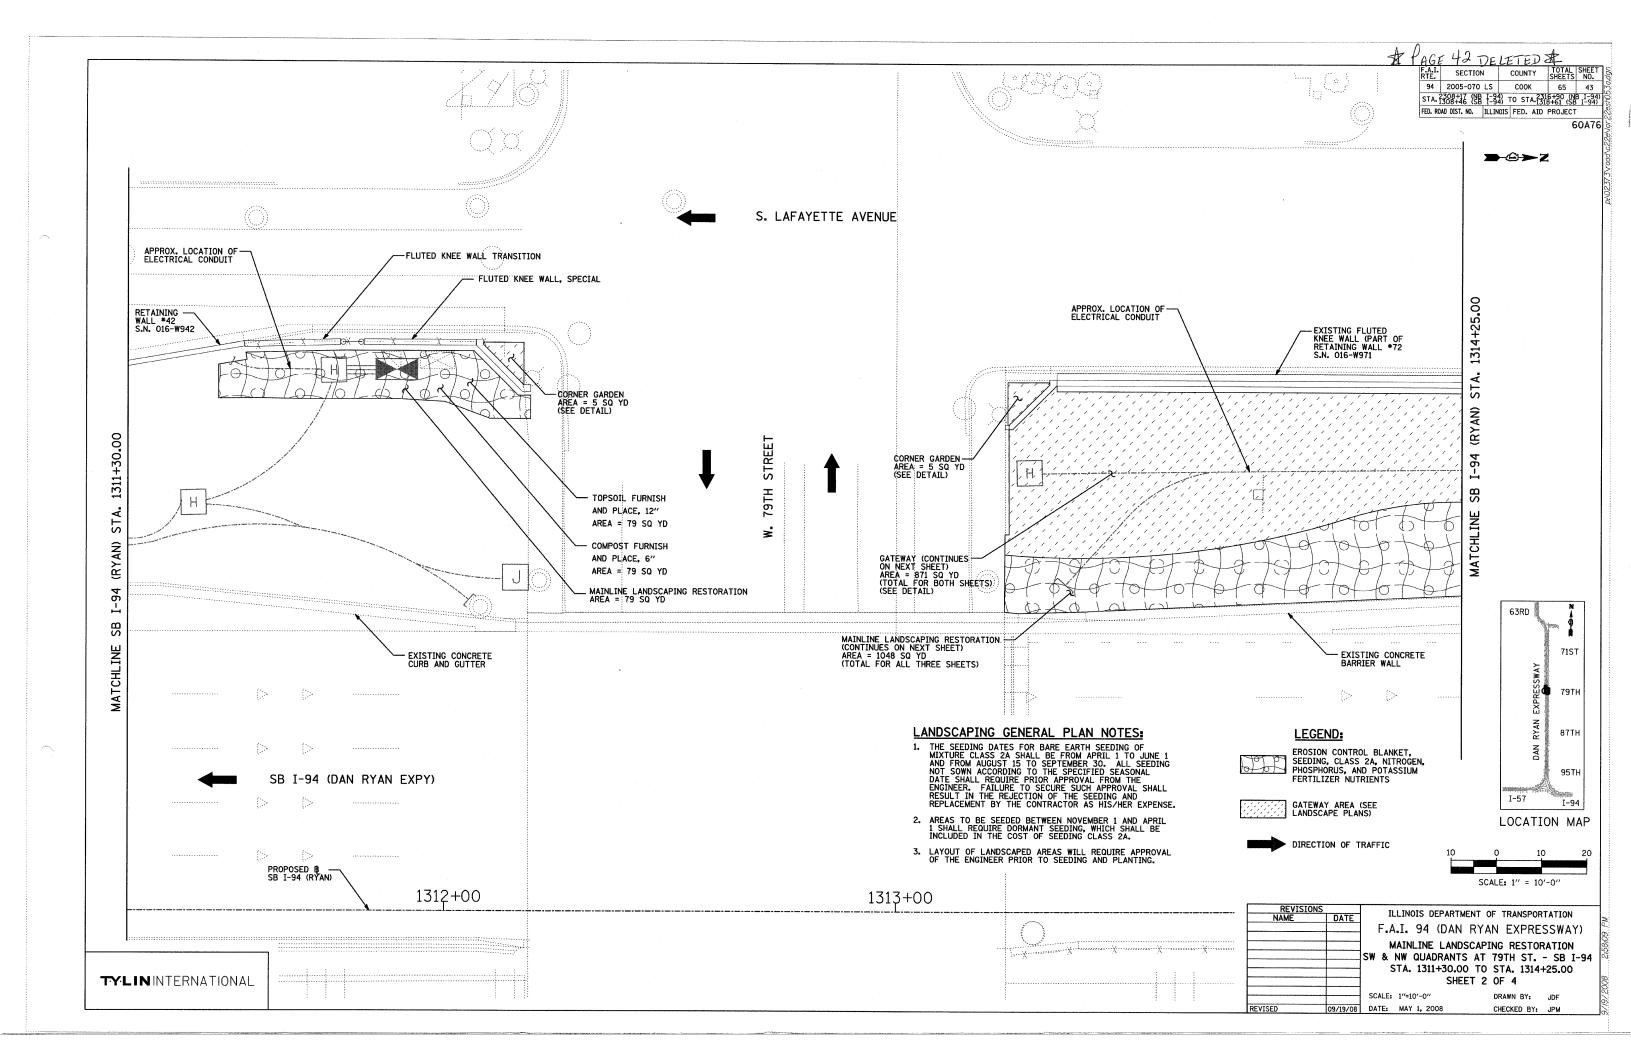


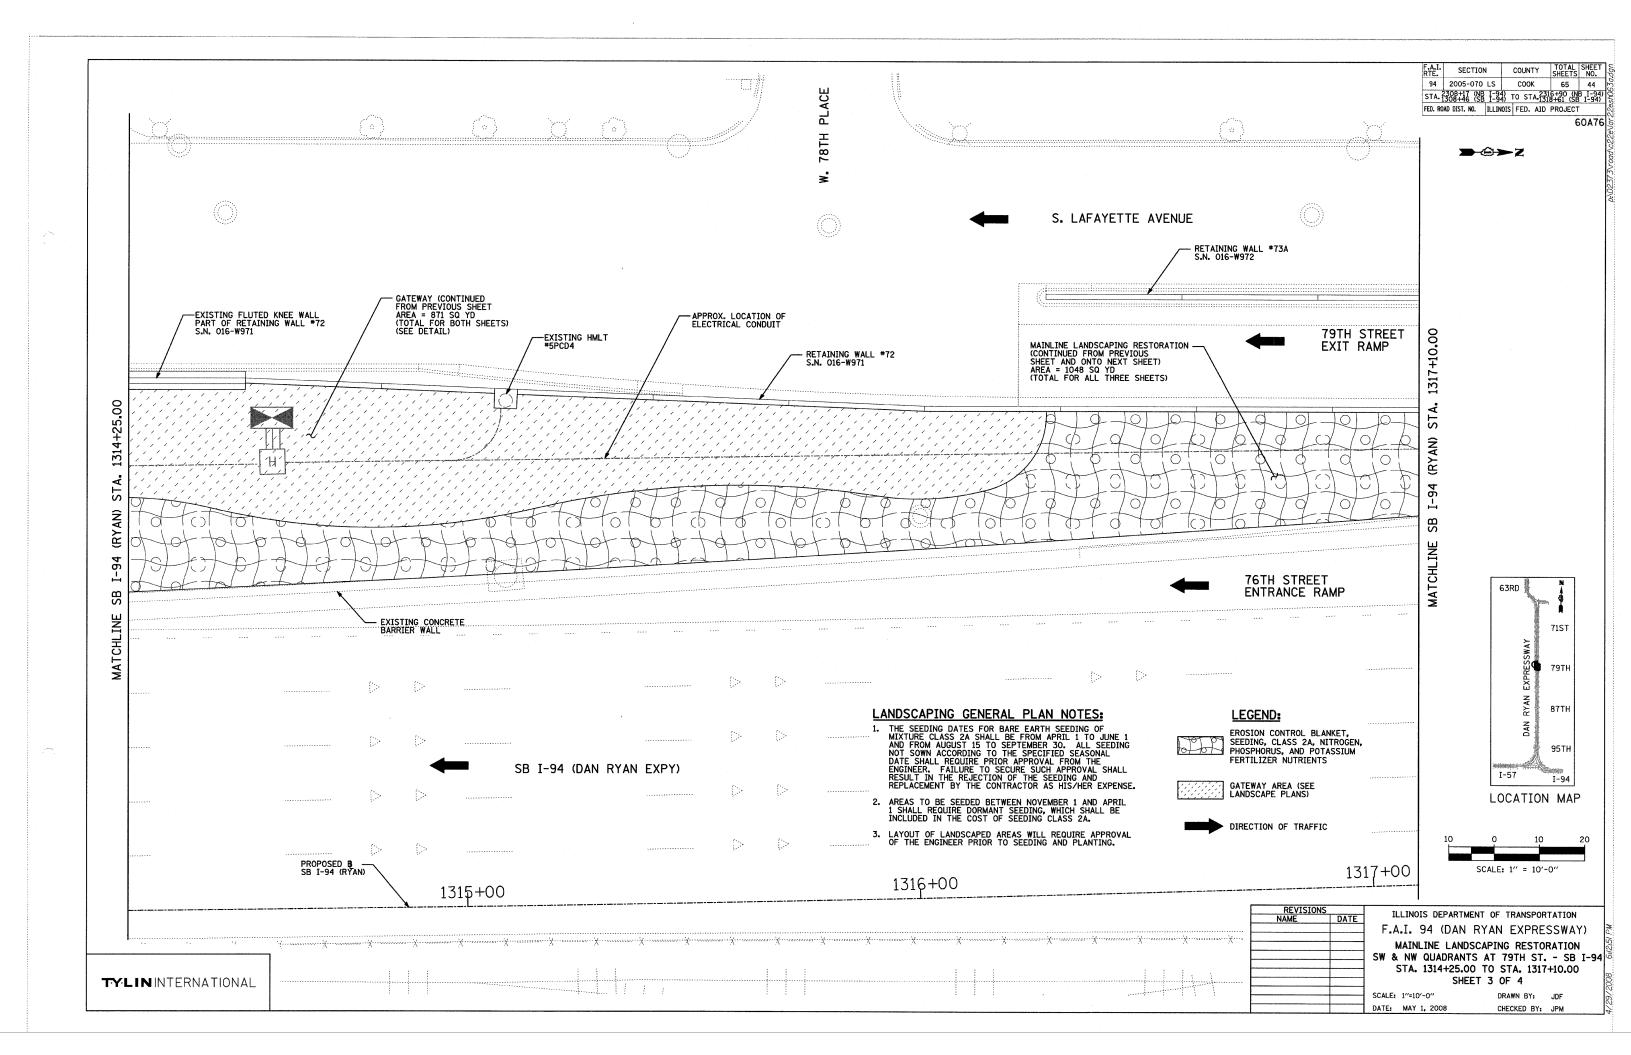


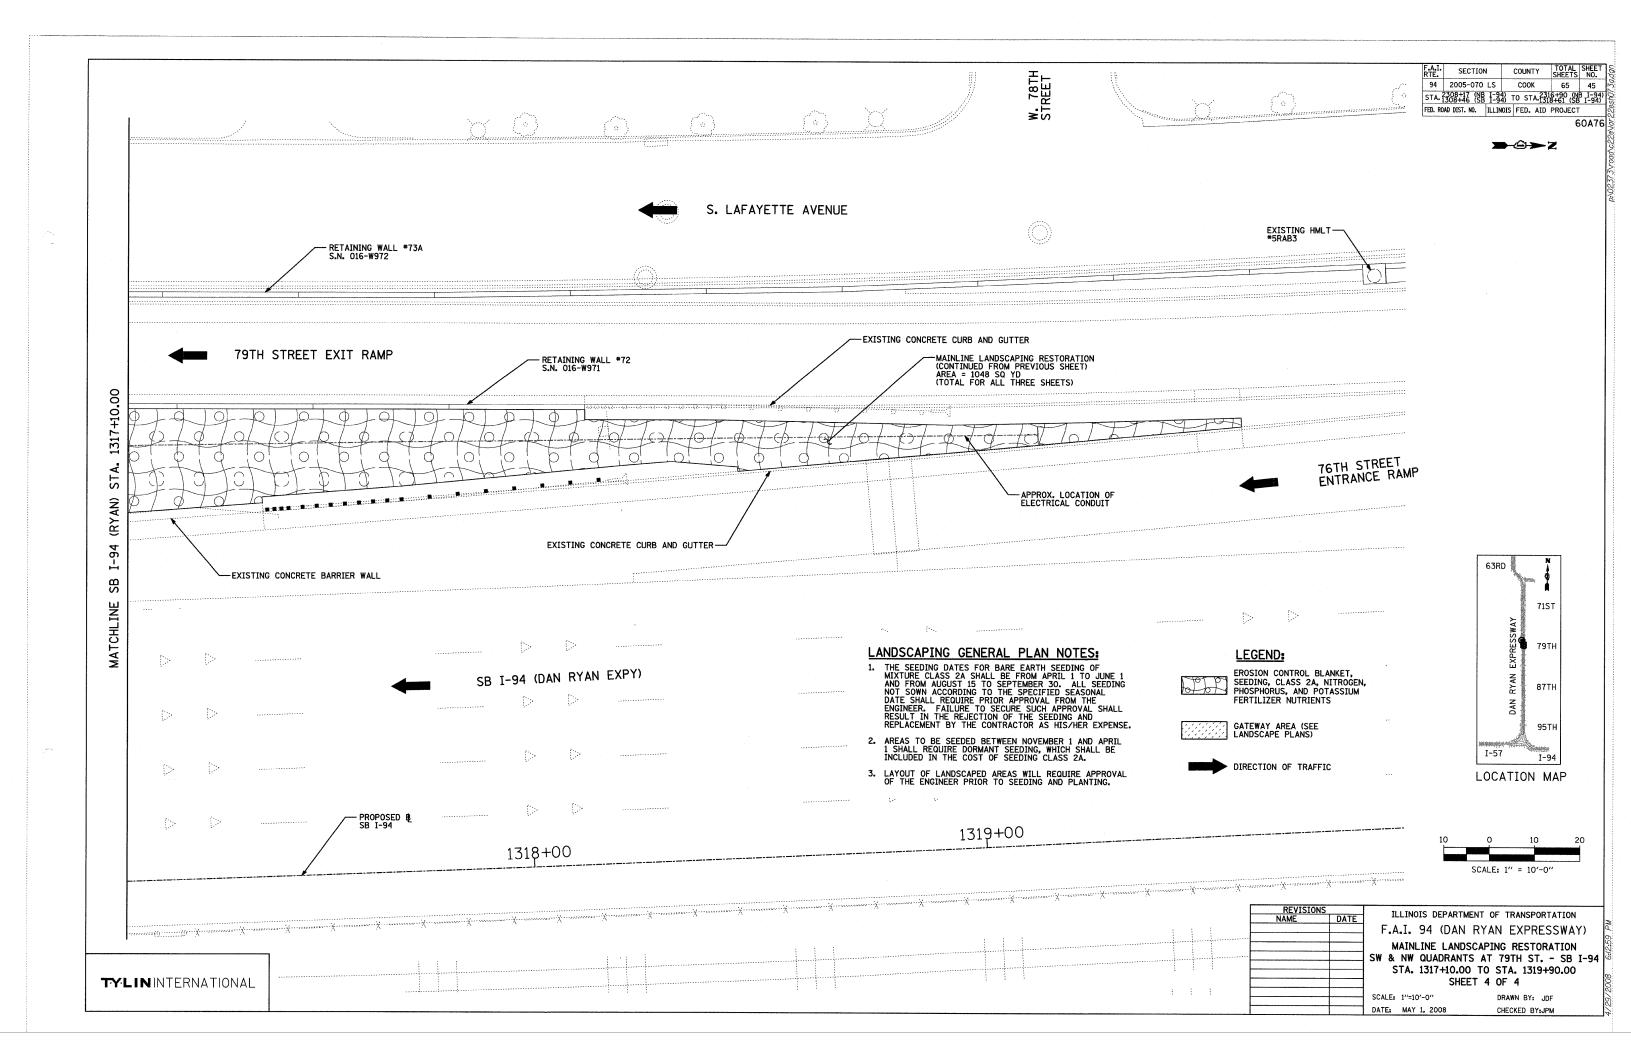


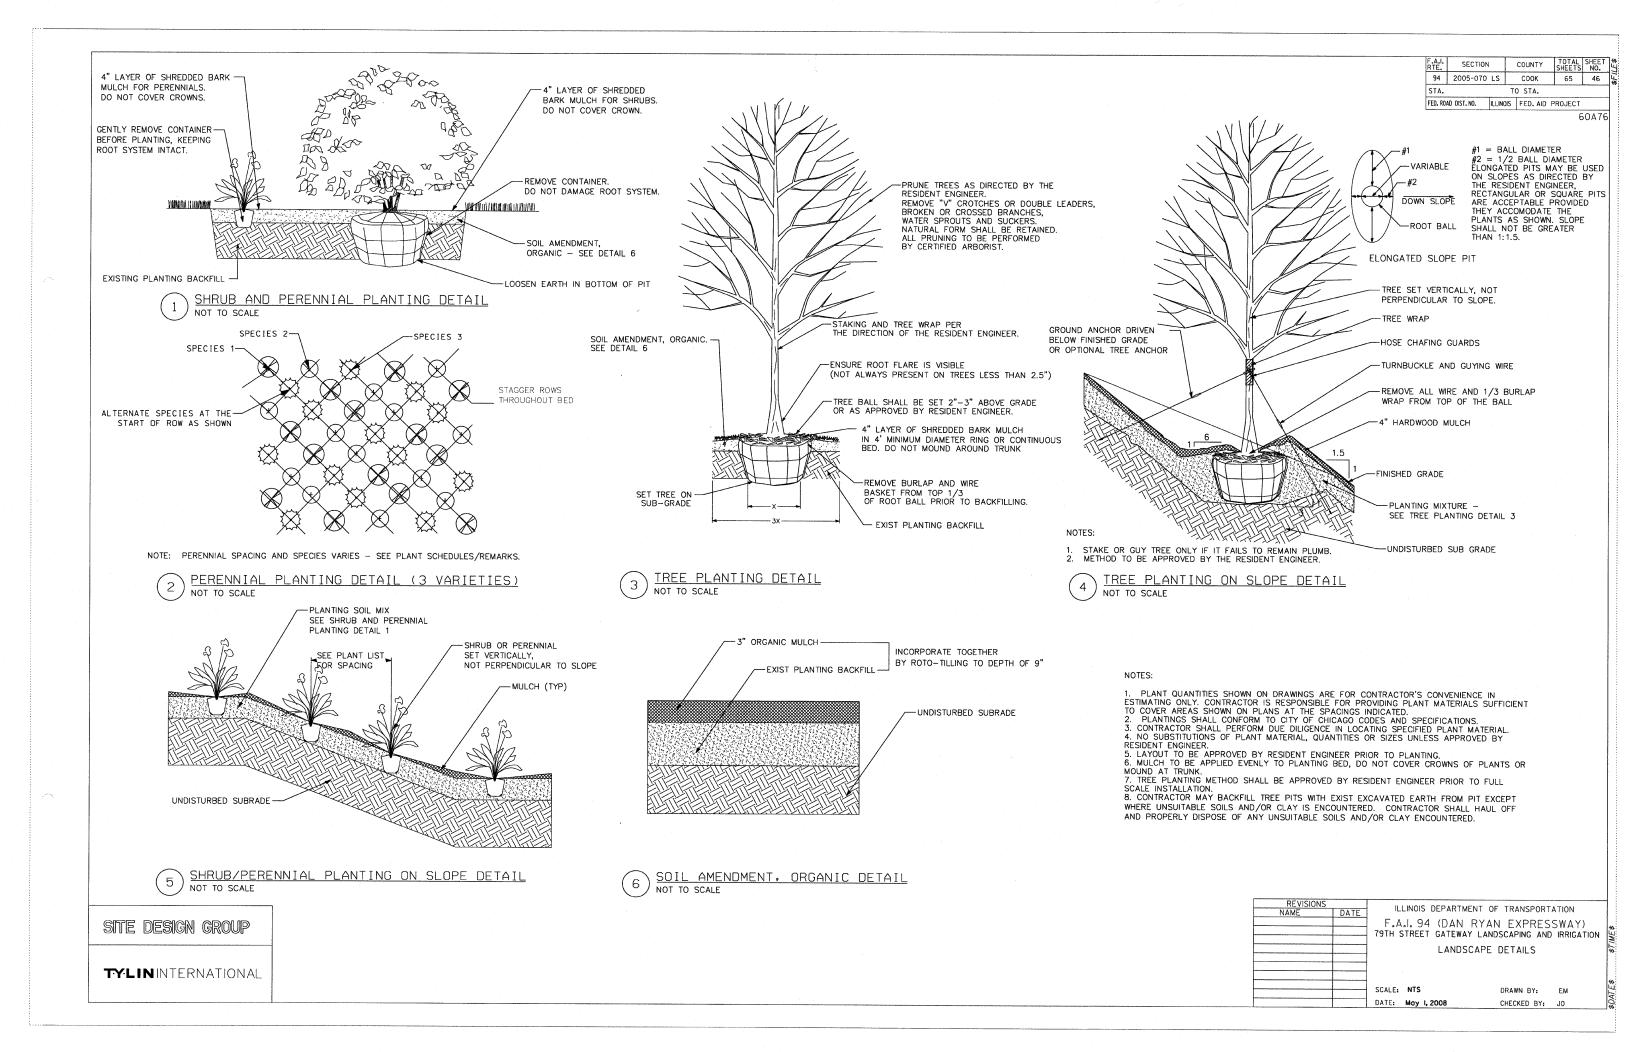


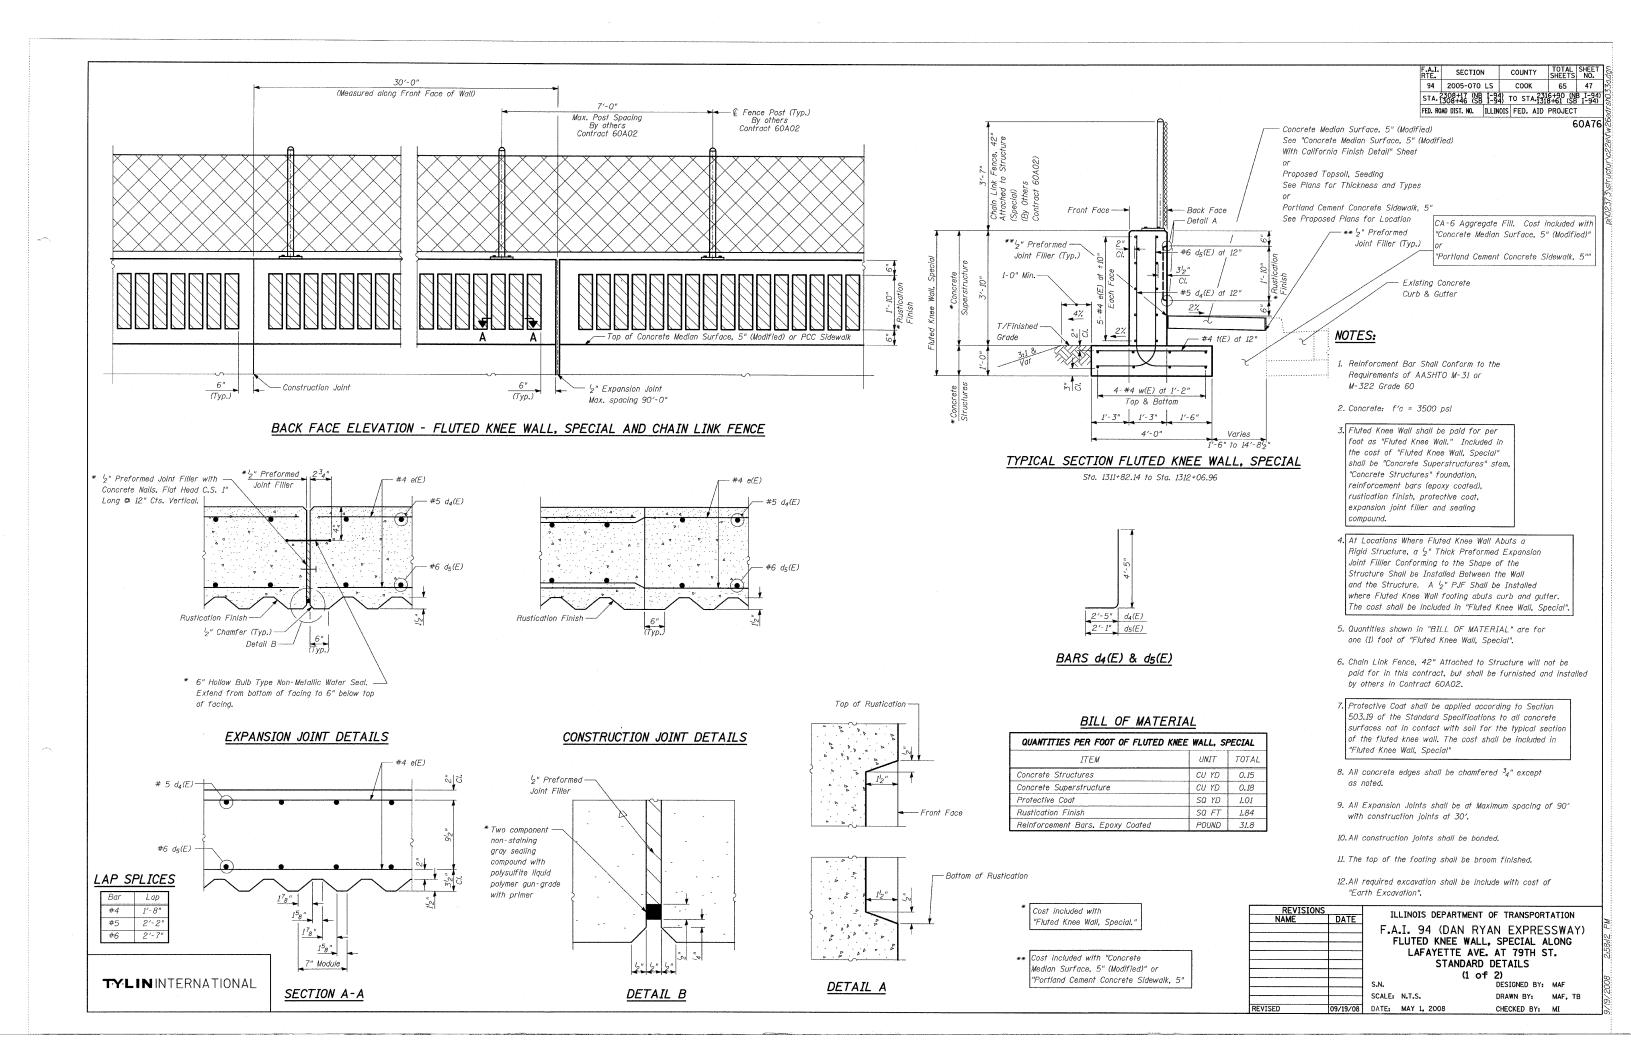


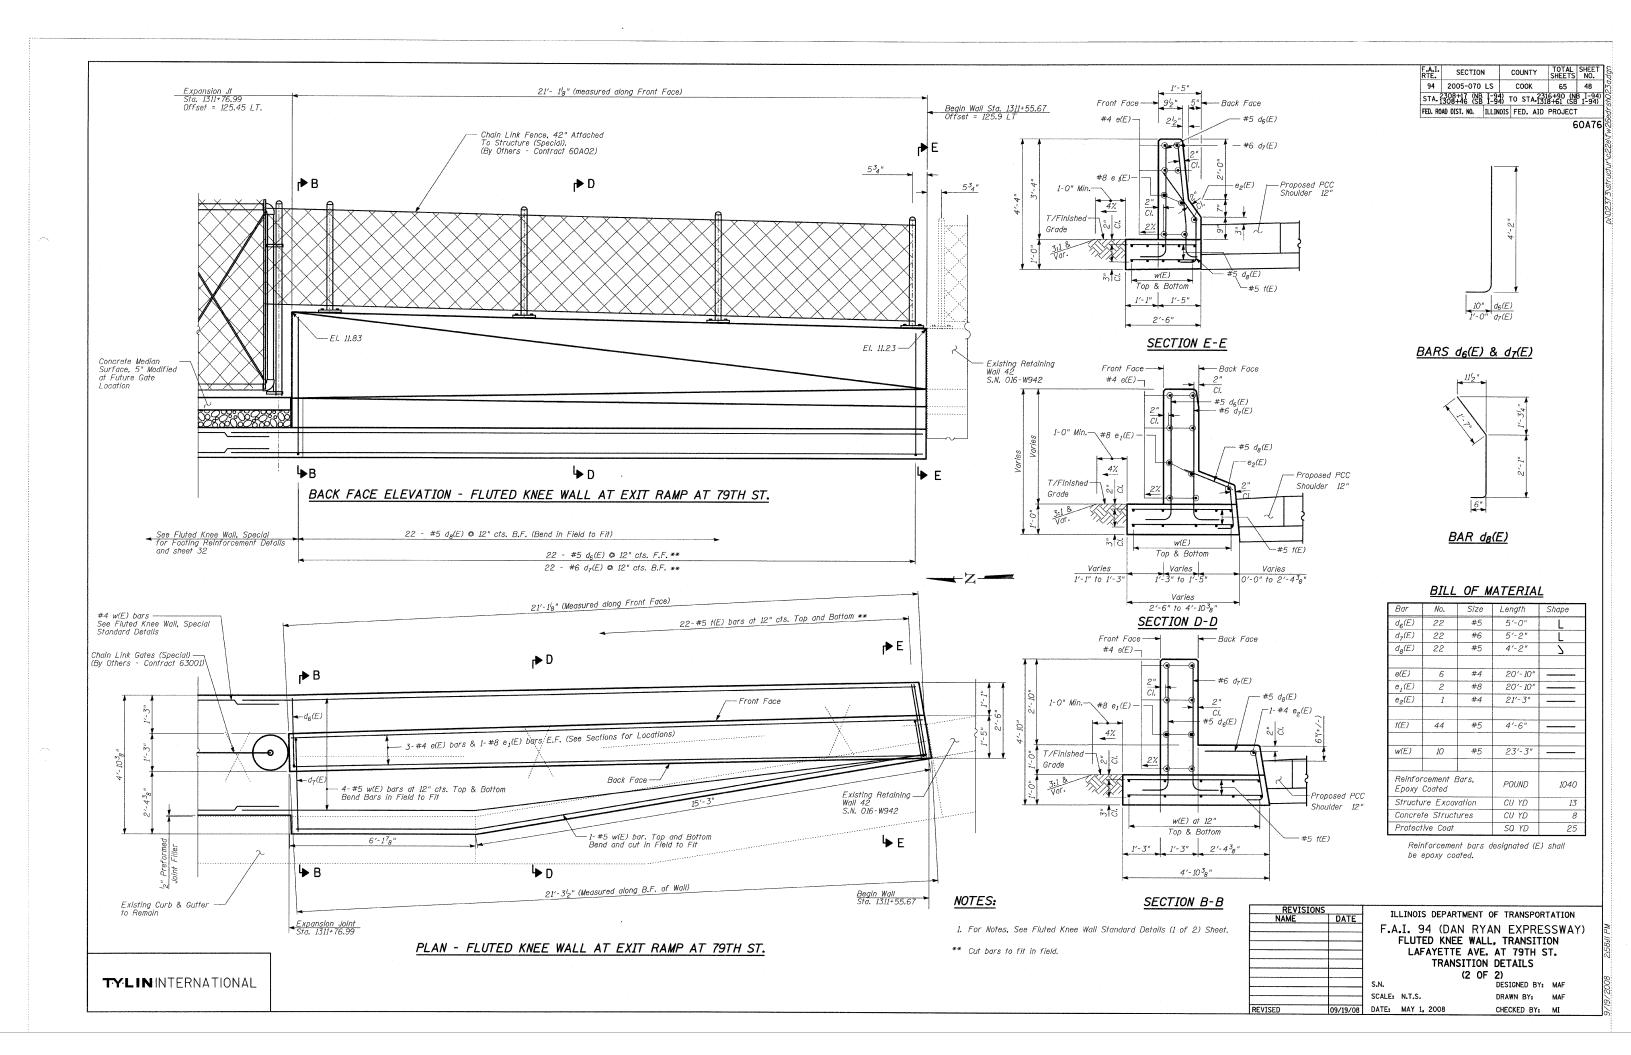

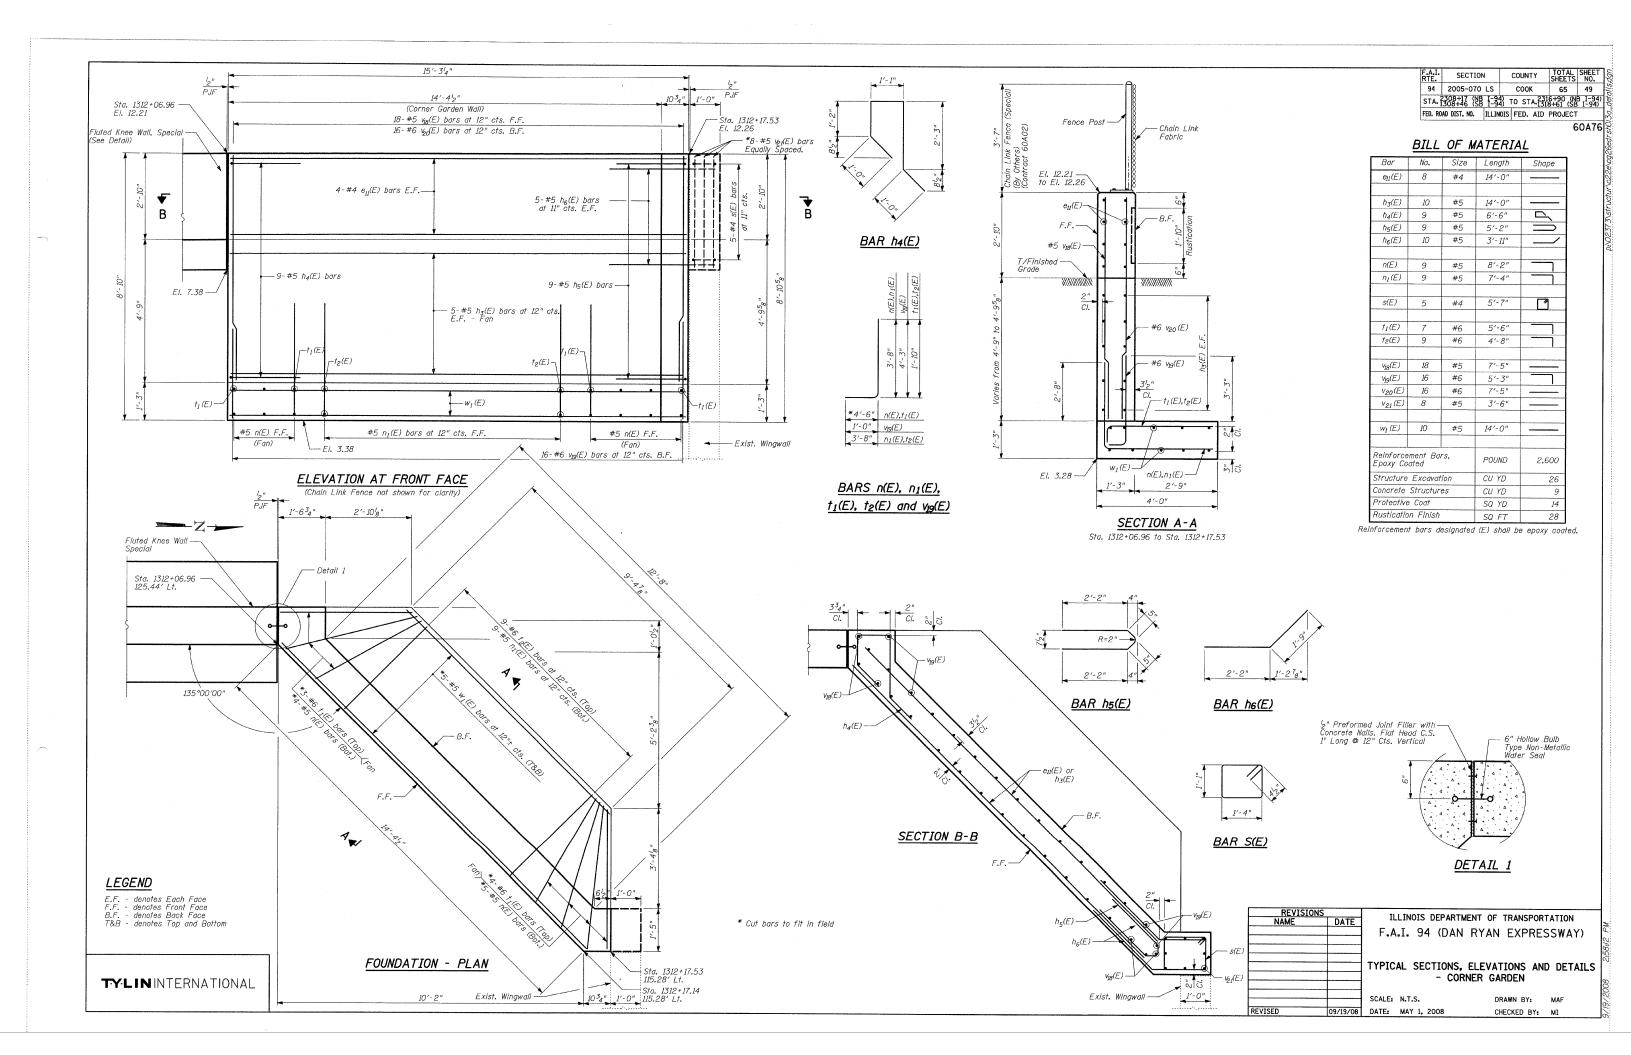


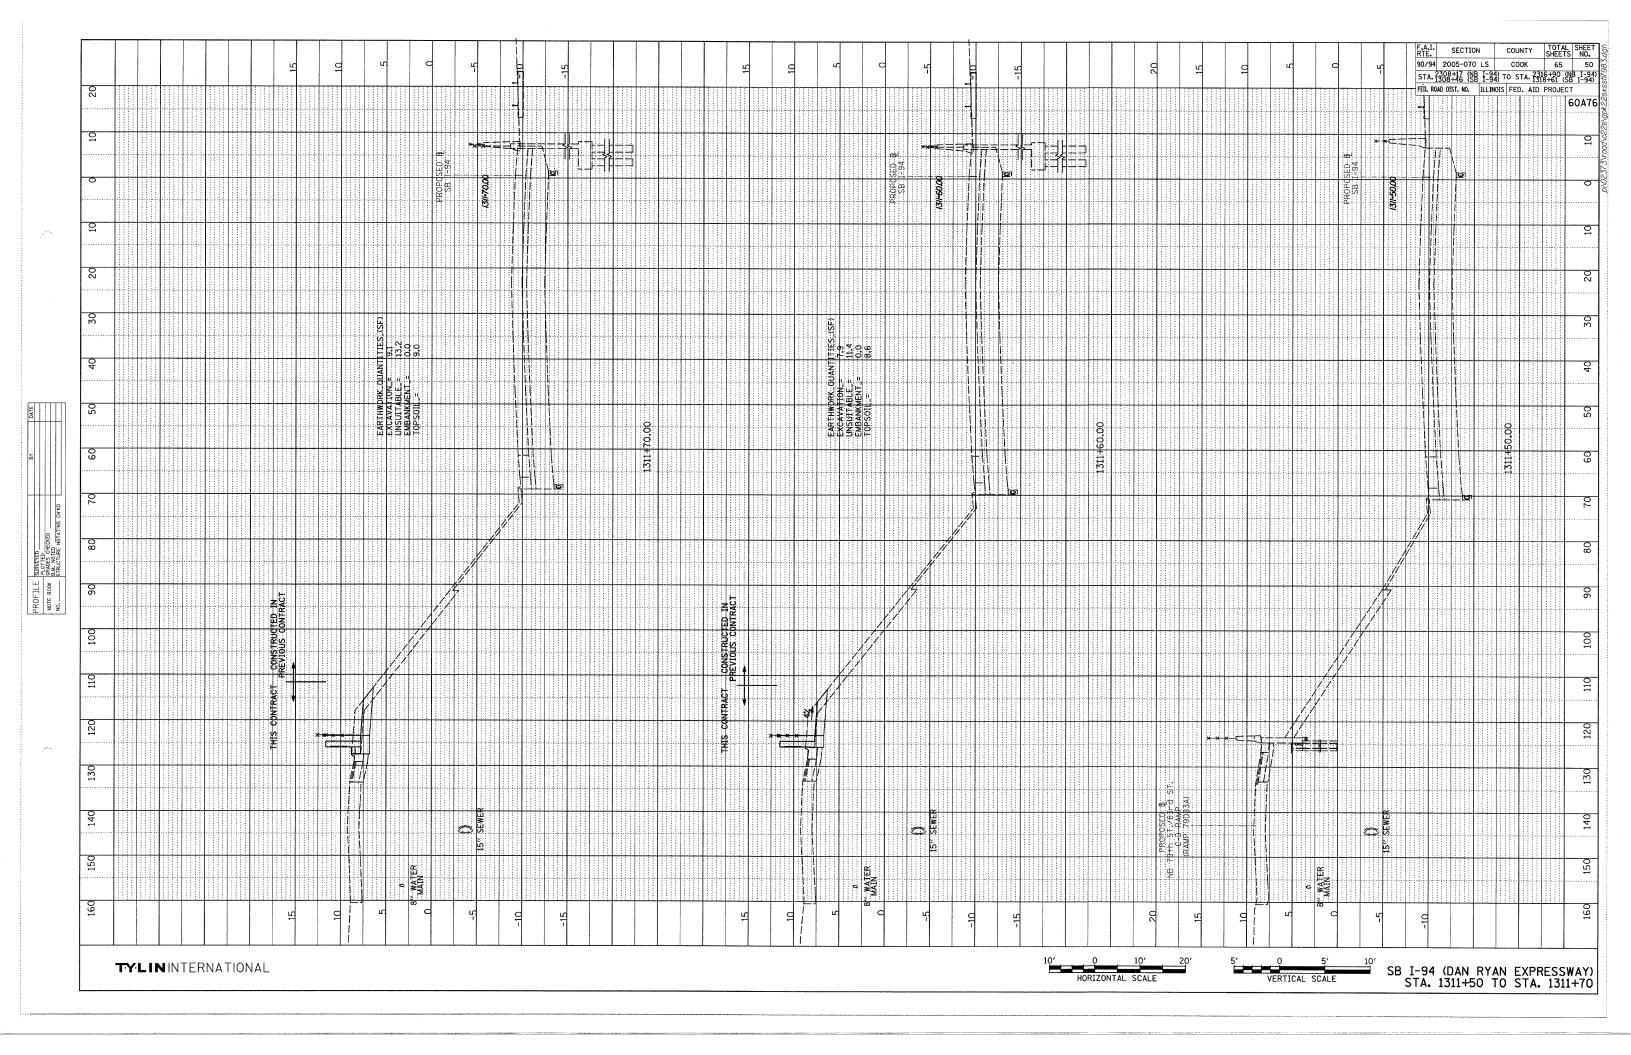

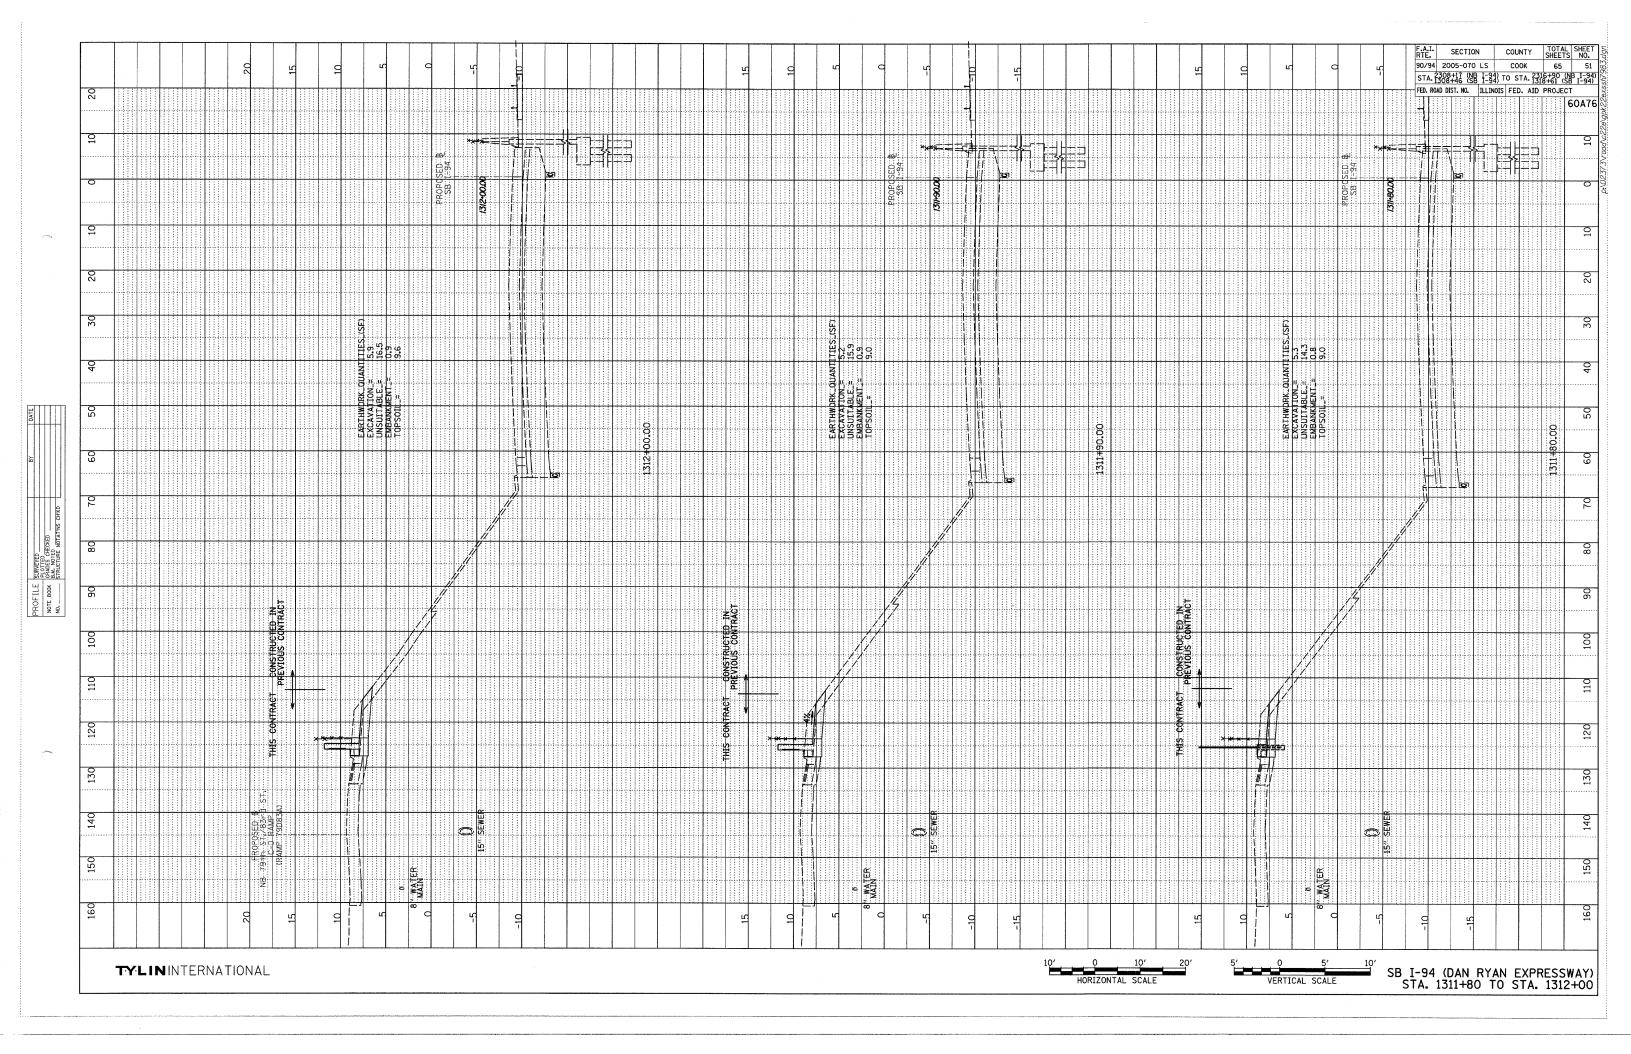


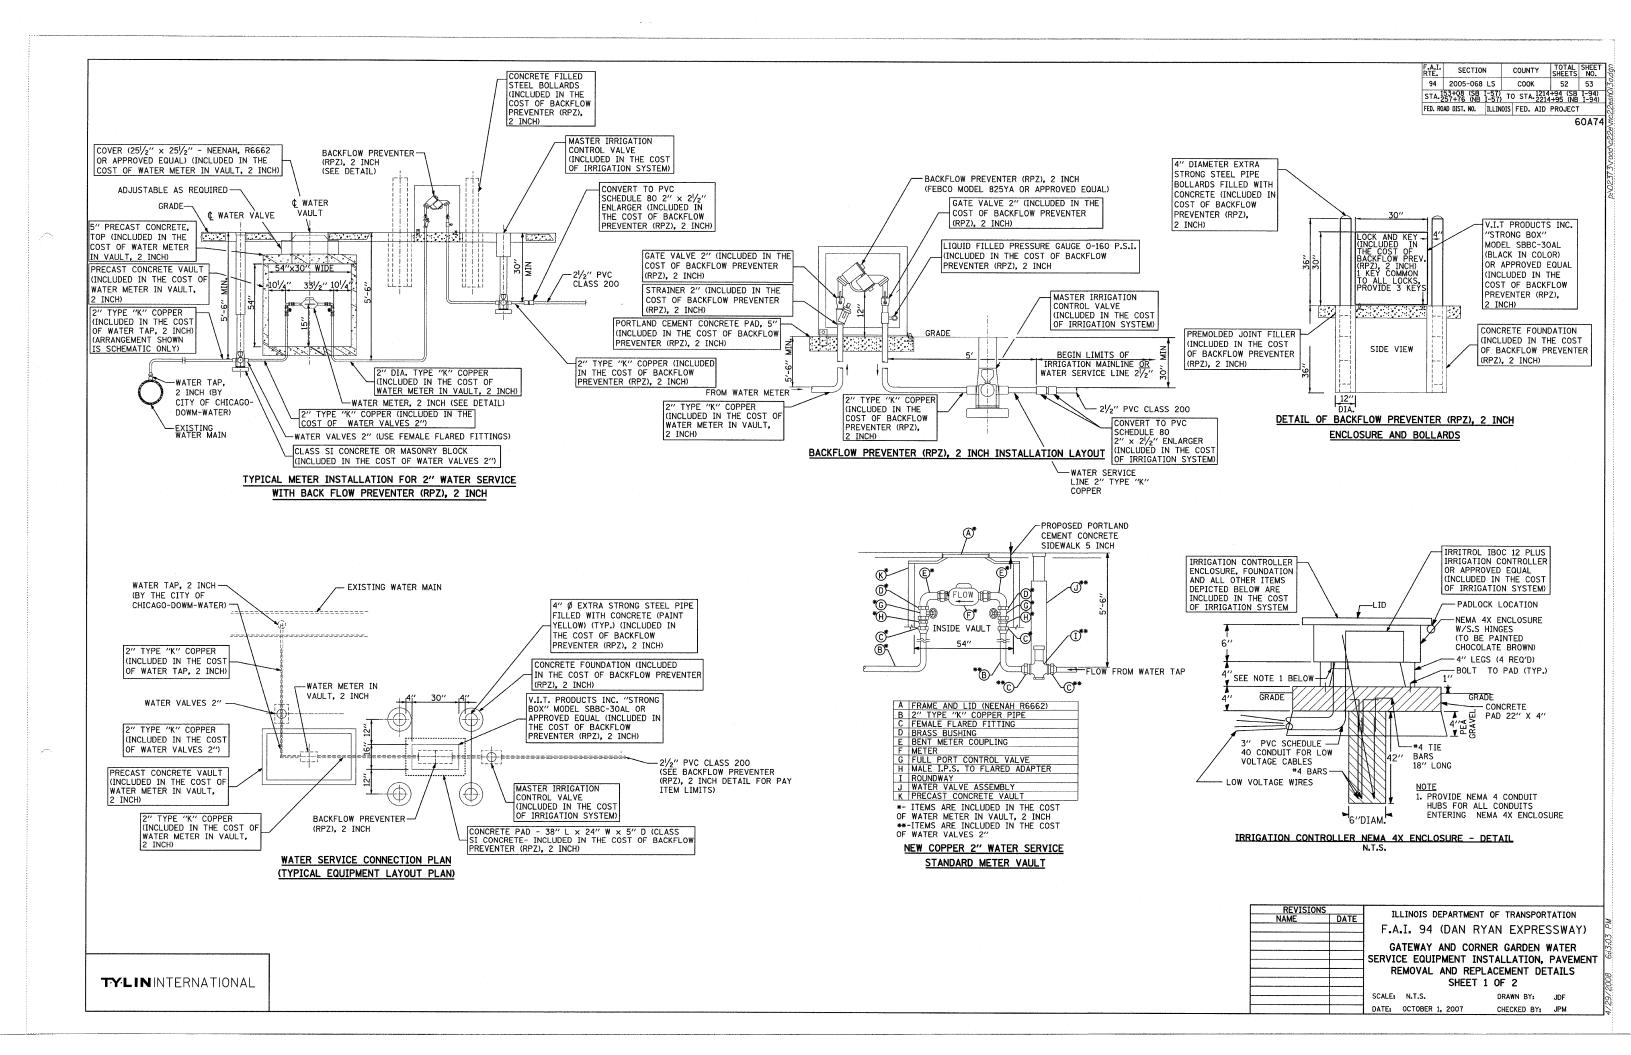

60A76 ⋛

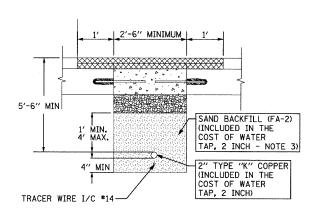


2" TYPE "K" COPPER PIPE (INCLUDED IN THE COST OF WATER TAP, 2 INCH) - PAVEMENT SECTION N.T.S.

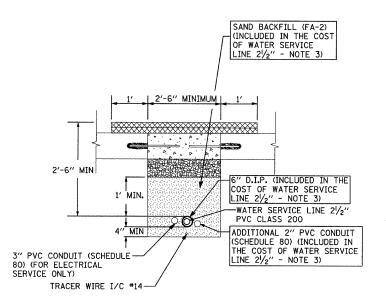


WATER SERVICE LINE 21/2"

21/2" PVC CLASS 200 - PAVEMENT SECTION


N.T.S.

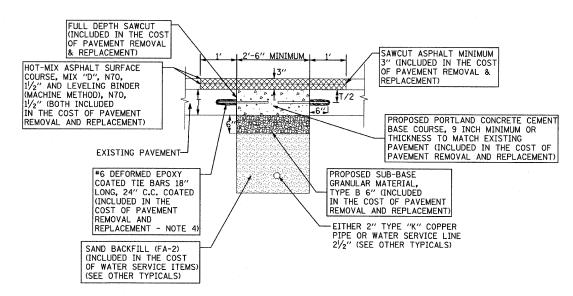

PAVEMENT REMOVAL & REPLACEMENT - TYPICAL N.T.S.

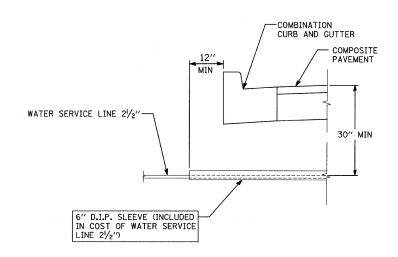

SLEEVING INSTALLATION REQUIREMENTS WITH CURB

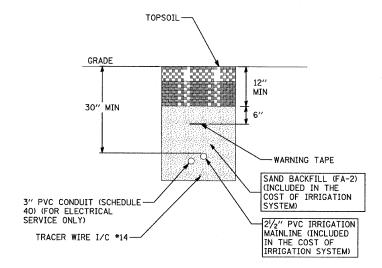

TYPICAL SECTION OF 21/2" IRRIGATION MAINLINE IN GATEWAY

NOTE

- 1. ALL TIE BARS TO BE EPOXY COATED (INCLUDED IN THE COST OF PAVEMENT REMOVAL AND REPLACEMENT).
- 2. ADDITIONAL ONE FOOT (1') OF HOT-MIX ASPHALT SURFACE REMOVAL ON EITHER SIDE OF CONCRETE PATCH SHALL BE REMOVED PRIOR TO PLACING HOT-MIX ASPHALT SURFACE COURSE.
- 3. PIPE BEDDING, TAMPED IN PLACE 4" MINIMUM UNDER PIPE AND 1'-0" ABOVE TOP OF PIPE. SHALL BE WELL SPADED ON BOTH SIDES OF PIPE.
- 4. TIE BARS MAY BE DELETED SUBJECT TO APPROVAL BY THE ENGINEER.
- 5. ALL CONTROL WIRING MUST BE PLACED INSIDE 3" SCHEDULE 80 PVC PIPE FOR ALL PAVED AREA CROSSINGS. THIS WORK AND MATERIALS SHALL CONFORM TO THE NATIONAL ELECTRICAL CODE REQUIREMENTS. THE COST OF THIS WORK WILL BE INCLUDED IN COST OF IRRIGATION SYSTEM.


ILLINOIS DEPARTMENT OF TRANSPORTATION
F.A.I. 94 (DAN RYAN EXPRESSWAY)
GATEWAY AND CORNER GARDEN WATER
SERVICE EQUIPMENT INSTALLATION, PAVEMENT
REMOVAL AND REPLACEMENT DETAILS
SHEET 2 OF 2
SCALE: N.T.S. DRAWN BY: JDF

CHECKED BY: JPM

DATE: MAY 1, 2008

TYLIN INTERNATIONAL

SECTION COUNTY 94 2005-070 LS COOK 65 55 STA. 2308+147 (NB 1-94) TO STA. 2316+90 (NB 1-94) SEPTIMENT OF STA

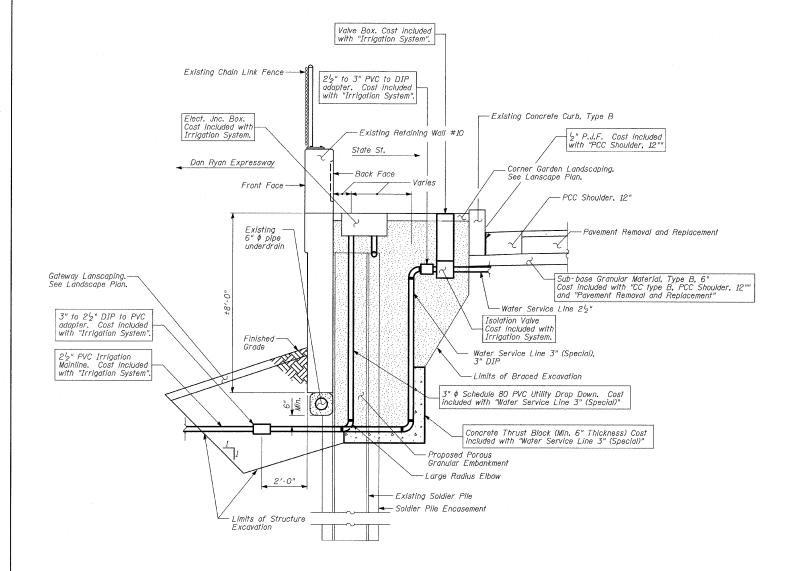

ELEVATION - WATER SERVICE & ELECTRICAL LINES AT SOLDIER PILE RETAINING WALL #10 (BETWEEN PILES)

(79th Street)

# Existing Concrete Curb, Type B Concrete Thrust Block (Min. 6" Thickness) Cost included with "Water Service Line 3" (Special)" Limits of Braced Excavation (Typ.) 3" ¢ Schedule 80 PVC Utility Drop Down. Cost included with "Water Service Line 3" (Special)" Water Service Line 3" (Special), 3" DIP. Existing Soldier Pile and Encasement Front Face -Limits of Structure Excavation (Typ.) Center between piles 5′-0" ±11'-0"

PLAN - WATER SERVICE & ELECTRICAL

LINES AT SOLDIER PILE RETAINING WALL

## BILL OF MATERIAL

ITEM	UNIT	TOTAL
Porous Granular Embankment	CU YD	10
Structure Excavation	CU YD	7
Braced Excavation	CU YD	10
Water Service Line 3" (Special)	FOOT	15

KE A 12 TOWS		ILLINOIS DEPARTMENT OF TRANSPORTATION
AME	DATE	ILLINOIS DEPARTMENT OF TRANSPORTATION
		F.A.I. 94 (DAN RYAN EXPRESSWAY)
		GATEWAY AND CORNER GARDEN
	!	UTILITY DROP DOWN DETAILS

SCALE: N.T.S. DATE: MAY 1, 2008


DRAWN BY: CHECKED BY: DAK


### **LEGEND**

Porous Granular Embankment

Portland Cement Concrete

**TY:LIN**INTERNATIONAL

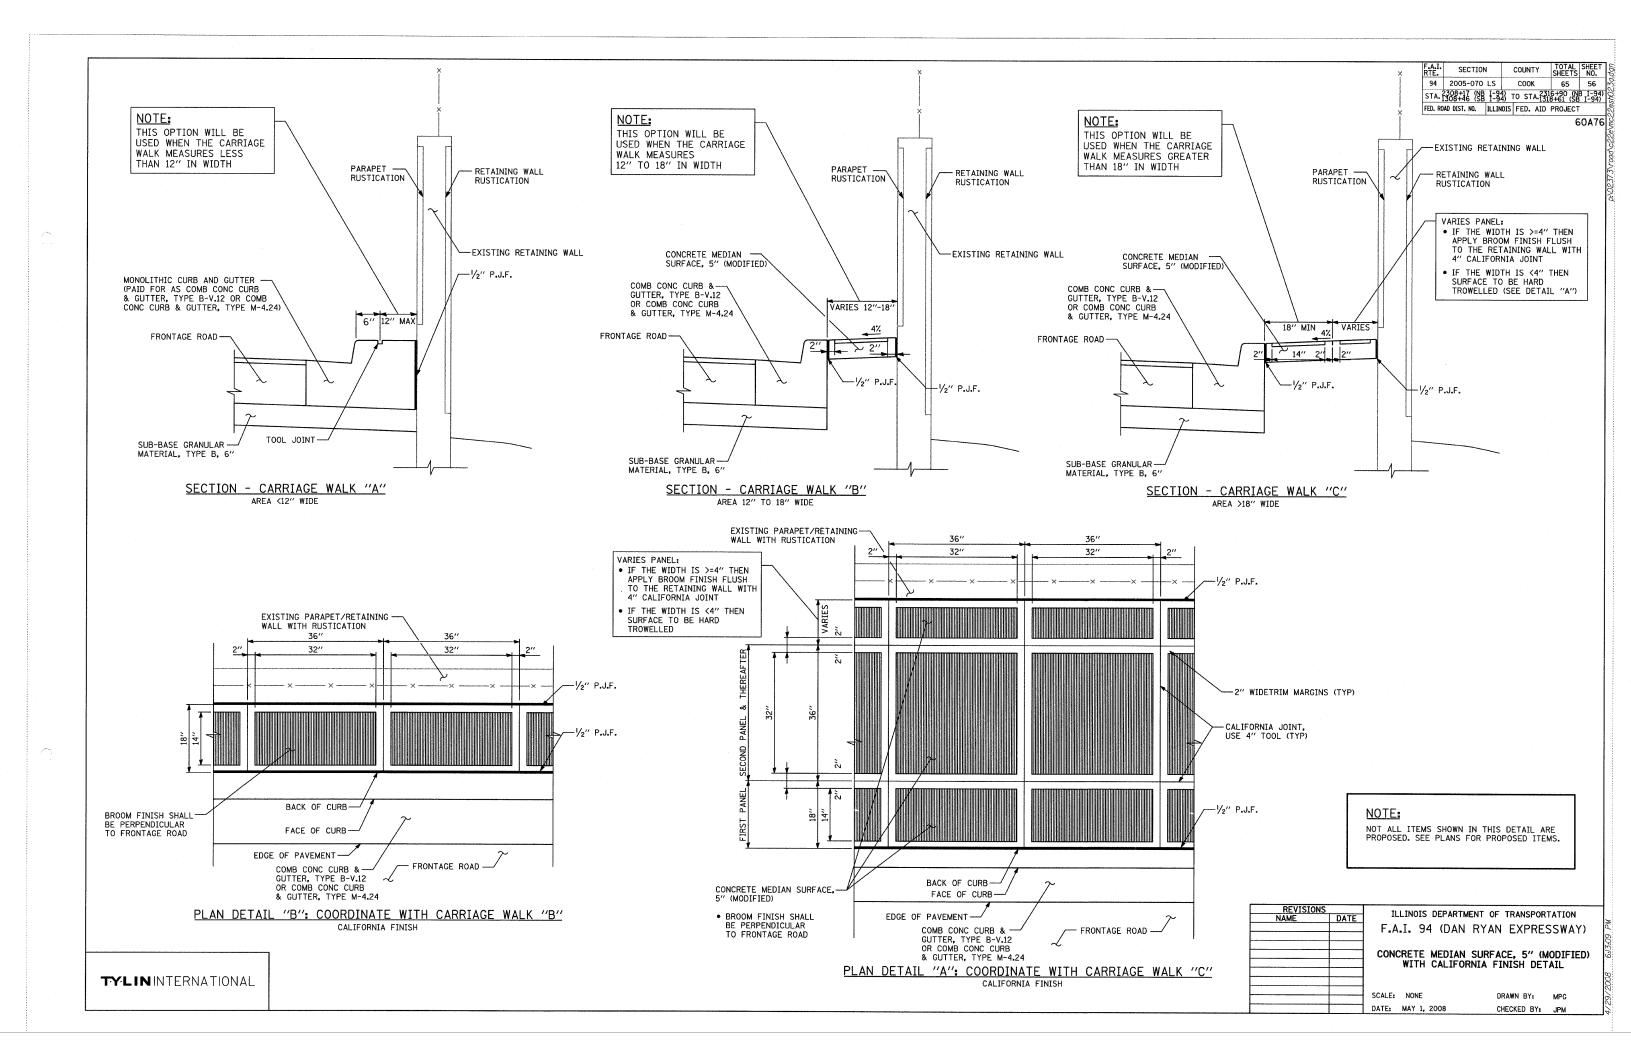

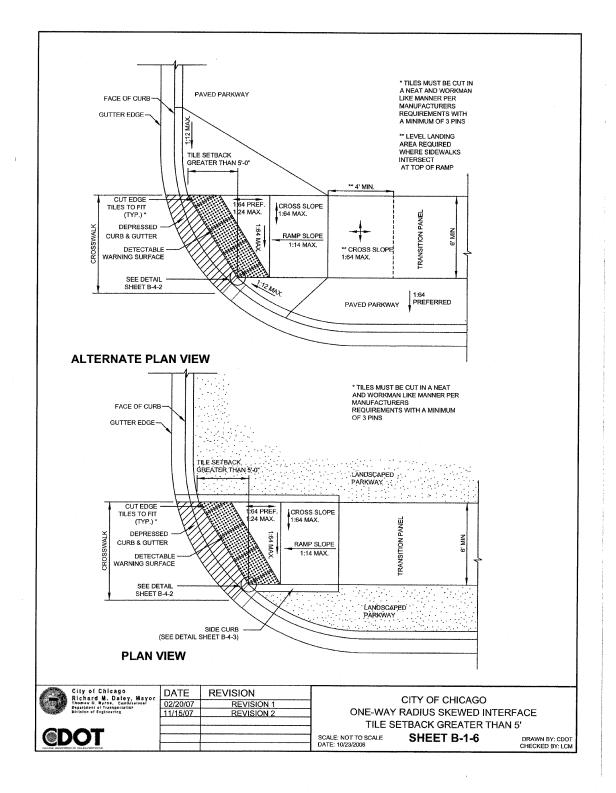

#### **GENERAL NOTES**

- 1. THE DETECTABLE WARNING TILES SHALL BE CERAMIC CEMENT OR COMPOSITE POLYMER CONCRETE (CRC) TILES WHICH MEET THE CHICAGO DEPARTMENT OF TRANSPORTATION SPECIFICATION (AVAILABLE ON THE CITY OF CHICAGO WEBSITE). IN THE CENTRAL BUSINESS DISTRICT, GRANITE OR OTHER SPECIALTY PAVING MATERIALS MAY BE SUBMITTED TO THE COMMISSIONER FOR APPROVAL.
- 2. TILES MUST BE INSTALLED A MAXIMUM OF 8" OR LESS FROM FACE OF CURB (SEE DETAIL SHEET B-4-2).
- 3. TILES MUST COVER FULL WIDTH OF RAMP EXCLUDING SIDE FLARES. WHERE SIDEWALK OR RAMP IS FLUSH WITH STREET (DEPRESSED CURB), TILES MUST BE PROVIDED.
- 4. WHERE APPLICABLE, A COMBINATION OF DIFFERING SIZE TILES MAY BE USED ON COMPOUND AND LARGE RADII. CONTRACTOR MUST MAKE THIS DETERMINATION AND VERIFY IN FIELD.
- 5. TILES MUST CONTRAST WITH ADJACENT PAVEMENT. IF LIGHT COLORED PAVEMENT IS USED THE TILE COLOR SHALL BE RED. IF A DARK COLORED PAVEMENT IS USED THE TILE COLOR SHALL BE YELLOW. CONTRACTOR TO VERIFY THAT PROPER CONTRAST IS OBTAINED.
- 6. RAMP WIDTH MUST BE A MINIMUM OF 6'-0" AND IN INCREMENTS OF 1'-0", EXCEPT WHEN USING THE PERPENDICULAR RAMP AT CORNER, WHICH HAS A MINIMUM WIDTH OF 4'-0".
- 7. PRIOR TO PLACING CONCRETE FOR DEPRESSED CURBS AND RAMPS THE CONTRACTOR SHALL NOTIFY THE COMMISSIONER TO RECEIVE LAYOUT APPROVAL. A PRE-MANUFACTURED TILE, APPROVED BY THE COMMISIONER, MUST BE USED TO ACHIEVE THE DETECTABLE WARNING SURFACE.
- 8. THE MAXIMUM ALLOWABLE RAMP RUNNING SLOPE IS 1:14, MEASURED AT ANY PORTION OF THE RAMP. IF POSSIBLE, A MORE GRADUAL SLOPE SHALL BE USED. GRADE BREAKS AT THE TOP AND BOTTOM OF RAMPS SHALL BE PERPENDICULAR TO THE DIRECTION OF RAMP RUN.
- 9. THE MAXIMUM ALLOWABLE RAMP CROSS SLOPE IS 1:64, MEASURED AT ANY PORTION OF THE RAMP. IF POSSIBLE, A MORE GRADUAL SLOPE SHALL BE USED.
- 10. UTILITIES, SUCH AS LIGHT POLES, TRAFFIC POLES AND HYDRANTS, MAY BE LOCATED IN THE FLARE OF THE RAMP BUT ARE NOT ALLOWED ON THE RAMP SURFACE OR LANDING AREAS.
- 11. ALTERATIONS SHALL NOT DECREASE THE ACCESSIBILITY OF EXISTING FACILITIES
- 12. THE MINIMUM CROSSWALK WIDTH IS 6'-0". CROSSWALKS SHALL BE LOCATED AS SHOWN IN THE PLAN SHEETS DEPENDING ON THE TYPE OF CURB RAMP USED. BEYOND THE CURB FACE AT THE BASE OF CURB RAMPS, A CLEAR SPACE OF 4'-0" BY 4'-0" MINIMUM SHALL BE PROVIDED WITHIN THE WIDTH OF THE CROSSWALK.
- 13. IF SIDEWALK AND ALLEY ARE AT THE SAME GRADE, A RAMP IS NOT REQUIRED. IF SIDEWALK AND DRIVEWAY ARE AT THE SAME GRADE, A RAMP IS NOT REQUIRED BUT DETECTABLE WARNING TILES ARE STILL REQUIRED IF THE DRIVEWAY HAS TRAFFIC CONTROL DEVICES (I.E. TRAFFIC SIGNALS).
- 14. MAIN LINE SIDEWALK SHALL HAVE A MAXIMUM CROSS SLOPE NOT TO EXCEED 1:64 FOR THE FULL WIDTH OF WALK UNLESS OTHERWISE APPROVED BY THE COMMISSIONER.
- 15. MAIN LINE SIDEWALK RUNNING SLOPES SHALL NOT EXCEED 1:24 OR THE GENERAL GRADE ESTABLISHED FOR THE ADJACENT STREET, WHICH EVER IS HIGHER.
- 16. CURB RAMPS AND KEYSTONE TO BE CONSTRUCTED WITH 8" THICK CONCRETE AT ALL TRAFFIC SIGNALIZED INTERSECTIONS AND INDUSTRIAL STREET INTERSECTIONS. AT ALL OTHER LOCATIONS, 5" THICK CONCRETE TO BE USED
- 17. NO DEVIATIONS FROM THESE STANDARDS ARE ALLOWED WITHOUT WRITTEN  $\,$  APPROVAL FROM THE COMMISSIONER.
- 18. ALL CONSTRUCTION DOCUMENTS MUST BE STAMPED BY A LICENSED ARCHITECT/LANDSCAPE ARCHITECT/ENGINEER TO CERTIFY THAT THEY ARE IN ACCORDANCE WITH THE AMERICANS WITH DISABILITIES ACT (ADA) AND ALL CODES AND BUILDING ORDINANCES OF THE CITY OF CHICAGO AND STATE OF ILLINOIS.

	City of Chicago Richard M. Daley, Mayor Thomas G. Ryrne. Cammissions: Department of transpersation Dirikton of Engineering
@D	OT

DATE REVISION
02/20/07 REVISION 1
11/15/07 REVISION 2

CITY OF CHICAGO GENERAL NOTES

SHEET B-3-2

CHECKED BY: LCM

60A76

ILLINOIS DEPARTMENT OF TRANSPORTATION
F.A.I. 94 (DAN RYAN EXPRESSWAY)
CITY OF CHICAGO STANDARD DETAILS
DETAILS OF CURB RAMPS FOR
PEOPLE WITH DISABILITIES
SHEET 1 OF 3

SCALE: NONE
DATE: MAY 1, 2008

DRAWN BY: CDOT
CHECKED BY:

#### ADA COMPLIANCE AND TRANSITION GUIDELINES

POLICY STATEMENT: ANY ALTERATION OF THE PUBLIC WAY MUST BE RESTORED IN AN ADA COMPLIANT MANNER

#### I. STREET RESURFACING / RECONSTRUCTION \*

FOR ANY RESURFACING/RECONSTRUCTION PROJECT WHERE, WITHIN THE PROJECT LIMITS, A CROSSWALK IS ENCOUNTERED OR WHERE THE PROJECT LIMITS TERMINATE WITHIN 4' OR LESS OF A CROSSWALK, THOSE CROSSWALKS AND THE ASSOCIATED CURB RAMPS MUST BE IMPROVED TO CURRENT ADA STANDARDS. WHERE RESURFACING/RECONSTRUCTION ENCOUNTERS LESS THAN 1/4 POINT OF THE STREET SURFACE (LONGITUDINAL CUT), IT IS ACCEPTABLE PRACTICE TO EXCLUDE IMPROVEMENTS TO THE ASSOCIATED CROSSWALKS AND CURB RAMPS.

WHEN A PROJECT SCOPE OF WORK CALLS FOR ONLY AN INTERSECTION TO BE REPAVED, THE INTERSECTION LIMITS AS DEFINED BY THE AREA OUTLINED BY OUTERMOST CROSSWALK LINES AND ADJACENT CURB FACES AND ALL ADJOINING CROSSWALKS AND CURB RAMPS MUST BE IMPROVED TO CURRENT ADA STANDARDS.

WHEN A PROJECT SCOPE OF WORK IS LIMITED TO A SINGLE CORNER OF AN INTERSECTION, THE CURB RAMP MUST BE IMPROVED TO CURRENT ADA STANDARDS AND THE ADJACENT PAVEMENT MUST BE RESURFACED, AS NECESSARY TO PROVIDE FOR A FLUSH TRANSITION.

FOR ANY RESURFACING / RECONSTRUCTION PROJECT WHERE, WHITHIN THE PROJECT LIMITS, AN ALLEY APRON IS INCLUDED, THE ASSOCIATED CURB RAMPS AND SIDEWALKS MUST BE IMPROVED TO CURRENT ADA STANDARDS

#### II. SIDEWALK INSTALLATION / REPAIRS / RECONSTRUCTION

THE LIMITS OF ANY MAINLINE SIDEWALK REPLACEMENT, GREATER THAN TEN FEET (10') IN LENGTH, THAT ABUT AN EXISTING RAMP LOCATION (INCLUDING THE FOUR FOOT (4') LANDING AREA AND/OR THE "KEYSTONE"), SHALL BE EXTENDED TO INCLUDE THE AFFECTED RAMPS ANDTHESE RAMPS SHALL BE RECONSTRUCTED TO CURRENT ADA STANDARDS. IN ADDITION, ALL NEWLY PLACED SIDEWALK TEN FEET (10') OR MORE IN LENGTH SHALL BE CONSTRUCTED IN ACCORDANCE WITH ALL CURRENT APPLICABLE STANDARDS WHICH INCLUDE PROVIDING A MINIMUM FOUR FEET (4') WIDTH ACCESSIBLE PATHWAY WITH A CROSS SLOPE NOT TO EXCEED 1:64.

#### III. GUIDELINES FOR TRANSITIONING TO EXISTING NON-COMPLIANT CONDITION

NEW SIDEWALK PLACEMENTS GREATER THAN TEN FEET IN CONTIGUOUS LENGTH:
THE LIMITS OF ANY MAINLINE SIDEWALK REPLACEMENT, GREATER THAN TEN FEET (10') IN LENGTH,
MUST BE EXTENDED FOR A MINIMUM FIVE ADDITIONAL FEET (5') EITHER SIDE IN ORDER TO PROVIDE
A REASONABLE TRANSITION TO MATCH THE EXISTING SIDEWALK. THE LENGTH OF TRANSITION
SHALL BE LENGTHENED AS NECESSARY TO ENSURE THAT THE RUNNING SLOPE OF THE TRANSITION
DOES NOT EXCEED A SLOPE OF 1:24 (PREFERRED) OR 1:14 (MAXIMUM) AT ANY POINT.

NEW SIDEWALK REPLACEMENTS TEN FEET OR LESS IN CONTIGUOUS LENGTH (REPAIRS): IT IS ACCEPTABLE PRACTICE TO MATCH ADJACENT SIDEWALKS AT THE EXISTING SLOPE.

#### **CURB RAMP REPLACEMENTS:**

SIDEWALK REPLACEMENT BEYOND THE LIMITS OF THE LANDING AREA AND/OR THE "KEYSTONE" MUST BE EXTENDED A MINIMUM OF AN AN ADDITIONAL FIVE FEET (5') EITHER SIDE IN ORDER TO PROVIDE A REASONABLE TRANSITION TO MATCH THE EXISTING SIDEWALK. THE TRANSITION SHALL BE LENGTHENED AS NECESSARY TO ENSURE THAT THE RUNNING SLOPE OF THE TRANSITION DOES NOT EXCEED A SLOPE OF 1:24 (PREFERRED) OR 1:14 (MAXIMUM) AT ANY POINT.

NO EXCEPTIONS TO THE ABOVE WILL BE ALLOWED WITHOUT WRITTEN APPROVAL FROM THE COMMISSIONER.

\* THE REQUIREMENTS OF SECTION I. SHALL APPLY ONLY TO CITY AGENCIES

City of Chicago
Richard M. Daley, Mayor
Thomas G. Qyrae. Commissions:
Department of Transportation
Division at Engineering

@DOT

DATE REVISION
02/20/07 REVISION 1
11/15/07 REVISION 2


REVISION CITY OF CHICAGO

REVISION 1 ADA COMPLIANCE AND TRANSITION GUIDELINES

SCALE: NOT TO SCALE SHEET B-3-3
DATE: 10/23/2006


DRAWN BY: CDOT CHECKED BY: LCM | F.A.L | SECTION | COUNTY | STEETS | NO. |
| 94 | 2005-070 LS | COOK | 65 | 58 | 65 |
| STA. 2308447 (\sqrt{8} \sqrt{1-94}) TO STA. 2318490 (\sqrt{8} \sqrt{1-94}) |
| FED. ROAD DIST. NO. | ILLINOIS | FED. AID | PROJECT |
| 60A76

**GENERAL NOTE:** THE ROWS OF DOMES IN THE DETECTABLE WARNING MATERIAL MUST BE ALIGNED WITH THE PATH OF WHEELCHAIR TRAVEL WHICH IS REQUIRED TO BE PERPENDICULAR TO THE GRADE BREAK AT THE BOTTOM OF THE RAMP TO PERMIT TRACKING BETWEEN DOME ROWS. ON BLENDED TRANSITIONS, DOME ORIENTATION IS NOT SIGNIFICANT

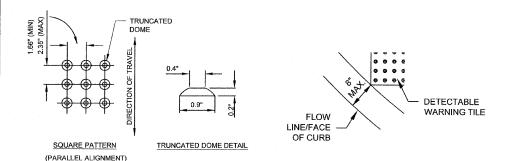

#### **TILE PATTERN DETAIL**

#### TILE PLACEMENT ON A RADIUS

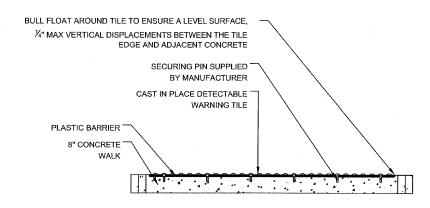

#### **DETECTABLE TILE WARNING SECTION**

	City of Chicago Richard M. Daley, Mayor	DATE	REVISION
	Richard M. Daley, Mayor Thomas G. Byrns. Cammissioner Desarings; of Transportation	02/20/07	REVISION 1
1	Division of Engineering	11/15/07	REVISION 2
-			

**©DOT** 

CITY OF CHICAGO DETECTABLE WARNING TILE DETAILS


SCALE: NOT TO SCALE SHEET B-4-2
DATE: 10/23/2006

DRAWN BY: CDOT CHECKED BY: LCM

REVISIO		ILLINOIS DEPARTMENT OF TRANSPORTATION
NAME	DATE	ILLINOIS DEPARTMENT OF TRANSPORTATION
		F.A.I. 94 (DAN RYAN EXPRESSWAY)
		CITY OF CHICAGO STANDARD DETAILS
		DETAILS OF CURB RAMPS FOR
		PEOPLE WITH DISABILITIES
		SHEET 2 OF 3
		SCALE: NONE DRAWN BY: CDOT

SCALE: NONE DR.
DATE: MAY 1, 2008 CHE

CHECKED BY:

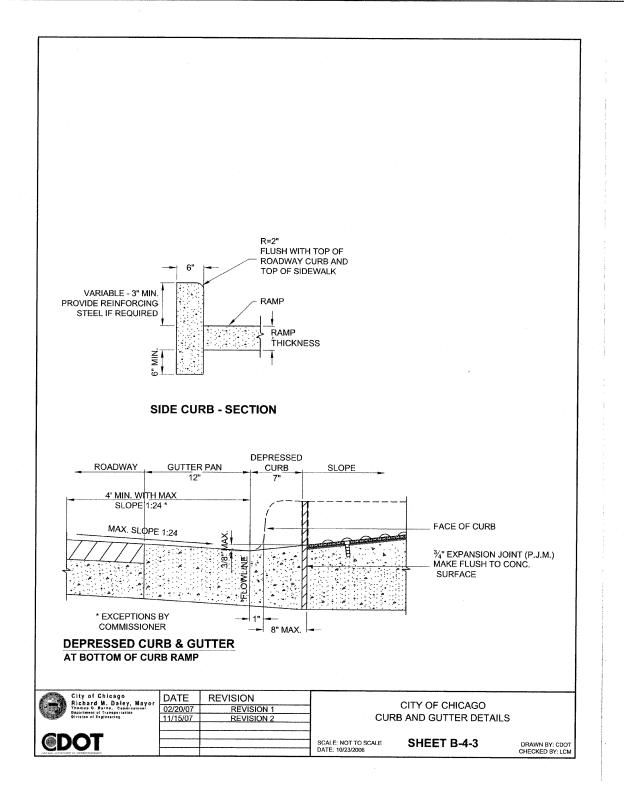


60A7

REVISIONS	ILLINOIS DEPARTMENT OF TRANSPORTATION	•
NAME DATE	ILLINOIS DEPARTMENT OF TRANSPORTATION	
	F.A.I. 94 (DAN RYAN EXPRESSWAY)	
	CITY OF CHICAGO STANDARD DETAILS	
	DETAILS OF CURB RAMPS FOR	
	PEOPLE WITH DISABILITIES	
	SHEET 3 OF 3	
	SCALE: NONE DRAWN BY: CDOT	

DATE: MAY 1, 2008

CHECKED BY:

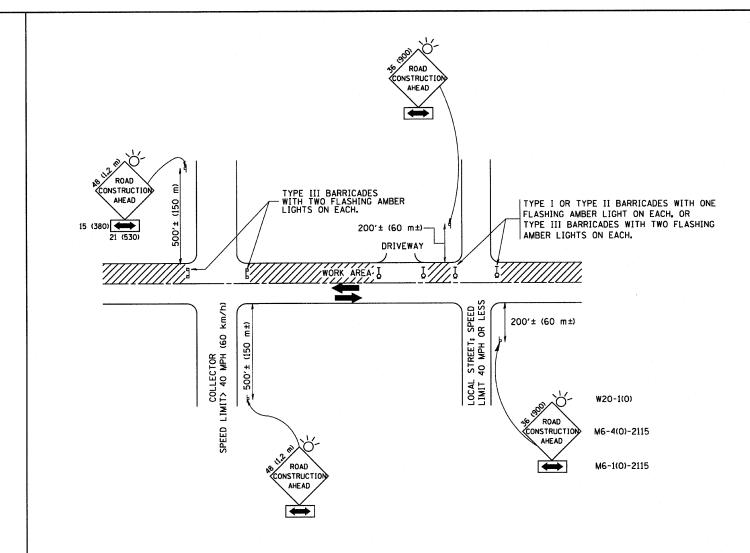

TRAFFIC CONTROL AND PROTECTION FOR SIDE ROADS, INTERSECTIONS, AND DRIVEWAYS

#### NOTES:

- A. FOR NO LANE RESTRICTION ON THE SIDE ROAD OR DRIVEWAYS
- 1. SIDE ROAD WITH A SPEED LIMIT OF 40 MPH (60 km/h) OR LESS AS SHOWN ON THE DRAWING AND AS DIRECTED BY THE ENGINEER:
- O) ONE ROAD CONSTRUCTION AHEAD SIGN 36 x 36 (900x900) WITH A FLASHER AND FLAG MOUNTED ON IT APPROXIMATELY 200' (60 m) IN ADVANCE OF THE MAIN ROUTE.
- b) THE CLOSED PORTION OF THE MAIN ROUTE SHALL BE PROTECTED BY BLOCKING WITH TYPE I, TYPE II OR TYPE III BARRICADES, 1/3 OF THE CROSS SECTION OF THE CLOSED PORTION.
- 2. SIDE ROAD WITH A SPEED LIMIT GREATER THAN 40 MPH (60 km/h) AS SHOWN ON THE DRAWING AND AS DIRECTED BY THE ENGINEER:
- 0) ONE ROAD CONSTRUCTION AHEAD SIGN 48  $\times$  48 (1.2 m  $\times$  1.2 m) WITH A FLASHER MOUNTED ON IT APPROXIMATELY 500° (150 m) IN ADVANCE OF THE MAIN ROUTE.
- b) THE CLOSED PORTION OF THE MAIN ROUTE SHALL BE PROTECTED BY BLOCKING WITH TYPE III BARRICADES, 1/2 OF THE CROSS SECTION OF THE CLOSED PORTION.
- 3. WHEN THE SIDE ROAD LIES BETWEEN THE BEGINNING OF THE MAINLINE SIGNING AND THE WORK ZONE, A SINGLE HEADED ARROW (M6-1) SHALL BE USED IN LIEU OF THE DOUBLE HEADED ARROW (M6-4).

SCALE: NONE

- B. FOR A LANE CLOSURE ON A SIDE ROAD OR DRIVEWAY:
- USE APPLICABLE PORTIONS OF THE TYPICAL APPLICATION OF TRAFFIC CONTROL DEVICES (STD. 701501, STD. 701606 OR THE APPROPRIATE STANDARD). THE SPACING OF SIGNS AND BARRICADES SHALL BE ADJUSTED FOR FIELD CONDITIONS AS DIRECTED BY THE ENGINEER. THE DIRECTIONAL ARROW SHALL BE COVERED OR REMOVED WHEN NO LONGER CONSISTENT WITH THE SIDE ROAD LANE CLOSURE.
- C. ADVANCE WARNING SIGNS ARE TO BE OMITTED ON DRIVEWAY UNLESS OTHERWISE NOTED.
- D. THE TRAFFIC CONTROL AND PROTECTION FOR SIDE ROADS, INTERSECTIONS, AND DRIVEWAYS SHALL BE INCIDENTAL TO THE COST OF SPECIFIED TRAFFIC CONTROL STANDARDS OR ITEMS.


All dimensions are in millimeters (inches) unless otherwise shown.


FILE NAME =	USER NAME = gaglianobt	DESIGNED - LHA	REVISED - J. OBERLE 10-18-95
W:\diststd\22x34\tc10.dgn		DRAWN -	REVISED - A. HOUSEH 03-06-96
	PLOT SCALE = 50.000 '/ IN.	CHECKED ~	REVISED - A. HOUSEH 10-15-96
	PLOT DATE = 1/4/2008	DATE - 06-89	REVISED -T. RAMMACHER 01-06-00


STATE	OF	ILLINOIS
DEPARTMENT	OF	TRANSPORTATION

TR	AFFI	C	CON	TR	OL AND P	ROTEC	TION FOR			
SIDE	RO/	\DS	S, IN	TE	RSECTIONS	, AND	DRIVEWAYS			
SHEET	NO.	1	OF	1	SHEETS	STA.		TO	STA.	

F.A RTE.	SECTION	COUNTY	TOTAL SHEETS	SHEET NO.
94	2005-070 LS	COOK	65	60
	TC-10	CONTRACT	NO.	
FED. R	OAD DIST. NO. 1   ILLINOIS FED. A	ID PROJECT		

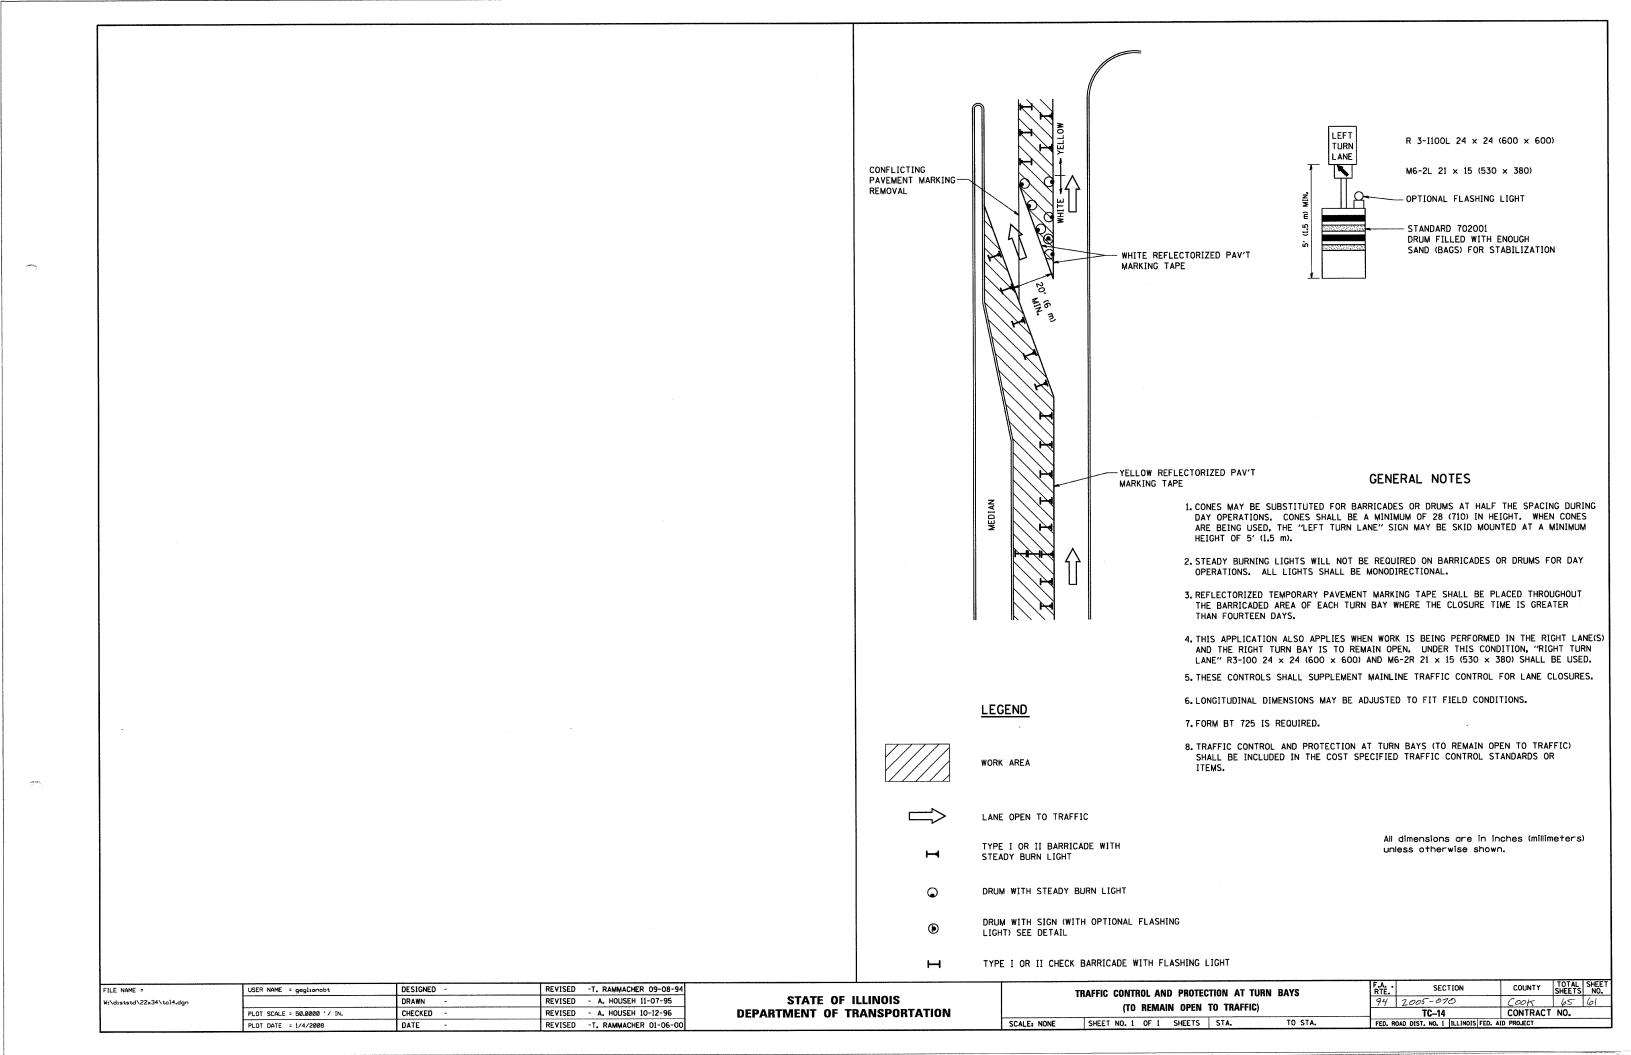

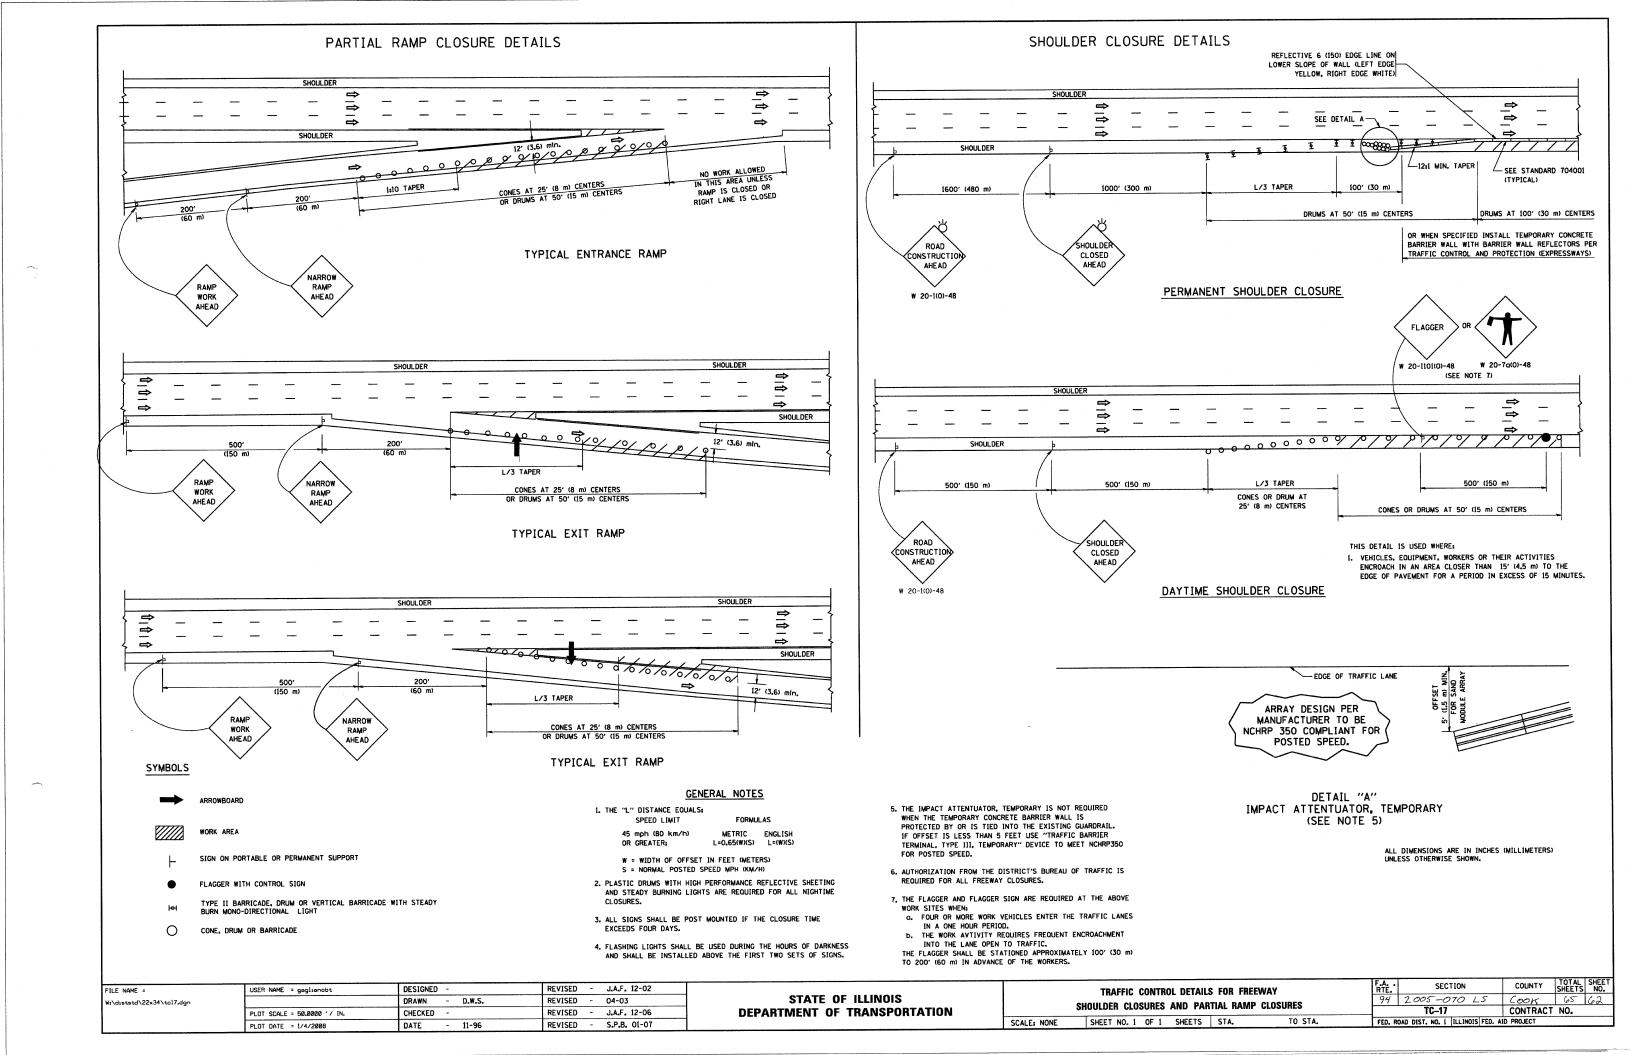

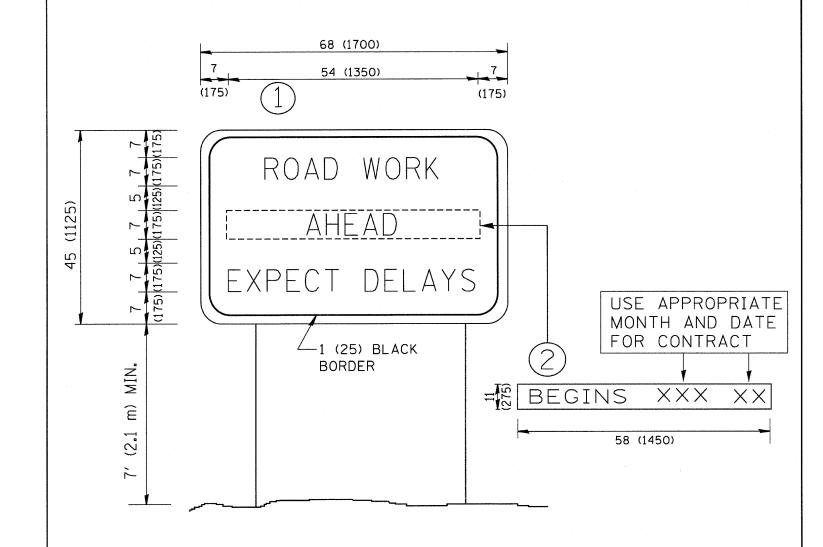



## NOTES:

- 1. USE BLACK LETTERING ON ORANGE BACKGROUND.
- 2. ERECT SIGNS IN ADVANCE OF THE LOCATION FOR THE "ROAD CONSTRUCTION AHEAD" SIGN AT LOCATIONS AS DIRECTED BY THE ENGINEER.
- 3. ERECT SIGN (1) WITH INSTALLED PANEL (2) ONE WEEK PRIOR TO THE START OF CONSTRUCTION.
- 4. REMOVE PANEL (2) SOON AFTER THE START OF CONSTRUCTION.
- 5. SEE SPECIAL PROVISION FOR "TEMPORARY INFORMATION SIGNING" FOR ADDITIONAL INFORMATION.
- 6. ONE SIGN ASSEMBLY EQUALS 25.70 SQ. FT. (2.3 SQ. M.)
- 7. SHALL BE PAID FOR AS TEMPORARY INFORMATION SIGNING.


ALL DIMENSIONS ARE IN INCHES (MILLIMETERS) UNLESS OTHERWISE SHOWN.

- 1	FILE NAME =	USER NAME = gaglianobt	DESIGNED -	REVISED - R. MIRS 09-15-97		ARTERIAL ROAD	F.A. SECTION	COUNTY TOTAL SHEET
ŀ	Wi\diststd\22x34\tc22.dgn		DRAWN -	REVISED - R. MIRS 12-11-97	STATE OF ILLINOIS	INFORMATION SIGN	94 2005-070 LS	COOK 65 63
1		PLOT SCALE = 50.000 '/ IN.	CHECKED -	REVISED -T. RAMMACHER 02-02-99	DEPARTMENT OF TRANSPORTATION		TC-22	CONTRACT NO.
1		PLOT DATE = 1/4/2008	DATE -	REVISED - C. JUCIUS 01-31-07		SCALE: NONE SHEET NO. 1 OF 1 SHEETS STA. TO STA.	FED. ROAD DIST. NO. 1 ILLINOIS FED.	AID PROJECT

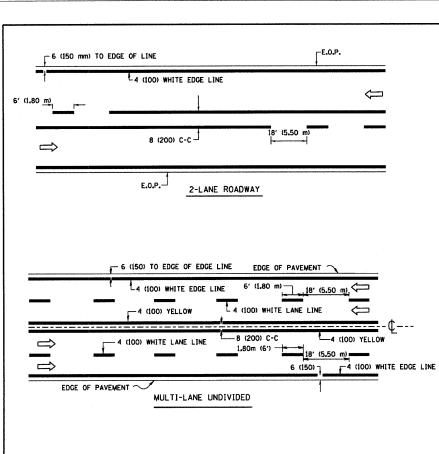


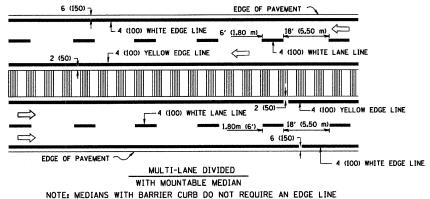

## TYPICAL LANE AND EDGE LINE MARKING

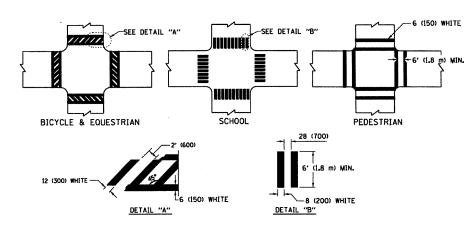


## TYPICAL CROSSWALK MARKING

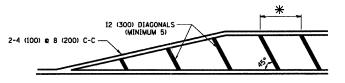


- \*FOR MEDIAN LENGTHS WHERE DIAGONAL SPACING CANNOT BE ATTAINED, USE 5 (FIVE) EQUALLY SPACED DIAGONAL LINES.
- \* DIAGONAL LINE SPACING: 20' (6.1 m) C-C

#### PAINTED MEDIANS

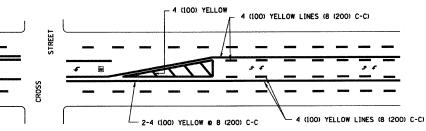


A MINIMUM OF TWO PAIRS OF TURN ARROWS SHALL BE USED, WHITE IN COLOR. ADDITIONAL PAIRS SHALL BE PLACED AT 200' (60 m) TO 300' (90 m) INTERVALS.

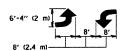

MEDIAN WITH TWO-WAY LEFT TURN LANE

#### TYPICAL PAINTED MEDIAN MARKING

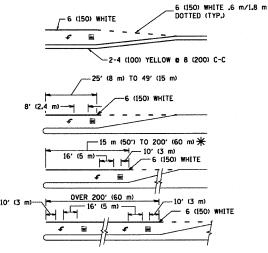


FULL SIZE LETTERS 8' (2.4 m) AND ARROWS SHALL BE USED.  $\P$  AREA = 15.8 SQ. FT. (1.47 m²)  $\P$  AREA = 22.9 SQ. FT. (2.13 m²)

\* TURN LANES IN EXCESS OF 400' (120 m) IN LENGTH MAY HAVE AN ADDITIONAL SET OF ARROW - "ONLY" INSTALLED MIDWAY BETWEEN THE OTHER TWO SETS OF ARROW - "ONLY".

TYPICAL LEFT (OR RIGHT) TURN LANE

#### TYPICAL TURN LANE MARKING

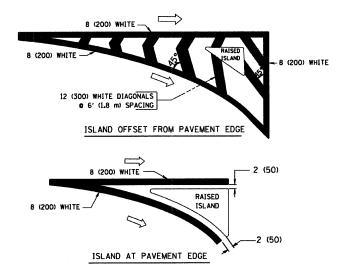

## TYPICAL ISLAND MARKING

TYPE OF MARKING	WIDTH OF LINE	PATTERN	COLOR	SPACING / REMARKS
CENTERLINE ON 2 LANE PAVEMENT	4 (100)	SKIP-DASH	YELLOW	6' (1.80 m) LINE WITH 18' (5.50 m) SPACE
CENTERLINE ON MULTI-LANE UNDIVIDED PAVEMENT	2 2 4 (100)	SOLID	YELLOW	8 (200) C-C
NO PASSING ZONE LINES: FOR ONE DIRECTION FOR BOTH DIRECTIONS	4 (100) 2 <b>e</b> 4 (100)	SOL ID SOL ID	YELLOW YELLOW	8 (200) C-C
LANE LINES	4 (100) 5 (125) ON FREEWAYS	SKIP-DASH SKIP-DASH	WHITE WHITE	6' (1.80 m) LINE WITH 18' (5.50 m) SPACE
DOTTED LINES (EXTENSIONS OF CENTER, LANE OR TURN LANE MARKINGS)	SAME AS LINE BEING EXTENDED	SKIP-DASH	SAME AS LINE BEING EXTENDED	2' (600) LINE WITH 6' (1.8) SPACE
EDGE LINES	4 (100)	SOLID	YELLOW-LEFT WHITE-RIGHT	OUTLINE MOUNTABLE MEDIANS IN YELLOW; EDGE LINES ARE NOT USED NEXT TO BARRIER CURB
TURN LANE MARKINGS	6 (150) LINE; FULL SIZE LETTERS & SYMBOLS (8' (2.4 m))	SOLID	WHITE	SEE TYPICAL TURN LANE MARKING DETAIL
TWO WAY LEFT TURN MARKING	2 e 4 (100) EACH DIRECTION	SKIP-DASH AND SOLID	YELLOW	6' (1.8 m) LINE WITH 18' (5.50 m) SPACE FOR SKIP-DASH: 8 (200) C-C BETWEEN SOLID LINE AND SKIP-DASH LINE
	8' (2.4 m) LEFT ARROW	IN PAIRS	WHITE	SEE TYPICAL TWO-WAY LEFT TURN MARKING DETAIL
CROSSWALK LINES (PEDESTRIAN) A. DIAGONALS (BIKE & EQUESTRIAN) B. LONGITUDINAL BARS (SCHOOL)	2 <b>e</b> 6 (150) 12 (300) <b>e</b> 45° 8 (200) <b>e</b> 90°	SOLID SOLID SOLID	WHITE WHITE WHITE	NOT LESS THAN 6' (1.8 m) APART 2' (500) APART 2'-4" (700) APART SEE TYPICAL CROSSWALK MARKING DETAILS.
STOP LINES	24 (600)	SOLID	WHITE	PLACE 4' (1.2 m) IN ADVANCE OF AND PARALLEL TO CROSSMALK, IF PRESENT, OTHERMISE, PLACE AT DESIRED STOPPING POINT. PARALLEL TO CROSSROAD CENTERLINE, WHERE POSSIBLE
PAINTED MEDIANS	2 @ 4 (100) WITH 12 (300) DIAGONALS @ 45°	SOLID	YELLOW: TWO WAY TRAFFIC WHITE: ONE WAY TRAFFIC	8 (200) C-C FOR THE DOUBLE LINE SEE TYPICAL PAINTED MEDIAN MARKING.
GORE MARKING AND CHANNELIZING LINES	8 (200) WITH 12 (300) DIAGONALS @ 45°	SOLID	WHITE	DIAGONALS: 20' (6,1 m) (LESS THAN 30 MPH (50 km/h))
RAILROAD CROSSING	24 (600) TRANSVERSE LINES; "RR" IS 6' (1,8 m) LETTERS; 16 (400) LINE FOR "X"	SOLID	WHITE	SEE STATE STANDARD 780001 AREA OF: "R"-3.6 SO. FT. (0.33m <sup>2</sup> ) EACH "X"-54.0 SO. FT. (5.0 m <sup>2</sup> )


FOR FURTHER DETAILS ON PAVEMENT MARKING REFER TO STREET MARKING STANDARDS, PRINTED BY CITY OF CHICAGO, DEPARTMENT OF TRANSPORTATION, BUREAU OF TRAFFIC.


ALL DIMENSIONS ARE IN INCHES (MILLIMETERS) UNLESS OTHERWISE SHOWN.

FILE NAME = USER NAME = gaglionobt DESIGNED - REVISED -T. RAMMACHER 12-07-00
Wi\distatd\22x34\to24.dgn

PLOT SCALE = 50.000 '/ IN. CHECKED - REVISED PLOT DATE = 1/4/2008 DATE - REVISED -

STATE OF ILLINOIS
DEPARTMENT OF TRANSPORTATION

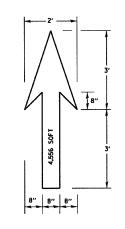

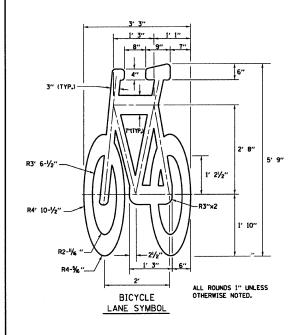


- NOTE:

  1.) FOR BIKE LANE SYMBOLS ONLY,

  USE PRE-FORMED THERMOPLASTIC WITH A MINIMUM THICKNESS OF 90 MILS, MINIMUM SKID RESISTANCE VALUE OF 60 BPN, & A MINIMUM INDEX OF REFRACTION OF 1.50.
- 2.) THE RESIDENT ENGINEER SHALL CONTACT MR. BEN GOMBERG AT 312-744-8093 AT LEAST ONE CALENDAR WEEK PRIOR TO INSTALLING BIKE LANE SYMBOLS.

TYPICAL BIKE LANE SYMBOLS DRAWING #28

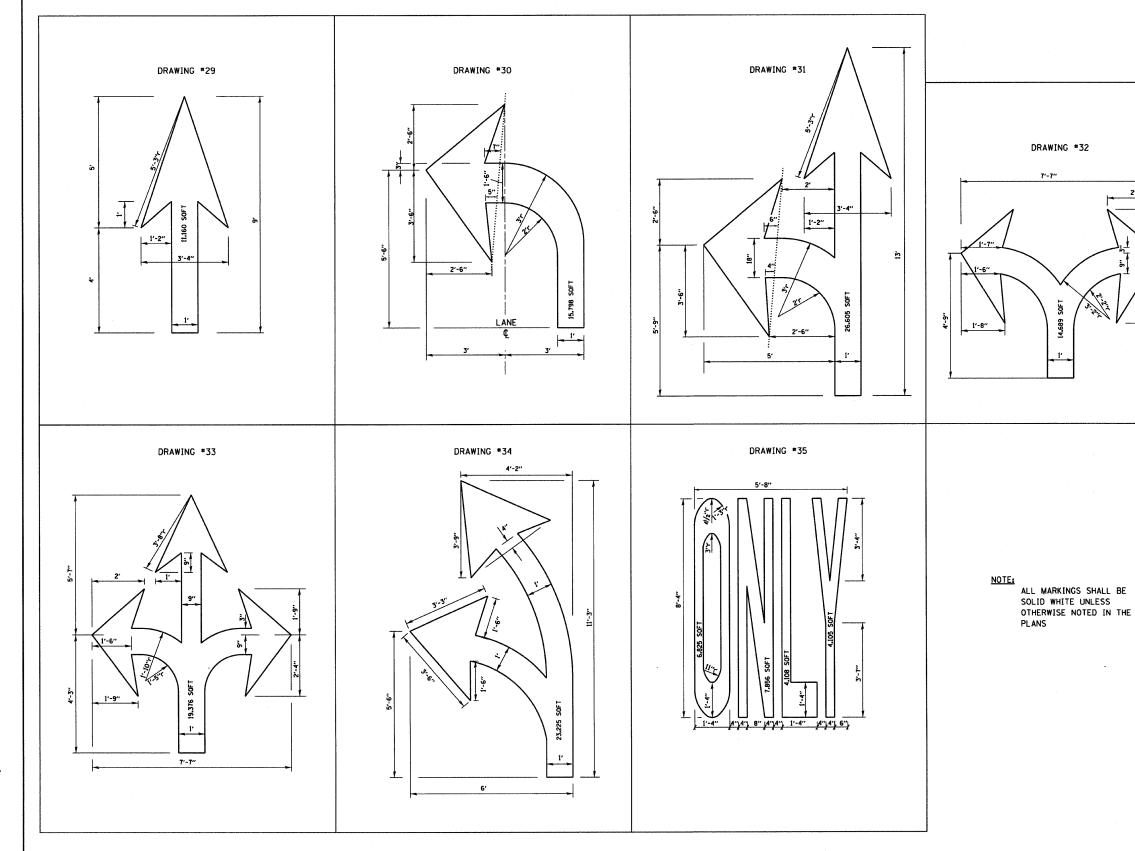

FILE NAME =	USER NAME = gaglianobt	DESIGNED -	REVISED -T. RAMMACHER 12-07-00			CITY OF CHICAGO	F.A. SECTION	COUNTY SHEETS NO.
W:\diststd\22x34\tc24.dgn		DRAWN -	REVISED -	STATE OF ILLINOIS	TYPICAL PAVEMENT MARKINGS		94 2005-070 LS	COOK 15 65
	PLOT SCALE = 50.000 // IN.	CHECKED -	REVISED -	DEPARTMENT OF TRANSPORTATION			TC-24	CONTRACT NO.
	PLOT DATE = 1/4/2008	DATE -	REVISED -		SCALE: NONE	SHEET NO. 2 OF 2 SHEETS STA. TO STA.	FED. ROAD DIST. NO. 1 ILLINOIS FE	D. AID PROJECT