

# **INDEX OF SHEETS**

- 1 COVER SHEET
- 2 INDEX OF SHEETS, STANDARDS & GENERAL NOTES 3 - 21 SUMMARY OF QUANTITIES
- 22 30 TYPICAL SECTIONS
- 31 49 SCHEDULE OF QUANTITIES
- 50 52 ALIGNMENT, TIES AND BENCHMARKS
- 53 68 REMOVAL PLANS
- 69 84 ROADWAY PLAN AND PROFILE
- 85 114 MAINTENANCE OF TRAFFIC
- 115 131 EROSION CONTROL PLANS 132 - 142 DRAINAGE PLANS
- 143 148 RIGHT-OF-WAY PLANS
- 149 158 ADA RAMP DETAILS
- 159 ISLAND MEDIAN DETAILS
- 160 174 PAVEMENT MARKING AND SIGNING PLANS
- 175 183 LANDSCAPE PLANS
- 184 242 TRAFFIC SIGNAL PLANS
- 243 246 DUPAGE COUNTY DOT STANDARD DETAILS
- 247 261 IDOT DISTRICT 1 STANDARD DETAILS
- 262 294 CROSS SECTIONS

### **HIGHWAY STANDARDS**

000001-07	STANDARD SYMBOLS, ABBREVIATIONS AND PATTERNS
001006	DECIMAL OF AN INCH AND OF A FOOT
280001-07	TEMPORARY EROSION CONTROL SYSTEMS
424001-11	PERPENDICULAR CURB RAMPS FOR SIDEWALKS
424006-04	DIAGONAL CURB RAMPS FOR SIDEWALKS
424011-04	CORNER PARALLEL CURB RAMPS FOR SIDEWALKS
424016-05	MID-BLOCK CURB RAMPS FOR SIDEWALKS
424021-05	DEPRESSED CORNER FOR SIDEWALKS
424031-02	MEDIAN PEDESTRIAN CROSSINGS
442201-03	CLASS C AND D PATCHES
482001-02	HMA SHOULDER ADJACENT TO FLEXIBLE PAVEMENT
542301-03	PRECAST REINFORCED CONCRETE FLARED END SECTION
601001-05	PIPE UNDERDRAINS
601101 <b>-</b> 02	CONCRETE HEADWALL FOR PIPE UNDERDRAIN
602001-02	CATCH BASIN, TYPE A
602402-02	PRECAST MANHOLE, TYPE A, 5' (1.52 M) DIAMETER
602406-10	PRECAST MANHOLE, TYPE A, 6' (1.83 M) DIAMETER
602416-08	PRECAST MANHOLE, TYPE A, 8' (2.44 M) DIAMETER
602421-08	PRECAST MANHOLE, TYPE A, 9' (2.74 M) DIAMETER
604001-05	FRAME AND LIDS, TYPE 1
604036-03	GRATE, TYPE 8
604051 <b>-</b> 04	FRAME AND GRATE, TYPE 11
606001-07	CONCRETE CURB TYPE B AND COMBINATION CONCRETE CURB AND GUTTER
606101-05	TYPE A GUTTER (INLET, OUTLET, AND ENTRANCE)
606301-04	PC CONCRETE ISLANDS AND MEDIANS
630001-12	STEEL PLATE BEAM GUARDRAIL
630301-09	SHOULDER WIDENING FOR TYPE 1 (SPECIAL) GUARDRAIL TERMINALS
631011-10	TRAFFIC BARRIER TERMINAL, TYPE 2
631031-16	TRAFFIC BARRIER TERMINAL, TYPE 6
701101-05	OFF-ROAD OPERATIONS, MULTILANE, 15' (4.5 M) TO 24" (600 MM) FROM PAVEMENT EDGE
701106-02	OFF-ROAD OPERATIONS, MULTILANE, MORE THAN 15' (4.5 M) AWAY
701426-09	LANE CLOSURE, MULTILANE, INTERMITTENT OR MOVING OPERATION, FOR SPEEDS >= 45 MPH
701456-05	PARTIAL EXIT RAMP CLOSURE FREEWAY/EXPRESSWAY URBAN LANE CLOSURE, 2L, 2W, UNDIVIDED
701501-06 701601-09	URBAN LANE CLOSURE, 2L, 2W, UNDIVIDED URBAN LANE CLOSURE, MULTILANE, 1W OR 2W WITH NONTRAVERSABLE MEDIAN
701602-10	URBAN LANE CLOSURE, MULTILANE, 1W OR 2W WITH NONTRAVERSABLE MEDIAN
701611-01	URBAN HALF ROAD CLOSURE, MULTILANE, 2W WITH DIDIRECTIONAL LETT TORN LANE
701701-10	URBAN LANE CLOSURE, MULTILANE INTERSECTION
701801-06	SIDEWALK, CORNER OR CROSSWALK CLOSURE
701901-08	TRAFFIC CONTROL DEVICES
720001-01	SIGN PANEL MOUNTING DETAILS
720006-04	SIGN PANEL ERECTION DETAILS
725001-01	OBJECT AND TERMINAL MARKERS
728001-01	TELESCOPING STEEL SIGN SUPPORT
780001-05	TYPICAL PAVEMENT MARKINGS
782006-01	GUARDRAIL AND BARRIER WALL REFLECTOR MOUNTING DETAILS
814001-03	HANDHOLES
814006-02	DOUBLE HANDHOLES
838001-01	BREAKAWAY DEVICES
857001-01	STANDARD PHASE DESIGNATION DIAGRAMS AND PHASE SEQUENCES
862001-01	UNINTERRUPTABLE POWER SUPPLY (UPS)
873001-02	TRAFFIC SIGNAL GROUNDING & BONDING
877001-08	STEEL MAST ARM ASSEMBLY AND POLE 16' THROUGH 55'
877006-06	STEEL MAST ARM ASSEMBLY AND POLE WITH DUAL MAST ARMS
877011-10	STEEL COMBINATION MAST ARM ASSEMBLY AND POLE 16' THROUGH 55'
878001-10	CONCRETE FOUNDATION DETAILS
880001-01	SPAN WIRE MOUNTED SIGNALS AND FLASHING BEACON INSTALLATION
880006-01	TRAFFIC SIGNAL MOUNTING DETAILS
886001-01	DETECTOR LOOP INSTALLATIONS

# **DUPAGE COUNTY DOT STANDARD DETAILS**

PAVEMENT MARKING LOCATION	
SAG FRAME & LID	10
COMMERCIAL DRIVEWAY DETAIL	12
STEEL PLATE BEAM GUARDRAIL ADJACENT TO CURB AND GUTTER	
MEDIAN DETAILS	
RECESSED PAVEMENT MARKER	13
TYPICAL CURBED SIDE ROAD APPROACH	13
TRENCH BACKFILL DETAIL	
TRENCH BACKFILL STANDARD IN PAVED AREAS	
TYPICAL TURN BAYS	14
TYPICAL CURBED SIDE ROAD APPROACH UNCURBED HIGHWAY	14
PAVEMENT MARKINGS AND PAVEMENT MARKERS	
	10

# **IDOT DISTRICT 1 STANDARD DETAILS**

BD-07	STORM SEWER CONNECTION TO EXISTING SEWER	
BD-08	FRAMES AND LIDS ADJUSTMENT WITH MILLING	
BD-12	MANHOLE WITH RESTRICTOR PLATE	
BD-22	PAVEMENT PATCHING FOR HMA SURFACED PAVEMENT	
BD-24	CURB OR CURB AND GUTTER REMOVAL AND REPLACEMENT	
BD-32	BUTT JOINT AND HMA TAPER DETAILS	
BD-51	BENCHING DETAIL FOR EMBANKMENT WIDENING	
BE-240	COMBINATION LIGHTING, TRAFFIC SIGNAL SCHEMATIC	
TC-10	TRAFFIC CONTROL AND PROTECTION FOR SIDE ROADS, INTERSECTIONS, AND DRIVEWAYS	
TC-11	TYPICAL APPLICATIONS RAISED REFLECTIVE PAVEMENT MARKERS (SNOW-PLOW RESISTANT)	
TC-13	DISTRICT ONE TYPICAL PAVEMENT MARKINGS	
TC-14	TRAFFIC CONTROL AND PROTECTION AT TURN BAYS (TO REMAIN OPEN TO TRAFFIC)	
TC-16	SHORT TERM PAVEMENT MARKING LETTERS AND SYMBOLS	
TC-17	TRAFFIC CONTROL DETAILS FOR FREEWAY SHOULDER CLOSURES AND PARTIAL RAMP CLOSURES	
TC-22	ARTERIAL ROAD INFORMATION SIGN	
TC-26	DRIVEWAY ENTRANCE SIGNING	
TS-05	DISTRICT ONE STANDARD TRAFFIC SIGNAL DESIGN DETAILS	-
TS-07	DISTRICT 1 - DETECTOR LOOP INSTALLATION DETAILS FOR ROADWAY RESURFACING	

# **GENERAL NOTES**

- 1. NO WORK SHALL COMMENCE UNTIL TRAFFIC CONTROL REQUIREMENTS ARE MET.
- ALL UTILITIES, SCHOOL DISTRICTS, LOCAL POLICE, AND FIRE DEPARTMENTS SHALL BE NOTIFIED BY THE CONTRACTOR PRIOR TO THE START OF CONSTRUCTION. FOR UTILITY CONTACT INFORMATION SEE SPECIAL PROVISION FOR STATUS OF UTILITIES.
  - · VILLAGE OF OAK BROOK NON-EMERGENCY POLICE (630) 368-8700
  - VILLAGE OF OAK BROOK NON-EMERGENCY FIRE (630) 368-5200
  - · BUTLER SCHOOL DISTRICT 53 (630) 573-2887
  - DOWNERS GROVE SCHOOL DISTRICT 58 (630) 719-5800
  - HIGH SCHOOL DISTRICT 99 (630) 795-8400
  - HIGH SCHOOL DISTRICT 86 (630) 655-6100
- 3. UNLESS AUTHORIZED BY THE ENGINEER, ALL EXISTING ACCESS POINTS SHALL BE MAINTAINED AT ALL TIMES BY THE CONTRACTOR.
- 4. TREES NOT MARKED FOR REMOVAL SHALL BE CONSIDERED AS DESIGNATED TO BE SAVED AND SHALL BE PROTECTED UNDER THE PROVISIONS OF ARTICLE 201.05 OF THE STANDARD SPECIFICATIONS.
- 5. ALL LIMBS, BRANCHES, AND OTHER DEBRIS RESULTING FROM THIS WORK SHALL BE DISPOSED OF BY THE CONTRACTOR OUTSIDE THE LIMITS OF THE RIGHT-OF-WAY.
- 6. OVERHANGING LIMBS ARE TO BE TRIMMED OR CUT OFF TO PROVIDE A MINIMUM VERTICAL CLEARANCE OF TWENTY (20) FEET FROM THE FINISHED SURFACE OF THE ROAD. CLEARANCE TO SIDEWALKS OR PATHS SHALL BE AS DIRECTED BY THE ENGINEER.
- 7. LIMB PRUNING SHALL BE UNDERTAKEN IN A TIMELY FASHION SO AS NOT TO INTERFERE WITH CONSTRUCTION.
- TOPSOIL SHALL BE PLACED TO A DEPTH OF SIX (6) INCHES AND BE MEASURED IN SQUARE YARDS.
- 9. THE CROSS SECTIONS INDICATE THE FINISHED GRADE OF TOPSOIL.
- 10. TOPSOIL SHALL NOT BE STOCKPILED WITHIN THE LIMITS OF CONSTRUCTION; THE LOCATIONS OF TOPSOIL STOCKPILES WITHIN THE RIGHT-OF-WAY MUST BE APPROVED BY THE ENGINEER.

	DESIGNED D.M.S.	REVISED -			F.A.U RTE	SECTION	COUNTY TO	OTAL SHEET HEETS NO.
KNIGHT	DRAWN D.M.S.	REVISED -	STATE OF ILLINOIS	INDEX OF SHEETS, STANDARDS, & GENERAL NOTES	1467	14-00259-05-CH	DUPAGE 3	294 2
Engineers & Architects	CHECKED - D.J.C.	REVISED -	DEPARTMENT OF TRANSPORTATION				CONTRACT N	VO. 61G12
	DATE - 09-01-2020	REVISED -		SCALE: NONE SHEET 1 OF 1 SHEETS STA. TO STA.		ILLINOIS FED.	AID PROJECT	

11. ALL EXISTING CULVERTS, STORM SEWERS, OR DRAINAGE STRUCTURES MARKED FOR REMOVAL ON THE PLANS OR DESIGNATED IN THE FIELD BY THE ENGINEER TO BE REMOVED SHALL BE REMOVED AND ANY EXCAVATION SHALL BE BACKFILLED WITH A GRANULAR MATERIAL MEETING THE SPECIFICATIONS FOR FA-1 OR FA-2.

12. THE CONTRACTOR SHALL NOT CROSS COMPLETED BASE COURSE OR EXISTING PAVEMENT, NOT SCHEDULED TO BE REMOVED, WITH TRACK EQUIPMENT OR LOADED SCRAPERS.

 ALL EMBANKMENTS AND SUB-GRADE SHALL BE COMPACTED TO THE SATISFACTION OF THE ENGINEER PRIOR TO PLACING AGGREGATE SUBGRADE OR SUB-BASE GRANULAR MATERIAL.

14. THE SUBGRADE STABILITY SHALL BE VERIFIED BY PROOF ROLLING WITH A FULLY LOADED TANDEM-AXLE TRUCK.

15. ANY AGGREGATE SUBGRADE IMPROVEMENT CONTAMINATED AND/OR DAMAGED BY THE CONTRACTOR'S VEHICLES AND/OR EQUIPMENTS IS TO BE REMOVED AND REPLACED' AS DIRECT BY THE ENGINEER AT CONTRACTOR EXPENSE.

16. THE CONTRACTOR WILL HAVE THE OPTION OF REMOVING EXISTING HOT-MIX ASPHALT PAVEMENT BY GRINDING OR EXCAVATING. IF THE HOT-MIX ASPHALT PAVEMENT IS REMOVED BY EXCAVATION, IT MAY NOT BE USED IN EMBANKMENT AREAS UNLESS SPECIFICALLY AUTHORIZED BY THE ENGINEER. HOT-MIX ASPHALT PAVEMENT REMOVED BY GRINDING MAY BE USED AS EMBANKMENT MATERIAL. NO HOT-MIX ASPHALT PAVEMENT SHALL BE REMOVED IN AREAS TO BE USED FOR TEMPORARY ROADWAY.

17. HOT-MIX ASPHALT SURFACE COURSE SHALL NOT BE PLACED UNTIL ALL EARTH EXCAVATION, TOPSOIL PLACEMENT, BASE COURSE, AND HOT-MIX ASPHALT BINDER COURSE HAVE BEEN COMPLETED.

18. SAWCUT CONSTRUCTION JOINTS SHALL BE PROVIDED AT PAVED COMMERCIAL OR PRIVATE ENTRANCES AND AT ALL SIDE ROADS.

19. HOT-MIX ASPHALT BASE COURSE SHALL NOT BE PLACED ADJACENT TO CURB AND GUTTER UNTIL THE CURB AND GUTTER HAS BEEN BACKFILLED TO THE SATISFACTION OF THE ENGINEER.

20. QUANTITY FOR REMOVAL AND DISPOSAL OF UNSUITABLE MATERIAL HAS BEEN INCLUDED IN THE SUMMARY OF QUANTITIES AS A PROVISION FOR POTENTIAL UNDERCUTS. THE ENGINEER SHALL DETERMINE IN THE FIELD THE AREAS THAT WILL REQUIRE THE USE OF THE REMOVAL AND DISPOSAL OF UNSUITABLE MATERIAL ITEM.

21. THE CONTRACTOR SHALL REVIEW THE LICENSE AGREEMENT WITH RESPECT TO THE FOREST PRESERVE DISTRICT AND COMPLY WITH THE REQUIREMENTS SET FORTH THEREIN.

22. ITEMS FOR AGGREGATE SUBGRADE IMPROVEMENT (CU YD) AND GEOTECHNICAL FABRIC FOR GROUND STABILIZATION (SQ YD) HAVE BEEN PROVIDED FOR USE IN LOCATIONS WHERE IN THE DETERMINATION OF THE ENGINEER UNDERCUTS ARE REQUIRED BELOW THE 12 INCH IMPROVED SUBGRADE LAYER WHERE POOR SOILS ARE ENCOUNTERED.

23. POSTS FOR STEEL PLATE BEAM GUARDRAIL SHALL BE STEEL WITH THE EXCEPTION OF THE WOOD BREAKAWAY POSTS USED FOR THE TERMINAL SECTIONS.

·	r	<b>-</b>	·····	1	STP 70% FED 30% DUPAGE	T
NO.	CODE NO.	ITEM DESCRIPTION	UNIT	TOTAL QUANT I TY	ROADWAY	3
1	20100110	TREE REMOVAL (6 TO 15 UNITS DIAMETER)	UNIT	180	180	-
2	20101000	TEMPORARY FENCE	FOOT	100	50	
3	20101100	TREE TRUNK PROTECTION	EACH	13	13	
4	20200100	EARTH EXCAVATION	 CU YD	4,425	4,095	
5	20201200	REMOVAL AND DISPOSAL OF UNSUITABLE MATERIAL	CU YD	527	312	
6	20800150	TRENCH BACKFILL	CU YD	269	266	
7	21001000	GEOTECHNICAL FABRIC FOR GROUND STABILIZATION	SQ YD	768	718	
8	21101505	TOPSOIL EXCAVATION AND PLACEMENT	CU YD	1,348	1,348	
9	21101625	TOPSOIL FURNISH AND PLACE, 6"	SQ YD	600	500	
10	25000210	SEEDING, CLASS 2A	ACRE	0.5	0.5	
10	25000210			0.5	0.5	
11	25000400	NITROGEN FERTILIZER NUTRIENT	POUND	89	81	
12	25000600	POTASSIUM FERTILIZER NUTRIENT	POUND	89	81	
13	25100115	MULCH, METHOD 2	ACRE	1.5	1.37	-
14	25100630	EROSION CONTROL BLANKET	SQ YD	2,116	2,116	
CIALTY IT						

KNIGHT		DRAWN -	D.M.S.	REVISED -	STATE OF ILLINOIS			SUN	ЛМА	RY OF C
Engineers & Architects		CHECKED -	D.J.C.	REVISED -	DEPARTMENT OF TRANSPORTATION					
		DATE -	09-01-2020	REVISED -		SCALE: NONE	SHEET	1	OF	19 SHEE
	I			J		·				

			F.A.U RTE.	SECTION	COUNTY	TOTAL SHEETS	SHEET NO.
QU/	ANTITIES		1467	14-00259-05-CH	DUPAGE	294	3
					CONTRAC	T NO. 6	1G12
ETS	STA.	TO STA.		ILLINOIS FED.	AID PROJECT		

NO	CODE NO.	ITEM DESCRIPTION	UNIT	T QU
15	25200100	SODD I NG	SQ YD	
16	25200110	SODDING, SALT TOLERANT	SQ YD	
17	25200200	SUPPLEMENTAL WATERING	UNIT	
18	28000250	TEMPORARY EROSION CONTROL SEEDING	POUND	
19	28000400	PERIMETER EROSION BARRIER	FOOT	
20	28000500	INLET AND PIPE PROTECTION	EACH	
21	28000510	INLET FILTERS	EACH	
22	28100125	STONE RIPRAP, CLASS B3	SQ YD	
23	30300001	AGGREGATE SUBGRADE IMPROVEMENT	CU YD	
24	30300112	AGGREGATE SUBGRADE IMPROVEMENT 12"	SQ YD	
25	30300116	AGGREGATE SUBGRADE IMPROVEMENT 16"	SQ YD	
26	30300124	AGGREGATE SUBGRADE IMPROVEMENT 24"	SQ YD	
27	31101100	SUBBASE GRANULAR MATERIAL, TYPE B	CU YD	
28	31101180	SUBBASE GRANULAR MATERIAL, TYPE B 2"	SQ YD	
	 . ITEM			

KNIICHT	DESIGNED - DRAWN -	D.M.S. D.M.S.	REVISED - REVISED -	STATE OF ILLINOIS			SHW		av u	FQU	~
KNIGHT Engineers & Architects	CHECKED -	D.J.C.	REVISED -	DEPARTMENT OF TRANSPORTATION			3014		11 0	r uo	<u></u>
•	DATE -	09-01-2020	REVISED -		SCALE: NONE	SHEET	2	OF	19 S	HEETS	ę

	CTD I	FUNDS
	70% FFD	70% FFD
	70% FED 30% DUPAGE ROADWAY	70% FED 30% DUPAGE ROADWAY
	URBAN	URBAN
Y	0004	0005
		117
	[	
	3,268	579
	5.0	77
	56	27
	112	13
	2,896	727
	4	2
	4	2
-		
	34	109
	19	
	239	17
	239	17
	1,042	
	7,177	499
		322
	128	
	234	698

		F.A.U RTE.	SECTION	COUNTY	TOTAL SHEETS	SHEET NO.
VTITIES		1467	14-00259-05-CH	DUPAGE	294	4
				CONTRAC	T NO. 6	1G12
STA.	TO STA.		ILLINOIS FED.	AID PROJECT		

NO .	CODE NO.	ITEM DESCRIPTION	UN I T	Г 
29	31102000	SUBBASE GRANULAR MATERIAL, TYPE C	CU YD	 >
30	35101800	AGGREGATE BASE COURSE, TYPE B 6"	SQ YD	) 
31	35102000	AGGREGATE BASE COURSE, TYPE B 8"	SQ YD	)
32	35400200	PORTLAND CEMENT CONCRETE BASE COURSE WIDENING 7"	SQ YD	) )
33	35501290	HOT-MIX ASPHALT BASE COURSE, 3"	SQ YD	 )
34	35501312	HOT-MIX ASPHALT BASE COURSE, 7"	SQ YD	)
35	35501314	HOT-MIX ASPHALT BASE COURSE, 7 1/2"	SQ YD	 >
36	35600706	HOT-MIX ASPHALT BASE COURSE WIDENING, 7 1/2"	SQ YD	)
37	40201000	AGGREGATE FOR TEMPORARY ACCESS	TON	
38	40600275	BITUMINOUS MATERIALS (PRIME COAT)	POUND	 )
39	40600290	BITUMINOUS MATERIALS (TACK COAT)	POUND	)
40	40600400	MIXTURE FOR CRACKS, JOINTS, AND FLANGEWAYS	TON	
4.1	40600000		SQ YD	
41	40600990	TEMPORARY RAMP		
42	40603080	HOT-MIX ASPHALT BINDER COURSE, IL-19.0, N50	TON	
	TEM			

KNIGHT	 DESIGNED - DRAWN -	D.M.S. D.M.S.	REVISED - REVISED -	STATE OF ILLINOIS			SUM	IMAR'	YOFO	DUANT
Engineers & Architects	CHECKED -	D.J.C.	REVISED -	DEPARTMENT OF TRANSPORTATION						
	DATE -	09-01-2020	REVISED -		SCALE: NONE	SHEET	3	OF 19	9 SHEE	TS ST

	670	
		FUNDS
	70% FED 30% DUPAGE	70% FED 30% DUPAGE
Υ	ROADWAY URBAN	ROADWAY URBAN
1	0004	0005
_		
	2	
	7	41
	250	22
	473	45
		_
	268	
	200	
	4 100	455
	4,199	455
	753	
	24	
	166	
	17,773	1,124
	20,257	65,614
		•
	17.9	52.3
		-
	127	331
	127	100
	105	1.0
	105	10

NTITIES		F.A.U RTE.	SECTION	COUNTY	TOTAL SHEETS	SHEET NO.	
		1467	14-00259-05-	CH DUPAGE	294	5	
			CONTRACT NO. 61G12				
STA.	TO STA.		ILLINOIS FED. AID PROJECT				

NO .	CODE NO.	ITEM DESCRIPTION	UNIT	TC QUA
43	40603085	HOT-MIX ASPHALT BINDER COURSE, IL-19.0, N70	TON	
44	40603200	POLYMERIZED HOT-MIX ASPHALT BINDER COURSE, IL-4.75, N50	TON	5
45	40604060	HOT-MIX ASPHALT SURFACE COURSE, IL-9.5, MIX "D", N50	TON	
46	40604172	POLYMERIZED HOT-MIX ASPHALT SURFACE COURSE, IL-9.5, MIX "E", N70	TON	1
47	42001300	PROTECTIVE COAT	SQ YD	2
48	42400200	PORTLAND CEMENT CONCRETE SIDEWALK 5 INCH	SQ FT	
49	42400800	DETECTABLE WARNINGS	SQ FT	
50	44000100	PAVEMENT REMOVAL	SQ YD	
51	44000159	HOT-MIX ASPHALT SURFACE REMOVAL, 2 1/2"	SQ YD	1
52	44000200	DRIVEWAY PAVEMENT REMOVAL	SQ YD	
53	44000500	COMBINATION CURB AND GUTTER REMOVAL	FOOT	
		· · · ·	· ·	
54	44000600	SIDEWALK REMOVAL	SQ FT	
55	44003100	MEDIAN REMOVAL	SQ FT	
56	44004250	PAVED SHOULDER REMOVAL	SQ YD	
-				

 
 KNIGHT
 Designed
 D.M.S.
 ReVISED

 Engineers & Architects
 DATE
 O.9-01-2020
 REVISED
 STATE OF ILLINOIS DEPARTMENT OF TRANSPORTATION
 SUMMARY
 SUMMARY
 OF UP
 SUMMARY
 OF UP
 SUMMARY
 OF UP SHEET
 STATE OF ILLINOIS

	STP F	UNDS
	70% FED 30% DUPAGE	70% FED 30% DUPAGE
	I ROADWAY I	ROADWAY
Υ	URBAN 0004	URBAN 0005
	0004	0005
	10	49
	1,304	4,081
	, •	,
	89	301
	3,119	9,161
	2,112	5,101
	2,020	840
	2 107	5 704
	2,107	6,284
	241	584
	1 0 2 2	
	1,023	
	21,284	96,456
	208	
	6,563	330
	227	594
	1,671	1,096
	1,071	1,020
	<u> </u>	
	1,158	
	I	

NTITIES		F.A.U RTE.	F.A.U SECTION		TOTAL SHEETS	SHEET NO.
		1467	14-00259-05-CH	DUPAGE	294	6
				CONTRAC	T NO. 61	IG12
STA.	TO STA.		ILLINOIS FED. A	ID PROJECT		

Г		DRAWN - D.M.S. REVISED -	STATE OF ILLINOIS	SUMM	IARY OF QUAN			
CIALTY IT		DESIGNED - D.M.S. REVISED -						
70	550A0480	STORM SEWERS, CLASS A, TYPE 2 48"		FOOT	223			
69	550A0450	STORM SEWERS, CLASS A, TYPE 2 36"		FOOT	92			
	FE040450			FOOT				
68	550A0410	STORM SEWERS, CLASS A, TYPE 2 24"		FOOT	8			
				······				
67	550A0380	STORM SEWERS, CLASS A, TYPE 2 18"		FOOT	26			
66	550A0340	STORM SEWERS, CLASS A, TYPE 2 12"		FOOT	215			
65	550A0050	STORM SEWERS, CLASS A, TYPE 1 12"		FOOT	21			
64	542A1081	PIPE CULVERTS, CLASS A, TYPE 2 36"		FOOT	32			
	F 4 2 4 1 0 0 1							
63	54213681	1 PRECAST REINFORCED CONCRETE FLARED END SECTIONS 36"						
			· · · ·					
62	48203035	HOT-MIX ASPHALT SHOULDERS, 9 1/2"		SQ YD	483			
61	48203029	HOT-MIX ASPHALT SHOULDERS, 8"		SQ YD	34			
60	44201821	CLASS D PATCHES, TYPE IV, 14 INCH		SQ YD	1,907			
59	44201819	CLASS D PATCHES, TYPE III, 14 INCH		SQ YD	4,754			
					:			
58	44201815	CLASS D PATCHES, TYPE II, 14 INCH		SQ YD	4,754			
	44201011							
57	44201811	CLASS D PATCHES, TYPE I, 14 INCH		SQ YD	1,585			
t	NO.	ITEM DESCRIPTION		UN I T	QUANTIT			

KNIGHT	DRAWN -	D.M.S.	REVISED -	STATE OF ILLINOIS			SUMM	ARY OF	QUAN	ſ.
Engineers & Architects	CHECKED -	D.J.C.	REVISED -	DEPARTMENT OF TRANSPORTATION						
	DATE -	09-01-2020	REVISED -		SCALE: NONE	SHEET	5 OF	19 SHE	ETS S	л.
										_

	STP I	UNDS
	70% FED 30% DUPAGE	70% FED 30% DUPAGE ROADWAY
	ROADWAY	ROADWAY
Ϋ́	URBAN	URBAN
	0004	0005
	376	1,209
	1,127	3,627
	1,127	3,627
	376	1,531
	34	
		483
	1	
	32	
	21	
	21	
	215	
	26	
	8	
	92	
	223	

NTITIES		F.A.U RTE.	SECTION		COUNTY TOTAL SHEETS		SHEET NO.
		1467	14-00259-05-0	DUPAGE	294	7	
			CONTRACT NO. 61G12				
STA.	TO STA.		ILLINOIS FED. AID PROJECT				

KNIGH	Т		DRAWN - D.M.S.	REVISED -	STATE OF ILLINOIS	SUMN	ARY OF QUANT
			DESIGNED - D.M.S.	REVISED -		1	
	CIALTY I CIAL PR	L TEM OVISION				I	l
* *	84	60250500	CATCH BASINS TO BE ADJUSTED WITH NEW TYP	PE 1 FRAME, CLOSED LID		EACH	4
**	83	60238800	D INLETS, TYPE A			EACH	3
							-
* *	82	6022412	5 MANHOLES, TYPE A, 7'-DIAMETER			EACH	2
**	81	6022407	5 MANHOLES, TYPE A, 6'-DIAMETER			EACH	2
**	80	6020240	5 CATCH BASINS, TYPE A, 4'-DIAMETER			EACH	7
**	/9	60108204	4 PIPE UNDERDRAINS, TYPE 2, 4"			FOOT	1,983
**	70	6010000					1.002
**	78	6010810	8 PIPE UNDERDRAINS, TYPE 1, 8"			FOOT	427
	77	6010810	0 PIPE UNDERDRAINS 4" (SPECIAL)			FOOT	133
**	76	6010094	5 PIPE DRAINS 12"			FOOT	45
		0010000					
	75	6010006	0 CONCRETE HEADWALLS FOR PIPE DRAINS			EACH	3
	74	5510160	0 STORM SEWER REMOVAL 36"			FOOT	113
	73	5510070	0 STORM SEWER REMOVAL 15"			FOOT	232
	72	5510050	0 STORM SEWER REMOVAL 12"			FOOT	196
**	71	550A552	0 STORM SEWERS, CLASS A, TYPE 2 EQUIVALEN	T ROUND-SIZE 54"		FOOT	181
		NO.					QUANTITY
	NO.	CODE	ITEM DESCRIPTION			UNIT	TOTAL

KNIGHT	DRAWN -	D.M.S.	REVISED -	 STATE OF ILLINOIS	1		SUM	<b>MAR</b>	YOFQ	UANT
Engineers & Architects	CHECKED -	D.J.C.	REVISED -	DEPARTMENT OF TRANSPORTATION	L					
<b>.</b>	DATE -	09-01-2020	REVISED -		SCALE: NONE	SHEET	6	OF 1	9 SHEET	S ST/

	STP	FUNDS
	70% FED	70% FED 30% DUPAGE ROADWAY
	ROADWAY	ROADWAY
Ϋ́	URBAN 0004	URBAN 0005
	181	
	196	
	232	
	113	
		*******
	3	
	45	
	133	
		427
	1,983	
_		
	7	
	2	
	2	
	۷	
	3	
	J	
	4	
	-+	

		F.A.U RTE.	SECTION	COUNTY	TOTAL SHEETS	SHEET NO.
NTITIES		1467	14-00259-05-CH	DUPAGE	294	8
				CONTRAC	T NO. 63	1G12
STA.	TO STA.		ILLINOIS FED.	AID PROJECT		

		F.A.U RTE.	SECTION	COUNTY	SHEETS	NO.	
TITIES		1467	14-00259-05-CH	DUPAGE	294	8	Ì
A. TO STA.			T NO. 6	1G12			
			ILLINOIS FED.	AID PROJECT			

NO.	CODE NO .	ITEM DESCRIPTION	UNIT	۲ QU
85	60255800	MANHOLES TO BE ADJUSTED WITH NEW TYPE 1 FRAME, CLOSED LID	EACH	
86	60256930	MANHOLES TO BE ADJUSTED WITH NEW TYPE 23 FRAME AND GRATE	EACH	
87	60402210	GRATES, TYPE 8	EACH	
88	60403400	GRATES, TYPE A	EACH	
89	60404940	FRAMES AND GRATES, TYPE 23	EACH	
90	60406100	FRAMES AND LIDS, TYPE 1, CLOSED LID	EACH	
91	60500050	REMOVING CATCH BASINS	EACH	
92	60500060	REMOVING INLETS	EACH	
93	60500080	REMOVING CATCH BASINS TO MAINTAIN FLOW	EACH	
94	60500090	REMOVING INLETS TO MAINTAIN FLOW	EACH	
95	60600095	CLASS SI CONCRETE (OUTLET)	CU YD	
96	60602500	CONCRETE GUTTER, TYPE A	FOOT	
97	60603500	COMBINATION CONCRETE CURB AND GUTTER, TYPE B-6.06	FOOT	
98	60603800	COMBINATION CONCRETE CURB AND GUTTER, TYPE B-6.12	FOOT	

\*\* SPECIAL PROVISION

	 DESIGNED -	D.M.S.	REVISED -					F.A.U BTE.	SECTION	COUNTY	TOTAL SHEET SHEETS NO.
KNIGHT	DRAWN -	D.M.S.	REVISED -	STATE OF ILLINOIS		SUMMARY OF QUANTITIES		1467	14-00259-05-CH	DUPAGE	294 9
Engineers & Architects	CHECKED -	D.J.C.	REVISED -	DEPARTMENT OF TRANSPORTATION						CONTRACT	NO. 61G12
	DATE -	09-01-2020	REVISED -		SCALE: NONE	SHEET 7 OF 19 SHEETS STA.	TO STA.		ILLINOIS FED	AID PROJECT	

	STP	FUNDS
	70% FED 30% DUPAGE ROADWAY URBAN	70% FED 30% DUPAGE ROADWAY URBAN
	ROADWAY	ROADWAY
Υ	0004	0005
	3	
	1	
	2	
	1	
	9	
	2	
	3	
	3	
	1	
	2	
	5	
	1	
	1	
	24	
	· ·	
	1,579	
	2,738	
_		

KNIGH Engi	IT neers & Ar	chitects	DRAWN         D.M.S.         REVISED         -           CHECKED         D.J.C.         REVISED         -           DATE         09-01-2020         REVISED         -	STATE OF ILLINOIS DEPARTMENT OF TRANSPORTATION		TARY OF QUAN
** SP	ECIAL PR		DESIGNED - D.M.S. REVISED -			
			<u> </u>			
*	112	66901003	REGULATED SUBSTANCES FINAL CONSTRUCTION REPORT		LSUM	1
*	111	66901001	REGULATED SUBSTANCES PRE-CONSTRUCTION PLAN		LSUM	1
*	110	66900530	SOIL DISPOSAL ANALYSIS		EACH	3
				· · ·		
*	109	66900200	NON-SPECIAL WASTE DISPOSAL		CU YD	1,236
	108	63200310	GUARDRAIL REMOVAL		FOOT	157
*	107	63100085	TRAFFIC BARRIER TERMINAL, TYPE 6		EACH	2
*	106	63100045	TRAFFIC BARRIER TERMINAL, TYPE 2		EACH	2
*	105	63000001	STEEL PLATE BEAM GUARDRAIL, TYPE A, 6 FOOT POSTS		FOOT	75
	104	60620000	CONCRETE MEDIAN, TYPE SB-6.24		SQ FT	851
	103	60619600	CONCRETE MEDIAN, TYPE SB-6.12		SQ FT	82
	102	60619200	CONCRETE MEDIAN, TYPE SB-6.06		SQ FT	80
	101	60618300	CONCRETE MEDIAN SURFACE, 4 INCH		SQ FT	1,362
	100	60605000	COMBINATION CONCRETE CURB AND GUTTER, TYPE B-6.24		FOOT	833
	99	60604400	COMBINATION CONCRETE CURB AND GUTTER, TYPE B-6.18		FOOT	2,031
		NO .				QUANTIT
	NO.	CODE	ITEM DESCRIPTION		UNIT	TOTAL

	CTD	
	70% FED	FUNDS
	70% FED 30% DUPAGE ROADWAY URBAN	70% FED 30% DUPAGE ROADWAY
		ROADWAY URBAN
Ϋ́	0004	0005
	0004	0005
		······
	2,031	
	833	
	1,362	
	80	
	82	
	851	
	75	
	2	
	2	
	157	
	1,236	
		•
	_	
	3	
	1	
	_	
	1	

NTITIES		F.A.U RTE.	SECTION	COUNTY	TOTAL SHEETS	SHEET NO.
		1467	14-00259-05-CH	DUPAGE	294	10
				CONTRAC	T NO. 6	IG12
STA.	TO STA.		ILLINOIS FED	. AID PROJECT		

RS AND SYMBOLS	STATE OF ILLINOIS	. SQ FT FOOT FOOT	510 4,300 1,502
		· SQ FT	4,300
		· SQ FT	4,300
	· · ·	· SQ FT	4,300
		. SQ FT	
	· · ·	. SQ FT	
	· ·		510
· · · · · · · · · · · · · · · · · · ·			
		FOOT	281
		FOOT	215
		FOOT	2,390
		FOOT	4,442
		FOOT	16,380
SYMBOLS		SQ FT	704
	·	FOOT	7,416
		CAL DA	168
		L SUM	1
		CAL MO	16
		CAL DA	40
		UNIT	TOTAL QUANTIT

	STP	FUNDS
	70% FED 30% DUPAGE	70% FED 30% DUPAGE
	I ROADWAY	I ROADWAY
ГΥ	URBAN	URBAN
	0004	0005
	40	
	0	0
	8	8
	0.5	0.5
	168	
	2,192	5,224
	704	
	, , ,	
	16,380	
		<u> </u>
	4,442	
	2,390	
	2,390	
	215	
	····	
	281	
	F 1 0	
	510	
	4,300	
	-, <u>5</u> 00	
	1,502	
1		

									SECTION	COUNTY	TOTAL SHEETS	SHEET NO.
		<b>S</b> U	MNIA	<b>AK</b> Y	OF QU	ANTITES		1467	14-00259-05-CH	DUPAGE	294	11
										CONTRAC	T NO. 6	1G12
SCALE: NONE	SHEET	9	OF	19	SHEETS	STA.	TO STA.		ILLINOIS FED. /	ID PROJECT		

	neers & Arc	chitects	DESIGNED         D.M.S.         REVISED         -           DRAWN         D.M.S.         REVISED         -           CHECKED         D.J.C.         REVISED         -           DATE         09-01-2020         REVISED         -	STATE OF ILLINOIS DEPARTMENT OF TRANSPORTATION		ARY OF QUAN
	ECIALTY I		DESIGNED - D.M.S. REVISED -			
*		78000200	THERMOPLASTIC PAVEMENT MARKING - LINE 4"		FOOT	59,674
*	139	78000100	THERMOPLASTIC PAVEMENT MARKING - LETTERS AND SYMBOLS		SQ FT	2,582
*	138	72800100	TELESCOPING STEEL SIGN SUPPORT	· · ·	FOOT	597
*	137	72400710			SQ FT	30
*	136	72400600	RELOCATE SIGN PANEL ASSEMBLY - TYPE B		EACH	6
*	135	72400320	REMOVE SIGN PANEL - TYPE 2		SQ FT	43
·	154	72400310				
*	13/	72400310	REMOVE SIGN PANEL - TYPE 1		SQ FT	25
*	133	72400200	REMOVE SIGN PANEL ASSEMBLY - TYPE B		EACH	10
*	132	72400100	REMOVE SIGN PANEL ASSEMBLY - TYPE A		EACH	21
*	131	72000200	SIGN PANEL - TYPE 2		SQ FT	39
*	121	72000200				20
*	130	72000100	SIGN PANEL - TYPE 1		SQ FT	506
* *	129	70300924	PAVEMENT MARKING TAPE, TYPE IV 24"		FOOT	165
	120	70300912	FAVENENT MARKING TAFE, TIFE IV 12			554
* *	178	70300912	PAVEMENT MARKING TAPE, TYPE IV 12"		FOOT	354
* *	127	70300908	PAVEMENT MARKING TAPE, TYPE IV 8"		FOOT	2,038
	NO.	NO.	ITEM DESCRIPTION			QUANTIT
		CODE			UNIT	TOTAL

	STP I	UNDS
	70% FED 30% DUPAGE ROADWAY	70% FED
	ROADWAY	30% DUPAGE ROADWAY
Ϋ́	URBAN 0004	URBAN 0005
_		
	2,038	
	354	
	165	
	500	
	506	
	39	
	21	
	10	
	25	
	25	
	43	
	6	
_	20	
	30	
	597	
	1,454	1,128
	10,473	49,201
-		

1		F.A.U RTE.	SECTION	COUNTY	TOTAL SHEETS	SHEET NO.
	SUMMARY OF QUANTITIES	1467	14-00259-05-CH	DUPAGE	294	12
				CONTRACT	. NO. 61	G12
	SCALE: NONE SHEET 10 OF 19 SHEETS STA. TO STA.		ILLINOIS FED. AI	D PROJECT		

1467	14-0025	9-05-CH		DUPAGE
				CONTRACT
		ILLINOIS	FED. A	D PROJECT

KNIGH	Ters & Arc	bitacts	DRAWN - CHECKED -	D.M.S.	REVISED - REVISED -	STATE OF ILLINOIS DEPARTMENT OF TRANSPORTATION	SUMI	MARY OF QUAN
** SPE	CIAL PRO		DESIGNED -	D.M.S.	REVISED -	Τ		
							· · · · · · · · · · · · · · · · · · ·	
*	154	81028750	UNDERGROUND CONDUIT, COIL	UNDERGROUND CONDUIT, COILABLE NONMETALLIC CONDUIT, 2" DIA.				
							FOOT	1,881
*	153	81028240	UNDERGROUND CONDUIT, GALV	ANIZED STEE	L, 4" DIA.		FOOT	1,357
*	152	81028220	UNDERGROUND CONDUIT, GALV	ANIZED STEE	L, 3" DIA.	· · · · · · · · · · · · · · · · · · ·	FOOT	707
*	151	81028200	UNDERGROUND CONDUIT, GALV				FOOT	1,443
*	150	80500020	SERVICE INSTALLATION - PO	LE MOUNTED			EACH	3
	149	78300200	RAISED REFLECTIVE PAVEMEN	T MARKER RE	MOVAL		EACH	1,373
*	148	78009024	MODIFIED URETHANE PAVEMEN	T MARKING -	LINE 24"		FOOT	23
*	147	78009006	MODIFIED URETHANE PAVEMEN	T MARKING -	LINE 6"		FOOT	435
*	146	78009004	MODIFIED URETHANE PAVEMEN	T MARKING -	LINE 4"		FOOT	1,001
*	145	78009000	MODIFIED URETHANE PAVEMEN	I MARKING -	LETTERS AND SYMBOLS		SQ FT	146
Jł		70000000						146
*	144	78000650	THERMOPLASTIC PAVEMENT MA	RKING - LIN	JE 24"		FOOT	970
*	143	78000600	THERMOPLASTIC PAVEMENT MA	RKING - LIN	JE 12"		FOOT	5,653
								1,217
*	142	78000500	THERMOPLASTIC PAVEMENT MA	BKING - LIN	IF 8"		FOOT	1,247
*	141	78000400	THERMOPLASTIC PAVEMENT MA	RKING - LIN	JE 6"		FOOT	10,998
	NO .	NO.	ITEM DESCRIPTION				UN I T	QUANTIT
		CODE						TOTAL

DATE - 09-01-2020

REVISED -

	STP I	UNDS
	30% DUPAGE	70% FED 30% DUPAGE
	I ROADWAY	I ROADWAY
ΤY	URBAN	URBAN
	0004	0005
	5,379	5,619
	1,247	
	_ ,	
	1,100	4,553
	-,	.,
	411	559
	146	
	1,001	
	- ,	
	435	
	23	
	218	1,155
	3	
	1,443	
	707	
	1,357	
	1,881	

								F.A.U RTE.	SECTION	COUNTY	TOTAL SHEETS	SHEET NO.
		SU	MMA	<b>NRY</b>	OF QU	ANTITIES		1467	14-00259-05-CH	DUPAGE	294	13
										CONTRACT	NO. 63	IG12
SCALE: NONE	SHEET	11	OF	19	SHEETS	STA.	TO STA.		ILLINOIS FED. A	D PROJECT		

		NO.	CODE NO .	ITEM DESCRIPTION			UNIT	TOTAL QUANT I T
**	*	155	81400100	HANDHOLE			EACH	16
**	*	156	81400200	HEAVY-DUTY HANDHOLE			EACH	1
			01400200					1
**	*	157	81400300	DOUBLE HANDHOLE			EACH	5
-								
	*	158	81702110	ELECTRIC CABLE IN CONDUIT, 600V (XLP-TY	PE USE) 1/C NO. 10		FOOT	520
	*	159	81702420	ELECTRIC CABLE IN CONDUIT, 600V (XLP-TY	PE USE) 3-1/C NO. 8	,	FOOT	507
	*	160	84200500	REMOVAL OF LIGHTING UNIT, SALVAGE			EACH	6
	*	161	84200804	REMOVAL OF POLE FOUNDATION			EACH	6
**	*	162	85000200	MAINTENANCE OF EXISTING TRAFFIC SIGNAL			EACH	7
**	*	163	87300925	ELECTRIC CABLE IN CONDUIT, TRACER, NO. 3	14 1C		FOOT	2,767
**	*	164	87301215	ELECTRIC CABLE IN CONDUIT, SIGNAL NO. 14	4 2C		FOOT	3,003
**	*	165	87301225	ELECTRIC CABLE IN CONDUIT, SIGNAL NO. 14	4 3C		FOOT	5,873
				· · ·		· .		
**	*	166	87301245	ELECTRIC CABLE IN CONDUIT, SIGNAL NO. 14	4 5C		FOOT	9,256
* *	*	167	87301255	ELECTRIC CABLE IN CONDUIT, SIGNAL NO. 14	A 7C		FOOT	1,271
		107	67501255	LEECTRIC CABLE IN CONDUCT, SIGNAL NO. 14	4 /C			1,271
**	*	168	87301305	ELECTRIC CABLE IN CONDUIT, LEAD-IN, NO.	14 1 PAIR		FOOT	3,247
		CIALTY I CIAL PRO	TEM DVISION	1.				
				DESIGNED - D.M.S.	REVISED -	r		
k	NIGH			DESIGNED - D.M.S. DRAWN - D.M.S. CHECKED - D.J.C.	REVISED - REVISED - REVISED -	STATE OF ILLINOIS DEPARTMENT OF TRANSPORTATION	SUMN	IARY OF QUAN
	Engine	eers & Ard	cnitects	DATE - 09-01-2020	REVISED -		SCALE: NONE SHEET 12 OF	19 SHEETS ST

	стр	FUNDS
		70% FED
	70% FED 30% DUPAGE ROADWAY	70% FED 30% DUPAGE ROADWAY
Υ	URBAN	URBAN
1	0004	0005
	16	
	1	
	5	
	520	
	507	i
	G	
	6	
	6	
	7	
	2,767	
	3,003	
	5,873	
	0.055	
	9,256	
	1,271	
_		
	3,247	
	5,24/	

								F.A.U RTE.	SECTION	COUNTY	TOTAL SHEETS	SHEET NO.
		SU	MINIA	<b>KK</b> Y	OF QU	ANTITIES		1467	14-00259-05-CH	DUPAGE	294	14
										CONTRACT	F NO. 6	1G12
SCALE: NONE	SHEET	12	OF	19	SHEETS	STA.	TO STA.		ILLINOIS FED. A	D PROJECT		

KNIGH	IT neers & Ar		DESIGNED - D.M.S. DRAWN - D.M.S. CHECKED - D.J.C.	REVISED - REVISED - REVISED -	STATE OF ILLINOIS DEPARTMENT OF TRANSPORTATION	SUMM	ARY OF QUAN
	ECIALTY I ECIAL PR		DESIGNED - D.M.S.	REVISED -		1	
** *	182	87800100	CONCRETE FOUNDATION, TYPE A			FOOT	52
** *	181	87702970	STEEL COMBINATION MAST ARM ASSEMBLY ,	AND POLE 48 FT.		EACH	1
** *	180	87702950	STEEL COMBINATION MAST ARM ASSEMBLY A	AND POLE 44 FT.	· · · ·	EACH	2
** *	179	87702930	STEEL COMBINATION MAST ARM ASSEMBLY .	AND POLE 40 FT.		. EACH	2
** *	178	87702596	STEEL MAST ARM ASSEMBLY AND POLE WIT	H DUAL MAST ARMS, 38 FT.	AND 40 FT.	EACH	1
		07700200	STELE MAST ANN ASSEMUET AND TOLE, 44				
** *	177	87700260	STEEL MAST ARM ASSEMBLY AND POLE, 44	ст		EACH	1
** *	176	87700230	STEEL MAST ARM ASSEMBLY AND POLE, 38	FT.		EACH	1
** *	175	87700220	STEEL MAST ARM ASSEMBLY AND POLE, 36	FT.		EACH	1
** *	174	87700190	STEEL MAST ARM ASSEMBLY AND POLE, 30	FT.		EACH	1
** *	173	87700170	STEEL MAST ARM ASSEMBLY AND POLE, 26	FT.		EACH	3
	172	07502520					
** *	172	87502520	TRAFFIC SIGNAL POST, GALVANIZED STEE	1 10 ET		EACH	1
** *	171	87502500	TRAFFIC SIGNAL POST, GALVANIZED STEE	L 16 FT.		EACH	9
*	170	87301900	ELECTRIC CABLE IN CONDUIT, EQUIPMENT	GROUNDING CONDUCTOR, NO	. 6 1C	FOOT	3,357
** *	169	87301805	ELECTRIC CABLE IN CONDUIT, SERVICE,	NO. 6 2 C		FOOT	961
		NO.	ITEM DESCRIPTION			UNIT	QUANTIT

DATE - 09-01-2020

REVISED -

	CTD.	
	31P	FUNDS
	70% FED 30% DUPAGE ROADWAY URBAN	70% FED 30% DUPAGE ROADWAY URBAN
	ROADWAY	ROADWAY
٦Y	URBAN	URBAN
	0004	0005
	0.6.1	
	961	
	3,357	
	5,55,	
	9	
	1	
	3	
_		1
	1	
	1	
	1	
	1	
	1	
	-	
_		
;	1	
	2	
	2	
	-	
]		
	_	
	1	
	52	

								F.A.U RTE.	SECTION	COUNTY	TOTAL SHEETS	SHEET NO.
		SUI	MMA	ARY	OF QU	ANTITIES		1467	14-00259-05-CH	DUPAGE	294	15
										CONTRAC	T NO. 6	1G12
SCALE: NONE	SHEET	13	OF	19	SHEETS	STA.	TO STA.		ILLINOIS FED.	AID PROJECT		

К	NIGH <sup>-</sup> Engine	Γ eers & Arr	chitects	DRAWN - D.M.S. RE CHECKED - D.J.C. RE	EVISED         -           EVISED         -           EVISED         -           EVISED         -	STATE OF ILLINOIS DEPARTMENT OF TRANSPORTATION		IARY OF QUANT
		CIALTY I CIAL PRO	TEM DVISION	DESIGNED - D.M.S. RE	EVISED -			
~ Ŧ			88200510	TRAFFIC SIGNAL BACKPLATE, RETROREFLECTIVE			EACH	24
**	*	106	88200510					24
* *	*	195	88200410	TRAFFIC SIGNAL BACKPLATE, LOUVERED, FORME	D PLASTIC		EACH	10
		194	00102/1/	I EDESTIMAN STOWAL HEAD, LED, I-FACE, BRAC				10
**	*	10/	88102717	PEDESTRIAN SIGNAL HEAD, LED, 1-FACE, BRAC		 NTDOWN TIMER	EACH	16
* *	*	193	88030110	SIGNAL HEAD, LED, 1-FACE, 5-SECTION, MAST	- ARM MOUNTED		EACH	1
**	*	192	88030100	SIGNAL HEAD, LED, 1-FACE, 5-SECTION, BRAC			EACH	3
**	*	191	88030070	SIGNAL HEAD, LED, 1-FACE, 4-SECTION, BRAC	KET MOUNTED		EACH	2
**	*	190	88030050	SIGNAL HEAD, LED, 1-FACE, 3-SECTION, BRAC	CKET MOUNTED		EACH	15
**	*	189	88030020	SIGNAL HEAD, LED, 1-FACE, 3-SECTION, MAST	-ARM MOUNTED		EACH	33
					······································			
	*	188	88030012	SIGNAL HEAD, LED, 1-FACE, 1-SECTION, BRAC	KET MOUNTED		EACH	1
**	*	187	88000105	5 FLASHING BEACON INSTALLATION			EACH	1
	*	186	87900200	DRILL EXISTING HANDHOLE			EACH	16
**	*	185	87800415	5 CONCRETE FOUNDATION, TYPE E 36-INCH DIAME	:TER		FOOT	133
**	*	184	87800400	CONCRETE FOUNDATION, TYPE E 30-INCH DIAME	ETER		FOOT	30
**	*	183	87800150	CONCRETE FOUNDATION, TYPE C			FOOT	12
		NO .	CODE NO.	ITEM DESCRIPTION			UNIT	TOTAL QUANTIT
		<b>F</b>	1					

STP	FUNDS
70% FED 30% DUPAGE ROADWAY URBAN	70% FED 30% DUPAGE ROADWAY URBAN
ROADWAY	ROADWAY
URBAN	URBAN
0004	0005
12	
	1
30	
133	
1.0	
16	
1	
1	
22	
33	
15	
2	
3	
د	
1	
	•
16	
1.0	
10	
24	

		F.A.U RTE.	SECTION	COUNTY	TOTAL SHEETS	SHEET NO.
VTITIES		1467	14-00259-05-CH	DUPAGE	294	16
				CONTRAC	F NO. 61	IG12
STA.	A. TO STA.		ILLINOIS FED. A	ID PROJECT		

		NO.	CODE NO.	ITEM DESCRIP	PTION					UN I 1	TOTAL QUANTIT
**	*	197	88500100	INDUCTIVE LOOP DE	TECTOR					EACH	13
**	*	198	88600100	DETECTOR LOOP, TY	PE I					FOOT	1,734
**	*	199	88700090	CONFIRMATION BEAC	ON					EACH	7
**	*	200	88700200	LIGHT DETECTOR						EACH	10
**	*	201	88700300	LIGHT DETECTOR AM	PLIFIER					EACH	3
**	*	202	89000100	TEMPORARY TRAFFIC	SIGNAL I	NSTALLATIO	N			EACH	3
**	*	203	89502210	MODIFY EXISTING C	ONTROLLER	CABINET				EACH	4
	*	204	89502300	REMOVE ELECTRIC C	ABLE FROM	CONDUIT				FOOT	5,280
**	*	205	89502375	REMOVE EXISTING T	RAFFIC SI	GNAL EQUIP	MENT			EACH	8
	*	206	89502380	REMOVE EXISTING H	ANDHOLE					EACH	32
	*	207	89502382	REMOVE EXISTING D	OUBLE HAN	DHOLE				EACH	1
	*	208	89502385	REMOVE EXISTING C	ONCRETE F	OUNDATION				EACH	23
* *		209	Z0004562	COMBINATION CONCR	ETE CURB A	AND GUTTER	REMOVAL AND REPLAC	EMENT		FOOT	4,069
**		210	Z0005216	HOT-MIX ASPHALT S	TABILIZAT	ION 6" AT	STEEL PLATE BEAM GU	IARD RA	IL	SQ YD	35
		CIALTY I CIAL PRO	TEM OVISION	<u> </u>							
	NIGH	T		999 999 999 999 999 999 999 999 999 99	DESIGNED - DRAWN -	D.M.S.	REVISED - REVISED -		STATE OF ILLINOIS	CIIM	MARY OF QUAN
		eers & Are	chitects	· · ·	CHECKED -		REVISED -		DEPARTMENT OF TRANSPORTATION	30141	UCAN OF COAN

REVISED -

DATE - 09-01-2020

	STP I	FUNDS
	70% FED	70% FED
	70% FED 30% DUPAGE ROADWAY	70% FED 30% DUPAGE ROADWAY
Υ	URBAN	URBAN
'	0004	0005
	13	
	1,734	
	7	
	10	
	3	
	3	
	4	
	5,280	
	8	
	32	
	1	
	23	
	119	3,950
	35	
- 1	l	

T									F.A.U RTE.	SEC	TION	COUNTY	TOTAL SHEETS	SHEET NO.
I			SUN	ANIA	\KY	OF QU/	ANTITE	:S	1467	14-0025	9-05-CH	DUPAGE	294	17
ļ												CONTRAC	T NO. 6	1G12
	SCALE: NONE	SHEET	15	OF	19	SHEETS	STA.	TO STA.			ILLINOIS FED.	AID PROJECT		

		NO.	CODE	ITEM DESCRIP	PTION			UNIT	TOTAL
			NO.						QUANTIT
**		211	Z001379	8 CONSTRUCTION LAYO	UT			L SUM	1
**		212	Z001840	0 DRAINAGE STRUCTUR	ES TO BE ADJUSTED			EACH	20
**			7001050						
~ 4		213	Z001860	DRATNAGE STRUCTUR	ES TO BE RECONSTRUCT			EACH	5
**		214	Z003085	0 TEMPORARY INFORMA	TION SIGNING			SQ FT	315
**	*	215	Z003305	6 OPTIMIZE TRAFFIC	SIGNAL SYSTEM			EACH	1
**		216	Z0033700	D LONGITUDINAL JOIN	T SEALANT			FOOT	49,570
**		217	Z0053700	0 RESETTING SURVEY	MONUMENTS			EACH	6
**		218	Z0062456	5 TEMPORARY PAVEMEN	Т	<u>,                                     </u>		SQ YD	111
**	*	219	Z0073510	TEMPORARY TRAFFIC	SIGNAL TIMING			EACH	3
-									
**	#	220	Z0076600	D TRAINEES				HOUR	500
**	林	221	Z0076604	TRAINEES TRAINING	PROGRAM GRADUATE			HOUR	500
	-13			· · ·	· ·		· · ·		
**	*	222	X0324085	5 EMERGENCY VEHICLE	PRIORITY SYSTEM LINE	E SENSOR CABLE, NO. 20	3/C	FOOT	2,104
* *	*	223	X0325476	5 RADAR VEHICLE DET	ECTION SYSTEM			EACH	3
**	*								
**	*	224	X0325922	2 CELLULAR MODEM				EACH	1
		CIALTY I							
	** SPE		OVISION						
	NICH	Τ			DESIGNED - D.M.S. DRAWN - D.M.S.	REVISED - REVISED -	STATE OF ILLINOIS	CUISARI	IARY OF QUAN
ľ	NIGH Engin	eers & Ar	chitects		CHECKED - D.J.C. DATE - 09-01-2020	REVISED - REVISED - REVISED -	DEPARTMENT OF TRANSPORTATION	SOIVIN	

	CT0	
	51P   70% EED	FUNDS
	30% DUPAGE	70% FED 30% DUPAGE ROADWAY
	ROADWAY	ROADWAY
Ϋ́	UNDAN	UNDAN
	0004	0005
	1	1
		20
		5
	315	
	1	
	7,620	41,950
	6	
	111	
	3	
	250	250
	250	250
	2,104	
	3	
	1	

		F.A.U RTE.	SECTION	COUNTY	TOTAL SHEETS	SHEET NO.
NTITIES		1467	14-00259-05-CH	DUPAGE	294	18
				CONTRAC	T NO. 61	IG12
STA.	TO STA.		ILLINOIS FED. 4	AID PROJECT		

		NO.	CODE NO .	ITEM DESCRIP	TION									UNIT	TOTAL QUANTIT
**		225	X0327036	BIKE PATH REMOVAL										SQ YD	700
**	*	226	X0327698	LED INTERNALLY ILI	LUMINATED	STREET NAME	S I GN							EACH	8
* *		227	X0327979	PAVEMENT MARKING F	REMOVAL -	GRINDING								SQ FT	8,660
* *		228	X0327980	PAVEMENT MARKING F	REMOVAL -	WATER BLAST	ING							SQ FT	690
**		229	X1200023	CATCH BASINS, TYPE	E A, 5'-D	IAMETER, DUP	AGE SAG FRAME AND	GRATI						EACH	1
													<u> </u>		
**	*	230	X1400081	FULL-ACTUATED CON	TROLLER A	ND TYPE SUPE	R P CABINET (SPEC	IAL)						EACH	2
									, , , , , , , , , , , , , , , , , , , ,						
**	*	231	X1400102	OUTDOOR RATED NET	WORK CABL	E								FOOT	849
**	*	232	X1400150	SERVICE INSTALLAT	ION, GROU	ND MOUNTED, 1	METERED					~~~~		EACH	3
**	*	233	X1400215	REMOTE CONTROLLED	VIDEO SY	STEM								EACH	3
* *	*	234	X1400216	LAYER II (DATALINK	<) SWITCH									EACH	4
							······································								
**	*	235	X1400221	UPGRADE EXISTING (	CONTROLLE	R TO NTCIP SE	PECIAL							EACH	4
														,	
* *	*	236	X1400238	LUMINAIRE, LED, SF	PECIAL									EACH	4
					·								*****		
**	*	237	X1400335	WIRELESS TRANSMISS	SION SYST	EM POINT TO F	POINT							EACH	2
**	*	238	X1400367	PEDESTRIAN SIGNAL	POST. 10	FT.								EACH	3
	* SPE		ТЕМ												
		CIAL PRO													
V	NIGH	T			DESIGNED - DRAWN -	D.M.S. D.M.S.	REVISED - REVISED -			STATE OF				SIIMM	ARY OF QUANT
		ers & Arc	hitects		CHECKED - DATE -	D.J.C.	REVISED - REVISED -		DEPAR		RANSPORTATIO	N	SCALE: NONE		19 SHEETS ST

	стр	FUNDS
	70% FED	70% FED 30% DUPAGE ROADWAY
	70% FED 30% DUPAGE ROADWAY	30% DUPAGE
		URBAN
ΤY	0004	0005
	165	535
	8	
	Ů	
	0.660	
	8,660	
	690	
	1	
	2	
	849	
	3	
	3	
	5	
	4	
	4	
	4	
		•
	4	
	ч	
	2	
	3	

		F.A.U RTE.	SECTION	COUNTY	TOTAL	SHEET
NTITIES					SHEETS	NO,
		1467 14-00259-05-CH			DUPAGE 294 19	
				CONTRAC	T NO. 63	IG12
STA.	TO STA.		ILLINOIS FED. A	ID PROJECT		

		NO.	CODE NO.	ITEM DESCRIP	TION							UNIT	TOTAL
**	*	239	X1400373	RADAR VEHICLE DET	ECTION SYSTEM, S	SINGLE	APPROACH, STOP BAR AN	FAR BACK				EACH	2
* *	*	240	X1400378	PEDESTRIAN SIGNAL	POST, 5 FT.							EACH	6
**	*	241	X1400424	ELECTRIC CABLE IN	CONDUIT, STREET	NAME	SIGN, NO. 14 3C, TYPE	SOOW				FOOT	1,509
* *		242	X1800002	RIVER ROCK								TON	1
**		243	X4400501	COMBINATION CURB	AND GUTTER REMOV	AL AND	REPLACEMENT LESS THA	I OR EQUAL TO 1	0 FEET			FOOT	913
**													
* *		244	X4401198	HOT-MIX ASPHALT SU	URFACE REMOVAL,	VARIAB						SQ YD	3,271
* *		245	X6020096	MANHOLES, TYPE A	6'-DIAMETER, WI	тн 2 т	YPE 1 FRAME, CLOSED L		PLATE			EACH	2
				····,									
**		246	X6030310	FRAMES AND LIDS TO BE ADJUSTED (SPECIAL)						EACH	45		
**		247	X6060500	CORRUGATED MEDIAN	REMOVAL							SQ FT	1,325
													-
**		248	X7010216	TRAFFIC CONTROL AN	ND PROTECTION, (	SPECIA	L)					L SUM	1
* *		249	X7030005	TEMPORARY PAVEMENT	T MARKING REMOVA	۰L						SQ FT	15,492
* *	*	250	X7810300	RECESSED REFLECTIV	VE PAVEMENT MARK	ER						EACH	1,737
**	*	251	X8100105	CONDUIT SPLICE								EACH	3
						·····							
* *	*	252	X8140115	HANDHOLE TO BE AD.	JUSTED							EACH	1
	* SPF		TEM										
		CIAL PRO											
K	NIGH	т			DESIGNED - D.M.S. DRAWN - D.M.S.		REVISED - REVISED -		STATE OF ILLINOIS			SUMM	ARY OF QUAN
		ers & Arc	hitects		CHECKED - D.J.C. DATE - 09-01-2020	-	REVISED - REVISED -	DEPART	MENT OF TRANSPO				

	CTD	
	20% EED	FUNDS
	30% DUPAGE	30% DUPAGE
	70% FED 30% DUPAGE ROADWAY URBAN	ROADWAY URBAN
Ϋ́	0004	70% FED 30% DUPAGE ROADWAY URBAN 0005
	2	
	6	
	1,509	
	1,505	
		1
	50	863
	3,271	
	2	
	3	42
	-	
		1 225
		1,325
-		
	1	
_		
	15,492	
	319	1,418
_		
	3	
	-	
		1
		1

NTITIES		F.A.U RTE.	SECTION	COUNTY	TOTAL SHEETS	SHEET NO.		
		1467	14-00259-05-CH	DUPAGE	294	20		
				CONTRACT	NO. 6	IG12		
STA.	TO STA.		ILLINOIS FED. AID PROJECT					

		NO.	CODE									TOTAL
		NO .	NO.	ITEM DESCRIP	TON						UNIT	QUANTIT
**	*	253	X8570226	FULL-ACTUATED CON							EACH	1
			X0370220								LACH	1
**	*	254	X8620200	UNINTERRUPTABLE PO	OWER SUPPL	Y, SPECIAL					EACH	3
											F 	
**	*	255	X8620250	UNINTERRUPTABLE PO	OWER SUPPL	Y AND CABINE	ET, SPECIAL				EACH	1
**	*	256	X8710030	FIBER OPTIC CABLE	48 FIBERS	, SINGLE MOD	DE				FOOT	2,813
**	*	257	X8730106	ELECTRIC CABLE IN	CONDUIT,	SIGNAL NO. 1	.0 5C				FOOT	699
**	*	258	X8760200	ACCESSIBLE PEDEST	RIAN SIGNA	LS					EACH	30
-												
**	*	259	X8780010	CONCRETE FOUNDATION, TYPE A 10-INCH DIAMETER							FOOT	36
**	*	260	X8950212	MODIFY EXISTING CO							EACH	4
		200	10950212								EACH	4
**	*	261	XX003338	TEST HOLE							EACH	8
									·····			
**	*	262	XX007622	ELECTRIC METER							EACH	4
**	*	263	XX007952	TERMINAL SERVER			· · ·	· · · · · · · · · · · · · · · · · · ·			EACH	2
* *	*	264	XX009046	VEHICLE DETECTION		PECIAL					EACH	2
K	NIGH	Т		· · · · · · · · · · · · · · · · · · ·		D.M.S. D.M.S.	REVISED - REVISED -	STATE OF IL	LINOIS		SUMM	ARY OF QUAN
		eers & Arc	hitects			D.J.C. 09-01-2020	REVISED - REVISED -	DEPARTMENT OF TRA		SCALE: NONE SHI		19 SHEETS ST


	STP	FUNDS
	70% FED 30% DUPAGE ROADWAY URBAN	70% FED 30% DUPAGE ROADWAY URBAN 0005
	ROADWAY	ROADWAY
٢Y	URBAN 0004	URBAN
	0004	0005
	1	
	-	
	3	
	1	
	2,813	
_		
	699	
	30	
	50	
	36	
	4	
	8	
	4	
	2	
	۷	
	2	


NTITIES		F.A.U RTE.	SECTION	COUNTY	TOTAL SHEETS	SHEET NO.
		1467	14-00259-05-CH	DUPAGE	294	21
				CONTRAC	T NO. 63	1G12
STA.	TO STA.		ILLINOIS FED.	AID PROJECT		

1407 14-00255-05-Ch1 D01AGE 254 2	ITITIES		F.A.U RTE.	SECTION	COUNTY	TOTAL SHEETS	SHEET NO.		
			1467	14-00259-05-CH	DUPAGE	294	21		
TA. TO STA. ILLINOIS FED. AID PROJECT				CONTRACT NO. 61G12					
	TA.	TO STA.		ILLINOIS FED.	AID PROJECT				


۱ <u>ـ</u> ـــــــــــــــــــــــــــــــــــ		VARIES		€ 31ST STREE	Т	50'
		33' - 50' 12'	12'	VARIES	12'	12
EX I NOW	-			0' - 12' FLUSH MEDIAN OR LEFT TURN		
LEGEND		V	V			
EXISTING HOT-MIX ASPHALT PAVEMENT         VARIES 13" TO 18"         B       EXISTING AGGREGATE SUBGRADE         VARIES 6" TO 8"		·	 	PGL	 	  
C EXISTING CC&G B6.18	L+-					
D EXISTING HOT-MIX ASPHALT SHOULDER						
E EXISTING CC&G B6.12	C	A		XISTING TYPICAL SECT 23+66 TO STA 86+50, 31ST 9		
G EXISTING AGGREGATE SHOULDER 3" HMA						
<ol> <li>HOT-MIX ASPHALT SURFACE REMOVAL, 2 1/2"</li> <li>POLYMERIZED HOT-MIX ASPHALT SURFACE COURSE, IL-9.5, MIX "E", N70 (1<sup>3</sup>/<sub>4</sub>")</li> <li>POLYMERIZED HOT-MIX ASPHALT BINDER COURSE, IL-4.75, N50 (<sup>3</sup>/<sub>4</sub>")</li> <li>PCC BASE COURSE WIDENING, 7"</li> </ol>						
5 COMBINATION CONCRETE CURB & GUTTER, TYPE B-6.18				ଦୁ 31ST STREE	Т	
6 HOT-MIX ASPHALT SHOULDERS, 9 1/2"		VARIES 33' - 50'				50'
7) AGGREGATE SUBGRADE IMPROVEMENT, 16"	10'	12'	12'	VARIES	12'	12'
8 HOT-MIX ASPHALT BASE COURSE, 7"		Π	П	FLUSH MEDIAN OR LEFT TURN	Λ	Δ
COMBINATION CONCRETE CURB & GUTTER, TYPE B-6.12		24		ΠΛ	42	42
10 TOPSOIL FURNISH AND PLACE, 6"		$\vee$		(A M)		
11) SODDING, SALT TOLERANT				PGL		
12) SUBBASE GRANULAR MATERIAL, TYPE C						
(13) SEEDING, CLASS 2A	Ĺ					
$(14)$ HOT-MIX ASPHALT SURFACE COURSE, IL-9.5, MIX "D", N50 $(1\frac{3}{4}")$						
(15) AGGREGATE SUBGRADE IMPROVEMENT, 12"	D	Ā	EX	SISTING TYPICAL SECT	FION B	
$\sim$			STA	86+50 TO STA 115+00, 31ST	STREET	
(16) HOT-MIX ASPHALT SURFACE COURSE, MIX "D" N50 (1∮")						
(16) HOT-MIX ASPHALT SURFACE COURSE, MIX "D" N50 (1 $\frac{1}{2}$ ") (17) HOT-MIX ASPHALT BASE COURSE, 3"						
17 HOT-MIX ASPHALT BASE COURSE, 3"						
<ul> <li>HOT-MIX ASPHALT BASE COURSE, 3"</li> <li>SUBBASE GRANULAR MATERIAL, TYPE B</li> <li>COMBINATION CONCRETE</li> </ul>						
<ul> <li>HOT-MIX ASPHALT BASE COURSE, 3"</li> <li>SUBBASE GRANULAR MATERIAL, TYPE B</li> <li>COMBINATION CONCRETE CURB &amp; GUTTER, TYPE B-6.24</li> </ul>						

	DESIGNED D.M.S.	REVISED -			
KNIGHT	DRAWN D.M.S.	REVISED -	STATE OF ILLINOIS		TYPICAL SEC
Engineers & Architects	CHECKED - D.J.C.	REVISED -	DEPARTMENT OF TRANSPORTATION		
	DATE - 09-01-2020	REVISED -		SCALE: NONE	SHEET 1 OF 9 SHEET

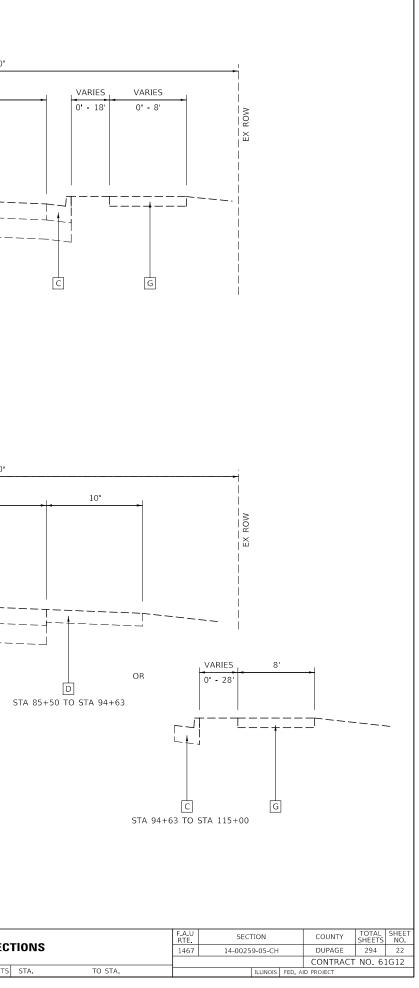

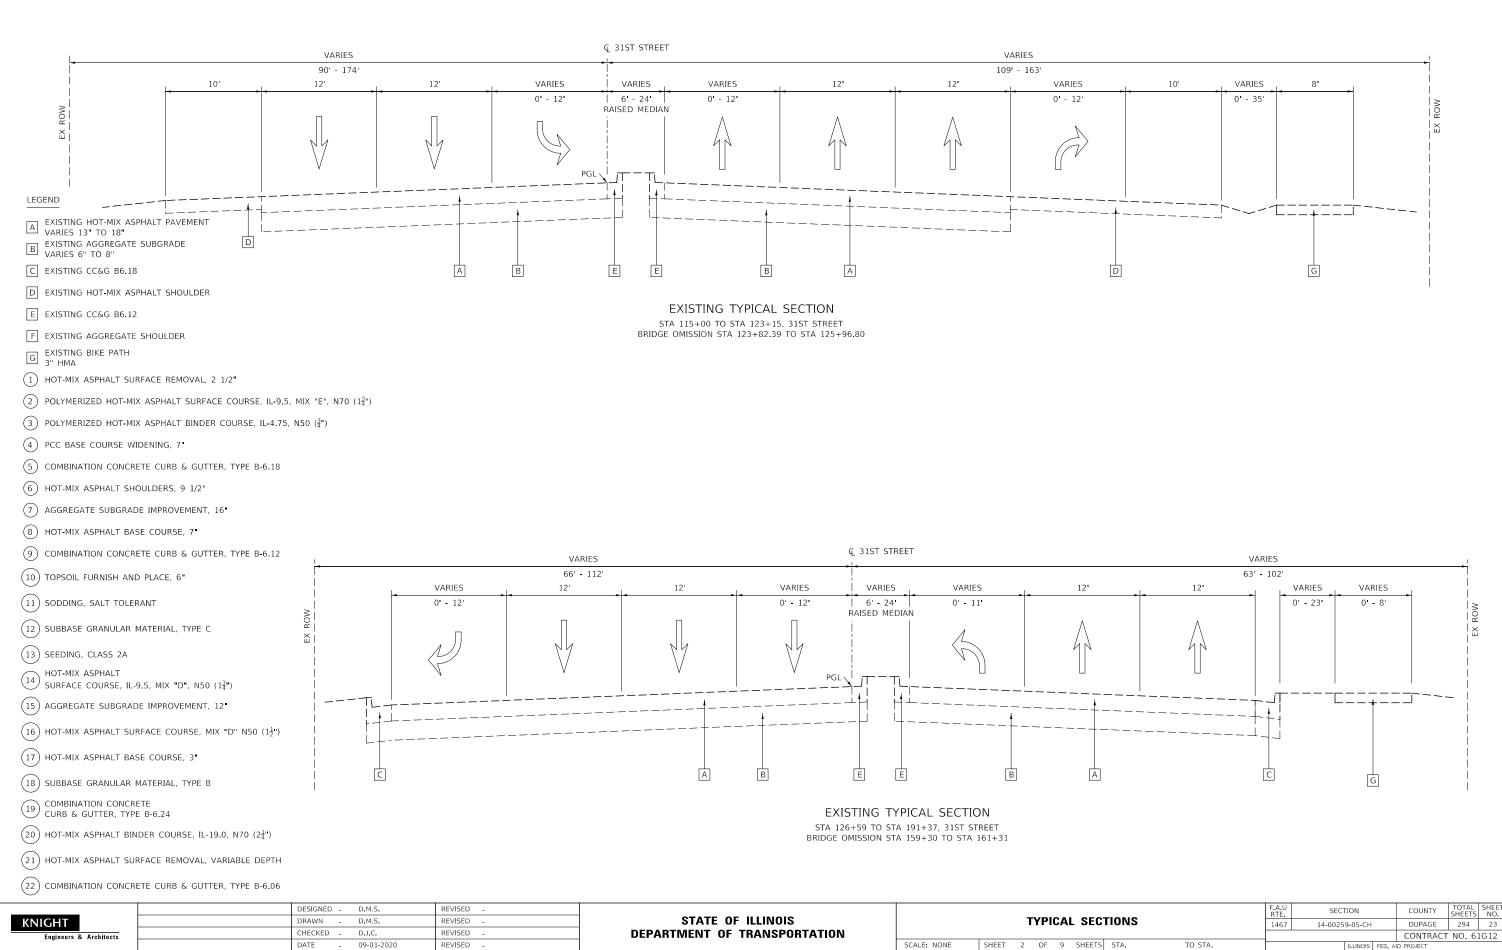

PORTATION					
	SCALE NONE	SHEET	2	OF	a

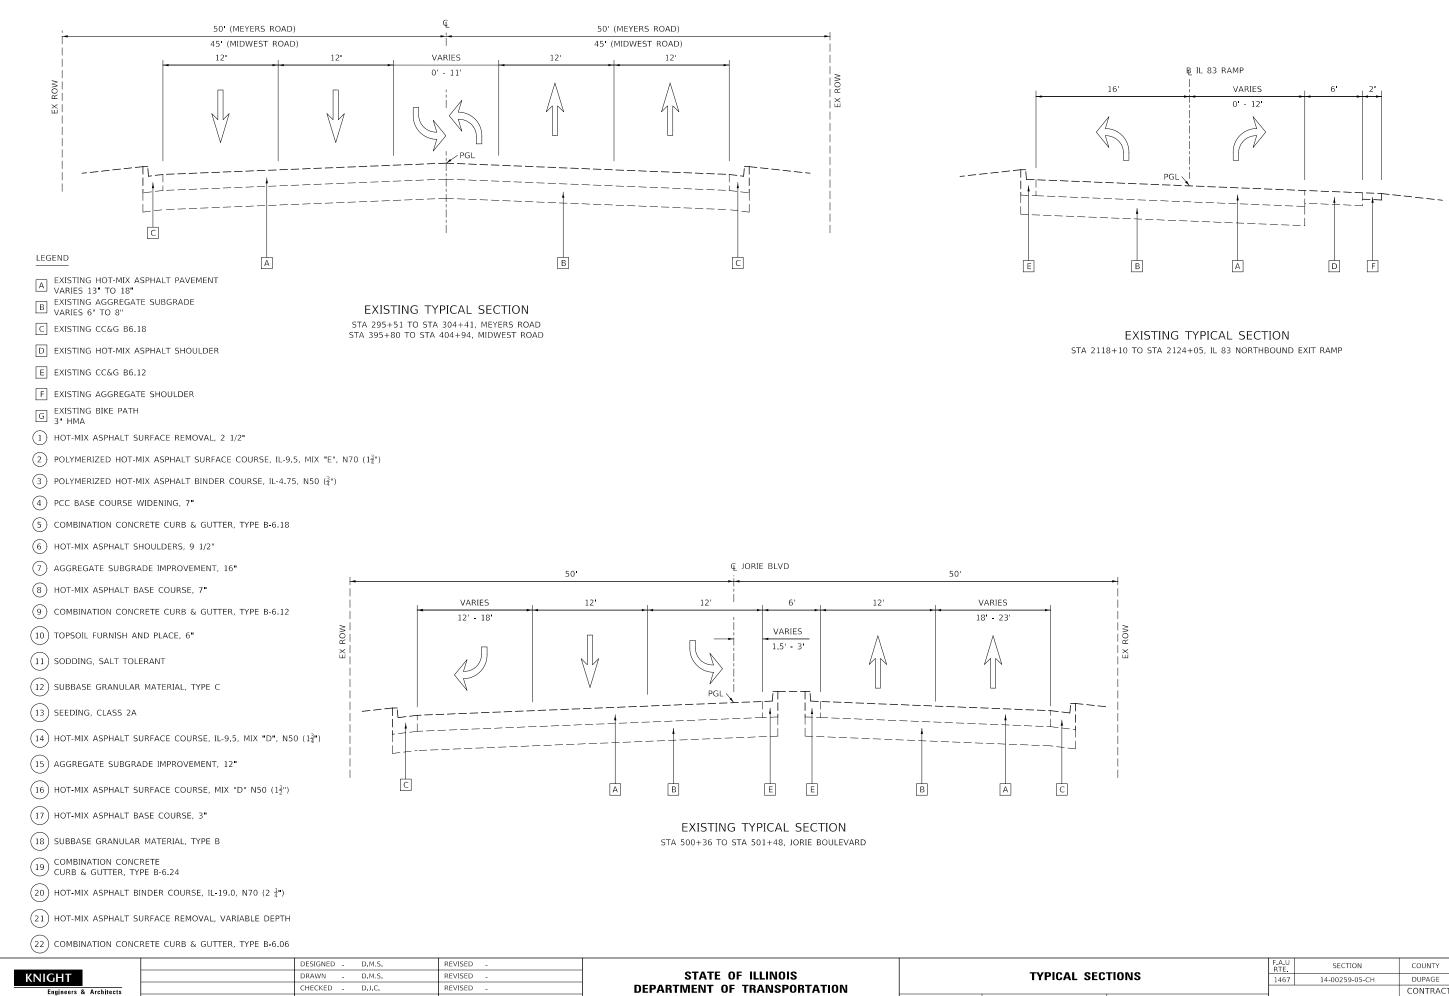


DATE

09-01-2020


REVISED

EPARTMENT OF TRANSPORTATION						
	SCALE: NONE	SHEET	3	OF	9	SHEETS

			F.A.U RTE	SECT	TION		COUNTY	TOTAL SHEETS	SHEET NO.
C	FIONS		1467	14-0025	9-05-CH		DUPAGE	294	24
							CONTRACT	NO. 6	IG12
TS	STA.	TO STA.			ILLINOIS	FED. A	ID PROJECT		

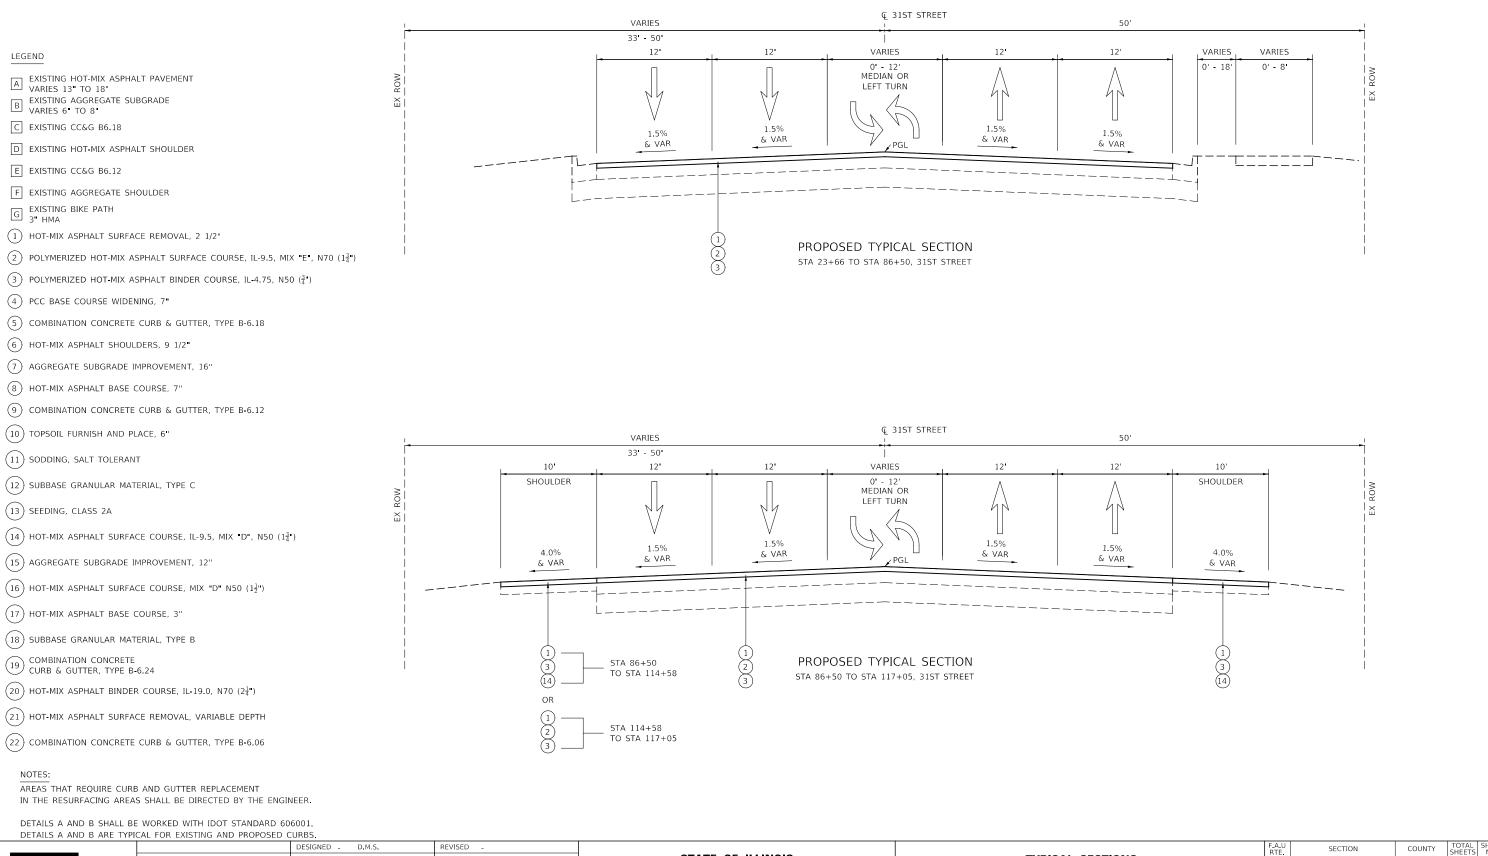



	DESIGNED D.M.S.	REVISED -					F.A.U BTE	SECTION	COUNTY TOTAL SHEETS	SHEET NO.
KNIGHT	 DRAWN D.M.S.	REVISED -	STATE OF ILLINOIS		TYPICAL SECTIONS		1467	14-00259-05-CH	DUPAGE 294	25
Engineers & Architects	CHECKED D.J.C.	REVISED -	DEPARTMENT OF TRANSPORTATION						CONTRACT NO. 61	1G12
	DATE - 09-01-2020	REVISED -		SCALE: NONE	SHEET 4 OF 9 SHEETS STA.	TO STA.		ILLINOIS FED.	AID PROJECT	

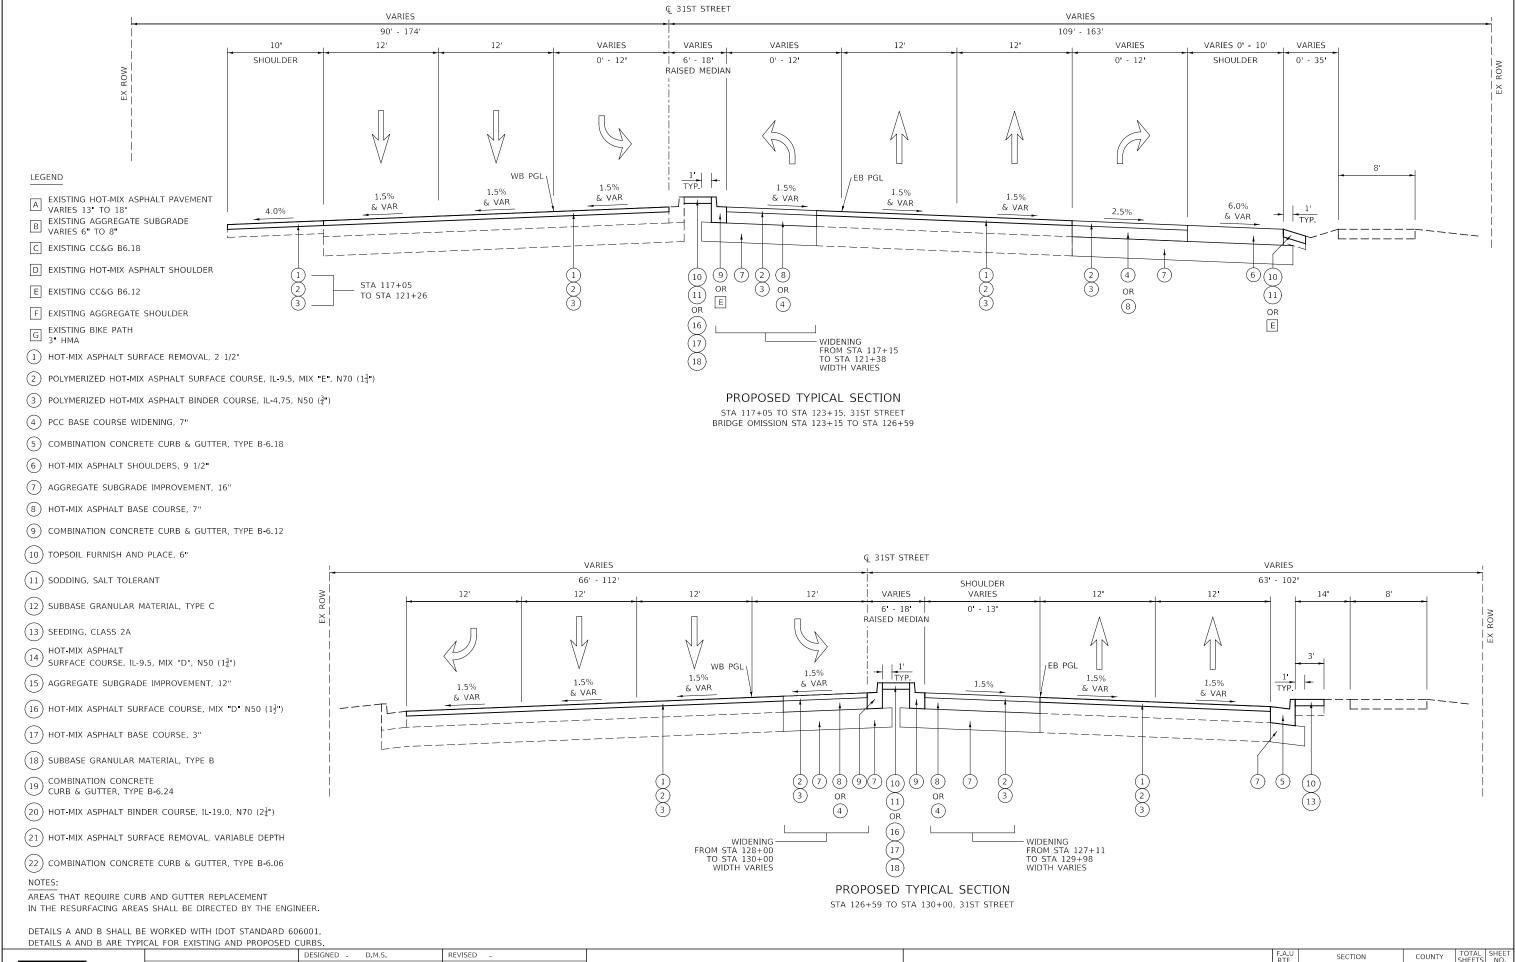


KNIGHT	DESIGNED D.M.S. DRAWN D.M.S.	REVISED - REVISED -	STATE OF ILLINOIS		TYPICAL SEC
Engineers & Architects	CHECKED - D.J.C.	REVISED -	DEPARTMENT OF TRANSPORTATION		
	DATE - 09-01-2020	REVISED -		SCALE: NONE	SHEET 5 OF 9 SHEETS

			RTE.	SEC	ION		COUNTI	SHEETS	NO.	
:C	TIONS		1467	14-0025	9-05-CH		DUPAGE	294	26	
							CONTRACT	NO. 61	G12	1
TS	STA.	TO STA.			ILLINOIS	FED. AI	ID PROJECT			1

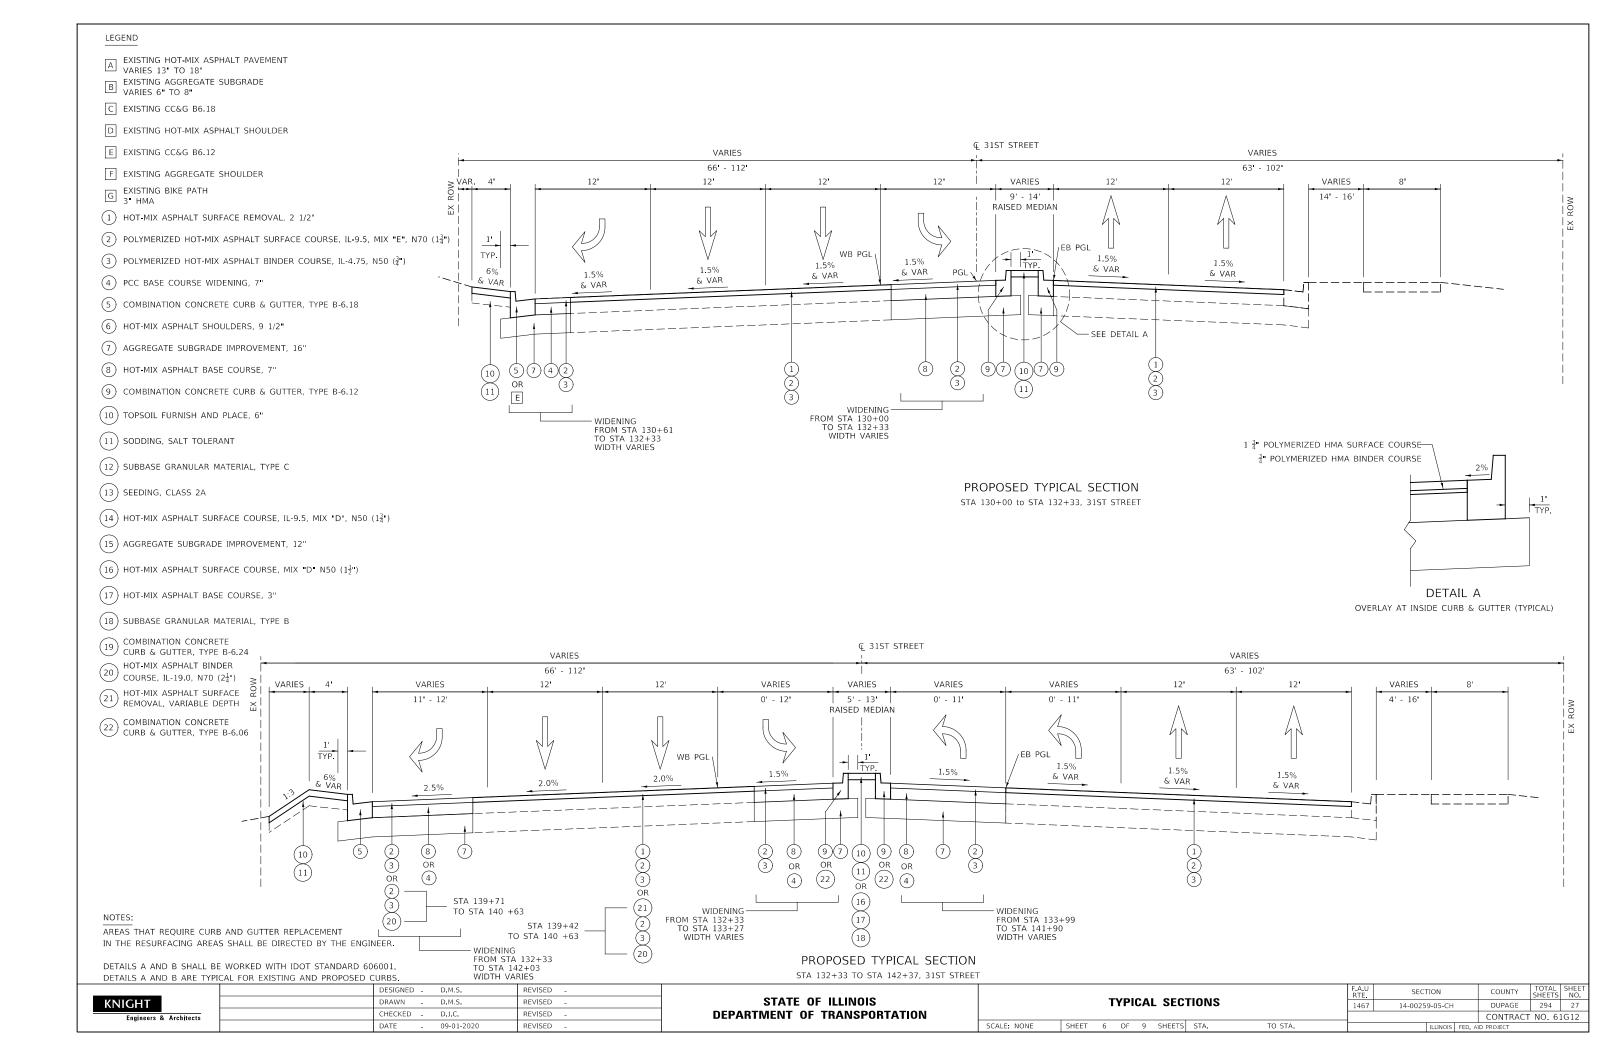

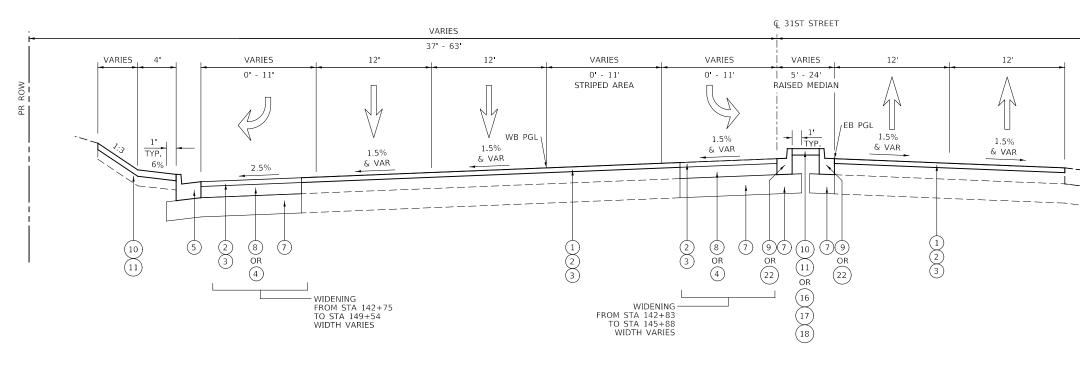

PROPOSED TYPICAL SECTION STA 142+37 to STA 149+54, 31ST STREET

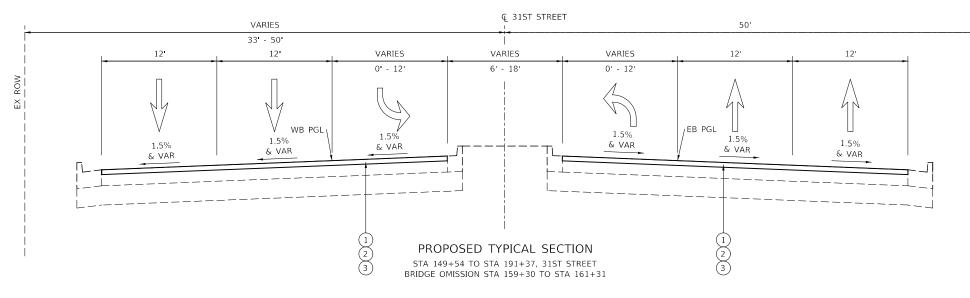

NOTES:

AREAS THAT REQUIRE CURB AND GUTTER REPLACEMENT


IN THE RESURFACING AREAS SHALL BE DIRECTED BY THE ENGINEER.

DETAILS A AND B SHALL BE WORKED WITH IDOT STANDARD 606001. DETAILS A AND B ARE TYPICAL FOR EXISTING AND PROPOSED CURBS.

	DESIGNED D.M.S.	REVISED -			
KNIGHT	DRAWN D.M.S.	REVISED -	STATE OF ILLINOIS	1	TYPICAL SECT
Engineers & Architects	CHECKED - D.J.C.	REVISED -	DEPARTMENT OF TRANSPORTATION	1	
	DATE - 09-01-2020	REVISED -		SCALE: NONE	SHEET 7 OF 9 SHEETS


VARIES					•		
39 - 63 VAR	IFS	8'					
4' -	<b>-</b> -	8.			ROW -		
 	·						
	L						
	LEGE	IND					
	<u>а</u> ,	EXISTING HOT-MIX ASP VARIES 13" TO 18" EXISTING AGGREGATE			 		
	в,	VARIES 6" TO 8"					
		EXISTING CC&G B6.18					
		EXISTING HOT-MIX ASP EXISTING CC&G B6.12	HALI :	SHOULDER			
		EXISTING AGGREGATE	SHOUL	_DER			
		EXISTING BIKE PATH 3" HMA					
	$\sim$	HOT-MIX ASPHALT SUR	FACE I	REMOVAL, 2 1/2"			
	2	POLYMERIZED HOT-MIX	ASPH.	ALT SURFACE COURSE, IL-9	5, MIX "	E", N70	$(1\frac{3}{4}")$
	3	POLYMERIZED HOT-MIX	ASPH.	ALT BINDER COURSE, IL-4.7	5, N50 (	3 <sup>1</sup> ")	
	(4)	PCC BASE COURSE WII	DENINC	G, 7"			
	$\sim$			RB & GUTTER, TYPE B-6.18			
	$\sim$	HOT-MIX ASPHALT SHC					
	$\sim$	AGGREGATE SUBGRAD HOT-MIX ASPHALT BAS					
Ì	$\sim$			RB & GUTTER, TYPE B-6.12			
ROW	$\sim$	TOPSOIL FURNISH AND					
	(11)	SODDING, SALT TOLER	ANT				
	(12)	SUBBASE GRANULAR M	1ATERI	AL, TYPE C			
Ì	(13)	SEEDING, CLASS 2A					
	(14)	HOT-MIX ASPHALT SUR	FACE	COURSE, IL-9.5, MIX "D", N	50 (1 <u>3</u> ")		
ļ	(15)	AGGREGATE SUBGRAD	e impr	ROVEMENT, 12"			
		HOT-MIX ASPHALT SUR	FACE	COURSE, MIX "D" N50 (1½)			
l	17	HOT-MIX ASPHALT BAS	e cou	RSE, 3"			
	18	SUBBASE GRANULAR M	1ATERI	AL, TYPE B			
		COMBINATION CONCRE CURB & GUTTER, TYPE		4			
	20	HOT-MIX ASPHALT BINI	DER CO	OURSE, IL-19.0, N70 (2 <sup>1</sup> ")			
	21	HOT-MIX ASPHALT SUR	FACE I	REMOVAL, VARIABLE DEPTH			
	(22)	COMBINATION CONCRE	TE CU	RB & GUTTER, TYPE B-6.06			
			F.A.U RTE	SECTION	COUNTY	TOTAL SHEETS	SHEET NO.
CTIONS			1467	14-00259-05-CH	DUPAGE	294	28

•			1467	14-0025	9-05-CH		DUPAGE	294	28	
							CONTRACT	NO. 63	1G12	l
S	STA.	TO STA.			ILLINOIS	FED. A	D PROJECT			1

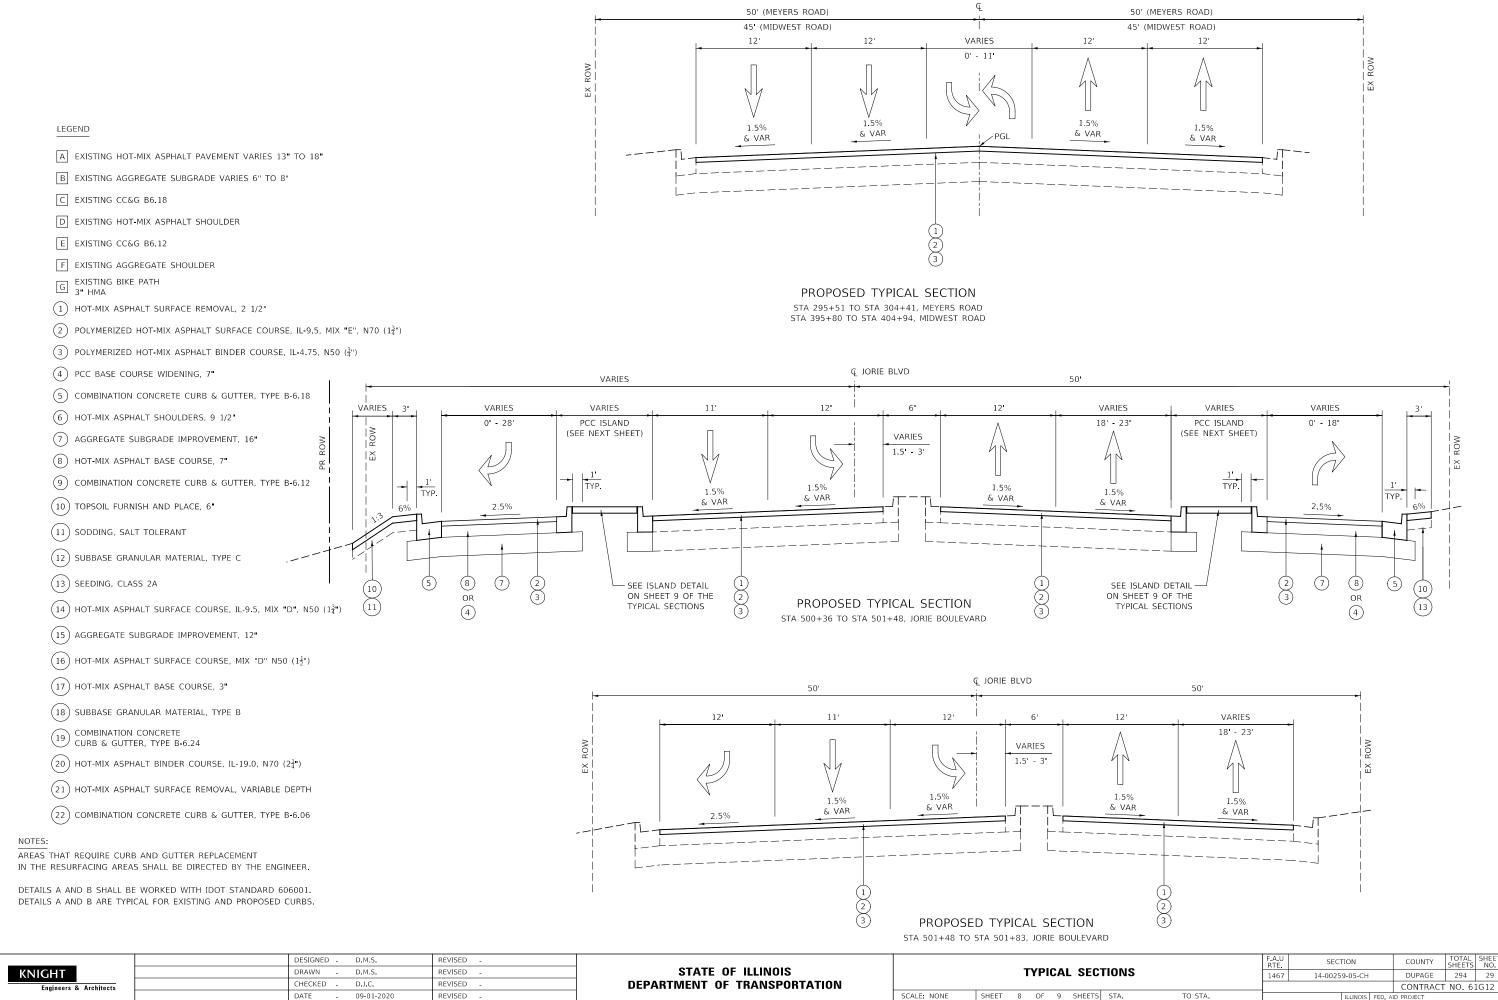

SHEE NO.

	DESIGNED D.M.S.	REVISED -			
KNIGHT	DRAWN D.M.S.	REVISED -	STATE OF ILLINOIS		TYPICAL SEC
Engineers & Architects	CHECKED - D.J.C.	REVISED -	DEPARTMENT OF TRANSPORTATION		
	DATE - 09-01-2020	REVISED -		SCALE: NONE	SHEET 8 OF 9 SHEETS

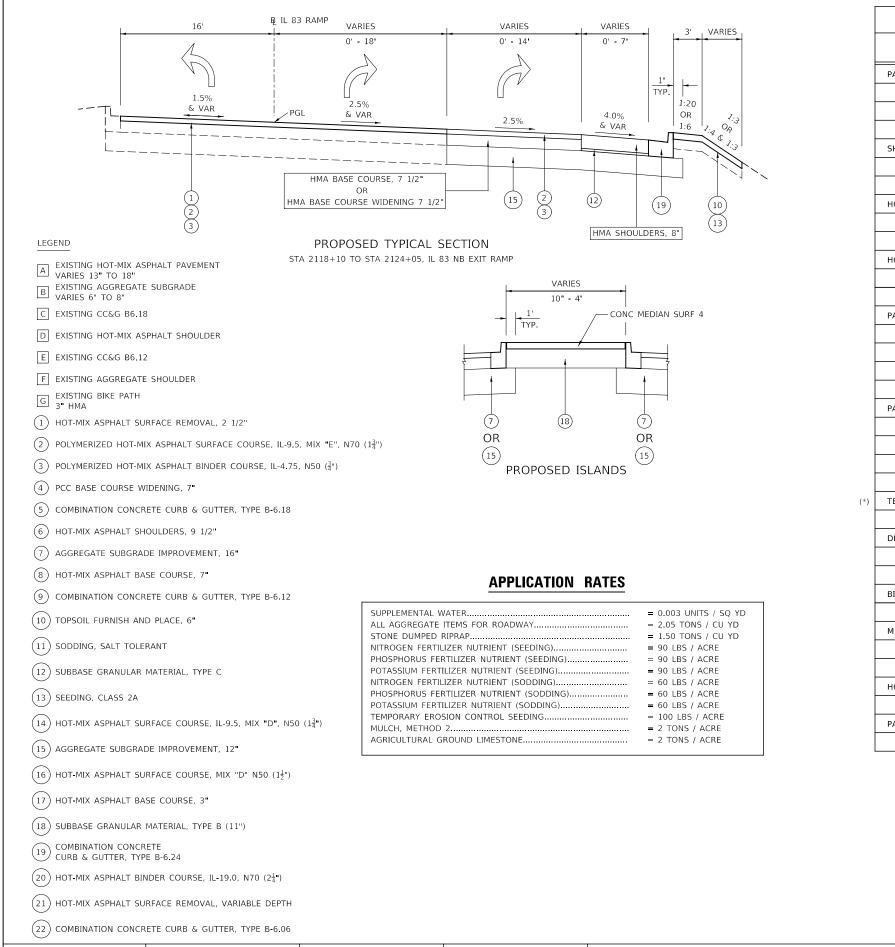

# MIXTURE TYP PAVEMENT RESURFACING POLYMERIZED HOT-MIX ASPHALT SURFACE COUR POLYMERIZED HOT-MIX ASPHALT BINDER COURSE HOT-MIX ASPHALT BINDER COURSE, IL-19.0, N70; SHOULDER RESURFACING (31ST STREET) HOT-MIX ASPHALT SURFACE COURSE, MIX "D", NS POLYMERIZED HOT-MIX ASPHALT BINDER COURSE HOT-MIX ASPHALT SHOULDERS, 8" (IL-83 RAMP B) HOT-MIX ASPHALT SURFACE COURSE, MIX "D", N HOT-MIX ASPHALT BINDER COURSE (IL-19 mm), HOT-MIX ASPHALT SHOULDERS, 9 1/2 (31ST STREE HOT-MIX ASPHALT SURFACE COURSE, MIX "D", N HOT-MIX ASPHALT BINDER COURSE (IL-19 mm), PAVEMENT WIDENING (IL-83 RAMP B) POLYMERIZED HOT-MIX ASPHALT SURFACE COURS POLYMERIZED HOT-MIX ASPHALT BINDER COURSE HOT-MIX ASPHALT BASE COURSE (HMA BINDER, HOT-MIX ASPHALT BASE COURSE WIDENING (HMA PAVEMENT WIDENING (31ST STREET) POLYMERIZED HOT-MIX ASPHALT SURFACE COUR POLYMERIZED HOT-MIX ASPHALT BINDER COURSE HOT-MIX ASPHALT BASE COURSE (HMA BINDER, HOT MIX ASPHALT BINDER COURSE, IL 19.0, N70; TEMPORARY PAVEMENT HOT-MIX ASPHALT BINDER COURSE, IL-19 mm, N DRIVEWAYS HOT-MIX ASPHALT SURFACE COURSE, MIX "D", N HOT-MIX ASPHALT BINDER COURSE, IL-19.0, N50 BIKE PATHS HOT-MIX ASPHALT SURFACE COURSE, MIX "D", N MEDIANS $\leq 4'$ HOT-MIX ASPHALT SURFACE COURSE, MIX "D", NS HOT-MIX ASPHALT BASE COURSE (HMA BINDER, HOT-MIX ASPHALT STABILIZATION 6" AT STEEL PLAT HOT-MIX ASPHALT BINDER COURSE (IL-19 mm), PATCHING CLASS D PATCHES (HMA BINDER IL-19mm)

THE UNIT WEIGHT USED TO CALCULATE ALL HMA SURFACE MIXTURE QUANTITIES IS 112 LBS/SQ YD/IN.

FOR USE OF RECYCLED MATERIALS SEE SPECIAL PROVISIONS.

THE "AC TYPE" FOR POLYMERIZED HMA MIXES SHALL BE "SBS/SBR PG 76-22" AND FOR NON-POLYMERIZED HMA THE "AC TYPE" SHALL BE "PG 64-22" UNLESS MODIFIED BY DISTRICT ONE SPECIAL PROVISIONS.

NO HMA SURFACE IS USED FOR HMA SHOULDERS, 6" AT GUARDRAILS.

(\*) IF USED, PC CONCRETE TEMPORARY PAVEMENT SHALL CONSIST OF CLASS PV CONCRETE MEETING THE REQUIREMENTS OF ARTICLE 1020 OF THE STANDARD SPECIFICATIONS, SHALL BE THE SAME THICKNESS AS SPECIFIED FOR HMA TEMPORARY PAVEMENT, AND DOES NOT REQUIRE DOWEL BARS.

	DESIGNED -	D.M.S.	REVISED -	STATE OF ILLINOIS				F.A.U RTE	SECTION	COUNTY	TOTAL SHEETS	SHEET NO.
KNIGHT Engineers & Architects	CHECKED -	D.M.S. D.J.C.	REVISED - REVISED -	STATE OF ILLINOIS DEPARTMENT OF TRANSPORTATION		TYPICAL SECTIONS		1467	14-00259-05-CH	DUPAGE CONTRACT	294 NO. 6	30 G12
	DATE -	09-01-2020	REVISED -		SCALE: NONE	SHEET 9 OF 9 SHEETS STA.	TO STA.		ILLINOIS FED.	AID PROJECT		

MIXTURE TYPE	PERCENT AIR VOIDS @ NDES
3	
IX ASPHALT SURFACE COURSE, MIX "E", N70 (IL-9.5mm); 1.75"	4% @ 70 GYR
IX ASPHALT BINDER COURSE, IL-4.75, N50 0.75"	3.5% @ 50 GYR
NDER COURSE, IL-19.0, N70; 2.25" (WHERE NECESSARY)	4% @ 70 GYR
G (31ST STREET)	
IRFACE COURSE, MIX "D", N50 (IL-9.5mm), 1.75"	4% @ 50 GYR
IX ASPHALT BINDER COURSE, IL-4.75, N50 0.75"	3.5% @ 50 GYR
ILDERS, 8" (IL-83 RAMP B)	
IRFACE COURSE, MIX "D", N70 (IL-9.5mm), 1.75"	4% @ 70 GYR
NDER COURSE (IL-19 mm), 6.75"	4% @ 70 GYR
LDERS, 9 1/2" (31ST STREET)	
IRFACE COURSE, MIX "D", N50 (IL-9.5mm), 1.75"	4% @ 50 GYR
NDER COURSE (IL-19 mm), 7.75"	4% @ 70 GYR
83 RAMP B)	
IX ASPHALT SURFACE COURSE, MIX "E", N70 (IL-9.5mm); 1.75"	4% @ 70 GYR
IX ASPHALT BINDER COURSE, IL-4.75, N50 0.75"	3.5% @ 50 GYR
SE COURSE (HMA BINDER, IL-19.0); 7 1/2" (WIDTH > 6')	4% @ 70 GYR
SE COURSE WIDENING (HMA BINDER, IL-19.0); 7 1/2" (WIDTH $\leq$ 6')	4% @ 70 GYR
1ST STREET)	
IX ASPHALT SURFACE COURSE, MIX "E", N70 (IL-9.5mm); 1.75"	4% @ 70 GYR
IX ASPHALT BINDER COURSE, IL-4.75, N50 0.75"	3.5% @ 50 GYR
SE COURSE (HMA BINDER, IL-19.0); 7" (WIDTH >6')	4% @ 70 GYR
NDER COURSE, IL-19.0, N70; 2.25" (WHERE NECESSARY)	4% @ 70 GYR
NDER COURSE, IL-19 mm, N50; 10"	4% @ 50 GYR
IRFACE COURSE, MIX "D", N50 (IL-9.5mm); 1.5"	4% @ 50 GYR
NDER COURSE, IL-19.0, N50; 7.5"	4% @ 50 GYR
IRFACE COURSE, MIX "D", N50 (IL-9.5mm); 3"	4% @ 50 GYR
IRFACE COURSE, MIX "D", N50 (IL-9.5mm), 1.5"	4% @ 50 GYR
SE COURSE (HMA BINDER, IL-19.0); 3"	4% @ 50 GYR
ILIZATION 6" AT STEEL PLATE BEAM GUARDRAIL	
NDER COURSE (IL-19 mm), 6"	4% @ 70 GYR
IMA BINDER IL-19mm)	4% @ 70 GYR

31ST	DN-SPECIAL ASTE AREA	STA 117+00.00 117+06.00 117+50.00 118+00.00 118+50.00 119+50.00 120+00.00 120+50.00 121+50.00 121+50.00 122+50.00 123+50.00 123+66.22 DGE OMISS 126+03.09 126+50.00 127+00.00 127+50.00 127+50.00 128+50.00 128+50.00 128+50.00 128+50.00 129+00.00	46.91 50.00	CUT END AREA (SF) 0.00 16.00 24.00 34.00 42.00 46.00 52.00 51.00 45.00 39.00 34.00 27.00 19.00 32.00 0.00 13.00 	FILL END AREA (SF) 0.00 0.00 0.00 1.00 3.00 2.00 1.00 1.00 1.00 0.00 0.00 0.00 0	CUT AVG END AREA (SF) 8.00 20.00 29.00 38.00 44.00 49.00 51.50 48.00 42.00 36.50 30.50 23.00 25.50 16.00	FILL AVG END AREA (SF) 0.00 0.00 0.00 0.50 2.00 2.50 1.50 1.50 1.00 0.50 0.00 0.00 0.00	66900200 NON-SPECIAL WASTE DISPOSAL (CY) 0.00 0.00 0.00 0.00 0.00 0.00 0.00 0.	20200100 EARTH EXCAVATION (CY) 1.78 32.59 53.70 70.37 81.48 90.74 95.37 88.89 77.78 67.59	SUITABLE FOR EMBANKMENT (-15% SHRINKAGE) (CY) 1.51 27.70 45.65 59.81 69.26 77.13 81.06 75.56 66.11 57.45	EMBANKMENT REQUIRED (CY) 0.00 0.00 0.93 3.70 4.63 2.78 1.85 0.93 0.00	BALANCE (+) WAST (-) SHORTA (CY) 1.51 27.70 45.65 58.89 65.56 72.50 78.29 73.70 65.19 57.45
WASI           31ST		117+00.00 117+06.00 117+50.00 118+50.00 118+50.00 119+00.00 120+50.00 120+50.00 120+50.00 122+50.00 122+50.00 123+50.00 123+66.22 DGE OMISS 126+03.09 126+50.00 127+50.00 127+50.00 128+00.00 128+50.00 128+50.00 128+50.00 128+50.00 129+00.00	(FT) 6.00 44.00 50.0	(SF) 0.00 16.00 24.00 34.00 42.00 46.00 52.00 51.00 45.00 39.00 34.00 27.00 19.00 32.00 0.00 13.00	(SF) 0.00 0.00 0.00 1.00 3.00 2.00 1.00 1.00 0.00 0.00 0.00 0.00 0.00 0.00	AREA (SF) 8.00 20.00 29.00 38.00 44.00 49.00 51.50 48.00 42.00 36.50 30.50 23.00 25.50	AREA (SF) 0.00 0.00 0.50 2.00 2.50 1.50 1.00 0.50 0.00 0.00	DISPOSAL (CY) 0.00 0.00 0.00 0.00 0.00 0.00 0.00 0.	(CY) 1.78 32.59 53.70 70.37 81.48 90.74 95.37 88.89 77.78	(-15% SHRINKAGE) (CY) 1.51 27.70 45.65 59.81 69.26 77.13 81.06 75.56 66.11	(CY) 0.00 0.00 0.93 3.70 4.63 2.78 1.85 0.93	(-) SHORTA (CY) 1.51 27.70 45.65 58.89 65.56 72.50 78.29 73.70 65.19
	(BR	117+06.00 117+50.00 118+00.00 118+50.00 119+50.00 120+00.00 120+50.00 120+50.00 121+50.00 122+50.00 123+50.00 123+66.22 DGE OMISS 126+03.09 126+50.00 127+50.00 127+50.00 127+50.00 128+00.00 128+50.00 128+50.00	6.00 44.00 50.00 50.00 50.00 50.00 50.00 50.00 50.00 50.00 50.00 50.00 50.00 16.22 ION) 46.91 50.00	0.00 16.00 24.00 34.00 42.00 46.00 52.00 51.00 45.00 39.00 34.00 27.00 19.00 32.00 0.00 13.00	0.00 0.00 0.00 1.00 3.00 2.00 1.00 1.00 1.00 0.00 0.00 0.00 0	8.00 20.00 29.00 38.00 44.00 49.00 51.50 48.00 42.00 36.50 30.50 23.00 25.50	0.00 0.00 0.50 2.00 2.50 1.50 1.00 0.50 0.00 0.00	0.00 0.00 0.00 0.00 0.00 0.00 0.00 0.0	1.78 32.59 53.70 70.37 81.48 90.74 95.37 88.89 77.78	1.51 27.70 45.65 59.81 69.26 77.13 81.06 75.56 66.11	0.00 0.00 0.93 3.70 4.63 2.78 1.85 0.93	1.51 27.70 45.65 58.89 65.56 72.50 78.29 73.70 65.19
	(BR	117+06.00 117+50.00 118+00.00 118+50.00 119+50.00 120+00.00 120+50.00 120+50.00 121+50.00 122+50.00 123+50.00 123+66.22 DGE OMISS 126+03.09 126+50.00 127+50.00 127+50.00 127+50.00 128+00.00 128+50.00 128+50.00	44.00 50.00 50.00 50.00 50.00 50.00 50.00 50.00 50.00 50.00 50.00 16.22 ION) 46.91 50.00	16.00 24.00 34.00 42.00 52.00 51.00 45.00 39.00 34.00 27.00 19.00 32.00 0.00 13.00	0.00 0.00 1.00 3.00 2.00 1.00 1.00 0.00 0.00 0.00 0.00 0	20.00 29.00 38.00 44.00 51.50 48.00 42.00 36.50 30.50 23.00 25.50	0.00 0.50 2.00 2.50 1.50 1.00 0.50 0.00	0.00 0.00 0.00 0.00 0.00 0.00 0.00 0.0	32.59 53.70 70.37 81.48 90.74 95.37 88.89 77.78	27.70 45.65 59.81 69.26 77.13 81.06 75.56 66.11	0.00 0.93 3.70 4.63 2.78 1.85 0.93	27.70 45.65 58.89 65.56 72.50 78.29 73.70 65.19
	(BR	117+50.00 118+00.00 118+50.00 119+00.00 120+00.00 120+00.00 120+50.00 121+50.00 122+00.00 122+50.00 123+50.00 123+66.22 DGE OMISS 126+03.09 126+50.00 127+00.00 127+50.00 128+50.00 128+50.00 128+50.00	44.00 50.00 50.00 50.00 50.00 50.00 50.00 50.00 50.00 50.00 50.00 16.22 ION) 46.91 50.00	24.00 34.00 42.00 52.00 51.00 45.00 39.00 34.00 27.00 19.00 32.00 0.00 13.00	0.00 0.00 1.00 2.00 1.00 1.00 0.00 0.00 0.00 0.00 0.00 0.00	20.00 29.00 38.00 44.00 51.50 48.00 42.00 36.50 30.50 23.00 25.50	0.00 0.50 2.00 2.50 1.50 1.00 0.50 0.00	0.00 0.00 0.00 0.00 0.00 0.00 0.00 0.0	32.59 53.70 70.37 81.48 90.74 95.37 88.89 77.78	27.70 45.65 59.81 69.26 77.13 81.06 75.56 66.11	0.00 0.93 3.70 4.63 2.78 1.85 0.93	27.70 45.65 58.89 65.56 72.50 78.29 73.70 65.19
	(BR	118+00.00 118+50.00 119+00.00 120+00.00 120+50.00 121+50.00 121+50.00 122+50.00 122+50.00 123+60.22 DGE OMISS 126+03.09 126+50.00 127+00.00 127+50.00 128+50.00 128+50.00 128+50.00	50.00 50.00 50.00 50.00 50.00 50.00 50.00 50.00 50.00 50.00 50.00 50.00 16.22 ION) 46.91 50.00	34.00 42.00 46.00 52.00 51.00 45.00 39.00 34.00 27.00 19.00 32.00 0.00 13.00	0.00 1.00 3.00 2.00 1.00 1.00 0.00 0.00 0.00 0.00 0.00 0.00	29.00 38.00 44.00 51.50 48.00 42.00 36.50 30.50 23.00 25.50	0.00 0.50 2.00 2.50 1.50 1.00 0.50 0.00 0.00	0.00 0.00 0.00 0.00 0.00 0.00 0.00 0.0	53.70 70.37 81.48 90.74 95.37 88.89 77.78	45.65 59.81 69.26 77.13 81.06 75.56 66.11	0.00 0.93 3.70 4.63 2.78 1.85 0.93	45.65 58.89 65.56 72.50 78.29 73.70 65.19
	(BR	118+50.00 119+00.00 119+50.00 120+00.00 121+00.00 121+50.00 122+00.00 122+50.00 123+00.00 123+60.22 DGE OMISS 126+03.09 126+50.00 127+50.00 127+50.00 127+50.00 128+50.00 128+50.00	50.00 50.00 50.00 50.00 50.00 50.00 50.00 50.00 50.00 50.00 16.22 ION) 46.91 50.00	42.00 46.00 52.00 51.00 45.00 39.00 34.00 27.00 19.00 32.00 0.00 13.00	1.00 3.00 2.00 1.00 0.00 0.00 0.00 0.00 0.00 0	38.00 44.00 51.50 48.00 42.00 36.50 30.50 23.00 25.50	0.50 2.00 2.50 1.50 1.00 0.50 0.00 0.00	0.00 0.00 0.00 0.00 0.00 0.00 0.00	70.37 81.48 90.74 95.37 88.89 77.78	59.81 69.26 77.13 81.06 75.56 66.11	0.93 3.70 4.63 2.78 1.85 0.93	58.89 65.56 72.50 78.29 73.70 65.19
	(BR	119+00.00 119+50.00 120+00.00 121+00.00 121+50.00 122+50.00 122+50.00 123+00.00 123+50.00 123+66.22 DGE OMISS 126+03.09 126+50.00 127+00.00 127+50.00 128+00.00 128+50.00	50.00 50.00 50.00 50.00 50.00 50.00 50.00 50.00 50.00 16.22 ION) 46.91 50.00	46.00 52.00 51.00 45.00 39.00 34.00 27.00 19.00 32.00 0.00 13.00	3.00 2.00 1.00 0.00 0.00 0.00 0.00 0.00 0	44.00 49.00 51.50 48.00 42.00 36.50 30.50 23.00 25.50	2.00 2.50 1.50 0.50 0.00 0.00	0.00 0.00 0.00 0.00 0.00 0.00	81.48 90.74 95.37 88.89 77.78	69.26 77.13 81.06 75.56 66.11	3.70 4.63 2.78 1.85 0.93	65.56 72.50 78.29 73.70 65.19
	(BR	119+50.00 120+00.00 120+50.00 121+00.00 121+50.00 122+50.00 123+50.00 123+50.00 123+66.22 DGE OMISS 126+03.09 126+50.00 127+00.00 127+50.00 128+50.00 128+50.00	50.00 50.00 50.00 50.00 50.00 50.00 50.00 50.00 16.22 ION) 46.91 50.00	52.00 51.00 45.00 39.00 27.00 19.00 32.00 0.00 13.00	2.00 1.00 0.00 0.00 0.00 0.00 0.00 0.00	49.00 51.50 48.00 42.00 36.50 30.50 23.00 25.50	2.50 1.50 1.00 0.50 0.00 0.00	0.00 0.00 0.00 0.00 0.00	90.74 95.37 88.89 77.78	77.13 81.06 75.56 66.11	4.63 2.78 1.85 0.93	72.50 78.29 73.70 65.19
	(BR	120+00.00 120+50.00 121+00.00 121+50.00 122+00.00 122+50.00 123+50.00 123+66.22 DGE OMISS 126+03.09 126+50.00 127+00.00 127+50.00 128+00.00 128+50.00	50.00 50.00 50.00 50.00 50.00 50.00 50.00 16.22 ION) 46.91 50.00	51.00 45.00 39.00 27.00 19.00 32.00 0.00 13.00	1.00 1.00 0.00 0.00 0.00 0.00 0.00 0.00	51.50 48.00 42.00 36.50 30.50 23.00 25.50	1.50 1.00 0.50 0.00 0.00	0.00 0.00 0.00 0.00	95.37 88.89 77.78	81.06 75.56 66.11	2.78 1.85 0.93	78.29 73.70 65.19
	(BR	120+50.00 121+00.00 121+50.00 122+00.00 123+50.00 123+50.00 123+66.22 DGE OMISS 126+03.09 126+50.00 127+50.00 127+50.00 128+00.00 128+50.00	50.00 50.00 50.00 50.00 50.00 50.00 16.22 ION) 46.91 50.00	45.00 39.00 27.00 19.00 32.00 0.00 13.00	1.00 0.00 0.00 0.00 0.00 0.00 0.00	48.00 42.00 36.50 30.50 23.00 25.50	1.00 0.50 0.00 0.00	0.00 0.00 0.00	88.89 77.78	75.56 66.11	1.85 0.93	73.70 65.19
	(BR	121+00.00 121+50.00 122+00.00 122+50.00 123+50.00 123+66.22 DGE OMISS 126+03.09 126+50.00 127+50.00 127+50.00 128+00.00 128+50.00	50.00 50.00 50.00 50.00 50.00 50.00 16.22 ION) 46.91 50.00	39.00 34.00 27.00 19.00 32.00 0.00 13.00	0.00 0.00 0.00 0.00 0.00 0.00	42.00 36.50 30.50 23.00 25.50	0.50 0.00 0.00	0.00	77.78	66.11	0.93	65.19
	(BR	121+50.00 122+00.00 122+50.00 123+50.00 123+66.22 DGE OMISS 126+03.09 126+50.00 127+50.00 127+50.00 128+00.00 128+50.00	50.00 50.00 50.00 50.00 16.22 ION) 46.91 50.00	34.00 27.00 19.00 32.00 0.00 13.00	0.00 0.00 0.00 0.00 0.00	36.50 30.50 23.00 25.50	0.00	0.00				
	(BR	122+00.00 122+50.00 123+00.00 123+50.00 123+66.22 DGE OMISS 126+03.09 126+03.09 126+50.00 127+50.00 127+50.00 128+00.00 128+50.00	50.00 50.00 50.00 16.22 ION) 46.91 50.00	27.00 19.00 32.00 0.00 13.00	0.00 0.00 0.00 0.00	30.50 23.00 25.50	0.00		h/ 54	57.45		
	(BR	122+50.00 123+00.00 123+50.00 123+66.22 DGE OMISS 126+03.09 126+50.00 127+00.00 127+50.00 128+00.00 128+50.00 129+00.00	50.00 50.00 50.00 16.22 ION) 46.91 50.00	19.00 32.00 0.00 13.00	0.00 0.00 0.00	23.00 25.50						
	(BR	123+00.00 123+50.00 123+66.22 DGE OMISS 126+03.09 126+50.00 127+00.00 127+50.00 128+00.00 128+50.00 129+00.00	50.00 50.00 16.22 ION) 46.91 50.00	32.00 0.00 13.00	0.00	25.50	0.00	0.00	56.48	48.01	0.00	48.01
	(BR	123+50.00 123+66.22 DGE OMISS 126+03.09 126+50.00 127+00.00 127+50.00 128+00.00 128+50.00 129+00.00	50.00 16.22 ION) 46.91 50.00	0.00 13.00	0.00		0.00	0.00	42.59	36.20	0.00	36.20
	(BR	123+66.22 DGE OMISS 126+03.09 126+50.00 127+00.00 127+50.00 128+00.00 128+50.00 129+00.00	16.22 ION) 46.91 50.00	13.00		16.00	0.00	0.00	47.22	40.14	0.00	40.14
	(BR	DGE OMISS 126+03.09 126+50.00 127+00.00 127+50.00 128+00.00 128+50.00 129+00.00	ION) 46.91 50.00		0.00	0.50	0.00	0.00	29.63	25.19	0.00	25.19
		126+03.09 126+50.00 127+00.00 127+50.00 128+00.00 128+50.00 129+00.00	46.91 50.00	12.00		6.50	0.00	0.00	3.90	3.32	0.00	3.32
		126+50.00 127+00.00 127+50.00 128+00.00 128+50.00 129+00.00	50.00	12.00	0.00							
		127+00.00 127+50.00 128+00.00 128+50.00 129+00.00	50.00	0.00	0.00	6.00	0.02	0.00	10.40	0.00	0.00	0.00
		127+50.00 128+00.00 128+50.00 129+00.00		0.00	0.00	6.00	0.00	0.00	10.42	8.86	0.00	8.86
		128+00.00 128+50.00 129+00.00		8.00	0.00	4.00	0.00	0.00	7.41	6.30	0.00	6.30
		128+50.00 129+00.00	50.00	34.00	0.00	21.00	0.00	0.00	38.89	33.06	0.00	33.06
		129+00.00	50.00	34.00	1.00	34.00	0.50	0.00	62.96	53.52	0.93	52.59
			50.00 50.00	30.00 30.00	1.00	32.00 30.00	1.00	0.00	59.26 55.56	50.37 47.22	1.85	48.52
				30.00							1.85	45.37
		129+50.00 130+00.00	50.00 50.00	29.00	1.00	31.00 30.50	1.00	0.00	57.41 56.48	48.80 48.01	1.85 1.85	46.94
		130+00.00	50.00	30.00	1.00	29.50	1.00	0.00	54.63	46.44	1.85	46.16 44.58
		130+50.00		30.00	2.00	29.50 30.50	1.00	0.00				
			50.00						56.48	48.01	2.78	45.23
		131+50.00	50.00	35.00	0.00	33.00	1.00	0.00	61.11	51.94	1.85	50.09
		132+00.00	50.00	35.00	2.00	35.00	1.00 2.50	0.00	64.81	55.09	1.85	53.24
		132+50.00 133+00.00	50.00 50.00	32.00 27.00	3.00 3.00	33.50 29.50	3.00	0.00	62.04 54.63	52.73 46.44	4.63 5.56	48.10 40.88
		133+50.00	50.00	22.00	2.00	29.50	2.50	0.00	45.37	38.56	4.63	33.94
		134+00.00	50.00	22.00	3.00	24.50	2.50	0.00	41.67	35.42	4.63	30.79
		134+50.00	50.00	29.00	5.00	22.30	4.00	0.00	48.15	40.93	7.41	33.52
		135+00.00	50.00	34.00	0.00	31.50	2.50	0.00	58.33	49.58	4.63	44.95
		135+50.00	50.00	36.00	0.00	35.00	0.00	0.00	64.81	55.09	0.00	55.09
		136+00.00	50.00	35.00	0.00	35.50	0.00	0.00	65.74	55.88	0.00	55.88
		136+50.00	50.00	33.00	0.00	34.00	0.00	0.00	62.96	53.52	0.00	53.50
		137+00.00	50.00	32.00	0.00	34.00	0.00	0.00	60.19	51.16	0.00	51.16
		137+50.00	50.00	31.00	2.00	31.50	1.00	0.00	58.33	49.58	1.85	47.73
		137+30.00	50.00	30.00	3.00	30.50	2.50	0.00	56.48	48.01	4.63	47.73
		138+50.00	50.00	30.00	5.00	30.00	4.00	0.00	55.56	47.22	7.41	39.81
		139+00.00	50.00	27.00	12.00	28.50	8.50	0.00	52.78	44.86	15.74	29.12
		139+00.00	30.00	36.00	3.00	31.50	7.50	0.00	35.00	29.75	8.33	29.12
		139+30.00	20.00	25.00	11.00	31.50	7.00	0.00	22.59	19.20	6.33 5.19	14.02
	х	140+00.00	50.00	19.00	67.00	22.00	39.00	35.19	40.74	0.00	72.22	-72.22
	× X	140+00.00	50.00	23.00	27.00	22.00	47.00	42.59	38.89	0.00	87.04	-72.22
	× X	140+30.00	50.00	23.00	33.00	21.00	30.00	53.70	48.15	0.00	55.56	-57.04
	× X	141+50.00	50.00	42.00	26.00	35.50	29.50	77.78	65.74	0.00	54.63	-54.63
	X	141+50.00	50.00	74.00	11.00	58.00	29.50	137.04	107.41	0.00	34.83	-34.83
	~	142+36.91	36.91	0.00	0.00	37.00	5.50	0.00	50.58	42.99	7.52	35.47
		142+50.00	13.09	0.00	0.00	0.00	0.00	0.00	0.00	0.00	0.00	0.00
		142+30.00	50.00	42.00	5.00	21.00	2.50	0.00	38.89	33.06	4.63	28.43
		143+50.00	50.00	52.00	0.00	47.00	2.50	0.00	87.04	73.98	4.63	69.35
		143+70.00	20.00	52.00	0.00	52.00	0.00	0.00	38.52	32.74	0.00	32.74
		144+00.00	30.00	52.00	0.00	52.00	0.00	57.78	57.78	0.00	0.00	0.00
	х	144+00.00	50.00	62.00	1.00	57.00	0.50	114.81	105.56	0.00	0.00	-0.93
	X X	145+00.00	50.00	75.00	1.00	68.50	1.00	138.89	126.85	0.00	1.85	-0.95
	Х	145+50.00	50.00	102.00	1.00	88.50	1.00	138.89	163.89	0.00	1.85	-1.85
	X X	145+50.00	50.00	67.00	4.00	84.50	2.50	124.07	156.48	0.00	4.63	-1.63
	X X X	146+00.00	50.00	25.00	4.00	46.00	4.00	46.30	85.19	0.00	7.41	-4.63
	X X X X	146+50.00	50.00	15.00	4.00	20.00	9.50	27.78	37.04	0.00	17.59	-7.41
	X X X X X	147+00.00	50.00	25.00	8.00	20.00	9.50	46.30	37.04	0.00	21.30	-17.59
	X X X X X X X	147+50.00		25.00			5.00		50.00	0.00		
	X X X X X X X X	140+00.00	50.00		2.00	27.00		53.70			9.26	-9.26
	X X X X X X X X X	140,50.00	50.00	24.00	1.00	26.50	1.50	44.44	49.07	0.00	2.78	-2.78
	X X X X X X X X X X	148+50.00	50.00	17.00	1.00	20.50	1.00	31.48	37.96	0.00	1.85	-1.85
	X X X X X X X X X X	149+00.00	50.00	8.00	0.00	12.50	0.50	14.81	23.15	0.00	0.93	-0.93
	X X X X X X X X X X		4.21	0.00	0.00	4.00	0.00	0.00	0.62	0.00	0.00	0.00

						FARTHW		ARY				
						Buttin		66900200	20200100			
LOCATION	NON-SPECIAL WASTE AREA	STA	LENGTH	CUT END AREA	FILL END AREA	CUT AVG END AREA	FILL AVG END AREA	NON-SPECIAL WASTE DISPOSAL	EARTH EXCAVATION	SUITABLE FOR EMBANKMENT (-15% SHRINKAGE)	EMBANKMENT REQUIRED	BALANCE (+) WASTE (-) SHORTAGE
			(FT)	(SF)	(SF)	(SF)	(SF)	(CY)	(CY)	(CY)	(CY)	(CY)
RAMP B		2118+00.00		0.00	0.00							
		2118+50.00	50.00	10.00	16.00	5.00	8.00	0.00	9.26	7.87	14.81	-6.94
		2119+00.00	50.00	9.00	34.00	9.50	25.00	0.00	17.59	14.95	46.30	-31.34
		2119+50.00	50.00	14.00	62.00	11.50	48.00	0.00	21.30	18.10	88.89	-70.79
		2120+00.00	50.00	18.00	69.00	16.00	65.50	0.00	29.63	25.19	121.30	-96.11
		2120+50.00	50.00	16.00	104.00	17.00	86.50	0.00	31.48	26.76	160.19	-133.43
		2121+00.00	50.00	12.00	86.00	14.00	95.00	0.00	25.93	22.04	175.93	-153.89
		2121+50.00	50.00	17.00	40.00	14.50	63.00	0.00	26.85	22.82	116.67	-93.84
		2122+00.00	50.00	19.00	17.00	18.00	28.50	0.00	33.33	28.33	52.78	-24.44
		2122+50.00	50.00	18.00	17.00	18.50	17.00	0.00	34.26	29.12	31.48	-2.36
		2123+00.00	50.00	20.00	7.00	19.00	12.00	0.00	35.19	29.91	22.22	7.69
		2123+50.00	50.00	40.00	6.00	30.00	6.50	0.00	55.56	47.22	12.04	35.19
		2124+00.00	50.00	23.00	0.00	31.50	3.00	0.00	58.33	49.58	5.56	44.03
	SIDEWALK											
									168.39	143.13	0.00	143.13
MEDIAN RE	MOVAL IN RESU	JRFACING A	REAS									
		110+60.00		4.00	0.00							
		112+20.00	160.00	26.00	0.00	15.00	0.00	0.00	88.89	75.56	0.00	75.56
		184+65.00		21.00	0.00							
		186+10.00	145.00	6.00	0.00	13.50	0.00	0.00	72.50	61.63	0.00	61.63
							TOTAL	1236 CU YD	4425 CU YD			1370 CU YE

	DESIGNED -	D.M.S.	REVISED -					F.A.U BTE	SECTION	COUNTY TOTAL SHEET
KNIGHT	DRAWN -	D.M.S.	REVISED -	STATE OF ILLINOIS		SCHEDULE OF QUANTITIES		1467	14-00259-05-CH	DUPAGE 294 31
Engineers & Architects	CHECKED -	D.J.C.	REVISED -	DEPARTMENT OF TRANSPORTATION						CONTRACT NO. 61G12
-	DATE -	09-01-2020	REVISED -		SCALE: NONE	SHEET 1 OF 19 SHEETS STA.	TO STA.		ILLINOIS FED. A	ID PROJECT

			TO 15 UNITS DIAMETER)	<u>21001000</u>				OUND STABILIZATION				<u>NITROGE</u>
JNIT	STA	OFF	REMARKS	SQ YD	STA	STA	OFFSET	REMARKS	SQ FT	FUND CODE		ACRES
31	ST STREE	ET			31ST 9	STREET					:	31ST STREE
10	130+21	RT	MEDIAN	32	109+07	112+23	CTR	MEDIAN W. OF PASHCAL	2,884	0005 RESURFACING	8	0.1
10	140+00	LT	DITCH	118	117+05	123+10	RT	RT TURN W. OF 83	10,628	0004 WIDENING	41	0.7
)	140+00	LT	DITCH	31	117+05	122+51	RT	MEDIAN W. OF 83	2,792	0004 WIDENING		RAMP B
	140+00	LT	DITCH	12	117+15	121+38	RT	EB MEDIAN CURB	1,093	0004 WIDENING	39	0.4
)	140+00	LT	DITCH	3	123+10	123+36	RT	ISLAND	235	0004 WIDENING		
)	140+00	LT	DITCH	2	126+41	126+65	LT	ISLAND	194	0004 WIDENING	81	0004 WIDE
0	140+00	LT	DITCH	40	126+59	141+80	LT	WB MEDIAN CURB	3,604	0004 WIDENING	8	0005 RES
0	140+00	LT	DITCH	40	126+59	141+80	RT	EB MEDIAN CURB	3,618	0004 WIDENING	89	TOTAL
0	140+00	LT	DITCH	25	127+11	129+98	RT	EB MEDIAN REMOVAL	2,212	0004 WIDENING		
	144+27	LT	PARKWAY WB 31ST STREET	43	128+00	133+27	CTR	WB MEDIAN REMOVAL	3,843	0004 WIDENING	25000600	) POTASSI
	145+99	LT	PARKWAY WB 31ST STREET	28	130+61	138+83	LT	WB CURB	2,536	0004 WIDENING	23000800 POUND	
	146+26	LT	PARKWAY WB 31ST STREET	101	130+61	142+04	LT	WB RT TURN	9,089	0004 WIDENING		31ST STREE
	146+90	LT	PARKWAY WB 31ST STREET	80	134+00	141+90	CTR	EB LT TURN	7,235	0004 WIDENING	8	0.1
	146+95	LT	PARKWAY WB 31ST STREET	10	139+77	141+90	LT	WB CURB	861	0004 WIDENING	41	0.7
	147+35	LT	PARKWAY WB 31ST STREET	26	142+75	149+54	LT	WB CURB	2,302	0004 WIDENING	41	RAMP B
	147+57	LT	PARKWAY WB 31ST STREET	87	142+75	149+54	LT	RT TURN E. OF JORIE	7,817	0004 WIDENING	39	0.4
)	148+50	LT	PARKWAY WB 31ST STREET	9	141+38	142+16	LT	ISLAND W. OF JORIE	840	0004 WIDENING	39	0.4
	149+09	LT	PARKWAY WB 31ST STREET	21	142+78	143+21	LT	ISLAND E. OF JORIE	1,874	0004 WIDENING	81	0004 WIDE
				36	142+83	145+88	CTR	MEDIAN E. OF JORIE	3,268	0004 WIDENING	8	0004 WIDI
כ	TOTAL			6	142+83	149+46	CTR	WB CURB	553	0004 WIDENING		
				18	184+61	186+16	CTR	B/W GRANT & LINCOLN	1,610	0005 RESURFACING	89	TOTAL
400			FOTION									
	TREE TRU			718	0004 WIDE	NING						
СН	STA		REMARKS	50	0005 RESL	JRFACING						
	31ST STR			768	TOTAL							
1 1	132+72	57' LT										
	133+24	54' LT		25000240		1 4 6 6 2 4						
1 1	133+97	55' LT		-	SEEDING, C			0.57				
	134+62 135+22	54' LT		ACRE	STA		CTR/RT S	ערו				
1	135+22	55' LT		0 407	RAMP	D		0.040				
	135+83	53' LT		0.437	2118+10		RT 1	9,042				
1	136+34	53' LT		0.407								
	137+66	53' LT			TOTAL							
	137+97	59' LT		0.500	ROUNDED							
	145+79	63' LT										
	148+80	42' LT										
	149+28	43' LT										
1	149+54	40' LT										
3	TOTAL											

	DESIGNED -	D.M.S.	REVISED -						F.A.U BTE	SECTION	COUNTY TOTAL SHEET SHEETS NO.
KNIGHT	DRAWN -	D.M.S.	REVISED -	STATE OF ILLINOIS		SCHEDULE OF QUA	ANTITIES		1467	14-00259-05-CH	DUPAGE 294 32
Engineers & Architects	CHECKED -	D.J.C.	REVISED -	DEPARTMENT OF TRANSPORTATION							CONTRACT NO. 61G12
	DATE -	09-01-2020	REVISED -		SCALE: NONE	SHEET 2 OF 19 SHEETS	STA.	TO STA.		ILLINOIS FED. /	AID PROJECT

# EN FERTILIZER NUTRIENT

# REMARKS

#### EET

## FUND CODE

SEE SCHEDULE FOR SODDING 0005 RESURFACING SEE SCHEDULE FOR SODDING 0004 WIDENING

SEE SCHEDULE FOR SEEDING 0004 WIDENING

DENING

SURFACING

REMARKS

# SIUM FERTILIZER NUTRIENT

## FUND CODE

# EET

SEE SCHEDULE FOR SODDING 0005 RESURFACING

SEE SCHEDULE FOR SODDING 0004 WIDENING

SEE SCHEDULE FOR SEEDING 0004 WIDENING

DENING

SURFACING

<u>25100115</u>	MULCH, M	IETHOD 2	2	<u>25200100</u>	SODDIN	G		2800040	0 PERIMETER EROSION BARRI	ER	<u>28000510</u>	INLET
ACRE	O/S	SQ FT	REMARKS	SQ YD	SQ FT	REMARK	S LT/CTR/RT	FOOT	STA STA LT/CTR/	RT FUND CODE	EACH	STA
	31ST S	STREET							31ST STREET		3	BIST ST
0.005	RT	217	SW CORNER	71	634	SW CORI	NER MIDWEST ROAD	727	ADA RAMPS	0005 RESURFACING	1	25+3
0.004	RT	160	SE CORNER	12	101	SE CORN	IER MIDWEST ROAD	108	ADA RAMPS	0004 WIDENING	1	25+9
0.005	LT	203		34	302	SW CORI	NER SPRING ROAD	2086		0004 WIDENING	1	26+0
0.004	RT	155							RAMP B		1	26+7
0.003	RT	129		117	TOTAL			702	2118+12 2123+57 RT	0004 WIDENING	1	26+8
0.002	RT	108									1	30+9
0.004	RT	177		25200110	SODDIN	G, SALT TO		2896	0004 WIDENING		1	30+9
0.005	LT	217		<u>23200110</u> SQ YD	0/S	SQ FT	REMARKS SQ FT REMARKS	727	0005 RESURFACING		1	35+1
0.001	RT	25				STREET	REMARKS SQTT REMARKS	3623	TOTAL		1	35+1
0.035	RT	1,527	WIDENING BEGINS	26	RT	232	SW CORNER MIDWEST CLUB PKWY				1	38+0
0.049	CTR	2,140	MEDIAN	18	RT	160	SE CORNER MIDWEST CLUB PKWY	2800050	0 INLET AND PIPE PROTECTIO	N	1	38+0
0.003	RT	117	SW CORNER RAMP C	24	LT	213	NW CORNER OF CONCORD DRIVE	EACH	STA LT/CTR/RT	FUND CODE	1	43+5
0.002	RT	93	SE CORNER RAMP C	16	RT	144	SW CORNER OF TRINITY LANE		MEYERS ROAD		1	43+5
0.006	LT	245	NW CORNER RAMP A	15	RT	130	SE CORNER OF TRINITY LANE	1	26+87 RT	0005 RESURFACING	1	46+1
0.001	RT	64	SW CORNER RAMP B	12	RT	108	SW CORNER MAYSLAKE DRIVE		31ST STREET		1	46+1
0.018	CTR	804	MEDIAN	20	RT	179	SE CORNER OF MAYSLAKE DRIVE	1	140+04 LT	0004 WIDENING	1	46+3
0.008	RT	354	SE CORNER RAMP B	25	LT	217	NW CORNER OF REGENT DRIVE	1	140+11 LT	0004 WIDENING	1	46+3
0.135	LT	5,895	MEDIAN	3	RT	25	SW CORNER OF ST. PASCHAL DRIVE	1	177+44 LT	0005 RESURFACING	1	52+0
0.111	LT	4,831	NW CORNER JORIE	170	RT	1527	WEST OF IL-83 (WIDENING BEGINS)		RAMP B		1	52+0
0.003	RT	126	SW CORNER HUNTERS	238	CTR	2140	MEDIAN WEST OF IL-83	1	2120+34 RT	0004 WIDENING	1	55+2
0.007	RT	302	SE CORNER HUNTERS	13	RT	117	SW CORNER RAMP C	1	2118+13 RT	0004 WIDENING	1	55+6
0.013	LT	584	NE CORNER JORIE	8	RT	64	SE CORNER RAMP C				1	57+3
0.163	LT	7,102	NE CORNER JORIE	28	LT	245	NW CORNER RAMP A	4	0004 WIDENING		1	57+3
0.035	CTR	1,535	WIDENING ENDS	8	RT	64	SW CORNER RAMP B	2	0005 RESURFACING		1	62+2
0.024	RT	1,060		90	CTR	804	MEDIAN EAST OF IL-83	6	TOTAL		1	62+2
0.009	LT	400		6	RT	46	SE CORNER RAMP B	•	IOTAL		1	68+0
0.008	LT	366		655	CTR	5895	MEDIAN EAST OF IL-83				1	68+0
0.006	LT	251		430	LT	3865	WB RT TURN JORIE TO IL-83				1	70+5
0.003	CTR	148		525	LT	4722	NW CORNER JORIE				1	70+5
0.003	RT	150		14	RT	126	SW CORNER HUNTERS				1	72+9
	RAN	ЛР В		57	RT	509	SE CORNER HUNTERS				1	72+9
0.439	RT	19,124	RT	65	LT	584	NE CORNER JORIE				1	76+C
	MEYER	S ROAD		790	LT	7102	NE CORNER JORIE				1	76+0
0.002		101	NW CORNER	171	CTR	1535	MEDIAN EAST OF JORIE				1	79+0
0.001		43	NE CORNER	84	RT	751	SW CORNER OF SPRING ROAD				1	79+8
0.003		109	SW CORNER	37	LT	328	NW CORNER OF SPRING ROAD				1	82+2
0.010		430	SE CORNER	45	LT	400	NW CORNER POLO DRIVE				1	82+2
	MIDWES			38	LT	339	NE CORNER POLO DRIVE				1	84+6
0.027		1,178	SW CORNER	28	LT	251	MID BLOCK CROSSING NORTH SIDE				1	84+6
0.002		78	SE CORNER	17	CTR	148	MID BLOCK CROSSING CENTER				1	93+6
				17	RT	150	MID BLOCK CROSSING SOUTH SIDE				1	94+4
1.2	TOTAL				MEYE	RS ROAD					1	97+5
1.5	ROUNDED	)		13		116	NW CORNER				1	99+8
				5		43	NE CORNER				1	101+
25100630	EROSION	CONTRO	L BLANKET	13		109	SW CORNER				1	108+
SQ YD	STA		LT/CTR/RT SQ FT	38		340	SE CORNER				1	108+
=		ЛРВ			MIDWE	EST ROAD					1	110+
2116	2118+10		RT 19,042	64		571	SW CORNER				1	114+
-			,	10		88	SE CORNER				1	114+8
2116	TOTAL			11		96	BEHIND CURB & GUTTER AT CHURCH				1	118+8
											1	121+2
				3847	TOTAL						1	121+7
											1	128+

	RTE	SECTION	COUNTY SHEETS NO.
HEDULE OF QUANTITIES	1467	14-00259-05-CH	DUPAGE 294 33
			CONTRACT NO. 61G12
3 OF 19 SHEETS STA.	TO STA.	ILLINOIS FED.	AID PROJECT
		1407	IEDULE OF QUANTITIES

	28000510	INLET FIL	TERS				
	EACH	STA	LT/CTR/RT	FUND	CODE		
	3	1ST STRE	ET				
	1	25+36	LT	0005	RESURF		
	1	25+97	LT	0005	RESURF		
	1	26+01	RT	0005	RESURF		
	1	26+77	LT	0005	RESURF		
	1	26+84	RT	0005	RESURF		
	1	30+91	LT	0005	RESURF		
	1	30+91	RT	0005	RESURF		
	1	35+11	LT	0005	RESURF		
	1	35+11	RT	0005	RESURF		
	1	38+06	LT	0005	RESURF		
	1	38+06	RT	0005	RESURF		
	1	43+57	LT	0005	RESURF		
	1	43+57	RT	0005	RESURF		
	1	46+12	LT	0005	RESURF		
	1	46+12	RT	0005	RESURF		
	1	46+30	LT	0005	RESURF		
	1	46+30	RT	0005	RESURF		
	1	52+06	LT	0005	RESURF		
	1	52+06	RT	0005	RESURF		
	1	55+29	LT	0005	RESURF		
	1	55+69	RT	0005	RESURF		
	1	57+30	LT	0005	RESURF		
	1	57+30	RT		RESURF		
	1	62+27	LT	0005	RESURF		
	1	62+27	RT		RESURF		
	1	68+07	LT		RESURF		
	1	68+07	RT	0005	RESURF		
	1	70+56	LT	0005	RESURF		
	1	70+56	RT		RESURF		
	1	72+95	LT		RESURF		
	1	72+95	RT		RESURF		
	1	76+09	LT		RESURF		
	1	76+09	RT		RESURF		
	1	79+04	LT		RESURF		
	1	79+89	RT		RESURF		
	1	82+29	LT		RESURF		
	1	82+29	RT		RESURF		
	1 1	84+60	LT		RESURF		
	1	84+60 93+61	RT RT				
	1	93+01 94+44	RT		RESURF		
	1	94+44 97+57	RT				
	1	97+37 99+80	RT		RESURF		
	1	99+80 101+89	RT		RESURF		
	1	108+39	RT				
	1	108+53	RT				
	1	110+99	RT				
	1	114+09	RT				
	1	114+09	RT		RESURF		
	1	118+89	CTR			2	
	1	121+27	LT				
	1	121+27	RT				
	1	121+72	LT				
	•	120110	F.A.U			TOTAL	SHEET
ITIE	S		RTE 1467	SECTION 14-00259-05-CH	COUNTY DUPAGE	SHEETS 294	NO.

28000510	INLET FIL	TERS (CONT'D)		28000510	D INLET FILT	ERS (CONT'D)		30300001	AGGREGA	TE SUBGRA		VEMENT				
EACH	STA I	LT/CTR/RT	FUND CODE	EACH	STA L	T/CTR/RT	FUND CODE	CU YD	STA	STA	OFFSET	REMARKS	SQ FT	FUND CODE		
31	IST STREE			:	31ST STREE				31ST S	STREET						
1	129+86	LT	0004 WIDENING	1	177+35	LT	0005 RESURF	11	109+07	112+23	CTR	MEDIAN W. OF PASHCAL	2,884	0005 RESURFACING		
1	129+88	CTR	0004 WIDENING	1	177+35	RT	0005 RESURF	39	117+05	123+10	RT	RT TURN W. OF 83	10,628	0004 WIDENING		
1	132+12	LT	0004 WIDENING	1	178+30	RT	0005 RESURF	10	117+05	122+51	RT	MEDIAN W. OF 83	2,792	0004 WIDENING		
1	132+12	CTR	0004 WIDENING	1	178+30	LT	0005 RESURF	4	117+15	121+38	RT	EB MEDIAN CURB	1,093	0004 WIDENING		
1	132+12	RT	0004 WIDENING	1	179+20	RT	0005 RESURF	1	123+10	123+36	RT	ISLAND	235	0004 WIDENING		
1	132+12	LT	0004 WIDENING	1	179+20	LT	0005 RESURF	1	126+41	126+65	LT	ISLAND	194	0004 WIDENING		
1	132+13	CTR	0004 WIDENING	1	179+20	RT	0005 RESURF	•								
				1				13	126+59	141+80	LT	WB MEDIAN CURB	3,604			
	134+25	LT	0004 WIDENING	1	179+40	LT	0005 RESURF	13	126+59	141+80	RT	EB MEDIAN CURB	3,618	0004 WIDENING		
	134+33	RT	0004 WIDENING	-	180+22	RT	0005 RESURF	8	127+11	129+98	RT	EB MEDIAN REMOVAL	2,212	0004 WIDENING		
	136+72	LT	0004 WIDENING		180+22	LT	0005 RESURF	14	128+00	133+27	CTR	WB MEDIAN REMOVAL	3,843	0004 WIDENING		
1	136+73	RT	0004 WIDENING	1	181+22	RT	0005 RESURF	9	130+61	138+83	LT	WB CURB	2,536	0004 WIDENING		
1	136+81	LT	0004 WIDENING	1	181+22	LT	0005 RESURF	34	130+61	142+04	LT	WB RT TURN	9,089	0004 WIDENING		
1	138+97	LT	0004 WIDENING	1	182+40	RT	0005 RESURF	27	134+00	141+90	CTR	EB LT TURN	7,235	0004 WIDENING		
1	138+97	LT	0004 WIDENING	1	182+40	LT	0005 RESURF	3	139+77	141+90	LT	WB CURB	861	0004 WIDENING		
1	138+97	RT	0004 WIDENING	1	185+03	RT	0005 RESURF	9	142+75	149+54	LT	WB CURB	2,302	0004 WIDENING		
1	139+97	LT	0004 WIDENING	1	185+03	LT	0005 RESURF	29	142+75	149+54	LT	RT TURN E. OF JORIE	7,817	0004 WIDENING		
1	139+98	RT	0004 WIDENING	1	186+55	RT	0005 RESURF	3	141+38	142+16	LT	ISLAND W. OF JORIE	840	0004 WIDENING		
1	140+54	LT	0004 WIDENING	1	186+55	LT	0005 RESURF	7	142+78	143+21	LT	ISLAND E. OF JORIE	1,874	0004 WIDENING		
1	140+55	RT	0004 WIDENING	1	188+00	RT	0005 RESURF	12	142+83	145+88	CTR	MEDIAN E. OF JORIE	3,268	0004 WIDENING		
1	140+57	RT	0004 WIDENING	1	188+00	LT	0005 RESURF	2	142+83	149+46	CTR	WB CURB	553	0004 WIDENING		
1	142+62	RT	0004 WIDENING	1	189+12	RT	0005 RESURF	6	184+61	186+16	CTR	B/W GRANT & LINCOLN	1,610	0005 RESURFACING		
1	145+95	LT	0004 WIDENING	1	189+12	LT	0005 RESURF						.,			
1	146+04	RT	0004 WIDENING	1	190+11	RT	0005 RESURF	239	0004 WIDEI	NING						
1	146+14	LT	0004 WIDENING	1	190+11	LT	0005 RESURF	17	0005 RESU							
1	146+60	LT	0004 WIDENING	1	190+94	RT	0005 RESURF	256	TOTAL							
1	146+60	LT	0004 WIDENING	1	190+94	LT	0005 RESURF	250	TOTAL							
1	146+60	RT	0004 WIDENING	1	190+34	RT	0005 RESURF									
1	146+60 146+67		0004 WIDENING	1	191+28	LT	0005 RESURF	<u>30300112</u>	AGGREGA	TE SUBGRA	DE IMPRO	VEMENT 12"				
		LT					0000 RESURF	SQ YD	STA	STA	SQ FT	REMARKS				
	146+78	LT	0004 WIDENING		IEYERS ROA				RAM	ИР В						
	151+07	LT	0005 RESURF	1	297+51	RT	0005 RESURF	1042			9379	RAMP B				
1	151+27	RT	0005 RESURF	1	297+55	LT	0005 RESURF									
1	151+43	LT	0005 RESURF	1	295+51	RT	0005 RESURF	1,042	TOTAL							
1	153+22	RT	0005 RESURF	1	295+55	LT	0005 RESURF	1,042	TOTAL							
1	153+22	LT	0005 RESURF	М	IDWEST ROA	AD										
1	155+50	RT	0005 RESURF	1	396+88	RT	0005 RESURF									
1	155+50	LT	0005 RESURF	1	396+88	LT	0005 RESURF									
1	163+36	LT	0005 RESURF	1	398+70	RT	0005 RESURF									
1	164+70	LT	0005 RESURF	1	398+74	LT	0005 RESURF									
1	164+70	RT	0005 RESURF		RAMP B											
1	165+78	LT	0005 RESURF	1	2118+13	RT	0004 WIDENING									
1	165+78	RT	0005 RESURF													
1	165+94	LT	0005 RESURF	34	0004 WIDE	NING										
1	165+94	RT	0005 RESURF	109	0005 RESU											
1	166+67	LT	0005 RESURF	143	TOTAL											
1	166+67	RT	0005 RESURF	170	IVIAL											
1	167+50	LT	0005 RESURF													
1	167+50	RT	0005 RESURF	<u>28100125</u>	5 STONE RIF	RAP, CLASS B3										
				SQ YD	STA (	OFFSET SQ FT	г									
	168+60	LT	0005 RESURF		Ramp B											
	168+60	RT	0005 RESURF	19	2118+10	171										
	170+64	LT	0005 RESURF													
1	170+64	RT	0005 RESURF	19	TOTAL											
1	172+81	LT	0005 RESURF													
1	172+81	RT	0005 RESURF													
			DESIGNED -	D.M.S.	REVISED									F A U RTE	SECTION	COUNTY TOTAL SHEET SHEETS NO.
KNIGHT			DRAWN - CHECKED -	D.M.S. D.J.C.	REVISED REVISED			STATE OF ILI				SCHEDULE OF O	UANTITIES	1467	14-00259-05-CH	DUPAGE 294 34
Engineers	s & Architects		DATE -	09-01-2020	REVISED		DEPART	MENT OF TRA	NINOLOUUIAI		SCALE: NO	ONE SHEET 4 OF 19 SHEET	S STA.	TO STA.	ILLINOIS FE	CONTRACT NO 61G12
•		•	1		1							1		1		

SQ FT	FUND CODE
	I GILD GODE

2,884	0005 RESURFACING
10,628	0004 WIDENING
2,792	0004 WIDENING
1,093	0004 WIDENING
235	0004 WIDENING
194	0004 WIDENING
3,604	0004 WIDENING
3,618	0004 WIDENING
2,212	0004 WIDENING
3,843	0004 WIDENING
2,536	0004 WIDENING
9,089	0004 WIDENING
7,235	0004 WIDENING
861	0004 WIDENING
2,302	0004 WIDENING
7,817	0004 WIDENING
840	0004 WIDENING
1,874	0004 WIDENING
3,268	0004 WIDENING
553	0004 WIDENING
1,610	0005 RESURFACING

<u>30300116</u>	AGGREGA	IE SUBGRA	DE IMPROV	EMENT 16"			31101180	SUBBASE GI	VANULAR IN	AILNIAL,		
SQ YD	STA	STA	OFFSET	REMARKS	SQ FT	FUND CODE	SQ YD	STA.	STA	REMAR	RKS	
	31ST S	STREET						SIDEV	VALKS			
320	109+07	112+23	CTR	MEDIAN W. OF PASHCAL	2,884	0005 RESURFACING	18			NW CO	RNER AT MEYERS	ROAD
1,181	117+05	123+10	RT	RT TURN W. OF 83	10,628	0004 WIDENING	9			NE COF	NER AT MEYERS	ROAD
310	117+05	122+51	RT	MEDIAN W. OF 83	2,792	0004 WIDENING	9			SW CO	RNER AT MEYERS	ROAD
121	117+15	121+38	RT	EB MEDIAN CURB	1,093	0004 WIDENING	24			SE COF	NER AT MEYERS	ROAD
26	123+10	123+36	RT	ISLAND	235	0004 WIDENING	26			SW CO	RNER AT MIDWES	T CLUB PARKWAY ROA
22	126+41	126+65	LT	ISLAND	194	0004 WIDENING	18			SE COF	NER AT MIDWES	CLUB PARKWAY ROAD
400	126+59	141+80	LT	WB MEDIAN CURB	3,604	0004 WIDENING	76			SW CO	RNER AT MIDWES	T ROAD
402	126+59	141+80	RT	EB MEDIAN CURB	3,618	0004 WIDENING	10			SE COF	NER AT MIDWES	r Road
246	127+11	129+98	RT	EB MEDIAN REMOVAL	2,212	0004 WIDENING	10			NW CO	RNER AT CONCOP	RD DRIVE
427	128+00	133+27	CTR	WB MEDIAN REMOVAL	3,843	0004 WIDENING	43			SW CO	RNER AT TRINITY	_ANE
282	130+61	138+83	LT	WB CURB	2,536	0004 WIDENING	51			SE COF	NER AT TRINITY L	ANE
1,010	130+61	142+04	LT	WB RT TURN	9,089	0004 WIDENING	21			SW CO	RNER AT MAYSLA	KE
804	134+00	141+90	CTR	EB LT TURN	7,235	0004 WIDENING	42			SE COF	NER AT MAYSLA	ΚE
96	139+77	141+90	LT	WB CURB	861	0004 WIDENING	7			NW CO	RNER AT REGENT	DRIVE
256	142+75	149+54	LT	WB CURB	2,302	0004 WIDENING	31			SW CO	RNER AT PASCHA	L DRIVE
869	142+75	149+54	LT	RT TURN E. OF JORIE	7,817	0004 WIDENING	13			SW CO	RNER AT SB 83 EI	NTRANCE RAMP
93	141+38	142+16	LT	ISLAND W. OF JORIE	840	0004 WIDENING	29			SE COF	NER AT SB 83 EN	TRANCE RAMP
208	142+78	143+21	LT	ISLAND E. OF JORIE	1,874	0004 WIDENING	18			SW CO	RNER AT NB 83 EX	IT RAMP
363	142+83	145+88	CTR	MEDIAN E. OF JORIE	3,268	0004 WIDENING	22			MEDIAN	I AT NB 83 EXIT RA	MP
61	142+83	149+46	CTR	WB CURB	553	0004 WIDENING	20			SE COF	NER AT NB 83 EX	T RAMP
179	184+61	186+16	CTR	B/W GRANT & LINCOLN	1,610	0005 RESURFACING	22			NE COF	NER AT JORIE BO	ULEVARD
							16			SW CO	RNER AT JORIE B	DULEVARD
7,177	0004 WIDEI	NING					58			SE COF	NER AT JORIE BO	ULEVARD
499	0005 RESU	RFACING					12			MEDIAN	I AT JORIE BOULE	VARD
7,676	TOTAL						19			NW CO	RNER AT SPRING	ROAD
							87			SW CO	RNER AT SPRING	ROAD
20200424							23			NW CO	RNER AT POLO DI	RIVE
<u>30300124</u> SQ YD	STA	<u>TE SUBGRA</u> STA			SQ FT		15			SW CO	RNER AT POLO DI	RIVE
SQTD			OFFSEI	REMARKS	SQFI		38			N MIDBI	OCK CROSSING	
200		STREET	рт		0.000		18			MIDBLC	CK CROSSING	
322	076+09	079+02	RT	IN FRONT OF COMM CHURCH	2,902		41			S MIDB	OCK CROSSING	
322	TOTAL						635	0005 RESUR	F			
							213	0004 WIDENI	NG			
31101100	SUBBASE	GRANULAR	MATERIAL,	TYPE B			698	RESURF+109	% CONTINGE	NCY		
CU YD	STA	STA	SQ FT	REMARKS			234	WIDENING+1	0% CONTING	GENCY		
	MED	IANS										
10	127+40	128+26	284	MEDIAN E. OF 83			932	TOTAL				
66	134+96	141+80	1944	MEDIAN W. OF JORIE								
6	143+03	144+35	182	MEDIAN E. OF JORIE			31102000	SURBASE	GRANULAR		TYPE C	
	ISLA	NDS					CU YD		STA	SQ FT		
20	126+70	127+06	597	ISLAND E. OF 83			0010		LDERS	JULI		
20	141+63	142+16	597	ISLAND W. OF JORIE			2	2118+10		313	RAMP B	
6	142+81	143+16	168	ISLAND E. OF JORIE			2		2123700	313		

	DESIGNED - D.M.S.	REVISED -			F.A.U SECTION	COUNTY TOTAL SHEET SHEETS NO.
KNIGHT	DRAWN - D.M.S.	REVISED -	STATE OF ILLINOIS	SCHEDULE OF QUANTITIES	1467 14-00259-05	CH DUPAGE 294 35
Engineers & Architects	CHECKED - D.J.C.	REVISED -	DEPARTMENT OF TRANSPORTATION			CONTRACT NO. 61G12
	DATE - 09-01-2020	REVISED -		SCALE: NONE SHEET 5 OF 19 SHEETS STA. TO STA.	ILLIN	DIS FED. AID PROJECT

|--|

### FUND CODE

160	0005 RESURF
84	0005 RESURF
77	0005 RESURF
212	0005 RESURF
232	0005 RESURF
165	0005 RESURF
683	0005 RESURF
89	0005 RESURF
89	0005 RESURF
384	0005 RESURF
462	0005 RESURF
186	0005 RESURF
376	0005 RESURF
61	0005 RESURF
276	0005 RESURF
120	0004 WIDENING
265	0004 WIDENING
166	0004 WIDENING
200	0004 WIDENING
181	0004 WIDENING
202	0004 WIDENING
147	0004 WIDENING
524	0004 WIDENING
109	0004 WIDENING
168	0005 RESURF
783	0005 RESURF
208	0005 RESURF
136	0005 RESURF
346	0005 RESURF
164	0005 RESURF
372	0005 RESURF

35101800 AGGREGATE BASE C									<u>35501290</u>	HOT-MIX ASPHALT BASE COURSE, 3"				
SQ YD	STA.	STA	SQ FT	SQ YD	THICK (IN	) REMA	ARKS		FUND CODE	SQ YD	STA	STA	SQ FT	REMARKS
	SIDEWA	LKS										DIANS		
23			209	23	3.00		AT MEYERS		0005 RESURF	32	127+40	128+26	284	MEDIAN E. OF 83
6	128+47	128+52	54	6	3.00		N CROSSING AT SOUT	'H PATH		216	133+00	141+80	1944	MEDIAN W. OF JORIE
14			122	14	3.00	NW CORNE	R AT SPRING ROAD		0005 RESURF	20	143+03	144+35	182	MEDIAN E. OF JORIE
6	0004 WIDENII									268	TOTAL			
37	0005 RESURF									35501312	ΗΟΤ-ΜΙΧ Δ	SPHALT BA	SE COURS	F 7"
										SQ YD	STA	STA	SQ FT	
7	0004 WIDENI	NG+10% C	ONTINGE	NCY								STREET		
41	0005 RESURF	+10% CO	NTINGEN	CY						287	109+07	112+23	2585	WEST OF ST PASCHAL
										249	117+15	121+38	2242	MEDIAN W. OF 83
48	TOTAL									698	117+05	123+11	6279	RIGHT TURN W. OF 83
										214	127+11	129+97	1923	EB MEDIAN E. OF 83
35102000	AGGREGAT	F BASE O	OURSE 1		3"					364	128+00	133+50	3275	WB MEDIAN E. OF 83
SQ YD	STA	<u>E BASE C</u> STA	SQ F	,	<u>,</u> MARKS			FUND	CODE	929	131+83	142+04	8364	RIGHT TURN W. OF JORIE
	DRIVE									525 775	101100	172.04	6973	EB LT TURN W. OF JORIE
250	139+11	139+47	2248			ORS DRIVEW	Δ٧	0004 W	VIDENING	28			255	ISLAND W. OF JORIE
11	76+34	76+70	99				H DRIVEWAY WEST		ESURF	30			266	ISLAND E. OF JORIE
11	76+97	77+31	96				H DRIVEWAY EAST		ESURF	834	142+75	149+53	7505	RIGHT TURN E. OF JORIE
	10131	11.01	50	U.A.				0000 1		79	142175	1-3100	708	MEDIAN E. OF JORIE
250	0004 WIDEN	ING								167	181+61	186+16	1507	B/W GRANT & LINCOLN
230	0004 WIDLI									107	101101	100+10	1507	D/W GIVANT & LINCOLN
272	TOTAL	N								4199	0004 WIDE	NING		
212	TOTAL									455	0004 WIDL			
										4,654	TOTAL			
35400200	PORTLAND	CEMENT	CONCRET	TE BASE	COURSE V	VIDENING 7"				4,004	TOTAL			
SQ YD	STA	STA	SQ F	T RE	MARKS		FUND CODE							
	31ST S	TREET								<u>35501314</u>	HOT-MIX A	ASPHALT BA	SE COUR	<u>SE, 7.5"</u>
33			299	WES	ST OF ST P	ASCHAL	0005 RESURF			SQ YD	STA	STA	SQ FT	REMARKS
34			310	MED	DIAN W. OF	83	0004 WIDENING				RA	MP B		
27			240	MED	DIAN W. OF	83	0004 WIDENING			753	2118+13	2123+80	6776	RAMP B RT TURN LANE
33			299	RIG	HT TURN W	. OF 83	0004 WIDENING							
26			235	FOR	MER RAM	P C ISLAND	0004 WIDENING			753	TOTAL			
22			195	FOR	MER RAM	P A ISLAND	0004 WIDENING							
4			34	EB N	MEDIAN E.	OF 83	0004 WIDENING			25600706				
28			255	EB N	MEDIAN E.	OF 83	0004 WIDENING			<u>35600706</u>				BEMARKS
38			346	WB	MEDIAN E	OF 83	0004 WIDENING			SQ YD	STA	STA	SQFI	REMARKS
25			222	WB	MEDIAN E	OF 83	0004 WIDENING			04		MP B	040	
73			657	RIG	HT TURN W	. OF JORIE	0004 WIDENING			24	2110+13	2123+80	219	RAMP B RT TURN LANE
8			68	RIG	HT TURN W	. OF JORIE	0004 WIDENING				TOTAL			
29			258	EB L	T TURN W	. OF JORIE	0004 WIDENING			24	TOTAL			
17			155	ISLA	ND W. OF	JORIE	0004 WIDENING							
3			31	ISLA	ND E. OF	JORIE	0004 WIDENING			40201000	AGGREGATE	FOR TEMP	ORARY AC	CESS
7			67	RIG	HT TURN E	OF JORIE	0004 WIDENING			TON	STA.	STA	SQ FT	FT THICK
27			245	RIG	HT TURN E	OF JORIE	0004 WIDENING					RIVEWAY		
43			389	MED	DIAN E. OF	JORIE	0004 WIDENING			166	138+83	139+77	3142	0.79
28			255	MED	DIAN E. OF	JORIE	0004 WIDENING							
11			103	B/W	GRANT &	LINCOLN	0005 RESURF			166	TOTAL			
	0004 WIDEN	ING												
473														
473 45	0005 RESU	٦F												

KNIGHT Engineers & Architects	DESIGNED D.M.S.	REVISED -			F.A.U BTF	SECTION	COUNTY TOTAL SHEET SHEETS NO.
	 DRAWN D.M.S.	REVISED -	STATE OF ILLINOIS	SCHEDULE OF QUANTITIES	1467	14-00259-05-CH	DUPAGE 294 36
	 CHECKED - D.J.C.	REVISED -	DEPARTMENT OF TRANSPORTATION				CONTRACT NO. 61G12
	DATE - 09-01-2020	REVISED -		SCALE NONE SHEET 6 OF 19 SHEETS STA. TO STA.	ILLINOIS FED.		AID PROJECT

FUND CODE

0005 RESURFACING 0004 WIDENING 0005 RESURFACING

10600990	<u>TEMPORAR</u>	<u>Y RAMP</u>					40603200	POLYMERI	ZED HOT-M	IIX ASPHA	LT BIND	ER COURSE, IL-4.75, N50	
SQ YD	STA.	STA	LENGTH	I WIDT	H FUND CODE		TON	STA.	STA	SQ FT	SQ YD	REMARKS	FUND CODE
	31ST S	TREET						31ST \$	SREET				
40	23+66	23+72	6	60	0005 RESURF		2890	023+66	117+05	619346	68816	WEST OF IL 83	0005 RESUR
20	93+90	94+20	6	30	0005 RESURF		13	109+07	112+23	2884	320	MED. WEST OF ST PASCHA	L 0005 RESUR
47	103+51	104+22	6	71	0005 RESURF		216	117+05	123+82	46389	5154	WEST OF IL 83	0004 WIDENI
24	172+06	172+42	6	36	0005 RESURF		822	125+97	149+53	176061	19562	EAST OF IL 83	0004 WIDENI
40	191+31	191+37	6	60	0005 RESURF		252	149+53	159+30	53978	5998	EAST OF JORIE	0005 RESURI
10	MEYER		Ū				762	161+31	191+37	163349	18150	EAST OF SALT CREEK	0005 RESUR
40	295+51	295+57	6	60	0005 RESURF		50	117+05	123+10	10,628	1181	RT TURN W. OF 83	0004 WIDENI
40	304+35	304+41	6	60	0005 RESURF		13	117+05	122+51	2,792	310	MEDIAN W. OF 83	0004 WIDENI
40	MIDWES		0	00			13	123+10	123+36	2,792		ISLAND	0004 WIDEN
40		395+86	6	60	0005 RESURF		1	123+10		235 194	26	ISLAND	0004 WIDEN
40	395+80								126+65		22		
40	404+88	404+94	6	60	0005 RESURF		10	127+11	129+98	2,212	246		0004 WIDENI
	JORIE		0				18	128+00	133+27	3,843	427	WB MEDIAN REMOVAL	0004 WIDENII
44	501+42	501+48	6	66	0004 WIDENING		42	130+61	142+04	9,089	1010	WB RT TURN	0004 WIDENII
	RAN						34	134+00	141+90	7,235	804	EB LT TURN	0004 WIDENII
19	1110+73	1110+79	6	28	0004 WIDENING		36	142+75	149+54	7,817	869	RT TURN E. OF JORIE	0004 WIDENI
	RAN						4	141+38	142+16	840	93	ISLAND W. OF JORIE	0004 WIDENIN
11	2118+10	2118+15	6	16	0004 WIDENING		9	142+78	143+21	1,874	208	ISLAND E. OF JORIE	0004 WIDENII
	RAN	PC					15	142+83	145+88	3,268	363	MEDIAN E. OF JORIE	0004 WIDENII
19	3114+36	3114+42	6	29	0004 WIDENING		8	184+61	186+16	1610	179	MED. B/W GRANT & LINCOL	N 0005 RESURF
	RAN	P D						RAM	IP B				
15	4110+34	4110+40	6	22	0004 WIDENING		33	2118+13	2123+80	6995	777	RAMP B RT TURN LANE	0004 WIDENII
20	4110+63	4110+69	6	30	0004 WIDENING			SHOU	LDERS				
							23	86+43	93+51	4849	539	31ST LEFT	0005 RESURF
127	0004 WIDEN	ING					21	86+43	93+20	4570	508	31ST RIGHT	0005 RESURF
331	0005 RESUR	F					75	94+54	114+58	16093	1788	31ST LEFT	0005 RESURF
458	TOTAL						31	114+58	121+26	6597	733	31ST LEFT	0005 RESUR
							6	115+73	117+05	1356	151	31ST RIGHT	0005 RESURF
	HOT-MIX AS				i		1304	0004 WIDE	NING				
TON	STA.	STA	SQ FT	SQYD	REMARKS	FUND CODE	4081	0005 RESL	JRF				
	DRIVEWAYS						5,385	TOTAL					
105	139+11	139+47	2248	250	DUPAGE MAYORS DRIVEWAY	0004 WIDENING	-,						
5	76+34	76+70	99	11	OAK BROOK COMM CHURCH DRIVEWAY WEST	0005 RESURFACING							
5	76+97	77+31	96	11	OAK BROOK COMM CHURCH DRIVEWAY EAST	0005 RESURFACING							
105	0004 WIDEN	ING											
10	0005 RESUF	FACING											
115	TOTAL												
10602005		יים ד ואוום			9 0 N70								
	5 HOT-MIX AS STA.				<u>9.0, N70</u> REMARKS	FUND CODE							
TON			3471	JUIN									
10	WB 31ST 9		0.400	004									
49		140+63	3430		PR PROFILE HIGHER THAN EX PROFILE	0005 RESURF							
10	139+71	140+63	699	78	PR PROFILE HIGHER THAN EX PROFILE	0004 WIDENING							
10	0004 WIDEN												
	0005 RESUR	F											
49 <b>59</b>	TOTAL												

	DESIGNED D.M.S.	REVISED -					F.A.U BTE	SECTION	COUNTY TOTAL SHEET
KNIGHT	DRAWN D.M.S.	REVISED -	STATE OF ILLINOIS		SCHEDULE OF QUANTITIES		1467	14-00259-05-CH	DUPAGE 294 37
Engineers & Architects	CHECKED D.J.C.	REVISED -	DEPARTMENT OF TRANSPORTATION						CONTRACT NO. 61G12
	DATE - 09-01-2020	REVISED -		SCALE: NONE	SHEET 7 OF 19 SHEETS STA.	TO STA.		ILLINOIS FED.	AID PROJECT

	HOT-MIX A			,	,				-			CONCRETE SIDEWALK 5 INCH
TON	STA.	STA	SQ FT	SQYD	THICK (IN	I) REMARKS		FUND CODE	SQ FT	STA.	STA	REMARKS
	SIDEV	VALKS								SIDEW	ALKS	
4	400	100	209	23	3.00	SE CORNER AT M		0005 RESURF				
1	128+47	128+52	54	6	3.00		DSSING AT SOUTH PATH	0004 WIDENING	160			NW CORNER AT MEYERS ROAD
2			122	14	3.00	NW CORNER AT S	SPRING ROAD	0005 RESURF	84			NE CORNER AT MEYERS ROAD
		IANS							77			SW CORNER AT MEYERS ROAD
3	127+40	128+26	284	32	1.50	MEDIAN E. OF 83		0004 WIDENING	212			SE CORNER AT MEYERS ROAD
18	133+00	141+80	1944	216	1.50	MEDIAN W. OF JO	DRIE	0004 WIDENING	232			SW CORNER AT MIDWEST CLUB PA
2	143+03	144+35	182	20	1.50	MEDIAN E. OF JO	RIE	0004 WIDENING	165			SE CORNER AT MIDWEST CLUB PA
	SHOU	LDERS							683			SW CORNER AT MIDWEST ROAD
53	86+43	93+51	4849	539	1.75	31ST LEFT		0005 RESURF	89			SE CORNER AT MIDWEST ROAD
50	86+43	93+20	4570	508	1.75	31ST RIGHT		0005 RESURF	89			NW CORNER AT CONCORD DRIVE
175	94+54	114+58	16093	1788	1.75	31ST LEFT		0005 RESURF	384			SW CORNER AT TRINITY LANE
15	115+73	117+05	1356	151	1.75	31ST RIGHT		0005 RESURF	462			SE CORNER AT TRINITY LANE
47	117+05	122+51	4350	483	1.75	31ST RIGHT		0004 WIDENING	186			SW CORNER AT MAYSLAKE
3	2118+10	2118+99	305	34	1.75	RAMP B RIGHT		0004 WIDENING	376			SE CORNER AT MAYSLAKE
	DRIV	EWAY							61			NW CORNER AT REGENT DRIVE
15	139+11	139+47	1625	181	1.50	DUPAGE MAYOR	S DRIVEWAY	0004 WIDENING	276			SW CORNER AT PASCHAL DRIVE
1	76+34	76+70	99	11	1.50	OAK BROOK COM	IM CHURCH DRIVEWAY WES	T 0005 RESURF	120			SW CORNER AT SB 83 ENTRANCE
1	76+97	77+31	96	11	1.50		IM CHURCH DRIVEWAY EAS		265			SE CORNER AT SB 83 ENTRANCE F
									166			SW CORNER AT NB 83 EXIT RAMP
89	0004 WIDE	NING							200			MEDIAN AT NB 83 EXIT RAMP
301	0005 RESL								181			SE CORNER AT NB 83 EXIT RAMP
390	TOTAL								203			NE CORNER AT JORIE BOULEVARD
390	IUIAL								203 147			SW CORNER AT JORIE BOULEVAR
									524			SE CORNER AT JORIE BOULEVAR
						<u>RSE, IL-9.5, MIX E, N</u>						
TON	STA.	STA	SQ FT	SQYD	REMAR	<b>KS</b>	FUND CODE		109			
	31ST :								168			
6744	23+66	117+05	619346		WEST O		0005 RESURF		783			
32	109+07	112+23	2884	320		EST OF ST PASCHA			208			NW CORNER AT POLO DRIVE
06	117+05	123+82	46389	5154	WEST O	F IL 83	0004 WIDENING		136			SW CORNER AT POLO DRIVE
917	125+97	149+53	176061	19562	EAST OF	FIL 83	0004 WIDENING		346			N MIDBLOCK CROSSING
588	149+53	159+30	53978	5998	EAST OF	JORIE	0005 RESURF		164			MIDBLOCK CROSSING
779	161+31	191+37	163349	18150	EAST OF	SALT CREEK	0005 RESURF		372			S MIDBLOCK CROSSING
75	114+58	121+26	6888	765	RT TURN	W. OF 83	0004 WIDENING		1915	0004 WIDEN	NING	
116	117+05	123+10	10,628	1181	RT TURN	W. OF 83	0004 WIDENING		5713	0005 RESU	RF	
30	117+05	122+51	2,792	310	MEDIAN	W. OF 83	0004 WIDENING					
3	123+10	123+36	235	26	ISLAND		0004 WIDENING		2107	WIDENING+	- 10% CON	NTINGENCY
2	126+41	126+65	194	22	ISLAND	`	0004 WIDENING		6284	RESURF+10	0% CONTI	NGENCY
24	127+11	1 <b>29+98</b>	2,212	246	EB MEDI	AN REMOVAL	0004 WIDENING					
42	128+00	133+27	3,843	427	WB MED	IAN REMOVAL	0004 WIDENING		8,391	TOTAL		
99	130+61	142+04	9,089	1010	WB RT T	URN	0004 WIDENING		44000100	PAVEMENT	REMOVA	NL
79	134+00	141+90	7,235	804	EB LT TU	JRN	0004 WIDENING		SQ YD	STA	STA	REMARKS
85	142+75	149+54	7,817	869	RT TURN	E. OF JORIE	0004 WIDENING			31ST S	TREET	
9	141+38	142+16	840	93		N. OF JORIE	0004 WIDENING		11	128+00		SLIVER WB 31ST
20	142+78	143+21	1,874	208		E. OF JORIE	0004 WIDENING		1	133+13	133+27	
36	142+83	145+88	3,268	363		E. OF JORIE	0004 WIDENING		772	133+27	141+90	
18	184+61	186+16	1610	179		V GRANT & LINCOL			75	141+63	142+16	
10			1010	119								
76			6005	777					31	142+81	143+16	
76	2118+13	2123+80	6995	777	RAMP B	RT TURN LANE	0004 WIDENING		1	145+74		SLIVER WB 31ST
	000 / \···=-								130	145+88		
3119	0004 WIDE								2	149+23	149+54	SLIVER WB 31ST
9161 <b>2,280</b>	0005 RESU	JRF							1,023	TOTAL		
	_				DESIGNED	- D.M.S.	REVISED -			TOTAL		
NIGHT					DRAWN CHECKED	- D.M.S. - D.J.C.	REVISED -	STATE O DEPARTMENT OF	F ILLINOIS	ΤΔΤΙΩΝΙ		SCHEDULE OF QUA
Enginee	rs & Architects				DATE	- 09-01-2020	REVISED -	DEFANTIMENT OF			SCA	ALE: NONE SHEET 8 OF 19 SHEETS

 S ROAD
 0005 RES

 ST CLUB PARKWAY ROAD
 0005 RES

 ST ROAD
 0005 RES

 ANE
 0005 RES

 LANE
 0005 RES

 LANE
 0005 RES

 LANE
 0005 RES

 AKE
 0005 RES

 AKE
 0005 RES

 AKE
 0005 RES

 NTRANCE RAMP
 0004 WIE

 NTRANCE RAMP
 0004 WIE

 AMP
 0004 WIE

 OULEVARD
 0004 WIE

 OULEVARD
 0004 WIE

 OULEVARD
 0004 WIE

 ROAD
 0005 RES

 ROAD
 0005 RES

</tabr>

0005 RESURF 0004 WIDENING 0005 RESURF 0005 RESURF 0005 RESURF 0005 RESURF 0005 RESURF 0005 RESURF 0005 RESURF

FUND CODE

	0			F 01			•	F.A.U RTE	SEC	TION		COUNTY	TOTAL SHEETS	SHEET NO.
	2	CHE	וטע	E UI	r uu	JANTITIE	5	1467	14-0025	9-05-CH		DUPAGE	294	38
												CONTRAC	T NO. 63	1G12
SCALE: NONE	CALE: NONE SHEET 8 OF 19 SHEETS STA. TO STA.									ILLINOIS	FED. AI	D PROJECT		

4000159	HOT-MIX A	SPHALT S	URFACE	REMOVAL, 2 1/2"		4400060	0 SIDEWALI	K REMOVA	=			<u>48203029</u>	HOT-MIX	ASPHALT SI	HOULDE	RS, 8"
Q YD	STA.	STA	REMA	RKS FUND CODE		SQ FT	STA.	STA	REMARKS		FUND CODE	SQ YD	STA.	STA	SQ FT	REMAR
	31ST S	TREET					31ST	STREET					SHOU	JLDERS		
72308	23+66	117+05	EB/WE	3 31ST STREET 0005 RESURF		128	25+86	25+97	NW CORNER A	T MEYERS ROAD	0005 RESURF	34	2118+10	2118+99	305	RAMP B
5154	117+05	123+84	EB/WE	3 31ST STREET 0004 WIDENING		79	26+82	26+90	NE CORNER AT	MEYERS ROAD	0005 RESURF					
16130	125+97	149+54	EB/WE	3 31ST STREET 0004 WIDENING		118	78+91	79+03	SW CORNER A	T MIDWEST ROAD	0005 RESURF	34	TOTAL			
5998	149+54	159+30	EB/WE	31ST STREET 0005 RESURF		61	79+99	80+14	SE CORNER AT	MIDWEST ROAD	0005 RESURF					
18150	161+31	191+37	EB/WE	3 31ST STREET 0005 RESURF		70	93+58	93+70	SW CORNER A	T CONCORD DRIVE	0005 RESURF	40000005				
						105	94+39	94+54	SE CORNER AT	CONCORD DRIVE	0005 RESURF			ASPHALT SI		
21284	0004 WIDE	NING				33	114+50	114+56	SW CORNER A	T ST PASCHAL	0005 RESURF	SQ YD	STA.	STA	SQ FT	REMARK
96456	0005 RESU	RF				79	126+43	126+49	SW CORNER A	T NB 83 EXIT RAMP	0004 WIDENING	482		JLDERS	4250	
17,740	TOTAL					148	142+42	143+04	NE CORNER AT	JORIE BOULEVARD	0004 WIDENING	483	117+05	122+51	4350	EB 31ST
						227	0004 WIDE	ENING				483	TOTAL			
	DRIVEWAY					594	0005 RESI	URF								
SQ YD		STA	REMA	RKS		821	TOTAL									
	31ST S															
208	139+10	139+48	DMMC													
						-	0 MEDIAN R									
208	TOTAL					SQ FT		REMAR	S							
								STREET								
000500	COMBINAT	ION CURB	AND GL	ITTER REMOVAL		236	123+24		TRANCE RAMP	0004 WIDENING						
FOOT	STA	STA	OFF	REMARKS	FUND CODE	195	126+51		TRANCE RAMP	0004 WIDENING						
	31ST ST	REET				507	126+81	NB 83 EX		0004 WIDENING						
36	115+37	115+54	CTR	MEDIAN AT REGENT DRIVE	0005 RESURF	182	141+68		BOULEVARD	0004 WIDENING						
424	117+15	121+38	RT	EB 31ST STREET MEDIAN	0004 WIDENING	58	141+82		IST STREET	0004 WIDENING						
30	126+16	126+18	LT	NW CORNER AT NB 83 ENTRANCE RA	0004 WIDENING	402	142+89		BOULEVARD	0004 WIDENING						
1,527	126+52	141+75	RT	EB 31ST STREET MEDIAN	0004 WIDENING	91	142+93		IST STREET	0004 WIDENING						
1,525	126+52	141+75	CTR	WB 31ST STREET MEDIAN	0004 WIDENING	1096	185+00	EB/WB 3	IST STREET	0005 RESURF						
402	127+53	128+50	RT	SE CORNER AT NB 83 EXIT RAMP	0004 WIDENING											
1,113	131+73	142+02	LT	WB 31ST STREET OUTSIDE	0004 WIDENING	1671	0004 WIDE									
9	139+43	139+43	LT	DMMC DRIVEWAY	0004 WIDENING	1096	0005 RESI	URF								
81	142+00	142+00	LT	NW CORNER AT JORIE BLVD	0004 WIDENING	2,767	TOTAL									
761	142+77	149+53	LT	WB 31ST STREET OUTSIDE	0004 WIDENING											
47	143+02	143+49	RT	EB 31ST STREET MEDIAN	0004 WIDENING	4400425	0 PAVED SH	HOULDER R	EMOVAL							
644	143+02	149+56	RT	WB 31ST STREET MEDIAN	0004 WIDENING	SQ YD		STA	REMARKS							
148	184+64	186+10	LT	EB 31ST STREET MEDIAN	0005 RESURF			STREET								
146	186+64	186+11	LT	WB 31ST STEET MEDIAN	0005 RESURF	950			EB OUTSIDE SH							
								MP B								
	0004 WIDE1					208			OUTSIDE SHOU	LDER						
		RF														
6,563 330	0005 RESU															

	DESIGNED D.M.S.	REVISED -					F.A.U RTE	SECTION	COUNTY TOTAL SH
KNIGHT	DRAWN - D.M.S.	REVISED -	STATE OF ILLINOIS		SCHEDULE OF QUANTITIES		1467	14-00259-05-CH	DUPAGE 294
Engineers & Architects	CHECKED - D.J.C.	REVISED -	DEPARTMENT OF TRANSPORTATION						CONTRACT NO. 61G
	DATE - 09-01-2020	REVISED -		SCALE: NONE	SHEET 9 OF 19 SHEETS STA.	TO STA.		ILLINOIS FED. /	AID PROJECT

FOOT	STA.	STA	REMAR	KS
		STREET		
297	076+09		OAK BR	OOK COMM CHURCH PONDING AREA
130	076+09			OOK COMM CHURCH 13 EACH @ 10' LENGT
				-
427	TOTAL			
FOOT	STA.	STA	REMA	RKS
24		MP B		
24	2110+10	2110+34	ALONG	RIGHT SIDE OF RIGHT TURN LANE
24	TOTAL			
<u>60603500</u>	COMBINA		CRETE CU	RB & GUTTER TYPE B-6.06
FOOT	STA	STA	OFFSET	REMARKS
c /=	31ST S			
647	135+33			WB MEDIAN
647	135+33			
95 110	143+07 143+07			WB MEDIAN EB MEDIAN
110	143+07	144 + 17		EB MEDIAN
50				NW ISLAND AT JORIE
30				NE ISLAND AT JORIE
1,579	TOTAL			
-,				
60603800			CRETE CU	RB & GUTTER TYPE B-6.12
FOOT	STA	STA	OFFSET	REMARKS
	31ST S	TREET		
881	126+59			WB MEDIAN
545		149+46		WB MEDIAN
423	117+15			
879 10	126+58 144+17	135+33 144+27		EB MEDIAN EB MEDIAN
10	144117	144121		
2,738	TOTAL			
				RB & GUTTER TYPE B-6.18
FOOT	STA	STA TREET	OFFSET	REMARKS
82	31ST S	IREEI		EB 31ST AT RAMP B
1,201				W. OF JORIE
748				E. OF JORIE
2,031	TOTAL			

<u>6060500</u> 0	<u>COMBIN</u> A	TION CON	ICRETE CU	IRB & GUTTER TYPE B-6.24	<u>63000001</u>	STEEL PL	ATE BEAN	I GUARDRAIL, TYPE	E A, 6 FOOT POSTS
FOOT	STA	STA		REMARKS	FOOT	STA	STA		REMARKS
	31ST S	TREET				31ST S	STREET		
579				RAMP B	75	126+14	125+88		
	ISLA	NDS							
133				RAMP B ISLAND	75	TOTAL			
73				W. OF JORIE					
48				E. OF JORIE					
10					<u>63100045</u>	TRAFFIC	BARRIER	TERMINAL, TYPE 2	
833	TOTAL				EACH	STA	STA		
000	IUIAL					31ST S	STREET		
					1	123+56	123+58		
<u>60618300</u>	CONCRET	E MEDIAN	I SURFACE	E, 4 INCH	1	125+84	125+88		
SQ FT	STA.	STA	REMA	RKS					
	31ST	STREET			2	TOTAL			
597			ISLANE	) E. OF 83					
597			ISLANE	W. OF JORIE					
168								TERMINAL, TYPE 6	
100					EACH	STA	STA		
1,362	TOTAL					31ST S	STREET		
1,302	TOTAL				1	123+58	123+94		
					1	125+85	126+14		
<u>60619200</u>	CONCRET	E MEDIAN	I, TYPE SB	-6.06					
SQ FT	STA	STA	OFFSET	REMARKS	2	TOTAL			
	31ST S	STREET							
40	141+79	141+88	С	31ST ST MEDIAN	00000040			<i>.</i>	
40	143+00	143+08	С	31ST ST MEDIAN		GUARDRA			
					FOOT	STA	STA	OFF	FUNDING
80	TOTAL						STREET		
					37	123+66		52' RT TO 43' RT	0004 WIDENING
					120	125+85	125+84	43 LT TO 130 LT	0004 WIDENING
<u>60619600</u>	CONCRET	E MEDIAN	I, TYPE SB	-6.12					
SQ FT	STA	STA	OFFSET	REMARKS	157	TOTAL			
	31ST S	STREET							
38	123+14	123+23	С	31ST ST MEDIAN					
44	126+50	126+59	С	31ST ST MEDIAN					
82	TOTAL								
	CONCRET								
SQ FT	STA	STA	OFFSET	REMARKS					
		IP B							
138	2123+27	2123+55	RT	RAMP B ISLAND NW CORNER					
80	2123+86	2123+98	RT	RAMP B ISLAND NE CORNER					
198	2123+90	2124+05	RT	RAMP B ISLAND S CORNER					
	31ST 8	JORIE							
68	500+60	500+71	RT	JORIE SB ISLAND N CORNER					
78	500+31	500+40	RT	JORIE SB ISLAND W CORNER					
115	500+31	500+44	RT	JORIE SB ISLAND SE CORNER					
42	500+46	500+52	LT	JORIE NB ISLAND N CORNER					
60	500+30	500+39	LT	JORIE NB ISLAND SW CORNER					
72	500+30	500+39	LT	JORIE NB ISLAND E CORNER					
. –									
851	TOTAL								

	DESIGNED -	D.M.S.	REVISED -					F.A.U RTE	SECTION	COUNTY	TOTAL SHEET SHEETS NO.
KNIGHT	DRAWN -	D.M.S.	REVISED -	STATE OF ILLINOIS		SCHEDULE OF QUANTITIES		1467	14-00259-05-CH	DUPAGE	294 40
Engineers & Architects	CHECKED -	D.J.C.	REVISED -	DEPARTMENT OF TRANSPORTATION						CONTRACT	F NO. 61G12
-	DATE -	09-01-2020	REVISED -		SCALE: NONE	SHEET 10 OF 19 SHEETS STA.	TO STA.		ILLINOIS FED. /	AID PROJECT	

# <u>STS</u>

SQ FT	STATION		EMENT MARKING - LETTERS & SYMBOLS IT REMARKS	- 11.5	121+24	RT	EB LT LANE THROUGH ARROW	20.8	170+35	<u>THEI</u> F
	31ST ST	REET		20.8	122+72	RT	EB LT LANE ONLY	15.6	170+61	F
20.8	23+76	CTR	EB LT TURN LANE ONLY	11.5	122+98	RT	EB LT LANE THROUGH ARROW	20.8	182+90	F
15.6	24+02	CTR	EB LT TURN LANE ARROW	11.5	126+74	LT	WB LT LANE THROUGH ARROW	15.6	183+16	F
20.8	25+38	CTR	EB LT TURN LANE ONLY	20.8	127+00	LT	WB LT LANE ONLY	20.8	186+59	С
15.6	25+64	CTR	EB LT TURN LANE ARROW	15.6	126+80	LT	WB RT TURN LANE ARROW	15.6	186+85	С
15.6	27+13	CTR	WB LT TURN LANE ARROW	20.8	127+06	LT	WB RT TURN LANE ONLY	15.6	188+04	С
20.8	27+39	CTR	WB LT TURN LANE ONLY	15.6	128+28	LT	WB RT TURN LANE ARROW	20.8	188+30	С
15.6	29+11	CTR	WB LT TURN LANE ARROW	20.8	128+54	LT	WB RT TURN LANE ONLY	15.6	189+52	С
20.8	29+37	CTR	WB LT TURN LANE ONLY	15.6	130+98	LT	WB RT TURN LANE ARROW	20.8	189+78	С
15.6	57+54	CTR	WB LT TURN LANE ARROW	20.8	131+24	LT	WB RT TURN LANE ONLY		MEYER	S ROA
20.8	57+80	CTR	WB LT TURN LANE ONLY	15.6	133+68	LT	WB RT TURN LANE ARROW	20.8	302+48	С
20.8	76+00	CTR	EB LT TURN LANE ONLY	20.8	133+94	LT	WB RT TURN LANE ONLY	15.6	302+22	С
15.6	76+26	CTR	EB LT TURN LANE ARROW	11.5	128+51	LT	WB LT LANE THROUGH ARROW	20.8	301+00	С
20.8	78+50	CTR	EB LT TURN LANE ONLY	20.8	128+78	LT	WB LT LANE ONLY	15.6	300+74	С
15.6	78+76	CTR	EB LT TURN LANE ARROW	11.5	130+26	LT	WB LT LANE THROUGH ARROW	15.6	299+29	С
15.6	80+20	CTR	WB LT TURN LANE ARROW	20.8	130+52	LT	WB LT LANE ONLY	20.8	299+08	С
20.8	80+46	CTR	WB LT TURN LANE ONLY	11.5	132+01	LT	WB LT LANE THROUGH ARROW	15.6	297+86	С
15.6	82+68	CTR	WB LT TURN LANE ARROW	20.8	132+27	LT	WB LT LANE ONLY	20.8	297+60	C
20.8	82+94	CTR	WB LT TURN LANE ONLY	20.8	135+43	RT	EB FAR LT TURN LANE ONLY		MIDWES	
20.8	91+73	CTR	EB LT TURN LANE ONLY	15.6	135+69	RT	EB FAR LT TURN LANE ARROW	20.8	403+61	C
15.6	91+99	CTR	EB LT TURN LANE ARROW	20.8	135+43	RT	EB LT TURN LANE ONLY	15.6	403+35	C
20.8	93+16	CTR	EB LT TURN LANE ONLY	15.6	135+69	RT	EB LT TURN LANE ARROW	20.8	400+98	C
15.6	93+42	CTR	EB LT TURN LANE ARROW	20.8	138+42	RT	EB FAR LT TURN LANE ONLY	15.6	400+72	C
15.6	94+70	CTR	WB LT TURN LANE ARROW	15.6	138+68	RT	EB FAR LT TURN LANE ARROW	15.6	399+34	C
20.8	94+96	CTR	WB LT TURN LANE ONLY	20.8	138+42	RT	EB LT TURN LANE ONLY	20.8	399+08	c
15.6	96+21	CTR	WB LT TURN LANE ARROW	15.6	138+68	RT	EB LT TURN LANE ARROW	15.6	397+66	C
20.8	96+47	CTR	WB LT TURN LANE ONLY	20.8	141+42	RT	EB FAR LT TURN LANE ONLY	20.8	397+40	c
15.6	105+40	CTR	WB LT TURN LANE ARROW	15.6	141+68	RT	EB FAR LT TURN ARROW	20.0		IP D
20.8	105+66	CTR	WB LT TURN LANE ONLY	20.8	141+42	RT	EB LT TURN LANE ONLY	20.8	4111+06	
20.8	113+57	CTR	EB LT TURN LANE ONLY	15.6	141+68	RT	EB FAR LT TURN ARROW	15.6	4110+80	-
15.6	113+83	CTR	EB LT TURN LANE ARROW	15.6	143+15	RT	WB LT TURN LANE ARROW	20.8	4110+92	r
15.6	115+79	LT	WB RT TURN LANE ARROW	20.8	143+41	RT	WB LT TURN LANE ONLY	15.6	4110+66	F
20.8	116+05	LT	WB RT TURN LANE ONLY	15.6	145+04	RT	WB LT TURN LANE ARROW	10.0	RAN	
15.6	117+31	LT	WB RT TURN LANE ARROW	20.8	145+30	RT	WB LT TURN LANE ONLY	20.8	2121+20	
20.8	117+57	LT	WB RT TURN LANE ONLY	15.6	142+39	RT	NB LT TURN LANE ARROW	15.6	2121+26	-
15.6	115+69	CTR	WB IT TURN LANE ARROW	20.8	142+39	RT	NB LT TURN LANE ONLY	20.8	2121+40	5
20.8	115+95	CTR	WB LT TURN LANE ONLY	26.0	142+52	RT	NB RT LANE THRU/RIGHT ARROW	15.6	2121+26	
	117+22	CTR	WB LT TURN LANE ARROW	15.6	143+22	LT	WB RT TURN LANE ARROW	20.8	2121+40	
15.6					143+22		WB RT TURN LANE ONLY	20.8 15.6	2121+20	г с
20.8	117+48	CTR		20.8		LT	WB RT TURN LANE ARROW	20.8	2121+40 2123+30	г 1
20.8	119+15	RT		15.6	145+02			20.8 15.6	2123+30	
15.6	119+41	RT		20.8	145+28	LT				L F
20.8	120+90	RT		15.6	146+81	LT		20.8 15.6	2123+26 2123+50	г г
15.6	121+16	RT		20.8	147+07	LT				г г
20.8	122+67	RT		20.8	149+61	RT		15.6	2123+19	r -
15.6	122+93	RT		15.6	149+87	RT		20.8	2123+44	
20.8	119+25	RT		15.6	152+93	LT		00.0	JORIE	BLVD
11.5	119+51	RT		20.8	153+19	LT		20.8	501+42	
20.8	120+98	RT	EB LT LANE ONLY	20.8	162+78	RT		15.6	501+16	l
				15.6	163+04	RT	EB LT TURN LANE ARROW	20.8	500+81	l
								15.6	500+55	

	DESIGNED D.M.S.	REVISED -			
KNIGHT	DRAWN D.M.S.	REVISED -	STATE OF ILLINOIS		SCHEDULE OF QUA
Engineers & Architects	CHECKED - D.J.C.	REVISED -	DEPARTMENT OF TRANSPORTATION		
	DATE - 09-01-2020	REVISED -		SCALE: NONE	SHEET 11 OF 19 SHEETS

HERMOPLASTIC PAVEMENT MARKING - LETTERS & SYMBOLS (CONT'D) RT EB LT TURN LANE ONLY RT EB LT TURN LANE ARROW EB LT TURN LANE ONLY RT RT EB LT TURN LANE ARROW CTR EB LT TURN LANE ONLY CTR EB LT TURN LANE ARROW CTR WB LT TURN LANE ARROW CTR WB LT TURN LANE ONLY CTR WB LT TURN LANE ARROW CTR WB LT TURN LANE ONLY DAD CTR SB LT TURN LANE ONLY CTR SB LT TURN LANE ARROW CTR SB LT TURN LANE ONLY CTR SB LT TURN LANE ARROW CTR NB LT TURN LANE ARROW CTR NB LT TURN LANE ONLY CTR NB LT TURN LANE ARROW CTR NB LT TURN LANE ONLY OAD CTR SB LT TURN LANE ONLY CTR SB LT TURN LANE ARROW CTR SB LT TURN LANE ONLY CTR SB LT TURN LANE ARROW CTR NB LT TURN LANE ARROW CTR NB LT TURN LANE ONLY CTR NB LT TURN LANE ARROW CTR NB LT TURN LANE ONLY LT SB RT TURN LANE ONLY LT SB RT TURN LANE ARROW RT SB LT TURN LANE ONLY RT SB LT TURN LANE ARROW NB LT TURN LANE ONLY LT LT NB LT TURN LANE ARROW NB RT TURN LANE ONLY RT RT NB RT TURN LANE ARROW RT NB FAR RT TURN LANE ONLY NB FAR RT TURN LANE ARROW RT LT NB LT TURN LANE ONLY LT NB LT TURN LANE ARROW RT NB RT TURN LANE ONLY NB RT TURN LANE ARROW RT RT NB FAR RT TURN LANE ARROW RT NB FAR RT TURN LANE ONLY /D SB RT TURN LANE ONLY LT LT SB RT TURN LANE ARROW SB LT TURN LANE ONLY LT LT SB LT TURN LANE ARROW

			F.A.U RTE	SECT	ION		COUNTY	TOTAL SHEETS	SHEET NO.
ι	UANTITIES			14-0025	9-05-CH		DUPAGE	294	41
_							CONTRACT	NO. 61	IG12
S	STA.	TO STA.			ILLINOIS	FED. AI	D PROJECT		

	THERMOPLA						78000200			EMENT M	ARKING - LINE 4" (CON
FOOT	STATION	STATION	LENGTH	FACTOF	R REMARKS	190	115+53	123+07	754	0.25	WB LANE LINE 10' SO
	31ST S1	IREET				564	115+63	121+26	564	1	WB OUTSIDE EDGE
430	23+66	25+81	215	2	MEDIAN DOUBLE SOLID - YELLOW	684	115+73	122+57	684	1	EB OUTSIDE EDGE L
50	23+66	25+80	215	0.25	EB LANE LINE 10' SOLID WITH 30' SPACE - WHITE	47	123+52	123+99	47	1	EB OUTSIDE EDGE L
50	23+66	25+78	212	0.25	WB LANE LINE 10' SOLID WITH 30' SPACE - WHITE	12	123+55	123+67	12	1	WB OUTSIDE EDGE
300	26+96	39+13	1217	0.25	WB LANE LINE 10' SOLID WITH 30' SPACE - WHITE	10	123+55	123+76	17	0.25	WB LANE LINE 10' SO
500	26+97	29+47	250	2	MEDIAN DOUBLE SOLID - YELLOW	41	125+81	126+22	41	1	WB OUTSIDE EDGE
720	26+97	55+79	2882	0.25	EB LANE LINE 10' SOLID WITH 30' SPACE - WHITE	7	126+13	126+20	7	1	EB OUTSIDE EDGE L
1744	29+47	38+20	872	2	EB MEDIAN DOUBLE SOLID - YELLOW	3081	126+51	141+87	3081	1	CENTER RAISED ME
1746	29+47	38+20	873	2	WB MEDIAN DOUBLE SOLID - YELLOW	380	126+58	141+84	1527	0.25	WB LANE LINE 10' SO
180	39+70	46+89	719	0.25	WB LANE LINE 10' SOLID WITH 30' SPACE - WHITE	370	127+11	141+84	1472	0.25	EB LANE LINE 10' SC
1438	39+70	46+89	719	2	MEDIAN DOUBLE SOLID - YELLOW	150	134+04	140+00	597	0.25	WB AUX LANE LINE
472	47+45	49+84	236	2	MEDIAN DOUBLE SOLID - YELLOW	1580	142+96	150+85	1584	1	CENTER RAISED ME
790	47+45	78+93	3147	0.25	WB LANE LINE 10' SOLID WITH 30' SPACE - WHITE	200	142+98	150+78	787	0.25	EB LANE LINE 10' SC
1192	49+84	55+83	596	2	EB MEDIAN DOUBLE SOLID - YELLOW	200	142+99	150+72	785	0.25	WB LANE LINE 10' S
1210	49+84	55+83	605	2	WB MEDIAN DOUBLE SOLID - YELLOW	1521	151+71	159+33	1521	1	CENTER RAISED ME
262	56+59	57+90	131	2	MEDIAN DOUBLE SOLID - YELLOW	190	151+73	159+22	749	0.25	WB LANE LINE 10' S
560	56+59	78+92	2233	0.25	EB LANE LINE 10' SOLID WITH 30' SPACE - WHITE	190	151+75	159+37	762	0.25	EB LANE LINE 10' SC
1056	57+90	63+18	528	2	EB MEDIAN DOUBLE SOLID - YELLOW	50	161+23	163+37	214	0.25	WB LANE LINE 10' S
1056	57+90	63+18	528	2	WB MEDIAN DOUBLE SOLID - YELLOW	416	161+28	163+36	416	1	CENTER RAISED ME
1636	63+18	71+36	818	2	MEDIAN DOUBLE SOLID - YELLOW	400	161+38	177+48	1610	0.25	EB LANE LINE 10' SC
908	71+36	75+90	454	2	EB MEDIAN DOUBLE SOLID - YELLOW	1530	164+20	171+79	1530	1	CENTER RAISED ME
908	71+36	75+90	454	2	WB MEDIAN DOUBLE SOLID - YELLOW	189	164+41	171+75	754	0.25	WB LANE LINE 10' SO
606	75+90	78+93	303	2	MEDIAN DOUBLE SOLID - YELLOW	990	172+56	177+48	993	1	CENTER RAISED ME
600	80+04	83+04	300	2	MEDIAN DOUBLE SOLID - YELLOW	120	172+58	177+48	491	0.25	WB LANE LINE 10' SO
340	80+05	93+58	1354	0.25	EB LANE LINE 10' SOLID WITH 30' SPACE - WHITE	150	177+59	183+77	618	0.25	WB LANE LINE 10' SO
340	80+05	93+58	1354	0.25	WB LANE LINE 10' SOLID WITH 30' SPACE - WHITE	1234	177+59	183+74	1234	1	CENTER RAISED ME
752	83+04	86+80	376	2	EB MEDIAN DOUBLE SOLID - YELLOW	230	177+59	186+86	936	0.25	EB LANE LINE 10' SC
752	83+04	86+80	376	2	WB MEDIAN DOUBLE SOLID - YELLOW	390	184+61	186+53	390	1	CENTER RAISED ME
716	86+42	93+53	716	1	EB OUTSIDE EDGE LINE SOLID -WHITE	60	184+89	186+92	235	0.25	WB LANE LINE 10' SO
708	86+43	93+51	708	1	WB OUTSIDE EDGE LINE SOLID - WHITE	390	184+60	186+53	195	2	MEDIAN DOUBLE SC
240	86+80	88+00	120	2	MEDIAN DOUBLE SOLID - YELLOW	390	184+60	186+53	196	2	MEDIAN DOUBLE SC
726	88+00	91+63	363	2	EB MEDIAN DOUBLE SOLID - YELLOW	88	186+53	186+97	44	2	MEDIAN DOUBLE SC
726	88+00	91+63	363	2	WB MEDIAN DOUBLE SOLID - YELLOW	400	187+88	189+88	200	2	MEDIAN DOUBLE SC
390	91+63	93+58	195	2	MEDIAN DOUBLE SOLID - YELLOW	90	187+88	191+37	349	0.25	WB LANE LINE 10' SO
1993	94+54	114+47	1993	1	WB OUTSIDE EDGE LINE SOLID - WHITE	90	187+88	191+37	350	0.25	EB LANE LINE 10' SC
410	94+54	96+59	205	2	MEDIAN DOUBLE SOLID - YELLOW	298	189+88	191+37	149	2	EB MEDIAN DOUBLE
220	94+54	103+26	873	0.25	EB LANE LINE 10' SOLID WITH 30' SPACE - WHITE	300	189+88	191+37	150	2	WB MEDIAN DOUBLE
500	94+54	114+47	1993	0.25	WB LANE LINE 10' SOLID WITH 30' SPACE - WHITE		MEYERS	S ROAD			
770	96+59	100+43	385	2	EB MEDIAN DOUBLE SOLID - YELLOW	398	295+51	297+50	199	2	NB MEDIAN DOUBLE
768	96+59	100+43	384	2	WB MEDIAN DOUBLE SOLID - YELLOW	398	295+51	297+50	199	2	SB MEDIAN DOUBLE
566	100+43	103+30	283	2	EB MEDIAN DOUBLE SOLID - YELLOW	100	295+51	299+44	393	0.25	NB LANE LINE 10' SC
584	100+43	103+30	292	2	WB MEDIAN DOUBLE SOLID - YELLOW	100	295+51	299+46	395	0.25	SB LANE LINE 10' SC
300	104+26	105+76	150	2	MEDIAN DOUBLE SOLID - YELLOW	392	297+50	299+46	196	2	MEDIAN DOUBLE SC
260	104+26	114+47	1020	0.25	EB LANE LINE 10' SOLID WITH 30' SPACE - WHITE	400	300+58	302+58	200	2	MEDIAN DOUBLE SC
1744	105+76	114+50	872	2	EB MEDIAN DOUBLE SOLID - YELLOW	110	300+58	304+92	433	0.25	NB LANE LINE 10' SC
1762	105+76	114+50	881	2	WB MEDIAN DOUBLE SOLID - YELLOW	110	300+58	304+92	434	0.25	SB LANE LINE 10' SC
1562	115+46	123+23	1562	1	CENTER RAISED MEDIAN SINGLE SOLID - YELLOW	468	302+58	304+92	234	2	NB MEDIAN DOUBLE
190	115+48	123+15	767	0.25	EB LANE LINE 10' SOLID WITH 30' SPACE - WHITE	468	302+58	304+92	234	2	SB MEDIAN DOUBLE
1											

		DESIGNED D.M.S.	REVISED -			F.A.U SECTION	COUNTY TOTAL SHEET SHEETS NO.
KNIGHT Engineers & Architects	DRA	DRAWN D.M.S.	REVISED -	STATE OF ILLINOIS DEPARTMENT OF TRANSPORTATION	SCHEDULE OF QUANTITIES	1467 14-00259-05-CH	DUPAGE 294 42
		CHECKED - D.J.C.	REVISED -				CONTRACT NO. 61G12
-		DATE - 09-01-2020	REVISED -		SCALE NONE SHEET 12 OF 19 SHEETS STA. TO STA.	ILLINOIS FED.	AID PROJECT

### ONT'D)

SOLID WITH 30' SPACE - WHITE GE LINE SOLID - WHITE E LINE SOLID -WHITE E LINE SOLID -WHITE GE LINE SOLID - WHITE SOLID WITH 30' SPACE - WHITE GE LINE SOLID - WHITE E LINE SOLID -WHITE MEDIAN SINGLE SOLID - YELLOW SOLID WITH 30' SPACE - WHITE SOLID WITH 30' SPACE - WHITE E 10' SOLID WITH 30' SPACE - WHITE MEDIAN SINGLE SOLID - YELLOW SOLID WITH 30' SPACE - WHITE SOLID WITH 30' SPACE - WHITE MEDIAN SINGLE SOLID - YELLOW SOLID WITH 30' SPACE - WHITE SOLID WITH 30' SPACE - WHITE SOLID WITH 30' SPACE - WHITE MEDIAN SINGLE SOLID - YELLOW SOLID WITH 30' SPACE - WHITE MEDIAN SINGLE SOLID - YELLOW SOLID WITH 30' SPACE - WHITE MEDIAN SINGLE SOLID - YELLOW SOLID WITH 30' SPACE - WHITE SOLID WITH 30' SPACE - WHITE MEDIAN SINGLE SOLID - YELLOW SOLID WITH 30' SPACE - WHITE MEDIAN SINGLE SOLID - YELLOW SOLID WITH 30' SPACE - WHITE SOLID - YELLOW SOLID - YELLOW SOLID - YELLOW SOLID - YELLOW SOLID WITH 30' SPACE - WHITE SOLID WITH 30' SPACE - WHITE LE SOLID - YELLOW BLE SOLID - YELLOW LE SOLID - YELLOW

BLE SOLID - YELLOW SOLID WITH 30' SPACE - WHITE SOLID WITH 30' SPACE - WHITE SOLID - YELLOW SOLID - YELLOW SOLID WITH 30' SPACE - WHITE SOLID WITH 30' SPACE - WHITE BLE SOLID - YELLOW BLE SOLID - YELLOW

	<u>78000200</u>	THERMOPL	ASTIC PAV	EMENT M	ARKING - LINE 4" (CONT'D)	78000
	MIDWES	T ROAD				FOC
302	395+80	397+30	151	2	NB MEDIAN DOUBLE SOLID - YELLOW	
302	395+80	397+30	151	2	SB MEDIAN DOUBLE SOLID - YELLOW	21
90	395+80	399+51	372	0.25	NB LANE LINE 10' SOLID WITH 30' SPACE - WHITE	10
90	395+80	399+50	371	0.25	SB LANE LINE 10' SOLID WITH 30' SPACE - WHITE	90
440	397+30	399+50	220	2	MEDIAN DOUBLE SOLID - YELLOW	25
630	400+56	403+71	315	2	MEDIAN DOUBLE SOLID - YELLOW	50
110	400+56	404+94	438	0.25	NB LANE LINE 10' SOLID WITH 30' SPACE - WHITE	13
110	400+56	404+94	439	0.25	SB LANE LINE 10' SOLID WITH 30' SPACE - WHITE	48
248	403+71	404+94	124	2	NB MEDIAN DOUBLE SOLID - YELLOW	50
248	403+71	404+94	124	2	SB MEDIAN DOUBLE SOLID - YELLOW	30
	JORIE BO	JLEVARD				10
20	500+54	501+48	94	0.25	NB LANE LINE 10' SOLID WITH 30' SPACE - WHITE	89
	RAM	ΡC				30
25	3114+57	3114+91	25	1	RAMP C LT EDGE LINE SOLID - YELLOW	50
	RAM	РА				50
30	1110+48	1110+73	25	1	RAMP A LT EDGE LINE SOLID - YELLOW	19
0	RAM	РВ				74
570	2118+10	2123+80	570	1	RAMP B LT EDGE LINE SOLID - YELLOW	63
560	2118+10	2123+63	557	1	RAMP B RT EDGE LINE SOLID - WHITE	20
						50
9,674	TOTAL					10
						78
						15
						50
						3
						10
						21
						50
						20
						4
						50
						40
						50
						38
						22
						5
						1
						18
						58
						5
						5
						65
						65
						78
						6
						30
						39
						50
						36
						51
						13

000400	THERMOPLA		IENT MARKI	NG - LINE	<u>= 6"</u>
FOOT	STATION	STATION	LENGTH	FACTOR	REMARKS
	31ST S	TREET			
215	23+66	25+80	215	1	EB LT TURN LANE SOLID - WHITE
105	25+88	26+93	105	1	MEYERS ROAD SOUTH CROSSWA
90	25+96	26+86	90	1	MEYERS ROAD SOUTH CROSSWA
251	26+96	29+47	251	1	WB LT TURN LANE SOLID - WHITE
50	29+47	31+47	200	0.25	WB LT TURN LANE 2' SOLID WITH 6
131	56+59	57+90	131	1	WB LT TURN LANE SOLID - WHITE
48	57+90	59+82	192	0.25	WB LT TURN LANE 2' SOLID WITH 6
50	73+90	75+90	200	0.25	EB LT TURN LANE 2' SOLID WITH 6'
303	75+90	78+92	303	1	EB LT TURN LANE SOLID - WHITE
109	78+95	80+04	109	1	MIDWEST ROAD SOUTH CROSSWA
89	79+03	79+92	89	1	MIDWEST ROAD SOUTH CROSSWA
300	80+04	83+04	300	1	WB LT TURN LANE SOLID - WHITE
50	83+04	85+04	200	0.25	WB LT TURN LANE 2' SOLID WITH 6
50	89+63	91+63	200	0.25	EB LT TURN LANE 2' SOLID WITH 6'
195	91+63	93+58	195	1	EB LT TURN LANE SOLID - WHITE
74	93+67	94+41	74	1	CONCORD DRIVE SOUTH CROSSW
63	93+72	94+36	63	1	CONCORD DRIVE SOUTH CROSSW
205	94+54	96+59	205	1	WB LT TURN LANE SOLID - WHITE
50	96+59	98+59	200	0.25	WB LT TURN LANE 2' SOLID WITH 6
100	103+37	104+37	100	1	MAYSLAKE SOUTH CROSSWALK -
78	103+48	104+26	78	1	MAYSLAKE SOUTH CROSSWALK -
150	104+26	105+76	150	1	WB LT TURN LANE SOLID - WHITE
50	105+76	107+76	200	0.25	WB LT TURN LANE 2' SOLID WITH 6
31	112+22	113+47	124	0.25	EB LT TURN LANE 2' SOLID WITH 6'
100	113+47	114+47	100	1	EB LT TURN LANE SOLID - WHITE
213	115+54	117+67	213	1	WB RT TURN LANE SOLID - WHITE
50	117+67	119+67	200	0.25	WB RT TURN LANE 2' SOLID WITH 6
205	115+53	117+58	205	1	WB LT TURN LANE SOLID - WHITE
41	117+58	119+21	163	0.25	WB LT TURN LANE 2' SOLID WITH 6
50	117+15	119+15	200	0.25	EB LT TURN LANE 2' SOLID WITH 6'
400	119+15	123+15	400	1	EB LT TURN LANE SOLID - WHITE
50	117+05	119+05	200	0.25	EB RT TURN LANE 2' SOLID WITH 6'
386	119+05	122+92	386	1	EB RT TURN LANE SOLID - WHITE
22	123+55	123+76	22	1	WB LT TURN LANE SOLID - WHITE
5	123+84	123+89	5	1	EB LT TURN LANE SOLID - WHITE
17	126+03	126+20	17	1	EB LT TURN LANE SOLID - WHITE
184	126+80	128+64	184	1	WB RT TURN LANE SOLID - WHITE
580	126+58	132+37	580	1	WB LT TURN LANE SOLID - WHITE
50	132+37	134+37	200	0.25	WB LT TURN LANE 2' SOLID WITH 6
50	132+33	135+33	200	0.25	EB LT TURN LANE 2' SOLID WITH 6'
651	135+33	141+84	651	1	EB FAR LEFT LT TURN LANE SOLID
651	135+33	141+84	651	1	EB LT TURN LANE SOLID - WHITE
78	141+93	142+70	78	1	HUNTER TRAILS CROSSWALK - WH
62	142+00	142+62	62	1	HUNTER TRAILS CROSSWALK - WH
30	142+48	142+48	30	1	NB LT LANE SOLID - WHITE
396	143+21	147+17	396	1	WB RT TURN LANE SOLID - WHITE
50	147+17	149+17	200	0.25	WB RT TURN LANE 2' SOLID WITH 6
36	145+40	146+83	143	0.25	WB LT TURN LANE 2' SOLID WITH 6
51	147+49	149+51	202	0.25	EB LT TURN LANE 2' SOLID WITH 6'
134	149+51	150+85	134	1	EB LT TURN LANE SOLID - WHITE
72	150+85	150+95	72	1	SPRING ROAD CROSSWALK - WHI
81	150+85	150+95	81	1	SPRING ROAD CROSSWALK - WHI
		100.00		•	

	DESIGNED -	D.M.S.	REVISED -			
KNIGHT	DRAWN -	D.M.S.	REVISED -	STATE OF ILLINOIS		SCHEDULE OF QUANTITIES
Engineers & Architects	CHECKED -	D.J.C.	REVISED -	DEPARTMENT OF TRANSPORTATION		
	DATE -	09-01-2020	REVISED -		SCALE: NONE	SHEET 13 OF 19 SHEETS STA.

```
ALK - WHITE
ALK - WHITE
6' SPACE - WHITE
6' SPACE - WHITE
6' SPACE - WHITE
VALK - WHITE
VALK - WHITE
6' SPACE - WHITE
6' SPACE - WHITE
WALK - WHITE
WALK - WHITE
6' SPACE - WHITE
- WHITE
- WHITE
6' SPACE - WHITE
.ID - WHITE
VHITE
VHITE
6' SPACE - WHITE
6' SPACE - WHITE
6' SPACE - WHITE
HITE
HITE

        COUNTY
        TOTAL
SHEETS
        SHEET
NO.

        DUPAGE
        294
        43

                                   F.A.U
RTE
1467
                                                SECTION
```

14-00259-05-CH

ILLINOIS FED. AID PROJECT

TO STA.

CONTRACT NO. 61G12

	<u>78000400</u>	THERMOPL	<u>AS IIC PAV</u>	EMENIM	ARKING - LINE 6" (CONT'D)	<u>78000500</u>	THERMOPLA	STIC PAVE	EMENT MARKING - LINE 8"
155	151+74	153+29	155	1	WB LT TURN LANE SOLID - WHITE	FOOT	STATION	STATION	REMARKS
49	153+29	155+26	197	0.25	WB LT TURN LANE 2' SOLID WITH 6' SPACE - WHITE		31ST S1	REET	
34	161+34	162+68	134	0.25	EB LT TURN LANE 2' SOLID WITH 6' SPACE - WHITE	38	122+92	123+30	RAMP C GORE EDGE SOLID - WHITE
65	162+68	163+33	65	1	EB LT TURN LANE SOLID - WHITE	35	126+45	126+80	RAMP A GORE EDGE SOLID - WHITE
43	168+53	170+25	172	0.25	EB LT TURN LANE 2' SOLID WITH 6' SPACE - WHITE	135	128+64	134+04	WB RT TURN LANE 3' SOLID WITH 9' SP.
150	170+25	171+75	150	1	EB LT TURN LANE SOLID - WHITE	113	140+00	141+14	JORIE BOULEVARD CHANNELIZING EDO
39	172+04	172+43	39	1	POLO DRIVE CROSSWALK - WHITE	49	141+14	141+63	JORIE BOULEVARD GORE EDGE SOLID
36	172+06	172+42	36	1	POLO DRIVE CROSSWALK - WHITE	241	142+99	145+40	LT TURN LANE GORE EDGE SOLID - WH
24	177+48	177+59	24	1	EB BIKE CROSSWALK - WHITE	241	142+99	145+40	GORE EDGE SOLID - WHITE
24	177+48	177+59	24	1	EB BIKE CROSSWALK - WHITE	22	142+99	143+21	RAISED ISLAND EDGE SOLID - WHITE
23	177+48	177+59	23	1	WB BIKE CROSSWALK - WHITE		RAMI	° C	
23	177+48	177+59	23	1	WB BIKE CROSSWALK - WHITE	51	3114+73	3115+09	RAMP C TURN LANE SOLID - WHITE
44	181+03	182+80	177	0.25	EB LT TURN LANE 2' SOLID WITH 6' SPACE - WHITE	24	3114+73	3114+97	RAMP C GORE EDGE SOLID - WHITE
90	182+80	183+70	90	1	EB LT TURN LANE SOLID - WHITE		RAMI	ΡA	
39	184+96	186+53	157	0.25	EB LT TURN LANE 2' SOLID WITH 6' SPACE - WHITE	48	1110+29	1110+63	RAMP A TURN LANE SOLID - WHITE
44	186+53	186+96	44	1	EB LT TURN LANE SOLID - WHITE	23	1110+40	1110+63	RAMP A GORE EDGE SOLID - WHITE
200	187+88	189+88	200	1	WB LT TURN LANE SOLID - WHITE		RAMI	РВ	
37	189+88	191+37	149	0.25	WB LT TURN LANE 2' SOLID WITH 6' SPACE - WHITE	7	2123+20	2123+27	RAMP B LT TURN RT EDGE SOLID - WHI
	MEYERS	ROAD				7	2123+20	2123+27	RAMP B RT TURN LT EDGE SOLID - WHI
44	295+24	297+50	175	0.25	NB LT TURN LANE 2' SOLID WITH 6' SPACE - WHITE				
195	297+50	299+45	195	1	NB LT TURN LANE SOLID- WHITE		JORIE BOL	JLEVARD	
200	300+58	302+58	200	1	SB LT TURN LANE SOLID- WHITE	129	500+31	500+99	JORIE RT TURN LANE SOLID - WHITE
44	302+58	304+33	175	0.25	SB LT TURN LANE 2' SOLID WITH 6' SPACE - WHITE	60	500+39	500+99	JORIE GORE EDGE SOLID -WHITE
44	303+17	304+92	175	0.25	NB LT TURN LANE 2' SOLID WITH 6' SPACE - WHITE	24	500+29	500+40	NB RT TURN LANE SOLID - WHITE
	MIDWES								
38	395+80	397+30	151	0.25	NB LT TURN LANE 2' SOLID WITH 6' SPACE - WHITE	1,247	TOTAL		
220	397+30	399+51	220	1	NB LT TURN LANE SOLID- WHITE				
70	399+60	400+30	70	1	MIDWEST ROAD WEST CROSSWALK - WHITE				
75	399+60	400+35	75	1	MIDWEST ROAD WEST CROSSWALK - WHITE				
315	400+56	403+71	315	1	SB LT TURN LANE SOLID- WHITE				
31	403+71	404+94	124	0.25	SB LT TURN LANE 2' SOLID WITH 6' SPACE - WHITE				
	RAM	РВ							
75	2118+10	2121+10	300	0.25	NB LT TURN LANE 2' SOLID WITH 6' SPACE - WHITE				
210	2121+10	2123+20	210	1	NB LT TURN LANE SOLID- WHITE				
257	2121+10		257	1	NB RT TURN LANE SOLID- WHITE				
15	2123+63	2123+91	58	0.25	NB FAR RIGHT RT TURN LANE DOTTED 2' SOLID WITH 6' SPACE - WHITE				
17	2123+76	2123+86	17	1	RAMP B WEST CROSSWALK - WHITE				
17	2123+76	2123+86	17	1	RAMP B WEST CROSSWALK - WHITE				
36	2123+63	2123+80	36	1	RAMP B EAST CROSSWALK - WHITE				
33	2123+63	2123+80	33	1	RAMP B EAST CROSSWALK - WHITE				
	RAM								
37	3114+61	3114+71	37	1	RAMP C CROSSWALK - WHITE				
30	3114+61	3114+71	30	1	RAMP C CROSSWALK - WHITE				
	JORIE BOL				···-				
73	499+56	500+29	73	1	JORIE BLVD EAST CROSSWALK - WHITE				
73	499+56	500+29	73	1	JORIE BLVD EAST CROSSWALK - WHITE				
109	500+39	501+48	109	1	SB LT TURN LANE SOLID- WHITE				
20	500+47	500+64	20	1	JORIE BLVD NE CROSSWALK - WHITE				
20	500+47 500+42	500+59	20	1	JORIE BLVD NE CROSSWALK - WHITE				
49	500+99	501+48	20 49	1	SB RT TURN LANE SOLID- WHITE				
				'					
0,998	TOTAL								

	DESIGNED D.M.S.	REVISED -					F.A.U BTF	SECTION	COUNTY	TOTAL SHEET SHEETS NO.	
KNIGHT	 DRAWN D.M.S.	REVISED -	STATE OF ILLINOIS DEPARTMENT OF TRANSPORTATION	SCHEDULE OF QUANTITIES					14-00259-05-CH	DUPAGE	294 44
	CHECKED D.J.C.	REVISED -								CONTRAC	T NO. 61G12
	DATE - 09-01-2020	REVISED -		SCALE: NONE	SHEET 14 OF 19 SHEETS	STA.	TO STA.		ILLINOIS FED. AID PROJECT		

```
SPACE - WHITE (540' length * 0.25 factor)
EDGE SOLID - WHITE
LID - WHITE
WHITE
```

VHITE

VHITE

			EMENT MARKING - LINE 12"	<u>78000650</u>
FOOT	STATION		REMARKS	FOOT
	31ST ST			
224	25+84	25+92	MEYERS WEST CROSSWALK 2' APART @ 90 DEG - WHITE (28 8" BARS)	43
248	26+84	26+92	MEYERS EAST CROSSWALK 2' APART @ 90 DEG - WHITE (31 8" BARS)	47
239	29+47	38+20	PAINTED MEDIAN 30' C-C @ 45 DEG - YELLOW	42
208	49+84	55+82	PAINTED MEDIAN 30' C-C @ 45 DEG - YELLOW	42
128	57+90	63+18	PAINTED MEDIAN 30' C-C @ 45 DEG - YELLOW	40
239	71+36	75+90	PAINTED MEDIAN 30' C-C @ 45 DEG - YELLOW	21
180	78+96	79+04	MIDWEST WEST CROSSWALK 2' APART @ 45 DEG - WHITE (18 10" BARS)	23
51	83+04	86+80	PAINTED MEDIAN 30' C-C @ 45 DEG - YELLOW	36
142	88+00	91+63	PAINTED MEDIAN 30' C-C @ 45 DEG - YELLOW	36
190	93+62	93+70	CONCORD DRIVE WEST CROSSWALK 2' APART @ 90 DEG - WHITE	36
160	93+67	94+41	CONCORD DRIVE SOUTH CROSSWALK 2' APART @ 45 DEG - WHITE	19
231	96+59	100+43	PAINTED MEDIAN 30' C-C @ 45 DEG - YELLOW	36
92	100+43	103+29	PAINTED MEDIAN 30' C-C @ 45 DEG - YELLOW	24
269	103+37	104+37	MAYSLAKE CROSSWALK 2' APART @ 45 DEG - WHITE	24
294	105+76	114+50	PAINTED MEDIAN 30' C-C @ 45 DEG - YELLOW	36
173	114+57	114+63	ST PASCHAL CROSSWALK 2' APART @ 90 DEG - WHITE	46
54	122+92	123+37	RAMP C GORE CHEVRONS - WHITE	25
44	126+38	126+80	RAMP A GORE CHEVRONS - WHITE	46
76	127+12	130+00	PAINTED MEDIAN 30' C-C @ 45 DEG - YELLOW	
134	141+63	142+16	JORIE BOULEVARD NORTH APPROACH GORE CHEVRONS - WHITE	47
209	141+93	142+70	HUNTER TRAILS CROSSWALK 2' APART @ 45 DEG - WHITE	46
190	142+87	142+95	JORIE BOULEVARD EAST CROSSWALK 2' APART @ 45 DEG - WHITE (19 10" BARS)	
141	142+99	145+40	JORIE BOULEVARD EAST APPROACH GORE CHEVRONS - WHITE	45
215	150+85	150+95	SPRING ROAD WEST CROSSWALK 2' APART @ 45 DEG - WHITE	36
112	172+04	172+43	POLO DRIVE CROSSWALK 2' APART @ 45 DEG - WHITE	
78	177+48	177+59	WB BIKE CROSSWALK 2' APART @ 45 DEG - WHITE	30
80	177+48	177+59	EB BIKE CROSSWALK 2' APART @ 45 DEG - WHITE	16
84	184+60	186+53	PAINTED MEDIAN 30' C-C @ 45 DEG - YELLOW	
50	189+88	191+37	PAINTED MEDIAN 30' C-C @ 45 DEG - YELLOW	18
	MEYERS			
54	295+51	297+50	PAINTED MEDIAN 30' C-C @ 45 DEG - YELLOW	16
240	299+49		MEYERS SOUTH CROSSWALK 2' APART @ 45 DEG - WHITE (24 10" BARS)	33
232	300+46	300+54	MEYERS NORTH CROSSWALK 2' APART @ 90 DEG - WHITE (29 8" BARS)	
33	302+58	304+92	PAINTED MEDIAN 30' C-C @ 45 DEG - YELLOW	18
	MIDWEST			
47	395+80		PAINTED MEDIAN 30' C-C @ 45 DEG - YELLOW	23
240	399+54		MIDWEST SOUTH CROSSWALK 2' APART @ 45 DEG - WHITE (24 10" BARS)	20
20	403+71	404+94	PAINTED MEDIAN 30' C-C @ 45 DEG - YELLOW	
	RAMF			970
38	3114+61	3114+71	RAMP C CROSSWALK 2' APART @ 45 DEG - WHITE	
	RAMF			
50	2123+76		RAMP B WEST CROSSWALK 2' APART @ 45 DEG - WHITE	
104	2123+63		RAMP B EAST CROSSWALK 2' APART @ 45 DEG - WHITE	
	JORIE BOU			
60	500+43	500+63	JORIE BOULEVARD NE CROSSWALK 2' APART @ 45 DEG - WHITE (6 10" BARS)	

### 5,653 TOTAL

		DESIGNED D.M.S.	REVISED -					F.A.U BTF	SECTION	COUNTY	TOTAL	SHEET NO.
KNIGHT Engineers & Architects	DRAWI	DRAWN D.M.S.	REVISED -	STATE OF ILLINOIS		SCHEDULE OF QUANTITIES		1467	14-00259-05-CH	DUPAGE	294	45
		CHECKED - D.J.C.	REVISED -	DEPARTMENT OF TRANSPORTATION				CONTRAC			T NO. 61	G12
		DATE - 09-01-2020	REVISED -		SCALE: NONE	SHEET 15 OF 19 SHEETS STA.	TO STA.		ILLINOIS FED.	AID PROJECT		

000650	THERMOPLA	STIC PAV	EMENT MARKING - LINE 24"	<u>78009000</u>	MODIFIED U	RETHANE P	AVEMENT M	ARKING -	LETTERS & SYMBOLS
TOOT	STATION	LT/CTR/R	T REMARKS	SQ FT	STATION	LT/CTR/RT	REMARKS		—
	31ST ST	REET			31ST S	TREET			
43	25+80	RT	EB STOP BAR	15.6	124+17	LT	WB LT TURN	I LANE AF	RROW
47	26+96	LT	WB STOP BAR	20.8	124+43	LT	WB LT TURN	LANE OF	NLY
42	78+92	RT	EB STOP BAR	15.6	125+52	LT	WB LT TURN	I LANE AF	RROW
42	80+04	LT	WB STOP BAR	20.8	125+78	LT	WB LT TURN	LANE OF	NLY
40	93+58	RT	EB STOP BAR	20.8	123+94	RT	EB LT TURN	LANE ON	ILY
21	94+82	LT	SB STOP BAR	15.6	124+20	RT	EB LT TURN	LANE AR	ROW
23	94+04	RT	NB STOP BAR	20.8	125+30	RT	EB LT TURN	LANE ON	ILY
36	94+54	LT	WB STOP BAR	15.6	125+56	RT	EB LT TURN	LANE AR	ROW
36	114+47	RT	EB STOP BAR						
36	115+53	LT	WB STOP BAR	146	TOTAL				
19	115+58	LT	WB STOP BAR						
36	123+15	RT	EB STOP BAR	78000004					
24	123+55	LT	WB STOP BAR	78009004 FOOT	STATION		AVEMENT M		
24	126+20	RT	EB STOP BAR	FUUT	31ST S	STATION	LENGTH	FACIO	R REMARKS
36	126+58	LT	WB STOP BAR	214	123+67	125+81	214	1	WB OUTSIDE EDGE LINE - WHITE
46	141+84	RT	EB STOP BAR	423	123+87	125+91	423	1	MEDIAN INSIDE EDGE LINE - YELLOW
25	142+48	RT	NB STOP BAR	214	123+99	126+13	423 214	1	EB OUTSIDE EDGE LINE - WHITE
46	142+99	LT	WB STOP BAR	50	123+33	125+86	214	0.25	WB 10' SOLID WITH 30' SPACE - WHITE
	MEYERS	ROAD		50	123+72	126+08	214	0.25	EB 10' SOLID WITH 30' SPACE - WHITE
47	299+54	RT	NB STOP BAR	50	159+22	161+23	201	0.25	WB 10' SOLID WITH 30' SPACE - WHITE
46	300+58	LT	SB STOP BAR		100122	101.20	201	0.20	
	MIDWEST	r Road		1,001	TOTAL				
45	399+51	RT	NB STOP BAR	1,001	TOTAL				
36	400+56	LT	SB STOP BAR	78009006	MODIFIED U	RETHANE P	AVEMENT M	ARKING -	LINE 6"
	RAME	P D		FOOT	STATION	STATION	LENGTH	FACTOF	R REMARKS
30	4110+67	LT	WEST STOP BAR		31ST S	TREET			
16	4110+50	RT	EAST STOP BAR	221	123+67	125+88	221	1	WB LT TURN LANE - WHITE
	RAME	Р С		214	123+89	126+03	214	1	EB LT TURN LANE - WHITE
18	3114+84	LT	STOP BAR						
	RAME	РВ		435	TOTAL				
16	2123+72	LT	WEST STOP BAR						
33	2123+63	RT	EAST STOP BAR	<u>78009024</u>	MODIFIED U	RETHANE P	AVEMENT M	ARKING -	LINE 24"
	RAME	PA		FOOT			REMARKS		
18	1110+50	RT	STOP BAR		31ST S				
	JORIE BOU	ILEVARD		11	124+01	LT			FOP BAR - WHITE
23	500+39	LT	SB STOP BAR	12	125+72	RT	EB LT TURN	LANE ST	OP BAR - WHITE
20	500+48	RT	NB STOP BAR						
				23	TOTAL				
970	TOTAL								

## 78009000 MODIFIED URETHANE PAVEMENT MARKING - LETTERS & SYMBOLS

LT	WB LT TURN LANE ARROW
LT	WB LT TURN LANE ONLY
LT	WB LT TURN LANE ARROW
LT	WB LT TURN LANE ONLY
RT	EB LT TURN LANE ONLY
RT	EB LT TURN LANE ARROW
RT	EB LT TURN LANE ONLY
PT	ER I T TURNI I ANE ARROW

EACH	RAISED REFLECTIVE STA. STA		REMARKS	EACH	<u>REMOVAL</u> STA	REMA		£	EACH	STA
LACH		LLINGII	REMARKS	LACIT			113		LACIT	31ST ST
6	EB 31ST STREET	216	2 SPA @ 80' (PROJECT BEGIN TO MEYER)	2	3131	STREET		JORIE BOULEVARD	2	3131 31
11		432	LEFT TURN AT MEYERS	2				ORIE BOULEVARD	2	
130		5179	2 SPA @ 80' (MEYERS TO MIDWEST)	1				JORIE BOULEVARD	1	
96		3809	CENTER SPA @ 40' (MEYERS TO MIDWEST CLUB LEFT TURN)	1					1	
56		2226	CENTER SPA @ 40' (MIDWEST CLUB TO MIDWEST)						I	
20		782	LEFT TURN AT MIDWEST	6	TOTAL				6	TOTAL
20 31		1208	CENTER SPA @ 40' (MIDWEST TO CONCORD)	Ŭ	IOTAL				Ū	TOTAL
34		1348	2 SPA @ 80' (MIDWEST TO CONCORD)							
19		725	LEFT TURN AT CONCORD	<u>Z0004562</u>	2 COMBINA	TION CON	ICRETE CL	JRB AND GUTTER REMO	VAL AND REP	LACEMENT
28		1081	CENTER SPA @ 40' (CONCORD TO MAYSLAKE)	FOOT	STA	STA	OFFSET	REMARKS		
20 50		1981	2 SPA @ 80' (CONCORD TO PASCHALS)		31ST S	STREET				
29		1160	LEFT TURN AT MAYSLAKE	287	76+04	78+91		WEST OF MIDWEST RO	DAD	
17		649	LEFT TURN AT PASCHAL	2,738	23+66	191+37		10% REMOVAL OF CUP	RB IN RESURF	ACING AREA
19		755	2 SPA @ 80' (PASCHAL TO BRIDGE)	2,700	20,00	101.07		75% ALLOCATED TO >	10 FOOT ITEM	
37		1442	2 SPA @ 80' (FASCINE TO JORIE)		SIDEV	VALKS				
20		786	2 SPA @ 80' (JORIE TO SPRING)	21				NW MEYERS		
8		289	LEFT TURN AT SPRING	22				NE MEYERS		
99		3960	2 SPA @ 80' (SPRING TO PROJECT END)	34				SW MEYERS		
9		3900 324	LEFT TURN AT POLO	25				SE MEYERS		
3 7		270	LEFT TURN AT GRANT	24				SW MIDWEST CLUB		
1		270	LEFT TORN AT GRANT	42				SE MIDWEST CLUB		
6	WB 31ST STREET	216		310				SW MIDWEST		
6		216 773	2 SPA @ 80' (PROJECT BEGIN TO MEYER) LEFT TURN AT MEYERS	28				SE MIDWEST		
20 130		5179		20				NW CONCORD		
17		646	2 SPA @ 80' (MEYERS TO MIDWEST) LEFT TURN AT MIDWEST CLUB	43				SW TRINITY		
24		960	LEFT TURN AT MIDWEST	40				SE TRINITY		
24 34		1348	2 SPA @ 80' (MIDWEST TO CONCORD)	35				SW MAYSLAKE		
19		727	LEFT TURN AT CONCORD	49				SE MAYSLAKE		
50		1981	2 SPA @ 80' (CONCORD TO PASCHALS)	26				NW PASCHAL		
9		324	RIGHT TURN AT PASCHAL	12				SW PASCHAL		
9 8			LEFT TURN AT PASCHAL	18				SW RAMP C		
8 19		304 755	2 SPA @ 80' (PASCHAL TO BRIDGE)	17				SE RAMP C		
				15				SW RAMP B		
46 27		1805 1442		22				SW HUNTERS TRAIL		
37			2 SPA @ 80' (BRIDGE TO JORIE) RIGHT TURN AT JORIE	47				SE HUNTERS TRAIL		
8 4		281 144	LEFT TURN AT JORIE	23				NW SPRING		
-				21				SW SPRING		
20 9		786 349	2 SPA @ 80' (JORIE TO SPRING)	42				NW POLO		
				44				NE POLO		
99	MEVEDO	3960	2 SPA @ 80' (SPRING TO PROJECT END)	16				N MIDBLOCK		
20	MEYERS	787	2 SPA @ 80' (NB)	16				MIDBLOCK		
		787		16				MIDBLOCK		
20	MIDWERT	101	2 SPA @ 80' (SB)	16				S MIDBLOCK		
20	MIDWEST	705								
20 20		785 785	2 SPA @ 80' (NB)	119	0004 WIDE	ENING				
20		785	2 SPA @ 80' (SB)	3,950	0005 RES	URFACING	3			
2	JORIE	70	2 SPA @ 80' (NR)	4,069	TOTAL					
2		70 220	2 SPA @ 80' (NB) 2 SPA @ 80' (SB)							
6										

	DESIGNED - D.M.S.	REVISED -			F.A.U RTE	SECTION	COUNTY TOTAL SHEET SHEETS NO.
KNIGHT Engineers & Architects	DRAWN - D.M.S. CHECKED - D.J.C.	REVISED - REVISED -	STATE OF ILLINOIS DEPARTMENT OF TRANSPORTATION	SCHEDULE OF QUANTITIES	1467	14-00259-05-CH	DUPAGE 294 46 CONTRACT NO 61G12
	DATE - 09-01-2020	REVISED -		SCALE: SHEET 16 OF 19 SHEETS STA. TO STA.		ILLINOIS FED.	AID PROJECT

### OF POLE FOUNDATION

REMARKS

### STREET

NW CORNER OF JORIE BOULEVARD NE CORNER OF JORIE BOULEVARD SW CORNER OF JORIE BOULEVARD SE CORNER OF JORIE BOULEVARD

FUND CODE

0005 RESURFACING

EA - 0005 RESURFACING

0005 RESURFACING 0005 RESURFACING 0005 RESURFACING 0005 RESURFACING 0005 RESURFACING 0005 RESURFACING 0005 RESURFACING 0005 RESURFACING 0005 RESURFACING 0005 RESURFACING 0005 RESURFACING 0005 RESURFACING 0005 RESURFACING 0005 RESURFACING 0005 RESURFACING 0004 WIDENING 0004 WIDENING 0004 WIDENING 0004 WIDENING 0004 WIDENING 0005 RESURFACING 0005 RESURFACING

Z0005216	нот-міх а	SPHALT S	TABILIZATIO	N 6" AT STEEL PLATE BEAM GUARDRAIL	Z003370(	) LONGITU	DINAL JOINT	SEALANT			X0327036	BIKE PAT	H REMOVAL				
SQ YD	STA.	STA	SQ FT	REMARKS	FOOT	STA		OFFSET REMARKS	FUND C	ODE	SQ YD	SQ FT	STA.	STA	FUND	REMARKS	
	GUAR	DRAIL			;	31ST STREI	ET						31ST S	TREET			
17	123+56	123+94	150	SW CORNER IL 83 BRIDGE (GUARDRAIL)	9,349	23+66	117+15	LL WB	0005 RE	ESURF	44	396	26+89	27+17	0005	SE CORNER AT MEYERS R	OAD
19	125+85	126+20	168	NE CORNER IL 83 BRIDGE (GUARDRAIL)	657	117+15	123+71	LL WB	0004 W	IDENING	26	231	55+29	55+62	0005	SW CORNER AT MIDWEST	CLUB PARKWAY
				· · · · · · · · · · · · · · · · · · ·	9,351	23+66	117+15	LL EB	0005 RE		18	166	56+63	56+80	0005	SE CORNER AT MIDWEST	CLUB PARKWAY
35	TOTAL				678	117+15	123+93	LL EB		IDENING	66	591	78+59	78+91	0005	SW CORNER AT MIDWEST	
	10 I/LE				2,368	125+86	149+54	LL WB		IDENING	16	146	78+92	79+04	0005	SW CORNER AT MIDWEST	
					969	149+54	159+22	LL WB	0005 RE		31	283	93+26	93+58	0005	SW CORNER AT CONCORD	
			RES TO BE A	DJUSTED	2,347	126+06	149+54	LL EB			27	243	94+54	94+75	0005	SE CORNER AT CONCORD	
EACH	STA.	O/S	REMARKS		984	149+54	159+37	LL EB	0005 RE		23	211	103+21	103+47	0005	SW CORNER AT MAYSLAK	
					3,014	161+23	191+37	LL WB	0005 RE		41	365	104+24	104+64	0005	SE CORNER AT MAYSLAKE	
1	25+96	LT			2,999	161+38	191+37	LL EB	0005 RE		13	116	123+07	123+23	0004	SW CORNER AT SB 83 ENT	
1	26+84	RT			2,000 9,180	23+66	115+46	CL	0005 RE		30	271	123+56	123+80	0004	SE CORNER AT SB 83 ENTI	
1	76+06	RT			60	123+23	123+82	CL		IDENING	10	93	126+53	126+58	0004	SW CORNER AT NB 83 EXIT	
1	79+03	RT			54	125+97	126+51	CL		IDENING	30	267	127+18	127+49	0004	SE CORNER AT NB 83 EXIT	
1	93+61	RT			1,152	134+68	146+20	CL		IDENING	6	207 54	127+18	127+49	0004	UNDERDRAIN CROSSING A	
1	94+44	RT			1,152	150+69	140+20 151+74	CL	0004 VV 0005 RE		6 16	54 141	120+47 141+80	120+52	0004	SW CORNER AT HUNTERS	
1	142+44	RT							0005 RE 0005 RE								
13	Additional q	uantity prov	ided for engine	er's use in curb removal and replacement areas if necessary.	. 95 . 97	163+33	164+28	CL			55 5	496	142+64	143+06	0004		
					87 767	171+75	172+62	CL	0005 RE		5	45	142+92	143+00	0004	NE CORNER AT JORIE BOU	
20	TOTAL				767	183+70	191+37	CL	0005 RE	SURF	91	818	150+65	151+10	0005		
						IEYERS RO					24	220	150+75	152+92	0005	NW CORNER AT OAK BROO	
					418	295+51	299+70	LL NB	0005 RE		21	189	171+82	172+04	0005	NW CORNER AT POLO DRIV	
				ECONSTRUCTED	419	295+51	299+70	LL SB	0005 RE		14	123	172+43	172+57	0005	NE CORNER AT POLO DRIV	
EACH	STA.	REMARK			412	300+30	304+41	LL NB	0005 RE		30	270	177+48	177+59	0005	31ST STREET MIDCROSSIN	
			ENGINEER)		411	300+31	304+42	LL SB	0005 RE	ESURF	20	177	177+48	177+59	0005	31ST STREET MIDCROSSIN	
45	FRAMES A	ND LIDS TO	BE ADJUST	ED (SPECIAL)	419	295+51	299+70	CL	0005 RE	SURF	43	389	177+48	177+59	0005	31ST STREET MIDCROSSIN	G
					411	300+30	304+41	CL	0005 RE	ESURF							
5	10% ESTIM	ATED TO E	E RECONSTR	RUCTED	MI	IDWEST RO	DAD										
					388	395+80	399+68	LL NB	0005 RE	ESURF	165	0004	WIDENING	3			
5	TOTAL				387	395+80	399+67	LL SB	0005 RE	ESURF	535	0005	RESURFA	CING			
					465	400+29	404+94	LL NB	0005 RE	ESURF							
					466	400+28	404+94	LL SB	0005 RE	ESURF	700	TOTAL					
					388	395+80	399+67	CL	0005 RE	ESURF							
					466	400+29	404+94	CL	0005 RE	ESURF							
					,	JORIE ROA	D										
					152	500+31	501+83	LL NB	0004 W	IDENING							
					152	500+31	501+83	LL SB	0004 W	IDENING							
					7,620	0004 WIDI	ENING										
					41,950	0005 RES	URF										
					'	TOTAL											
					,												
														MOVAL AN	ID REPLA	CEMENT LESS THAN OR EQU	
								F	FOOT STA		OFFSE	T REMAR	RKS				FUND CODE
									319	ST STREET							
									863 23+6	6 191+3	17	EST. 10	% REMOVAL	OF CURB	IN RESU	IRFACING AREA -	0005 RESURFACING
									2310	19113	,	25% AL	LOCATED TO	) <= 10 FO	OT ITEM		
									50			NOMINA	L ESTIMATE	D QUANTI	ty in wie	DENING AREA	0004 WIDENING
									50 0004 V	VIDENING							
									863 0005 F	RESURFACI	NG						
									913 TOTA	L							
	<b>T</b>			DESIGNED         D.M.S.         REVISED           DRAWN         D.M.S.         REVISED			CTAT						OF QUANT	ידובפ ודובפ		F A U RTE SECTION	COUNTY TOTAL SHEE SHEETS NO.
KNIGH				DRAWN         D.M.S.         REVISED         -           CHECKED         D.J.C.         REVISED         -		DF		E OF ILLINOIS OF TRANSPORTATI	on		ગ	JUEDOLE	OF QUANT	IIIEƏ		1467 14-00259-05-CH	DUPAGE 294 47 CONTRACT NO. 61G12
Engine	eers & Architects			DATE - 09-01-2020 REVISED -						SCALE:	SHEET	17 OF 19	SHEETS STA.		TO STA.	ILLINOIS FE	D AID PROJECT

								-						
						•		F.A.U RTE	SEG	TION		COUNTY	TOTAL SHEETS	SHEET NO.
	SCHEDULE OF QUANTITIES								1467 14-00259-05-CH				294	47
												CONTRACT	NO. 6	1G12
SCALE:	SHEET	17 OF	19	SHEETS	STA.	TO ST	۹.			ILLINOIS	FED. A	ID PROJECT		

EACH	STA	FUND CODE	EACH	STATION	STATION	LENGTH	SPACING	FACTO	R REMARKS	FUND COL
_/	31ST STRI			31ST S						
1	45+01	0005 RESURF	13	23+66	25+81	215	40	2	MEDIAN DOUBLE SOLID - YELLOW	0005 RESI
1	46+14	0005 RESURF	7	23+66	25+80	215	40	1	EB LT TURN LANE SOLID - WHITE	0005 RESI
1	46+94	0005 RESURF	7	23+66	25+80	215	40	1	EB LANE LINE 10' SOLID WITH 30' SPACE - WHITE	0005 RESI
1	49+10	0005 RESURF	7	23+66	25+78	212	40	1	WB LANE LINE 10' SOLID WITH 30' SPACE - WHITE	0005 RESI
1	52+08	0005 RESURF	8	26+96	29+47	251	40	1	WB LT TURN LANE SOLID - WHITE	0005 RES
1	88+87	0005 RESURF	32	26+96	39+13	1217	40	1	WB LANE LINE 10' SOLID WITH 30' SPACE - WHITE	0005 RES
1	91+06	0005 RESURF	63	26+97	39+12	1217	40	2	MEDIAN DOUBLE SOLID - YELLOW	0005 RES
1	101+00	0005 RESURF	39	39+67	46+89	722	40	2	MEDIAN DOUBLE SOLID - YELLOW	0005 RES
1	114+13	0005 RESURF	74	26+96	55+80	2882	40	1	EB LANE LINE 10' SOLID WITH 30' SPACE - WHITE	0005 RES
1	151+17	0005 RESURF	74 19	39+70	46+89	719	40 40	1	WB LANE LINE 10' SOLID WITH 30' SPACE - WHITE	0005 RES
1	151+17	0005 RESURF	44	47+45	55+82	837	40 40	2	MEDIAN DOUBLE SOLID - YELLOW	0005 RES
1	151+30	0005 RESURF	3	47+43 55+82	55+82 55+82	037	40	2	END OF PAINTED MEDIAN DOUBLE SOLID-YELLOW	
1	151+42	0005 RESURF	57	56+59		0000	40	1	EB LANE LINE 10' SOLID WITH 30' SPACE - WHITE	0005 RES 0005 RES
•					78+92	2233	40	•		0005 RES
1	163+34		80	47+46	78+93	3147	40	1	WB LANE LINE 10' SOLID WITH 30' SPACE - WHITE	
1	170+64	0005 RESURF	5	56+59	57+90	131	40	1	WB LT TURN LANE SOLID - WHITE	0005 RES
1	172+25	0005 RESURF	114	56+59	78+93	2234	40	2	MEDIAN DOUBLE SOLID - YELLOW	0005 RES
1	184+57	0005 RESURF	9	75+90	78+92	303	40	1	EB LT TURN LANE SOLID - WHITE	0005 RES
1	186+55		70	80+04	93+58	1354	40	2	MEDIAN DOUBLE SOLID - YELLOW	0005 RES
1	187+15	0005 RESURF	9	80+04	83+04	300	40	1	WB LT TURN LANE SOLID - WHITE	0005 RES
1	188+06	0005 RESURF	35	80+05	93+53	1349	40	1	EB LANE LINE 10' SOLID WITH 30' SPACE - WHITE	0005 RES
1	189+15	0005 RESURF	35	80+05	93+58	1349	40	1	WB LANE LINE 10' SOLID WITH 30' SPACE - WHITE	0005 RES
1	190+11	0005 RESURF	6	91+63	93+58	195	40	1	EB LT TURN LANE SOLID - WHITE	0005 RES
1	190+85	0005 RESURF	7	94+54	96+59	205	40	1	WB LT TURN LANE SOLID - WHITE	0005 RES
1	190+94	0005 RESURF	46	94+54	103+29	875	40	2	MEDIAN DOUBLE SOLID - YELLOW	0005 RES
1	191+11	0005 RESURF	23	94+54	103+26	873	40	1	EB LANE LINE 10' SOLID WITH 30' SPACE - WHITE	0005 RES
1	191+32	0005 RESURF	51	94+54	114+46	1993	40	1	WB LANE LINE 10' SOLID WITH 30' SPACE - WHITE	0005 RES
	MEYERS		3	103+29	103+29				END OF PAINTED MEDIAN DOUBLE SOLID-YELLOW	0005 RES
9		0005 RESURF	54	104+26	114+50	1024	40	2	MEDIAN DOUBLE SOLID - YELLOW	0005 RES
	MIDWEST		5	104+26	105+76	150	40	1	WB LT TURN LANE SOLID - WHITE	0005 RES
7		0005 RESURF	27	104+26	114+47	1020	40	1	EB LANE LINE 10' SOLID WITH 30' SPACE - WHITE	0005 RES
	JORIE		4	113+47	114+47	100	40	1	EB LT TURN LANE SOLID - WHITE	0005 RES
3		0004 WIDENING	3	114+50	114+50				END OF PAINTED MEDIAN DOUBLE SOLID-YELLOW	0005 RES
3	0004 WIDE	NING	21	115+48	123+15	766	40	1	EB LANE LINE 10' SOLID WITH 30' SPACE - WHITE	0004 WIE
42	0005 RESI	JRF	20	115+53	123+07	754	40	1	WB LANE LINE 10' SOLID WITH 30' SPACE - WHITE	0004 WIE
			7	115+53	117+58	205	40	1	WB LT TURN LANE SOLID - WHITE	0004 WIE
45	TOTAL		7	115+53	117+63	210	40	1	WB RT TURN LANE SOLID - WHITE	0004 WIE
			11	119+15	123+15	400	40	1	EB LT TURN LANE SOLID - WHITE	0004 WIE
			11	119+05	122+92	386	40	1	EB RT TURN LANE SOLID - WHITE	0004 WIE
		TED MEDIAN REMOVAL	16	126+58	132+37	580	40	1	WB LT TURN LANE SOLID - WHITE	0004 WIE
SQ FT	STA.	REMARKS	40	126+58	141+84	1527	40	1	WB LANE LINE 10' SOLID WITH 30' SPACE - WHITE	0004 WIE
	31ST :	STREET	16	134+04	140+00	597	40	1	WB AUX LANE LINE 10' SOLID WITH 30' SPACE - WH	
1325	109+07	EB/WB 31ST STREET	6	126+80	128+64	184	40	1	WB RT TURN LANE SOLID - WHITE	
			39	126+72	141+84	1512	40	1	EB LANE LINE 10' SOLID WITH 30' SPACE - WHITE	0004 WIE
1,325	TOTAL		18	135+33	141+84	651	40	1	EB FAR LEFT LT TURN LANE SOLID - WHITE	0004 WIE
			18	135+33	141+84	651		1	EB LT TURN LANE SOLID - WHITE	0004 WIE
							40 40			0004 WIE
			21	143+03	150+86	782	40 40	1	EB LANE LINE 10' SOLID WITH 30' SPACE - WHITE	0004 WIE
			21	143+04	150+85	781	40 40	1	WB LANE LINE 10' SOLID WITH 30' SPACE - WHITE	0004 WIE
			7	143+05	145+40	235	40	1		0004 WIE
			11	143+21	147+17	396	40	1	WB RT TURN LANE SOLID - WHITE	0004 WID
			5	149+51	150+85	134	40	1	EB LT TURN LANE SOLID - WHITE	0004 WIE

	DESIGNED - D.M.S.	REVISED -						F.A.U RTE	SECTION	COUNTY TOT	)TAL SHEET (EETS NO.
KNIGHT Engineers & Architects	DRAWN - D.M.S. CHECKED - D.J.C.	REVISED - REVISED -	STATE OF ILLINOIS DEPARTMENT OF TRANSPORTATION		SCHEDULE OF QU	JANIIIES		1467	14-00259-05-CH	DUPAGE 29	<u>94 48</u>
	DATE - 09-01-2020	REVISED -		SCALE:	SHEET 18 OF 19 SHEETS	STA.	TO STA.		ILLINOIS FED	AID PROJECT	<u></u>


10300	RECESSED F	REFLECTIVE	PAVEMENT	MARKER (0	CONT'D)			<u>X814011</u>	<u>5 HANDHOI</u>	LE TO BE ADJUSTED
20	151+73	159+22	749	40	1	WB LANE LINE 10' SOLID WITH 30' SPACE - WHITE	0005 RESURF	EACH	STA.	REMARKS
5	151+74	153+29	155	40	1	WB LT TURN LANE SOLID - WHITE	0005 RESURF		31ST STF	REET
21	151+75	159+37	762	40	1	EB LANE LINE 10' SOLID WITH 30' SPACE - WHITE	0005 RESURF	1		SW CORNER OF TRINITY LAN
7	161+23	163+37	214	40	1	WB LANE LINE 10' SOLID WITH 30' SPACE - WHITE	0005 RESURF			
65	161+38	186+94	2557	40	1	EB LANE LINE 10' SOLID WITH 30' SPACE - WHITE	0005 RESURF	1	TOTAL	
3	162+68	163+33	65	40	1	EB LT TURN LANE SOLID - WHITE	0005 RESURF			
20	164+22	171+75	754	40	1	WB LANE LINE 10' SOLID WITH 30' SPACE - WHITE	0005 RESURF			
5	170+25	171+75	150	40	1	EB LT TURN LANE SOLID - WHITE	0005 RESURF			
29	172+58	183+76	1119	40	1	WB LANE LINE 10' SOLID WITH 30' SPACE - WHITE	0005 RESURF			
4	182+80	183+70	90	40	1	EB LT TURN LANE SOLID - WHITE	0005 RESURF			
7	184+89	186+92	235	40	1	WB LANE LINE 10' SOLID WITH 30' SPACE - WHITE	0005 RESURF			
14	184+62	186+97	235	40	2	MEDIAN DOUBLE SOLID - YELLOW	0005 RESURF			
3	184+60	184+60				END OF PAINTED MEDIAN DOUBLE SOLID-YELLOW	0005 RESURF			
3	186+53	186+96	44	40	1	EB LT TURN LANE SOLID - WHITE	0005 RESURF			
6	187+88	189+88	200	40	1	WB LT TURN LANE SOLID - WHITE	0005 RESURF			
20	187+88	191+37	349	40	2	MEDIAN DOUBLE SOLID - YELLOW	0005 RESURF			
10	187+88	191+37	349	40	1	WB LANE LINE 10' SOLID WITH 30' SPACE - WHITE	0005 RESURF			
10	187+88	191+37	350	40	1	EB LANE LINE 10' SOLID WITH 30' SPACE - WHITE	0005 RESURF			
	MEYERS	S ROAD								
22	295+51	299+46	395	40	2	MEDIAN DOUBLE SOLID - YELLOW	0005 RESURF			
11	295+51	299+44	393	40	1	NB LANE LINE 10' SOLID WITH 30' SPACE - WHITE	0005 RESURF			
11	295+51	299+46	395	40	1	SB LANE LINE 10' SOLID WITH 30' SPACE - WHITE	0005 RESURF			
6	297+50	299+45	195	40	1	NB LT TURN LANE SOLID- WHITE	0005 RESURF			
6	300+58	302+58	200	40	1	SB LT TURN LANE SOLID- WHITE	0005 RESURF			
22	300+58	304+41	382	40	2	MEDIAN DOUBLE SOLID - YELLOW	0005 RESURF			
11	300+58	304+41	383	40	1	NB LANE LINE 10' SOLID WITH 30' SPACE - WHITE	0005 RESURF			
11	300+58	304+41	383	40	1	SB LANE LINE 10' SOLID WITH 30' SPACE - WHITE	0005 RESURF			
	MIDWES	T ROAD								
21	395+80	399+50	370	40	2	MEDIAN DOUBLE SOLID - YELLOW	0005 RESURF			
11	395+80	399+51	372	40	1	NB LANE LINE 10' SOLID WITH 30' SPACE - WHITE	0005 RESURF			
11	395+80	399+50	371	40	1	SB LANE LINE 10' SOLID WITH 30' SPACE - WHITE	0005 RESURF			
7	397+30	399+51	220	40	1	NB LT TURN LANE SOLID- WHITE	0005 RESURF			
9	400+56	403+71	315	40	1	SB LT TURN LANE SOLID- WHITE	0005 RESURF			
24	400+56	404+94	438	40	2	MEDIAN DOUBLE SOLID - YELLOW	0005 RESURF			
12	400+56	404+94	438	40	1	NB LANE LINE 10' SOLID WITH 30' SPACE - WHITE	0005 RESURF			
12	400+56	404+94	439	40	1	SB LANE LINE 10' SOLID WITH 30' SPACE - WHITE	0005 RESURF			
	RAM	РВ								
7	2121+10	2123+20	210	40	1	NB LT TURN LANE SOLID- WHITE	0004 WIDENING			
8	2121+10	2123+63	257	40	1	NB RT TURN LANE SOLID- WHITE	0004 WIDENING			
	JORIE BO	ULEVARD								
5	500+39	501+83	144	40	1	SB LT TURN LANE SOLID- WHITE	0004 WIDENING			
4	500+99	501+83	84	40	1	SB RT TURN LANE SOLID- WHITE	0004 WIDENING			

319 0004 WIDENING

1418 0005 RESURF

1,737 TOTAL


	DESIGNED D.M.S.	REVISED -				F.A.U RTE	SECTION	COUNTY TOTAL SHEET SHEETS NO.
KNIGHT	DRAWN D.M.S.	REVISED -	STATE OF ILLINOIS		SCHEDULE OF QUANTITIES	1467	14-00259-05-CH	DUPAGE 294 49
Engineers & Architects	CHECKED D.J.C.	REVISED -	DEPARTMENT OF TRANSPORTATION					CONTRACT NO. 61G12
	DATE - 09-01-2020	REVISED -		SCALE:	SHEET 19 OF 19 SHEETS STA. TO STA.		ILLINOIS FED. /	AID PROJECT

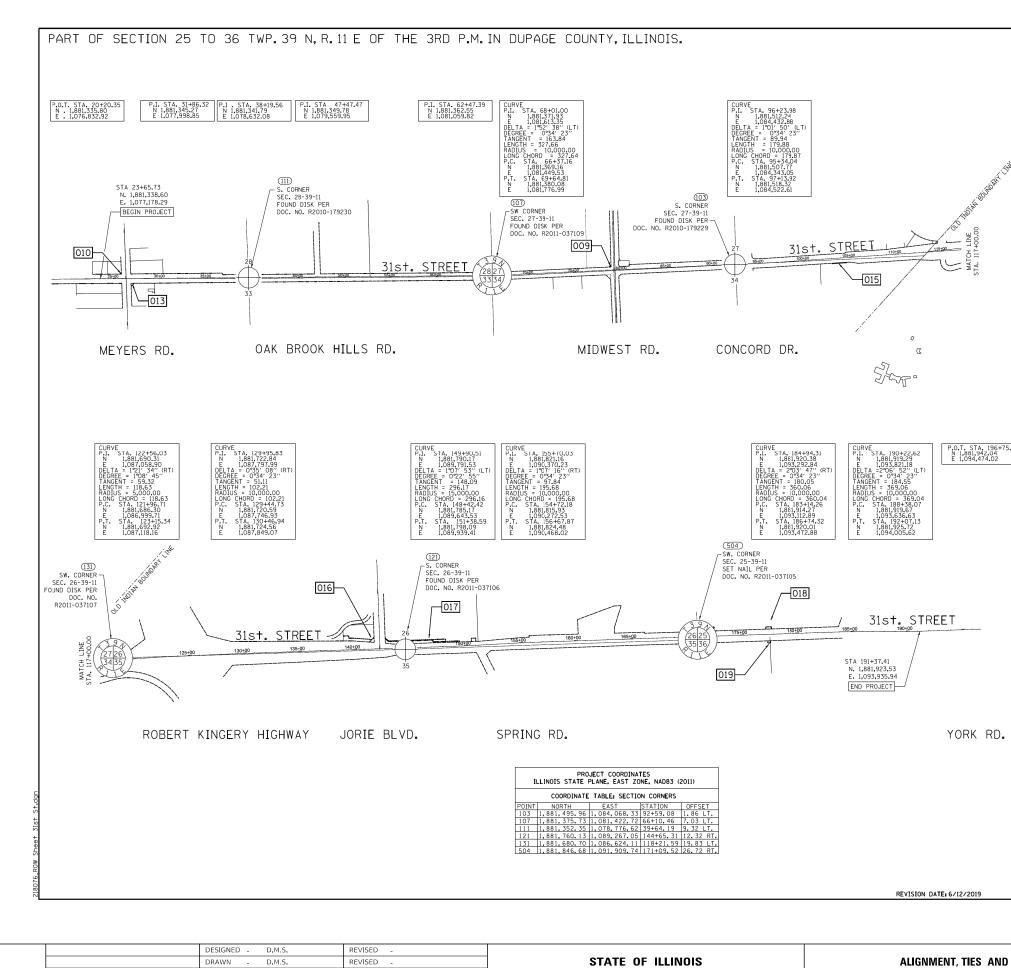


KNIGHT	DRAWN -	D.M.S.	REVISED -	STATE OF ILLINOIS		ALIGNMENT,
Engineers & Architects	CHECKED -	D.J.C.	REVISED -	DEPARTMENT OF TRANSPORTATION		
	DATE -	09-01-2020	REVISED -		SCALE: NONE	SHEET 1 OF


	<u>LEGEND</u>		
9 10 16 15 CORM	16 ( ) 15 SI	UARTER ECTION DRNER	
P	OUARTER SECT ULATTED LOT PROPERTY (DE APPARENT PRO	LINES SCALE: G ED: LINE	RAPHIC ONLY
	PROPOSED RIG	IT OF WAY LINE HT OF WAY LINE	
129.32	MEASURED DIM	GEMENT IENSION	
		DING	
PLANE COORDINATE	ANCES ARE REFERENCED TO SYSTEM, NAD83 (2011 ADJUS) RE MEASURED UNLESS OTHERW	TMENT), EAST ZONE.	
IRON PIPE OR ROD FOUR CUT CROSS FOUND OR S	GET ● 5 / 8" REBAR		
MARKER TO MONUM DATA AND SURVEYO M STAKING OF PROPO	DEED RIGHT OF WAY, SET DI ENT THE POSITION SHOWN, IC DRS REGISTRATION NUMBER.	ENTIFIED BY INSCRIPTIC	IN
MARKER POSITION	WETAL ROD 20 INCHES BELOW IDENTIFIED BY COLORED PLAS RATION NUMBER. 1 MARKER, I.D.O.T. STANDARD	STIC CAP BEARING	
	KING PROPOSED TO BE SET		
	F.A.U RTE	SECTION	COL

	-				F.A.U RTE	SECT	TION		COUNTY	TOTAL SHEETS	SHEET NO.
NI,	TIES	s and	BENCHMARKS		1467	14-0025	9-05-CH		DUPAGE	294	50
									CONTRACT	NO. 61	lG12
OF	3	SHEETS	STA.	TO STA.			ILLINOIS	FED. AI	D PROJECT		

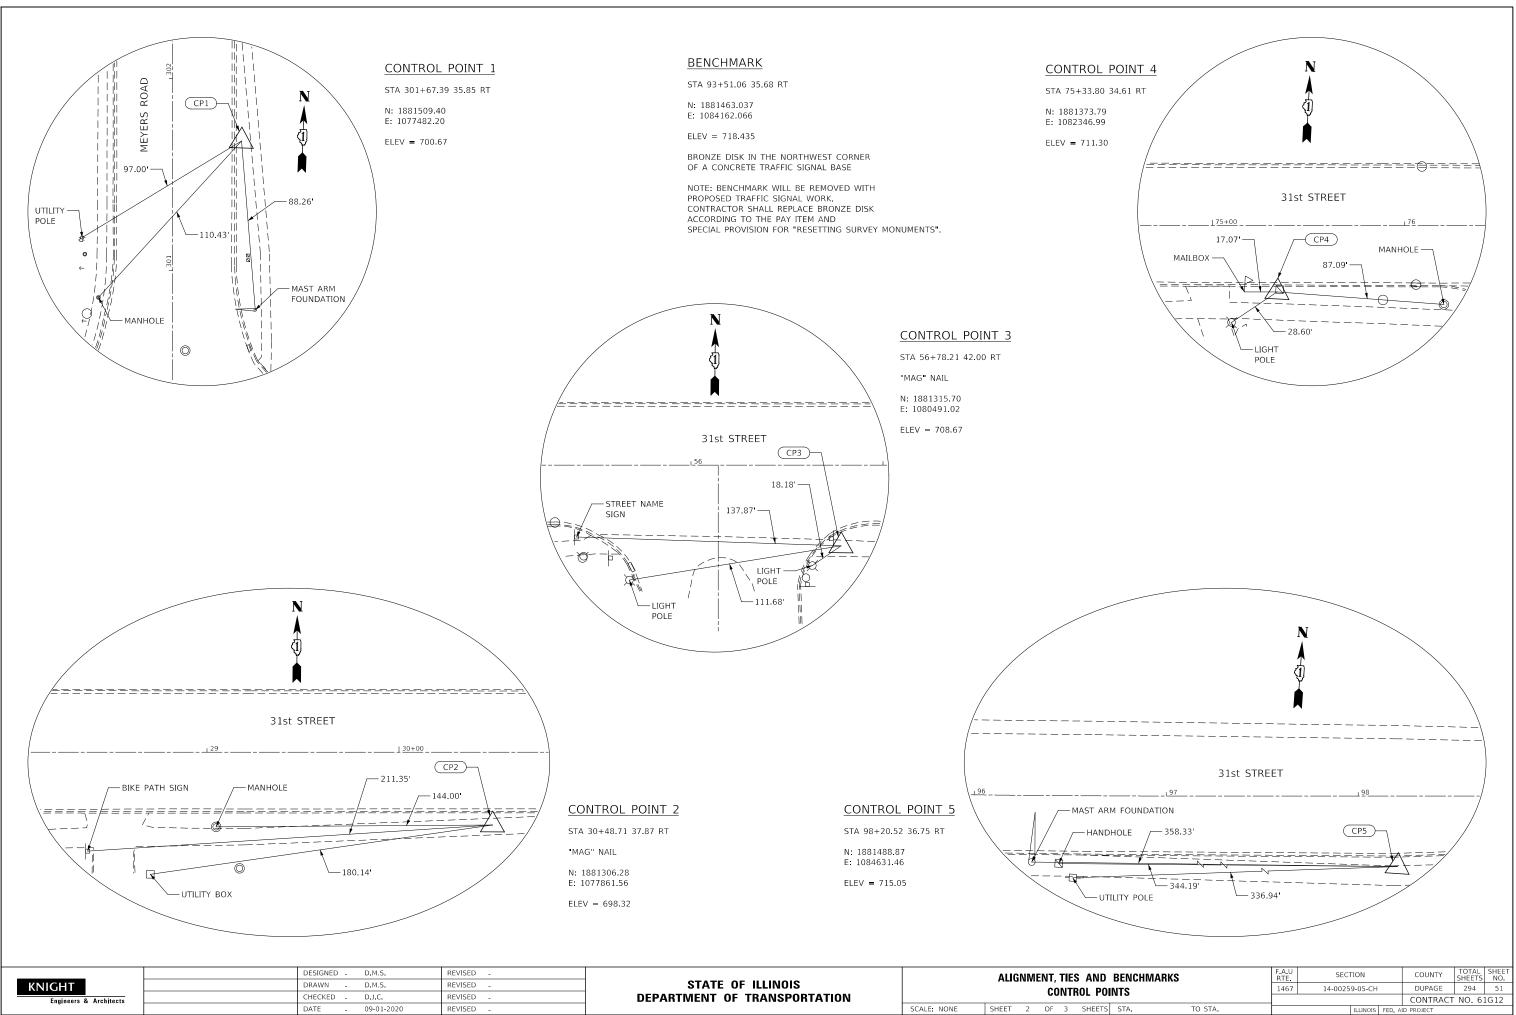


KNIGHT	DESIGNED D.M.S. DRAWN D.M.S.	REVISED -	STATE OF ILLINOIS		ALIGNMENT, TIES AND
Engineers & Architects	CHECKED D.J.C.	REVISED -	DEPARTMENT OF TRANSPORTATION		CONTROL POI
	DATE - 09-01-2020	REVISED -		SCALE: NONE	SHEET 2 OF 3 SHEETS

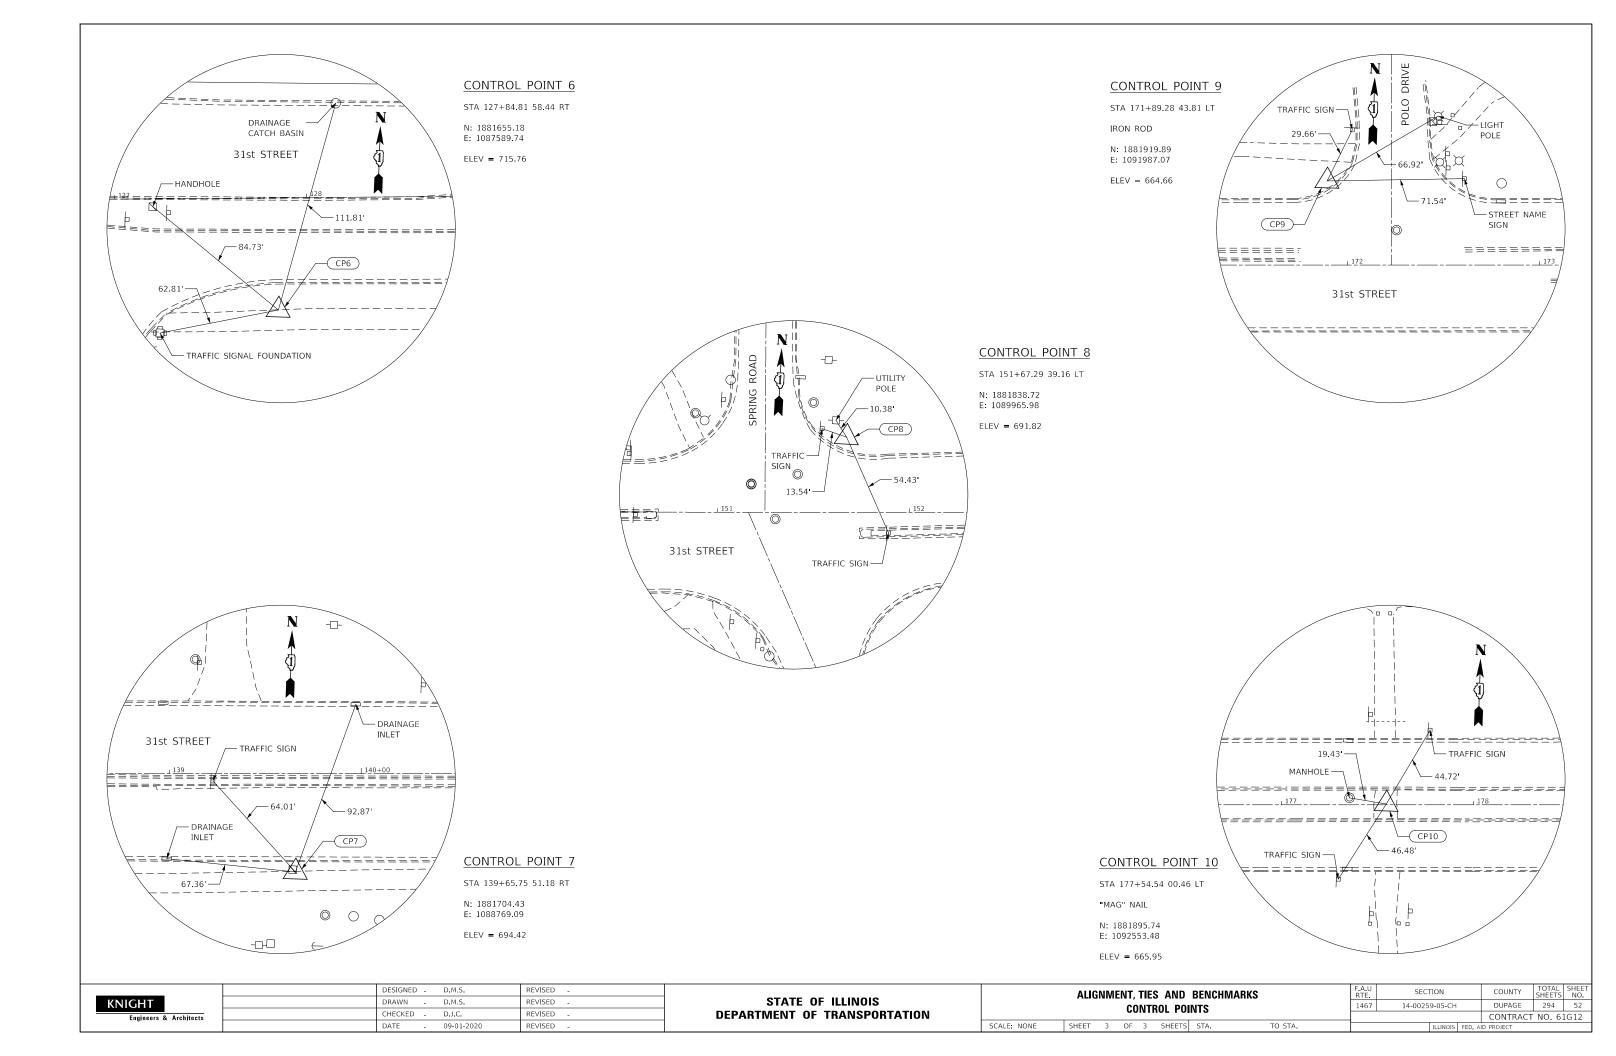

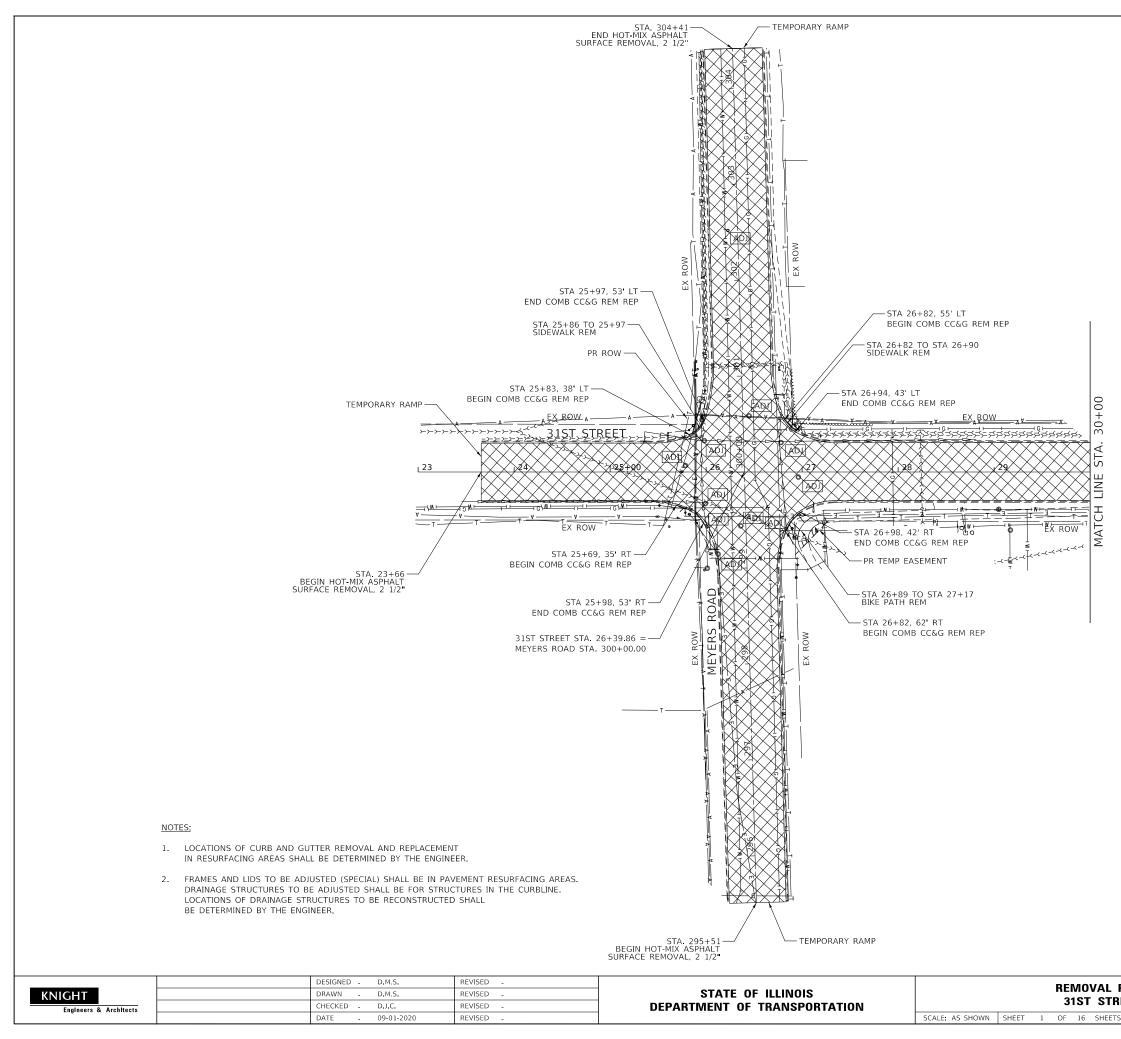

P	LAN				F.A.U RTE	SECT	TION		COUNTY	TOTAL SHEETS	SHEET NO.
2 6	ET				1467	14-0025	9-05-CH		DUPAGE	294	53
	- 8 8								CONTRACT	NO. 6	IG12
s	STA.	23+00	TO STA.	30+00			ILLINOIS	FED. AI	ID PROJECT		

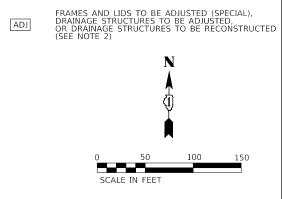



ADJ

DRIVEWAY PAVEMENT REMOVAL HOT-MIX ASPHALT SURFACE REMOVAL VARIABLE DEPTH



PAVED SHOULDER REMOVAL





PAVEMENT REMOVAL





LEGEND:













\_\_\_\_\_ LINEAR REMOVAL ITEM (AS NOTED)


HOT-MIX ASPHALT SURFACE REMOVAL, 2 1/2"

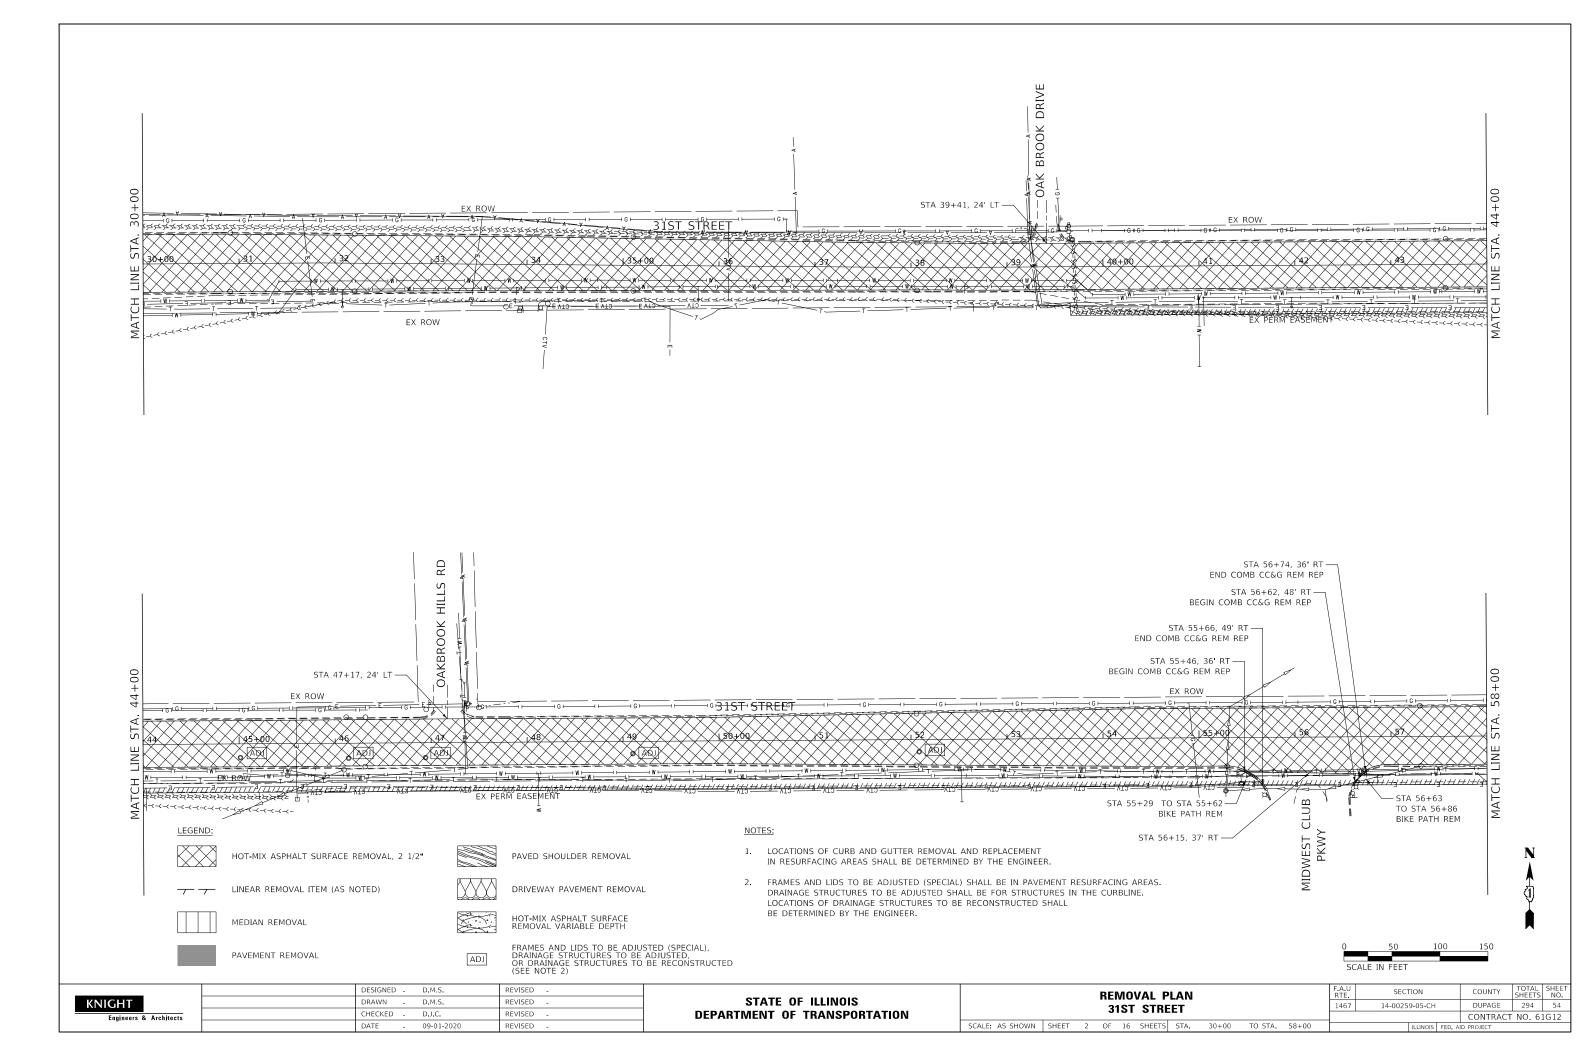


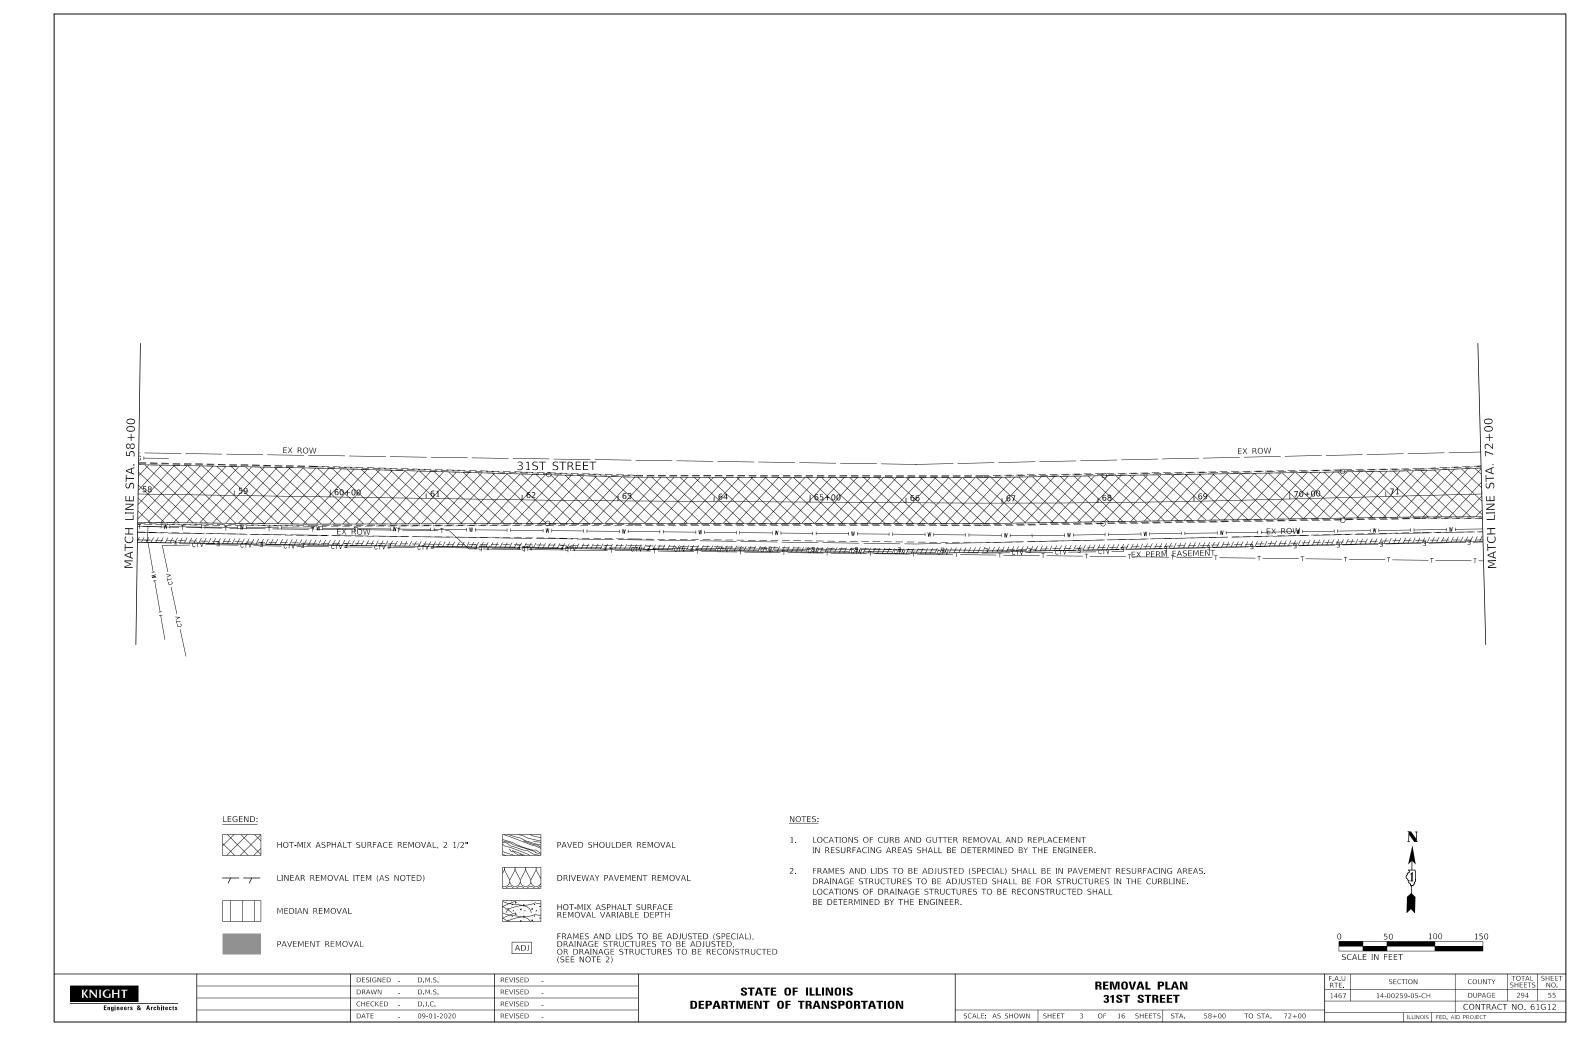


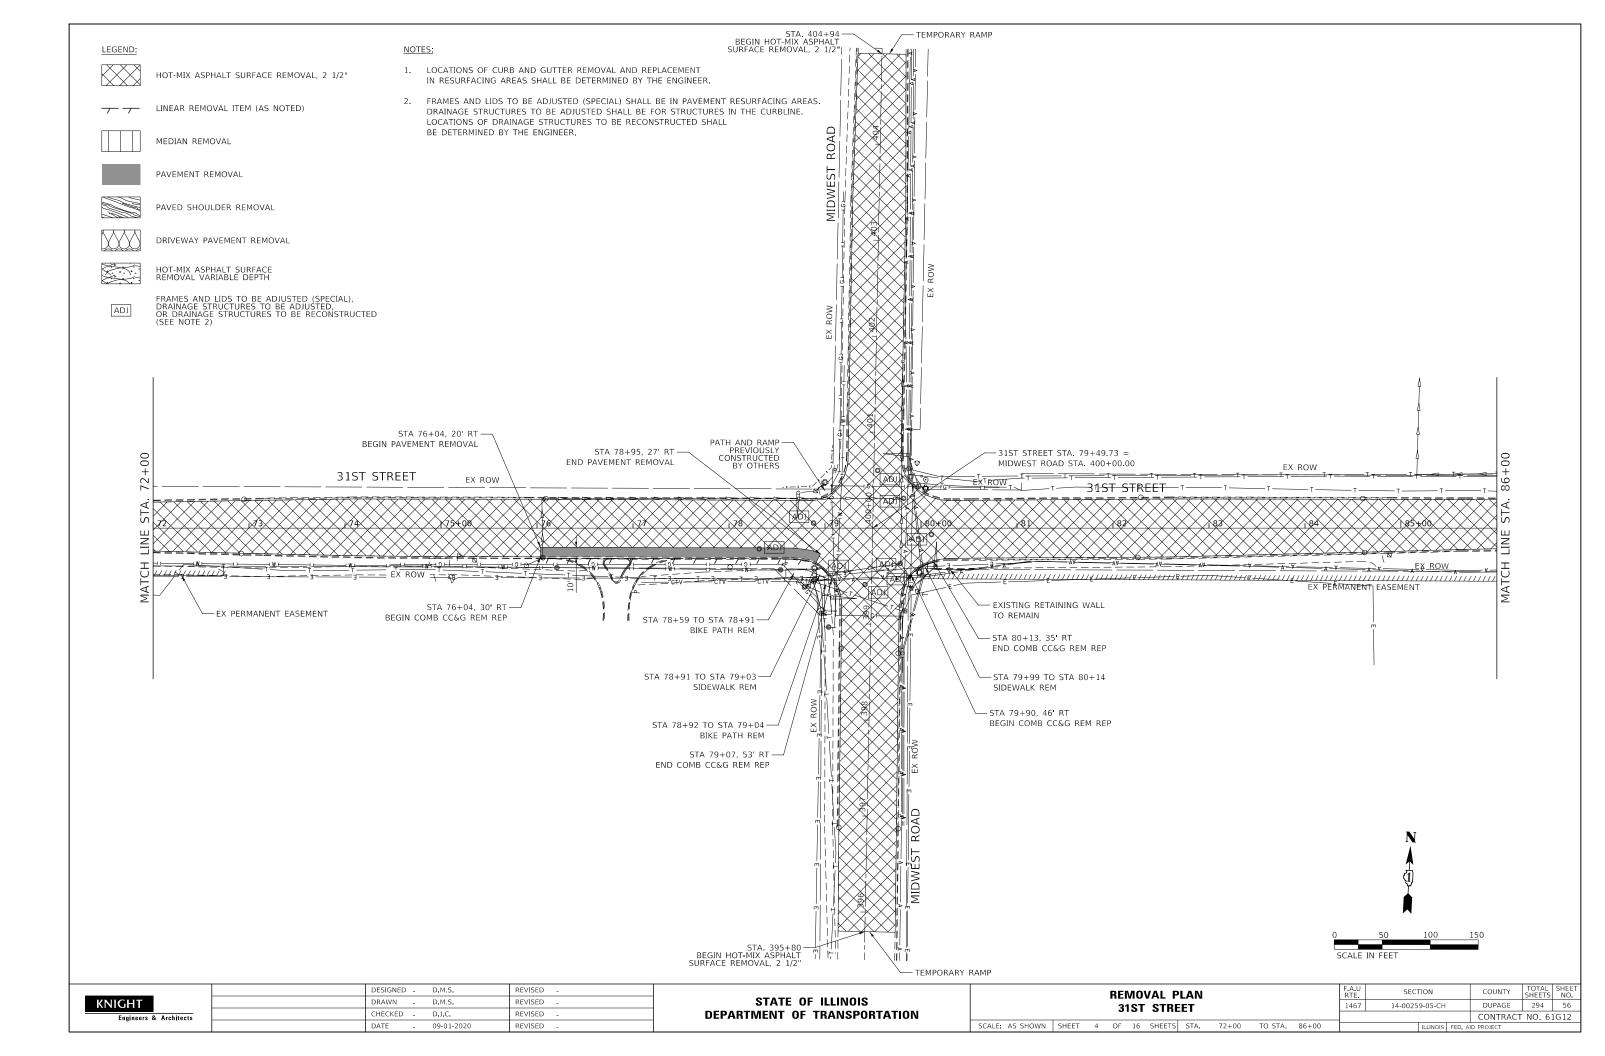


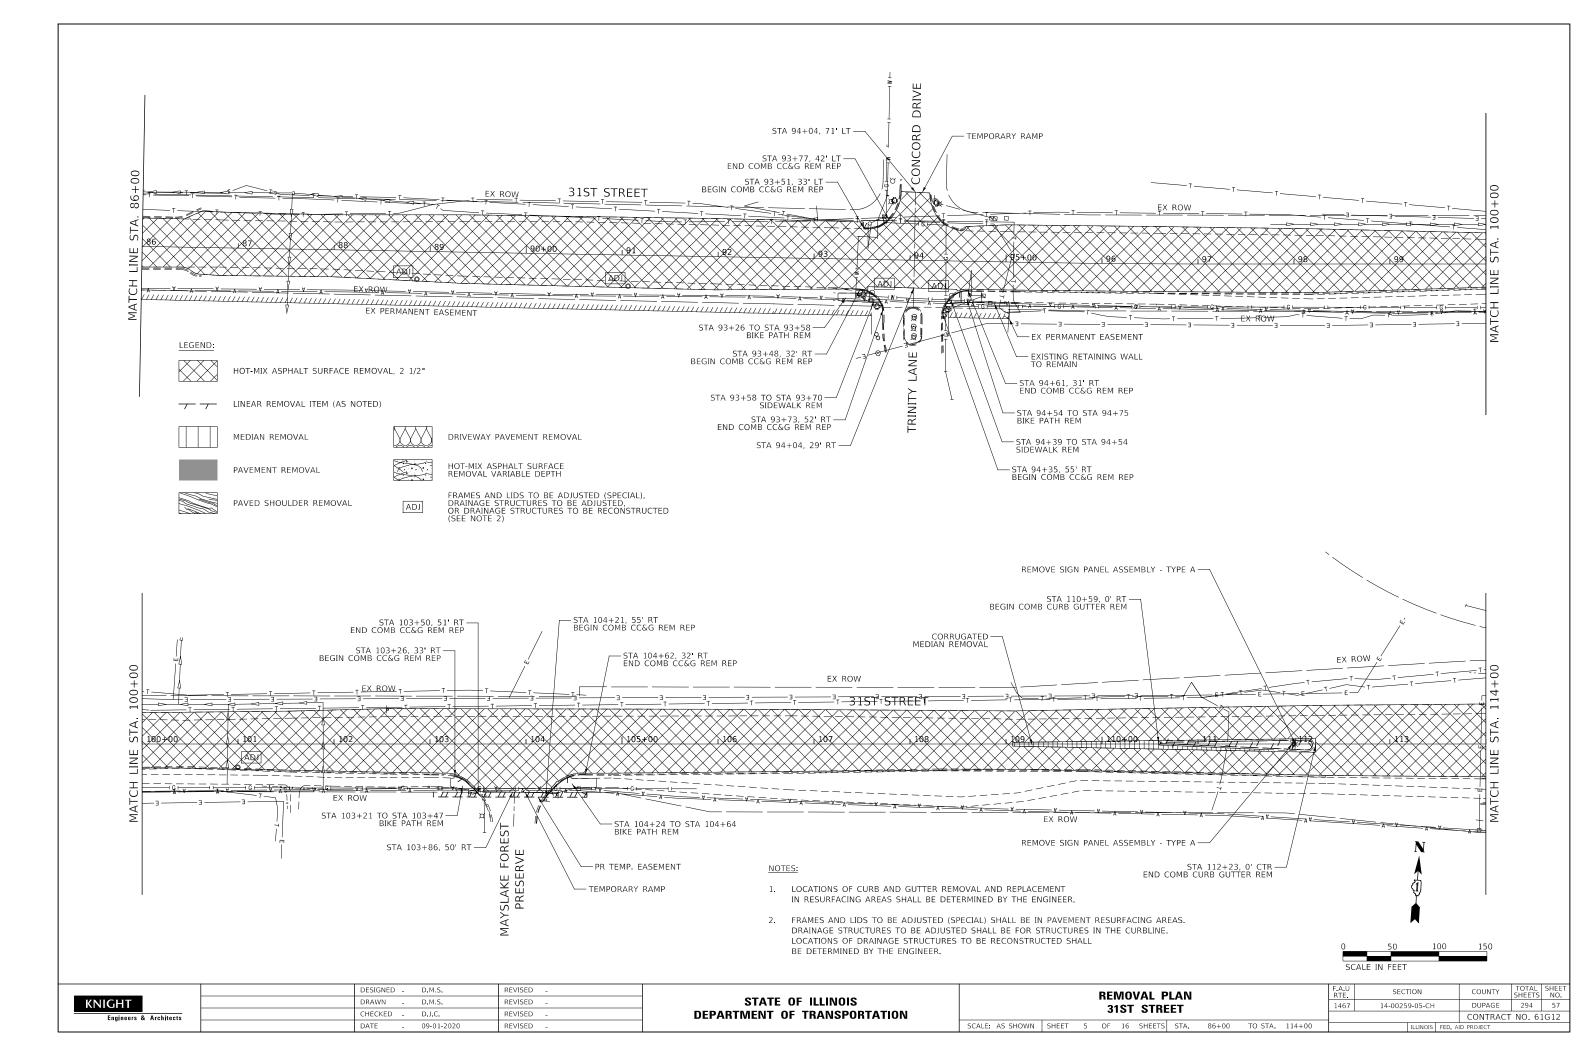

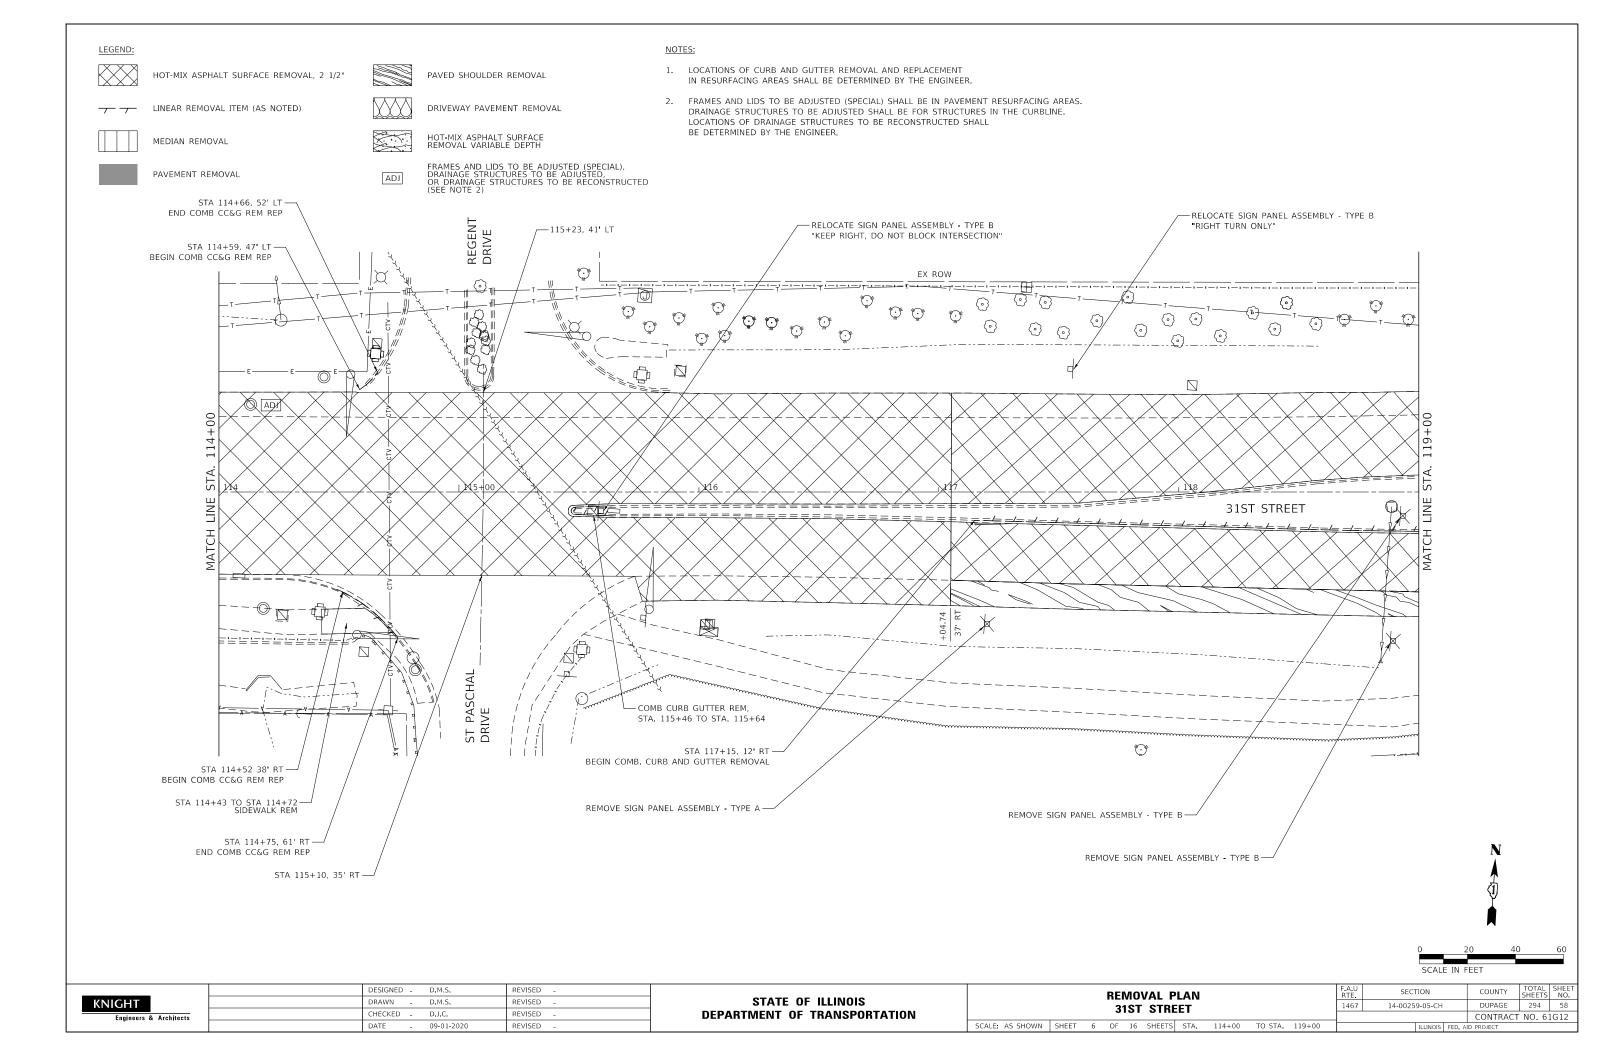

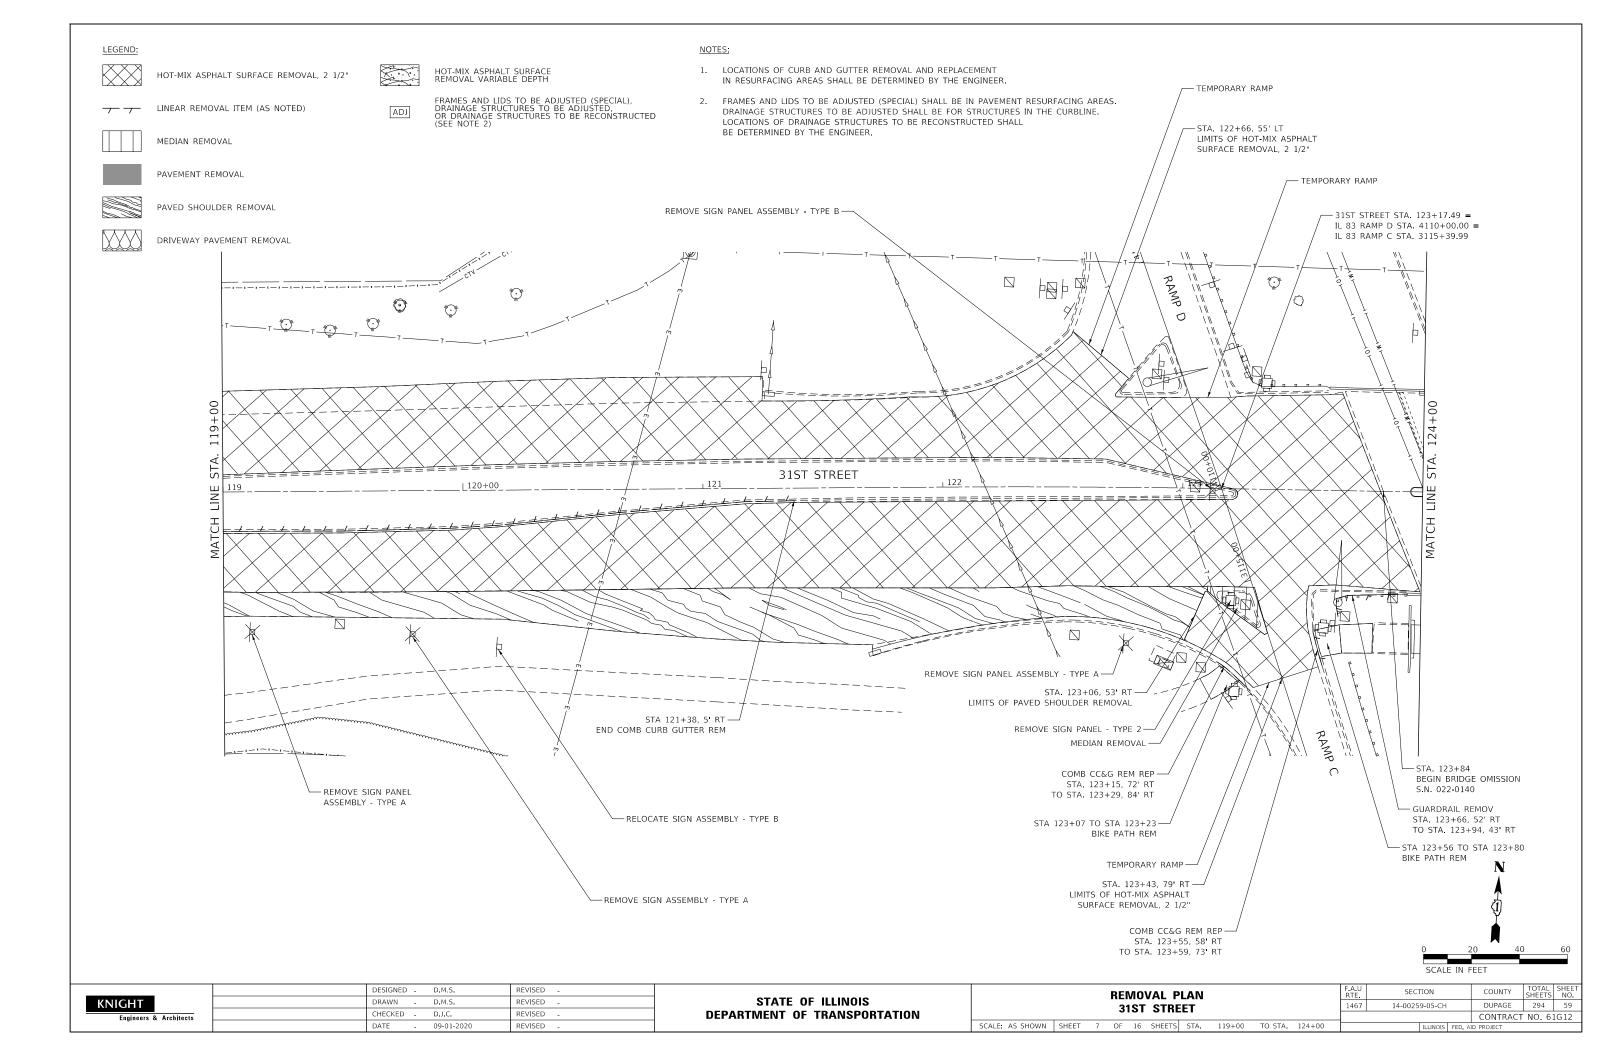


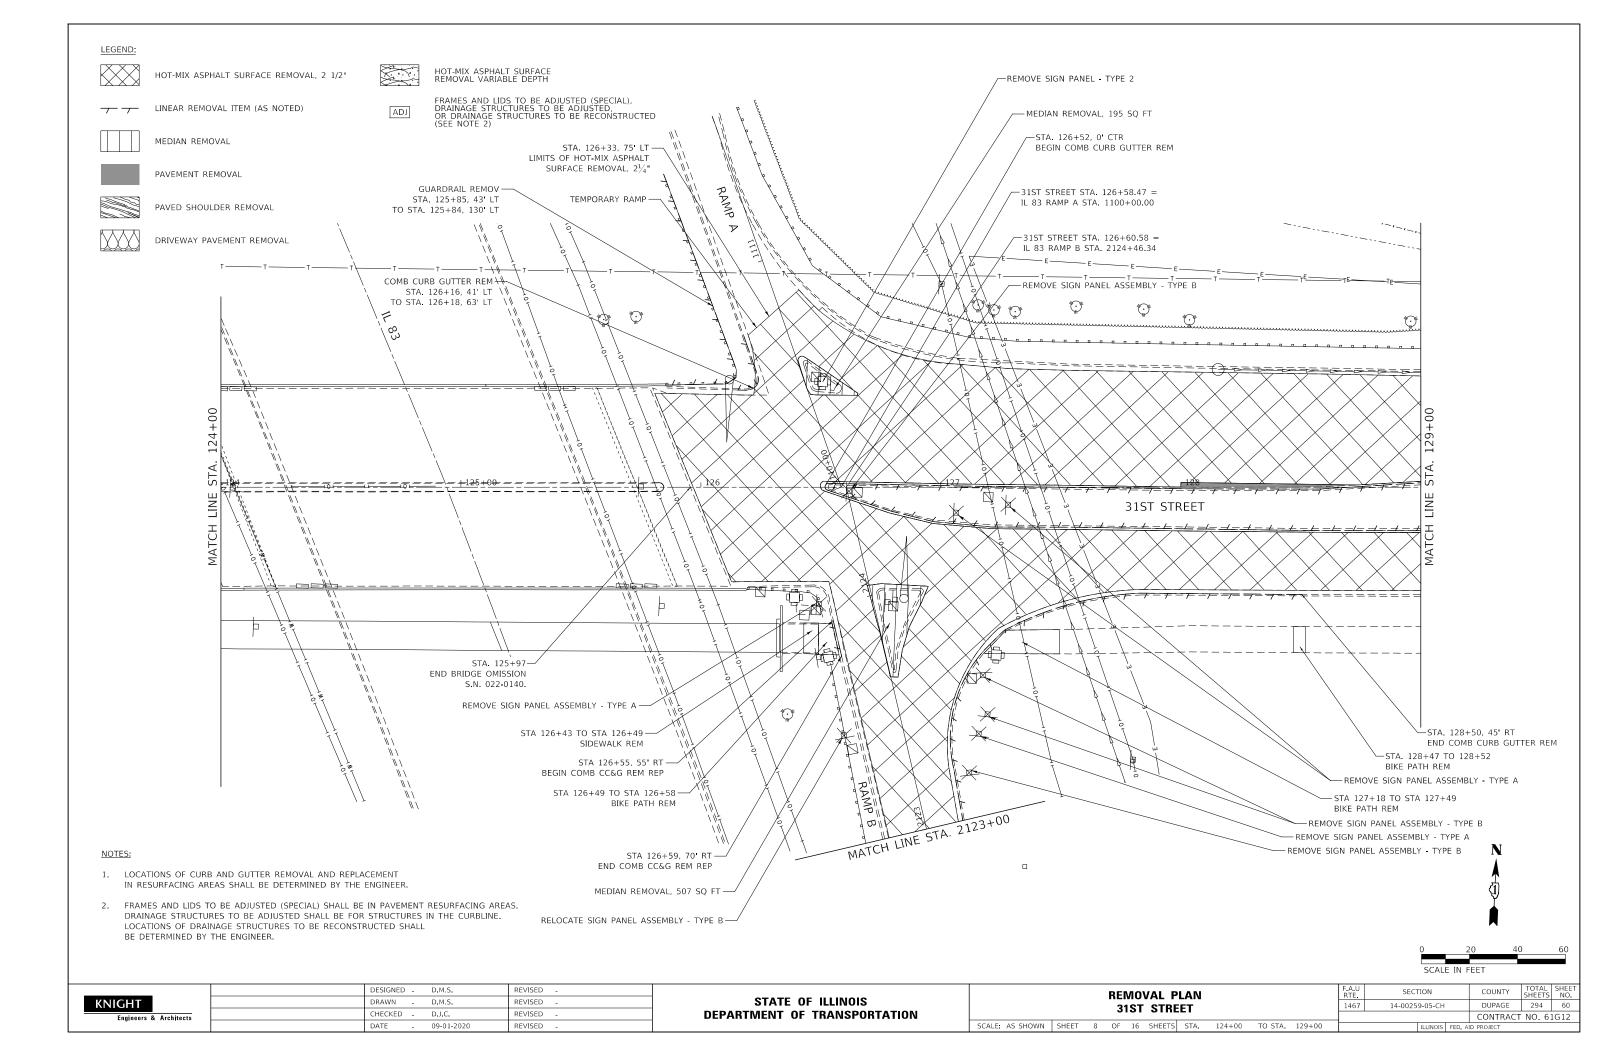


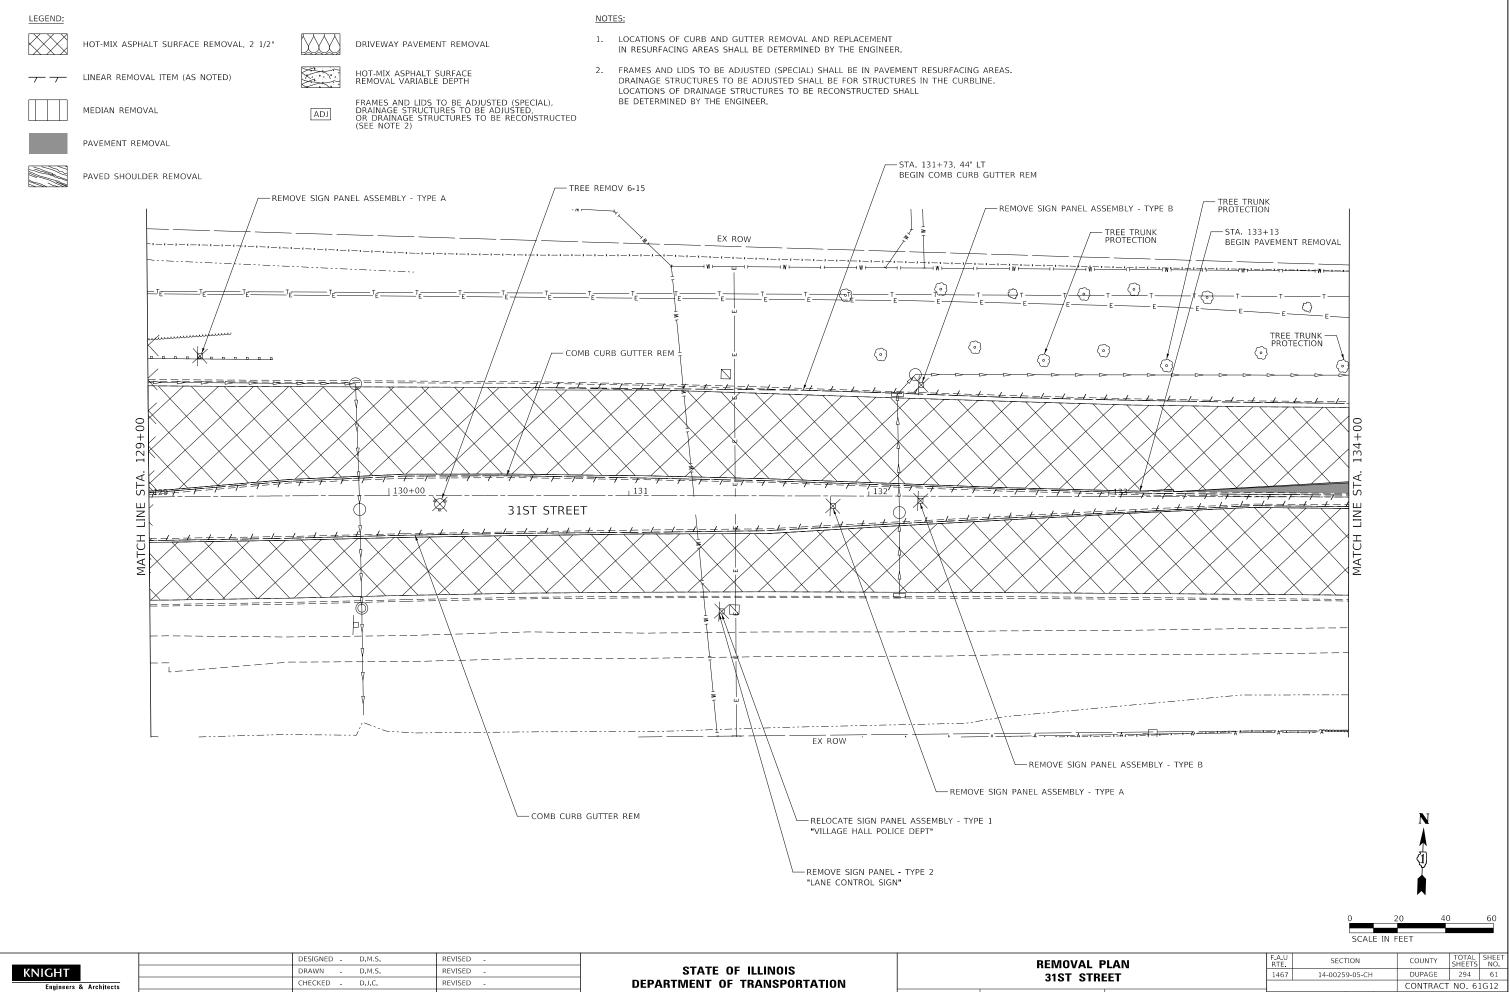


**REVISED** 

г	LAN				RIE.					SHEETS	NO.
RF	ET				1467	14-0025	9-05-CH		DUPAGE	294	61
									CONTRACT	NO. 61	G12
TS	STA.	129+00	TO STA.	134+00			ILLINOIS	FED. AI	D PROJECT		

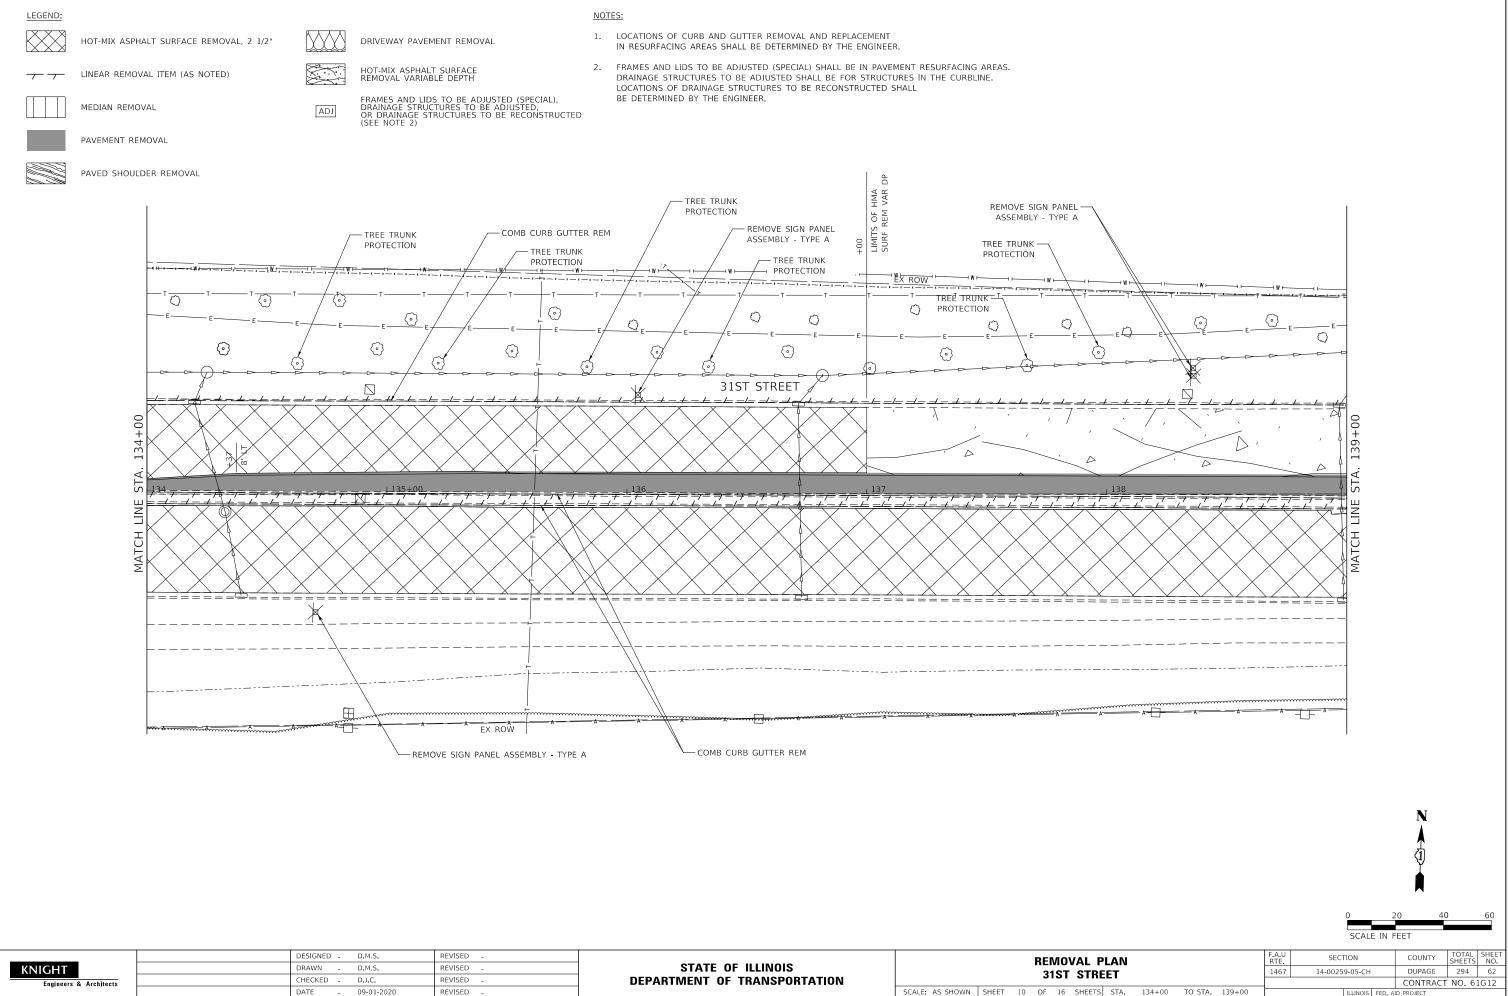


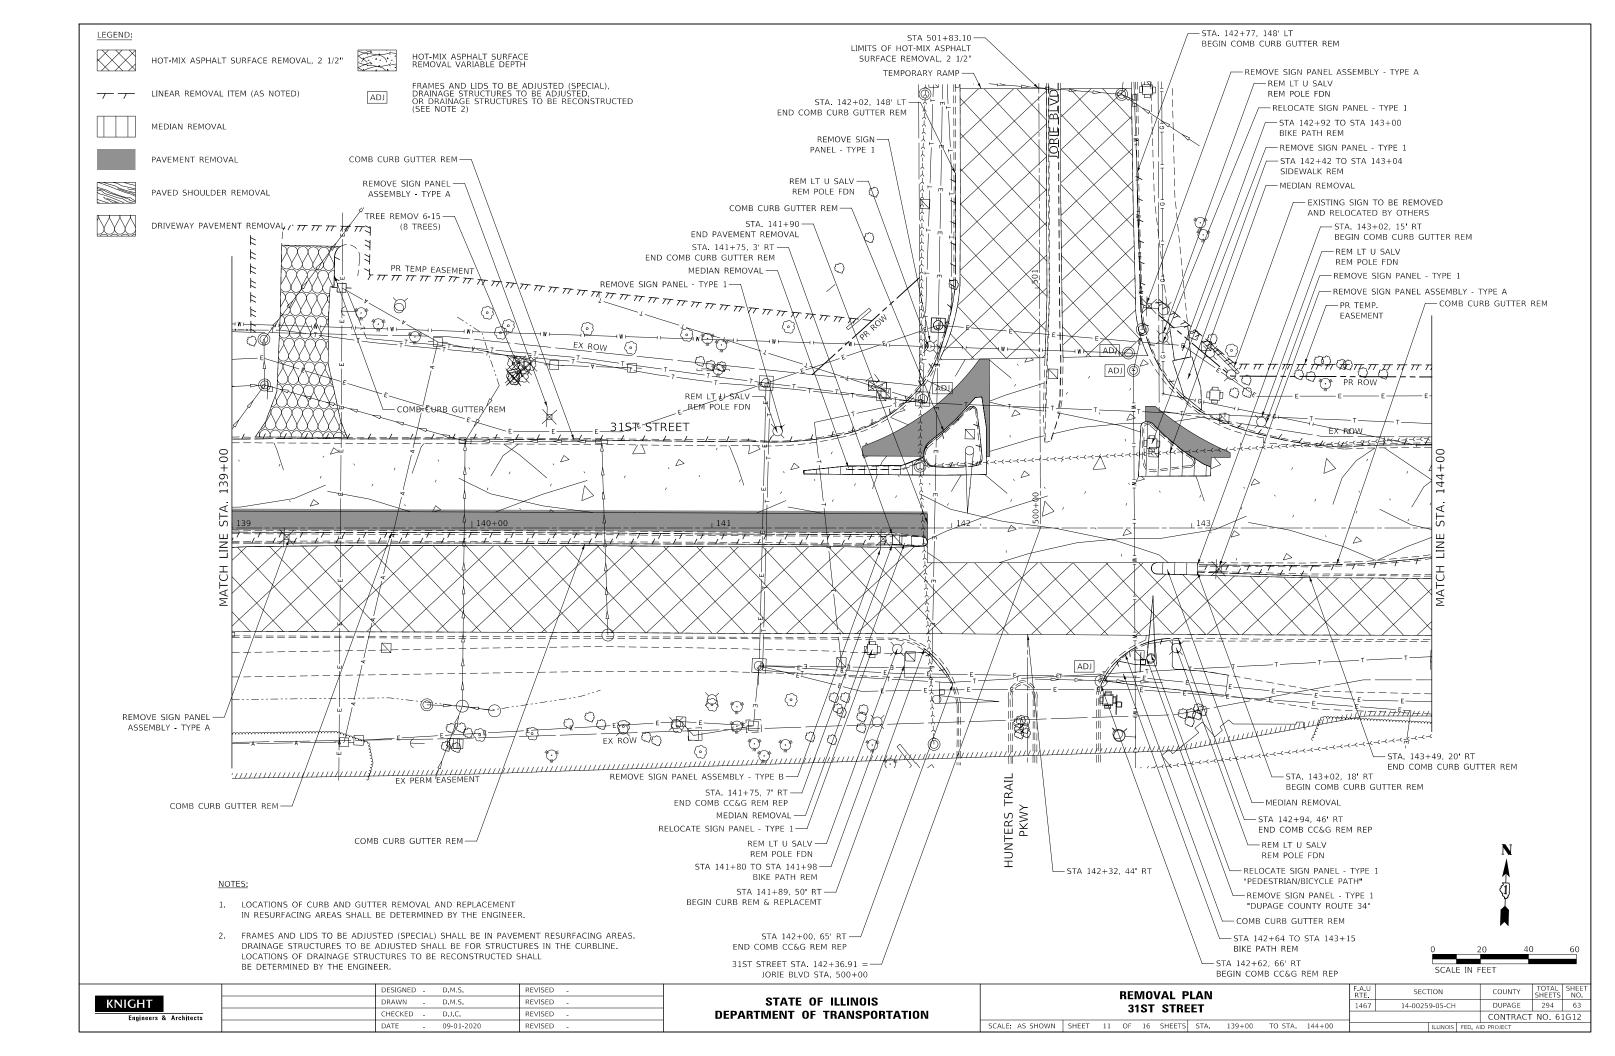

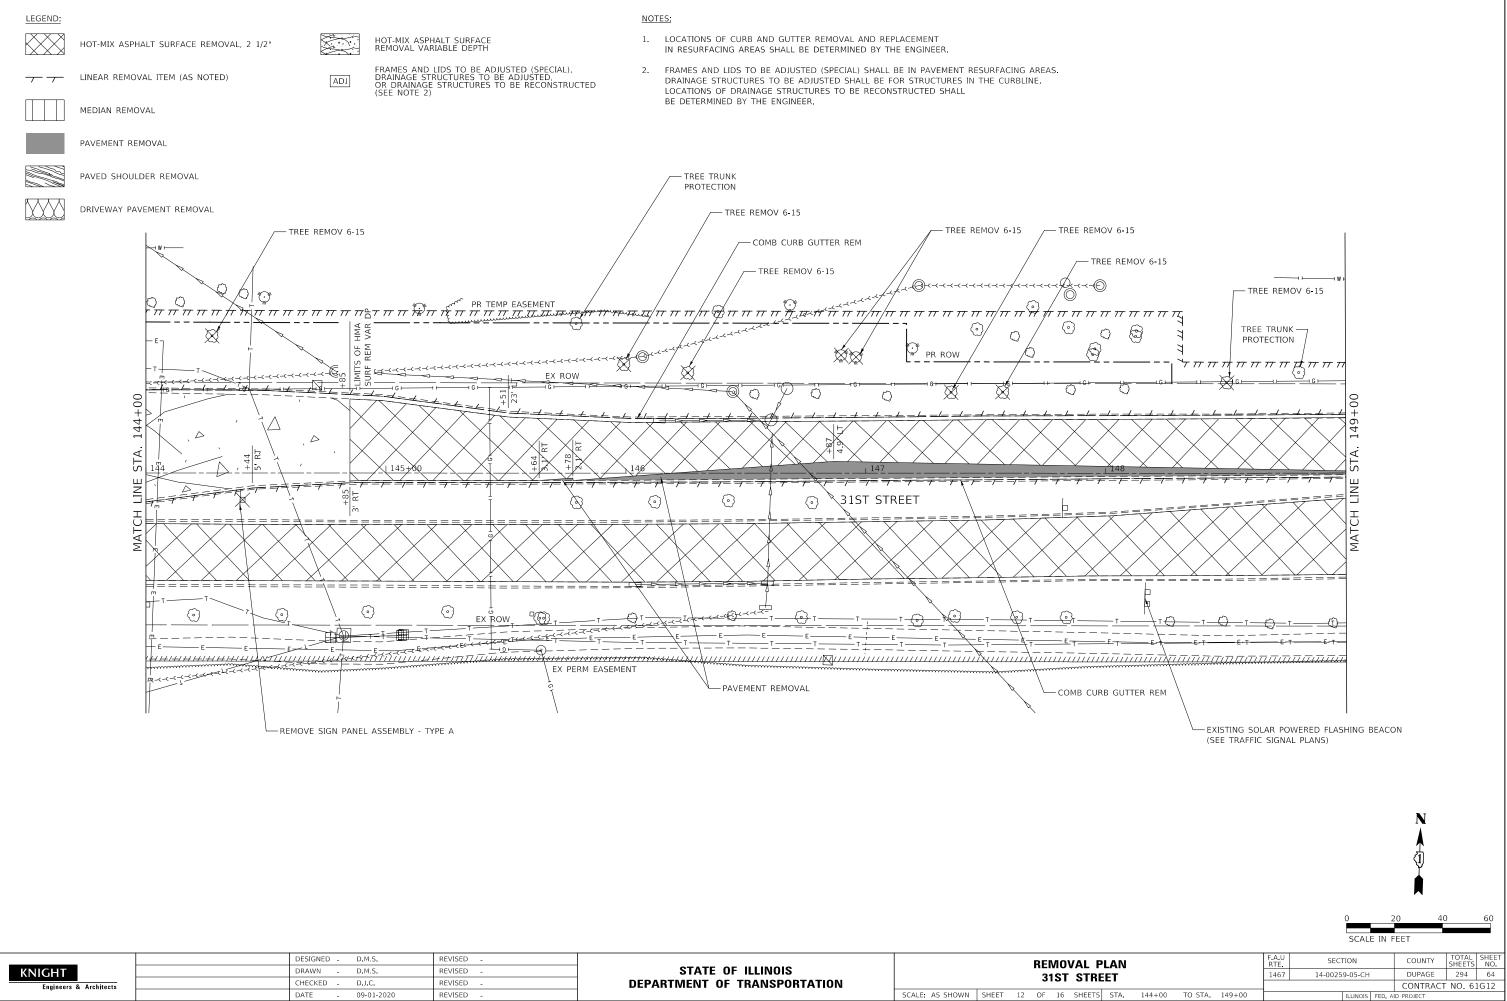



	DESIGNED D.M.S.	REVISED -		REMOVAL
KNIGHT	DRAWN D.M.S.	REVISED -	STATE OF ILLINOIS	
Engineers & Architects	CHECKED D.J.C.	REVISED -	DEPARTMENT OF TRANSPORTATION	31ST ST
	DATE - 09-01-2020	REVISED -		SCALE: AS SHOWN SHEET 12 OF 16 SHEE

			1467	14-0025	9-05-CH		DUPAGE	294
							CONTRACT	NO. 6
4+00	TO STA.	149+00			ILLINOIS	FED. A	D PROJECT	

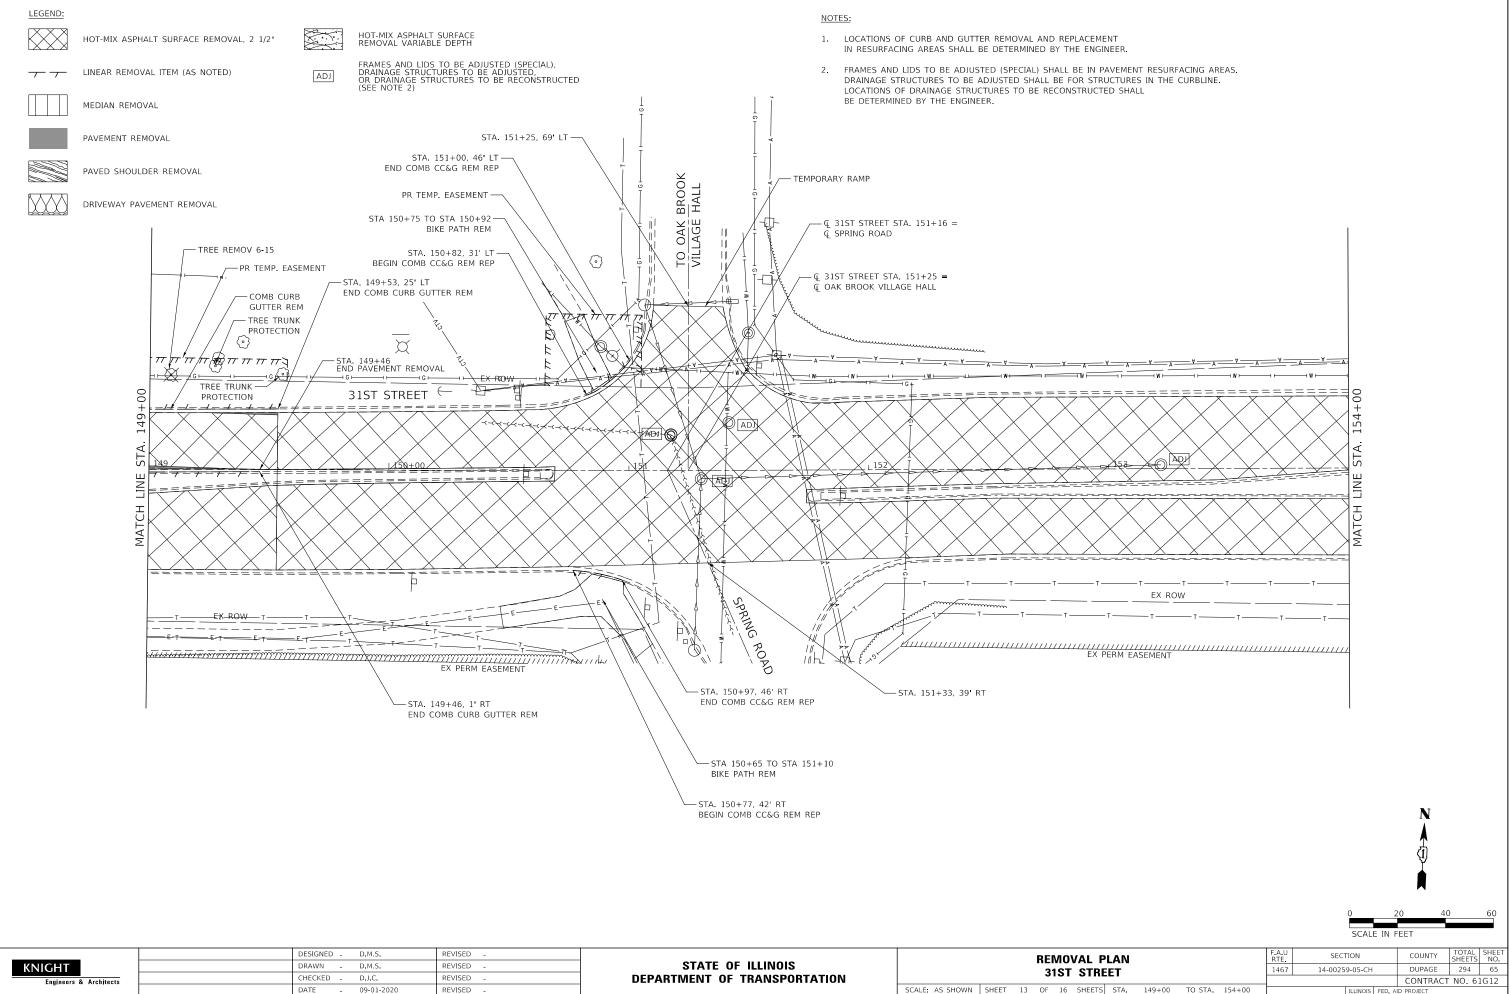

	DESIGNED -	D.M.S.	REVISED -				D	EMOVA
KNIGHT	DRAWN -	D.M.S.	REVISED -	STATE OF ILLINOIS				31ST S
Engineers & Architects	CHECKED -	D.J.C.	REVISED -	DEPARTMENT OF TRANSPORTATION				2121 3
	DATE -	09-01-2020	REVISED -		SCALE: AS SHOWN	SHEET	13 O	- 16 SH

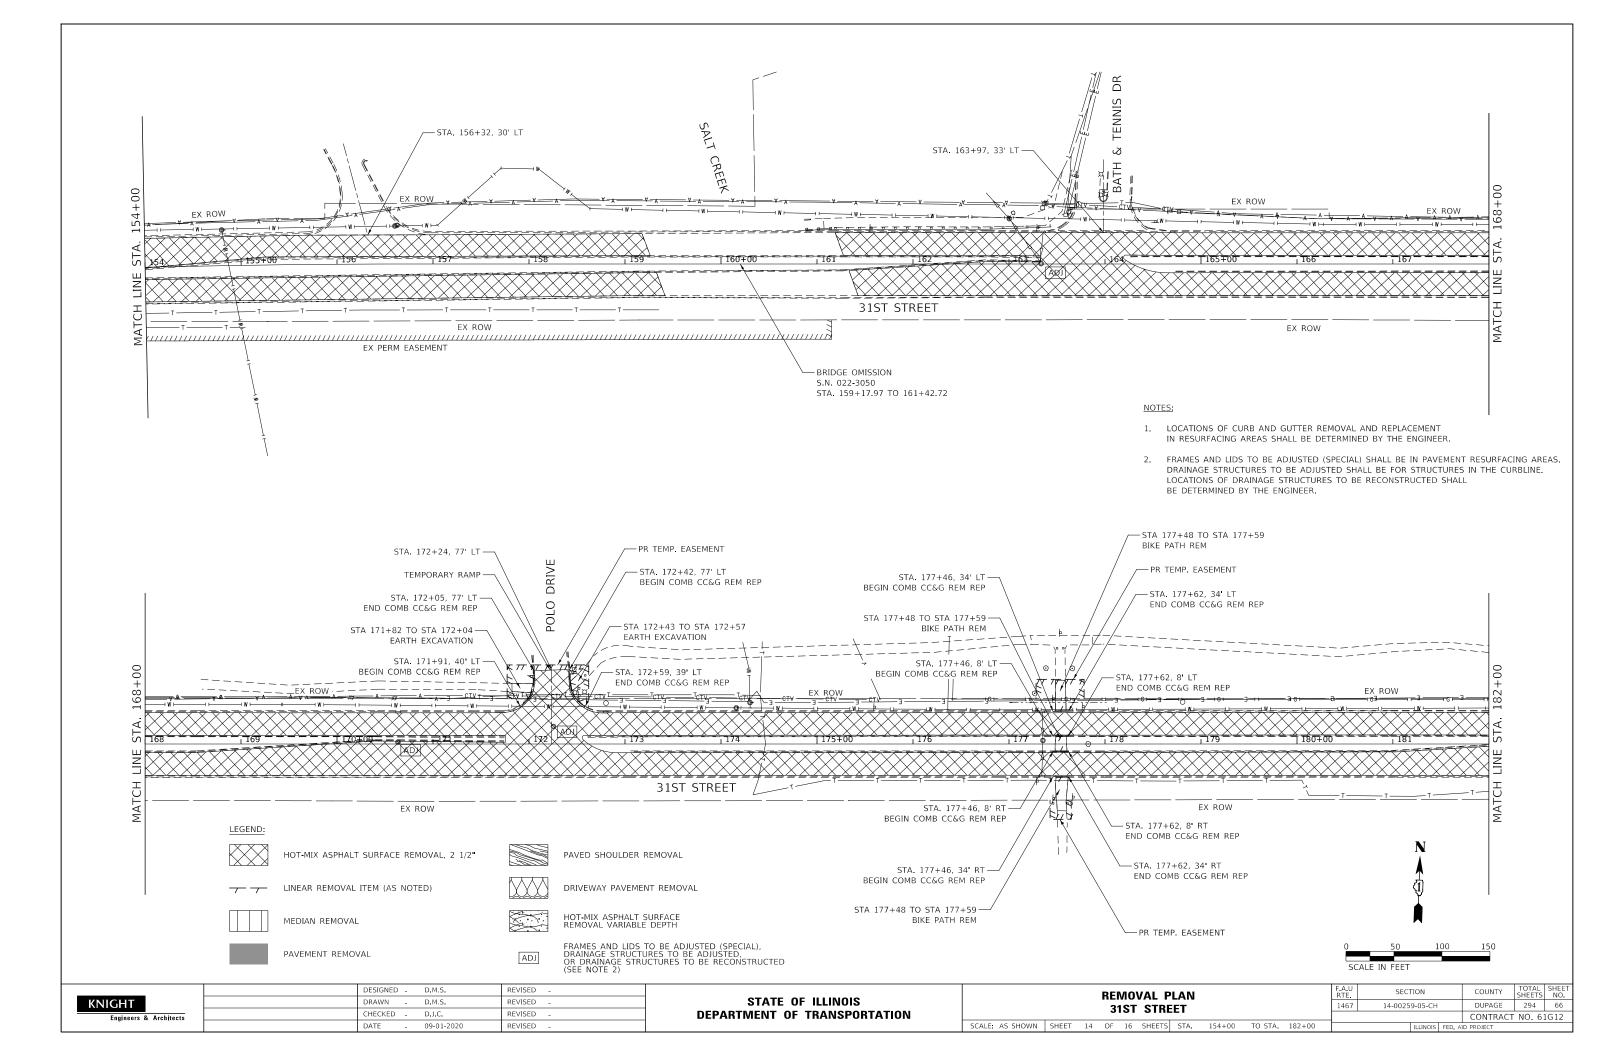


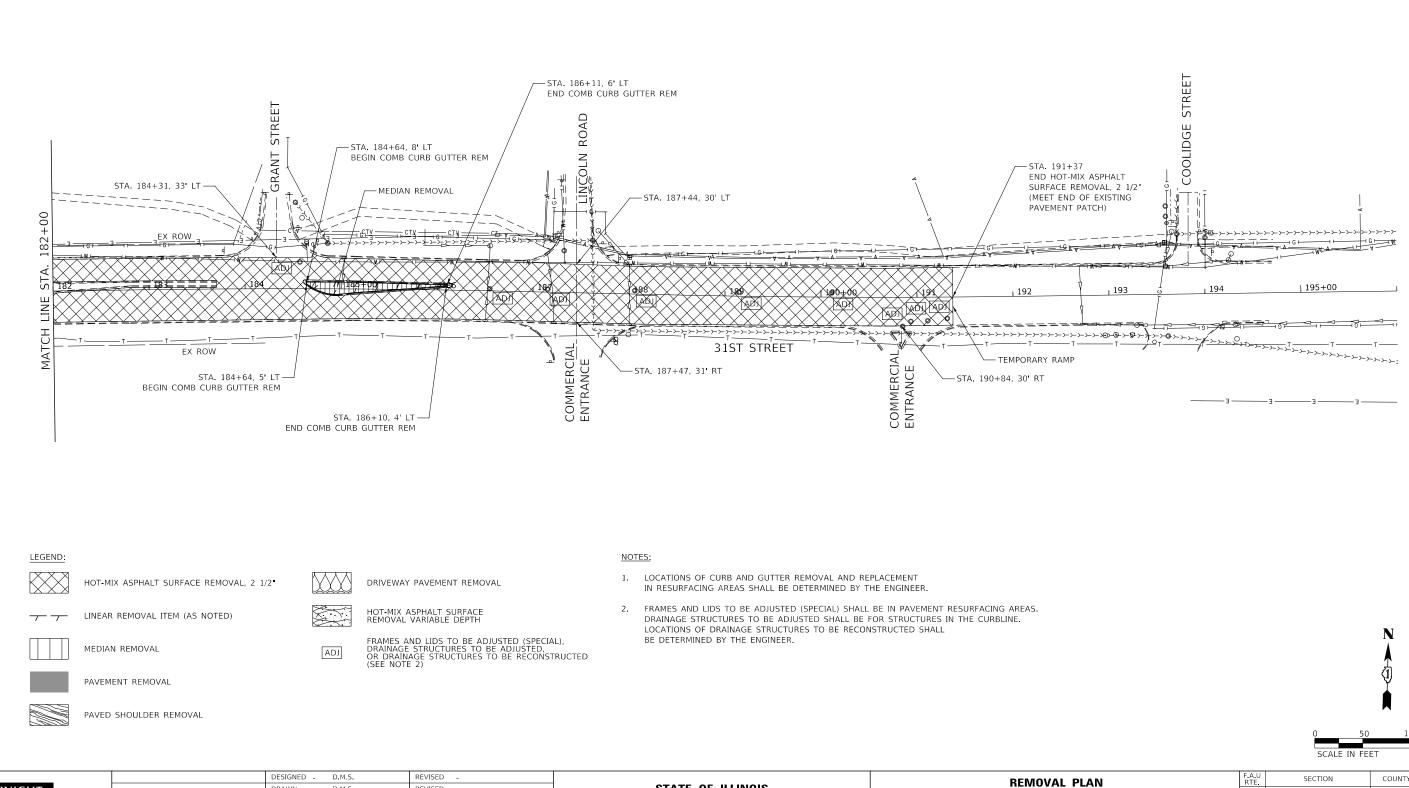

KNIGHT	DRAWN D.M.S.	REVISED -	STATE OF ILLINOIS	ALWOVAL FL
Engineers & Architects	CHECKED D.J.C.	REVISED -	DEPARTMENT OF TRANSPORTATION	31ST STRE
	DATE - 09-01-2020	REVISED -		SCALE: AS SHOWN SHEET 15 OF 16 SHEETS


0	50	100	150
SCAL	E IN FEET		


REI	NO	VAL P	LAN				F.A.U RTE	SECT	FION	COUNTY	TOTAL SHEETS	SHEET NO.
3.	IST	STRE	FT				1467	14-0025	9-05-CH	DUPAGE	294	67
		01112								CONTRACT	NO. 61	G12
OF	16	SHEETS	STA.	182+00	TO STA.	196+00			ILLINOIS FED. AI	D PROJECT		

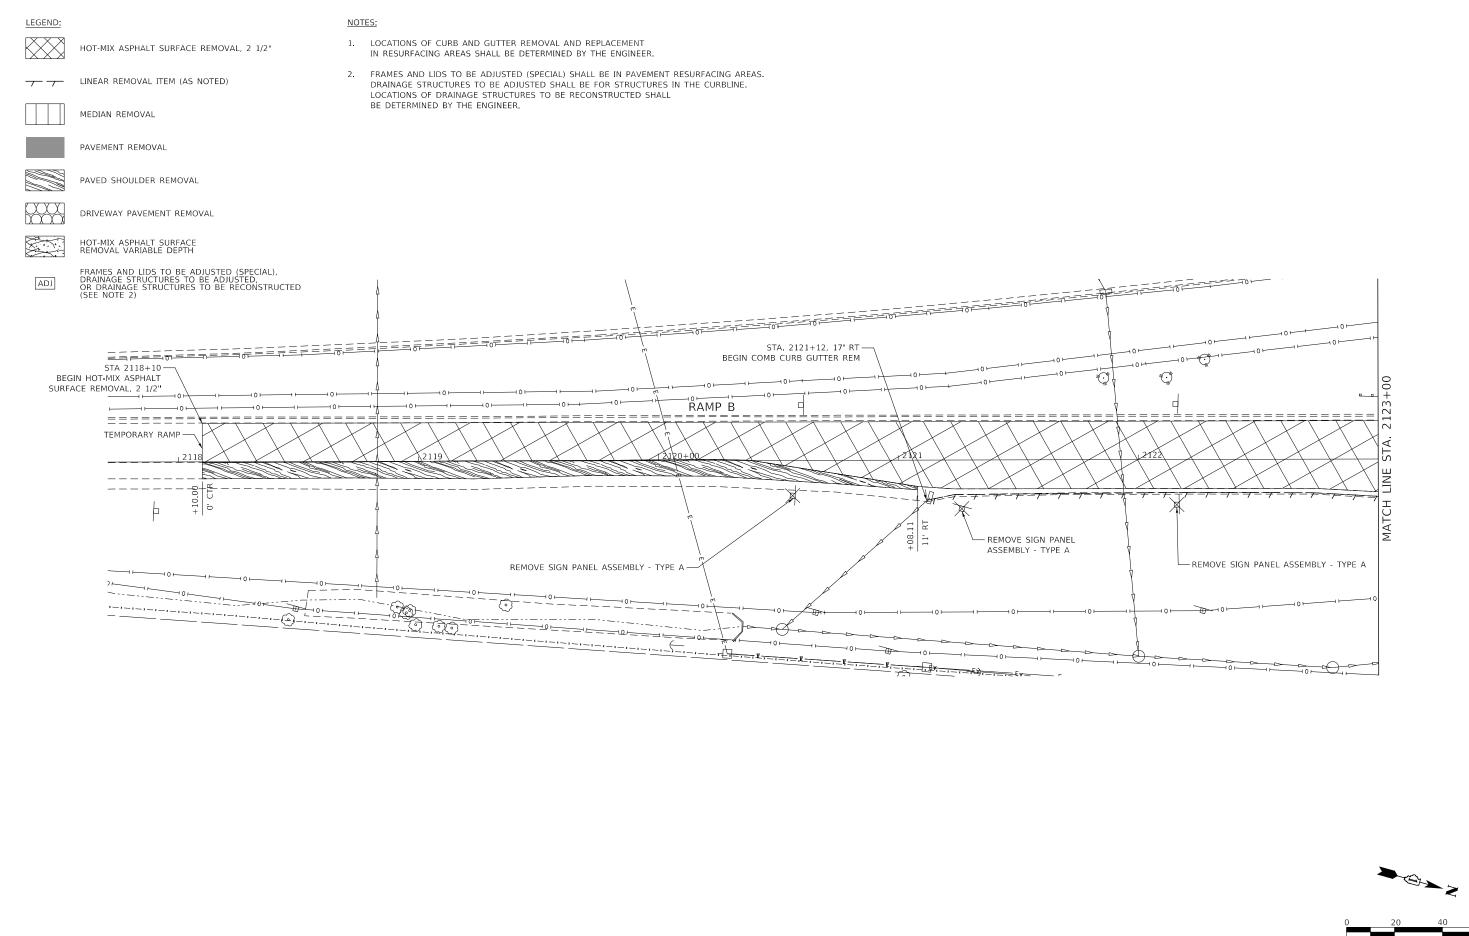


KNIGHT	DESIGNED - D.M	4.5. F	REVISED -	STATE OF ILLINOIS DEPARTMENT OF TRANSPORTATION	REMOVAL PLAN			SECTION	COUNTY TOTAL SHEET SHEETS NO.
KNIGHT	DRAWN D.M.S.	4.S. F	REVISED -		RAMP B		1467	14-00259-05-CH	DUPAGE 294 68
Engineers & Architects	CHECKED - D.J.		REVISED -						CONTRACT NO. 61G12
	DATE - 09-0	-01-2020 F	REVISED -		SCALE: AS SHOWN SHEET 16 O	DF 16 SHEETS STA. 2118+00 TO STA. 2123+00		ILLINOIS FED AI	D PROJECT


0	20	40	60
SCAL	E IN FEET		

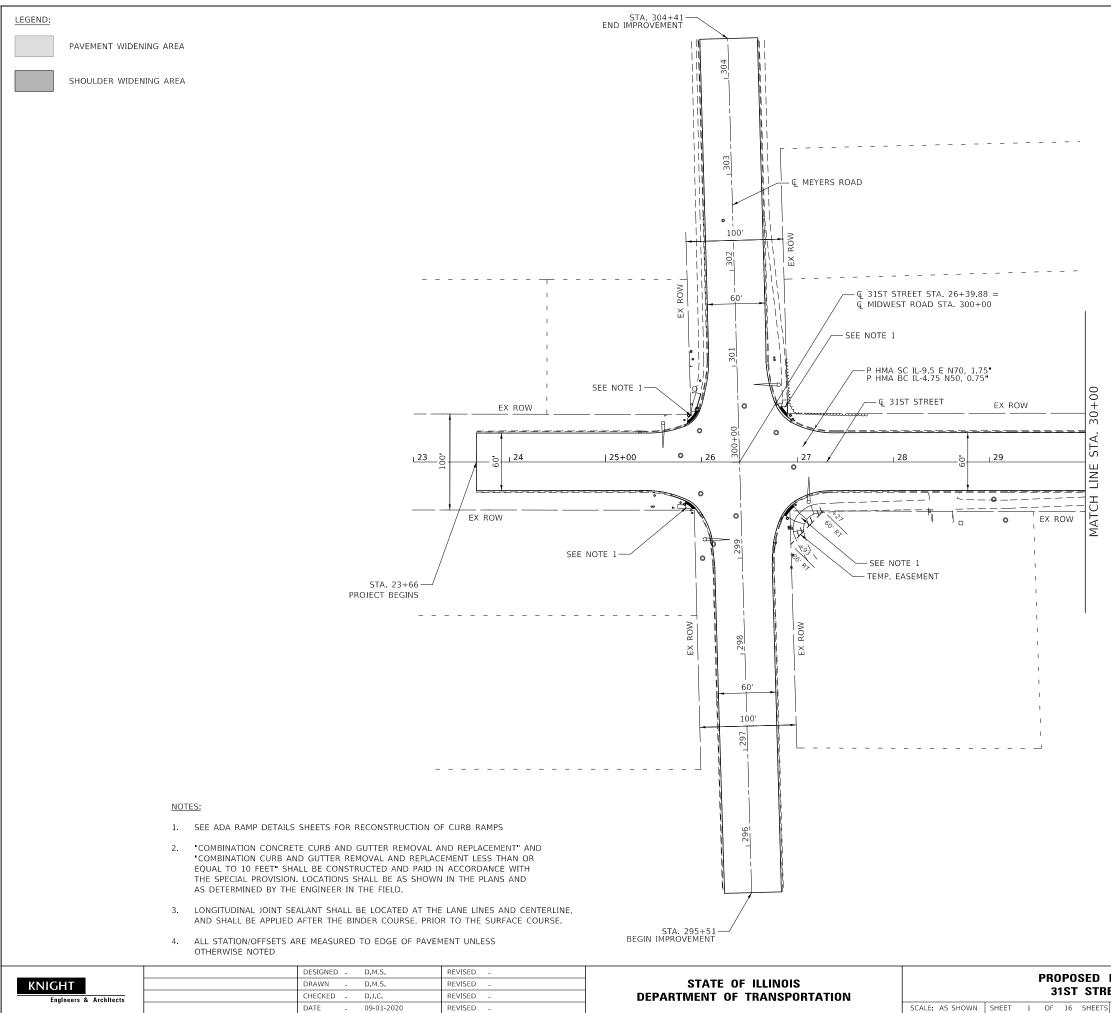


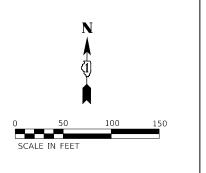



	PLAN				F.A.U RTE	SECTION	COUNTY	TOTAL SHEETS	SHEET NO.
RF	ET				1467	14-00259-05-CH	DUPAGE	294	69
							CONTRACT	NO. 6	1G12
TS	STA.	23+00	TO STA.	30+00		ILLINOIS FED. A	ID PROJECT		

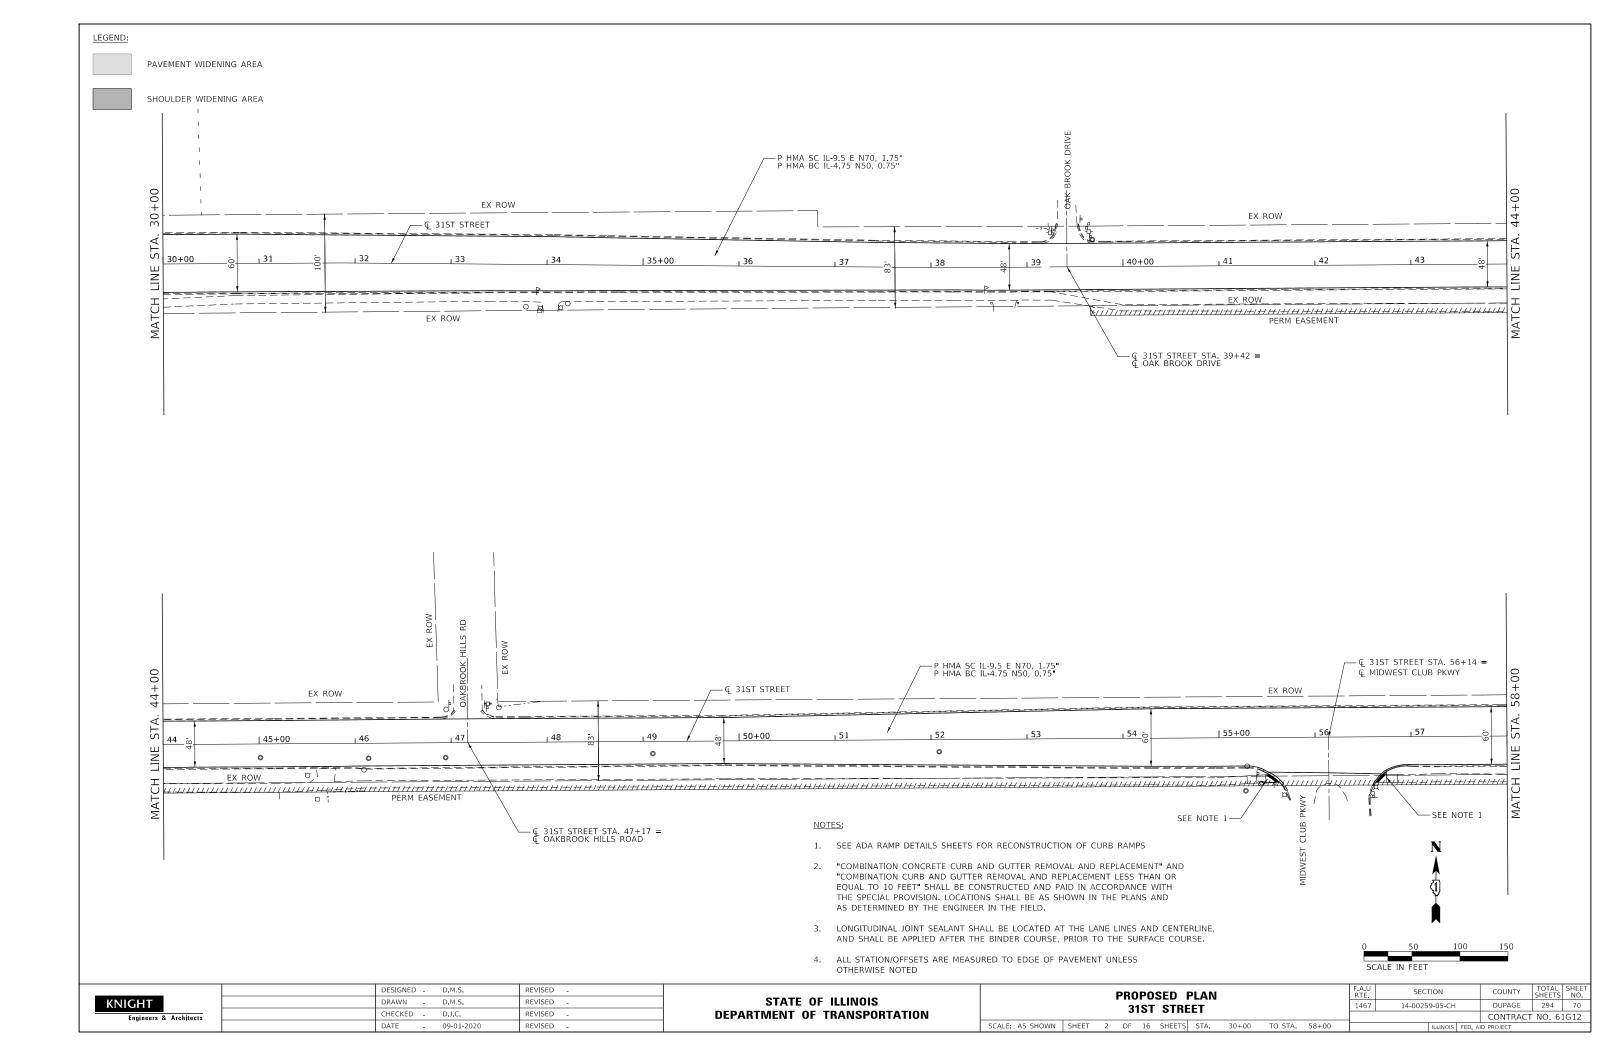


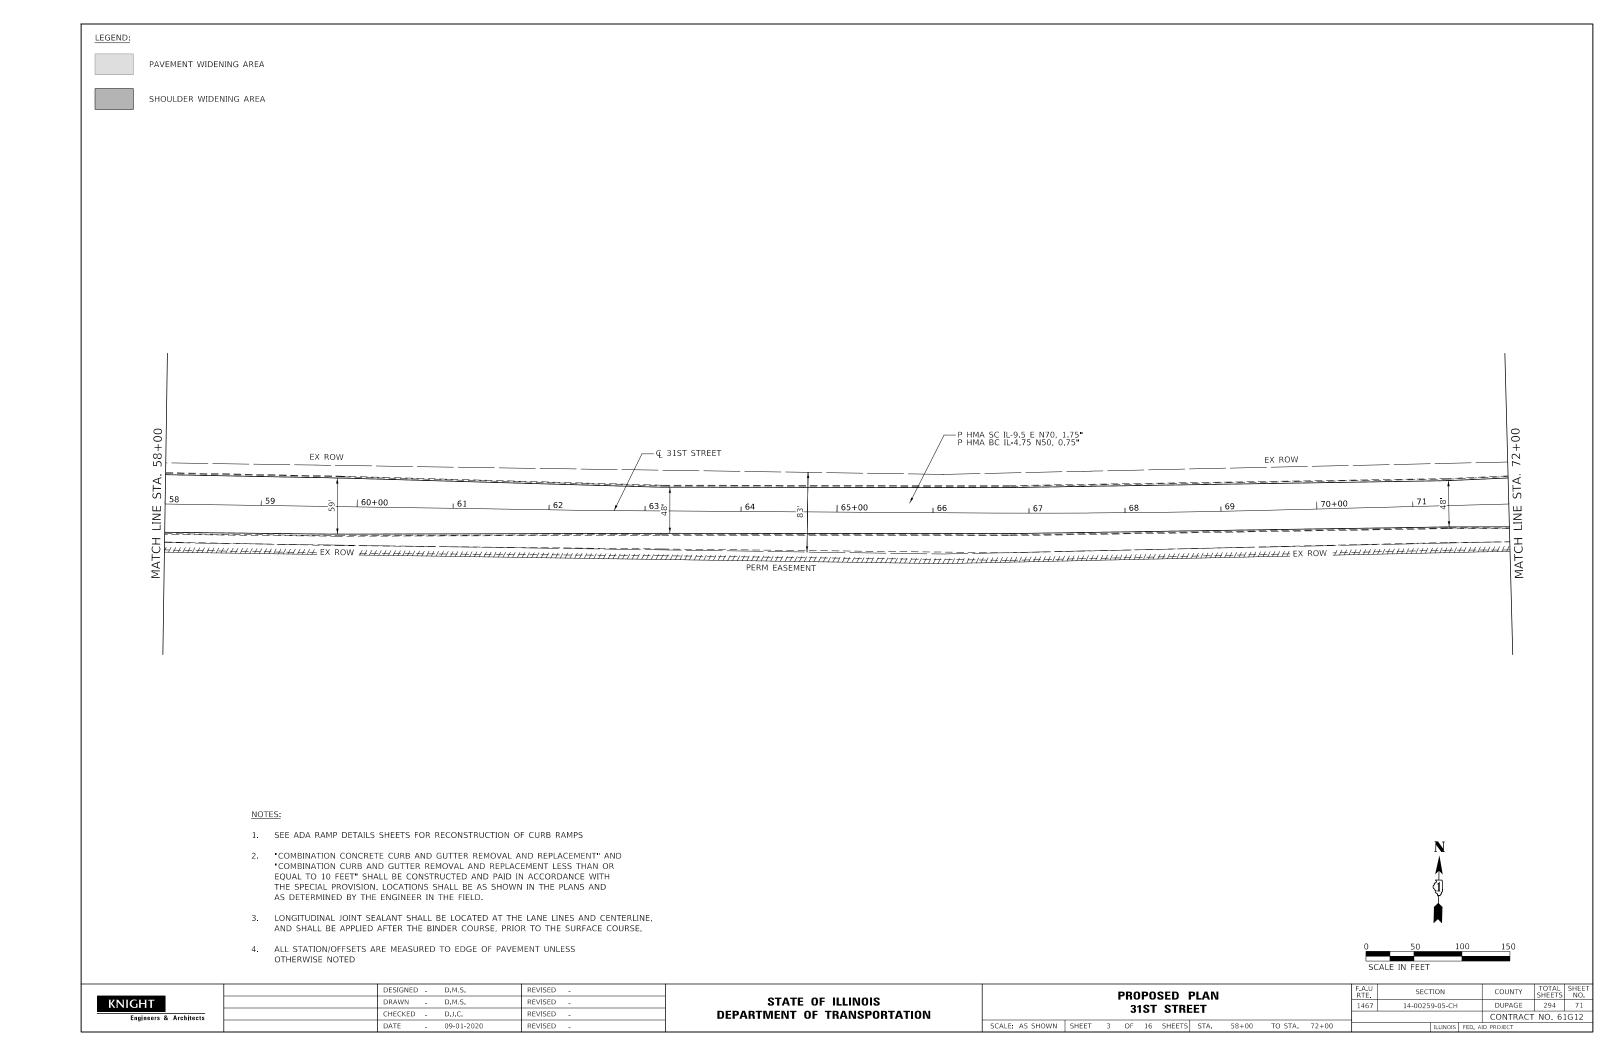


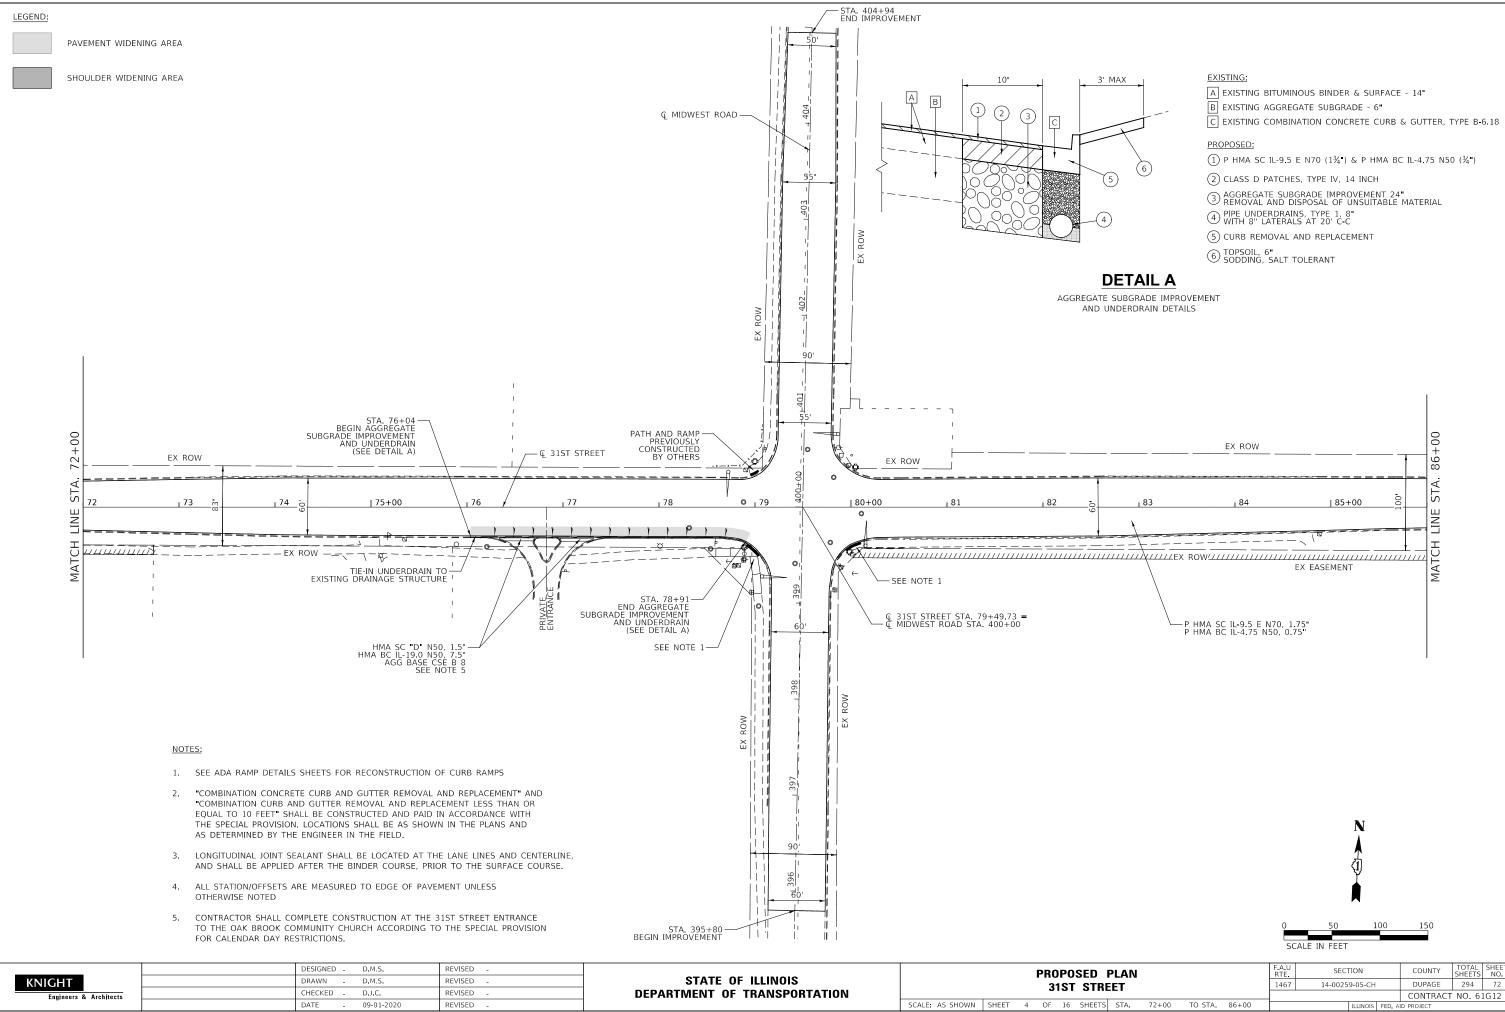


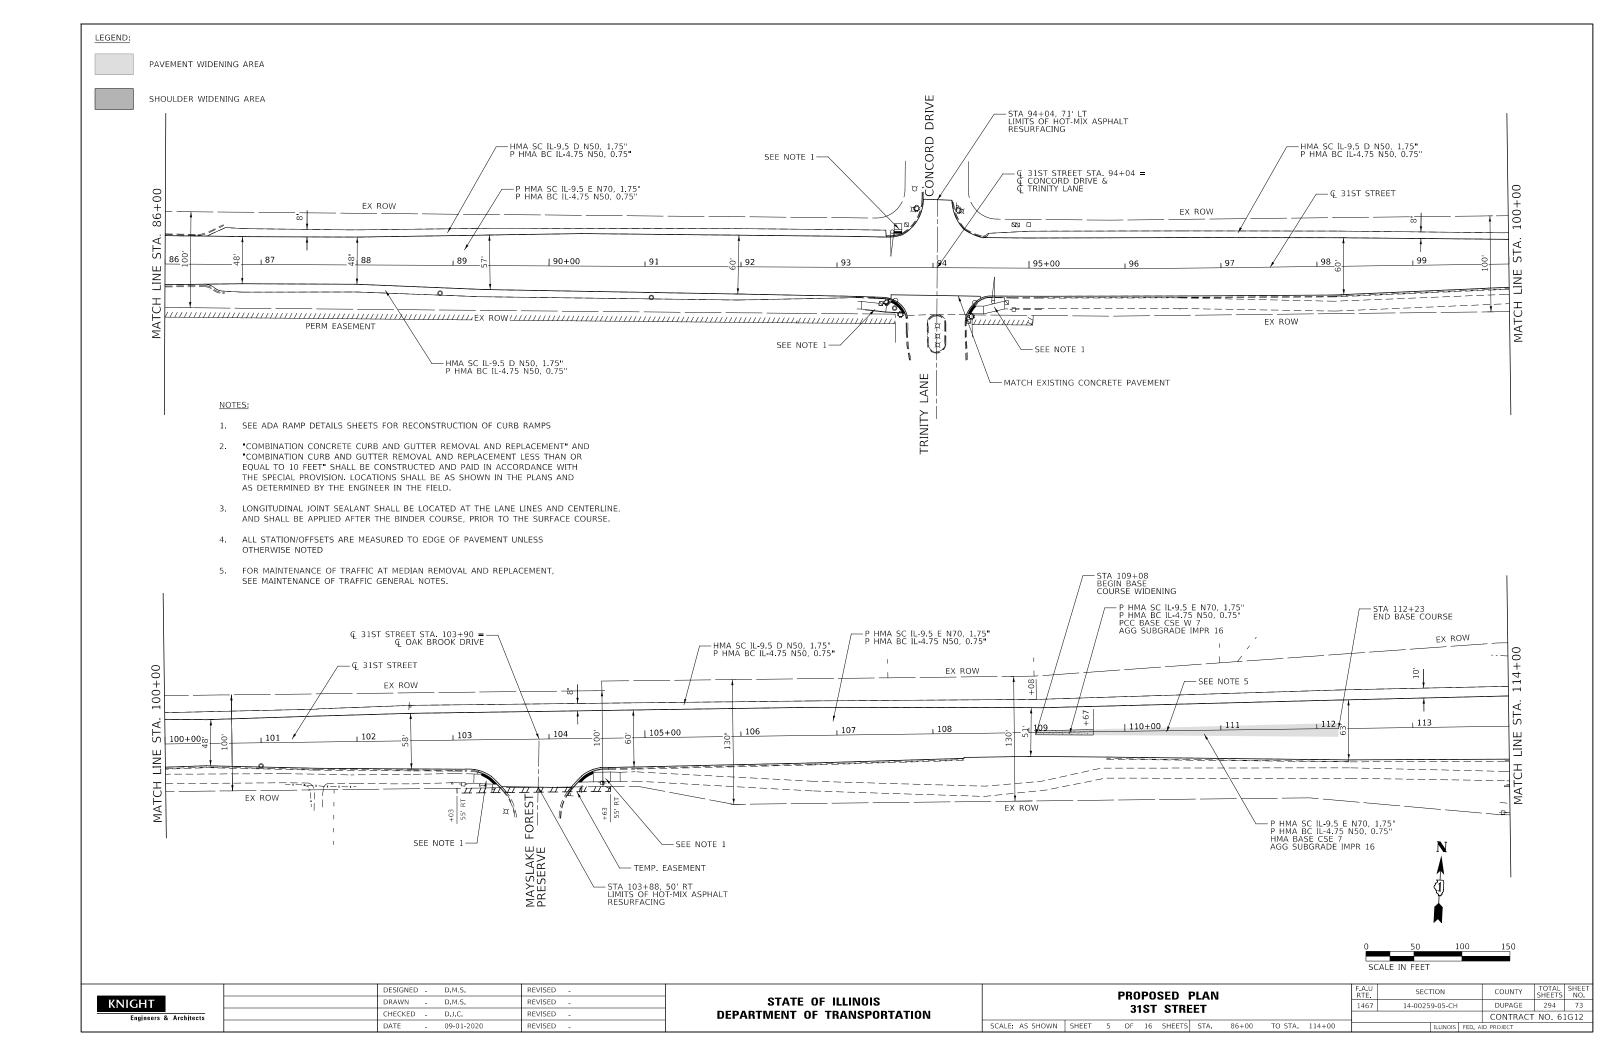


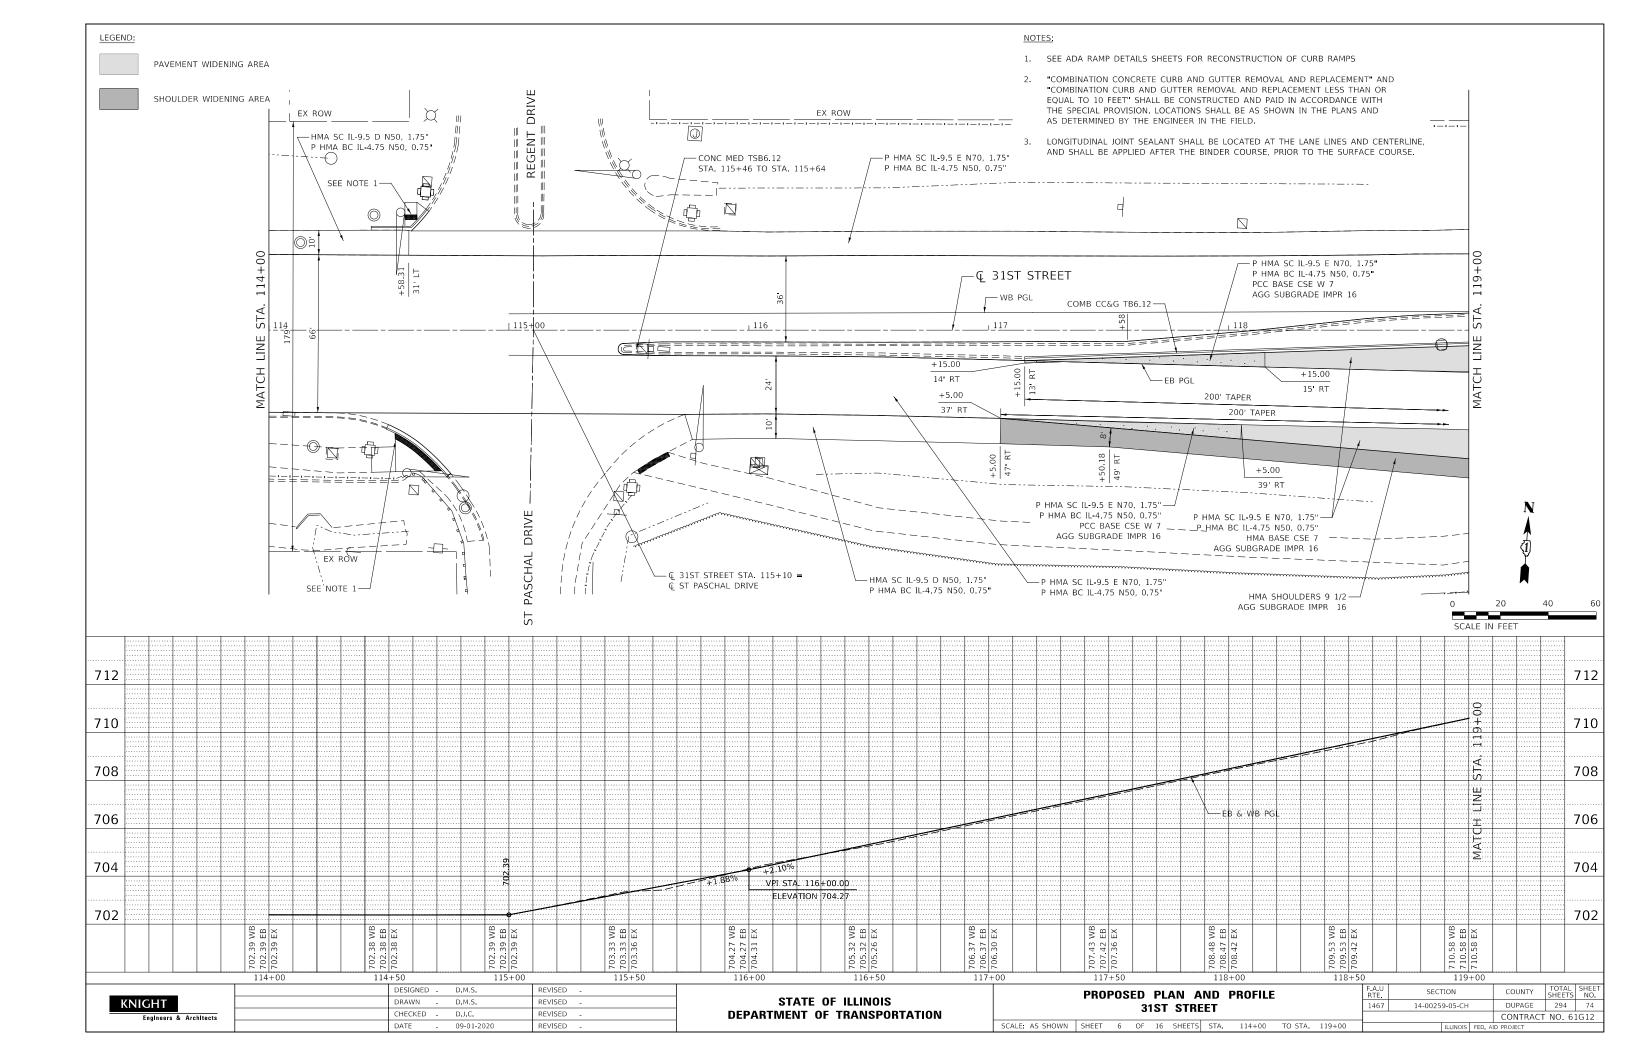


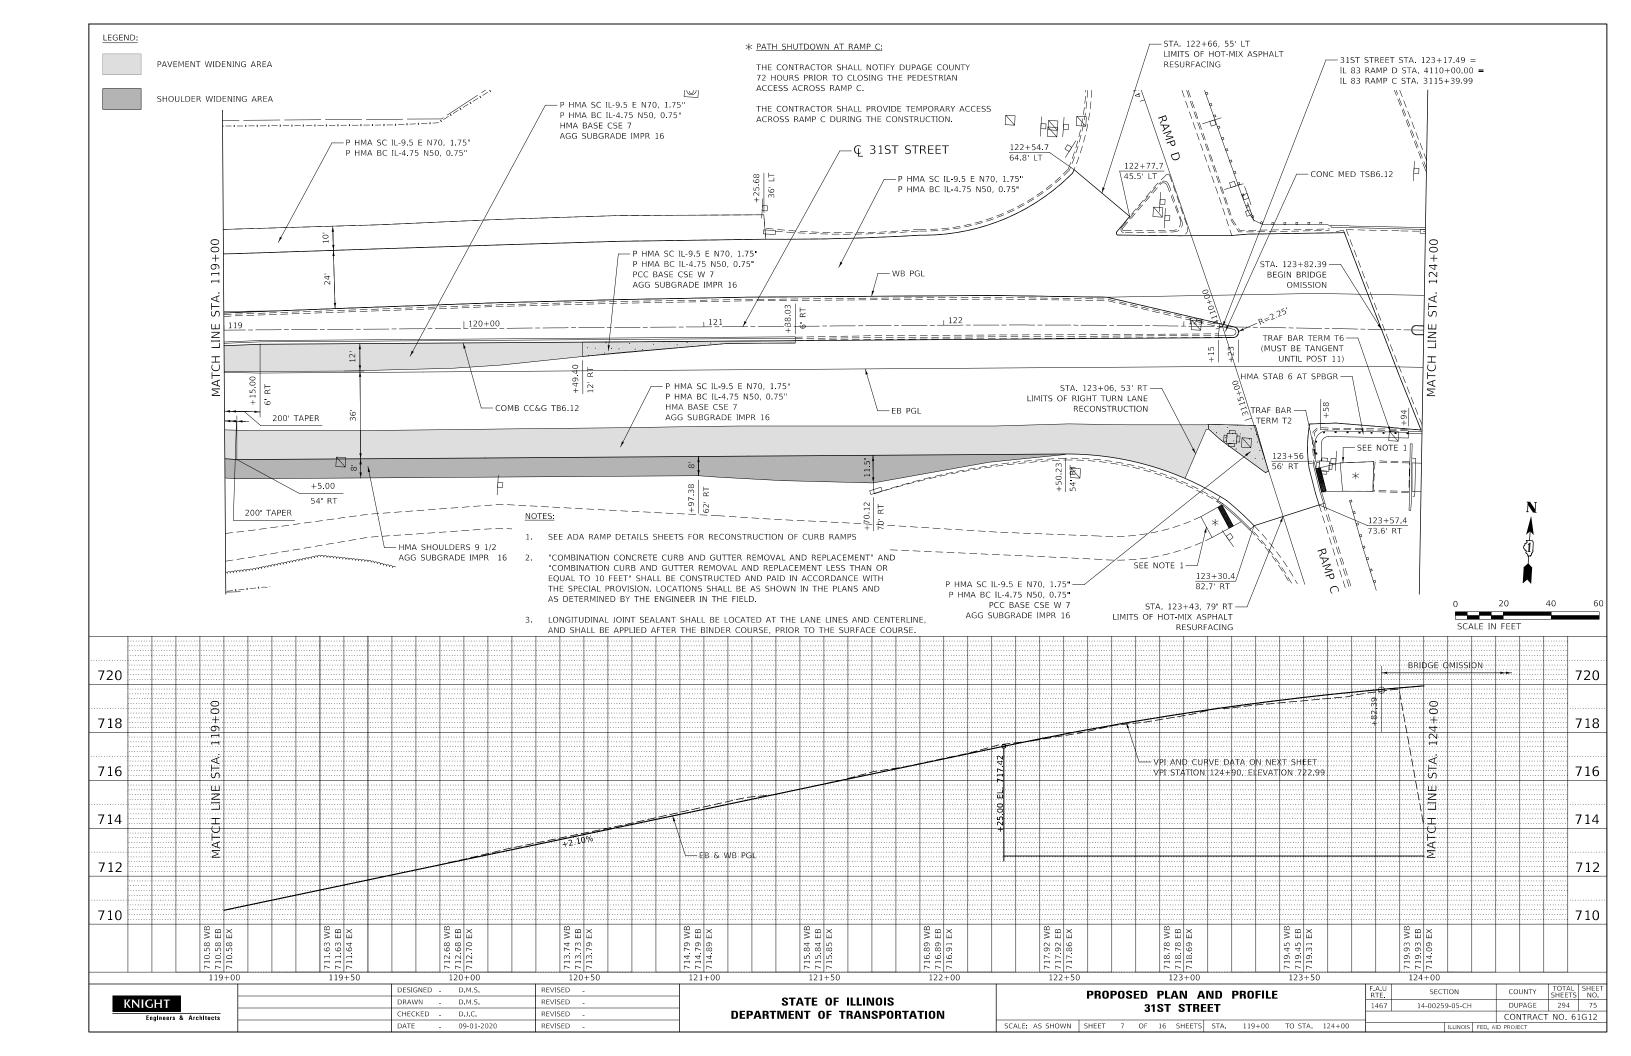


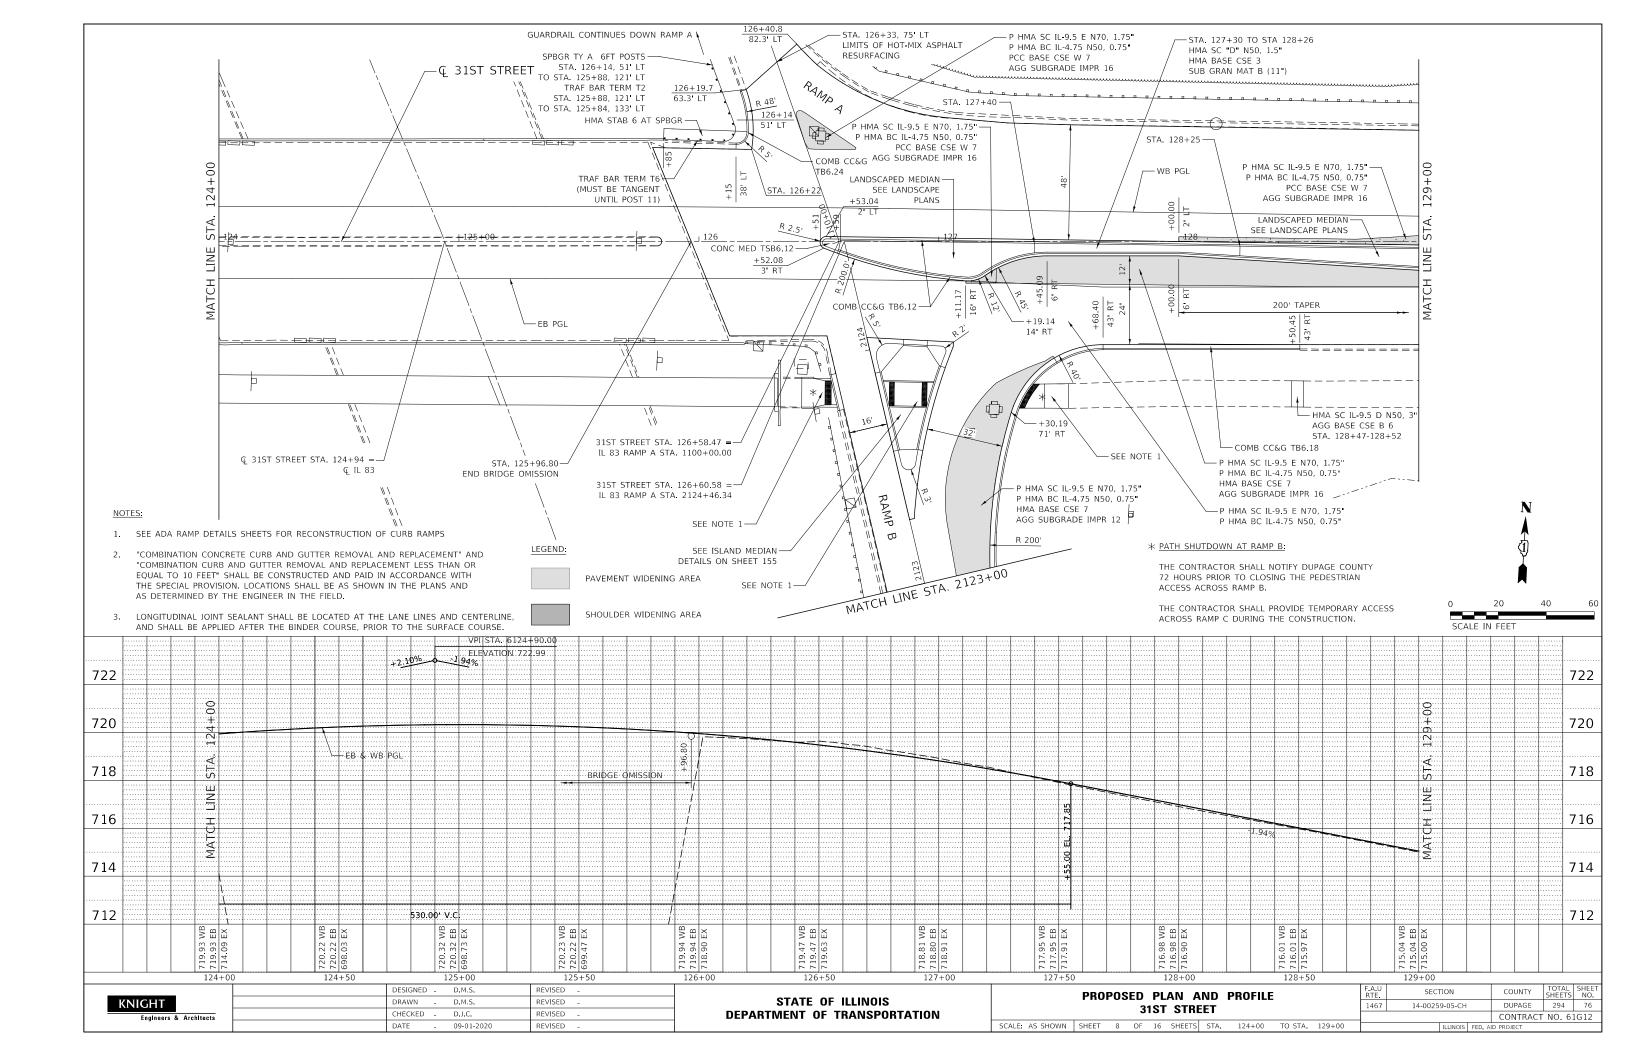


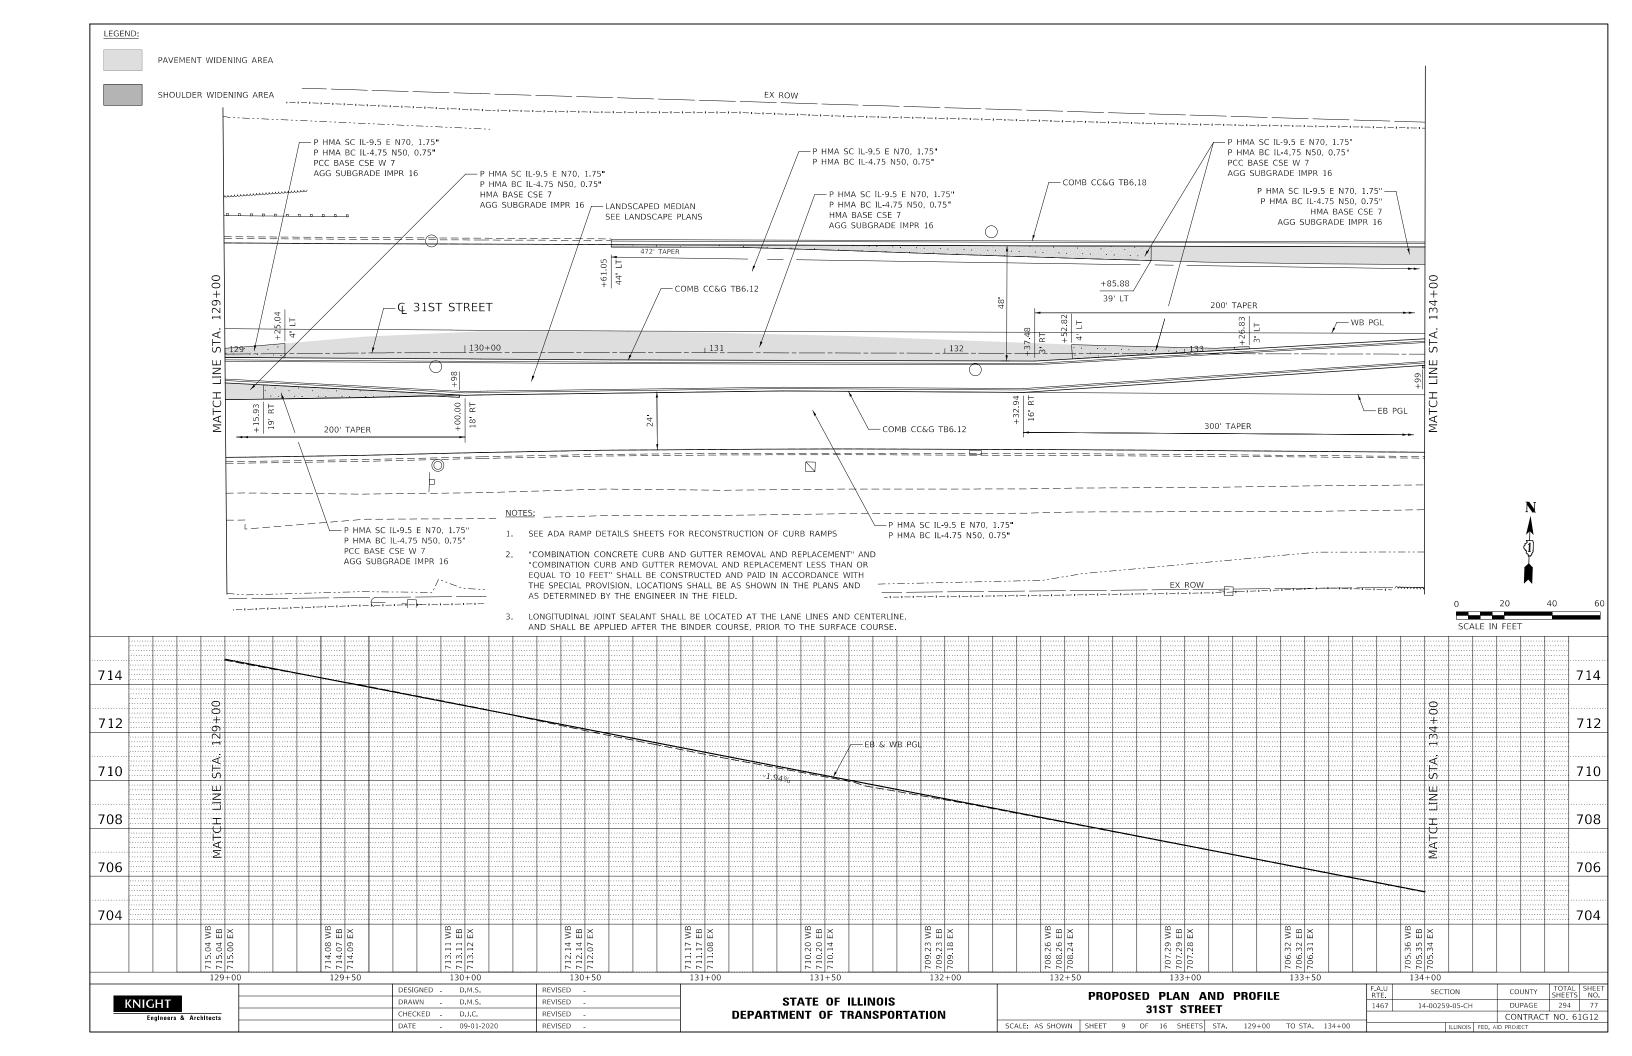


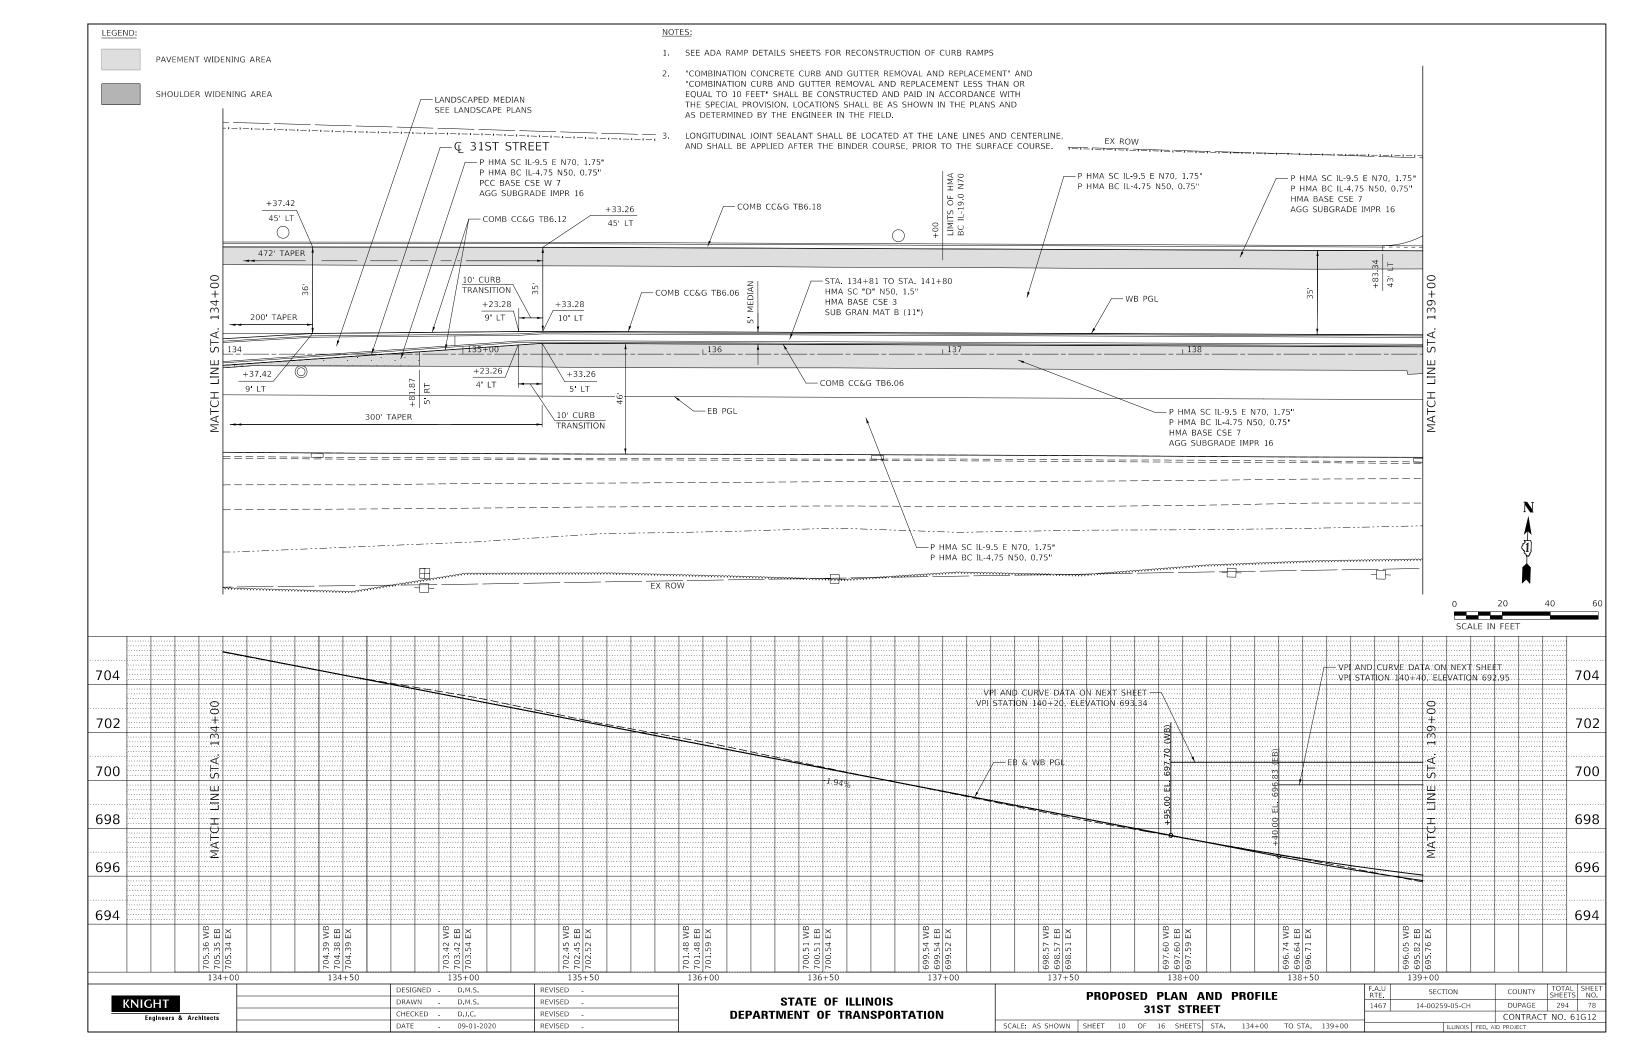


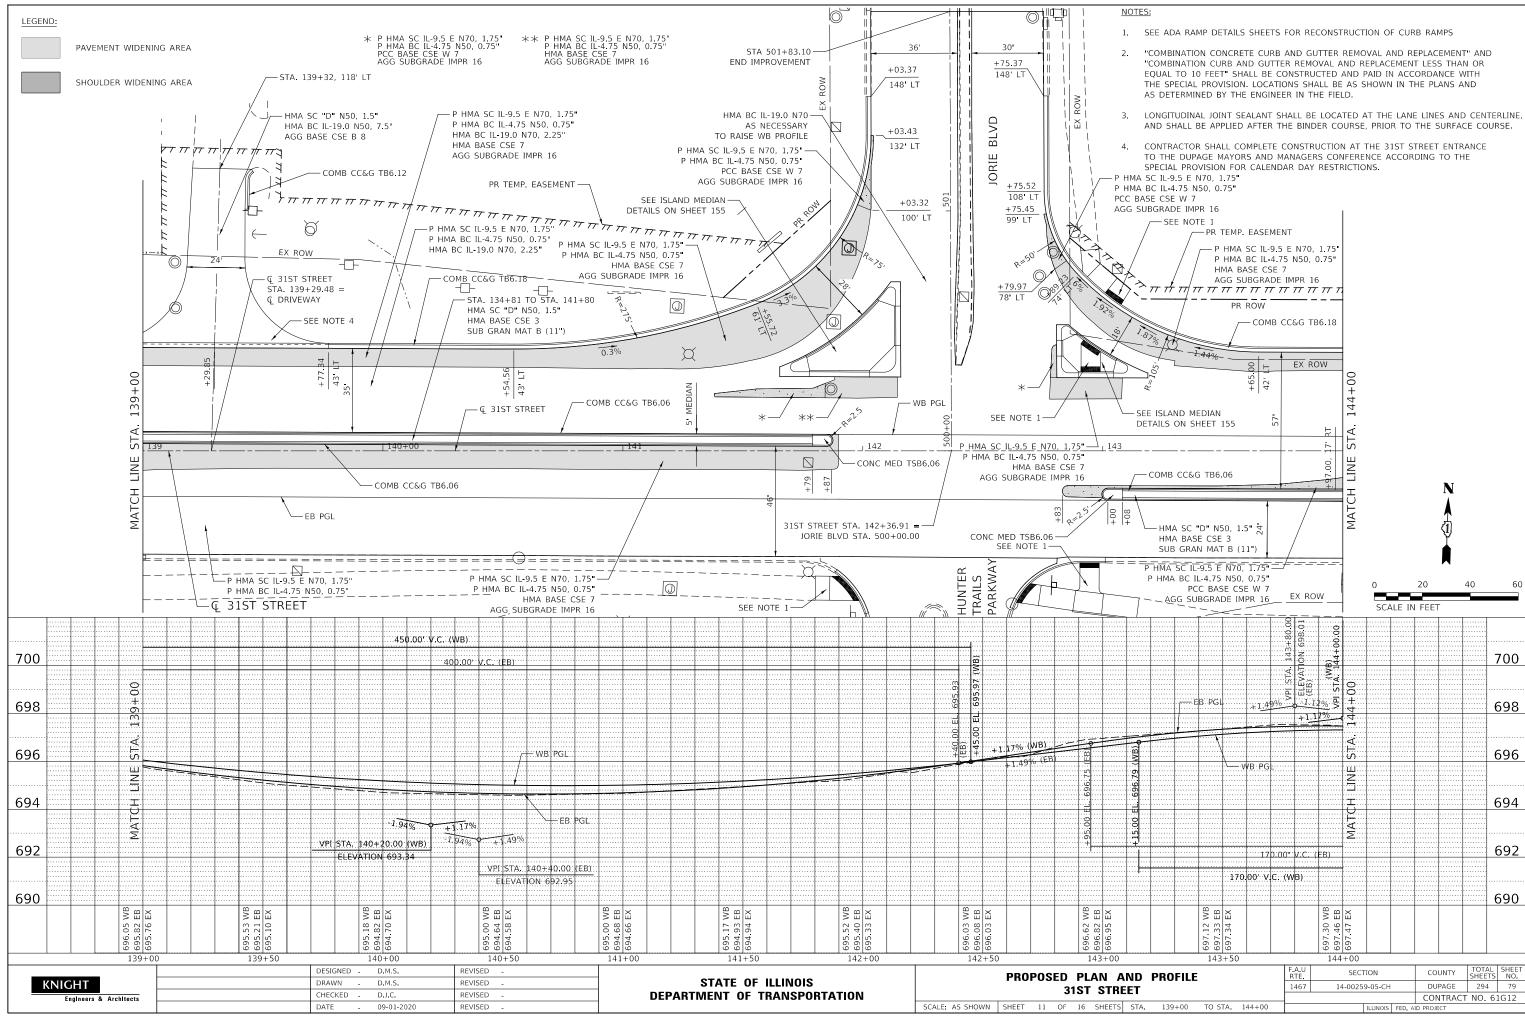

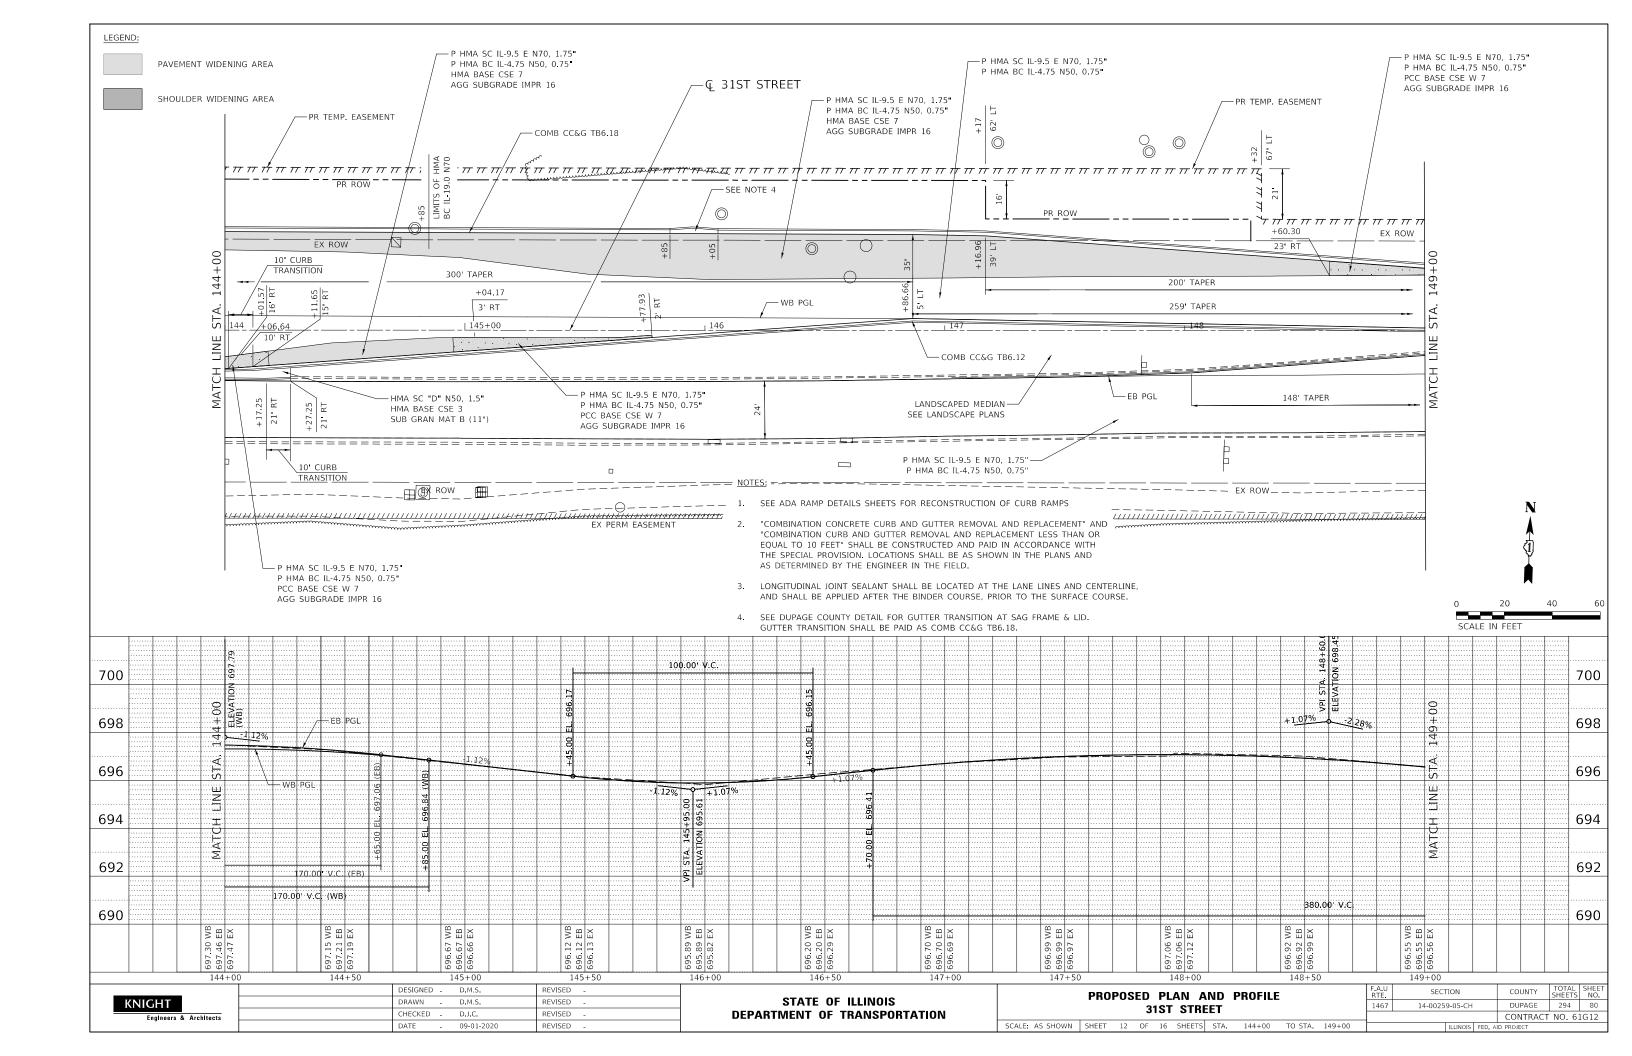


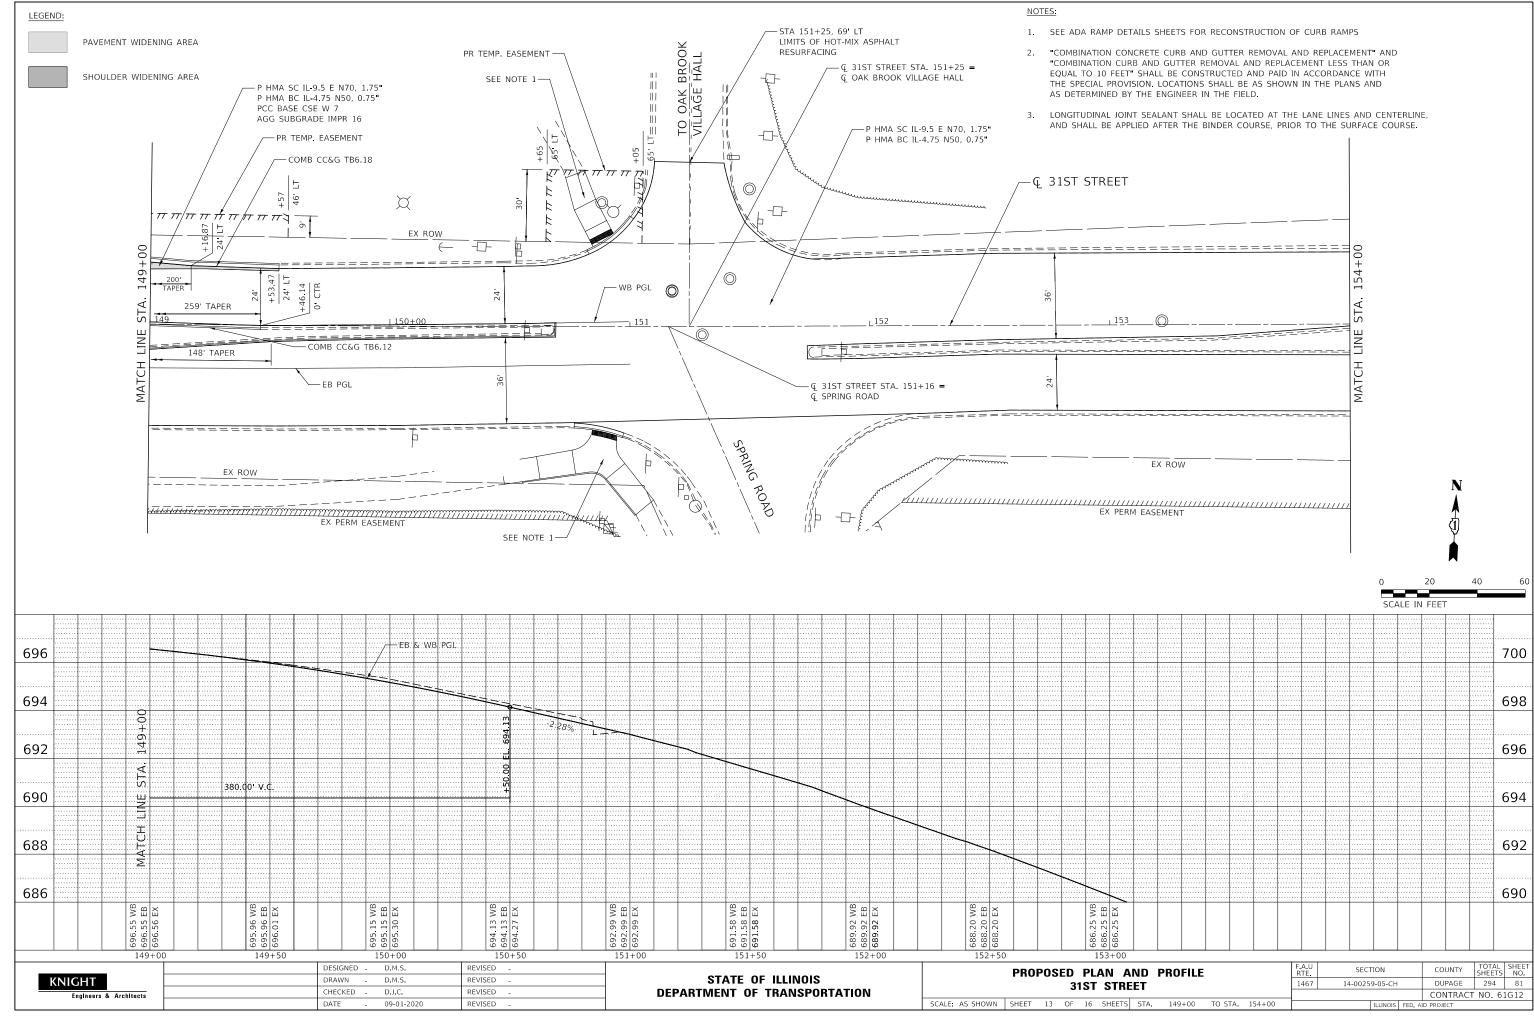

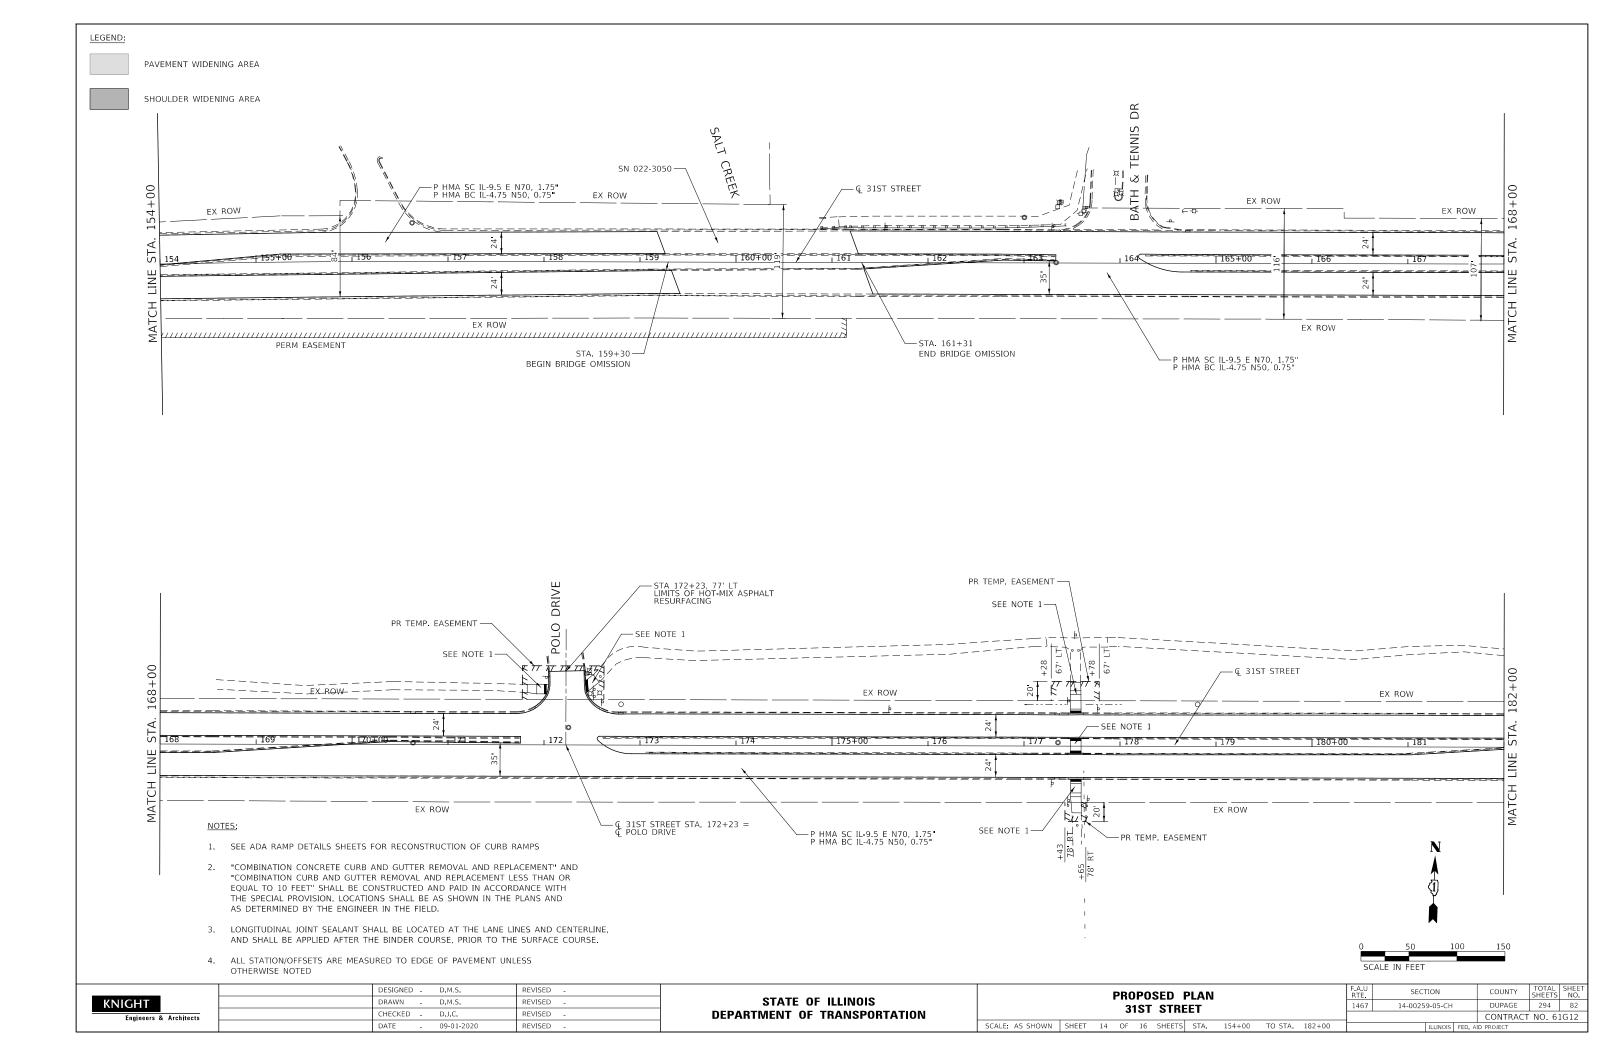


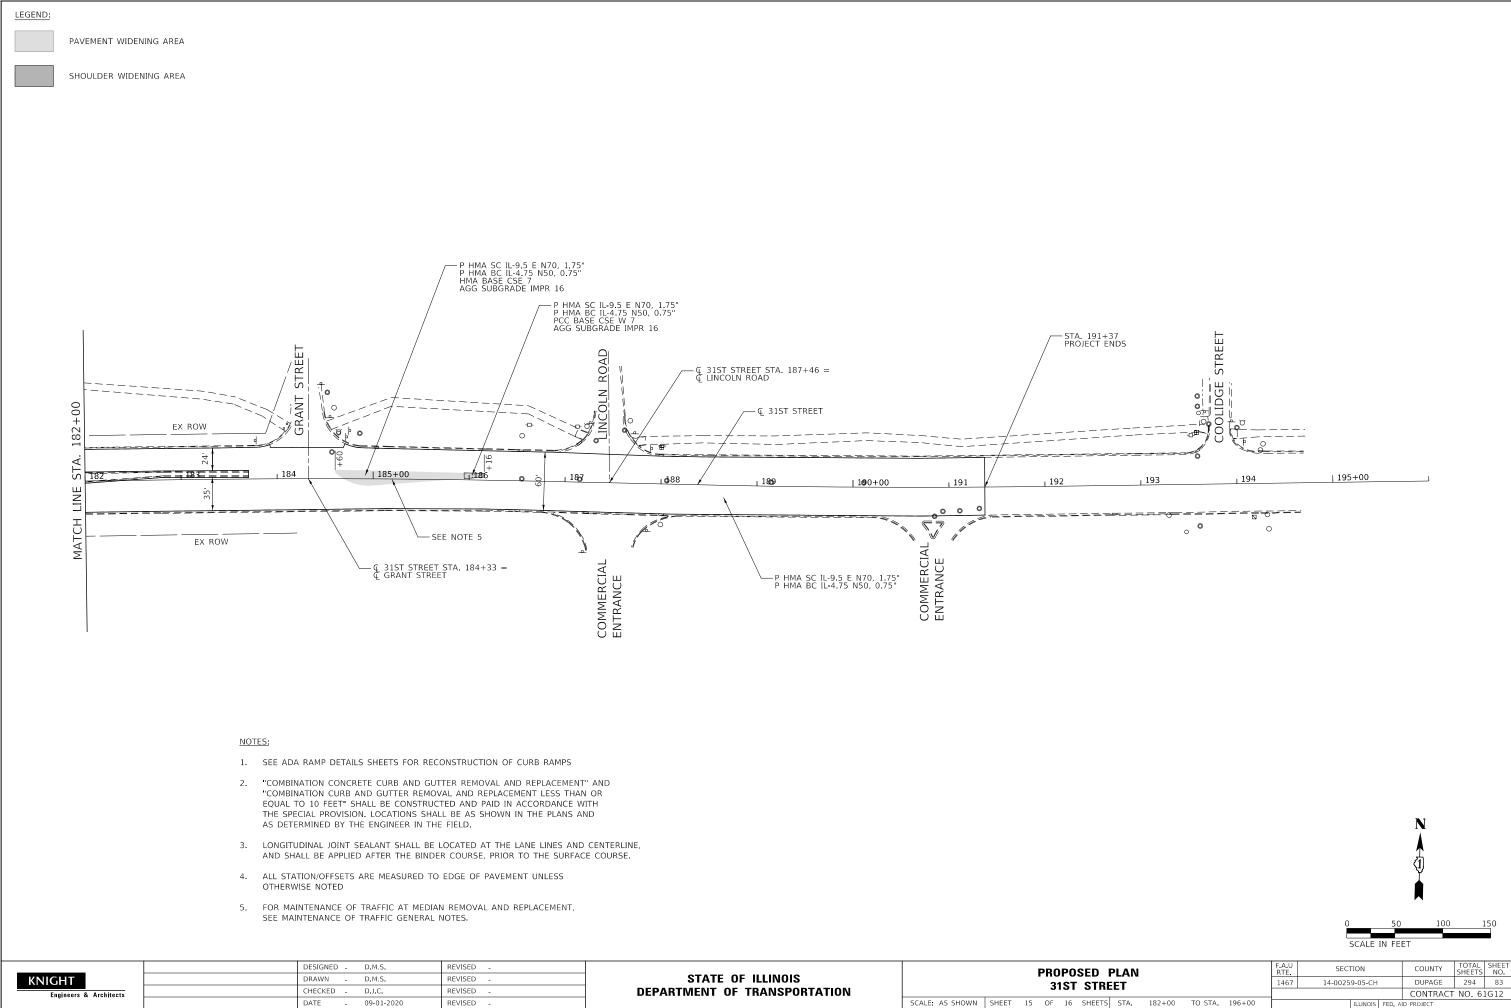

F	PLAN				RTE.	JLC	non		COONT	SHEETS	NO.
RF	ET				1467	14-0025	9-05-CH		DUPAGE	294	83
								CONTRACT	NO. 61	lG12	
٢S	STA.	182+00	TO STA.	196+00			ILLINOIS	FED. A	ID PROJECT		

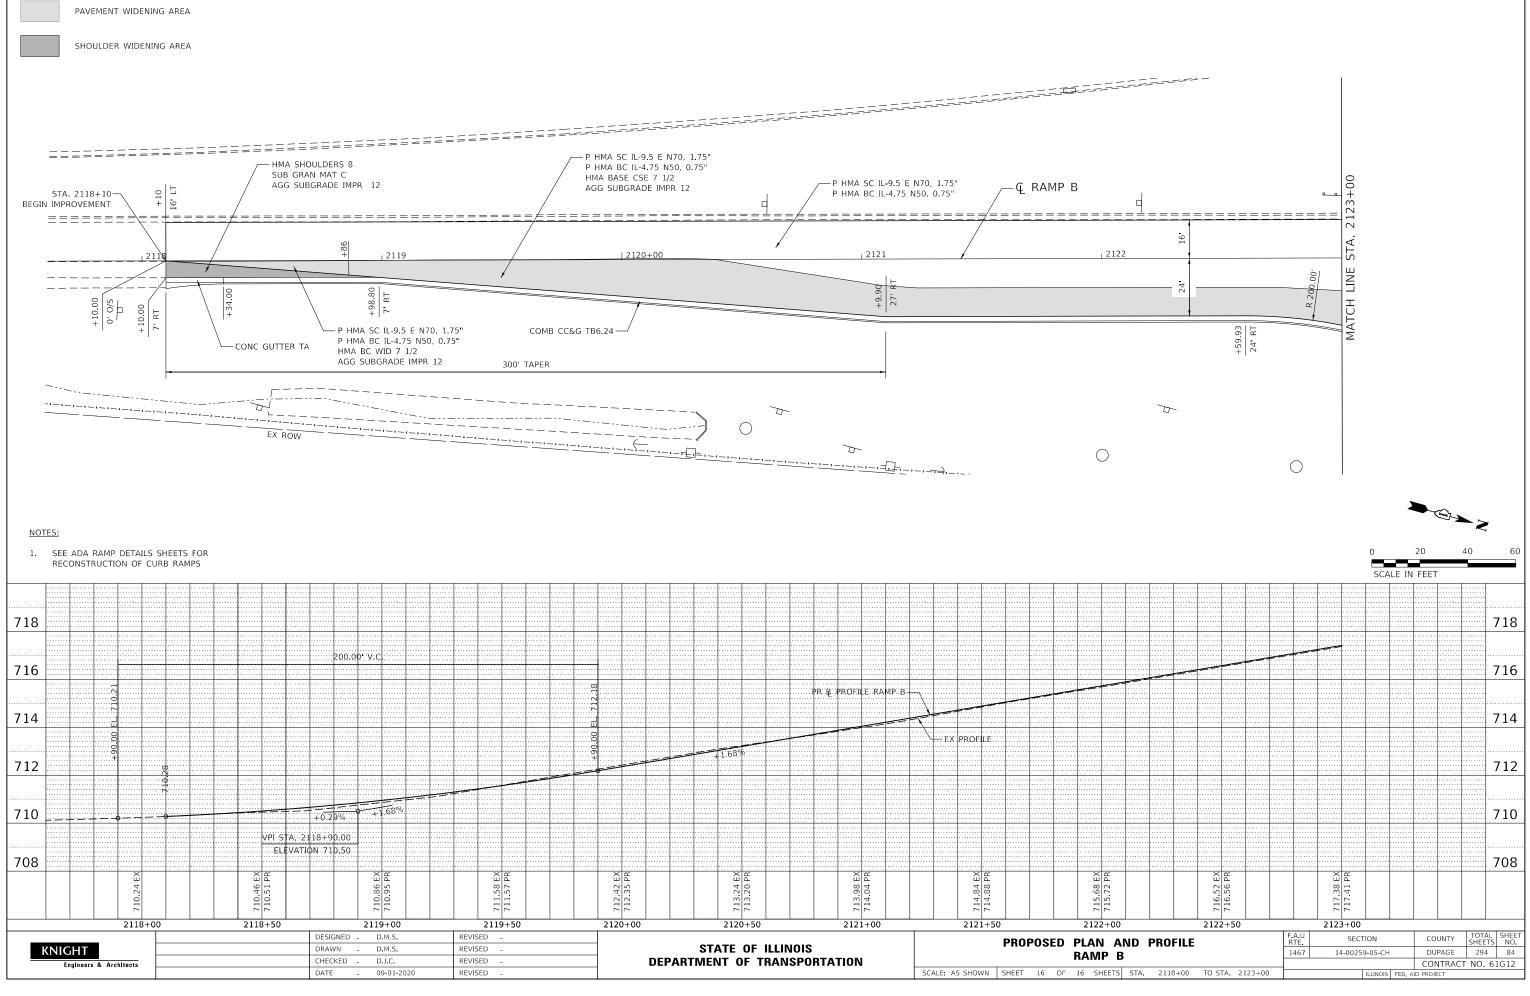

LEGEND:

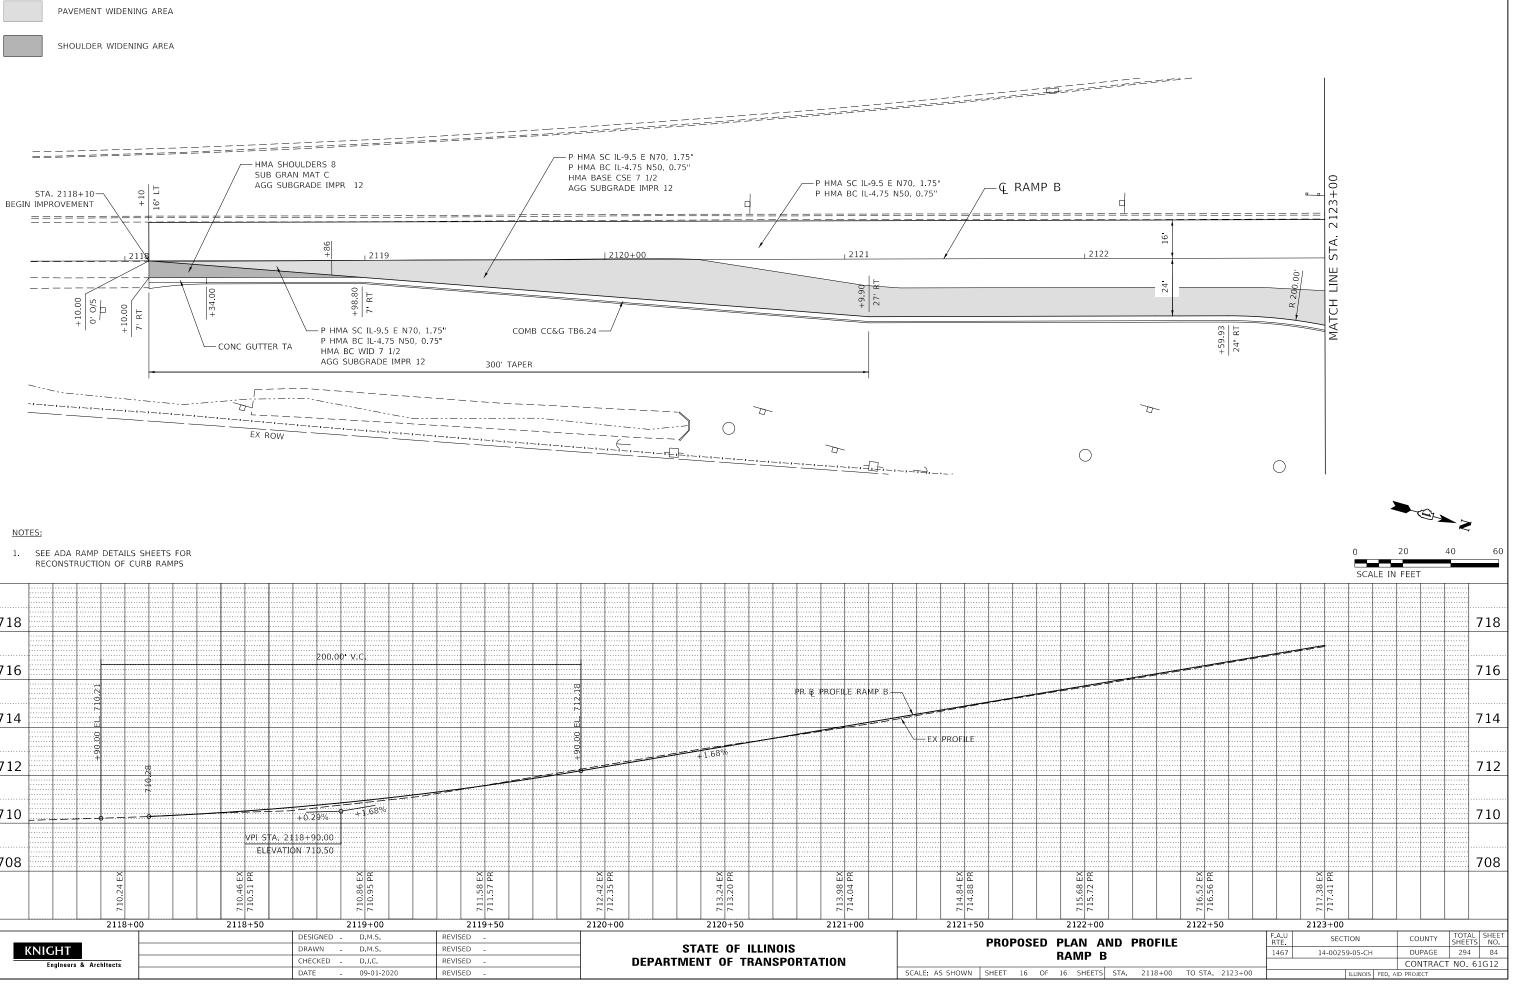

## **MAINTENANCE OF TRAFFIC GENERAL NOTES**

- TRAFFIC CONTROL AND PROTECTION SHALL BE PERFORMED IN ACCORDANCE WITH THE TRAFFIC CONTROL PLAN, TRAFFIC SIGNAL PLANS, THESE NOTES, APPLICABLE SPECIAL PROVISIONS, AND SECTION 701 OF THE STANDARD SPECIFICATION AS AMENDED BY THE SPECIAL PROVISION FOR WORK ZONE TRAFFIC CONTROL (CHECK SHEET LRS 3).
- 2. THE TYPE III BARRICADES ARE TO BE PLACED IN ACCORDNACE WITH STANDARD 701901 UNLESS AUTHORIZED BY THE ENGINEER TO USE AN ALTERNATE ARRANGEMENT.
- 3. EXISTING TRAFFIC CONTROL SIGNS AND DEVICES MAY BE REMOVED BY THE DUPAGE COUNTY DIVISION OF TRANSPORTATION AFTER THE TRAFFIC CONTROL REQUIREMENTS ARE MET OR AS AUTHORIZED BY THE ENGINEER; ANY SIGNS OR DEVICES LEFT IN PLACE AT THIS TIME ARE TO BE RELOCATED, MAINTAINED AND PROTECTED FROM DAMAGE BY THE CONTRACTOR AND ANY DAMAGED OR LOST SIGNS WILL BE REPLACED BY THE CONTRACTOR.
- 4. TYPE I OR TYPE II BARRICADES, DRUMS, OR VERTICAL PANELS WITH MONODIRECTIONAL STEADY-BURN LIGHTS SHALL BE REQUIRED ALONG TEMPORARY ROADS, DETOURS, AND SIDE STREETS TO DELINEATE THE TRAVELED WAY WITHIN THE CONSTRUCTION ZONE. THE MAXIMUM SPACING FOR THESE DEVICES SHALL BE 100 FEET CENTER TO CENTER.
- ANY DROP OFF GREATER THAN THREE (3) INCHES WITHIN SIXTEEN (16) FEET OF A 5 TRAVEL LANE SHALL BE PROTECTED BY TYPE I OR TYPE II BARRICADES, DRUMS OR VERTICAL PANELS WITH MONODIRECTIONAL STEADY-BURN LIGHTS AT 50 FOOT (MAXIMUM) CENTER TO CENTER SPACING. IF THE DROP OFF IS GREATER THAN TWENTY-FOUR (24) INCHES AND EXISTS FOR LONGER THAN 24 HOURS, IT SHALL BE PROTECTED BY TEMPORARY CONCRETE BARRIER. TEMPORARY CONCRETE BARRIER SHALL HAVE MONODIRECTIONAL STEADY-BURN LIGHTS AT 50 FOOT (MAXIMUM) CENTER TO CENTER SPACING. THE CONTRACTOR SHALL SCHEDULE HIS WORK AND OPERATIONS SUCH THAT A DROP OFF OF GREATER THAN 24 INCHES DOES NOT REMAIN WITHIN SIXTEEEN FEET OF A TRAVEL LANE FOR MORE THAN 24 HOURS. THE CONTRACTOR MAY PLACE COMPACTED EXCAVATED MATERIAL, AGGREGATE, OR OTHER MATERIAL IN THE DROP OFF TO SATISFY THIS REQUIREMENT. THE PLANS INDICATE AREAS (IF ANY) IN WHICH THE DEPARTMENT EXPECTS THAT TEMPORARY CONCRETE BARRIER WILL BE REQUIRED FOR A DROP OFF OF GREATER THAN 24 INCHES TO REMAIN FOR MORE THAN 24 HOURS.
- 6. BARRICADES THAT MUST BE PLACED IN EXCAVATED AREAS SHALL HAVE LEG EXTENSIONS INSTALLED SUCH THAT THE TOP OF THE BARRICADE IS IN COMPLIANCE WITH THE HEIGHT REQUIREMENTS OF STANDARD 701901.
- 7. TYPE I OR TYPE II BARRICADES WITH TWO-WAY FLASHING LIGHTS SHALL BE REQUIRED AT ALL OPEN TRENCHES, EXCAVATIONS, OPEN OR EXPOSED SEWER STRUCTURES, TRANSVERSE PAVEMENT JOINTS, MATERIALS OR EQUIPMENT WITHIN THE RIGHT-OF-WAY (NUMBER AND SPACING DEPENDS ON THE CONDITIONS); AND AT LOCATIONS DESIGNATED BY THE ENGINEER OR LOCAL LAW ENFORCEMENT AGENCIES.
- 8. FOR LIGHTS ON BARRICADES REFER TO SUPPLEMENTAL SPECIFICATIONS AND RECURRING SPECIAL PROVISIONS ADOPTED JANUARY 1, 2020.
- 9. WHERE REQUIRED, TRAFFIC SIGNS SHALL BE RELOCATED FOR EACH STAGE OF CONSTRUCTION.
- 10. ARROW BOARDS WILL BE REQUIRED WHEN IMPLEMENTING ALL LANE CLOSURES.
- 11. PRIOR TO THE START OF CONSTRUCTION, REQUIRED TRAFFIC CONTROL DEVICES SHALL BE IN PLACE.
- 12. ANY CLOSURE OF THE EXISTING PATH SHALL BE COORDINATED AT LEAST 72 HOURS IN ADVANCE WITH SID KENYON AT DUPAGE COUNTY DOT AT (630) 407-6900.
- 13. THE CONTRACTOR SHALL CONTACT THE IDOT TRAFFIC SUPERVISOR AT KALPANA.KANNAN-HOSADURGA@ILLINOIS.GOV 72 HOURS IN ADVANCE OF BEGINNING WORK.
- 14. ACCESS TO THE SOUTH DRIVEWAY FOR THE DUPAGE MAYORS & MANAGERS CONFERENCE (1220 OAK BROOK ROAD) OFF OF 31ST STREET WILL BE CLOSED FOR RECONSTRUCTION DURING STAGE 1. DURING THIS STAGE, THE EAST DRIVEWAY FOR THE DUPAGE MAYORS & MANAGERS CONFERENCE OFF OF JORIE BOULEVARD SHALL REMAIN OPEN. THIS WORK SHALL BE COORDINATED WITH DUPAGE MAYORS AND MANAGERS 2 WEEKS IN ADVANCE OF CLOSURE. CONTACT SUZETTE QUINTELL AT DMMC AT 630-571-0480.
- 15. DURING CONSTRUCTION, THE NORTH RIGHT-IN/RIGHT-OUT DRIVEWAY TO OAK BROOK COMMUNITY CHURCH (3100 MIDWEST ROAD) WILL BE CLOSED FOR UNDERDRAIN INSTALLATION AND CURB AND GUTTER REMOVAL AND REPLACEMENT PRIOR TO RESURFACING OF 31ST STREET. THIS WORK SHALL BE STAGED SO THAT EITHER THE RIGHT-IN ENTRANCE OR RIGHT-OUT EXIT PORTION OF THE DRIVEWAY REMAINS OPEN TO TRAFFIC WHILE THE OTHER SECTION IS UNDER CONSTRUCTION. PRIMARY ACCESS TO OAK BROOK COMMUNITY CHURCH SHALL BE MAINTAINED THROUGH UTILIZATION OF THE EAST DRIVEWAY OFF OF MIDWEST ROAD. THIS WORK SHALL BE COORDINATED WITH OAK BROOK COMMUNITY CHURCH TWO WEEKS IN ADVANCE OF CLOSURE. CONTACT OAK BROOK COMMUNITY CHURCH AT - 630-986-0310.

- 16. THE REMOVAL OF THE MEDAIN AND THE CONSTRUCTION OF FULL-DEPTH PAVEMENT IN ITS PLACE AT STA. 109+08 TO STA. 112+23 AND STA. 184+60 TO STA. 186+16 SHALL BE COMPLETED USING A LANE CLOSURE ACCORDING TO IDTO STANDARD 701602.
- 17. THE FOLLOWING TRAFFIC CONTROL STANDARDS ARE THE MINIMUM REQUIREMENTS FOR THE TRAFFIC CONTROL FOR THIS PROJECT:
  - 701101-05 OFF-RD OPERATIONS, MULTILANE, 15' TO 24" FROM PAVEMENT EDGE
  - 701106-02 OFF-RD OPERATIONS, MULTILANE, MORE THAN 15 AWAY
  - 701426-09 LANE CLOSURE, MULTILANE, INTERMITTENT OR MOVING OPERATION, FOR SPEEDS >=45MPH
  - 701456-05 PARTIAL EXIT RAMP CLOSURE FREEWAY/EXPRESSWAY
  - 701501-06 URBAN LANE CLOSURE, 2L, 2W, UNDIVIDED
  - 701601-09 URBAN LANE CLOSURE, MULTILANE, 1W OR 2W W/ NONTRAVERSABLE MEDIAN 701602-10 URBAN LANE CLOSURE, MULTILANE, 2W WITH BIDIRECTIONAL LEFT TURN LANE
  - 701602-10 URBAN LANE CLOSORE, MULTILANE, 2W WITH BIDIRECTIONAL LEFT TORN 701611-01 UBAN HALF ROAD CLOSURE, MULTILANE, 2W WITH MOUNTABLE MEDIAN
  - 701701-10 URBAN LANE CLOSURE, MULTILANE INTERSECTION
  - 701801-06 LANE CLOSURE, MULTILANE, 1W OR 2W CROSSWALK OR SIDEWALK CLOSURE
  - 701901-08 TRAFFIC CONTROL DEVICES
  - TC-10 TRAFFIC CONTROL AND PROTECTION FOR SIDE ROADS, INTERSECTIONS, AND DRIVEWAYS
  - TC-11 TYPICAL APPLICATIONS RAISED REFLECTIVE PAVEMENT MARKERS (SNOW PLOW RESISTANT)
  - TC-13 DISTRICT ONE TYPICAL PAVEMENT MARKINGS
  - TC-14 TRAFFIC CONTROL AND PROTECTION AT TURN BAYS (TO REMAIN OPEN TO TRAFFIC)
  - TC-16 SHORT TERM PAVEMENT MARKING LETTERS AND SYMBOLS
  - TC-17 TRAFFIC CONTROL DETAILS FOR FREEWAY SHOULDER CLOSURES AND PARTIAL RAMP CLOSURES
  - TC-22 ARTERIAL ROAD INFORMATION SIGN TC-26 DRIVEWAY ENTRANCE SIGNING

	DESIGNED D.M.S.	REVISED -			MAINTENANCE OF TRAFFIC		F.A.U BTE	SECTION	COUNTY TOTAL SHEET
KNIGHT	DRAWN D.M.S.	REVISED -	STATE OF ILLINOIS		GENERAL NOTES		1467	14-00259-05-CH	DUPAGE 294 85
Engineers & Architects	CHECKED - D.J.C.	REVISED -	DEPARTMENT OF TRANSPORTATION	GENERAL NUIES		_		CONTRACT NO. 61G12	
	DATE - 09-01-2020	REVISED -		SCALE: NONE	SHEET 1 OF 1 SHEETS STA.	TO STA.		ILLINOIS FED.	AID PROJECT

## SUGGESTED CONSTRUCTION SEQUENCING

### PREAMBLE TO THE MAINTENANCE OF TRAFFIC

FOR THE REFERENCES MADE TO 31ST STREET, LANE 1 IS THE THROUGH LANE ALONG THE MEDIAN, LANE 2 IS THE OUTSIDE LANE.

FOR THE RAMPS, LANE 1 IS THE INSIDE LANE CLOSEST TO IL ROUTE 83 AND LANE 2 IS THE OUTSIDE LANE FURTHEST FROM IL ROUTE 83

OFF PEAK HOURS ARE AS DEFINED IN "KEEPING ARTERIAL ROADWAYS OPEN TO TRAFFIC" SPECIAL PROVISIONS

#### CONSTRUCTION STAGING

THE FOLLOWING IS THE CONSTRUCTION STAGING FOR THIS PROJECT. THE PURPOSE OF THIS STAGING IS TO MINIMIZE DELAYS TO THE MOTORIST. THE CONTRACTOR MAY ALTER THE SEQUENCE OF CONSTRUCTION WITH THE PRIOR APPROVAL OF THE ENGINEER.

#### PRE-STAGE

#### 31ST STREET

CONSTRUCTION TO BE COMPLETED

- INSTALL TEMPORARY TRAFFIC SIGNALS AT INTERSECTIONS FOR JORIE BOULEVARD AND IL ROUTE 83. EXISTING TRAFFIC SIGNALS AT THESE LOCATIONS SHALL BE REMOVED AFTER TEMPORARY SIGNALS ARE OPERATIONAL. SEE TEMPORARY TRAFFIC SIGNAL PLANS.
- INSTALL INITIAL EROSION CONTROL ITEMS AND PERFORM TREE REMOVALS THIS STAGE. SEE EROSION CONTROL PLAN AND SCHEDULE OF QUANTITIES SHEET FOR LOCATIONS.
- RELOCATE CONFLICTING TRAFFIC SIGNS THIS STAGE. SEE PAVEMENT MARKINGS AND SIGNING PLANS.
- CONSTRUCT SIDEWALKS AT SOUTHEAST AND SOUTHWEST CORNERS OF HUNTER TRAILS PARKWAY AND SOUTHWEST CORNER OF SPRING ROAD.

#### MAINTENANCE OF TRAFFIC

PRE-STAGE WORK WILL BE PERFORMED DURING OFF-PEAK HOURS IN ACCORDANCE WITH STANDARDS SHOWN IN THE PLANS

#### IL ROUTE 83 RAMPS A, B, C, AND D

CONSTRUCTION TO BE COMPLETED

- ON IL ROUTE 83 RAMPS A AND C. REMOVE EXISTING CHANNELIZING ISLANDS AND CONSTRUCT PROPOSED PAVEMENT UP TO BINDER FOR FLUSH MEDIANS AS SHOWN ON THE PLANS.
- ON IL ROUTE 83 RAMP B. REMOVE EXISTING CHANNELIZING ISLAND AND CONSTRUCT TEMPORARY PAVEMENT AS SHOWN ON THE PLANS.
- ON IL ROUTE 83 RAMP D, EXISTING ISLAND TO REMAIN AFTER EXISTING SIGNALS ARE REMOVED.

MAINTENANCE OF TRAFFIC

IL ROUTE 83 RAMPS TO REMAIN OPEN DURING THIS STAGE. WORK WILL BE PERFORMED DURING OFF-PEAK HOURS. TRAFFIC CONTROL SHALL BE IN ACCORDANCE WITH STANDARDS SHOWN IN THE PLANS.

#### JORIE BOULEVARD

CONSTRUCTION TO BE COMPLETED

REMOVE EXISTING CHANNELIZING ISLANDS AT THE NORTHEAST AND NORTHWEST CORNERS OF THE IL ROUTE 83 INTERSECTION AND CONSTRUCT TEMPORARY AND PROPOSED PAVEMENT AS SHOWN ON THE PLANS. PROPOSED PAVEMENT SHALL BE CONSTRUCTED UP TO BINDER DURING THIS STAGE

MAINTENANCE OF TRAFFIC

WORK WILL BE PERFORMED DURING OFF-PEAK HOURS, TRAFFIC CONTROL SHALL BE IN ACCORDANCE WITH STANDARDS SHOWN IN THE PLANS.

### STAGE 1

KNIGHT

Engineers & Architects

31ST STREET

CONSTRUCTION TO BE COMPLETED

- CONSTRUCT PROPOSED DRAINAGE IMPROVEMENTS ON WESTBOUND 31ST STREET, EAST AND WEST OF JORIE BOULEVARD.
- CONSTRUCT EASTBOUND 31ST STREET RIGHT TURN LANE AND ASPHALT SHOULDER UP TO BINDER WEST OF IL ROUTE 83 RAMP C.
- CONSTRUCT GUARDRAIL IMPROVEMENTS AT SW AND NE CORNERS OF IL ROUTE 83 BRIDGE.

DESIGNED D.M.S.

D.M.S.

D.J.C

09-01-2020

DRAWN

DATE

HECKED -

- CONSTRUCT WESTBOUND 31ST STREET RIGHT TURN LANE/ AUXILARY LANE WIDENING UP TO BINDER BETWEEN IL ROUTE 83 AND JORIE BOULEVARD
- CONSTRUCT WESTBOUND 31ST STREET RIGHT TURN LANE WIDENING UP TO BINDER EAST OF JORIE BOULEVARD.
- RE-CONSTRUCT COMMERCIAL ENTRANCE AT 1220 OAK BROOK ROAD.
- REMOVE EXISTING CURB AND CONSTRUCT PROPOSED CURB EASTBOUND 31ST STREET EAST OF IL ROUTE 83 RAMP B, WESTBOUND 31ST STREET RIGHT TURN LANE/AUXILARY LANE WIDENING BETWEEN IL ROUTE 83 AND JORIE BOULEVARD AND WESTBOUND 31ST STREET RIGHT TURN LANE WIDENING EAST OF JORIE BOULEVARD.
- CONSTRUCT SIDEWALKS AT NORTHWEST CORNER OF REGENT DRIVE, NORTHEAST CORNER OF JORIE BOULEVARD AND NORTHWEST CORNER OF SPRING ROAD.

#### MAINTENANCE OF TRAFFIC

- MAINTAIN ONE (1) 11' TRAVEL LANE IN EACH DIRECTION AND SHIFT EASTBOUND 31ST STREET TRAFFIC NORTH AND WESTBOUND 31ST STREET TRAFFIC SOUTH UTILIZING EXISTING PAVEMENT AND CLOSING LANE 2.
- PROVIDE ONE (1) 11' OR 12' LEFT TURN LANE AT SIGNALIZED INTERSECTIONS IN EACH DIRECTION AS SHOWN ON THE PLANS.
- AT INTERSECTIONS WHERE INDICATED, THE TRAVEL LANE WILL ACT AS A COMBINATION THROUGH-RIGHT TURN LANE.
- CLOSE ENTRANCE LANE TO DUPAGE MAYORS AND MANAGERS CONFERENCE FROM 31ST STREET, TRAFFIC WILL USE EAST EXIT TO JORIE BOULEVARD

#### IL ROUTE 83 RAMPS B, AND C

CONSTRUCTION TO BE COMPLETED

- CONSTRUCT SIDEWALKS ON WEST SIDE OF IL ROUTE 83 RAMP C AND EAST SIDE OF IL ROUTE 83 RAMP B FOR THE EXISTING MULTI-USE PATH.
- CONSTRUCT PROPOSED DRAINAGE IMPROVEMENTS ON EAST SIDE OF IL ROUTE 83 RAMP B
- REMOVE EXISTING CURB AND CONSTRUCT PROPOSED CURB ON EAST SIDE OF IL ROUTE 83 RAMP B.
- CONSTRUCT DUAL RIGHT TURN LANE WIDENING UP TO BINDER ON EAST SIDE OF IL ROUTE 83 RAMP B.

#### MAINTENANCE OF TRAFFIC

- MAINTAIN ONE (1) 16' TRAVEL LANE ON IL ROUTE 83 RAMP C.
- MAINTAIN ONE (1) 11 TRAVEL LANE ALONG IL ROUTE 83 RAMP B. AT THE TOP OF IL ROUTE 83 RAMP B, PROVIDE (1) 11' LEFT TURN LANE AND ONE (1) 20' RIGHT TURN LANE AS SHOWN IN THE PLANS

#### JORIE BOULEVARD

CONSTRUCTION TO BE COMPLETED

CONSTRUCT REMAINING RADIUS RETURNS AND WIDENING FOR BOTH NORTHWEST AND NORTHEAST CORNERS OF 31ST STREET INTERSECTION.

MAINTENANCE OF TRAFFIC

PROVIDE ONE (1) 11' LEFT TURN LANE AND ONE (1) 11' COMBINATION RIGHT TURN LANE FOR SOUTHBOUND JORIE BOULEVARD AT THE IL ROUTE 83 INTERSECTION.

### **STAGE 1A**

#### 31ST STREET

CONSTRUCTION TO BE COMPLETED (SEE STAGE 1) MAINTENANCE OF TRAFFIC (SEE STAGE 1)

#### IL ROUTE 83 RAMP B

CONSTRUCTION TO BE COMPLETED

CONSTRUCT CHANNELIZING ISLAND FOR RAMP

MAINTENANCE OF TRAFFIC

MAINTAIN (1) 11' TRAVEL LANE ALONG IL ROUTE 83 RAMP B. AT THE TOP OF IL ROUTE 83 RAMP B, PROVIDE (1) 11' LEFT TURN LANE AND ONE (1) 20' RIGHT TURN LANE AS SHOWN IN THE PLANS

STATE OF ILLINOIS

**DEPARTMENT OF TRANSPORTATION** 

#### JORIE BOULEVARD

REVISED

REVISED

REVISED

REVISED

CONSTRUCTION TO BE COMPLETED (SEE STAGE 1) MAINTENANCE OF TRAFFIC (SEE STAGE 1)

### STAGE 2

31ST STREET

#### CONSTRUCTION TO BE COMPLETED

- MEDIAN, WEST OF IL ROUTE 83.
- WEST OF IL ROUTE 83.
- 31ST STREET, EAST OF IL ROUTE 83.
- ON WESTBOUND 31ST STREET EAST OF IL ROUTE 83.

MAINTENANCE OF TRAFFIC

#### IL ROUTE 83 RAMPS A, B, C, & D

CONSTRUCTION TO BE COMPLETED THIS STAGE

WEST SIDE OF IL ROUTE 83 RAMP B.

#### MAINTENANCE OF TRAFFIC

TURN LANE

### JORIE BOULEVARD

- CONSTRUCTION TO BE COMPLETED THIS STAGE
- 31ST STREET INTERSECTION.

#### MAINTENANCE OF TRAFFIC

### FINAL STAGE

### 31ST STREET, IL 83 RAMPS, AND JORIE BOULEVARD

#### CONSTRUCTION TO BE COMPLETED

- ST. PASCHAL DRIVE.

MAINTENANCE OF TRAFFIC

SCALE: NONE

SUGGESTED CONSTRUCT

SHEET 1 OF 1 SHEET

INSTALL PROPOSED DRAINAGE IMPROVEMENTS AT EASTBOUND 31ST STREET

CONSTRUCT LEFT TURN LANE EXTENSION PAVEMENT AT EASTBOUND 31ST STREET,

CONSTRUCT PAVEMENT WIDENING UP TO BINDER ON NORTH SIDE OF EASTBOUND

REMOVE EXISTING MEDIAN AND CONSTRUCT PROPOSED MEDIAN WEST OF IL ROUTE 83, BETWEEN IL ROUTE 83 AND JORIE BOULEVARD, AND EAST OF JORIE BOULEVARD

CONSTRUCT LEFT TURN EXTENSION PAVEMENT UP TO BINDER

CONSTRUCT LEFT TURN LANE EXTENSION PAVEMENT UP TO BINDER AND CONSTRUCT AN ADDITONAL LEFT TURN LANE UP TO BINDER TO PROVIDE DUAL LEFT TURN LANES FOR EASTBOUND 31ST STREET, WEST OF THE JORIE BOULEVARD INTERSECTION.

CONSTRUCT LEFT TURN LANE EXTENSION PAVEMENT UP TO BINDER FOR WESTBOUND 31ST STREET, EAST OF THE JORIE BOULEVARD INTERSECTION.

MAINTAIN ONE (1) 11' TRAVEL LANE IN EACH DIRECTION AND SHIFT EASTBOUND 31ST STREET TRAFFIC SOUTH AND WESTBOUND 31ST STREET TRAFFIC NORTH UTILIZING EXISTING PAVEMENT AND CLOSING LANE 1.

PROVIDE ONE (1) 11' LEFT TURN LANE AT 31ST STREET SIGNALIZED INTERSECTIONS FOR EASTBOUND AND WESTBOUND DIRECTIONS AS SHOWN ON THE PLANS.

MAINTAIN ONE (1) 11' RIGHT TURN LANE AT THE FOLLOWING LOCATIONS: EASTBOUND 31ST STREET WEST OF IL ROUTE 83, WESTBOUND 31ST STREET EAST OF IL ROUTE 83, AND WESTBOUND 31ST STREET EAST OF JORIE BOULEVARD.

CONSTRUCT SIDEWALKS AT THE EAST SIDE OF IL ROUTE 83 RAMP C AND

MAINTAIN 16' TRAVEL LANES ALONG IL ROUTE 83 RAMPS A, B, C, AND D. AT THE TOP OF IL ROUTE 83 RAMP B, PROVIDE ONE (1) 14' LEFT TURN LANE AND ONE (1) 16' RIGHT

CONSTRUCT CHANNELIZING ISLANDS AT NORTHEAST AND NORTHWEST CORNERS OF THE

MAINTAIN 12' LANES ON SOUTHBOUND JORIE BOULEVARD: (1) RIGHT TURN LANE, (1) THROUGH LANE, AND (1) LEFT TURN LANE. MAINTAIN (2) 15' LANES ON NORTHBOUND JORIE BOULEVARD.

PERFORM HMA SURFACE REMOVAL AS SHOWN ON THE PLANS.

REMOVE PAVEMENT, INSTALL UNDERDRAIN, PERFORM CURB AND GUTTER REMOVAL AND REPLACEMENT IN FRONT OF OAK BROOK COMMUNITY CHURCH ON 31ST STREET.

CONSTRUCT SIDEWALKS IN RESURFACING AREAS AS SHOWN ON THE PLANS.


PERFORM PAVEMENT PATCHING AND INSTALL HMA SURFACE COURSE IN WIDENING AND RESURFACING AREAS.

INSTALL PROPOSED TRAFFIC SIGNAL EQUIPMENT AT THE IL ROUTE 83 RAMPS AND JORIE BOULEVARD AND INSTALL PROPOSED PEDESTRIAN PUSH-BUTTON AT MEYERS ROAD, MIDWEST ROAD, CONCORD DRIVE, AND

PERFORM FINAL LANDSCAPING AND RESTORATION IN DISTURBED AREAS

ALL LANES IN FINAL CONFIGURATION. CONSTRUCTION ACTIVITIES TO BE PERFORMED USING IDOT HIGHWAY STANDARDS SHOWN IN THE PLANS.

MAINTENANCE OF TRAFFIC	F.A.U RTE	SECTION		COUNTY	TOTAL SHEETS	SHEET NO.
ESTED CONSTRUCTION SEQUENCING	1467	14-00259-05-CH		DUPAGE	294	86
				CONTRACT	NO. 6	1G12
1 OF 1 SHEETS STA. TO STA.		ILLINOIS	ID PROJECT			

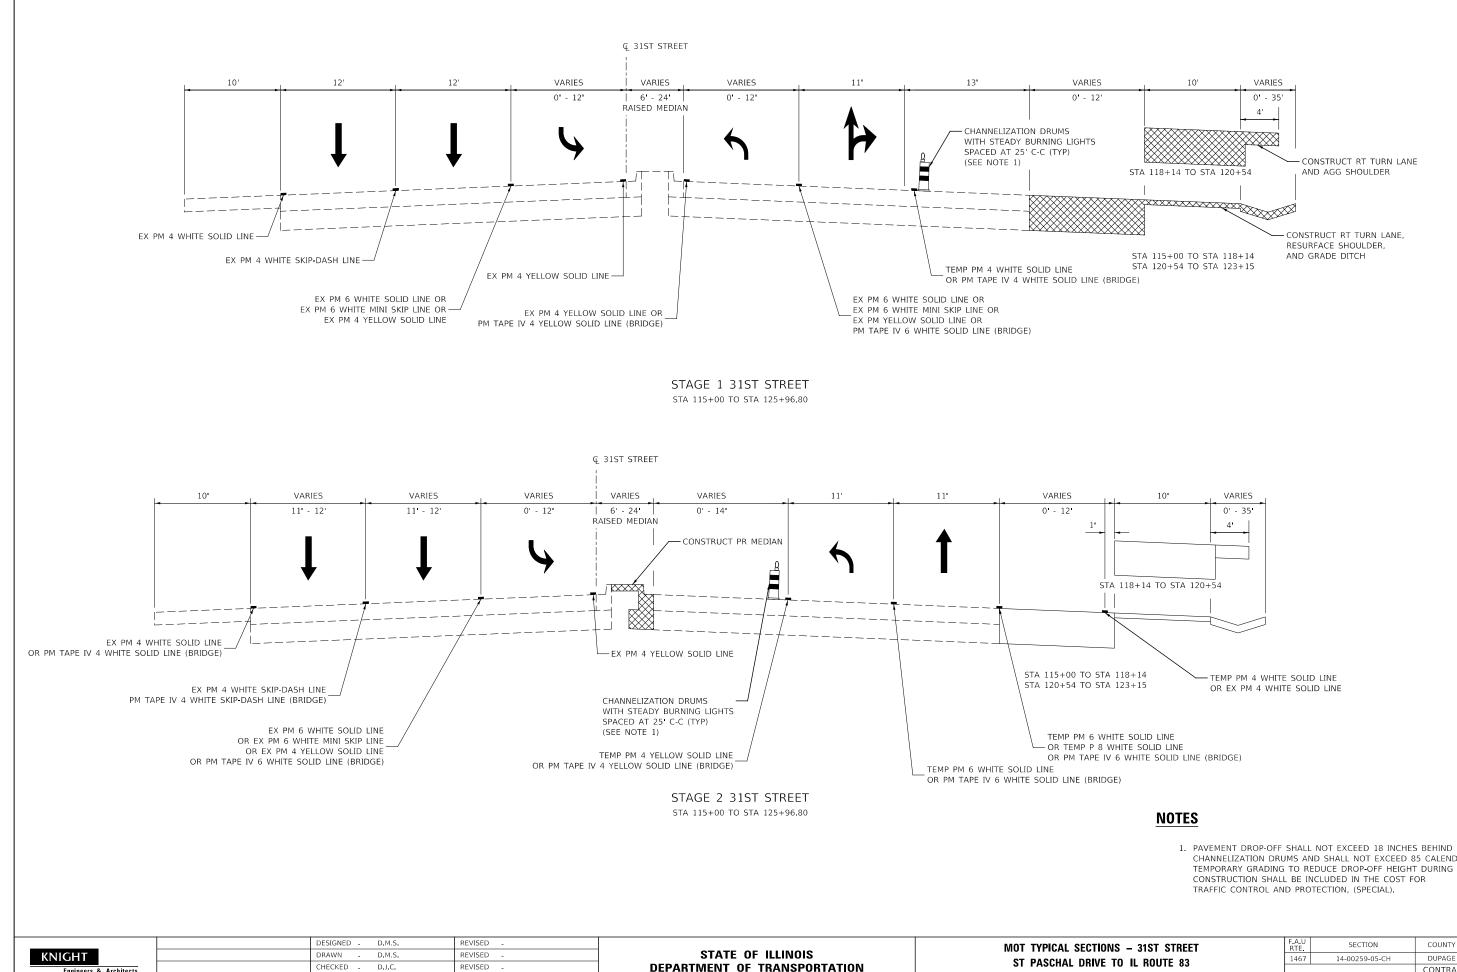

REVISED

DATE


09-01-2020


Engineers & Architects

SCALE: NONE

CHANNELIZATION DRUMS AND SHALL NOT EXCEED 85 CALENDAR DAYS. TEMPORARY GRADING TO REDUCE DROP-OFF HEIGHT DURING CONSTRUCTION SHALL BE INCLUDED IN THE COST FOR


MOT TYPICAL SECTIONS – 31ST STREET							F.A.U RTE	SECTION	COUNTY	TOTAL SHEETS	SHEET NO.
ST PASCHAL DRIVE TO IL ROUTE 83						1467	14-00259-05-CH	DUPAGE	294	87	
 ST PASCHAL DRIVE TO IL ROUTE 83						00			CONTRACT	NO. 6	IG12
SHEET	1	OF	5	SHEETS	STA.	TO STA.	ILLINOIS FED. AID PROJECT				

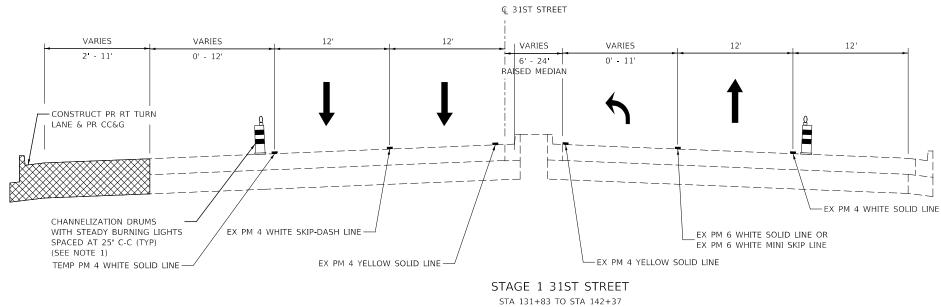

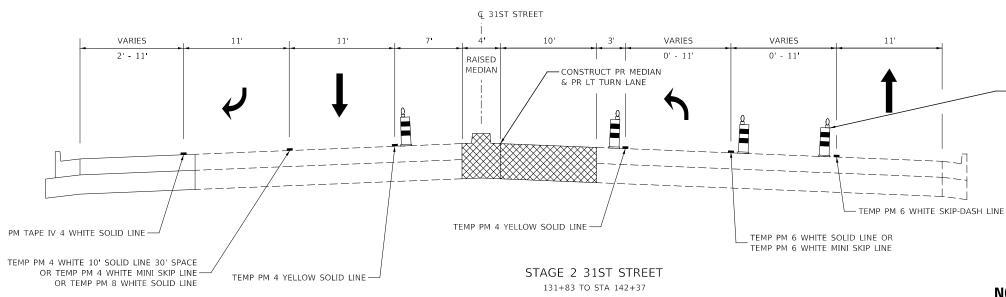


KNIGHT Engineers & Architects	DESIGNED - D.M.S. DRAWN - D.M.S. CHECKED - D.J.C.	REVISED - REVISED - REVISED -	STATE OF ILLINOIS DEPARTMENT OF TRANSPORTATION		MOT TYPICAL SECTIONS – 31ST STREET Il Route 83 to Jorie Boulevard	F.A.U RTE 1467	SECTION 14-00259-05-CH	COUNTY TOTAL SHEETS DUPAGE 294	SHEET NO. 88
	DATE - 09-01-2020	REVISED -		SCALE: NONE	SHEET 2 OF 5 SHEETS STA. TO STA.		ILLINOIS FE	D. AID PROJECT	



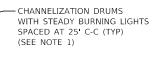




1. PAVEMENT DROP-OFF SHALL NOT EXCEED 18 INCHES BEHIND CHANNELIZATION DRUMS AND SHALL NOT EXCEED 85 CALENDAR DAYS. TEMPORARY GRADING TO REDUCE DROP-OFF HEIGHT DURING CONSTRUCTION SHALL BE INCLUDED IN THE COST FOR TRAFFIC CONTROL AND PROTECTION, (SPECIAL).

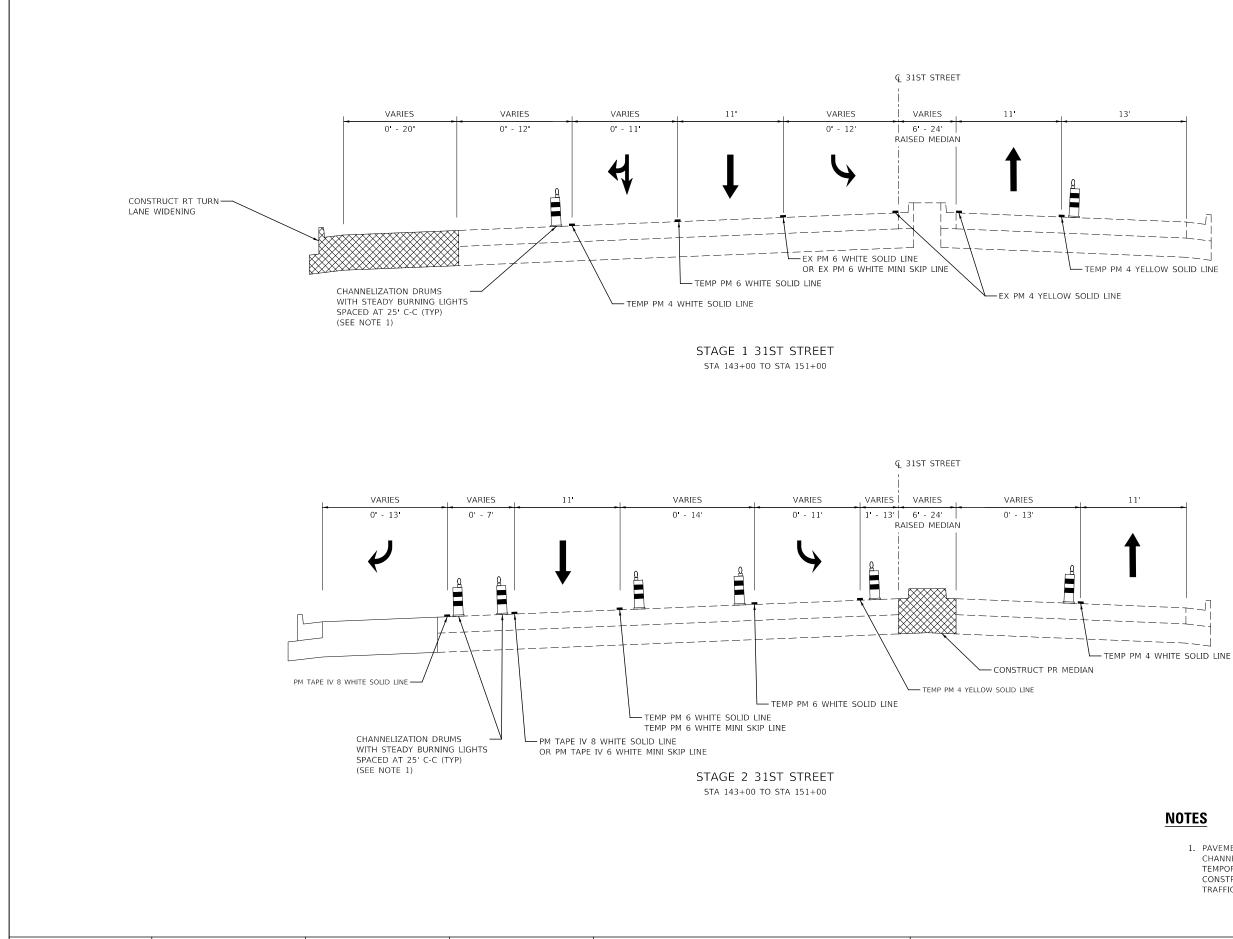


	DESIGNED - D.M.S. R	REVISED -		MOT TYPICAL SECTIONS – 31ST STREET	F.A.U RTE	SECTION	COUNTY TOTAL SHEET SHEETS NO.
KNIGHT	DRAWN D.M.S. R CHECKED D.J.C. R	REVISED -	STATE OF ILLINOIS DEPARTMENT OF TRANSPORTATION	JORIE BOULEVARD TO SPRING ROAD	1467	14-00259-05-CH	DUPAGE 294 89
Engineers & Architects	DATE - 09-01-2020 R	REVISED -	DEFAITMENT OF THANOI ONTATION	SCALE: NONE SHEET 3 OF 5 SHEETS STA. TO STA.		ILLINOIS FED. /	AID PROJECT

1. PAVEMENT DROP-OFF SHALL NOT EXCEED 18 INCHES BEHIND CHANNELIZATION DRUMS AND SHALL NOT EXCEED 85 CALENDAR DAYS. TEMPORARY GRADING TO REDUCE DROP-OFF HEIGHT DURING CONSTRUCTION SHALL BE INCLUDED IN THE COST FOR TRAFFIC CONTROL AND PROTECTION (SPECIAL).

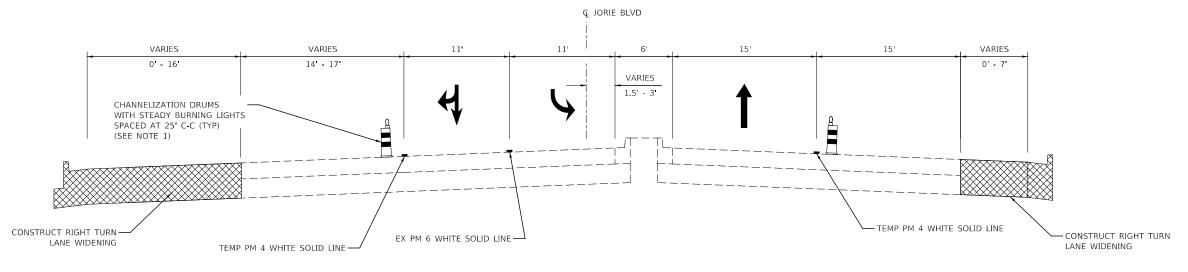



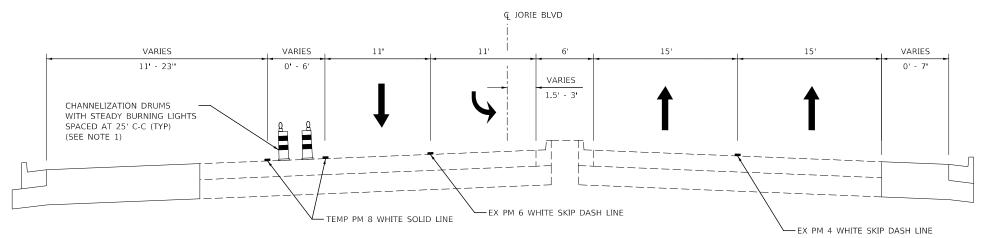


STAGE 2 JORIE BOULEVARD STA 500+84 TO STA 501+48

	DESIGNED - D.M.S.	REVISED -			MOT TYPICAL SECTIONS – JORIE BOULEVARD	F A U RTE	SECTION	COUNTY	TOTAL SHEET SHEETS NO.
KNIGHT	DRAWN D.M.S.	REVISED -	STATE OF ILLINOIS 21ST STREET TO EXPERIMENT		1467	14-00259-05-CH	DUPAGE	294 90	
Engineers & Architects	CHECKED - D.J.C.	REVISED -	DEPARTMENT OF TRANSPORTATION			_		CONTRACT	NO. 61G12
	DATE - 09-01-2020	REVISED -		SCALE: NONE	SHEET 4 OF 5 SHEETS STA. TO STA.		ILLINOIS FED.	AID PROJECT	


# **NOTES**

 PAVEMENT DROP-OFF SHALL NOT EXCEED 18 INCHES BEHIND CHANNELIZATION DRUMS AND SHALL NOT EXCEED 85 CALENDAR DAYS. TEMPORARY GRADING TO REDUCE DROP-OFF HEIGHT DURING CONSTRUCTION SHALL BE INCLUDED IN THE COST FOR TRAFFIC CONTROL AND PROTECTION, (SPECIAL).

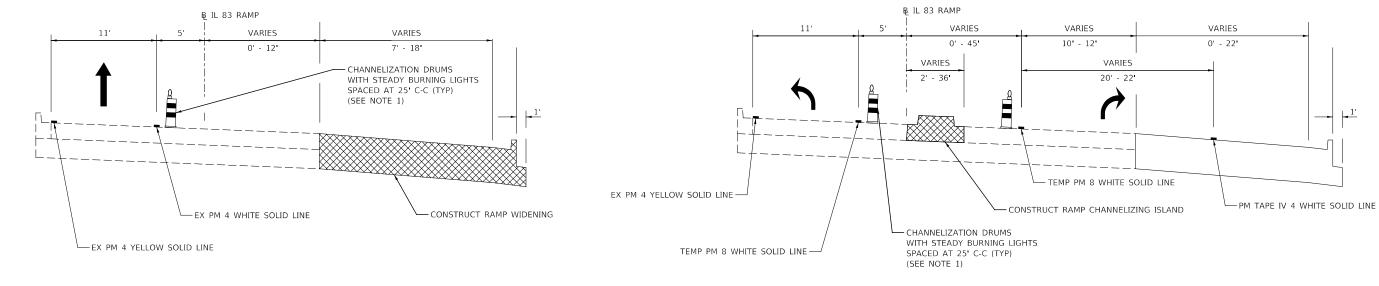





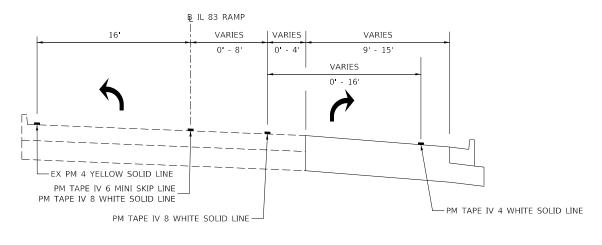




	DESIGNED - D.M.S.	REVISED -		MOT TYPICAL SECTIONS – IL 83 NB RAMP B	F.A.U RTF	SECTION	COUNTY TOTAL SHEET
KNIGHT	DRAWN - D.M.S.	REVISED -	STATE OF ILLINOIS	IL ROUTE 83 TO 31ST STREET	1467	14-00259-05-CH	DUPAGE 294 91
Engineers & Architects	CHECKED D.J.C.	REVISED -	DEPARTMENT OF TRANSPORTATION				CONTRACT NO. 61G12
	DATE - 09-01-2020	REVISED -		SCALE: NONE SHEET 5 OF 5 SHEETS STA. TO STA.		ILLINOIS FED.	AID PROJECT

## STAGE 1A IL 83 NORTHBOUND OFF RAMP (RAMP B)

STA 2122+70 TO STA 2124+05


# NOTES

1. PAVEMENT DROP-OFF SHALL NOT EXCEED 18 INCHES BEHIND CHANNELIZATION DRUMS AND SHALL NOT EXCEED 85 CALENDAR DAYS. TEMPORARY GRADING TO REDUCE DROP-OFF HEIGHT DURING CONSTRUCTION SHALL BE INCLUDED IN THE COST FOR TRAFFIC CONTROL AND PROTECTION, (SPECIAL).

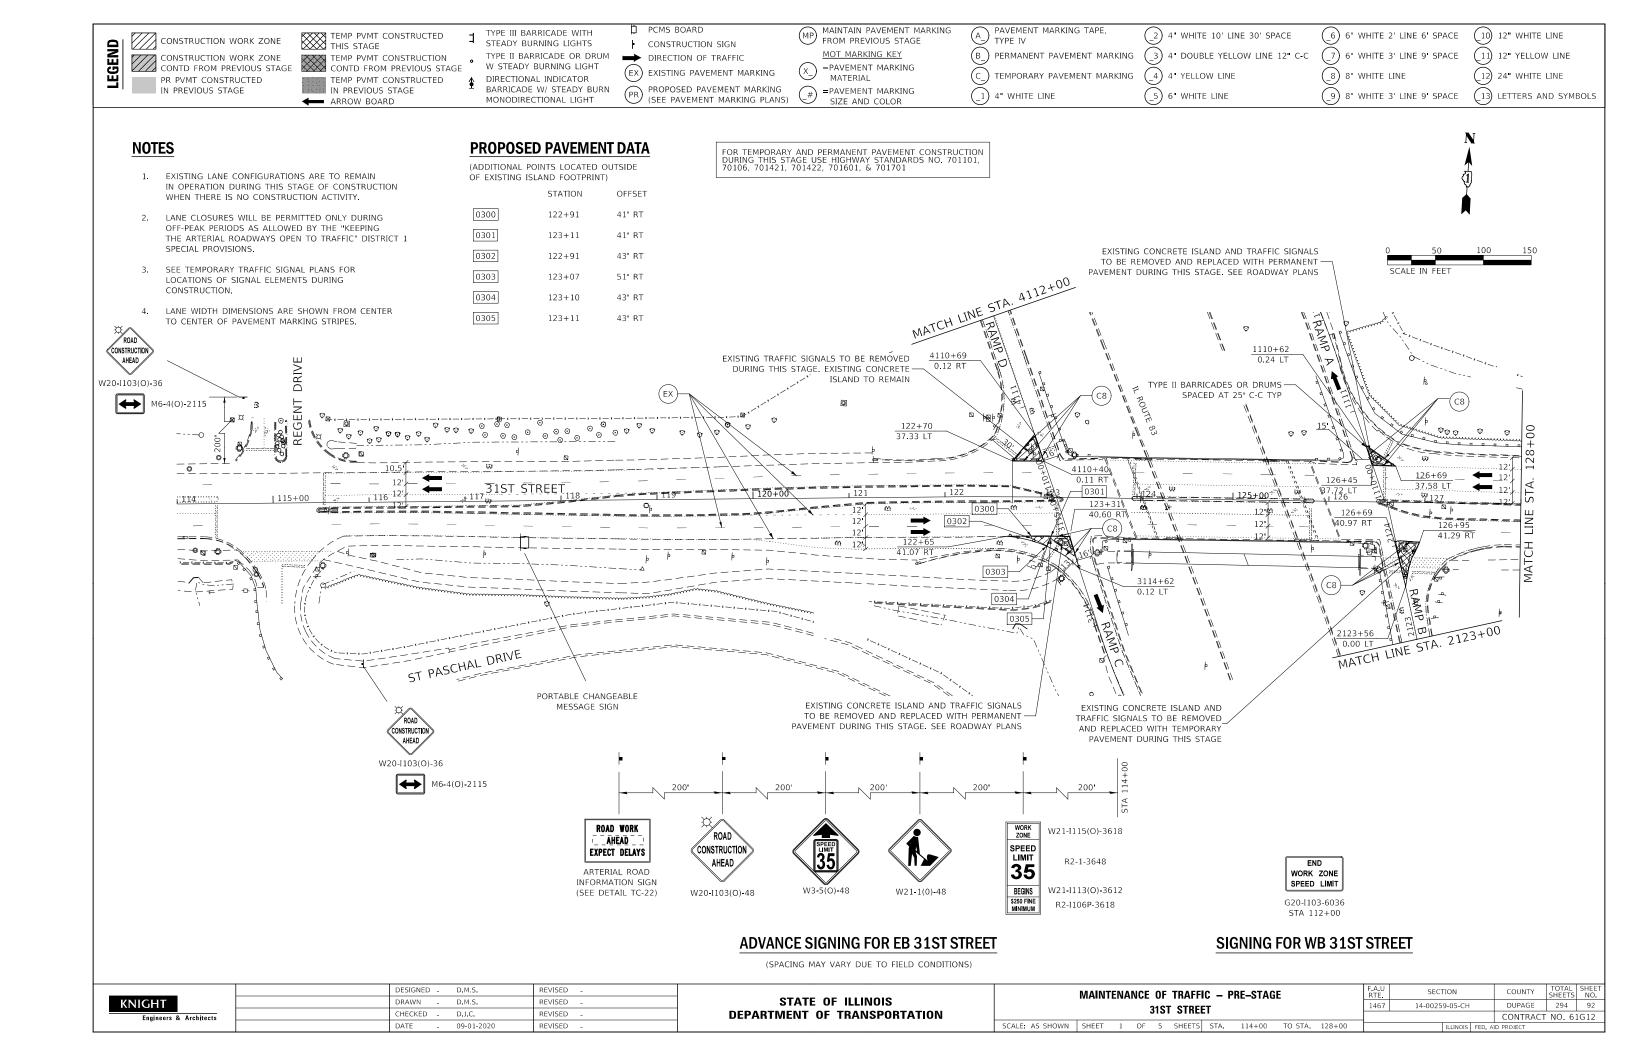


	CONSTRUCTION WORK ZONE	TEMP PVMT CONSTRUCTED         THIS STAGE         TEMP PVMT CONSTRUCTION         CONTD FROM PREVIOUS STAGE         TEMP PVMT CONSTRUCTED         IN PREVIOUS STAGE         ARROW BOARD	⊐ ∘ €	TYPE III BARRICADE WITH STEADY BURNING LIGHTS TYPE II BARRICADE OR DRUM W STEADY BURNING LIGHT DIRECTIONAL INDICATOR BARRICADE W/ STEADY BURN MONODIRECTIONAL LIGHT	$\sim$	PCMS BOARD CONSTRUCTION SIGN DIRECTION OF TRAFFIC EXISTING PAVEMENT MARKING PROPOSED PAVEMENT MARKING (SEE PAVEMENT MARKING PLANS)	MP MAINTAIN PAVEMENT MARKING FROM PREVIOUS STAGE <u>MOT MARKING KEY</u> =PAVEMENT MARKING MATERIAL # =PAVEMENT MARKING SIZE AND COLOR		) PAVEMENT MARKING TAPE, TYPE IV ) PERMANENT PAVEMENT MARKING ) TEMPORARY PAVEMENT MARKING ) 4" WHITE LINE		4" WHITE 4" DOUBLE 4" YELLOW 6" WHITE
--	------------------------	---	-------------	---	--------	---	---	--	--	--	--

1. NO CONSTRUCTION ACTIVITY SHOWN ON THIS SHEET.

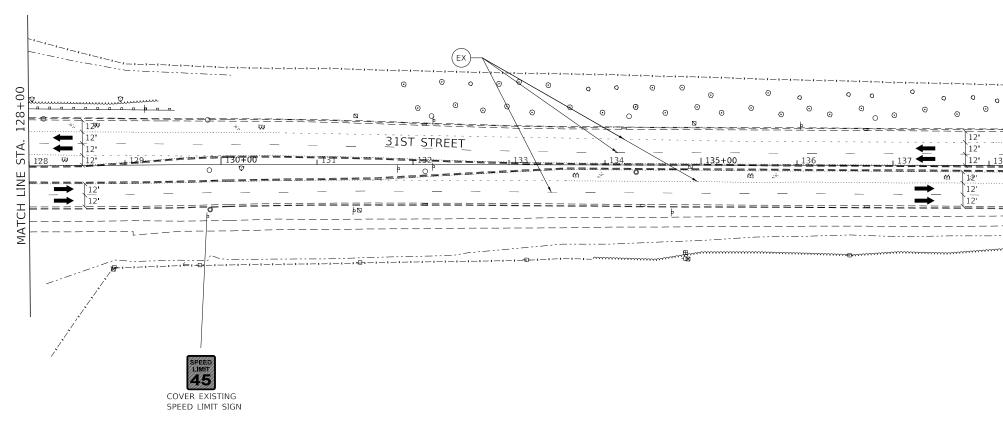


	DESIGNED D.M.S.	REVISED -		P	MAINTEN		EOET	RAFFIC
KNIGHT	DRAWN D.M.S.	REVISED -	STATE OF ILLINOIS	<b>`</b>		ANUL		
Engineers & Architects	CHECKED D.J.C.	REVISED -	DEPARTMENT OF TRANSPORTATION				3121	STREET
	DATE - 09-01-2020	REVISED -		SCALE: AS SHOWN	SHEET 2	OF	5 5	SHEETS


TE 10' LINE 30' SPACE BLE YELLOW LINE 12" C-C .OW LINE TE LINE	6" WHITE 3'	LINE 6' SPACE LINE 9' SPACE NE LINE 9' SPACE	<ul> <li>(10) 12" WHITE LINE</li> <li>(11) 12" YELLOW LINE</li> <li>(12) 24" WHITE LINE</li> <li>(13) LETTERS AND SYMBOLS</li> </ul>
0 SCALE IN	50 100 FEET		
			ATCH LINE STA. 141+0
	F.A.U		COUNTY TOTAL SHEETS NO.

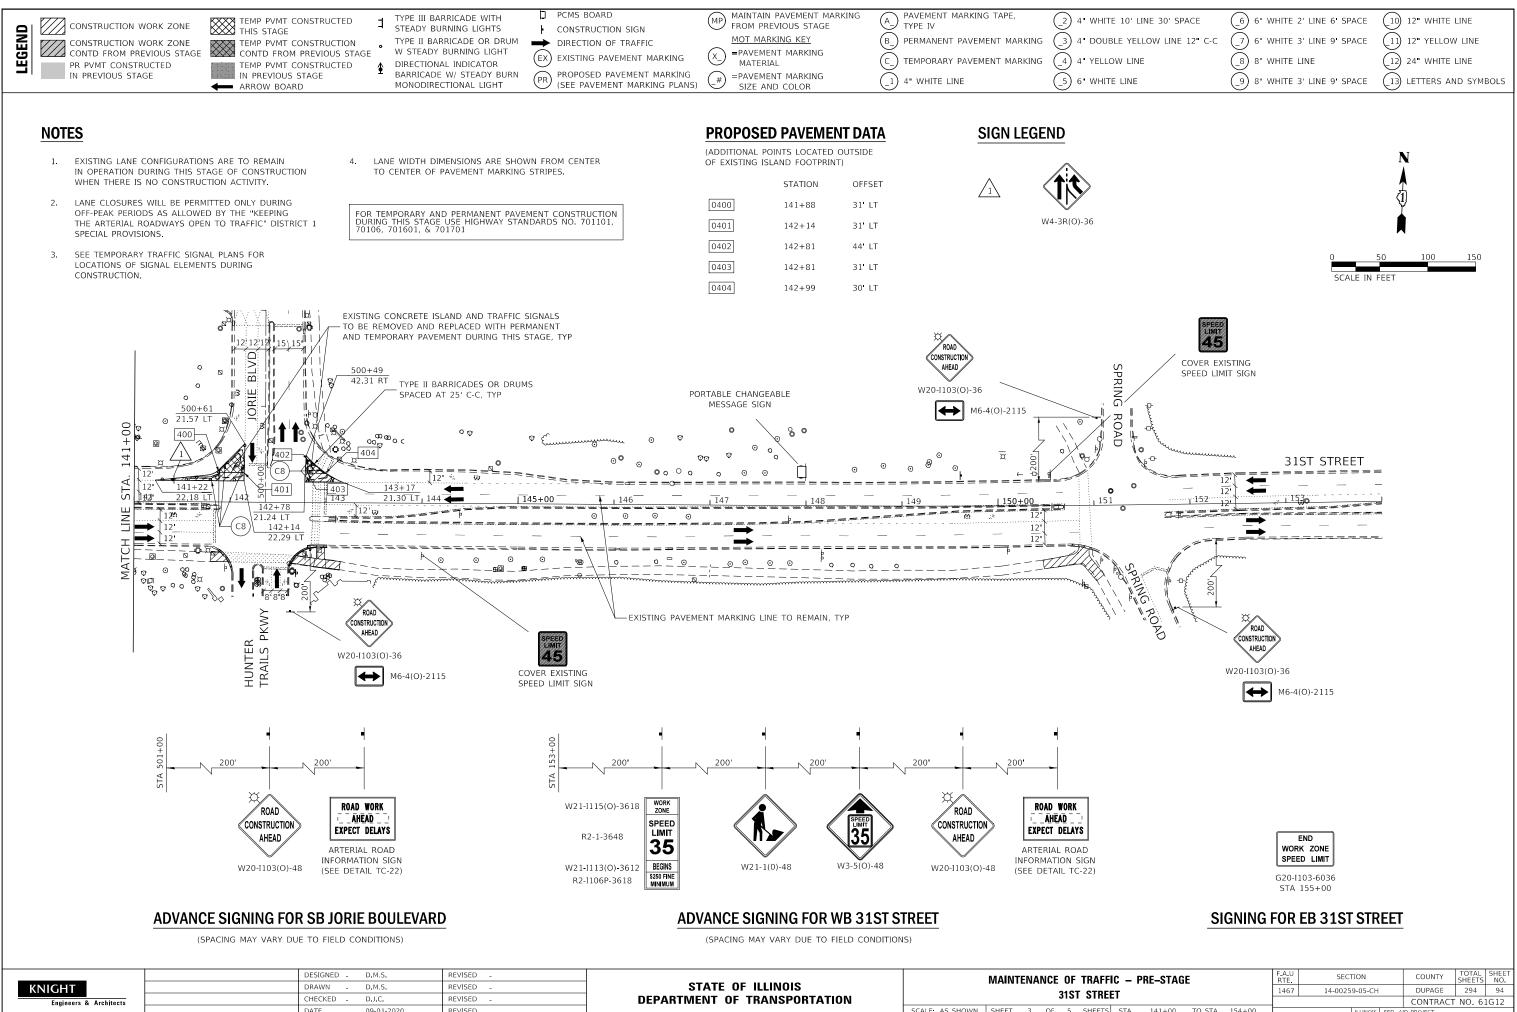


	DESIGNED - D.M.S.	REVISED -		MAINTENANCE	DF TRAFFIC – PRE–STAGE	RTE	SECTION	COUNTY SH	HEETS	SF
KNIGHT	DRAWN D.M.S.	REVISED -	STATE OF ILLINOIS		IST STREET	1467	14-00259-05-CH	DUPAGE	294	_
Engineers & Architects	CHECKED - D.J.C.	REVISED -	DEPARTMENT OF TRANSPORTATION	3				NO. 61	G	
	DATE - 09-01-2020	REVISED -		SCALE: AS SHOWN SHEET 3 OF	5 SHEETS STA. 141+00 TO STA. 154+00		ILLINOIS FED. AID	PROJECT		-

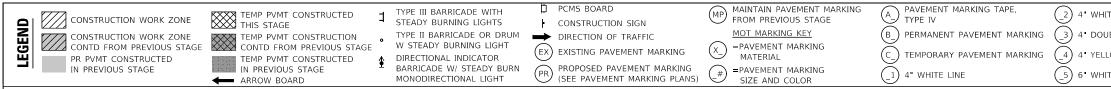

- 1. EXISTING LANE CONFIGURATIONS ARE TO REMAIN IN OPERATION DURING THIS STAGE OF CONSTRUCTION WHEN THERE IS NO CONSTRUCTION ACTIVITY.
- 2. LANE CLOSURES WILL BE PERMITTED ONLY DURING OFF-PEAK PERIODS AS ALLOWED BY THE "KEEPING THE ARTERIAL ROADWAYS OPEN TO TRAFFIC" DISTRICT 1 SPECIAL PROVISIONS.
- SEE TEMPORARY TRAFFIC SIGNAL PLANS FOR LOCATIONS OF SIGNAL ELEMENTS DURING 3. CONSTRUCTION.
- 4. LANE WIDTH DIMENSIONS ARE SHOWN FROM CENTER TO CENTER OF PAVEMENT MARKING STRIPES.

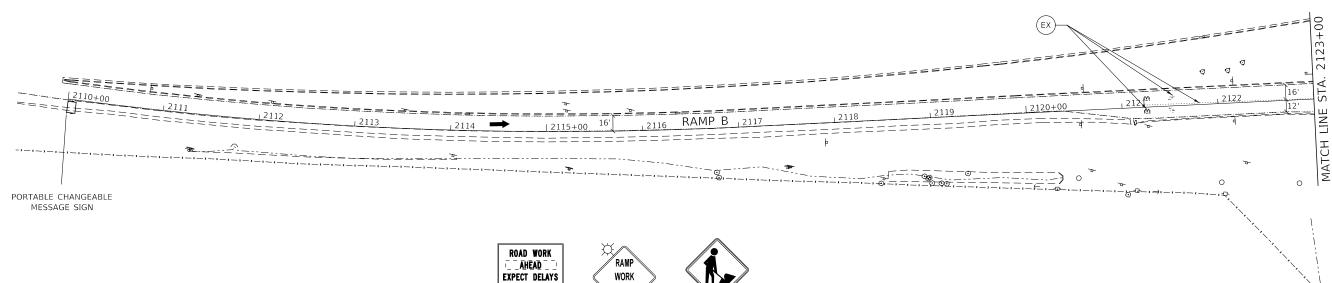

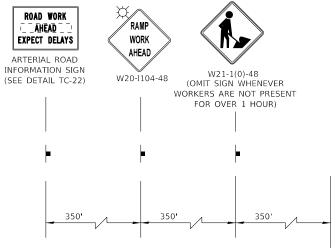

# **ADVANCE SIGNING FOR RAMP B**

KNIGHT	DESIGNED D.M.S.	REVISED -		MAINTENANCE OF TRAFFIC - PRE-STAGE	F.A.U SECTION	COUNTY TOTAL SHEET SHEETS NO.	
	DRAWN - D.M.S. REVISED -	REVISED -	STATE OF ILLINOIS	IL 83 NB ENTRANCE RAMP – RAMP B	1467 14-00259-05-CH	DUPAGE 294 95	
	Engineers & Architects	CHECKED - D.J.C.	REVISED -	DEPARTMENT OF TRANSPORTATION	IE 03 ND ENTRANCE HAMI - HAMI D		CONTRACT NO. 61G12
		DATE - 09-01-2020	REVISED -		SCALE: AS SHOWN SHEET 4 OF 5 SHEETS STA. 2110+00 TO STA. 2123+00	ILLINOIS FED.	AID PROJECT


IITE LINE	9 8" WHITE 3' LINE 9' SPACE	13 LETTERS AND SYMBOLS					
LOW LINE	$\left( \begin{array}{c} 8 \end{array} \right)$ 8" white line	12) 24" WHITE LINE					
UBLE YELLOW LINE 12" C-C	7 6" WHITE 3' LINE 9' SPACE	11) 12" YELLOW LINE					
IITE 10' LINE 30' SPACE	$\begin{pmatrix} 6 \\ -6 \end{pmatrix}$ 6" WHITE 2' LINE 6' SPACE	10 12" WHITE LINE					
		-					

S CEN

SCALE IN FEET

		MP MAINTAIN PAVEMENT MARKING FROM PREVIOUS STAGE MOT MARKING KEY	A PAVEMENT MARKING TAPE, TYPE IV B PERMANENT PAVEMENT MARKING	(_2) 4" WHITE 10' LINE 30' SPACE (_3) 4" DOUBLE YELLOW LINE 12" C-C		10 12" WHITE LINE (11) 12" YELLOW LINE
CONTD FROM PREVIOUS STAGE CONTD FROM PREVIOUS STAGE W STEADY B	(EX) EXISTING PAVEMENT MARKING	X =PAVEMENT MARKING MATERIAL	C_) TEMPORARY PAVEMENT MARKING	(_4) 4" YELLOW LINE	8 WHITE LINE	(12) 24" WHITE LINE
	STEADY BURN (PR) PROPOSED PAVEMENT MARKING DNAL LIGHT (SEE PAVEMENT MARKING PLANS		1 4" WHITE LINE	5 6" WHITE LINE	9 8" WHITE 3' LINE 9' SPACE	13 LETTERS AND SYMBOLS

- EXISTING LANE CONFIGURATIONS ARE TO REMAIN IN OPERATION DURING THIS STAGE OF CONSTRUCTION WHEN THERE IS NO CONSTRUCTION ACTIVITY.
- LANE CLOSURES WILL BE PERMITTED ONLY DURING OFF-PEAK PERIODS AS ALLOWED BY THE "KEEPING THE ARTERIAL ROADWAYS OPEN TO TRAFFIC" DISTRICT 1 SPECIAL PROVISIONS.
- SEE TEMPORARY TRAFFIC SIGNAL PLANS FOR LOCATIONS OF SIGNAL ELEMENTS DURING CONSTRUCTION.
- 4. LANE WIDTH DIMENSIONS ARE SHOWN FROM CENTER TO CENTER OF PAVEMENT MARKING STRIPES.

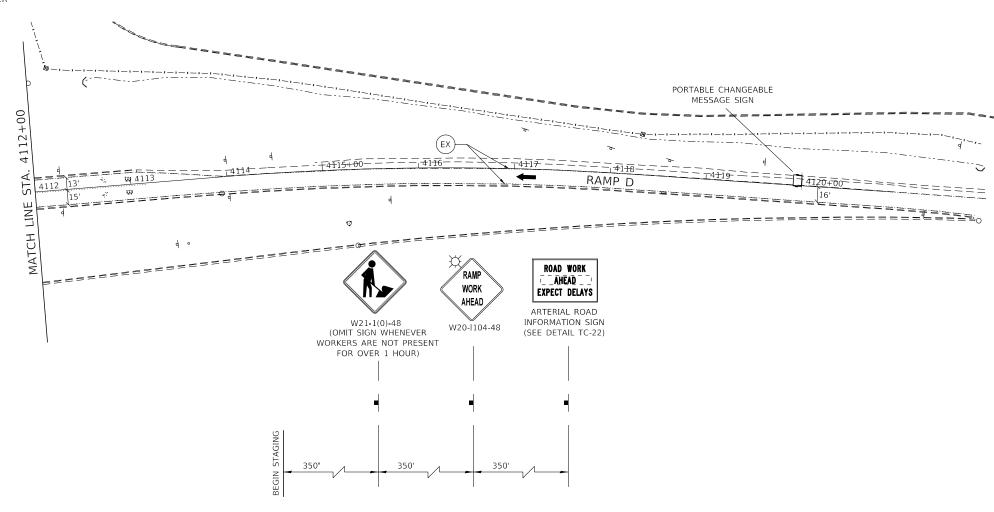


ADVANCE SIGNING FOR RAMP D

	C	DESIGNED D.M.S.	REVISED -		MAINTENANCE OF TRAFFIC - PRE-STAGE	F.A.U BTF	SECTION	COUNTY TOTAL SHEET SHEETS NO.
KNIGHT	C	DRAWN D.M.S.	REVISED -	STATE OF ILLINOIS	IL 83 SB ENTRANCE RAMP – RAMP D	1467	14-00259-05-CH	DUPAGE 294 96
Engineers & Architects		CHECKED - D.J.C.	REVISED -	DEPARTMENT OF TRANSPORTATION	IL 05 5D ENTRANCE NAME D	_		CONTRACT NO. 61G12
	C	DATE - 09-01-2020	REVISED -		SCALE: AS SHOWN SHEET 5 OF 5 SHEETS STA. 4112+00 TO STA. 4120+00		ILLINOIS FED. A	AID PROJECT

S CEN


SCALE IN FEE

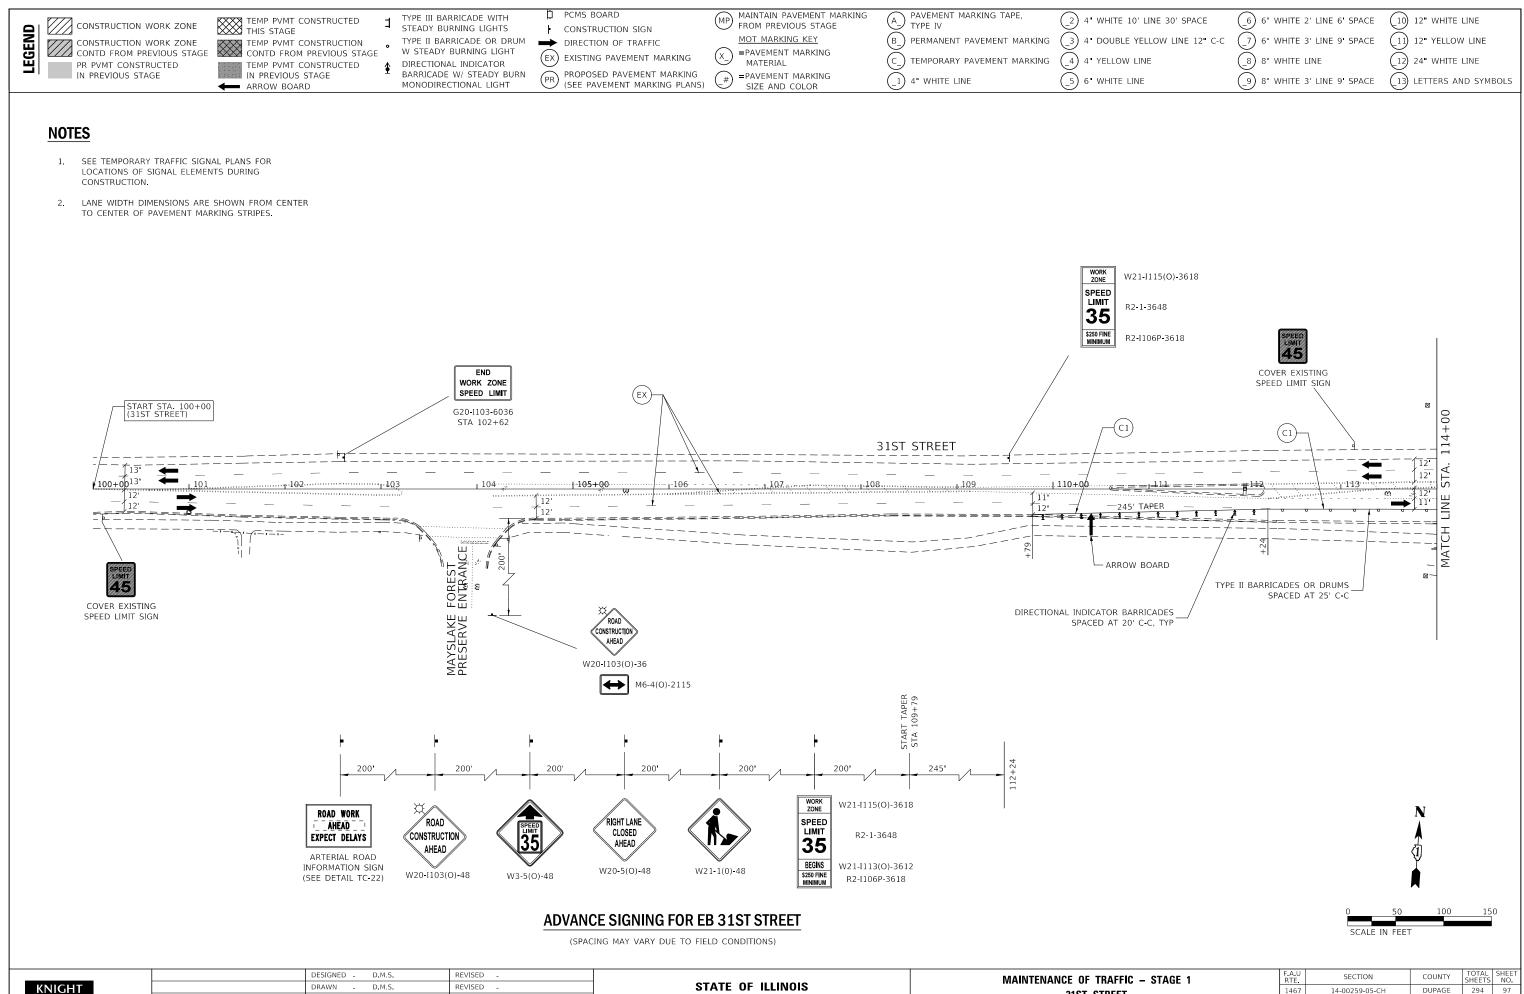


KNIGHT	DESIGNED -	D.M.S.	REVISED -			MAINTENANCE OF TRAFFIC – STAGE 1	F.A.U RTF	SECTION	COUNTY SHEETS NO.
	DRAWN -	D.M.S.	REVISED -	STATE OF ILLINOIS					DUPAGE 294 97
Engineers & Architects	CHECKED -	D.J.C.	REVISED -	DEPARTMENT OF TRANSPORTATION		31ST STREET			CONTRACT NO. 61G12
	DATE -	09-01-2020	REVISED -	SCALE	SCALE: AS SHOWN	SHEET 1 OF 8 SHEETS STA. 100+00 TO STA. 114+00		ILLINOIS FF	D. AID PROJECT

CONSTRUCTION WORK ZONE CONSTRUCTION WORK ZONE CONSTRUCTION WORK ZONE CONTD FROM PREVIOUS STAGE PR PVMT CONSTRUCTED IN PREVIOUS STAGE PR PVMT CONSTRUCTED IN PREVIOUS STAGE MONODIRECTIONAL	LIGHTS CONSTRUCTION SIGN E OR DRUM IG LIGHT CATOR EADY BURN CATOR EADY BURN CONSTRUCTION SIGN DIRECTION OF TRAFFIC EXISTING PAVEMENT MARKING PROPOSED PAVEMENT MARKING	$G \qquad (\#) = PAVEMENT MARKING$	A PAVEMENT MARKING TAPE, TYPE IV     B PERMANENT PAVEMENT MARKING     C. TEMPORARY PAVEMENT MARKING     1 4" WHITE LINE	
--	--	------------------------------------	--	--


- LOCATIONS OF SIGNAL ELEMENTS DURING

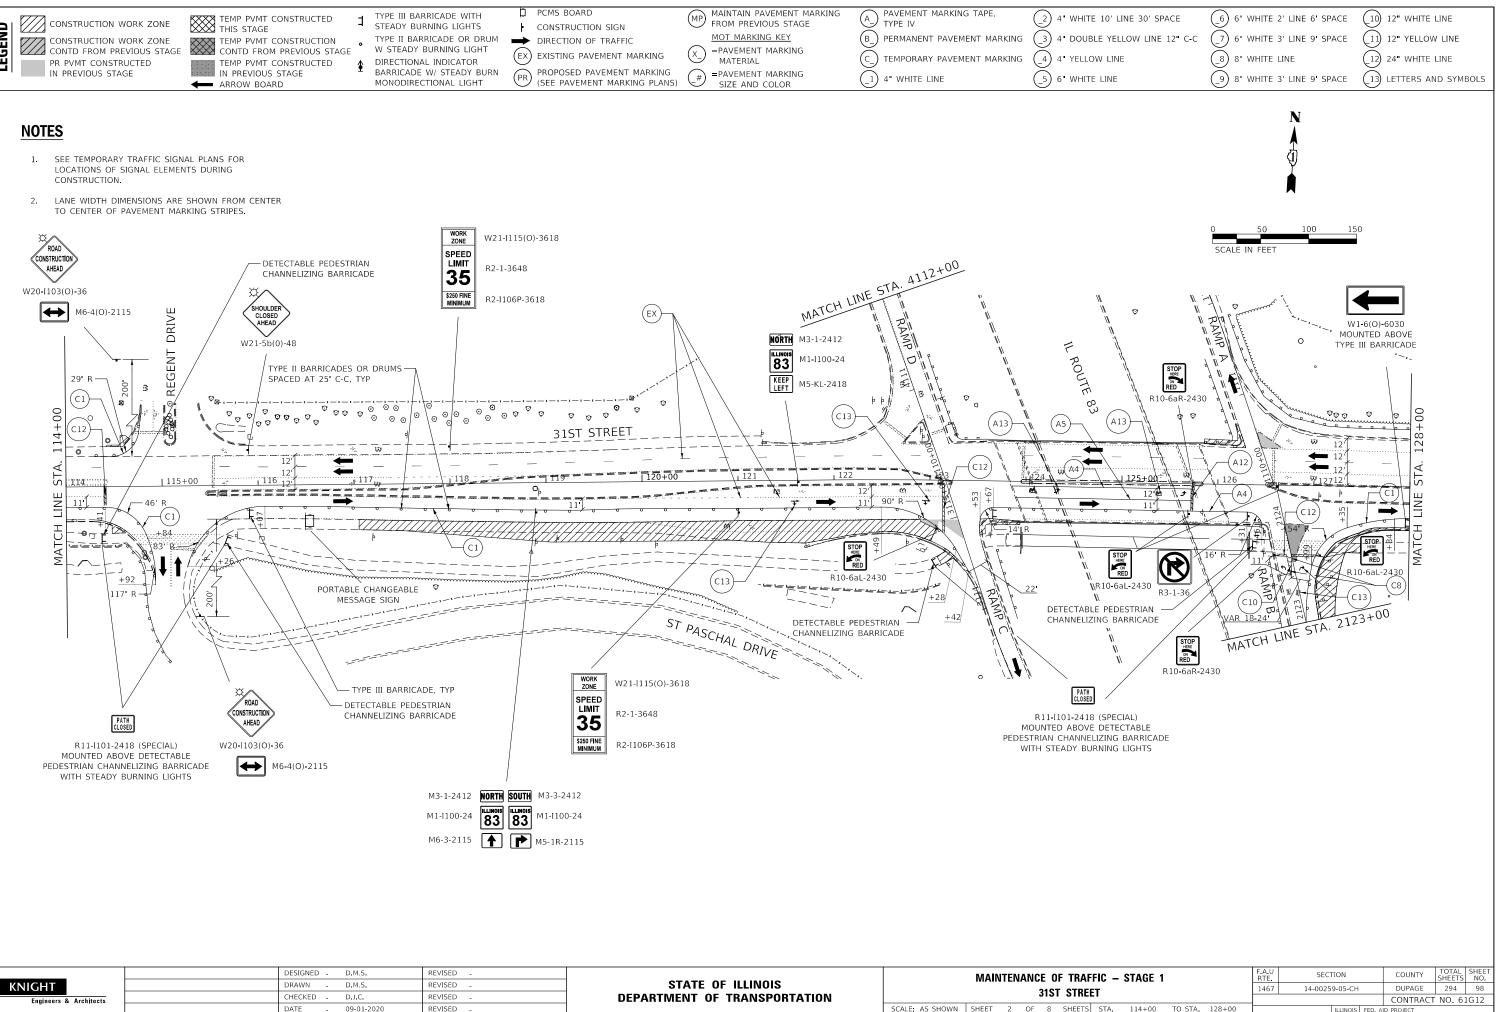

		DESIGNED -	D.M.S.	REVISED -			MAIN	TENIAN		DF TR	VEEL
	KNIGHT	DRAWN -	D.M.S.	REVISED -	STATE OF ILLINOIS		WAIN	LINAN			
Engineers & Architects	CHECKED -	D.J.C.	REVISED -	DEPARTMENT OF TRANSPORTATION				315	T STF	{EE I	
		DATE -	09-01-2020	REVISED -		SCALE: AS SHOWN	SHEET	2 0	F 8	SHEE	.TS S

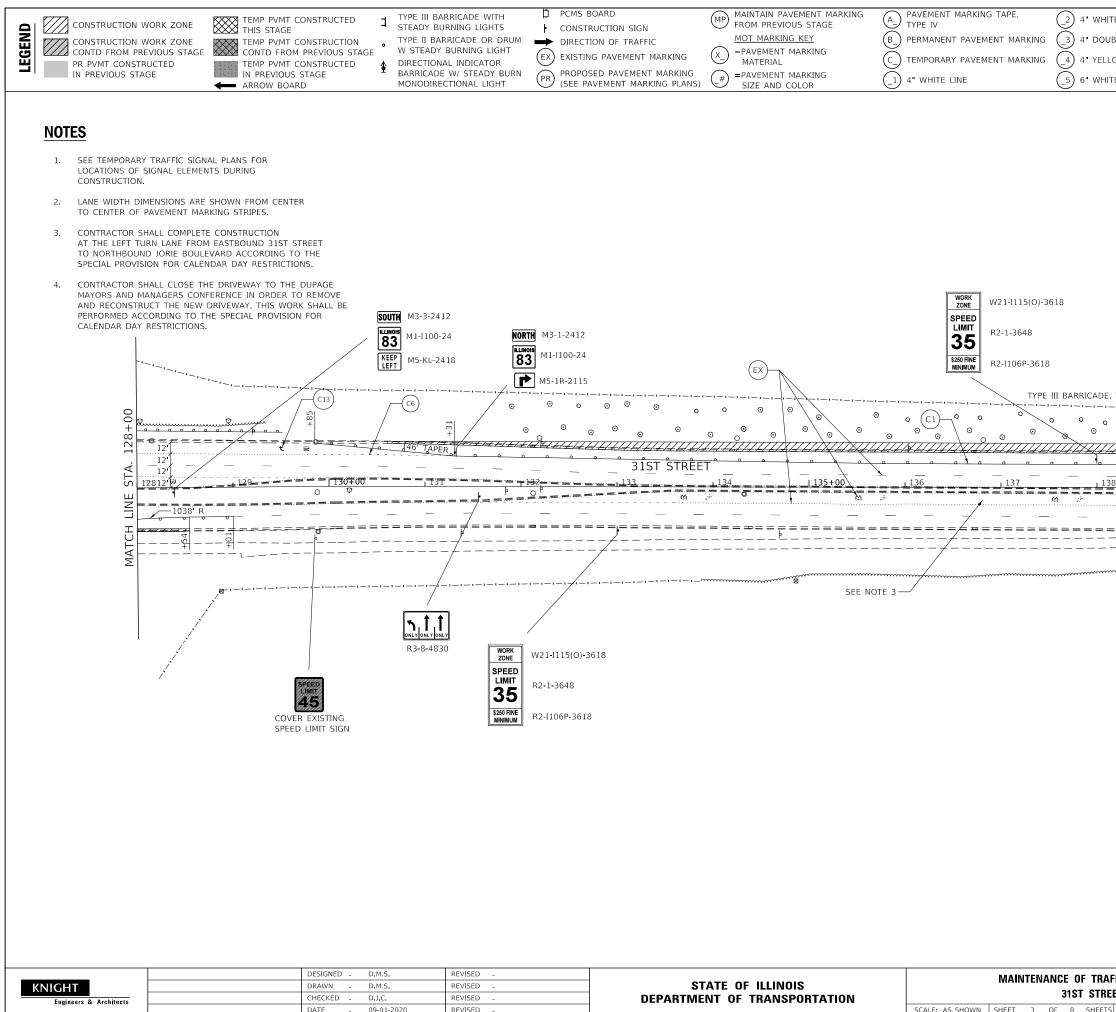

PAVEMENT MARKING TAPE, TYPE IV	2 4" WHITE 10' LINE 30' SPACE	6 6" WHITE 2' LINE 6' SPACE	(10) 12" WHITE LINE
PERMANENT PAVEMENT MARKING	(_3) 4" DOUBLE YELLOW LINE 12" C-C	$\begin{pmatrix} \\ -7 \end{pmatrix}$ 6" WHITE 3' LINE 9' SPACE	11) 12" YELLOW LINE
TEMPORARY PAVEMENT MARKING	4" YELLOW LINE	(-8) 8" WHITE LINE	(12) 24" WHITE LINE
4" WHITE LINE	(5) 6" WHITE LINE	(_9) 8" WHITE 3' LINE 9' SPACE	(13) LETTERS AND SYMBOLS
			(1) LETTERS AND STMBOLS
WORK ZONE SPEED LIMIT R2-1-3648	618	0 50 1 SCALE IN FEET	00 150
<b>35</b> <b>350 FINE</b> MINIMUM R2-1106P-3618			
		R3-1-36	
	III BARRICADE, TYP		
			요 () () () () () () () () () () () () ()
¥ <i>∐ĤĤ</i>		Affinition	STA.141+00
		12 -	
	138 139 m		<b>a</b> u
		12' <b></b>	
=======================================			MATCH
/		• • • • •	
~~~~~~~~~~~~~~~~~~~~~~~~~~~~~~~~~~~~~~~			 ©
_/		3	
MAINTENA	NCE OF TRAFFIC – STAGE 1	F.A.U RTE SECTION	COUNTY TOTAL SHEET NO.
	31ST STREET	1467 14-00259-05-C	CONTRACT NO. 61G12
SCALE: AS SHOWN SHEET 3 (	OF 8 SHEETS STA. 128+00 TO STA.	141+00 ILLINOI	S FED. AID PROJECT

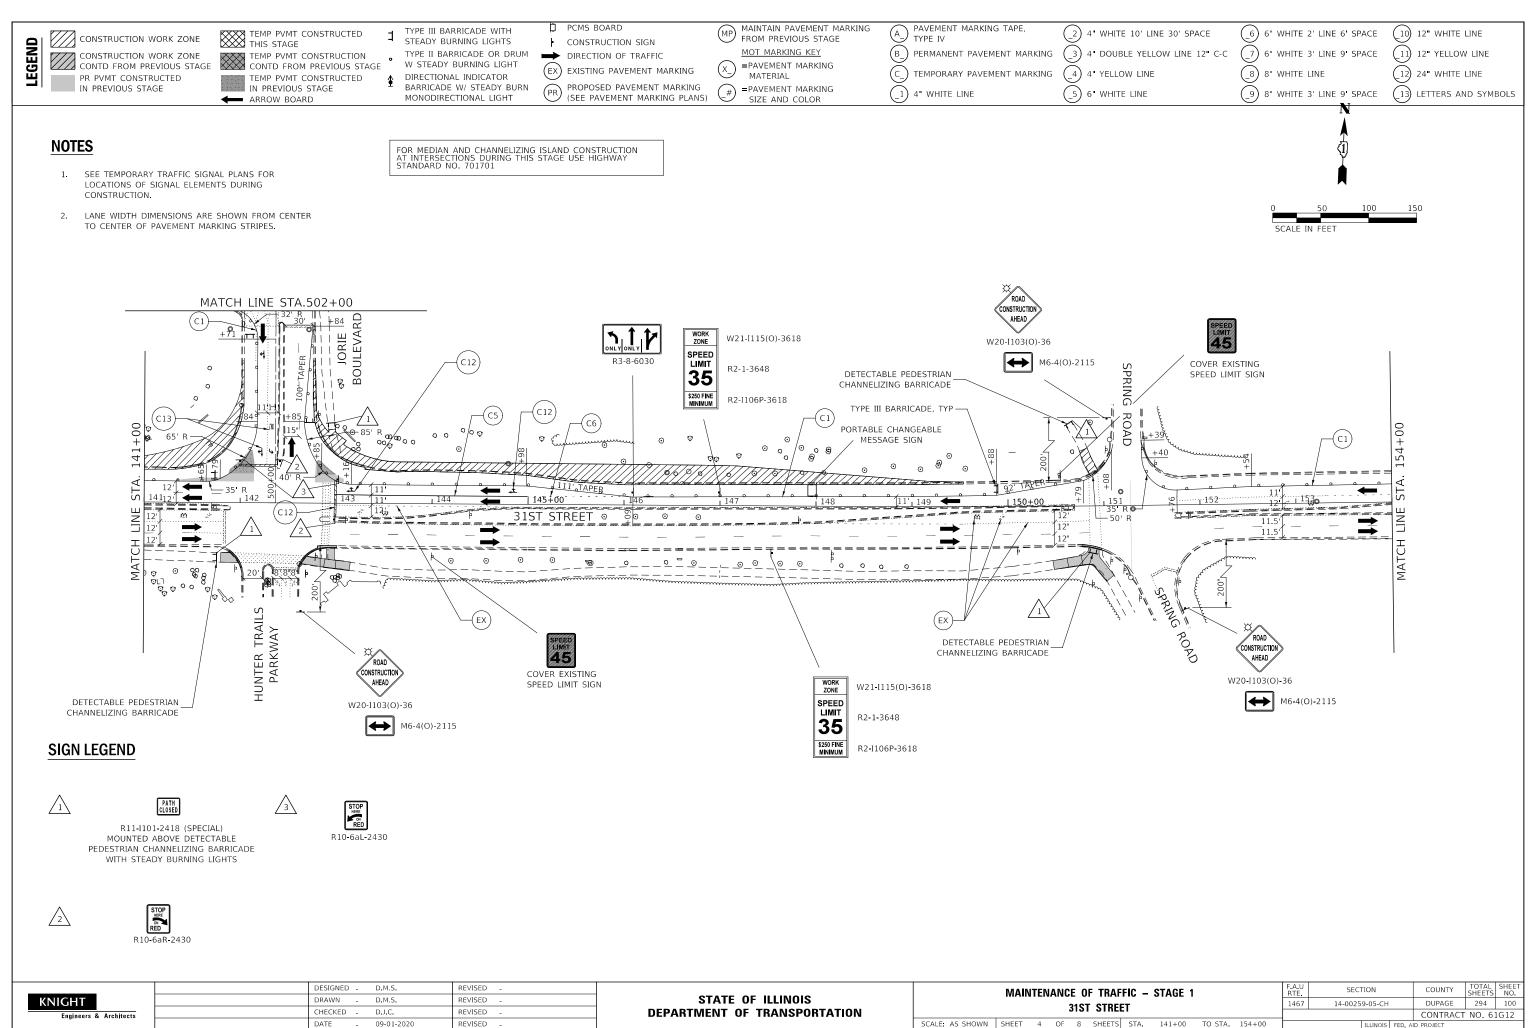

KNICHT	DESIGNED D.M.S. DRAWN D.M.S.	REVISED - REVISED -	STATE OF ILLINOIS		MAIN	TENA	NCE	OF TRA	AFFIC
KNIGHT Engineers & Architects	CHECKED D.J.C.	REVISED -	DEPARTMENT OF TRANSPORTATION	ł			315	ST STR	EET
	DATE - 09-01-2020	REVISED -		SCALE: AS SHOWN	SHEET	4	OF 8	SHEET	ts s