INDEX OF SHEETS ON SHEET NO. 2

STATE OF ILLINOIS DEPARTMENT OF TRANSPORTATION DIVISION OF HIGHWAYS PLANS FOR PROPOSED FEDERAL AID PROJECT LOCAL AGENCY PAVEMENT PRESERVATION (LAPP) FAU ROUTE 1026 (DIVISION STREET)

TRAFFIC DATA ADT (2009) = 4,500 POSTED SPEED LIMIT = 30 MPH **DESIGN SPEED LIMIT = 35 MPH**

DESIGN DESIGNATION COLLECTOR

> PROJECT LOCATED IN THE VILLAGE OF MELROSE PARK



Know what's **below**. **Call** before you dig.

PROJECT BEGINS

SCALE: 1" = 10' SCALE: 1" = 20 SCALE: 1" = 30" SCALE: 1" = 40" SCALE: 1" = 50"

FULL SIZE PLANS HAVE BEEN PREPARED USING STANDARD ENGINEERING SCALES. REDUCED SIZED PLANS WILL NOT CONFORM TO STANDARD SCALES. IN MAKING MEASUREMENTS ON REDUCED PLANS. THE ABOVE SCALES MAY BE USED.

CONTRACT NO. 63290

25th AVENUE TO 14th AVENUE **SECTION NO. 09-00113-00-RS PROJECT ARA-9003(327) VILLAGE OF MELROSE PARK COOK COUNTY JOB NO. C-91-636-09**



AREA OF IMPROVEMENT

NOT TO SCALE

GROSS LENGTH OF IMPROVEMENT = 3,692 FT = 0.70 MI

NET LENGTH OF IMPROVEMENT = 3.692 FT = 0.70 MI

FAU 1026 09-00113-00-RS соок ILLINOIS PROJECT ARA-9003(327)



LOCATION OF SECTION INDICATED THUS:

STATE OF ILLINOIS ILLINOIS DEPARTMENT OF TRANSPORTATION DIVISION OF HIGHWAYS m. O'Kent (PRINTED BY AUTHORITY OF THE STATE OF ILLINOIS

PROJECT ENDS STATION 37+05 **DIVISION STREET**

RANGE 12 FAST, 3RD PRINCIPAL MERIDIAN



EDWIN HANCOCK ENGINEERING COMPANY 9933 ROOSEVELT ROAD PHONE: (708) 865-0300 WESTCHESTER, ILLINOIS 60154

EXISTING AND PROPOSED TYPICAL CROSS SECTIONS

5-7 **DIVISION STREET PAVING PLANS**

DETAILS FOR FRAMES AND LIDS ADJUSTMENT WITH MILLING (BD 08)

10 **CURB AND GUTTER REMOVAL AND REPLACEMENT (BD 24)**

11 **BUTT JOINT AND HMA TAPER DETAILS (BD 32)**

12 TRAFFIC CONTROL AND PROTECTION FOR SIDE ROADS, INTERSECTIONS, AND DRIVEWAYS (TC 10)

13 DISTRICT ONE TYPICAL PAVEMENT MARKINGS (TC 13)

TRAFFIC CONTROL AND PROTECTIONS AT TURN BAYS (TO REMAIN OPEN TO TRAFFIC) (TC 14)

I.D.O.T. STANDARD DRAWINGS

STANDARD NO.	TITLE OR DESCRIPTION
000001-05	STANDARD SYMBOLS, ABBREVIATIONS AND PATTERNS
424001-05	CURB RAMPS FOR SIDEWALKS
442201-03	CLASS C&D PATCHES
604001-03	FRAMES AND LIDS, TYPE 1
701501-05	URBAN LANE CLOSURE, 2-LANE, 2-WAY, UNDIVIDED
701606-06	URBAN LANE CLOSURE, MULTILANE, 2-WAY, WITH MOUNTABLE MEDIAN
701701-06	URBAN LANE CLOSURE, MULTILANE INTERSECTION
701801-04	LANE CLOSURE, MULTILANE, 1W OR 2W CROSSWALK OR SIDEWALK CLOSURE
701901-01	TRAFFIC CONTROL DEVICES
780001-02	TYPICAL PAVEMENT MARKINGS

GENERAL NOTES

STANDARDS

ANY REFERENCE TO STANDARDS THROUGHOUT THE PLANS OR SPECIAL PROVISIONS SHALL BE INTERPRETED TO BE THE LATEST STANDARD OF THE ILLINOIS DEPARTMENT OF TRANSPORTATION AS SHOWN ON THE INDEX OF SHEETS IN THE PLANS. ALL CONSTRUCTION SHALL BE DONE IN ACCORDANCE WITH THE STANDARD SPECIFICATIONS FOR ROAD AND BRIDGE CONSTRUCTION ADOPTED JANUARY 1, 2007, THE "SUPPLEMENTAL SPECIFICATIONS AND RECURRING SPECIAL PROVISIONS" ADOPTED JANUARY 1, 2009, THE LATEST EDITION OF THE "ILLINOIS MANUAL ON UNIFORM TRAFFIC CONTROL DEVICES FOR STREETS AND HIGHWAYS," "THE STANDARD SPECIFICATIONS FOR WATER AND SEWER MAIN CONSTRUCTION IN ILL INDIS MAY 1996 FIFTH EDITION, AND THE "DETAILS" IN THE PLANS AND THE "SPECIAL PROVISIONS"

UNDERGROUND UTILITIES

BEFORE STARTING ANY EXCAVATION, THE CONTRACTOR SHALL CALL "JULIE" AT 811 FOR FIELD LOCATIONS OF BURIED ELECTRICAL, TELEPHONE AND GAS FACILITIES, (48 HOURS NOTIFICATION

THE LOCATIONS OF THE UNDERGROUND UTILITIES IF SHOWN ON THE PLANS HAVE BEEN OBTAINED BY FIELD SURVEYS AND SEARCHES OF AVAILABLE RECORDS. IT IS BELIEVED THAT DATA IS ESSENTIALLY CORRECT, BUT THE VILLAGE OF MELROSE PARK, THE ILLINOIS DEPARTMENT OF TRANSPORTATION AND/OR OTHER OFFICES AND AGENCIES ASSOCIATED WITH THE DEVELOPMENT OF THESE PLANS DO NOT GUARANTEE THEIR ACCURACY OR COMPLETENESS. THE CONTRACTOR WILL BE REQUIRED TO VERIFY THE EXACT LOCATION OF EACH FACILITY WITH THE UTILITY COMPANY, AND SHALL TAKE DUE CARE IN ALL PHASES OF THE CONSTRUCTION TO PROTECT ANY SUCH FACILITIES WHICH MAY BE AFFECTED BY THE WORK. ANY DAMAGE TO EXISTING UTILITIES SHALL BE REPAIRED AT THE CONTRACTOR'S EXPENSE.

THE CONTRACTOR SHALL COORDINATE CONSTRUCTION ACTIVITIES WITH UTILITY COMPANIES AND THE VILLAGE OF MELROSE PARK

FRAMES AND LIDS

THE TYPE OF FRAMES AND LIDS REQUIRED FOR ALL MANHOLES AND VALVE VAULTS LISTED IN THE SUMMARY OF QUANTITIES MAY BE FOUND ON THE PLANS AT THEIR RESPECTIVE LOCATIONS. WHERE LIDS ARE CALLED FOR ON THE PLANS, THEY SHALL BE IN ACCORDANCE WITH ARTICLE 604.04 OF THE STANDARD SPECIFICATIONS AND THE TERM LID IS USED IN LIEU OF GRATE. ALL LIDS ON SANITARY MANHOLES, COMBINED SEWER MANHOLES, AND VALVE VAULTS SHALL BE OF THE SELE SEALING TYPE

ON ALL IMPROVEMENTS, THE FRAMES AND LIDS OF EXISTING CATCH BASINS, INLETS, MANHOLES, AND VALVE VAULTS WHICH ARE TO BE ABANDONED DUE TO CONSTRUCTION OF THIS IMPROVEMENT ARE TO REMAIN THE PROPERTY OF THE VILLAGE OF MELROSE PARK AND BE SALVAGED. THESE ITEMS SHALL BE DELIVERED TO THE VILLAGE OF MELROSE PARK PUBLIC WORKS DEPARTMENT.

MANHOLE OR VALVE COVERS

THE WORD "WATER", "SANITARY", OR "STORM" SHALL BE CAST INTO THE LID OF EACH RESPECTIVE MANHOLE OR VALVE VAULT.

MAINTENANCE OF SEWER FLOWS

THE CONTRACTOR SHALL CONDUCT HIS OPERATIONS AS TO MAINTAIN AT ALL TIMES FLOW THROUGH EXISTING STORM AND SANITARY SEWER SYSTEMS. HE SHALL ALSO PROVIDE AND MAINTAIN AN EFFICIENT PUMPING PLANT IF NECESSARY AND A TEMPORARY OUTLET AND BE PREPARED AT ALL TIMES TO DISPOSE OF THE WATER COLLECTED IN A SAFE MANNER WITHOUT DAMAGE OF ANY KIND TO ADJACENT PROPERTIES. THE ENDS OF EXISTING DRAINAGE LINES WHICH ARE NOT TO BE INCORPORATED INTO THE PROJECT ARE TO BE SEALED AS SPECIFIED IN THE SPECIAL PROVISIONS. EXISTING STRUCTURES ARE TO BE INSPECTED BEFORE CONSTRUCTION STARTS - ANY ACCUMULATION OF MATERIAL IN THE STRUCTURE DUE TO CONSTRUCTION OPERATIONS SHALL BE REMOVED BY THE CONTRACTOR AT HIS EXPENSE.

MAINTENANCE OF EXISTING DRAINAGE STRUCTURES

WHEN DURING THE CONSTRUCTION OPERATIONS, ANY LOOSE MATERIAL IS DEPOSITED IN THE FLOW LINE OF ANY GUTTERS AND DRAINAGE STRUCTURE SO THAT THE NATURAL FLOW OF WATER IS OBSTRUCTED, IT SHALL BE REMOVED AT THE CLOSE OF EACH WORKING DAY. AT THE CONCLUSION OF THE CONSTRUCTION OPERATIONS, ALL DRAINAGE FACILITIES SHALL BE CLEAN AND FREE OF ALL OBSTRUCTIONS DUE TO CONSTRUCTION OPERATIONS. THE COST OF THIS WORK SHALL BE INCIDENTAL TO THE CONTRACT.

SAW CUTTING

THE CONTRACTOR SHALL SAW CUT ASPHALT PAVEMENT AS INDICATED ON THE PLANS TO SEPARATE THE EXISTING PAVEMENT TO BE REMOVED BY APPROVED MEANS OR AN APPROVED CONCRETE SAW TO A DEPTH AS DIRECTED BY THE ENGINEER. SUITABLE GUIDELINES OR DEVICES SHALL BE USED TO ASSURE CUTTING A NEAT, STRAIGHT LINE AS SHOWN ON THE PLANS. CARE SHALL BE TAKEN BY THE CONTRACTOR AS NOT TO DAMAGE THE REMAINING PAVEMENT DIRECTLY ADJACENT TO THE PAVEMENT TO BE REMOVED. ANY DAMAGE TO THE EXISTING PAVEMENT RESULTING FROM PAVEMENT REMOVAL OPERATIONS SHALL BE REPAIRED AT THE CONTRACTOR'S EXPENSE. THE COST OF SAW CUTTING DESCRIBED ABOVE SHALL BE INCLUDED IN THE ITEM BEING REMOVED. SAW CUTS FOR PAVEMENT PATCHING WILL BE INCLUDED IN THE COST OF PATCHING.

FRAMES AND LIDS TO BE ADJUSTED (SPECIAL)

THIS ITEM ONLY PERTAINS TO STRUCTURES LOCATED IN THE CONCRETE OR HOT-MIX ASPHALT ROADWAY PAVEMENT AREAS THAT WILL REQUIRE CONCRETE OR HOT-MIX SURFACE REMOVAL. THE ENGINEER WILL MARK IN THE FIELD ALL STRUCTURES TO BE DONE UNDER THIS ITEM. SEE DETAIL SHEET FOR "FRAMES AND LIDS ADJUSTMENT WITH MILLING."

PRIME COAT

PRIME COAT MUST BE INSTALLED NO EARLIER THAN TWENTY-FOUR (24) HOURS PRIOR TO PLACEMENT OF HOT-MIX ASPHALT.

FIELD OFFICE

THE CONTRACTOR WILL NOT BE ALLOWED TO SET UP A YARD OR FIELD OFFICE ON STATE OR VILLAGE PROPERTY WITHOUT WRITTEN PERMISSION FROM THE DEPARTMENT OR THE VILLAGE

BARRICADES

THE CONTRACTOR SHALL PROVIDE AND INSTALL TWO (2) WEIGHTED SANDBAGS ON EACH TYPE I OR TYPE II BARRICADE USED, ONE (1) WEIGHTED SANDBAG ACROSS EACH BOTTOM RAIL

BUTT JOINTS

BUTT JOINT WILL BE INSTALLED AT THE ENDS OF ALL RESURFACING (WHERE RESURFACING MEETS EXISTING PAVEMENT). IN ACCORDANCE WITH THE "BUTT JOINT AND HMA TAPER DETAILS" SHEET INCLUDED IN THE PLANS, UNLESS OTHERWISE SPECIFIED.

MILLED PAVEMENT OPEN TO TRAFFIC

WHEN MILLED PAVEMENT IS OPEN TO TRAFFIC THE MAXIMUM GRADE DIFFERENTIAL BETWEEN PASSES OF THE MILLING MACHINE SHALL NOT EXCEED 1-1/2 INCHES (40 MM) WHERE THE SPEED LIMIT IS 45 MPH (80 KM/H) OR LESS AND 1 INCH (25 MM) WHERE THE SPEED LIMIT IS GREATER THAN 45 MPH (80 KM/H). WITH WRITTEN APPROVAL FROM THE ENGINEER, A MAXIMUM GRADE DIFFERENTIAL OF 3 INCHES (75 MM) MAY BE ALLOWED IF THE EDGE OF THE MILLING IS SLOPED A MINIMUM 1:3 (V:H)

PAVING OPERATIONS

CONTRACTOR MUST PAVE IN A MAXIMUM OF 2 PASSES. IF THE CONTRACTOR IS NOT ABLE TO COMPLETE ALL THE PAVING IN ONE (1) DAY, THE LONGITUDINAL JOINT SHALL BE SEALED.

PAVEMENT PATCHING

LOCATIONS OF PATCHES ON PLANS ARE APPROXIMATE. EXACT LOCATIONS WILL BE DETERMINED IN FIELD BY ENGINEER.

SHEET NO. 1 OF 1 SHEETS STA.

ROUTE NO.	SECTION	COUNTY	TOTAL SHEETS	SH
1026	09-00113-00-RS	COOK	14	
		CONTRACT	NO. 63	290
FFD ROAD	DIST NO 1 HILINOIS FED	AID PROJECT A	PA-0003/3	271

Division Street LAPP Application\Quantities-DivisionSt.dwg Aug 13, 2009 -
sion Street LAPP Application\Quantities-DivisionSt.dwg Aug 13, 20
sion Street LAPP Application\Quantities-DivisionSt.dwg Aug 1
sion Street LAPP Application\Quantitie
sion Street LAPP Application\Quantitie
sion Street LAPP Application\Quantitie
sion Street LAPP Applica
sion Street L
sion Str
Division

		SUMMARY OF QUANTITIES			
				1000	1000
	CODE	PAY ITEM	UNIT	TOTAL	100% FEDERAL
				QUANTITY	0% LOCAL
	21101615	TOPSOIL FURNISH AND PLACE, 4"	SQYD	400	400
	25000400	NTROGEN FERTILIZER NUTRIENT	POUND	5	5
	25000500	PHOSPHORUS FERTILIZER NUTRIENT	POUND	5	5
	25000600	POTASSIUM FERTILIZER NUTRIENT	POUND	5	5
	25200100	SODDING	SQYD	400	400
	25200200	SUPPLEMENTAL WATERING	UNIT	10	10
	40201000	AGGREGATE FOR TEMPORARY ACCESS	TON	40	40
	40600100	BITUMINOUS MATERIALS (PRIME COAT)	GALLON	1,650	1,650
	40600982	HOT-MIX ASPHALT SURFACE REMOVAL - BUTT JOINT	SQYD	450	450
	40603335	HOT-MIX ASPHALT SURFACE COURSE, MIX "D", N50	TON	1,800	1,800
	40800050	INCIDENTAL HOT-MIX ASPHALT SURFACING	TON	10	10
	42101300	PROTECTIVE COAT	SQYD	150	150
	42300300	PORTLAND CEMENT CONCRETE DRIVEWAY PAVEMENT, 7 INCH	SQYD	50	50
	42400200	PORTLAND CEMENT CONCRETE SIDEWALK 5 INCH	SQFT	500	500
٥	42400800	DETECTABLE WARNINGS	SQFT	40	40
0	44000198	HOT-MIX ASPHALT SURFACE REMOVAL, VARIABLE DEPTH	SQYD	16,500	16,500
0	44000200	DRIVEWAY PAVEMENT REMOVAL	SQYD	50	50
٥	44000600	SIDEWALK REMOVAL	SQFT	500	500
٥	44001700	COMBINATION CONCRETE CURB AND GUTTER REVIOVAL AND REPLACEMENT	FOOT	350	350
0	44201717	CLASS DPATCHES, TYPE II, 6 INCH	SQYD	50	50
0	44201723	CLASS DPATCHES, TYPE IV, 6 INCH	SQYD	50	50
	60257900	MANHOLES TO BE RECONSTRUCTED	EACH	1	1
	60300305	FRAMES AND LIDS TO BE ADJUSTED	EACH	1	1
0	60300310	FRAMES AND LIDS TO BE ADJUSTED (SPECIAL)	EACH	52	52
٥	60406000	FRAMES AND LIDS, TYPE 1, OPEN LID	EACH	5	5
0	60406100	FRAMES AND LIDS, TYPE 1, CLOSED LID	EACH	5	5
	67100100	MOBILIZATION	LSUM	1,	1
0	70101700	TRAFFIC CONTROL AND PROTECTION	LSUM	1	1
*	78000100	THERMOPLASTIC PAVEMENT MARKING - LETTERS AND SYMBOLS	SQFT	85	85
*	78000200	THERMOPLASTIC PAVEMENT MARKING - LINE 4"	FOOT	1,000	1,000
*	78000400	THERMOPLASTIC PAVEMENT MARKING - LINE 6"	FOOT	3,000	3,000
*	78000600	THERMOPLASTIC PAVEMENT MARKING - LINE 12"	FOOT	100	100
*	78000650	THERMOPLASTIC PAVEMENT MARKING - LINE 24"	FOOT	400	400
0	Z0004900	BITUMINOUS MIXTURE FOR PATCHING POTHOLES (HOT MIX)	TON	20	20
	X4067107	POLYMERIZED LEVELING BINDER (MACHINE METHOD), IL-4.75, N50	TON	1,000	1,000
ı			<u> </u>		


- ★ DENOTES SPECIALTY ITEM
- O DENOTES THAT A SPECIAL PROVISION HAS BEEN PROVIDED

HANCOCI	
Civil Engineers	Westchesler
♦ Municipal Consultants	
A 15-4-115-1-3 1011	

	USER NAME	DESIGNED	TG	REVISED
		DRAWN	TG/LEV	REVISED
	PLOT SCALE	CHECKED	JG	REVISED
x: 708/965-0300 x: 708/965-1212	PLOT DATE	DATE	08/12/09	REVISED

SUMMARY OF QUANTITIES					10	26						
CHE	ET	NO	4	O.F.	CHEETE	1 CTA	TA	CTA				

DIVISION STREET STATION 0+13 TO STATION 37+05

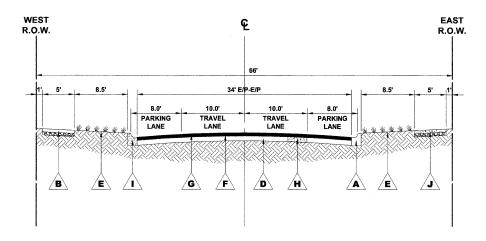

PROPOSED TYPICAL SECTION DIVISION STREET STATION 0+13 TO STATION 37+05

LEGEND OF SYMBOLS

SYMBOL	DESCRIPTION
A	EXISTING COMBINATION CONCRETE CURB & GUTTER, TYPE B-6.12
B	EXISTING PORTLAND CEMENT CONCRETE SIDEWALK
C	EXISTING HOT-MIX ASPHALT BINDER & SURFACE COURSES
D	EXISTING AGGREGATE BASE COURSE
E	EXISTING LANDSCAPED PARKWAY
F	PROPOSED POLYMERIZED LEVELING BINDER (MACHINE METHOD), IL-4.75, N50, 1"
G	PROPOSED HOT-MIX ASPHALT COURSE, 1 3/4"
<u> H</u>	PROPOSED CLASS D PATCH, 6"
<u> </u>	PROPOSED INTERMITTENT COMBINATION CONCRETE CURB AND GUTTER REMOVAL AND REPLACEMENT
<u>\</u>	PROPOSED PORTLAND CEMENT CONCRETE SIDEWALK, 5"

HOT-MIX ASPHALT (HMA) MIXTURE REQUIREMENTS					
ITEM	A C TYPE	VOIDS			
HOT-MIX ASPHALT SURFACE COURSE, MIX D, N50, (IL - 9.5 mm)	PG 64 - 22	4% @ 50 GYR.			
POLYMERIZED LEVELING BINDER (MACHINE METHOD), IL-4.75, N50	SBS/SBR PG 76 - 28/ - 22 🛊	4% @ 50 GYR.			
BITUMINOUS MIXTURE FOR PATCHING POTHOLES (HOT MIX), MIX C, N50	PG 64 - 22	4% @ 50 GYR.			
INCIDENTAL HOT-MIX ASPHALT SURFACING, MIX C, N50	PG 64 - 22	4% @ 50 GYR.			
CLASS D PATCHES (HMA BINDER, IL - 9.5 mm), 6"	PG 64 - 22 #	4% @ 50 GYR.			

THE UNIT WEIGHT USED TO CALCULATE ALL HMA SURFACE COURSE IS 112 LBS/SQYD/IN.

* WHEN RAP EXCEEDS 20 %, THE NEW ASPHALT BINDER IN THE MIX SHALL BE PG 58 - 22.

ANCOCK

O Civil Engineers

Municipal Consultants


Established 1911


STATE OF ILLINOIS
DEPARTMENT OF TRANSPORTATION


EXISTING AND PROPOSED TYPICAL CROSS SECTIONS

SHEET NO. 1 OF 1 SHEETS STA.

E.H.E. PROJECT NO. 600-09-159

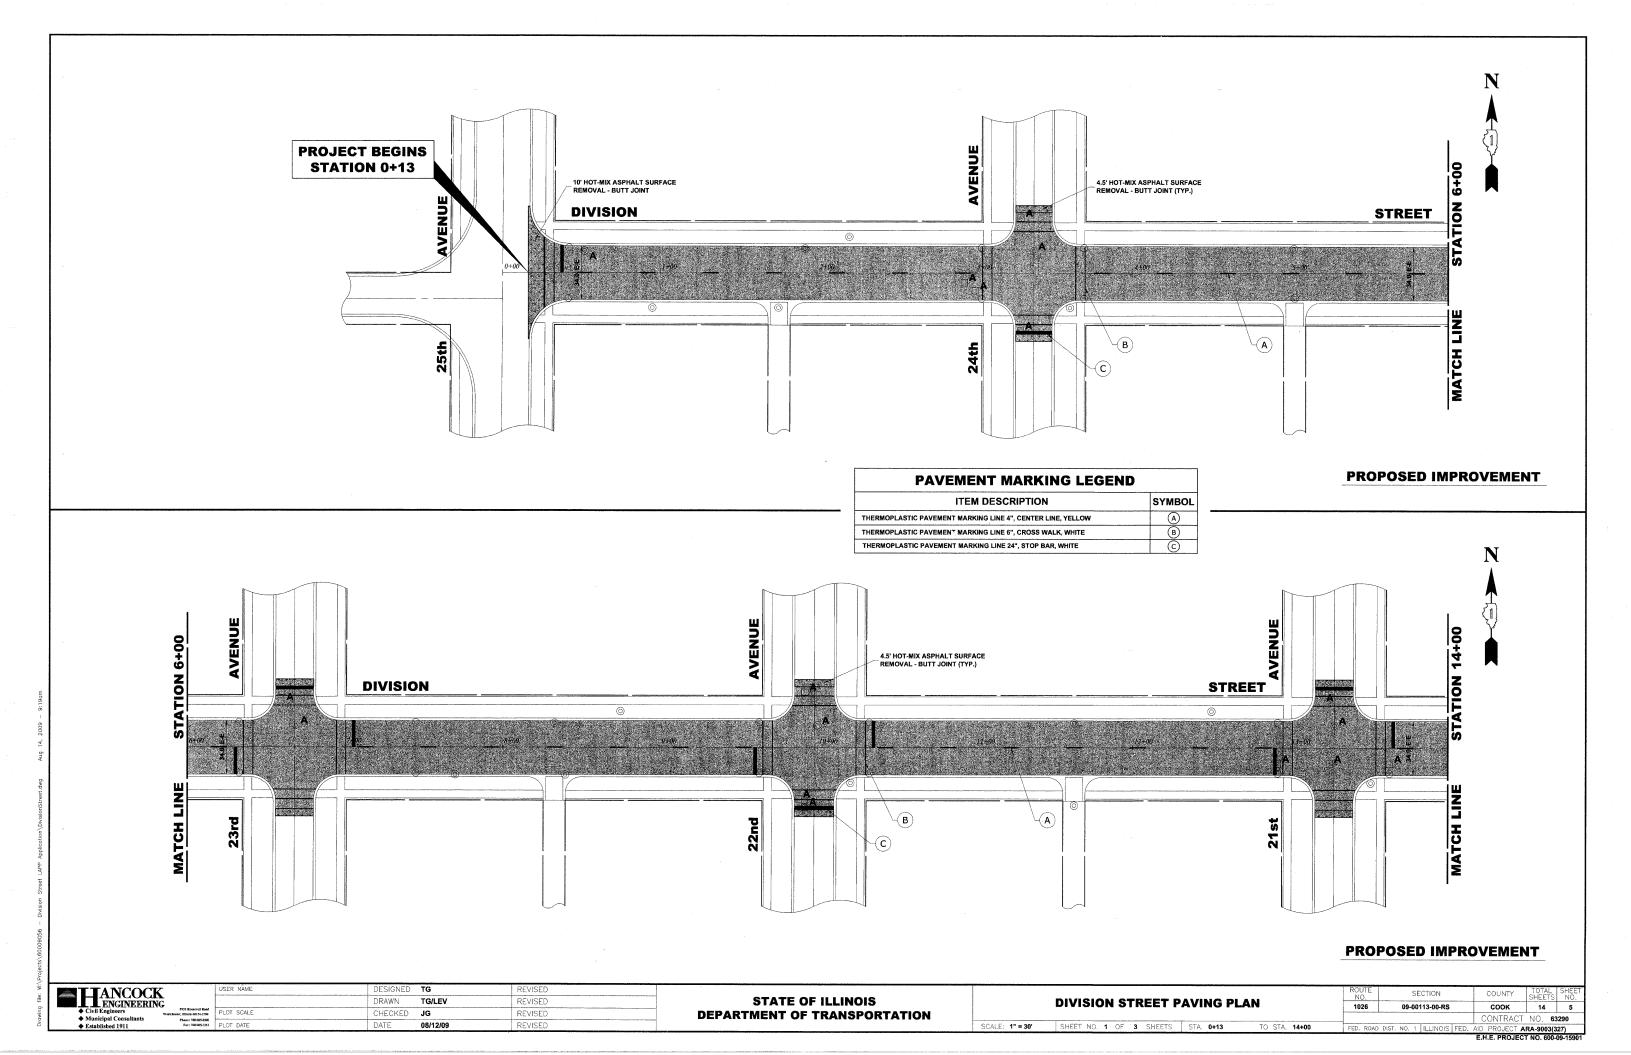

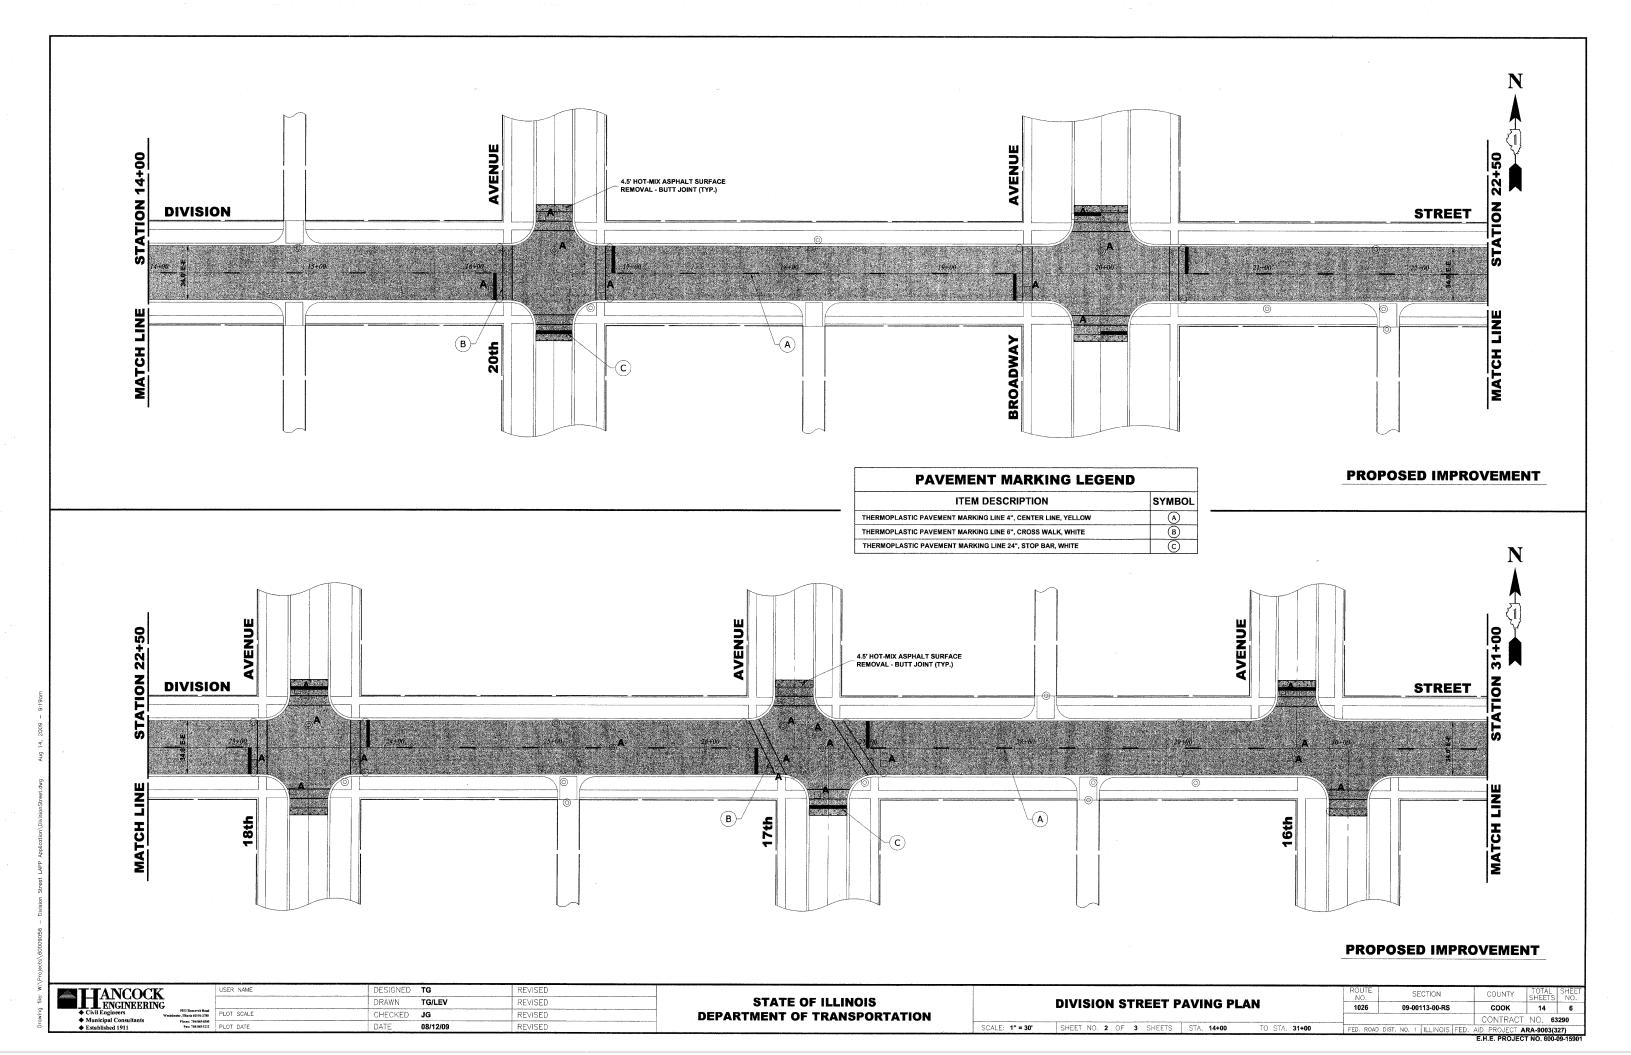

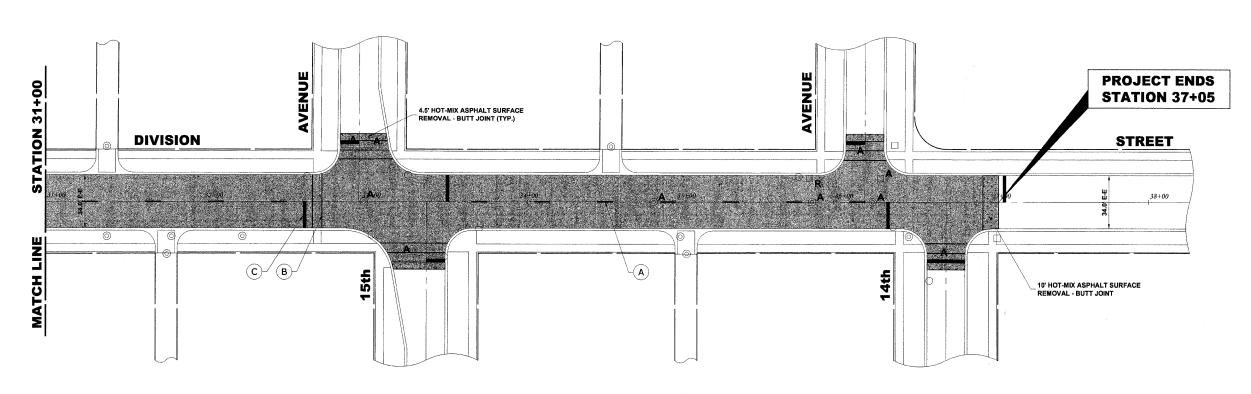

PAVEMENT MARKING LEGEND SYMBOL ITEM DESCRIPTION THERMOPLASTIC PAVEMENT MARKING LINE 4", CENTER LINE, YELLOW THERMOPLASTIC PAVEMENT MARKING LINE 6", CROSS WALK, WHITE THERMOPLASTIC PAVEMENT MARKING LINE 24", STOP BAR, WHITE

PROPOSED IMPROVEMENT

HANCOCK ENGINEERING	,
◆ Civil Engineers	
◆ Municipal Consultants	

9933 Rossevelt Road schoster, Elisofa 60154-2786	PL
Phone: 109/865-0300 Fax: 109/865-1212	PU

	OSEN TO ME	DESIGNED	10	NEVISED
		DRAWN	TG/LEV	REVISED
Roservelt Road rota 60154-2780 e: 708/865-0300	PLOT SCALE	CHECKED	JG	REVISED
x: 708/865-1212	PLOT DATE	DATE	08/12/09	REVISED

ROUTE NO.	SECTION	COUNTY	TOTAL	SHEE NO.			
1026	09-00113-00-RS	COOK	14	7			
		CONTRACT NO. 63290					
FED. ROAL	DIST. NO. 1 ILLINOIS FED.	AID PROJECT A	RA-9003(3	27)			


COMBINATION CONCRETE CURB & GUTTER TYPE B-6.12 (MODIFIED)

CAST IRON MANHOLE FRAME AND LID, NEENAH FOUNDRY NO. R-1713 OR EQUAL WITH WORD "STORM," "SANITARY," OR "WATER" CAST INTO LID MINIMUM OF 2" AND MAXIMUM OF 6" OF PRECAST REINFORCED CONCRETE ADJUSTMENT RINGS KEYED JOINT WITH O-RING OR MASTIC SEAL PRECAST REINFORCED CONCRETE SECTIONS FABRICATED IN ACCORDANCE WITH A.S.T.M.


STRUCTURE RECONSTRUCTION

3/4" PREMOLDED, NON-EXTENDING - JOINT FILLER AT EXPANSION JOINT. SEE NOTES FOR LOCATIONS. EXPANSION JOINT FILLER TO CONFORM WITH CURB AND GUTTER CROSS SECTION. TRIM ANY EXCESS. GREASED PLASTIC EXPANSION CAP 3/4"DIA. -18" EPOXY COATED SMOOTH DOWEL BAR. TWO (2) EACH PER JOINT EXPANSION JOINTS ARE TO BE CONSTRUCTED AT ALL PC'S AND PT'S
OF INTERSECTION RETURNS AND ALL
OTHER SHORT RADIUS SECTIONS,
CONSTRUCTION JOINTS & AS CONCRETE CURB AND **GUTTER SECTION** DIRECTED BY THE ENGINEER.

TYPICAL CURB AND GUTTER **EXPANSION JOINT**

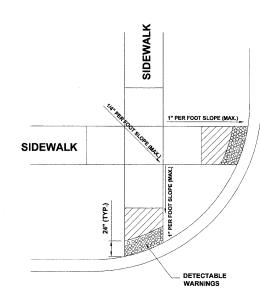

A.D.A. RAMP

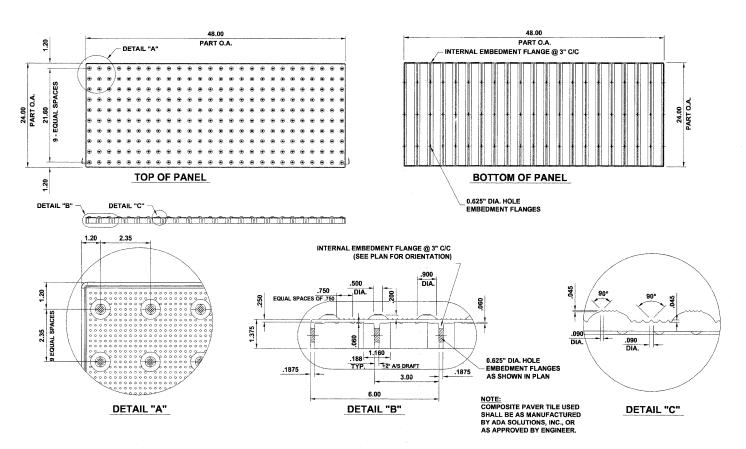

CAST-IN-PLACE DETECTABLE WARNING

HANCOCK
ENGINEERING
Civil Engineers DESIGNED TG DRAWN TG/LEV REVISED CHECKED JG REVISED 08/12/09

STATE OF ILLINOIS DEPARTMENT OF TRANSPORTATION

SECTION COUNTY TOTAL SHEE **DETAILS** 1026 COOK 14 8 09-00113-00-RS CONTRACT NO. 63290

SHEET NO. 1 OF 1 SHEETS STA. FED. ROAD DIST. NO. 1 ILLINOIS FED. AID PROJECT ARA-9003(327)

E.H.E. PROJECT NO. 600-09-15901

DESIGNED - R. SHAH

10-25-94

DRAWN

DATE

CHECKED


FILE NAME =


W:\dastatd\22x34\bd88.dgr

USER NAME = gagliandat

PLOT DATE = 1/4/2008

PLOT SCALE = 58.0800 '/ INL

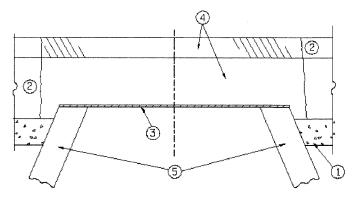

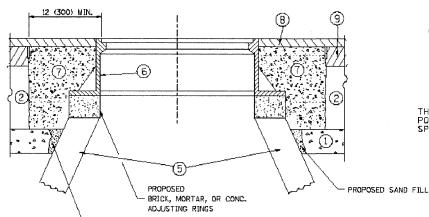

EXISTING BROKEN FRAMES AND LIDS SHALL BE REMOVED AND DISPOSED OF BY THE CONTRACTOR AND SHALL BE REPLACED AS DIRECTED BY THE ENGINEER. REPLACEMENT FRAMES AND LIDS WILL BE PAID FOR IN ACCORDANCE WITH ARTICLE 109.04 OF THE STANDARD SPECIFICATIONS UNLESS A SEPARATE PAY ITEM HAS BEEN PROVIDED.

PROPOSED

SAND FILL

IF THE EXISTING LIDS ARE OPEN, THE FRAME WILL BE ADJUSTED TO THE BLEVATION OF THE MILLED PAVEMENT SURFACE PRIOR TO THE MILLING OPERATION. THE FRAME WILL NOT BE REMOVED AND COVERED BY THE METAL PLATE.

CITY OF CHICAGO CASTINGS ARE THE PROPERTY OF THE CITY AND THE CONTRACTOR SHALL NOTIFY THE CITY FOR REMOVAL AND DISPOSITION OF THE CASTINGS.

THE METAL PLATE USED TO COVER THE STRUCTURE SHALL REMAIN THE PROPERTY OF THE CONTRACTOR.

WHEN STRUCTURES ARE TO BE ADJUSTED OR RECONSTRUCTED, THE LOWERING AND RAISING OF THE FRAMES AND LIDS WILL NOT BE PAID FOR SEPARATELY BUT WILL BE INCLUDED IN THE COST OF THE CORRESPONDING PAY ITEM.

SCALE: NONE

CONSTRUCTION PROCEDURES

STAGE 1 (BEFORE PAVEMENT MILLING)

- A) REMOVE A MINIMUM OF 12 (300) OF THE PAVEMENT FROM AROUND THE STRUCTURE.
- B) REMOVE THE EXISTING FRAME AND LID FROM THE STRUCTURE.
- C) COVER THE STRUCTURE OPENING WITH A 36 (900) DIAMETER METAL PLATE.
- D) BACKFILL WITH CRUSHED STONE AND A MINIMUM $1\!\!/_2$ (40) THICK HMA SURFACE MIX APPROVED BY THE ENGINEER.

STAGE 2 (AFTER PAVEMENT MILLING)

- A) REMOVE THE HMA SURFACE MIX AND CRUSHED STONE.
- B) INSTALL THE FRAME AND LID; ADJUST THE FRAME TO ITS FINAL SURFACE ELEVATION.
- C) THE SURROUNDING SPACE SHALL BE FILLED WITH CLASS SI CONCRETE, OR HMA SURRACE COURSE OR HMA BINDER COURSE TO THE ELEVATION OF THE SURFACE OF THE EXISTING BASE COURSE OR THE BINDER COURSE.

THE PROCEDURE EXPLAINED ABOVE SHALL CONFORM TO THE APPLICABLE PORTIONS OF SECTIONS 363, 406, 602, AND 603 OF THE STANDARD SPECIFICATIONS.

LEGEND

- 1 SUB-BASE GRANULAR MATERIAL
- 6 FRAME AND LID (SEE NOTES)
- (2) EXISTING PAVEMENT
- CLASS SI CONCRETE, HMA SURFACE COURSE OR HMA BINDER COURSE
- (3) 36 (900) DIAMETER METAL PLATE 4 PROPOSED CRUSHED STONE AND HMA SURFACE MIX
- (8) PROPOSED HMA SURFACE COURSE
- (5) EXISTING STRUCTURE
- 9 PROPOSED HMA BINDER COURSE

LOCATION OF STRUCTURES

THE CONTRACTOR WILL BE REQUIRED TO KEEP A RECORD OF THE LOCATIONS OF THE BURIED STRUCTURES ACCORDING TO THE STATION AND DISTANCE LEFT OR RIGHT OF THE CENTERLINE OF PAVEMENT. UPON COMPLETION OF THE WORK, THE CONTRACTOR WILL DELIVER THE RECORD TO THE ENGINEER.

BASIS OF PAYMENT:
THIS WORK WILL BE PAID FOR AT
THE CONTRACT UNIT PRICE PER EACH FOR
"FRAMES AND LIDS TO BE ADJUSTED, SPECIAL" NEW FRAMES AND LIDS, WHEN SPECIFIED, WILL BE PAID FOR SEPARATELY.

DETAILS FOR FRAMES AND LIDS ADJUSTMENT WITH MILLING

> ALL DIMENSIONS ARE IN INCHES (MILLIMETERS) UNLESS OTHERWISE SHOWN

REVISED - R. SHAH 03-10-95 REVISED - A. ABBAS 03-21-97 REVISED - R. WIEDEMAN 05-14-04 REVISED - R. BORO 01-01-07


STATE OF ILLINOIS **DEPARTMENT OF TRANSPORTATION**

DETAILS FOR FRAMES AND LIDS ADJUSTMENT WITH MILLING SHEET NO. 1 OF 1 SHEETS STA.

SECTION COUNTY SHEETS NO. COOK 14 9 1026 09-00113-00-RS BD000-03 (BD-8) CONTRACT NO. 63290

FED. ROAD DIST. NO. 1 | ILLINOIS | FED. AID PROJECT ARA-9003(327)

E.H.E. PROJECT NO. 600-09-15901

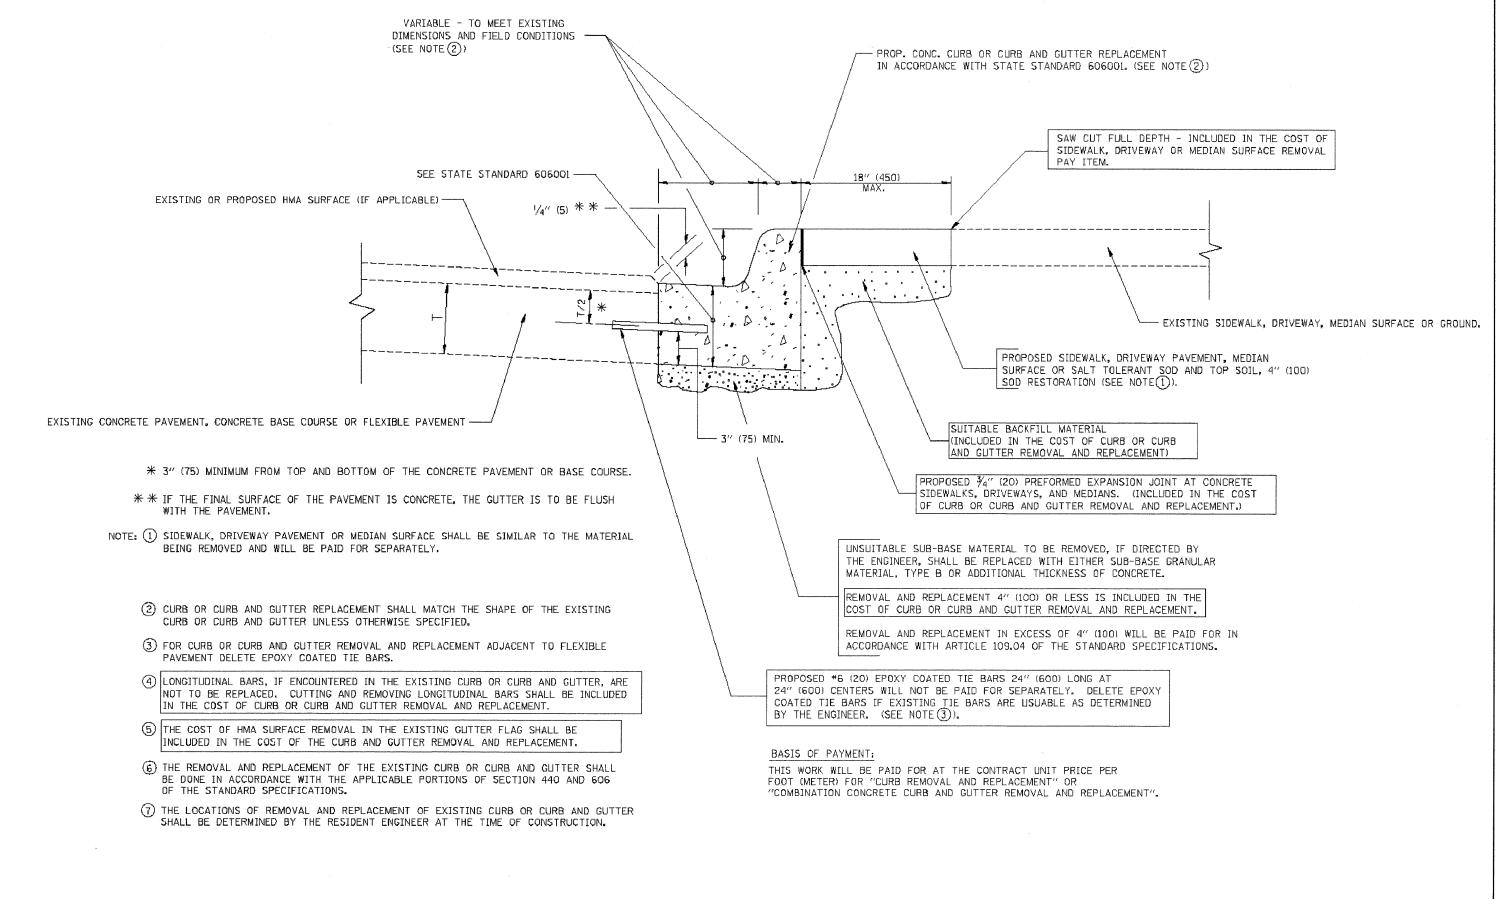

CURB OR CURB AND GUTTER REMOVAL AND REPLACEMENT

ALL DIMENSIONS ARE IN INCHES (MILLIMETERS) UNLESS OTHERWISE SHOWN.

FILE NAME = Vi\dsstatd\22x34\bd24.dgn

STATE OF ILLINOIS
DEPARTMENT OF TRANSPORTATION

CURB OR CURB AND GUTTER
REMOVAL AND REPLACEMENT
SHEET NO. 1 OF 1 SHEETS STA.


TO STA.

SCALE: NONE

E.H.E. PROJECT NO. 600-09-1590

(FOR BUTT JOINT AND HMA TAPER SEE DETAIL BELOW)


OPTION 1

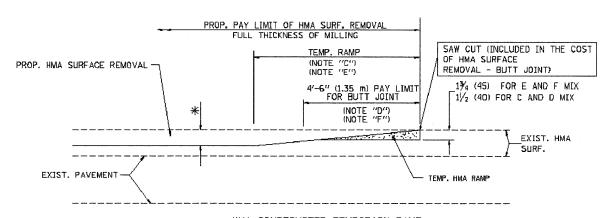

HMA CONSTRUCTED TEMPORARY RAMP (FOR BUTT JOINT AND HMA TAPER SEE DETAIL BELOW)

OPTION 2

TYPICAL TEMPORARY RAMP

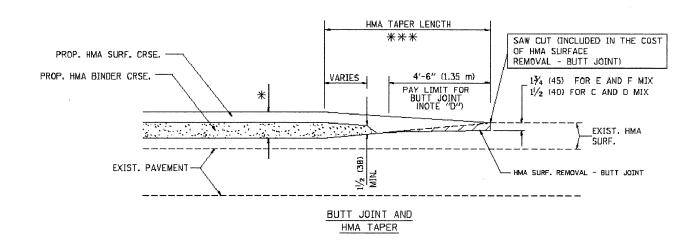


TYPICAL BUTT JOINT AND HMA TAPER FOR MILLING AND RESURFACING

USER NAME = geglienobt DESIGNED - M. DE YONG REVISEO - R. SHAH 10-25-94 DRAWN REVISED - A. ABBAS 03-21-97 PLOT SCALE = 50.0000 '/ INL CHECKED -REVISED - M. GOMEZ 04-06-01 PLOT DOTE = 1/4/200 DATE - 05-13-90 REVISED - R. BORO 01-01-07

STATE OF ILLINOIS DEPARTMENT OF TRANSPORTATION

F.A. . RTE. SECTION COUNTY TOTAL SHEET NO. **BUTT JOINT AND** 1026 09-00113-00-RS COOK 14 11 HMA TAPER DETAILS BD400-05 BD32 SHEET NO. 1 OF 1 SHEETS STA. TO STA.

PROP. HMA OR PCC SURFACE REMOVAL - BUTT JOINT SAW GUT (INCLUDED IN THE COST OF HMA OR P.C.C. SURFACE REMOVAL EXIST. HMA OR PCC SURFACE 30'-0" (9.0 m) (NOTE "A") 15'-0" (4.5 m) (NOTE "B") - BUTT JOINT) (NOTE "D") 1 1/4 (45) FOR E AND F MIX 1/2 (40) FOR C AND D MIX * * EXIST. PAVEMENT BUTT JOINT DETAIL

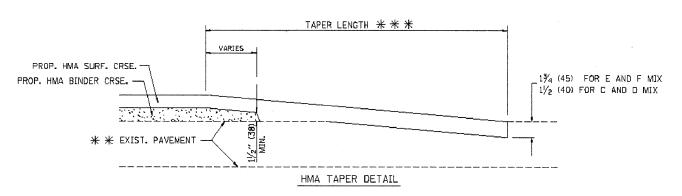

TYPICAL BUTT JOINT AND HMA TAPER FOR RESURFACING ONLY

* PC CONCRETE, HMA OR HMA RESURFACED PAVEMENT.

NOTES

- A: MAINLINE ROADWAYS AND MAJOR SIDE ROADS.
- B: MINOR SIDE ROADS.
- C: THE TEMP. RAMP SHALL BE CONSTRUCTED IMMEDIATELY UPON REMOVAL OF THE EXISTING HMA SURFACE.
- D: THE BUTT JOINT SHALL BE CONSTRUCTED IMMEDIATELY PRIOR TO PLACING THE PROPOSED HMA COURSES.
- E: TAPER THE TEMP. RAMP AT A RATE OF 3'-0" (900 mm) PER 1 INCH (25 mm) OF MILLING THICKNESS.
- F: INSTALLATION AND REMOVAL OF THE 4'-6" (1.35 m) TEMP. RAMP IS INCLUDED IN COST OF HMA SURFACE REMOVAL - BUTT JOINT
- G: SEE ARTICLE 406.08 AND 406.14 OF THE STANDARD SPECIFICATIONS FOR "HMA AND/OR PCC SURFACE REMOVAL, BUTT JOINT".
- * SEE TYPICAL SECTIONS FOR MILLING THICKNESS.
- ** ** ** 20'-0" (6.1 m) PER 1 (25) RESURFACING (NOTE "A") 10'-0" (3.0 m) PER 1 (25) RESURFACING (NOTE "B")

BASIS OF PAYMENT:


THE BUTT JOINT WILL BE PAID FOR AT THE CONTRACT UNIT PRICE PER SQUARE YARD (SQUARE METER)
FOR "HOT-MIX ASPHALT SURFACE REMOVAL - BUTT JOINT" OR FOR "PORTLAND CEMENT CONCRETE SURFACE REMOVAL - BUTT JOINT".

SCALE: NONE

ALL DIMENSIONS ARE IN INCHES (MILLIMETERS) UNLESS OTHERWISE SHOWN.

FILE NAME = W:\daststd\22x34\bd32.dgn

CONTRACT NO. 63290 AID PROJECT ARA-9003(327) E.H.E. PROJECT NO. 600-09-15901

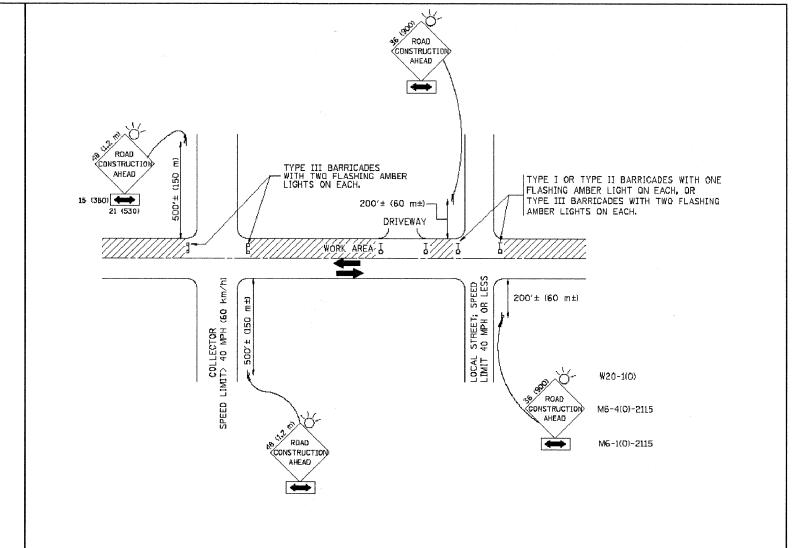

TRAFFIC CONTROL AND PROTECTION FOR SIDE ROADS, INTERSECTIONS, AND DRIVEWAYS

NOTES:

- A. FOR NO LANE RESTRICTION ON THE SIDE ROAD OR DRIVEWAYS
- 1. SIDE ROAD WITH A SPEED LIMIT OF 40 MPH (60 km/h) OR LESS AS SHOWN ON THE DRAWING AND AS DIRECTED BY THE ENGINEER₃
- O) ONE ROAD CONSTRUCTION AMEAD SIGN 36 x 36 (900x900) WITH A FLASHER AND FLAG MOUNTED ON IT APPROXIMATELY 200' (60 m) IN ADVANCE OF THE MAIN ROUTE.
- b) THE CLOSED PORTION OF THE MAIN ROUTE SHALL BE PROTECTED BY BLOCKING WITH TYPE I, TYPE II OR TYPE III BARRICADES, 1/3 OF THE CROSS SECTION OF THE CLOSED PORTION.
- 2. SIDE ROAD WITH A SPEED LIMIT GREATER THAN 40 MPH (60 km/h) AS SHOWN ON THE DRAWING AND AS DIRECTED BY THE ENGINEER:
- o) ONE ROAD CORRESPONDENCE AHEAD SIGN $48 \times 48 \ (1.2 \ m \times 1.2 \ m)$ WITH A FLASHER MOUNTED ON IT APPROXIMATELY 500' (150 m) IN ADVANCE OF THE MAIN ROUTE.
- b) THE CLOSED PORTION OF THE MAIN ROUTE SHALL BE PROTECTED BY BLOCKING WITH TYPE III BARRICADES, 1/2 OF THE CROSS SECTION OF THE CLOSED PORTION

SCALE: NONE

3. WHEN THE SIDE ROAD LIES BETWEEN THE BEGINNING OF THE MAINLINE SIGNING AND THE WORK ZONE, A SINGLE HEADED ARROW (MG-1) SHALL BE USED IN LIEU OF THE DOUBLE HEADED ARROW (MG-4).

- B. FOR A LANE CLOSURE ON A SIDE RUAD OR DRIVEWAY:
- USE APPLICABLE PORTIONS OF THE TYPICAL APPLICATION OF TRAFFIC CONTROL DEVICES (STD. 701501, STD. T01605 OR THE APPROPRIATE STANDARD). THE SPACING OF SIGNS AND BARRICADES SHALL BE ADJUSTED FOR FIELD CONDITIONS AS DIRECTED BY THE ENGINEER. THE DIRECTIONAL ARROW SHALL BE COVERED OR REMOVED WHEN NO LONGER CONSISTENT WITH THE SIDE ROAD LANE CLOSURE.
- C. ADVANCE WARNING SIGNS ARE TO BE OMITTED ON DRIVEWAY UNLESS OTHERWISE NOTED.
- D. THE TRAFFIC CONTROL AND PROTECTION FOR SIDE ROADS, INTERSECTIONS, AND DRIVEWAYS SHALL BE INCIDENTAL TO THE COST OF SPECIFIED TRAFFIC CONTROL STANDARDS OR ITEMS.

All dimensions are in millimaters (inches) unless otherwise shown.


STATE OF ILLINOIS
DEPARTMENT OF TRANSPORTATION


TRAFFIC CONTROL AND PROTECTION FOR
SIDE ROADS, INTERSECTIONS, AND DRIVEWAYS
SHEET NO. 1 OF 1 SHEETS STA. TO STA.

| TC-10 | COUNTY | SHEET | SHE

NO. 1 | ILLINOIS FED. AID PROJECT ARA-9003(327)


E.H.E. PROJECT NO. 600-09-15901

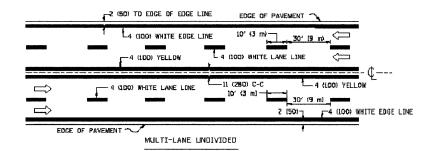

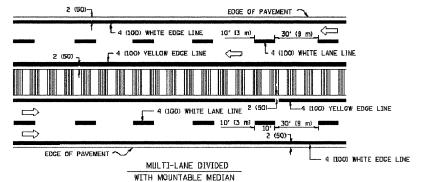


NOTE: MEDIANS WITH BARRIER CURB DO NOT REQUIRE AN EDGE LINE


TYPICAL LANE AND EDGE LINE MARKING

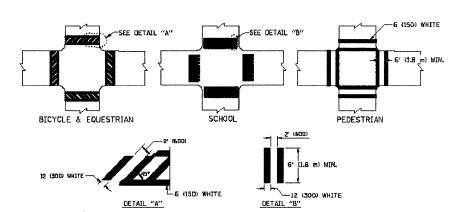

TYPICAL CROSSWALK MARKING

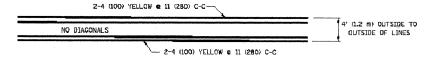


4' (1.2 m) WIDE MEDIANS ONLY

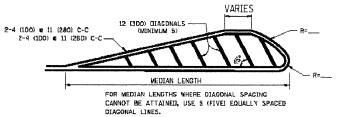


DIAGONAL LINE SPACING: 50' (15 m) C-C (LESS THAN 30MPH (50 km/h))
75' (26 m) C-C 30MPH (50 km/h) TO 46MPH (70 km/h)) 150' (45 m) C-C (MORE THAN 45MPH (7D km/h))

MEDIANS OVER 4' (1.2 m) WIDE

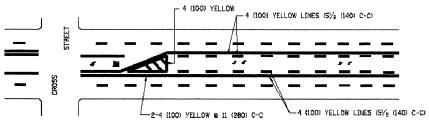


A MINIMUM OF TWO PAIRS OF TURN ARROWS SHALL BE USED, WHITE IN COLOR. ADDITIONAL PAIRS SHALL BE PLACED AT 200' (60 m) TO 300' (90 m) INTERVALS.

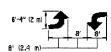

MEDIAN WITH TWO-WAY LEFT TURN LANE

TYPICAL PAINTED MEDIAN MARKING

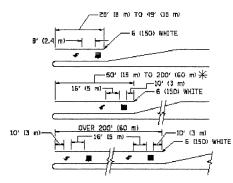


FULL SIZE LETTERS 8' (2.4 m) AND ARROWS SHALL BE USED. ↑ AREA = 16.6 SQ. FT. (1.6 m²) (1.7 AREA = 20.8 SQ. FT. [1.9 m²)

* TURN LANES IN EXCESS OF 400' (120 m) IN LENGTH MAY HAVE AN ADDITIONAL SET OF ARROW - "ONLY" INSTALLED MIDWAY BETWEEN THE OTHER TWO SETS OF ARROW - "ONLY".

TYPICAL LEFT (OR RIGHT) TURN LANE

TYPICAL TURN LANE MARKING

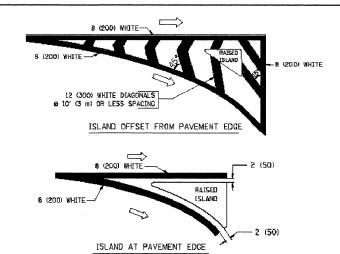

TYPICAL ISLAND MARKING

				
TYPE OF MARKING	WIDTH OF LINE	PATTERN	COLOR	SPACING / REMARKS
CENTERLINE ON 2 LANE PAVEMENT	4 (100)	SKIP-DASH	YELLOW	30' (3 m) LINE WITH 30' (9 m) SPACE
CENTERLINE ON MULTI-LANE UNDIVEDED PAVEMENT	2 @ 4 (100)	SOLID	YELLOW	11 (280) C-C
NO PASSING ZONE LINES: FOR ONE DIRECTION FOR BOTH DIRECTIONS	4 (100) 2 e 4 (100)	SOLID SOLID	YELLOW YELLOW	5½ (14D) C-C FROM SKIP-DASH CENTERLINE 11 (28G) C-C ONIT SKIP-DASH CENTERLINE BETWEEN
LANE LINES	4 (100) 5 (125) ON FREEWAYS	SKIP-DASH SKIP-DASH	WHITE WHITE	10' (3 m) LINE WITH 30' (9 m) SPACE
DOTTED LINES (EXTENSIONS OF CENTER, LANE OR TURN LANE MARKINGS)	SAME AS LINE BEING EXTENDED	SKIP-DASH	SAME AS LINE BEING EXTENDED	2' (600) LINE WITH 6' (L8 m) SPACE
EOGE LINES	4 (100)	SOLIO	YELLOW-LEFT WHITE-RIGHT	OUTLINE MOUNTABLE MEDIANS IN YELLOW, EDGE LINES ARE NOT USED NEXT TO BARRIER CURB
TURN LANE MARKINGS	6 (150) LINE; FULL SIZE LETTERS & SYMBOLS (B' (2.4m))	SOLID	WHITE	SEE TYPICAL TURN LANE MARKING DETAIL
TWO WAY LEFT TURN MARKING	2 cg 4 (100) EACH DIRECTION	SKIP-DASH AND SOLID	YELLOW	10' (3 m) LINE WITH 30' IB m) SPACE FOR SKIP-DASH: 5½ (140) C-C BETWEEN SOLID LINE AND SKIP-DASH LINE
	B' (2.4m) LEFT ARROW	IN PAIRS	WHITE	SEE TYPICAL TWO-WAY LEFT TURN MARKING DETAIL
CROSSWALK LINES (PEDESTRIAN) A. DIAGONALS IBIKE & EQUESTRIAN) B. LONGITUDINAL BARS (SCHOOL)	2 c 5 (150) 12 (300) c 45° 12 (300) c 90°	SOLID SOLID SOLID	WHITE WHITE WHITE	NDT LESS THAN 6' (L8 m) APART 2' (500) APART 2' (500) APART SEE TYPICAL CROSSWALK MARKING DETAILS.
STOP LINES	24 (600)	SOLID	WHITE	PLACE 4' 11.2 ml IN ADVANCE OF AND PARALLEL TO EXCESSIONALY, IF PRESENT. OTHERWISE, PLACE AT DESIRED STOPPING POINT. PARALLEL TO CROSSROAD CENTERLINE, WHERE POSSIBLE
PAINTED MEDIANS	2 to 4 (100) WITH 12 (300) DIAGONALS	SOLID	YELLOW: TWO WAY TRAFFIC	31 (280) C-C FOR THE DOUBLE LINE
	R 45° ND DIAGONALS USED FOR 4' (1.2 m) WIDE MEDIANS		WHITE: DNE WAY TRAFFIC	SEE TYPICAL PAINTED MEDIAN MARKING.
CORE MARKING AND CHANNELIZING LINES	8 (200) WITH 12 (300) DIAGONALS & 45°	SOLID	WHITE	DIACONALS: 15' (4.5 m) C-C (LESS THAN 30MPH (50 km/h)) 20' (6 m) C-C 30MPH (50 km/h) TO 45MPH (70 km/h)) 30' (9 m) C-C (DVER 45MPH (70 km/h))
RAILROAD CROSSING	24 (600) TRANSVERSE LINES, "RR" IS 6' (1.8 m) LETTERS; 16 (400) LINE FOR "X"	50LID	WHITE	SEE STATE STANDARD 78000L AREA OF- "R"=3.6 SQ. FT. (0.33 m ²) EACH "X"=54.0 SQ. FT. (5.0 m ²)
SHOULDER DIAGONALS	12 (300) @ 45°	SOLID	WHITE - RIGHT YELLOW - LEFT	SO' (15 m) C-C (LESS THAN 30MPH (50 km/h)) 75' (25 m) C-C (30 MPH (50 km/h) TO 45MPH (70 km/h)) 150' (45 m) C-C (0VER 45MPH (70 km/h))

FOR FURTHER DETAILS ON PAVEMENT MARKING REFER TO STANDARD SPECIFICATIONS FOR ROAD AND BRIDGE CONSTRUCTION AND STATE STANDARD 780001.


SCALE:

All dimensions are in inches imilimeters) unless otherwise shown.

FILE NAME =	USER NAME = gaglianobt	DESIGNED - EVERS	REVISED	-T. RAMMACHER 10-27-9
di\distatd\22x94\to19.dgn		DRAWN	REVISED	-A. HOUSEH 10-09-96
	PLOT SCALE = 69.000 ' / IN.	CHECKED -	REVISED	-A. HOUSEH 10-17-96
	PLOT DATE = 1/4/2008	DATE - 03-19-90	REVISED	- T. RAMMACHER OL-DG-C

STATE OF ILLINOIS DEPARTMENT OF TRANSPORTATION

DISTRICT ONE				F.A RTE.	SECTION	COUNTY	TOTAL SHEETS	SHEET NO.	
TYPICAL PAVEMENT MARKINGS					1026	09-00113-00-RS	соок	14	13
					TC-13		CONTRACT	NO.	63290
. NONE	SHEET NO. 1 OF 1	SHEETS	STA.	TO STA.	FEG. R	DAD DIST. NO. 1 ILLINOIS FED.	AID PROJECT ARA	9003(327)	

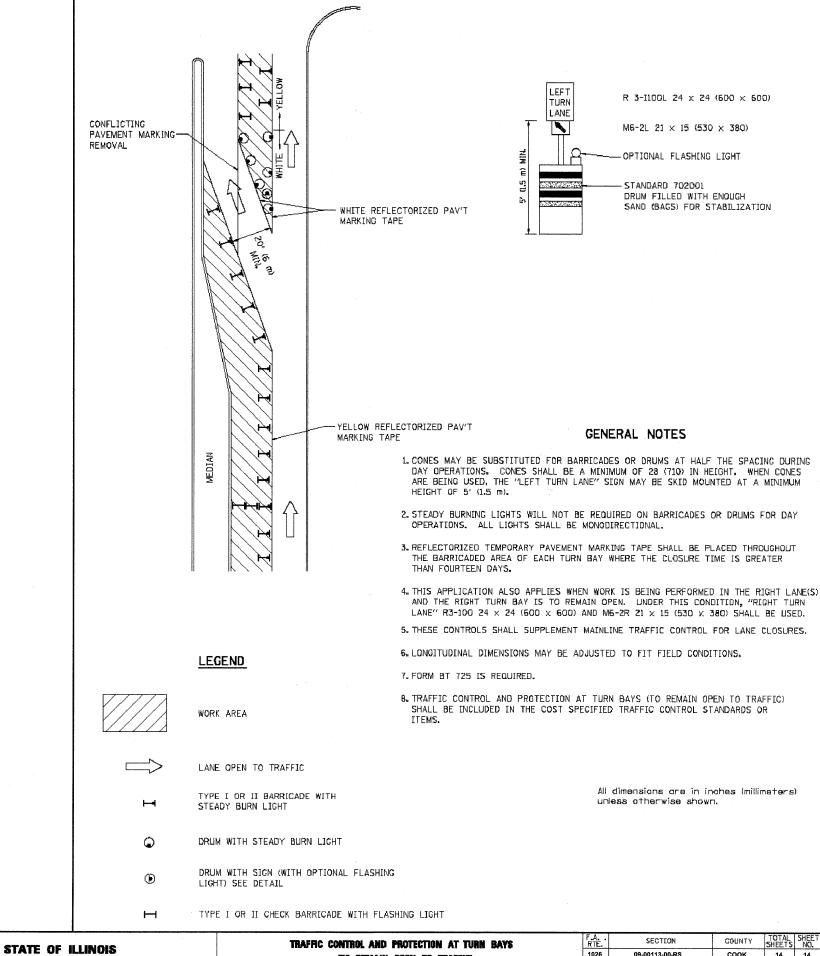

ojects\60009056 - Division Street LAPP Application\Markings-DivisionSt.dwg Aug 12, 2009 - 4:00pm

FILE NAME = W:\duststd\22x34\te14.dgn

STATE OF ILLINOIS
DEPARTMENT OF TRANSPORTATION

TRAFFIC CONTROL AND PROTECTION AT TURN BAYS

(TO REMAIN OPEN TO TRAFFIC)

SHEET NO. 1 OF 1 SHEETS STA. TO STA.

SCALE: NONE

E.H.E. PROJECT NO. 600-09-1590