
EROSION CONTROL BLANKET (25100630)




INLET FILTERS (28000510)

PERIMETER EROSION BARRIER (SILT FENCE) (28000400)

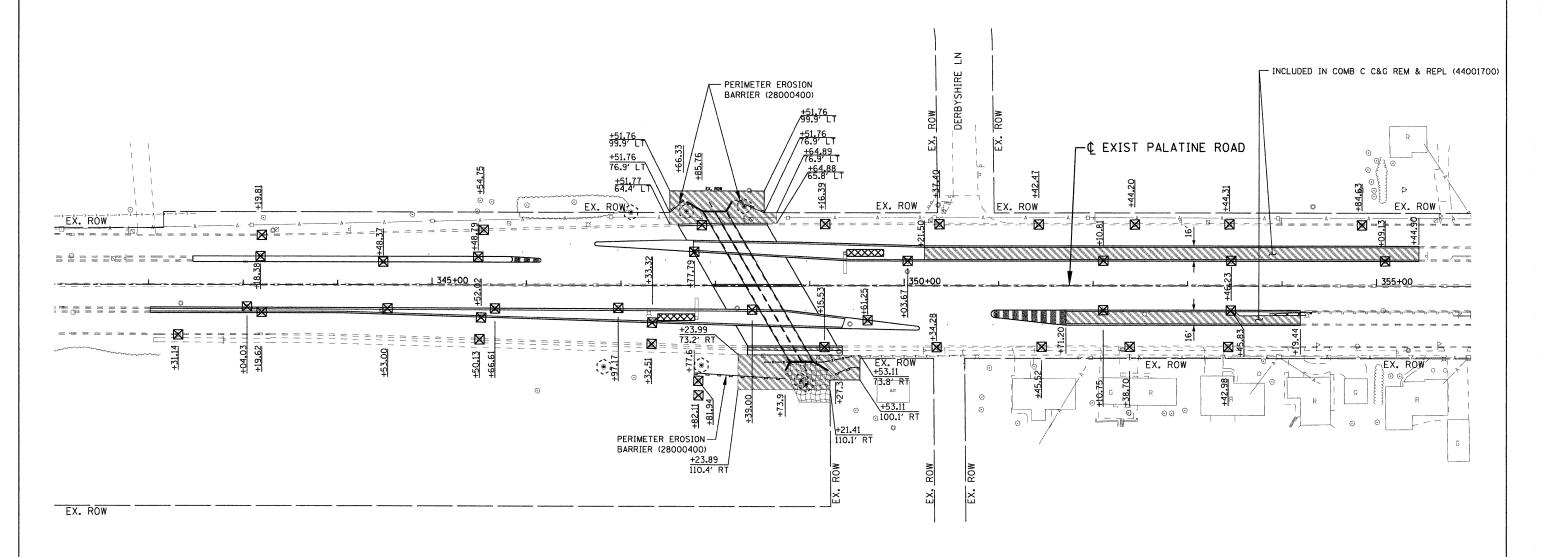

EROSION CONTROL NOTES

- 1. TEMPORARY EROSION CONTROL DEVICES SHALL BE CONTRUCTED AS SHOWN ON THE PLANS.
- 2. THE CONTRACTOR SHALL CONFINE ACTIVITIES TO FALL WITHIN THE EXISTING RIGHT-OF-WAY AS SHOWN ON THE PLANS.
- 3. ANY DEVIATION FROM THE TEMPORARY EROSION CONTROL PLAN OR SCHEDULE BY THE CONTRACTOR SHALL BE AT THE DISCRETION OF THE ENGINEER.
- 4. PERIMETER EROSION BARRIER IS TO BE INSTALLED IN ALL AREAS PRIOR TO START OF CONSTRUCTION.
- 5. INLET AND PIPE PROTECTION FOR EXISTING STRUCTURES SHALL BE INSTALLED AT THE START OF CONSTRUCTION.

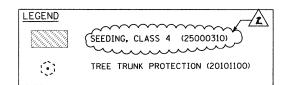

FILE NAME =	USER NAME = 2pienid	DESIGNED -	DLP	REVISED - 2 10/9/09		McDONALD CREEK CULVERT	F.A.P. SECT	ION COUNT	TY TOTAL SHEET
G:\project\2082305\CADD\C1v1\Sht\002\@	Ø2PLMLLSØ1.dgn	DRAWN -	ENTRAN	REVISED -	STATE OF ILLINOIS		305 0913.		SHEETS NO.
	PLOT SCALE = 50.0286 '/ IN.	CHECKED -	ТМН	REVISED -	DEPARTMENT OF TRANSPORTATION	EROSION CONTROL AND LANDSCAPING PLANS	303 0313.		RACT NO. 60E53
	PLOT DATE = 10/9/2009	DATE -	03/09	REVISED -		SCALE: 1"= 50' SHEET NO. OF SHEETS STA. TO STA.	FED. ROAD DIST. NO. 1 I		