J.U.L.I.E.

11-05-2021 LETTING ITEM 101

JOINT UTILITY LOCATION

INFORMATION FOR EXCAVATION

1-800-892-0123 OR 811

STATE OF ILLINOIS DEPARTMENT OF TRANSPORTATION **DIVISION OF HIGHWAYS** PROPOSED HIGHWAY PLANS FOR

# SAFE ROUTES TO SCHOOL PROJECT FROM WILSON MIDDLE SCHOOL TO THE YMCA IN MOLINE


FAU 5842: 48TH ST./48TH ST. PL./FAU 5844: 53RD ST.

SECTION #: 19-00273-00-SW **PROJECT #: HZY8(709)** JOB #: C-92-019-21 SRTS # CRTS 019-2004 **CONTRACT #85712** 

# 48TH \$T\_ / 48TH ST. PL. 53RD ST. FROM WILSON MIDDLE SCHOOL TO THE YMCA

GROSS LENGTH: 1,929 L.F. = 0.365 MI. NET LENGTH: 1,929 L.F. = 0,365 MI. MAJOR COLLECTOR ADT: 5000 (2021) - 5% TRUCKS

# PROJECT LOCATION MAP ROCK ISLAND-

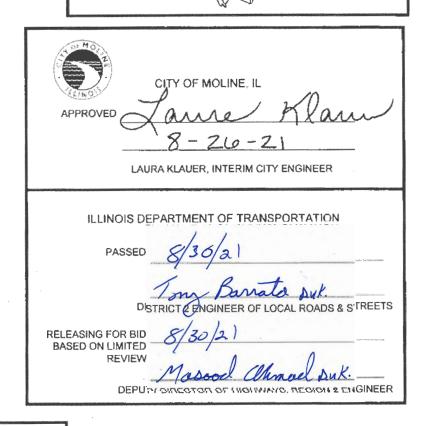

# INDEX OF SHEETS

01 TITLE SHEET

**GENERAL NOTES** 

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## HIGHWAY STANDARDS

000001-08 STANDARD SYMBOLS, ABBREVIATIONS, AND PATTERNS

280001-07 TEMPORARY EROSION CONTROL SYSTEMS

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424011-04 CORNER PARALLEL CURB RAMPS FOR SIDEWALKS

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424021-06 DEPRESSED CORNER FOR SIDEWALKS 424026-03 ENTRANCE/ALLEY PEDESTRIAN CROSSINGS

424031-02 MEDIAN PEDESTRIAN CROSSINGS

604006-05 FRAME & GRATE TYPE 3

606001-07 CONCRETE CURB & GUTTER TYPE B & COMBINATION

CONCRETE CURB & GUTTER

701501-06 URBAN LANE CLOSURE, 2L, 2W, UNDIVIDED

701701-10 URBAN LANE CLOSURE, MULTILANE INTERSECTION

701801-06 SIDEWALK CORNER OR CROSSWALK CLOSURE

701901-08 TRAFFIC CONTROL DEVICES


720011-01 METAL POSTS FOR SIGNS, MARKERS, & DELINEATORS

728001-01 TELESCOPING STEEL SIGN SUPPORTS

729001-01 APPLICATIONS OF TYPES A&B METAL POSTS

878001-11 CONCRETE FOUNDATION DETAILS

TYPICAL APPLICATION OF TRAFFIC CONTROL DEVICES FOR CONSTRUCTION ON RURAL LOCAL HIGHWAYS

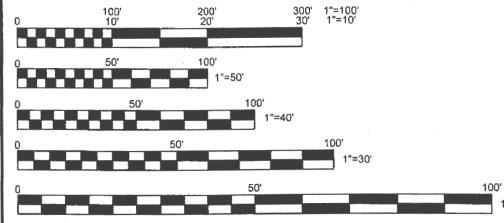

11X17 PLANS HAVE BEEN PREPARED USING STANDARD ENGINEERING SCALES. REDUCED SIZE PLANS MAY NOT CONFORM TO STANDARD SCALES. IN MAKING MEASUREMENTS ON REDUCED PLANS, THE ABOVE SCALES MAY BE USED.



I HEREBY CERTIFY THAT THESE PLANS WERE PREPARED BY ME OR UNDER MY DIRECT PERSONAL SUPERVISION AND THAT I AM A DULY REGISTERED PROFESSIONAL ENGINEER UNDER THE LAWS OF THE STATE OF ILLINOIS.

LAURA C. KLAUER, P.E. LICENSE NO. 062-060373

EXPIRES 11-30-21

## **GENERAL NOTES**

- 1. THIS PROJECT SHALL BE CONSTRUCTED IN ACCORDANCE WITH THE FOLLOWING STANDARDS: THE "STANDARD SPECIFICATIONS FOR ROAD AND BRIDGE CONSTRUCTION" ADOPTED APRIL 1, 2016 BY THE ILLINOIS DEPARTMENT OF TRANSPORTATION: THE "SUPPLEMENTAL SPECIFICATIONS AND RECURRING SPECIAL PROVISIONS" ADOPTED JANUARY 1, 2021 BY THE ILLINOIS DEPARTMENT OF TRANSPORTATION: THE "2017 SUPPLEMENTAL SPECIFICATIONS" ADOPTED JANUARY 1. 2017 BY THE CITY OF MOLINE; AND THE SPECIAL PROVISIONS CONTAINED WITHIN THE BIDDING DOCUMENTS.
- 2. ALL POINTS OF POSSIBLE CONFLICT WITH UTILITIES ARE TO BE EXCAVATED AS NECESSARY TO VERIFY THE EXACT LOCATION AND ELEVATION BEFORE COMMENCEMENT OF CONSTRUCTION. THIS WORK SHALL BE CONSIDERED INCIDENTAL TO THE CONTRACT.
- TRAFFIC CONTROL SHALL BE IN ACCORDANCE WITH THE "MANUAL ON UNIFORM TRAFFIC CONTROL DEVICES" ADOPTED 2009 BY THE FEDERAL HIGHWAY ADMINISTRATION, THE "STANDARD SPECIFICATIONS FOR ROAD AND BRIDGE CONSTRUCTION" ADOPTED APRIL 1, 2016 BY THE ILLINOIS DEPARTMENT OF TRANSPORTATION, AND THE SPECIAL PROVISIONS CONTAINED WITHIN THE BIDDING DOCUMENTS.
- 4. THE CONTRACTOR SHALL PROVIDE PROTECTION TO THE PUBLIC IN ACCORDANCE WITH ARTICLE 107.14 OF THE "STANDARD SPECIFICATIONS FOR ROAD AND BRIDGE CONSTRUCTION" ADOPTED APRIL 1, 2016 BY THE ILLINOIS DEPARTMENT OF TRANSPORTATION. THIS SHALL INCLUDE TRAFFIC CONTROL AND OTHER NECESSARY MEASURES TO UPHOLD AN ADEQUATE LEVEL OF SAFETY. TRAFFIC CONTROL SHALL BE PROVIDED, TO THE SATISFACTION OF THE ENGINEER, INCLUDING ALL PROTECTION DEEMED NECESSARY BEYOND THAT SHOWN IN THE PLANS OR SPECIAL PROVISIONS. THE ABSENCE OF TRAFFIC CONTROL DRAWINGS DOES NOT RELIEVE THE CONTRACTOR OF THEIR RESPONSIBILITY TO ENSURE PUBLIC SAFETY.
- 5. THE CONTRACTOR SHALL PROTECT ALL EXISTING SIDEWALK, PAVEMENT, LANDSCAPING, AND RETAINING WALLS THAT ARE NOT MARKED FOR REMOVAL. ANY DAMAGE CAUSED DURING CONSTRUCTION SHALL BE REPAIRED AT THE CONTRACTOR'S EXPENSE.
- 6. EXISTING FIRE HYDRANTS AND VALVES SHALL REMAIN THE PROPERTY OF THE CITY OF MOLINE WATER DEPARTMENT.
- 7. PLEASE REFER TO THE SPECIAL PROVISIONS FOR THE INSTRUCTIONS FOR TRACER WIRE INSTALLATION FOR PROPOSED WATER MAIN.
- 8. ALL STORM AND SANITARY SEWER PIPE CONNECTIONS SHALL BE CONSIDERED INCIDENTAL TO THE CONTRACT.
- ALL PAVEMENT JOINTS SHALL BE SEALED IN ACCORDANCE WITH STANDARD DRAWING #5 FOUND IN THE "2017 SUPPLEMENTAL SPECIFICATIONS" ADOPTED JANUARY 1, 2017 BY THE CITY OF MOLINE, AND SHALL BE CONSIDERED INCIDENTAL TO THE CONTRACT.
- 10. THE REMOVAL, STORAGE, AND REINSTALLATION OF EXISTING SIGNS AND FENCING WITHIN THE CONSTRUCTION LIMITS SHALL BE CONSIDERED INCIDENTAL TO THE
- 11. THE CONTRACTOR SHALL NOTIFY INDIVIDUAL RESIDENTS PRIOR TO THE REMOVAL OF DRIVEWAYS OR TREES. THE CONTRACTOR SHALL BE RESPONSIBLE FOR COORDINATING THE REMOVAL AND RECONSTRUCTION SCHEDULE OF DRIVEWAYS WITH INDIVIDUAL RESIDENTS IN ORDER TO MINIMIZE DISRUPTIONS TO DRIVEWAY ACCESS. THIS WORK SHALL BE CONSIDERED INCIDENTAL TO THE CONTRACT.
- 12. THE CONTRACTOR SHALL ENSURE THE CONTINUATION OF MAIL SERVICES AND GARBAGE COLLECTION SERVICES TO RESIDENTS THROUGHOUT THE DURATION OF THE PROJECT. THE CONTRACTOR SHALL NOTIFY RESIDENTS PRIOR TO ANY CHANGES OR DISRUPTIONS IN THESE SERVICES. THIS WORK SHALL BE CONSIDERED INCIDENTAL TO THE CONTRACT.
- 13. ALL HONEYCOMBING AND/OR POROUS AREAS IN BACK OF CURB WILL BE CORRECTED AS DIRECTED BY THE ENGINEER. SLUMP NOT TO EXCEED 3". REQUIRED AIR, 5% - 8%. NO WATER MAY BE ADDED AT JOBSITE TO EXCEED THE DESIGN SLUMP. ALL TIE BARS. DOWEL BARS AND REINFORCING STEEL SHALL BE EPOXY COATED.
- 14. THE CONTRACTOR SHALL REVIEW ALL NOTES, THE "2017 SUPPLEMENTAL SPECIFICATIONS" ADOPTED JANUARY 1, 2017 BY THE CITY OF MOLINE, AND THE SPECIAL PROVISIONS CONTAINED WITHIN THE BIDDING DOCUMENTS PRIOR TO BIDDING EACH

## **UTILITIES**

THE FOLLOWING UTILITY COMPANIES MAY HAVE FACILITIES LOCATED WITHIN THE PROJECT AREA:

## CITY OF MOLINE PUBLIC UTILITIES:

- ELECTRICAL MAINTENANCE DEPARTMENT
- STORMWATER DEPARTMENT
- STREET DEPARTMENT
- WATER POLLUTION CONTROL DEPARTMENT
- WATER DEPARTMENT

## PRIVATE GAS AND ELECTRIC:

MIDAMERICAN ENERGY

## PRIVATE TELECOMMUNICATIONS:

- AT&T
- CENTURY LINK
- GENESEO COMMUNICATIONS
- MEDIACOM
- VERIZON
- WINDSTREAM
- OTHERS TO BE DETERMINED

THE CONTRACTOR SHALL CALL J.U.L.I.E. AT 1-800-892-0123 OR 811 TO CONTACT ALL UTILITY COMPANIES WHICH MAY HAVE FACILITIES WITHIN THE PROJECT AREA. PRIOR TO THE COMMENCEMENT OF CONSTRUCTION, ALL POINTS OF POSSIBLE CONFLICT SHALL BE EXCAVATED TO VERIFY EXACT LOCATIONS AND ELEVATIONS.

## **COMMITMENTS**


1. THE DRIVEWAY AT 4815 18TH AVENUE WILL BE RECONSTRUCTED IN ITS ENTIRETY USING 100% CITY FUNDS.



CITY OF MOLINE PUBLIC WORKS DEPARTMENT **ENGINEERING DIVISION** (309) 524-2350 3635 4TH AVENUE, MOLINE, IL 61265

# SRTS SIDEWALK INSTALLATION

Wilson Middle School to the YMCA General Notes & Highway Standards

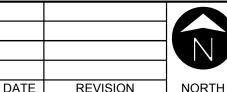



SCALED FOR 11"X17" PAPER

SCALE: N.T.S.

Date 05-06-21 19-00273-Project 00-SW

Designer

OF

SHEET

02

		ITEM	UNIT	TOTAL QTY.	SRTS FUND	100% CITY
	20200100	EARTH EXCAVATION	CU YD	4	4	
*	21001000	GEOTECHNICAL FABRIC FOR GROUND STABILIZATION	SQ YD	365	365	
	25100630	EROSION CONTROL BLANKET	SQ YD	500	500	:
*	35101800	AGGREGATE BASE COURSE, TYPE B 6"	SQ YD	500	500	
*	42000300	PORTLAND CEMENT CONCRETE PAVEMENT 8"	SQ YD	325	325	
*	42300300	PORTLAND CEMENT CONCRETE DRIVEWAY PAVEMENT, 7 INCH	SQ YD	526	368	158
*	42400200	PORTLAND CEMENT CONCRETE SIDEWALK 5 INCH	SQ FT	13632	13632	· l
*	42400300	PORTLAND CEMENT CONCRETE SIDEWALK 6 INCH	SQ FT	1553	1553	
*	42400800	DETECTABLE WARNINGS	SQ FT	133	133	
	44000100	PAVEMENT REMOVAL	SQ YD	21	21	
	44000200	DRIVEWAY PAVEMENT REMOVAL	SQ YD	302	302	
	44000500	COMBINATION CURB AND GUTTER REMOVAL	FOOT	405	405	
	44000600	SIDEWALK REMOVAL	SQ FT	4365	4365	
△*	56400400	FIRE HYDRANTS TO BE RELOCATED	EACH	1	1	
	60260500	INLETS TO BE ADJUSTED WITH NEW TYPE 3 FRAME AND GRATE	EACH	1	1	
	60266600	VALVE BOXES TO BE ADJUSTED	EACH	4	4	
*	60300305	FRAMES AND LIDS TO BE ADJUSTED	EACH	2	2	
*	60603900	COMBINATION CONCRETE CURB AND GUTTER, TYPE B6.12 (ABUTTING EXISTING PAVEMENT)	FOOT	405	405	
	67100100	MOBILIZATION	L.SUM	1	1	
△*	78001130	PAINT PAVEMENT MARKING - LINE 6"	FOOT	561	561	
△*	78001150	PAINT PAVEMENT MARKING - LINE 12"	FOOT	304	304	
*	K1005421	SEEDING (SPECIAL)	ACRE	0.1	0.1	
*	X0327301	RELOCATE EXISTING MAILBOX	EACH	3	3	
*	X7010216	TRAFFIC CONTROL AND PROTECTION (SPECIAL)	L.SUM	1	1	
△*	Z0033058	POST MOUNTED FLASHING BEACON INSTALLATION (SPECIAL)	EACH	2	2	

- INDICATES SPECIAL PROVISION
- A SECIALTY ITEMS



# **SRTS SIDEWALK INSTALLATION**

Wilson Middle School to the YMCA Summary of Quantities

	:	
		N
DATE	REVISION	NORT

	CALED F	
0'	0'	0'
SC	ALE: N.	Г.S.

SHEET Date **05-06-21** Project 19-00273-03 00-SW OF 29 Designer

4	C.Y.
4	C.Y.

### 21001000

GEOTECHNICAL FABRIC FOR GROUND STABILI	ZATION	
18TH AVENUE	365	S.Y.
TOTAL:	365	S.Y.

## 25100630

EROSION CONTROL BLANKET		
ENTIRE PROJECT	500	S.Y.
TOTAL:	500	S.Y.

## 35101800

AGGREGATE BASE COURSE, TYPE B 6"		
18TH AVENUE	365	S.Y.
STA. 6+51.9 / 19.62' RT - 6+74.16 / 44.05' RT	13	S.Y.
STA. 6+32.48 / 20.39 - 6+84.17 / 20.18' LT	17	S.Y.
STA. 7+38.71 / 20.29' LT - 7+86.52 / 20.04' LT	15	S.Y.
STA. 10+04.57 / 23.48' LT - 10+16.37 / 45.47' LT	9	S.Y.
STA. 10+53.64 / 23.76' LT - 10+42.12 / 47.32' LT	9	S.Y.
STA. 10+76.13 / 20.57' LT - 11+29.85 / 20.14' LT	18	S.Y.
STA. 11+98.21 / 20.18' LT - 12+65.77 / 29.59' LT	23	S.Y.
STA. 13+97.20 / 20.62' LT - 14+61.20 / 20.25' LT	21	S.Y.
STA. 24+48.94 / 25.63' LT - 24+60.09 / 39.81' LT	6	S.Y.
STA. 42+85.97 / 16.66' LT - 42+96.81 / 16.70' LT	4	S.Y.
TOTAL:	500	S.Y.

## 42000300

PORTLAND CEMENT CONCRETE PAVEMENT 8"		
18TH AVENUE	325	S.Y.
TOTAL:	325	S.Y.

\*\* INCIDICATES WORK 100% CITY FUNDED

42300300		
PORTLAND CEMENT CONCRETE DRIVEWAY PAVE	EMENT, 7	INCH
STA. 6+34.54 / 20.89' LT- 6+75.00 / 20.88' LT	74	S.Y.
STA. 7+40.83 / 20.83' LT - 7+86.52 / 20.04' LT	49	S.Y.
STA. 10+78.14 / 20.94' LT - 11+27.85 / 20.64' LT	67	S.Y.
STA. 12+00.21 / 20.68' LT - 12+65.77 / 20.59' LT	98	S.Y.
STA. 13+99.15 / 20.62' LT - 14+56.90 / 20.82' LT	80	S.Y.
** STA. 30+36.91 / 12.53' LT - 30+78.77 / 12.50' LT	158	S.Y.
TOTAL:	526	S.Y.

### 42400200

PORTLAND CEMENT CONCRETE SIDEWALK 5 INCI	1	
STA. 6+46.54 / 24.57' RT - 6+51.91 / 24.43' RT	44	S.F.
STA. 6+69.42 / 43.84' RT - 6+69.89 / 55.58' RT	84	S.F.
STA. 6+21.61 / 27.74' LT - 6+45.62 / 29.76' LT	164	S.F.
STA. 6+90.01 / 29.83' LT - 7+53.21 / 30.09' LT	483	S.F.
STA. 7+77.21 / 29.98' LT - 9+97.67 / 29.74' LT	1731	S.F.
STA. 9+66.05 / 33.57' LT - 9+65.14 / 61.74' LT	95	S.F.
STA. 10+13.95 / 43.30' LT - 10+13.68 / 47.31' LT	16	S.F.
STA. 10+61.44 / 30.16' LT - 10+86.5 / 29.19' LT	205	S.F.
STA. 11+19.45 / 29.1' LT - 12+16.93 / 29.37' LT	788	S.F.
STA. 12+53.46 / 29.09' LT - 14+13.32 / 29.63' LT	1278	S.F.
STA. 14+49.19 / 29.89' LT - 15+34.88 / 29.66' LT	683	S.F.
STA. 30+22.37 / 25.43' LT - 30+46.2.2 / 25.04' LT	120	S.F.
STA. 16+16.91 / 30.31' LT - 24+39.75 / 35.23' LT	6648	S.F.
STA. 19+04.15 / 36.70' LT - 19+03.47 / 68.53' LT	125	S.F.
STA. 24+49.93 / 47.37' LT - 42+81.26 / 25.98' LT	1046	S.F.
STA. 43+02.27 / 26.11' LT - 43+23.08 / 22.81' LT	122	S.F.
TOTAL:	13632	S.F.

## 42400300

PORTLAND CEMENT CONCRETE SIDEWALK 6 INCH		
STA. 6+51.91 / 24.43' RT - 6+69.42 / 43.84' RT	279	S.F.
STA. 6+68.03 / 28.49' LT - 6+90.01 / 29.83' LT	217	S.F.
STA. 9+97.67 / 29.74' LT - 10+11.56 / 30.02' LT	166	S.F.
STA. 10+45.08 / 45.04' LT - 10+61.44 / 30.16' LT	173	S.F.
STA. 15+34.88 / 29.66' LT - 15+49.77 / 29.12' LT	137	S.F.
STA. 15+98.59 / 29.28' LT - 16+16.91 / 30.31' LT	166	S.F.
STA. 24+39.75 / 35.23' LT - 24+49.93 / 47.37' LT	199	S.F.
STA. 42+81.26 / 25.98' LT - 43+02.27 / 26.11' LT	216	S.F.
TOTAL:	1553	S.F.

## 42400800

DETECTABLE WARNINGS		
STA. 6+69.98 / 28.88' RT	14	S.F.
STA. 6+78.65 / 20.84' LT	10	S.F.
STA. 10+11.56 / 30.02' LT	22	S.F.
STA. 10+48.15 / 29.65' LT	21	S.F.
STA. 15+49.77 / 29.12' LT	28	S.F.
STA. 15+98.59 / 29.28' LT	18	S.F.
STA. 24+55.28 / 32.17' LT	10	S.F.
STA. 42+91.66 / 17.14' LT	10	S.F.
TOTAL:	133	S.F.

## 44000100

PAVEMENT REMOVAL		
18TH AVENUE	21	S.Y.
TOTAL:	21	S.Y.

### 44000200

44000200		
DRIVEWAY PAVEMENT REMOVAL		
STA. 6+42.15 / 20.88' LT - 6+69.81 / 20.85' LT	67	S.Y.
STA. 7+50.28 / 20.86' LT - 7+67.88 / 20.76' LT	28	S.Y.
STA. 10+86.96 / 20.79' LT -11+10.42 / 20.72' LT	41	S.Y.
STA. 12+10.46 / 20.70' LT - 12+58.04 / 20.59' LT	84	S.Y.
STA. 14+10.69 / 20.71' LT - 14+61.53 / 20.75' LT	82	S.Y.
TOTAL:	302	S.Y.

## 44000500

COMBINATION CURB AND GUTTER REMOVAL		
STA. 6+51.9 / 19.62' RT - 6+74.16 / 44.05' RT	40	L.F.
STA. 6+32.48 / 20.39 - 6+84.17 / 20.18' LT	50	L.F.
STA. 7+38.71 / 20.29' LT - 7+86.52 / 20.04' LT	46	L.F.
STA. 10+04.57 / 23.48' LT - 10+16.37 / 45.47' LT	26	L.F.
STA. 10+53.64 / 23.76' LT - 10+42.12 / 47.32' LT	27	L.F.
STA. 10+76.13 / 20.57' LT - 11+29.85 / 20.14' LT	54	L.F.
STA. 11+98.21 / 20.18' LT - 12+65.77 / 29.59' LT	68	L.F.
STA. 13+97.20 / 20.62' LT - 14+61.20 / 20.25' LT	64	L.F.
STA. 24+48.94 / 25.63' LT - 24+60.09 / 39.81' LT	19	L.F.
STA. 42+85.97 / 16.66' LT - 42+96.81 / 16.70' LT	11	L.F.
TOTAL:	405	L.F.

4400000		
SIDEWALK REMOVAL		
STA. 6+46.54 / 24.57' RT - 6+69.89 / 55.58' RT	337	S.F.
STA. 6+21.61 / 27.74' LT - 6+47.02 / 27.7' LT	98	S.F.
STA. 6+68.03 / 28.49' LT - 7+55.30 / 28.12' LT	344	S.F.
STA. 7+70.22 / 27.97' LT - 10+13.95 / 43.30' LT	1113	S.F.
STA. 10+45.08 / 45.04' LT - 10+90.78 / 26.96' LT	250	S.F.
STA. 11+09.89 / 27.22' LT - 12+20.79 / 26.76' LT	432	S.F.
STA. 12+53.72 / 27.71' LT - 14+15.83 / 27.67' LT	641	S.F.
STA. 14+58.23 / 27.71 LT - 14+88.57 / 27.43' LT	120	S.F.
STA. 19+04.28 / 20.83' LT - 19+03.47 / 68.53' LT	239	S.F.
STA. 41+07.04 / 22.17' LT - 43+23.08 / 22.81' LT	791	S.F.
TOTAL:	4365	S.F.

## 56400400

FIRE HYDRANTS TO BE RELOCATED		
STA. 42+44.59 / 24.62' LT	1	EA.
TOTAL:	1	EA.

### 60260500

INLETS TO BE ADJUSTED WITH NEW TYPE 3 FRAM	IE AND G	RATE
STA. 14+64.14 / 20.12' LT	1	EA.
TOTAL:	1	EA.

## 60266600

VALVE BOXES TO BE ADJUSTED		
STA. 7+54.09 / 23.20' LT	1	EA.
STA. 11+27.60 / 28.71' LT	1	EA.
STA. 14+70.41 / 33.10' LT	1	EA.
STA. 42+25.33 / 25.25' LT	1	EA.
TOTAL:	4	EA.







CITY OF MOLINE PUBLIC WORKS DEPARTMENT **ENGINEERING DIVISION** (309) 524-2350 3635 4TH AVENUE, MOLINE, IL 61265

# **SRTS SIDEWALK INSTALLATION**

Wilson Middle School to the YMCA Schedule of Quantities 1 / 2

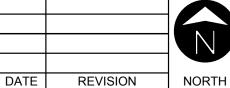



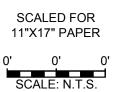

Date **05-06-21** Project 19-00273-00-SW Designer

SHEET 04 OF

60300305		
FRAMES AND LIDS TO BE ADJUSTED		
STA. 30+44.55 / 4.62' LT	1	EA.
STA. 16+16.91 / 30.31' LT	1	EA.
TOTAL:	2	FΔ

K1005421	
SEEDING (SPECIAL)	
ENTIRE PROJECT	0.1 ACRE
TOTAL:	0.1 ACRE

## 60603900

COMBINATION CONCRETE CURB AND GUTTER, TY (ABUTTING EXISTING PAVEMENT)	PE B6.12	!
STA. 6+51.9 / 19.62' RT - 6+74.16 / 44.05' RT	40	L.F.
STA. 6+32.48 / 20.39 - 6+84.17 / 20.18' LT	50	L.F.
STA. 7+38.71 / 20.29' LT - 7+86.52 / 20.04' LT	46	L.F.
STA. 10+04.57 / 23.48' LT - 10+16.37 / 45.47' LT	26	L.F.
STA. 10+53.64 / 23.76' LT - 10+42.12 / 47.32' LT	27	L.F.
STA. 10+76.13 / 20.57' LT - 11+29.85 / 20.14' LT	54	L.F.
STA. 11+98.21 / 20.18' LT - 12+65.77 / 29.59' LT	68	L.F.
STA. 13+97.20 / 20.62' LT - 14+61.20 / 20.25' LT	64	L.F.
STA. 24+48.94 / 25.63' LT - 24+60.09 / 39.81' LT	19	L.F.
STA. 42+85.97 / 16.66' LT - 42+96.81 / 16.70' LT	11	L.F.
TOTAL:	405	L.F.

## X0327301

RELOCATE EXISTING MAILBOX		
STA. 6+35.56 / 20.92' LT	1	EA.
STA. 7+84.96 / 20.76' LT	1	EA.
STA. 30+79.21 / 12.44' LT (18TH AVE.)	1	EA.
TOTAL:	3	EA.
<del></del>		

## X7010216

OTECTION (SPECIAL)	TRAFFIC CONTROL AN
1 L.SUM	ENTIRE PROJECT
1 L.SUM	TOTAL:
1 L.S	TOTAL:

## Z0033058

165

75

96

80

145

561

L.F.

L.F.

L.F.

L.F.

L.F.

L.F.

POST MOUNTED FLASHING BEACON INSTALLATION (SPECIAL)		
STA. 6+62.30 / 33.30' RT	1	EA.
STA. 6+84.00 / 23.30' LT	1	EA.
TOTAL:	2	EA.

## 78001150

TOTAL:

78001130

PAINT PAVEMENT MARKINGS - LINE 6 SCHOOL PEDESTRIAN CROSSING

49TH STREET INTERSECTION

18TH AVENUE INTERSECTION

20TH AVENUE INTERSECTION

53RD ST. & 19TH AVE. INTERSECTION

PAINT PAVEMENT MARKINGS - LINE 12		
SCHOOL PEDESTRIAN CROSSING	89	L.F.
49TH STREET INTERSECTION	40	L.F.
18TH AVENUE INTERSECTION	47	L.F.
20TH AVENUE INTERSECTION	45	L.F.
53RD ST. & 19TH AVE. INTERSECTION	83	L.F.
TOTAL:	304	L.F.

CITY OF MOLINE PUBLIC WORKS DEPARTMENT **ENGINEERING DIVISION** (309) 524-2350 3635 4TH AVENUE, MOLINE, IL 61265

# **SRTS SIDEWALK INSTALLATION**

Wilson Middle School to the YMCA Schedule of Quantities 2 / 2

ATE	REVISION	NORT

SCALE: N.T.S.


SCALED FOR 11"X17" PAPER

Date **05-06-21** Project 19-00273-

Designer

05 00-SW OF 29


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DATE

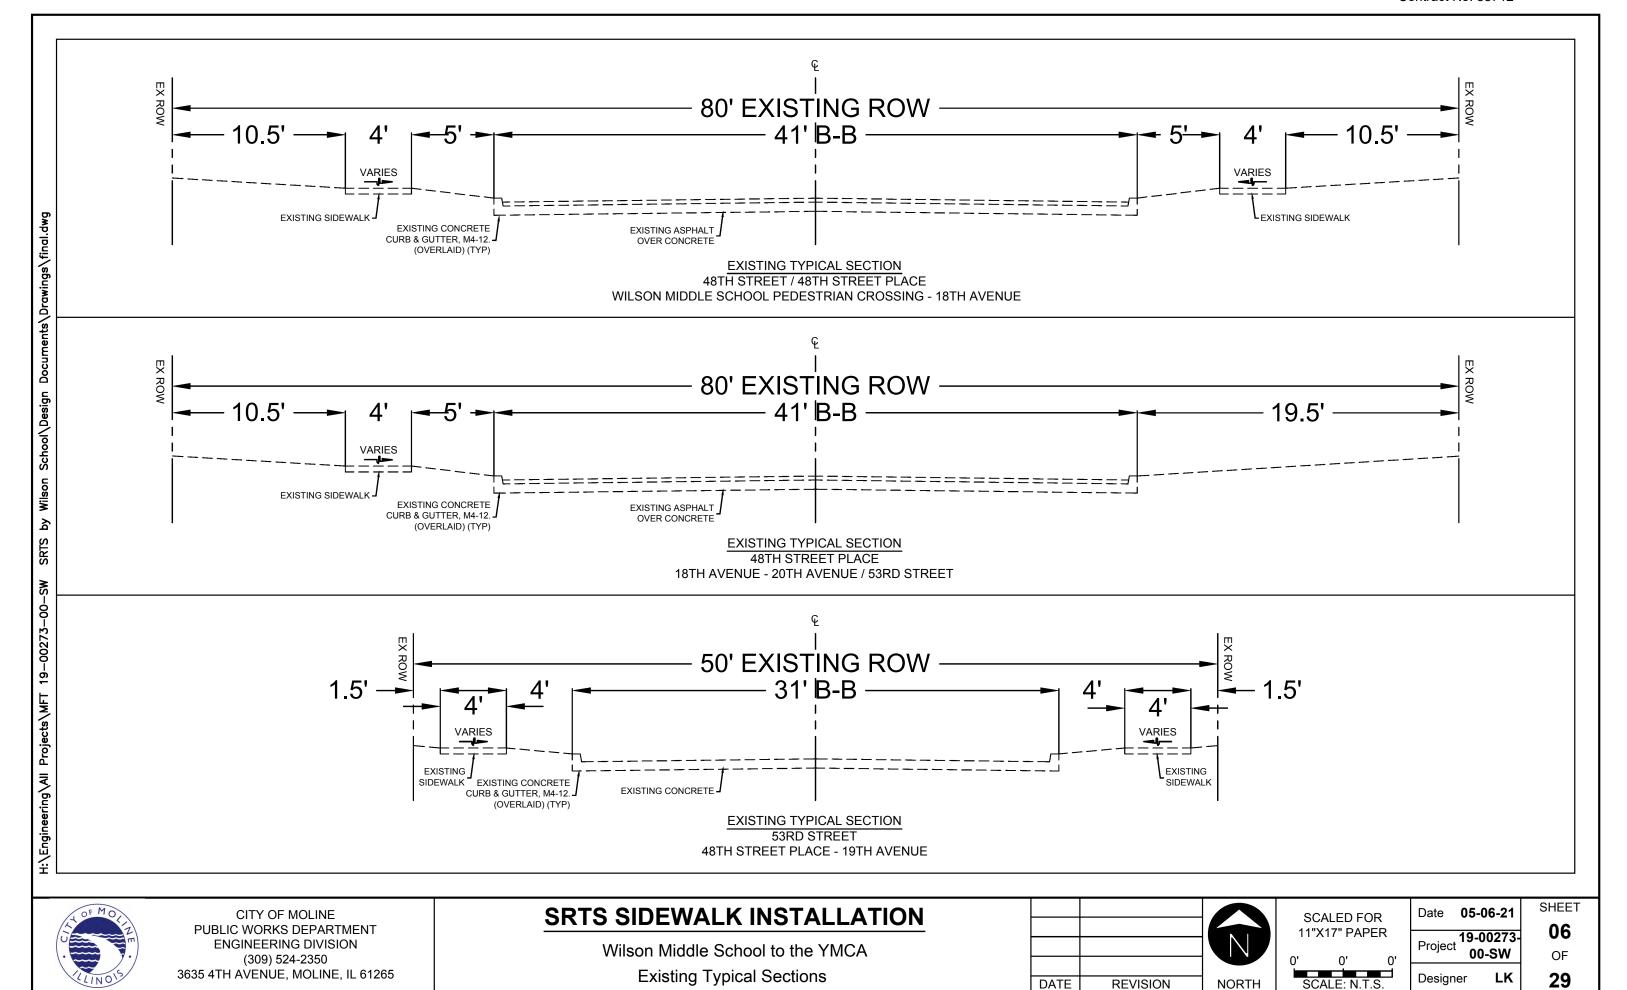REVISION

NORTH



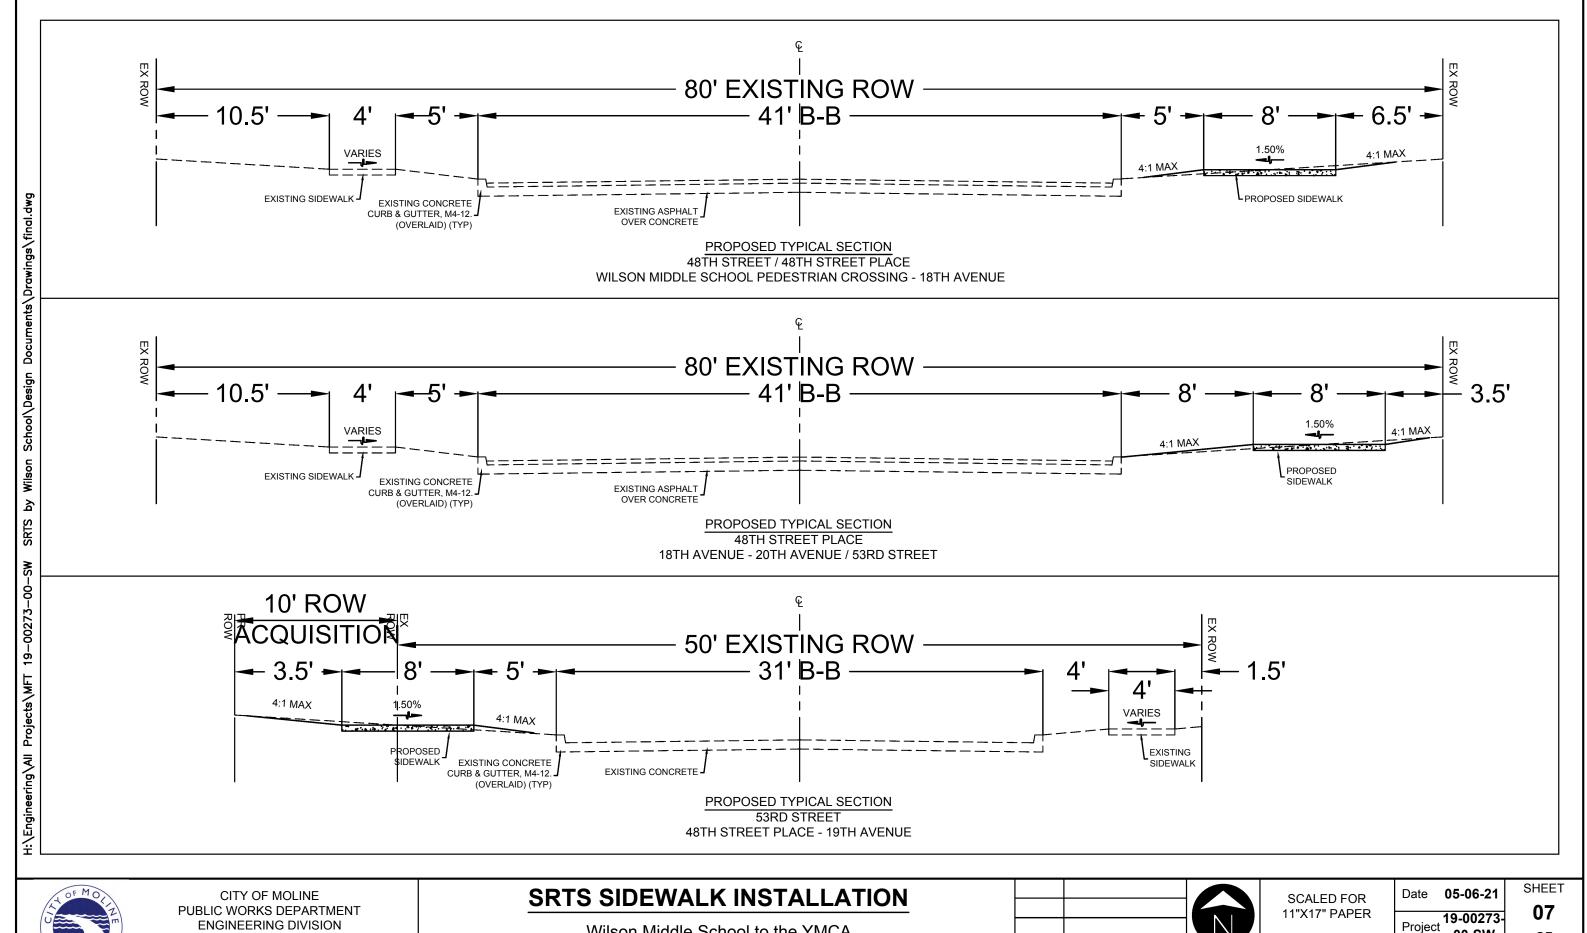

(309) 524-2350 3635 4TH AVENUE, MOLINE, IL 61265

Wilson Middle School to the YMCA **Proposed Typical Sections** 


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DATE	REVISION	NORTH	Ì

SCALED FOR 11"X17" PAPER			
0'	0'	0'	
SCA	ALE: N.T	.S.	

Project 00-SW

OF

Designer

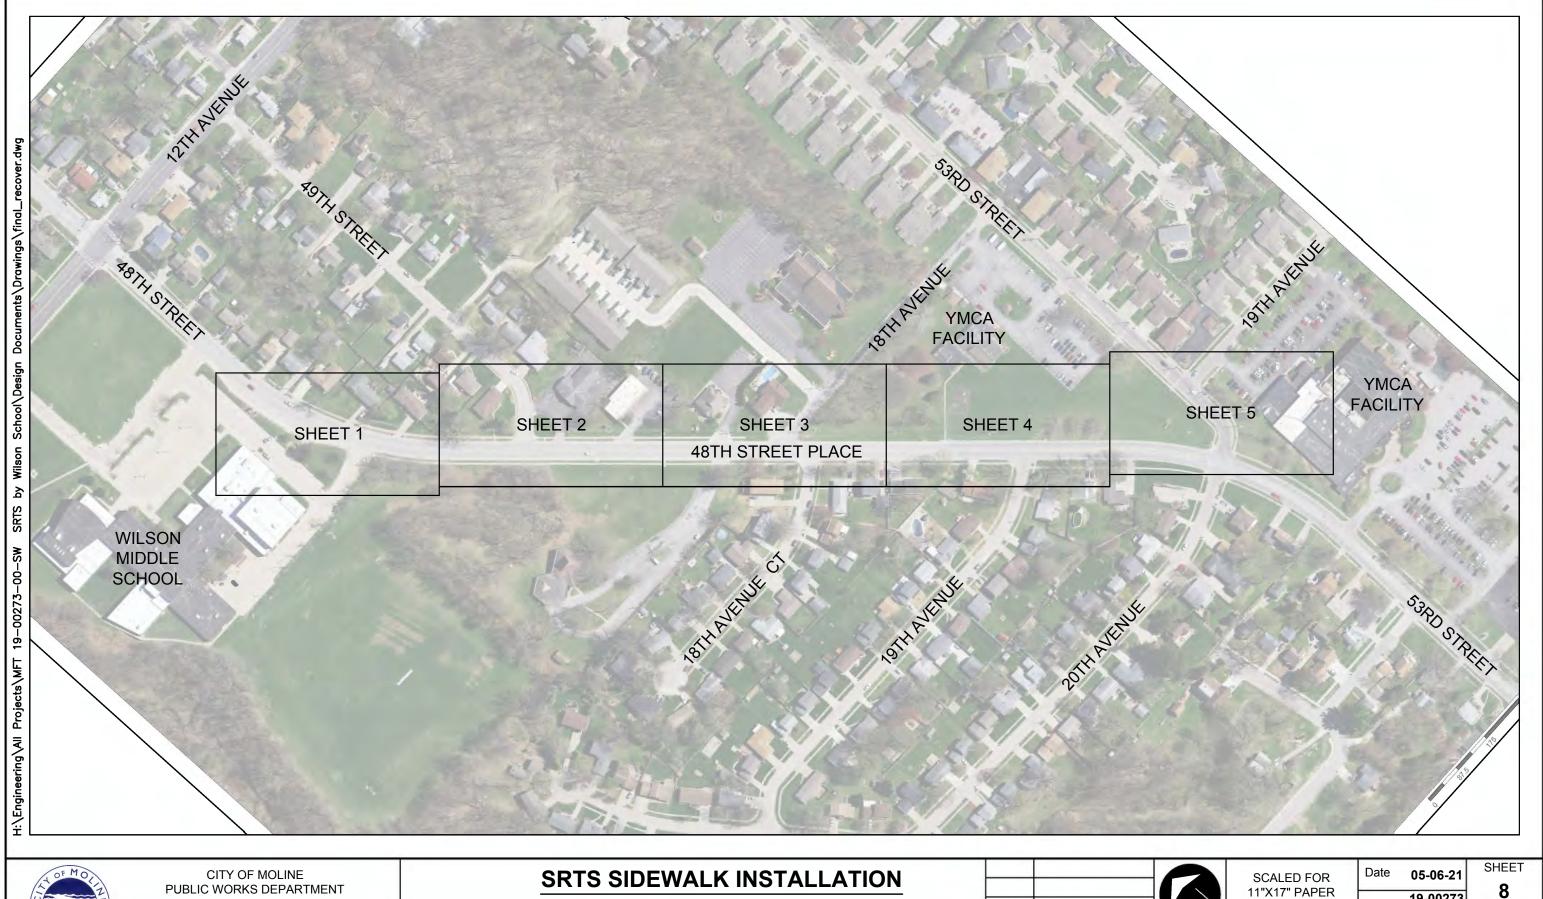



Wilson Middle School to the YMCA Index of Plan Sheets


		1
DATE	REVISION	NORTH

SCALED FOR 11"X17" PAPER	
0' 100' 200	)'

Project 19-00273 00-SW LK Designer SCALE: 1" = 200'

OF

29

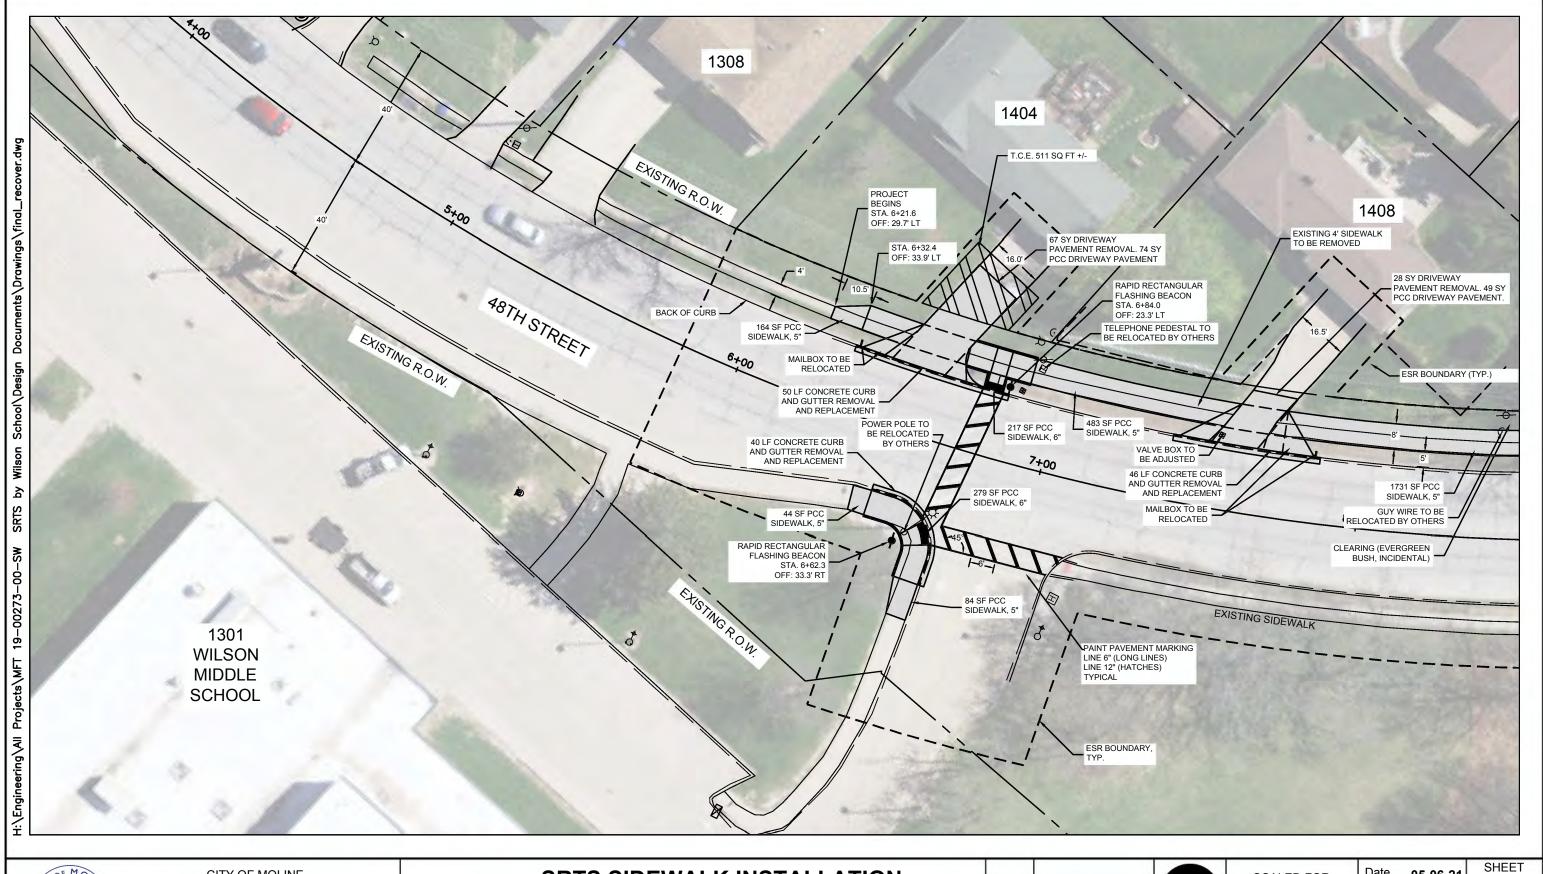



# **SRTS SIDEWALK INSTALLATION**


Wilson Middle School to the YMCA
Plan Sheet 1 / 5

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REVISION	NORTH

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SCALED FOR 11"X17" PAPER			
0'	15'	30'	
SCA	LE: 1" =	30'	

Date	05-06-21	SHEE
-	19-00273	00
Project	00-SW	OF
Designe	er <b>LK</b>	29

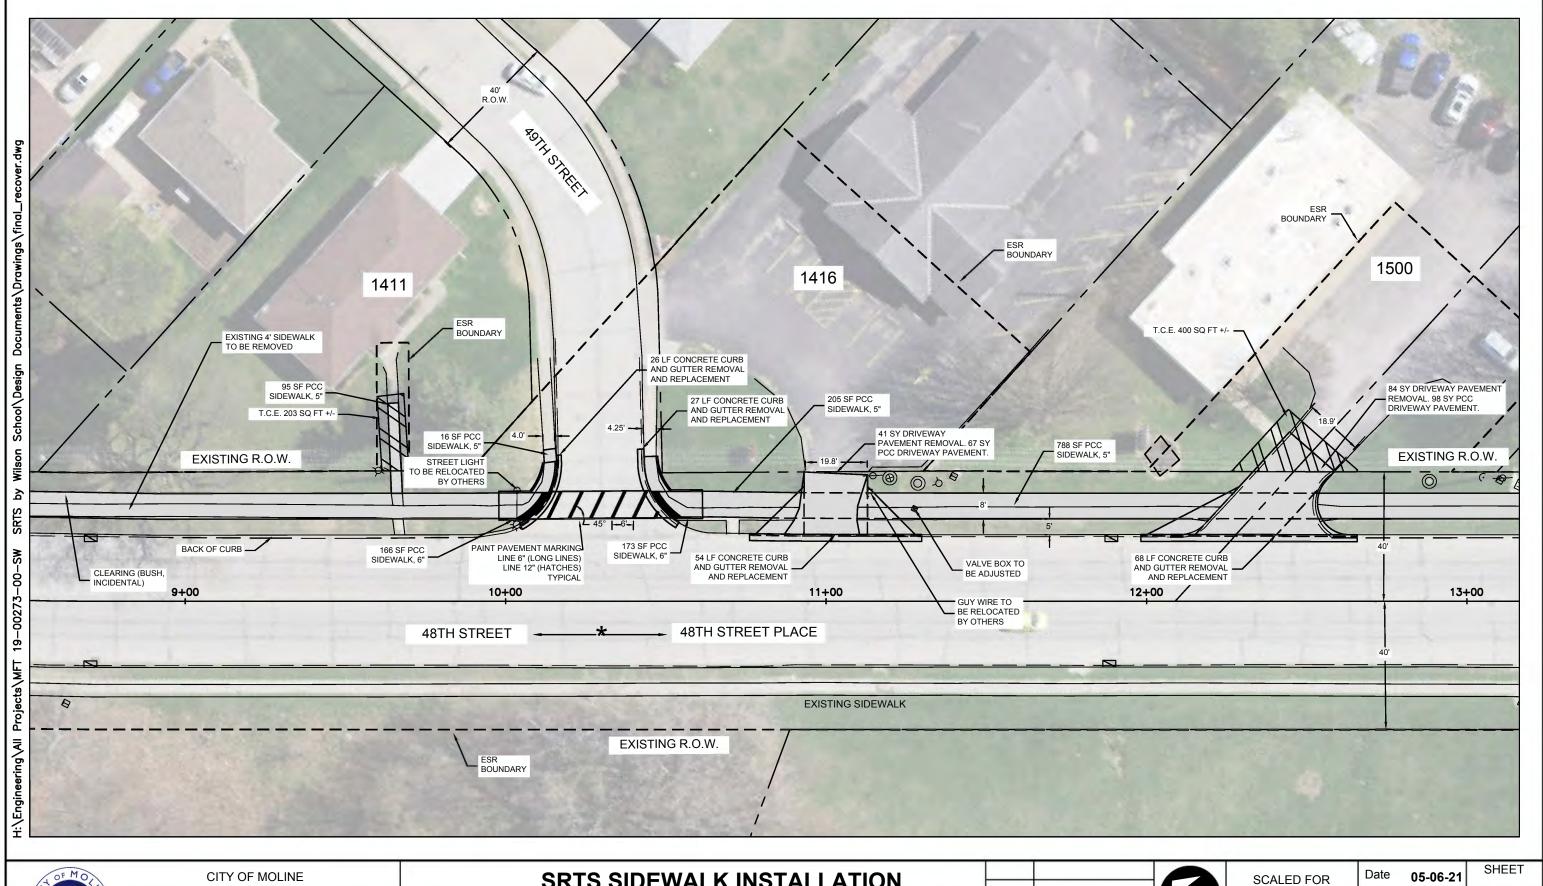


# **SRTS SIDEWALK INSTALLATION**


Wilson Middle School to the YMCA Plan Sheet 2 / 5

		6
DATE	REVISION	NORTH

SCALED FOR		
11"X17" PAPER 0' 15' 30'	F	
SCALE: 1" = 30'	[	

Date	05-06-21	SHEE
	19-00273	40
Project	00-SW	OF
Designe	er <b>LK</b>	29

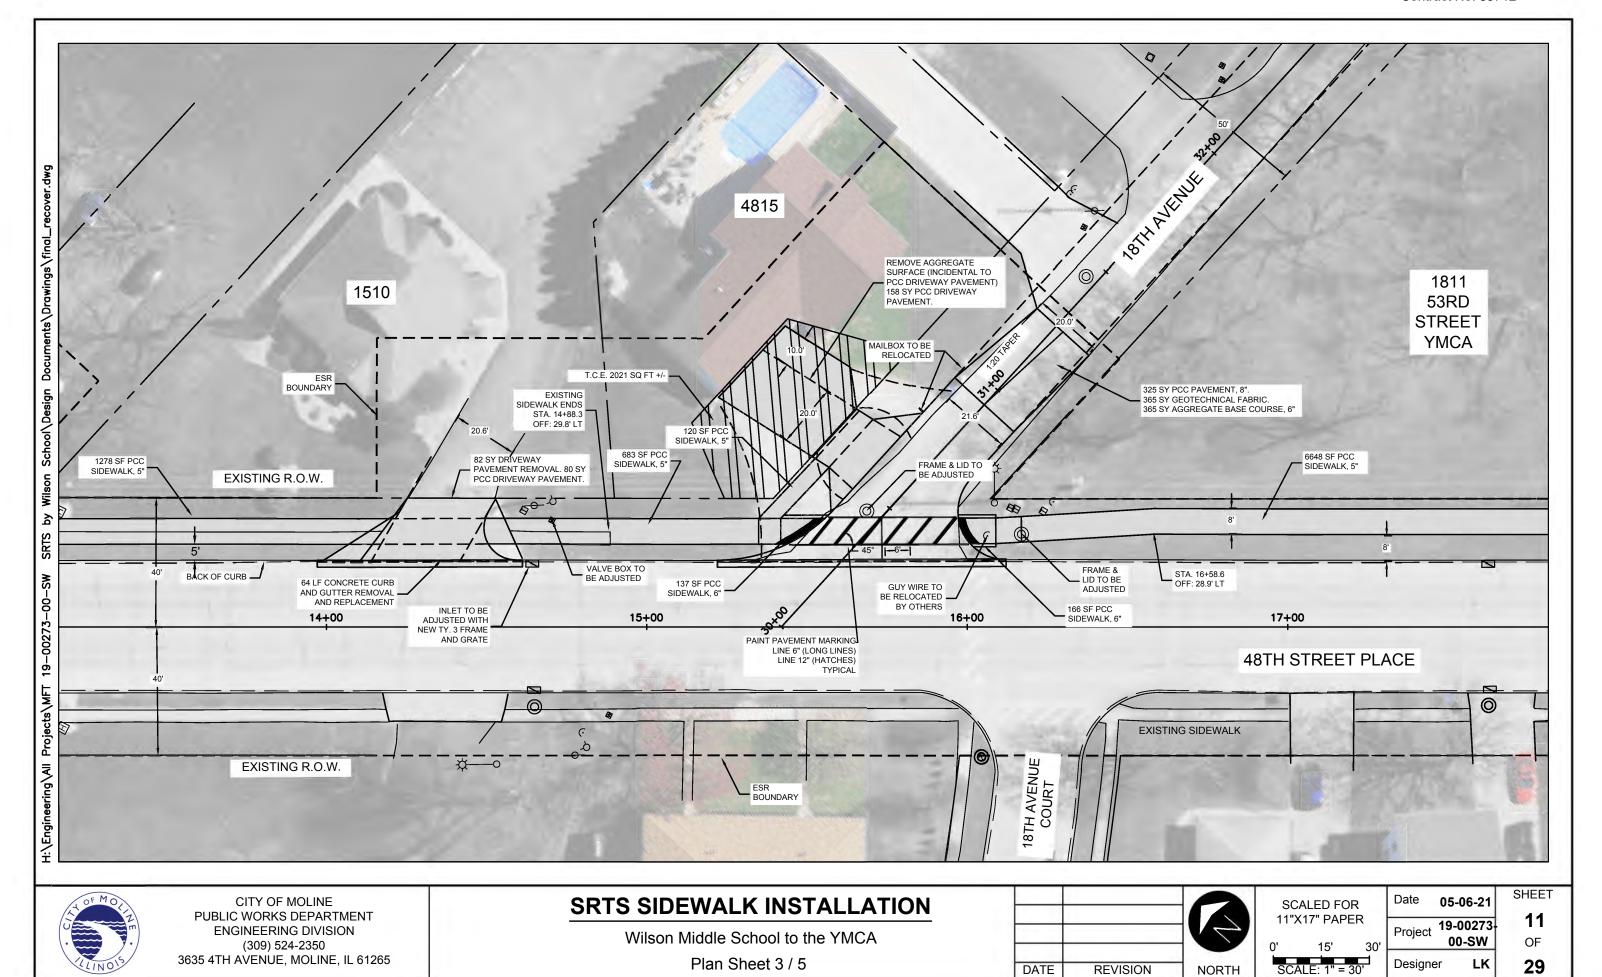

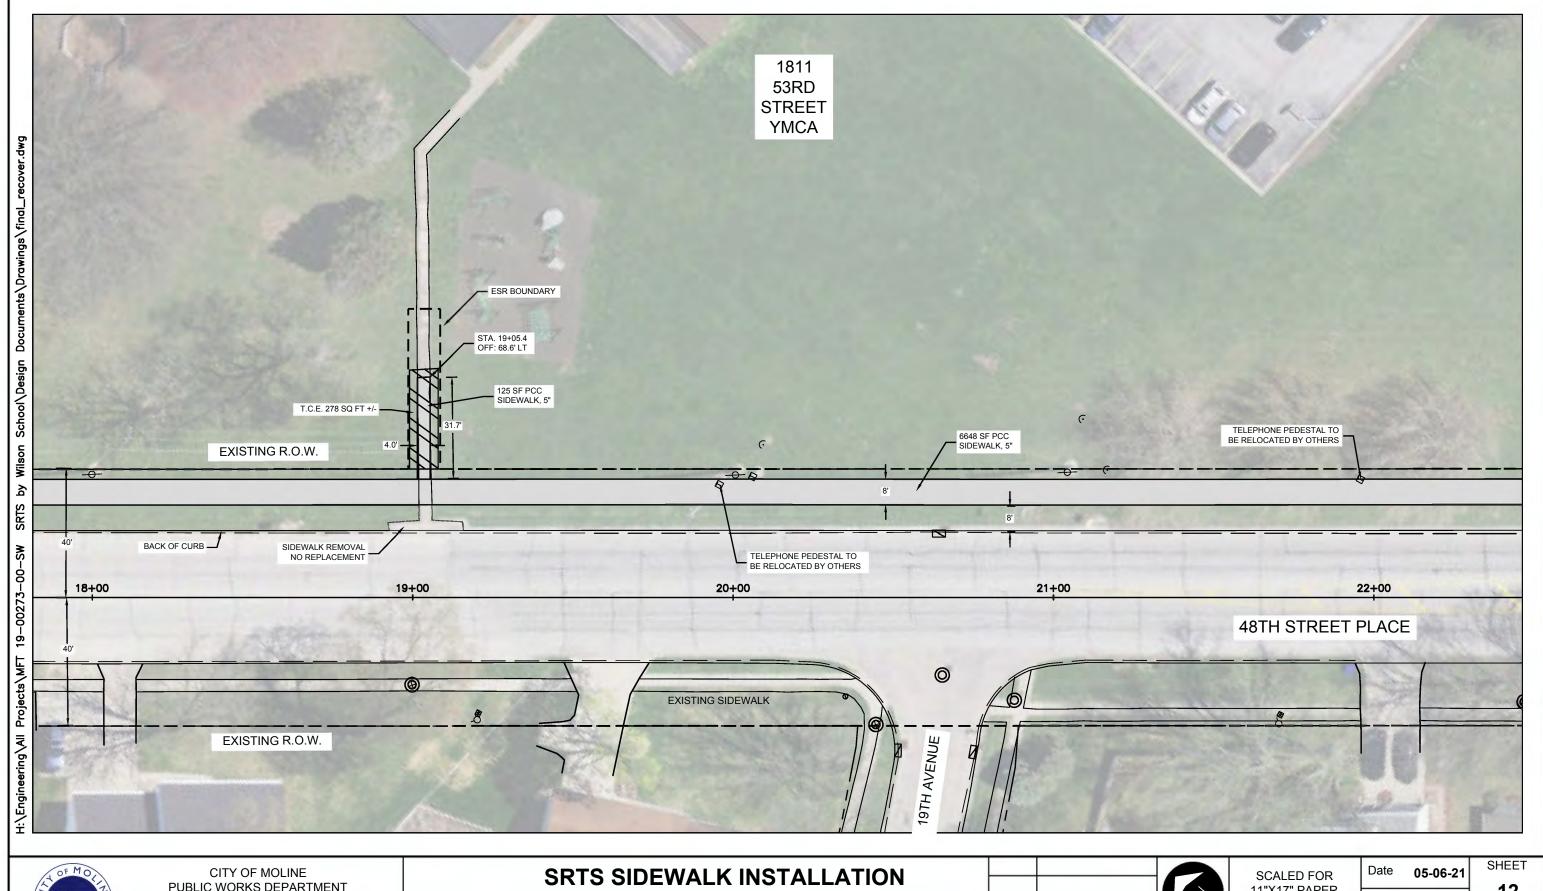




Wilson Middle School to the YMCA
Plan Sheet 4 / 5

		2
DATE	REVISION	NORTH

	LED FO 17" PAPI	• •
0'	15'	30'
SCALE: 1" = 30'		

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		40
Project	19-00273	. 12
Fioject	19-00273 00-SW	OF
Designe	er <b>LK</b>	29

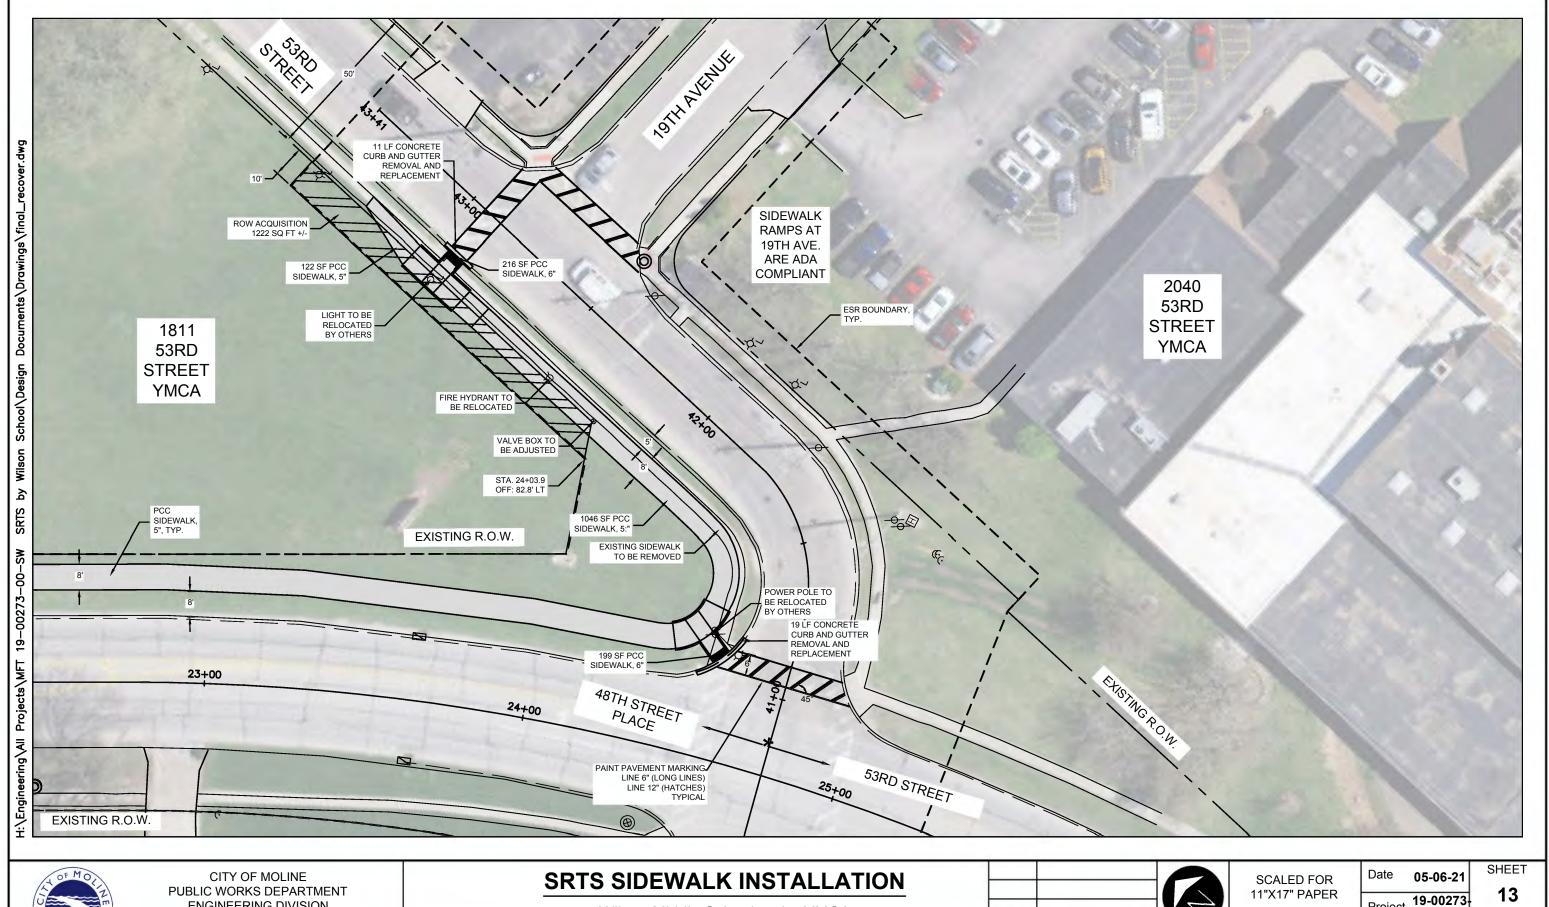

TOP HOLE

PUBLIC WORKS DEPARTMENT ENGINEERING DIVISION (309) 524-2350 3635 4TH AVENUE, MOLINE, IL 61265


Wilson Middle School to the YMCA
Plan Sheet 5 / 5

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	5
REVISION	NORTH

DATE

SCALED FOR 11"X17" PAPER		
0'	15'	30'
SCAI	E: 1" = :	30'

Date	05-06-21	SHEET
		13
Project	19-00273	0
	19-00273 00-SW	OF
Designe	er <b>LK</b>	29

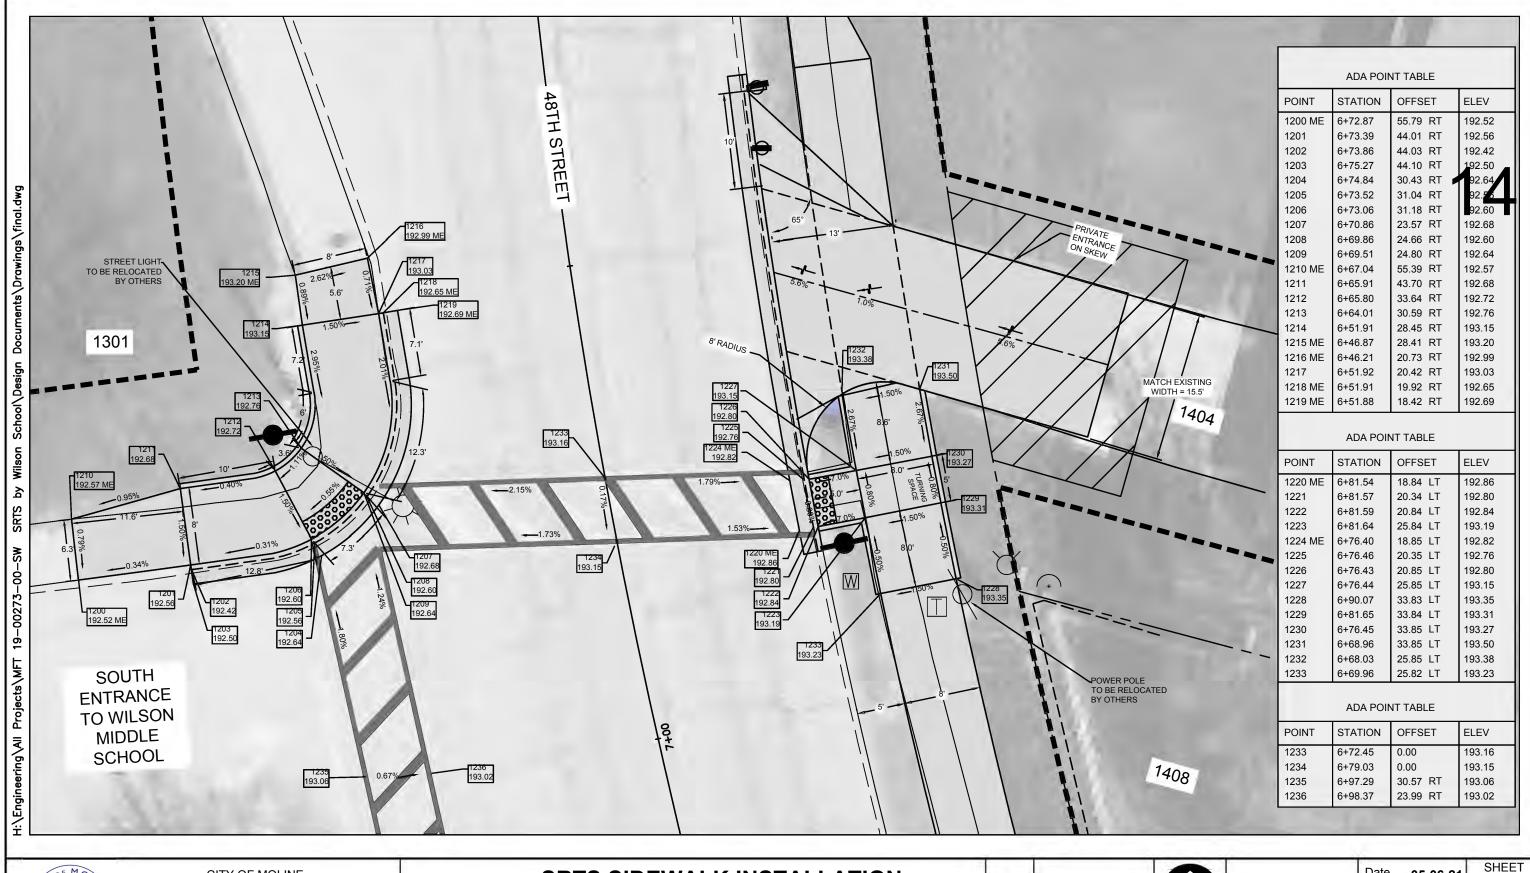




# **SRTS SIDEWALK INSTALLATION**

Wilson Middle School to the YMCA
ADA Details 1 / 5

		J
DATE	REVISION	NC

	CALED FO X17" PAF	
0'	5'	10
SC	ALE: 1" =	10'

	Date <b>05</b> .	-06-21	SHEE
R	40	00273	14
10'	Project 19-	0-SW	OF
<b>□</b>	Designer	LK	29

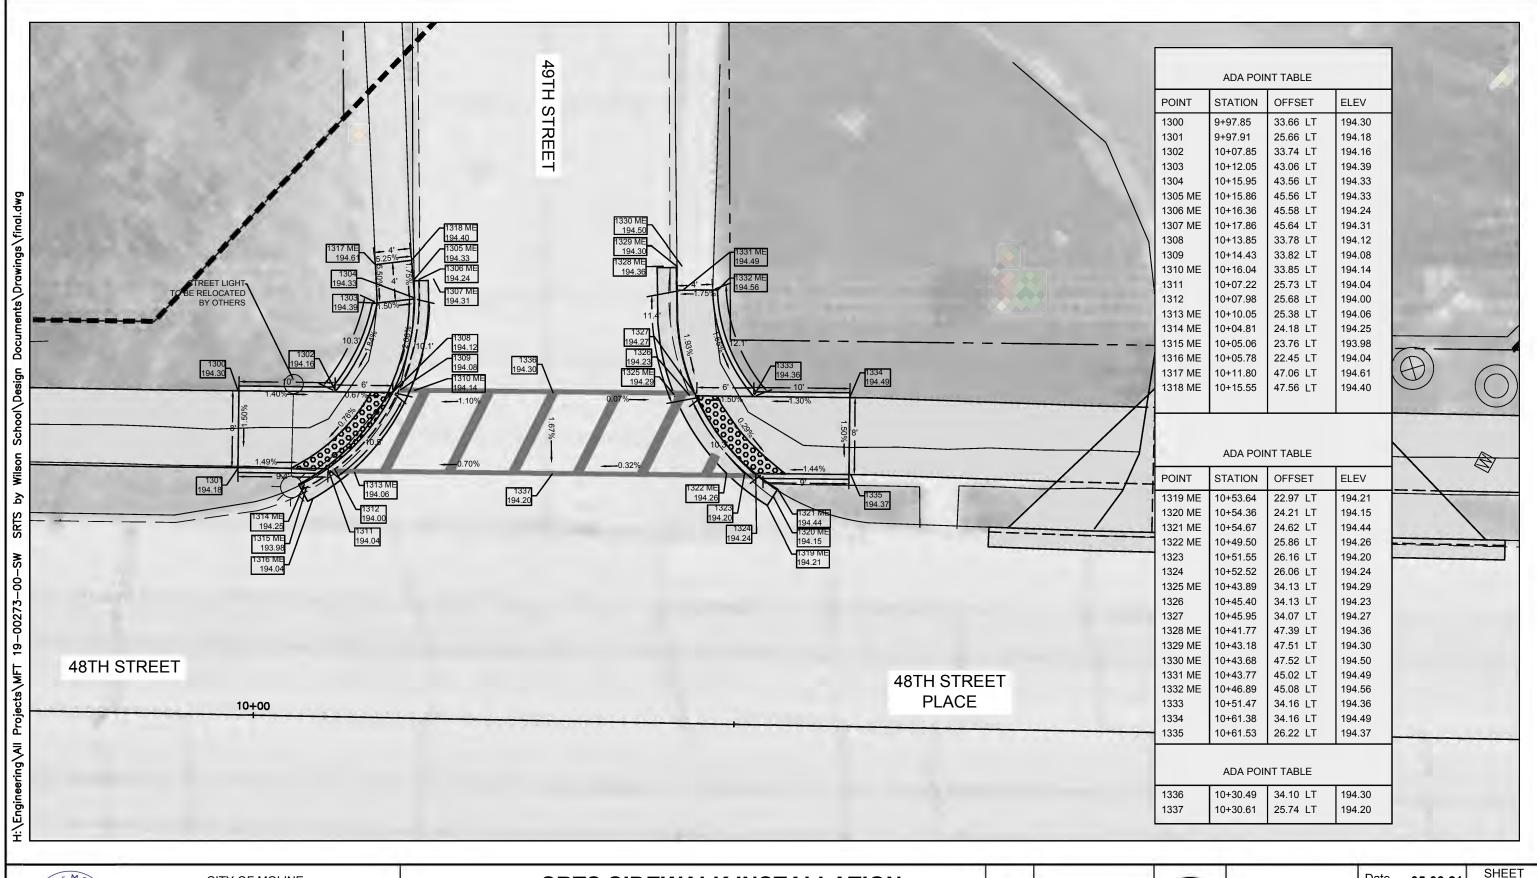



# **SRTS SIDEWALK INSTALLATION**

Wilson Middle School to the YMCA
ADA Details 2 / 5

		-6
		V
DATE	REVISION	N


	CALED F	
0'	5'	1

	Date	05-06-21	5
0'	Project	19-00273- 00-SW	
ť	Designe	er <b>LK</b>	

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OF

29



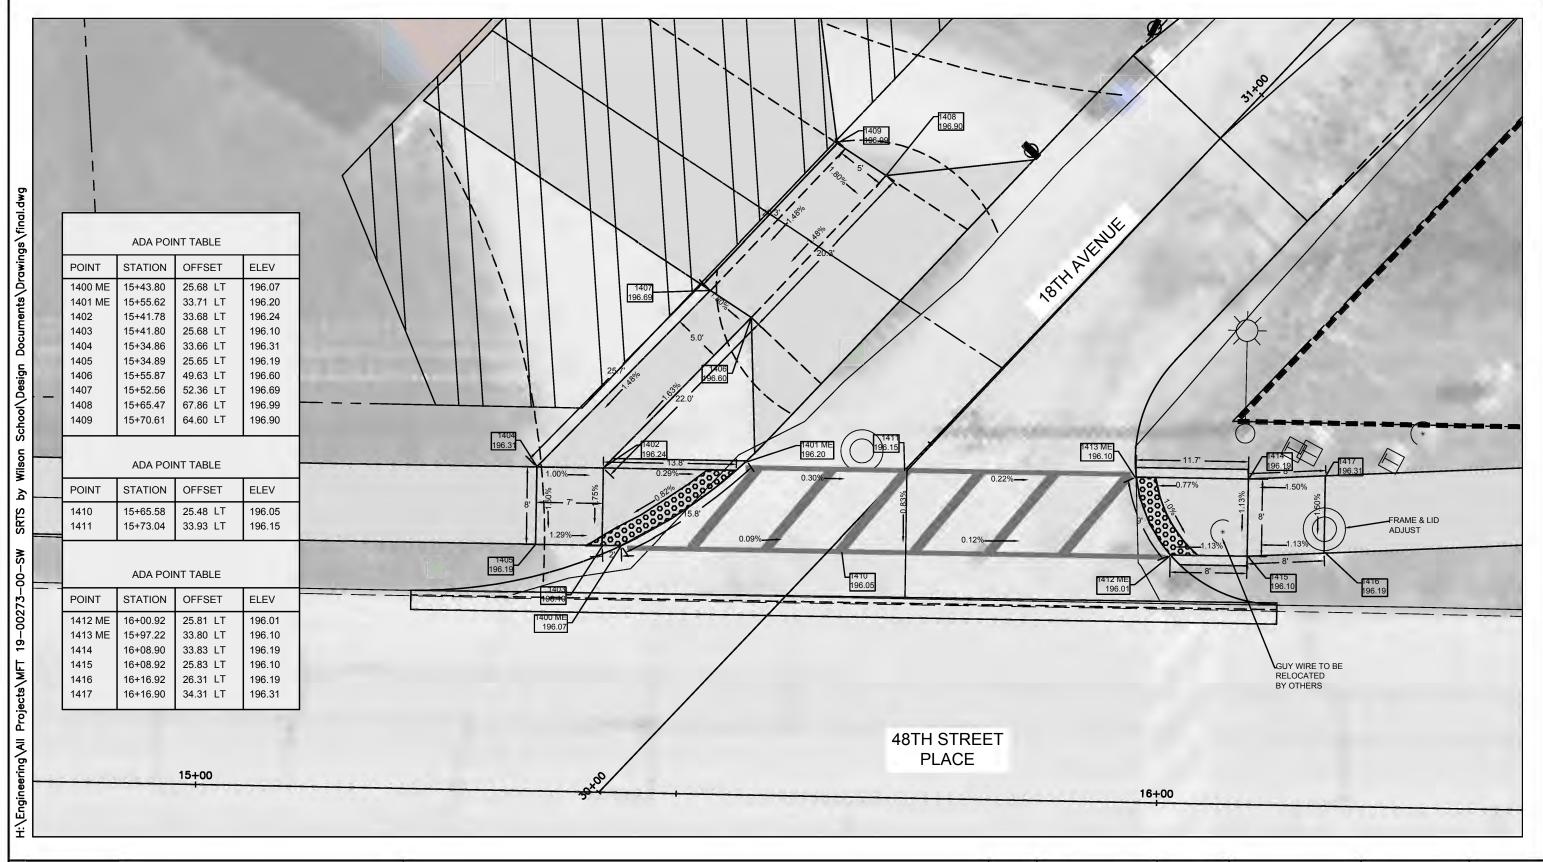


# **SRTS SIDEWALK INSTALLATION**

Wilson Middle School to the YMCA
ADA Details 3 / 5

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ATE	REVISION	NO

	ALED FO X17" PAF	
0'	5'	10
SCA	ALE: 1" =	10'

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₹		4.0
10'	Project 19-00273	OF
Ħ.	Designer <b>LK</b>	29

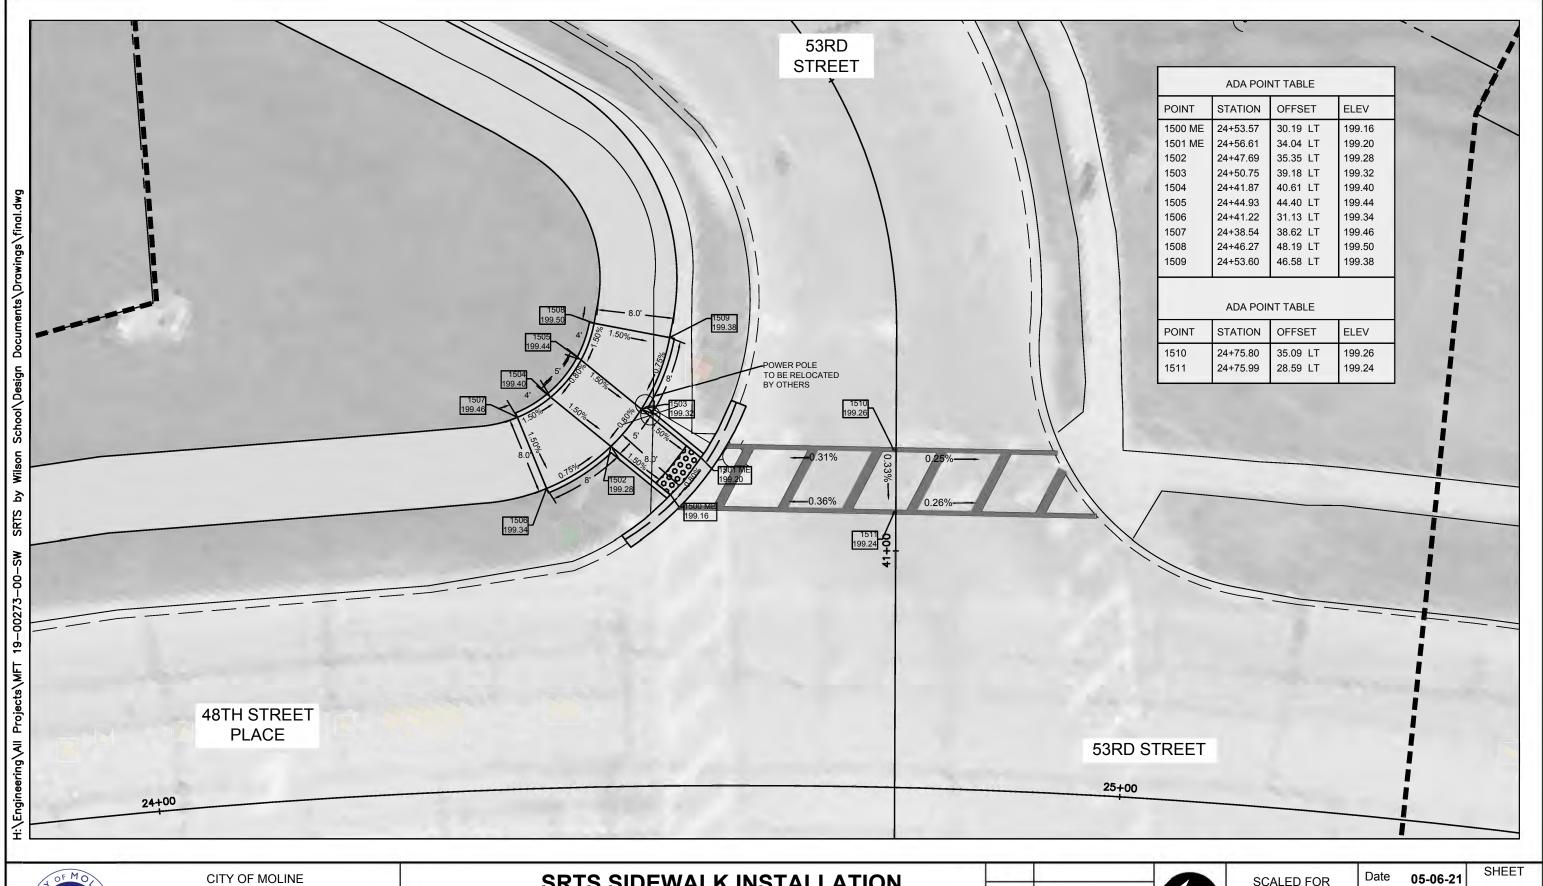



# **SRTS SIDEWALK INSTALLATION**

Wilson Middle School to the YMCA ADA Details 4 / 5

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DATE	REVISION	NC


	CALED FO X17" PAF	•
0'	5'	1
SC	ALE: 1" =	10'

CALED FOR	Date	05-06-21
X17" PAPER 5' 10'	Project	19-00273- 00-SW
ALE: 1" = 10'	Designe	er <b>LK</b>

17

OF

29

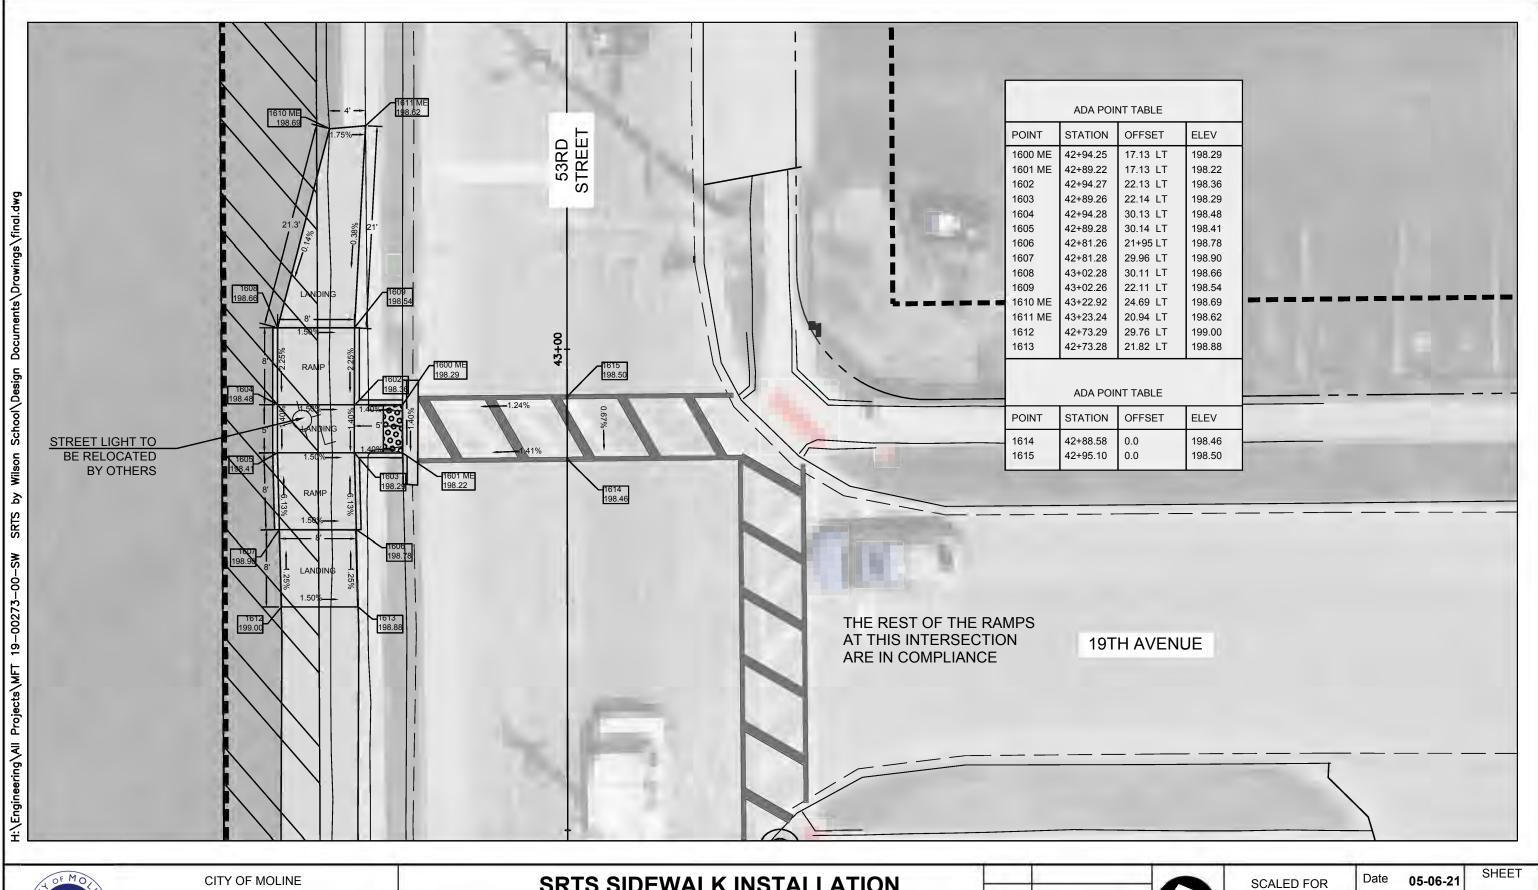


# **SRTS SIDEWALK INSTALLATION**

Wilson Middle School to the YMCA ADA Details 5 / 5

		W
DATE	REVISION	NORTH

	ALED F K17" PAF	•
0'	5'	10'
SC	ALE: 1" =	10'

Date 05	-06-21	SHEE
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Project 19-	0-SW	OF
Designer	LK	29

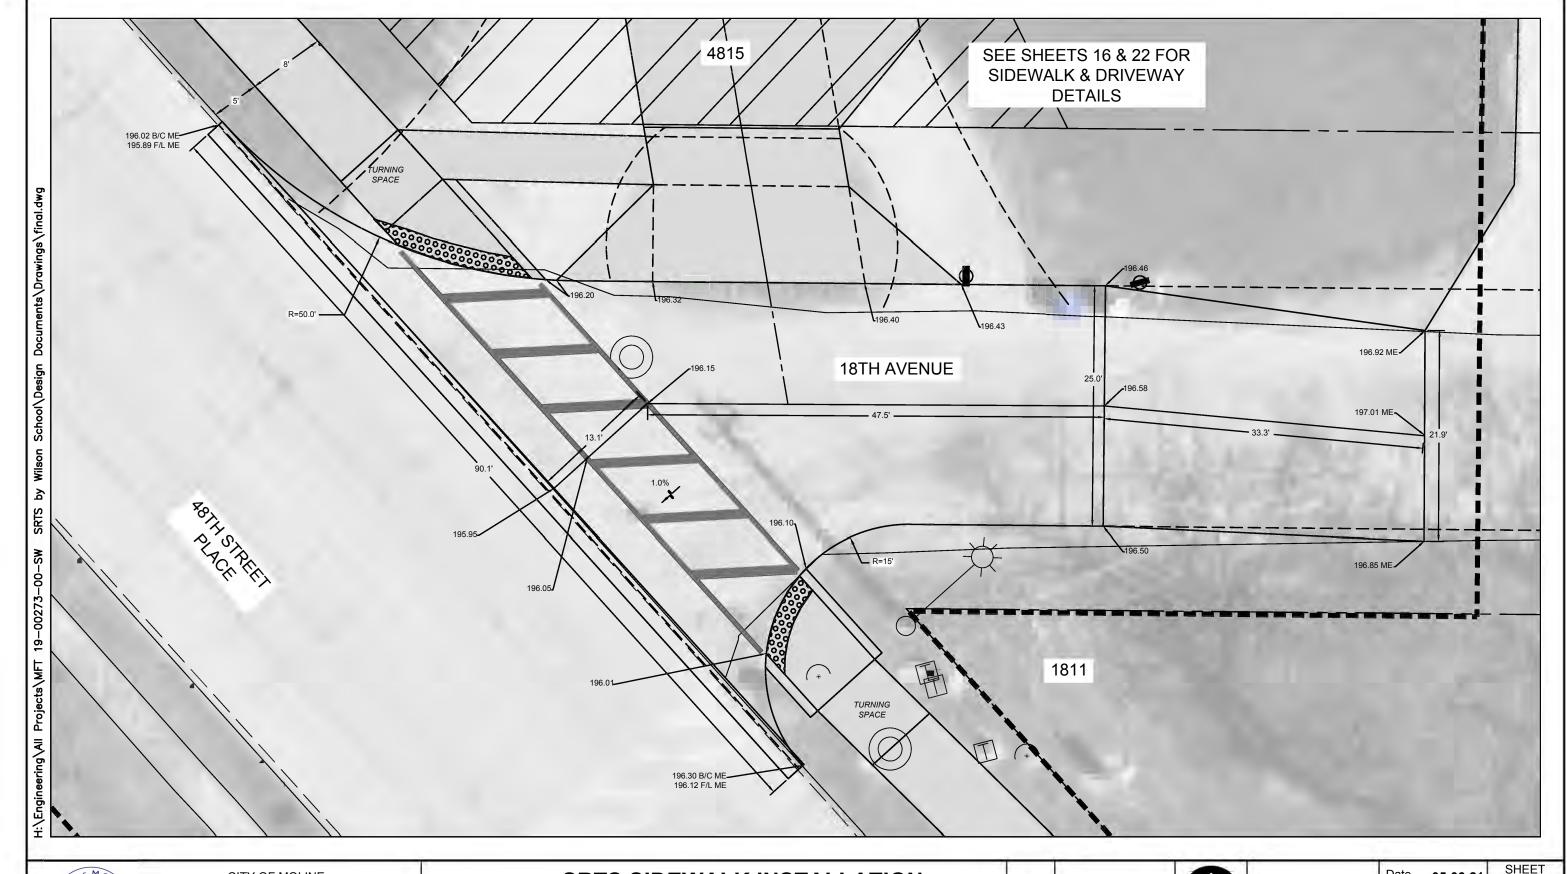



# **SRTS SIDEWALK INSTALLATION**


Wilson Middle School to the YMCA 18th Avenue Elevation Details

+	REVISION	NORTH
	KEVISION	INORIN

DATE

SCALED FOR 11"X17" PAPER		
0'	5'	10'
SCALE: 1" = 10'		

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0'	Project 19-00273-		OF
	Designer	LK	29

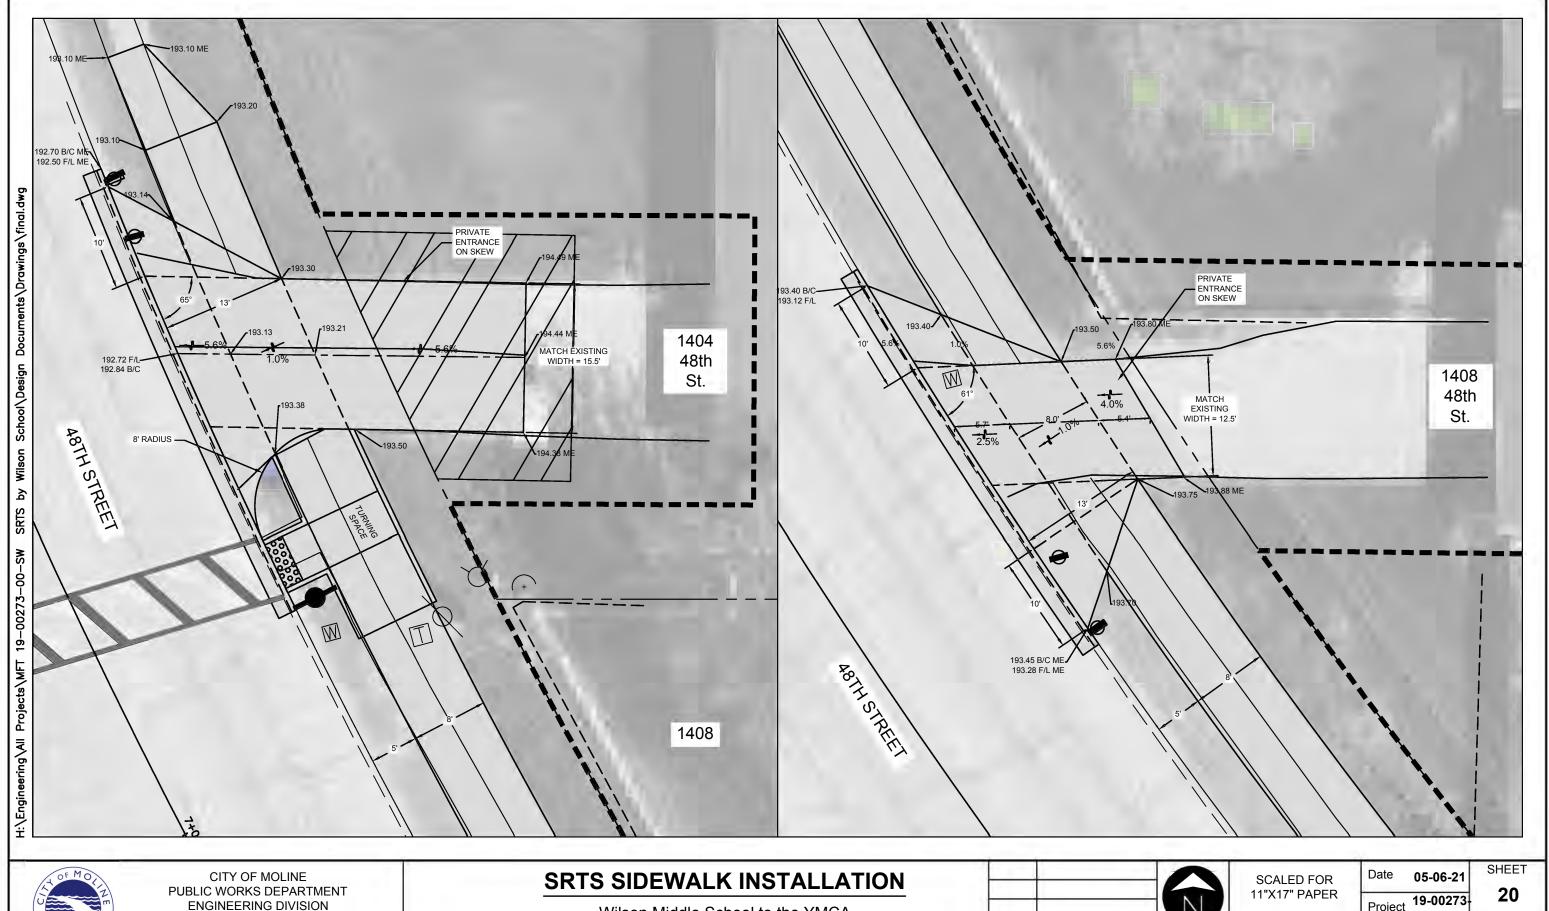


ENGINEERING DIVISION (309) 524-2350 3635 4TH AVENUE, MOLINE, IL 61265

Wilson Middle School to the YMCA Driveway Details 1/3

		N
DATE	REVISION	NORTH

SCALED FOR 11"X17" PAPER				
0'	5'	10'		
SC	ALE: 1" =	10'		

Date	Date <b>05-06-21</b>	
Project	19-00273 00-SW	OF
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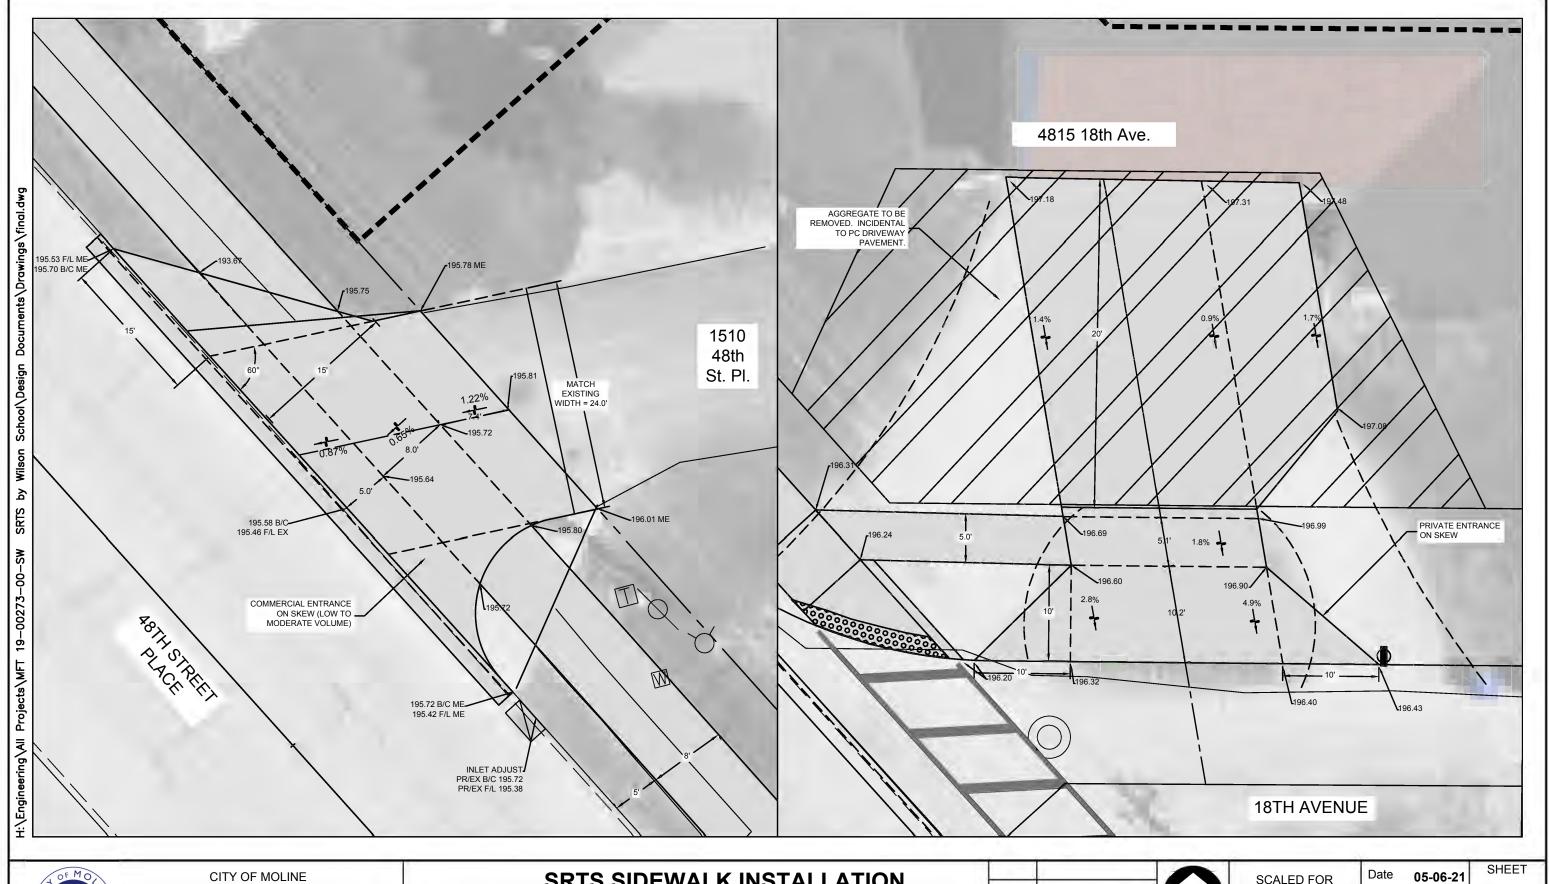
# **SRTS SIDEWALK INSTALLATION**

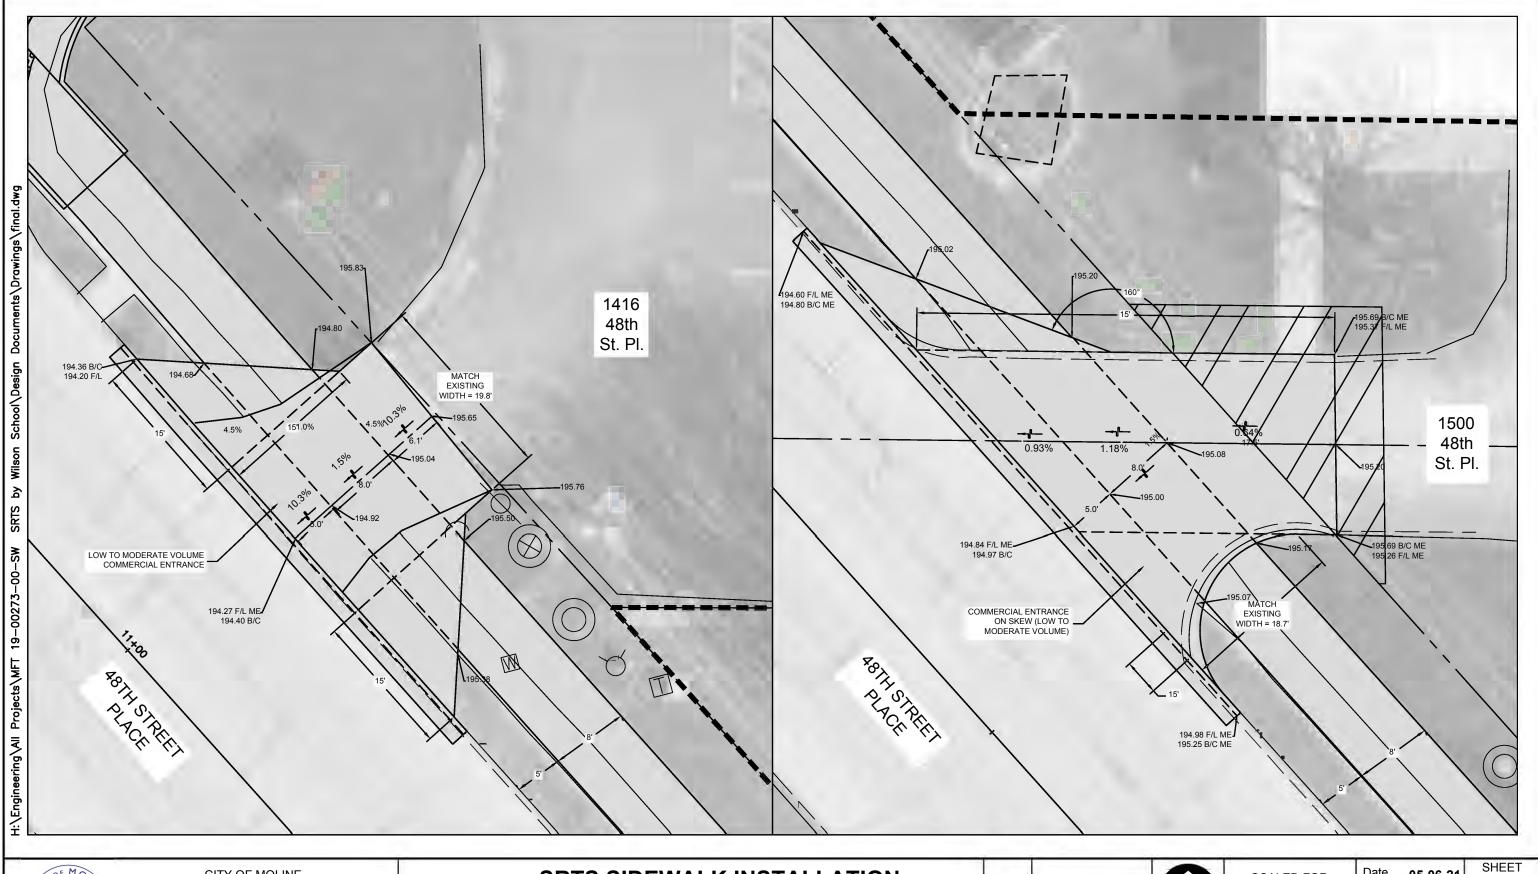Wilson Middle School to the YMCA
Driveway Details 2 / 3

		6
DATE	REVISION	NORTH

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0' SCA	5' LE: 1" =	10'

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10'	Project 19-00273	0
≓"	Designer <b>LK</b>	2





# **SRTS SIDEWALK INSTALLATION**

Wilson Middle School to the YMCA Driveway Details 3 / 3

		N
DATE	REVISION	NORTH

SCALED FOR 11"X17" PAPER				
0'	5'	10'		
SCA	ALE: 1" =	10'		

1	Date	05-06-21	SHEET
	Project	19-00273 00-SW	22
		00-SW	OF
	Designe	r <b>LK</b>	29

# CATCH BASIN OR INLETS TO BE ADJUSTED OR RECONSTRUCTED

(DETAILS FOR CURB & GUTTER REPLACEMENT)

CONCRETE CURB AND GUTTER SHALL BE CONSTRUCTED IN ACCORDANCE WITH SECTION 606 OF THE STANDARD SPECIFICATIONS, SUPPLEMENTAL SPECIFICATIONS, STANDARD 606001 AND THIS DRAWING.

CLASS SI CONCRETE SHALL BE USED THROUGHOUT. A HOLE 1-1/2 IN DIAMETER AND 9 DEEP SHALL BE DRILLED IN THE EXISTING CONCRETE CURB AS SHOWN. A 1-1/4 X 18 SMOOTH DOWEL BAR SHALL BE GROUTED IN THE HOLE LONGITUDINALLY.


JOINTS OF A TYPE SIMILAR TO THAT IN THE UNDER-LYING PAVEMENT (EXPANSION OR CONTRACTION) SHALL BE INSTALLED IN THE CONCRETE CURB IN ALIGNMENT WITH THE JOINTS IN THE PAVEMENT.

THE PROPOSED CONFIGURATION OF THE CURB AND GUTTER SHALL MATCH THAT REMOVED.

THE LOCATION OF THE DOWEL BAR SHALL BE DETERMINED BY THE ENGINEER.


ALL EXISTING TIE BARS IN EDGE OF PAVEMENT SLAB THRU REPLACEMENT AREA SHALL BE CUT OFF.

THE WORK SHALL BE DONE IN ACCORDANCE WITH SECTION 602 OF THE STANDARD SPECIFICATIONS AND INCLUDES THE REMOVAL AND REPLACEMENT OF SOD, CONCRETE PAVEMENT AND/OR CURB AND GUTTER ADJACENT TO CATCH BASINS OR INLETS TO BE ADJUSTED OR RECONSTRUCTED AND SHALL BE INCLUDED IN THE PAY ITEM OF CATCH BASINS OR INLETS TO BE ADJUSTED OR RECONSTRUCTED AS SPECIFIED.

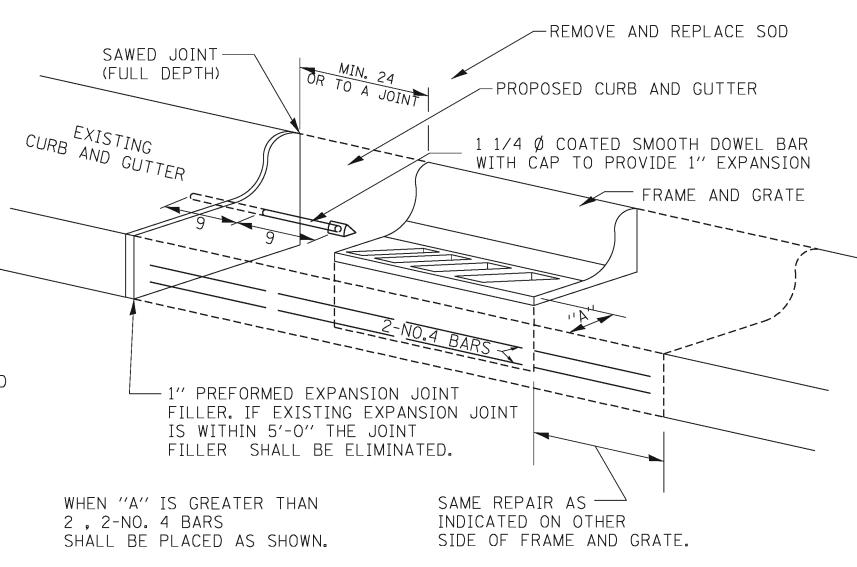



ALL DIMENSIONS ARE IN INCHES UNLESS OTHERWISE NOTED.

-	REVISED - 9-30-11		F.A. RTE.	SECTION	COUNTY	TOTAL SHEETS	SHEET NO.
ATE	REVISED -	REGION 2 / DISTRICT 2 STANDARD				29	23
	REVISED -				CONTRACT		
PL0	REVISED -	SCALE: 1.00000 ' / 1n. SHEET NO. OF SHEETS STA. TO STA.	FED. RO	DAD DIST. NO.   ILLINOIS	FED. AID PROJECT		

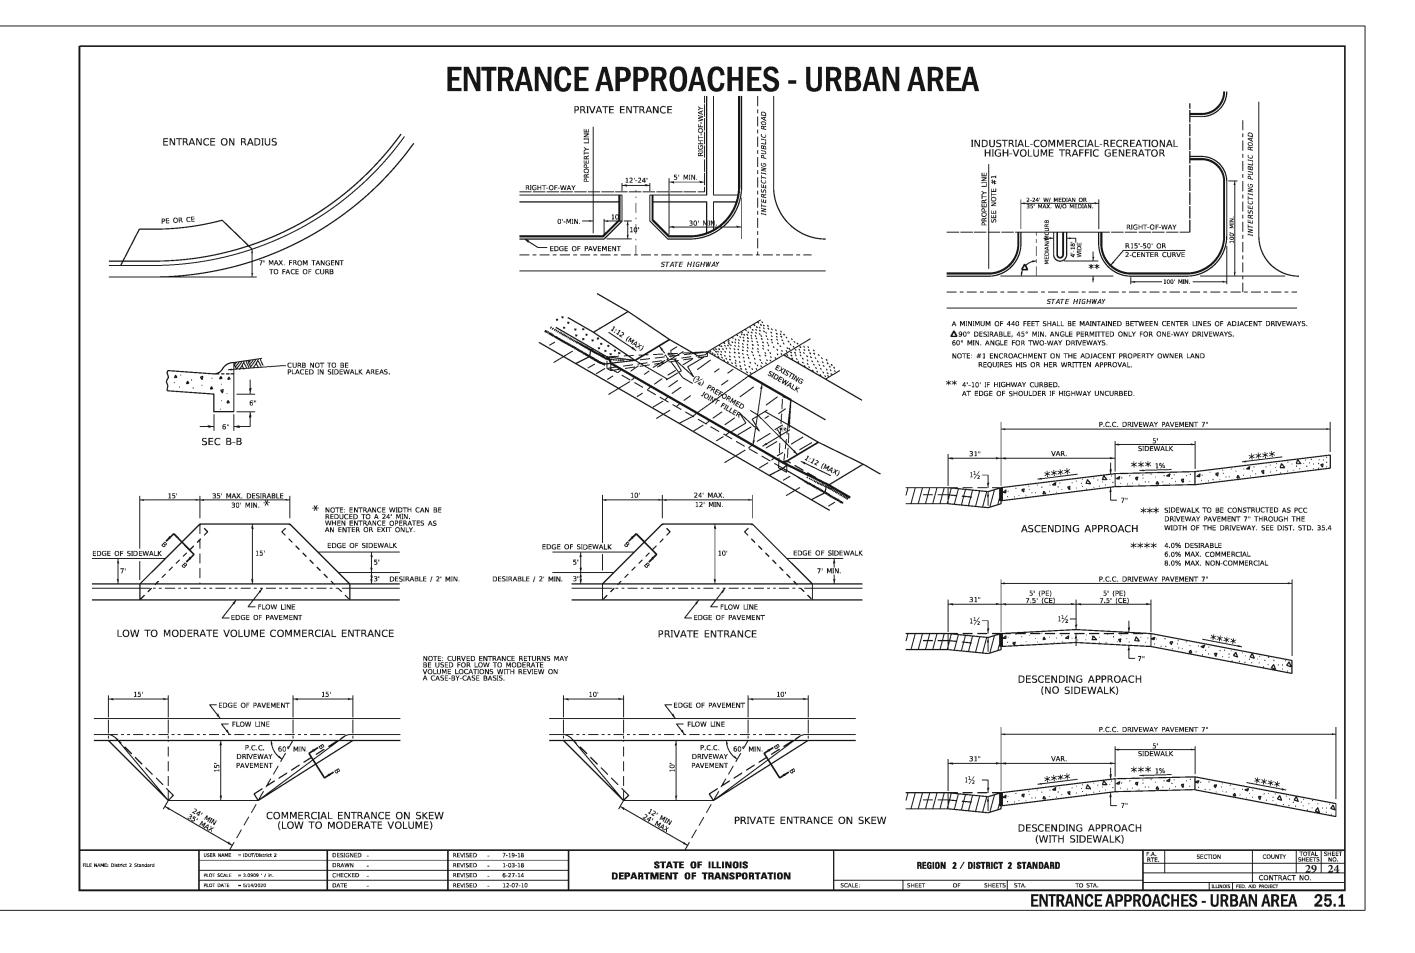

# SIDEWALK AND DRIVEWAY PAVEMENT PAY AREAS

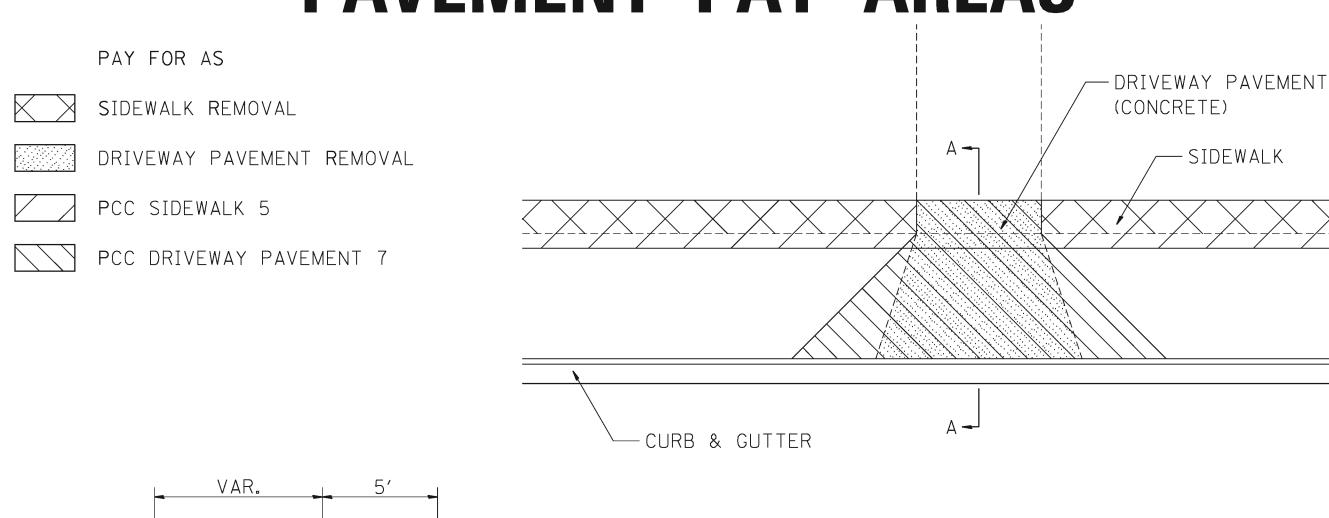


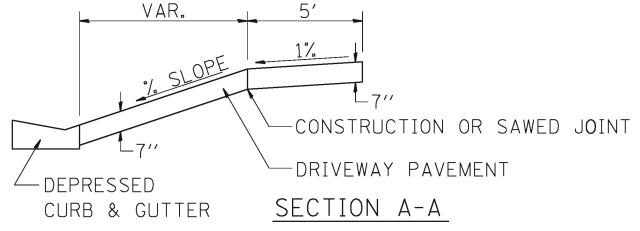



FOR DETAILS ON DIMENSIONS AND GRADES, SEE DISTRICT STANDARD 25.1 OR PLANS.

ALL DIMENSIONS ARE IN INCHES UNLESS OTHERWISE NOTED.

1	REVISED - 6-27-14		F.A. RTE.	SECTION	COUNTY	TOTAL SHEETS	SHEET NO.
4TE	REVISED - 10-03-11	REGION 2 / DISTRICT 2 STANDARD				29	25
	REVISED -				CONTRACT	NO. 85	5712
PLO	REVISED -	SCALE: 1.0000 '/ in. SHEET NO. OF SHEETS STA. TO STA.	FED. RO	DAD DIST. NO.   ILLINOIS FED. AID	) PROJECT		

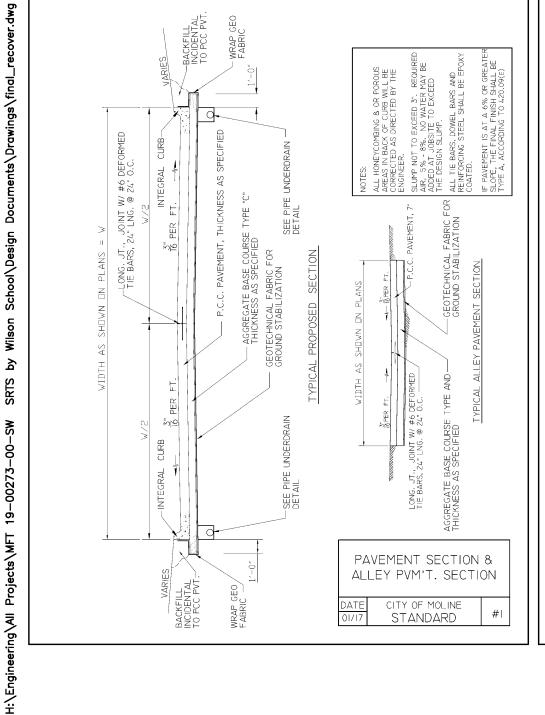

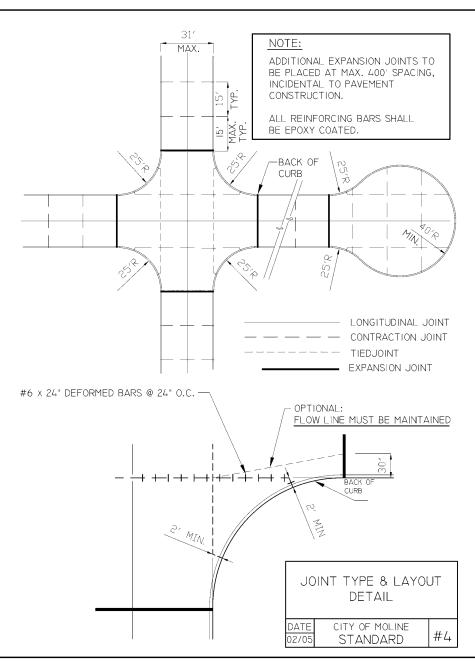

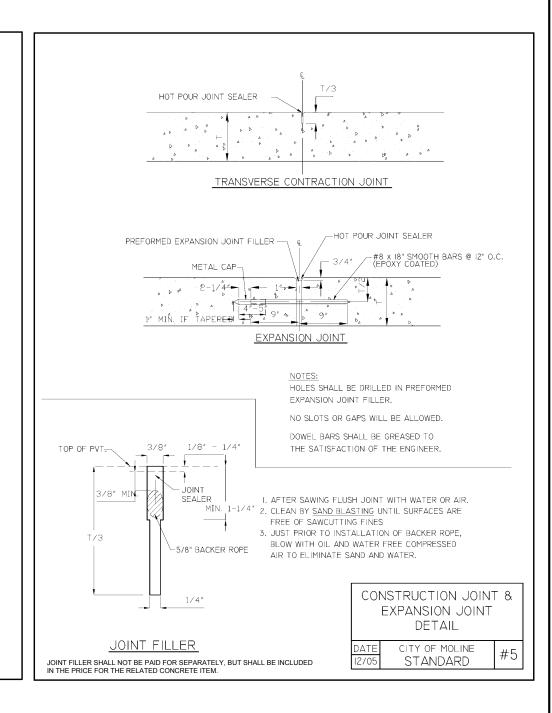



# **SRTS SIDEWALK INSTALLATION**


Wilson Middle School to the YMCA City of Moline Details 1 / 4


DATE	REVISION	NORTH


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0'	0'	0

SCALED FOR	Date <b>05-06-21</b>
11"X17" PAPER	Project <b>19-00273 00-SW</b>
SCALE: N.T.S.	Designer <b>LK</b>

SHEET OF

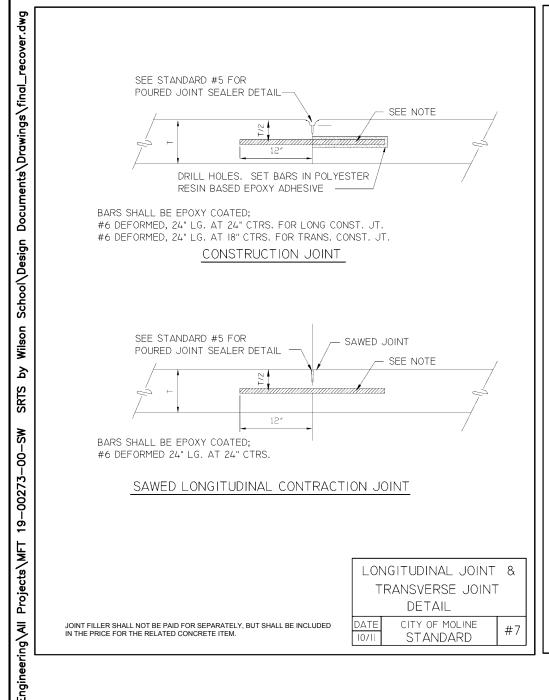

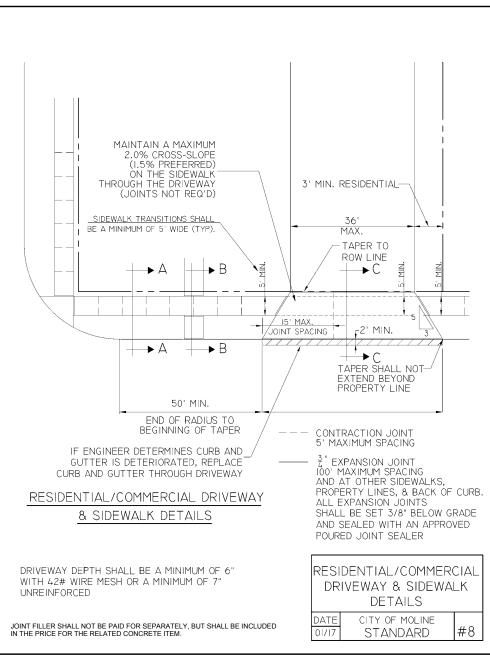

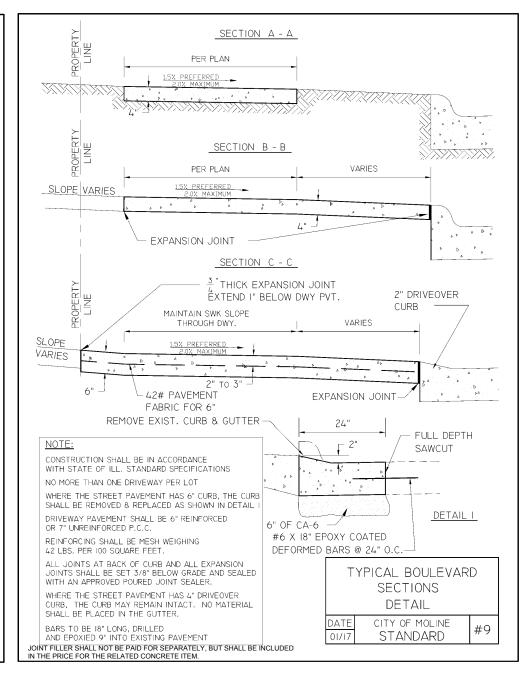



# **SRTS SIDEWALK INSTALLATION**

Wilson Middle School to the YMCA City of Moline Details 2 / 4


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DATE	REVISION	NORTH


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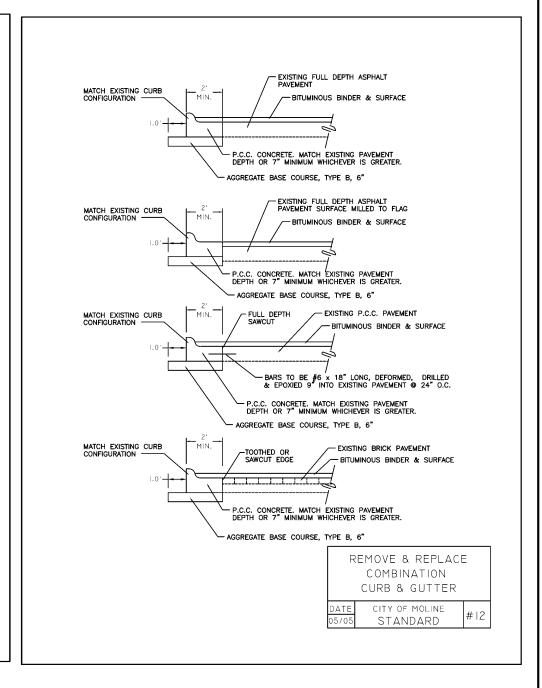
SCALE: N.T.S.

Date 05-06-21 19-00273-Project 00-SW Designer

SHEET OF



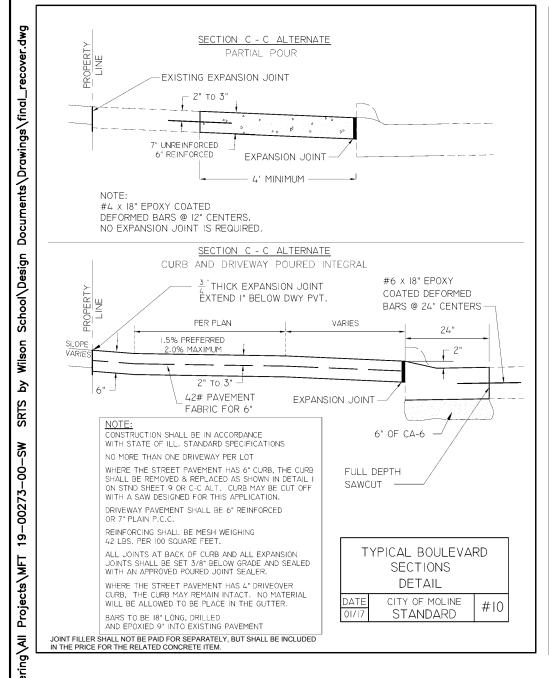

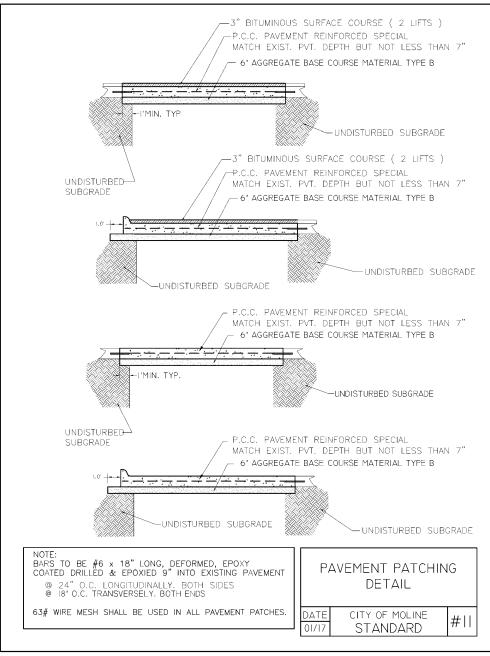



# **SRTS SIDEWALK INSTALLATION**

Wilson Middle School to the YMCA

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SCALED FOR 11"X17" PAPER		
0'	0'	

SCALE: N.T.S.


Date 05-06-21 19-00273-Project 00-SW


OF

SHEET

Designer

City of Moline Details 3 / 4

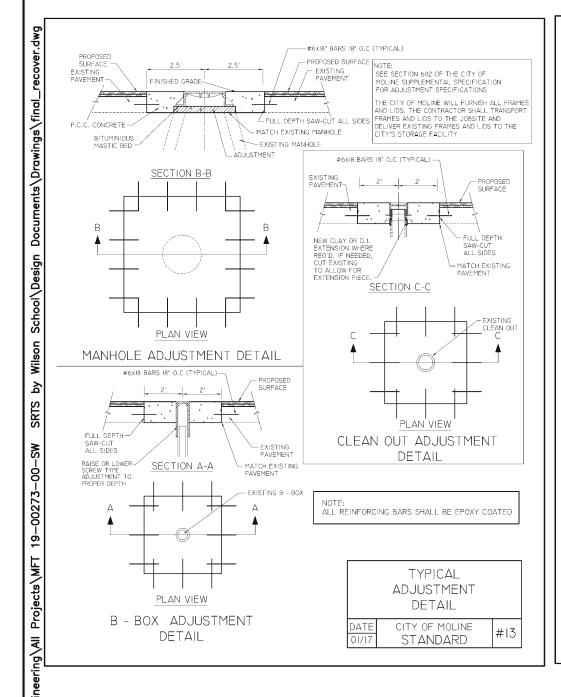

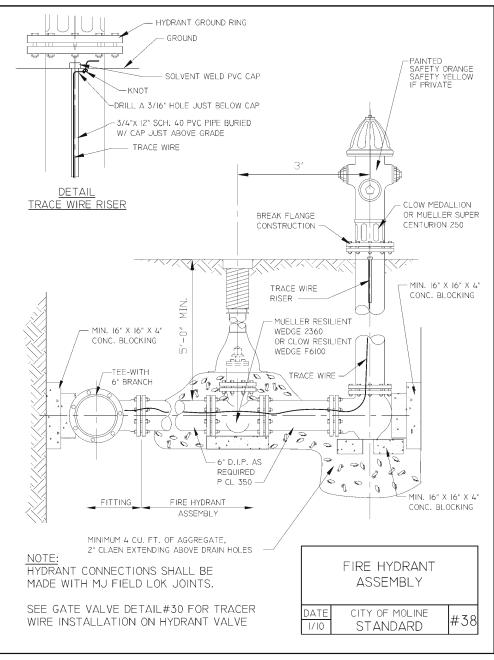



# **SRTS SIDEWALK INSTALLATION**

Wilson Middle School to the YMCA City of Moline Details 4 / 4

DATE	REVISION	NORTH

SCALED FOR 11"X17" PAPER		
0'	0'	C

SCALED FOR	Date <b>05-06-21</b>
11"X17" PAPER 0' 0' 0'	Project <b>19-00273 00-SW</b>
SCALE: N.T.S.	Designer <b>LK</b>

SHEET OF