


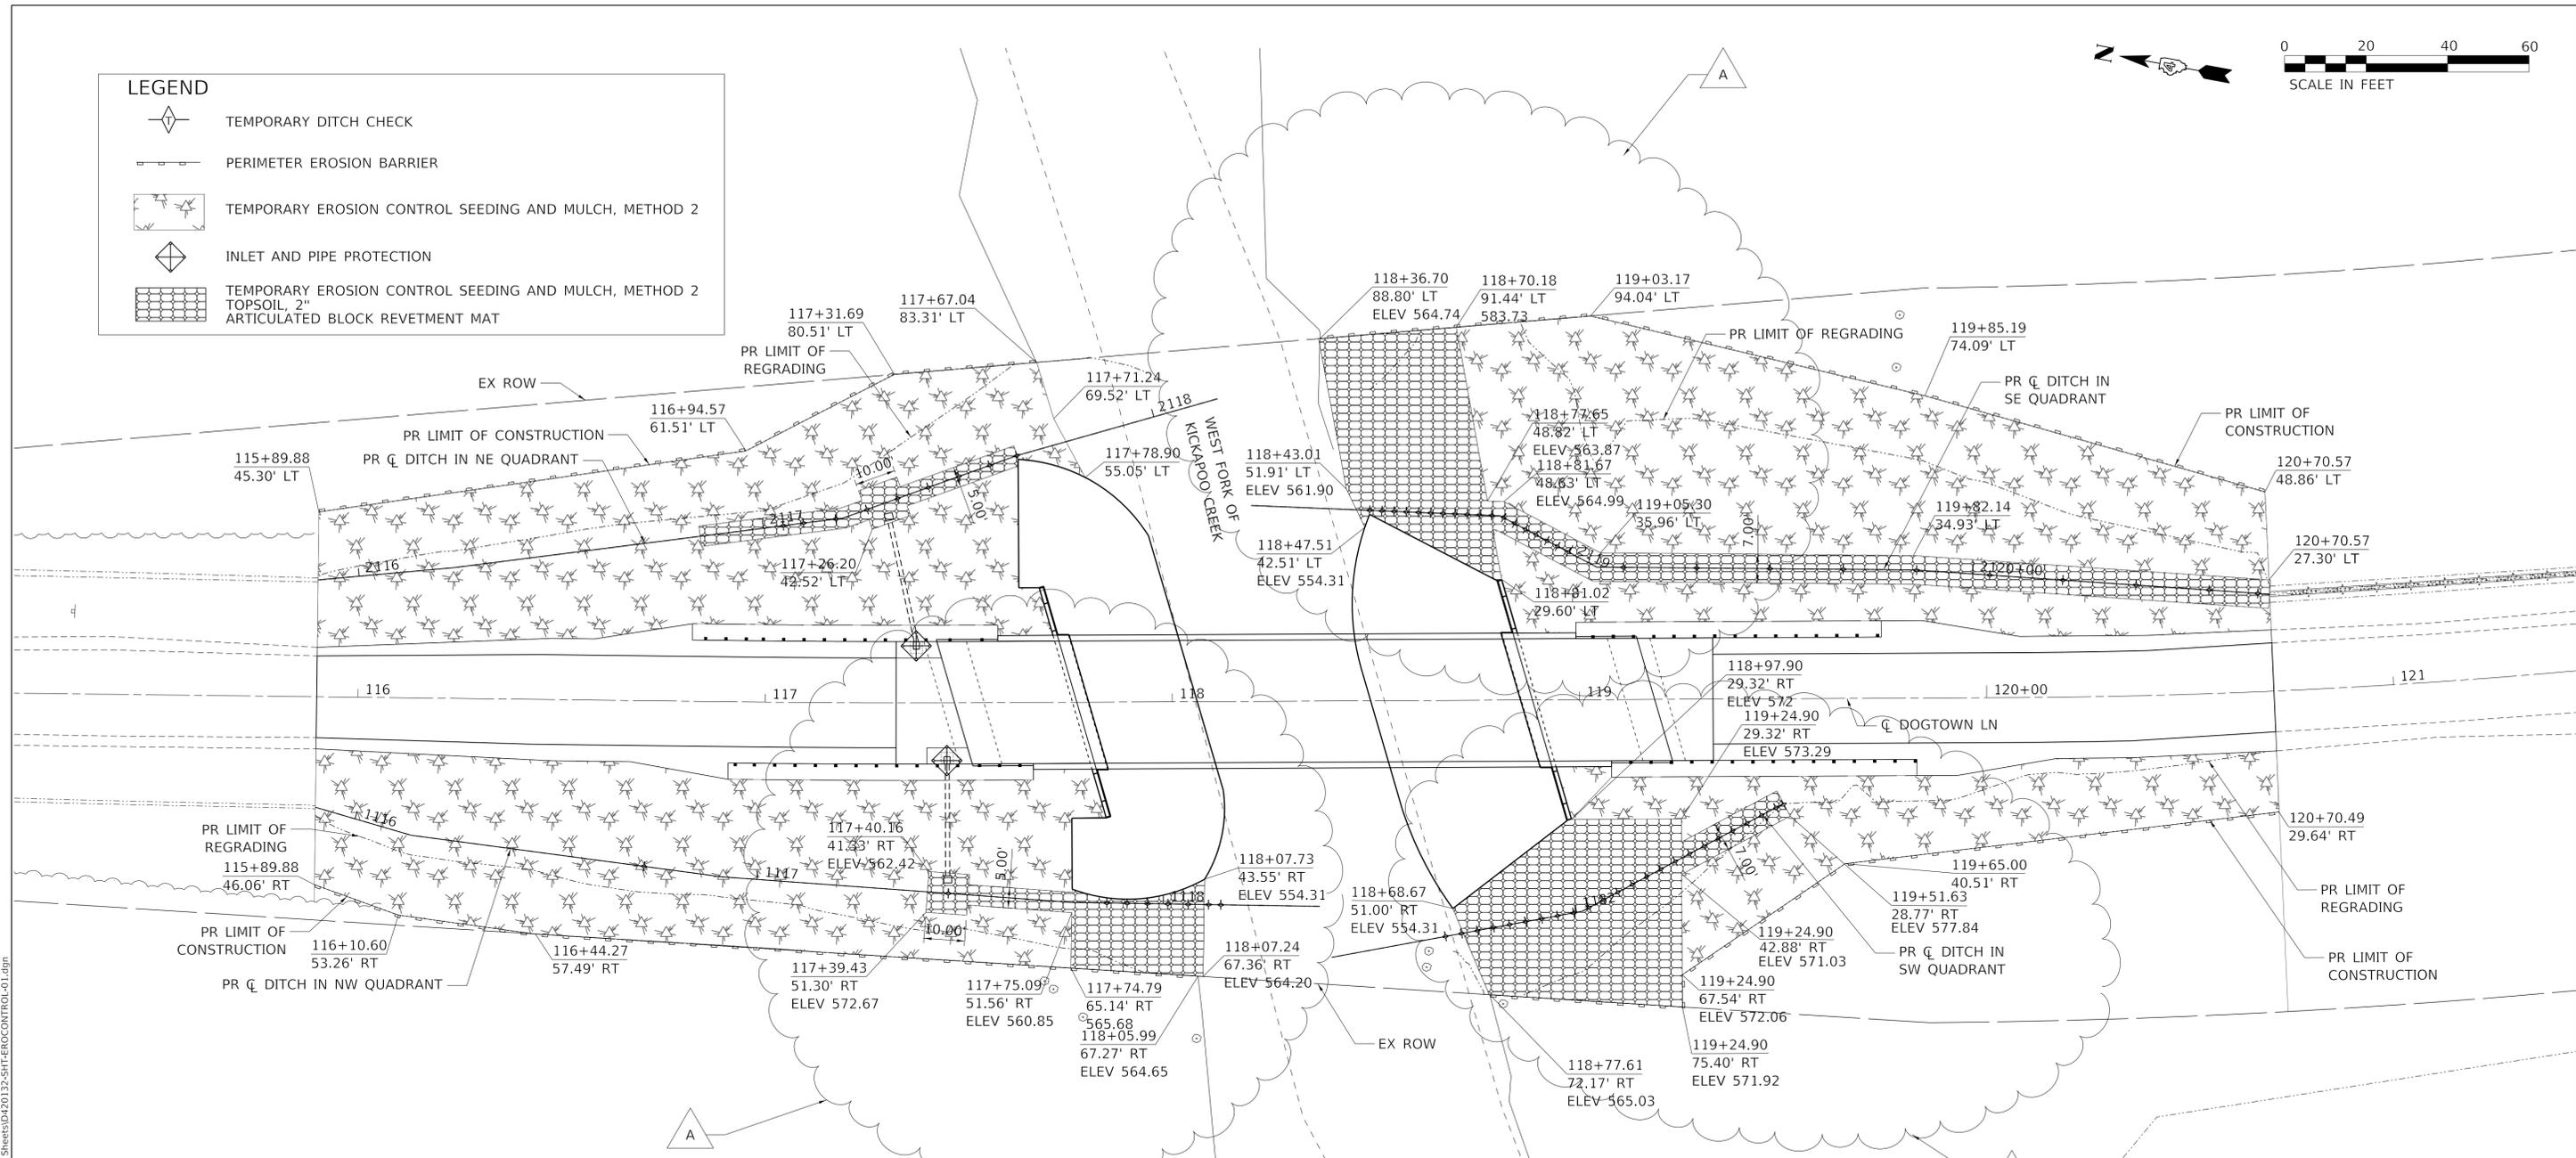

LEGEND	
	TEMPORARY DITCH CHECK
	PERIMETER EROSION BARRIER
	TEMPORARY EROSION CONTROL SEEDING AND MULCH, METHOD 2
	INLET AND PIPE PROTECTION
	TEMPORARY EROSION CONTROL SEEDING AND MULCH, METHOD 2 TOPSOIL, 2\"/>
	ARTICULATED BLOCK REVETMENT MAT



TEMPORARY EROSION CONTROL NOTES

- ALL SEDIMENT AND EROSION CONTROL DEVICES SHALL BE FUNCTIONAL PRIOR TO DISTURBING ANY ESTABLISHED SURFACE. DEVICES SHALL REMAIN IN GOOD WORKING ORDER UNTIL SITE HAS BEEN RESTORED, OR AS DIRECTED BY THE ENGINEER.
- STOCK PILES OF CONSTRUCTION MATERIAL OR EXCAVATED EARTH SHALL NOT BE STORED DIRECTLY UPSTREAM OF IN-PLACE RIPRAP. IN-PLACE RIPRAP SHALL BE PROTECTED FROM SEDIMENT CAUSED BY CONSTRUCTION-RELATED ACTIVITIES, IF SEDIMENT IS DESPOSITED INTO IN-PLACE RIPRAP, CONTRACTOR SHALL CLEAN RIPRAP AS DIRECTED BY THE ENGINEER.
- CONCRETE WASH-OUT WILL NOT BE PERMITTED INTO THE STREAM OR INTO EXISTING VEGETATION. CONCRETE WASH-OUT SHALL BE INTO A DESIGNATED WATERTIGHT CONTAINER TO AVOID RUNOFF.
- PERIMETER EROSION BARRIER MUST BE REMOVED AFTER SITE HAS BEEN RESTORED.
- MAINTENANCE OF TEMPORARY EROSION CONTROL SYSTEMS SHALL BE IN ACCORDANCE WITH SECTION 280 OF THE STANDARD SPECIFICATIONS.

REVETMENT MAT NOTES

- ARTICULATED BLOCK REVETMENT MAT IS TO BE OPEN CELLED WITH 2" TOPSOIL COVER FOR ALL REVETMENT MAT PLACED ABOVE THE TYPICAL WATER SURFACE ELEVATION (E.W.S.E.=556.33) AND CLOSED CELLED BELOW THE TYPICAL WATER SURFACE ELEVATION.
- REVETMENT MAT PANELS SHALL BE TOED INTO THE GROUND PER MANUFACTURER SPECIFICATIONS.

NOTE

- SEE DRAINAGE PLANS FOR SECTION DETAILS OF REVETMENT MAT LINED DITCHES.

MODEL: Default; FILE NAME: \\projects\2021\32 Peoria County Kickapoo Creek - SEE PROJECT\WSE\Design\CADD\Transportation\CADD_Sheets\0420132-SHT-EROCONTROL-01.dgn



USER NAME = ColinC	DESIGNED - DM	REVISED - ADDENDUM A
FILENAME = D420132-SHT-EROCONTROL-01.dgn	DRAWN - AE	REVISED -
PLOT SCALE = 20.0000' / in.	CHECKED - ET	REVISED -
PLOT DATE = 10/22/2021 11:59:34 AM	DATE - 10/22/2021	REVISED -

**STATE OF ILLINOIS
DEPARTMENT OF TRANSPORTATION**

**EROSION CONTROL AND SEDIMENT PLAN
DOGTOWN LANE OVER WEST FORK OF KICKAPOO CREEK**

SCALE: 1"=20' SHEET 1 OF 1 SHEETS STA. TO STA.

F.A. RTE.	SECTION	COUNTY	TOTAL SHEETS	SHEET NO.
R23	17-00132-00-BR	PEORIA	46	12
DOGTOWN LN BRIDGE			CONTRACT NO. 89811	
ILLINOIS		FED. AID PROJECT		