WHERE CONSTRUCTION ACTIVITY WILL RESUME ON A PORTION OF THE SITE WITHIN 14 DAYS FROM WHEN ACTIVITIES CEASED, (EG, THE TOTAL TIME PERIOD THAT CONSTRUCTION ACTIVITY IS TEMPORARILY CEASED IS LESS THAN 14 DAYS) THEN STABILIZATION MEASURES DO NOT HAVE TO BE INITIATED ON THAT PORTION OF THE SITE BY THE SEVENTH (7) DAY AFTER CONSTRUCTION

ACTIVITY TEMPORARILY CEASED.

C. THE FOLLOWING PRACTICES ARE ACCEPTABLE STABILIZATION MEASURES:

OBSERVATION REPORTS SHOULD BE MAINTAINED ONSITE AS PART OF THE SWPPP.

SODDING

4N BOOK

TEMPORARY SEEDING: MAY CONSIST OF SPRING OATS (100 LBS/ACRE) AND/OR WHEAT OR CEREAL RYE (150 LBS/ACRE).

PERMANENT SEEDING: IN ACCORDANCE WITH THE APPROVED LANDSCAPE PLANS. THE APPROPRIATE STABILIZATION MEASURE SHALL BE DETERMINED BASED ON SITE CONDITIONS AT THE TIME THE CONSTRUCTION ACTIVITY HAS CEASED, INCLUDING BUT NOT LIMITED TO WEATHER CONDITIONS

AND LENGTH OF TIME MEASURE MUST BE EFFECTIVE.

<u>DEWATERING OPERATIONS:</u> DURING DEWATERING/PUMPING OPERATIONS, ONLY UNCONTAMINATED WATER SHOULD BE ALLOWED TO DISCHARGE TO PROTECTED NATURAL AREAS, WATERS OF THE STATE, OR TO A STORM SEWER SYSTEM (IN ACCORDANCE WITH LOCAL PERMITS).

MAINTENANCE: THE FOLLOWING IS A DESCRIPTION OF PROCEDURES THAT SHOULD BE USED TO MAINTAIN, IN GOOD AND EFFECTIVE OPERATION CONDITIONS, VEGETATION, EROSION AND SEDIMENT CONTROL MEASURES AND OTHER PROTECTIVE MEASURES IDENTIFIED IN THIS PLAN AND STANDARD SPECIFICATIONS. RIPRAP OUTLET PROTECTION: RIPRAP SHOULD BE INSPECTED FOR ANY SCOUR BENEATH THE RIPRAP OR FOR STONES THAT HAVE BEEN DISLODGED. SEDIMENT ACCUMULATION IN THE OUTFALL AREA SHOULD

BE REMOVED AS NEEDED.
SILT FILTER FENCE: SILT FENCES SHOULD BE INSPECTED REGULARLY FOR UNDERCUTTING WHERE THE FENCE MEETS THE GROUND, OVERTOPPING, AND TEARS ALONG THE LENGTH OF THE FENCE.

DEFICIENCIES SHOULD BE REPAIRED IMMEDIATELY. REMOVE ACCUMULATED SEDIMENTS FROM THE FENCE
BASE WHEN THE SEDIMENT REACHED ONE—HALF THE FENCE HEIGHT. DRING FINAL STABILIZATION,
PROPERLY DISPOSE OF ANY SEDIMENT THAT HAS ACCUMULATED ON THE SILT FENCE. INSTANCES WHEN
AREAS OF SILT FENCE CONTINUALLY FAIL, REPLACE SILT FENCE WITH ANOTHER BMP AS SEEN FIT. INSPECTIONS: THE OWNER SHALL DESIGNATE A QUALIFIED PERSONNEL TO BE RESPONSIBLE FOR SEDIMENT AND EROSION CONTROL OBSERVATION REPORTING. THIS QUALIFIED PERSONNEL SHALL MEET THE REQUIREMENTS NOTED IN THE ILR10 PERMIT CONDITIONS AND LOCAL CODES.

SITE OBSERVATIONS SHOULD OCCUR AT LEAST ONCE EVERY SEVEN CALENDAR DAYS AND WITHIN 24 HOURS OF THE END OF A STORM THAT IS 0.5 INCHES OR GREATER, OR EQUIVALENT SNOWFALL. SITE

A. DISTURBED AREAS AND AREAS USED FOR THE STORAGE OF MATERIALS THAT ARE EXPOSED TO PRECIPITATION SHALL BE CHECKED FOR EVIDENCE OF, OR POTENTIAL FOR, POLLUTANTS
ENTERING THE DRAINAGE SYSTEM. THE EROSION AND SEDIMENT CONTROL MEASURES IDENTIFIED IN THE PLAN SHALL BE OBSERVED TO ENSURE THAT THEY HAVE BEEN INSTALLED AND ARE OPERATING CORRECTLY. WHERE DISCHARGE POINTS ARE ACCESSIBLE, THEY SHOULD BE CHECKED TO ASCERTAIN WHETHER EROSION CONTROL MEASURES ARE EFFECTIVE IN PREVENTING SIGNIFICANT IMPACTS TO THE RECEIVING WATERS. LOCATIONS WHERE VEHICLES ENTER AND EXIT THE SITE SHOULD BE CHECKED FOR OFF-SITE SEDIMENT TRACKING. ALL PUMPING OPERATIONS AND ALL OTHER POTENTIAL NON-STORM WATER DISCHARGES SHOULD BE OBSERVED

BASED ON THE RESULTS OF THE SITE OBSERVATION, THE DESCRIPTION OF POTENTIAL POLLUTANT SOURCES IDENTIFIED, AND TEH POLLUTION PREVENTION MEASURES DESCRIBED IN THIS PLAN SHALL BE REVISED AS APPROPRIATE, AS SOON AS PRACTICABLE AFTER OBSERVATION. THE MODIFICATIONS, IF ANY, SHALL PROVIDE FRO TIMELY IMPLEMENTATION OF ANY CHANGES TO THE PLAN WITHIN 7 CALENDAR DAYS FOLLOWING THE SITE OBSERVATION.

C. A REPORT SUMMARIZING THE SCOPE OF THE OBSERVATION, NAME(S) AND QUALIFICATIONS OF

PERSONNEL MAKING THE OBSERVATION, THE DATE(S) OF THE OBSERVATION, MAJOR
OBSERVATIONS RELATING TO THE IMPLEMENTATION OF THE STORM WATER POLLUTION
PREVENTION PLAN, AND ACTIONS TAKEN IN ACCORDANCE WITH PARAGRAPH B ABOVE SHALL BE MADE AND RETAINED AS PART OF THE STORM WATER POLLUTION PREVENTION PLAN FOR AT LEAST THREE YEARS FROM THE DATE OF FINAL STABILIZATION OR PERMIT COVERAGE IS TERMINATED. THE REPORT SHALL BE SIGNED IN ACCORDANCE WITH PART VI.G (SIGNATORY REQUIREMENTS) OF THE ILR10 NPDES PERMIT.


THE OWNER SHALL NOTIFY THE APPROPRIATE AGENCY FIELD OPERATIONS SECTION OFFICE BY EMAIL AT EPA.SWNONCOMP@ILLINOIS.GOV, TELEPHONE, OR FAX WITHIN 24 HOURS OF ANY INCIDENCE OF NONCOMPLIANCE FOR ANY VIOLATION OF THE STORM WATER POLLUTION PREVENTION PLAN OBSERVED DURING A SITE OBSERVATION, OR FOR VIOLATIONS OF ANY CONDITION OF THE PERMIT. THE OWNER SHALL COMPLETE AND SUBMIT WITHIN 5 DAYS AN INCIDENCE OF NONCOMPLIANCE (ION) REPORT FOR ANY VIOLATION OF THE STORM WATER POLLUTION PREVENTION PLAN OBSERVED DURING AN INSPECTION CONDUCTED. SUBMISSION SHALL BE ON FORMS PROVIDED BY THE AGENCY AND INCLUDE SPECIFIC INFORMATION ON THE CAUSE OF NONCOMPLIANCE, ACTIONS WHICH WERE TAKEN TO PREVENT ANY FURTHER CAUSES OF NONCOMPLIANCE, AND A STATEMENT DETAILING ANY ENVIRONMENTAL IMPACT, WHICH MAY HAVE RESULTED FROM THE NONCOMPLIANCE


ALL REPORTS OF NONCOMPLIANCE SHALL BE SIGNED BY A RESPONSIBLE AUTHORITY AS DEFINED IN PART VI.G OF THE ILR10 NPDES PERMIT (SIGNATORY REQUIREMENTS).


F. ALL REPORTS OF NONCOMPLIANCE SHALL BE MAILED TO THE AGENCY AT THE FOLLOWING ADDRESS: ILLINOIS ENVIRONMENTAL PROTECTION AGENCY

DIVISION OF WATER POLLUTION CONTROL COMPLIANCE ASSURANCE SECTION 1021 NORTH GRAND AVENUE EAST POST OFFICE BOX 19276 SPRINGFIELD, ILLINOIS 62794-9276

SEDIMENT CONTROL NOTES: STREET CLEANING: ALL ADJACENT STREETS MUST BE KEPT CLEAR OF DEBRIS, INSPECTED DAILY, AND CLEANED WHEN NECESSARY. TEMPORARY SEDIMENT STORAGE BASIN: ADDRESS

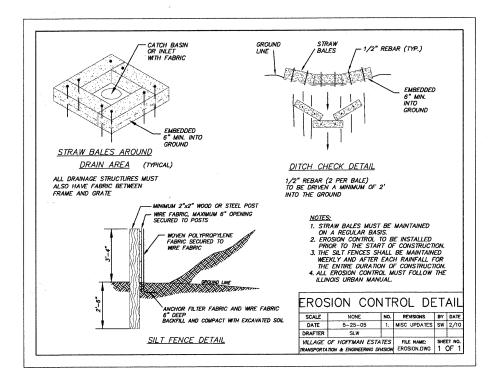

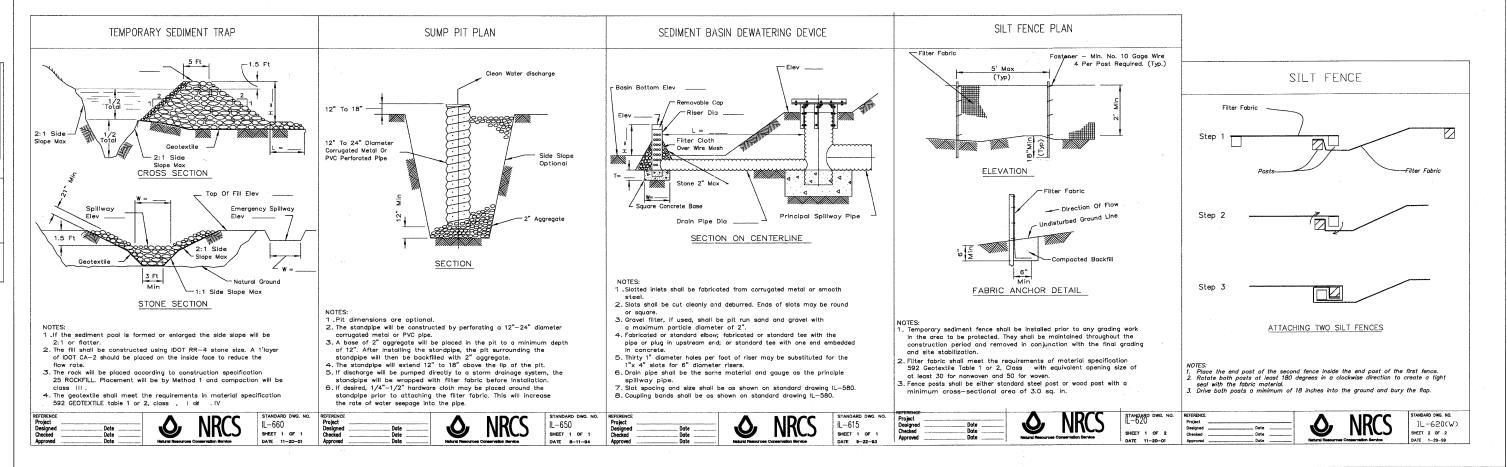

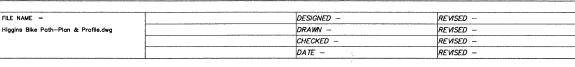



VILLAGE OF HOFFMAN ESTATES
Hassell Road, Hoffman Estates, IL 60169
Phone Number: 847 252-5800 1900

Higgins Road Bicycle and Pedestrian Project Drainage, Utilities & Erosion and Sediment Contro SCALE: 1" = 20' SHEET NO. 1 OF 8 SHEETS STA.

	F.A.P. RTE.	SECTION			COUNTY		TOTAL SHEETS	SHEE NO.
ol	341	08-00080-00-BT			Cook		86	20
					CONTRA	CT	NO. 6	3233
			ILLINOIS	FED. A	ID PROJECT	CMM	9003(243	5)