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STATE OF ILLINOIS **DEPARTMENT OF TRANSPORTATION DIVISION OF HIGHWAYS**

PROPOSED HIGHWAY PLANS

VARIOUS ROUTES SECTION 2010-077-I VARIOUS LOCATIONS SCOUR COUNTERMEASURES DUPAGE, WILL, AND KENDALL COUNTIES C-91-769-10

LOCATION 1: S.N. 022-0037, ILLINOIS ROUTE 59 LOCATION 3: S.N. 047-0029, U.S. ROUTE 30 **OVER BLACKBERRY CREEK** LOCATION 4: S.N. 099-0271, WOLF ROAD

FOR INDEX OF SHEETS, SEE SHEET NO. 2

IMPROVEMENTS LOCATED IN THE

UINCORPORATED DUPAGE COUNTY

VILLAGE OF PLAINFIELD

VILLAGE OF MONTGOMERY VILLAGE OF MOKENA


LOCATION 2: S.N. 099-0262, ILLINOIS ROUTE 126

ENGINEERING SCALES. REDUCED SIZED PLANS WILL NOT CONFORM TO STANDARD SCALES, IN MAKING MEASUREMENTS ON REDUCED PLANS, THE ABOVE SCALES MAY BE USED.

JOINT UTILITY LOCATION INFORMATION FOR EXCAVATION 1-800-892-0123 OR 811

OVER KRESS CREEK

OVER LILY CACHE CREEK

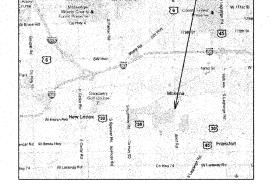

OVER HICKORY CREEK

VAR. 2010-077-I CONTRACT NO. 60L65 FED. ROAD DIST. NO 1 ILLINOIS

D-91-769-10



STATE OF ILLINOIS DEPARTMENT OF TRANSPORTATION

PROFESSIONAL ENGINEER'S SIGN & SEAL Chrotyphe M. Harth EXPIRES: 11-30-2011

> PRINTED BY THE AUTHORITY OF THE STATE OF ILLINOIS

CONTRACT NO. 60L65

INDEX OF SHEETS

- COVER SHEET
- 2 INDEX OF SHEETS, LIST OF STATE STANDARDS, AND GENERAL NOTES SCOUR COUNTERMEASURES
 - SUMMARY OF QUANTITIES
- 4 LOCATION MAPS
- 5-6 SCOUR COUNTERMEASURES ILLINOIS ROUTE 59 OVER KRESS CREEK
- 7-8 SCOUR COUNTERMEASURES ILLINOIS ROUTE 126 OVER LILY CACHE CREEK
- 9-10 SCOUR COUNTERMEASURES U.S. ROUTE 30 OVER BLACKBERRY CREEK
- 11-12 SCOUR COUNTERMEASURES WOLF ROAD OVER HICKORY CREEK
- 13-16 CROSS SECTIONS SCOUR COUNTERMEASURES
- 17 TRAFFIC CONTROL AND PROTECTION FOR SIDE ROADS, INTERSECTIONS, AND DRIVEWAYS
- 18 ARTERIAL ROAD INFORMATION SIGN
- 19-21 DEWATERING SYSTEM DETAILS SCOUR COUNTERMEASURES

LIST OF STATE STANDARDS

STANDARD NO. DESCRIPTION

STANDARD NO. DESCRIPTION

701426-04 LANE CLOSURE, MULTILANE, INTERMITTENT OR MOVING OPER., FOR SPEEDS >= 45 MPH

URBAN LANE CLOSURE, 2L, 2W, UNDIVIDED

701501-*06*

URBAN LANE CLOSURE, 2L. 2W. WITH BIDIRECTIONAL LEFT TURN LANE

701502-*04* 701606-*0*7

URBAN LANE CLOSURE, MULTILANE, 2W WITH MOUNTABLE MEDIAN

701901-01

TRAFFIC CONTROL DEVICES

COMMITMENTS

NONE

GENERAL NOTES

- BEFORE STARTING ANY EXCAVATION, THE CONTRACTOR SHALL CALL "JULIE" (JOINT UTILITY LOCATION INFORMATION FOR EXCAVATION) AT 8-1-1 OR (800) 892-0123 FOR FIELD LOCATIONS OF BURIED ELECTRIC, TELEPHONE, AND GAS FACILITIES (48 HOUR NOTIFICATION IS REQUIRED).
- THE CONTRACTOR WILL NOT BE ALLOWED TO SET UP A YARD OR FIELD OFFICE ON STATE PROPERTY WITHOUT WRITTEN PERMISSION FROM THE DEPARTMENT.
- 3. EXCAVATION INTO THE STREAM BED FOR STONE RIPRAP INSTALLATION SHALL NOT BE DEEPER THAN THE BOTTOM OF THE FOOTING ON THE PIER OR ABUTMENT TO BE PROTECTED.
- 4. DEBRIS REMOVAL, IF ENCOUNTERED, SHALL BE INCLUDED IN THE COST OF THE STONE RIPRAP.
- 5. IT SHALL BE THE CONTRACTORS RESPONSIBILITY TO VERIFY ALL DIMENSIONS & CONDITIONS EXISTING IN THE FIELD PRIOR TO CONSTRUCTION ORDERING OF MATERIAL.
- 6. THE CONTRACTOR SHALL CONTACT THE DISTRICT ONE ARTERIAL TRAFFIC CONTROL SUPERVISOR AT (847) 705-4470 A MINIMUM OF 72 HOURS IN ADVANCE OF BEGINNING WORK.
- 7. ALL AREAS (INCLUDING WETLAND AREAS) OUTSIDE THE LIMITS OF RIPRAP PLACEMENT AND/OR EXCAVATION WHICH ARE DISTURBED (WHERE EXISTING SOIL CONTOURS HAVE BEEN ALTERED AND/OR EXISTING VEGETATION HAD BEEN DESTROYED BY THE CONTRACTORS OPERATIONS) SHALL BE RESTORED BY REGRADING TO THE ORIGINAL CONTOURS AND/OR SEEDING WITH SEEDING, CLASS 4, AND MULCHING WITH EROSION CONTROL BLANKETS. PLACE TEMPORARY SEEDING AND TEMPORARY EROSION CONTROL BLANKETS AS NEEDED. THIS WORK WILL NOT BE PAID FOR SEPERATELY, BUT THE COSTS SHALL BE CONSIDERED INCLUDED IN THE CONTRACT UNIT PRICES FOR THE CONSTRUCTION ITEMS INVOLVED, AND NO ADDITIONAL COMPENSATION WILL BE ALLOWED.
- 8. THE CONTRACTOR IS ADVISED TO AVOID OR MINIMIZE ANY DISTURBANCE TO EXISTING VEGETATION OUTSIDE THE LIMITS OF RIPRAP PLACEMENT AND CHANNEL EXCAVATION.
- THE CONTRACTOR MUST PROTECT PAVEMENT WHEN DUMPING RIPRAP ONTO PAVEMENT AND WILL BE RESPONSIBLE FOR RESTORING PAVEMENT MARKINGS.
- 10. ANY GUARDRAIL OR SIGNS DAMAGED BY THE CONTRACTOR'S OPERATIONS SHALL BE REPLACED IN KIND AT THE CONTRACTORS EXPENSE.
- 11. THE CONTRACTOR SHALL BE REQUIRED TO PROVIDE ACCESS TO ABUTTING PROPERTY AT ALL TIMES DURING THE CONSTURCTION OF THIS PROJECT.
- 12. DO NOT SCALE PLANS FOR CONSTRUCTION DIMENSIONS.
- 13. THE CONTRACTOR SHALL SUBMIT DEWATERING AND SEDIMENT CONTROL PLANS FOR EACH SITE TO THE ENGINEER FOR APPROVAL.
- 14. THE CONTRACTOR SHALL CONTACT THE ENGINEER AFTER DEWATERING FOR FINAL RIPRAP OR SLOPE MATTRESS PLACEMENT.
- 15. NIGHT TIME CLOSURES WILL NOT BE REQUIRED FOR THIS PROJECT.
- 16. UNLESS OTHERWISE NOTED, EXCAVATION OF MATERIAL REQUIRED TO INSTALL STONE RIPRAP OR SLOPE MATTRESS SHALL BE INCLUDED IN THE ITEM BEING INSTALLED.

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STATE OF ILLINOIS
DEPARTMENT OF TRANSPORTATION

INDEX OF SHEETS, LIST OF STATE STANDARDS, AND GENERAL NOTES SCOUR COUNTERMEASURES

SCALE: SHEET NO. 1 OF 1 SHEETS STA. TO STA.

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	SUMMARY OF QUANTITIES		URBAN		00	014	
CODE NO.	ITEM .	UNIT	100% STATE TOTAL OUANTITY	LOCATION 1 IL RTE 59 DUPAGE CO	LOCATION 2 IL RTE 126 WILL CO	LOCATION 3 US RTE 30 KENDALL CO	LOCATION 4 WOLF WILL CO
20300100	CHANNEL EXCAVATION	CU YD	8		6.5		1.5
28100107	STONE RIPRAP, CLASS A4	SQ YD	902	323	187	392	
28200200 <i>28400100</i> 28401000	FILTER FABRIC GADIONS SLOPE MATTRESS 12"	SQ YD CU YO SQ YD	1740 35 478	483	411 8 140	686 8 178	160 <i>1</i> 9 160
67000400	ENGINEER'S FIELD OFFICE, TYPE A	CAL MO	4	1	1	1	1
67100100	MOBILIZATION	L SUM	1	0.25	0.25	0.25	0.25
70102620	TRAFFIC CONTROL AND PROTECTION, STANDARD 701501	L SUM	1		0.5		0.5
70102622	TRAFFIC CONTROL AND PROTECTION, STANDARD 701502	L SUM	1			1 .	
70102625	TRAFFIC CONTROL AND PROTECTION, STANDARD 701606	L SUM	1	1		F	
X0301852	DEWATERING STRUCTURE NO. 1	EACH	1	1			
X0301853	DEWATERING STRUCTURE NO. 2	EACH	1		1		
X0301854	DEWATERING STRUCTURE NO. 3	EACH	1			1	
X0301855	DEWATERING STRUCTURE NO. 4	EACH	1	2 .			1
Z0030850	TEMPORARY INFORMATION SIGNING	SQ FT	205.6	51.4	51.4	51.4	51.4

SPECIALTY ITEMS

REVISED -REVISED -REVISED -REVISED -PLOT SCALE = N/A PLOT DATE = 7/19/2011

STATE OF ILLINOIS DEPARTMENT OF TRANSPORTATION

SUMMARY OF QUANTITIES SCALE: N/A SHEET NO. 1 OF 1 SHEETS STA.

TO STA.


R. 9 E.

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- LOCATION 3 - KENDALL COUNTY STRUCTURE NUMBER: 047-0029 U.S. ROUTE 30 OVER BLACKBERRY CREEK LOCATED IN BRISTOL TOWNSHIP VILLAGE OF MONTGOMERY TRAFFIC DATA
SPEED LIMIT = 55 MPH
2009 ADT = 15,800 Victoria Dr [30] E Base Line Rd E Base Line Rd [30] T. 37 Keck Memorial Cemeterv Caterpillar Dr

TRAFFIC DATA
SPEED LIMIT = 55 MPH 2009 ADT = 16,500

LOCATION 2 - WILL COUNTY STRUCTURE NUMBER: 099-0262 ILLINOIS ROUTE 126 OVER LILY CACHE CREEK LOCATED IN PLAINFIELD TOWNSHIP VILLAGE OF PLAINFIELD

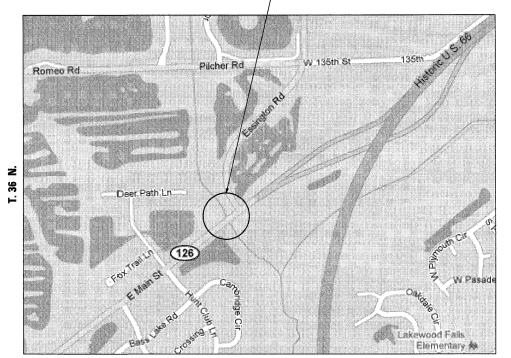


R. 9 E.

TRAFFIC DATA SPEED LIMIT = 45 MPH 2008 ADT = 12,100

SCALE: N/A

- LOCATION 4 — WILL COUNTY STRUCTURE NUMBER: 099–0271 WOLF ROAD OVER HICKORY CREEK LOCATED IN FRANKFORT TOWNSHIP VILLAGE OF MOKENA

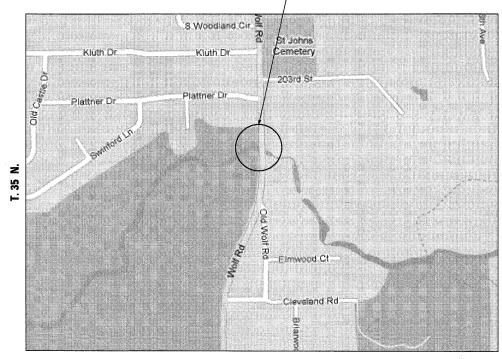

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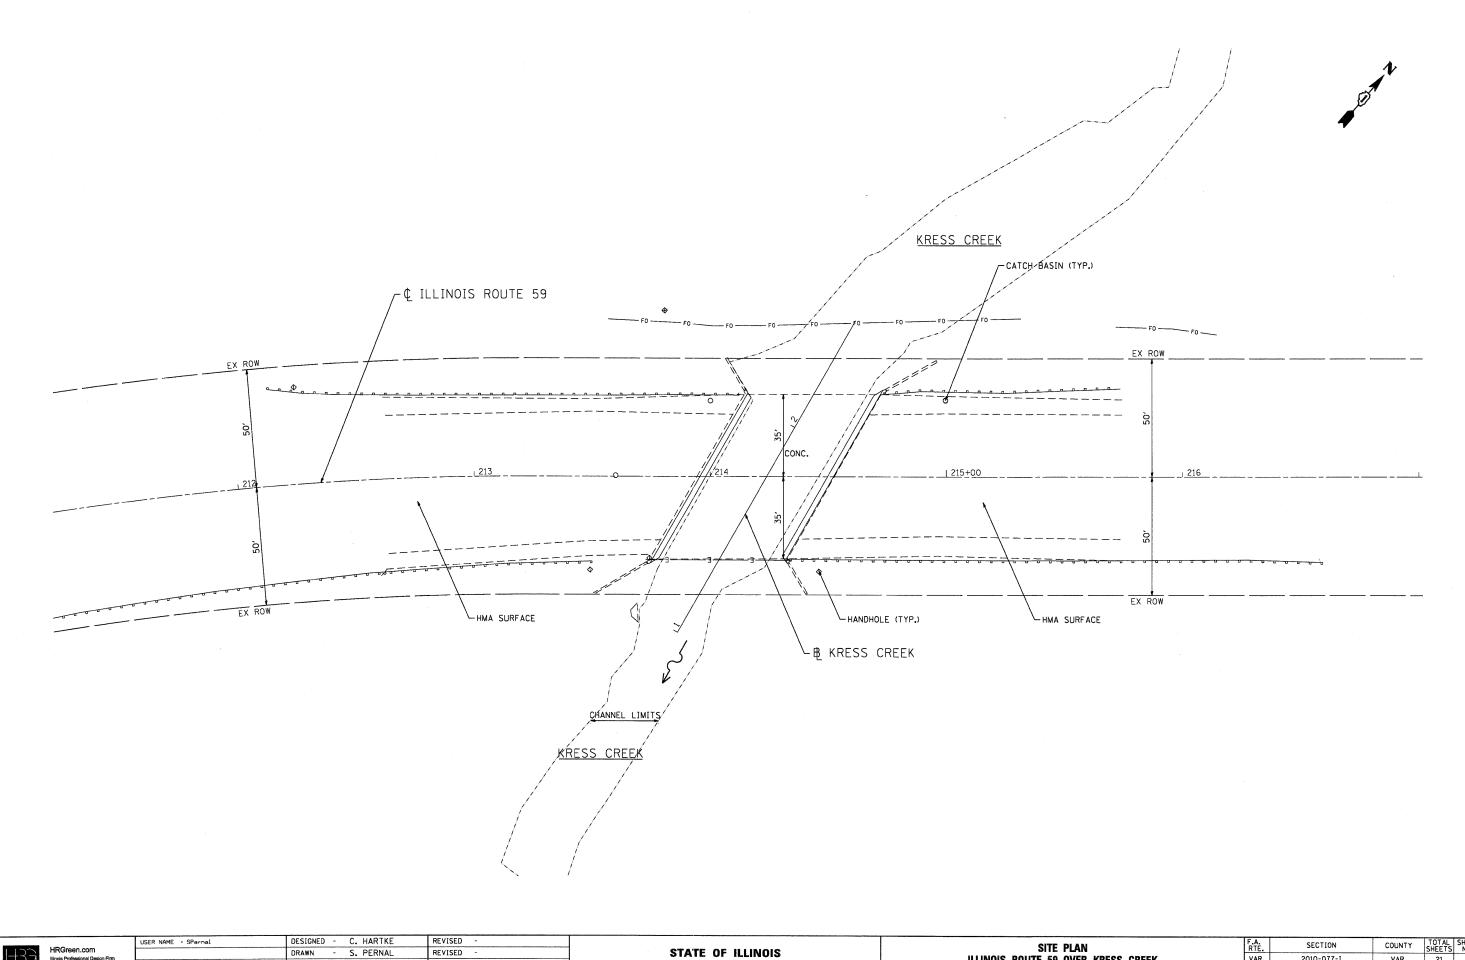
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-	DRAWN -	S. PERNAL	REVISED -	STATE OF ILLINOIS
PLOT SCALE = N/A	CHECKED -	T. HAMILTON	REVISED -	DEPARTMENT OF TRANSPORTATION
PLOT DATE = 7/20/2011	DATE -	7/20/11	REVISED -	

R. 7 E.

COUNTY TOTAL SHEE SHEETS NO. SECTION LOCATION MAPS SCOUR COUNTERMEASURES VAR. 2010-077-I VAR. 21 4 CONTRACT NO. 60L6 SHEET NO. 1 OF 1 SHEETS STA. TO STA. FED. ROAD DIST. NO. | ILLINOIS FED. AID PROJECT

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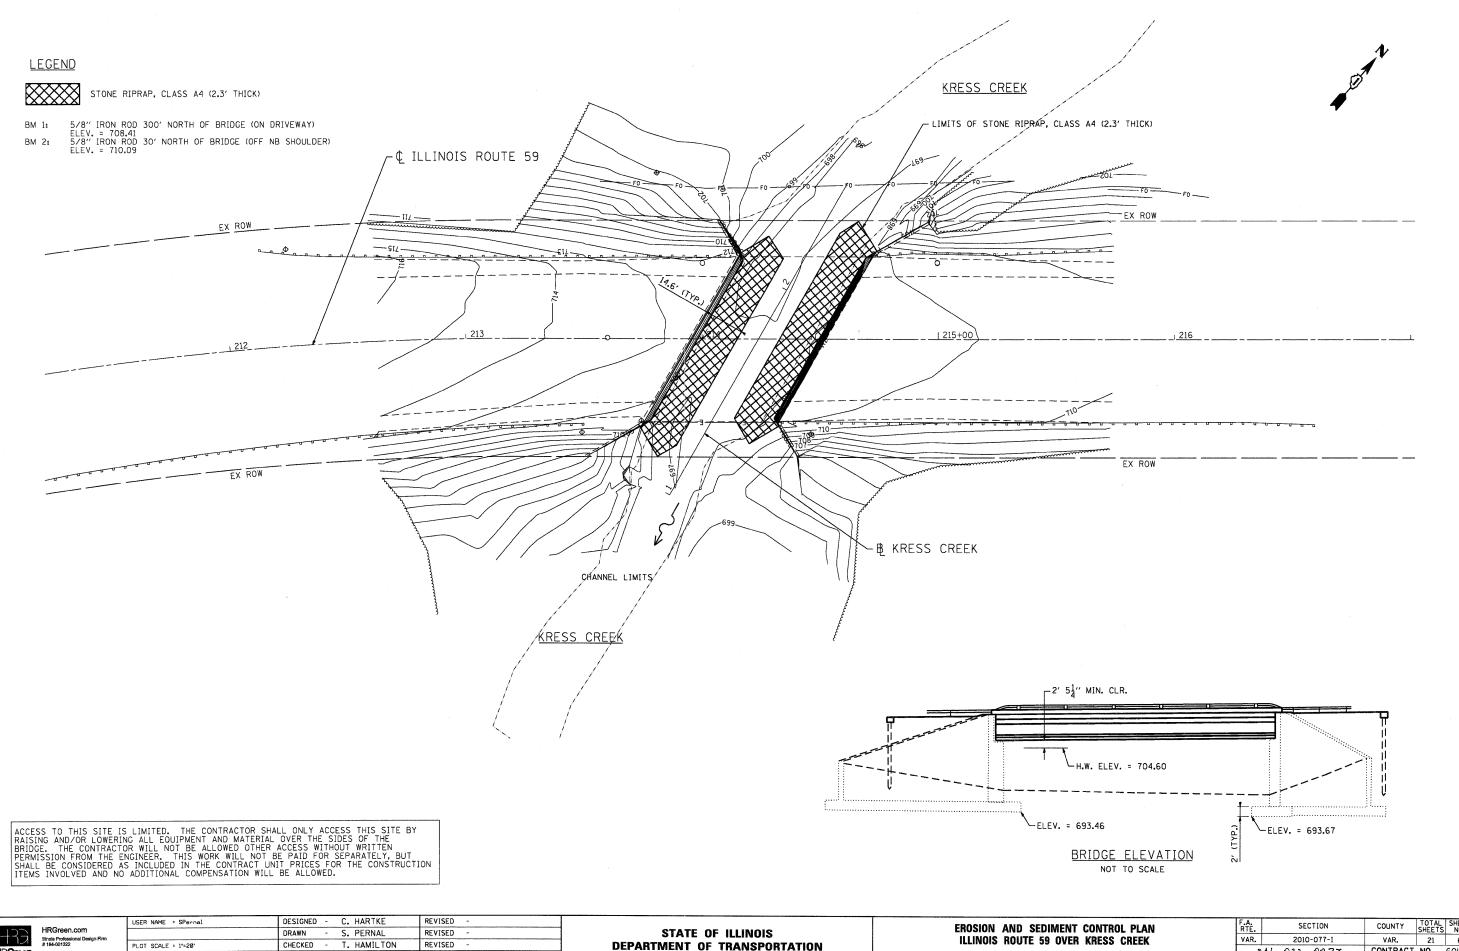


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DRAWN - S. PERNAL
CHECKED - T. HAMILTON
DATE - 7/19/11 REVISED -PLOT DATE = 7/19/2011

STATE OF ILLINOIS
DEPARTMENT OF TRANSPORTATION

SITE PLAN ILLINOIS ROUTE 59 OVER KRESS CREEK SCALE: 1"=20" SHEET NO. 1 OF 2 SHEETS STA. 212+00 TO STA. 216+00



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- 7/19/11 REVISED


DEPARTMENT OF TRANSPORTATION

SHEET NO. 2 OF 2 SHEETS STA. 212+00 TO STA. 216+00


COUNTY TOTAL SHEET NO.

VAR. 21 6 S. N. 022 - 00 37 CONTRA CONTRACT NO. 60L65

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COMPANY NAME: SCOM PROJECT CONTACT: SUPPO CLIENT: SCOT, DATE PLOTTED: 7/19/ PLOT DRIVER: DOF, PEN TABLE: STOM

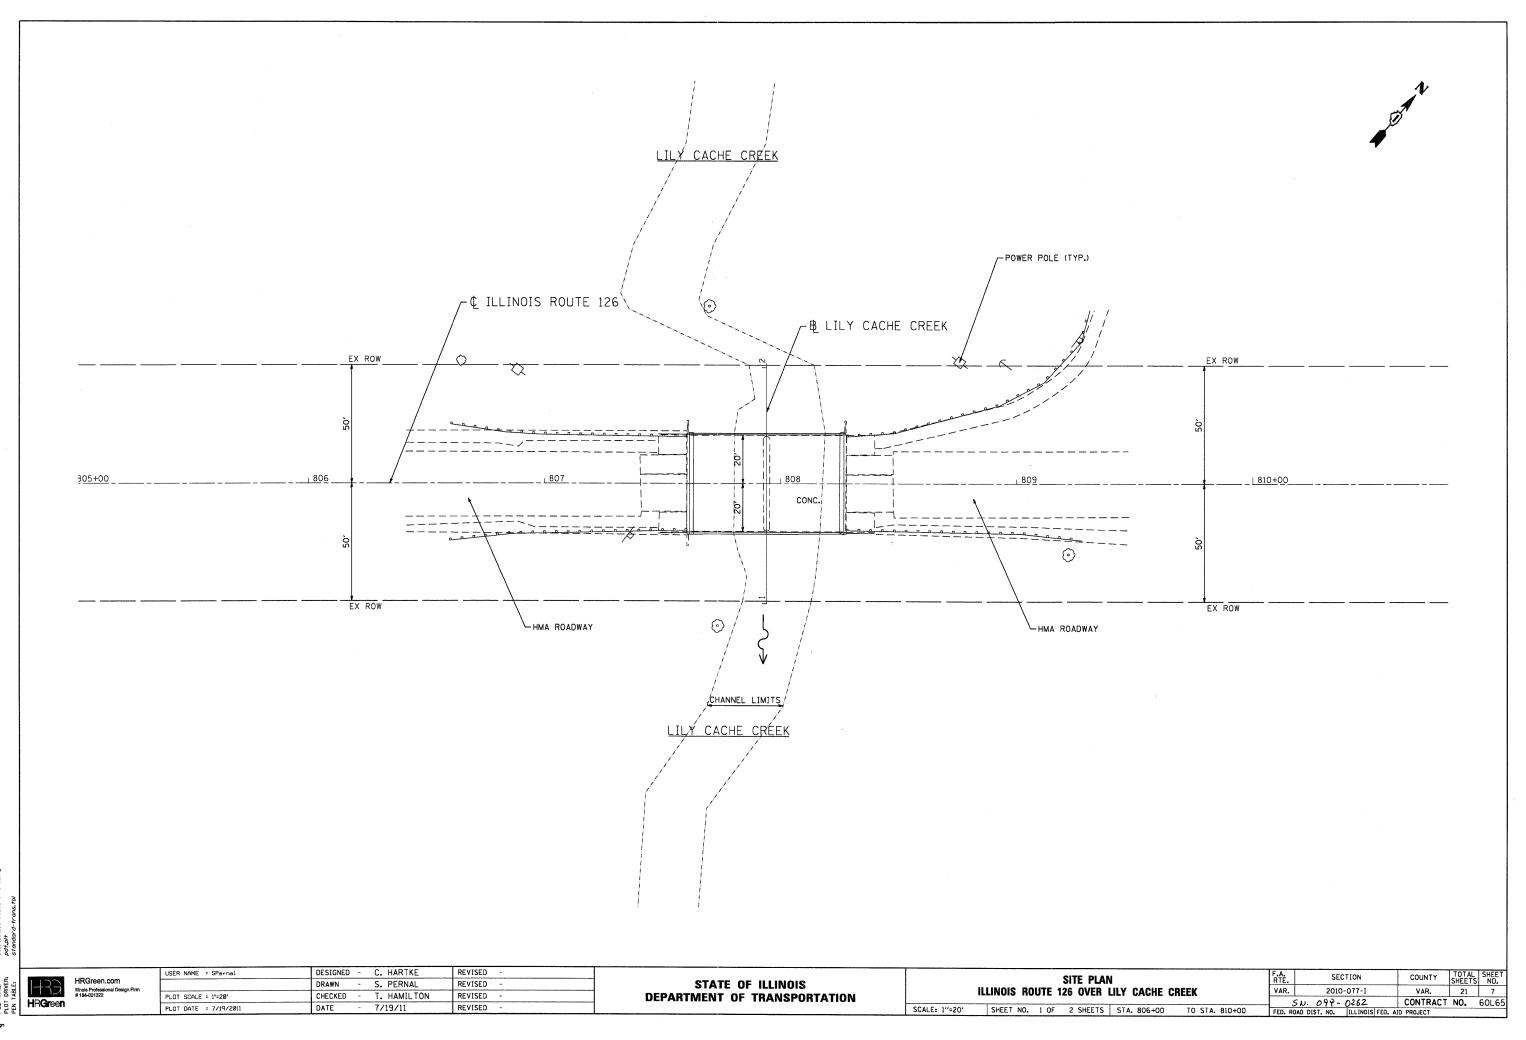
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STATE OF ILLINOIS
DEPARTMENT OF TRANSPORTATION

EROSION AND SEDIMENT CONTROL PLAN
ILLINOIS ROUTE 126 OVER LILY CACHE CREEK

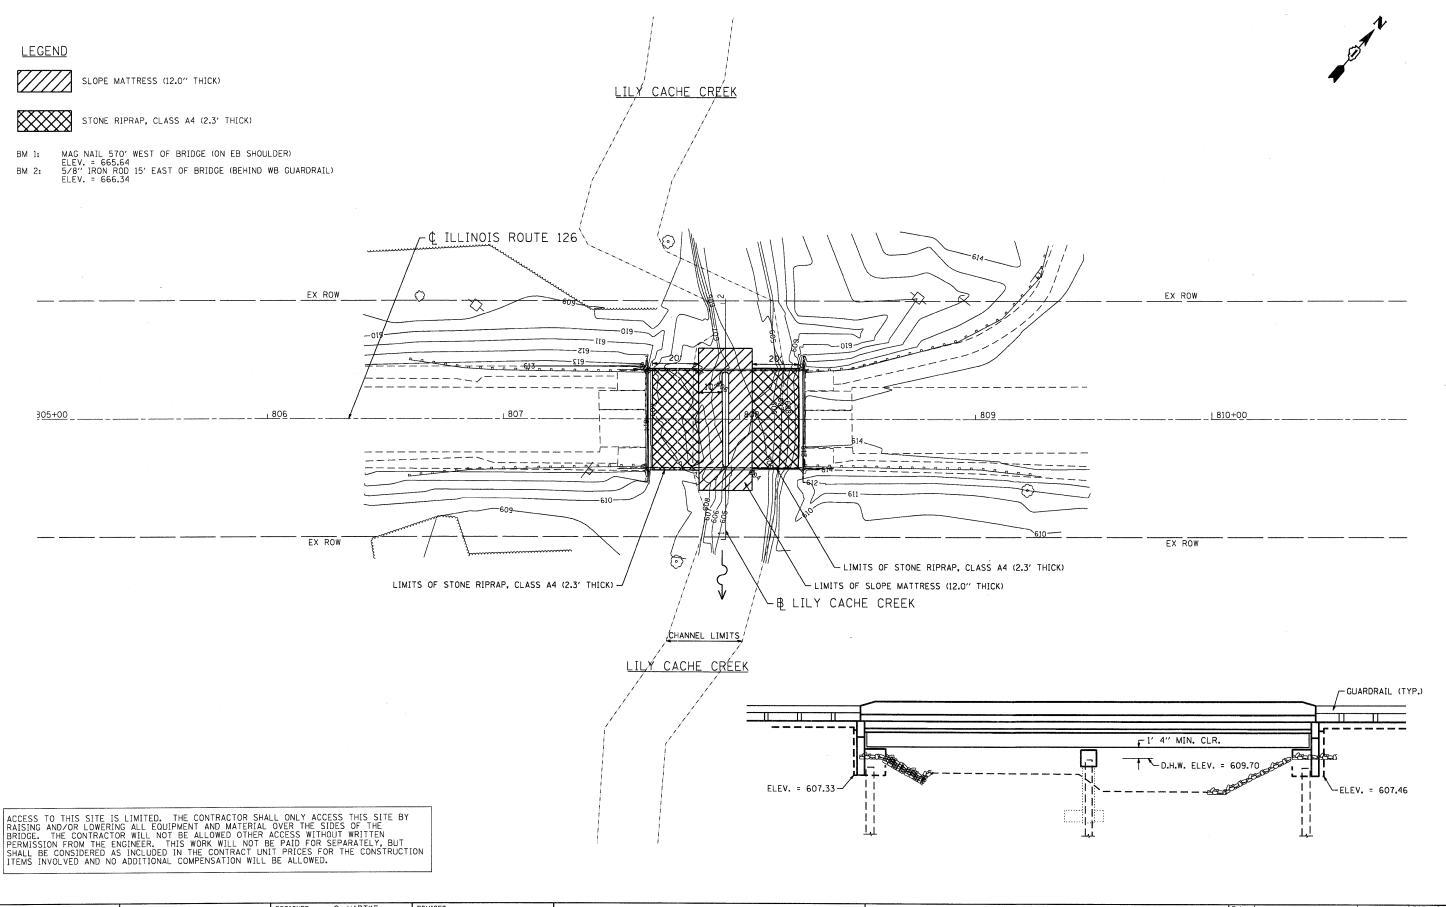SHEET NO. 2 OF 2 SHEETS STA. 806+00 TO STA. 810+00

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PLOT SCALE = 1'=20' PLOT DATE = 7/19/2011

DRAWN - S. PERNAL REVISED - T. HAMILTON REVISED - 7/19/11 REVISED

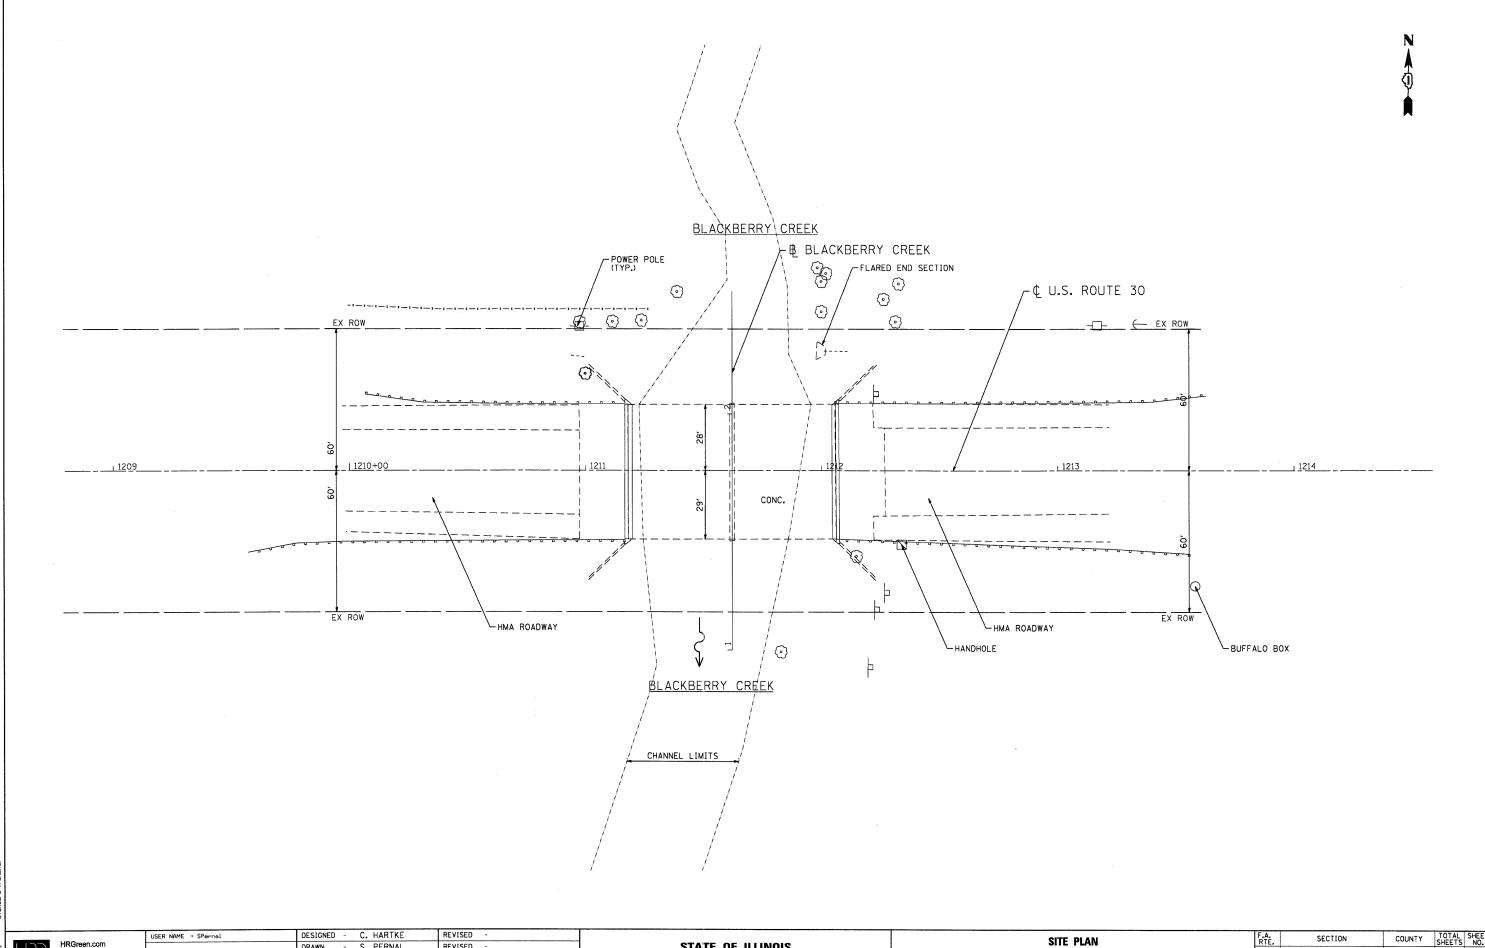STATE OF ILLINOIS **DEPARTMENT OF TRANSPORTATION**


SITE PLAN
U.S. ROUTE 30 OVER BLACKBERRY CREEK SCALE: 1"=20' SHEET NO. 1 OF 2 SHEETS STA. 1210+00 TO STA. 1213+00

COUNTY TOTAL SHEETS NO.

VAR. 21 9

CONTRACT NO. 60L65 2010-077-I Sp. 047-0029

FED. ROAD DIST. NO. | ILLINOIS FE

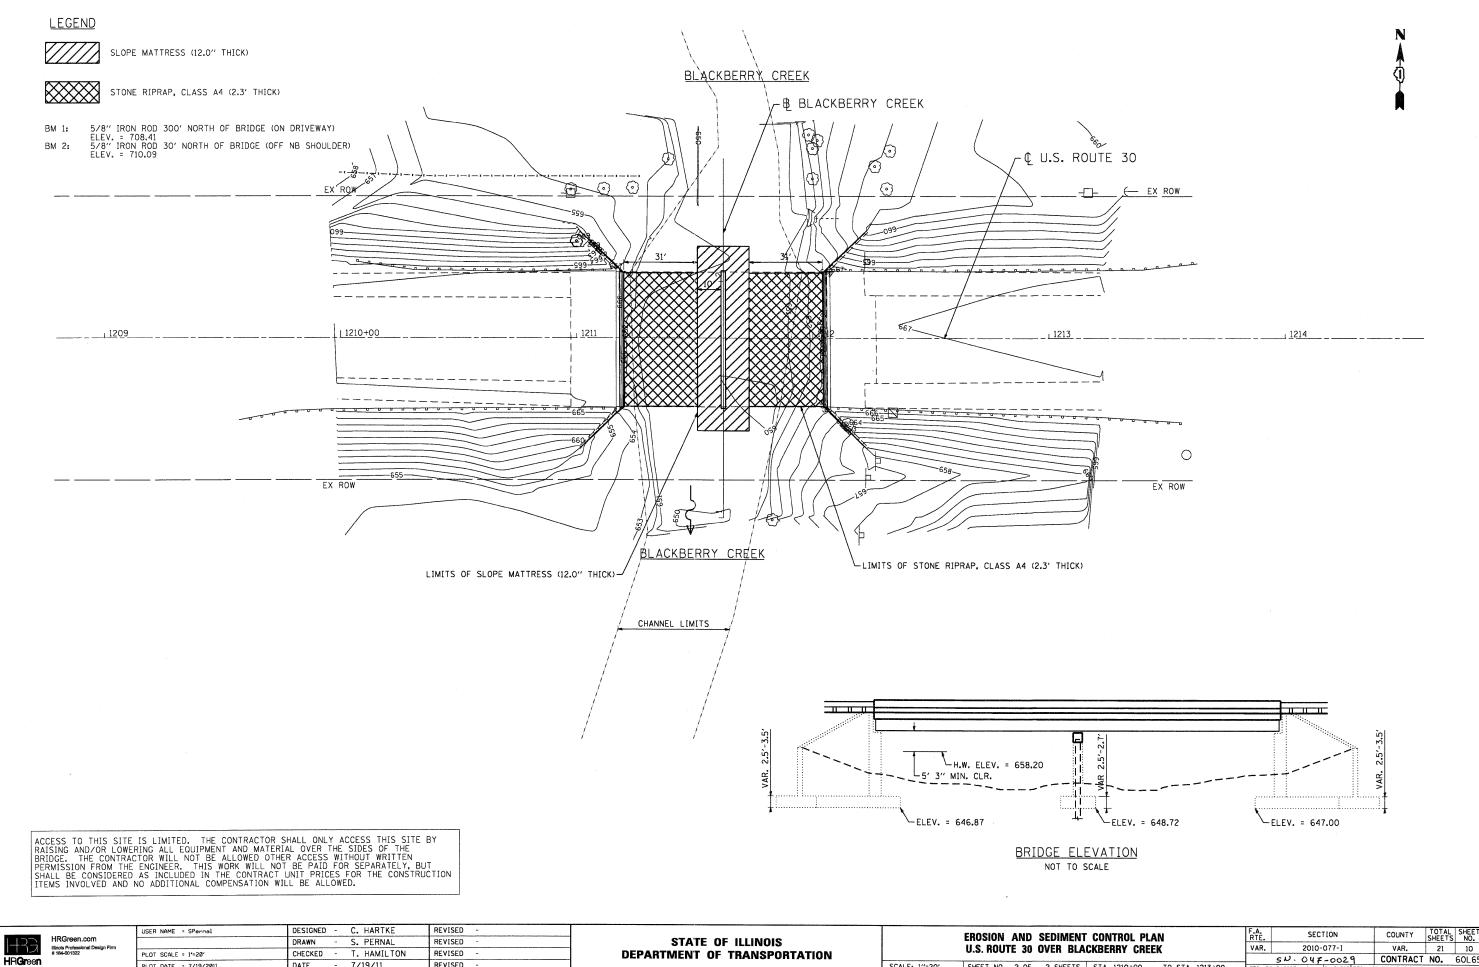


PLOT DATE = 7/19/2011 DATE - 7/19/11 REVISED

DEPARTMENT OF TRANSPORTATION

SHEET NO. 2 OF 2 SHEETS STA. 1210+00 TO STA. 1213+00

FED. ROAD DIST. NO. ILLINOIS FED. AID CONTRACT NO. 60L65

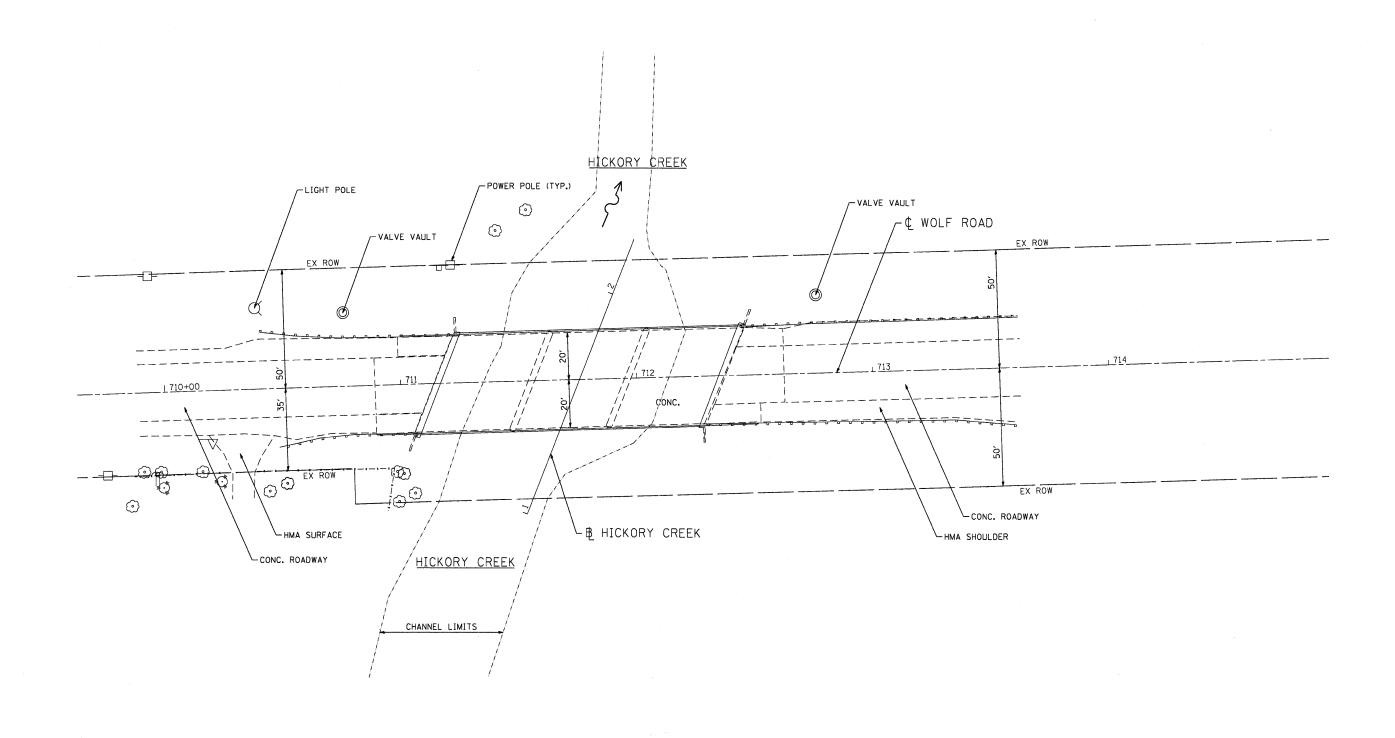

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	DRAWN	-	S. PERNAL	REVISED -	
PLOT SCALE = 1'=20'	CHECKED	-	T. HAMILTON	REVISED -	
PLOT DATE = 7/19/2011	DATE		7/19/11	REVISED -	

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	SITE PLA	N		F.A. RTÉ.	SECTION	COUNTY	TOTAL	SHEET NO.
	WOLF ROAD OVER HI	CKORY CREEK		VAR.	2010-077-1	VAR.	21	11
				5 P. (299-0271	CONTRACT	NO.	60L65
 SCALE: 1"=20'	SHEET NO. 1 OF 2 SHEETS	STA. 710+00	TO STA. 714+00	FED. ROAD DIST.	NO. ILLINOIS FED.	AID PROJECT		

86100196.03 86100196.03 86100196.03-60L65-site **LEGEND**

SLOPE MATTERESS (12.0" THICK)

MAG NAIL 80' SOUTH OF BRIDGE (ON SB SHOULDER) ELEV. = 663.58 MAG NAIL 80' NORTH OF BRIDGE (ON NB SHOULDER) ELEV. = 663.84

HICKORY CREEK LIMITS OF SLOPE MATTRESS (12.0" THICK PLACEMENT) LIMITS OF SLOPE MATTRESS (12.0" THICK PLACEMENT) - ¢ WOLF ROAD EX ROW └ B HICKORY CREEK HICKORY CREEK CHANNEL LIMITS -GUARDRAIL (TYP.) -H.W. ELEV. = 662.60

ACCESS TO THIS SITE IS LIMITED. THE CONTRACTOR SHALL ONLY ACCESS THIS SITE BY RAISING AND/OR LOWERING ALL EQUIPMENT AND MATERIAL OVER THE SIDES OF THE BRIDGE. THE CONTRACTOR WILL NOT BE ALLOWED OTHER ACCESS WITHOUT WRITTEN PERMISSION FROM THE ENGINEER. THIS WORK WILL NOT BE PAID FOR SEPARATELY, BUT SHALL BE CONSIDERED AS INCLUDED IN THE CONTRACT UNIT PRICES FOR THE CONSTRUCTION ITEMS INVOLVED AND NO ADDITIONAL COMPENSATION WILL BE ALLOWED.

BRIDGE ELEVATION NOT TO SCALE

►ELEV. = 648.0


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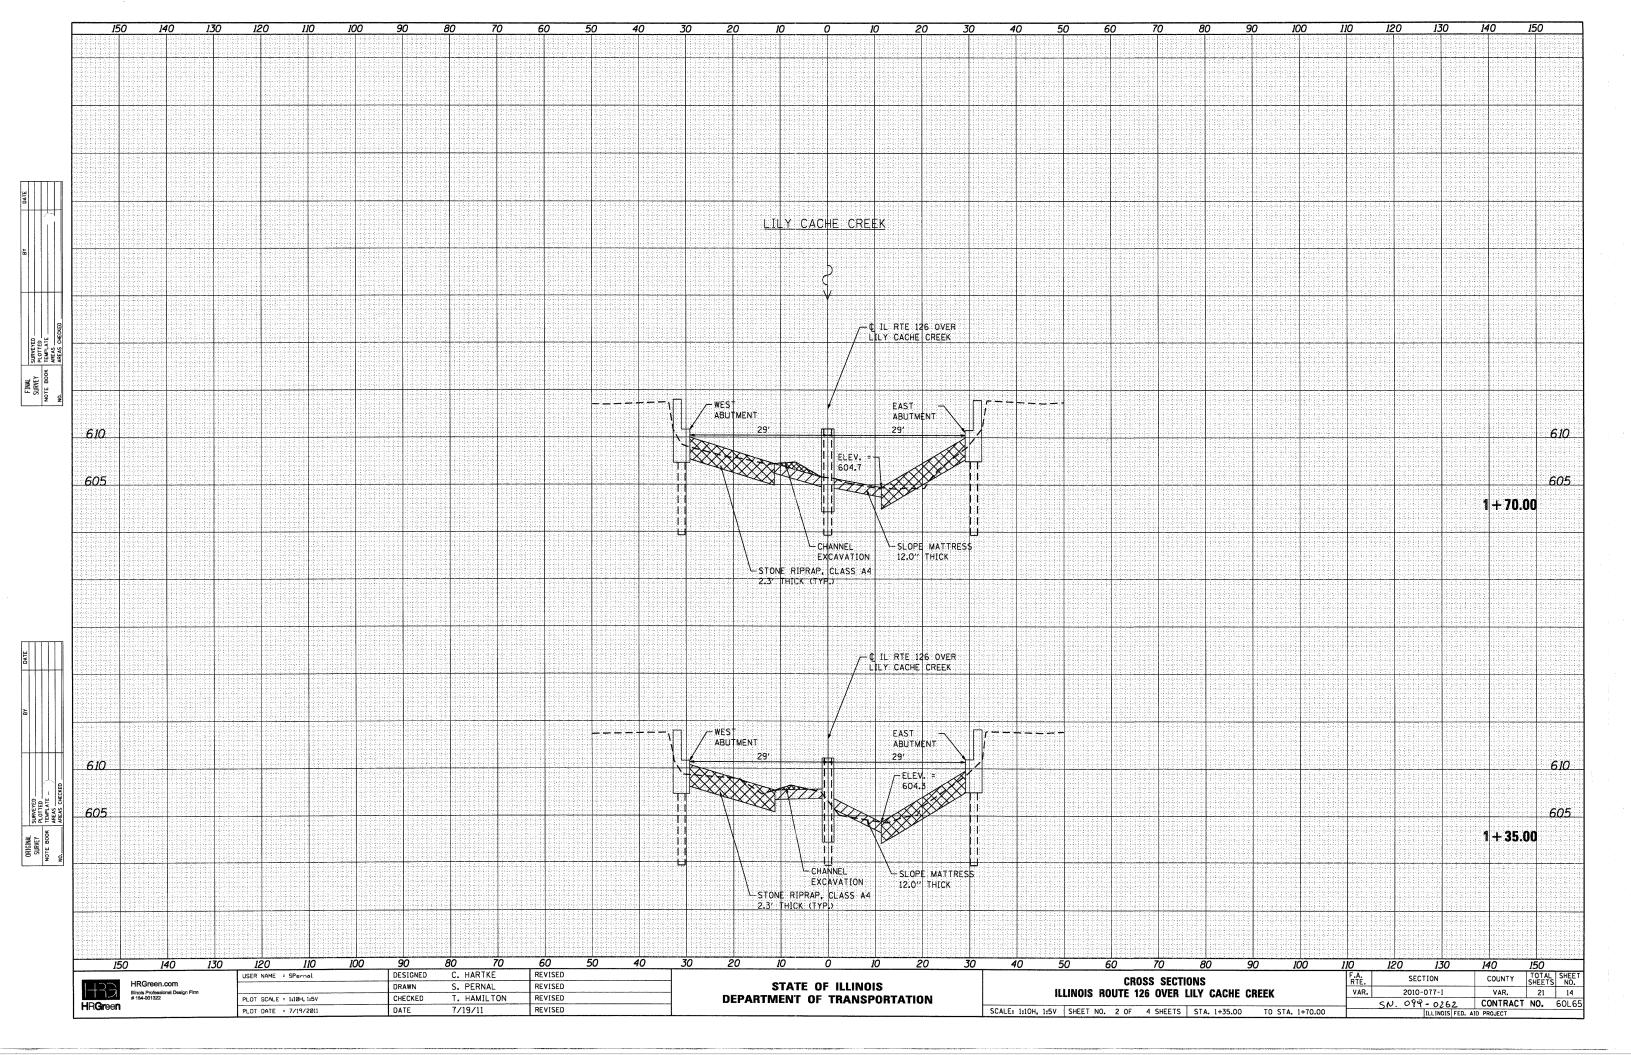
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een.com ofessional Design Firm		DRAWN	-	S. PERNAL	REVISED	-	
1322	PLOT SCALE = 1"=20"	CHECKED -	-	T. HAMILTON	REVISED	-	
	PLOT DATE = 7/19/2011	DATE	-	7/19/11	REVISED	-	


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DEPARTMENT	OF 7	TRANSPORTATION


- 1	EROSION	AND SEDIMEN	T CONTROL PL	.AN	F.A. RTE.	SECTION	COUNTY	TOTAL	SHEET NO.
-	WOLF	ROAD OVER H	ICKORY CREEK		VAR.	2010-077-I	VAR.	21	12
					4	510.099-0271	CONTRACT	NO.	60L65
SCA	ALE: 1"=20' SHEET NO.	2 OF 2 SHEETS	STA. 710+00	TO STA. 714+00	FED. RO	DAD DIST. NO. ILLINOIS FED. A	ID PROJECT		


₩ ELEV. = 648.0



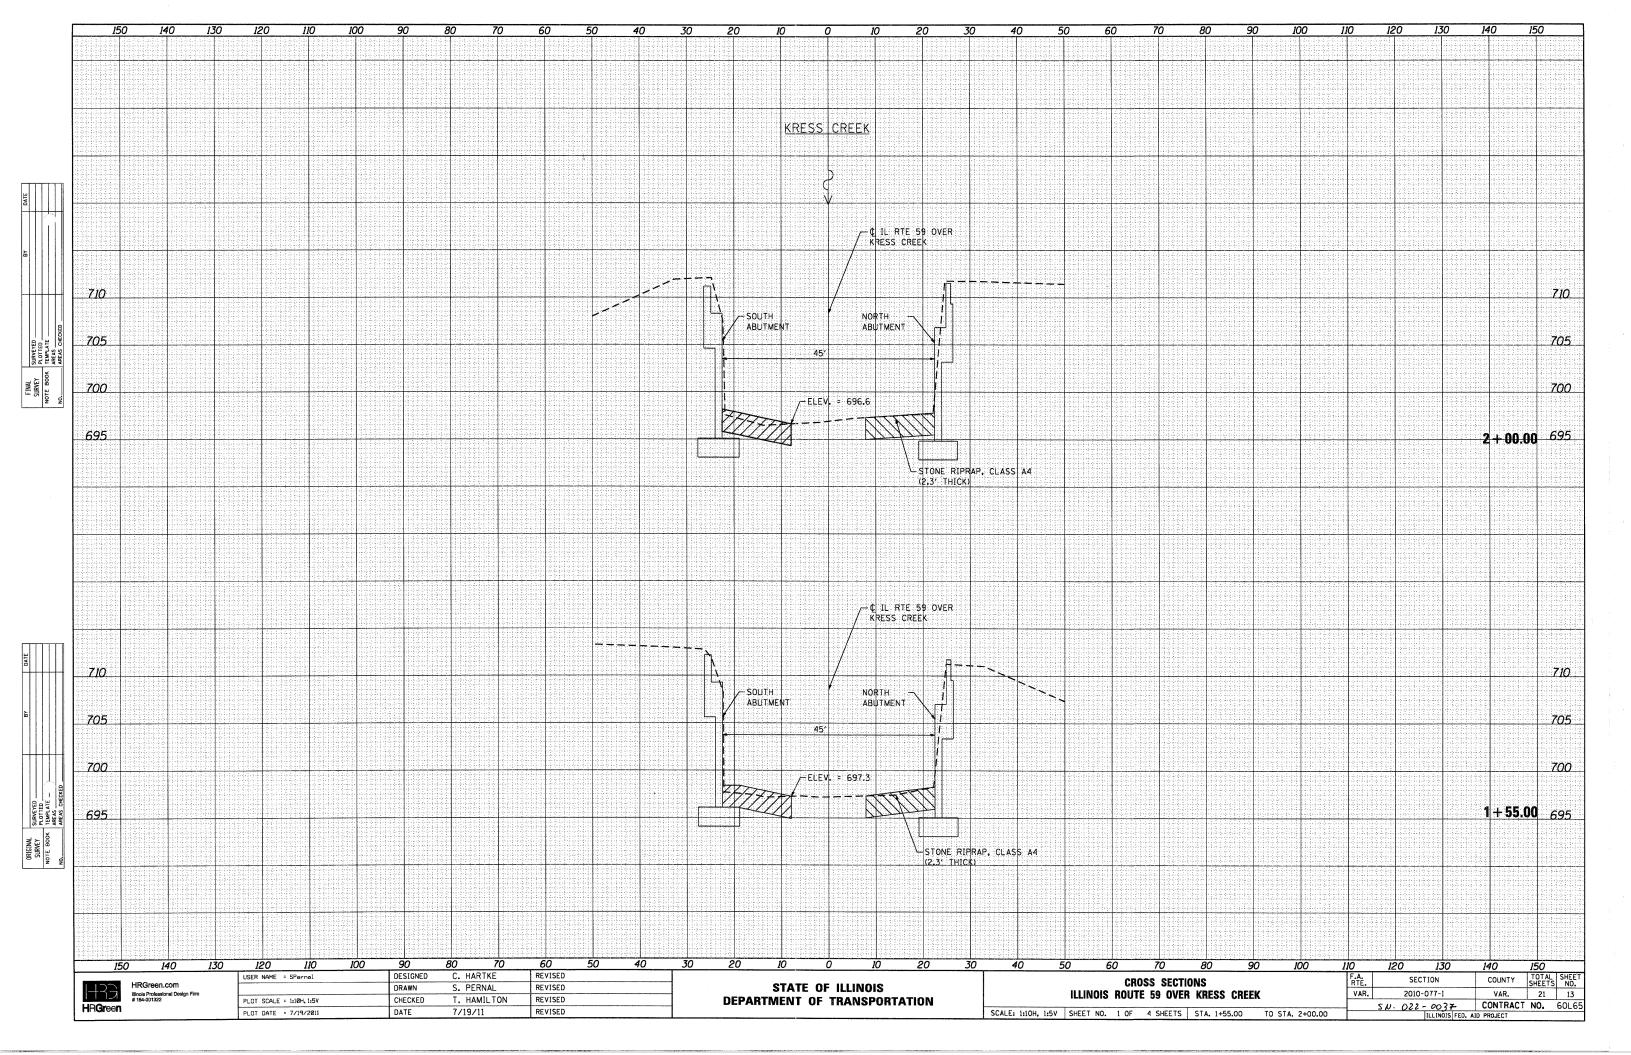

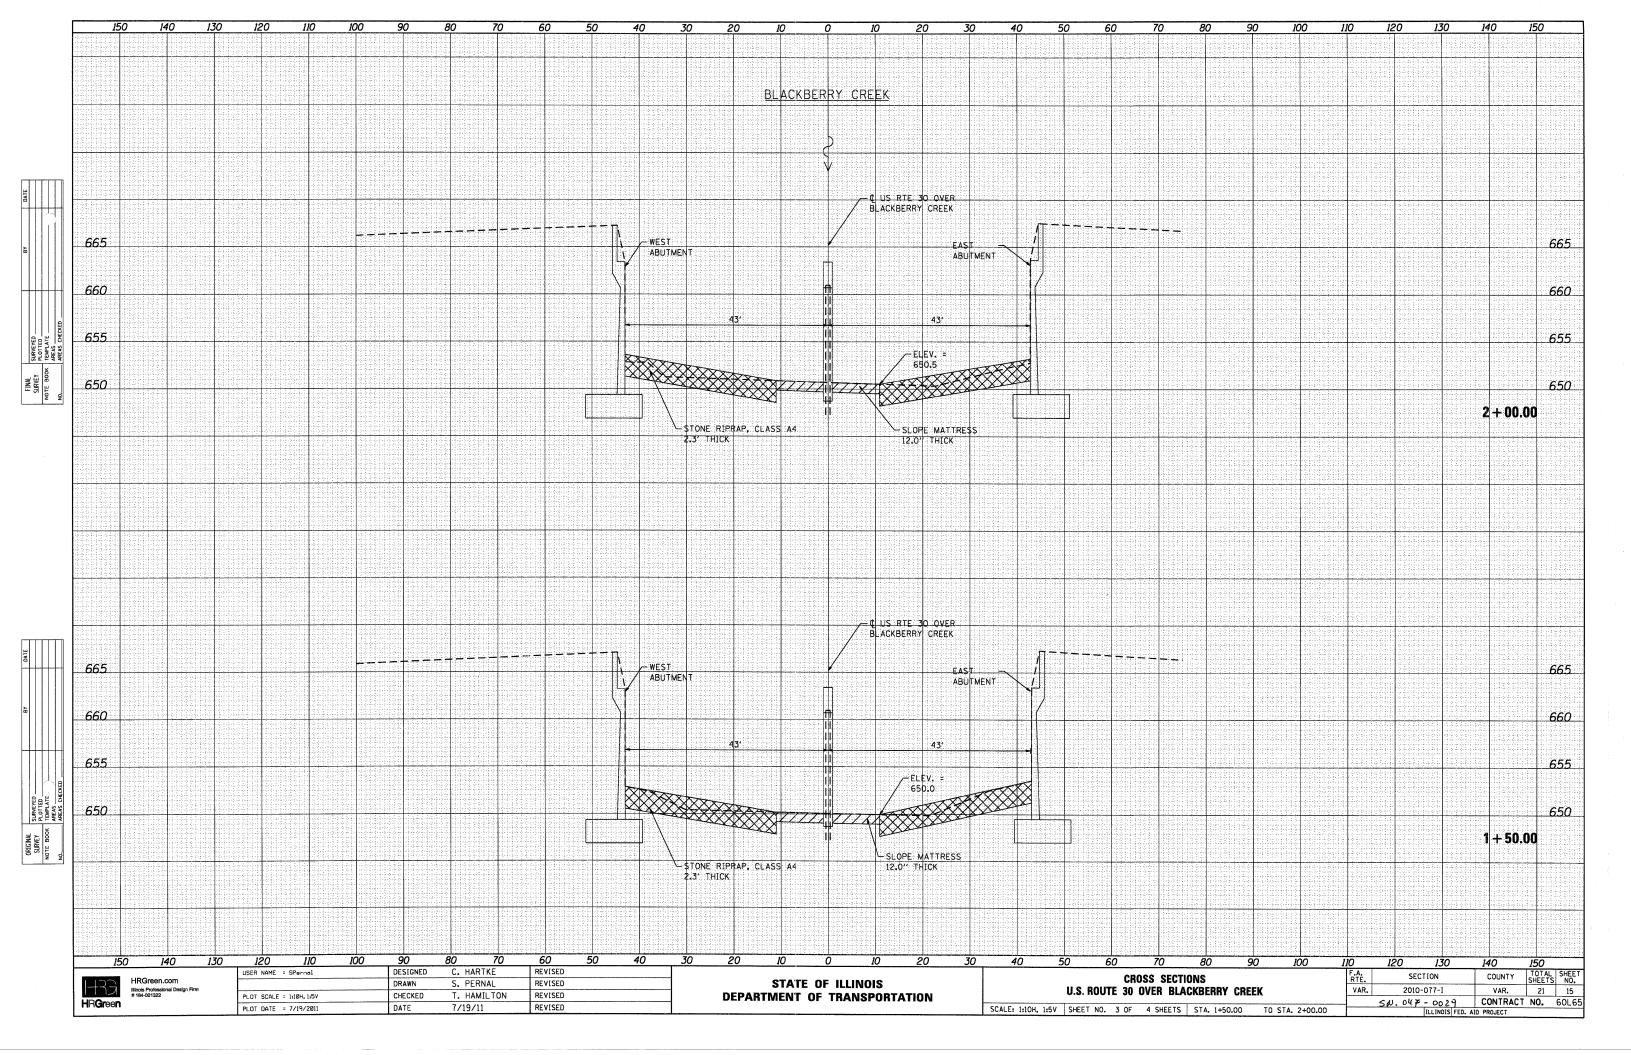

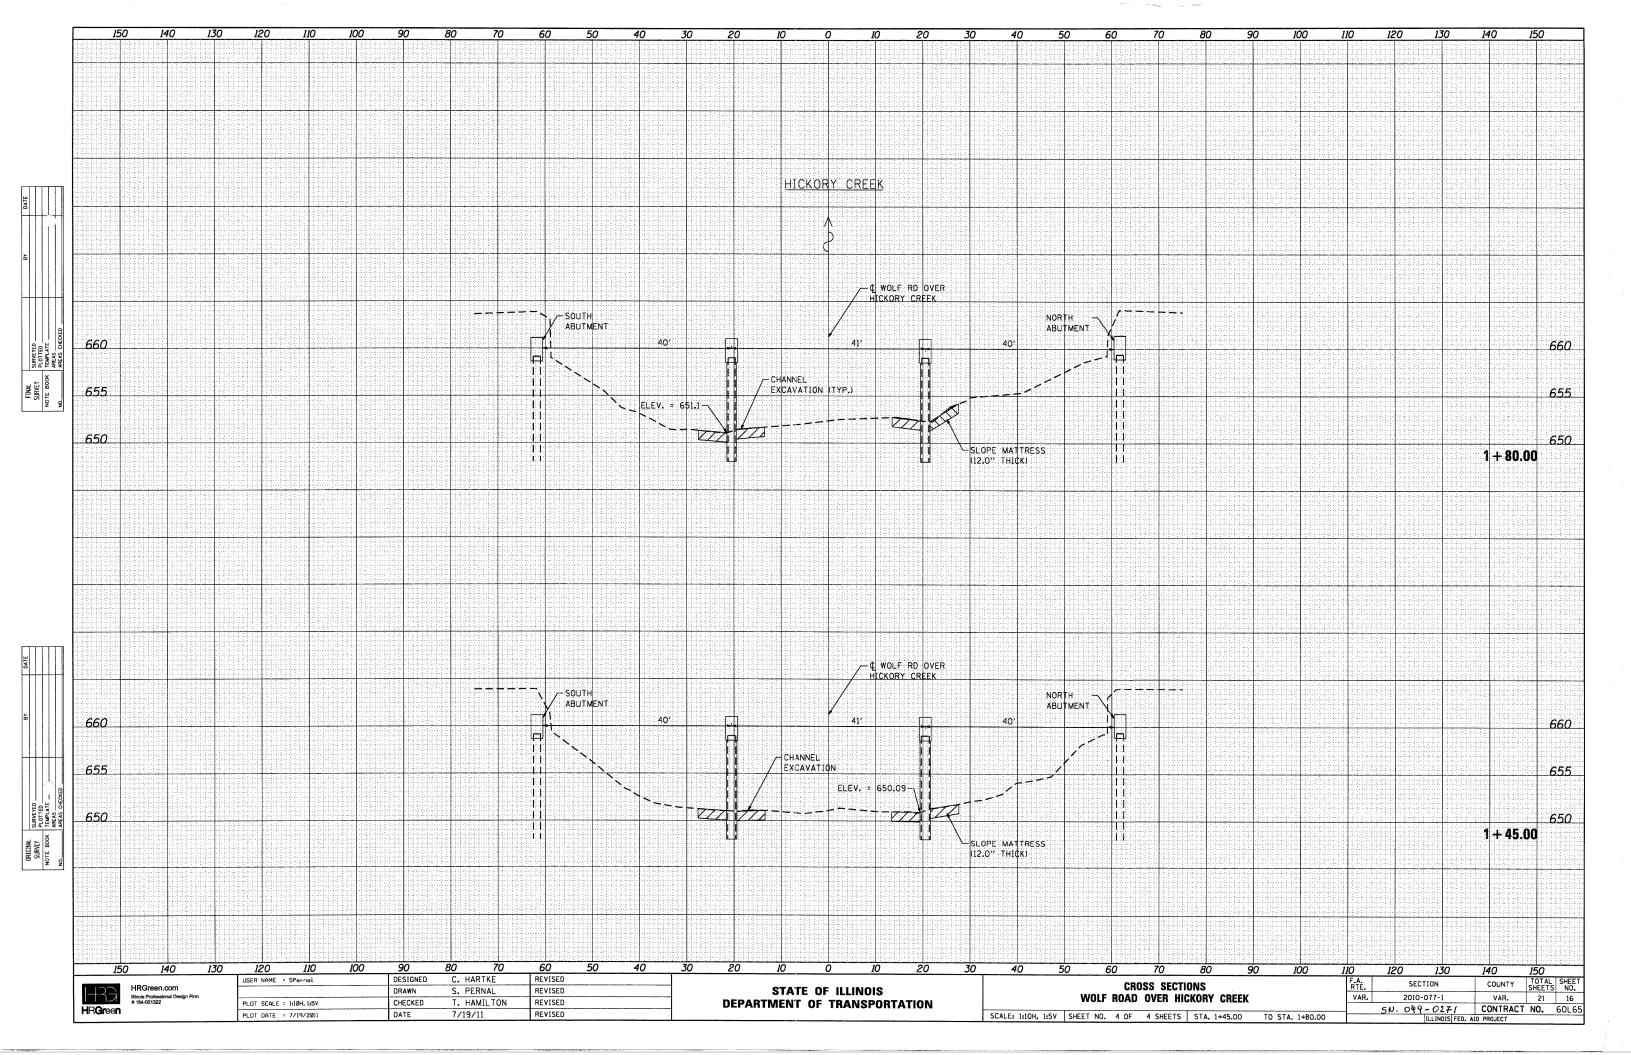

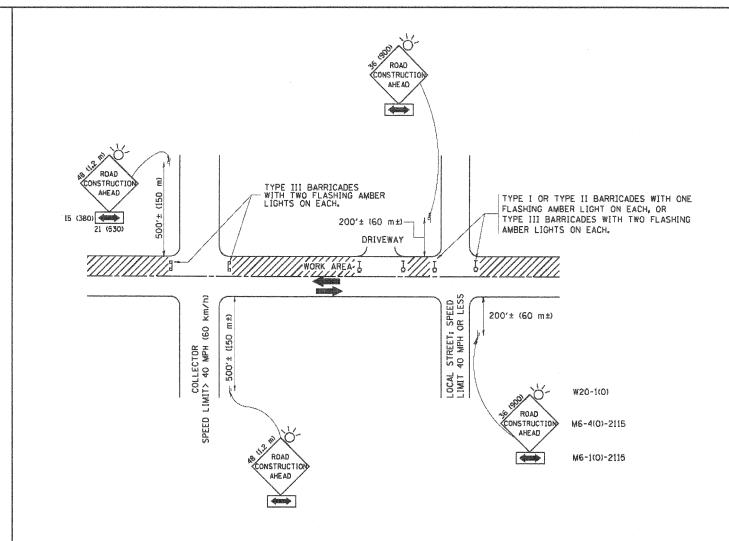

TRAFFIC CONTROL AND PROTECTION FOR SIDE ROADS, INTERSECTIONS, AND DRIVEWAYS

NOTES:

- A. FOR NO LAME RESTRICTION ON THE SIDE ROAD OR DRIVEWAYS
- 1. SIDE ROAD WITH A SPEED LIMIT OF 40 MPH (60 km/h) OR LESS AS SHOWN ON THE DRAWING AND AS DIRECTED BY THE ENGINEERS
- OF ONE HOAD CONSTRUCTION AHEAD SIGN 36 x 36 (900×900) WITH A FLASHER AND FLAG MOUNTED ON IT APPROXIMATELY 200' (60 m) IN ADVANCE
- b) THE CLOSED PORTION OF THE MAIN ROUTE SHALL BE PROTECTED BY BLOCKING WITH TYPE I, TYPE II OR TYPE III BARRICADES, 1/3 OF THE CROSS SECTION OF THE CLOSED PORTION.
- 2. SIDE ROAD WITH A SPEED LIMIT GREATER THAN 40 MPH (60 km/h) AS SHOWN ON THE DRAWING AND AS DIRECTED BY THE ENGINEERS
- of ONE ROAD CONSTRUCTION AHEAD SIGN 48 × 48 (1.2 m x 1.2 m) WITH A FLASHER MOUNTED ON IT APPROXIMATELY 500' (150 m) IN ADVANCE OF THE MAIN ROUTE.
- BITHE CLOSED PORTION OF THE MAIN ROUTE SHALL BE PROTECTED BY BLOCKING WITH TYPE III BARRICADES, 1/2 OF THE CROSS SECTION OF THE CLOSED PORTION.
- 3. WHEN THE SIDE ROAD LIES BETWEEN THE BEGINNING OF THE MAINLINE SIGNING AND THE WORK ZONE, A SINGLE HEADED ARROW (M6-1) SHALL BE USED IN LIEU OF THE DOUBLE HEADED ARROW (MG-4).

- B. FOR A LANE CLOSURE ON A SIDE ROAD OR DRIVEWAYS
- USE APPLICABLE PORTIONS OF THE TYPICAL APPLICATION OF TRAFFIC CONTROL DEVICES (STD. 701501, STD. 701606 OR THE APPROPRIATE STANDARD).
 THE SPACING OF SIGNS AND BARRICADES SHALL BE ADJUSTED FOR FIELD CONDITIONS AS DIRECTED BY THE ENGINEER. THE DIRECTIONAL ARROW SHALL BE COVERED OR REMOVED WHEN NO LONGER CONSISTENT WITH THE SIDE ROAD LANE CLOSURE.
- C. ADVANCE WARNING SIGNS ARE TO BE OMITTED ON DRIVEWAY UNLESS OTHERWISE NOTED.
- D. THE TRAFFIC CONTROL AND PROTECTION FOR SIDE ROADS, INTERSECTIONS, AND DRIVEWAYS SHALL BE INCIDENTAL TO THE COST OF SPECIFIED TRAFFIC CONTROL STANDARDS OR ITEMS.

All dimensions are in millimeters (inches) unless otherwise shown.

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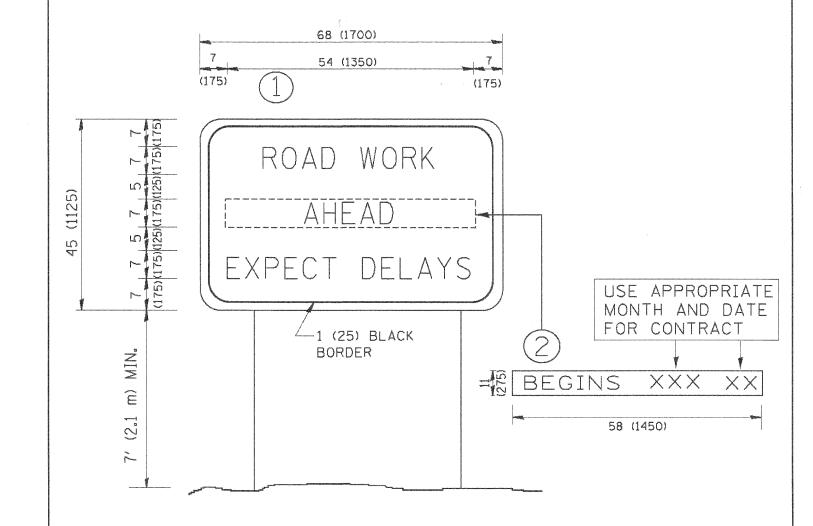
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DESIGNED - LHA REVISED - J. OBERLE 10-18-95 USER NAME = gaglienobt REVISED - A. HOUSEH 03-06-96 DRAWN PLOT SCALE = 50.000 '/ IN. CHECKED REVISED - A. HOUSEH 10-15-96 PLOT DATE = 1/4/2008 REVISED -T. RAMMACHER 01-06-00

STATE OF ILLINOIS **DEPARTMENT OF TRANSPORTATION**

COUNTY TOTAL SHEE NO. SECTION TRAFFIC CONTROL AND PROTECTION FOR VAR. 21 17 2010-077-1 VAR. SIDE ROADS, INTERSECTIONS, AND DRIVEWAYS TC-10 CONTRACT NO. 60L65 SCALE: NONE SHEET NO. 1 OF 5 SHEETS STA. TO STA. FED. ROAD DIST. NO. 1 | ILLINOIS FED. AND PROJECT



NOTES:

- 1. USE BLACK LETTERING ON ORANGE BACKGROUND.
- 2. ERECT SIGNS IN ADVANCE OF THE LOCATION FOR THE "ROAD CONSTRUCTION AHEAD" SIGN AT LOCATIONS AS DIRECTED BY THE ENGINEER.
- 3. ERECT SIGN (1) WITH INSTALLED PANEL (2) ONE WEEK PRIOR TO THE START OF CONSTRUCTION.
- 4. REMOVE PANEL (2) SOON AFTER THE START OF CONSTRUCTION.
- 5. SEE SPECIAL PROVISION FOR "TEMPORARY INFORMATION SIGNING" FOR ADDITIONAL INFORMATION.
- 6. ONE SIGN ASSEMBLY EQUALS 25.70 SQ. FT. (2.3 SQ. M.)
- 7. SHALL BE PAID FOR AS TEMPORARY INFORMATION SIGNING.

ALL DIMENSIONS ARE IN INCHES (MILLIMETERS) UNLESS OTHERWISE SHOWN.

stCOMPANY.NAME)

1. stPROJECT.CONTACT)

stCLIENT)

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	PLOT SCALE = 50.000 '/ IN.	CHECKED -	REVISED -T. RAMMACHER 02-02-99
	PLOT DATE = 1/4/2008	DATE -	REVISED - C. JUCIUS 01-31-07

STATE	OF	ILLINOIS
DEPARTMENT	0F	TRANSPORTATION

	***************************************		***************************************	***************************************						
		A	URTERIAL RO	AD		F.A. RTÉ.	SECTION	COUNTY	TOTAL SHEETS	SHEET NO.
		IN	FORMATION	SIGN		VAR.	2010-077-1	VAR.	21	18
							TC-22	CONTRACT	NO.	60L6
SCALE: NONE	SHEET NO.	2 OF	5 SHEETS	STA.	TO STA.	FEO. R	OAD DIST. NO. 1 ILLINOIS FED. A	ID PROJECT		
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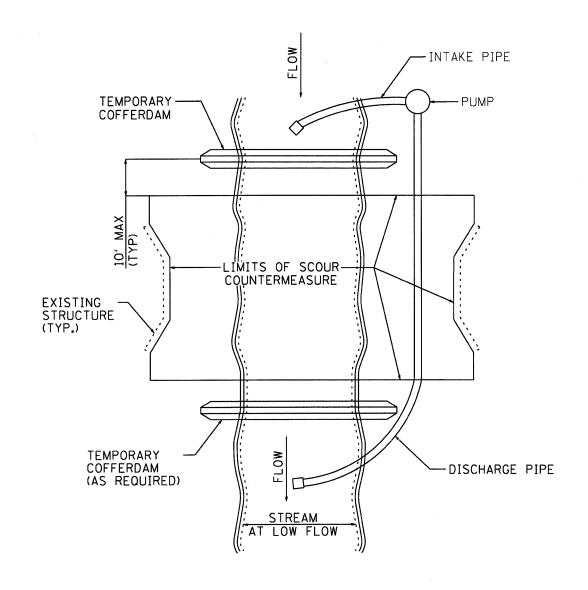


FIGURE D1. TEMPORARY COFFERDAM WITH PUMP BYPASS

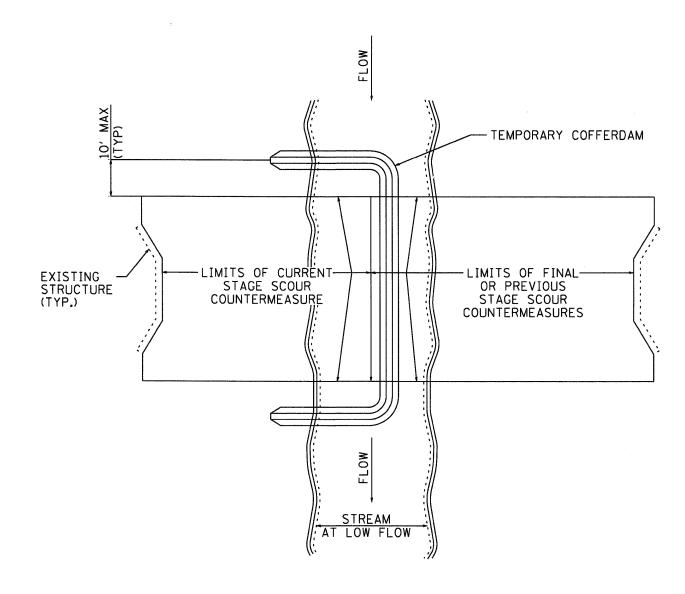


FIGURE D2. STAGED IN-STREAM COFFERDAM DIVISION

NOTE: DEWATERING SYSTEM DETAILS SHALL BE USED IN CONJUCTION WITH THE PROJECT SPECIAL PROVISIONS.

USER NAME = SPernal	DESIGNED -	REVISED -
,	DRAWN -	REVISED -
PLOT SCALE = N/A	CHECKED -	REVISED -
PLOT DATE = 7/19/2011	DATE - 7/19/11	REVISED -

STATE OF ILLINOIS **DEPARTMENT OF TRANSPORTATION**


			DETAILS	
36001	1 600	JNTERME	ASURES	

SCALE: N/A

F.A. RTE. VAR. COUNTY TOTAL SHEET NO.

VAR. 21 19 SECTION CONTRACT NO. 60L65

TO STA. SHEET NO. 3 OF 5 SHEETS STA.

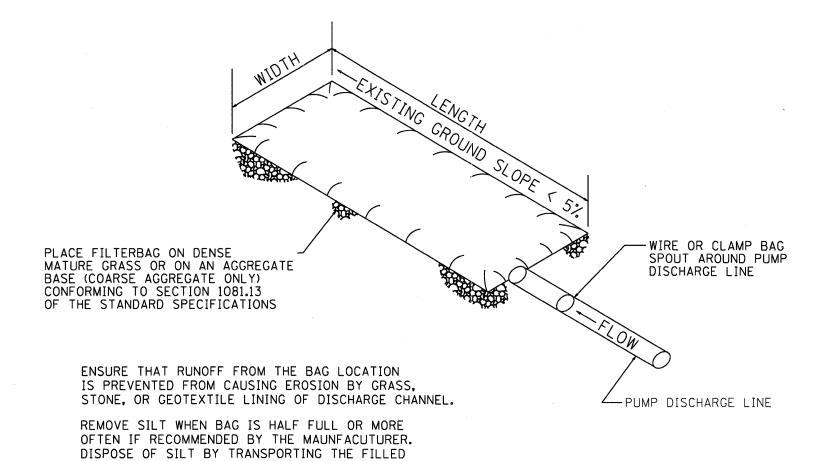

SILT INTO EXISTING TOPOGRAPHY, SEED AND MULCH MAINTAIN EXTRA FILTER BAGS ON SITE. REPLACE DAMAGED BAGS PROMPTLY.

BAG TO DISPOSAL AREA. SLIT THE BAG, BLEND

TYPICAL FLOW RATE: 10 GPM x W x L

FIGURE S1. SEDIMENT FILTER BAG

NOTE: DEWATERING SYSTEM DETAILS SHALL BE USED IN CONJUCTION WITH THE PROJECT SPECIAL PROVISIONS.


HRGreen

 USER NAME = SPernal	DESIGNED -	REVISED -	
-	DRAWN -	REVISED -	
PLOT SCALE = N/A	CHECKED -	REVISED -	
PLOT DATE = 7/19/2011	DATE - 7/19/11	REVISED -	


STATE OF ILLINOIS **DEPARTMENT OF TRANSPORTATION**

DEWATERING SYSTEM DETAILS SCOUR COUNTERMEASURES					F.A. RTE.	SECTION	
					VAR.	2010-077-I	
	SHEET NO.	4 OF	5 SHEETS	STA.	TO STA	FED PO	DAD DIST NO THE INDISTRE

VAR. 21 20 CONTRACT NO. 60L6 SCALE: N/A

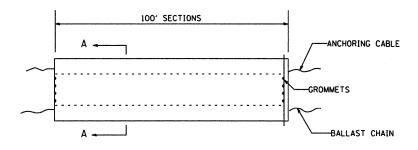

ELEVATION

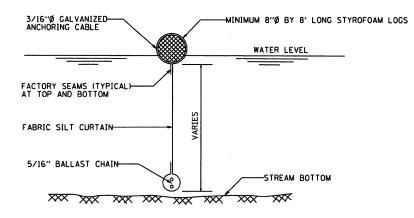


SECTION A-A

FLOTATION BOOM


NOTES:

- FLOTATION BOOM SHALL BE ANCHORED TO PREVENT DRIFT SHOREWARD OR DOWNSTREAM. ANCHORAGES SHALL BE INSTALLED ON BOTH SHORE AND STREAM SIDE.
- 2. SHORE ANCHORS SHALL CONSIST OF A POST WITH DEADMAN OR APPROVED EQUAL. STREAM ANCHORS SHALL BE SUFFICIENT SIZE TO STABILIZE THE BARRIER WITH NUMBER AND SPACING DEPENDENT ON WATERWAY VELOCITIES.
- 3. FABRIC SECTIONS SHALL BE CONNECTED END TO END WITH MINIMUM 5/8" DIAMETER POLYPROPYLENE ROPE
- 4. DESIGN OF BOOM AND ANCHORAGE SHALL BE IN ACCORANDANCE WITH MANUFACTURER'S RECOMENDATIONS. BOTTOM OF BOOM SHALL REACH BOTTOM OF WATERWAY USING ONE OR TWO VERTICAL SECTIONS AS REQUIRED.
- 5. MAINTENANCE SHALL BE PERFORMED AS NEEDED, CONTRACTOR SHALL REMOVE THE BOOM AT COMPLETION OF WORK IN A MANNER THAT WILL PREVENT SILTATION OF THE WATERWAY.

APPLICATION: FLOTATION BOOMS TO BE USED TO CONTROL EROSION, TURBIDITY AND DEBRIS WHEN WORKING IN WATERWAYS.

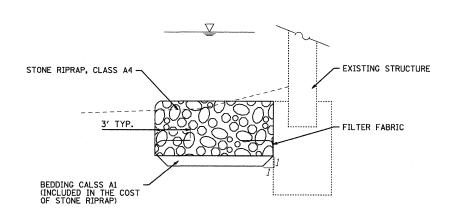

FILTER FABRIC/ RIPRAP DETAIL

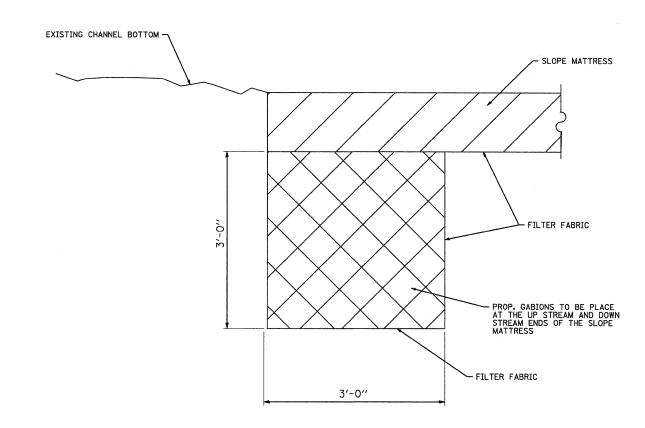

MATTRESS ANCHORING DETAIL

(CT: \$(PROJECT_CONTACT) \$(CLIENT) 7/21/2011 44752 Pl 86100196.03-d9+-05, pdf_ptf STANDARD-TRANS.TBL

PROJECT CONTACT: SCOURY
PROJECT CONTACT: SUPPROJECT
CLENT:
DATE PLOTTED: 7/21/20
FILE NAME: 86/20/39
PLOT DRIVER: OFF,D/F
PLOT DRIVER: OFF,D/F
PLOT DRIVER: OFF,D/F

HRGreen.com
#Illinois Professional Design Firm
#184-001322

USER NAME = JGuerrı	DESIGNED -	REVISED -
	DRAWN -	REVISED -
PLOT SCALE = N/A	CHECKED -	REVISED -
PLOT DATE = 7/21/2011	DATE - 7/21/11	REVISED -

STATE OF ILLINOIS
DEPARTMENT OF TRANSPORTATION

SCOUR COUNTERMEASURES					F.A. RTE.	SECTION	COUNTY	TOTAL SHEETS	SHEET NO.	
					VAR.	2010-077-I	VAR.	21	21	
							CONTRACT	NO.	60L6	
SCALE: N/A	SHEET NO.	5 OF	5 SHEETS	STA.	TO STA.	FED. RO	DAD DIST. NO. ILLINOIS FED. A	ID PROJECT		