#### **DESIGN DESIGNATION**

09-22-2023 LETTING ITEM 011

I-94 - ACCESS CONTROLLED INTERSTATE

#### TRAFFIC VOLUME

I-94 /DUNDEE ROAD - 102,650 (2021 AADT) I-94 /TOWER ROAD - 94,450 (2021 AADT)

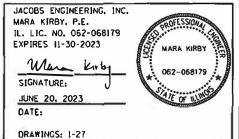
I-94 /LAKE AVE - 101,600 (2021 AADT)

#### POSTED SPEED LIMIT

I-94 - 55 MPH

FOR INDEX OF SHEETS AND LIST OF HIGHWAY STANDARDS, SEE SHEET NO. 2

IMPROVEMENTS LOCATED IN THE VILLAGES OF NORTHBROOK, NORTHFIELD, AND WILMETTE



SINGH & ASSOCIATES, INC.
RASHESHKUMAR D, PATEL, P.E.
IL. LIC. NO. 062-064617
EXPIRES 11-30-2023

SIGNATURE:
JUNE 30, 2023

DATE:


DRAWINGS: 28-84

# STATE OF ILLINOIS DEPARTMENT OF TRANSPORTATION
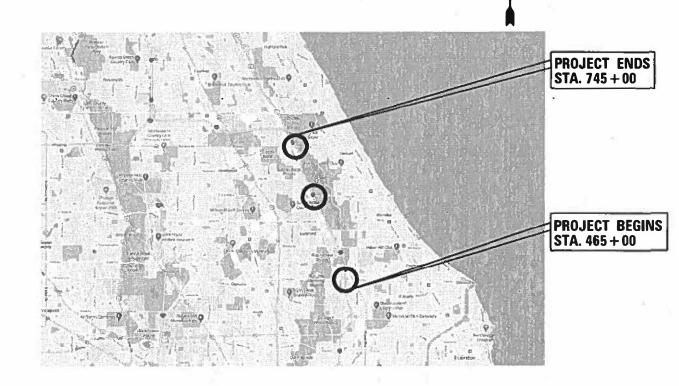
## PROPOSED HIGHWAY PLANS

FAI ROUTE 94 (I-94/US41) AT LAKE AVE, TOWER RD, AND DUNDEE RD INTERCHANGES
SECTION 2016-071L
PROJECT HSIP-FZAB(086)
LED LIGHTING
COOK COUNTY

C-91-105-17



GROSS LENGTH = 27800 FT. = 5.27 MILES

NET LENGTH = 18300 FT. = 3.47 MILES

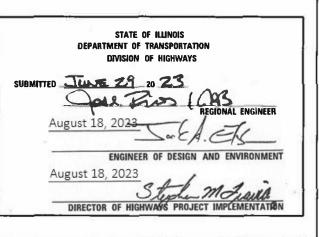
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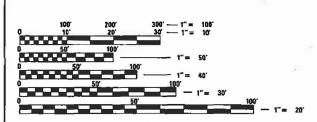


Jacobs

525 W. MONROE SUITE 1600 CHICAGO, BLUNOIS 60661 TELEPHONE: 312.251.3000 ILLINOIS PROESSIONAL DESIGN FIRM REGISTRATION NO. 184.000942



PRINTED BY THE AUTHORITY OF THE STATE OF ILLINOIS



FULL SIZE PLANS HAVE BEEN PREPARED USING STANDARD ENGINEERING SCALES. REDUCED SIZED PLANS WILL NOT CONFORM TO STANDARD SCALES, IN MAKING MEASUREMENTS ON REDUCED PLANS. THE ABOVE SCALES MAY BE USED.

J.U.L.I.E.

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JOINT UTILITY LOCATION INFORMATION FOR EXCAVATION 1-800-892-0123

OR 811

MEADE ELECTRIC CO. DISTRICT ONE ELECTRICAL MAINTENANCE CONTRACTOR LOCATES IDOT ELECTRICAL EQUIPMENT AND UNDERGROUND CABLES 773–287–7672

PROJECT MANAGER: TONY GODINHO 847-705-4442 ELECTRICAL ENGINEER: TONY GODINHO 847-705-4442 CONTRACT NO. 62D82

## INDEX OF SHEETS

1	COV-01	COVER SHEET				
2	IND-01	INDEX OF SHEETS				
3	GEN-01	GENERAL NOTES				
4 - 7	S0Q-01 TO S0Q-04	SUMMARY OF QUANTITIES				
8 - 16	ATB-01 TO ATB-09	ALIGNMENT, TIES AND BENCHMARKS				
17 - 19	CTP-01 TO CTP-03	CONTROL POINTS				
20 - 21	MOT-01 TO MOT-02	MAINTENANCE OF TRAFFIC				
22 - 26	CIV-01 TO CIV-05	CIVIL SITE PLANS				
27	SGN-01	SIGNING PLANS				
28 - 57	LT <b>-</b> 01 TO LT-30	LIGHTING PLANS				
58 - 67	LT-31 TO LT-40	LIGHTING AS-BUILT INFORMATION				
68 - 77	LT-41 TO LT-50	DISTRICT ONE ELECTRICAL DETAILS				
78 - 84		DISTRICT ONE DETAILS				

### NOTICE TO UTILITY COMPANIES

THE DESIGN INTENT OF THIS PROJECT IS NOT TO REQUIRE ANY UTILITY RELOCATIONS. DETAILS ON DEPTH OF FOUNDATIONS AND CONDUIT INSTALLATION ARE AS FOLLOWS:

DESCRIPTION	MAX DEPTH
HELIX LIGHT POLE FOUNDATION	8 FT
CONDUIT	3 FT

## **IDOT HIGHWAY STANDARDS**

000001-08	STANDARD SYMBOLS, ABBREVIATIONS AND PATTERNS
001006	DECIMAL OF AN INCH AND OF A FOOT
701001-02	OFF-RD OPERATIONS, 2L, 2W, MORE THAN 15' AWAY
701006-02	OFF-RD OPERATIONS, 2L, 2W, 15' TO 24" FROM PAVEMENT EDGE
701106-05	OFF-RD OPERATIONS MULTILANE, MORE THAN 15' AWAY
701400-11	APPROACH TO LANE CLOSURE, FREEWAY/EXPRESSWAY
701401-13	LANE CLOSURE, FREEWAY/EXPRESSWAY
701411-09	LANE CLOSURE, MULTILANE, AT FREEWAY ENTRANCE OR EXIT RAMP, FOR SPEEDS > 45MPH
701428-01	TRAFFIC CONTROL SETUP AND REMOVAL FREEWAY/EXPRESSWAY
701446-11	TWO LANE CLOSURE, FREEWAY/EXPRESSWAY
701502-09	URBAN LANE CLOSURE, 2L, 2W, WITH BIDIRECTIONAL LEFT TURN LANE
701601-09	URBAN LANE CLOSURE, MULTILANE, 1W OR 2W WITH NONTRAVERABLE MEDIAN
701606-10	URBAN SINGLE LANE CLOSURE, MULTILANE, 2W WITH MOUNTABLE MEDIAN
701801-06	SIDEWALK, CORNER OR CROSSWALK CLOSURE
701901-08	TRAFFIC CONTROL DEVICES

## **DISTRICT 1 STANDARDS**

TC-08 TC-10 TC-17 TC-18	ENTRANCE AND EXIT RAMP CLOSURE DETAILS TRAFFIC CONTROL AND PROTECTION FOR SIDE ROADS, INTERSECTIONS, AND DRIVEWAYS TRAFFIC CONTROL DETAILS FOR FREEWAY SHOULDER CLOSURES AND PARTIAL RAMP CLOSURES FREEWAY/EXPRESSWAY SIGNING FOR FLAGGING OPERATIONS AT WORK ZONE OPENINGS ON FREEWAYS/EXPRESSWAYS
BE-206 BE-220 BE-305 BE-400 BE-701 BE-702 BE-901	LIGHTING CONTROLLER, BASE MOUNTED, 480VOLT, 200AMP (DUAL) RADIO SCADA - FIBER OPTIC PROVISION ELECTRICAL SERVICE INSTALLATION AERIAL, REMOTE DISCONNECT LIGHT POLE FOUNDATION, METAL ALUMINUM LIGHT POLE 47'-6" MOUNTING HEIGHT LUMINAIRE SAFETY CABLE ASSEMBLY MISC. ELECTRICAL DETAILS SHEET A SUSPENDED MOUNT LED UNDERPASS LUMINAIRE INSTALLATION DETAILS

## IND-01

	USER NAME = k⊕rabmp	DESIGNED - RAS	REVISED -		INDEX OF SHEETS	F.A.	SECTION COUNTY TOTAL SHEETS NO.	ĘΠ
Jacobs		DRAWN - MPK	REVISED -	STATE OF ILLINOIS	INDEX OF SHEETS	I-94	2016-071L COOK 84 2	
	PLOT SCALE =	CHECKED - MMK	REVISED -	DEPARTMENT OF TRANSPORTATION SO			CONTRACT NO. 62D82	-
	PLOT DATE = \$/10/2023	DATE - 08/11/2023	REVISED -		SCALE: NTS SHEET 1 OF 1 SHEETS STA. TO STA.	1	ILLINOIS FED. AID PROJECT	

#### **GENERAL NOTES**

- 1. SEVENTY-TWO (72) HOURS BEFORE STARTING EXCAVATION, THE CONTRACTOR SHALL CALL JULIE AT 1-800-892-0123 TO HAVE THE LOCATION OF EXISTING UNDERGROUND UTILITIES MARKED IN THE FIELD. THE CONTRACTOR SHALL CALL THE IDOT ELECTRICAL MAINTENANCE CONTRACTOR TO LOCATE IDOT MAINTAINED EQUIPMENT AND UNDERGROUND CONDUIT AND CABLES.
- A MINIMUM OF SEVENTY-TWO HOURS PRIOR TO ANY PLACEMENT OR RELOCATION OF MAINTENANCE OF TRAFFIC DEVICES, CONTACT ILLINOIS DEPARTMENT OF TRANSPORTATION (IDOT) DISTRICT 1 BUREAU OF TRAFFIC.
- 3. THE CONTRACTOR IS RESPONSIBLE FOR OBTAINING ALL NECESSARY PERMITS TO PERFORM WORK.
- 4. EXCEPT WHERE DESIGNATED OTHERWISE, THE LOCATIONS AND/OR DEPTHS OF UNDERGROUND UTILITIES SHOWN HAVE BEEN TAKEN FROM OFFICE RECORD INFORMATION FURNISHED BY THE UTILITY OWNERS AND THE SUBSURFACE UTILITY ENGINEERING (SUE) SURVEYS. ALL UNDERGROUND UTILITIES MUST BE CONSIDERED APPROXIMATE.
- 5. THE CONTRACTOR SHALL BE RESPONSIBLE FOR THE PROTECTION OF ALL UNDERGROUND OR SURFACE UTILITIES EVEN THOUGH THEY MAY NOT BE SHOWN IN THE PLANS. ANY UTILITY THAT IS DAMAGED DURING CONSTRUCTION SHALL BE REPAIRED OR REPLACED TO THE SATISFACTION OF THE ENGINEER. THIS WORK WILL BE AT THE CONTRACTOR'S EXPENSE.
- THE CONTRACTOR SHALL COORDINATE WORK WITH UTILITIES IN ADVANCE OF WORKING IN THE VICINITY OF THEIR FACILITIES. COORDINATION EFFORTS SHALL BE INCLUDED IN THE COST OF THE CONTRACT BID PRICE.
- 7. IT SHALL BE THE CONTRACTOR'S RESPONSIBILITY TO VERIFY ALL DIMENSIONS AND CONDITIONS EXISTING IN THE FIELD PRIOR TO ORDERING MATERIALS AND BEGINNING CONSTRUCTION.
- 8. THE CONTRACTOR WILL NOT BE ALLOWED TO SET UP A YARD OR FIELD OFFICE ON STATE PROPERTY WITHOUT WRITTEN PERMISSION FROM THE DEPARTMENT.
- 9. ALL HORIZONTAL DATUM ARE BASED ON NORTH AMERICAN DATUM OF 1983 (NAD 83). ALL VERTICAL DATUM ARE BASED ON NORTH AMERICAN VERTICAL DATUM 1988 (NAVD88).
- 10. WHEN ARTIFICIAL LIGHTING IS USED IN NIGHT OPERATIONS THE CONTRACTOR SHALL EXERCISE THE UTMOST PRECAUTIONS IN PREVENTING ADVERSE VISIBILITY TO THE MOTORING PUBLIC, AIR TRAFFIC, AND ADJOINING COMMERCIAL AND RESIDENTIAL AREAS.
- 11. THE CONTRACTOR SHALL REQUEST AND GAIN APPROVAL FROM THE ILLINOIS DEPARTMENT OF TRANSPORTATION'S EXPRESSWAY TRAFFIC OPERATIONS ENGINEER AT WWW.IDOTLCS.COM TWENTY-FOUR (24) HOURS IN ADVANCE OF ALL DAILY LANE, RAMP AND SHOULDER CLOSURES AND 7 DAYS IN ADVANCE OF ALL PERMANENT AND WEEKEND CLOSURES ON ALL FREEWAYS AND/OR EXPRESSWAYS IN DISTRICT ONE. THIS ADVANCE NOTIFICATION IS CALCULATED BASED ON WORKWEEK OF MONDAY THROUGH FRIDAY AND SHALL NOT INCLUDE WEEKENDS OR HOLIDAYS.
- 12. RESTORATION OF DISTURBED AREAS SHALL BE INCLUDED IN THE RELATED PAY ITEMS AND NO EXTRA COMPENSATION SHALL BE ALLOWED. ALL DAMAGED SURFACES SUCH AS PAVEMENT, SHOULDERS, MEDIANS, AND BARRIER WALLS SHALL BE REPLACED IN KIND. ALL DISTURBED EARTH SURFACES SHALL RECEIVE PROPER EROSION CONTROL MEASURES AND SHALL BE SEEDED IN ACCORDANCE WITH A PLAN DEVELOPED BY THE CONTRACTOR AND APPROVED BY THE ENGINEER AND NO EXTRA COMPENSATION SHALL BE ALLOWED.
- 13. THE CONTRACTOR SHALL AVOID TRENCHING THROUGH WETLAND AREAS, ROADSIDE DITCHES, AND RETENTION PONDS AND SHALL NOT IMAPACT WETLAND AREAS. WETLANDS SHALL BE PROTECTED FROM ANY WORK WITHIN THE IMMEDIATE VICINITY OF THE WETLAND LIMITS AND NO EXTRA COMPENSATION SHALL BE ALLOWED.

#### COMMITMENTS

1. PACE BUS OPERATES ON THE RIGHT SHOULDER BETWEEN DUNDEE ROAD AND CICERO AVE. THE CONTRACTOR MUST CONTACT THE PACE OPERATIONS CENTER AT (847) 724-4144 72 HOURS IN ADVANCE OF ANY SHOULDER CLOSURES.

#### **GEN-01**

USER NAME = OGORMAN	DESIGNED	-	JJZ	REVISED -
	DRAWN	-	MPK	REVISED -
PLOT SCALE =	CHECKED	-	MMK	REVISED -
PLOT DATE = 6/23/2023	DATE	-	01/31/2023	REVISED -

SCALE: NTS

						CONSTRUC	CTION CODE	
				90% FEDERAL	90% FEDERAL	0011011100		
	1	T	URBAN	10% STATE	10% STATE			
CODE	ITEM	UNIT	TOTAL	COOK 0021	COOK 0044			
NO.	I I EIVI	UNIT	QUANTITY	LIGHTING	OTHER / SIGNAGE			
			_	2.0				
20101400	NITROGEN FERTILIZER NUTRIENT	POUND	5		5			
20101600	POTASSIUM FERTILIZER NUTRIENT	POUND	5		5			
21101685	TOPSOIL FURNISH AND PLACE, 24"	SQ YD	262		262			
25000210	SEEDING, CLASS 2A	ACRE	0.25		0.25			
25100630	EROSION CONTROL BLANKET	SQ YD	262		262			
25100630	EROSION CONTROL BLANKET	SQTD	202		202			
* 66900200	NON-SPECIAL WASTE DISPOSAL	CU YD	120		120			
* 66900530	SOIL DISPOSAL ANALYSIS	EACH	6		6			
* 66901001	REGULATED SUBSTANCES PRE-CONSTRUCTION PLAN	L SUM	1		1			
* 66901003	REGULATED SUBSTANCES FINAL CONSTRUCTION REPORT	L SUM	1		1			
33331333	The section as a section of the sect							
* 66901006	DECUL ATER CURRETANCES MONITORING	CAL DA	45		45			
* 66901006	REGULATED SUBSTANCES MONITORING	CAL DA	15		15			
67100100	MOBILIZATION	L SUM	1		1			
70200100	NIGHTTIME WORK ZONE LIGHTING	L SUM	1	1				
<b>*</b> 72400710	RELOCATE SIGN PANEL - TYPE 1	SQ FT	73		73			
<b>*</b> 72400720	RELOCATE SIGN PANEL - TYPE 2	SQ FT	60		60			
12130120								
00400400	ELECTRIC CERVICE INCTALLATION	FA011		2				+
80400100	ELECTRIC SERVICE INSTALLATION	EACH	3	3				

**★** SPECIALTY ITEM

**SOQ-01** 

Jacobs

DRAWN         -         MPK         REVISED         -           PLOT SCALE =         CHECKED         -         MMK         REVISED         -	USER NAME = DGORMAN	DESIGNED -	RAS	REVISED -
PLOT SCALE = CHECKED - MMK REVISED -	ſ	DRAWN -	MPK	REVISED -
	PLOT SCALE =	CHECKED -	MMK	REVISED -
PLOT DATE = 6/23/2023 DATE - 01/31/2023 REVISED -	PLOT DATE = 6/23/2023	DATE -	01/31/2023	REVISED -

STATE OF ILLINOIS DEPARTMENT OF TRANSPORTATION SCALE: NTS SHEET 1 OF 4 SHEETS STA. TO STA.

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			LIDDANI	90% FEDERAL	90% FEDERAL			
			URBAN	10% STATE	10% STATE			
CODE	ITEM	UNIT	TOTAL	COOK 0021	COOK 0044			
NO.		UNIT	QUANTITY	LIGHTING	OTHER / SIGNAGE			
					OTTLERY CICIARCE			
80400200	ELECTRIC UTILITY SERVICE CONNECTION	L SUM	1	1				
81028240	UNDERGROUND CONDUIT, GALVANIZED STEEL, 4" DIA.	FOOT	2,373	2,373				
81100320	CONDUIT ATTACHED TO STRUCTURE, 1" DIA., PVC COATED GALVANIZED STEEL	FOOT	1,243	1,243				
		-	,,,	1,2.5				
04400005	COMPUIT ATTACHED TO OTRUCTURE OF RIA DIVO CONTER CALVANITED CTEE	FOOT	100	400				
81100805	CONDUIT ATTACHED TO STRUCTURE, 3" DIA., PVC COATED GALVANIZED STEEL	FOOT	106	106				
81300220	JUNCTION BOX, STAINLESS STEEL, ATTACHED TO STRUCTURE, 6" X 6" X 4"	EACH	13	13				
81300530	JUNCTION BOX, STAINLESS STEEL, ATTACHED TO STRUCTURE, 12" X 10" X 6"	EACH	11	11				
81300830	UNCTION BOX, STAINLESS STEEL, ATTACHED TO STRUCTURE, 18" X 18" X 8"	EACH	4	4				
81603081	UNIT DUCT, 600V, 3-1C NO.2, 1/C NO.4 GROUND, (XLP-TYPE USE), 1 1/2" DIA. POLYETHYLENE	FOOT	41,447	41,447				
01003001	ONTI DOCT, 000V, 3-10 NO.2, 110 NO.4 GNOOND, (ALF-TIFE OSE), 1 1/2 DIA. FOLTETTILENE	1001	41,447	41,447				
2.1=22.1.12								
81702110	ELECTRIC CABLE IN CONDUIT, 600V (XLP-TYPE USE) 1/C NO. 10	FOOT	5,272	5,272				
81702220	ELECTRIC CABLE IN CONDUIT, 600V (XLP-TYPE USE) 1/C 350MCM	FOOT	1,218	1,218				
82110008	LUMINAIRE, LED, ROADWAY, OUTPUT DESIGNATION H	EACH	198	198				
82110027	LUMINAIRE, LED, UNDERPASS, SUSPENDED, OUTPUT DESIGNATION E	EACH	13	13				
83050810	LIGHT POLE, ALUMINUM, 47.5 FT. M.H., 15 FT. MAST ARM	EACH	182	182				
2220010		+	.02	1.02				
00000005	LIQUE DOLE FOUNDATION METAL ASSIDENT OFFICE ASSIVES	FAGU	100	400				
83600365	LIGHT POLE FOUNDATION, METAL, 15" BOLT CIRCLE, 10" X 8'	EACH	182	182				
			+					
83800205	BREAKAWAY DEVICE, TRANSFORMER BASE, 15 INCH BOLT CIRCLE	EACH	182	182				
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## **SOQ-02**

**Jacobs** 

USER NAME = DGORMAN	DESIGNED	-	RAS	REVISED -	
	DRAWN	-	MPK	REVISED -	
PLOT SCALE =	CHECKED	-	MMK	REVISED -	
PLOT DATE = 6/23/2023	DATE	-	01/31/2023	REVISED -	

STATE OF ILLINOIS
DEPARTMENT OF TRANSPORTATION

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84200500	REMOVAL OF LIGHTING UNIT, SALVAGE	EACH	1	1		
			·	·		
84200600	REMOVAL OF LIGHTING UNIT, NO SALVAGE	EACH	66	66		
84200804	REMOVAL OF POLE FOUNDATION	EACH	27	27		
84500110	REMOVAL OF LIGHTING CONTROLLER	EACH	3	3		
						1
84500120	REMOVAL OF ELECTRIC SERVICE INSTALLATION	EACH	3	3		
			_	_		
84500130	REMOVAL OF LIGHTING CONTROLLER FOUNDATION	EACH	3	3		
X0100003	CLEARING AND GRUBBING	SQ YD	100		100	
X0100003	CLEARING AND GRUDDING	30 10	100		100	
X0327234	LIGHTING UNIT IDENTIFICATION DECAL	EACH	4	4		
70027204	EIGHTING ONLY IDENTIFICATION DECAL	LACIT	4	7		
X1400190	REMOVAL OF HIGH MAST LUMINAIRES, SALVAGE	EACH	91	91		
X1100100	TEMOTILE OF THOTTHINGS ESTIMATICES, O'LEVICE	2,1011	01	01		
X1400341	REMOVAL OF LUMINAIRE, SALVAGE	EACH	119	119		
	,					
X1400402	LIGHTING CONTROLLER, BASE MOUNTED, 480VOLT, 200AMP (DUAL), RADIO SCADA, FIBER OPTIC	EACH	3	3		
X1400507	REMOVAL OF TRANSFORMER BASE, SALVAGE	EACH	27	27		
X1400509	REMOVAL OF LIGHTING ARM, NO SALVAGE	EACH	8	8		
X1400510	6 FT DUAL MAST ARMS, ALUMINUM, 180 DEGREES APART	EACH	8	8		
X1700123	CONCRETE BARRIER WALL REPAIR	EACH	39	39		

**SOQ-03** 

**Jacobs** 

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	DRAWN	-	MMO	REVISED -	
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STATE OF ILLINOIS
DEPARTMENT OF TRANSPORTATION

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	NO.			QUANTITY	LIGHTING	OTHER / SIGNAGI				
*	)/0700//0	ENGINEERIG FIELD OFFICE TYPE A (OPEGIAL)	041.140	45	45					
*	X6700410	ENGINEER'S FIELD OFFICE, TYPE A (SPECIAL)	CAL MO	15	15					
ļ										
*	X7011015	TRAFFIC CONTROL AND PROTECTION (EXPRESSWAYS)	L SUM	1		1				
ļ	71011010	The trib contribution (Extraction of	20011	,		<u>'</u>			1	
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*	X8420111	REMOVAL OF UNDERPASS LIGHTING UNIT, NO SALVAGE	EACH	12	12					
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*	84200505	REMOVAL OF LIGHT TOWER, SALVAGE	EACH	23	23					
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*	X8420510	REMOVAL OF TOWER FOUNDATION	EACH	23	23					
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*	70040700	CONCTRUCTION LAVOUT	LCUM	4		1				
	Z0013798	CONSTRUCTION LAYOUT	L SUM	1		1				
ļ										
*	Z0033020	LUMINAIRE SAFETY CABLE ASSEMBLY	EACH	198	198					
-	20000020				100					
*	Z0033028	MAINTENANCE OF LIGHTING SYSTEM	CAL MO	15	15					
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Ø	Z0076600	TRAINEES	HOURS	1000	1000					
ď	70070004	TRAINIFFO TRAINING PROCRAM CRADUATE	HOURS	1000	4000					
Ø	Z0076604	TRAINEES - TRAINING PROGRAM GRADUATE	HOURS	1000	1000					
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	70102622	TRAFFIC CONTROL AND PROTECTION, STANDARD 701502	LSUM	1	1					
	70102022	TO SECTION TO LEGITOR, OT MIDAILE TO 1002	LOUIVI	<u> </u>	'					
	70102625	TRAFFIC CONTROL AND PROTECTION, STANDARD 701606	LSUM	1	1					
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l	70102630	TRAFFIC CONTROL AND PROTECTION, STANDARD 701601	LSUM	1	1			11		
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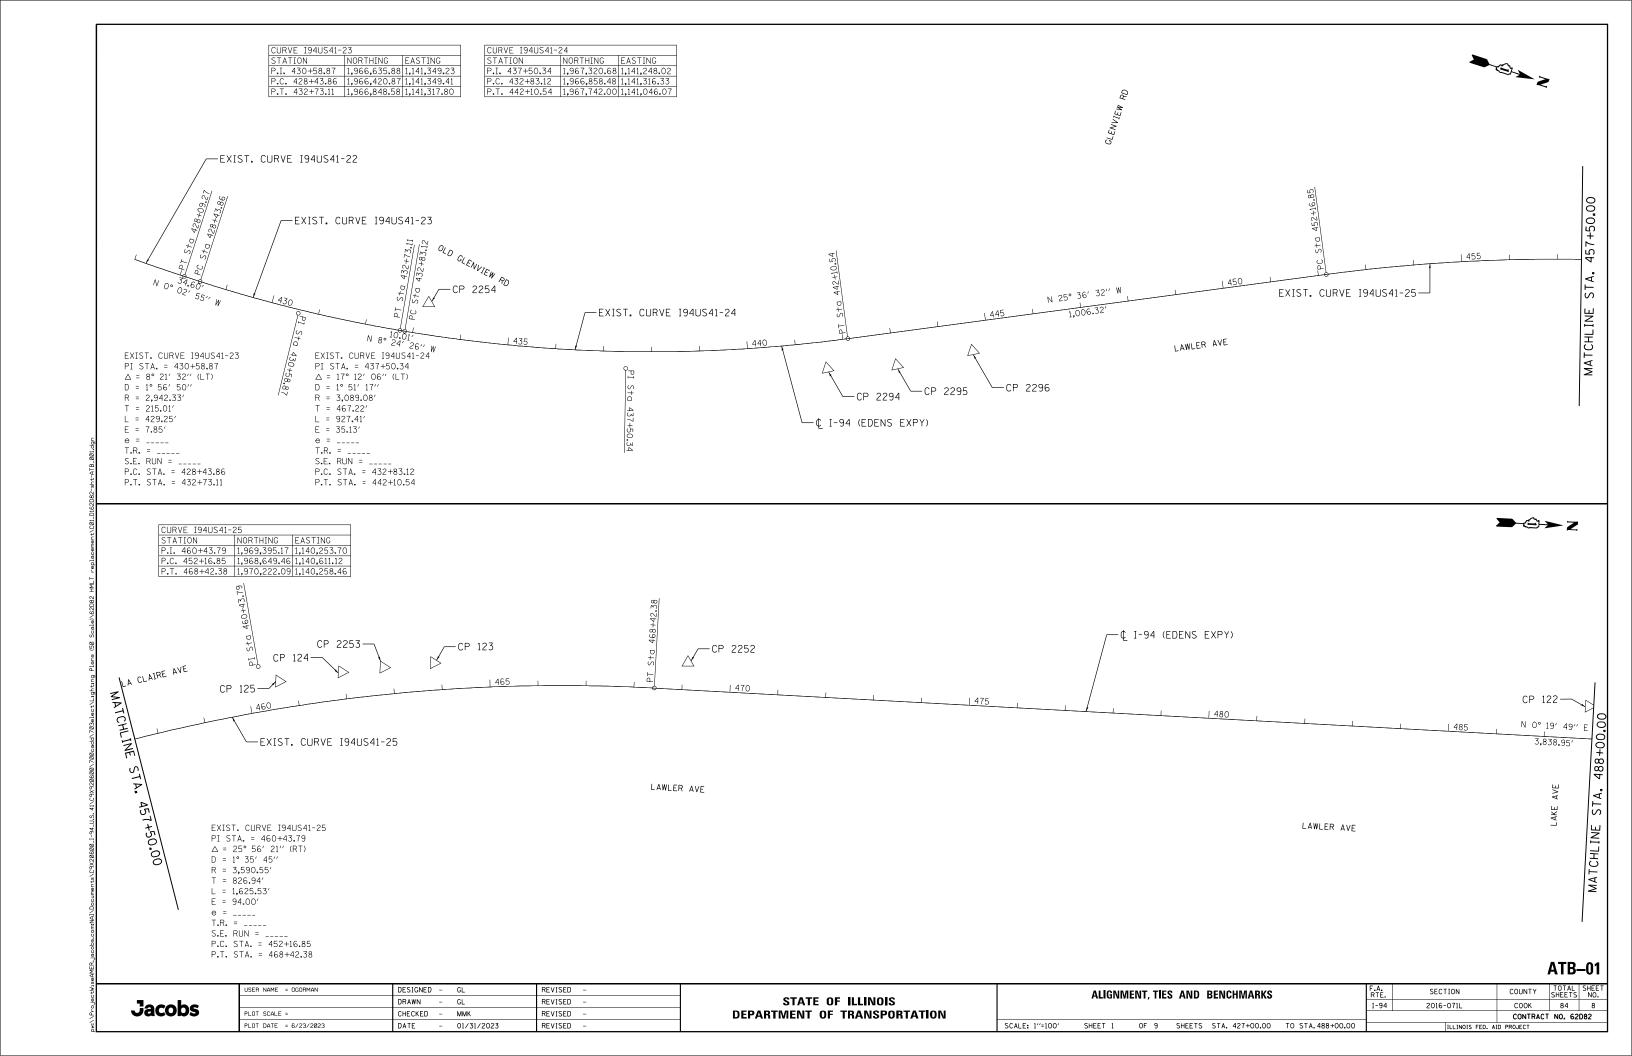
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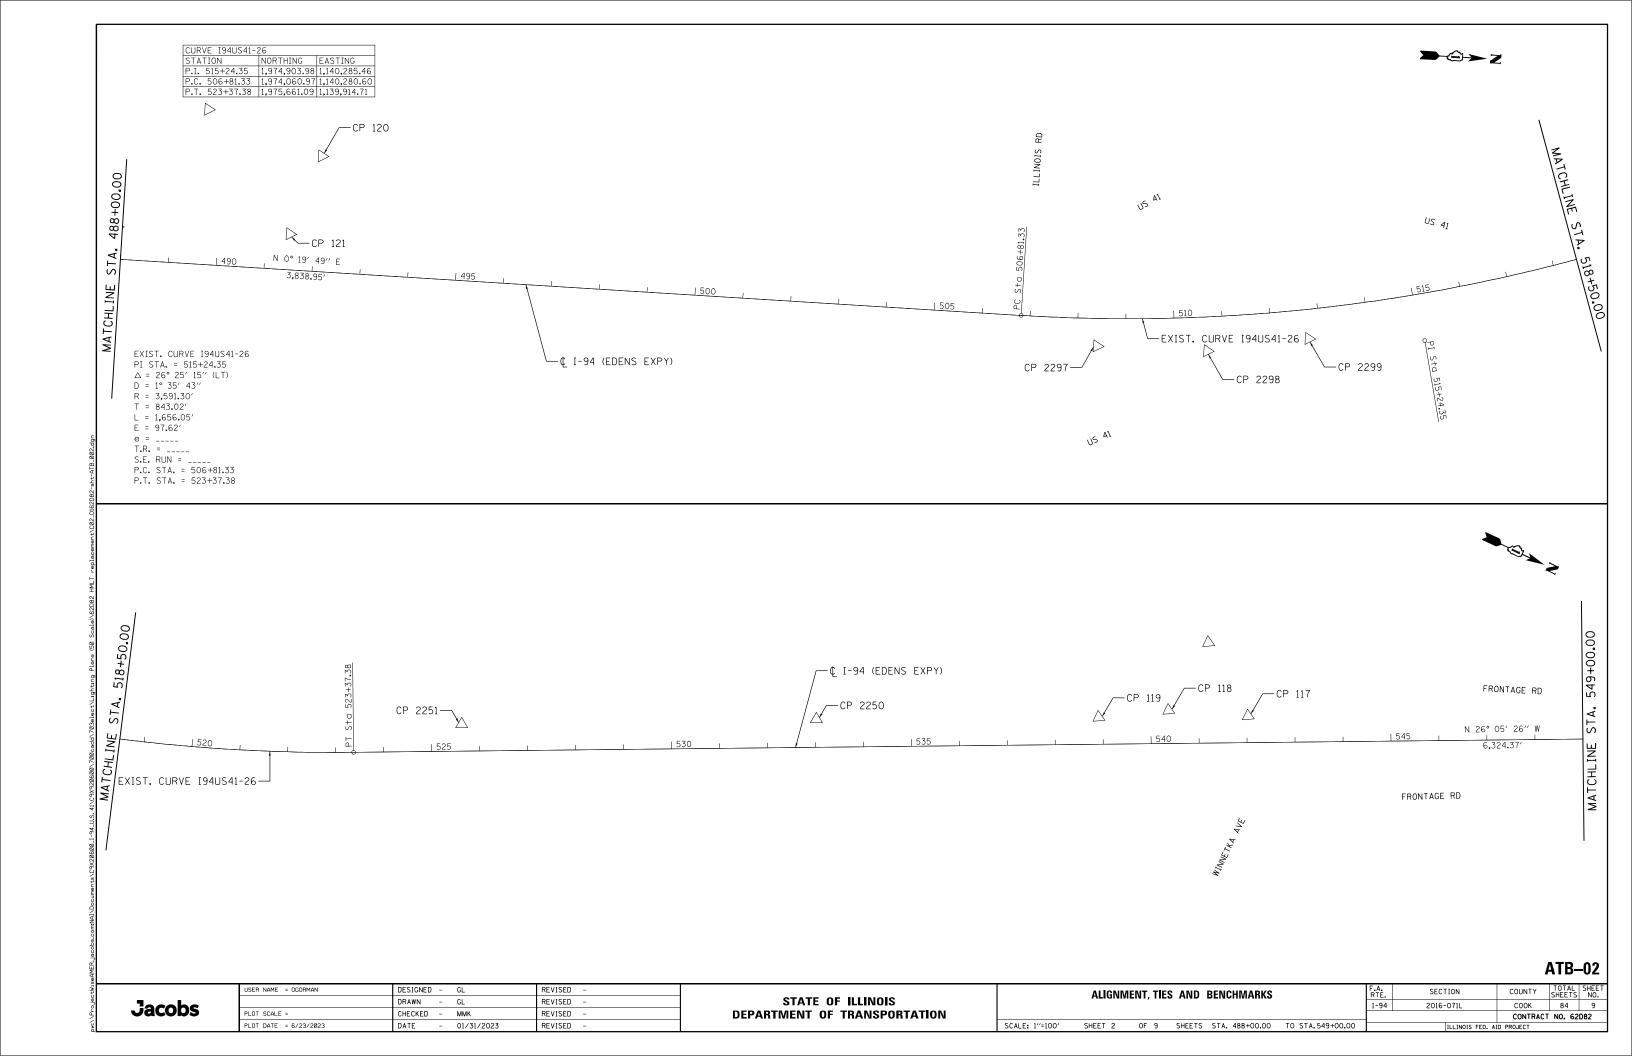
Jacobs

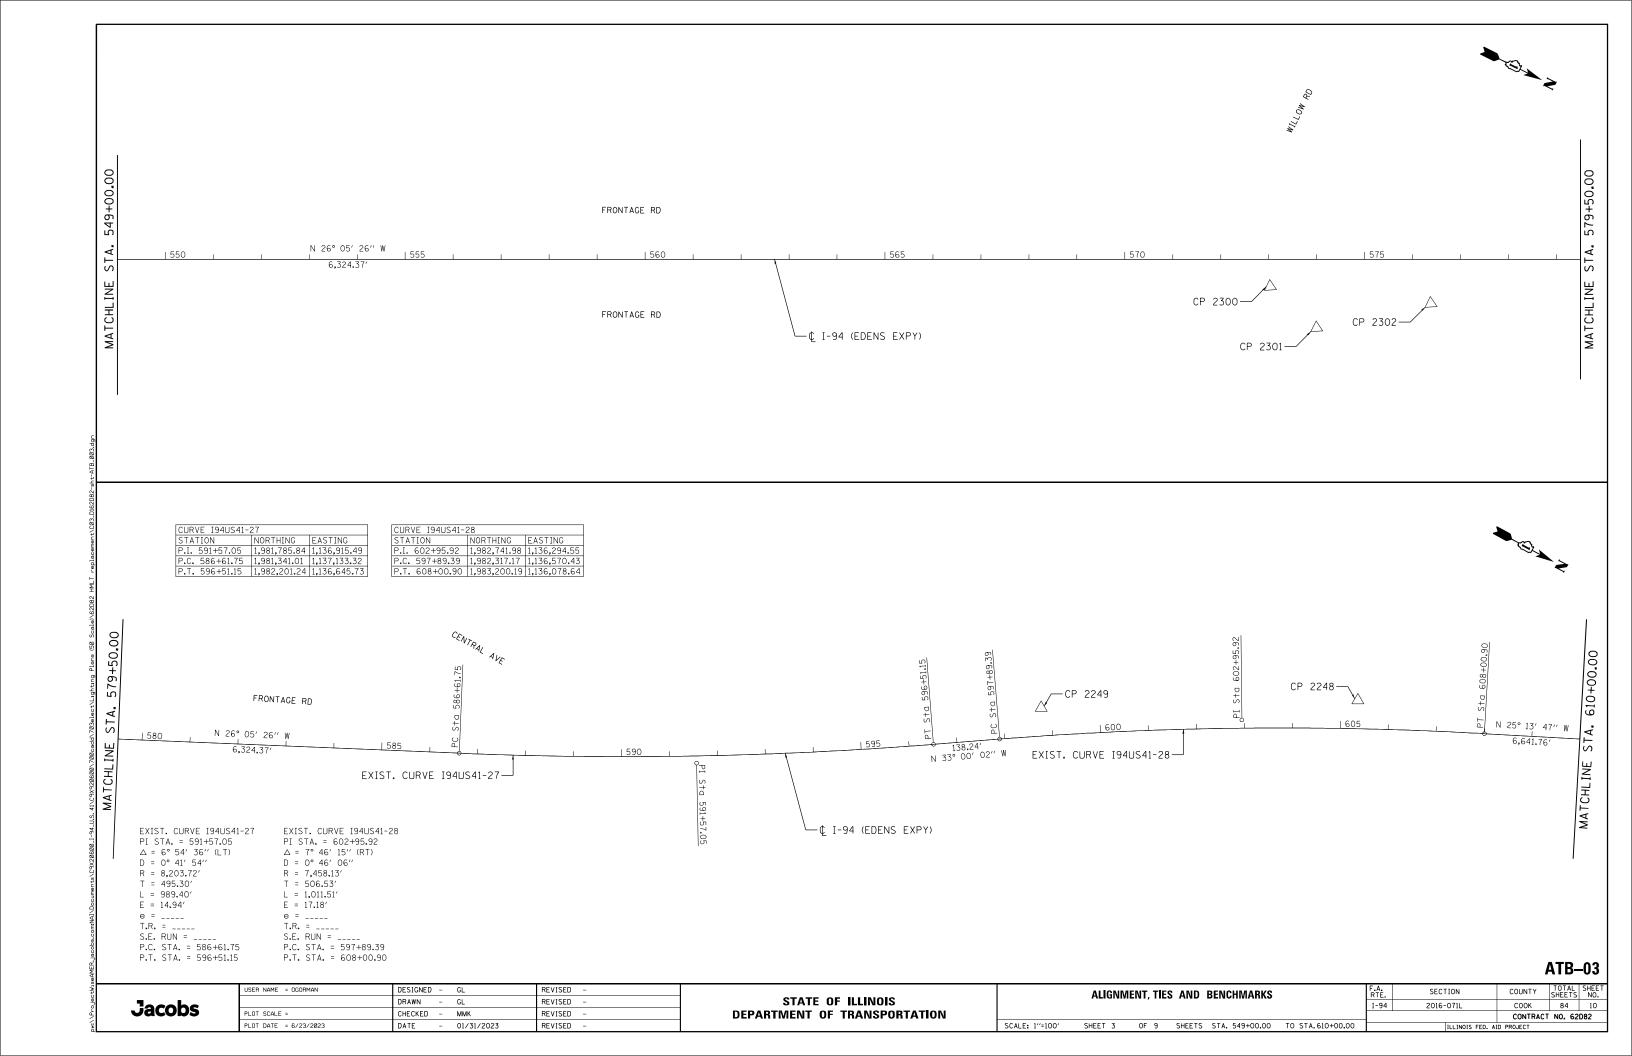
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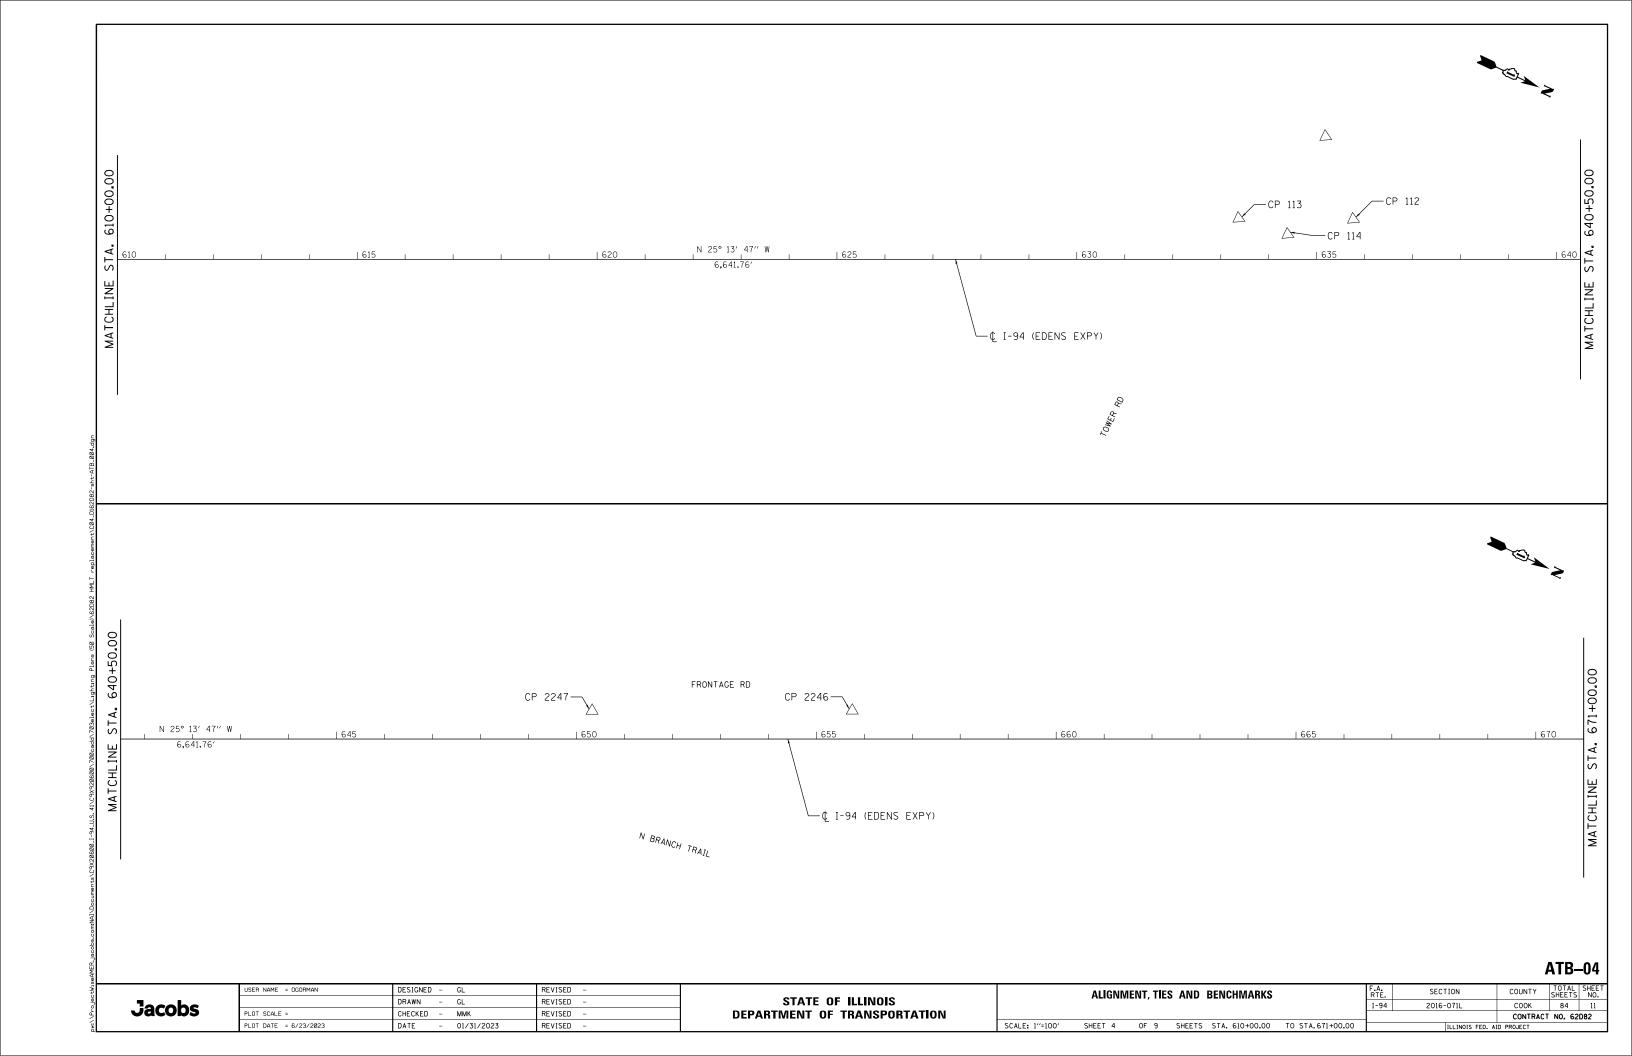
STATE OF ILLINOIS
DEPARTMENT OF TRANSPORTATION

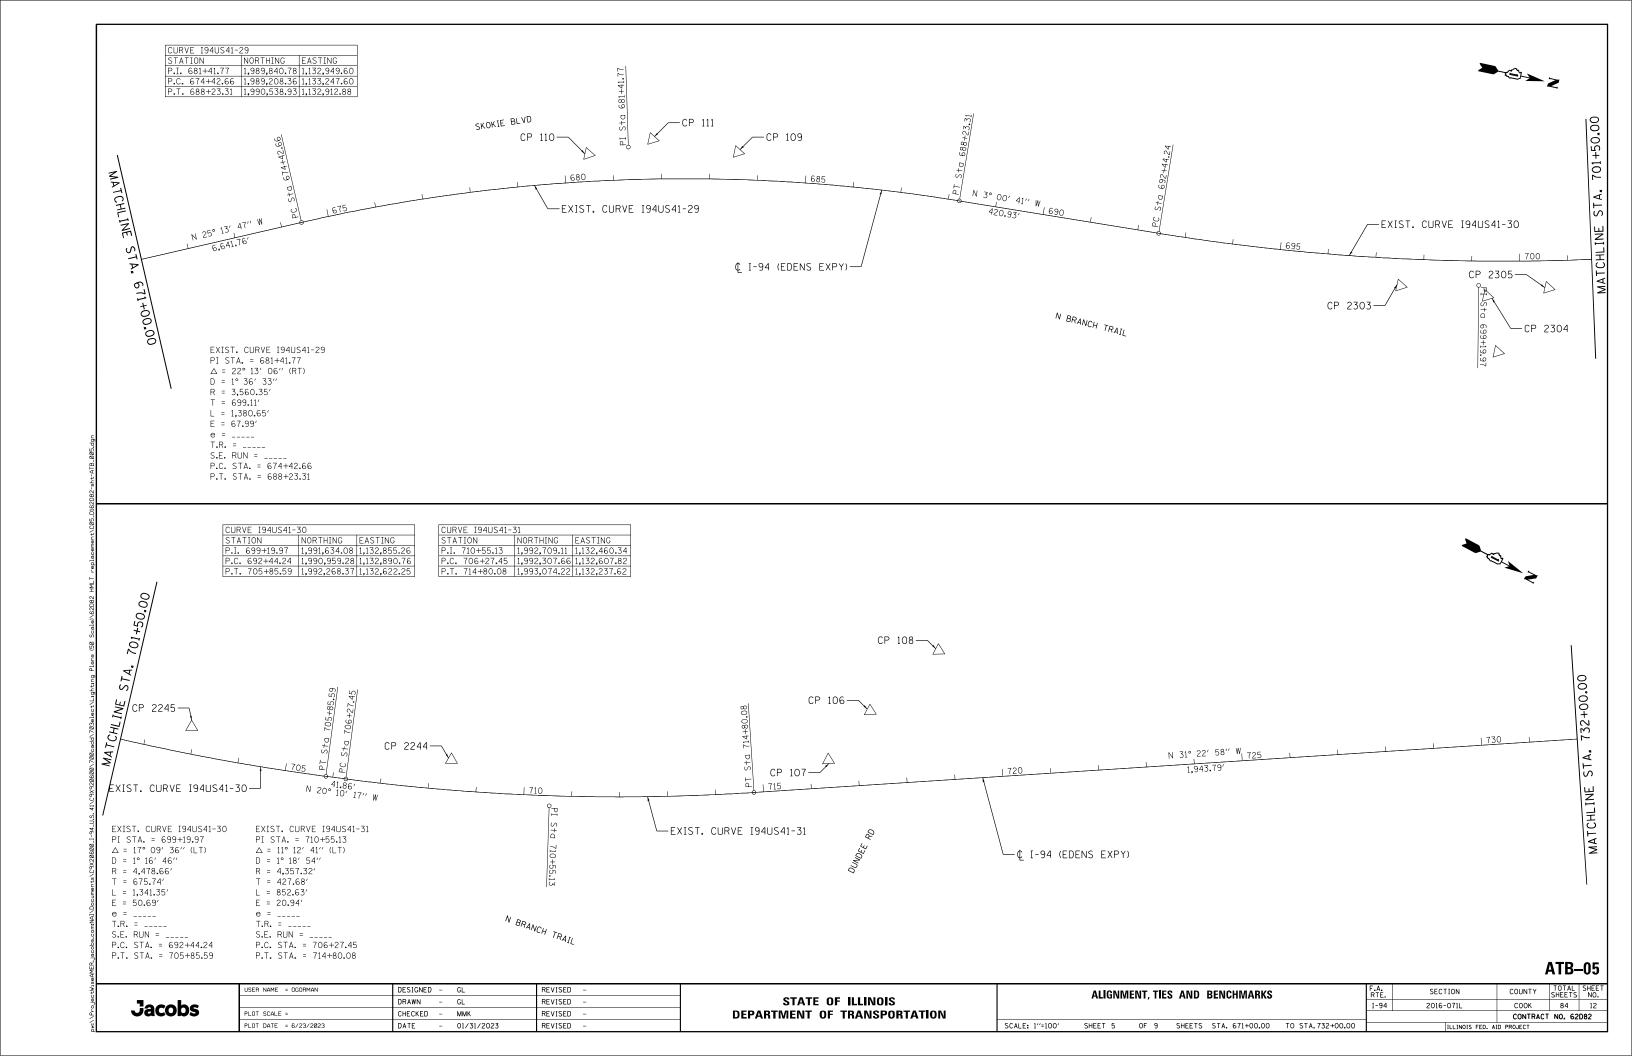
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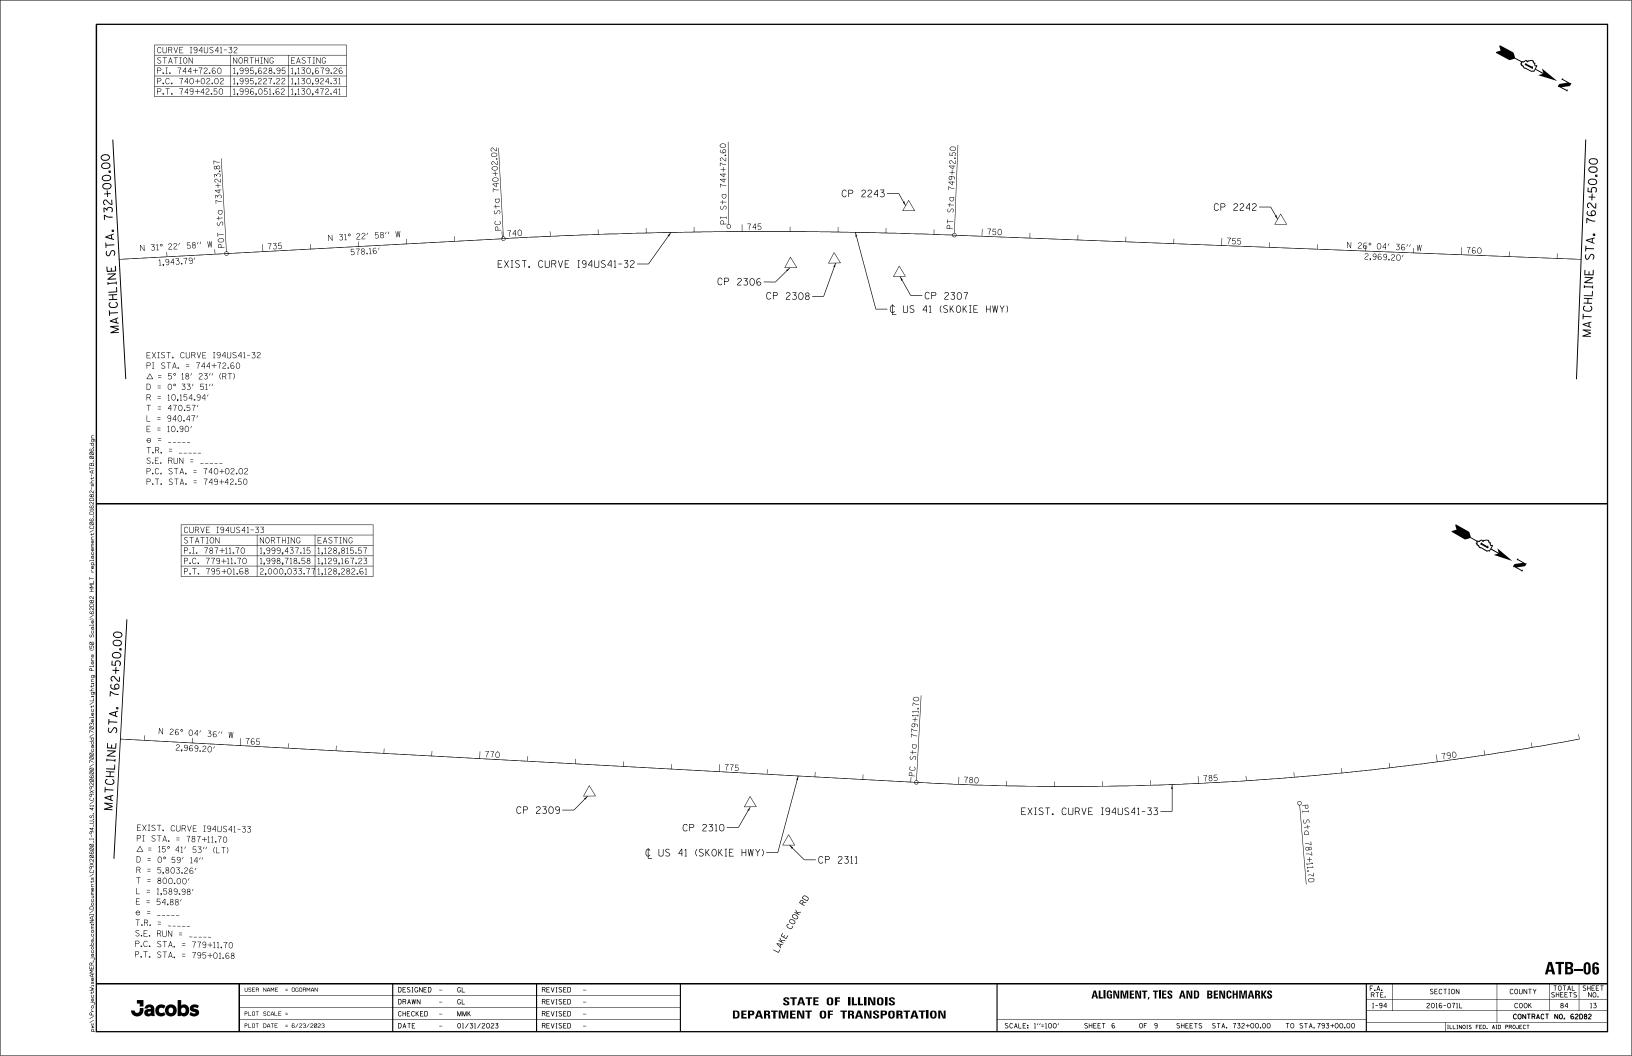


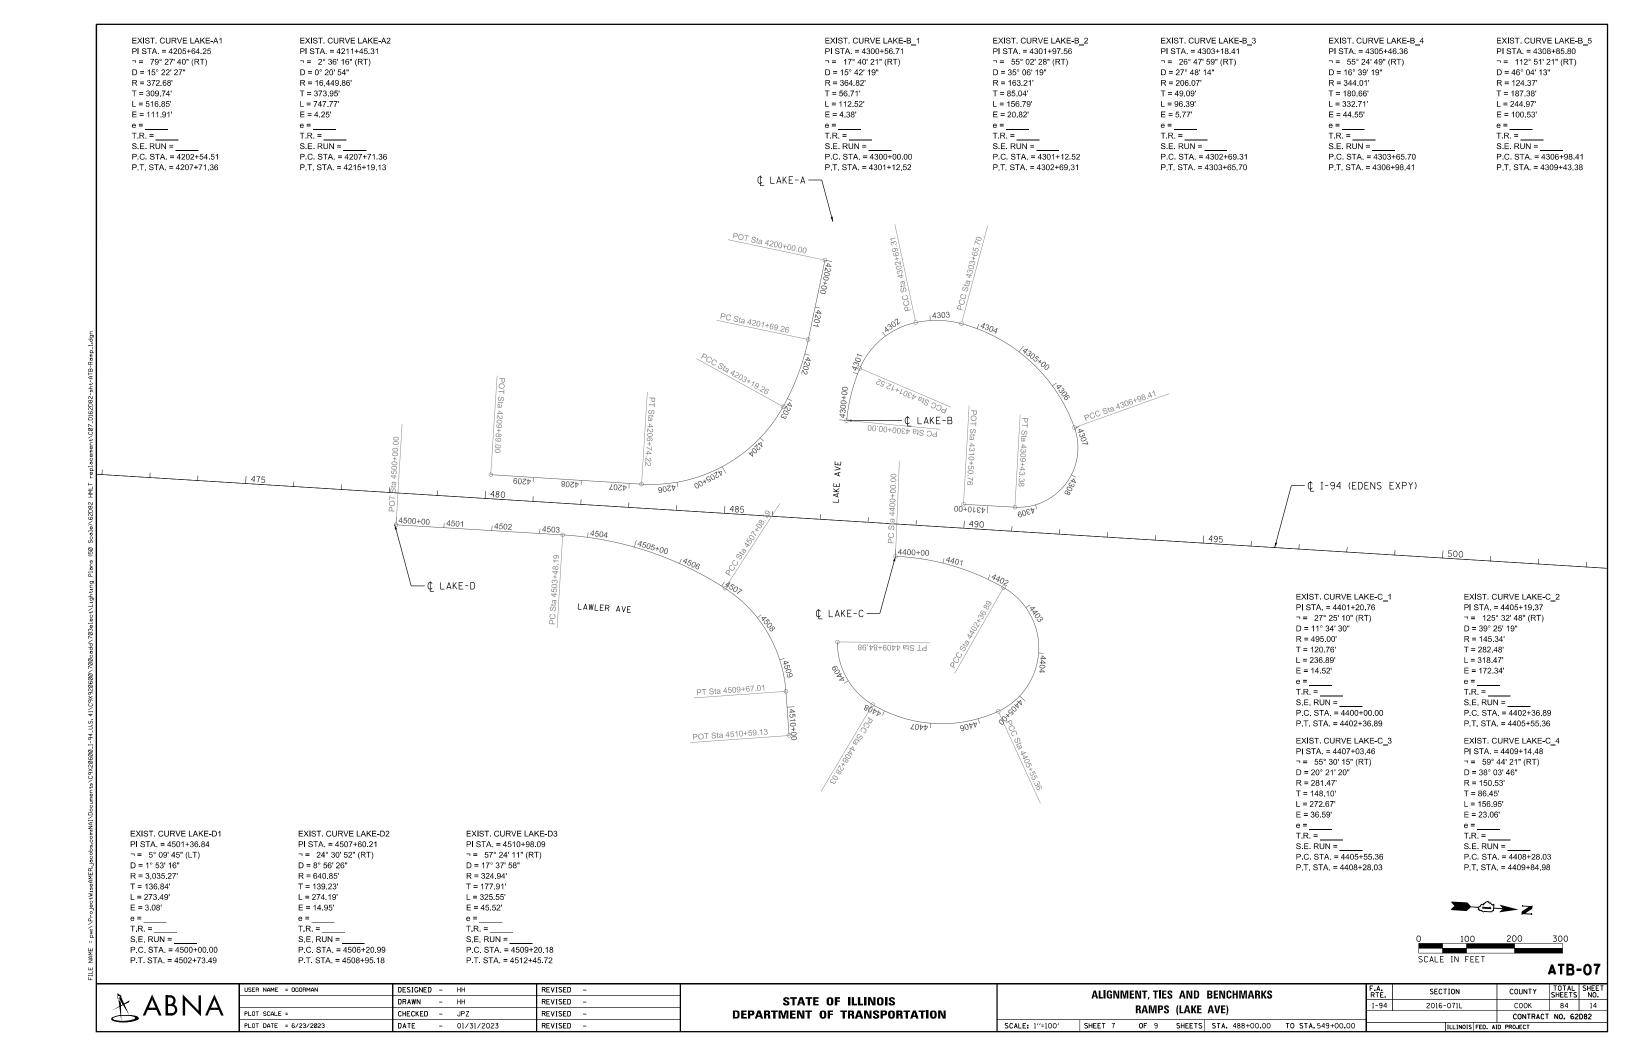


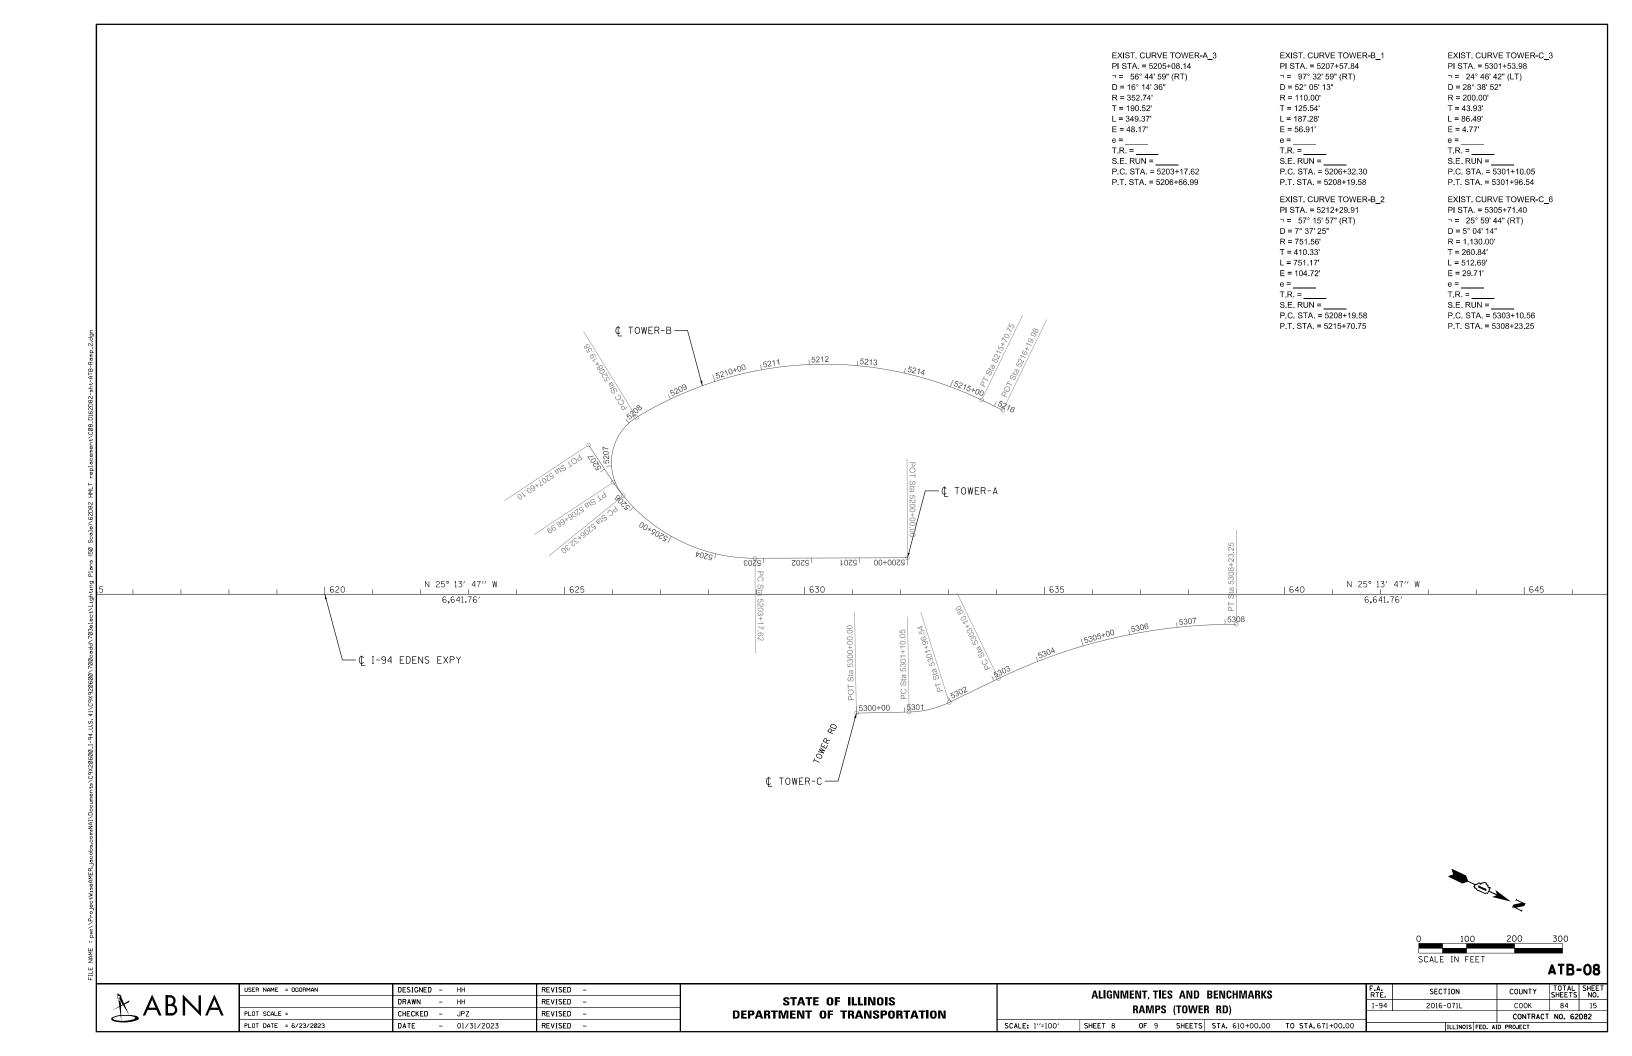


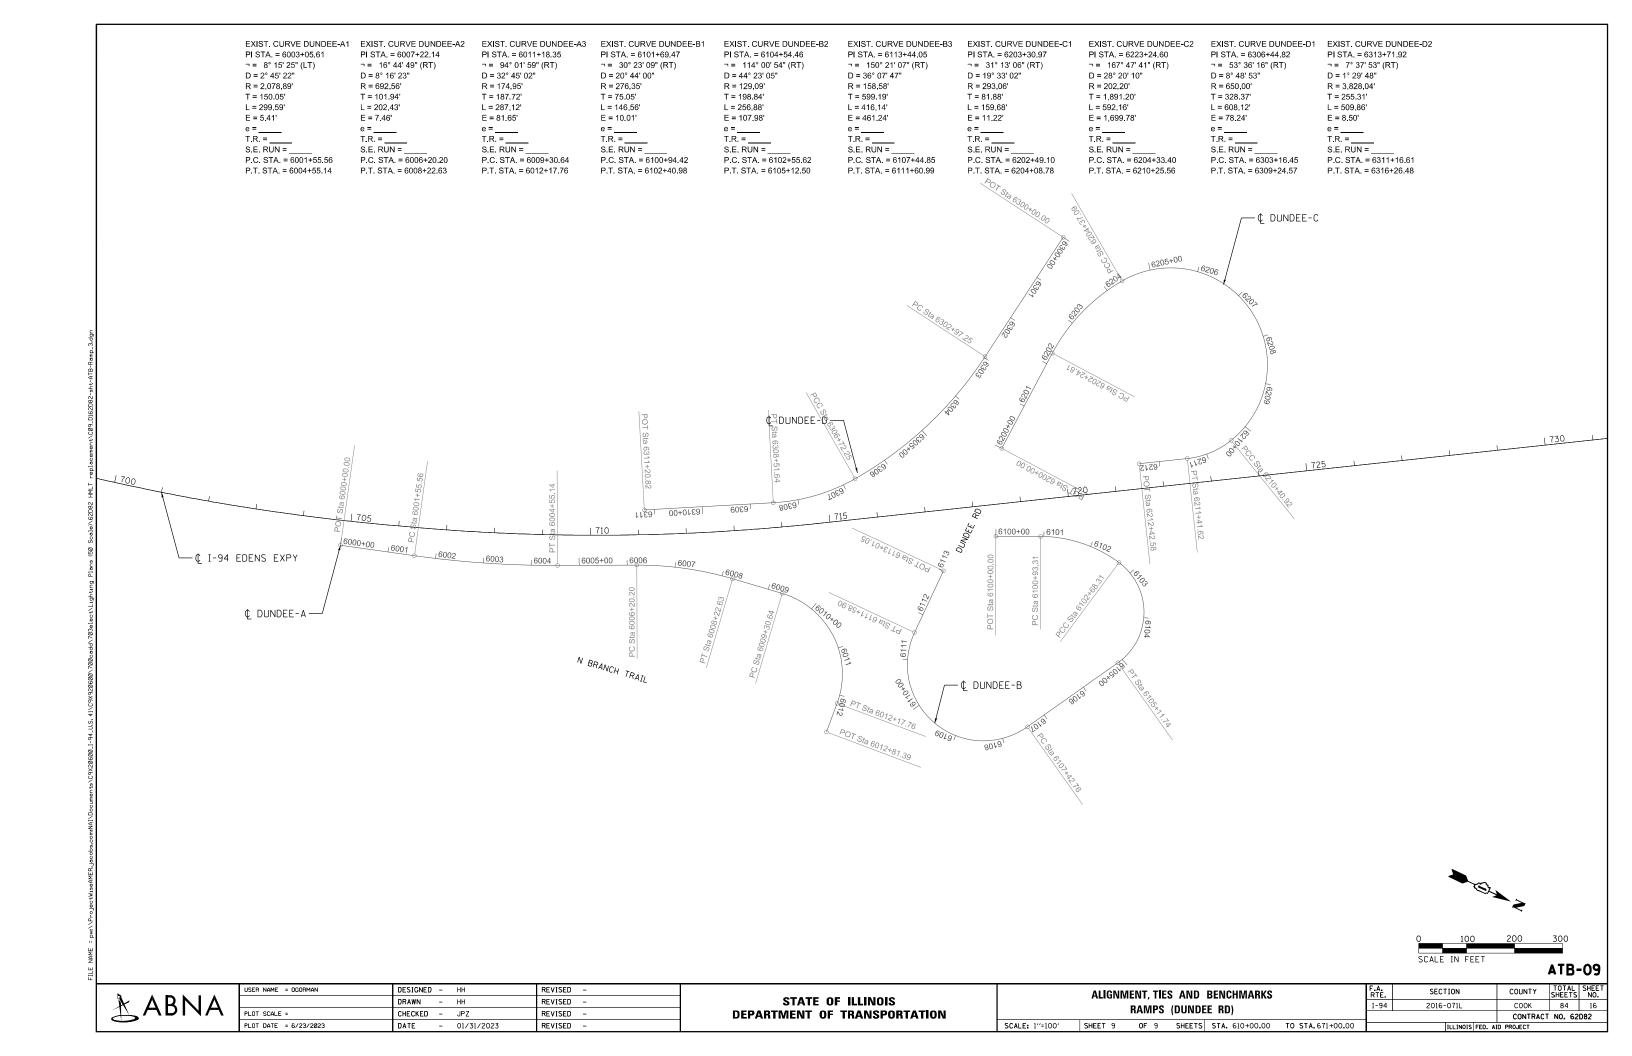














CONTROL POINT	NORTHING	EASTING	ELEVATION	MARKER	STATION	OFFSET
2242	1996636.70	1130124.04	636.94	CPS	756+21.15	55.73 LT
2243	1995940.21	1130466.59	635.40	CPS	748+45.50	54.67 LT
2244	1992484.28	1132470.27	629.99	TPR	708+43.88	62 <b>.</b> 92 LT
2245	1991972.80	1132661.24	629.18	CPS	702+90.83	55.73 LT
2246	1987493.67	1133990.19	628.16	TPR	655+75.00	59 <b>.</b> 14 LT
2247	1987003.20	1134221.53	629.36	TPR	650+32.71	58 <b>.</b> 93 LT
2248	1982935.05	1136143.47	627.48	TPR	605+35.46	59 <b>.</b> 14 LT
2249	1982362.29	1136471.94	629.36	TPR	598+80.16	58.59 LT
2250	1976502.29	1139437.70	624.59	TPR	533+02.64	58.46 LT
2251	1975839.19	1139764.94	629.05	CPS	525+63.19	56.19 LT
2252	1970289.77	1140202.08	626.04	CPS	469+09.73	56.78 LT
2253	1969656.47	1140242.69	624.96	CPS	462+83.20	56.66 LT
2254	1966888.31	1141245.34	620.31	TPR	433+23.88	65.61 LT

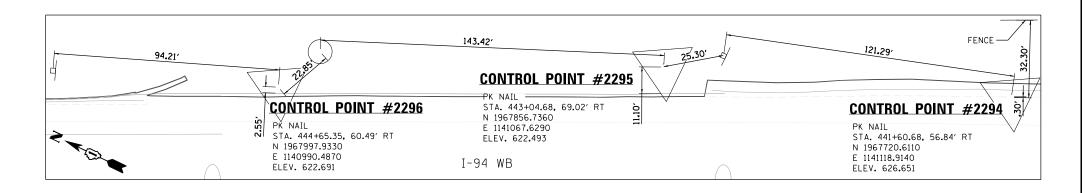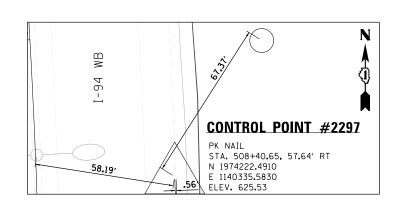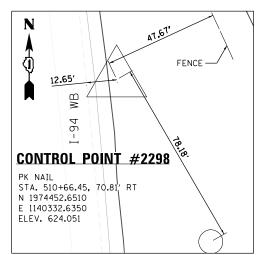
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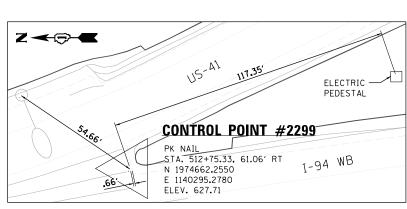
TPR- SET IRON ROD WITH CAP CPS- COTTON PICKER SPINDLE IRC- FOUND IRON ROD WITH CAP TPK- TRAVERSE POINT PK NAIL

TPX- CUT CROSS









## CTP-01

COUNTY TOTAL SHEET NO. COOK 84 17

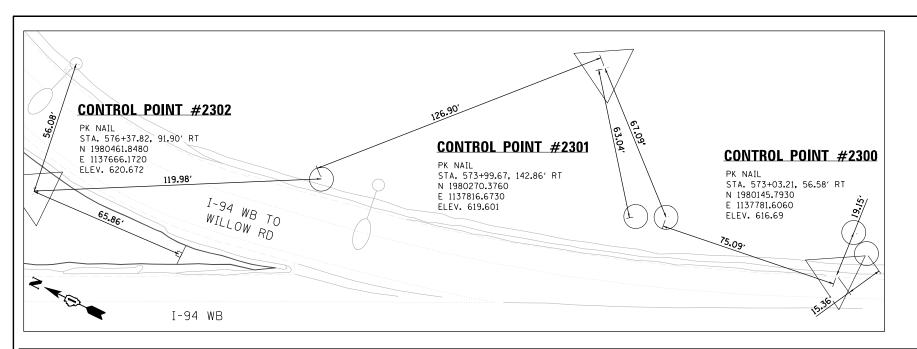
CONTRACT NO. 62D82

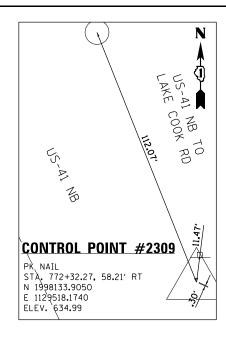
**Jacobs** 

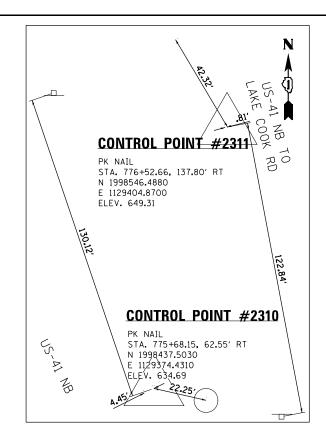
USER NAME = OGORMAN	DESIGNED	-	GL	REVISED -
	DRAWN	-	GL	REVISED -
PLOT SCALE =	CHECKED	-	MMK	REVISED -
PLOT DATE = 6/23/2023	DATE	-	01/31/2023	REVISED -

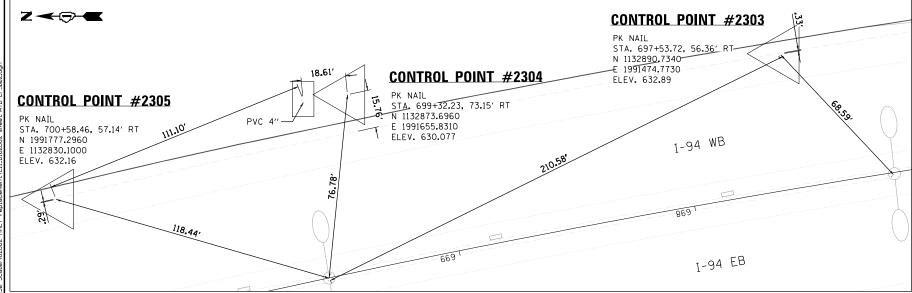
STATE OF ILLINOIS
DEPARTMENT OF TRANSPORTATION

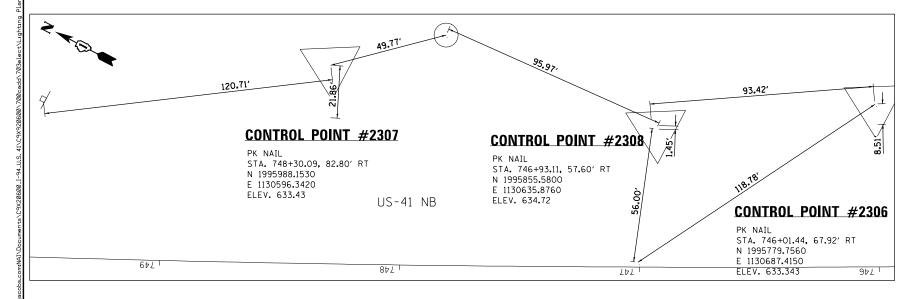
	CONTROL POINTS								
					I-94	2016-071L			
SCALE: 1"=20"	SHEET 1	OF 3	SHEETS STA.	TO STA.		ILLINOIS F			












CTP-02

o twise	USER NAME = OGORMAN	DESIGNED - GL	REVISED -				CONTROL POINTS		F.A.	SECTION	COUNTY	TOTAL	SHEET
Jacobs		DRAWN - GL	REVISED -	STATE OF ILLINOIS			CONTINUE 1 CHAIG		I-94	2016-071L	СООК	84	18
Jacobs	PLOT SCALE =	CHECKED - MMK	REVISED -	DEPARTMENT OF TRANSPORTATION							CONTRAC	CT NO. 62	D82
in d	PLOT DATE = 6/23/2023	DATE - 01/31/2023	REVISED -		SCALE: 1"=20"	SHEET 2	OF 3 SHEETS STA.	TO STA.		ILLINOIS FED. A	AID PROJECT		

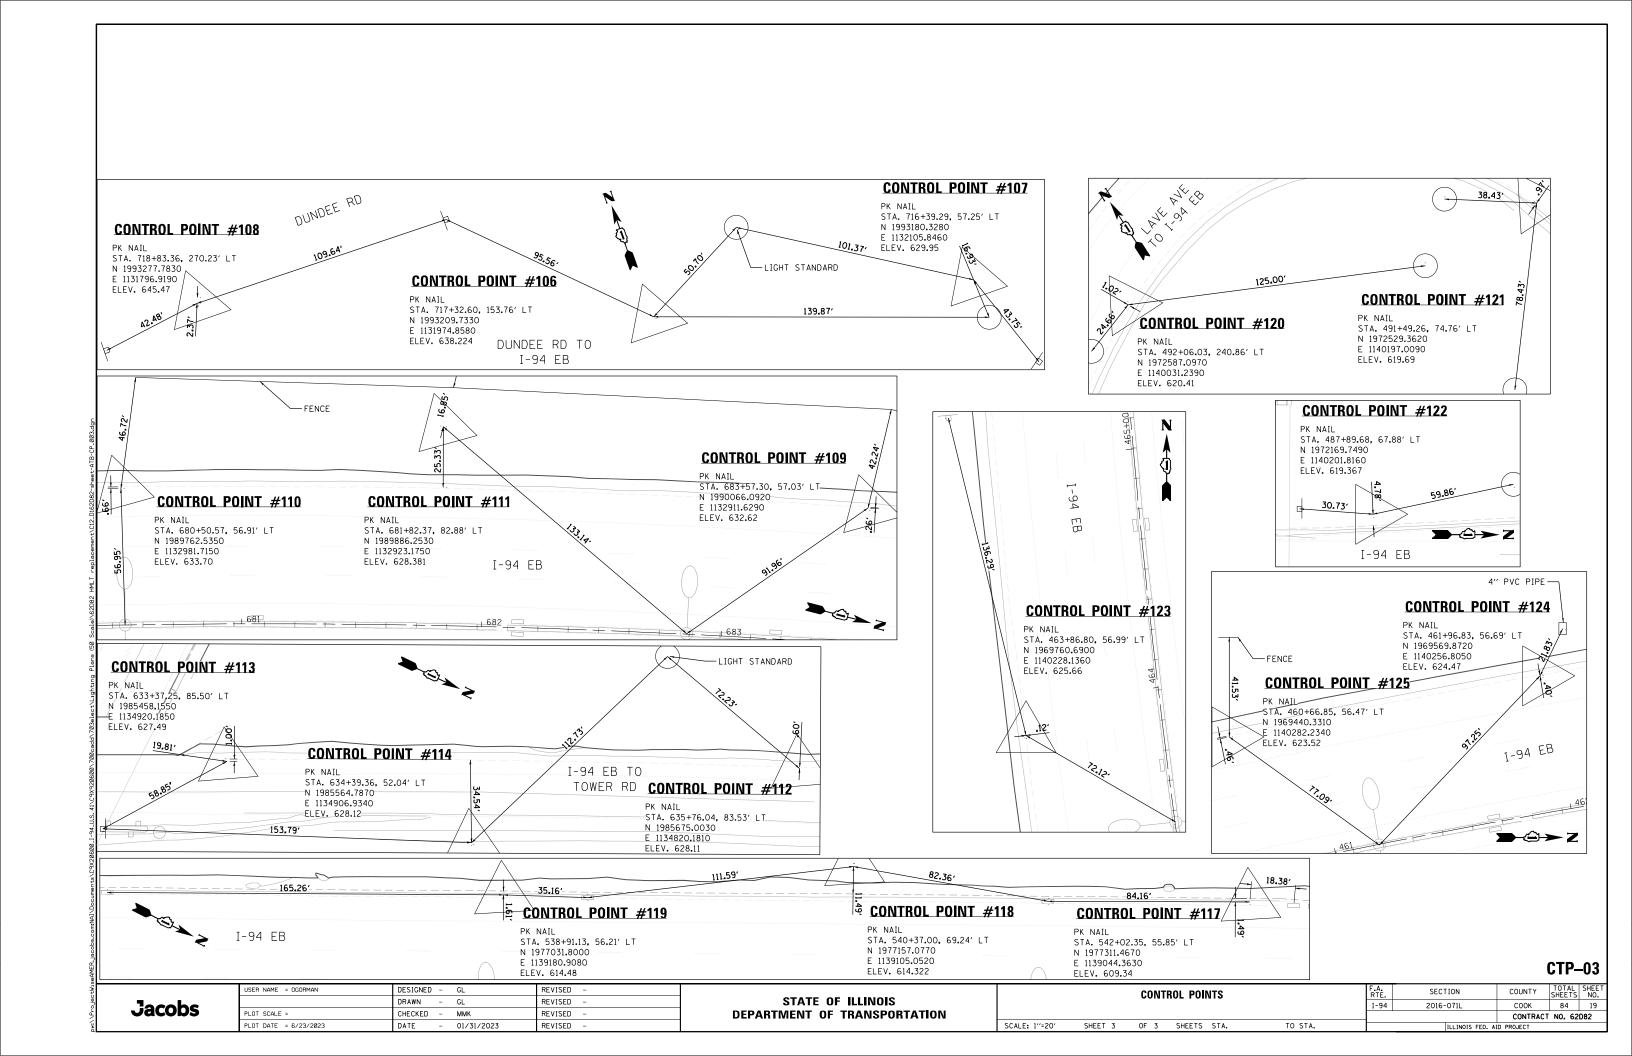

#### MAINTENANCE OF TRAFFIC GENERAL NOTES

- 1. THE CONTRACTOR'S VEHICLES SHALL ALWAYS MOVE WITH AND NOT AGAINST OR ACROSS THE FLOW OF TRAFFIC, AND THEY SHALL ENTER OR LEAVE WORK AREAS IN A MANNER WHICH IS NOT HAZARDOUS TO TRAFFIC AND WILL NOT INTERFERE WITH NORMAL TRAFFIC. THE CONTRACTOR'S VEHICLES SHALL NOT PARK OR STOP EXCEPT WITHIN DESIGNATED WORK AREAS. PERSONAL VEHICLES ARE NOT PERMITTED TO PARK WITHIN THE RIGHT-OF-WAY EXCEPT IN AREAS DESIGNATED BY THE ENGINEER.
- 2. THE EXACT NUMBER, LOCATION, AND SPACING OF ALL SIGNS AND TRAFFIC CONTROL DEVICES SHALL BE FIELD FIT TO CONDITIONS AS DIRECTED BY THE ENGINEER.
- 3. EXISTING TRAFFIC CONTROL SIGNS AND DEVICES SHALL BE REMOVED OR RELOCATED BY THE CONTRACTOR AFTER THE TRAFFIC CONTROL REQUIREMENTS ARE MET OR AS AUTHORIZED BY THE ENGINEER; ANY SIGNS OR DEVICES LEFT IN PLACE ARE TO BE PROTECTED FROM DAMAGE AND MAINTAINED.
- 4. BORING PITS ARE TO BE PLACED AT LEAST 15' FROM THE TRAVELED WAY ON THE MAINLINE TO ELIMINATE THE NEED FOR TRAFFIC CONTROL AND PROTECTION PER IDOT HIGHWAY STANDARD 701106-02.
- 5. USE IDOT DISTRICT 1 STANDARD TC-17 FOR PARTIAL RAMP CLOSURES AND SHOULDER CLOSURES ON I-94.
- 6. IF BORING PIT IS LOCATED WITHIN THE CLEAR ZONE BUT OUTSIDE OF CONSTRUCTION CLEAR ZONE, TRAFFIC CONTROL AND PROTECTION MUST REMAIN IN PLACE ADJACENT TO BORING PIT UNTIL EXCAVATED AREA IS FILLED.
- 7. TOWER REMOVAL LAYDOWN AREAS MUST BE APPROVED BY THE ENGINEER PRIOR TO USE, ADDITIONAL TRAFFIC CONTROL WILL NOT BE PROVIDED SOLELY FOR TOWER LAYDOWN AREAS.
- 8. TRAFFIC CONDITIONS, CRASHES, AND OTHER UNFORESEEN EMERGENCY CONDITIONS MAY REQUIRE THE ENGINEER TO RESTRICT, MODIFY, OR REMOVE LANE CLOSURES OR CHANNELIZATIONS SHOWN ON THE PLANS. THE CONTRACTOR SHALL MAKE THE NECESSARY ADJUSTMENTS AS DIRECTED BY THE ENGINEER WITHOUT DELAY, COMPLIANCE WITH THIS REQUIREMENT SHALL BE CONSIDERED INCLUDED IN THE CONTRACT UNIT PRICE OF "TRAFFIC CONTROL AND PROTECTION (EXPRESSWAYS)" (X7011015). NO ADDITIONAL COMPENSATION WILL BE ALLOWED.
- 9. THE MAINTENANCE OF TRAFFIC PLANS SHALL SERVE AS A GUIDE FOR THE SAFE DIVERSION OF TRAFFIC DURING EXECUTION OF THE CONTRACT, THE CONTRACTOR MAY MODIFY THE MAINTENANCE OF TRAFFIC PLANS TO MEET CONSTRUCTION NEEDS, BUT NOT AT THE EXPENSE OF PUBLIC SAFETY OR CONVENIENCE. ANY CHANGES TO THE TRAFFIC CONTROL SHALL BE SUBMITTED TO THE ENGINEER FOR REVIEW AND APPROVAL.
- 10. THE CONTRACTOR SHALL REMOVE OR COVER ALL EXISTING SIGNS THAT CONFLICT WITH OR DO NOT APPLY TO THE REVISED TRAFFIC PATTERNS AND SHALL RESTORE THE SIGNS AT THE END OF CONSTRUCTION AS DIRECTED BY THE ENGINEER.
- 11. THE CONTRACTOR SHALL REQUEST AND GAIN APPROVAL FROM THE ILLINOIS DEPARTMENT OF TRANSPORTATION'S EXPRESSWAY TRAFFIC OPERATIONS ENGINEER AT WWW.IDOTLCS.COM
  TWENTY-FOUR (24) HOURS IN ADVANCE OF ALL DAILY LANE, RAMP AND SHOULDER CLOSURES AND 7 DAYS IN ADVANCE OF ALL PERMANENT AND WEEKEND CLOSURES ON ALL FREEWAYS AND/OR
  EXPRESSWAYS IN DISTRICT ONE.

#### **CONSTRUCTION STAGING NOTES**

#### STAGE 1

CONSTRUCTION:

1. INSTALL AND ENERGIZE PROPOSED LIGHTING ALONG THE OUSIDE SHOULDER.

TRAFFIC CONTROL:

 DAILY SHOULDER CLOSURE, PER STANDARD TC-17 [TRAFFIC CONTROL DETAILS FOR FREEWAY SHOULDER CLOSURES AND PARTIAL RAMP CLOSURES].

#### STAGE 2

CONSTRUCTION:

- 1. INSTALL AND ENERGIZE PROPOSED LIGHING ALONG MEDIAN.
- 2. REMOVE MEDIAN LIGHTING PER PLAN.

TRAFFIC CONTROL:

 NIGHTLY LANE CLOSURE, IN ACCORDANCE WITH KEOTT SPECIAL PROVISION, PER STANDARD 701406 AND 701400 FOR LANE CLOSURE, FREEWAY/EXPRESSWAY, AND APPROACH TO LANE CLOSURE, FREEWAY/ EXPRESSWAY.

#### STAGE 3

CONSTRUCTION:

1. REMOVE LIGHTING ALONG THE OUTSIDE SHOULDER PER PLAN AND RESTORE.

TRAFFIC CONTROL:

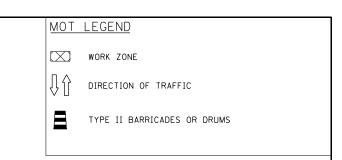
 DAILY SHOULDER CLOSURE, PER STANDARD TC-17 [TRAFFIC CONTROL DETAILS FOR FREEWAY SHOULDER CLOSURES AND PARTIAL RAMP CLOSURES].

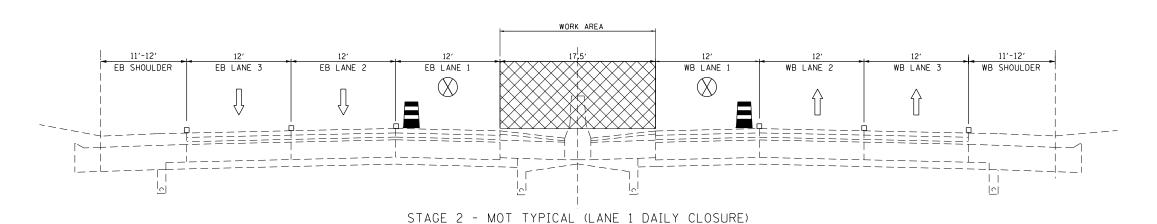
**MOT**-01

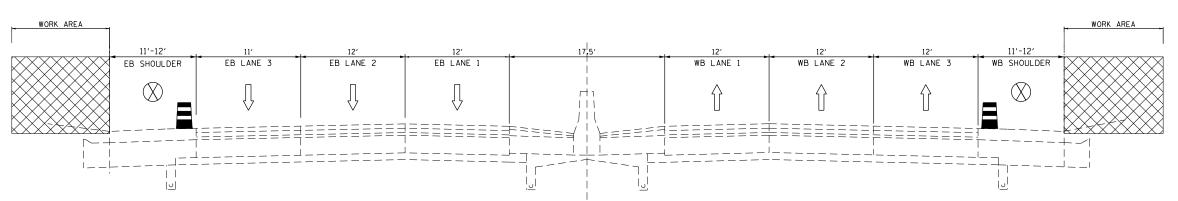


ER NAME = zvolanjj	DESIGNED	-	JJZ	REVISED -	
	DRAWN	-	MPK	REVISED -	
OT SCALE =	CHECKED	-	MMK	REVISED -	
OT DATE = 8/11/2023	DATE	-	08/11/2023	REVISED -	

SCALE: NTS







STAGE 1 AND 3 - MOT TYPICAL (SHOULDER DAILY CLOSURE)

## MOT-02

Sctwis	USER NAME = korabmp	DESIGNED - JPZ	REVISED -			MAINTENANCE OF TRAFFIC		F.A. RTE.	SECTION	COUNTY TOTAL SHEE SHEETS NO.
i x ARNIA I		DRAWN - JPZ	REVISED -	STATE OF ILLINOIS		TYPICAL SECTIONS		I-94	2016-071L	COOK 84 21
	PLOT SCALE =	CHECKED - TPP	REVISED -	DEPARTMENT OF TRANSPORTATION						CONTRACT NO. 62D82
30.	PLOT DATE = 8/10/2023	DATE - 08/11/2023	REVISED -		SCALE: NTS	SHEET 2 OF 2 SHEETS STA.	TO STA.		ILLINOIS FED. AI	D PROJECT

#### **CIVIL RESTORATION GENERAL NOTES**

- 1. ADDITIONAL PAYMENT WILL NOT BE PROVIDED FOR ANY DISTURBANCE AND RELATED RESTORATION OUTSIDE OF RESTORATION AREAS AS SHOWN IN THE PLANS INCLUDING BORING PIT RESTORATION.
- 2. CLEAR ZONE DISTANCES PROVIDED ARE BASED ON 4:1 FRONT SLOPE.
- 3. RESTORATION AREA INCLUDES SEEDING, TOPSOIL, NUTRIENTS AND EROSION CONTROL BARRIER AS REQUIRED.
- 4. WHEN CONNECTING PROPSED UNIT DUCT TO EXISTING LIGHTING UNIT. WILL NEED TO EXCAVATE NEAR THE EXISTING FOUNDATION TO TAP INTO THE EXISTING CONDUIT IN EXISTING FOUNDATION.

#### **LEGEND**

EXISTING LIGHT POLE AND TOWER RESTORATION AREA FOUNDATION TO BE REMOVED 24" BELOW GRADE RESTORE WITH:
TOPSOIL FURNISH AND PLACE, 24"
NITROGEN FERTILIZER NUTRIENT
POTASSIUM FERTILIZER NUTRIENT
MULCH, METHOD 2

#### LIGHT POLE RESTORATION SCHEDULE OF QUANTITIES

		20101400	20101600	21101685	25000210	25100630
		NITROGEN FERTILIZER NUTRIENT	POTASSIUM FERTILIZER NUTRIENT	TOPSOIL FURNISH AND PLACE, 24"	SEEDING, CLASS 2A	EROSION CONTROL BLANKET
		POUND	POUND	SQ YD	ACRE	SQ YD
CIV-02	13	2.1	2.1	113	.02	113
CIV-03	2	.03	.03	17	.01	17
CIV-04	6	1.0	1.0	52	.01	52
CIV-05	9	1.5	1.5	79	.02	79
TOTALS		5	5	262	0.25	262

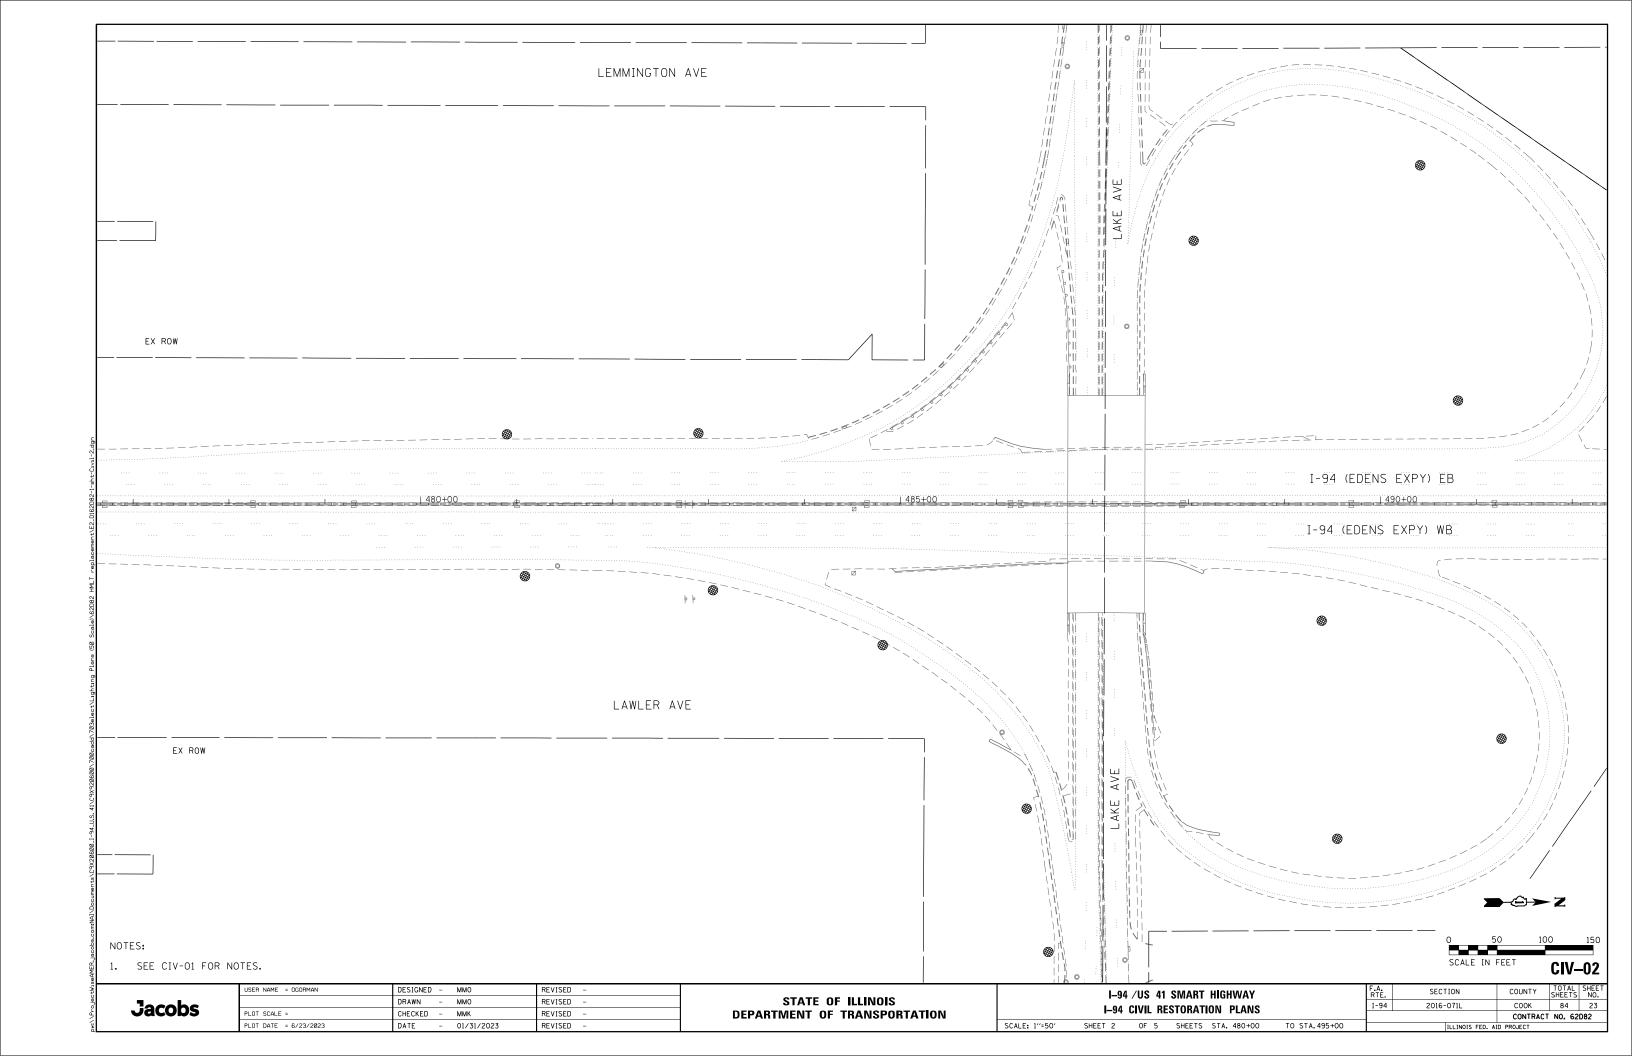
**CIV-01** 

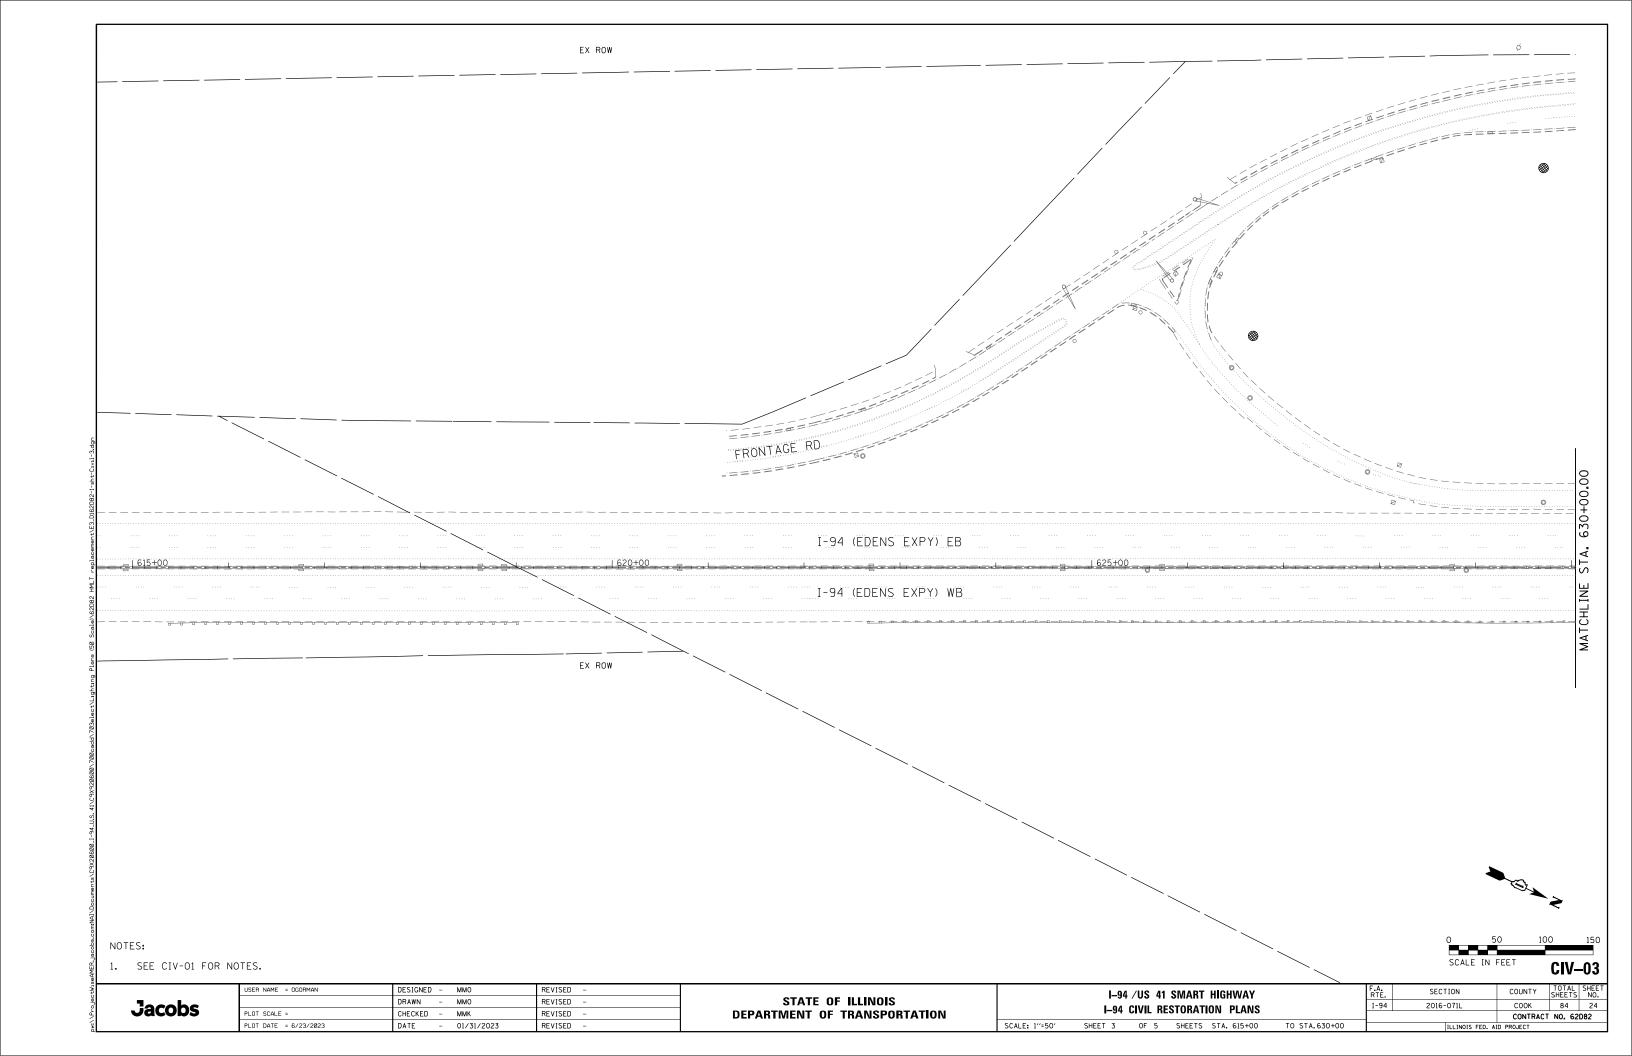
Jacobs

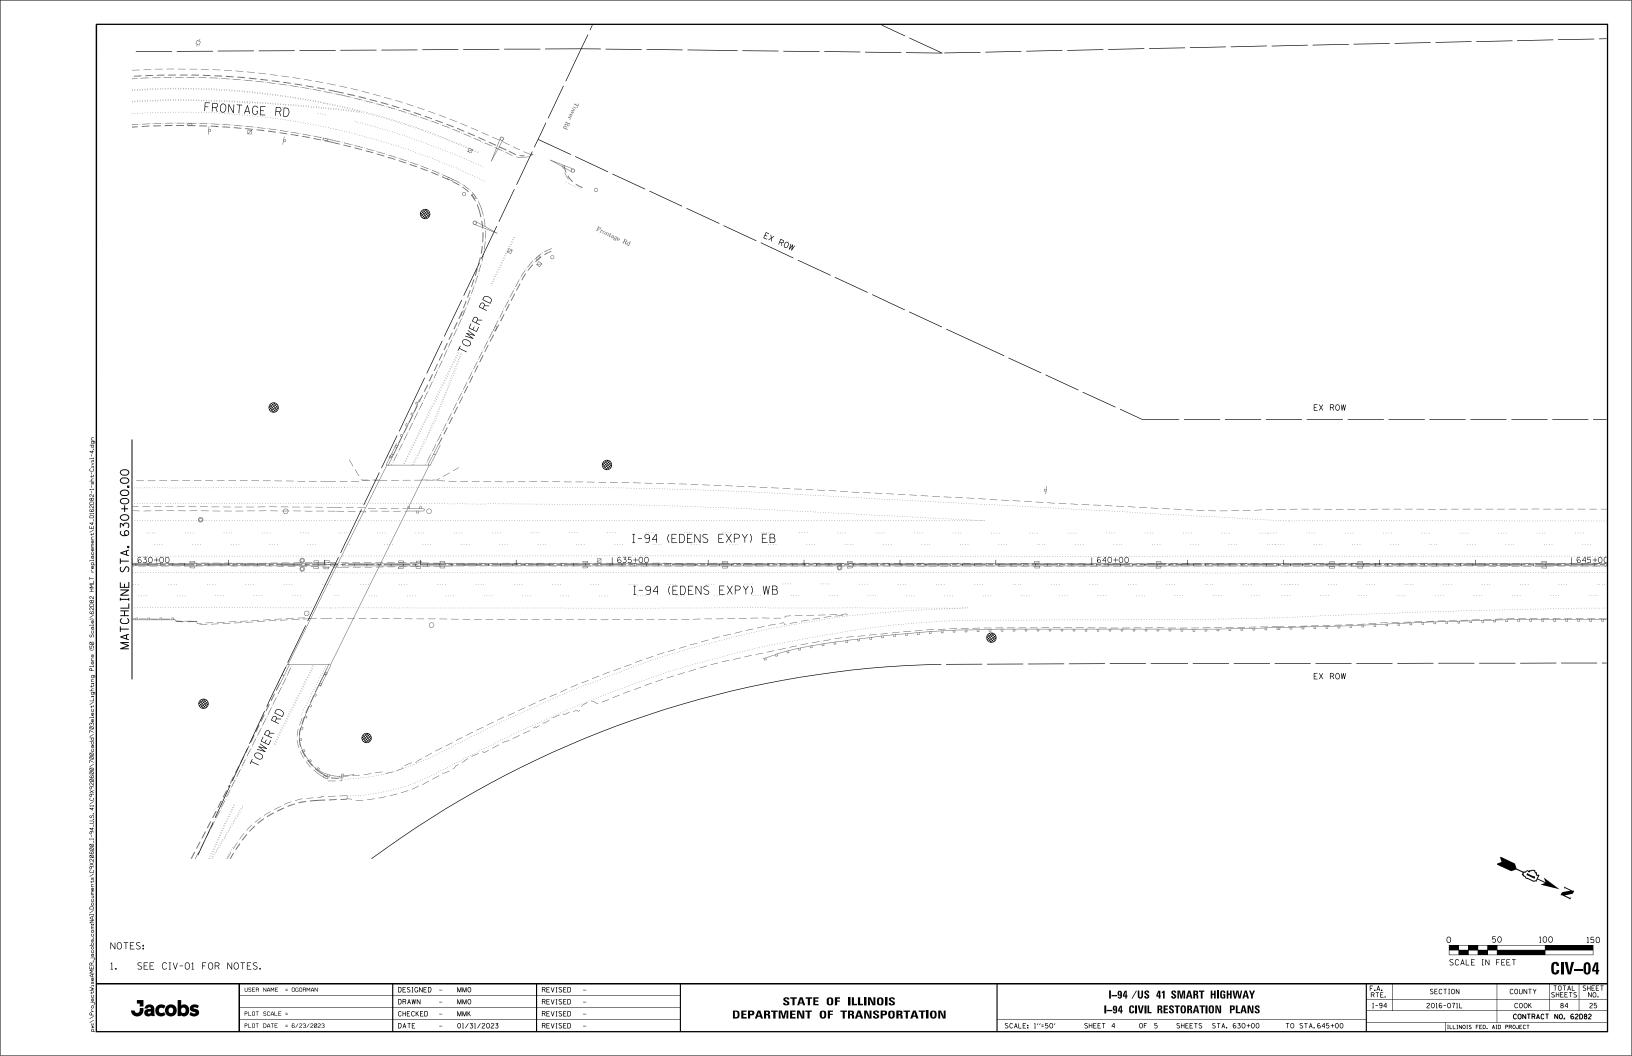
USER NAME = korabmp	DESIGNED - JJZ	REVISED -
	DRAWN - MPK	REVISED -
PLOT SCALE =	CHECKED - MMK	REVISED -
PLOT DATE = 8/10/2023	DATE - 08/11/2023	REVISED -

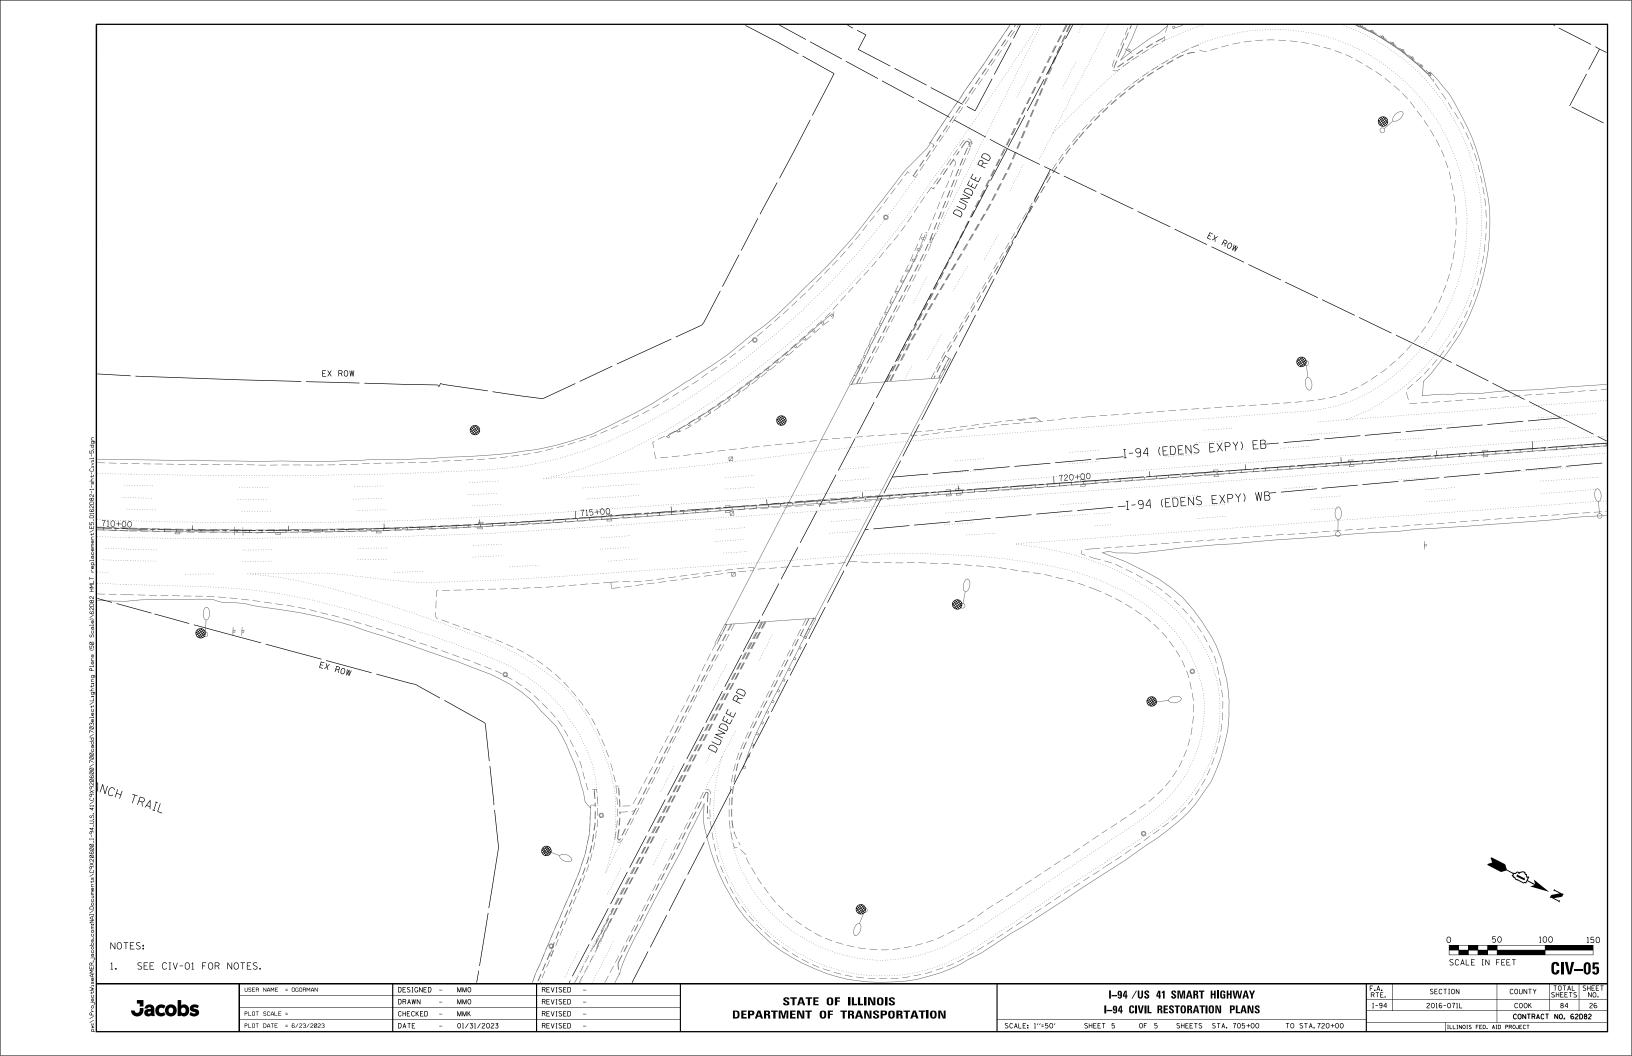
SCALE:

I-94 /US 41 SMART HIGHWAY				RTE.		
I-94 CIVIL	RESTOR	ΔΤΙΩΝ	GENIFRAI	NOTES	I-94	
1 37 OIVIL	ILCIO	AIION	OLIVLIIAL	140120		
SHEET 1	OF 5	SHEETS	STA.	TO STA.		









## SIGN SCHEDULE

ALIGNMENT		PROPOSED POLE NO.	RELOCATE SIGN PANEL TYPE 1	RELOCATE SIGN PANEL TYPE 2				
		FOLE NO.				FOLE NO.	72400710	72400720
							(SQ FT)	(SQ FT)
I-94	476+93.75	LJ10	EAST	M3-2	36X18	LB2	4.5	
I-94	476+93.75	LJ10	INTERSTATE 94	M1-1	36X36	LB2	9	
I-94	478+88.70	LI9	SPEED LIMIT 55	R2-1	36X48	LA2		12
LAKE AVE	4201+03.50	LJ7	USE PROHIBITED	R5-I100	48x60	LB7		20
LAKE AVE	4202+97.70	LJ6	EAST	M3-2	36X18	LB6	4.5	
LAKE AVE	4202+97.70	LJ6	INTERSTATE 94	M1-1	36X36	LB6	9	
LAKE AVE	4202+97.70	LJ6	ARROW	M6-2	30X21	LB6	4.4	
LAKE AVE	4504+85.35	LJ3	RAMP 35 MPH	W13-3	36X48	LD3		12
LAKE AVE	4506+80.00	LJ3	YIELD AHEAD	W3-2	48X48	LC3		16
LAKE AVE	4506+80.00	LJ3	WRONG WAY	R5-1A	36X24	LC3	6	
LAKE AVE	4508+95.70	LJ1	PEDESTRIAN	W11-2	36X36	LC2	9	
LAKE AVE	4508+95.70	LJ1	ARROW	W16-7P	24X12	LC2	2	
LAKE AVE	4508+95.70	LJ1	DO NOT ENTER	R5-1	36X36	LC2	9	
LAKE AVE	4509+24.55	L <b>i</b> 2	DO NOT ENTER	R5-1	36X36	LD1	9	
US 41	4620+70.55	LC10	WRONG WAY	R5-1A	36X24	LE9	6	

## **EXISTING SIGNING**

RELOCATE EXISTING SIGN PANELS THAT ARE ATTACHED TO EXISTING LIGHTING UNITS BEING REMOVED.

SIGN PANELS SHALL BE RELOCATED TO THE PROPOSED LIGHT POLE IN CLOSEST PROXIMITY TO ITS EXISTING LOCATION. SIGN TO BE RELOCATED THE SAME DAY THAT THE SIGN WAS REMOVED.

THIS WORK WILL BE PAID FOR PER SO FT OF RELOCATE SIGN PANEL, OF THE TYPE SPECIFIED.

SGN-01

COUNTY TOTAL SHEET NO.

COOK 84 27

CONTRACT NO. 62D82

USER NAME = OGORMAN	DESIGNED	-	QA	REVISED -
	DRAWN	-	ВВ	REVISED -
PLOT SCALE =	CHECKED	-	JF	REVISED -
PLOT DATE = 6/23/2023	DATE	-	01/31/2023	REVISED -

SIGNING						F.A.I RTE.	SECTION	COUNTY
SIGN SCHEDULE					I-94	2016-071L	СООК	
		Jidiv	JUILD	JLL				CONTRA
SCALE: N.T.S.	SHEET 1	OF 1	SHEETS	STA. N/A	TO STA.N/A		ILLINOIS FED. AI	D PROJECT

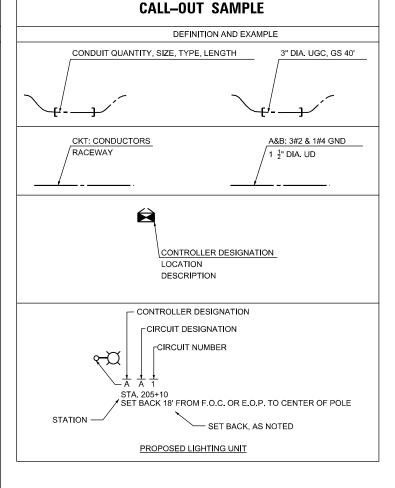
LIGHTIN	G AND ELECTRICAL LEGEND
SYMBOL	DESCRIPTION
↓↓ R]	EXISTING HIGH MAST LIGHTING FOUNDATION AND TOWER TO BE REMOVED, NO SALVAGE. LUMINAIRES TO BE SALVAGED
Œ,	EXISTING LIGHTING FOUNDATION (GROUND MOUNTED ONLY), POLE, MAST ARM REMOVED, NO SALVAGE. LUMINAIRES AND TRANSFORMER BASES REMOVED SHALL BE SALVAGED
Œ <del>_</del> ¤	EXISTING LIGHTING FOUNDATION (PARAPET MOUNTED ONLY), POLE, MAST ARM REMOVED, NO SALVAGE. LUMINAIRES REMOVED SHALL BE SALVAGED
<b>%</b>	EXISTING LIGHTING FOUNDATION (MEDIAN MOUNTED) TO REMAIN, POLE TO BE REMOVED (NO SALVAGE), MAST ARMS TO BE REMOVED (NO SALVAGE), LUMINAIRES TO BE REMOVED (SALVAGE), MEDIAN BARRIER TO BE RESTORED
<b>E-</b> -E	EXISTING LIGHTING FOUNDATION (MEDIAN MOUNTED) TO REMAIN, POLE TO REMAIN, MAST ARM TO BE REMOVED (NO SALVAGE), LUMINAIRES TO BE REMOVED (SALVAGE)
æ	PROPOSED IDOT LIGHTING UNIT MOUNTED ON BREAKAWAY DEVICE METAL FOUNDATION, 47.5 FT M.H. U.N.O., 15 FT MAST ARM, LUMINAIRE TO BE LED, HORIZONTAL MOUNT, OUTPUT DESIGNATION H (240 VAC) U.N.O.
•-)0(	EXISTING IDOT LIGHTING UNIT MOUNTED ON EXISTING PARAPET OR BARRIER FOUNDATION, 47.5' M.H., EXISTING MAST ARM, PROPOSED LED LUMINAIRE, HORIZONTAL MOUNT, OUTPUT DESIGNATION H (240V) U.N.O.
<b>※・※</b>	EXISTING IDOT LIGHTING UNIT MOUNTED ON EXISTING MEDIAN FOUNDATION, PROPOSED 6-FT TWIN ARM, PROPOSED LED LUMINAIRE, HORIZONTAL MOUNT, OUTPUT DESIGNATION H (240V) U.N.O.
<b>○</b>	EXISTING TOLLWAY LIGHTING UNIT TO REMAIN
<u>—</u>	EXISTING LIGHTING UNIT TO REMAIN
	EXISTING SIGN LIGHTING TO REMAIN
O E	EXISTING UNDERPASS LUMINAIRE TO REMAIN
10 <sub>R</sub>	EXISTING UNDERPASS LUMINAIRE TO BE REMOVED, NO SALVAGE
Ō	PROPOSED UNDERPASS LED LUMINAIRE, SUSPENDED MOUNT
IJ <sub>E</sub>	EXISTING JUNCTION BOX TO REMAIN
J <sub>R</sub>	EXISTING JUNCTION BOX TO BE REMOVED
J	PROPOSED JUNCTION BOX, SIZE AND TYPE AS NOTED
$\bigotimes_{R}$	EXISTING IDOT LIGHTING CONTROLLER TO BE REMOVED, SALVAGE
<b>₩</b>	PROPOSED IDOT LIGHTING CONTROLLER
Å <sub>R</sub>	EXISTING ELECTRIC UTILITY SERVICE TO BE REMOVED
<b>A</b>	PROPOSED ELECTRIC UTILITY SERVICE
⊗	TEMPORARY WOOD POLE TO REMAIN
	PROPOSED CABLE IN CONDUIT, SIZE AND TYPE AS NOTED
— — R ——	EXISTING UNDERGROUND CABLE AND UNIT DUCT TO BE ABANDONED
——Е——	EXISTING CIRCUIT TO REMAIN
- <del></del>	EXISTING UNIT DUCT IN EXISTING UNDERGROUND CONDUIT.
	PROPOSED UNIT DUCT, SIZE AND TYPE AS NOTED
<del></del>	PROPOSED UNIT DUCT IN UNDERGROUND CONDUIT, SIZE AND TYPE AS NOTED

	ABBREVIATIONS
ABBREVIATION	DESCRIPTION
AC	ALTERNATING CURRENT
A/C	AERIAL CABLE
ATS	ATTACHED TO STRUCTURE
B.O.C.	BACK OF CURB
СВ	CIRCUIT BREAKER
CKT	CIRCUIT
СМ	CENTIMETER
COMED	COMMONWEALTH EDISON COMPANY
CP	CONTROL PANEL
СТ	CURRENT TRANSFORMER
DA	DAVIT ARM
DC	DIRECT CURRENT
DIA	DIAMETER
DP	DISTRIBUTION PANEL
E	EXISTING UNIT TO REMAIN
EX.	EXISTING
ECA EIS	ELECTRIC CABLE ASSEMBLY EMBEDDED IN STRUCTURE
E.O.P.	EDGE OF PAVEMENT
F.O.C.	FACE OF CURB
FT	FEET OR FOOT
FU	FUSE
GND	GROUND
HID	HIGH INTENSITY DISCHARGE
HMLT	HIGH MAST LIGHTING UNIT
JB	JUNCTION BOX
KVA	KILOVOLT-AMPERE
KW	KILOWATTS
LED	LIGHT EMITTING DIODE
LP	LIGHT POLE
М	METER
MA	MAST ARM
MC	MULTI-CONDUCTOR
MM	MILLIMETER
M.H.	MOUNTING HEIGHT
MW NESC	MESSENGER WIRE NATIONAL ELECTRIC SAFETY CODE
NO.#	NUMBER
N.T.S.	NOT TO SCALE
N.1.5.	PROPOSED
PB	PUSH BUTTON
PNL	PANEL
PVC	POLYVINYL CHLORIDE
PVCC RGC	PVC COATED RIGID GALVANIZED CONDUIT
PT	POTENTIAL TRANSFORMER
R	EXISTING UNIT TO BE REMOVED
	(OWNER SALVAGED U.N.O.)
RR	EXISTING UNIT TO BE REMOVED AND
	REINSTALLED
RECP	RECEPTACLE
RGC	RIGID GALVANIZED CONDUIT
SEL SW	SELECTOR SWITCH
SPARE	SPACE
SPACE	SPACE STAINLESS STEEL
SS STA	STAINLESS STEEL STATION
T/F	TOP OF FOUNDATION
UD UD	UNIT DUCT
U.N.O.	UNLESS NOTED OTHERWISE
UGC, GS	UNDERGROUND CONDUCT, GALVANIZED STEEL

VOLTS, ALTERNATING CURRENT

LIQUID TIGHT FLEXIBLE METALLIC

HIGH PRESSURE SODIUM LOW PRESSURE SODIUM



#### **GENERAL NOTES**

- THE ELECTRICAL WORK SHALL BE PERFORMED IN ACCORDANCE WITH THE LATEST CODES, STANDARDS AND THE IDOT STANDARD SPECIFICATIONS FOR ROAD AND BRIDGE CONSTRUCTION ADOPTED JANUARY 1, 2022, AND SUPPLEMENTAL SPECIFICATIONS AND RECURRING SPECIAL PROVISIONS.
- THE CONTRACTOR SHALL CONTACT MEADE ELECTRIC CO, DISTRICT ONE ELECTRICAL MAINTENANCE CONTRACTOR TO LOCATE IDOT ELECTRICAL EQUIPMENT AND UNDERGROUND CABLES 773-287-7672.
- COMED ENERGY CONTACT PERSON: CONTROLLER L & O: NORA CABRALES TELEPHONE NUMBER: (847) 929-2357 EMAIL: NORA.COBRALES@COMED.COM

CONTROLLER R: ALLYSEN BEARD TELEPHONE NUMBER: (847) 816-5215 EMAIL: ALLYSEN.BEARD@COMED.COM

#### **IDOT-D1 STANDARDS**:

STANDARD NO.	TITLE

BE-206 LIGHTING CONTROLLER, BASE MOUNTED. 480VOLT, 200AMP (DUAL) RADIO SCADA - FIBER OPTIC PROVISION

BE-220 ELECTRIC SERVICE INSTALLATION SERVICE AERIAL. REMOTE DISCONNECT

BE-305 LIGHT POLE FOUNDATION, METAL

ALUMINUM LIGHT POLE 47'-6" MOUNTING HEIGHT

BE-701 LUMINAIRE SAFETY CABLE ASSEMBLY
BE-702 MISC. ELECTRICAL DETAILS SHEET A

TO STA.

BE-901 SUSPENDED MOUNT LED UNDERPASS LUMINAIRE INSTALLATION DETAILS

## **INDEX OF SHEETS**

DRAWING <u>NUMBER</u>	DESCRIPTION
LT-01	LIGHTING LEGEND AND GENERAL NOTES
LT-02	SCHEDULE OF QUANTITIES
LT-03 TO LT-13	I-94/US-41 SMART HIGHWAY LIGHTING REMOVAL PLANS
LT-14 TO LT-24	I-94/US-41 SMART HIGHWAY PROPOSED LIGHTING PLANS
LT-25	UNDERPASS LIGHTING REMOVAL PLAN I-94 AT LAKE AVENUE
LT-26	PROPOSED UNDERPASS LIGHTING INSTALLATION PLAN I-94 AT LAKE AVENUE
LT-27	PROPOSED UNDERPASS LIGHTING INSTALLATION PLAN I-94 AT TOWER ROAD
LT-28	UNDERPASS LIGHTING AS-BUILT INFORMATION
LT-29	I-94/US-41 SMART HIGHWAY PROPOSED LIGHTING SCHEMATIC - CONTROLLER L
LT-30	I-94/US-41 SMART HIGHWAY PROPOSED LIGHTING SCHEMATIC - CONTROLLER O
LT-31	I-94/US-41 SMART HIGHWAY PROPOSED LIGHTING SCHEMATIC - CONTROLLER R
LT-32 TO LT-35	CONTROLLER L AS-BUILT INFORMATION
LT-36 TO LT-37	CONTROLLER O AS-BUILT INFORMATION
LT-38 TO LT-40	CONTROLLER R AS-BUILT INFORMATION
LT-41 TO LT-50	IDOT D1-BUREAU OF ELECTRICAL DETAIL STANDARDS

LT-01



USER NAME = DGORMAN	DESIGNED - VN	REVISED -
	DRAWN - VN	REVISED -
PLOT SCALE =	CHECKED - RP/MG	REVISED -
PLOT DATE = 6/23/2023	DATE - 06/07/2023	REVISED -

VAC

WP

LPS

LTFM

XFMR HPS WATTS

WOOD POLE TRANSFORMER

> STATE OF ILLINOIS DEPARTMENT OF TRANSPORTATION

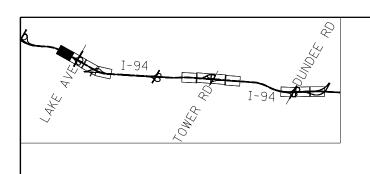
LIGHTING LEGEND AND GENERAL NOTES

SCALE: NTS SHEET 1 OF 30 SHEETS STA.

SIN	
SINGH + A	SSOCIATES, INC.


ER NAME = OGORMAN	DESIGNED - VN	REVISED -				F.A.I RTF.	SECTION	COUNTY	TOTAL SHEETS	SHEET NO.		
	DRAWN - VN	REVISED -	STATE OF ILLINOIS	SCHEDULE OF QUANTITIES			94	2016-071L	СООК	84	29	
OT SCALE =	CHECKED - RP/MG	REVISED -	DEPARTMENT OF TRANSPORTATION						2010 0.12	CONTRAC	T NO. 62	2D82
OT DATE = 6/23/2023	DATE - 06/07/2023	REVISED -		SCALE: NTS	SHEET 2 OF	30 SHEETS STA.	TO STA.		ILLINOIS FED.			

LT-02





LT-03

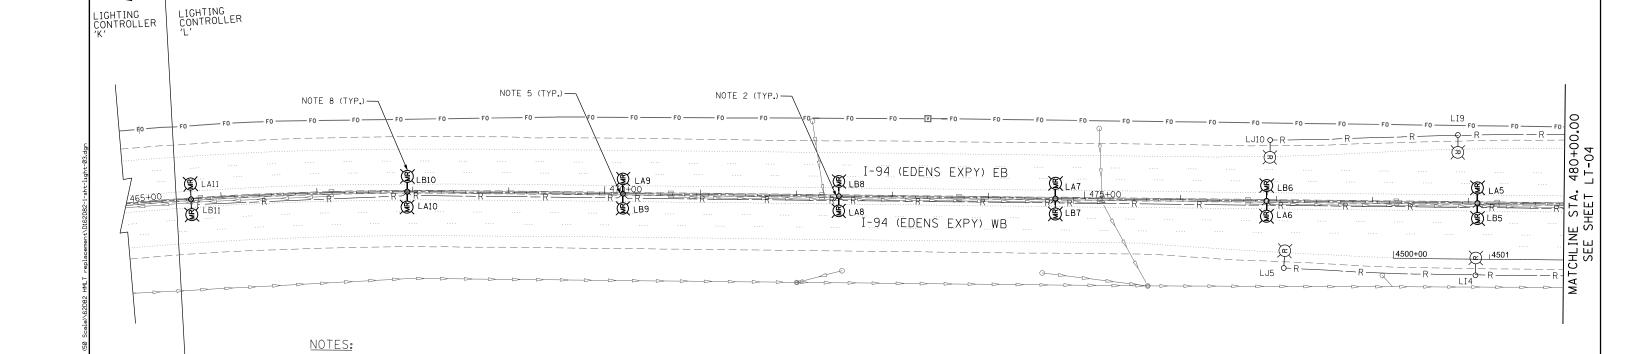

8. EXISTING HPS LUMINAIRES BEING REMOVED ARE TO BE SALVAGED TO IDOT.

TO BE REPAIRED.

REFER TO SHEET LT-01 FOR ELECTRICAL GENERAL NOTES AND LEGEND.
 EXISTING HPS LUMINAIRES BEING REMOVED ARE TO BE SALVAGED TO IDOT.

3. EXISTING GROUND AND MEDIAN MOUNTED LIGHTING AND HIGH MAST LIGHTING SHALL REMAIN OPERATIONAL UNTIL PROPOSED LIGHTING SYSTEM IS INSTALLED

5. ALL EXISTING TRANSFORMER BASES BEING REMOVED SHALL BE SALVAGED TO IDOT.

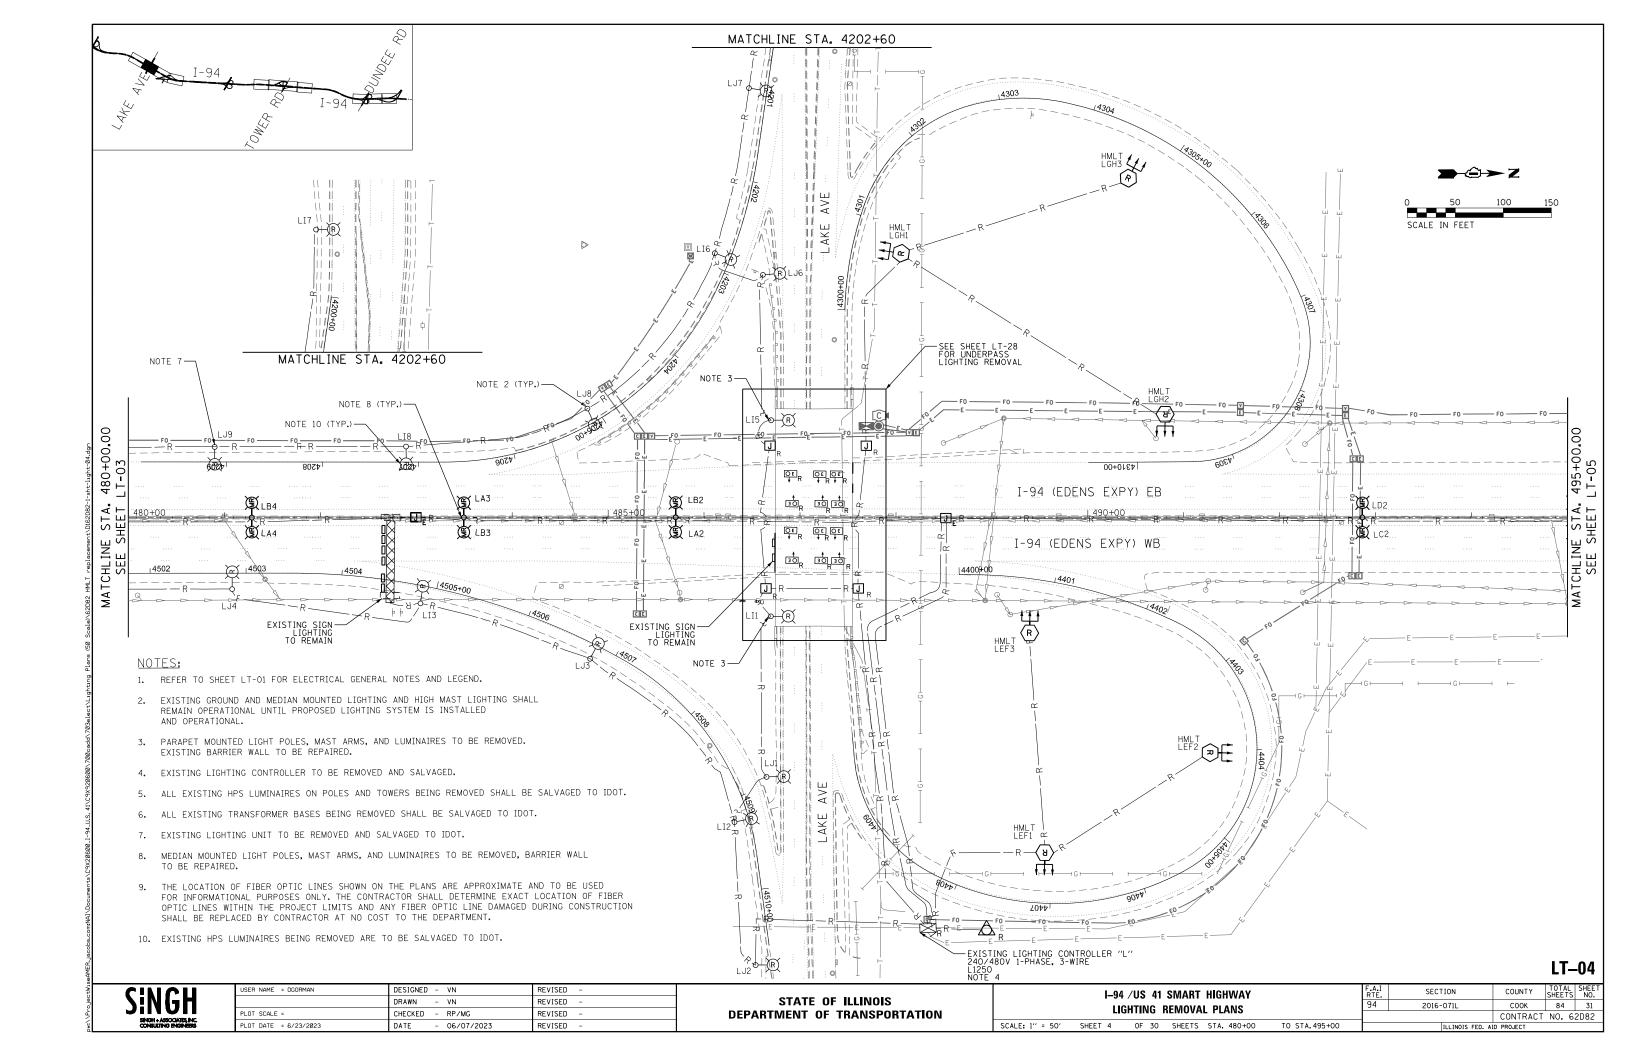
4. ALL EXISTING HPS LUMINAIRES ON POLES AND TOWERS BEING REMOVED SHALL BE SALVAGED TO IDOT.

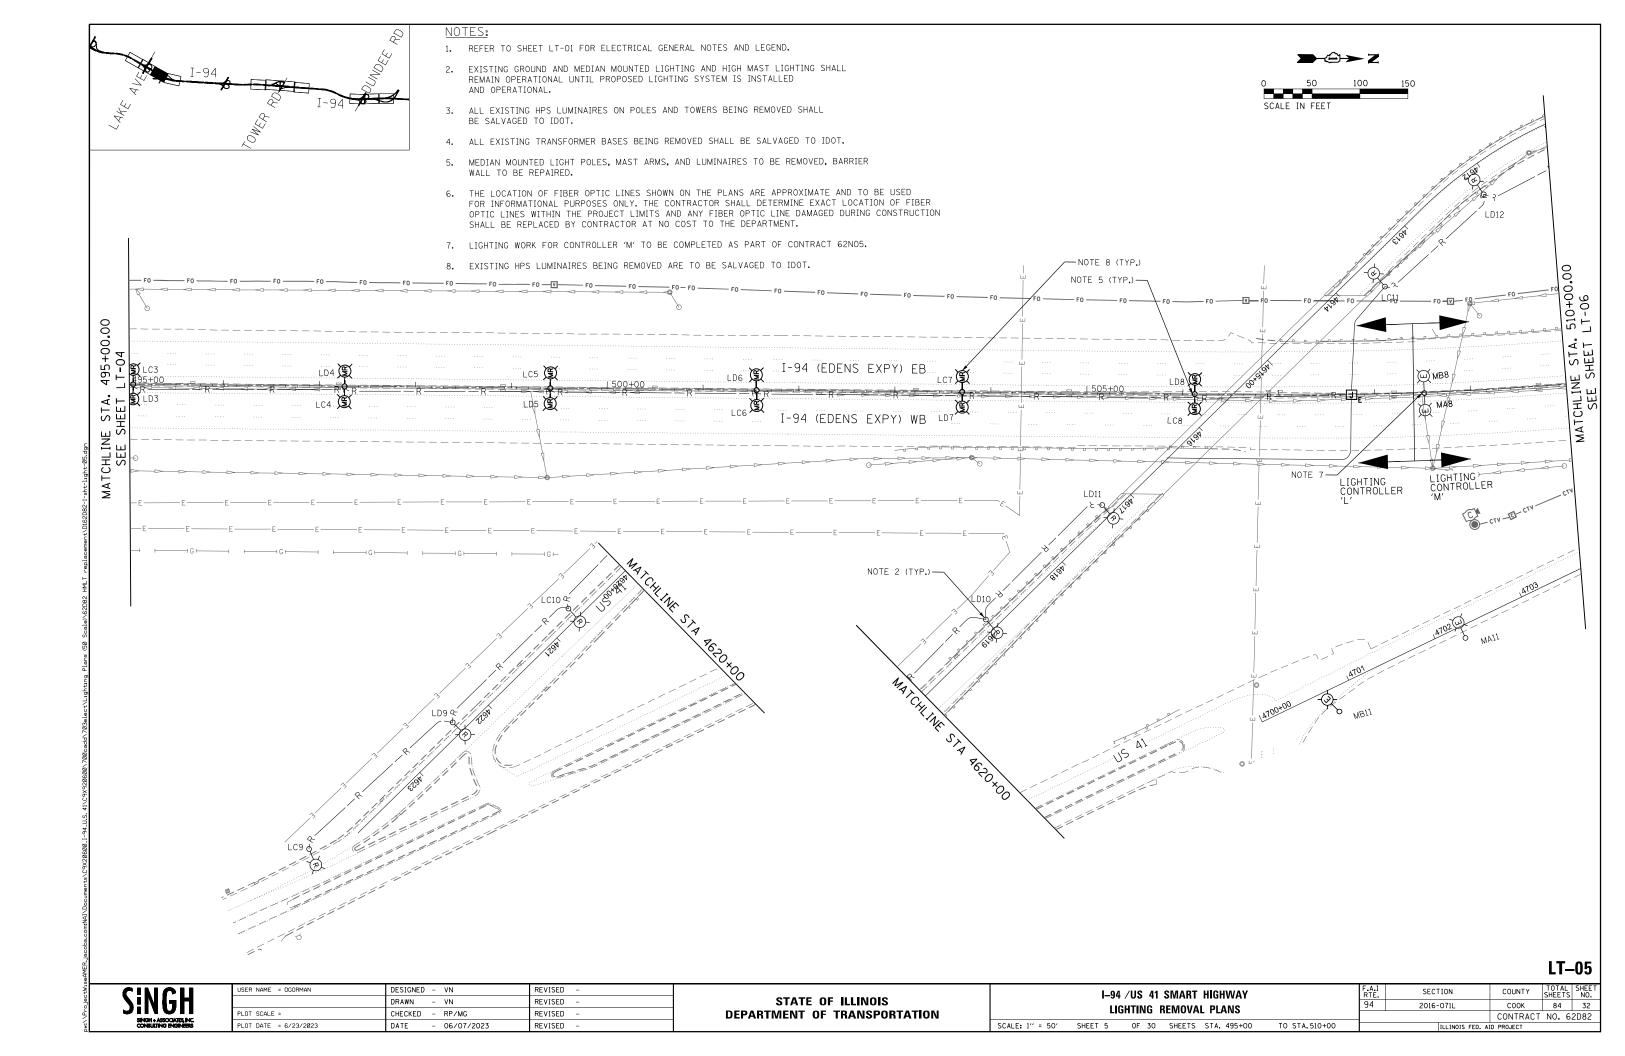
7. THE LOCATION OF FIBER OPTIC LINES SHOWN ON THE PLANS ARE APPROXIMATE AND TO BE USED FOR INFORMATIONAL PURPOSES ONLY. THE CONTRACTOR SHALL DETERMINE EXACT LOCATION OF FIBER OPTIC LINES WITHIN THE PROJECT LIMITS AND ANY FIBER OPTIC LINE DAMAGED DURING CONSTRUCTION SHALL BE REPLACED BY CONTRACTOR AT NO COST TO THE DEPARTMENT.

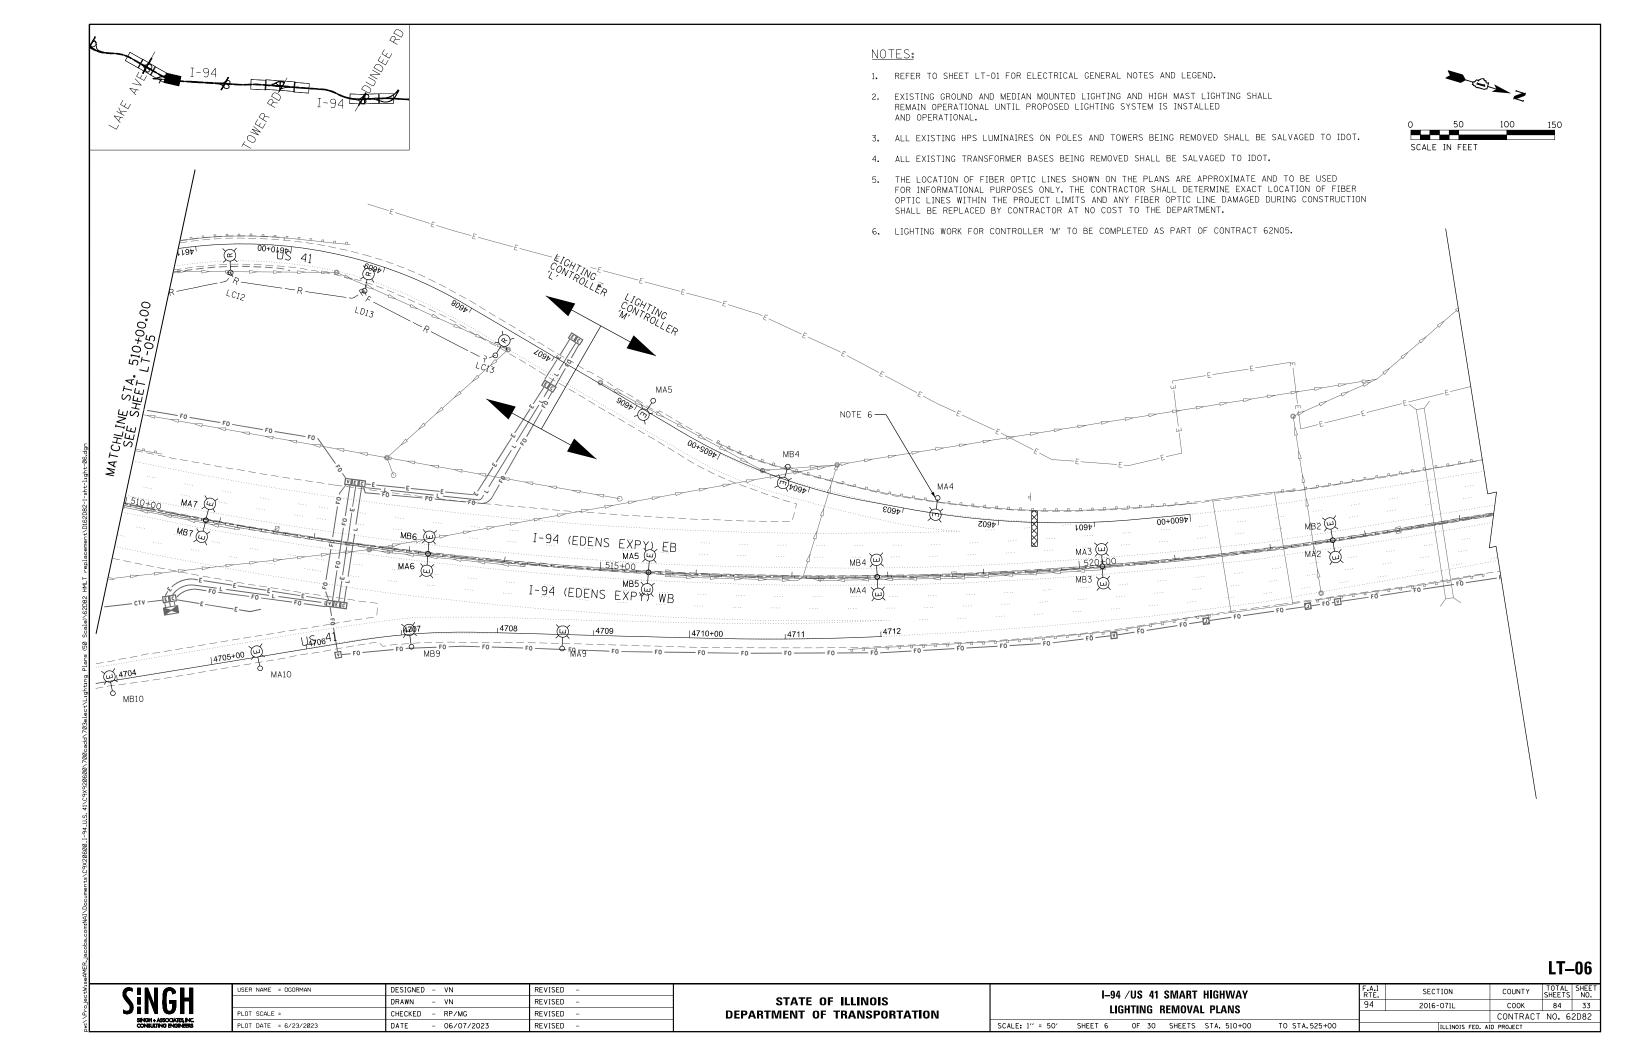
6. MEDIAN MOUNTED LIGHT POLES, MAST ARMS, AND LUMINAIRES TO BE REMOVED, BARRIER WALL

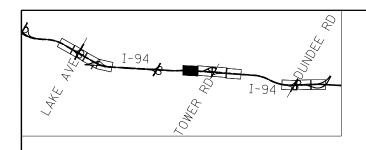
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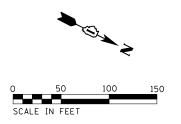
USER NAME = DGORMAN	DESIGNED - VN	REVISED -	STATE OF ILLINOIS	I-94 /US 41 SMART HIGHWAY		F.A.I RTF.	SECTION	COUNTY	TOTAL SHE	EET O.
	DRAWN - VN	REVISED -					2016-071L	соок	84 3	30
PLOT SCALE =	CHECKED - RP/MG	REVISED -	DEPARTMENT OF TRANSPORTATION LIGHTING REMOVAL PLANS		'		CONTRACT	NO. 62D8	32	
PLOT DATE = 6/23/2023	DATE - 06/07/2023	REVISED -		SCALE: 1" = 50' SHEET 3 OF 30 SHEETS STA. 465+00	TO STA.480+00		ILLINOIS FED.	AID PROJECT		

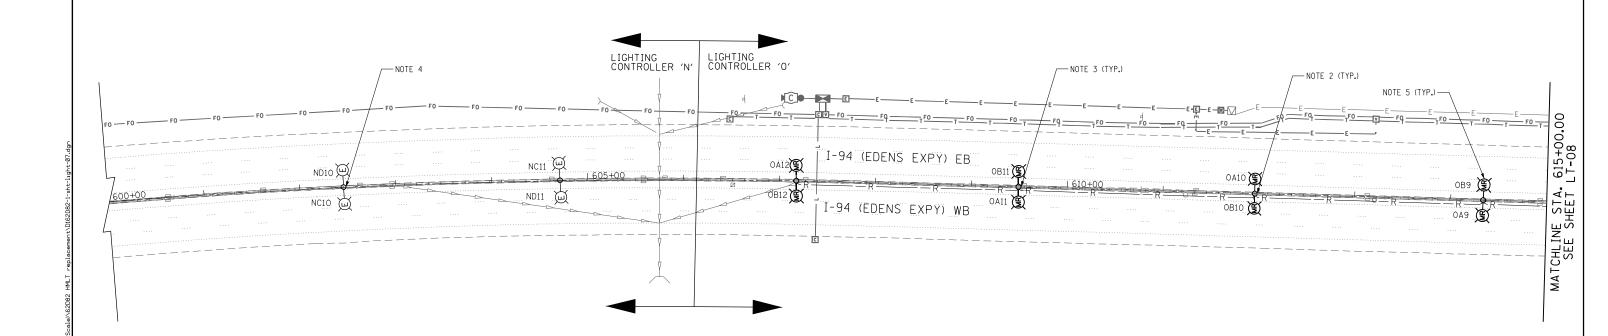












#### NOTES:

SCALE: 1" = 50' SHEET 7

- 1. REFER TO SHEET LT-01 FOR ELECTRICAL GENERAL NOTES AND LEGEND.
- 2. EXISTING GROUND AND MEDIAN MOUNTED LIGHTING AND HIGH MAST LIGHTING SHALL REMAIN OPERATIONAL UNTIL PROPOSED LIGHTING SYSTEM IS INSTALLED AND OPERATIONAL.
- 3. MEDIAN MOUNTED LIGHT POLES, MAST ARMS, AND LUMINAIRES TO BE REMOVED, BARRIER WALL TO BE REPAIRED.
- 4. LIGHTING WORK FOR CONTROLLER 'N' TO BE COMPLETED AS PART OF CONTRACT 62N05
- 5. EXISTING HPS LUMINAIRES BEING REMOVED ARE TO BE SALVAGED TO IDOT.

## LT-07

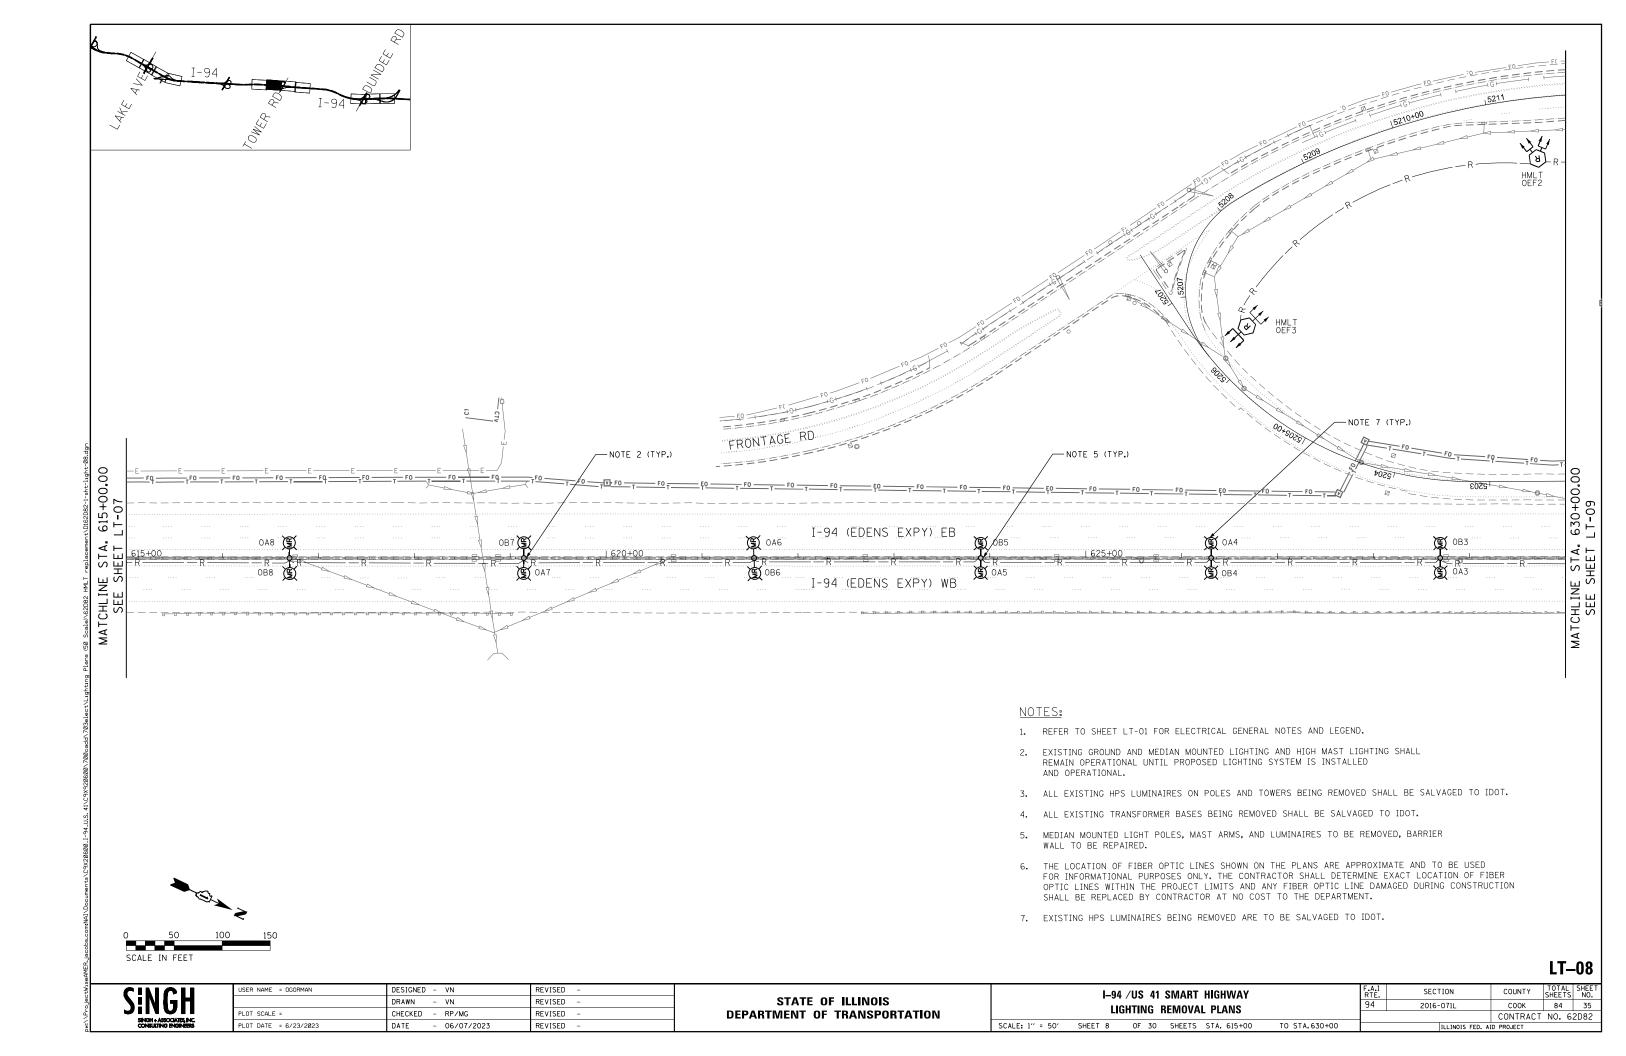
SINGH SINGH-ASSOCIATE, INC. SOCIALITING BYGINESS

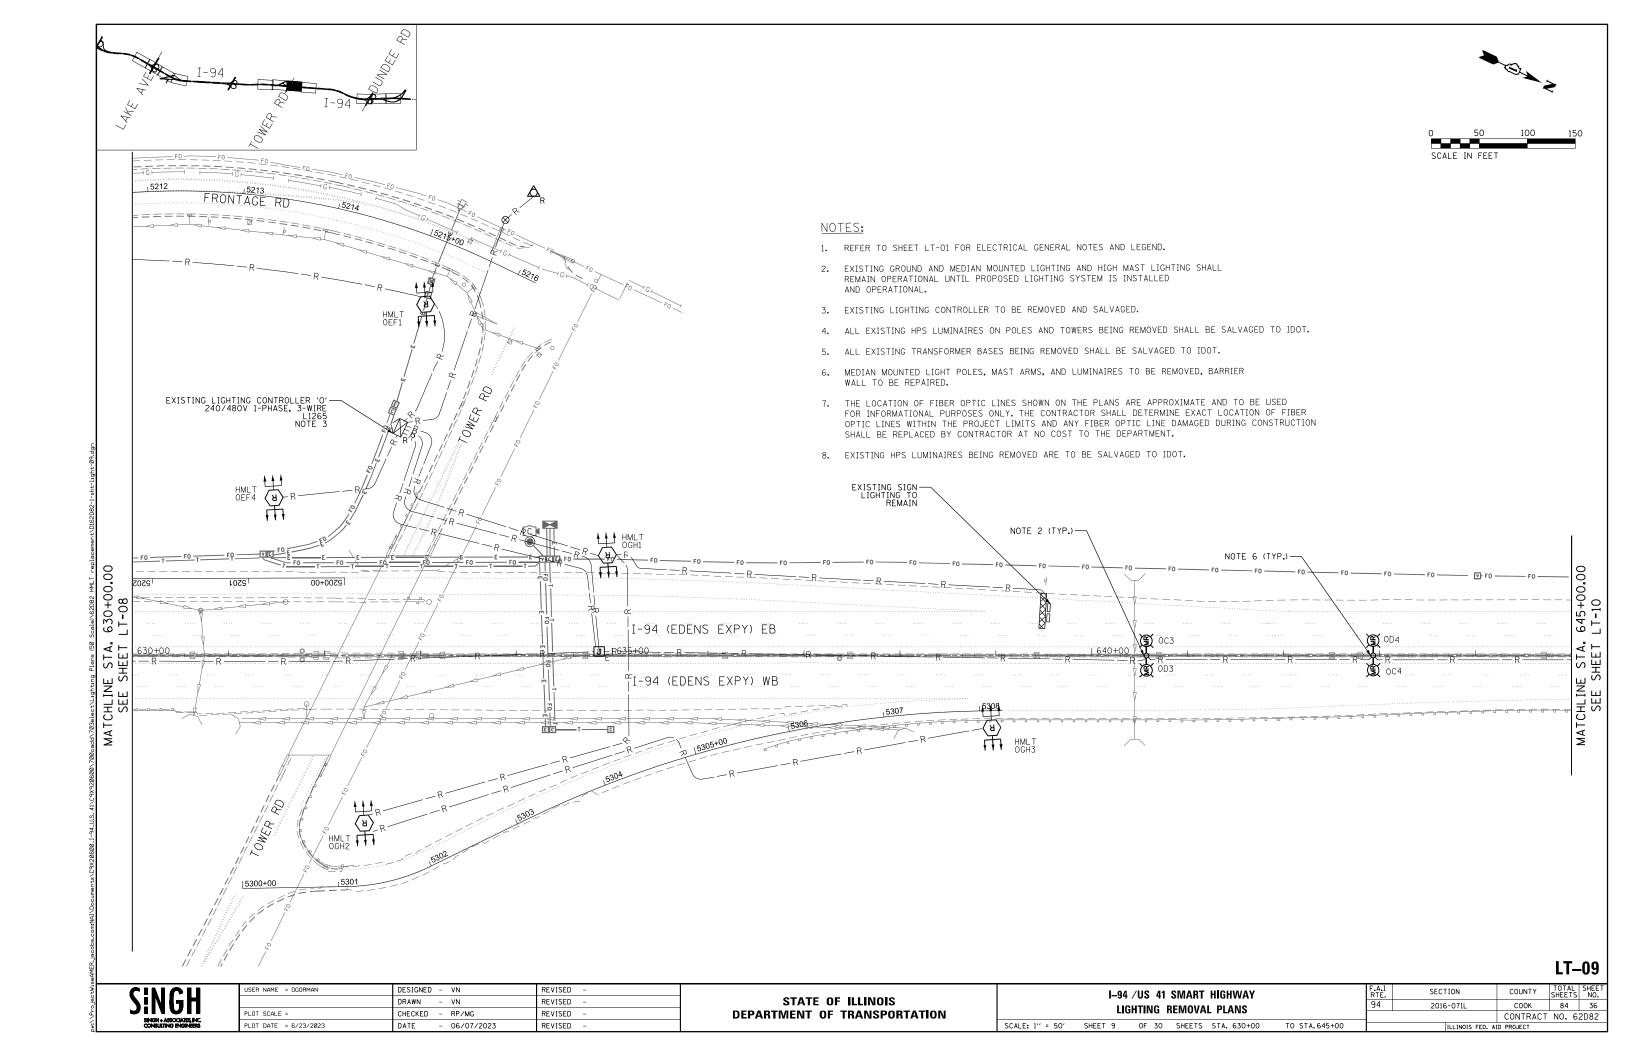
SER NAME = OGORMAN	DESIGNED - VN	REVISED -	
	DRAWN - VN	REVISED -	
LOT SCALE =	CHECKED - RP/MG	REVISED -	
LOT DATE = 6/23/2023	DATE - 06/07/2023	REVISED -	

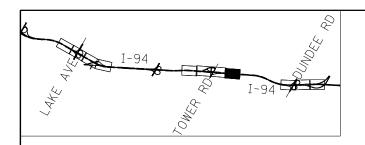
STATE OF ILLINOIS					
DEPARTMENT OF TRANSPORTATION					

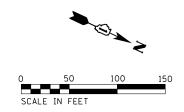
	I-94 /US 41 SMART HIGHWAY				F.A.I RTE.	SECTIO		
LIGHTING REMOVAL PLANS				94	2016-07			
	LIG		<u> </u>	ILIVIOVA	L I LAND			
ΞΤ	7	OF	30	SHEETS	STA. 600+00	TO STA.615+00		11.1

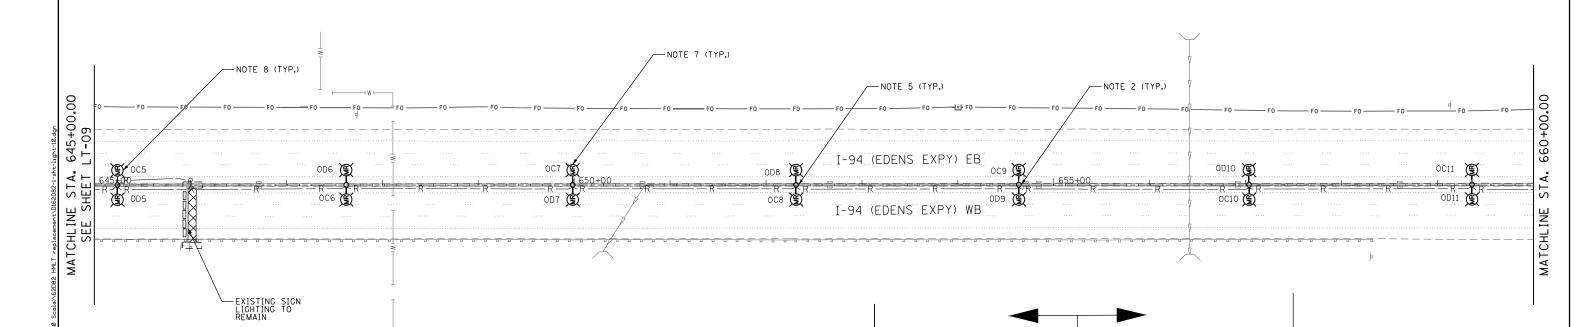
Ė.	SECTION	COUNTY	SHEETS	NO.				
4	2016-071L	соок	84	34				
	CONTRACT NO. 62D82							
	ILLINOIS FED. A	ID PROJECT						











### NOTES:

- 1. REFER TO SHEET LT-01 FOR ELECTRICAL GENERAL NOTES AND LEGEND.
- 2. EXISTING GROUND AND MEDIAN MOUNTED LIGHTING AND HIGH MAST LIGHTING SHALL REMAIN OPERATIONAL UNTIL PROPOSED LIGHTING SYSTEM IS INSTALLED AND OPERATIONAL.
- 3. ALL EXISTING HPS LUMINAIRES ON POLES AND TOWERS BEING REMOVED SHALL BE SALVAGED TO IDOT.
- 4. ALL EXISTING TRANSFORMER BASES BEING REMOVED SHALL BE SALVAGED TO IDOT.
- 5. MEDIAN MOUNTED LIGHT POLES, MAST ARMS, AND LUMINAIRES TO BE REMOVED, BARRIER WALL TO BE REPAIRED.
- 6. THE LOCATION OF FIBER OPTIC LINES SHOWN ON THE PLANS ARE APPROXIMATE AND TO BE USED FOR INFORMATIONAL PURPOSES ONLY. THE CONTRACTOR SHALL DETERMINE EXACT LOCATION OF FIBER OPTIC LINES WITHIN THE PROJECT LIMITS AND ANY FIBER OPTIC LINE DAMAGED DURING CONSTRUCTION SHALL BE REPLACED BY CONTRACTOR AT NO COST TO THE DEPARTMENT.
- 7. EXISTING HPS LUMINAIRES BEING REMOVED ARE TO BE SALVAGED TO IDOT.

# LT-10

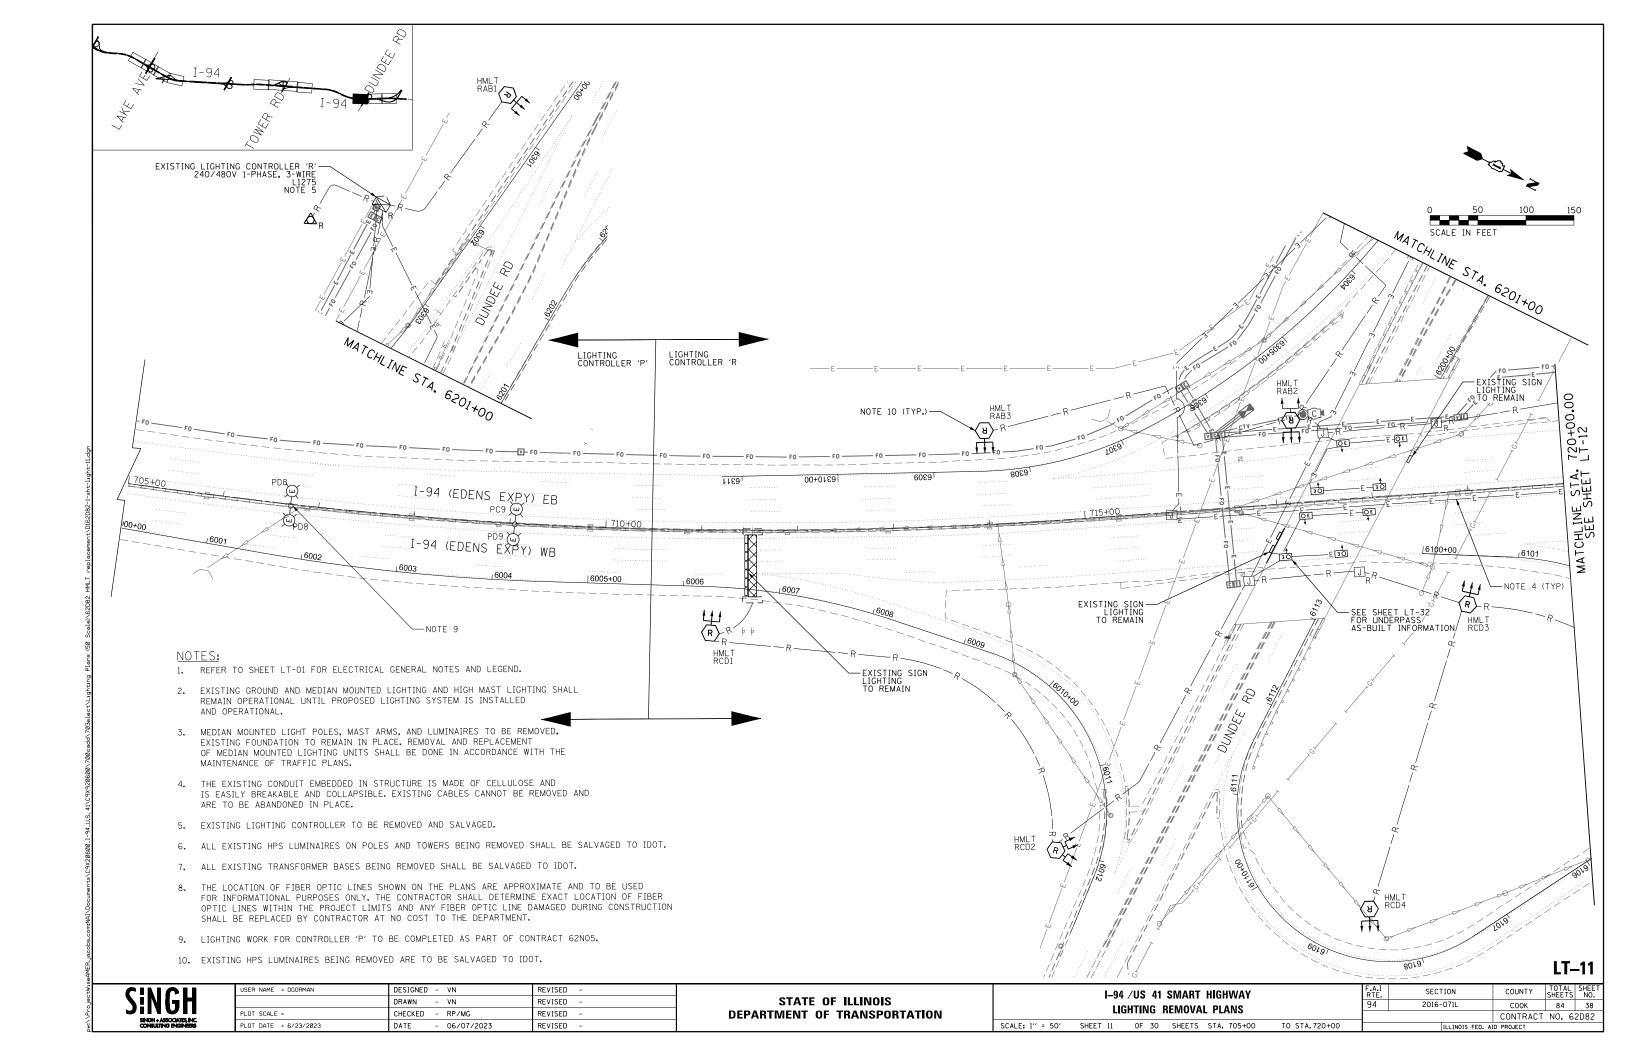


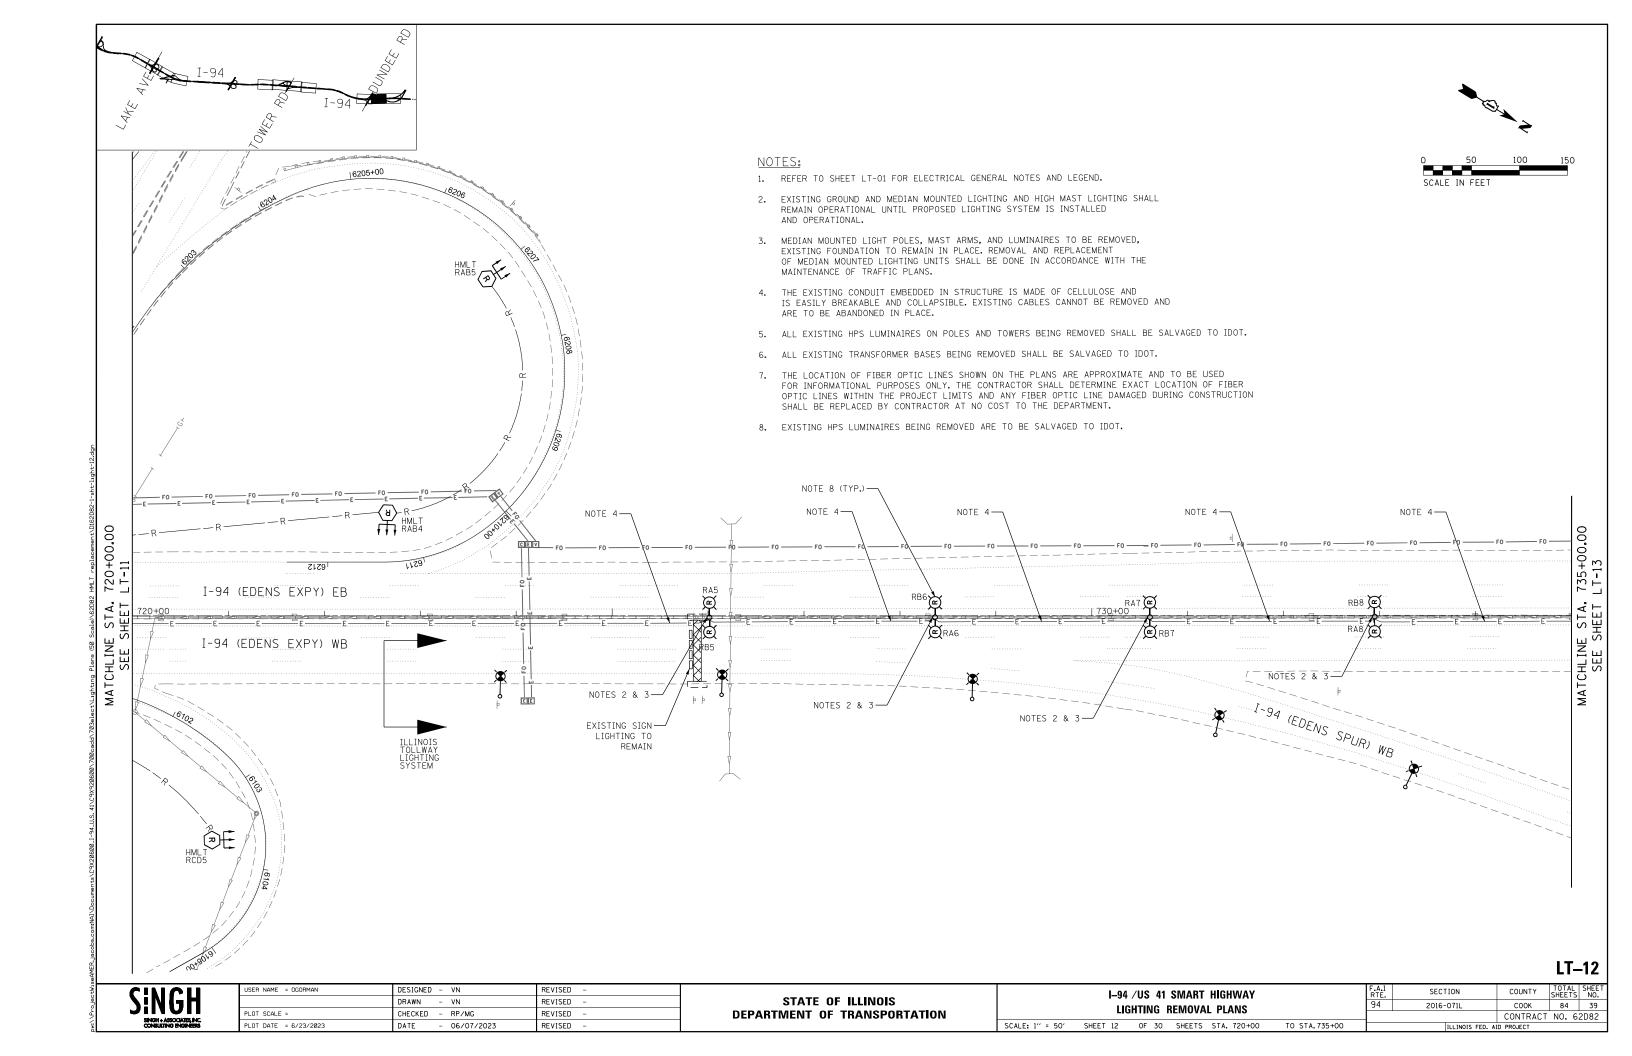
JSER NAME = OGORMAN	DESIGNED - VN	REVISED -	
	DRAWN - VN	REVISED -	
PLOT SCALE =	CHECKED - RP/MG	REVISED -	
PLOT DATE = 6/23/2023	DATE - 06/07/2023	REVISED -	

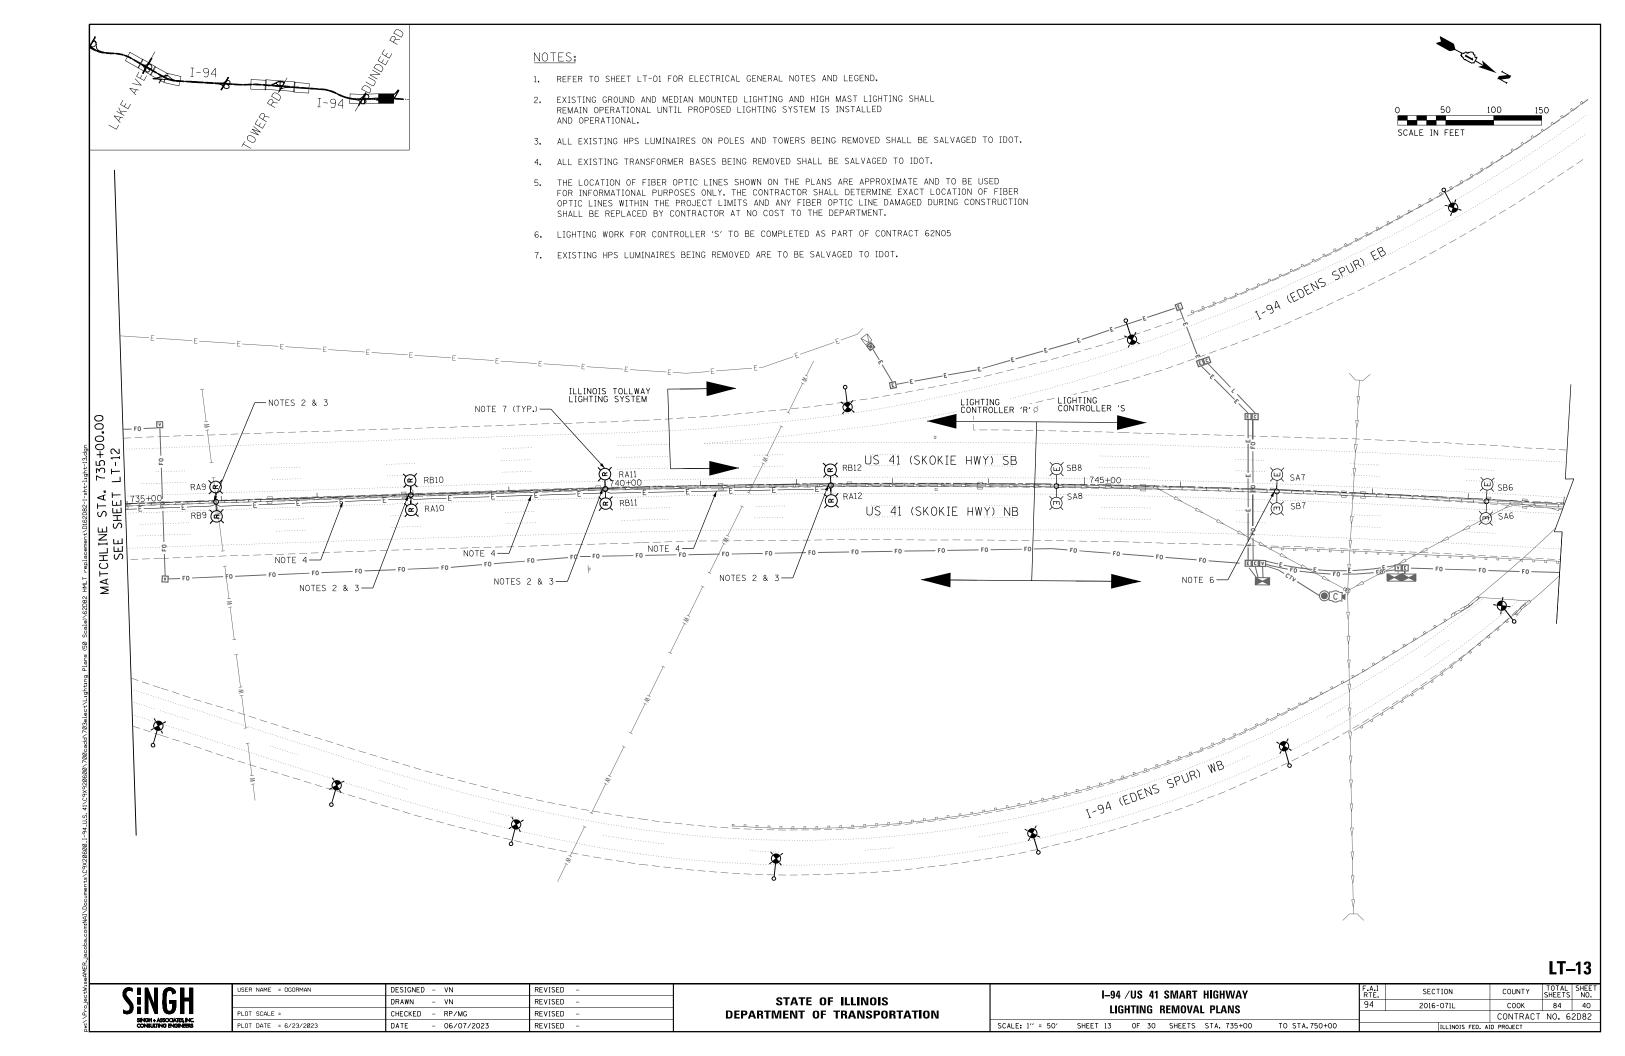
STATE OF	F ILLINOIS
DEPARTMENT OF	TRANSPORTATION

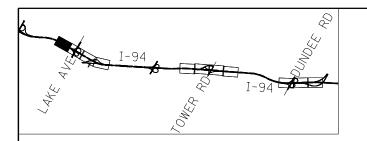
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I-94 /US 41 SMART HIGHWAY	F.A.I RTE.	SECTION	COUNTY	TOTAL SHEETS	SHEET NO.
LIGHTING REMOVAL PLANS	94	2016-071L	COOK	84	37
LIGHTING HEMOVAL LEANS			CONTRACT	NO. 6	2D82
SCALE: 1" = 50' SHEET 10 OF 30 SHEETS STA. 645+00 TO STA. 660+00		ILLINOIS FED. A	D PROJECT		

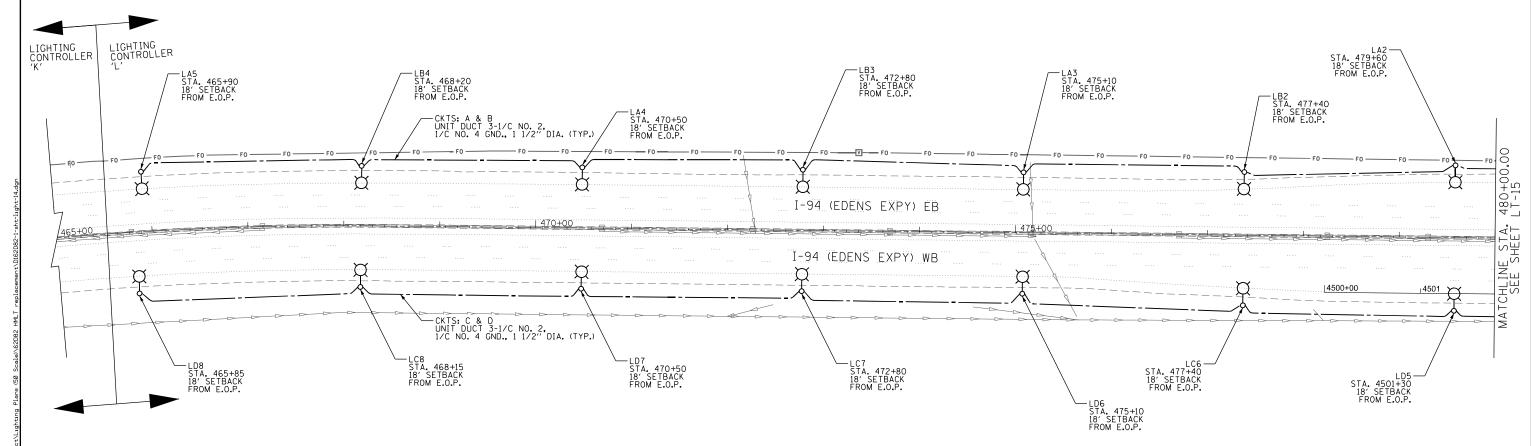












### <u>NOTES</u>

- 1. REFER TO SHEET LT-01 FOR ELECTRICAL GENERAL NOTES AND LEGEND.
- 2. THE LOCATION OF FIBER OPTIC LINES SHOWN ON THE PLANS ARE APPROXIMATE AND TO BE USED FOR INFORMATIONAL PURPOSES ONLY. THE CONTRACTOR SHALL DETERMINE EXACT LOCATION OF FIBER OPTIC LINES WITHIN THE PROJECT LIMITS AND ANY FIBER OPTIC LINE DAMAGED DURING CONSTRUCTION SHALL BE REPLACED BY CONTRACTOR AT NO COST TO THE DEPARTMENT.
- 3. CONTRACTOR SHALL VERIFY EXACT LOCATIONS OF UNDERGROUND UTILITIES WITHIN THE PROJECT LIMITS. IF A PROPOSED LIGHT POLE FOUNDATION IS DETERMINED TO BE IN CONFLIXT WITH AN EXISTING UNDERGROUND UTILITY, THE LIGHT POLE FOUNDATION SHALL BE SET BACK FURTHER AWAY FROM THE EDGE OF PAVEMENT AND IN NO INSTANCE SHOULD THE SETBACK BE CLOSER THAN 18 FT FROM THE EDGE OF PAVEMENT. MAINTAIN AT LEAST 3 FT OF CLEARANCE BETWEEN THE LIGHT POLE FOUNDATION AND EXISTING UNDERGROUND UTILITY.
- 4. CONTRACTOR SHALL NOT DISTRUB OR DEPOSIT ANY MATERIAL IN WETLAND AREAS.

## LT-14

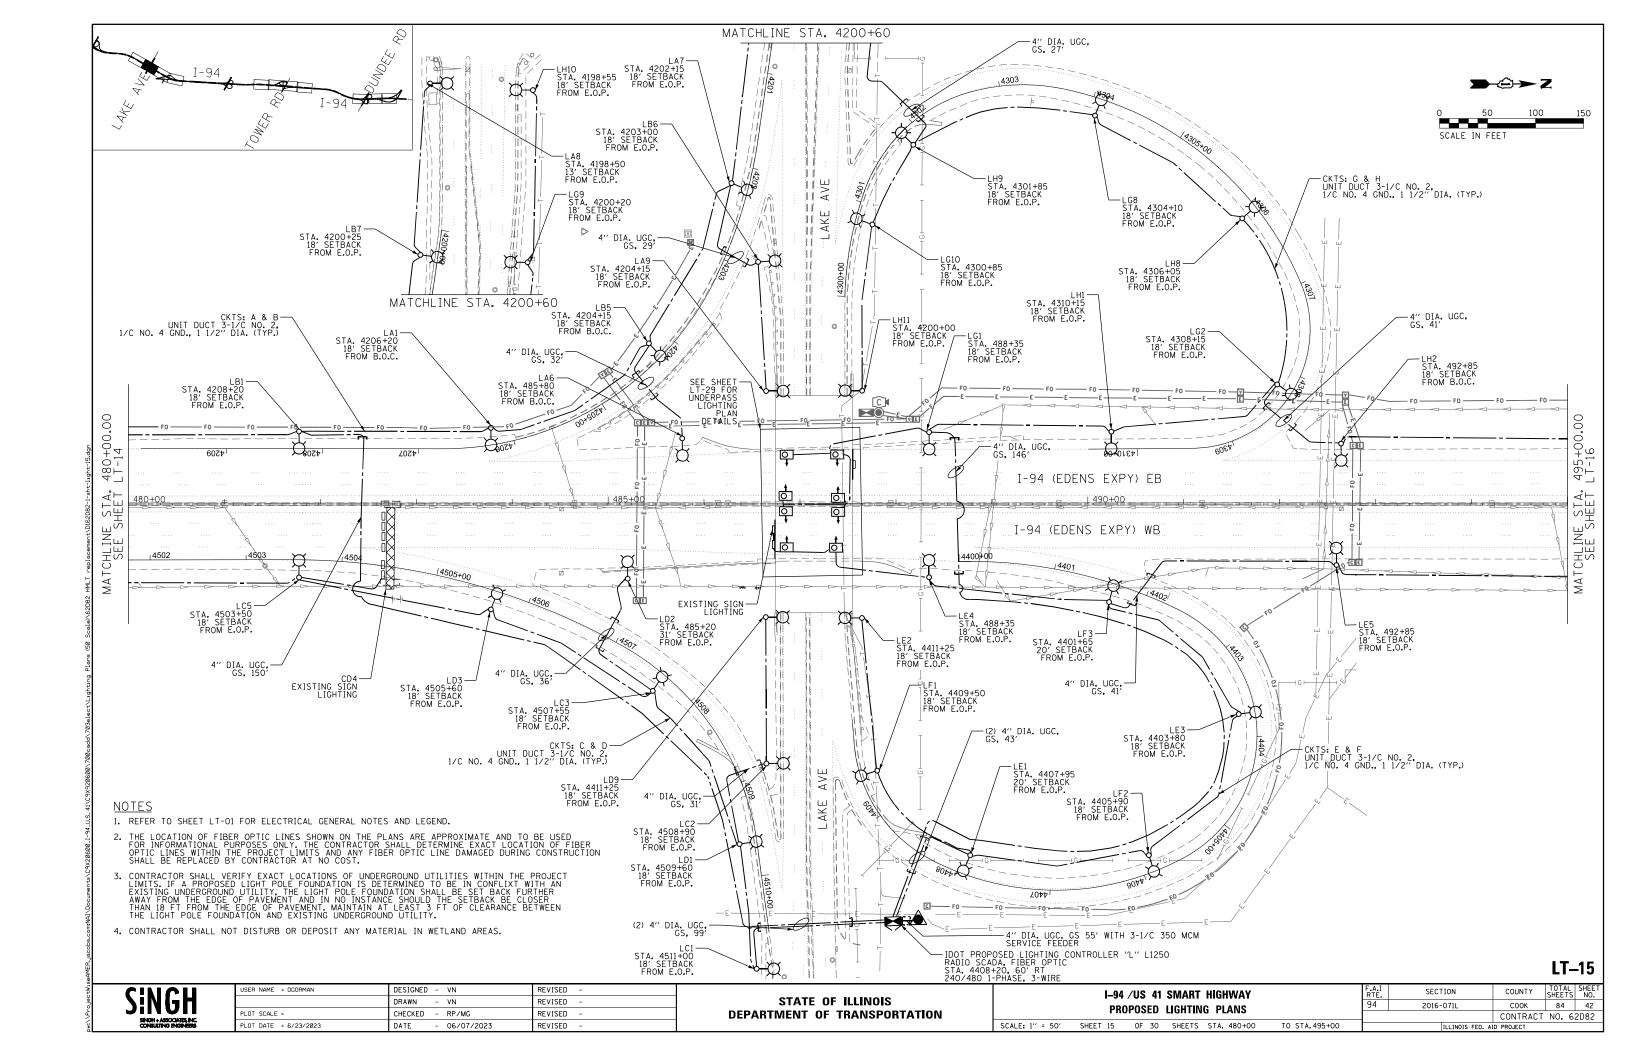


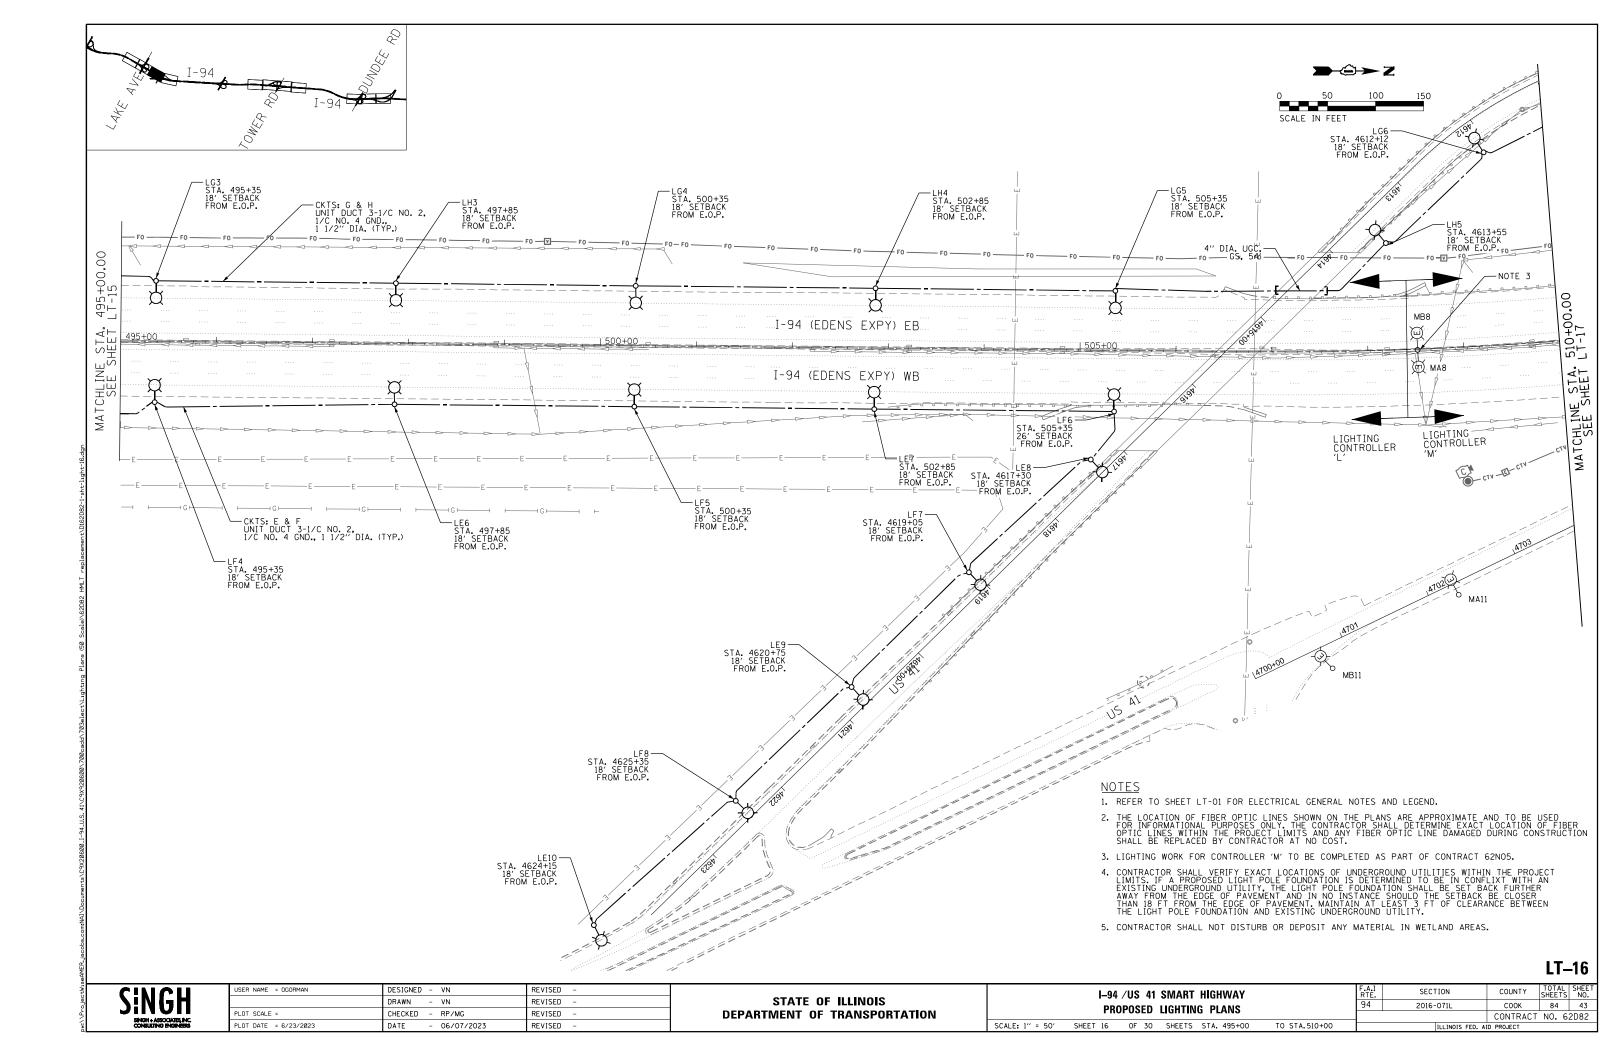
JSER NAME = DGORMAN	DESIGNED - VN	REVISED -
	DRAWN - VN	REVISED -
PLOT SCALE =	CHECKED - RP/MG	REVISED -
PLOT DATE = 6/23/2023	DATE - 06/07/2023	REVISED -

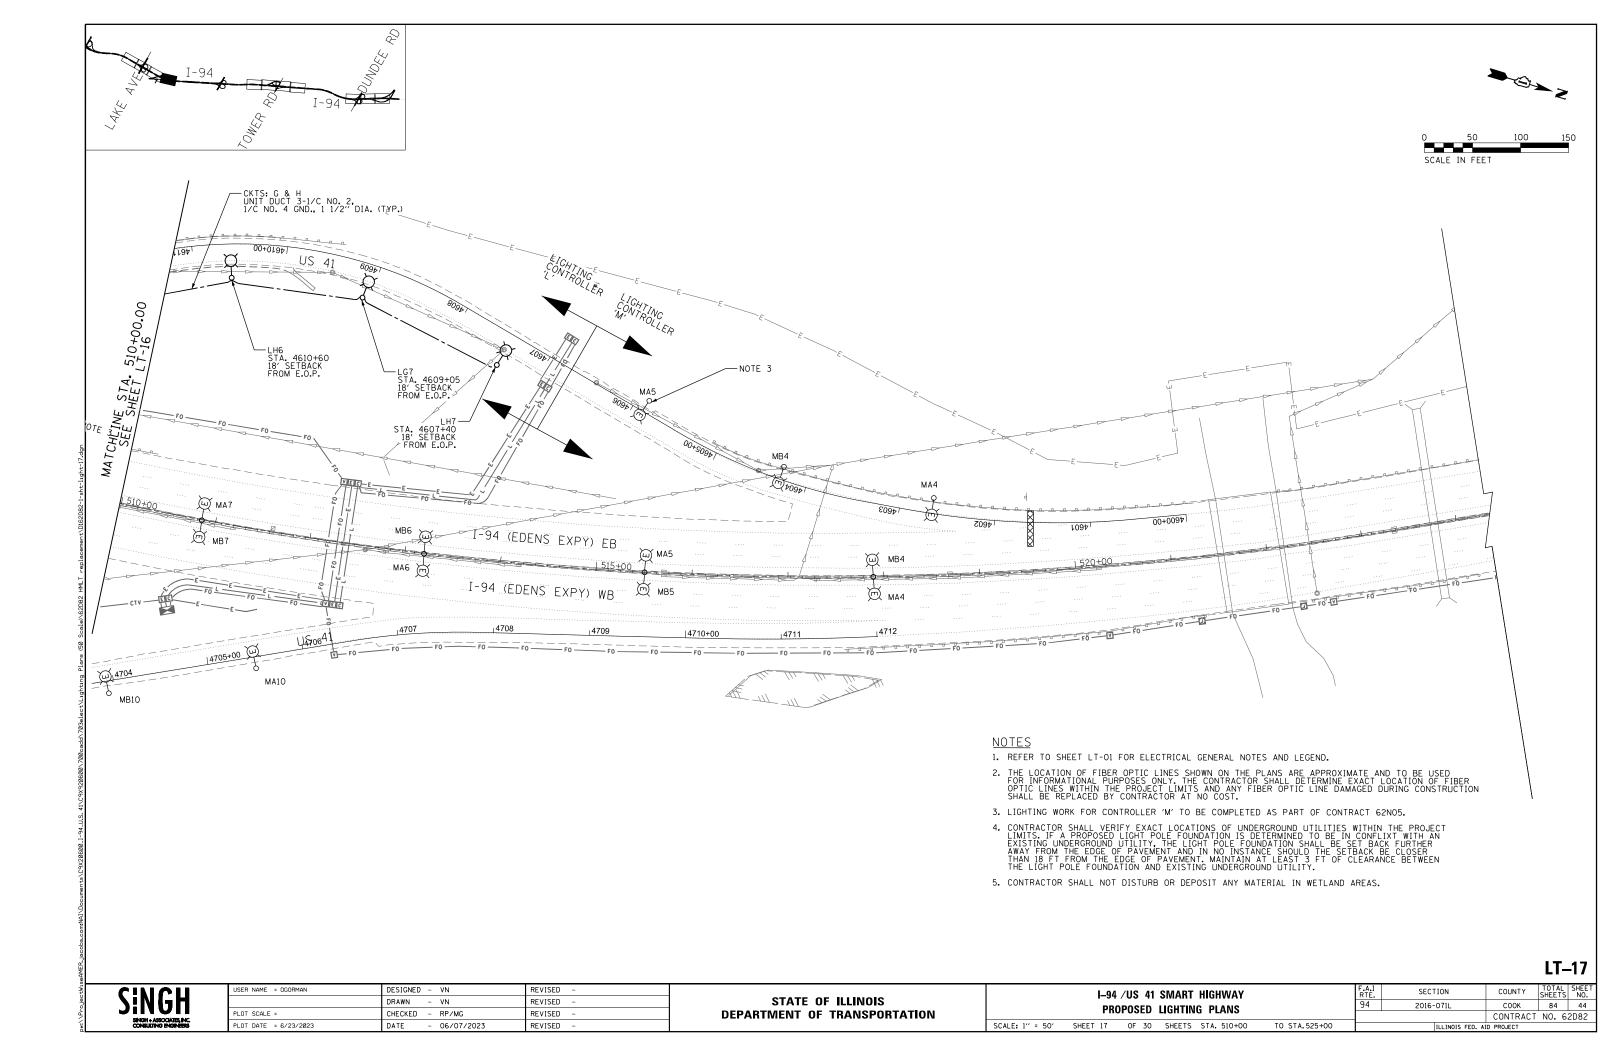
STATE OF ILLINOIS DEPARTMENT OF TRANSPORTATION

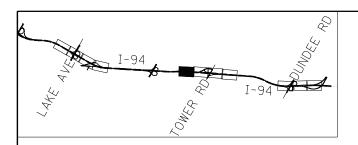
I-94 /US 41 SMART HIGHWAY						
	PRO	OPOSED	LIGHTING PLANS			
SCALE: 1" = 50"	SHEET 14	OF 30	SHEETS STA. 465+00	TO STA. 480+		

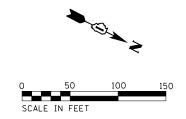
.A.I SECTION COUNTY TOTAL SHEETS NO. 34 2016-071L COOK 84 41 CONTRACT NO. 62D82

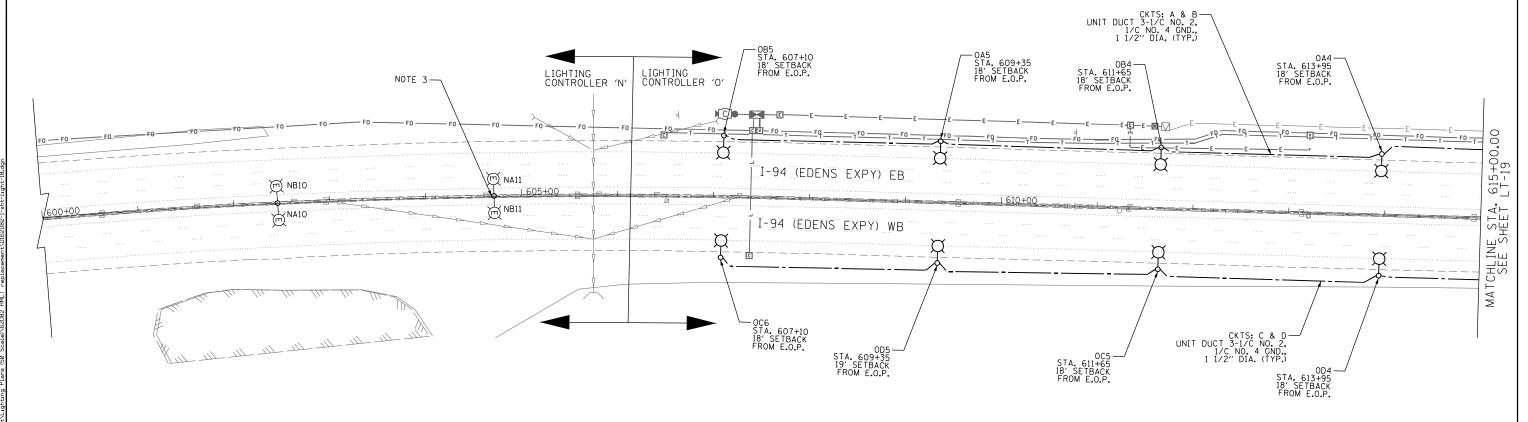












### <u>NOTES</u>

- 1. REFER TO SHEET LT-01 FOR ELECTRICAL GENERAL NOTES AND LEGEND.
- THE LOCATION OF FIBER OPTIC LINES SHOWN ON THE PLANS ARE APPROXIMATE AND TO BE USED FOR INFORMATIONAL PURPOSES ONLY. THE CONTRACTOR SHALL DETERMINE EXACT LOCATION OF FIBER OPTIC LINES WITHIN THE PROJECT LIMITS AND ANY FIBER OPTIC LINE DAMAGED DURING CONSTRUCTION SHALL BE REPLACED BY CONTRACTOR AT NO COST.
- 3. LIGHTING WORK FOR CONTROLLER 'N' TO BE COMPLETED AS PART OF CONTRACT 62NOS.
- 4. CONTRACTOR SHALL VERIFY EXACT LOCATIONS OF UNDERGROUND UTILITIES WITHIN THE PROJECT LIMITS. IF A PROPOSED LIGHT POLE FOUNDATION IS DETERMINED TO BE IN CONFLIXT WITH AN EXISTING UNDERGROUND UTILITY, THE LIGHT POLE FOUNDATION SHALL BE SET BACK FURTHER AWAY FROM THE EDGE OF PAVEMENT AND IN NO INSTANCE SHOULD THE SETBACK BE CLOSER THAN 18 FT FROM THE EDGE OF PAVEMENT. MAINTAIN AT LEAST 3 FT OF CLEARANCE BETWEEN THE LIGHT POLE FOUNDATION AND EXISTING UNDERGROUND UTILITY.
- 5. CONTRACTOR SHALL NOT DISTURB OR DEPOSIT ANY MATERIAL IN WETLAND AREAS.

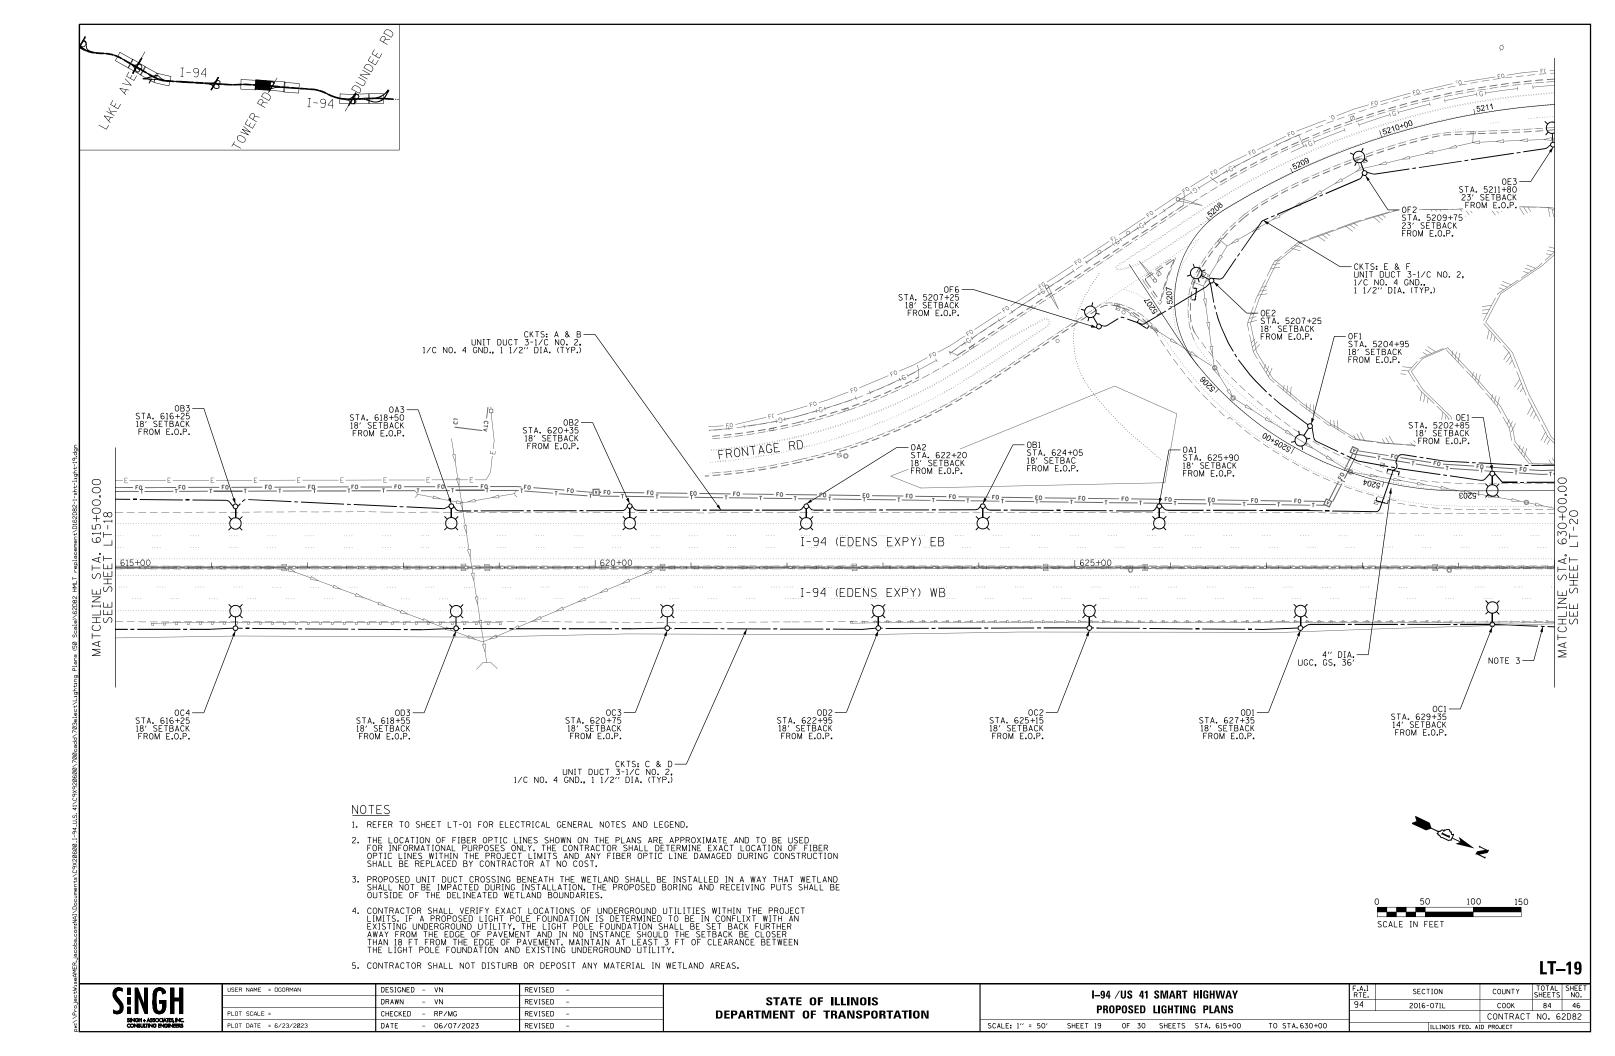
# LT-18

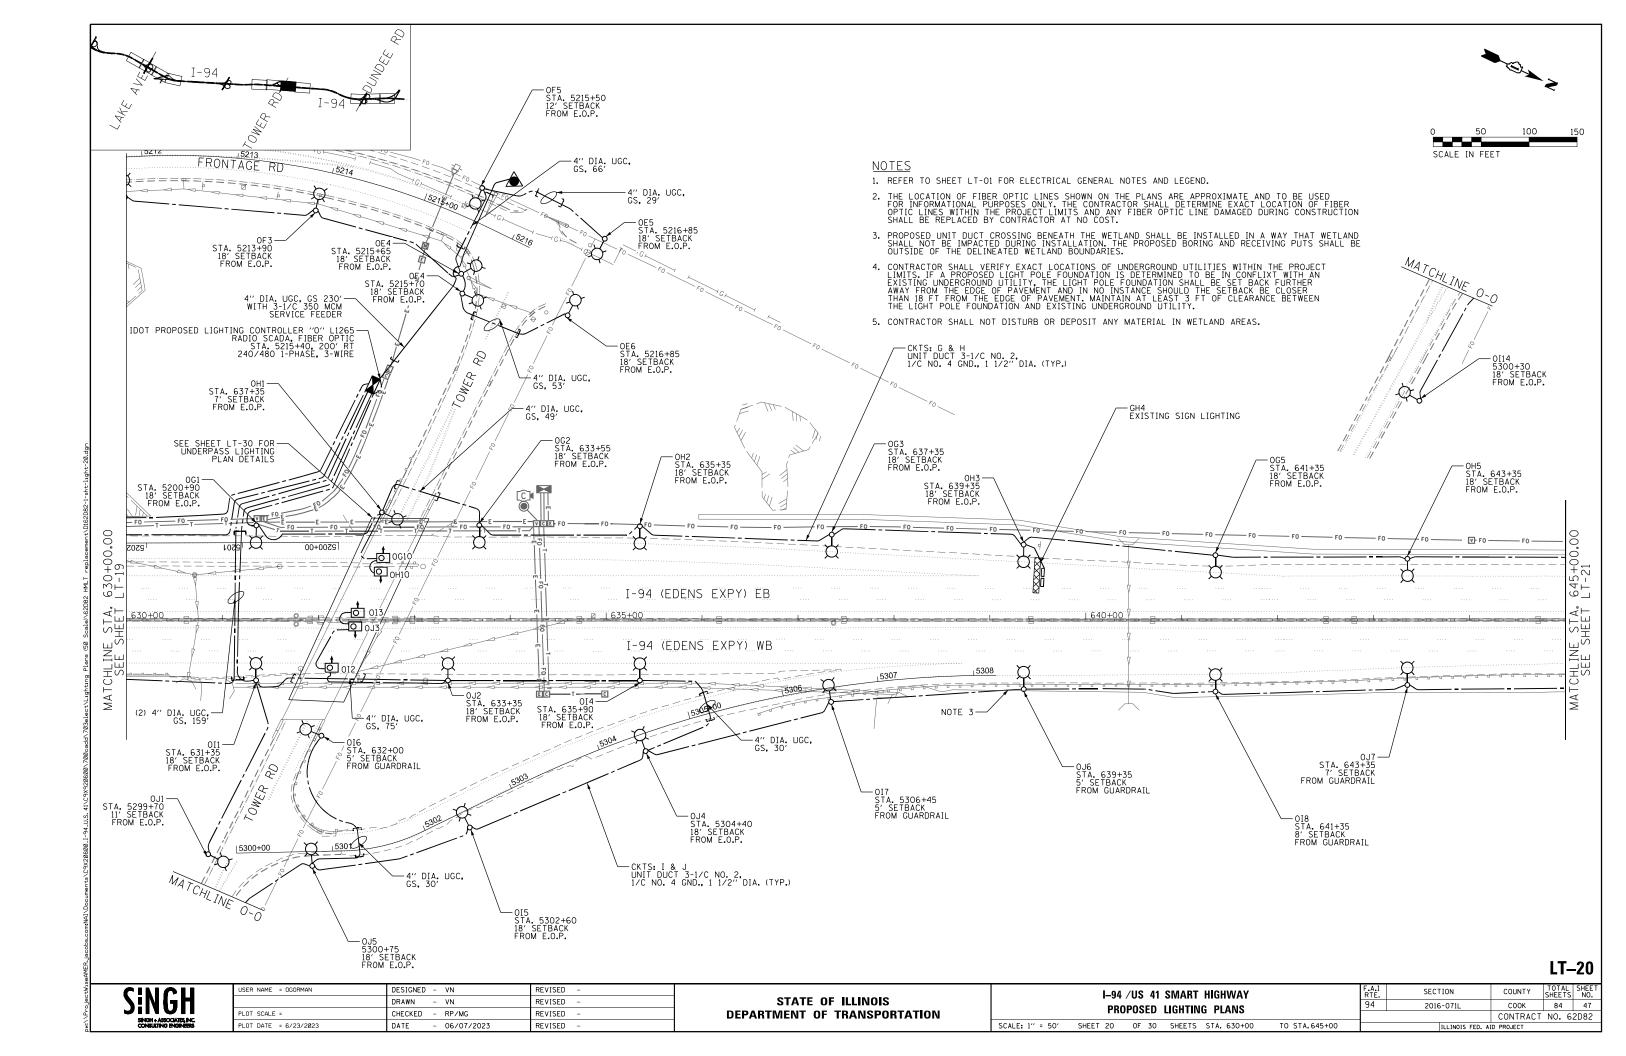


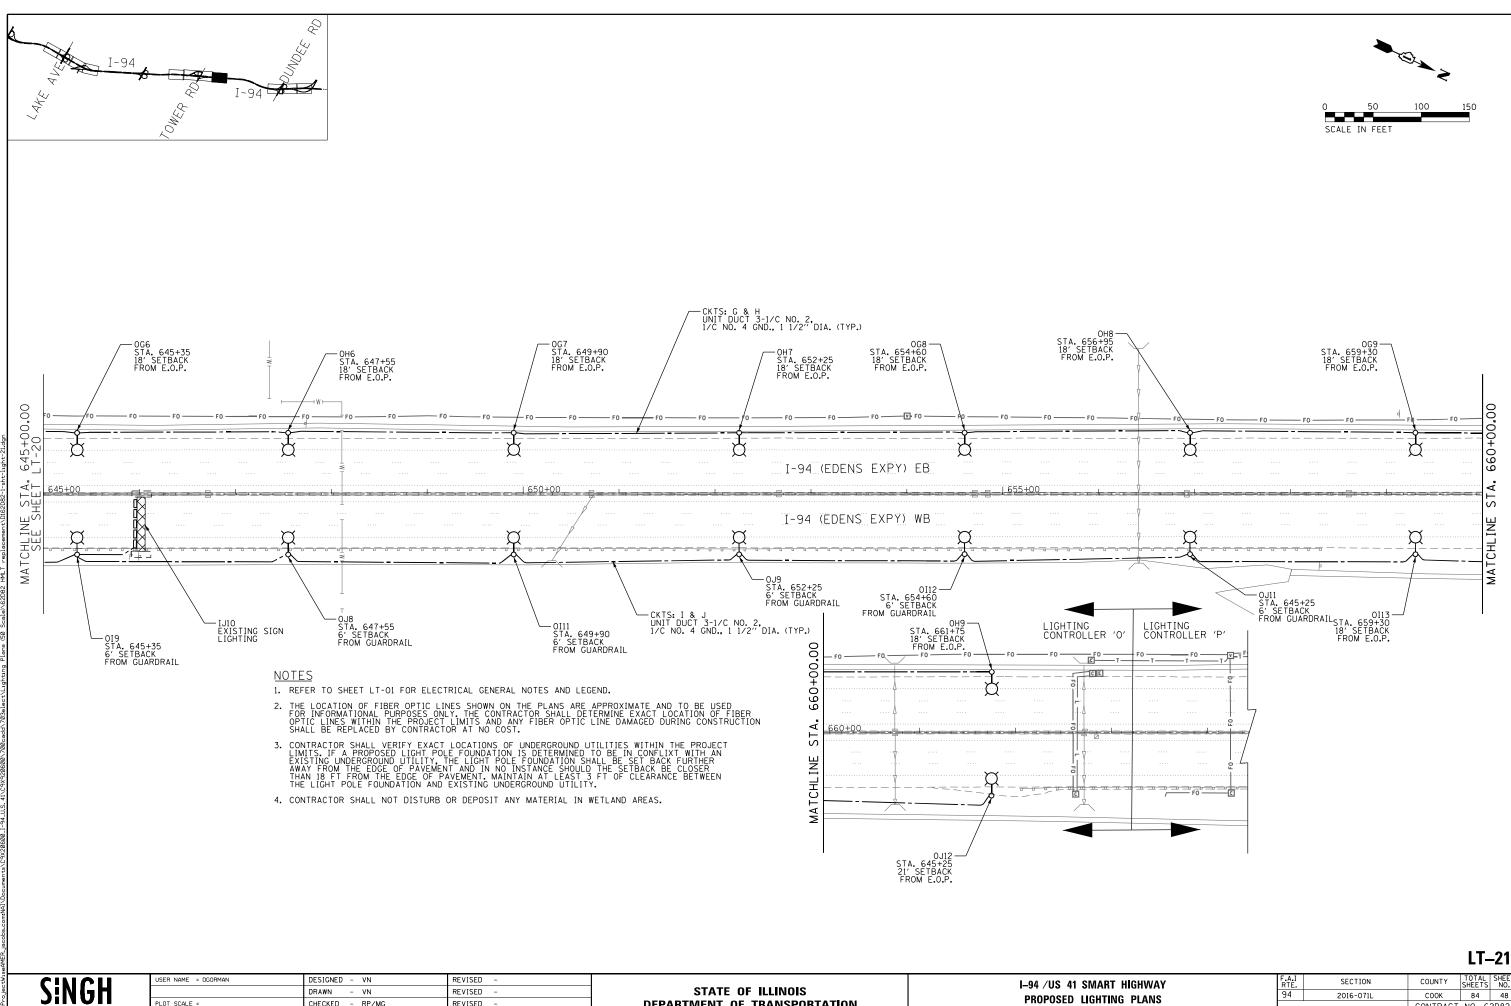
SER NAME = OGORMAN	DESIGNED - VN	REVISED -
	DRAWN - VN	REVISED -
LOT SCALE =	CHECKED - RP/MG	REVISED -
_OT DATE = 6/23/2023	DATE - 06/07/2023	REVISED -

STATE OF ILLINOIS DEPARTMENT OF TRANSPORTATION

					F.A.I RTE.	SECTION
	PROPOSED LIGHTING PLANS					
SCALE: 1" = 50"	SHEET 18	OF 30	SHEETS STA. 600+00	TO STA.615+00		ILLINOIS F







COUNTY TOTAL SHEETS NO.


COOK 84 48


CONTRACT NO. 62D82


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PLOT SCALE =	CHECKED - RP/MG	REVISED -
PLOT DATE = 6/23/2023	DATE - 06/07/2023	REVISED -

**DEPARTMENT OF TRANSPORTATION** 

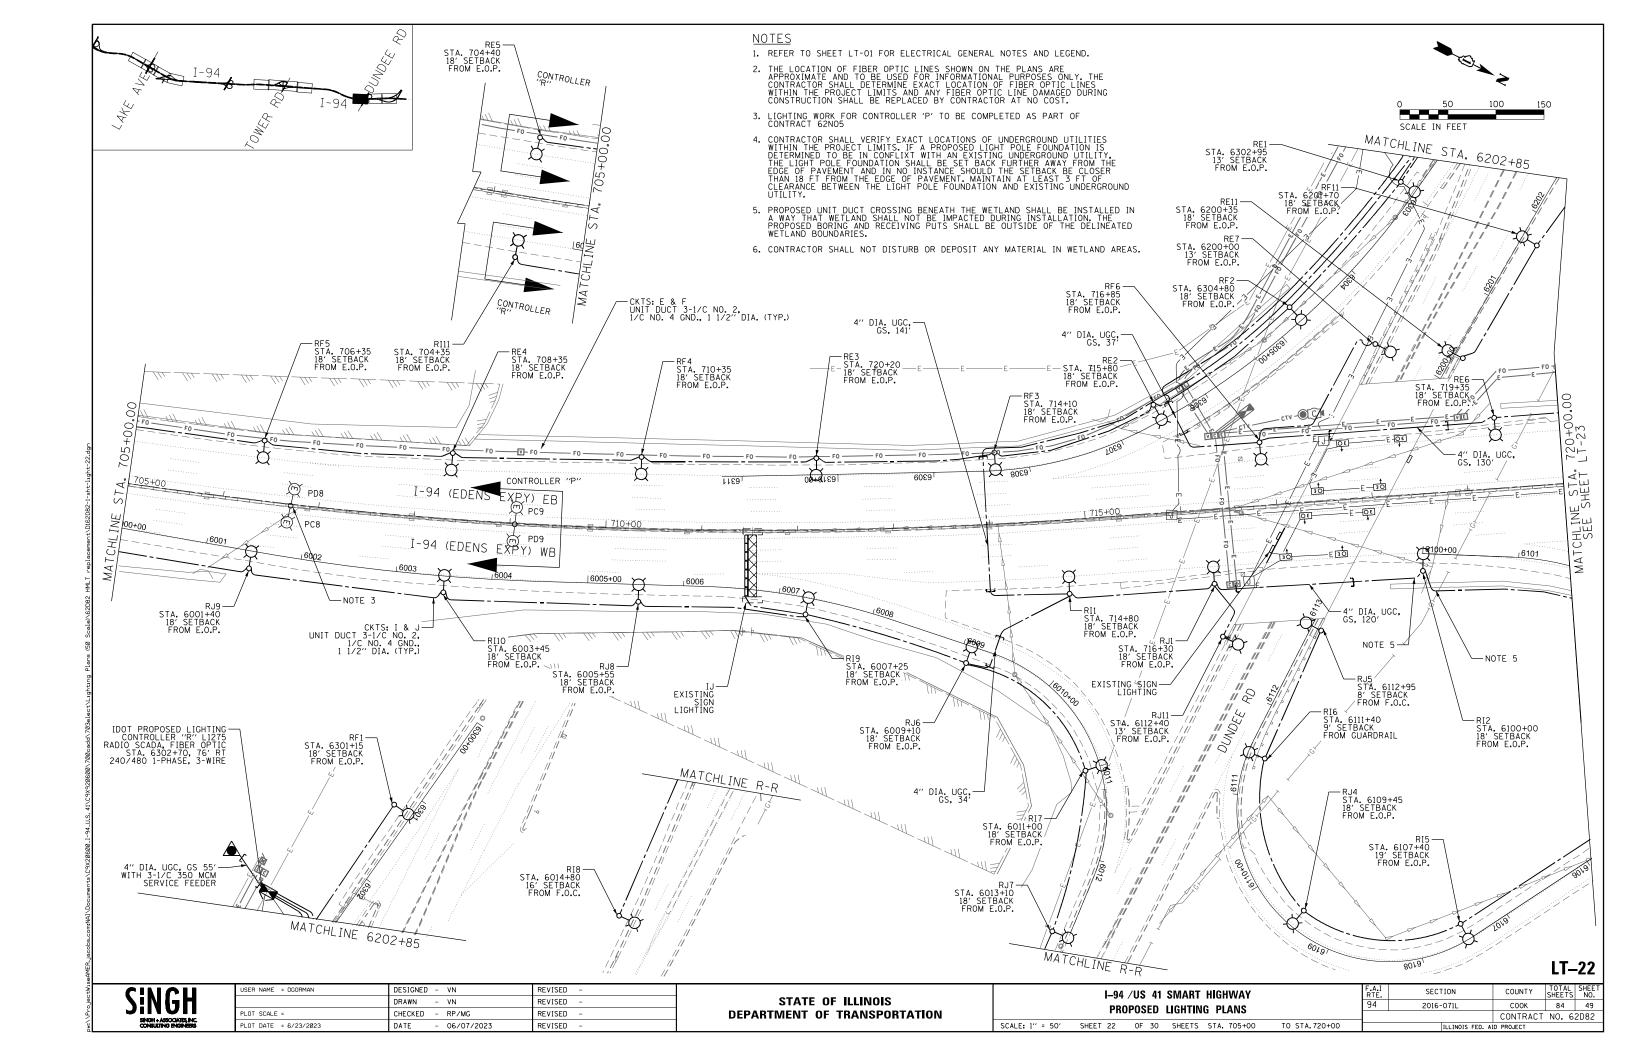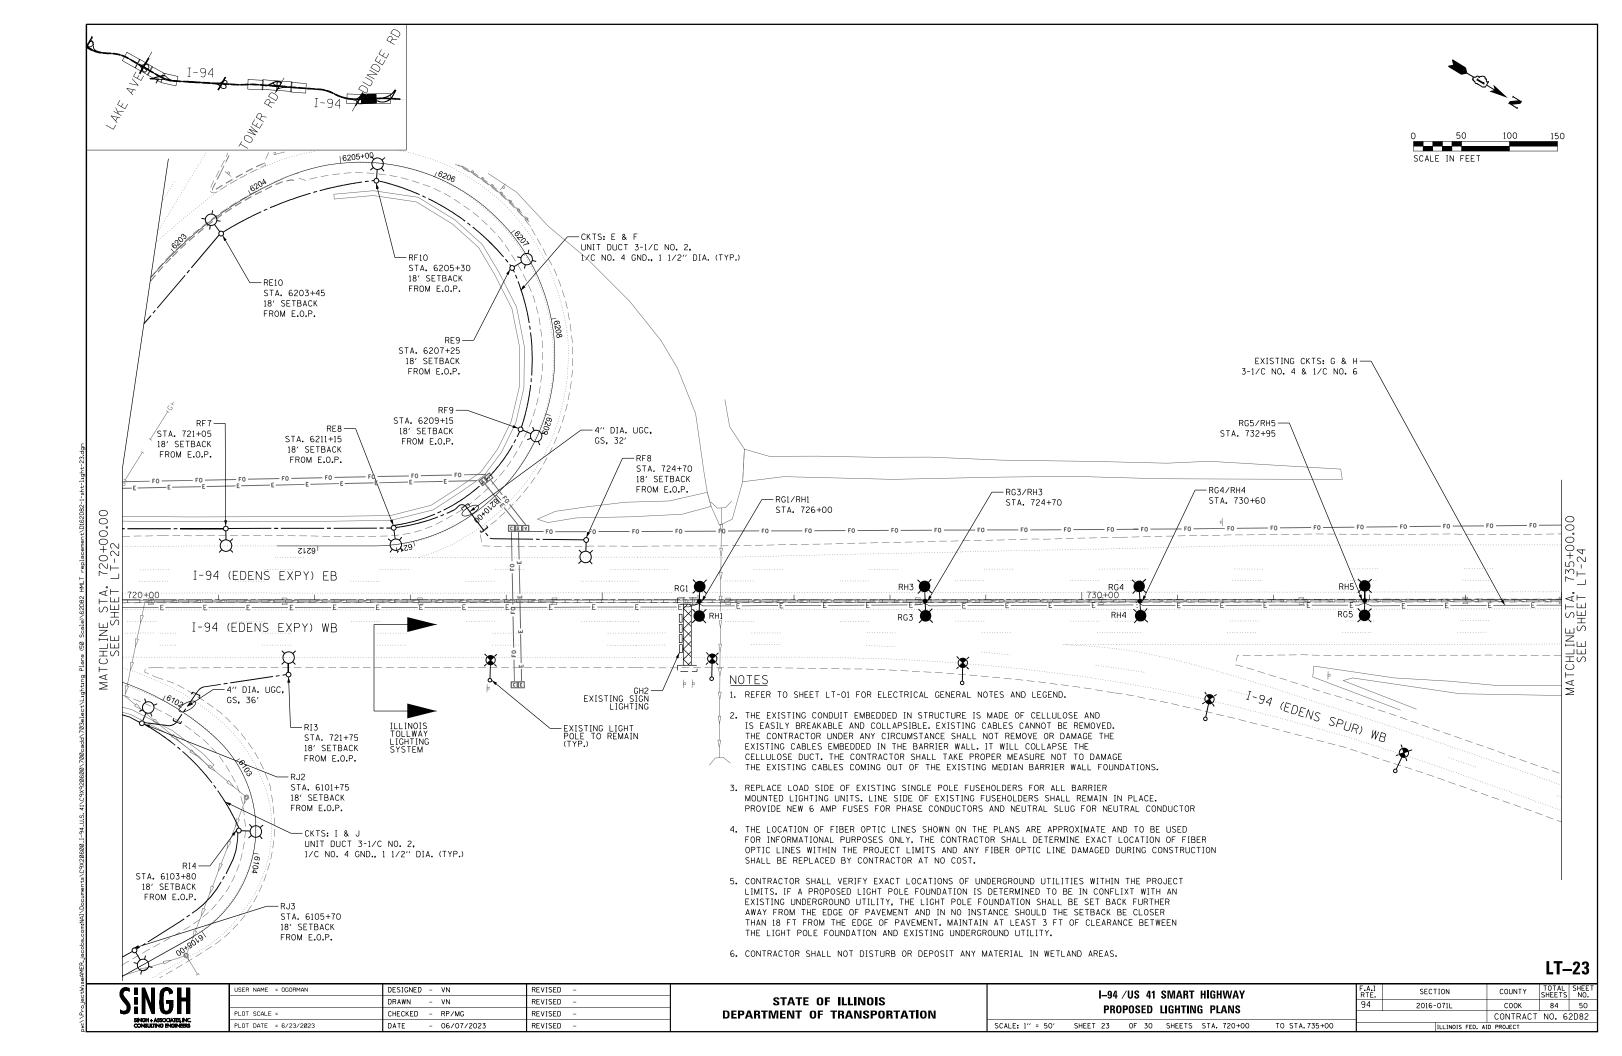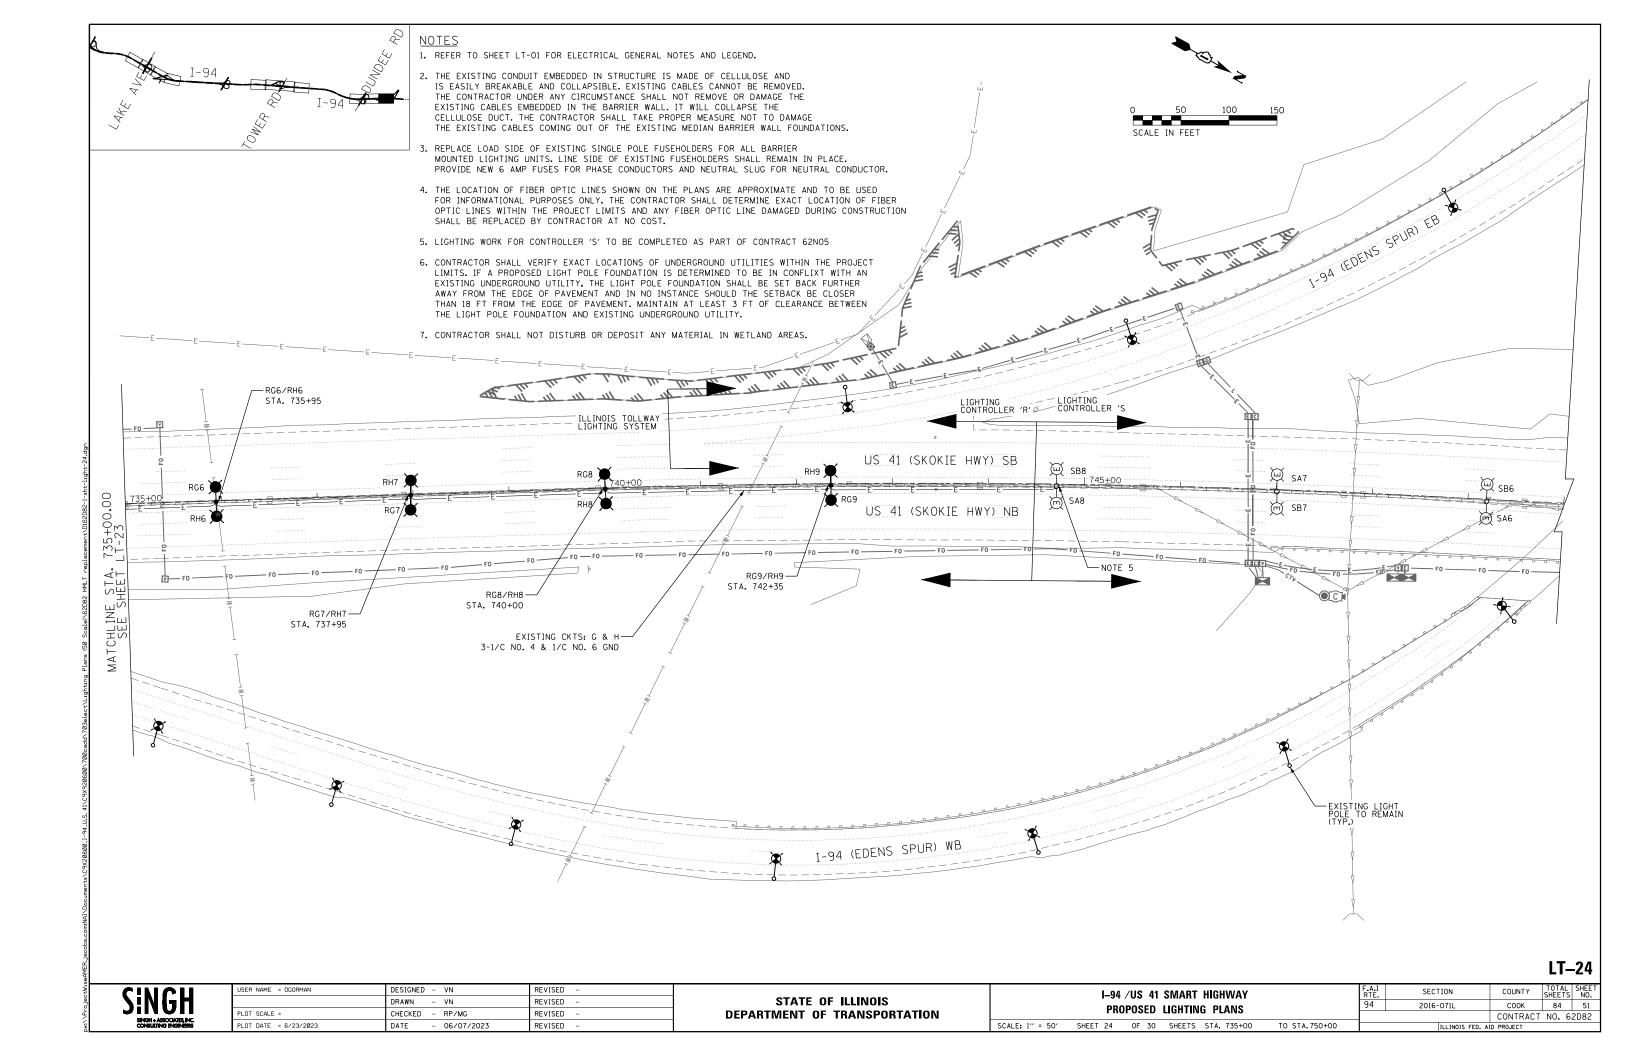
PROPOSED LIGHTING PLANS SCALE: 1" = 50' SHEET 21 OF 30 SHEETS STA. 645+00 TO STA.660+00








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USER NAME = OGORMAN	DRAWN - VN	REVISED -	STATE OF ILLINOIS		J_94	. ,
PLOT SCALE =	CHECKED - RP/MG	REVISED -	DEPARTMENT OF TRANSPORTATION		PROPOSED LIC	GHTING SO
PLOT DATE = 6/23/2023	DATE - 06/07/2023	REVISED -		SCALE: INTS	SHEET 25	OF 30

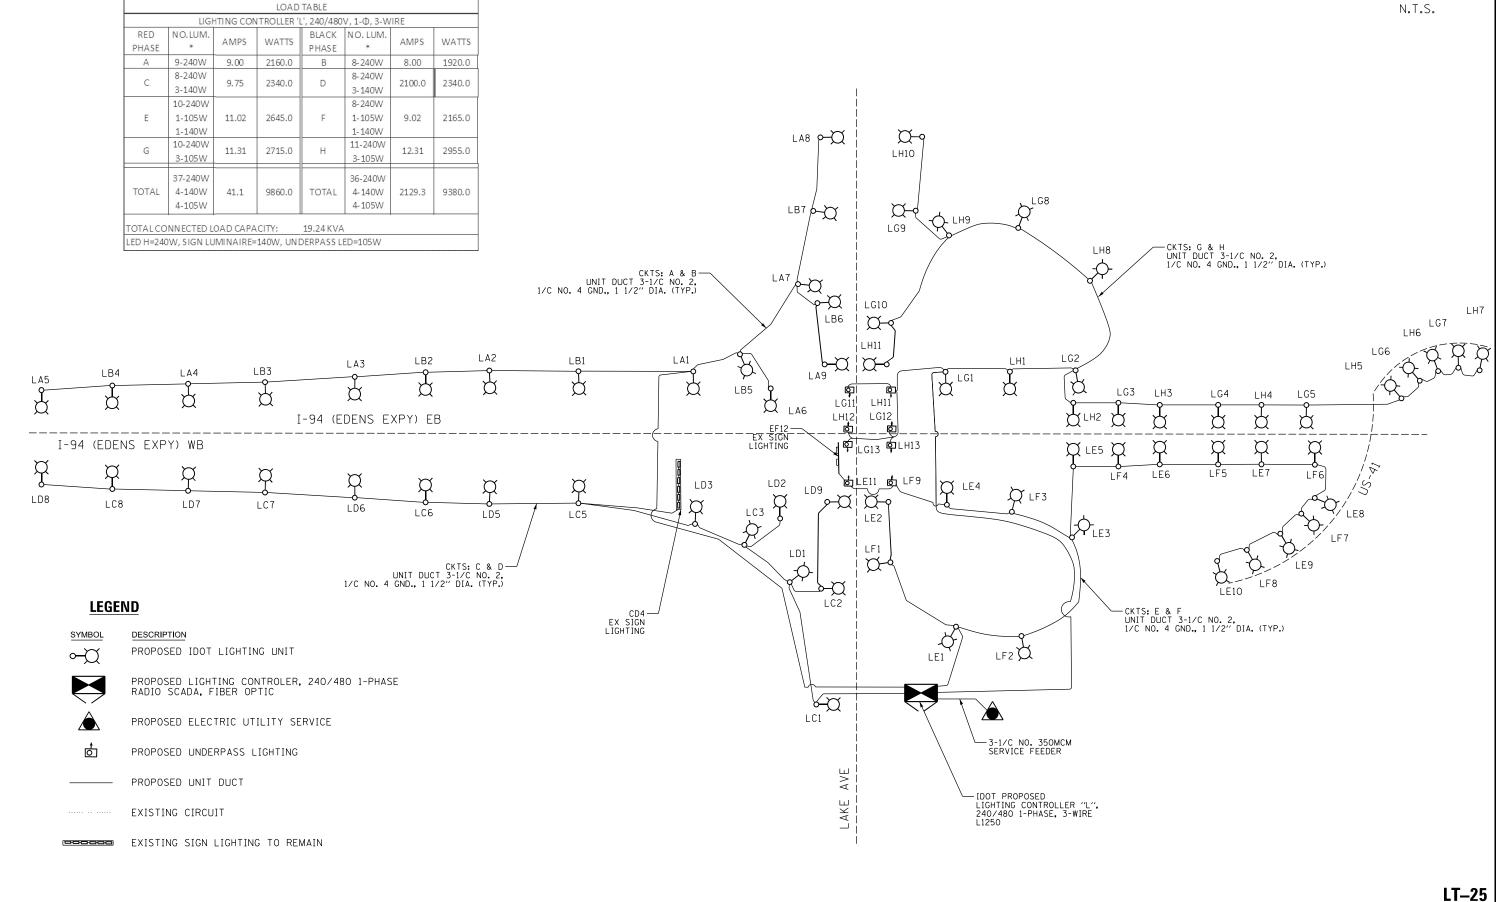





USER NAME = UGURMAN	DESIGNED - VN	REVISED -
	DRAWN - VN	REVISED -
PLOT SCALE =	CHECKED - RP/MG	REVISED -
PLOT DATE = 6/23/2023	DATE - 06/07/2023	REVISED -

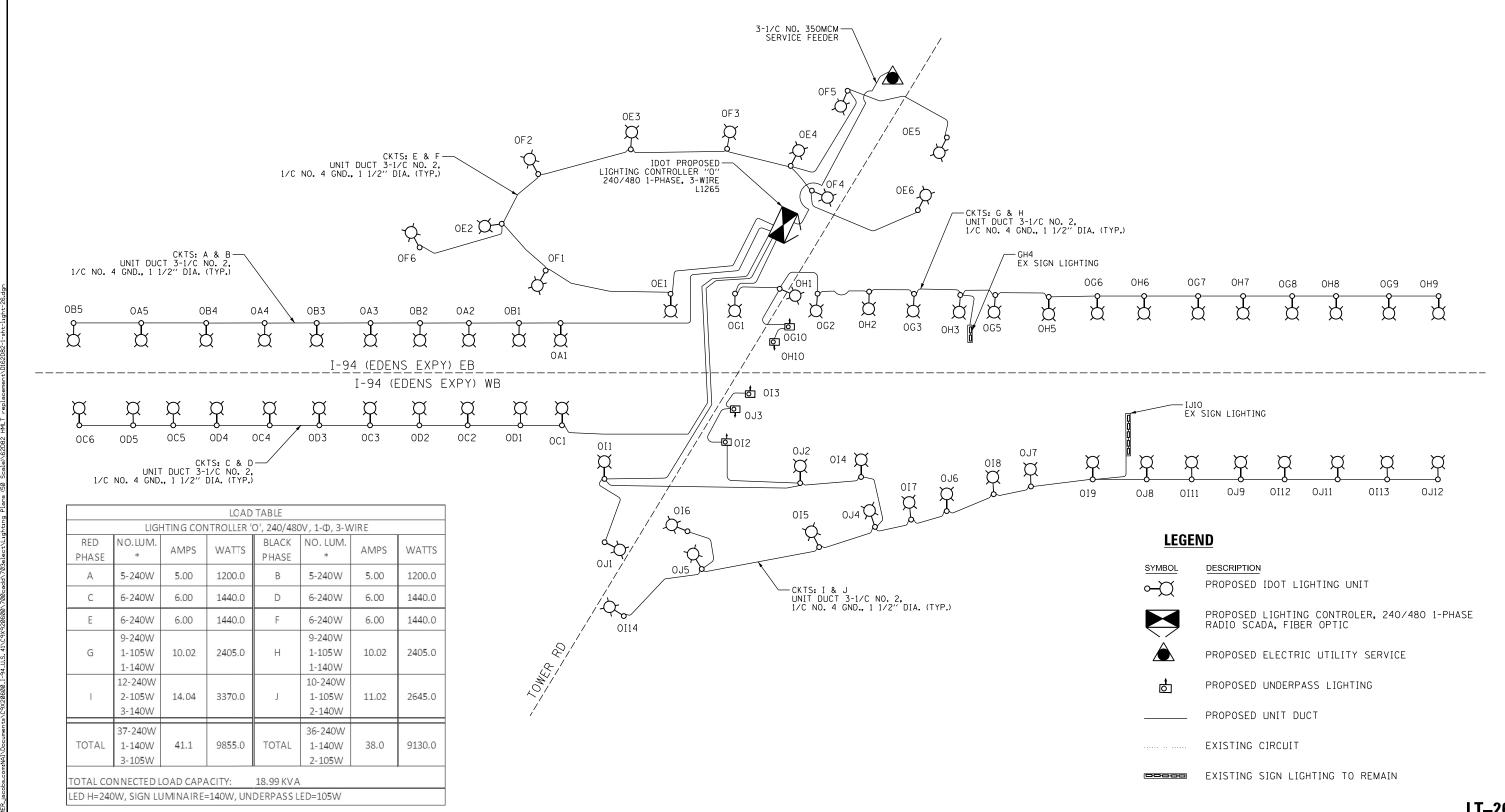STATE OF ILLINOIS **DEPARTMENT OF TRANSPORTATION** 

SCALE: NATTS


I-94 /US 41 SMART HIGHWAY							F.	
PROPOSED LIGHTING SCHEMATIC - CONTROLLER O							9	
1 1101 0025				O.I.E.III./ ( )				
SHEET	26	OF	30	SHEETS	STA.	TO STA.	ı	_

COUNTY TOTAL SHEETS NO.

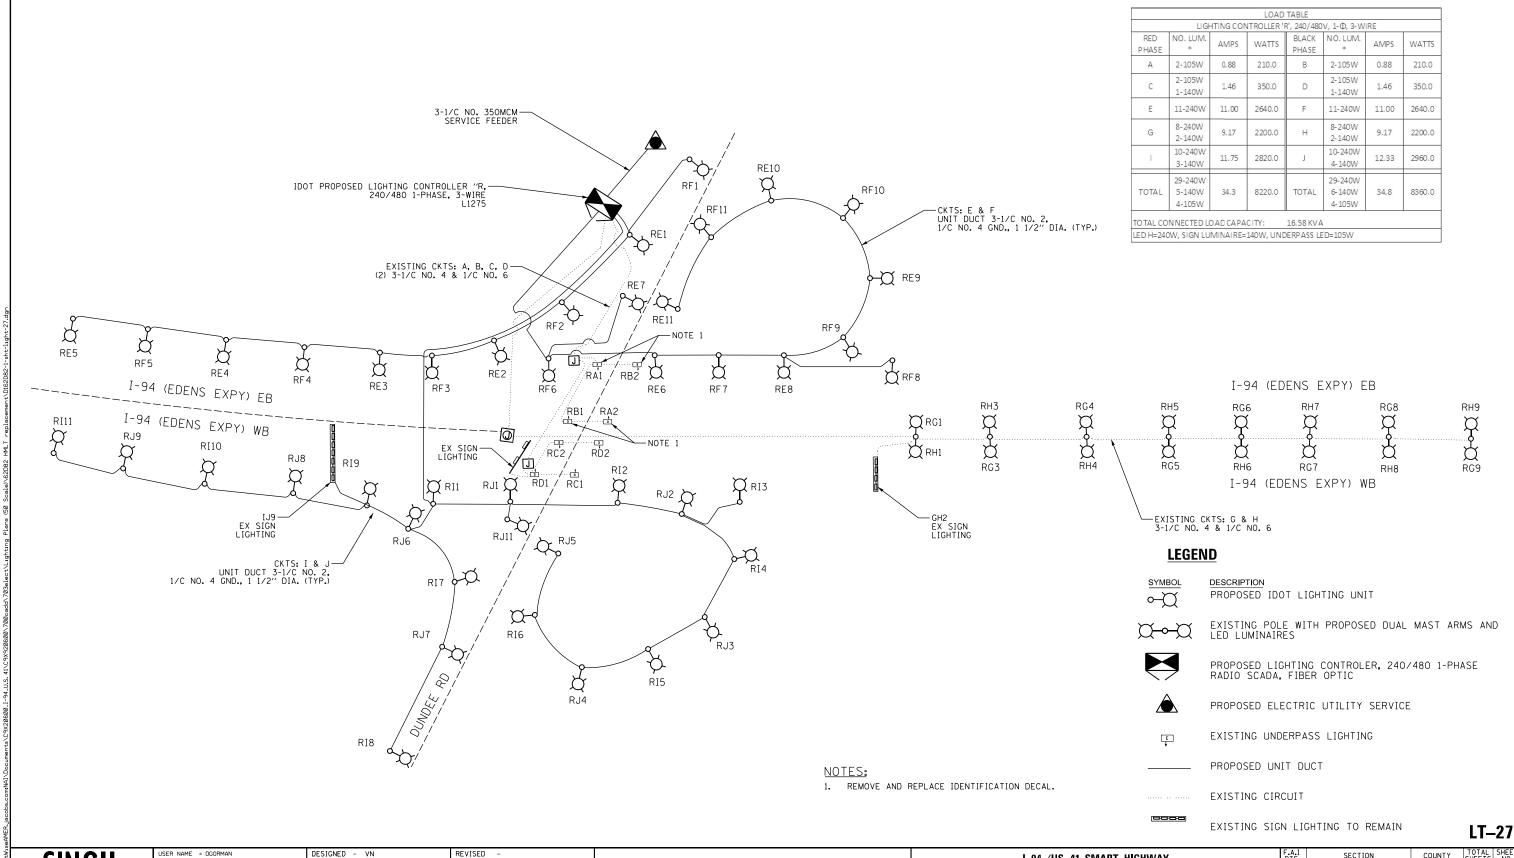COOK 84 53 SECTION 2016-071L CONTRACT NO. 62D82








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STATE OF ILLINOIS
DEPARTMENT OF TRANSPORTATION

PROPOSED LIGHTING SCHEMATIC - CONTROLLER R

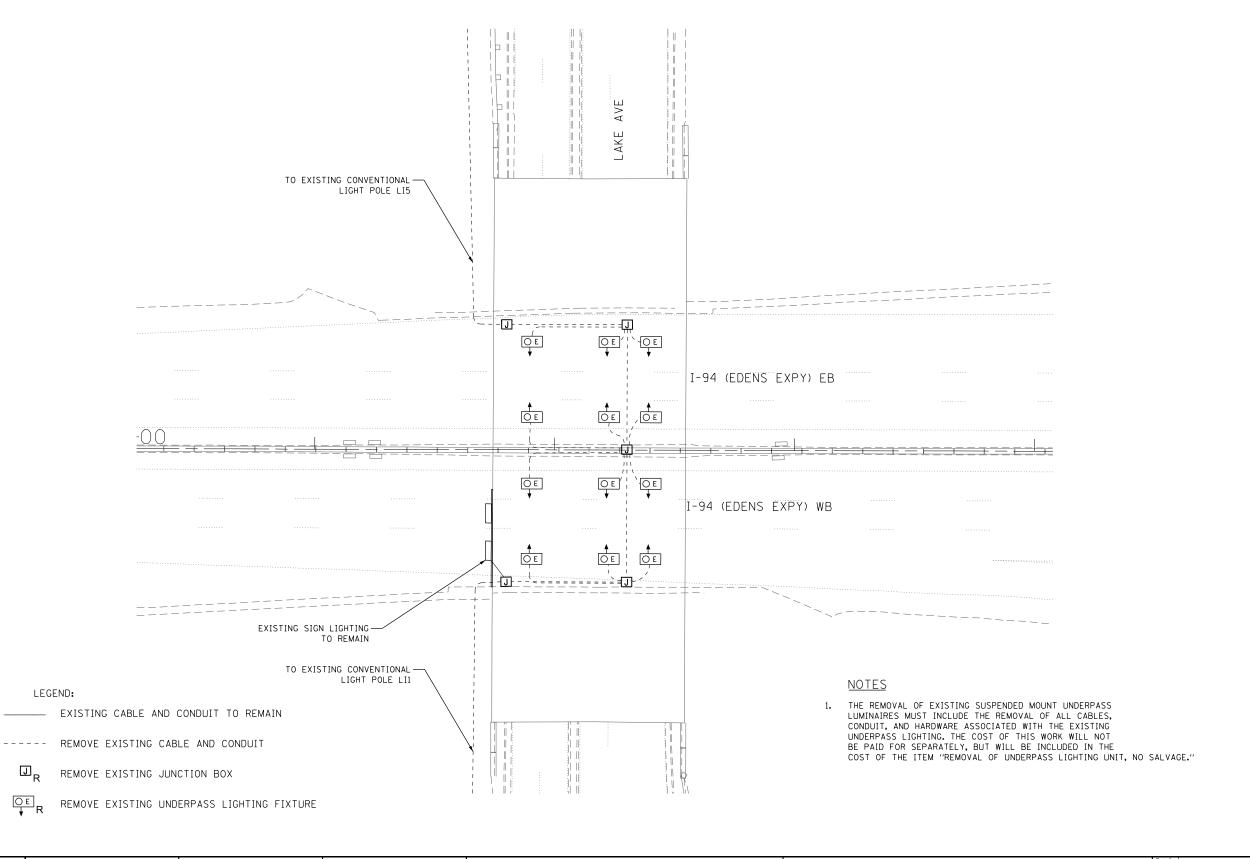SHEET 27 OF 30 SHEETS STA. TO STA.







LEGEND:

USER NAME = OGORMAN	DESIGNED - VN	REVISED -
	DRAWN - VN	REVISED -
PLOT SCALE =	CHECKED - RP/MG	REVISED -
PLOT DATE = 6/23/2023	DATE - 06/07/2023	REVISED -

STATE OF ILLINOIS **DEPARTMENT OF TRANSPORTATION** 

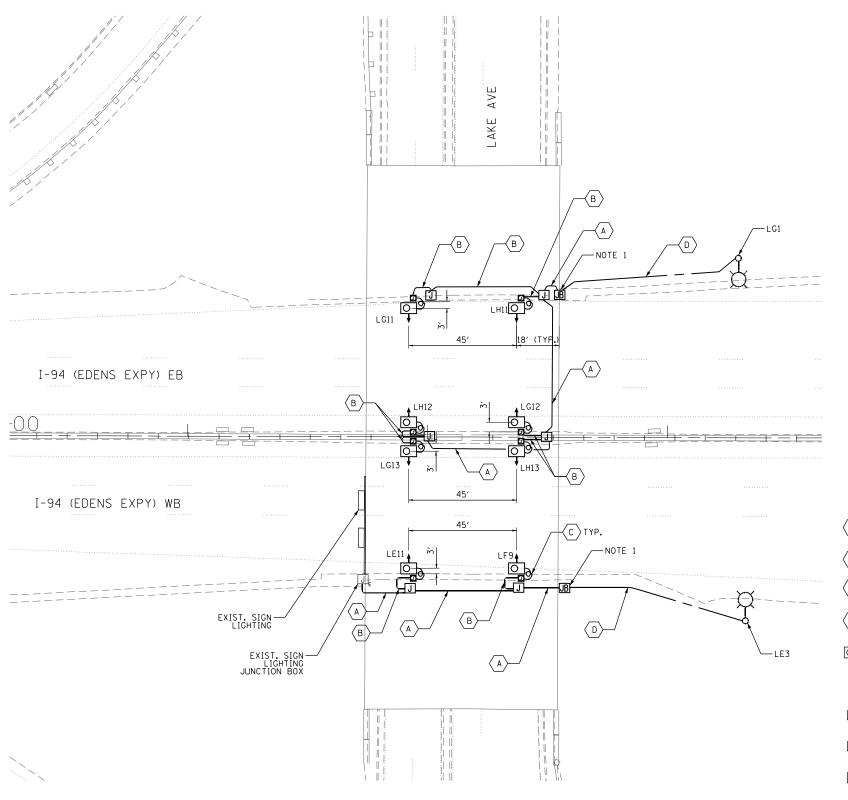
UNDERPASS LIGHTING REMOVAL PLAN I-94 AT LAKE AVENUE SCALE: 1" = 20' SHEET 28 OF 30 SHEETS STA. TO STA.

COUNTY TOTAL SHEETS NO.

COOK 84 55 SECTION 2016-071L CONTRACT NO. 62D82

1. INSTALL FUSEHOLDER WITH 30 AMP FUSES & NEUTRAL SLUG INSIDE THE JUNCTION BOX.





<u>LEGEND</u>

A 3-1/C NO.10 AND 1/C NO.10 GND IN 1" PVCC RGC

B 2-1/C NO.10 AND 1/C NO.10 GND IN 1"PVCC RGC

C 2-1/C NO.10 AND 1-1/C NO.10 GND IN 3/4" LIQUID-TIGHT FLEXIBLE CONDUIT

(D) UNIT DUCT, 600V, 3-1/C NO. 2 1/C NO. 4, GND 1 1/2" DIA. (TYP)

LUMINAIRE, LED, UNDERPASS, SUSPENDED, OUTPUT DESIGNATION E (14.5-FT M.H.)

JUNCTION BOX, STAINLESS STEEL, ATTACHED TO STRUCTURE, 6"X6"X4"

JUNCTION BOX, STAINLESS STEEL, ATTACHED TO STRUCTURE, 12" X 10" X 6"

B JUNCTION BOX, STAINLESS STEEL, ATTACHED TO STRUCTURE, 18" X 18" X 8"

J EXISTING JUNCTION BOX

LT-29





R NAME = OGORMAN	DESIGNED - VN	REVISED -	
	DRAWN - VN	REVISED -	
SCALE =	CHECKED - RP/MG	REVISED -	
DATE = 6/23/2023	DATE - 06/07/2023	REVISED -	

STATE OF ILLINOIS DEPARTMENT OF TRANSPORTATION

PROPO	SED UNDE	RPASS	LIGHTING	<b>INSTALLATIO</b>	N PLAN
	I	–94 AT	LAKE AV	ENUE	
SCALE: 1" = 20'	SHEET 29	OF 30	SHEETS :	STA.	TO STA.

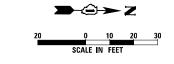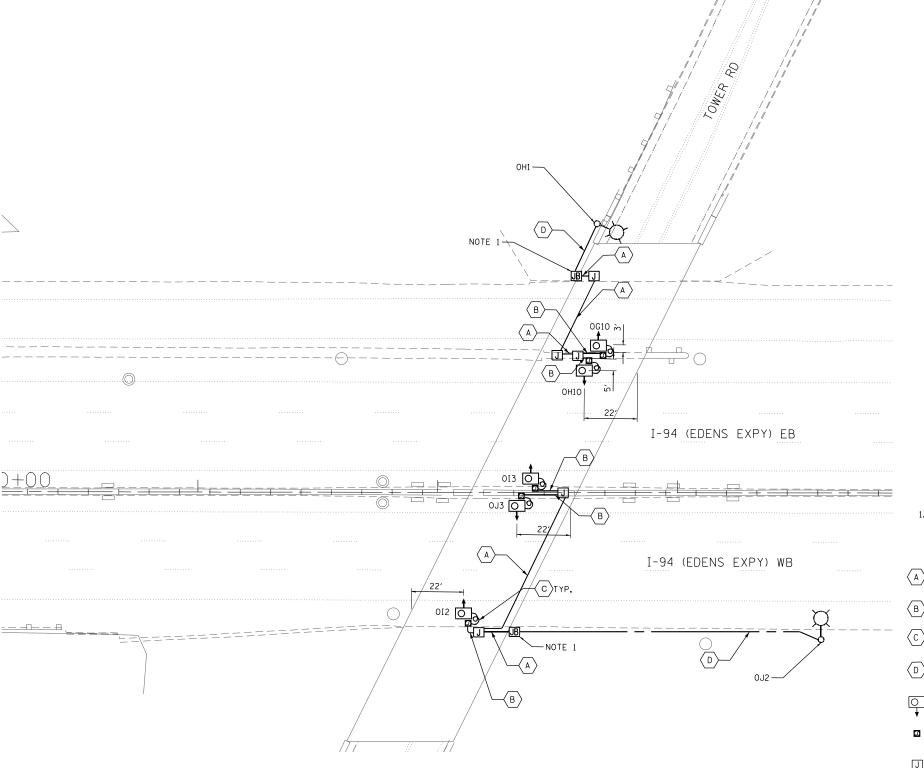F.A.I SECTION COUNTY TOTAL SHEETS NO. 94 2016-071L COOK 84 56 CONTRACT NO. 62D82





## <u>NOTES</u>

 INSTALL FUSEHOLDER WITH 30 AMP FUSES & NEUTRAL SLUG INSIDE THE JUNCTION BOX.

## LEGEND

- A 3-1/C NO.10 AND 1/C NO.10 GND IN 1" PVCC RGC
- B 2-1/C NO.10 AND 1/C NO.10 GND IN 1"PVCC RGC
- C 2-1/C NO.10 AND 1-1/C NO.10 GND IN 3/4" LIQUID-TIGHT FLEXIBLE CONDUIT
- (D) UNIT DUCT, 600V, 3-1/C NO. 2 1/C NO. 4, GND 1 1/2" DIA. (TYP)
- LUMINAIRE, LED, UNDERPASS, SUSPENDED, OUTPUT DESIGNATION E (14.5-FT M.H.)
- JUNCTION BOX, STAINLESS STEEL, ATTACHED TO STRUCTURE, 6"X6"X4"
- JUNCTION BOX, STAINLESS STEEL, ATTACHED TO STRUCTURE, 12" X 10" X 6"
- $\overline{\mbox{JB}}$   $\mbox{JUNCTION BOX, STAINLESS STEEL, ATTACHED TO STRUCTURE, 18" X 18" X 8" }$

LT-30



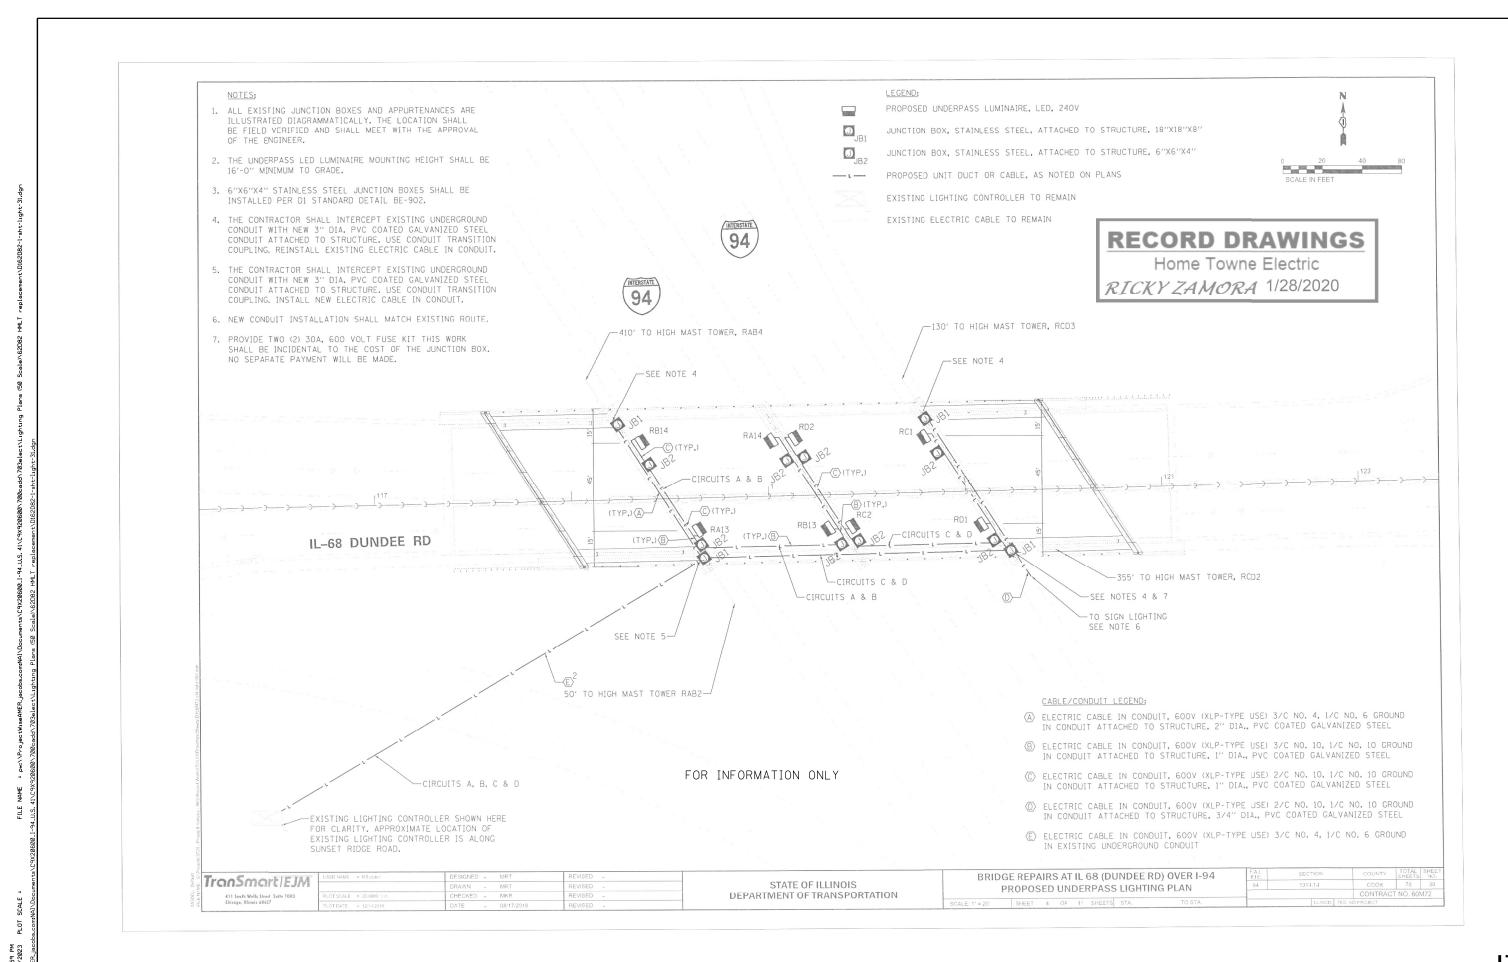
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	DRAWN - VN	REVISED -
DT SCALE =	CHECKED - RP/MG	REVISED -
DT DATE = 6/23/2023	DATE - 06/07/2023	REVISED -

STATE OF ILLINOIS
DEPARTMENT OF TRANSPORTATION

PROPOSED UNDERPASS LIGHTING INSTALLATION PLAN

I-94 AT TOWER ROAD

SCALE: 1" = 20" SHEET 30 OF 30 SHEETS STA. TO STA.



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Si	NGH + A	SSOCIAT	ELINC.
	ONSULTI	NG ENG	NEEKS

TIME


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	DRAWN - VN	REVISED -	STATE OF ILLINOIS		UNDERPASS LIGH	HTING AS-BUILT INFO	RMATION	94	2016-071L	
PLOT SCALE =	CHECKED - RP/MG	REVISED -	DEPARTMENT OF TRANSPORTATION							
PLOT DATE = 6/23/2023	DATE - 06/07/2023	REVISED -		SCALE: NTS	SHEET 1 OF	10 SHEETS STA.	TO STA.		ILLINOIS FED. A	.ID F

LT-31

COUNTY TOTAL SHEETS NO.

COOK 84 58

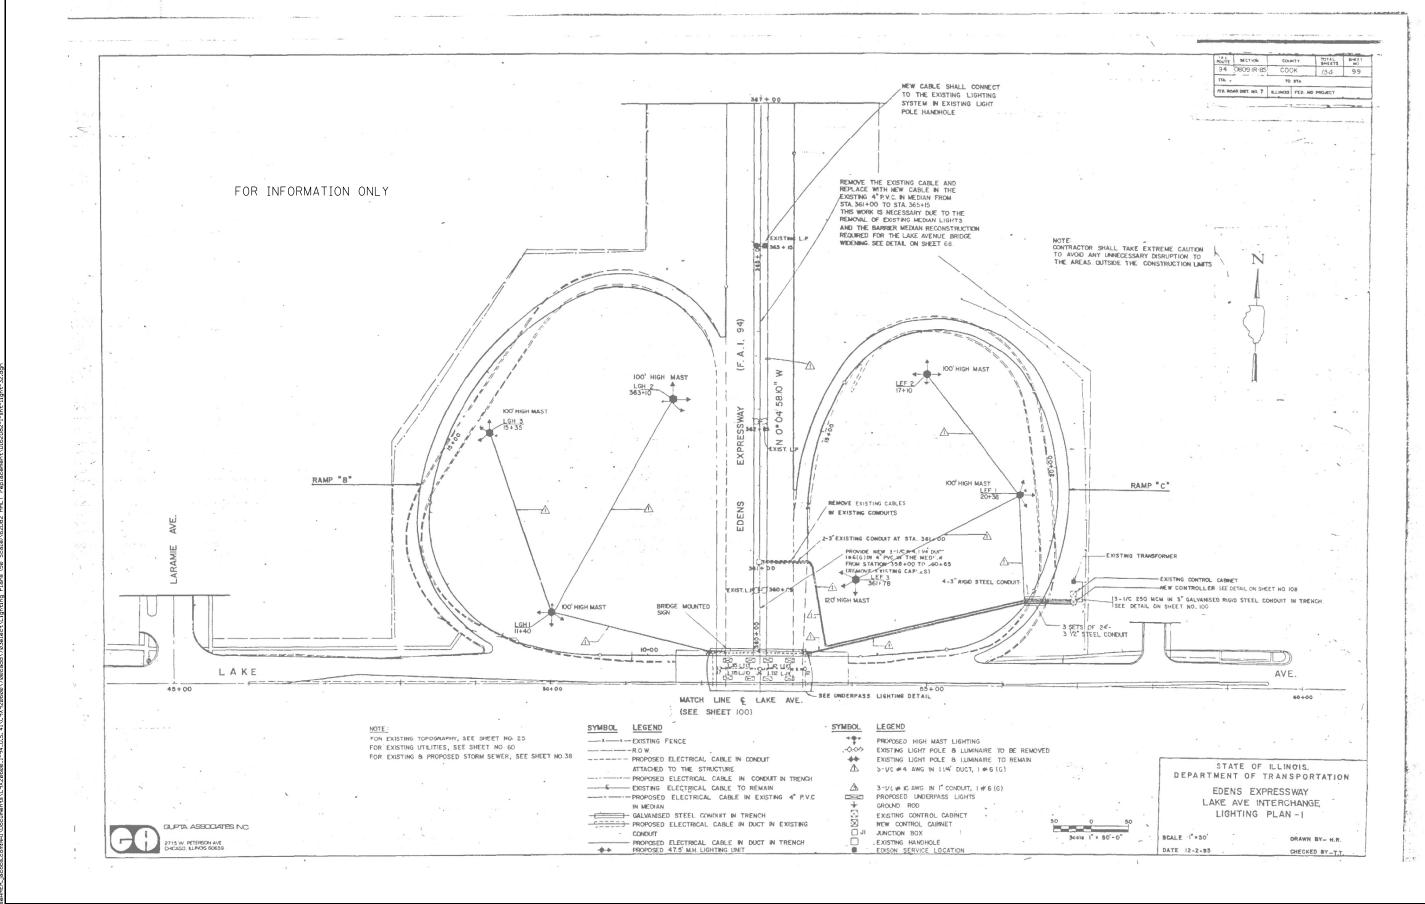CONTRACT NO. 62D82



SINGH SNGH-ASSOCIATE NC CONSUMING BROWNERS 
 USER NAME
 = OGORMAN
 DESIGNED
 VN
 REVISED

 PLOT SCALE
 =
 CHECKED
 RP/MG
 REVISED


 PLOT DATE
 = 6/23/2023
 DATE
 06/07/2023
 REVISED

STATE OF ILLINOIS
DEPARTMENT OF TRANSPORTATION

CONTROLLER L AS-BUILT INFORMATION

SHEET 2 OF 10 SHEETS STA. TO S


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T IME DATE

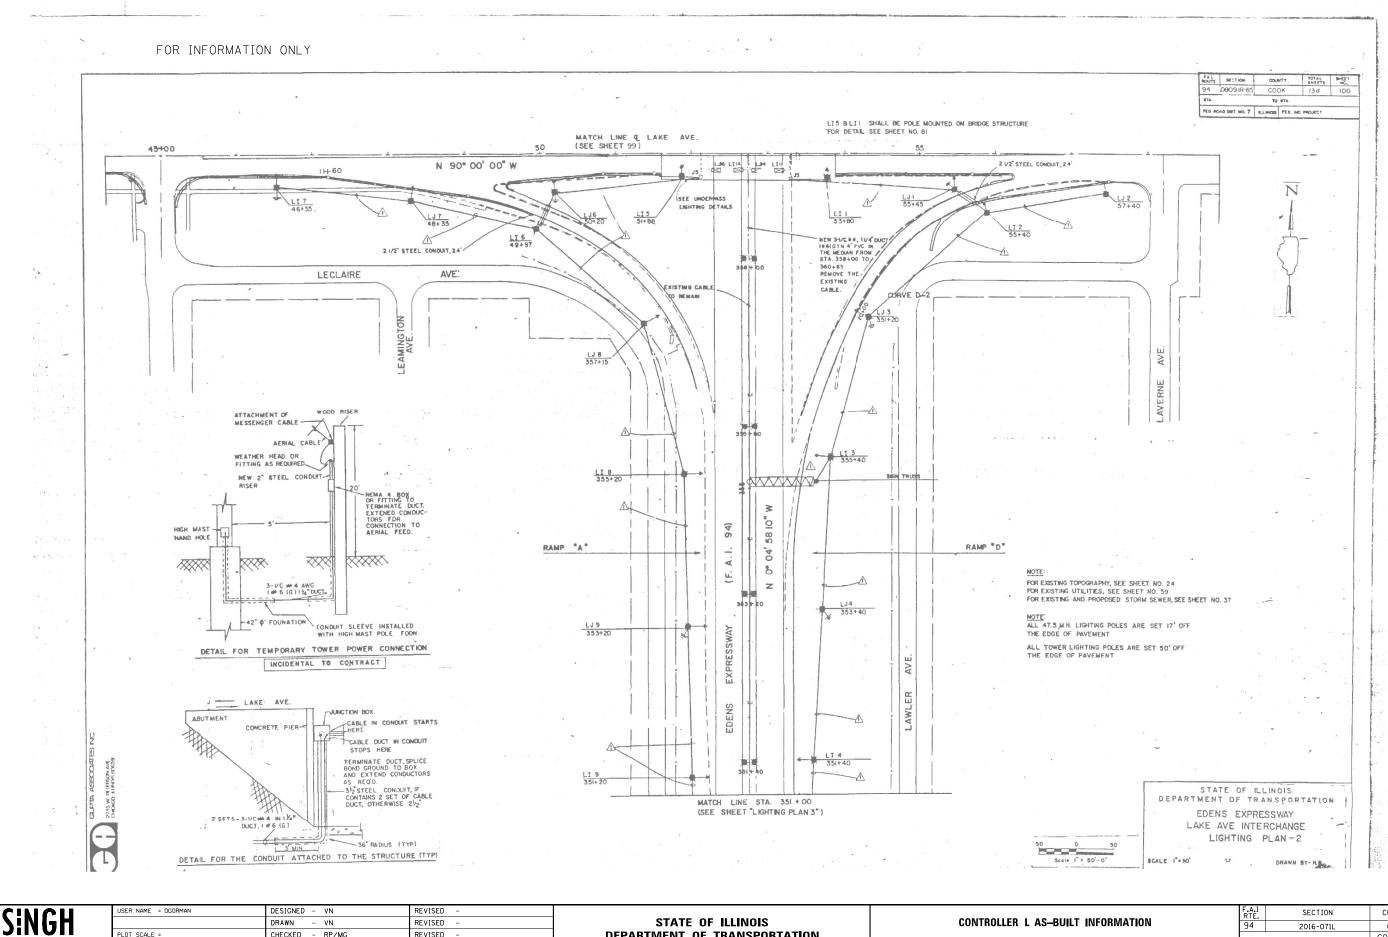COUNTY TOTAL SHEET NO.

COOK 84 60 JSER NAME = OGORMAN DESIGNED - VN REVISED SECTION STATE OF ILLINOIS CONTROLLER L AS-BUILT INFORMATION DRAWN - VN REVISED 2016-071L PLOT SCALE = CHECKED - RP/MG REVISED **DEPARTMENT OF TRANSPORTATION** CONTRACT NO. 62D82 PLOT DATE = 6/23/2023 SCALE: NTS SHEET 3 OF 10 SHEETS STA. DATE - 06/07/2023 REVISED




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COUNTY TOTAL SHEET NO.

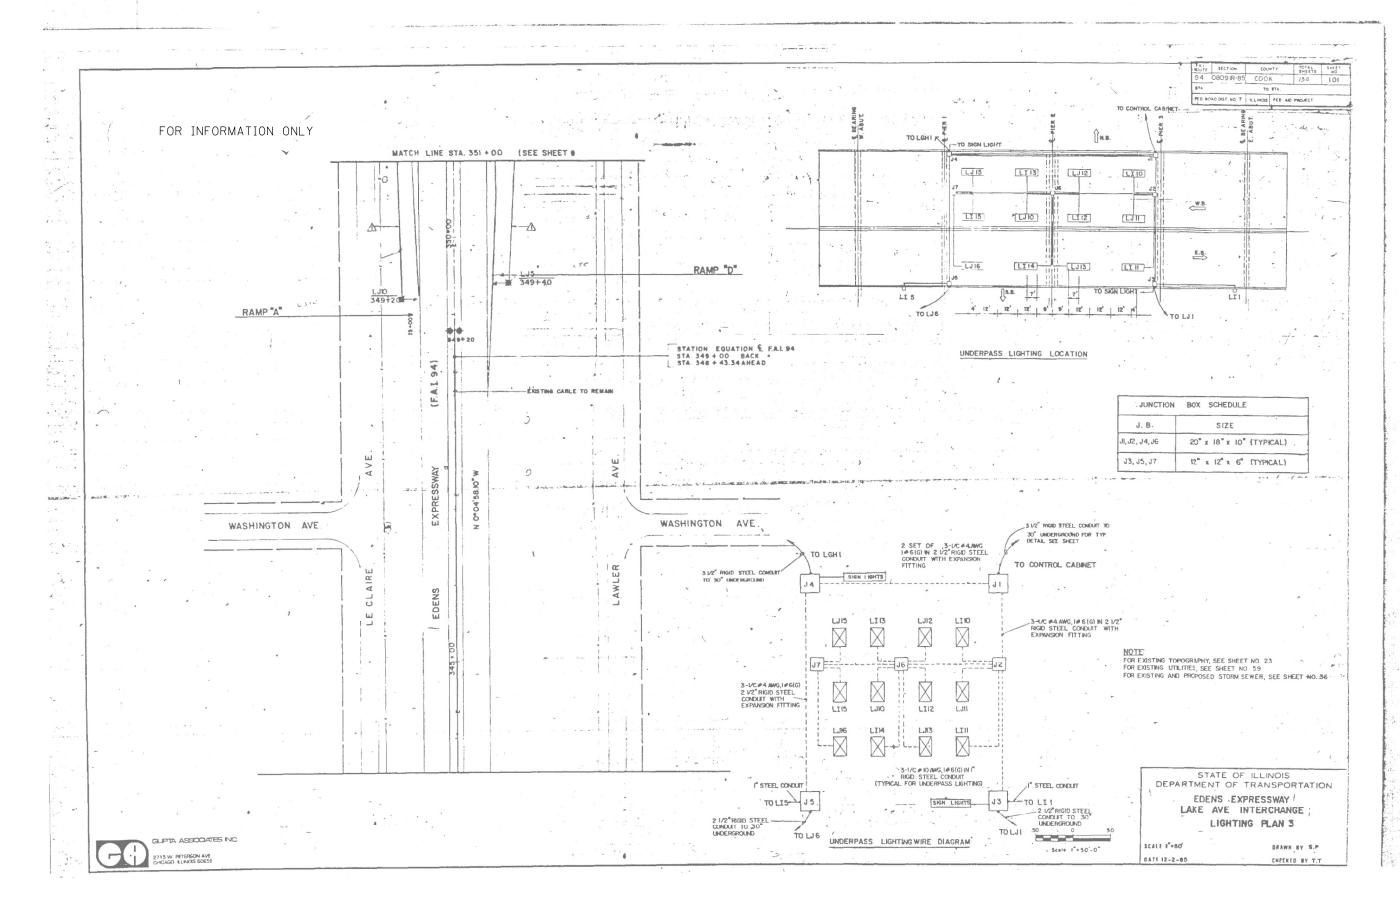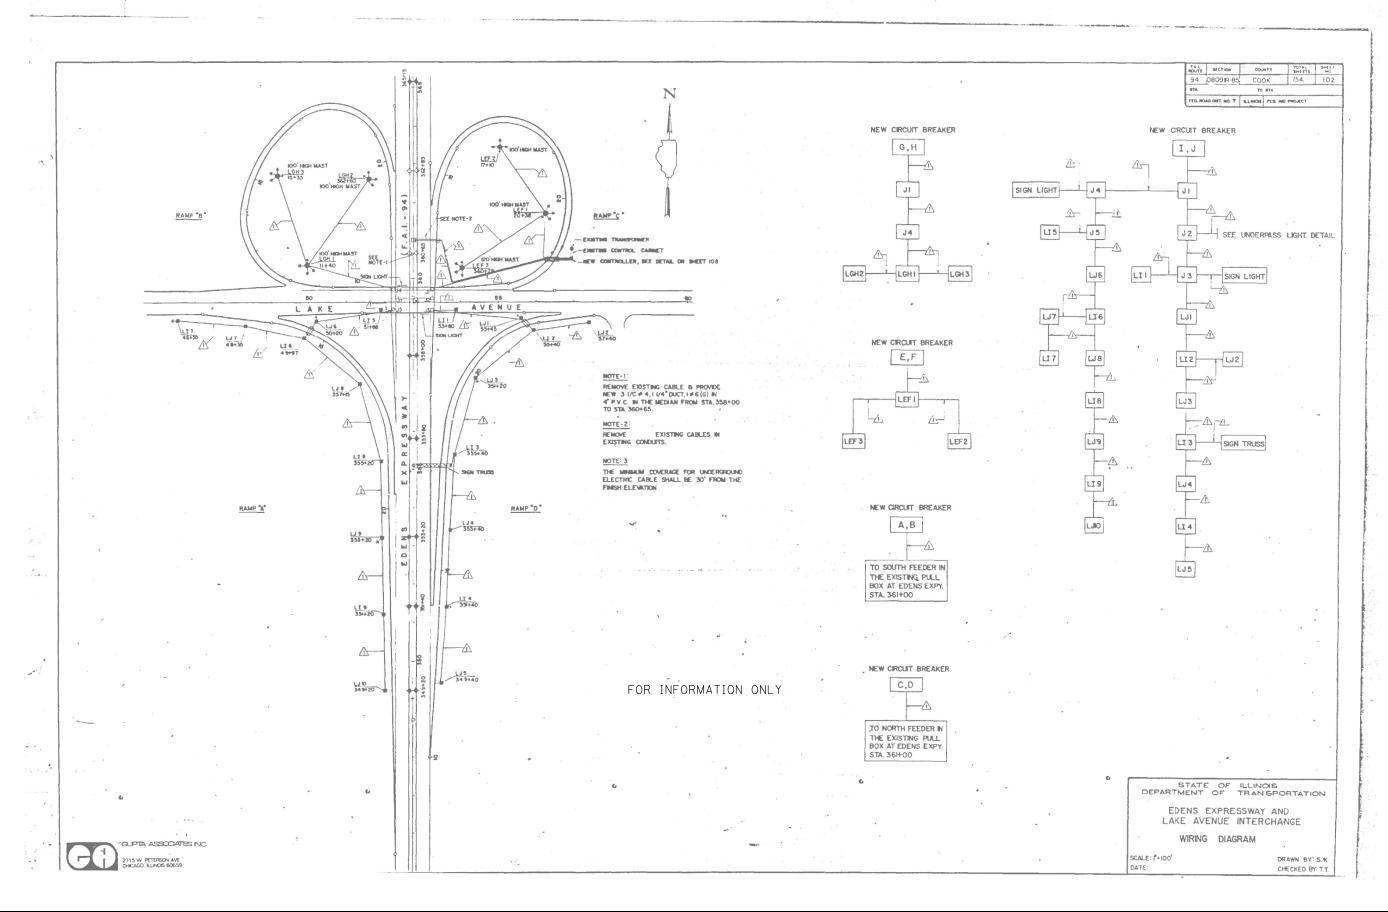COOK 84 61 ISER NAME = OGORMAN DESIGNED - VN REVISED SECTION STATE OF ILLINOIS CONTROLLER L AS-BUILT INFORMATION DRAWN - VN REVISED 2016-071L PLOT SCALE = CHECKED - RP/MG REVISED **DEPARTMENT OF TRANSPORTATION** CONTRACT NO. 62D82 PLOT DATE = 6/23/2023 DATE - 06/07/2023 SCALE: NTS SHEET 4 OF 10 SHEETS STA. REVISED



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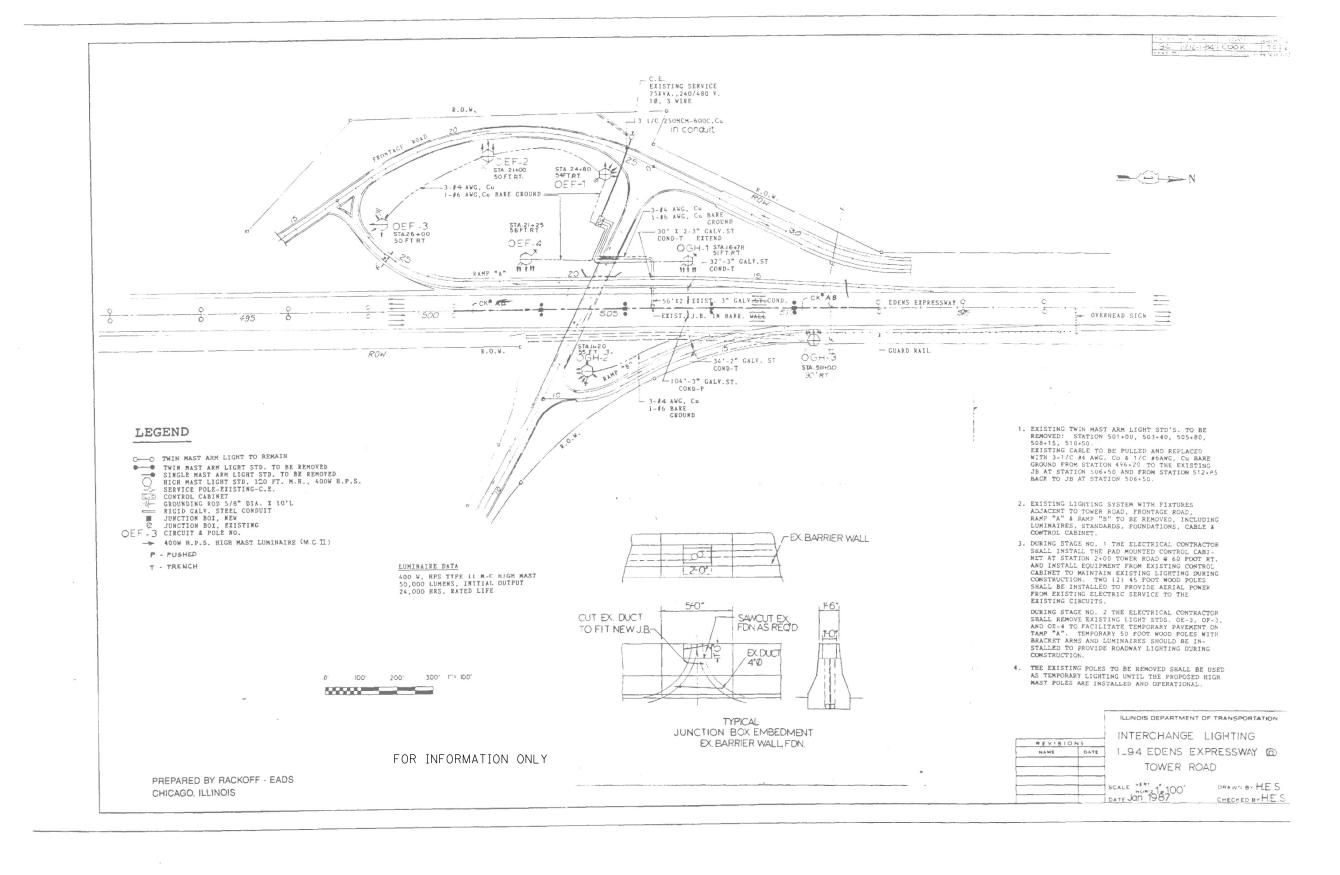
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STATE OF ILLINOIS
DEPARTMENT OF TRANSPORTATION

CONTROLLER L AS-BUILT INFORMATION

SHEET 5 OF 10 SHEETS STA. TO STA

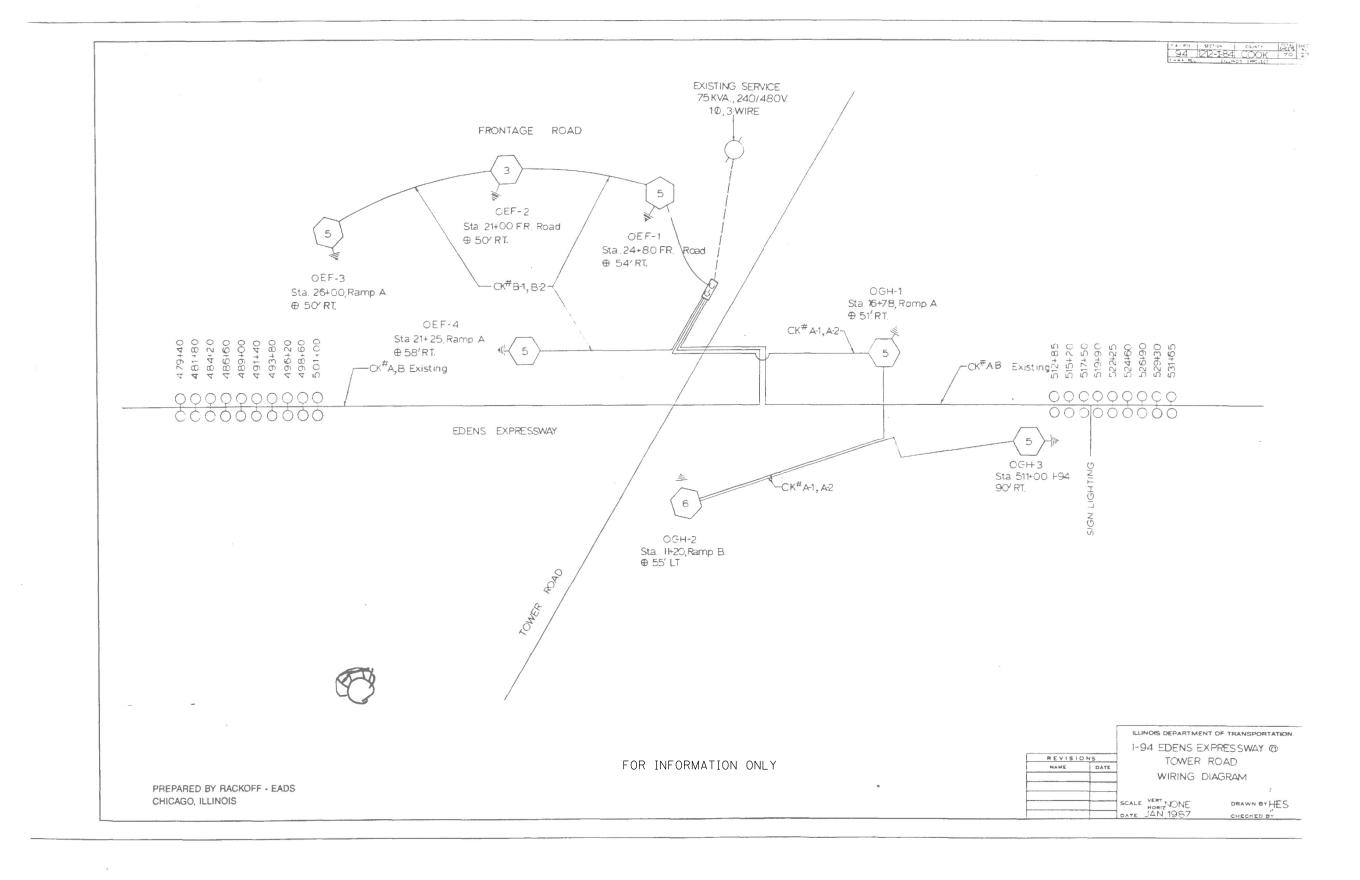
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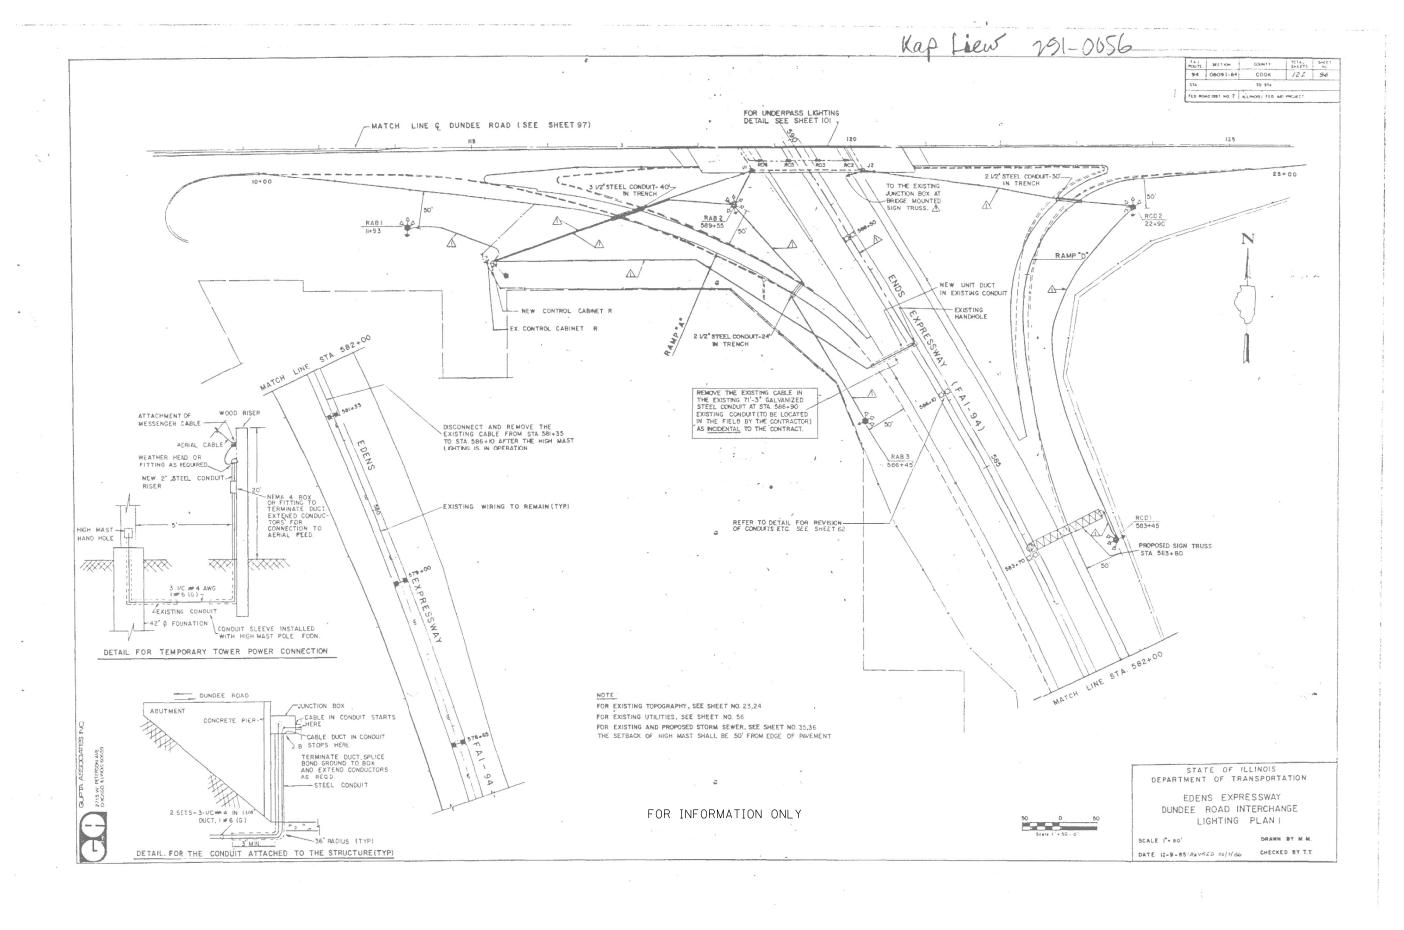
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COUNTY TOTAL SHEET NO.
COOK 84 65

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 PLOT DATE
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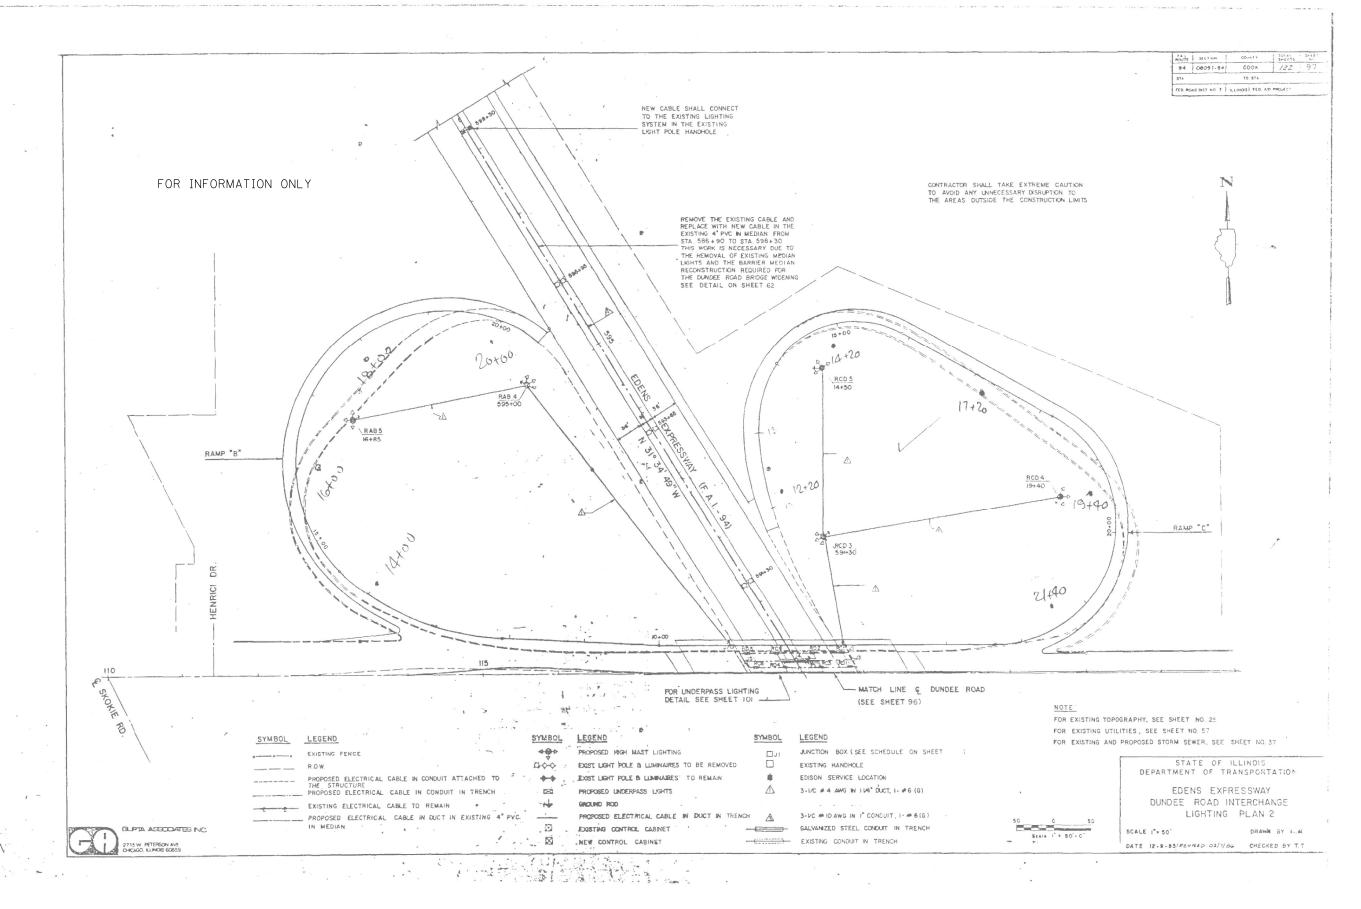
STATE OF ILLINOIS
DEPARTMENT OF TRANSPORTATION

CONTROLLER R AS-BUILT INFORMATION

SCALE: NTS SHEET 8 OF 10 SHEETS STA. TO S

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 PLOT DATE = 6/23/2023
 DATE - 06/07/2023
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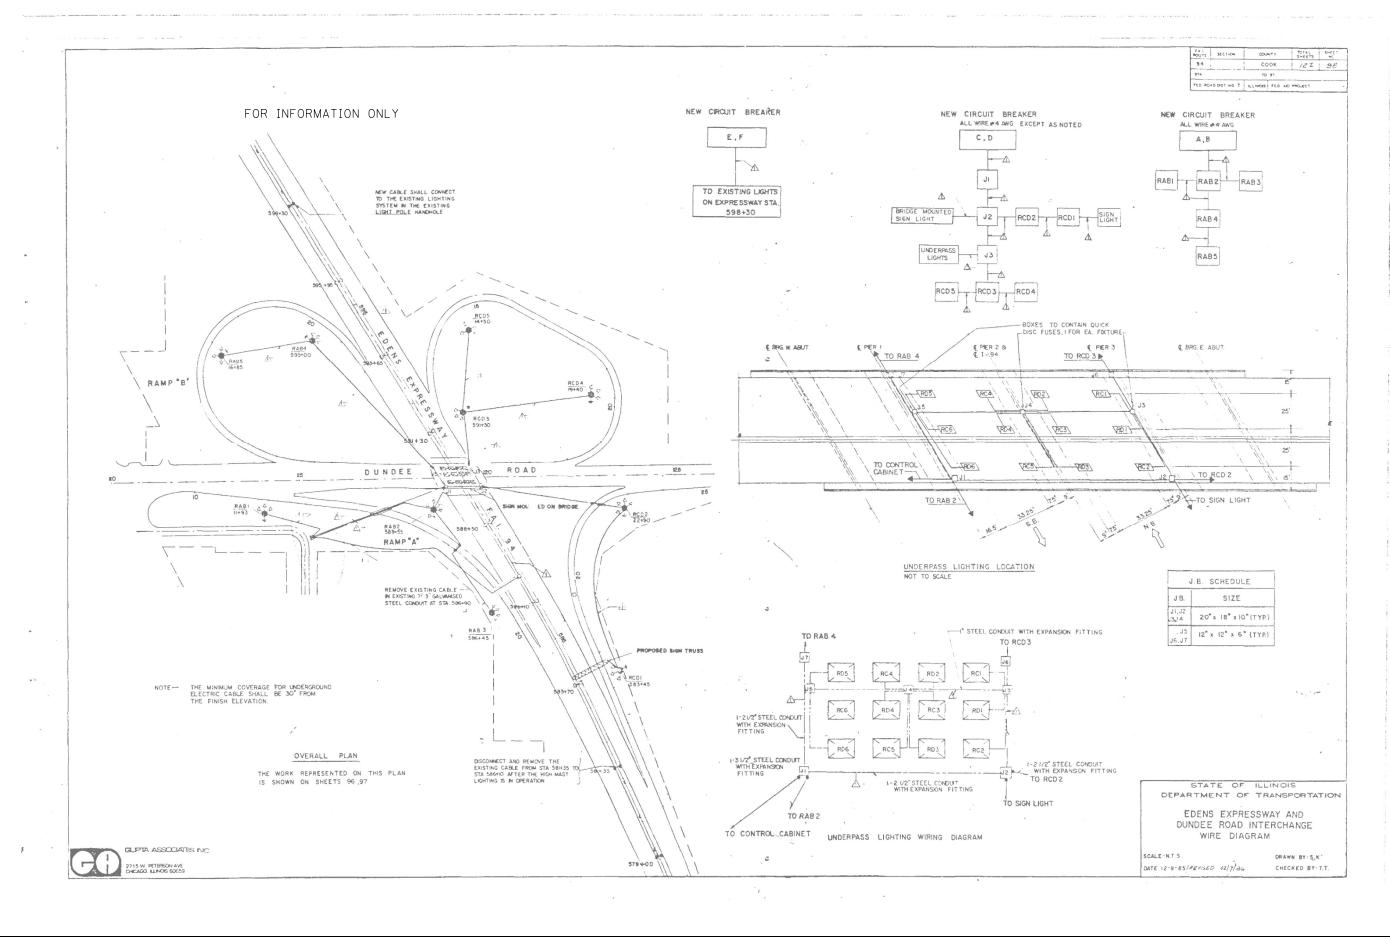
STATE OF ILLINOIS DEPARTMENT OF TRANSPORTATION CONTROLLER R AS—BUILT INFORMATION

SHEET 9 OF 10 SHEETS STA. TO STA.

SCALE: NTS

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94 2016-071L COOK 84 66

CONTRACT NO. 62D82



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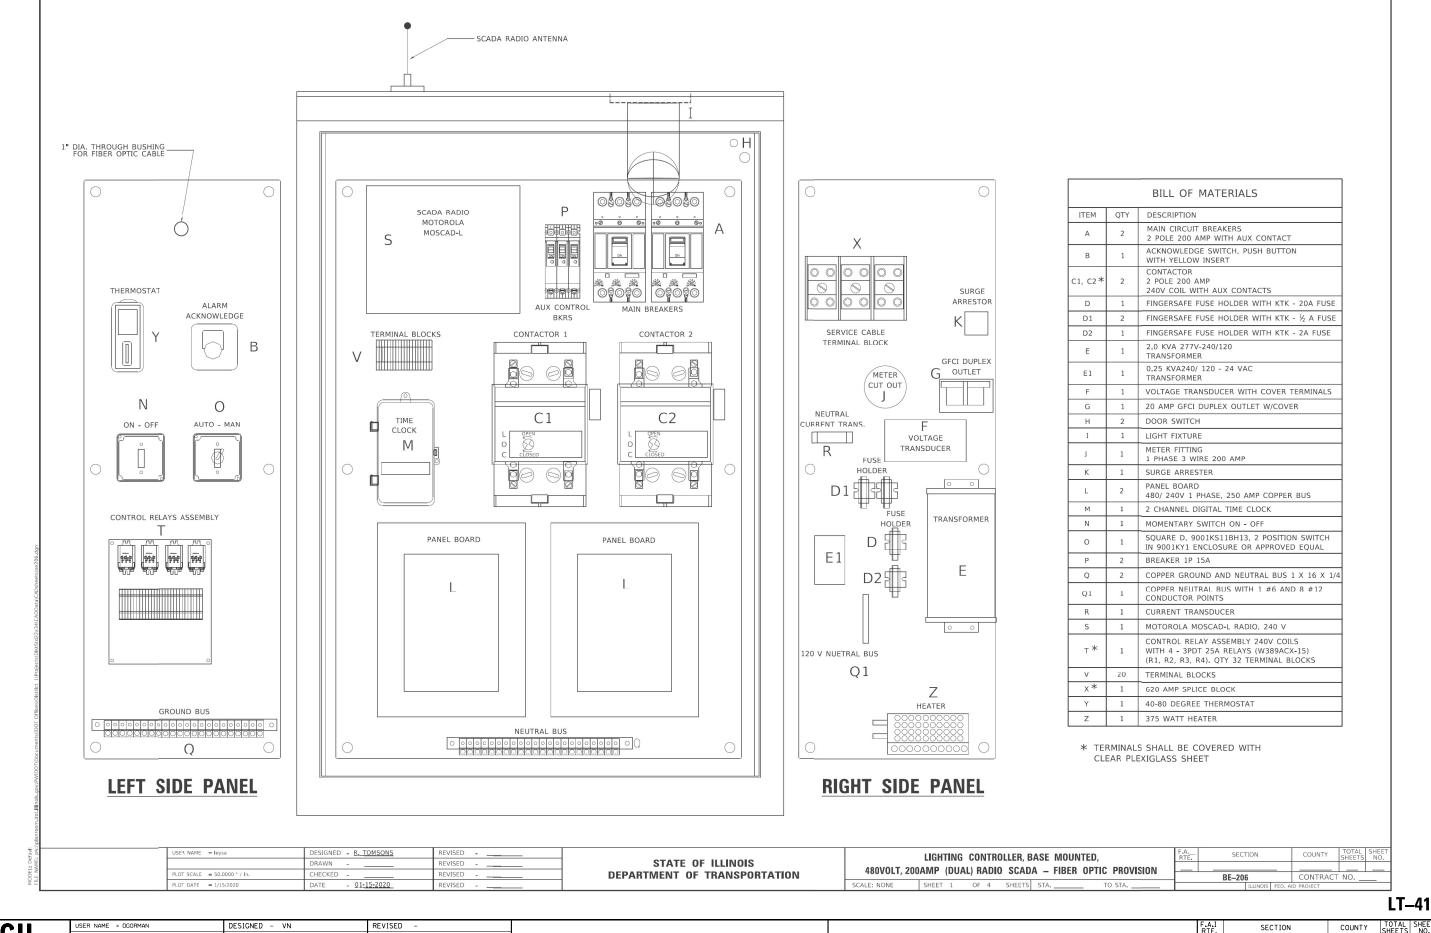
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STATE OF ILLINOIS
DEPARTMENT OF TRANSPORTATION

CONTROLLER R AS-BUILT INFORMATION

SHEET 10 OF 10 SHEETS STA. TO S

SCALE: NTS



STATE OF ILLINOIS

**DEPARTMENT OF TRANSPORTATION** 

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DATE

PLOT DATE = 6/23/2023

CHECKED - RP/MG

- 06/07/2023

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IDOT D1-BUREAU OF ELECTRICAL DETAIL STANDARDS

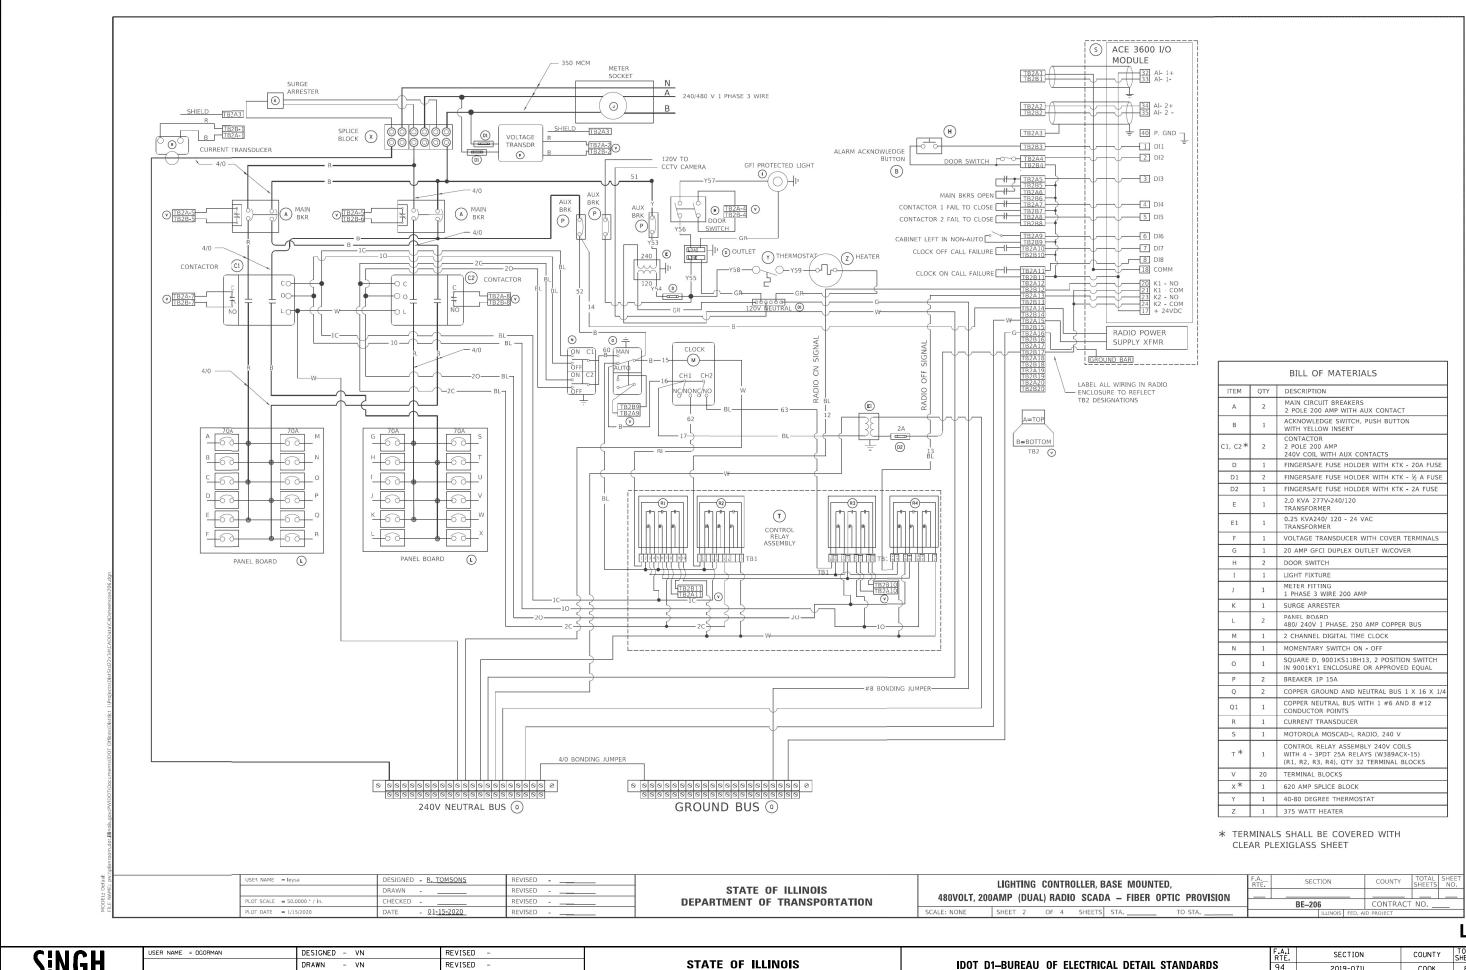
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SCALE:

2019-071L

COOK 84 68

CONTRACT NO. 62D82



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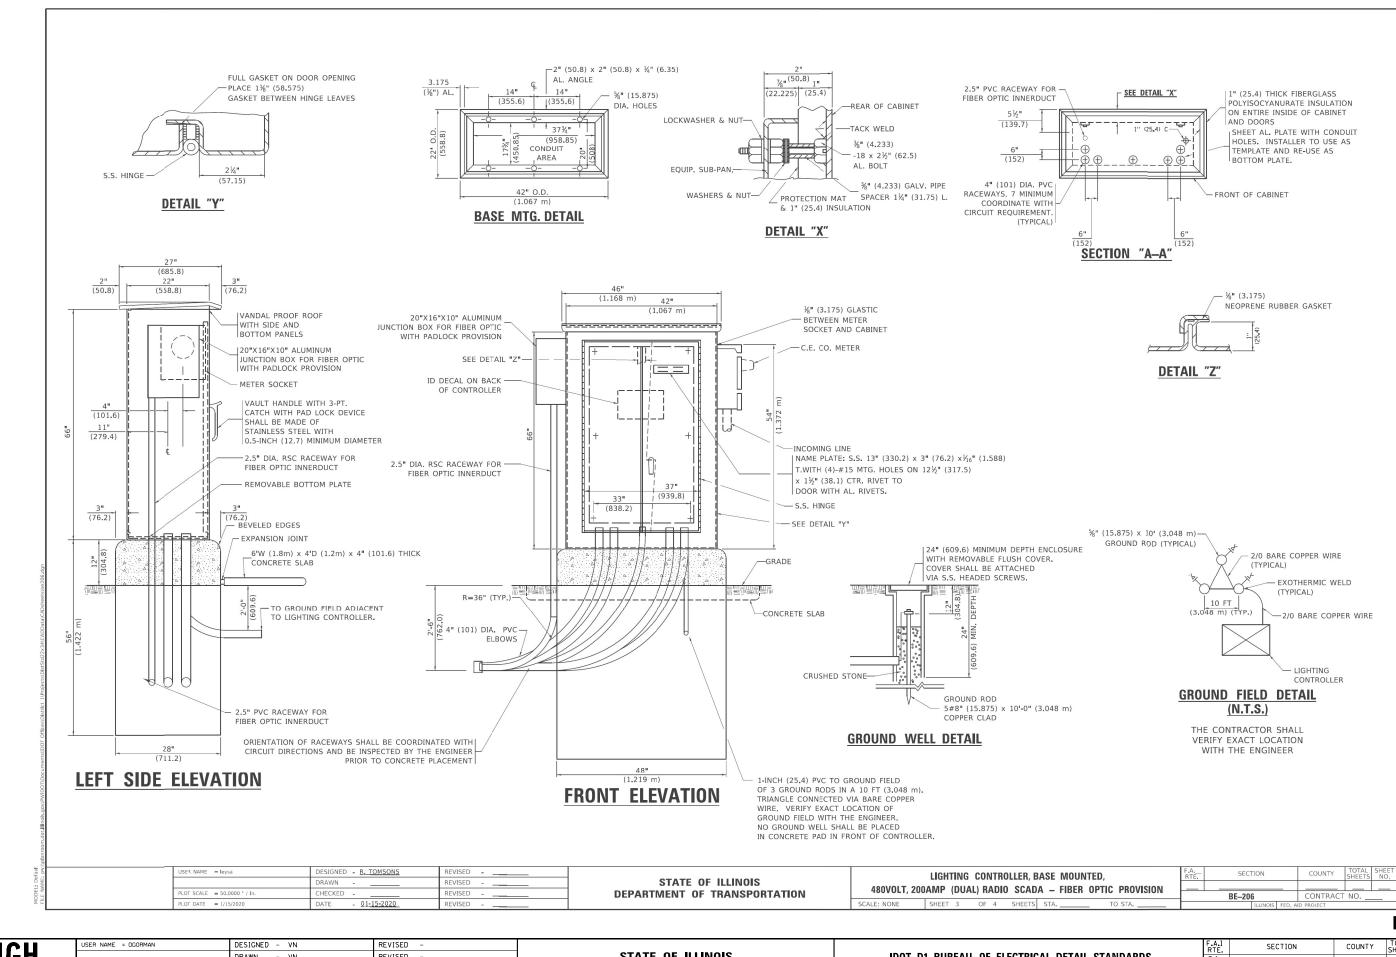
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**DEPARTMENT OF TRANSPORTATION** 

IDOT D1-BUREAU OF ELECTRICAL DETAIL STANDARDS SHEET 2 OF 10 SHEETS STA.

SCALE:

COOK 84 69 2019-071L CONTRACT NO. 62D82



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STATE OF ILLINOIS
DEPARTMENT OF TRANSPORTATION

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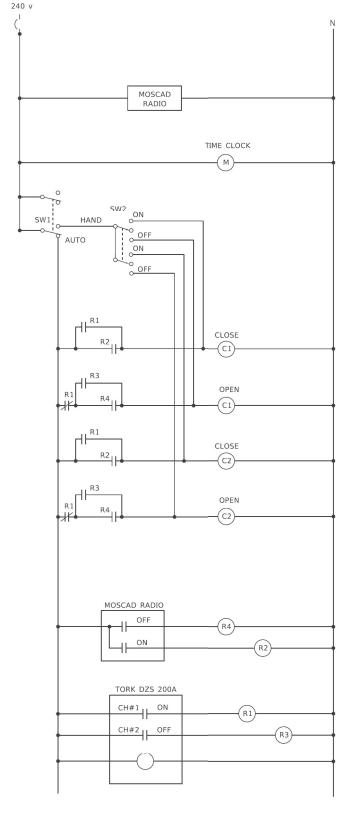
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#### **NOTES**

- CABINET SHALL BE FABRICATED FROM 0.125-INCH (3.175) SHEET ALUMINUM #3003H14, FORMED AND ARC WELDED.
- ALL SCREWS AND HARDWARE SHALL BE PLATED, GALVANIZED, OR MADE OF BRASS, ALUMINUM OR STAINLESS STEEL, UNLESS OTHERWISE NOTED.
- 3. NAME PLATE SHALL HAVE ENGRAVED 0.75-INCH (19.05) HIGH LETTERS FILLED IN BLACK: "STATE OF ILLINOIS LIGHTING CONTROLS" UNLESS OTHERWISE SPECIFIED.
- 4. ONE INCH THICK POLYISOCYANURATE INSULATION SHALL BE INSTALL AND PERMANENTLY CEMENTED ON ALL SIDES OF THE CABINET AND DOORS.
- 5. CABINET SHALL BE PRIMED AND PAINTED AS SPECIFIED.
- 6. ELECTRIC UTILITY METER BOX SHALL BE MOUNTED ON THE SIDE OF CONTROL CABINET AS SHOWN ON THE PANEL LAYOUT DIAGRAM.
- 7. THE COMPLETED CONTROLLER SHALL BE U.L. LISTED AS AN INDUSTRIAL CONTROL PANEL
- 8. METAL MOUNTING PANEL SHALL BE FABRICATED FROM THE SAME MATERIAL AS THE CABINET AND SHALL BE FLANGED BACK 0.75-INCHES I.D. ON 4 SIDES.
- 9. CIRCUIT BREAKERS AND CONTACTORS AND OTHER COMPONENTS SHALL BE MOUNTED ON 0.125-INCH (3.175) THICK GLASTIC INSULATION BACK PANEL.
- 10. ALL DEVICES SHALL BE FRONT REMOVABLE.
- 11. TIME CLOCK CHANNEL 1 N.O. CONTACT IS CLOSED NIGHT AND OPEN DAY (LIGHTS ON).
- 12. SET LATITUDE TO 42 DEGREES. SET CH.1 TO 23 MINUTES AFTER ASTRONOMICAL SUNSET, 50 MINUTES BEFORE ASTRONOMICAL SUNRISE. SET CH.2 TO 60 MINUTES AFTER ASTRONOMICAL SUNSET (WITH A SIGNAL LENGTH OF 1 SECOND), +28 MINUTES AFTER ASTRONOMICAL SUNRISE (WITH A SIGNAL LENGTH OF 7 SECONDS.)
- 13. BUS BAR SHALL HAVE 22 LUG TERMINALS SIZED TO ACCOMMODATE REQUIRED WIRE SIZES. 240V NEUTRAL BUS SHALL BE PAINTED WHITE, GROUND BUS SHALL BE PAINTED GREEN, AND THE 120V NEUTRAL BUS SHALL BE PAINTED GREY.
- 14. ALL LUGS SHALL BE OF COPPER SCREWS AND CONNECTORS, SPRING HELD.
- 15. ALL WIRING TERMINATIONS SHALL BE RATED NOT LESS THAN 75 DEGREE CENTIGRADE.
- 16. ALL CONTROL WIRING SHALL BE 600V #12 TYPE MTW, SCADA WIRING SHALL BE #18.
- 17. ALL POWER WIRING SHALL BE 600V TYPE RHH/RHW.
- 18. ALL WIRING WITHIN THE CABINET SHALL BE COLOR CODED AS INDICATED;

R = REDY = YFILOWB = BLACKW = WHITE BL = BLUEG = GREEN G = GREY

- MOSCAD I/O WIRING SHALL BE: DIGITAL INPUT (DI) WIRING SHALL BE #18 MTW PURPLE. ANALOG INPUT (AI) WIRING SHALL BE #18, 2/C SHIELDED. AI AND DI WIRING MAY BE BUNDLED TOGETHER, BUT SHALL NOT BE BUNDLED WITH OTHER WIRING.
- 20. ALL DIMENSIONS ARE IN INCHES (MILLIMETERS) UNLESS OTHERWISE INDICATED.
- 21. SCHEMATIC SHOWN WITH BREAKER OPEN, CONTACTOR OPEN, CABINET DOOR CLOSED, CLOCK NOT ACTIVE (DE-ENERGIZED STATE).
- 22. A LAMINATED COPY OF THE CIRCUIT SCHEMATIC AND SCADA I/O DIAGRAM (NO SMALLER THAN 11"x17" EACH) SHALL BE ATTACHED TO THE INSIDE OF THE CONTROLLER WITH STAINLESS STEEL SCREWS.



	MOSCAD I/O ASSIGNMENTS							
TERM	MOSCAD DESTINATION	DESCRIPTION OF INPUT						
1	DIGITAL INPUT 1	ALARM KNOWLEDGE						
2	DIGITAL INPUT 2	DOOR OPEN						
3	DIGITAL INPUT 3	MAIN(S) BREAKER OPEN						
4	DIGITAL INPUT 4	CONTACTOR 1 OPEN						
5	DIGITAL INPUT 5	CONTACTOR 2 OPEN						
6	DIGITAL INPUT 5	CABINET IN NON-AUTO						
7	DIGITAL INPUT 7	BACK-UP CLOCK OFF CALL						
8	DIGITAL INPUT B	BACK-UP CLOCK ON CALL						
17	24 V+	24+VDC						
18	DI COMMON	COMMON						
21	K1 C	K1 COMMON						
22	K1 NO	LIGHTS ON CALL						
24	K2 C	K2 COMMON						
25	K2 NO	LIGHTS OFF CALL						
32	ANALOG INPUT 1 (+)	CABINET NEUTRAL CURRENT						
33	ANALOG INPUT 1 (-)	CABINET NEUTRAL CURRENT						
34	ANALOG INPUT 2 (+)	CABINET SERVICE VOLTAGE						
35	ANALOG INPUT 2 (-)	CABINET SERVICE VOLTAGE						
40	P. GROUND	GROUND						

ALL ANALOG INPUTS WILL BE 4-20 MA ONLY. DIGITAL OUTPUT RELAYS WILL BE ELECTRICALLY ENERGIZED AND MOMENTARILY HELD

MIXED I/O MODULE MODEL NUMBER V436

## CONTROL CIRCUIT LADDER LOGIC DIAGRAM

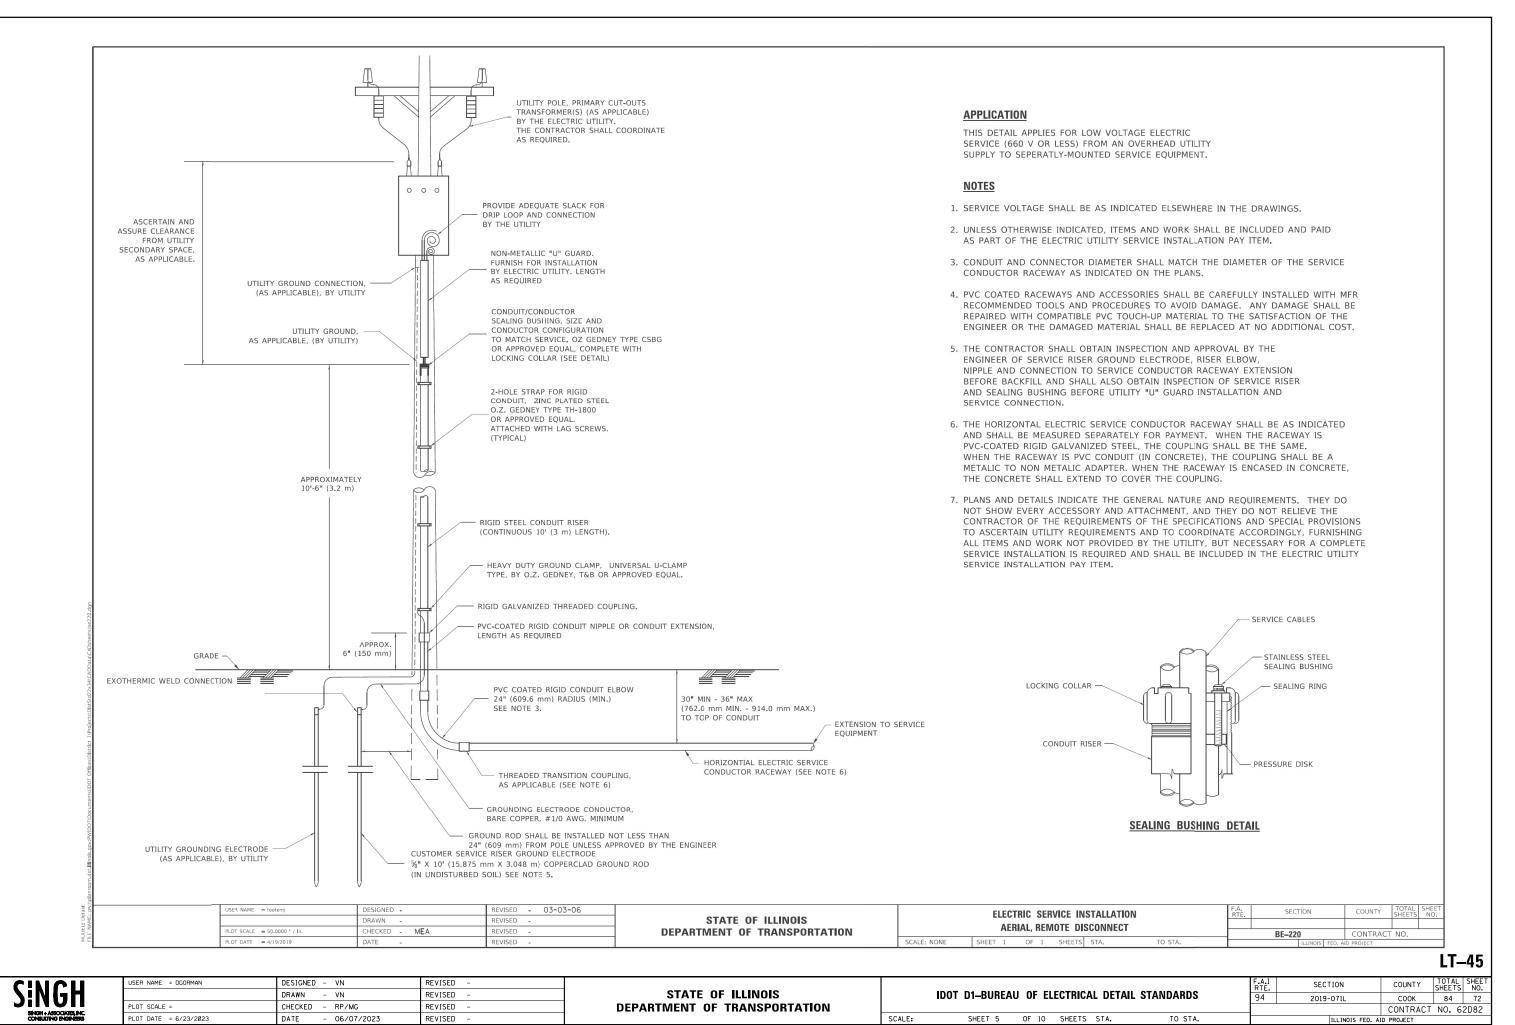
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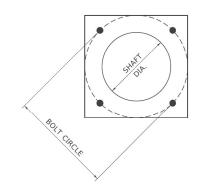
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/ad	USER NAME = leysa	DESIGNED - R. TOMSONS	REVISED		LIGHTING CONTROLLER, BASE MOUNTED,	F.A	SECTION	COUNTY	TOTAL SHEET
AME		DRAWN	REVISED	STATE OF ILLINOIS		IXIE.		+	SHEETS NO.
N N	PLOT SCALE = 50.0000 ' / in.	CHECKED	REVISED	DEPARTMENT OF TRANSPORTATION	480VOLT, 200AMP (DUAL) RADIO SCADA – FIBER OPTIC PROVISION		BE-206	CONTRACT	NO.
£ E	PLOT DATE = 1/15/2020	DATE - <u>01-15-2020</u>	REVISED		SCALE: NONE SHEET 4 OF 4 SHEETS STA TO STA		ILLINOIS FEE	D. AID PROJECT	


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PLOT DATE = 6/23/2023	DATE - 06/07/2023	REVISED -

STATE OF ILLINOIS **DEPARTMENT OF TRANSPORTATION**  IDOT D1-BUREAU OF ELECTRICAL DETAIL STANDARDS SHEET 4 OF 10 SHEETS STA.

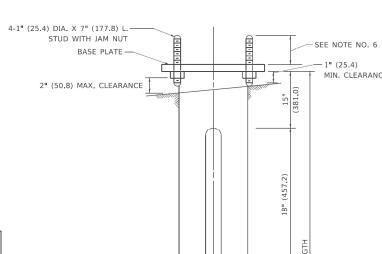SECTION COUNTY 84 71 2019-071L COOK CONTRACT NO. 62D82







(63.5)

SHAFT DIA.

## **HELIX FOUNDATION SIZE**

POLE MOUNTING HEIGHT	BOLT CIRCLE	SHAFT DIAMETER	SHAFT LENGTH	BASEPLATE
30 FT.	11½"	8%"	6 FT.	12"x12"x1"
31 FT35 FT.	11½"	8%"	6 FT.	12"x12"x1"
36 FT40FT.	15"	8%"	6 FT.	15"x15"x1¼"
41 FT45 FT.	15"	8%"	6 FT.	15"x15"x1¼"
46 FT50 FT.	15"	10"	8 FT.	15"x15"x1¼"

## METAL HELIX FOUNDATION MATERIALS

ITEM	MATERIAL REQUIREMENT		
BASEPLATE	AASHTO M 270M, GRADE 36 (M270M, GRADE 250)		
SHAFT	ASTM A 252, GRADE 2 (PHOSPHOROUS 0.04% MAXIMUM, SULFUR 0.05% MAXIMUM)		
HELIX SCREW	AASHTO M 183 (ASTM A 635)		
PILOT POINT	AASHTO M 270 (ASTM A 575)		
ANCHOR RODS/STUDS	AASHTO M 314 (ASTM F 1554)		
HEXAGON NUTS	AASHTO M 291M (ASTM A 563) GRADE DH, OR AASHTO M 292 (ASTM A 194) GRADE 2H		
WASHERS	AASHTO M 293 (ASTM F 436)		

## **NOTES**

- 1. ALL DIMENSION IN INCHES (MILLIMETERS) UNLESS OTHERWISE SHOWN.
- 2. ALL MATERIAL SHALL BE GALVINIZED ACCORDING TO AASHTO M111, UNLESS OTHERWISE SPECIFIED.
- 3. ALL WELDS SHALL BE CONTINUOUS AND NOT LESS THAN 1#4" (6.35 mm) FILLET WELDS. THE WELDED FOUNDATION SHALL BE CAPABLE OF WITHSTANDING 10,000 FT/LBS (13558.18 n.m) OF INSTALLATION TORQUE APPLIED ABOUT THE AXIS OF THE FOUNDATION.
- 4. THE HELIX FOUNDATION SHAFT SHALL BE INSTALLED VERTICAL AND THE BASE PLATE SHALL BE IN LEVEL. THE BREAKAWAY COUPLINGS AND HARDWARE SHALL NOT BE USED TO ALIGN THE POLE INSTALLATION.
- 5. THE CABLE TRENCH SHALL BE BACKFILLED AND FIRMLY COMPACTED BEFORE THE INSTALLATION OF THE LIGHT POLE.
- 6. THE CONTRACTOR SHALL COORDINATE EXTENSION OF ANCHOR BOLTS ABOVE TOP OF THE BASE PLATE WITH THE BREAKAWAY DEVICE MANUFACTURER'S REQUIREMENTS.
- 7. ANY VOIDS WITHIN THE METAL FOUNDATION SHALL BE FILLED WITH FINE AGGREGATE.
- 8. METAL FOUNDATIONS SHALL BE INSTALLED IN UNDISTURBED SOIL. PREDRILLING A PILOT HOLE AND/OR BACKFILLING AROUND THE FOUNDTION IS NOT ALLOWED.
- 9. THE METAL FOUNDATION SHALL NOT BE INSTALLED TO A TORQUE WHICH EXCEEDS THE MANUFACTURER'S MAXIMUM TORQUE RATING NOR SHALL IT BE INSTALLED TO AN INSTALLATION TORQUE VALUE OF LESS THAN 3,500 FT LB (4,750 KNM), METAL FOUNDATIONS THAT ARE NOT INSTALLED TO FULL INSTALLATION DEPTH OR DO NOT ACHIEVE THE MINIMUM INSTALLATION TORQUE SHALL BE REMOVED AND REPLACED WITH A CONCRETE FOUNDATION AT NO ADDITIONAL COST.
- 10. THE BASEPLATE SHALL BE PERPENDICULAR TO THE SHAFT AXIS ( $\pm$  1 $^{\circ}$  ) AND THE HOLE CENTERLINE SHALL BE CONCENTRIC (± 0.188) TO THE SHAFT AXIS.
- 11. THE PILOT POINT AND SHAFT AXIS SHALL BE CONCENTRIC (± 0,125) AND IN LINE ( $\pm$  2 $^{\circ}$  ).
- 12. THE BASEPLATE SHALL BE STAMPED WITH THE MANUFACTURERS NAME AND DATE OF MANUFACTURE.

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STATE OF ILLINOIS **DEPARTMENT OF TRANSPORTATION** 

1¼" (31.75) DIA.

MIN. CLEARANCE

- 0.25" WALL, MIN.

						F.A. RTE.	SEC	TION		COUNTY	TOTAL SHEETS	SHE
	LIGHT POLE FOUNDATION, METAL											
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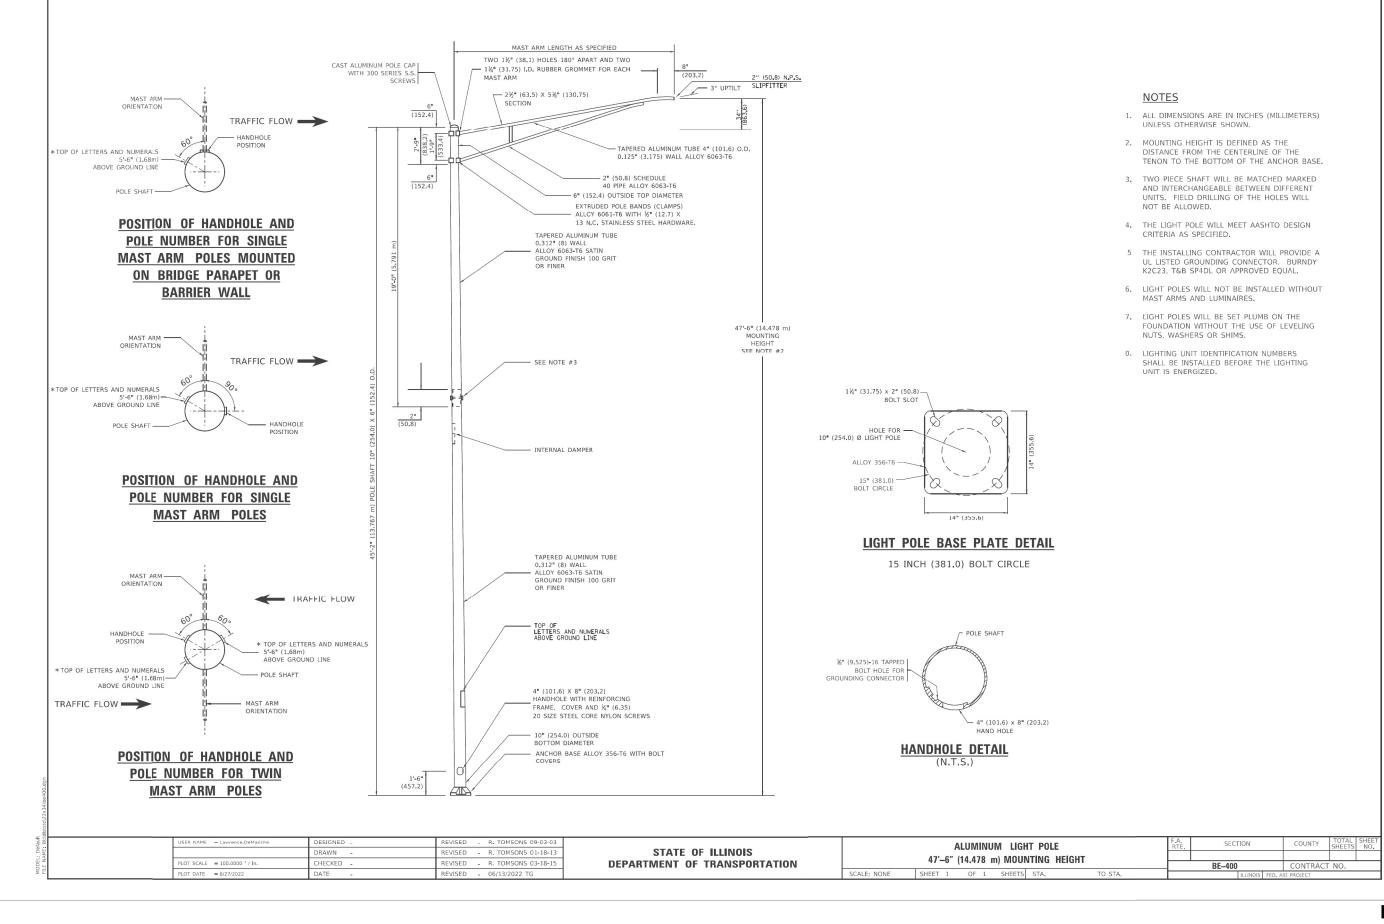
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COOK 84 73

CONTRACT NO. 62D82



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LT-47

SINGH ASSOCIATES, INC. CONSULTING ENGINEERS


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DEPARTMENT OF TRANSPORTATION

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CONTRACT NO. 62D82						
ILLINOIS FED. AID PROJECT						



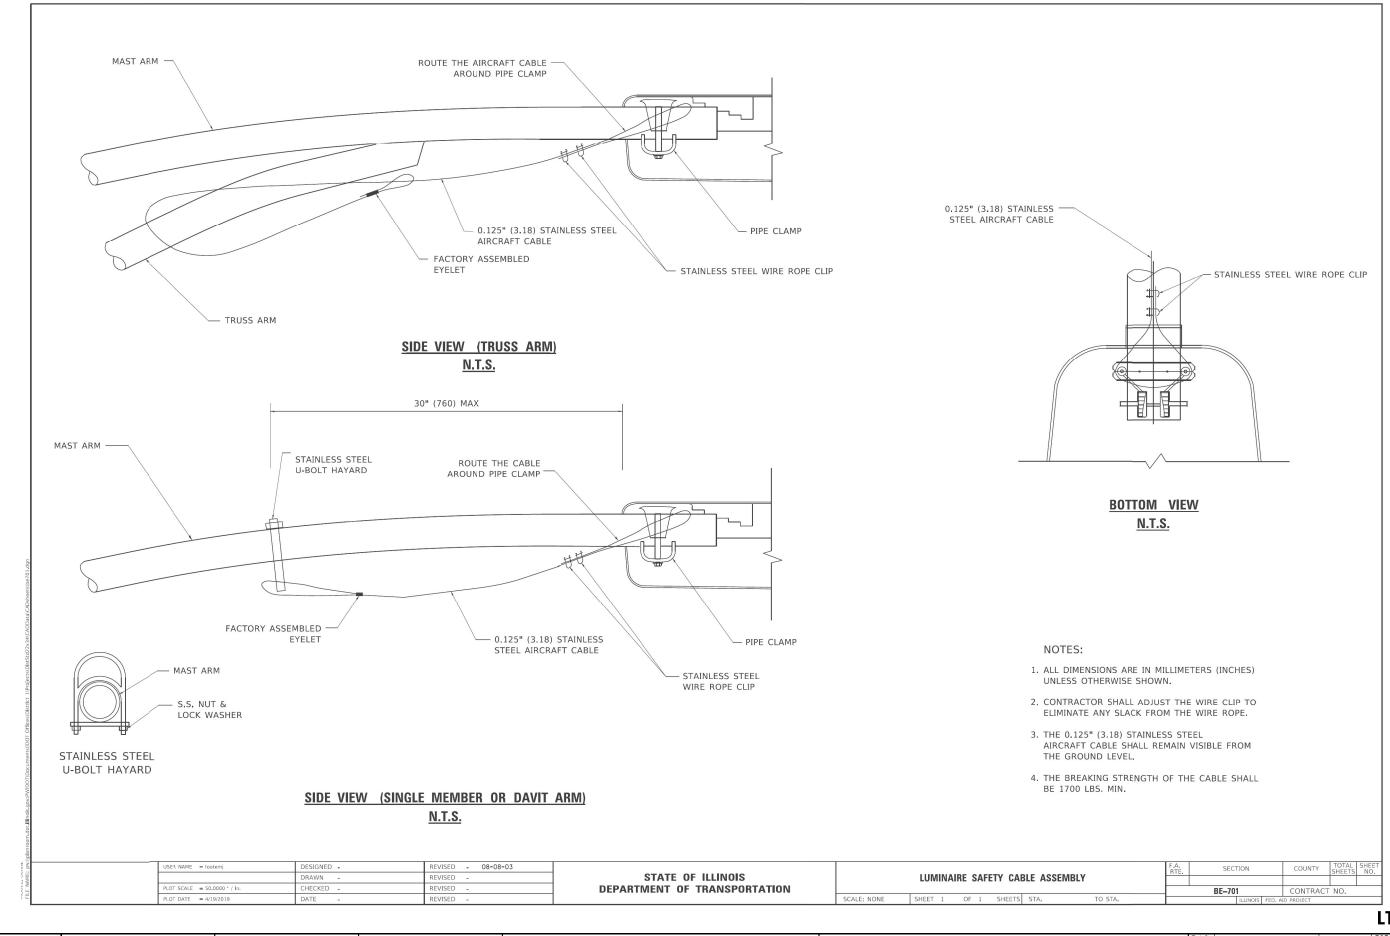LT-48

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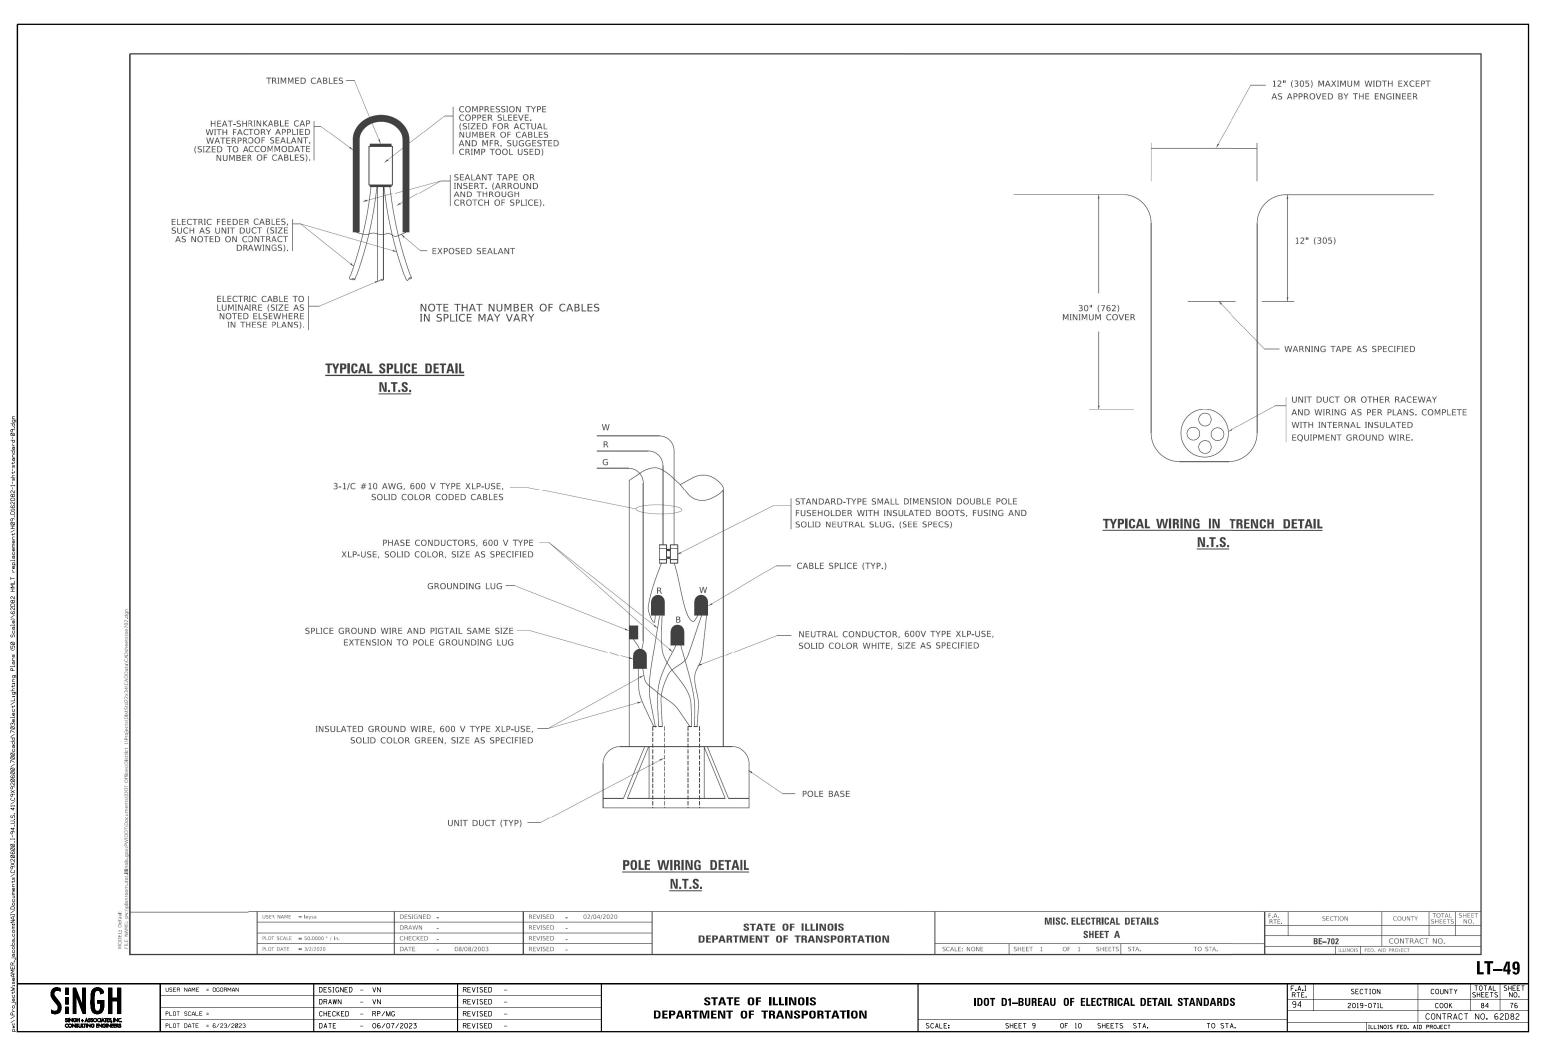
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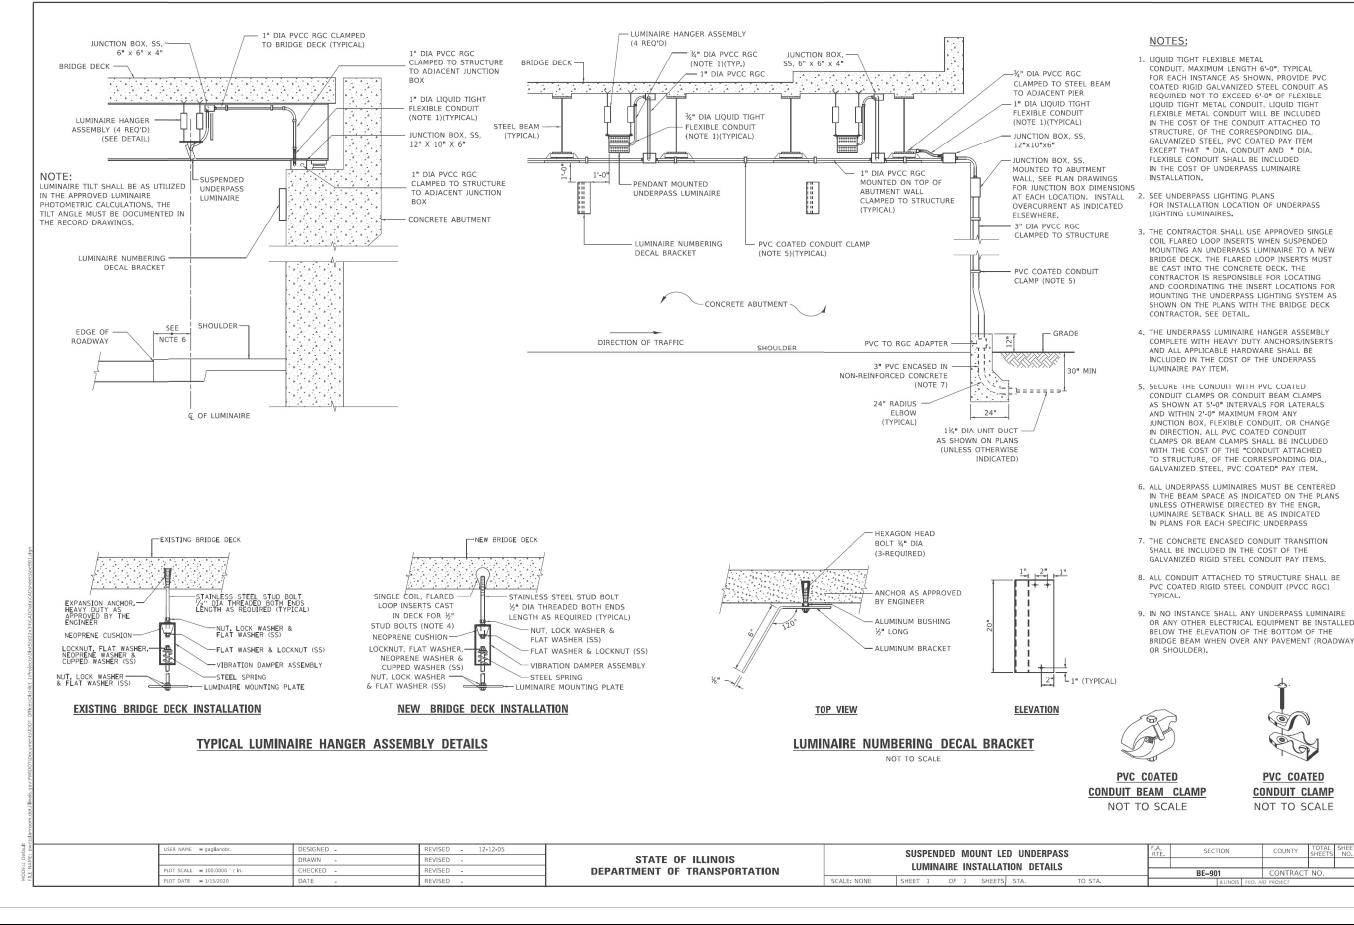
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STATE OF ILLINOIS
DEPARTMENT OF TRANSPORTATION

SCALE: SHEET 8 OF 10 SHEETS STA. TO STA.





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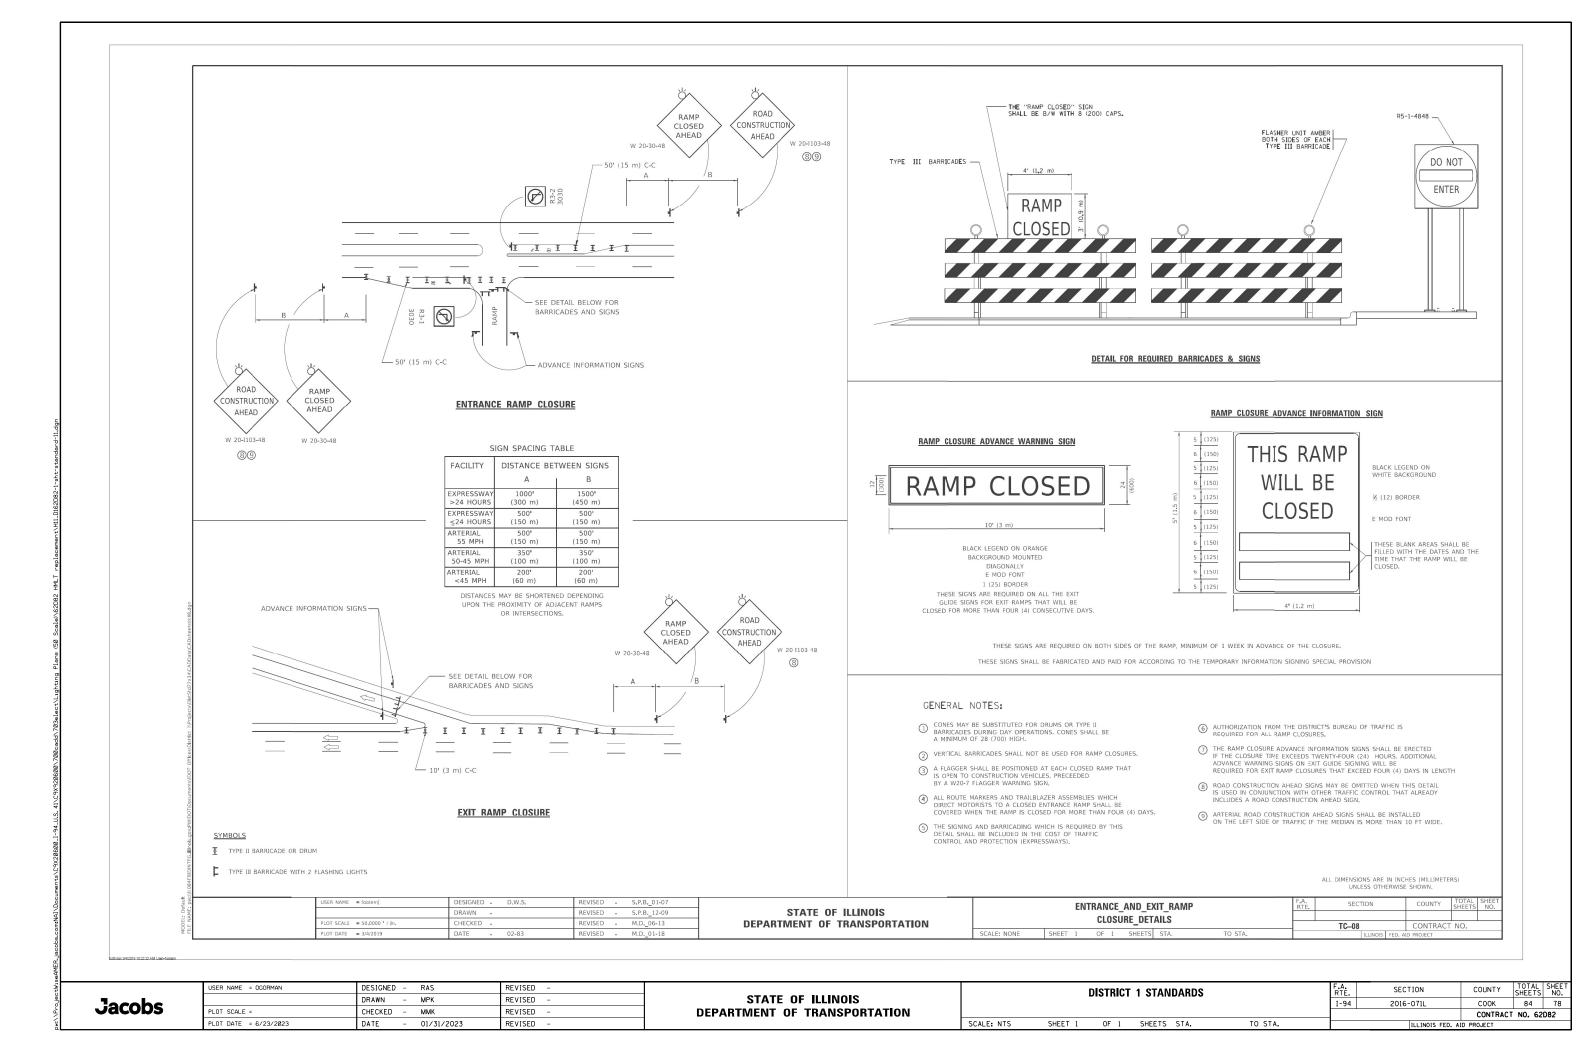
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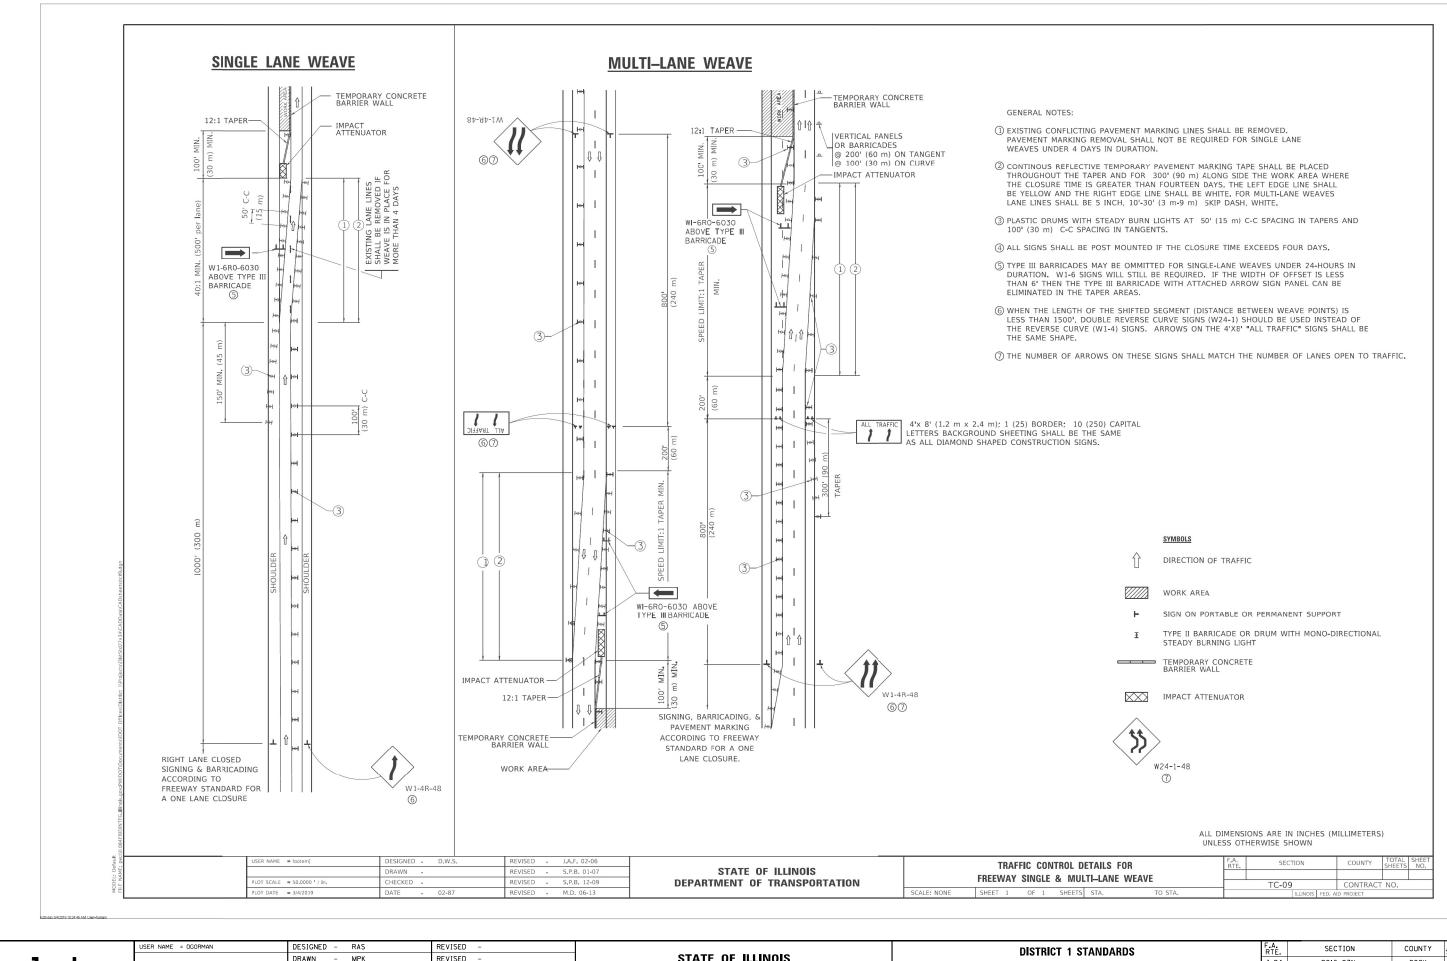
STATE OF ILLINOIS
DEPARTMENT OF TRANSPORTATION

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IDOT D1-BUREAU OF ELECTRICAL DETAIL STANDARDS

SHEET 10 OF 10 SHEETS STA. TO STA.





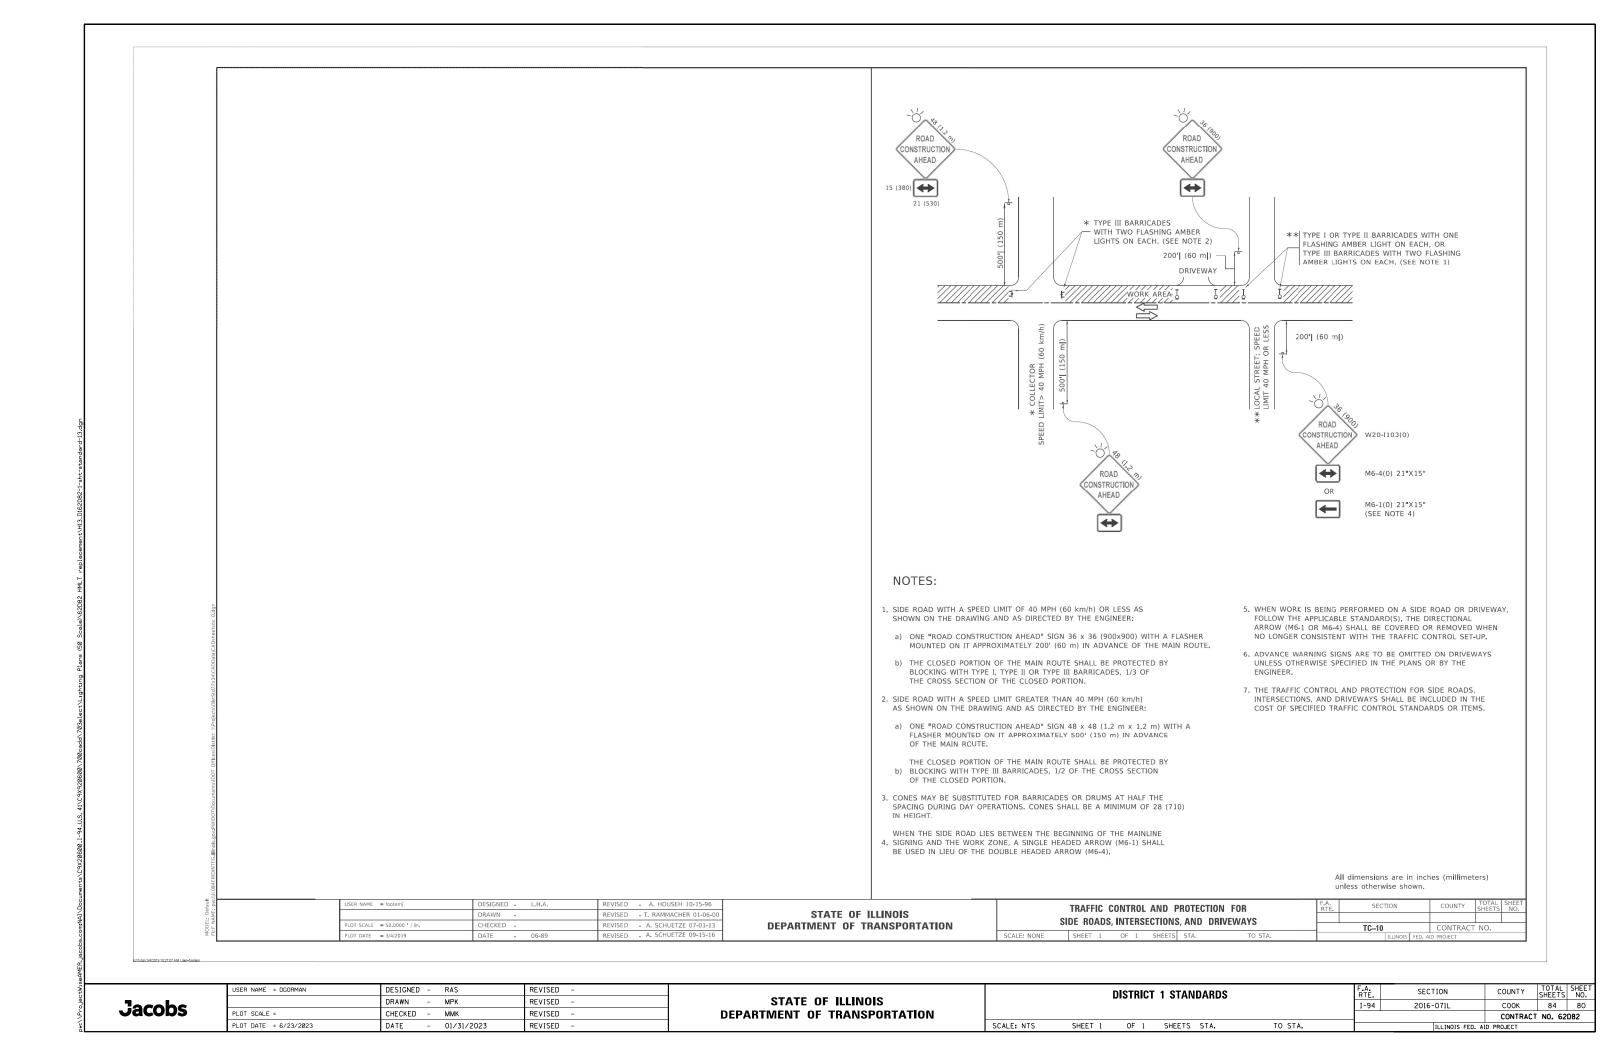
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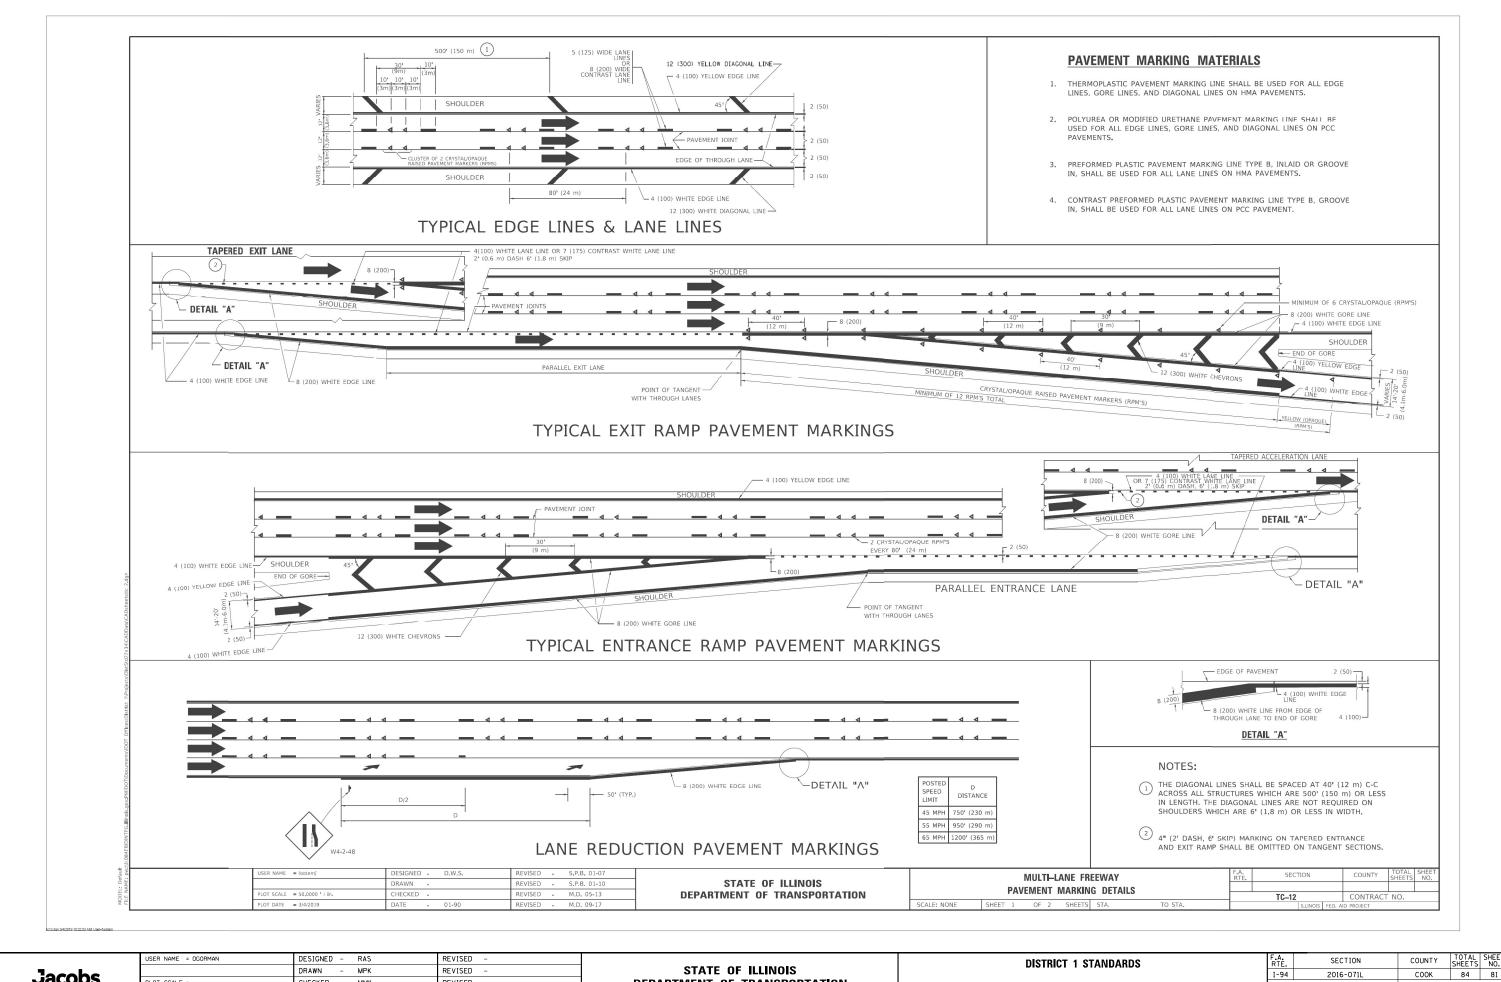
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STATE OF ILLINOIS
DEPARTMENT OF TRANSPORTATION

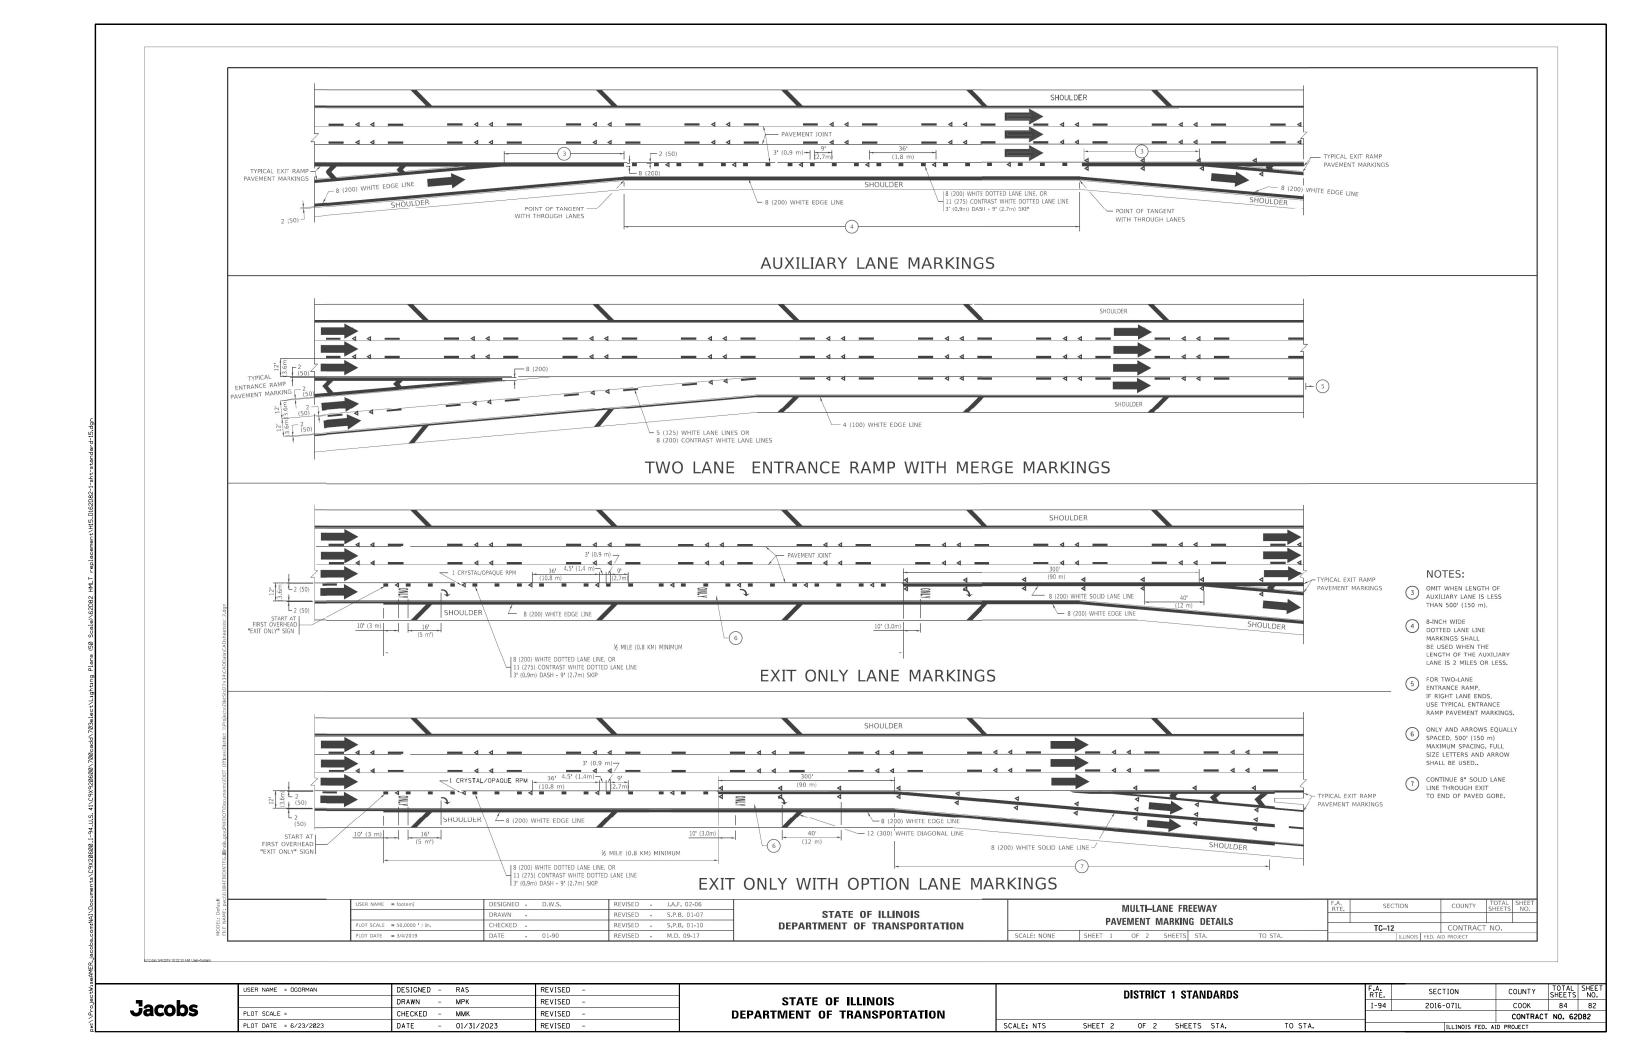
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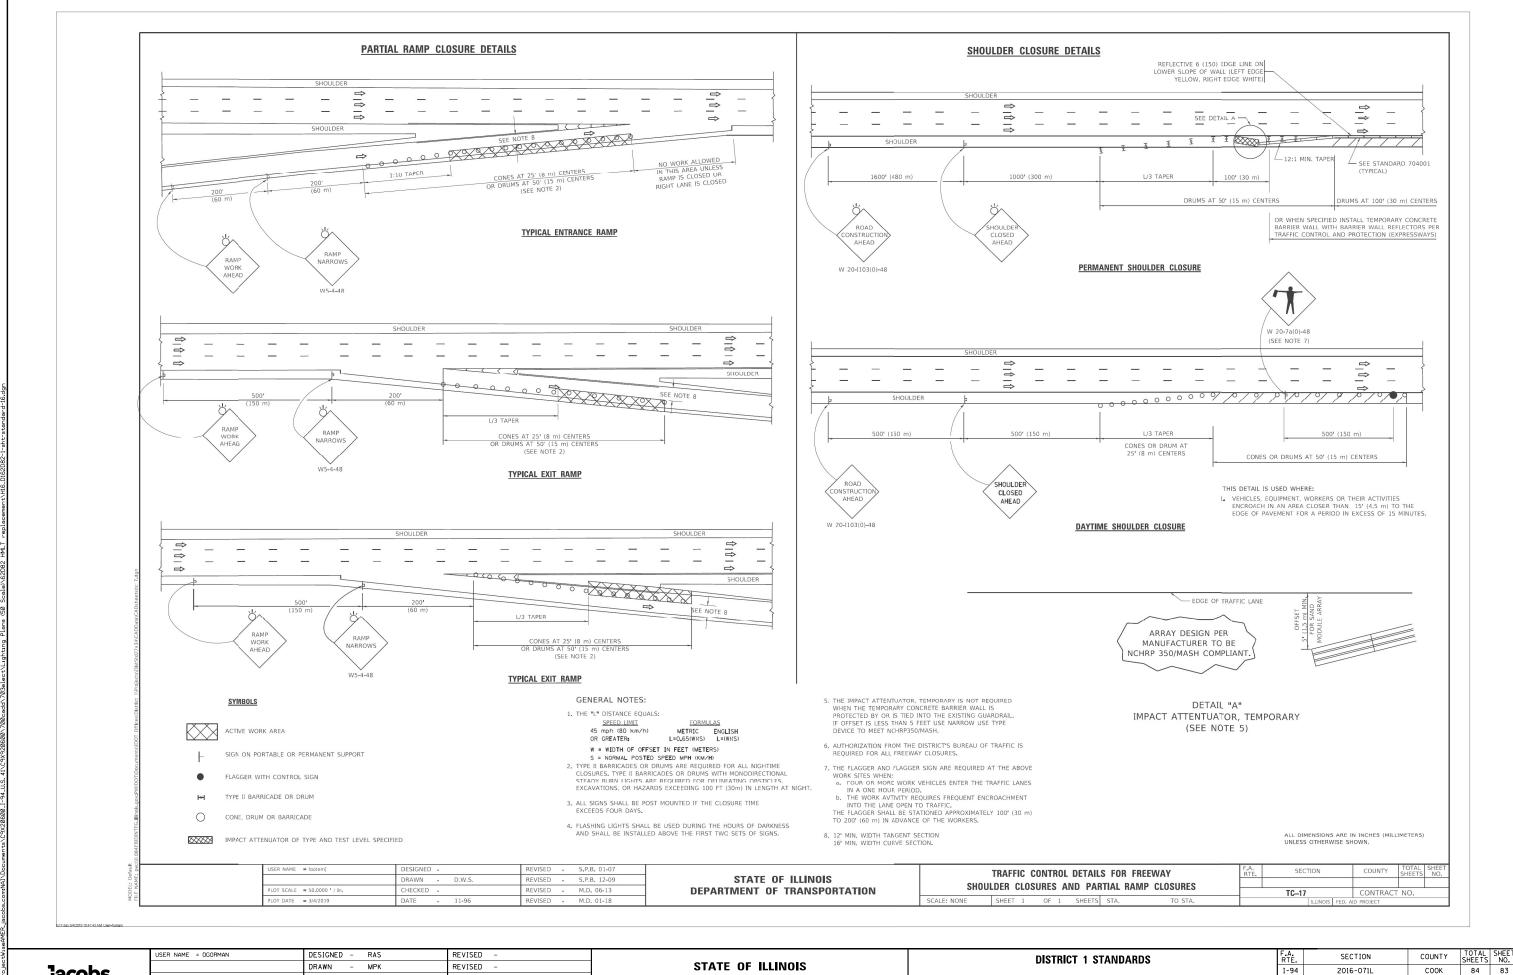
SCALE: NTS





**Jacobs** PLOT SCALE = CHECKED MMK REVISED **DEPARTMENT OF TRANSPORTATION** CONTRACT NO. 62D82 PLOT DATE = 6/23/2023 01/31/2023 SCALE: NTS SHEET 1 OF 2 SHEETS STA. TO STA. DATE REVISED






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STATE OF ILLINOIS					
DEPARTMENT	OF TRANSPORTA	ATION			

SCALE: NTS

DISTRICT 1 STANDARDS			F.A. RTE.	SECTION	COUNTY	TOTAL SHEETS	SHEE NO.	
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						CONTRACT	NO. 62	D82
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STATE OF ILLINOIS					
DEPARTMENT OF TRANSPORTATION					

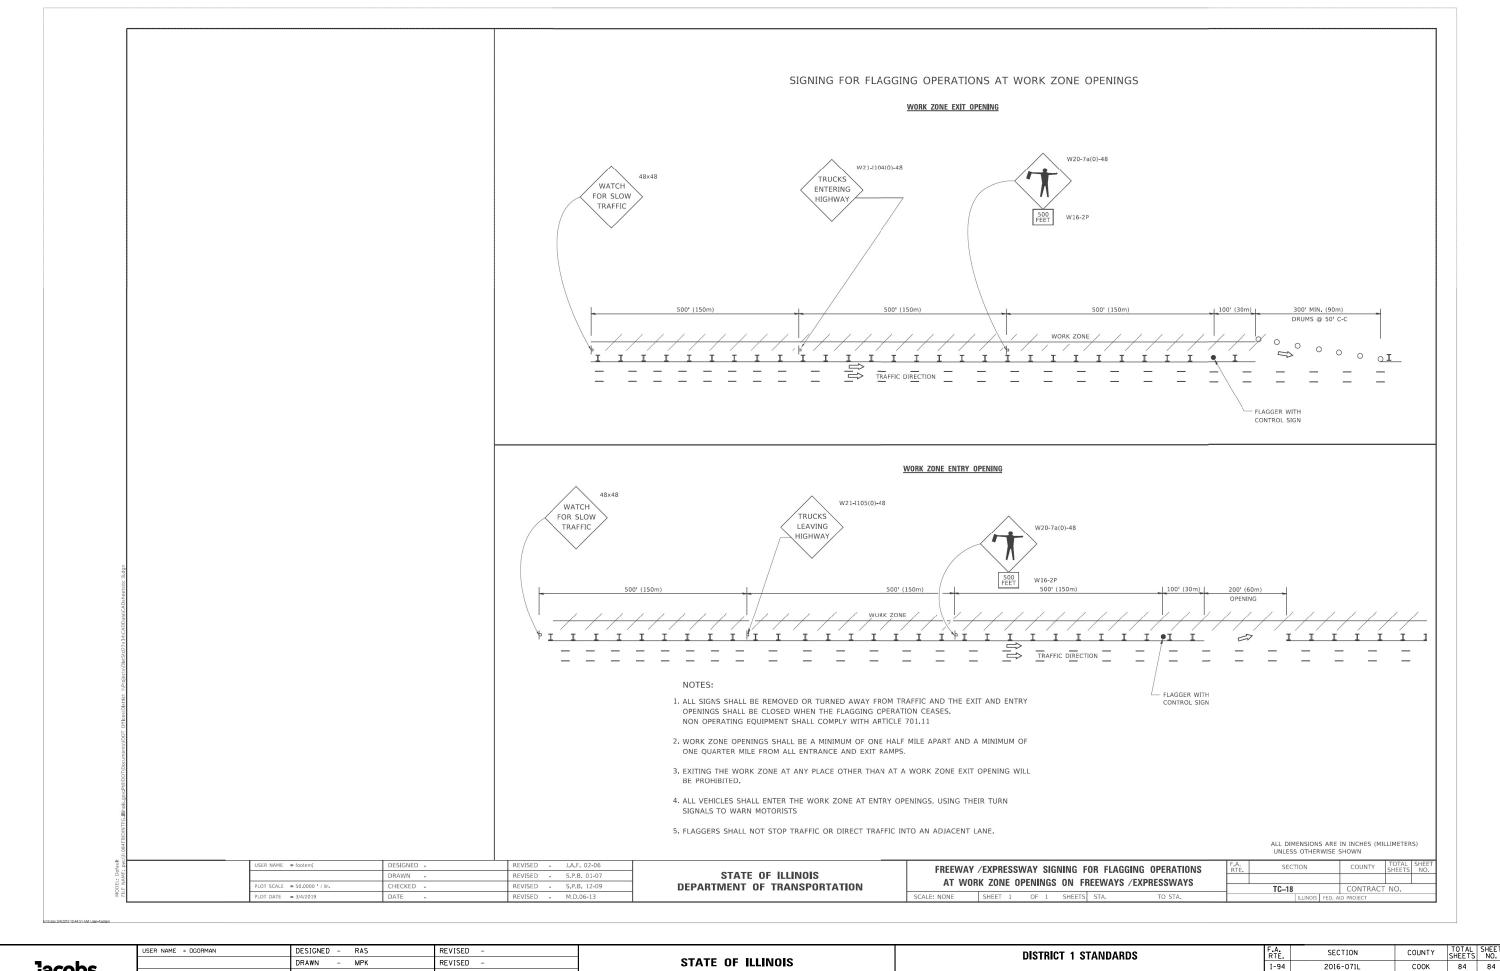SCALE: NTS

DISTRICT 1 STANDARDS					RTE.	SECTION
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CONTRACT NO. 62D82