- GENERAL NOTES, COMMITMENTS AND SCHEDULE OF QUANTITIES

DEMOLITION

- SUMMARY OF QUANTITIES DEMOLITION PLANS
- 3A SUMMARY OF QUANTITIES STATION RENOVATION PLANS

DEMOLITION PLANS

4 REMOVAL PLAN - N. 4TH STREET

STATION RENOVATION PLANS

GENERAL

- G1.0 COVER SHEET
- G1. 1 GENERAL NOTES
- G1. 2 ABBREVIATIONS AND LEGENDS

- CO. 01 ABBREVIATIONS, SYMBOLS AND NOTES
- C1.00 EXISTING CONDITIONS PLAN
- C1.01 DEMOLITION PLAN
- C1.02 OVERALL SITE PLAN
- 12 C2. 01 SITE PLAN


- A1.1 FIRST FLOOR DEMOLITION PLAN
- 14 A1.2 FIRST FLOOR PLAN

STATE OF ILLINOIS 09-22-2017 LETTING ITEM 053 **DEPARTMENT OF TRANSPORTATION**

DIVISION OF HIGHWAYS

PROPOSED DEMOLITION AND STATION RENOVATION PLANS

F.A.U. ROUTE 8024 (N. 4TH STREET) SECTION 15-HSRT3-03-RR **PROJECT BUILDING DEMOLITION AND STATION RENOVATION** SANGAMON COUNTY / CAPITAL TOWNSHIP

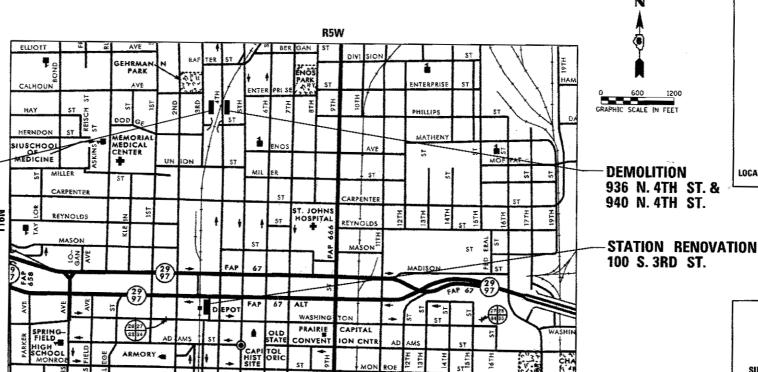

LOCATION MAP

062-058574 REGISTERED PROFESSIONAL ENGINEER

3rd P.M.

STATE OF ILLINOIS DEPARTMENT OF TRANSPORTATION

LOCATION OF SECTION INDICATED THUS: -

COUNTY TOTAL SHEET SHEETS NO.

SANGAMON 14 1 CONTRACT NO. 93640

DOT#294299H

MP 184.42

SECTION 15-HSRT3-03-RR

8024

PRINTED BY THE AUTHORITY OF THE STATE OF ILLINOIS

DISTRICT 6 NO. (217) 782-7301

ENGINEERING SCALES. REDUCED SIZED PLANS WILL NOT

JOINT UTILITY LOCATION INFORMATION FOR EXCAVATION

CONFORM TO STANDARD SCALES. IN MAKING MEASUREMENTS ON REDUCED PLANS, THE ABOVE SCALES MAY BE USED.

PROJECT ENGINEER: KEITH DONOVAN (217) 782-4761

TOWNSHIP: CAPITAL

1-800-892-0123

OR 811

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 \circ

CONTRACT NO. 93640

345 EAST ASH AVENUE, SUITE B DECATUR, ILLINOIS 62526

939 N. 4TH ST. & 941 N. 4TH ST.

CITY OF SPRINGFIELD

SECTION 27

- COMMITMENTS
 - NONE

- CONTRACT WORK CONSISTS OF TWO COMPONENTS NEAR THE UNION PACIFIC RAILROAD.
 DEMOLITION PLANS ALONG THE EAST AND WEST SIDE OF FOURTH STREET AND
 STATION RENOVATION PLANS FOR WORK AT THE TRAIN STATION ON THIRD STREET.
- IN GENERAL, THE DEMOLITION PLANS INCLUDE REMOVAL AND DISPOSAL OF THREE RESIDENTIAL HOUSES AND ONE GARAGE AS INDICATED IN THE PLANS AND RELATED SPECIFICATIONS.
- 3. IN GENERAL, THE STATION RENOVATION PLANS INCLUDE PARKING LOT IMPROVEMENTS (STRIPING, SIGNAGE, HMA PATCHING AND OVERLAY) AND ADJUSTMENT/REMOVAL/REPLACEMENT OF TOILET FIXTURES AND ACCESSORIES.
- 4. EACH OF THE TWO DISTINCT PLAN COMPONENTS HAVE THEIR OWN UNIQUE PLANS AND SPECIFICATIONS AND UNLESS OTHERWISE NOTED. APPLY ONLY AT THEIR SPECIFIC LOCATIONS AND UNDER ONE OVERALL IDOT CONTRACT LETTING. SPECIFICATIONS BY MULLER & MULLER AND WSP USA ARE TITLED SPRINGFIELD STATION RENOVATIONS AND APPLY ONLY AT THE THIRD STREET TRAIN STATION LOCATION. REMAINING SPECIFICATIONS/SPECIAL PROVISIONS APPLY ONLY AT THE FOURTH STREET LOCATION, UNLESS OTHERWISE NOTED.
- 5. CONTRACTOR SHALL BID THE CONTRACT STATION RENOVATION COMPONENT WITH LUMP SUM PAY ITEMS "STATION PARKING LOT COMPLETE" AND "STATION TOILET COMPLETE" SEE SPECIAL PROVISIONS.
- 6. BEFORE STARTING ANY EXCAVATION, THE CONTRACTOR SHALL CALL "JULIE" AT 1-800-892-0123 OR 811 FOR FIELD LOCATIONS OF BURIED ELECTRIC. TELEPHONE AND GAS FACILITIES. THE CONTRACTOR SHALL CONTACT THE MUNICIPALITY FOR ANY MUNICIPAL OWNED UTILITIES. (MINIMUM 48 HOURS NOTIFICATION IS REOUIRED). THE CONTRACTOR SHALL CALL THE UNION PACIFIC "CALL BEFORE YOU DIG" OPERATION AT 1-800-336-9193 FOR FIELD LOCATIONS OF BURIED FIBER OPTIC CABLES IN UNION PACIFIC RIGHT OF WAY.
- 7. IN ADDITION TO WORK SHOWN IN THE PLANS, ROADWAY AND RAILROAD CROSSING CONSTRUCTION (BY OTHERS) MAY BE IN THE VICINITY. CONTRACTOR SHALL CONTACT UPRR, JOHN JEROME AT JRJEROME@UP.COM TO COORDINATE WORK SCHEDULE AND TIMELINES.

SCHEDULE OF QUANTITIES

STATION	(LT / RT)	OFFSET	BUILDING REMOVAL NO.	R&D FRIABL ASB BLD NO.	R&D NON-FR ASB BLD NO.
EX. 4TH STREET		FOOT			,
50+00	RT	66	1	1	1
50+34	RT	78	2	2	2
49+90	LT	148	4	4	4
50+42	LT_	72	3	3	3

RIVEWAY	PAVEMENT	& SIDEWALK	REMOVAL	SCHEDULE	
				44000200	44000600
SHEET	STATION	STATION	OFFSET	DRIVEWAY SIDEWAL PAVEMENT REMOVAL	
				SQ YD	SQ FT
4	49+96.32	50+00.76	RT		152
4	50+00.76	50+57.96	RT	142	
4	50+29.66	50+33.00	RT		39
4	49+72.84	50+16.51	LT	142	
4	49+89, 46	50+01.03	LT		92
4	50+36.55	50+42.81	LT		86
			TOTALS	284	369

FENCE RE	MOVAL SCHE	DULE		
				Z0022800
SHEET	STATION	NOITATZ	OFFSET	FÉNCE REMOVAL
				F00T
4	50+20.01	50+20.47	RT	42
4	49+89.10	50+62.00	LΤ	128
4	49+98.08	50+21.79	LΤ	127
4	49+98.71	50+22.01	LT	25
4	50+20.98	50+43.11	LT	23
			TOTALS	345

-	USER NAME = \$USER\$	DESIGNED	-	ACW	REVISED -
4		DRAWN	-	SRS	REVISED -
	PLOT SCALE = #SCALE#	CHECKED	_	ACW	REVISED -
	PLOT DATE = \$DATE\$	DATE	-	06-30-2017	REVISED -
					

DEMOLITION PLANS	F.A.U. SECTION COUNTY TOTAL SHEETS NO.
GENERAL NOTES, COMMITMENTS	8024 15-HSRTS-03-RR SANGAMON 14 2
AND SCHEDULE OF QUANTITIES	CONTRACT NO. 93640
SCALE: NONE SHEET 1 OF 1 SHEETS STA. TO STA.	ILLINOIS FED. AID PROJECT

	SUMMARY OF QUANTITIES (DEMOLITION	PLANS)	CONSTRUCTION CODE ROADWAY 294299H
CODE		-	TOTAL	100% HSR PPS #6-10791-0000
NO.	ITEM	UNIT	QUANTITY	0004
44000200	DRIVEWAY PAVEMENT REMOVAL	SO YD	284	284
44000600	SIDEWALK REMOVAL	SO FT	369	369
Z0007601	BUILDING REMOVAL NO. 1	L SUM	1	1
Z0007602	BUILDING REMOVAL NO. 2	L SUM	1	1
Z0007603	BUILDING REMOVAL NO. 3	L SUM	1	1
Z0007604	BUILDING REMOVAL NO. 4	L SUM	1	1
Z0022800	FENCE REMOVAL	FOOT	345	345
Z0048665	RAILROAD PROTECTIVE LIABILITY INSURANCE	L SUM	1	1
Z0049801	REMOVAL AND DISPOSAL OF FRIABLE ASBESTOS, BUILDING NO. 1	L SUM	1	1
Z0049802	REMOVAL AND DISPOSAL OF FRIABLE ASBESTOS, BUILDING NO. 2	L SUM	1	1
Z0049803	REMOVAL AND DISPOSAL OF FRIABLE ASBESTOS, BUILDING NO. 3	L SUM	1	1
Z0049804	REMOVAL AND DISPOSAL OF FRIABLE ASBESTOS, BUILDING NO. 4	L SUM	1	1
Z0049901	REMOVAL AND DISPOSAL OF NON-FRIABLE ASBESTOS, BUILDING NO. 1	L SUM	1	1
Z0049902	REMOVAL AND DISPOSAL OF NON-FRIABLE ASBESTOS, BUILDING NO. 2	L SUM	1	1
Z0049903	REMOVAL AND DISPOSAL OF NON-FRIABLE ASBESTOS, BUILDING NO. 3	L SUM	1	1
Z0049904	REMOVAL AND DISPOSAL OF NON-FRIABLE ASBESTOS, BUILDING NO. 4	L SUM	1	1

* = SPECIALTY ITEM

_	USER NAME = SUSERS	DESIGNED	_	ACW	REVISED -
ı		DRAWN	-	SRS	REVISED -
ı	PLOT SCALE = \$SCALE\$	CHECKED	-	ACW W	REVISED -
	PLOT DATE = *DATE*	DATE	-	06-30-2017	REVISED -

	S	_			FION I		-
SCALE: NONE	SHEET	1	OF	2	SHEETS	STA.	

	RTE.	SECTION	COUNTY	SHEETS	N
	8024	15-HSRTS-03-RR	 SANGAMON	14	3
_	1		CONTRACT	NO. 9	364
		THE THOSE FEE	 O PROJECT		

SUMMARY OF QUANTITIES (STATION RENOVATION PLANS)							
ITEM	UNIT	TOTAL QUANTITY	100% HSR PPS #6-10791-0000				
N PARKING LOT COMPLETE	L SUM	1	1				
N TOILET COMPLETE	L SUM	1	1				
_		ITEM UNIT ON PARKING LOT COMPLETE L SUM	ITEM UNIT OUANTITY ON PARKING LOT COMPLETE L SUM 1				


* = SPECIALTY ITEM

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USER NAME = SUSER#	DESIGNED	-	ACW	REVISED	-
	DRAWN	-	SRS	REVISED	-
PLOT SCALE = \$SCALE\$	CHECKED	-	ACW	REVISED	-
PLOT DATE = *DATE*	DATE	-	06-30-2017	REVISED	-


	SI	_			TION F OF QU	LANS ANTITIES	
SCALE: NONE	SHEET	2	OF	2	SHEETS	STA.	TO STA

TE.	SECTION	COUNTY	TOTAL	NO.
024	15-HSRTS-03-RR	SANGAMON	14	3A
		CONTRACT	NO. 9	3640
	ILLINOIS FED. A	ID PROJECT		

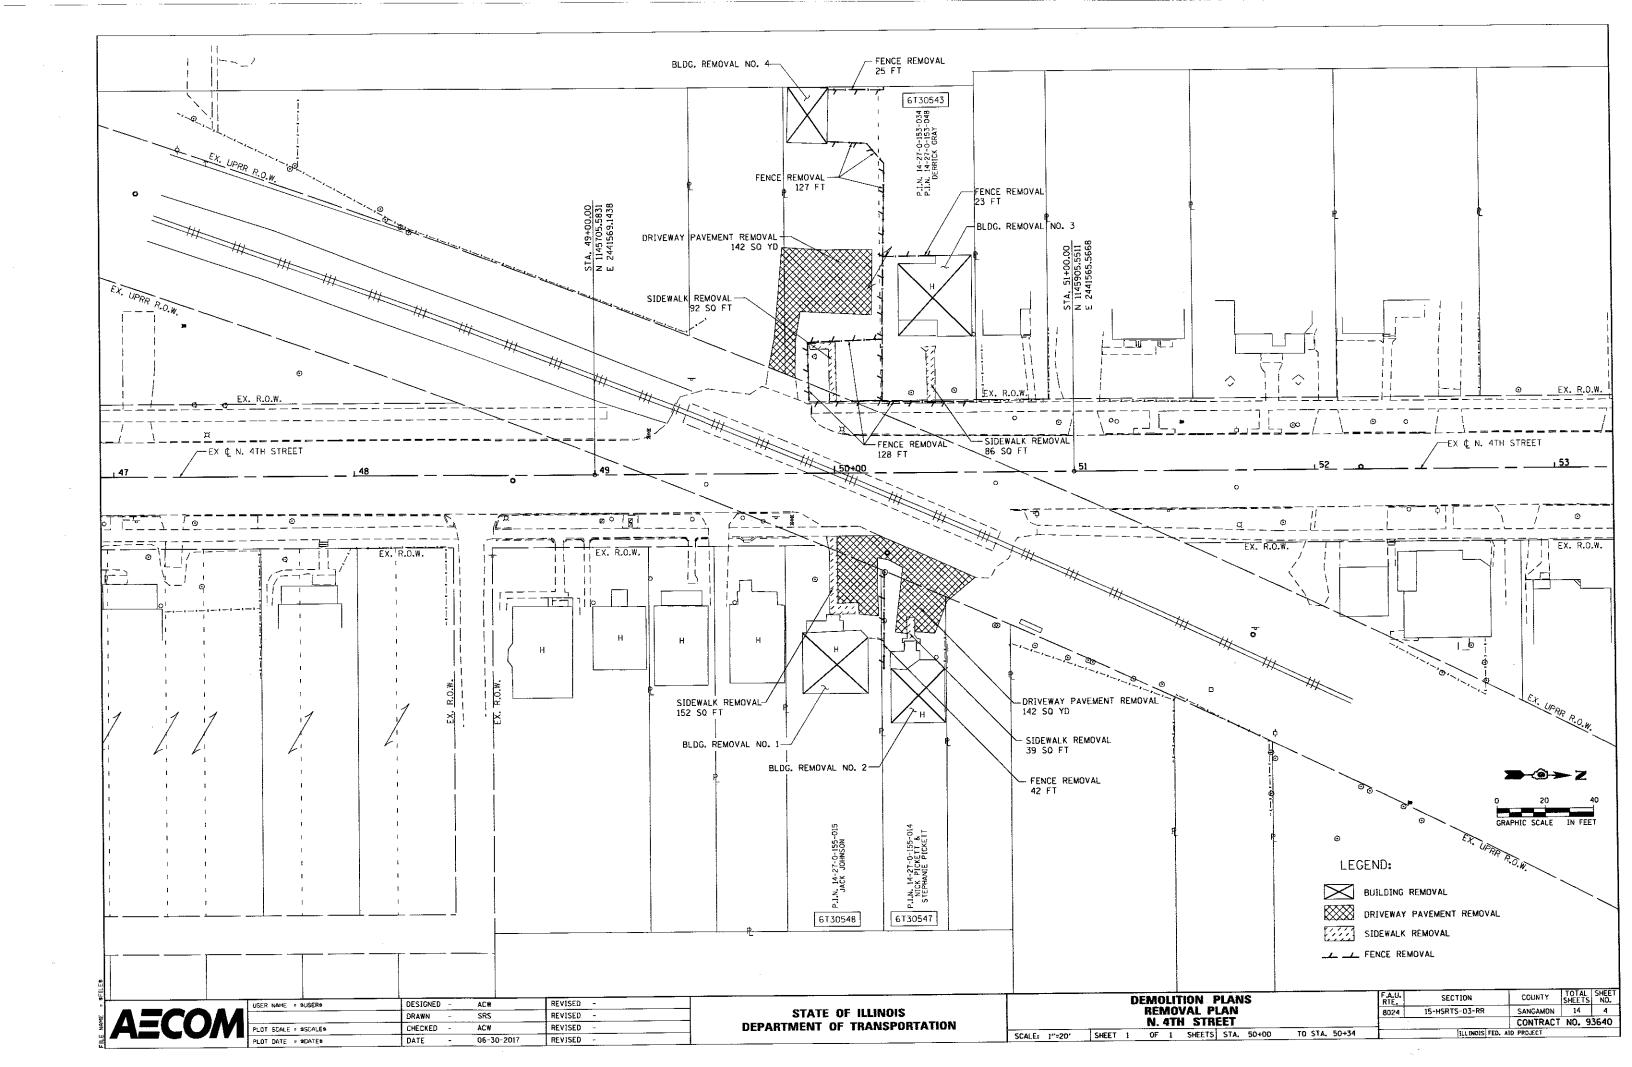

SPRINGFIELD STATION RENOVATION **100 SOUTH 3RD STREET SPRINGFIELD, IL 62701**



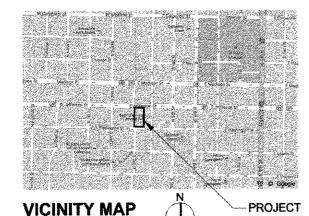

HOST RAILROAD INFORMATION

HOST RAILROAD: TRACK SUBDIVISION: UNION PACIFIC RAILROAD (UPRR) SPRINGFIELD

AMTRAK STATION CLASS.: SPI

BUILDING CODE INFORMATION

APPLICABLE BUILDING CODES - CITY OF SPRINGFIELD, ILLINOIS

ICC INTERNATIONAL BURDING CODE (2012 ED)
ICC INTERNATIONAL EXISTING BURDING CODE (2012 ED)
ICC INTERNATIONAL FIRE CODE (2012 ED)
INSTIGNAL ELECTRIC CODE (2011 ED)
INCL INTERNATIONAL INCOMENCIAL CODE (2012 ED)
ICC INTERNATIONAL MECHANICAL CODE (2012 ED)
ICC INTERNATIONAL MECHANICAL CODE (2012 ED)
ICC INTERNATIONAL FUEL, CAS CODE (2012 ED)
ICC INTERNATIONAL ELECTRIC CODE (2012 ED)
ICL INTERNATIONAL ELECTRIC CONSERVATION CODE (ECC) (2012 ED)
ILI NICIS PLUMBING CODE (2010 ED)
ILI NICIS ACCESSIBLITY CODE (ACCESSIBLE DESIGN
ILLINOIS ACCESSIBLITY CODE (ACCESSIBLE TANDE)
INFA 101 LIES SAFETY CODE
INFA 101 LIES SAFETY CODE
INFA 101 LIES SAFETY CODE

PROJECT CONTACTS

ARCHITECT:



MULLER & MULLER, LTD. 700 N. SANGAMON ST. CHICAGO, IL 60622 312.432.4180 FAX 312.432.4184

DATE

SIGNED JACOB J. MULLER, AIA

LICENSE: 010214 EXPIRES: 11/30/2017

CIVIL:



WSP USA 211 N. BROADWAY, SUITE 2800 ST. LOUIS, MO 63102 314.206.4200

LICENSE: 062.064748 EXPIRES: 11/30/2017

JUNE 2, 2017

ISSUED FOR CONSTRUCTION

MULLER MULLER

700 N SANGAMON CHICAGO, IL 50642

115]

Suite 2800 St. Louis, MO 58102

CHISL HIGH-SPEED RAIL **SPRINGFIELD STATION** RENOVATION

T: 314,206,4444 F: 314,421,1741 www.wsp.com

100 SOUTH 3RD STREET SPRINGFIELD, ILLINOIS



Illinois Department of Transportation



ILLINOIS HIGH-SPEED RAIL



EXPIRES 11/30/2017

DRAWING INDEX

GENERAL G1.0 COVER SHEET G1.1 GENERAL NOTES

ABBREVIATIONS AND LEGENDS

ABBREVIATIONS SYMBOLS AND NOTES **EXISTING CONDITIONS PLAN** C1.00

DEMOLITION PLAN OVERALL SITE PLAN C1.02

SITE DETAILS

ARCHITECTURAL
A1.1 FIRST FLOOR DEMOLITION PLAN

A1.2 FIRST FLOOR PLAN

1 06/02/17 ISSUED FOR CONSTRUCTION NO DATE ISSUED FOR

COVER SHEET

W SHEET NO. G1.0 JOB NO. 14-1011



USER NAME = SUSERS	DESIGNED	-		REVISED	-
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PLOT SCALE = \$SCALE\$	CHECKED	-		REVISED	-
PLOT DATE : *DATE*	DATE	-	06-30-2017	REVISED	-

SHEET 1 OF 10 SHEETS STA.

SCALE: NONE

GENERAL NOTES - SCOPE

THE PROJECT GENERALLY CONSISTS OF THE RENOVATION OF AN EXISTING AMTRAK TRAIN STATION IN SPRINGFIELD, ILLINOIS. THE EXISTING TWO STORY 5,159 SQUARE FOOT BRICK CLAD STATION BURDING WITH BASEMENT, BURT IN 1985, WILL RECEIVE LIMITED INTERIOR UPGRADES WHICH WALL BE CONFINED TO THE PUBLIC RESTROOMS, PORTIONS OF THE EXISTING STATION PARKING JOLACENT TO THE NORTH AND SOUTH SIDES OF THE STATION BUILDING ENTRANCE WILL BE RE-STRIPED TO PROVIDE TWO (2) ADDITIONAL ADA PARKING STALLS.

GENERAL NOTES- PERMIT

- THE CONTRACTOR WILL PERFORM ALL WORK IN ACCORDANCE WITH THE CURRENT BUILDING CODE AND ALL APPLICABLE COUNTY, STATE, AND FEDERAL LAWS, CODIES, ORDINANCES, AND REQULATIONS BY THE CITY OF SPRINGRIELD AND MUNICIPAL AUTHORITIES HAVING JURISDICTION, INCLUDING THE OCCUPATIONAL SAFETY AND HEALTH ACT (OSHA) AND REGULATIONS ADOPTED PURSUANT THERETO, STATE OF ILLINOIS ACCESSIBILITY STANDANDS AND ADA GUIDELINES.
- THE GENERAL CONTRACTOR IS RESPONSIBLE FOR APPLYING, PROCURING, AND PAYING FOR ALL PERMITS AND INSPECTIONS REQUIRED TO COMPLETE THE SCOPE OF WORK UNLESS NOTED OTHERWISE.
- ANSI A-10.6 "SAFETY REQUIREMENTS FOR DEMOLITION" WILL GOVERN EXCEPT AS OTHERWISE MODIFIED HEREIN. WHERE THE REQUIREMENTS SPECIFIED HEREIN OR CONTAINED IN THE ANSI STANDARD DIFFER FROM OTHER APPLICABLE RULES, REGULATIONS, AND CODES, THE MORE STRINGENT REQUIREMENTS SHALL GOVERN THE WORK UNDER THIS CONTRACT.
- 4. PROVIDE ADEQUATE FIRE PROTECTION IN ACCORDANCE WITH THE CITY FIRE DEPARTMENT REQUIREMENTS.
- PRIOR TO STARTING CONSTRUCTION THE GENERAL CONTRACTOR SHALL BE RESPONSIBLE TO VERIFY THAT ALL REQUIRED PERMITS AND APPROVALS HAVE BEEN OBTAINED. NEITHER CONSTRUCTION NOR FABRICATION OF ANY ITEM SHALL BEGIN UNTIL THE CONTRACTOR HAS PRIOR TO STARTING CORSTRUTION THE GENERAL CONTROLOG STALL BE RESPONSED TO YEAR! THAT THE REGULATOR FEMAL APPROVALS FAVE BEEN OBTAINED, NEITHER CONSTRUCTION NOR FABRICATION OF ANY TEMS HALL BEEN UNTIL THE CONTRACTOR HAS RECEIVED ALL PLANS AND ANY OTHER APPROVALS FROM GOVERNMENTAL AGENCIES OR OTHER REGULATORY AUTHORITIES HAVING JURISDICTION OVER THE PROJECT, FALLURE OF THE CONTRACTOR TO FOLLOW THIS PROJECULAR SHALL CAUSE THE CONTRACTOR TO ASSUME FULL RESPONSIBILITY FOR ANY SUBSEQUENT MODIFICATION OF THE WORK MANDATED BY REGULATORY AUTHORITY.
- 6. ALL INTERIOR FINISHES TO BE AT LEAST CLASS 1 FLAME SPREAD RATING OF 0-25.7.

GENERAL NOTES-BIDDING

- CONTRACTOR SHALL VISIT THE SITE AND FULLY REVIEW CONDITIONS AND QUANTITIES OF THIS BUILDING AND SITE PRIOR TO SUBMISSION OF PRICING PROPOSAL TO GAIN FULL KNOWLEDGE OF THE DEMOLITION REQUIREMENTS. CONTRACTOR SHALL INVESTIGATE, VERIEY, AND BE RESPONSIBLE FOR ALL CONDITIONS OF THE PROJECT AND SHALL NOTIFY THE OWNER OF ANY DOTTONIS REQUIREMS MODIFICATION. ALL DEMOLITION FOR THE PROJECT, INCLUDING REQUIRED PERMITS, IS UNDER THIS CHANGE ORDER CONTRACT MODIFICATION.
- TO THE BEST OF THE OWNER'S KNOWLEDGE THESE DRAWINGS REPRESENT THE EXISTING CONDITIONS OF THE BUILDING AND SITE AS OF THE DATE OF ISSUED FOR CONSTRUCTION, BUILDING ELEMENTS TO BE DEMOLISHED OR REJACYED ARE DIAGRAMMATICALLY SHOWN, EXACT LOCATIONS, SIZES, EXTENT, AND CONDITIONS OF EXISTING CONSTRUCTION TO BE DEMOLISHED MOVED, RELOCATED, OR TO REMAIN SHALL BE VERRIFED AT THE BUILDING SITE BY THE CONTRACTOR, CONTRACTOR TO REPORT DISCREPANCIES IN WRITING PRIOR TO SUBMISSION OF
- RAILROAD OPERATIONS WILL REMAIN FUNCTIONAL AT ALL TIMES, 24 HOURS A DAY, 7 DAYS A WEEK UNLESS NOTED OTHERWISE. STATION AND PLATFORM ARE TO REMAIN IN OPERATION DURING HOURS OF SERVICE OPERATION. CONTRACTOR TO COORDINATE WITH AMTRAK.
- NOTES APPEAR ON VARIOUS SHEETS FOR DIFFERENT SYSTEMS AND MATERIALS, NOTES ON ANY ONE SHEET ARE TO BE APPLIED TO RELATED DRAWINGS AND DETAILS. WHEN THERE ARE DISCREPANCIES BETWEEN DRAWINGS AND SPECIFICATIONS, CONSULT THE OWNER DURING THE PRICING PERIOD FOR ANY CLARIFICATIONS NEEDED PRIOR TO SUBMISSION OF PRICING PROPOSAL IF THE OWNER IS NOT CONSULTED DURING RICING PERIOD, THE MORE STRINGENT REQUIREMENT SHALL APPLY.
- THE SUBMISSION OF A PRICING PROPOSAL WILL BE CONSTRUED AS EVIDENCE THAT THE CONTRACTOR HAS FAMILIARIZED HIMSELF WITH ALL CONSTRUCTION DOCUMENTS AND EXISTING CONDITIONS OF THE CONSTRUCTION STEL. CLAMS MADE SUBSEQUENT TO THE PROPOSAL FOR MATERIALS AND LABOR BECAUSE OF DIFFICULTIES ENCOUNTERED WILL NOT BE RECOGNIZED IT THEY COULD HAVE BEEN FORESEEN HAD PROPER EXAMINATION OF THE SITE AND/OR CONSTRUCTION DOCUMENTS BEEN MADE.

GENERAL NOTES - DEMOLITION

- DEMOLISH ALL ITEMS NOTED AND IN SCOPE OF WORK NOTES, CONTRACTOR IS RESPONSIBLE FOR COMPLETE REMOVAL OF ALL ITEMS AS INDICATED IN THE CONSTRUCTION DOCUMENTS.
- 2. ITEMS OF CONSTRUCTION SHOWN AND NOTED TO BE REMOVED SHALL REPRESENT SANILAR CONDITIONS AND CONSTRUCTION UNLESS NOTED
- PROVIDE, ERECT, AND MAINTAIN TEMPORARY WORK INCLUDING, BUT NOT LIMITED TO BARRICADES, WARNING SIGNS, ETC. AS REQUIRED FOR PROPER PROTECTION OF THE PUBLIC AND PROPERTY DURING REMOVAL OPERATIONS.
- 4. CONTRACTOR MUST NOTIFY THE OWNER IN WRITING OF ANY DISCREPANCIES ON THE DRAWINGS OR THE UNCOVERING OF HIDDEN
- 5. NO BURNING OF MATERIAL ON THE PREMISES WILL BE PERMITTED.
- 5. UPON COMPLETION OF REMOVAL WORK, REMOVE ALL TOOLS, MATERIALS, APPARATUS, AND RUBBISH OF ANY SORT, THE JOB SITE MUST BE
- LIGHTING, GRAPHICS, COMMUNICATIONS, SIGNAL, AND FIBER OPTICS SYSTEMS MUST BE MAINTAINED DURING CONSTRUCTION EITHER BY USING ORIGINAL, TEMPORARY, OR NEW SYSTEMS.
- 8. SALVAGED ITEMS REQUESTED BY THE OWNER MUST BE CAREFULLY REMOVED, KEPT FREE OF DAMAGE, AND DELIVERED TO THE DESIGNATED STORAGE AREA, MATERIALS AND/OR ITEMS REMOVED AND NOT DESIGNATED TO BECOME THE PROPERTY OF THE OWNER WILL BECOME PROPERTY OF THE CONTRACTOR AND REMOVED FROM SITE,
- 9, ANY EXISTING COMPONENT REMOVED OR DAMAGED TO ALLOW WORK TO OCCUR MUST BE REINSTALLED OR REPLACED AT THE COMPLETION
- REMOVE ALL EXISTING MECHANICAL PLUMBING, AND ELECTRICAL SYSTEMS NOT UTBIZED IN THE NEW CONSTRUCTION. REMOVED UTBIJIES
 MUST BE REMOVED TO THE SOURCE AND CAPPED AS REQUIRED BY CODE.
- 11. DO NOT CUT INTO, REMOVE, OR ALTER ANY EXISTING STRUCTURAL MEMBER OR PORTION OF THE FLOOR SYSTEM UNLESS NOTED OTHERWISE
- 12. SUBMIT WRITTEN REQUEST TO OWNER IN ADVANCE OF CUTTING OR ALTERING ELEMENTS WHICH AFFECT:

 6. STRUCTURAL INTEGRITY OF ELEMENT

 6. INTEGRITY OF WEATHER-EXPOSED OR MOISTURE-RESISTANT ELEMENTS.
- 13. CONTRACTOR SHALL SAWOUT SIDEWALKS IN A CLEAN AND STRAIGHT MANNER AT THE LIMITS OF THE DESIGNATED REMOVAL.
- 14. CONTRACTOR SHALL SAWCUT ALL MASONRY WALLS, CONCRETE FLOORS, AND CONCRETE WALLS IN A CLEAN AND STRAIGHT MANNER, AT THE LIMITS OF THE DESIGNATED REMOVAL.
- 15. REMOVE DEBRIS AND ABANDONED ITEMS FROM THE CONSTRUCTION AREA ON A DAILY SASIS.
- 16. CONTRACTOR(S) SHALL VISIT THE SITE AND BE KNOWLEDGEABLE OF ALL CONDITIONS THEREON, CONTRACTOR(S) SHALL INVESTIGATE, VERIFY, AND BE RESPONSIBLE FOR ALL CONDITIONS OF THE PROJECT AND SHALL NOTIFY THE OWNER OF ANY CONDITIONS REQUIRING MODIFICATION BEFORE PROCEEDING WITH THE WORK.
- 17. CONTRACTOR SHALL BE RESPONSIBLE FOR PROTECTION OF EXISTING CONSTRUCTION TO REMAIN, ANY WORK DAMAGED FOR ANY REASON SHALL BE REPLACED AT NO COST TO THE OWNER.
- CONTRACTOR TO PERFORM DEMOLITION SCOPE OF WORK AS REQUIRED TO COMPLETE NEW CONSTRUCTION. COORDINATE ARCHITECTURAL DEMOLITION WITH CIVIL. AND PLUMBING DEMOLITION SCOPE OF WORK.
- 19. ALL ITEMS OF DEMOLITION NOT INDICATED TO BE SAVED SHALL BE REMOVED IN THEIR ENTIRETY INCLUDING ALL ASSOCIATED MACHINERY, FRAMING, ANCHORS, HOUSING, ETC. AND BE DISPOSED OF ON A DAILY BASIS TO AVOID ACCUMULATION OF ANY DEBRIS ON THE SITE.

GENERAL NOTES - CONSTRUCTION

- CONTRACTOR WILL BE SOLELY RESPONSIBLE FOR QUALITY CONTROL, CONSTRUCTION MEANS, METHODS, TECHNIQUES, SEQUENCES, PHASING OR PROCEDURES, SAFETY PRECAUTIONS, AND PROGRAMS IN CONNECTION WITH THE WORK.
- THE OWNER WILL NOT BE RESPONSIBLE FOR NOR WELL HAVE ANY CONTROL OVER OR CHARGE OF CONSTRUCTION MEANS, METHODS, TECHNIQUES, SEQUENCES, PHASING, OR PROCEDURES OF SAFETY PRECAUTIONS AND PROGRAMS I CONNECTION WITH THE WORK, NOR WILL BE RESPONSIBLE FOR THE CONTRACTORS FALLURE TO CARRY OUT THE WORK IN ACCORDANCE WITH THE REQUIREMENTS OF THE CONTRACT DOCUMENTS. THE OWNER WILL NOT BE RESPONSIBLE FOR OR NAVE CONTROL OR CHARGE OVER THE ERRORS OR OMBSISONS OF THE CONTRACTOR, SUBCONTRACTORS, THEIR AGENTS, EMPLOYEES, OR ANY OTHER PERSON PERFORMING ANY OF THE WORK.
- 3. ALL DIMENSIONS ARE FACE OF PARTITIONS, COLUMN CENTERLINE, OR FINISHED FACE OF EXTERIOR WALL UNLESS
- 4. CONTRACTOR SHALL PROVIDE PROOF TO OWNER THAT ADEQUATE LIABILITY INSURANCE HAS BEEN OBTAINED.
- CONTRACTOR TO REMOVE ANY GRAFFITI WITHIN 24 HOURS DURING CONSTRUCTION
- THE DWINER EXPRESSLY DISCLAIMS ANY RESPONSIBILITY ARISING FROM ANY UNAUTHORIZED USE OF THESE CONTRACT DOCUMENTS, ANY AUTHORIZATION MUST BE IN WRITING. THE CONTRACT DRAWINGS MAY HAVE BEEN REPRODUCED AT A SIZE DIFFERENT THAN ORIGINALLY DRAWN.
- THE CONTRACTOR MUST BE RESPONSIBLE FOR COORDINATION WITH THE UPRR REGARDING ALL NEW AND/OR REMEDIAL CONSTRUCTION INCLUDING BUT NOT LIMITED TO SIGNAL WORK, COMMUNICATIONS, ETC. THAT THE UPRR MAY HAVE IN CONSTRUCTION INCLUDING BUT NOT LI PROGRESS WITHIN THE SAME PERIOD.
- CONTRACTOR SHALL REVIEW AND HAVE A COMPLETE COMMAND OF THE VARIOUS PHASES OF THE CONSTRUCTION WORK PLUS A TOTAL UNDERSTANDING OF THE UNDUE MANDOWER AND SUPPLY SCHEDULE REQUIREMENTS SPECIFIC TO THE SITE. CONTRACTOR MUST COORDINATE ALL CONSTRUCTION RELATED ACTIVITIES WITH TRAIN SCHEDULES, OPERATING REQUIREMENTS, AND ANY RESULTING HAZARDOUS CONDITIONS.
- CONTRACTOR MUST COORDINATE AND CONFIRM WITH AMTRAK AND UPRR THE HOURS OF CONSTRUCTION AND RAILWAY OPERATIONS FOR THE ENTIRE SCHEDULE OF THE WORK, SEE PHASING GENERAL NOTES.
- CONTRACTOR MUST BE RESPONSIBLE FOR SECURING THE JOB SITE AND THE PROTECTION OF THE GENERAL PUBLIC
- GENERAL CONTRACTOR AND/OR TRADE CONTRACTOR MUST PROTECT ALL EXISTING SITE ELEMENTS FROM DAMAGE DUE TO ALTERATIONS AND CONSTRUCTION OPERATIONS, AND REPAIR OR REPLACE ELEMENTS DAMAGED DURING THIS PROJECT AT CONTRACTOR(S) OWN EXPENSE.
- PROVIDE ACCESS PANELS AS REQUIRED BY APPLICABLE CODES AND AS REQUIRED FOR MECHANICAL AND ELECTRICAL
- ALL PIPES, CONDUITS, AND DUCTWORK THAT PENETRATE WALLS, FLOOR, OR ROOF SLABS SHALL BE INSTALLED IN A OR SLABS AND THE BUILDING. FIRESTOP ALL PENETRATIONS IN WALLS TO MATCH HOURLY RATING OF WALL
- DRAWINGS THAT REPRESENT THE EXISTING PLAN CONDITIONS ARE DIAGRAMMATICALLY SHOWN. EXACT LOCATIONS SIZES EXTENT AND CONDITIONS OF EXISTING CONSTRUCTION TO BE REMOVED, RELOCATED, OR TO REMAIN SHALL BE ON THE BUILDING SITE BY THE CONTRACTOR AND INCLUDED IN THE WORK SCOPE AND BID.
- 15. ALL GYPSUM BOARD TO BE 5/8' TYPE 'X' UNLESS NOTED OTHERWISE. IN DAMP AREAS, MOISTURE AND MOLD RESISTAN GYPSUM BOARD SHALL BE USED IN LIEU OF REGULAR GYPSUM BOARD, IN WET AREAS CEMENTITIOUS BACKER UNITS.
- 16. ALL EXISTING AREAS DAMAGED BY WORK OF THIS PROJECT SHALL BE PATCHED TO MATCH EXISTING ADJACENT FACES IN FINISH, COLOR, AND TEXTURE UNLESS OTHERWISE INDICATED.
- ALL EXISTING PAINTED SURFACES DAMAGED OR PATCHED AS PART OF THIS PROJECT SHALL BE PAINTED TO MATCH EXISTING ADJACENT COLOR, TEXTURE, AND FINISH, EXISTING PAINT COLOR, TEXTURE, AND FINISH SHALL BE VERIFIED BY CONTRACTOR IN THE FIELD PRIOR TO CONSTRUCTION.
- 18. ALL EXISTING FLOOR SURFACES DAMAGED OR PATCHED AS PART OF THIS PROJECT SHALL BE PATCHED TO MATCH EXISTING ADJACENT COLOR, TEXTURE, AND FINISH. EXISTING FLOOR FINISH SHALL BE VERIFIED AND DOCUMENTED BY CONTRACTOR IN THE FIELD PRIOR TO CONSTRUCTION.
- 19. ANY DETAILS, SYSTEMS, OR MATERIALS (LE. ARCHITECTURAL, STRUCTURAL, MECHANICAL, ETC.) WHICH ARE PROPOSED TO BE CHANGED OR SUBSTITUTED MUST SE FIRST REVIEWED AND APPROVED BY THE OWNER PRIOR TO THE PREPARATION AND SUBMITTAL OF SHOP DRAWINGS. THE OWNER RESERVES THE RIGHT TO REJECT SUBSTITUTIONS, THE CONTRACTOR IS RESPONSIBLE FOR ADDED JOB COSTS DUE TO HIS SUBSTITUTIONS IMPACTED ON OTHER TRADES.
- 20. THE CONTRACTOR MUST BE RESPONSIBLE FOR PROVIDING ALL REQUIRED BLOCKING, SUPPORTS, AND BRACING REQUIRED TO ACHIEVE SPECIFIED REQUIREMENTS AND STANDARDS WHETHER SPECIFICALLY INDICATED OR NOT. FIRE RETARDANT BLOCKING MUST BE PROVIDED.
- 21. ALL DISSIMILAR METALS MUST BE EFFECTIVELY ISOLATED FROM EACH OTHER TO AVOID GALVANIC ACTION.
- 22. REFER TO THE TECHNICAL SPECIFICATIONS FOR ADDITIONAL INFORMATION AND COORDINATION OF THE WORK. IN THE EVENT OF DISCREPANCIES BETWEEN DRAWINGS OR DRAWINGS AND SPECIFICATIONS, THE MOST STRINGENT OR COSTLY SHALL BE PROVIDED PER CONTRACT.
- 23. THE CONTRACTOR MUST ASSURE ITSELF BY INDEPENDENT SURVEY THAT NO HAZARDOUS MATERIALS ARE HANDLED OR DISTRIBUTED. IF HAZARDOUS MATERIALS ARE ENCOUNTERED, IT MUST BE BROUGHT TO THE IMMEDIATE ATTENTION OF
- THE CONTRACTOR MUST BE RESPONSIBLE FOR COORDINATION WITH WORK NOTED "(N.I.C.)", IF ANY, WHICH IS BEING PERFORMED UNDER SEPARATE CONTRACT WHERE IT INTERFACES WITH OR AFFECTS WORK UNDER THIS CONTRACT.
- DRAWINGS ARE TO BE ISSUED TO THE SUSCONTRACTORS BY THE CONTRACTOR IN COMPLETE SETS SO THAT THE EXTENT AND COORDINATION OF WORK IS MADE POSSIBLE.
- 26. THE CONTRACTOR MUST BE SOLELY RESPONSIBLE FOR THE ACCURATE PLACEMENT AND CONDITIONS OF THE WORK,
- 27. CONTRACTOR TO BALANCE SYSTEM FOR ADEQUATE AIR DISTRIBUTION WITHIN ALL CONDITIONED AREAS
- 28. GENERAL CONTRACTOR TO PROVIDE TWO FINAL CLEANINGS AT THE DIRECTION OF THE TENANT OWNER.

GENERAL NOTES - PHASING

- DUMPSTER PLACEMENT LOCATIONS MUST BE APPROVED BY THE OWNER.
- GENERAL CONTRACTOR'S PRIMARY RESPONSIBILITY IN ALL PHASES OF THE PROJECT IS SAFETY, THE RESPONSIBILITY FOR SAFETY INCLUDES THE PATRONS AND EMPLOYEES OF THE RAILROAD, CONTRACTOR'S EMPLOYEES AND ANY PERSON(S) WHO MAY ENTER UPON OR BE PROXIMATE TO THE WORK AREA, WHETHER OR NOT WORK IS IN PROGRESS.
- CONTRACTOR'S WORK MUST NOT INTERFERE WITH UPRR OR AMTRAK OPERATIONS.
- DEMOLITION AND CONSTRUCTION SHALL BE PHASED TO ALLOW FOR CONTINUOUS USE OF THE STATION WAITING ROOM, PUBLIC RESTROOMS, PLATFORM, AND SITE THROUGHOUT THE COMPLETE SCOPE OF WORK, CONTRACTOR MUST COMPLETE ON HALF OF THE PARKING LOT WORK AT AT TIME TO ENSURE ADA ACCESSIBLE PARKING AND ADA ACCESS TO THE STATION BUILDING AT ALL TIMES.
- GENERAL CONTRACTOR WILL BE ALLOWED TO STORE MATERIALS AND EQUIPMENT ONLY IN AREAS APPROVED BY THE CHYNER AND IN ACCORDANCE WITH THE CONTRACT DOCUMENTS.
- CONTRACTOR MUST PROVIDE GRAPHIC SIGNS WARNING THE PUBLIC OF HAZARDOUS AREAS AND EXIT
- ALL UNFINISHED WORK MUST BE PROPERLY SECURED IN PLACE AND PRESENT NO DANGER TO AMTRAK PATRONS, PERSONREL AND EQUIPMENT. AT COMPLETION OF EACH WORK PERIOD, CONTRACTOR SHALL REMOVE AND DET PLACE INTO THE STORAGE AREA ALL CONSTRUCTION EQUIPMENT, MATERIALS, DERRIS AND CLEAR THE AREA FOR RAILROAD OPERATIONS, IF CONTRACTOR USES ANY PARTIALLY OR COMPLETELY FINISHED WORK AGEA FOR STORAGE, CAME SHALL BE TAKEN TO AVOID DAMAGE TO SUCH WORK. ANY DAMAGE WILL BE REPAIRED OR REPLACED AT THE CONTRACTOR'S EXPENSE.
- CONTRACTOR MUST PROVIDE TOLLET FACILITIES FOR HIS OWN WORKERS, TOLLETS IN THE BUILDING MUST NOT BE USED BY THE CONTRACTOR.

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CHISL **HIGH-SPEED RAIL SPRINGFIELD** STATION RENOVATION

100 SOUTH 3RD STREET SPRINGFIELD, ILLINOIS







EXPIRES 11/30/2017

06/02/17 ISSUED FOR CONSTRUCTION NO DATE ISSUED FOR SHEET TITLE

W SHEET NO. MV CHECKED: PPROVED:

GENERAL NOTES

G1.1 JOB NO. 14-1011 COUNTY


SHEET 2 OF 10 SHEETS STA.

SCALE: NONE


ARCHITECTURAL ABBREVIATIONS

	AMERICANS WITH	GC	GENERAL CONTRACTOR	₽Ļ	PLATE
ADA	DISABLITIES ACT	GFCMU	GROUND FACE CONCRETE	PLRG	PLASTIC PLUMBING
\FF	ABOVE FINISHED FLOOR		MASONRY UNIT		
CT	ACOUSTICAL TILE	GFI	GROUND FAULT INTERRUPTER	PLSTR	PLASTER
ICM	ASBESTOS CONTAINING MATERIAL	GL	GLASS, GLAZING	PLYWD	PLYWOOD
NDJ	ADJACENT	GLCMU	GLAZED CONCRETE	PORC	PORCELAIN TILE
VC	AIR CONDITIONING		MASONRY UNIT	PR	PAIR
VLUM	ALUMINUM	GYP	GYPSUM	PREFAB	PREFABRICATE(D)
APPROX	APPROXIMATE(LY)	GWB	GYPSUM WALL BOARD	PT	POINT
TENDA	AF FROAIRINGE!			PTD	PAINTED
·	BEAM	нв	HOSE BIB	PVC	POLYVINYL CHLORIDE
		HBG	HIGH BARRIER GATE	PVMT	PAVEMENT
STWN	BETWEEN	HC	HOLLOW CORE		
9 I T	BITUMINOUS	HDWD	HARDWOOD	OT	QUARRY TILE
BLKG	BLOCKING		HEIGHT	•	
3/	BOTTOM OF	HGT HM	HOLLOW METAL		
BLDG	BUILDING			R	RISER
		HORIZ	HORIZONTAL.	RD	ROOF DRAIN
		H₽	HIGH FORVT	REF	REFERENCE:
CAB	CABINET	HDRW	HARDWARE	REINF	REINFORCE(D)(ING)
CI	CAST IRON	HW	HOT WATER	REQ'D	REQUIRED
OPP C	CAST IN PLACE	HWH	HOT WATER HEATER	RET	RETURN
28	CATCH BASIN			RH	RIGHT HAND
CLG	CEILING	ID:	INSIDE DIAMETER	RM	ROOM
ω.	CONTROL JOINT	IN	INCH(ES)	RO	ROUGH OPENING
	CENTERLINE	NO	INCLUDE(D)(ING)	NO	NOOGII OF LIGHT
e ST	CERAMIC TILE	INFO	INFORMATION		
CLOS	CLOSET	INSLE.	INSULATION	SAN	SANITARY
CLR		INT	INTERIOR, INTERNAL	SCHED	SCHEDULE
	CLEAR(ANCE)	••••	2	SCMD	SOLID CORE WOOD DOOR
CMU CO	CONCRETE MASONRY UNIT	ic.	JANITOR'S CLOSET	SCONC	SEALED CONCRETE
	CLEAN OUT	JST	JOIST	SD	SITE DRAIN
COL	COLUMN	11	JOINT	SFCMU	SPLIT FACE CONCRETE
CONC	CONCRETE	4.	your!		MASONRY UNIT
CONST	CONSTRUCTION	160	e/Error area Mana	SGFT	STRUCTURAL GLAZED
CONT	CONTINUOUS	KS	KITCHEN SINK		FACING TILE
CORR	CORRIDOR			SH	SHOWER
CPT	CARPET	LAM	LAMINATE(D)	SHT	SHEET
CRS	COURSE(\$)	LAV	LAVATORY	SIM	SIMILAR
CW	COLD WATER	LBP	LEAD-BASED PAINT	SQ	SQUARE
		LB(S)	POUND(S)	STGT	STRUCTURAL GLAZED TILE
co	CLEAN OUT	LF	LINEAR FEET	STL	STEEL
		ᄖ	LEFT HAND	ST STL	STAINLESS STEEL
AEC	DIAMETER	LLH	LONG LEG HORIZONTAL	SUSP	SUSPENDED
DIM	DIMENSION	LLV	LONG LEG VERTICAL	Suar	SUSPERIOED
DBI.	DOUBLE	LP.	LOW POINT	т	TREAD
DN	DOWN	£TL	LINTEL.	T/	TOP OF
DF	DRINKING FOUNTAIN				TOP AND BOTTOM
DWG	DRAWING	MAT	MATERIAL(S)	T&B	
J#15	LACTURES	MAX	MAXIMUM	T&G	TONGUE AND GROOVE
EA		MECH	MECHANICA)	TD	TRENCH DRAIN
	EACH	MEP	MECHANICAL, ELECTRICAL	TEL	TELEPHONE
EJ.	EXPANSION JOINT	.,,_	PLUMBING	TERR	TERRAZZO
EL.	ELEVATION	MEZZ	MEZZANINE	TYP	TYPICAL
ELEC	ELECTRICAL	MFR	MANUFACTURE(R)(D)		
ENCL.	ENCLOSURE	MH:	MANHOLE	LINEX	UNEXCAVATED
EC	END CABINET	MON	MINIMUM	UNFIN	UNFINISHED
ENTR	ENTRANCE	MISC	MISCELLANEOUS	UNO	UNLESS NOTED OTHERWISE
EQ	EQUAL	MO	MASONRY OPENING	UR	URINAL
EQPT	EQUIPMENT	MTO	MOUNTED	UR	United.
	ELECTRIC WATER COOLER	MTG	MOUNTING		I STATE MARKET
E₩C			METAL	VB	VINYL BASE
EXH EXH	EXHAUST			VCT	VINYL COMPOSITION TILE
	EXHAUST EXISTING	MTL.	~~ ~		
EXH		MTL MWK	MILLWORK	VERT	VERTICAL
EXH EXIST EXP	EXISTING EXPOSED	MWK	MILLWORK	VERT VIF	VERTICAL VERIFY IN FIELD
EXH EXIST EXP EXT	EXISTING EXPOSED EXTERIOR	MWK	MILLWORK NOT IN CONTRACT	VERT	VERTICAL
EXH EXIST EXP EXT EP	EXISTING EXPOSED EXTERIOR EPOXY PAINT	MWK NEC NO	MILLWORK NOT IN CONTRACT NUMBER	VERT VIF VTR	VERTICAL VERIFY IN FIELD VENT THROUGH ROOF
EXH EXIST EXP EXT	EXISTING EXPOSED EXTERIOR	MWK NIC NO NOM	MELWORK NOT IN CONTRACT NUMBER NOMINAL	VERT VIF VTR	VERTICAL VERIFY IN FIELD VENT THROUGH ROOF WITH
EXH EXIST EXP EXT EP ETR	EXISTING EXPOSED EXTERIOR EPOXY PAINT EXISTING TO REMAIN	MWK NEC NO	MILLWORK NOT IN CONTRACT NUMBER	VERT VIF VTR	VERTICAL VERIFY IN FIELD VENT THROUGH ROOF
EXH EXIST EXP EXT EP ETR	EXISTING EXPOSED EXTENDOR EPOXY PAINT EXISTING TO REMAIN FLOOR DRAIN	MWK NIC NO NOM	MELWORK NOT IN CONTRACT NUMBER NOMINAL	VERT VIF VTR	VERTICAL VERIFY IN FIELD VENT THROUGH ROOF WITH
EXH EXIST EXP EXT EP ETR	EXISTING EXPOSED EXPOSED EXPOSED EXPOSED EXPOSED EXPOSED EXPOSED EXPOSED FOUNDATION	MWK NIC NO NOM	MELWORK NOT IN CONTRACT NUMBER NOMINAL	VERT VIF VTR W/ WC	VERTICAL VERIFY IN FIELD VENT THROUGH ROOF WITH WATER CLOSET
EXH EXIST EXP EXT EP ETR FO FON FIN	EXISTING EXPOSED EXTERIOR EPOXY PAINT EXISTING TO REMAIN FLOOR DRAIN FOUNDATION FINISH(ED)	MWK NEC NO NOM NTS	MELWORK NOT IN CONTRACT NUMBER NOMINAL NOT TO SCALE	VERT VIF VTR W/ WC WD WH	VERTICAL VERFY IN FIELD VENT THROUGH ROOF WITH WATER CLOSET WOOD WALL HUNG
EXH EXIST EXP EXT EP ETR FO FON FIN FF	EXISTING EXPOSED EXTERIOR EPOXY PAINT EXISTING TO REMAIN FLOOR DRAIN FOURDATION FINISH(ED) FINISHED FLOOR	MWK NEC NO NOM NTS	MILLWORK NOT IN CONTRACT NUMBER NOMINAL NOT TO SCALE ON CENTER	VERT VIF VTR W/ WC WD	VERTICAL VERITY IN FIELD VENT THROUGH ROOF WITH WATER CLOSET WOOD WALL HUNG WIRE MESSH
EXH EXIST EXP EXT EP ETR FO FON FIN FF	EXISTING EXPOSED EXTERIOR EPOXY PAINT EXISTING TO REMAIN FLOOR DRAIN FOUNDATION FINISHED FLOOR FLOOR	MWK NEC NO NOM NTS	MILLWORK NOT IN CONTRACT NUMBER NOMINAL NOT TO SCALE ON CENTER	VERT VIF VTR W/ WC WD WH WM WM	VERTICAL VERRY IN FIELD VENT THROUGH ROOF WITH WATER CLOSET WOOD WALL HUNG WIRE MESH WATERROOF(ING)
EXH EXIST EXP EXT EP ETR FO FON FFIN FF FLR FLLIOR	EXISTING EXPOSED EXTERIOR EPOXY PAINT EXISTING TO REMAIN FLOOR ORAIN FOUNDATION FINISH(ED) FINISHED FLOOR FLOOR FLOOR FLOOR	MWK NEC NO NOM NTS OC OD	MILLWORK NOT IN CONTRACT NUMBER NOMINAL NOT TO SCALS ON CENTER OUTSIDE DIAMETER OPENING	VERT VIF VTR W/ WC WD WH WM WP WPSC	VERTICAL VERIFY IN FIELD VENT THROUGH ROOF WITH WATER CLOSET WOOD WALL HUNG WIRE MESH WATERPROOF(ING) WATERPROOF SILL COCK
EXH EXIST EXP EXT EP FO FON FIN FF FF FLR FLUOR FT	EXISTING EXPOSED EXTERIOR EPOXY PAINT EXISTING TO REMAIN FLOOR DRAIN FOUNDATION PINISHED FINISHED FLOOR FLOOR FLOORSCENT FEET, FOOT	MVVX NEC NO NOM NTS OC OD OPING	MALWORK NOT IN CONTRACT NUMBER NOMINAL NOT TO SCALS ON CENTER OUTSIDE DIAMETER	VERT VIF VTR W/ WC WO WH WM WP WPSC WPT	VERTICAL VERIFY IN FIELD VENT THROUGH ROOF WITH WATER CLOSET WOOD WALL HUNG WINE MESH WATERPROOF (ING) WATERPROOF SILL COCK WORIGING POINT
EXH EXIST EXP EXT EXP EXT EXP FON FIN FF FLR FLLOOR FT FTG	EXISTING EXPOSED EXTERIOR EPOXY PAINT EXISTING TO REMAIN FOUNDATION FINISH(ED) FINISHED FLOOR FLOOR FLUORESCENT FEET, FOOT FOOTING	MWX NEC NO NOM NTS OC OD OPNG OH PD	MILLWORK NOT IN CONTRACT NUMBER NOMINAL NOT TO SCALE ON CENTER OUTSIDE DIAMETER OPENING OPPOSITE HAND PLANTER DRAIN	VERT VIF VIR W/ WC WD WH WM WP WPSC WPT WR	VERITCAL VERITY IN FIELD VERT THROUGH ROOF WITH WATER CLOSET WOOD WILL HUNG WINE MESH WATERPROOF(ING) WATERPROOF SILL COCK WORIGNG PORIT WATER RESISTANT
EXH EXIST EXP EXT EP FO FON FIN FF FF FLR FLUOR FT	EXISTING EXPOSED EXTERIOR EPOXY PAINT EXISTING TO REMAIN FLOOR DRAIN FOUNDATION PINISHED FINISHED FLOOR FLOOR FLOORSCENT FEET, FOOT	MVVX NEC NO NOM NTS OC OD OPING	MILLWORK NOT IN CONTRACT NUMBER NOMINAL NOT TO SCALE ON CENTER OUTSIDE DIAMETER OPENING OPPOSITE HAND	VERT VIF VTR W/ WC WO WH WM WP WPSC WPT	VERTICAL VERIFY IN FIELD VENT THROUGH ROOF WITH WATER CLOSET WOOD WALL HUNG WINE MESH WATERPROOF (ING) WATERPROOF SILL COCK WORIGING POINT

ARCHITECTURAL TARGET LEGEND

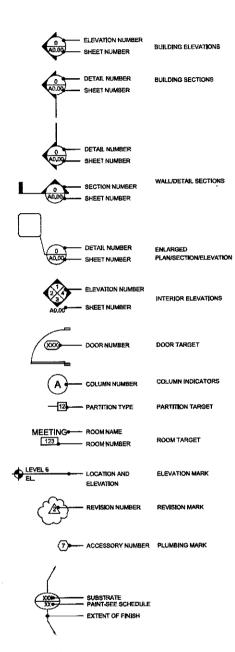

ARCHITECTURAL SYMBOL LEGEND

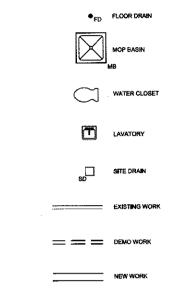

MULLER-MULLER

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CHISL
HIGH-SPEED RAIL
SPRINGFIELD
STATION
RENOVATION

100 SOUTH 3RD STREET SPRINGFIELD, ILLINOIS







EXPIRES 11/30/2017

1 08/02/17 ISSUED FOR CONSTRUCTION
NO DATE ISSUED FOR
SHEET TITLE

ABBREVIATIONS AND LEGENDS

DRAWN: VW SHEET NO.
CHECKED: MV
APPROVED: MV
JOB NO. 14-1011



	USER NAME = \$USER\$	DESIGNED	_		REVISED	*
ı		DRAWN	-		REVISED	-
	PLOT SCALE = \$SCALE\$	CHECKED			REVISED	-
•	PLOT DATE = *DATE*	DATE	-	06-30-2017	REVISED	-

GENERAL NOTES

- THE PROJECT LIMITS OF CONSTRUCTION AND PROPERTY LINES ARE SHOWN ON THE PLANS. UNLESS OTHERWISE INDICATED, THE LIMITS OF CONSTRUCTION GENERALLY CONSIST OF THE AREA BETWEEN THE EAST WASHINGTON STREET AND EAST JEFFERSON STREET RIGHTS—OF—WAY ON THE SOUTH AND NORTH SIDES OF THE SITE RESPECTIVELY, EIGHT FEET EAST OF THE STATION BIULDING TO THE FIRST PARKING LOT DRIVE
- 2. THE GENERAL CONTRACTOR SHALL COORDINATE ALL SITE RELATED OPERATIONS PERFORMED BY SUB-CONTRACTORS TO ACCOMPLISH THE WORK.
- THE CONTRACTOR IS ADVISED THAT WORK ON SEPARATE CONTRACTS MAY BE UNDERWAY IN THE VICINITY OF THIS PROJECT. THE CONTRACTOR SHALL COORDINATE WITH OTHER CONTRACTORS IN THE PHASING AND PERFORMANCE OF HIS WORK SO AS NOT TO DELAY, INTERRUPT OR HINDER THE PROGRESS OR COMPLETION INTERRUPT OR HINDER THE PROGRESS OR COMPLETION OF THE WORK BEING PERFORMED BY OTHER CONTRACTORS. NO ADDITIONAL COMPENSATION WILL BE ALLOWED FOR COMPLIANCE WITH THE ABOVE REQUIREMENTS NOR ANY DELAYS OR INCONVENIENCES RESULTING FROM THE ACTIVITIES OF OTHER CONTRACTORS.
- THE GENERAL CONTRACTOR IS RESPONSIBLE FOR APPLYING, PROCURING AND PAYING FOR ALL PERMITS AND INSPECTIONS REQUIRED TO COMPLETE THE SCOPE
- THE CONTRACTOR SHALL PROTECT ALL PROPERTY MARKERS AND MONUMENTS UNTIL THE OWNER AND AN AUTHORIZED SURVEYOR HAS REFERENCED THEIR
- 6. THE CONTRACTOR SHALL VERIFY ALL CONDITIONS AND DIMENSIONS IN THE FIELD PRIOR TO ORDERING MATERIALS AND BEGINNING THE WORK.
- THE CONTRACTOR SHALL DISPOSE OF ALL REMOVALS, SURPLUS, UNSTABLE AND/OR UNSUITABLE MATERIALS RESULTING FROM CONSTRUCTION, UNLESS OTHERWISE INDICATED, SUCH MATERIALS SHALL SE DISPOSED OF BY THE CONTRACTOR LEGALLY OFF-SITE AND AT THE
- 8. ALL PAVEMENT MILLINGS SHALL BE REMOVED FROM THE SITE AND TAKEN TO AN APPROVED MATERIAL RECYCLING
- THE CONTRACTOR SHALL REPORT ANY DISCREPANCIES FOUND WITH REGARD TO EXISTING CONDITIONS OR PROPOSED DESIGN IMMEDIATELY TO THE ENGINEER. THE CONTRACTOR SHALL NOT WILLFULLY PROCEED WITH CONSTRUCTION AS DESIGNED WHERE DISCREPANCIES EXIST. THE CONTRACTOR SHALL BE RESPONSIBLE FOR ALL REVISIONS TO THE WORK WHERE NO NOTICE WAS GIVEN TO THE ENGINEER.
- 10. THE PROJECT BOUNDARY, RIGHT-OF-WAY AND TOPOGRAPHIC SURVEY WAS COMPLETED BY MILHOUSE ENGINEERING AND CONSTRUCTION.
- 11. CONTRACTOR SHALL PROTECT EXISTING BUILDINGS AND IMPROVEMENTS TO REMAIN FROM DAMAGE DUE TO CONSTRUCTION ACTUTIES. DAMAGED ITEMS SHALL BE REPAIRED / REPLACED TO A CONDITION ACCEPTABLE TO THE ENGINEER, AT NO ADDITIONAL COST.
- 12. CONTRACTOR TO VERIFY LOCATIONS OF ALL UTILITY STRUCTURES, COVERS AND GRATES AFFECTED BY PROJECT BEFORE BIDDING THE WORK AND AGAIN BEFORE BEGINNING WORK.
- 1.3. THE CONTRACTOR SHALL REMOVE AND REPLACE, OR WORK AROUND ITEMS TO REMAIN WITHIN THE CONSTRUCTION LIMITS. NO ADDITIONAL COMPENSATION WILL BE PROVIDED FOR THIS WORK.
- 14. THE CONTRACTOR SHALL LEAVE AREAS OF CONSTRUCTION IN A CLEAN, NEAT AND SAFE CONDITION AT THE END OF EACH WORK DAY.
- 15. THE EXISTING BUILDING AND SITE SHALL REMAIN IN SERVICE AND OPEN TO THE PUBLIC DURING CONSTRUCTION. MAINTAIN SAFE PUBLIC ACCESS TO BUILDING ENTRANCES, PARKING AND PLATFORM AREAS. THE CONTRACTOR SHALL PHASE THE WORK

UNDERGROUND FACILITY LOCATIONS

- UNDERGROUND FACILITIES, STRUCTURES, AND UTILITIES HAVE BEEN PLOTTED FROM THE BEST AVAILABLE RECORDS, THEREFORE, THE RELATIONSHIP BETWEEN PROPOSED WORK AND EXISTING FACILITIES, STRUCTURES AND UTILITIES MUST BE CONSIDERED APPROXIMATE. IT IS THE CONTRACTOR'S RESPONSIBILITY TO DETERMINE THE EXACT LOCATION AND THE EXISTENCE OF ANY UTILITIES SHOWN OR NOT SHOWN, INCLUDING BUT NOT LIMITED TO UTILITY SERVICE BRANCHES TO PRIVATE PROPERTIES.
- 2. UTILITY INFORMATION REPRESENTS THE BEST INFORMATION AVAILABLE AND IS ONLY INCLUDED FOR THE CONVENIENCE OF THE BIDDER. THE CONTRACTOR SHALL TAKE THIS INTO CONSIDERATION WHEN PREPARING HIS/HER BID. NO ADDITIONAL COMPENSATION WILL BE ALLOWED FOR ANY DELAY OR OR INCONVENIENCE CAUSED BY THE UTILITY INFORMATION SHOWN OR NOT SHOWN.
- 3. THE CONTRACTOR SHALL CONTACT ALL UTILITY COMPANIES AND OBTAIN THE DEPTH AND LOCATION OF ALL UTILITIES PRIOR TO BEGINNING WORK.
- 4. THE CONTRACTOR SHALL NOTIFY ALL UTILITIES, BEFORE ANY EXCAVATION IS DONE ON THE PROJECT, AT LEAST TEN (10) WORKING DAYS PRIOR TO STARTING WORK. ANY DAMAGE TO EXISTING OR PROPOSED FACILITIES AND/OR UTILITIES SHALL BE REPAIRED OR REPLACED IMMEDIATELY AT THE CONTRACTORS SHOULD SHALL BE REPAIRED OR REPLACED IMMEDIATELY AT THE
- 5. ALL VALVES, MANHOLES, UTILITY COVERS AND BOXES WITHIN MODIFIED OR NEW PAVEMENT AREAS SHALL BE ADJUSTED TO MEET FLUSH WITH FINISH GRADE AND RE-ORIENTED. RE-ORIENT AND RELOCATE UTILITY BOXES PARALLEL TO SIDEWALK JOINTING OR ADJACENT PAVEMENT EDGES UNLESS OTHERWISE INDICATED ON THE DRAWINGS.
- 6. CONTRACTOR SHALL COORDINATE AND PAY FOR THE ADJUSTMENT TO FINISHED GRADE OF ALL UTILITY VAULT, VALVE, METER, HAND HOLE AND BOX FRAMES, CAPS, STONES, GRATINGS, LIDS, AND COVERS WITHIN THE WORK AREA UNLESS OTHERWISES INJURIED THE WORK SHALL BE CONSIDERED INCIDENTAL TO THE CONTRACT
- 7. CONTRACTOR TO FOLLOW UTILITY PROVIDER REQUIREMENTS FOR ADJUSTMENTS NOT COMPLETED BY UTILITY PROVIDERS.
- B. THE CONTRACTOR SHALL RECORD DIMENSION TO ALL UPLIFY LOCATIONS UNFARTHED DURING CONSTRUCTION AND PROVIDE THE PROPERTY OWNER A COPY OF THIS INFORMATION UPON COMPLETION OF THE PROJECT.

CONSTRUCTION NOTES

- CONTRACTOR TO STAKE OUT / MARK LOCATIONS OF IMPROVEMENTS FOR APPROVAL PRIOR TO STARTING CONSTRUCTION, MARKING/STAKING SHALL BE INCIDENTAL TO THE WORK.
- ALL DIMENSIONS ARE FROM CENTER OF STRUCTURES, FACE OF CURBS, CENTER OF TREES AND LIGHT FIXTURES, POINT OF TANGENCY / CURVATURE OR CORNER OF RAMP UNLESS OTHERWISE INDICATED.
- PROTECT AND CLEAN CONCRETE SPLATTER FROM PAYERS, POSTS AND OTHER FINISHED SURFACES WHILE FINISHING CONCRETE SURFACES.
- THE CONTRACTOR SHALL BE RESPONSIBLE FOR PROVIDING AND MAINTAINING EROSION AND SILTATION CONTROL, AS RECEDE, TO PREVENT DAMAGE OF OFFSITE PROPERTIES UNTIL THE PAVEMENT SURFACE HAS BEEN INSTALLED AND VEGETATION IS ESTABLISHED IN ALL DISTURBED AREAS, AT WHICH TIME THE CONTRACTOR SHALL REMOVE ALL EROSION CONTROL AND REPAIR ANY ERODED AREAS.
- 5. IF REQUESTED BY THE OWNER THE CONTRACTOR SHALL PROVIDE CERTIFICATION BY A LICENSED SURVEYOR THAT PROPOSED GRADES ARE IN CONFORMANCE WITH DESIGN ELEVATIONS.
- 6. SEE GENERAL PHASING NOTES ON G1.1 FOR CONSTRUCTION IMPLEMENTATION.

ABBREVIATIONS

AREA INLET
APPROXIMATE
ASPHALT
SALLED AND BURLAPPED
BOTTOM OF CURB
BILL DING APPROX. ASPH. B&B BC BLDG. CATV BUILDING
CABLE TV
CURB INLET
CONTROL JOINT
CLEAR, CLASS\
CLEAN OUT CONCRETE CONSTRUCTION JOINT DIAMETER EDGE OF PAVEMENT ELECTRIC BOX EXPANSION JOINT ELEC. ELEV. ESMT EQ. E.W. E.F. EASEMENT EACH FACE FINISH FLOOR FINISH GRADE FLOWLINE GAS GRATE INLET GROUNDING INSIDE DIAMETER IRON PIPE IRON ROD MAXIMUM MATCH EXISTING GRADE

GI GV GRD ID

FG FL G

MAX.
M.E.G.
MH.
NTS.
O.C.
PVMT
PB
PERM.
PERF.
PCC
PP
PVC
RAD.,R
RCP,
ROW, R/W MINIMUM NOT TO SCALE ON CENTER PAVEMENT

PULL BOX POLYETHYLENE, PERMANENT EASEMENT PERFORATED PORTLAND CEMENT CONCRETE

PORTLAND CEMENT CONCRETE
POWER POLE
POWER POLE
RADIUS
REDNEORCED CONCRETE PIPE
RIGHT-OF-WAY
SEWER
TOP OF CURB
TOP OF CURB
TOP BE REMOVED AND REPLACED
TYPICAL
UTILITY BOX
UNDERGROUND ELECTRIC
UNDERGROUND
UNDERGR

PROJECT CONTROL AND BENCHMARK DATA

△ POINT	NORTHING	EASTING	ELEVATION	DESCRIPTION	LOCATION
1	1142436.68	2441906.11	595.82	CUT CROSS	SW QUAD OF N. 5TH ST AND E. JEFFERSON ST. 4' NORTH OF THE BACK OF WALK
2	1142445.83	2441251.18	592.83	PK NAIL	SE QUAD OF RAILROAD CROSSING AND E. JEFFERSON ST. 4' NORTH OF GUARDRAIL
3	1142112.14	2441247.41	592.13	PK NAIL	NE QUAD OF RAILROAD CROSSING AND E. WASHINGTON ST. 3.5° SOUTH OF GUARDRAIL

BENCHMARKS:

NGS MONUMENT KB1001 ELEVATION 603.27'.

LOCATION: AT THE ILLINOIS CENTRAL RAILROAD STATION AT N 63H ST AND E MADISON ST. IN THE NORTH WALL, 8 FEET EAST OF THE BAGGAGE ROOM DOOR, 2 FEET WEST OF THE NORTHEAST CORNER OF THE BUILDING, AND ABOUT 4 FEET ABOVE THE TRACK, SET VERTICALLY

EXISTING CONCRETE SPOT GRADE FENCE -3-----GUARDRAIL POST / BOLLARD 3 TREE TREE STUMP BUSH O SIGN LIGHT POLE X POWER POLE -[]-FIRE HYDRAN 0 MANHOLE 0 DRAIN INLET (222) 25 SURVEY CONTROL MARK BRICK / UNIT PAVERS F/////// BUILDING

COMBINED STORM AND SANITARY SEWER ----- SS/ST-----

OVERHEAD COMCAST ----- CTV -----

NATURAL GAS ELECTRIC

FISER OPTIC TELEPHONE

EXISTING LEGEND

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T; 314.206.4444 F; 314.421.1741

T: 312.432.4180 F: 312.432.4184


CHISL HIGH-SPEED RAIL SPRINGFIELD STATION RENOVATION

MULLE**R**+MULLE**R**

100 NORTH 3RD STREET SPRINGFIELD, ILLINOIS





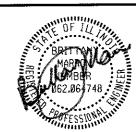

UTILITY CONTACTS

CONTRACTOR SHALL NOTIFY UTILITY AGENCIES AND UTILITY LOCATING COMPANY OF THE PROJECT AND CONSTRUCTION START DATE AT LEAST 10 DAYS PRIOR TO BEGINNING CONSTRUCTION TELEPHONE DATA / BROADBAND OTHER

UNION PACIFIC SIGNAL UNION PACIFIC FIBER OPTIC CITY WATER, LIGHT AND POWER (CWLP) MUNICIPAL CENTER EAST, 4TH FLOOR STATE OF ILLINOIS - CMS ' UP-FIBER (800) 336-9193 UP-SIGNAL (507) 329-1475 CITY OF SPRINGFIELD 300 S. SEVENTH STREET (847) 420-9115 (217) 785-7500 (618) 236-6281 (224) 229-3185 NOT A J.U.L.I.E. MEMBER NOT A J.U.L.I.E. MEMBER SPRINGFIELD, IL 62701 800 EAST MONROE SPRINGFIELD, IL 62757 (630) 573-5450 (217) 789-2255 ILLINOIS NETWORK ALLIANCE * * TWIGGS (314) 270-8738 (708) 955-6659 WINDSTREAM KDL, INC. * (800) 289-1901 (972) 729-6322

* MEMBER UTILITIES IN THE JOINT UTILITY LOCATING INFORMATION FOR EXCAVATORS (J.U.L.LE)

JULLE, WILL NOTIFY ALL UTILITY COMPANIES (BELONGING TO THE JULLIE, SYSTEM) THAT THEIR RESPECTIVE UTILITY SHOULD BE LOCATED. A MINIMUM OF 48-HOURS NOTICE IS REQUIRED. INFORMATION REQUIRED BY JULLIE, INCLUDES THE FOLLOWING:

COUNTY: SANGAMON

LOCATION: 100 N. 3RD ST., SPRINGFIELD, IL 62701


DESIGNED REVISED USER NAME = \$USER\$ STATION RENOVATION PLANS STATE OF ILLINOIS DRAWN REVISED **DEPARTMENT OF TRANSPORTATION** PLOT SCALE = #SCALE# CHECKED REVISED SCALE: NONE SHEET 4 OF 10 SHEETS STA. PLOT DATE = *DATE* DATE REVISED


ISSUED FOR CONSTRUCTION NO DATE ISSUED FOR SHEET TITLE


ABBREVIATIONS SYMBOLS AND NOTES


SHEET NO. HECKED HLM C0.01 PROVED WK OB NO. 10.07.1


SECTION COUNTY SANGAMON 14 8 8024 15-HSRT3-03-RR CONTRACT NO. 93640

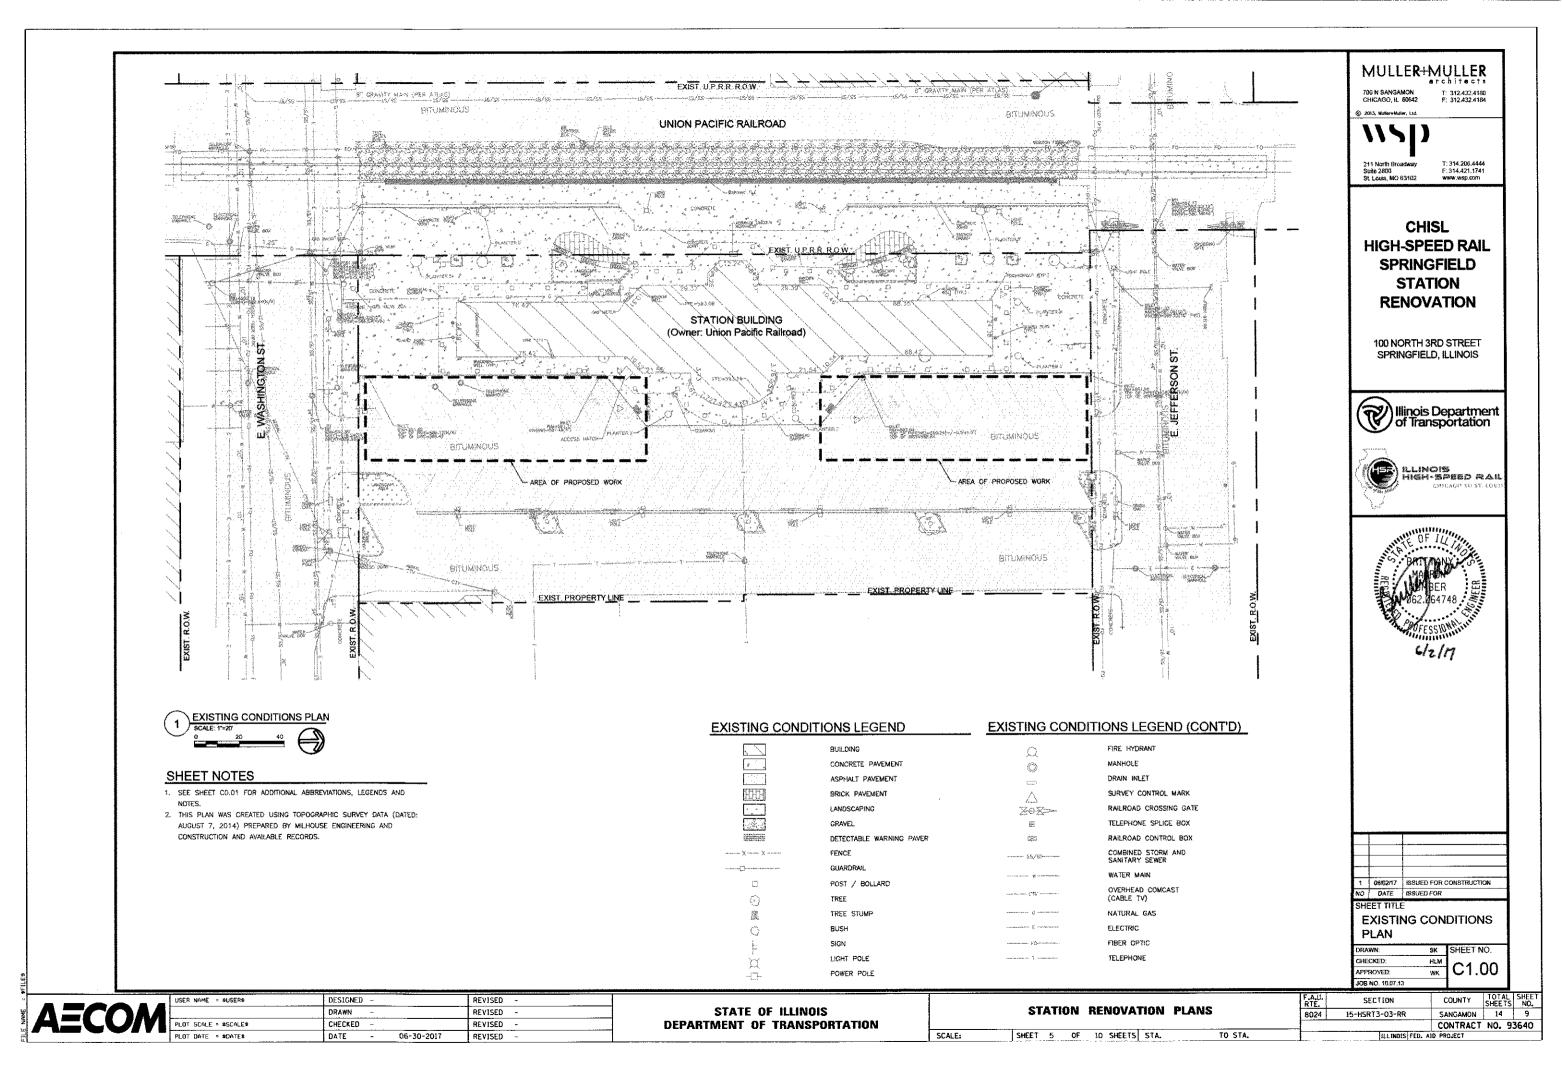

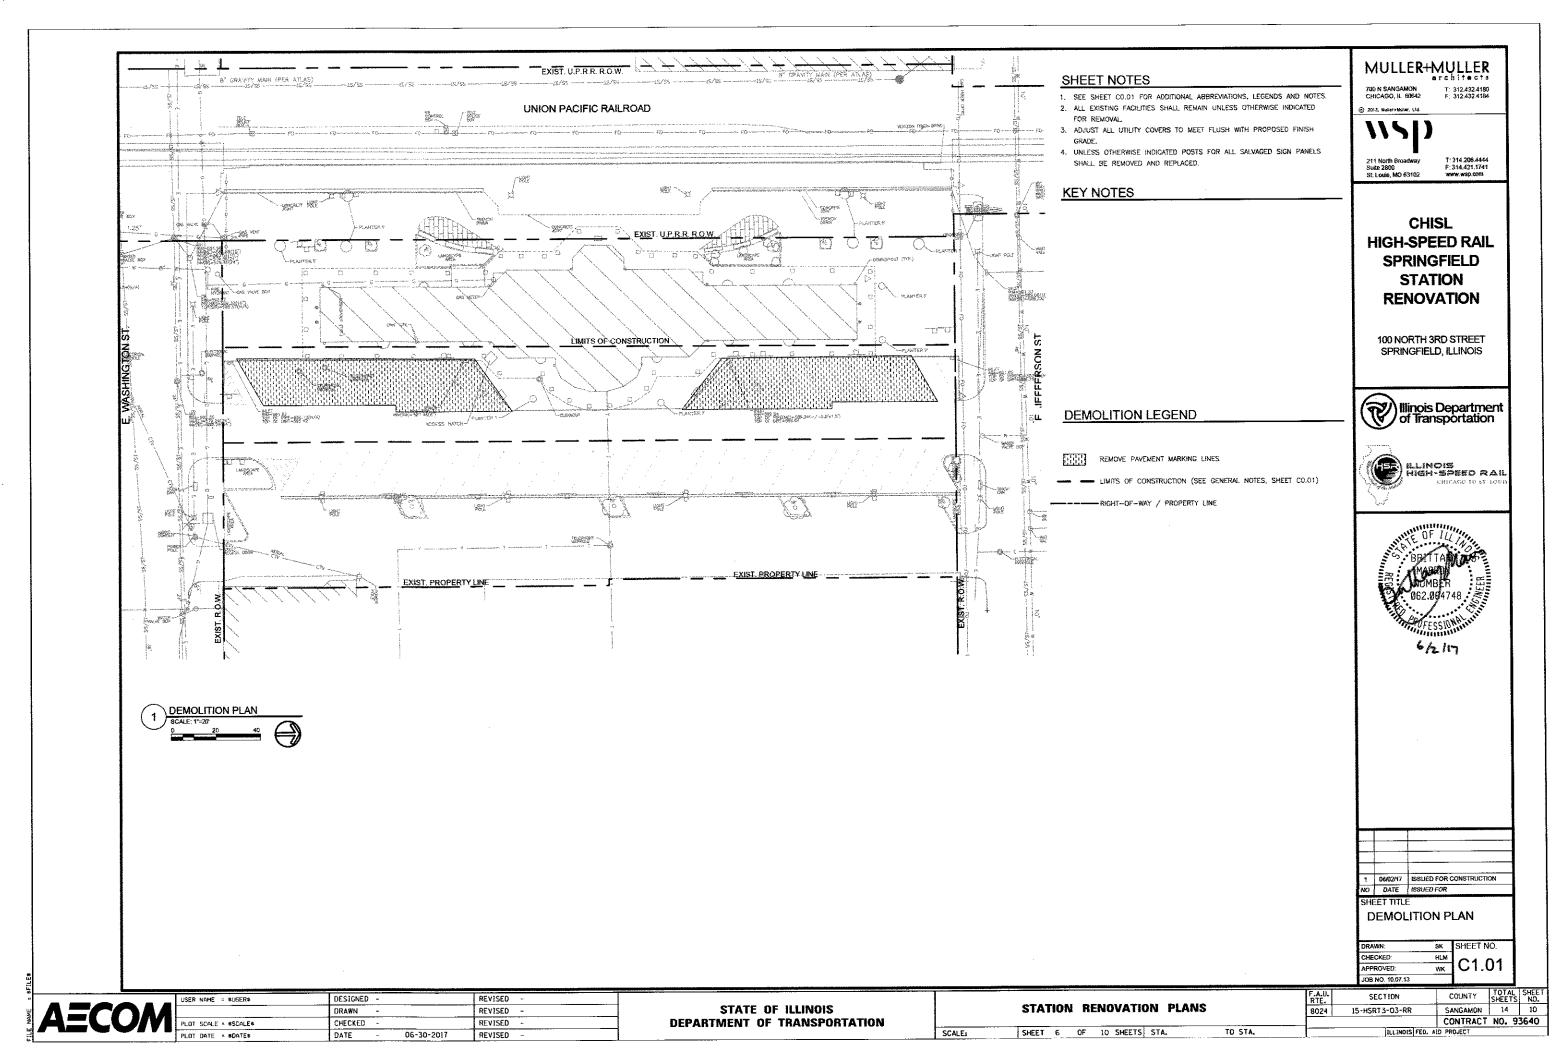


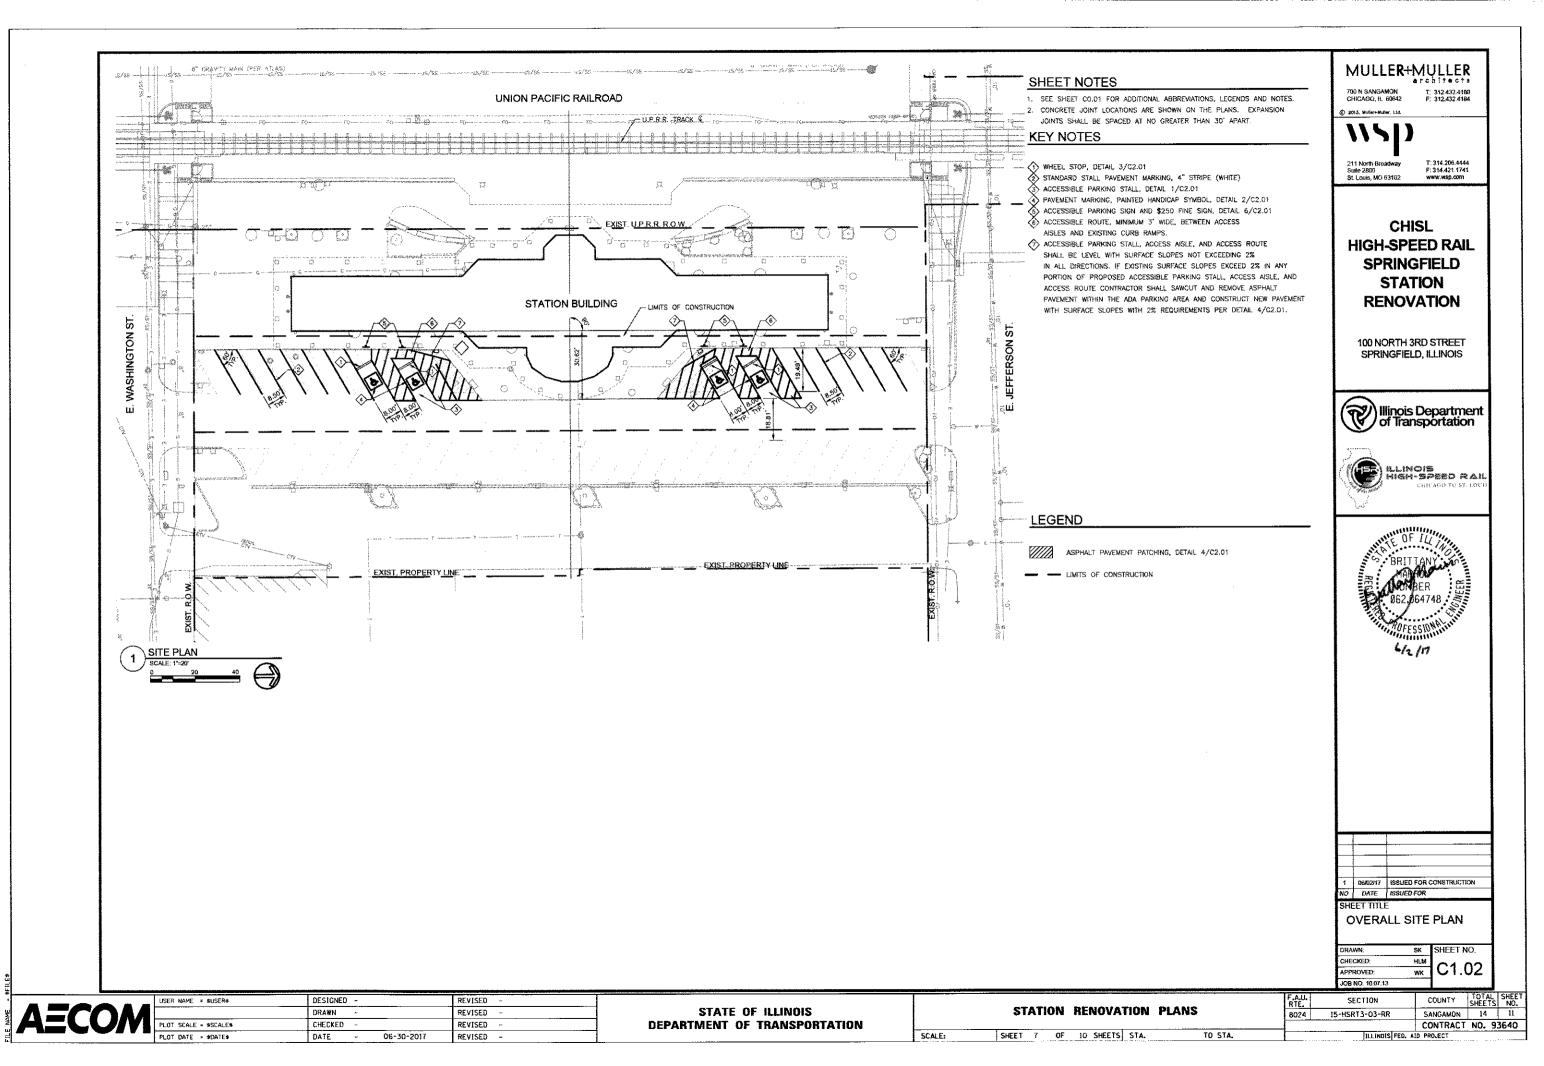

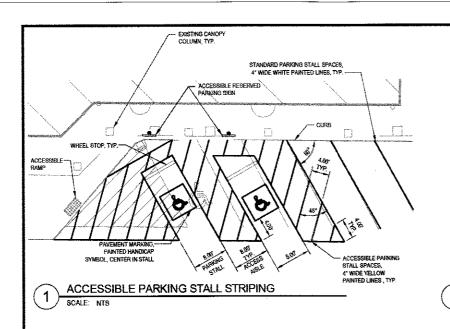

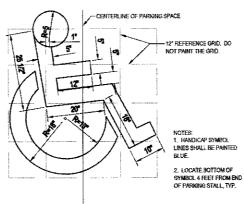

PAVEMENT MARKING, HANDICAP SYMBOL

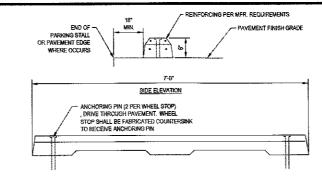


FRONT ELEVATION

NOTES:


1. CURB STOP BLOCK SHALL BE OFFSET FROM EDIGE OF THE PAYEMENT AS DETAILED AND ORIENTED PERPENDICULAR TO THE PARKING STALL STRING.

SCALE: 1" = 1'-0"

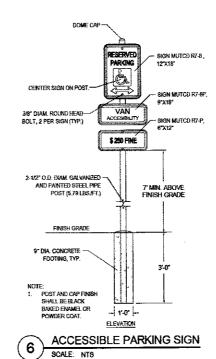

SCALE:

WHEEL STOP

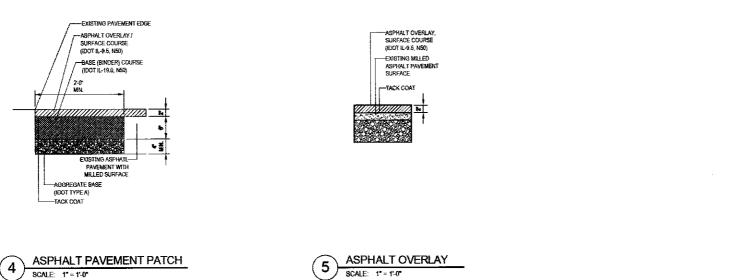

SCALE: 1" = 1'-0"

HMA MIXTURE REQUIREMENTS

MAXTURE USE	SURFACE	BINDER
PG	PG 64-22	PG 64-22
DESIGN AIR VOIDS	4.0% @ NSD	4.8% @ N50
MIX COMPOSITION	11-9.5	1L-19.0
FRICTION AGG.	MIXC	N/A
QUALITY MANAGEMENT	QC/QA	QC/QA
SUBLOT SIZE	N/A	N/A

NOTE: CONTRACTOR TO ASSUME A QUANTITY OF APPROXIMATELY 300s FOR HMA.

CHISL

T: 314.206.4444 F: 314.421.1741 www.wsp.com

MULLER+MULLER

700 N SANGAMON CHICAGO, IL \$0642

1151)


211 North Broadway Suite 2800 St. Louis, MO 63192

HIGH-SPEED RAIL SPRINGFIELD STATION RENOVATION

100 NORTH 3RD STREET SPRINGFIELD, ILLINOIS





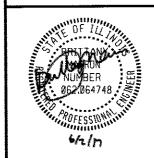

1	06/02/17	ISSUED FOR CONSTRUCTION		
NO	DATE	ISSUED FOR		
SHE	ET TITL	E		
SITE DETAILS				


DRAWN:	SHEET NO.
CHECKED:	
APPROVED:	U2.0
IOR NO 1007 13	


DESIGNED -REVISED REVISED DRAWN CHECKED REVISED DATE 06-30-2017 REVISED

STATE OF ILLINOIS **DEPARTMENT OF TRANSPORTATION**

STATION RENOVATION PLANS SHEET B OF 10 SHEETS STA.

COUNTY TOTAL SHEET SHEETS NO.
SANGAMON 14 12 SECTION 15-HSRT3-03-RR 8024 CONTRACT NO. 93640

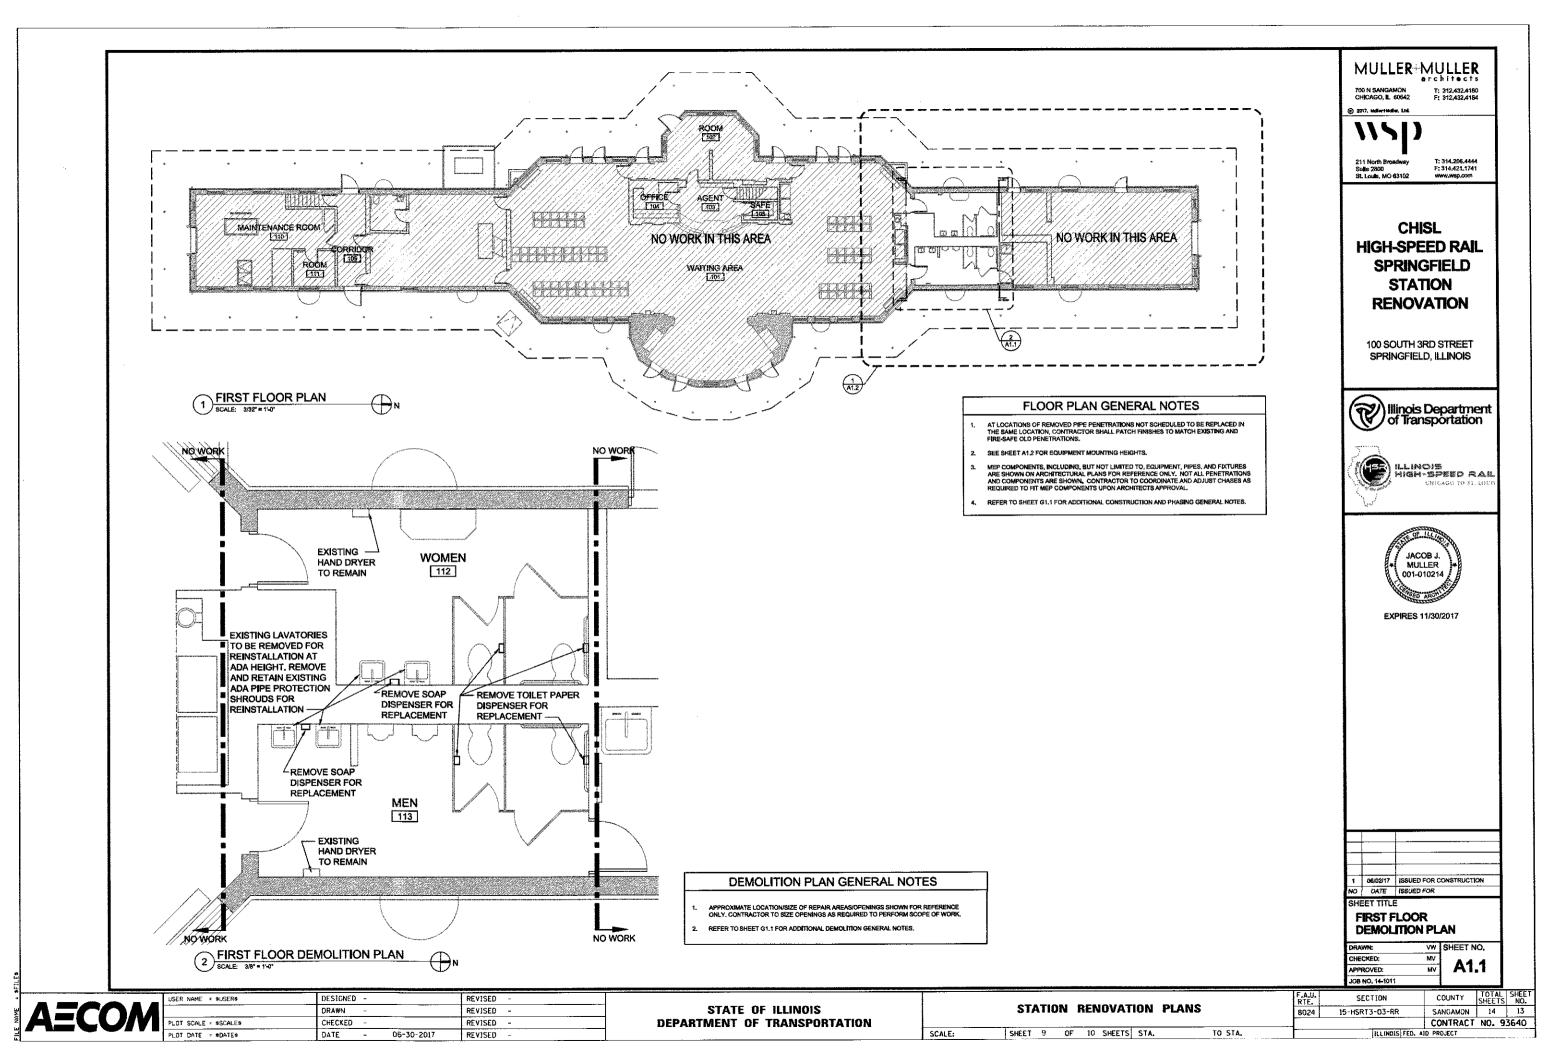

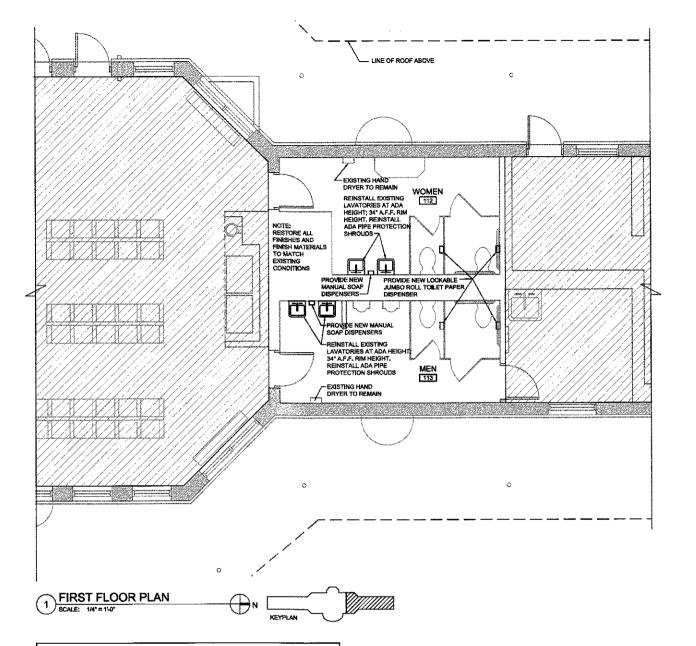

FLOOR PLAN GENERAL NOTES

- AT LOCATIONS OF REMOVED PIPE PENETRATIONS NOT SCHEDULED TO BE REPLACED IN THE SAME LOCATION, CONTRACTOR SHALL PATCH FINISHES TO MATCH EXISTING AND FIRE-SAFE OLD PENETRATIONS.
- 2. SEE SHEET A1.2 FOR EQUIPMENT MOUNTING HEIGHTS.
- MEP COMPONENTS, INCLUDING, BUT NOT LIMITED TO, EQUIPMENT, PIPES, AND FEXTURES ARE SHOWN ON ARCHITECTURAL PLANS FOR REFERENCE ONLY. NOT ALL PENETRATIONS AND COMPONENTS ARE SHOWN. CONTRACTOR TO COORDINATE AND ADJUST CHASES AS REQUIRED TO FIT MEP COMPONENTS UPON ARCHITECTS APPROVAL.
- REFER TO SHEET G1.1 FOR ADDITIONAL CONSTRUCTION AND PHASING GENERAL NOTES.

TOILET FIXTURES & ACCESSORIES KEYNOTE LEGEND

1 TOILET PAPER DISPENSER

MOUNT AT 47" A.F.F. MAX TO OUTLET AT ADA STALL MIN. 1 1/2" CLEAR BETWEEN GRAB BARS MOUNT AT 22" A.F.F. AT ALTERNATE STALL

2 LAVATORY

MOUNT AT 34" A.F.F. RIM HEIGHT KNEE SPACE: 27" A.F.F. BOTTOM OF APRONE 29" A.F.F.

(3) SOAP DISPENSER MOUNT AT 45" A.F.F. TO HIGHEST OPERABLE PART

TOILET ACCESSORIES SCHEDULE & MOUNTING HEIGHTS NOTES

- PROVIDE CONTINUOUS BLOCKING IN WALL AREAS FOR ALL GRAB BARS.
- 2. PER ANSI A117.1-2003 SECTION 604.7 REQUIREMENTS TOILET PAPER DISPENSER TO BE MOUNTED WITH OUTLET OF DISPENSER AT A MIN OF 15" AFF. MAINTAIN MIN. CLEARANCE 1 1/2" BELOW HORIZONTAL GRAB BAR.
- MINIMUM CLEARANCES MAINTAINED ARCLIND WATER CLOSETS PER ICCIANSI A117.1-2003 REQUIREMENTS.
- WHEN A DIMENSION ON A DRAWING IS GIVEN, THE CONSTRUCTION TOLERANCE ALLOWED IS + ½* TO ½* OF THE DIMENSION ON THE DRAWING.
- WHEN A RANGE IS GIVEN FOR A DIMENSION ON A DRAWING, THERE IS NO CONSTRUCTION TOLERANCE ALLOWED. THE ITEM MUST BE INSTALLED IN THE RANGE INDICATED,
- 6. CONTRACTOR TO PROVIDE SCHLUTER TOLLEX-EHK/-HKS* (OR APPROVED EQUAL) STAINLESS STEEL COVE TILE STRIPS AT BASE TRANSITIONS BETWEEN WALL AND FLOOR TILE IN RESTROOMS.
- NEW CONSTRUCTION, ALTERATIONS, AND REPLACEMENTS MUST COMPLY WITH THE DIMENSIONS ON THIS SHEET.

FEN. CLG TYPICAL ADA JUMBO ROLL TOILET PAPER DISPENSER MOUNTING SOAP DISPENSER LAVATORY

2 TYPICAL MOUNTING HEIGHTS
SCALE: 1/2"=11-0"

SCALE:

MULLER+**MULLER**

700 N SANGAMON CHICAGO, B. 80642

T: 312.432.4180 F: 312.432,4184



Sulte 2800 St. Louis, MO 63102

T: 314.206.4444 F: 314.421.1741 www.wsp.com

CHISL **HIGH-SPEED RAIL SPRINGFIELD STATION** RENOVATION

100 SOUTH 3RD STREET SPRINGFIELD, ILLINOIS







EXPIRES 11/30/2017

1 86/02/17 ISSUED FOR CONSTRUCTION NO DATE ISSUED FOR SHEET TITLE FIRST FLOOR PLAN

W SHEET NO. CHECKED: A1.2 APPROVED: JOB NO. 14-1011



USER NAME = SUSERS	DESIGNED -	REVISED -
	DRAWN -	REVISED -
PLOT SCALE * \$SCALE\$	CHECKED -	REVISED -
PLOT DATE = \$DATE\$	DATE - 06-30-2017	REVISED -

8024