09-22-2017 LETTING ITEM 005

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### STATE OF ILLINOIS **DEPARTMENT OF TRANSPORTATION**

**PROPOSED** 

**HIGHWAY PLANS** 

F.A.P. ROUTE 846 (US 52 /IL 53)

**OVER HICKORY CREEK** 

SECTION 99-4-B-I


BRIDGE DECK OVERLAY & JOINT REPAIR (SN 099-0083)

C-91-204-11

RANGE 10 E

WILL COUNTY
PROJECT NHPP-0846 (027)

#26+2= 28 total pages

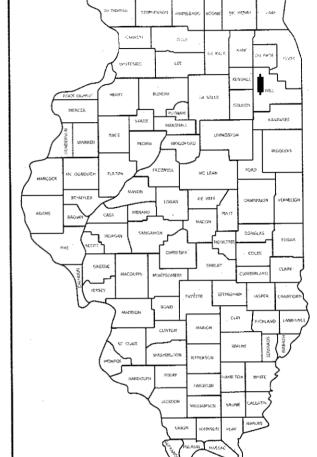

STATE OF ILLINOIS DEPARTMENT OF TRANSPORTATION

SUBMITTED JUNE 27 20 17

LOCATION OF SECTION INDICATED THUS: -

PRINTED BY THE AUTHORITY OF THE STATE OF ILLINOIS

## FOR INDEX OF SHEETS, SEE SHEET NO.

**EXISTING ADT** = 26,400 (2015)POSTED SPEED LIMIT = 40 MPH

THIS PROJECT IS LOCATED IN THE CITY OF JOLIET

> **PROPOSED IMPROVEMENT** . 4th Ave McKinley Park

> > GROSS LENGTH = 207.32 FT. = 0.039 MILE NET LENGTH = 207.32 FT. = 0.039 MILE

**JOLIET TOWNSHIP** 

ENGINEERING SCALES. REDUCED SIZED PLANS WILL NOT CONFORM TO STANDARD SCALES. IN MAKING MEASUREMENTS ON REDUCED PLANS, THE ABOVE SCALES MAY BE USED.

JOINT UTILITY LOCATION INFORMATION FOR EXCAVATION 1-800-892-0123

PROJECT ENGINEER JEAN ALAIN MIDY (847) 221-3056 PROJECT MANAGER ISSAM RAYYAN (847) 705-4178

CONTRACT NO. 60M98

#### INDEX OF SHEETS

	SHEET NO.	DESCRIPTION
	1	COVER SHEET
	2	INDEX OF SHEETS, STATE STANDARDS AND GENERAL NOTES
	3	SUMMARY OF QUANTITIES
	4	MAINTENANCE OF TRAFFIC STAGING SECTIONS
	5	STAGE 1 MAINTENANCE OF TRAFFIC
	6	STAGE 2 MAINTENANCE OF TRAFFIC
	7	PROPOSED PAVEMENT MARKINGS
	8-1 <b>9B</b>	STRUCTURE DRAWINGS
	20	BUTT JOINT AND HMA TAPER
	21	TRAFFIC CONTROL AND PROTECTION FOR SIDEROADS, INTERSECTIONS
		AND DRIVEWAYS
	22	TYPICAL APPLICATIONS RAISED REFLECTIVE PAVEMENT MARKERS (SNOW-PLOW
		RESISTANTI
	23	DISTRICT ONE TYPICAL PAVEMENT MARKINGS
	24	TRAFFIC CONTROL AND PROTECTION AT TURN BAYS (TO REMAIN OPEN TO TRAFFIC)
	25	PAVENENT MARKING LETTERS & SYMBOLS FOR TRAFFIC STAGING
	26	ARTERIAL ROAD INFORMATION SIGN
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#### STATE STANDARDS

#### STANDARD NO.

#### DESCRIPTION

782006	REFLECTOR MARKER AND MOUNTING DETAILS
701606-10	URBAN LANE CLOSURE MULTILANE, 2W WITH MOUNTABLE MEDIAN
701901-06	TRAFFIC CONTROL DEVICES
704001-08	TEMPORARY CONCRETE BARRIER
720001-01	SIGN PANEL MOUNTING DETAILS
720011-01	METAL POSTS FOR SIGNS, MARKERS AND DELINEATORS
729001-01	APPLICATIONS OF TYPE A AND B METAL POSTS (FOR SIGNS AND MA

#### GENERAL NOTES - ROADWAY

- BEFORE STARTING ANY EXCAVATION, THE CONTRACTOR SHALL CALL "J. U. L. [. E. " AT (800) 892-0123 FOR FIELD LOCATIONS OF SURIED ELECTRIC, TELEPHONE AND GAS UTILITIES. (48 HOUR NOTIFICATION IS REQUIRED.)
- THE CONTRACTOR SHALL COORDINATE CONSTRUCTION ACTIVITIES WITH BTILITY COMPANIES, AND THE LOCAL MUNICIPALITY.
- THE CONTRACTOR WILL NOT BE ALLOWED TO SET UP A YARD OR FIELD OFFICE ON STATE PROPERTY WITHOUT WRITTEN PERMISSION FROM THE DEPARTMENT.
- 4. ALL DAMAGE TO EXISTING PAVEMENT MARKING OR RAISED REFLECTIVE PAVEMENT MARKERS OUTSIDE THE REMOVAL LINE SHOWN ON THE PLANS SHALL BE REPLACED AT THE CONTRACTORS EXPENSE.
- WHEN MILLED PAVEMENT IS OPENED TO TRAFFIC THE MAXIMUM GRADE DIFFERENTIAL BETWEEN PASSES OF THE MILLING MACHINE SHALL NOT EXCEED 1 1/2 INCHES WHERE THE SPEED LIMIT IS 45 MPH OR LESS AND 1 INCH WHERE THE SPEED LIMIT IS GREATER THAN 45 MPH. WITH WRITTEN APPROVAL FROM THE ENGINEER, A MAXIMUM GRADE DIFFERENTIAL OF 3 INCHES MAY BE ALLOWED IF THE EDGE OF THE MILLING IS SLOPED A MINIMUM 1:3 (V: H).
- BUTT JOINTS WILL BE INSTALLED AT THE ENDS OF ALL RESURFACING (WHERE RESURFACING MEETS EXISTING PAVEMENT). IN ACCORDANCE WITH "BUTT JOINT AND HOT- MIX ASPHALT TAPER DETAILS" SHEET INCLUDED IN THE PLANS, UNLESS OTHERWISE SPECIFIED.
- 7. THE CONTRACTOR SHALL CONTACT THE DISTRICT ONE TRAFFIC CONTROL SUPERVISOR AT (847) 705-4470 A MINIMUM OF 72 HOURS IN ADVANCE OF BEGINNING WORK.
- WHEN ARTIFICIAL LIGHTING IS UTILIZED IN NIGHT OPERATIONS. THE CONTRACTOR SHALL EXERCISE THE UTMOST PRECAUTIONS IN PREVENTING ADVERSE VISIBILITY TO THE MOTORING PUBLIC AND ADJOINING RESIDENTIAL AREA.
- BEFORE BEGINNING ANY WORK, THE CONTRACTOR SHALL RETAIN AND RECORD (FOR FUTURE REFERENCES). ALL EXISTING PAVEMENT MARKING LINES AND RAISED REFLECTIVE PAVEMENT MARKERS IN ORDER THAT THESE LOCATIONS CAN BE RE- ESTABLISHED FOR STRIPING. EXACT LOCATIONS OF ALL STRIPING SHALL BE AS DIRECTED BY THE ENGINEER.
- 10. THE ENGINEER SHALL CONTACT LAWRENCE HILL TRAFFIC FIELD ENGINEER AT (815) 415-6475 A MINIMUM OF TWO WEEKS PRIOR TO PLACEMENT OF PERMANENT PAVEMENT MARKINGS.
- 11. THE "ADVANCE WARNING SIGN DETAIL FOR ARTERIAL TRAFFIC" LOCATED IN THE SPECIAL PROVISIONS FOR "TEMPORARY INFORMATION SIGNING FOR LANE CLOSURES" IS APPLICABLE ONLY TO ARTERIAL ROADS.
- 12. DO NOT SCALE PLANS FOR CONSTRUCTION DIMENSIONS.
- 13. THESE PLANS HAVE BEEN PREPARED FROM NOTES RECEIVED FROM DISTRICT 1 BRIDGE INSPECTORS.
- 14. SAW CUTTING OF PAVEMENTS, SHOULDERS, ETC., SHALL BE TO FULL DEPTH AND SHALL RESULT IN A CLEAN, STRAIGHT EDGE ON THE PORTION REMAINING. THE COST OF SAW CUTTING REMOVAL ITEMS SHALL BE INCLUDED IN THE UNIT PRICES OF
- 15. PLAN DIMENSIONS AND DETAILS RELATIVE TO EXISTING PLANS ARE SUBJECT TO ROUTINE VARIATION. THE CONTRACTOR SHALL FIELD VERIFY EXISTING DIMENSIONS AND DETAILS AFFECTING NEW CONSTRUCTION OR ORDERING MATERIALS. SUCH VARIATION SHALL NOT CAUSE FOR ADDITIONAL COMPENSATION FOR A CHANGE IN THE SCOPE OF THE WORK, HOWEVER, THE CONTRACTOR WILL BE PAID FOR QUANTITY ACTUALLY FURNISHED BASED AT THE UNIT PRICE BID FOR THE WORK.

#### GENERAL NOTES - TRAFFIC CONTROL & PROTECTION

- 1. TRAFFIC CONDITIONS, ACCIDENTS AND OTHER UNFORESEEN EMERGENCY CONDITIONS MAY REQUIRE THE ENGINEER TO RESTRICT, MODIFY OR REMOVE LANE CLOSURES OF CHANNELIZATION SHOWN IN THE PLANS. THE CONTRACTOR SHALL MAKE THE NECESSARY ADJUSTMENTS AS DIRECTED BY THE ENGINEER WITHOUT DELAY. THE CONTRACTOR SHALL RESPOND TO ANY REQUEST MADE BY THE ENGINEER FOR CORRECTION WITHIN TWO HOURS FROM THE TIME OF NOTIFICATION.
- ALL TEMPORARY PAVEMENT MARKINGS PROPOSED WITHIN THE WORK AREA SHALL BE COMPLETED PRIOR TO THE CONSTRUCTION PHASE CHANGE.



9901 S. Western Ave. Chicago, IL 60643

DESIGNED TPP REVISED -CHECKED SUL REVISED -DRAWN JS REVISED -CHECKED TOP REVISED -

STATE OF ILLINOIS **DEPARTMENT OF TRANSPORTATION** 

US 52 /IL53 OVER HICKORY CREEK SN. 099-0083 SCALE: NONE SHEET NO. OF SHEETS

INDEX OF SHEETS, STANDARDS, AND GENERAL NOTES STA. TO STA.

SECTION COLINTY 99-4-8-1 WILL CONTRACT NO. SOM98 TOTAL

QUANTITY

9

107

50

5. 8

118

54

235

900

33

0.5

37. 9

910

18245

425

36.4

340

125

1264

108

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CONSTRUCTION CODE TYPE

80% FED 20% STATE

167

107

50

25

118

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235

900

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18245

425

36.4

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108

CODE NO. ITEM DESCRIPTION 40600290 BITUMINOUS MATERIALS (TACK COAT) 40600985 PORTLAND CEMENT CONCRETE SURFACE REMOVAL - BUTT TOINT 40600990 TEMPORARY RAMP 40603085 HOT-MIX ASPHALT BINDER COURSE, 11-19.0, N70 HOT-MIX ASPHALT SURFACE COURSE, MIX "D". N70 42001300 PROTECTIVE COAT 44000500 COMBINATION CURB AND GUTTER REMOVAL 44003100 MEDIAN REMOVAL MEDIAN REMOVAL PARTIAL DEPTH 44003510 50102400 CONCRETE REMOVAL SLOPE WALL REMOVAL 50104650 50300225 CONCRETE STRUCTURES 50300255 CONCRETE SUPERSTRUCTURE 50300260 BRIDGE DECK GROOVING

FURNISHING AND ERECTING STRUCTURAL STEEL

RELOCATE TEMPORARY CONCRETE BARRIER

78000200 THERMOPLASTIC PAVEMENT MARKING - LINE 4"

78008250 POLYUREA PAVEMENT MARKING TYPE I - LINE 12"

X 127030005 TEMPORARY PAVEMENT MARKING REMOVA!

78000100 THERMOPLASTIC PAVEMENT MARKING - LETTERS AND SYMBOLS

THERMOPLASTIC PAVEMENT MARKING - LINE 6"

POLYUREA PAVEMENT MARKING TYPE 1 - LINE 4"

50800205 REINFORCEMENT BARS, EPOXY COATED POUND 5220 5220 EACH 124 124 50800515 BAR SPLICERS SQ YD 51100100 | SCOPE WALL, 4 INCH 52000110 PREFORMED JOINT STRIP SEAL FOOT 265 265 EACH FOOT (ala 54 فأفا 52100520 ANCHOR BOLTS, 1 60605200 | COMBINATION CURB AND GUTTER, TYPE 8-6.24 (DOWELLED) 54 67000400 ENGINEER'S FIELD OFFICE, TYPE A CAL MO L SUM 67100100 MOBILIZATION CAL DA 67 67 70103815 TRAFFIC CONTROL SURVEILLANCE 70400100. TEMPORARY CONCRETE BARRIER FOOT 675

>> X 782000 H BARRIER WALL REFLECTORS TYPE C DNON-PARTICIPATING

\* SPECIAL PROVISION

\*\* GUIDE BRIDGE SPECIAL PROVISION

\*\*\* BDE SPECIAL PROVISION

X SPECIALTY ITEMS

Chicago, IL 60643 Ph. 773-881-4788 F: 773-239-3728 DESIGN FIRM REG. 184.002117

70600350

78000400

78008210

9901 S. Western Ave. DESIGNED JS/SS CHECKED TPP DRAWN JS CHECKED TPP

IMPACT ATTENUATORS, RELOCATE (NON-REDIRECTIVE), TEST LEVEL 3

REVISED -REVISED REVISED -REVISED


STATE OF ILLINOIS **DEPARTMENT OF TRANSPORTATION** 

US52/L53 OVER HICKORY CREEK SN 099-0083 SCALE: NONE SHEET NO. OF SHEETS STA.


SUMMARY OF QUANTITIES

COUNTY TOTAL SHEET NO.
WILL 26 3 F.A.P. RTE, 846 SECTION WILL 26 3
CONTRACT NO. 60M98 99-4-8-I

				DIVDWIA	
	CODE NO.	ITEM DESCRIPTION	UNIT	TOTAL QUANTITY	CONSTRUCTION CODE TYPE 0014 80% FED 20% STATE
	X0327980	PAVEMENT MARKING REMOVAL- WATER BLASTING	SQ FT	474	474
	78300200	RAISED REFLECTIVE PAVEMENT MARKER REMOVAL	EACH	4	4
₽*	X0326394	FLOOR DRAINS TO BE CLEANED	EACH	15	15
*	X0326766	CLEAN AND RESEAL RELIEF JOINT	FOOT	134	134
	X7010216	TRAFFIC CONTROL AND PROTECTION, (SPECIAL)	L SUM	1	1
*	70300900	PAVEMENT MARKENS TAPETYPE IX - LETTERS AND SYMBOLS	SQ FT	36. 4	36. 4
	70360904 70001899	PAVEMENT MARKING LAPE. TYPE DY 4 INCH JACK AND REMOVE EXISTING BEARINGS	FOOT EACH	3566 31	3566 31
		APPROACH SLAB REPAIR (PARTIAL DEPTH)	SO YD	i	1
*	Z0001800 Z0001903	STRUCTURAL STEEL REMOVAL	Pound	7820	7820
- W	Z0006014	BRIDGE DECK LATEX CONCRETE OVERLAY, 2 1/2" INCHES	SO YD	1060	1060
<b>不 木</b>	Z0006014 Z0001905	STRUCTURAL STEEL REPAIR	POUND	300	300
* *	Z0012130	BRIDGE DECK SCARIFICATION 3/4"	SQ YD	1060	1060
* *	20012130	BRIDGE DECK SCARIFICATION 324	30 .5		
* *	20012754	STRUCTURAL REPAIR OF CONCRETE (DEPTH EQUAL TO	SQ FT	850	850
* *	20012134	OR LESS THAN 5 INCHES)			
* *	Z0012755	STRUCTURAL REPAIR OF CONCRETE (DEPTH GREATER THAN 5 INCHES)	SO FT	18	18
* * *	70600250	IMPACT ATTENUATORS, TEMPORARY (NON-REDIRECTIVE), TEST LEVEL 3	EACH	4	4
*	Z0030850	TEMPORARY INFORMATION SIGNING	SQ FT	102.8	102. 8
*	Z0073200	TEMPORARY SHORING AND CRIBBING	EACH	2	2
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STA. 10+59.87 TO STA. 11+18.52 STA. 12+85.84 TO STA. 14+84 STA. 15+39 TO STA. 17+95 +/-

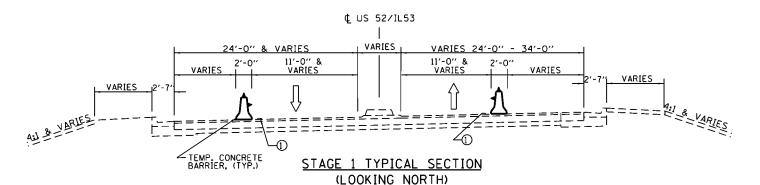


STAGE 1 TYPICAL SECTION (LOOKING NORTH) STA. 4+44 TO STA. 10+59.87 STA. 14+84 TO STA. 15+39
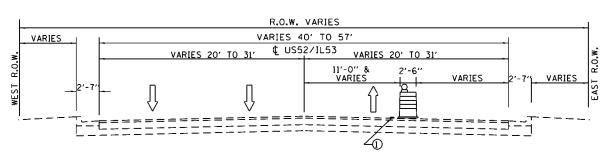
#### HOT-MIX ASPHALT MIXTURE REQUIREMENTS


MIXTURE TYPE	AIR VOIDS (%) AT N <sub>DES</sub>	OUALITY MANAGEMENT PROGRAM (OMP)
HOT-MIX ASPHALT SURFACE COURSE, MIX "D", N70, (IL-9.5mm), 1-3/4" & 2"	4.0% AT 70 GYR.	OC/QA
HOT-MIX ASPHALT BINDER COURSE, IL-19.0, N70, 2-1/4"	4.0% AT 70 GYR.	QC/QA

- THE UNIT WEIGHT USED TO CALCULATE ALL HMA SURFACE MIXTURE QUANTITIES IS 112 LBS/SQ.
- 2. THE "AC TYPE" FOR POLYMERIZED HMA MIXES SHALL BE "SBS/SBR PG 70-22" AND FOR NON-POLYMERIZED HMA THE "AC TYPE" SHALL BE "PG 64-22" UNLESS MODIFIED BY DISTRICT ONE SPECIAL PROVISIONS.
- 3. FOR USE OF RECYCLED MATEIRALS SEE DISTRICT ONE SPECIAL PROVISIONS.
- QUALITY MANAGEMENT PROGRAM IDENTIFIES THE PARTICULAR QUALITY CONTROL SPECIFICATION THAT APPLIES TO THE HMA MIXTURE.

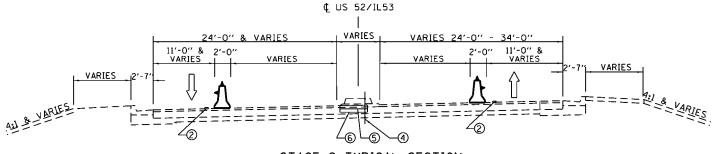

STAGE 2 TYPICAL SECTION (LOOKING NORTH)

STA. 10+59.87 TO STA. 11+18.52 STA. 12+85.84 TO STA. 14+84 STA. 15+39 TO STA. 21+34

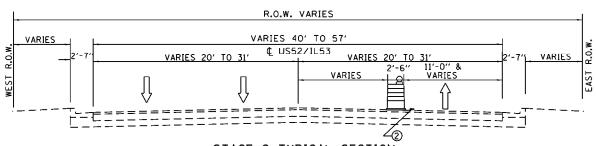

STAGE 2 TYPICAL SECTION (LOOKING NORTH) STA. 4+44 TO STA. 10+59.87

#### LEGEND:

- 1 WET REFLECTIVE TEMPORARY TYPE, TYPE III , 4" WHITE
- 2 WET REFLECTIVE TEMPORARY TYPE, TYPE III , 4" YELLOW
- (3) DRUM WITH STEADY BURN MONODIRECTIONAL LIGHT
- 4 CONCRETE MEDIAN REMOVAL (STA. 10+59.87 TO 11+18.52)
- (5) HMA SURFACE COURSE, MIX "D", N70, 2" (STA. 10+59.87 TO 11+18.52)
- 6 HMA BINDER COURSE, IL-19.0, N70, 2-1/4" (STA, 10+59.87 TO 11+18.52)

Chicago, IL 60643 Ph. 773-881-4788 F: 773-239-3728

9901 S. Western Ave. DESIGNED TPP REVISED -CHECKED RJL REVISED DRAWN REVISED CHECKED TPP REVISED -

US52/IL53 OVER HICKORY CREEK	MAINTENANCE OF TRAFFIC		SECTION	
SN 099-0083	STAGING SECTIONS	846	99-4-B-I	
314 033-0003	STAGING SECTIONS			Г
ALE- NONE SHEET NO OF SHEETS	STA. TO STA.	$\overline{}$	liu tuniel cen ai	'n

NOTES:

1. ERECT TEMPORARY CONSTRUCTION SIGNS FOR STAGE 1 MOT.

- 2. INSTALL TEMPORARY MOT FOR STAGE 1 REPAIR WORK ON BRIDGE.
- 3. CONSTRUCTION FOR NORTH AND SOUTH BOUND OUTSIDE LANES: BRIDGE DECK HYDRO-SCARIFICATION, BRIDGE DECK CONCRETE OVERLAY, JOINT RECONSTRUCTION, PARTIAL DEPTH APPROACH PAVEMENT AND DECK PATCHING, COMBINATION CURB & GUTTER REMOVAL, CLEAN DECK DRAINS, AND SUBSTRUCTURE REPAIRS.

<u>LEGEND</u> WORK AREA

DRUM WITH MONO-DIRECTIONAL STEADY BURNING LIGHT (@ 25' C-C)

▶ SIGN ON PORTABLE SUPPORT


TEMPORARY CONCRETE BARRIER

IMPACT ATTENUATOR, TEMPORARY (NON-REDIRECTIVE), TEST LEVEL 3

ARROW BOARD

TRAFFIC FLOW DIRECTION

..... PAVEMENT MARKING REMOVAL

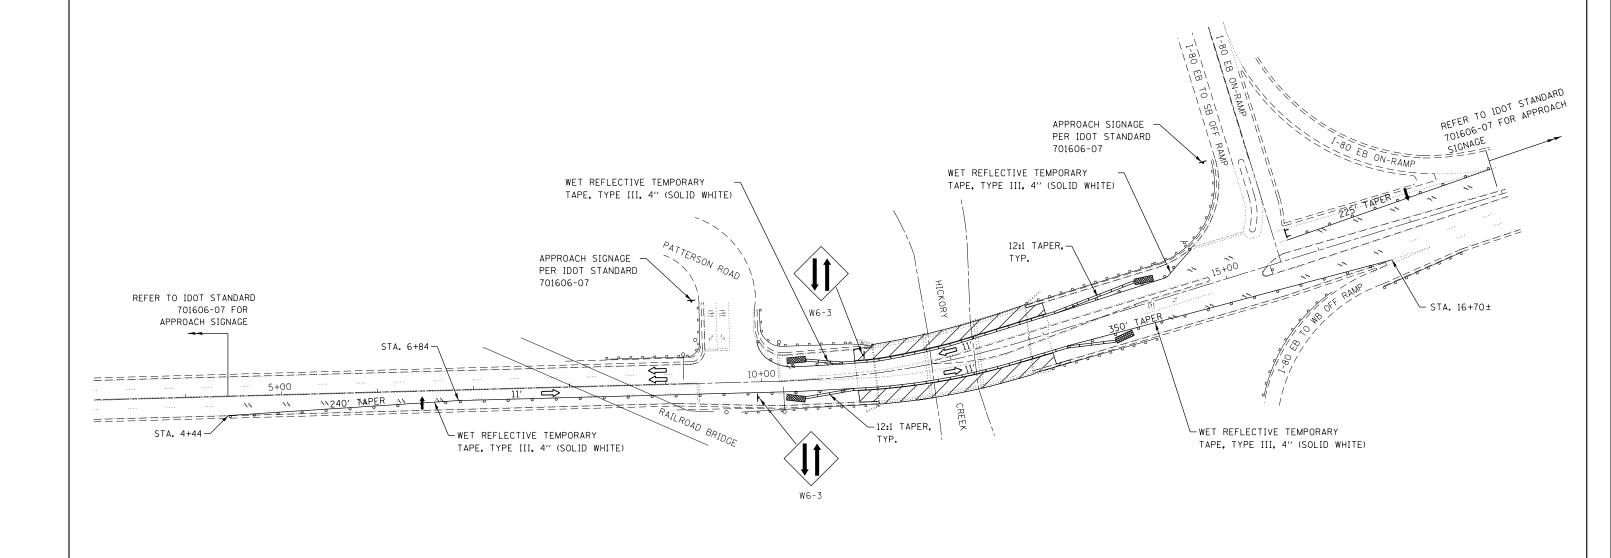

X	A	BI	V	Α
	DESIGN	FIRM	REC	184 002117

9901 S. Western Ave. Chicago, IL 60643 Ph. 773-881-4788 F: 773-239-3728


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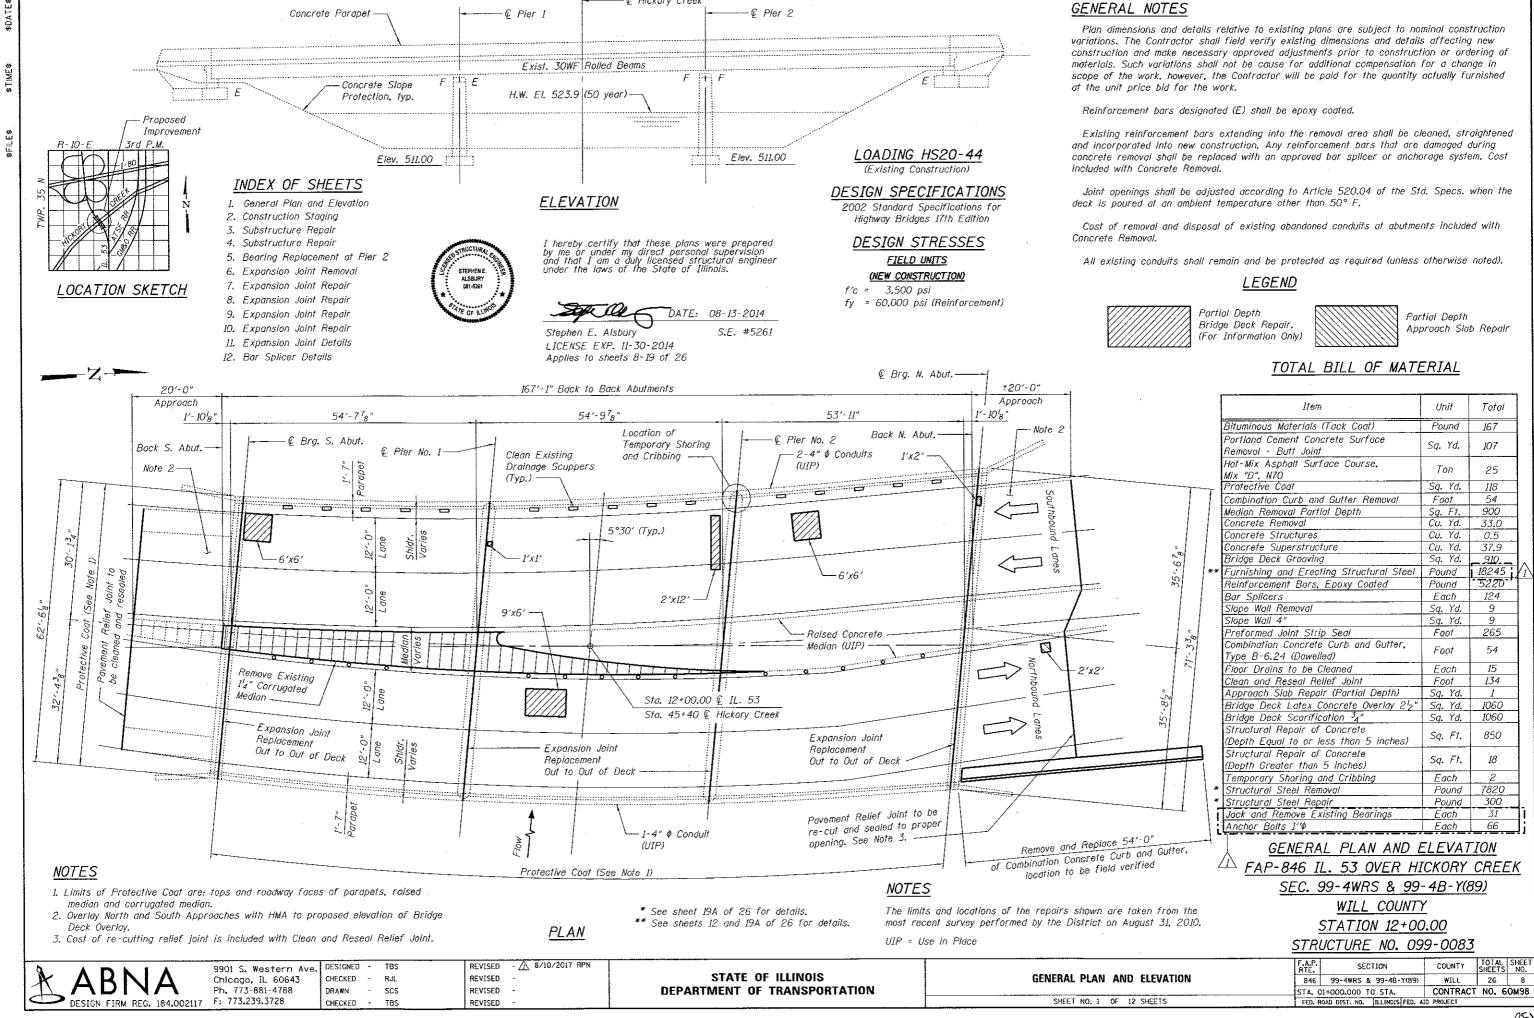
STATE OF ILLINOIS **DEPARTMENT OF TRANSPORTATION** 


US 52/IL 53 OVER HICKORY CREEK SN. 099-0083 SCALE: 1" = 50' SHEET NO. OF SHEETS


STAGE 1 MAINTENANCE OF TRAFFIC STA.

SECTION 846 99-4-B-I WILL 26 5 CONTRACT NO. 60M98




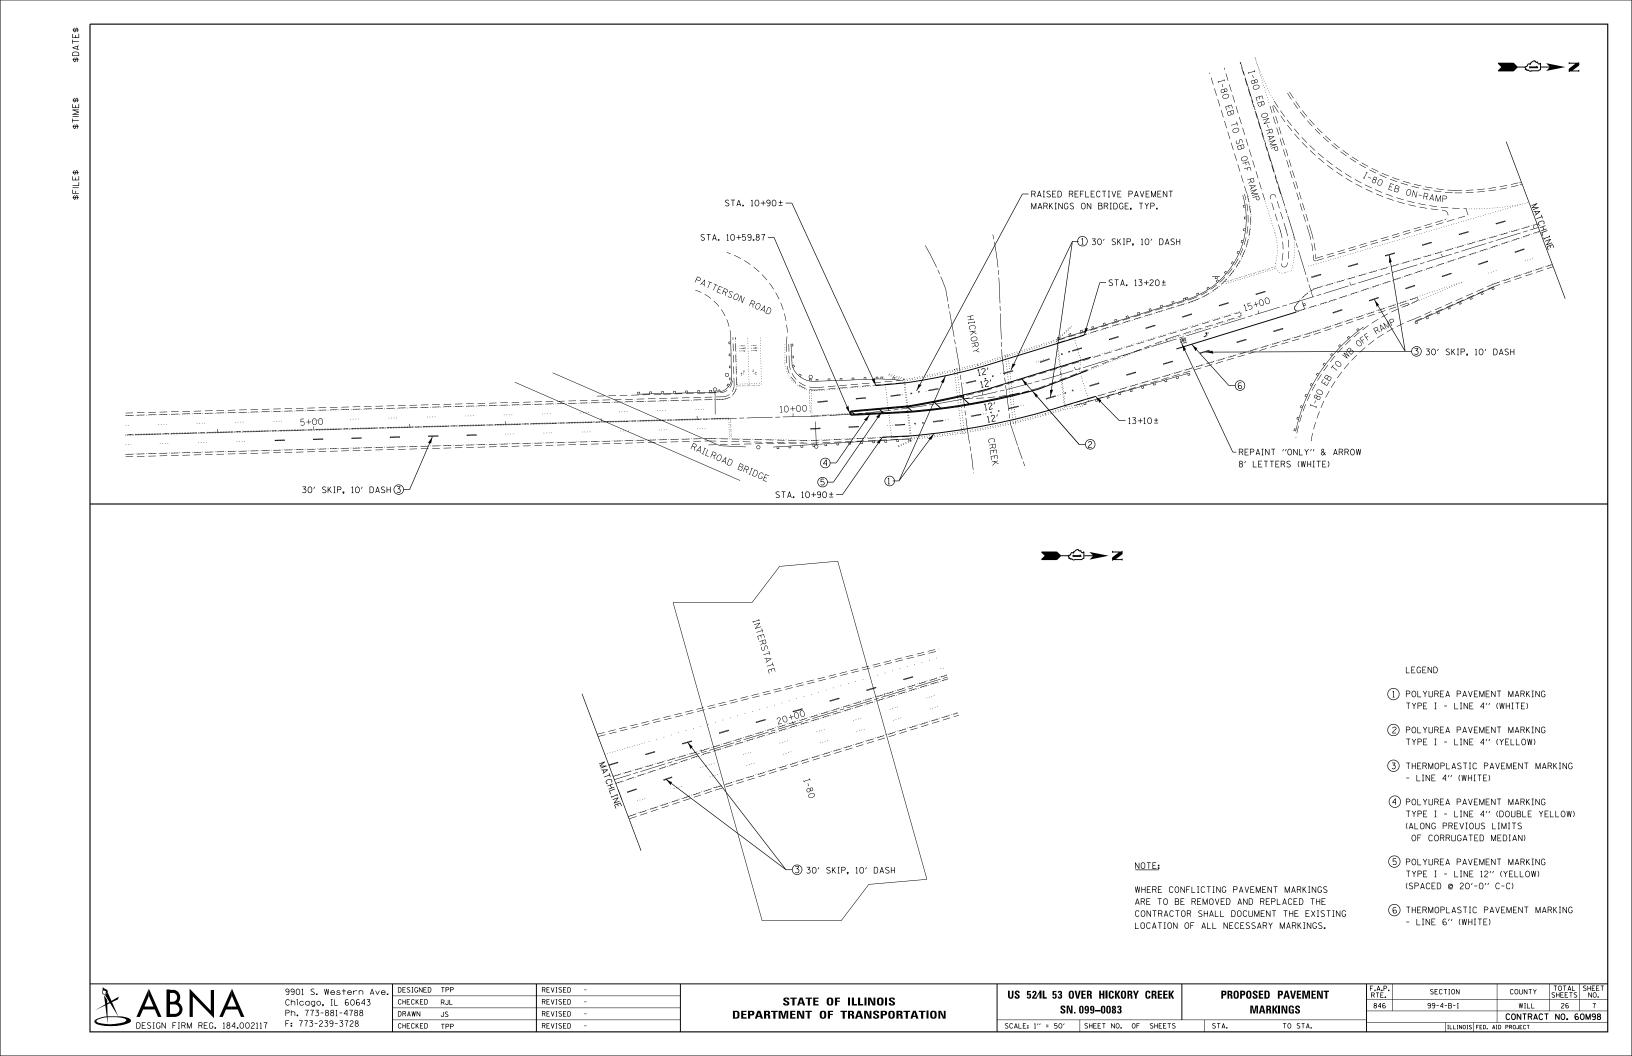

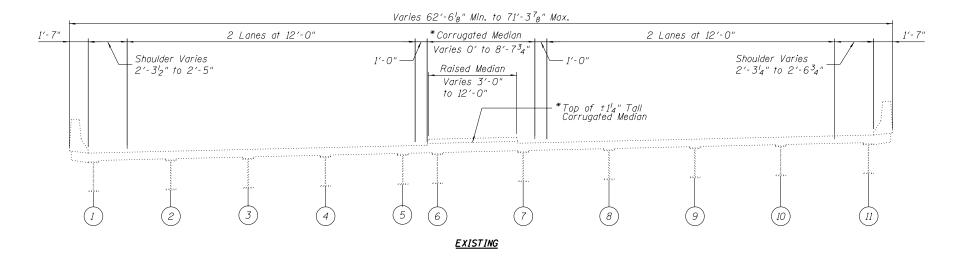

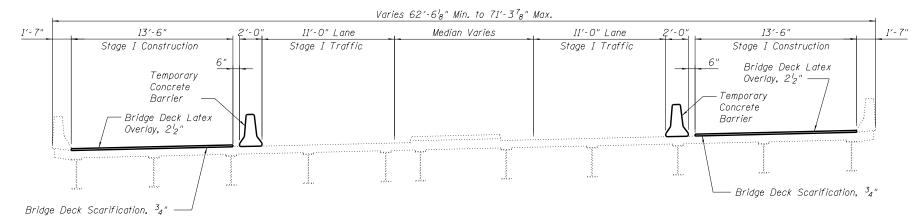

STAGE I

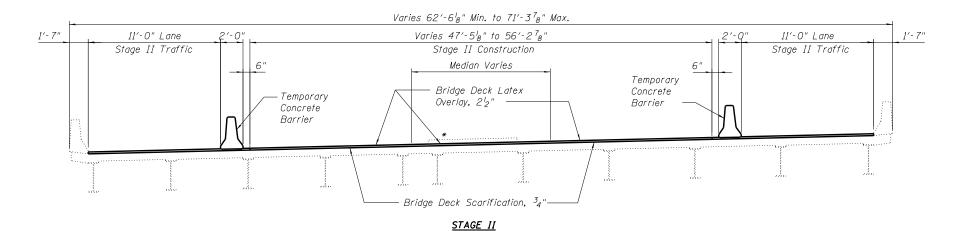


#### PROPOSED CONSTRUCTION STAGING

#### NOTE:


Temporary Concrete Barrier is paid for as Roadway Item. See Standard 704001-06

\*Corrugated Median to be removed and area scarified. New Concrete Overlay to be placed after scarification.

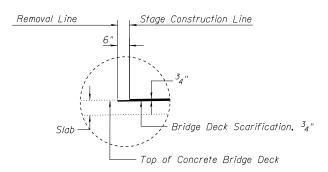


#### DETAIL A (Showing Removal)

(Looking North)

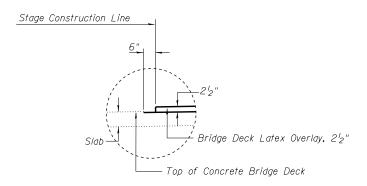


#### DETAIL B (Showing Proposed)

(Looking North)

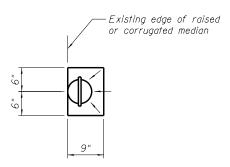

#### OVERLAY TREATMENT AT FLOOR DRAIN

Taper overlay from  $2\frac{1}{2}$ " to 1" at edge of drain.

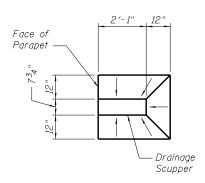

#### OVERLAY TREATMENT AT DRAINAGE SCUPPER

Taper overlay from  $2\frac{1}{2}$ " to 1" at edge of drain.




9901 S. Western Ave. Chicago, IL 60643 Ph. 773-881-4788


DESIGNED CHECKED DRAWN CHECKED

REVISED RJL REVISED SCS REVISED TBS REVISED

STATE OF ILLINOIS **DEPARTMENT OF TRANSPORTATION**  **CONSTRUCTION STAGING** SHEET NO. 2 OF 12 SHEETS

SECTION COUNTY 846 99-4WRS & 99-4B-Y(89) WILL 26 9 CONTRACT NO. 60M98 STA. 01+000.000 TO STA.

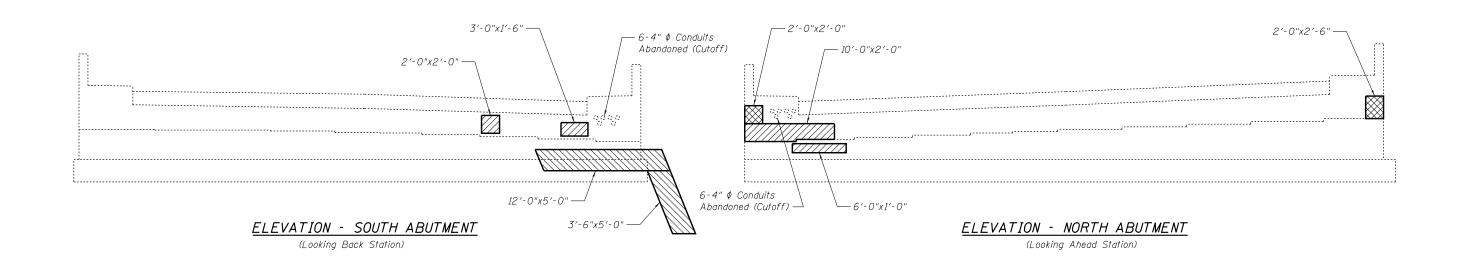

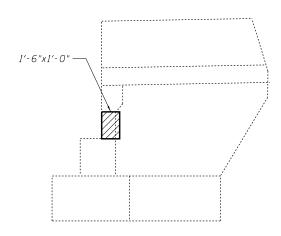

ELEVATION - N.E. WINGWALL

#### <u>NOTES</u>

- 1. The contractor shall take sufficient precautions to prevent pollution of creeks or streams with construction materials.
- 2. The contractor shall avoid placing construction devices in creeks or streams.
- Placement of any such items shall be subject to approval by IDOT. 3. Slopewall shall be reinforced with welded wire fabric, 6 in.  $\times$  6 in. - W4.0  $\times$  W4.0, weighing 58 lbs. per 100 sq. ft. The cost of reinforcement shall be included with pay item for Slope Wall,
- 4. A minimum of 6" overlap between existing and new welded wire fabric must be provided.

#### LEGEND



Structural Repair of Concrete (Depth Equal to or less than 5 in.)



Structural Repair of Concrete (Depth Greater than 5 in.)



Slope Wall Repair 4"



9901 S. Western Ave. Chicago, IL 60643 Ph. 773-881-4788


DESIGNED -CHECKED - RJL DRAWN scs CHECKED -TBS

REVISED REVISED REVISED REVISED

STATE OF ILLINOIS **DEPARTMENT OF TRANSPORTATION** 

SUBSTRUCTURE REPAIR SHEET 1 of 2 SHEET NO. 3 OF 12 SHEETS

SECTION COUNTY 846 99-4WRS & 99-4B-Y(89) 26 10 WILL CONTRACT NO. 60M98 STA. 01+000.000 TO STA.

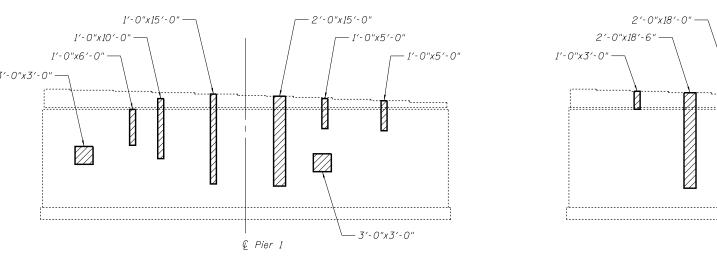

- 1'-0"x19'-0"

1'-0"x19'-2"

- 2'-0"x12'-5"

## — 1'-0"x18'-0" - 1'-0"x17'-6" - 1′-0"x5′-0" - 3′-0"x4′-0" — 4′-8<sup>3</sup>4" Ф -7′-0"x10′-0" © Pier 2

## 1'-0"x8'-0"

## REACTION TABLE (KIPS)

Structural Repair

(Depth Equal to or

less than 5 in.)

Concrete Removal

of Concrete

LEGEND


1/2(LL+I) Location DLSpan 2 34.9 38.8 34.9 38.9 Span 3

Note: Reaction Table provided for Temporary Shoring, Contractor shall provide shoring system designed to carry dead load plus 1/2 live load plus impact.

#### WEST END - PIER 2 NORTH ELEVATION - PIER 2

(Looking Back Station) - 1'-0"x4'-0" 2'-0"x19'-6" -2'-0"x19'-0"-- 1'-0"x17'-0" 2'-0"x19'-0" — 3'-0"x4'-0" 4'-8<sup>3</sup>4" — 3'-0"x5'-0" 8'-0"x8'-0" € Pier 2 - 1'-0"x17'-0"

SOUTH ELEVATION - PIER 2

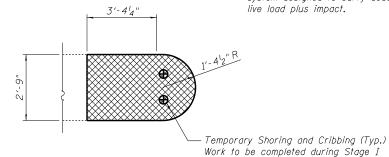


SECTION A-A

Note: Cost of anchor bolt removal is included in pay item Concrete Removal.

#### SOUTH ELEVATION - PIER 1 (Looking Ahead Station)

— 1'-0"x7'-0"

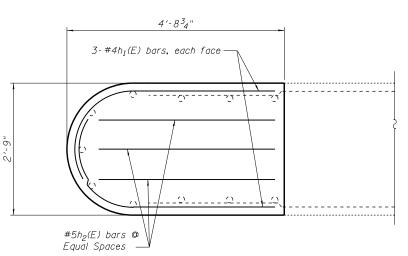


NORTH ELEVATION - PIER 1

© Pier 1


(Looking Back Station)

2'-0"x18'-7" —

5'-0"x2'-0"

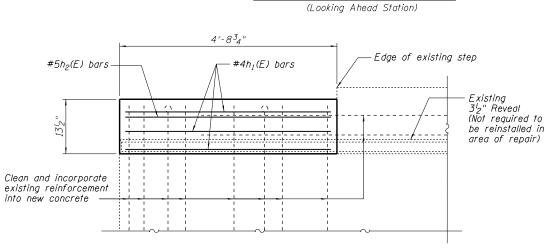

SOUTH ELEVATION

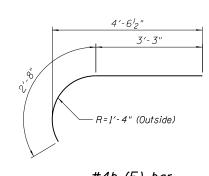

 $#4h_1(E)$  bar

Concrete	Removal	Cu. Y	J.	0.5

BILL OF MATERIAL

#5

Size Length Shape

3'-4"

Cu. Yd.

Pound

0.5

40

#4 5'-11"

No.

Concrete Structures

Reinforcement Bars,

Epoxy Coated

h<sub>2</sub>(E)

#### NOTES

- 1. The contractor shall take sufficient precautions to prevent pollution of creeks or streams with construction materials.
- 2. The contractor shall avoid placing construction devices in creeks or streams. Placement of any such items shall be subject to approval by IDOT.

A	ABNA	9901 S. Western Chicago, IL 606
	DESIGN FIRM REG. 184.002117	Ph. 773-881-4788 F: 773.239.3728
	DESIGN FIRM REG. 104.002111	1. 113.233.3120

9901 S. Western Ave. Chicago, IL 60643 Ph. 773-881-4788

DRAWN

PLAN

DESIGNED CHECKED RJL SCS CHECKED -TBS

REVISED REVISED REVISED REVISED

WEST END - PIER 2 REPAIRS

STATE OF ILLINOIS **DEPARTMENT OF TRANSPORTATION** 

SUBSTRUCTURE REPAIR SHEET 2 of 2 SHEET NO. 4 OF 12 SHEETS

SECTION COUNTY 846 99-4WRS & 99-4B-Y(89) WILL 26 11 STA. 01+000.000 TO STA. CONTRACT NO. 60M98

ABNA 9901 S. Western Ave. DESIGNED - TBS
Chicago, IL 60643
Ph. 773-881-4788
DESIGN FIRM REG. 184.002117 F: 773.239.3728


DESIGN FIRM REG. 184.002117 F: 773.239.3728


DESIGNED - TBS
CHECKED - TBS


REVISED - <u>A</u> 8/10/2017 RPN REVISED -REVISED -REVISED


STATE OF ILLINOIS **DEPARTMENT OF TRANSPORTATION** 


BEARING REPLACEMENT AT PIER 2 SHEET NO. 5 OF 12 SHEETS

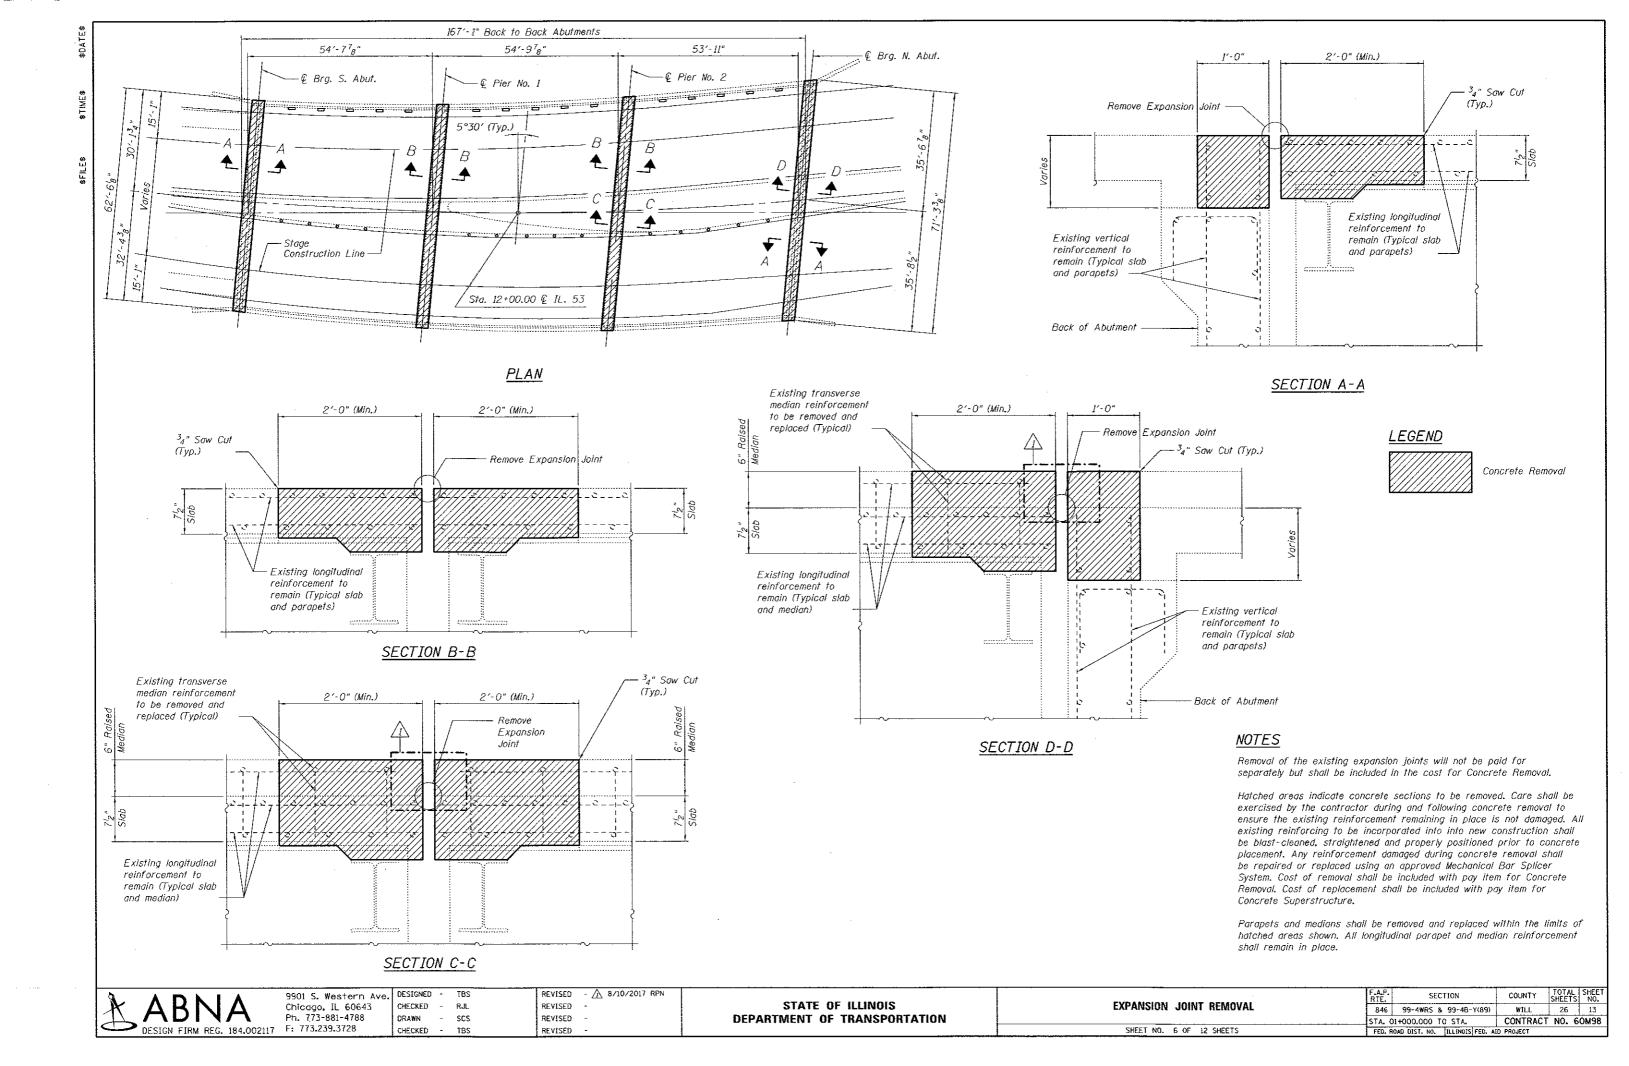


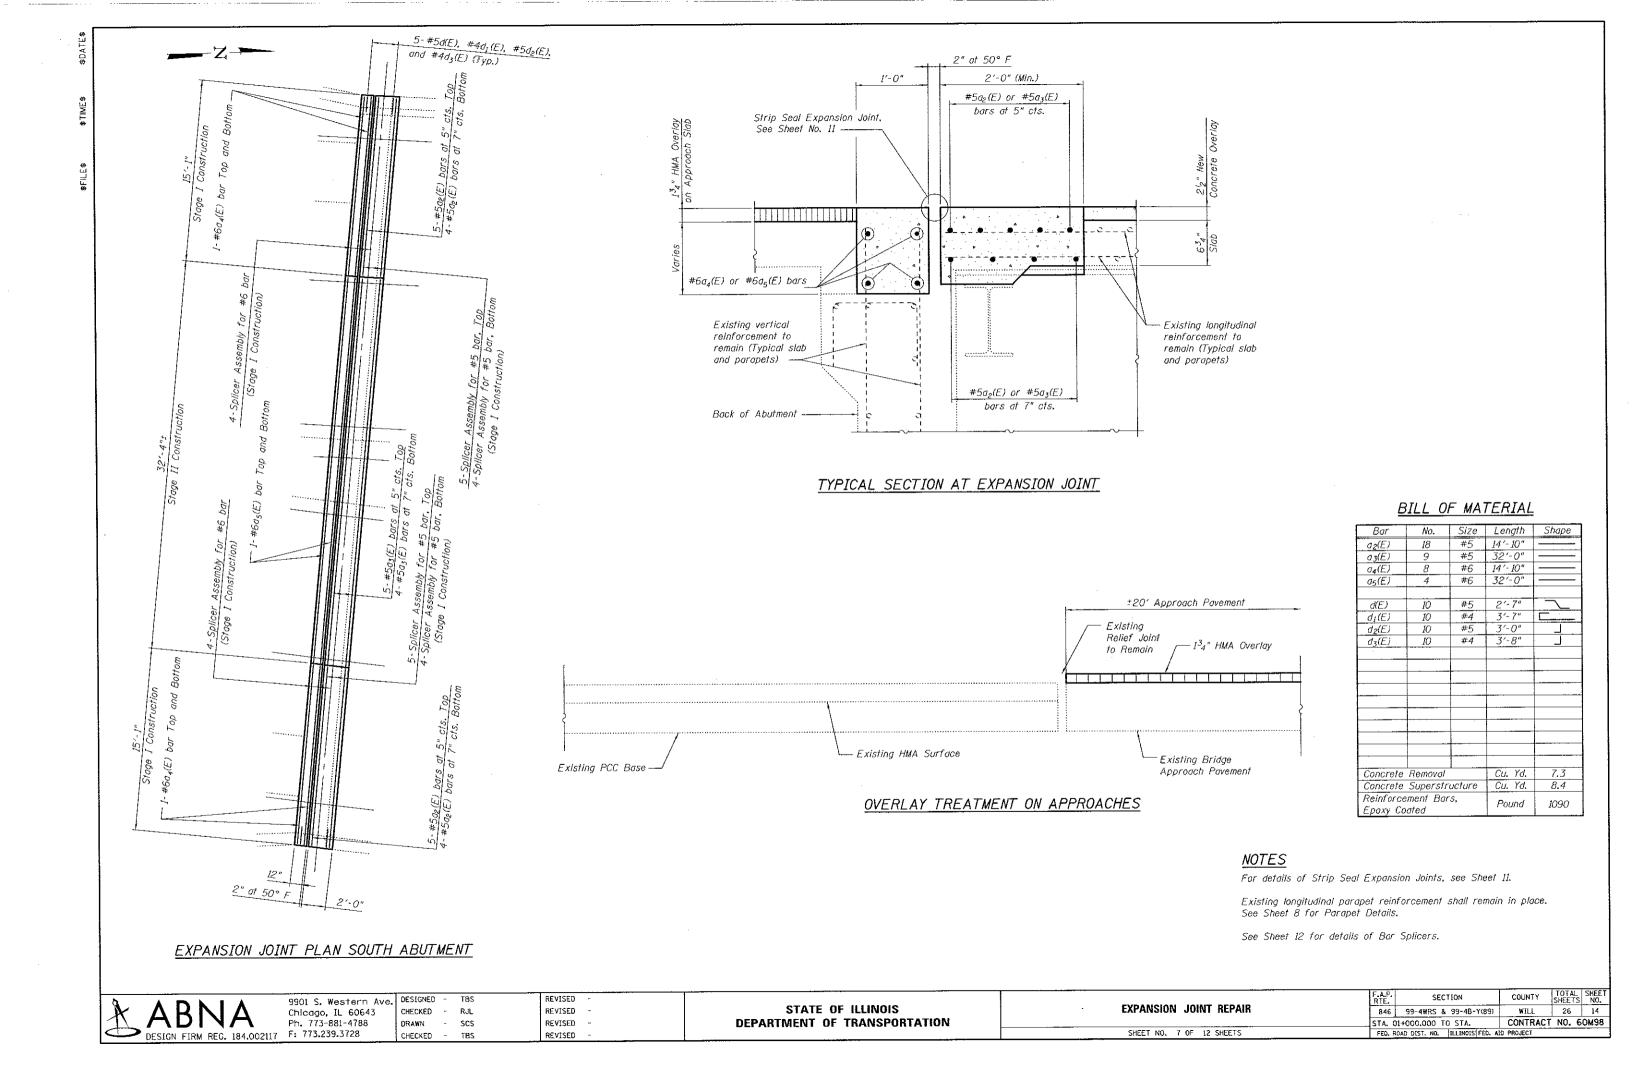

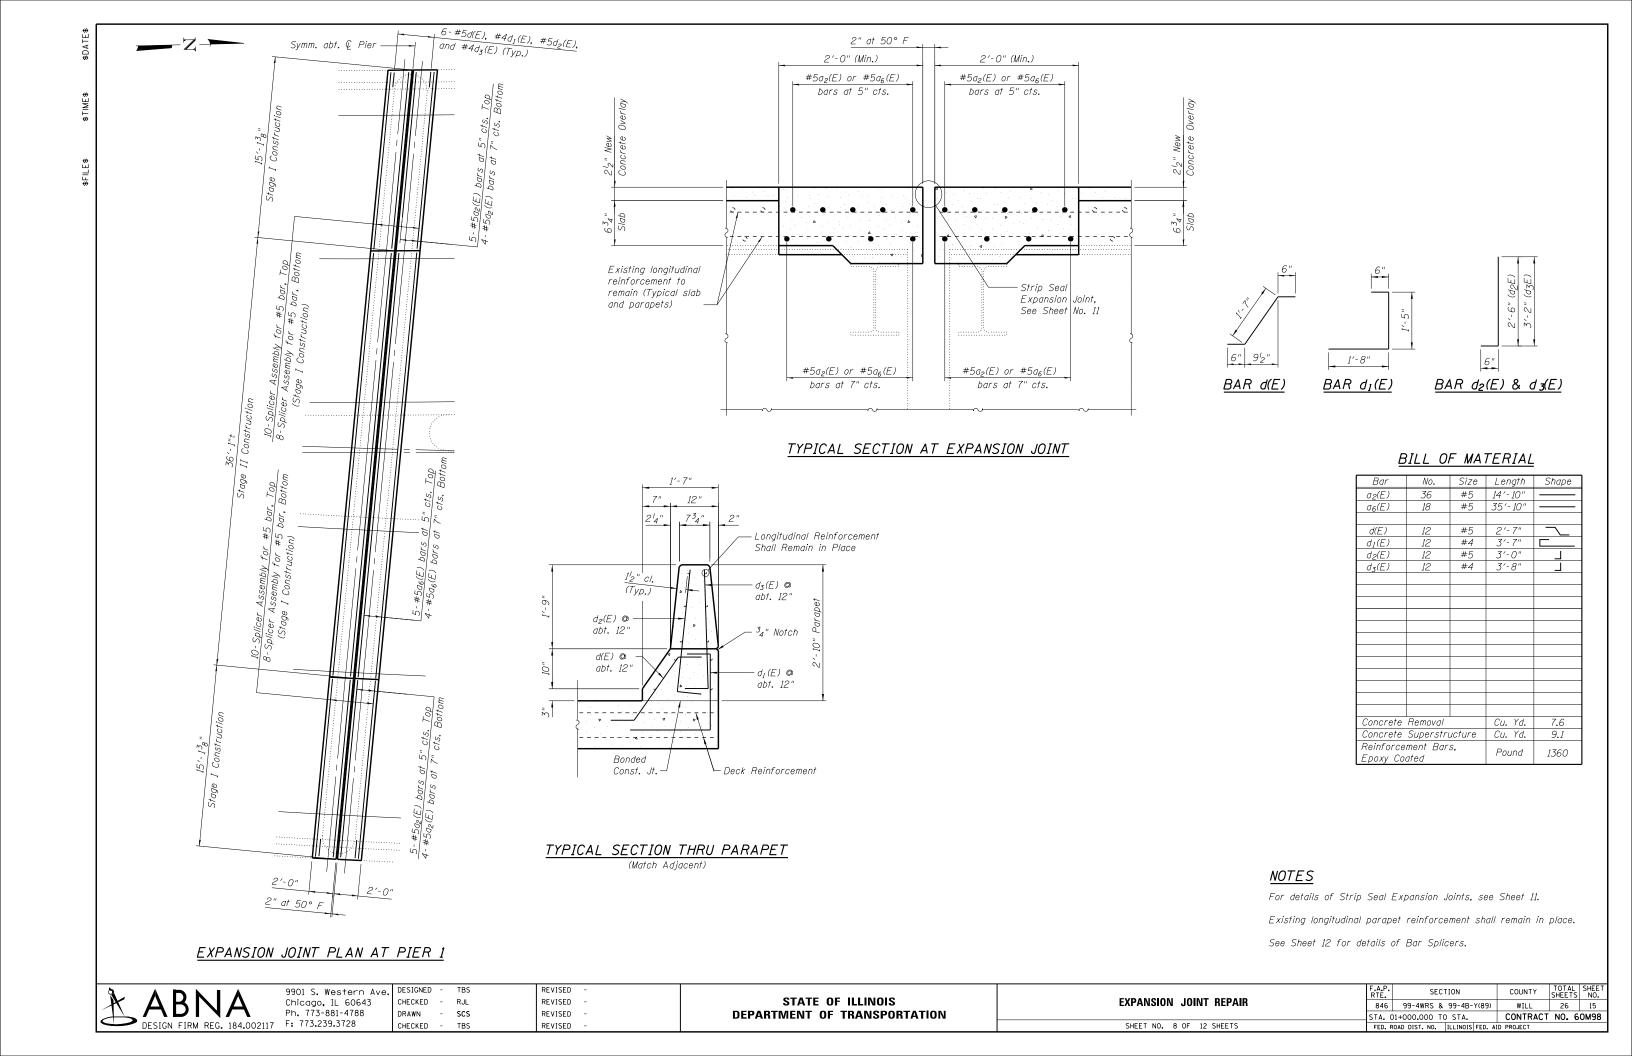

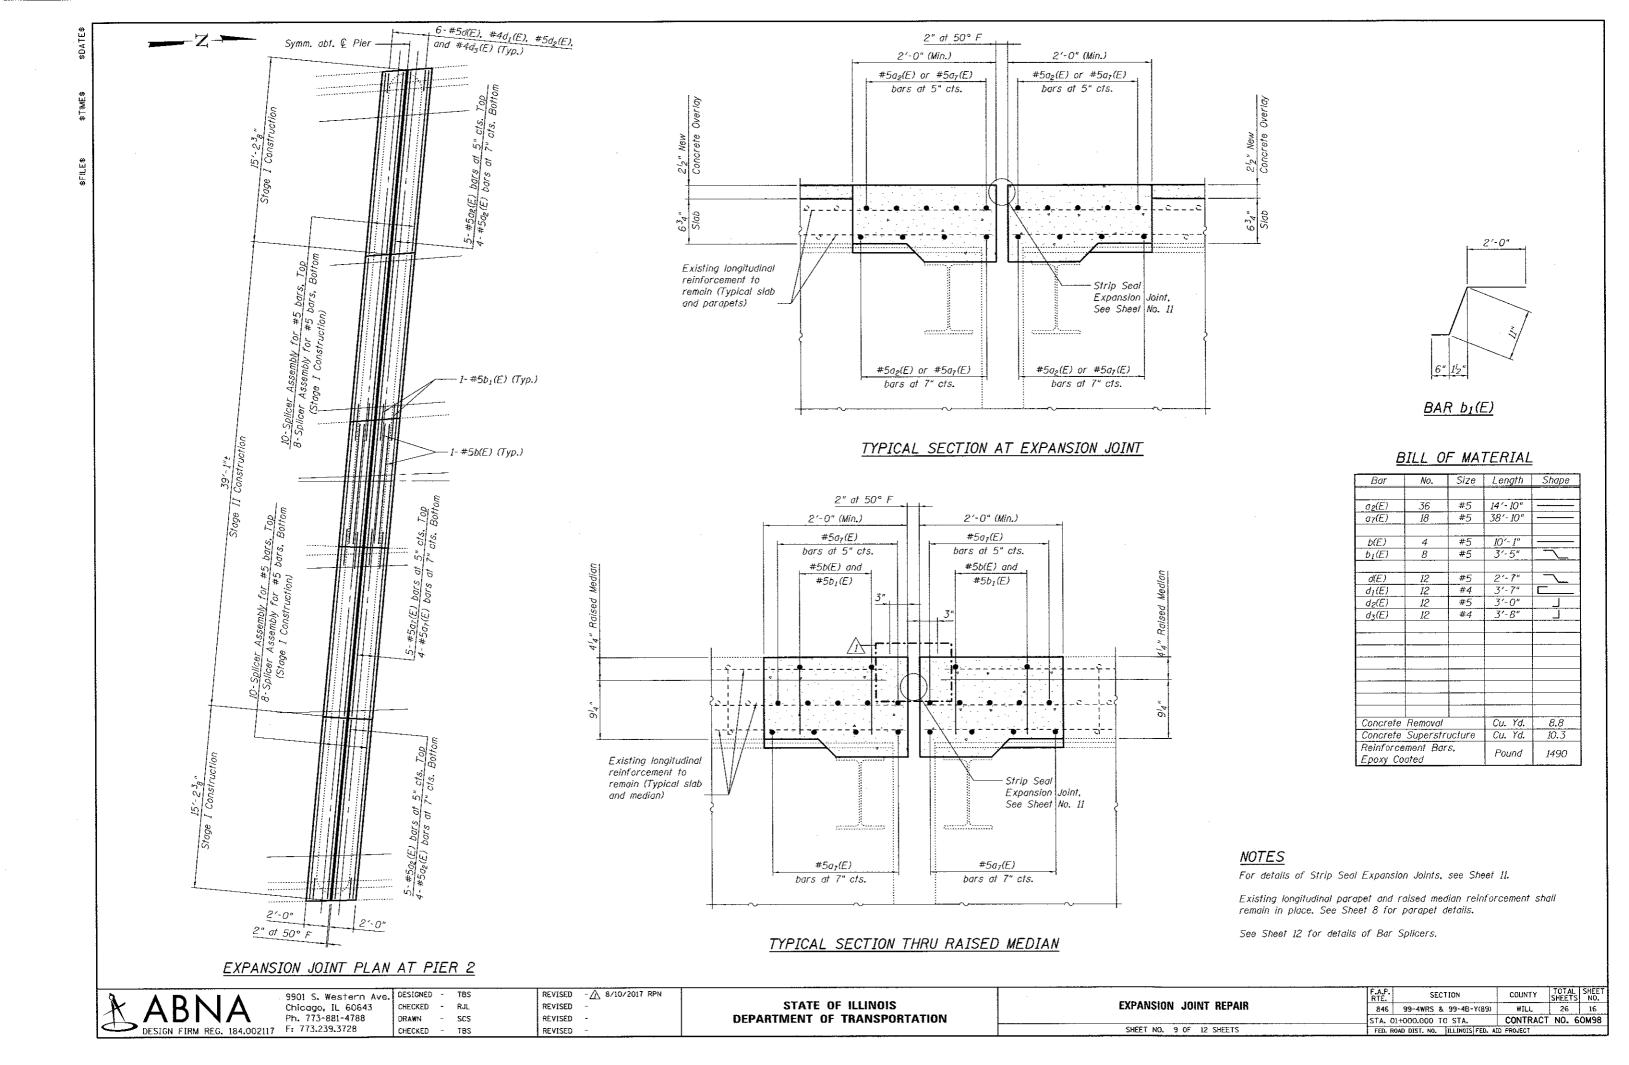

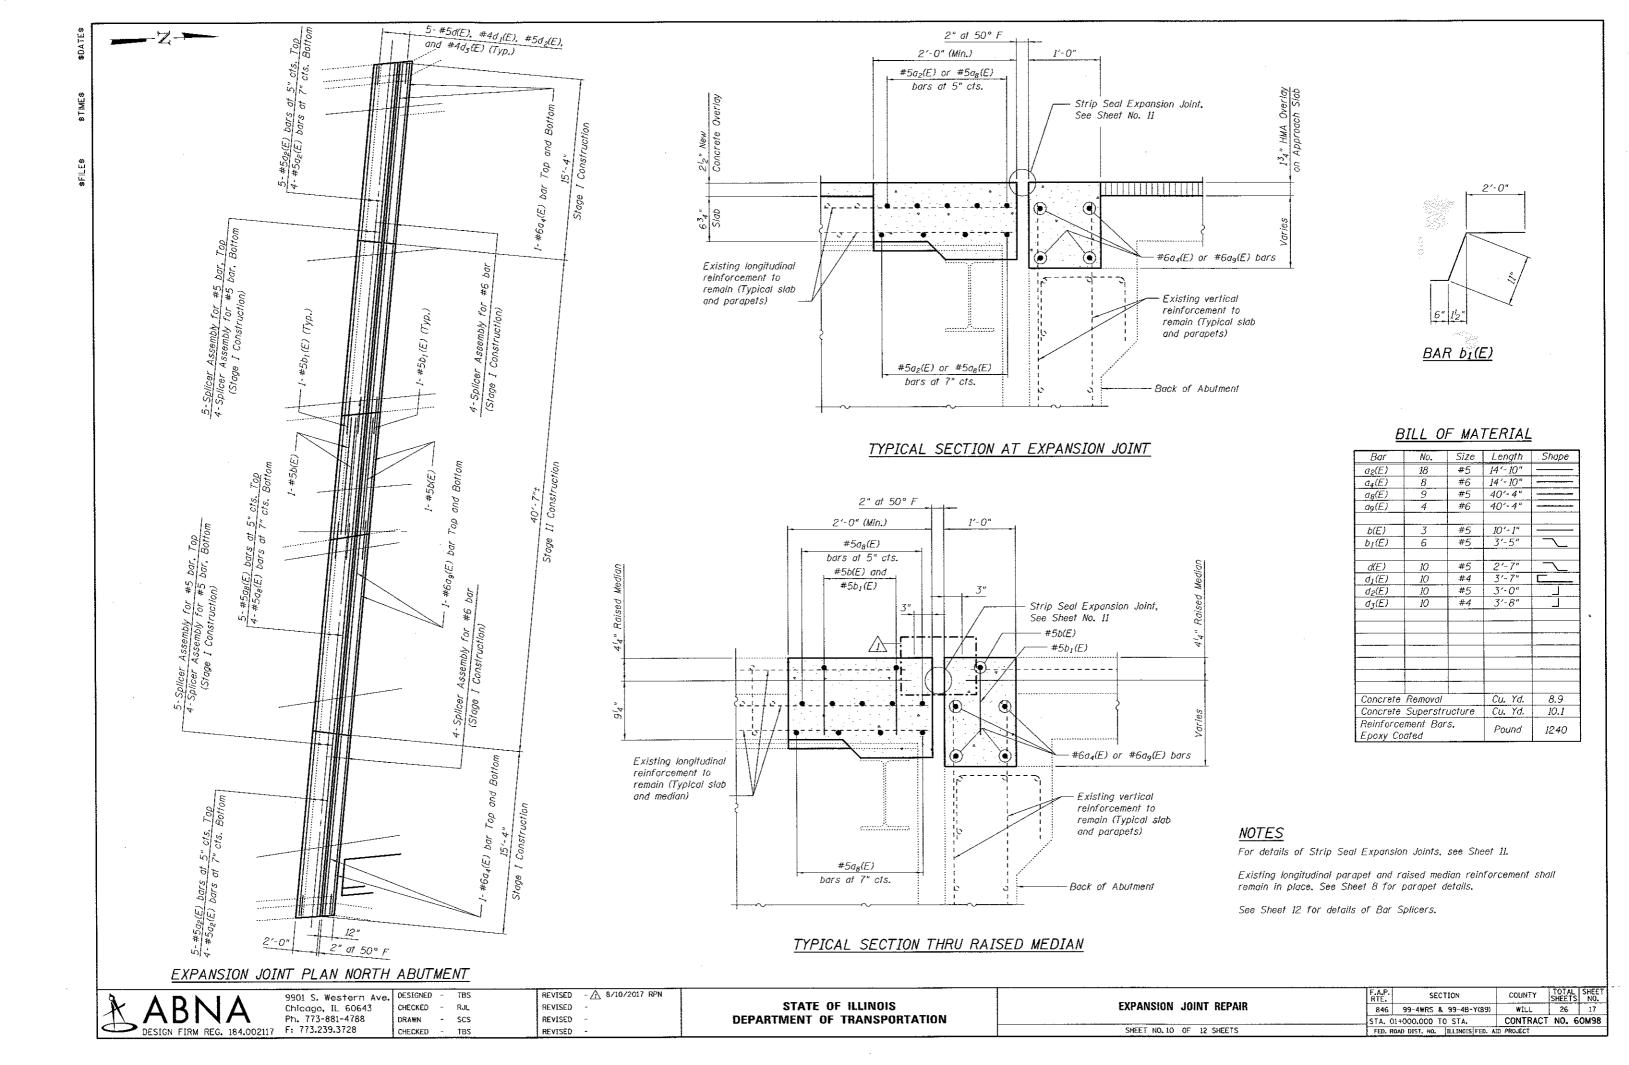

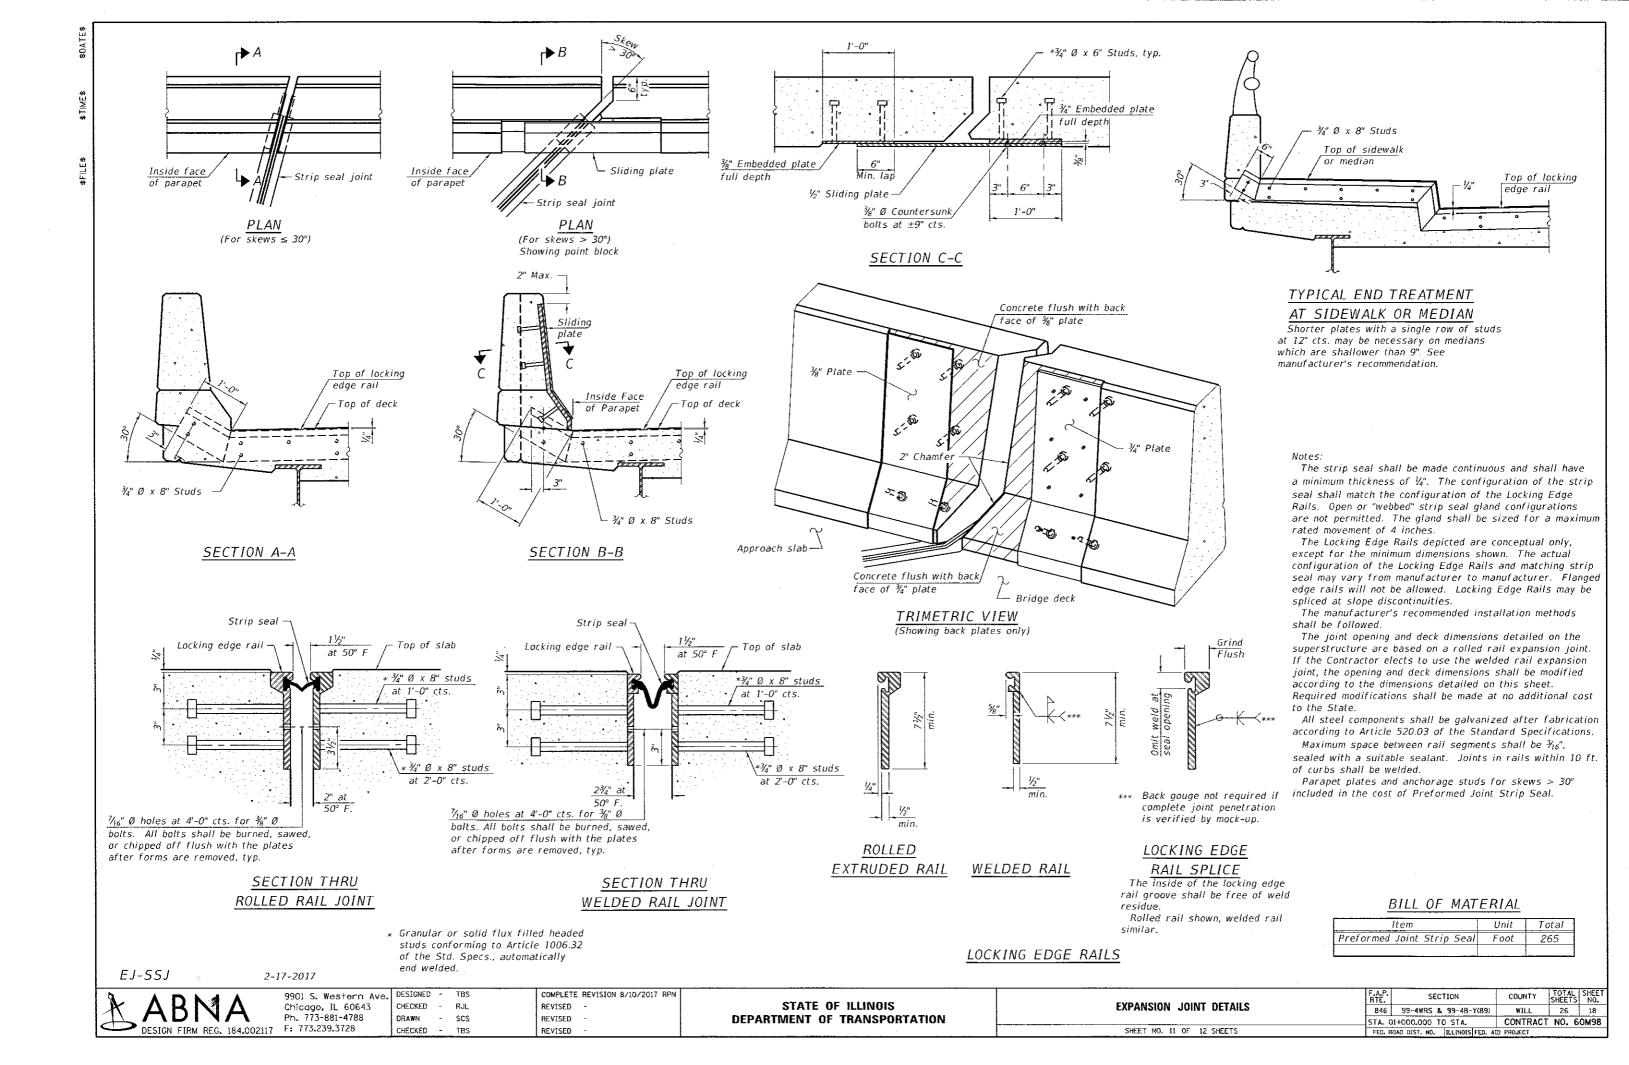


#### STANDARD BAR SPLICER ASSEMBLY

Threaded splicer bar length = min. lap length +  $I_2^{l}$ " + thread length


\* Epoxy not required on Bar Splicer Assembly components used in conjunction with black bars.

Location	Bar	No. assemblies	Minimum
Location	size	required	lap length
S. Abutment	5	18	3'-4"
S. Abutment	6	8	4'-0**
Pier 1	5	36	3′-6″
Pier 2	5	36	3'-6"
N. Abutment	5	18	3'-4"
N. Abutment	6	8	4'-0"

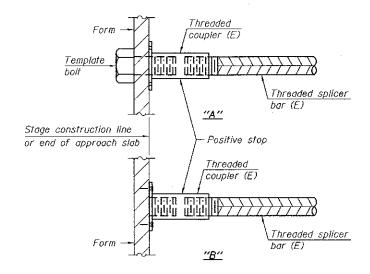


#### INSTALLATION AND SETTING METHODS

"A": Set bar splicer assembly by means of a template bolt. "B" : Set bar splicer assembly by nailing to wood forms or cementing to steel forms. (E): Indicates epoxy coating.

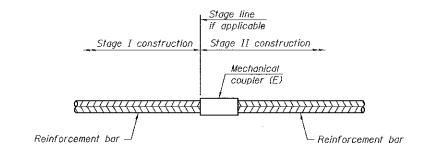

#### STANDARD MECHANICAL SPLICER

Location	Bar size	No. assemblies required

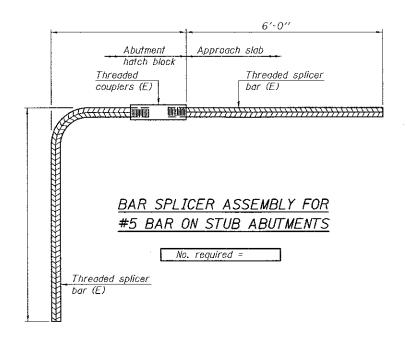

#### NOTES

Splicer bars shall be deformed with threaded ends and have a minimum 60 ksi yield strength.

All reinforcement shall be lapped and tied to the splicer bars. Bar splicer assemblies shall be epoxy coated according to the requirements for reinforcement bars. See Section 508 of the Standard Specifications. See approved list of bar splicer assemblies and mechanical splicers for

BSD-1

6-8-15

*	Α	BI	$\overline{J}$	A
	DESIGN	FIRM	REG.	184.002117

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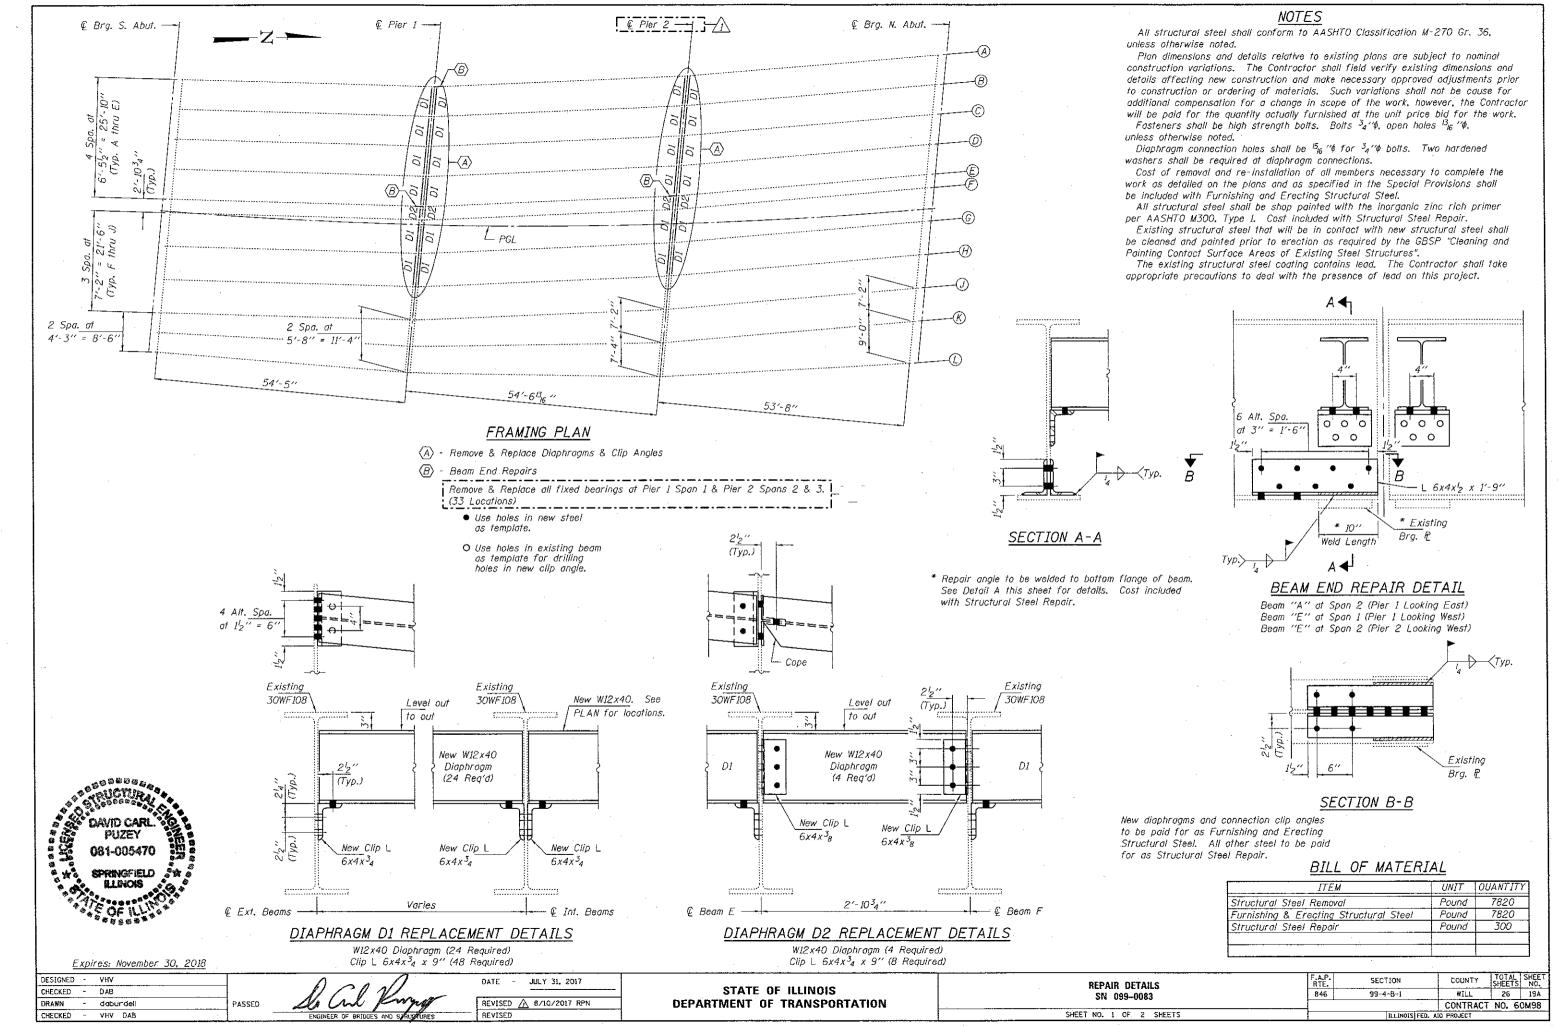
REVISED TBS CHECKED - RJL REVISED DRAWN - SCS REVISED CHECKED - TBS REVISED


STATE OF ILLINOIS **DEPARTMENT OF TRANSPORTATION** 

**BAR SPLICER DETAILS** SHEET NO. 12 OF 12 SHEETS

alternatives.

COUNTY TOTAL SHEET NO. SECTION 846 99-4WRS & 99-48-Y(89) WILL 26 19 STA. 01+000.000 TO STA. CONTRACT NO. 60M98 FED. ROAD DIST. NO. | ILLINOIS FED. AID PROJECT



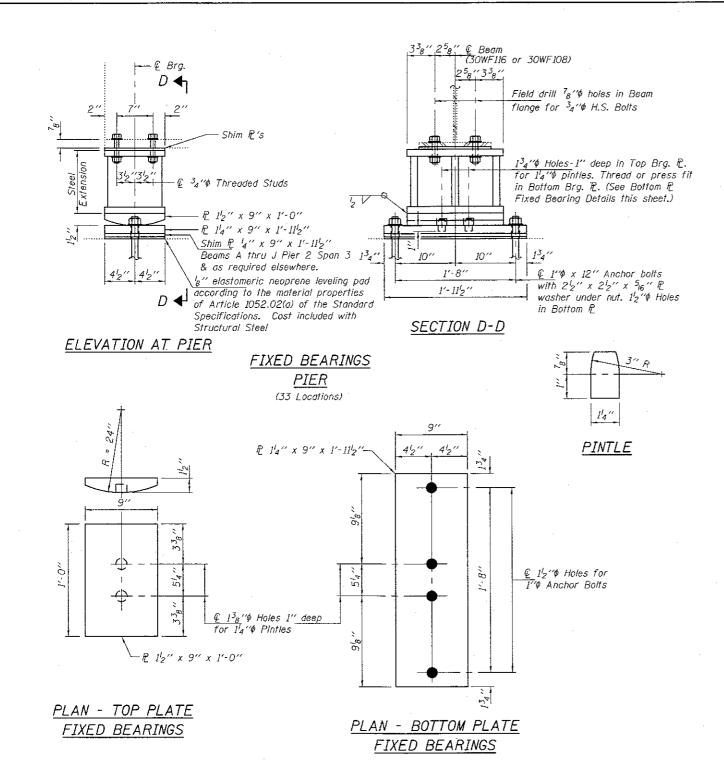

#### BEAM REACTIONS

		30WF116	30WF108
R₽	(K)	33.7	21.9
R4	(K)	43.3	37.9
Imp.	(K)	12.2	10.6
R (Total)	(K)	89.2	70.4


Notes:

Diaphragm removal and reinstallation may be required to facilitate drilling holes. Cost included with Furnishing and Erecting Structural Steel.


New steel extensions, shim plates and connection bolts are included with Furnishing and Erecting Structural Steel. Prior to ordering any material, the Contractor shall verify in the field all bearing height and shim thickness dimensions. Adjustment must account for deck heave due to pack rust (if present).


(if present).
Min. jack capacity = 50 Tons.
Anchor bolts shall be ASTM F1554 all-thread (or an Engineer-approved alternate material) of the grade(s) and diameter(s) specified. ASTM A307 Grade C anchor bolts may be used in lieu of ASTM F1554 Grade 36 (Fy=36ksi). The corresponding specified grade of AASHTO M314 anchor bolts may be used in lieu of ASTM F1554.

Drilled and set anchor bolts shall be installed according to Article 521.06 of the Standard Specifications.

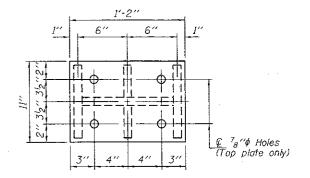


#### PLAN TOP AND BOTTOM PLATE

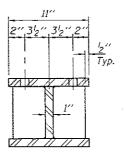

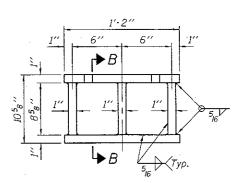

SECTION B-B

STEEL EXTENSION DETAIL

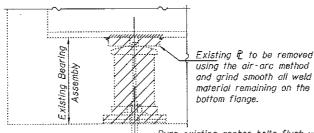

Burn existing anchor bolts flush with existing concrete surface. Grind existing anchor bolt smooth and seal with epoxy.

#### EXISTING BEARING REMOVAL DETAIL


Cost included with Jack and Remove Existing Bearings.

#### BILL OF MATERIAL

Item	Unit	Total
Jack and Remove Existing Bearings	Each	31
Furnishing and Erecting Structural Steel	Pound	10750
Anchor Bolts 1'4	Each	66

\* Jacking and Removing bearings at Beam A, Pier 2 is included with Temporary Shoring and Cribbing.


F.A.P. RTE. TOTAL SHEET SHEETS NO. SECTION COUNTY DESIGNED - VHV DATE - JULY 31, 2017 REPAIR DETAILS CHECKED - DAB STATE OF ILLINOIS 26 19B 99-4-B-1 WILL 846 SN 099-0083 SHEET ADDED 8/10/2017 RPN DEPARTMENT OF TRANSPORTATION CONTRACT NO. 60M98 DRAWN daburdel PASSED SHEET NO. 2 OF 2 SHEETS ILLINOIS FED. AID PROJECT CHECKED - VHV DAB REVISED

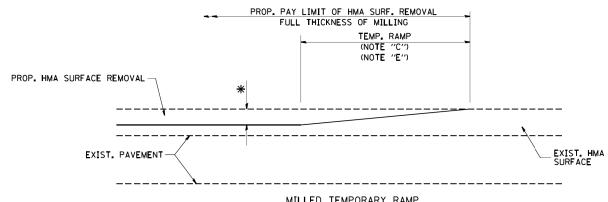

MILLED TEMPORARY RAMP

(FOR BUTT JOINT AND HMA TAPER SEE DETAIL BELOW)


#### OPTION 1

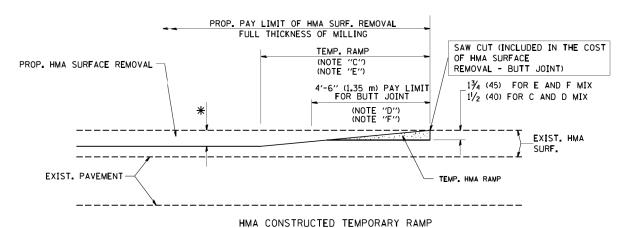


(FOR BUTT JOINT AND HMA TAPER SEE DETAIL BELOW)


#### OPTION 2

#### TYPICAL TEMPORARY RAMP

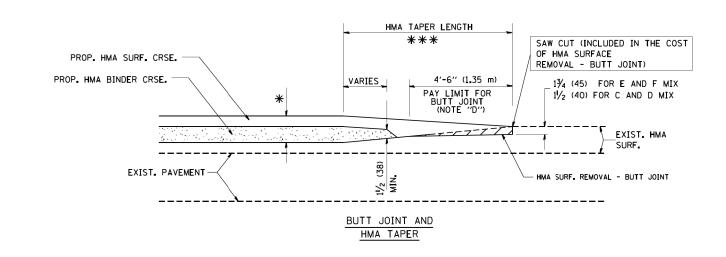

## TYPICAL BUTT JOINT AND HMA TAPER FOR MILLING AND RESURFACING

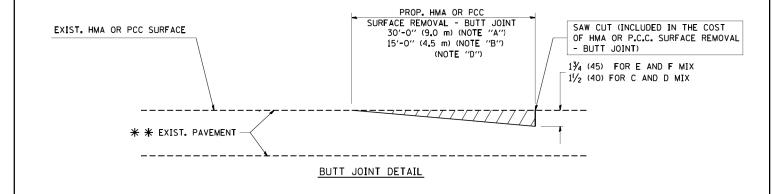

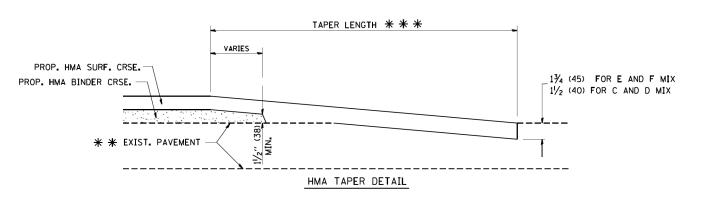

## TYPICAL BUTT JOINT AND HMA TAPER FOR RESURFACING ONLY

\* \* PC CONCRETE, HMA OR HMA RESURFACED PAVEMENT.

#### NOTES

- A: MAINLINE ROADWAYS AND MAJOR SIDE ROADS.
- B: MINOR SIDE ROADS.
- C: THE TEMP. RAMP SHALL BE CONSTRUCTED IMMEDIATELY UPON REMOVAL OF THE EXISTING HMA SURFACE.
- D: THE BUTT JOINT SHALL BE CONSTRUCTED IMMEDIATELY PRIOR TO PLACING THE PROPOSED HMA COURSES.
- E: TAPER THE TEMP. RAMP AT A RATE OF 3'-0" (900 mm) PER 1 INCH (25 mm) OF MILLING THICKNESS.
- F: INSTALLATION AND REMOVAL OF THE 4'-6" (1.35 m) TEMP. RAMP IS INCLUDED IN COST OF HMA SURFACE REMOVAL BUTT JOINT
- G: SEE ARTICLE 406.08 AND 406.14 OF THE STANDARD SPECIFICATIONS FOR "HMA AND/OR PCC SURFACE REMOVAL, BUTT JOINT".
- \* SEE TYPICAL SECTIONS FOR MILLING THICKNESS.
- \*\* \* 20'-0" (6.1 m) PER 1 (25) RESURFACING (NOTE "A") 10'-0" (3.0 m) PER 1 (25) RESURFACING (NOTE "B")

#### BASIS OF PAYMENT:

THE BUTT JOINT WILL BE PAID FOR AT THE CONTRACT UNIT PRICE PER SOUARE YARD (SOUARE METER) FOR "HOT-MIX ASPHALT SURFACE REMOVAL - BUTT JOINT" OR FOR "PORTLAND CEMENT CONCRETE SURFACE REMOVAL- BUTT JOINT".

SCALE: NONE

ALL DIMENSIONS ARE IN INCHES (MILLIMETERS) UNLESS OTHERWISE SHOWN.



9901 S. Western Ave. Chicago, IL 60643 Ph. 773-881-4788 F: 773-239-3728

 DESIGNED
 M. DE YONG
 REVISED
 - R. SHAH 10-25-94

 DRAWN
 REVISED
 - A. ABBAS 03-21-97

 CHECKED
 REVISED
 - M. GOMEZ 04-06-01

 DATE
 06-13-90
 REVISED
 - R. BORO 01-01-07

	BUTT JOINT AND HMA TAPER DETAILS			F.A.P. RTE.	SECTION	COUNTY	TOTAL SHEETS	SHEET NO.
				846	99-4-B-I	WILL	26	20
					BD400-05 BD32	CONTRACT	NO. 6	0м98
	SHEET NO. 1 OF 1 SHEETS	STA.	TO STA.	FFD RO	AD DIST NO 1 TILINOIS FED AT	D. PROJECT		

TRAFFIC CONTROL AND PROTECTION FOR SIDE ROADS, INTERSECTIONS, AND DRIVEWAYS

#### NOTES:

- A. FOR NO LANE RESTRICTION ON THE SIDE ROAD OR DRIVEWAYS
- 1. SIDE ROAD WITH A SPEED LIMIT OF 40 MPH (60 km/h) OR LESS AS SHOWN ON THE DRAWING AND AS DIRECTED BY THE ENGINEER:
- $^{\rm Q)}$  ONE road construction ahead sign 36  $\times$  36 (900×900) with a flasher and flag mounted on it approximately 200' (60 m) in advance of the main route.
- b) THE CLOSED PORTION OF THE MAIN ROUTE SHALL BE PROTECTED BY BLOCKING WITH TYPE I, TYPE II OR TYPE III BARRICADES, 1/3 OF THE CROSS SECTION OF THE CLOSED PORTION.
- 2. SIDE ROAD WITH A SPEED LIMIT GREATER THAN 40 MPH (60 km/h) AS SHOWN ON THE DRAWING AND AS DIRECTED BY THE ENGINEER:
- d) ONE ROAD CONSTRUCTION AHEAD SIGN  $48 \times 48$  (1.2 m  $\times$  1.2 m) WITH A FLASHER MOUNTED ON IT APPROXIMATELY 500' (150 m) IN ADVANCE OF THE MAIN ROUTE.
- b) THE CLOSED PORTION OF THE MAIN ROUTE SHALL BE PROTECTED BY BLOCKING WITH TYPE III BARRICADES, 1/2 OF THE CROSS SECTION OF THE CLOSED PORTION.
- 3. WHEN THE SIDE ROAD LIES BETWEEN THE BEGINNING OF THE MAINLINE SIGNING AND THE WORK ZONE, A SINGLE HEADED ARROW (MG-1) SHALL BE USED IN LIEU OF THE DOUBLE HEADED ARROW (MG-4).

SCALE: NONE

#### B. FOR A LANE CLOSURE ON A SIDE ROAD OR DRIVEWAY:

USE APPLICABLE PORTIONS OF THE TYPICAL APPLICATION OF TRAFFIC CONTROL DEVICES (STD. 701501, STD. 701606 OR THE APPROPRIATE STANDARD). THE SPACING OF SIGNS AND BARRICADES SHALL BE ADJUSTED FOR FIELD CONDITIONS AS DIRECTED BY THE ENGINEER. THE DIRECTIONAL ARROW SHALL BE COVERED OR REMOVED WHEN NO LONGER CONSISTENT WITH THE SIDE ROAD LANE CLOSURE.

- C. ADVANCE WARNING SIGNS ARE TO BE OMITTED ON DRIVEWAY UNLESS OTHERWISE NOTED.
- D. THE TRAFFIC CONTROL AND PROTECTION FOR SIDE ROADS, INTERSECTIONS, AND DRIVEWAYS SHALL BE INCIDENTAL TO THE COST OF SPECIFIED TRAFFIC CONTROL STANDARDS OR ITEMS.

All dimensions are in millimeters (inches) unless otherwise shown.




9901 S. Western Ave. Chicago, IL 60643
Ph. 773-881-4788
F: 773-239-3728


SII	DE ROAD	S, INTERS	ECTIONS		TION FOR DRIVEWAYS
	SHEET NO.	. 1 OF 1 SH	EETS	STA.	TO STA.

F.A.P. RTE.	SECTION	COUNTY	TOTAL SHEETS	SHEE NO.
846	99-4-B-I	WILL	26	21
	TC-10	CONTRACT	NO. 6	ом98
FED. RC	AD DIST, NO. 1 TILLINGIS FED. AT	D PROJECT		


TWO-LANE/TWO-WAY

\*\*\* REDUCE TO 40' (12 m) O.C. ON CURVES WITH POSTED OR ADVISORY SPEED 45 M.P.H. (70 km/h) OR LESS.

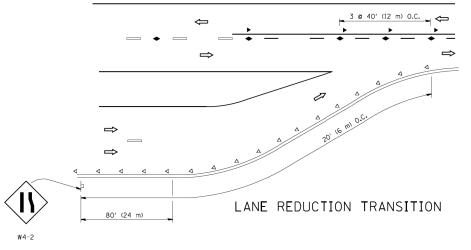


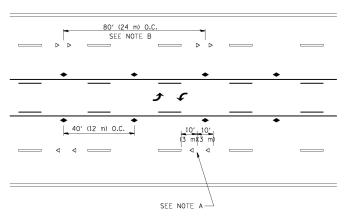

TWO-WAY LEFT TURN

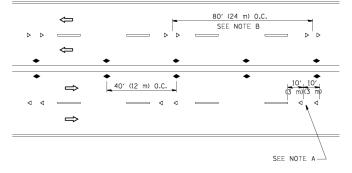

MULTI-LANE/UNDIVIDED

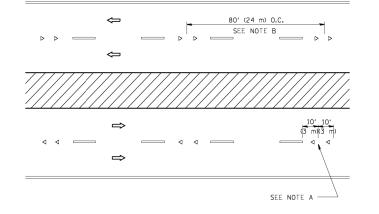

MULTI-LANE/DIVIDED

#### GENERAL NOTES

- 1. MARKERS USED WITH DASHED LINES SHALL BE CENTERED IN THE GAP BETWEEN SEGMENTS.
- 2. MARKERS USED ADJACENT TO SOLID LINES SHALL BE OFFSET 2 TO 3 (50 TO 75) TOWARD TRAFFIC AS SHOWN.
- 3. MARKERS THROUGH TANGENTS LESS THAN 500' (150 m) IN LENGTH BETWEEN CURVES SHALL BE INSTALLED AT THE LESSER OF THE TWO CURVE SPACINGS.

#### LANE MARKER NOTES

A. USE DOUBLE LANE LINE MARKERS SPACED AS SHOWN.

B. REDUCE TO 40' (12 m) O.C. ON CURVES WHERE ADVISORY SPEEDS ARE 10 M.P.H (20 km/h) LOWER THAN POSTED SPEEDS.

#### SYMBOLS

YELLOW STRIPE

── WHITE STRIP

- ONE-WAY AMBER MARKER
- ONE-WAY CRYSTAL MARKER (₩/O)
- ◆ TWO-WAY AMBER MARKER

#### DESIGN NOTES

- 1. DOUBLE LANE LINE MARKERS SHALL BE USED UNLESS SPECIFIED OTHERWISE.
- 2. EXCEPT AS SHOWN ON THE LANE REDUCTION TRANSITION AND FREEWAY EXIT RAMP DETAIL, MARKERS ARE NOT TO BE SPECIFIED ON RIGHT EDGE LINES.
- 3. THE EXACT MARKER LIMITS, SPACING, AND COLOR SHALL BE INCLUDED IN THE PLANS WHEN STANDARD SPECIFICATIONS ARE NOT BEING USED.
- MARKERS SHOULD NOT BE USED ALONGSIDE CURBS EXCEPT FOR EXTREMELY SHORT SECTIONS OF CURBS WHERE NOT MORE THAN TWO MARKERS WOULD BE INVOLVED.

#### 

LEFT TURN

All dimensions are in inches (millimeters) unless otherwise shown.



9901 S. Western Ave. Chicago, IL 60643 Ph. 773-881-4788 F: 773-239-3728

 DESIGNED
 REVISED
 -T. RAMMACHER 09-19-94

 DRAWN
 REVISED
 -T. RAMMACHER 03-12-99

 CHECKED
 REVISED
 -T. RAMMACHER 01-06-00


 DATE
 REVISED
 - C. JUCIUS 09-09-09


STATE OF ILLINOIS
DEPARTMENT OF TRANSPORTATION


TYPICAL APPLICATIONS

RAISED REFLECTIVE PAVEMENT MARKERS (SNOW-PLOW RESISTANT)

CALLE: NONE SHEET NO. 1 OF 1 SHEETS STA. TO STA.

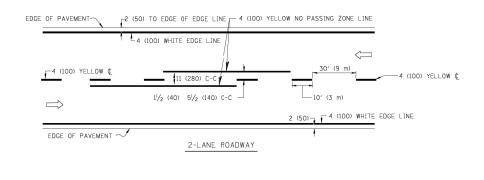

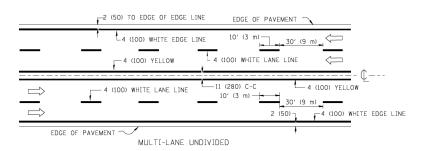

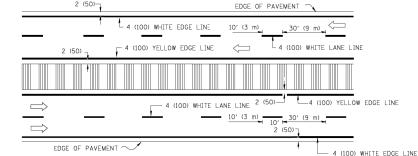


TYPICAL LANE AND EDGE LINE MARKING


MULTI-LANE DIVIDED
WITH MOUNTABLE MEDIAN
NOTE: MEDIANS WITH BARRIER CURB DO NOT REQUIRE AN EDGE LINE

# BICYCLE & EQUESTRIAN SCHOOL PEDESTRIAN SCHOOL PEDESTRIAN 12 (300) WHITE DETAIL "A" DETAIL "A" DETAIL "A" DETAIL "A" DETAIL "A" DETAIL "A"

TYPICAL CROSSWALK MARKING

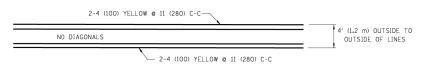


4' (1.2 m) WIDE MEDIANS ONLY

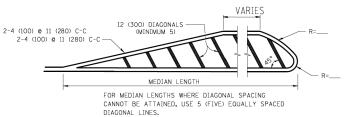


DIAGONAL LINE SPACING: 50' (15 m) C-C (LESS THAN 30MPH (50 km/h)) 75' (25 m) C-C 30MPH (50 km/h) TO 45MPH (70 km/h)) 150' (45 m) C-C (MORE THAN 45MPH (70 km/h))

#### MEDIANS OVER 4' (1.2 m) WIDE

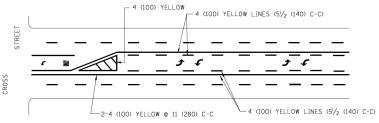


A MINIMUM OF TWO PAIRS OF TURN ARROWS SHALL BE USED, WHITE IN COLOR. ADDITIONAL PAIRS SHALL BE PLACED AT 200' (60 m) TO 300' (90 m) INTERVALS.

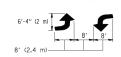

MEDIAN WITH TWO-WAY LEFT TURN LANE

#### TYPICAL PAINTED MEDIAN MARKING

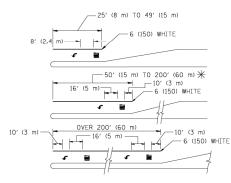


FULL SIZE LETTERS 8' (2.4 m) AND ARROWS SHALL BE USED.  $\P$  AREA = 15.6 SO. FT. (1.5 m<sup>2</sup> ) ONLY AREA = 20.8 SO. FT. (1.9 m<sup>2</sup>)

\* TURN LANES IN EXCESS OF 400' (120 m) IN LENGTH MAY HAVE AN ADDITIONAL SET OF ARROW - "ONLY" INSTALLED MIDWAY BETWEEN THE OTHER TWO SETS OF ARROW - "ONLY".

TYPICAL LEFT (OR RIGHT) TURN LANE

#### TYPICAL TURN LANE MARKING

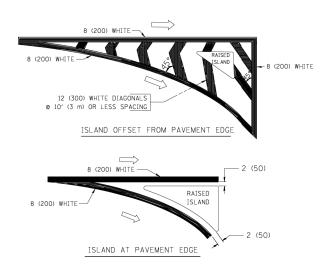

#### TYPICAL ISLAND MARKING

TYPE OF MARKING	WIDTH OF LINE	PATTERN	COLOR	SPACING / REMARKS
CENTERLINE ON 2 LANE PAVEMENT	4 (100)	SKIP-DASH	YELLOW	10' (3 m) LINE WITH 30' (9 m) SPACE
CENTERLINE ON MULTI-LANE UNDIVIDED PAVEMENT	2 @ 4 (100)	SOLID	YELLOW	11 (280) C-C
NO PASSING ZONE LINES: FOR ONE DIRECTION FOR BOTH DIRECTIONS	4 (100) 2 @ 4 (100)	SOLID SOLID	YELLOW YELLOW	5/2 (140) C-C FROM SKIP-DASH CENTERLINE 11 (280) C-C OMIT SKIP-DASH CENTERLINE BETWEEN
LANE LINES	4 (100) 5 (125) ON FREEWAYS	SKIP-DASH SKIP-DASH	WHITE WHITE	10' (3 m) LINE WITH 30' (9 m) SPACE
DOTTED LINES (EXTENSIONS OF CENTER, LANE OR TURN LANE MARKINGS)	SAME AS LINE BEING EXTENDED	SKIP-DASH	SAME AS LINE BEING EXTENDED	2' (600) LINE WITH 6' (1.8 m) SPACE
EDGE LINES	4 (100)	SOLID	YELLOW-LEFT WHITE-RIGHT	OUTLINE MOUNTABLE MEDIANS IN YELLOW: EDGE LINES ARE NOT USED NEXT TO BARRIER CURB
TURN LANE MARKINGS	6 (150) LINE; FULL SIZE LETTERS & SYMBOLS (8' (2.4m))	SOLID	WHITE	SEE TYPICAL TURN LANE MARKING DETAIL
TWO WAY LEFT TURN MARKING	2 @ 4 (100) EACH DIRECTION	SKIP-DASH AND SOLID	YELLOW	10' (3 m) LINE WITH 30' (9 m) SPACE FOR SKIP-DASH; 51/2 (140) C-C BETWEEN SOLID LINE AND SKIP-DASH LINE
	8' (2.4m) LEFT ARROW	IN PAIRS	WHITE	SEE TYPICAL TWO-WAY LEFT TURN MARKING DETAIL
CROSSWALK LINES (PEDESTRIAN) A. DIAGONALS (BIKE & EQUESTRIAN) B. LONGITUDINAL BARS (SCHOOL)	2 @ 6 (150) 12 (300) @ 45° 12 (300) @ 90°	SOLID SOLID SOLID	WHITE WHITE WHITE	NOT LESS THAN 6' (1.8 m) APART 2' (600) APART 2' (600) APART SEE TYPICAL CROSSWALK MARKING DETAILS.
STOP LINES	24 (600)	SOLID	WHITE	PLACE 4' (1,2 m) IN ADVANCE OF AND PARALLEL TO CROSSWALK, IF PRESENT. OTHERWISE, PLACE AT DESIRED STOPPING POINT. PARALLEL TO CROSSROAD CENTERLINE, WHERE POSSIBLE
PAINTED MEDIANS	2 @ 4 (100) WITH 12 (300) DIAGONALS @ 45° NO DIAGONALS USED FOR	SOLID	YELLOW: TWO WAY TRAFFIC WHITE: ONE WAY TRAFFIC	11 (280) C-C FOR THE DOUBLE LINE SEE TYPICAL PAINTED MEDIAN MARKING.
GORE MARKING AND CHANNELIZING LINES	4' (1.2 m) WIDE MEDIANS 8 (200) WITH 12 (300) DIAGONALS @ 45°	SOLID	WHITE	DIAGONALS: 15' (4.5 m) C-C (LESS THAN 30MPH (50 km/h)) 20' (6 m) C-C 30MPH (50 km/h) TO 45MPH (70 km/h)) 30' (9 m) C-C (OVER 45MPH (70 km/h))
RAILROAD CROSSING	24 (600) TRANSVERSE LINES; "RR" IS 6' (1.8 m) LETTERS; 16 (400) LINE FOR "X"	SOLID	WHITE	SEE STATE STANDARD 780001 AREA OF: "R"=3.6 SO. FT. (0.33 m <sup>2</sup> ) EACH "X"=54.0 SQ. FT. (5.0 m <sup>2</sup> )
SHOULDER DIAGONALS	12 (300) @ 45°	SOLID	WHITE - RIGHT YELLOW - LEFT	50' (15 m) C-C (LESS THAN 30MPH (50 km/h)) 75' (25 m) C-C (30 MPH (50 km/h) TO 45MPH (70 km/h)) 150' (45 m) C-C (0VER 45MPH (70 km/h))


FOR FURTHER DETAILS ON PAVEMENT MARKING REFER TO STANDARD SPECIFICATIONS FOR ROAD AND BRIDGE CONSTRUCTION AND STATE STANDARD 780001.

All dimensions are in inches (millimeters) unless otherwise shown.

ABNA
DESIGN FIRM REG. 184,002117

9901 S. Western Ave. Chicago, IL 60643 Ph. 773-881-4788 F: 773-239-3728

DISTRICT ONE	F.A.P. RTE.	SECTION	COUNTY	TOTAL SHEETS	
TYPICAL PAVEMENT MARKINGS	846	99-4-B-I	WILL	26	23
	TC-13		CONTRACT NO. 60M		ом98
SCALE: NONE   SHEET NO. 1 OF 1 SHEETS   STA. TO STA.	FED. RO	DAD DIST. NO. 1   ILLINOIS FED. A	ID PROJECT		

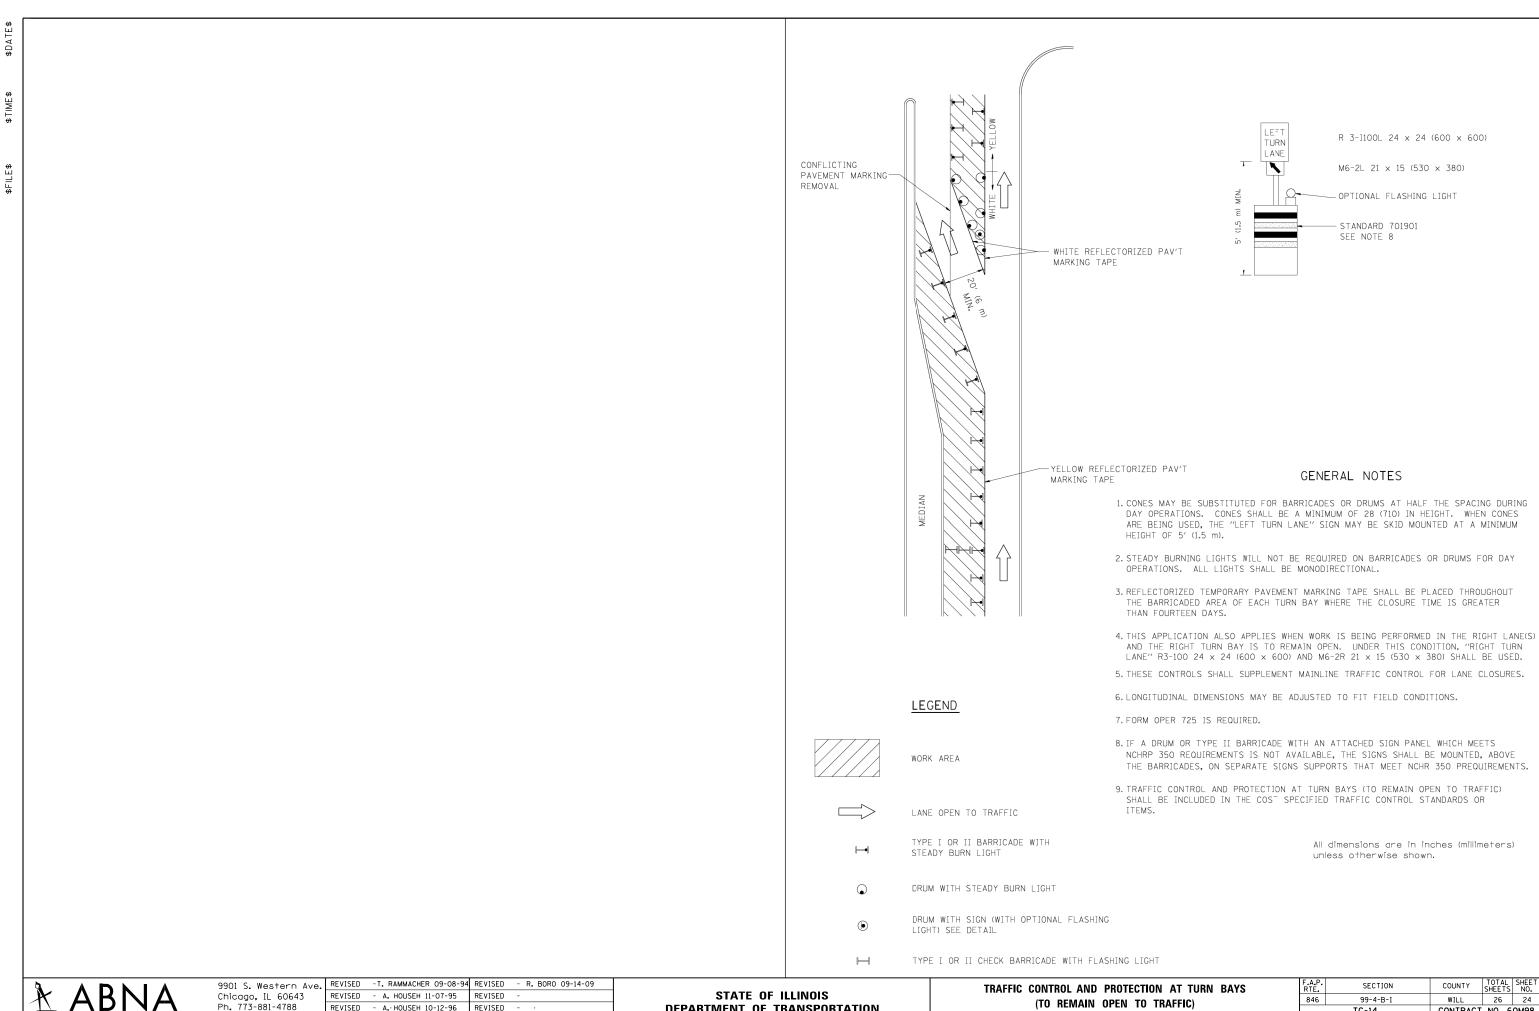

DESIGN FIRM REG. 184.002117 F: 773-239-3728


Ph. 773-881-4788

- A. HOUSEH 10-12-96 REVISED REVISED -T. RAMMACHER 01-06-00 REVISED


**DEPARTMENT OF TRANSPORTATION** 

SCALE: NONE SHEET NO. 1 OF 1 SHEETS STA.

TC-14 CONTRACT NO. 60M98 FED. ROAD DIST. NO. 1 | ILLINOIS FED. AID PROJECT

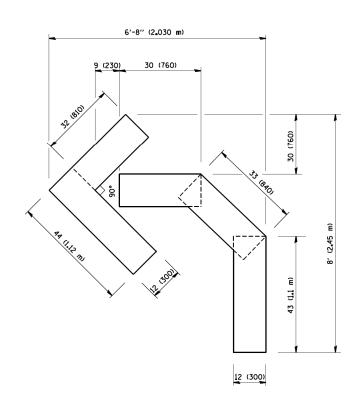

QUANTITY 4 (100) LINE = 45.5 ft. (13.9 m) 15.2 sq. ft. (1.39 sq. m)

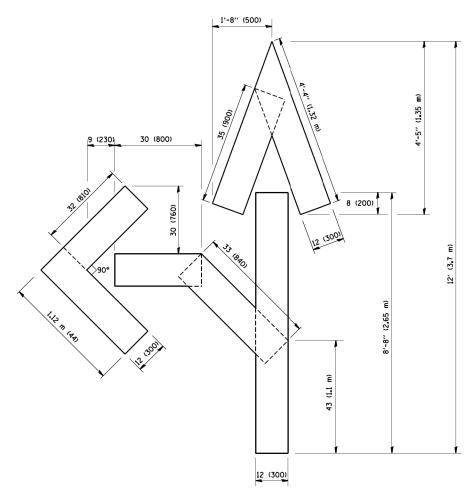


QUANTITY 4 (100) LINE = 82.5 ft. (25.3 m) 27.5 sq. ft. (2.53 sq. m)

> All dimensions are in inches (millimeters) unless otherwise shown.



/е <b>.</b>	DESIGNED	REVISED	-T. RAMMACHER 06-05-96
	DRAWN	REVISED	-T. RAMMACHER 11-04-97
	CHECKED	REVISED	-T. RAMMACHER 03-02-98
	DATE 09-18-94	REVISED	- E. GOMEZ 08-28-00

	PAVEMENT MARKING LETTERS AND SYMBOLS FOR TRAFFIC STAGING			SYMBOLS	F.A.P. RTE. 846	SECTION 99-4-B-I	COUNTY	TOTAL SHEETS 26	SHEET NO. 25
	Toll Harris Stading				TC-16	CONTRACT	NO. 6	0м98	
ı	SCALE: NONE	SHEET NO. 1 OF 1 SHEETS	STA.	TO STA.	FED. RO	AD DIST. NO. 1 ILLINOIS FED. A	D PROJECT		

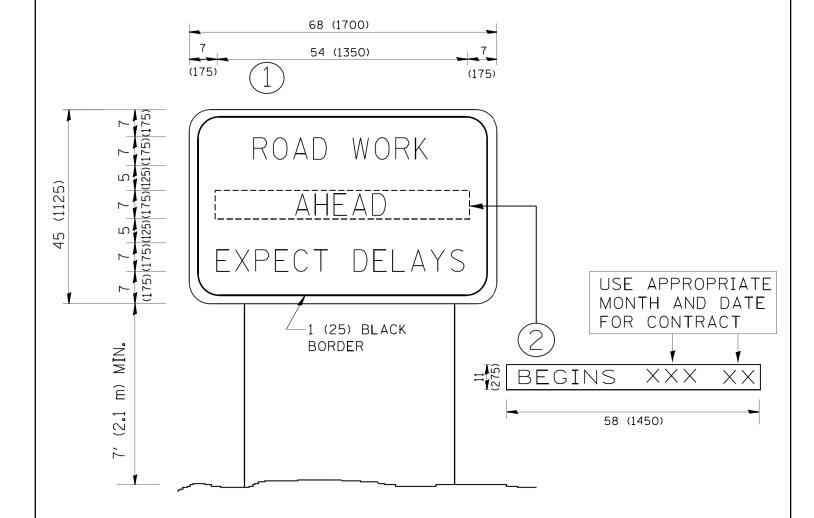

#### NOTES:

1. USE BLACK LETTERING ON ORANGE BACKGROUND.

SCALE: NONE

- 2. ERECT SIGNS IN ADVANCE OF THE LOCATION FOR THE "ROAD CONSTRUCTION AHEAD" SIGN AT LOCATIONS AS DIRECTED BY THE ENGINEER.
- 3. ERECT SIGN () WITH INSTALLED PANEL (2) ONE WEEK PRIOR TO THE START OF CONSTRUCTION.
- 4. REMOVE PANEL (2) SOON AFTER THE START OF CONSTRUCTION.
- 5. SEE SPECIAL PROVISION FOR "TEMPORARY INFORMATION SIGNING" FOR ADDITIONAL INFORMATION.
- 6. ONE SIGN ASSEMBLY EQUALS 25.70 SQ. FT. (2.3 SQ. M.)
- 7. SHALL BE PAID FOR AS TEMPORARY INFORMATION SIGNING.

ALL DIMENSIONS ARE IN INCHES (MILLIMETERS) UNLESS OTHERWISE SHOWN.



9901 S. Western Ave.				
Chicago, IL 60643				
h. 773-881-4788				
: 773-239-3728	С			

DESIGNED	REVISED	- R. MIRS 09-15-97
DRAWN	REVISED	- R. MIRS 12-11-97
CHECKED	REVISED	-T. RAMMACHER 01-06-00
DATE	REVISED	- C. JUCIUS 01-31-07

STATE OF ILLINOIS					
DEPARTMENT	OF TRANSPORTATI	ON			

		F.A.P. RTE.	SECTION	COUNTY	TOTAL SHEETS	SHEET NO.	
			846	99-4-B-I	WILL	26	26
			TC-22		CONTRACT	NO. 6	86MO
SHEET NO 1 OF 1 SHEETS	STA.	TO STA.	EED BO	AD DIST NO 1 THE INDISCRED AT	D DDO IECT		