SECTION 03-00026-00-PK MADISON

FEDERAL AID PROJECT

STANDARDS

STATE OF ILLINOIS DEPARTMENT OF TRANSPORTATION **DIVISION OF HIGHWAYS** LEWIS & CLARK TOWERS PHASE 2B

RESTROOM FACILITIES

PHASE 2B RESTROOMS

INDEX OF DRAWINGS

GENERAL DRAWINGS

A1-01 COVER SHEET

CIVIL DRAWINGS

GENERAL NOTES / SUMMARY OF QUANTITIES DETAILS

CONSTRUCTION PLAN GRADING PLAN / EROSION CONTROL PLAN 01--05 BIKE TRAIL ACCESS PLAN AND PROFILE

BIKE TRAIL ACCESS CROSS SECTIONS BIKE TRAIL ACCESS CROSS SECTIONS BIKE TRAIL ACCESS CROSS SECTIONS

STRUCTURAL DRAWINGS

TYPICAL DETAILS & GENERAL NOTES

FOUNDATION PLAN ROOF PLAN \$2.18 \$2.28

SECTIONS AND DETAILS SECTIONS AND DETAILS

ARCHITECTURE DRAWINGS

DOOR INFORMATION/MOUNTING HEIGHTS/PARTITION TYPES

FLOOR PLAN/ROOF PLAN/REFLECTED CEILING PLAN

MECHANICAL DRAWINGS N3-01 FLOOR PLAN - MECHANICAL

PLUMBING DRAWINGS BELOW FLOOR PLAN - PITIMEING

LEGEND, SCHEDULES & DETAILS - PLUMBING

ELECTRICAL DRAWINGS

ELECTRICAL SYMBOLS AND ABBREVIATIONS

ELECTRICAL SITE PLAN PLAZA LIGHTING PLAN

GROUND FLOOR POWER PLAN


ONE LINE DIAGRAM

ELECTRICAL DETAILS ELECTRICAL DETAILS

SCENIC BYWAY FUNDS:

SECTION <u>03-00026-00-PK</u> PROJECT NO. SBIL-IL03(009)

VILLAGE OF HARTFORD

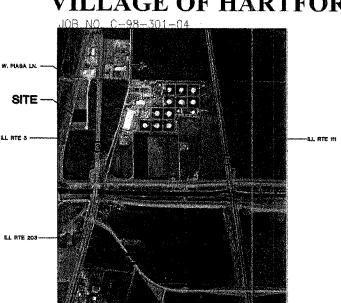

LOCATION MAP

NO SCALE





211 NORTH BROADWAY, SUITE 1900 ST. LOUIS, MO 63102 PH. (314) 241~8188 FAX (314) 241-0125



KAI

211 NORTH BROADWAY, SUITE 1900 ST. LOUIS, MO 63102 PH. (314) 241-8188 FAX (314) 241-0125



STRUCTURAL ENGINEER

S.S.E. INC.

138 W. CLINTON PLACE ST. LOUIS, MO 63122 PH. (314) 965-2233 FAX (314) 965-8269




CIVIL ENGINEER/ LAND SURVEY BLOTEVOGEL ASSOC. INC.

2 GINGER CREEK PARKWAY GLEN CARBON, IL 62034 PH. (618) 656-4166 FAX (618) 656-7127



KAI-asdate 211 NORTH BROADWAY, SUITE 1900

ST. LOUIS, MO 63102 PH. (314) 241-8188 FAX (314) 241-0125

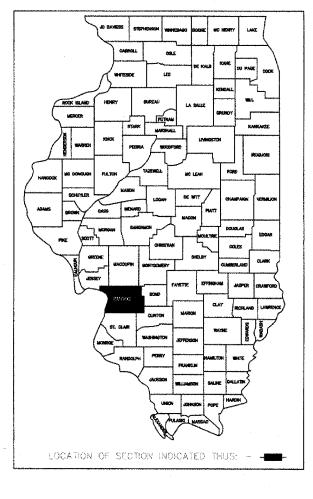

UTILITIES

AMEREN UE (ELEC.) PO BOX 66529 ST. LOUIS, MO 63166 1048 STATE ST.

CHARTER COMMUNICATIONS (CABLE)

EAST ST. LOUIS, IL 62201 1-800-211-4450

AMEREN IP (GAS) PO BOX 2543

1-800-552-7583

SBC (PHONE) 721 MISSOUŔI AVE

EAST ST. LOUIS, IL 62201 DECATUR, IL 62525 618-875-9856

1-800-755-5000

CONTRACT NO. 97300

WOOD RIVER DRAINAGE & LEVEE DISTRICT

543 W MADISON AVE WOOD RIVER, IL 62095 (618) 254-7457 (618) 779-9176

GEOTECHNICAL ENGINEER

SCI ENGINEERING INC. 15 EXECUTIVE DRIVE, SUITE 4

FAIRVIEW HEIGHTS, IL 62208 PH. (618) 624-6969 FAX (314) 231-6733 FAX (618)

PRINTED BY THE AUTHORITY OF THE STATE OF ILLINOIS

ILLINOIS DEPARTMENT OF

TRANSPORTATION

DISTRICT #8 ENGINEER OF LOCAL ROADS & STREETS

William E. Moore &
WILLIAM MOORE JR. BOARD PRESIDENT

DEPUTY DIRECTOR OF HIGHWAYS,

.20<u>07</u>

APPROVED DATE.

RELEASING FOR

BID BASED ON LIMITED REVIEW

	SUMMARY OF QUANT	1 1	-5			
CODED PAY ITEM	DESCRIPTION	T [NU	OUANT.	CONST. TYPE CODE Y 021	VILLAGE 20%	VILLAGE 100%
Q18000XX	CONCRETE PAVERS	SO FT	172	137.6	34.4	
XX003803	SANITARY SEWER SERVICE 6"	FOOT	43	34.4	8.6	
XX005452	FENCE RAIL	FOOT	265	212.0	53.0	
20200100	EARTH EXCAVATION	CU YD	7701	6.160.8	1.540.2	
25000910	SEEDING. CLASS 1 (MODIFIED)	ACRE	2.1	1.7	0.4	
25001850	SEEDING. CLASS 7 (MODIFIED)	ACRE	0.2	0.2	0.0	
25100630	EROSION CONTROL BLANKET	SO YD	749	599.2	149.8	
28000250	TEMPORARY EROSION CONTROL SEEDING	POUND	800	640.0	160.0	
28000300	TEMPORARY DITCH CHECKS	EACH.	1	0.8	0.2	
28000400	PERIMETER EROSION BARRIER	FOOT	1410	1.128.0	282.0	
28000500	INLET AND PIPE PROTECTION	EACH	2	1.6	0.4	
28100707	STONE DUMPED RIPRAP+ CLASS A4	SO YD	17	13.6	3.4	
28200200	FILTER FABRIC	SO YD	17	13.6	3.4	
30200650	PROCESSING MODIFIED SOIL. 12"	SO YD	2722	2.177.6	544.4	
30201500	LIME	TON	39	31.2	7.8	
31100100	SUB-BASE CRANULAR MATERIAL, TYPE A	TON	1348	1.078.4	269.6	
40300100	BITUMINOUS MATERIALS (PRIME COAT)	GALLON	575	460.0	115.0	
40603085	HOT MIX ASPHALT BINDER COURSE, IL-19.0, N70	TON	243	194.4	48.6	
40603065	HOT MIX ASPHALT SURFACE COURSE. MIX "C". NTO	TON	243	194.4	48.6	
42300400	PORTLAND CEMENT CONCRETE DRIVEWAY PAVEMENT. 8 INCH	SO YD	199	159.2	39.8	
42400200	PORTLAND CEMENT CONCRETE SIDEWALK 5 INCH	SO FT	5510	4,408.0	1.102.0	
42400800	DETECTABLE WARNINGS	SO FT	8	6.4	1.6	
542A0229	PIPE CULVERTS, CLASS A. TYPE 1. 24"	FOOT	164	131.2	32.8	
54213669	PRECAST REINFORCED CONCRETE FLARED END SECTIONS, 24"	EACH	4	3,2	0.8	
56200900	WATER SERVICE LINE 2 1/2".	FOOT	42	33.6	8.4	
60600605	CONCRETE CURB, TYPE B	FOOT	947	757.6	189.4	
70101700	TRAFFIC CONTROL & PROTECTION	L SUM	. 1	0.8	0.2	
70102620	TRAFFIC CONTROL & PROTECTION STANDARD 701501	L SUM	1	. 0.8	0.2	
72000100	SIGN PANEL - TYPE 1	SO FT	26	20.8	5.2	
73000100	WOOD SIGN SUPPORT	F001	156	124.8	31.2	
78000100	THERMOPLASTIC PAVEMENT MARKING - LETTERS & SYMBOLS	SO FT	. 14	11.2	2.8	
78000200	THERMOPLASTIC PAVEMENT MARKING - LINE. 4"	FLOT	1444	1.155.2	288.8	
78000600	THERMOPLASTIC PAVEMENT MARKING - LINE. 12"	FOOT	5	4.0	1.0	
XX007056	BUILDING	L SUM	1	0.8	0.2	
67100100	MOBILIZATION	1 Sum	1	A THE THE PARTY AND A PARTY OF		
0,114110		1				
	, , , , , , , , , , , , , , , , , , , ,					
		+				
		1				
		+	-			
			enter elisarement can sa			
		1 1			-	
		1				

SECTION COUNTY TOTAL SHEET SHEETS NO. 03-00026-00-PK MADISON

GENERAL NOTES

- 1. EXISTING UTILITIES HAVE BEEN SHOWN ON THE PLANS FROM THE BEST INFORMATION AVAILABLE AND ARE GIVEN FOR THE CONTRACTOR'S CONVENIENCE. THE EXACT LOCATION MAY DIFFER FROM THAT SHOWN. IT IS THE CONTRACTOR'S RESPONSIBILITY TO NOTIFY ALL UTILITIES TO DETERMINE THE EXACT LOCATION. THE CONTRACTOR IS RESPONSIBLE FOR DAMAGE DONE TO ANY UTILITY DURING EXECUTION OF THIS WORK. IT IS UNDERSTOOD AND ADRED THAT THE CONTRACTOR HAS TAKEN THE FOREGOING INTO CONSIDERATION IN PREPARING HIS/HER BID, AND NO ADDITIONAL COMPENSATION WILL BE ALLOWED FOR ANY DELAYS OR INCONVENIENCE CAUSED BY SAME.
- THE CONTRACTOR IS RESPONSIBLE FOR KEEPING THE CONSTRUCTION SITE FREE OF DEBRIS AT ALL TIMES AND SHALL KEEP DIRT/MUD OFF ALL PUBLIC STREETS ADJACENT TO THE CONSTRUCTION SITE.
- 3. ALL DISTURBED AREAS. FOR WHATEVER REASON. SHALL BE SEEDED ACCORDING TO THE SPECIAL PROVISIONS.
- CONSTRUCTION CREWS, EQUIPMENT, TRUCKS, TRAILERS, BACKHOES, ETC. SHALL NOT BE PERMITTED TO PARK WITHIN THE PUBLIC RIGHT-OF-WAY ALONG CONFLUENCE TOWER ORIVE DURING THE CONSTRUCTION OF THIS PROJECT.
- 5. ANY FACILITIES OR APPURIEMANCES WHICH ARE THE PROPERTY OF ANY PUBLIC UTILITY LOCATED WITHIN THE LIMITS OF CONSTRUCTION SHALL BE RELOCATED OR ADJUSTED BY THEIR RESPECTIVE OWNERS. THE CONTRACTOR SHALL NOTIFY AND COMPERATE WHITH THE OWNERS OF THAN SUCH FACILITY IN THEIR REMOVAL HON FEARTRANGMENT OPERATIONS IN OPODER THAT THESE OPERATIONS AND THE CONSTRUCTION OF THIS PROJECT MAY PROPERSS IN A REASONABLE MANNER. ALL ROADSIDE OBJECTS CUITLITY PUBLES, FIRE HYDRANTS, SIONS, ETC., I SHALL BE RELOCATED TO PROVIDE A MINIMUM OF 2 FEET CLEARANCE, MEASURED FROM THE PROPOSED CONSTRUCTION TO THE NEAR EDGE OF THE OBJECT.
- THE CONTRACTOR SHALL VERIFY ALL DIMENSIONS AND CONDITIONS IN THE FIELD PRIOR TO ORDERING MATERIALS AND COMMENCING CONSTRUCTION.
- 7. THE CONTRACTOR SHALL CONFINE ALL OPERATIONS WITHIN THE CONSTRUCTION LIMITS. ANY AREA DISTURBED BEYOND THESE LIMITS SHALL BE RESTORED TO ITS ORIGINAL CONDITION AT THE CONTRACTOR'S EXPENSE.
- 8. FOR WORK PERFORMED WITHIN THE RIGHT-OF-WAY OF CONFLUENCE TOWER DRIVE. TRAFFIC CONTROL SHALL BE ACCORDING TO 1.0.0.T. HIGHWAY STANDARDS 702001 AND 701301.
- WORK ON IMMEDIATELY ADJACENT PROJECTS MAY BE OCCURRING SIMULTANEOUSLY WITH THIS PROJECT. CONTRACTOR SMALL COORDINATE THIS WORK WITH SAID ADJACENT PROJECTS TO INSURE THAT NO ADDITIONAL WORK RESULTS FOR EITHER PROJECT. THIS COORDINATION SHALL BE PERFORMED AT NO ADDITIONAL COMPENSATION.
- ADJACENT PROJECTS SUBJECT TO THIS REQUIREMENT IS SECTION 06-00026-01-MS. WITH THE VILLAGE OF HARTFORD AS THE LEAD AGENCY.
- 10. ELEVATION CONVERSION FROM CIVIL DRAWINGS TO ARCHITECTURAL. STRUCTURAL. AND OTHER DRAWINGS IS AS FOLLOWS: EL. 435.50' = EL. 100'-0"

"NO COMMITMENTS"

211 North Broadway Suite 1900 5t, Louis, Missouri 6 ph (314) 241-8188 fax (314) 541-0125






phase 1 Lewis and Clark Memorial Tower

General Summary

KENNEDY PROJECT N 10-02048

SSUE DATE

SHEET NO.

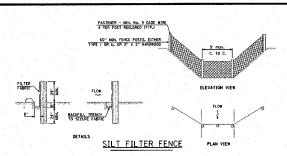


- . ALL SILT FENCES SHALL BE PLACED AS CLOSE TO THE CONTOUR AS POSSIBLE. WITH THE ENDS EXTENDING UPSLOPE. THE AREA BELOW THE FENCE MUST BE UNDISTURBED OR STABILIZED.
- WOOD POSTS WILL BE OF SOUND QUALITY WOOD WITH A MIN. CROSS SECTIONAL AREA OF 3.0 SO. IN. STEEL POSTS WILL BE STANDARD T AND U SECTIONS WEIGHING NOT LESS THAN 1.0 LBS.T.F. THE MAX. SPACING WILL BE 5 FEET. WHEN WIRE BACKING IS USED. THE MAX. SPACING MAY BE INCREASED TO 10 FEET. THE POSTS SHALL BE DRIVEN A MIN. OF 24 INTO THE GROUND. SPACING MAY NEED TO BE ADJUSTED SO THAT POSTS ARE LOCATED IN LOW AREAS WHERE WATER MAY POWD.
- 3. WIRE FENCE SHALL BE A MIN. 9 GAUGE TOP AND BOTTOM WIRES WITH A MAX. 6" MESH OPENING, OR AS APPROVED BY THE ENGINEER.
- THE FILTER FABRIC SHOULD BE FURNISHED IN A CONTINUOUS ROLL CUT TO THE LENGTH OF THE SILT FENCE NEEDED TO AVOID SPLICES. WHEN SPLICES ARE NECESSABY. THE FABRIC SHOULD BE SPLICED AT A SUPPORT POST WITH A MIN. 6" OVERLAP. FOLDED OVER AND SECURELY FASTERED.
- 5. THE SILT FENCE SHALL BE ENTRENCHED TO A MIN. DEPTH OF 8", WITH AN ADDITIONAL 6" EXTENDING ALONG THE BOTTOM OF THE IRRNOH IN THE UPSLOPE DIRECTION. THE TRENCH SHALL BE BACKFILLED AND THE SOIL COMPACTED OVER THE FABRIC.
- 6. THE FILTER FABRIC AND WIRE SUPPORT, IF USED, MUST BE SECURELY FASTENED TO THE UPSLOPE SIDE OF THE POSTS USING MEANY DUTY WIRE STAPLES AT LEAST DNE INCH LONG. TIE WIRES OR HOO RINGS. THE FABRIC SHALL NOT BE STAPLED OR WIRED TO THE WIRE SUPPORT. THE FABRIC SHALL NOT BE STAPLED TO EXISTING THE DIESESTAP.
- 7. INTERMEDIATE WIRE OF MESH SUPPORTS SHALL BE A MIN. OF GAGE No. 11.
- 8. GERATION AND MAINTENANCE OF SILT FENCE
 A. SILT FENCES SHALL BE REMOVED WHEN THEY HAVE SERVED THEIR USEFULNESS. BUT NOT BEFORE THE UPSLOPE
 AREAS HAVE BEEN PERMANENTLY STREATILIZED.
 B. SILT FENCES SHALL BE INSPECTED IMMEDIATELY AFTER EACH RAINFALL AND AT LEAST DAILY DURING PROLONGED
 RAINFALL.
 C. SHOULD THE FABRIC DECOMPOSE OR BECOME INEFFECTIVE PRIOR TO THE END OF THE EXPECTED USABLE LIFE AND
 THE FRECE STILL IS NECESSARY. THE FABRIC OR THE ENTIRE SISTEM SHALL BE REPLACED PROMPTLY.
 D. SED MENT DEPOSITS SHOULDED FOR THE ABBIC OR THE ENTIRE SISTEM SHALL BE REPLACED PROMPTLY.
 E. ANY SEDIMENT DEPOSITS FROMATION IN PLACE AFTER THE SILT FENCE IS NO LONGER REQUIRED SHALL BE DRESSED
 TO COMPORM TO THE EXISTING GRADE. A SEEDBED PREPARED AND THE SITE VEGETATED.


THE FOLLOWING EROSION CONTROL MEASURES SHALL BE PROVIDED BY THE CONTRACTOR:

- PERIMETER EROSION BARRIER (S)LT FENCE) SHALL BE ERECTED PRIOR TO EXCAVATION AND CLEARING IN THE UPSLOPE AREA.
- THE TEMPORARY EROSION CONTROL SYSTEMS SHALL BE PROPERLY MAINTAINED BY THE CONTRACTOR TO CONTROL SILTATION AT ALL TIMES DURING THE LIFE OF THE CONTRACT.
- AT ALL TIMES. EROSION CONTROL MEASURES SHALL BE EMPLOYED TO PREVENT SILT FROM LEAVING THE SITE. ALL EROSION CONTROL WORK IS TO BE DONE ACCORDING TO THE CURRENT EDITION OF THE STANDARD SPECIFICATIONS AND THE STORM WATER POLLUTION PREVENTION PLAN.
- 4. PRIOR TO THE START OF ANY EARTH MOVING DERATIONS. THE CONTRACTOR SHALL INSURE THAT A STORM WATER POLLUTION PREVENTION PLAN (SWPPP) AND A NOTICE OF INTENT INDIT HAVE BEEN PREPARED, SIGNED AND FILLED BY THE OWNER ACCORDING TO THE REVOLUTE ON THE NATIONAL PULLUTION DISCHARGE ELIMINATION SYSTEM (NPDES) PERMIT IL R 10 WHICH AUTHORIZES THE STORM WATER DISCHARGES ASSOCIATED WITH INDUSTRIAL ACTIVITY FROM THIS CONSTRUCTION SITES.
- ADDITIONAL EROSION PROTECTION DEVICES SHALL BE INSTALLED SHOULD OTHER AREAS OF EROSION IN THE DEVELOPMENT OCCUR, AS DIRECTED BY THE CONSTRUCTION MANAGER.
- 6. SEEDING SHALL BE APPLIED WITHIN 7 DAYS OF FINAL GRADING IN ALL DISTURBED AREAS.
- 7. ALL EROSION CONTROL ITEMS SHALL BE REMOVED AND BECOME THE PROPERTY OF THE CONTRACTOR AT THE COMPLETION OF THE CONTRACT, OR AS DIRECTED BY THE RESIDENT ENGINEER.



RESERVED PARKING SIGN DETAIL

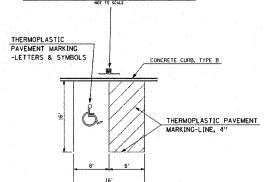


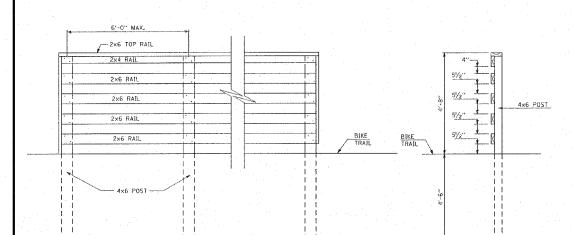

INSIDE RAIL ELEVATION

SECTION A-A

FENCE RAIL DETAILS

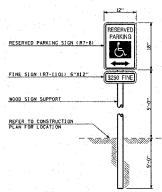

THERMOPLASTIC PAVEMENT MARKING
- LINE, 4" (YELLOW) (SOLID) FENCE RAIL 4.0% EARTH SHOULDER (TYP.) HOT-MIX ASPHALT SURFACE COURSE, MIX "C", N70 HOT-MIX ASPHALT BINDER COURSE, IL-19.0, N70 SUB-BASE GRANULAR MATERIAL, TYPE A, 8"

SECTION


03-00026-00-PK

COUNTY

SHEETS NO.

MADISON 34 3

PROPOSED BIKE TRAIL ACCESS

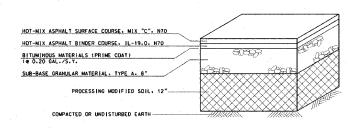

TYPICAL PARKING LOT SECTION

THE FOLLOWING MIXTURE F	REQUIREMENTS ARE APPLICA	BLE FOR THIS PROJECT:
MIXTURE USE	SURFACE	BINDER
AC/PG	PG 64-22	PG 64-22
RAP % (MAX)	10	15
DESIGN AIR VOIDS	4.0% @ NDES=70	4.0% @ NDES=70
MIX COMPOSITION		
(GRADATION MIXTURE)		IL 19.0
FRICTION AGG	MIXTURE C	MIXTURE B

STREET AND PAVEMENT CONSTRUCTION NOTES :

- ALL STREET WORK IS TO BE DONE ACCORDING TO THE ILLINOIS DEPARTMENT OF TRANSPORTATION STANDARD SPECIFICATIONS FOR RODA AND BRIDGE CONSTRUCTION-ADDRED JANUARY 1 2007 AND LATEST REVISIONS

- SAWED TRANSVERSE JOINTS (1/8" x 2") SHALL BE CREATED AT 15' INTERVALS. BARS ARE NOT REQUIRED. JOINTS TO BE SEALED WITH HOT POURED JOINT SEALER IN ALL CONCRETE CONSTRUCTION.
- 5. EMBANKMENT SHALL BE PLACED AS REQUIRED IN SECTION 205 OF THE ILLINOIS DEPARTMENT OF TRANSPORTATION STANDARD SPECIFICATIONS FOR ROAD AND BRIDDE CONSTRUCTION. ADDRED, JANUARY 1. 2007 AND LATEST REVISIONS. CONTRACTOR SHALL SUBMIT TO THE RESIDENT ENGINEER DOCUMENTATION OF COMPACTION TESTS FOR WRITTEN APPROVAL OF SAID COMPACTION FROM TO CONSTRUCTION OF ANY PAYEMENT/SIDENALK.
- CUT SECTIONS SHALL BE PROOF ROLLED AND APPROVED BY THE RESIDENT ENGINEER PRIOR TO CONSTRUCTION OF ANY PAVEMENT/SIDEWALK.

211 North Broadway Suite 1900 51. Louis, Missouri 6 ph (314) 241-8188 fax (314) 541-0125








phase 1 Lewis and Clark Memorial tower

KENNEDY PROJECT 10-02048

SHEET NO.

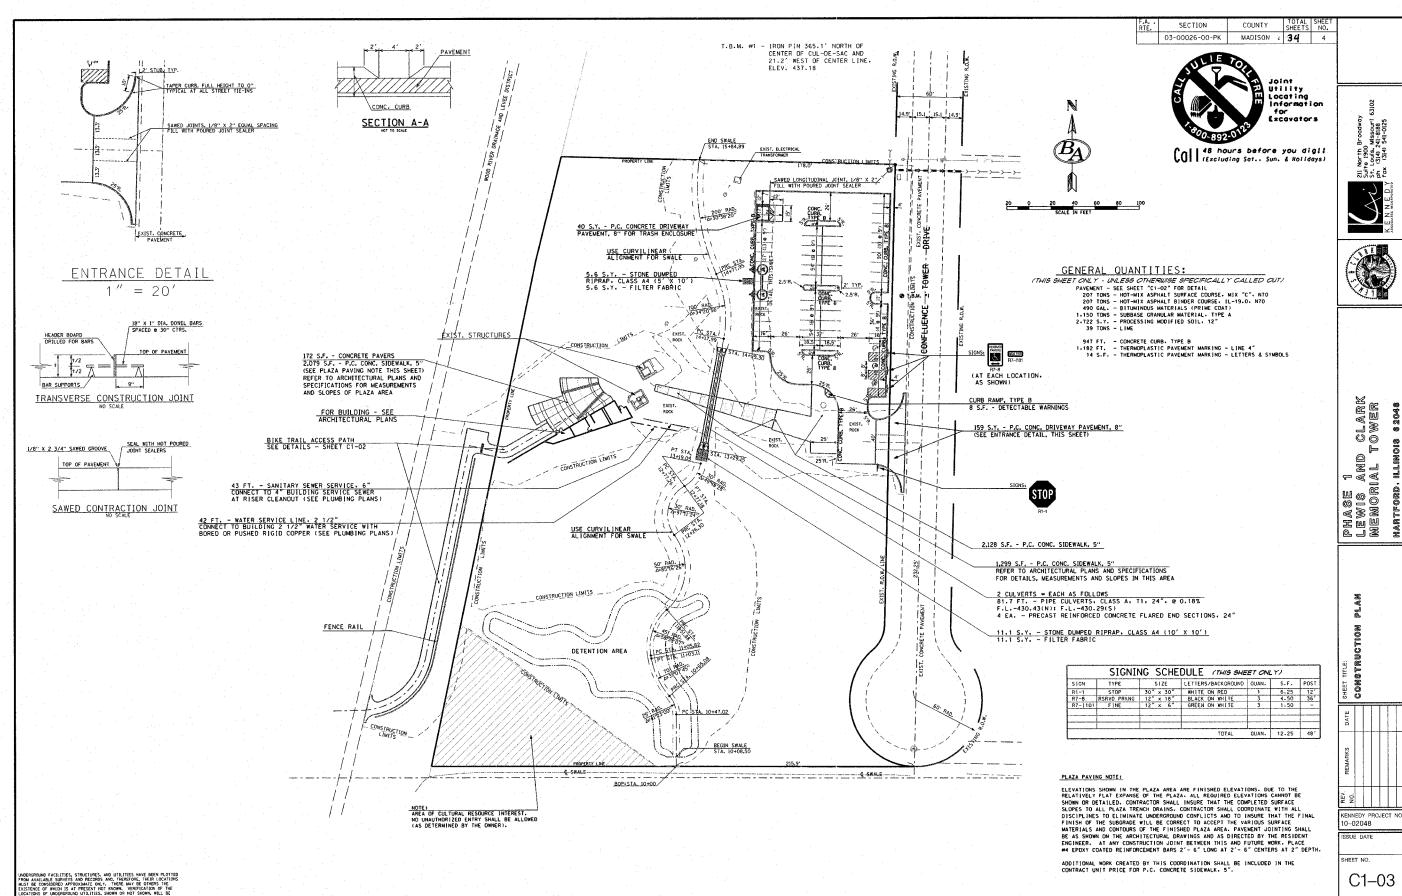


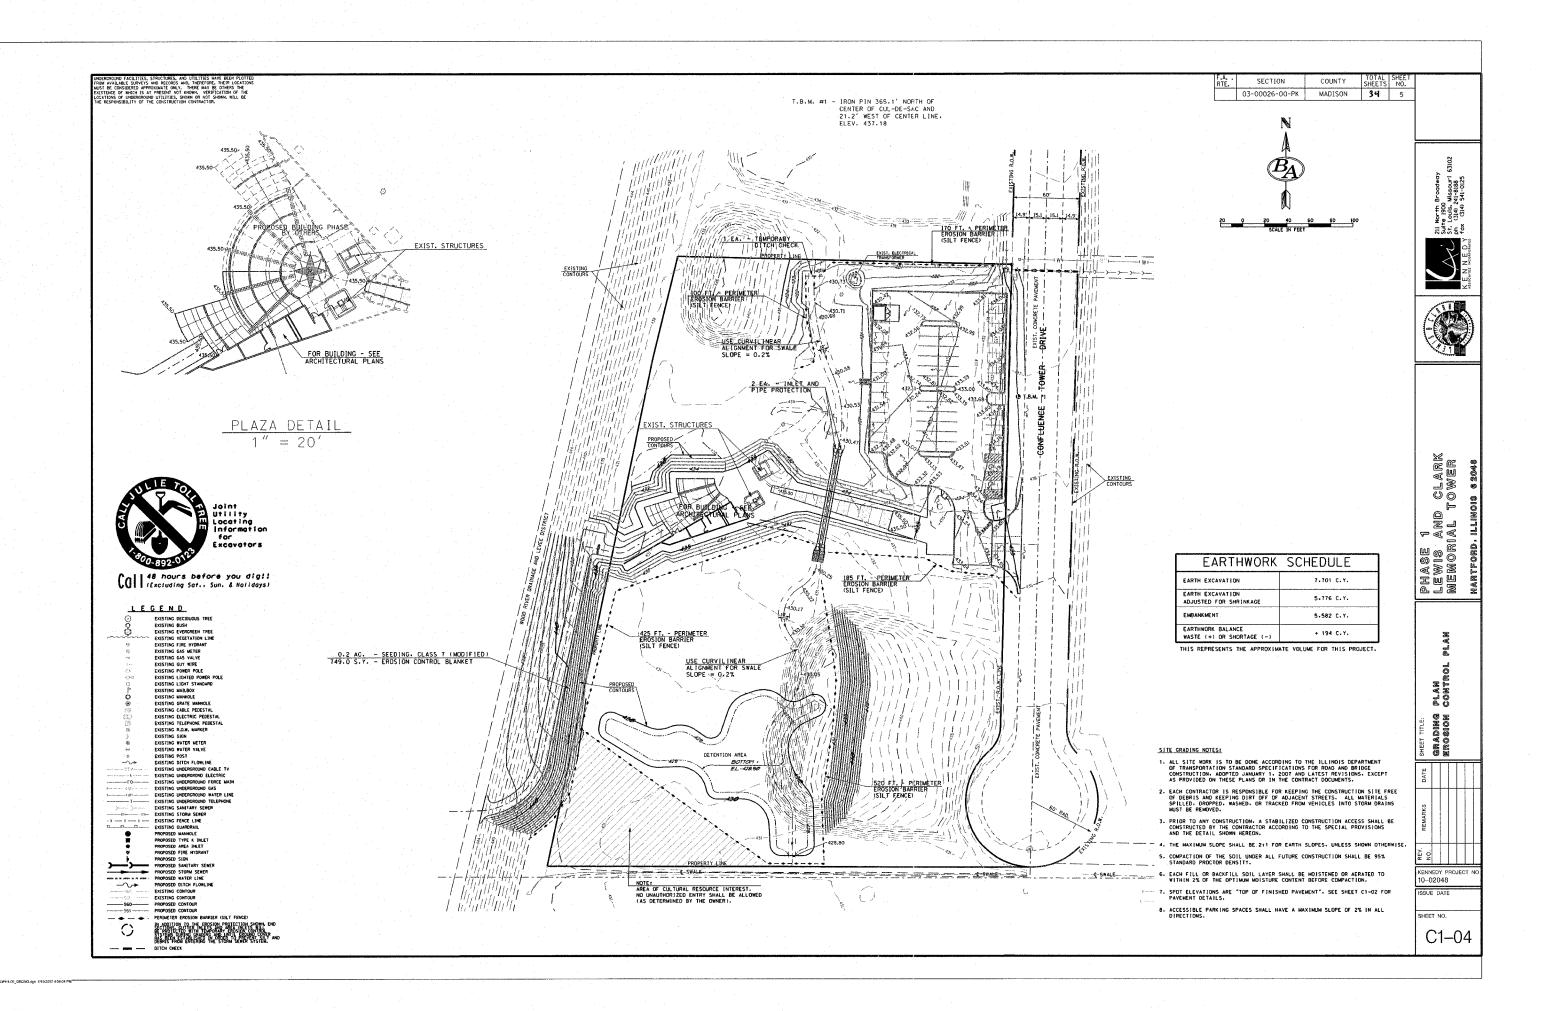

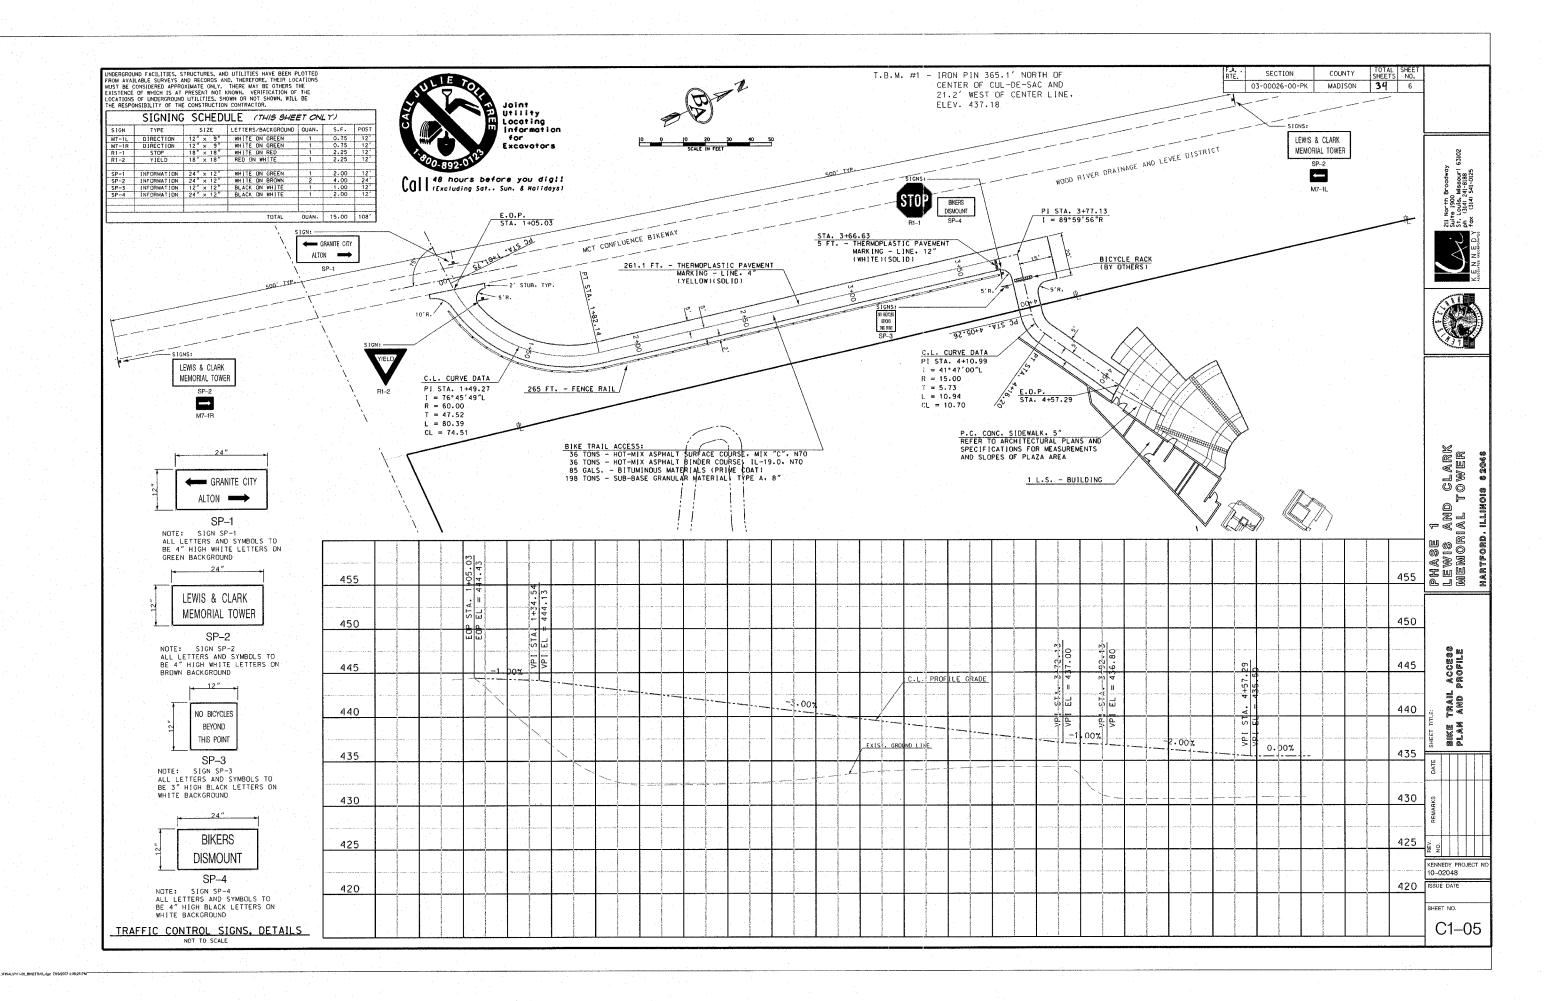

COUNTY TOTAL SHEETS NO.

MADISON 34 7 SECTION 03-00026-00-PK 211 North Broadway Suite 1900 St. Louis, Missouri 6: ph (314) 241-818 C fax (314) 541-0125

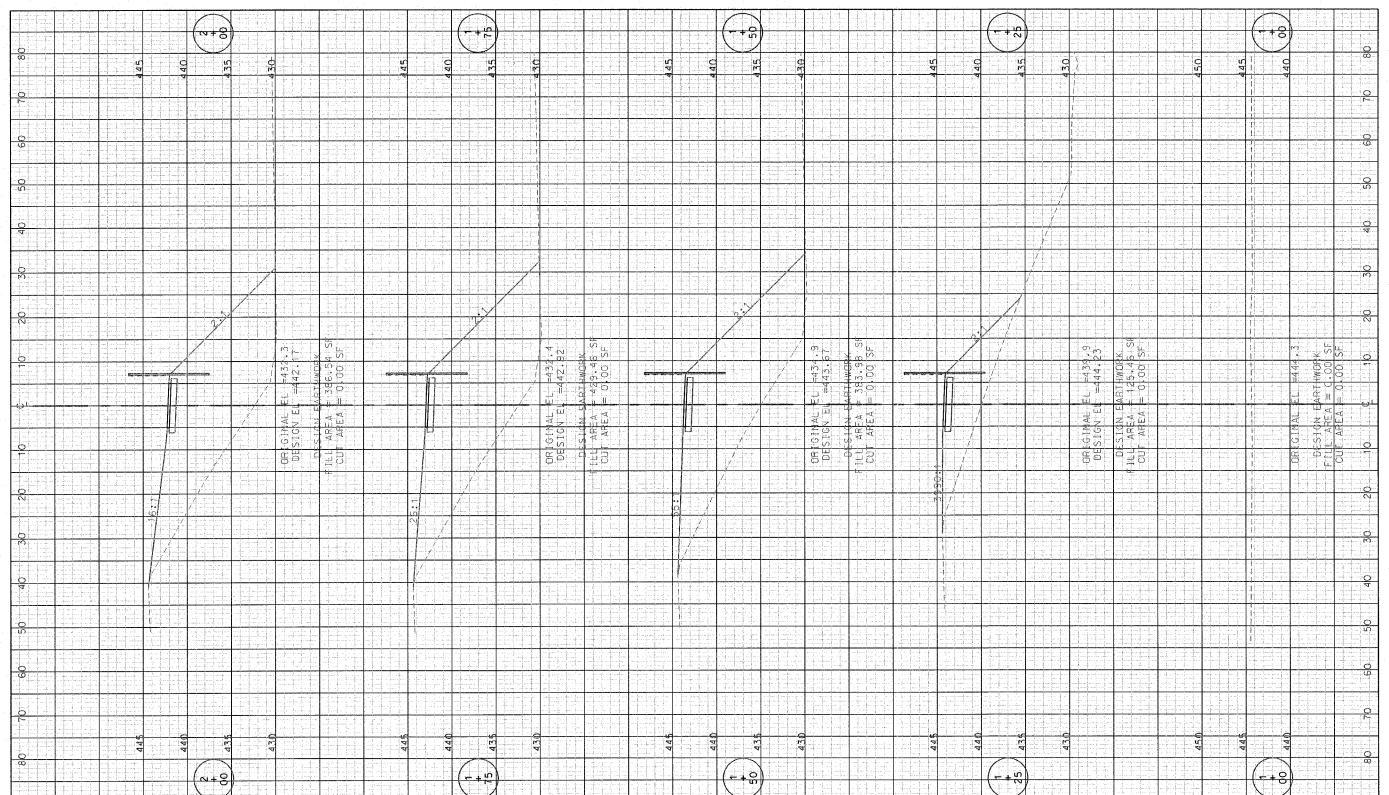


phase 1 Lewis and Clark Memorial Tower Village of Hartford, Illinois 140 west hawthorne

bike trail access cross sections

KENNEDY PROJECT N 10-02048

SHEET NO.

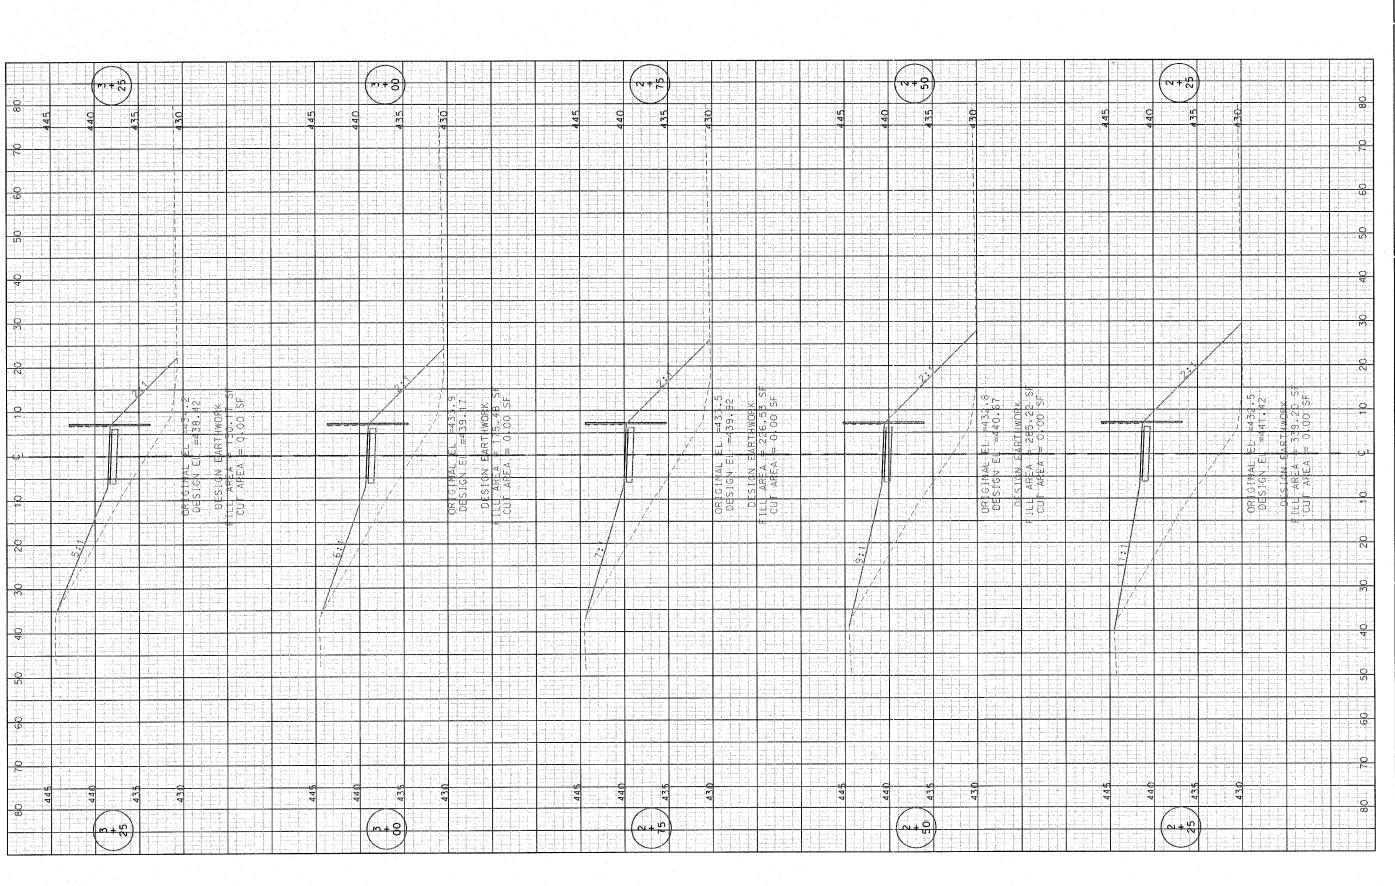

phase 1 Lewis and Clark Memorial Tower Village of Hartford, Illinois 140 West Hawthorne

211 North Broadway Sulte 1900 Sul

SECTION

03-00026-00-PK

RTE.

COUNTY


MADISON

Bike trail access cross sections

KENNEDY PROJECT NO

10-02048 ISSUE DATE

SHEET NO.

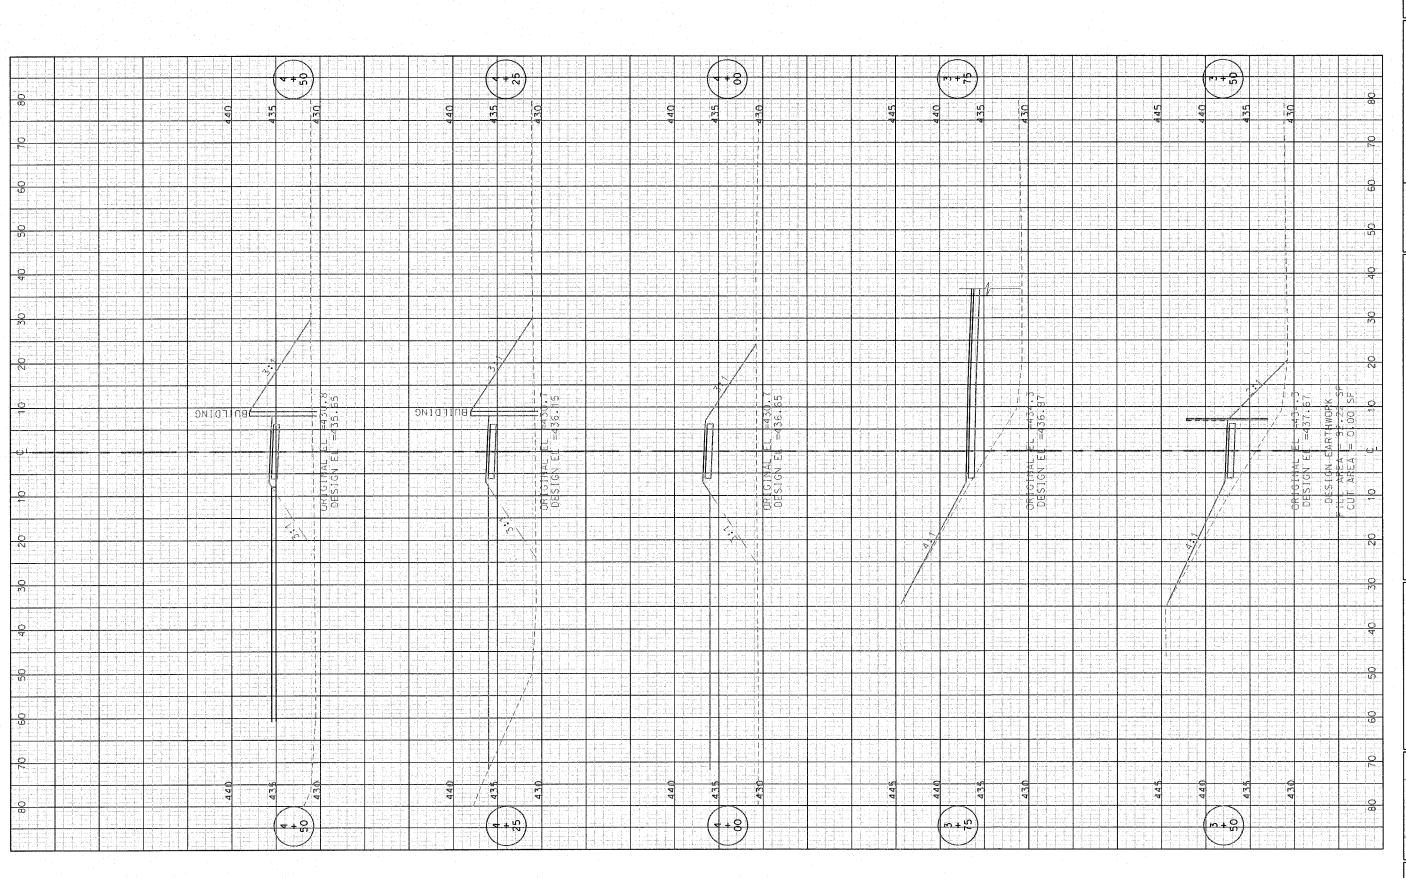

TOTAL SHEET SHEETS NO. SECTION COUNTY RTE. 03-00026-00-PK MADISON


Phase 1 Lewis and clark memorial tower Village of Hartford, illinois 140 west mawtmorne Martford, illinois 82048

211 North Broadway
54/4-9 1900
54/4-9 1900
F. Couls, Missouri 63102
F.

NO. KENNEDY PROJECT N 10-02048


bike trail access cross sections

SHEET NO.

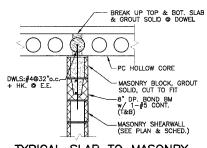

TYPICAL SLAB TO MASONRY SHEAR WALL CONNECTION


1.1C 3"=1'-0

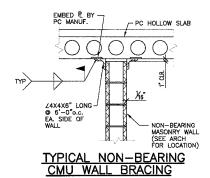



PC COL. (SEE PLAN)


- 4-3"ø A307 HEADED ANCHOR BOLTS 9" EMBED. IN FOOTING

₽.≩x13x13

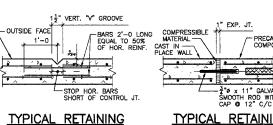

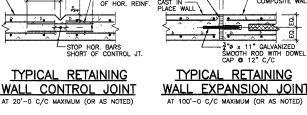

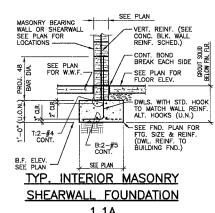

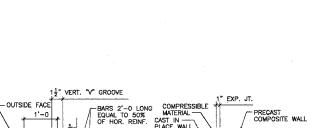




CONCRETE STRENGTH SCHEDULE

28 DAY COMPRESSIVE STRENGTH (fc')

5,000 PSI (TYP. U.N.O.)

4.000 PS

3.500 PSI

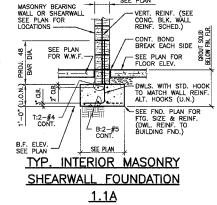

PRECAST SLAB, WALL, BEAM & COLUMN


CAST IN PLACE WALL

ALL OTHERS INCLUDING: FOOTING, ETC.

TYPICAL COL. TO FTG CONN.

GROUT SOLID @ POCKETS (GROUT TO FACE OF COL


FTG. (SEE PLAN)

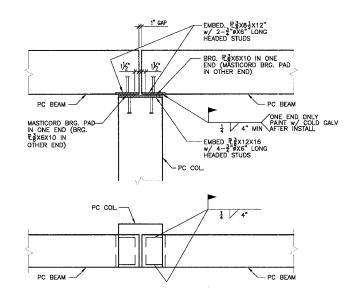


1½" TO EDGE €

NOMINAL BLOCK	VERTICAL REINFORCING	HORIZ	ONTAL REINF	ORCING (GALVA	NIZED)
THICKNESS	(GROUT SOLID)	TYPE	SIDE ROD	CROSS ROD	SPACING
6"	#4 @ 24" (2'-6 LAP)	LADDER	0.148"ø	0.148"ø	16"
8"	#5 @ 32" (2'-6 LAP)	LADDER	0.188"ø	0.148"ø	16"


FOOTING DOWELS TO MATCH WALL REINFORCING (TYP. U.N.O.)

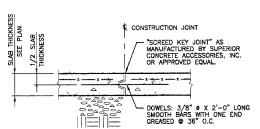

TYP. SLAB ON GRADE CONSTRUCTION JOINT CONSTRUCTION JOINTS TO BE LOCATED AT CONTROL JOINTS.

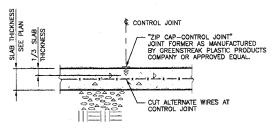


TYP. SLAB ON GRADE CONTROL CONTROL JOINTS AT 15'-0" O.C. MAXIMUM F.W. OR AS SHOWN ON PLAN

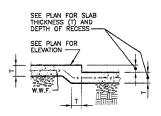


TYP. RECESS AT SLAB ON GRADE

1" CLR. 1-#4 CONT. T&B-2'-0 #4 @ 18"--8" MINIMUM


TYPICAL STEP IN SLAB ON GRADE SEE PLAN FOR SLAB THICKNESS, SLAB REINFORCING, AND DEPTH OF STEP.
 SEE DETAIL "A" WHERE TRENCH DRAIN OCCURS.

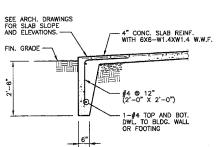


TYPICAL FROSTWALL

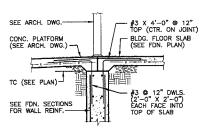

TYPICAL TOP OF WALL AT DOORWAY

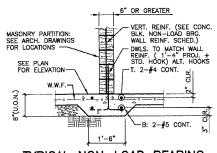

TYPICAL NON-LOAD BEARING MASONRY PARTITION FOUNDATION

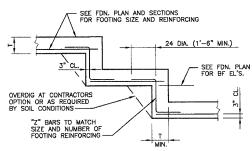

TYP. FOOTING STEP



1. BUILDING CODE: BOCA 1999

2.	FLOOR LIVE LOADS (PSF): N/A
3.	ROOF LIVE LOAD (PSF): 30
4.	ROOF SNOW LOAD:
	A. GROUND SNOW LOAD (PSF), Pg = 20
	B. FLATROOF SNOW LOAD (PSF), Pf = 14
	C. SNOW EXPOSURE FACTOR, Ce = 0.9
	D. SNOW IMPORTANCE FACTOR, I = 1.0
_	E. ROOF THERMAL FACTOR, Ct = 1.0
5.	WIND LOAD:
	A. BASIC WIND SPEED (MPH): 70
	B. WIND LOAD IMPORTANCE FACTOR, I = 1.0
_	C. WIND EXPOSURE: C
о.	EARTHQUAKE DESIGN DATA: A. PEAK VELOCITY—RELATED ACCELERATION, AV = 0.13
	B. PEAK ACCELERATION, AG = 0.12
	C. SEISMIC HAZARD EXPOSURE GROUP: I
	D. SEISMIC PERFORMANCE CATEGORY: C
	E. SOIL PROFILE TYPE: S3
	F. BASIC STRUCTURAL SYSTEM: LOAD BRG. WALL
	G. SEISMIC RESISTING SYSTEM: REINF, MASONRY SHEARWALL
	H. RESPONSE MODIFICATION FACTOR, R = 4.5
	I. DEFLECTION AMPLIFICATION FACTOR, Cd = 4
	J. SEISMIC ANALYSIS PROCEDURE: EQUIVALENT LATERAL FORCE

GENERAL NOTES

SECTION COUNTY TOTAL SHEET NO 03-00026-00-PK MADISON 33 14 FA-RTE SECTION

IN FIELD LAYOUT AND SHOP DETAILING, THE CONTRACTOR MUST VERIFY AND COORDINATE DIMENSIONS ON ARCHITECTURAL, MECHANICAL AND STRUCTURAL DRAWINGS AND REPORT ANY DISCREPANCIES TO THE ARCHITECT. ALL EXISTING DIMENSIONS AND CONDITIONS MUST BE FIELD VERIFIED BY CONTRACTOR.

FOUNDATIONS


- FOOTINGS HAVE BEEN PROPORTIONED FOR A NET MAXIMUM BEARING PRESSURE OF 2500 P.S.F. FOR ISOLATED COLUMN FOOTINGS & 2000 P.S.F. FOR CONTINUOUS FOOTINGS.
- FOOTINGS MUST EXTEND 2'-6 BELOW FINISHED GRADE, AND ARE TO BEAR ON UNDISTURBED SOIL OR ENGINEERED COMPACTED FILL.

GENERAL CONCRETE NOTES

- ALL CONCRETE SHALL BE NORMAL WEIGHT CONCRETE. SEE SCHEDULE THIS SHEET AND SPECIFICATION FOR CONCRETE STRENGTH.
- REINFORCING BARS SHALL CONFORM TO ASTM A615, GRADE 60 STEEL, UNLESS NOTED OTHERWISE.
- 3. ALL DETAILING, FABRICATION AND PLACEMENT OF BARS AND ALL DEJALING, FABRICATION AND PLACEMENT OF BARS AND THEIR SUPPORT IN THE FORMS WITH ACCESSORIES, UNLESS NOTED OTHERWISE, MUST FOLLOW THE ACI "MANUAL OF STANDARD PRACTICE FOR DETAILING REINFORCED CONCRETE STRUCTURES". (ACI 315 LATEST). REINFORCING STEEL PLACING PRAWINGS WILL MEET THE FOLLOWING MINIMUM REQUIREMENTS IN ADDITION TO THOSE STATED ABOVE:
- A. REINFORCING PLACING DRAWINGS FOR SLABS, BEAMS, JOISTS ETC. WILL BE SHOWN ON PLANS DRAWN TO A MINIMUM SCALE OF 1/8" = 1'-0". MINIMUM SHEET SIZE WILL BE 24" X 36".
- B. REINFORCING FOR FOUNDATION WALLS, RETAINING WALLS, SHEAR WALLS ETC. WILL BE SHOWN ON ELEVATIONS DRAWN TO A MINIMUM SCALE OF 1/4" = 1'-0".
- C. REINFORCING FOR BEAMS, COLUMNS AND SLABS MUST BE CLEARLY SHOWN IN SCHEDULES SIMILAR TO THOSE ON THE STRUCTURAL DRAWNIOS. COMPUTER PRINT—OUTS ATTACHED TO LARGER SHEETS AND REPRODUCED AS SHOP DRAWINGS WILL NOT BE PERMITTED.
- D. LOCATION OF REINFORCING NOT CLEARLY DESCRIBED IN SCHEDULED FORMAT MUST BE REFERENCED ON PLACING
- CONCRETE COVER OVER MAIN REINFORCING SHALL BE AS FOLLOWS: FOOTINGS 3", COLUMNS AND BEAMS 2", SOLID SLABS 1" AND WALLS 2" WHERE EXPOSED TO WEATHER OR GROUND AND 1" FOR INTERIOR SURFACES.
- ALL BARS IN WALLS AND GRADE BEAMS AND TEMPERATURE BARS IN SLABS SHALL LAP A MINIMUM OF 30 DIAMETERS (24" MIN.). SEE PLAN FOR SPECIAL REQUIREMENTS FOR BEAMS, COLUMNS, ETC. ANY SPLICE OF BARS OTHER THAN SHOWN ON PLANS MUST HAVE PRIOR APPROVAL OF THE ENGINEER.
- WELDED WIRE FABRIC MUST LAP A MINIMUM OF 1'-O" AND SHALL EXTEND 1'-O" INTO SUPPORTING BEAMS AND WALLS UNLESS EXPANSION JOINT IS CALLED FOR. WELDED WIRE FABRIC SHALL BE PLACED ON TOP OF ALL OTHER BARS, SLEEVES, CONDUITS, ETC.
- PROVIDE THE FOLLOWING ADDITIONAL REINFORCING UNLESS OTHERWISE CALLED FOR ON STRUCTURAL PLANS:
- A. 2-#5 BARS EACH SIDE OF 12" OR LARGER OPENINGS IN SLABS AND WALLS.
 B. CORNER BARS (2'-0" X 2'-0") IN OUTER FACE OF ALL CONCRETE WALLS AND GRADE BEAMS TO MATCH SIZE AND SPACING OF BARS IN WALL OR BEAM.
 C. WALLS, UNLESS NOTED OTHERWISE, #4012" EACH WAY, EACH FACE AND 2-#5 TOP AND BOTTOM.
- 8. ALL DOWELS MUST BE IN POSITION BEFORE PLACING CONCRETE PUSHING BARS INTO FRESHLY PLACED CONCRETE IS NOT ACCEPTABLE. PROVIDE ADDITIONAL SUPPORT BARS AS NECESSARY TO KEEP DOWELS IN PLACE.
- ALL STRUCTURAL STEEL MUST BE PROTECTED BY 3" OF CONCRETE WHERE EARTH WOULD OTHERWISE BE IN CONTACT WITH STEEL.
- ALL ABUTTING CONC. SHALL BE DOWELED TOGETHER UNLESS POURED MONOLITHIC. DOWELS SHALL BE EQUAL IN SIZE AND SPACING TO THE REINFORCING IN THE ABUTTING MEMBERS.
- 11. WHEN FOUNDATION WALLS SPAN FROM GROUND FLOOR TO FIRST FLOOR, BOTH GROUND FLOOR SLAB AND FIRST FLOOR SLAB MUST BE IN PLACE BEFORE BACKFILL IS PLACED, UNLESS NOTED OTHERWISE.
- 21. THE ARCHITECTURAL MECHANICAL AND ELECTRICAL DRAWINGS MUST BE REFERRED TO FOR ALL FLOOR, ROOF AND WALL REQUIREMENTS SUCH AS SLEEVES, OUTLET BOXES, ANOHORS, VENT OPENINGS, ETC., THAT MAY BE REQUIRED. HOLES OR NOTCHES WILL NOT BE ALLOWED IN ANY CONCRETE FRAMING UNLESS SIZE AND LOCATION HAVE BEEN APPROVED BY THE ENGINEER.
- 13. WHERE EPOXY DOWELS ARE INDICATED, INSTALL PER MANUFACTURERS RECOMMENDATIONS WITH ITW RAMSET/REDHEAD EPOON EPOXY SYSTEM, SIMPSON EPOXY—TIE ADHESIVE OR ANCHOR—IT EPOXY SYSTEM.

ABBREVIATION LIST BD = BOTTOM OF DECK BF = BOTTOM OF FOOTIN

BF = BOTTOM OF FOOTIN
BP = BRAM POCKET
BS = BRICK SHELF
BW = BOTTOM OF WALL
CJP = COMPLETE JOINT
PENETRATION
CP = COLUMN POCKET
CS = CONCRETE SHELF
TC = TOP OF CONCRETE
TF = TOP OF FOOTING
TP = TOP OF FOOTING
TP = TOP OF STEEL
TW = TOP OF STEEL
TW = TOP OF WALL
UNO = UNLESS NOTED
OTHERWISE

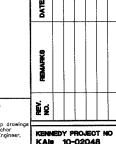

IRRUE DATÉ 03-JUNE-08

HEET NO

Z K

WER

01

MEMORIAL

ARK

PHASE 2 LEWIS AL VILLAGE HARTFORD,

ంర

DETAILS NOTES

TYPICAL [GENERAL

2B AND

ILLINOIS

Hartford,

These drawings are the property of SSE Inc. They are furnished


The seal(s) and signature(s) apply only the document to which they are affixed or other documents or instruments relati to or intended to be used for any part parts of the architectural or engineering project.

S1.1B

SSE PROJECT NO: 02111 PHASE 2B

TYPICAL PC BEAM TO PC COLUMN CONN.

1.1B \(\frac{3}{4}\)"=1'-0 NOTE: EXTEND BM OVER TO EDGE OF COL. WHERE BM OCCURS ONE SIDE ONLY.

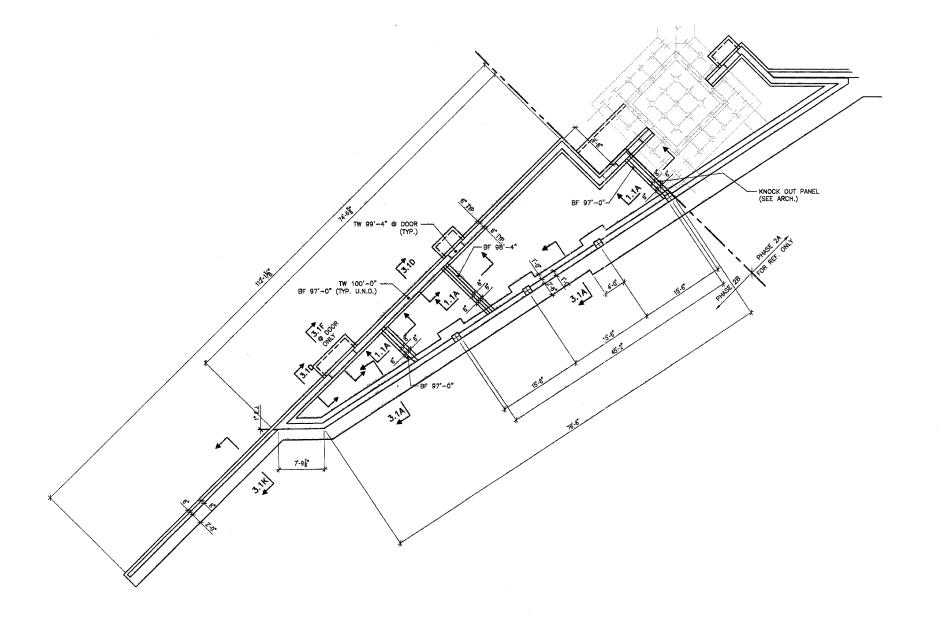



FIRST FLOOR FOUNDATION PLAN 1-1'-0

NOTES: 1. FIN. FLR. EL. 100"-0 (U.N.O.).

2. FLR. CONSTR: 4" CONC. SLAB ON GRANULAR FILL. REINF. SLAB W/ 6X6-W1.4XW1.4 W.W.F.
OR STRUX 90/40 FIBER REINF. BY GRACE CONSTR. PRODUCTS © THE DOSAGE
RATE OF 3.5 lbs./cubic yd. PER W.R. GRACE SPECS. (OR EQUAL) — U.N.O.

FA-RTE SECTION COUNTY TOTAL SHEET NO 03-00026-00-PK MADISON 33 15

211 N. Broadway Suite 1900 St. Louis, MO 63102 (314) 241-8188 FAX (314) 241-0125

Phase 2B Lewis and Clark Memorial Tower Village of Hartford, Illinois Hartford, Illinois 62049

FOUNDATION PLAN


전 전 전

SSE PROJECT NO: 02111 PHASE 2B

ISSUE DATE 03-JUNE-05 SHEET NO

KENNEDY PROJECT NO KAIP 10-02048

S2.1B

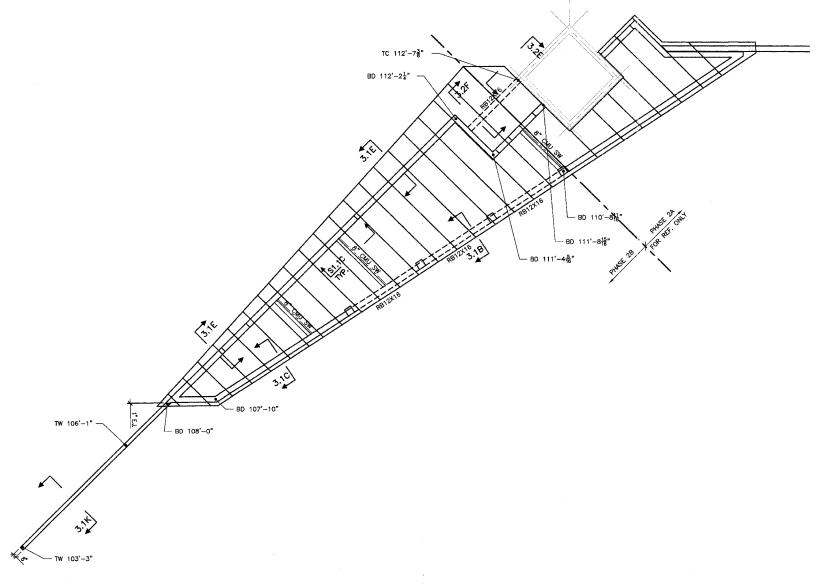



ROOF PLAN

NOTES:

NOTES:

1. ROOF CONSTR: RIGID INSULATION ON 4'-0"X8" DP. (MAX.) PRESTRESSED HOLLOW CORE NORM. WT. CONC. SLAB. (TYPE 4HC8-66-S OR APPROVAL EQUAL), TOP OF SLAB VARIES DESIGN CRITERIA: DL = 20PSF

2. ALL EMBEDS ARE GALVANIZED WHERE EXPOSED.

3. PRECAST CONTRACTOR TO PROVIDE CONNECTION BETWEEN WALL PANEL TO WALL PANEL, WALL PANEL TO COL. FOR 200 lbs/ft IN BOTH DIRECTIONS.

4. PRECASTER IS RESPONSIBLE FOR COORDINATING FABRICATION OF CONCRETE PANELS WITH LOCATION OF ALL ELECTRICAL, NECHANICAL, AND PLUMBING DEVICES. PANELS SHOULD BE DESIGNED TO INCLIDE ALL KNOCKOUTS AND VOIDS REQUIRED FOR DUCTYORK AND JUNCTION BOXES. THEY SHOULD ALSO INCLUDE CONDUIT FOR THE WIRING OF ALL DEVICES.

FA-RTE SECTION COUNTY TOTAL SHEET NO 03-00026-00-PK MADISON 33 16

211 N. Broadway Suite 1900 St. Louis, MO 63102 (314) 241-8188 AX (314) 241-0125

phase 2B Lewis and clark memorial Tower Village of Hartford, Illinois Hartford, Ilinois 82049

ROOF PLAN

DATE			
REMARKS			
N O			


SHEET NO

SSE PROJECT NO: 02111 PHASE 2B

S2.2B

KENNEDY PROJECT NO KAI: 10-02048

IBBUE DATE 03-JUNE-05

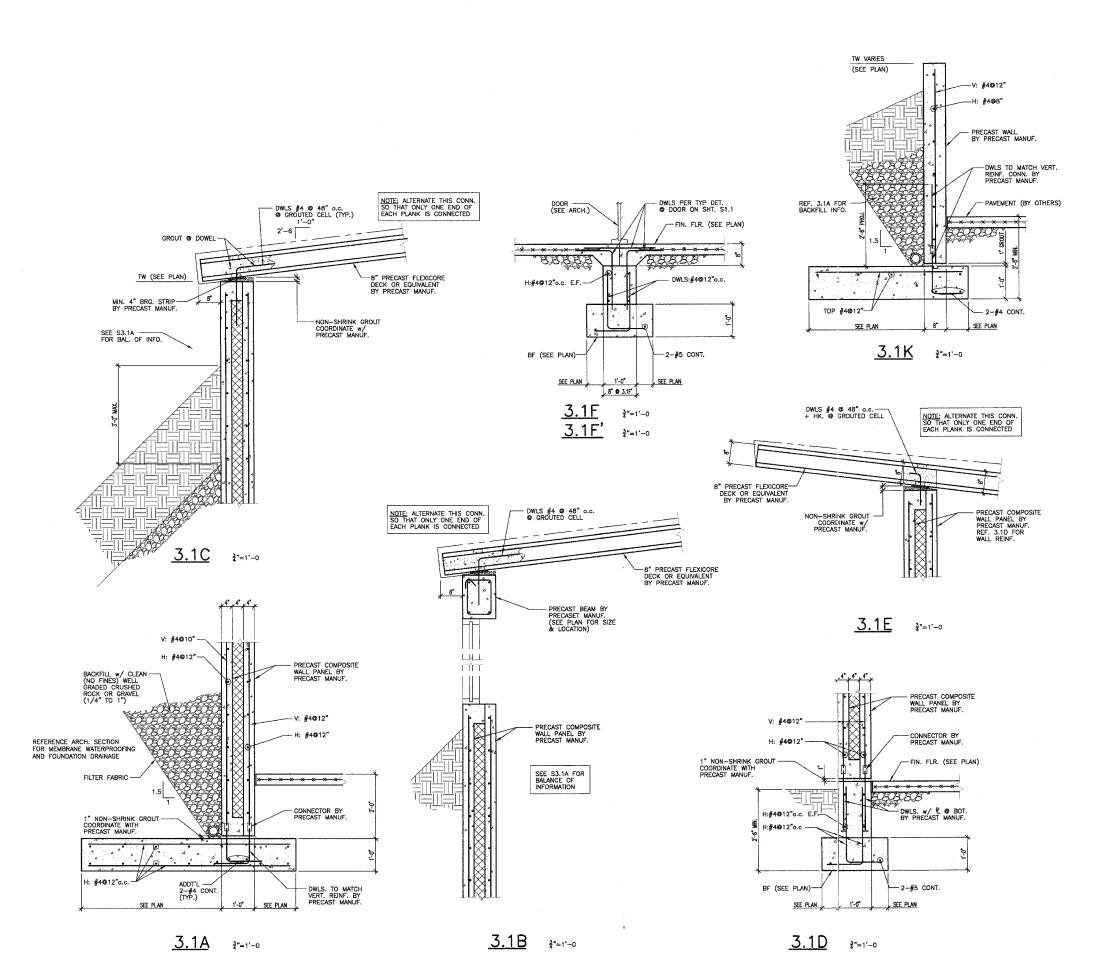

These drawings are the property of SSE Inc. They are furnished os contract documents only. Their use for reproducibles for shop die permitted, except for use as anchos setting plans, if approved by the Engibut at the user sink. The user shall remove all seals, firm the user shall remove all seals, firm the user shall remove all seals, firm the user shall be the provided that the shall be the

03-JUNE-05 SHEET NO SSE PROJECT NO: 02111 PHASE 28

S3.1B

FA-RTE SECTION COUNTY TOTAL SHEET NO 03-00026-00-PK MADISON 33 18

EXIST. CONC.

SET PRECAST HOLLOW
OFFICE SLAB BY
PRECAST MANUF.
(NOT IN PHASE 28)

2—TEFLON BRG. PAD — 3/32XSX11

REF. DETAIL. 3.1C. FOR
BALANCE OF INFORMATION

REF. D

phase 2B Lewis and clark memorial tower Village of Hartford, illinois Hartford, illnois 62049

211 N. Broadway Suite 1900 St. Louis, MO 63102 (314) 241-8188 FAX (314) 241-0125

SECTIONS & DETAILS

EV. REMARKS DATE

These drawings are the property of SSE Inc. They are furnished as contract documents only. Their use for reproducibles for shop drawin is permitted, except for use as anchor esting plans, if approved by the Engineer, but at the users risk. On the state of the state

The seal(s) and signature(s) apply only to the document to which they are affixed, all expressly disclaim any responsibility for all other plans, specifications, estimates, report of the reduction or other documents or instruments relating to or intended to be used for any port or parts of the architectural or engineering project.

ISSUE DATE 03-JUNE-05 SHEET NO

\$3.2B

KENNEDY PROJECT NO KAI: 10-02048

SSE PROJECT NO: 02111 PHASE 2B


PHASE 2B
LEWIS AND CLARK MEMORIAL TOWER
VILLAGE OF HARTFORD, ILLINOIS
HARTFORD, ILLINOIS


SHEET THE OVERALL SITE PLAN FOR REFERENCE ONLY

KENNEDY PROJECT NO KAI® 10-02048

ISSUE DATE 12-JULY-05

A1-02

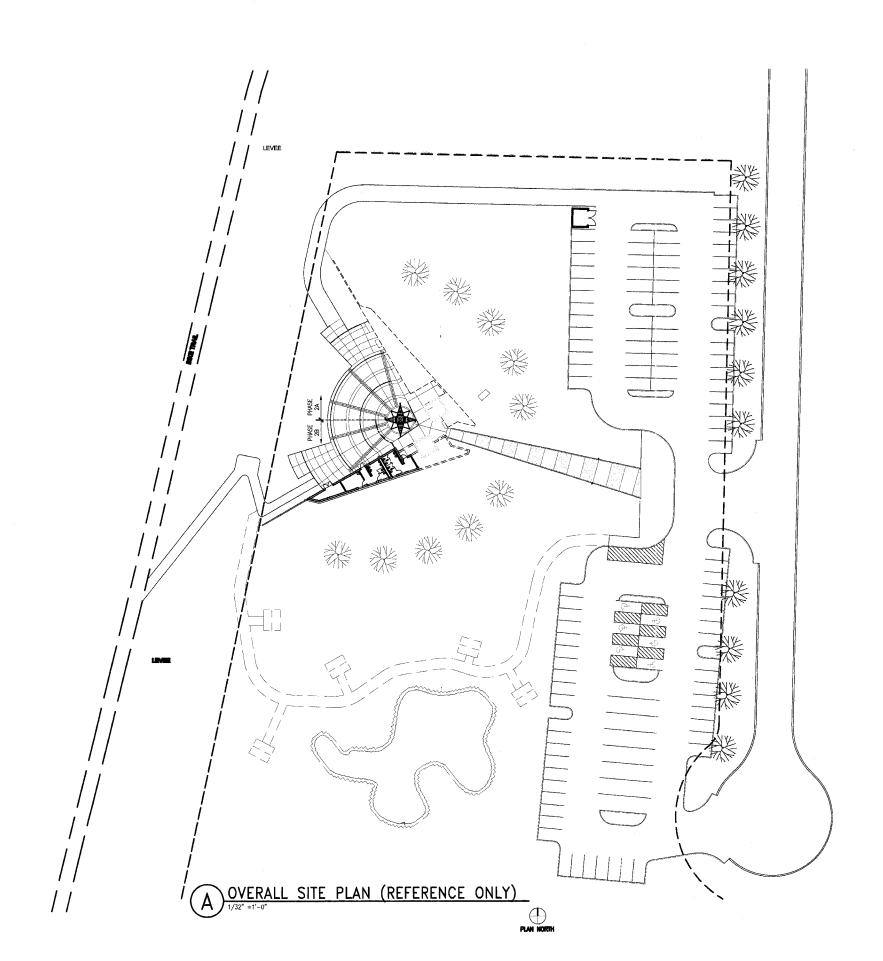

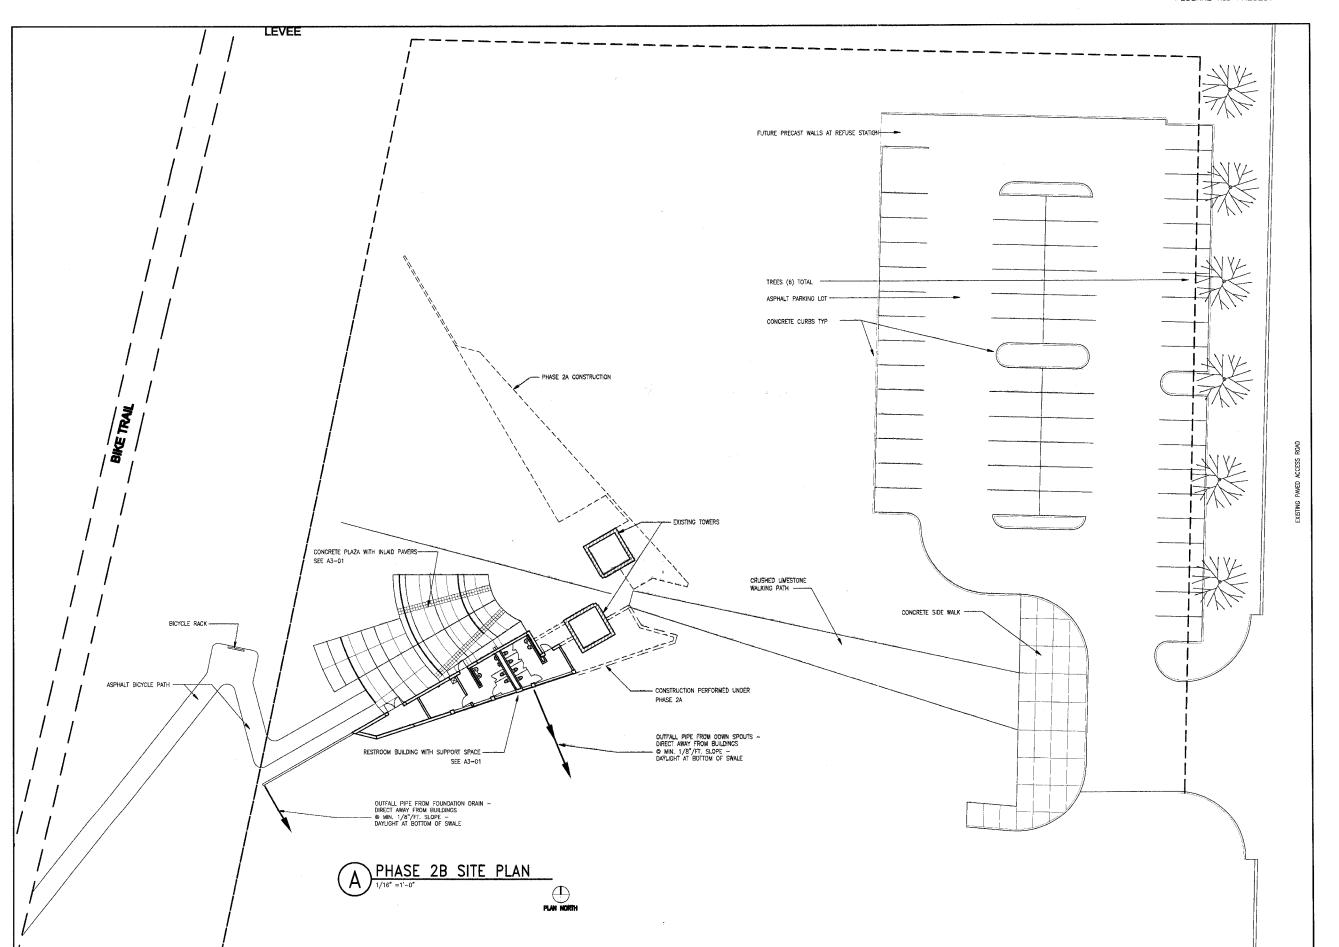

211 N. Brandway
Sude 1900
6. Lords, NO
6. Lords, NO
6714) 261-6168
FAX (814) 261-6128

PHASE 2B
LEWIS AND CLARK MEMORIAL TOWER
VILLAGE OF HARTFORD, ILLINOIS
HARTFORD, ILLINOIS 62049

PHASE 2B SITE PLAN


REV. REMARKS DATE


KENNEDY PROJECT NO KAI® 10-02048

ISSUE DATE 12-JULY-05

A1-03

wing Stamp Information

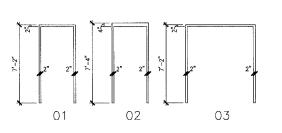

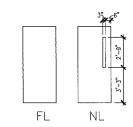

DO	OOR	ELE	/.	LEGEND
FI N		.USH ARROW	LIT	E

DOOR	MATERI	AL	LEGEND
НМ	HOLLOW	META	AL

DOOR	DOOR TYPE SCHEDULE										
DOOR TYPE	DOOR ELEV.	DOOR MATERIAL	FRAME ELEV.	DOOR RATING	REMARKS						
Α					NOT USED						
В	NL	HM/GL	01		PROVIDE PATTERNED GLASS IN LITE						
С					NOT USED						
D					NOT USED						
Ε	FL	НМ	02								
F					NOT USED						

НМ


 SECTION
 COUNTY
 TOTAL SHEETS NO.

 03-00026-00-PK
 MADISTIN
 38
 21

GENERAL NOTES:


1. ALL DOOR DIMENSIONS ARE 3'-0" \times 7'-0" UNLESS NOTED OTHERWISE.

2. SEE FINISH SCHEDULE FOR DOOR AND FRAME FINISHES.

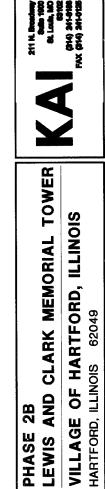

FRAME ELEVATION 1/4"=1'-0"

DOOR ELEVATIONS

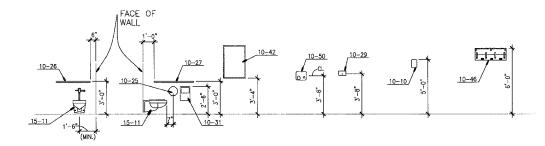

TYP. MOUNTING HEIGHTS
1/4"=1'-0"

PARTITION TYPES

1-1/2"=1'-0"

FINISH	SCHEDULE					
ROOM NO.	ROOM NAME	FLOOR	WALLS	CEILING FINISH	CEILING HEIGHT	REMARKS
110	WOMEN	SC	HPC	HPC	VARIES	PAINT DOORS & FRAMES WITH HPC
111	MEN	SC	HPC	HPC	VARIES	PAINT DOORS & FRAMES WITH HPC
112	ELECTRICAL / JANITOR	SC			VARIES	PAINT DOORS & FRAMES WITH HPC
113	STORAGE	SC			VARIES	PAINT DOORS & FRAMES WITH HPC

SC SEALED CONCRETE

FL

HPC HIGH PERFORMANCE COATING

KEYED NOTES:

04-22 8" CONCRETE MASONRY UNIT 04-23 6" CONCRETE MASONRY UNIT

04-62 COMPRESSIBLE FILLER

10-10 TACTILE SIGN PLATE 10-25 ACCESSIBLE TOILET TISSUE DISPENSER

10-26 36" GRAB BAR 10-27 42" GRAB BAR

10-29 ACCESSIBLE SOAP DISPENSER


10-31 ACCESSIBLE SANITARY NAPKIN DISPOSAL


10-42 MIRROR


10-46 UTILITY SHELF WITH HOOKS

10-50 ELECTRIC HAND DRYER

15-11 ACCESSIBLE WATER CLOSET

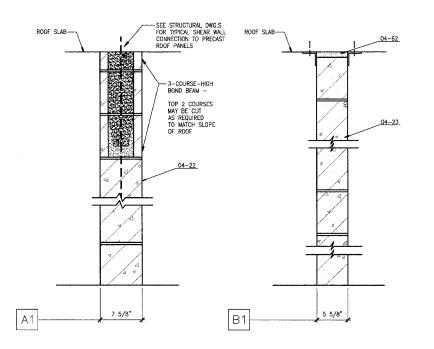

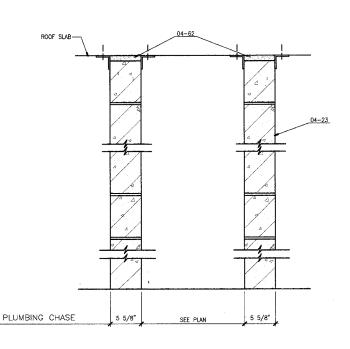

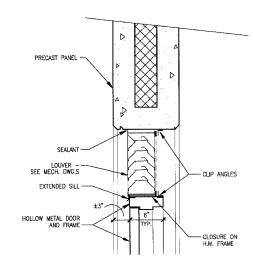




LOUVER DETAIL

SHEET TITLE
MOUNTING HEIGHTS/
PARTITION TYPES
DOOR INFORMATION

KENNEDY PROJECT NO KAI: 10-02048

ISSUE DATE 12-JULY-05

SHEET NO A2-01

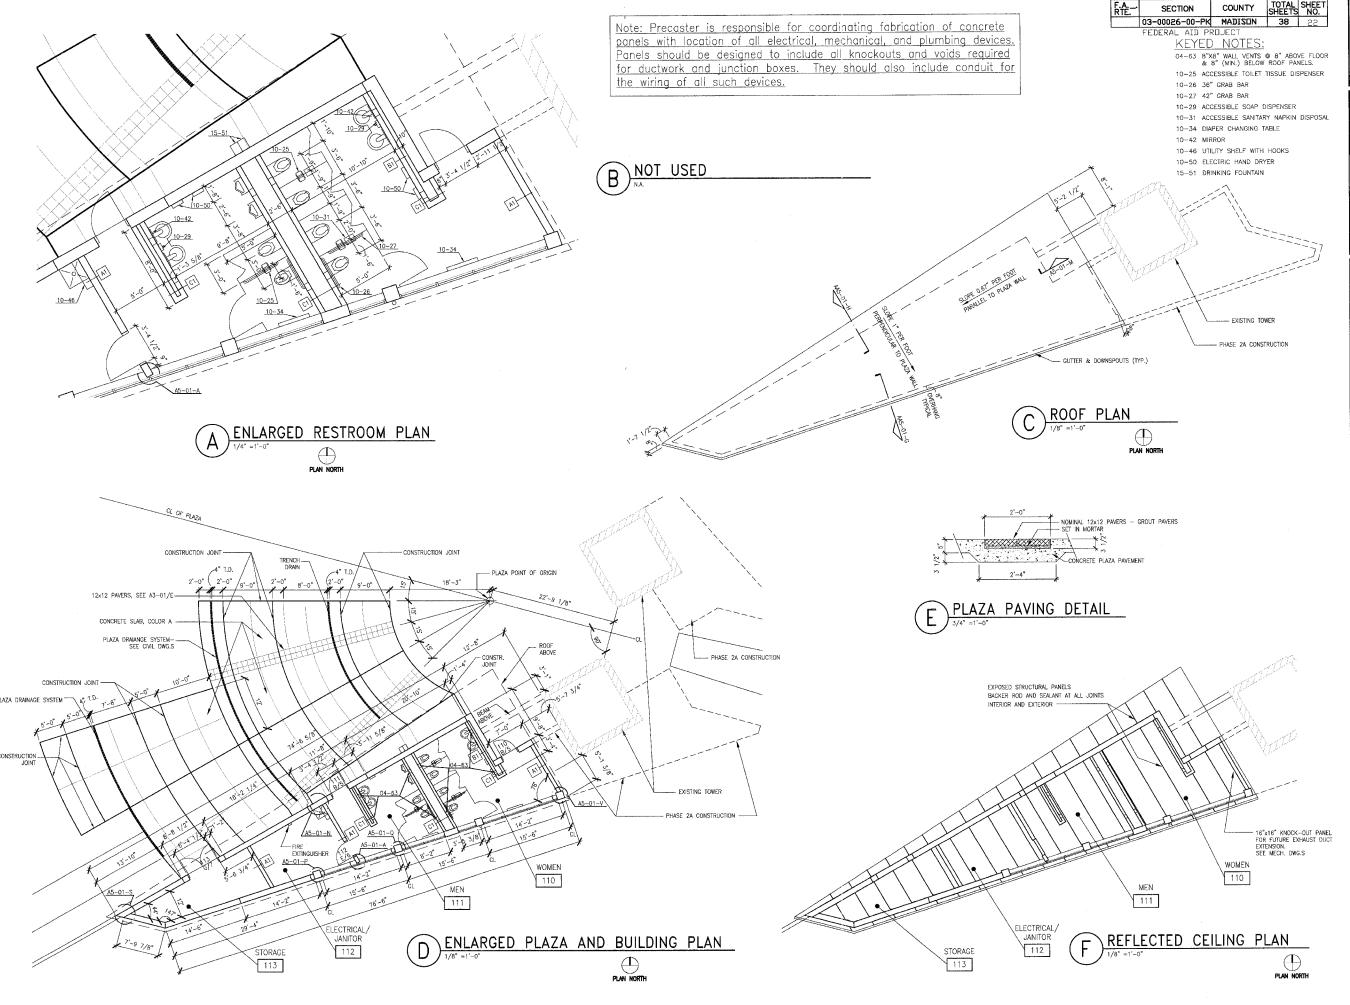

Broadway Suite 1900 Louis, MO 63102 241-8188 241-0125


PHASE 2B
LEWIS AND CLARK MEMORIAL TOWER
VILLAGE OF HARTFORD, ILLINOIS
HARTFORD, ILLINOIS 62049

PHASE 2B FLOOR PLAN AND ROOF PLAN

KENNEDY PROJECT NO KAIS 10-02048

ISSUE DATE 12-JULY-05 SHEET NO

A3-01

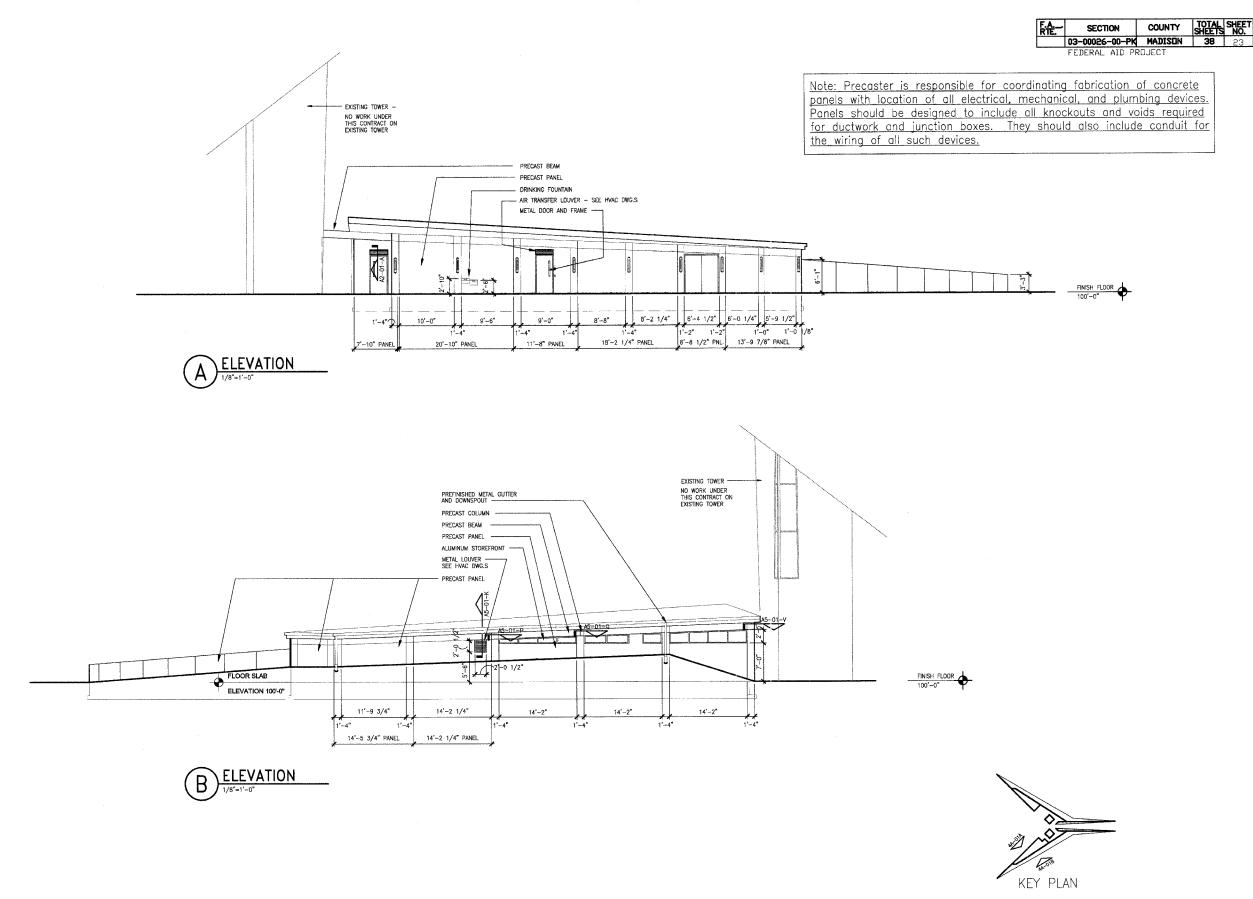


PHASE 2B
LEWIS AND CLARK MEMORIAL TOWER
VILLAGE OF HARTFORD, ILLINOIS
HARTFORD, ILLINOIS 62049

EXTERIOR ELEVATIONS


KENNEDY PROJECT NO KAI= 10-02048

12-JULY-05

A4-01

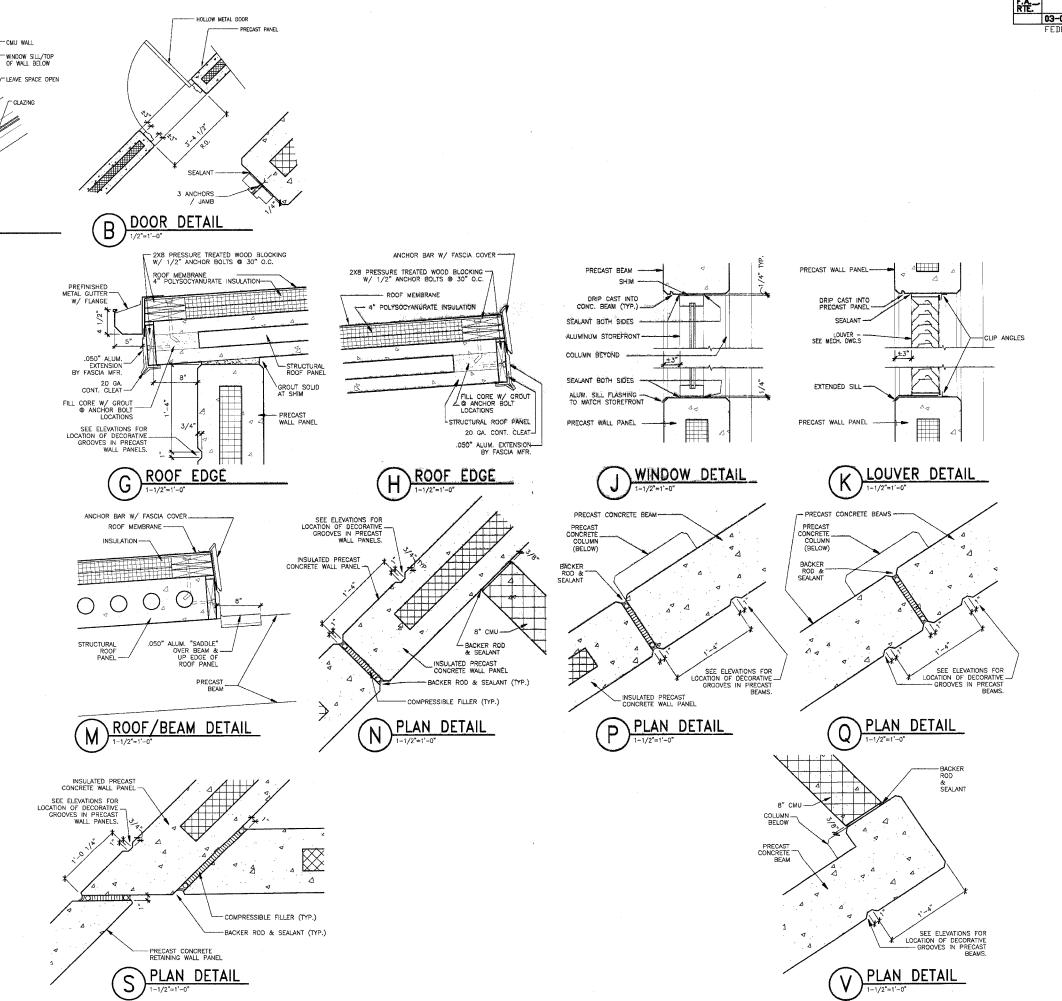


A PLAN DETAIL

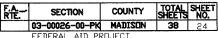

PHASE 2B LEWIS AND CLARK MEMORIAL TOWER OF HARTFORD, ILLINOIS ILLINOIS 62049 VILLAGE HARTFORD, I


DETAILS

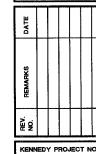

KENNEDY PROJECT NO KAI* 10-02048

12-JULY-05

A5-01

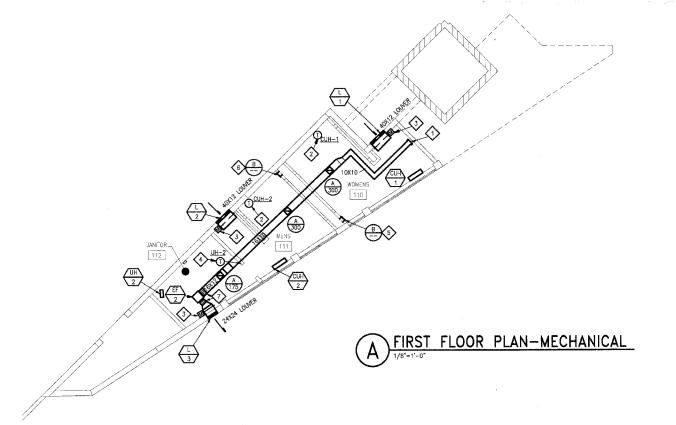

	ELECTRIC HEATER											
MARK	AREA	MFR.	MODEL	TYPE	CFM	KW	STEPS	мвн	ELECTRI		OPER.	NOTES
	SERVED	1911 13.	WOOLL		H/L	,,,,	012,0	MICH	V/PH/HZ	FLA (MCA)	WT. LBS.	
CUH-1	WOMEN'S	MARKEL	6333-06	FLOOR-MOUNT	250/230	6	2	20.4	208/3/60	17.6	118	1,2,3,4,5,6
CUH~2	MEN'S	MARKEL	6333-06	FLOOR-MOUNT	250/230	6	2	20.4	208/3/60	17.6	118	1,2,3,4,5,6
UH-2	JANITOR	MARKEL	5100	WALL-MOUNT	400	3.3	1	11.5	208/3/60	6.9	30	1,7,8,9,10
NOTES:								İ				

8.) OSHA FAN GUARD 9.) LOW VOLTAGE THERMOSTAT 10.) TRANSFORMER AND CONTACTOR

MARK

L-1 L-2

L-3

1.) 3-POLE CIRCUIT BREAKER/DISCONNECT

1.) 3-PULE VICTOR BEADARY DISCOUNT
2.) 1" PLEATED MEDIA FILTER
3.) KICK SPACE PEDESTAL
4.) FRONT INLET/TOP OUTLET
5.) FACTORY MOUNTED TRANSFORMER
6.) INTEGRAL THERMOSTAT
7.) WALL BRACKET WITH DUST SHIELD

	EXHAUST FAN													
MARK	AREA	MFR.	MODEL	TYPE	CFM	E.S.P.	RPM	DRIVE	SONES		ELECTRICAL	-	OPER.	
(EF)	SERVED					(" WC)				HP	V/PH/HZ	FLA (MCA)	WT. LBS.	NOTES
EF-2	TOL./PUMP	COOK	120SQN-B	ILC	1130	.35	1370	BELT	12.5	1/4	115/1/60	5.8	193	1,2,3,4,5,6,7,8,9,10,11,12
2.) EXTEN 3.) THERM 4.) SPRING	NOTES: 1.) PRE—WIRED DISCONNECT SWITCH 7.) 115V MOTORIZED DAMPER 1.1. C - INLINE CENTRIFUGAL EXHAUST OR SUPPY FAN 1.5 THERMAL OVERLOAD MOTOR 9.) FLANGED IULET 3.) THERMAL OVERLOAD MOTOR 9.) FLANGED OUTLET 4.) SERING VIBRATION ISOLATION HANGERS 10.) INLET COMPRESSION FLANGE 5.) OHSA GUARD/MOTOR COVER 11.) OUTLET COMPRESSION FLANGE 5.) CHAS GUARD/MOTOR COVER 11.) OUTLET COMPRESSION FLANGE 5.1 TAND 70°F.													

1.)	PRE-WIRED DISCONNECT SWITCH EXTENDED LUBRICATION LINES THERMAL OVERLOAD MOTOR SPRING VIBRATION ISOLATION HANGERS OHSA GUARD/MOTOR COVER	7.)	•
2.)	EXTENDED LUBRICATION LINES	8.)	1
3.)	THERMAL OVERLOAD MOTOR	9.)	1
4.)	SPRING VIBRATION ISOLATION HANGERS	10.)	1
5.)	OHSA GUARD/MOTOR COVER	11.)	1
6.)	24 HOUR TIME CLOCK	12.)	1
.,			

7.) 115V MOTORIZED DAMPER
8.) FLANGED INLET
9.) FLANGED OUTLET
10.) INLET COMPRESSION FLANGE
11.) OUTLET COMPRESSION FLANGE
12.) INLET/OUTLET FLEXIBLE DUCT CONNECTORS

					LOI	JVER						
	MFR.	MODEL.	SIZE HxWxD	FUNCTION		MATE	RIAL	FREE AREA	AREA RATIO PRE		NOTES	
					FRAME	BLADE	FINISH	VELOCITY	%	DROP		
T	RUSKIN	EME520DD	12X40X5	INTAKE	ALUM.	ALUM.	CLEAR, ANODIZED	500	99.3	.04	1	
Ι	RUSKIN	EME520DD	12X40X5	INTAKE	ALUM.	ALUM.	CLEAR. ANODIZED	500	99.3	.04	1	
ľ	RUSKIN	EME520DD	24X24X5	EXHAUST	ALUM.	ALUM.	CLEAR, ANODIZED	500	99.3	.04	1	

S:		 	
SECT	SCREEN		

H.V.A.C. DAI	MPER SPEC	CIFICATIONS
MANUFACTURER	RUSKIN	RUSKIN
MODEL	CD50	CD102
DANPÉR TYPE	CONTROL	CONTROL
FUNCTION	OUTSIDE AIR INTAKE	FAN DISCHARGE
SHAPE	RECTANGULAR	RECTANGULAR
MAX. PRESSURE ("WG)	6.2*	12.0"
MAX. VELOCITY (FPM)	4000	4000
MAX. PD @ MAX VELOCITY (24X24, 24"DIA)	0.02"WG	0.01 "WG
EAKAGE @ 1"WG (CFM/SQ.FT.)	2.0@1.0*WG	8.5@1.0*WG
BLADE MATERIAL	ALUMINUM	ALUMINUM
BLADE CONSTRUCTION	6" WIDE 6063-T5 EXTRUDED	7.75" WIDE 0.080 6063-T5 EXTRUDED
BLADE TYPE	AIRFOIL	AIRFOIL
BLADE SEAL MATERIAL	NEOPRENE	SILICONE RUBBER
FRAME MATERIAL	ALUMINUM	GALV. STEEL
FRAME CONSTRUCTION	5"X1" 0.125" EXTRUDED	10"X2" 12 GA. STEEL CHANNEL
AXLE MATERIAL	PLATED STEEL	plated Steel
AXLE DIAMETER	1/2"	3/4"
BEARING MATERIAL (TYPE)	SYNTHETIC	STAINLESS STEEL
NOTES	_	

H.V.A.C. DAI	MPER SPE	CIFICATIONS		
MANUFACTURER	RUSKIN	RUSKIN		
MODEL	CD50	CD102		
DANPÉR TYPE	CONTROL	CONTROL		
FUNCTION	OUTSIDE AIR INTAKE	FAN DISCHARGE		
SHAPE	RECTANGULAR	RECTANGULAR		
MAX. PRESSURE ("WG)	6.2*	12.0"		
MAX. VELOCITY (FPM)	4000	4000		
MAX. PD @ MAX VELOCITY (24X24, 24"DIA)	0.02*WG	0,01"WG		
LEAKAGE @ 17WG (CFM/SQ.FT.)	2.0@1.0"WG	8.5@1.0"WG		
BLADE MATERIAL	ALUMINUM	ALUMINUM		
BLADE CONSTRUCTION	6" WIDE 6063-T5 EXTRUDED	7.75" WIDE 0.080 6063-T5 EXTRUDED		
BLADE TYPE	AIRFOIL	AIRFOIL		
BLADE SEAL MATERIAL	NEOPRENE	SILICONE RUBBER		
FRAME MATERIAL	ALUMINUM	GALV. STEEL		
FRAME CONSTRUCTION	5"X1" 0.125" EXTRUDED	10"X2" 12 GA. STEEL CHANNEL		
AXLE MATERIAL	PLATED STEEL	Plated Steel		
AXLE DIAMETER	1/2"	3/4"		
BEARING MATERIAL (TYPE)	SYNTHETIC	STAINLESS STEEL		
NOTES	_			

F.A.	SECTION	COUNTY	TOTAL	SHEET NO.
	03-00026-00-PK	MADISON	38	25
	FEDERAL ALD PE	RIT. IF C.T.		

GENERAL NOTES:

1. THESE DRAWINGS ARE DIAGRAMATIC IN NATURE, ALL WORK IS TO BE COORDINATED BETWEEN ALL TRADES BEFORE CONSTRUCTION.

2. ALL DUCTWORK, EQUIPMENT AND PIPING IS TO BE INSTALLED IN ACCORDANCE WITH ALL PERTIMENT CODES AND SMACNA SEISMIC DESIGN REQUIREMENTS.

3. DUCT SIZES SHOWN ARE SHEETMETAL SIZES WITH 1"

KEYED NOTES:

- EXTEND 10"x10" EXHAUST DUCT AS ROUTED AND PROVIDE CAP AT WALL. SEAL AIR TIGHT. DUCT IS FOR FUTURE REGISTER LOCATED IN FUTURE PUMP ROOM.
 RUN DUCT AS TIGHT AS TO BOTTOM OF STRUCTURE AS
- 2> PROVIDE A SEVEN DAY PROGRAMMABLE HEATING/COOLING THERMOSTAT WITH WHITE METAL LOCKABLE THERMOSTAT GUARD.
- (3) INTERLOCK DAMPER TO OPEN WITH ACTIVATION OF EF-2. PROVIDE AN 20 GAGE GALVANIZED PLENUM TO MOUNT DAMPER.
- PROVIDE A LOW VOLTAGE HEATING ONLY THERMOSTAT WITH WHITE METAL LOCKABLE GUARD.
- MOUNT TOP OF GRILLE AT 1'-6" BELOW STRUCTURE. EXTEND DUCTWORK INTO CHASE AND LEAVE END OPEN TO SPACE.
- 6 MOUNT TOP OF GRILLE AT 1'-6" BELOW STRUCTURE. EXTEND DUCTWORK INTO CHASE AND LEAVE END OPEN TO SPACE.
- 7 FLEXIBLE CONNECTORS.

				E SO							
	EXHAUST / RETURN / TRANSFER GRILLES										
PLAN MARK	MANUFACTURER MODEL NO.	NECK SIZE	FACE SIZE	MOUNT	MATE- RIAL	ACCES SORIES	FINISH	TYPE	NOTES		
Α	TITUS 350FL	12X12	-	DUCT SIDEWALL	AL	vc	BWE	FAB			
В	TITUS 350FL	10X10	-	DRYWALL SIDEWALL	AL	-	BWE	FAB			
MATE AL -	RIAL - ALUMINUM	ACCES: VC -		CONTROL (DAMPER	TYPE FAB) ANGLE	BLADE		
FINIS BWE	i H — Baked White Enam	EL									



PHASE 2B
LEWIS AND CLARK MEMORIAL TOWER
VILLAGE OF HARTFORD, ILLINOIS
HARTFORD, ILLINOIS 62049

SHEET TILE.
FIRST FLOOR PLAN-MECHANICAL

1		 		
	DATE			
	REMARKS			
	HEV.			

KENNEDY PROJECT NO KAI* 10-02048

ISSUE DATE 12-JULY-05 SHEET NO

M3-01

SECTION COUNTY TOTAL SHEET NO.


| 03-00026-00-PK | MADISUN | 38 | 26 |
| FEDERAL AID PROJECT

KEYED NOTES:

8 3"UP TO, MB-1
9 3"UP TO, WCO
10 CAP 3/4" WATER AND 4" SANITARY PIPING 12" BEYOND PHASE 28 WORK. (STAKE AND MARK FOR FUTURE IDENTIFICATION AND EXTENSION)

PHASE 2B
LEWIS AND CLARK MEMORIAL TOWER
VILLAGE OF HARTFORD, ILLINOIS
HARTFORD, ILLINOIS 62049

SHEET TILE BELOW FLOOR PLAN-PLUMBING

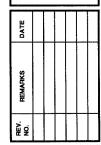


KENNEDY PROJECT NO KAI* 10-02048

ISSUE DATE 12-JULY-05

SHEET NO P3-01

BELOW FLOOR PLAN-PLUMBING

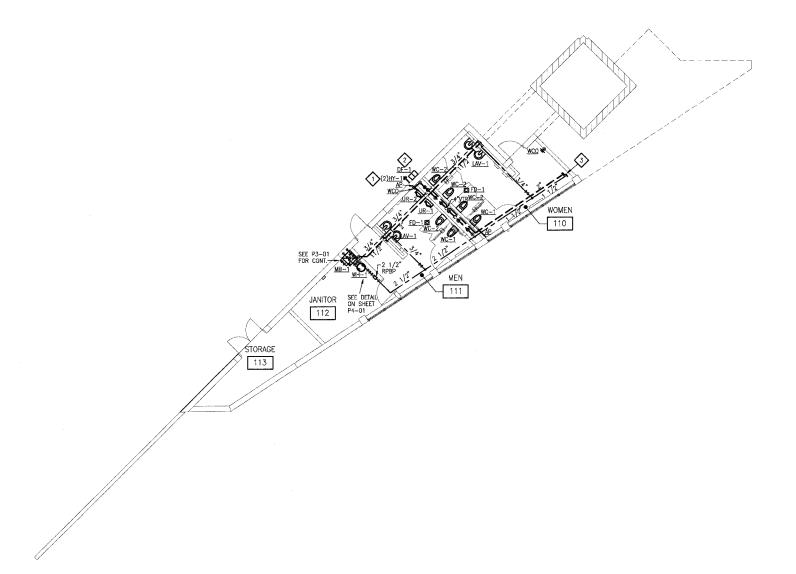

- KEYED NOTES:

 1 1HW HY-1 AND 1 CW HY-1, PROVIDE SHUT OFF VALVES ACCESSIBLE BY ACCESS PANEL TO SHUT OFF HY-1'S.


 2 PROVIDE SHUT OFF VALVE ACCESSIBLE BY ACCESS PANEL TO SHUT OFF DE-1.

 3 2" VENT, 1 1/2" WATER CAPPED FOR FUTURE EXTENSION IN PHASE 2A.



PHASE 2B
LEWIS AND CLARK MEMORIAL TOWER
VILLAGE OF HARTFORD, ILLINOIS
HARTFORD, ILLINOIS

SHEET THE. FIRST FLOOR PLAN-PLUMBING

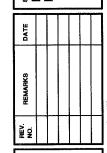

KENNEDY PROJECT NO KAI® 10-02048

ISSUE DATE 12-JULY-05 SHEET NO

P3-02


FIRST FLOOR PLAN-PLUMBING


PLUMBING FIXTURE CONNECTION SCHEDULE										
MARK	DESCRIPTION	WASTE	TRAP	VENT	GOLD WATER	HOT WATER	REMARKS	MAN. & MODEL NO.		
WC-1	WATER CLOSET, WALL HUNG	4"		2"	11/2"	-	ADA, 17"A.F.F., ELEC. FLUSH VALVE	KOHLER#K-4330/SLOAN#111ES-S		
WC-2	WATER CLOSET, WALL HUNG	4"	-	2"	11/2"		15"A.F.F., ELEC. FLUSH VALVE	KOHLER#K-4330/SLOAN#111ES-S		
UR-1	URINAL, WALL HUNG	2"		2"	1"		ADA, 17"A.F.F., ELEC. FLUSH VALVE	KOHLER#K-5016-ET/SLOAN#186-1.0ES-S		
UR-2	URINAL, WALL HUNG	2"	-	2"	1"		24"A.F.F., ELEC. FLUSH VALVE	KOHLER#K-5016-ET/SLOAN#186-1.0ES-S		
LAV1	LAVATORY	2"	11/2"	11/2"	1/2"	1/2"	ADA, ELEC. FAUCET	ACORN#3702-2-SO-EB-MXT		
DF-1	DRINKING FOUNTAIN	11/2"	-	11/4"	1/2"		(ADULT) ADA, 40"/36"A.F.F.	STERN WILLIAMS#BF-5000 FP		
MB-1	MOP BASIN, FLOOR SET	3"		2"	3/4"	3/4"	MANUAL FAUCET	STERN WILLIAMS#SB-902/T-10-VB/T-35/T-40/BP		
					3/4"	-	RECESSED, FREEZE PROOF	RECESSED, FREEZE PROOF		

				DRAIN SCHI	EDULE	
MARK	MANUFACTURER	MODEL NO.	OUTLET SIZE	STRAINER MATERIAL	REMARKS	
FD-1	J.R.SMITH	2010	3"	NICKEL BRONZE	TOILET ROOM	
NOTE:						

			MISCE	LLANEOU	S EQUIPMENT
MARK	MANUFACTURER	MODEL NO.	CONNECTIONS	INSTALLATION	UBÉ/LOCATION
RPBP-1	FEBCO	860	21/2"	HORIZONTAL	DOMESTIC WATER/MECHANICAL ROOM
NOTE:					

	ELECTRIC WATER HEATER SCHEDULE										
MARK	MANUFACTURER	MODEL NO.	STORAGE	RECOVERY	ELEMENT	VOLT/PH	REMARKS				
WH-1	BRADFORD WHITE	LD-WH30L3-1C015	30 GAL.	6 GPH	1.5KW	120/1	JANITOR CLOSET				

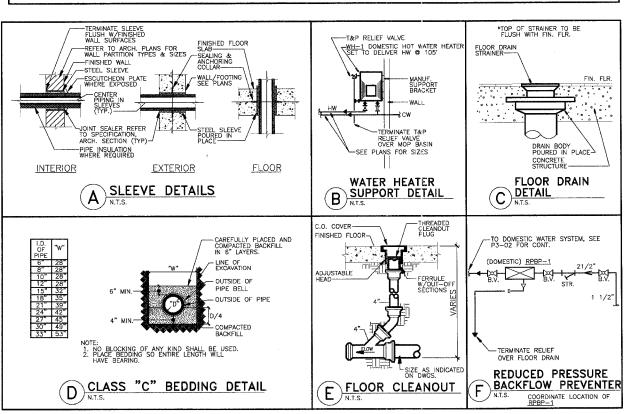

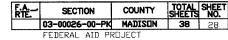



PHASE 2B LEWIS AND CLARK MEMORIAL TOWER ILLINOIS OF HARTFORD, ILLINOIS 62049 VILLAGE

SHET THE.
LEGEND, SCHEDULES
AND DETAILS
PLUMBING




KAI# 10-02048

ISSUE DATE 12-JULY-05

P4.01

SHEET NO

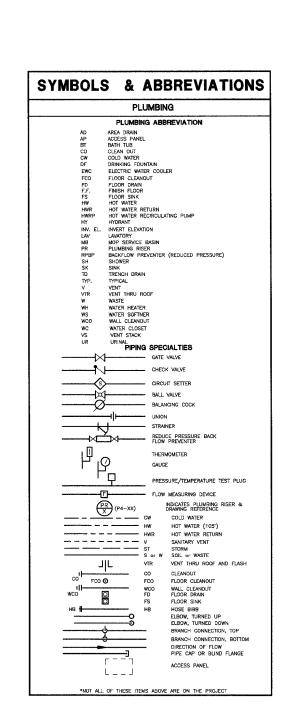

CLARK

AND

2

KENNEDY PROJECT NO KAI# 10-02048

ISSUE DATE 12-JULY-05

SHEET NO E1-01

GENERAL NOTES

1. REFER TO ARCHITECTURAL REFLECTED CEILING PLANS FOR EXACT LOCATION OF CEILING MOUNTED ELECTRICAL EQUIPMENT (LIGHT FIXTURES, OCCUPANCY SENSORS, ETC.)

2. REFER TO ARCHITECTURAL DRAWINGS FOR ELEVATION DRAWINGS INDICATING THE EXACT LOCATION OF WALL MOUNTED INTERIOR AND

3. IN GENERAL, CONDUIT ROUTING SHOWN ON THE DRAWINGS IS DIAGRAMMATIC. ACTUAL CONDUIT ROUTING SHALL BE DETERMINED IN THE FIELD.

4. WALL MOUNTED STARTERS, DISCONNECT SWITCHES, COMBINATION STARTERS, ETC. SHALL BE INSTALLED AT 48" TO THE CENTERLINE OF THE DEVICE UNLESS OTHERWISE NOTED ON

5. AT THE ROUGH-IN FOR ALL WALL HEIGHT PHONES, PROVIDE A

6. NOT ALL SYMBOLS ARE USED IN EACH PHASE OF THIS

ABBREVIATIONS

AMPERE(S) AMPERE INTERRUPTING CAPACITY
ALTERNATING CURRENT AMP FUSE AWG AS CATV CCTV CKT AMERICAN WIRE GUAGE AMP SWITCH CABLE TELEVISION CLOSED CIRCUIT TELEVISION CIRCUIT CONTR CONTRACTOR C/B CIRCUIT BREAKER CONDUCTOR COND CONN C CONT ELEC EMER EWC CONNECTION CONTROL ELECTRICAL EMERGENCY ELECTRIC WATER COOLER FACP FLA FULL LOAD AMPS FURNISHED GROUND FAULT INTERRUPTING HEAVY DUTY HIGH INTENSITY DISCHARGE HIGH PRESSURE SODIUM

INTERMEDIATE METAL CONDUI INCANDESCENT

INSTALLED

KII OWATTS

KILOVOLT AMPERES MINIMUM CIRCUIT AMPACITY MAIN CIRCUIT BREAKER THOUSAND CIRCULAR MILS MAIN LUGS ONLY NATIONAL ELECTRICAL CODE NON FUSED NIGHT LIGHT POWER FACTOR PHASE PANEL POLYVINYLCHLORIDE RECEPTACLE RECEP SEC SURF RECEPTACLE SURFACE SWITCHBOARD SOUTHWESTERN BELL TELEPHONE SYMMETRICAL TEMP THD TOTAL HARMONIC DISTORTION TRANSFORMER TELEPHONE TERMINAL BOARD TELEVISION UNIT HEATER VOLTAMPS VIDEO TERMINAL BOARD WEATHERPROOF TRANSFORMER

LIGHT FIXTURE DESIGNATION MATRIX

LIGHT FIXTURE - SYMBOL VARIES. SWITCH LEG. CIRCUIT NUMBER. CIRCUIT NUMBER IS NOT SHOWN WHERE NEW FIXTURES ARE BEING CONNECTED TO AN EXISTING CIRCUIT. SEQUENTIAL LETTER INDICATING FIXTURE TYPE. SEE LIGHTING FIXTURE SCHEDULE.

MISCELLANEOUS

2>-KEYED NOTE SYMBOL LARGE SCALE PLAN/DETAIL REFERENCE ----DETAIL DESIGNATION ON THE REFERENCED SHEET -----SHEET ON WHICH LARGE SCALE PLAN/DETAIL IS LOCATED DETAIL DESIGNATION ON THE REFERENCED SHEET SHEET ON WHICH SECTION IS SHOWN B120 ROOM NUMBER

LIGHTING

CEILING MOUNTED DOWNLIGHT WALL MOUNTED LIGHT FIXTURE Ю

CEILING MOUNTED FLUORESCENT FIXTURE

CEILING MOUNTED FLUORESCENT FIXTURE WITH EMERGENCY

0 CEILING MOUNTED EXIT SIGN WITH EMERGENCY BATTERY PACK

•[] POLE MOUNTED SITE LIGHTING LUMINAIRE

EXTERIOR FLOODLIGHT

(0)

DISTRIBUTION EQUIPMENT

BRANCH CIRCUIT PANELBOARD (SINGLE SECTION) BRANCH CIRCUIT PANELBOARD (TWO SECTION) DISTRIBUTION PANELBOARD

ONE LINE/WIRING/CONDUIT

CONDUIT INSTALLED CONCEALED WITHIN WALLS AND ABOVE CEILING. CONDUIT INSTALLED BELOW GRADE, SLAB OR FLOOR WIRING HOMERUN TO PANELBOARD SHORT STROKE INDICATES PHASE CONDUCTOR. LONG STROKE INDICATES NEUTRAL CONDUCTOR,
LONG STROKE WITH DOT INDICATES EQUIPMENT GROUND

CONDUIT UP CONDUIT DOWN CONDUIT CAPPED

CONDUIT STUB

38 FUSE

-----SWITCH

► G - GROUND BUS

ASD ADJUSTABLE SPEED DRIVE б DISCONNECT SWITCH

 \boxtimes

ឪ COMBINATION MAGNETIC STARTER/DISCONNECT SWITCH

> <PRE WIRED CONTROL PANEL CURRENT TRANSFORMERS (GFP)

MOTOR -- NUMBER WITHIN SYMBOL DENOTES HORSEPOWER RATING

WIRING DEVICES

ď DISCONNECT SWITCH - "WP" DENOTES WEATHERPROOF ELECTRIC MOTOR

SINGLE RECEPTACLE DUPLEX RECEPTACLE

DUPLEX RECEPTACLE INSTALLED ABOVE COUNTERTOP (42" WHERE NO COUNTERTOP)

DUPLEX RECEPTACLE - "GFI" INDICATES GROUND FAULT INTERRUPTING WITH TEST AND RESET BUTTONS, "P" INDICATES "GFI PROTECTED" BY UPSTREAM GFI DEVICE ON SAME CIRCUIT,

DOUBLE DUPLEX RECEPTACLE

DOUBLE DUPLEX RECEPTACLE INSTALLED ABOVE COUNTERTOP (42* WHERE NO COUNTERTOP)

0 JUNCTION BOX

SINGLE POLE SWITCH

4>3 3-WAY LIGHT SWITCH DIMMER SWITCH

CEILING MOUNTED OCCUPANCY SENSOR

С LIGHTING CONTACTOR LIGHTING CONTROL RELAY PANEL R

М MOTORIZED DAMPER

VOICE/DATA

TELEPHONE JACK OUTLET ROUGH-IN - "W" ADJACENT TO DEVICE.

VOICE/DATA JACK OUTLET ROUGH-IN - DESK HEIGHT

VOICE/DATA JACK OUTLET ROUGH-IN - ABOVE COUNTER

FIRE ALARM

FIRE ALARM STROBE LIGHT - NUMBER INDICATES CANDELA SETTING

FIRE ALARM COMBINATION HORN/STROBE LIGHT - NUMBER **E**■ 75 INDICATES CANDELA SETTING -

F FIRE ALARM PULL STATION

FIRE ALARM CONTROL PANEL **---**⑤

DUCT MOUNTED SMOKE DETECTOR WITH SAMPLING TUBE

(S) CEILING MOUNTED SMOKE DETECTOR

 \oplus HEAT DETECTOR TS TAMPER SWITCH

FS FLOW SWITCH СМ

MONITOR MODULE

NOTE

NOT ALL SYMBOLS AND ABBREVIATIONS ARE USED IN EACH PHASE OF THIS PROJECT.

- SECTION COUNTY SHEETS NO.

03-00026-00-PK MADISON 38 30 EDERAL AID PROJECT

KEYED NOTES

CONDUIT SHALL BE EXTENDED TO PROPERTY LINE, CAPPED AND LABELED TELEPHONE, AND STAKED FOR LOCATION.

DIMENSION DENOTES HEIGHT OF CONCRETE BASE ABOVE GRADE. TYPICAL FOR ALL POLES. SEE DETAILS ON SHEET 66-02 FOR ADDITIONAL INFORMATION.


3 E.C. SHALL FURNISH AND INSTALL TRANSFORMER PAD. SEE DETAIL B, SHEET E6-02.

EXTEND AND CONNECT TO PANEL VIA CONTACTOR C1. SEE SHEET E4-01 FOR CONTACTOR LOCATION.

(2) 5° UNDERGROUND PVC CONDUITS FOR PRIMARY SERVICE ENTRANCE. EXTEND TO PROPERTY LINE AND CAP OFF BELOW GRADE.

PHASE 2B
LEWIS AND CLARK MEMORIAL TOWER
VILLAGE OF HARTFORD, ILLINOIS
HARTFORD, ILLINOIS

SITE ELECTRICAL PLAN

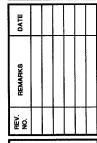

KENNEDY PROJECT NO KAI= 10-02048

ISSUE DATE 12-JULY-05 SHEET NO

E2-01


KEYED NOTES Ouazite type box installed flush in paved area. See detail a, sheet e6-01 for additional information. (3) 1" EMPTY CONDUITS WITH PULLWIRE FOR FUTURE SITE LIGHTING CIRCUITS. EXTEND AND CONNECT CONDUITS TO PANEL LP, SEE SHEET E3-01 FOR LOCATION OF PANEL LP. EXTEND CONDUITS 10' BEYOND BUILDING LINE AND CAP OFF BELOW GRADE. 4 EXTEND AND CONNECT TO PANEL VIA RELAY PANEL. (2) 1" EMPTY CONDUITS WITH PULLWIRE FOR POWER SUPPLY WIRING TO FUTURE FOUNTAIN PUMP AND FUTURE WATER WALL PUMP. 6 JUNCTION BOXES FOR CONNECTION OF FUTURE EMERGENCY POWER SUPPLY. SEE DETAILS D AND E ON SHEET E8-01. - 1" EMPTY CONDUIT WITH PULLWIRE FOR FUTURE SOUND SYSTEM WIRING. CAP OFF CONDUIT BELOW GRADE FOR FUTURE EXTENSION. · 3/4" EMPTY CONDUIT WITH PULLWIRE. DENOTES HEIGHT OF BASE ABOVE PLAZA PAVING - TYPICAL. -- 2" EMPTY CONDUIT WITH PULLWIRE FOR TELEPHONE SERVICE TO FUTURE CONSTRUCTION PHASE. RELAY CONTROL ZONE — TYPICAL. SEE RELAY SCHEDULE ON SHEET E7-02, — 2" EMPTY CONDUIT WITH
PULLWIRE FOR FUTURE SOUND
SYSTEM WIRING. EXTEND
CONDUIT MINIMUM 5'-0" BEYOND
PAYED SURFACE AND CAP. \$6 X FOR CONTINUATION, SEE SHEET E4-01 -1" EMPTY CONDUIT WITH PULLWIRE FOR FUTURE SOUND SYSTEM WIRING. PLAZA LIGHTING AND POWER PLAN

 SECTION
 COUNTY
 TOTAL SHEETS NO.

 03-00026-00-PK
 MADISIN
 38
 31

PHASE 2B
LEWIS AND CLARK MEMORIAL TOWER
VILLAGE OF HARTFORD, ILLINOIS
HARTFORD, ILLINOIS 62049

SHEET TITLE PLAZA LIGHTING PLAN

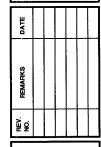

KENNEDY PROJECT NO KAI* 10-02048

12-JULY-05

SHEET NO E2-02

TOP OF FIXTURE AT 6'-B", CENTER ON COLUMN OR APPARENT COLUMN - TYPICAL ALL TYPE B FIXTURES. GROUND FLOOR LIGHTING PLAN

1/8"=1"-0" KEYED NOTES

EXTEND AND CONNECT TO PANEL VIA RELAY PANEL.

PHASE 2B
LEWIS AND CLARK MEMORIAL TOWER
VILLAGE OF HARTFORD, ILLINOIS
HARTFORD, ILLINOIS SHEET TITLES
GROUND FLOOR
LIGHTING PLAN

KENNEDY PROJECT NO KAI: 10-02048

ISSUE DATE 12-JULY-05

E3-01

E.C. SHALL PROVIDE 4" CONCRETE HOUSEKEEPING PAD. — TELEPHONE SERVICE ENTRANCE – SEE SHEET E2-01 FOR CONTINUATION. GROUND FLOOR POWER PLAN

KEYED NOTES

 \bigoplus e.c. shall furnish and install flush mounted enclosure for electronic flush valve. See details B and C, sheet E6–01.

QFI RECEPTACLE SHALL BE LOCATED AT 22-1/2"AFF FOR ELECTRONIC FAUCETS. COORDINATE LOCATION WITH APPROVED SHOP DRAWINGS.

3 2" CONDUIT STUB-UPS FOR FUTURE SOUND SYSTEM.

4 1" EMPTY CONDUIT WITH PULLWIRE FOR FUTURE FOUNTAIN PUMP POWER SUPPLY WIRING. EXTEND CONDUIT ABOVE FLOOR AND CAP OFF.

55 1" EMPTY CONDUIT STUB-UPS FOR FUTURE SOUND SYSTEM.



PHASE 2B
LEWIS AND CLARK MEMORIAL TOWER
VILLAGE OF HARTFORD, ILLINOIS
HARTFORD, ILLINOIS 62049

SHEET TILLS
GROUND FLOOR
POWER PLAN



KENNEDY PROJECT NO KAI# 10-02048

ISSUE DATE 12-JULY-05

E4-01

SHEET NO

FEDERAL AID PROJECT

211 N. Broadway
84th 1900
84. Lottle, NO
84. Lottle, NO
89162
89162
FAX (\$14) 241-8188

PHASE 2B
LEWIS AND CLARK MEMORIAL TOWER
VILLAGE OF HARTFORD, ILLINOIS
HARTFORD, ILLINOIS

ONE LINE DIAGRAM


NO. REMARKS DATE

KENNEDY PROJECT NO KAI= 10-02048


ISSUE DATE 12-JULY-05

SHEET NO


E5-01

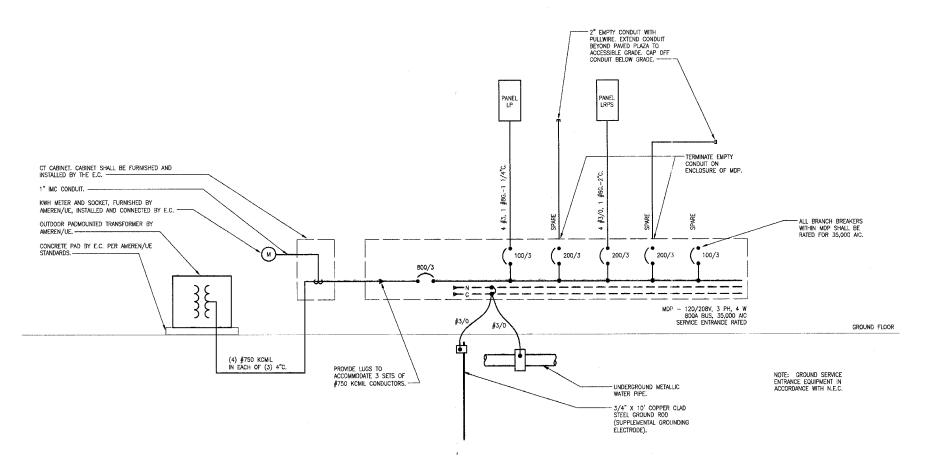



D LIFE SAFETY LIGHTING

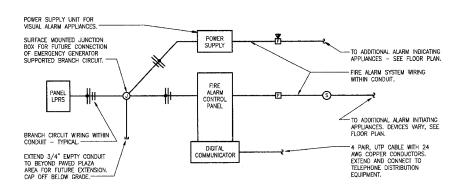


FIRE ALARM SYSTEM SCHEMATIC

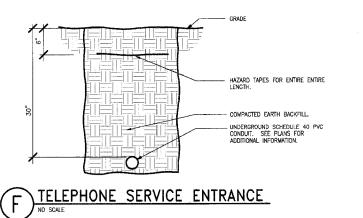

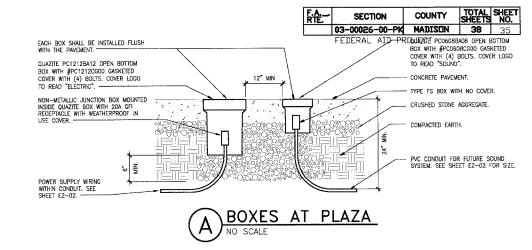

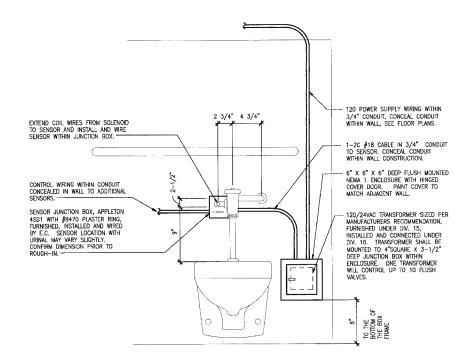

FLUSH VALVE DETAIL FOR WATER CLOSETS AND URINALS

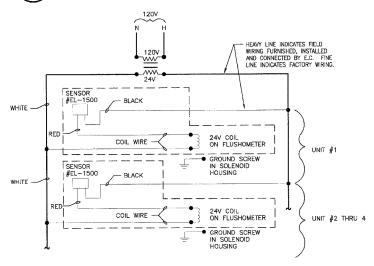

FLUSH VALVE WIRING DIAGRAM



AND CLARK MEMORIAL TOWER
E OF HARTFORD, ILLINOIS
D. ILLINOIS 62049

ELECTRICAL DETAILS LEWIS AN VILLAGE HARTFORD, I

HEV. REMARKS DATE 8

KENNEDY PROJECT NO KAI 10-02048

12-JULY-05 SHEET NO

E6-01

GRADE.


HAZARD TAPES FOR ENTIRE ENTIRE LENGTH, MINIMUM 6° BELOW GRADE, COOPDINATE DEPTH WITH CML DRAWINGS.

COMPACTED EARTH BACKFILL.


- UNDERGROUND SCHEDULE 40 PVC CONDUIT. SEE ONE LINE DIAGRAM FOR CONDUIT SYES.

SECONDARY SERVICE ENTRANCE DUCTBANK NO SCALE


000

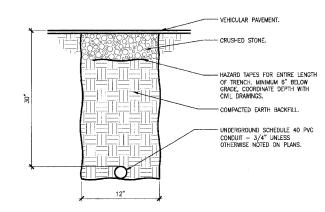


E CONDUIT TRENCH UNDER VEHICULAR PAVEMENT

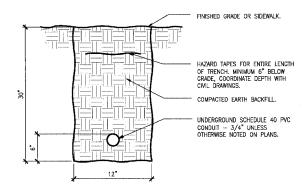


CONDUIT TRENCH IN GRASS OR UNDER SIDEWALK

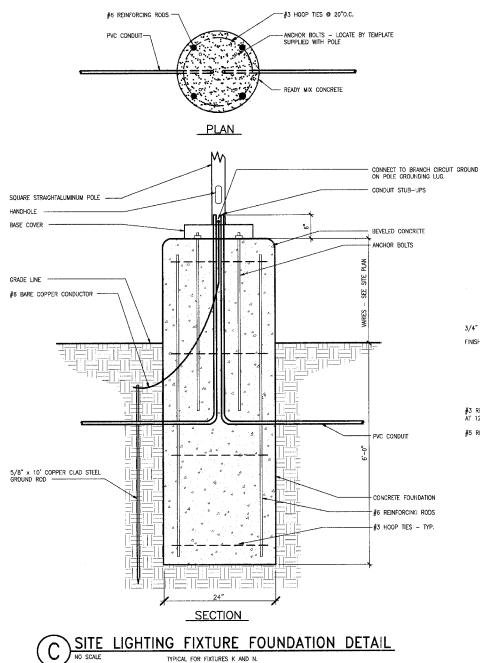

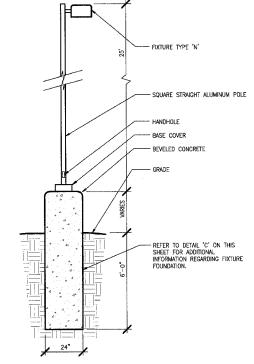

A SITE LIGHTING FIXTURE DETAIL "TYPE N"

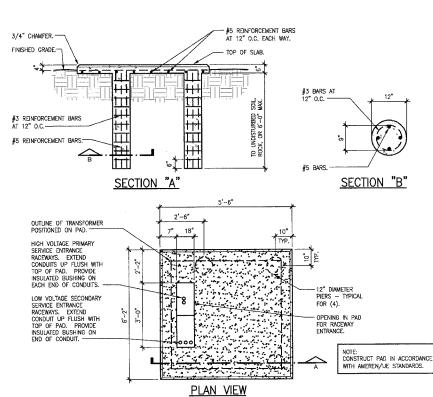

B TRANSFORMER PAD DETAIL

PHASE 2B
LEWIS AND CLARK MEMORIAL TOWER
VILLAGE OF HARTFORD, ILLINOIS
HARTFORD, ILLINOIS 62049

SHEET TITLE

ELECTRICAL DETAILS

L

HEV. REMARKS DATE

KENNEDY PROJECT NO KAIN 10-02048

ISSUE DATE 12-JULY-05

E6-02

RELAY UMBER	PANEL AND CIRCUIT NUMBER	RELAY CONTROL ZONE	CONTROL ZONE LOCATION	PRIMARY CONTROL SOURCE	SECONDARY CONTROL SOURCES	NOTES
1	LP-41	а	Coil in Contactor C1	PC	попе	11
2	LP-41	b	Coil in Contactor C2	PC	TC	2
3	LP-6	С	South Plaza Ltg.	PC	none	3
4	LP-8	d	North Plaza Ltg.	PC	none	3
5	LP-2	е	Exterior Bldg. Ltg.	PC	none	. 3
6	LP-4	f	Exterior Bldg. Ltg.	PC	none	3
7	LP-2	g	Water Wall Lighting	PC	TC	2
8	LP-4	h	Water Wall Lighting	PC	TC	2
9	LP-16	j	Water Wall Lighting	PC	TC	2
10	LP-18	k	Water Wall Lighting	PC	TC	2
11	LP-20	m	Water Wall Lighting	PC	TC	2
12	LP-22	n	Water Wall Lighting	PC	TC	2
13	LP-10	р	Fountain Lighting	PC	TC	2
14	spare relay	q				
15	spare relay	ſ				
16	spare relay	S				
17	spare relay	t				
18	spare relay	u				
19	spare relay	V				
20	spare relay	w				
21	spare relay	×				
22	spare relay	У				
23	spare relay	z				
24	spare relay	aa				
25	space for spare relay	bb				
26	space for spare relay	cc				
27	space for spare relay	dd				
28	space for spare relay	ee				
29	space for spare relay	ff				
30	space for spare relay	gg				
31	space for spare relay	hh				
32	space for spare relay	ii				

PC = PHOTOCELL
TC = TIME CLOCK (within relay panel controller)

NOTES

Note 1 - Photocell controls coil of contactor (via relay) to turn lights "ON" and "OFF" (dusk to dawn operation).

Note 2 - Photocell controls coil of contactor (via relay) to turn lights "ON", time clock controls coil of contactor (via relay) to turn lights "OFF".

Note 3 - Photocell controls relay to turn lights "ON" and "OFF" (dusk to dawn operation).

<u>NOTE</u>

ALL RELAYS ARE FURNISHED WITHIN THIS PANEL UNDER THIS CONTRACT.
ONLY RELAYS 3 AND 5 ARE UTILIZED UNDER THIS CONTRACT. ALL OTHER
RELAYS ARE FOR FUTURE USE UNDER A SEPARATE CONTRACT.


F.A.	SECTION	COUNTY	TOTAL SHEETS	SES:
	03-00026-00-PK	MADISON	38	37
	FEDERAL AID PR	ROJECT		

	LIGHTING FIXTURE SCHEDULE													
TYPE	VOLTS	FIXTURE TYPE	MOUNTING	LAMPS	REFLECTOR/DIFFUSER	FEATURES	APPROVED MANUFACTURERS							
A	120	4'x1' FLUORESCENT VANDAL RESISTANT	SURFACE - CEILING / WALL ON EXISTING ROUGH-IN IN STAR TOWER - SEE ELEVATIONS FOR ADDITIONAL INFORMATION	(2) F3218/TL835 PLUS/ALTO	.156 CLEAR PRISMATIC ACRYLIC LENS	16 GUAGE STEEL HOUSING, ELECTRONIC O' START COLD WEATHER BALLAST, WHITE POWER COAT FINISH	FAILSAFE FWS-232-120-EBB1 LITHONIA DAYBRITE COLUMIBA							
AE	120	4'x1' FLUORESCENT VANDAL RESISTANT WITH EMERGENCY BATTERY BALLAST	SURFACE — CEILING / WALL ON EXISTING ROUGH—IN IN STAIR TOWER — SEE ELEVATIONS FOR ADDITIONAL INFORMATION	(2) F32T8/TL835 PLUS/ALTO	.156 CLEAR PRISMATIC ACRYLIC LENS	16 GUAGE STEEL HOUSING, ELECTRONIC O' START COLD WEATHER BALLAST, WHITE POWER COAT FINISH, BODINE BSO EMERGENCY BATTERY BALLAST	FAILSAFE FWS-232-120-EB81-B50 LITHONIA DAYBRITE COLUMIBA							
В	120	FLUORESCENT WALL SCONCE	SURFACE - WALL	(1) PL-L 36W/B30	OPAL GLASS DIFFUSER	ELECTRONIC BALLAST WITH -15' STARTING, CUSTOM COLOR AS SELECTED BY ARCHITECT	BECA 4482P							
С	120	4'x1' FLUORESCENT VANDAL RESISTANT	SURFACE - WALL	(2) F032/830/EC0	.156 CLEAR PRISMATIC ACRYLIC LENS	16 GUAGE STEEL HOUSING, ELECTRONIC O' START COLD WEATHER BALLAST, WHITE POWER COAT FINISH	FAILSAFE FWW-232-120-EB81 LITHONIA DAYBRITE COLUMBA							
D	120	COMPACT FLUORESCENT SURFACE DOWNLIGHT	SURFACE - CEILING	(1) PL-T 42W/830	.225 BOROSILICATE GLASS	CAST ALUMINUM HOUSING, ELECTRONIC O' START BALLAST, BLACK FINISH, DUAL VOLTAGE BALLAST	FAILSAFE RDS-12-42CT-DT-BK LITHONIA DAYBRITE COLUMBA							
Ē		NOT USED												
F		NOT USED												
G		NOT USED	*											
н		NOT USED												
J		NOT USED												
к	120	HID LIGHT COLUMN	POLE MOUNTED	(1) CDM150/T6/830	ANODIZED ALUMINUM REFLECTOR	STAINLESS STEEL FINISH, IP86	LUMEC-SCHREDER NEC-150MH-120-SS							
L		NOT USED												
М		NOT USED												
N	208	HID SITE LIGHTING LUMINAIRE	POLE MOUNTED SEE DETAILS A AND C, SHEET E6-02	(1) MH400/U	SEGMENTED ALUMINUM TYPE 3	ALUMINUM POLE, UL LISTED WET LOCATION, GASKETED, PLATINUM SILVER FINISH, HIGH POWER FACTOR BALLAST	KIM 1A-AR3-400MH208-PSP-PSA25-5188 GARDCO GULLWING INVUE							
х		NOT USED												
			,											
	L		I	<u> </u>			-							



PHASE 2B
LEWIS AND CLARK MEMORIAL TOWER
VILLAGE OF HARTFORD, ILLINOIS
HARTFORD, ILLINOIS 62049

LIGHTING FIXTURE SCHEDULE

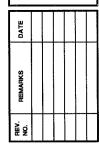

KENNEDY PROJECT NO KAI® 10-02048

12-JULY-05 SHEET NO

ISSUE DATE

E7-01

PANELBOARD - MOUNTING - ALC: RATING -	SURFAC	E		PHASE 3							AN		100	SPI -				
LOAD DESCRIPTION			(VA)		BRE	AKER	CIRCUIT		3 PH.		CIRCUIT	BRE			LOAD			LOAD DESCRIPTION
EG E DEGOTAL HOLY	LIGHT	RECEP.	HVAC	MSC.	AMP	POLES	0	A	BC	¢	P	POLES	AMP	LIGHT	RECEP.	HVAC	MISC.	
NW FLOODLIGHT	1650				20*	2	1	Т			2	1	20	912				EXTERIOR ENTRY LIGHTING
ANA ALCOCACACION I	1650			1	1 20	-	3	150			4	1	20*	742				EXTERIOR ENTRY LIGHTING
SW FLOODLIGHT	1650				20*	2	5	T		-	6	1	20	925				PLAZALIGHTING SCUT
SW FLOODLIGHT	1650				1 20"	-	7	1			8	1	20	925				PLAZA LIGHTING NOR TI
SE FLOODLIGHT	1650				20°	2	9	100			10	1	20*	1000				FOUNTAIN LIGHTING
SE FLOODLIGHT	1850				20-	- 2	11	183			12	. 2	20	500				PARKING LOT LIGHTING NORTH
NE FLOODLIGHT 165				 	20*	2	13	Г			14	1 -	20	500				PARKING EOI LIGHTING NORTH
NE FLUODLIGHT	1350				20"	1 -	15	T			16	1	20	1000				WATER WALL FLOODLIGHTS
PARKING LOT LIGHTING NORTH	1500			-	20	2	17	100		_	18	1	20	1000				WATER WALL FLOODLIGHTS
PARKING LOT LIGHTING NORTH	1500			-	20		19	1		0.9	20	1	20	1000		~~~~		WATER WALL FLOODLIGHTS
	730				20*	2	21	533			22	- 1	20	1000				WATER WALL FLOODLIGHTS
PARKING LOT LIGHTING SOUTH	750		ALAST 10				23	193	034		24	1	20					SPARE
	750				20*		25	1		80	26	1	20					SPARE
PARKING LOT LIGHTING SOUTH	750				20	2	27	150			28	1	20					SPARE
SPARE					20	1	29	188	130	2000	30	1	20					SPARE
SPARE	+			·	20	1	31	†~~			32	1	20					SPARE
SPARE				 	20	1-1-	33	550			34	1	20		ì			SPARE
SPARE		·			20	1	35	100	1834	-	36	1	20		-			SPARE
SPARE	1			+	20	1	37	Ť°	m	mi	38	- 1	20		1		· ·	SPARE
SPARE					20	1	39	62			40	1	20					SPARE
CONTACTORS C1 AND C2	100			 	20	1 1	41	1	loo!	-	42	7	20					SPARE

PANELBOARD - LRPS MOUNTING - SURFACE ALC, RATING - 22,000				208 / 120 3 4				AMP MCB AMP MCB AMP MLO 200			SPE	CWL FEA	ATURES -				
LOAD DESCRIPTION	T	LOAD	(VA)		BRE	KER	CIRCUIT	г	3 PH.	CIRCUIT	3REAKER			LOAD	(VA)		LOAD DESCRIPTION
EQAD DESCRIPTION	LIGHT	RECEP.	HVAC	MISC.	AMP	POLES	CIRCOII	A	BC	uncom	POLES	AMP	LIGHT	RECEP.	HVAC	MISC.	
GHTING	770				20	1	1	Г	000	2	1	20		1000			RECEPTACLE
			2000				3		100	4	1	20			900		EF-2 AND DAMPE
ABINET UNIT HEATER CUH-2			2600		25	3	5			6	1	20					SPAI
			2600		1		7	Γ.		8					1100		
			2000				9			10	3	20			1100		UNIT HEATER UP
ABINET UNIT HEATER CUH-1	-4.0		2000		25	3	11			12	1				1100		
			2000		1		13	_	182 81	14	1	20		2300			HAND DRY
				3276			15			16	1	20		2300			HAND DRY
UNTAIN PUMPS FP-1 & FP-2				3276	40*	3	17			18	1	20			400		MOTORIZED DAMPER
				3276	1	1	19		8348	20	1	20		1400			RECEPTACLI
OTORIZED DAMPER	1	-	*********	1000	20*	1	21	22		22	1	20		2300			HAND DRY
ÉCÉPTACLES		800			20*	1	23	133		24	1	20		2300			HAND DRY
ARE		†			20	1	25	1		26		200000			3333		
ARE	·				20	1	27	100	1 100	28	3	40*			3333		UNIT HEATER UP
ARE					20	1	29	t	ibsz ""	30	1				3333		
ATFORM RECEPTACLES	-	500			20*	1	31	1	0.00	32	1	20		1000			RECEPTACLE - FOOD WARMI
E SAFETY LIGHTING	360				20**	- i	33	18	+-	34	1	20		200			RECEPTACLE AT PODI
E ALARMOONTROL PANEL				1000	20**	1	35	æ	ted "	36	1	20				3000	
APPLIANCE PWR. SUPPLY	-			1000	20**	1	37	144	10 be	38	1	20	-			3000	WATER HEATER WI
ARE					20	1-1-	39	180	T E	40	1	20				3000	
DUNTAIN CONTROL PANEL				500	20*	Ħ	41	18	bol "	42	1	20					SPARE
SPARE	+				20		43	m	100000	44	1	20		-			SPARE
SPARE	+				20	1	45	100		46	1	20					SPARE .
SPARE	+				20	1	47	100	100	48	1	20		-			SPARE
SPARE					20	1	49	100		50	1	20					SPARE
SPARE	·	·			20	1	51	be	1	52	1	20					SPARE
SPARE	+	 			20	1	53	H		54	i i	20					SPARE
SPARE				_	20	1	55	ļ×8	100	56		20					SPARE
SPARE	+	+			20	1	57	10	-	58	1	20					SPARE
SPARE	+				20	1	59	100		60	 	20				_	SPARE
SPARE					20		61	r		62	1	20					SPARE
SPARE					20	i	63	ba	170	64	1	20					SPARE
SPARE	+	-			20	1	65	t in		66	T i	20		-			SPARE
SPARE	+				20	1	67	-	100	68	1	20					SPARE
SPARE		+			20	+	69	100	100	70	1 1	20					SPARE
SPARE	1			 	20	++	71	100	Sec.	72	+	20					SPARE
SPARE	+	+			26	+	73	142		74	H	20	 			h-min	SPARE
SPARE		+		_	20	++	75	100	1	76	+	20					SPARE
SPARE	+	+			20	+	77	1		78	1	20					SPARE
SPARE		+		ļ	20		79	198	100	80	++	20	 	 			SPARE
SPARE					20		81	las-		82	 -	20			-	_	SPARE
				-		+	83	188	100	84	 	20					SPARE
SPARE OTES: ALL CIRCUIT BREAKER S		1			20			1118	atosi _				1				

F.A.	SECTION	COUNTY	TOTAL	SHEET NO.
	03-00026-00-PK	MADISON	38	38

FEDERAL AID PROJECT

EQUIPMENT DATA SCHEDULE																						
JNE	MARK	EQUIPMENT	EQUIPMENT	FURN.		MOTO EQUIPME					ONNECT F EQUIPA				STARTE	R				(5)		
NO.	\ominus	DESCRIPTION	LOCATION	BY (DIV.)	① HP/KW	VOLTS/ PHASE	FLA	INST. BY	CONN. BY	② TYPE	FURN. BY	inst. By	CONN. BY	③ TYPE	FURN. BY	INST. BY	CONN. BY	(4) TYPE	FURN. BY	INST. BY	CONN. BY	REMARKS
1	CUH-1	CABINET UNIT HEATER	WOMEN'S RESTROOM	15	6 KW	208/3	17.6	15	16	CB	15	FAC	16	***		-	-	_	-	-	-	-
2	CUH-2	CABINET UNIT HEATER	MEN'S RESTROOM	15	6 KW	208/3	17.6	15	16	CB	15	FAC	16	_	-	_	-		-	_	-	-
3		,,,,,,,,,,,,,,,,,,,,,,,,,,,,,,,,,,,,,,												•								
4																						
5																						
6																						
7																						
8			**************************************																			
9	EF-2	EXHAUST FAN	TOILET ROOMS	15	1/4 HP	120/1		15	16	NF	15	FAC	16	_	-	-	-	TC	16	16	16	-
10																				,		
11																						
13							* * * * * * * * * * * * * * * * * * * *															
14			**************************************																			
15																	~~~					
16										***************************************												
17			Control of the Contro													***************************************						
18										_												
19	Yhdradali i harrad	and the state of t																				
20																						
21																						
22																						
23	WH1	WATER HEATER	- Aller and the second and the secon	15	1.5 KW	120/1	_	15	16	\$	16	16	16		-	-			-	-	-	
24		and the second s							ļ													
25		and the second of the second o	diament and the second and the secon						ļ													
26				ļ					ļ										-			
27																						
28												-		-								
29		<u> </u>	and the second s	ļ. <u></u>				-			-											
30									-										 			
31								-	1													
32												ļ			<u> </u>	ļ						
33		A LINE OF THE PROPERTY OF THE																	-			
34 35				 					-													
36				<u> </u>				-							-		-					
37									-			ļ			-							
38				 		-		-	-										-			
39											 											
40		and the second s		 				 							<u> </u>				1			
		The second selection of the second se	<u> </u>		L	L	L					L			L	<u></u>		L				

1 HORSEPOWER (HP) IS SHOWN UNLESS KILLOWATTS (KW) ARE CALLED OUT.

2) DISCONNECT TYPES:

CB = CIRCUIT BREAKER
F = FUSED
NF = NON FUSED
S = SWITCH (TOGGLE)
WP = WEATHERPROOF
FAC = FACTORY

3 STARTER TYPES:

3 STARTER TYPES:

COMB = COMBINATION MAGNETIC FVNR
WITH FUSIBLE DISCONNECT SWITCH
FVNR = FULL VOLTAGE NON-REVERSING
MAN = MANULL STARTER
PWCP = PRE-WIRED CONTROL PANEL
WITH INTEGRAL FVNR MAGNETIC
STARTER AND DISCONNECT SWITCH
SDS = STAR DELTA STARTER
VSD = VARIABLE SPEED DRIVE
2SZW = 2 SPEED, 2 WINDING MAGNETIC
STARTER

4 REMOTE CONTROL:

BAS = BULLING AUTOMATION SYSTEM
FAI = FIRE ALARM INTERLOCK
FST = FIRESTAT
INT = INTERLOCK WITH OTHER
EQUIPMENT
RAD = REMOTE ALARM DEVICE
RPB = REMOTE START—STOP PUSH
BUTTON
SSC = START—STOP CONTACT
TC = TIME CLOCK
TS = THERMOSTAT

5 REMARKS:

EMERGENCY POWER.
 SPEED, 2 WINDING MOTOR.
 STAND—BY UNIT.
 VARIABLE SPEED DRIVE WITH PRE-WIRED STARTER AND INTEGRAL DISCONNECT SWITCH.

PHASE 2B
LEWIS AND CLARK MEMORIAL TOWER
VILLAGE OF HARTFORD, ILLINOIS
HARTFORD, ILLINOIS 62049

DATA SHEET TITLE.
EQUIPMENT I

KENNEDY PROJECT NO KAI# 10-02048

SHEET NO

12-JULY-05

E7-02