COUNTY SECTION STATE OF ILLINOIS 06-00031-00-SW COOK C-91-301-06 CMM-8003 (622) **DEPARTMENT OF TRANSPORTATION** SEE SHT. NO 2 FOR INDEX OF SHEETS CONTRACT NO. 83960. SEE SHT. NO 2 FOR HIGHWAY STANDARDS **DIVISION OF HIGHWAYS** IO DAVIESS **PLANS FOR PROPOSED** WINNEBAGO 🗟 FEDERAL AID CMAQ PROJECT DUPAGE LEE VHITESIDE **MONARCH PEDESTRIAN PATH** WILL 187TH STREET/186TH PLACE STARK **LORETTO LANE TO WILLOW AVENUE** MARSHALL PEORIA WOODFORD SIDEWALK IMPROVEMENTS IROQUOI: PROJECT NO.: CMM-8003(622) TAZEWELI SECTION NO.: 06-00031-00-SW SCHUTLER **COOK COUNTY** PROJECT NUMBER: CMM-8003(621) 187TH STREET/186TH PLACE END PROJECT STA. 36+50 DOUGLAS JOB NO.: C-91-301-06 PIKE \ scott COLES **LOCATION MAP** GREENE ACOUPIN HILLSBORO JERSEY FAYETTE JASPER THIS PROJECT IS LOCATED WITHIN CLAY MARION CLINTON THE CITY OF ST. CLAIR 186th ST. **COUNTRY CLUB HILLS** PERRY PARK DISTRICT SOUTHWOOD ELEMENTARY INDICATES LOCATION OF IMPROVEMENT PROJECT NUMBER: CMM-8003(621) 187TH STREET/186TH PLACE BEGIN PROJECT STA. 10+19 MAPLE TER. "LICENSE EXPIRES 11-30-07 PROJECT MANAGER DATE: 6-07-07 STATE OF ILLINOIS DEPARTMENT OF TRANSPORTATION **DIVISION OF HIGHWAYS** R. 13 E. FULL SIZE PLANS HAVE BEEN PREPARED USING STANDARD ENGINEERING SCALES. REDUCED SIZED PLANS WILL NOT CONFORM TO STANDARD SCALES. IN MAKING MEASUREMENTS ON REDUCED SIZE PLANS, THE ABOVE SCALES SHALL BE USED. BREMEN TOWNSHIP **NO SCALE** PROJECT NUMBER: CMM-8003(621) nece PROJECT NUMBER: CMM-8003(621) 187TH STREET/186TH PLACE 187TH STREET/186TH PLACE CITY OF COUNTRY CLUB HILLS GROSS LENGTH OF IMPROVEMENT = 2,631 LIN. FT. OR 0.498 MILES NET LENGTH OF IMPROVEMENT = 1,909 LIN. FT. OR 0.362 MILES JULY 17-2007 DISTRICT 1 ENGINEER OF NET LENGTH OF OMISSION = 722 LIN. FT. OR 0.137 MILES LOCAL ROADS & STREETS BAXTER & WOODMAN, INC. STATE OF ILLINOIS - PROFESSIONAL DESIGN FIRM RELEASING FOR BID BASED ON LIMITED Plainfield, Illinois Grayslake, Illinois LICENSE NO. - 184-001121 - EXPIRES 4/30/2009 Crystal Lake, Illinois Burlington, Wisconsin July 17, 2007 815.459.1260 (OFFICE WHICH PREPARED PLANS) 262.763.7834 847.223.5088 815.609.7425 **CONTRACT NO. 83960** Rockford, Illinois Itasca, Illinois Madison, Wisconsin Mokena, Illinois DeKalb, Illinois WOODMAN HIGHWAYS, REGION 1 ENGINEER 608.347.1542 815.489.1551 815.787.3111 708.478.2090 Consulting Engineers

COUNTY: COOK SECTION: NUMBER: 06-00031-00-SW

PRINTED BY THE AUTHORITY OF THE STATE OF ILLINOIS PROJECT NO.: 051543.40

				TOTAL QUANTITY
				CONSTRUCTION CODE
			,	SFTY-1B
	CODE NO.	PAY ITEM	UNIT	TOTAL
:	20101000	TEMPORARY FENCE	FOOT	530
1	20101200	TREE ROOT PRUNING	EACH	11
:	20101400	NITROGEN FERTILIZER NUTRIENT	POUND	3
:	20101500	PHOSPHORUS FERTILIZER NUTRIENT	POUND	3
:	20101600	POTASSIUM FERTILIZER NUTRIENT	POUND	3
:	20101700	SUPPLEMENTAL WATERING	UNIT	2
	20200100	EARTH EXCAVATION	CU YD	. 5
-	20201200	REMOVAL AND DISPOSAL OF UNSUITABLE MATERIAL	CU YD	407
	20400800	FURNISHED EXCAVATION	CU YD	96
	20800150	TRENCH BACKFILL	CU YD	31
	21101615	TOPSOIL FURNISH AND PLACE, 4"	SQ YD	1,450
	21400100	GRADING AND SHAPING DITCHES	FOOT	31
- 1	25000400	NITROGEN FERTILIZER NUTRIENT	POUND	27
	25000500	PHOSPHORUS FERTILIZER NUTRIENT	POUND	27
	25000600	POTASSIUM FERTILIZER NUTRIENT	POUND	27
	25200110	SODDING, SALT TOLERANT	SQ YD	
	25200200	SUPPLEMENTAL WATERING	UNIT	44
- 1	28000300	TEMPORARY DITCH CHECKS	EACH	
	28000510	INLET FILTERS	EACH	
- 1	35101400	AGGREGATE BASE COURSE, TYPE B	TON	
	35101600	AGGREGATE BASE COURSE, TYPE B 4"	SQ YD	1,075
	42400200	PORTLAND CEMENT CONCRETE SIDEWALK 5 INCH	SQ FT	6,110
	42400410	PORTLAND CEMENT CONCRETE SIDEWALK 8 INCH	SQ FT	355
	42400430	PORTLAND CEMENT CONCRETE SIDEWALK 5 INCH, SPECIAL	SQ FT	3,175
1	42400800	DETECTABLE WARNINGS	SQ FT	70
	44000300	CURB REMOVAL	FOOT	50
	48101200	AGGREGATE SHOULDERS, TYPE B	TON	26
	54200637	PIPE CULVERTS, TYPE 1, CORRUGATED STEEL OR ALUMINUM CULVERT PIPE 12"	FOOT	42
ĺ	54201483	PIPE CULVERTS, TYPE 2, CORRUGATED STEEL OR ALUMINUM CULVERT PIPE 18"	FOOT	50
	54213867	STEEL END SECTIONS 12"	EACH	
	54213873	STEEL END SECTIONS 18"	EACH	2
	60220240	MANHOLES, TYPE A, 4'-DIAMETER, WITH SPECIAL FRAME, CLOSED LID	EACH	
	60611818	COMBINATION CONCRETE CURB AND GUTTER, TYPE M (SPECIAL) (ABUTTING EXISTING PAVEMENT)	FOOT	50
	67100100	MOBILIZATION	L SUM	
-	70102620	TRAFFIC CONTROL AND PROTECTION, STANDARD 701501	L SUM	
	70102640	TRAFFIC CONTROL AND PROTECTION, STANDARD 701801	L SUM	
	78000600	THERMOPLASTIC PAVEMENT MARKING - LINE 12"	FOOT	
	78000650	THERMOPLASTIC PAVEMENT MARKINGS - LINE 24"	FOOT	
	78300100	PAVEMENT MARKING REMOVAL	SQ FT	
- 1	X0301245	SHOULDER REMOVAL	SQ YD	l
-	X0321556	SANITARY MANHOLES TO BE ADJUSTED	EACH	
- 1	X0323973	SEDIMENT CONTROL, SILT FENCE	FOOT	
	X0323974	SEDIMENT CONTROL, SILT FENCE MAINTENANCE	FOOT	
	X0976500	END SECTIONS TO BE REMOVED	EACH	
	XX005656	INLET FILTER CLEANING	EACH	1
-	Z0018400	DRAINAGE STRUCTURES TO BE ADJUSTED	EACH	

ROUTE NO. SECTION		COUNTY	TOTAL SHEETS	SHEET NO.
	06-00031-00-SW	COOK	8	2
STA.	TO STA			
FED. ROAD C-91-3		ILLINOIS	FED AID CMM-80	
	301-06 ACT NO. 83960		CMM-80	03 (622

STANDARD NO.	HIGHWAY STANDARDS
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000001-04 STANDARD SYMBOLS AND ABBREVIATIONS 280001-03 TEMPORARY EROSION CONTROL SYSTEMS 424001-04 CURB RAMPS FOR SIDEWALKS 602401--01 MANHOLES, TYPE A 604001-02 FRAME AND LID, TYPE I 701501-03 URBAN LANE CLOSURE, 2L, 2W UNDIVIDED 701801-03 LANE CLOSURE MULTILANE 1W OR 2W CROSSWALK OR SIDEWALK CLOSURE 702001-06 TRAFFIC CONTROL DEVICES

LEGEND

ADJ 1	SANITARY	MANHOLES TO) BE	ADJUSTED
ADJ 2	DRAINAGE	STRUCTURES	TO	BE ADJUSTED

INDEX TO SHEETS

SHEET NO.	TITLE
1	COVER SHEET
2	INDEX OF SHEETS, HIGHWAY STANDARDS, SUMMARY OF QUANTITIES AND EARTH EXCAVATION SCHEDULE
3	GENERAL NOTES
4	TYPICAL SECTIONS, DETAILS AND BENCHMARKS
5	PLAN: 187TH STREET
6	PLAN: 186TH PLACE
7	CROSS SECTIONS: 187TH STREET / 186TH PLACE
8	DISTRICT ONE DETAIL TC-13: TYPICAL PAVEMENT MARKINGS

EARTH EXCAVATION SCHEDULE

LOCATIO	N	UNDERCUT	UNSUITABLE	REMOVAL &	EARTH	UTILITY	EXCESS	TOTAL	EXCAVATION	EMBANKMENT	EARTHWORK
		AND PGE	EXCAVATION	DISPOSAL OF	EXCAVATION	EXCAVATION	STRUCTURE	SUITABLE	TO BE USED		BALANCE WASTE (+)
STA TO	STA	REPLACEMENT	(TOPSOIL)	UNSUITABLE			EXCAVATION	EXCAVATION	IN EMBANKMENT		OR SHORTAGE (-)
	and the same of th	ļ		MATERIAL					(15% SHRINKAGE)		
		(CY)	(CY)	(CY)	(CY)	(CY)	(CY)	(CY)	(CY)	(CY)	(CY)
187TH 5	STREET										, , , , , , , , , , , , , , , , , , ,
10+35	11+00	0	17.78	17.78	0	0	0	0	0	19.26	-19.26
11+00	12+00	0	17.6	17.6	0	0	0	0	0	1.49	-1.49
12+00	13+00	0	17.97	17.97	0	О	0	0	0	1.49	-1.49
13+00	14+00	. 0	13.1	13.1	0	0	0	0	0	33.39	-33.39
14+00	15+00	0	25.77	25.77	0	0	0	0	0	9.54	-9.54
15+00	16+00	o	26.12	26.12	0	0	0	. 0	0	1.86	-1.86
16+00	17+00	0	28.15	28.15	О	0	0	0	- 0	8.52	-8.52
17+00	18+00	0	29.26	29.26	5	0	0	5	4	1.86	2.14
18+00	19+00	o	29.45	29.45	o	0	0	0	О	1.86	-1.86
19+00	19+82	0	22.78	22.78	o	0	0	0	0	5.41	-5.41
186TH F	PLACE										
27+32	28+00	0	15.5	15.5	О	О	0	0	0	1.38	-1.38
28+00	29+00	0	17.78	17.78	0	О	0	. 0	0	1.49	-1.49
29+00	30+00	0	17.78	17.78	0	О	0	0	0	1.49	-1.49
30+00	31+00	0	18.34	18.34	О	О	0	0	0	1.67	-1.67
31+00	32+00	0	17.6	17.6	0	0	0	0	0	1.49	-1.49
32+00	33+00	0	24.08	24.08	0	0	0	0	. 0	1.69	-1.69
33+00	34+00	0	21.6	21.6	0	0	0	0	. 0	1.63	-1.63
34+00	35+00	О	18.71	18.71	0	0	0	0	0	1.49	-1.49
35+00	36+00	0	17.78	17.78	0	0	0	0	0	1.49	-1.49
36+00	36+50	0	8.99	8.99	0	0	0	0	0	0.84	-0.84
	TOTALS	0	406.14	406.14	5	0	0	5	4	99.34	-95.34

EARTHWORK SUMMARY	
	TOTAL
EARTH EXCAVATION	5
REMOVAL AND DISPOSAL OF UNSUITABLE MATERIAL	406.14
POROUS GRANULAR EMBANKMENT	0
FURNISHED EXCAVATION	95.34

EARTHWORK NOTES:

ASSUME 4 INCH DEPTH OF TOPSOIL PLACEMENT FOR REMOVAL & DISPOSAL OF UNSUITABLE MATERIAL

ASSUME 9 INCH DEPTH OF TOPSOIL EXCAVATION FOR WALK

ASSUME 15% SHRINKAGE OF EARTH EXCAVATION TO BE REUSED AS EMBANKMENT.

NOT FOR BIDDING

* INDICATES SPECIALITY ITEM CONSULTANTS 1 5-29-07 CITY/IDOT REVIEW
2 6-07-07 CITY/IDOT REVIEW - REFER TO EQUIPMENT MANUFACTURER'S SHOP DRAWING



CITY OF COUNTRY CLUB HILLS, ILLINOIS 187th STREET/186TH PLACE SIDEWALK IMPROVEMENTS

INDEX OF SHEETS, HIGHWAY STANDARDS, SUMMARY OF QUANTITIES AND EARTH EXCAVATION SCHEDULE

NONE PROJECT NO. KAR CHECKED BY 051543.40 SHEET NO. 2 OF 8

F.A. ROUTE NO.	SECTION	COUNTY	TOTAL SHEETS	SHEET NO.	ě,
	06-00031-00-SW	соок	8	3	Ĭ.
STA.	TO STA				
FED. ROAD		ILLINOIS	FED AID		
C-91-3	301-06		CMM-800	03 (622)	

CONTRACT NO. 83960

- 1. THE CONTRACTOR SHALL PROTECT AND CAREFULLY PRESERVE ALL SECTION OR SUBSECTION MONUMENTS OR PROPERTY OR REFERENCE MARKERS UNTIL THE OWNER, HIS AGENT, OR AN AUTHORIZED SURVEYOR HAS WITNESSED OR OTHERWISE REFERENCED THEIR LOCATIONS
- 2. THE CONTRACTOR SHALL BE RESPONSIBLE FOR CONTACTING THE OWNERS OF ALL EXISTING UTILITIES SO THAT THE UTILITIES AND THEIR APPURTENANCES MAY BE LOCATED AND ADJUSTED OR MOVED, IF NECESSARY, PRIOR TO THE START OF CONSTRUCTION OPERATIONS. THE CONTRACTOR SHALL COOPERATE WITH ALL UTILITY OWNERS AS PROVIDED IN THE STANDARD SPECIFICATIONS AND/OR SPECIAL PROVISIONS. UTILITY LOCATIONS ARE APPROXIMATE ONLY. THE CONTRACTOR SHALL USE CAUTION WHERE THERE ARE POTENTIAL CONFLICTS.
- 3. THE CONTRACTOR SHALL BE RESPONSIBLE FOR THE PROTECTION OF ALL UNDERGROUND OR SURFACE UTILITIES EVEN THOUGH THEY MAY NOT BE SHOWN ON THE PLANS. ANY UTILITY THAT IS DAMAGED DURING CONSTRUCTION SHALL BE REPAIRED TO THE SATISFACTION OF THE ENGINEER OR THE OWNER OR REPLACED. THIS WORK SHALL BE AT THE CONTRACTOR'S EXPENSE.
- 4. ALL AGGREGATE USED ON THIS PROJECT SHALL BE CRUSHED MATERIAL
- 5. THE CONTRACTOR SHALL MAINTAIN POSITIVE DRAINAGE TO STRUCTURES AT ALL TIMES.
- 6. WHERE THE PROPOSED PAVEMENT, SIDEWALK, OR CURB AND GUTTER ABUTS THE EXISTING PAVEMENT OR CONCRETE TO REMAIN IN PLACE, THE EXISTING PAVEMENT OR CONCRETE SHALL BE SAWCUT TO PROVIDE A NEAT VERTICAL FACE BETWEEN THE PROPOSED AND THE EXISTING SURFACES. THIS SHALL BE CONSIDERED INCIDENTAL TO THE CONTRACT.
- THE CONTRACTOR SHALL PROTECT AND REPLACE ALL SIGNS REMOVED DURING CONSTRUCTION AS NEAR AS POSSIBLE TO THEIR ORIGINAL LOCATION, OR AS DETERMINED BY THE ENGINEER. THIS WORK SHALL BE CONSIDERED INCIDENTAL TO THE
- 8. REMOVAL OF EXISTING POST AND ATTACHING EXISTING SIGN ONTO NEW POLE IS INCIDENTAL TO THE CONTRACT.
- 9. ALL CONSTRUCTION SHALL BE DONE IN ACCORDANCE WITH THE DETAILS IN THE PLANS, THE SPECIAL PROVISIONS INCLUDED IN THE CONTRACT DOCUMENTS, AND THE LATEST EDITION OF THE FOLLOWING STATE OF ILLINOIS SPECIFICATIONS: "THE STANDARD SPECIFICATIONS FOR ROAD AND BRIDGE CONSTRUCTION" (REFERED TO AS THE "STANDARD SPECIFICATIONS"), THE "SUPPLEMENTAL SPECIFICATIONS AND RECURRING SPECIAL PROVISIONS", THE "STANDARD SPECIFICATIONS FOR TRAFFIC CONTROL ITEMS", THE "MANUAL ON UNIFORM TRAFFIC CONTROL DEVICES FOR STREETS AND HIGHWAYS", THE "MANUAL OF TEST PROCEDURES FOR MATERIALS" AND THE "STANDARD SPECIFICATIONS FOR WATER AND SEWER MAIN CONSTRUCTION IN ILLINOIS".
- 10. THE LOCATIONS OF PUBLIC OR PRIVATE UTILITIES SHOWN ON THE PLANS ARE APPROXIMATE AND THE CITY DOES NOT GUARANTEE THEIR ACCURACY. THE CONTRACTOR SHALL HAVE THE RESPECTIVE UTILITY COMPANIES FIELD LOCATE ALL THEIR FACILITIES PRIOR TO BEGINNING CONSTRUCTION. THE CONTRACTOR SHALL ALSO VERIFY THE DEPTHS OF THE EXISTING UTILITIES IF NECESSARY. ANY RELOCATION OR LOWERING OF UTILITIES SHALL BE COORDINATED BY THE CONTRACTOR.
- 11. THE CONTRACTOR SHALL BE RESPONSIBLE FOR THE PROTECTION OF ALL UNDERGROUND OR SURFACE UTILITIES EVEN THOUGH THEY MAY NOT BE SHOWN ON THE PLANS. ANY UTILITY THAT IS DAMAGED DURING CONSTRUCTION SHALL BE REPAIRED OR REPLACED AT THE CONTRACTOR'S EXPENSE TO THE SATISFACTION OF THE ENGINEER OR CITY.
- 12. THE CONTRACTOR SHALL NOTIFY THE CITY PUBLIC WORKS ADMINISTRATOR AT LEAST 48 HOURS IN ADVANCE OF BEGINNING WORK TO OBTAIN CITY UTILITY LOCATIONS AND SHALL COORDINATE ALL CONSTRUCTION OPERATIONS WITH THE ENGINEER.
- 13. MATERIALS RESULTING FROM THE REMOVAL OF PAVEMENT, DRIVEWAYS, CURB AND GUTTER, HOT-MIX ASPHALT SURFACES, ETC. SHALL BE REMOVED AT THE END OF EACH DAY TO AN APPROVED SITE. IN THE JUDGMENT OF THE CITY, SHOULD IT BE NECESSARY TO REMOVE SUCH MATERIALS, THE CITY WILL HAVE THE MATERIAL REMOVED AND THE CONTRACTOR WILL BE BILLED
- 14. THE CONTRACTOR MAY OBTAIN MUNICIPAL WATER IN BULK, AT NO CHARGE, AS LONG AS THERE IS NOT A "WATERING BAN IN EFFECT. THE INDISCRIMINATE USE OF FIRE HYDRANTS IS STRICTLY PROHIBITED. WATER FOR CONSTRUCTION SHALL BE METERED OR OTHERWISE ACCOUNTED FOR AND A DAILY LOG MAINTAINED. THE CONTRACTOR SHALL PROVIDE THE WATER TRUCK AND DRIVER REQUIRED TO OBTAIN AND TRANSPORT THIS WATER. THE CITY RESERVES THE RIGHT TO RESTRICT OR REFUSE THE USE OF CITY WATER IF DEEMED NECESSARY.
- 15. IT WILL BE THE CONTRACTOR'S RESPONSIBILITY TO NOTIFY RESIDENTS AND THE CITY WHEN ACCESS TO THEIR DRIVEWAYS WILL BE TEMPORARILY CLOSED DUE TO CURB AND GUTTER AND/OR DRIVEWAY REPLACEMENT. THE CONTRACTOR SHALL DISTRIBUTE NOTICES PROVIDED BY THE CITY TO RESIDENTS. EVERY EFFORT SHALL BE MADE TO ACCOMMODATE ACCESS TO THESE PROPERTIES INCLUDING KNOCKING ON DOORS WHEN DRIVEWAYS ARE ABOUT TO BE CLOSED.
- 16. ANY SIGNS OR MAILBOXES THAT ARE IN CONFLICT WITH THE PROPOSED CONSTRUCTION SHALL BE REMOVED AND REPLACED IN ACCORDANCE WITH CITY STANDARDS AND INCLUDED IN THE PAY ITEM FOR PORTLAND CEMENT CONCRETE SIDEWALK. MAIL SERVICE SHALL BE MAINTAINED AT ALL TIMES.
- 17. IN AREAS WHERE THE EXISTING DRIVEWAY OR CURB AND GUTTER IS TO BE REMOVED AND REPLACED. THE REMOVAL AND DISPOSAL OF ANY ADDITIONAL MATERIAL REQUIRED TO ESTABLISH THE PROPOSED DRIVEWAY, SIDEWALK, OR CURB AND GUTTER SUBGRADE ELEVATION SHALL BE INCLUDED IN THE PAY ITEMS, EARTH EXCAVATION OR CURB REMOVAL.

18.	ALL SIDEWALKS SHALL BE REINFORCED WITH THREE (3) NUMBER FOUR (#4) REBAR, MINIMUM TEN FEET LONG, ACROSS ALL
	SEWER, WATER, AND UTILITY TRENCHES AND SHALL BE INCLUDED IN THE PORTLAND CEMENT CONCRETE SIDEWALK 5 INCH
	(SPECIAL) PAY ITEM.

- 19. THE CONTRACTOR SHALL PROVIDE AND INSTALL TWO (2) WEIGHTED SANDBAGS ON EACH TYPE I OR TYPE II BARRICADE USED. ONE (1) WEIGHTED SANDBAG SHALL BE PLACED ACROSS EACH BOTTOM RAIL.
- 20. ALL POSTS, RAILROAD TIES, AND DECORATIVE TIMBER IN CONFLICT WITH THE PROPOSED IMPROVEMENTS SHALL BE REMOVED AND RELOCATED AS DETERMINED BY THE ENGINEER AT THE TIME OF CONSTRUCTION AND SHALL BE INCLUDED IN THE COST OF THE CONTRACT. EVERY EFFORT SHALL BE MADE BY THE CONTRACTOR WHEN REMOVING THESE ITEMS TO PRESERVE THEM FROM HARM. ITEMS NOT RELOCATED SHALL BE PROPERLY DISPOSED OF BY THE CONTRACTOR.
- 21. IN ALL TRENCHES CROSSING DRIVEWAYS, SIDEWALKS, AND ALL PROPOSED AND EXISTING ROADWAYS, THE MATERIAL FOR THE TOP 12 INCHES SHALL BE CA-6 CRUSHED GRAVEL OR CRUSHED STONE AND BE INCLUDED IN THE PAY ITEM FOR TRENCH BACKFILL. THE BACKFILL SHALL EXTEND TO AND BE MEASURED FOR PAYMENT TO THE EXISTING GROUND OR SURFACE
- 22. FRAME ELEVATIONS GIVEN ON THE PLANS ARE ONLY TO ASSIST THE CONTRACTOR IN DETERMINING THE APPROXIMATE OVERALL HEIGHT OF THE STRUCTURE. FRAMES ON ALL NEW STRUCTURES SHALL BE ADJUSTED TO THE FINAL ELEVATION OF THE AREA IN WHICH THEY ARE LOCATED AS PART OF COST OF THE STRUCTURE.
- 23. A PORTABLE BATHROOM(S) SHALL BE PLACED ON THE JOB SITE(S) AND RELOCATED WHEN NECESSARY SO IT IS ACCESSIBLE TO WORKERS. IF WORK IS OCCURRING AT SEVERAL LOCATIONS, ONE PORTABLE BATHROOM SHALL BE PLACED AT EACH LOCATION WITHIN A REASONABLE DISTANCE FROM THE WORK AS DETERMINED BY THE ENGINEER. THIS SHALL BE INCLUDED IN THE PAY ITEM FOR MOBILIZATION.
- 24. FOR STEEL BARS CERTIFICATION, PLEASE CONTACT IDOT BUREAU OF MATERIALS AT (847) 705-4361.
- 25. THE CONTRACTOR SHALL TAKE EXTRA CARE IN GRADING AND EXCAVATING NEAR TREES WHICH ARE NOT MARKED FOR REMOVAL SO AS NOT TO CAUSE INJURY® TO THE ROOT SYSTEM OR TRUNKS. HAND EXCAVATION SHALL BE PERFORMED IF MAJOR ROOTS ARE PRESENT. MAJOR ROOTS OF A TREE THAT ARE TO REMAIN IN PLACE EXTENDING INTO THE EXCAVATION AREAS AT AN ELEVATION THAT WOULD INTERFERE WITH ANY PORTION OF THE PLANNED CONSTRUCTION SHALL BE SEVERED AT A POINT IMMEDIATELY OUTSIDE OF THE EXCAVATION AREA IN A MANNER THAT WILL CAUSE THE LEAST AMOUNT OF SYSTEMIC DAMAGE TO THE REMAINING TREE STRUCTURE. THE EXPENSE OF ANY REQUIRED HAND EXCAVATION AS DESCRIBED SHALL BE CONSIDERED INCIDENTAL TO THE CONTRACT ITEM BEING REMOVED OR INSTALLED AT THAT LOCATION.
- 26. TREE ROOT PRUNING IS TO BE USED ON EXISTING TREES TO PREVENT THE RIPPING UP OF ROOTS WHEN TRENCHING OR EXCAVATION IS WITHIN THE ROOT ZONE OF ADJACENT TREES TO REMAIN. SUPPLEMENTAL WATERING AND FERTILIZATION OF TREES SHOULD BEGIN IMMEDIATELY AFTER ROOT PRUNING OF THE TREES HAS OCCURRED.
- 27. TEMPORARY FENCE SHOULD BE ERECTED ALONG THE DRIPLINE OF EXISTING TREES TO REMAIN WITHIN THE LIMITS OF CONSTRUCTION. AFTER TREES ARE SAFELY FENCED NOTHING IS TO BE STORED, DRIVEN OR DISTURBED INSIDE THE FENCE. REMOVE PROTECTIVE TEMPORARY FENCE ONLY AFTER ALL CONSTRUCTION WORK HAS BEEN COMPLETED.
- 28. THE CONTRACTOR SHALL TAKE ALL NECESSARY PRECAUTIONS FOR THE PROTECTION OF EXISTING PLANT MATERIAL FOR WHICH THE CONTRACT DOES NOT PROVIDE REMOVAL. THE PROTECTION OF EXISTING PLANT MATERIAL AND THE REPAIR OR REPLACEMENT OF EXISTING PLANT MATERIAL DAMAGED BY THE CONTRACTOR SHALL BE DONE IN ACCORDANCE WITH THE REQUIREMENTS OF SECTION 201 OF THE STANDARD SPECIFICATIONS.


CONSULTANTS REV. NO. DATE DESCRIPTION 5-29-07 CITY/IDOT REVIEW 6-07-07 CITY/IDOT REVIEW - REFER TO EQUIPMENT MANUFACTURER'S SHOP DRAWIN





CITY OF COUNTRY CLUB HILLS, ILLINOIS 187th STREET/186TH PLACE SIDEWALK IMPROVEMENTS

GENERAL NOTES

NOT FOR BIDDING MWP DRAWN BY PROJECT NO KAR CHECKED BY 051543.40 SHEET NO. MWP 3 OF 8

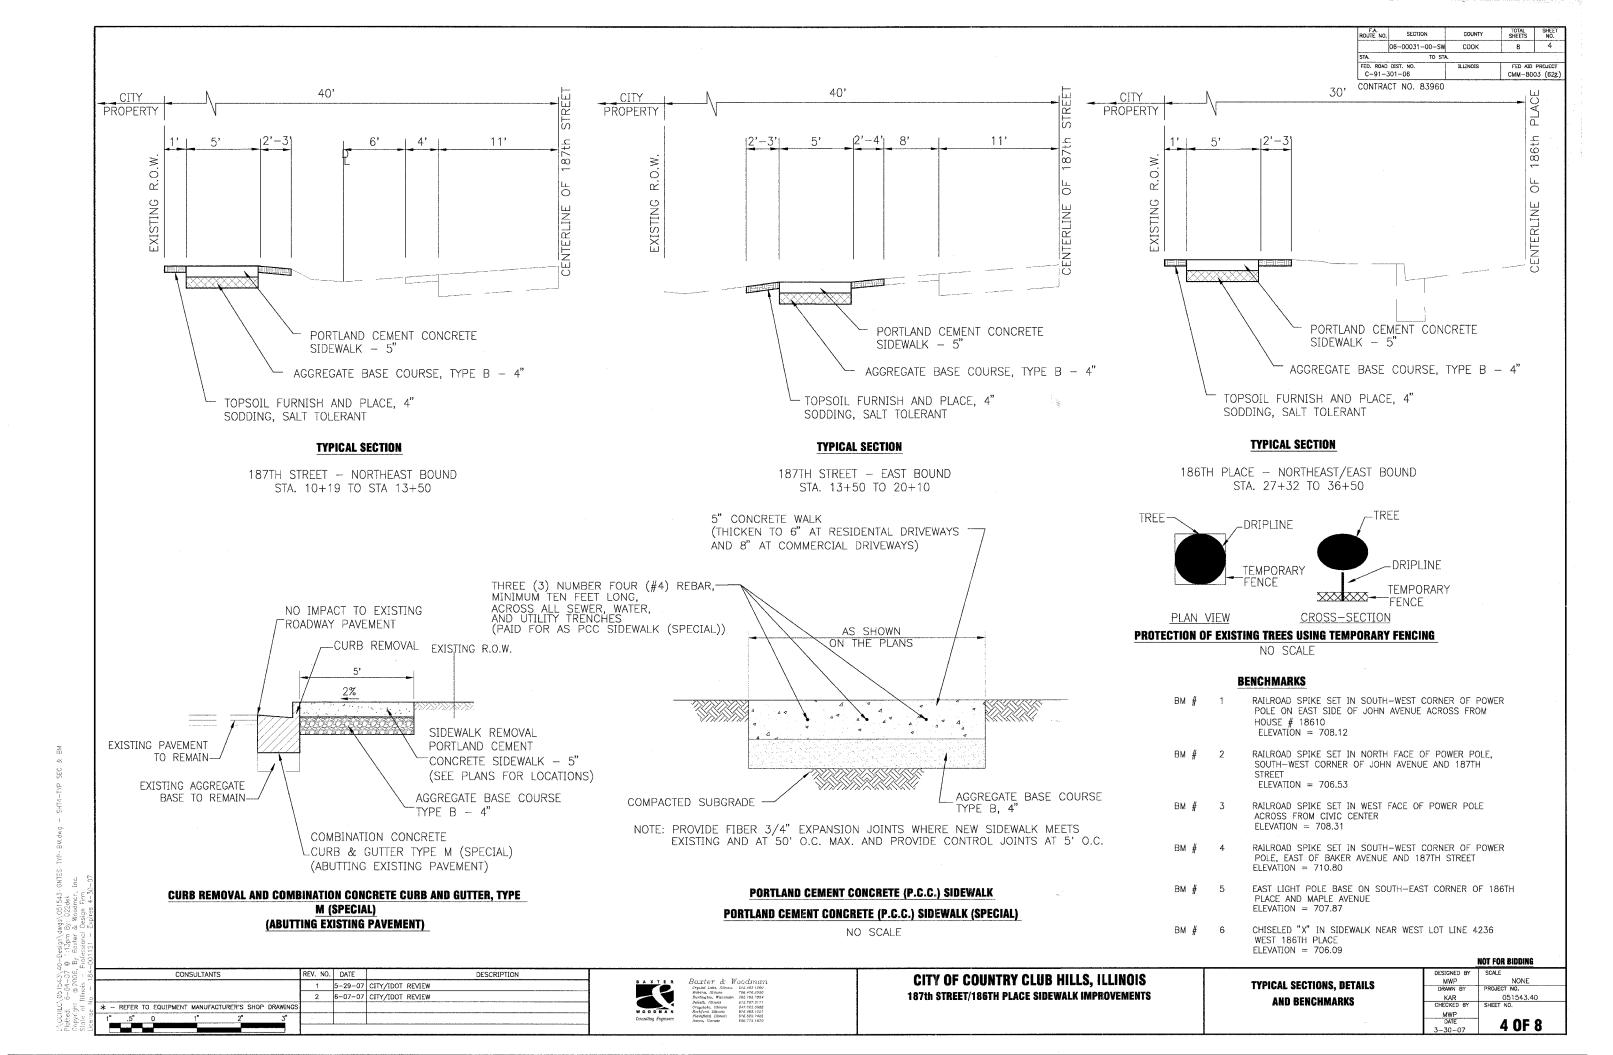

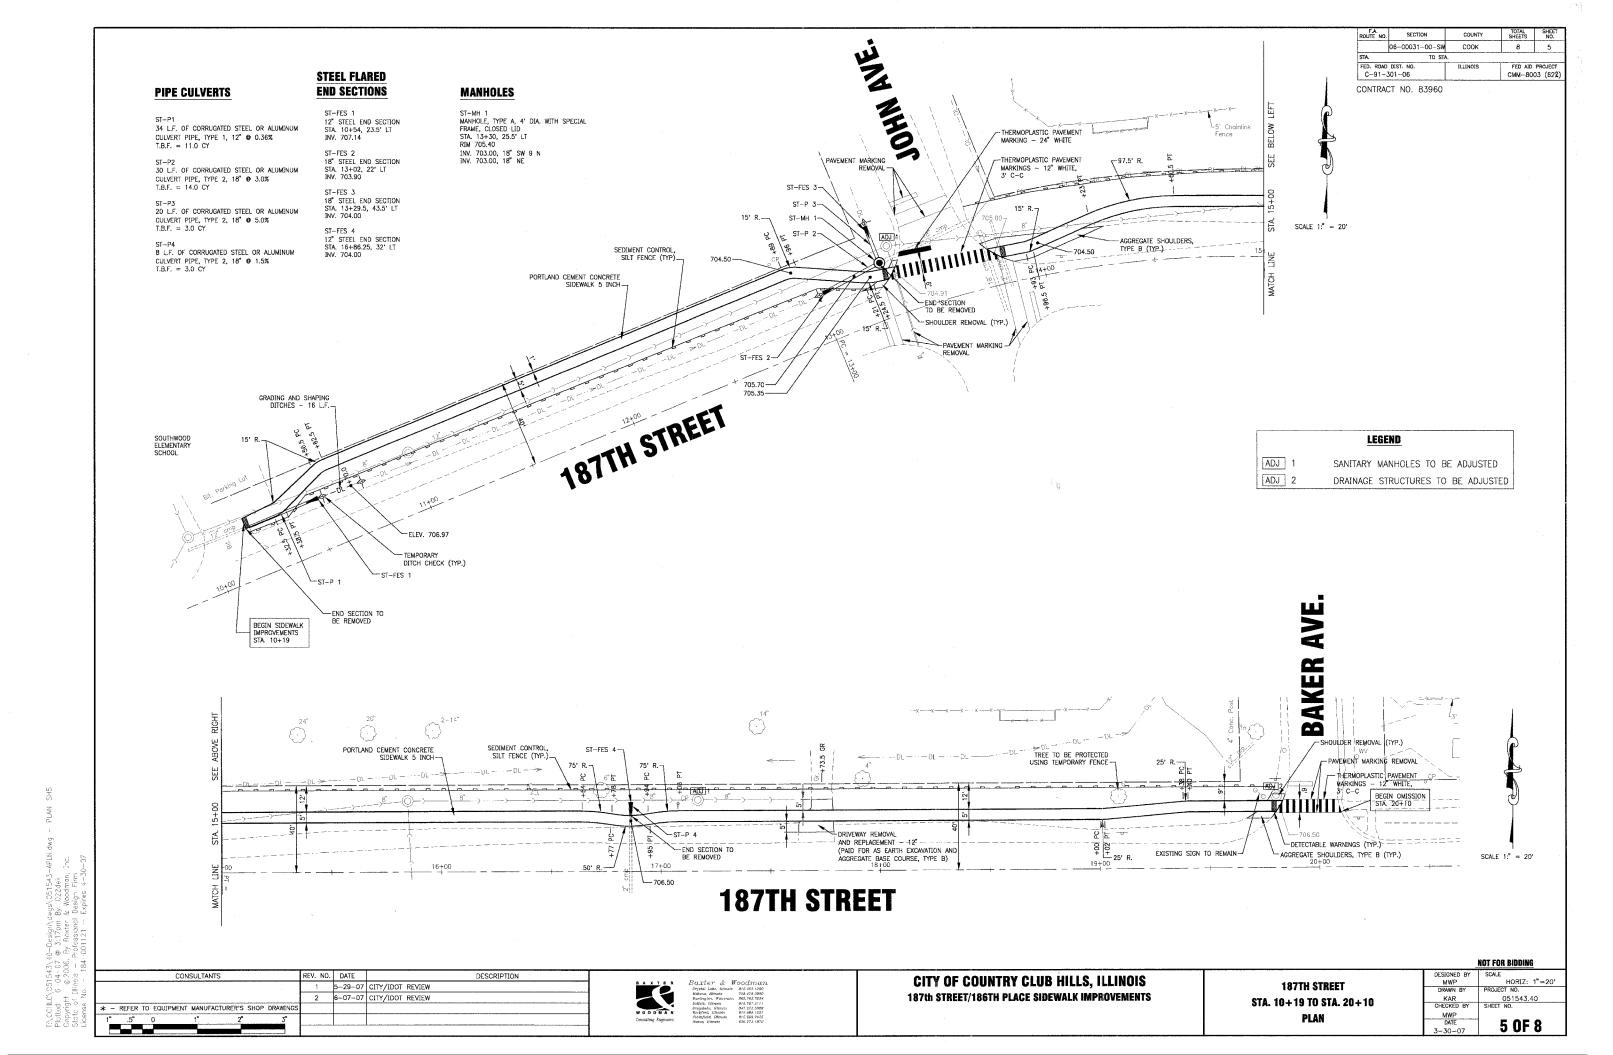


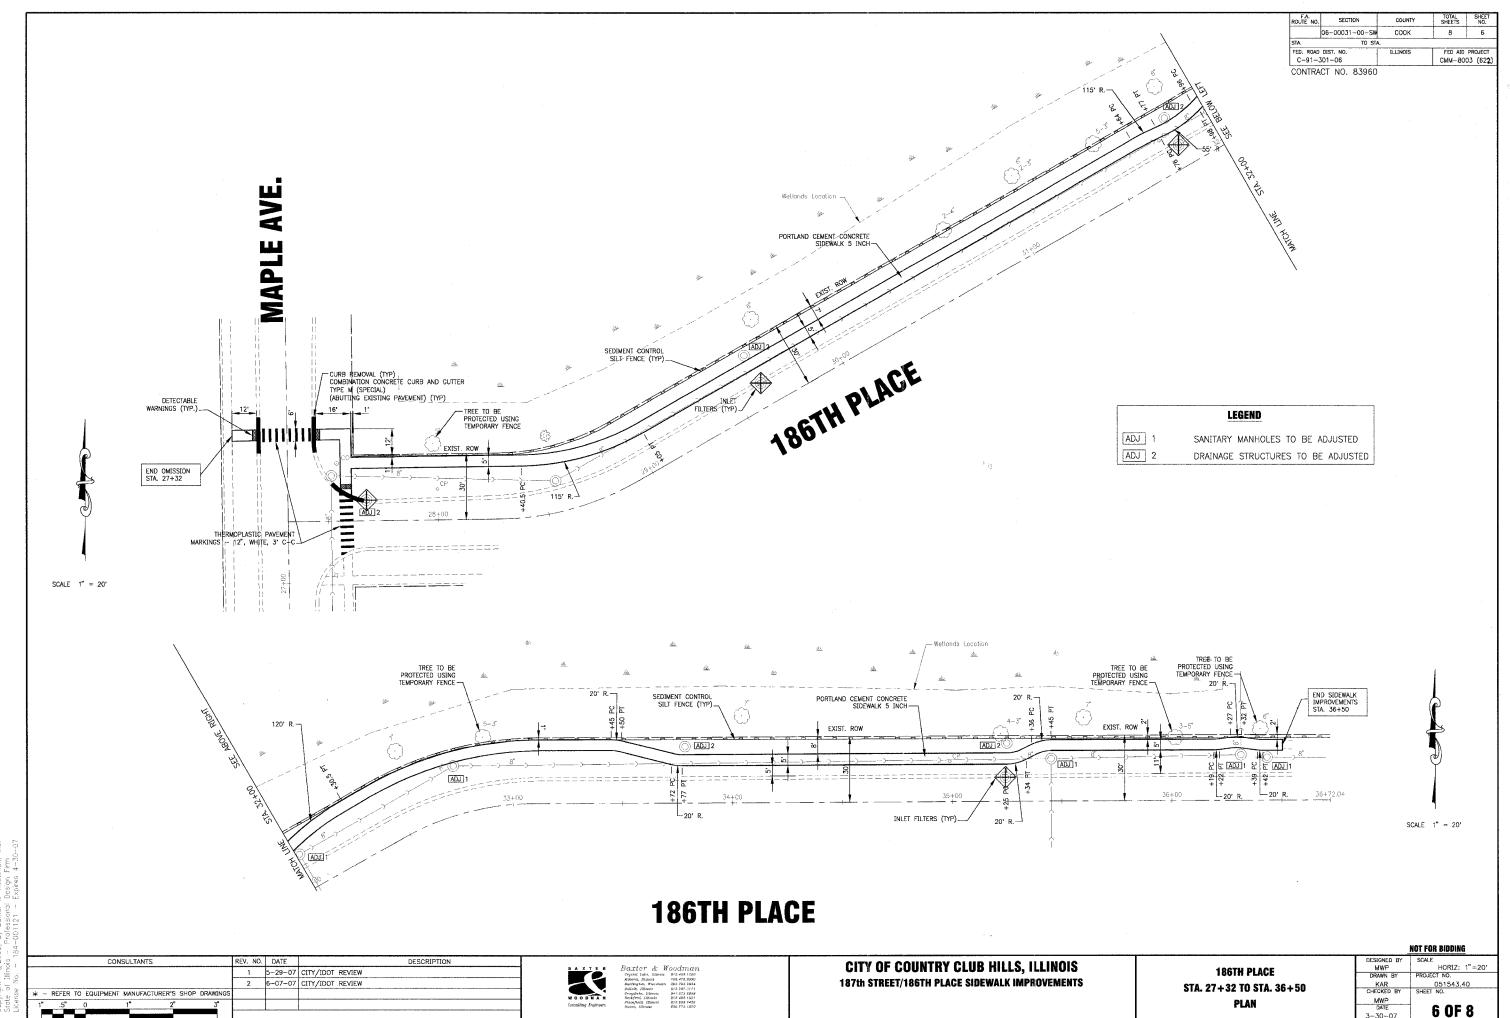

TOTAL SHEET NO. SECTION 06-00031-00-SW 8 7 соок FED AID PROJECT CMM-8003 (622) FED. ROAD DIST. NO. C-91-301-06 15+00 32+00 CONTRACT NO. 83960 708 708 706. REM. DISP. UNSUIT. MAT. (TOPSOIL) = 4.6 S.F. FURNISH EXCAVATION = 0.3 S.I REM. DISP. UNSUIT. MAT. (TOPSDIL) = 6.8 S. 19+00 31+00 36+00 14+00 708 708 708 705. REM. DISP. UNSUIT. MAT. (TOPSDIL) = 4.9 S.F.
FURNISH EXCAVATION = 0.5 S.F. REM. DISP. UNSUIT. MAT. (TOPSOIL) = 4.7 S.F. FURNISH EXCAVATION = 0.4 S.F. -γυ REM. DISP. UNSUIT. MAT. (TOPSOIL) = 7.9 S.F FURNISH FXCAVATION = 0.5 S.F REM DISP. UNSUIT. MAT. (TOPSDIL) = 5.3 S FURNISH EXCAVATION = 0.5 S.35+00 30+00 18+00 13-00 708 708 708 708 H REM. DISP. UNSUIT. MAT. (TOPSDIL) = 5.0 S.F.
FURNISH EXCAVATION = 0.4 S.F. DISP: UNSUIT. MAT. (TOPSOIL) = 4.9 S.F. FURNISH EXCAVATION = 0.4 S.F. REM. DISP. UNSUIT. MAT. (TOPSDIL) = 4.8 S REM. DISP. UNSUIT. MAT. (TOPSDIL) = 7.9 S. FURNISH EXCAVATION = 0.4 S FURNISH EXCAVATION = 0.5 S.F 34+00 12+00 17+00 29+00 708 -20 D

REM. DISP. UNSUIT MAT. (TOPSDIL) = 4.6 S.F.
FURNISH EXCAVATION = 0.4 S.F. -20 -5.2 S.F. -20 REM. DISP. UNSUIT. MAT. (TOPSOIL) = 4.9 S.F. FURNISH EXCAVATION = 0.4 S.F. FURNISH EXCAVATION = 0.4 S.F. REM. DISP. UNSUIT. MAT. (TOPSDIL) = 7.9 S. 11+00 33+00 28+00 16+00 708 708 708 708 INSULT MAT (TOPSOIL) = 4.6 S.F. FURNISH EXCAVATION = 0.4 S.F. REM. DISP. UNSUIT. MAT. (TOPSOIL) = 5.4 S.F. FURNISH EXCAVATION = 0.5 S.F. REM. DISP. UNSUIT. MAT. (TOPSDIL) = 5.0 S.F REM. DISP. UNSUIT. MAT. (TOPSDIL) = 7.3 S. FURNISH EXCAVATION = 0.5 S NOT FOR BIDDING DESIGNED BY SCALE VERT: 1° = 5'
MWP HORIZ: 1"=10'
DRAWN BY PROJECT NO. CONSULTANTS REV. NO. DATE DESCRIPTION CITY OF COUNTRY CLUB HILLS, ILLINOIS MWP DRAWN BY 1 5-29-07 CITY/IDOT REVIEW 187TH STREET STA. 10+35 TO STA. 19+82 187th STREET/186TH PLACE SIDEWALK IMPROVEMENTS 2 6-07-07 CITY/IDOT REVIEW KAR 051543.40 CHECKED BY SHEET NO. 186TH PLACE STA. 27+32 TO STA. 36+50 - REFER TO EQUIPMENT MANUFACTURER'S SHOP DRAWIN **CROSS SECTIONS** 7 OF 8

Action Control Agency (12) pm By: 022dek Pitted: 6-04-0/ @ 1/21pm By: 022dek Copyright @ 2006, By Baxter & Woodman, Inc. State of Ulmois Prolessional Design Franicense No. - 18E-007.21 - Expires 4-30-07

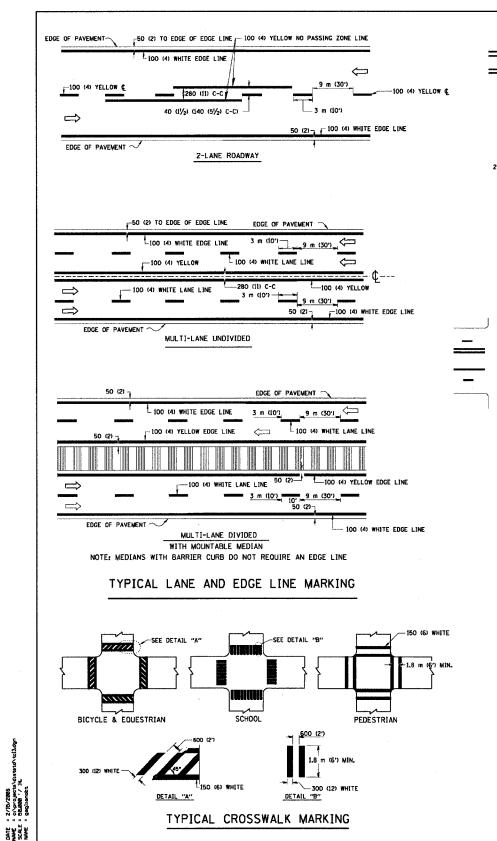


2-100 (4) YELLOW @ 280 (1) C-C-1.2 m (4') OUTSIDE TO NO DIAGONALS OUTSIDE OF LINES - 2-100 (4) YELLOW e 280 (11) C-C 1.2 m (4') WIDE MEDIANS ONLY


2-100 (4) # 280 (1) C-C MEDIAN LENGTH FOR MEDIAN LENGTHS WHERE DIAGONAL SPACING CANNOT BE ATTAINED, USE 5 (FIVE) EQUALLY SPACED DIAGONAL LINES.

DIAGONAL LINE SPACING: 15 m (50°) C-C (LESS THAN 50 km/h (30 MPH))
25 m (75°) C-C (50 km/h (30 MPH) TO 70 km/h (45 MPH))
45 m (150°) C-C (MORE THAN 70 km/h (45 MPH))

MEDIANS OVER 1.2 m (4') WIDE

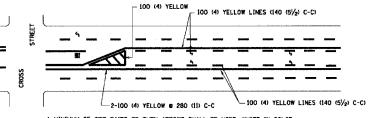


A MINIMUM OF TWO PAIRS OF TURN ARROWS SHALL BE USED, WHITE IN COLOR, ADDITIONAL PAIRS SHALL BE PLACED AT 60 m (200') TO 90 m (300') INTERVALS.

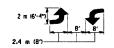

MEDIAN WITH TWO-WAY LEFT TURN LANE

TYPICAL PAINTED MEDIAN MARKING

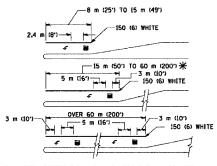

FULL SIZE LETTERS 2.4 m (8') AND ARROWS SHALL BE USED. \P AREA = 1.5 m² (15.6 SO. FT.) ONLY AREA = 1.9 m² (20.8 SO. FT.)

* TURN LAMES IN EXCESS OF 120 m (400°) IN LENGTH MAY HAVE AN ADDITIONAL SET OF ARROW - "ONLY" INSTALLED MIDWAY BETWEEN THE OTHER TWO SETS OF ARROW - "ONLY".


TYPICAL LEFT (OR RIGHT) TURN LANE

TYPICAL TURN LANE MARKING

200 (8) WHITE ---300 (12) WHITE DIAGONALS e 3 m (10') OR LESS SPACING ISLAND OFFSET FROM PAVEMENT EDGE

CONTRACT NO.

F.A. SECTION COUNTY TOTAL SHEETS NO. 06-00031-00-SW COOK 8 8 TO STA. FED. ROAD DIST. NO. | ILLINOIS | FED. AID | PROJECT | C-91-301-06 | CMM-8003 (622) CONTRACT NO.: 83960

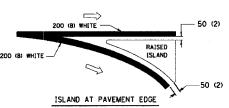

TYPICAL ISLAND MARKING

TYPE OF MARKING	WIDTH OF LINE	PATTERN	COLOR	SPACING / REMARKS
CENTERLINE ON 2 LANE PAVEMENT	100 (4)	SKIP-DASH	YELLOW	3 m (10") LINE WITH 9 m (30") SPACE
CENTERLINE ON MULTI-LANE UNDIVEDED PAVENENT	2 p 100 (4)	SOLID	YELLOW	280 (f) C-C
NO PASSING ZONE LINES: FOR ONE DIRECTION FOR BOTH DIRECTIONS	100 (4) 2 8 100 (4)	SOLID SOLID	YELLOW YELLOW	140 (5½) C-C FROM SKIP-DASH CENTERLINE 280 (11) C-C OMIT SKIP-DASH CENTERLINE BETWEEN
LANE LINES	100 (4) 125 (5) ON FREEWAYS	SKIP-DASH SKIP-DASH	WHITE WHITE	3 m (10") LINE WITH 9 m (30") SPACE
DOTTED LINES (EXTENSIONS OF CENTER, LANE OR TURN LANE MARKINGS)	SAME AS LINE BEING EXTENDED	SKIP-DASH	SAME AS LINE BEING EXTENDED	600 (2') LINE WITH 1.8 m (6') SPACE
EDGE LINES	100 (4)	SOLID	YELLOW-LEFT WHITE-RIGHT	OUTLINE MOUNTABLE MEDIANS IN YELLOW; EDGE LINES ARE NOT USED NEXT TO BARRIER CURB
TURN LANE MARKINGS	150 (6) LINE; FULL SIZE LETTERS & SYMBOLS (2.4 m (8"))	SOLID	WHITE	SEE TYPICAL TURN LANE MARKING DETAIL
TWO WAY LEFT TURN MARKING	2 e 100 (4) EACH DIRECTION	SKIP-DASH AND SOLID	YELLOW	3 m (10°) LINE WITH 9 m (30°) SPACE FOR SKIP-DASH ₈ 140 (5½) C-C BETWEEN SOLID LINE AND SKIP-DASH LINE
	2.4 m (8') LEFT ARROW	IN PAIRS	WHITE	SEE TYPICAL TWO-WAY LEFT TURN MARKING DETAIL
CROSSWALK LINES (PEDESTRIAN) A. DIAGONALS (BIKE & EQUESTRIAN) B. LONGITUDINAL BARS (SCHOOL)	2 @ 150 (6) 300 (12) @ 45° 300 (12) @ 90°	SOLID SOLID SOLID	WHITE WHITE WHITE	NOT LESS THAN 1.8 m (6') APART 600 (2') APART 600 (2') APART SEE TYPICAL CROSSWALK MARKING DETAILS.
STOP LINES	600 (24)	SOLID	WHITE	PLACE L2 m (4') IN ADVANCE OF AND PARALLEL TO CROSSWALK, IF PRESENT. OTHERWISE, PLACE AT DESIRED STOPPING POINT. PARALLEL TO CROSSROAD CENTERLINE, WHERE POSSIBLE
PAINTED MEDIANS	2 m 100 (4) WITH 300 (12) DIAGONALS m 45° NO DIAGONALS USED FOR 1.2 m (4') WIDE MEDIANS	SOLID	YELLOW: TWO WAY TRAFFIC WHITE: ONE WAY TRAFFIC	280 (1) C-C FOR THE DOUBLE LINE SEE TYPICAL PAINTED MEDIAN MARKING.
GORE MARKING AND CHANNELIZING LINES	200 (8) WITH 300 (12) DIAGONALS & 45°	SOLID	WHITE	DIACONALS: 4.5 m (15') C-C (LESS THAN 50 km/h (30 MPH)) 6 m (20') C-C (50 km/h (30 MPH) TO 70 km/h (45 MPH) 9 m (30') C-C (OVER 70 km/h (45 MPH))
RAILROAD CROSSING	600 (24) TRANSVERSE LINES "RR" IS 1.8 m (6') LETTERS 400 (16) LINE FOR "X"	SOLID	WHITE	SEE STATE STANDARD 780001 AREA OF: "R"-0.33m2 [3.6 SO. FT.) EACH "X"-5.0 m2 (54.0 SO. FT.)
SHOULDER DIAGONALS	300 (12) c 45°	SOLID	WHITE - RIGHT	15 m (50') C-C (LESS THAN 50 km/h (30 MPH)) 25 m (75') C-C (50 km/h (30 MPH) TO 70 km/h (45 MPH) 45 m (150') C-C (0VER 70 km/h (45 MPH))

FOR FURTHER DETAILS ON PAVEMENT MARKING REFER TO STANDARD SPECIFICATIONS FOR ROAD AND BRIDGE CONSTRUCTION AND STATE STANDARD 780001.

REVISIONS		ILLINOIS DEPARTMENT OF TRANSPORTATIO					
NAME	DATE	ILLINOIS DEFAITING	IN OF TRANSPORTATION				
VERS	03-19-90						
RAMMACHER	10-27-94	DISTR	TOT ONE				
ALEX HOUSEH	10-09-96	DISTRICT ONE					
ALEX HOUSEH	10-17-96	TYPICAL	PAVEMENT				
F. RAMMACHER 01-06-00		MARKINGS					
		MAR	KKINGS				
•	1						
		SCALE: NONE					
·		SCALEI NUNE	DRAWN BY CADD				
		DATE: 2/15/2006	CHECKED BY				

REVISION DATE: 01/06/00

CHECKED BY