FOR INDEX OF SHEETS SEE SHEET NO. 2

STATE OF ILLINOIS DEPARTMENT OF TRANSPORTATION **DIVISION OF HIGHWAYS**

PLANS FOR PROPOSED FEDERAL AID HIGHWAY

ILLINOIS PRAIRIE PATH IMPROVEMENTS AT IHB RAILROAD OVERPASS, SECURITY FENCING, LIGHTING, AND PAVEMENT MARKING


SECTION NO: 06-00133-00-BT

PROJECT: TE-D001(756)

VILLAGE OF BELLWOOD

COOK COUNTY

JOB NO: C-91-143-07

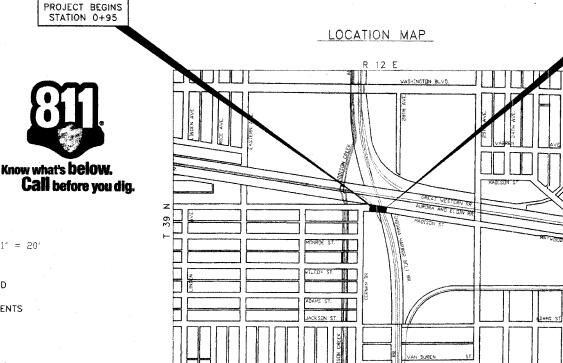

STATE OF ILLINOIS DEPARTMENT OF TRANSPORTATION DIVISION OF HIGHWAYS VILLAGE OF BELLWOOD, PRESIDENT HICH CHRUSTAPHER HOLT DISTRICT | ENGINEER OF LOCAL ROADS & STREETS (PRINTED BY AUTHORITY OF THE STATE OF ILLINOIS)

CONTRACT NO. 83933

LOCATION OF SECTION INDICATED THUS:

PROJECT ENDS

STATION 5+17

ENGINEERING SCALES. REDUCED SIZED PLANS WILL NOT CONFORM TO STANDARD SCALES. IN MAKING MEASUREMENTS ON REDUCED PLANS, THE ABOVE SCALES MAY BE USED.

FULL SIZE PLANS HAVE BEEN PREPARED USING STANDARD

CONTRACT NO. 83933

PROJECT LOCATED IN THE VILLAGE OF BELLWOOD

Phone: 708/865-0300

PROVISO TOWNSHIP MAP SCALE : 1" = 1'

AREA OF IMPROVEMENT

GROSS LENGTH OF IMPROVEMENT = 373.0 FT. = 0.07 MI.

♦ Municipal Consultants ENGINEERING • Established 1911

E.H.E. NO. 080-03-08580

INDEX OF SHEETS

SHEET NO.	DESCRIPTION
1	TITLE SHEET, LOCATION MAP
2	INDEX OF SHEETS, LEGEND OF SYMBOLS, AND STANDARD DRAWINGS
3	SUMMARY OF QUANTITIES
4	SITE PLAN
5	LIGHTING AND P.C.C. SIDEWALK, 5" DETAILS
6-8	OVERPASS LIGHTING PLAN AND LIGHTING DETAILS
9-10	CHAIN LINK FENCE DETAILS
11	PIER/ABUTMENT MOUNTED UNDERPASS LUMINAIRE INSTALLATION DETAILS
12	PORTLAND CEMENT CONCRETE/COMPOSITE CONCRETE DETAILS
13	SIGN PANEL MOUNTING DETAILS
1 4	SIGN PANEL ERECTION DETAILS
15	STANDARD SYMBOLS, ABBREVIATIONS AND PATTERNS

GENERAL NOTES

ROUTE NO.	SECTION	COUNTY	SHEETS	SHEET NO.
		COOK	15	2
ILLINOIS PROJEC	T _			
VILLAGE SECTION				

CONTRACT NO. 83933

STANDARDS

ANY REFERENCE TO STANDARDS THROUGHOUT THE PLANS OR SPECIAL PROVISIONS SHALL BE INTERPRETED TO BE THE LATEST STANDARD OF THE ILLINOIS DEPARTMENT OF TRANSPORTATION AS SHOWN ON THE INDEX OF SHEETS IN THE PLANS.

UNDERGROUND UTILITIES

BEFORE STARTING ANY EXCAVATION, THE CONTRACTOR SHALL CALL "JULIE" AT 800-892-0123 FOR FIELD LOCATIONS OF BURIED ELECTRICAL, TELEPHONE AND GAS FACILITIES. (48 HOURS NOTIFICATION IS REQUIRED).

THE LOCATIONS OF THE UNDERGROUND UTILITIES IF SHOWN ON THE PLANS HAVE BEEN OBTAINED BY FIELD SURVEYS AND SEARCHES OF AVAILABLE RECORDS. IT IS BELIEVED THAT THE DATA IS ESSENTIALLY CORRECT, BUT THE VILLAGE OF BROOKFIELD, THE ILLINOIS DEPARTMENT OF TRANSPORTATION AND/OR OTHER OFFICES AND AGENCIES ASSOCIATED WITH THE DEVELOPMENT OF THESE PLANS DO NOT GUARANTEE THEIR ACCURACY OR COMPLETENESS OF THIS INFORMATION. THE
CONTRACTOR WILL BE REQUIRED TO VERIFY THE EXACT LOCATION OF EACH FACILITY
WITH THE RESPECTIVE UTILITY COMPANY, AND SHALL TAKE DUE CARE IN ALL PHASES
OF THE CONSTRUCTION TO PROTECT ANY SUCH FACILITIES WHICH MAY BE AFFECTED
BY THE WORK. ANY DAMAGE TO EXISTING UTILITIES SHALL BE REPAIRED AT THE CONTRACTOR'S EXPENSE.

THE CONTRACTOR SHALL COORDINATE CONSTRUCTION ACTIVITIES WITH UTILITY COMPANIES AND THE VILLAGE OF BELLWOOD.

FIELD OFFICE

THE CONTRACTOR WILL NOT BE ALLOWED TO SET UP A YARD OR FIELD OFFICE ON STATE OR VILLAGE PROPERTY WITHOUT WRITTEN PERMISSION FROM THE DEPARTMENT OR THE VILLAGE .

THE CONTRACTOR SHALL PROVIDE AND INSTALL TWO (2) WEIGHTED SANDBAGS ON EACH TYPE I OR TYPE II BARRICADE USED, ONE (1) WEIGHTED SANDBAG ACROSS EACH BOTTOM RAIL

THE CONTRACTOR SHALL SAW CUT SIDEWALK AS INDICATED ON THE PLANS TO SEPARATE THE EXISTING SIDEWALK TO BE REMOVED BY APPROVED MEANS OR AN APPROVED CONCRETE SAW TO A DEPTH AS DIRECTED BY THE ENGINEER. SUITABLE GUIDELINES OR DEVICES SHALL BE USED TO ASSURE CUTTING A NEAT, STRAIGHT LINE AS SHOWN ON THE PLANS. CARE SHALL BE TAKEN BY THE CONTRACTOR AS NOT TO DAMAGE THE REMAINING SIDEWALK DIRECTLY ADJACENT TO THE SIDEWALK TO BE REMOVED. ANY DAMAGE TO THE EXISTING SIDEWALK RESULTING FROM SIDEWALK REMOVAL OPERATIONS SHALL BE REPAIRED AT THE CONTRACTOR'S EXPENSE. THE COST OF SAW CUTTING SHALL BE INCLUDED IN THE ITEM BEING REMOVED.

LEGEND OF SYMBOLS

EXISTING	PROPOSED	DESCRIPTION
		COMBINATION SEWER
		COMBINED RELIEF SEWER
'		STORM SEWER
W		WATER MAIN
		MANHOLE, TYPE A, 4' DIAMETER
		INLET, TYPE A
		CATCH BASIN
R		FIRE HYDRANT
· ⊗		WATER MAIN VALVE BOX
Ø		WATER SERVICE BOX
		ELECTRIC HANDHOLE
WAR THE TOTAL TO T		CURB & GUTTER TO BE REMOVED & REPLACED
ф>0		LIGHT STANDARD
		UNDERPASS BRIDGE LIMIT
•	• .	FENCE POST
	-0-0-0-	FENCE
		CONDUIT ATTACHED TO STRUCTURE
		CONDUIT IN TRENCH
		UNDERPASS LUMINAIRE
		JUNCTION BOX
		UNIT DUCT

I.D.O.T. STANDARD DRAWINGS

STANDARD NO.	TITLE OR DESCRIPTION
000001-04	STANDARD SYMBOLS, ABBREVIATIONS AND PATTERNS
664001-01	CHAIN LINK FENCE
720001	SIGN PANEL MOUNTING DETAILS
720006-01	SIGN PANEL ERECTION DETAILS
814001-01	HANDHOLES

SUMMARY OF QUANTITIES

Code No.	ltem	Unit	Total Quantity	SFTY-1B	SFTY-1D	SFTY-1E
20200100	EARTH EXCAVATION	Cu Yd	100	100		
21101615	TOPSOIL, FURNISH AND PLACE, 4"	Sq Yd	, 650	650		
25000310	SEEDING, CLASS 4	Acre	0.5	0.5		
25100105	MULCH METHOD 1	Acre	0.5	0.5	,	
42400200	PORTLAND CEMENT CONCRETE SIDEWALK, 5"	Sq Ft	200	200		
44000600	SIDEWALK REMOVAL	Sq Ft	200	200		
66400405	CHAIN LINK FENCE, 7'	Lin Ft	700	700		
66408300	CHAIN LINK GATE, 7'X8' DOUBLE	Each	2	2		
66410300	CHAIN LINK FENCE REMOVAL	Lin Ft	350	350		
67100100	MOBILIZATION	LSum	1	1		
70102620	TRAFFIC CONTROL AND PROTECTION STANDARD 701501	LSum	1	1		
72000100	SIGN PANEL, TYPE I	Sq FT	2	2		
78000100	THERMOPLASTIC PAVEMENT MARKING LETTERS AND SYMBOLS	Sq Ft	32	¥	32	
78000200	THERMOPLASTIC PAVEMENT MARKING LINE, 4	Lin Ft	200		200	
80400100	ELECTRIC SERVICE INSTALLATION	EACH	1			1 1
81000600	CONDUIT IN TRENCH, 2" DIAMETER GALV STEEL	Lin Ft	10			10
81100600	CONDUIT ATTACHED TO STRUCTURE, 2" DIAMETER GALVANIZED STEEL	Lin Ft.	510	* 111		510
81300210	JUNCTION BOX, STAINLESS STEEL, ATTACHED TO STRUCTURE, 6X4X4	Each	6		-	6
81400100	HANDHOLE	Each	2			2
81603050	UNIT DUCT, 600V, 3 1/C No.6 & 1/C No.8 GROUND, (XLP-TYPE USE) 1" DIAMETER, POLYETHYLENE	Lin Ft	537			537
81702415	ELECTRICAL CABLE IN CONDUIT, 600 V, (XLP TYPE USE), 3 1/C No. 6	Lin Ft	510			510
81900200	TRENCH AND BACKFILL FOR ELECTRICAL WORK	Lin Ft	700			700
82107505	UNDERPASS LUMINAIRE, 250 WATT, HIGH PRESSURE SODIUM, ALUMINUM HOUSING	Each	11			11
X0350800	BOLLARDS CONTROL	Each	4	4		
XX007034	LIGHT POLE, CONCRETE, 15.5 FOOT MOUNTING HEIGHT, POST TOP LUMINAIRE, 120 VOLT, 200 WATT HIGH PRESSURE SODIUM LUMINAIRE AND LAMP	Each	4			4




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ILLINOIS PRAIRIE PATH IMPROVEMENTS VILLAGE OF BELLWOOD, ILLINOIS

SUMMARY OF QUANTITIES

		SCALE:	NONE	S
		DRAWN BY:	MK	1
AS PER !DOT REVIEW	5/31/07	BOOK NO.:	AERIAL	
AS PER IDOT REVIEW	5/22/07	DATE:	2/09/07	7
 REVISION:		E.H.E. NO.:	080-03-08580	╗

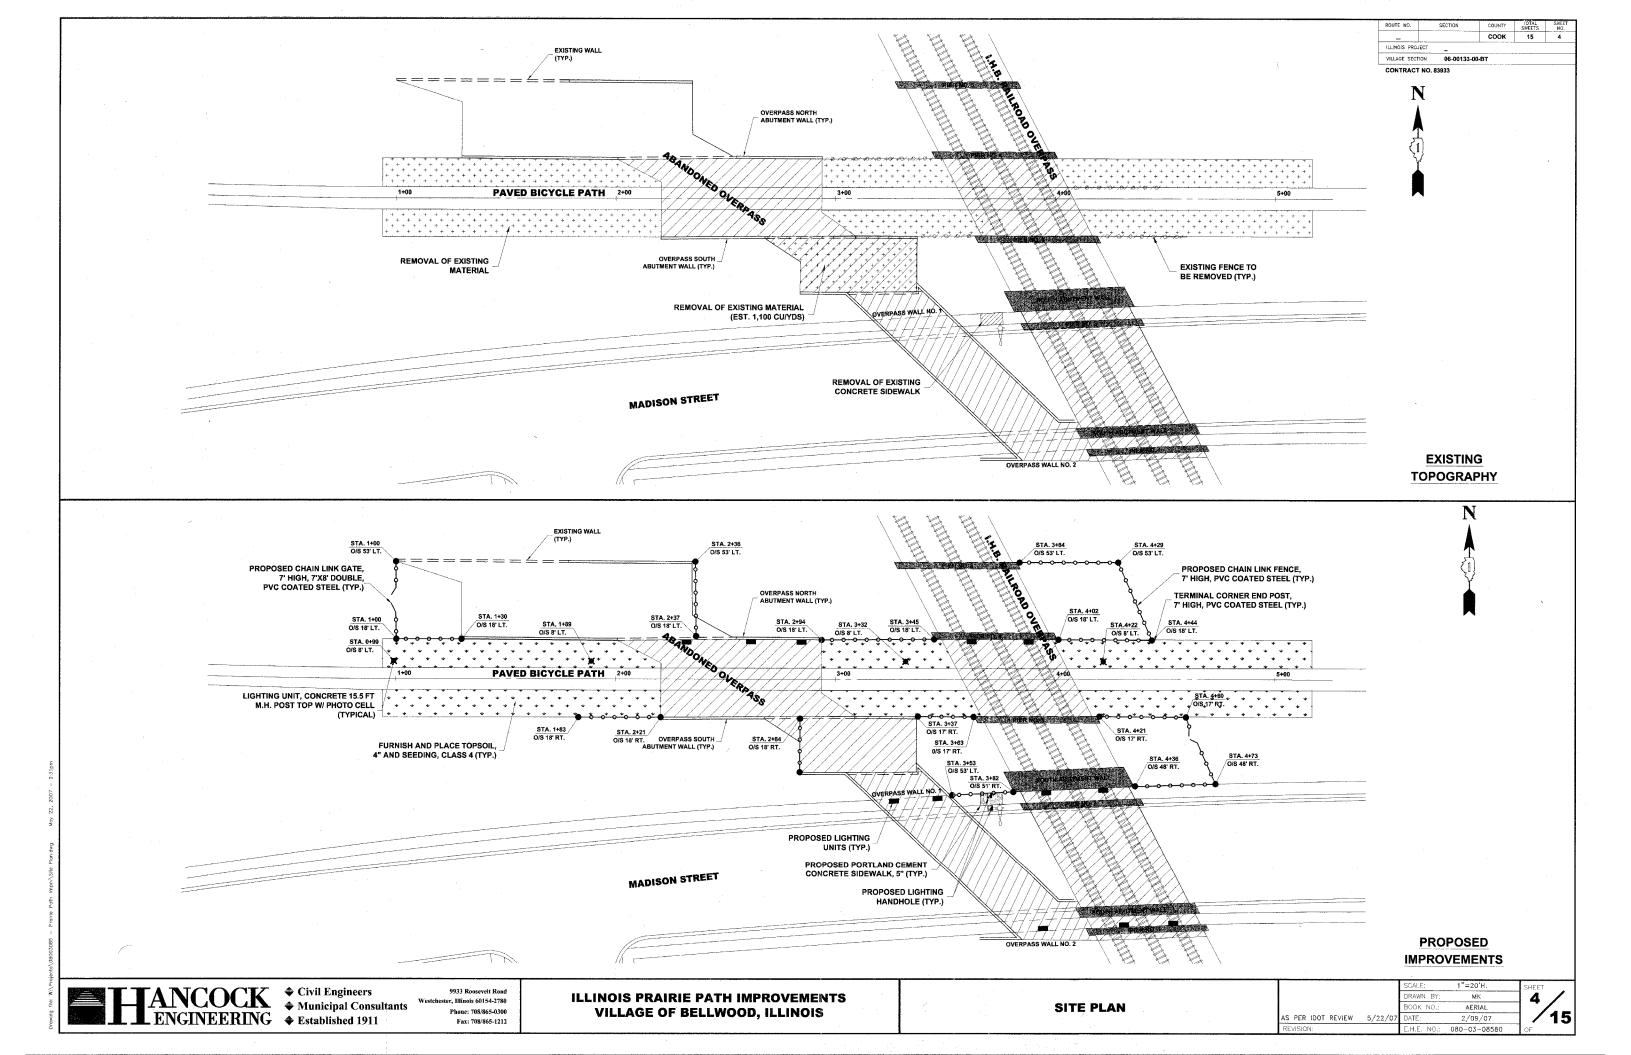


- QUICK DISCONNECT STANDARD 2 POLE SMALL DIMENSION 600 VOLT FUSE HOLDERS WITH BOOTS AND FUSING (SLOW BLOW FUSE AND SOLID SLUG) FUSE SIZE TO BE 3 AMP.
- 2) NO. 10 WIRE TO LUMINAIRE
- 3 MULTIPLE COMPRESSION FITTING
- 4 1-1/4" UNIT DUCT w/3-1/C NO. 4 AND 1/C NO. 8
- (5) NEW NO. 10 GROUND WIRE TO GROUND ROD WITH EXOTHERMIC WELD
- 6 GROUND LUG
- 7 SEAL ENDS OF UNIT DUCT AGAINST THE ENTRANCE OF WATER

NOTE: ALLOW 30" LOOP OF CABLES TO INSURE SUFFICIENT SLACK FOR WITHDRAWAL OF THE CONNECTORS OUTSIDE OF THE POLE HANDHOLE.

POLE HANDHOLE WIRING DIAGRAM

ILLUMINATION GENERAL NOTES


- THE LATEST EDITIONS OF THE "STANDARD SPECIFICATIONS FOR ROAD AND BRIDGE CONSTRUCTION" PREPARED BY THE ILLINOIS DEPARTMENT OF TRANSPORTATION AND THE SUPPLEMENTAL "SPECIAL PROVISIONS" SHALL GOVERN ALL WORK ASSOCIATED WITH THIS PROJECT.
- 2. THE LOCATIONS OF THE UTILITIES AS SHOWN ON THE PLANS ARE APPROX-MATE ONLY AND MUST BE VERIFIED BY EACH RESPECTIVE UTILITY COMPANY, IT SHALL BE THE CONTRACTOR'S RESPONSIBILITY TO NOTIFY ALL THE PUBLIC UTILITY COMPANIES (GAS, ELECTRIC, TELEPHONE, ETC.) PRIOR TO THE COMMENCMENT OF CONSTRUCTION FOR EXACT FIELD LOCATION OF ALL ITILITIES.
- SERVICE POLE LOCATIONS AND CONTROL CENTER LOCATIONS ARE APPROXI-MATE. ACTUAL LOCATIONS SHALL BE DETERMINED BY THE ENGINEER IN THE FIELD.
- 4. ALL ITEMS INCLUDED IN THE PLANS OR SPECIAL PROVISIONS NOT APPEARING IN THE SUMMARY OF QUANTITIES SHALL BE CONSIDERED INCIDENTAL TO THE COST OF CONSTRUCTION.
- 5. GALVANIZED STEEL CONDUIT SHALL BE PLACED UNDER ALL PAVEMENT CROSSINGS OF THE SIZE AND LOCATION INDICATED ON THE PLANS. PAYMENT SHALL BE LIMITED TO THE ACTUAL WIDTH OF PAVEMENT TO BE PUSHED PLUS TWO FEET (2') ON EACH SIDE OF PAVEMENT.
- ALL CABLE OR CONDUIT SHALL BE AS SHOWN ON THE PLANS UNLESS OTHERWISE DIRECTED BY THE ENGINEER AND SHALL BE AT A BURIAL DEPTH OF THIRTY INCHES (30") BELOW EXISTING GRADES.
- ANY PERMANENT TYPE PAVEMENT, DRIVEWAY, OR SIDEWALK WHICH MUST BE REMOVED SHALL BE SAW CUT PRIOR TO REPLACEMENT.
- 8. ALL TRENCHES SHALL BE THOROUGHLY COMPACTED
- THE CONTRACTOR SHALL BE REQUIRED TO DISPOSE OF, OFF-SITE, ALL EXCAVATED OR EXCESS MATERIALS DUE TO CONSTRUCTION OPERATIONS, AT HIS EXPENSE. NO PAYMENT SHALL BE MADE FOR THE CONTRACTOR'S EXPENSE TO HAUL OR TRUCK THE MATERIAL TO DISTANT DUMPING SITES.

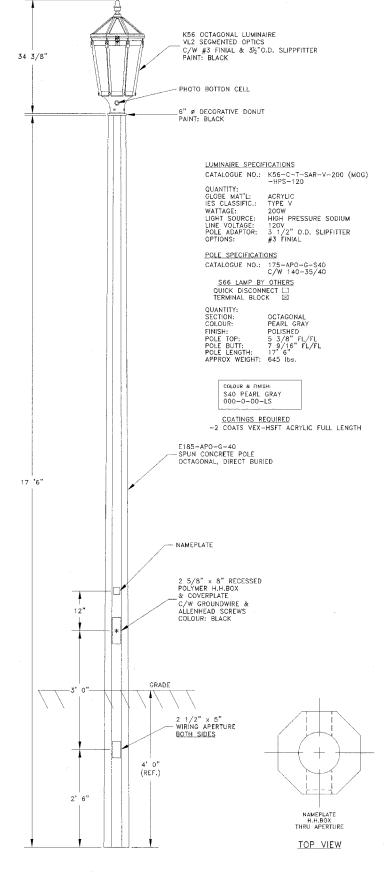


POLE DETAIL



CONTRACT NO. 83933

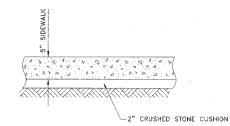


P.C.C. SIDEWALK, 5"

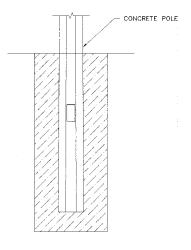

. AUGER THE SETTING HOLE 2. SET POLE IN HOLE AND PLUMB STRAIGHT 5. BACKFILL WITH CA-16 BACKFILL, TAMPING EVERY 4" TO 6" WITH SHOVEL OR OTHER ACCEPTABLE DEVICE APPROVED BY THE ENGINEER.

FOOTING DETAIL

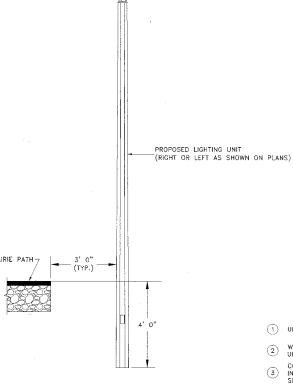

1) UNIT DUCT AS PER SPECIFICATIONS

1)-

2 WARNING TAPE INSTALLED ONLY WHEN UNIT DUCT IS INSTALLED BY TRENCHING

(3) COMPACTED GRANULAR BACKFILL (CA-6) IN AREAS UNDER PAVEMENT. COMPACTED SELECTED BACKFILL IN TURF AREAS.

POLE LOCATION DETAIL

TYPICAL TRENCH DETAIL





Westchester, Illinois 60154-2780 Fax: 708/865-1212 **ILLINOIS PRAIRIE PATH IMPROVEMENTS VILLAGE OF BELLWOOD, ILLINOIS**

DETAILS

NONE RAWN BY MK AERIAL S PER IDOT REVIEW 5/22/07 2/09/07



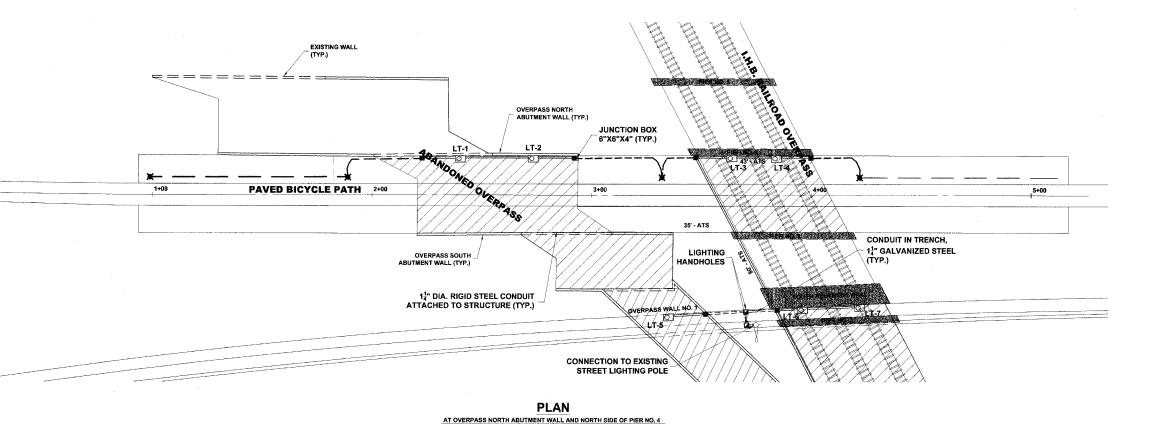

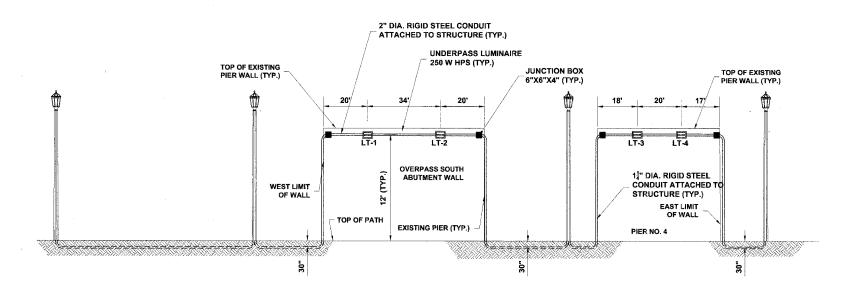


UNDERPASS LIGHTING DETAILS AT OVERPASS SOUTH ABUTMENT WALL AND NORTH SIDE OF PIER NO. 4

9933 Roosevelt Road Westchester, Illinois 60154-2780 Phone: 708/865-0300 Fax: 708/865-1212

ILLINOIS PRAIRIE PATH IMPROVEMENTS VILLAGE OF BELLWOOD, ILLINOIS

OVERPASS LIGHTING PLAN AND LIGHTING DETAILS

CALE: 1"=20'H. & 1"=4'V AERIAL AS PER IDOT REVIEW 5/22/0

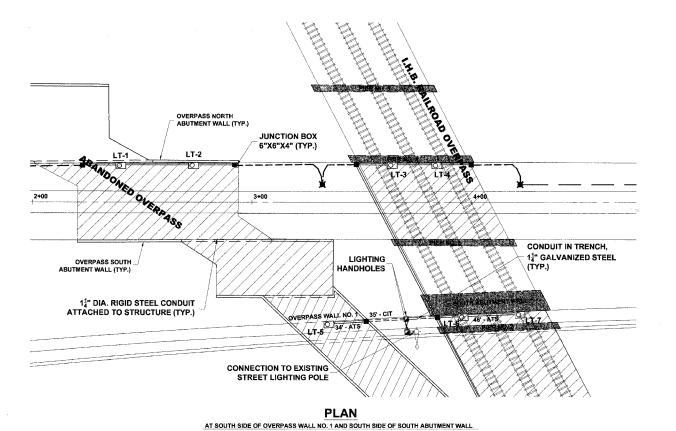

JUNCTION BOX $\mathbf{1}_{4}^{1}$ " DIA. RIGID STEEL CONDUIT ATTACHED TO STRUCTURE (TYP.) 8"X8"X4" (TYP.) UNDERPASS LUMINAIRE 250 W HPS (TYP.) 20' TOP OF EXISTING PIER WALL (TYP.) TOP OF EXISTING PIER WALL (TYP.) 14" DIA. RIGID STEEL CONDUIT ATTACHED TO STRUCTURE (TYP.) TOP OF PATH CONDUIT IN TRENCH, 14" GALVANIZED STEEL (TYP.)

UNDERPASS LIGHTING DETAILS

LIGHTING HANDHOLE

AT SOUTH SIDE OF OVERPASS WALL NO. 1 AND SOUTH SIDE OF SOUTH ABUTMENT WALL

ENGINEERINGCivil Engineers

Municipal Consultants

Established 1911


9933 Roosevelt Road Westchester, Illinois 60154-2780 Phone: 708/865-0300 Fax: 708/865-1212


ILLINOIS PRAIRIE PATH IMPROVEMENTS VILLAGE OF BELLWOOD, ILLINOIS

OVERPASS LIGHTING PLAN AND LIGHTING DETAILS

AERIAL



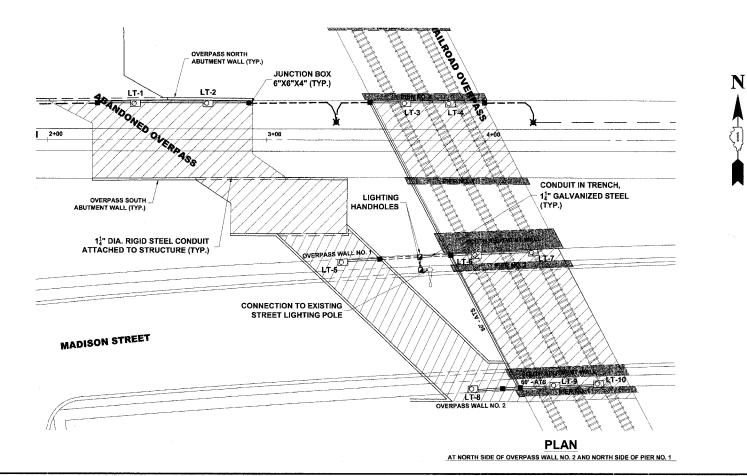

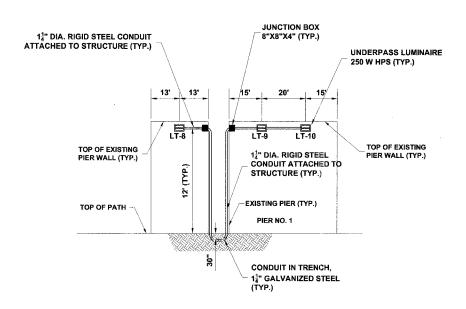

UNDERPASS LIGHTING DETAILS


AT NORTH SIDE OF OVERPASS WALL NO. 2 AND NORTH SIDE OF PIER NO. 1


9933 Roosevelt Road Westchester, Illinois 60154-2780 Phone: 708/865-0300 Fax: 708/865-1212


ILLINOIS PRAIRIE PATH IMPROVEMENTS VILLAGE OF BELLWOOD, ILLINOIS


OVERPASS LIGHTING PLAN AND LIGHTING DETAILS

	SCALE: 1	"=20'H. & 1"=4'V	SHEET
	DRAWN BY:	MK	R
	BOOK NO.:	AERIAL	· •
AS PER IDOT REVIEW 5/22/07	DATE:	2/09/07	/
REVISION:	E.H.E. NO.:	080-03-08580	OF

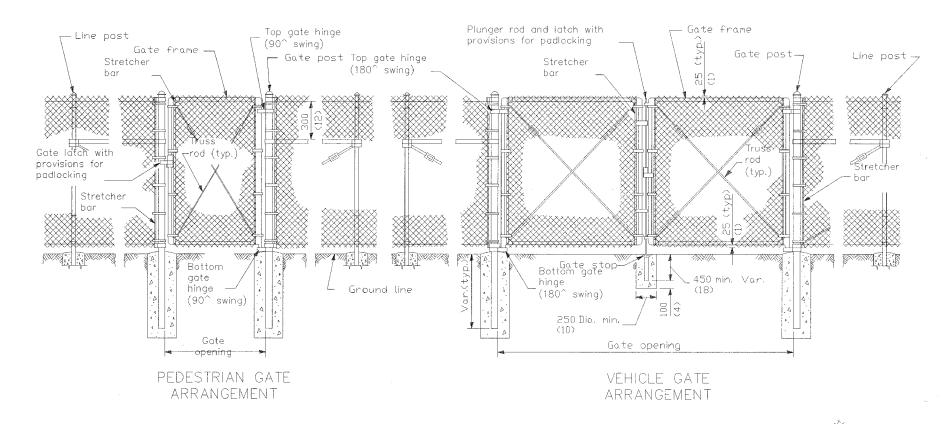

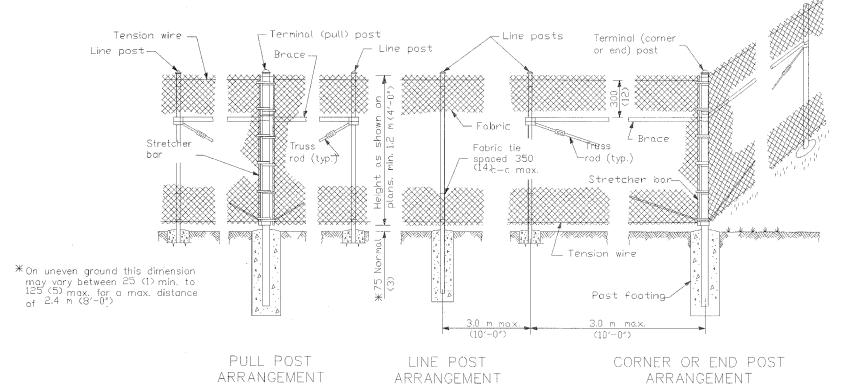

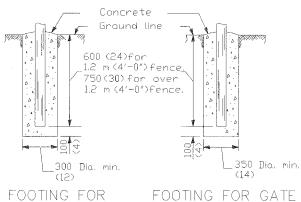

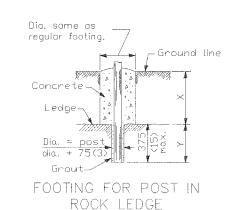

LINE POST

GENERAL NOTES

& TERMINAL POST

Pull posts shall be placed at locations determined by the Engineer. They shall be placed at 200 m (660') intervals between posts to which the ends of the fabric are clamped or midway between such posts when the distance is less than 400 m (1320') and greater than 200 m (660').

X + Y shall not exceed 600 mm (24"), 750 mm (30") or 900 mm (36"), as applicable. When X is 0 (0) to 225 mm (9"), 380 mm (15"), or 525 mm (21"), Y= 375 mm (15"), and the post shall be shortened as required. When X exceeds 225 mm (9"), 380 mm (15"), or 525 mm (21"), Y shall be decreased correspondingly.



◆ Civil Engineers
 ◆ Municipal Consultants
 ◆ Established 1911

9933 Rossevelt Ro2d Westchester, Illinois 69154-2789 Phone: 708/865-0300 Fax: 708/865-1212

REVISIONS

NAME DATE

M. DE YOUNG 06/13/90

M. DE YOUNG 07/03/90

M. DE YOUNG 3/27/92

R. SHAH 09/09/94

R. SHAH 10/25/94


A. ABBAS 03/21/97

M. GOMEZ 94/06/01 S


ILLINOIS DEPARTMENT OF TRANSPORTATION

CHAIN LINK FENCE


/97
/01 SCALE: NONE DRAWN BY: CADD
DATE: 03/25/02 CHECKED BY:

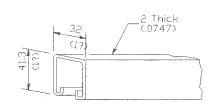


ROLL FORMED SECTION OF BRACE

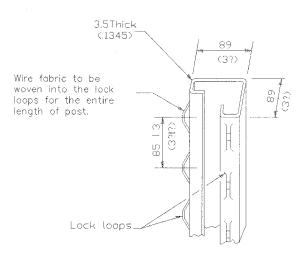

ROLL FORMED SECTION OF TERMINAL & GATE POST

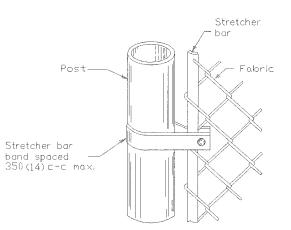

METHOD OF FASTENING STRETCHER BAR TO POST

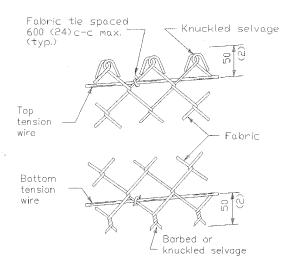

METHOD OF TYING FABRIC TO TENSION WIRES

LINE POST	
Section	kg/m (lbs./ft.)
Pipe Type A 48.3 [J.D. (1.90)	4.05 (2.72)
Pipe Type B 48.30.D. (1.90)	3.39 (2.28)
Pipe Type C 48.3 []. []. (1.90)	3.36 (2.26)
H 47.6×41.3 (1.875×1.625)	4.05 (2.72)
C	2.38 (1.60)
. I	3.42 (2.30)

TERMINAL PE	T2[
Section	kg/m (lbs./ft.)
Pipe Type A 60.3 [].D. (2.375)	5.43 (3.65)
Pipe Type B 60.3 D.D. (2.375)	4.63 (3.11)
Pipe Type C 60.3 D.D. (2.375)	4.60 (3.09)
Roll Formed 89.0x89.0 (3?x3?)	See detail
Sq. Tubing 63,5×63,5 (2?×2?)	6.43 (4.32)

m (ft.)

Up to 2.5

(8)

Over 2.5 to 5.0

Over 5.0 to 7.4 (16) (24)

Double

(8) (16)

Gate Opening *

Single

(4) (8)

Up to 1.2 (4)

Over 1.2 to 2.5

Over 2.5 to 3.6

Section	kg/m (lbs./ft.)
Pipe Type A 42.2 D.D. (1.66)	3.38 (2.27)
Pipe Type B 42.2 🗓 D. (1.66)	2.72 (1.83)
Pipe Type C 42.2 (1.1). (1.66)	2.71 (1.82)
H 33.3×38.1 (1.31×1.5)	3.35 (2.25)
Roll Formed 41.3x31.8 (1?x1?)	See detail

Sq.	Tubing	Pipe ⁻	Гуре В
Size	kg/m (lbs./ft.)	Size (0.D.)	kg/m '(lbs./ft.)
63.5	6.43	60.3	4.63
(2?)	(4.32)	(2.375)	(3.11)
76.2	8.60	73.0	6.91
(3)	(5.78)	(2.875)	(4.64)

^{*} The 89.0 \times 89.0 (3? \times 3?) roll formed section as detailed may be used as gate posts for single gate up to 1.8 m (6') and double gate up to 3.6 m (12').

GATE POSTS *

Size (O.D.)

73.0 (2.875)

89.0 (3.5)

Pipe Type A

8.62 (5.79)

GATE FRAMES	
Section	kg/m (lbs./ft.)
Pipe Type A 42.2 🗆.D. (1.66)	3.38 (2.27)
Pipe Type B 42.2 🛮 . D. (1.66)	2.72 (1.83)
Pipe Type C 42.2 B.D. (1.66)	2.71 (1.82)

HANCOCK ENGINEERING

♦ Civil Engineers
 ♦ Municipal Consultants
 ♦ Established 1911

9933 Roosevelt Road tchester, Illinois 60154-2780 Phone: 708/865-6300 Fax: 708/865-1212

NAME DATE

M. DE YOUNG 06/13/90

M. DE YOUNG 07/03/90

M. DE YOUNG 3/27/92

R. SHAH 09/09/94

R. SHAH 10/25/94

A. ABBAS 03/21/97


M. GOMEZ 04/06/01 SCALE:

ILLINOIS DEPARTMENT OF TRANSPORTATION

CHAIN LINK FENCE


NONE



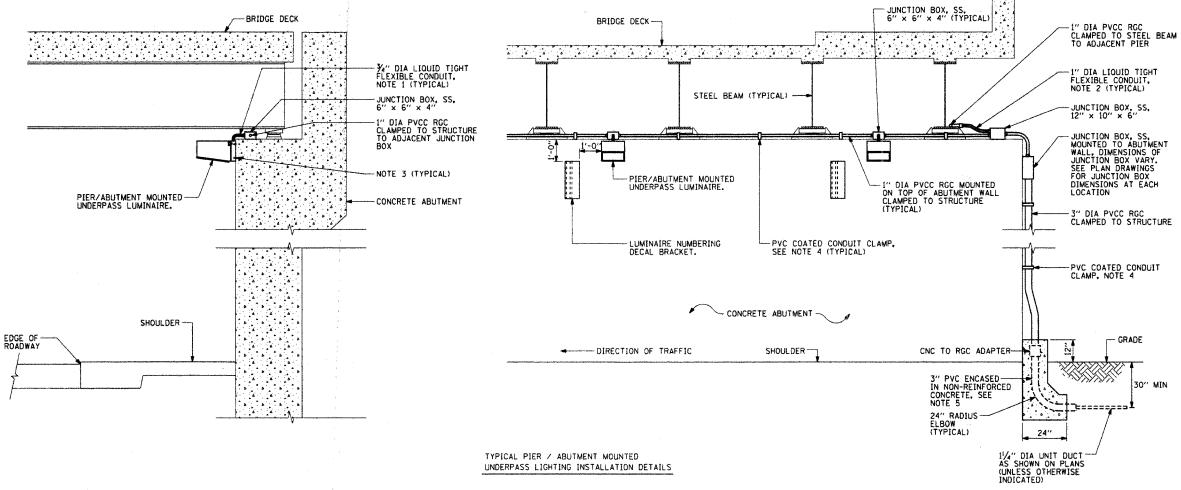

NOTES:

- 1. LIQUID TIGHT FLEXIBLE METAL
 CONDUIT, MAXIMUM LENGTH 6'-O", TYPICAL
 FOR EACH INSTANCE AS SHOWN. PROVIDE PVC
 COATED RIGID GALVANIZED STEEL CONDUIT AS
 REQUIRED NOT TO EXCEED 6'-O" OF FLEXIBLE
 LIQUID TIGHT METAL CONDUIT. LIQUID TIGHT
 FLEXIBLE METAL CONDUIT WILL BE INCLUDED
 IN THE COST OF THE CONDUIT ATTACHED TO
 STRUCTURE, OF THE CORRESPONDING DIA.
 GALVANIZED STEEL, PVC COATED PAY ITEM
 EXCEPT THAT THE COST OF THE "" DIA.
 RIGID STEEL CONDUIT AND "" DIA. FLEXIBLE
 CONDUIT SHALL BE INCLUDED IN THE LUMINAIRE
 INSTALLATION.
- 2. UNDERPASS LUMINAIRE MOUNTED TO FACE OF PIER OR ABUTMENT WALL. MOUNTING HEIGHT OF 1" BELOW THE TOP OF PIER OR ABUTMENT WALL TYPICAL FOR ALL PIER/ABUTMENT MOUNTED UNDERPASS LUMINAIRES UNLESS OTHERWISE NOTED.
- 3. EXPANSION ANCHOR, POWDER ACTUATED FASTENERS WILL NOT BE ALLOWED. EXPANSION ANCHOR MUST BE SIZED IN ACCORDANCE WITH MANUFACTURERS REQUIREMENTS.
- 4. SECURE THE CONDUIT WITH PVC COATED CONDUIT CLAMPS OR CONDUIT BEAM CLAMPS AS SHOWN AT 5'-O" INTERVALS FOR LATERALS AND WITHIN 2'-O" MAXIMUM FROM ANY JUNCTION BOX, FLEXIBLE CONDUIT, OR CHANGE IN DIRECTION. ALL PVC COATED CONDUIT CLAMPS OR BEAM CLAMPS SHALL BE INCLUDED WITH THE COST OF THE "CONDUIT ATTACHED TO STRUCTURE, OF THE CORRESPONDING DIA, GALVANIZED STEEL, PVC COATED" PAY ITEM.
- 5. THE CONCRETE ENCASED CONDUIT TRANSITION SHALL BE INCLUDED IN THE COST OF THE GALVANIZED RIGID STEEL CONDUIT PAY ITEMS.
- 6. ALL CONDUIT ATTACHED TO STRUCTURE SHALL BE PVC COATED RIGID STEEL CONDUIT (PVCC RGC) TYPICAL.

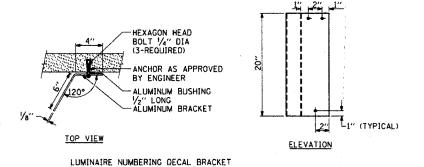

NOT TO SCALE



NOT TO SCALE



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- **♦** Municipal Consultants ♦ Established 1911
- 9933 Roosevelt Road er, Illinois 60154-2780

ĺ	NAME	DATE	ı
	M. DE YOUNG	06/13/90	ı
	M. DE YOUNG	07/03/90	ı
	M. DE YOUNG	3/27/92	l
	R. SHAH	09/09/94	ı
	R. SHAH	10/25/94	ı
	A. ABBAS	03/21/97	1
	M. GOMEZ	04/06/01	3
i			

ILLINOIS DEPARTMENT OF TRANSPORTATION


PIER/ABUTMENT MOUNTED **UNDERPASS LUMINAIRE INSTALLATION DETAILS**

CHECKED BY

VILLAGE SECTION 06-00133-00-BT


CONTRACT NO. 83933

— Conduit

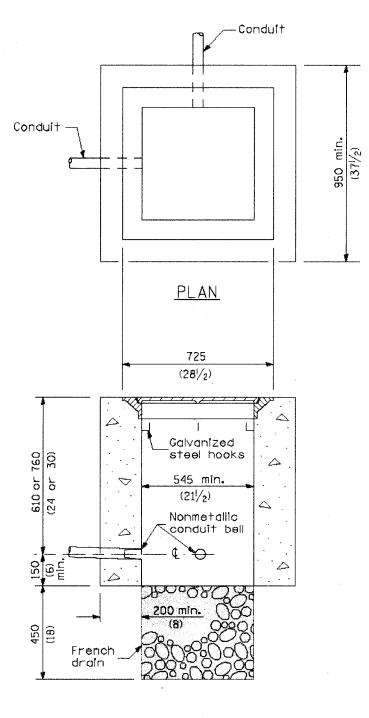

ELEVATION

PORTLAND CEMENT CONCRETE

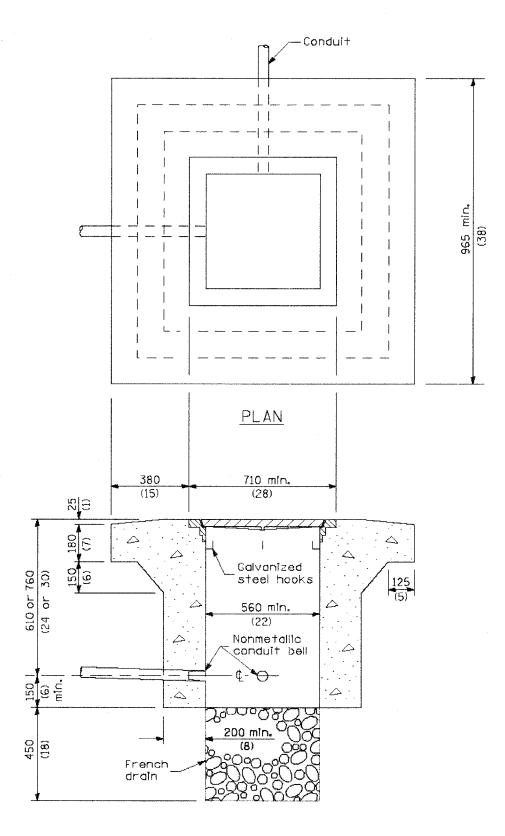

Conduit 610 min. (24) PLAN 660 min. (26) Galvanized steel hooks 610 min. (24) Nonmetallic conduit bell 450 French drain **ELEVATION**

COMPOSITE CONCRETE

All dimensions are in millimeters (inches) unless otherwise shown.

ELEVATION

PORTLAND CEMENT CONCRETE HEAVY DUTY



♦ Civil Engineers ♦ Municipal Consultants ♦ Established 1911


10/25/94 A. ABBAS M. GOMEZ 03/21/97

ILLINOIS DEPARTMENT OF TRANSPORTATION


PORTLAND CEMENT CONCRETE/COMPOSITE CONCRETE DETAILS

E.H.E. PROJECT NO. 080-03-085

UTE N	0.	SECTION	COUNTY	TOTAL	SHEET NO.		
		**	COOK	15	13		
NOIS F	NOIS PROJECT						
LAGE S	GE SECTION 06-00133-00-BT						

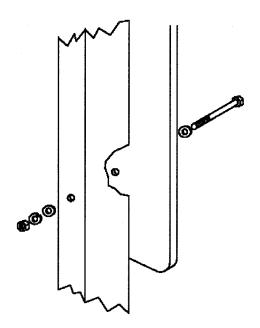


Sign panel 900 (36) wide or less

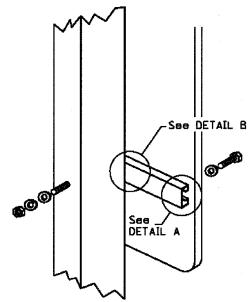


Sign panel over 900 (36) wide




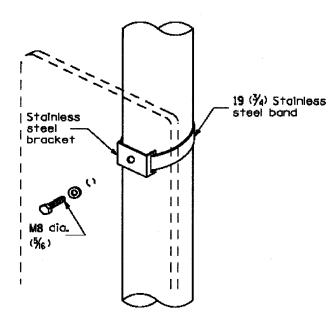


Sign panel 900 (36) wide or less

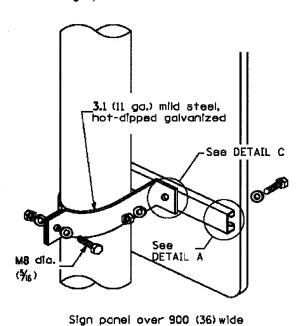

LIGHT OR SIGNAL STANDARDS

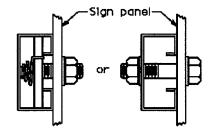

DETAIL A

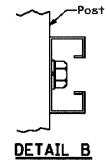


Mounting bracket

DETAIL C


 Section modulus (minimum)
 Axis A
 Axis B


 Steel
 819 mm ³ (0.050 in.³)
 1720 mm ³ (0.105 in.³)

 Aluminum
 2458 mm ³ (0.150 in.³)
 5162 mm ³ (0.315 in.³)

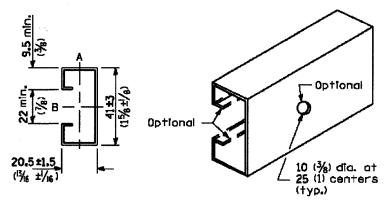

SUPPORTING CHANNEL DETAILS

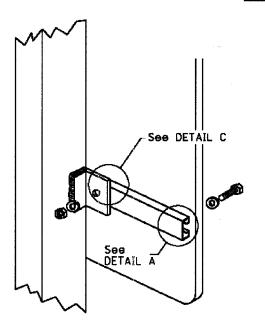

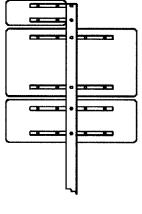

ROUTE MARKER ASSEMBLY

BREAKAWAY STEEL TUBING POSTS

(All sign panel sizes)

All dimensions are in millimeters (inches) unless otherwise shown.



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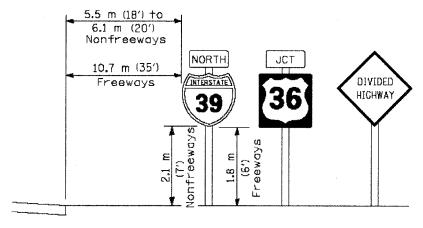
	DATE	NAME
	06/13/90	M. DE YOUNG
	07/03/90	M. DE YOUNG
	3/27/92	M. DE YOUNG
	09/09/94	R. SHAH
	10/25/94	R. SHAH
	03/21/97	A. ABBAS
SI	04/06/01	M. GOMEZ


ILLINOIS DEPARTMENT OF TRANSPORTATION


SIGN PANEL MOUNTING DETAILS

CALE: NONE DRAWN BY: CADD


ATE: 03/25/02 CHECKED BY:



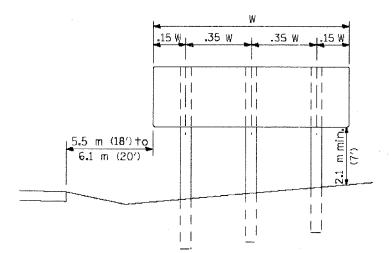

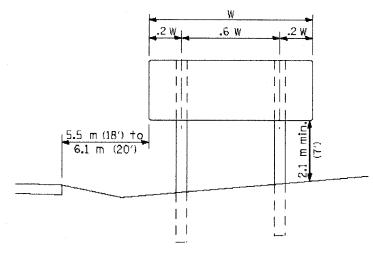


MULTILANE HIGHWAYS

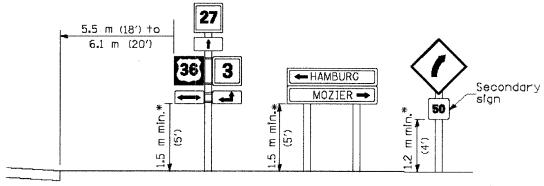

* In any area where parking is likely to occur or where there are obstructions to view or where signs are located over sidewalks, the height shall be at least 2.1 m (7').


TWO LANE RURAL HIGHWAYS

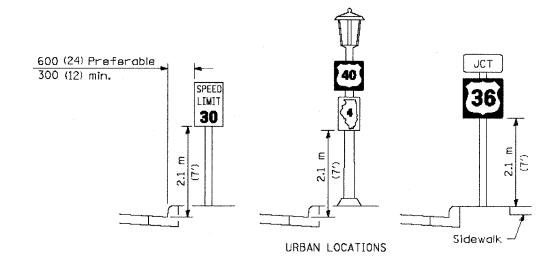


TYPICAL INSTALLATIONS

Signs in any area shall be erected to a uniform height above the edge of the pavement.

POST SPACING FOR NON-FREEWAY SIGN PANELS

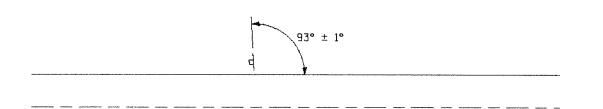

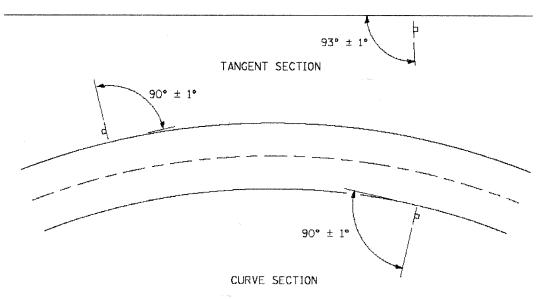

GROUND MOUNT SIGN POSITIONING

All dimensions are in millimeters (inches) unless otherwise shown.



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♦ Established 1911

M. DE YOUNG 06/13/90 M. DE YOUNG M. DE YOUNG A. ABBAS SCALE:

ILLINOIS DEPARTMENT OF TRANSPORTATION

SIGN PANEL ERECTION DETAILS

ROUTE NO.	SECTION	COUNTY	TOTAL SHEETS	SHEET NO.			
	**	соок	15	15			
ILLINOIS PROJECT							
VILLAGE SECTION 06-00133-00-BT							

ABV	ABOVE	D	DEGREE OF CURVE	INST	INSTALLATION	RR	RAILROAD	T	TANGENT DISTANCE
A/C	ACCESS CONTROL	DC	DEPRESSED CURVE	IDS	INTERSECTION DESIGN STUDY	RRS	RAILROAD SPIKE	T.R.	TANGENT RUNOUT DISTANCE
AC	AGRÉ	DET	DETECTOR	INV	INVERT	RPS	REFERENCE POINT STAKE	TEL	TELEPHONE
ADJ	ADJUST	DIA	DIAMETER	[·b	IRON PIPE	REF	REFLECTIVE	TB	TELEPHONE BOX
AS	AERIAL SURVEYS	DIST	DISTRICT	IR	IRON ROD	RCCP	REINFORCED CONCRETE	TP	TELEPHONE POLE
AGG	AGGREGATE	DOM	DOMESTIC	JT	JOINT		CULVERT PIPE	TEMP	TEMPORARY
AH	AHEAD	DBL	DOUBLE	ka	KILOGRAM	REINF	REINFORCEMENT	ТВМ	TEMPORARY BENCH MARK
APT	APARTMENT	OSEL	DOWNSTREAM ELEVATION	km	KILOMETER	REM	REMOVAL	TD	TILE DRAIN
ASPH	ASPHALT	DSFL	DOWNSTREAM FLOWLINE	LS	LANDSCAPING	RC	REMOVE CROWN	TBE	TO BE EXTENDED
AUX	AUXILIARY	DR	DRAINAGE OR DRIVE	LN	LANE	REP	REPLACEMENT	TBR	TO BE REMOVED
AGS	AUXILIARY GAS VALVE	DI	DRAINAGE INLET OR DROP INLET		LEFT	REST	RESTAURANT	TBS	TO BE SAVED
NO.3	(SERVICE)	DRV	DRIVEWAY	LP	LIGHT POLE	RESURF	RESURFACING	TWP	TOWNSHIP
A 3.40°		DCT							and the second s
AVE	AVENUE		DUCT	LGT	LIGHTING	RET	RETAINING	TR	TOWNSHIP ROAD
AX	AXIS OF ROTATION	EA	EACH	LF	LINEAL FEET OR LINEAR FEET	RT	RIGHT	TS	TRAFFIC SIGNAL
ВК	BACK	EB	EASTBOUND	L	LITER OR CURVE LENGTH	ROW	RIGHT-OF-WAY	TSCB	TRAFFIC SIGNAL CONTROL BOX
B-B	BACK TO BACK	EOP	EDGE OF PAVEMENT	LC	LONG CHORD	RD	ROAD	TSC	TRAFFIC SYSTEMS CENTER
BKPL	BACKPLATE	E-CL	EDGE TO CENTERLINE	LNG	LONGITUDINAL	RDWY	ROADWAY	TRVS	TRANSVERSE
В	BARN	E-E	EDGE TO EDGE	L SUM	LUMP SUM	RTE	ROUTE	TRVL	TRAVEL
BARR	BARRICADE	EL.	ELEVATION	MACH	MACHINE	SAN	SANITARY	TRN	TURN
BCN	BEGIN	ENTR	ENTRANCE	MB	MAIL BOX	SANS	SANITARY SEWER	ΤY	TYPE
ВМ	BENCHMARK	EXC	EXCAVATION	MH	MANHOLE	SEC	SECTION	T - A	TYPE A
BIND	BINDER	EX	EXISTING	MATL	MATERIAL	SEED	SEEDING	TYP	TYPICAL
BIT	BITUMINOUS	EXPWAY	EXPRESSWAY	MED	MEDIAN	SHAP	SHAPING	UNDGND	UNDERGROUND
ВТМ	BOTTOM	E	EXTERNAL DISTANCE OF	m	METER	S	SHED	USGS	U. S. GEOLOGICAL SURVEY
BLVD	BOULEVARD	_	HORIZONTAL CURVE	METH	METHOD	SH	SHEET	USEL	UPSTREAM ELEVATION
BRK	BRICK	É	OFFSET DISTANCE TO	M	MID-ORDINATE	SHLD	SHOULDER	USFL	UPSTREAM FLOWLINE
ввох	BUFFALO BOX	•	VERTICAL CURVE	mm	MILLIMETER	SW	SIDEWALK OR SOUTHWEST	UTIL	UTILITY
BLDC	BUILDING	F-F	FACE TO FACE		MILLIMETER DIAMETER	\$1G	SIGNAL	VBOX	VALVE BOX
CIP	CAST IRON PIPE	FA	FEDERAL AID		MIXTURE				
			FEDERAL AID INTERSTATE	MIX		SOD	SODDING	۷V	VALVE VAULT
CB	CATCH BASIN	FAI		MBH	MOBILE HOME	SM	SOLID MEDIAN	VLT	VAULT
c-c	CENTER TO CENTER	FAP	FEDERAL AID PRIMARY	MOD	MODIFIED	SB	SOUTHBOUND	VEH	VEHICLE
CL	CENTERLINE OR CLEARANCE	FAS	FEDERAL AID SECONDARY	MF T	MOTOR FUEL TAX	SE	SOUTHEAST	VP	VENT PIPE
CL-E	CENTERLINE TO EDGE	FAUS	FEDERAL AID URBAN SECONDARY		NAIL & BOTTLE CAP	SPL	SPECIAL	VERT	VERTICAL
CL-F	CENTERLINE TO FACE	FΡ	FENCE POST	N & C	NAIL & CAP	SD	SPECIAL DITCH	VC	VERTICAL CURVE
CTS	CENTERS	FE	FIELD ENTRANCE	N & W	NAIL & WASHER	SO FT	SQUARE FEET	VPC	VERTICAL POINT OF CURVATURE
CERT	CERTIFIED	FH	FIRE HYDRANT	NOAA	NATIONAL OCEANIC ATMOSPHERIC	m 2	SOUARE METER	VPT	VERTICAL POINT OF INTERSECTION
CHSLD	CHISELED	FL	FLOW LINE		ADMINISTRATION	mm 2	SQUARE MILLIMETER	VPT	VERTICAL POINT OF TANGENCY
CS	CITY STREET	FΒ	FOOT BRIDGE	NC	NORMAL CROWN	SQ YD	SQUARE YARD	WM:	WATER METER
CP	CLAY PIPE	FDN	FOUNDATION	NB	NORTHBOUND	STB	STABILIZED	WV	WATER VALVE
CLSD	CLOSED	FR	FRAME	NE	NORTHEAST	STO	STANDARD		WATED LAATE
CLID	CLOSED LID	F&C	FRAME & GRATE	NW	NORTHWEST	SBI	STATE BOND ISSUE	WB	WESTBOUND
CT.	COAT OR COURT	FRWAY	FREEWAY	OLID	OPEN LID	SR	STATE ROUTE		WILDFLOWERS
COMB	COMBINATION	GAL	GALLON	PAT	PATTERN	STA	STATION	W	WITH
C	COMMERCIAL BUILDING	GALV	GALVANIZED	PVD	PAVED	SPBGR			
	COMMERCIAL ENTRANCE	G:	GARAGE				STEEL PLATE BEAM GUARDRAIL	WO	WITHOUT
CE				PVMT	PAVEMENT	SS	STORM SEWER		
CONC	CONCRETE	GM:	GAS METER	PM	PAVEMENT MARKING	STY	STORY		
CONST	CONSTRUCT	GV	GAS VALVE	PED	PEDESTAL	ST	STREET		
CONTD	CONTINUED	GRAN	GRANULAR	PNT	POINT	STR	STRUCTURE		
CONT	CONTINUOUS	GR	GRATE	PC	POINT OF CURVATURE	е	SUPERELEVATION RATE		
COR	CORNER	GRVL	GRAVEL	PI	POINT OF INTERSECTION OF	S.E. RU	N. SUPERELEVATION RUNOFF		
CORR	CORRUGATED	GND	GROUND		HORIZONTAL CURVE		LENGTH		
CMP	CORRUGATED METAL PIPE	GUT	GUTTER	PRC	POINT OF REVERSE CURVE	SURF	SURFACE		
CNTY	COUNTY	GP	GUY POLE	PT	POINT OF TANGENCY	SMK	SURVEY MARKER		
CH	COUNTY HIGHWAY	GW	GUY WIRE	POT	POINT ON TANGENT				
CSE	COURSE	HH	HANDHOLE	POLYETH	POLYETHYLENE				
XSECT	CROSS SECTION	HATCH	HATCHING	PCC	PORTLAND CEMENT CONCRETE				
m ³	CUBIC METER	HD	HEAD	PP	POWER POLE OR PRINCIPAL POINT	ŗ			
mm ⁻³	CUBIC MILLIMETER	HDW	HEADWALL	PRM	PRIME				
CU YD	CUBIC YARD	HDUTY	HEAVY DUTY	PE	PRIVATE ENTRANCE				
CULV	CULVERT	ha:	HECTARE	PROF	PROFILE				
C&G	CURB & GUTTER	HWY	HIGHWAY	PGL	PROFILE GRADELINE				
040	Canal G. Corren	HORIZ	HORIZONTAL	PROJ	PROJECT				
		HSE	HOUSE						
				P.C.	PROPERTY CORNER				
		IL	ILL INOIS	PL	PROPERTY LINE			REVISIO	TELINOIS DEFARIMENT OF IRA
		IMP	IMPROVEMENT	PR:	PROPOSED		ATTANCOCK	NAME	DATE
		44 4 4	INCH DIAMETER	R	RADIUS		HANCOCK	M. DE YOUNG	06/13/90 STANDARD SYME
		INL	INLET				L L ENGINEERING	M. DE YOUNG	
								M. DE YOUNG	ABBREVIATIONS

Civil Engineers
Municipal Consultants
Established 1911

M. DE YOUNG R. SHAH R. SHAH

ILLINOIS DEPARTMENT OF TRANSPORTATION

STANDARD SYMBOLS, **ABBREVIATIONS AND PATTERNS**