DEPARTMENT OF TRANSPORTATION **DIVISION OF HIGHWAYS** 

# **PROPOSED** HIGHWAY PLANS

F.A.P. ROUTE 533: ILL ROUTE 176 **SECTION: 2004-117 RS** 

**RESURFACING (DETOUR ROUTE)** 

MILLSTREAM ROAD (IL 176 TO GARDEN VALLEY ROAD) GARDEN VALLEY ROAD (MILLSTREAM ROAD TO NORTH UNION ROAD) NORTH UNION ROAD (GARDEN VALLEY ROAD TO IL 176) MCHENRY COUNTY

C-91-052-05

RD. 2005 ADT = 9,200STA. 124+65 TO 128+12 SPEED LIMIT = 55 MPH COLLINS LIMIT OF IMPROVEMENT: MILLSTREAM RD. STA. 65 + 91 GARDEN VALLEY RD. STA. 100 + 00 LIMIT OF IMPROVEMENT: GARDEN VALLEY RD. STA. 153 + 28 NORTH UNION RD. STA. 256 + 08 ARDEN VALLEY RD. 1. STA. 28+96 TO 30+44 2. STA. 21 + 24 TO 22 + 80 STA. 242+55 TO 243+40 **MARENGO** LIMIT OF IMPROVEMENT: WEST UNION RD. MILLSTREAM RD. STA. 0+00 LIMIT OF IMPROVEMENT: NORTH UNION RD. STA. 200+00 CORAL SENECA TOWNSHIP

LOCATION MAP

GROSS LENGTH OF IMPROVEMENT = 17,527 FEET = 3.3 MILES NET LENGTH OF IMPROVEMENT = 16,791 FEET = 3.2 MILES

STATE OF ILLINOIS


FOR INDEX OF SHEETS, SEE SHEET NO. 2

IMPROVEMENT LOCATED IN UNINCORPORATED MCHENRY COUNTY

ENGINEERING SCALES. REDUCED SIZED PLANS WILL NOT CONFORM TO STANDARD SCALES. IN MAKING MEASUREMENTS ON REDUCED PLANS, THE ABOVE SCALES MAY BE USED.

JOINT UTILITY LOCATION INFORMATION FOR EXCAVATION 1-800-892-0123

**CONTRACT NO. 62873** 

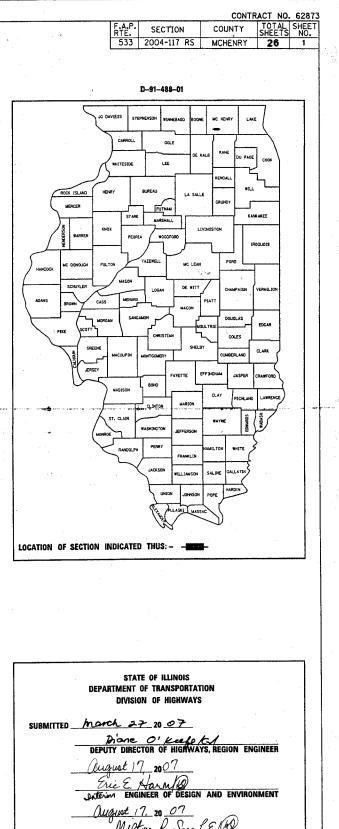

PRINTED BY THE AUTHORITY OF THE STATE OF ILLINOIS

# CONTRACT NO. 62873

I	F.A.P. RTE.	SECTIO	N	COUNTY	TOTAL SHEETS	SHEET NO.
	533	2004-117	RS	MCHENRY	26	2
	STA.		TO	STA.		
.[	FED. RO	AD DIST. NO. 1	ILLINOIS	HIGHWAY	PROJECT	

# INDEX OF SHEETS

- COVER SHEET
- INDEX OF SHEETS, STATE STANDARDS, AND GENERAL NOTES
- SUMMARY OF QUANTITIES
- EXISTING AND PROPOSED TYPICAL SECTIONS
- ROADWAY AND PAVEMENT MARKING PLANS
- PAVEMENT PATCHING FOR HMA SURFACED PAVEMENT
- BUTT JOINT AND HMA TAPER DETAILS
- TRAFFIC CONTROL AND PROTECTION FOR SIDE ROADS. INTERSECTIONS AND DRIVEWAYS
- TRAFFIC CONTROL & PROTECTION AT TURN BAYS (TO REMAIN OPEN TO TRAFFIC)
- TYPICAL RECESSED REFLECTIVE PAVEMENT MARKERS
- 17 DISTRICT ONE TYPICAL PAVEMENT MARKINGS
- TEMPORARY INFORMATION SIGNING
- PAVEMENT MARKING LETTERS & SYMBOLS FOR TRAFFIC STAGING

20-26 CROSS SECTIONS

# GENERAL NOTES

BEFORE STARTING ANY EXCAVATION, THE CONTRACTOR SHALL CALL "JULIE" AT 1-800-892-0123 FOR FIELD LOCATIONS OF BURIED ELECTRIC, TELEPHONE AND GAS FACILITIES. (48 HOURS NOTIFICATION IS REQUIRED)

THE CONTRACTOR SHALL COORDINATE CONSTRUCTION ACTIVITIES WITH UTILITY COMPANIES, SENECA TOWNSHIP, AND MCHENRY COUNTY.

THE CONTRACTOR WILL NOT BE ABLE TO SET UP A YARD OR FIELD OFFICE ON STATE PROPERTY WITHOUT THE WRITTEN PERMISSION OF THE DEPARTMENT.

ALL HOT-MIX ASPHALT PAVEMENT PATCHING SHALL BE CLASS D

THE UNIT WEIGHT (CONVERSION FACTOR) QUOTED IS FOR ESTIMATING PLAN QUANTITIES ONLY. ACTUAL QUANTITIES TO FULFILL CONTRACT REQUIREMENTS WILL BE DETERMINED BASED ON UNIT WEIGHT OF APPROVED MIX DESIGN. PLAN DIMENSIONS, AND DENSITY LIMITATIONS, MAXIMUM PAYMENT WILL BE COMPUTED BASED ON WEIGHT AVERAGE DENSITIES OF THE IN-PLACE MIXTURE.

BUTT JOINTS WILL BE INSTALLED AT THE ENDS OF ALL RESURFACING (WHERE RESURFACING MEETS EXISTING PAVEMENT). IN ACCORDANCE WITH THE "BUTT JOINT AND HMA TAPER DETAILS" SHEETS INCLUDED IN THE PLANS UNLESS OTHERWISE SPECIFIED.

THE RESIDENT ENGINEER SHALL CONTACT DEBBIE HANLEN, AREA TRAFFIC ENGINEER, AT (847) 438-2300 A MINIMUM OF 72 HOURS PRIOR TO PLACEMENT OF PERMANENT PAVEMENT MARKINGS.

WHEN MILLED PAVEMENT IS OPEN TO TRAFFIC, THE MAXIMUM GRADE DIFFERENTIAL BETWEEN PASSES OF THE MILLING MACHINE SHALL NOT EXCEED 11/2 INCHES WHERE THE SPEED LIMIT IS 45 MPH OR LESS AND 1 INCH WHERE THE SPEED LIMIT IS OVER 45 MPH WITHOUT WRITTEN APPROVAL FROM THE RESIDENT ENGINEER. A MAXIMUM GRADE DIFFERENTIAL OF 3 INCHES MAY BE ALLOWED IF THE EDGE OF THE MILLING IS SLOPED A MINIMUM OF 1:3 (V:H).

SCHEDUL	E OF QUAI	NTITIES (E/	ARTHWORK)		
1	2	3	4	5	6
IL 176 (DETOUR ROUTE)	EARTH EXCAVATION (CU YD)	EMBANKMENT (CU YD)	ADJUSTMENT FOR SHRINKAGE (CU YD)	FURNISHED EXCAVATION (CU YD)	TOP SOIL FURNISH AND PLACE (SQ YD)
MILLSTREAM RD.: STA. 64+41 - STA. 65+21	12.98	16.11	11.03	-5.08	263
GARDENVALLEY RD.: STA. 100+20 - STA. 101+60	12.32	22.22	10.47	-11.75	
IL 176: STA. 500+20 - STA. 500+80	15.21	7.24	12.93	5.69	
NORTH UNION RD.: STA. 699+65 TO STA. 200+85	12.18	14.93	10.35	-4.58	168
TOTAL	52.69	60.50	44.78	-15.72	431

COLUMN 1: LOCATION FROM PLANS COLUMN 2: CUT QUANTITIES COLUMN 3: FILL QUANTITIES

COLUMN 4: EARTH EXCAVATION THAT IS TO BE USED AS FILL MATERIAL IN THE EMBANKMENT, SHRINKAGE FACTOR WAS DETERMINED TO BE 15%

COLUMN 5: COLUMN 4 - COLUMN 3, POSITIVE QUANTITY= EXTRA EXCAVATION, NEGATIVE QUANTITY= FURNISHED **EXCAVATION NEEDED** COLUMN 6: TOPSOIL FURNISH AND PLACE = AREA OF SEEDING

# STATE STANDARDS

000001-04 STANDARD SYMBOLS. ABBREVIATIONS. AND PATTERNS

420001-06 PAVEMENT JOINTS

442201-02 CLASS C & D PATCHES

482011-02 HMA SHOULDER STRIPS/SHLDRS, WITH RESURFACING OR WIDENING AND RESURFACING PROJECTS

701006-02 OFF-ROAD OPERATIONS, 2L, 2W 4.5M (15') TO PAVEMENT EDGE, FOR SPEEDS ≥ 45 MPH

701011-01 OFF-ROAD MOVING OPERATIONS, 2L, 2W DAY ONLY, FOR SPEEDS ≥ 45 MPH

701301-02 LANE CLOSURE, 2L, 2W, SHORT TIME OPERATIONS

701306-01 LANE CLOSURE, 2L, 2W SLOW MOVING OPERATIONS DAY ONLY, FOR SPEED ≥ 45 MPH

702001-06 TRAFFIC CONTROL DEVICES

781001-02 TYPICAL APPLICATIONS RAISED REFLECTIVE PAVEMENT MARKERS

ILLINOIS DEPARTMENT OF TRANSPORTATION DETOUR FOR BRIDGE OVER THE SOUTH BRANCH KISHWAUKEE RIVER ON IL 176 INDEX OF SHEETS, GENERAL NOTES, AND STATE STANDARDS SCALE: VERT. CHECKED BY

7/20/2007

# CONTRACT NO. 62873

RTE.	SECTION		COUNT	Υ	TOTAL SHEETS	SHEE.
533	2004-117 RS		MCHENE	RΥ	26	3
FED.	ROAD DIST. NO. 1	ILL	INOIS	HIG	HWAY PRO	JECT

	SUMMARY OF QUANTITIES		URBAN 100% STATE		CONSTRUC	CTION TYPE	CODE			SUMMARY OF QUANTITIES		URBAN 100% STATE			CONSTRUCT	ION TYPE (	CODE	
CODE NO	ITEM TO THE PROPERTY OF THE PR	UNIT	TOTAL QUANTITIES	ROADWAY				-	CODE NO	ITEM	UNIT	TOTAL QUANTITIES	ROADWAY 1000-2A					
20200100	EARTH EXCAVATION	CU YD	53	53					67000400	ENGINEER'S FIELD OFFICE, TYPE A	CAL MO	3	3					
20201006	GRADING AND SHAPING SHOULDERS	UNIT	368	368					67100100	MOBILIZATION	L SUM	1	1					
20400800	FURNISHED EXCAVATION	CU YD	16	16			-		70100450	TRAFFIC CONTROL AND PROTECTION,	L SUM	1	1					
21101615	TOPSOIL FURNISH AND PLACE, 4"	SQ YD	431	431		:			70100450	STANDARD 701201								
25000210	SEEDING, CLASS 2A	ACRE	0.1	0. 1					70100460	TRAFFIC CONTROL AND PROTECTION, STANDARD 701306	L SUM	1	1		J.			
25000400	NITROGEN FERTILIZER NUTRIENT	POUND	10	10					70100600	TRAFFIC CONTROL AND PROTECTION,	L SUM	1	1					
25000500	PHOSPHORUS FERTILIZER NUTRIENT	POUND	10	10					70103815	STANDARD 701336 TRAFFIC CONTROL SURVEILLANCE	CAL DA	10	10					
25000600	POTASSIUM FERTILIZER NUTRIENT	POUND	10	10					70300100	SHORT-TERM PAVEMENT MARKING	CAL DA	10	10300		-			
25100630	EROSION CONTROL BLANKET	SQ YD	431	431							FOOT	10300	44210			:		
25200200	SUPPLEMENTAL WATERING	UNIT	6	6		:			70300220	TEMPORARY PAVEMENT MARKING - LINE 4"	FOOT	44210	44210					
28000250	TEMPORARY EROSION CONTROL SEEDING	POUND	10	10	-				70300260	TEMPORARY PAVEMENT MARKING	FOOT	340	340	••				
28000300	TEMPORARY DITCH CHECKS	EACH	30	30					70300280	TEMPORARY PAVEMENT MARKING	FOOT	18	18				** .	
28000400	PERIMETER EROSION BARRIER	FOOT	355	355					10300280	- LINE 24"	1001	10	10					
31101200	SUB-BASE GRANULAR MATERIAL, TYPE B 4"	SQ YD	165	165	Ì				70301000	WORK ZONE PAVEMENT MARKING REMOVAL	SQ FT	18206	18206		-			
35600704	HOT-MIX ASPHALT BASE COURSE WIDENING,	SQ YD	240	240					<b>*</b> 72000100	SIGN PANEL - TYPE 1	SQ FT	10	10					
40600200	BITUMINOUS MATERIALS (PRIME COAT)	TON	19	19				:	¥ 78005110	EPOXY PAVEMENT MARKING - LINE 4"	FOOT	44210	44210					
40600300	AGGREGATE (PRIME COAT)	TON	95	95					<b>*</b> 78005150	EPOXY PAVEMENT MARKING - LINE 12"	FOOT	340	340					
40600400	MIXTURE FOR CRACKS, JOINTS,	TON	5	5					<b>*</b> 78005180	EPOXY PAVEMENT MARKING - LINE 24"	F00T	18	18					
	AND FLANGEWAYS								X0322256	TEMPORARY INFORMATION SIGNING	SQ FT	102.8	102.8					
40600895	CONSTRUCTING TEST STRIP	EACH	2 .	2				-	* XX006257	RECESSED REFLECTIVE PAVMENT MARKER	EACH	273	273					
40600982	HOT-MIX ASPHALT SURFACE REMOVAL - BUTT JOINT	SQ YD	262	262														
40601005	HOT-MIX ASPHALT REPLACEMENT OVER PATCHES	TON	35	35														
40603085	HOT-MIX ASPHALT BINDER COURSE, IL-19.0, N70	TON	5965	5965						. "		·						
40603340	HOT-MIX ASPHALT SURFACE COURSE, MIX "D", N70	TON	3980	3980												- Annual Control of the Control of t		
44000158	HOT-MIX ASPHALT SURFACE REMOVAL, 2 1/4"	SQ YD	47285	47.285														
44002212	HOT-MIX ASPHALT REMOVAL OVER PATCHES, 3"	SQ YD	200	200												- Control of the Cont		
44201741	CLASS D PATCHES, TYPE II, 8 INCH	SQ YD	200	200									. *					
48102100	AGGREGATE WEDGE SHOULDER, TYPE B	TON	1472	1472														

\* - SPECIALTY ITEM

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REVISIONS
NAME DATE

ILLINOIS DEPARTMENT OF TRANSPORTATION SUMMARY OF QUANTITIES

PLOT DATE: 7/20/2007

| CONTRACT NO. 62873 | FA.P. | SECTION | COUNTY | TOTAL | SHEETS |


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# EXISTING TYPICAL CROSS SECTION

MILLSTREAM RD.: STA. 00+00 TO STA. 21+24 STA. 22+80 TO STA. 28+96 STA. 30+44 TO STA. 65+91

GARDEN VALLEY RD.: STA. 100+00 TO STA. 124+65 STA. 128+12 TO STA. 153+28

NORTH UNION RD.: STA. 200+00 TO STA. 242+55 STA. 243+40 TO STA. 265+00

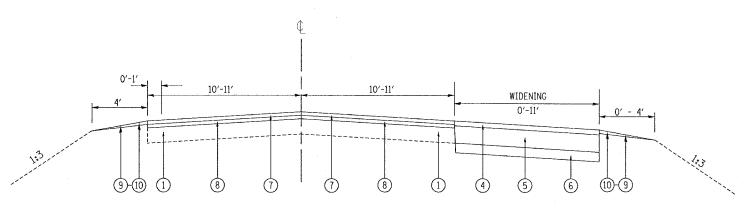

# PROPOSED TYPICAL CROSS SECTION

MILLSTREAM RD.: STA. 00+00 TO STA. 21+24 STA. 22+80 TO STA. 28+96 STA. 30+44 TO STA. 65+91

GARDEN VALLEY RD.: STA. 100+00 TO STA. 124+65 STA. 128+12 TO STA. 153+28

NORTH UNION RD.: STA. 200+00 TO STA. 242+55 STA. 243+40 TO STA. 265+00

# NOTE:

THESE ROUTES ARE CLASSIFIED AS CLASS II TRUCK ROUTE. THEREFORE, TO ACCOMMODATE THE TURNS OF TRUCKS, THE PROPOSED WIDENINGS ARE AT TURN RADII ONLY.

# LEGEND

- (1) EXISTING HMA PAVEMENT, 6"±
- (2) EXISTING AGGREGATE SHOULDER
- (3) PROPOSED HMA SURFACE REMOVAL, 21/4"
- 4 PROPOSED WIDENING HMA SURFACE COURSE, MIX "D", N50, 2 "
- (5) PROPOSED HMA BASE COURSE WIDENING, 7"
- 6) PROPOSED SUB-BASE GRANULAR MATERIAL TYPE B, 4"
- 7) PROPOSED HMA SURFACE COURSE, MIX "D", N70, 11/2"
- (8) PROPOSED HMA BINDER COURSE IL-19.0, N70, 21/4"
- (9) PROPOSED AGGREGATE SHOULDERS, TYPE B
- (10) PROPOSED GRADING & SHAPING SHOULDERS

# HOT-MIX ASPHALT MIXTURE REQUIREMENTS

	MIXTURE TYPE	AC/PG	AIR VOIDS (%)
ROADWAY	HOT-MIX ASPHALT BINDER COURSE, IL-19.0, N70, 2/4"	PG 64-22*	4% @ 70 GYR
NOADWAT	HOT-MIX ASPHALT SURFACE COURSE, MIX "D", N70, IL 9.5 MM, 11/2"	PG 64-22	4% @ 70 GYR
PATCHING	CLASS D PATCHES, IL-19, 8"	PG 64-22*	4% @ 70 GYR
1717 0712110	HOT-MIX ASPHALT REPLACEMENT OVER PATCHES	PG 64-22*	4% <b>©</b> 70 GYR
WIDENING	HOT-MIX ASPHALT BASE COURSE WIDENING, 7"	PG 64-22*	4% @ 50 GYR
SHOULDER	HOT-MIX ASPHALT SHOULDERS, 8"	PG 64-22*	4% @ 70 GYR

UNIT WEIGHT USED TO CALCULATE ALL HMA SURFACE MIXTURE QUANTITIES IS 112 LBS/SQ YD/IN
\*WHEN RAP EXCEEDS 20%, THE NEW ASPHALT BINDER IN THE MIX SHALL BE PG 58-22

REVISIONS	ILLINOIS DEPARTMEN	NT OF TRANSPORTATION
NAME DATE	DETOUR FOR	BRIDGE OVER SHWAUKEE RIVER ON IL-176
		AND PROPOSED _ SECTIONS
	SCALE: VERT. HORIZ. DATE 7/19/2007	DRAWN BY CHECKED BY

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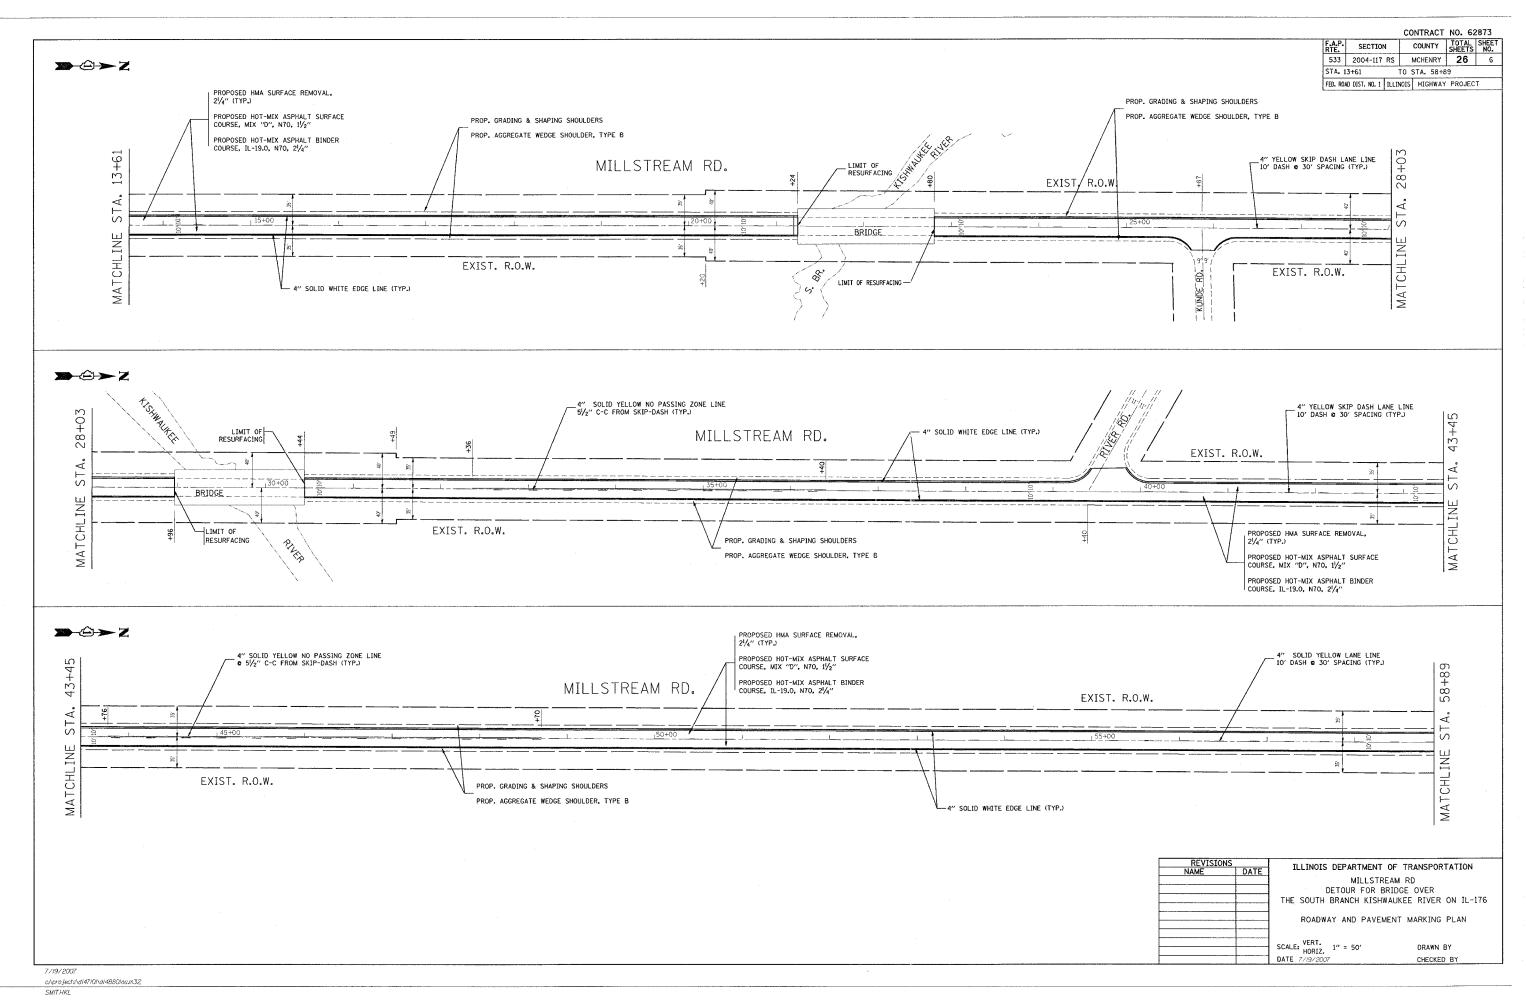
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 CONTRACT NO. 62873

 F.A.P. RTE.
 SECTION
 COUNTY SHEETS NO.

 533
 2004-117 RS
 MCHENRY
 26
 5
 STA. 0+00 TO STA, 13+61 FED. ROAD DIST. NO. 1 ILLINOIS HIGHWAY PROJECT IMPROVEMENT LIMIT STA. 00+00 STA. 800+00 BACK = STA. 00+00 FORWARD PROPOSED HMA SURFACE REMOVAL, 21/4" (TYP.) (WIDENING) PROP. 2' HMA SURFACE COURSE, PROP. 7" HMA BASE COURSE WIDENING
PROP. 5" HMA BASE GRANULAR MATERIAL
TYPE 8, 4" PROPOSED HOT-MIX ASPHALT SURFACE COURSE, MIX "D", N70, 11/2" MILLSTREAM RD. 13+61 PROPOSED HOT-MIX ASPHALT BINDER COURSE, IL-19.0, N70, 21/4" 4" WHITE EDGE LINE (TYP.) EXIST. R.O.W. EXIST. R.O.W. DUNHAM ROAD EXIST. R.O.W. MATCH 4" SOLID YELLOW LANE LINE 10' DASH @ 30' SPACING (TYP.) PROP. GRADING & SHAPING SHOULDERS PROP. AGGREGATE WEDGE SHOULDER, TYPE B RTE. 176 ILLINOIS DEPARTMENT OF TRANSPORTATION MILLSTREAM RD DETOUR FOR BRIDGE OVER
THE SOUTH BRANCH KISHWAUKEE RIVER ON IL-176 ROADWAY AND PAVEMENT MARKING PLAN SCALE: VERT. HORIZ. DATE 7/19/2007 DRAWN BY CHECKED BY 7/19/2007 c:\projects\d/47/0/\d/4880laa.m32


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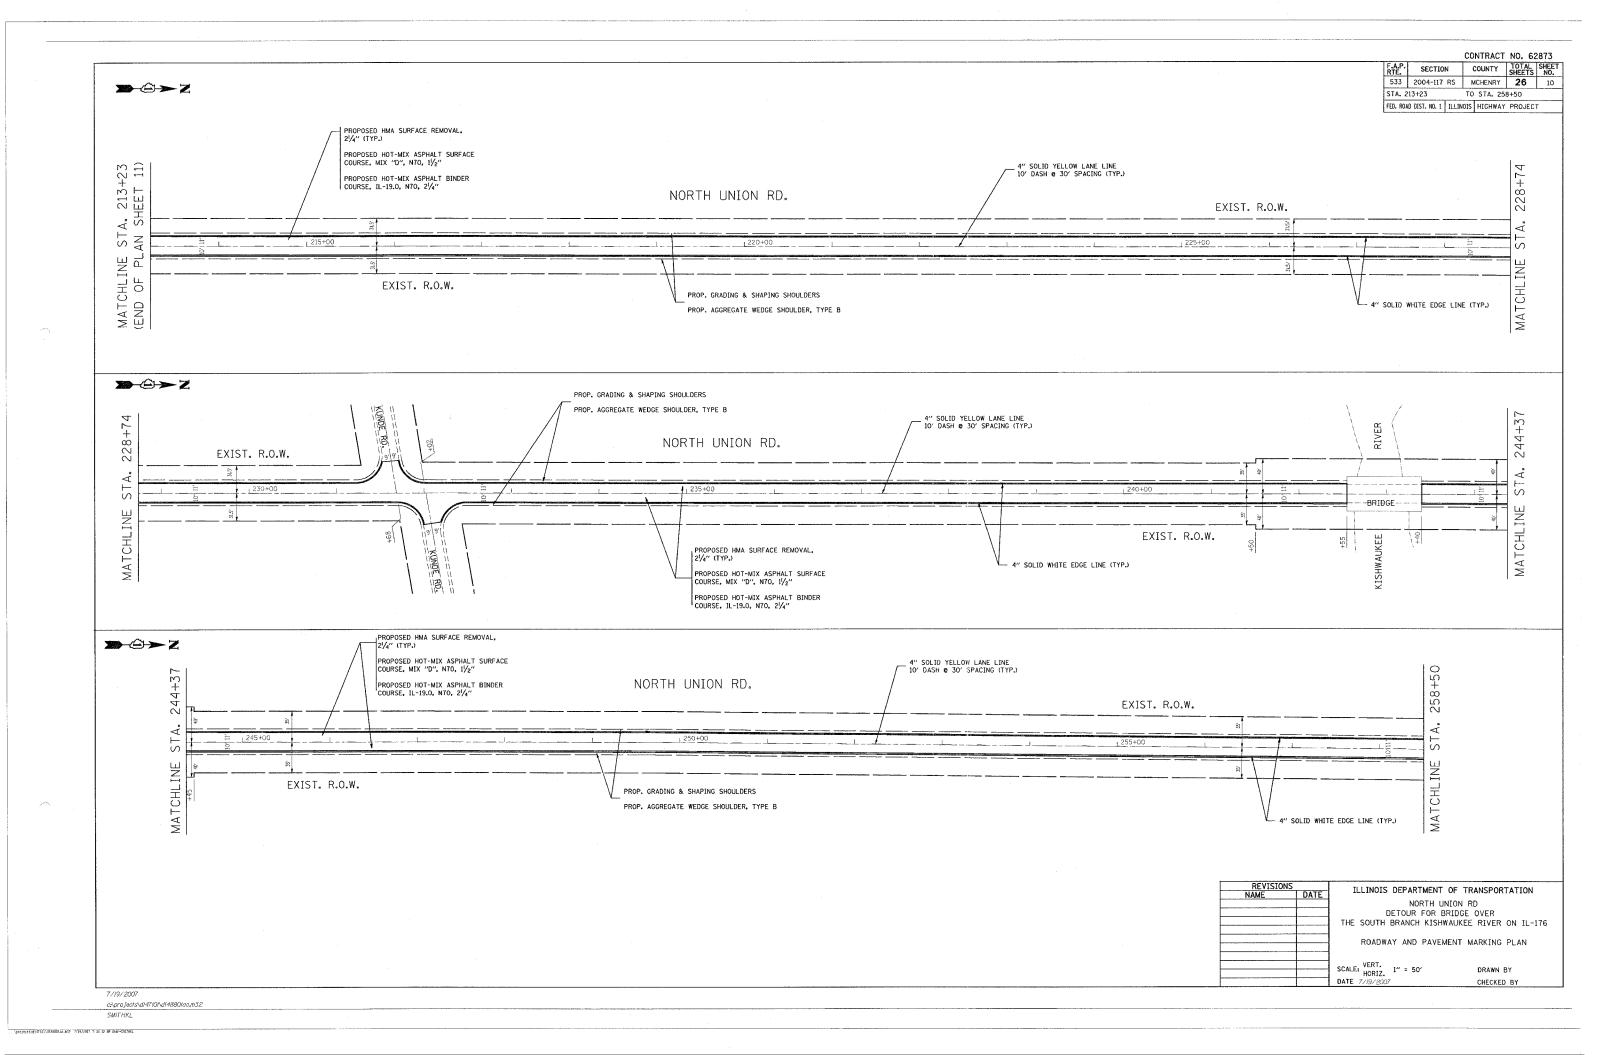
STA. 58+89 TO STA, 111+06 FED. ROAD DIST. NO. 1 ILLINOIS HIGHWAY PROJECT 111+06 4" YELLOW SKIP DASH LANE LINE 10' DASH @ 30' SPACING (TYP.) MILL STREAM RD. -- 12" WHITE LINES. 5 @ 51/2' SPACING C-C (TYP.) STA. GARDEN VALLEY RD. IMPROVEMENT LIMIT EXIST. R.O.W. STA. 65+91 MATCHLINE 24" WHITE STOP BAR (TYP.) -PROP. GRADING & SHAPING SHOULDERS EXIST. R.O.W. PROP. AGGREGATE WEDGE SHOULDER, TYPE B 4" SOLID YELLOW NO PASSING ZONE LINE 4" WHITE EDGE LINE (TYP.) PROPOSED HMA SURFACE REMOVAL, 21/4" (TYP.) SEEDING CLASS 2A WITH -SEE DETAIL BELOW PROPOSED HOT-MIX ASPHALT SURFACE COURSE, MIX "D", N70, 11/2" PROPOSED HOT-MIX ASPHALT BINDER COURSE, IL-19.0, N70, 21/4" - PERIMETER EROSION BARRIER EXIST. R.O.W. 4" SOLID WHITE EDGE LINE (TYP.) GARDEN VALLEY RD. S TREAM EXIST. R.O.W. RD I PROPOSED EDGE OF HMA PAVEMENT 2 CENTER CURVE R1=60' R2=345' LUTILITY BOX COMED POLE PROP. 2' HMA SURFACE COURSE, MIX "D", NSO PROP. 7" HMA BASE COURSE WIDENING PROP. SUB-BASE GRANULAR MATERIAL TYPE B, 4" 4" SOLID YELLOW LANE LINE 10' DASH @ 30' SPACING (TYP.) 4" WHITE EDGE LINE 2 CENTER CURVE R1=55' R2=450' CURVE DETAIL SCALE = 20 CROSS TRAFFIC DOES NOT STOP PROP. GRADING & SHAPING SHOULDERS PROP. AGGREGATE WEDGE SHOULDER, TYPE B \* SIGN PANEL TO BE MOUNTED UNDER STOP SIGN MATCHLINE STA. 58+89 ILLINOIS DEPARTMENT OF TRANSPORTATION MILLSTREAM RD. / GARDEN VALLEY RD. DETOUR FOR BRIDGE OVER
THE SOUTH BRANCH KISHWAUKEE RIVER ON IL-176 ROADWAY AND PAVEMENT MARKING PLAN SCALE: VERT. 1" = 50' HORIZ. DATE 7/20/2007 CHECKED BY c:\projects\di4710I\di4880laa.m32


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STA. 141+31 TO STA. 258+50
FED. ROAD DIST. NO. 1 ILLINOIS HIGHWAY PROJECT GARDEN VALLEY RD. IMPROVEMENT LIMIT STA. 153+28 4" SOLID YELLOW LANE LINE 10' DASH @ 30' SPACING (TYP.) 141+31 GARDEN VALLEY RD. EXIST. R.O.W. MATCHL] EXIST. R.O.W. PROP. GRADING & SHAPING SHOULDERS (WIDENING)
PROP. 2' HMA SURFACE COURSE, MIX """, NSO \_
PROP. 7" HMA BASE COURSE WIDENING
PROP. SUB-BASE GRANULAR MATERIAL TYPE B, 4" PROP. AGGREGATE SHOULDER, TYPE B 4" SOLID WHITE EDGE LINE (TYP.) PROPOSED HMA SURFACE REMOVAL, 21/4" (TYP.) PROPOSED HOT-MIX ASPHALT SURFACE COURSE, MIX "D", NTO, 11/2" PROPOSED HOT-MIX ASPHALT BINDER COURSE, IL-19.0, N70, 21/4" NORTH 4" SOLID WHITE EDGE LINE (TYP.) UNION \_ 4" SOLID YELLOW LANE LINE 10' DASH @ 30' SPACING (TYP.) EXIST. R.O.₩. PROP. GRADING & SHAPING SHOULDERS PROP. AGGREGATE SHOULDER, TYPE B CROSS TRAFFIC DOES NOT STOF MATCHLINE STA. 258+50 (END OF PLAN SHEET 10) \* SIGN PANEL TO BE MOUNTED UNDER STOP SIGN REVISIONS NAME ILLINOIS DEPARTMENT OF TRANSPORTATION DATE GARDEN VALLEY RD. / NORTH UNION RD.
DETOUR FOR BRIDGE OVER
THE SOUTH BRANCH KISHWAUKEE RIVER ON IL-176 ROADWAY AND PAVEMENT MARKING PLAN SCALE: VERT. 1" = 50' DATE 7/20/2007 DRAWN BY CHECKED BY c:\projects\d147101\d14880laa.m32


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533 2004-117 RS MCHENRY **26** 12 FED. ROAD DIST. NO. 1 ILLINOIS FED. AID PROJECT



# NOTES:

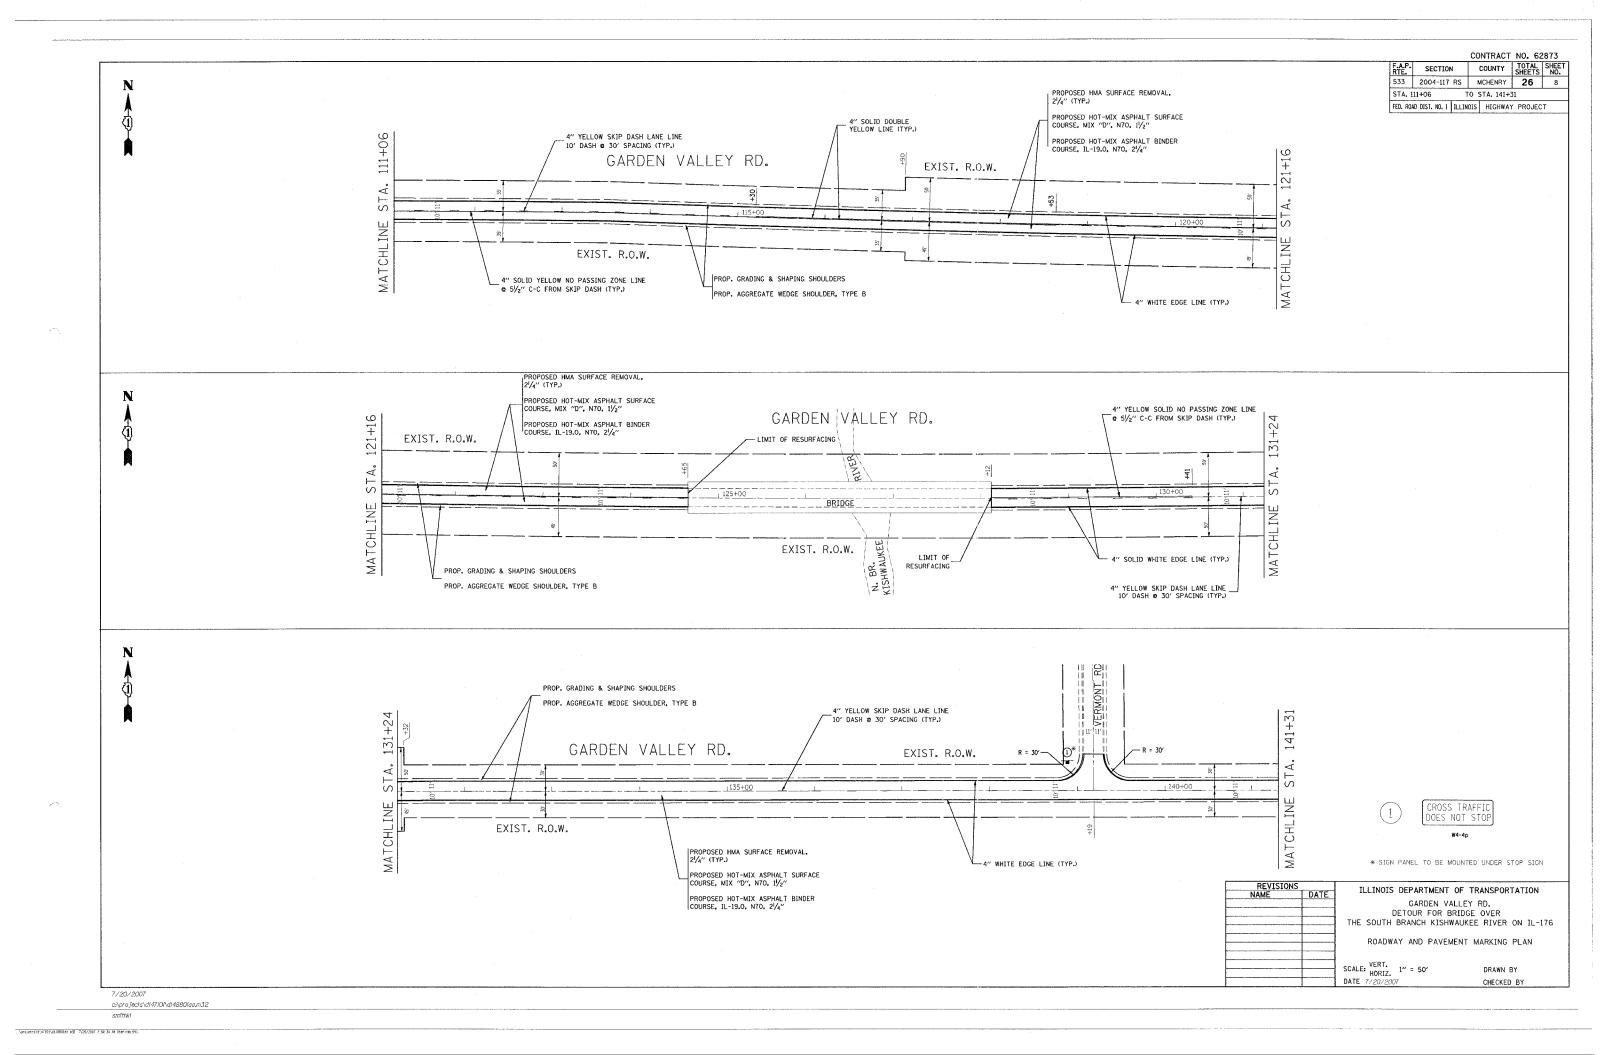- 1. THE WIDTH OF THE FULL DEPTH PATCH OVER A TRENCH SHALL BE 12 (300) WIDER ON EACH SIDE OF THE TRENCH.
- 2. FOR METHOD OF MEASUREMENT AND BASIS OF PAYMENT, SEE RECURRING SPECIAL PROVISION "PATCHING WITH HOT-MIX ASPHALT OVERLAY REMOVAL".

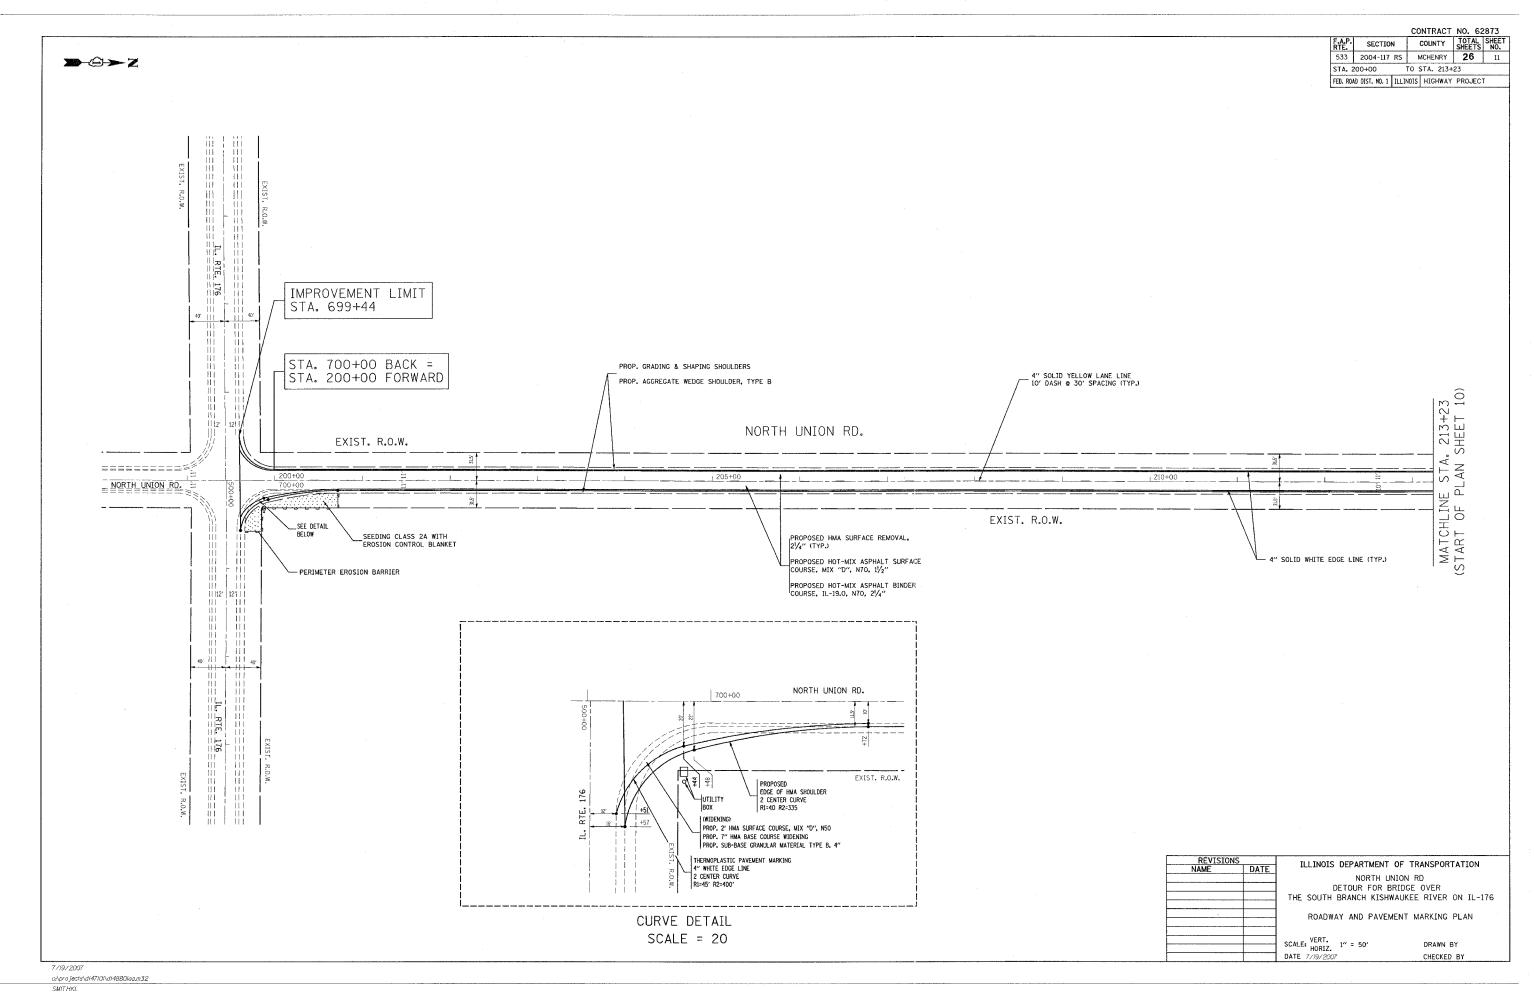
# SEQUENCE OF CONSTRUCTION

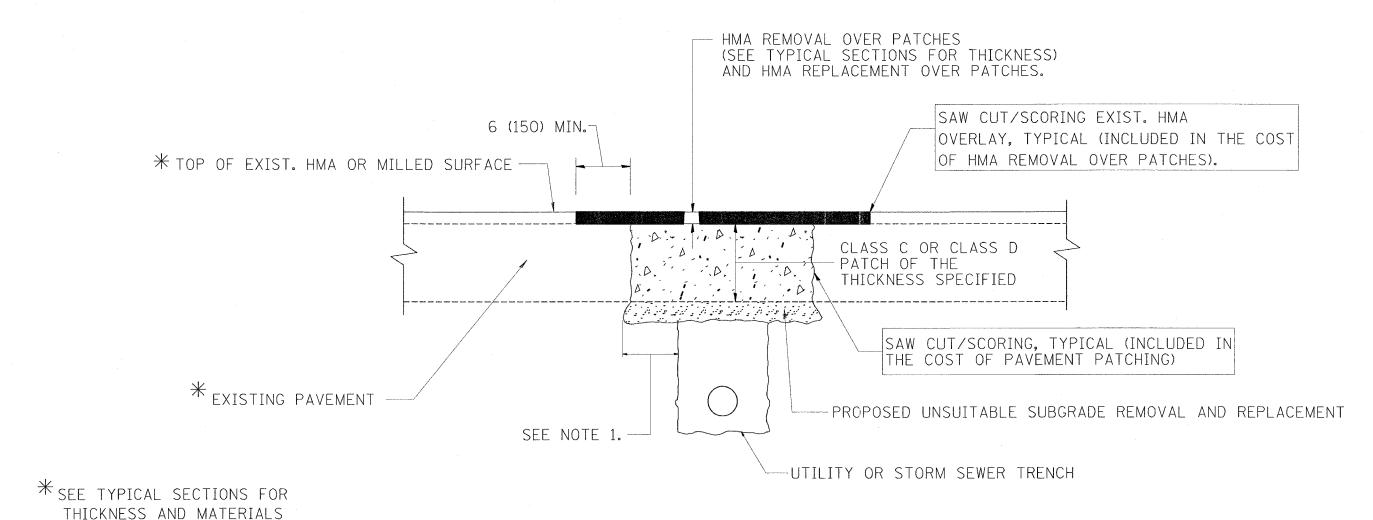
- 1. REMOVE THE EXISTING HMA MATERIAL OVER THE AREA TO BE PATCHED.
- 2. REMOVE AND REPLACE FULL DEPTH PATCHES
- 3. REPLACE HMA MATERIAL OVER THE AREA TO BE PATCHED.

ALL DIMENSIONS ARE IN INCHES (MILLIMETERS) UNLESS OTHERWISE SHOWN.

REVISIONS		THE THICKS DEPARTMENT	OF TRANSPORTATION
NAME	DATE	ILLINOIS DEFANTMENT	OF TRANSPORTATION
R. SHAH	10/25/94		
R. SHAH	01/14/95		
R. SHAH	03/23/95	PAVEMENT P	ATCHING FOR
R. SHAH	04/24/95	HMA CI	IREACED
A. HOUSEH	03/15/96		
A. ABBAS	03/21/97	PAVE	MENT
A. ABBAS	01/20/98		
ART ABBAS	04/27/98	SCALE: VERT. NONE	DRAWN BY
R. BORO	01/01/07	SCALE: VERT. NONE	DRAWN DI

CHECKED BY

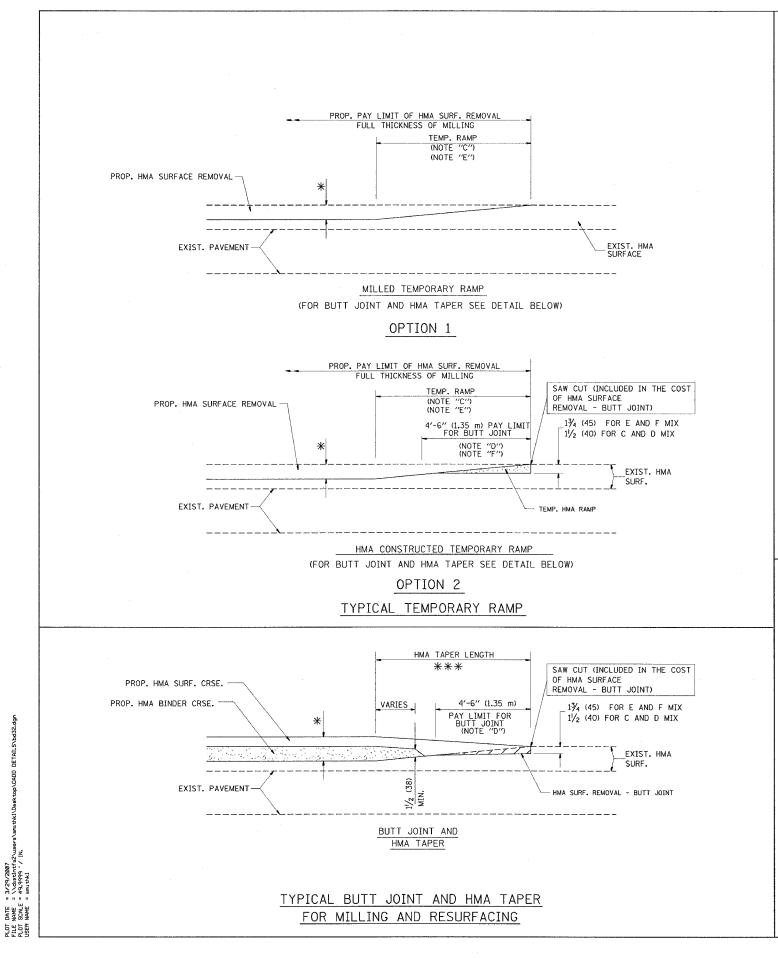

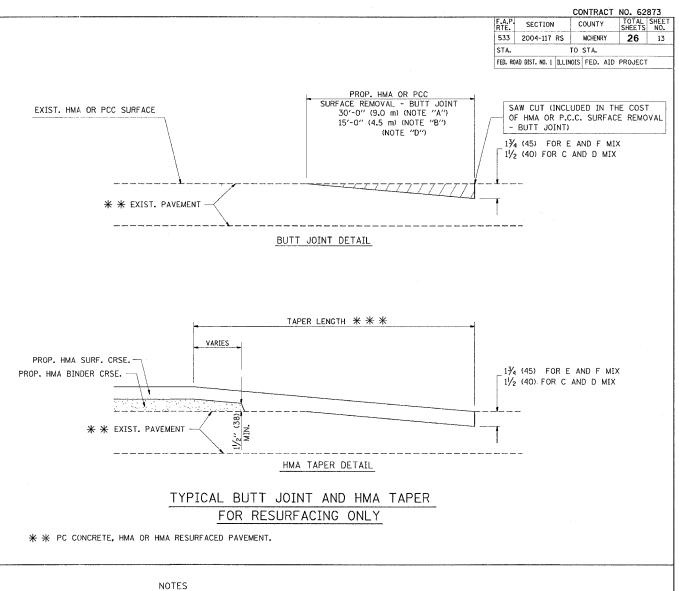

- A: MAINLINE ROADWAYS AND MAJOR SIDE ROADS.
- B: MINOR SIDE ROADS.
- C: THE TEMP. RAMP SHALL BE CONSTRUCTED IMMEDIATELY UPON REMOVAL OF THE EXISTING HMA SURFACE.
- D: THE BUTT JOINT SHALL BE CONSTRUCTED IMMEDIATELY PRIOR TO PLACING THE PROPOSED HMA COURSES.
- E: TAPER THE TEMP, RAMP AT A RATE OF 3'-0" (900 mm) PER 1 INCH (25 mm) OF MILLING THICKNESS.
- F: INSTALLATION AND REMOVAL OF THE 4'-6" (1.35 m) TEMP. RAMP IS INCLUDED IN COST OF HMA SURFACE REMOVAL - BUTT JOINT
- G: SEE ARTICLE 406.08 AND 406.14 OF THE STANDARD SPECIFICATIONS FOR "HMA AND/OR PCC SURFACE REMOVAL, BUTT JOINT".
- \* SEE TYPICAL SECTIONS FOR MILLING THICKNESS.
- $\mbox{\ensuremath{\mbox{\#}}}\mbox{\ensuremath{\mbox{\#}}}\mbox{\ensuremath{\mbox{\#}}}\mbox{\ensuremath{\mbox{0'}}}\mbox{\ensuremath{\mbox{0''}}}\mbox{\ensu$

ALL DIMENSIONS ARE IN INCHES (MILLIMETERS) UNLESS OTHERWISE SHOWN.

# BASIS OF PAYMENT:

THE BUTT JOINT WILL BE PAID FOR AT THE CONTRACT UNIT PRICE PER SQUARE YARD (SQUARE METER) FOR "HOT-MIX ASPHALT SURFACE REMOVAL - BUTT JOINT" OR FOR "PORTLAND CEMENT CONCRETE SURFACE REMOVAL- BUTT JOINT".

REVISIO	NS
NAME	DATE
M. DE YONG	6-13-90
M. DE YONG	7-3-90
M. DE YONG	3-27-92
R. SHAH	09/09/94
R. SHAH	10/25/94
A. ABBAS	03/21/97
M. GOMEZ	04/06/01
R. BORO	01/01/07

ILLINOIS DEPARTMENT OF TRANSPORTATION

BUTT JOINT AND HMA TAPER DETAILS

SCALE: VERT. NONE

DRAWN BY CHECKED BY

BD400-05 (VI=BD32) REVISION DATE: 01/01/07

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COUNTY NO. 62873

COUNTY TOTAL SHEET SHEET NO. SECTION 533 2004-117 RS MCHENRY 26 14 STA. TO STA. FED. ROAD DIST. NO. ILLINOIS FED. AID PROJECT ROAD CONSTRUCTION AHEAD TYPE III BARRICADES WITH TWO FLASHING AMBER LIGHTS ON EACH, TYPE I OR TYPE II BARRICADES WITH ONE FLASHING AMBER LIGHT ON EACH, OR TYPE III BARRICADES WITH TWO FLASHING 200'± (60 m±)-AMBER LIGHTS ON EACH. DRIVEWAY 200'± (60 m±) 09) STREET; COLLECTOR LIMIT> 40 MPH ( LOCAL W20-1(0) ROAD CONSTRUCTION M6-4(0)-2115 AHEAD **4** M6-1(0)-2115

# TRAFFIC CONTROL AND PROTECTION FOR SIDE ROADS, INTERSECTIONS, AND DRIVEWAYS

# NOTES:

- A. FOR NO LANE RESTRICTION ON THE SIDE ROAD OR DRIVEWAYS
- 1. SIDE ROAD WITH A SPEED LIMIT OF 40 MPH (60 km/h) OR LESS AS SHOWN ON THE DRAWING AND AS DIRECTED BY THE ENGINEER:
- d) ONE ROAD CONSTRUCTION AHEAD SIGN 36 x 36 (900x900) WITH A FLASHER AND FLAG MOUNTED ON IT APPROXIMATELY 200' (60 m) IN ADVANCE
- b) THE CLOSED PORTION OF THE MAIN ROUTE SHALL BE PROTECTED BY BLOCKING WITH TYPE I, TYPE II OR TYPE III BARRICADES, 1/3 OF THE CROSS SECTION OF THE CLOSED PORTION.
- 2. SIDE ROAD WITH A SPEED LIMIT GREATER THAN 60 km/h (40 MPH) AS SHOWN ON THE DRAWING AND AS DIRECTED BY THE ENGINEER:
- a) ONE ROAD CONSTRUCTION AHEAD SIGN 48 x 48 (1.2 m x 1.2 m) WITH A FLASHER MOUNTED ON IT APPROXIMATELY 500' (150 m) IN ADVANCE OF THE MAIN ROUTE.
- b) THE CLOSED PORTION OF THE MAIN ROUTE SHALL BE PROTECTED BY BLOCKING WITH TYPE III BARRICADES, 1/2 OF THE CROSS SECTION OF THE CLOSED PORTION.
- 3. WHEN THE SIDE ROAD LIES BETWEEN THE BEGINNING OF THE MAINLINE SIGNING AND THE WORK ZONE, A SINGLE HEADED ARROW (MG-1) SHALL BE USED IN LIEU OF THE DOUBLE HEADED ARROW (MG-4).

- B. FOR A LANE CLOSURE ON A SIDE ROAD OR DRIVEWAY:
- USE APPLICABLE PORTIONS OF THE TYPICAL APPLICATION OF TRAFFIC CONTROL DEVICES (STD. 701501, STD. 701606 OR THE APPROPRIATE STANDARD). THE SPACING OF SIGNS AND BARRICADES SHALL BE ADJUSTED FOR FIELD CONDITIONS AS DIRECTED BY THE ENGINEER. THE DIRECTIONAL ARROW SHALL BE COVERED OR REMOVED WHEN NO LONGER CONSISTENT WITH THE SIDE ROAD LANE CLOSURE.
- C. ADVANCE WARNING SIGNS ARE TO BE OMITTED ON DRIVEWAY UNLESS OTHERWISE NOTED,
- D. THE TRAFFIC CONTROL AND PROTECTION FOR SIDE ROADS, INTERSECTIONS, AND DRIVEWAYS SHALL BE INCIDENTAL TO THE COST OF SPECIFIED TRAFFIC CONTROL STANDARDS OR ITEMS.

All dimensions are in millimeters (inches)

	SN	REVISIO
	DATE	NAME
TE	6/89	LHA
11	09/08/94	T. RAMMACHER
	10/18/95	J. OBERLE
_ c	03/06/96	A. HOUSEH
ے ا	10/15/96	A. HOUSEH
	01/06/00	T. RAMMACHER
-		
SC		


ILLINOIS DEPARTMENT OF TRANSPORTATION RAFFIC CONTROL AND PROTECTION FOR SIDE ROADS, INTERSECTIONS, AND DRIVEWAYS

CALE: DATE: 3/29/2007

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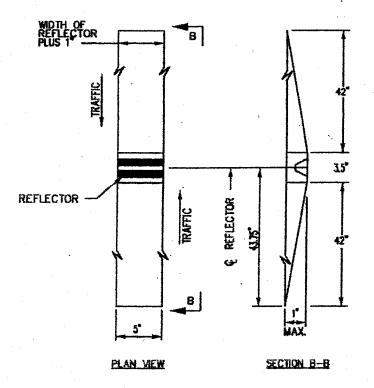
TC-10 REVISION DATE: 01/06/00


... \Desktop\CACO DETASLS\\circlo.dgn = 3/29/2007 t0: 33: 01 MM Gear-smithk1

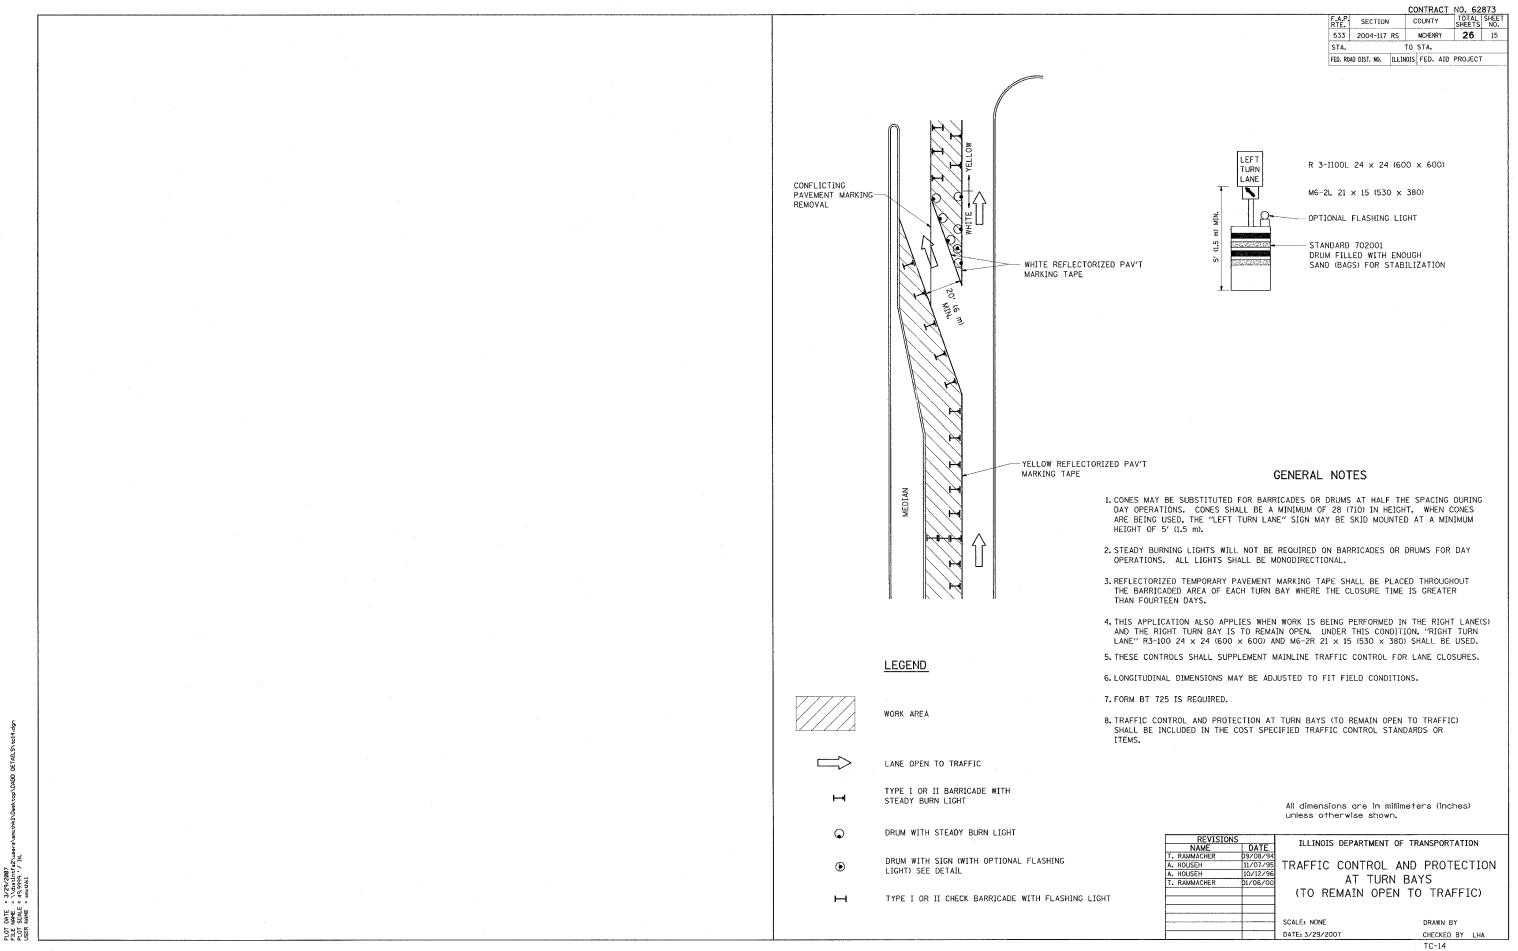

REVISION DATE: 01/06/00

| CONTRACT NO. 62873 | RTE. | SECTION | COUNTY | SHEETS | SHEETS | MO. 533 | 2004-117 RS | MCHENRY | 26 | 16 | STA. | TO STA. | ILLINOIS | FED. AID | PROJECT |



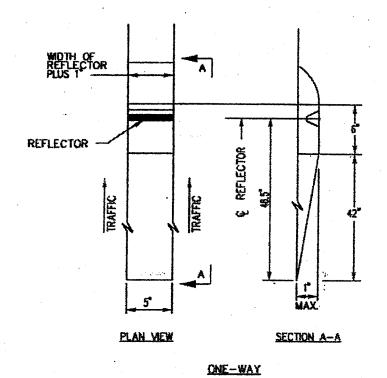

TWO-WAY

# **GENERAL NOTES:**

- Installation shall conform to IDOT Highway Standard 781001-02 (or latest) for marker placement.
- 2. IDOT Standard 781001-02 shall be modified to reflect recessed povement markers instead of raised povement markers.


# RECESSED REFLECTIVE PAVEMENT MARKERS


# INSTALLATION NOTES:

- 1. Saw cut to dimensions shown.
- Sawcut areas to be dry and free or material that adversely affects the adhesive band.
- 3. Install the reflector with an approved two-component epoxy adhesive. Epoxy should not obscure or block the lens.
- 4. Install top of reflector 1/2 to 1/4 Inch below the povement surface.
- 5. Reflector shall be 3M Series 190.


TYPICAL RECESSED REFLECTIVE PAVEMENT MARKERS

STANDARD KC781001-03

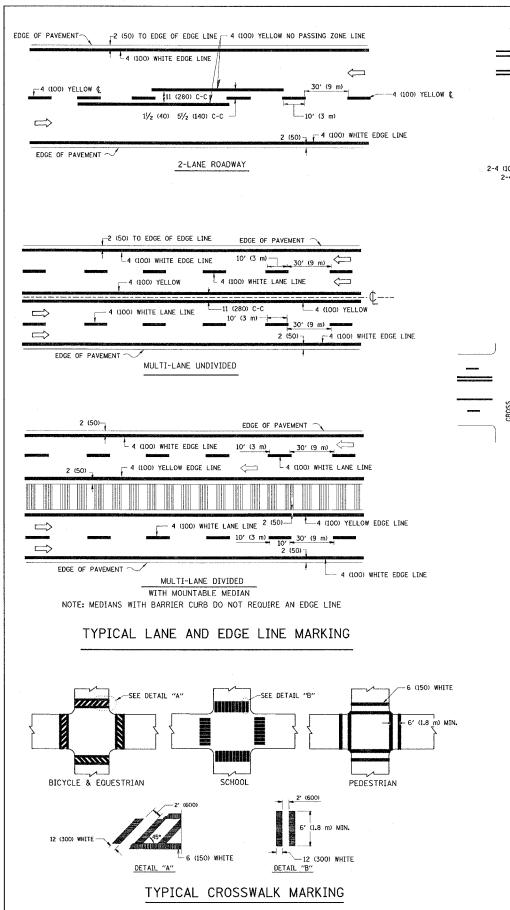

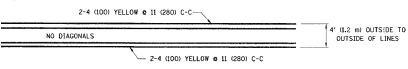


# 4' (1.2 m) WIDE MEDIANS ONLY

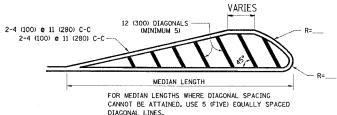


DIAGONAL LINE SPACING: 50' (15 m) C-C (LESS THAN 30MPH (50 km/h))
75' (25 m) C-C 30MPH (50 km/h) TO 45MPH (70 km/h))
150' (45 m) C-C (MORE THAN 45MPH (70 km/h))

# MEDIANS OVER 4' (1.2 m) WIDE

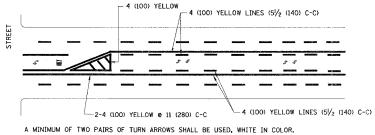


ADDITIONAL PAIRS SHALL BE PLACED AT 200' (60 m) TO 300' (90 m) INTERVALS.

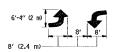

MEDIAN WITH TWO-WAY LEFT TURN LANE

# TYPICAL PAINTED MEDIAN MARKING

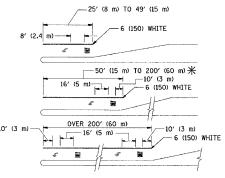


FULL SIZE LETTERS 8' (2.4 m) AND ARROWS SHALL BE USED.  $\P$  AREA = 15.6 SQ. FT. (1.5 m²) ) ([[Y] AREA = 20.8 SQ. FT. (1.9 m²)

\* TURN LANES IN EXCESS OF 400' (120 m) IN LENGTH MAY HAVE AN ADDITIONAL SET OF ARROW - "ONLY" INSTALLED MIDWAY BETWEEN THE OTHER TWO SETS OF ARROW - "ONLY".

TYPICAL LEFT (OR RIGHT) TURN LANE

# TYPICAL TURN LANE MARKING

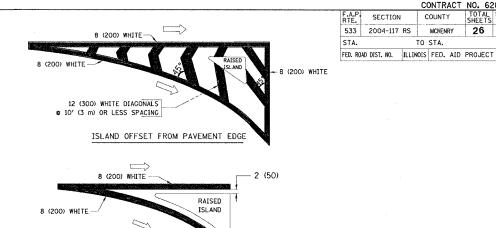

# TYPICAL ISLAND MARKING

ISLAND AT PAVEMENT EDGE

TYPE OF MARKING	WIDTH OF LINE	PATTERN	COLOR	SPACING / REMARKS
CENTERLINE ON 2 LANE PAVEMENT	4 (100)	SKIP-DASH	YELLOW	10' (3 m) LINE WITH 30' (9 m) SPACE
CENTERLINE ON MULTI-LANE UNDIVEDED PAVEMENT	2 @ 4 (100)	SOLID	YELLOW	11 (280) C-C
NO PASSING ZONE LINES: FOR ONE DIRECTION FOR BOTH DIRECTIONS	4 (100) 2 & 4 (100)	SOLID SOLID	YELLOW YELLOW	5½ (140) C-C FROM SKIP-DASH CENTERLINE 11 (280) C-C OMIT SKIP-DASH CENTERLINE BETWEEN
LANE LINES	4 (100) 5 (125) ON FREEWAYS	SKIP-DASH SKIP-DASH	WHITE WHITE	10' (3 m) LINE WITH 30' (9 m) SPACE
DOTTED LINES (EXTENSIONS OF CENTER, LANE OR TURN LANE MARKINGS)	SAME AS LINE BEING EXTENDED	SKIP-DASH	SAME AS LINE BEING EXTENDED	2' (600) LINE WITH 6' (1.8 m) SPACE
EDGE LINES	4 (100)	SOLID	YELLOW-LEFT WHITE-RIGHT	OUTLINE MOUNTABLE MEDIANS IN YELLOW; EDGE LINES ARE NOT USED NEXT TO BARRIER CURB
TURN LANE MARKINGS	6 (150) LINE; FULL SIZE LETTERS & SYMBOLS (8' (2.4m))	SOLID	WHITE	SEE TYPICAL TURN LANE MARKING DETAIL
TWO WAY LEFT TURN MARKING	2 @ 4 (100) EACH DIRECTION	SKIP-DASH AND SOLID	YELLOW	10' (3 m) LINE WITH 30' (9 m) SPACE FOR SKIP-DASH; 5½ (140) C-C BETWEEN SOLID LINE AND SKIP-DASH LINE
	8' (2.4m) LEFT ARROW	IN PAIRS	WHITE	SEE TYPICAL TWO-WAY LEFT TURN MARKING DETAIL
CROSSWALK LINES (PEDESTRIAN) A. DIAGONALS (BIKE & EQUESTRIAN) B. LONGITUDINAL BARS (SCHOOL)	2 @ 6 (150) 12 (300) @ 45° 12 (300) @ 90°	SOLID SOLID SOLID	WHITE WHITE WHITE	NOT LESS THAN 6' (1.8 m) APART 2' (600) APART 2' (600) APART SEE TYPICAL CROSSWALK MARKING DETAILS.
STOP LINES	24 (600)	SOLID	WHITE	PLACE 4' (1.2 m) IN ADVANCE OF AND PARALLEL TO CROSSWALK, IF PRESENT. OTHERWISE, PLACE AT DESIRED STOPPING POINT. PARALLEL TO CROSSROAD CENTERLINE, WHERE POSSIBLE
PAINTED MEDIANS	2 @ 4 (100) WITH 12 (300) DIAGONALS	SOLID	YELLOW: TWO WAY TRAFFIC	11 (280) C-C FOR THE DOUBLE LINE
	0 45° NO DIAGONALS USED FOR 4' (1.2 m) WIDE MEDIANS		WHITE: ONE WAY TRAFFIC	SEE TYPICAL PAINTED MEDIAN MARKING.
GORE MARKING AND CHANNELIZING LINES	8 (200) WITH 12 (300) DIAGONALS & 45°	SOLID	WHITE	DIAGONALS: 15' (4.5 m) C-C (LESS THAN 30MPH (50 km/h)) 20' (6 m) C-C 30MPH (50 km/h) TO 45MPH (70 km/h)) 30' (9 m) C-C (OVER 45MPH (70 km/h))
RAILROAD CROSSING	24 (600) TRANSVERSE LINES; "RR" IS 6' (1.8 m) LETTERS; 16 (400) LINE FOR "X"	SOLID	WHITE	SEE STATE STANDARD 780001 AREA OF: "R"=3.6 SQ. FT. (0.33 m <sup>2</sup> ) EACH "X"=54.0 SQ. FT. (5.0 m <sup>2</sup> )
SHOULDER DIAGONALS	12 (300) <b>@</b> 45°	SOLID	WHITE - RIGHT YELLOW - LEFT	50' (15 m) C-C (LESS THAN 30MPH (50 km/h)) 75' (25 m) C-C (30 MPH (50 km/h) TO 45MPH (70 km/h)) 150' (45 m) C-C (0VER 45MPH (70 km/h))

FOR FURTHER DETAILS ON PAVEMENT MARKING REFER TO STANDARD SPECIFICATIONS FOR ROAD AND BRIDGE CONSTRUCTION AND STATE STANDARD 780001.

All dimensions are in millimeters (inches) unless otherwise shown.

REVISIONS		THE THOIS DEPARTME	ENT OF TRANSPORTATION
NAME	DATE	ILLINOIS DEPARTME	INT OF TRANSPORTATION
EVERS	03-19-90		
T. RAMMACHER	10-27-94	DISTR	RICT ONF
ALEX HOUSEH	10-09-96	01311	ATOT ONL
ALEX HOUSEH	10-17-96	TYPICAL	PAVEMENT
T. RAMMACHER	01-06-00	LAAF	RKINGS
i		MAF	(VING)
		SCALE: NONE	DRAWN BY CADD
		SCALE: NONE	DRAWN BT CADU
		DATE: 3/29/2007	CHECKED BY
			TC-13

REVISION DATE: 01/06/00

CONTRACT NO. 62873 TOTAL SHEE SHEETS NO.


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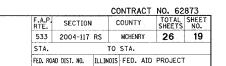
SECTION COUNTY


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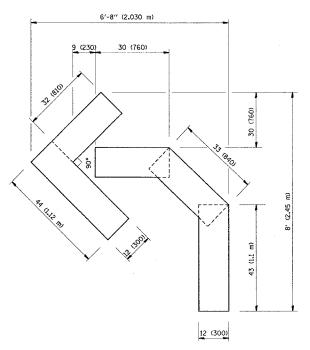
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DATE :: NAME :: SCALE :: NAME ::








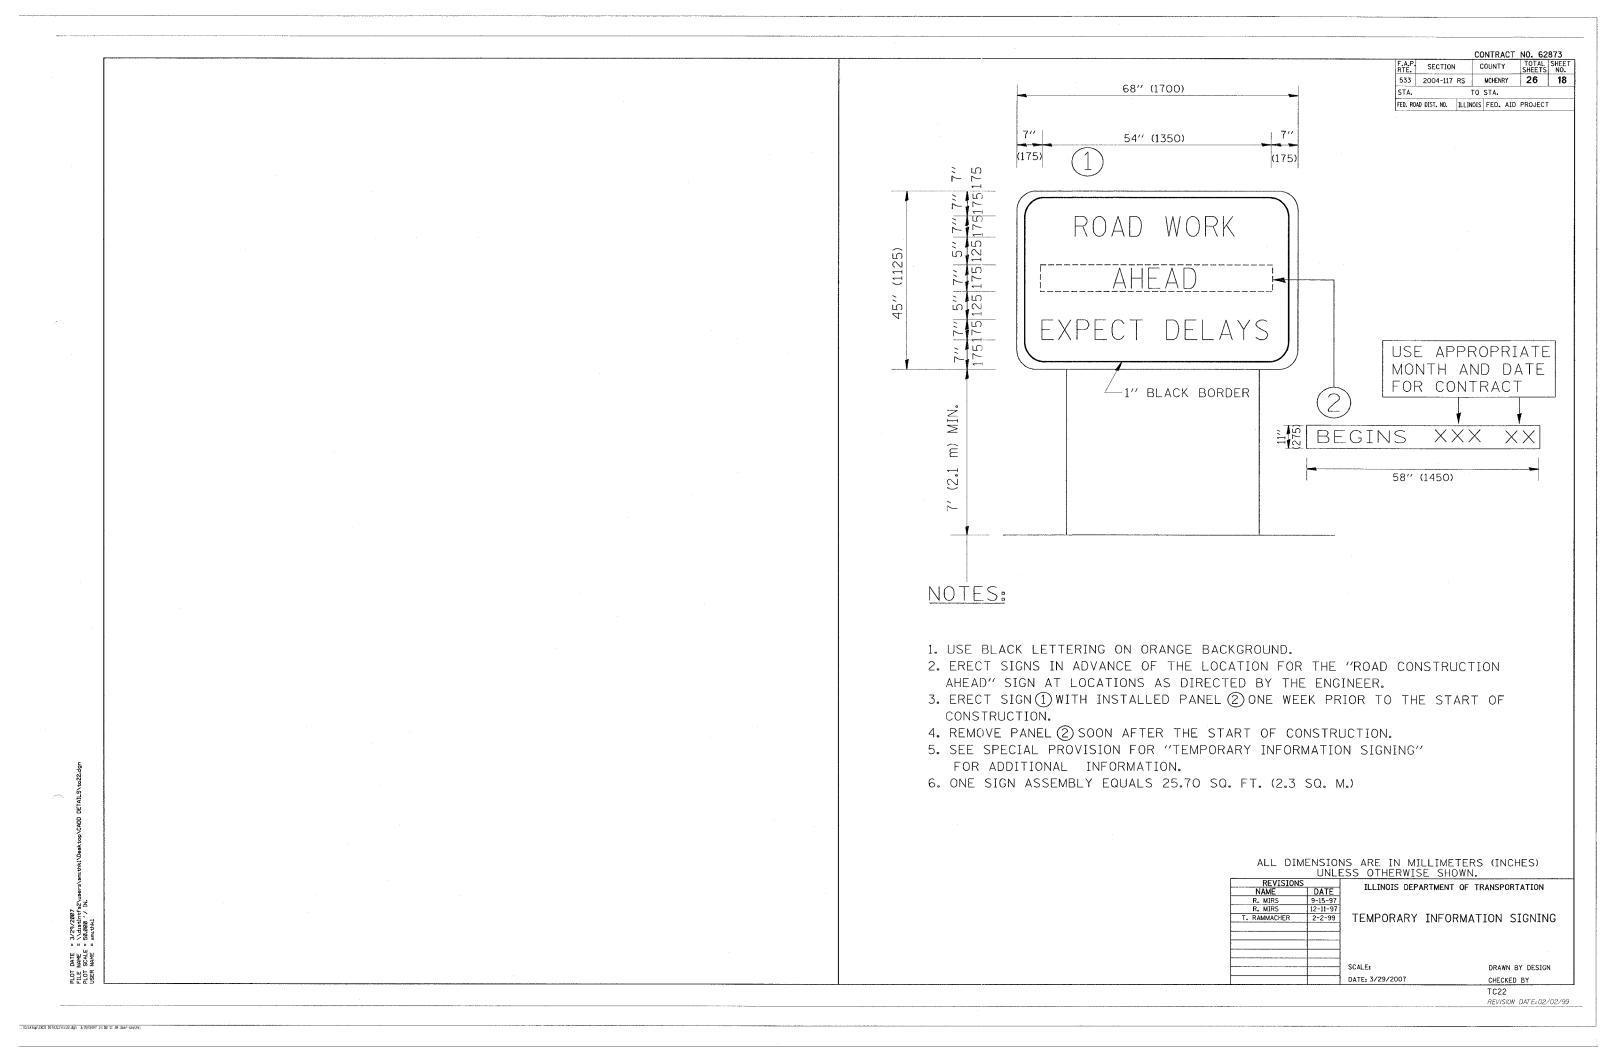

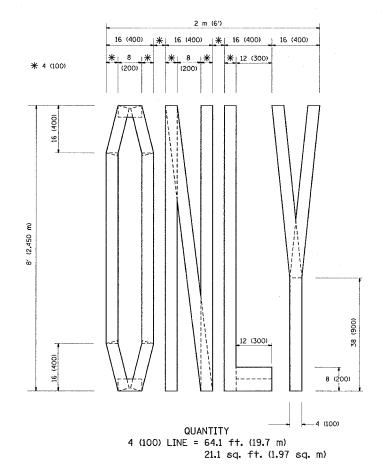QUANTITY 4 (100) LINE = 45.5 ft. (13.9 m) 15.2 sq. ft. (1.39 sq. m)

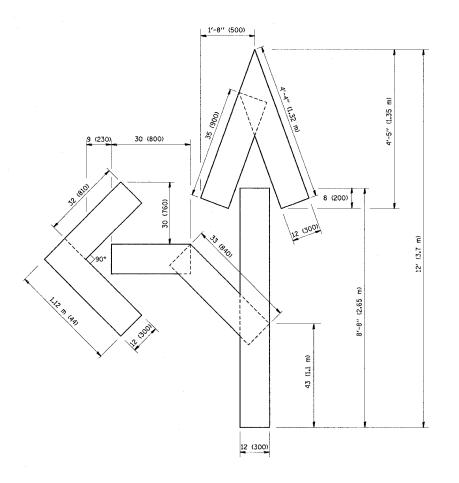

QUANTITY 4 (100) LINE = 82.5 ft. (25.3 m) 27.5 sq. ft. (2.53 sq. m)

All dimensions are in millimeters (inches) unless otherwise shown.


09/18/94
06/01/96
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11/04/97
03/02/98
08/28/00

ILLINOIS DEPARTMENT OF TRANSPORTATION

PAVEMENT MARKING LETTERS AND SYMBOLS FOR TRAFFIC STAGING

SCALE: NONE DATE: 3/29/2007 DRAWN BY CADD CHECKED BY TC-16

10,011 BYEE 08,108,11

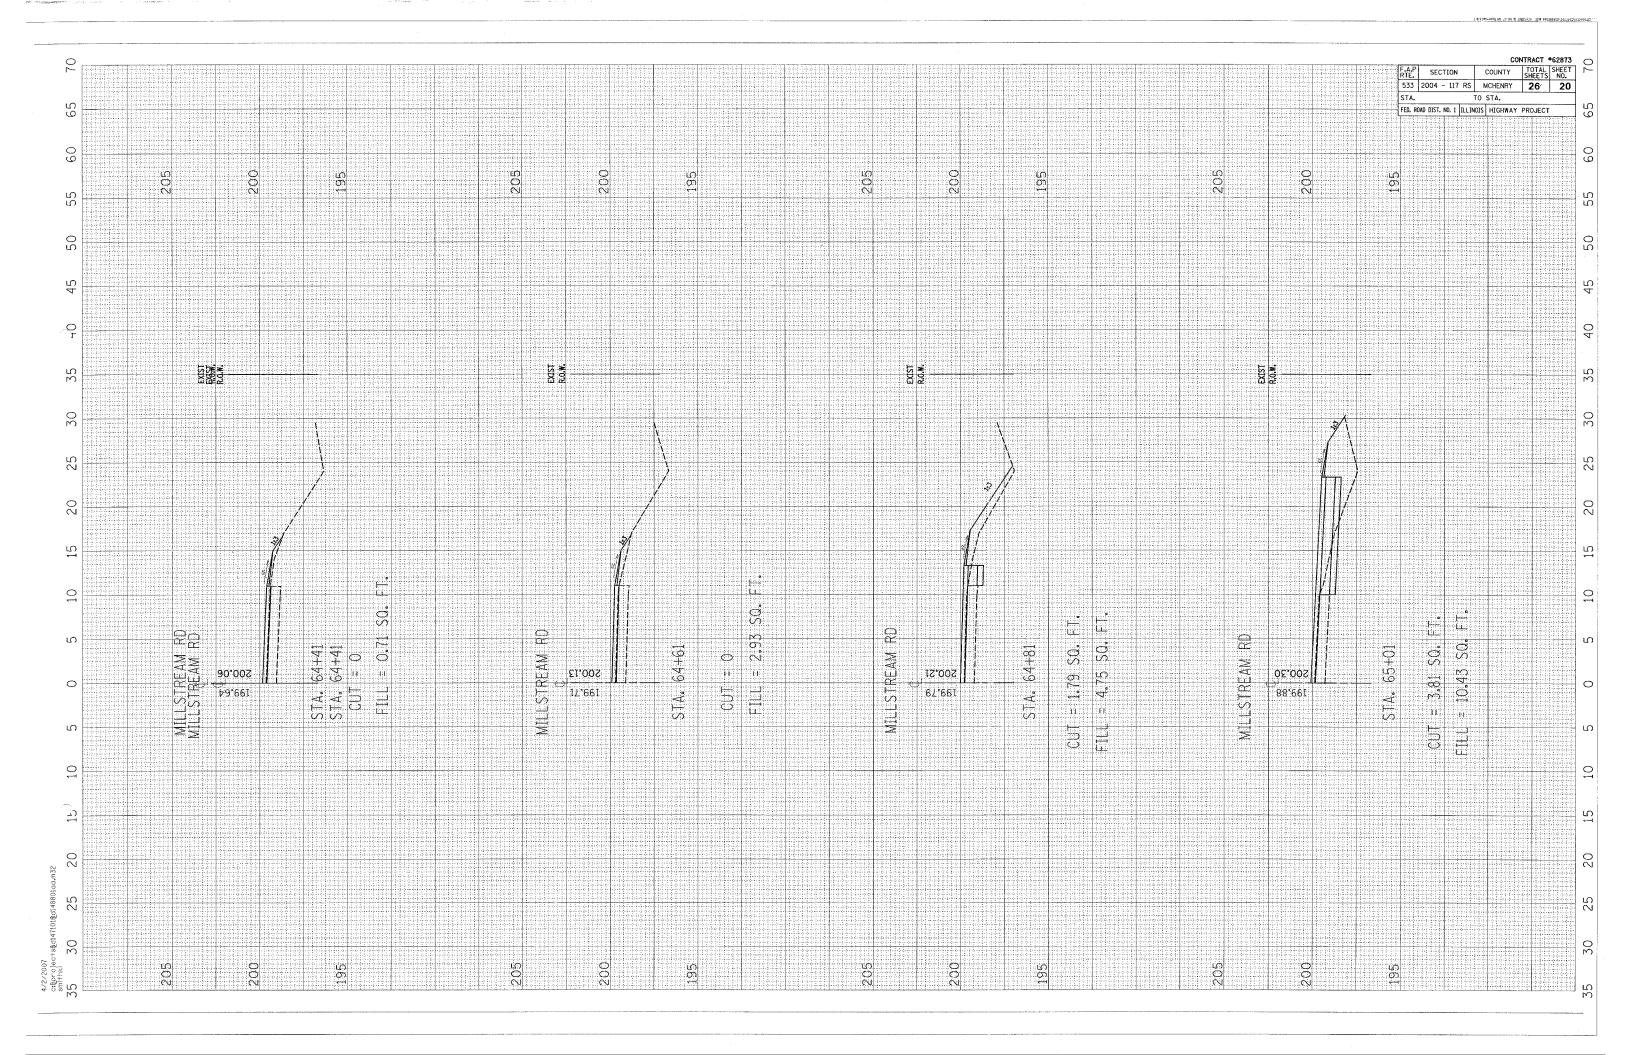

MILINE-1980 NA 129 AE 18 TODS/S/4 SEN NATOBOATU/10172-11/21/2016/2

