#### 09-20-2024 LETTING ITEM 014

FOR INDEX OF SHEETS, SEE SHEET NO. 2

FOR LIST OF HIGHWAY STANDARDS, SEE SHEET NO. 2

PROJECT IS LOCATED IN THE CITY OF ELMHURST

#### **TRAFFIC DATA:**

0

US ROUTE 20 S.N. 022-0090 2022 ADT = 13,300

**DESIGN CLASSIFICATION = INTERSTATE** 

POSTED SPEED = 55 MPH

INTERSTATE I-290 2022 ADT = 102.100

**DESIGN CLASSIFICATION - INTERSTATE (I-290)** 

POSTED SPEED = 55 MPH

#### 100' 200' 300'—1"=100' 0 10' 20' 30'—1"=10' 0 50' 100' 1"= 50' 0 50' 100' 1"= 40' 0 50' 100' 100' - 1"= 30' 0 50' 100' - 1"= 20'

FULL SIZE PLANS HAVE BEEN PREPARED USING STANDARD ENGINEERING SCALES. REDUCED SIZED PLANS WILL NOT CONFORM TO STANDARD SCALES. IN MAKING MEASUREMENTS ON REDUCED PLANS, THE ABOVE SCALES MAY BE USED.

J.U.L.I.E

JOINT UTILITY LOCATION INFORMATION FOR EXCAVATION 1-800-892-0123

OR 811

0


PROJECT ENGINEER: RODRIGO LEDEZMA (847) 705-4580 PROJECT MANAGER: J. ALAIN MIDY (847) 221-3056

**CONTRACT NO. 62W80** 

# STATE OF ILLINOIS DEPARTMENT OF TRANSPORTATION

# PROPOSED HIGHWAY PLANS

FAI ROUTE I-29 0 (EISENHOWER EXPW)
AT US ROUTE 20 (LAKE ST)
SECTION (22-2-3HB) BR 24
WING WALL REPAIR
DUPAGE COUNTY

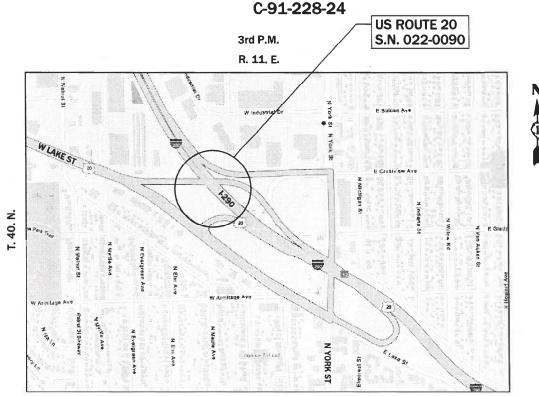

**ADDISON TOWNSHIP** 

## **LOCATION MAP**

**NOT TO SCALE** 


GROSS LENGTH = 2628 FT. = 0.50 MILES NET LENGTH = 12 FT. = 0.002 MILES




6/26/2024

Shiraz Tarique Date Illinois Registered Engineer No. 062-064219 Registration Expires Nov. 30, 2025

## F.A.I. SECTION COUNTY TOTAL SHEET NO. 290 (22-2-3HB) BR 24 DUPAGE 27 1 1 ILLINOIS CONTRACT NO. 62W80

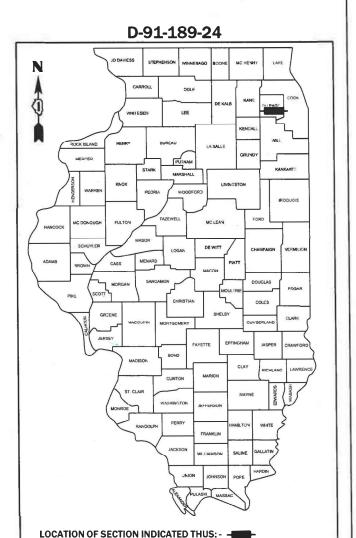



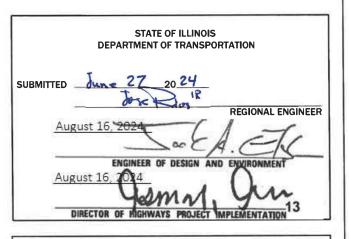

PRINTED BY THE AUTHORITY
OF THE STATE OF ILLINOIS

#### INDEX OF SHEETS

1 COVER SHEET

INDEX, HIGHWAY STANDARDS & GENERAL NOTES

3 - 6 SUMMARY OF QUANTITIES

7 - 10 STAGING PLAN 11 - 12 ROADWAY PLAN

13 EROSION CONTROL PLAN

14 - 16 STRUCTURAL PLAN

17 - 27 DISTRICT ONE STANDARDS

#### **HIGHWAY STANDARDS**

000001-08 STANDARD SYMBOLS, ABBREVIATIONS AND PATTERNS 001001-02 AREAS OF REINFORCEMENT BARS

001001-02 AREAS OF REINFORCEMENT BARS 001006 DECIMAL OF AN INCH AND OF A FOOT

280001-07 TEMPORARY EROSION CONTROL SYSTEMS

442101-09 CLASS B PATCHES

482006-03 HMA SHOULDER ADJACENT TO RIGID PAVEMENT

643001-02 SAND MODULE IMPACT ATTENUATORS

701106-02 OFF-ROAD OPERATIONS, MULTILANE, MORE THAN 15' (4.5 M) AWAY

701400-12 APPROACH TO LANE CLOSURE, FREEWAY/EXPRESSWAY

701401-13 LANE CLOSURE, FREEWAY/EXPRESSWAY

701411-09 LANE CLOSURE, MULTILANE, AT ENTRANCE OR EXIT RAMP, FOR SPEEDS  $\geq$  45 MPH 701423-10 LANE CLOSURE, MULTILANE, WITH BARRIER, FOR SPEEDS  $\geq$  45 MPH TO 55 MPH

701423-10 LANE CLOSURE, MULTILANE, WITH BARRIER, FOR SPEEDS ≥ 45 MPH TO 55 MPH
701428-01 TRAFFIC CONTROL, SETUP AND REMOVAL, FREEWAY/EXPRESSWAY

701446-11 TWO LANE CLOSURE, FREEWAY/EXPRESSWAY

701901-09 TRAFFIC CONTROL DEVICES

704001-08 TEMPORARY CONCRETE BARRIER

782006-01 GUARDRAIL AND BARRIER WALL REFLECTOR MOUNTING DETAILS

#### **DISTRICT STANDARDS**

TC-8 ENTRANCE AND EXIT RAMP CLOSURE DETAILS

TC-11 TYPICAL APPLICATIONS RAISED REFLECTIVE PAVEMENT MARKERS (SNOW-PLOW RESISTANT)

TC-12 MULTI-LANE FREEWAY PAVEMENT MARKING DETAILS

TC-13 DISTRICT ONE TYPICAL PAVEMENT MARKINGS

TC-17 TRAFFIC CONTROL DETAILS FOR FREEWAY SHOULDER CLOSURES AND PARTIAL RAMP CLOSURES

TC-18 FREEWAY/EXPRESSWAY SIGNING FOR FLAGGING OPERATIONS AT WORK ZONE OPENINGS

ON FREEWAYS/EXPRESSWAYS
BM-21 REMOVE AND REERECT STEEL PLATE BEAM GUARDRAIL

HOT- MIX ASPHALT MIXTURE REQUIREMENTS							
MIXTURE TYPE	AIR VOIDS	QUALITY MANAGEMENT PROGRAM (QMP)					
SHOULDER REPAIR							
HMA SURFACE COURSE, MIX "D", IL-9.5, N70, 1½" 4.0% @ 70 GYR. QC/QA							
QMP DESIGNATION: QUALITY CONTROL/QUALITY ASSURANCE (QC/QA); QUALITY CONTROL FOR PERFORMANCE (QCP)							

#### **MIXTURE TABLE NOTES**

- 1. THE UNIT WEIGHT USED TO CALCULATE ALL HOT-MIX ASPHALT SURFACE MIXTURE QUANTITIES IS 112 LBS/SQYD/IN.
- 2. THE AC TYPE FOR POLYMERIZED HMA MIXES SHALL BE "SBS/SBR PG 76-22" AND FOR NON-POLYMERIZED HMA THE AC TYPE SHALL BE "PG 64-22" UNLESS MODIFIED BY RECLAIMED MATERIALS SPECIFICATION.

FACTORS FOR ESTIMATING PLAN QUANTITIES ARE AS FOLLOWS AND SHALL NOT BE USED FOR THE BASIS OF FINAL QUANTITIES:

AGGREGATE SHOULDERS	1.60 TONS/CU YD
SEEDING, CLASS 2A	200 LB/ACRE
NITROGEN FERTILIZER NUTRIENT	90 LB/ACRE
PHOSPHORUS FERTILIZER NUTRIENT	90 LB/ACRE
POTASSIUM FERTILIZER NUTRIENT	90 LB/ACRE
SHORT TERM PAVEMENT MARKING	10 FT/100 FT
GRANULAR MATERIAL	2.05 TONS/CU YD
MULCH	2 TON/ACRE

#### **GENERAL NOTES**

- THE THICKNESS OF HMA SHOWN ON THE PLANS IS THE NOMINAL THICKNESS. DEVIATIONS FROM THE NOMINAL THICKNESS
  WILL BE PERMITTED WHEN SUCH DEVIATIONS OCCUR DUE TO IRREGULARITIES IN THE EXISTING SURFACE OR BASE ON
  WHICH THE HMA IS PLACED.
- 2. BEFORE BEGINNING ANY WORK, THE CONTRACTOR SHALL RETAIN AND RECORD FOR FUTURE REFERENCE, ALL EXISTING PAVEMENT MARKING LINES AND RAISED REFLECTIVE PAVEMENT MARKERS THAT CONFLICT WITH TEMPORARY MARKINGS, IN ORDER THAT THESE LOCATIONS CAN BE RE-ESTABLISHED FOR PROPOSED STRIPING AT THE COMPLETION OF THIS CONTRACT. EXACT LOCATIONS OF ALL PROPOSED PAVEMENT MARKINGS SHALL BE DIRECTED BY THE RESIDENT ENGINEER.
- THE CONTRACTOR WILL NOT BE ALLOWED TO SET UP A YARD OR FIELD OFFICE ON STATE PROPERTY WITHOUT WRITTEN PERMISSION FROM THE DEPARTMENT.
- 4. IT SHALL BE THE CONTRACTORS RESPONSIBILITY TO VERIFY ALL DIMENSIONS AND CONDITIONS EXISTING IN THE FIELD PRIOR TO CONSTRUCTION AND ORDERING MATERIALS.
- 5. THE CONTRACTOR SHALL COORDINATE CONSTRUCTION ACTIVITIES WITH AFFECTED UTILITY COMPANIES AND THE VILLAGE OF ELMHURST.
- 6. THE CONTRACTOR SHALL CONTRACT THE DISTRICT ONE TRAFFIC CONTROL SUPERVISOR AT (847) 705-4155, ARTERIAL TRAFFIC CONTROL SUPERVISOR AT KALPANA.KANNAN-HOSADURGA@ILLINOIS.GOV, AND THE EXPRESSWAY TRAFFIC CONTROL SUPERVISOR AT CARLOSMUNOZ@ILLINOIS.GOV A MINIMUM OF 72 HOURS IN ADVANCE OF BEGINNING ANY WORK.
- 7. DURING CONSTRUCTION OPERATIONS, IF ANY LOOSE MATERIAL IS DEPOSITED IN THE FLOW LINE OF DRAINAGE STRUCTURES SUCH THAT THE NATURAL FLOW OF WATER IS OBSTRUCTED, THE MATERIAL SHALL BE REMOVED AT THE CLOSE OF EACH WORKDAY, AT THE CONCLUSION OF CONSTRUCTION OPERATIONS, ALL UTILITY STRUCTURES SHALL BE FREE FROM DUST AND DEBRIS. THE WORK SPECIFIED ABOVE WILL NOT BE PAID SEPARATELY BUT SHALL BE INCLUDED IN THE COST OF THE CONTRACT.
- 8. TWO WEEKS PRIOR TO THE PLACEMENT OF PERMANENT PAVEMENT MARKINGS, THE ENGINEER SHALL CONTACT EMAD ALHUSSEINI, THE AREA TRAFFIC FIELD ENGINEER, AT EMAD.ALHUSSEINI@ILLINOIS.GOV.
- 9. THE CONTRACTOR MUST VERIFY THE EXISTING SUBBASE AND PAVEMENT DEPTH IF APPLICABLE.
- 10. ALL STAGE CHANGES REQUIRING THE STOPPING AND/OR THE PACING OF TRAFFIC SHALL TAKE PLACE DURING THE ALLOWABLE HOURS FOR FULL EXPRESSWAY CLOSURES AND SHALL BE APPROVED BY THE DEPARTMENT. THE CONTRACTOR SHALL NOTIFY THE DISTRICT ONE EXPRESSWAY TRAFFIC CONTROL SUPERVISOR AT LEAST 3 WORKING DAYS (WEEKENDS AND HOLIDAYS DO NOT COUNT INTO THIS 72 HOURS NOTIFICATION) IN ADVANCE OF ANY PROPOSED STAGE CHANGE.
- 11. A MAINTENANCE OF TRAFFIC PLAN SHALL BE SUBMITTED TO THE DISTRICT ONE EXPRESSWAY TRAFFIC CONTROL SUPERVISOR 14 DAYS IN ADVANCE OF ANY STAGE CHANGES OR FULL EXPRESSWAY CLOSURES. THE MAINTENANCE OF TRAFFIC PLAN SHALL INCLUDE, BUT NOT BE LIMITED TO: LANE AND RAMP CLOSURES, EXISTING GEOMETRICS, AND EOUIPMENT AND MATERIAL LOCATION.
- 12. ALL DRAINAGE STRUCTURES LOCATIONS MUST BE FIELD VERIFIED BY THE CONTRACTOR PRIOR TO BEGINNING CONSTRUCTION
- 13. FOR ALL LOCATIONS OF PATCHING IMPROVEMENTS SHOWN IN THE PLANS, THE REMOVAL OF BOTH THE EXISTING PCC PAVEMENT AND HMA OVERLAY SHALL BE INCLUDED IN THE COST OF THE CLASS B PATCHING ITEM.
- 14. PAVEMENT MARKING TAPE, TYPE IV SHALL BE USED FOR SHORT TERM PAVEMENT MARKINGS ON ALL FINAL SURFACES.

SCALE: N.T.S.

 	US
LIN ENGINEERING,LTD.	
Consulting Engineers	PL
Westmont, Illinois	PL

T	USER NAME = jkehn	DESIGNED - JK	REVISED -
Γ		DRAWN - JK	REVISED -
Γ	PLOT SCALE = 100.0000 / in.	CHECKED - RC	REVISED -
	PLOT DATE = \$DATE\$	DATE - 5/2	024 REVISED -

I-	290 A	r us	RO	UT	E 20 (V	V LAKE	STREET)	F.A.I. RTE	SEC	TION		COUNTY	TOTAL SHEETS	SHEET NO.
INDEX, HIGHWAY STANDARDS & GENERAL NOTES						290	(22-2-3H	B) BR 24	1	DUPAGE	27	2		
INDEX	, man	**^	1 31	~! <b>`</b>	יאורטי	J G GL	ILITAL HOTES					CONTRACT	NO. 62	W80
N.T.S.	SHEET	1	OF	1	SHEETS	STA.	TO STA.			ILLINOIS	FED. AI	D PROJECT		

			-	
				CONSTRUCTION CODE
				100% STATE
				SN 022-0090
CODE	ITEM	UNIT	TOTAL	0059
NO.	1164	ONT	QUANTITY	BRIDGE
				BNIDGE
20200100	EARTH EXCAVATION	CU YD	5	5
25000210	SEEDING, CLASS 2A	ACRE	0.25	0.25
25000400	NITROGEN FERTILIZER NUTRIENT	POUND	30	30
25000500	PHOSPHORUS FERTILIZER NUTRIENT	POUND	30	30
25000600	POTASSIUM FERTILIZER NUTRIENT	POUND	30	30
25100630	EROSION CONTROL BLANKET	SQ YD	8	8
28000400	PERIMETER EROSION BARRIER	FOOT	24	24
28000500	INLET AND PIPE PROTECTION	EACH	1	1
40600290	BITUMINOUS MATERIALS (TACK COAT)	POUND	4	4
40604062	HOT-MIX ASPHALT SURFACE COURSE, IL-9.5, MIX "D", N70	TON	0.4	0.4
44200966	CLASS B PATCHES, TYPE I, 10 INCH	SQ YD	5	5
44213206	TIE BARS 5/8"	EACH	7	7
50102400	CONCRETE REMOVAL	CU YD	5.5	5.5
50200100	STRUCTURE EXCAVATION	CU YD	13.8	13.8
				<del></del>

#### \* SPECIALTY ITEM



USER NAME = jkehn	DESIGNED	-	JK	REVISED	-
	DRAWN	-	JK	REVISED	-
PLOT SCALE = 100.0000 / in.	CHECKED	-	RC	REVISED	-
PLOT DATE = \$DATE\$	DATE	-	5/2024	REVISED	-

STATE OF ILLINOIS
DEPARTMENT OF TRANSPORTATION

-					•	V LAKE: ANTITIE	STREET) S
	SHEET	1	OF	4	SHEETS	STA	TO STA

SCALE: N.T.S.

F.A.I. RTE.	SEC <sup>-</sup>	ПОИ	COUNTY	TOTAL SHEETS	SHEE NO.	
290	(22-2-3HI	DUPAGE	27	3		
				CONTRACT	NO. 62	W80
		ILLINOIS	FED. AI	D PROJECT		

			Γ	CONSTRUCTION
				CODE
				100% STATE
COD 5				SN 022-0090
CODE NO.	ITEM	UNIT	TOTAL QUANTITY	0059
			,	BR I DGE
50300255	CONCRETE SUPERSTRUCTURE	CU YD	5.5	5.5
50300300	PROTECTIVE COAT	SQ YD	5.4	5 . 4
50800205	REINFORCEMENT BARS, EPOXY COATED	POUND	730	730
30000203	RETAIN GROUPENT BARS, ET ONT COATES	1 00145	730	, 50
52000110	PREFORMED JOINT STRIP SEAL	FOOT	1	1
52200020	TEMPORARY SOIL RETENTION SYSTEM	SQ FT	122	122
58600101	GRANULAR BACKFILL FOR STRUCTURES	CU YD	12.1	12.1
63301235	REMOVE AND REERECT STELL PLATE BEAM GUARDRAIL, ATTACHED TO STRUCTURES	FOOT	400	400
67100100	MOBILIZATION	L SUM	1	1
66900200	NON-SPECIAL WASTE DISPOSAL	CU YD	10	10
66900530	SOIL DISPOSAL ANALYSIS	EACH	1	1
				<u> </u>
66901001	REGULATED SUBSTANCES PRE-CONSTRUCTION PLAN	L SUM	1	1
66901003	REGULATED SUBSTANCES FINAL CONSTRUCTION REPORT	L SUM	1	1
00301003	REGULATED SUBSTANCES FINAL CONSTRUCTION REPORT	L JUIVI	1	1
66901006	REGULATED SUBSTANCES MONITORING	CAL DA	2	2
70107025	CHANGEABLE MESSAGE SIGN	CAL DA	35	35

LIN ENGINEERING,LTD.

Consulting Engineers

Consulting Engineers
Westmont, Illinois

\* SPECIALTY ITEM

USER NAME = jkehn	DESIGNED	-	JK	REVISED	-
	DRAWN	-	JK	REVISED	-
PLOT SCALE = 100.0000 ' / in.	CHECKED	-	RC	REVISED	-
PLOT DATE = \$DATE\$	DATE	-	5/2024	REVISED	-

STATE OF ILLINOIS DEPARTMENT OF TRANSPORTATION

										F.A.I. RTE. SECTION				COUNTY TOTA	
										(22-2-3HE	DUPAGE	27			
	Solition to QUANTITIES								CONTRACT NO					NO.	
	SCALE: N.T.S.	SHEET	2	OF	4	SHEETS	STA.	TO STA.			ILLINOIS	FED. AI	D PROJECT		

				CONSTRUCTION CODE
			-	
				100% STATE
CODE			TOTAL	SN 022-0090
NO.	ITEM	UNIT	QUANTITY	0059
				BR I DGE
70300100	SHORT TERM PAVEMENT MARKING	FOOT	244	244
70300150	SHORT TERM PAVEMENT MARKING REMOVAL	SQ FT	888	888
70307100	TEMPORARY PAVEMENT MARKING LETTERS AND SYMBOLS - TYPE IV TAPE	SQ FT	73	73
70307120	TEMPORARY PAVEMENT MARKING - LINE 4" - TYPE IV TAPE	FOOT	1,403	1,403
70307130	TEMPORARY PAVEMENT MARKING - LINE 6" - TYPE IV TAPE	FOOT	202	202
70307140	TEMPORARY PAVEMENT MARKING - LINE 8" - TYPE IV TAPE	FOOT	690	690
70307160	TEMPORARY PAVEMENT MARKING - LINE 12" - TYPE IV TAPE	FOOT	149	149
70400100	TEMPORARY CONCRETE BARRIER	FOOT	112.5	112.5
70600260	IMPACT ATTENUATORS, TEMPORARY (FULLY REDIRECTIVE, NARROW), TEST LEVEL 3	EACH	1	1
78000200	THERMOPLASTIC PAVEMENT MARKING - LINE 4"	FOOT	1,109	1,109
			,	<u> </u>
78000500	THERMOPLASTIC PAVEMENT MARKING - LINE 8"	FOOT	1,051	1,051
78000600	THERMOPLASTIC PAVEMENT MARKING - LINE 12"	FOOT	91	91
	PREFORMED PLASTIC PAVEMENT MARKING - LINE 5"	FOOT	347	347
78004625				
78004625	MODIFIED URETHANE PAVEMENT MARKING - LINE 4"	FOOT	1,033	1,033

\* SPECIALTY ITEM



	USER NAME = jkehn	DESIGNED	-	JK	REVISED	-
		DRAWN	-	JK	REVISED	-
	PLOT SCALE = 100.0000 / in.	CHECKED	-	RC	REVISED	-
	PLOT DATE = \$DATE\$	DATE	-	5/2024	REVISED	-
_						

STATE OF ILLINOIS
DEPARTMENT OF TRANSPORTATION

	SUMMARY OF QUANTI	· 	000				
		290	(22-2-3HB) BR 24	(22-2-3HB) BR 24 DUPAGE			
	SOMMAN OF QUANTI	CONTRACT NO. 62W80					
SCALE: N.T.S. SHEE	T 3 OF 4 SHEETS STA.	TO STA.		ILLINOIS FED	AID PROJECT		

				CONSTRUCTION CODE					
				100% STATE					
				SN 022-0090					
CODE	ITEM	UNIT	TOTAL	0059					
NO.			QUANTITY	BRIDGE					
				BILLEGE					
78011030	GROOVING FOR RECESSED PAVEMENT MARKING 6"	FOOT	347	347					
78300202	PAVEMENT MARKING REMOVAL - WATER BLASTING	SQ FT	885	885					
X6700407	ENGINEER'S FIELD OFFICE, TYPE A (D1)	CAL MO	12	12					
X7011015	TRAFFIC CONTROL AND PROTECTION (EXPRESSWAYS)	L SUM	1	1					
X7013820	20 TRAFFIC CONTROL SURVEILLANCE, EXPRESSWAYS CAL DA 10								
X7200061	TEMPORARY INFORMATION SIGNING	SQ FT	27	27					
X7830050	RAISED REFLECTIVE PAVEMENT MARKER, REFLECTOR REMOVAL	EACH	36	36					
X7830052	RAISED REFLECTIVE PAVEMENT MARKER, REFLECTOR REPLACEMENT  EACH 36								
Z0013798	CONSTRUCTION LAYOUT	L SUM	1	1					

\* SPECIALTY ITEM



	USER NAME = jkehn	DESIGNED -	JK	REVISED -
		DRAWN -	JK	REVISED -
	PLOT SCALE = 100.0000 / in.	CHECKED -	RC	REVISED -
	PLOT DATE = \$DATE\$	DATE -	5/2024	REVISED -
-				

	I-290 AT US ROUTE 20 (W LAKE STREET) SUMMARY OF OUANTITIES											SECT				TOTAL SHEETS	SHEET NO.
												(22-2-3HB) BR 24			DUPAGE	27	6
L	SUMMANT OF QUANTITIES										CONTRACT NO. 62W80				W80		
l	SCALE:	N.T.S.	SHEET	4	OF	4	SHEETS	STA.	TO STA.		ILLINOIS FED. AID PROJECT						

#### MAINTENANCE OR TRAFFIC GENERAL NOTES

- THE MAINTENANCE OF TRAFFIC PLANS SHALL SERVE AS A GUIDE FOR THE SAFE DIVERSION
  OF TRAFFIC DURING THE EXECUTION OF THIS CONTRACT. THE CONTRACTOR MAY MODIFY
  THE MAINTENANCE OF TRAFFIC PLANS TO MEET CONSTRUCTION NEEDS BUT NOT AT THE
  EXPENSE OF PUBLIC SAFETY OR CONVENIENCE. ANY CHANGES TO THE TRAFFIC CONTROL
  PLANS SHALL BE SUBMITTED TO THE ENGINEER FOR APPROVAL.
- 2. EXISTING PAVEMENT MARKINGS THAT CONFLICT WITH TEMPORARY MARKINGS SHALL BE REMOVED. THIS WORK WILL BE PAID FOR AT THE CONTRACT UNIT PRICE PER SQUARE FOOT FOR PAVEMENT MARKING REMOVAL WATER BLASTING.
- 3. EXISTING RAISED REFLECTIVE PAVEMENT MARKER REFLECTORS THAT CONFLICT WITH THE REVISED TRAFFIC PATTERNS, SHALL BE REMOVED FROM THE EXISTING CASTINGS LOCATED IN THE PAVEMENT. THIS WORK WILL BE PAID FOR AT THE CONTRACT UNIT PRICE EACH FOR RAISED REFLECTIVE PAVEMENT MARKER, REFLECTOR REMOVAL.
- 4. THE REMOVAL OF ALL PAVEMENT MARKING TAPE WILL BE PAID FOR AT THE CONTRACT UNIT PRICE SQUARE FOOT FOR SHORT TERM PAVEMENT MARKING REMOVAL.
- ALL TRAFFIC CONTROL DEVICES SHALL BE REFLECTORIZED PRIOR TO INSTALLATION AND CLEANED AS SPECIFIED IN THE TRAFFIC CONTROL SPECIAL PROVISIONS OR AS DIRECTED BY THE ENGINEER.
- 6. EXISTING SIGNS WITHIN THE LIMITS OF TRAFFIC CONTROL WHICH ARE OBSTRUCTED BY OR OTHERWISE INTERFERED WITH BY CONSTRUCTION OPERATIONS OF DESIGNATED TRAFFIC CONTROL, SHALL BE COVERED OR REMOVED BY THE CONTRACTOR UNLESS SPECIFIED IN THE PLANS OR WHEN DIRECTED BY THE ENGINEER. THIS WORK SHALL BE AS SPECIFIED IN ARTICLE 107.25 OF THE STANDARD SPECIFICATIONS.
- 7. SEE STRUCTURAL PLANS FOR WINGWALL RECONSTRUCTION INFORMATION.
- THE CONTRACTOR SHALL CONTACT THE DISTRICT ONE EXPRESSWAY TRAFFIC CONTROL SUPERVISOR AT (847) 705-4155 A MINIMUM OF 72 HOURS IN ADVANCE OF BEGINNING ANY WORK.
- 9. ALL STAGE CHANGES REQUIRING THE STOPPING AND/OR THE PACING OF TRAFFIC SHALL TAKE PLACE DURING THE ALLOWABLE HOURS FOR FULL EXPRESSWAY CLOSURES AND SHALL BE APPROVED BY THE DEPARTMENT. THE CONTRACTOR SHALL NOTIFY THE DISTRICT ONE EXPRESSWAY TRAFFIC CONTROL SUPERVISOR AT LEAST 3 WORKING DAYS (WEEKENDS AND HOLIDAYS DO NOT COUNT INTO THIS 72 HOURS NOTIFICATION) IN ADVANCE OF ANY PROPOSED STAGE CHANGE.
- 10.A MAINTENANCE OF TRAFFIC PLAN SHALL BE SUBMITTED TO THE DISTRICT ONE EXPRESSWAY TRAFFIC CONTROL SUPERVISOR 14 DAYS IN ADVANCE OF ANY STAGE CHANGES OR FULL EXPRESSWAY CLOSURES. THE MAINTENANCE OF TRAFFIC PLAN SHALL INCLUDE, BUT NOT BE LIMITED TO: LANE AND RAMP CLOSURES, EXISTING GEOMETRICS, AND EQUIPMENT AND MATERIAL LOCATION.
- 11.ALL DRUMS SHALL BE PLACED AT 50' CENTERS ON TANGENTS, 20' CENTERS ON TAPERS AND 10' CENTERS ON RADII AND CURVES.
- 12. ALL DRUMS, VERTICAL PANELS, AND BARRICADES ADJACENT TO THE EDGE OF THE TRAVELED WAY SHALL BE EQUIPPED WITH MONO- DIRECTIONAL STEADY BURNING LIGHTS.
- 13.THE CONTRACTOR SHALL REQUEST AND GAIN THE APPROVAL FROM THE ILLINOIS DEPARTMENT OF TRANSPORTATION'S EXPRESSWAY TRAFFIC OPERATIONS ENGINEER AT WWW.IDOTLCS.COM TWENTY FOUR (24) HOURS IN ADVANCE OF ALL DAILY LANE, RAMP AND SHOULDER CLOSURES AND 7 DAYS IN ADVANCE OF ALL PERMANENT AND WEEKEND CLOSURES ON ALL FREEWAYS AND/OR EXPRESSWAYS IN DISTRICT 1. THIS ADVANCE NOTIFICATION IS CALCULATED BASED ON WORK WEEK OF MONDAY THROUGH FRIDAY AND SHALL NOT INCLUDE WEEKENDS OR HOLIDAYS.
- 14. ENGINEER WILL CONFIRM THE MESSAGE AND THE LOCATION OF THE PORTABLE CHANGEABLE MESSAGE SIGNS, CHANGEABLE MESSAGE SIGNS TO BE PLACED 14 DAYS PRIOR TO CLOSURE.

A ROAD CONSTRUCTION AHEAD SIGN AND PCMS SHALL BE PLACED 3 TO 5 MILES IN ADVANCE OF THE PROJECT LIMITS IN A LOCATION DETERMINED BY THE ENGINEER.

#### SUGGESTED SEQUENCE OF OPERATIONS

#### STAGE 1

- INSTALL TEMPORARY TRAFFIC CONTROL DEVICES, TEMPORARY SIGNAGE, & TEMPORARY PAVEMENT MARKINGS TO CLOSE
  THE RIGHT LANE OF THE NB I-290 EXIT RAMP TO US ROUTE 20 (W LAKE STREET) AS THE LOCATIONS SHOWN IN THE
  STAGING PLANS.
- 2. REMOVE EXISTING GUARDRAIL TERMINAL AS SHOWN ON THE ROADWAY PLANS.
- 3. PERFORM WINGWALL RECONSTRUCTION AT S.N. 022-0090 AS SHOWN IN THE ROADWAY AND STRUCTURAL PLANS.
- 4. CONSTRUCT SHOULDER APPROACH PAVEMENT REPAIRS AT LOCATIONS SHOWN IN THE ROADWAY PLANS.
- 5. RE-ERECT THE EXISTING GUARDRAIL TERMINAL AS SHOWN ON THE ROADWAY PLANS.

#### POST STAGE


 DURING THE ALLOWABLE HOURS LISTED IN THE SPECIAL PROVISIONS, UTILIZE HIGHWAY AND DISTRICT STANDARDS TO INSTALL TRAFFIC CONTROL DEVICES AS REQUIRED TO PLACE PERMANENT PAVEMENT MARKINGS AT THE LOCATIONS SHOWN IN THE PLANS.

 E	LIN ENGINEERING,LTD.  Consulting Engineers  Westmont, Illinois
	Westmont, Illinois

	USER NAME = Jkehn	DESIGNED	-	JK	REVISED -
٠		DRAWN	-	JK	REVISED -
	PLOT SCALE = 100.0000 / in.	CHECKED	-	RC	REVISED -
	PLOT DATE = \$DATE\$	DATE	-	5/2024	REVISED -

						,		STREET) FED SEQUENCE
SCALE:	N.T.S.	SHEET	1	OF	4	SHEETS	STA.	TO STA.

F.A.I. RTE.	SECTION	COUNTY	TOTAL SHEETS	SHEE NO.
290	(22-2-3HB) BR 24	DUPAGE	27	7
		CONTRACT	NO. 62	W80
	ILLINOIS FED A	ID PROJECT		

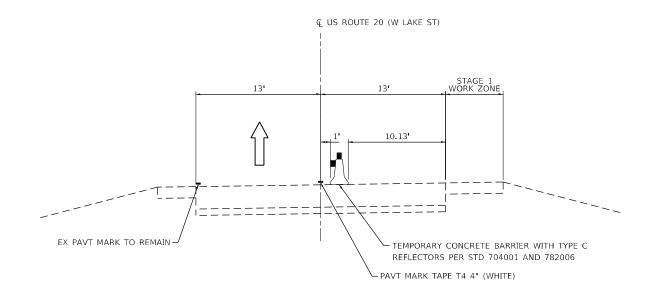

## STAGE 1 TYPICAL SECTION - US RTE 20

US RTE 20 (W LAKE ST) OVER I-290 LOOKING NORTHWEST


LIN ENGINEERING,LTD.	
Consulting Engineers	-
Westmont, Illinois	


USER NAME = Jkehn	DESIGNED - JK	REVISED -	Г
	DRAWN - JK	REVISED -	l
PLOT SCALE = 10.0000 / in.	CHECKED - RC	REVISED -	
PLOT DATE = \$DATE\$	DATE - 5/2024	REVISED -	

STATE OF ILLINOIS DEPARTMENT OF TRANSPORTATION

SCALE: N.T.S.


I-290 AT US ROUTE 20 (W LAKE STREET) STAGING TYPICAL SECTIONS		SECTION	COUNTY	TOTAL SHEETS	SHEET NO.
		(22-2-3HB) BR24	соок	27	8
STAGING TH TOAL SECTIONS			CONTRACT	NO. 62	W80
SHEET 2 OF 4 SHEETS STA. TO STA.		TILINOIS FED A	D PROJECT		

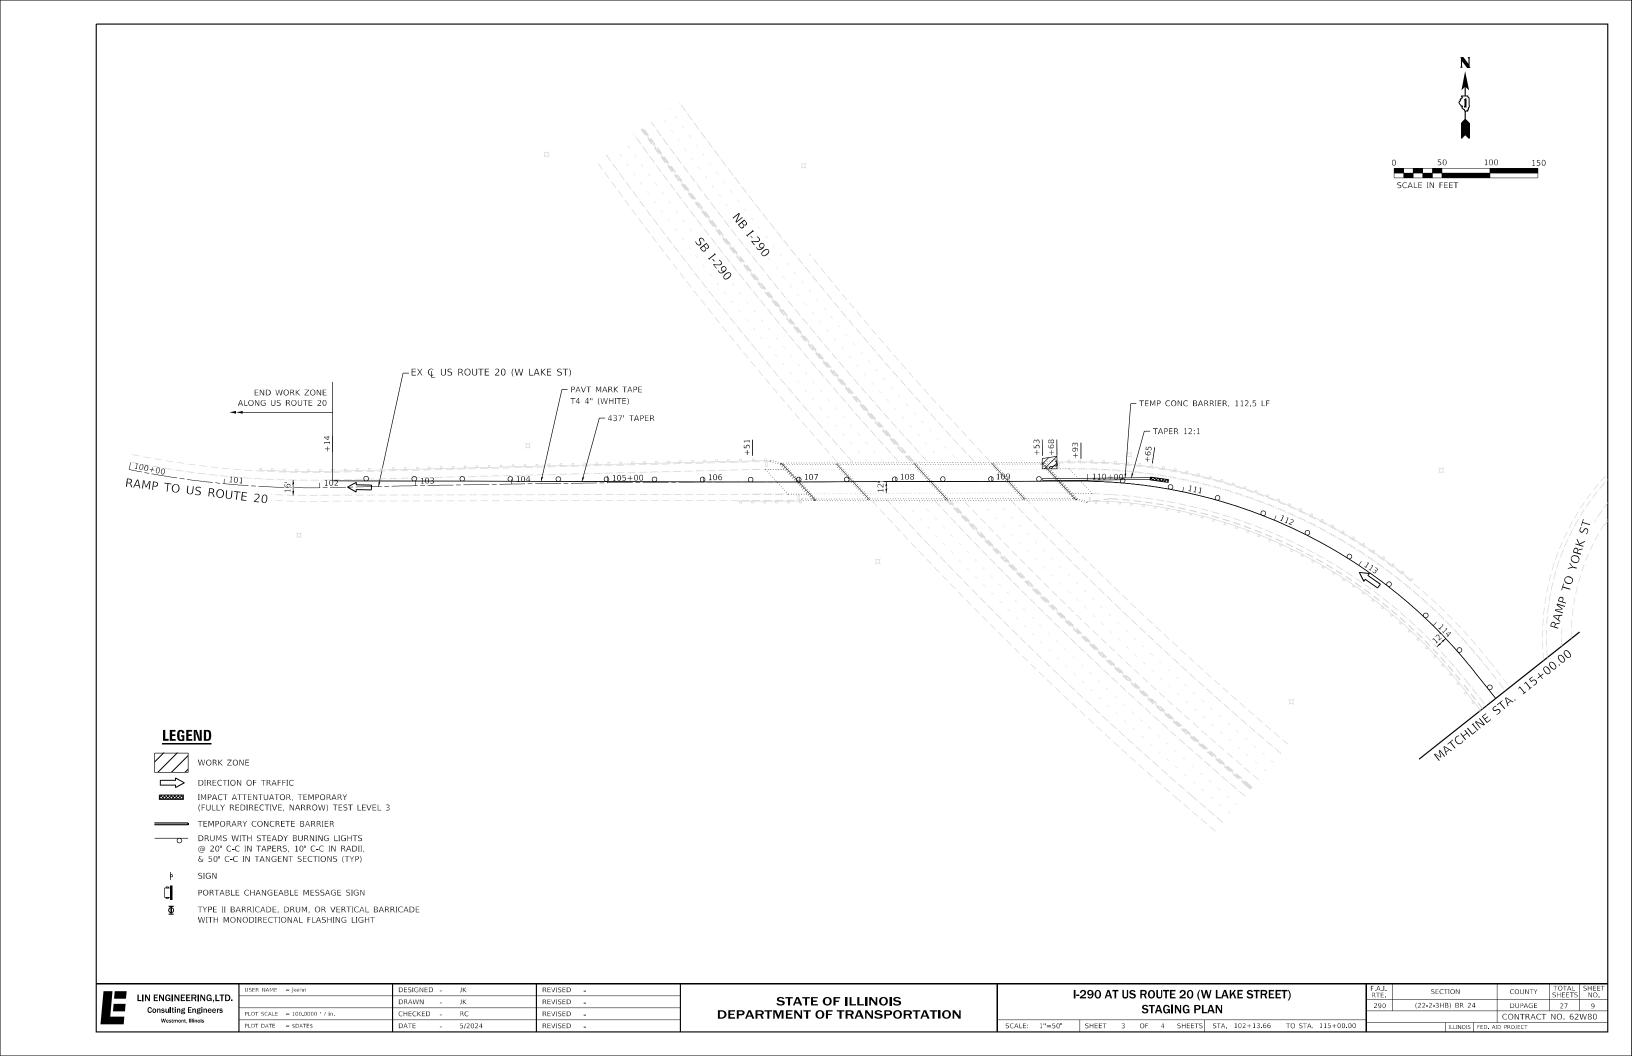


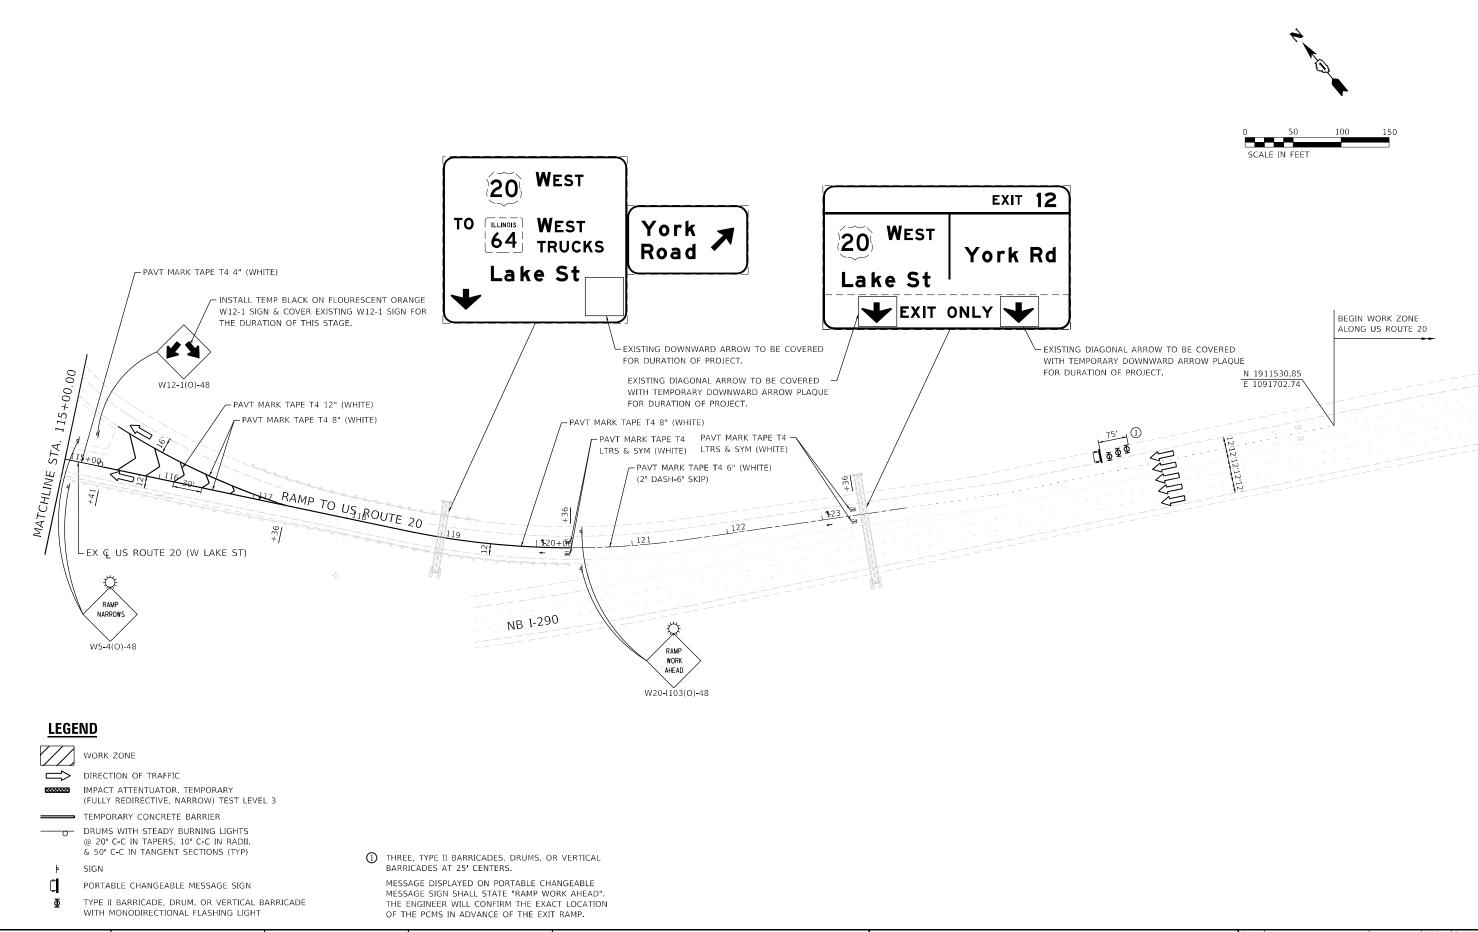


LIN ENGINEERING,LTD.
Consulting Engineers
Westmont, Illinois

STATE OF ILLINOIS
DEPARTMENT OF TRANSPORTATION

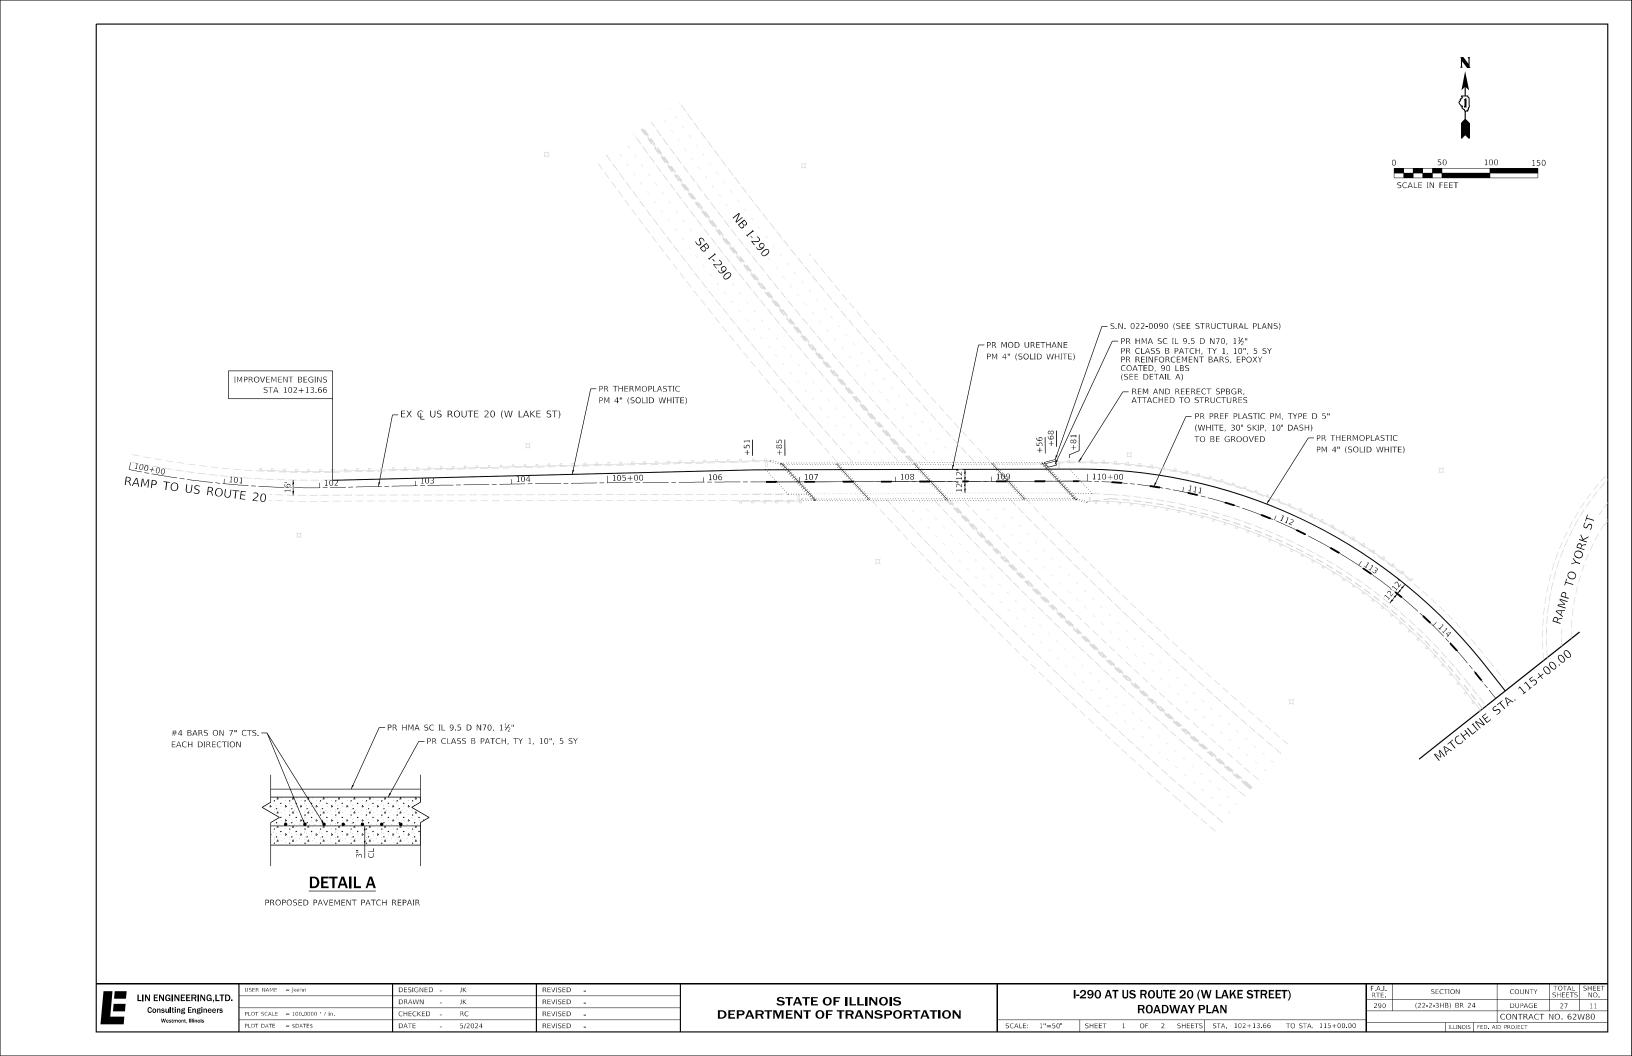


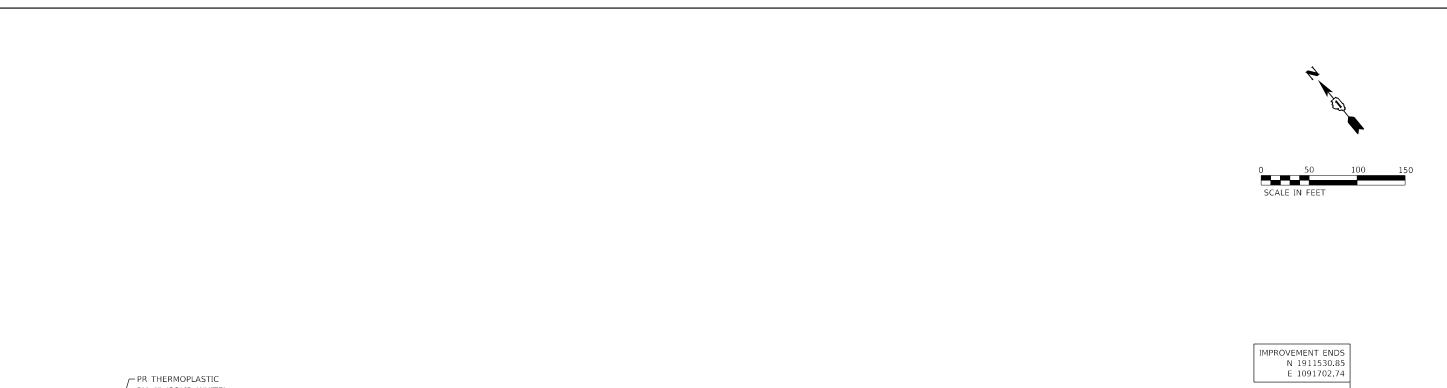

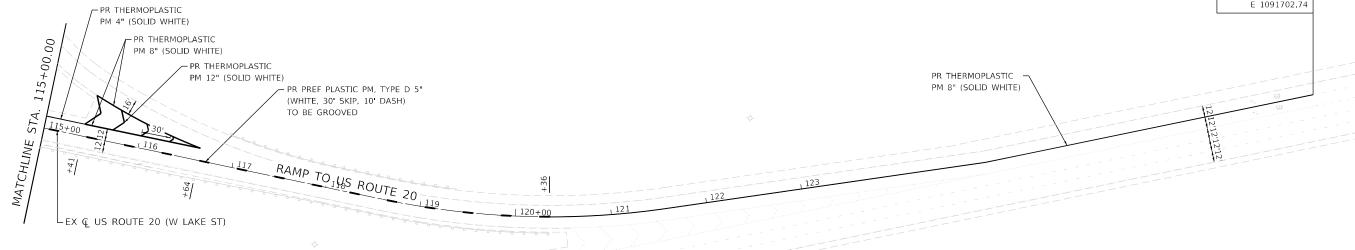


NB 1-290


LIN ENGINEEDING LTD	USER NAME = jkehn	DESIGNED - JK	REVISED -		I-290 AT US ROUTE 20 (W LAKE STREET)			SECTION	COUNTY	TOTAL SHEET
LIN ENGINEERING,LTD.	THE DRAWN - JK REVISED -   SIAIE U		STATE OF ILLINOIS	•	ROADWAY PLAN	290	(22-2-3HB) BR 24	DUPAGE	27 12	
Consulting Engineers	PLOT SCALE = 100.0000 / in	CHECKED - RC	REVISED -	DEPARTMENT OF TRANSPORTATION	RUADWAY PLAN				CONTRACT	NO. 62W80
Westmont, Illinois	PLOT DATE = \$DATE\$	DATE - 5/2024	REVISED -		SCALE: 1"=50'	SHEET 2 OF 2 SHEETS STA. 115+00.00 TO STA		ILLINOIS FED.	AID PROJECT	

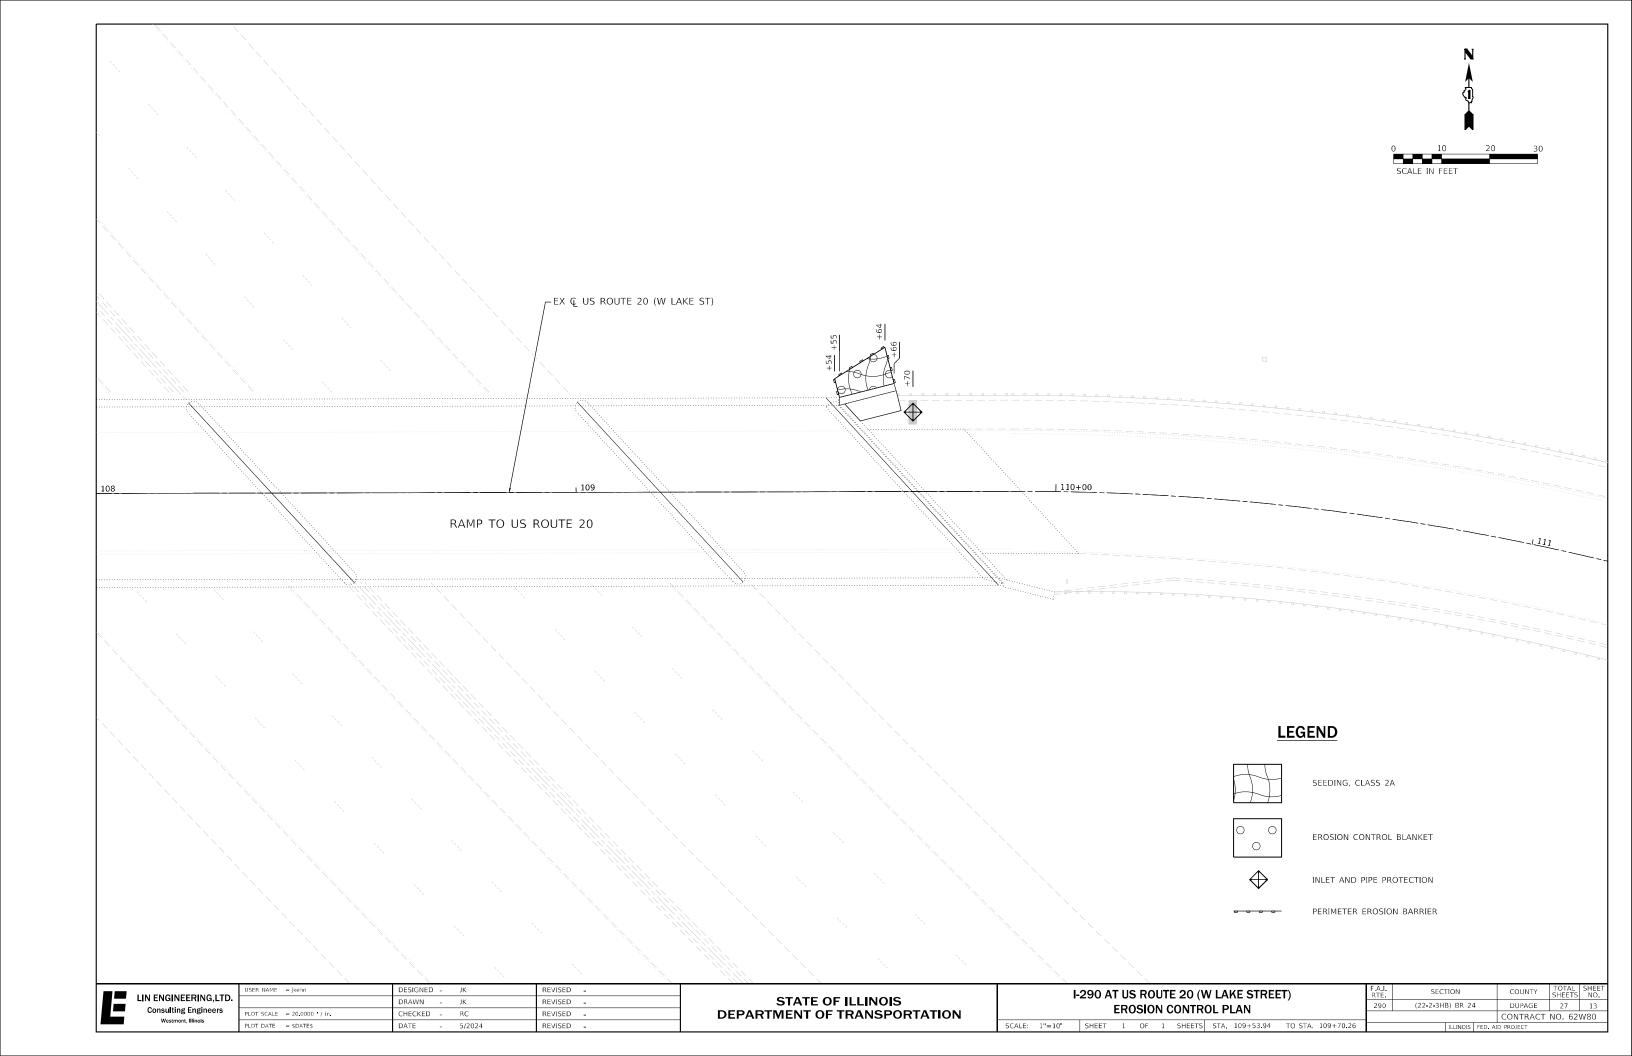

Existing Structure: SN 022-0090 built in 1962 as FAI Route 90, Section 22-3HB, Sta. 18+01.07. In 1985, the deck and approach slabs were replaced along with the upper portion of the wingwalls. In 2014, the deck joints were replaced, the deck and approaches were repaired, a new concrete overlay was applied, substructure units were repaired, abutment bearings and slope walls were replaced. The structure is a 4-span bridge with a 9" overlaid deck on steel beams, measuring 276'-6" back to back abutments, 39'-2" out to out, with a 42°30' right ahead skew. The substructure consists of concrete pile supported stub abutments and multi-column concrete piers supported on spread footing foundations. Temporary barrier will be provided during construction to shift traffic away from work zone.

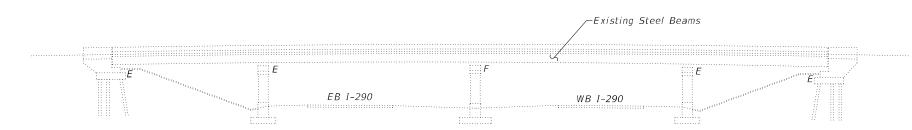

#### ELEVATION

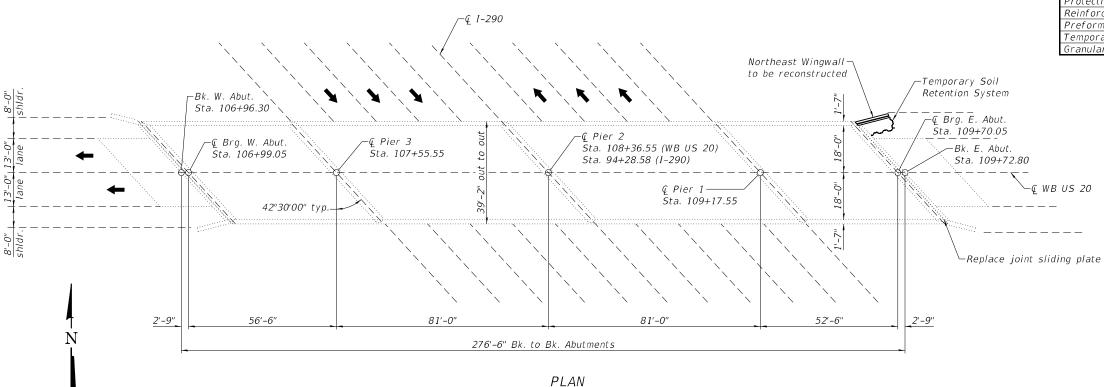

#### DESIGN SPECIFICATIONS

(New Construction) 2002 AASHTO Standard Specifications for Highway Bridges

## DESIGN STRESSES

FIELD UNITS - NEW CONSTRUCTION f'c = 4,000 psi

fy = 60,000 psi (Reinforcement)

## LOADING HS-20 & ALT.

No allowance for future wearing surface.

#### SCOPE OF WORK

- 1. Remove portion of existing shoulder and place Temporary Sheet Piling.
- 2. Remove the northeast wingwall above its footing and replace in-kind.
- 3. Re-assemble portion of expansion joint assembly in new parapet.
- 4. Place backfill, remove Temporary Sheet Piling, and re-construct shoulder in-kind.
- 5. Replace sliding plate at southeast wingwall.



Michael T. Haley

06/26/2024

Date

Licensed Structural Engineer State of Illinois No. 081-005991

Expires 11/30/2024

#### GENERAL NOTES

- 1. Reinforcement bars designated (E) shall be epoxy coated.
- 2. Plan dimensions and details relative to the existing structure have been taken from existing plans are subject to nominal construction variations. The Contactor shall field verify existing dimensions and details affecting new construction and make necessary approved adjustments prior to construction or ordering of materials. Such variations shall not be cause for additional compensation for a change in scope of the work, however, the Contractor will be paid for the quantity actually furnished at the unit price bid for the work.
- 3. Existing reinforcement shall be cleaned, straightened and incorporated into the new construction. Cost included with Concrete Removal.
- 4. Protective Coat shall be applied to the inside and top surfaces of the new concrete wingwall.

#### TOTAL BILL OF MATERIAL

ITEM	UNIT	SUPER	SUB	TOTAL
Concrete Removal	Cu. Yd.	-	5.5	5.5
Structure Excavation	Cu. Yd.	-	13.8	13.8
Concrete Superstructure	Cu. Yd.	-	5.5	5.5
Protective Coat	Sq. Yd.	5.4	-	5.4
Reinforcement Bars, Epoxy Coated	Pound	-	730	730
Preformed Joint Strip Seal	Foot	1	-	1
Temporary Soil Retention System	Sq. Ft.	-	122	122
Granular Backfill for Structures	Cu. Yd.	_	12.1	12.1

#### INDEX OF SHEETS

- 1. General Plan and Elevation
- 2. Northeast Wingwall Reconstruction
- 3. Expansion Joint Details




GENERAL PLAN AND ELEVATION WB US RTE. 20 OVER I-290 FAI RTE. 290 SECTION (22-2-3HB) BR 24 DUPAGE COUNTY STATION 108+36.55 STRUCTURE NO. 022-0090

LIN ENGINEERING.LTD Consulting Engineers

USER NAME = DESIGNED - MTH REVISED -CHECKED - CL REVISED -PLOT SCALE= DRAWN MTH REVISED PLOT DATE = 7/8/2024 REVISED -CHECKED -

STATE OF ILLINOIS **DEPARTMENT OF TRANSPORTATION** 

TOTAL SHEET NO. 27 14 SECTION COUNTY (22-2-3HB) BR 24 DUPAGE 290 CONTRACT NO. 62W80 SHEET 1 OF 3 SHEETS

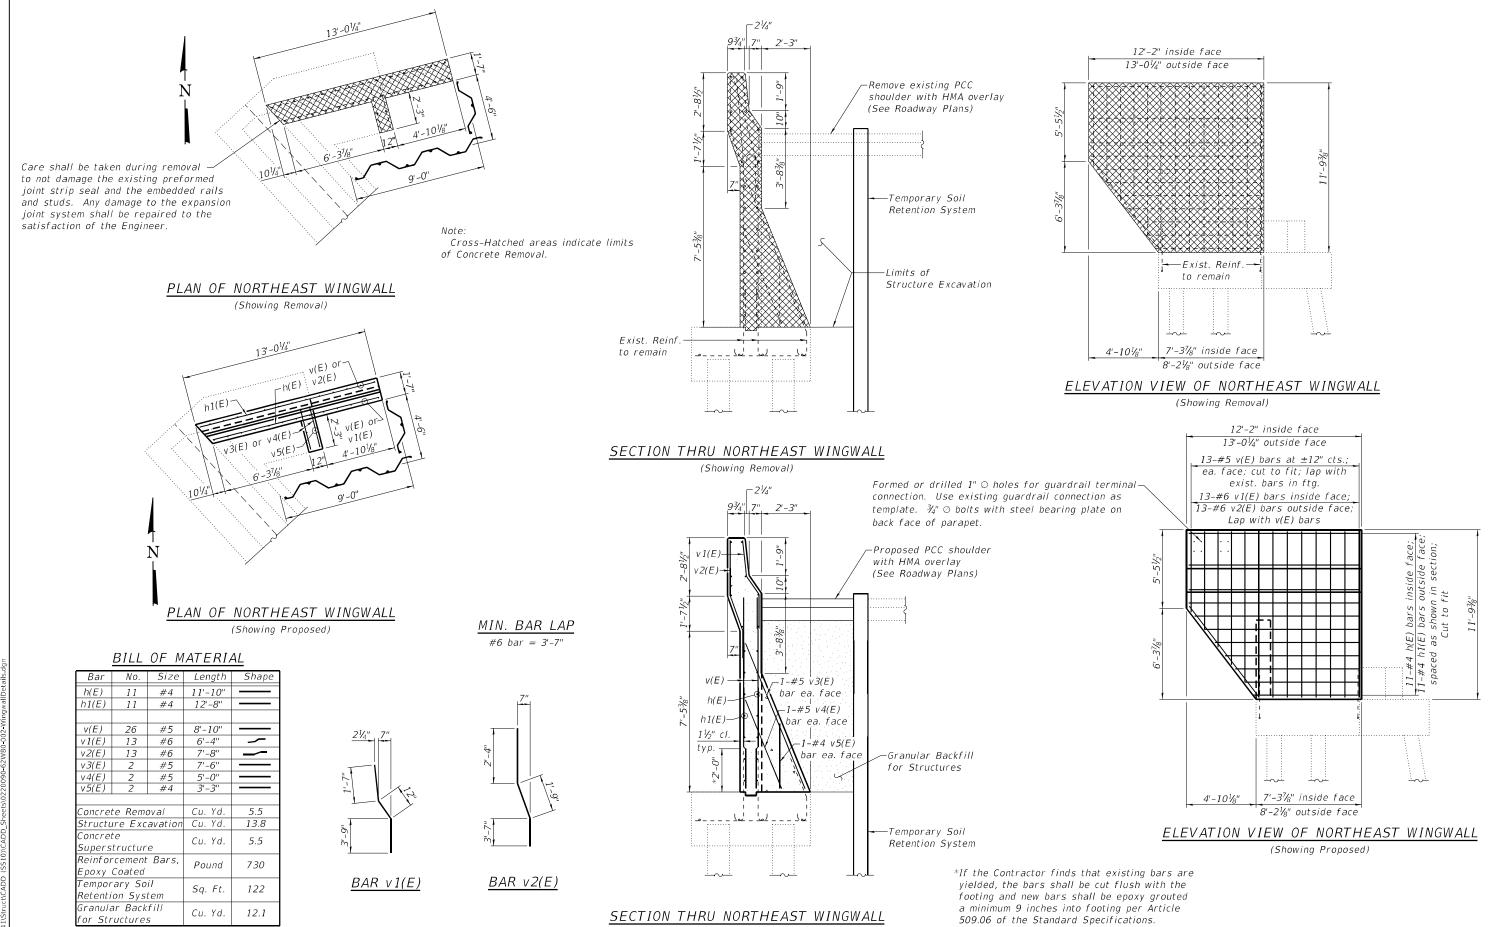

Consulting Engineers

USER NAME = DESIGNED - MTH REVISED -LIN ENGINEERING, LTD. CHECKED - CL REVISED -PLOT SCALE= DRAWN REVISED PLOT DATE = 7/8/2024 CHECKED -REVISED -


**STATE OF ILLINOIS DEPARTMENT OF TRANSPORTATION** 

(Showing Proposed)

SECTION NORTHEAST WINGWALL RECONSTRUCTION 290 **STRUCTURE NO. 022-0090** SHEET 2 OF 3 SHEETS

COUNTY 27 15 (22-2-3HB) BR 24 DUPAGE CONTRACT NO. 62W80 \*Granular or solid flux filled headed studs conforming to Article 1006.32 of the Std. Specs., automatically end welded.


\*\*Intended to match existing opening.

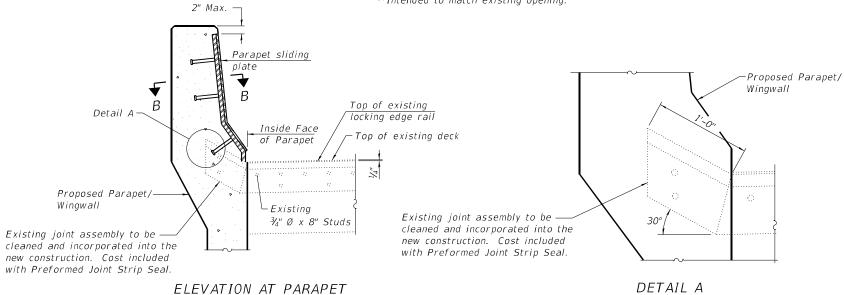


#### Notes:

The manufacturer's recommended installation methods shall be followed.

All steel components shall be galvanized after fabrication according to Article 520.03 of the Standard Specifications. Cost of parapet sliding plates, embedded plates, and anchorage studs included with Preformed Joint Strip Seal. Contractor shall field verify all dimensions prior to ordering material.

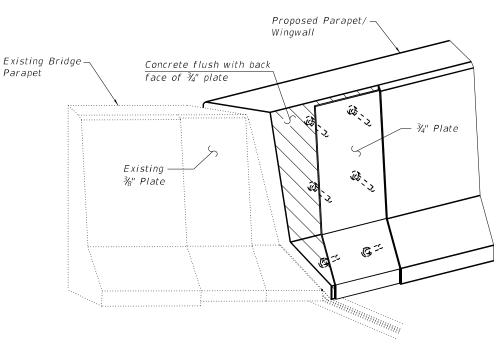

TRIMETRIC VIEW
(Showing embedded plates only)

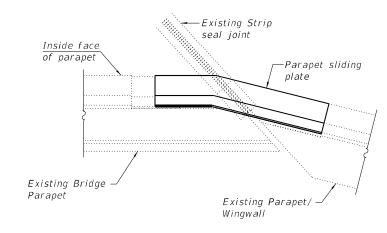

## PLAN AT SOUTHEAST WINGWALL

The ½" sliding plate shall be replaced, with new countersunk bolts.

#### BILL OF MATERIAL

Item	Unit	Total
Preformed Joint Strip Seal	Foot	1

LIN ENGINEERING,LTD.
Consulting Engineers
Springfield, Illinois

 USER NAME =
 DESIGNED - MTH
 REVISED - RE

STATE OF ILLINOIS
DEPARTMENT OF TRANSPORTATION

EXPANSION JOINT DETAILS STRUCTURE NO. 022-0090

SHEET 3 OF 3 SHEETS

 
 F.A.I. RTE.
 SECTION
 COUNTY SHEETS
 TOTAL NO.
 SHEETS NO.


 290
 (22-2-3HB) BR 24
 DUPAGE
 27
 16


 CONTRACT NO. 62W80

(SS10)\CADD\_Sheets\0220090-62W80-003-ExpJtDetails

L: Default AME: E:\1910-41\Stru

E NAME

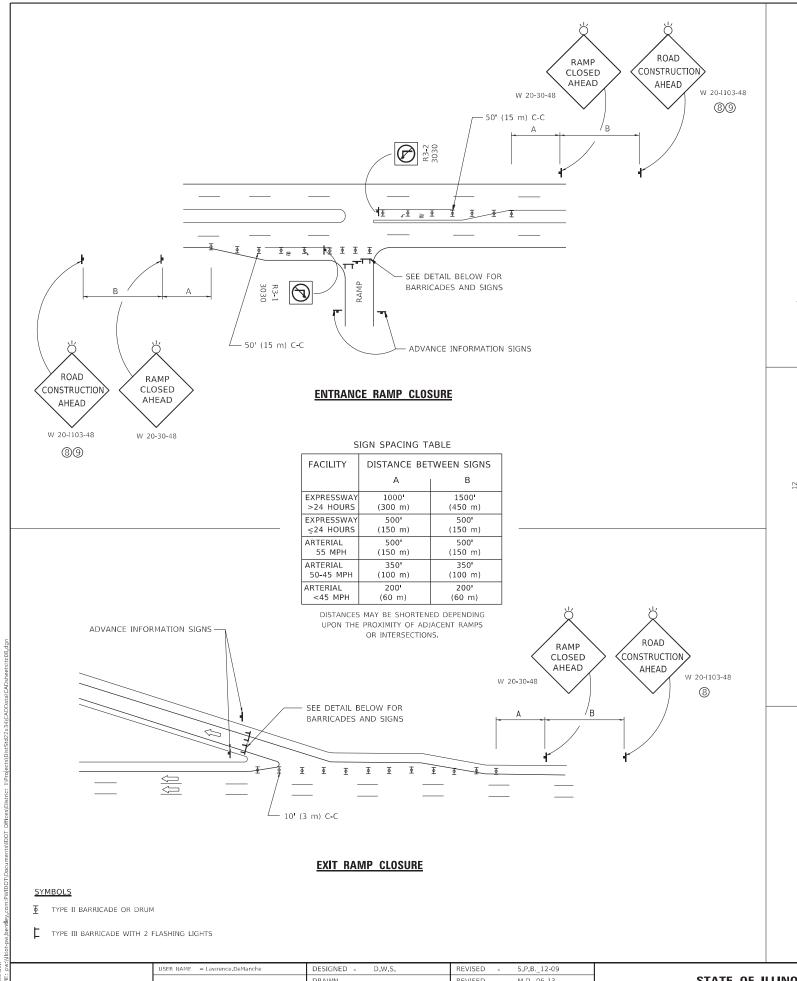

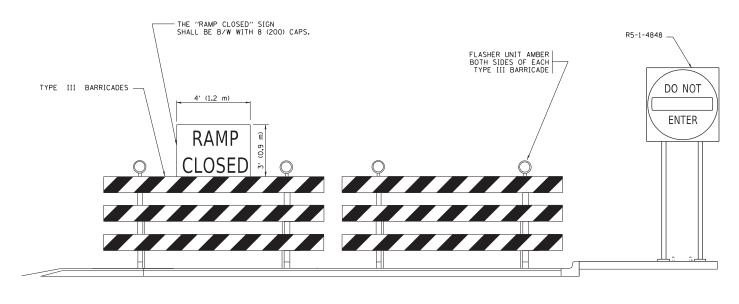

**DETAIL FOR REQUIRED BARRICADES & SIGNS** 

## RAMP CLOSURE ADVANCE INFORMATION SIGN

#### RAMP CLOSURE ADVANCE WARNING SIGN

RAMP CLOSED 101 (3 m)

CLOSED FOR MORE THAN FOUR (4) CONSECUTIVE DAYS.

BLACK LEGEND ON ORANGE BACKGROUND MOUNTED DIAGONALLY E MOD FONT 1 (25) BORDER THESE SIGNS ARE REQUIRED ON ALL THE EXIT GUIDE SIGNS FOR EXIT RAMPS THAT WILL BE

THIS RAMP 6 (150) 5 (125) BLACK LEGEND ON WHITE BACKGROUND 6 (150) 5 (125) ½ (12) BORDER **CLOSED** 6 (150) E MOD FONT 5 (125) 6 (150) THESE BLANK AREAS SHALL BE FILLED WITH THE DATES AND THE 5 (125) TIME THAT THE RAMP WILL BE 6 (150) (125)

THESE SIGNS ARE REQUIRED ON BOTH SIDES OF THE RAMP, MINIMUM OF 1 WEEK IN ADVANCE OF THE CLOSURE.

THESE SIGNS SHALL BE FABRICATED AND PAID FOR ACCORDING TO THE TEMPORARY INFORMATION SIGNING SPECIAL PROVISION

#### GENERAL NOTES:


- CONES MAY BE SUBSTITUTED FOR DRUMS OR TYPE II BARRICADES DURING DAY OPERATIONS. CONES SHALL BE A MINIMUM OF 28 (700) HIGH.
- (2) VERTICAL BARRICADES SHALL NOT BE USED FOR RAMP CLOSURES.
- 3 A FLAGGER SHALL BE POSITIONED AT EACH CLOSED RAMP THAT IS OPEN TO CONSTRUCTION VEHICLES, PRECEEDED BY A W20-7 FLAGGER WARNING SIGN.
- 4 ALL ROUTE MARKERS AND TRAILBLAZER ASSEMBLIES WHICH DIRECT MOTORISTS TO A CLOSED ENTRANCE RAMP SHALL BE COVERED WHEN THE RAMP IS CLOSED FOR MORE THAN FOUR (4) DAYS.
- THE SIGNING AND BARRICADING WHICH IS REQUIRED BY THIS DETAIL SHALL BE INCLUDED IN THE COST OF TRAFFIC CONTROL AND PROTECTION (EXPRESSWAYS).


- 6 AUTHORIZATION FROM THE DISTRICT'S BUREAU OF TRAFFIC IS REQUIRED FOR ALL RAMP CLOSURES.
- THE RAMP CLOSURE ADVANCE INFORMATION SIGNS SHALL BE ERECTED IF THE CLOSURE TIME EXCEEDS TWENTY-FOUR (24) HOURS. ADDITIONAL ADVANCE WARNING SIGNS ON EXIT GUIDE SIGNING WILL BE REQUIRED FOR EXIT RAMP CLOSURES THAT EXCEED FOUR (4) DAYS IN LENGTH
- (8) ROAD CONSTRUCTION AHEAD SIGNS MAY BE OMITTED WHEN THIS DETAIL IS USED IN CONJUNCTION WITH OTHER TRAFFIC CONTROL THAT ALREADY INCLUDES A ROAD CONSTRUCTION AHEAD SIGN.
- ARTERIAL ROAD CONSTRUCTION AHEAD SIGNS SHALL BE INSTALLED ON THE LEFT SIDE OF TRAFFIC IF THE MEDIAN IS MORE THAN 10 FT WIDE.


ALL DIMENSIONS ARE IN INCHES (MILLIMETERS) UNLESS OTHERWISE SHOWN.

27 17

SECTION COUNTY ENTRANCE\_AND\_EXIT\_RAMP STATE OF ILLINOIS DRAWN REVISED M.D. 06-13 (22-2-3HB) BR 24 DUPAGE. **CLOSURE DETAILS** HECKED REVISED M.D.\_01-18 **DEPARTMENT OF TRANSPORTATION** CONTRACT NO. 62W80 OF 1 SHEETS STA SHEET 1 PLOT DATE = 5/3/2024 D.S. 05-24 SCALE: NONE TO STA. DATE REVISED -

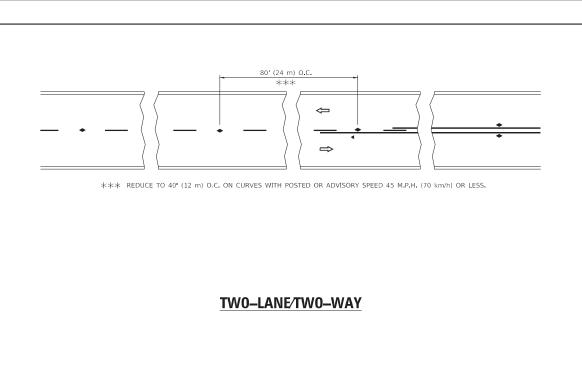

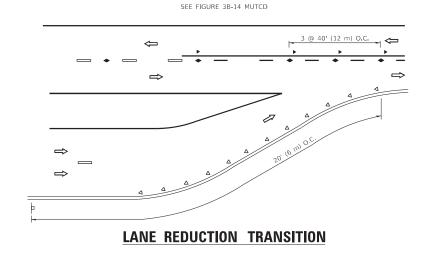

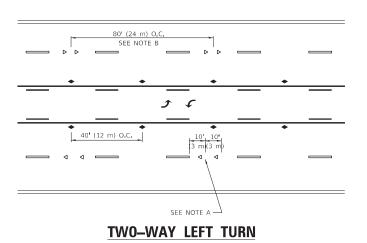

**SYMBOLS** 


ONE-WAY AMBER MARKER


TWO-WAY AMBER MARKER

ONE-WAY CRYSTAL MARKER (W/O)

YELLOW STRIPE


WHITE STRIPE

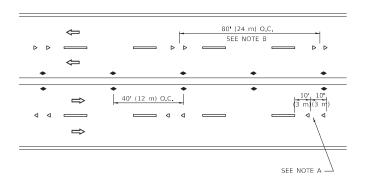


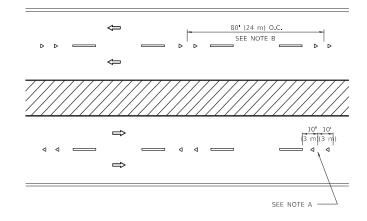

#### MULTI-LANE/UNDIVIDED



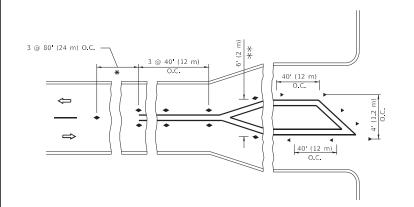

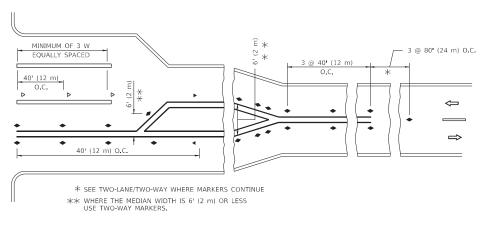

## TURN LANES

#### **GENERAL NOTES**

- MARKERS USED WITH DASHED LINES SHALL BE CENTERED IN THE GAP BETWEEN SEGMENTS.
- 2. MARKERS USED ADJACENT TO SOLID LINES SHALL BE OFFSET 2 TO 3 (50 TO 75) TOWARD TRAFFIC AS SHOWN.
- MARKERS THROUGH TANGENTS LESS THAN 500' (150 m) IN LENGTH BETWEEN CURVES SHALL BE INSTALLED AT THE LESSER OF THE TWO CURVE SPACINGS.
- 4. MARKERS ARE TO BE USED ADJACENT TO BOTH SOLID WHITE LINES IN DUAL LEFT TURN LANES

#### LANE MARKER NOTES


- A. USE DOUBLE LANE LINE MARKERS SPACED AS SHOWN.
- B. REDUCE TO 40' (12 m) O.C. ON CURVES WHERE ADVISORY SPEEDS ARE 10 M.P.H (20 km/h) LOWER THAN POSTED SPEEDS.


#### **DESIGN NOTES**


- 1. DOUBLE LANE LINE MARKERS SHALL BE USED UNLESS SPECIFIED OTHERWISE.
- EXCEPT AS SHOWN ON THE LANE REDUCTION TRANSITION AND FREEWAY EXIT
  RAMP DETAIL, MARKERS ARE NOT TO BE SPECIFIED ON RIGHT EDGE LINES.
- 3. THE EXACT MARKER LIMITS, SPACING, AND COLOR SHALL BE INCLUDED IN THE PLANS WHEN STANDARD SPECIFICATIONS ARE NOT BEING USED.
- MARKERS SHOULD NOT BE USED ALONGSIDE CURBS EXCEPT FOR EXTREMELY SHORT SECTIONS OF CURBS WHERE NOT MORE THAN TWO MARKERS WOULD BE INVOLVED.

All dimensions are in inches (millimeters) unless otherwise shown.

JSER NAME = footemj DESIGNED REVISED - T. RAMMACHER 03-12-99 SECTION TYPICAL APPLICATIONS STATE OF ILLINOIS DRAWN REVISED - T. RAMMACHER 01-06-00 DUPAGE. 27 18 (22-2-3HB) BR 24 RAISED REFLECTIVE PAVEMENT MARKERS (SNOW-PLOW RESISTANT) CHECKED REVISED -**DEPARTMENT OF TRANSPORTATION** TC-11 CONTRACT NO. 62W80 SHEET 1 OF 1 SHEETS STA. DATE C. JUCIUS 07-01-13 PLOT DATE = 3/4/2019 REVISED -

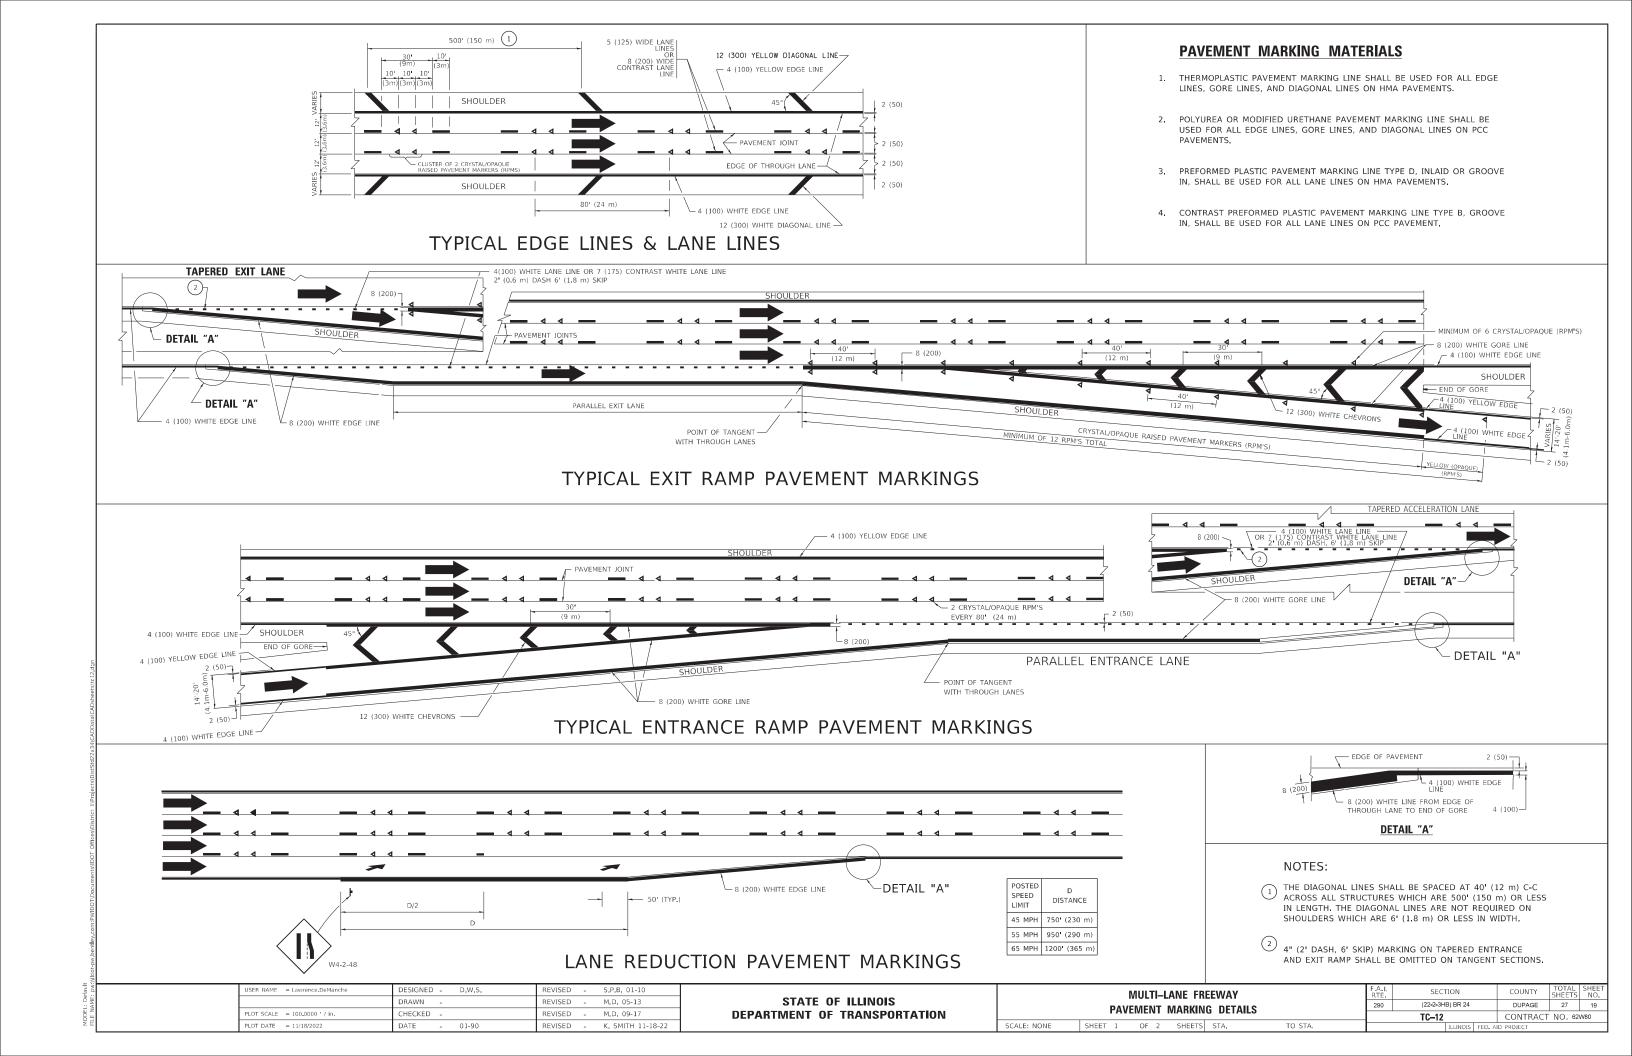

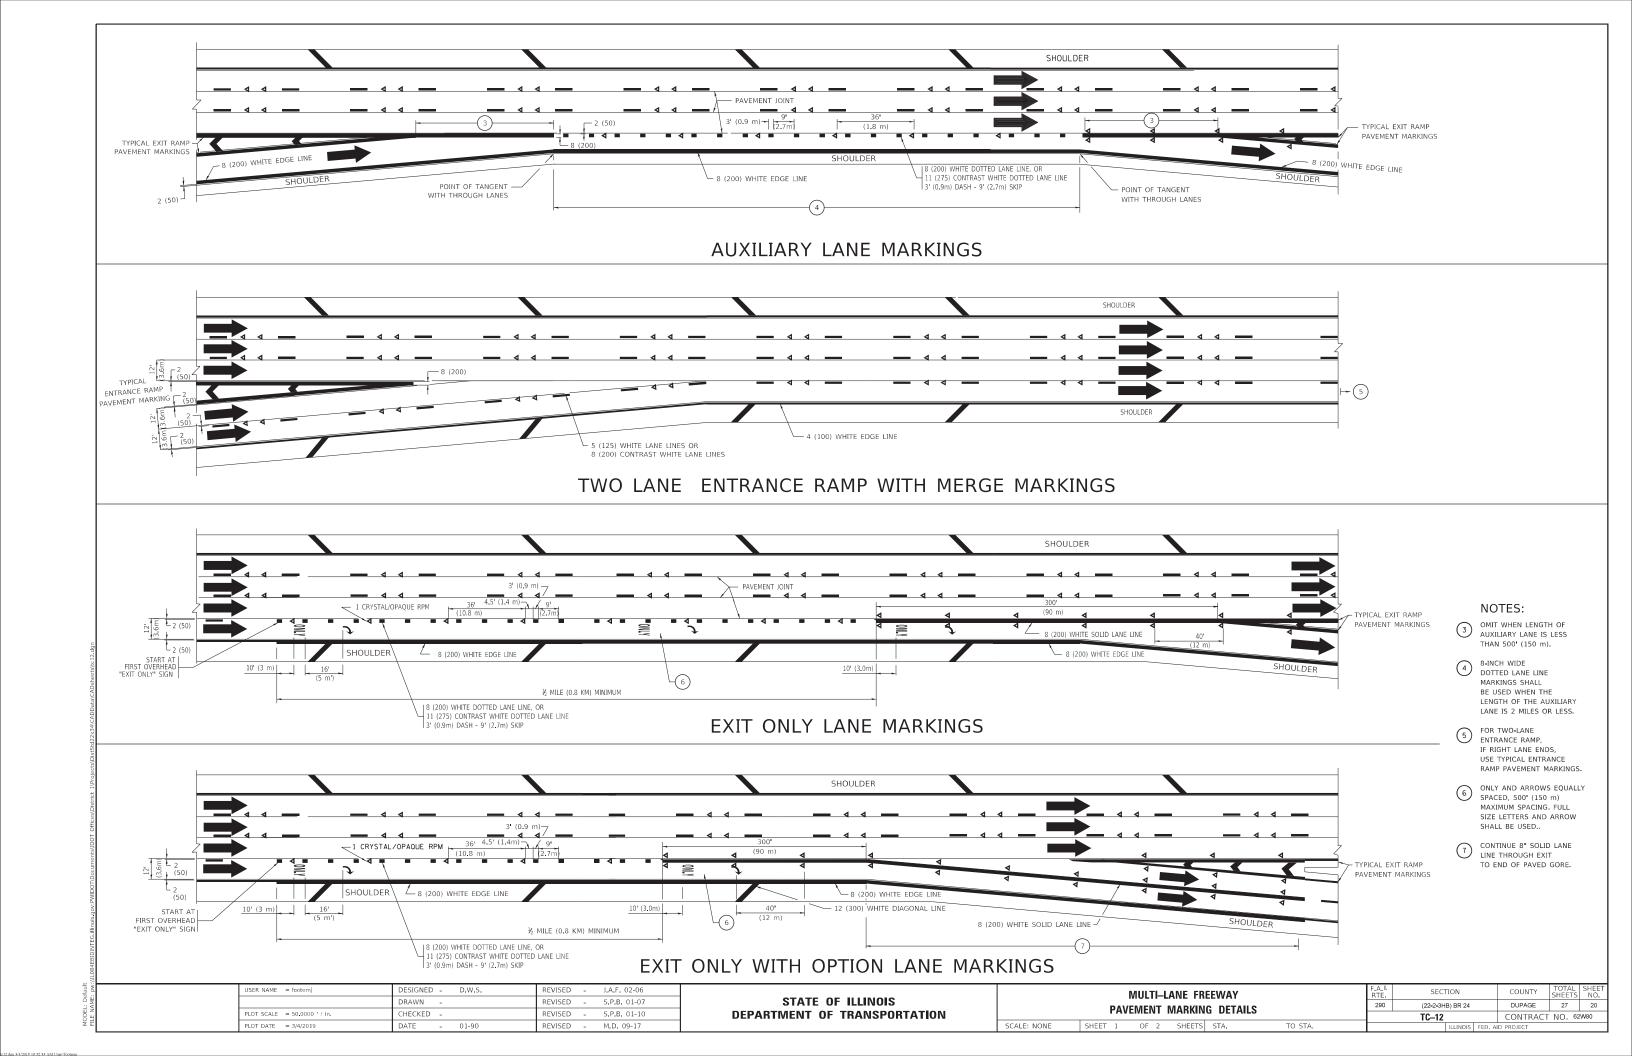

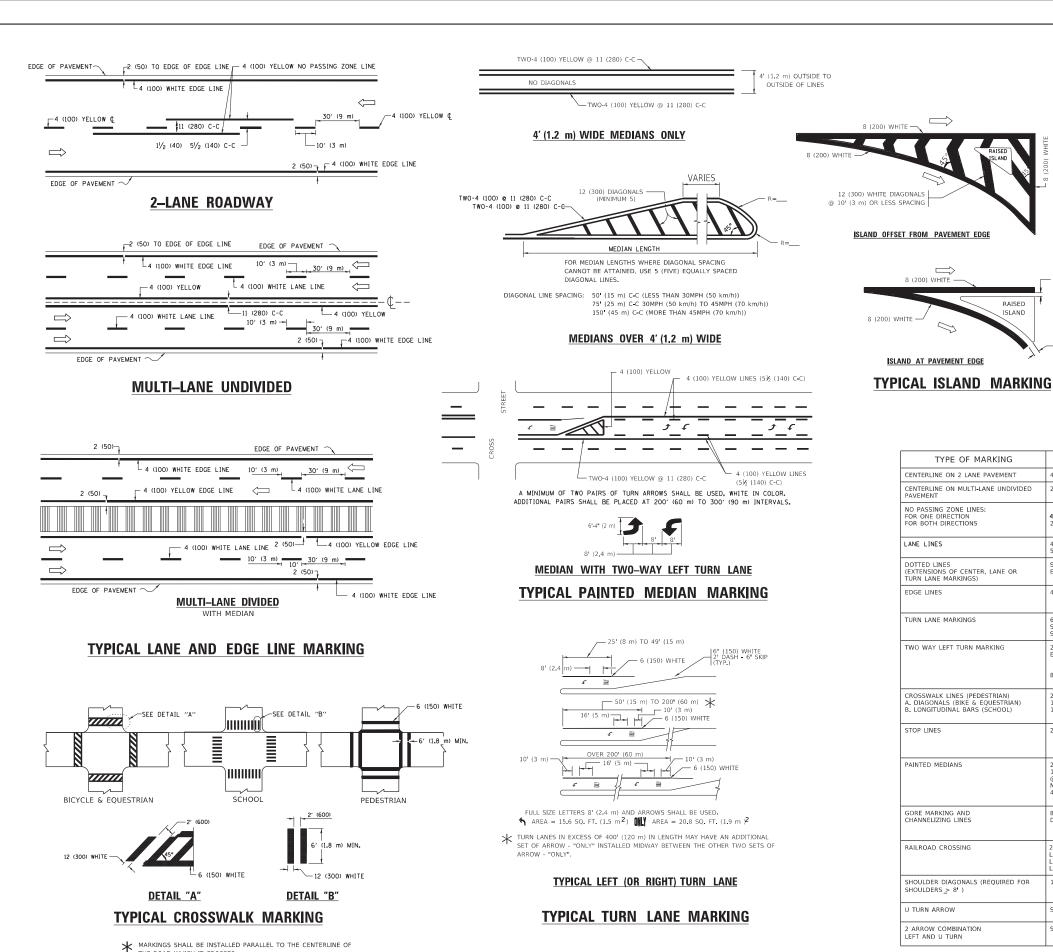

FOR FURTHER DETAILS ON PAVEMENT MARKING REFER TO STANDARD SPECIFICATIONS FOR ROAD AND BRIDGE CONSTRUCTION AND STATE STANDARD 780001.

SHEET

SCALE: NONE

8 (200) WHITE -

D(FT)

665

750

LANE REDUCTION TRANSITION \* LANE REDUCTION ARROWS REQUIRED AT SPEEDS OF 45 MPH OR GREATER OR WHEN SPECIFIED IN PLANS.

SPACING / REMARKS

10' (3 m) LINE WITH 30' (9 m) SPACE

SPEED LIMIT

45

50

55

#### SER NAME = footemj DESIGNED -EVERS C. JUCIUS 09-09-09 DRAWN REVISED C. JUCIUS 07-01-13 HECKED REVISED C. JUCIUS 12-21-15 DATE

THE ROAD WHICH IT CROSSES

STATE OF ILLINOIS **DEPARTMENT OF TRANSPORTATION** 

DISTRICT ONE TYPICAL PAVEMENT MARKINGS		F.A. I. RTE.	SECTION	COUNTY	TOTAL SHEETS	SHEET NO.			
		290	(22-2-3HB) BR 24	DUPAGE	27	21			
TIFICAL PAVEIVIENT IVIANKINUS				TC-13	CONTRACT	NO. 62	W80		
T 1	OF 2	SHEETS	STA.	TO STA.		ILLINOIS FED. A	ID PROJECT		

30.4 SF

SOLID YELLOW 11 (280) C-C NO PASSING ZONE LINES: FOR ONE DIRECTION FOR BOTH DIRECTIONS **4 (100)** 2 @ 4 (100) YELLOW YELLOW 5½ (140) C-C FROM SKIP-DASH CENTERLINE 11 (280) C-C OMIT SKIP-DASH CENTERLINE BETWEEN LANE LINES SKIP-DASH 10' (3 m) LINE WITH 30' (9 m) SPACE 4 (100) 5 (125) ON FREEWAYS SKIP-DASH DOTTED LINES (EXTENSIONS OF CENTER, LANE OR TURN LANE MARKINGS) SAME AS LINE BEING EXTENDED SKIP-DASH SAME AS LINE BEING EXTENDED 2' (600) LINE WITH 6' (1.8 m) SPACE EDGE LINES SOLID 4 (100) YELLOW-LEFT WHITE-RIGHT OUTLINE MEDIANS IN YELLOW 6 (150) LINE; FULL SIZE LETTERS & SYMBOLS (8' (2.4m) SEE TYPICAL TURN LANE MARKING DETAIL URN LANE MARKINGS SOLID 10' (3 m) LINE WITH 30' (9 m) SPACE FOR SKIP-DASH; 5½ (140) C-C BETWEEN SOLID LINE AND SKIP-DASH LINE SEE TYPICAL TWO-WAY LEFT TURN MARKING DETAIL TWO WAY LEFT TURN MARKING 2 @ 4 (100) EACH DIRECTION 8' (2.4m) LEFT ARROW 2 @ 6 (150) 12 (300) @ 45° 12 (300) @ 90° CROSSWALK LINES (PEDESTRIAN) A. DIAGONALS (BIKE & EOUESTRIAN) NOT LESS THAN 6' (1.8 m) APART ' (600) APART . LONGITUDINAL BARS (SCHOOL) SEE TYPICAL CROSSWALK MARKING DETAILS PLACE 4' (1.2 m) IN ADVANCE OF AND PARALLEL TO CROSSWALK, IF PRESENT, OTHERWISE, PLACE AT DESIRED STOPPING POINT, PARALLEL TO CROSSROAD CENTERLINE, WHERE POSSSIN F. STOP LINES 24 (600) SOLID WHITE PAINTED MEDIANS SOLID 11 (280) C-C FOR THE DOUBLE LINE SEE TYPICAL PAINTED MEDIAN MARKING. 2 @ 4 (100) WITH 12 (300) DIAGONALS YELLOW: TWO WAY TRAFFIC WHITE: ONE WAY TRAFFIC @ 45° NO DIAGONALS USED FOR 4' (1.2 m) WIDE MEDIANS DIAGONALS: 15' (4.5 m) C-C (LESS THAN 30MPH (50 km/h)) 20' (6 m) C-C 30MPH (50 km/h) TO 45MPH (70 km/h)) 30' (9 m) C-C (OVER 45MPH (70 km/h)) 24 (600) TRANSVERSE LINES; "RR" IS 6' (1.8 m) LETTERS; 16 (400) LINE FOR "X" RAILROAD CROSSING SOLID WHITE SEE STATE STANDARD 780001 AREA OF: "R"=3.6 SQ. FT. (0.33 m 2 EACH "X"=54.0 SQ. FT. (5.0 m)2 50' (15 m) C-C (LESS THAN 30MPH (50 km/h)) 75' (25 m) C-C (30 MPH (50 km/h) TO 45MPH (70 km/h)) 150' (45 m) C-C (OVER 45MPH (70 km/h)) SHOULDER DIAGONALS (REQUIRED FOR 12 (300) @ 45° SOLID WHITE - RIGHT YELLOW - LEFT SHOULDERS\_> 8') J TURN ARROW SEE DETAIL SOLID WHITE 2 ARROW COMBINATION LEFT AND U TURN

SOLID

COMBINATION

LEFT AND U-TURN

5'-4" (1620)

32 R (810)

**U-TURN** 

COLOR

YELLOW

PATTERN

SKIP-DASH

— 2 (50)

2 (50)


WIDTH OF LINE

RAISED

ISLAND

TYPE OF MARKING

ENTERLINE ON 2 LANE PAVEMENT

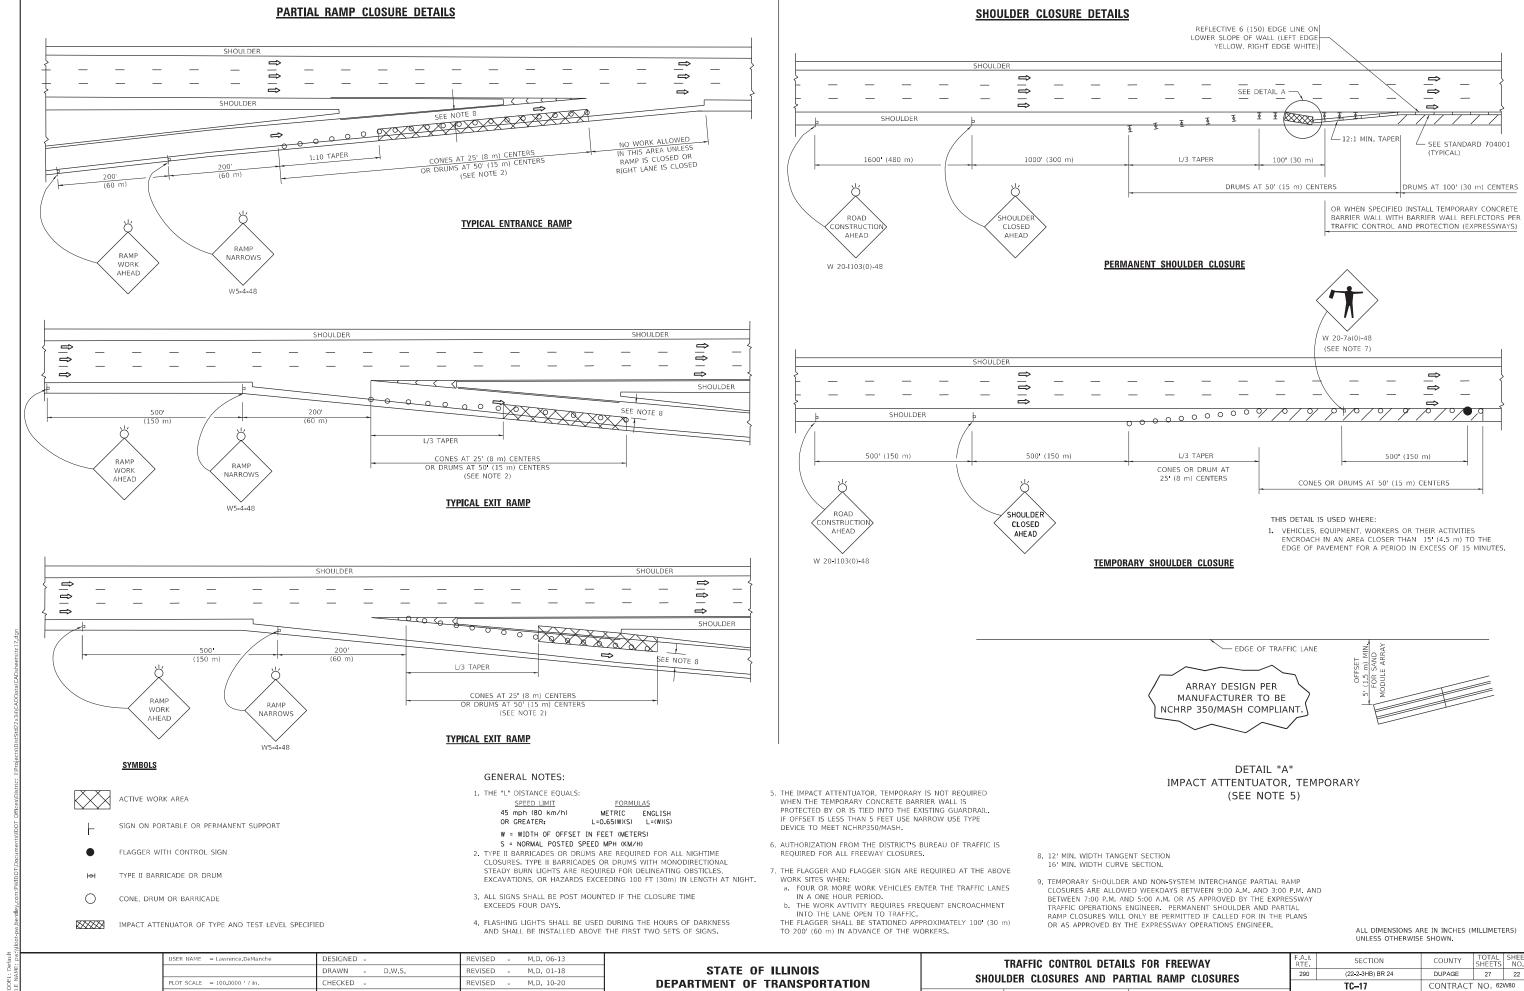

D.S. 05-24

REVISED -


SHEET 1 OF 1 SHEETS STA.

PLOT DATE = 5/3/2024


DATE

#### SIGNING FOR FLAGGING OPERATIONS AT WORK ZONE OPENINGS

#### WORK ZONE EXIT OPENING

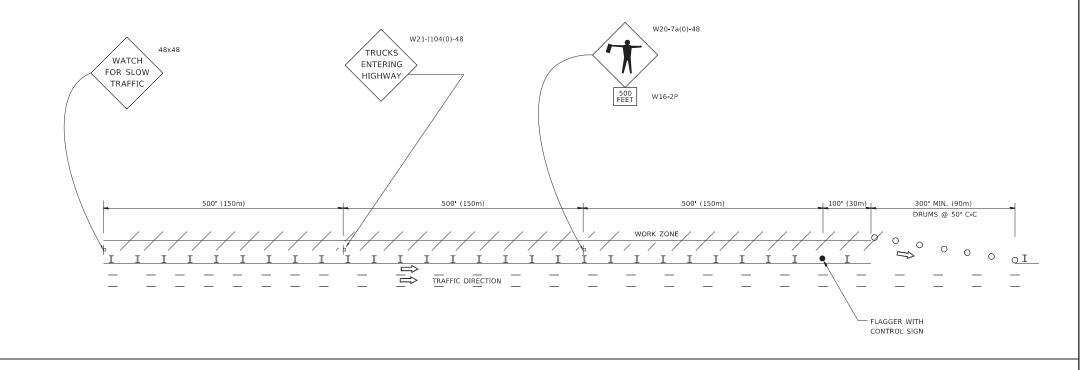

#### WORK ZONE ENTRY OPENING

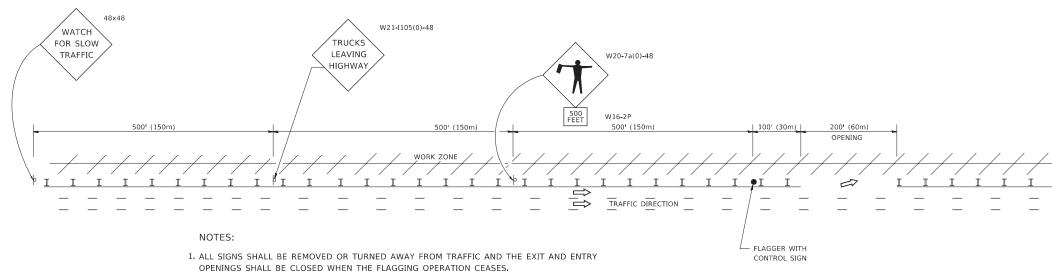


- OPENINGS SHALL BE CLOSED WHEN THE FLAGGING OPERATION CEASES. NON OPERATING EQUIPMENT SHALL COMPLY WITH ARTICLE 701.11
- 2. WORK ZONE OPENINGS SHALL BE A MINIMUM OF ONE HALF MILE APART AND A MINIMUM OF ONE QUARTER MILE FROM ALL ENTRANCE AND EXIT RAMPS.
- 3. EXITING THE WORK ZONE AT ANY PLACE OTHER THAN AT A WORK ZONE EXIT OPENING WILL BE PROHIBITED.
- 4. ALL VEHICLES SHALL ENTER THE WORK ZONE AT ENTRY OPENINGS, USING THEIR TURN SIGNALS TO WARN MOTORISTS
- 5. FLAGGERS SHALL NOT STOP TRAFFIC OR DIRECT TRAFFIC INTO AN ADJACENT LANE.

ALL DIMENSIONS ARE IN INCHES (MILLIMETERS) UNLESS OTHERWISE SHOWN


JSER NAME = footemj DESIGNED -J.A.F. 02-06 REVISED -DRAWN REVISED S.P.B. 01-07 CHECKED REVISED -S.P.B. 12-09 PLOT DATE = 3/4/2019 DATE M.D.06-13 REVISED -


STATE OF ILLINOIS **DEPARTMENT OF TRANSPORTATION**  FREEWAY /EXPRESSWAY SIGNING FOR FLAGGING OPERATIONS AT WORK ZONE OPENINGS ON FREEWAYS /EXPRESSWAYS SHEET 1 OF 1 SHEETS STA.

SECTION 290 (22-2-3HB) BR 24 DUPAGE 27 23 TC-18 CONTRACT NO. 62W80

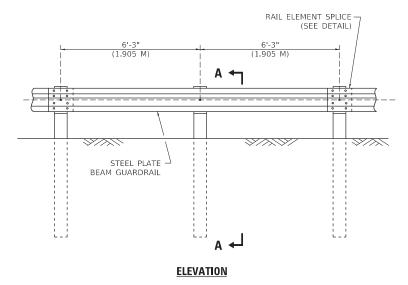


TYPE A 6'-3" (1.905 M) TYPICAL POST SPACING

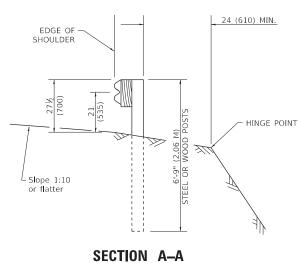


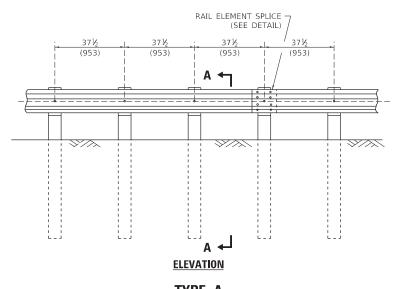


TYPE A 37½ (953) CLOSED POST SPACING

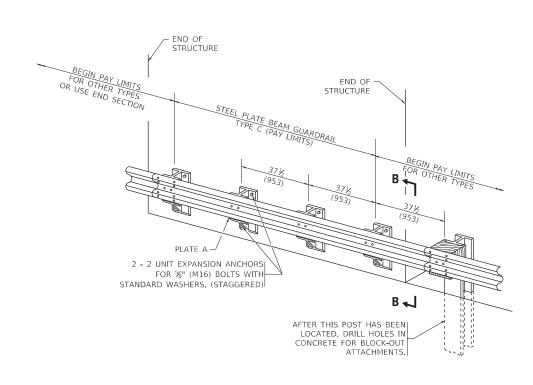


TYPE C  $37\frac{1}{2}$  (953) BLOCK-OUT SPACING

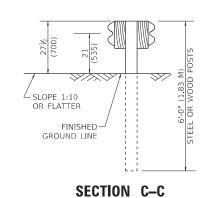

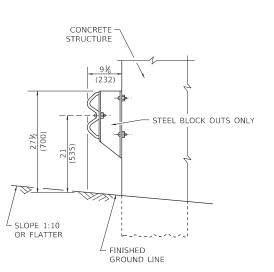

SECTION B-B

SCALE: NONE

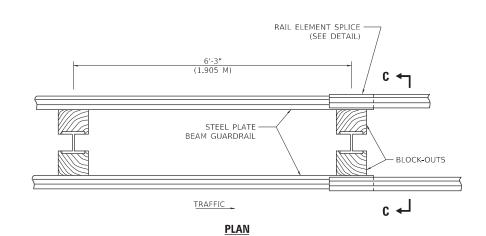

## TYPE D

DOUBLE STEEL PLATE BEAM GUARDRAIL 6'-3" (1.905 M) TYPICAL POST SPACING

#### **GENERAL NOTES**

ALL SLOPE RATIOS ARE EXPRESSED AS UNITS OF VERTICAL DISPLACEMENT TO UNITS OF HORIZONTAL DISPLACEMENT (V:H).

ALL DIMENSIONS ARE IN INCHES (MILLIMETERS) UNLESS OTHERWISE SHOWN.


THE EXISTING STEEL POSTS MAY BE DRILLED TO MATCH THE BOLT PATTERN SHOWN HEREIN FOR THE WOOD BLOCK-OUT, OR A NEW STEEL POST SHALL BE PROVIDED.

THIS DETAIL IS APPLICABLE TO THE GUARDRAIL SYSTEM USED PRIOR TO JANUARY 1, 2007. FOR DETAILS ON THE MIDWEST GUARDRAIL SYSTEM, SEE STANDARD 630001.


USER NAME = footemj	DESIGNED -	REVISED -
	DRAWN -	REVISED -
PLOT SCALE = 50.0000 / in.	CHECKED -	REVISED -
PLOT DATE = 3/11/2019	DATE -	REVISED -

STATE OF ILLINOIS	
DEPARTMENT OF TRANSPORTATION	

REMOVE AND REERECT				F.A.I. RTE.	SECTION	COUNTY	TOTAL SHEETS	SHEET NO.		
				290	(22-2-3HB) BR 24	DUPAGE	27	24		
SILLE FLATE BEAIN GOARDRAIL			BM-21 CONTRA			2W80				
	SHEET 1	OF 4	SHEETS	STA.	TO STA.		ILLINOIS FED. A	ID PROJECT		

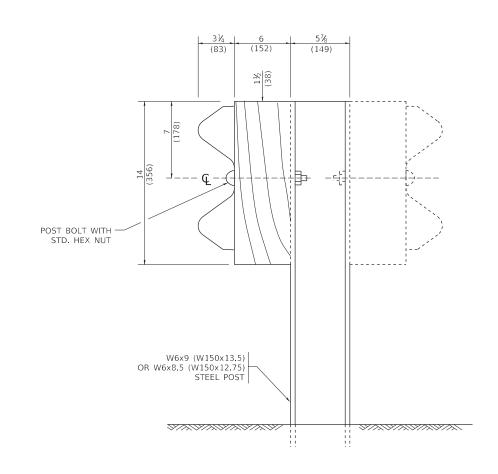


## STEEL POST CONSTRUCTION

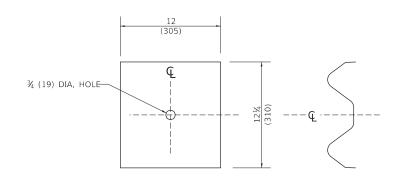


#### NOTE:

PLATE A SHALL BE PLACED BETWEEN RAIL ELEMENT AND BLOCK-OUT AT NON-SPLICE MOUNTING POINTS ONLY WHEN STEEL BLOCK-OUTS ARE USED.


## PLATE A

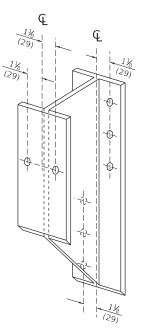

STEEL BLOCK-OUT DETAIL

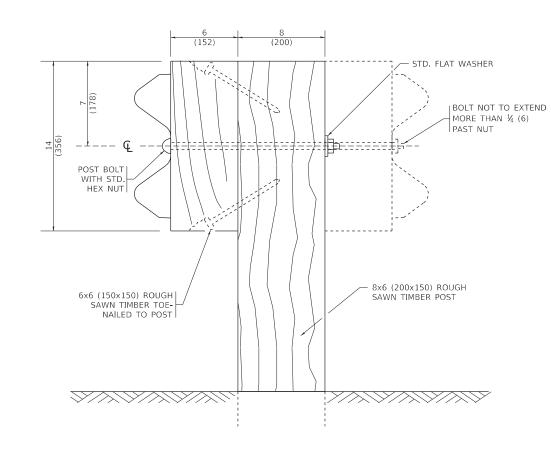

## **WOOD POST CONSTRUCTION**

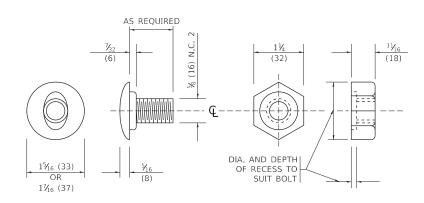



POST OR SPLICE BOLT & NUT

SCALE: NONE


USER NAME = footemj	DESIGNED -	REVISED -
	DRAWN -	REVISED -
PLOT SCALE = 50.0000 / in.	CHECKED -	REVISED -
PLOT DATE = 3/11/2019	DATE -	REVISED -

REMOVE AND REERECT STEEL PLATE BEAM GUARDRAIL				F.A. I. RTE.	SECTION	COUNTY	TOTAL SHEETS	SHEET NO.	
				290	(22-2-3HB) BR 24	DUPAGE	27	25	
				BM-21		CONTRACT NO. 62W80			
SHEET 2	OF 4	SHEETS	STA.	TO STA.		ILLINOIS FED. A	ID PROJECT		

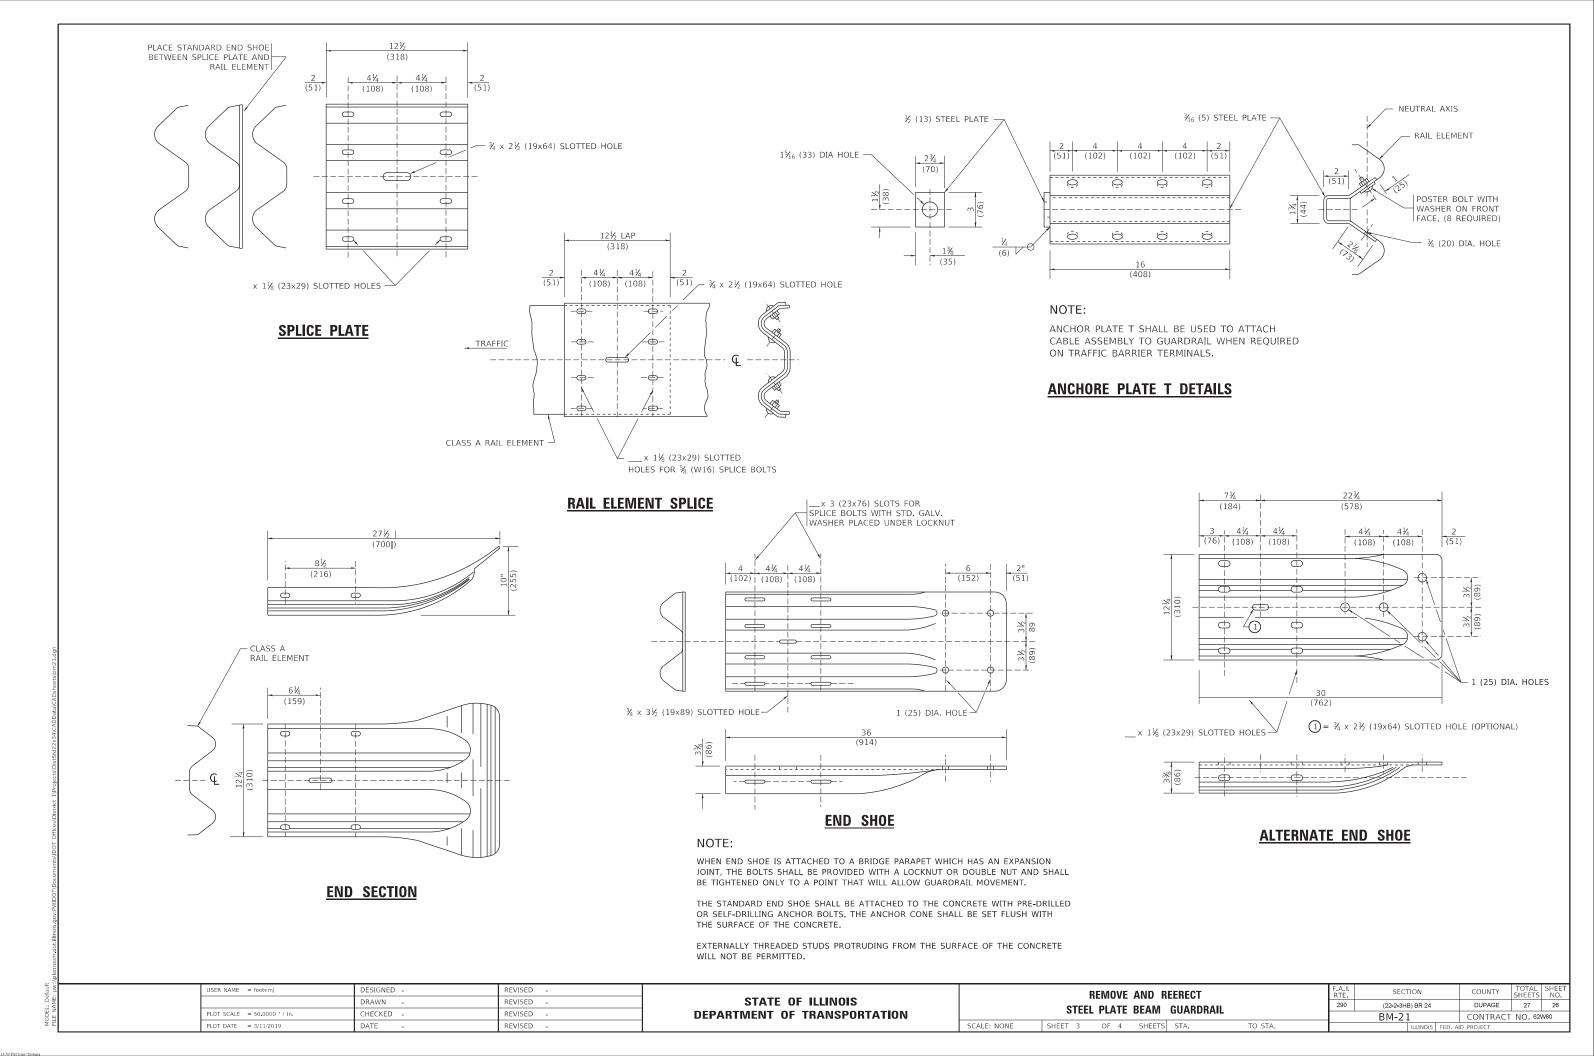

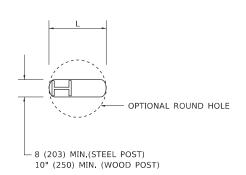

#### **PLAN**

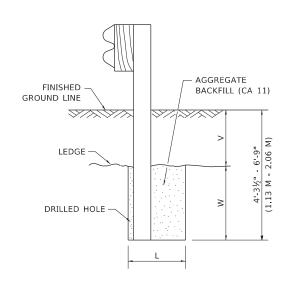


#### NOTE:

LEDGE LINE IS TOP OF ROCK LEDGE OR HARD SLAG FILL.

#### **ELEVATION**

## FOOTING FOR POST WHEN IMPERVIOUS MATERIAL IS ENCOUNTERED

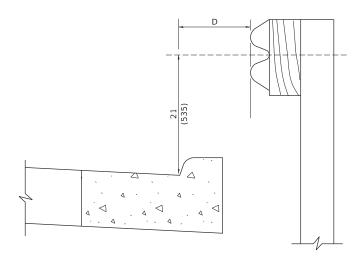


#### NOTE:

IF IT IS NECESSARY FOR D TO BE MORE THAN 12 (300) AND LESS THAN 10'-0" (3.0 M) TYPE M-2 (M-5) CURB AND GUTTER (STD. 606001) SHALL BE USED IN FRONT OF AND IN ADVANCE OF THE GUARDRAIL.


#### **GUARDRAIL PLACED BEHIND CURB**

(D = O DESIRABLE TO 12 (300) MAXIMUM)

V	w	L		
V	VV	STEEL POST	WOOD POST	
0 - 18	24	21	23	
(0 - 460)	(610)	(530)	(580)	
>18 - 41.5	12	8	10	
(> 460 - 825)	(305)	(203)	(250)	
>41.5 - 53.5	12 - 0	8	10	
(> 825 - 1.13 M)	(350 - 0)	(203)	(250)	

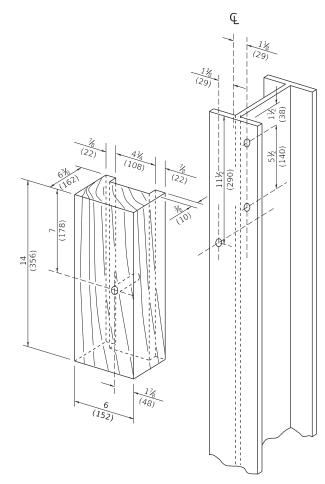

# WOOD BLOCK - OUT AND STEEL POST DETAILS

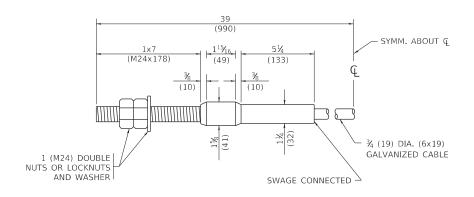

## **CABLE ASSEMBLY**

(40,000 LBS (18,100 KG) MIN. BREAKING STRENGTH)
TIGHTEN TO TAUT TENSION

	USER NAME = footemj	DESIGNED -	REVISED -
		DRAWN -	REVISED -
	PLOT SCALE = 50.0000 / in.	CHECKED -	REVISED -
[	PLOT DATE = 3/11/2019	DATE -	REVISED -

STATE OF ILLINOIS
DEPARTMENT OF TRANSPORTATION