09-20-2019 LETTING ITEM 068

#### INDEX OF SHEETS

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- 10-11 BUILDING PLANS & ELEVATIONS
- 12 STRUCTURAL DETAILS

#### HIGHWAY STANDARDS

000001-06 STANDARD SYMBOLS, ABBREVIATIONS AND PATTERNS 701201-05 LANE CLOSURE, 2L, 2W, DAY ONLY, FOR SPEEDS >= 45 MPH

FULL SIZE PLANS HAVE BEEN PREPARED USING STANDARD ENGINEERING SCALES, REDUCED SIZED PLANS WILL NOT CONFORM TO STANDARD SCALES, IN MAKING MEASUREMENTS ON REDUCED PLANS, THE ABOVE SCALES MAY BE USED.

J.U.L.I.E. JOINT UTILITY LOCATION INFORMATION FOR EXCAVATION 1-800-892-0123 OR 811

PROJECT MANAGER: MICHAEL IRWIN, PE SQUAD LEADER: TIMOTHY SHARP

217-524-7165 217-524-9160

CONTRACT NO. 46528


STATE OF ILLINOIS

**DEPARTMENT OF TRANSPORTATION** 

# **PROPOSED** HIGHWAY PLANS

F.A.P. 320 (IL 121) SECTION D6 PUMP STATION 2019 **NEW AUTOMATIC TRANSFER SWITCH** AND MISC. IMPROVEMENTS LOGAN COUNTY

C-30-011-19

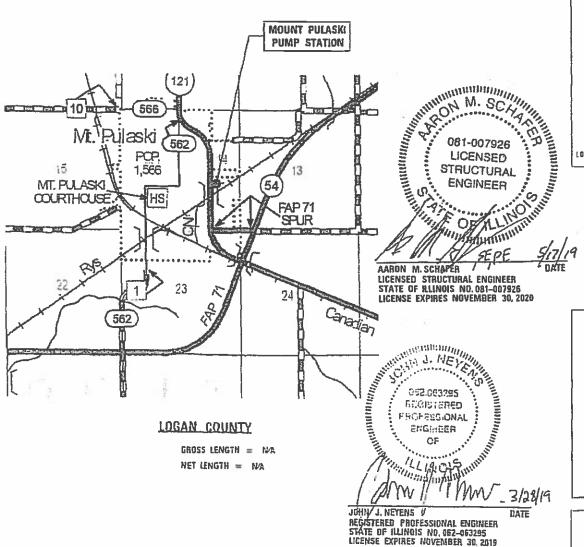

Intacti CONTRACT NO. 46528



## KLINGNES BASSOCIATES, P.C. Engineers · Architects · Surveyors

Quincy, Illinois E16 Name 200 Street 217 223 3620

English, C. Sulviger, IA Felix IA Harman, NO Columba, 110 STATE OF ALIMOIS DEEDGIS FIRM NO. 184-2729

DEPARTMENT OF TRANSPORTATION

PRINTED BY THE AUTHORITY OF THE STATE OF ILLINOIS

#### GENERAL NOTES

- PLAN DIMENSIONS AND DETAILS RELATIVE TO EXISTING STRUCTURES HAVE BEEN TAKEN FROM EXISTING PLANS AND ARE SUBJECT TO NOMINAL CONSTRUCTION VARIATIONS. IT SHALL BE THE CONTRACTOR'S RESPONSIBILITY TO VERIFY SUCH DIMENSIONS AND DETAILS IN THE FIELD, AND MAKE NECESSARY APPROVED ADJUSTMENTS PRIOR TO CONSTRUCTION OR ORDERING MATERIALS.
- 2. THE CONTRACTOR SHALL SECURE ANY LOCAL, STATE, COUNTY PERMITS NEEDED FOR THIS PROJECT.
- 3. THE CONTRACTOR SHALL PERFORM ALL CONSTRUCTION FOR THE PROJECT IN A MANNER AND SEQUENCE THAT ARE BASED ON ACCEPTED INDUSTRY STANDARDS THAT RECOGNIZE THE INTERACTION OF THE COMPONENTS THAT COMPRISE THE STRUCTURE, WITHOUT CAUSING DISTRESS, UNANTICIPATED MOVEMENTS OR IRREGULAR LOAD PATHS AS A RESULT OF THE CONSTRUCTION MEANS AND METHODS EMPLOYED.
- 4. CONSTRUCTION LOADS SHALL NOT EXCEED DESIGN LIVE LOAD. THE CONTRACTOR IS RESPONSIBLE FOR ALL DESIGN REQUIRED TO SUPPORT CONSTRUCTION EQUIPMENT USED IN CONSTRUCTING THIS PROJECT. SHORING AND RESHORING IS THE RESPONSIBILITY OF THE CONTRACTOR.
- 5. UTILITIES LOCATIONS / INFORMATION ON PLANS

ILLINOIS STATE LAW REQUIRES A 48-HOUR NOTICE TO BE GIVEN TO UTILITIES BEFORE DIGGING. FIELD MARKING OF FACILITIES MAY BE OBTAINED BY CONTACTING J.U.L.I.E. OR FOR NON-MEMBERS, THE UTILITY COMPANY DIRECTLY. AGENCIES KNOWN TO HAVE FACILITIES WITHIN THE PROJECT AREA ARE AS EQULOWS:

\* AMEREN ILLINOIS

MEMBERS OF J.U.L.I.E. CALL TOLL FREE (800) 892-0123 OR 811 AND ARE INDICATED BY \*. NON-J.U.L.I.E. MEMBERS MUST BE NOTIFIED INDIVIDUALLY

- 6. IT IS THE CONTRACTOR'S RESPONSIBILITY TO ENFORCE ALL APPLICABLE SAFETY CODES AND REGULATIONS DURING ALL PHASES OF CONSTRUCTION.
- 7. ALL CONTRACTORS ARE REQUIRED TO EXAMINE THE DRAWINGS AND SPECIAL PROVISIONS CAREFULLY, VISIT THE SITE AND FULLY INFORM THEMSELVES AS TO ALL EXISTING CONDITIONS AND LIMITATIONS, PRIOR TO AGREEING TO PERFORM THE WORK. FAILURE TO VISIT THE SITE AND FAMILIARIZE THEMSELVES WITH THE EXISTING CONDITIONS AND LIMITATIONS WILL IN NO WAY RELIEVE THE CONTRACTOR FROM FURNISHING ANY MATERIALS OR PERFORMING ANY WORK IN ACCORDANCE WITH THE DRAWINGS AND SPECIFICATIONS WITHOUT ADDITIONAL COST TO THE OWNER.
- 8. DURING CONSTRUCTION THE CONTRACTOR SHALL BE RESPONSIBLE FOR MAINTENANCE OF THE EXISTING PUMP STATION BUILDING.
- 9. DRAWINGS ARE NOT TO SCALE, UNLESS NOTED OTHERWISE.
- 10. THE DEPARTMENT RESERVES THE RIGHT TO NOTIFY THE CONTRACTOR TO CHANGE THE CONSTRUCTION SCHEDULE IF NEEDED TO ENSURE PROPER DEWATERING NEEDS FOR THE DEPARTMENT.
- 11. THE DEPARTMENT STRONGLY ENCOURAGES THE PRIME CONTRACTOR AND THEIR APPROVED SUB-CONTRACTORS TO HIRE MINORITY, MWOMEN AND DISADVANTAGED INDIVIDUALS FROM ITS FEDERALLY FUNDED HIGHWAY CONSTRUCTION CAREERS TRAINING PROGRAM (HCCTP) TO HELP MEET WORKFORCE AND TRAINEE GOALS. THIS PROGRAM IS TRAINING MINORITIES, WOMEN AND DISADVANTAGED INDIVIDUALS IN HIGHWAY CONSTRUCTION RELATED SKILLS, E.G., MATH FOR THE TRADES, JOB READINESS, TECHNICAL SKILLS COURSEWORK (CARPENTRY, CONCRETE FLATWORK, BLUEPRINT READING, SITE PLANS, SITE WORK, TOOLS USE, ETC.) AND OSHA 10 HOUR CERTIFICATION TO PREPARE THEM FOR A CAREER IN THE HIGHWAY CONSTRUCTION TRADES, GRADUATES ARE WELL TRAINED AND READY TO BECOME PRODUCTIVE ENTRY LEVEL CONSTRUCTION WORKERS. CONTACT THE DISTRICT 8 EEO OFFICE AT 618-346-3360 AND/OR THE HCTP COORDINATOR AT 618-874-6528 TO LEARN MORE ABOUT THE PROGRAM AND FOR ASSISTANCE IN MEETING WORKFORCE AND TRAINEE GOALS.
- 12. DURING DEMOLITION AND CONSTRUCTION, THE CONTRACTOR SHALL USE TRAFFIC CONTROL AND PROTECTION STANDARD 701201, AS DIRECTED BY THE ENGINEER.

#### STRUCTURAL NOTES

DESIGN LOADS:

A. OCCUPANCY CATEGORY II

B. ROOF LOADS

I. DEAD LOAD = 100 PSF (SELF WEIGHT)

II. \* LIVE LOAD = 60 PSF

C. ROOF SNOW LOAD

I. \* GROUND SNOW LOAD, PG = 20 PSF

\* DESIGN IS BASED ON MOST CRITICAL EFFECT OF ROOF LIVE LOAD OR ROOF SNOW LOAD.

D. WIND LOADING I. BASIC WIND SPEED (3 SECOND GUST) = 115 MPH II. EXPOSURE CATEGORY B III. IMPORTANCE FACTOR, IW = 1.0 IV. DIRECTIONAL FACTOR, KD = 0.85IW. TOPOGRAPHIC EFFECT, KZ = 1.0V. INTERNAL PRESSURE COEFFICIENT, GCPI =  $\pm 0.55$  (PARTIALLY ENCLOSED) SEISMIC LOADING - EQUIVALENT LATERAL FORCE PROCEDURE I.IMPORTANCE FACTOR, IE = 1.0 II.SITE CLASS D III.SDS = 0.199 (SS = 18.7%)IV.SD1 = 0.098 (S1 = 9.8%)V.SEISMIC DESIGN CATEGORY B VI.BASE SHEAR A. RESISTING SYSTEM - ORDINARY REINFORCED MASONRY SHEAR WALLS B. RESPONSE COEFFICIENT, R = 2

#### STRUCTURAL STEEL

- DETAILING, FABRICATION AND ERECTION SHALL CONFORM TO THE AISC SPECIFICATIONS AND STANDARD CODE OF PRACTICE.
- 2. STEEL FABRICATION AND ERECTION SHALL FOLLOW OSHA REQUIRMENTS.

C. DEFLECTION AMPLIFICATION FACTOR, CD = 1.75

D. SYSTEM OVERSTRENGTH FACTOR.  $\Omega$ O = 2.5

E. BASE SHEAR, V = 0.099W

- 3. STRUCTURAL STEEL:
  - a. STEEL ANGLES, RODS, AND PLATES ASTM A36 (Fy=36 ksi)
  - b. WASHERS ASTM F436
  - c. NUTS ASTM A563
  - d. ANCHOR BOLTS ASTM F1554 GRADE 36 (Fy=36 ksi)
- 4. ALL STEEL SHALL BE HOT DIPPED GALVANIZED.
- 5. REPAIR GALVANIZED SURFACES PER ASTM A780.
- ALL STEEL SHALL BE FURNISHED IN ACCORDANCE WITH ARTICLE 505 OF THE STANDARD SPECIFICATIONS FOR ROAD AND BRIDGE CONSTRUCTION
- 7. EPOXY ANCHORS SHALL FOLLOW ARTICLE 584 OF THE STANDARD SPECIFICATIONS.

#### MASONRY

- ALL MASONRY SHALL CONFORM TO "BUILDING CODE REQUIREMENTS FOR MASONRY STRUCTURES" (ACI 530/ASCE 5/TMS 402) AND "SPECIFICATIONS FOR MASONRY STRUCTURES" (ACI 530.1/ASCE 6/TMS 602).
- GROUT TO FILL CORES SHALL BE ASTM C476, COARSE GROUT (3/8" MAXIMUM AGGREGATE)
  WITH A MINIMUM COMPRESSIVE STRENGTH OF 3000 PSI IN 28 DAYS.
- CONCRETE MASONRY UNITS SHALL BE UNITS CONFORMING TO ASTM C90, GRADE N, TYPE I, NORMAL WEIGHT (DENSITY OF UNIT=135 pcf), MIN. BLOCK COMPRESSIVE STRENGTH = 2400 psi, SPECIFIED DESIGN STRENGTH OF MASONRY, fm'=1500.
- ASTM C270 TYPE "S" MORTAR WITH A MINIMUM COMPRESSIVE STRENGTH OF 1800 PSI SHALL BE USED FOR ALL MASONRY.
- 5. REINFORCING BARS SHALL CONFORM TO ASTM A615, GRADE 60.
- 5. ALL CORES WITH REINFORCEMENT SHALL BE FILLED SOLID WITH GROUT. PLACE REINFORCEMENT BARS BEFORE GROUTING. CONSOLIDATE GROUT BY MECHANICAL VIBRATION.
- PROPERLY SECURE VERTICAL REINFORCEMENT BARS TO ENSURE BAR IS LOCATED IN THE CENTER
  OF THE CMU CELL.
- 8. ALL CMU SHALL BE TEMPORARILY BRACED DURING CONSTRUCTION. TEMPORARY BRACING IS THE SOLE RESPONSIBILITY OF THE CONTRACTOR. COST SHALL BE INCLUDED IN "MASONRY WALL CONSTRUCTION". THE CONTRACTOR IS RESPONSIBLE FOR ALL COST ASSOCIATED WITH REPAIRS RESULTING FROM IMPROPER OR INSUFFICIENT BRACING.
- THE COST OF THE EXISITING BRICK MASONRY DEMOLITION SHALL BE INCLUDED IN "MASONRY REMOVAL".

#### PRECAST STRUCTURAL CONCRETE

- PRECAST STRUCTURAL CONCRETE CONSTRUCTION SHALL CONSIST OF THE DESIGN, MANUFACTURE, TRANSPORTATION, AND ERECTION OF THE STRUCTURAL PRECAST ROOF PANEL.
- DESIGN OF PRECAST MEMBERS SHALL BE IN ACCORDANCE WITH APPLICABLE SECTIONS OF 1042 OF THE STANDARD SPECIFICATIONS
- PRECAST MEMBERS MAY BE CONVENTIONALLY REINFORCED AND/OR PRESTRESSED, CONSISTENT WITH THE DESIGN LOADS, SPANS, HANDLING STRESSES, ETC. DESIGN LOADS ARE SHOWN ON DRAWINGS.
- 4. PRECAST CONTRACTOR SHALL FURNISH COMPLETE DESIGN CALCUALTIONS SIGNED BY A LICENSED STRUCTURAL ENGINEER LICENSED IN ILLINOIS, INCLUDING DETAILS OF CONNECTIONS.
- PRECAST CONTRACTOR SHALL FURNISH AND PLACE ANY TEMPORARY SHORING, BRACING, ETC. REQUIRED FOR ERECTION OF PRECAST WORK.
- . PRECAST CONTRACTOR SHALL FURNISH ALL THREADED INSERTS, LIFTING ANCHORS, LIFTING COVERS, ETC., REQUIRED TO CONNECT THE PRECAST TO THE STRUCTURAL STEEL ANGLES.
- PRECAST MANUFACTURER SHALL CAST IN STRUCTURAL INSERTS AND LIFTING ANCHORS AS SHOWN ON THE STRUCTURAL DESIGN PLANS.

STATE OF ILLINOIS
DEPARTMENT OF TRANSPORTATION

## ILLINOIS DEPARTMENT OF TRANSPORTATION


## SUMMARY OF QUANTITIES

				CONSTR	EUCTION TYPE CODE
CODE NO.	ITEM	UNIT	TOTAL QUANTITY	LOGAN 0044	
50100100	REMOVAL OF EXISTING STRUCTURES	EACH	1	1	
50500405	FURNISHING AND ERECTING STRUCTURAL STEEL	POUND	186	186	
58700300	CONCRETE SEALER	SQ FT	330	330	
67100100	MOBILIZATION	L SUM	1	1	
70100450	TRAFFIC CONTROL AND PROTECTION, STANDARD 701201	L SUM	1	1	
X0335700	PUMP STATION GENERAL WORK	L SUM	1	1	
X0783300	PUMP STATION ELECTRICAL WORK	L SUM	1	1	
Z0007101	CONTAINMENT AND DISPOSAL OF LEAD PAINT CLEANING RESIDUES NO. 1	L SUM	1	1	
Z0012754	STRUCTURAL REPAIR OF CONCRETE (DEPTH EQUAL TO OR LESS THAN 5 INCHES)	SQ FT	0.8	0.8	
Z0034100	MASONRY WALL CONSTRUCTION	SQ FT	130	130	

L		
П	KLINGNER	USE
	& ASSOCIATES, P.C.	
H	Engineers • Architects • Surveyors	PLO
L	616 N.24TH ST. QUINCY, ILLINOIS 62301 217 223 3670 STATE OF ILLINOIS DESIGN FIRM NO. 184-2738	PLO

USER NAME = ebb	DESIGNED - JNN	REVISED -
	DRAWN - AMS	REVISED -
PLOT SCALE = 2:0 '-:" / 10.	CHECKED - JNN	REVISED -
PLOT DATE = 6/27/2019	DATE - 5/16/2019	REVISED -

				SHMI	ΟΠΑΝΤ	ITIES	RTE.	_				
SUMMARY OF QUANTITIES												
									ļ			
SCALE:	NONE	SHEET	1	OF	1	SHEETS	STA.	TO STA.				

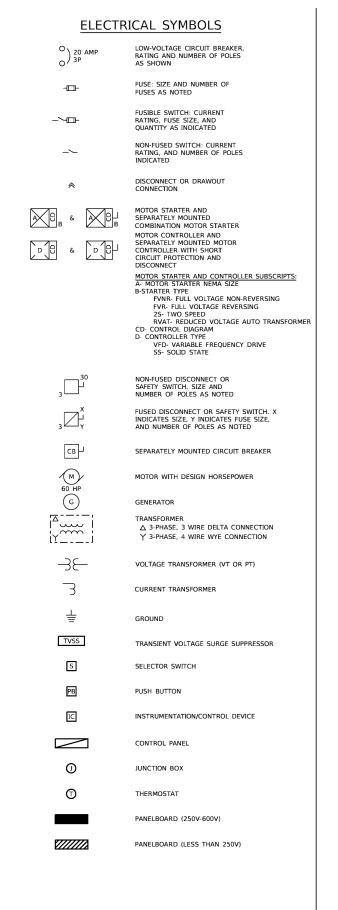

# **ELECTRICAL SYMBOLS** CONTROL SYMBOLS

ELEC	TRICAL STMBULS		CONTROL STMBOLS
\$	LIGHT SWITCH	<b>-</b>	ELECTRICAL CONNECTION
<b>\$</b> ×	LIGHT SWITCH, X WAY		NO ELECTRICAL CONNECTION
0	FLOOR BOX WITH DUPLEX RECEPTACLE	어Ю	NORMALLY OPEN CONTACT
<b>©</b>	FLOOR BOX FOR DATA/COMMUNICATION	01/40	NORMALLY CLOSED CONTACT
•	WALL BOX FOR DATA/COMMUNICATION	~°	NORMALLY OPEN TIME DELAY RELAY CONTACT. CLOSES UPON TIME DELAY AFTER ACTIVATING COIL
€	DUPLEX RECEPTACLE OUTLET	070	NORMALLY CLOSED TIME DELAY RELAY CONTACT. OPENS UPON TIME DELAY AFTER ACTIVATING COIL
<b>⊕</b> GFCI	DUPLEX RECEPTACLE OUTLET WITH GROUND FAULT INTERRUPTER	<b>√°</b>	NORMALLY OPEN TIME DELAY RELAY CONTACT. OPENS UPON TIME DELAY AFTER DE-ACTIVATING COIL
<b>⊕</b> WP	WEATHERPROOF RECEPTACLE OUTLET WITH CFCI PROTECTION	0.10	NORMALLY CLOSED TIME DELAY RELAY CONTACT. CLOSES UPON TIME DELAY AFTER DE-ACTIVATING COIL
₩=	QUAD RECEPTACLE OUTLET	~ <u>~</u>	NORMALLY OPEN TEMPERATURE SWITCH: CLOSES ON RISING TEMPERATURE
`X:##	CIRCUITING NOTATION: X DENOTES PANEL AND ## DENOTES CIRCUIT NUMBER	0.70	NORMALLY CLOSED TEMPERATURE SWITCH: OPENS ON RISING TEMPERATURE
1	DENOTES CIRCUITING FOR STANDARD ELECTRICAL DEVICES	~	NORMALLY OPEN FLOW SWITCH: CLOSES ON INCREASING FLOW
Е	UNDERGROUND ELECTRIC	oto	NORMALLY CLOSED FLOW SWITCH: OPENS ON INCREASING FLOW
A	OVERHEAD ELECTRIC	>	NORMALLY OPEN LEVEL SWITCH: CLOSES ON INCREASING LEVEL
		<b>े</b> ७	NORMALLY CLOSED LEVEL SWITCH: OPENS ON INCREASING LEVEL
		20	NORMALLY OPEN PRESSURE SWITCH: CLOSES ON INCREASING PRESSURE
		0 दु	NORMALLY CLOSED PRESSURE SWITCH: OPENS ON INCREASING PRESSURE
		~0	NORMALLY OPEN LIMIT SWITCH: CLOSES UPON REACHING LIMIT
		O⊸O PLC	NORMALLY CLOSED LIMIT SWITCH: OPENS ON REACHING LIMIT
		□ PLC	MICROPROCESSOR INPUT
			MICROPROCESSOR OUTPUT
		00	FIELD WIRING EXTERNAL TO CONTROL PANEL
		H O A	
			3-POSITION SELECTOR SWITCH, MAINTAINED CONTACTS
		O O OOX	
		0 0	NORMALLY OPEN PUSHBUTTON, MOMENTARY CONTACT
		ماه	NORMALLY CLOSED PUSHBUTTON, MOMENTARY CONTACT
		•X•	INDICATING LIGHT, X INDICATES COLOR
		0 (x)0	PUSH TO TEST INDICATING LIGHT, X INDICATES COLOR  LENS COLOR: R- RED Y-YELLOW G- GREEN W-WHITE B-BLUE A- AMBER
		o- <b>\</b> -0	SOLENOID VALVE
		<u>x</u>	THERMAL OVERLOAD ELEMENT
		o₩o or	THERMAL OVERLOAD ELEMENT RELAY CONTACT

							F.A.P. RTE.	SECTION	C OUNTY	TOTAL	SHEET NO.
STATE OF ILLINOIS			ELEC	TRICAL I	LEGEND		320	D6 PUMP STATION 2019	LOGAN	12	4
RTMENT OF TRANSPORTATION									C ONTRAC	T NO. 4	16528
	SCALE: NONE	SHEET 1	0F 4	SHEETS	STA.	TO STA.		ILLINOIS FED. A	ID PROECT		



DESIGNED JNN R VEISED DRAWN BGJ REVISED PLOT SCALE = 0:2 ':m / 1 n. CHECKED JNN REVI SED DATE 5/16/2019 REVISSED -

D PART

ELAPSED TIME METER

MOTOR STARTS COUNTER

ETM

MSC

#### EXISTING ELECTRICAL PLAN SCALE: 1/2"=1'-0"

### KEY NOTES (APPLICABLE TO THIS SHEET ONLY)


- ☐ INSTALL NEW SERVICE ENTRANCE CONDUCTORS AS SHOWN
- $\begin{tabular}{ll} \blacksquare \blacksquare \end{tabular}$  REMOVE EXISTING SERVICE ENTRANCE CONDUCTORS/CONDUIT DOWNSTREAM OF EXISTING METER
- 3 NEW SERVICE DISCONNECT SWITCH.
- ANEW AUTOMATIC TRANSFER SWITCH.
- 5 INSTALL NEW FEEDER AS SHOWN.
- 6 NEW GENERATOR QUICK CONNECTION ENCLOSURE.
- REMOVE EXISTING LIGHT FIXTURE AND PREPARE CIRCUIT FOR RE-USE.
- 8 NEW MCC. MODIFY EXISTING HOUSEKEEPING PAD IF NECESSARY TO ACCOMMODATE NEW MCC DIMENSIONS.
- TO EXISTING ALARM BEACON TO BE SALVAGED AND RE-INSTALLED.
- 10 REMOVE/REINSTALL EXISTING CONDUIT AND ELECTRICAL EQUIPMENT LOCATED ON ROOF AND UPPER WALLS AS NECESSARY TO FACILITATE BUILDING MODIFICATIONS.

### GENERAL NOTES

- EXISTING ELECTRICAL EQUIPMENT, CIRCUITS, AND CONDUITS NOT NOTED TO BE MODIFIED SHALL REMAIN AND BE RECONNECTED TO NEW ELECTRICAL EQUIPMENT AS APPLICABLE. THIS INCLUDES BUT IS NOT LIMITED TO WATER LEVEL MEASUREMENT SYSTEM, RECEPTACLES, AND LOWER LEVEL LIGHTING.
- 2. AN ELECTRICAL SHOCK AND ARC FLASH HAZARD ANALYSIS SHALL BE PERFORMED IN ACCORDANCE WITH THE LATEST VERSION OF NFPA-70E AND IEEE-1584 FOR ALL OWNER OWNED EQUIPMENT FROM THE SERVICE ENTRANCE UP TO AND INCLUDING THE MCC. WRITTEN RESULTS OF THE ANALYSIS SHALL BE PROVIDED TO THE OWNER AND NFPA-70 E COMPLIANT ARC FLASH WARNING LABELS APPLIED TO THE EQUIPMENT. MINIMUM INFORMATION REQUIRED FOR LABELS IS AS FOLLOWS:

  A. VOLTAGE EXPOSURE

  B. LIMITED APPROACH BOLINDARY.
- VOLTAGE EXPOSURE
  LIMITED APPROACH BOUNDARY
  RESTRICTED APPROACH BOUNDARY
  INCIDENT ENERGY AT THE WORKING DISTANCE OR ARC FLASH PPE
  CATEGORY
  ARC FLASH PROTECTION BOUNDARIES
  REQUIRED PPE AND GLOVE RATING
  EQUIPMENT NAME
  DATE PREPARED

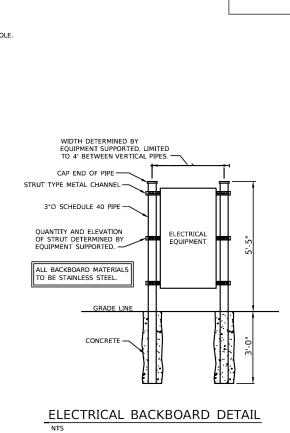



SCALE: 1/2"=1'-0"

EXISTING PUMP STATION

-PNB LOCATED

WITHIN MCC.

PNB-3

**®**O

SCALE: 1/2" = 1'-0"

9/1/9	KLINGNER
11.65	
5	En gineers • Architects • Surveyors
5	6 KN.24TH ST. QUINCY, ILLINOIS 62301 217.223.3670

PLOT DATE = 5/21/20019	DATE	5/16/2019	REVISSED -
PLOT SCALE = 10:2 fin / in	CHECKED	JNN	REVI SED -
	DRAW N	<b>B</b> GJ	REVISED -
USER NEAM ams	D ESIGN ED	-JNN	R EVISED -

STATE OF ILLINOIS DEPARTMENT OF TRANSPORTATION

1		F.A.P. RTE.	SECTION	COUNTY	TOTAL SHEETS	SHEET NO.
ı	ELECTRICAL PLAN AND DETAILS	320	D6 PUMP STATION 2019	LO GAN	12	5
ı				C NOTRAC	T N 04	6528
ļ	SQALE:½″=1′-0 SHEET 2 OF 4 SHEETS STA. TO STA.		ILLINOIS FED. A	D P_RIBCT		$\neg$


EXISTING DISCHARGE BOX


TO MCC

[5]

- EXISTING UTILITY POLE AND WEATHER HEAD TO REMAIN.

— EXISTING UTILITY POLE TO REMAIN.

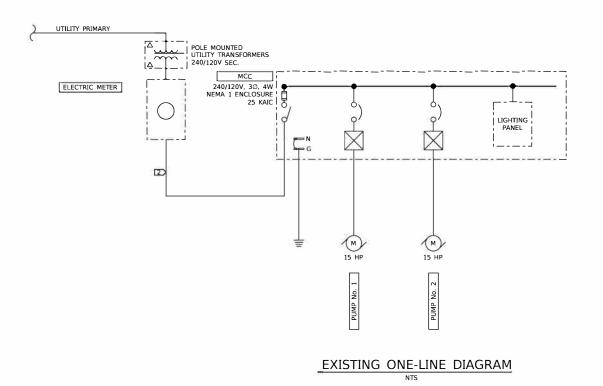


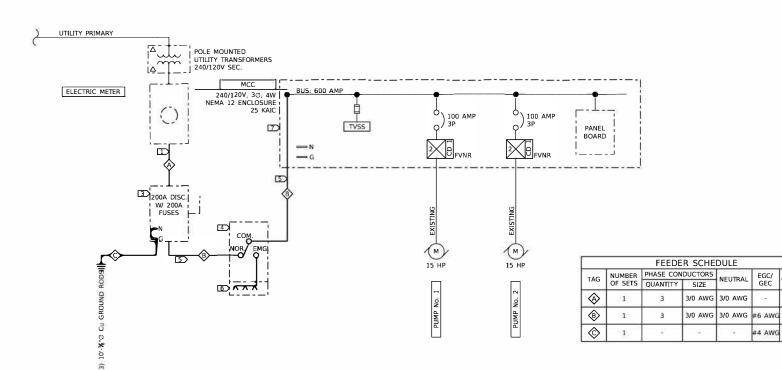

## PROPOSED ONE-LINE DIAGRAM

## KEY NOTES (APPLICABLE TO THIS SHEET ONLY)

- INSTALL NEW SERVICE ENTRANCE CONDUCTORS AS SHOWN.
- PREMOVE EXISTING SERVICE ENTRANCE CONDUCTORS/CONDUIT DOWNSTREAM OF EXISTING METER.
- NEW SERVICE DISCONNECT SWITCH.
- 4 NEW AUTOMATIC TRANSFER SWITCH.
- 5 INSTALL NEW FEEDER AS SHOWN.
- 6 NEW GENERATOR QUICK CONNECTION ENCLOSURE.
- NEW MCC

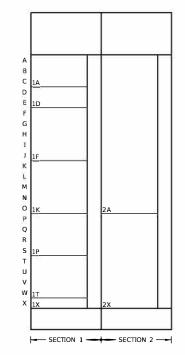

PROPOSED MCC ELEVATION

										_																														
					MC	C S	CH	IEC	UL																															
							JX			С	ON	TRO	L D	EVI	CES																									
ID							LKS		USI TTO			NITO					ATII HTS		OTHER		OTHER		OTHER		OTHER		OTHER		OTHER		OTHER		OTHER		OTHER		OTHER		R	
SECTION	CELL	STARTER, CLASS, OR DESCRIPTION	SIZE (INCHES)	CB TRIP/FUSE CLIPS (A)	HP RATING	мо	NC	START-STOP	FWD-REV-STOP	FAST-SLOW-STOP	HAND-OFF-AUTO	ON-OFF	FWD-OFF-REV	FAST-OFF-SLOW	GREEN	RED	AMBER	PUSH TO TEST	ELAP SED TIME METER	MOTOR STARTS COUNTER	CURRENT SWITCH																			
1	Α	MAIN LUGS	9							$\dashv$			7		Н				$\vdash$			MAIN LUGS																		
1	D	TVSS	6		1			-										-				TVSS																		
1	F	COMB. FVNR STARTER	15	100	15					$\Box$	Х				Х		Х	Х	X	X	X	PUMP No. 1																		
. 1	К	COMB. FVNR STARTER	15	100	15					$\neg$	Х		$\neg$		Х		Х	Х	Х	Х	X	PUMP No. 2																		
1	Р	SPACE	12															-				SPACE																		
1	T	SPACE	12																			SPACE																		
1	Х	SPACE	3																			SPACE																		
2	Α	RELAY SECTION	45									=		= 4								CONTROLS																		
2	Х	PANELBOARD	27	. 100																		PANELBOARD																		

	PANELBOARD						Area Served	PUMP STATION :	
Location:				100 A 1			3 Wire	100AMP MAIN BREAKER	
		Brkr.		Loa			Brkr.		
No.	Description	Amps	Α	В	В	Α	Amps	Description	No
1	PANEL HEATERS	20	400			100	20	LEVEL MEASUREMENT	2
3	LIGHTS	20	=	500	100		20	CONTROLS	4
5	RECEPTACLES	20	720			100	20	ALARM BEACON	6
7	SPARE	20					20	SPARE	. 8
9	SPARE	20			- 2		20	SPARE	10
11	SPACE							SPACE	12
13	SPACE	4 4 5			- 5		2	SPACE	- 14
15	SPACE			$\overline{}$				SPACE	16
17	SPACE						1	SPACE	18
-			1120	500	100	200		***	
	Totals	Phas	e A	Phas	e B	Total Wa	attage(V	Capacity	
		132	20	600	)	19	920	24000	

PE I			LIGHTING FIXTURE SCHEDULE													
	MANUFACTURER	MODEL NUMBER	VOLTS	LUMENS	WATTS	DISTRIBUTION	COLOR TEMP	COMMENTS								
Į.	LITHONIA	CLX-L48-7000LM-SEF-RDL-WD-MVOLT-GZ10-40K-80CRI	120	7,000	49											
ED STRIP LIGHT	METALUX	4SLSTP5540DD-UNV	120	5,845	49	WIDE	4,000 K									
1	DAY BRITE	FSI-4-70L-840-UNV-DIM	120	7,000	58											
L	LITHONIA	OLWX1 LED 20W 40K PE	120	2,697	20			PROVIDE WITH INTEGRAL								
.ED WALL PACK	LUMARK	XTOR2B	120	2,135	18		4,000 K	PHOTOCELL. DARK BRONZE								
F	RAB	SLIM18N/PC	120	2,556	18			FINISH.								
_	STRIP LIGHT  WALL PACK	STRIP LIGHT METALUX DAY BRITE LITHONIA D WALL PACK LUMARK	STRIP LIGHT	DESTRIP LIGHT         METALUX         4SLSTP5540DD-UNV         120           DAY BRITE         FSI-4-70L-840-UNV-DIM         120           LITHONIA         OLWX1 LED 20W 40K PE         120           D WALL PACK         LUMARK         XTOR2B         120	METALUX         4SLSTP5540DD-UNV         120         5,845           DAY BRITE         FSL4-70L-840-UNV-DIM         120         7,000           LITHONIA         OLWX1 LED 20W 40K PE         120         2,697           DWALL PACK         LUMARK         XTOR2B         120         2,135	METALUX         4SLSTP5540DD-UNV         120         5,845         49           DAY BRITE         FSI-4-70L-840-UNV-DIM         120         7,000         58           LITHONIA         OLWX1 LED 20W 40K PE         120         2,897         20           D WALL PACK         LUMARK         XTOR2B         120         2,135         18	STRIP LIGHT   METALUX   4SLSTP5540DD-UNV   120   5,845   49   WIDE	STRIP LIGHT   METALUX   4SLSTP5540DD-UNV   120   5,845   49   WIDE   4,000 K								




U SKEMME = ams	DESIGNED 344	KE VISED -
	DRAWN BGJ	REVISED -
PLOT SCALE = 02 ':10 / 10.	CHECKED JNN	REVISED -
PLOT DAT = 521/2019	DATE 5/16/2019	REVISED -


## STATE OF ILLINOIS DEPARTMENT OF TRANSPORTATION


CONDUIT


SCALE NONE

ELECTRICAL ONE-LINE DIAGRAM					F.A.P. RTE.	SECTION	COUNTY	TOTAL	SHEE		
ELEVATION AND SCHEDULES				320	D6 PUMP STATION 2019	LOGAN	12	6			
					-04	CON	TTRN AD C4	1652			
	SHEET	3	0F 4	SHEETS	STA.	T OSTA.		IL UN OS, FED. I	D P RO. J JEC	T	

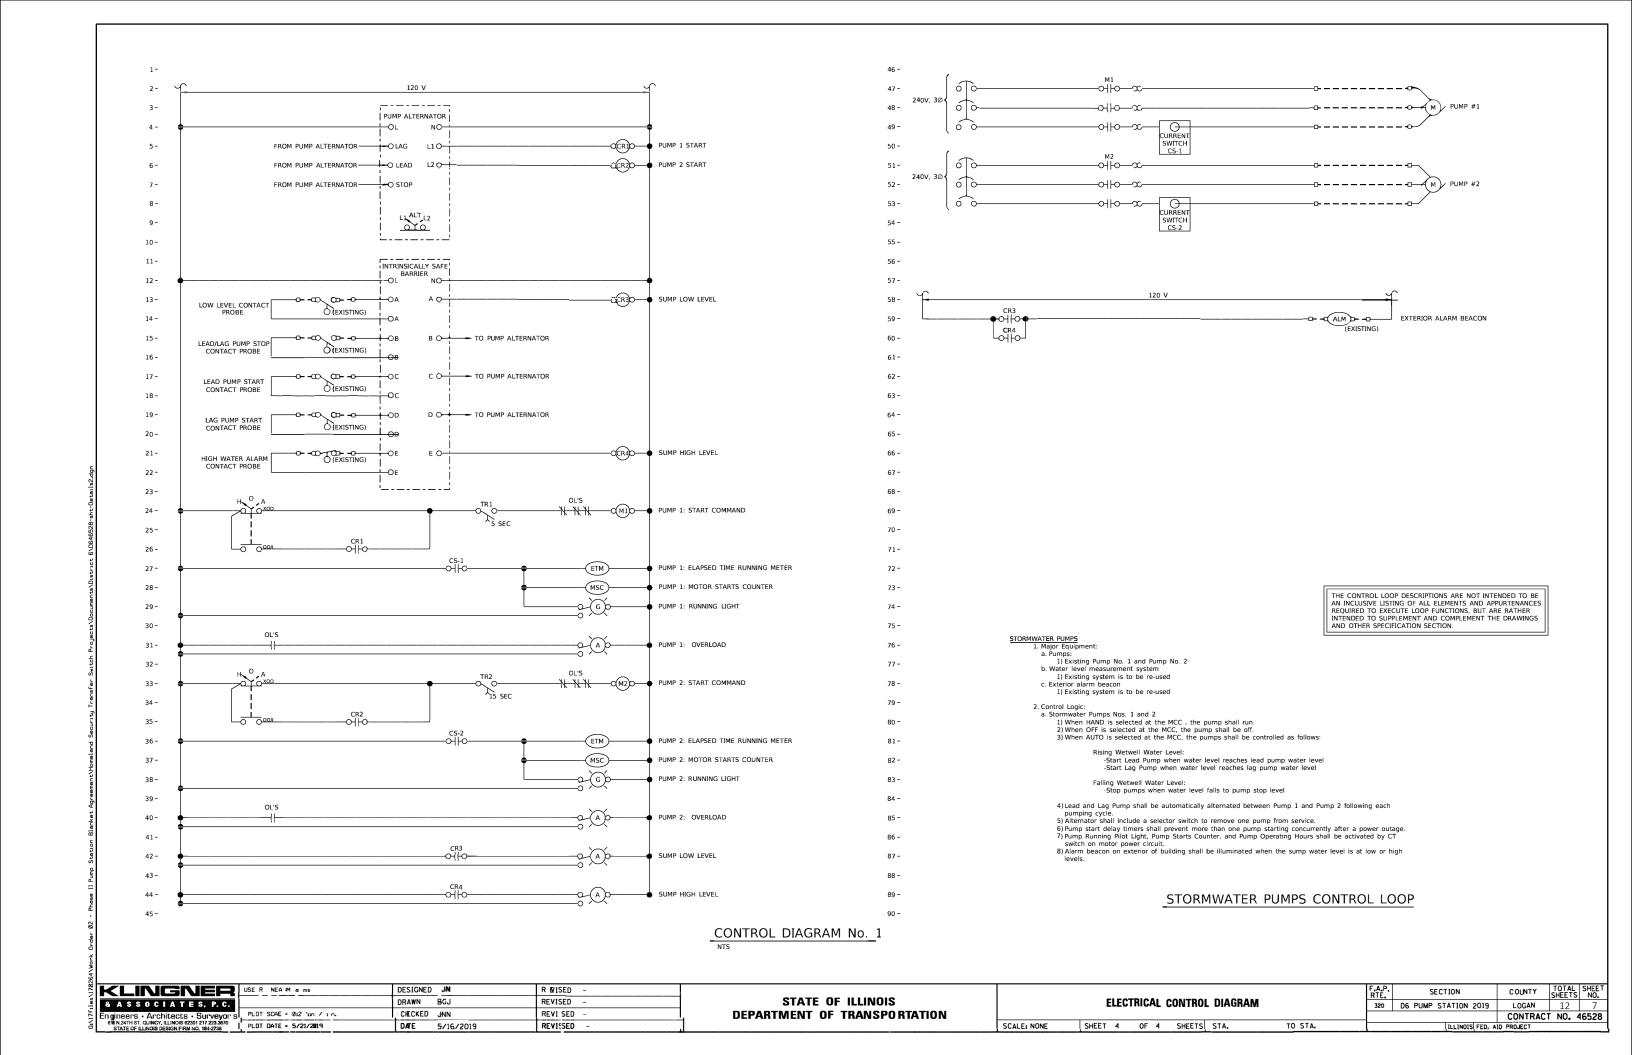

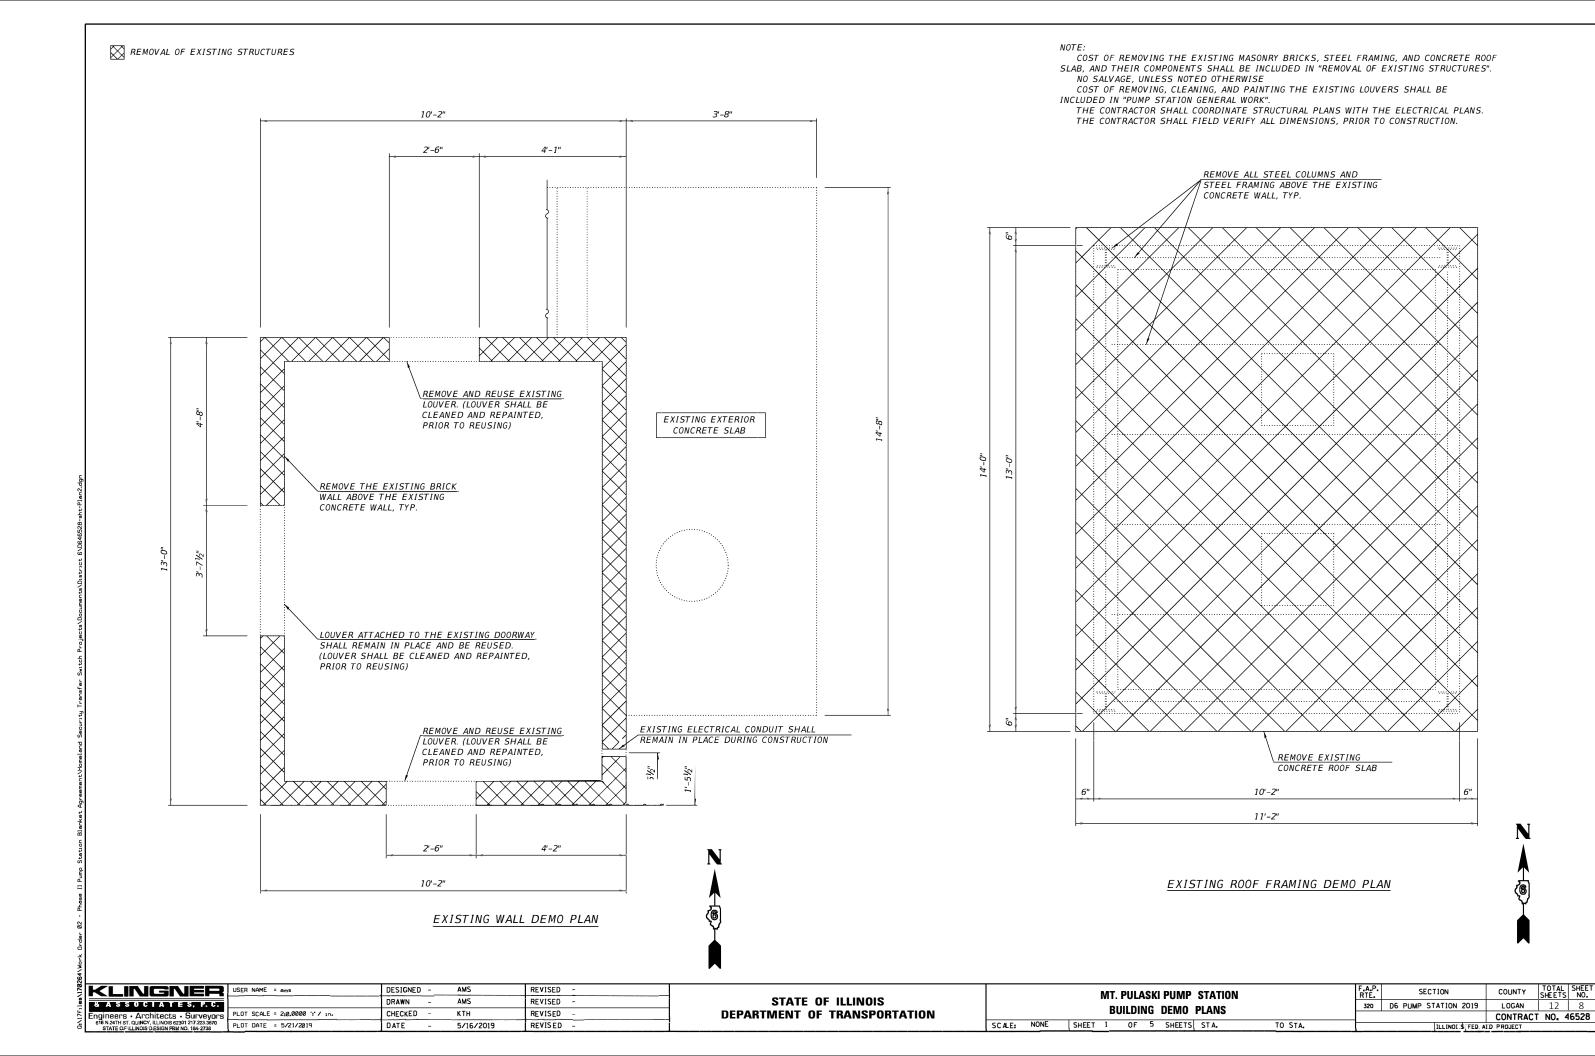

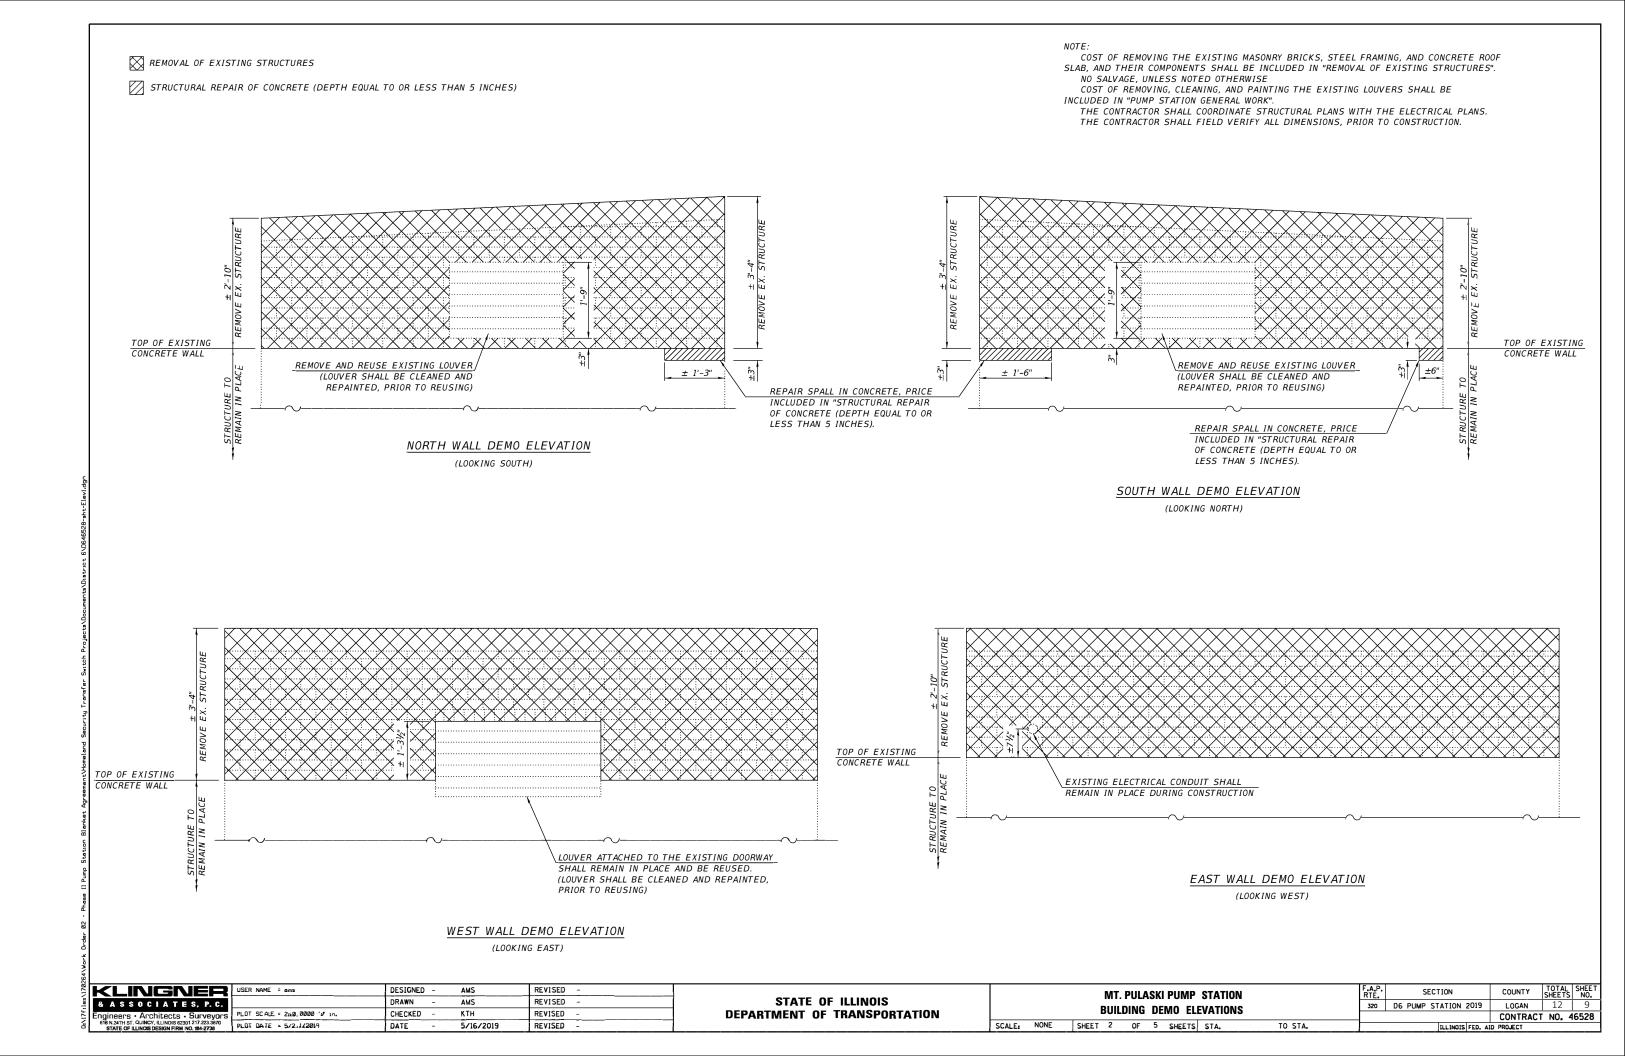

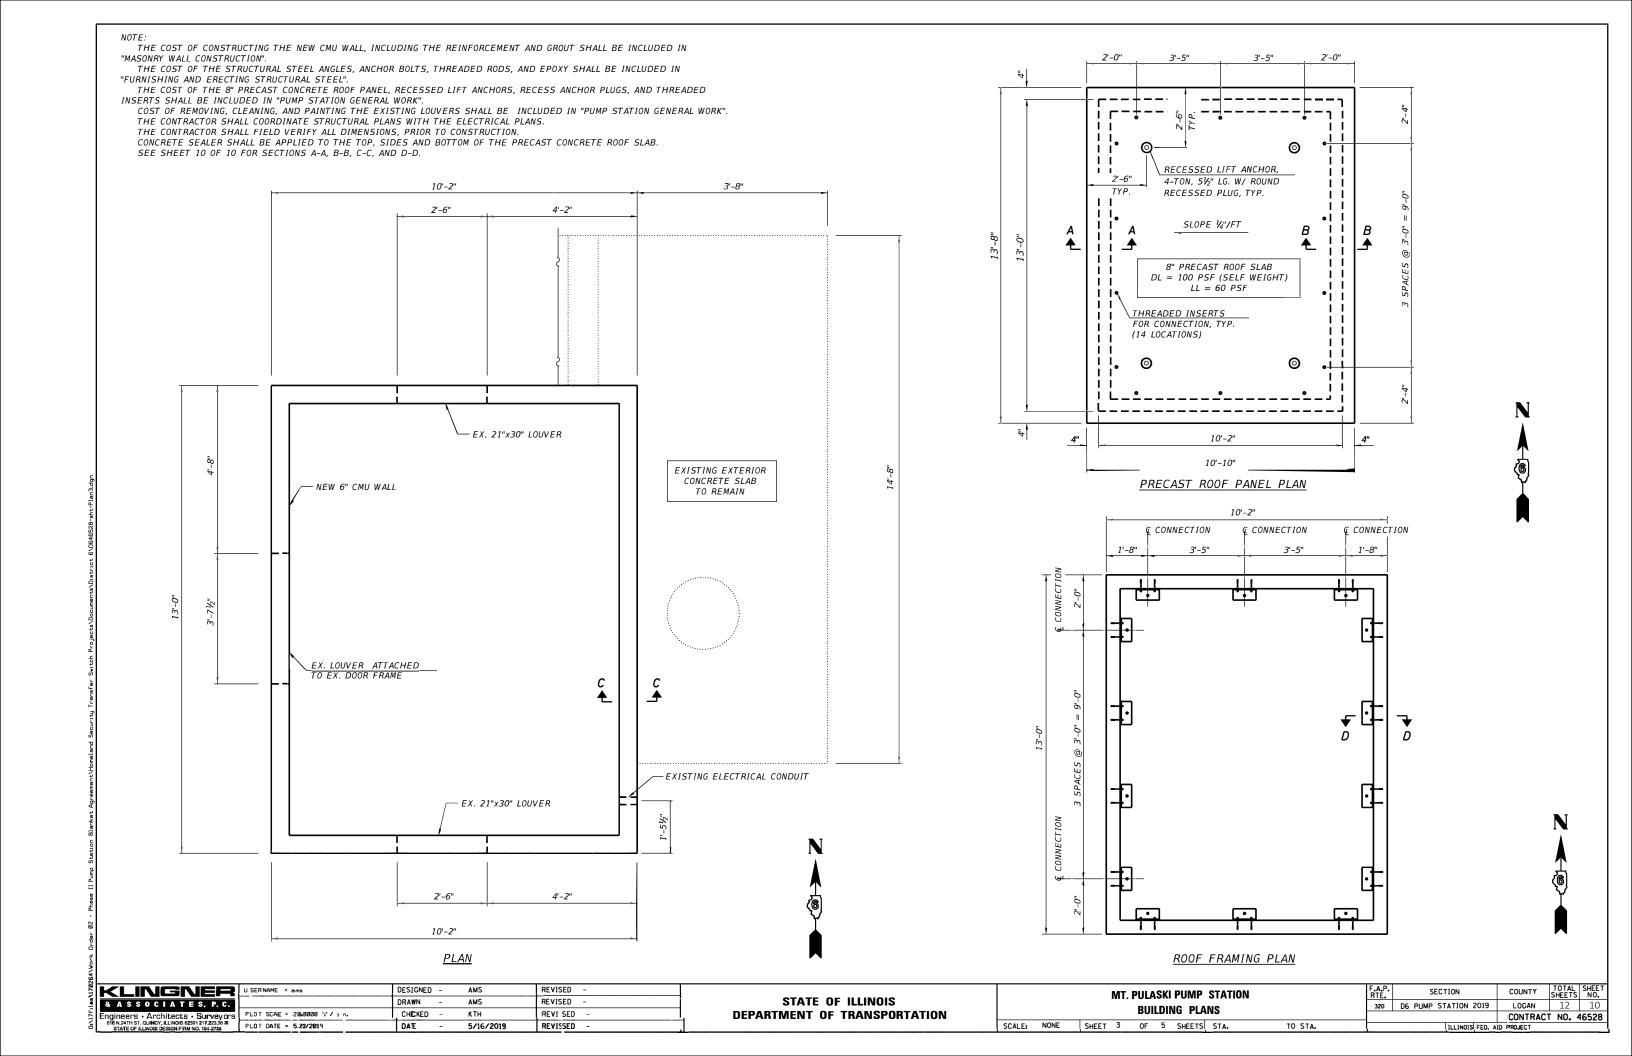

THE COST OF CONSTRUCTING THE NEW CMU WALL, INCLUDING THE REINFORCEMENT AND GROUT SHALL BE INCLUDED IN "MASONRY WALL CONSTRUCTION".

"MASONRY WALL CONSTRUCTION".

THE COST OF THE STRUCTURAL STEEL ANGLES, ANCHOR BOLTS, THREADED RODS, AND EPOXY SHALL BE INCLUDED IN
"FURNISHING AND ERECTING STRUCTURAL STEEL".

THE COST OF THE 8" PRECAST CONCRETE ROOF PANEL, RECESSED LIFT ANCHORS, RECESS ANCHOR PLUGS, AND THREADED
INSERTS SHALL BE INCLUDED IN "PUMP STATION GENERAL WORK".

COST OF REMOVING, CLEANING, AND PAINTING THE EXISTING LOUVERS SHALL BE INCLUDED IN "PUMP STATION GENERAL WORK".

THE CONTRACTOR SHALL COORDINATE STRUCTURAL PLANS WITH THE ELECTRICAL PLANS.


THE CONTRACTOR SHALL FIELD VERIFY ALL DIMENSIONS, PRIOR TO CONSTRUCTION.

CONCRETE SEALER SHALL BE APPLIED TO THE TOP, SIDES, AND BOTTOM OF THE PRECAST CONCRETE ROOF PANEL.

MASONRY WALL FINISH AND COLOR SHALL BE SELECTED BY THE "OWNER"


MASONRY WALL FINISH AND COLOR SHALL BE SELECTED BY THE "OWNER"

MASONRY UNITS SHALL BE FABRICATED WITH INTEGRAL WATER REPELLANT ADDITIVE.

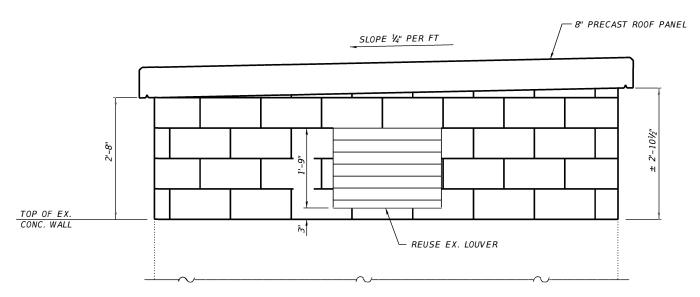


NORTH ELEVATION

(LOOKING SOUTH)

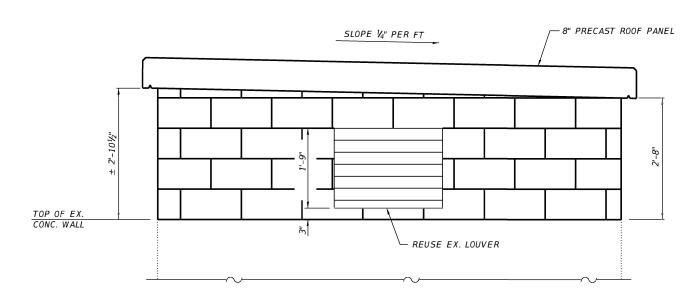

**SOUTH ELEVATION** 

(LOOKING NORTH)

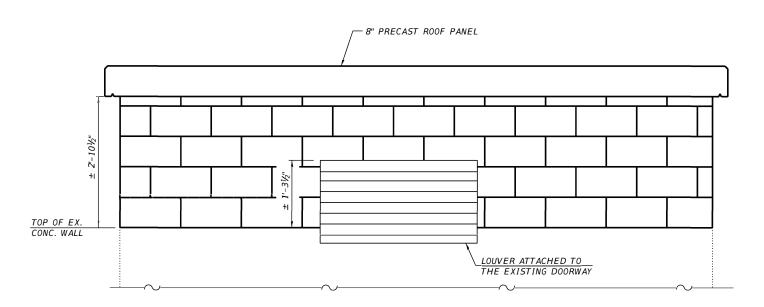

<u>WEST ELEVATION</u>

(LOOKING EAST)

CONC. WALL EXISTING ELECTRICAL CONDUIT SHALL

TOP OF EX.

KLINGNER & ASSOCIATES, P.C. ngineers • Architects • Surveyors 616 N.24TH ST. QUINCY, ILLINOIS 62301 217 223.3670 STATE OF ILLINOIS DESIGN FRM NO. 184-2738

USER NAME = ams	DESIGNED		AMS	REVISED -
	DRAWN	-	AMS	REVISED -
PLOT SCALE = 2:0.0000 ':' / in-	CHECK ED		KTH	REVISED -
PLOT DATE = 5/21/2019	DATE		5/16/2019	REVISED -

STATE OF ILLINOIS **DEPARTMENT OF TRANSPORTATION** 

MT. PULASKI PUMP STATION BUILDING ELEVATIONS							F.A.F RTE.	
							320	
		OILDI	1140	LLLVAI	10143			
HEET	4	0F	5	SHEETS	ST A.	TO STA.		

EAST ELEVATION

(LOOKING WEST)

	ID PROJECT			
		CONTRACT	NO. 4	16528
320	D6 PUMP STATION 2019	LOGAN	12	11
F.A.P. RTE.	SECTION	COUNTY	TOTAL SHEETS	SHEET NO.

SCALE: NONE SH

-8" PRECAST ROOF PANEL

