09-19-2025 LETTING ITEM 010

FOR INDEX OF SHEETS, HIGHWAY STANDARDS, AND LEGEND SEE SHEET NO. 2

TRAFFIC DATA
STATE STREET
MAJOR COLLECTOR
POSTED SPEED LIMIT = 30 M.P.H.
2023 ADT = 4,000

100 200 300 1°= 100 10° 20° 30° 1°= 10° 60° 100° 1°= 50° 100° 1°= 40° 100° 1°= 30°

FULL SIZE PLANS HAVE BEEN PREPARED USING STANDARD ENGINEERING SCALES. REDUCED SIZED PLANS WILL NOT CONFORM TO STANDARD SCALES. IN MAKING MEASUREMENTS ON REDUCED PLANS, THE ABOVE SCALES MAY BE USED.




CONTRACT NO. 61L74

STATE OF ILLINOIS DEPARTMENT OF TRANSPORTATION

PLANS FOR PROPOSED FEDERAL-AID HIGHWAY

SAFE ROUTES TO SCHOOL SIDEWALK IMPROVEMENTS FAU 0098 (STATE STREET) MUN 4050 (HIGH AVENUE) MUN 1040 (ELM STREET) MUN 4030 (PANAMA AVENUE) SECTION 24-00021-00-SW PROJECT NUMBER: FQPA (231) VILLAGE OF HAMPSHIRE KANE COUNTY JOB NO. C-91-279-24

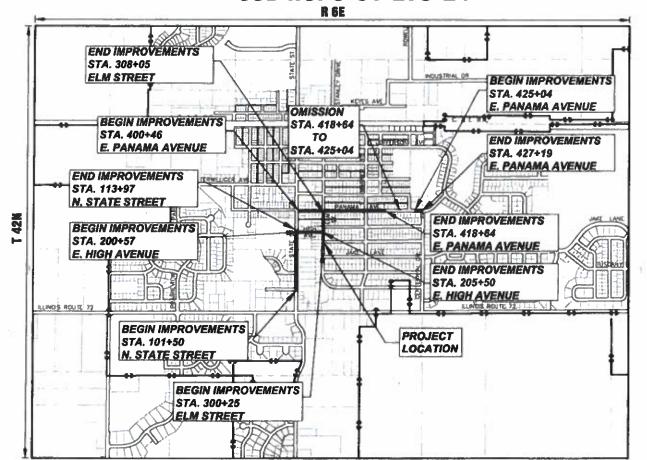



LOCATION MAP (SCALE 1"=1000")

NW 1/4 OF SECTION 27, T42N, R6E, HAMPSHIRE TOWNSHIP
GROSS LENGTH OF PROJECT = 4,555 FEET (0.863 MILES)

NET LENGTH OF PROJECT = 4,555 FEET (0.863 MILES)



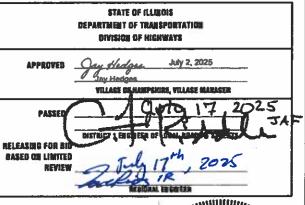

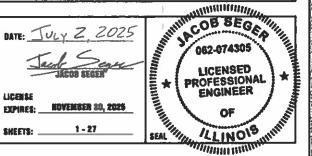



Engineering Enterprises, Inc. CONSULTING ENGINEERS 52 Wheeler Road Sugar Grove, Illinois 60554 Phone: (630) 466-6700

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OF THE STATE OF ILLINOIS

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GENERAL NOTES

SPECIFICATIONS, STANDARDS, AND SPECIAL PROVISIONS

ALL CONSTRUCTION SHALL BE DONE IN ACCORDANCE WITH THE "STANDARD SPECIFICATIONS FOR ROAD AND BRIDGE CONSTRUCTION, "ADOPTED JANUARY 1, 2022 (HEREINAFTER REFERRED TO AS THE STANDARD SPECIFICATIONS), THE "SUPPLEMENTAL SPECIFICATIONS AND RECURRING SPECIAL PROVISIONS," ADOPTED JANUARY 1, 2025, THE LATEST EDITION OF THE 'ILLINOIS MANUAL ON UNIFORM TRAFFIC CONTROL DEVICES FOR STREETS AND HIGHWAYS', THE 'STANDARD SPECIFICATIONS FOR WATER & SEWER MAIN CONSTRUCTION IN ILLINOIS". SEVENTH EDITION. THE CODES AND ORDINANCES OF THE VILLAGE OF SUGAR GROVE, ILLINOIS, THE DETAILS IN THE PLANS AND THE SPECIAL PROVISIONS INCLUDED IN THE

NO SUBSTITUTIONS OR VARIANCES WILL BE PERMITTED TO ANY STANDARD NOTES OR ORDINANCES UNLESS APPROVED OTHERWISE IN WRITING PRIOR TO COMMENCING CONSTRUCTION ACTIVITY.

ALL TRAFFIC CONTROL AND OTHER ADVISORY SIGNS NEEDED FOR CONSTRUCTION ARE TO BE FURNISHED BY THE CONTRACTOR IN ACCORDANCE WITH ARTICLE 107.14 OF THE STANDARD SPECIFICATIONS

THE CONTRACTOR SHALL AT ALL TIMES PROVIDE PROTECTION FOR TRAFFIC AS CALLED FOR IN THE APPLICATION OF TRAFFIC CONTROL DEVICES, THE STANDARD SPECIFICATIONS, THE SPECIAL PROVISIONS AND THE PLANS

THE CONTRACTOR SHALL COOPERATE WITH THE OWNER IF ANY UTILITY IMPROVEMENTS ARE REQUIRED WITHIN THE DURATION OF THE CONTRACT.

THE CONTRACTOR SHALL BE RESPONSIBLE FOR CONTACTING THE OWNERS OF ALL UTILITIES PRIOR TO CONSTRUCTION TO DETERMINE THE LOCATION OF ALL EXISTING AND PROPOSED UTILITY EQUIPMENT. THE CONTRACTOR SHALL COOPERATE WITH ALL UTILITY OWNERS AS PROVIDED FOR IN THE STANDARD SPECIFICATIONS IF UTILITY RELOCATION, ADJUSTMENT, OR PROTECTION IS NECESSARY.

THE LOCATION OF EXISTING DRAINAGE STRUCTURES, STORM SEWERS, WATER MAINS, SANITARY SEWERS, FIELD TILES AND ANY OTHER PUBLIC OR PRIVATE UTILITIES AS SHOWN ON THE PLANS IS APPROXIMATE AND NOT NECESSARY COMPLETE: THEIR

IF EXISTING UTILITY LINES OF ANY NATURE ARE ENCOUNTERED WHICH CONFLICT IN LOCATION WITH NEW CONSTRUCTION, THE CONTRACTOR SHALL NOTIFY THE ENGINEER SO THAT THE CONFLICT MAY BE RESOLVED.

UNDER NO CIRCUMSTANCES SHALL THE CONTRACTOR OPERATE ANY VALVES OR HYDRANTS.

THE CONTRACTOR SHALL PROTECT AND CAREFULLY PRESERVE ALL SECTION OR SUBSECTION MONUMENTS, PROPERTY CORNERS, AND REFERENCE MARKERS UNTIL THE OWNER, THE OWNER'S AGENT, OR AN AUTHORIZED SURVEYOR HAS WITNESSED OR OTHERWISE REFERENCED THEIR LOCATIONS.

ALL OFFSET LOCATIONS GIVEN ON THE DETAILED PLANS ARE FROM THE CENTERLINE AS SHOWN ON THE PLANS.

THE THICKNESS OF ASPHALT MIXTURES SHOWN IN THE PLANS ARE NOMINAL. DEVIATIONS MAY OCCUR DUE TO IRREGULARITIES IN THE SURFACES OR BASES ON WHICH THE ASPHALT MIXTURES ARE TO BE PLACED.

IT IS THE CONTRACTOR'S RESPONSIBILITY TO ASCERTAIN EXISTING FIELD CONDITIONS BEFORE BIDDING ON THIS CONTRACT.

WHERE NEW WORK MEETS EXISTING FEATURES TO REMAIN, THE CONTRACTOR SHALL FIELD CHECK ALL DIMENSIONS AND ELEVATIONS BEFORE PROCEEDING WITH CONSTRUCTION. IMMEDIATELY NOTIFY THE ENGINEER OF ANY DISCREPANCIES.

THE CONTRACTOR WILL BE REQUIRED TO COMPLY WITH ALL STATE REGULATIONS REGARDING AIR, WATER AND NOISE POLLUTION. THE CONTRACTOR IS PROHIBITED FROM BURNING ANY MATERIAL WITHIN OR ADJACENT TO THE IMPROVEMENT.

THE ENGINEER IS NOT RESPONSIBLE FOR THE CONSTRUCTION MEANS, METHODS, TECHNIQUES, SEQUENCES OR PROCEDURES, TIME OF PERFORMANCE, PROGRAMS OR FOR ANY SAFETY PRECAUTIONS USED BY THE CONTRACTOR. THE CONTRACTOR IS SOLELY RESPONSIBLE FOR EXECUTION OF THEIR WORK IN ACCORDANCE WITH THE CONTRACT DOCUMENTS AND

THE CONTRACTOR SHALL MAINTAIN EXISTING SIDE STREET AND DRIVEWAY ACCESS TO EACH ABUTTING PROPERTY AT ALL TIMES DURING CONSTRUCTION OF THE PROJECT UNLESS OTHERWISE NOTED ON THE PLANS OR DIRECTED BY THE ENGINEER.

THE CONTRACTOR SHALL DISPOSE OF AND REMOVE FROM THE SITE EACH DAY ALL CURB AND GUTTER, PAVEMENT AND ALL OTHER EXCAVATED MATERIAL NOT FOR SALVAGE.

THE STORAGE OF EQUIPMENT AND/OR MATERIALS WITHIN THE RIGHT-OF-WAY OF ANY STREET AND/OR PARK PROPERTY SHALL REQUIRE PRIOR APPROVAL OF THE ENGINEER.

SIDEWALK REMOVAL AND REPLACEMENT AND COMBINATION CONCRETE CURB AND GUTTER REMOVAL AND REPLACEMENT QUANTITIES AND LOCATIONS WILL BE VERIFIED IN THE FIELD BY THE ENGINEER PRIOR TO CONSTRUCTION.

ALL EXISTING SIGNS (INCLUDING THOSE LOCATED ON UTILITY/LIGHT POLES) THAT DO NOT CONFLICT WITH THE IMPROVEMENTS SHALL REMAIN IN PLACE UNLESS DIRECTED BY THE ENGINEER.

CONTRACTOR SHALL TAKE PRECAUTION BY PRESERVING EXISTING TREES WITHIN THE RIGHT OF WAY. IF ANY DAMAGE OCCURS, TREES SHALL BE REPLACED IN KIND PER ARTICLE 201.07 REPAIR OR REPLACEMENT OF EXISTING PLANT MATERIAL REQUIREMENTS STATED HEREIN.

PAY LIMITS FOR EARTH EXCAVATION SHALL EXTEND TO THE FULL WIDTH OF THE PROPOSED AGGREGATE BASE.

"RESTORATION" CALLOUT IN THE PLANS CONSISTS OF THE FOLLOWING PAY ITEMS: TOPSOIL FURNISHING AND PLACEMENT 4" FERTILIZER NUTRIENTS (NITROGEN, PHOSPHORUS AND POTASSIUM); AND SEEDING, CLASS 2A.

THE PAY LIMITS FOR PAY ITEMS ASSOCIATED WITH RESTORATION SHALL EXTEND A MAXIMUM WIDTH OF 2 FEET FROM THE EDGE OF PROPOSED SIDEWALK. ANY DISTURBANCE BEYOND THESE LIMITS SHALL BE RESTORED.

COMMITMENTS NONE

COVER SHEET

GENERAL NOTES, HIGHWAY AND INDEX OF SHEETS

INDEX OF SHEETS

SUMMARY OF QUANTITIES

5.-8. TYPICAL SECTIONS

9.-12. STATE STREET PLAN AND PROFILE

13.-14. HIGH AVENUE PLAN AND PROFILE

15.-16. ELM STREET PLAN AND PROFILE 17.-22. PANAMA STREET PLAN AND PROFILE

VILLAGE DETAILS

24.-27. IDOT DISTRICT 1 DETAILS

IDOT DISTRICT ONE STD. DETAILS

24.

(BD-22) PAVEMENT PATCHING FOR HMA SURFACED PAVEMENT

(BD-24) CURB OR CURB AND GUTTER REMOVAL AND REPLACEMENT

TRAFFIC CONTROL AND PROTECTION FOR SIDE ROADS, INTERSECTIONS AND DRIVEWAYS

(TC-13) TYPICAL PAVEMENT MARKINGS

442201-03 CLASS C AND D PATCHES

000001-08

424001-12

424006-06

424011-05

424016-06

424021-07

CONCRETE CURB TYPE B AND COMBINATION 606001-08

IDOT HIGHWAY STANDARDS

STANDARD SYMBOLS, ABBREVIATIONS,

DIAGONAL CURB RAMPS FOR SIDEWALKS

MID-BLOCK CURB RAMPS FOR SIDEWALKS

DEPRESSED CORNER FOR SIDEWALKS

PERPENDICULAR CURB RAMPS FOR SIDEWALKS

CORNER PARALLEL CURB RAMPS FOR SIDEWALKS

AND PATTERNS

CONCRETE CURB AND GUTTER

701001-02 OFF-RD OPERATIONS, 2L, 2W, MORE THAN 15' (4.5m) AWAY

701006-05 OFF-RD OPERATIONS, 2L, 2W, 15'(4.5M) TO 24" (600MM) FROM PAVEMENT EDGE

701011-04 OFF-RD MOVING OPERATIONS, 2L, 2W, DAY ONLY

701301-04 LANE CLOSURE, 2L, 2W, SHORT TIME OPERATIONS

701311-03 LANE CLOSURE, 2L, 2W, MOVING OPERATIONS - DAY ONLY

701501-06 URBAN LANE CLOSURE 2L, 2W, UNDIVIDED

SIDEWALK, CORNER OR CROSSWALK CLOSURE 701801-06


TRAFFIC CONTROL DEVICES 701901-10

SIGN PANEL MOUNTING DETAILS 720001-01

720006-04 SIGN PANEL ERECTION DETAILS

728001-01 TELESCOPING STEEL SIGN SUPPORT

780001-05 TYPICAL PAVEMENT MARKINGS

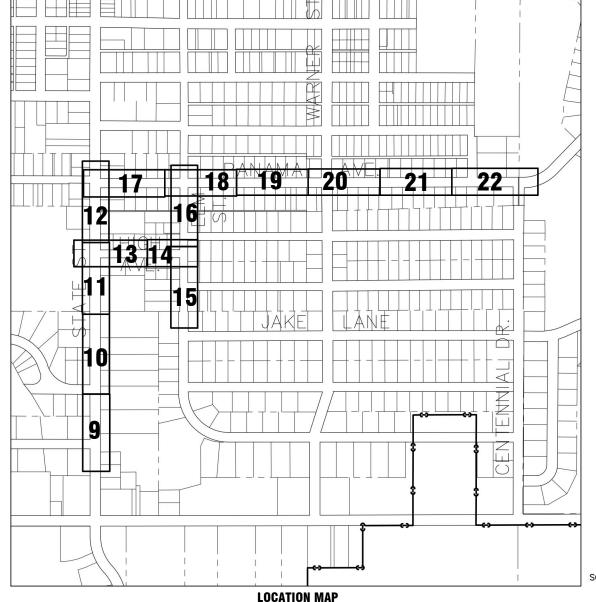

TO STA.

Engineering Enterprises, Inc Wheeler Road 630,466,6700 / www.eeiweb.co

DESIGNED DRAWN REVISED PLOT SCALE : CHECKED REVISED PLOT DATE = July 3, 2025 @ 7:57 AM DATE

STATE OF ILLINOIS **DEPARTMENT OF TRANSPORTATION**

GENERAL NOTES, HIGHWAY STANDARDS,	_
SUPPLEMENTAL LEGEND AND INDEX OF SHEETS	

OF 1 SHEETS STA.

SCALE: N.T.S.

SHEET 1

FAU RTE.	SECTION	COUNTY	TOTAL SHEETS	SHEE NO.	
0098	24-0002I-00-SW	KANE	27	2	
		CONTRACT N	10. 6IL74	1	
	ILLINOIS FED A	ID PROJECT			

	CODE NUMBER	ITEM DESCRIPTION	UNIT	TOTAL QUANTITY	SIDEWALK 80% FEDERAL 20% LOCAL	FIRE HYDRANT 0% FEDERAL 100% LOCAL
	20101100	TREE TRUNK PROTECTION	EACH	13	13	
	20101200	TREE ROOT PRUNING	EACH	13	13	
	20101300	TREE PRUNING (1 TO 10 INCH DIAMETER)	EACH	2	2	
	20101350	TREE PRUNING (OVER 10 INCH DIAMETER)	EACH	11	11	
	20200100	EARTH EXCAVATION	CU YD	764	764	
	21101615	TOPSOIL FURNISH AND PLACE, 4"	SQ YD	2,735	2,735	
	21400100	GRADING AND SHAPING DITCHES	FOOT	50	50	
	25000210	SEEDING, CLASS 2A	ACRE	0.75	0.75	
	25000400	NITROGEN FERTILIZER NUTRIENT	POUND	68	68	
	25000500	PHOSPHORUS FERTILIZER NUTRIENT	POUND	68	68	
	25000600	POTASSIUM FERTILIZER NUTRIENT	POUND	68	68	
	25100630	EROSION CONTROL BLANKET	SQ YD	2,735	2,735	
	28000510	INLET FILTERS	EACH	4	4	
	35101400	AGGREGATE BASE COURSE, TYPE B	TON	528	528	
	40200800	AGGREGATE SURFACE COURSE, TYPE B	TON	1	1	
	42300200	PORTLAND CEMENT CONCRETE DRIVEWAY PAVEMENT, 6 INCH	SQ YD	133	133	
	42400200	PORTLAND CEMENT CONCRETE SIDEWALK 5 INCH	SQ FT	21,345	21,345	
	42400300	PORTLAND CEMENT CONCRETE SIDEWALK 6 INCH	SQ FT	2,730	2,730	
	42400800	DETECTABLE WARNINGS	SQ FT	284	284	
+	44000200	DRIVEWAY PAVEMENT REMOVAL	SQ YD	677	677	

△ INDICATES SPECIALTY ITEM

Engineering Enterprises, Inc.
CONSULTING ENGINEERS
52 Wheeler Rond
Sugar Grove, Illinois 60554
630.466.6700 / www.eelweb.com

USER NAME = Kris Pung	DESIGNED -	REVISED -
	DRAWN -	REVISED -
PLOT SCALE =	CHECKED -	REVISED -
PLOT DATE = July 29, 2025 @ 3:28 PM	DATE -	REVISED -

STATE OF ILLINOIS
DEPARTMENT OF TRANSPORTATION

SCALE: N.T.S.

SUMMARY OF QUANTITIES				FAU RTE.	SECTION	COUNTY	TOTAL SHEETS	SHEET NO.		
						0098	24-0002I-00-SW	KANE	27	3
								CONTRACT N	NO. 6IL74	1
	SHEET 1	0F 2	SHEETS	STA.	TO STA.	ILLINOIS FED. AID PROJECT				

	CODE NUMBER	ITEM DESCRIPTION	UNIT	TOTAL QUANTITY	SIDEWALK 80% FEDERAL 20% LOCAL	FIRE HYDRANT 0% FEDERAL 100% LOCAL
	44000600	SIDEWALK REMOVAL	SQ FT	2,290	2,290	
	44201670	CLASS D PATCHES, TYPE I, 2 INCH	SQ YD	42	42	
	44201672	CLASS D PATCHES, TYPE II, 2 INCH	SQ YD	90	90	
	44201676	CLASS D PATCHES, TYPE IV, 2 INCH	SQ YD	135	135	
1	56400500	FIRE HYDRANT TO BE REMOVED	EACH	1		1
١	56400825	FIRE HYDRANT WITH AUXILIARY VALVE, VALVE BOX AND TEE	EACH	1		1
	60255500	MANHOLES TO BE ADJUSTED	EACH	1	1	
Δ Δ Δ Δ Δ Δ Δ	67100100	MOBILIZATION	L SUM	1	1	
	70102620	TRAFFIC CONTROL AND PROTECTION, STANDARD 701501	L SUM	1	1	
	70102640	TRAFFIC CONTROL AND PROTECTION, STANDARD 701801	L SUM	1	1	
1	72000100	SIGN PANEL - TYPE 1	SQ FT	34	34	
	72400310	REMOVE SIGN PANEL - TYPE 1	SQ FT	36	36	
1	72400500	RELOCATE SIGN PANEL ASSEMBLY - TYPE A	EACH	1	1	
1	72800100	TELESCOPING STEEL SIGN SUPPORT	FOOT	45	45	
	78000600	THERMOPLASTIC PAVEMENT MARKINGS - LINE 12"	FOOT	900	900	
	78000650	THERMOPLASTIC PAVEMENT MARKINGS - LINE 24"	FOOT	197	197	
	X4060280	HOT-MIX ASPHALT DRIVEWAY PAVEMENT, 3"	SQ YD	267	267	
	X4400501	COMBINATION CONCRETE CURB AND GUTTER REMOVAL AND REPLACEMENT LESS THAN OR EQUAL TO 10 FEET	FOOT	38	38	
	X4400503	COMBINATION CONCRETE CURB AND GUTTER REMOVAL AND REPLACEMENT GREATER THAN 10 FEET	FOOT	280	280	
	X6026050	SANITARY MANHOLES TO BE ADJUSTED	EACH	3	3	


△ INDICATES SPECIALTY ITEM


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CONSULTING ENGINEERS
52 Wheeler Road
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630.466.6700 / www.eelweb.com

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PLOT DATE = July 29, 2025 @ 3:28 PM	DATE -	REVISED -

STATE OF ILLINOIS					
DEPARTMENT OF TRANSPORTATION					

		SUMMARY OF QUANTITIES					FAU RTE.	SECTION	COUNTY	TOTAL SHEETS	SHEE NO.
_							0098	24-0002I-00-SW	KANE	27	4
1							CONTRACT I	NO. 6IL74	4		
	SCALE: N.T.S.	SHEET 2	0F 2	SHEETS	STA.	TO STA.		ILLINOIS FED. AI	ID PROJECT		

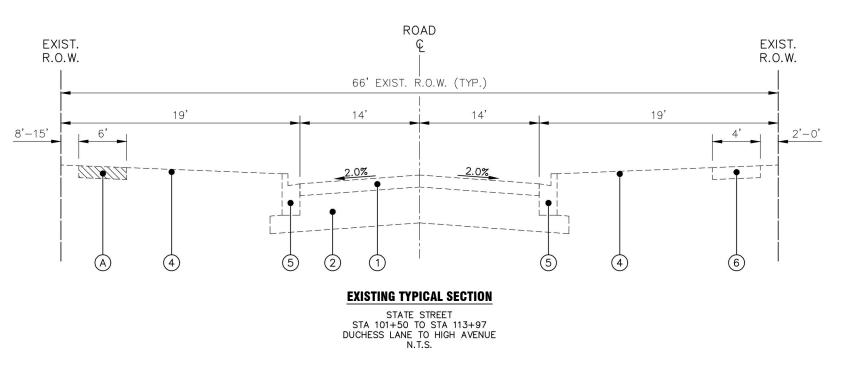

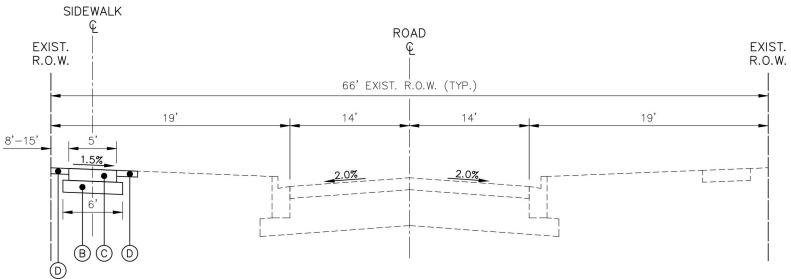

PROPOSED TYPICAL SECTION

STATE STREET
STA 101+50 TO STA 113+97
DUCHESS LANE TO HIGH AVENUE
N.T.S.

HOT-MIX ASPHALT MIXTURE REQUIREMENTS

OPERATION	MIXTURE TYPE	AIR VOIDS MOES	QMP						
CLASS D PATCHES	HOT-MIX ASPHALT SURFACE COURSE, IL-9.5, MIX "D", N50, 2"	4% @ 50 GYR.	LR1030-2						
HOT-MIX ASPHALT DRIVEWAY PAVEMENT, 3"	HOT-MIX ASPHALT SURFACE COURSE, IL-9.5, MIX "D", N50, 3" (IN TWO LIFTS)	4% @ 50 GYR.	LR1030-2						
	QMP DESIGNATION: QUALITY CONTROL/QUALITY ASSURANCE (QC/QA) PELR 1030-2.	IR .							

THE UNIT WEIGHT TO CALCULATE ALL HMA SURFACE MIXTURE QUANTITIES IS 112 LBS/SQ YD/IN

THE "AC TYPE" FOR POLYMERIZED HMA MIXES SHALL BE "SBS/SBR PG 76-22" AND FOR NON-POLYMERIZED HMA THE "AC TYPE" SHALL BE "PG 64-22". UNLESS MODIFIED BY RECLAIMED MATERIALS SPECIFICATIONS.

组

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PLOT DATE = July 3, 2025 @ 7:58 AM	DATE -	REVISED -	

STATE OF ILLINOIS
DEPARTMENT OF TRANSPORTATION

SCALE: N.T.S.

EXISTING LEGEND

EXISTING AGGREGATE BASE COURSE

PROPOSED LEGEND

(A) EARTH EXCAVATION

AGGREGATE BASE COURSE, TYPE B PROPOSED P.C.C. SIDEWALK, 5 INCH (6 INCH AT DRIVEWAYS)

TOPSOIL, 4", FERTILIZER, SEED, CLASS 2A AND EROSION CONTROL BLANKET

(1) EXISTING ASPHALT PAVEMENT


EXISTING TURF SHOULDER
EXISTING TURF PARKWAY

EXISTING CURB AND GUTTER

EXISTING SIDEWALK


(B)

KPROJ\HA_HAMPSHIRE\2025\HA2505\DWG F

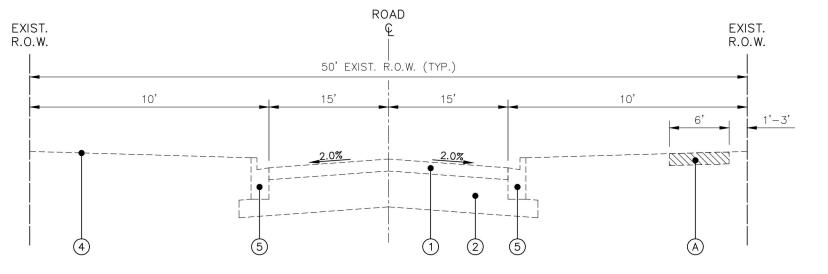

EXISTING TYPICAL SECTION

HIGH AVENUE STA 200+57 TO STA 205+50 STATE STREET TO ELM STREET N.T.S.

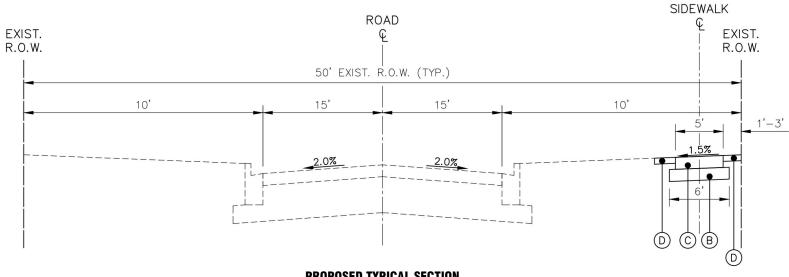

EXISTING LEGEND

- 1) EXISTING ASPHALT PAVEMENT
- EXISTING AGGREGATE BASE COURSE
- EXISTING TURF SHOULDER
- (4) EXISTING TURF PARKWAY
- EXISTING CURB AND GUTTER
- EXISTING SIDEWALK

PROPOSED LEGEND

- (A) EARTH EXCAVATION
- B) AGGREGATE BASE COURSE, TYPE B
- PROPOSED P.C.C. SIDEWALK, 5 INCH (6 INCH AT DRIVEWAYS)
- TOPSOIL, 4", FERTILIZER, SEED, CLASS 2A AND EROSION CONTROL BLANKET

PROPOSED TYPICAL SECTION

HIGH AVENUE STA 200+57 TO STA 205+50 STATE STREET TO ELM STREET N.T.S.


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STATE OF ILLINOIS **DEPARTMENT OF TRANSPORTATION**


SCALE: N.T.S.

TYPICAL SECTIONS SECTION COUNTY **HIGH AVENUE** 24-0002I-00-SW KANE 27 6 CONTRACT NO. 6IL74 SHEET 2 OF 4 SHEETS STA. TO STA.



EXISTING TYPICAL SECTION

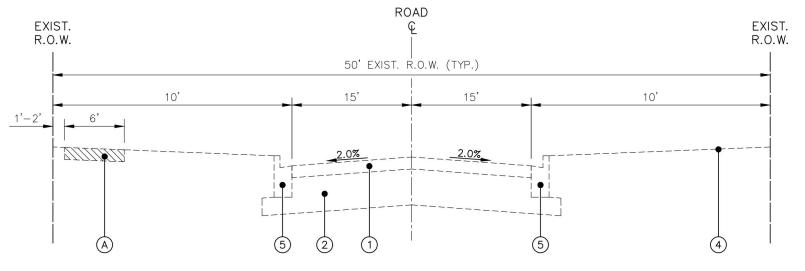ELM STREET
STA 300+25 TO STA 308+05
JAKE LANE TO PANAMA AVENUE
N.T.S.

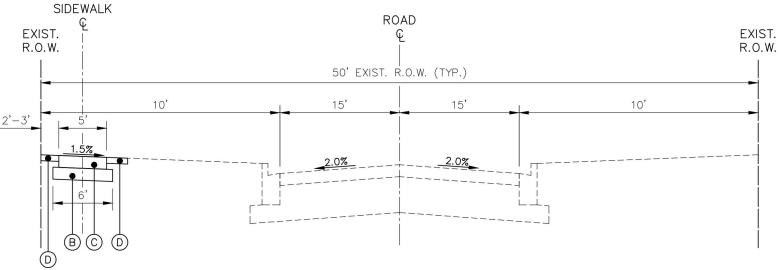

EXISTING LEGEND

- (1) EXISTING ASPHALT PAVEMENT
- EXISTING AGGREGATE BASE COURSE
- (3) EXISTING TURF SHOULDER
- (4) EXISTING TURF PARKWAY
- 5 EXISTING CURB AND GUTTER
- (6) EXISTING SIDEWALK

PROPOSED LEGEND

- (A) EARTH EXCAVATION
- B) AGGREGATE BASE COURSE, TYPE B
- PROPOSED P.C.C. SIDEWALK, 5 INCH (6 INCH AT DRIVEWAYS)
- TOPSOIL, 4", FERTILIZER, SEED, CLASS 2A AND EROSION CONTROL BLANKET

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PLOT DATE = July 3, 2025 @ 7:59 AM	DATE -	REVISED -


STATE OF ILLINOIS DEPARTMENT OF TRANSPORTATION

SCALE: N.T.S.


TYPICAL SECTIONS						FAU RTE. SECTION		COUNTY TO		
ELM STREET					0098	24-0002I-00-SW		KANE	1	
	•								CONTRACT	NO.
	SHEET 3	OF 4	SHEETS	STA.	TO STA.		ILLINOIS FED	. AID	PROJECT	

PROPOSED TYPICAL SECTION

ELM STREET
STA 300+25 TO STA 308+05
JAKE LANE TO PANAMA AVENUE
N.T.S.

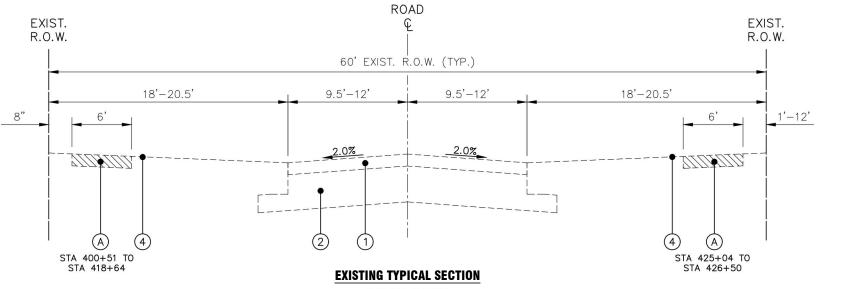

PANAMA AVENUE
STATE STREET TO CENTENNIAL DRIVE
STA 400+46 TO STA 418+64, STA 425+04 TO STA 427+19
N.T.S.

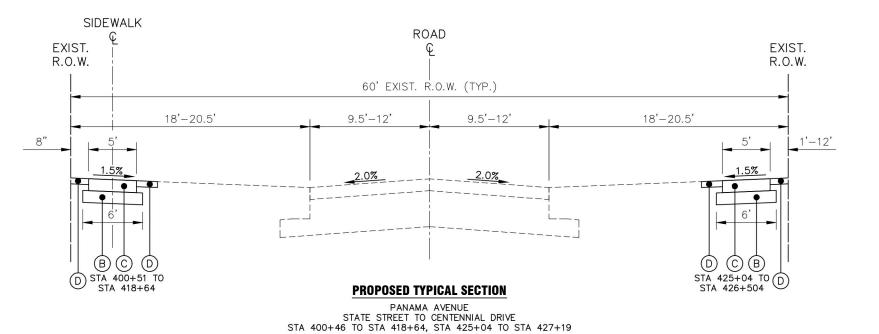

N.T.S.

EXISTING LEGEND

- (1) EXISTING ASPHALT PAVEMENT
- (2) EXISTING AGGREGATE BASE COURSE
- (3) EXISTING TURF SHOULDER
- 4) EXISTING TURF PARKWAY
- (5) EXISTING CURB AND GUTTER
- (6) EXISTING SIDEWALK

PROPOSED LEGEND

- (A) EARTH EXCAVATION
- B AGGREGATE BASE COURSE, TYPE B
- PROPOSED P.C.C. SIDEWALK, 5 INCH (6 INCH AT DRIVEWAYS)
- (D) TOPSOIL, 4", FERTILIZER, SEED, CLASS 2A AND EROSION CONTROL BLANKET

OMISSION FROM STA 418+64 TO STA 423+47 AND STA 424+26 TO STA 425+04

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52 Wheeler Road
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STATE OF ILLINOIS DEPARTMENT OF TRANSPORTATION

SCALE: N.T.S.


SHEET 4


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					_		
OF	4	SHEETS	STA.	TO STA.			

SECTION COUNTY TOTAL SHEETS NO.

8 24-0002I-00-SW KANE 27 8

CONTRACT NO. GIL74

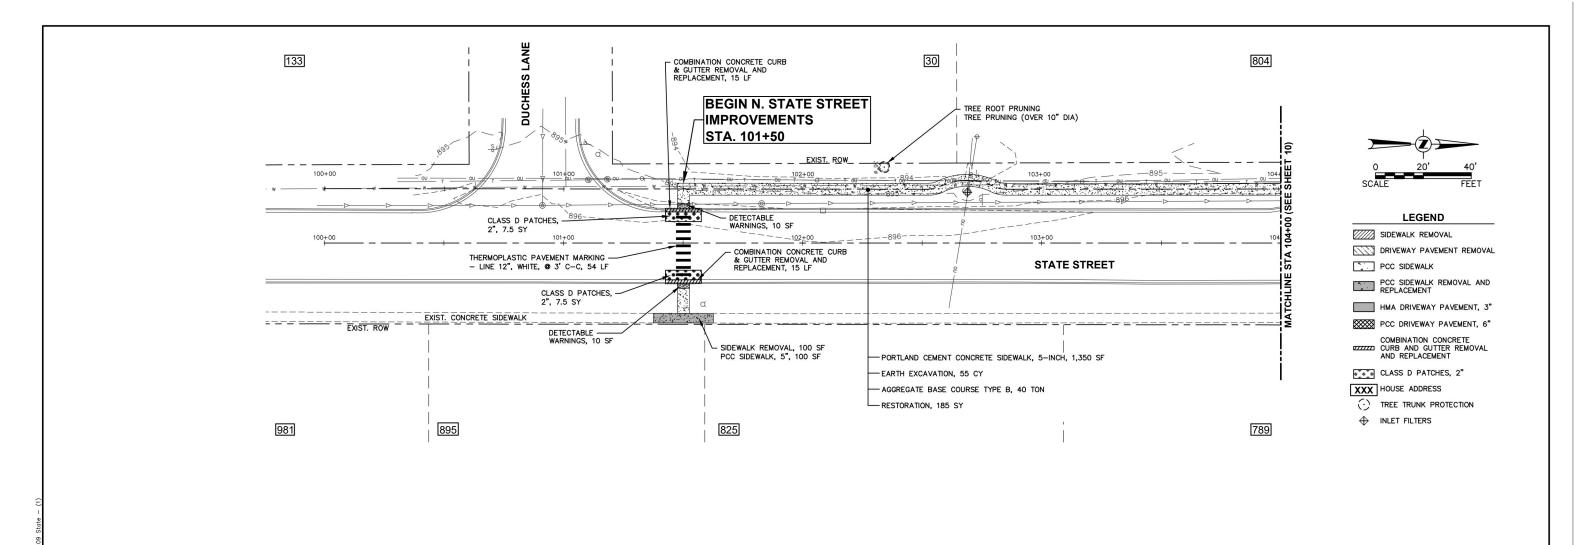

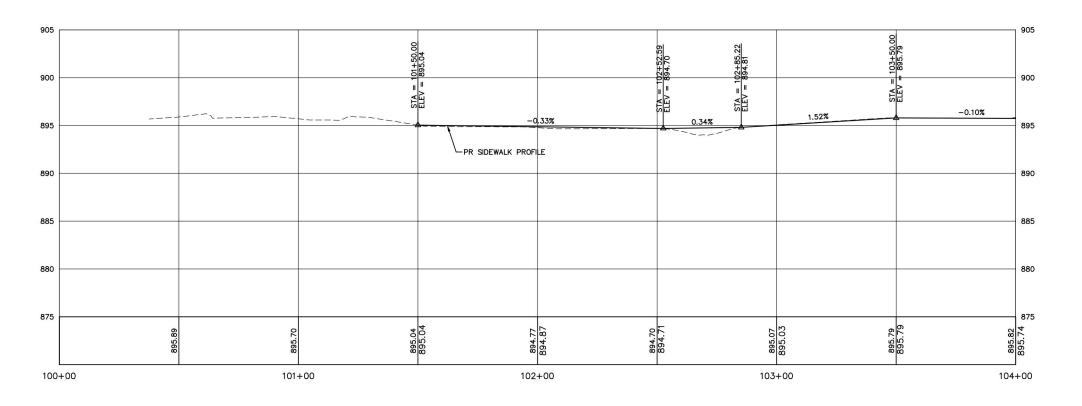


Engineering Enterprises, Inc. CONSULTING ENGINEERS
52 Wheeler Road
Sugar Grove, Illinois 60554
630.466.6700 / www.eeiweb.com


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	DRAWN -	REVISED -
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PLOT DATE = July 3, 2025 @ 7:59 AM	DATE -	REVISED -


STATE OF ILLINOIS DEPARTMENT OF TRANSPORTATION

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SHEET 1	OF	4	SHEETS	AT2	101+50	TO STA	104+00	

	SECTION	COUNTY	TOTAL SHEETS	SHEET NO.
3	24-0002I-00-SW	KANE	27	9
		CONTRACT N	10. 6IL74	1
	ILLINOIS EED AIT	PROJECT		

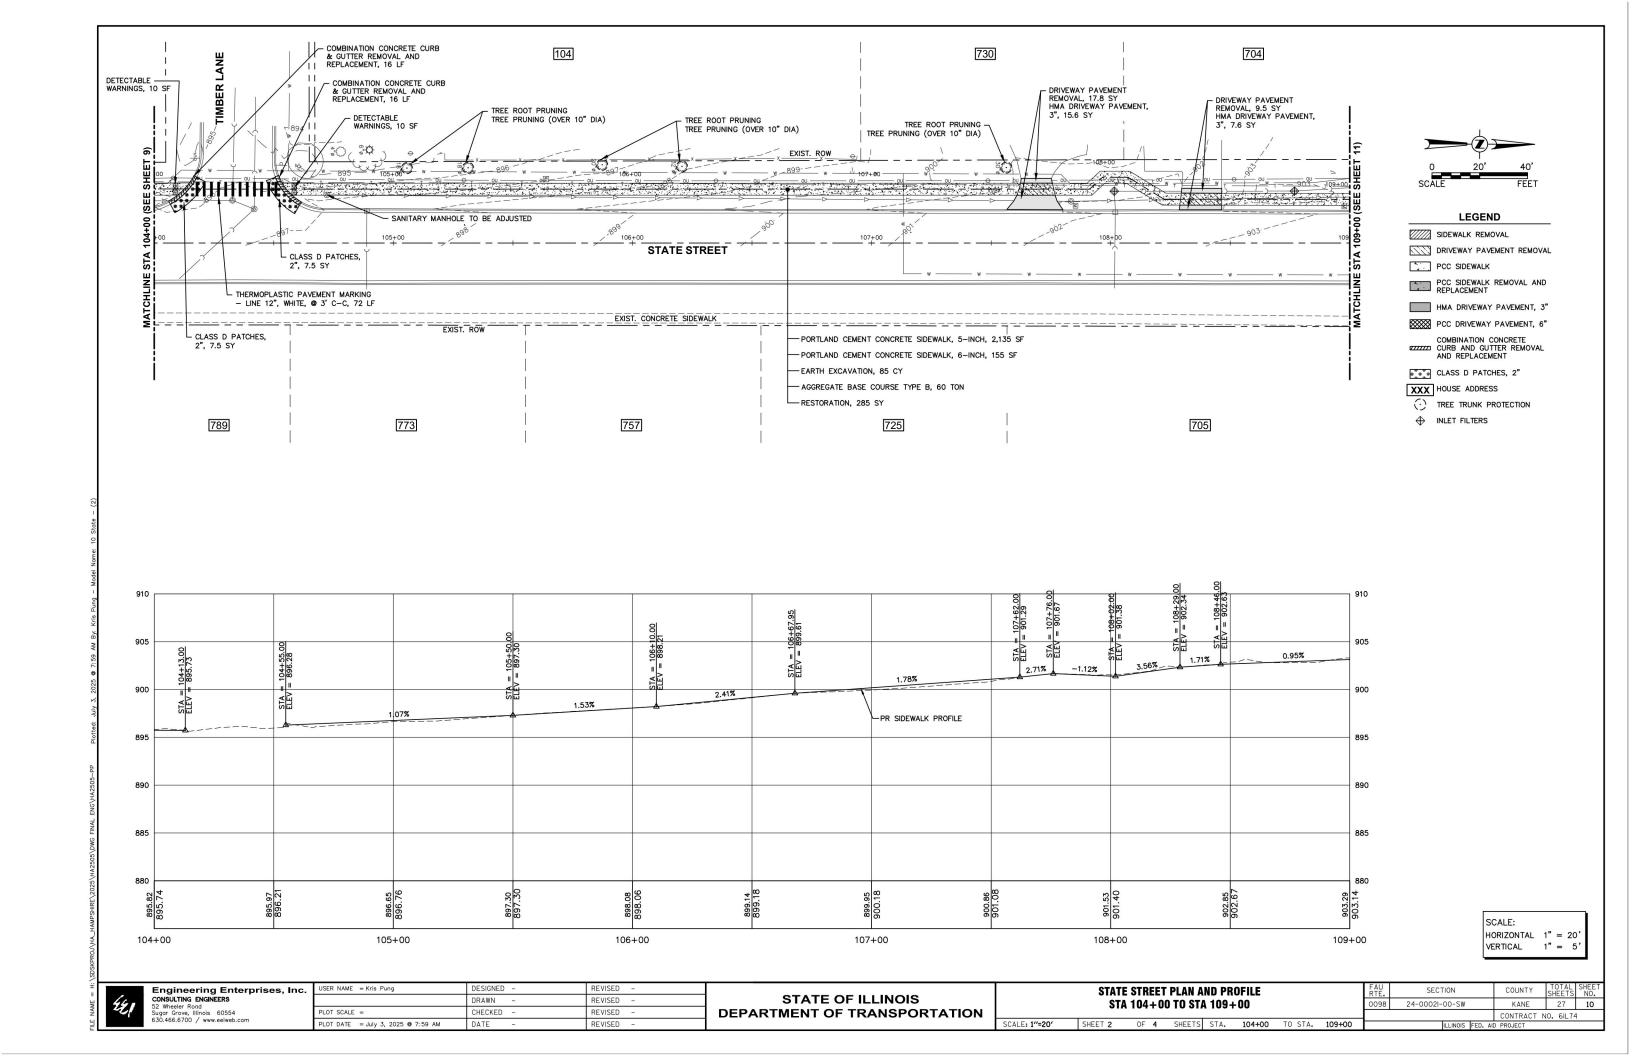

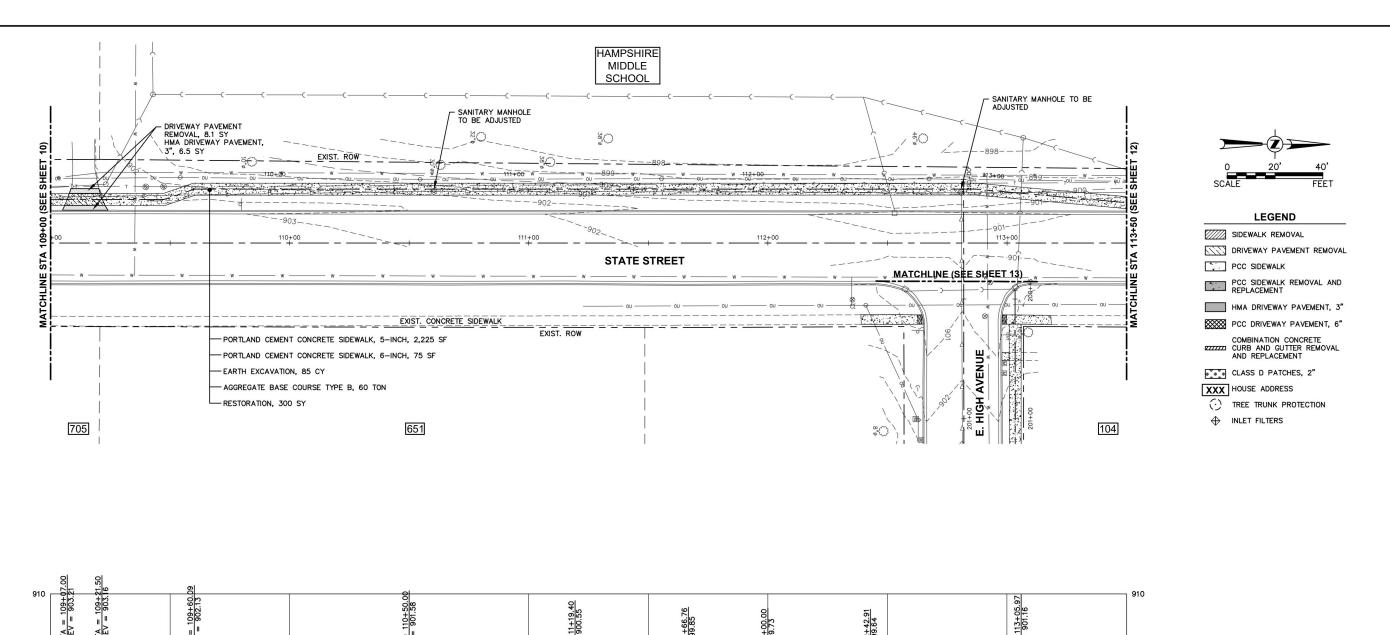

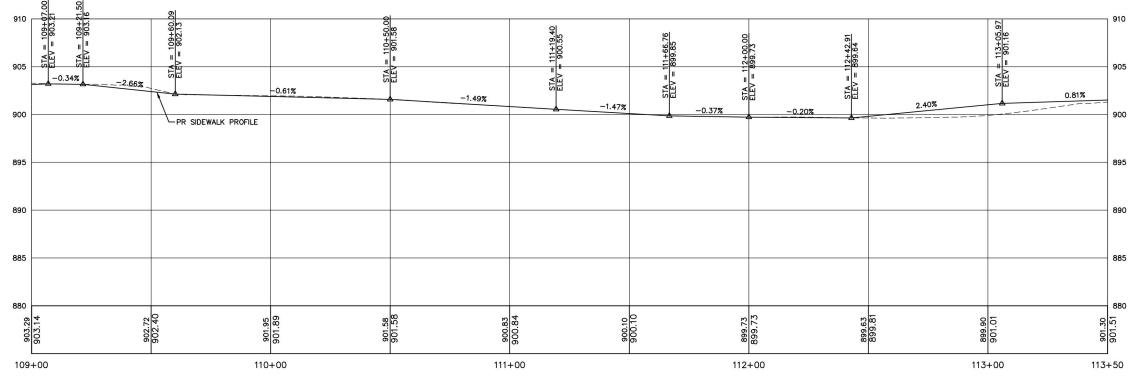

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9	Sugar 630.46


Engineering Enterprises, Inc. CONSULTING ENGINEERS 52 Wheeler Rood Sugar Grove, Illinois 60554 630.466.6700 / www.eelweb.com


٠.	USER NAME = Kris Fully	DESIGNED -	KEVISED -
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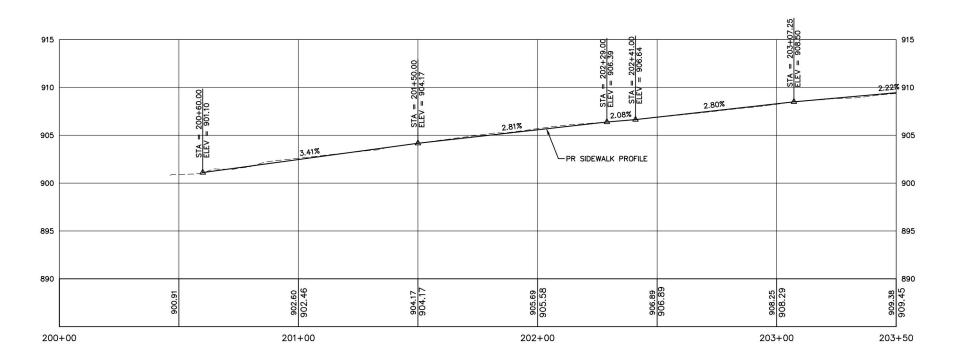
STATE OF ILLINOIS					
DEPARTMENT OF TRANSPORTATION					

			T PLAN A 10 to Sta				
SHEET 3	OF	4	SHEETS	STA.	109+00	TO STA.	113+50

AU ΓΕ.	SECTION	COUNTY	TOTAL SHEETS	SHEE NO.
98	24-0002I-00-SW	KANE	27	11
		CONTRACT N	10. 6IL74	1
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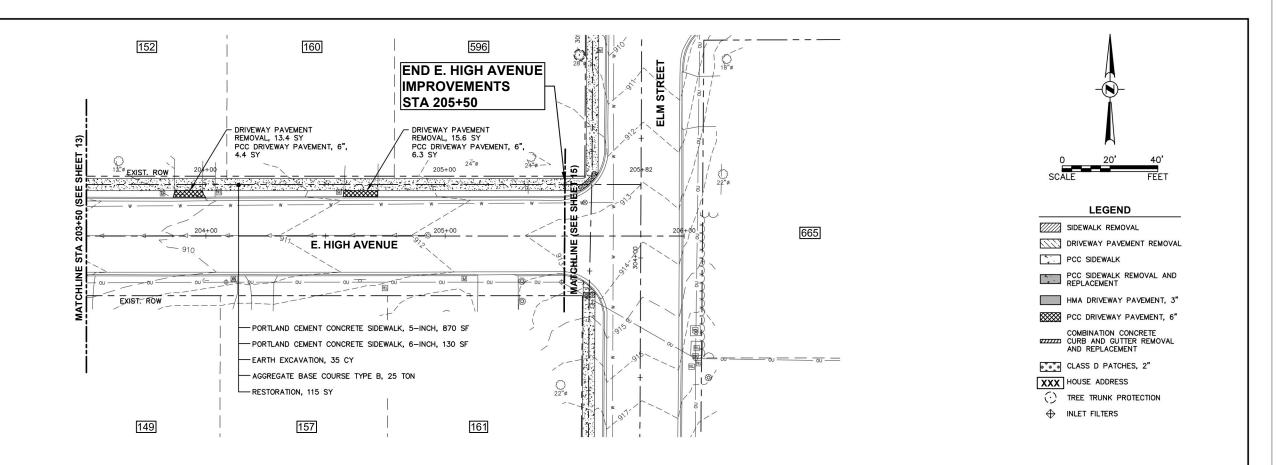
Engineering Enterprises, Inc. CONSULTING ENGINEERS 52 Wheeler Road Sugar Grove, Illinois 60554 630.466.6700 / www.eeiweb.com


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PLOT SCALE =	CHECKED -	REVISED -
PLOT DATE = July 3, 2025 @ 8:00 AM	DATE -	REVISED -

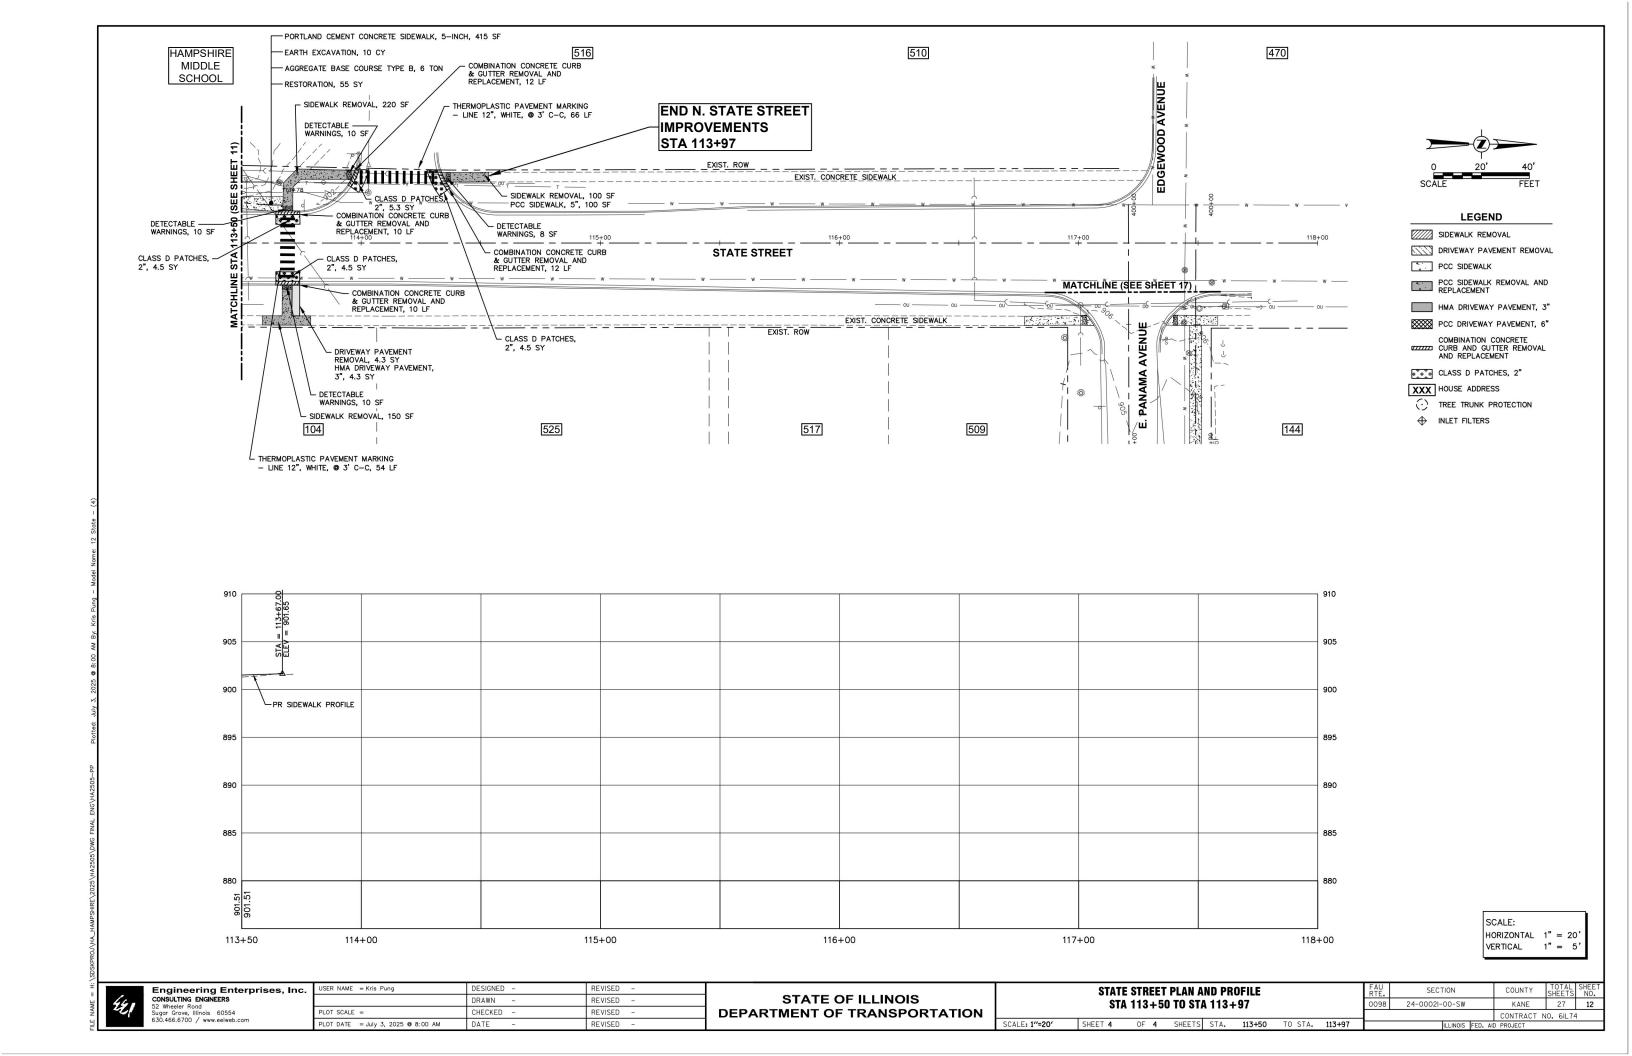STATE OF ILLINOIS
DEPARTMENT OF TRANSPORTATION

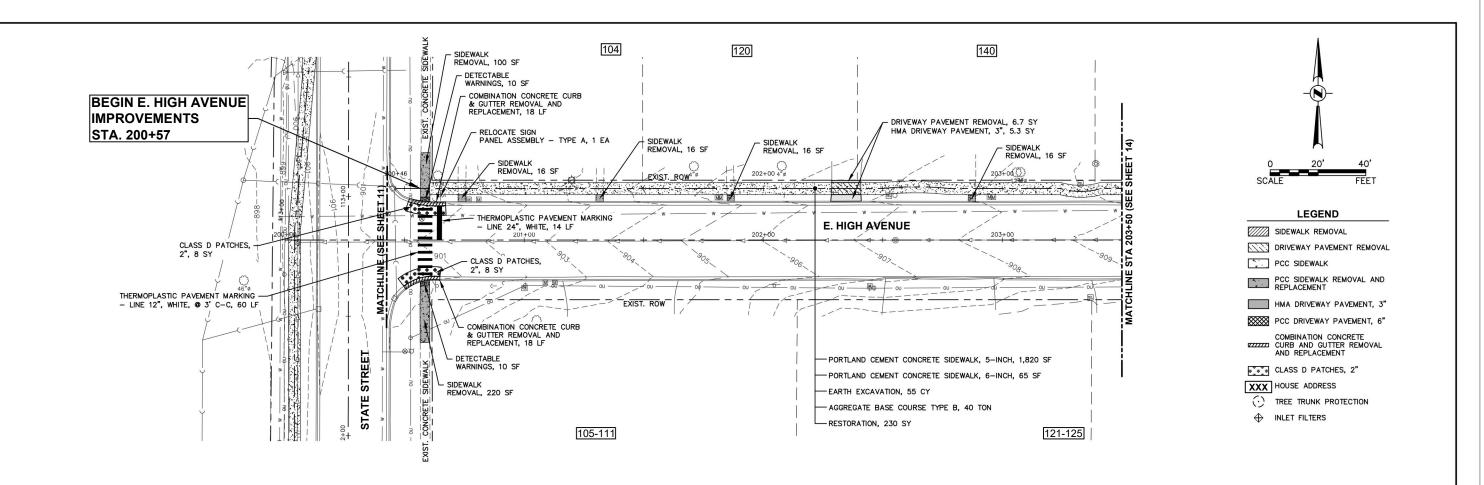		1 AVENUI 200+57					
SCALE: 1"=20'	SHEET 1	OF 2	SHEETS	STA.	200+57	TO STA.	203+50

	SECTION	COUNTY	SHEETS	SHEET NO.
8	24-0002I-00-SW	KANE	27	13
		CONTRACT N	10. 6IL74	1
	ILLINOIS FED. AI	D PROJECT		



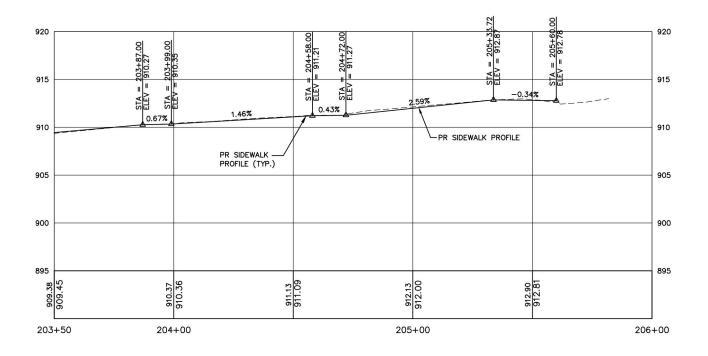

SCALE: HORIZONTAL 1" = 20"1" = 5 VERTICAL

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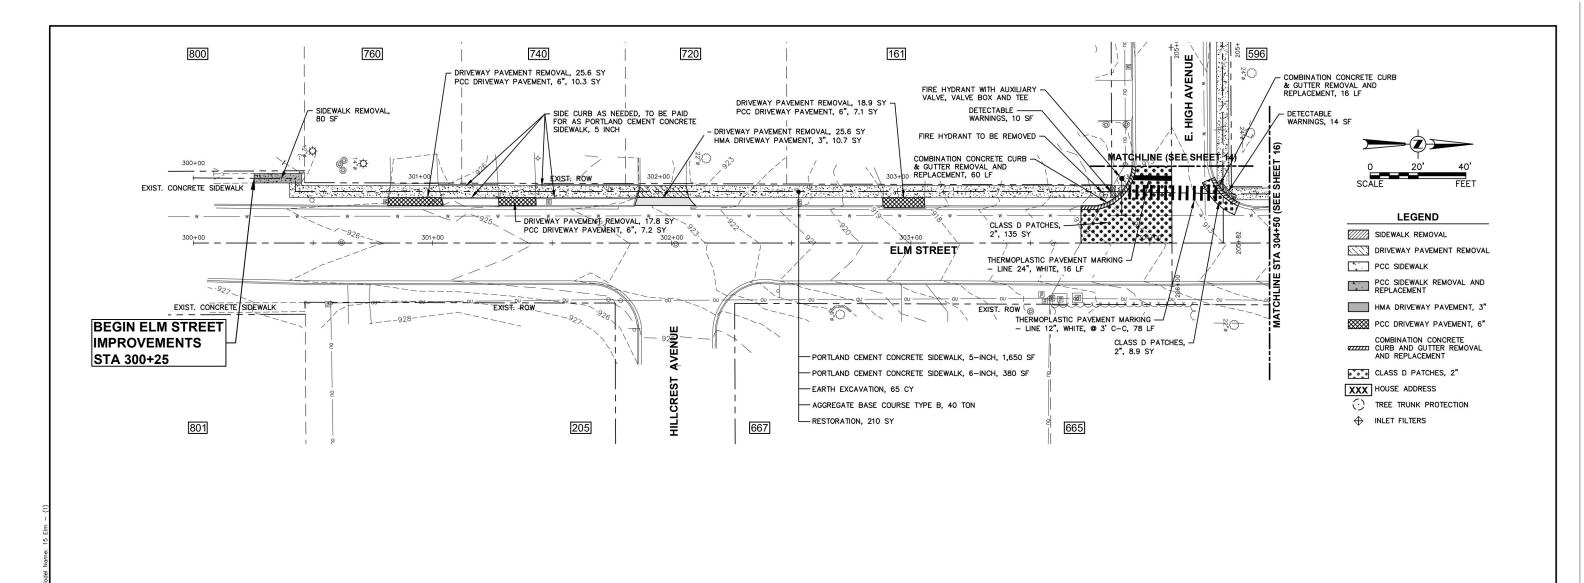
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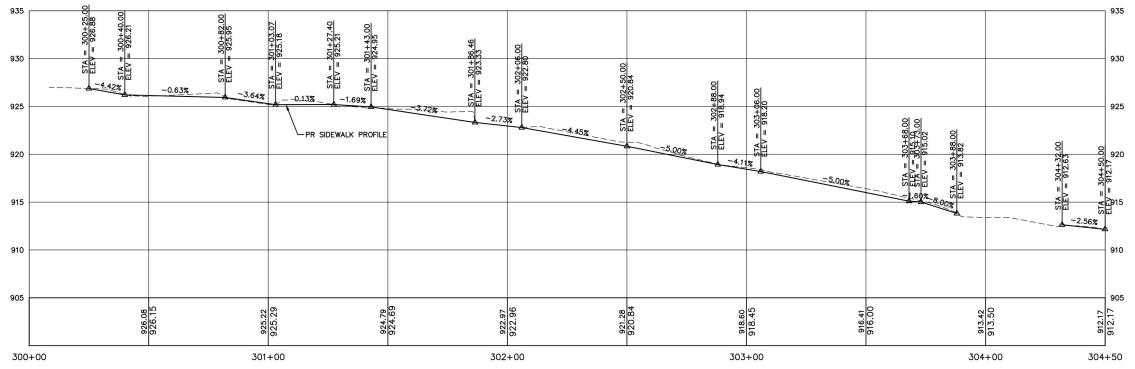
STATE OF ILLINOIS DEPARTMENT OF TRANSPORTATION E. HIGH AVENUE PLAN AND PROFILE STA 203+00 TO 205+50

SCALE: 1"=20'

SECTION COUNTY KANE 27 14 24-0002I-00-SW CONTRACT NO. 6IL74

SHEET 2 OF 2 SHEETS STA. 203+50 TO STA. 205+50





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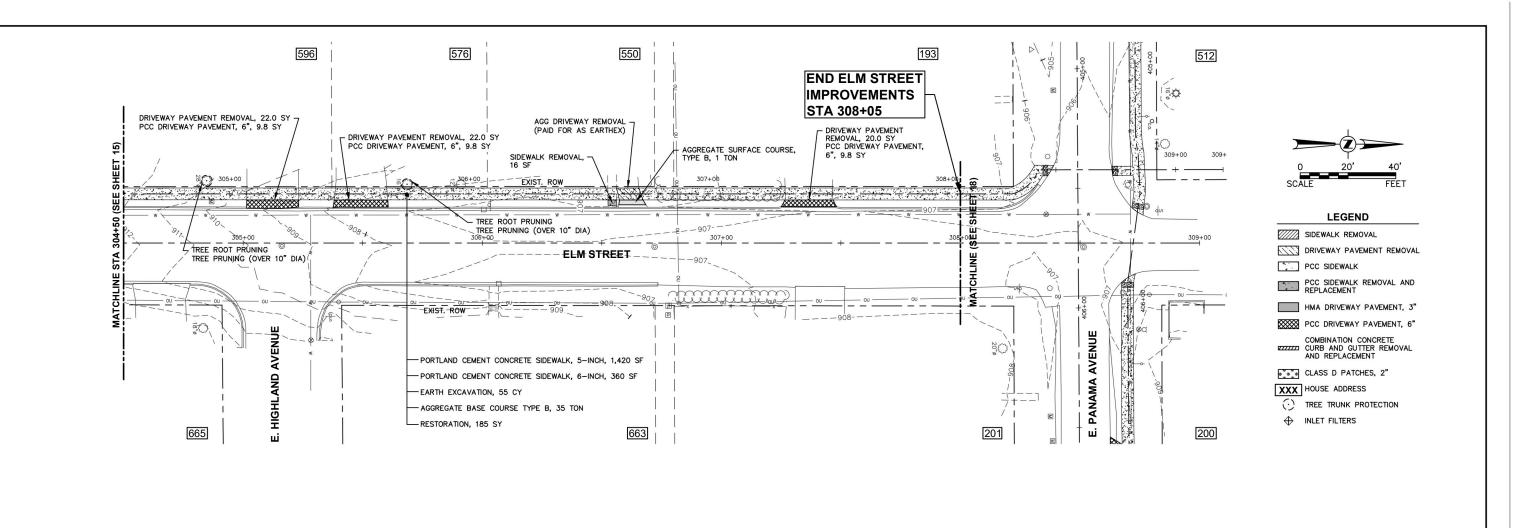
Engineering Enterprises, Inc. CONSULTING ENGINEERS 52 Wheeler Road Sugar Grove, Illinois 60554 630.466.6700 / www.eeiweb.com


Э.	USER NAME = Kris Pung	DESIGNED -	REVISED -
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	PLOT DATE = July 3, 2025 @ 8:01 AM	DATE -	REVISED -

STATE OF ILLINOIS
DEPARTMENT OF TRANSPORTATION

	ST	I STREET A 300+2	5 TO ST	A 304	+50		
Ī	SHEET 1	OF 2	SHEETS	STA.	300+75	TO STA.	304+50

FAU RTE.	SECTION	COUNTY	TOTAL SHE	ET O.
0098 24-0002I-00-SW		KANE	27 19	5
		CONTRACT N	10. 6IL74	
	ILLINOIS FED. AI	D PROJECT		



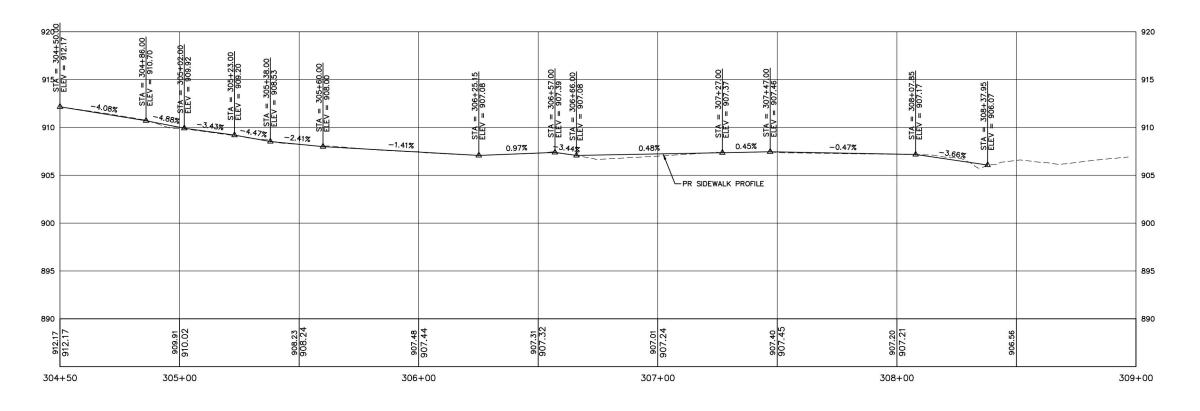

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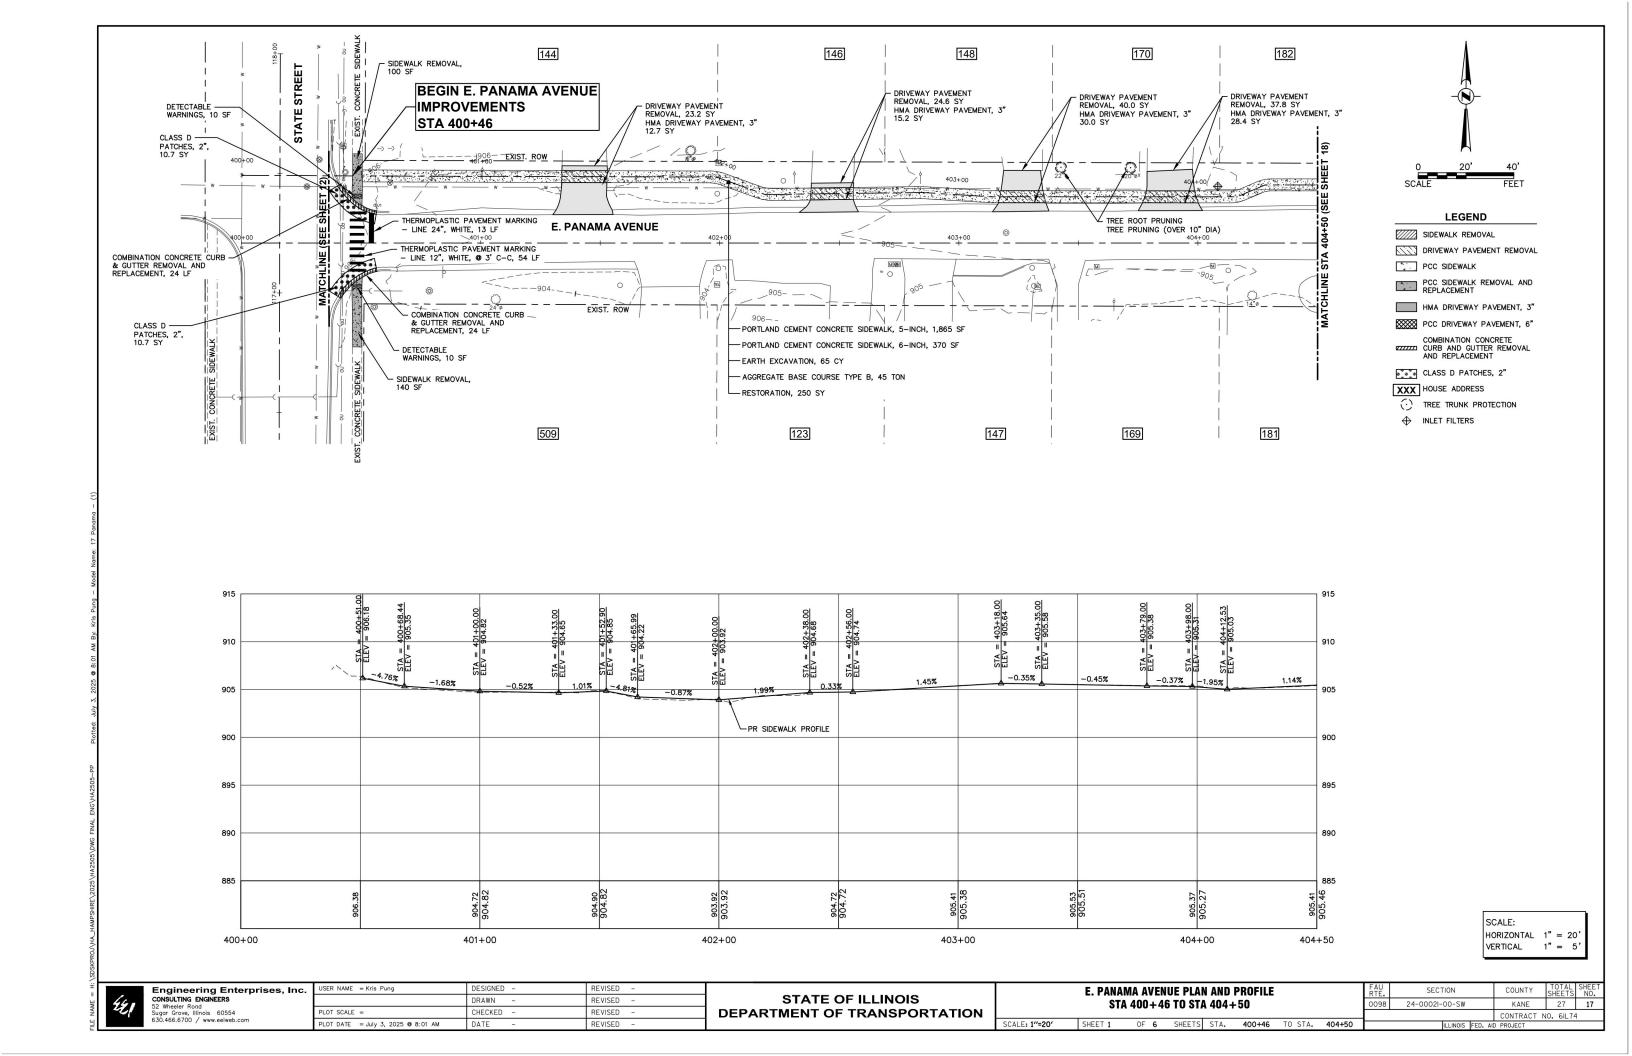
Engineering Enterprises, Inc. CONSULTING ENGINEERS 52 Wheeler Rond Sugar Grove, Illinois 60554 630.466.6700 / www.eeiweb.com


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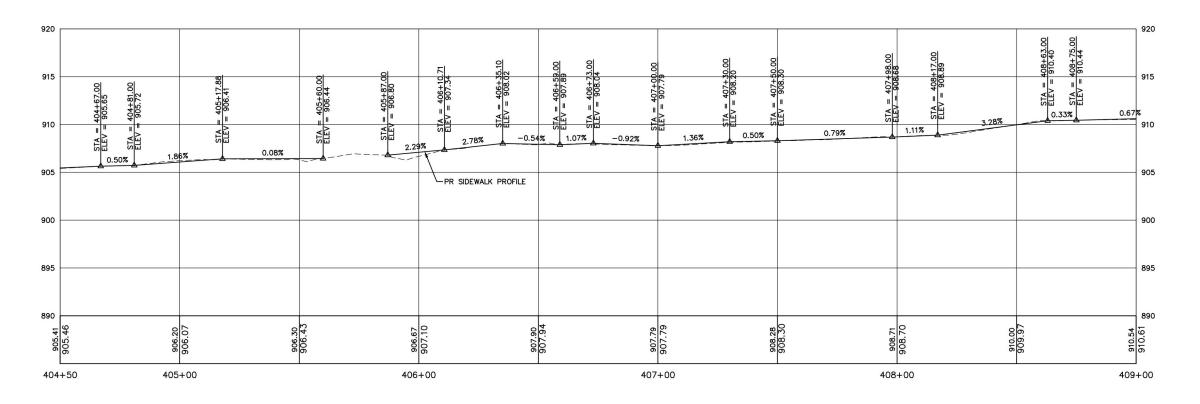
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DEPARTMENT OF TRANSPORTATION	1

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Ī	SHEET	2	OF	2	SHEETS	STA.	304+50	TO STA.	308+05

FAU RTE.	SECTION	COUNTY	SHEETS	SHEET NO.
0098	24-0002I-00-SW	KANE	27	16
		CONTRACT N	10. 6IL74	4
	ILLINOIS FED. AI	D PROJECT		





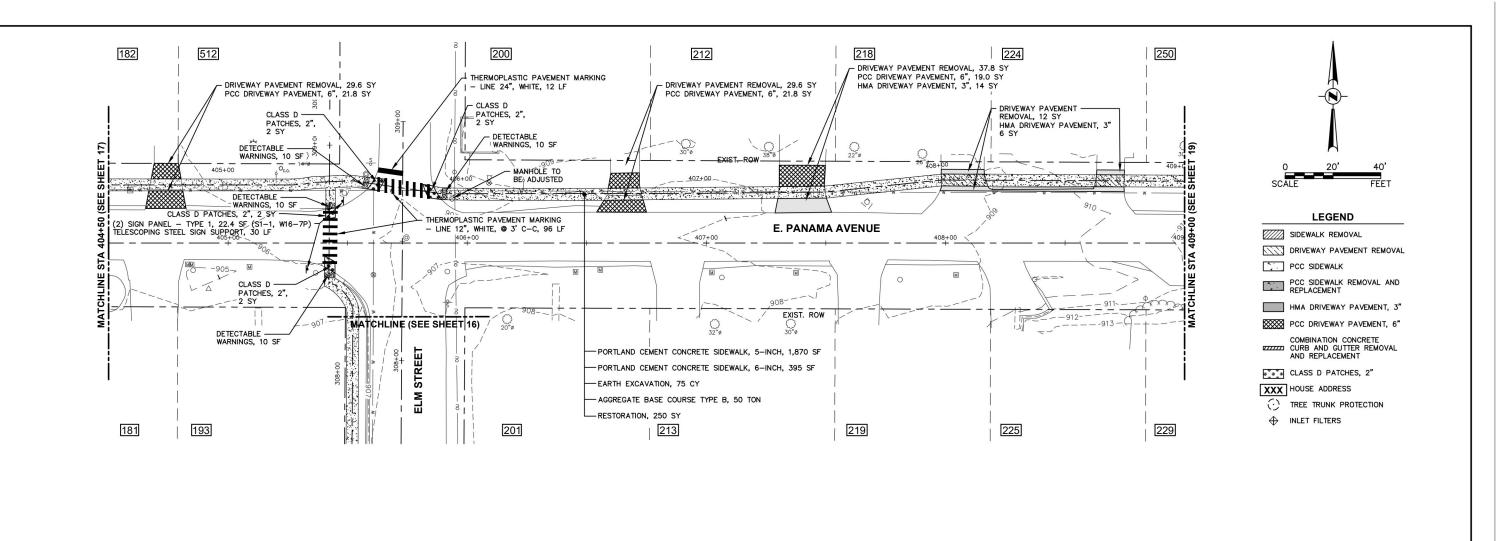



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STATE OF ILLINOIS
DEPARTMENT OF TRANSPORTATION

SCALE: 1"=20'



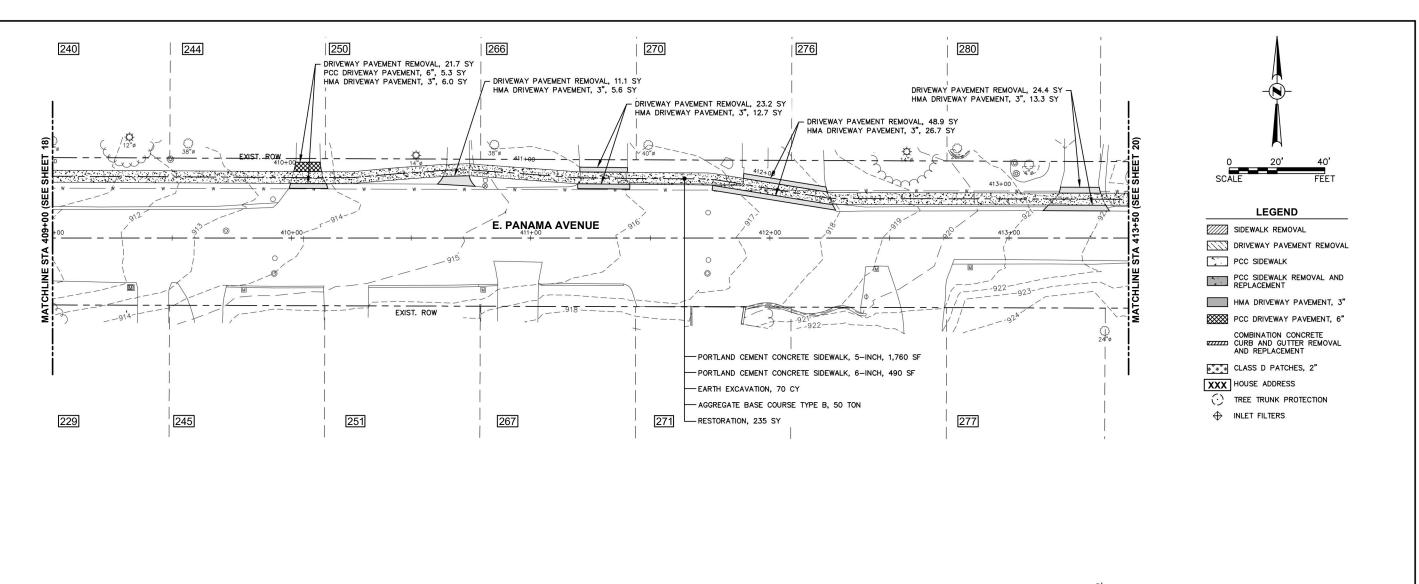

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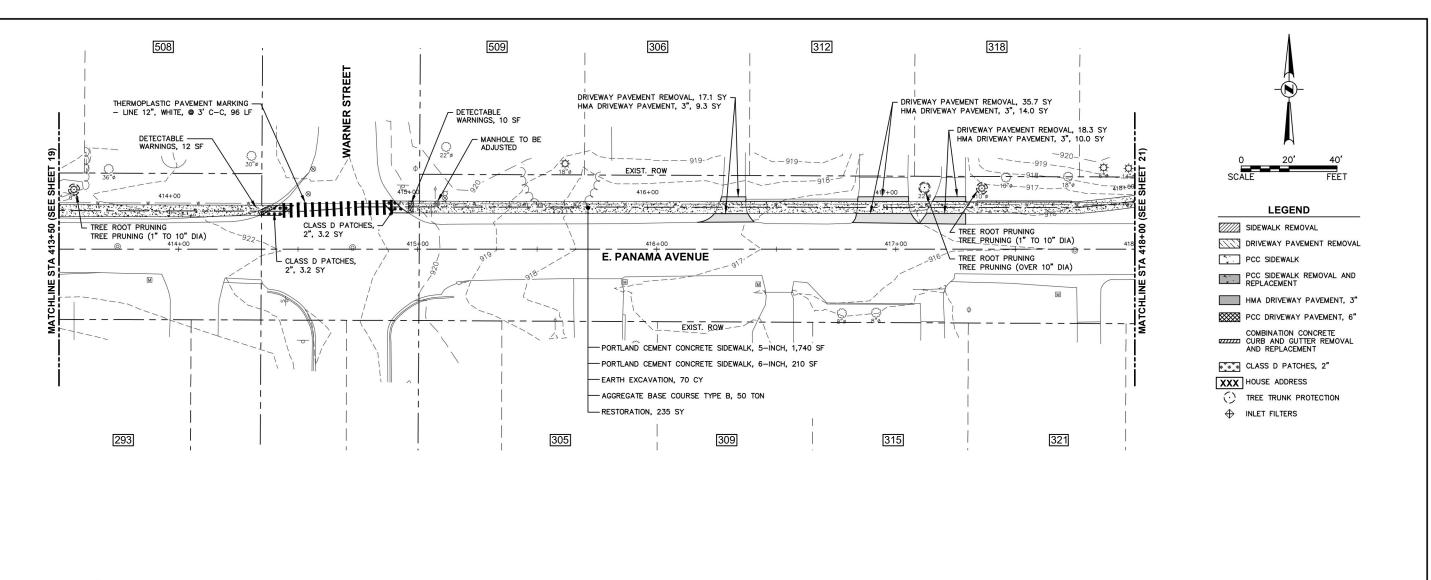
Engineering Enterprises, Inc. CONSULTING ENGINEERS 52 Wheeler Road Sugar Grove, Illinois 60554 630.466.6700 / www.eelweb.com

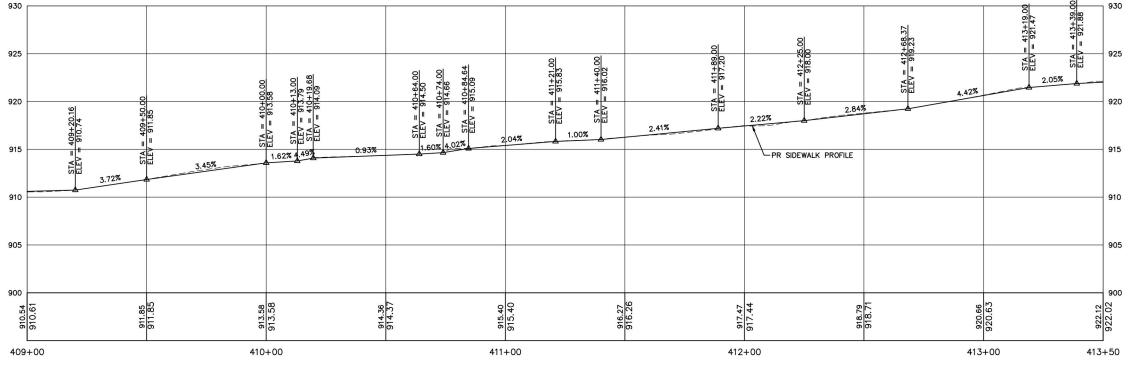
3.	USER NAME = Kris Pung	DESIGNED -	REVISED -
		DRAWN -	REVISED -
	PLOT SCALE =	CHECKED -	REVISED -
	PLOT DATE = July 3, 2025 @ 8:02 AM	DATE -	REVISED -

STATE OF ILLINOIS DEPARTMENT OF TRANSPORTATION

				NUE PLAI Do to st <i>i</i>		PROFILE +50			
SHEET	3	OF	6	SHEETS	STA.	409+00	TO STA.	413+50	

FAU RTE.	SECTION		COUNTY	SHEETS	SHEET NO.
0098	24-0002I-00-SW		KANE	27	19
			CONTRACT N	10. 6IL74	1
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Engineering Enterprises, Inc. CONSULTING ENGINEERS 52 Wheeler Road Sugar Grove, Illinois 60554 630.466.6700 / www.eelweb.com

 C.
 USER NAME
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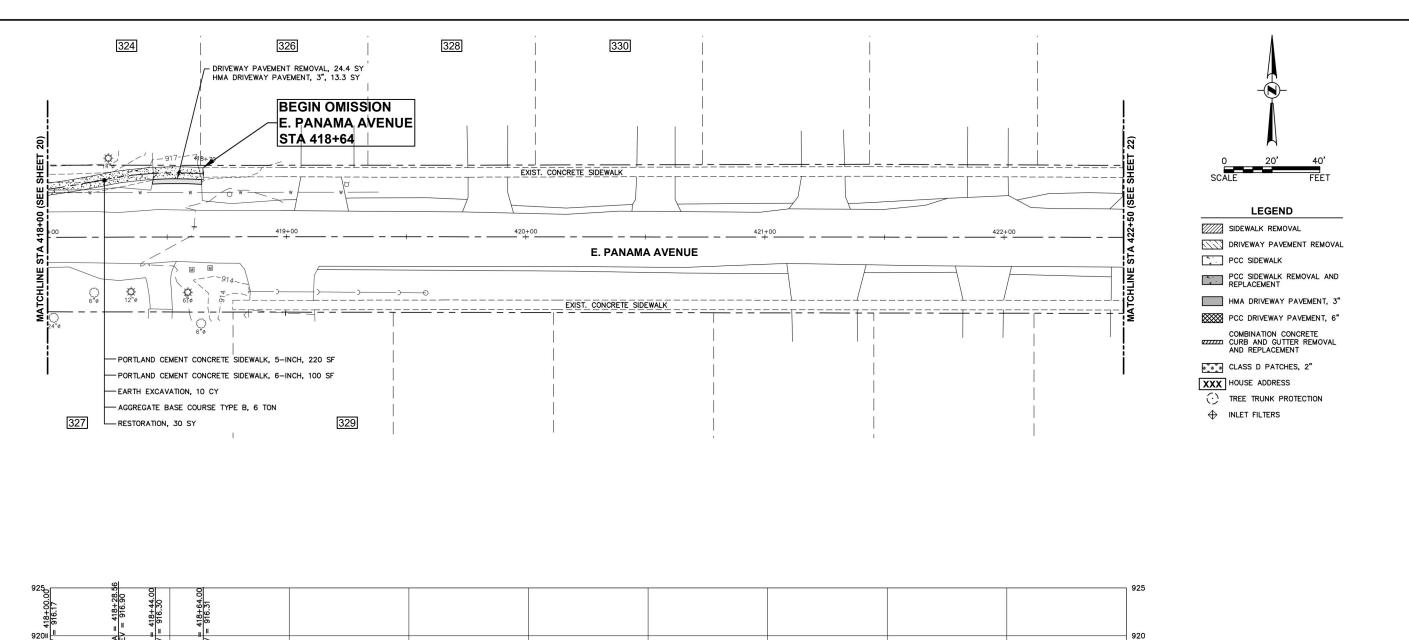
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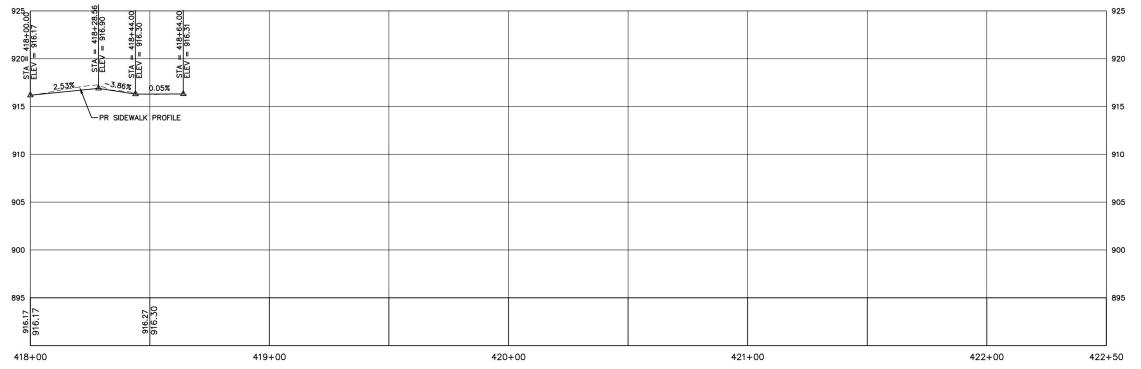
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STATE OF ILLINOIS
DEPARTMENT OF TRANSPORTATION

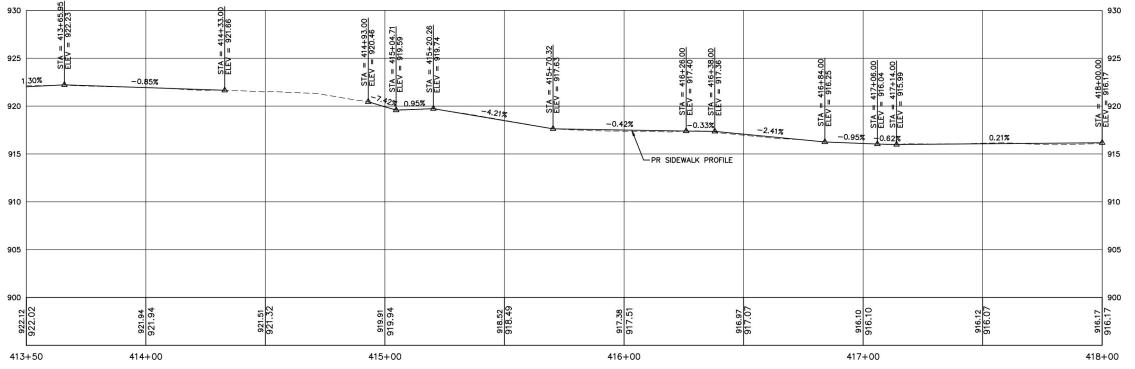SCALE: 1"=20'

FAU RTE. SECTION COUNTY TOTAL SHEETS NO. 2008 24-00021-00-SW KANE 27 20 CONTRACT NO. 6IL 74





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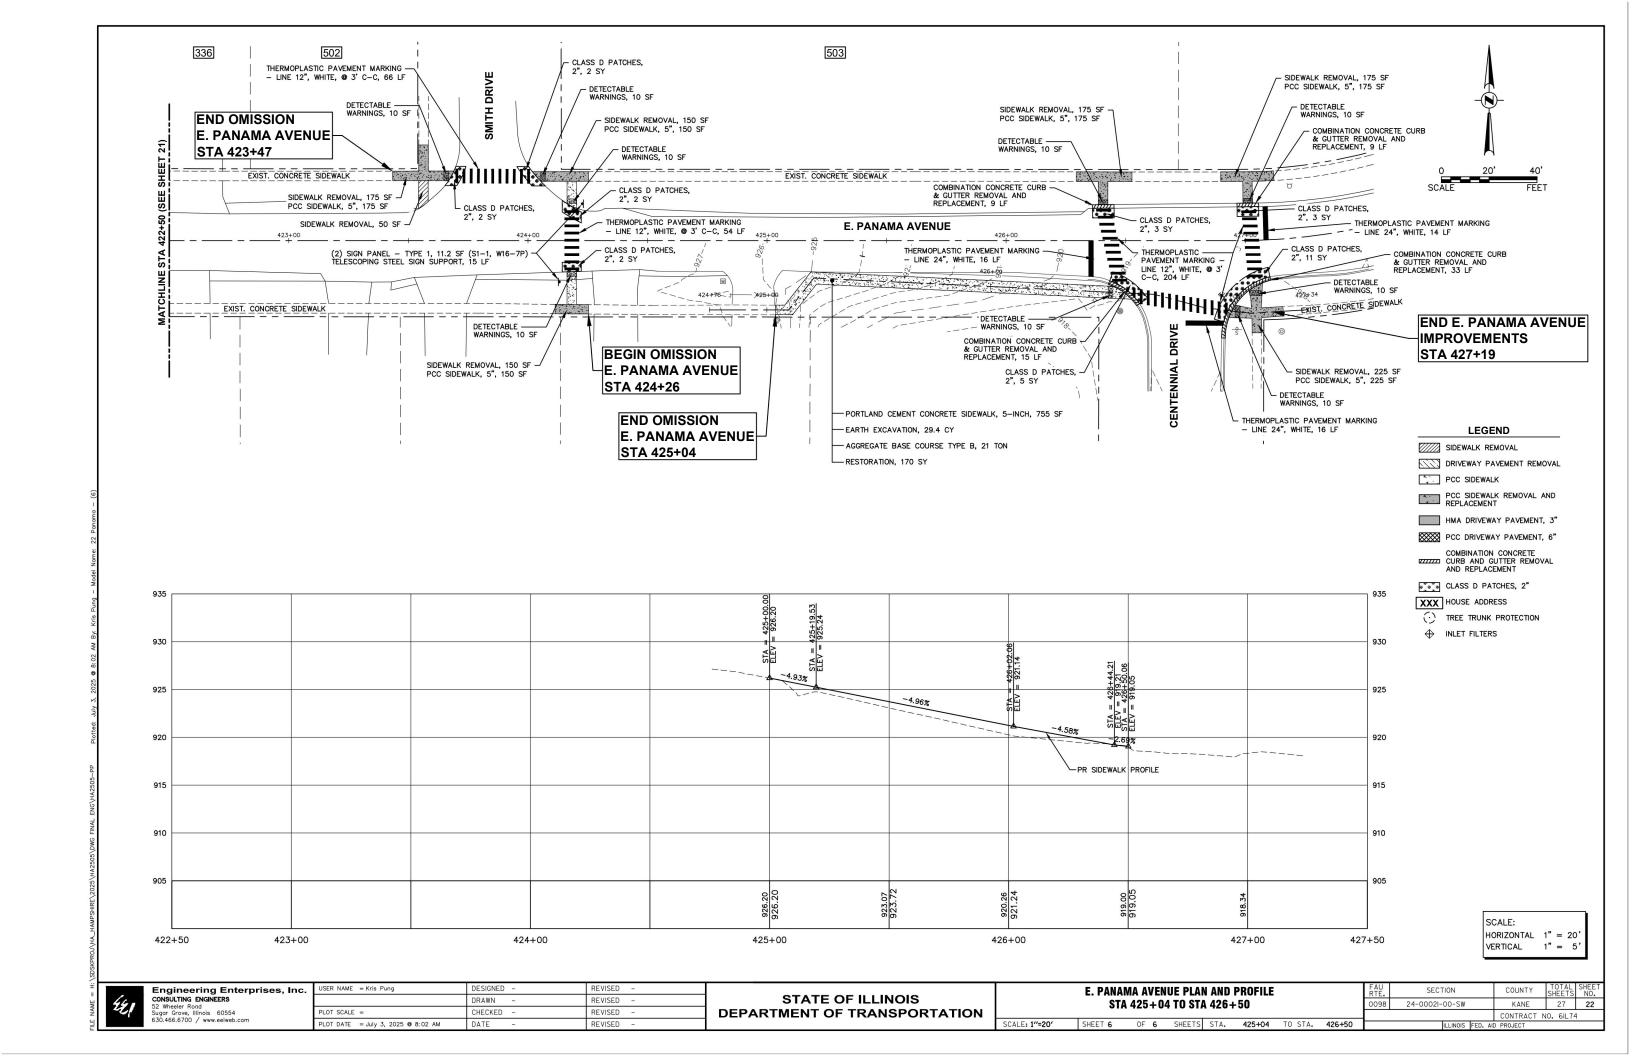
Engineering Enterprises, Inc. CONSULTING ENGINEERS 52 Wheeler Rood Sugar Grove, Illinois 60554 630.466.6700 / www.eelweb.com


USER NAME = Kris Pung	DESIGNED -	REVISED -
	DRAWN -	REVISED -
PLOT SCALE =	CHECKED -	REVISED -
PLOT DATE = July 3, 2025 @ 8:02 AM	DATE -	REVISED -

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DEPARTMENT OF TRANSPORTATION	L
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E. PANAMA AVENUE PLAN AND PROFILE							
	STA	418+00	D TO STA	418+	-64		-
SCALE: 1"=20'	SHEET 5	0F 6	SHEETS	STA.	418+00	TO STA.	418+64

	SECTION	COUNTY	SHEETS	NO.
8	24-0002I-00-SW	KANE	27	21
		CONTRACT N	10. 6IL74	4
	ILLINOIS FED. A	ID PROJECT		



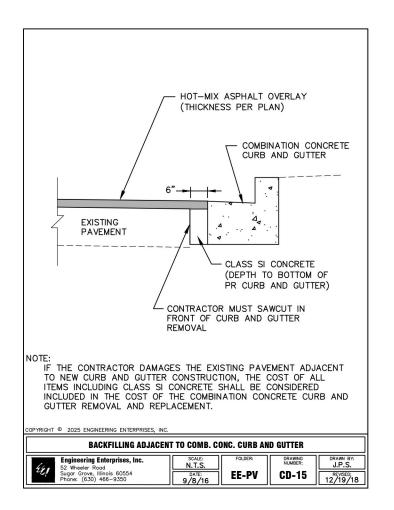

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Engineering Enterprises, Inc. CONSULTING ENGINEERS 52 Wheeler Road Sugar Grove, Illinois 60554 630.466.6700 / www.eelweb.com
 USER NAME
 = Kris Pung
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 PLOT SCALE
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 PLOT DATE
 = July 3, 2025 © 8:02 AM
 DATE
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STATE OF ILLINOIS
DEPARTMENT OF TRANSPORTATION


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METHOD OF MEASUREMENT

REFER TO SECTION 442 OF THE STANDARD SPECIFICATIONS FOR ROAD AND BRIDGE CONSTRUCTION AND THE RECURRING SPECIAL PROVISION "PATCHING WITH HOT-MIX ASPHALT OVERLAY REMOVAL."

BASIS OF PAYMENT

- 1. REFER TO SECTION 442 OF THE STANDARD SPECIFICATIONS FOR ROAD AND BRIDGE CONSTRUCTION AND THE RECURRING SPECIAL PROVISION "PATCHING WITH HOT-MIX ASPHALT OVERLAY REMOVAL."
- 2. SAW CUT/SCORING OF EXISTING HMA OVERLAY IS INCLUDED IN THE COST OF PAVEMENT PATCHING.
- 3. SAW CUT/SCORING OF EXISTING PAVEMENT IS INCLUDED IN THE COST OF PAVEMENT PATCHING.

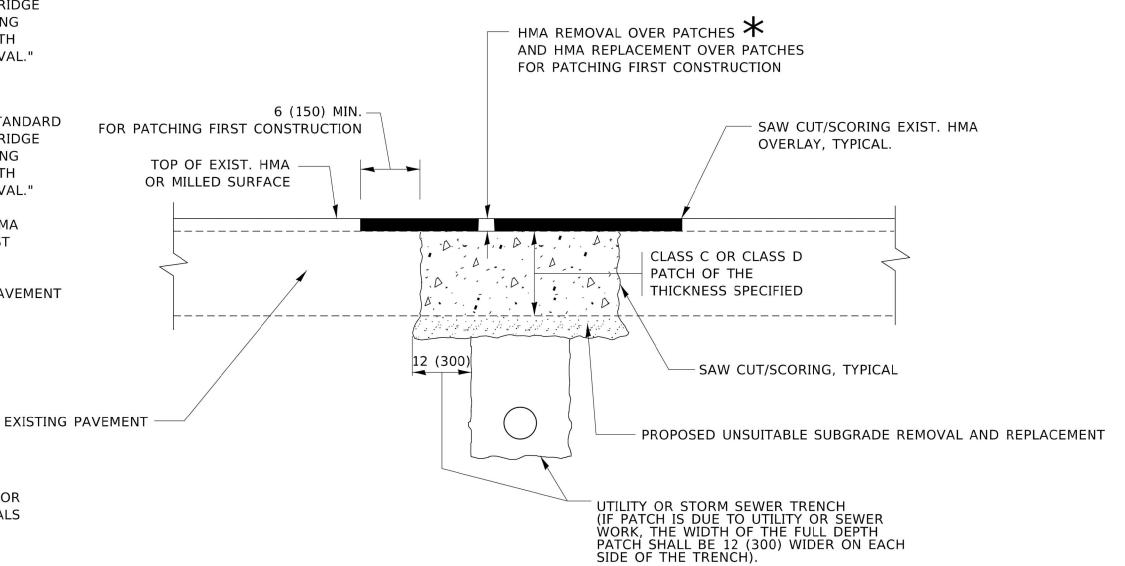

THICKNESS AND MATERIALS

★ SEE TYPICAL SECTIONS FOR

SEQUENCE OF CONSTRUCTION (PATCHING FIRST)


- 1. REMOVE THE EXISTING HMA MATERIAL OVER THE AREA TO BE PATCHED.
- 2. REMOVE AND REPLACE WITH CLASS C OR D PATCH.
- 3. REPLACE HMA MATERIAL OVER THE AREA TO BE PATCHED.

SEQUENCE OF CONSTRUCTION (MILLING FIRST)

- 1. MILL HMA FIRST IF THERE IS AT LEAST 4½ INCHES OR MORE OF HMA MATERIAL ON TOP OF THE EXISTING PAVEMENT OR IF THE PAVEMENT IS FULL DEPTH HMA. A MINIMUM OF 2 INCHES OF HMA MATERIAL SHALL BE IN PLACE AFTER MILLING.
- 2. REMOVE AND REPLACE WITH FULL DEPTH CLASS D PATCHES TO TOP OF MILLED SURFACE.

ALL DIMENSIONS ARE IN INCHES (MILLIMETERS) UNLESS OTHERWISE SHOWN.

- 1	Engineering Enterprises, Inc.	USER NAME = Lawrence.DeManche	DESIGNED - R. SHAH	REVISED -	R. BORO 01-01-07			PAVEMENT PATCHING FOR	F.,	A.	SECTION	COUNTY	SHEETS	SHEE
- 1	CONSULTING ENGINEERS		DRAWN -	REVISED -	R. BORO 09-04-07	STATE OF ILLINOIS			F.,		24-00021-00-SW	KANE	27	24
- 1	52 Wheeler Road Sugar Grove, Illinois 60554	PLOT SCALE = 100.0000 ' / in.	CHECKED -	REVISED -	K. ENG 10-27-08	DEPARTMENT OF TRANSPORTATION		HMA SURFACED PAVEMENT		BI	D400-04 (BD-22)	CONTRAC	T NO. 6	1L74
L	630.466.6700 / www.eelweb.com	PLOT DATE = 11/18/2022	DATE - 10-25-94	REVISED -	K. SMITH 11-18-22		SCALE: NONE	SHEET 1 OF 1 SHEETS STA. TO STA.			ILLINOIS FED.	AID PROJECT		

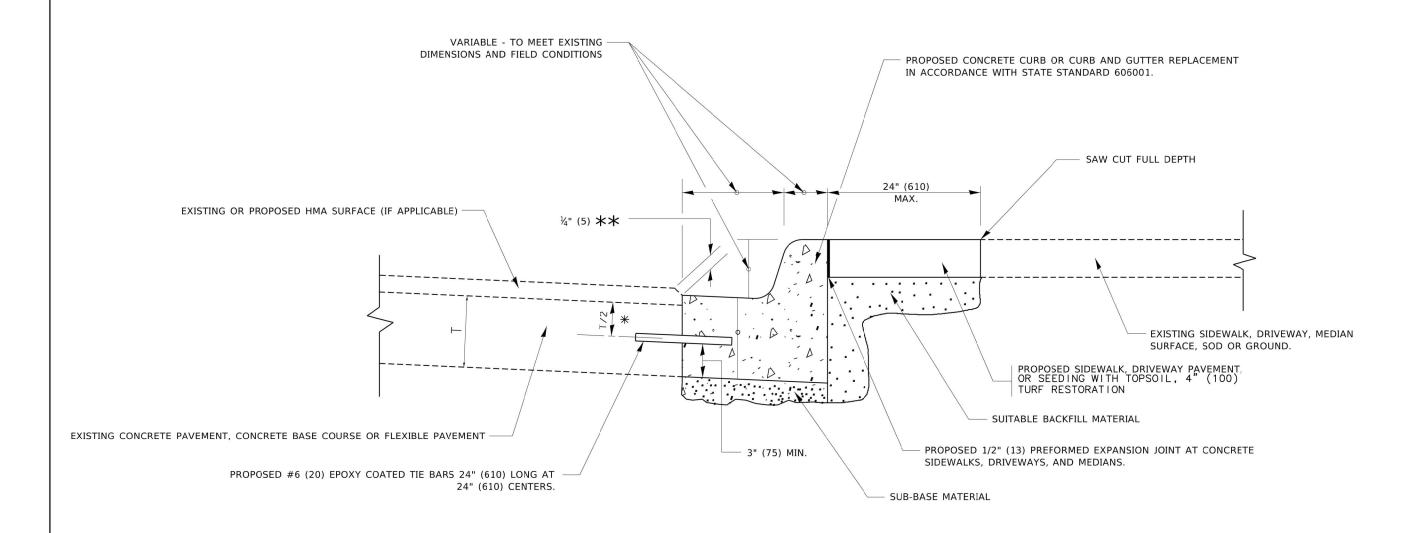

- X 3" (75) MINIMUM FROM TOP AND BOTTOM OF THE CONCRETE PAVEMENT OR BASE COURSE.
- ** IF THE FINAL SURFACE OF THE PAVEMENT IS CONCRETE, THE GUTTER IS TO BE FLUSH WITH THE PAVEMENT.

CURB OR CURB AND GUTTER REMOVAL AND REPLACEMENT


ALL DIMENSIONS ARE IN INCHES (MILLIMETERS) UNLESS OTHERWISE SHOWN.



Engineering Enterprises, Inc.	USER NAME = footemj	DESIGNED - A. HOUSEH	REVISED -	A. ABBAS 03-21-97
CONSULTING ENGINEERS 52 Wheeler Road		DRAWN -	REVISED -	M. GOMEZ 01-22-01
Sugar Grove, Illinois 60554 630.466.6700 / www.eeiweb.com	PLOT SCALE = 50.0000 ' / in.	CHECKED -	REVISED -	R. BORO 12-15-09
030.400.0700 / www.eelweb.com	PLOT DATE = 7/11/2019	DATE - 03-11-94	REVISED -	K. SMITH 07-11-19

STATE OF ILLINOIS
DEPARTMENT OF TRANSPORTATION

nd24 dem 7/11/2019 1-53-2

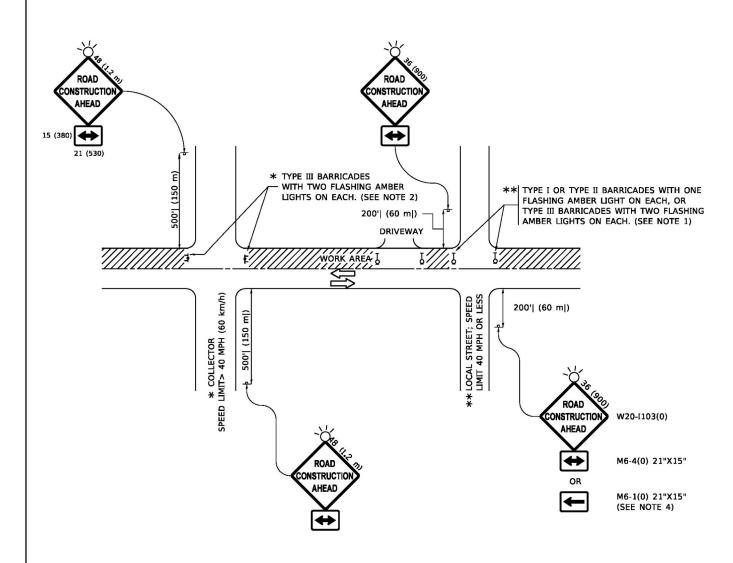

NOTES:

- 1. SIDE ROAD WITH A SPEED LIMIT OF 40 MPH (60 km/h) OR LESS AS SHOWN ON THE DRAWING AND AS DIRECTED BY THE ENGINEER:
- a) ONE "ROAD CONSTRUCTION AHEAD" SIGN 36 x 36 (900x900) WITH A FLASHER MOUNTED ON IT APPROXIMATELY 200' (60 m) IN ADVANCE OF THE MAIN ROUTE.
- b) THE CLOSED PORTION OF THE MAIN ROUTE SHALL BE PROTECTED BY BLOCKING WITH TYPE I, TYPE II OR TYPE III BARRICADES, 1/3 OF THE CROSS SECTION OF THE CLOSED PORTION.
- SIDE ROAD WITH A SPEED LIMIT GREATER THAN 40 MPH (60 km/h) AS SHOWN ON THE DRAWING AND AS DIRECTED BY THE ENGINEER:
- a) ONE "ROAD CONSTRUCTION AHEAD" SIGN 48 x 48 (1.2 m x 1.2 m) WITH A FLASHER MOUNTED ON IT APPROXIMATELY 500' (150 m) IN ADVANCE OF THE MAIN ROLITE.
- THE CLOSED PORTION OF THE MAIN ROUTE SHALL BE PROTECTED BY
 b) BLOCKING WITH TYPE III BARRICADES, 1/2 OF THE CROSS SECTION
 OF THE CLOSED PORTION.
- CONES MAY BE SUBSTITUTED FOR BARRICADES OR DRUMS AT HALF THE SPACING DURING DAY OPERATIONS. CONES SHALL BE A MINIMUM OF 28 (710) IN HEIGHT.
- WHEN THE SIDE ROAD LIES BETWEEN THE BEGINNING OF THE MAINLINE
 4. SIGNING AND THE WORK ZONE, A SINGLE HEADED ARROW (M6-1) SHALL
 BE USED IN LIEU OF THE DOUBLE HEADED ARROW (M6-4).

SCALE: NONE

- 5. WHEN WORK IS BEING PERFORMED ON A SIDE ROAD OR DRIVEWAY, FOLLOW THE APPLICABLE STANDARD(S). THE DIRECTIONAL ARROW (M6-1 OR M6-4) SHALL BE COVERED OR REMOVED WHEN NO LONGER CONSISTENT WITH THE TRAFFIC CONTROL SET-UP.
- ADVANCE WARNING SIGNS ARE TO BE OMITTED ON DRIVEWAYS UNLESS OTHERWISE SPECIFIED IN THE PLANS OR BY THE ENGINEER.
- THE TRAFFIC CONTROL AND PROTECTION FOR SIDE ROADS, INTERSECTIONS, AND DRIVEWAYS SHALL BE INCLUDED IN THE COST OF SPECIFIED TRAFFIC CONTROL STANDARDS OR ITEMS.

All dimensions are in inches (millimeters) unless otherwise shown.

Et !

ngineering Enterprises, Inc. ONSULTING ENGINEERS 2. Wheeler Road igar Grove, Illinois 60554 90.466.6700 / www.eelweb.com

 USER NAME
 Lawrence.DeManche
 DESIGNED
 L.H.A.
 REVISED
 - T. RAMMACHER 01-06-00

 DRAWN
 REVISED
 - A. SCHUETZE 07-01-13


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 - A. SCHUETZE 09-15-16


 PLOT DATE
 = 5/3/2024
 DATE
 06-89
 REVISED
 D. SENDERAK 05-03-24

STATE OF ILLINOIS
DEPARTMENT OF TRANSPORTATION

TRAFFIC CONTROL AND PROTECTION FOR SIDE ROADS, INTERSECTIONS, AND DRIVEWAYS

SHEET 1 OF 1 SHEETS STA. TO STA

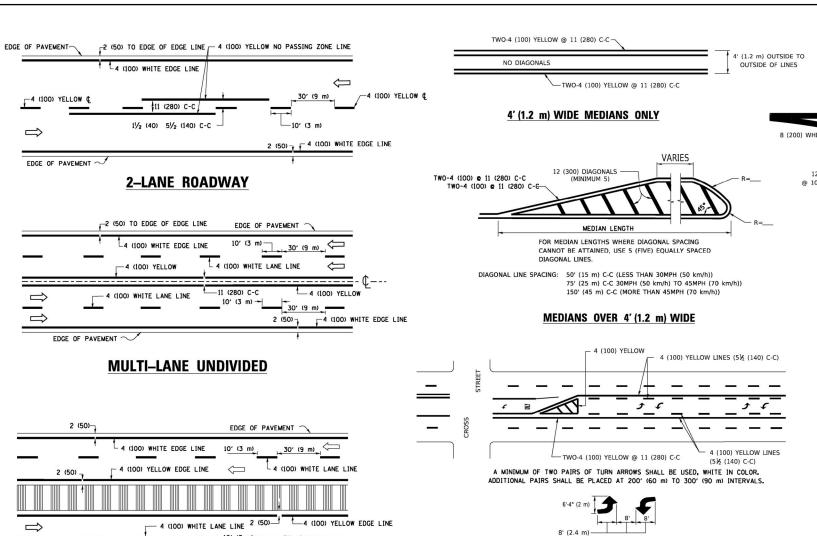

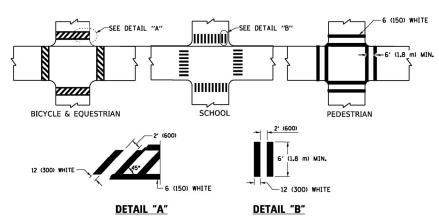


MULTI-LANE DIVIDED

TYPICAL LANE AND EDGE LINE MARKING

TYPICAL CROSSWALK MARKING

EDGE OF PAVEMENT

* MARKINGS SHALL BE INSTALLED PARALLEL TO THE CENTERLINE OF THE ROAD WHICH IT CROSSES

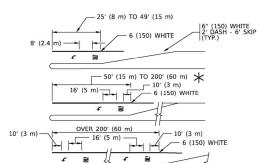

MEDIAN WITH TWO-WAY LEFT TURN LANE


TYPICAL PAINTED MEDIAN MARKING

FULL SIZE LETTERS 8' (2.4 m) AND ARROWS SHALL BE USED. AREA = 15.6 SQ. FT. (1.5 m²) (11) AREA = 20.8 SQ. FT. (1.9 m)²

* TURN LANES IN EXCESS OF 400' (120 m) IN LENGTH MAY HAVE AN ADDITIONAL SET OF ARROW - "ONLY" INSTALLED MIDWAY BETWEEN THE OTHER TWO SETS OF

TYPICAL LEFT (OR RIGHT) TURN LANE

TYPICAL TURN LANE MARKING

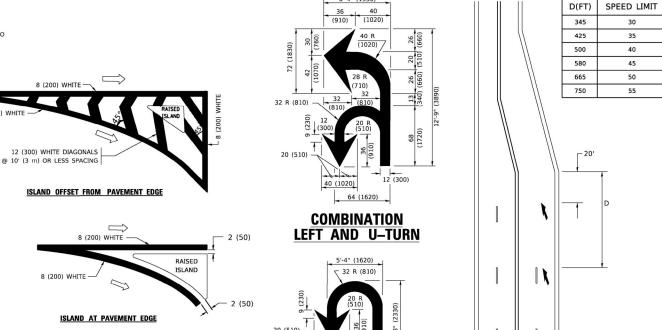

LANE REDUCTION TRANSITION

* LANE REDUCTION ARROWS REQUIRED AT SPEEDS OF 45 MPH OR GREATER OR WHEN SPECIFIED IN PLANS.

			<u> </u>	
TYPE OF MARKING	WIDTH OF LINE	PATTERN	COLOR	SPACING / REMARKS
CENTERLINE ON 2 LANE PAVEMENT	4 (100)	SKIP-DASH	YELLOW	10' (3 m) LINE WITH 30' (9 m) SPACE
CENTERLINE ON MULTI-LANE UNDIVIDED PAVEMENT	2 @ 4 (100)	SOLID	YELLOW	11 (280) C-C
NO PASSING ZONE LINES: FOR ONE DIRECTION FOR BOTH DIRECTIONS	4 (100) 2 @ 4 (100)	SOLID SOLID	YELLOW YELLOW	5½ (140) C-C FROM SKIP-DASH CENTERLINE 11 (280) C-C OMIT SKIP-DASH CENTERLINE BETWEEN
LANE LINES	4 (100) 5 (125) ON FREEWAYS	SKIP-DASH SKIP-DASH	WHITE WHITE	10' (3 m) LINE WITH 30' (9 m) SPACE
DOTTED LINES (EXTENSIONS OF CENTER, LANE OR TURN LANE MARKINGS)	SAME AS LINE BEING EXTENDED	SKIP-DASH	SAME AS LINE BEING EXTENDED	2' (600) LINE WITH 6' (1.8 m) SPACE
EDGE LINES	4 (100)	SOLID	YELLOW-LEFT WHITE-RIGHT	OUTLINE MEDIANS IN YELLOW
TURN LANE MARKINGS	6 (150) LINE; FULL SIZE LETTERS & SYMBOLS (8' (2.4m))	SOLID	WHITE	SEE TYPICAL TURN LANE MARKING DETAIL
TWO WAY LEFT TURN MARKING	2 @ 4 (100) EACH DIRECTION 8' (2.4m) LEFT ARROW	SKIP-DASH AND SOLID IN PAIRS	YELLOW	10' (3 m) LINE WITH 30' (9 m) SPACE FOR SKIP-DASH; 5½ (140) C-C BETWEEN SOLID LINE AND SKIP-DASH LINE SEE TYPICAL TWO-WAY LEFT TURN MARKING DETAIL
CROSSWALK LINES (PEDESTRIAN) A. DIAGONALS (BIKE & EQUESTRIAN) B. LONGITUDINAL BARS (SCHOOL)	2 @ 6 (150) 12 (300) @ 45° 12 (300) @ 90°	SOLID SOLID SOLID	WHITE WHITE WHITE	NOT LESS THAN 6' (1.8 m) APART 2' (600) APART 2' (600) APART SEE TYPICAL CROSSWALK MARKING DETAILS.
STOP LINES	24 (600)	SOLID	WHITE	PLACE 4' (1.2 m) IN ADVANCE OF AND PARALLEL TO CROSSWALK, IF PRESENT: OTHERWISE, PLACE AT DESIRED STOPPING POINT. PARALLEL TO CROSSROAD CENTERLINE, WHERE POSSIBLE
PAINTED MEDIANS	2 @ 4 (100) WITH 12 (300) DIAGONALS @ 45° NO DIAGONALS USED FOR 4' (1.2 m) WIDE MEDIANS	SOLID	YELLOW: TWO WAY TRAFFIC WHITE: ONE WAY TRAFFIC	11 (280) C-C FOR THE DOUBLE LINE SEE TYPICAL PAINTED MEDIAN MARKING.
GORE MARKING AND CHANNELIZING LINES	8 (200) WITH 12 (300) DIAGONALS @ 45°	SOLID	WHITE	DIAGONALS: 15' (4.5 m) C-C (LESS THAN 30MPH (50 km/h)) 20' (6 m) C-C 30MPH (50 km/h) TO 45MPH (70 km/h)) 30' (9 m) C-C (OVER 45MPH (70 km/h))
RAILROAD CROSSING	24 (600) TRANSVERSE LINES; "RR" IS 6' (1.8 m) LETTERS; 16 (400) LINE FOR "X"	SOLID	WHITE	SEE STATE STANDARD 780001 AREA OF: "R"=3.6 SQ. FT. (0.33 m PEACH "X"=54.0 SQ. FT. (5.0 m PEACH
SHOULDER DIAGONALS (REQUIRED FOR SHOULDERS > 8')	12 (300) @ 45°	SOLID	WHITE - RIGHT YELLOW - LEFT	50' (15 m) C-C (LESS THAN 30MPH (50 km/h)) 75' (25 m) C-C (30 MPH (50 km/h) TO 45MPH (70 km/h)) 150' (45 m) C-C (OVER 45MPH (70 km/h))
U TURN ARROW	SEE DETAIL	SOLID	WHITE	16.3 SF
2 ARROW COMBINATION LEFT AND U TURN	SEE DETAIL	SOLID	WHITE	30.4 SF

U-TURN

FOR FURTHER DETAILS ON PAVEMENT MARKING REFER TO

SCALE: NONE

TYPICAL ISLAND MARKING

All dimensions are in inches (millimeters) unless otherwise shown

REVISED -USER NAME = footemi DESIGNED -EVERS C. JUCIUS 09-09-09 CHECKED REVISED C. JUCIUS 12-21-15 PLOT SCALE = 50.0000 ' / in PLOT DATE = 3/4/2019 DATE 03-19-90 REVISED C. JUCIUS 04-12-16

2 (50) 7

STATE OF ILLINOIS **DEPARTMENT OF TRANSPORTATION**

SECTION DISTRICT ONE KANE 27 27 24-00021-00-SW TYPICAL PAVEMENT MARKINGS CONTRACT NO. 61L74 TC-13 SHEET 1 OF 2 SHEETS STA. TO STA.