GENERAL NOTES:

1. ALL CONSTRUCTION SHALL BE DONE IN ACCORDANCE WITH THE STATE OF ILLINOIS "STANDARD SPECIFICATIONS FOR ROAD AND BRIDGE CONSTRUCTION" ADOPTED JAN 1, 2012, THE CITY OF AURORA STANDARD SPECIFICATIONS, THE DETAILS IN THESE PLANS AND THE SPECIAL PROVISIONS INCLUDED IN THE CONTRACT DOCUMENTS.

- 2. NO WORK SHALL COMMENCE UNTIL TRAFFIC CONTROL REQUIREMENTS
- 3. ALL UTILITIES, SCHOOL DISTRICTS, LOCAL POLICE, AND FIRE DEPARTMENT SHALL BE NOTIFIED BY CONTRACTOR PRIOR TO THE START OF CONSTRUCTION: SEE SHEET 3 FOR CONTACT LIST.
- UNLESS AUTHORIZED BY THE ENGINEER, ALL EXISTING ACCESS POINTS SHALL BE MAINTAINED AT ALL TIMES BY THE CONTRACTOR.
- 5. DURING THE CONSTRUCTION, THE CONTRACTOR WILL BE REQUIRED, AT HIS EXPENSE, TO HAVE AVAILABLE A WATER TRUCK OR SIMILAR EQUIPMENT TO CONTROL DUST. IF NECESSARY, THE CONTRACTOR SHALL BE REQUIRED TO CONTROL DUST DURING NON-WORKING HOURS.
- 6. ALL EXCESS MATERIAL (BROKEN CONCRETE, CULVERT PIPE, WASTE ROADWAY EXCAVATIONS, SURPLUS MATERIAL FROM SEWER TRENCHES, ETC.) SHALL BE LEGALLY DISPOSED OF OUTSIDE LIMITS OF THE RIGHT-OF-WAY. IT SHALL BE THE CONTRACTOR'S RESPONSIBILITY TO SELECT DUMP SITES AND OBTAIN PERMISSION AND ALL NECESSARY PERMITS TO USE SUCH DUMP SITES. PAYMENT FOR THIS WORK SHALL BE INCLUDED IN THE CONTRACT UNIT PRICE FOR REMOVAL AND DISPOSAL OF INISTITABLE MATERIAL (ITEM 2021/200) AND DISPOSAL OF UNSUITABLE MATERIAL. (ITEM 20201200)
- TREE REMOVAL CLEARING HEDGE REMOVAL
 THE CONTRACTOR'S ATTENTION IS CALLED TO THE FACT THAT THE
 PRESERVATION OF EXISTING TREES IS OF UTMOST IMPORTANCE TO
 THE CITY OF AURORA. ALL TREE PROTECTION, TREE REMOVAL,
 PRUNING AND ROOT PRUNING SHALL BE COMPLETED BEFORE
 CONSTRUCTION OPERATIONS COMMENCE IN ANY AREA. AT NO TIME
 SHALL THE CONTRACTOR PRUNE OR REMOVE ANY TREE UNLESS SPECIFICALLY DIRECTED BY THE ENGINEER.
- 8. THE CONTRACTOR SHALL ERECT A TEMPORARY FENCE AROUND ALL TREES WITHIN THE CONSTRUCTION AREA TO ESTABLISH A "TREE PROTECTION ZONE" BEFORE ANY WORK BEGINS OR ANY MATERIAL IS DELIVERED TO THE JOBSITE. NO WORK IS TO BE PERFORMED (OTHER THAN ROOT PRUNING), MATERAILS STORED OR VEHICLES DRIVEN OR PARKED WITHIN THE "TREE PROTECTION ZONE". REMOVE PROTECTIVE TEMPORARY FENCE ONLY AFTER ALL CONSTRUCTION WORK HAS BEFOR COMPLETED. REMOVE PROTECTIVE TEMPORARY FENC WORK HAS BEEN COMPLETED.
- 9. THE CONTRACTOR SHALL TAKE EXTRA CARE IN GRADING AND EXCAVATING NEAR TREES WHICH ARE NOT MARKED FOR REMOVAL SO AS NOT TO CAUSE INJURY TO THE ROOT SYSTEM OR TRUNKS. ANY DAMAGE DONE TO EXISITING ITEMS BY THE CONTRACTOR SHALL BE REPAIRED BY THE CONTRACTOR AT THE CONTRACTOR'S OWN
- 10. TREE ROOT PRUNING IS TO BE USED ON EXISTING TREES TO PREVENT THE RIPPING UP OF ROOTS WHEN TRENCHING OR EXCAVATION IS WITHIN THE ROOT ZONE OF ADJACENT TREES TO REMAIN. SUPPLEMENTAL WATERING OF TREES SHOULD BEGIN IMMEDIATELY AFTER ROOT PRUNING OF THE TREES HAS OCCURRED.
- 11. PRUNE TREE LIMBS THAT MIGHT BE DAMAGED BY EQUIPMENT OPERATIONS AT LEAST ONE WEEK PRIOR TO THE START OF CONSTRUCTION BY A CERTIFIED ARBORIST, ANY TREE LIMBS THAT ARE BROKEN BY CONSTRUCTION EQUIPMENT AFTER THE INITIAL PRUNING MUST BE PRUNED CORRECTLY WITHIN 72 HOURS.
- 12. SUPPLEMENTAL WATERING IS SPECIFIED FOR TREES AND SHRUBS THAT WILL BE DISTURBED BY CONSTRUCTION BUT WILL REMAIN, NOTE THAT WATERING SHOULD BEGIN IMMEDIATELY AFTER ROOT PRUNING, TOP PRUNING OR OTHER CONSTRUCTION DISTURBANCE.
- 13. THE EMERALD ASH BORER IS AFFECTING MANY TREES WITHIN DISTRICT ONE WHICH AT THE TIME THE TREE SURVEY WAS COMPLETED THE TREE MAY HAVE BEEN HEALTHY AND SOUND. THE RESIDENT ENGINEER MAY REQUEST ADDITIONAL TREE(S) WITHIN THE RIGHT-OF-WAY TO BE REMOVED THAT WERE NOT ORIGINALLY SHOWN FOR REMOVAL IF THE TREE(S) IS UNSTRUCTURALLY SOUND, DISEASED, OR DEAD.

DISTRICT DETAILS STANDARDS

BUTT JOINT AND HMA TAPER DETAILS

BD-01

BD-02

BD-32

DRIVEWAY DETAILS - DISTANCE BETWEEN ROW AND FACE OF CURB & EDGE OF SHOULDER >= 15' (4.5 m)

DRIVEWAY DETAILS DISTANCE BETWEEN ROW AND FACE OF CURB < 15' (4.5 m)

DETAILS FOR DEPRESSED CURB & GUTTER AND SHOULDER TREATMENT AT TBT TY 1 SPL

- 14. TREES NOT MARKED FOR REMOVAL SHALL BE CONSIDERED AS DESIGNATED TO BE SAVED AND SHALL BE PROTECTED UNDER THE PROVISIONS OF ARTICLE 201.05 OF THE STANDARD SPECIFICATIONS.
- 15. ALL LIMBS, BRANCHES, AND OTHER DEBRIS RESULTING FROM THIS WORK SHALL BE DISPOSED OF BY THE CONTRACTOR AT HIS OWN EXPENSE OUTSIDE THE LIMITS OF THE RIGHT-OF-WAY.
- 16. ALL CLEARING REMOVAL OF BUSHES, HEDGES AND TREES UNDER SIX (6) INCHES IN DIAMETER WILL BE INCLUDED IN THE CONTRACT UNIT PRICE FOR EARTH EXCAVATION. (ITEM 20200100)

OVERHANGING LIMBS

17. OVERHANGING LIMBS ARE TO BE TRIMMED OR CUT OFF TO PROVIDE A MINIMUM VERTICAL CLEARANCE OF TWENTY (20) FEET FROM THE FINISHED SURFACE OF THE ROAD.

LIMB PRUNING SHALL BE PERFORMED UNDER THE SUPERVISION OF AN APPROVED TREE EXPERT AS STATED IN THE SPECIAL PROVISIONS AND SHALL BE UNDERTAKEN IN A TIMELY FASHION SO AS NOT TO

ALL CUTS OVER ONE (1) INCH IN DIAMETER SHALL BE MADE FLUSH WITH THE NEXT LARGE BRANCH.

ALL LIMBS, BRANCHES, AND OTHER DEBRIS RESULTING FROM THIS WORK SHALL BE DISPOSED OF BY THE CONTRACTOR AT HIS EXPENSE OUTSIDE THE LIMITS OF THE RIGHT-OF-WAY.

TOPSOIL

- TOPSOIL SHALL BE PLACED TO A DEPTH OF FOUR (4) INCHES AND BE MEASURED IN SQUARE YARDS. (ITEM 21101615)
- 19. THE CROSS SECTIONS INDICATE TO FINISHED GRADE OF TOPSOIL.
- 20. THE LOCATIONS OF TOPSOIL STOCKPILED WITHIN THE RIGHT-OF-WAY MUST BE APPROVED BY THE ENGINEER. TOPSOIL STOCKPILE WILL REQUIRE EROSION CONTROL.

ROADWAY EXCAVATION

- RUADWAY EXCAVATION

 21. ALL EXISTING GRANULAR AND HOT-MIX ASPHALT TO BE REMOVED AND NOT PAID AS A SPECIFIC ITEM SHALL BE CONSIDERED EARTH EXCAVATION. AND WILL BE PAID FOR AT THE UNIT PRICE FOR EARTH EXCAVATION. THE CONTRACTOR WILL HAVE THE OPTION OF REMOVING THE EXISTING HOT-MIX ASPHALT BY GRINDING OR EXCAVATING THE MATERIAL.
- 22. THE CONTRACTOR SHALL NOT CROSS COMPLETED BASE COURSE OR EXISTING PAVEMENT, NOT SCHEDULED TO BE REMOVED WITH LOAD SCRAPERS OR TRACK EQUIPMENT.

STORM SEWER STRUCTURES STORM SEWER STRUCTURES UTILITIES 23. THE STATION / OFFSET / ELEVATIONS NOTED FOR ALL DRAINAGE STRUCTURES LOCATED IN THE CURB LINE REFER TO THE POSITION OF THE ADJACENT PROPOSED EDGE OF PAVEMENT UNLESS OTHERWISE NOTED. THE CONTRACTOR SHALL BE RESPONSIBLE FOR DETERMINING THE OFFSET NECESSARY FOR THE STRUCTURES TO SET THE FRAME AND GRATES IN THE PROPER LOCATION. ALL OTHER STRUCTURES ARE DIMENSIONED TO THE CENTER OF THE STRUCTURES UNLESS OTHERWISE NOTED: ELEVATIONS INDICATES RIM GRADES.

- 24. THE CONTRACTOR SHALL BE RESPONSIBLE FOR CONTACTING LOCAL AGENCIES MAINTAINING SANITARY SEWERS WATERMAINS TO VERIFY THE MATERIALS AND METHODS ALLOWED FOR THE ADJUSTMENT, RELOCATION, OR EXTENSION OF THE UTILITY INVOLVED.
- 25. THE LOCATIONS AND ELEVATION OF EXISTING UTILITIES ARE APPROXIMATE AND ARE PROVIDED BY THE OWNERS. THE EXACT LOCATIONS AND ELEVATION ARE TO BE VERIFIED BY THE CONTRACTOR.
- 26. ALL ADJUSTMENTS OR RECONSTRUCTIONS SHALL INCLUDE THE REMOVAL AND REPLACEMENT, AT THE CONTRACTOR'S EXPENSE, OF ALL UNSUITABLE MATERIAL TWO (2) FOOT INSIDE DIAMETER
- 27. ADJUSTMENT AND RECONSTRUCTION OF STRUCTURES MAINTAINED BY OTHER AGENCIES SHALL BE MADE TO THE SATISFACTION OF THE ENGINEER AND THE AGENCY MAINTAINING THE SYSTEM OF THE STRUCTURES INVOLVED. THE FINAL STRUCTURE SHOULD NOT HAVE MORE THAN (8) INCHES OF ADJUSTMENT RINGS.

HOT-MIX ASPHALT

28. HOT-MIX ASPHALT SURFACE COURSE SHALL NOT BE PLACED UNTIL ALL EARTH EXCAVATION, TOPSOIL PLACEMENT, AGGREGATE BASE COURSE, AND HOT-MIX ASPHALT BINDER COURSE HAVE BEEN COMPLETED TO THE SATISFACTION OF THE

TRAFFIC CONTROL AND PROTECTION FOR SIDE ROADS, INTERSECTIONS AND DRIVEWAYS

TC-13 DISTRICT ONE TYPICAL PAVEMENT MARKINGS

TC-26 DRIVEWAY ENTRANCE SIGNING

- 29. SAW CUT CONSTRUCTION JOINTS SHALL BE PROVIDED AT PAVED COMMERCIAL OR PRIVATE ENTRANCES AND AT ALL SIDE ROAD. THE COST SHALL BE INCLUDED IN THE CONTRACT UNIT PRICE FOR
- 30. THE MINIMUM COMPACTED THICKNESS OF ANY LIFT OF BINDER SHALL
- 31. BASE COURSE SHALL NOT BE PLACED ADJACENT TO CURB AND GUTTER UNTIL THE CURB AND GUTTER HAS BEEN BACKFILLED TO THE SATISFACTION OF THE ENGINEER.

- TRAFFIC CONTROL AND PROTECTION

 32. TRAFFIC CONTROL AND PROTECTION SHALL BE PERFORMED
 IN ACCORDANCE WITH THE TRAFFIC CONTROL PLAN AND SECTION 701
 OF THE STANDARD SPECIFICATIONS AS AMENDED BY THE SPECIAL
 PROVISION FOR CONSTRUCTION ZONE TRAFFIC CONTROL (CHECK
- 33. THE TYPE III BARRICADES ARE TO BE PLACED IN ACCORDANCE WITH STANDARD 701901 UNLESS AUTHORIZED BY THE ENGINEER TO USE AN ALTERNATE ARRANGEMENT.
- 34. EXISTING TRAFFIC CONTROL SIGNS AND DEVICES SHALL BE REMOVED BY THE CONTRACTOR AFTER TRAFFIC CONTROL REQUIREMENTS ARE MET, OR AS AUTHORIZED BY THE ENGINEER, AND DELIVERED TO THE CITY OF AURORA AS DIRECTED BY THE ENGINEER. ANY SIGNS OR DEVICES LEFT IN PLACE ARE TO BE RELOCATED, MAINTAINED AND PROTECTED FROM DAMAGE BY THE CONTRACTOR AT NO EXPENSE TO THE CITY OF AURORA.
- 35. ANY DROP OFF GREATER THAN THREE (3) INCHES BUT LESS THAN SIX (6) INCHES, WITHIN EIGHT (8) FEET OF THE PAVEMENT EDGE. SHALL BE PROTECTED BY TYPE I OR TYPE II BARRICADES, DRUM OR VERTICAL PANELS WITH MONODIRECTIONAL STEADY-BURN LIGHTS AT 100 FOOT CENTER TO CENTER SPACING. IF THE DROP OFF WITHIN EIGHT (8) FEET OF THE PAVEMENT EDGE EXCEEDS SIX (6) INCHES, THE BARRICADES, DRUMS OR VERTICAL PANELS MENTIONED ABOVE SHALL BE PLACED AT FIFTY (50) FOOT CENTER TO CENTER SPACING, BARRICADES THAT MUST BE PLACED IN EXCAVATED AREAS SHALL HAVE LEG EXTENSIONS INSTALLED SUCH THAT THE TOP OF THE BARRICADE IS IN COMPLIANCE WITH THE HEIGHT REQUIREMENTS OF STANDARD 701901.
- 36. TYPE I OR TYPE II BARRICADES WITH TWO-WAY FLASHING LIGHTS SHALL BE REQUIRED AT ALL OPEN TRENCHES, EXCAVATIONS, OPEN OR EXPOSED SEWER STRUCTURES, TRANSVERSE PAVEMENT JOINTS, MATERIAL OR EQUIPMENT WITHIN THE RIGHT-OF-WAY (NUMBER AND SPACING DEPENDS ON THE CONDITIONS) AND AT LOCATIONS DESIGNATED BY THE ENGINEER OR LOCAL LAW ENFORCEMENT AGENCIES.
- 37. TYPE I, II AND / OR III BARRICADES WITH TWO-WAY FLASHING LIGHTS WILL BE REQUIRED TO GUIDE TRAFFIC AWAY FROM PAVEMENT AREAS CLOSED FOR CONSTRUCTION.
- 38. THE COST OF SUPPLYING, ERECTING, AND MAINTAINING BARRICADES, WARNING LIGHTS, AND SIGNS WILL BE INCLUDED IN THE CONTRACT LUMP SUM PRICE FOR TRAFFIC CONTROL AND
- PROTECTION, (SPECIAL). (ITEM X7010216)

 CONSTRUCTION SEQUENCE

 39. PAVEMENT CONSTRUCTION SHALL NOT BEGIN UNTIL A LEAST ONE MONTH AFTER FINAL COMPLETION OF THE NEW EMBANKMENT TO REDUCE THE AMOUNT OF DIFFERENTIAL SETTLEMENT.

RAILROAD FLAGGERS

40. IT IS THE CONTRACTOR'S SOLE RESPONSIBILITY TO COORDINATE WITH THE BNSF RAILROAD WHENEVER CONSTRUCTION ACTIVITY IS WITHIN 25 FEET OF THE RAILROAD ROW. THE CONTRACTOR SHALL RETAIN FLAGMEN EMPLOYED AND DESIGNATED BY THE BNSF RAILROAD TO MONITOR ON-COMING TRAIN TRAFFIC, AND ADVISE CONTRACTOR PERSONNEL WHEN ACTIVITY ON OR NEAR THE RAILROAD RIGHT-OF-WAY MAY PROCEED. THIS ITEM WILL BE PAID FOR ACCORDING TO ARTICLE 107.12 AND WILL BE REIMBURSED ACCORDING TO ARTICLE 109.05.

NOTE: BOXED ITEMS ARE INCLUDED IN THE COST OF THE CONTRACT.

SHEET NO. INDEX OF SHEETS TITLE SHEET

TITLE SHEET
GENERAL NOTES, INDEX OF SHEETS AND LIST OF STANDARDS
SUMMARY OF QUANTITIES
EARTHWORK SCHEDULE OF QUANTITIES
SCHEDULE OF DRAINAGE QUANTITIES
TYPICAL SECTIONS
ALIGNMENT AND TIES
REMOVAL PLANS
ROADWAY PLAN AND PROFILES
INTERSECTION PAVING PLANS
MAINTERNANCE OF TRAFFIC-DETOUR ROUTE PLAN
DRAINAGE AND UTILITIES PLAN AND PROFILE
SANITARY SEWER PLAN AND PROFILE
WATER MAIN PLAN AND PROFILE 13-16 17-23 24-25 26 27-33 34

35-37 WATER MAIN PLAN AND PROFILE FOX METRO WRD DETAILS RIPRAP DETAIL

RIPRAP DETAILS
RIPRAP DETAILS
PRAINAGE STRUCTURES, NO. 1 DETAILS 1
DRAINAGE STRUCTURES, NO. 1 DETAILS 1
DRAINAGE STRUCTURES, NO. 2 DETAILS 2
DRAINAGE STRUCTURES, NO. 2 DETAILS 1
DRAINAGE STRUCTURES, NO. 2 DETAILS 2
JUNCTION BOX 202 AND 207 TEMPORARY SHEET PILING
BERSION AND SEDIMENT CONTROL PLAN
LANDSCAPING, SIGNING, AND PAVEMENT MARKING PLAN
IDOT PLAT OF HIGHWAYS
DISTRICT ONE DETAILS
CONDUIT SUPPORT ATTACHED TO BRIDGE DECK DETAIL
GENERAL PLAN AND ELEVATION
GENERAL PLAN AND ELEVATION
GENERAL DATA
FOUNDATION PLAN

∆(45-49B)

54-63 64-70

GENERAL DATA
FOUNDATION PLAN
TOP OF SLAB ELEVATIONS
TOP OF SOUTH AND NORTH APPROACH SLAB ELEVATIONS
DECK PLAN AND CROSS SECTION
SUPERSTRUCTRE DETAIL AND DIAPHRAGM DETAILS
BRIDGE APPROACH SLAB DETAILS
BRIDGE FENCE RAILING, PARAPET MOUNTED AND PARAPET RAILING DETAILS 75-80 81-82 83

84-85 86-87 88-89

FRAMING PLAN 91-92 93-94 95 STRUCTURAL STEEL DETAILS BEARING DETAILS SOUTH ABUTMENT NORTH ABUTMNET

PIER 1 AND PIER 2 HP PILE DETAILS BAR SPLICER ASSEMBLY AND MECHANICAL SPLICER DETAILS 97-98

100 BAR SPLICER ASSEMBLY AND MECHANICAL SPLICER DETAILS
101-105 BORING LOGS
106-107 GENERAL PLAN AND ELEVATION SOUTH RETAINING WALLS
108 GENERAL PLAN AND ELEVATION NORTH RETAINING WALLS
109 GENERAL DATA RETAINING WALLS
109A-110 MOMENT SLAB PLAN AND ELEVATION SOUTHEAST RETAINING WALL
111 MOMENT SLAB PLAN AND ELEVATION NORTHEAST RETAINING WALL
112 RETAINING WALL DETAILS
113-114 TRANSMISSION MAIN PROTECTION SYSTEM
115 BUCYCLE RALLING DETAILS

115 BICYCLE RAILING DETAILS 116-120 BORING LOGS RETAINING WALLS 121-136 CROSS SECTIONS

HIGHWAY STANDARDS

STANDARD SYMBOLS, ABBREVIATIONS AND PATTERNS
AREAS OF REINFORCEMENT BARS
DECIMAL OF AN INCH AND OF A FOOT
TEMPORARY EROSION CONTROL SYSTEMS
PCC PAVEMENT ROUNDOUTS
BRIDGE APPROACH PAVEMENT CONNECTOR
PERPENDICULAR CURB RAMPS FOR SIDEWALKS
CORNER PARALLEL CURB RAMPS FOR SIDEWALKS
MID-BLOCK CURB RAMPS FOR SIDEWALKS
MID-BLOCK CURB RAMPS FOR SIDEWALKS
DEPRESSED CORNER FOR SIDEWALKS
DEPRESSED CORNER FOR SIDEWALKS
PLATE FOR BRIDGES
PRECAST REINFORCED CONCRETE FLARED END SECTION
TRAVERSABLE PIPE GRATE
CATCH BASIN, TYPE A
MANHOLE, TYPE A
MANHOLE, TYPE A
MANHOLE, TYPE A
MANHOLE STEPS
FRAME AND LIDS, TYPE 1 420111-03 420401-10 424001-07 424011-01 424016-01 424021-02 515001-03 542301-03 542311-05 602001-02 602301-0**4** 602401-03 602421-04 602501-02 602701-02 604001-03 604036-02 604056-03 FRAME AND LIDS, TYPE 1 GRATE, TYPE 8 FRAME AND GRATE, TYPE 11V CONCRETE CURB TYPE B AND COMBINATION CONCRETE CURB AND GUTTER 606001-05 CONCRETE CURB TYPE B AND COMBINATION CONCRETE CURB
AND GUTTER
STEEL PLATE BEAM GUARDRAIL
SHOULDER WIDENING FOR TYPE I (SPECIAL) GAURDRAIL TERMINALS
TRAFFIC BARRIER TERMINAL, TYPE 2
TRAFFIC BARRIER TERMINAL, TYPE 5
TRAFFIC BARRIER TERMINAL, TYPE 6
REFLECTOR AND TERMINAL MARKER PLACEMENT
REFLECTOR MARKER AND MOUNTING DETAILS
CHAIN LINK FENCE
OFF-RD OPERATIONS, 2L, 2W 15 (4.5m) TO 24" (600mm)
FROM PAVEMENT EDGE
OFF-RD MOVING OPERATIONS, 2L, 2W, DAY ONLY
LANE CLOSURE, 2L, 2W SHORT TIME OPERATIONS
URBAN LANE CLOSURE 2L, 2W, UNDIVIDED
SIDEWALK, CORNER OR CROSSWALK CLOSURE
TRAFFIC CONTROL DEVICES
SIGN PANEL MOUNTING DETAILS
ISION PANEL ERECTION DETAILS
SIGN PANEL RECTION DETAILS
TELESCOPING STEEL SIGN SUPPORT
APPLICATIONS OF TYPES A AND B METAL POSTS (FOR SIGNS
& MARKERS)
TYPICAL PAMEMENT MARKINGS

630001-10 630301-06 631011-09 631026-05 631031-12

701011-04 701301-04 701301-04 701501-06 701801-05 701901-03

720001-01 720006-04 720011-01 728001-01


729001-01

780001-04 TYPICAL PAVEMENT MARKINGS

DESIGNED - MLB REVISED - ▲ 8-22-14 CHII\0130\Rood\Shoots\10130-SHT-GenNotes.dgn DRAWN - MLB REVISED PLOT SCALE * N/A CHECKED - MWS REVISED

STATE OF ILLINOIS **DEPARTMENT OF TRANSPORTATION**

COUNTY TOTAL SHEE NO. GENERAL NOTES, INDEX OF SHEETS 4087 08-00278-00-8R KANE 136 AND LIST OF STANDARDS CONTRACT NO. 63859 SCALE: N.T.S. SHEET NO. 2 OF 136 SHEETS STA. TO STA.

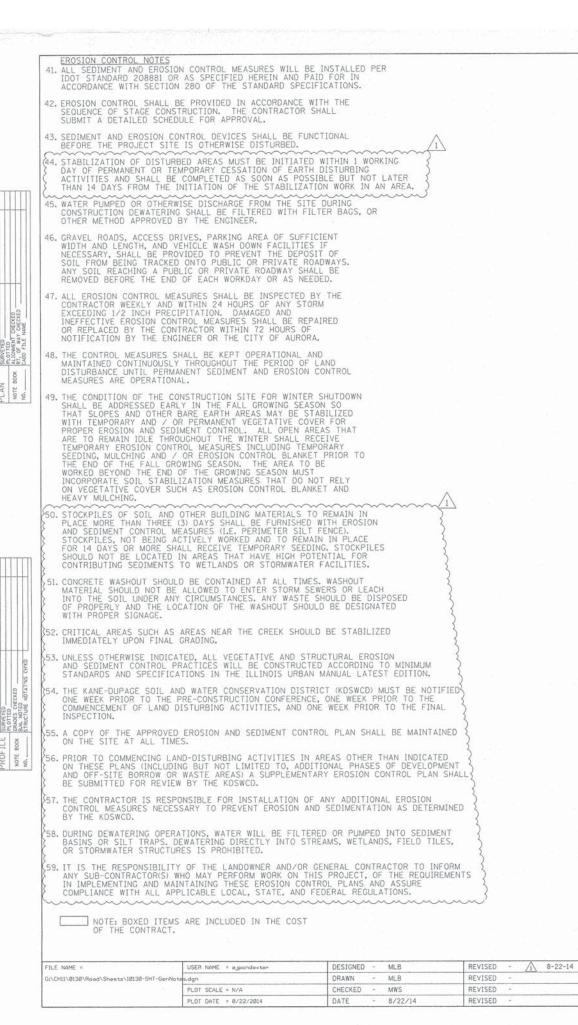

CONTACIS
AURORA TOWNSHIP HIGHWAY COMMISSIONER
JOHN SHOEMAKER
630-892-0266
200 BUTTERFIELD ROAD
NORTH AURORA, IL 60542-1316

NICOR GAS
CONSTANCE LANE
630-388-3830
1844 FERRY ROAD
NAPERVILLE, IL 60563

AT&T OSP ENGINEER
LEGAL MANDATE GROUP
BOB ELSINGA
630-573-5452
1000 COMMERCE DRIVE
OAK BROOK, IL 60523

COMED
ANA KUNZE
630-437-2129
2 LINCOLN CENTER-6TH FL
OAK BROOK TERRACE, IL 60181

FOX METRO WATER RECLAMATION DISTRICT
ZACHERY BONESZ
630-301-6805
682 STATE ROUTE 31
OSWEGO, IL 60543

COMCAST CABLE
MARTHA GIERAS
630-600-6352
2 688 INDUSTRIAL DRIVE
ELMHURST, IL 60126

AURORA POLICE DEPARTMENT
MAIN HEADOUARTERS
630-256-5000
1200 EAST INDIAN TRAIL ROAD
AURORA, IL 60505

PACE SUBURBAN BUS SERVICE
(Specify Relevant Department)
847-364-7223
550 W. Algonquin Rd.
Arlington Heights, IL 60005

CITY OF AURORA
630-256-5636
44 E. DOWNER PLACE
AURORA, IL 60505

EAST AURORA SCHOOL DISTRICT 131
630-299-5550
417 FIFTH STREET
AURORA, IL 60505

SIMMONS MIDDLE SCHOOL
630-299-4150
1130 SHEFFER RD.
AURORA, IL 60505

HERMES ELEMENTARY SCHOOL
630-299-8200
1000 JUNGLES AVE.
AURORA, IL 60505

ROLLINS ELEMENTARY SCHOOL
630-299-5480
950 KANE STREET
AURORA, IL 60505

OAK PARK ELEMENTARY SCHOOL
630-299-5250
1200 FRONT STREET
AURORA, IL 60505

COWHERD MIDDLE SCHOOL
630-299-8250
1210 FRONT STREET
AURORA, IL 60505

COWHERD MIDDLE SCHOOL
630-299-500
411 N. FARNSWORTH
AURORA, IL 60505

AURORA FIRE DEPARTMENT
CENTRAL STATION
630-256-4000
75 N. BROADWAY
AURORA, IL 60505

STABILIZATION TYPE	JAN.	FEB.	MAR.	APR.	MAY.	JUNE	JULY	AUG.	SEPT.	OCT.	NOV.	DEC.
PERMANENT SEEDING	N/A	NZA	N/A	N/A								
DORMANT SEEDING	N/A	N/A	N/A	N/A								
TEMPORARY SEEDING	A											-
SODDING						-						-
MULCHING	N/A	N/A	N/A	N/A								

	GENERAL NOTES, INDEX OF SHEETS				F.A.P. RTE.	SECTION	COUNTY	TOTAL	SHEET NO.
STATE OF ILLINOIS DEPARTMENT OF TRANSPORTATION		AND LIST OF			4087	08-00278-00-BR	KANE	136 T NO. 6	3 63859
DEPARTMENT OF TRANSPORTATION	SCALE: N.T.S.	SHEET NO. 3 OF 136 SHEETS	STA.	TO STA.		ILLINOIS FED.	AID PROJECT	1 110. 0	,5003


CODE			SCHOOL STATE	TOTAL	CC	ONSTRUCTION CODE	
NUMBE	R	PAY ITEM	UNIT	QUANTITY	ROA	DWAY	BRIDGE 80% FED 20% LOCAL AGENCY 0011
					80% FED 20% LOCAL AGENCY	100% LOCAL AGENCY	20% LOCAL
					0004		0011
Z00573	00 SANITARY SEWER 18"		FOOT	351	351		
200657	04 BITUMINOUS COATED AGG	REGATE SLOPEWALL 6"	SQ YD	730			730
Z00766	00 TRAINEES		HOUR	1000	1000		
Z00766	TRAINEES TRAINING PROG	RAM GRADUATE	HOUR	1000	1000		
m	97 STABILIZED CONSTRUCTION	WENTENDER	SQ YD	1600	1600		~~~


DENOTES SPECIALTY ITEM NON-PARTICIPATING = 100% LOCAL CONSTRUCTION TYPE CODE 0042


CONSTRUCTION	٠	11	-	U


PLAN SIRREYED
NOTE BOOK ALIONEN CRECKED
NO. CAOS FILE NAME
NO. CAOS FILE NAME

FILE NAME =	USER NAME * ajpondexter	DESIGNED - MLB	REVISED - /1 8-22-14			F.A.P.	SECTION	COUNTY	TOTAL	SHE
G:\CHII\@I3@\Road\Sheets\1013@-SHT-S00.dgn		DRAWN - MLB	REVISED -	STATE OF ILLINOIS	SUMMARY OF QUANTITIES	RTE.	SECTION	CODIVIT	SHEETS	, NO
	PLOT SCALE = N/A	CHECKED - YSK	REVISED -	DEPARTMENT OF TRANSPORTATION	Community of Community	4087	08-00278-00-BR	CONTRAC	136 CT NO. 6	5A
	PLOT DATE = 8/22/2014	DATE - 8/22/14	REVISED -		SCALE: N.T.S. SHEET NO. 5A OF 136 SHEETS STA. TO STA.		ILLINOIS FEO	, AID PROJECT	1 110. 6	0000

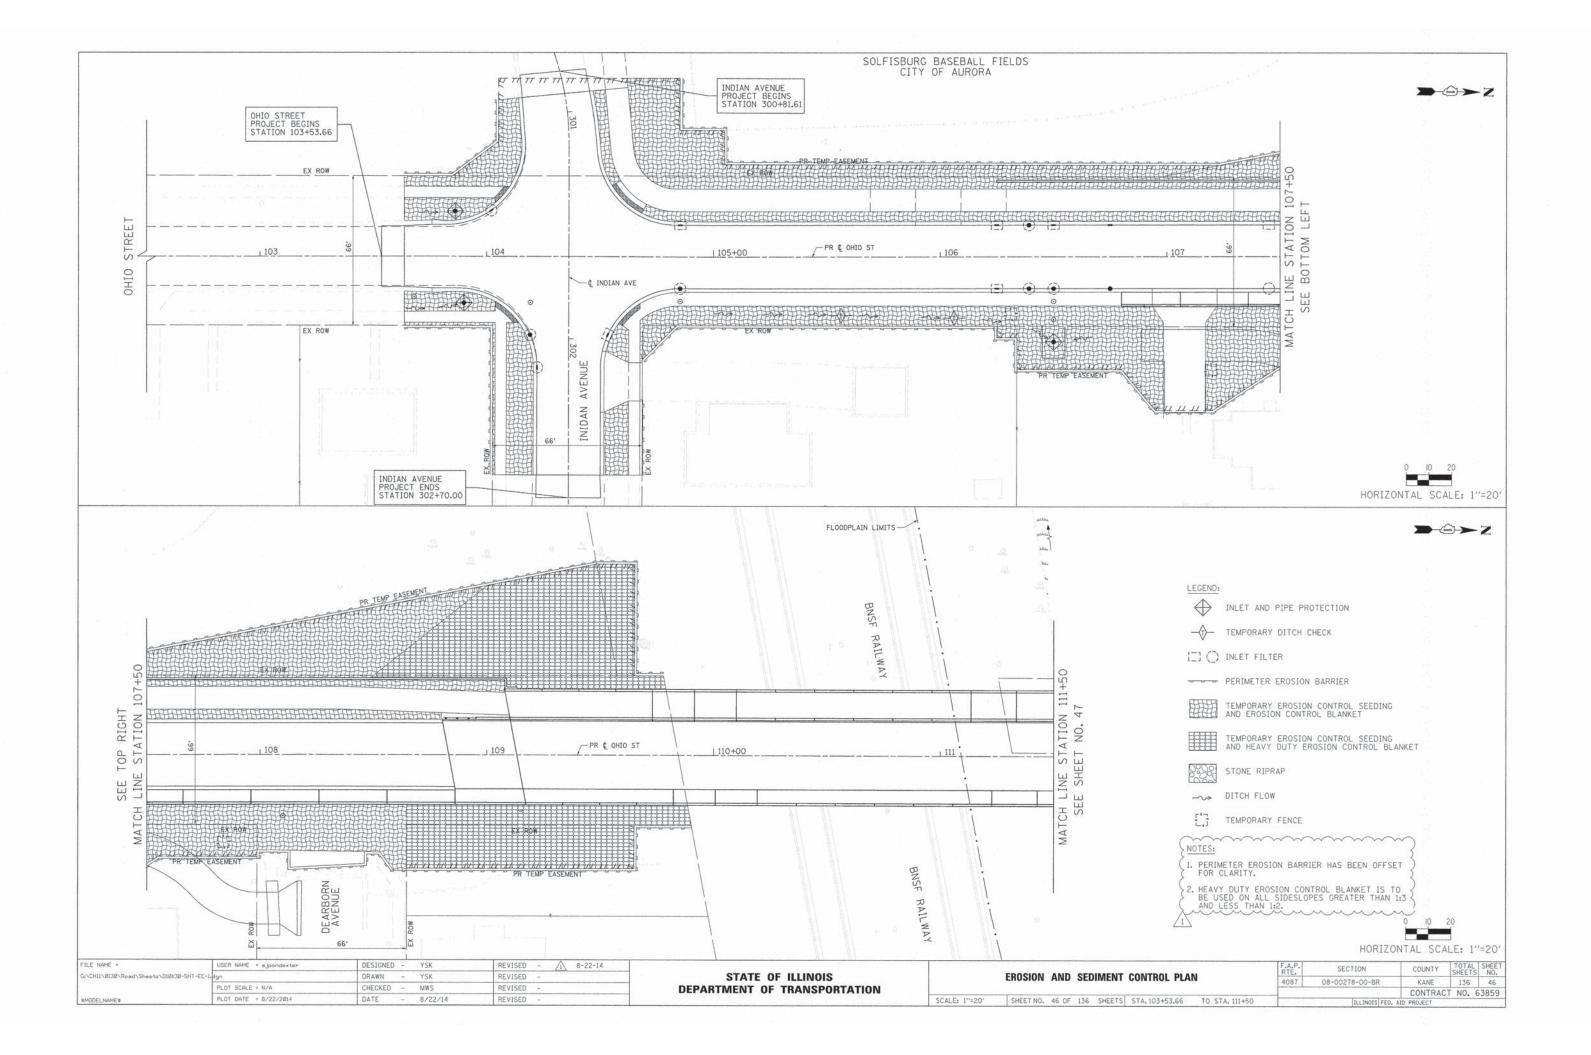

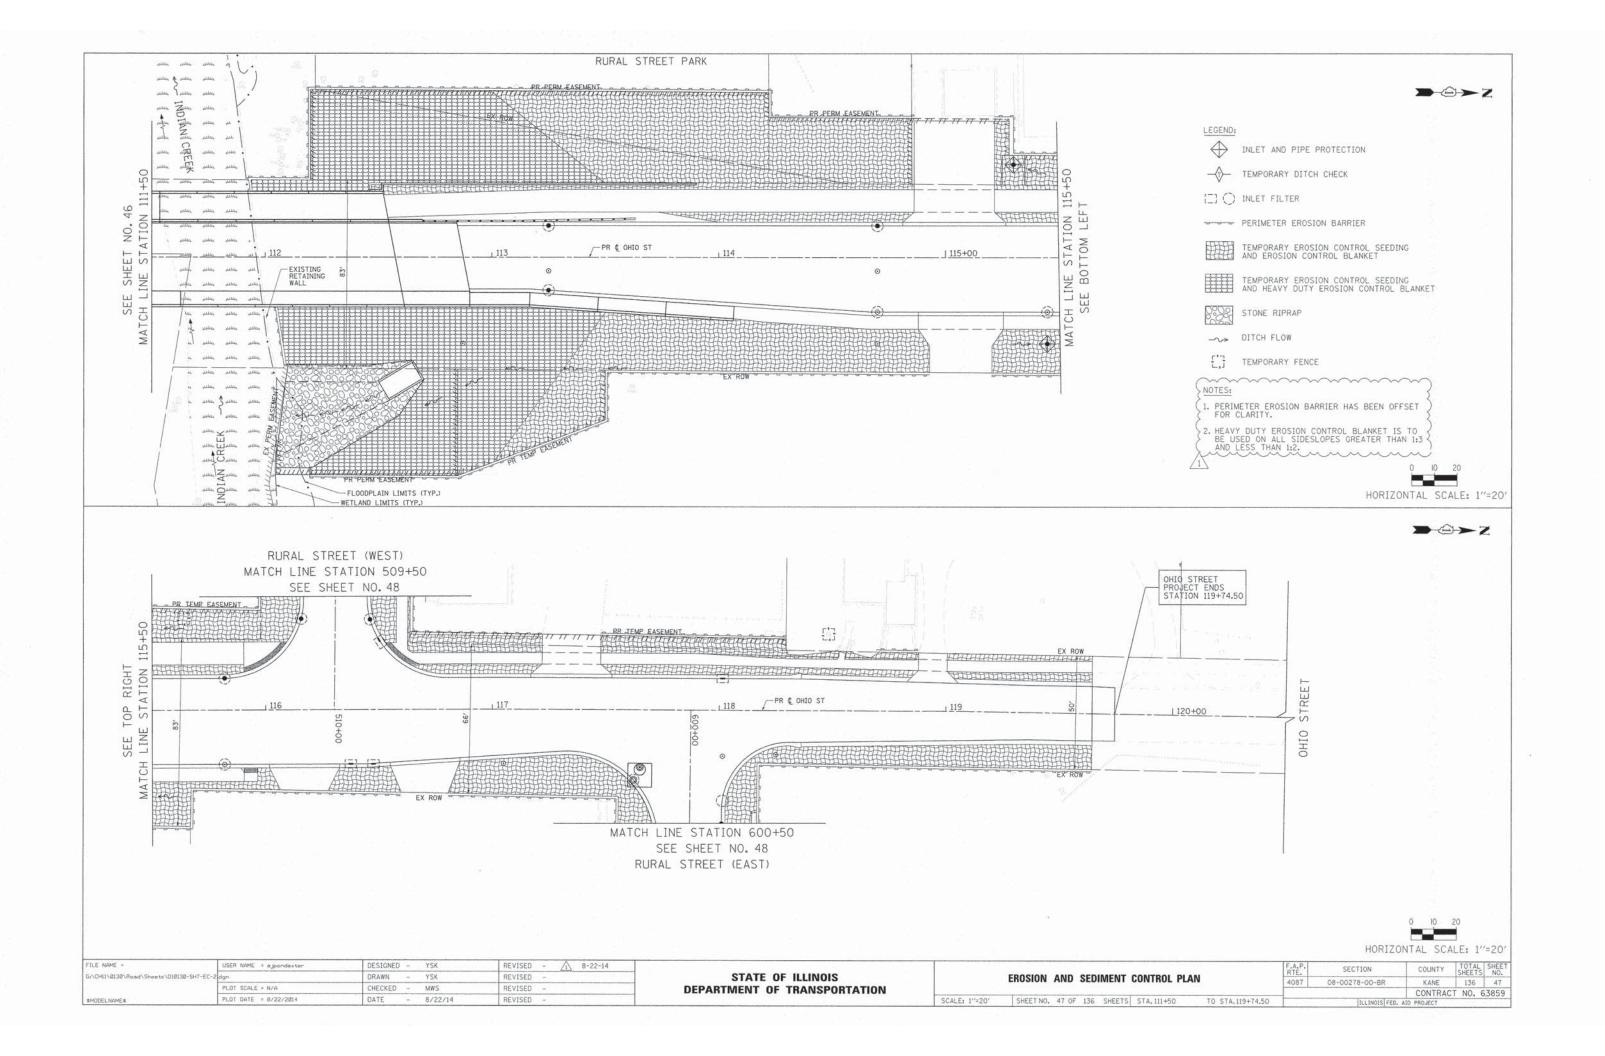

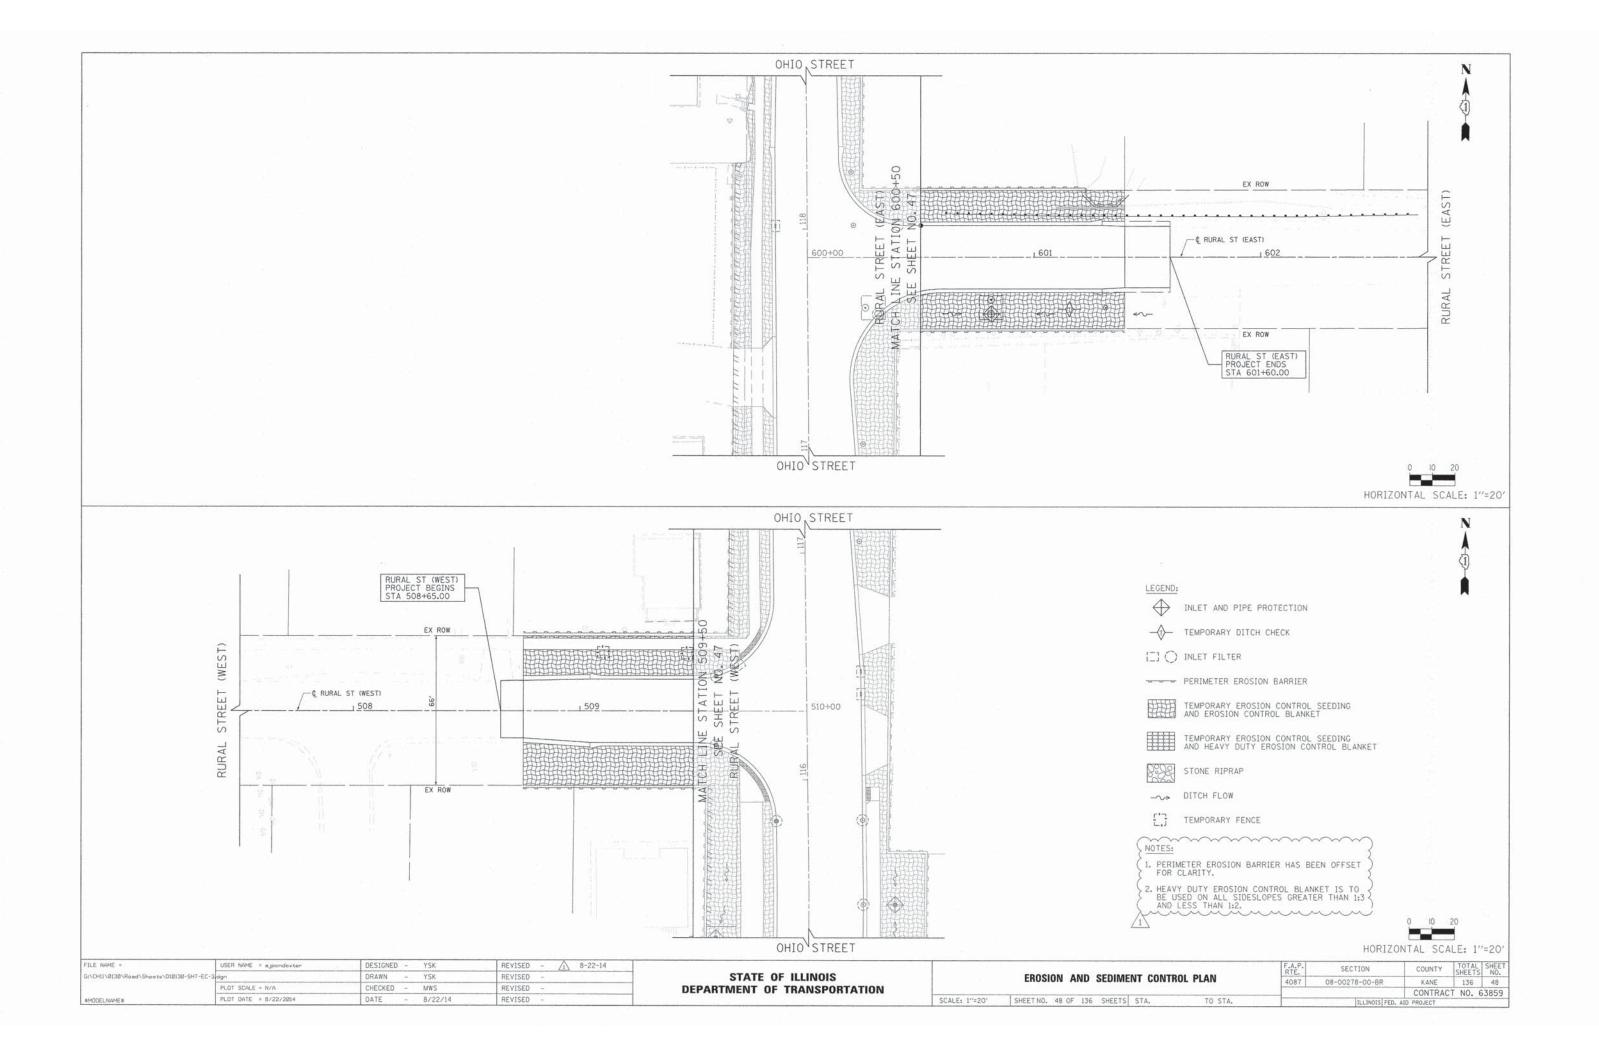


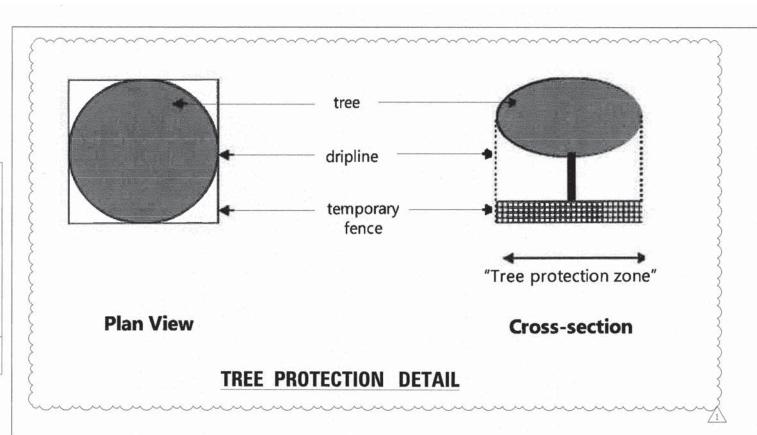



PROFILE SURVEYED BY 0ATE
PROFILE SURVEYED
NOT BOOK BAN WITCOM
NO. KIRCHES MATANG CHOO


ELE NAME -	LICED NAME	DESTANED YEN	DEUTCED			
FILE MADE	USER RHITE = ajpondexter	DESIGNED - 12K	HEA12ED - \(\frac{1}{1}\) 0-55-14			
\CH11\8138\Rood\Sheets\D18138-SHT-EC-4.d	pn .	DRAWN - YSK	REVISED -	STATE OF ILLINOIS		EROSION AND SEDIMENT CONTROL DETAILS
	PLOT SCALE = N/A	CHECKED - MWS	REVISED -	DEPARTMENT OF TRANSPORTATION		
	PLOT DATE = 8/22/2014	DATE - 8/22/14	REVISED -		SCALE:	SHEET NO. 49 OF 136 SHEETS STA. TO STA.


F.A.P. SECTION 4087 08-00278-00-BR

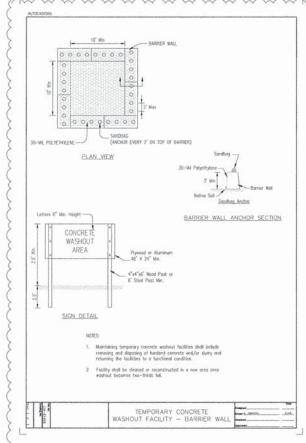


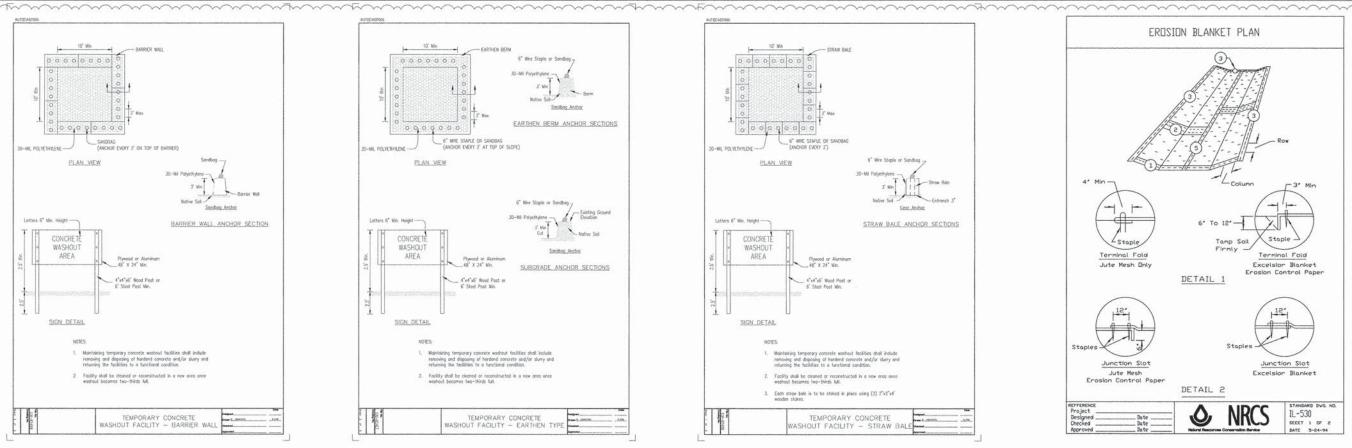


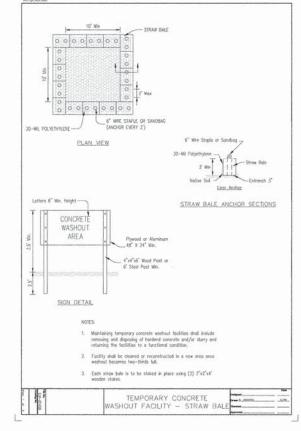


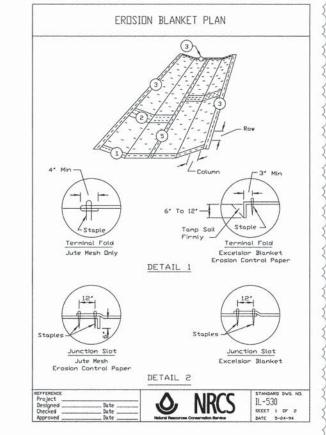

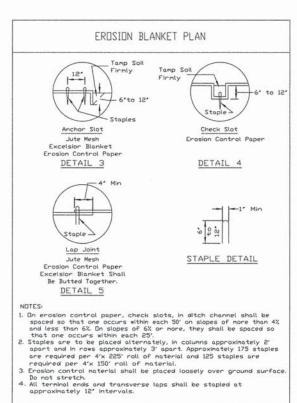

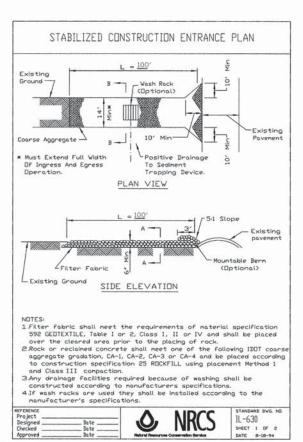

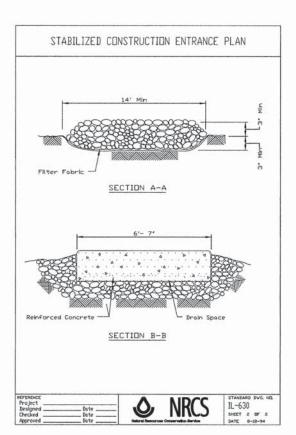

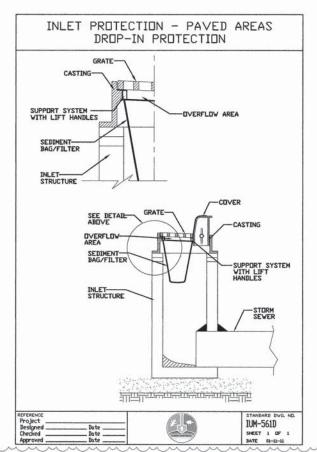





IL-530


STATE OF ILLINOIS **DEPARTMENT OF TRANSPORTATION**

	FROCIONI AND CEDIMENT CONTROL DETAILS	F.A.P. RTÉ.	SECTION	COUNTY	TOTAL	SHEET NO.
	EROSION AND SEDIMENT CONTROL DETAILS	4087	08-00278-00-BR	KANE	136	49A
				CONTRAC	T NO. E	3859
SCALE:	SHEET NO. 49A OF 136 SHEETS STA. TO STA		ILLINOIS FED.	AID PROJECT		



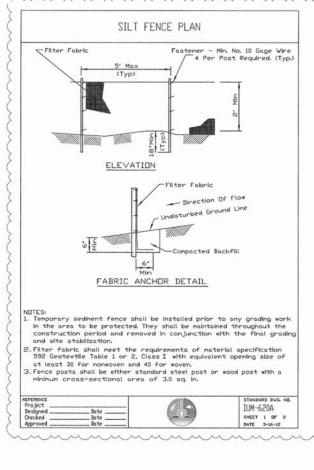

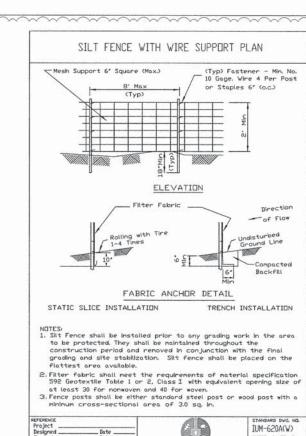

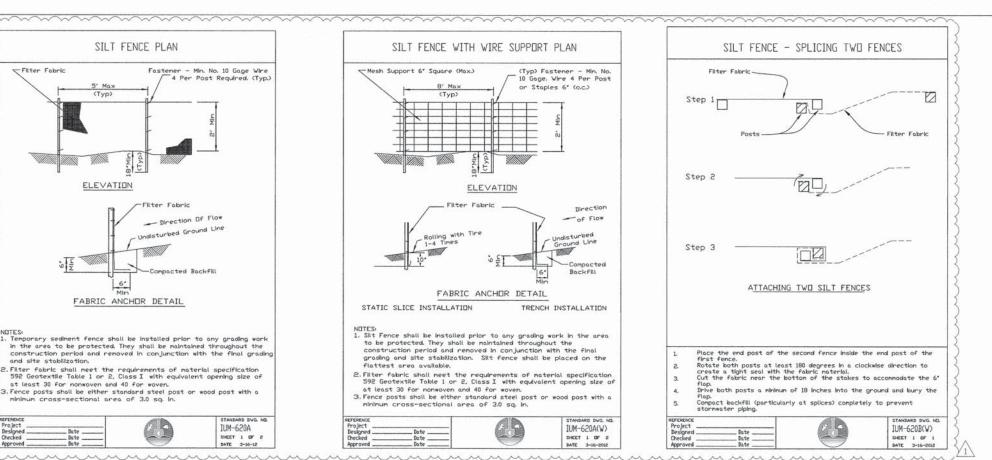



FILE NAME =	USER NAME = ajpondexter	DESIGNED - YSK	REVISED - 1 8-22-14
G:\CH11\0130\Rood\Sheets\D10130-SHT-EC-4.d	an .	DRAWN - YSK	REVISED -
	PLOT SCALE = N/A	CHECKED - MWS	REVISED -
	PLOT DATE = 8/22/2014	DATE - 8/22/14	REVISED -

STATI	E OI	FILLINOIS
DEPARTMENT	OF	TRANSPORTATION

	FRACION AND OFFINERAL CONTROL DETAILS	F.A.P. RTE.	SECTION	COUNTY TOTA	TOTAL	SHEET NO.
	EROSION AND SEDIMENT CONTROL DETAILS	4087	08-00278-00-BR	KANE	136	498
				CONTRAC	T NO. 6	3859
SCALE:	SHEET NO. 49B OF 136 SHEETS STA. TO STA.		ILL INOIS FED.	AID PROJECT		