
FOR INDEX OF SHEETS, SEE SHEET NO. 2


FOR INDEX OF HIGHWAY STANDARDS, SEE SHEET NO. 2

STATE OF ILLINOIS **DEPARTMENT OF TRANSPORTATION DIVISION OF HIGHWAYS**

PLANS FOR PROPOSED FEDERAL AID PROJECT

INDIANWOOD BLVD (BLACKHAWK DR TO ORCHARD DR) STREET LIGHTING PROJECT NO.: TCSP-06IL(010) SECTION 07-00091-00-LT **VILLAGE OF PARK FOREST COOK COUNTY**

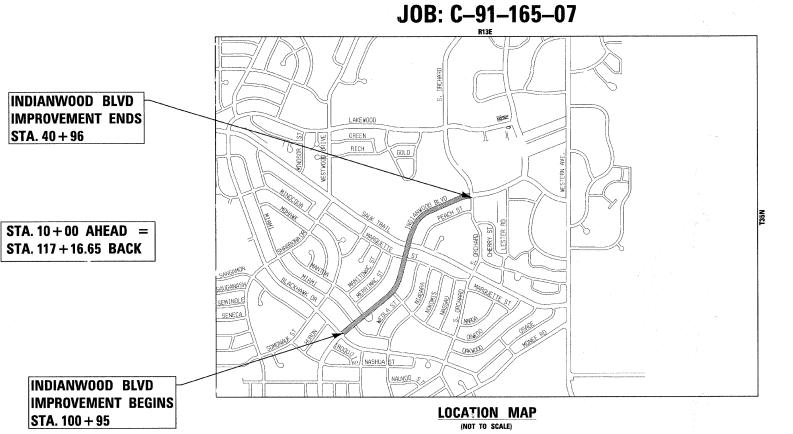

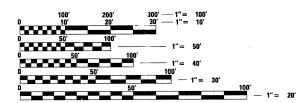

FULL SIZE PLANS HAVE BEEN PREPARED USING STANDARD ENGINEERING SCALES. REDUCED SIZED PLANS WILL NOT CONFORM TO STANDARD SCALES. IN MAKING MEASUREMENTS ON REDUCED PLANS, THE ABOVE SCALES MAY BE USED.

J.U.L.I.E.

JOINT UTILITY LOCATION INFORMATION FOR EXCAVATION 1-800-892-0123

RICH TOWNSHIP
GROSS AND NET LENGTH OF IMPROVEMENT = 4,648 LF OR 0.880 MILES


Burlington, Wisconsin Crystal Lake, Illinois DeKalb, Illinois Itasca, Illinois Mokena, Illinois Grayslake, Illinois (Plainfield, Illinois) Rockford, Illinois Madison, Wisconsin 815.787.3111 630.773.1870 708.478.2090 847.223.5088 815.609.7425 815.489.1551 (OFFICE WHICH PREPARED PLANS)

FED. ROAD DIST. NO ILLINOIS

CONTRACT NO. 83991 ** 07-00091-00-LT





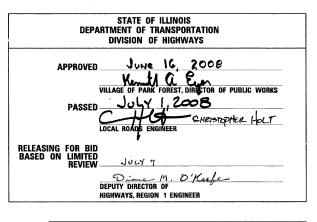

PRINTED BY THE AUTHORITY OF THE STATE OF ILLINOIS

ALL CONSTRUCTION SHALL BE DONE IN ACCORDANCE WITH THE DETAILS IN THE PLANS, THE SPECIAL PROVISIONS INCLUDED IN THE CONTRACT DOCUMENTS, AND THE LATEST EDITION OF THE FOLLOWING STATE OF ILLINOIS SPECIFICATIONS: "THE STANDARD SPECIFICATIONS FOR ROAD AND BRIDGE CONSTRUCTION" (REFERRED TO AS THE "STANDARD SPECIFICATIONS"), THE "SUPPLEMENTAL SPECIFICATIONS AND RECURRING SPECIAL PROVISIONS", THE "STANDARD SPECIFICATIONS FOR TRAFFIC CONTROL ITEMS", THE "MANUAL ON UNIFORM TRAFFIC CONTROL DEVICES FOR STREETS AND HIGHWAYS", THE "MANUAL OF TEST PROCEDURES FOR MATERIALS" AND THE "STANDARD SPECIFICATIONS FOR WATER AND SEWER MAIN CONSTRUCTION IN ILLINOIS".

UTILITY LOCATIONS HAVE NOT BEEN SHOWN ON THESE PLANS. THE CONTRACTOR SHALL HAVE THE RESPECTIVE UTILITY COMPANIES FIELD LOCATE ALL THEIR FACILITIES PRIOR TO BEGINNING CONSTRUCTION. THE CONTRACTOR SHALL ALSO VERIFY THE DEPTHS OF THE EXISTING UTILITIES IF NECESSARY. ANY RELOCATION OR LOWERING OF UTILITIES SHALL BE COORDINATED BY THE

THE CONTRACTOR SHALL BE RESPONSIBLE FOR THE PROTECTION OF ALL UNDERGROUND OR SURFACE UTILITIES EVEN THOUGH THEY MAY NOT BE SHOWN ON THE PLANS. ANY UTILITY THAT IS DAMAGED DURING CONSTRUCTION SHALL BE REPAIRED OR REPLACED AT THE CONTRACTOR'S EXPENSE TO THE SATISFACTION OF THE ENGINEER OR VILLAGE.

THE CONTRACTOR SHALL NOTIFY THE VILLAGE PUBLIC WORKS ADMINISTRATOR AT LEAST 48 HOURS IN ADVANCE OF BEGINNING WORK TO OBTAIN VILLAGE UTILITY LOCATIONS AND SHALL COORDINATE ALL CONSTRUCTION OPERATIONS WITH THE ENGINEER.

MATERIALS RESULTING FROM THE REMOVAL OF PAVEMENT, DRIVEWAYS, CURB AND GUTTER, HOT-MIX ASPHALT SURFACES, ETC. SHALL BE REMOVED AT THE END OF EACH DAY TO AN APPROVED SITE. IN THE JUDGMENT OF THE VILLAGE, SHOULD IT BE NECESSARY TO REMOVE SUCH MATERIALS, THE VILLAGE WILL HAVE THE MATERIAL REMOVED AND THE CONTRACTOR WILL BE BILLED (CHARGED)

THE CONTRACTOR MAY OBTAIN MUNICIPAL WATER IN BULK, AT NO CHARGE, AS LONG AS THERE IS NOT A "WATERING BAN" IN EFFECT. THE INDISCRIMINATE USE OF FIRE HYDRANTS IS STRICTLY PROHIBITED. WATER FOR CONSTRUCTION SHALL BE METERED OR OTHERWISE ACCOUNTED FOR AND A DAILY LOG MAINTAINED. THE CONTRACTOR SHALL PROVIDE THE WATER TRUCK AND DRIVER REQUIRED TO OBTAIN AND TRANSPORT THIS WATER. THE VILLAGE RESERVES THE RIGHT TO RESTRICT OR REFUSE THE USE OF VILLAGE WATER IF DEEMED NECESSARY.

IT WILL BE THE CONTRACTOR'S RESPONSIBILITY TO NOTIFY RESIDENTS AND THE VILLAGE WHEN ACCESS TO THEIR DRIVEWAYS WILL BE TEMPORARILY CLOSED. THE CONTRACTOR SHALL DISTRIBUTE NOTICES PROVIDED BY THE VILLAGE TO RESIDENTS. EVERY EFFORT SHALL BE MADE TO ACCOMMODATE ACCESS TO THESE PROPERTIES INCLUDING KNOCKING ON DOORS WHEN DRIVEWAYS ARE ABOUT TO BE CLOSED.

THE CONTRACTOR SHALL PROTECT AND CAREFULLY PRESERVE ALL SECTION OR SUBSECTION MONUMENTS OR PROPERTY OR REFERENCE MARKERS UNTIL THE OWNERS, HIS AGENT OR AN AUTHORIZED SURVEYOR HAS WITNESSED OR OTHERWISE REFERENCED THEIR LOCATIONS.

ACCESS TO PRIVATE DRIVEWAYS SHALL BE PROVIDED AT ALL TIMES EXCEPT DURING ACTUAL CONSTRUCTION ADJACENT THERE TO. TEMPORARY RAMPS SHALL BE CONSTRUCTED AS NEEDED TO PROVIDE SUCH ACCESS, UTILIZING CRUSHED STONE OR CRUSHED GRAVEL.

THE CONTRACTOR SHALL PROVIDE A REQUEST FOR MATERIAL TESTING TO THE ILLINOIS DEPARTMENT OF TRANSPORTATION BUREAU OF MATERIALS ORDER BOARD (PHONE (847) 705-4337) BY 4 PM, 24-HOURS IN ADVANCE OF CONSTRUCTION FOR INSPECTION OF ALL HOT-MIX ASPHALT AND CONCRETE MATERIALS USED ON THIS PROJECT.

THE CONTRACTOR SHALL PROVIDE AND INSTALL TWO (2) WEIGHTED SANDBAGS ON EACH TYPE I OR TYPE II BARRICADE USED. ONE (1) WEIGHTED SANDBAG SHALL BE PLACED ACROSS EACH BOTTOM RAIL.

EXISTING STREET LIGHTING UNITS TO REMAIN IN OPERATION AND TO BE MAINTAINED BY THE CONTRACTOR UNTIL NEW STREET LIGHTS ARE OPERATIONAL AND ACCEPTED BY THE VILLAGE.

THE CONTRACTOR SHALL ADJUST LOCATION OF LIGHT POLES AT INTERSECTION SO AS NOT TO BLOCK VIEW OF EXISTING TRAFFIC SIGNALS.

CARE IS TO BE TAKEN AS NOT TO DAMAGE ANY OF THE EXISTING TRAFFIC SIGNAL CONDUITS, DETECTORS AND EQUIPMENT. IF ANY OF THE TRAFFIC SIGNAL CONDUIT AND/OR EQUIPMENT IS DAMAGED THE CONTRACTOR SHALL REPAIR AND/OR REPLACE THE CONDUIT AND/OR EQUIPMENT AT NO COST TO THE COUNTY OR THE VILLAGE.

THE CONTRACTOR SHALL MAKE SPECIAL NOTE OF THE REQUIREMENT FOR BURIED WARNING TAPE, SPECIFIED AS PART OF "TRENCH AND BACKFILL FOR ELECTRICAL WORK". THE INSTALLATION OF THE TAPE SHALL BE INSPECTED AND APPROVED BY THE RESIDENT ENGINEER PRIOR TO BACKFILLING OR DURING PLOWING OPERATIONS, AS APPLICABLE.

THE CONTRACTOR SHALL BE RESPONSIBLE FOR THE ESTABLISHMENT OF FINISHED GRADE. THE RESIDENT ENGINEER MAY ASSIST THE CONTRACTOR, AS APPLICALBE, BUT THE RESPONSIBILITY FOR COORDINATING THE FINISHED GRADE ELEVATION WITH THE TOP OF FOUNDATION HEIGHTS AND THE LIGHT SHALL REMAIN WITH THE CONTRACTOR.

THE CONTRACTOR SHALL MAKE SPECIAL NOTE OF THE REQUIREMENTS FOR WIRE MARKERS AND SHALL TAG ALL WIRE ACCORDINGLY.

EQUIPMENT GROUND CONDUCTORS SHALL BE SPLICED AND/OR BONDED AT EACH LIGHT POLE OR OTHER PIECE OF EQUIPMENT.

CONDUIT AND UNIT DUCT MUST BE POSITIONED IN THE FIELD TO AVOID CONFLICT WITH TREES, BUSHES, DRAINS AND OTHER UTILITIES AND LANDSCAPING.

ALL DISTURBED AREAS WHERE RESTORATION IS NOT COVERED BY APPLICABLE SECTIONS OF THE SPECIAL PROVISIONS MUST BE RESTORED TO THE SATISFACTION OF THE ENGINEER. THE WORK MUST BE CONSIDERED INCIDENTAL TO THE CONTRACT. SEPARATE PAYMENT WILL NOT BE MADE.

THE EXACT LOCATIONS OF ALL UTILITIES SHALL BE VERIFIED BY THE CONTRACTOR BEFORE THE INSTALLATION OF ANY COMPONENTS OF THE LIGHTING SYSTEM. FOR THE LOCATIONS OF THE UTILITIES, CALL JULIE TOLL FREE AT 1-800-892-0123. IT IS THE CONTRACTOR'S RESPONSIBILITY TO LOCATE EXISTING TRAFFIC SIGNAL CABLES AND CONDUITS.

SUMMARY OF QUANTITIES

| | ITEM NO. | DESCRIPTION | UNIT | QUANTITY Y030-1E |
|---|----------|--|--------|---------------------|
| * | 20101100 | TREE TRUNK PROTECTION | EACH | 5 |
| | 67100100 | MOBILIZATION | L SUM | 1 |
| | 70102630 | TRAFFIC CONTROL AND PROTECTION, STANDARD 701601 | L SUM | 1 |
| | 70102635 | TRAFFIC CONTROL AND PROTECTION, STANDARD 701701 | L SUM | 1 |
| | 80300100 | LOCATING UNDERGROUND CABLE | FOOT | 1000 |
| | 80400100 | ELECTRICAL SERVICE INSTALLATION | EACH | 2 |
| | 80400200 | ELECTRICAL UTILITY SERVICE CONNECTION | LSUM | 1 |
| | 81000600 | CONDUIT IN TRENCH, 2" DIA., GALVANIZED STEEL | FOOT | 165 |
| | 81018500 | CONDUIT PUSHED, 2" DIA., GALVANIZED STEEL | FOOT | 900 |
| | XX007275 | UNIT DUCT, 600V, 4-1C NO. 6 1/C NO. 8 GROUND, | FOOT | 4700 |
| | | (XLP-TYPE USE), 1 1/4" DIA. POLYETHYLENE | | |
| | 81702400 | ELECTRIC CABLE IN CONDUIT, 600 V. (XLP-TYPE USE) 3-1/C NO. 2 | FOOT | 400 |
| | 81900200 | TRENCH AND BACKFILL FOR ELECTRICAL WORK | FOOT | 165 |
| | 82102250 | LUMINAIRE, SODIUM VAPOR, HORIZONTAL MOUNT, 250 WATT | EACH | 42 |
| | 82500505 | LIGHTING CONTROLLER, SPECIAL | EACH | 2 |
| | XX007277 | LIGHTPOLE, FIBERGLASS BREAKAWAY, DIRECT EMBED, 35 FT. | EACH | 21 |
| | | M.H.,TWIN 12 FT. MAST ARMS | | |
| * | XX007278 | PARKWAY RESTORATION | SQ.YD. | 500 |
| | 84200500 | REMOVAL OF EXISTING LIGHTING UNIT, SALVAGE | EACH | 2 |
| | 84200600 | REMOVAL OF EXISTING LIGHTING UNIT, NO SALVAGE | EACH | 14 |

^{*}SPECIALTY ITEMS

INDEX OF SHEETS

SHEET NO. TITLE

701901

- COVER SHEET
- GENERAL NOTES, SUMMARY OF QUANTITIES, INDEX OF SHEETS

STA.

AND HIGHWAY STANDARDS

STREET LIGHTING DETAILS

- 3 7 STREET LIGHTING PLANS
- DISTRICT ONE DETAIL TC-10: TRAFFIC CONTROL AND PROTECTION

SECTION

FED. ROAD DIST. NO


** 07-00091-00-LT

- FOR SIDEROADS, INTERSECTIONS AND DRIVEWAYS
- DISTRICT ONE DETAIL TC-14: TRAFFIC CONTROL AND PROTECTION AT TURN BAYS (TO REMAIN OPEN TO TRAFFIC)

HIGHWAY STANDARDS

| STANDARD NO. | TITLE | | | |
|--------------|--|--|--|--|
| 000001-05 | STANDARD SYMBOLS, ABBREVIATIONS AND PATTER | | | |
| 701601-05 | URBAN LANE CLOSURE, MULTI-LANE, 1W OR 2W WITH NON-TRAVERSABLE MEDIAN | | | |
| 701701-05 | URBAN LANE CLOSURE, MULTI-LANE INTERSECTION | | | |
| | | | | |

TRAFFIC CONTROL DEVICES

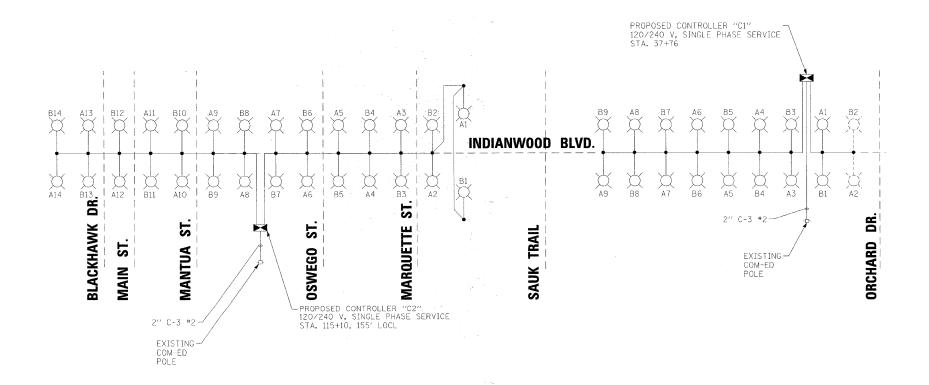

CONSULTANTS REV. NO. DATE DESCRIPTION * REFER TO EQUIPMENT MANUFACTURER'S SHOP DRAWINGS DRAWING FILE: ...\06|389-GEN_NOTES.s

Baxter & Woodman Crystal Lake, Illinois Burlington, Wisconsin Mokena, Illinois DeKalb, Illinois Grayslake, Illinois Rockford, Illinois

VILLAGE OF PARK FOREST, ILLINOIS INDIANWOOD BLVD BLACKHAWK DR TO ORCHARD DR

GENERAL NOTES, WIRING DIAGRAM, SUMMARY OF QUANTITIES,

1" = 20' PROJECT NO. 061389 SHEET NO. BCD CHECKED BY 06-13-08

TOTAL SHEE SHEETS NO.

10


CONTRACT NO. 83991


COUNTY COOK


ILLINOIS

Plainfield, Illinois

708.478.209 815.787.3111 815,489,155 815.609.742 INDEX OF SHEETS & HIGHWAY STANDARDS

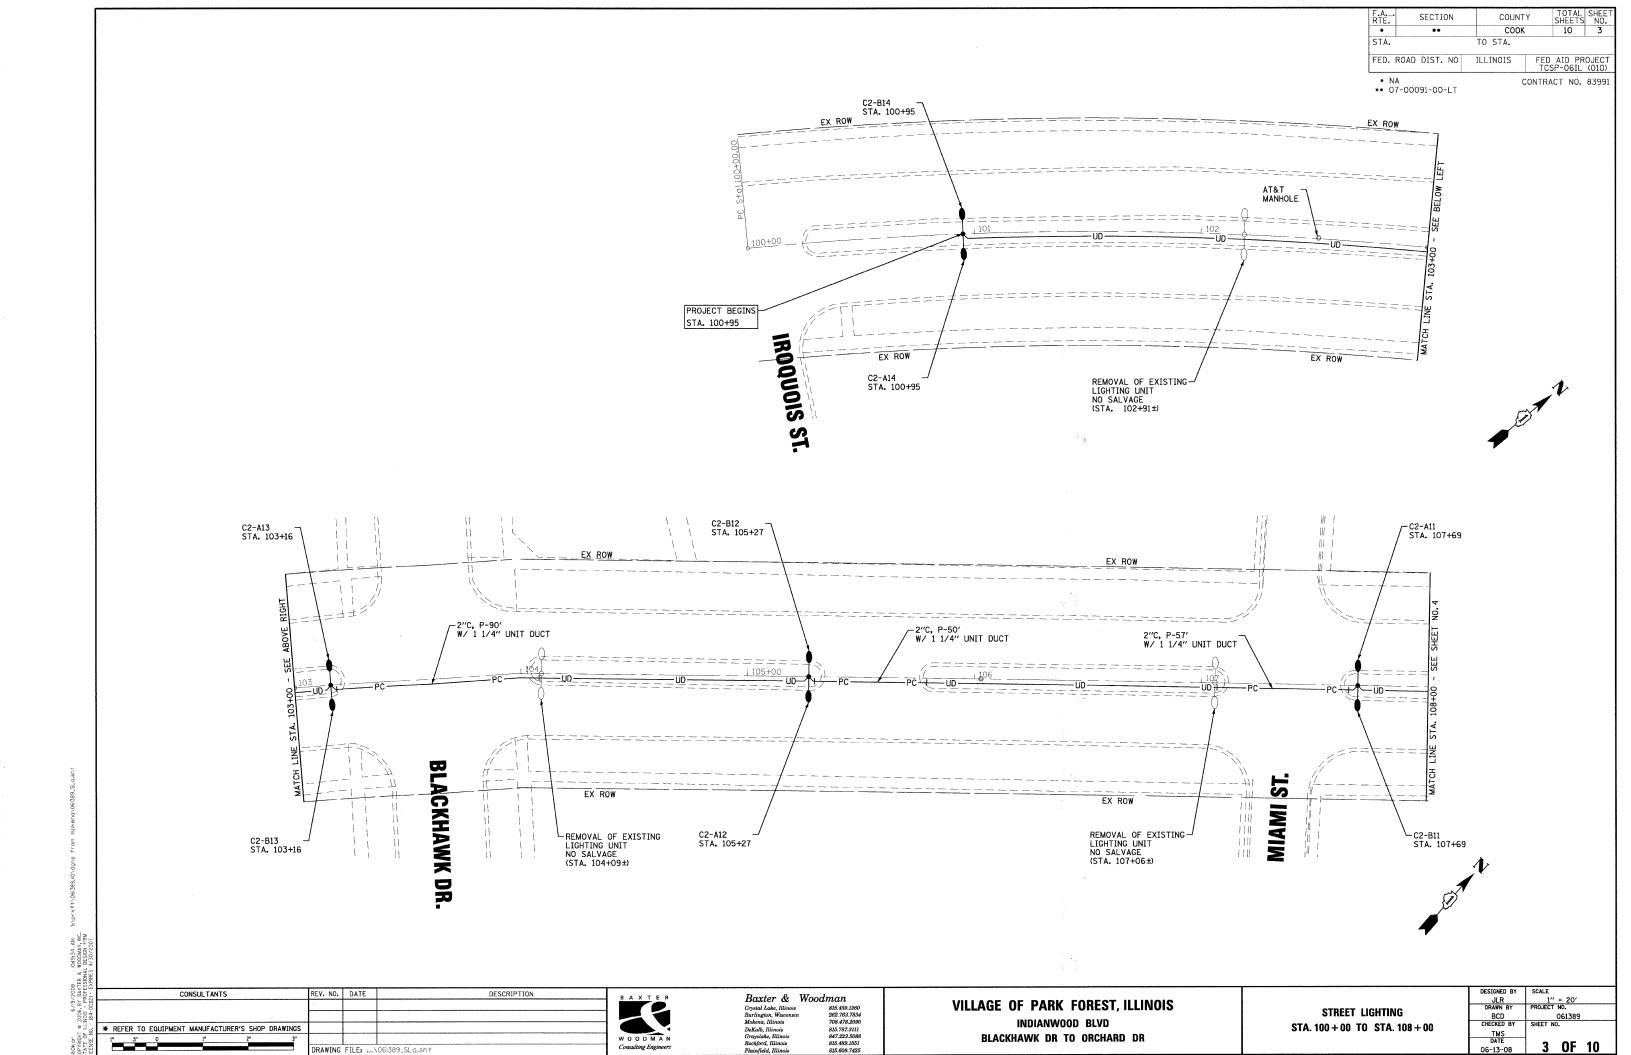

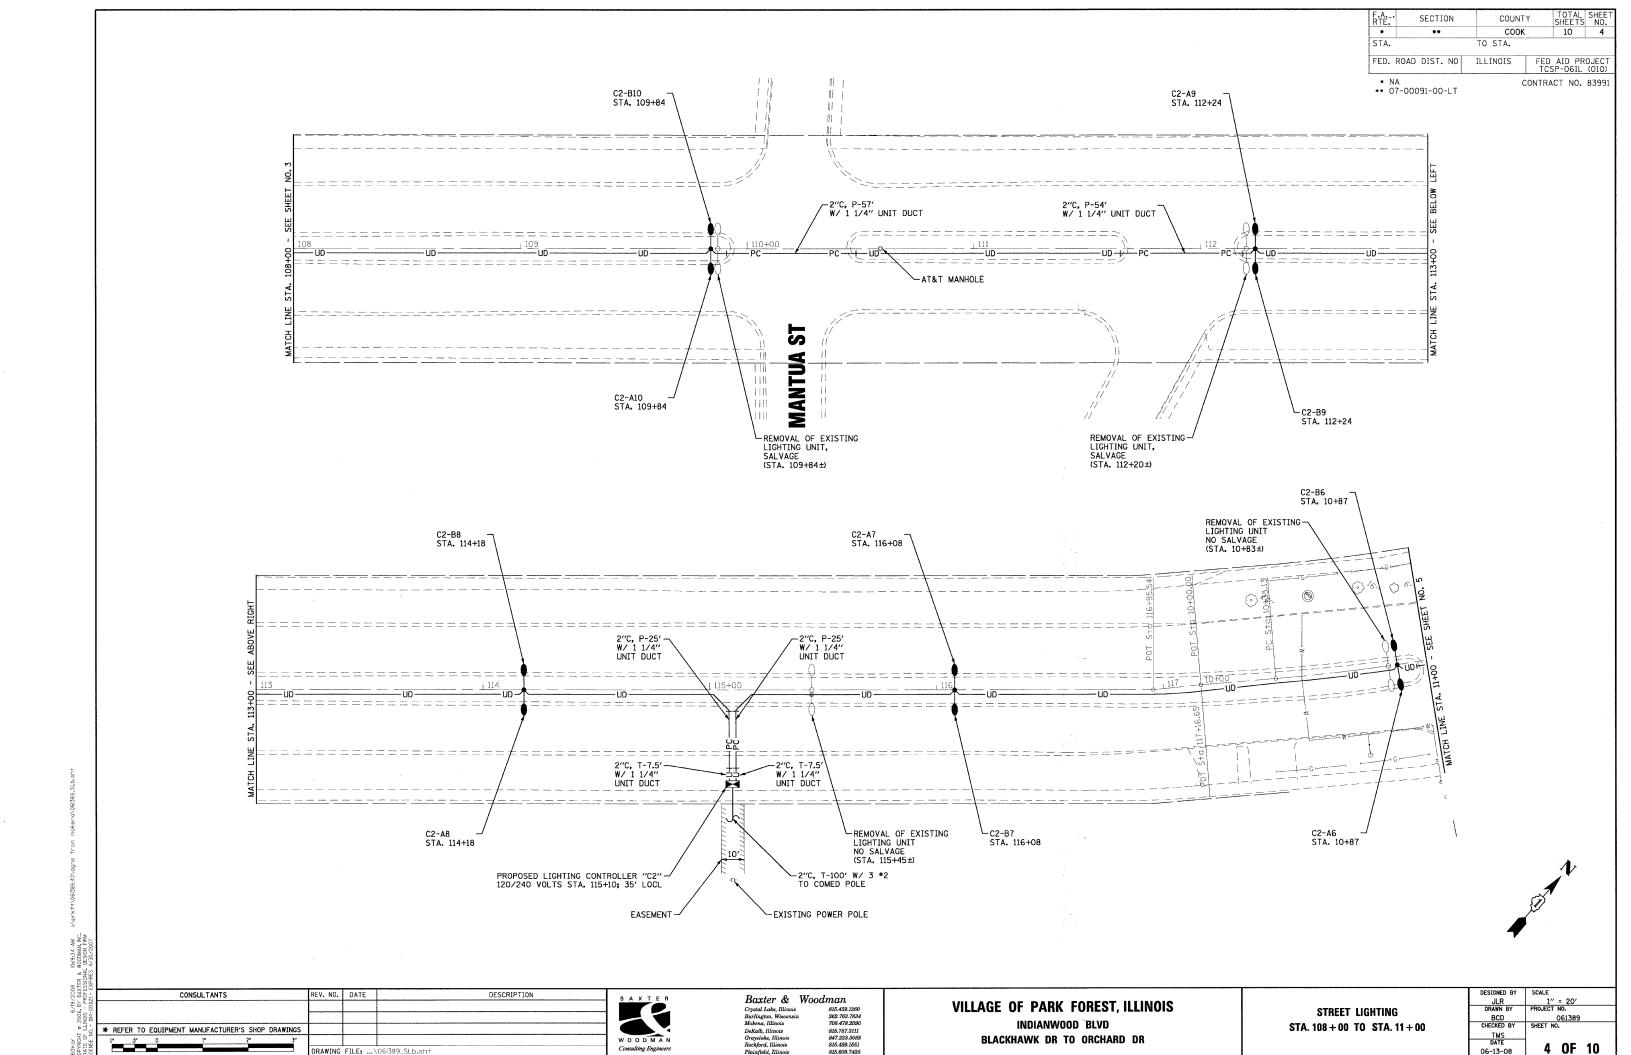

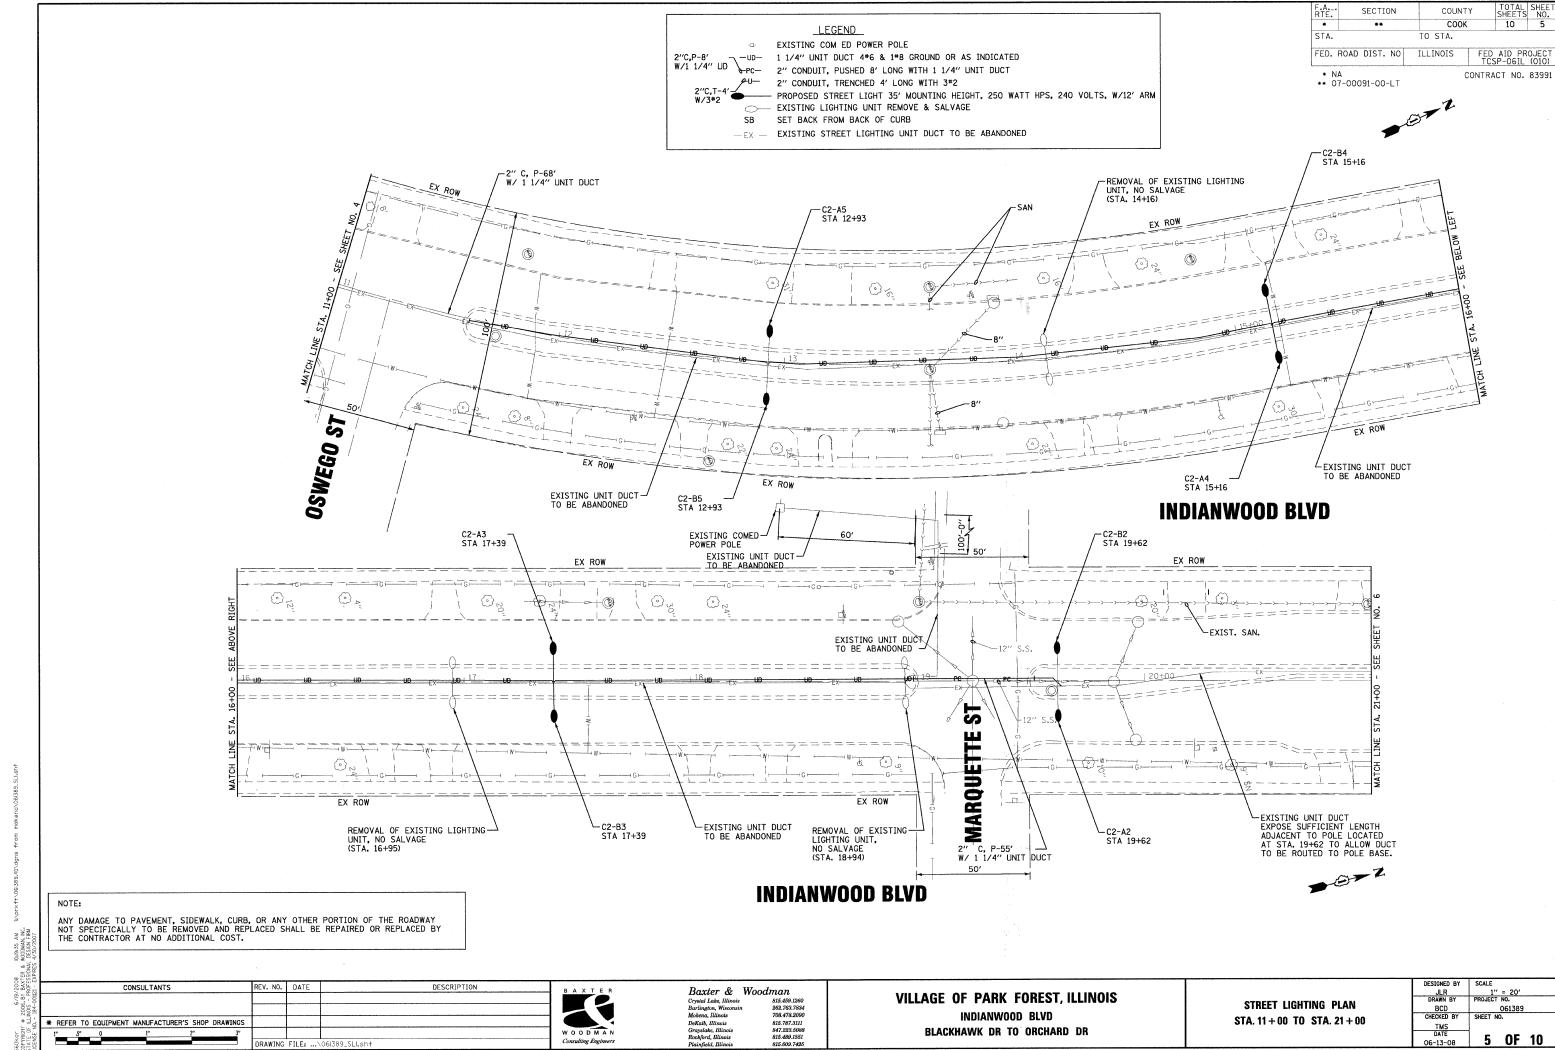



RAWING FILE: ...


815.787.3111 847.223.5088 815.489.1551

BLACKHAWK DR TO ORCHARD DR

5 OF 10

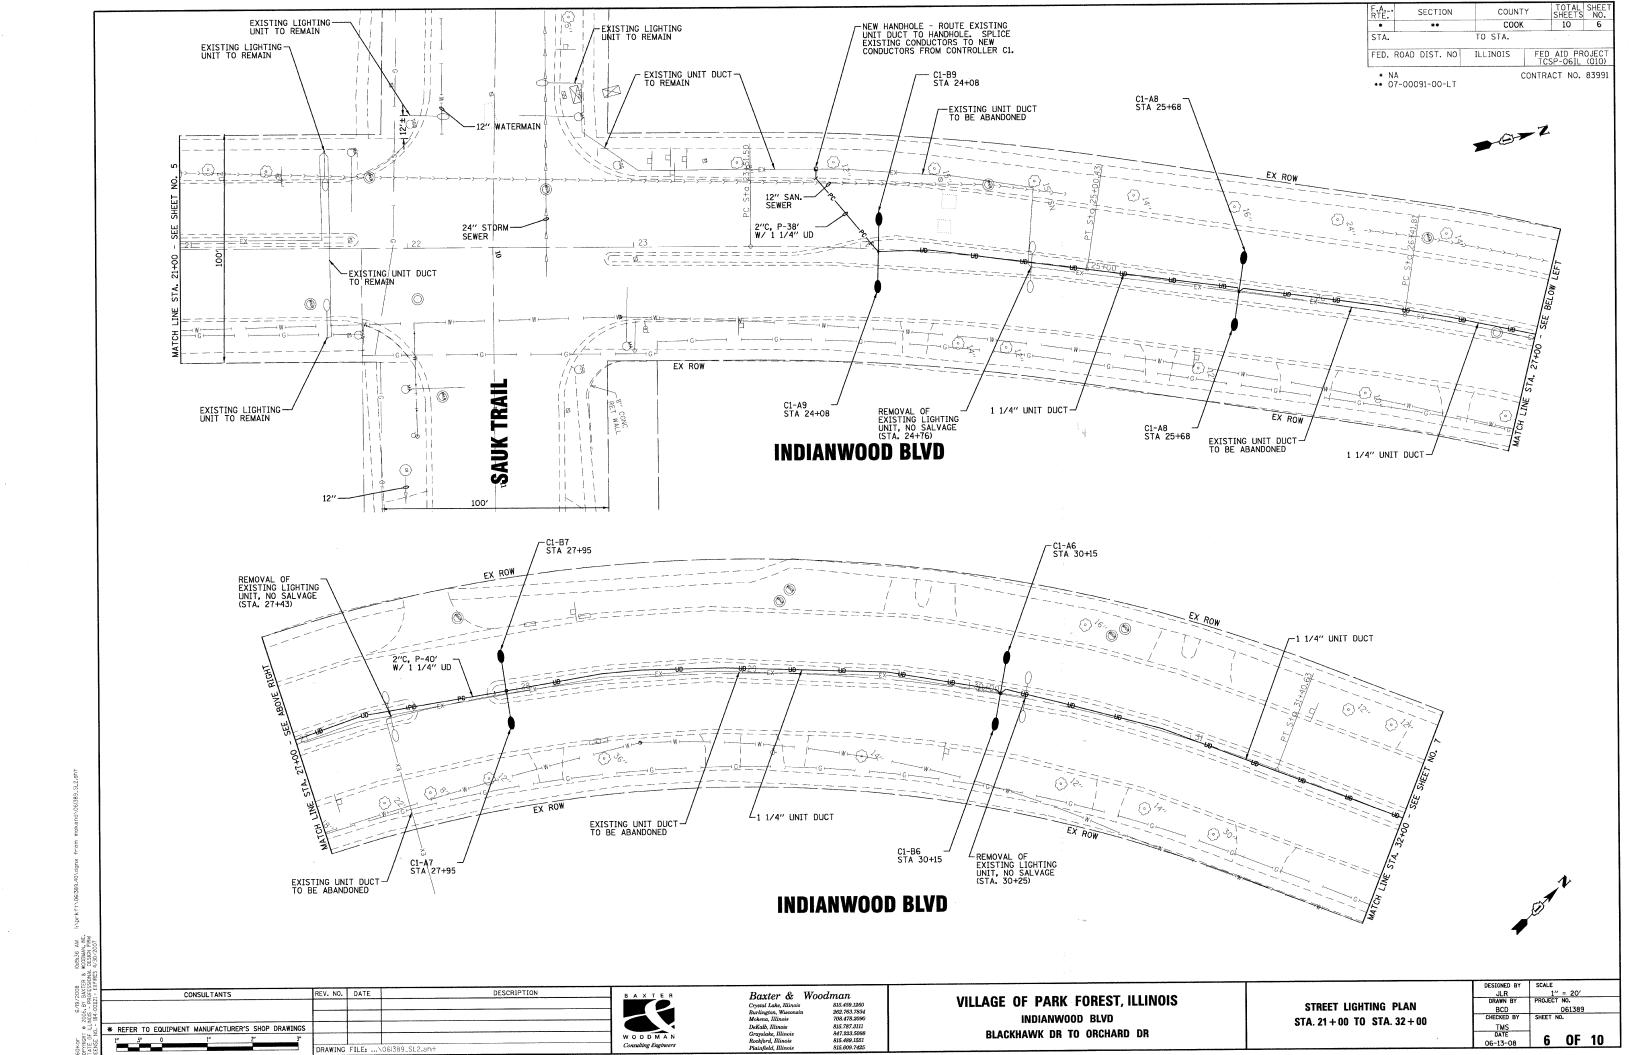

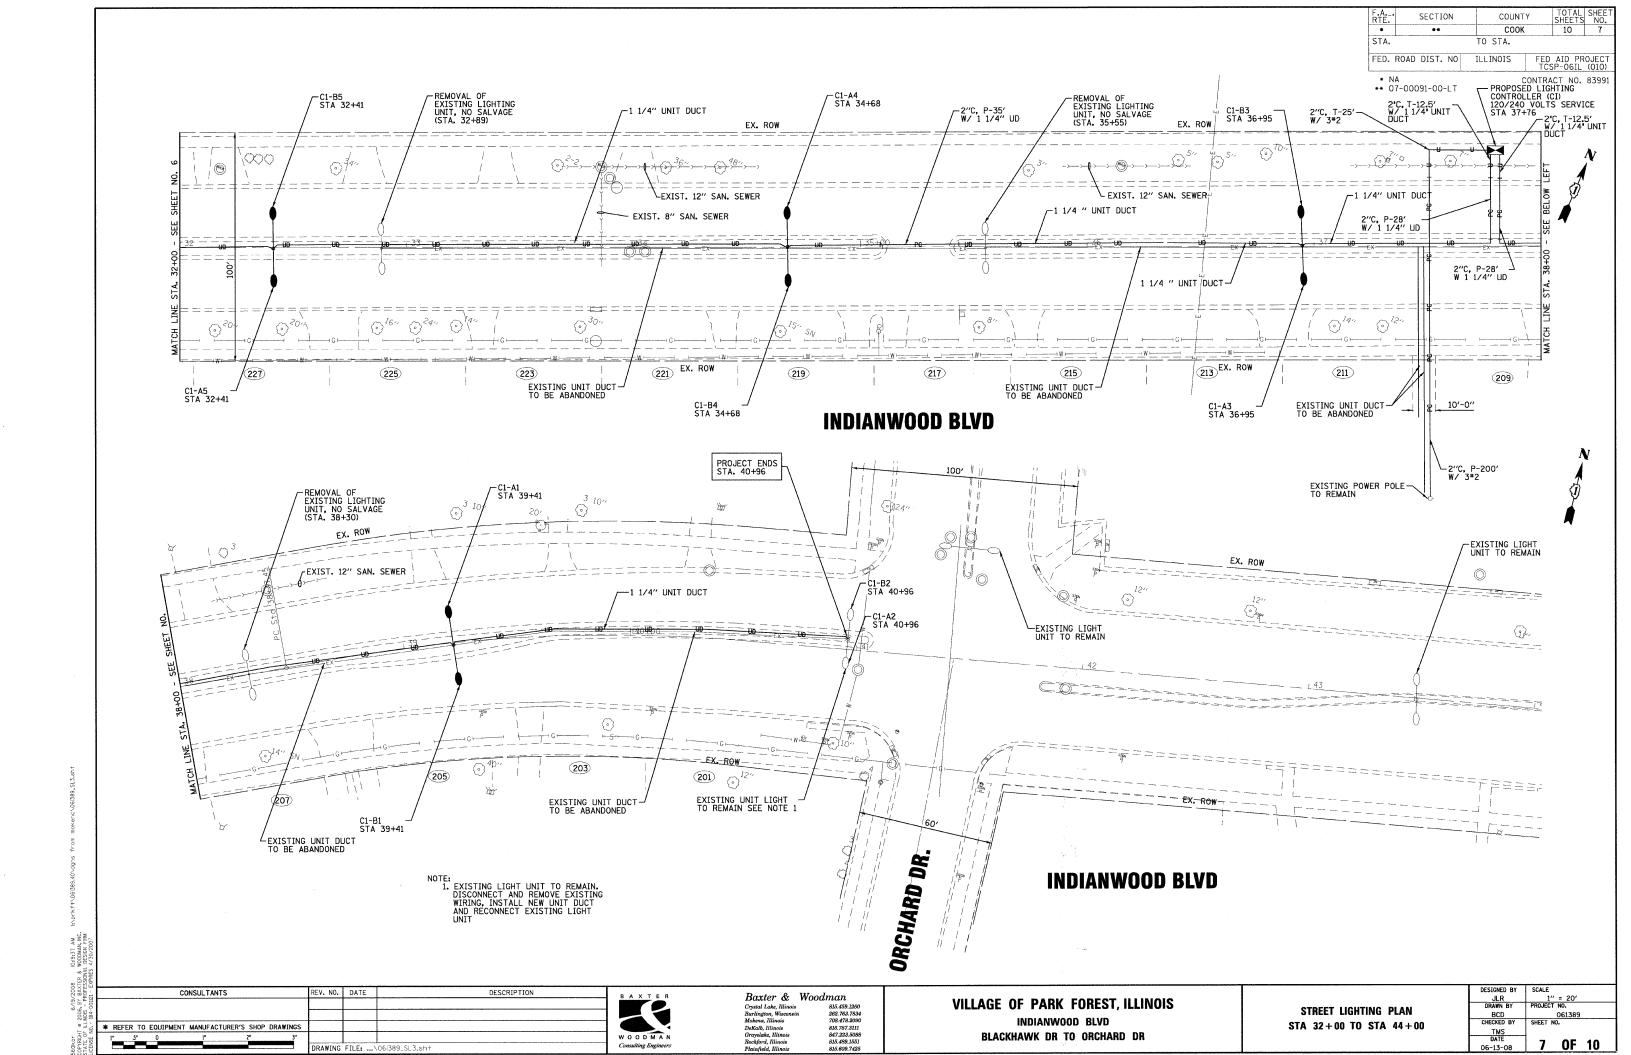

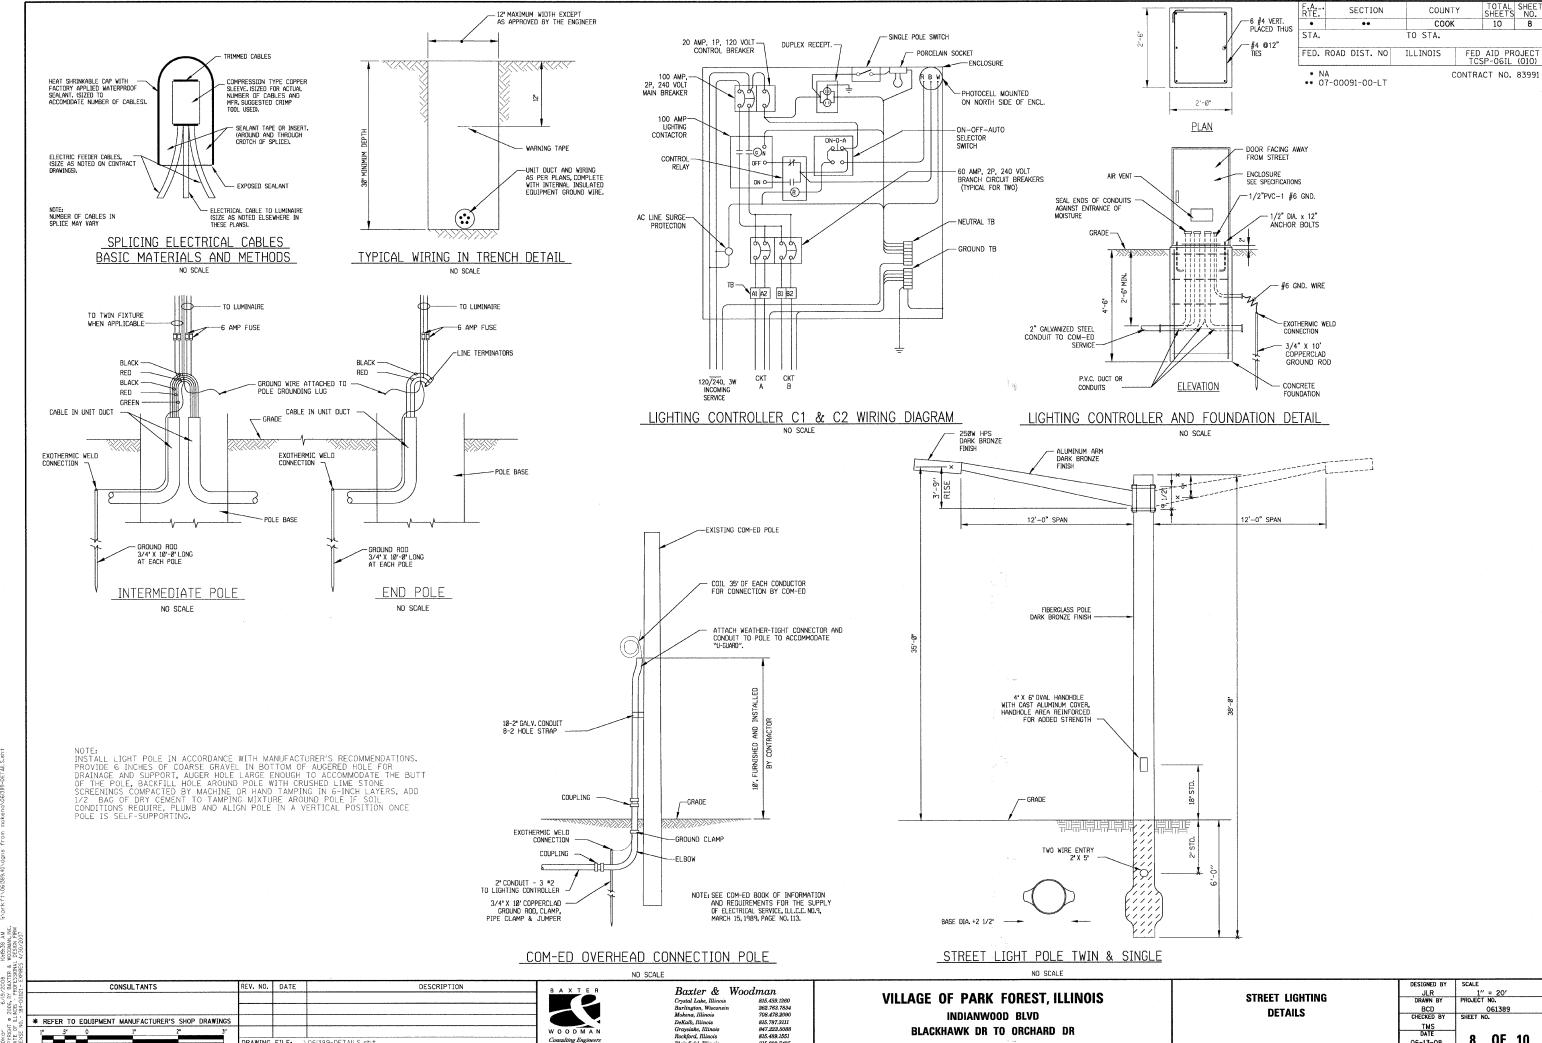

815.489.1551

815.609.742

OF 10

06-13-08

DRAWING FILE: ... \061389-DETAILS.sht

CONTRACT NO. 83991 COUNTY TOTAL SHEET NO. соок 10 9 TO STA. FED ROAD DIST. NO. (LLIND(S FED. AID PROJECT TCSP-06IL (010) ** 07-00091-00-LT TYPE III BARRICADES WITH TWO FLASHING AMBER LIGHTS ON EACH. TYPE I OR TYPE IL BARRICADES WITH ONE FLASHING AMBER LIGHT ON EACH, OR TYPE III BARRICADES WITH TWO FLASHING 60 m± (200'±)---AMBER LIGHTS ON EACH. DRIVEWAY 60 m± (200'±) MPH OR COLLECTOR. ST 40 W20-1(0) CONSTRUCTIONS M6-4t0:-2115 AHEAD M6-1(0)-2115

TRAFFIC CONTROL AND PROTECTION FOR SIDE ROADS, INTERSECTIONS, AND DRIVEWAYS

NOTES:

- A. FOR NO LANE RESTRICTION ON THE SIDE ROAD OR DRIVEWAYS
- 1. SIDE ROAD WITH A SPEED LIMIT OF 60 km/h (40 MPH) OR LESS AS SHOWN ON THE DRAWING AND AS DIRECTED BY THE ENGINEER:
- OF ONE ROAD CONSTRUCTION AHEAD SIGN 900x900 (36x36) WITH A FLASHER AND FLAG MOUNTED ON IT APPROXIMATELY 60 m (200") IN ADVANCE OF THE MAIN ROUTE.
- b) THE GLOSED PORTION OF THE MAIN ROUTE SHALL BE PROTECTED BY BLOCKING WITH TYPE I, TYPE II OR TYPE III BARRICADES, 1/3 OF THE CROSS SECTION OF THE CLOSED PORTION.
- 2, SIDE ROAD WITH A SPEED LIMIT GREATER THAN 60 km/h (40 MPM) AS SHOWN ON THE DRAWING AND AS DIRECTED BY THE ENGINEER:
- a) ONE ROAD CONSTRUCTION AHEAD SIGN 1.2 m x 1.2 m (48x48) WITH A FLASHER MOUNTED ON IT APPROXIMATELY 150 m (500") IN ADVANCE OF THE MAIN ROUTE.
- b) THE CLOSED PORTION OF THE MAIN ROUTE SHALL BE PROTECTED BY BLOCKING WITH TYPE III BARRICADES, 1/2 OF THE CROSS SECTION OF THE GLOSED PORTION.
- 3. WHEN THE SIDE ROAD LIES BETWEEN THE BEGINNING OF THE MAINLINE SIGNING AND THE WORK ZONE, A SINGLE HEADED ARROW (MG-1) SHALL BE USED IN LIEU OF THE DOUBLE HEADED ARROW (M6-4).

B. FOR A LANE CLOSURE ON A SIDE ROAD OR ORIVEWAY:

USE APPLICABLE PORTIONS OF THE TYPICAL APPLICATION OF TRAFFIC CONTROL DEVICES (STD. 70150), STD. 701606 OR THE APPROPRIATE STANDARD).
THE SPACING OF SIGNS AND BARRICADES SHALL BE ADJUSTED FOR FIELD
CONDITIONS AS DIRECTED BY THE ENGINEER. THE DIRECTIONAL ARROW
SHALL BE COVERED OR REMOVED WHEN NO LONGER CONSISTENT WITH THE SIDE ROAD LANE CLOSURE.

- C. ADVANCE WARNING SIGNS ARE TO BE OMITTED ON DRIVEWAY LINLESS
- D. THE TRAFFIC CONTROL AND PROTECTION FOR SIDE ROADS, INTERSECTIONS, AND DRIVEWAYS SHALL BE INCIDENTAL TO THE COST OF SPECIFIED TRAFFIC CONTROL STANDARDS OR ITEMS.

| REVISIO | NS | ILLINOIS DEPARTM | |
|--------------|----------|--|--|
| HAME | DATE | THE BURNEY OF BURNEY HIS INVESTIGATION | |
| LHA | 6/89 | TRAFFIC CONTRO | |
| T. RAMWACHER | 09/08/94 | TIME TO SUBSTITUTE | |
| J. OBERLE | 1d/18/95 | | |
| A, HOUSEH | 03/06/96 | SIDE ROADS. IN | |
| A. HOUSEH | 1d/15/95 | * | |
| T, RAMMACHER | 01/06/00 | DRI | |
| | | | |
| | | SCALE: | |
| | i : | | |


ENT OF TRANSPORTATION OL AND PROTECTION FOR NTERSECTIONS, AND

IVEWAYS

DATE: 2/15/2006

DRAWN BY CHECKED BY TC-10

REVISION DATE: 01/06/00

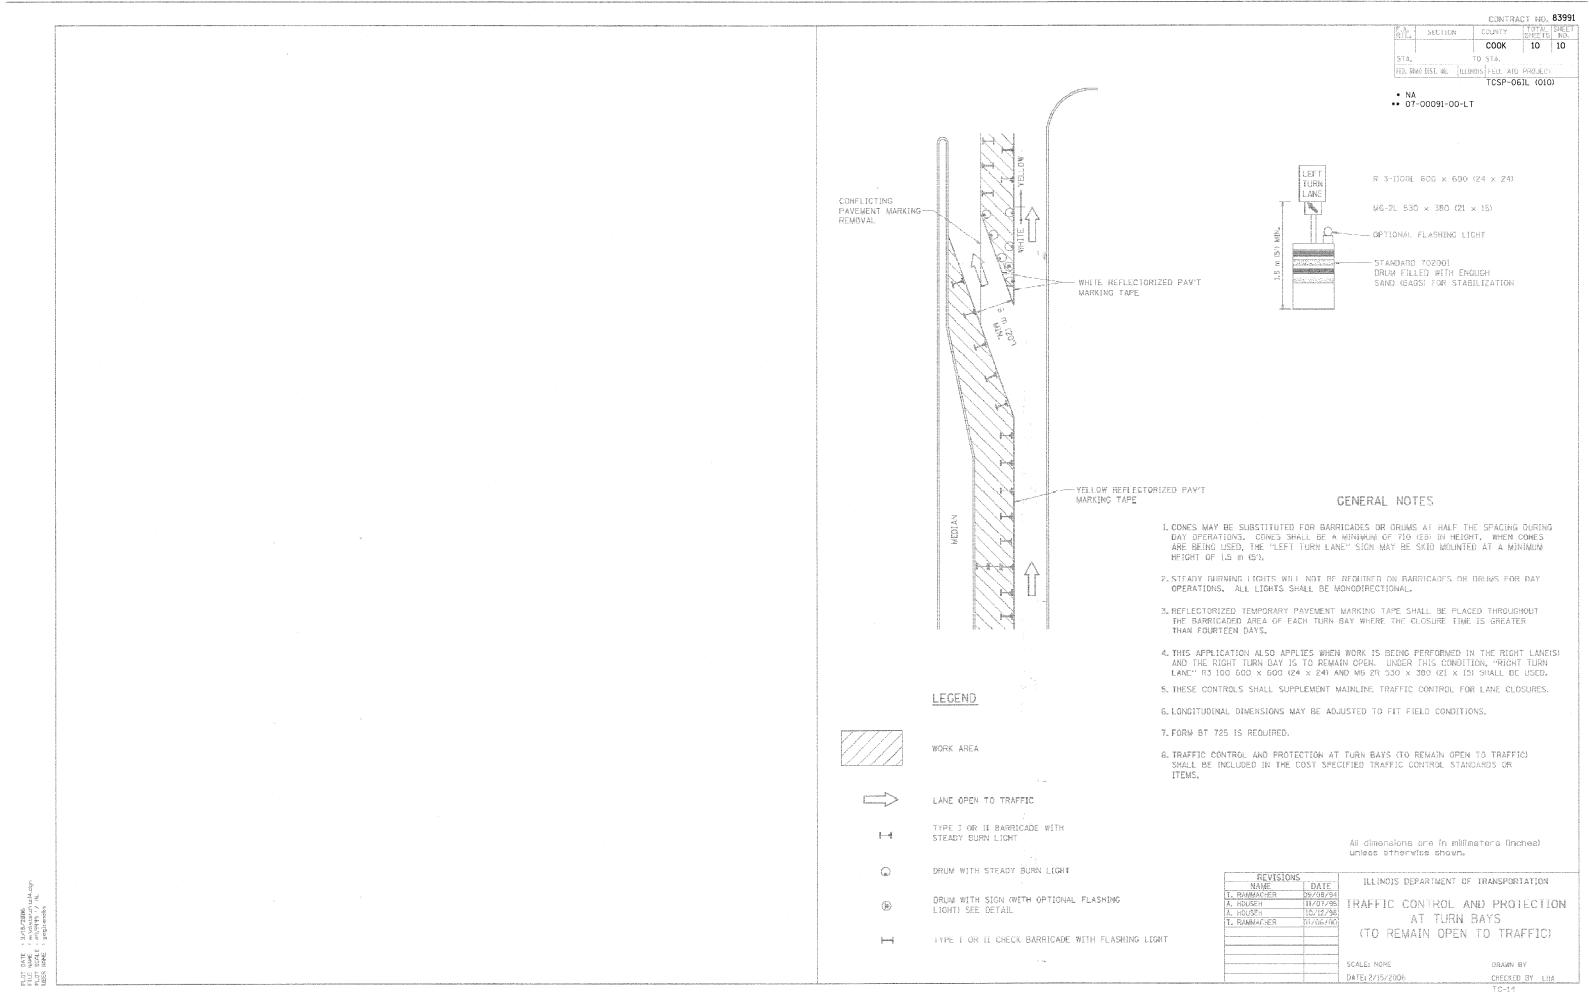

REVISION DATE-UZORZOD