DEPARTMENT OF TRANSPORTATION

DIVISION OF HIGHWAYS

PROPOSED HIGHWAY PLANS

F.A.P. 330 / U.S. 45 / 52 (96TH AVE.) **SECTION: 17 B-1-I-1 OVER SMALL STREAM (3.4 MI. S. OF U.S. 52)** BRIDGE BEAM REPLACEMENT, NEW DECK **WILL COUNTY** C-91-087-08

> **PEOTONE TOWNSHIP** R. 12 E.

W JOLIET RD W 9000N RD

GROSS LENGTH OF PROJECT = 162.1 FEET = 0.031 MILES **NET LENGTH OF PROJECT = 162.1 FEET = 0.031 MILES**

LOCATION:

U.S. 45 / 52 **OVER SMALL STREAM** S.N. 099-0122

FOR INDEX OF SHEETS, SEE SHEET NO. 2

DESIGN DESIGNATION:

2005 ADT = 8,1002021 ADT = 7,695

MUNICIPALITY INVOLVED:

UNINCORPORATED WILL COUNTY

OTHER PRINCIPAL ARTERIAL POSTED SPEED: 55 M.P.H.

ENGINEERING SCALES. REDUCED SIZED PLANS WILL NOT CONFORM TO STANDARD SCALES. IN MAKING MEASUREMENTS ON REDUCED PLANS, THE ABOVE SCALES MAY BE USED.

JOINT UTILITY LOCATION INFORMATION FOR EXCAVATION 1-800-892-0123

CONTRACT NO. 60D68

CHRISTIAN-ROGE & ASSOCIATES, INC. ENGINEERS / PLANNERS / SURVEYORS 211 W. WACKER DRIVE CHICAGO, IL. 60606 D-91-087-08

17 B-1-I-1

WILL 29 1 ILLINOIS CONTRACT NO. 60D68



STATE OF ILLINOIS DEPARTMENT OF TRANSPORTATION **DIVISION OF HIGHWAYS**

Bir der S. Sachdeva BIRINDER S. SACHDEVA. P.E.

6-30-08

Bhareon N. Sheh BHADRESH N. SHAH, S.E., P.E.

EXPIRES: 11-30-2009

6-30-2008

PRINTED BY THE AUTHORITY OF THE STATE OF ILLINOIS

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INDEX OF SHEETS

| 1 . | COVER SHEET |
|---------|---|
| 2 | INDEX OF SHEETS, LIST OF STATE STANDARDS, SCOPE OF WORK AND GENERAL NOTES |
| 3 | SUMMARY OF QUANTITIES |
| 4 | TYPICAL SECTIONS AND DETAILS |
| 5 | ALIGNMENT, TIES AND PAVEMENT MARKINGS U.S. 45/52 |
| 6 | EXISTING CONDITIONS AND PROPOSED PLAN AND PROFILE U.S. 45/52 |
| 7 | CONSTRUCTION STAGING AND MAINTENANCE OF TRAFFIC NOTES AND DETAILS U.S. 45/52 |
| 8 | SUGGESTED TRAFFIC CONTROL AND STAGING PLAN U.S. 45/52 |
| 9 - 10 | TEMPORARY TRAFFIC SIGNAL PLANS |
| 11 | TEMPORARY LIGHTING PLAN U.S. 45/52 |
| 12 | TEMPORARY LIGHTING NOTES AND DETAILS U.S. 45/52 |
| 13 - 23 | STRUCTURAL DRAWINGS U.S. 45/52 OVER SMALL STREAM |
| 24 | TEMPORARY LIGHT POLE DETAILS (BE-800) |
| 25 | TEMPORARY AERIAL CABLE INSTALLATION (BE-801) |
| 26 | TYPICAL APPLICATIONS RAISED REFLECTIVE PAVEMENT MARKERS (SNOW-PLOW RESISTANT) (TC-11) |
| 27 | DISTRICT ONE TYPICAL PAVEMENT MARKINGS (TC-13) |
| 28 | BUTT JOINT AND HMA TAPER DETAIL (BD-32) |
| 29 | STEEL PLATE BEAM GUARDRAIL ADJACENT TO CURB AND GUTTER AND STABILIZATION AT TBT TY 1 SPL. (BD-34) |

LIST OF STATE STANDARDS

| STANDARD NO. | DESCRIPTION |
|---------------------|--|
| 000001-05 | STANDARD SYMBOLS, ABBREVIATIONS AND PATTERNS |
| 420401-06 | BRIDGE APPROACH PAVEMENT |
| 542301 - 0/ | PRECAST REINFORCED CONCRETE FLARED END SECTION |
| 630001-07 | STEEL PLATE BEAM GUARDRAIL |
| 630301 - <i>04</i> | SHOULDER WIDENING FOR TYPE 1 (SPECIAL) GUARDRAIL |
| 631031 - 06 | TRAFFIC BARRIER TERMINAL, TYPE 6 |
| 635006 - 02 | REFLECTOR AND TERMINAL MARKER PLACEMENT |
| 635011 - 01 | REFLECTOR AND MARKER AND MOUNTING DETAILS |
| 701201 - <i>0</i> 2 | LANE CLOSURE, 2L, 2W, DAY ONLY, FOR SPEEDS > 45 MPH |
| 701321 - 09 | LANE CLOSURE, 2L, 2W, BRIDGE REPAIR, WITH BARRIER |
| 701901 | TRAFFIC CONTROL DEVICES |
| 704001- 04 | TEMPORARY CONCRETE BARRIER |
| 880001 | SPAN WIRE MOUNTED SIGNALS AND FLASHING BEACON INSTALLATION |

SCOPE OF WORK

THE SCOPE OF WORK FOR THIS PROJECT CONSISTS OF:

- INSTALLING TEMPORARY LIGHTING AND BRIDGE TRAFFIC SIGNALS.
- REMOVE EXISTING HMA BRIDGE DECK.
- REMOVE AND REPLACE BEAMS.
- PLACE CONCRETE WEARING SURFACE.
- REPLACE APPROACH SLABS.
- INSTALL NEW GUARDRAIL TERMINALS.

GENERAL NOTES

- 1. THESE PLANS HAVE BEEN PREPARED FROM NOTES RECEIVED FROM IDOT FIELD MAINTENANCE ENGINEERS.
- 2. PLAN DIMENSIONS AND DETAILS RELATIVE TO EXISTING PLANS ARE SUBJECT TO ROUTINE VARIATIONS. THE CONTRACTOR SHALL FIELD VERIFY EXISTING DIMENSIONS AND DETAILS AFFECTING NEW CONSTRUCTION AND MAKE NECESSARY APPROVED ADJUSTMENTS PRIOR TO CONSTRUCTION OR ORDERING MATERIALS. SUCH VARIATIONS SHALL NOT BE CAUSE FOR ADDITIONAL COMPENSATION FOR A CHANGE IN THE SCOPE OF THE WORK, HOWEVER, THE CONTRACTOR WILL BE PAID FOR THE QUANTITY ACTUALLY FURNISHED BASED UPON THE UNIT PRICE.
- 3. FORTY-EIGHT HOURS BEFORE STARTING EXCAVATION, THE CONTRACTOR WILL CALL J.U.L.I.E. (1-800-892-0123) OR 811 TO HAVE THE LOCATION OF EXISTING UTILITIES STAKED.
- 4. THE CONTRACTOR WILL NOT BE ALLOWED TO SET UP A YARD OR FIELD OFFICE ON STATE PROPERTY WITHOUT WRITTEN PERMISSION FROM THE DEPARTMENT.
- 5. SAW CUTTING PRIOR TO ANY REMOVAL ITEMS NOTED ON THE PLANS OR DIRECTED BY THE ENGINEER SHALL BE CONSIDERED INCLUDED IN THE COST OF THE ITEMS BEING REMOVED.
- 6. DO NOT SCALE PLANS FOR CONSTRUCTION DIMENSIONS.
- 7. THE CONTRACTOR SHALL USE CARE IN REMOVING OR EXCAVATING NEAR ALL EXISTING ITEMS WHICH WILL REMAIN. ANY DAMAGE DONE TO EXISTING ITEMS BY THE CONTRACTOR SHALL BE REPAIRED AT THE CONTRACTOR'S EXPENSE.
- 8. WHEN ARTIFICIAL LIGHTING IS UTILIZED IN NIGHT OPERATIONS, THE CONTRACTOR SHALL EXERCISE THE UTMOST PRECAUTIONS IN PREVENTING ADVERSE VISIBILITY TO THE MOTORING PUBLIC AS WELL AS ADJOINING RESIDENTIAL AREAS.
- 9. THE CONTRACTOR SHALL OBTAIN ALL NECESSARY PERMITS, AS REQUIRED, PRIOR TO COMMENCING WITH
- 10. THE CONTRACTOR SHALL TAKE AL! NECESSARY MEASURES TO ASSURE THAT NO DEBRIS FALLS IN THE CREEK. THE COST OF THIS WORK SHALL BE INCLUDED IN THE VARIOUS PAY ITEMS.
- 11. THE CONTRACTOR SHALL CONTACT THE TRAFFIC CONTROL SUPERVISOR AT (847) 705-4470 A MINIMUM OF 72 HOURS PRIOR TO THE PLACEMENT OF ANY TEMPORARY TRAFFIC CONTROL DEVICES.
- 12. THE CONTRACTOR SHALL CONTACT CORA MATHIS, THE AREA TRAFFIC FIELD ENGINEER, AT (815) 485-6475 TWO (2) WEEKS PRIOR TO THE PLACEMENT OF PERMANENT PAVEMENT MARKINGS.
- 13. ALL DAMAGE TO EXISTING PAVEMENT MARKINGS OUTSIDE THE REMOVAL LINE SHOWN ON THE PLANS SHALL BE REPLACED AT THE CONTRACTOR'S EXPENSE.
- 14. ALL DISTURBED AREAS SHALL BE COVERED WITH SEEDING, CLASS 2A AND EROSION CONTROL BLANKET. THE COST OF THE NITROGEN, PHOSPHORUS AND POTASSIUM FERTILIZER SHALL BE INCLUDED IN THE BID PRICE FOR SEEDING, CLASS 2A.
- 15. ON HIGHWAY STANDARD 420401 "BRIDGE APPROACH PAVEMENT", SUBBASE GRANULAR MATERIAL TYPE B SHALL BE USED IN LIEU OF THE TYPE A SHOWN ON THE STANDARD.

NOTE: BOXED ITEMS ARE INCIDENTAL.

FILE NAME = 60068 index.dgr PLOT DATE = 7/7/2008

CHRISTIAN-ROGE & ASSOCIATES, IN ENGINEERS-PLANNERS-SURVEYOR PHONE: (312)372-2023 FAX: (312)372-

| NC. | DESIGNED | - | S.J.P. | REVISED | - |
|------|----------|---|--------------|---------|---|
| S | DRAWN | - | A.Y. | REVISED | - |
| | CHECKED | - | E.J.M. | REVISED | - |
| 5274 | DATE | - | JULY 7, 2008 | REVISED | - |

STATE OF ILLINOIS **DEPARTMENT OF TRANSPORTATION**

| IN | NDEX | OF | | - | | | | | TANDARD U.S. 45 | S, SCOPE OF WORK / 52 |
|--------|------|----|-------|-----|---|----|---|--------|--------------------|--------------------------|
| SCALE: | NONE | | SHEET | NO. | 1 | OF | 1 | SHEETS | STA. | TO STA. |

COUNTY TOTAL SHEET NO. WILL 29 2 SECTION COUNTY 17 B-1-I-1 CONTRACT NO. 60D68

| | | SUMMARY OF QUANTITIES | • | URBAN 1001. STATE | CONSTRUCTION TYPE CODE | | | SUMMARY OF QUANTITIES | | URBAN 1001.STATE | CONSTRUCTION TYPE CODE |
|---|----------|---|--------------|------------------------------------|-----------------------------------|----|---------------|---|--------|---------------------|-----------------------------------|
| | CODE NO | ITEM | UNIT | TOTAL QUANTITIES | U.S. 45 / 52 BRIDGE SFTY-2A | | CODE NO | ITEM | UNIT | TOTAL QUANTITIES | U.S. 45 / 52 BRIDGE SFTY-2A |
| | 20200100 | EARTH EXCAVATION | | 176 | 176 | | 70301000 | WORK ZONE PAVEMENT MARKING REMOVAL | SQ FT | 665 | 665 |
| | 25000210 | SEEDING, CLASS 2A | ACRE | 0.2 | 0.2 | | 70400100 | TEMPORARY CONCRETE BARRIER | FOOT | 313 | 313 |
| | 25100630 | EROSION CONTROL BLANKET | SQ YD | 660 | 660 | | 70400200 | RELOCATE TEMPORARY CONCRETE BARRIER | FOOT | 313 | 313 |
| | 31101200 | SUB-BASE GRANULAR MATERIAL, TYPE B 4" | SQ YD | 314 | 314 | * | 78008210 | POLYUREA PAVEMENT MARKING TYPE I - LINE 4" | FOOT | 760 | 760 |
| | 40600100 | BITUMINOUS MATERIALS (PRIME COAT) | GALLON | 26 | 26 | * | 78100100 | RAISED REFLECTIVE PAVEMENT MARKER | EACH | 2 | 2 |
| | 40600300 | AGGREGATE (PRIME COAT) | TON | 1 | 1 | * | 78100105 | RAISED REFLECTIVE PAVEMENT MARKER (BRIDGE) | EACH | 2 | 2 |
| | 40600982 | HOT-MIX ASPHALT SURFACE REMOVAL - BUTT JOINT | SQ YD | 22 | 22 | × | 78200410 | GUARDRAIL MARKERS, TYPE A | EACH | 4 | 4 |
| | 40600990 | TEMPORARY RAMP | SQ YD | 13 | 13 | * | 78200530 | BARRIER WALL MARKERS, TYPE C | EACH | 12 | 12 |
| | 40603080 | HOT MIX ASPHALT BINDER COURSE, IL-19.0, N50 | TON | 26 | 26 | * | 78201000 | TERMINAL MARKER-DIRECT APPLIED | EACH | 4 | 4 |
| | 40603335 | HOT-MIX ASPHALT SURFACE COURSE, MIX "D", N50 | TON 26 26 78 | | | ٠. | 78300100 | PAVEMENT MARKING REMOVAL | SQ FT | 230 | 230 |
| | 42001165 | BRIDGE APPROACH PAVEMENT | SQ YD | 294 | 294 | | 78300200 | RAISED REFLECTIVE PAVEMENT MARKER REMOVAL | EACH | 3 | 3 |
| | 42001430 | BRIDGE APPROACH PAVEMENT CONNECTOR (FLEXIBLE) | SQ YD | 72 | 72 | | 80400100 | ELECTRIC SERVICE INSTALLATION | EACH | 1 | 1 |
| | 44000086 | HOT-MIX ASPHALT SURFACE REMOVAL COMPLETE | SQ YD | 196 | 196 | | 80400200 | ELECTRIC UTILITY SERVICE CONNECTION | L SUM | 1 | 1 |
| | 44000155 | HOT-MIX ASPHALT SURFACE REMOVAL, 1 1/2" | SQ YD | 255 | 255 | * | 81800300 | AERIAL CABLE, 3-1/C NO. 2 WITH MESSENGER WIRE | FOOT | 1,350 | 1,350 |
| | 44000700 | APPROACH SLAB REMOVAL | SQ YD 192 | | 192 | * | 82103400 | LUMINAIRE, SODIUM VAPOR, HORIZONTAL MOUNT, PHOTO-CELL CONTROL, 400 WATT | EACH | 6 | . 6 |
| | 44004250 | PAVED SHOULDER REMOVAL | | LIGHT POLE, WOOD, 25 FOOT, CLASS 4 | EACH | 2 | 2 | | | | |
| | 48203021 | HOT-MIX ASPHALT SHOULDERS, 6" | SQ YD | 95 | 95 | * | 83057355 | LIGHT POLE, WOOD, 60 FOOT, CLASS 4, WITH 15FT MAST ARM | EACH | 6 | 6 |
| | 50102400 | CONCRETE REMOVAL | CU YD | 5.9 | 5.9 | * | 84100110 | REMOVAL OF TEMPORARY LIGHTING UNITS | EACH | 6 | 6 |
| | 50300255 | CONCRETE SUPERSTRUCTURE | CU YD | 8.3 | 8.3 | | X0320047 | REMOVAL OF EXISTING PRECAST PRESTRESSED CONCRETE DECK BEAMS | SQ FT | 348 | 348 |
| | 50300260 | BRIDGE DECK GROOVING | SQ YD | 180 | 180 | | X0321468 | PLUG EXISTING DECK DRAINS | EACH | 6 | 6 |
| | 50300300 | PROTECTIVE COAT | SQ YD | 217 | . 217 | | X0322467 | TEMPORARY INFORMATION SIGNING FOR LANE CLOSURE | SQ FT | 48 | 48 |
| | 50400305 | PRECAST PRESTRESSED CONCRETE DECK BEAMS (17" DEPTH) | SQ FT | 348 | 348 | * | X0323574 | MAINTENANCE OF LIGHTING SYSTEM | CAL MO | 4 | 4 |
| | 50800205 | REINFORCEMENT BARS, EPOXY COATED | POUND | 4,310 | 4,310 | | X0325305 | STRUCTURAL REPAIR OF CONCRETE (DEPTH EQUAL TO OR LESS THAN 5 INCH E S) | SQ FT | 272 | 272 |
| | 50800515 | BAR SPLICERS | EACH | 39 | 39 | | X0325775 | WET REFLECTIVE TEMPORARY TAPE, TYPE III, 4 INCH | FOOT | 1,780 | 1,780 |
| | 54200445 | PIPE CULVERTS, TYPE 1 RCCP 30" | FOOT | 30 | 30 | | X5030305 | CONCRETE WEARING SURFACE, 5" | SQ YD | 203 | 203 |
| | 54213675 | PRECAST REINFORCED CONCRETE FLARED END SECTIONS 30" | EACH | 2 | 2 | * | X8900005 | TEMPORARY BRIDGE TRAFFIC SIGNAL INSTALLATION | EACH | 1 | 1 |
| * | 63100085 | TRAFFIC BARRIER TERMINAL, TYPE 6 | EACH | 4 | 4 | * | XX006937 | GROUND ROD, 5/8" DIA. × 10 FT. | EACH | 2 | 2 |
| * | 63100167 | TRAFFIC BARRIER TERMINAL, TYPE 1 (SPECIAL) TANGENT | EACH | 4 | 4 | * | X0325949 | ELECTRIC SERVICE DISCONNECT, LIGHTING AND TRAFFIC SIGNAL | EACH | 1 | 1 |
| | 63200310 | GUARDRAIL REMOVAL | FOOT | 292 | 292 | | Z0013798 | CONSTRUCTION LAYOUT | L SUM | 1 | 1 |
| | 67000400 | ENGINEER'S FIELD OFFICE, TYPE A | CAL MO | 4 | 4 | | Z0030240 | IMPACT ATTENUATORS, TEMPORARY (NON-REDIRECTIVE), TEST LEVEL 2 | EACH | 2 | 2 |
| | 67100100 | MOBILIZATION | L SUM | 1 | 1 | | Z0030340 | IMPACT ATTENUATORS, RELOCATE (NON- REDIRECTIVE), TEST LEVEL 2 | EACH | 2 | 2 |
| | 70100405 | TRAFFIC CONTROL AND PROTECTION, STANDARD 701321 | EACH | 1 | 1 | | Z0032700 | KEYWAY REPAIR | FOOT | 350 | 350 |
| | 70100450 | TRAFFIC CONTROL AND PROTECTION, STANDARD 701201 | L SUM | 1 | 1 | * | SPECIALTY ITE | М | | | |

FILE NAME = 60068 summary.dgn PLOT DATE = 7/10/2008

CHRISTIAN-ROGE & ASSOCIATES, INC.

ENGINEERS-PLANNERS-SURVEYORS
211 WEST WACKER DRIVE
CHICAGO, LILINOIS 80066
CHICAGO, LILINOIS 80066
PHONE: (312)372-2023 FAX: (312)372-5274
DATE

JULY 10, 2008 REVISED -REVISED -REVISED -REVISED -

| | SUMMARY OF QUANTITIES U.S. 45 / 52 | | | | | | | | F.A.P. RTE. | SECTION | COUNTY | TOTAL SHEETS | SHEET NO. | | |
|---|------------------------------------|------|-------|-----|---|----|---|--------|----------------|------------|-----------|-----------------------------|--------------|-------|------|
| ١ | | | | | | | | | 330 | 17 B-1-I-1 | WILL | 29 | 3 | | |
| ŀ | | | | | | | | | | | | | CONTRACT | NO. 6 | 0D68 |
| ┙ | SCALE | NONE | SHEET | NO. | 1 | 0F | 1 | SHEETS | STA. | TO STA. | FED. ROAD | DIST. NO. 1 ILLINOIS FED. A | ID PROJECT | | |

| HOT-MIX ASPHALT MIXTURE REQUIREMENTS | | | | | | | | | | |
|--|-------------------|--------------|--|--|--|--|--|--|--|--|
| MIXTURE TYPE | AC TYPE | AIR VOIDS | | | | | | | | |
| PAVEMENT RESURFACING | | | | | | | | | | |
| HOT-MIX ASPHALT SURFACE COURSE, MIX "D", N50 (IL 9,5 mm) | PG 64-22 | 4% € 50 Gyr. | | | | | | | | |
| HOT-MIX ASPHALT BINDER COURSE, IL-19.0, N50; 1" - 31/2" | *PG 64-22 | 4% @ 50 Gyr. | | | | | | | | |
| TEMPORARY RAMP | | | | | | | | | | |
| LEVELING BINDER (MACHINE METHOD), N50 3/4" - 11/2" | * PG 64-22 | 4% @ 50 Gyr. | | | | | | | | |
| BRIDGE APPROACH PAVEMENT CONNECTOR (FLEXIBLE) | | | | | | | | | | |
| HOT-MIX ASPHALT SURFACE COURSE, MIX "D", N50 (IL 9.5 mm), $1^{1}\!/_{2}$ " | PG 64-22 | 4% @ 50 Gyr. | | | | | | | | |
| HOT-MIX ASPHALT BINDER COURSE, IL-19.0, N50; 131/2" ** | PG 64-22 | 4% @ 50 Gyr. | | | | | | | | |
| HOT-MIX ASPHALT SHOULDER | | | | | | | | | | |
| HOT-MIX ASPHALT SURFACE COURSE, MIX "D", N50 (IL 9.5 mm), $1^{1}\!/_{2}$ " | PG 64-22 | 4% @ 50 Gyr. | | | | | | | | |
| HOT-MIX ASPHALT BINDER COURSE, IL-19.0, N50; 41/2" *** | PG 64-22 | 4% @ 50 Gyr. | | | | | | | | |

NOTE: THE UNIT WEIGHT USED TO CALCULATE HMA MIXTURE QUANTITIES IS 112 LBS/SQ YD/IN. WHEN RAP EXCEEDS 20%, THE NEW ASPHALT BINDER IN THE MIX SHALL BE PG 58-22.

** PLACE IN 5 LIFTS.

* * * PLACE IN 2 LIFTS.

THE FOLLOWING RATES OF APPLICATION HAVE BEEN USED TO CALCULATE THE PLAN QUANTITIES:

HOT-MIX ASPHALT MATERIALS (PRIME COAT)


0.100 GAL / SQ YD

HOT-MIX ASPHALT SURFACE / BINDER

0.056 TON / SQ YD PER 1"

NOTES:

1. EXISTING PAVEMENT TO BE OVERLAID WILL BE CLEANED AND PRIMED PER ARTICLE 407.06 OF THE 2007 STANDARD SPECIFICATIONS.

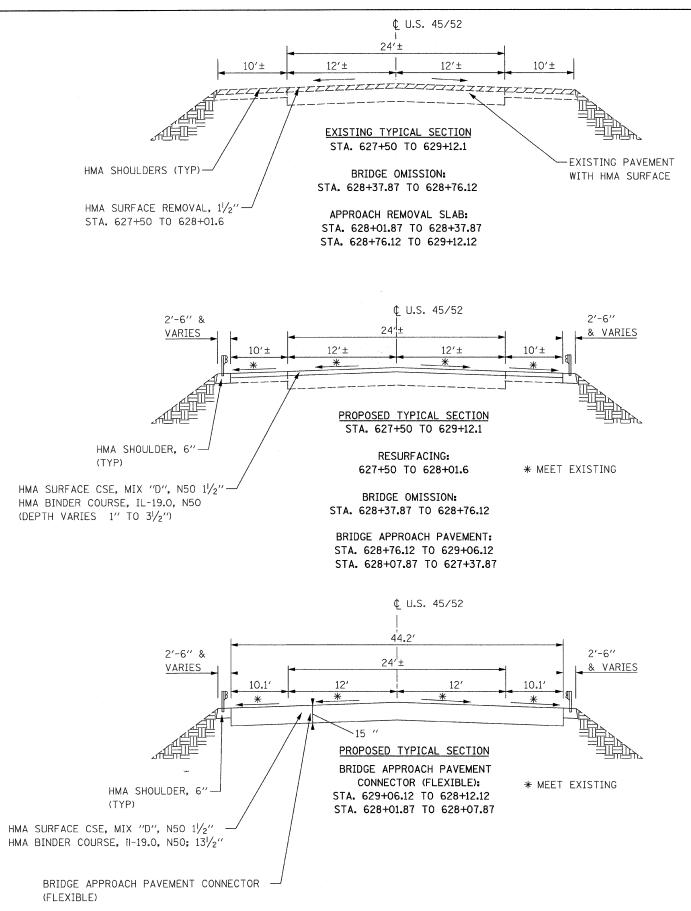


FILE NAME = 60068 typ.dgn PLOT DATE = 7/7/2008

FNGINFERS_PLANNERS_SURVEYORS PHONE: (312)372-2023 FAX: (312)372-5274 DATE

CHRISTIAN-ROGE & ASSOCIATES, INC. DESIGNED - S.J.P. REVISED DRAWN - A.Y. REVISED -CHECKED - E.J.M. REVISED - JULY 7, 2008 REVISED


| TYPICAL SECTIONS & DETAILS | F.A.P. RTE. | SECTION | COUNTY | TOTAL SHEETS | |
|--|----------------|------------------------------------|------------|-----------------|------|
| U.S. 45 / 52 | 330 | 17 B-1-I-1 | WILL | 29 | 4 |
| | | | CONTRACT | NO. 6 | 0D68 |
| SCALE: NONE SHEET NO. 1 OF 1 SHEETS STA. TO STA. | FED. I | ROAD DIST. NO. 1 ILLINOIS FED. A | ID PROJECT | | |



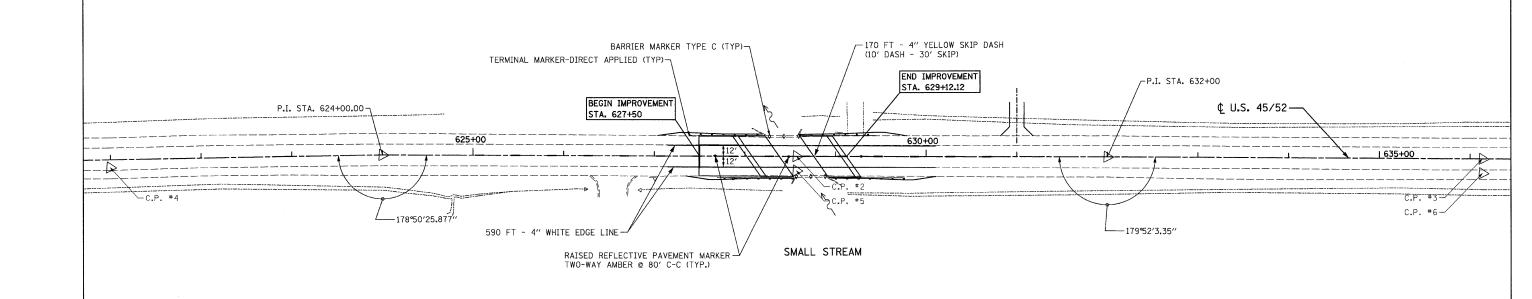

PAVEMENT MARKING NOTES:

1. ALL PAVEMENT MARKINGS ON BRIDGE DECK AND PAVEMENT SHALL BE POLYUREA, TYPE I.

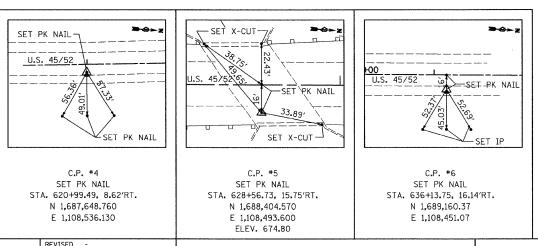

| | | NORTHING | EASTING | STATION |
|-------|------|-----------------|-----------------|-----------|
| P. I. | 4006 | 1,687,622.99 | 1, 108, 529, 49 | 620+74.31 |
| P. I. | 4001 | 1,687,947.70 | 1, 108, 504. 16 | 624+00.00 |
| P. T. | 4002 | 1, 688, 403. 94 | 1,108,477.86 | 628+57.00 |
| P. I. | 4003 | 1, 688, 746. 36 | 1, 108, 457. 98 | 632+00.00 |
| P. I. | 4005 | 1, 689, 170. 71 | 1, 108, 434. 33 | 636+25.00 |


| FILE | NAME | = | 6ØD68 | alıgn | pm.dgn | |
|------|------|---|-------|-------|--------|--|
|------|------|---|-------|-------|--------|--|

PLOT DATE = 7/7/2008

CHRISTIAN-ROGE & ENGINEERS-PLANN 211 WEST WA CHICAGO, ILLI

| & ASSOCIATES, INC. | DESIGNED | - | S.J.P. | REVISED | - |
|------------------------------|----------|---|--------------|---------|---|
| NNERS-SURVEYORS VACKER DRIVE | DRAWN | - | A.Y. | REVISED | - |
| LINOIS 60606 | CHECKED | - | E.J.M. | REVISED | - |
| 23 FAX: (312)372-5274 | DATE | - | JULY 7, 2008 | REVISED | - |
| | | | | | |

| ALIGNMENT, TIES, AND PAVEMENT MARKINGS | F.A.P. RTE. | SECTION | COUNTY | TOTAL | SHEET NO. |
|--|----------------|-----------------------------------|------------|-------|--------------|
| U.S. 45 /52 | 330 | 17 B-1-I-1 | WILL | 29 | 5 |
| | | | CONTRACT | NO. 6 | 0D68 |
| SCALE: 1"=50' SHEET NO. 1 OF 1 SHEETS STA. 621+00 TO STA. 636+00 | FED. R | DAD DIST. NO. 1 ILLINOIS FED. A | ID PROJECT | | |

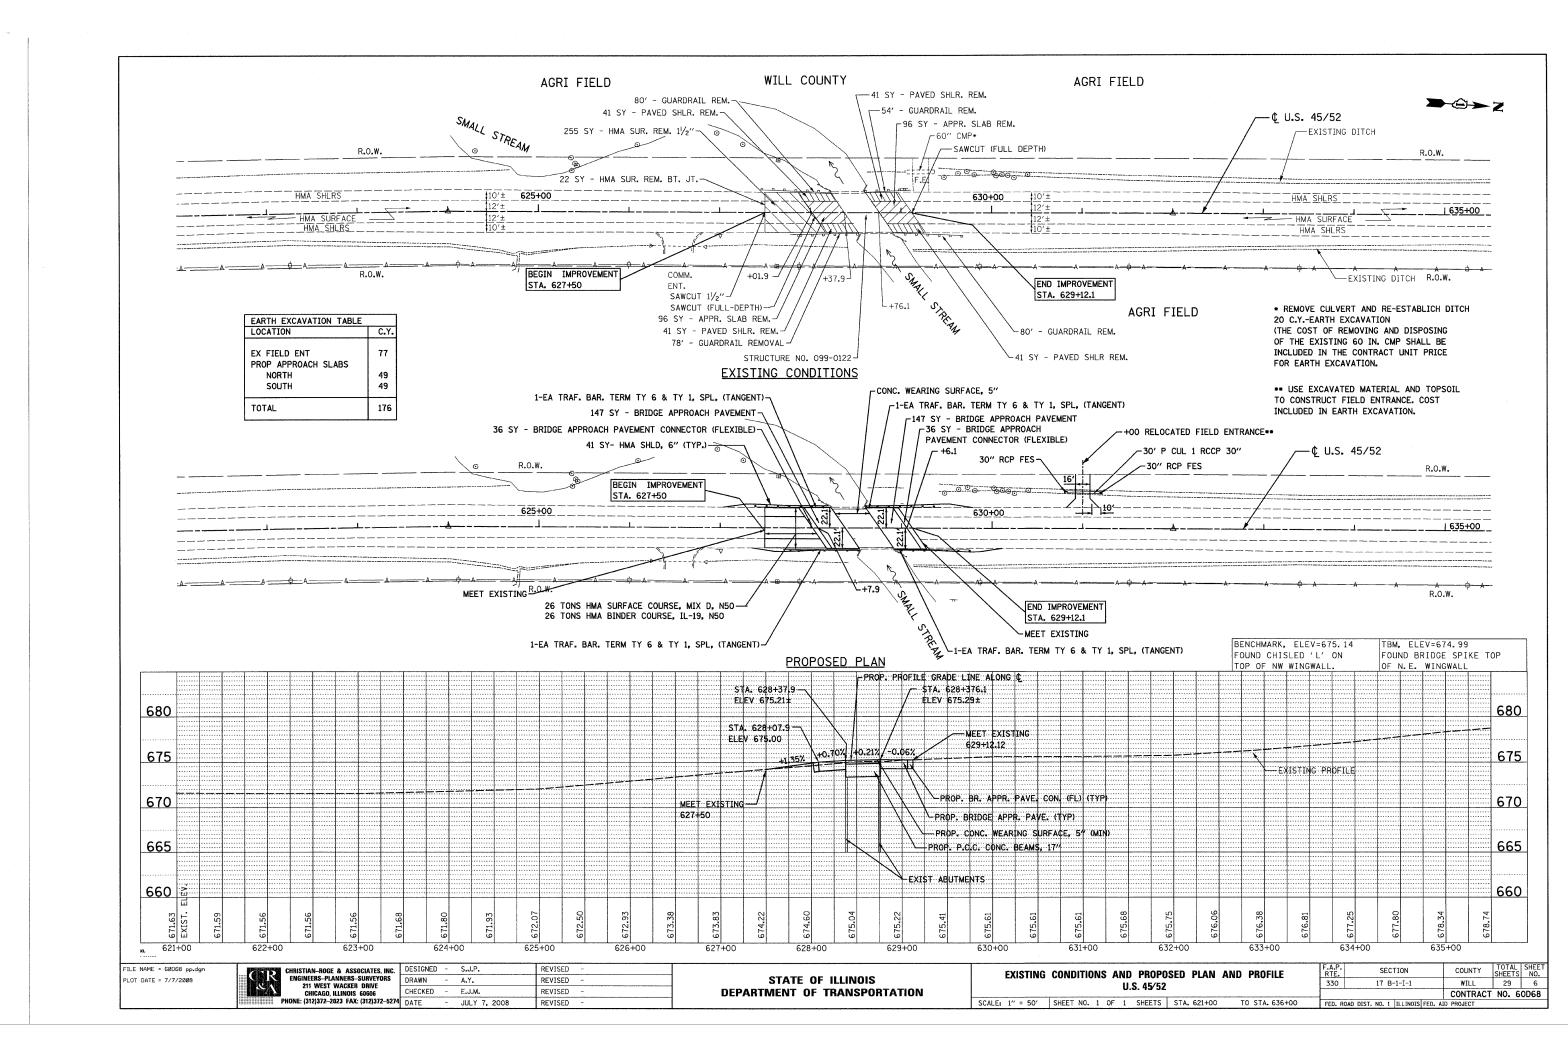

SUGGESTED STAGING AND MAINTENANCE OF TRAFFIC

CONSTRUCTION STAGING

PRE-STAGE

- INSTALL TEMPORARY LIGHTING, TEMPORARY BRIDGE TRAFFIC SIGNAL AND TRAFFIC CONTROL DEVICES FOR STAGE I.
- RELOCATE FIELD ENTRANCE

STAGE I - EAST HALF OF BRIDGE

- REMOVE HMA WEARING SURFACE, REPLACE BEAMS, PLACE CONC. WEARING SURFACE AND RECONSTRUCT PARAPET WALL.
- RECONSTRUCT APPROACH SLAB, PLACE CONNECTOR PAVEMENT, RESURFACE PAVEMENT, PLACE HMA SHOULDER AND INSTALL GUARDRAIL.
- PLACE TEMPORARY HMA RAMP TO MEET NEW APPROACH PAVEMENT.
- PLACE TEMPORARY HMA RAMPS AS NEEDED.

STAGE II - WEST HALF OF BRIDGE

- REMOVE HMA WEARING SURFACE, REPLACE BEAMS, PLACE CONC. WEARING SURFACE AND RECONSTRUCT PARAPET WALL.
- RECONSTRUCT APPROACH SLAB, PLACE CONNECTOR PAVEMENT, RESURFACE PAVEMENT, PLACE HMA SHOULDER AND INSTALL GUARDRAIL.

MAINTENANCE OF TRAFFIC

PRE-STAGE

- USE DAILY LANE CLOSURES TO INSTALL TEMP. LIGHTING AND SIGNALS AND PLACE TRAFFIC CONTROL DEVICES FOR STAGE I. USE IDOT STANDARD 701201 - LANE CLOSURE, 2L, 2W, DAY ONLY, FOR SPEEDS > 45 MPH.

STAGE I


- CLOSE NORTHBOUND LANE AS SHOWN ON THE SUGGESTED TRAFFIC CONTROL AND STAGING ALONG WITH THE NOTES AND DETAILS ON IDOT STANDARD 701321.
- MAINTAIN ONE-LANE TWO-WAY TRAFFIC ON SOUTHBOUND PAVEMENT ACROSS BRIDGE.

STAGE II


- CLOSE SOUTHBOUND LANE AS SHOWN ON THE SUGGESTED TRAFFIC CONTROL AND STAGING ALONG WITH THE NOTES AND DETAILS ON IDOT STANDARD 701321.
- SHIFT ONE-LANE TWO-WAY TRAFFIC TO NORTHBOUND PAVEMENT ACROSS BRIDGE.
- REMOVE TEMPORARY BRIDGE TRAFFIC SIGNALS, LIGHTING AND TRAFFIC CONTROL DEVICES USING DAILY
 LANE CLOSURES. SEE IDOT STANDARD 701201 LANE CLOSURE, 2L, 2W, DAY ONLY, FOR SPEEDS > 45 MPH.

TRAFFIC CONTROL GENERAL NOTES

- USE SUGGESTED TRAFFIC CONTROL AND STAGING PLAN IN CONJUNCTION WITH STANDARD 701321.
- 2. FLUORESCENT VESTS: ALL CONSTRUCTION PERSONNEL WILL BE REQUIRED TO WEAR FLUORESCENT VESTS AT ALL TIMES WHILE ON THE CONSTRUCTION SITE, COMPLIANCE WITH THIS REQUIREMENT SHALL BE CONSIDERED INCIDENTAL TO THE CONTRACT.
- 3. CONTRACTOR SHALL MAINTAIN SATISFACTORY INGRESS AND EGRESS TO ADJACENT PROPERTIES THROUGHOUT THE CONSTRUCTION.
- 4. INSTALL TEMPORARY SIGN PANEL ASSEMBLY AS SHOWN IN PLANS AND AS DIRECTED BY THE ENGINEER, TO BE PAID FOR BY ITEM "TEMPORARY INFORMATION SIGNING FOR LANE CLOSURE".
- 5. EACH DETECTOR LOOP SHALL BE CONNECTED TO A SEPARATE DETECTOR AMPLIFIER.
- 6. ALL TEMPORARY PAVEMENT MARKING SHALL BE WET REFLECTIVE TEMPORARY TAPE, TYPE III.
- THE FIRST TWO SIGNS ENTERING THE WORK ZONE SHALL HAVE MONO-DIRECTIONAL FLASHING BEACONS.
- 8. THE COST OF THE ADDITIONAL TRAFFIC SIGNAL EQUIPMENT FOR THE SIGNALS AT THE COMMERCIAL ENTRANCE, INCLUDING VIDEO DETECTION FOR THE DRIVEWAY, SHALL BE INCLUDED IN THE CONTRACT LUMP SUM PRICE FOR "TEMPORARY BRIDGE TRAFFIC SIGNALS".

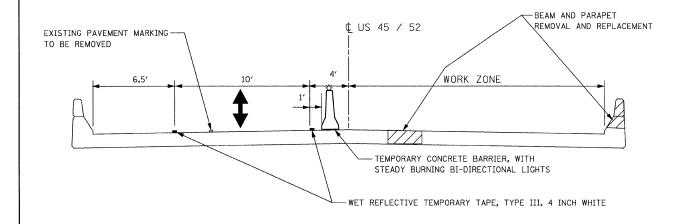

MAINTENANCE OF TRAFFIC - STAGE I SECTION A-A

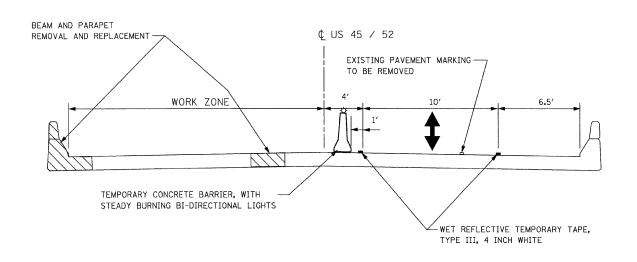

MAINTENANCE OF TRAFFIC - STAGE II SECTION B-B


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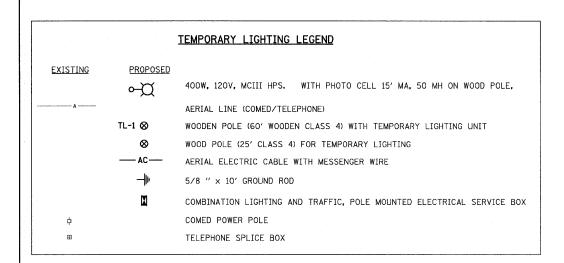
CHRISTIAN-ROGE & ASSOCIATES, INC.
ENGINEERS-PLANNERS-SURVEYORS
211 WEST WACKER DRIVE
CHICAGO, IILLINOIS 66666
PHONE: (312)372-2023 FAX: (312)372-5274
DATE


STATE OF ILLINOIS
DEPARTMENT OF TRANSPORTATION


CONSTRUCTION STAGING AND MAINTENANCE OF TRAFFIC NOTES AND DETAILS U.S. 45 / 52

SCALE: NONE SHEET NO. 1 OF 2 SHEETS STA. 621+00 TO STA. 636+00



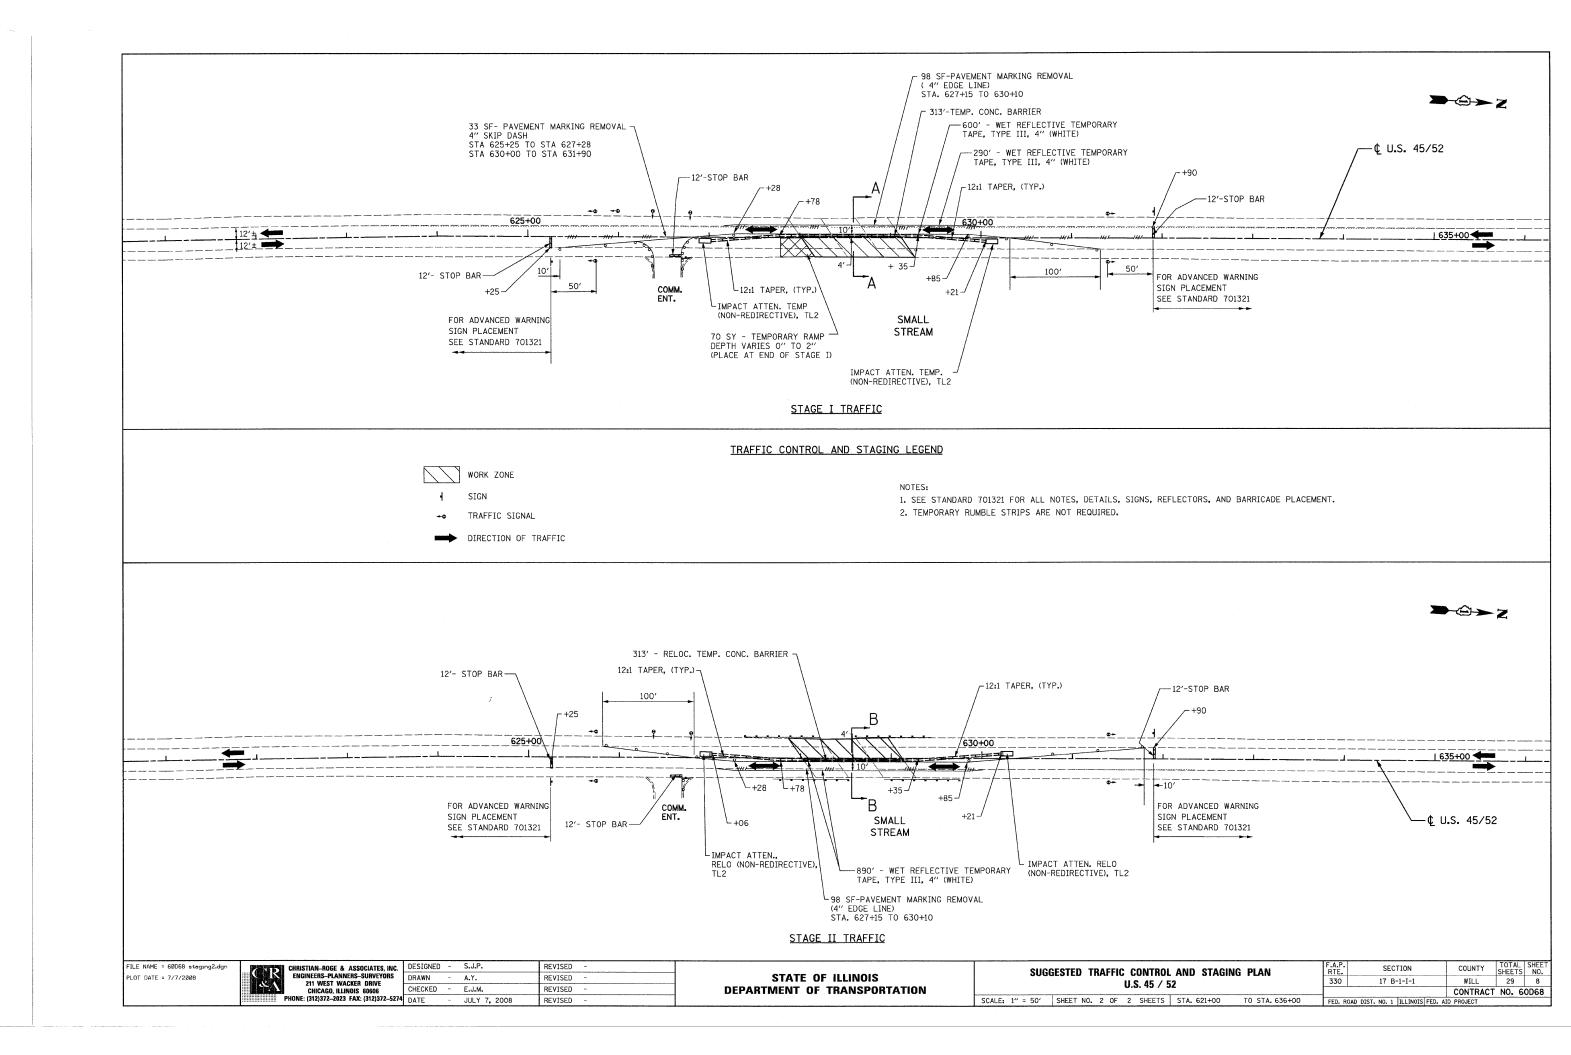

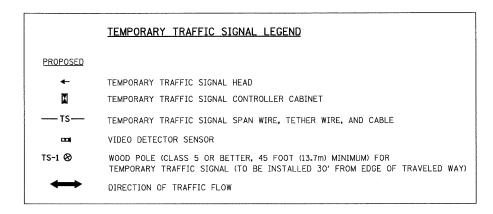

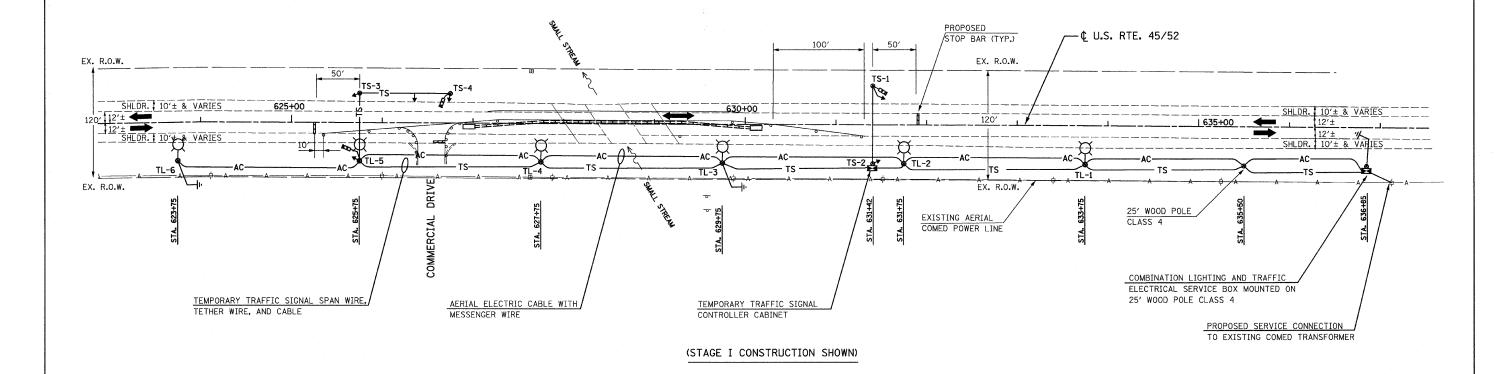

FILE NAME = 600068 signal 1.dgn

PLOT DATE = 7/7/2008


CHRISTIAN-ROGE & ASSOCIATES, INC.
ENGINEERS-PLANNERS-SURVEYORS
211 WEST WACKER DRIVE
CHICAGO, ILLINOIS 66066
PHONE: (312)372-2023 FAX: (312)372-527/


| INC. | DESIGNED | - | M.A. | REVISED | - |
|-------|----------|---|---------------|---------|---|
| RS | DRAWN | - | M.A. | REVISED | - |
| | CHECKED | - | S.J.P. / M.A. | REVISED | |
| -5274 | DATE | - | 07-07-08 | REVISED | - |

STATE OF ILLINOIS
DEPARTMENT OF TRANSPORTATION

| TEMPORARY TRAFFIC SIGNAL PLAN | F.A.P. RTE. | SECTION | COUNTY | TOTAL | SHEET NO. |
|---|----------------|-----------------------------------|-----------|-------|--------------|
| U.S. 45 / 52 | 330 | 17 B-1-I-1 | WILL | 29 | 9 |
| | | | CONTRACT | NO. 6 | OD68 |
| SCALE: 1"= 50' SHEET NO. 1 OF 2 SHEETS STA. 621+00 TO STA. 636+00 | FED. RO | DAD DIST. NO. 1 ILLINOIS FED. A | D PROJECT | | |

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- THE MATERIALS AND INSTALLATION METHODS SHALL COMPLY WITH THE LATEST CODES, STANDARDS AND ORDINANCES OF FEDERAL, STATE AND LOCAL GOVERNING BODIES HAVING JURISDICTION. ALL WORKS SHOWN ON THE PLANS AND DESCRIBED ELSEWHERE SHALL ALSO CONFORM TO THE LATEST NATIONAL ELECTRICAL CODE.
- 2. ALL MATERIAL PARTS OF THE LIGHT POLES SHALL BE GROUNDED AND BONDED CONFORMING TO NEC ARTICLE 250. THE EQUIPMENT GROUND SHALL BE CONTINUOUS AND CONNECTED UP TO THE ELECTRICAL SYSTEM GROUND. THIS WORK SHALL BE PART OF THE LIGHT POLE PAY ITEM.
- 3. THE LIGHT POLE SETBACK FROM THE EDGE OF TRAVEL PAVEMENT SHALL BE 30' TO AVOID CLEARZONE, CONFLICT WITH COMED POWER POLES, AND DRAINAGE DITCH. WHEN LIGHT POLES ARE BEHIND GUARDRAIL THEY SHALL BE AT LEAST EIGHT FOOT FROM THE BACK OF THE SHOULDER AND OR AS DIRECTED BY THE ENGINEER.
- 4. THE TEMPORARY LIGHT POLES SHALL HAVE IDENTIFICATION NUMBERS AS SHOWN ON THE PLANS.
- 5. THE CONTRACTOR SHALL BE RESPONSIBLE FOR ANY DAMAGE TO THE LIGHTING AND TRAFFIC SIGNAL INSTALLATION. THE CONTRACTOR SHALL NOT INSTALL DAMAGED EQUIPMENT OR DEFECTIVE DEVICES, INSTEAD THE CONTRACTOR SHALL REPLACE IT WITH NEW ONES AT NO COST TO IDOT AND/OR AS DIRECTED BY THE ENGINEER.
- 6. THE CONTRACTOR SHALL SPLICE AERIAL CABLE AT THE LIGHT POLE USING HEAT SHRINKABLE CAPS WITH THE FACTORY APPLIED WATERPROOF SEALANT. THE INSTALLATION AND REQUIRED MATERIAL SHALL BE PART OF THE LIGHT POLE PAY ITEM.

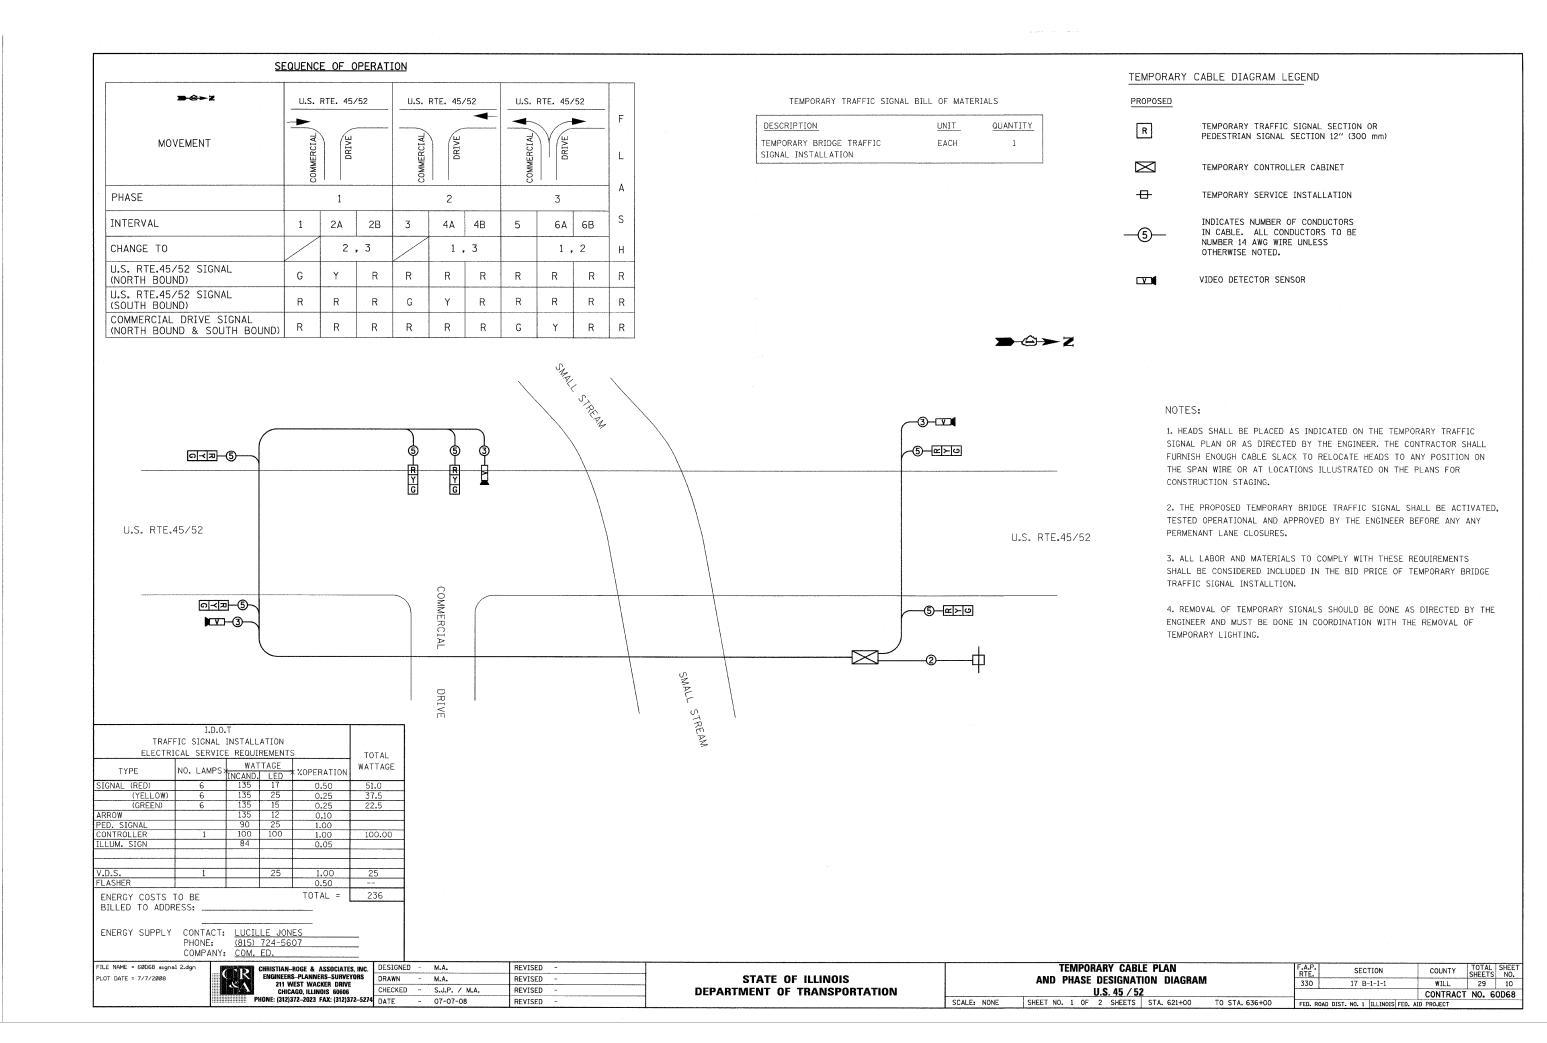
- AS DIRECTED BY THE ENGINEER. FURTHERMORE, THE CONTRACTOR SHALL COORDINATE ALL SUCH ACTIVITIES BEING DONE IN THE SAME AREA BY THE UTILITY COMPANIES OR OTHER CONTRACTORS AND SETUP COORDINATION MEETINGS IF NECESSARY WITHOUT ANY ADDITIONAL FINANCIAL COMPENSATION.
- 8. THE PROPOSED TEMPORARY LIGHTING SHALL BE COMPLETED, TESTED, OPERATIONAL AND VERIFIED BY IDOT BEFORE STAGE I TRAFFIC CONTROL IS IN PLACE. THE CONTRACTOR SHALL SUBMIT STAGING SCHEDULE IDENTIFYING STARTING AND COMPLETION DATES PRIOR TO THE COMMENCEMENT OF WORK FOR PROCUREMENT, INSTALLATION AND OR REMOVAL OF EXISTING MATERIAL/EQUIPMENT.
- 9. ALL AREAS DISTURBED UNDER THIS CONTRACT SHALL BE RESTORED TO THE ORIGINAL CONDITION OR BETTER TO THE SATISFACTION OF THE ENGINEER.
- 10. LIGHTING SHALL BE KEPT OPERATIONAL AND ACTIVE FROM ONE HOUR BEFORE SUNSET TO ONE HOUR AFTER SUNRISE. AS PER "NATIONAL ELECTRIC CODE", OVERHEAD SPANS OF AERIAL CABLE AND MESSENGER WIRE MUST HAVE A VERTICAL CLEARANCE OF 18' MINIMUM ABOVE THE GROUND AT ALL TIMES AND AT ALL LOCATIONS ON THE PROJECT.
- 11. THE CONTRACTOR SHALL INSTALL ALL EQUIPMENT SO AS TO COMPLY WITH REQUIRED ELECTRICAL CLEARANCES PER NATIONAL ELECTRICAL CODE (NEC) SECTION 225-18, NATIONAL ELECTRICAL SAFETY CODE AND COMED REQUIREMENTS.
- 12. GROUND RODS SHALL BE INSTALLED AT EVERY THIRD TEMPORARY LIGHT POLE, AND SHALL BE PAID FOR AS "GROUND ROD, 5/8" DIA. x 10 FT.". GROUND WIRES AND CONNECTION OF GROUND 18. RODS AT LIGHT POLES ARE INCLUDED IN THE COST OF GROUND RODS. THE GROUND ROD AT SERVICE DISCONNECT BOX IS INCLUDED IN THE COST OF THE ITEM "ELECTRIC SERVICE DISCONNECT, LIGHTING AND TRAFFIC SIGNAL".

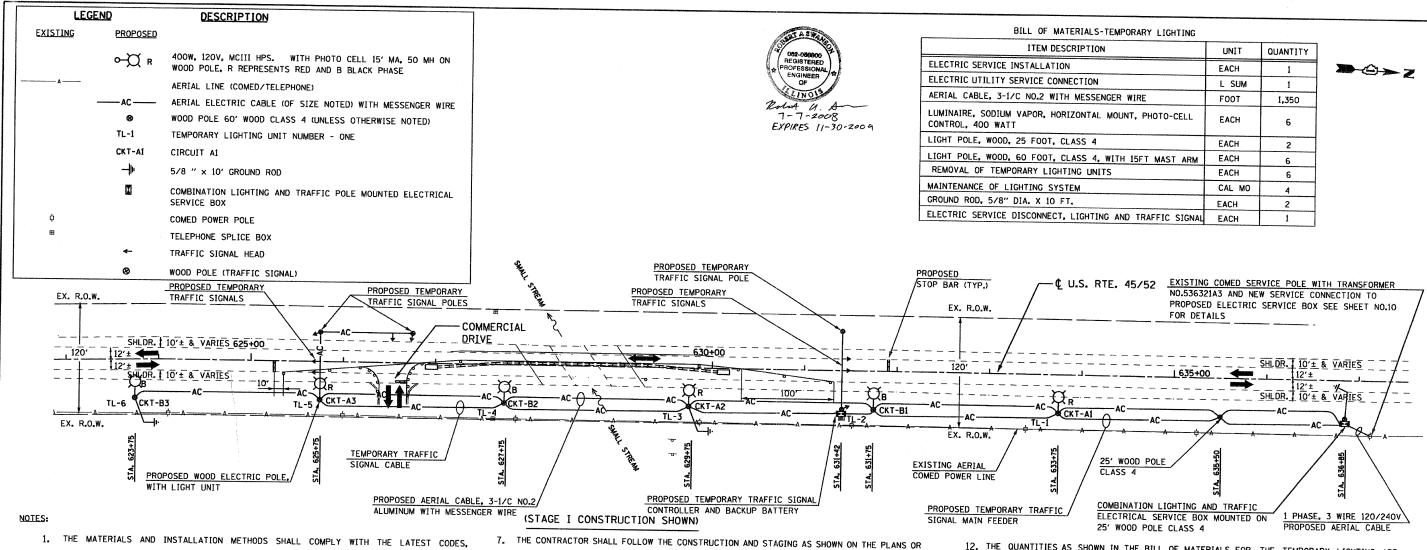- 12. THE QUANTITIES AS SHOWN IN THE BILL OF MATERIALS FOR THE TEMPORARY LIGHTING ARE APPROXIMATE. THE CONTRACTOR SHALL BE RESPONSIBLE FOR FIELD VERIFYING ALL QUANTITIES PRIOR TO ORDERING ANY MATERIALS OR EQUIPMENT.
- 13. THE TEMPORARY LIGHTING SHALL USE AERIAL CABLES AS SHOWN ON THE PLANS. HOWEVER, THE UNDER GROUND NEW ELECTRICAL INSTALLATION IF ANY SHALL BE AT A MINIMUM 30 INCHES BELOW GRADE AND SHALL HAVE ELECTRICAL WARNING TAPE CONFORMING TO THE IDOT STANDARDS.
- 14. THE CONTRACTOR SHALL NOTIFY UTILITY COMPANY AS SOON AS POSSIBLE CONCERNING PENDING ELECTRICAL SERVICE INSTALLATION AND CONNECTION TO ENSURE AVAILABILITY OF ELECTRICAL POWER SUPPLY IN A TIMELY MANNER.
- 15. THE CONTRACTOR MAY MODIFY ELECTRICAL IDOT STANDARD DETAILS AS NECESSARY TO SUIT SPECIFIC SITE CONDITIONS. HOWEVER, THE CONTRACTOR SHALL OBTAIN ENGINEER'S APPROVAL PRIOR TO THE INSTALLATION.
- 16. THE REMOVAL OF TEMPORARY LIGHTING UNITS SHALL INCLUDE AND NOT BE LIMITED TO: ALL POLES, LUMINAIRES WITH MAST ARMS, MESSENGER WIRES / CABLES, COM ED SERVICE CABLES, CONDUITS, ETC., AND HAULING AWAY OF THESE ITEMS FROM THE PROJECT SITE.
- 17. THE CONTRACTOR SHALL PROVIDE, INSTALL AND REMOVE ALL WOOD POLES REQUIRED FOR TEMPORARY LIGHTING. THE PROPOSED TRAFFIC SIGNAL POLES WILL NOT BE PAID FOR AS LIGHT POLES. REFER TO THE TEMPORARY TRAFFIC SIGNAL PLAN FOR PAY ITEMS ASSOCIATED WITH THE PROVISION, INSTALLATION, AND REMOVAL OF THE TEMPORARY TRAFFIC SIGNAL POLES.
- 18. EXACT LOCATION OF EXISTING POWER POLE WITH COMED TRANSFORMER TO BE DETERMINED IN THE FIELD. COMED CONTACT INFORMATION FOR THIS PROJECT IS AS FOLLOWS: FIELD REPRESENTATIVE: LUCILLE JONES (815)724-5607, ACCOUNT NO. 2896102062. TRANSFORMER NO. 536321A3

FILE NAME = 60068 lightldgn PLOT DATE = 7/7/2008

| CHRISTIAN-ROGE & ASSOCIATES, INC. | DESIGNED | - | M.A. | REVISED | ~ |
|--|----------|---|-------------------------------|---------|---|
| ENGINEERS-PLANNERS-SURVEYORS 211 WEST WACKER DRIVE CHICAGO, ILLINOIS 60606 | DRAWN | - | M.A./A.Y | REVISED | • |
| CHICAGO, ILLINOIS 60606 | CHECKED | - | R _s S _s | REVISED | ~ |
| PHONE: (312)372-2023 FAX: (312)372-5274 | DATE | - | JULY 3, 2008 | REVISED | - |
| | | | | | |

| TEMPORARY LIGHTING PLAN | F.A.P. RTE. | SECTION | COUNTY | TOTAL SHEETS | SHEET NO. | | | | | |
|--|----------------|---------------------------------|--------|-----------------|--------------|--|--|--|--|--|
| U.S. 45 / 52 | 330 | 17 B-1-I-1 | WILL | 29 | 11 | | | | | |
| CALE: NONE SHEET NO. 1 OF 2 SHEETS STA. 621+00 TO STA. 636+00 | FED B | DAD DIST NO (HI INDIC FED A) | | NO. 6 | OD68 | | | | | |
| STAL 521-00 TO STAL 536+00 FED. ROAD DIST. NO. 1 ILLINOIS FED. AID PROJECT | | | | | | | | | | |

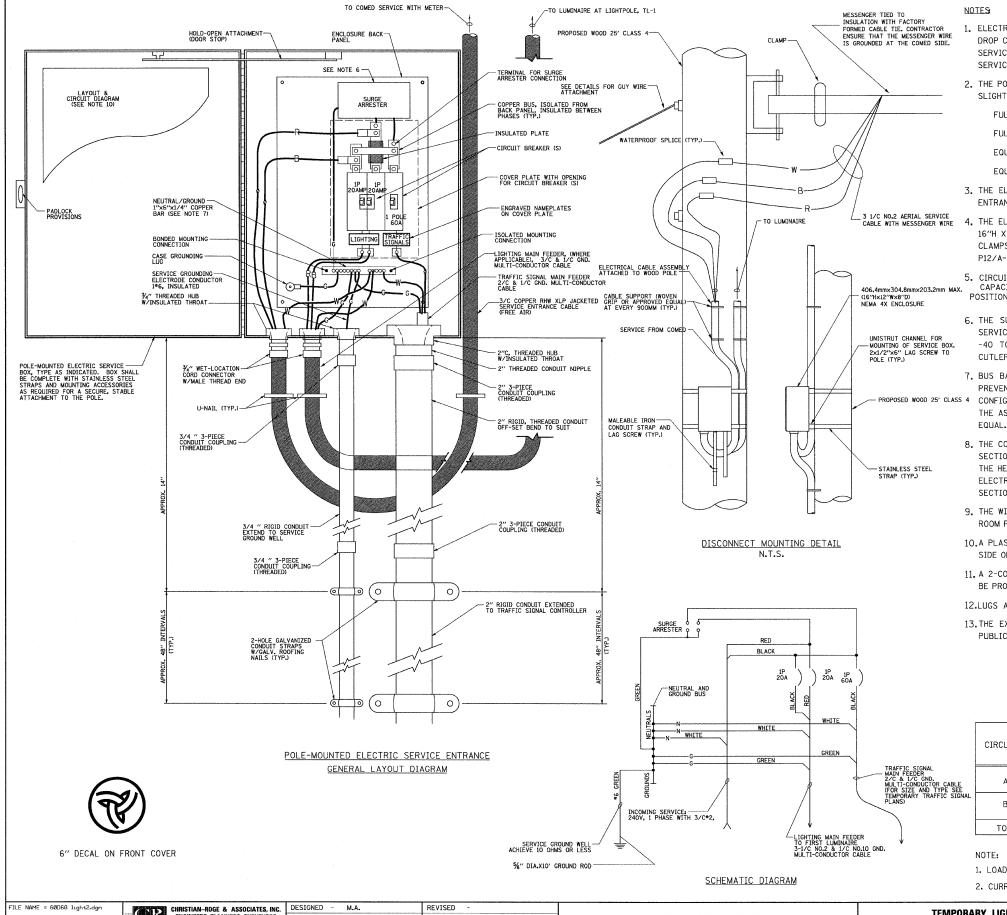

- ELECTRIC SERVICE SHALL BE OF THE VOLTAGE INDICATED OR DESIGNATED BY THE ENGINEER, AND SERVICE DROP CABLE SHALL BE COMPATIBLE WITH THE SERVICE ACCORDINGLY. SOME INSTALLATIONS MAY CALL FOR SERVICE ENTRANCE EQUIPMENT SUITABLE FOR 3-WIRE SERVICE EVEN THOUGH INITIALLY WIRED FOR 2-WIRE SERVICE.
- 2. THE POLE-MOUNTED ELECTRIC SERVICE BOX DETAIL DEPICTS THE BASIC CONSTRUCTION OF THE EQUIPMENT. SLIGHT MODIFICATIONS APPLY FOR DIFFERING SERVICES AND APPLICATIONS AS FOLLOWS:

FULLY EQUIPPED FOR 240/120V. 3W SERVICE, COMPLETE WITH LIGHTING MAIN BREAKER

FULLY EQUIPPED FOR 240/120V, 3W SERVICE, BLANK COVER IN LIEU OF LIGHTING MAIN BREAKER

EQUIPPED FOR 120V. SERVICE, COMPLETE WITH 1P, 60A. TRAFFIC SIGNALS MAIN BREAKER

EQUIPPED FOR 120V. SERVICE, COMPLETE WITH 1P, 40A. TRAFFIC SURVEILLANCE MAIN BREAKER

- 3. THE ELECTRIC SERVICE EQUIPMENT ASSEMBLY SHALL BE UL LISTED AS SUITABLE FOR USE AS SERVICE ENTRANCE EQUIPMENT.
- 4. THE ELECTRIC SERVICE EQUIPMENT ENCLOSURE SHALL BE NEMA 4X STAINLESS STEEL, NOMINALLY 12"W X 16"H X 8"D, WITH A PIANO-HINGED DOOR, STEEL BACK PANEL, FAST-ACTING STAINLESS STEEL ENCLOSURE CLAMPS, PADLOCK PROVISIONS AND DOOR STOP, HOFFMAN CATALOG NO. A-16H12O8SS6LP/A-16, P12/A-DSTOPK/C-PMK12, OR APPROVED EQUAL.
- 5. CIRCUIT BREAKERS SHALL BE THERMAL MAGNETIC BOLT-ON TYPE WITH A MINIMUM INTERRUPTING CAPACITY OF 25,000 SYMMETRICAL AMPERES AT 120 VOLTS. THEY SHALL BE LOCKABLE IN THE "OFF" POSITION FOR COMPLIANCE WITH OSHA LOCK-OUT/TAG-OUT REQUIREMENTS. HANDLES SHALL BE TRIP FREE.
- 6. THE SURGE PROTECTOR SHALL BE SUITABLE FOR 240/120 VOLT SINGLE PHASE 60HZ AC ELECTRICAL SERVICE, WITH A SURGE ENERGY CAPABILITY OF 2160 JOULES OR BETTER AT 8/20 MICRO- SECONDS, RATED -40 TO 60 DEGREES C., WITH LED OPERATING INDICATORS, AND SHALL BE UL LISTED PER UL 1449, CUTLER-HAMMER CMOV230L065XST OR APPROVED EQUAL.
- 7. BUS BARS, CONNECTORS, AND LUGS SHALL BE COPPER, INSULATED AND ISOLATED, AND CONFIGURED TO PREVENT SHORTED CONDITIONS FROM TIGHTENING TERMINATIONS, ETC. THE OVERALL BUS SECTION SHALL BE CONFIGURED BEHIND AN INSULATING BARRIER SHIELD WHICH IS REMOVABLE FOR ACCESS TO CONNECTIONS, OR THE ASSEMBLY SHALL BE A MANUFACTURED SPECIALTY PANELBOARD, CUTLER-HAMMER PRL2A OR APPROVED
- 8. THE COMBINATION GROUND AND NEUTRAL BAR SHALL BE CONFIGURED WITH SEPARATE GROUND AND NEUTRAL SECTIONS AND SPARE TERMINALS AS INDICATED. THE HEADS OF GROUND SCREWS SHALL BE PAINTED GREEN. THE HEADS OF NEUTRAL SCREWS SHALL BE PAINTED WHITE. THE SERVICE NEUTRAL AND SERVICE GROUNDING ELECTRODE CONDUCTOR SHALL BE TERMINATED ADJACENT TO EACH OTHER AT THE DIVIDE BETWEEN THE SECTIONS AND WIRING SHALL BE TERMINATED ONLY UPON THE APPROPRIATE SECTION.
- 9. THE WIRING TERMINALS, INCLUDING THE GROUND/NEUTRAL BAR SHALL BE ARRANGED TO PROVIDE ADEQUATE ROOM FOR PERFORMING FIELD TERMINATIONS.
- 10.A PLASTIC LAMINATED LAYOUT AND CIRCUIT DIAGRAM SHALL BE MECHANICALLY SECURED TO THE INTERIOR SIDE OF THE ENCLOSURE DOOR.
- 11. A 2-COLOR ENGRAVED PLASTIC NAMEPLATE, ATTACHED WITH SCREWS, AND ENGRAVED AS INDICATED, SHALL BE PROVIDED FOR EACH MAIN BREAKER.

12.LUGS AND CONNECTORS SHALL BE RATED FOR 75 C CONDUCTOR.

13. THE EXACT MOUNTING HEIGHT OF THE BOX SHALL BE FIELD DETERMINED TO AVOID OBSTRUCTIONS AND PUBLIC ACCESS. TYPICAL HEIGHT SHALL BE APPROXIMATELY 10 FEET ABOVE GRADE.

| CIRCUIT NO. | CIRCUIT BREAKER / POLES | UTILITY DESCRIPTION | LOAD ¹ (WATTS) | CURRENT 2 (AMPERES) |
|-------------|-------------------------------|---|---------------------------|---------------------|
| А | 20A / 1P | (3) 400W HPS POLE NOS.TL-1, TL-3, & TL-5 | 1,440 | 12.63 |
| В | 20A / 1P | 20A / 1P (3) 400W HPS POLE NOS.TL-2, TL-4, & TL-6 | | 12.63 |
| TOTAL | | | 2,880 | 25.26 |

TOTAL SHEE SHEETS NO.

29

CONTRACT NO. 60D68

COUNTY

WTLI

- 1. LOAD INCLUDES 20% BALLAST LOSSES FOR LUMINAIRES
- 2. CURRENT CALCULATIONS INCLUDE A POWER FACTOR OF 0.95.

PLOT DATE = 7/7/2008


211 WEST WACKER DRIVE CHICAGO, ILLINOIS 60606 PHONE: (312)372-2023 FAX: (312)372-527

DRAWN - M.A. REVISED CHECKED -DATE REVISED JULY 2, 2008

STATE OF ILLINOIS **DEPARTMENT OF TRANSPORTATION**

SCALE:

SECTION TEMPORARY LIGHTING NOTES AND DETAILS 330 17 B-1-I-1 U.S. 45 / 52 SHEET NO. 2 OF 2 SHEETS STA. TO STA. FED. ROAD DIST. NO. 1 | ILLINOIS FED. AID PROJECT

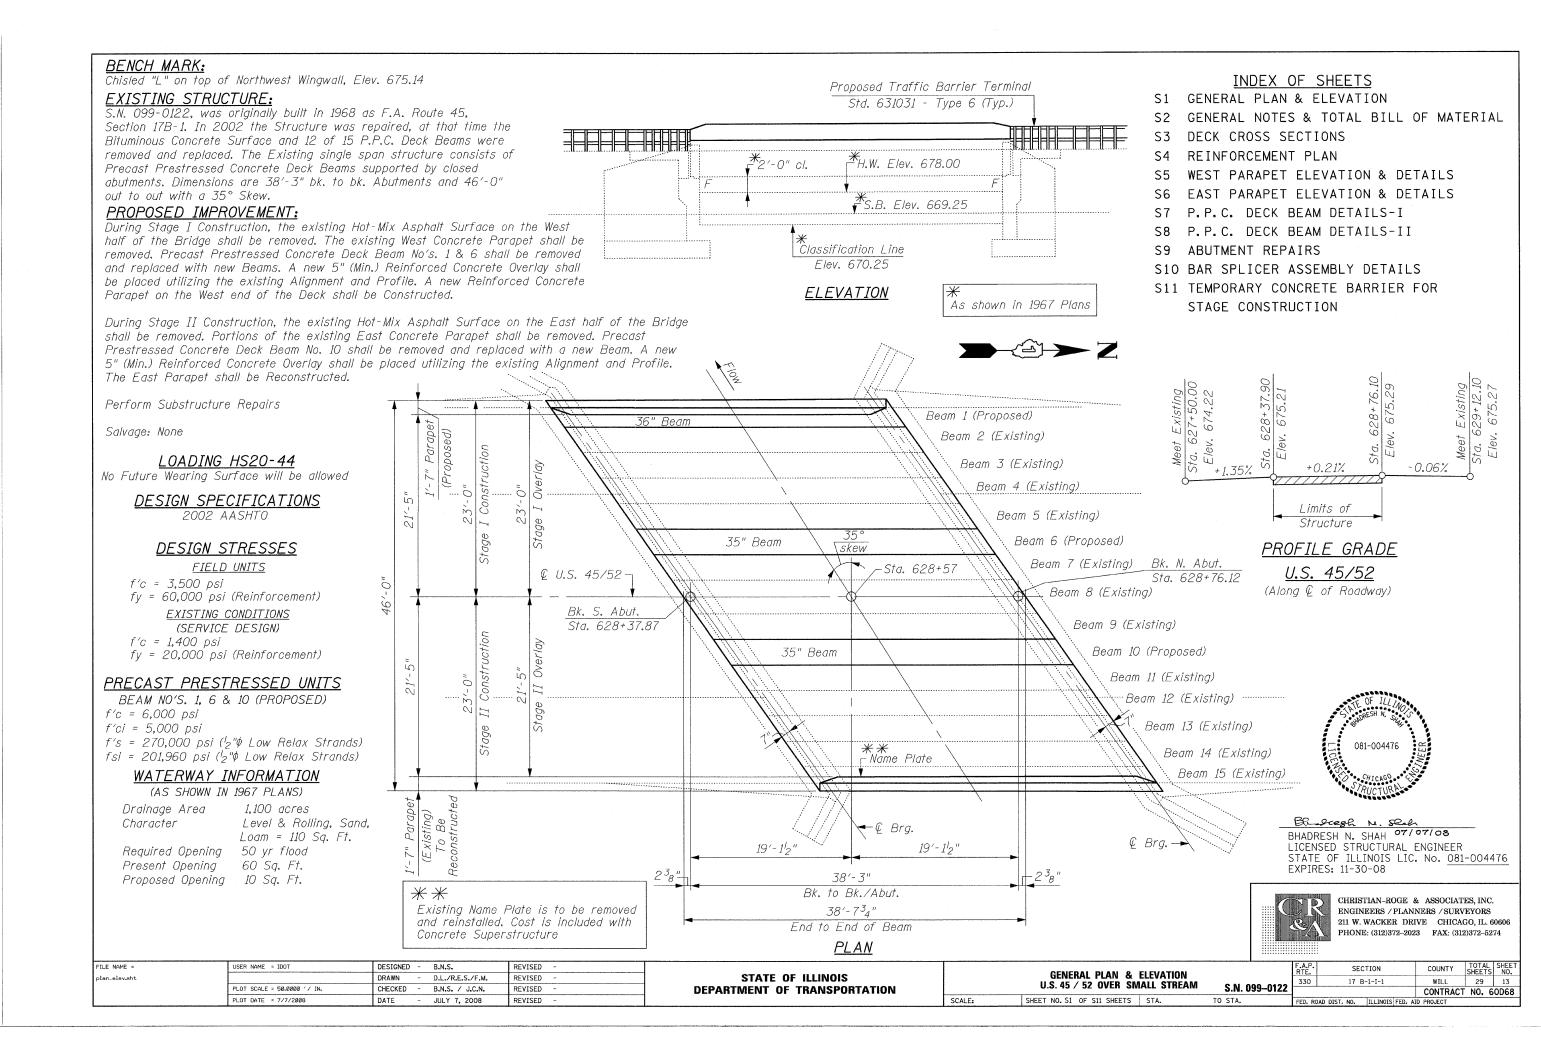

TOTAL BILL OF MATERIAL

| DESCRIPTION | UNIT | SUPER. | SUB. | TOTAL |
|--|---------|--------|--|-------|
| Hot-Mix Asphalt Surface Removal Complete | Sq. Yd. | 196 | - | 196 |
| Removal of Existing Precast Prestressed Concrete Deck Beams | Sq. Ft. | 348 | - | 348 |
| Concrete Superstructure | Cu. Yd. | 8.3 | - | 8.3 |
| Concrete Removal | Cu. Yd. | 5.9 | - | 5.9 |
| Bridge Deck Grooving | Sq. Yd. | 180 | _ | 180 |
| Protective Coat | Sq. Yd. | 217 | - | 217 |
| Concrete Wearing Surface, 5" | Sq. Yd. | 203 | - | 203 |
| Precast Prestressed Concrete Deck Beams (17" Depth) | Sq. Ft. | 348 | - | 348 |
| Reinforcement Bars, Epoxy Coated | Pound | 4,310 | - | 4,310 |
| Bar Splicers | Each | 39 | _ | 39 |
| Structural Repair of Concrete (Depth Equal to or Less Than 5 In.) | Sq. Ft. | - | 272 | 272 |
| Plug Existing Deck Drains | Each | 6 | - | 6 |
| Keyway Repair | Foot | 350 | THE STATE OF THE S | 350 |
| | | | | |
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米 Based on the Field Notes from I.D.O.T. Maintenance Engineers, dated November 7, 2007


GENERAL NOTES:


- 1. Plan dimensions and details relative to existing plans are subject to routine varations. The Contractor shall field verify existing dimensions and details affecting new construction and make necessary approved adjustments prior to construction or ordering of materials. Such variations shall not be cause for additional compensation for a change in the scope of work, however, the Contractor will be paid for the quantity actually furnished based upon the unit price bid for the work.
- 2. The minimum thickness of the Concrete Overlay shall be 5 inches and varies as required to adjust for the new Profile Grade and Beam Camber.
- 3. The Contractor is advised that the existing PPC Deck Beams are in a deteriorated condition with reduced load carrying capacity. It is the Contractor's responsibility to account for the condition of the Beams when developing Construction Procedures.
- 4. If the Contractor's procedure for Existing Beam Removal or Placement of new Beams involves placement of Cranes or other heavy equipment on the Bridge, a detailed procedure shall be submitted to the Engineer for approval. The procedure shall include calculations, prepared and sealed by an Illinois Licensed Structural Engineer, verifying that the Equipment and Procedure used will not overstress the New or Existing Beams. To distribute Load to multiple Beams and protect the existing surface, in all cases a Double Layer Mat of heavy Timber shall be used at all times under Crane Tracks or Wheels and any Outriggers in the down position. If Necessary, Shims shall be used under the Crane Mat to ensure uniform contact with the underlying Beams. If Heavy Equipment will be placed on new PPC Deck Beams, the following shall be done prior to placement of the Timber Mats: placement and tightening of Transverse Tie Assemblies, Grouting and Curing the Dowel Rods 24 Hours minimum and Grouting and Curing the Shear Keys.
- 5. Any damage done to the Bridge during Beam removal shall be repaired by the Contractor. Cost to be included in the cost of Removal of Existing PPC Deck Beams.
- 6 The Top Surface of the Beams shall be finished according to the IDOT Manual for Fabrication of Precast Prestressed Concrete Products.
- 7. Temporary Concrete Barrier shall only be anchored into the Overlay and not the PPC Deck Beams.
- 8. No in-stream work will be allowed on this Project.
- 9. Slipforming of the Parapets is not allowed.
- 10. The Contractor must not use Milling Equipment for Hot-Mix Asphalt Surface Removal Complete.
- 11. The Contractor must not scarify any portion of the PPC Deck Beams.
- 12. The Contractor must remove the existing Wearing Surface, Waterproofing and any Foreign Materials using Hand Methods or Shotblasting. Cost is included with Hot-Mix Asphalt Surface Removal Complete.
- 13. Existing Reinforcement Bars extending into the Removal Area shall be cleaned, straightened and incorporated into the New Construction. Any Reinforcement Bars that are damaged during Concrete Removal shall be replaced with an approved Bar Splicer or Anchorage System. Cost included with Concrete Removal.
- 14. Reinforcement Bars shall conform to the requirements of ASTM A 706, Grade 60. See Special Provisions.
- 15. Reinforcement Bars designated (E) shall be Epoxy Coated.
- 16. A Protective Coat shall be applied to the entire top surface of the Bridge Deck and to the top and the inside vertical faces of the Parapets.





CHRISTIAN-ROGE & ASSOCIATES, INC.
ENGINEERS / PLANNERS / SURVEYORS
211 W. WACKER DRIVE CHICAGO, IL. 60606
PHONE: (312)372-2023 FAX: (312)372-5274


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|---|-------------------|-----------------------------|---------------------------|-----------|------------------------------|---|----------|-------------------------|------------------------|-----------|-------|
| | FILE NAME = | USER NAME = IDOT | DESIGNED - B.N.S. | REVISED - | | GENERAL NOTES & TOTAL BILL OF MATERIAL | | RTE. SECTIO | ON COUNTY | SHEETS | NO. |
| | general_notes.sht | | DRAWN - D.L./R.E.S./F.M. | REVISED - | STATE OF ILLINOIS | The second of the comments of | | 330 17 B-1- | I-1 WILL | 29 | 14 |
| i | | PLOT SCALE = 50.0000 '/ IN. | CHECKED - B.N.S. / J.C.N. | REVISED - | DEPARTMENT OF TRANSPORTATION | U.S. 43 / 32 OVER SWALL STREAM S.N. U | 99-0122 | | CONTRAC | CT NO. 60 | D68 |
| | | DLOT DATE - 7/10/2000 | DATE _ ULV 10 2009 | prvisen - | 1 | SCALE: SHEET NO. S2 OF S11 SHEETS STA. TO STA. | F | FED. ROAD DIST, NO. ILL | INOIS FED. AID PROJECT | | |

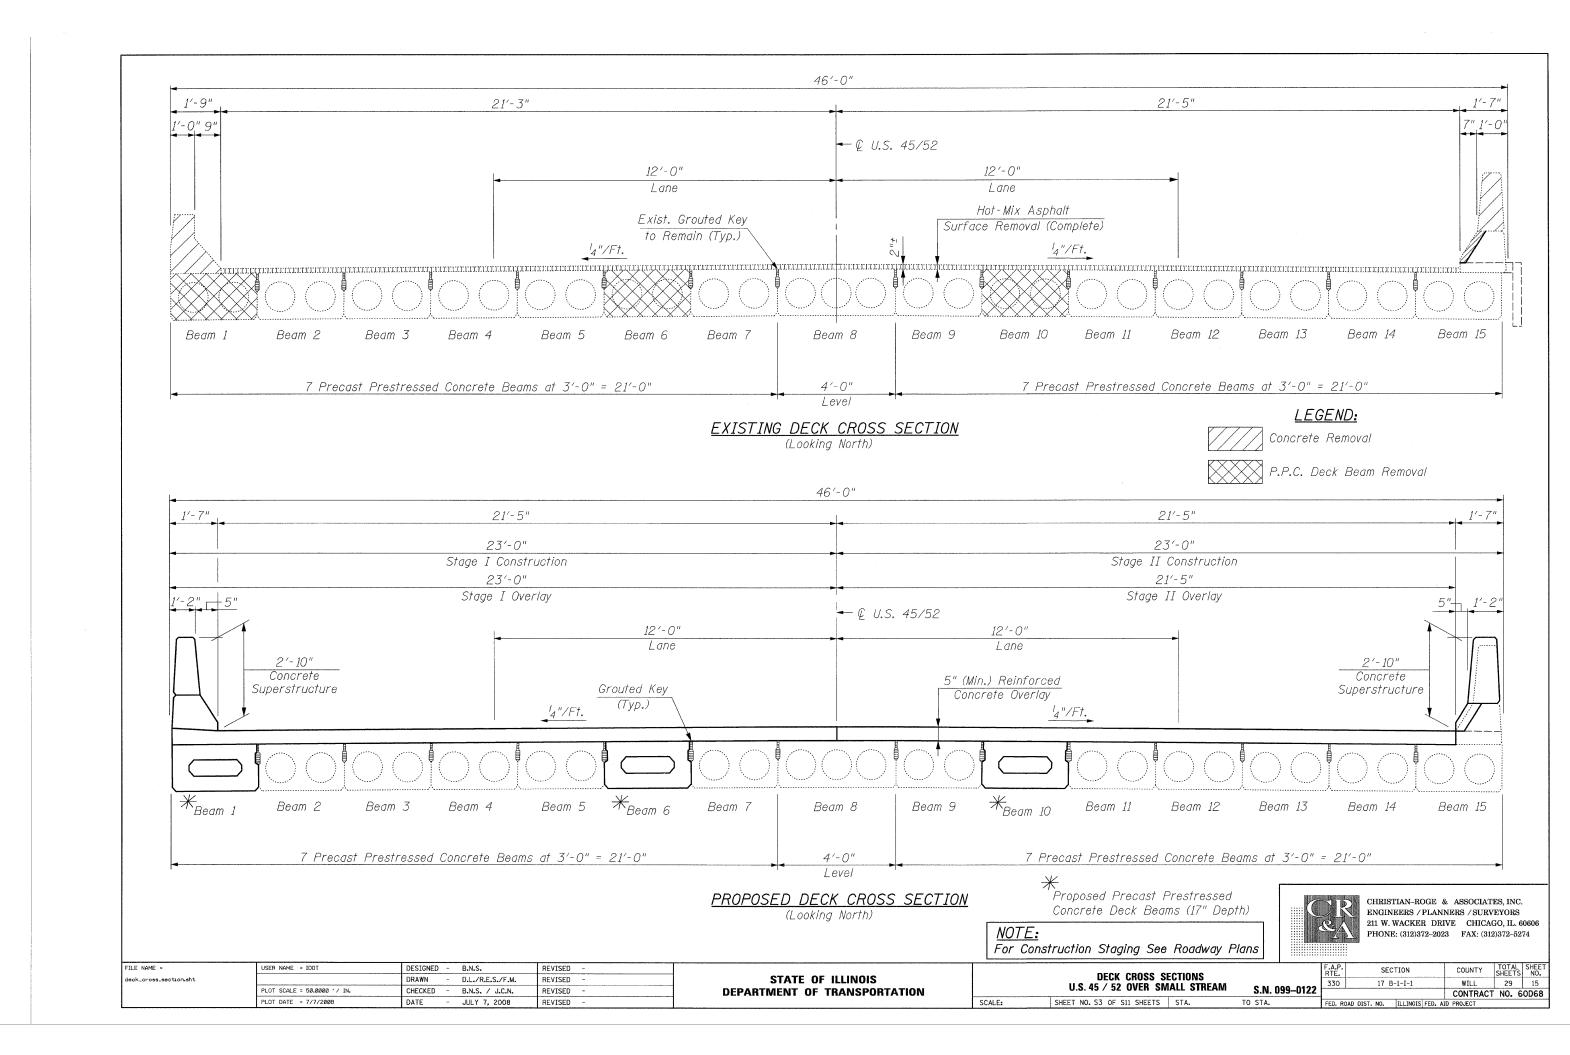


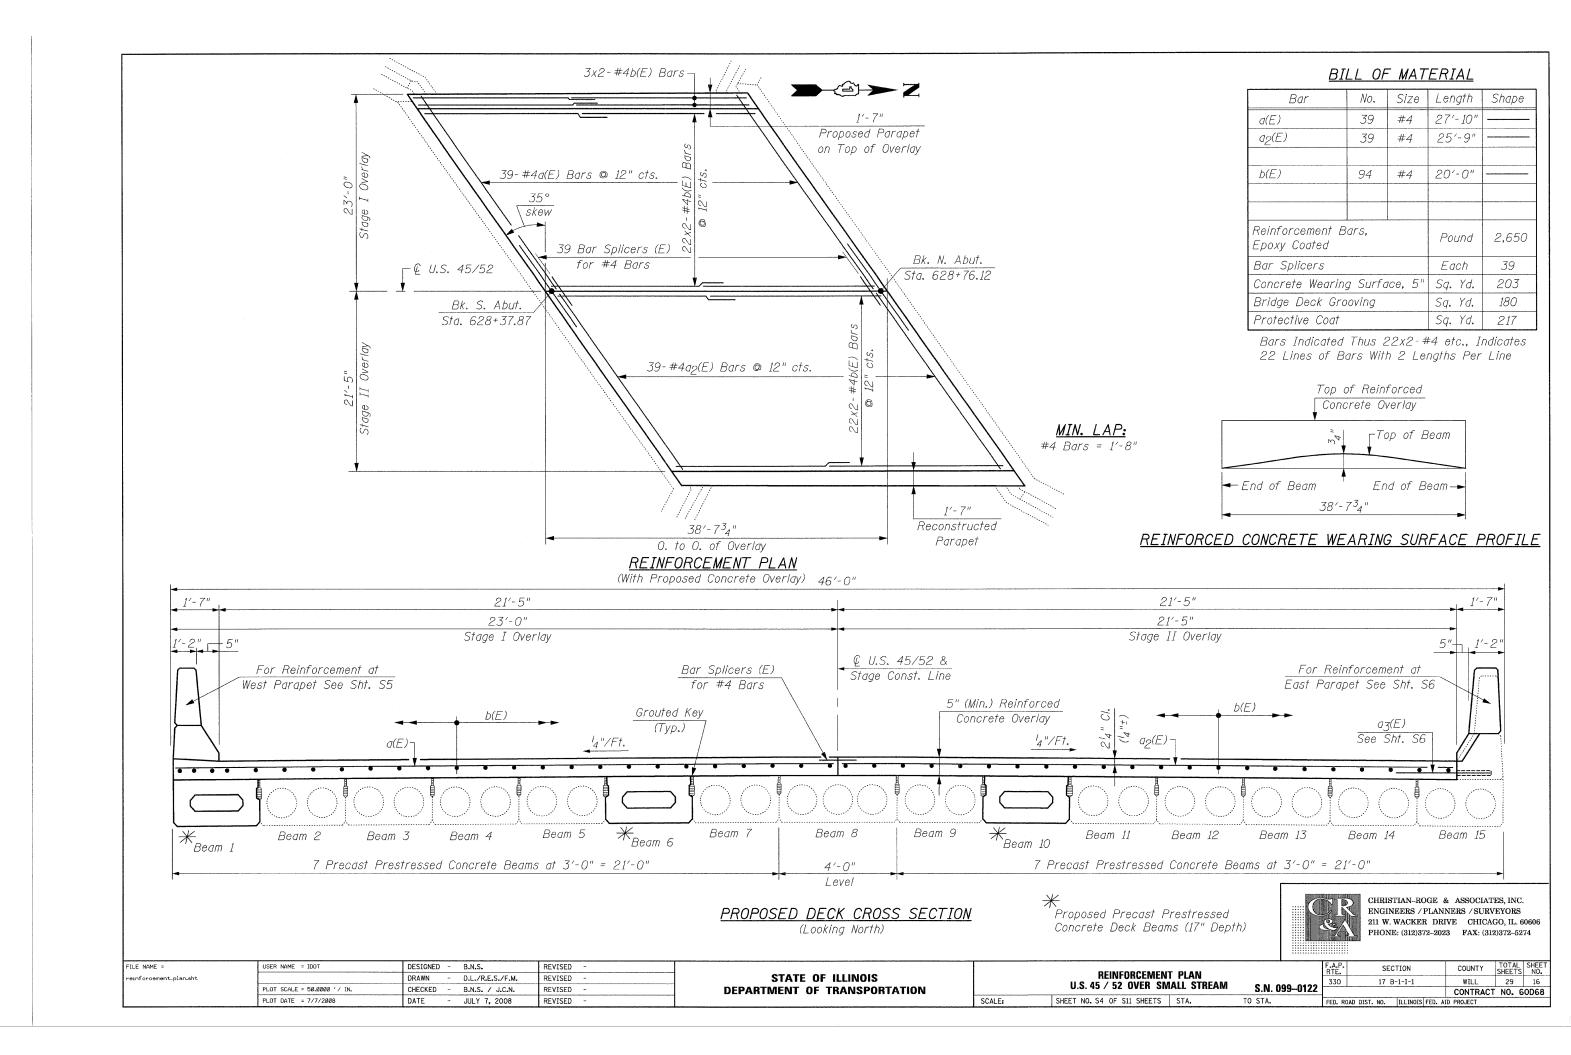


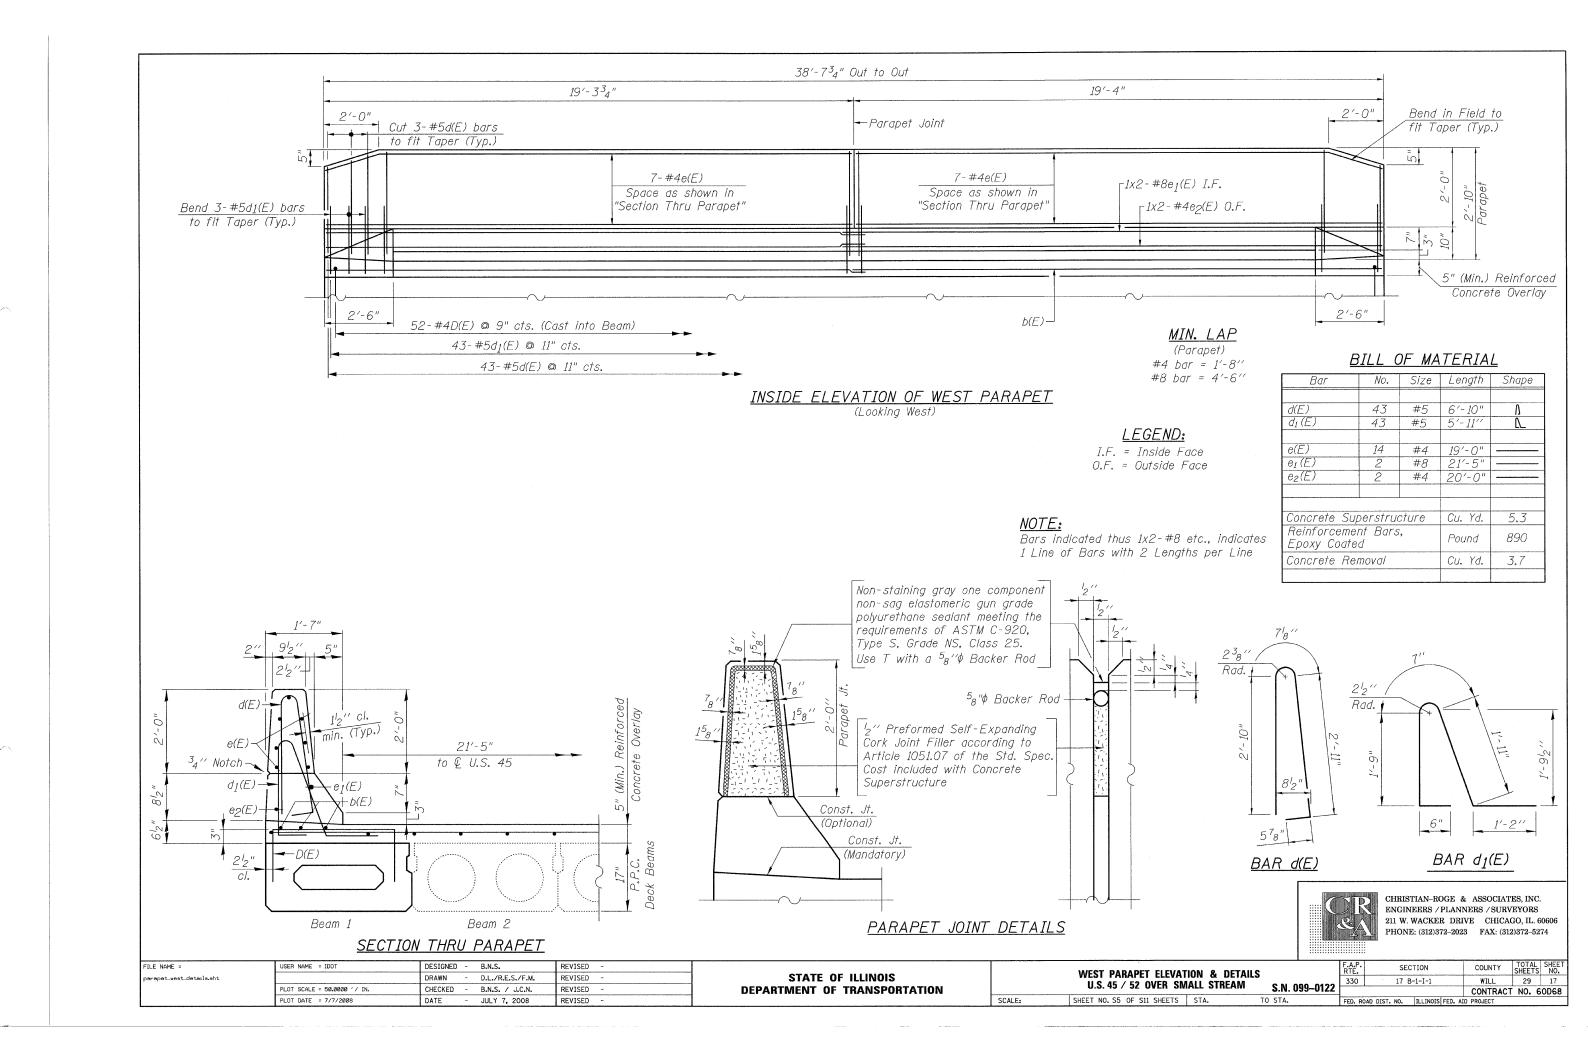


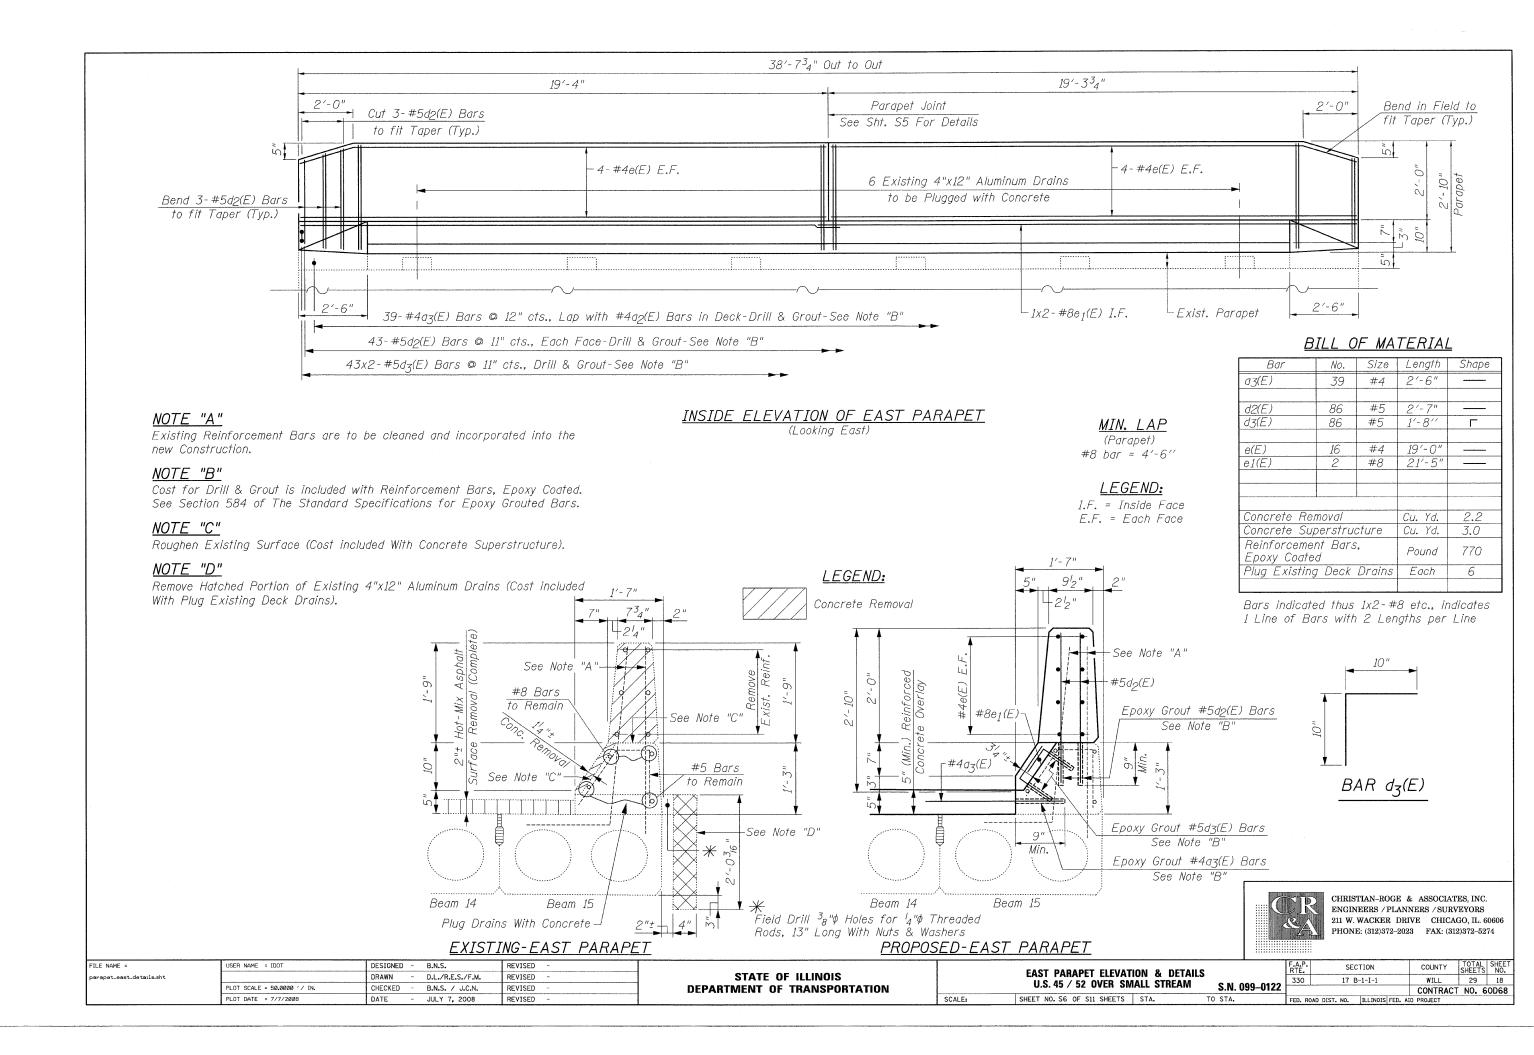


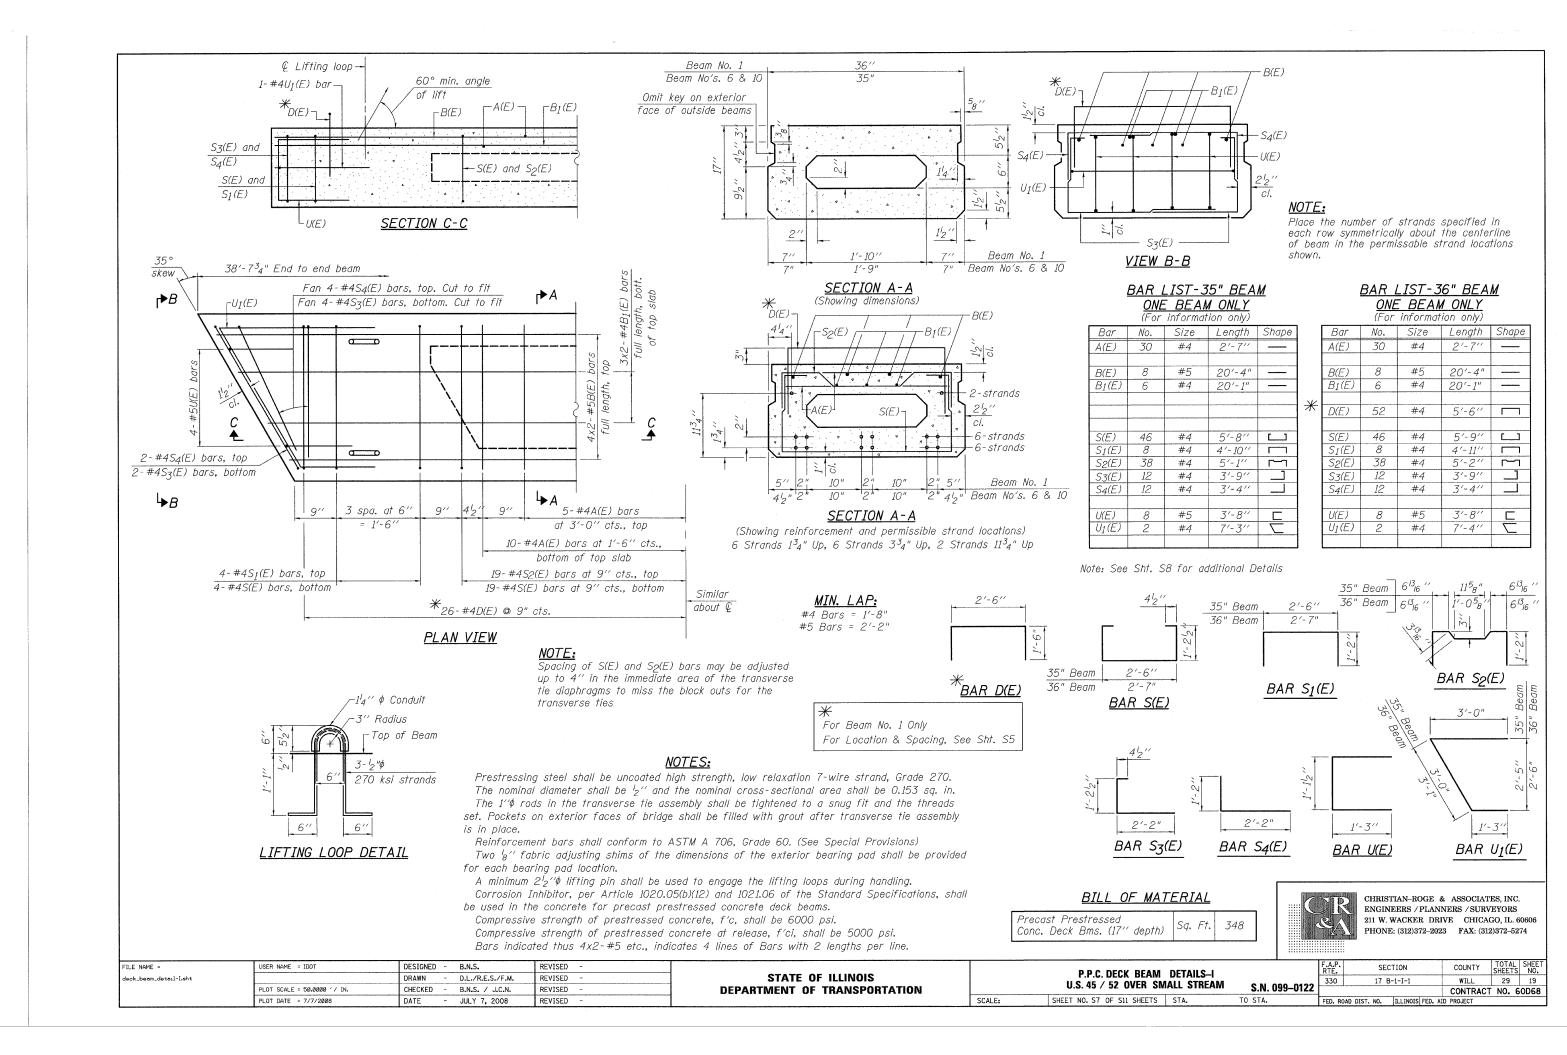

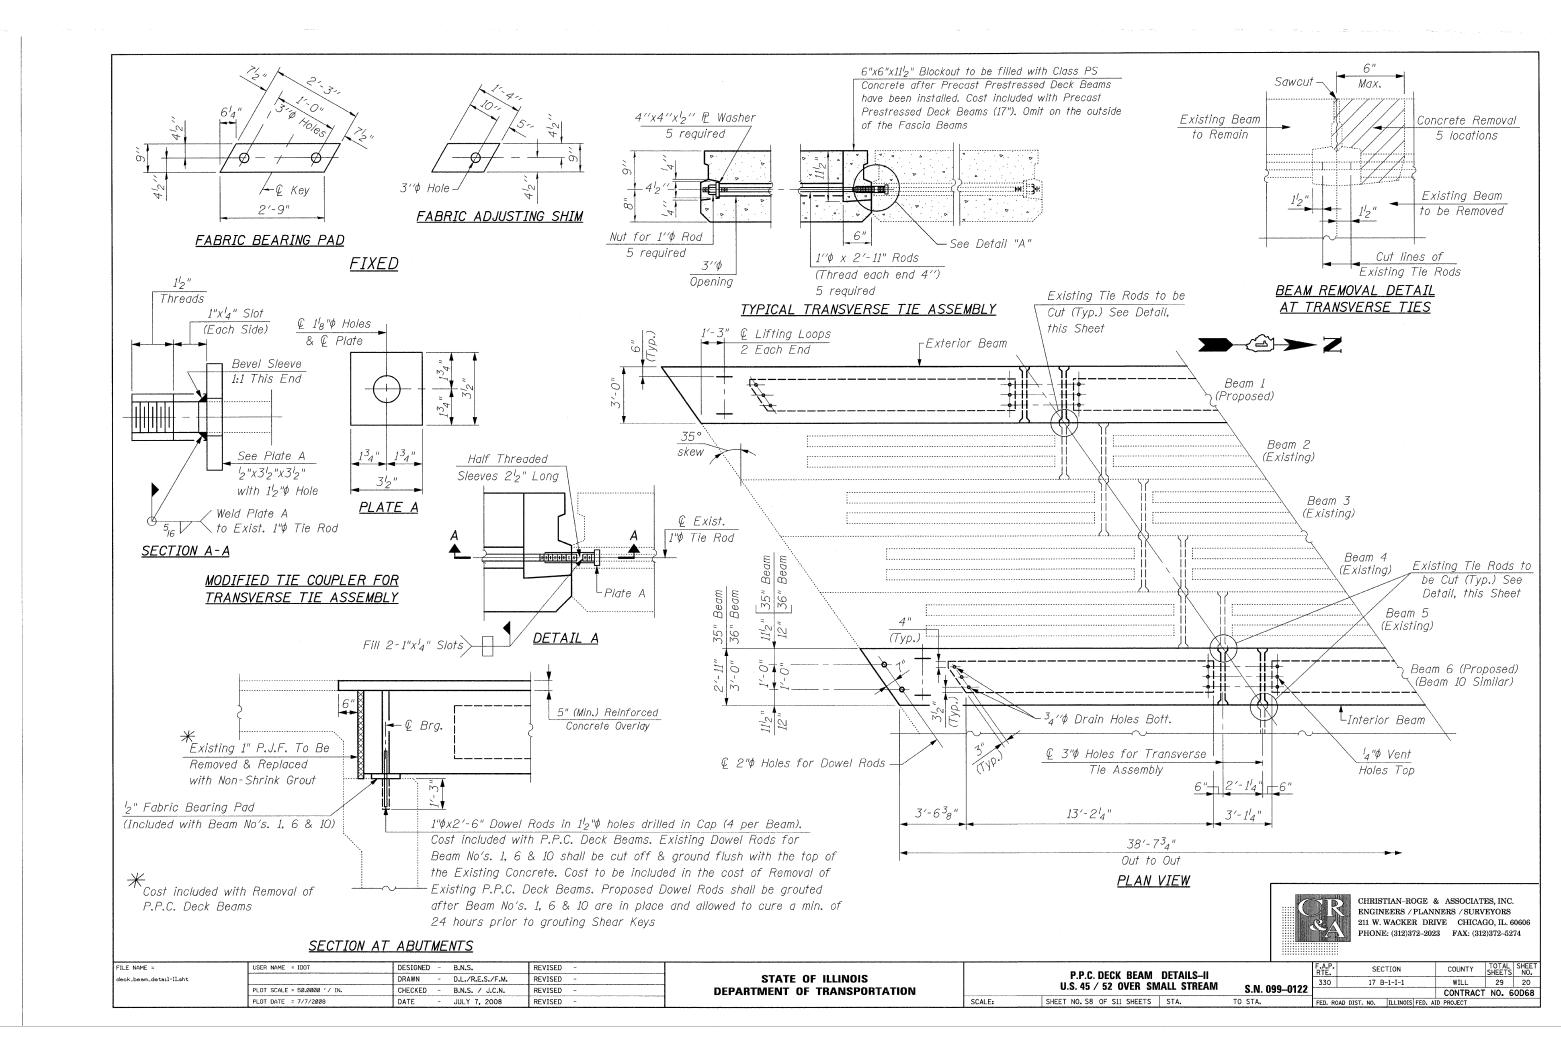

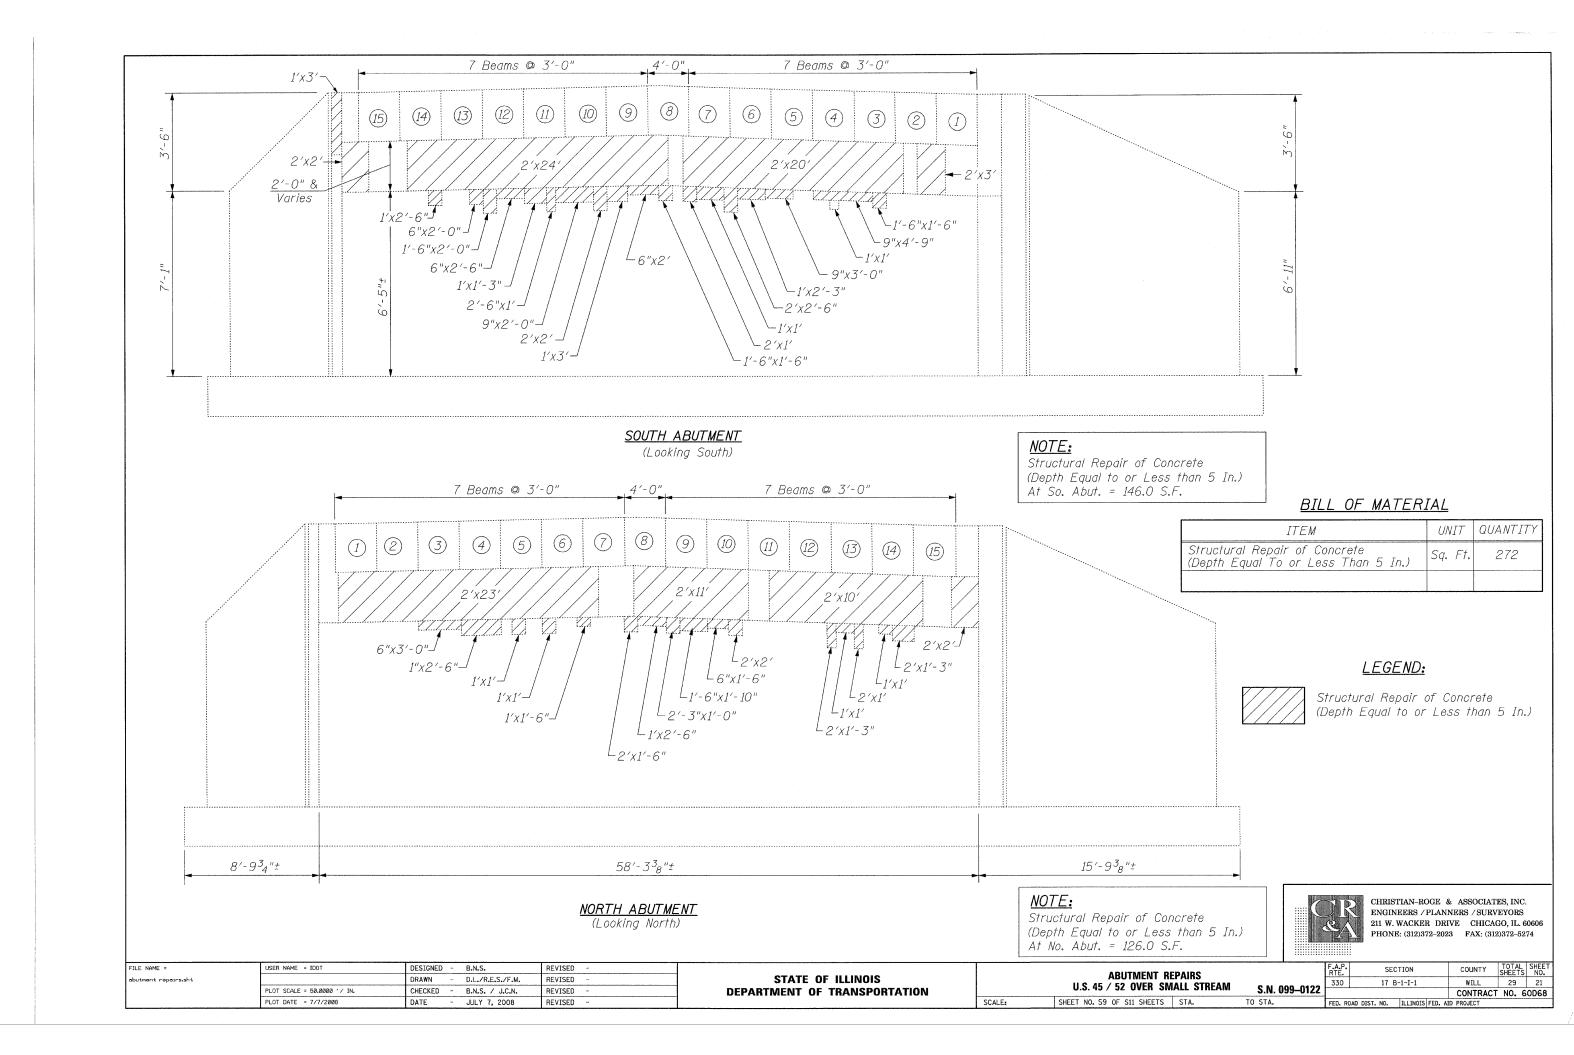

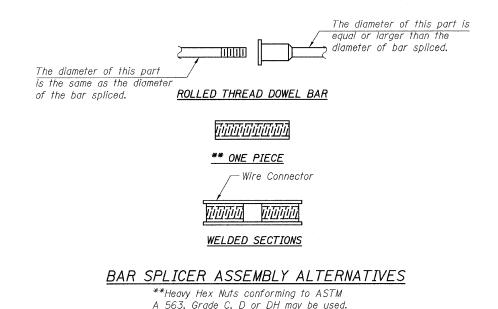

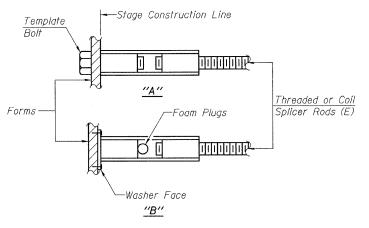

INSTALLATION AND SETTING METHODS

"A" :Set bar splicer assembly by means of a template bolt. "B" :Set bar splicer assembly by nailing to wood forms or cementing to steel forms. (E): Indicates epoxy coating.

Strength Requirements Splicer Rod or Bar Size to Min. Capacity | Min. Pull-Out Strength Dowel Bar Length be Spliced kips - tension kips - tension 7.9 #4 1'-8' 14.7 12.3 #5 2'-0" 23.0 17.4 2'-7" 33.1 #6 23.8 45.1 #7 3'-5" 4'-6' 58.9 31.3 #8 #9 5'-9' 75.0 39.6 95.0 #10 7'-3" 50.3 9'-0" 117.4 61.8 #11

BAR SPLICER ASSEMBLIES

NOTES Bar splicer assemblies shall be of an approved type and shall develop in tension at least

Splicer rods shall be of minimum 60 ksi yield strength, threaded or coiled full length. All reinforcement bars shall be lapped and tied to the splicer rods or dowel bars. Bar splicer assemblies shall be epoxy coated according to the requirements for

Other systems of similar design may be submitted to the Engineer for approval. Approval

shall be based on certified test results from an approved testing laboratory that the proposed

125 percent of the yield strength of the lapped reinforcement bars.

bar splicer assembly satisfies the following requirements:

(Tension in kips)

Minimum Capacity (Tension in kips) = 1.25 x fy x A_t

Stage I Construction


Threaded or Coil

Loop Couplers (E)

Minimum *Pull-out Strength = $0.66 \times fy \times A_t$

Where fy = Yield strength of lapped reinforcement bars in ksi. A_t = Tensile stress area of lapped reinforcement bars. * = 28 day concrete


reinforcement bars.

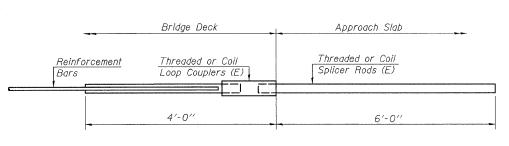

FOR INTEGRAL OR SEMI-INTEGRAL ABUTMENTS

Bar Splicer for #5 bar Min. Capacity = 23.0 kips - tension Min. Pull-out Strength = 12.3 kips - tension

No. Required =

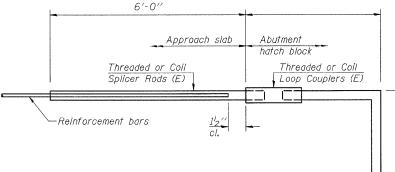

FOR STUB ABUTMENTS

| | Bai | - Spi | licer | fo | r #5 | bar | | |
|------|----------|-------|-------|-----|-------|--------|---|---------|
| Min. | Capacity | = 2 | 3.0 | kip | s - : | tensio | n | |
| Min. | Pull-out | Stre | ength |) = | 12.3 | kips | | tension |
| No. | Required | = | - | | | | | |



| Bar Size | No. Assemblies Required | Location |
|-------------|----------------------------|--------------|
| #4 | 39 | Deck Overlay |
| | | |
| | | |
| | | |
| | | |

STANDARD

CHRISTIAN-ROGE & ASSOCIATES, INC. ENGINEERS / PLANNERS / SURVEYORS 211 W. WACKER DRIVE CHICAGO, IL. 60606 PHONE: (312)372-2023 FAX: (312)372-5274

Reinforcement

Bars

BSD-1 5-16-08

| FILE NAME = | USER NAME = IDOT | DESIGNED | - | B.N.S. | REVISED - |
|--------------------------|-----------------------------|----------|---|------------------|-----------|
| bar_splicer_assembly.sht | | DRAWN | - | D.L./R.E.S./F.M. | REVISED - |
| | PLOT SCALE = 50.0000 '/ IN. | CHECKED | - | B.N.S. / J.C.N. | REVISED - |
| | PLOT DATE = 7/7/2008 | DATE | - | JULY 7, 2008 | REVISED - |

STATE OF ILLINOIS **DEPARTMENT OF TRANSPORTATION**

BAR SPLICER ASSEMBLY DETAILS U.S. 45 / 52 OVER SMALL STREAM SCALE: SHEET NO. S10 OF S11 SHEETS STA.

Reinforcement

Bars


COUNTY SHEETS NO.
WILL 29 22 SECTION 17 B-1-I-1 330 S.N. 099-0122 CONTRACT NO. 60D68 TO STA.

Stage Construction Line

Stage II Construction

Threaded or Coil

Splicer Rods (E)

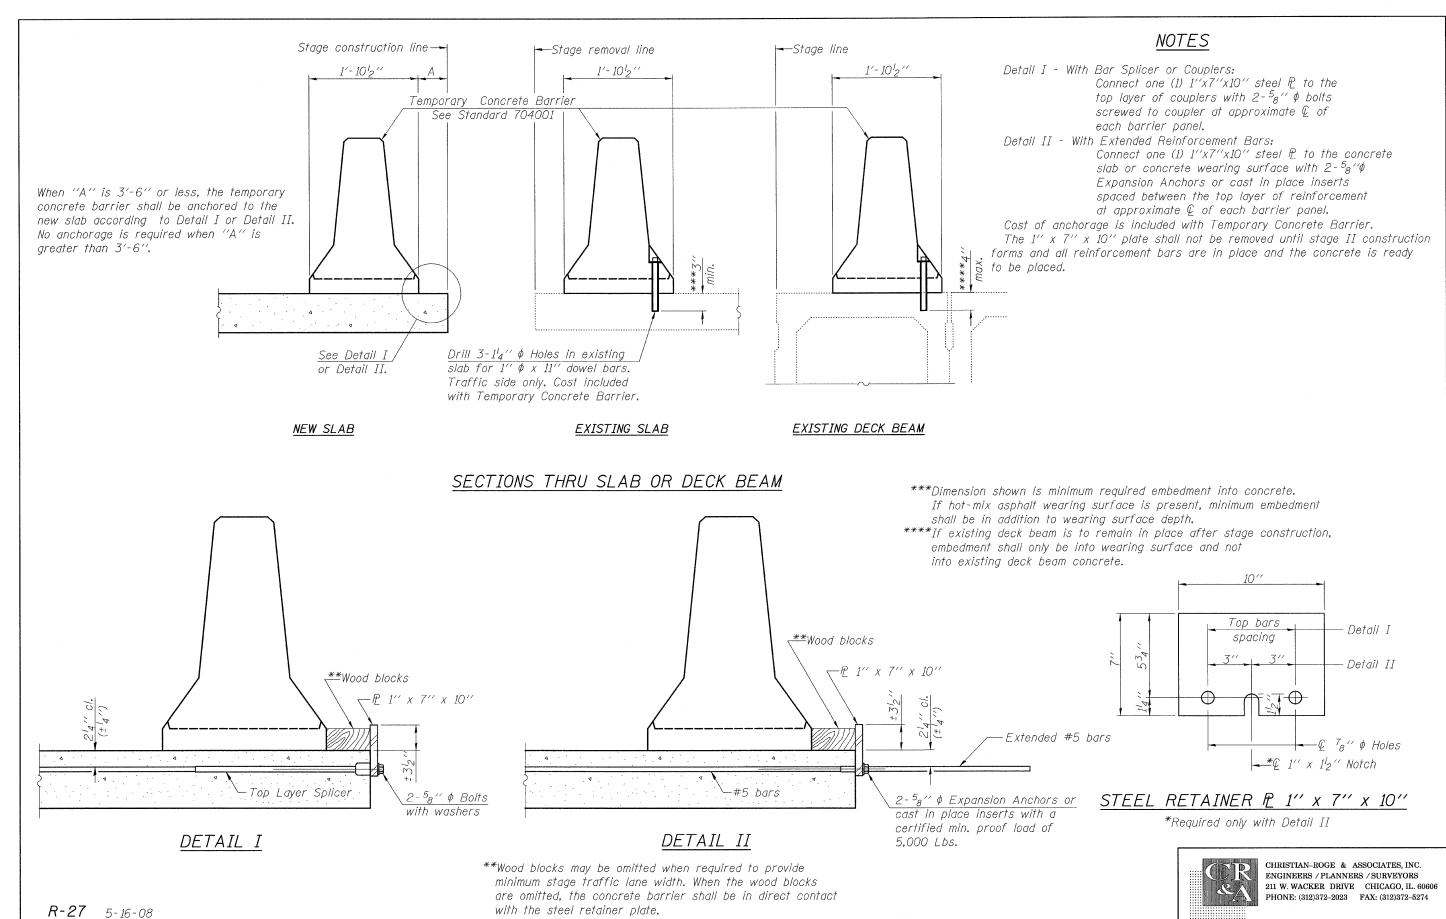

FILE NAME = temp_cono_barrier.sht

USER NAME = IDOT DESIGNED - B.N.S. REVISED -- D.L./R.E.S./F.M. REVISED -PLOT SCALE = 50.0000 '/ IN. CHECKED - B.N.S. / J.C.N. REVISED PLOT DATE = 7/7/2008 DATE JULY 7, 2008 REVISED


STATE OF ILLINOIS **DEPARTMENT OF TRANSPORTATION**


SCALE:

TEMPORARY CONCRETE BARRIER FOR STAGE CONSTRUCTION U.S. 45 / 52 OVER SMALL STREAM

SECTION COUNTY TOTAL SHEE WILL 29 23
CONTRACT NO. 60D68 17 B-1-I-1

S.N. 099-0122 SHEET NO. S11 OF S11 SHEETS STA. TO STA.

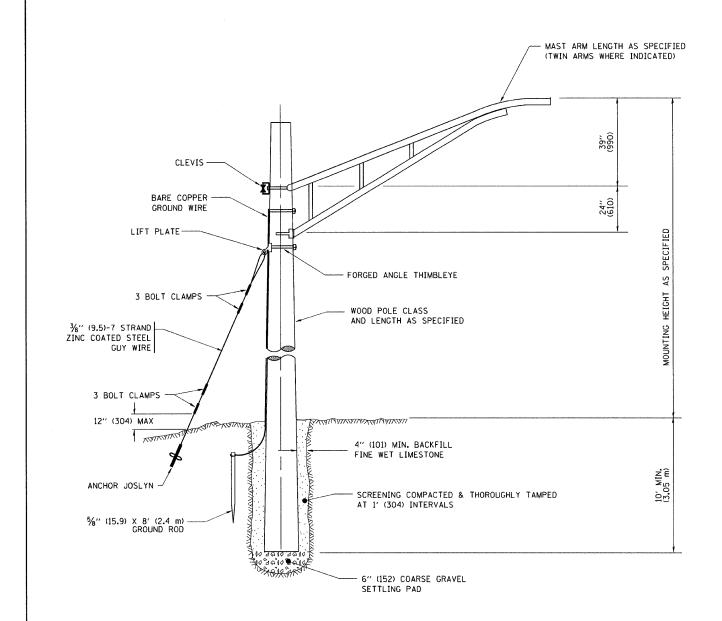

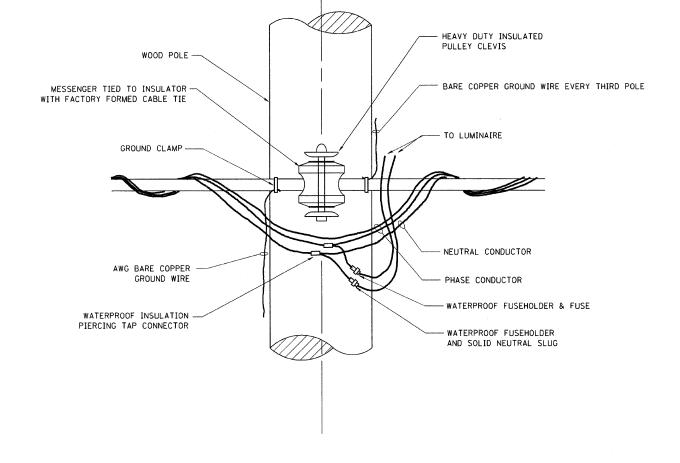


TEMPORARY LIGHT POLE ATTACHMENT DETAIL


TEMPORARY LIGHT POLE DETAIL

NOTES


1. ALL DIMENSIONS IN INCHES (MILLIMETERS) UNLESS OTHERWISE INDICATED

| FILE NAME ≈ | USER NAME = gaglianobt | DESIGNED - | REVISED - 08-08-03 | | | TEMPORARY LIGHT POLE DETAILS | | F.A.P. | SECTION | COUNTY | TOTAL | SHEET |
|----------------------------|----------------------------|------------|--------------------|------------------------------|--------------------------------|-------------------------------------|----------------|---|------------|----------|--------|-------|
| W:\diststd\22x34\be800.dgn | | DRAWN - | REVISED - | STATE OF ILLINOIS | ILIMIFORANT LIGHT FOLL DETAILS | | | 330 | 17 B-1-I-1 | WILL | 29 | 24 |
| | PLOT SCALE = 50.000 '/ IN. | CHECKED - | REVISED - | DEPARTMENT OF TRANSPORTATION | | | | | BE800 | CONTRACT | NO. 60 | 368 |
| | PLOT DATE = 1/4/2008 | DATE - | REVISED - | SCALE: NO | | SHEET NO. 1 OF 1 SHEETS STA. 621+00 | TO STA, 636+00 | FED. ROAD DIST. NO. 1 ILLINOIS FED. A | | | | |

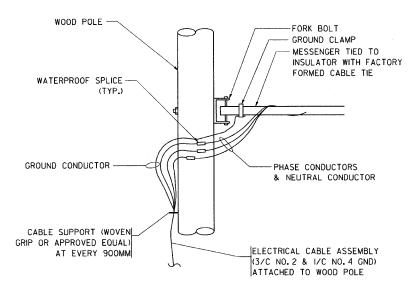

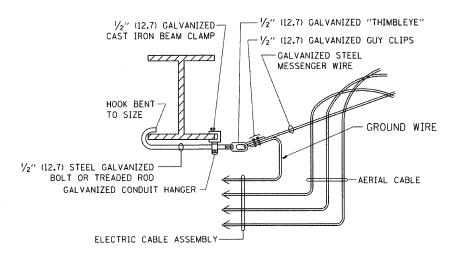

AERIAL CABLE ATTACHED TO STRUCTURE NOT TO SCALE

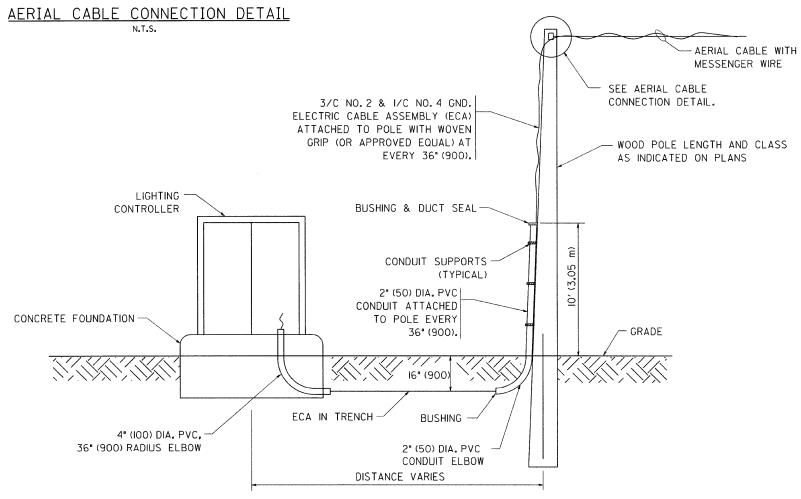


NOTES:

- 1. ALL DIMENSIONS IN INCHES (MILLIMETERS)
 UNLESS OTHERWISE INDICATED.
- 2. SEE PROPOSED LIGHTING PLAN FOR CONDUIT, CABLE AND ROUTING.
- 3. THE CONTRACTOR SHALL PROVIDE INTERMEDIATE SUPPORTS TO MAINTAIN MINIMUM CLEARANCES. REFER TO AERIAL AERIAL CABLE ATTACHED TO STRUCTURE DETAIL.
- 4. COST OF SPLICES AND MOUNTING HARDWARE SHALL BE INCLUDED IN THE UNIT PRICE FOR AERIAL CABLE.


WOOD POLE TO LIGHTING CONTROLLER WIRING CONNECTION DETAIL


N.T.S.


| FILE NAME = | | USER NAME = gaglianobt | DESIGNED - | REVISED - 08-08-03 | | TEMPORARY AERIAL CABLE INSTALLATION | | FAP | SECTION | COUNTY | TOTAL | SHEET |
|-----------------|------------------------|-----------------------------|------------|--------------------|------------------------------|-------------------------------------|--|------|----------------------------------|-------------|----------|-------|
| W:\diststd\22x3 | :34\be801 . dgn | | DRAWN - | REVISED - | STATE OF ILLINOIS | | | 330 | 17 B-1-I-1 | WILL | 29 | 25 |
| | | PLOT SCALE = 50.000 ' / IN. | CHECKED - | REVISED - | DEPARTMENT OF TRANSPORTATION | | | | BE-801 | CONTRACT | I NO. 60 | 3D68 |
| | | PLOT DATE = 1/4/2008 | DATE - | REVISED - | | SCALE: NONE | SHEET NO. 1 OF 1 SHEETS STA. 621+00 TO STA. 636+00 | FED. | ROAD DIST. NO. 1 ILLINOIS FED. | AID PROJECT | | |

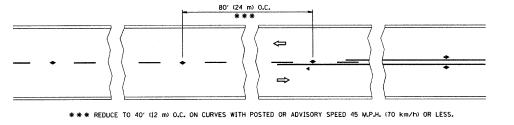


TWO-LANE/TWO-WAY

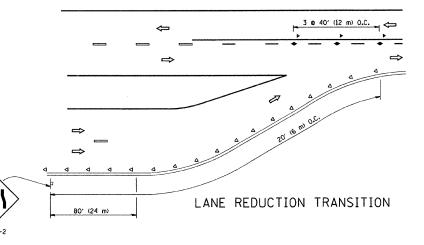

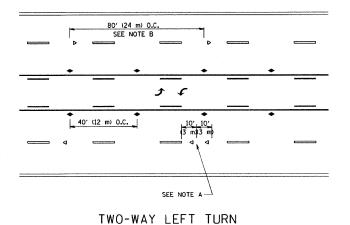

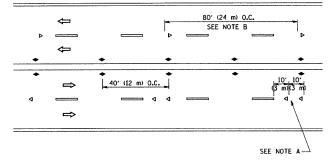

MULTI-LANE/UNDIVIDED

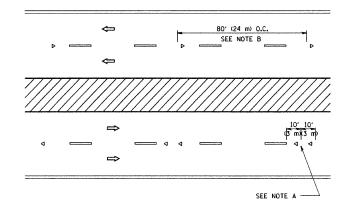

MULTI-LANE/DIVIDED

GENERAL NOTES

- 1. MARKERS USED WITH DASHED LINES SHALL BE CENTERED IN THE GAP BETWEEN SEGMENTS.
- 2. MARKERS USED ADJACENT TO SOLID LINES SHALL BE OFFSET 2 TO 3 (50 TO 75) TOWARD TRAFFIC AS SHOWN.
- 3. MARKERS THROUGH TANGENTS LESS THAN 500' (150 m) IN LENGTH BETWEEN CURVES SHALL BE INSTALLED AT THE LESSER OF THE TWO CURVE SPACINGS.

LANE MARKER NOTES

- B. REDUCE TO 40' (12 m) O.C. ON CURVES WHERE ADVISORY SPEEDS ARE 10 M.P.H (20 km/h) LOWER THAN POSTED SPEEDS.
- A. USE DOUBLE LANE LINE MARKERS SPACED AS SHOWN.

SYMBOLS

- YELLOW STRIPE
- WHITE STRIPE
- ONE-WAY AMBER MARKER
- ONE-WAY CRYSTAL MARKER (W/O)
- ◆ TWO-WAY AMBER MARKER


DESIGN NOTES


- 1. DOUBLE LANE LINE MARKERS SHALL BE USED UNLESS SPECIFIED OTHERWISE.
- 2. EXCEPT AS SHOWN ON THE LANE REDUCTION TRANSITION AND FREEWAY EXIT RAMP DETAIL, MARKERS ARE NOT TO BE SPECIFIED ON RIGHT EDGE LINES.
- 3. THE EXACT MARKER LIMITS, SPACING, AND COLOR SHOULD BE INCLUDED IN THE PLANS.
- 4. MARKERS SHOULD NOT BE USED ALONGSIDE CURBS EXCEPT FOR EXTREMELY SHORT SECTIONS OF CURBS WHERE NOT MORE THAN TWO MARKERS WOULD BE INVOLVED.

LEFT TURN


All dimensions are in inches (millimeters) unless otherwise shown.

| FILE NAME = | USER NAME = gaglianobt | DESIGNED - | REVISED - T. RAMMACHER 09-19-94 | | | TYPICAL APPLICATIONS | F.A.P. | SECTION | COUNTY | TOTAL SHEET |
|---------------------------|-----------------------------|------------|---------------------------------|------------------------------|-------------|--|-----------|------------|----------|-------------|
| W:\distatd\22x34\tc11.dgn | | DRAWN - | REVISED - T. RAMMACHER 03-12-99 | STATE OF ILLINOIS | | | 330 | 17 B-1-I-1 | WILL | 29 26 |
| | PLOT SCALE = 50.000 ' / IN. | CHECKED - | REVISED -T. RAMMACHER 01-06-00 | DEPARTMENT OF TRANSPORTATION | RAISED F | REFLECTIVE PAVEMENT MARKERS (SNOW-PLOW RESISTANT) | | TC-11 | CONTRACT | NO. 60D68 |
| | PLOT DATE = 1/4/2008 | DATE - | REVISED - | | SCALE: NONE | SHEET NO. 1 OF 1 SHEETS STA. 621+00 TO STA. 636+00 | FED. ROAD | | | |

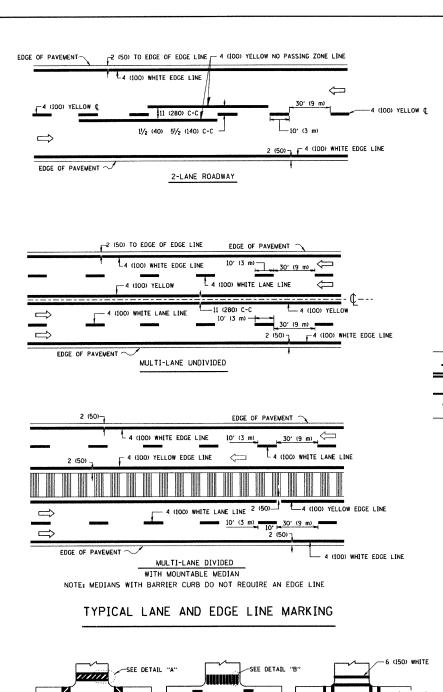


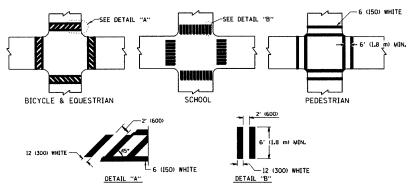

TYPICAL CROSSWALK MARKING

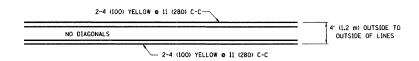

4' (1.2 m) WIDE MEDIANS ONLY

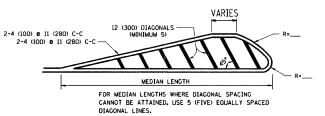


DIAGONAL LINE SPACING: 50' (15 m) C-C (LESS THAN 30MPH (50 km/h))


75' (25 m) C-C 30MPH (50 km/h) TO 45MPH (70 km/h))

150' (45 m) C-C (MORE THAN 45MPH (70 km/h))

MEDIANS OVER 4' (1.2 m) WIDE

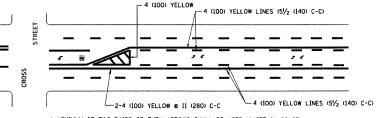


A MINIMUM OF TWO PAIRS OF TURN ARROWS SHALL BE USED, WHITE IN COLOR, ADDITIONAL PAIRS SHALL BE PLACED AT 200' (60 m) TO 300' (90 m) INTERVALS.

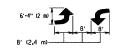

MEDIAN WITH TWO-WAY LEFT TURN LANE

TYPICAL PAINTED MEDIAN MARKING

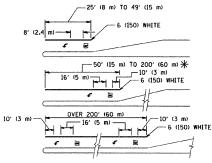



FULL SIZE LETTERS 8' (2.4 m) AND ARROWS SHALL BE USED. \P AREA = 15.6 SO. FT. (1.5 m²) DILY AREA = 20.8 SO. FT. (1.9 m²)

* TURN LANES IN EXCESS OF 400' (120 m) IN LENGTH MAY HAVE AN ADDITIONAL SET OF ARROW - "ONLY" INSTALLED MIDWAY BETWEEN THE OTHER TWO SETS OF ARROW - "ONLY".

TYPICAL LEFT (OR RIGHT) TURN LANE

TYPICAL TURN LANE MARKING

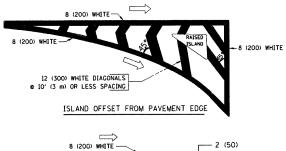

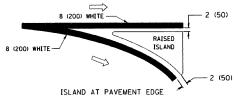

TYPICAL ISLAND MARKING

| TYPE OF MARKING | WIDTH OF LINE | PATTERN | COLOR | SPACING / REMARKS |
|---|---|-------------------------|---|--|
| CENTERLINE ON 2 LANE PAVEMENT | 4 (100) | SKIP-DASH | YELLOW | 10' (3 m) LINE WITH 30' (9 m) SPACE |
| CENTERLINE ON MULTI-LANE UNDIVEDED PAVEMENT | 2 & 4 (100) | SOLID | YELLOW | 11 (280) C-C |
| NO PASSING ZONE LINES: FOR ONE DIRECTION FOR BOTH DIRECTIONS | 4 (100) 2 2 4 (100) | SOLID SOLID | YELLOW YELLOW | 5½ (140) C-C FROM SKIP-DASH CENTERLINE 11 (280) C-C OMIT SKIP-DASH CENTERLINE BETWEEN |
| LANE LINES | 4 (100) 5 (125) ON FREEWAYS | SKIP-DASH SKIP-DASH | WHITE WHITE | 10' (3 m) LINE WITH 30' (9 m) SPACE |
| DOTTED LINES (EXTENSIONS OF CENTER, LANE OR TURN LANE MARKINGS) | SAME AS LINE BEING EXTENDED | SKIP-DASH | SAME AS LINE BEING EXTENDED | 2' (600) LINE WITH 6' (1.8 m) SPACE |
| EDGE LINES | 4 (100) | SOLID | YELLOW-LEFT WHITE-RIGHT | OUTLINE MOUNTABLE MEDIANS IN YELLOW: EDGE LINES ARE NOT USED NEXT TO BARRIER CURB |
| TURN LANE MARKINGS | 6 (150) LINE; FULL SIZE LETTERS & SYMBOLS (8' (2.4m)) | SOLID | WHITE | SEE TYPICAL TURN LANE MARKING DETAIL |
| TWO WAY LEFT TURN MARKING | 2 @ 4 (100) EACH DIRECTION | SKIP-DASH AND SOLID | YELLOW | 10' (3 m) LINE WITH 30' (9 m) SPACE FOR SKIP-DASH; 5½ (140) C-C BETWEEN SOLID LINE AND SKIP-DASH LINE |
| | 8' (2.4m) LEFT ARROW | IN PAIRS | WHITE | SEE TYPICAL TWO-WAY LEFT TURN MARKING DETAIL |
| CROSSWALK LINES (PEDESTRIAN) A. DIAGONALS (BIKE & EQUESTRIAN) B. LONGITUDINAL BARS (SCHOOL) | 2 @ 6 (150) 12 (300) @ 45° 12 (300) @ 90° | SOLID SOLID SOLID | WHITE WHITE WHITE | NOT LESS THAN 6' (1.8 m) APART 2' (500) APART 2' (500) APART SEE TYPICAL CROSSWALK MARKING DETAILS. |
| STOP LINES | 24 (600) | SOLID | WHITE | PLACE 4' (1,2 m) IN ADVANCE OF AND FARALLEL TO CROSSWALK, IF PRESENT, OTHERWISE, PLACE AT DESIRED STOPPING POINT. PARALLEL TO CROSSROAD CENTERLINE, WHERE POSSIBLE |
| PAINTED MEDIANS | 2 @ 4 (100) WITH 12 (300) DIAGONALS @ 45° NO DIAGONALS USED FOR 4' (1.2 m) WIDE MEDIANS | SOLID | YELLOW: TWO WAY TRAFFIC WHITE: ONE WAY TRAFFIC | II (280) C-C FOR THE DOUBLE LINE SEE TYPICAL PAINTED MEDIAN MARKING. |
| GORE MARKING AND CHANNELIZING LINES | 8 (200) WITH 12 (300) DIAGONALS @ 45° | SOLID | WHITE | DIACONALS: 15' (4,5 m) C-C (LESS THAN 30MPH (50 km/h)) 20' (6 m) C-C 30MPH (50 km/h) TO 45MPH (70 km/h 30' (9 m) C-C (OVER 45MPH (70 km/h)) |
| RAILROAD CROSSING | 24 (600) TRANSVERSE LINES; "RR" IS 6' (1.8 m) LETTERS; 16 (400) LINE FOR "X" | SOLID | WHITE | SEE STATE STANDARD 780001 AREA OF: "R"3.6 SO. FT. (0.33 m ²) EACH "X"=54.0 SO. FT. (5.0 m ²) |
| SHOULDER DIAGONALS | 12 (300) & 45° | SOLID | WHITE - RIGHT | 50' (15 m) C-C (LESS THAN 30MPH (50 km/h)) 75' (25 m) C-C (30 MPH (50 km/h) TO 45MPH (70 km 150' (45 m) C-C (0VER 45MPH (70 km/h)) |


FOR FURTHER DETAILS ON PAVEMENT MARKING REFER TO STANDARD SPECIFICATIONS FOR ROAD AND BRIDGE CONSTRUCTION AND STATE STANDARD 780001.

All dimensions are in inches (millimeters) unless otherwise shown.

| FILE NAME = | USER NAME = gaglianobt | DESIGNED - EVERS | REVISED - | -T. RAMMACHER 10-27-94 |
|---------------------------|----------------------------|------------------|-----------|------------------------|
| W:\diststd\22x34\tc13.dgn | | DRAWN - | REVISED - | -A. HOUSEH 10-09-96 |
| | PLOT SCALE = 50.000 '/ IN. | CHECKED - | REVISED | -A. HOUSEH 10-17-96 |
| | PLOT DATE = 1/4/2008 | DATE - 03-19-90 | REVISED | -T. RAMMACHER 01-06-00 |


| STATE | : OF | ILLINOIS |
|------------|------|----------------|
| DEPARTMENT | OF | TRANSPORTATION |

| | DIS | TRICT ON | √E | | F.A.P. | SECTION | COUNTY | TOTAL SHEETS | SHEET NO. | |
|-------------|------------------|-------------|-------------|----------------|--------|----------------------------------|-----------|-----------------|--------------|--|
| | TYPICAL PA | VEMENT | MARKINGS | | 330 | 17 B-1-l-1 | WILL | 29 | 27 | |
| | ITTIUML FA | A CIAICIA I | INAUVIIA | | | TC-13 | CONTRACT | NO. 60 | D68 | |
| SCALE: NONE | SHEET NO. 1 OF 1 | SHEETS | STA. 621+00 | TO STA. 636+00 | FED. R | DAD DIST. NO. 1 ILLINOIS FED. AI | D PROJECT | | | |

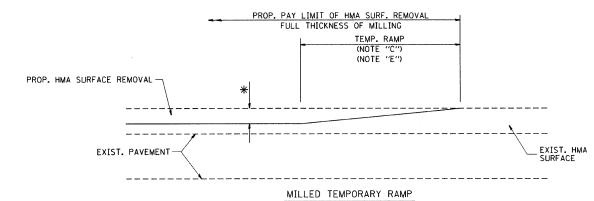

(FOR BUTT JOINT AND HMA TAPER SEE DETAIL BELOW)


OPTION 1

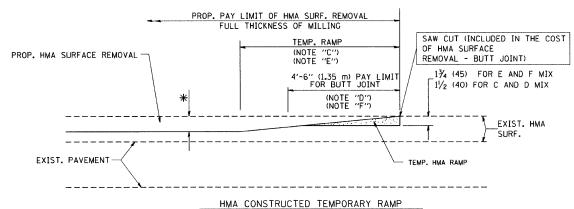


(FOR BUTT JOINT AND HMA TAPER SEE DETAIL BELOW)


OPTION 2

TYPICAL TEMPORARY RAMP

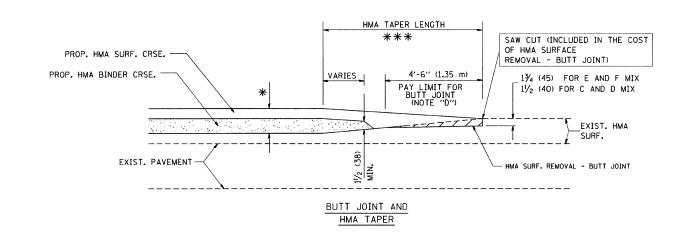

TYPICAL BUTT JOINT AND HMA TAPER FOR MILLING AND RESURFACING

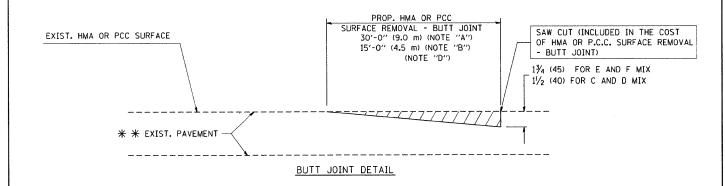

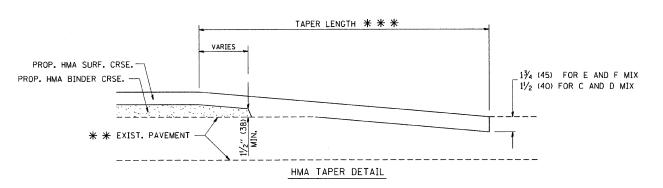

TYPICAL BUTT JOINT AND HMA TAPER FOR RESURFACING ONLY

 $***$ PC CONCRETE, HMA OR HMA RESURFACED PAVEMENT.

NOTES


- A: MAINLINE ROADWAYS AND MAJOR SIDE ROADS.
- B: MINOR SIDE ROADS.
- C: THE TEMP. RAMP SHALL BE CONSTRUCTED IMMEDIATELY UPON REMOVAL OF THE EXISTING HMA SURFACE.
- D: THE BUTT JOINT SHALL BE CONSTRUCTED IMMEDIATELY PRIOR TO PLACING THE PROPOSED HMA COURSES.
- E: TAPER THE TEMP. RAMP AT A RATE OF 3'-O" (900 mm) PER 1 INCH (25 mm) OF MILLING THICKNESS.
- F: INSTALLATION AND REMOVAL OF THE 4'-6" (1.35 m) TEMP. RAMP IS INCLUDED IN COST OF HMA SURFACE REMOVAL BUTT JOINT
- G: SEE ARTICLE 406.08 AND 406.14 OF THE STANDARD SPECIFICATIONS FOR "HMA AND/OR PCC SURFACE REMOVAL, BUTT JOINT".
- * SEE TYPICAL SECTIONS FOR MILLING THICKNESS.
- $\mbox{\ensuremath{\mbox{\#}}}$

BASIS OF PAYMENT:

THE BUTT JOINT WILL BE PAID FOR AT THE CONTRACT UNIT PRICE PER SQUARE YARD (SQUARE METER) FOR "HOT-MIX ASPHALT SURFACE REMOVAL - BUTT JOINT" OR FOR "PORTLAND CEMENT CONCRETE SURFACE REMOVAL- BUTT JOINT".

ALL DIMENSIONS ARE IN INCHES (MILLIMETERS) UNLESS OTHERWISE SHOWN.

| FILE NAME = | USER NAME = gaglianobt | DESIGNED - M. DE YONG | REVISED - R. SHAH 10-25-94 | | BUTT JOINT AND | FAP. SECTION | COUNTY TOTAL SHEET |
|---------------------------|-----------------------------|-----------------------|-----------------------------|------------------------------|--|---------------------------------------|--------------------|
| W:\diststd\22x34\bd32.dgn | | DRAWN - | REVISED - A. ABBAS 03-21-97 | STATE OF ILLINOIS | | 330 17 B-1-I-1 | WILL 29 28 |
| | PLOT SCALE = 50.0000 '/ IN. | CHECKED - | REVISED - M. GOMEZ 04-06-01 | DEPARTMENT OF TRANSPORTATION | HMA TAPER DETAILS | BD400-05 BD32 | CONTRACT NO. 60D68 |
| | PLOT DATE = 1/4/2008 | DATE - 06-13-90 | REVISED - R. BORO 01-01-07 | | SCALE: NONE SHEET NO. 1 OF 1 SHEETS STA. 621+00 TO STA. 636+00 | FED. ROAD DIST. NO. 1 ILLINOIS FED. A | ID PROJECT |

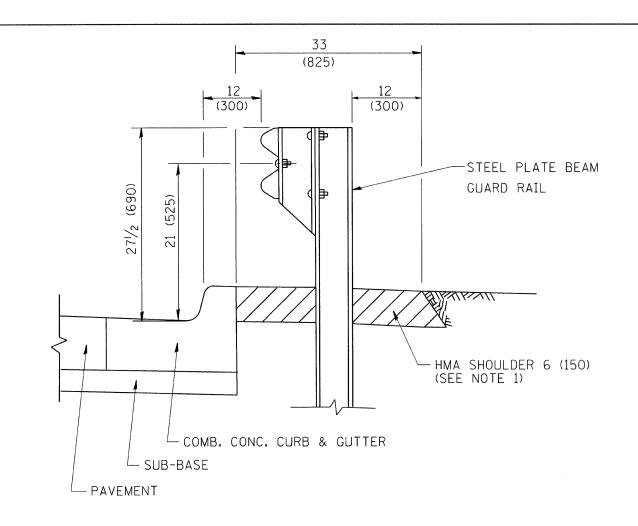

NOTES: 1. THE HMA SHOULDER SHALL EXTEND UNDER THE TRAFFIC BARRIER TERMINAL

2. GUARD RAIL MAY BE PLACED AT THE BACK OF CURB WHEN DIRECTED BY THE ENGINEER.

BASIS OF PAYMENT: HMA SHOULDER 6 (150) WILL BE


PAID FOR AT THE CONTRACT UNIT PRICE
PER SQUARE YARD (SQUARE METER) FOR
"HOT-MIX ASPHALT SHOULDER 6" (150 mm)".

STEEL PLATE BEAM GUARD RAIL AND TRAFFIC BARRIER TERMINAL, OF THE TYPE SPECIFIED WILL BE PAID FOR SEPARATELY.

DETAILS FOR STEEL PLATE BEAM

GUARD RAIL ADJACENT TO CURB AND GUTTER

[FOR ROADWAY SPEED 35 MPH (60 kmh) TO 45 MPH (70 kmh)]

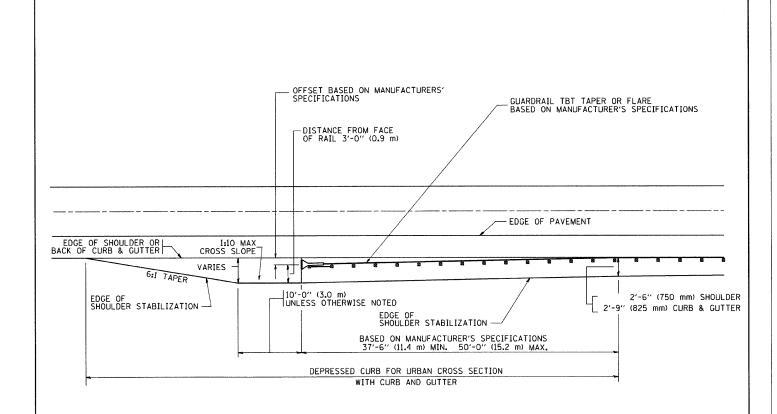

STABILIZATION AT TBT TY. 1 SPL.

TBT = TRAFFIC BARRIER TERMINAL

ALL DIMENSIONS ARE IN INCHES (MILLIMETERS) UNLESS OTHERWISE SHOWN.

| FILE NAME = | USER NAME = gaglianobt | DESIGNED - M. DE YONG | REVISED - R. SHAH 02-23-95 | | n, | ETAILS FOR STEEL PLATE BEAM GUARD RAIL ADJACENT | FAP. SECTION | COUNTY TOTAL SHEET NO. |
|---------------------------|-----------------------------|-----------------------|-----------------------------|------------------------------|-------------|--|-------------------------------------|------------------------|
| Wi\diststd\22x34\bd34.dgn | | DRAWN - | REVISED - A. ABBAS 03-21-97 | STATE OF ILLINOIS | | | 330 17 B-1-I-1 | WILL 29 29 |
| | PLOT SCALE = 50.0000 '/ IN. | CHECKED - | REVISED - E. GOMEZ 08-28-00 | DEPARTMENT OF TRANSPORTATION | I I | TO CURB AND GUTTER STABILIZATION AT TBT TY 1 SPL. | | CONTRACT NO. 60D68 |
| | PLOT DATE = 1/4/2008 | DATE - 09-22-90 | REVISED - R. BORO 01-01-07 | SC | SCALE: NONE | SHEET NO. 1 OF 1 SHEETS STA. 621+00 TO STA. 636+00 | FED. ROAD DIST. NO. 1 [LLINOIS FED. | AID PROJECT |